

Replace Roof Systems, Multiple Assets Farmington Correctional Center Farmington, Missouri

OWNER: STATE OF MISSOURI
MICHAEL L PARSON,
GOVERNOR

DEPARTMENT OF
CORRECTIONS



STATE OF MISSOURI CERTIFICATE OF AUTHORITY #2018019473

PROJECT
MANAGEMENT: OFFICE OF ADMINISTRATION
DIVISION OF FACILITIES MANAGEMENT,
DESIGN AND CONSTRUCTION


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CONSULTANT: JOHN A JURGIEL & ASSOCIATES
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PROJECT NUMBER: C1922-01

SITE NUMBER: 7008
ASSET NUMBER: 9327008082, 9327008081, 9327008080, 9327008079,
9327008089, 9327008090, 9327008091




BID DOCUMENTS

SHEET TITLE:
COVER SHEET

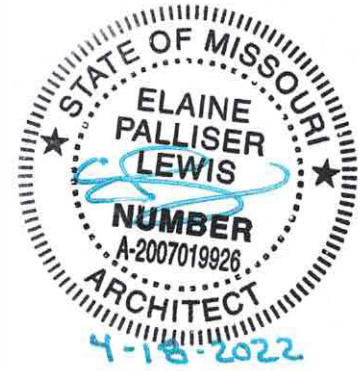SHEET NUMBER:

G000

SHEET 1 OF 29
04-18-2022

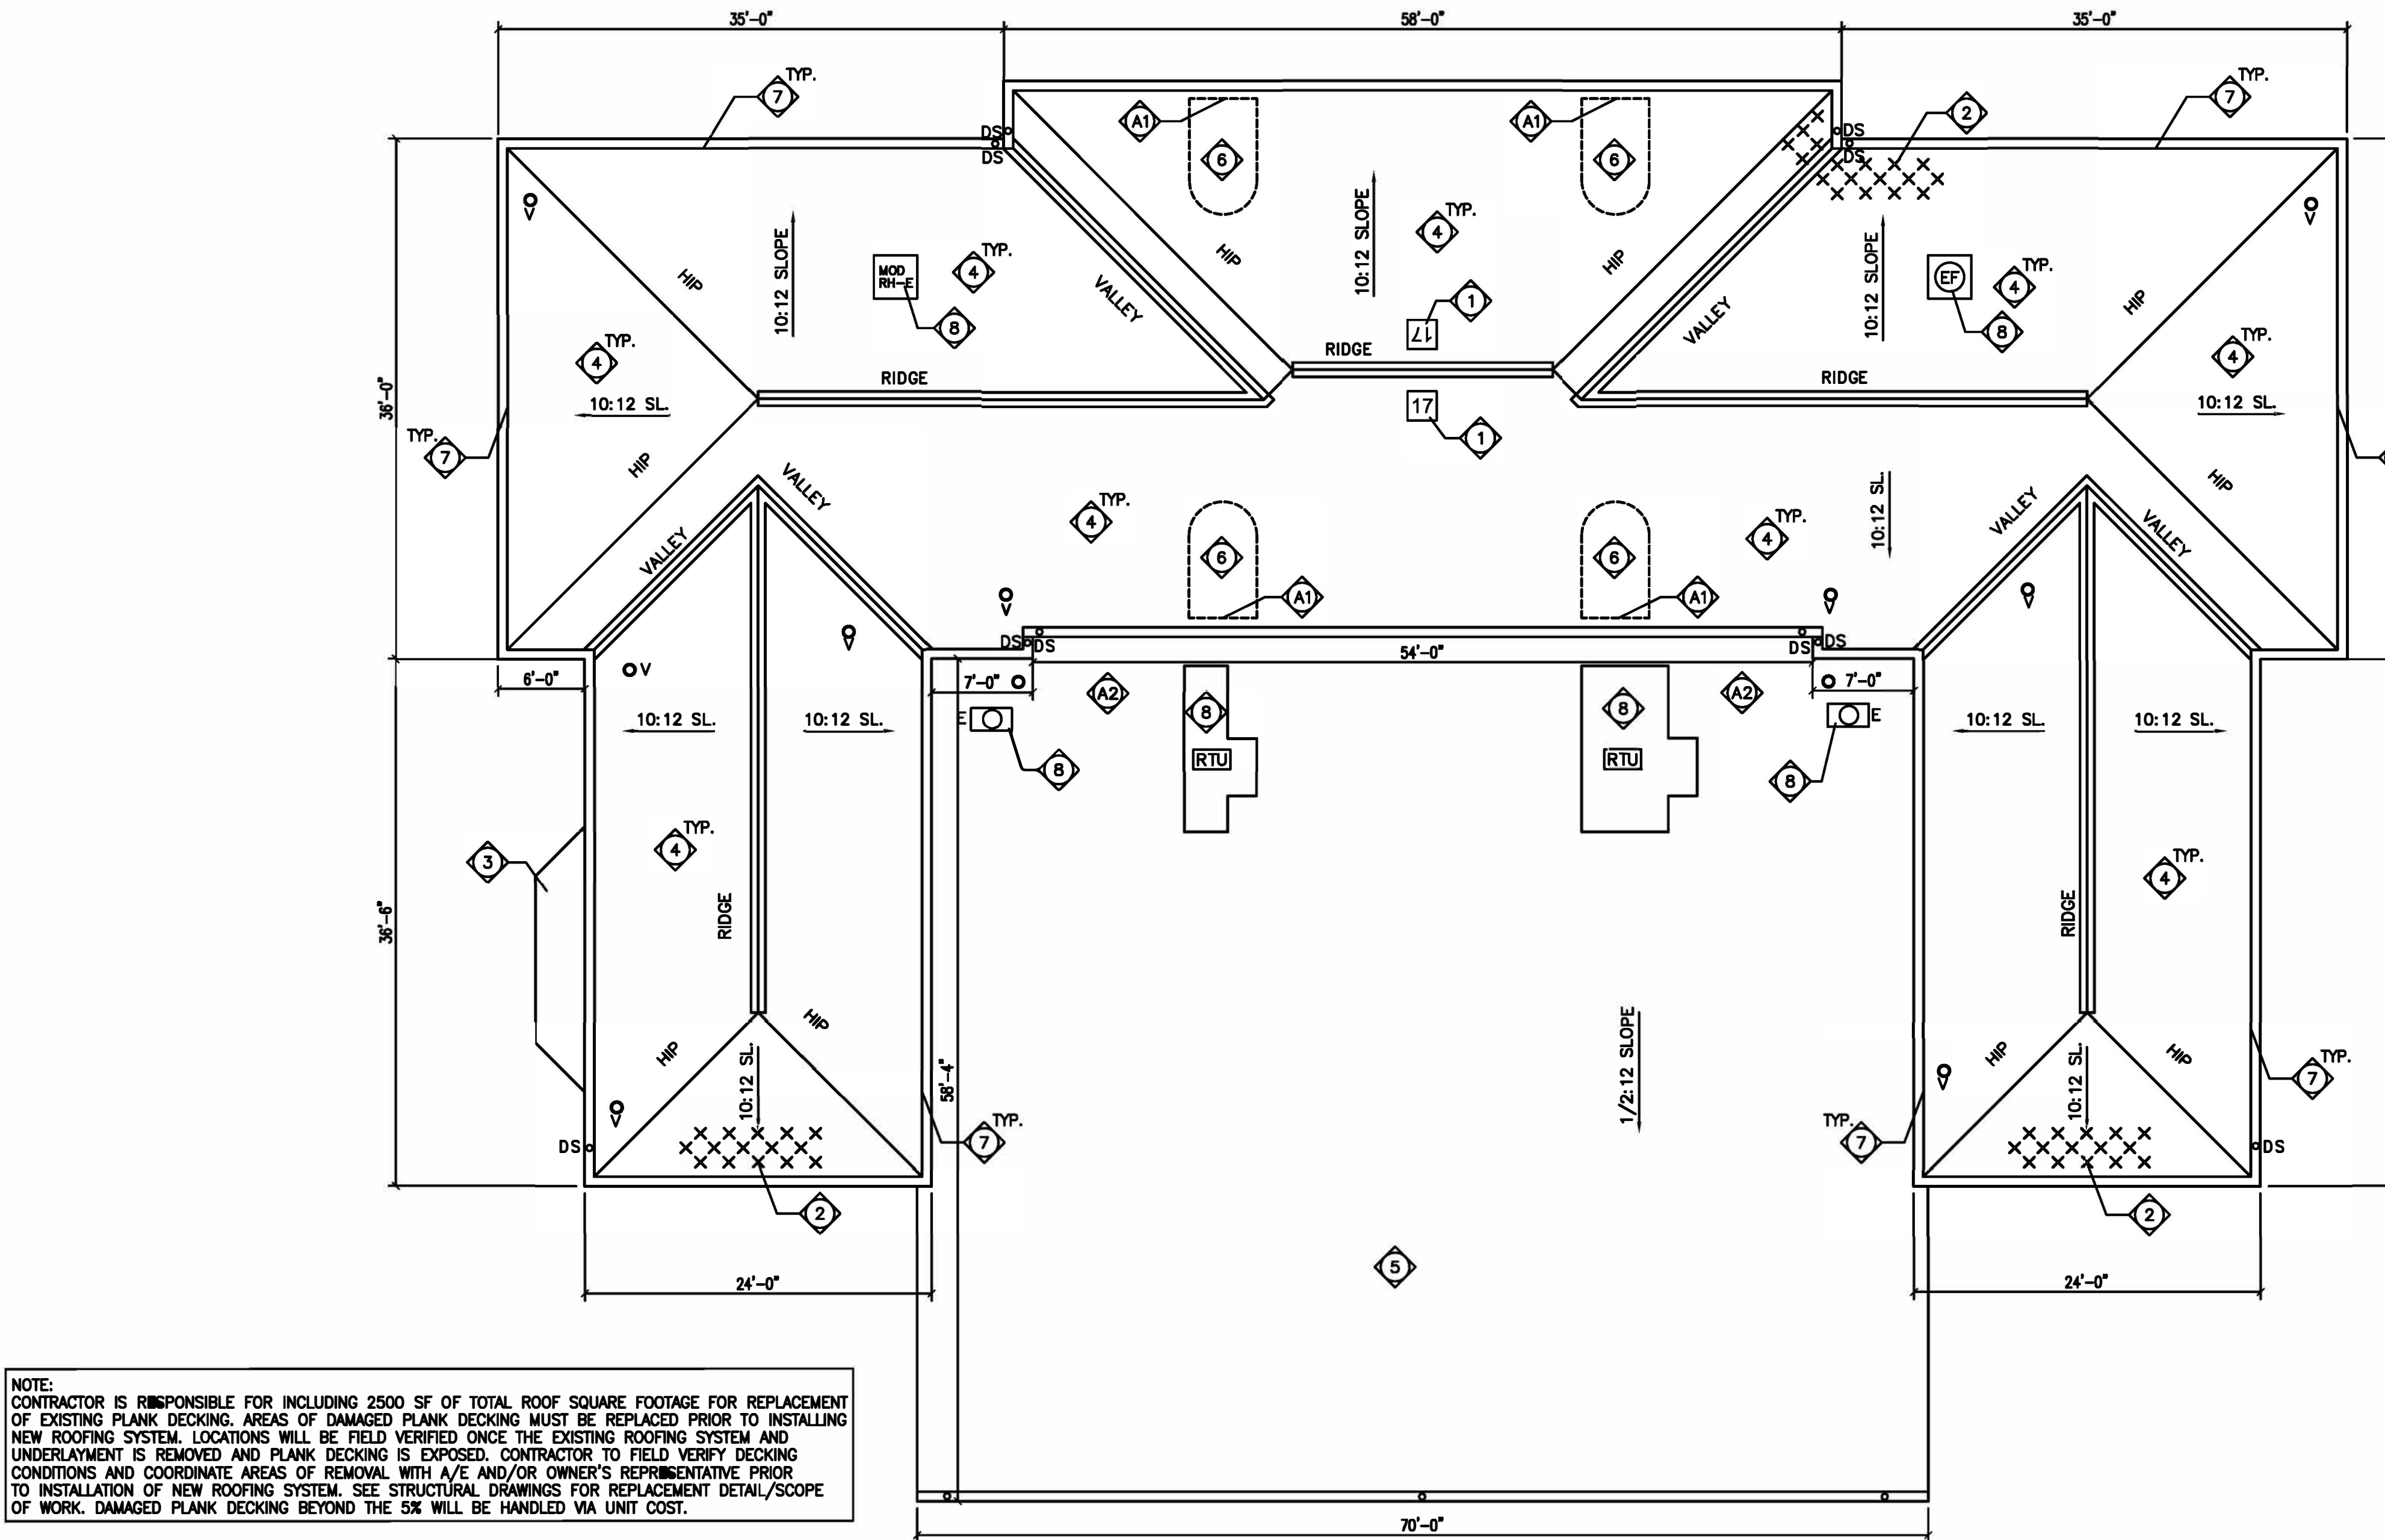

1 FOOD SERVICE BUILDING #17 - DEMOLITION ROOF PLAN
AD102 1/8" = 1'-0"




- GENERAL NOTES -- HAZARDOUS MATERIALS:**
- A. LEAD-BASED PAINT WAS IDENTIFIED ON NUMEROUS SUBSTRATES ASSOCIATED WITH THE ROOFING REPLACEMENT PROJECT. THE INSPECTION RESULTS ARE FOUND IN THE REPORT TITLED "LIMITED ASBESTOS AND LEAD SURVEY".
 - B. THE PAINTING CONTRACTOR'S EMPLOYEES SHALL HAVE HAD THE EPA LEAD RENOVATION, REPAIR AND PAINTING (RRP) CERTIFIED RENOVATOR COURSE. EPA'S RRP RULE REQUIRES RENOVATION, REPAIR AND PAINTING FIRMS WORKING ON PRE-1978 BUILDINGS TO ASSIGN TO EACH JOB A CERTIFIED RENOVATOR WHO IS TRAINED IN LEAD-SAFE WORK PRACTICES. THE TRAINING MUST BE TAUGHT BY AN EPA OR STATE ACCREDITED TRAINING PROVIDER.
 - C. PAINTING CONTRACTOR MUST BE FAMILIAR WITH EPA DOCUMENT TITLED "SMALL ENTITY COMPLIANCE GUIDE" TO RENOVATE RIGHT: EPA'S LEAD-BASED PAINT RENOVATION, RENOVATION, REPAIR AND PAINTING PROGRAM" (REVISED SEPTEMBER 2011 VERSION).
 - D. THE PAINTING CONTRACTOR MUST USE LEAD-SAFE WORK PRACTICES WHEN CONDUCTING PAINTING OPERATIONS ON BUILDINGS 17, 18, 31, 32, AND 33.
 - E. THE PAINTING CONTRACTOR MUST COMPLY WITH ALL REQUIREMENTS OF THE OCCUPATIONAL SAFETY AND HEALTH ADMINISTRATION (OSHA) STANDARD 29 CFR 1926.62, LEAD IN CONSTRUCTION, INCLUDING AIR SAMPLING OF REPRESENTATIVE TASKS TO DETERMINE RESPIRATOR REQUIREMENTS IF WARRANTED.
 - F. ALL PAINT CHIPS AND GENERATED WASTE FROM BUILDINGS 17, 18, 31, 32, AND 33 SHALL BE TESTED BY THE PAINTING CONTRACTOR USING TOXIC CHARACTERISTIC LEACHATE PROCESSES (TCLP) ANALYTICAL METHODS TO DETERMINE PROPER WASTE DISPOSAL METHODS.
 - G. TRACE AMOUNTS OF LEAD BELOW THE EPA HUD DEFINITION OF LEAD-BASED PAINT WERE IDENTIFIED IN OTHER AREAS OF THE PROJECT. IT SHOULD BE NOTED THAT OSHA DOES NOT RECOGNIZE THE XRF THRESHOLD VALUE OF 1.0 MG/CM2 FOR LEAD EXPOSURE. ALTHOUGH THE POTENTIAL LEAD HAZARD FOR NORMAL CONSTRUCTION ACTIVITIES IS LOW, ACTUAL LEAD EXPOSURE MAY VARY SIGNIFICANTLY DEPENDING UPON THE SPECIFIC TASK, PROCEDURE AND OTHER WORK AREA CONDITIONS. PROPER OSHA COMPLIANCE IS CONSIDERED PERFORMANCE BASED AND INCLUDING EVALUATING POTENTIAL WORK EXPOSURES WITH AIR MONITORING OR BIOLOGICAL EXPOSURE MONITORING (BLOOD LEAD TESTING), IF REQUIRED.
 - H. THE LOCATIONS OF WASTE DISPOSAL CONTAINERS SHALL BE FIELD VERIFIED WITH THE CORRECTIONAL CENTER AND/OR THE CORRECTIONAL CENTER'S REPRESENTATIVE.
 - J. AT THE DISCRETION OF THE CORRECTIONAL CENTER, ADDITIONAL AIR SAMPLING MAY BE CONDUCTED DURING PAINTING OPERATIONS TO ENSURE LEAD DUST IS NOT MIGRATING AWAY FROM THE WORK SITE.
 - K. ASBESTOS WINDOW GLAZING WAS IDENTIFIED FOR BUILDING 17. AVOID CONTACT WITH THIS ASBESTOS MATERIAL. DO NOT SCRAPE, ABRASE OR OTHERWISE IMPACT THE ASBESTOS.

- GENERAL NOTES -- ROOF PLANS:**
- L. THE CONTRACTOR IS TO VISIT THE SITE DURING THE BIDDING PERIOD AND IS TO ADVISE THE ARCHITECT OF ANY SITUATION OR DISCREPANCY WHICH WILL NOT ALLOW SUCCESSFUL COMPLETION OF THE WORK. THE ARCHITECT'S DECISION WILL CLARIFY THE SCOPE OF WORK.
 - M. INFORMATION IS TAKEN FROM OWNER PROVIDED DOCUMENTS AND SITE INVESTIGATION. THE CONTRACTOR SHALL FIELD VERIFY ALL EXISTING CONDITIONS AND DIMENSIONS PRIOR TO FABRICATION AND INSTALLATION OF NEW WORK.
 - N. PRIOR TO BIDDING, CONTRACTOR IS REQUIRED TO BE FAMILIAR ON SITE WITH THE STATUS OF THE EXISTING ROOF AND VERIFY ALL INFORMATION INDICATED IN THE DOCUMENTS.
 - P. THE CONTRACTOR IS RESPONSIBLE FOR PROTECTING EXISTING ITEMS TO REMAIN DURING DEMOLITION AND NEW CONSTRUCTION.
 - Q. PATCH EXISTING TO MATCH ADJACENT MATERIALS WERE DEMOLITION AND NEW CONSTRUCTION OCCUR UNLESS INDICATED OTHERWISE.
 - R. ALL DIMENSIONS REQUIRED FOR WORK SHALL BE VERIFIED BY CONTRACTOR IN THE FIELD PRIOR TO WORK. DIMENSIONS SHOWN FOR INFORMATION ONLY AND MAY BE PLUS/MINUS WHAT IS INDICATED.
 - S. ALL MANUFACTURED ARTICLES, MATERIALS AND EQUIPMENT SHALL BE APPLIED, INSTALLED, CONNECTED, ERECTED, CLEANED AND CONDITIONED AS DIRECTED BY THE MANUFACTURER, UNLESS INDICATED OTHERWISE.
 - T. CURRENT STANDARDS OF ROOFING INSTALLATION, CONSTRUCTION AND WATERPROOFING, NRCA AND ASHRAE APPLY TO THE PERFORMANCE AND DETAILS OF ROOFING CONSTRUCTION INDICATED IN THESE DOCUMENTS.
 - U. THE CONTRACTOR SHALL COORDINATE WITH THE FACILITY TO ESTABLISH PROCEDURES FOR THE CONTROLLED ENTRY OF MEN AND MATERIALS INTO THE WORK AREA AND SHALL COMPLY WITH ALL RULES AND REGULATIONS ESTABLISHED BY THE FACILITY. THE INTERRUPTION OF SECURITY AND COMMUNICATIONS WILL NOT BE PERMITTED. CONTRACTOR SHALL INFORM AND COORDINATE WITH SECURITY OFFICIALS 48 HOURS IN ADVANCE OF ANY WORK RELATED TO SECURITY OR COMMUNICATIONS.

- GENERAL NOTES -- BUILDING 17 ABATEMENT:**
- V. THE ABATEMENT SCOPE OF WORK CONSISTS OF REMOVING WINDOWS CONTAINING ASBESTOS WINDOW GLAZING AND CLEANING UP OF ASBESTOS WINDOW GLAZING DEBRIS FROM METAL CORRUGATED ROOF FROM BUILDING 17. WINDOWS WITH ASBESTOS GLAZING WILL BE REMOVED USING DISMANTLING TECHNIQUE. GLAZING DEBRIS WILL BE CLEANED USING HEPA VACUUMS AND GENERAL WET CLEANING METHODS INSIDE A REGULATED AREA.
 - W. ALL ABATEMENT WORK SHALL BE CONDUCTED IN ACCORDANCE WITH ALL FEDERAL, STATE AND LOCAL REGULATIONS AND SPECIFICALLY THE CORRECTIONAL CENTER'S REPRESENTATIVE.
 - X. THE LOCATIONS AND QUANTITIES OF ASBESTOS MATERIAL SHALL BE FIELD VERIFIED BY THE ABATEMENT CONTRACTOR.
 - Y. ALL ABATEMENT WORK SHALL BE CONDUCTED DURING DAYLIGHT HOURS (7:00 AM TO 5:00 PM) MONDAY - FRIDAY, EXCLUDING FEDERAL HOLIDAYS. WORK SCHEDULING SHALL BE COORDINATED WITH THE CORRECTIONAL CENTER AND/OR THE CORRECTIONAL CENTER'S REPRESENTATIVE.
 - Z. THE ABATEMENT CONTRACTOR SHALL SUBMIT A DETAILED WORK PLAN AND ABATEMENT SCHEDULE WITH THE REQUIRED SUBMITTALS.
 - AA. THE LOCATIONS OF WASTE DISPOSAL CONTAINERS AND LOADOUT PROCEDURES SHALL BE FIELD VERIFIED WITH THE CORRECTIONAL CENTER AND/OR THE CORRECTIONAL CENTER'S REPRESENTATIVE.
 - BB. STRICT COORDINATION BETWEEN THE CORRECTIONAL CENTER, CORRECTIONAL CENTER'S REPRESENTATIVE, ABATEMENT CONTRACTOR AND GENERAL CONTRACTOR WILL BE REQUIRED FOR SUCCESSFUL COMPLETION OF THE WORK.

- KEYED NOTES -- DEMOLITION ROOF PLAN:**
- 1. REMOVE EXISTING ROOF NUMBER SIGNAGE.
 - 2. REMOVE EXISTING ICE/SNOW GUARDS, LOCATIONS SHOWN FOR INFORMATION ONLY.
 - 3. EXISTING COPPER ROOFING SYSTEM TO REMAIN, PROTECT AS REQUIRED DURING DEMOLITION.
 - 4. REMOVE EXISTING ASPHALT SHINGLES, UNDERLAYMENT, FLASHING, GUTTERS, DOWNSPOUTS AND ASSOCIATED ROOFING COMPONENTS DOWN TO EXISTING DECKING. EXISTING WOOD FASCIA BOARD, TRIM AND SOFFITS TO REMAIN UNLESS NOTED OTHERWISE, PROTECT AS REQUIRED DURING DEMOLITION AND NEW ROOF SYSTEM INSTALLATION.
 - 5. REMOVE EXISTING METAL ROOFING SYSTEM, FLASHING, GUTTERS AND DOWNSPOUTS AS REQUIRED FOR THE INSTALLATION OF A NEW STANDING SEAM METAL ROOFING SYSTEM. EXISTING BUILDING STRUCTURE, DECK AND SUPPORTS TO REMAIN. EXISTING METAL WRAPPED FASCIA BOARD TO REMAIN.
 - 6. REMOVE EXISTING WOOD/ASPHALT SHINGLE DORMER AND ASSOCIATED WINDOW/LOUVER IN ITS ENTIRETY.
 - 7. EXISTING WOOD FASCIA BOARD AND SOFFITS TO REMAIN, PROTECT AS REQUIRED DURING ROOFING SYSTEM DEMOLITION AND REMOVAL.
 - 8. EXISTING EQUIPMENT. SEE MECHANICAL/ELECTRICAL DOCUMENTS FOR REMOVAL/REINSTALLATION REQUIREMENTS FOR ROOFING REPLACEMENT.
- KEYED NOTES -- BUILDING 17 ABATEMENT:**
- A1. COVER ASBESTOS WINDOW GLAZING WITH DUCT TAPE OR SIMILAR PRIOR TO WINDOW REMOVAL. REMOVE WINDOWS CONTAINING ASBESTOS WINDOW GLAZING FROM THE DORMERS OF BUILDING 17 USING DISMANTLING TECHNIQUE. REMOVAL SHALL BE CONDUCTED FROM OUTSIDE THE BUILDING. CRITICAL BARRIERS MUST BE INSTALLED INSIDE THE BUILDING TO PREVENT ANY GLAZING THAT MAY COME LOOSE DURING REMOVAL OPERATIONS FROM ENTERING THE BUILDING. TEMPORARY WEATHER TIGHT BARRIERS SHALL BE PLACED IN THE OPENINGS ONCE THE WINDOWS HAVE BEEN REMOVED.
 - (4) DORMER WINDOWS WITH ASBESTOS GLAZING
 - A2. INSIDE A REGULATED AREA, HEPA VACUUM ASBESTOS WINDOW GLAZING DEBRIS FROM THE METAL CORRUGATED ROOF IN THE REAR OF BUILDING 17 AND THEN WET WIPE AREA AFTER VACUUMING. GLAZING DEBRIS IS IN CLOSE PROXIMITY TO THE BUILDING.
 - 20 SQUARE FEET OF ROOF SURFACE AREA, TOTAL

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1012 WEST COLUMBIA ST.
FARMINGTON, MO 63640

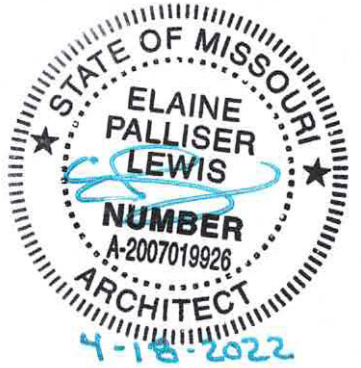REPLACE ROOF SYSTEMS
MULTIPLE ASSETS
FARMINGTON
CORRECTIONAL CENTER

FARMINGTON, MISSOURI

PROJECT # C1922-01
SITE # 7008
ASSET # 9327008089,
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REVISION: _____
DATE: _____
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DATE: _____

ISSUE DATE: APRIL 18, 2022

CAD DWG FILE: AD-100
DRAWN BY: EL
CHECKED BY: EL
DESIGNED BY: EL


SHEET TITLE:

BUILDING #17
DEMO ROOF PLAN


SHEET NUMBER:

AD102

3 OF 29 SHEETS
04/18/2022

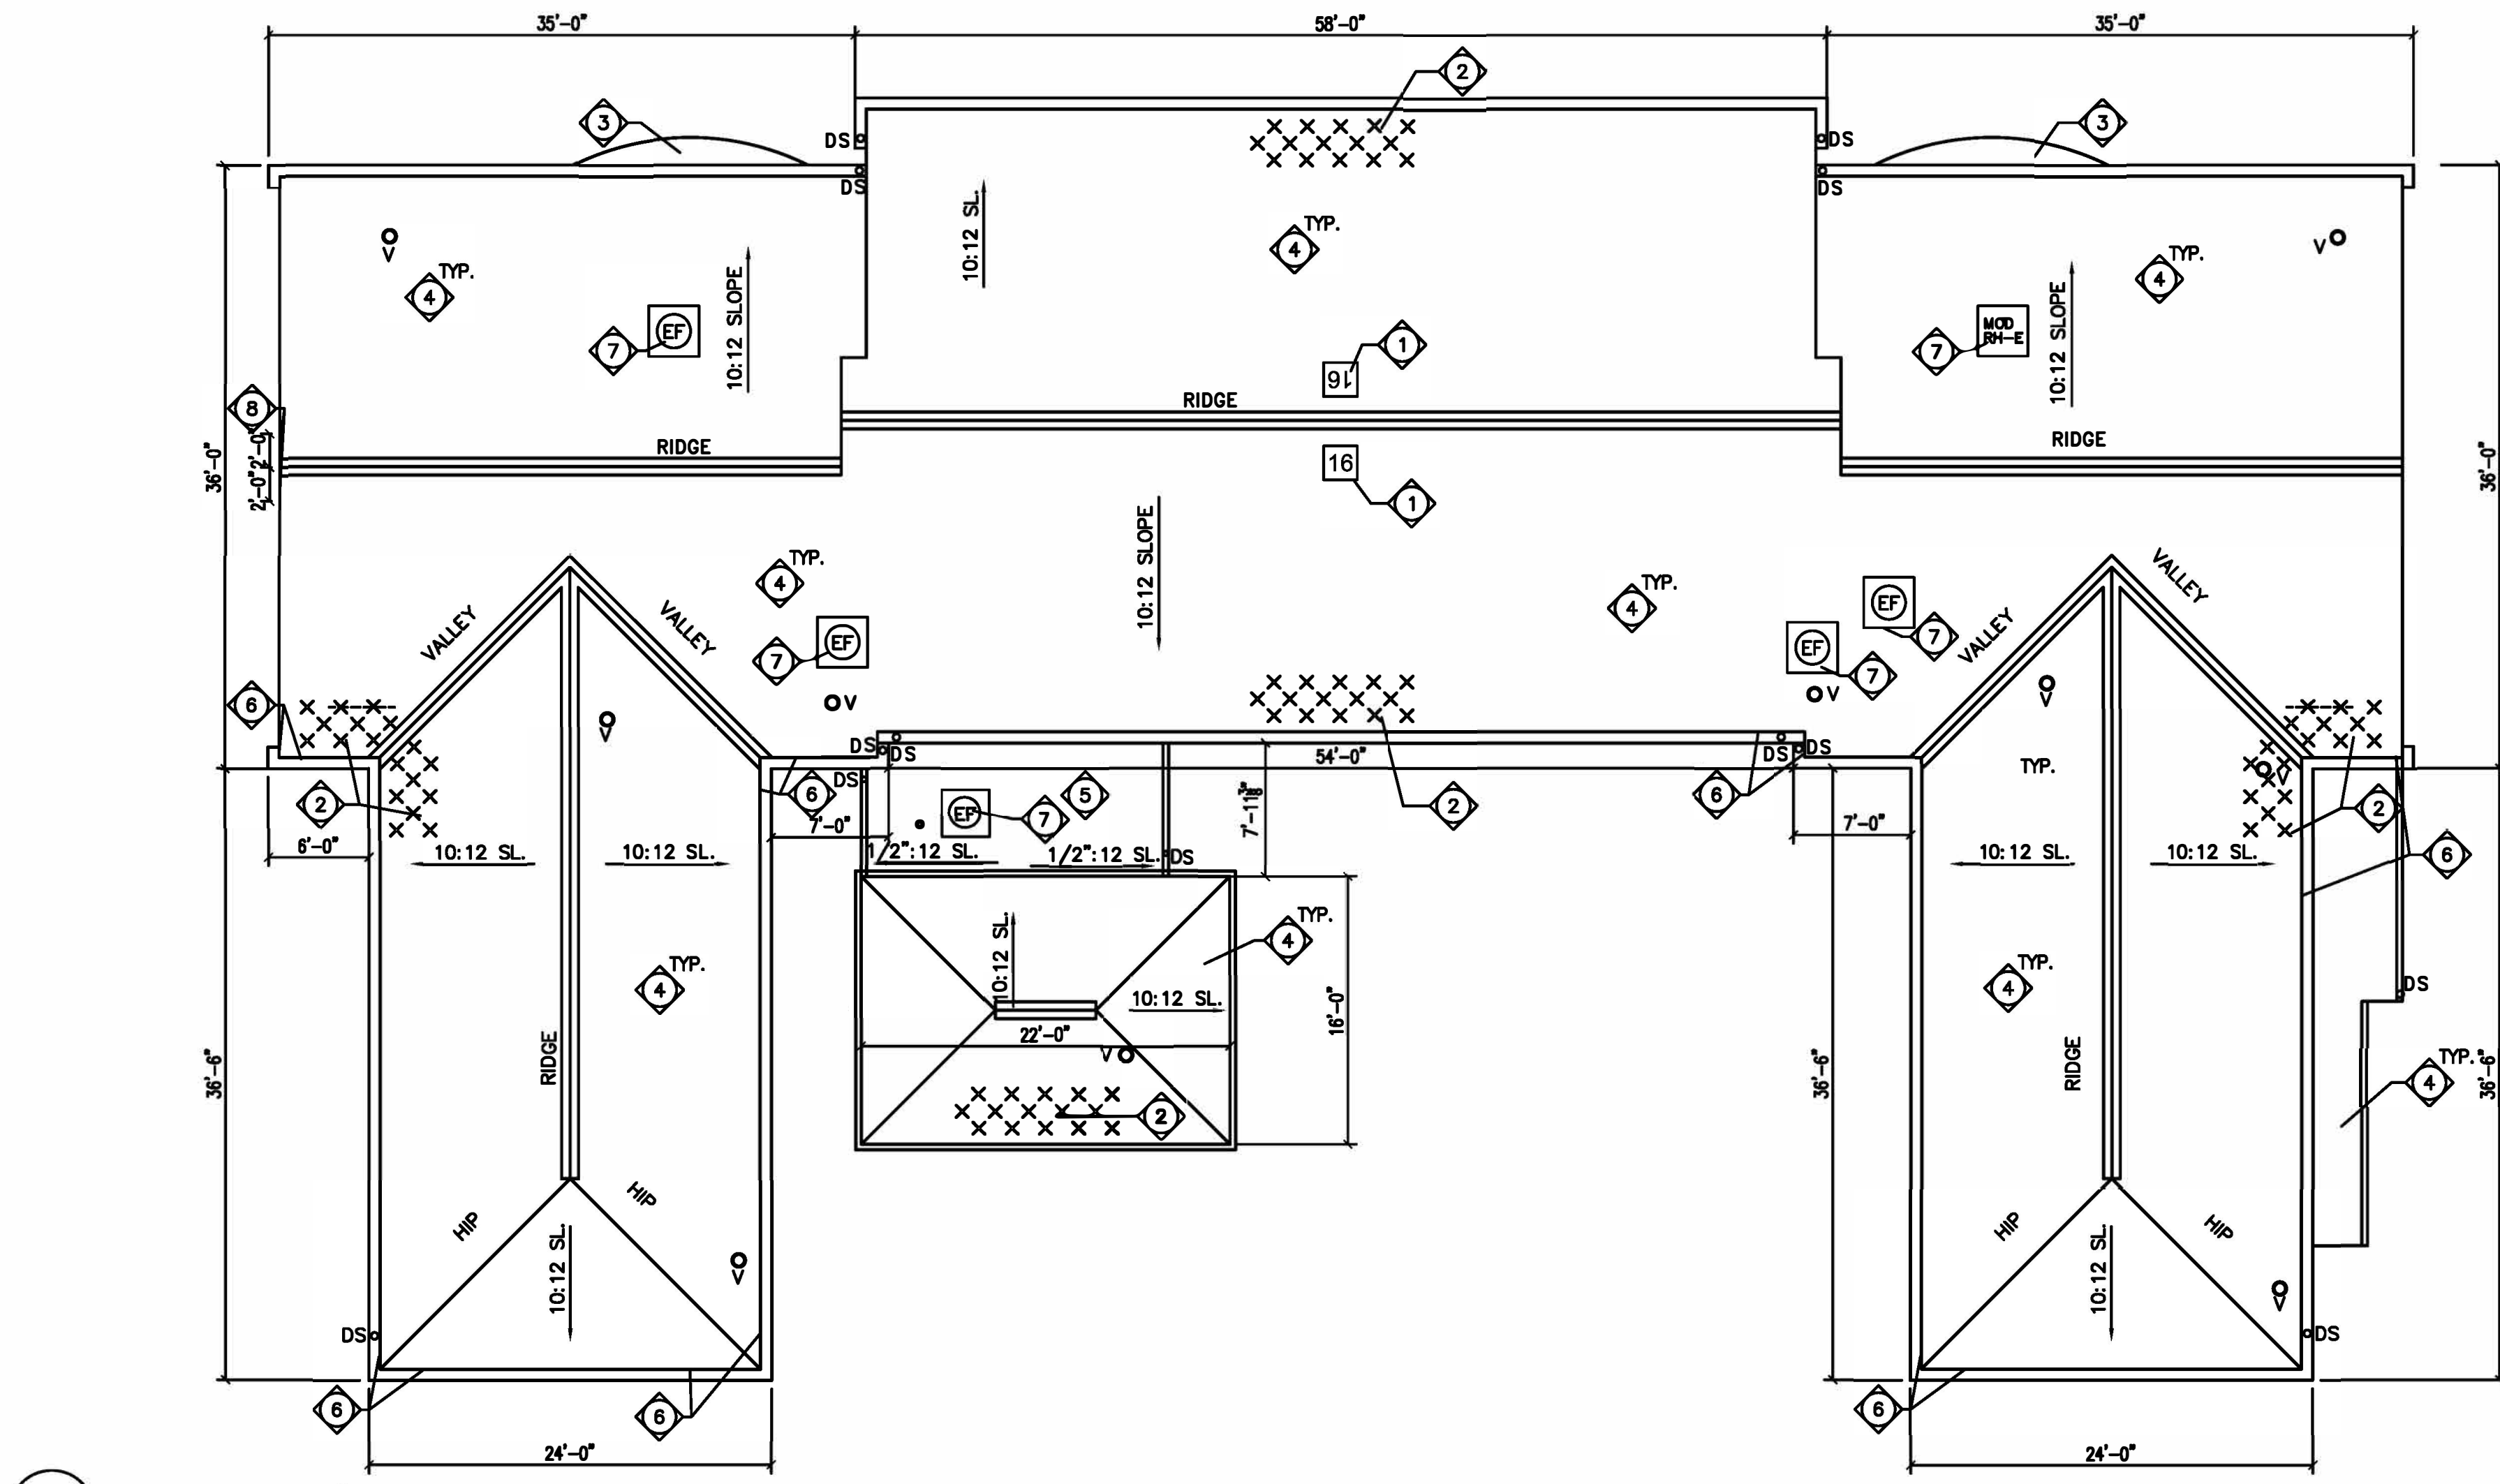

2 MEDICAL BUILDING #16 - DEMOLITION ROOF PLAN
A101 1/8" = 1'-0"

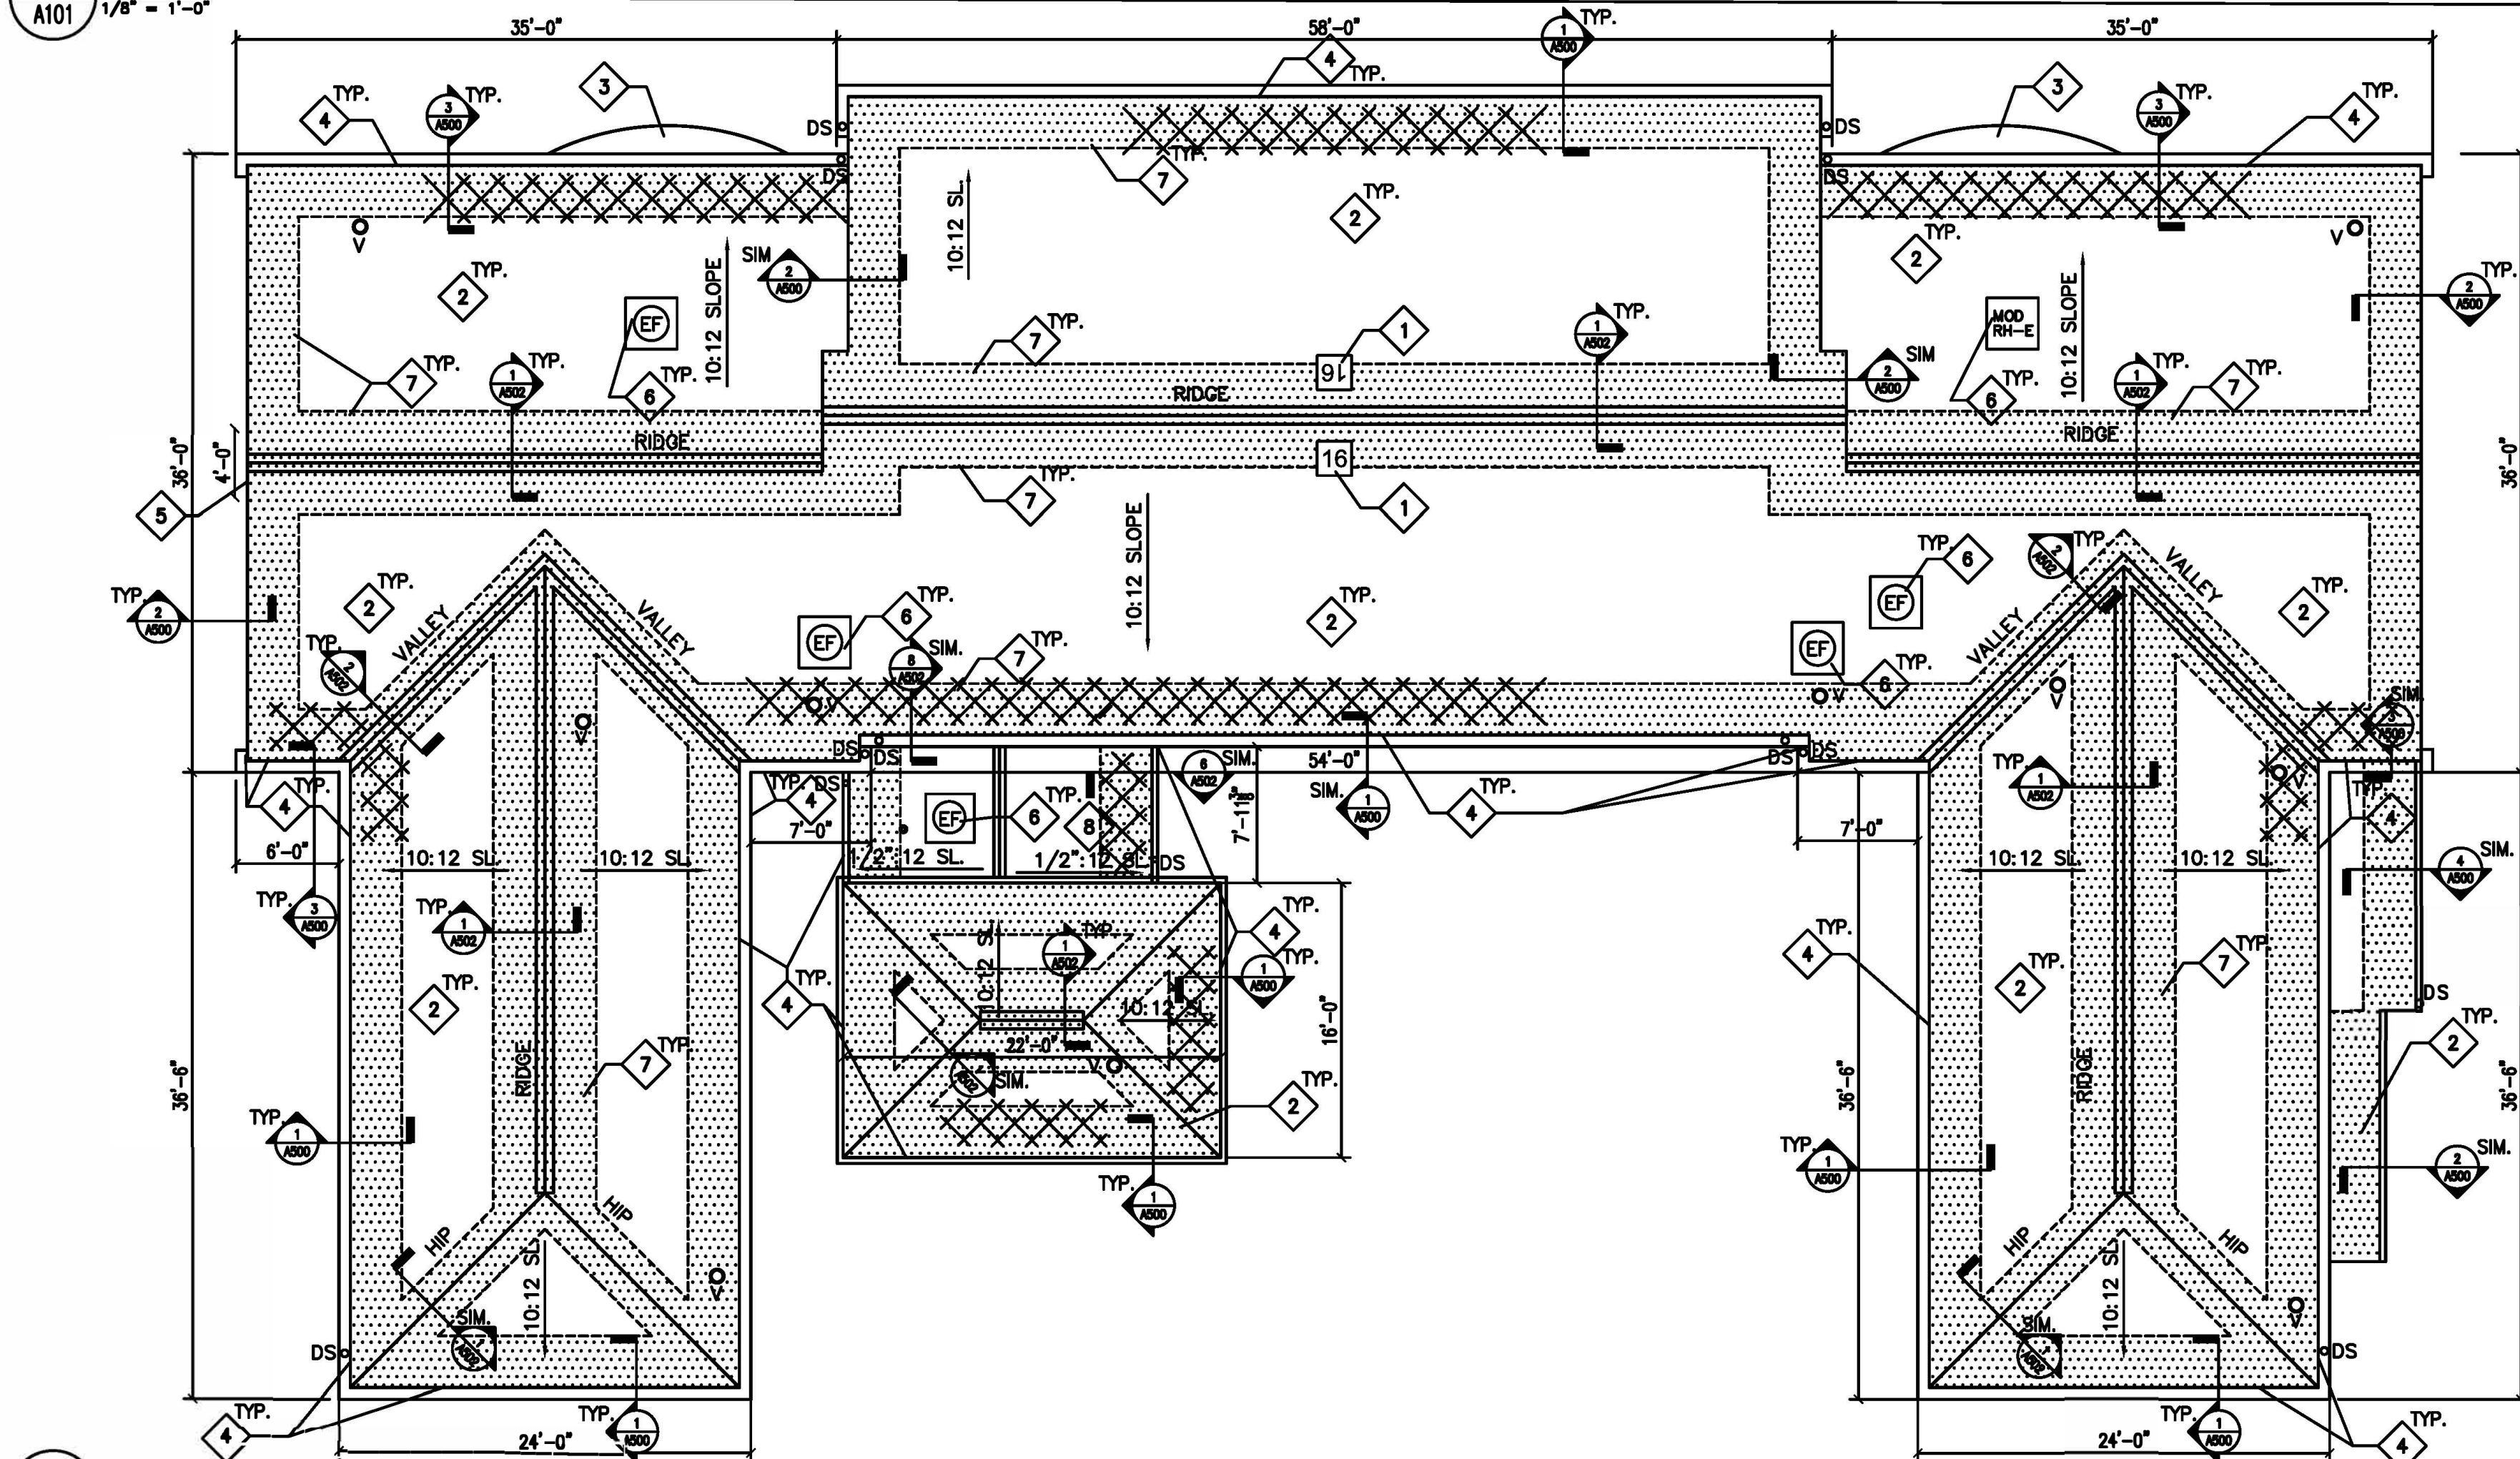

1 MEDICAL BUILDING #16 - ROOF PLAN
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GENERAL NOTES - ROOF PLANS:

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- CURRENT STANDARDS OF ROOFING INSTALLATION, CONSTRUCTION AND WATERPROOFING, NRCA AND ASHRAE APPLY TO THE PERFORMANCE AND DETAILS OF ROOFING CONSTRUCTION INDICATED IN THESE DOCUMENTS.
- THE CONTRACTOR SHALL COORDINATE WITH THE FACILITY TO ESTABLISH PROCEDURES FOR THE CONTROLLED ENTRY OF MEN AND MATERIALS INTO THE WORK AREA AND SHALL COMPLY WITH ALL RULES AND REGULATIONS ESTABLISHED BY THE FACILITY. THE INTERRUPTION OF SECURITY AND COMMUNICATIONS WILL NOT BE PERMITTED. CONTRACTOR SHALL INFORM AND COORDINATE WITH SECURITY OFFICIALS 48 HOURS IN ADVANCE OF ANY WORK RELATED TO SECURITY OR COMMUNICATIONS.
- AT MECHANICAL/ELECTRICAL ROOF EQUIPMENT AND VENTS, PROVIDE FLASHING PER ROOFING MFR. FOR WATERTIGHT ROOF INSTALLATION.
- PROVIDE SNOW AND ICE GUARDS AT NEW STANDING SEAM METAL ROOFS AS INDICATED ON THE PLANS AND LOCATED DIRECTLY ABOVE EXIST. DOOR LOCATIONS AND 5'-0" ON EITHER SIDE OF DOOR OPENING.
- PROVIDE NEW DOWNSPOUTS AT ALL EXISTING DOWNSPOUT LOCATIONS, SIZE PER EXISTING.

NOTE:
CONTRACTOR IS RESPONSIBLE FOR INCLUDING 2500 SF OF TOTAL ROOF SQUARE FOOTAGE FOR REPLACEMENT OF EXISTING PLANK DECKING. AREAS OF DAMAGED PLANK DECKING MUST BE REPLACED PRIOR TO INSTALLING NEW ROOFING SYSTEM. LOCATIONS WILL BE FIELD VERIFIED ONCE THE EXISTING ROOFING SYSTEM AND UNDERLAYMENT IS REMOVED AND PLANK DECKING IS EXPOSED. CONTRACTOR TO FIELD VERIFY DECKING CONDITIONS AND COORDINATE AREAS OF REMOVAL WITH A/E AND/OR OWNER'S REPRESENTATIVE PRIOR TO INSTALLATION OF NEW ROOFING SYSTEM. SEE STRUCTURAL DRAWINGS FOR REPLACEMENT DETAIL/SCOPE OF WORK. DAMAGED PLANK DECKING BEYOND THE 5% WILL BE HANDLED VIA UNIT COST.



PLAN NORTH

KEYED NOTES - DEMOLITION ROOF PLAN:

- REMOVE EXISTING ROOF NUMBER SIGNAGE.
- REMOVE EXISTING ICE/SNOW GUARDS, LOCATIONS SHOWN FOR INFORMATION ONLY.
- EXISTING COPPER ROOFING SYSTEM TO REMAIN, PROTECT AS REQUIRED DURING DEMOLITION.
- REMOVE EXISTING ASPHALT SHINGLES, UNDERLAYMENT, FLASHING, GUTTERS, DOWNSPOUTS AND ASSOCIATED ROOFING COMPONENTS DOWN TO EXISTING DECKING. EXISTING WOOD FASCIA BOARD, AND TRIM TO REMAIN UNLESS NOTED OTHERWISE, PROTECT AS REQUIRED DURING DEMOLITION AND NEW ROOF SYSTEM INSTALLATION.
- REMOVE EXISTING ASPHALT ROOFING, UNDERLAYMENT, FLASHING, GUTTERS AND DOWNSPOUTS. IN ITS ENTIRETY DOWN TO EXISTING DECKING. EXISTING WOOD FASCIA BOARD, TRIM AND SOFFITS TO REMAIN, PROTECT AS REQUIRED DURING DEMOLITION AND NEW ROOF SYSTEM INSTALLATION.
- REMOVE/REPLACE DAMAGED AREAS OF PAINTED WOOD FASCIA BOARD, MATCH EXISTING PROFILE ALIGN FLUSH WITH EXISTING FASCIA TRIM, DIMENSIONS FOR REFERENCE ONLY, FIELD VERIFY LOCATIONS.
- EXISTING EQUIPMENT, SEE MECHANICAL/ELECTRICAL DOCUMENTS FOR REMOVAL/REINSTALLATION REQUIREMENTS FOR ROOFING REPLACEMENT.
- REMOVE/REPLACE DAMAGED AREA OF PAINTED WOOD GABLE TRIM TO MATCH EXISTING PROFILE ALIGN FLUSH WITH EXISTING FASCIA TRIM AND PAINT ENTIRE LENGTH TO MATCH EXISTING.

KEYED NOTES - ROOF PLAN:

- ROOF NUMBER SIGNAGE SECURE TO STANDING SEAM METAL ROOF PER MANUFACTURER SO AS NOT TO VOID WARRANTY. SIGNAGE SHALL BE 36"x36" SQUARE. THE BUILDING NUMBER AS INDICATED SHALL BE BLACK WITH A REFLECTIVE WHITE BACKGROUND. FONT SIZE SHALL FIT 36"x36" SIGN.
- NEW STANDING SEAM METAL ROOFING SYSTEM OVER EXISTING WOOD DECKING ON WOOD STRUCTURAL SYSTEM, INCLUDING: UNDERLAYMENT, FLASHING, GUTTERS AND DOWNSPOUTS TO MATCH NEW ROOF SYSTEM. PROVIDE METAL ROOFING FLASHING AND ACCESSORIES AS REQUIRED FOR A WATERTIGHT INSTALLATION AND AT EXIST. VENTS AND ELECTRICAL/MECHANICAL EQUIPMENT TO MATCH METAL ROOFING SYSTEM. PROVIDE PANEL INSTALLATION TO MATCH EXISTING SLOPES AND ACCESSORIES AS REQUIRED FOR WATERTIGHT INSTALLATION OF METAL ROOFING SYSTEM TO MATCH EXISTING ROOF LAYOUT, SHAPE AND CONSTRUCTION.
- EXISTING COPPER ROOFING SYSTEM TO REMAIN.
- ALL EXISTING WOOD FASCIA BOARD AND REPLACEMENT BOARDS TO BE WRAPPED WITH SHEET METAL FLASHING TO MATCH NEW GUTTER AND ROOFING SYSTEM, EXISTING GABLE TRIM TO REMAIN AS EXISTING. REPLACE AREA OF GABLE TRIM TO MATCH EXISTING, ALIGN FLUSH AND PAINT FROM PEAK TO CORNER, MATCH EXISTING.
- EXISTING EQUIPMENT, SEE MECHANICAL/ELECTRICAL DOCUMENTS FOR REMOVAL/REINSTALLATION REQUIREMENTS FOR ROOFING REPLACEMENT, FLASH CURBS PER ROOF MFR RECOMMENDATIONS.
- LINE OF SELF-ADHERED WATER AND ICE MEMBRANE, INSTALL ALONG ROOF EDGE, RIDGE AND VALLEY PER DETAILS ON SHEETS A500, A501 AND A502.
- NEW STANDING SEAM METAL ROOFING SYSTEM OVER EXIST. ROOF DECK. PROVIDE REQUIRED FRAMING AND SECURE TO EXISTING ROOF DECK/STRUCTURE FOR STANDING SEAM METAL ROOF INSTALLATION TO ESTABLISH PROPER DRAINAGE FIELD VERIFY EXISTING CONDITIONS. PROVIDE METAL ROOFING FLASHING/ACCESSORIES AT EXIST VENTS AND ELECTRICAL/MECHANICAL EQUIPMENT TO MATCH METAL ROOFING SYSTEM.



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SITE # 7008

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ISSUE DATE: APRIL 18, 2022

CAD DWG FILE: A-100

DRAWN BY: EL

CHECKED BY: EL

DESIGNED BY: EL

SHEET TITLE:

BUILDING #16
ROOF PLANS

SHEET NUMBER:

A101

4 OF 29 SHEETS
04/18/2022



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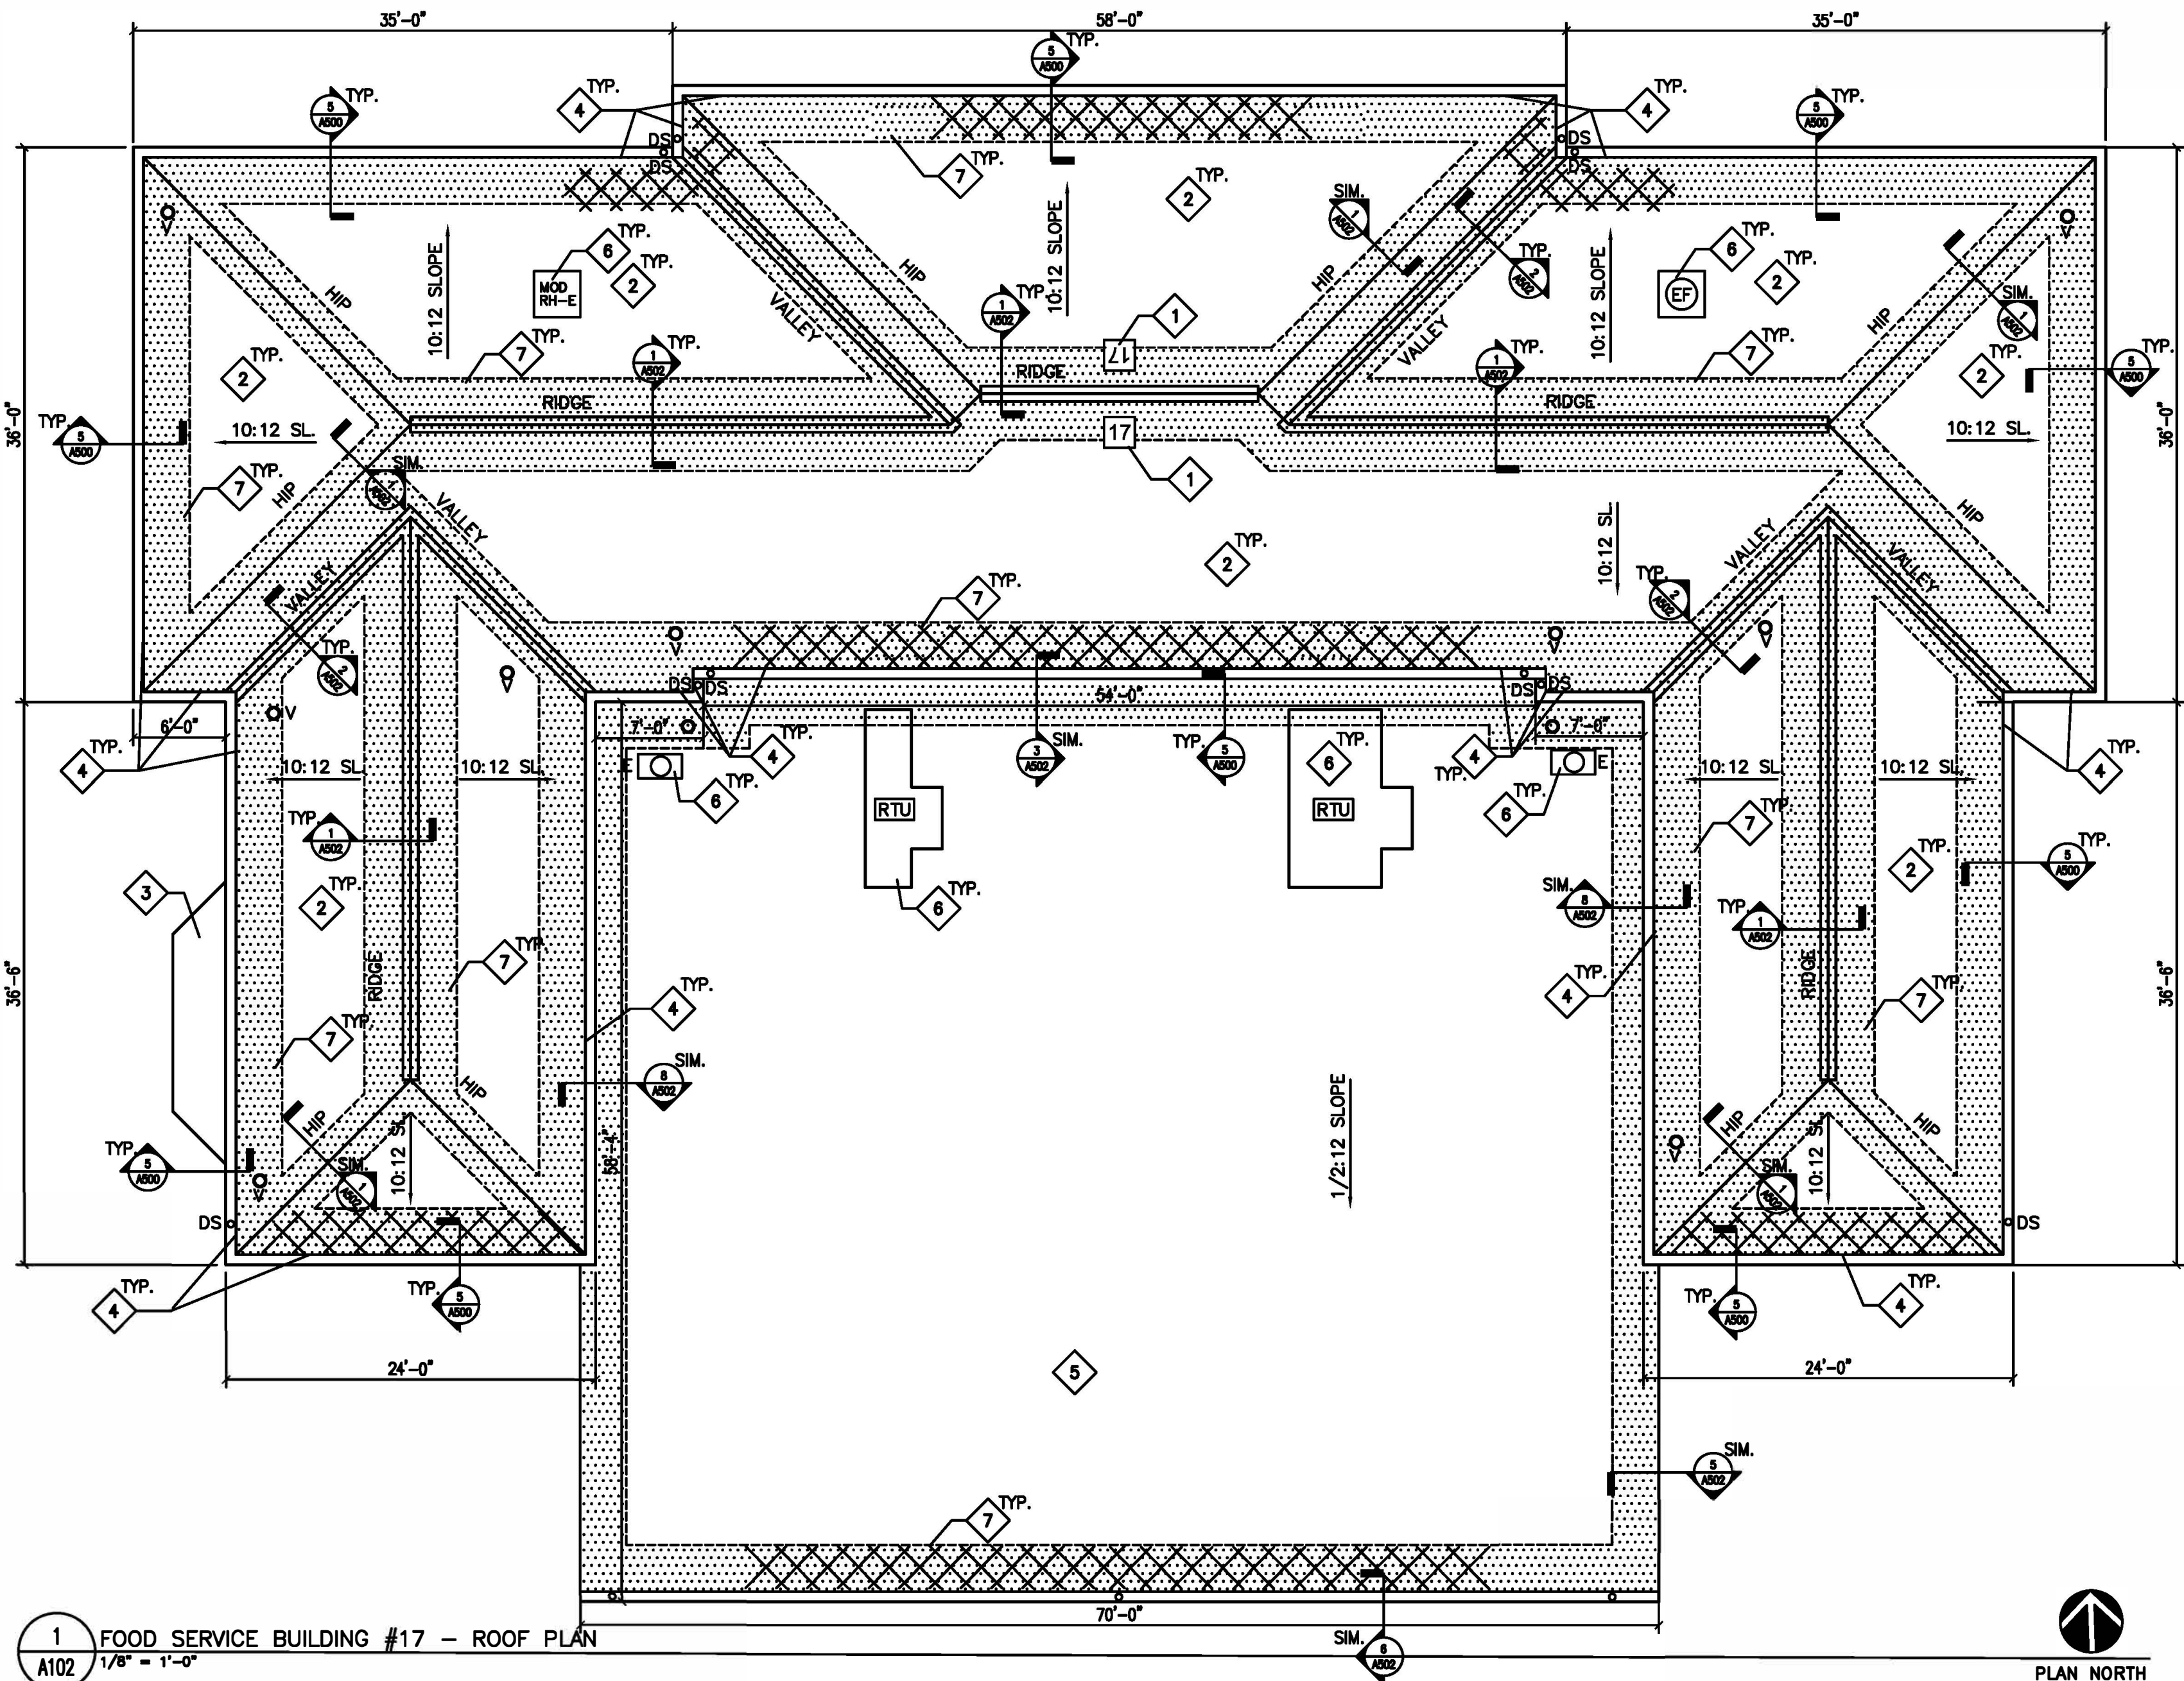
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DRAWN BY: EL
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BUILDING #17
ROOF PLAN

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A102

5 OF 29 SHEETS
04/18/2022



GENERAL NOTES – HAZARDOUS MATERIALS:



- LEAD-BASED PAINT WAS IDENTIFIED ON NUMEROUS SUBSTRATES ASSOCIATED WITH THE ROOFING REPLACEMENT PROJECT. THE INSPECTION RESULTS ARE FOUND IN THE REPORT TITLED "LIMITED ASBESTOS AND LEAD SURVEY".
- THE PAINTING CONTRACTOR'S EMPLOYEES SHALL HAVE HAD THE EPA LEAD RENOVATION, REPAIR AND PAINTING (RRP) CERTIFIED RENOVATOR COURSE. EPA'S RRP RULE REQUIRES RENOVATION, REPAIR AND PAINTING FIRMS WORKING ON PRE-1978 BUILDINGS TO ASSIGN TO EACH JOB A CERTIFIED RENOVATOR WHO IS TRAINED IN LEAD-SAFE WORK PRACTICES. THE TRAINING MUST BE TAUGHT BY AN EPA OR STATE ACCREDITED TRAINING PROVIDER.
- PAINTING CONTRACTOR MUST BE FAMILIAR WITH EPA DOCUMENT TITLED "SMALL ENTITY COMPLIANCE GUIDE TO RENOVATE RIGHT: EPA'S LEAD-BASED PAINT RENOVATION, RENOVATION, REPAIR AND PAINTING PROGRAM" (REVISED SEPTEMBER 2011 VERSION).
- THE PAINTING CONTRACTOR MUST USE LEAD-SAFE WORK PRACTICES WHEN CONDUCTING PAINTING OPERATIONS ON BUILDINGS 17, 18, 31, 32, AND 33.
- THE PAINTING CONTRACTOR MUST COMPLY WITH ALL REQUIREMENTS OF THE OCCUPATIONAL SAFETY AND HEALTH ADMINISTRATION (OSHA) STANDARD 29 CFR 1926.62, LEAD IN CONSTRUCTION, INCLUDING AIR SAMPLING OF REPRESENTATIVE TASKS TO DETERMINE RESPIRATOR REQUIREMENTS IF WARRANTED.
- ALL PAINT CHIPS AND GENERATED WASTE FROM BUILDINGS 17, 18, 31, 32, AND 33 SHALL BE TESTED BY THE PAINTING CONTRACTOR USING TOXIC CHARACTERISTIC LEACHATE PROCESS (TCLP) ANALYTICAL METHODS TO DETERMINE PROPER WASTE DISPOSAL METHODS.
- TRACE AMOUNTS OF LEAD BELOW THE EPA HUD DEFINITION OF LEAD-BASED PAINT WERE IDENTIFIED IN OTHER AREAS OF THE PROJECT. IT SHOULD BE NOTED THAT OSHA DOES NOT RECOGNIZE THE XRF THRESHOLD VALUE OF 1.0 MG/CM2 FOR LEAD EXPOSURE. ALTHOUGH THE POTENTIAL LEAD HAZARD FOR NORMAL CONSTRUCTION ACTIVITIES IS LOW, ACTUAL LEAD EXPOSURE MAY VARY SIGNIFICANTLY DEPENDING UPON THE SPECIFIC TASK, PROCEDURE AND OTHER WORK AREA CONDITIONS. PROPER OSHA COMPLIANCE IS CONSIDERED PERFORMANCE BASED AND INCLUDES EVALUATING POTENTIAL WORK EXPOSURES WITH AIR MONITORING OR BIOLOGICAL EXPOSURE MONITORING (BLOOD LEAD TESTING), IF REQUIRED.
- THE LOCATIONS OF WASTE DISPOSAL CONTAINERS SHALL BE FIELD VERIFIED WITH THE CORRECTIONAL CENTER AND/OR THE CORRECTIONAL CENTER'S REPRESENTATIVE.
- AT THE DISCRETION OF THE CORRECTIONAL CENTER, ADDITIONAL AIR SAMPLING MAY BE CONDUCTED DURING PAINTING OPERATIONS TO ENSURE LEAD DUST IS NOT MIGRATING AWAY FROM THE WORK SITE.
- ASBESTOS WINDOW GLAZING WAS IDENTIFIED FOR BUILDING 17. AVOID CONTACT WITH THIS ASBESTOS MATERIAL. DO NOT SCRAPE, ABRASE OR OTHERWISE IMPACT THE ASBESTOS.

GENERAL NOTES – ROOF PLANS:

- THE CONTRACTOR IS TO VISIT THE SITE DURING THE BIDDING PERIOD AND IS TO ADVISE THE ARCHITECT OF ANY SITUATION OR DISCREPANCY WHICH WILL NOT ALLOW SUCCESSFUL COMPLETION OF THE WORK. THE ARCHITECT'S DECISION WILL CLARIFY THE SCOPE OF WORK.
- INFORMATION IS TAKEN FROM OWNER PROVIDED DOCUMENTS AND SITE INVESTIGATION. THE CONTRACTOR SHALL FIELD VERIFY ALL EXISTING CONDITIONS AND DIMENSIONS PRIOR TO FABRICATION AND INSTALLATION OF NEW WORK.
- PRIOR TO BIDDING, CONTRACTOR IS REQUIRED TO BE FAMILIAR ON SITE WITH THE STATUS OF THE EXISTING ROOF AND VERIFY THE INFORMATION INDICATED IN THE DOCUMENTS.
- THE CONTRACTOR IS RESPONSIBLE FOR PROTECTING EXISTING ITEMS TO REMAIN DURING DEMOLITION AND NEW CONSTRUCTION.
- PATCH EXISTING TO MATCH ADJACENT MATERIALS WERE DEMOLITION AND NEW CONSTRUCTION OCCUR UNLESS INDICATED OTHERWISE.
- ALL DIMENSIONS REQUIRED FOR WORK SHALL BE VERIFIED BY CONTRACTOR IN THE FIELD PRIOR TO WORK. DIMENSIONS SHOWN FOR INFORMATION ONLY AND MAY BE PLUS/MINUS WHAT IS INDICATED.
- ALL MANUFACTURED ARTICLES, MATERIALS AND EQUIPMENT SHALL BE APPLIED, INSTALLED, CONNECTED, ERECTED, CLEANED AND CONDITIONED AS DIRECTED BY THE MANUFACTURER, UNLESS INDICATED OTHERWISE.
- CURRENT STANDARDS OF ROOFING INSTALLATION, CONSTRUCTION AND WATERPROOFING, NRCA AND ASHRAE APPLY TO THE PERFORMANCE AND DETAILS OF ROOFING CONSTRUCTION INDICATED IN THESE DOCUMENTS.
- THE CONTRACTOR SHALL COORDINATE WITH THE FACILITY TO ESTABLISH PROCEDURES FOR THE CONTROLLED ENTRY OF MEN AND MATERIALS INTO THE WORK AREA AND SHALL COMPLY WITH ALL RULES AND REGULATIONS ESTABLISHED BY THE FACILITY. THE INTERRUPTION OF SECURITY AND COMMUNICATIONS WILL NOT BE PERMITTED. CONTRACTOR SHALL INFORM AND COORDINATE WITH SECURITY OFFICIALS 48 HOURS IN ADVANCE OF ANY WORK RELATED TO SECURITY OR COMMUNICATIONS.
- AT MECHANICAL/ELECTRICAL ROOF EQUIPMENT AND VENTS, PROVIDE FLASHING PER ROOFING MFR. FOR WATERTIGHT ROOF INSTALLATION.
- PROVIDE SNOW AND ICE GUARDS AT NEW STANDING SEAM METAL ROOFS AS INDICATED ON THE PLANS AND LOCATED DIRECTLY ABOVE EXIST. DOOR LOCATIONS AND 5'-0" ON EITHER SIDE OF DOOR OPENING.
- PROVIDE NEW DOWNSPOUTS AT ALL EXISTING DOWNSPOUT LOCATIONS, SIZE PER EXISTING.

KEYED NOTES – ROOF PLAN:

- ROOF NUMBER SIGNAGE SECURE TO STANDING SEAM METAL ROOF PER MANUFACTURER SO AS NOT TO VOID WARRANTY. SIGNAGE SHALL BE 36"x36" SQUARE. THE BUILDING NUMBER AS INDICATED SHALL BE BLACK WITH A REFLECTIVE WHITE BACKGROUND. FONT SIZE SHALL FIT 36"x36" SIGN.
- NEW STANDING SEAM MTL ROOFING SYSTEM OVER EXISTING WOOD DECKING ON WOOD STRUCTURAL SYSTEM, INCLUDING: UNDERLAYMENT, FLASHING, GUTTERS AND DOWNSPOUTS TO MATCH NEW ROOF SYSTEM. PROVIDE METAL ROOFING FLASHING AND ACCESSORIES AS REQUIRED FOR A WATERTIGHT INSTALLATION AND AT EXIST. VENTS AND ELECTRICAL/MECHANICAL EQUIPMENT TO MATCH METAL ROOFING SYSTEM. PROVIDE PANEL INSTALLATION TO MATCH EXISTING SLOPES AND ACCESSORIES AS REQUIRED FOR WATERTIGHT INSTALLATION OF METAL ROOFING SYSTEM TO MATCH EXISTING ROOF LAYOUT, SHAPE AND CONSTRUCTION.
- EXISTING COPPER ROOFING SYSTEM TO REMAIN.
- ALL EXISTING WOOD FASCIA BOARD TO BE WRAPPED WITH SHEET METAL FLASHING TO MATCH NEW GUTTER AND ROOFING SYSTEM.
- NEW STANDING SEAM METAL ROOFING SYSTEM, UNDERLAYMENT, FLASHING, GUTTERS AND DOWNSPOUTS WITH R30 RIGID INSULATION OVER EXISTING ROOF DECK. PROVIDE METAL ROOFING FLASHING/ACCESSORIES AT EXIST VENTS AND ELECTRICAL/MECHANICAL EQUIPMENT TO MATCH METAL ROOFING SYSTEM.
- EXISTING EQUIPMENT. SEE MECHANICAL/ELECTRICAL DOCUMENTS FOR REMOVAL/REINSTALLATION REQUIREMENTS FOR ROOFING REPLACEMENT, FLASH CURVES PER ROOF MFROR RECOMMENDATIONS.
- LINE OF SELF-ADHERED WATER AND ICE MEMBRANE, INSTALL ALONG ROOF EDGE, RIDGE AND VALLEY PER DETAILS ON SHEETS A500, A501 AND A502.

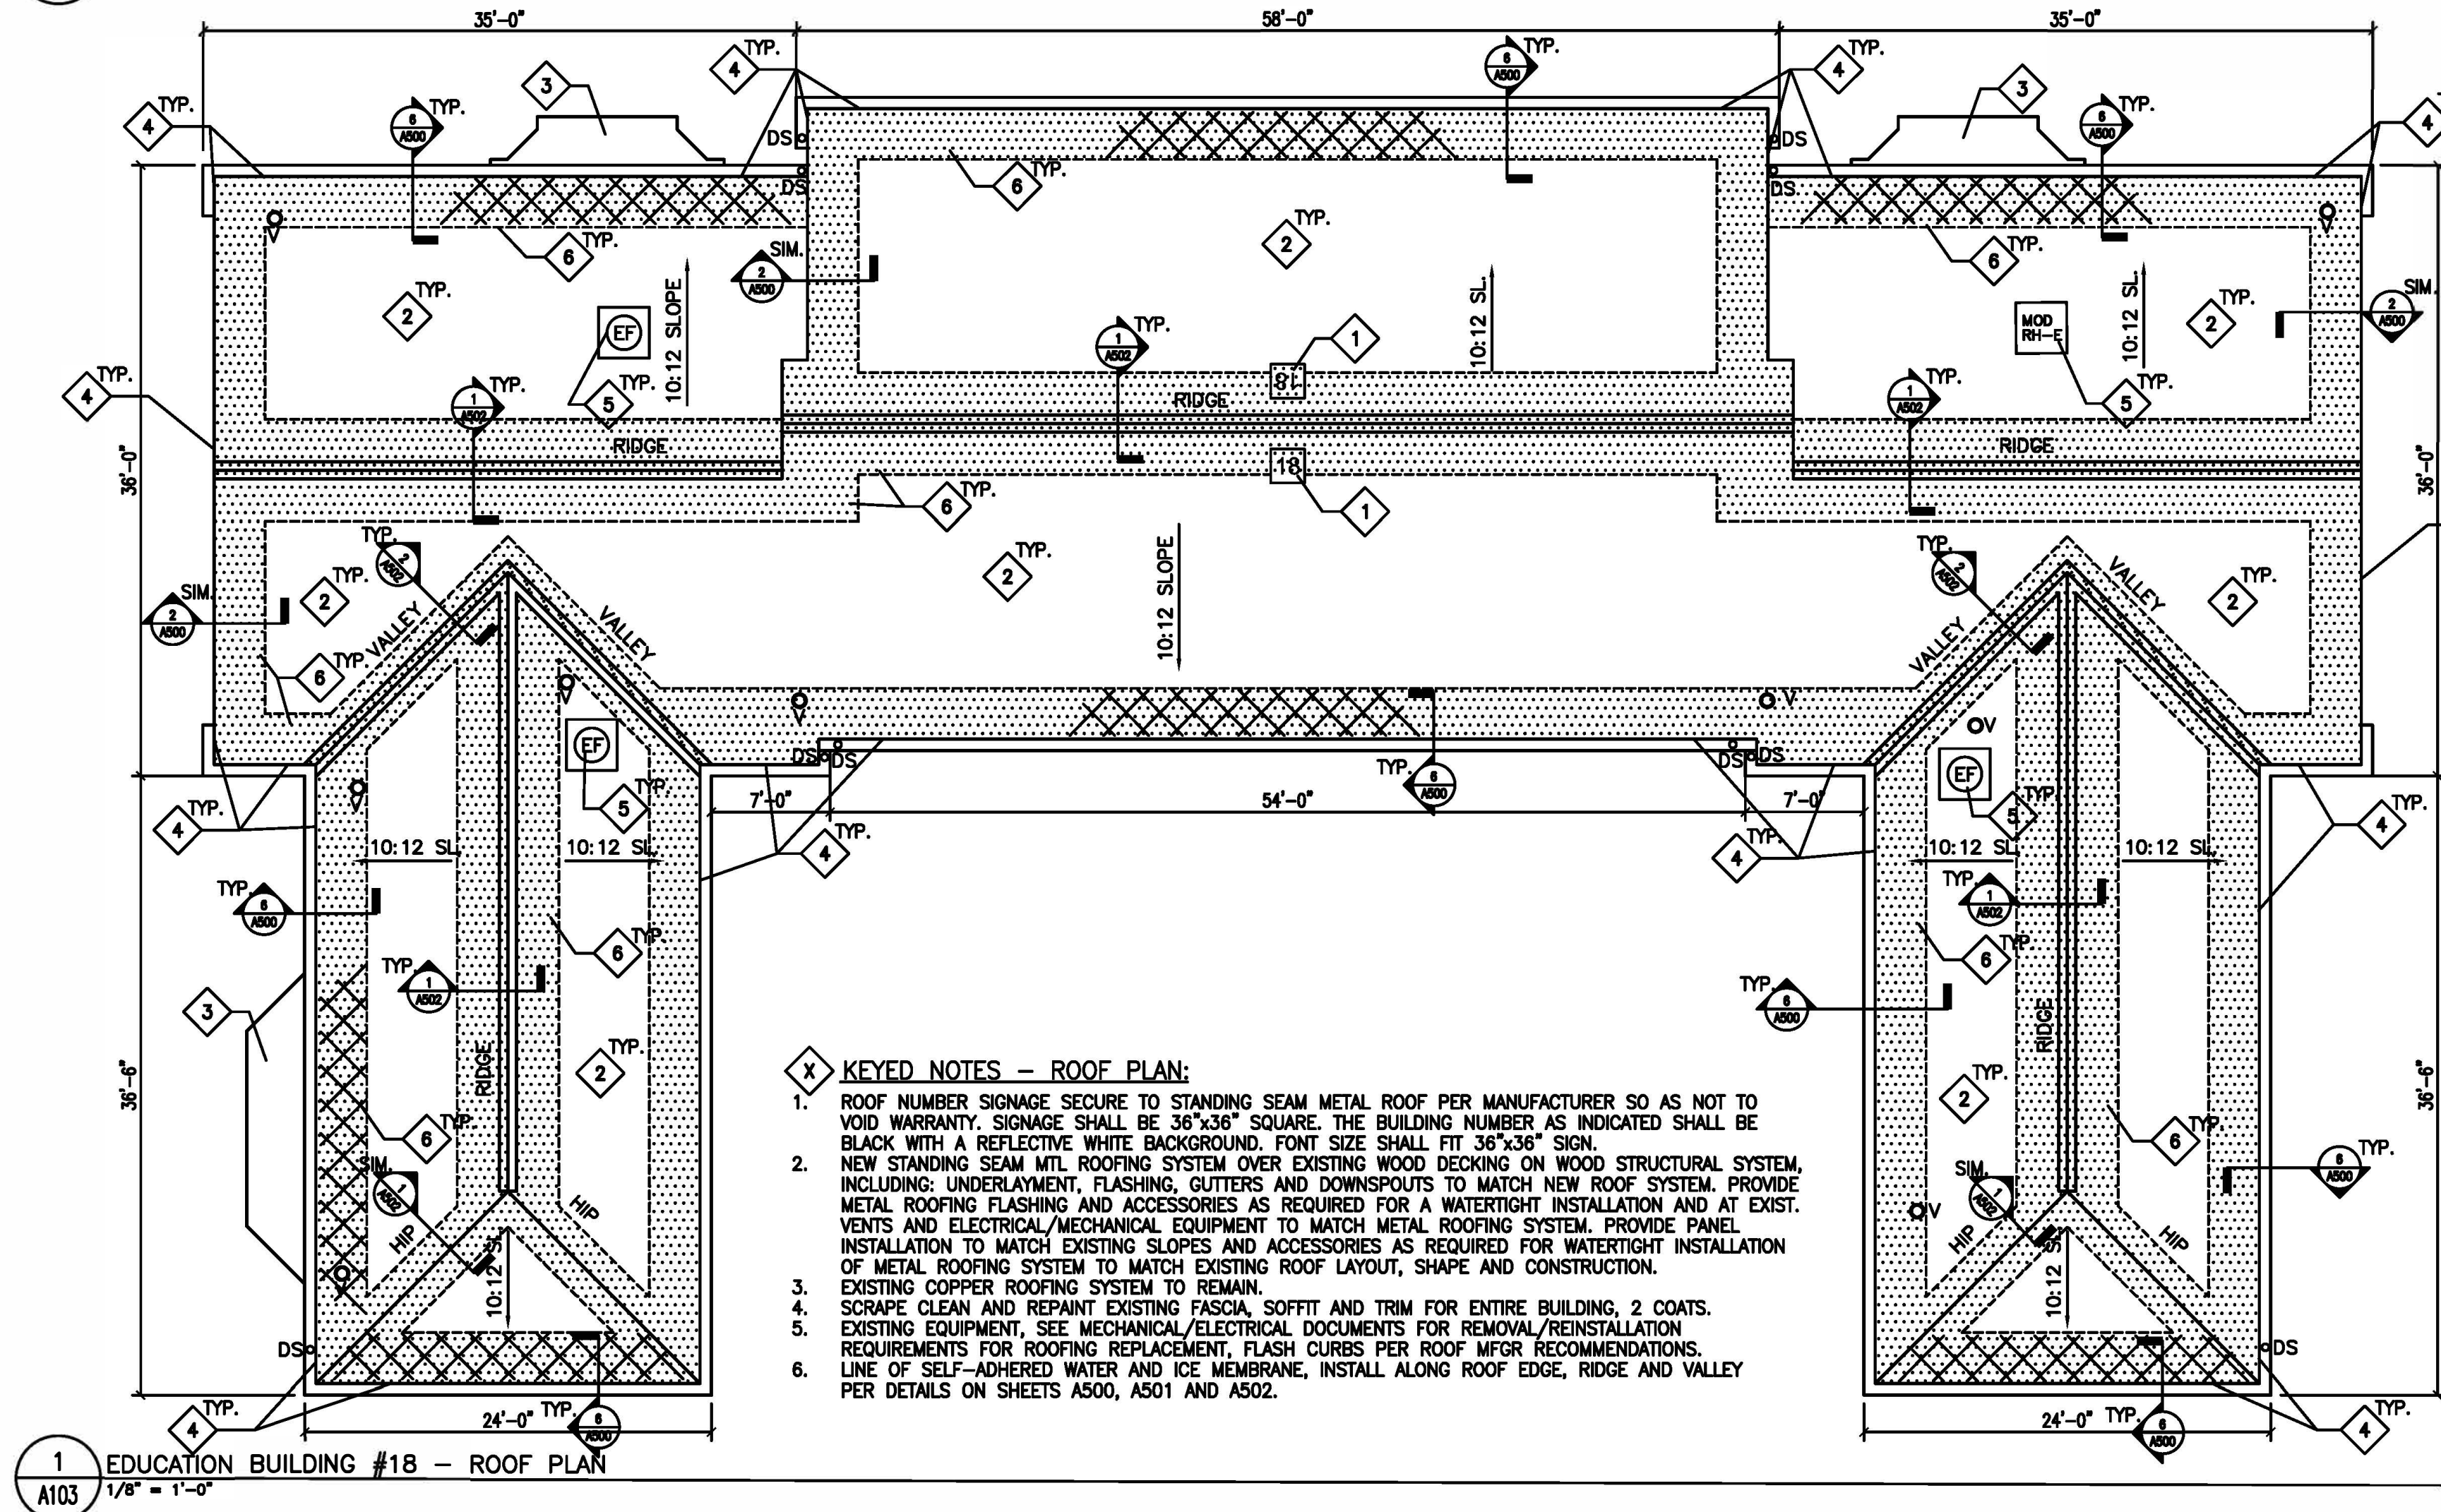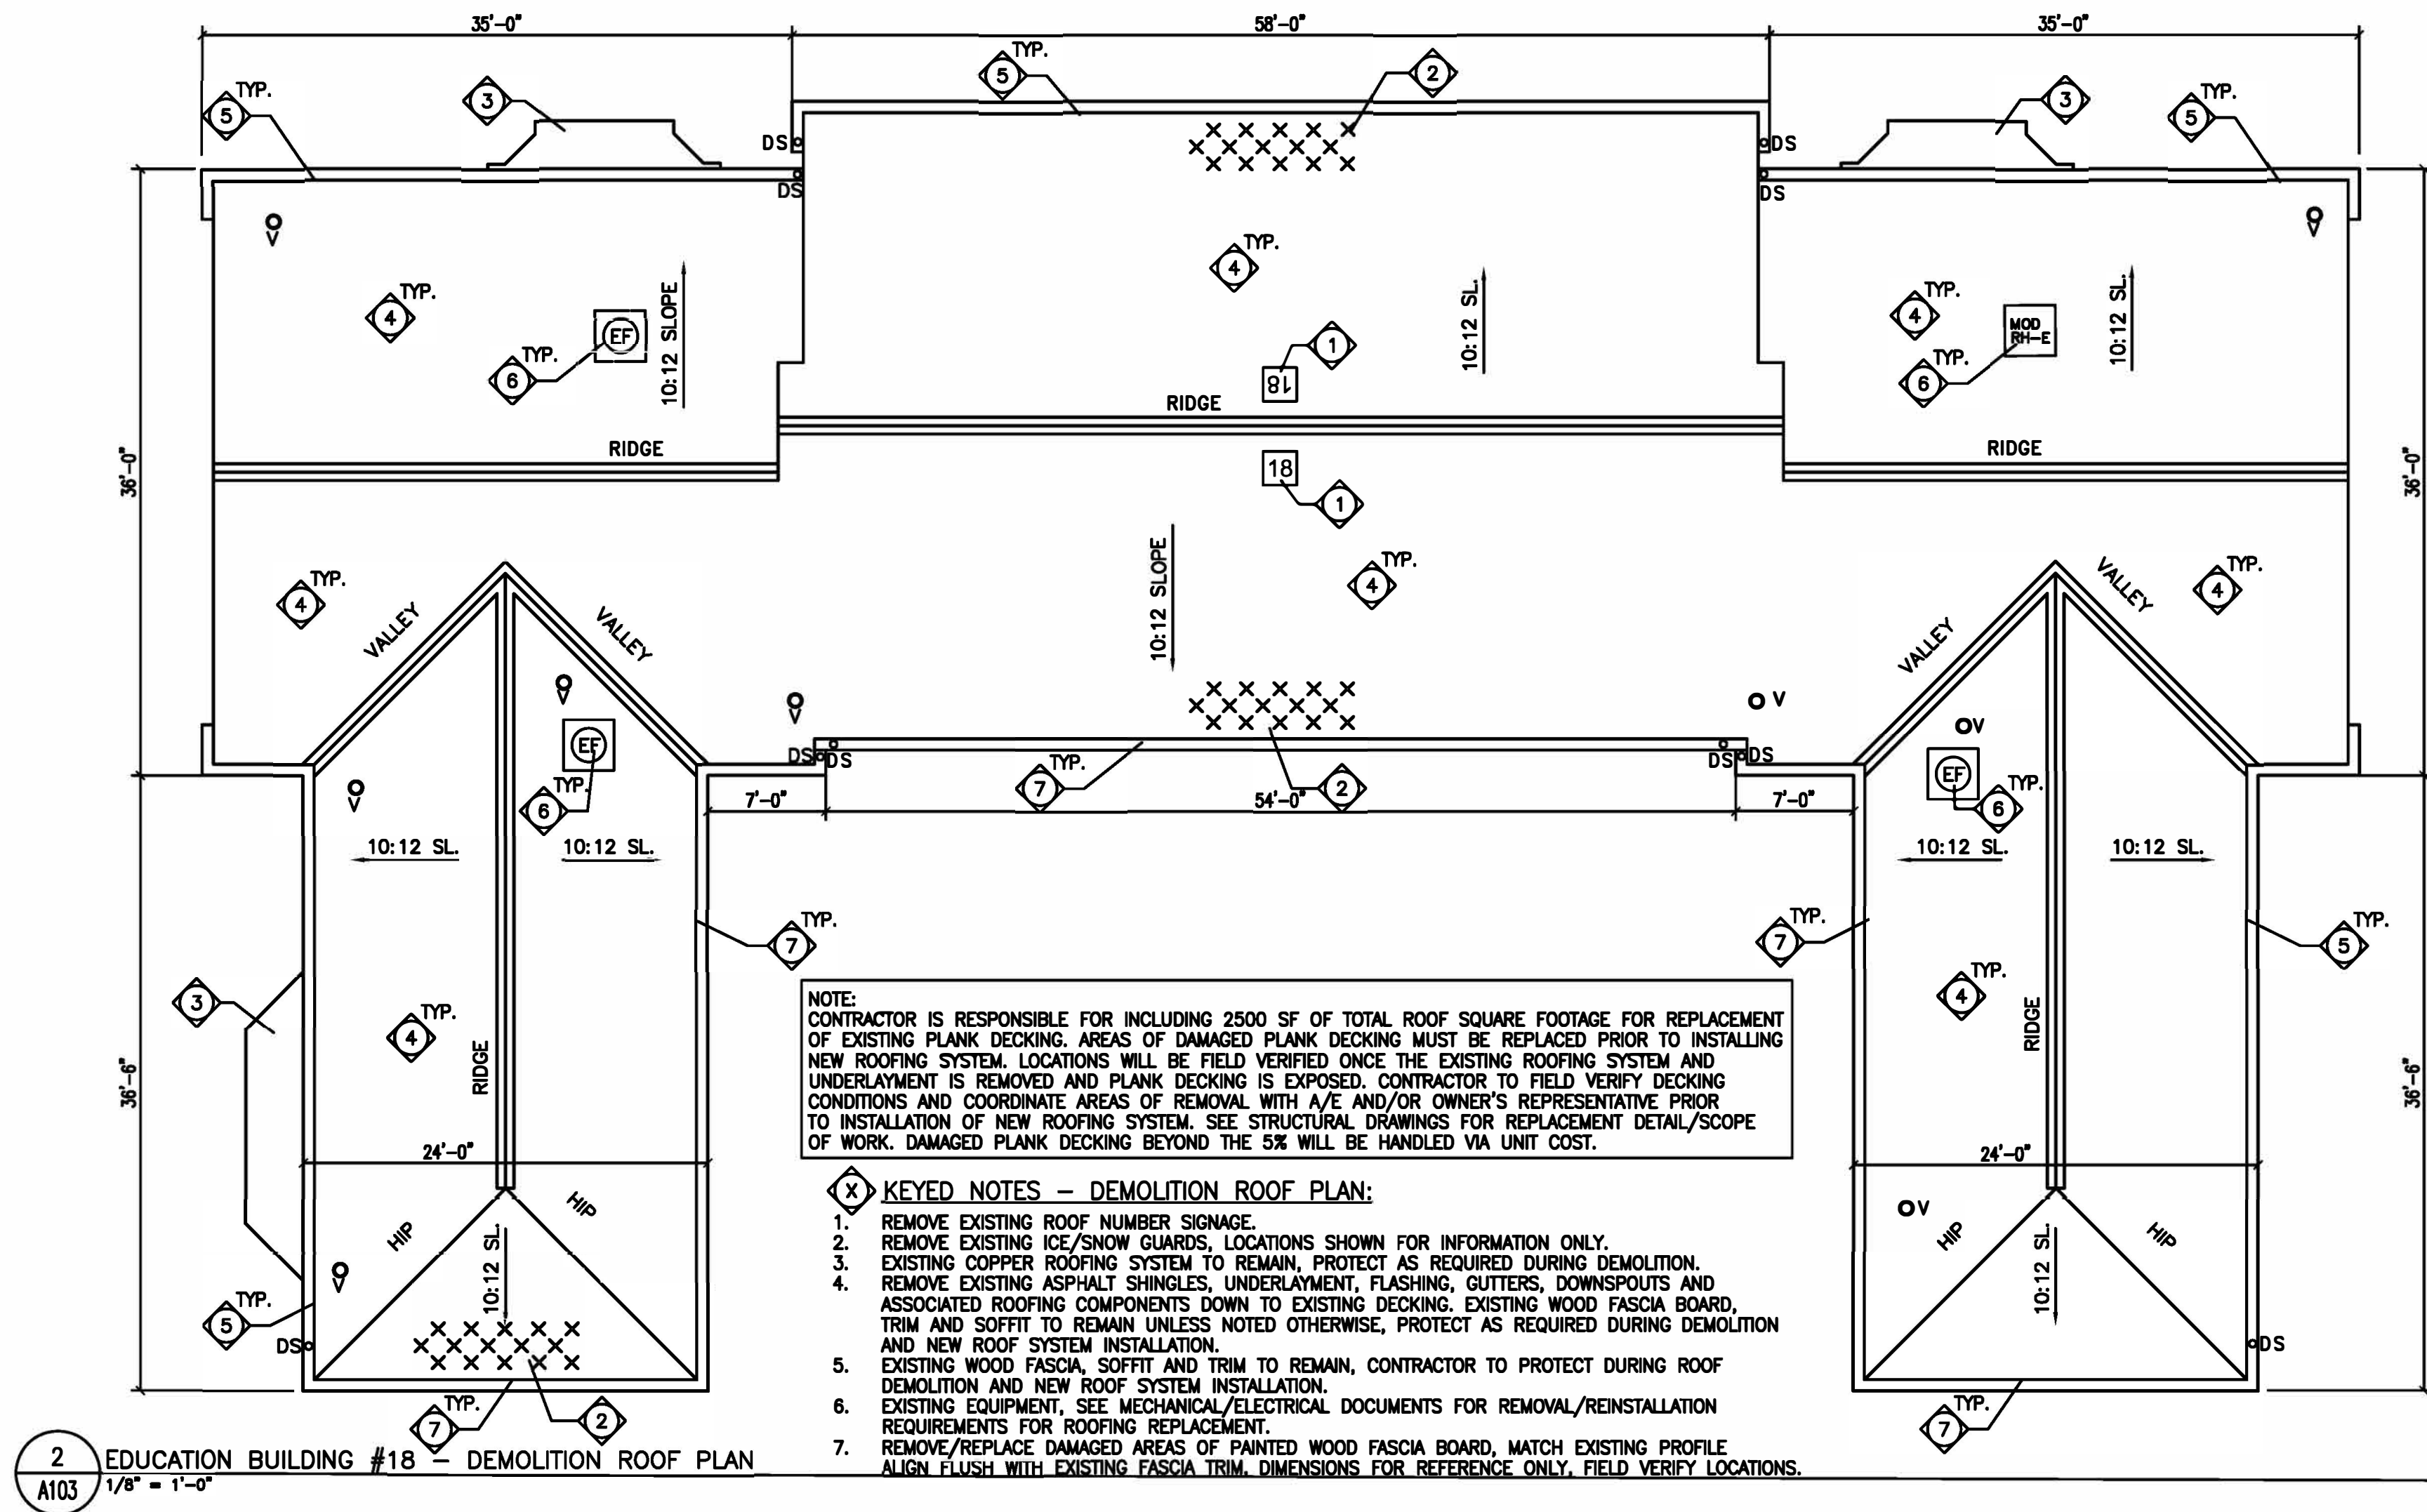

GENERAL NOTES — HAZARDOUS MATERIALS:

- LEAD-BASED PAINT WAS IDENTIFIED ON NUMEROUS SUBSTRATES ASSOCIATED WITH THE ROOFING REPLACEMENT PROJECT. THE INSPECTION RESULTS ARE FOUND IN THE REPORT TITLED "LIMITED ASBESTOS AND LEAD SURVEY".
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GENERAL NOTES — ROOF PLANS:

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- PROVIDE SNOW AND ICE GUARDS AT NEW STANDING SEAM METAL ROOFS AS INDICATED ON THE PLANS AND LOCATED DIRECTLY ABOVE EXIST. DOOR LOCATIONS AND 5'-0" ON EITHER SIDE OF DOOR OPENING.
- PROVIDE NEW DOWNSPOUTS AT ALL EXISTING DOWNSPOUT LOCATIONS, SIZE PER EXISTING.

STATE OF MISSOURI
MICHAEL L PARSON,
GOVERNOR



STATE OF MISSOURI
CERTIFICATE OF AUTHORITY #2018019473

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IMEG CORP.
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OFFICE OF ADMINISTRATION
DIVISION OF FACILITIES
MANAGEMENT,
DESIGN AND CONSTRUCTION
DEPARTMENT OF
CORRECTIONS

1012 WEST COLUMBIA ST.
FARMINGTON, MO 63640

REPLACE ROOF SYSTEMS
MULTIPLE ASSETS
FARMINGTON
CORRECTIONAL CENTER

FARMINGTON, MISSOURI

PROJECT # C1922-01
SITE # 7008
ASSET # 9327008089,
9327008090, 9327008091, 9327008082
9327008081, 9327008080, 9327008079

REVISION: -
DATE: -
REVISION: -
DATE: -
REVISION: -
DATE: -

ISSUE DATE: APRIL 18, 2022

CAD DWG FILE: A-100
DRAWN BY: EL
CHECKED BY: EL
DESIGNED BY: EL

SHEET TITLE:

BUILDING #18
ROOF PLANS
(ALTERNATE NO. 1)

SHEET NUMBER:

A103

6 OF 29 SHEETS
04/18/2022



ENGINEER
IMEG CORP.

**1012 WEST COLUMBIA ST.
FARMINGTON, MO 63640**

FARMINGTON, MISSOURI

REVISION:-
DATE:-
REVISION:-
DATE:-
REVISION:-
DATE:-

CAD DWG FILE: A-100
DRAWN BY: EL
CHECKED BY: EL
DESIGNED BY: EL

**BUILDING #19
ROOF PLANS
(ALTERNATE NO. 2)**

A104

GENERAL NOTES: HAZARDOUS MATERIALS:

A. LEAD-BASED PAINT WAS IDENTIFIED ON NUMEROUS SUBSTRATES ASSOCIATED WITH THE ROOFING REPLACEMENT PROJECT. THE INSPECTION RESULTS ARE FOUND IN THE REPORT TITLED "LIMITED ASBESTOS AND LEAD SURVEY".

B. THE PAINTING CONTRACTOR'S EMPLOYEES SHALL HAVE HAD THE EPA LEAD RENOVATION, REPAIR AND PAINTING (RPP) CERTIFIED RENOVATOR COURSE. EPA'S RRP RULE REQUIRES RENOVATION, REPAIR AND PAINTING FIRMS WORKING ON 15,000 BLDG BUILDINGS TO DESIGN TO EACH JOBS A CERTIFIED RENOVATOR WHO IS TRAINED IN LEAD-SAFE WORK PRACTICES. THE TRAINING MUST BE TAUGHT BY AN EPA OR STATE ACCREDITED TRAINING PROVIDER.

C. PAINTING CONTRACTOR MUST BE FAMILIAR WITH EPA DOCUMENT TITLED "SMALL ENTITY COMPLIANCE GUIDE" TO RENOVATE RIGHT: EPA'S LEAD-BASED PAINT RENOVATION, RENOVATION, REPAIR AND PAINTING PROGRAM" (REVISED SEPTEMBER 2001, 2011 VERSION).

D. THE PAINTING CONTRACTOR MUST HAVE LEAD-SAFE WORK PRACTICES WHEN CONDUCTING PAINTING OPERATIONS ON BUILDINGS 17, 18, 31, 32, AND 33.

E. THE PAINTING CONTRACTOR MUST COMPLY WITH ALL REQUIREMENTS OF THE OCCUPATIONAL SAFETY AND HEALTH ADMINISTRATION (OSHA) STANDARD 29 CFR 1926.62, LEAD IN CONSTRUCTION, INCLUDING AIR SAMPLING OF REPRESENTATIVE SITES TO DETERMINE RESPIRATOR REQUIREMENTS IF WARRANTED.

F. ALL PAINT CHIPS AND CONTAMINATED BUILDING MATERIALS 17, 18, 31, 32, AND 33 SHALL BE TESTED BY THE PAINTING CONTRACTOR USING TOXIC CHARACTERISTIC LEACHATE PROCESS (TCLP) ANALYTICAL METHODS TO DETERMINE PROPER WASTE DISPOSAL METHODS.

G. TRACE AMOUNTS OF LEAD BELOW THE EPA HUD DEFINITION OF LEAD-BASED PAINT WERE IDENTIFIED IN OTHER AREAS OF THE PROJECT. IT SHOULD BE NOTED THAT OSHA DOES NOT RECOGNIZE THE XRF TOTAL LEAD VALUE OF 0.01% OF LEAD EXPOSURE. ALTHOUGH THE POTENTIAL LEAD HAZARD FOR NORMAL CONSTRUCTION ACTIVITIES IS LOW, ACTUAL LEAD EXPOSURE MAY VARY SIGNIFICANTLY DEPENDING UPON THE SPECIFIC TASK, PROCEDURE AND OTHER WORK AREA CONDITIONS. PROPER OSHA COMPLIANCE IS CONSIDERED PERFORMANCE BASED AND INCLUDES EVALUATING POTENTIAL WORK EXPOSURES WITH AIR MONITORING OR BIOLOGICAL MONITORING (BLOOD-LEAD TESTING), REQUIRED.

H. THE LOCATIONS OF SITE DISPOSAL CONTAINERS SHALL BE FIELD VERIFIED WITH THE CORRECTIONAL CENTER AND/OR THE CORRECTIONAL CENTER'S REPRESENTATIVE.

J. AT THE DISCRETION OF THE CORRECTIONAL CENTER, ADDITIONAL AIR SAMPLING MAY BE CONDUCTED DURING PAINTING OPERATIONS TO ENSURE LEAD DUST IS NOT MIGRATING AWAY FROM THE WORK SITE.

K. REMOVE WINDOW SILLINGS FROM THE FACILITY OR SUBSTRATE. IF ANY CONTACT WITH THIS ASBESTOS MATERIAL. DO NOT SCRAPE, ABRAD, OR OTHERWISE IMPACT THE ASBESTOS.

GENERAL NOTES – ROOF PLANS:

L. THE CONTRACTOR IS TO VISIT THE SITE DURING THE BIDDING PERIOD AND IS TO ADVISE THE ARCHITECT OF ANY SITUATION OR DISCREPANCY WHICH WILL NOT ALLOW SUCCESSFUL COMPLETION OF THE WORK. THE ARCHITECTS DECISION WILL CLARIFY THE SCOPE OF WORK.

M. INFORMATION IS TAKEN FROM OWNER PROVIDED DOCUMENTS AND SITE INVESTIGATION. THE CONTRACTOR SHALL FIELD VERIFY ALL EXISTING CONDITIONS AND DIMENSIONS PRIOR TO FABRICATION AND INSTALLATION.

N. PRIOR TO BIDDING, CONTRACTOR IS REQUIRED TO BE FAMILIAR ON SITE WITH THE STATUS OF THE EXISTING ROOF AND VERIFY ALL INFORMATION INDICATED IN THE DOCUMENTS.

P. THE CONTRACTOR IS RESPONSIBLE FOR PROTECTING EXISTING ITEMS TO REMAIN DURING DEMOLITION AND NEW CONSTRUCTION.

Q. PATCHING EXISTING TO MATCH ADJACENT MATERIALS WERE DEMOLITION AND NEW CONSTRUCTION OCCUR UNLESS INDICATED OTHERWISE.

R. ALL DIMENSIONS REQUIRED FOR WORK SHALL BE VERIFIED BY CONTRACTOR IN THE FIELD PRIOR TO WORK. DIMENSIONS SHOWN FOR INFORMATION ONLY AND MAY BE PLUS/MINUS WHAT IS INDICATED.

S. ALL MANUFACTURED ARTICLES, MATERIALS AND EQUIPMENT SHALL BE APPLIED, INSTALLED, CONNECTED, ERECTED OR CLAINED TO BE DIRECTLY BY THE MANUFACTURER, UNLESS INDICATED OTHERWISE.

T. CURRENT STANDARDS OF ROOFING INSTALLATION, CONSTRUCTION AND WATERPROOFING, NRCA AND ASHRAE APPLY TO THE PERFORMANCE AND DETAILS OF ROOFING CONSTRUCTION INDICATED IN THESE DOCUMENTS.

U. THE CONTRACTOR SHALL COORDINATE WITH THE FACILITY TO ESTABLISH PROCEDURES FOR THE CONTROLLED ENTRY OF MEN AND MATERIALS INTO THE WORK AREA AND SHALL COMPLY WITH ALL ROLLING AND REGULATIONS ESTABLISHED BY THE FACILITY. THE FACILITY'S SECURITY AND COMMUNICATIONS WILL NOT BE PERMITTED. CONTRACTOR SHALL INFORM AND COORDINATE WITH SECURITY OFFICIALS 48 HOURS IN ADVANCE OF ANY WORK RELATED TO SECURITY OR COMMUNICATIONS.

V. AT MECHANICAL/ELECTRICAL ROOF EQUIPMENT AND VENTS, PROVIDE FLASHING PER ROOFING MFG. FOR WATER/TIGHT ROOF INSTALLATION.

W. SNOW REMOVAL SHALL BE AWARDS ON NEW STANDING SEAM METAL ROOFS AS INDICATED ON THE PLANS.

X. AND LOCATED DIRECTLY ABOVE EXIST. DOOR LOCATIONS AND 5'-0" ON EITHER SIDE OF DOOR OPENING.

Y. PROVIDE NEW DOWNSPOUTS AT ALL EXISTING DOWNSPOUT LOCATIONS, SIZE PER EXISTING.




KEYED NOTES — ROOF PLAN:


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2. NEW STANDING SEAM MTL ROOFING SYSTEM OVER EXISTING WOOD DECKING ON WOOD STRUCTURAL SYSTEM, INCLUDING: UNDERLAYMENT, FLASHING, GUTTERS AND DOWNSPOUTS TO MATCH NEW ROOF SYSTEM. PROVIDE METAL ROOFING FLASHING AND ACCESSORIES AS REQUIRED FOR A WATERTIGHT INSTALLATION AND AT EXIST. VENTS AND ELECTRICAL/MECHANICAL EQUIPMENT TO MATCH METAL ROOFING SYSTEM. PROVIDE PANEL INSTALLATION TO MATCH EXISTING SLOPES AND ACCESSORIES AS REQUIRED FOR WATERTIGHT INSTALLATION OF METAL ROOFING SYSTEM TO MATCH EXISTING ROOF LAYOUT, SHAPE AND CONSTRUCTION.
3. EXISTING COPPER ROOFING SYSTEM TO REMAIN.
4. ALL EXISTING WOOD FASCIA BOARD AND REPLACEMENT BOARDS TO BE WRAPPED WITH SHEET METAL FLASHING TO MATCH NEW GUTTER AND ROOFING SYSTEM, EXISTING GABLE TRIM TO REMAIN AS EXISTING.
5. EXISTING EQUIPMENT, SEE MECHANICAL/ELECTRICAL DOCUMENTS FOR REMOVAL/REINSTALLATION REQUIREMENTS FOR ROOFING REPLACEMENT, FLASH CURBS PER ROOF MFR RECOMMENDATIONS.
6. LINE OF SELF-ADHERED WATER AND ICE MEMBRANE, INSTALL ALONG ROOF EDGE, RIDGE AND VALLEY PER DETAILS ON SHEETS A500, A501 AND A502.



PLAN NORTH

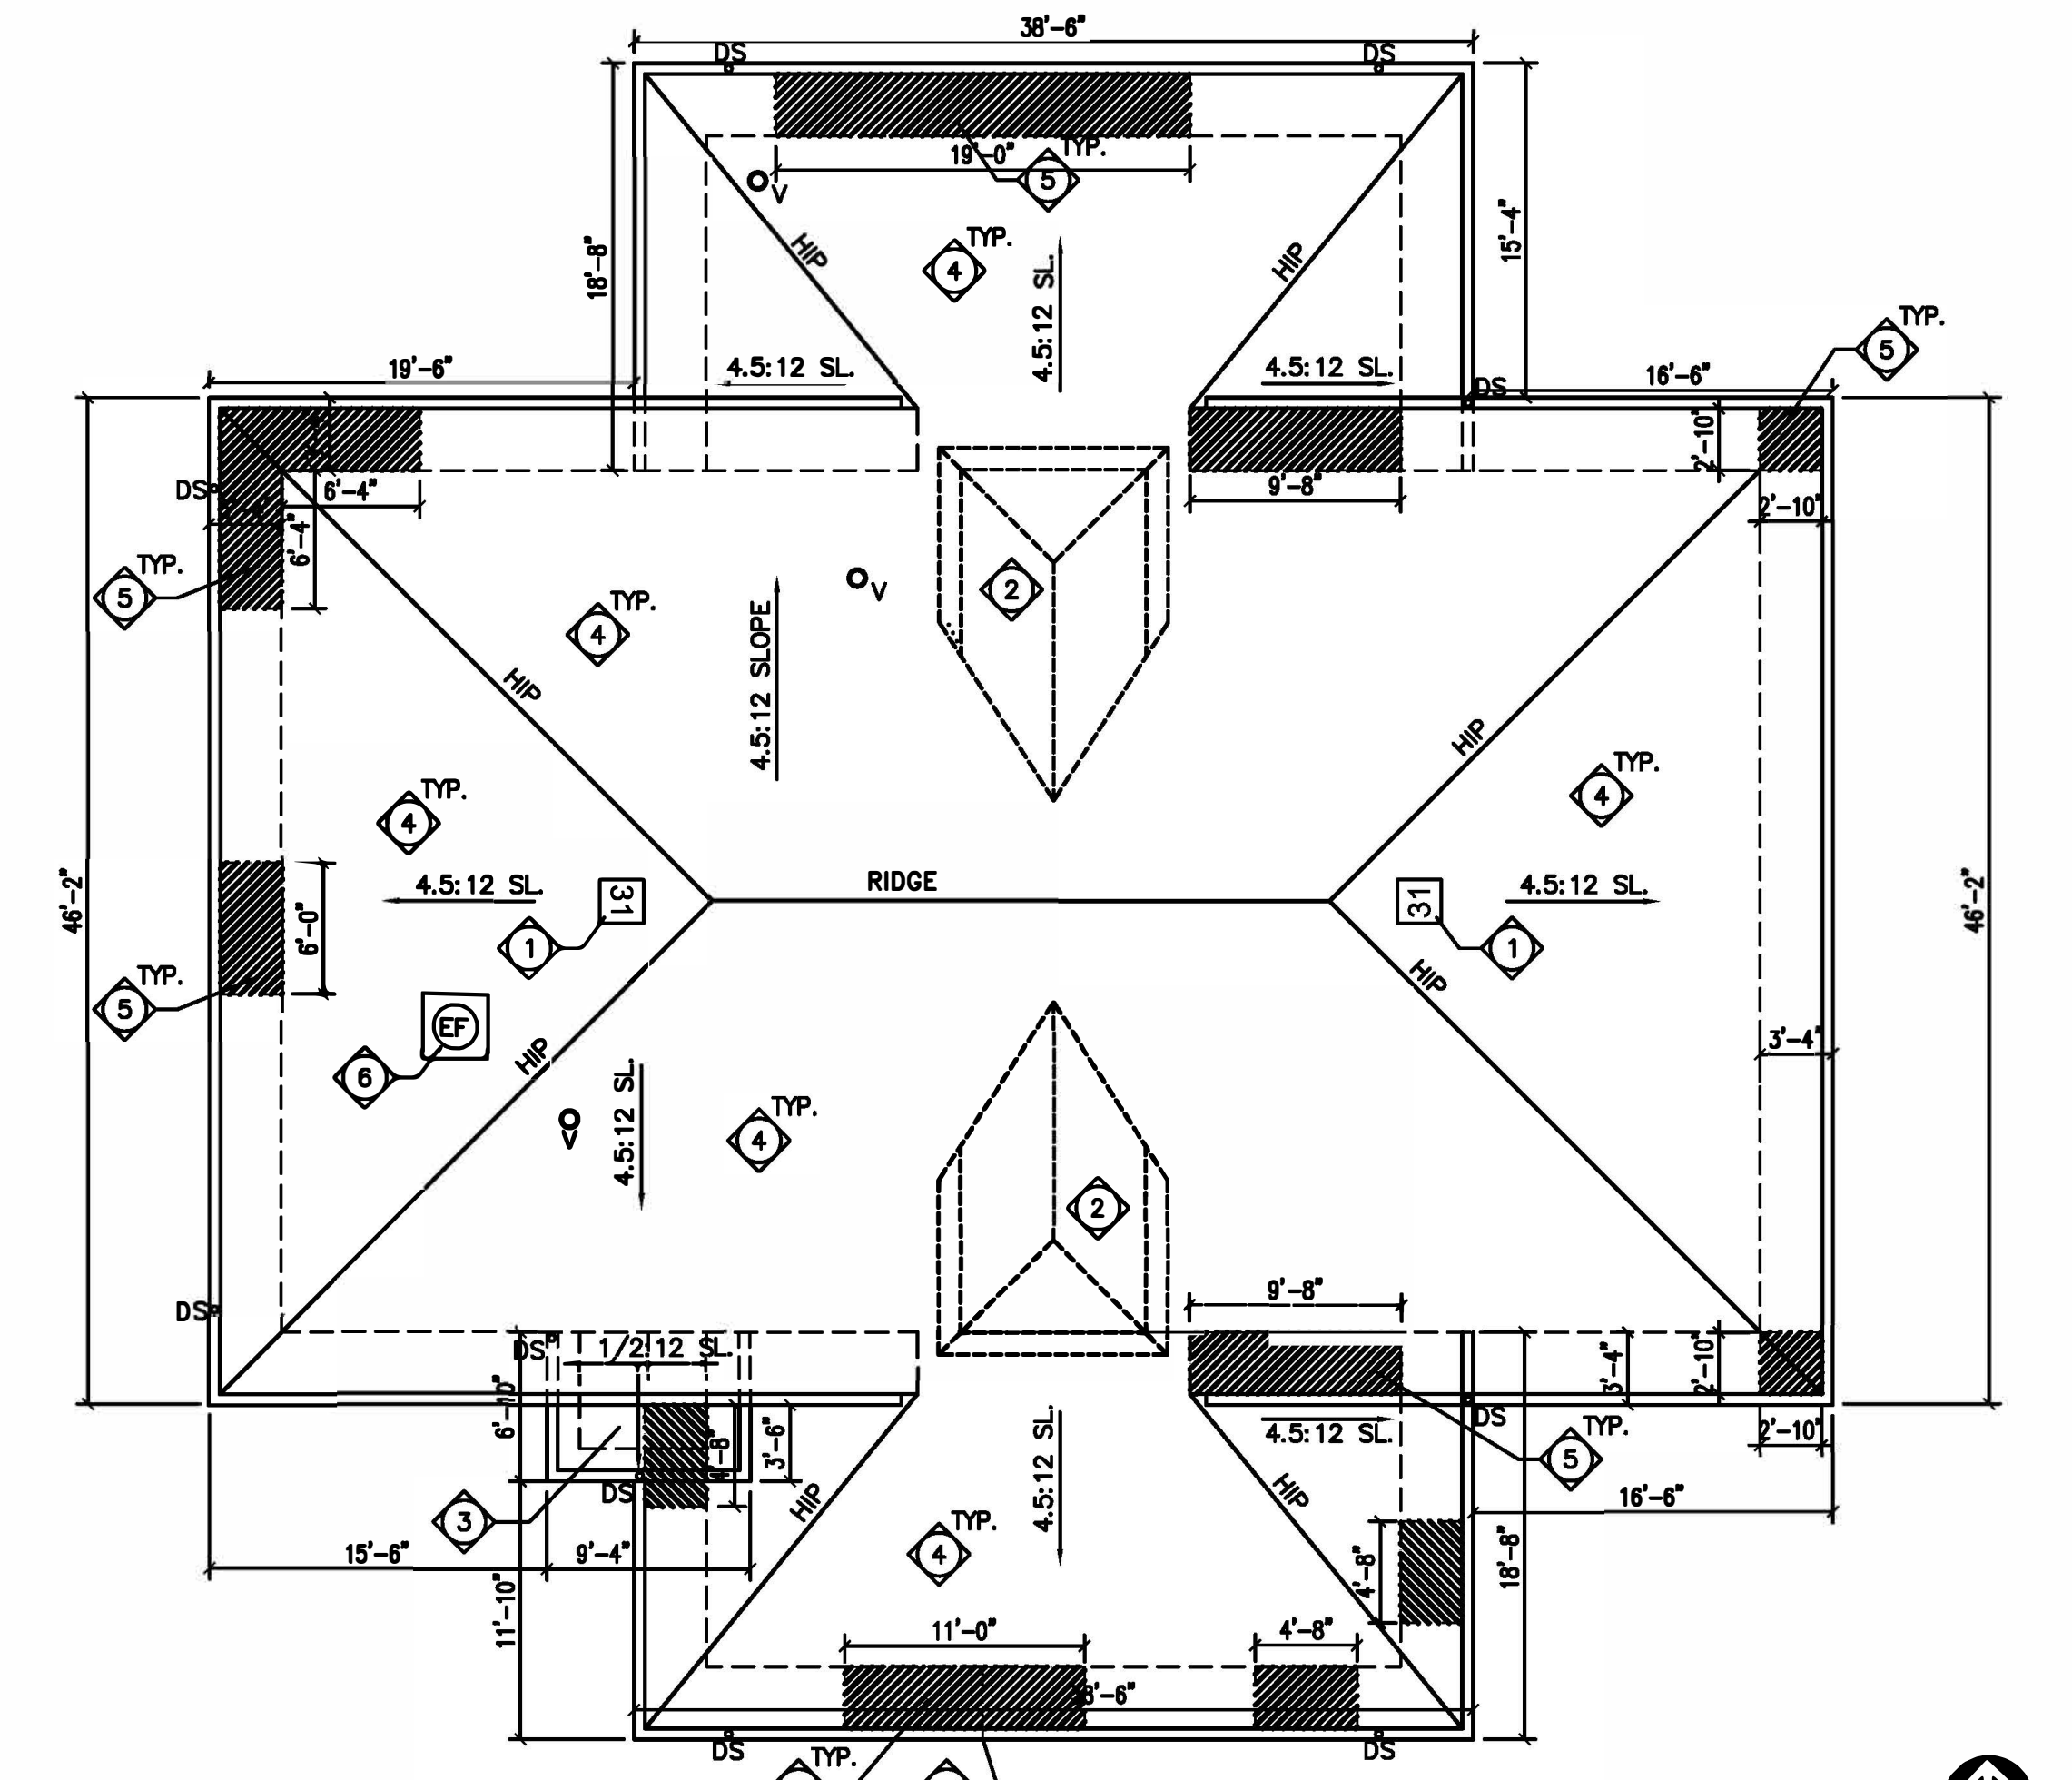

2 BOOT CAMP BUILDING #31 - DEMOLITION ROOF PLAN
1/8" = 1'-0"

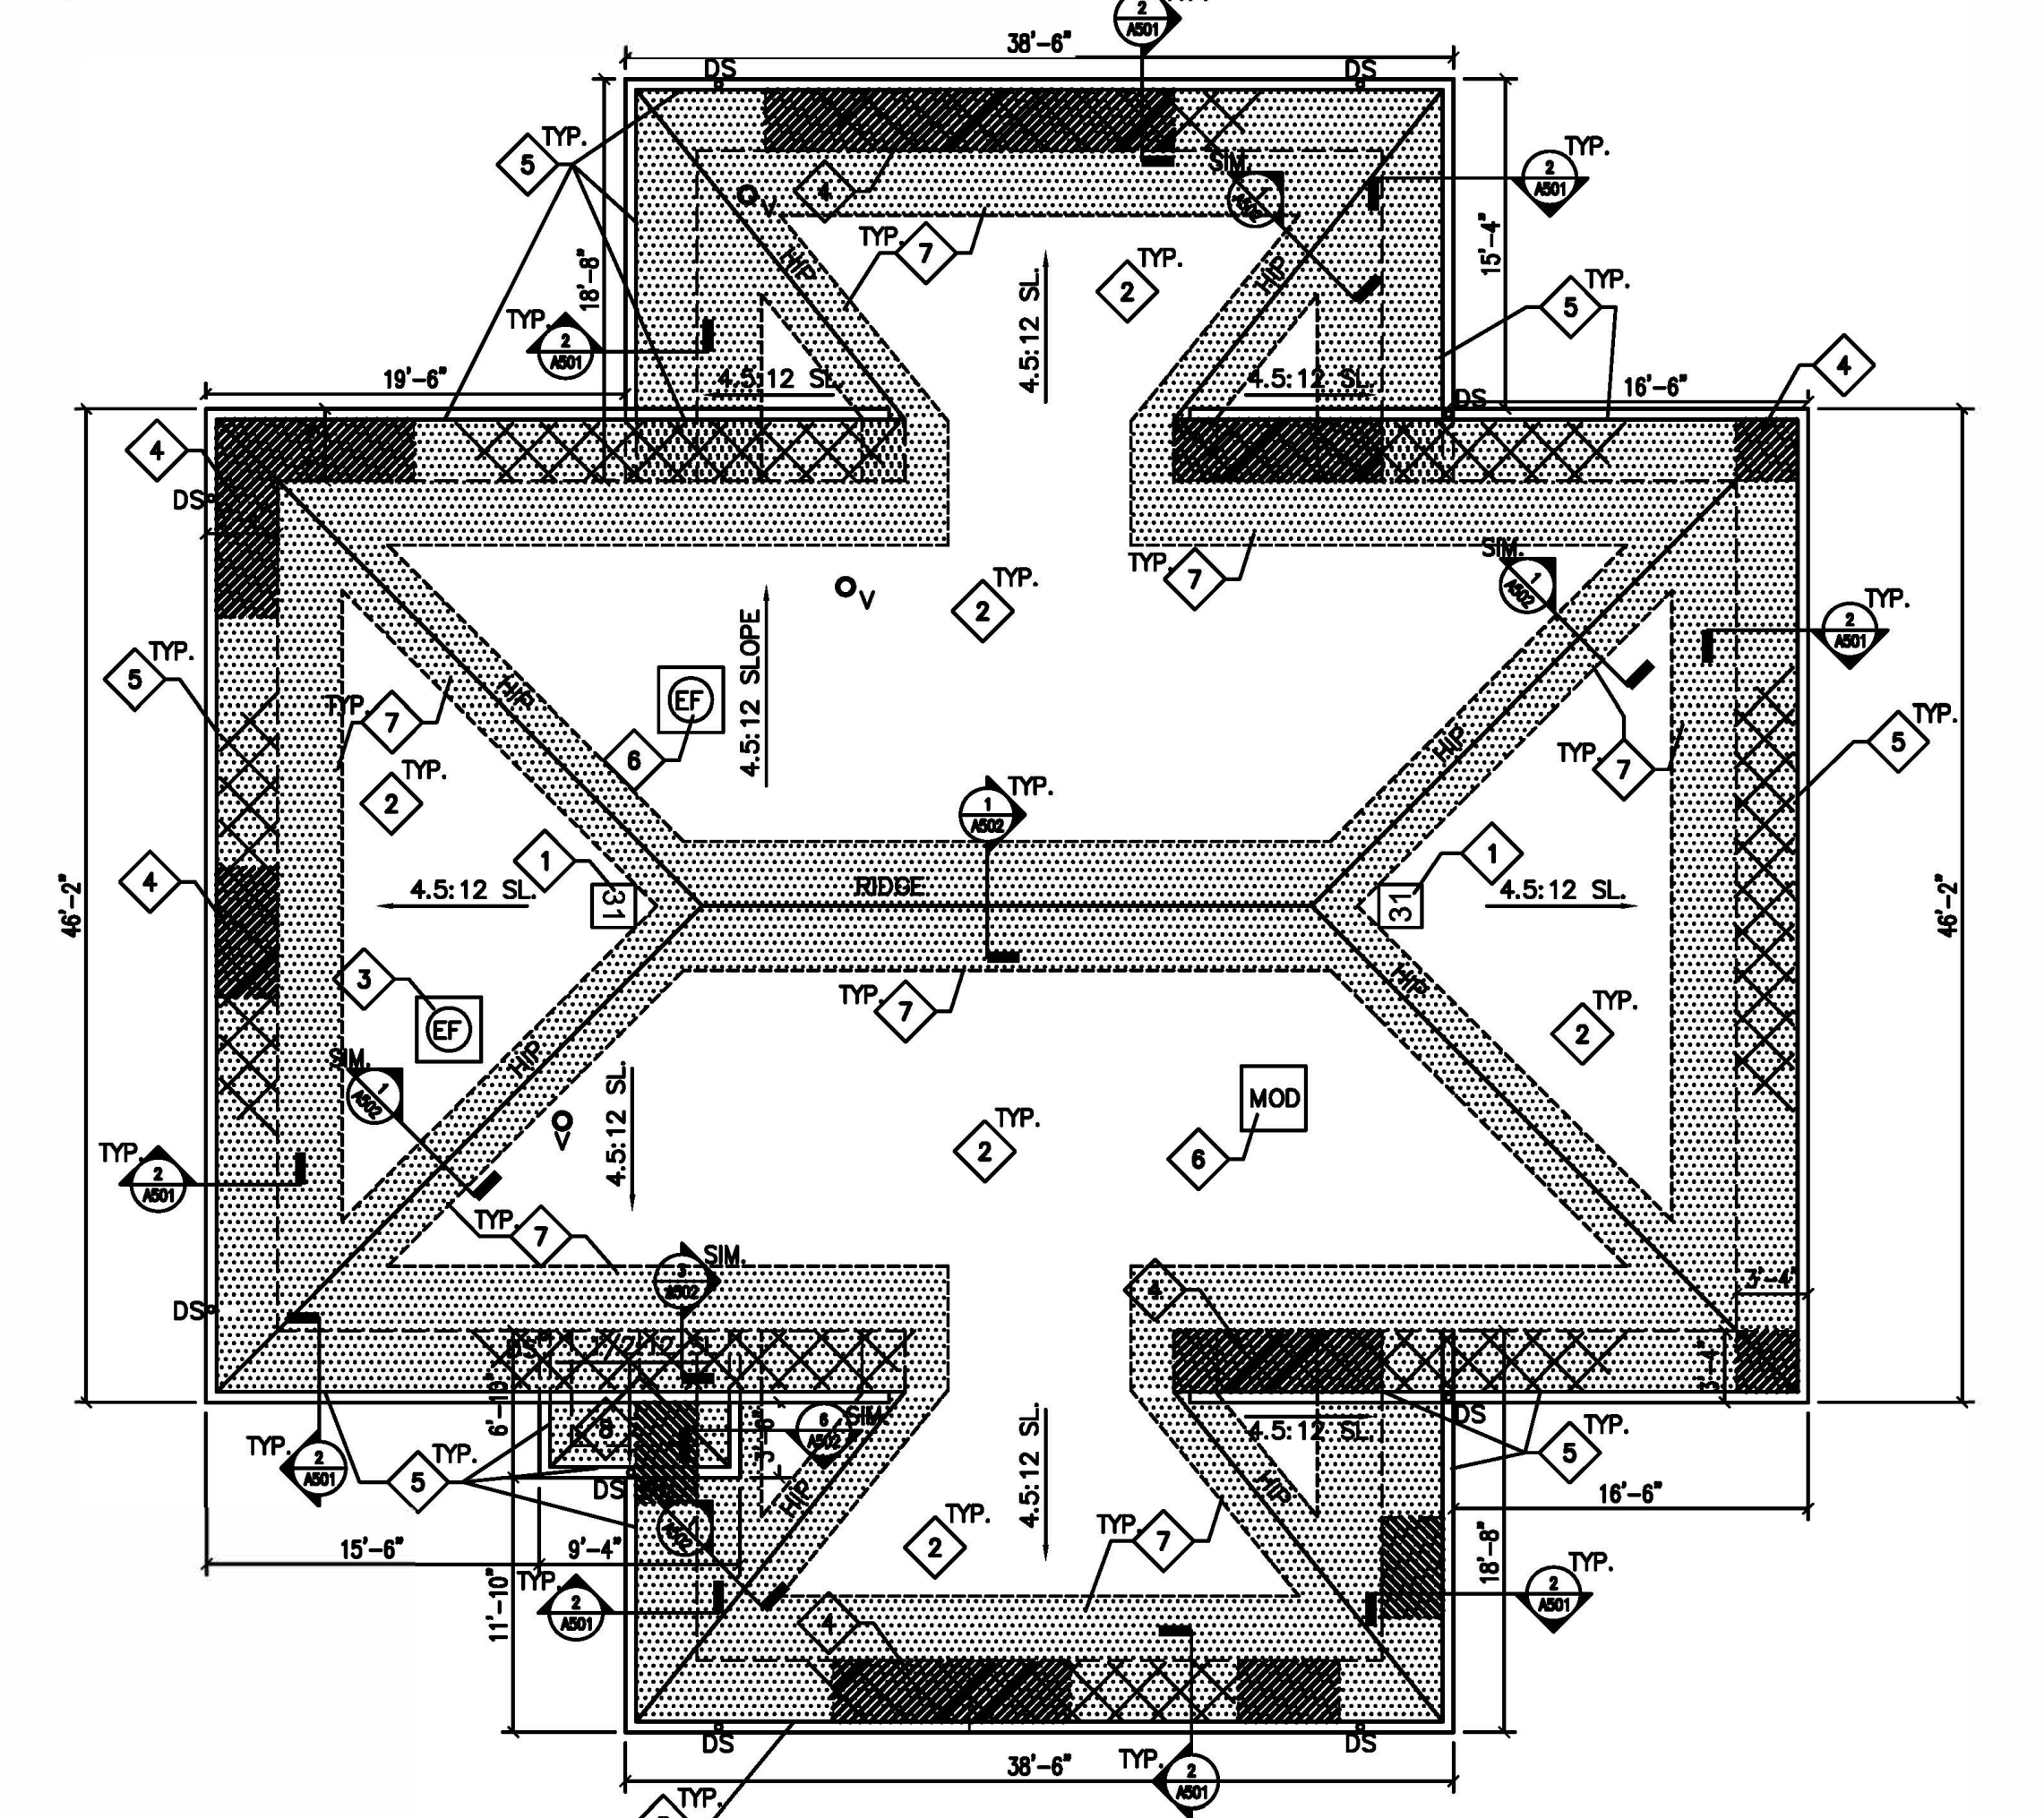

1 BOOT CAMP BUILDING #31 - ROOF PLAN
1/8" = 1'-0"

- GENERAL NOTES -- HAZARDOUS MATERIALS:**
- A. LEAD-BASED PAINT WAS IDENTIFIED ON NUMEROUS SUBSTRATES ASSOCIATED WITH THE ROOFING REPLACEMENT PROJECT. THE INSPECTION RESULTS ARE FOUND IN THE REPORT TITLED "LIMITED ASBESTOS AND LEAD SURVEY".
 - B. THE PAINTING CONTRACTOR'S EMPLOYEES SHALL HAVE HAD THE EPA LEAD RENOVATION, REPAIR AND PAINTING (RRP) CERTIFIED RENOVATOR COURSE. EPA'S RRP RULE REQUIRES RENOVATION, REPAIR AND PAINTING FIRMS WORKING ON PRE-1978 BUILDINGS TO ASSIGN TO EACH JOB A CERTIFIED RENOVATOR WHO IS TRAINED IN LEAD-SAFE WORK PRACTICES. THE TRAINING MUST BE TAUGHT BY AN EPA OR STATE ACCREDITED TRAINING PROVIDER.
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 - N. PRIOR TO BIDDING, CONTRACTOR IS REQUIRED TO BE FAMILIAR ON SITE WITH THE STATUS OF THE EXISTING ROOF AND VERIFY ALL INFORMATION INDICATED IN THE DOCUMENTS.
 - P. THE CONTRACTOR IS RESPONSIBLE FOR PROTECTING EXISTING ITEMS TO REMAIN DURING DEMOLITION AND NEW CONSTRUCTION.
 - Q. PATCH EXISTING TO MATCH ADJACENT MATERIALS WERE DEMOLITION AND NEW CONSTRUCTION OCCUR UNLESS INDICATED OTHERWISE.
 - R. ALL DIMENSIONS REQUIRED FOR WORK SHALL BE VERIFIED BY CONTRACTOR IN THE FIELD PRIOR TO WORK. DIMENSIONS SHOWN FOR INFORMATION ONLY AND MAY BE PLUS/MINUS WHAT IS INDICATED.
 - S. ALL MANUFACTURED ARTICLES, MATERIALS AND EQUIPMENT SHALL BE APPLIED, INSTALLED, CONNECTED, ERECTED, CLEANED AND CONDITIONED AS DIRECTED BY THE MANUFACTURER, UNLESS INDICATED OTHERWISE.
 - T. CURRENT STANDARDS OF ROOFING INSTALLATION, CONSTRUCTION AND WATERPROOFING, NRCA AND ASHRAE APPLY TO THE PERFORMANCE AND DETAILS OF ROOFING CONSTRUCTION INDICATED IN THESE DOCUMENTS.
 - U. THE CONTRACTOR SHALL COORDINATE WITH THE FACILITY TO ESTABLISH PROCEDURES FOR THE CONTROLLED ENTRY OF MEN AND MATERIALS INTO THE WORK AREA AND SHALL COMPLY WITH ALL RULES AND REGULATIONS ESTABLISHED BY THE FACILITY. THE INTERRUPTION OF SECURITY AND COMMUNICATIONS WILL NOT BE PERMITTED. CONTRACTOR SHALL INFORM AND COORDINATE WITH SECURITY OFFICIALS 48 HOURS IN ADVANCE OF ANY WORK RELATED TO SECURITY OR COMMUNICATIONS.
 - V. WHERE DAMAGED AREAS OF WOOD TRIM, SOFFIT AND FASCIA ARE REMOVED/REPLACED, PAINT ENTIRE LENGTH FROM CORNER TO CORNER TO MATCH EXISTING COLOR AND FINISH. SCRAPE AND CLEAN EXISTING WOOD PRIOR TO PAINTING.
 - W. ANY WOOD TRIM, REMOVED FROM BUILDINGS 31, 32, AND 33 SHOULD BE RETURNED TO THE FACILITY.
 - X. AT MECHANICAL/ELECTRICAL ROOF EQUIPMENT AND VENTS, PROVIDE FLASHING PER ROOFING MFR. FOR WATER-TIGHT ROOF INSTALLATION.
 - Y. PROVIDE SNOW AND ICE GUARDS AT NEW STANDING SEAM METAL ROOFS AS INDICATED ON THE PLANS.
 - Z. AND LOCATED DIRECTLY ABOVE EXIST. DOOR LOCATIONS AND 5'-0" ON EITHER SIDE OF DOOR OPENING.
- KEYED NOTES -- DEMOLITION ROOF PLAN:**
- 1. REMOVE EXISTING ROOF NUMBER SIGNAGE.
 - 2. REMOVE EXISTING WOOD/ASPHALT SHINGLE DORMER AND ASSOCIATED LOUVER IN ITS ENTIRETY. SEE STRUCTURAL DOCUMENTS FOR INFILL DETAILS PRIOR TO NEW ROOF SYSTEM INSTALLATION.
 - 3. REMOVE EXISTING RUBBER MEMBRANE ROOFING SYSTEM, UNDERLAYMENT, FLASHING, GUTTERS AND DOWNSPOUTS IN ITS ENTIRETY DOWN TO EXISTING DECKING.
 - 4. REMOVE EXISTING ASPHALT SHINGLES, UNDERLAYMENT, FLASHING, GUTTERS, DOWNSPOUTS AND ASSOCIATED ROOFING COMPONENTS DOWN TO EXISTING DECKING. EXISTING WOOD FASCIA BOARD, TRIM AND SOFFITS TO REMAIN UNLESS NOTED OTHERWISE, PROTECT AS REQUIRED DURING DEMOLITION AND NEW ROOF SYSTEM INSTALLATION.
 - 5. REMOVE/REPLACE DAMAGED AREAS OF PAINTED WOOD FASCIA BOARD AND WOOD PLANK SOFFIT. SEE STRUCTURAL FOR SOFFIT DETAILS. ALIGN FASCIA AND SOFFIT FLUSH WITH EXISTING FASCIA TRIM. DIMENSIONS FOR REFERENCE ONLY, FIELD VERIFY LOCATIONS. EXISTING EXTERIOR WOOD TRIM TO REMAIN, PROTECT AS REQUIRED DURING SOFFIT REPLACEMENT. SOFFITS TO BE REPLACED ENTIRELY BETWEEN EXISTING WOOD SUPPORTS, PAINT ENTIRE LENGTH TO MATCH EXISTING.
 - 6. EXISTING EQUIPMENT, SEE MECHANICAL/ELECTRICAL DOCUMENTS FOR REMOVAL/REINSTALLATION REQUIREMENTS FOR ROOFING REPLACEMENT.
 - 7. REMOVE/REPLACE DAMAGED WOOD SOFFIT SUPPORT BEAM, SEE STRUCTURAL FOR DETAILS, PAINT TO MATCH EXISTING, EXTERIOR WOOD TRIM TO REMAIN, PROTECT AS REQUIRED, PATCH TO MATCH EXISTING.
- NOTE:**
CONTRACTOR IS RESPONSIBLE FOR INCLUDING 2500 SF OF TOTAL ROOF SQUARE FOOTAGE FOR REPLACEMENT OF EXISTING PLANK DECKING. AREAS OF DAMAGED PLANK DECKING MUST BE REPLACED PRIOR TO INSTALLING NEW ROOFING SYSTEM. LOCATIONS WILL BE FIELD VERIFIED ONCE THE EXISTING ROOFING SYSTEM AND UNDERLAYMENT IS REMOVED AND PLANK DECKING IS EXPOSED. CONTRACTOR TO FIELD VERIFY DECKING CONDITIONS AND COORDINATE AREAS OF REMOVAL WITH A/E AND/OR OWNER'S REPRESENTATIVE PRIOR TO INSTALLATION OF NEW ROOFING SYSTEM. SEE STRUCTURAL DRAWINGS FOR REPLACEMENT DETAIL/SCOPE OF WORK. DAMAGED PLANK DECKING BEYOND THE 5% WILL BE HANDLED VIA UNIT COST.
- KEYED NOTES -- ROOF PLAN:**
- 1. ROOF NUMBER SIGNAGE SECURE TO STANDING SEAM METAL ROOF PER MANUFACTURER SO AS NOT TO VOID WARRANTY. SIGNAGE SHALL BE 36"x36" SQUARE. THE BUILDING NUMBER AS INDICATED SHALL BE BLACK WITH A REFLECTIVE WHITE BACKGROUND. FONT SIZE SHALL FIT 36"x36" SIGN.
 - 2. NEW STANDING SEAM MTL ROOFING SYSTEM OVER EXISTING WOOD DECKING ON WOOD STRUCTURAL SYSTEM, INCLUDING: UNDERLAYMENT, FLASHING, GUTTERS AND DOWNSPOUTS TO MATCH NEW ROOF SYSTEM. PROVIDE METAL ROOFING FLASHING AND ACCESSORIES AS REQUIRED FOR A WATER-TIGHT INSTALLATION AND AT EXIST. VENTS AND ELECTRICAL/MECHANICAL EQUIPMENT TO MATCH METAL ROOFING SYSTEM. PROVIDE PANEL INSTALLATION TO MATCH EXISTING SLOPES AND ACCESSORIES AS REQUIRED FOR WATER-TIGHT INSTALLATION OF METAL ROOFING SYSTEM TO MATCH EXISTING ROOF LAYOUT, SHAPE AND CONSTRUCTION.
 - 3. EXISTING EQUIPMENT, SEE MECHANICAL/ELECTRICAL DOCUMENTS FOR REMOVAL/REINSTALLATION REQUIREMENTS FOR ROOFING REPLACEMENT, FLASH CURBS PER ROOF MFR RECOMMENDATIONS.
 - 4. AREAS OF WOOD FASCIA AND SOFFIT REPLACEMENT, PAINT TO MATCH EXISTING THE ENTIRE LENGTH OF EXISTING SOFFIT AND FASCIA FROM BUILDING CORNER TO BUILDING CORNER, SCRAPE AND CLEAN EXISTING WOOD PRIOR TO PAINTING.
 - 5. SCRAPE CLEAN AND REPAINT EXISTING FASCIA, SOFFIT, SOFFIT SUPPORT STRUCTURE AND TRIM AT TOP OF EXTERIOR WALL FOR ENTIRE BUILDING, AT AREAS OF SOFFIT/FASCIA REPLACEMENT INCLUDE PAINTING THE EXISTING SOFFIT SUPPORTS AND EXTERIOR WALL TRIM, 2 COATS.
 - 6. NEW MECHANICAL/ELECTRICAL EQUIPMENT, SEE MECHANICAL/ELECTRICAL DOCUMENTS FOR INSTALLATION REQUIREMENTS, FLASH CURBS PER ROOF MFR RECOMMENDATIONS.
 - 7. LINE OF SELF-ADHERED WATER AND ICE MEMBRANE, INSTALL ALONG ROOF EDGE, RIDGE AND VALLEY PER DETAILS ON SHEETS A500, A501 AND A502.
 - 8. NEW STANDING SEAM METAL ROOFING SYSTEM, UNDERLAYMENT, FLASHING, GUTTERS AND DOWNSPOUTS WITH R30 RIGID INSULATION OVER EXIST. ROOF DECK. PROVIDE REQUIRED FRAMING AND SECURE TO EXISTING ROOF DECK/STRUCTURE FOR STANDING SEAM METAL ROOF INSTALLATION TO ESTABLISH PROPER DRAINAGE FIELD VERIFY EXISTING CONDITIONS. PROVIDE METAL ROOFING FLASHING/ACCESSORIES AT EXIST VENTS AND ELECTRICAL/MECHANICAL EQUIPMENT TO MATCH METAL ROOFING SYSTEM.



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OFFICE OF ADMINISTRATION
DIVISION OF FACILITIES
MANAGEMENT,
DESIGN AND CONSTRUCTION

DEPARTMENT OF
CORRECTIONS

1012 WEST COLUMBIA ST.
FARMINGTON, MO 63640

REPLACE ROOF SYSTEMS
MULTIPLE ASSETS
FARMINGTON
CORRECTIONAL CENTER

FARMINGTON, MISSOURI

PROJECT # C1922-01
SITE # 7008
ASSET # 9327008089,
9327008090, 9327008091, 9327008082
9327008081, 9327008080, 9327008079
REVISION: -
DATE: -
REVISION: -
DATE: -
REVISION: -
DATE: -
ISSUE DATE: APRIL 18, 2022

CAD DWG FILE: A-100
DRAWN BY: EL
CHECKED BY: EL
DESIGNED BY: EL

SHEET TITLE:
BUILDING #31
ROOF PLANS
(ALTERNATE NO. 3)

SHEET NUMBER:
A105
8 OF 29 SHEETS
04/18/2022



STATE OF MISSOURI
CERTIFICATE OF AUTHORITY #2018019473

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1012 WEST COLUMBIA ST.
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REPLACE ROOF SYSTEMS
MULTIPLE ASSETS
FARMINGTON
CORRECTIONAL CENTER

FARMINGTON, MISSOURI

PROJECT # C1922-01

SITE # 7008

ASSET # 9327008089,
9327008090, 9327008091, 9327008082
9327008081, 9327008080, 9327008079

REVISION: -

DATE: -

REVISION: -

DATE: -

REVISION: -

DATE: -

ISSUE DATE: APRIL 18, 2022

CAD DWG FILE: A-100
DRAWN BY: EL
CHECKED BY: EL
DESIGNED BY: EL

SHEET TITLE:

BUILDING #32
ROOF PLANS

SHEET NUMBER:

A106

9 OF 29 SHEETS
04/18/2022

GENERAL NOTES — HAZARDOUS MATERIALS:

- LEAD-BASED PAINT WAS IDENTIFIED ON NUMEROUS SUBSTRATES ASSOCIATED WITH THE ROOFING REPLACEMENT PROJECT. THE INSPECTION RESULTS ARE FOUND IN THE REPORT TITLED "LIMITED ASBESTOS AND LEAD SURVEY".
- THE PAINTING CONTRACTOR'S EMPLOYEES SHALL HAVE HAD THE EPA LEAD RENOVATION, REPAIR AND PAINTING (RRP) CERTIFIED RENOVATOR COURSE. EPA'S RRP RULE REQUIRES RENOVATION, REPAIR AND PAINTING FIRMS WORKING ON PRE-1978 BUILDINGS TO ASSIGN TO EACH JOB A CERTIFIED RENOVATOR WHO IS TRAINED IN LEAD-SAFE WORK PRACTICES. THE TRAINING MUST BE TAUGHT BY AN EPA OR STATE ACCREDITED TRAINING PROVIDER.
- PAINTING CONTRACTOR MUST BE FAMILIAR WITH EPA DOCUMENT TITLED "SMALL ENTITY COMPLIANCE GUIDE" TO RENOVATE RIGHT: EPA'S LEAD-BASED PAINT RENOVATION, RENOVATION, REPAIR AND PAINTING PROGRAM" (REVISED SEPTEMBER 2011 VERSION).
- THE PAINTING CONTRACTOR MUST USE LEAD-SAFE WORK PRACTICES WHEN CONDUCTING PAINTING OPERATIONS ON BUILDINGS 17, 18, 31, 32, AND 33.
- THE PAINTING CONTRACTOR MUST COMPLY WITH ALL REQUIREMENTS OF THE OCCUPATIONAL SAFETY AND HEALTH ADMINISTRATION (OSHA) STANDARD 29 CFR 1926.62, LEAD IN CONSTRUCTION, INCLUDING AIR SAMPLING OF REPRESENTATIVE TASKS TO DETERMINE RESPIRATOR REQUIREMENTS IF WARRANTED.
- ALL PAINT CHIPS AND GENERATED WASTE FROM BUILDINGS 17, 18, 31, 32, AND 33 SHALL BE TESTED BY THE PAINTING CONTRACTOR USING TOXIC CHARACTERISTIC LEACHATE PROCESS (TCLP) ANALYTICAL METHODS TO DETERMINE PROPER WASTE DISPOSAL METHODS.
- TRACE AMOUNTS OF LEAD BELOW THE EPA HUD DEFINITION OF LEAD-BASED PAINT WERE IDENTIFIED IN OTHER AREAS OF THE PROJECT. IT SHOULD BE NOTED THAT OSHA DOES NOT RECOGNIZE THE XRF THRESHOLD VALUE OF 1.0 MG/CM2 FOR LEAD EXPOSURE. ALTHOUGH THE POTENTIAL LEAD HAZARD FOR NORMAL CONSTRUCTION ACTIVITIES IS LOW, ACTUAL LEAD EXPOSURE MAY VARY SIGNIFICANTLY DEPENDING UPON THE SPECIFIC TASK, PROCEDURE AND OTHER WORK AREA CONDITIONS. PROPER OSHA COMPLIANCE IS CONSIDERED PERFORMANCE BASED AND INCLUDES EVALUATING POTENTIAL WORK EXPOSURES WITH AIR MONITORING OR BIOLOGICAL EXPOSURE MONITORING (BLOOD LEAD TESTING), IF REQUIRED.
- THE LOCATIONS OF WASTE DISPOSAL CONTAINERS SHALL BE FIELD VERIFIED WITH THE CORRECTIONAL CENTER AND/OR THE CORRECTIONAL CENTER'S REPRESENTATIVE.
- AT THE DISCRETION OF THE CORRECTIONAL CENTER, ADDITIONAL AIR SAMPLING MAY BE CONDUCTED DURING PAINTING OPERATIONS TO ENSURE LEAD DUST IS NOT MIGRATING AWAY FROM THE WORK SITE.
- ASBESTOS WINDOW GLAZING WAS IDENTIFIED FOR BUILDING 17. AVOID CONTACT WITH THIS ASBESTOS MATERIAL DO NOT SCRAPE, ABRASIVE OR OTHERWISE IMPACT THE ASBESTOS.

GENERAL NOTES — ROOF PLANS:

- THE CONTRACTOR IS TO VISIT THE SITE DURING THE BIDDING PERIOD AND IS TO ADVISE THE ARCHITECT OF ANY SITUATION OR DISCREPANCY WHICH WILL NOT ALLOW SUCCESSFUL COMPLETION OF THE WORK. THE ARCHITECT'S DECISION WILL CLARIFY THE SCOPE OF WORK.
- INFORMATION IS TAKEN FROM OWNER PROVIDED DOCUMENTS AND SITE INVESTIGATION. THE CONTRACTOR SHALL FIELD VERIFY ALL EXISTING CONDITIONS AND DIMENSIONS PRIOR TO FABRICATION AND INSTALLATION OF NEW WORK.
- PRIOR TO BIDDING, CONTRACTOR IS REQUIRED TO BE FAMILIAR ON SITE WITH THE STATUS OF THE EXISTING ROOF AND VERIFY ALL INFORMATION INDICATED IN THE DOCUMENTS.
- THE CONTRACTOR IS RESPONSIBLE FOR PROTECTING EXISTING ITEMS TO REMAIN DURING DEMOLITION AND NEW CONSTRUCTION.
- PATCH EXISTING TO MATCH ADJACENT MATERIALS WERE DEMOLITION AND NEW CONSTRUCTION OCCUR UNLESS INDICATED OTHERWISE.
- ALL DIMENSIONS REQUIRED FOR WORK SHALL BE VERIFIED BY CONTRACTOR IN THE FIELD PRIOR TO WORK. DIMENSIONS SHOWN FOR INFORMATION ONLY AND MAY BE PLUS/MINUS WHAT IS INDICATED.
- ALL MANUFACTURED ARTICLES, MATERIALS AND EQUIPMENT SHALL BE APPLIED, INSTALLED, CONNECTED, ERECTED, CLEANED AND CONDITIONED AS DIRECTED BY THE MANUFACTURER, UNLESS INDICATED OTHERWISE.
- CURRENT STANDARDS OF ROOFING INSTALLATION, CONSTRUCTION AND WATERPROOFING, NRCA AND ASHRAE APPLY TO THE PERFORMING CONSTRUCTION INDICATED IN THESE DOCUMENTS.
- THE CONTRACTOR SHALL COORDINATE WITH THE FACILITY TO ESTABLISH PROCEDURES FOR THE CONTROLLED ENTRY OF MEN AND MATERIALS INTO THE WORK AREA AND SHALL COMPLY WITH ALL RULES AND REGULATIONS ESTABLISHED BY THE FACILITY. THE INTERRUPTION OF SECURITY AND COMMUNICATIONS WILL NOT BE PERMITTED. CONTRACTOR SHALL INFORM AND COORDINATE WITH SECURITY OFFICIALS 48 HOURS IN ADVANCE OF ANY WORK RELATED TO SECURITY OR COMMUNICATIONS.
- WHERE DAMAGED AREAS OF WOOD TRIM, SOFFIT AND FASCIA ARE REMOVED/REPLACED, PAINT ENTIRE LENGTH FROM CORNER TO CORNER TO MATCH EXISTING COLOR AND FINISH. SCRAPE AND CLEAN EXISTING WOOD PRIOR TO PAINTING.
- ANY WOOD TRIM, REMOVED FROM BUILDINGS 31, 32, AND 33 SHOULD BE RETURNED TO THE FACILITY.
- AT MECHANICAL/ELECTRICAL ROOF EQUIPMENT AND VENTS, PROVIDE FLASHING PER ROOFING MFR. FOR WATERTIGHT ROOF INSTALLATION.
- PROVIDE SNOW AND ICE GUARDS AT NEW STANDING SEAM METAL ROOFS AS INDICATED ON THE PLANS AND LOCATED DIRECTLY ABOVE EXIST. DOOR LOCATIONS AND 5'-0" ON EITHER SIDE OF DOOR OPENING.
- PROVIDE NEW DOWNSPOUTS AT ALL EXISTING DOWNSPOUT LOCATIONS, SIZE PER EXISTING.


KEYED NOTES — DEMOLITION ROOF PLAN:

- REMOVE EXISTING ROOF NUMBER SIGNAGE.
- REMOVE EXISTING ICE/SNOW GUARDS, LOCATIONS SHOWN FOR INFORMATION ONLY.
- REMOVE EXISTING WOOD/ASPHALT SHINGLE DORMER AND ASSOCIATED LOUVER IN ITS ENTIRETY. SEE STRUCTURAL DOCUMENTS FOR INFILL DETAILS PRIOR TO NEW ROOF SYSTEM INSTALLATION.
- REMOVE EXISTING ASPHALT SHINGLES, UNDERLAYMENT, FLASHING, GUTTERS, DOWNSPOUTS AND ASSOCIATED ROOFING COMPONENTS DOWN TO EXISTING DECKING. REMOVE/REPLACE EXISTING WOOD FASCIA BOARD, EXISTING WOOD TRIM AND SOFFIT TO REMAIN UNLESS NOTED OTHERWISE. PROTECT AS REQUIRED DURING DEMOLITION. FASCIA REPLACEMENT AND NEW ROOF SYSTEM INSTALLATION.
- REMOVE EXISTING RUBBER MEMBRANE ROOFING SYSTEM, UNDERLAYMENT, FLASHING, GUTTERS AND DOWNSPOUTS IN ITS ENTIRETY DOWN TO EXISTING DECKING.
- REMOVE EXISTING COPPER ROOFING SYSTEM IN ITS ENTIRETY DOWN TO EXISTING ROOF DECK.
- REMOVE EXISTING GABLE LOUVER.
- REMOVE/REPLACE DAMAGED AREAS OF PAINTED WOOD TRIM AND SOFFIT, MATCH EXISTING SIZE. MATCHING EXISTING TRIM PROFILE IS NOT REQUIRED BUT ALIGN FLUSH WITH EXISTING WOOD TRIM. DIMENSIONS FOR REFERENCE ONLY, FIELD VERIFY LOCATIONS AND PAINT ENTIRE LENGTH TO MATCH EXISTING.
- REMOVE/REPLACE DAMAGED AREAS OF PAINTED WOOD TRIM AND SOFFIT, AT DOWNSPOUT LOCATIONS MATCHING EXISTING TRIM PROFILE IS NOT REQUIRED BUT ALIGN WOOD FLUSH WITH EXISTING WOOD TRIM, PAINT TO MATCH EXISTING. SEE PHOTO #1 THIS SHEET.
- REMOVE/REPLACE DAMAGED WOOD GABLE TRIM, ALIGN FLUSH WITH EXISTING, PAINT ENTIRE LENGTH TO MATCH EXISTING. DIMENSIONS FOR REFERENCE ONLY, FIELD VERIFY LOCATIONS PAINT TO MATCH EXISTING.
- EXISTING EQUIPMENT, SEE MECHANICAL/ELECTRICAL DOCUMENTS FOR REMOVAL/REINSTALLATION REQUIREMENTS FOR ROOFING REPLACEMENT.
- REMOVE DAMAGED WOOD TRIM IN ITS ENTIRETY. REPLACE WOOD TRIM/BLOCKING AS REQUIRED FOR INSTALLATION OF NEW SHEET METAL TRIM/FLASHING PER INDICATED DETAILS ON 1/A106.


NOTE:
CONTRACTOR IS RESPONSIBLE FOR INCLUDING 2500 SF OF TOTAL ROOF SQUARE FOOTAGE FOR REPLACEMENT OF EXISTING PLANK DECKING AREAS OF DAMAGING PLANK DECKING MUST BE REPLACED PRIOR TO INSTALLING NEW ROOFING SYSTEM. LOCATIONS WILL BE FIELD VERIFIED ONCE THE EXISTING ROOFING SYSTEM AND UNDERLAYMENT IS REMOVED AND PLANK DECKING IS EXPOSED. CONTRACTOR TO FIELD VERIFY DECKING CONDITIONS AND COORDINATE AREAS OF REMOVAL WITH A/E AND/OR OWNER'S REPRESENTATIVE PRIOR TO INSTALLATION OF NEW ROOFING SYSTEM. SEE STRUCTURAL DRAWINGS FOR REPLACEMENT DETAIL/SCOPE OF WORK. DAMAGED PLANK DECKING BEYOND THE 5X WILL BE HANDLED VIA UNIT COST.

KEYED NOTES — ROOF PLAN:

- ROOF NUMBER SIGNAGE SECURE TO STANDING SEAM METAL ROOF PER MANUFACTURER SO AS NOT TO VOID WARRANTY. SIGNAGE SHALL BE 36"x36" SQUARE. THE BUILDING NUMBER AS INDICATED SHALL BE BLACK WITH A REFLECTIVE WHITE BACKGROUND. FONT SIZE SHALL FIT 36"x36" SIGN.
- NEW STANDING SEAM METAL ROOFING SYSTEM OVER EXISTING WOOD DECKING ON WOOD STRUCTURAL SYSTEM, INCLUDING: UNDERLAYMENT, FLASHING, GUTTERS AND DOWNSPOUTS TO MATCH NEW ROOF SYSTEM. PROVIDE METAL ROOFING FLASHING AND ACCESSORIES AS REQUIRED FOR A WATERTIGHT INSTALLATION AND AT EXIST. VENTS AND ELECTRICAL/MECHANICAL EQUIPMENT TO MATCH METAL ROOFING SYSTEM. PROVIDE PANEL INSTALLATION TO MATCH EXISTING SLOPES AND ACCESSORIES AS REQUIRED FOR WATERTIGHT INSTALLATION OF METAL ROOFING SYSTEM TO MATCH EXISTING ROOF LAYOUT, SHAPE AND CONSTRUCTION. PROVIDE NEW WOOD FASCIA BOARDS AT ALL DAMAGED AREAS, PAINT TO MATCH EXISTING.
- INSTALL NEW SINGLE PLY TPO ROOFING SYSTEM, R30 RIGID INSULATION, FLASHING, GUTTER AND DOWNSPOUT. FLASH PER ROOFING MANUFACTURER.
- INSTALL NEW DECORATIVE METAL GABLE VENT, TRIM AND FLASHING TO MATCH NEW STANDING SEAM METAL ROOF SYSTEM. FIELD VERIFY SIZE.
- EXISTING EQUIPMENT, SEE MECHANICAL/ELECTRICAL DOCUMENTS FOR REMOVAL/REINSTALLATION REQUIREMENTS FOR ROOFING REPLACEMENT, FLASH CURBS PER ROOF MFR RECOMMENDATIONS.
- AREAS OF WOOD TRIM/FASCIA AND SOFFIT REPLACEMENT, PAINT TO MATCH EXISTING THE ENTIRE LENGTH OF EXISTING SOFFIT AND TRIM/FASCIA FROM BUILDING CORNER TO BUILDING CORNER, SCRAPE AND CLEAN EXISTING WOOD PRIOR TO PAINTING.
- SCRAPE CLEAN AND REPAINT EXISTING SOFFIT FOR ENTIRE BUILDING, EXISTING DECORATIVE BUILDING TRIM IS NOT WITHIN THE SCOPE OF WORK.
- NEW MECHANICAL/ELECTRICAL EQUIPMENT, SEE MECHANICAL/ELECTRICAL DOCUMENTS FOR INSTALLATION REQUIREMENTS, FLASH CURBS PER ROOF MFR RECOMMENDATIONS.
- LINE OF SELF-ADHERED WATER AND ICE MEMBRANE, INSTALL ALONG ROOF EDGE, RIDGE AND VALLEY PER DETAILS ON SHEETS A500, A501 AND A502.
- NEW STANDING SEAM METAL ROOFING SYSTEM, UNDERLAYMENT, FLASHING, GUTTERS AND DOWNSPOUTS WITH R30 RIGID INSULATION OVER EXIST. ROOF DECK. PROVIDE REQUIRED FRAMING AND SECURE TO EXISTING ROOF DECK/STRUCTURE FOR STANDING SEAM METAL ROOF INSTALLATION TO ESTABLISH PROPER DRAINAGE. FIELD VERIFY EXISTING CONDITIONS. PROVIDE METAL ROOFING FLASHING/ACCESSORIES AT EXIST VENTS AND ELECTRICAL/MECHANICAL EQUIPMENT TO MATCH METAL ROOFING SYSTEM.
- REMOVE PORTION OF EXISTING WOOD RAKE TRIM, ALIGN FLUSH, PAINT TO MATCH EXISTING THE ENTIRE LENGTH FROM BUILDING CORNER TO PEAK, SCRAPE AND CLEAN EXISTING WOOD PRIOR TO PAINTING.

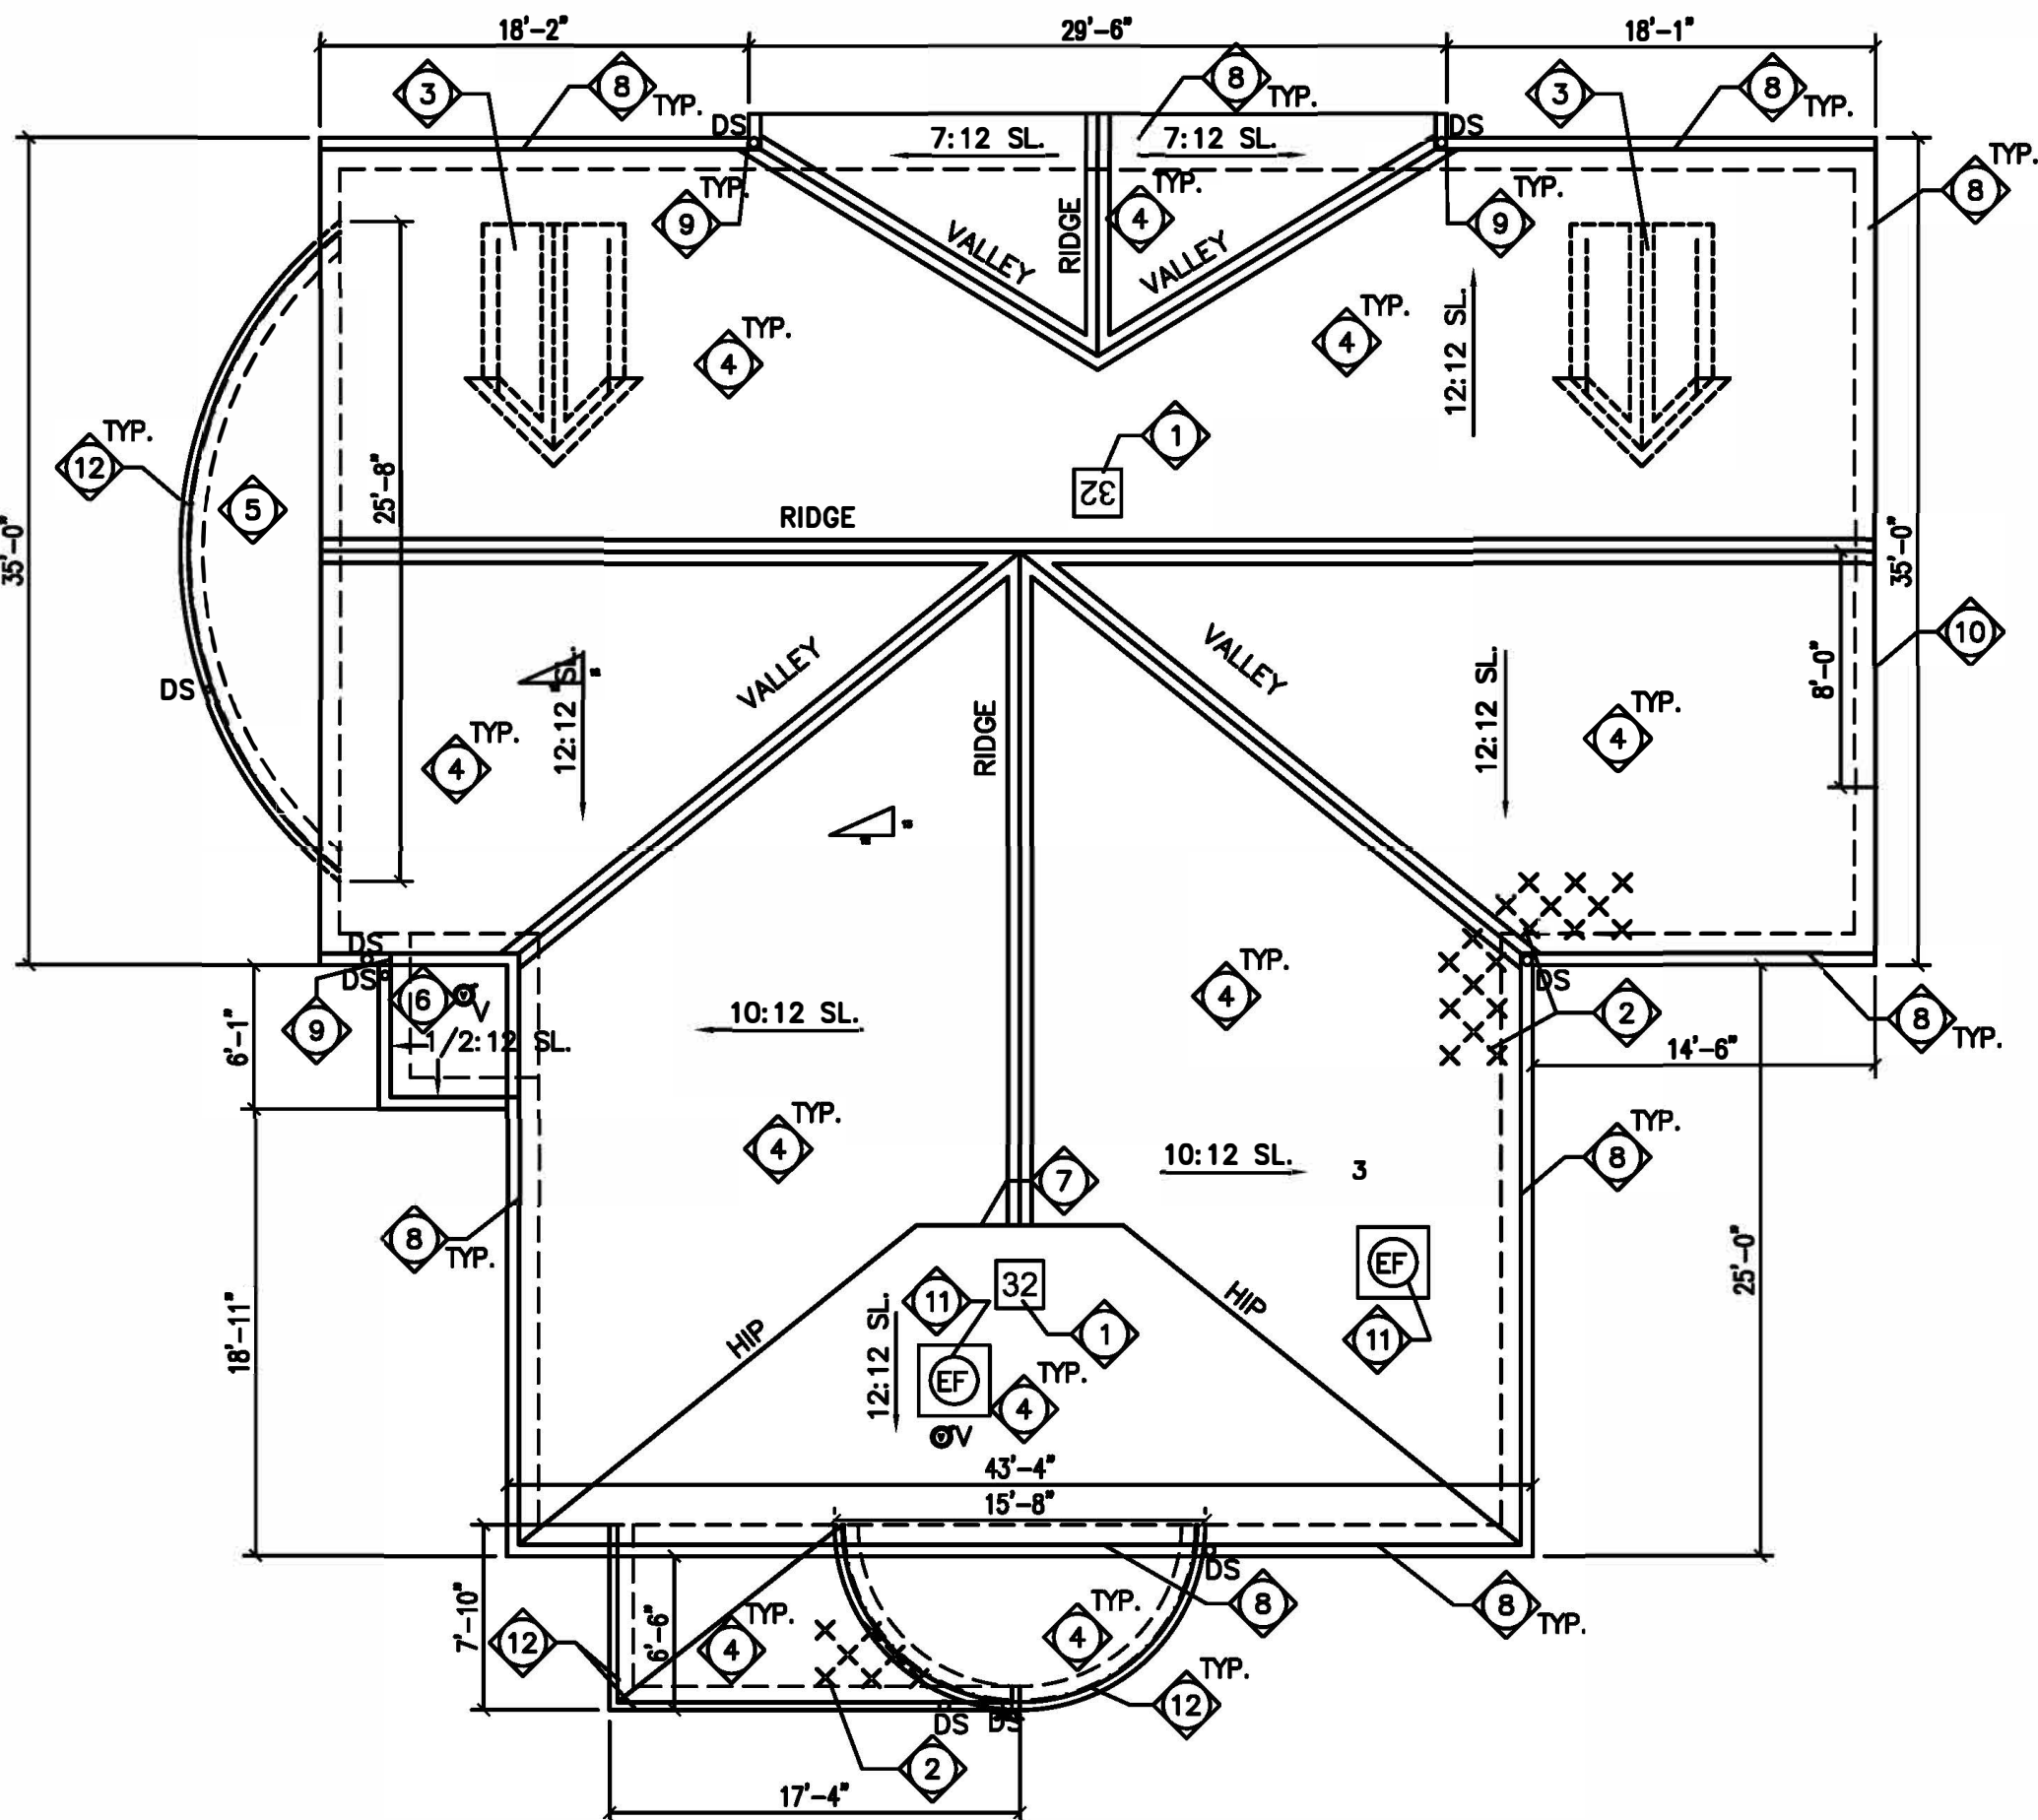

2 CHAPEL BUILDING #32 — DEMOLITION ROOF PLAN
1/8" = 1'-0"

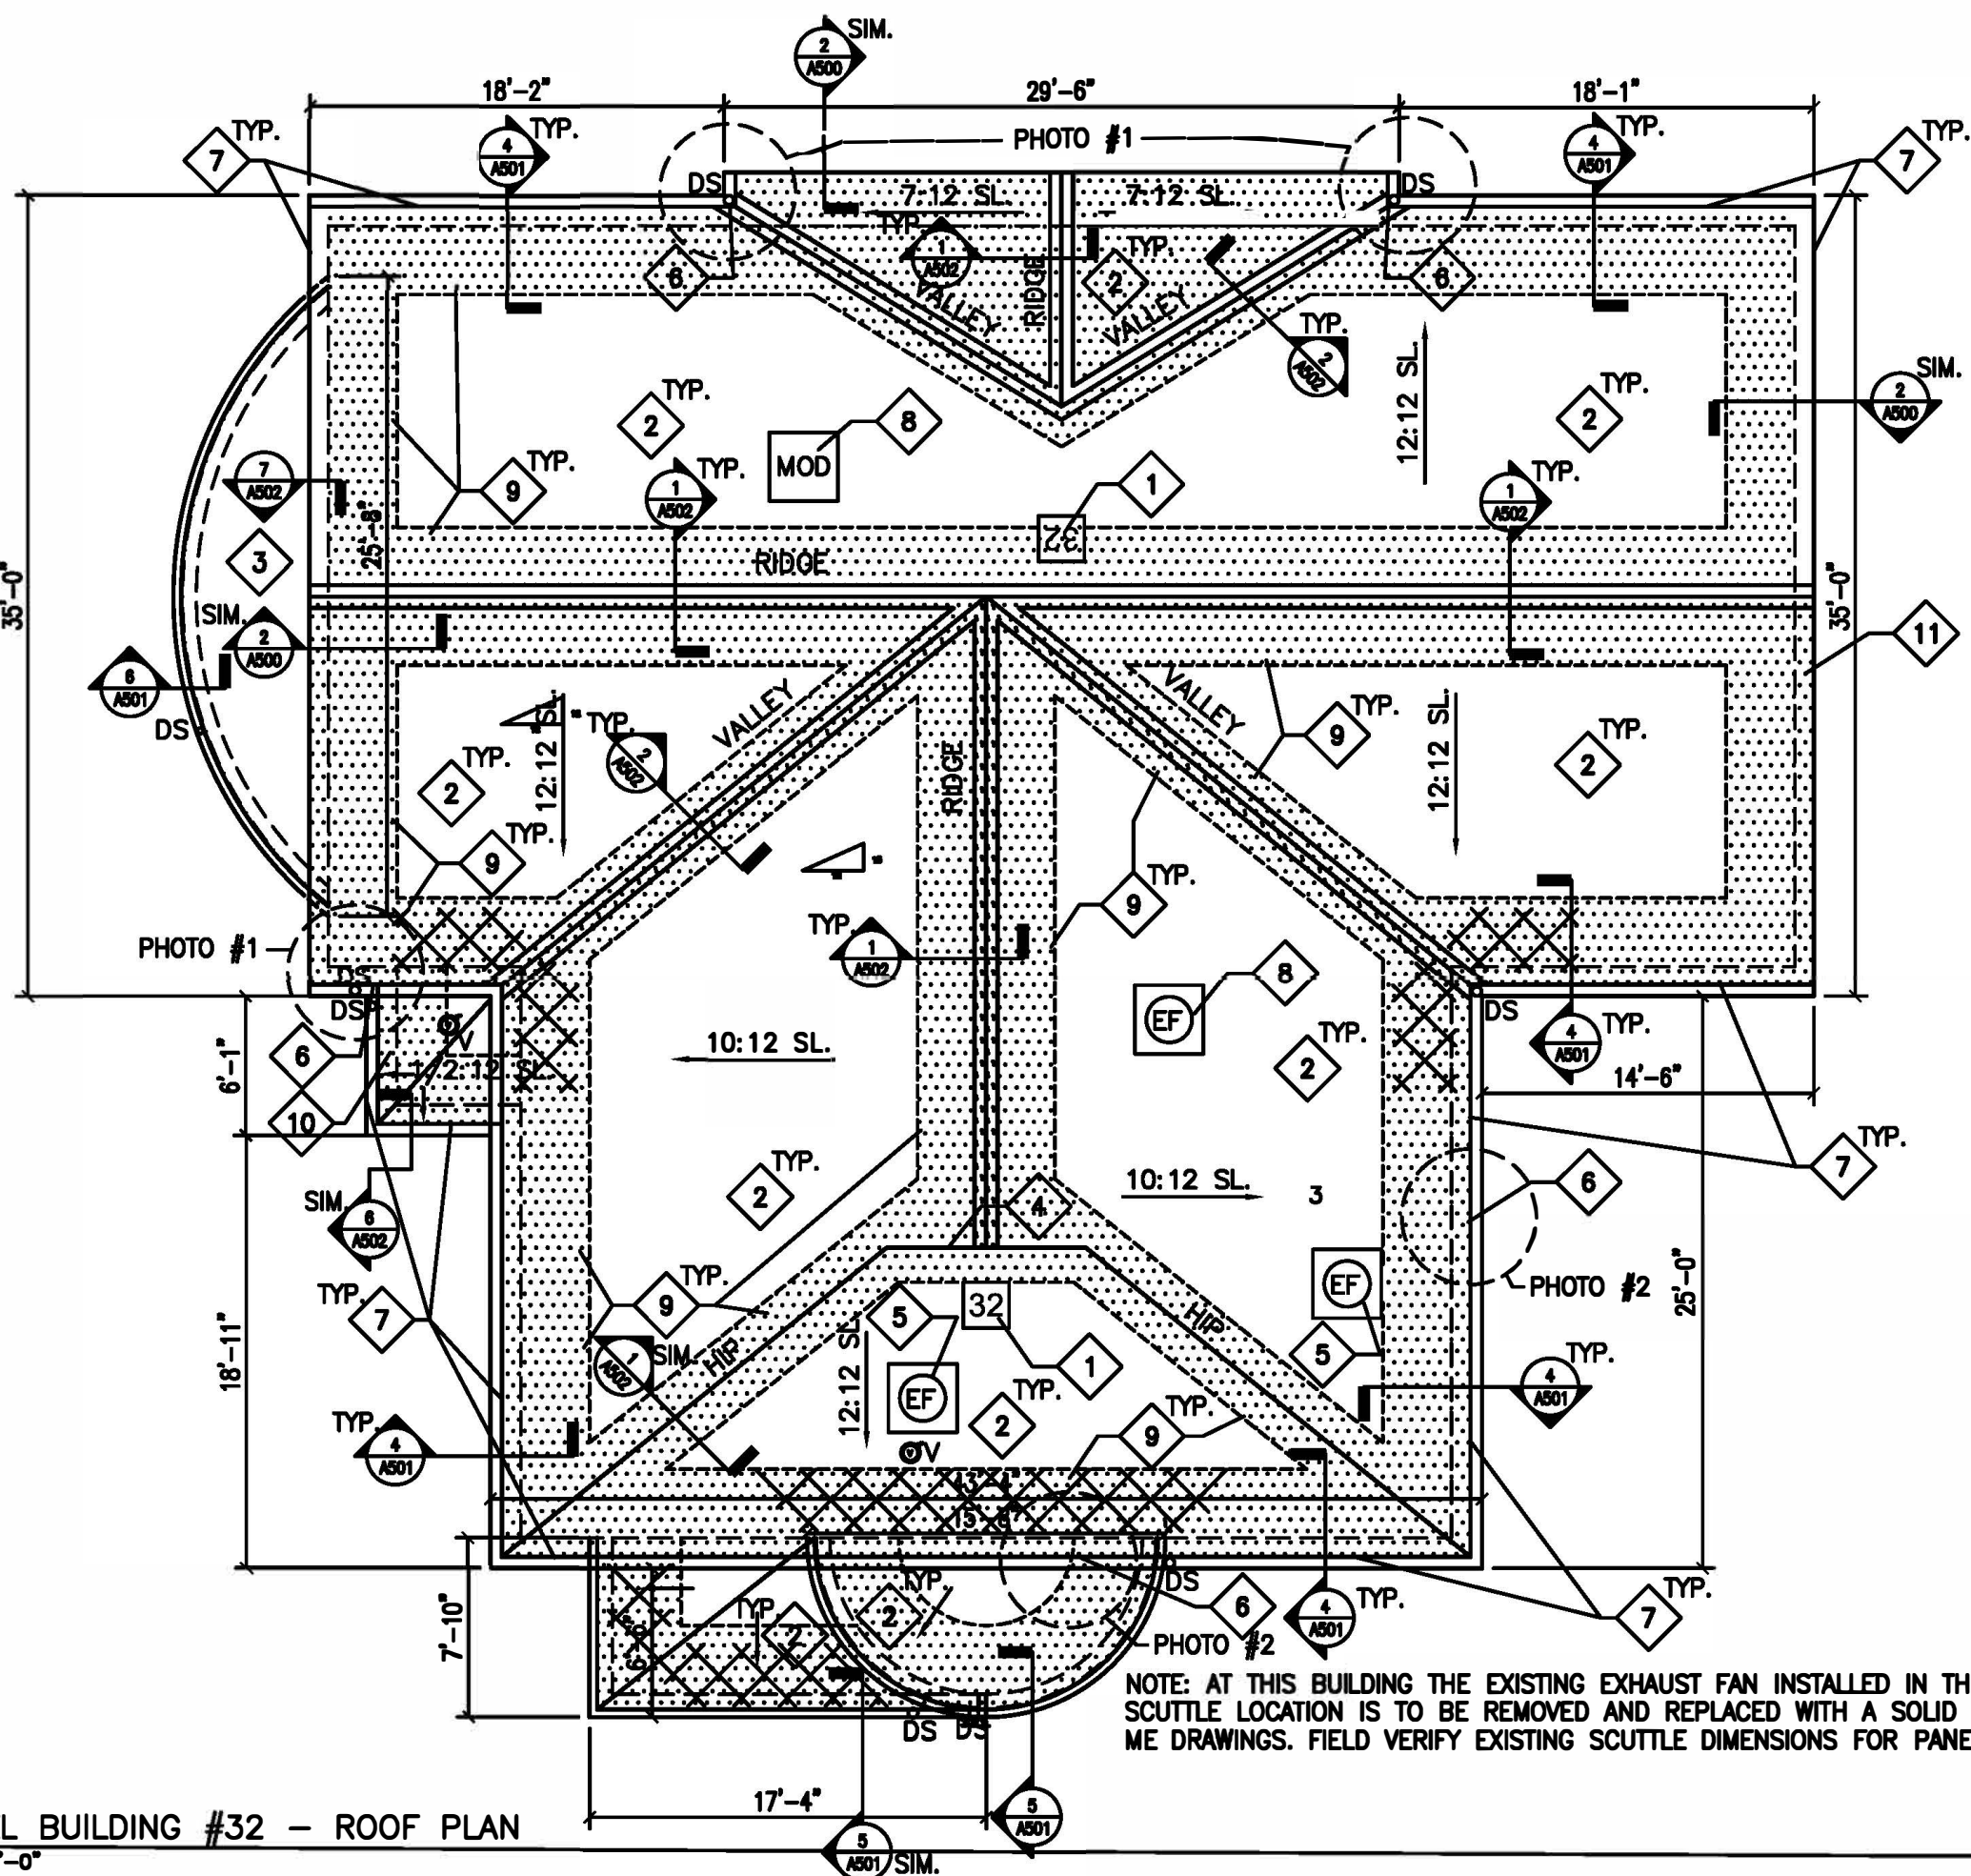

1 CHAPEL BUILDING #32 — ROOF PLAN
1/8" = 1'-0"

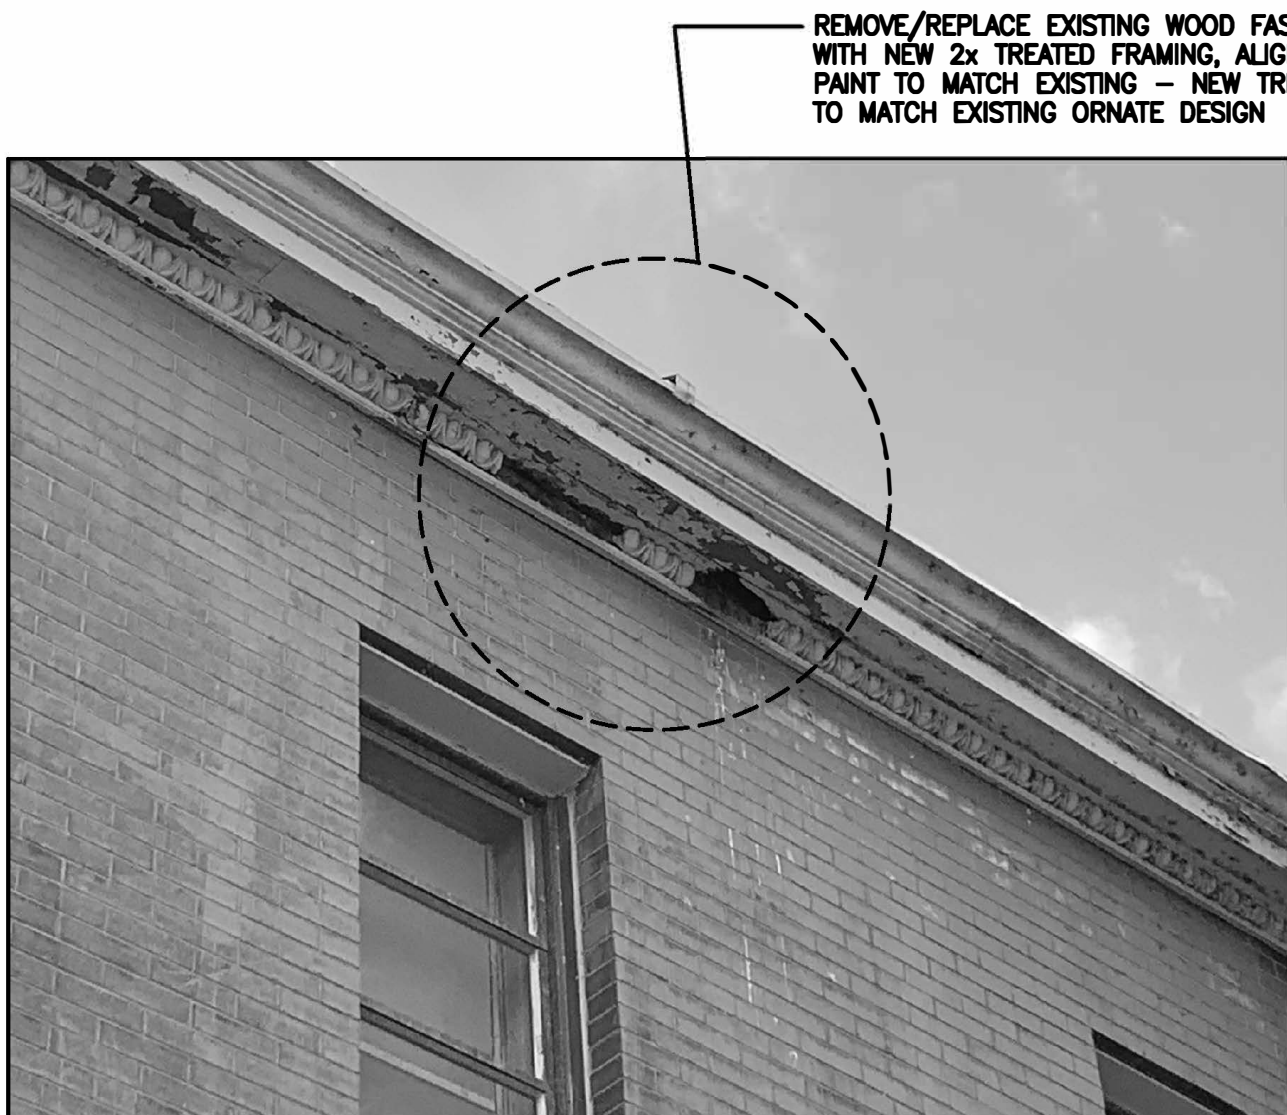


PHOTO #2 — TYPICAL EXISTING TRIM REPAIR/REPLACEMENT
NOT TO SCALE



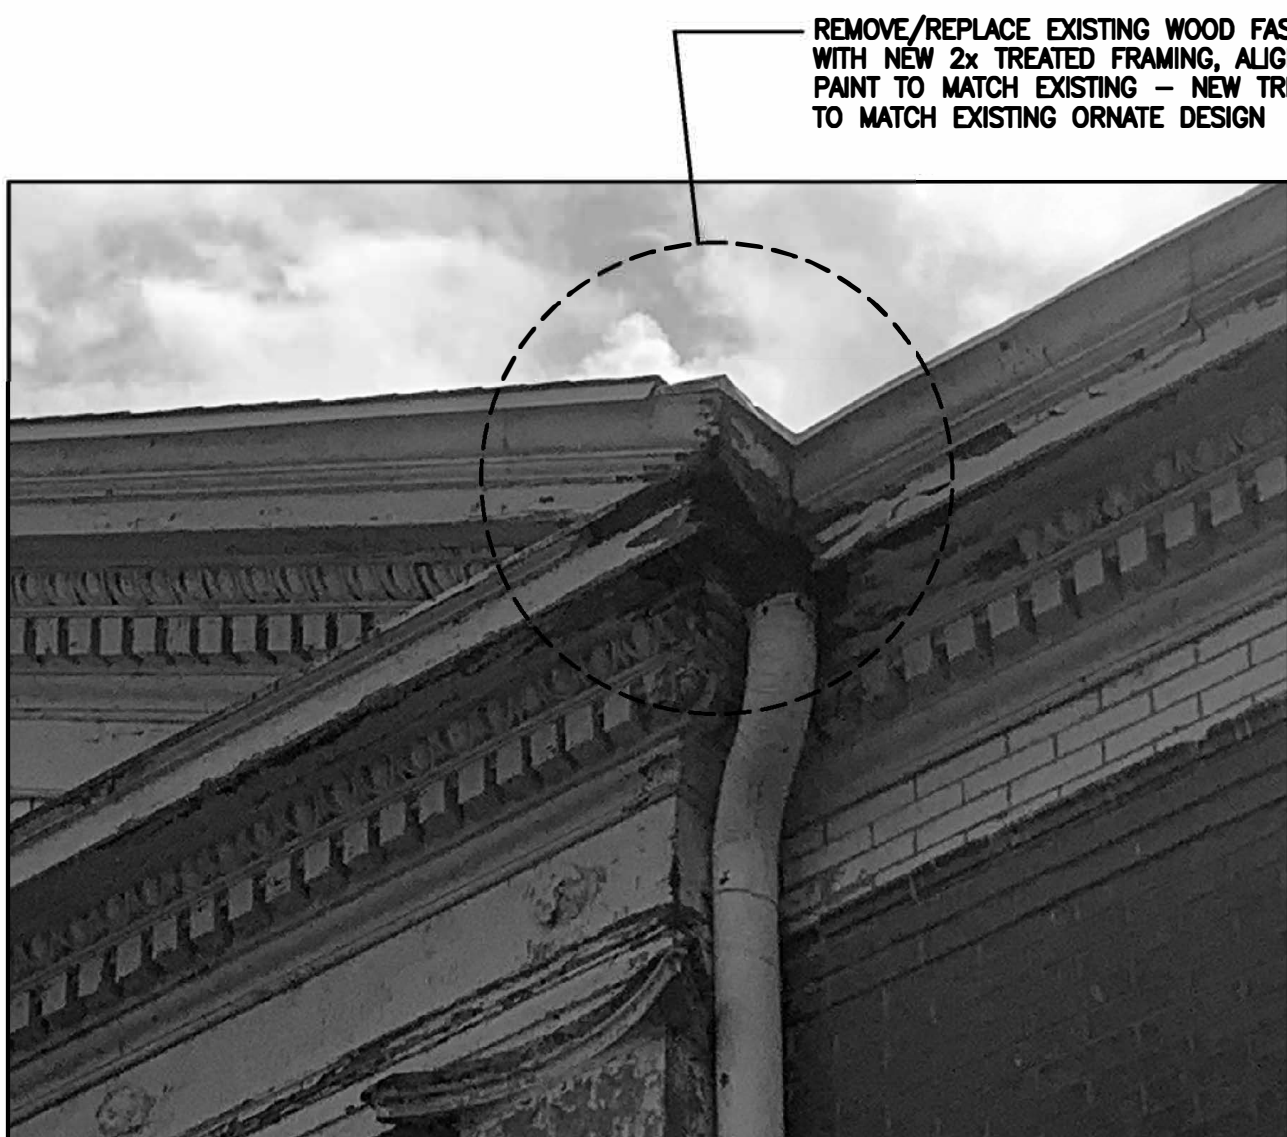


PHOTO #1 — TYPICAL EXISTING CORNER FASCIA/TRIM/SOFFIT DAMAGE TO BE REPAIRED
NOT TO SCALE

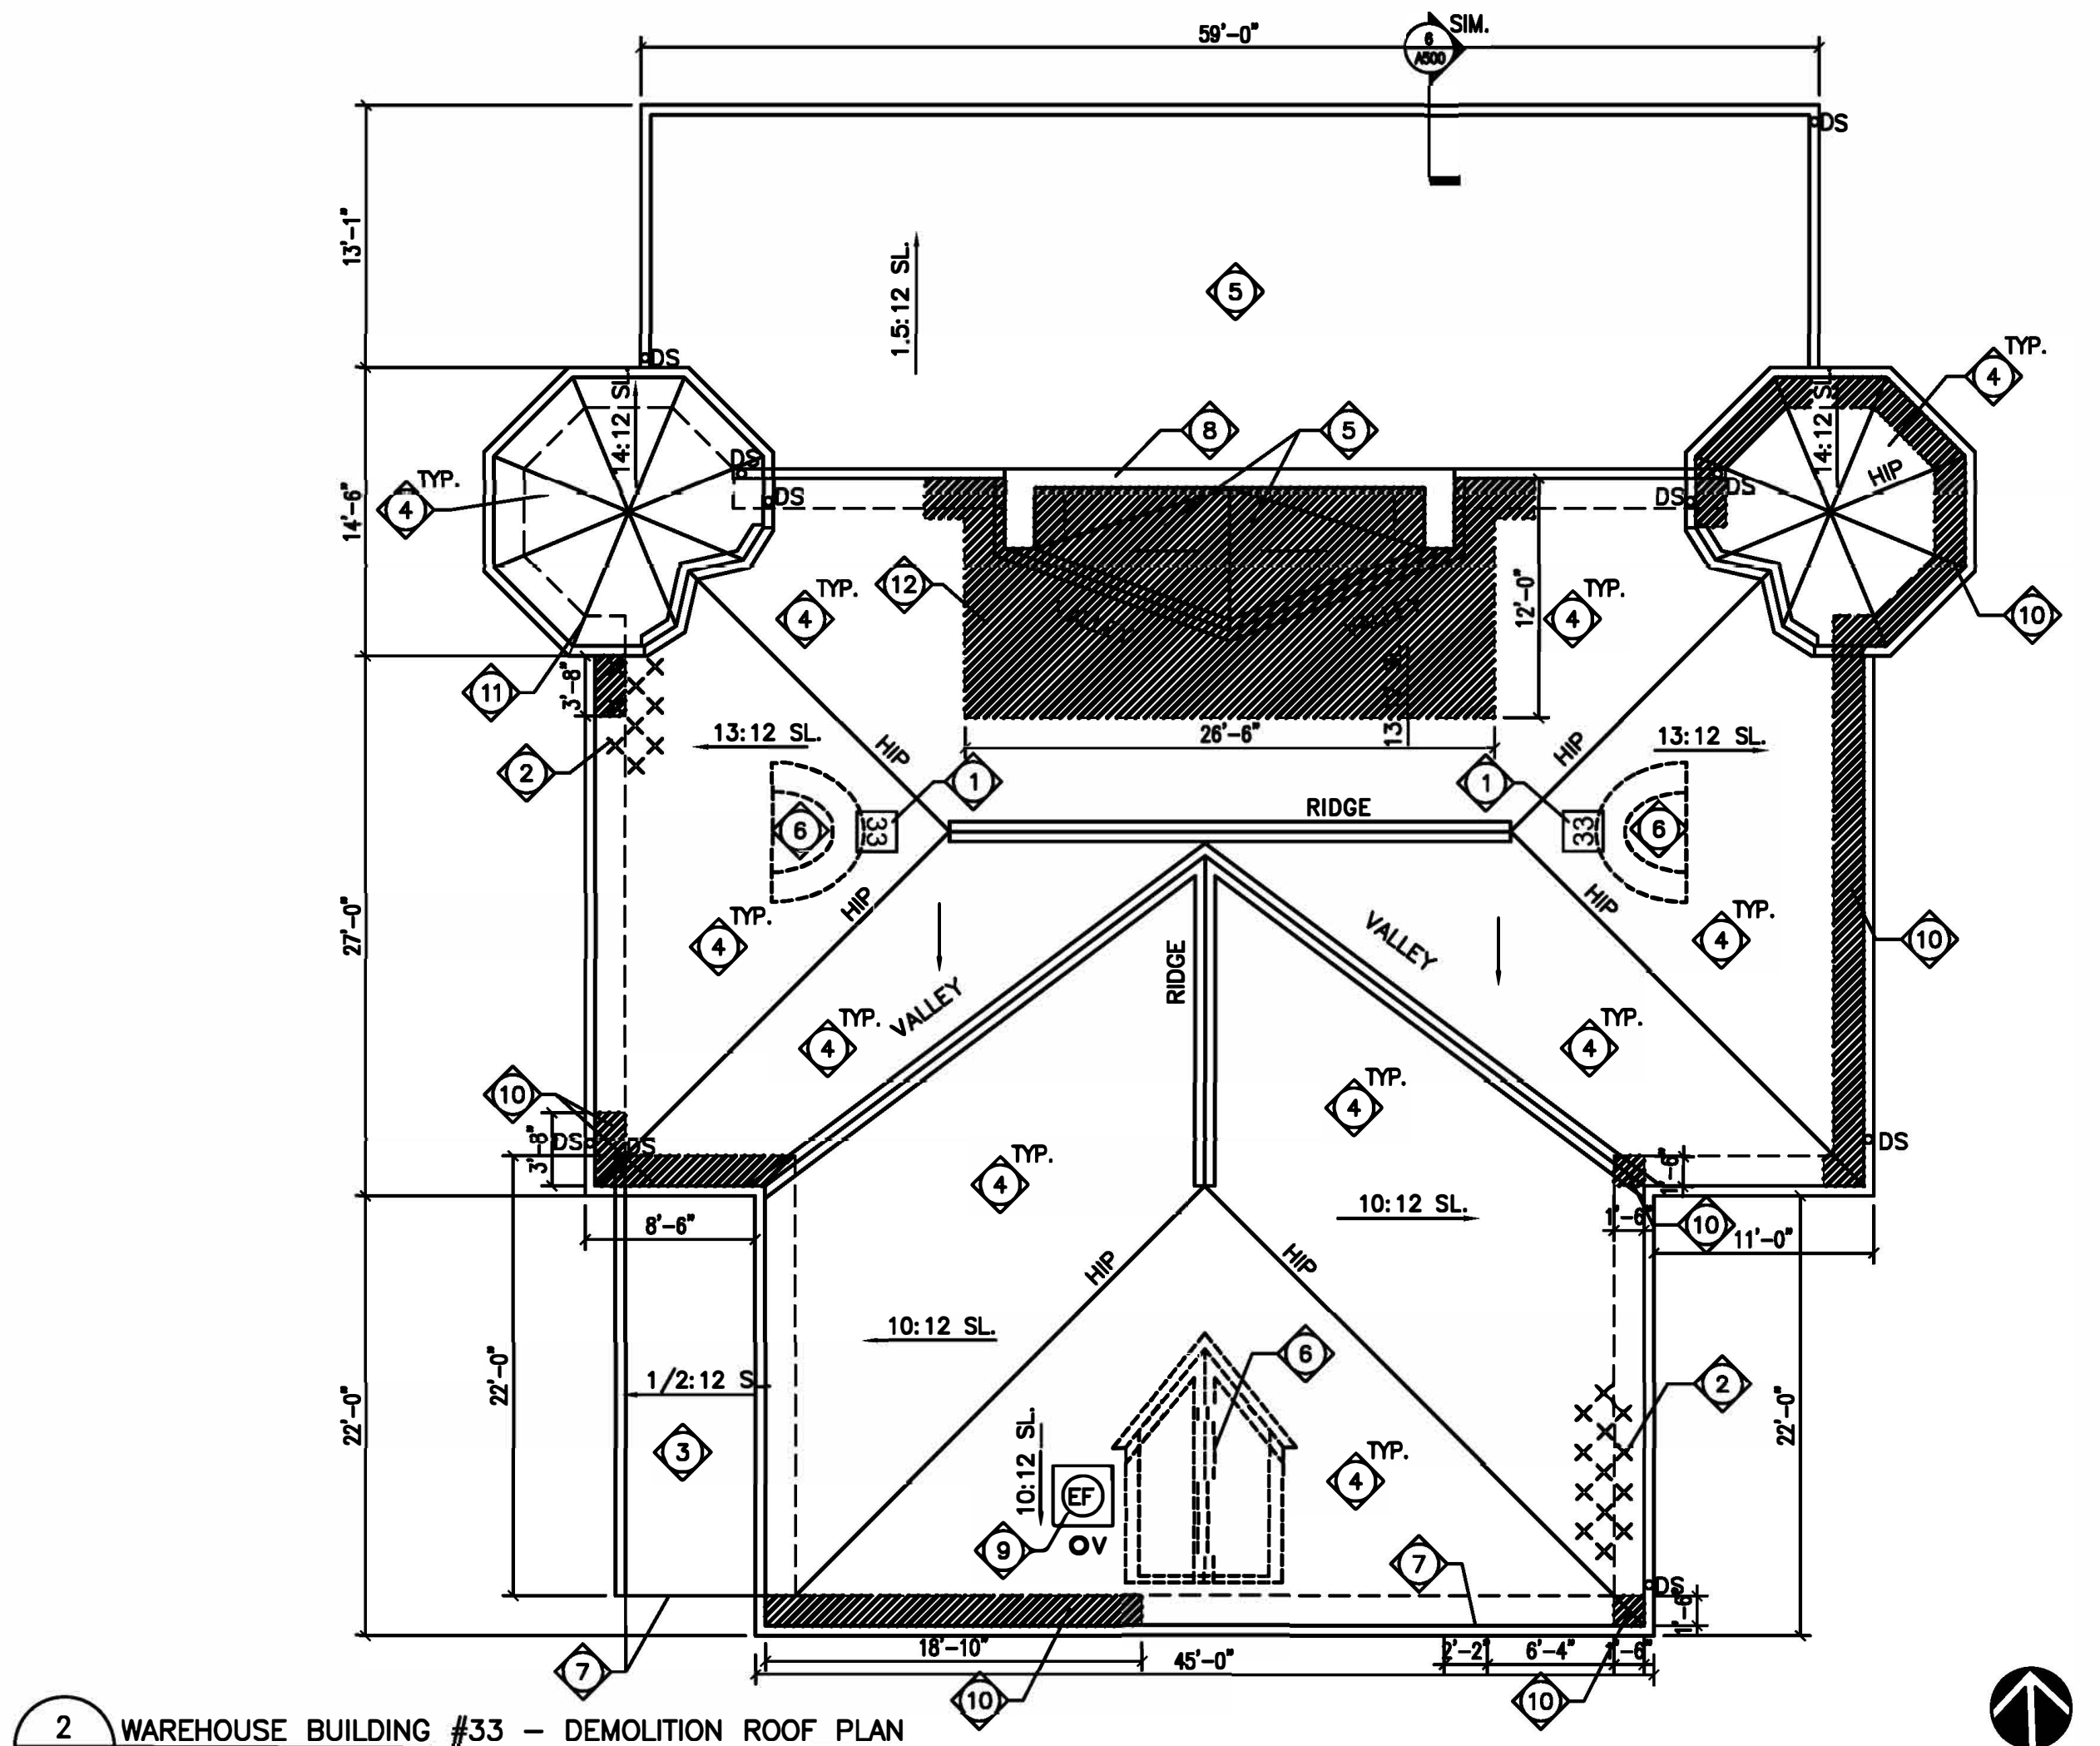

2 WAREHOUSE BUILDING #33 - DEMOLITION ROOF PLAN
1/8" = 1'-0"

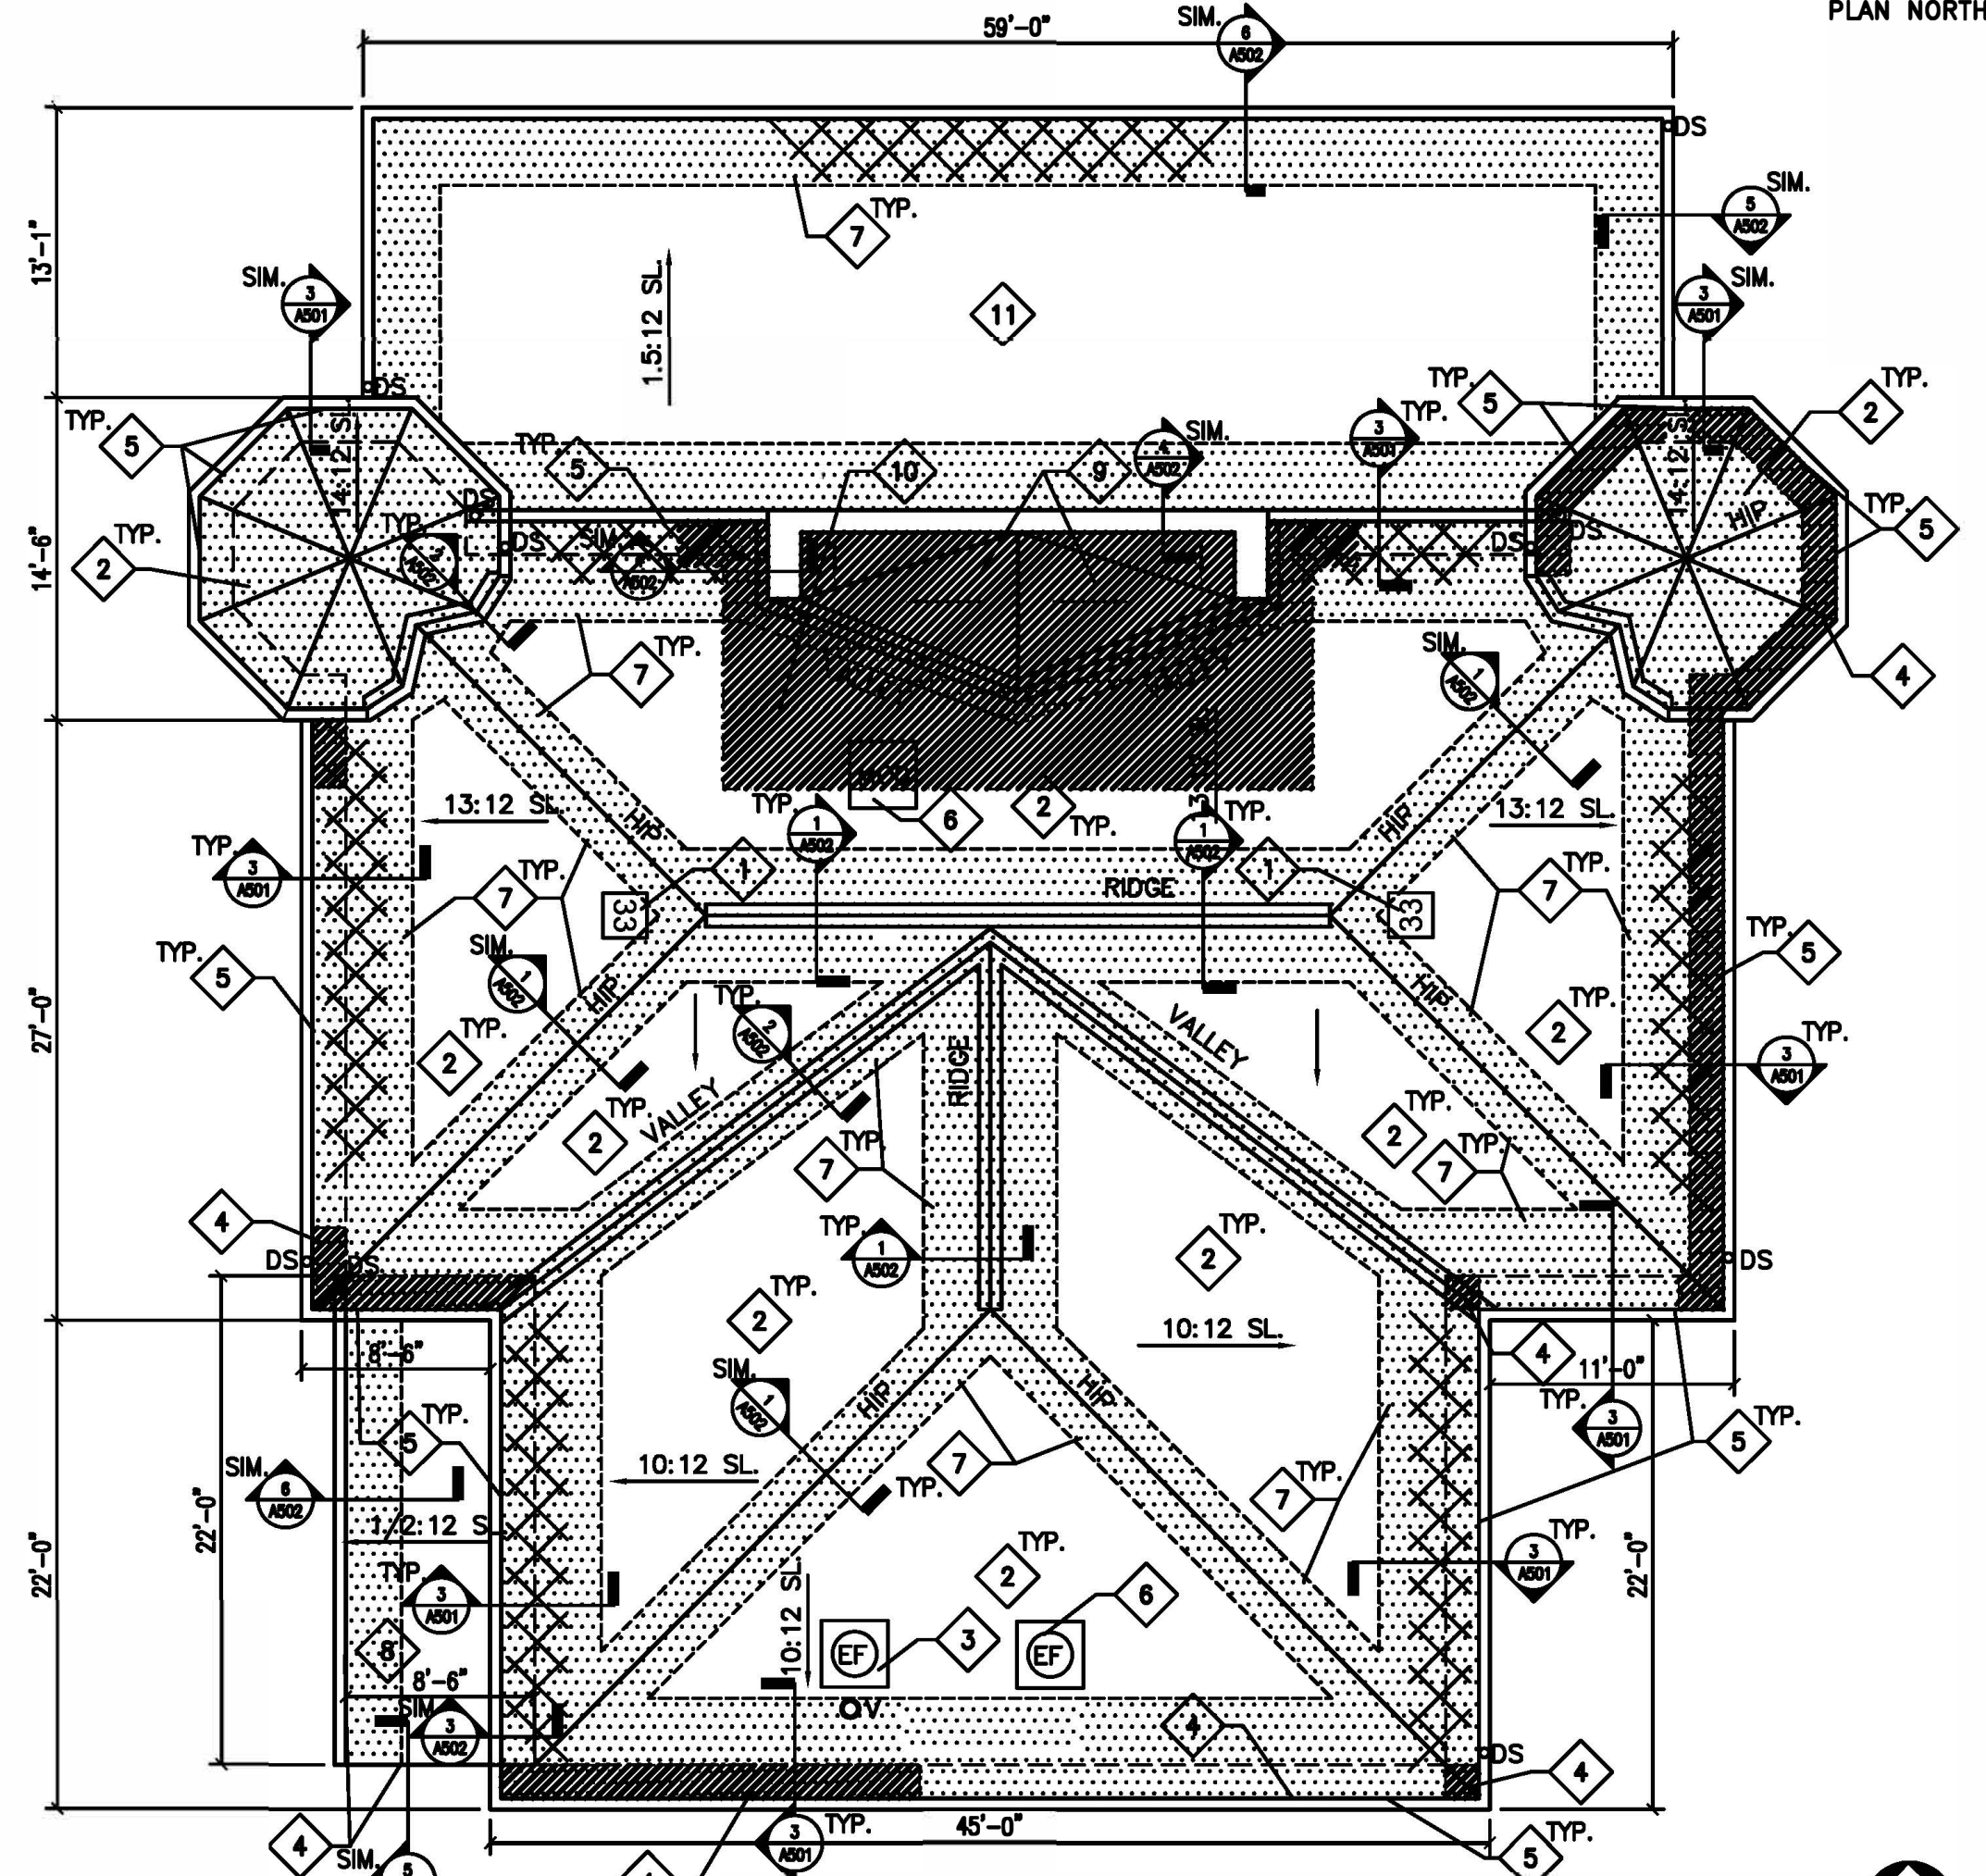

1 WAREHOUSE BUILDING #33 - ROOF PLAN
1/8" = 1'-0"

NOTE: AT THIS BUILDING THE EXISTING EXHAUST FAN INSTALLED IN THE EXISTING ATTIC SCUTTLE LOCATION IS TO BE REMOVED AND REPLACED WITH A SOLID SCUTTLE PANEL, SEE ME DRAWINGS. FIELD VERIFY EXISTING SCUTTLE DIMENSIONS FOR PANEL INSTALLATION.

GENERAL NOTES - HAZARDOUS MATERIALS:

- LEAD-BASED PAINT WAS IDENTIFIED ON NUMEROUS SUBSTRATES ASSOCIATED WITH THE ROOFING REPLACEMENT PROJECT. THE INSPECTION RESULTS ARE FOUND IN THE REPORT TITLED "LIMITED ASBESTOS AND LEAD SURVEY".
- THE PAINTING CONTRACTOR'S EMPLOYEES SHALL HAVE HAD THE EPA LEAD RENOVATION, REPAIR AND PAINTING (RRP) CERTIFIED RENOVATOR COURSE. EPA'S RRP RULE REQUIRES RENOVATION, REPAIR AND PAINTING FIRMS WORKING ON PRE-1978 BUILDINGS TO ASSIGN TO EACH JOB A CERTIFIED RENOVATOR WHO IS TRAINED IN LEAD-SAFE WORK PRACTICES. THE TRAINING MUST BE TAUGHT BY AN EPA OR STATE ACCREDITED TRAINING PROVIDER.
- PAINTING CONTRACTOR MUST BE FAMILIAR WITH EPA DOCUMENT TITLED "SMALL ENTITY COMPLIANCE GUIDE" (REVISED SEPTEMBER 2011 VERSION).
- THE PAINTING CONTRACTOR MUST USE LEAD-SAFE WORK PRACTICES WHEN CONDUCTING PAINTING OPERATIONS ON BUILDINGS 17, 18, 31, 32, AND 33.
- THE PAINTING CONTRACTOR MUST COMPLY WITH ALL REQUIREMENTS OF THE OCCUPATIONAL SAFETY AND HEALTH ADMINISTRATION (OSHA) STANDARD 29 CFR 1926.62, LEAD IN CONSTRUCTION, INCLUDING AIR SAMPLING OF REPRESENTATIVE TASKS TO DETERMINE RESPIRATOR REQUIREMENTS IF WARRANTED.
- ALL PAINT CHIPS AND GENERATED WASTE FROM BUILDINGS 17, 18, 31, 32, AND 33 SHALL BE TESTED BY THE PAINTING CONTRACTOR USING TOXIC CHARACTERISTIC LEACHATE PROCESS (TCLP) ANALYTICAL METHODS TO DETERMINE PROPER WASTE DISPOSAL METHODS.
- TRACE AMOUNTS OF LEAD BELOW THE EPA HUD DEFINITION OF LEAD-BASED PAINT WERE IDENTIFIED IN OTHER AREAS OF THE PROJECT. IT SHOULD BE NOTED THAT OSHA DOES NOT RECOGNIZE THE XRF THRESHOLD VALUE OF 1.0 MG/CM2 FOR LEAD EXPOSURE. ALTHOUGH THE POTENTIAL LEAD HAZARD FOR NORMAL CONSTRUCTION ACTIVITIES IS LOW, ACTUAL LEAD EXPOSURE MAY VARY SIGNIFICANTLY DEPENDING UPON THE SPECIFIC TASK, PROCEDURE AND OTHER WORK AREA CONDITIONS. PROPER OSHA COMPLIANCE IS CONSIDERED PERFORMANCE BASED AND INCLUDES EVALUATING POTENTIAL WORK EXPOSURES WITH AIR MONITORING OR BIOLOGICAL EXPOSURE MONITORING (BLOOD LEAD TESTING), IF REQUIRED.
- THE LOCATIONS OF WASTE DISPOSAL CONTAINERS SHALL BE FIELD VERIFIED WITH THE CORRECTIONAL CENTER AND/OR THE CORRECTIONAL CENTER'S REPRESENTATIVE.
- AT THE DISCRETION OF THE CORRECTIONAL CENTER, ADDITIONAL AIR SAMPLING MAY BE CONDUCTED DURING PAINTING OPERATIONS TO ENSURE LEAD DUST IS NOT MIGRATING AWAY FROM THE WORK SITE.
- ASBESTOS WINDOW GLAZING WAS IDENTIFIED FOR BUILDING 17. AVOID CONTACT WITH THIS ASBESTOS MATERIAL DO NOT SCRAPE, ABRASE OR OTHERWISE IMPACT THE ASBESTOS.

GENERAL NOTES - ROOF PLANS:

- THE CONTRACTOR IS TO VISIT THE SITE DURING THE BIDDING PERIOD AND IS TO ADVISE THE ARCHITECT OF ANY SITUATION OR DISCREPANCY WHICH WILL NOT ALLOW SUCCESSFUL COMPLETION OF THE WORK. THE ARCHITECT'S DECISION WILL CLARIFY THE SCOPE OF WORK.
- INFORMATION IS TAKEN FROM OWNER PROVIDED DOCUMENTS AND SITE INVESTIGATION. THE CONTRACTOR SHALL FIELD VERIFY ALL EXISTING CONDITIONS AND DIMENSIONS PRIOR TO FABRICATION AND INSTALLATION OF NEW WORK.
- PRIOR TO BIDDING, CONTRACTOR IS REQUIRED TO BE FAMILIAR ON SITE WITH THE STATUS OF THE EXISTING ROOF AND VERIFY ALL INFORMATION INDICATED IN THE DOCUMENTS.
- THE CONTRACTOR IS RESPONSIBLE FOR PROTECTING EXISTING ITEMS TO REMAIN DURING DEMOLITION AND NEW CONSTRUCTION.
- PATCH EXISTING TO MATCH ADJACENT MATERIALS WERE DEMOLITION AND NEW CONSTRUCTION OCCUR UNLESS INDICATED OTHERWISE.
- ALL DIMENSIONS REQUIRED FOR WORK SHALL BE VERIFIED BY CONTRACTOR IN THE FIELD PRIOR TO WORK. DIMENSIONS SHOWN FOR INFORMATION ONLY AND MAY BE PLUS/MINUS WHAT IS INDICATED.
- ALL MANUFACTURED ARTICLES, MATERIALS AND EQUIPMENT SHALL BE APPLIED, INSTALLED, CONNECTED, ERECTED, CLEANED AND CONDITIONED AS DIRECTED BY THE MANUFACTURER, UNLESS INDICATED OTHERWISE.
- CURRENT STANDARDS OF ROOFING INSTALLATION, CONSTRUCTION AND WATERPROOFING, NRCA AND ASHRAE APPLY TO THE PERFORMANCE AND DETAILS OF ROOFING CONSTRUCTION INDICATED IN THESE DOCUMENTS.
- THE CONTRACTOR SHALL COORDINATE WITH THE FACILITY TO ESTABLISH PROCEDURES FOR THE CONTROLLED ENTRY OF MEN AND MATERIALS INTO THE WORK AREA AND SHALL COMPLY WITH ALL RULES AND REGULATIONS ESTABLISHED BY THE FACILITY. THE INTERRUPTION OF SECURITY AND COMMUNICATIONS WILL NOT BE PERMITTED. CONTRACTOR SHALL INFORM AND COORDINATE WITH SECURITY OFFICIALS 48 HOURS IN ADVANCE OF ANY WORK RELATED TO SECURITY OR COMMUNICATIONS.
- WHERE DAMAGED AREAS OF WOOD TRIM, SOFFIT AND FASCIA ARE REMOVED/REPLACED, PAINT ENTIRE LENGTH FROM CORNER TO CORNER TO MATCH EXISTING COLOR AND FINISH. SCRAPE AND CLEAN EXISTING WOOD PRIOR TO PAINTING.
- ANY WOOD TRIM, REMOVED FROM BUILDINGS 31, 32, AND 33 SHOULD BE RETURNED TO THE FACILITY.
- AT MECHANICAL/ELECTRICAL ROOF EQUIPMENT AND VENTS, PROVIDE FLASHING PER ROOFING MFG. FOR WATERTIGHT ROOF INSTALLATION.
- PROVIDE SNOW AND ICE GUARDS AT NEW STANDING SEAM METAL ROOFS AS INDICATED ON THE PLANS AND LOCATED DIRECTLY ABOVE EXIST. DOOR LOCATIONS AND 5'-0" ON EITHER SIDE OF DOOR OPENING.
- PROVIDE NEW DOWNSPOUTS AT ALL EXISTING DOWNSPOUT LOCATIONS, SIZE PER EXISTING.

KEYED NOTES - DEMOLITION ROOF PLAN:

- REMOVE EXISTING ROOF NUMBER SIGNAGE.
- REMOVE EXISTING ICE/SNOW GUARDS, LOCATIONS SHOWN FOR INFORMATION ONLY.
- REMOVE EXISTING RUBBER MEMBRANE ROOFING SYSTEM, UNDERLAYMENT, FLASHING, GUTTERS AND DOWNSPOUTS IN ITS ENTIRETY DOWN TO EXISTING DECKING.
- REMOVE EXISTING ASPHALT SHINGLES, UNDERLAYMENT, FLASHING, GUTTERS, DOWNSPOUTS AND ASSOCIATED ROOFING COMPONENTS DOWN TO EXISTING DECKING. EXISTING WOOD FASCIA BOARD TRIM AND SOFFITS TO REMAIN UNLESS NOTED OTHERWISE, PROTECT AS REQUIRED DURING DEMOLITION AND NEW ROOF SYSTEM INSTALLATION.
- REMOVE EXISTING METAL ROOFING SYSTEM, FLASHING, GUTTERS AND DOWNSPOUTS AS REQUIRED FOR THE INSTALLATION OF A NEW STANDING SEAM METAL ROOFING SYSTEM. EXISTING BUILDING STRUCTURE, DECK AND SUPPORTS TO REMAIN. EXISTING METAL FASCIA BOARD TO REMAIN. PROTECT AS REQUIRED.
- REMOVE EXISTING WOOD/ASPHALT SHINGLE DORMER AND ASSOCIATED LOUVER IN ITS ENTIRETY, SEE STRUCTURAL DOCUMENTS FOR ALL DETAILS PRIOR TO NEW ROOF SYSTEM INSTALLATION.
- REMOVE/REPLACE DAMAGED AREAS OF PAINTED WOOD FASCIA AND TRIM, MATCH EXISTING SIZE AND PROFILE. ALIGN FLUSH WITH EXISTING WOOD TRIM, DIMENSIONS FOR REFERENCE ONLY. FIELD VERIFY LOCATIONS AND PAINT ENTIRE LENGTH TO MATCH EXISTING.
- LINE OF PARAPET MASONRY WALL TO REMAIN.
- EXISTING EQUIPMENT, SEE MECHANICAL/ELECTRICAL DOCUMENTS FOR REMOVAL/REINSTALLATION REQUIREMENTS FOR ROOFING REPLACEMENT.
- REMOVE/REPLACE DAMAGED AREAS OF PAINTED WOOD FASCIA BOARD AND WOOD PLANK SOFFIT, SEE STRUCTURAL FOR SOFFIT DETAILS. ALIGN FASCIA AND SOFFIT FLUSH WITH EXISTING FASCIA TRIM, DIMENSIONS FOR REFERENCE ONLY. FIELD VERIFY LOCATIONS. EXISTING EXTERIOR WOOD TRIM TO REMAIN. PROTECT AS REQUIRED DURING SOFFIT REPLACEMENT. SOFFITS TO BE REPLACED ENTIRELY BETWEEN EXISTING WOOD SUPPORTS.
- REMOVE/REPLACE DAMAGED WOOD SOFFIT SUPPORT BEAM, SEE STRUCTURAL FOR DETAILS. PAINT TO MATCH EXISTING, EXTERIOR WOOD TRIM TO REMAIN, PROTECT AS REQUIRED, PATCH TO MATCH EXISTING.
- REMOVE/REPLACE EXISTING WOOD PLANK DECKING, SEE STRUCTURAL FOR DETAIL.

NOTE:
CONTRACTOR IS RESPONSIBLE FOR INCLUDING 2500 SF OF TOTAL ROOF SQUARE FOOTAGE FOR REPLACEMENT OF EXISTING PLANK DECKING. AREAS OF DAMAGED PLANK DECKING MUST BE REPLACED PRIOR TO INSTALLING NEW ROOFING SYSTEM. LOCATIONS WILL BE FIELD VERIFIED ONCE THE EXISTING ROOFING SYSTEM AND UNDERLAYMENT IS REMOVED AND PLANK DECKING IS EXPOSED. CONTRACTOR TO FIELD VERIFY DECKING CONDITIONS AND COORDINATE AREAS OF REMOVAL WITH A/E AND/OR OWNER'S REPRESENTATIVE PRIOR TO INSTALLATION OF NEW ROOFING SYSTEM. SEE STRUCTURAL DRAWINGS FOR REPLACEMENT DETAIL/SCOPE OF WORK. DAMAGED PLANK DECKING BEYOND THE 5% WILL BE HANDLED VIA UNIT COST.

KEYED NOTES - ROOF PLAN:

- ROOF NUMBER SIGNAGE SECURE TO STANDING SEAM METAL ROOF PER MANUFACTURER SO AS NOT TO VOID WARRANTY. SIGNAGE SHALL BE 36"x36" SQUARE. THE BUILDING NUMBER AS INDICATED SHALL BE BLACK WITH A REFLECTIVE WHITE BACKGROUND. FONT SIZE SHALL FIT 36"x36" SIGN.
- NEW STANDING SEAM METAL ROOFING SYSTEM OVER EXISTING WOOD DECKING ON WOOD STRUCTURAL SYSTEM, INCLUDING: UNDERLAYMENT, FLASHING, GUTTERS AND DOWNSPOUTS TO MATCH NEW ROOF SYSTEM. PROVIDE METAL ROOFING FLASHING AND ACCESSORIES AS REQUIRED FOR A WATERTIGHT INSTALLATION AND AT EXIST. VENTS AND ELECTRICAL/MECHANICAL EQUIPMENT TO MATCH METAL ROOFING SYSTEM. PROVIDE PANEL INSTALLATION TO MATCH EXISTING SLOPES AND ACCESSORIES AS REQUIRED FOR WATERTIGHT INSTALLATION OF METAL ROOFING SYSTEM TO MATCH EXISTING ROOF LAYOUT, SHAPE AND CONSTRUCTION.
- EXISTING EQUIPMENT, SEE MECHANICAL/ELECTRICAL DOCUMENTS FOR REMOVAL/REINSTALLATION REQUIREMENTS FOR ROOFING REPLACEMENT, FLASH CURBS PER ROOF MFG. RECOMMENDATIONS.
- AREAS OF WOOD FASCIA, TRIM AND SOFFIT REPLACEMENT, PAINT TO MATCH EXISTING THE ENTIRE LENGTH OF EXISTING FASCIA, SOFFIT AND TRIM FROM BUILDING CORNER TO BUILDING CORNER, SCRAPE AND CLEAN EXISTING WOOD PRIOR TO PAINTING.
- SCRAPE CLEAN AND REPAINT EXISTING FASCIA, SOFFIT AND EXTERIOR WALL TRIM FOR THE ENTIRE BUILDING. AT AREAS OF SOFFIT/FASCIA REPLACEMENT INCLUDE PAINTING THE EXISTING EXTERIOR WALL TRIM, 2 COATS.
- NEW MECHANICAL/ELECTRICAL EQUIPMENT, SEE MECHANICAL/ELECTRICAL DOCUMENTS FOR INSTALLATION REQUIREMENTS, FLASH CURBS PER ROOF MFG. RECOMMENDATIONS.
- LINE OF SELF-ADHERED WATER AND ICE MEMBRANE, INSTALL ALONG ROOF EDGE, RIDGE AND VALLEY PER DETAILS ON SHEETS A500, A501 AND A502.
- NEW STANDING SEAM METAL ROOFING SYSTEM, UNDERLAYMENT, FLASHING, GUTTERS AND DOWNSPOUTS WITH R30 RIGID INSULATION OVER EXIST. ROOF DECK. PROVIDE REQUIRED FRAMING AND SECURE TO EXISTING ROOF DECK/STRUCTURE FOR STANDING SEAM METAL ROOF INSTALLATION TO ESTABLISH PROPER DRAINAGE FIELD VERIFY EXISTING CONDITIONS.
- STANDING SEAM METAL CRICKET, INSTALL PER METAL ROOFING MANUFACTURER TO MAINTAIN PROPER DRAINAGE AT EXISTING PARAPET LOCATION.
- AREA OF WOOD PLANK DECKING REPLACEMENT, SEE STRUCTURAL.
- NEW STANDING SEAM METAL ROOFING SYSTEM, UNDERLAYMENT, FLASHING, GUTTERS AND DOWNSPOUTS WITH R30 RIGID INSULATION OVER EXISTING ROOF DECK. PROVIDE METAL ROOFING FLASHING/ACCESSORIES AT EXIST VENTS AND ELECTRICAL/MECHANICAL EQUIPMENT TO MATCH METAL ROOFING SYSTEM.

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MICHAEL L PARSON,
GOVERNOR



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REPLACE ROOF SYSTEMS
MULTIPLE ASSETS
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CORRECTIONAL CENTER

FARMINGTON, MISSOURI

PROJECT # C1922-01

SITE # 7008

ASSET # 9327008089,
9327008090, 9327008091, 9327008082
9327008081, 9327008080, 9327008079

REVISION:-

DATE:-

REVISION:-

DATE:-

REVISION:-

DATE:-

ISSUE DATE: APRIL 18, 2022

CAD DWG FILE: A-100

DRAWN BY: EL

CHECKED BY: EL

DESIGNED BY: EL


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BUILDING #33
ROOF PLANS
(ALTERNATE NO. 4)


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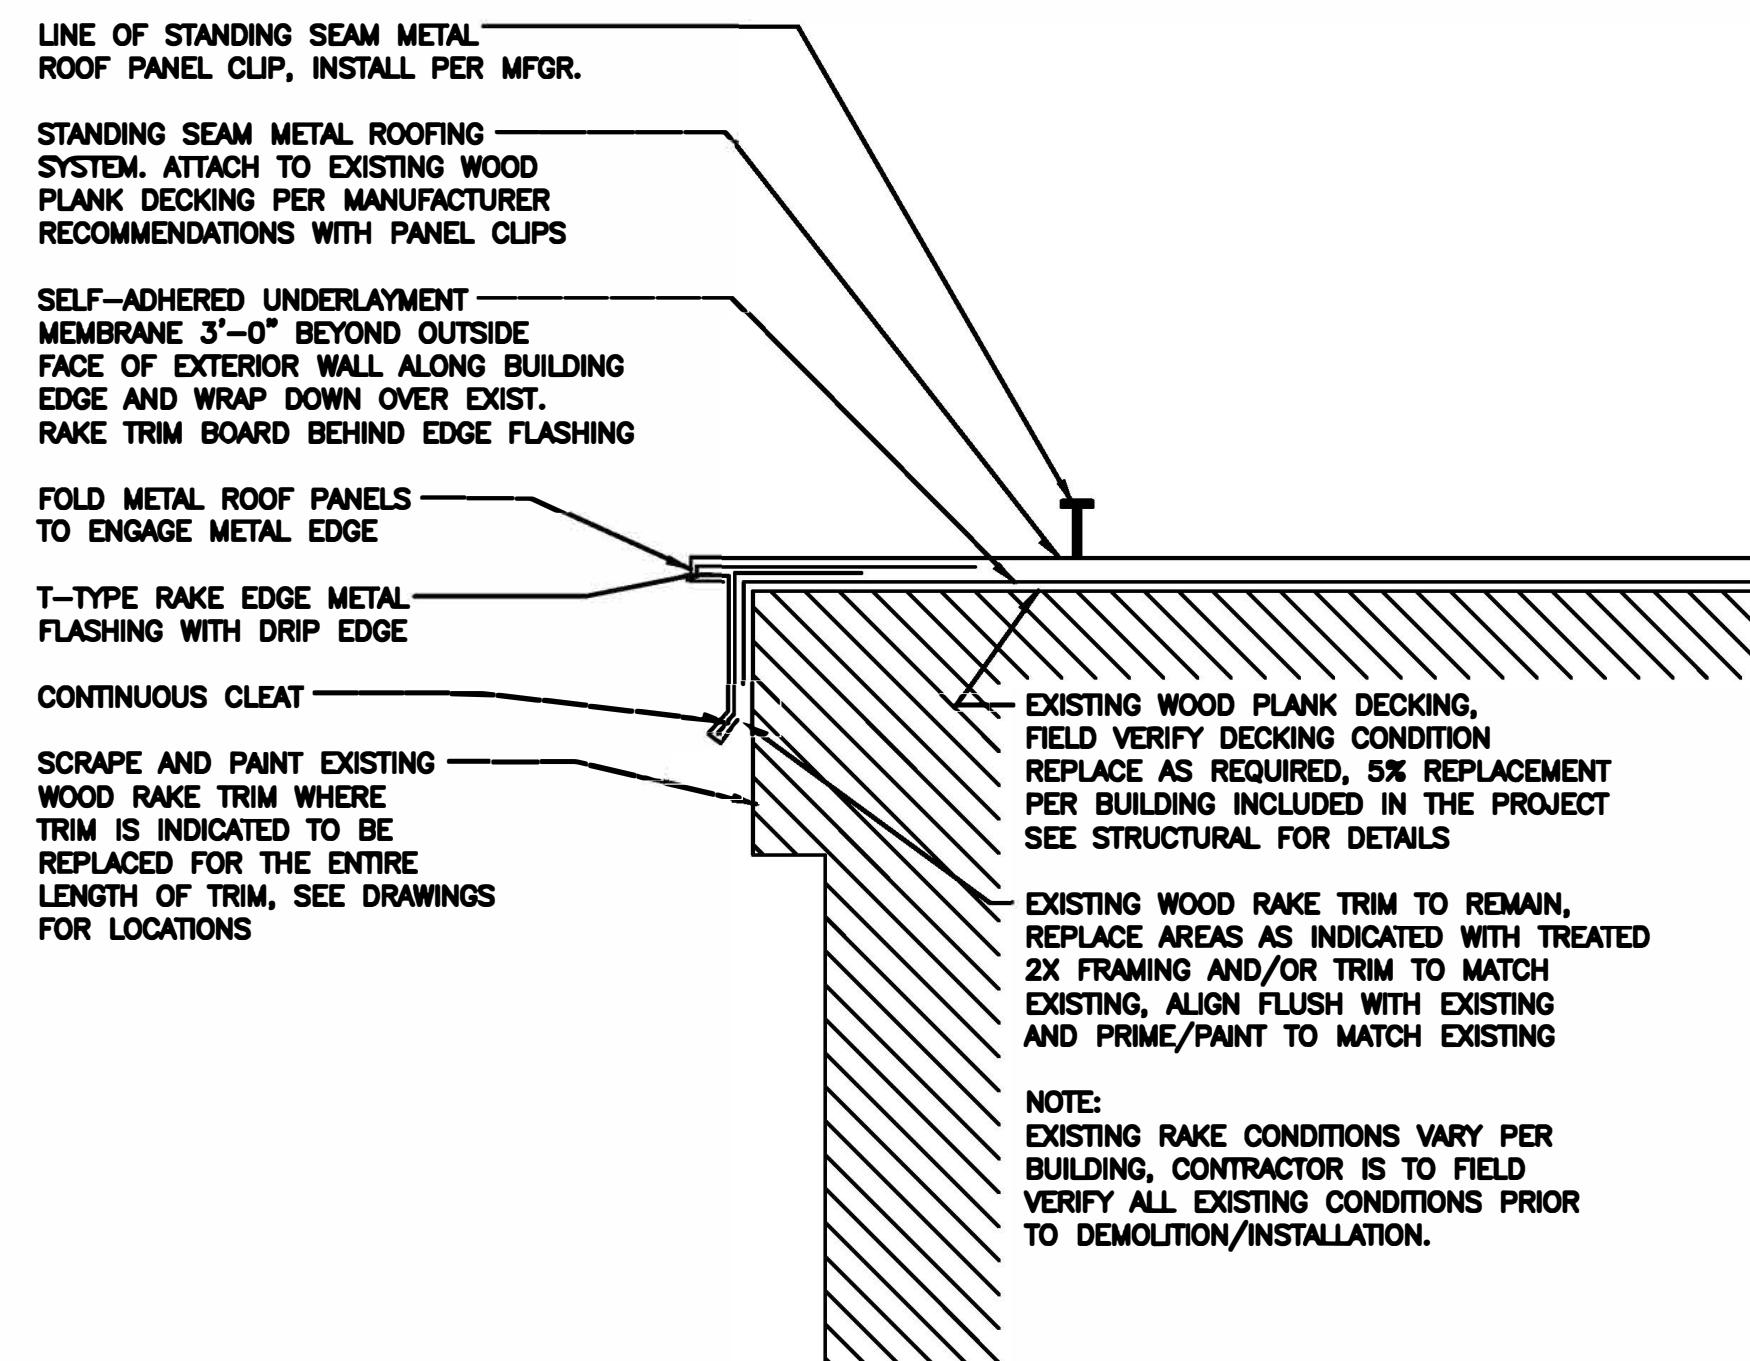
10 OF 29 SHEETS
04/18/2022




6 STANDING SEAM METAL ROOF DETAIL AT EAVE
3' = 1'-0"

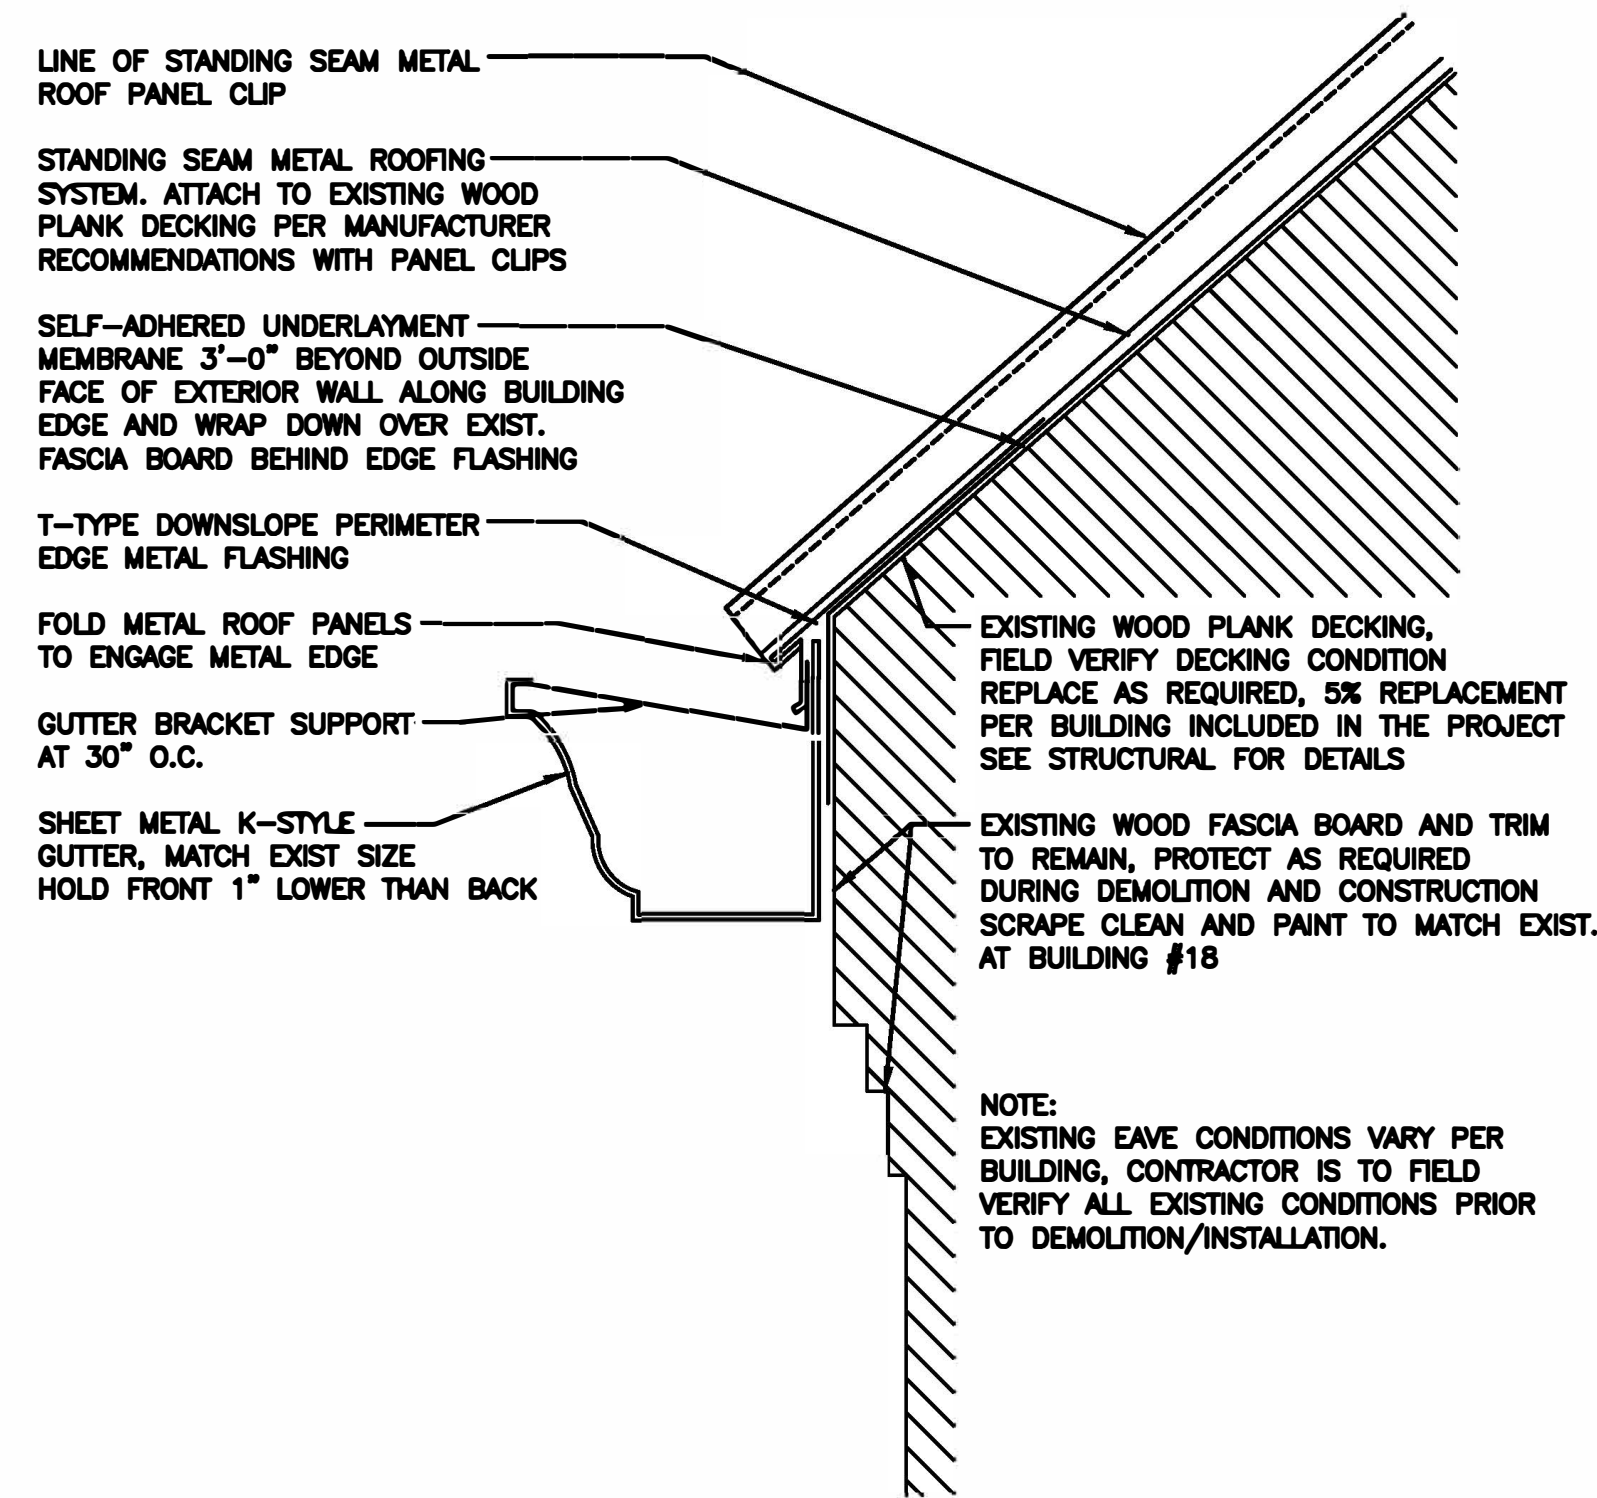


4 STANDING SEAM METAL ROOF EAVE DETAIL AT CANOPY
3' = 1'-0"

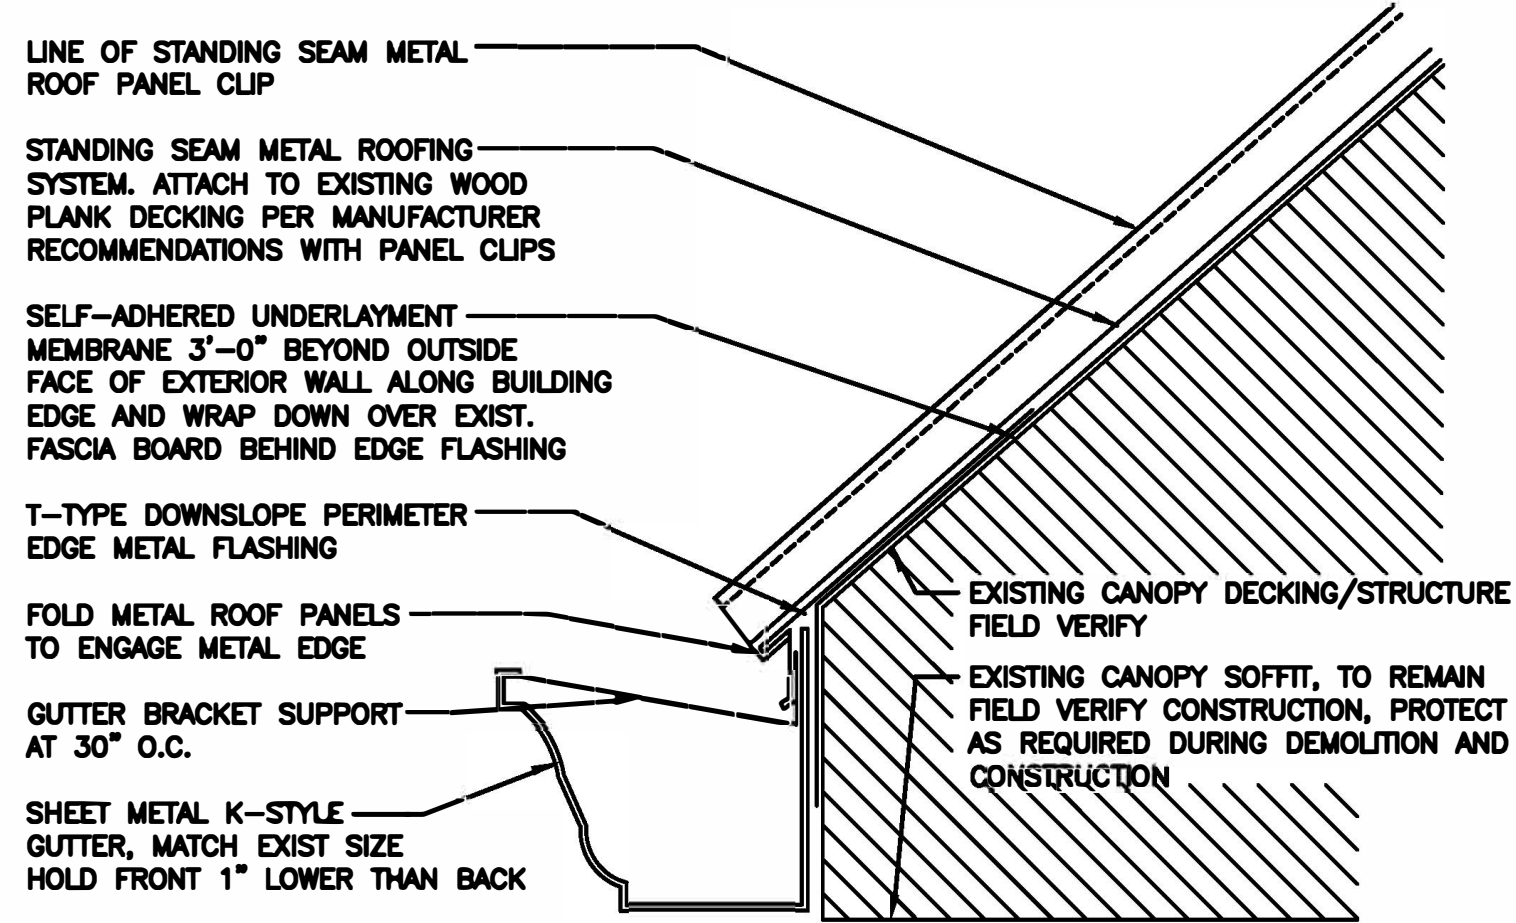


2 STANDING SEAM METAL ROOF DETAIL AT RAKE
3' = 1'-0"

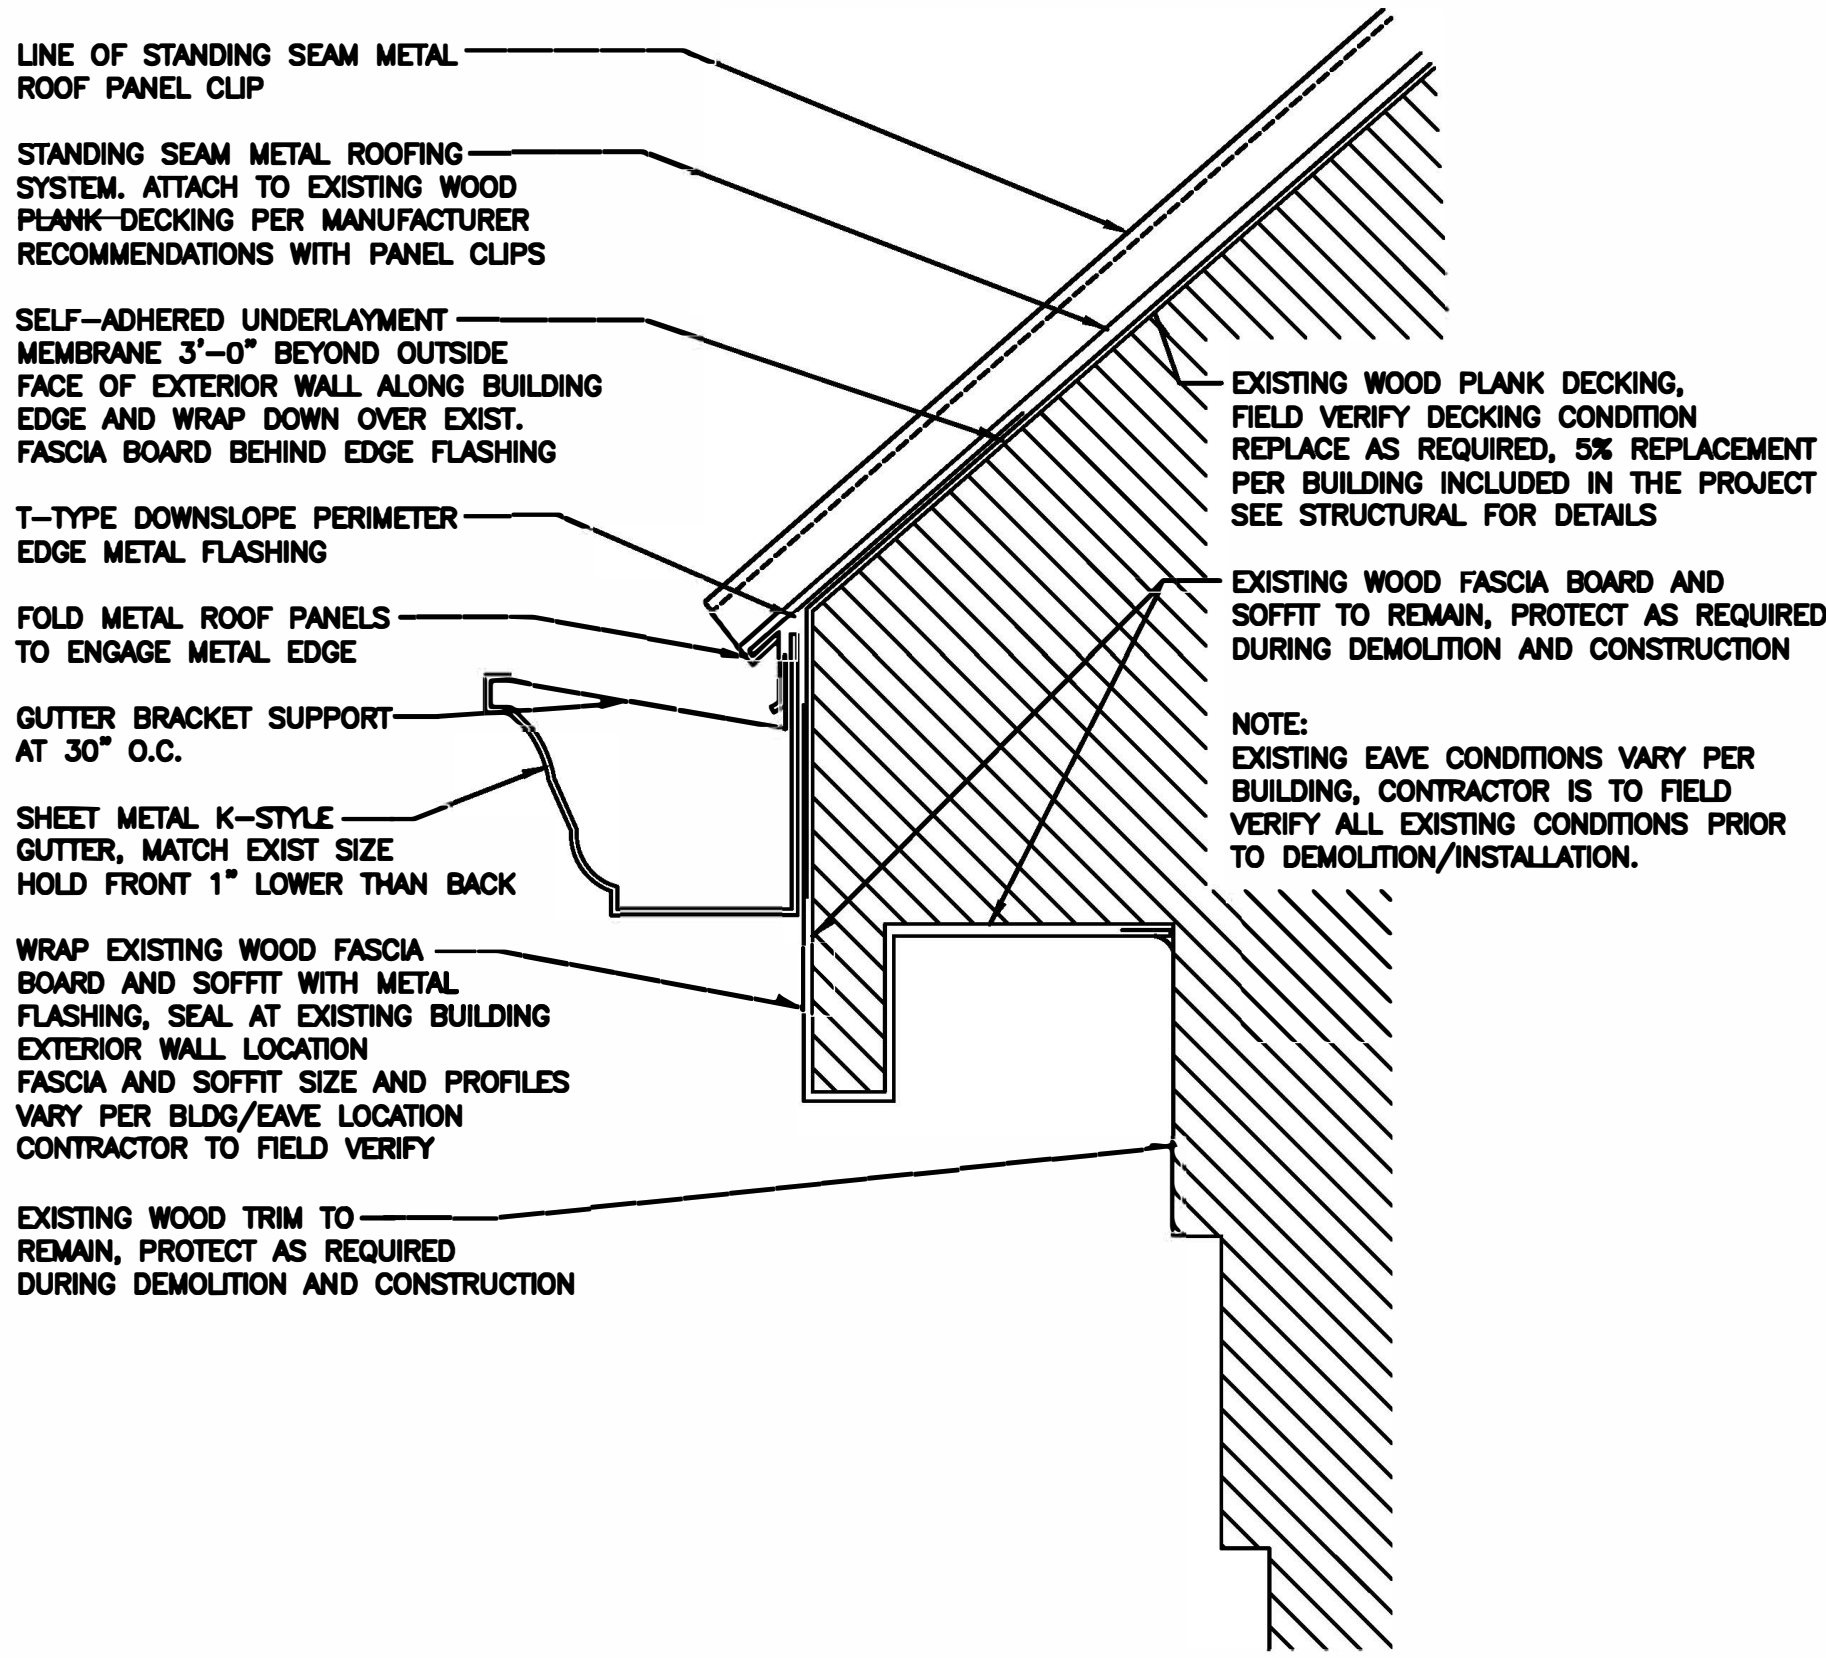

5 STANDING SEAM METAL ROOF DETAIL AT EAVE
3' = 1'-0"

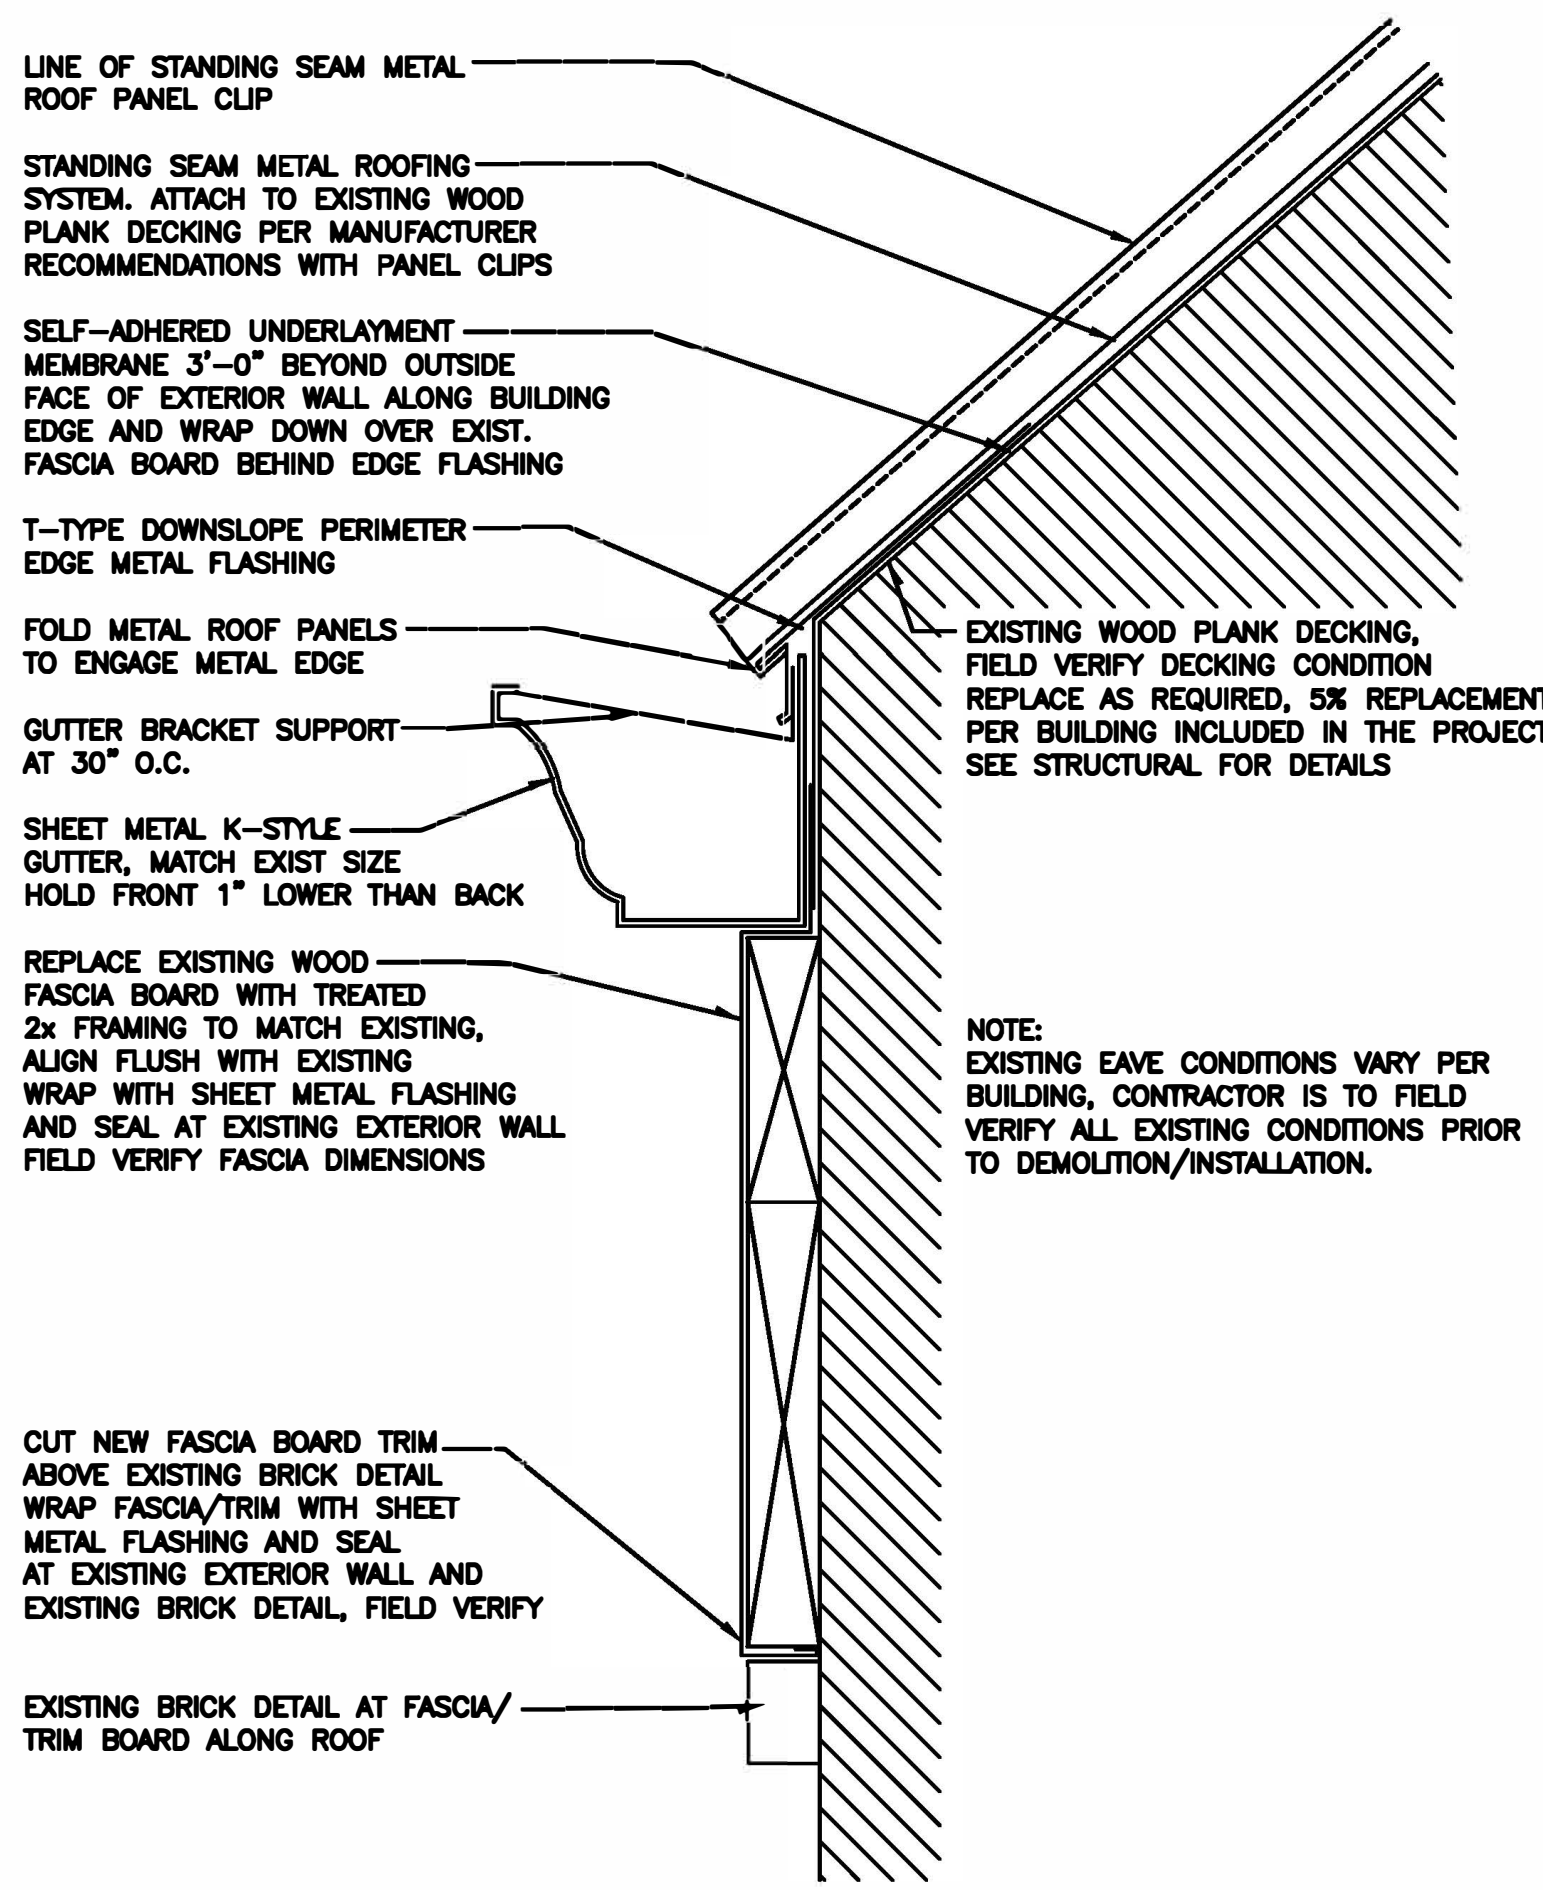

3 STANDING SEAM METAL ROOF DETAIL AT EAVE WITH BRICK DETAIL
3' = 1'-0"

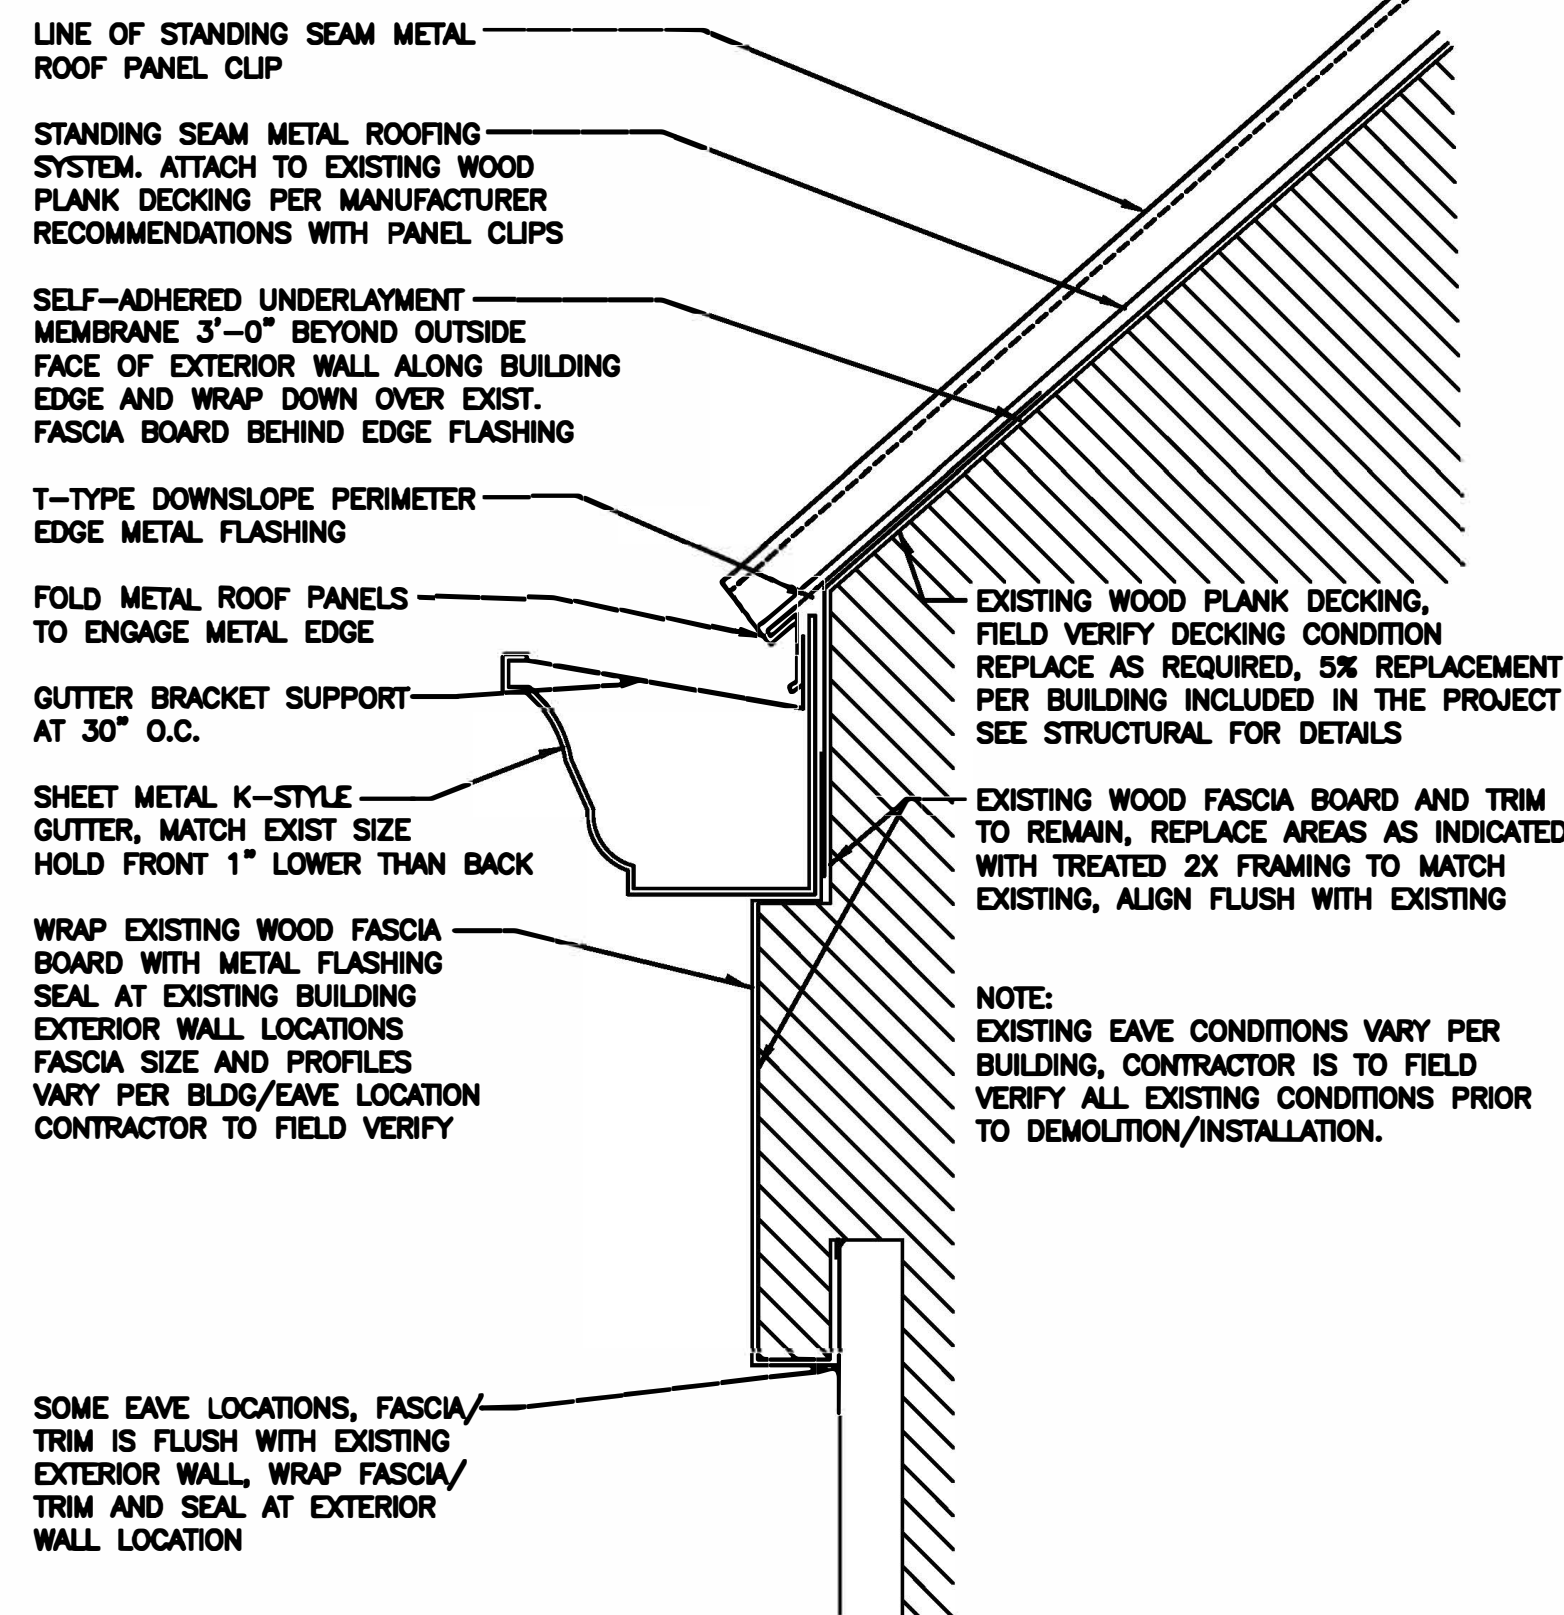

1 STANDING SEAM METAL ROOF DETAIL AT EAVE
3' = 1'-0"



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FARMINGTON, MISSOURI

PROJECT # C1922-01
SITE # 7008
ASSET # 9327008089,
9327008090, 9327008091, 9327008082
9327008081, 9327008080, 9327008079

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DATE: -
REVISION: -
DATE: -

ISSUE DATE: APRIL 18, 2022


CAD DWG FILE: A-500
DRAWN BY: EL
CHECKED BY: EL
DESIGNED BY: EL

SHEET TITLE:
ROOF DETAILS


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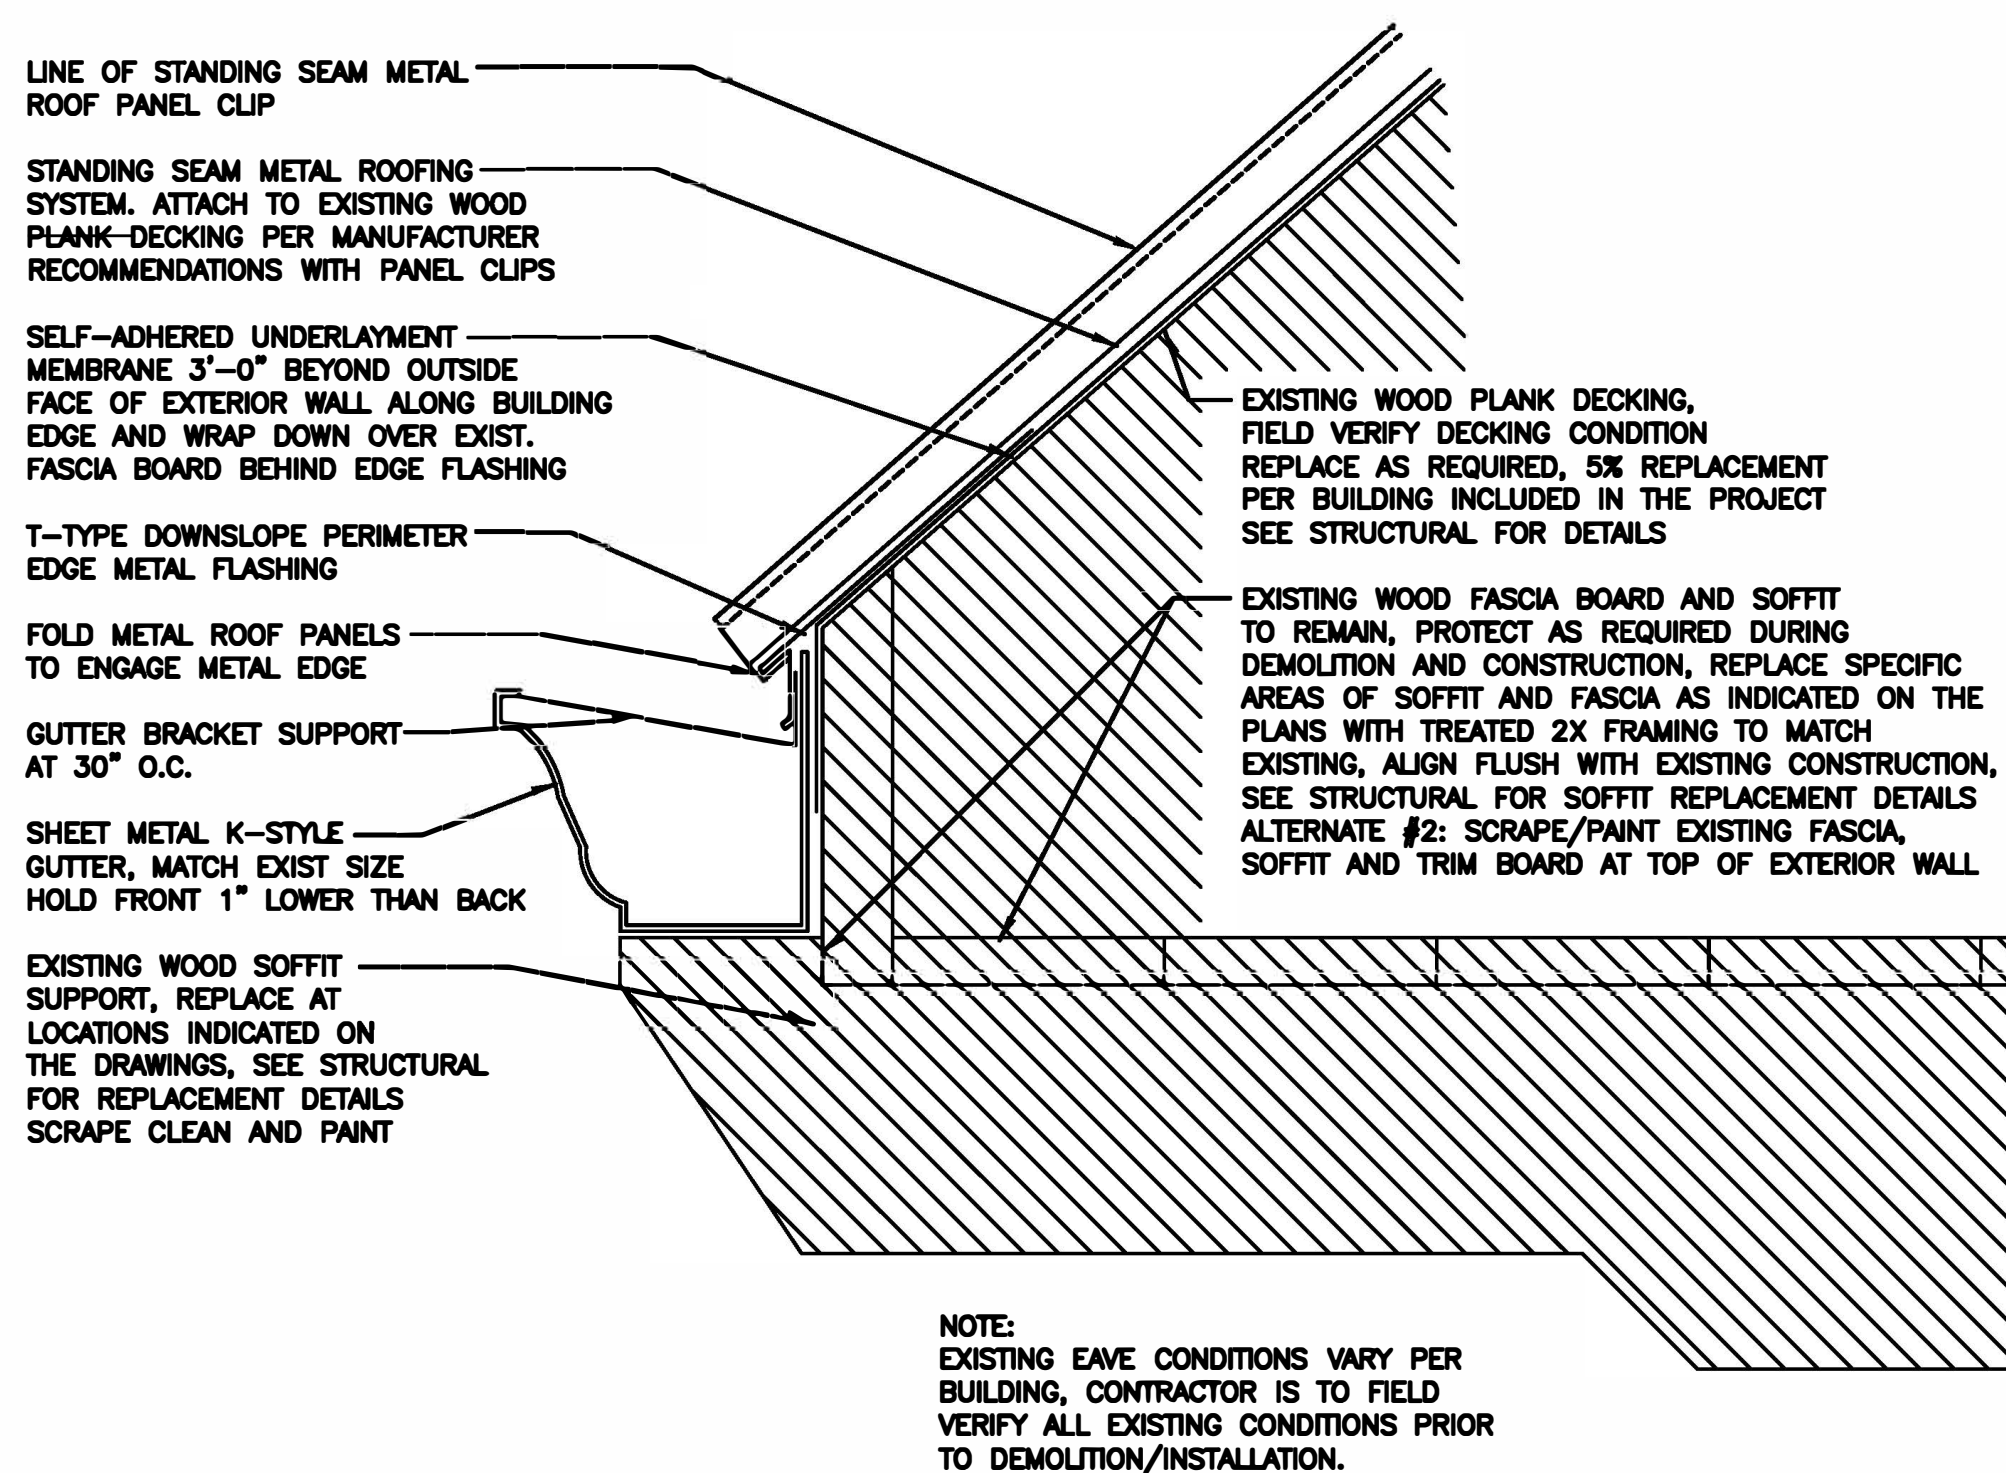
11 OF 29 SHEETS
04/18/2022




6 TPO ROOF DETAIL AT EAVE ALONG EXISTING CURVED WALL
A501 3" = 1'-0"

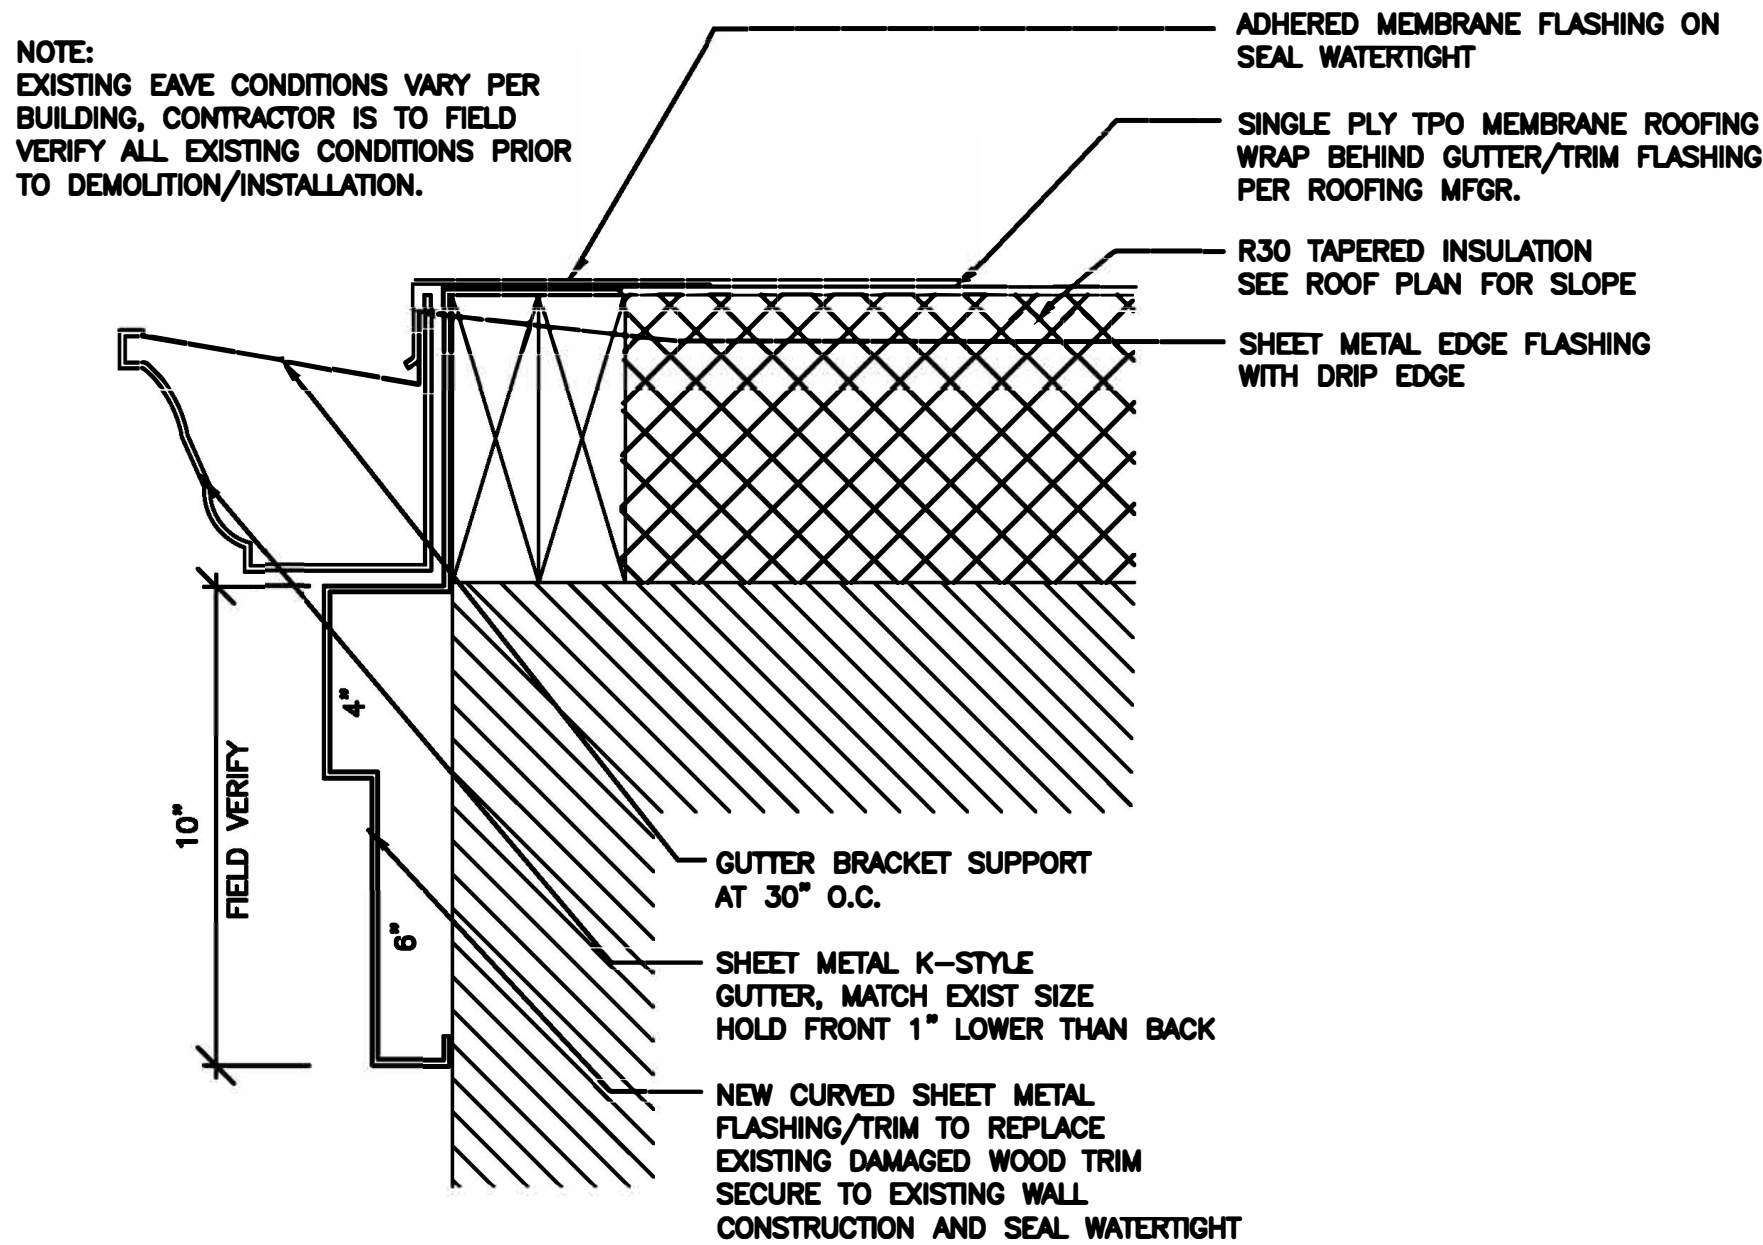


4 STANDING SEAM METAL ROOF DETAIL AT EAVE ALONG DECORATIVE TRIM
A501 3" = 1'-0"

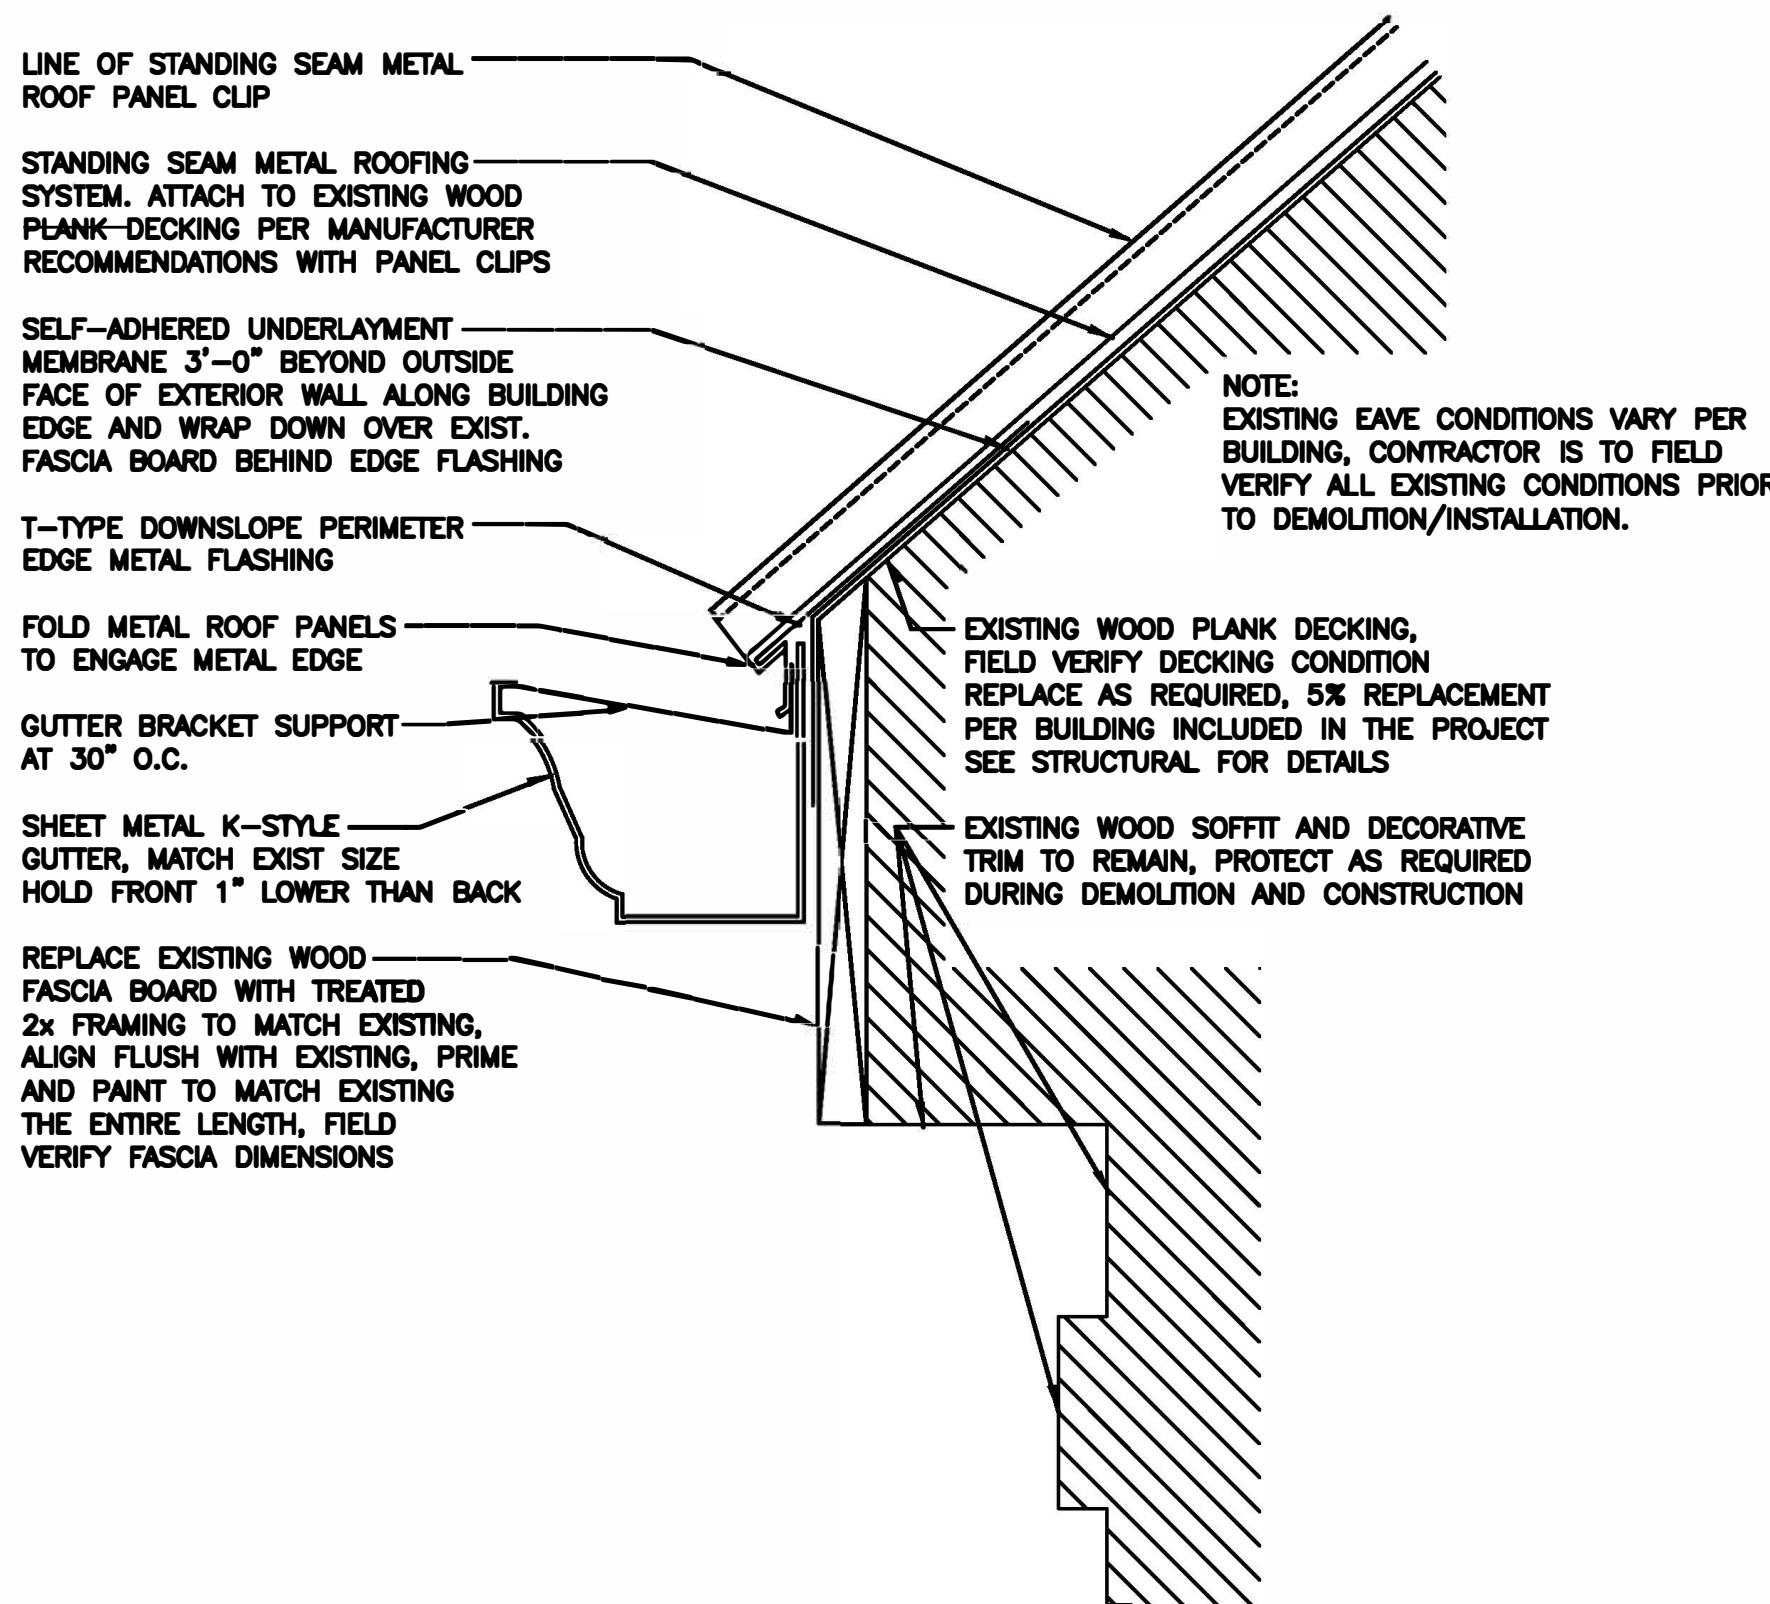


2 STANDING SEAM METAL ROOF DETAIL AT EAVE ALONG SOFFIT
A501 3" = 1'-0"

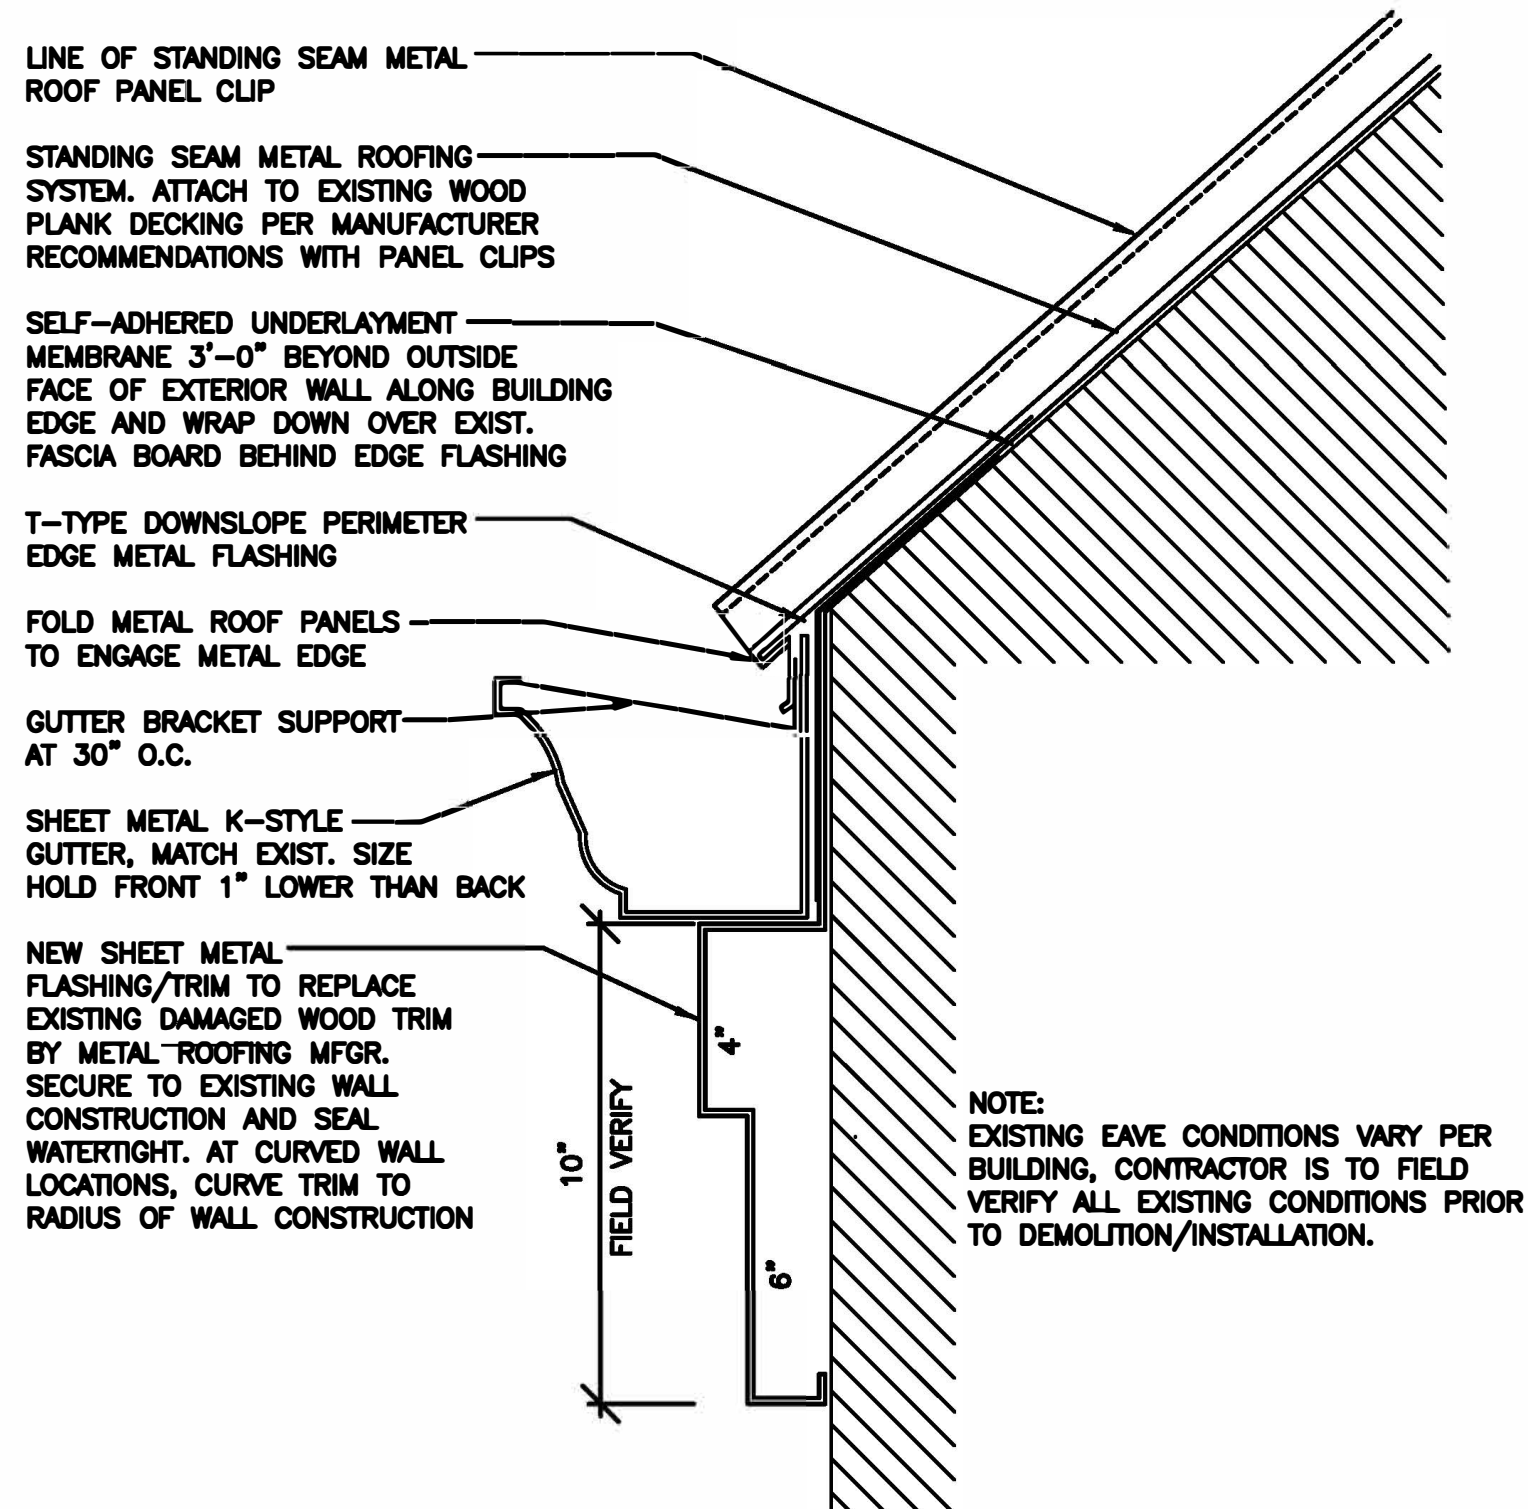

5 STANDING SEAM METAL ROOF DETAIL AT CURVED TRIM REPLACEMENT
A501 3" = 1'-0"

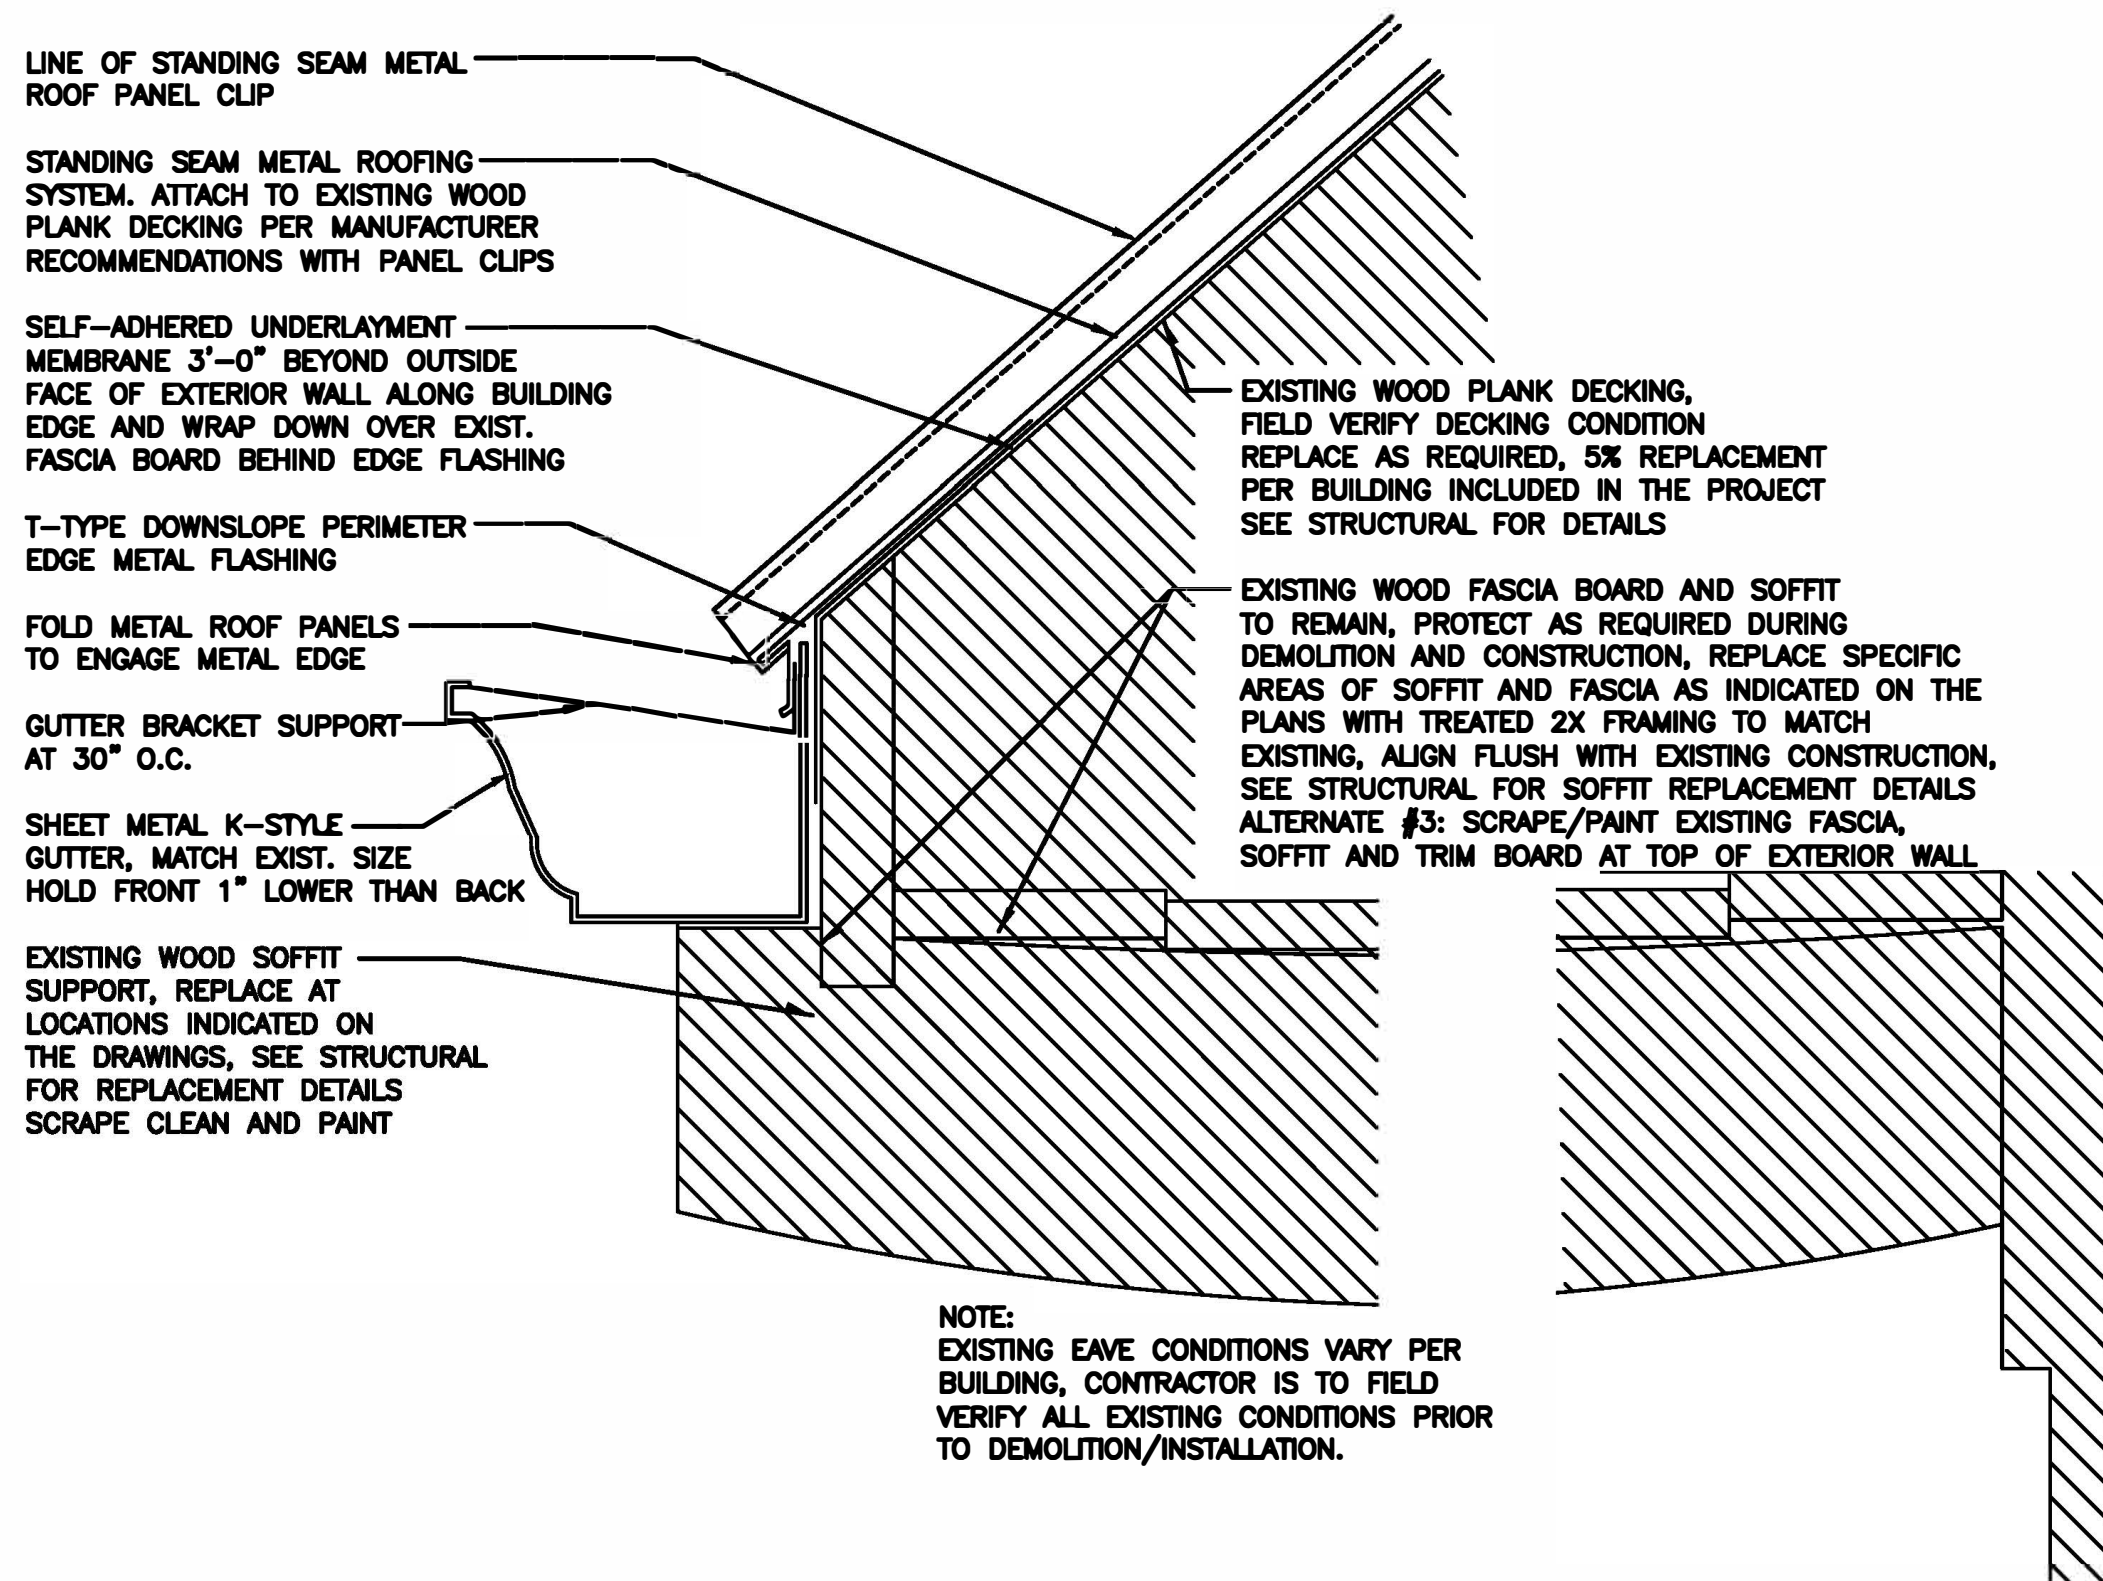

3 STANDING SEAM METAL ROOF DETAIL AT EAVE ALONG SOFFIT
A501 3" = 1'-0"

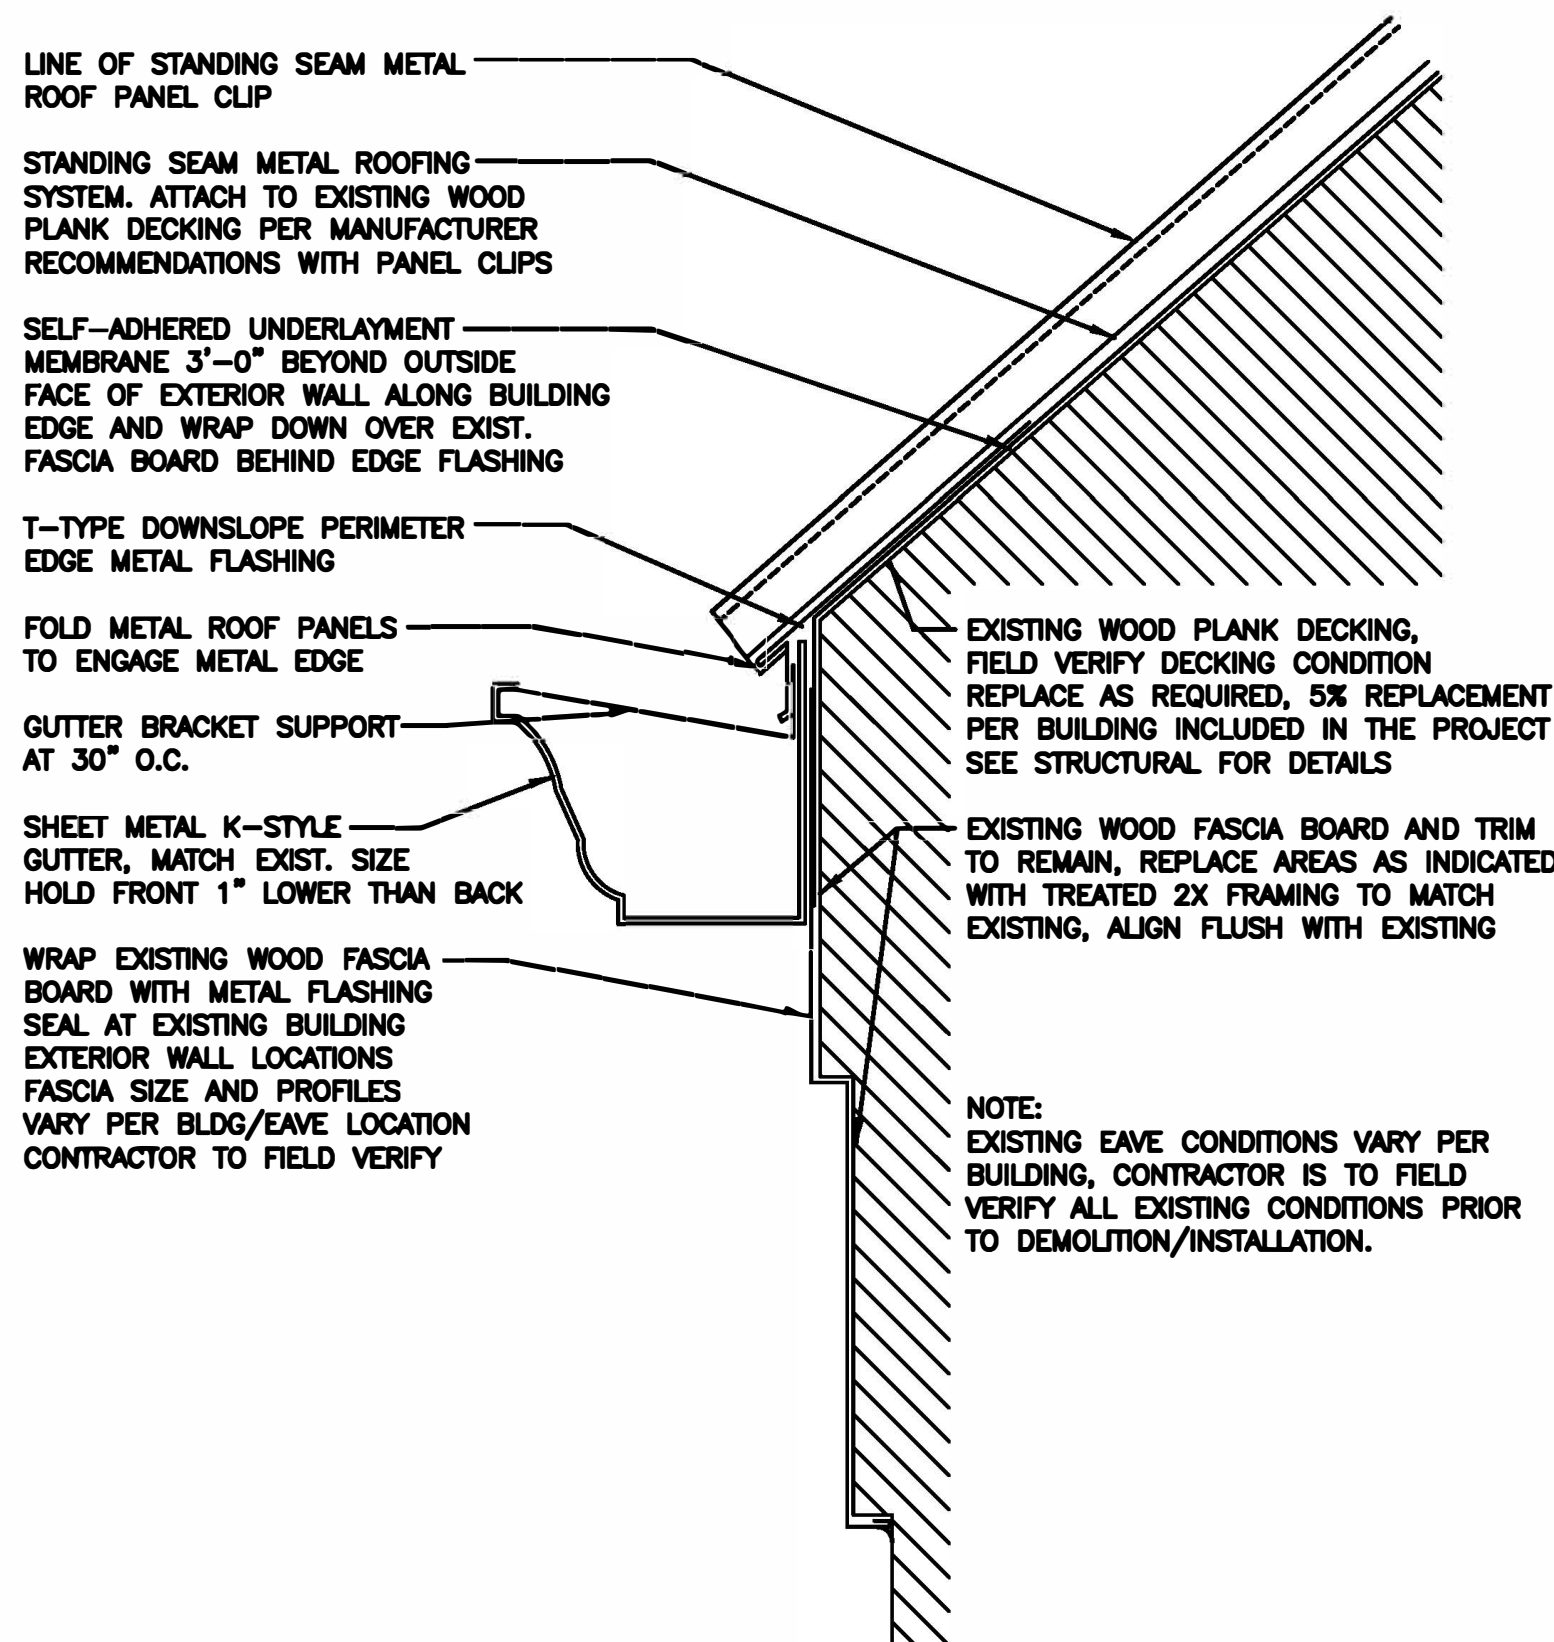

1 STANDING SEAM METAL ROOF DETAIL AT EAVE
A501 3" = 1'-0"



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FARMINGTON, MISSOURI

PROJECT # C1922-01
SITE # 7008
ASSET # 9327008089,
9327008090, 9327008091, 9327008082
9327008081, 9327008080, 9327008079

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REVISION: -
DATE: -

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CAD DWG FILE: A-500
DRAWN BY: EL
CHECKED BY: EL
DESIGNED BY: EL

SHEET TITLE:
ROOF DETAILS

SHEET NUMBER:

A501

12 OF 29 SHEETS
04/18/2022



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PROJECT # C1922-01

SITE # 7008

ASSET # 9327008089,
9327008090, 9327008091, 9327008082
9327008081, 9327008080, 9327008079

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REVISION: -

DATE: -

ISSUE DATE: APRIL 18, 2022

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CHECKED BY: EL

DESIGNED BY: EL









SHEET TITLE:

ROOF DETAILS

SHEET NUMBER:

A502

13 OF 29 SHEETS
04/18/2022

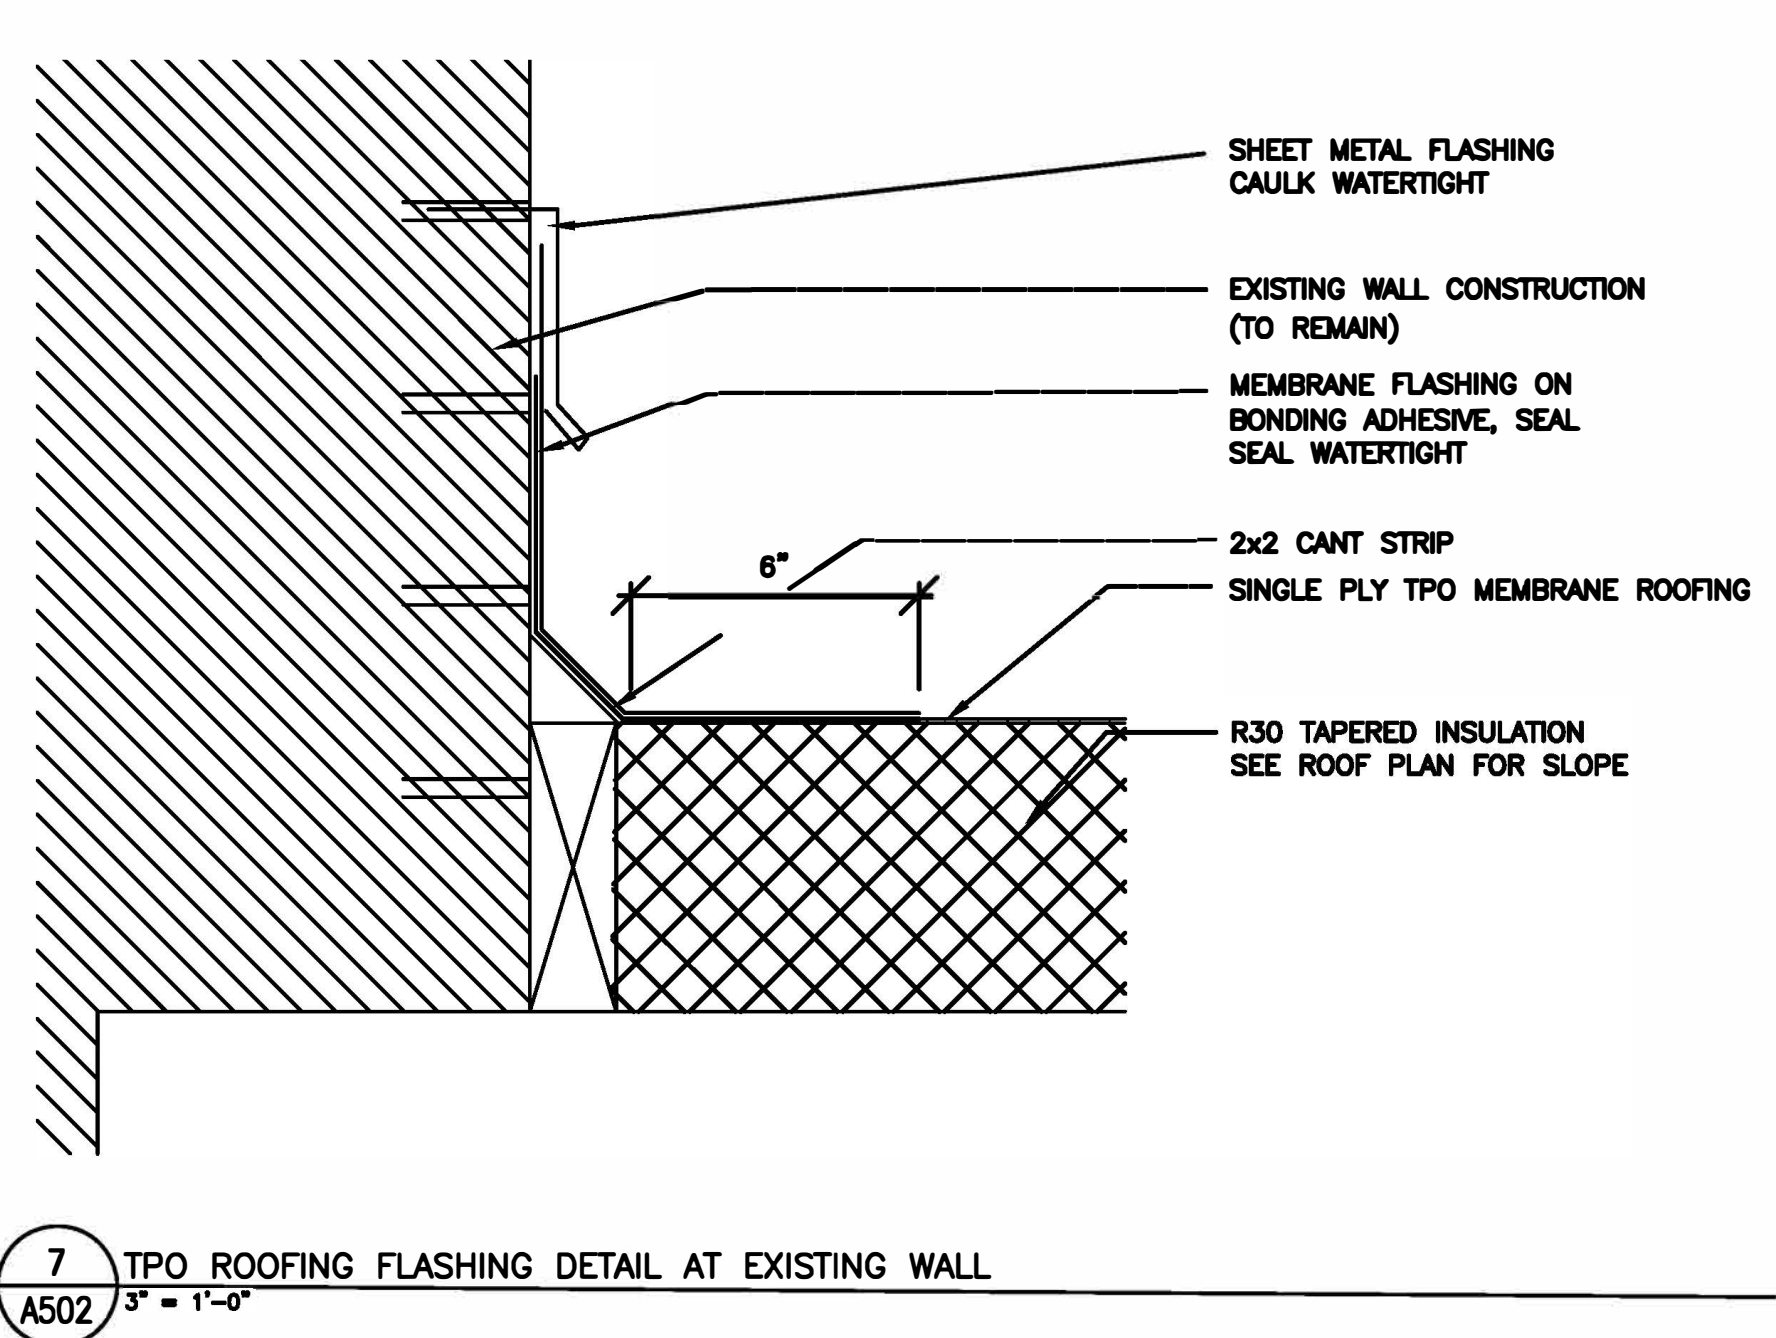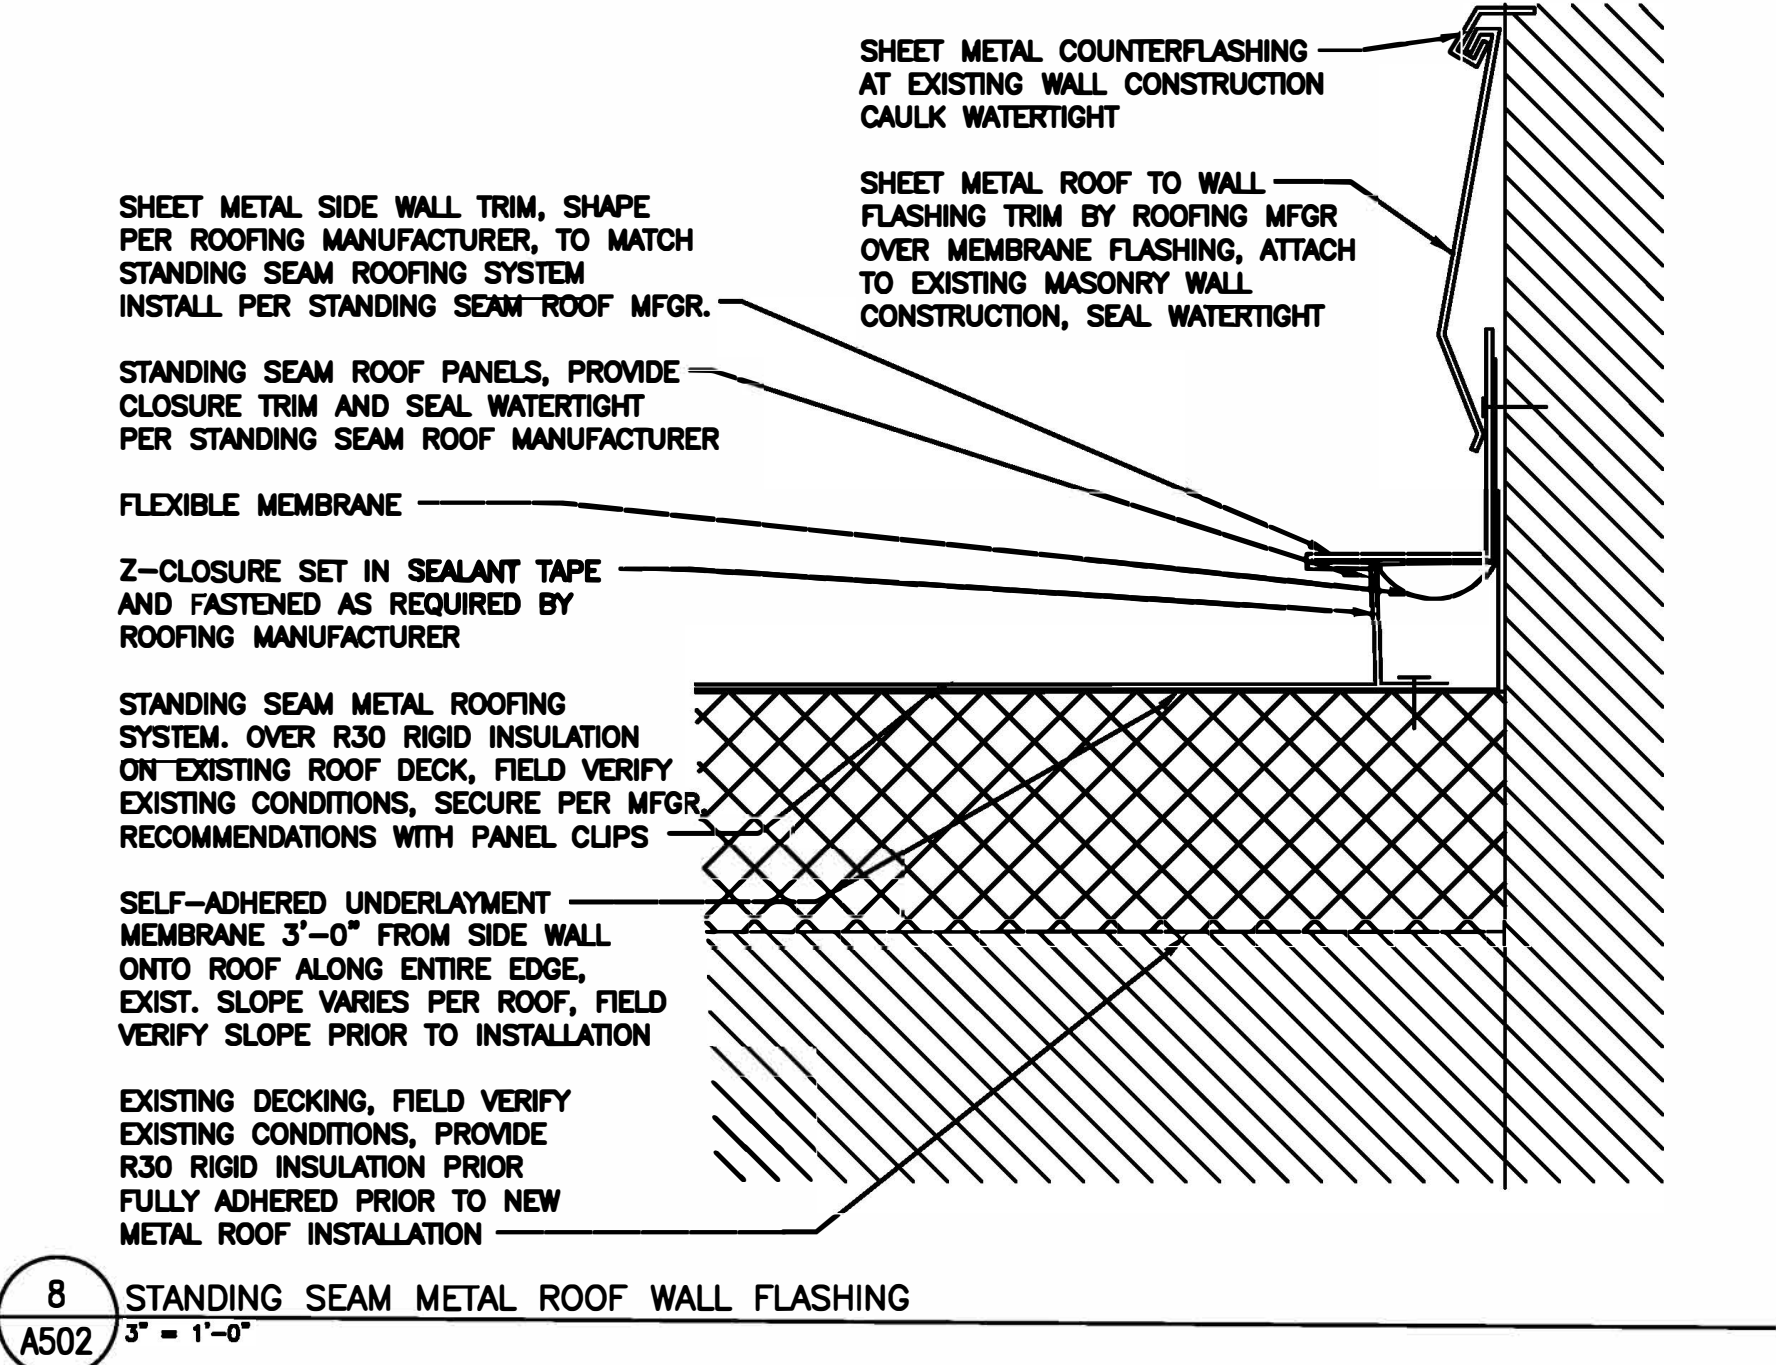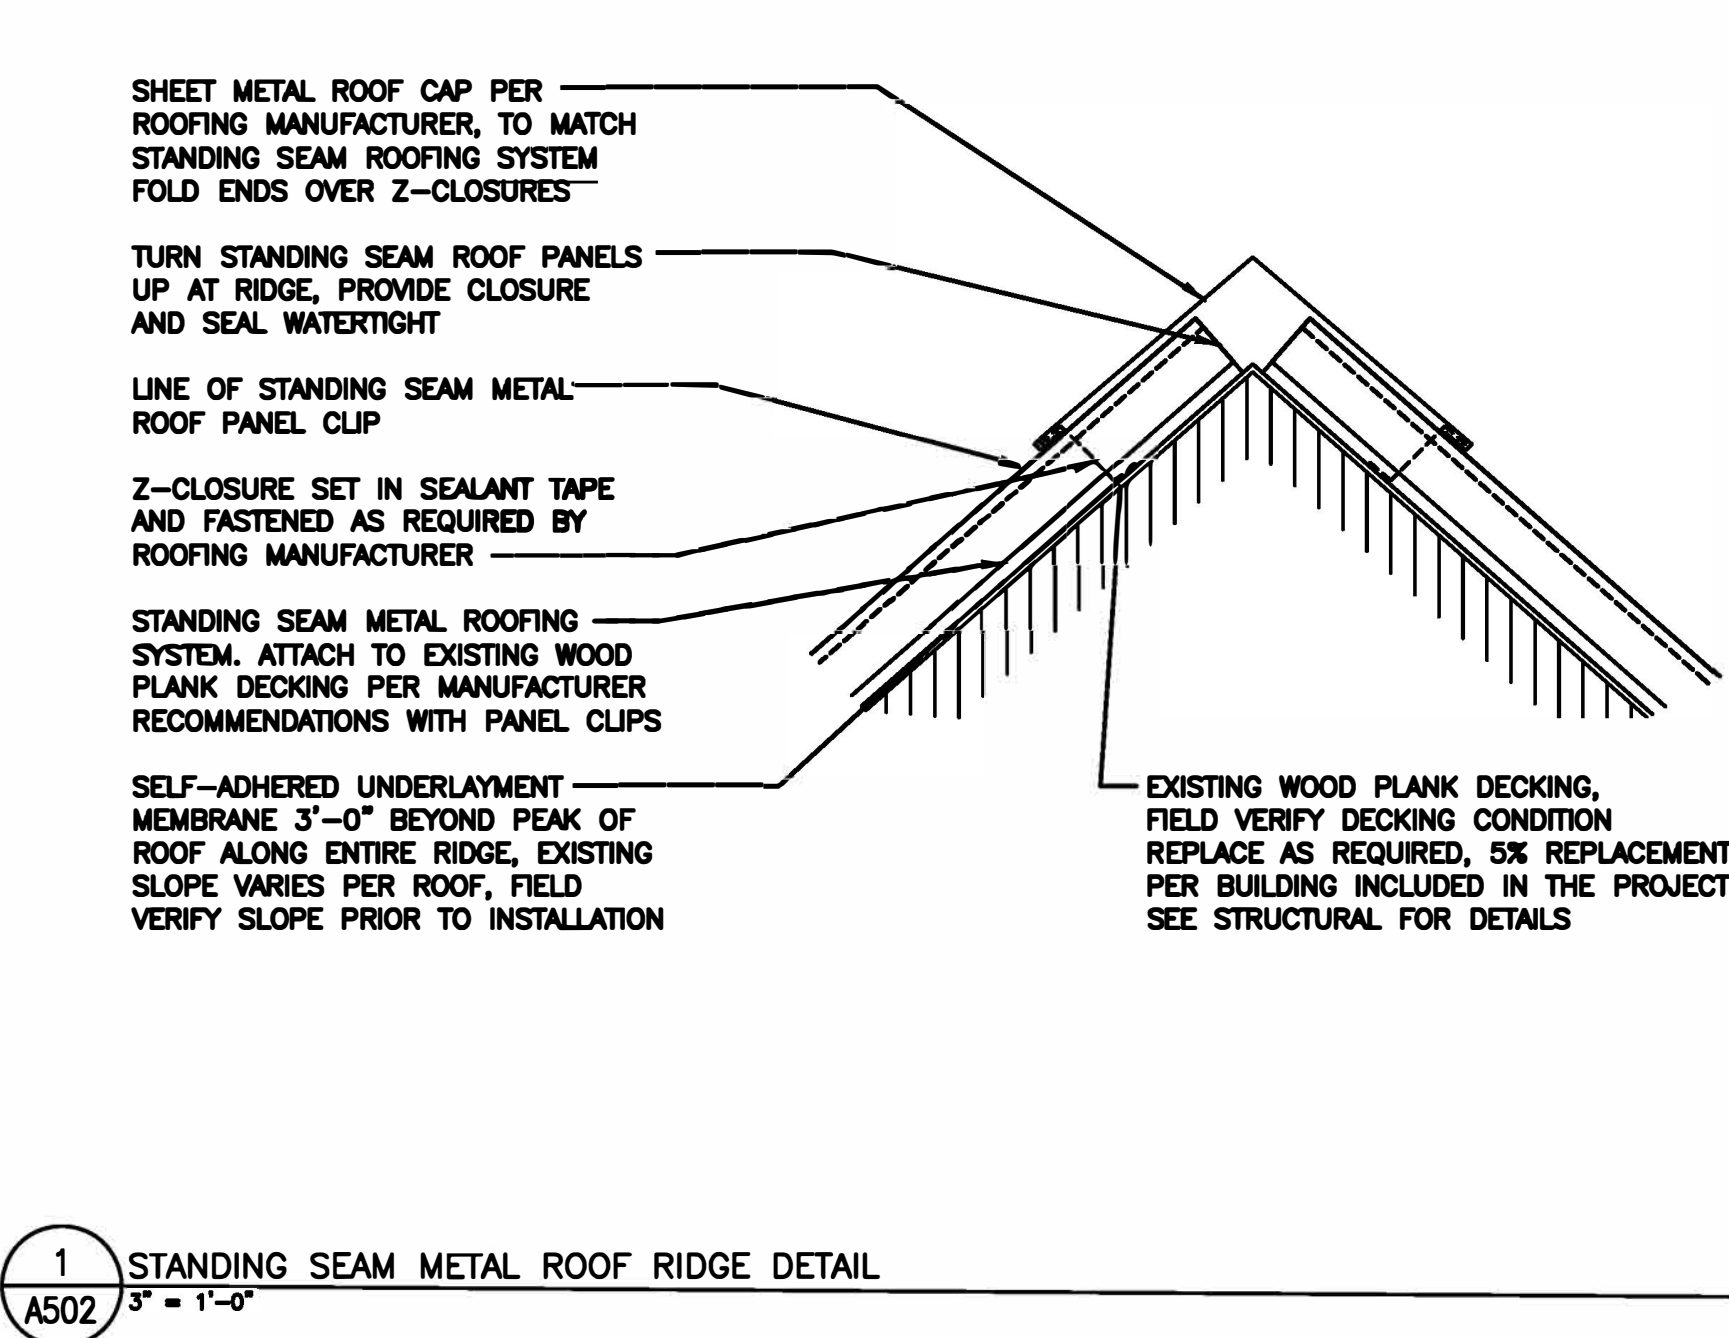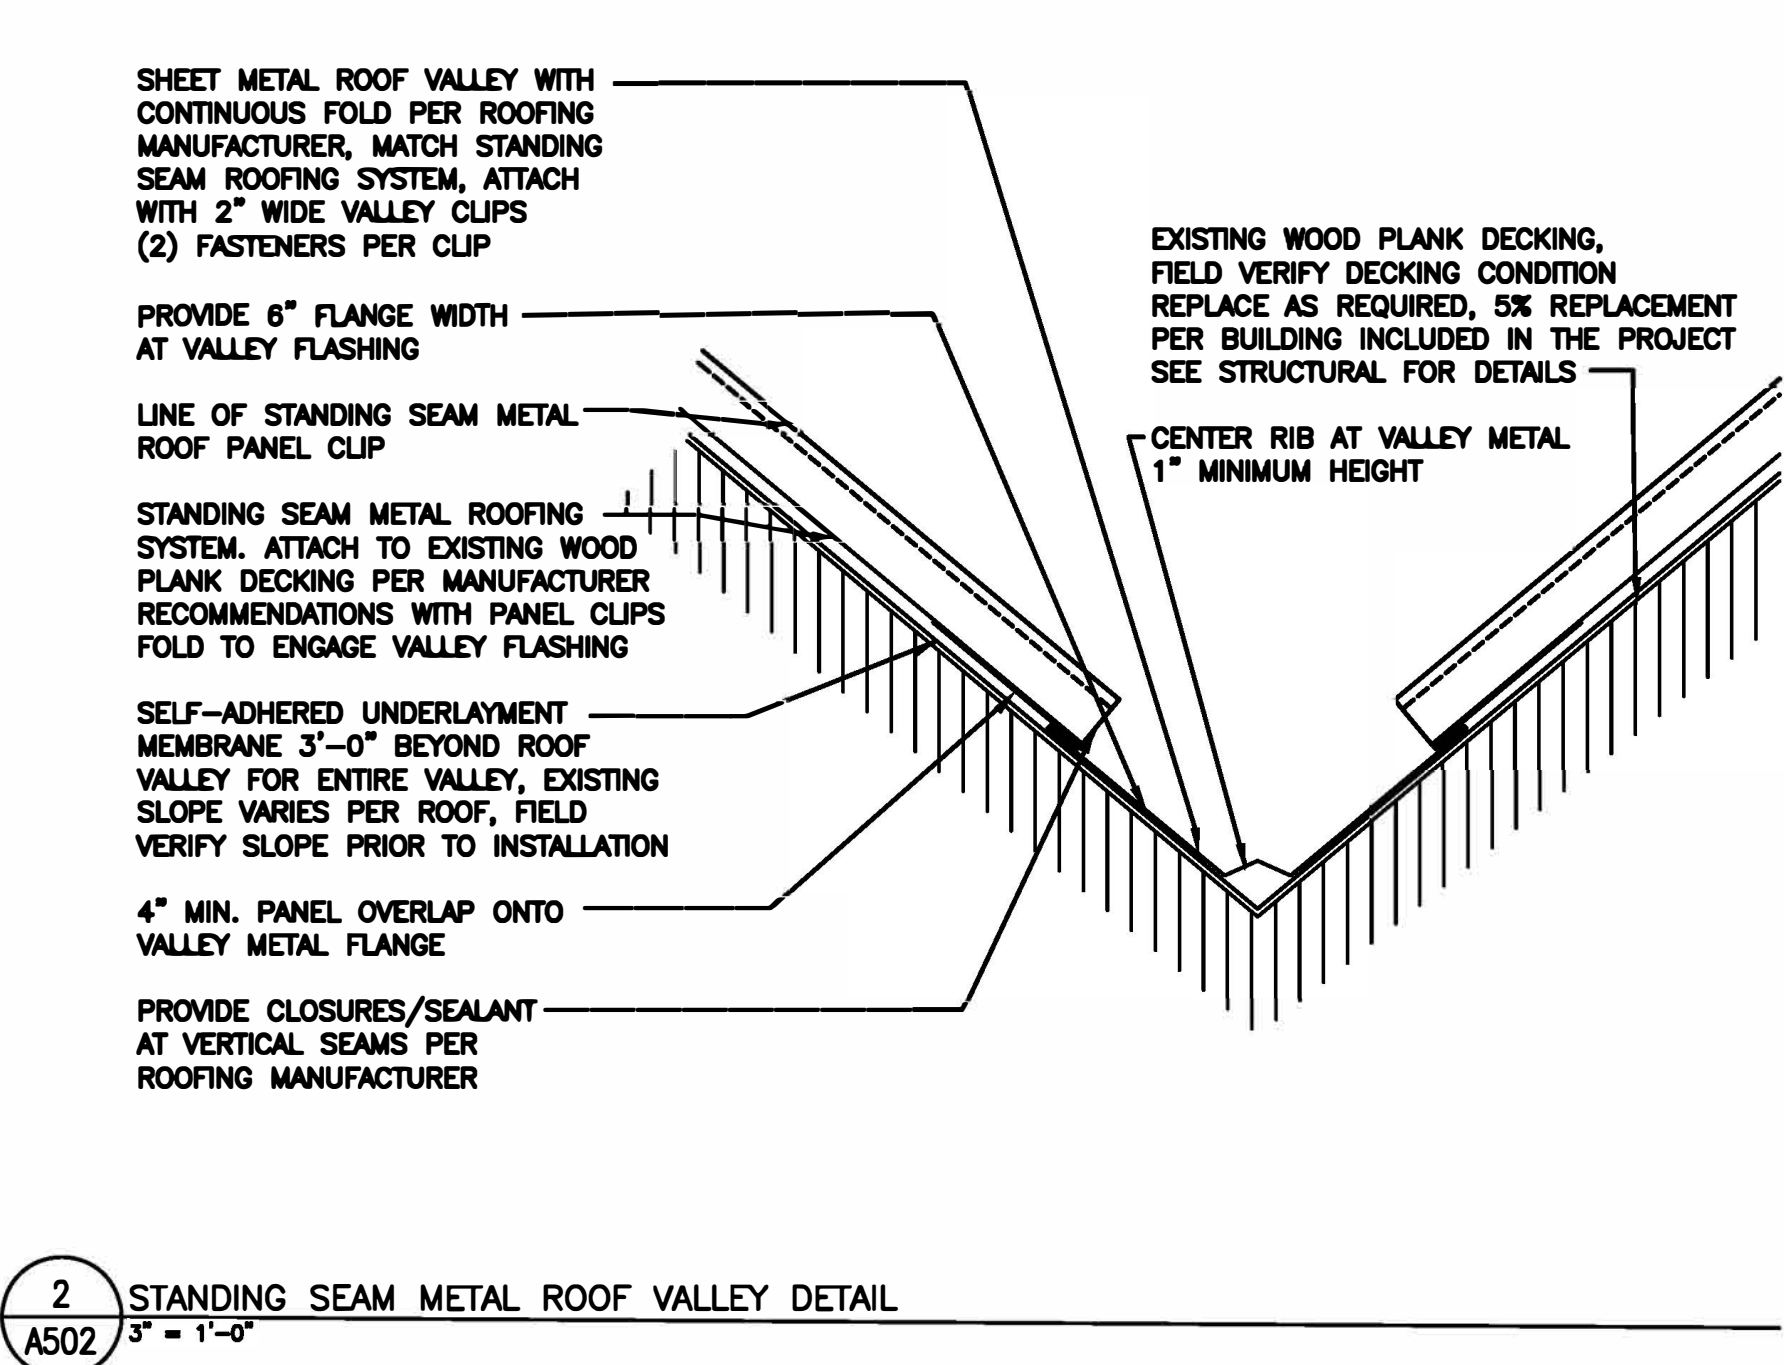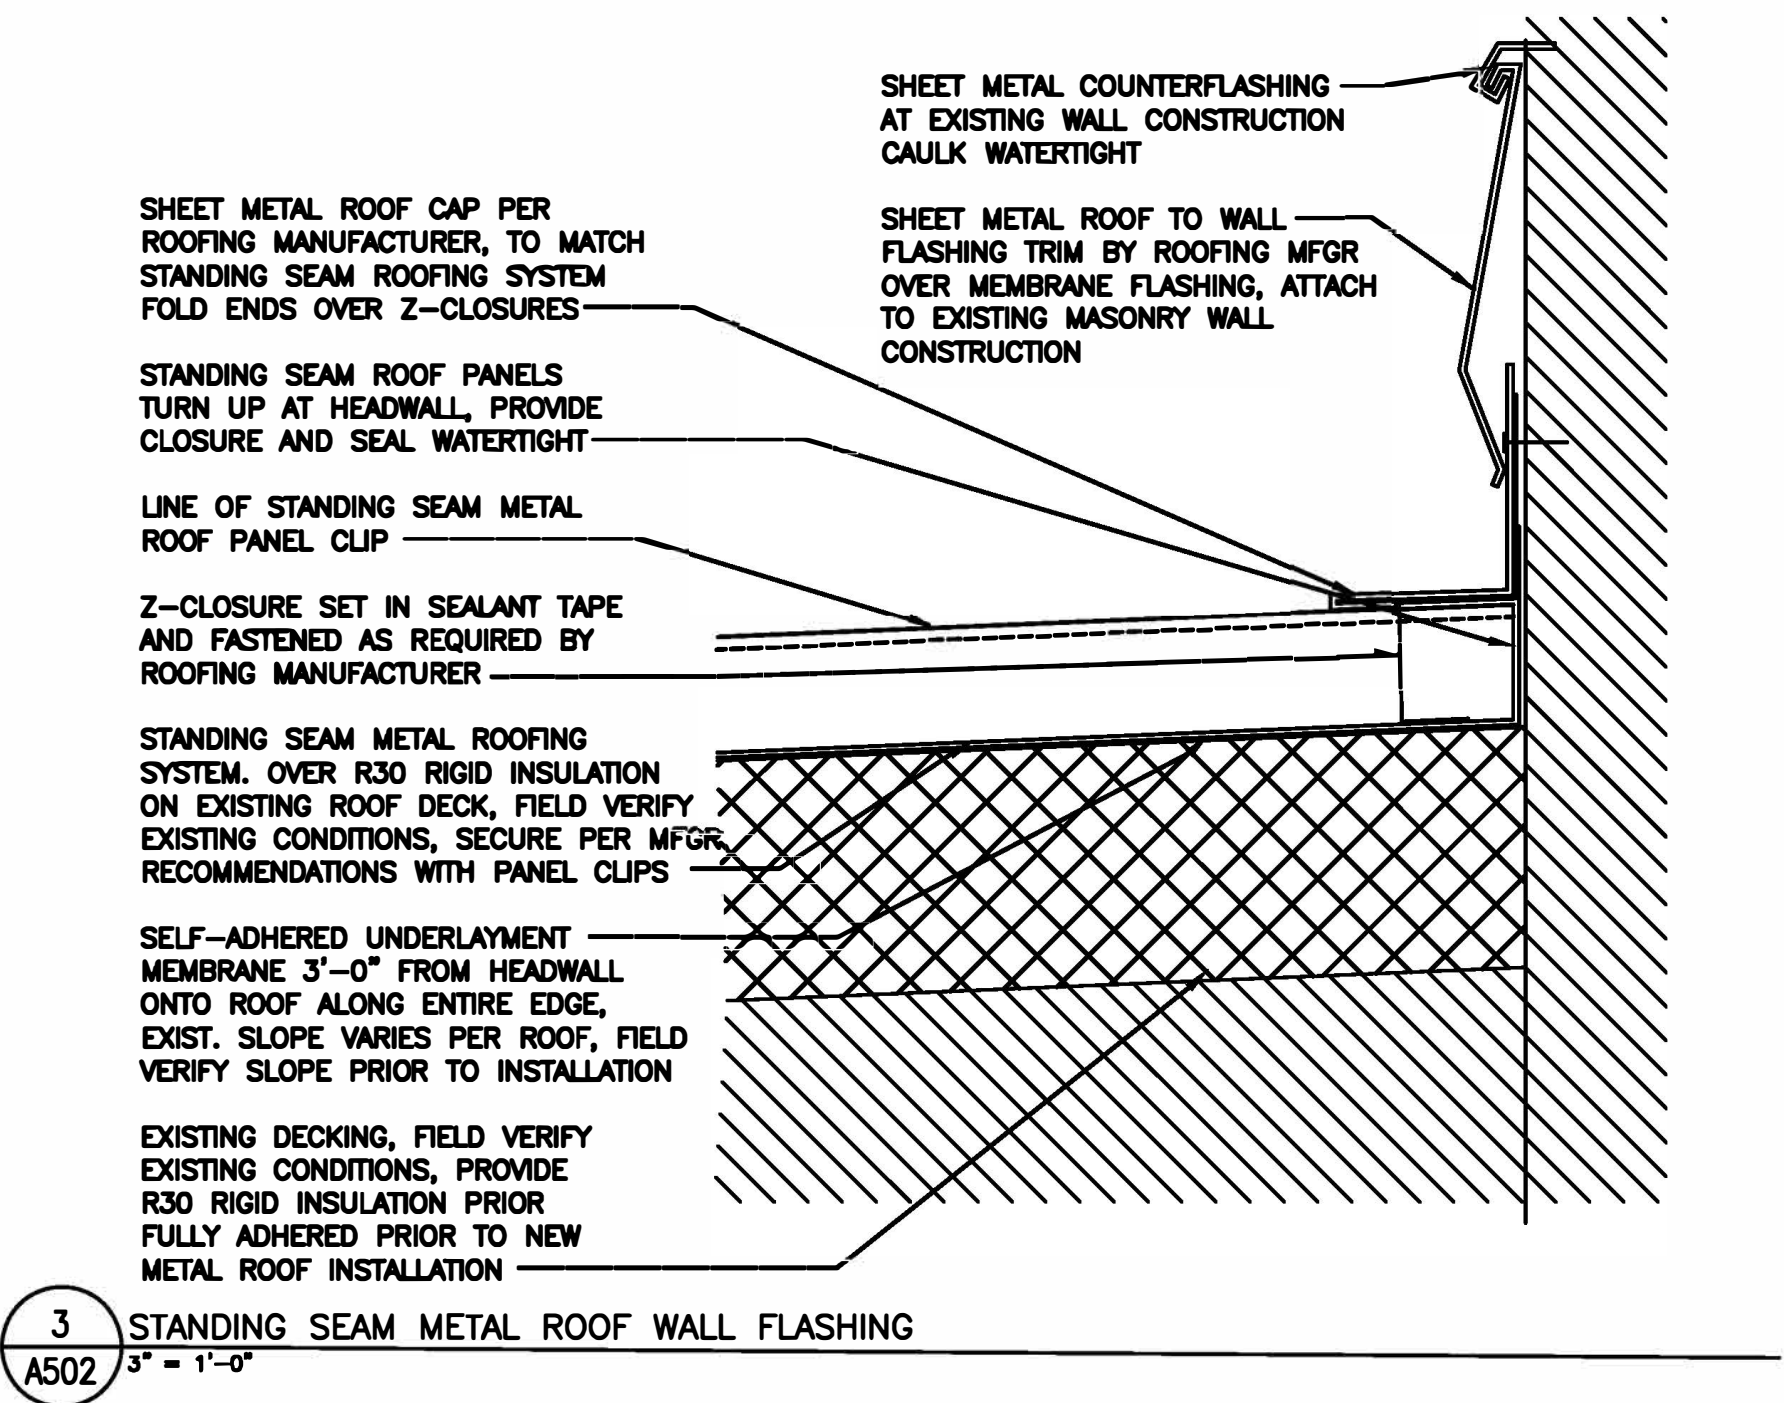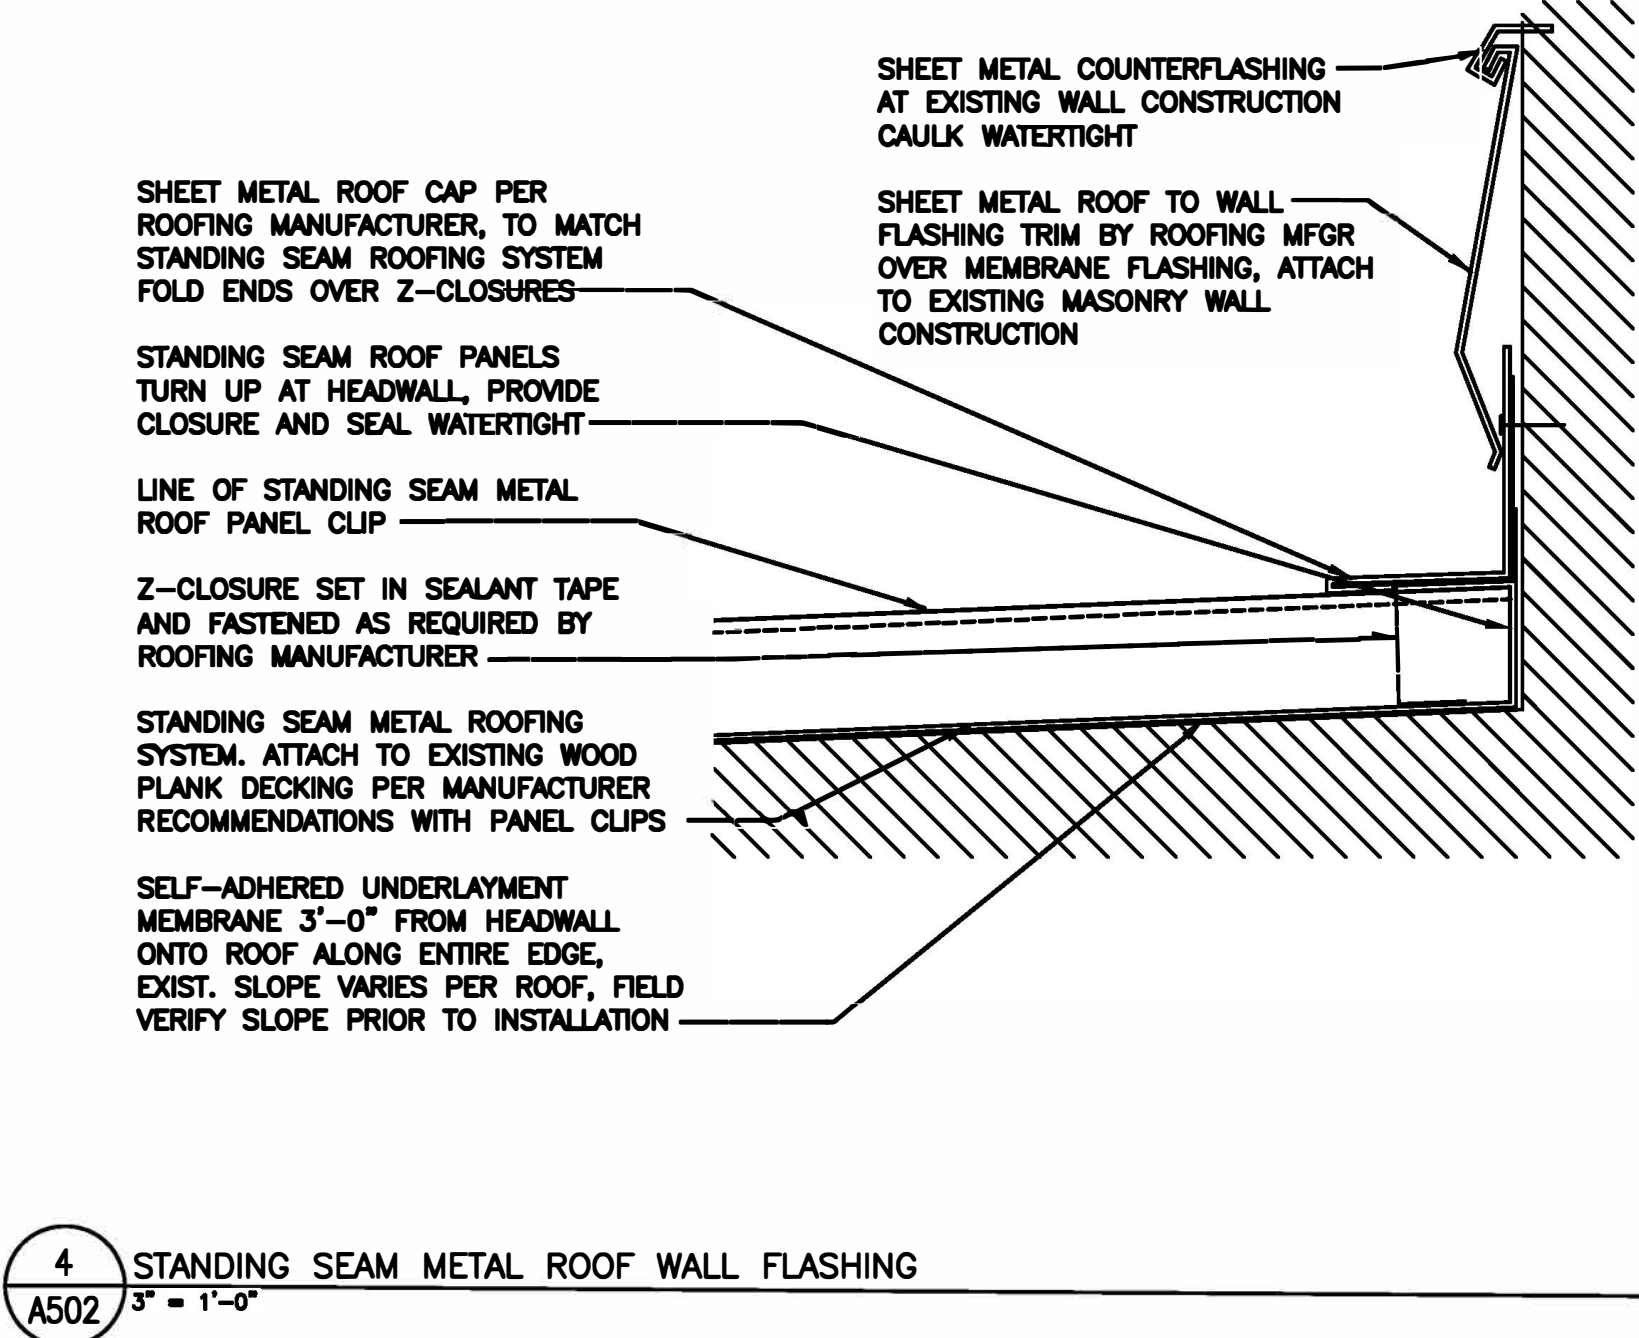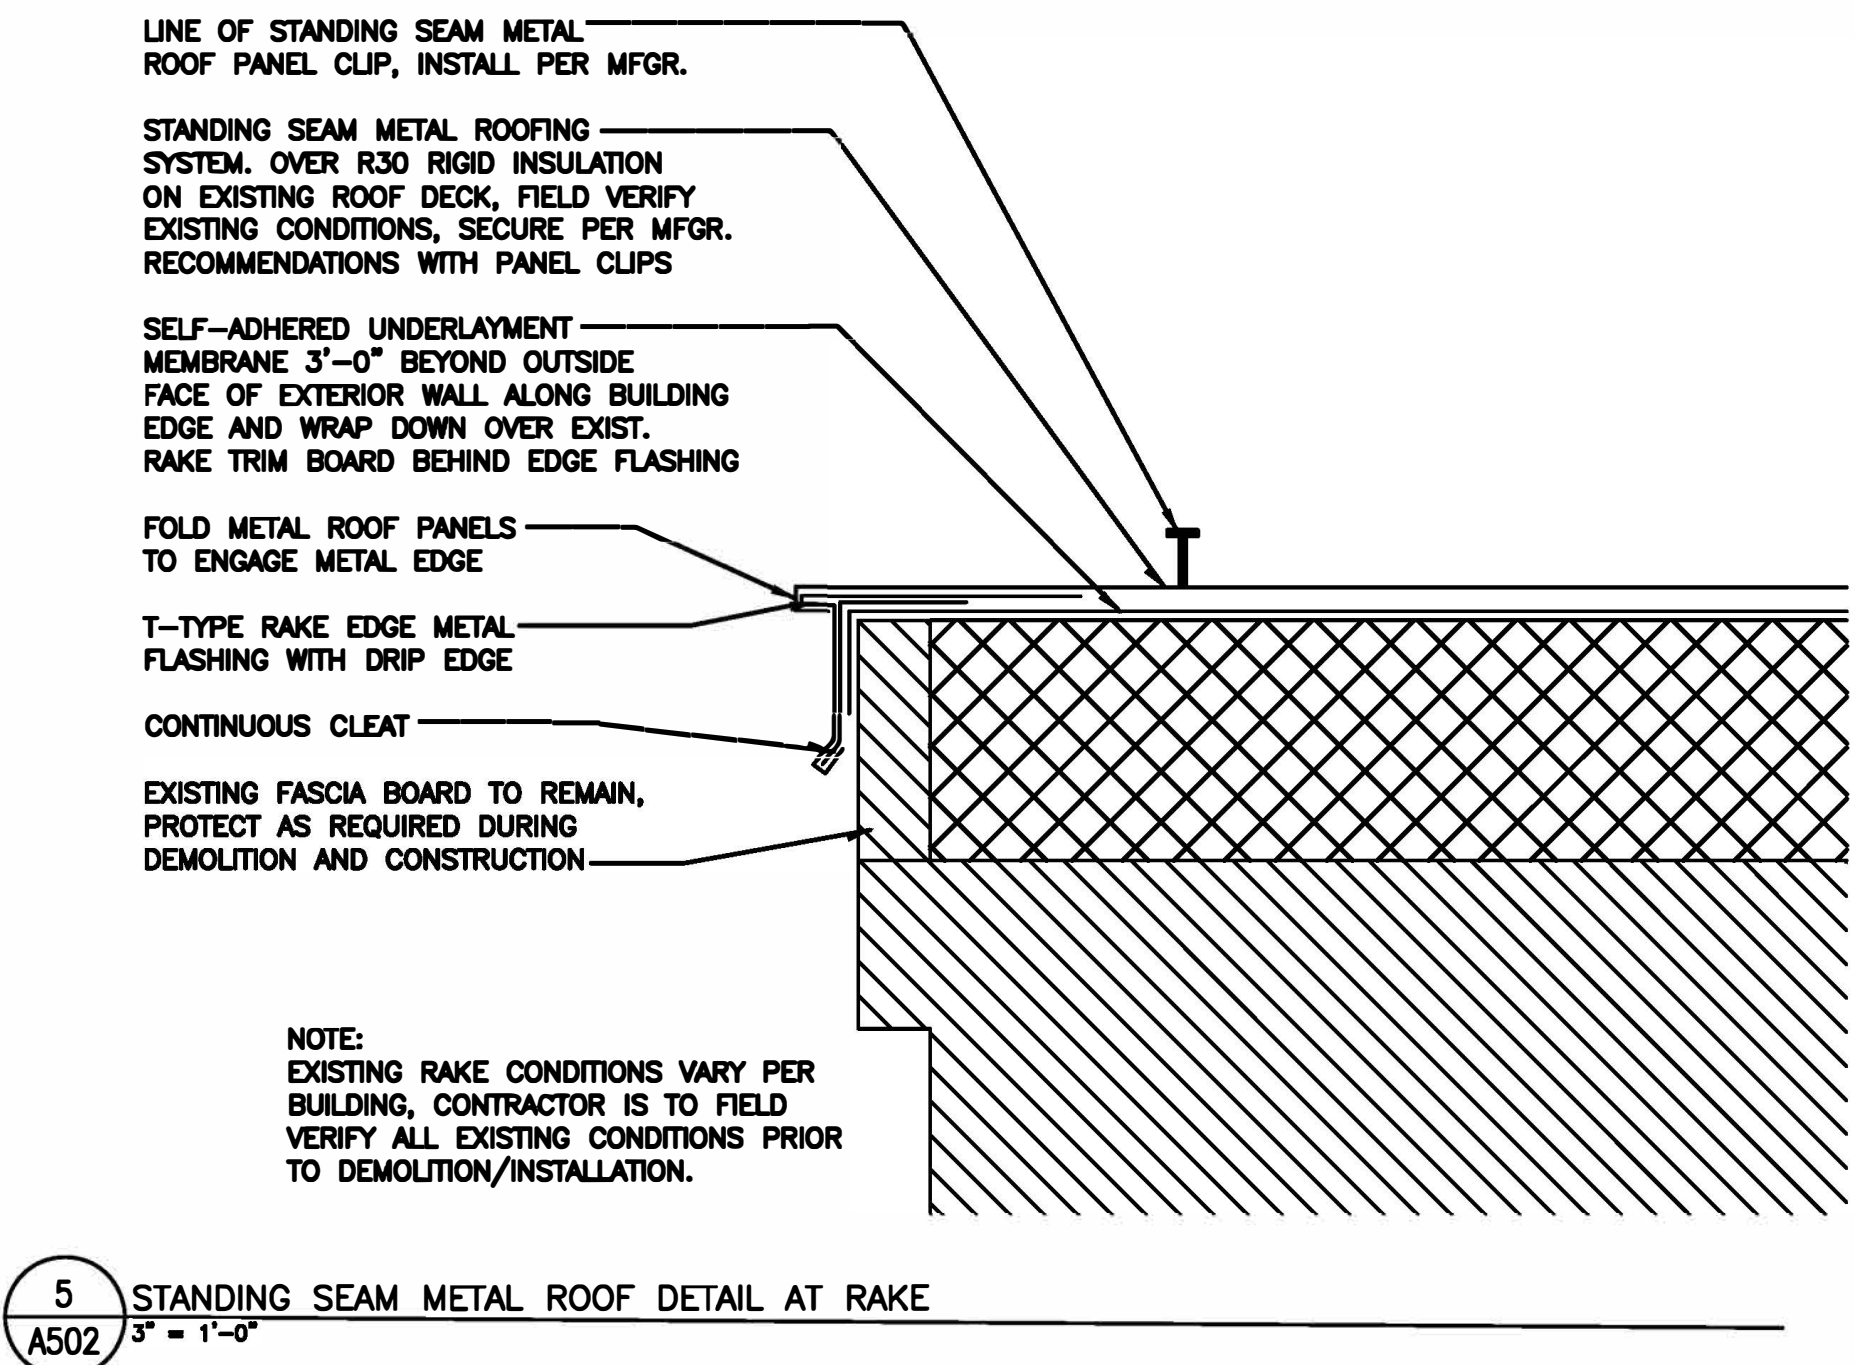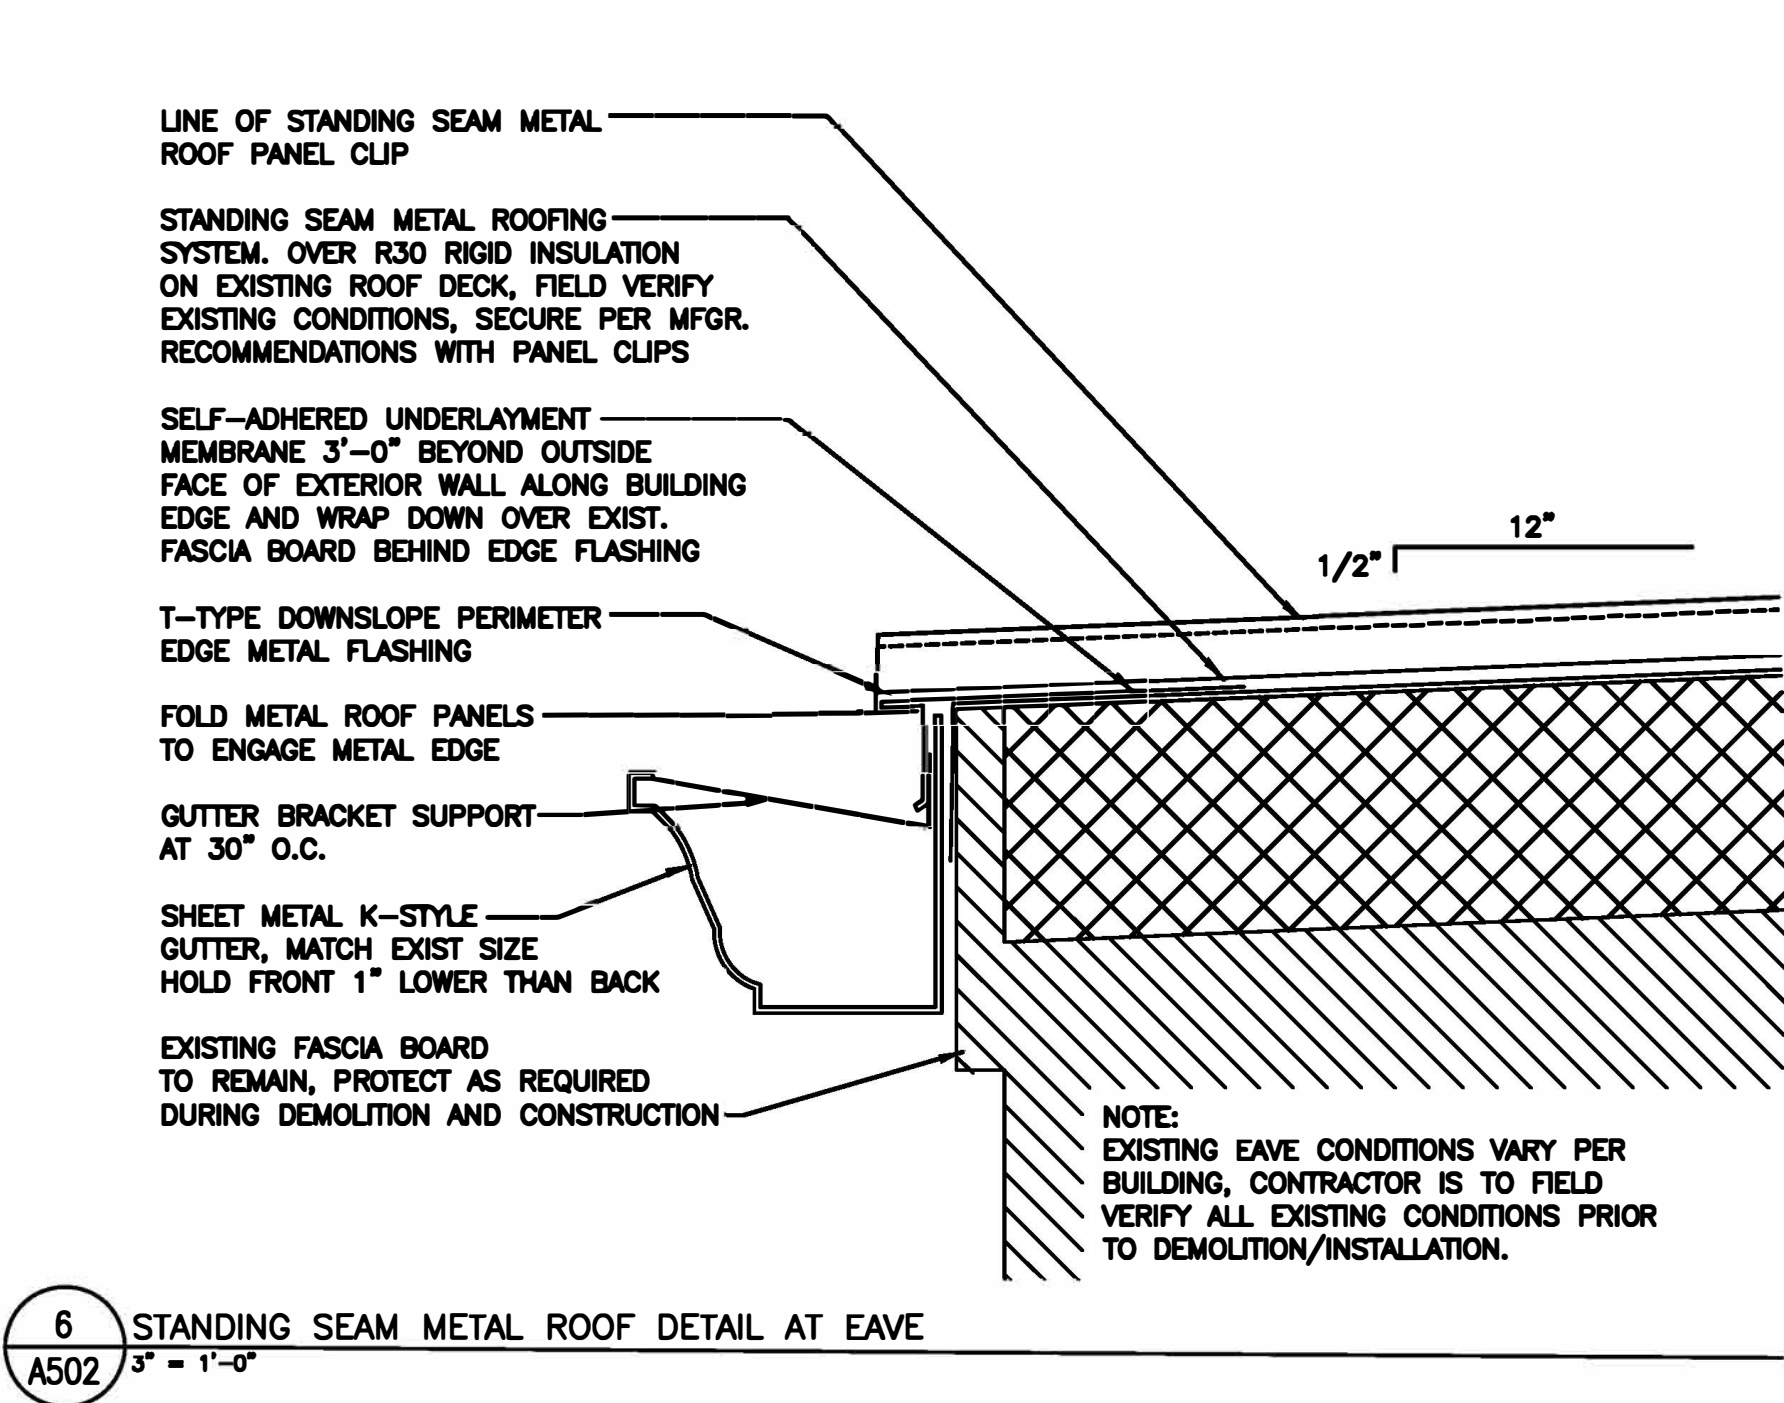

DESIGN CRITERIA AND LOADS

1. STRUCTURE HAS BEEN DESIGNED TO COMPLY WITH:
IBC 2018
ASCE/SEI 7-16
NDS-18 AND SDPWS-18

2. RISK CATEGORY
III

3. SEISMIC:
SEISMIC DESIGN CATEGORY
IMPORTANCE FACTOR
SOIL CLASSIFICATION
S_s
S₁
S_{ms}
S_{mi}

4. WIND:
BASIC WIND SPEED
IMPORTANCE FACTOR
EXPOSURE CLASS

5. LIVE LOADS:
TYPICAL ROOF

6. SNOW:
GROUND SNOW
SNOW EXPOSURE FACTOR
THERMAL FACTOR
IMPORTANCE FACTOR
DESIGN SNOW
RAIN-ON-SNOW SURCHARGE
- 1.25
D (ASSUMED)
0.58 g
0.216 g
0.526 g
0.288 g

115 MPH
1.15
C

20 PSF

20 PSF
0.9
1.1
20 PSF
5 PSF

GENERAL

1. NEITHER THE PROFESSIONAL ACTIVITIES OF THE ENGINEER, NOR THE PRESENCE OF THE ENGINEER OR THEIR EMPLOYEES AND SUBCONSULTANTS AT THE CONSTRUCTION SITE, SHALL RELIEVE THE CONTRACTOR AND ANY OTHER ENTITY OF THEIR OBLIGATIONS, DUTIES AND RESPONSIBILITIES INCLUDING BUT NOT LIMITED TO, CONSTRUCTION MEANS, METHODS, SEQUENCE, TECHNIQUES OR PROCEDURES NECESSARY FOR PERFORMING, SUPERINTENDING OR COORDINATING ALL PORTIONS OF THE CONSTRUCTION WORK IN ACCORDANCE WITH THE CONTRACT DOCUMENTS AND ANY HEALTH OR SAFETY PRECAUTIONS REQUIRED BY ANY REGULATORY AGENCIES. THE ENGINEER AND THEIR PERSONNEL HAVE NO AUTHORITY TO EXERCISE ANY CONTROL OVER ANY CONSTRUCTION CONTRACTOR OR OTHER ENTITY OR THEIR EMPLOYEES IN CONNECTION WITH THEIR WORK OR ANY HEALTH OR SAFETY PRECAUTIONS. THE CONTRACTOR IS SOLELY RESPONSIBLE FOR THE JOBSITE SAFETY. THE ENGINEER AND THE ENGINEER'S CONSULTANTS SHALL BE MADE ADDITIONAL INSUREDS UNDER THE CONTRACTOR'S GENERAL LIABILITY INSURANCE POLICY.
2. ALL DRAWINGS AND SPECIFICATIONS ARE CONSIDERED TO BE A PART OF THE CONTRACT DOCUMENTS. THE GENERAL CONTRACTOR SHALL BE RESPONSIBLE FOR THE REVIEW AND COORDINATION OF ALL DRAWINGS AND SPECIFICATIONS PRIOR TO THE START OF CONSTRUCTION. ANY DISCREPANCIES SHALL BE BROUGHT TO THE ATTENTION OF THE ARCHITECT OF RECORD (AOR) PRIOR TO THE START OF CONSTRUCTION SO A CLARIFICATION CAN BE ISSUED. ANY WORK PERFORMED IN CONFLICT WITH THE CONTRACT DOCUMENTS OR ANY CODE REQUIREMENTS SHALL BE CORRECTED BY THE CONTRACTOR AT THEIR OWN EXPENSE AND AT NO EXPENSE TO THE OWNER OR AOR.
3. ALL DIMENSIONS AND SITE CONDITIONS SHALL BE VERIFIED BY THE CONTRACTOR AT THE JOBSITE PRIOR TO CONSTRUCTION, START OF SHOP DRAWINGS, START OF CONSTRUCTION, AND/OR FABRICATION OF MATERIALS. IF DISCREPANCIES ARE ENCOUNTERED, OR CONDITIONS DEVELOP THAT ARE NOT COVERED BY THE CONTRACT DOCUMENTS, THE AOR SHALL BE NOTIFIED FOR CLARIFICATION.
4. CONTRACTOR SHALL PROVIDE AND BE RESPONSIBLE FOR THE PROTECTION AND REPAIR OF ADJACENT EXISTING SURFACES AND AREAS WHICH MAY BE DAMAGED AS A RESULT OF NEW WORK.
5. STRUCTURAL DRAWINGS INCLUDE DESIGN REQUIREMENTS AND DIMENSIONS FOR STRUCTURAL INTEGRITY BUT DO NOT SHOW ALL DETAIL DIMENSIONS TO FIT INTRICATE ARCHITECTURAL AND MECHANICAL DETAILS. CONTRACTOR SHALL SO CONSTRUCT THE WORK SO IT WILL CONFORM TO THE CLEARANCES REQUIRED BY ARCHITECTURAL, MECHANICAL AND ELECTRICAL DESIGN.
6. ALL SYMBOLS AND ABBREVIATIONS USED ON THE DRAWINGS ARE CONSIDERED TO BE CONSTRUCTION STANDARDS. IF CLARIFICATION IS REQUIRED, THE CONTRACTOR SHALL NOTIFY THE AOR PRIOR TO PROCEEDING WITH THE WORK.
7. DO NOT SCALE DRAWINGS. PRINTED DIMENSIONS HAVE PRECEDENCE OVER SCALED DRAWINGS AND LARGE-SCALE OVER SMALL-SCALE DRAWINGS. CONTRACTOR TO DETERMINE FINAL DIMENSION WITH AOR.
8. TYPICAL DETAILS SHALL APPLY UNLESS SPECIFICALLY DETAILED OTHERWISE. WHERE NO DETAILS ARE GIVEN, CONSTRUCTION SHALL BE AS SHOWN FOR SIMILAR WORK.
9. THE CONTRACT DOCUMENTS AND SPECIFICATIONS REPRESENT THE FINISHED STRUCTURE. THEY DO NOT INDICATE THE METHOD OF CONSTRUCTION. THE CONTRACTOR SHALL PROVIDE ALL MEASURES NECESSARY TO PROTECT THE STRUCTURE AND SAFETY OF WORKMEN DURING CONSTRUCTION. SUCH MEASURES SHALL INCLUDE, BUT NOT BE LIMITED TO, BRACING AND SHORING FOR LOADS DUE TO CONSTRUCTION EQUIPMENT, ETC. OBSERVATION VISITS TO THE SITE BY THE AOR OR STRUCTURAL ENGINEER OF RECORD (SEOR) SHALL NOT INCLUDE INSPECTION OR APPROVAL OF THE ABOVE ITEMS AND DOES NOT IN ANY WAY RELIEVE THE CONTRACTOR OF THEIR RESPONSIBILITIES FOR THE ABOVE.
10. ESTABLISH AND VERIFY ALL OPENINGS AND INSERTS FOR MECHANICAL, ELECTRICAL AND PLUMBING WITH APPROPRIATE TRADE CONTRACTORS. OPENING SIZES AND LOCATIONS SHOWN FOR DUCTS, PIPE, INSERTS AND OTHER PENETRATIONS WHEN SHOWN ARE FOR GENERAL INFORMATION ONLY AND SHALL BE VERIFIED PRIOR TO FORMING.
11. NO HOLES, NOTCHES, BLOCKOUTS, ETC. ARE ALLOWED IN STRUCTURAL ELEMENTS UNLESS SPECIFICALLY DETAILED ON THE STRUCTURAL DRAWINGS OR APPROVED BY THE SEOR.
12. BEFORE SUBMITTING A PROPOSAL FOR THIS WORK, EACH BIDDER SHALL VISIT THE PREMISES AND BECOME FULLY ACQUAINTED WITH THE EXISTING CONDITIONS, TEMPORARY CONSTRUCTION REQUIRED, QUANTITIES AND TYPE OF EQUIPMENT, ETC. THE BID SHALL INCLUDE ALL SUMS REQUIRED TO DO THE WORK WITHIN THE EXISTING CONDITIONS.
13. SHOP DRAWINGS SHALL BE REVIEWED AND COORDINATED PRIOR TO SUBMITTING TO THE AOR. EACH SHOP DRAWING SUBMITTED SHALL BE STAMPED INDICATING REVIEW BY THE CONSTRUCTION MANAGER/GENERAL CONTRACTOR AND REVIEW BY THE AOR SHALL NOT BEGIN UNTIL THIS IS COMPLETE. WORK SHALL NOT BEGIN WITHOUT REVIEW BY THE AOR/SEOR.
14. SHOP DRAWINGS SHALL BE REVIEWED BY THE AOR/SEOR FOR GENERAL CONFORMANCE WITH DESIGN CONCEPT ONLY. NOTATIONS MADE BY THE AOR/SEOR ON THE SHOP DRAWINGS DO NOT RELIEVE THE CONTRACTOR FROM COMPLYING WITH THE REQUIREMENTS OF THE DRAWINGS AND SPECIFICATIONS.
15. EXISTING CONDITIONS:
A. EXISTING STRUCTURAL INFORMATION SHOWN WAS OBTAINED FROM FIELD TAKE-OUT BY IMEG AS PERMITTED BY ACCESS RESTRICTIONS DURING DESIGN.
B. ALL INFORMATION SHOWN ON THE DRAWINGS RELATIVE TO EXISTING CONDITIONS IS GIVEN AS THE BEST PRESENT KNOWLEDGE. CONTRACTOR TO VERIFY EXISTING INFORMATION, DIMENSIONS AND SIZES AS REQUIRED TO COMPLETE THEIR WORK. WHERE ACTUAL CONDITIONS CONFLICT WITH THE DRAWINGS, THEY SHALL BE REPORTED TO THE AOR OR SEOR SO PROPER CLARIFICATION MAY BE MADE. MODIFICATION OF CONSTRUCTION DETAILS SHALL NOT BE MADE WITHOUT WRITTEN APPROVAL OF THE AOR OR SEOR.
16. STRUCTURAL PLANS DO NOT INCLUDE BUILDINGS 16, 18, 19, BUT WORK IS BEING DONE THERE - INCLUDING, BUT NOT LIMITED TO EXISTING WOOD PLANK REPLACEMENT, AND FASCIA/TRIM REPLACEMENT.

DEMOLITION

1. ALL DEMOLITION SHALL BE CARRIED OUT IN SUCH A WAY AS TO NOT DAMAGE EXISTING ELEMENTS WHICH ARE TO REMAIN.
2. ALL ELEMENTS WHICH ARE TO REMAIN AND WHICH ARE DAMAGED DURING DEMOLITION WORK SHALL BE REPLACED AT NO ADDED COST. EXISTING ELEMENTS ARE TO BE PROTECTED TO THE FULLEST EXTENT POSSIBLE TO REDUCE SUCH DAMAGE TO A MINIMUM.

WOOD


1. SHEATHING
A. SHALL CONFORM TO:
ROOF SHEATHING, SLOPED 3/4" THICK; 32/16 APA SPAN RATING PROVIDE 6d NAILS AT 6" OC ALONG ALL EDGES AND AT 12" OC AT INTERMEDIATE SUPPORTS
B. ALL SHEATHING WHICH IS EXPOSED TO OUTDOOR APPLICATIONS SHALL BE EXTERIOR TYPE. SHEATHING EXPOSED TO WEATHER ONLY DURING CONSTRUCTION SHALL BE EXPOSURE 1. ALL WOOD STRUCTURAL PANELS SHALL CONFORM TO 2303.1.4 AND WHEN USED IN HORIZONTAL DIAPHRAGM AND VERTICAL SHEAR WALLS SHALL BE FIVE-PLY MINIMUM.
2. DIMENSIONAL LUMBER
A. FRAMING SHALL BE DOUGLAS FIR (LARCH), HEM FIR, SPRUCE PINE FIR OR SOUTHERN PINE AND CONFORM TO THE FOLLOWING STRENGTHS:
#2 OR BETTER
F_b = 900 PSI F_c|| = 1350PSI
ALL LUMBER STRESSES SHOWN ABOVE ARE FOR VISUALLY STRESS-RATED LUMBER USED AT 19% MAXIMUM MOISTURE CONTENT, SINGLE MEMBER USE. ALL LUMBER SHALL BE GRADE MARKED.
B. OPENINGS NOT IDENTIFIED ARE TO BE TREATED AS FOLLOWS:
1) WHERE OPENING FITS BETWEEN JOISTS, FRAME WITH LUMBER EQUALING THE NOMINAL DIMENSIONS OF THE EXISTING JOISTS.
2) WHERE OPENING CUTS ONE JOIST, FRAME WITH LUMBER EQUALING THE NOMINAL DIMENSIONS OF THE EXISTING JOISTS. USE THIS FRAMING AS A HEADER FOR THE INTERRUPTED JOIST. FOR EACH JOIST BYPASSING THE OPENING, CUT AND SISTER A NEW JOIST. USE 1/2"ø LAG SCREWS AT 12" OC TO SISTER JOISTS TOGETHER. PENETRATIONS WHERE MORE THAN ONE JOIST IS CUT TO BE REVIEWED BY SEOR.
3. FASTENING
A. ALL NAILS SHALL BE COMMON WIRE NAILS. AT ALL EXPOSED NAILING TO WEATHER, (IE-DECKING & SIDING), USE HOT-DIPPED GALVANIZED NAILS. USE OF PLASTIC COATED OR CASING NAILS IS NOT ALLOWED. NAIL DESIGNATIONS SHALL MEET THE FOLLOWING LENGTHS AND DIAMETERS:
6d 2" x 0.113" 12d 3 1/4" x 0.148"
8d 2 1/2" x 0.131" 16d 3 1/2" x 0.152"
10d 3" x 0.148" 20d 4" x 0.192"
B. THE NUMBER AND SIZE OF NAILS CONNECTING WOOD MEMBERS SHALL NOT BE LESS THAN THE FOLLOWING:

CONNECTION	FASTENING
BLOCKING BETWEEN JOISTS OR RAFTERS TO TOP PLATE	(3) 8d TOENAILS
CEILING JOISTS TO PARALLEL RAFTERS	REFER TO TABLE 2308.7.3.1
RAFTER TO PLATE	(3) 10d TOENAILS

- C. USE OF MACHINE NAILING IS SUBJECT TO A SATISFACTORY JOBSITE DEMONSTRATION AND THE APPROVAL OF THE AOR/SEOR. THE APPROVAL IS SUBJECT TO CONTINUED SATISFACTORY PERFORMANCE. MACHINE NAILING IS NOT ALLOWED FOR 5/16" SHEATHING. IF THE NAIL HEADS PENETRATE MORE THAN WOULD BE NORMAL FOR A HANDHELD HAMMER, OR IF MINIMUM ALLOWABLE EDGE DISTANCES ARE NOT MAINTAINED, THE PERFORMANCE WILL BE DEEMED UNSATISFACTORY AND MACHINE NAILING WILL BE DISCONTINUED.
- D. USE STANDARD CUT WASHERS BETWEEN THE BOLT HEADS, BOLT NUTS AND LAG SCREW HEADS AND WOOD FRAMING.
- E. ALL WOOD CONNECTIONS MADE WITH LAG SCREWS SHALL BE MADE WITH SCREWS CONFORMING TO THE REQUIREMENTS OF ANSI/A308 B18.2.6. LEAD HOLES FOR THE SHANK SHALL HAVE THE SAME DIAMETER AS THE SHANK AND THE SAME DEPTH AS THE LENGTH OF UNTHREADED SHANK. THE LEAD HOLE FOR THE THREADED PORTION SHALL HAVE A DIAMETER EQUAL TO 60-75% OF THE THREADED PORTION.
- F. WHERE THERE ARE CONNECTOR NAILING ALTERNATIVES LISTED IN THE MANUFACTURER'S CATALOG, THE NAILING PROVIDING THE HIGHEST LOAD CAPACITY SHALL BE USED.
4. GENERAL CONSTRUCTION REQUIREMENTS:
A. FRAMING PLANS INDICATE GENERAL LAYOUT AND DIMENSIONAL CONTROL ONLY. REFER TO SHOP DRAWINGS FOR ENGINEERING AND ERECTION.
B. WHERE MULTIPLE JOISTS OR HEADERS OCCUR, THERE SHALL BE A SHOULDER STUD FOR EACH PLY (IE - PROVIDE DOUBLE STUDS UNDER DOUBLE JOISTS).
C. SOLID-SAWN LUMBER BEAMS, RAFTERS AND JOISTS SHALL HAVE LATERAL SUPPORT PREVENTING ROTATION OR DISPLACEMENT AS FOLLOWS BASED UPON SPAN-TO-DEPTH RATIOS:
1) 2:1, NO LATERAL SUPPORT IS REQUIRED;
2) 3:1 OR 4:1, THE ENDS SHALL BE HELD IN POSITION BY FULL-DEPTH BLOCKING, BRIDGINS, NAILING OR BOLTING TO OTHER FRAMING MEMBERS;
3) 5:1, ONE EDGE SHALL BE HELD IN LINE FOR ITS ENTIRE LENGTH;
4) 6:1, FULL-DEPTH BLOCKING, BRIDGING OR CROSS BRACING SHALL BE INSTALLED AT INTERVALS NOT EXCEEDING 8 FT UNLESS BOTH EDGES ARE HELD IN LINE;
5) 7:1, BOTH EDGES SHALL BE HELD IN LINE FOR THE ENTIRE LENGTH.
D. UNLESS SPECIFICALLY SHOWN ON THESE PLANS, NO STRUCTURAL MEMBER SHALL BE CUT, NEITHER DRILLED NOR NOTCHED, WITHOUT WRITTEN APPROVAL FROM THE SEOR.
1) AT NON-BEARING STUDS: A HOLE NOT GREATER THAN 40% OF THE STUD WIDTH MAY BE BORED. BORED HOLES NOT GREATER THAN 60% OF THE STUD WIDTH ARE PERMITTED WHERE EACH BORED STUD IS DOUBLED, PROVIDED NOT MORE THAN TWO SUCH SUCCESSIVE DOUBLE STUDS ARE SO BORED. IN NO CASE SHALL THE EDGE OF THE BORE HOLE BE NEARER THAN 5/8" TO THE STUD EDGE. BORE HOLES SHALL NOT BE LOCATED AT THE SAME SECTION IF CUT OR NOTCHED.
E. STRUCTURAL HEADERS OR OTHER STRUCTURAL COMPONENTS MAY BE SUBSTITUTED UPON APPROVAL OF THE SEOR. SUPPLIER SHALL PROVIDE SEALED DESIGN CALCULATIONS FOR THE COMPONENTS.

WOOD DECKING

1. DECKING MATERIALS SHALL COMPLY WITH THE FOLLOWING:
SIZE MATCH EXISTING, MINIMUM 1x8
GRADE NO. 2 MINIMUM
FASTENING MINIMUM (3) 8d COMMON NAILS AT EACH SUPPORT

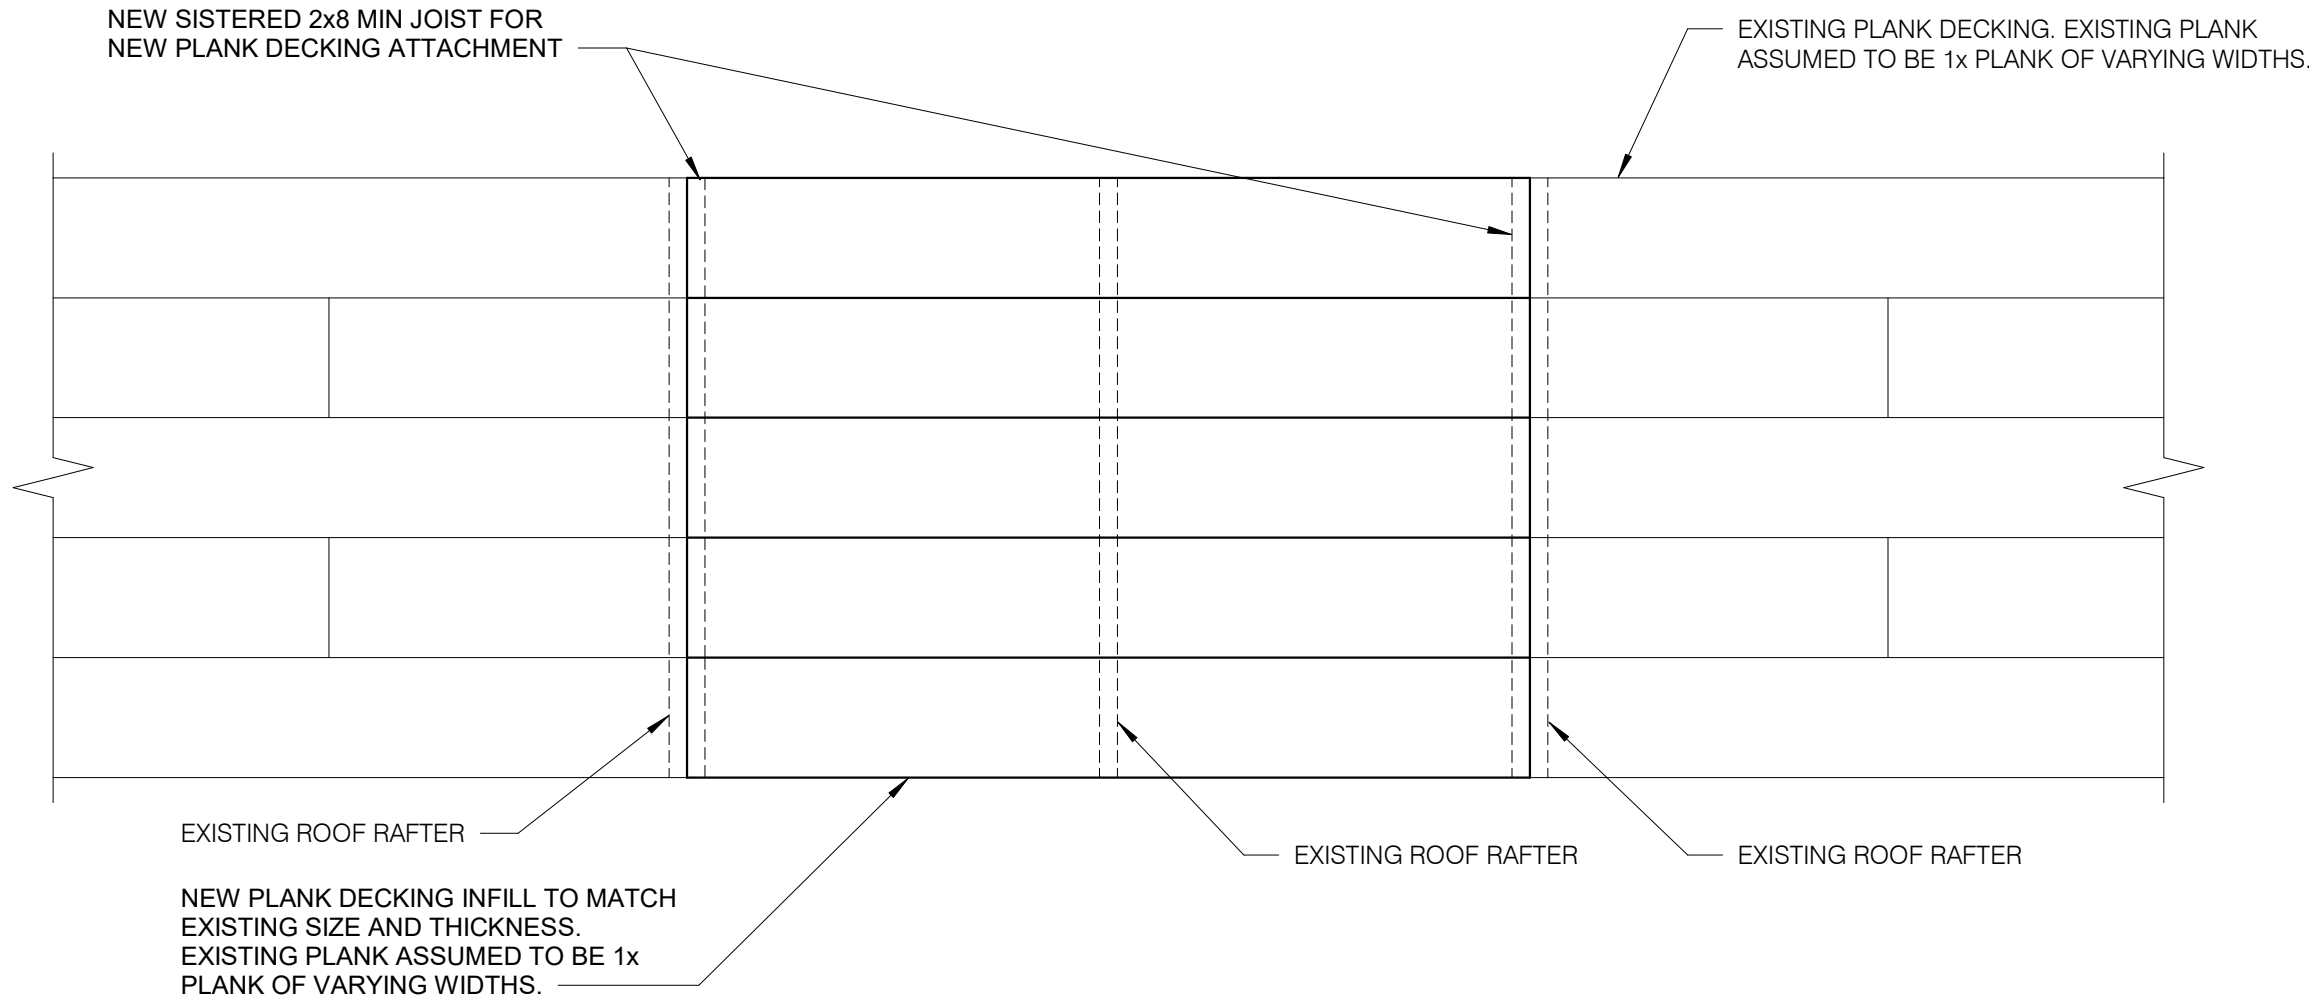

EXISTING ROOF PLANK DECKING REPLACEMENT DETAIL

3/4" = 1'-0"

NOTES:

1. NEW PLANK SHALL SPAN AT LEAST TWO SUPPORTS.
2. NAIL NEW PLANK TO RAFTERS WITH (3) 8d COMMON NAILS AT EACH PLANK AT EACH SUPPORT.
3. CONTRACTOR TO PUT IN BASE BID AN ALLOWANCE TO REPLACE 5% OF THE EXISTING ROOF PLANK DECKING AT BUILDINGS 16, 17, 18, 19, 31, 32, AND 33 TO ACCOUNT FOR DAMAGED ROOF DECK. THIS IS IN ADDITION TO THE INFILL AT THE EXISTING DORMERS. APPROXIMATE SQUARE FOOTAGE ASSUMED IS ± 2500 SQ FT. AREAS OF DAMAGED PLANK DECKING MUST BE REPLACED PRIOR TO INSTALLING THE NEW ROOFING SYSTEM. LOCATIONS WILL BE FIELD VERIFIED ONCE THE EXISTING ROOFING SYSTEM IS REMOVED AND PLANK DECKING IS EXPOSED. DAMAGED PLANK DECKING BEYOND THE 5% WILL BE HANDLED VIA UNIT COST.

STRUCTURAL ABBREVIATION KEY			
ABBR:	DESCRIPTION:	ABBR:	DESCRIPTION:
#	NUMBER OR POUNDS	LL	LONG LEG HORIZONTAL
@	DEGREE	LLH	LONG LEG VERTICAL
Ø	DIAMETER	LSH	LONG SIDE HORIZONTAL
-3	SLAB DEPRESSION	LSV	LONG SIDE VERTICAL
A.B.	ANCHOR BOLT	LO	LOW
AHU	AIR-HANDLING UNIT	LONG	LONGITUDINAL
ARCH	ARCHITECT -URE, -URAL	LT WT	LIGHTWEIGHT
B.O.	BOTTOM OF	M.B.	MACHINE BOLT
BF	BEAM FLANGE WIDTH	MAX	MAXIMUM
BLKG	BLOCKING	MECH	MECHANICAL
BN	BOUNDARY NAILING	MANUF	MANUFACTURER
B.O.F.	BOTTOM OF FOOTING	MIN	MINIMUM
BOTT	BOTTOM	MTL	METAL
BT	BASE PLATE	N	NORTH
BTWN	BETWEEN	(N)	NEW
CFSP	COLD FORM STEEL FRAMING	OC	NOT IN CONTRACT
CLR	CLEAR	NTS	NOT TO SCALE
CMU	CENTERLINE	OH	OPPOSITE HAND
COL	CONCRETE MASONRY UNIT	OPNG	OPENING
CONC	CONCRETE	PC	PIECE
CONT	CONTINUOUS	PCF	POUNDS PER CUBIC FOOT
DIA	DIAMETER	P.H.	PENTHOUSE
DIM	DIMENSION	PL	PLATE
DL	DEAD LOAD	PLF	POUNDS PER LINEAR FOOT
DET	DETAIL	PLYWD	PLYWOOD
DWG	DRAWING	PSF	POUNDS PER SQUARE FOOT
EAL	EACH	PSI	POUNDS PER SQUARE INCH
EA	EACH FACE	PTDF	PRESSURE TREADED DOUGLAS FIR
EF	ELEVATION	R	RADIUS
ELEC	ELECTRICAL	REINF	REINFORCING, -MENT, -ED
ELEV	ELEVATOR	REQD	REQUIRED
ED	EDGE OF DECK	RFU	ROOF-TOP UNIT
EOS	EDGE OF SLAB	SC	TC WITH CLASS A FAYING SURFACE
EQUIP	EQUIPMENT	SCBF	SPECIAL CONCENTRIC BRACE FRAME
EW	EACH WAY	SECT	SECTION
EXP	EXPANSION	SEPT	SEPARATION
EXT	EXTERIOR	SIM	SIMILAR
F _c	CONCRETE COMPRESSIVE STRENGTH	SL	SHEATHING
FDN	FOUNDATION	SLRS	SEISMIC LOAD RESISTING SYSTEM
FIN	FINISH -ED	SP	SLAB ON GRADE
FLR	FLOOR	SOG	SPACE(S)
F.N.	FIELD NAILING	SPEC	SPECIFICATION(S)
F.O.S.	FACE OF STUD	STIFF	STIFFENER
F.O.W.	FACE OF WALL	STL	STEEL
FRMG	FRAMING	SUPPT	SUPPORT
FTG	FOOT	SYM	SYMMETRICAL
FY	YIELD STRESS	T.O	TOP OF
GA	GAGE OR GAUGE	T.O.S.	TOP OF STEEL
GALV	GALVANIZED	T.O.W.	TOP OF WALL
GB	GRADE BEAM	TEMP	PRE-TENSIONED BOLT
HI	HIGH	THK	THICK
HORIZ	HORIZONTAL	TRANS	TRANSVERSE
HSB	HIGH STRENGTH BOLT	TP	TYPICAL
IN	INCH	UNO	UNLESS NOTED OTHERWISE
INT	INTERIOR	VERT	VERTICAL
JT	JOINT	VW	VERIFY WITH ARCHITECTURAL DRAWINGS
K	KILOPOUND (1,000 POUNDS)	WT	WORK POINT
KSP	KIPS PER SQUARE FOOT	WWR	WEIGHT
LB	POUND		WELED WIRE REINFORCING

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1012 WEST COLUMBIA ST.
FARMINGTON, MO 63640

REPLACE ROOF SYSTEMS
MULTIPLE ASSETS
FARMINGTON
CORRECTIONAL CENTER

FARMINGTON, MISSOURI

PROJECT # C1922-01
SITE # 7008
ASSET # 9327008089,
9327008090, 9327008091, 9327008082
9327008081, 9327008080, 9327008079

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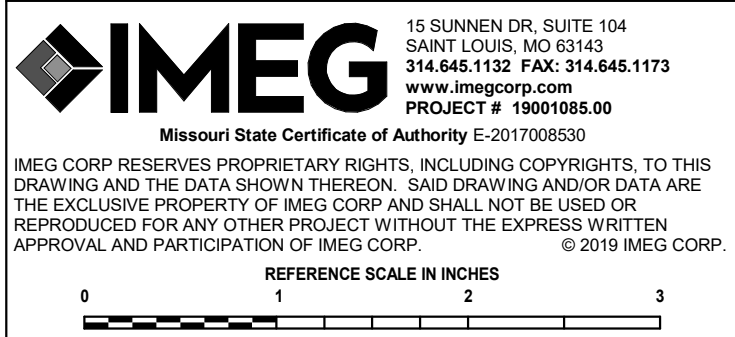
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DRAWN BY: WALLEW
CHECKED BY: TODBAR
DESIGNED BY: KATGOL


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GENERAL NOTES

SHEET NUMBER:

S000

14 OF 29 SHEETS
04/18/2022



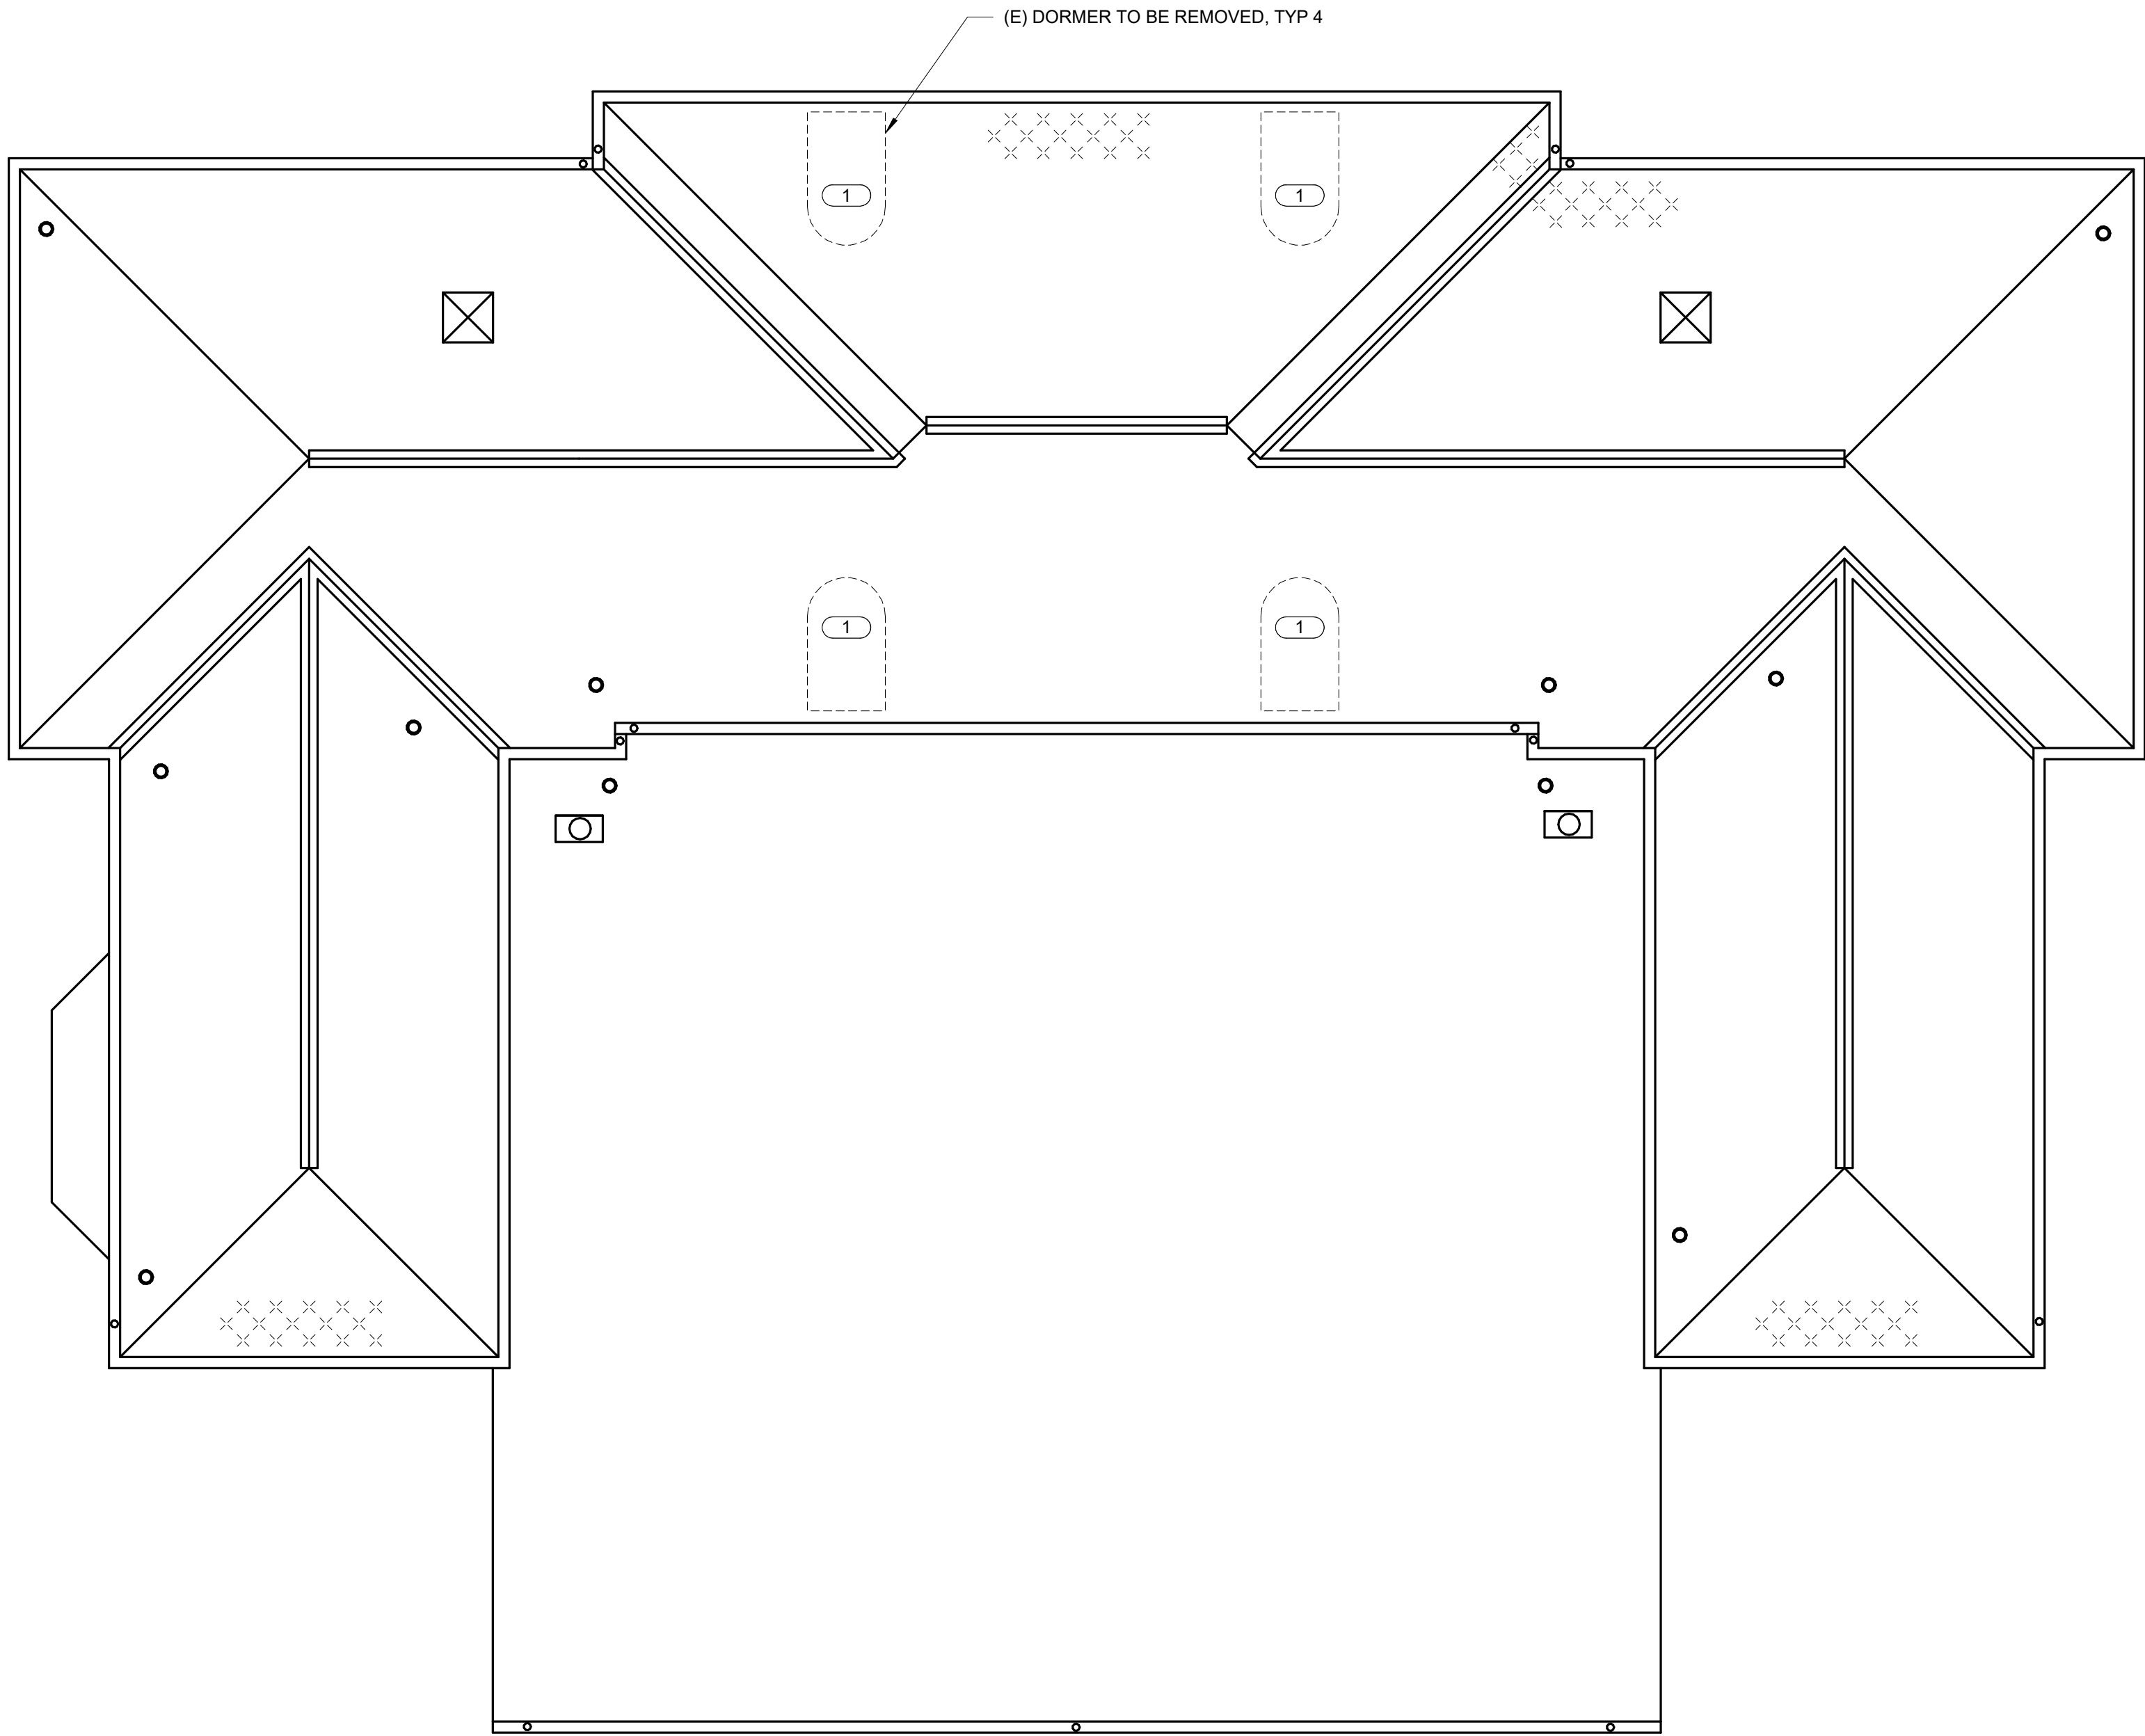


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ROOF FRAMING PLAN - BUILDING 17

1/8" = 1'-0"

KEYNOTES: (#)

1. INFILL EXISTING DORMER WITH NEW WOOD PLANK DECKING TO MATCH EXISTING PLANK DECKING SIZE. SPAN PLANK IN SAME DIRECTION AS EXISTING. REFER TO DETAIL 2/S101.

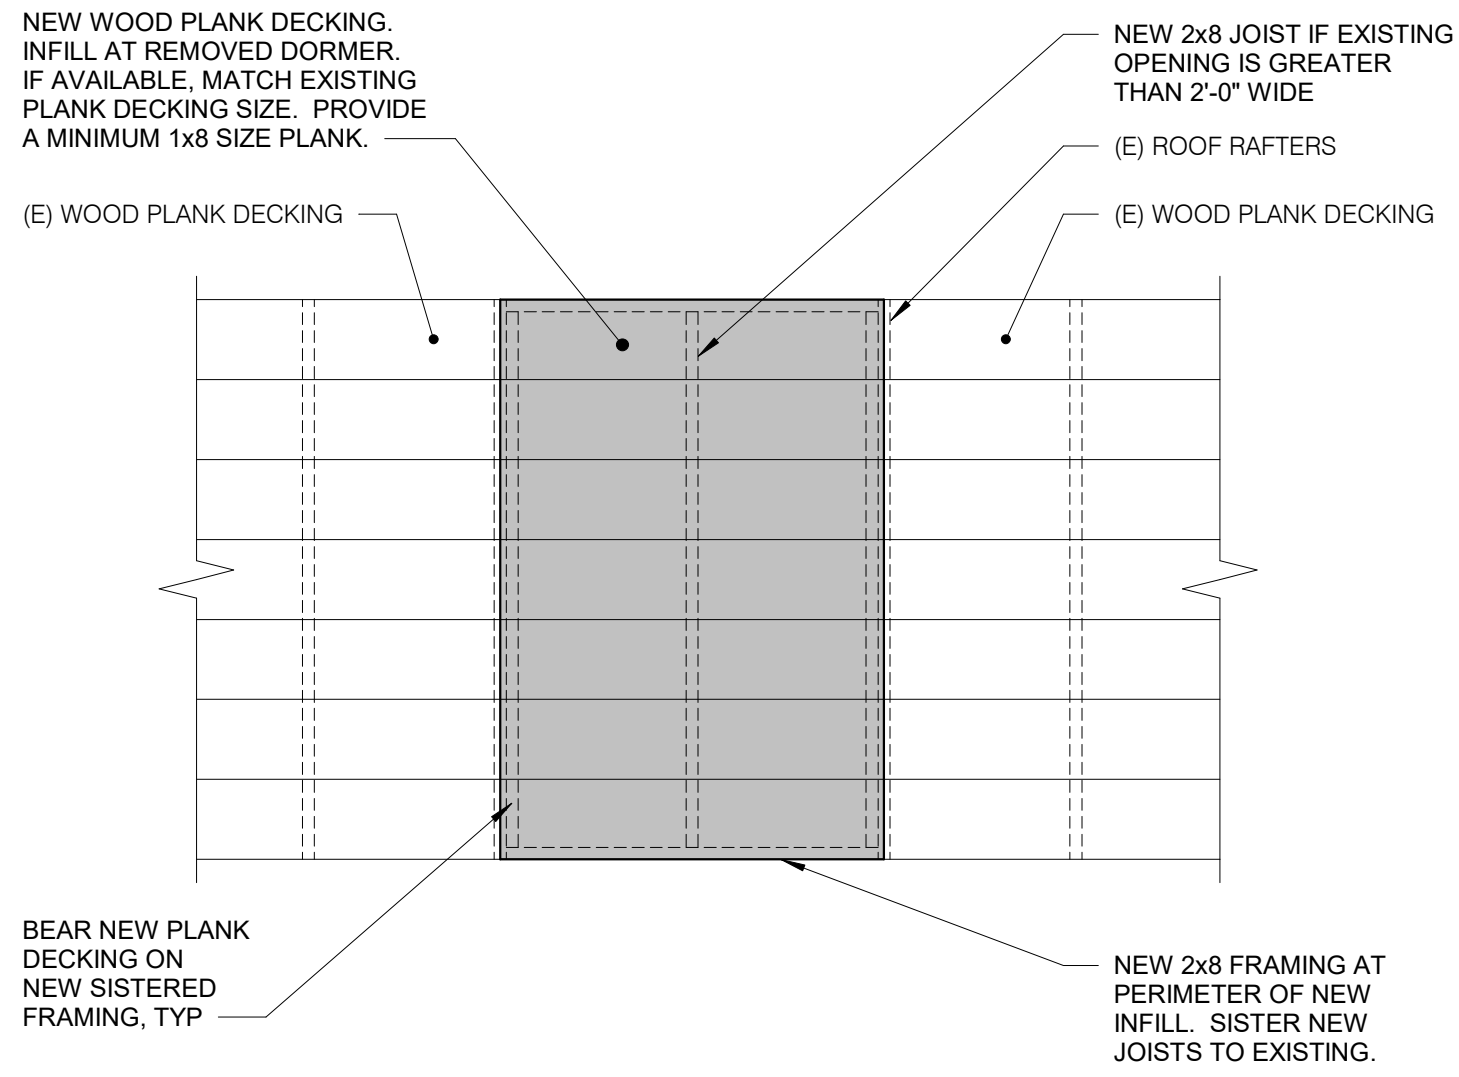


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TYPICAL ROOF DORMER INFILL DETAIL

1/2" = 1'-0"

NOTES:

1. IF EXACT THICKNESS OF PLANK DECKING IS NOT AVAILABLE, MATCH TOP OF PLANK TO EXISTING AND SHIM NEW AS NECESSARY. EXISTING PLANK ASSUMED TO BE 1x PLANK OF VARYING WIDTHS.
2. ATTACH ENDS OF NEW 2x8 JOISTS TO PERPENDICULAR FRAMING WITH SIMPSON LUS HANGER.



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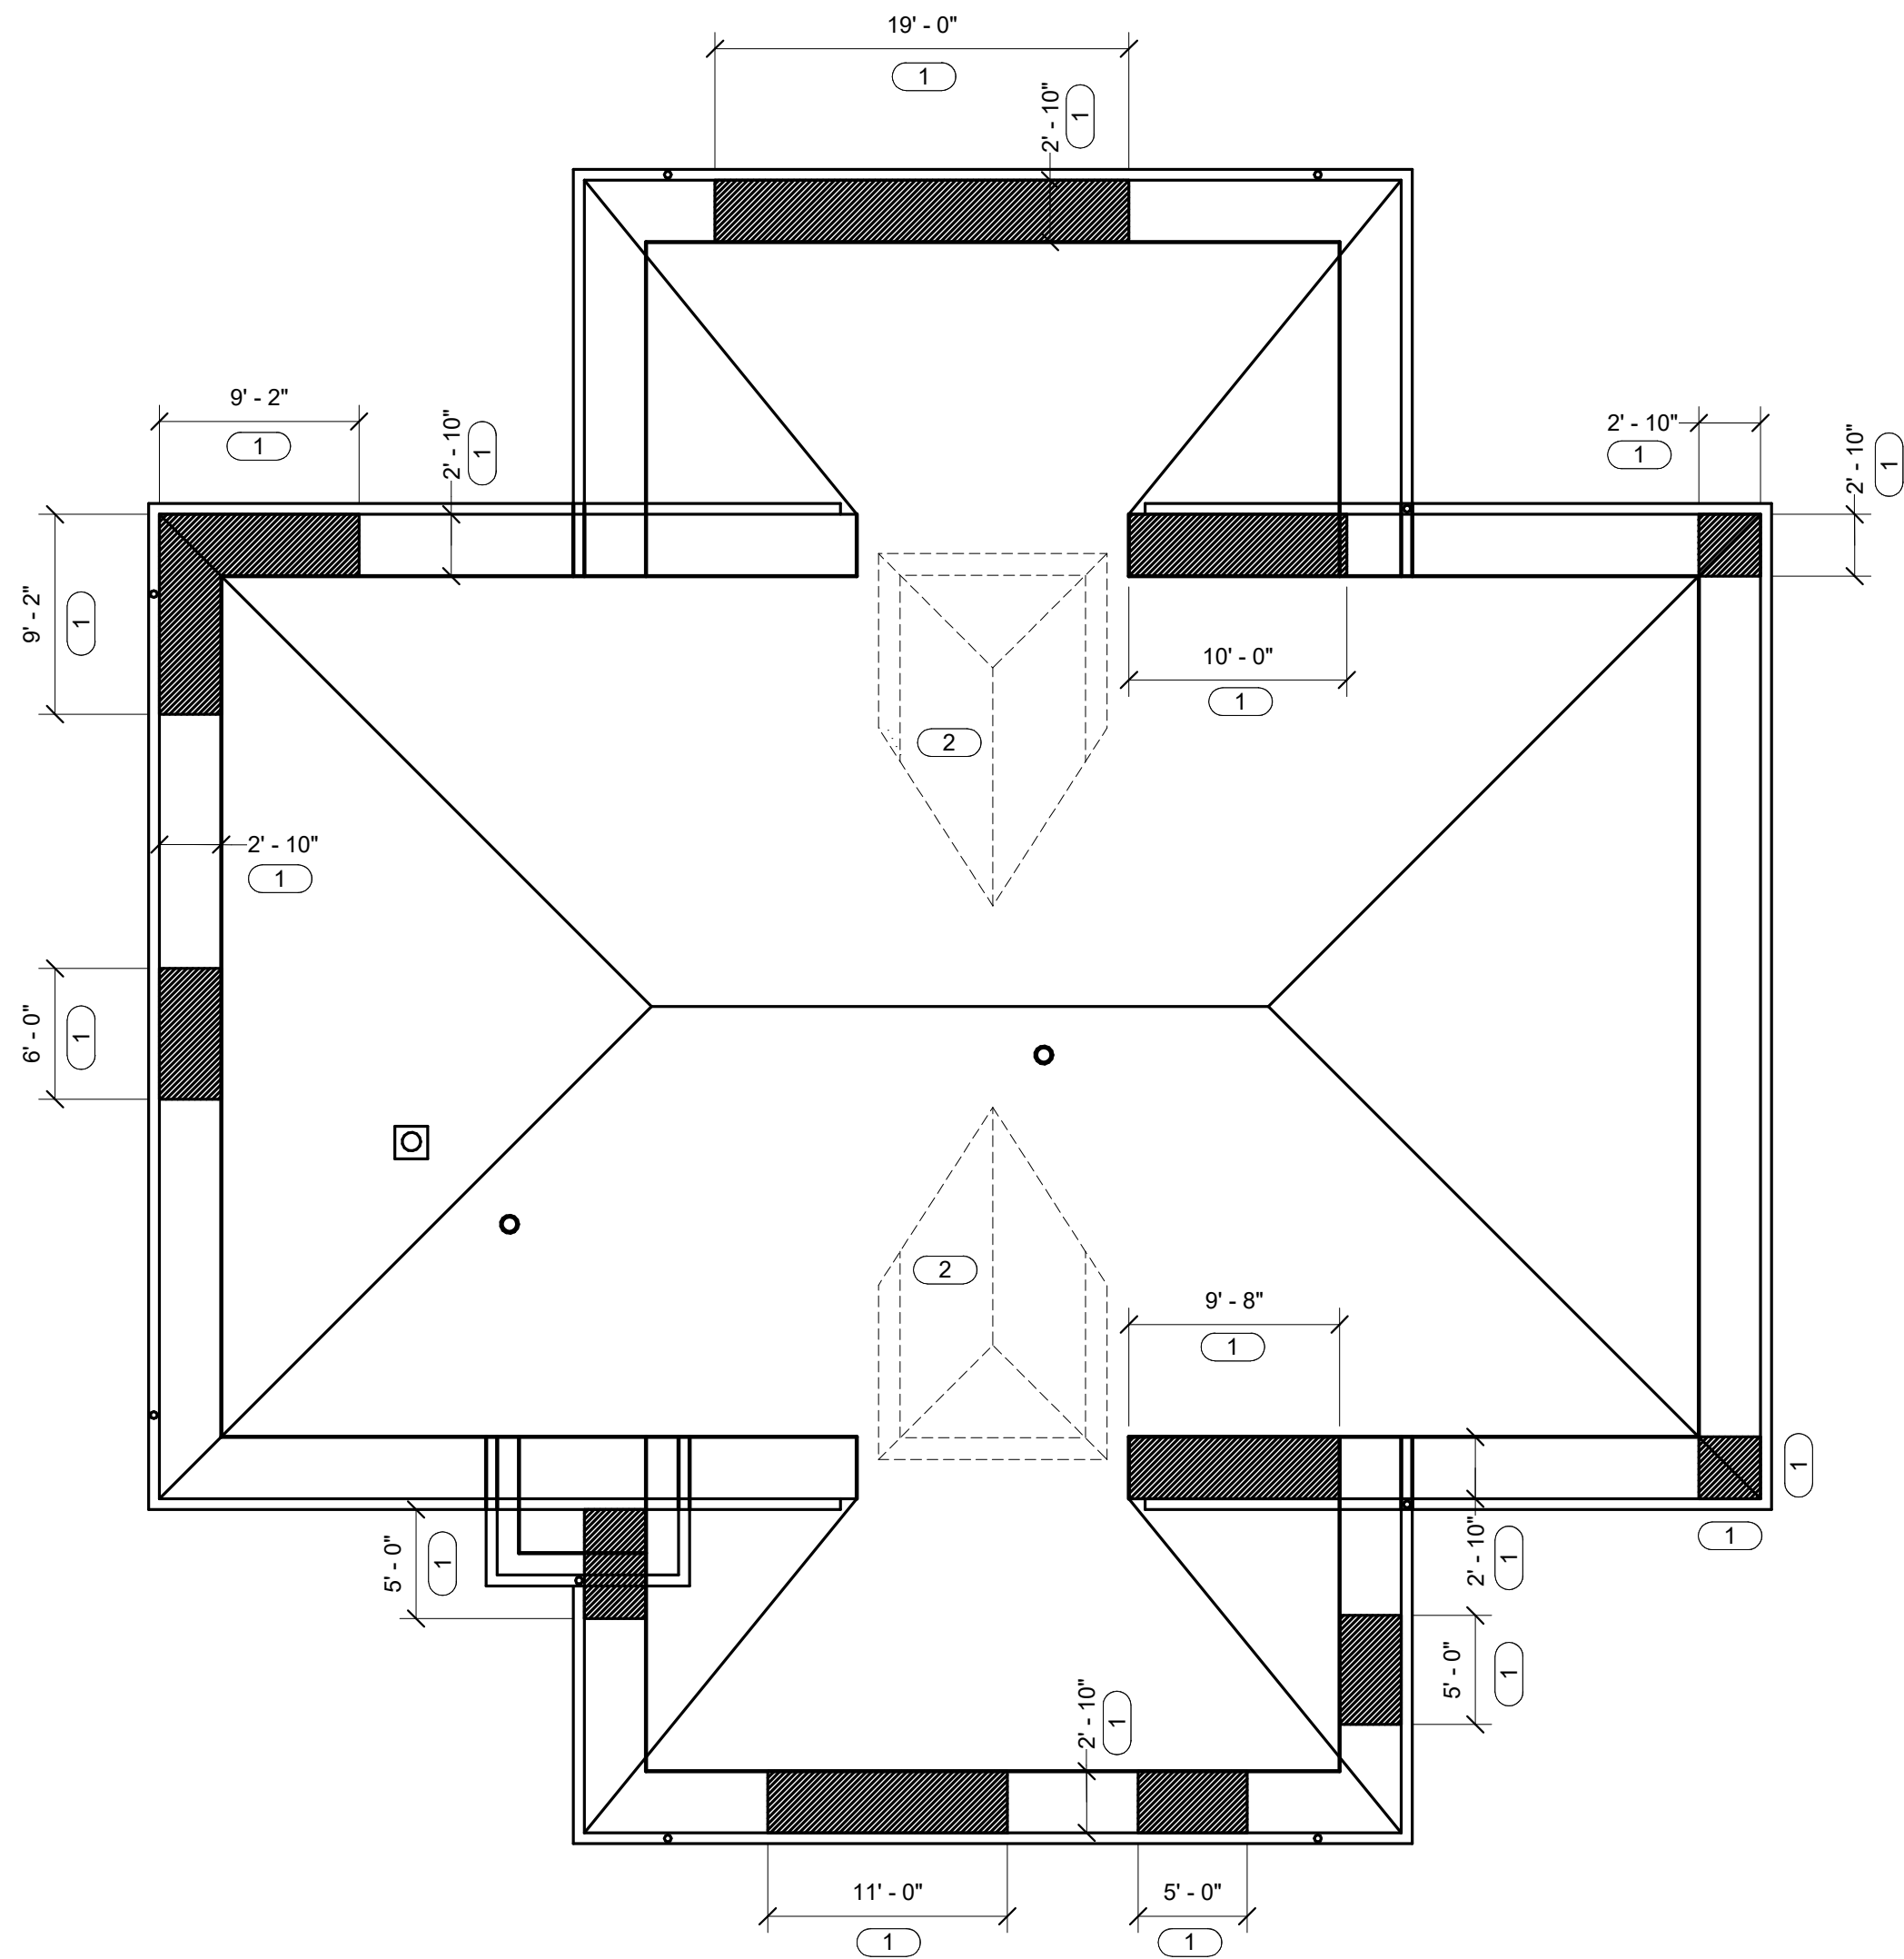
CAD DWG FILE: S101
DRAWN BY: WALLEW
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DESIGNED BY: KATGOL

SHEET TITLE:
ROOF FRAMING PLAN -
BUILDING 17

SHEET NUMBER:

S101

15 OF 29 SHEETS
04/18/2022



1 ROOF FRAMING PLAN - BUILDING 31 - ALTERNATE 3

1/8" = 1'-0"

NOTES:


- DAMAGED AND ROTTING SOFFIT FRAMING TO BE REMOVED AND REPLACED. REFER TO ARCHITECTURAL DRAWINGS FOR LOCATIONS AND PHOTO ON THIS SHEET EXEMPLIFYING SOFFIT CONDITIONS TO BE REPLACED. REFER TO DETAIL 2/S102 FOR SOFFIT FRAMING REPAIR DETAIL.

KEYNOTES:

- APPROXIMATE LOCATION OF DAMAGED SOFFIT IN NEED OF REPLACEMENT. REFER TO NOTE 1. DIMENSIONS TO BE FIELD VERIFIED AND VERIFIED WITH ARCHITECTURAL DRAWINGS.
- INFILL EXISTING DORMER WITH NEW WOOD PLANK DECKING TO MATCH EXISTING PLANK DECKING SIZE. SPAN PLANK IN SAME DIRECTION AS EXISTING. REFER TO DETAIL 2/S101.



PHOTO 1 - DAMAGED SOFFIT FRAMING TO BE REPLACED

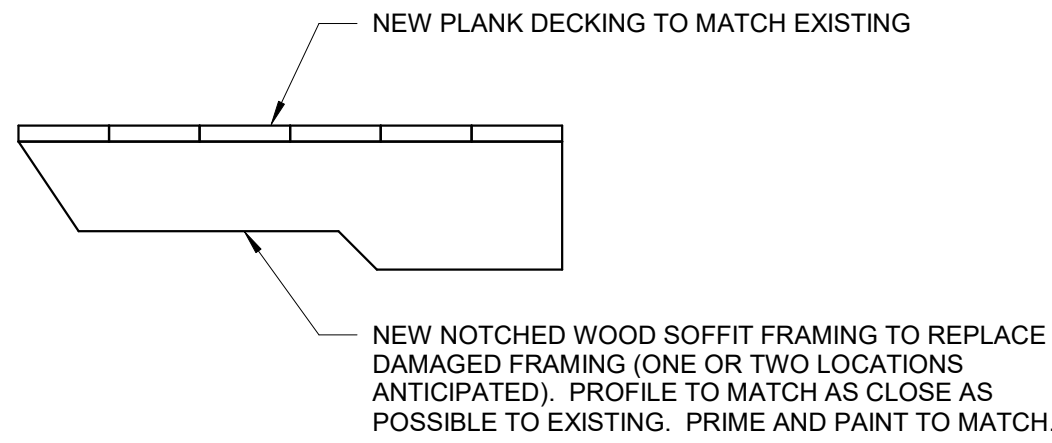


2 SOFFIT FRAMING REPAIR DETAIL

1" = 1'-0"

NOTES:

- NEW WOOD SHOULD BE PRESERVATIVE TREATED PRIOR TO PAINTING.
- ATTACHMENT OF NEW SUPPORT TO BUILDING FRAMING SHALL MATCH EXISTING.

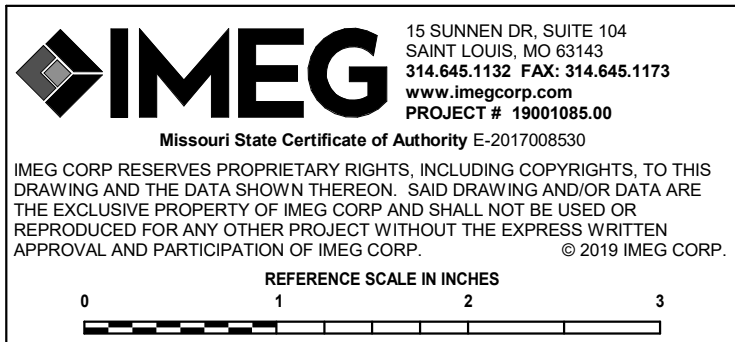

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DRAWN BY: WALLEW
CHECKED BY: TODBAR
DESIGNED BY: KATGOL

SHEET TITLE:
ROOF FRAMING PLAN -
BUILDING 31
(ALTERNATE NO. 3)

SHEET NUMBER:

S102

16 OF 29 SHEETS
04/18/2022



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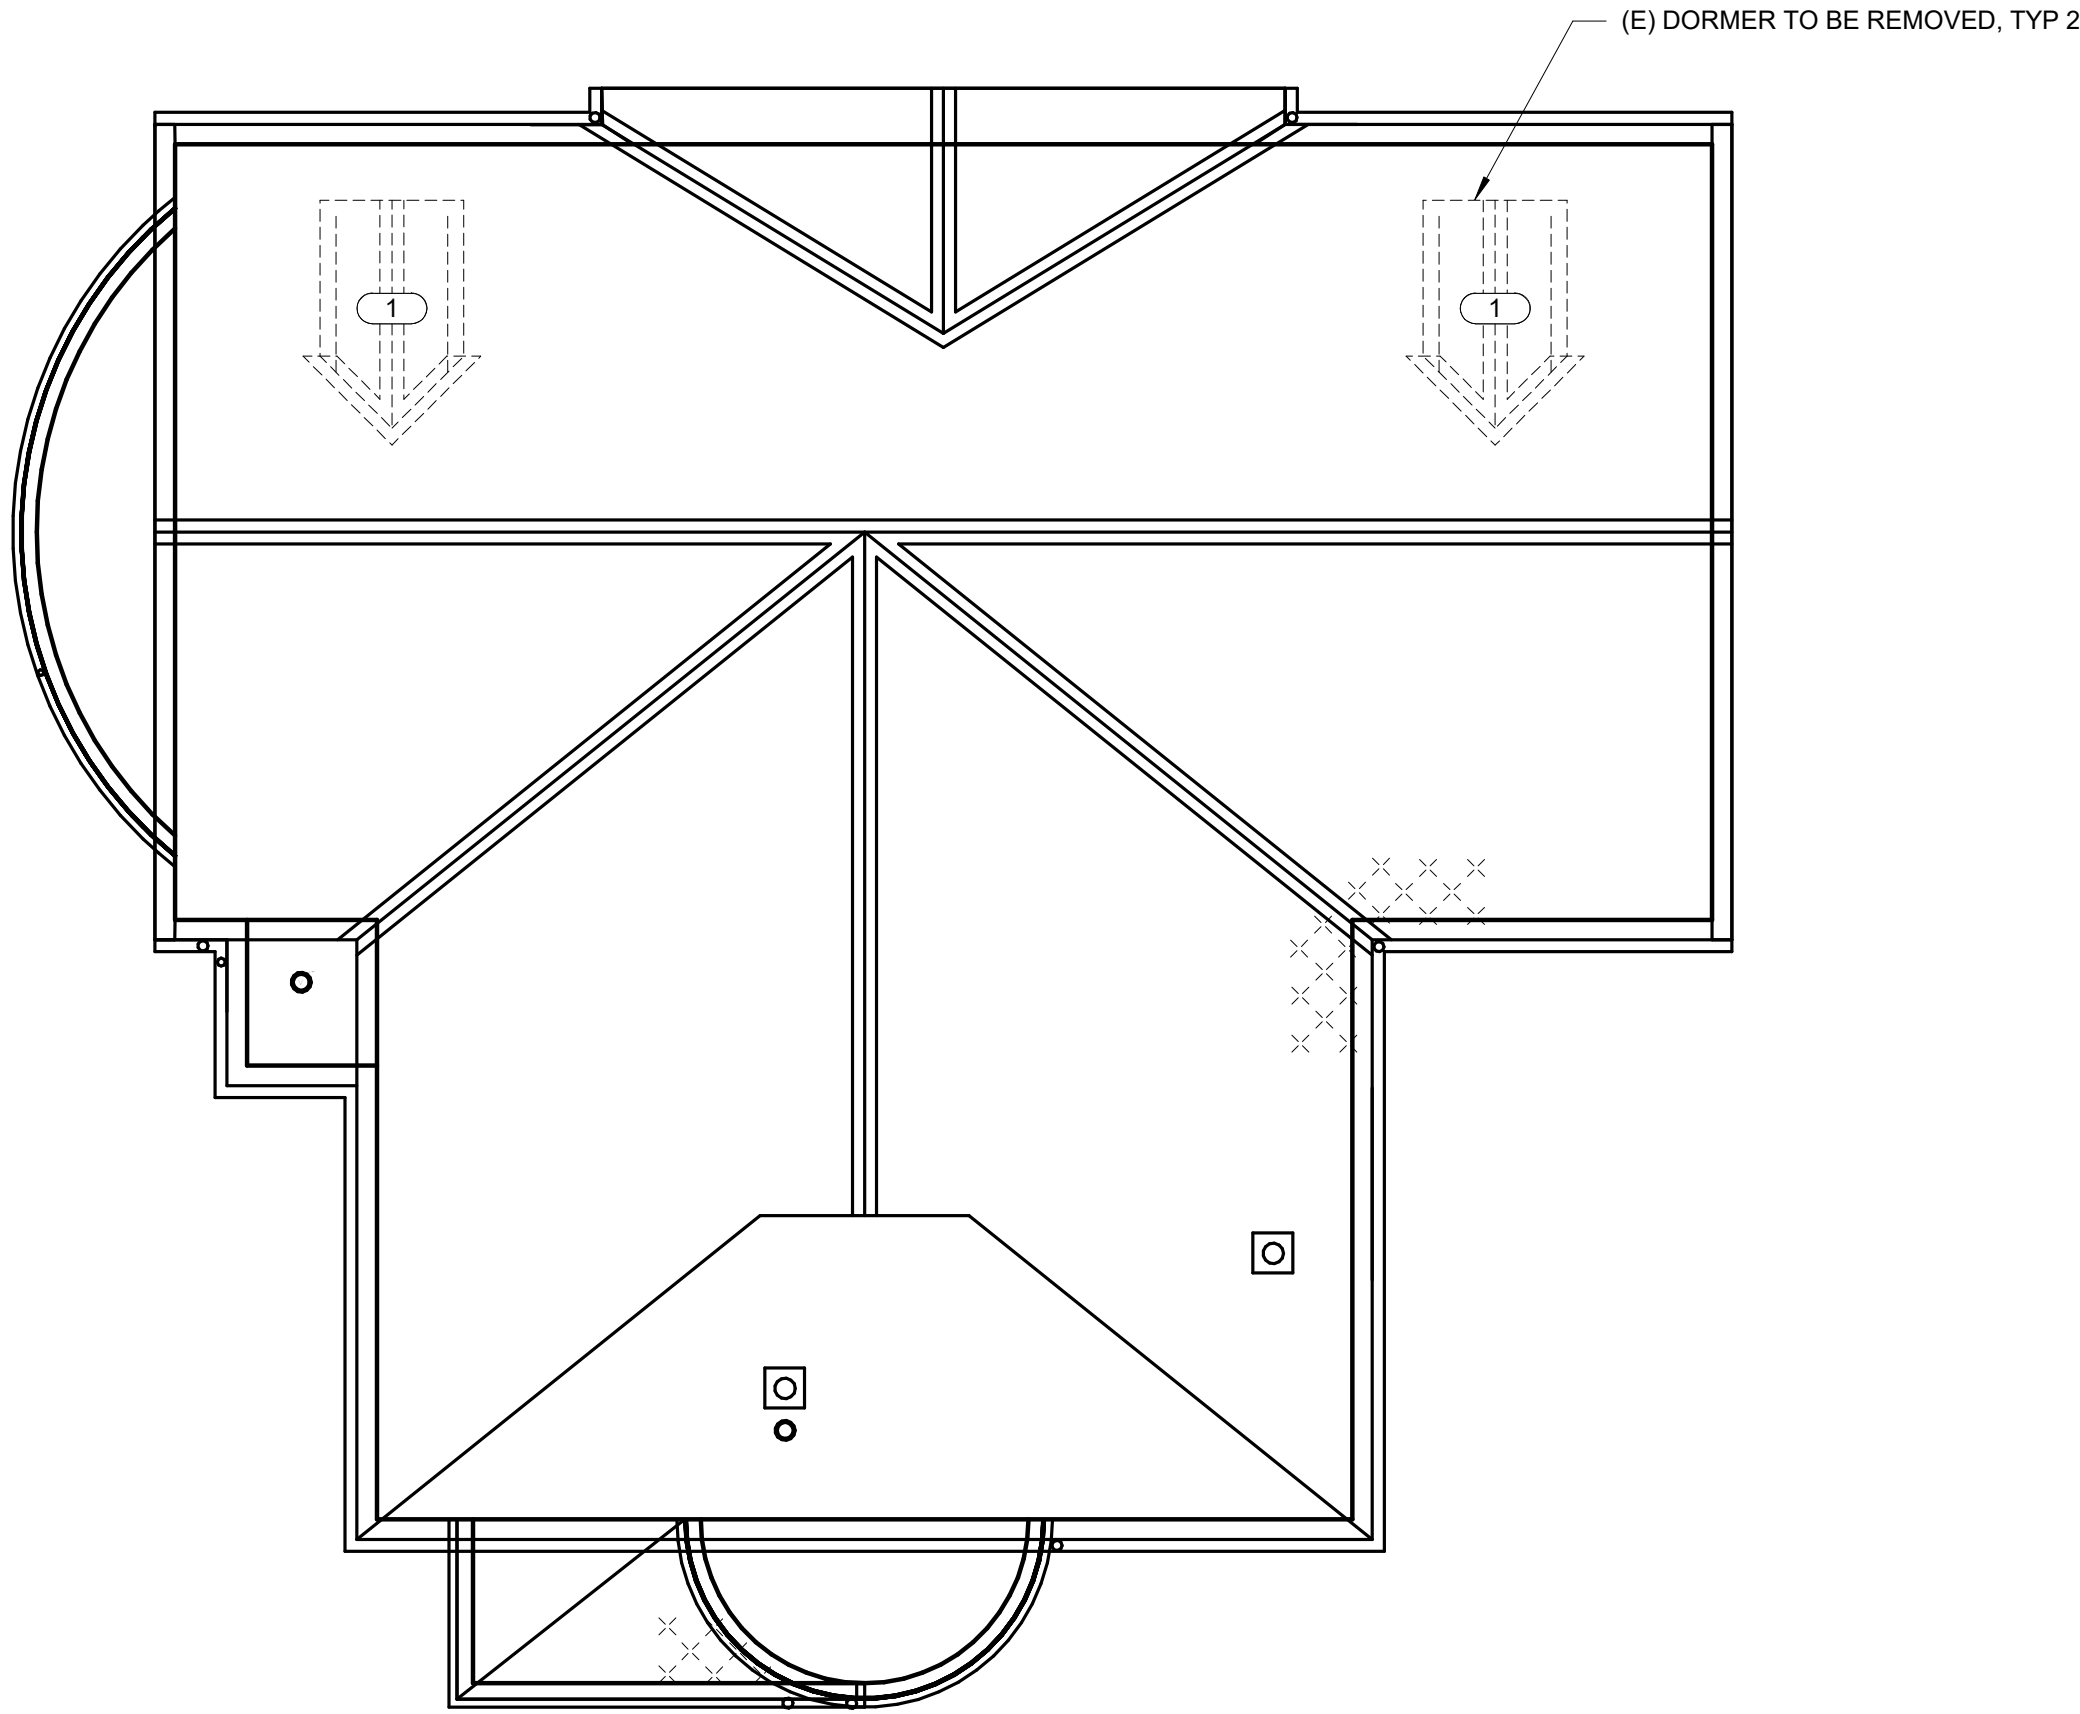
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DRAWN BY: WALLEW
CHECKED BY: TODBAR
DESIGNED BY: KATGOL

SHEET TITLE:
ROOF FRAMING PLAN -
BUILDING 32

SHEET NUMBER:

S103

17 OF 29 SHEETS
04/18/2022




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ROOF FRAMING PLAN - BUILDING 32

1/8" = 1'-0"

KEYNOTES: (#)

1. INFILL EXISTING DORMER WITH NEW WOOD PLANK DECKING TO MATCH EXISTING PLANK
DECKING SIZE. SPAN PLANK IN SAME DIRECTION AS EXISTING. REFER TO DETAIL 2/S101.



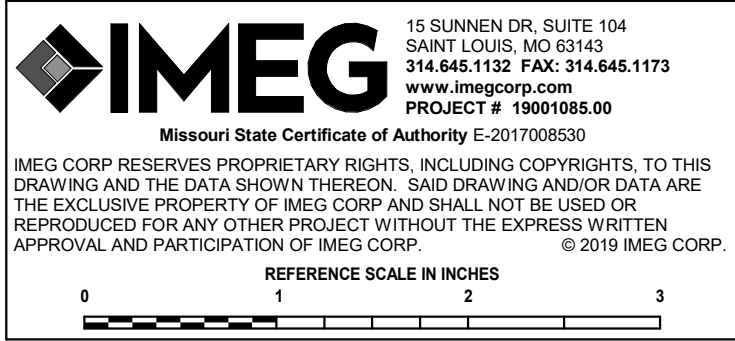

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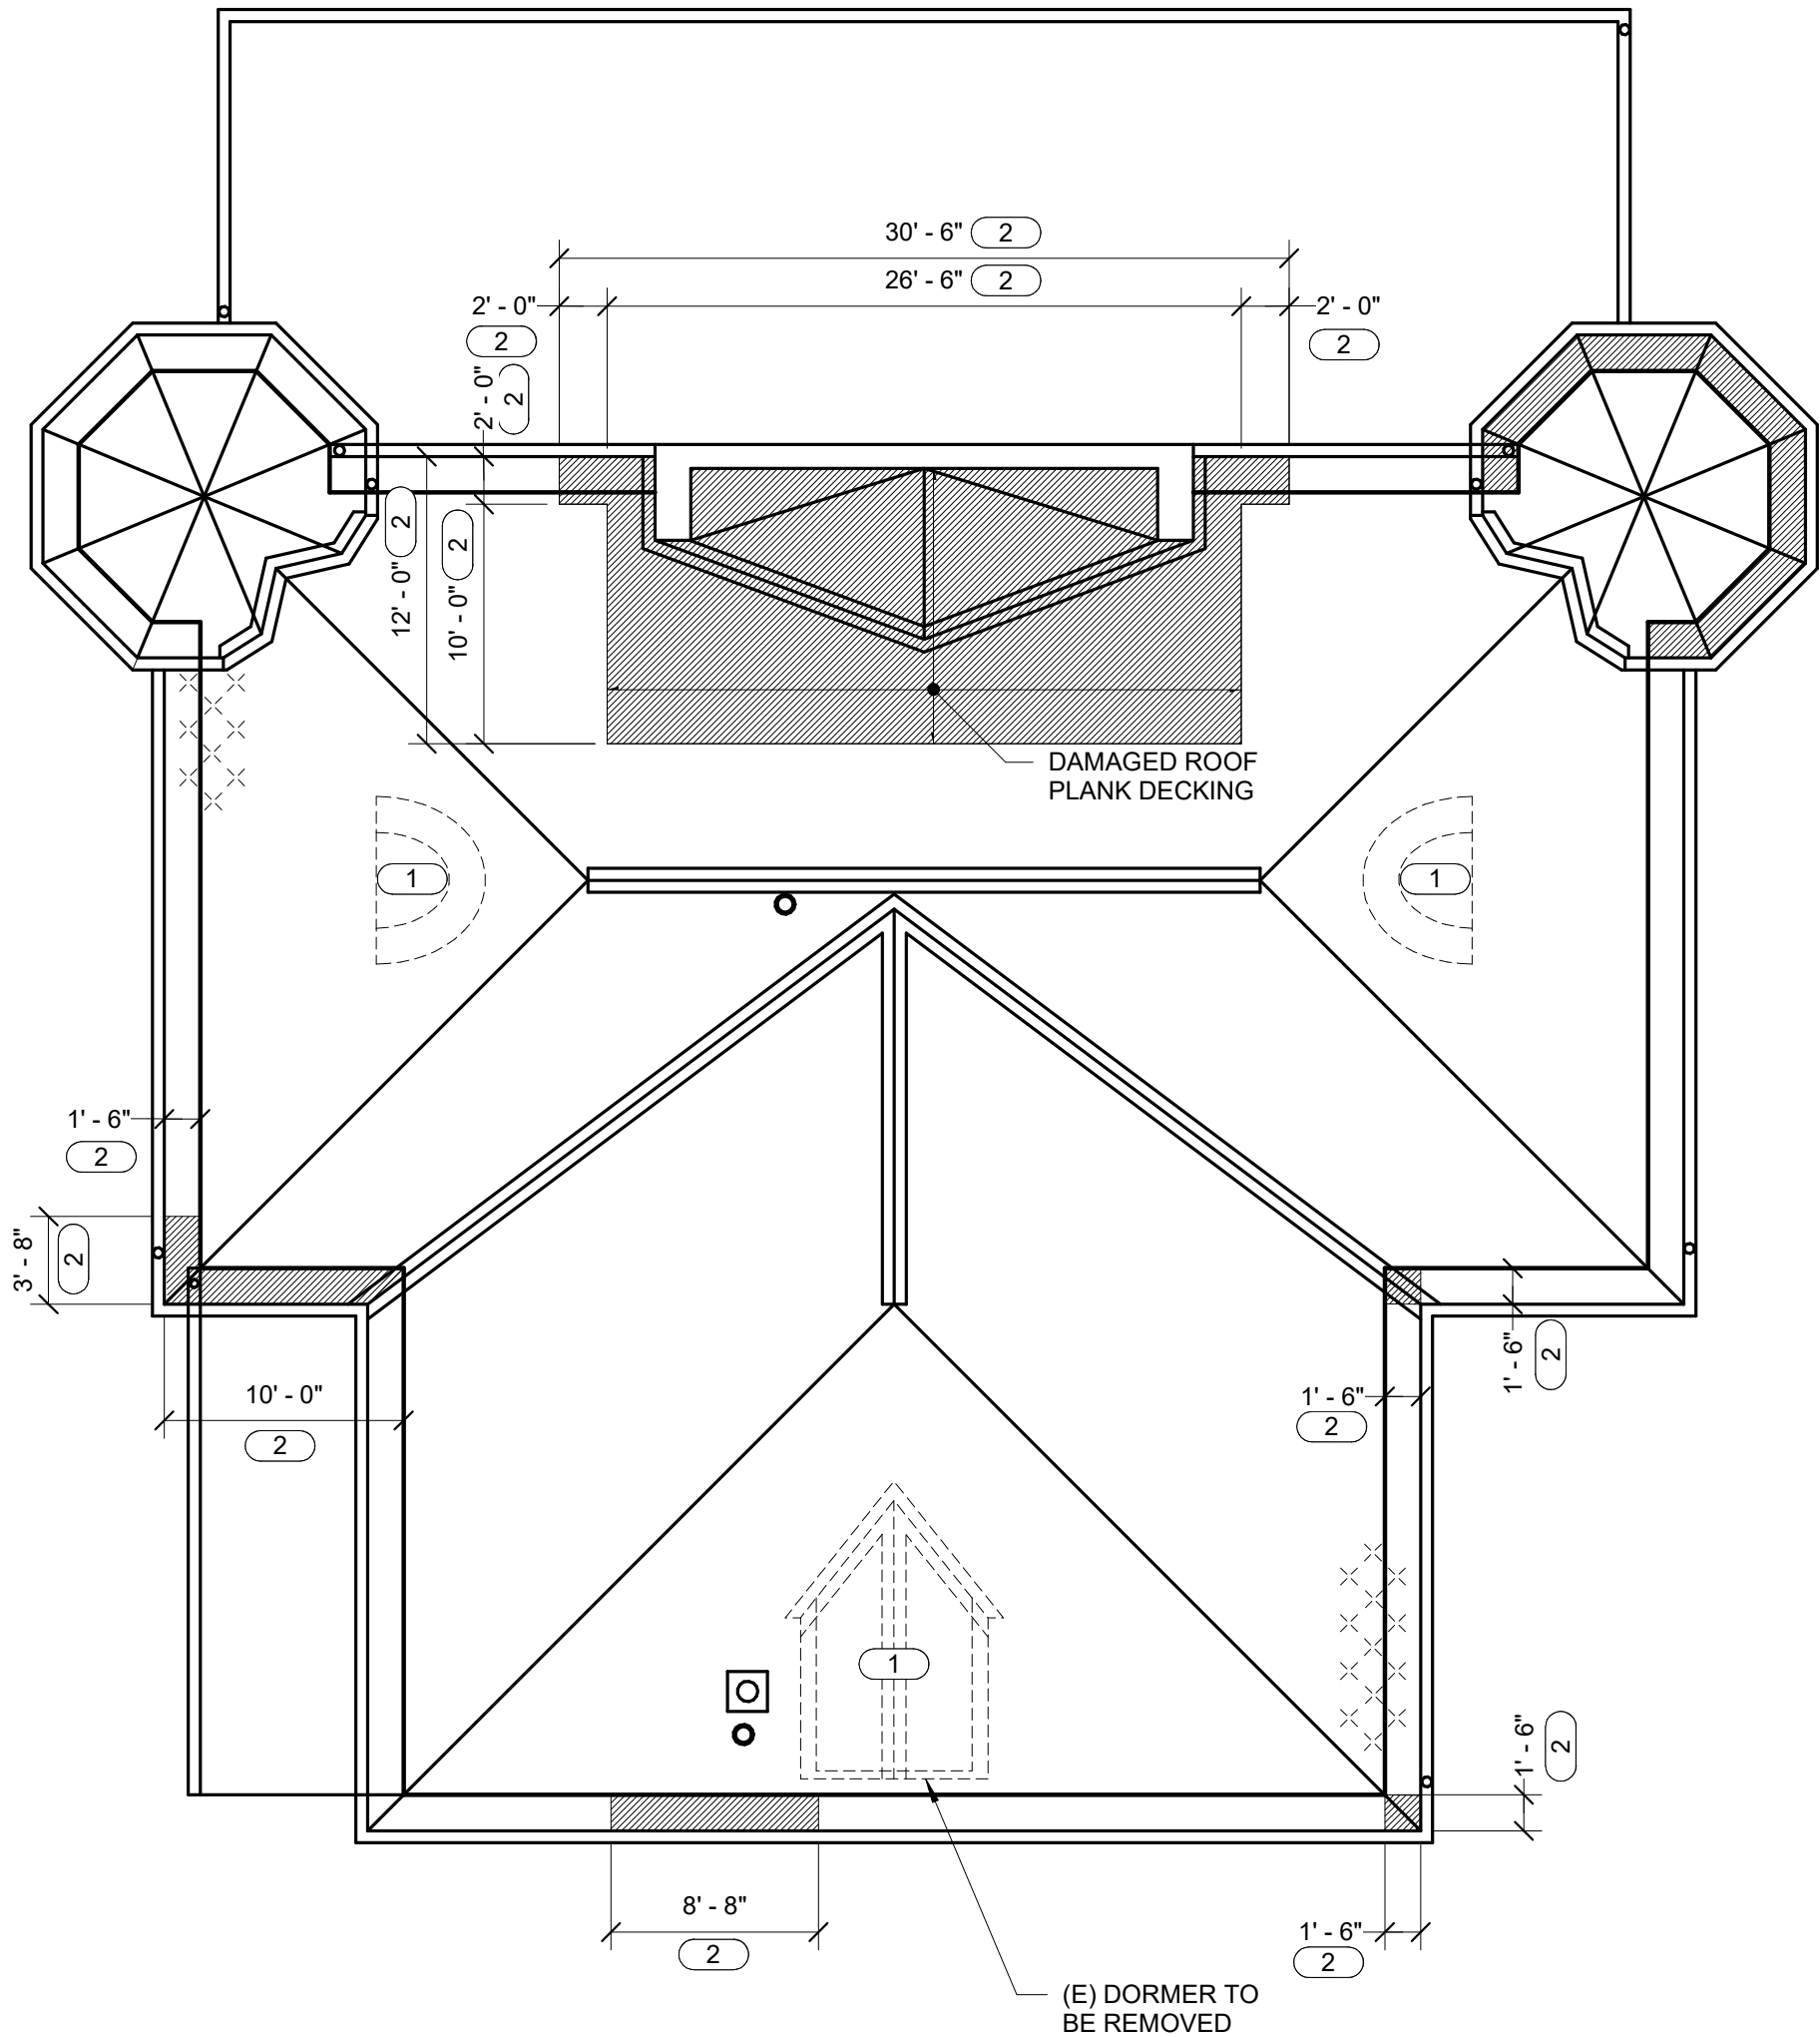
CAD DWG FILE: S104
DRAWN BY: WALLEW
CHECKED BY: TODBAR
DESIGNED BY: KATGOL

SHEET TITLE:
ROOF FRAMING PLAN -
BUILDING 33
(ALTERNATE NO. 4)

SHEET NUMBER:

S104

18 OF 29 SHEETS
04/18/2022



1 ROOF FRAMING PLAN - BUILDING 33 - ALTERNATE 4

1/8" = 1'-0"

NOTES:


- DAMAGED AND ROTTING SOFFIT FRAMING AND/OR WOOD PLANK DECKING TO BE REMOVED AND REPLACED. REFER TO ARCHITECTURAL DRAWINGS FOR LOCATIONS AND PHOTO ON THIS SHEET EXEMPLIFYING SOFFIT CONDITIONS TO BE REPLACED. REFER TO DETAIL 2/S104 FOR SOFFIT FRAMING REPAIR DETAIL.

KEYNOTES: (#)

- INFILL EXISTING DORMER WITH NEW WOOD PLANK DECKING TO MATCH EXISTING PLANK DECKING SIZE. SPAN PLANK IN SAME DIRECTION AS EXISTING. REFER TO DETAIL 2/S101.
- APPROXIMATE LOCATION OF DAMAGED SOFFIT AND ROOF PLANK DECKING IN NEED OF REPLACEMENT. REFER TO NOTE 1. DIMENSIONS TO BE FIELD VERIFIED AND VERIFIED WITH ARCHITECTURAL DRAWINGS.



PHOTO 1 - DAMAGED SOFFIT FRAMING TO BE REPLACED

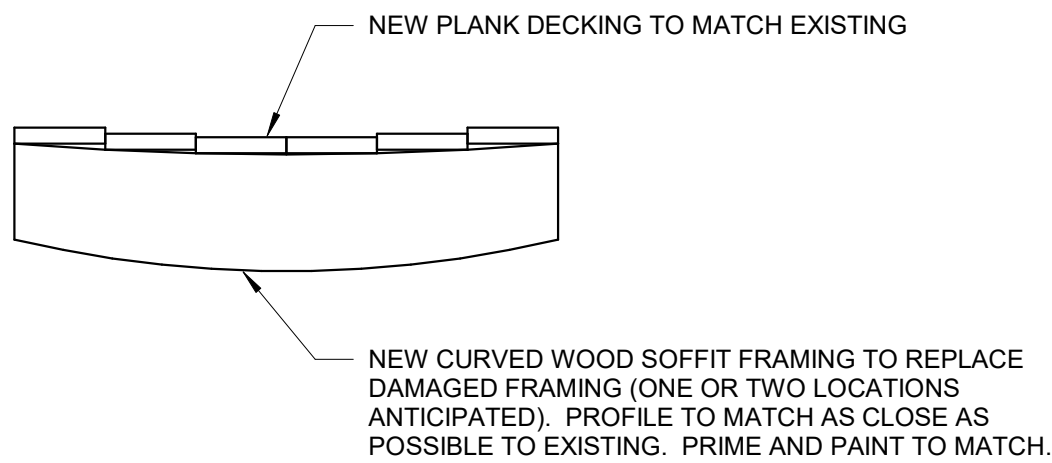



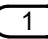

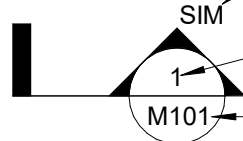
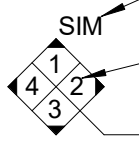




2 SOFFIT FRAMING REPAIR DETAIL

1" = 1'-0"

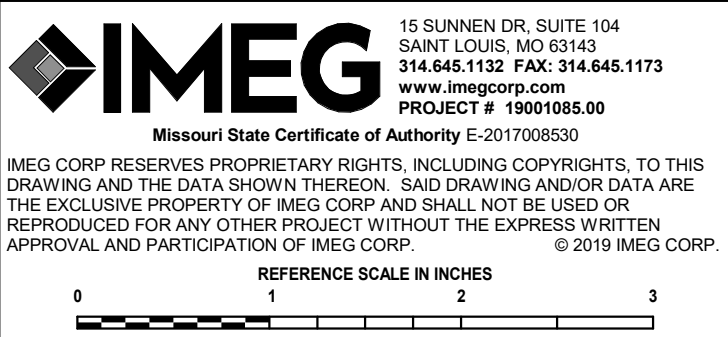NOTES:

- NEW WOOD SHOULD BE PRESERVATIVE TREATED PRIOR TO PAINTING.
- ATTACHMENT OF NEW SUPPORT TO BUILDING FRAMING SHALL MATCH EXISTING.



VIEW KEY	
 NAME 10' - 0" LEVEL NAME HEIGHT ABOVE PROJECT 0' - 0"	 INDICATES NOTE USED TO DESCRIBE ADDITIONAL INFORMATION ABOUT WORK REQUIRED, SPECIFIC TO THE SHEET AND/OR DETAIL
 INDICATES DIRECTION OF TRUE NORTH PLAN OR DETAIL NUMBER PLAN OR DETAIL NAME VIEW NAME 1/8" = 1'-0" PLAN OR DETAIL SCALE	
 INDICATES SIMILAR DETAIL REFERENCED IN MULTIPLE LOCATIONS DETAIL REFERRED TO BY SECTION CUT SHEET DETAIL IS LOCATED ON	
 INDICATES SIMILAR DETAIL REFERENCED IN MULTIPLE LOCATIONS DETAIL REFERRED TO BY ELEVATION SHEET DETAIL IS LOCATED ON	
<u>LINE TYPE KEY:</u>	
	NEW WORK BY THIS CONTRACTOR (DARK SOLID LINE)
	NEW WORK UNDERFLOOR OR UNDERGROUND BY THIS CONTRACTOR (DARK LONG DASHED LINE)
	NEW WORK BY OTHERS AND/OR EXISTING TO REMAIN (LIGHT SOLID LINE)
	EXISTING TO BE REMOVED BY THIS CONTRACTOR (DARK SHORT DASHED LINE)

CONTRACTOR ABBREVIATION KEY	
ABBR:	DESCRIPTION:
E.C.	ELECTRICAL CONTRACTOR
G.C.	GENERAL CONTRACTOR
M.C.	MECHANICAL CONTRACTOR
T.C.C.	TEMPERATURE CONTROLS CONTRACTOR

VENTILATION ABBREVIATION KEY	
ABBR:	DESCRIPTION:
AD	ACCESS DOOR
AFF	ABOVE FINISHED FLOOR
E	EXISTING
EA	EXHAUST/RELIEF AIR
MA	MIXED AIR
NC	NEW CONNECTION
N.C.	NORMALLY CLOSED
NC	NOT IN CONTRACT
N.O.	NORMALLY OPEN
OA	OUTSIDE AIR
RA	RETURN AIR
SA	SUPPLY AIR
TYP	TYPICAL
UNO	UNLESS NOTED OTHERWISE
VTR	VENT THROUGH ROOF

MECHANICAL SYMBOL LIST	
NOT ALL SYMBOLS MAY APPLY.	
SYMBOL:	DESCRIPTION:
	DUCT DOWN
	DUCT UP
	SUPPLY/OUTSIDE AIR DUCT SECTION
	RETURN AIR DUCT SECTION
	EXHAUST/RELIEF AIR DUCT SECTION
	OPPOSED BLADE DAMPER (REFER TO SCHEDULE)
	PARALLEL BLADE DAMPER (REFER TO SCHEDULE)
	THERMOSTAT/SENSOR
	TEMPERATURE SENSOR (DUCT MOUNTED)
	THERMOSTAT/SENSOR WITH HEAVY DUTY ENCLOSURE
	AIRFLOW MEASUREMENT SYMBOL XX - AHU SYMBOL Y - SEQUENTIAL NUMBER

MECHANICAL RENOVATION NOTES:

THESE NOTES APPLY TO ALL MECHANICAL SHEETS AND TRADES, INCLUDING BUT NOT LIMITED TO VENTILATION AND PLUMBING.

- EXISTING CONDITIONS ARE SHOWN BASED ON INFORMATION OBTAINED FROM FIELD SURVEYS, EXISTING BUILDING DOCUMENTS, AND STAFF. VERIFY EXISTING CONDITIONS AND REPORT ANY CONFLICTS BEFORE PROCEEDING.
- NOT ALL EXISTING DUCTWORK AND PIPING IS SHOWN. VERIFY EXISTING CONDITIONS BEFORE STARTING WORK. NOTIFY ENGINEER OF ANY CONFLICTS WITH NEW WORK.
- EACH CONTRACTOR SHALL CUT AND PATCH ROOFS, WALLS, AND FLOORS ASSOCIATED WITH HIS WORK.
- THE GENERAL CONTRACTOR IS RESPONSIBLE FOR REMOVAL AND REPLACEMENT OF CEILINGS, CEILING TILES, AND CEILING GRIDS ASSOCIATED WITH AREAS OF WORK BY ALL CONTRACTORS. NOTIFY THE GENERAL CONTRACTOR OF AFFECTED AREAS PRIOR TO BIDDING.
- WHERE EXISTING MECHANICAL SYSTEMS ARE LOCATED IN AREAS THAT CONFLICT WITH NEW EQUIPMENT, PIPING, OR DUCTWORK TO BE INSTALLED, EACH CONTRACTOR SHALL EITHER ARRANGE NEW EQUIPMENT, PIPING, OR DUCTWORK IN SUCH A FASHION THAT IT DOES NOT CONFLICT WITH EXISTING SYSTEMS, OR REWORK EXISTING MECHANICAL SYSTEMS TO ALLOW FOR INSTALLATION OF NEW EQUIPMENT, PIPING, OR DUCTWORK.
- PROVIDE TEMPORARY CONNECTIONS TO MAINTAIN EXISTING SYSTEMS IN SERVICE DURING CONSTRUCTION. MAINTAIN ACCESS TO EXISTING MECHANICAL INSTALLATIONS THAT REMAIN ACTIVE.
- OBTAIN PERMISSION FROM OWNER BEFORE SHUTTING DOWN ANY SYSTEM FOR ANY REASON. MAINTAIN SERVICE TO ALL COMPONENTS THAT ARE TO REMAIN UNTIL NEW SYSTEMS ARE INSTALLED.
- MAINTAIN EXISTING SYSTEM IN SERVICE UNTIL NEW SYSTEM IS COMPLETE AND READY FOR TIE IN AND SWITCHOVER. VERIFY ALL DIMENSIONS AND CLEARANCES PRIOR TO CONNECTIONS. OBTAIN PERMISSION FROM OWNER BEFORE PARTIALLY OR COMPLETELY DRAINING SYSTEM. MAKE CHANGEOVER TO NEW SYSTEMS WITH MINIMUM OUTAGE.

TAB PRE-DEMOLITION NOTES:

- BEFORE ANY DEMOLITION WORK IS BEGUN A COMPLETE AIR BALANCE TEST SHALL BE PERFORMED BY THE TESTING, ADJUSTING AND BALANCING (TAB) CONTRACTOR ON EXISTING AIR HANDLERS AND EXHAUST FANS SERVING THE AREAS AFFECTED BY CONSTRUCTION. EQUIPMENT TO BE DEMOLISHED DOES NOT REQUIRE TESTING. PROVIDE AIR BALANCE TESTING ONLY ON EQUIPMENT THAT WILL CONTINUE TO BE USED TO SERVE RENOVATED AREAS AFTER THE CONSTRUCTION PHASE IS COMPLETED.
- TAB CONTRACTOR SHALL COMPIL AND SUBMIT FOUR COPIES OF THE FINAL PRE-DEMOLITION REPORT WITHIN 10 WORKING DAYS AFTER THE FIELD MEASUREMENTS ARE COMPLETED. FINAL TAB REPORT SHALL BE SUBMITTED FOR REVIEW TO THE ARCHITECT/ENGINEER. TESTING SHALL INCLUDE ALL ITEMS REQUIRED IN THE SPECIFICATIONS.
- BALANCING CONTRACTOR SHALL PRE-BALANCE ALL EXISTING SYSTEMS TO REMAIN PER SPECIFICATION SECTION 23 05 93.

ELECTRICAL SYMBOL LIST

SYMBOL:	TAG:	SPEC SECTION:	DESCRIPTION:
	ECONN	26 05 33	ELECTRICAL CONNECTION

ELECTRICAL INSTALLATION NOTES:

- THE COMPLETE INSTALLATION SHALL BE IN ACCORDANCE WITH THE ADA STANDARDS FOR ACCESSIBLE DESIGN. REFER TO THE ADA GUIDELINES FOR ALL CONFIGURATION DETAILS ON THIS PAGE FOR ADDITIONAL INFORMATION.
- CONTRACTOR SHALL COORDINATE THE LOCATION OF ALL CEILING MOUNTED DEVICES AND EQUIPMENT WITH LUMINAIRES, SPRINKLER, AND CEILING DIFFUSERS. CENTER ALL DEVICES IN CEILING TILE PATTERN. SMOKE DETECTORS AND OCCUPANCY/VACANCY SENSORS SHALL BE LOCATED NO CLOSER THAN 3 FEET TO AN AIR SUPPLY DIFFUSER OR RETURN GRILLE.
- CONTRACTOR SHALL VERIFY ALL FURNITURE, MODULAR FURNITURE, AND EQUIPMENT LOCATIONS WITH ARCHITECTURAL PLANS, ELEVATIONS, AND REVIEWED SHOP DRAWINGS. PRIOR TO MAKING THE ACTUAL ELECTRICAL INSTALLATION, THIS CONTRACTOR SHALL ADJUST RECEPTACLES, OUTLETS, OR CONNECTION LOCATIONS TO ACCOMMODATE FURNITURE AND/OR EQUIPMENT.
- ELECTRICAL AND TECHNOLOGY EQUIPMENT SHALL BE MOUNTED TO AVOID IMPEDANCE OF OPERATION OF, AND/OR ACCESS TO ELECTRICAL AND MECHANICAL EQUIPMENT. ALL MOUNTING OF ELECTRICAL AND TELECOMMUNICATIONS EQUIPMENT, ON EQUIPMENT SUPPLIED BY ANOTHER CONTRACTOR, SHALL BE APPROVED IN ADVANCE BY THE OTHER CONTRACTOR.
- CONTRACTOR SHALL BE RESPONSIBLE FOR ALL OPENINGS REQUIRED IN WALLS. ALL OPENINGS SHALL BE REPAIRED TO MATCH EXISTING BY A QUALIFIED CONTRACTOR AT THE EXPENSE OF THIS CONTRACTOR. ALL CONDUITS THROUGH WALLS SHALL BE GROUTED OR SEALED INTO OPENINGS.
- ALL WELDING SHALL BE ACCORDING TO AMERICAN WELDING SOCIETY STANDARDS. CONTRACTOR SHALL FURNISH TO THE ARCHITECT/ENGINEER CERTIFICATES QUALIFYING EACH WELDER, PRIOR TO START OF WORK. THE ARCHITECT/ENGINEER RESERVES THE RIGHT TO REQUIRE QUALIFYING DEMONSTRATION, AT THE CONTRACTOR'S EXPENSE, OF ANY WELDERS ASSIGNED TO THE JOB.
- CONTRACTOR SHALL REMOVE AND REINSTALL ALL CEILING TILES AS REQUIRED FOR THE EXECUTION OF ELECTRICAL WORK. CONTRACTOR SHALL REPLACE CEILING TILES WITH IDENTICAL MATERIAL WHERE DAMAGED BY THIS CONTRACTOR.
- REFER TO ARCHITECTURAL REFLECTED CEILING PLAN, ELECTRICAL, TECHNOLOGY AUDIOVISUAL, AND OTHER ELECTRICAL PLANS FOR EXACT LOCATIONS OF ALL CEILING MOUNTED DEVICES, OTHER THAN SPRINKLERS.

ELECTRICAL GENERAL NOTES:

- ### INDICATES ELECTRICAL EQUIPMENT DEFINED IN ELECTRICAL SCHEDULES OR SPECIFICATION. REFER TO DRAWINGS CONTAINING ELECTRICAL SCHEDULES. PERMANENT NAMEPLATE SHALL MATCH FINAL EQUIPMENT NOMENCLATURE, NOT ELECTRICAL EQUIPMENT TAG NAME. REFER TO SPECIFICATIONS.

ELECTRICAL RENOVATION NOTES:

THESE NOTES APPLY TO ALL ELECTRICAL SHEETS AND TRADES, INCLUDING BUT NOT LIMITED TO, LIGHTING, POWER, AND SYSTEMS.

- EXISTING CONDITIONS ARE SHOWN BASED ON INFORMATION OBTAINED FROM FIELD SURVEYS, EXISTING BUILDING DOCUMENTS, AND STAFF. VERIFY EXISTING CONDITIONS AND REPORT ANY CONFLICTS BEFORE PROCEEDING.
- NOT ALL EXISTING EQUIPMENT, LUMINAIRES, AND CONDUIT ARE SHOWN. VERIFY EXISTING CONDITIONS AND REPORT ANY CONFLICTS WITH NEW WORK BEFORE STARTING WORK.
- FIELD VERIFY THE AVAILABLE CLEARANCES FOR CABLE TRAY, BUSWAY AND CONDUITS BEFORE FABRICATION. RISES AND DROPS MAY BE NECESSARY BECAUSE OF EXISTING FIELD CONDITIONS.
- EACH CONTRACTOR SHALL FIELD VERIFY ACCESSIBILITY TO THE AREA OF HIS/HER WORK AND SHALL NOTIFY THE GENERAL CONTRACTOR PRIOR TO BIDDING IF OTHER UTILITIES ARE REQUIRED TO BE REMOVED OR RELOCATED TO ALLOW ACCESS TO HIS/HER AREA OF WORK.
- THE GENERAL CONTRACTOR IS RESPONSIBLE FOR CUTTING, REMOVAL AND PATCHING OF ROOFS, WALLS, AND FLOORS ASSOCIATED WITH WORK BY ALL CONTRACTORS. CONTRACTORS SHALL NOTIFY THE GC OF AFFECTED AREAS PRIOR TO BIDDING.
- THE GENERAL CONTRACTOR IS RESPONSIBLE FOR REMOVAL AND REPLACEMENT OF CEILINGS, CEILING TILES, AND CEILING GRIDS ASSOCIATED WITH AREAS OF WORK BY ALL CONTRACTORS. NOTIFY THE GC OF AFFECTED AREAS PRIOR TO BIDDING.
- WHERE EXISTING ELECTRICAL SYSTEMS ARE LOCATED IN AREAS THAT CONFLICT WITH NEW EQUIPMENT, PIPING, OR DUCTWORK TO BE INSTALLED, EACH CONTRACTOR SHALL EITHER ARRANGE NEW EQUIPMENT, CONDUIT, OR DUCTWORK IN SUCH A FASHION THAT IT DOES NOT CONFLICT WITH EXISTING SYSTEMS, OR REWORK EXISTING ELECTRICAL SYSTEMS TO ALLOW FOR INSTALLATION OF NEW EQUIPMENT, PIPING, OR DUCTWORK.

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REPLACE ROOF SYSTEMS
MULTIPLE ASSETS
FARMINGTON
CORRECTIONAL CENTER

FARMINGTON, MISSOURI

PROJECT # C1922-01
SITE # 7008
ASSET # 9327008089,
9327008090, 9327008091, 9327008082
9327008081, 9327008080, 9327008079

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REVISION: _____
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DATE: _____
ISSUE DATE: APRIL 18, 2022


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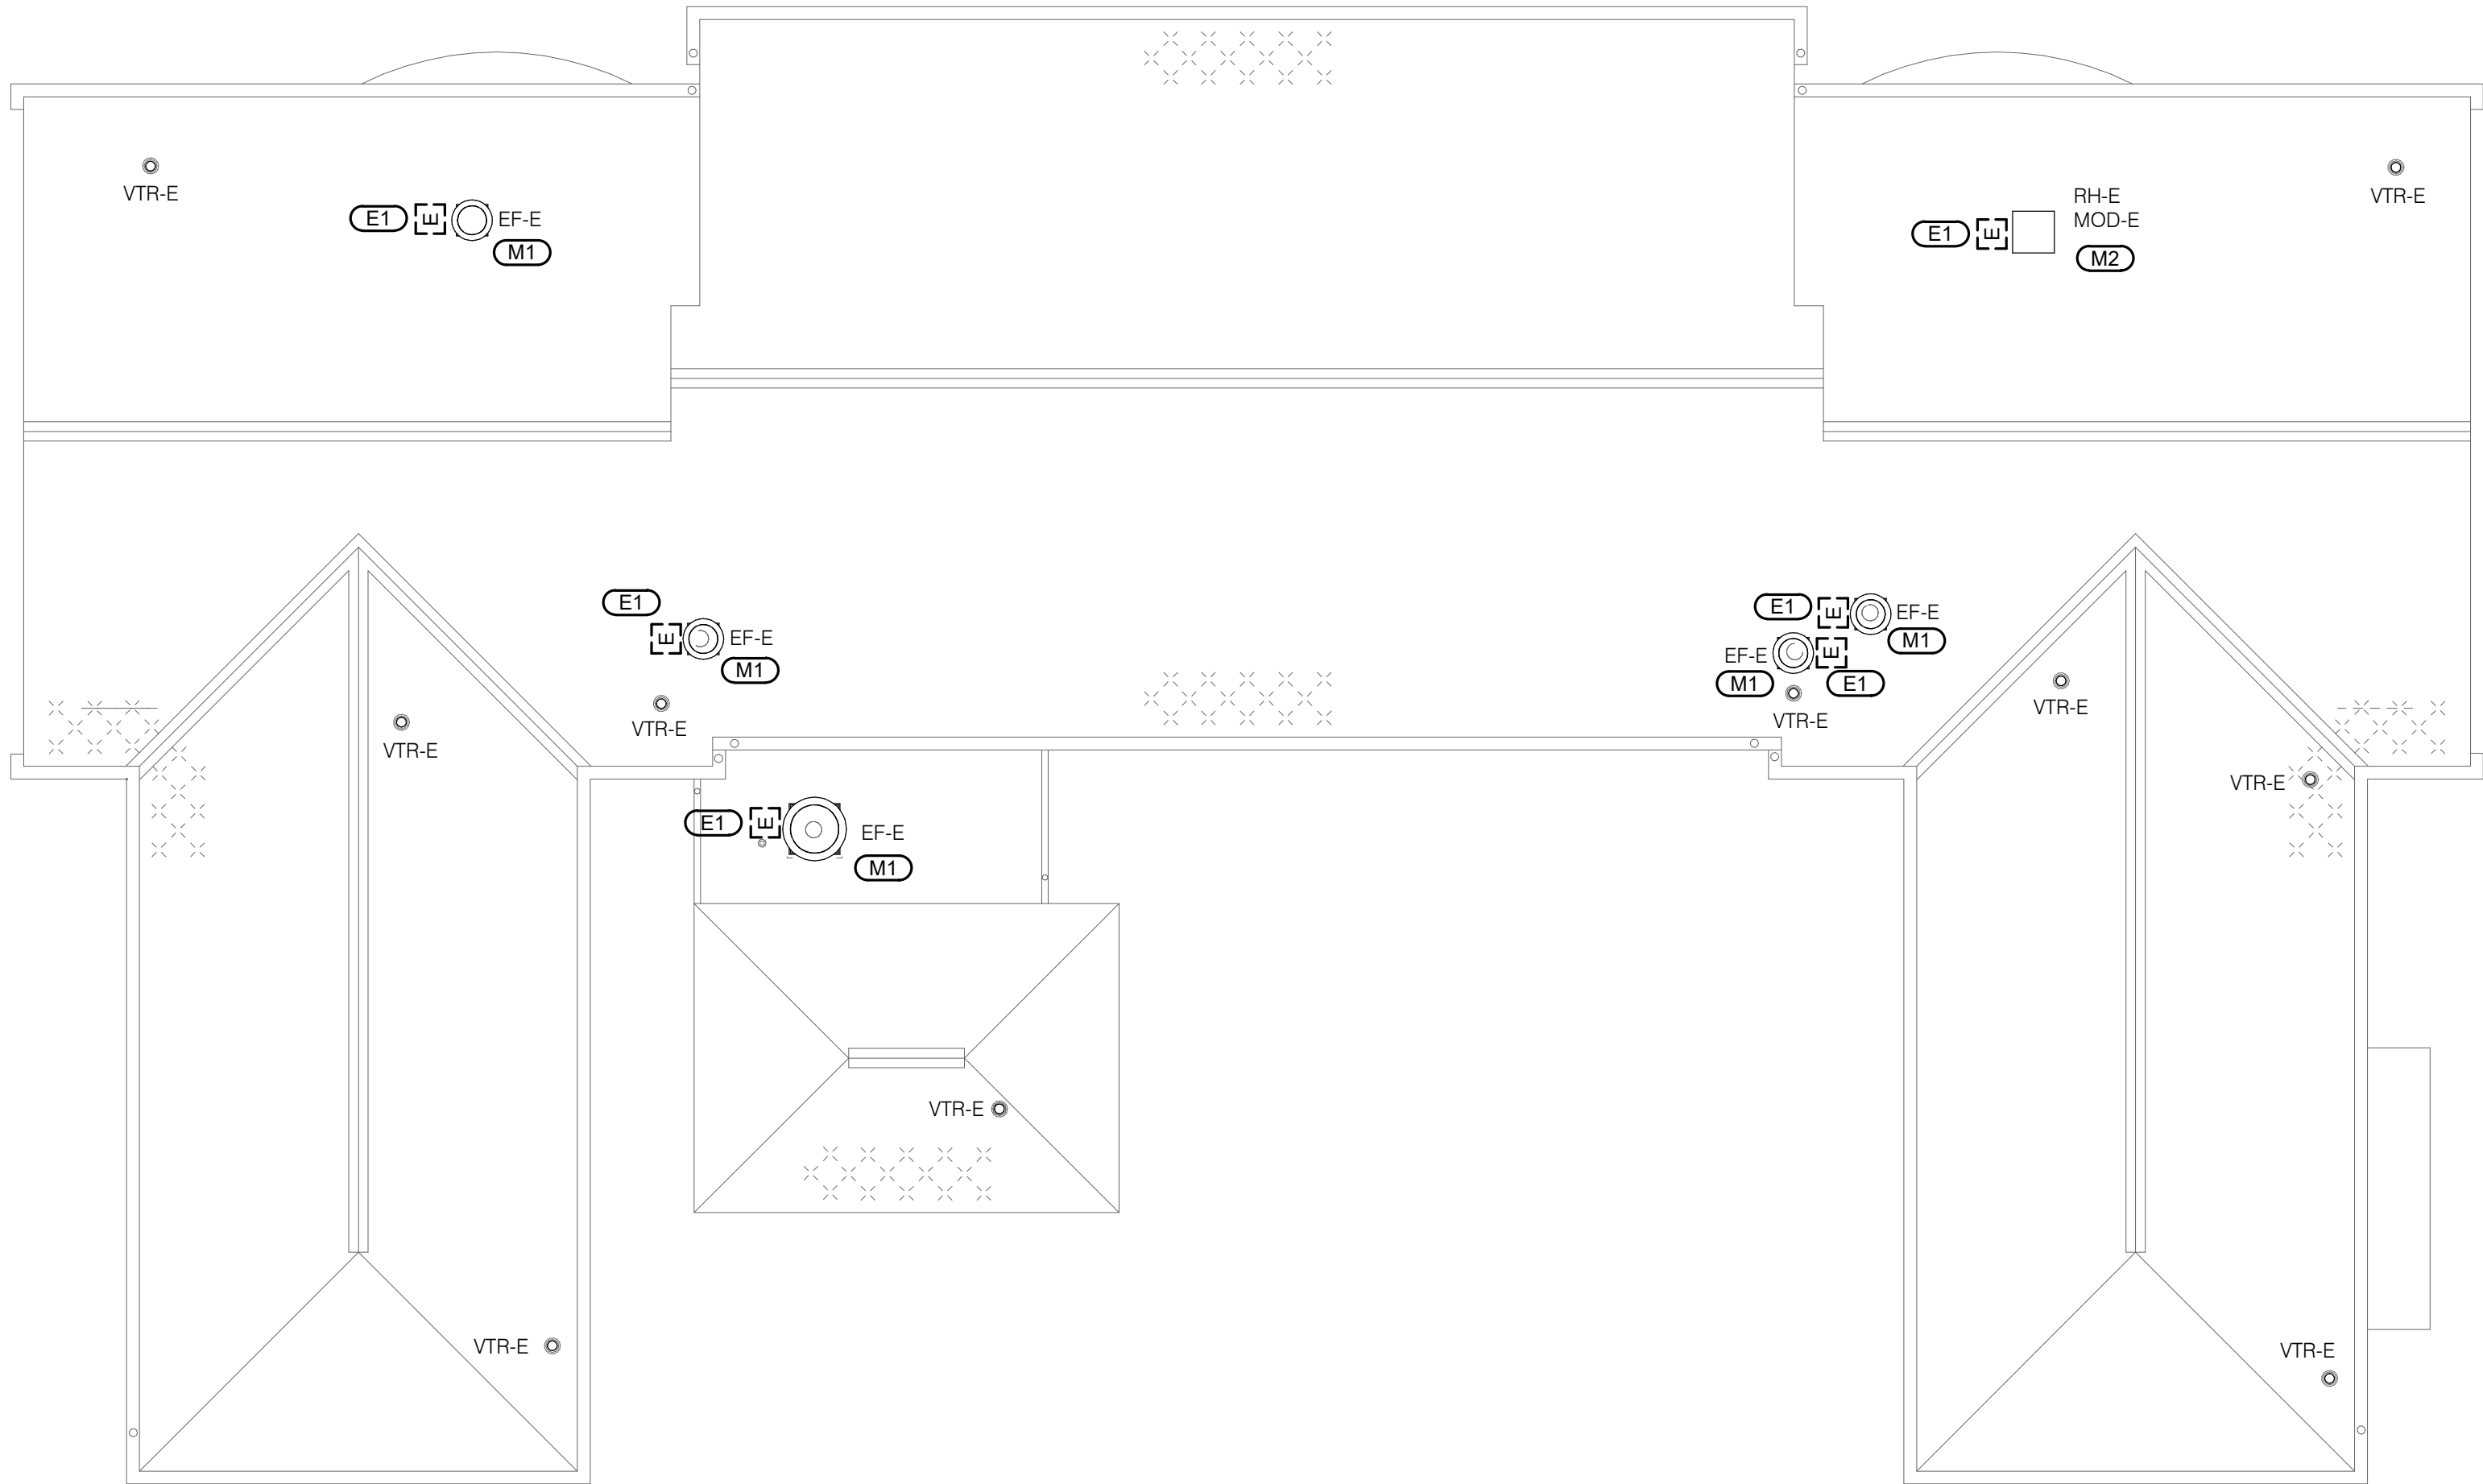
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MECHANICAL &
ELECTRICAL
COVERSHEET

SHEET NUMBER:

ME000

19 OF 29 SHEETS
04/18/2022




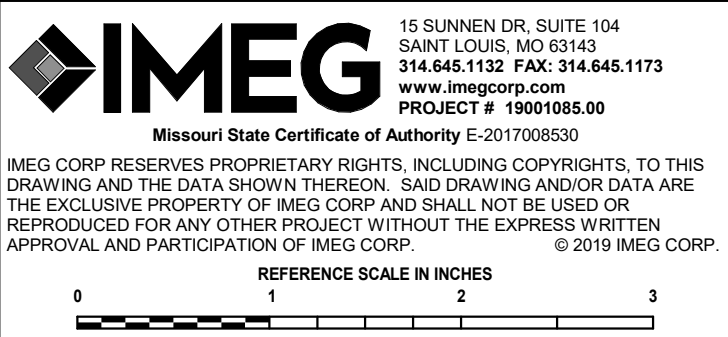

1

BLDG 16 ROOF PLAN - MECHANICAL & ELECTRICAL DEMOLITION

1/8" = 1'-0"

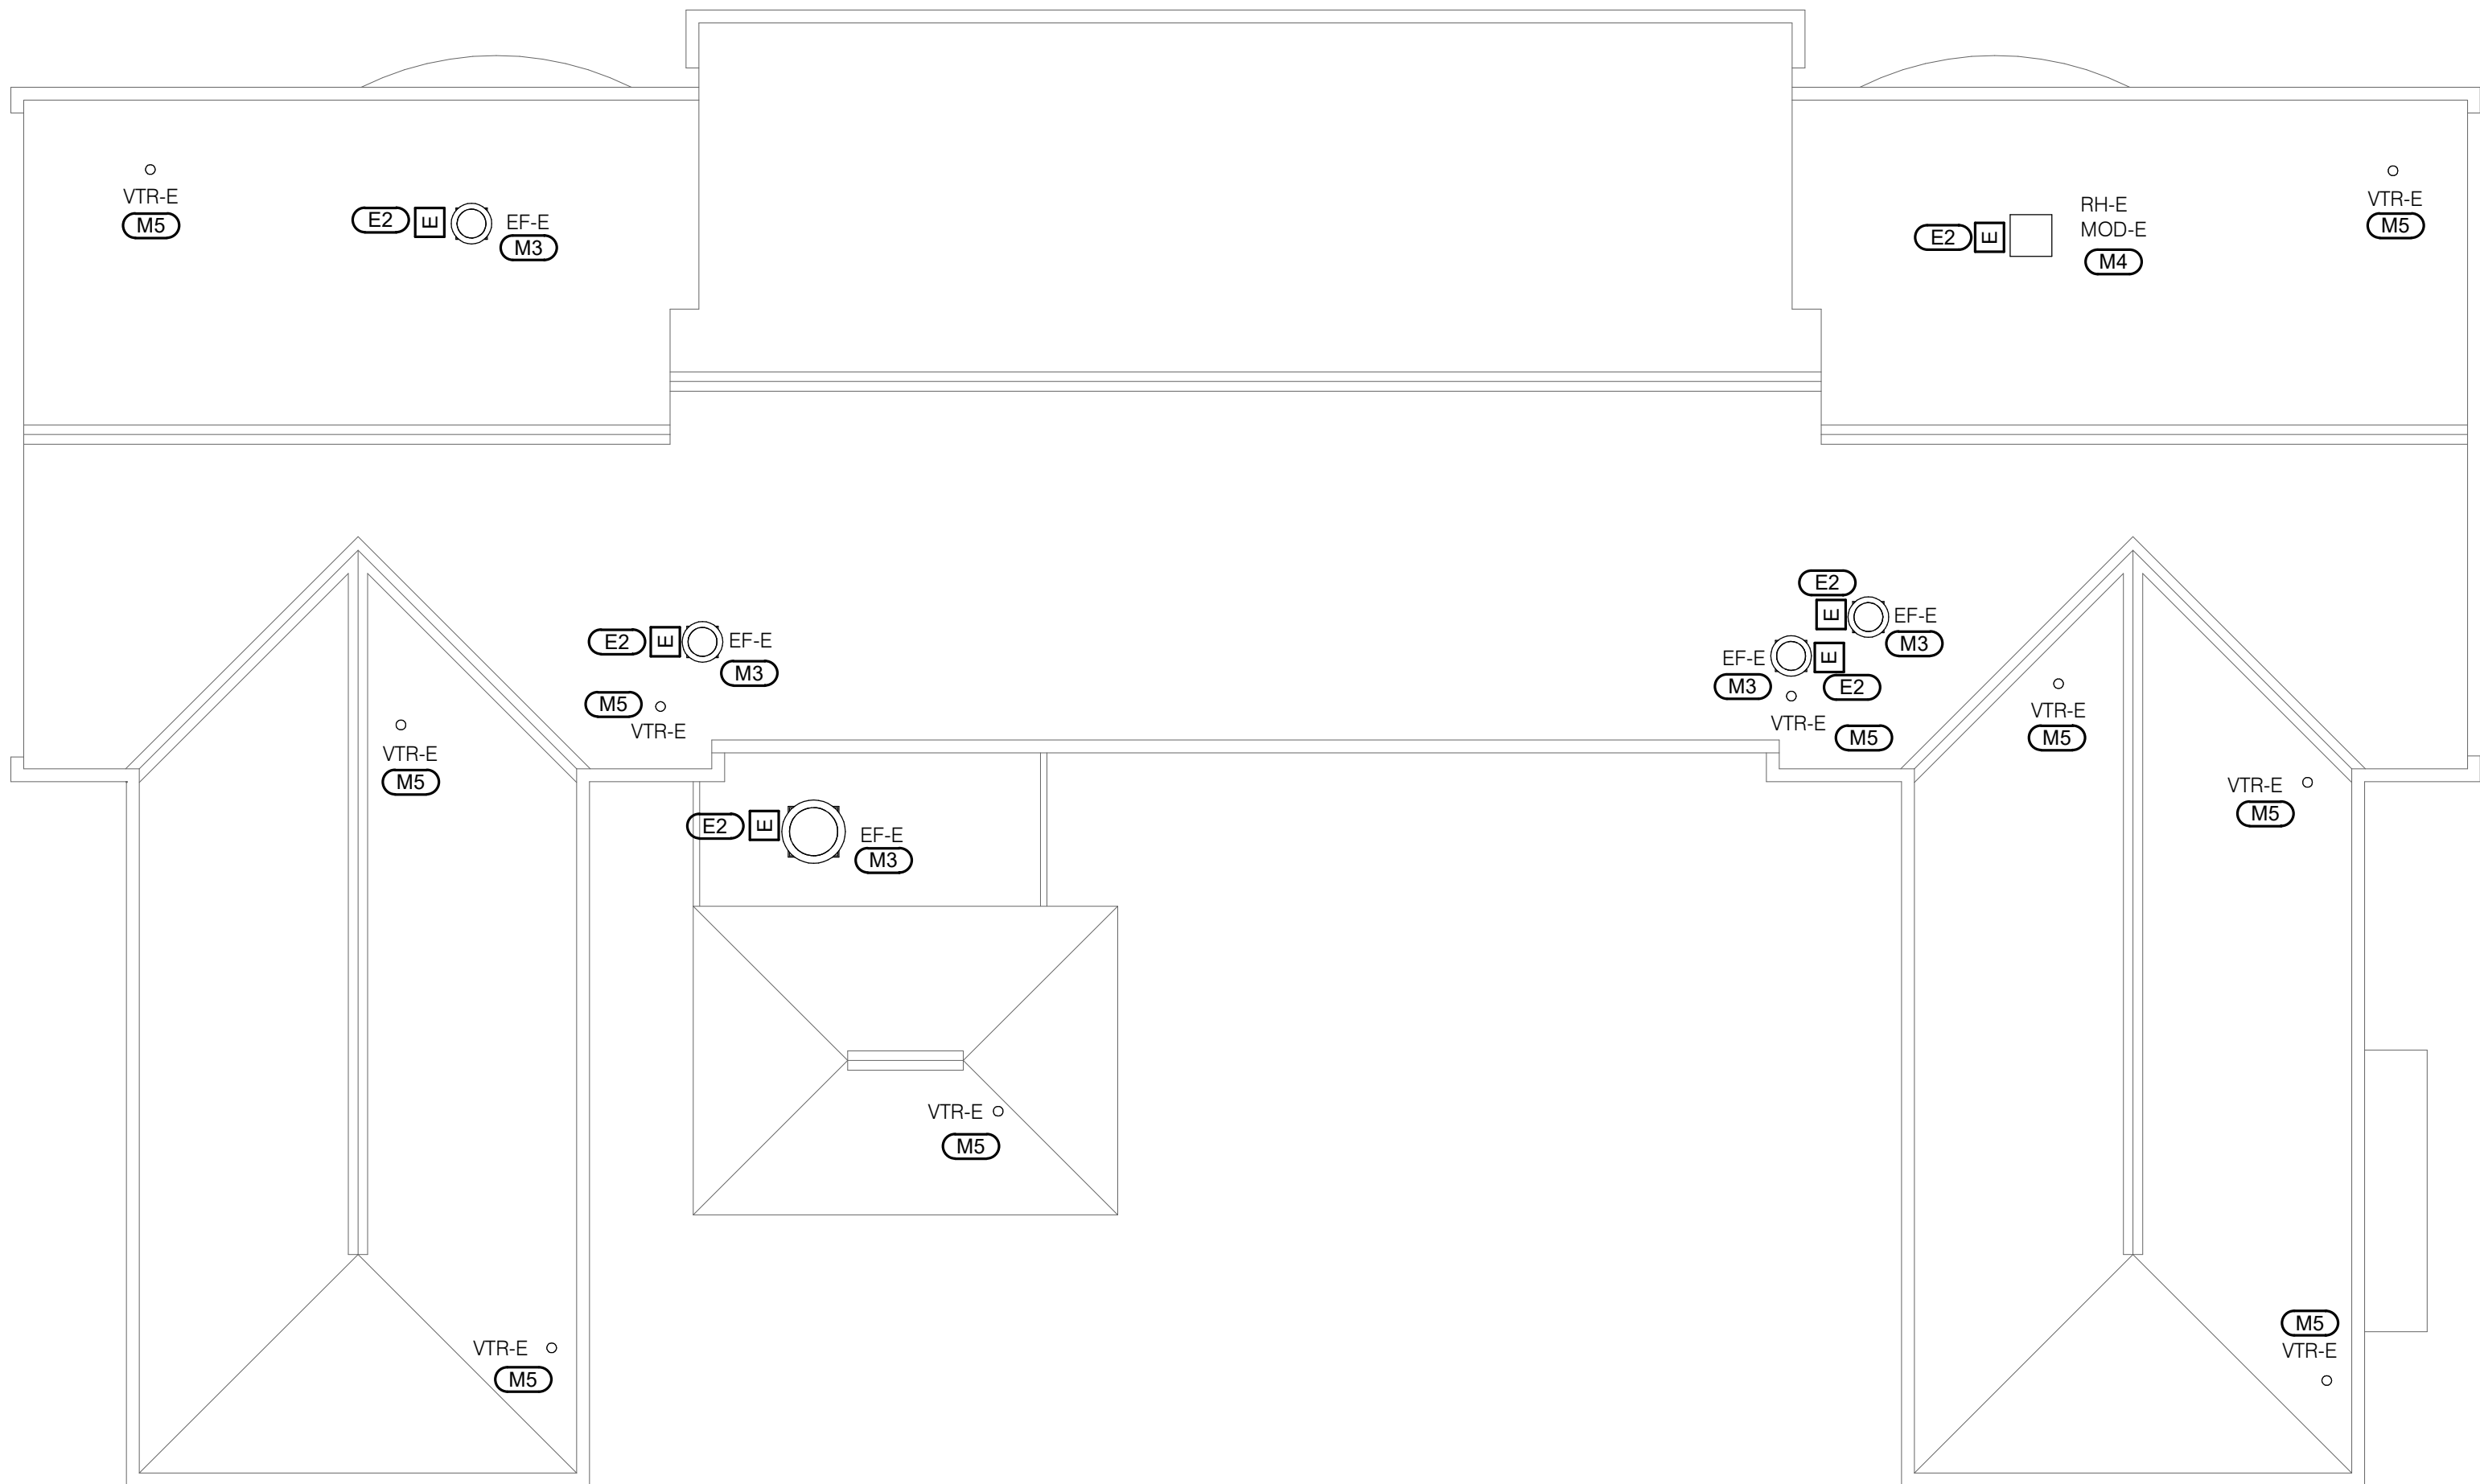

2

BLDG 16 ROOF PLAN - MECHANICAL & ELECTRICAL

1/8" = 1'-0"

GENERAL SHEET NOTES:


1. PERFORM A PRE-BALANCE OF ALL EQUIPMENT PRIOR TO DEMO. REFER TO SPECIFICATION SECTION 23 05 93 - TESTING, ADJUSTING, AND BALANCING FOR MORE INFORMATION.
2. PROVIDE OPERATIONAL TESTING ON ALL HVAC EQUIPMENT AFTER REINSTALLATION.
3. CONDITIONS SHOWN ARE BASED ON INFORMATION AVAILABLE FROM EXISTING DRAWINGS AND MEANS OF SITE INVESTIGATION. CONTRACTORS SHALL FIELD VERIFY ALL EXISTING CONDITIONS PRIOR TO BEGINNING WORK.
4. COORDINATE WITH ALL TRADES PRIOR TO PERFORMING ANY WORK.
5. NOTIFY OWNER OF ANY DAMAGED OR INOPERABLE EQUIPMENT PRIOR TO REMOVAL.

MECHANICAL KEYNOTES: (M#)

1. REMOVE EXISTING EXHAUST FAN AND STORE FOR PROPER FLASHING OF THE EXISTING EQUIPMENT CURB AND ROOF REPLACEMENT. PERFORM PREBALANCING ON FAN PRIOR TO REMOVAL. TEMPORARILY SEAL DUCT WHILE ROOF WORK IS OCCURING.
2. REMOVE EXISTING ROOF HOOD AND ASSOCIATED MOTOR OPERATED DAMPER AND STORE FOR ROOF REPLACEMENT.
3. REINSTALL EXISTING EXHAUST FAN ON EXISTING CURB. REBALANCE TO CFM MEASURED PRIOR TO REMOVAL. REFER TO 1/ME300 FOR ROOF MOUNTED EXHAUST FAN DETAIL.
4. REINSTALL EXISTING ROOF HOOD AND ASSOCIATED MOTOR OPERATED DAMPER.
5. PROVIDE NEW FLASHING AT EXISTING VENT PIPE FOR ROOF REPLACEMENT. REFER TO 3/ME300 FOR VENT PIPE FLASHING.

ELECTRICAL KEYNOTES: (E#)

1. PULL BACK CONDUCTORS AND CONDUIT TO ACCOMODATE ROOF REPLACEMENT. COORDINATE FINAL TERMINATION WITH MECHANICAL CONTRACTOR.
2. REFEED ELECTRICALLY POWERED MECHANICAL EQUIPMENT.




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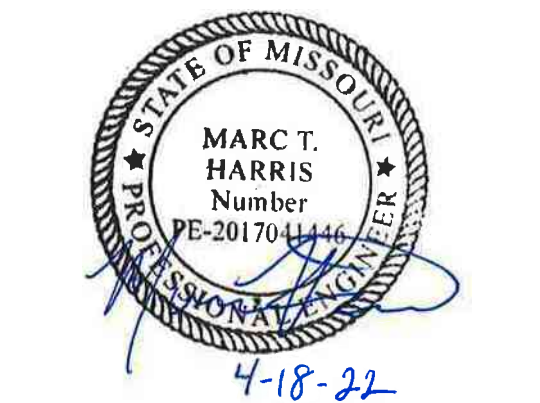
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REPLACE ROOF SYSTEMS
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FARMINGTON
CORRECTIONAL CENTER

FARMINGTON, MISSOURI

PROJECT # C1922-01
SITE # 7008
ASSET # 9327008089,
9327008090, 9327008091, 9327008082
9327008081, 9327008080, 9327008079

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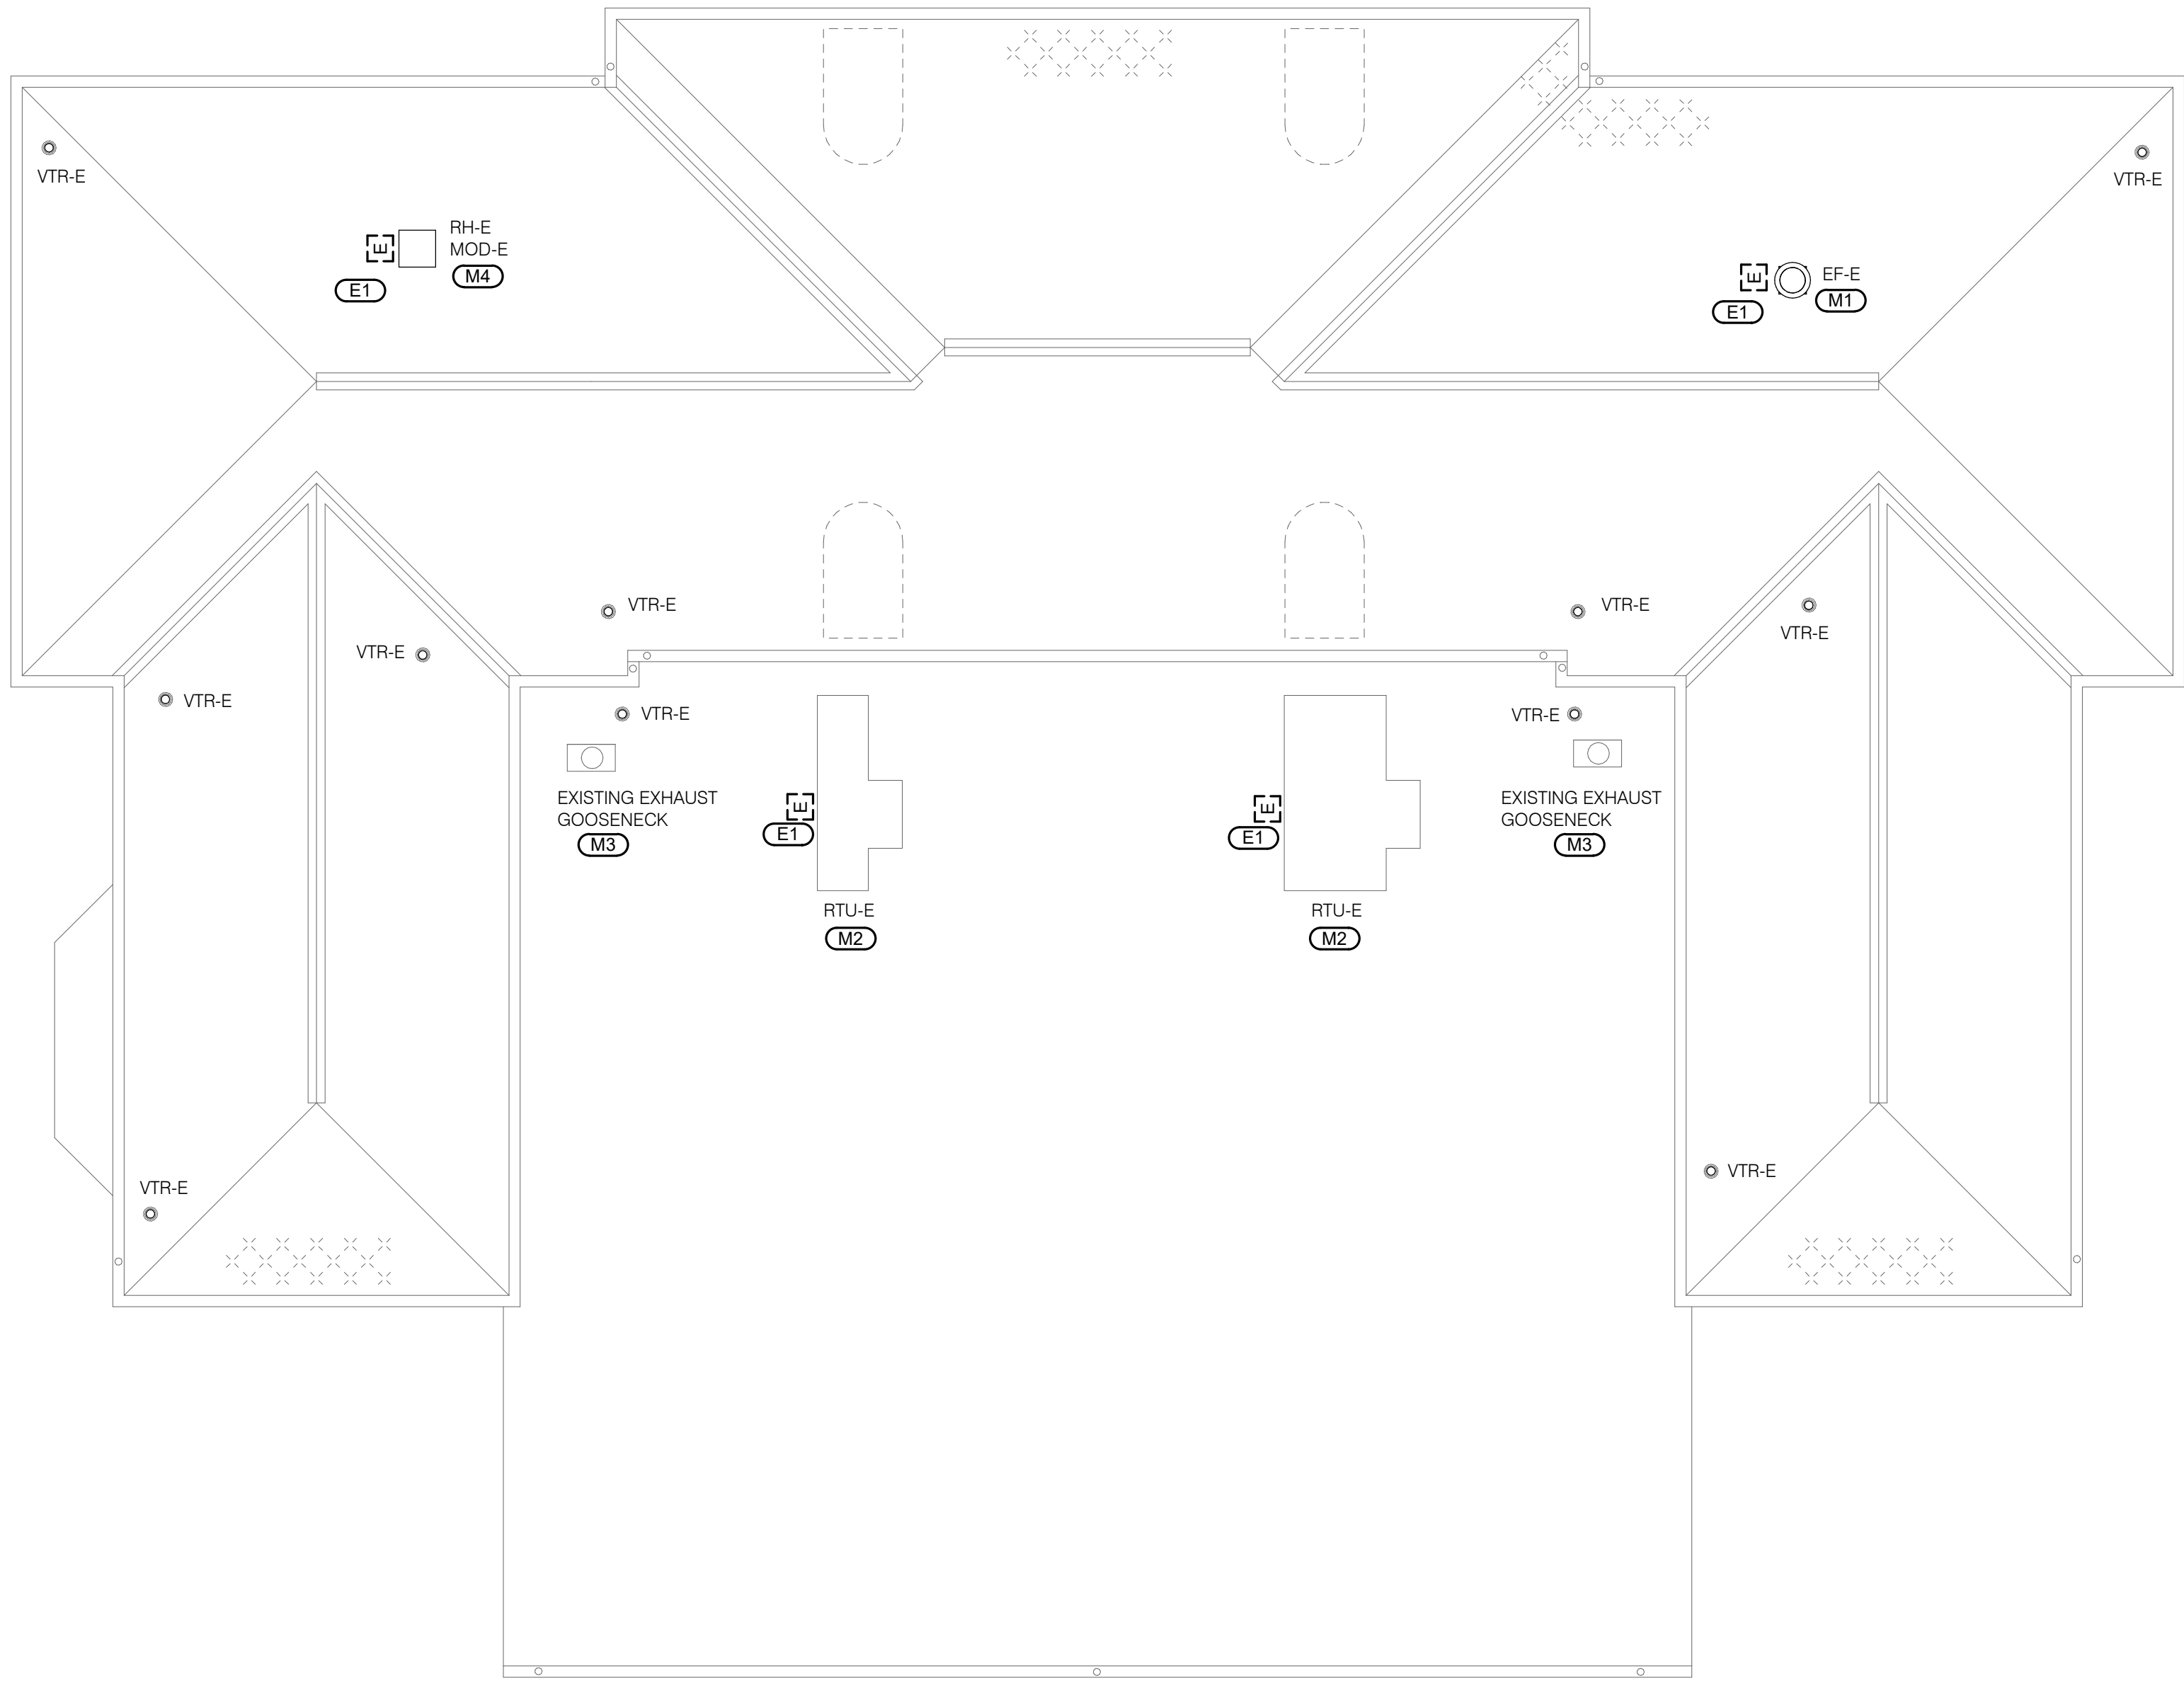
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DESIGNED BY: BRESAN/MASRYA

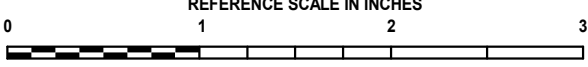SHEET TITLE:
BLDG 16 ROOF PLANS -
MECHANICAL &
ELECTRICAL

SHEET NUMBER:

ME200

20 OF 29 SHEETS
04/18/2022



1

BLDG 17 ROOF PLAN - MECHANICAL & ELECTRICAL DEMOLITION

1/8" = 1'-0"

GENERAL SHEET NOTES:

1. PERFORM A PRE-BALANCE OF ALL EQUIPMENT PRIOR TO DEMO. REFER TO SPECIFICATION SECTION 23 05 93 - TESTING, ADJUSTING, AND BALANCING FOR MORE INFORMATION.
2. CONDITIONS SHOWN ARE BASED ON INFORMATION AVAILABLE FROM EXISTING DRAWINGS AND MEANS OF SITE INVESTIGATION. CONTRACTORS SHALL FIELD VERIFY ALL EXISTING CONDITIONS PRIOR TO BEGINNING WORK.
3. COORDINATE WITH ALL TRADES PRIOR TO PERFORMING ANY WORK.
4. NOTIFY OWNER OF ANY DAMAGED OR INOPERABLE EQUIPMENT PRIOR TO REMOVAL.

MECHANICAL KEYNOTES: (M#)

1. REMOVE EXISTING EXHAUST FAN AND STORE FOR PROPER FLASHING OF THE EXISTING EQUIPMENT CURB AND ROOF REPLACEMENT. PERFORM PREBALANCING ON FAN PRIOR TO REMOVAL. TEMPORARILY SEAL DUCT WHILE ROOF WORK IS OCCURRING.
2. REMOVE EXISTING ROOFTOP UNIT AND STORE FOR PROPER FLASHING OF THE EXISTING EQUIPMENT CURB AND ROOF REPLACEMENT.
3. REMOVE EXISTING EXHAUST GOOSENECK BACK TO EXISTING ROOF LEVEL. CONTRACTOR SHALL CONFIRM SIZE OF GOOSENECK PRIOR TO REMOVAL.
4. REMOVE EXISTING ROOF HOOD AND ASSOCIATED MOTOR OPERATED DAMPER AND STORE FOR ROOF REPLACEMENT.

ELECTRICAL KEYNOTES: (E#)

1. PULL BACK CONDUCTORS AND CONDUIT TO ACCOMMODATE ROOF REPLACEMENT. COORDINATE FINAL TERMINATION WITH MECHANICAL CONTRACTOR.

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ISSUE DATE: APRIL 18, 2022


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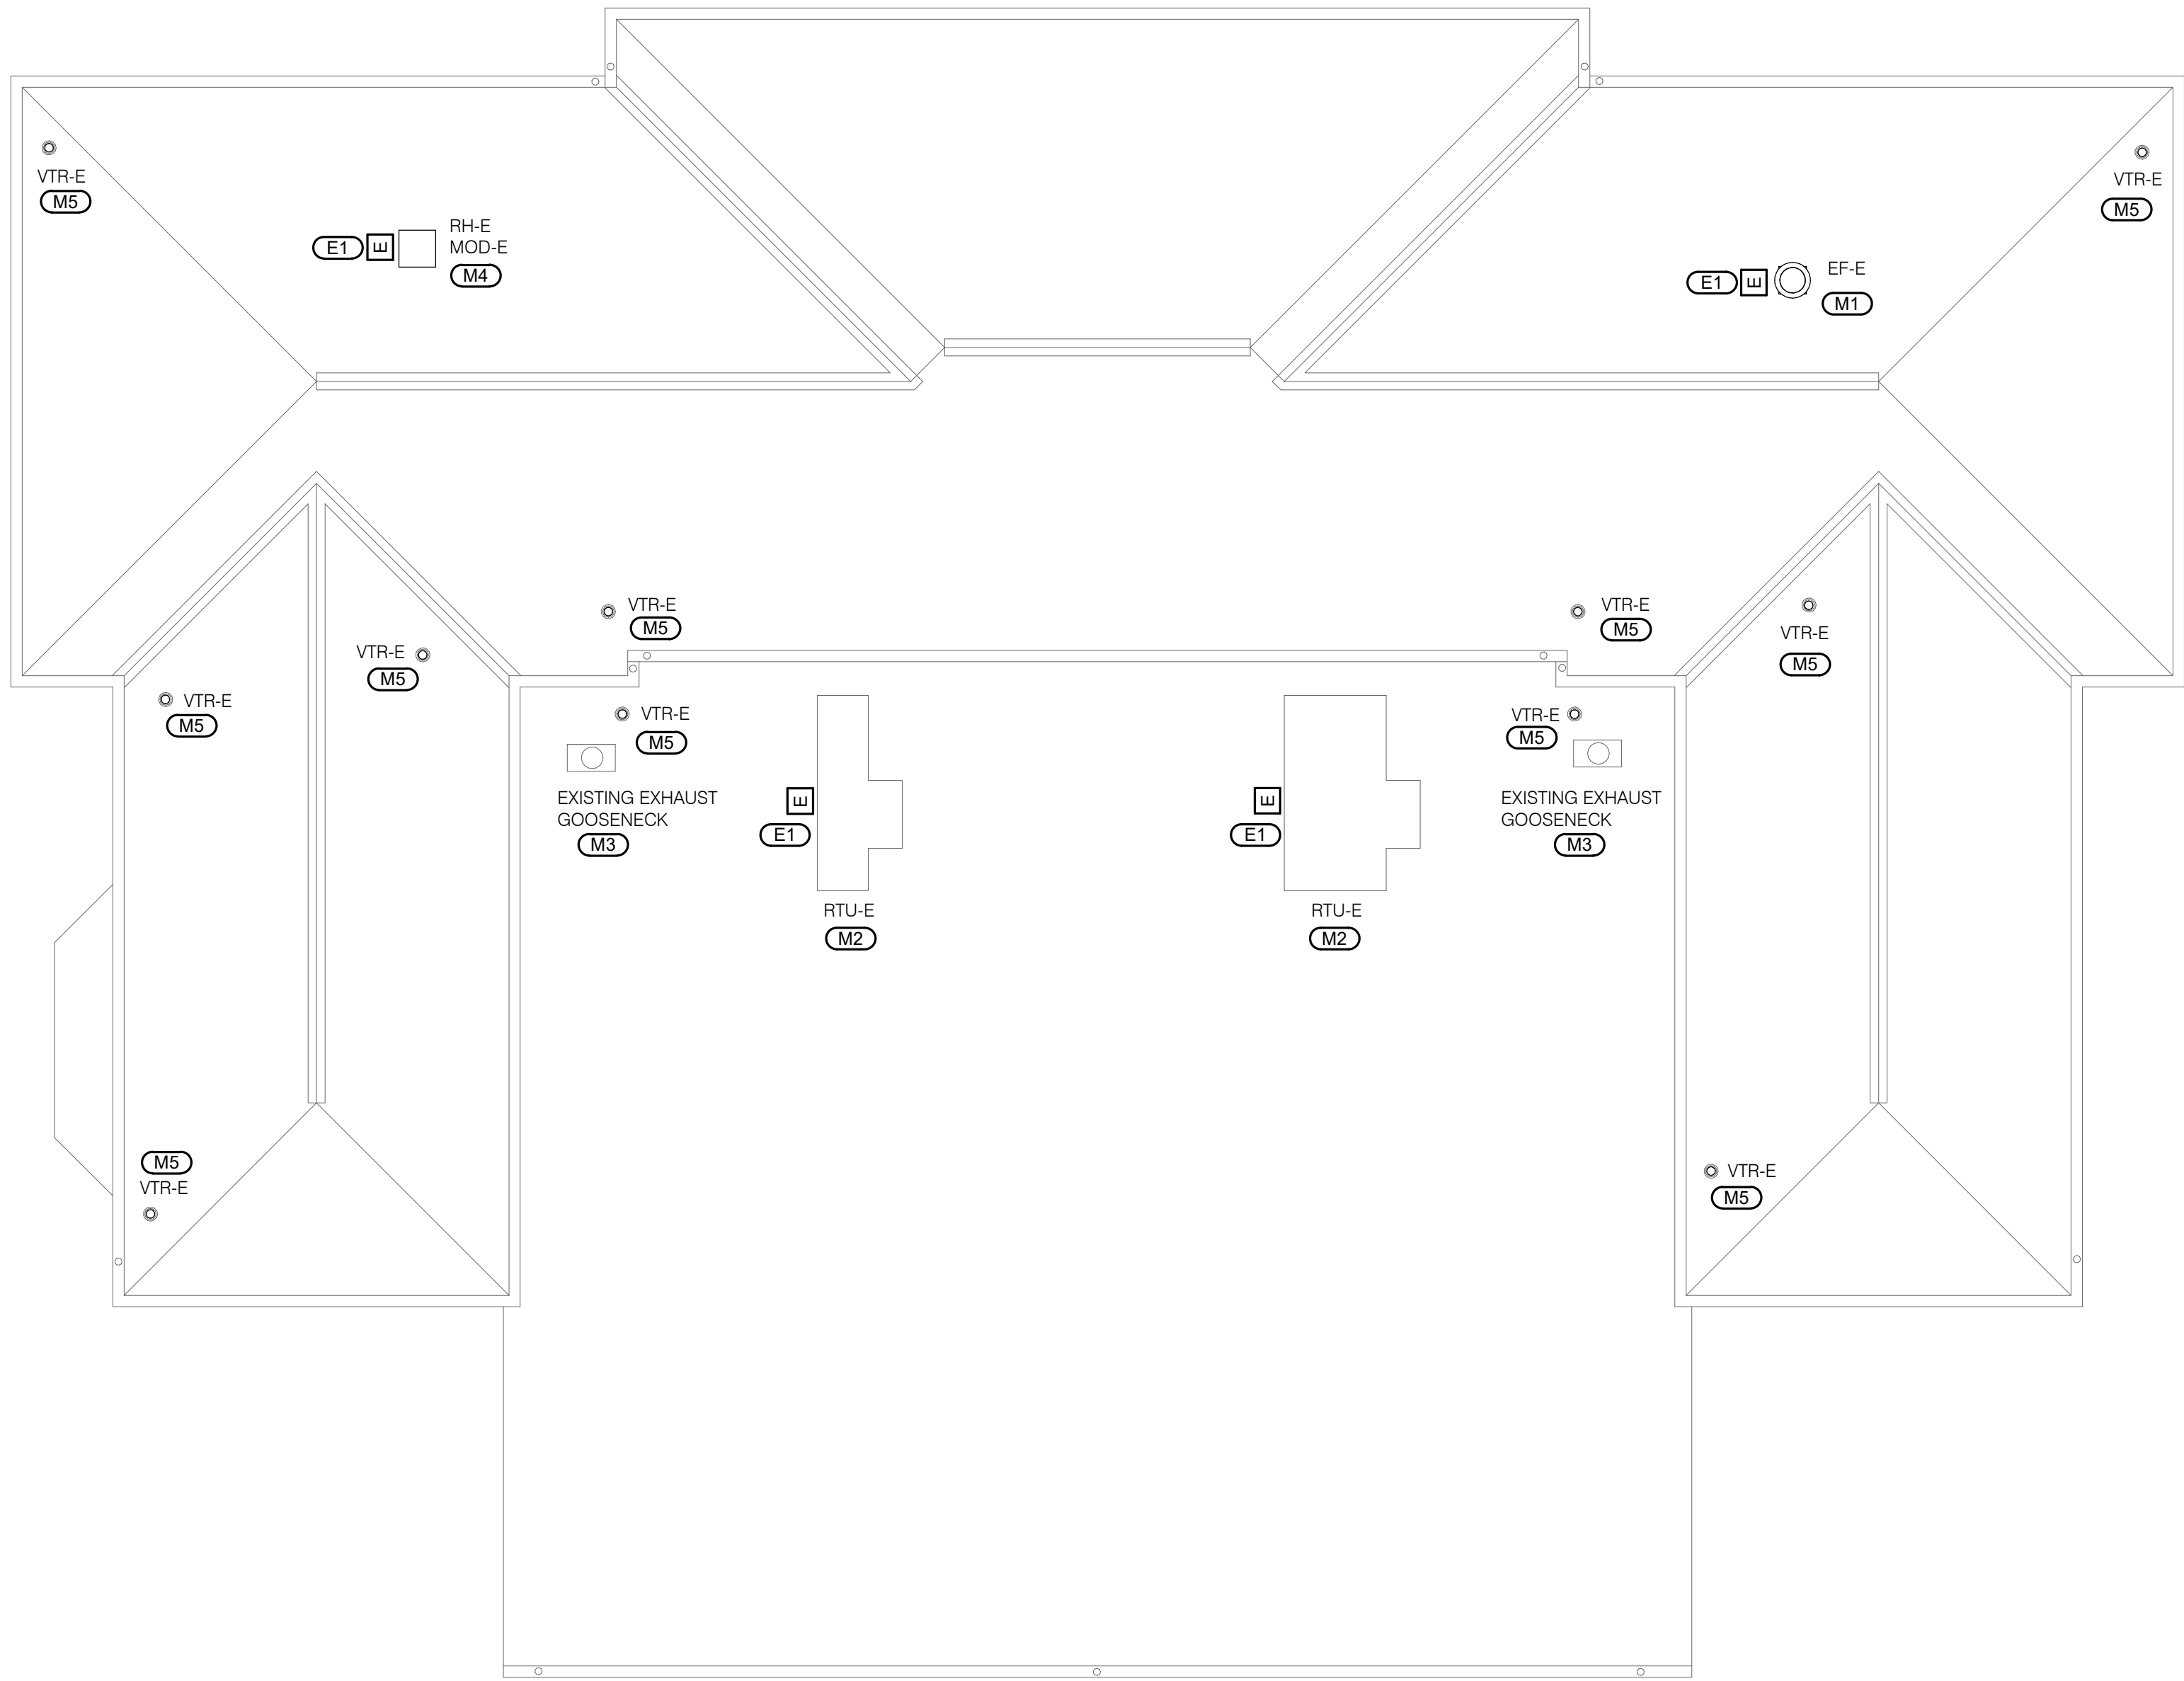
SHEET TITLE:
BLDG 17 ROOF PLAN -
MECHANICAL &
ELECTRICAL
DEMOLITION

SHEET NUMBER:

MED201

21 OF 29 SHEETS
04/18/2022



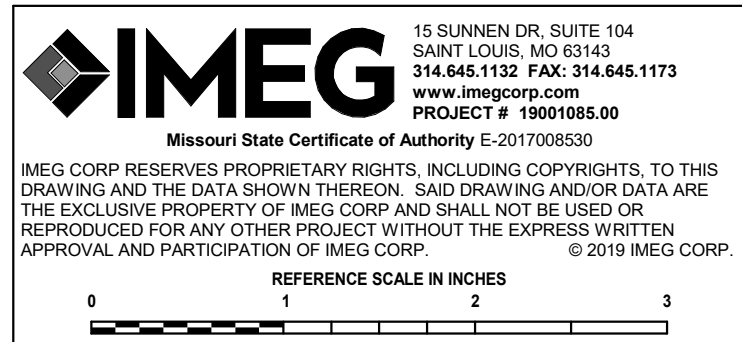

1

BLDG 17 ROOF PLAN - MECHANICAL & ELECTRICAL

1/8" = 1'-0"

GENERAL SHEET NOTES:

1. PROVIDE OPERATIONAL TESTING ON ALL HVAC EQUIPMENT AFTER REINSTALLATION.
2. CONDITIONS SHOWN ARE BASED ON INFORMATION AVAILABLE FROM EXISTING DRAWINGS AND MEANS OF SITE INVESTIGATION. CONTRACTORS SHALL FIELD VERIFY ALL EXISTING CONDITIONS PRIOR TO BEGINNING WORK.
3. COORDINATE WITH ALL TRADES PRIOR TO PERFORMING ANY WORK.

MECHANICAL KEYNOTES: (M#)

1. REINSTALL EXISTING EXHAUST FAN ON EXISTING CURB. REBALANCE TO CFM MEASURED PRIOR TO REMOVAL. REFER TO 1/ME300 FOR ROOF MOUNTED EXHAUST FAN DETAIL.
2. REINSTALL EXISTING ROOFTOP UNIT ON EXISTING CURB. REFER TO 4/ME300 FOR ROOFTOP UNIT DETAIL.
3. PROVIDE NEW DUCTWORK TO EXTEND GOOSENECK TO TERMINATE AT A MINIMUM OF 18" ABOVE THE NEW FINISHED ROOF LEVEL. CONTRACTOR SHALL MATCH EXISTING SIZE OF GOOSENECK FIELD-VERIFIED PRIOR TO REMOVAL. REFER TO 2/ME300 FOR GOOSENECK DETAIL.
4. REINSTALL EXISTING ROOF HOOD AND ASSOCIATED MOTOR OPERATED DAMPER.
5. PROVIDE NEW FLASHING AT EXISTING VENT PIPE FOR ROOF REPLACEMENT. REFER TO 3/ME300 FOR VENT PIPE FLASHING.

ELECTRICAL KEYNOTES: (E#)

1. REFEEED ELECTRICALLY POWERED MECHANICAL EQUIPMENT.

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1012 WEST COLUMBIA ST.
FARMINGTON, MO 63640

REPLACE ROOF SYSTEMS
MULTIPLE ASSETS
FARMINGTON
CORRECTIONAL CENTER

FARMINGTON, MISSOURI

PROJECT # C1922-01

SITE # 7008

ASSET # 9327008089,
9327008090, 9327008091, 9327008082
9327008081, 9327008080, 9327008079

REVISION: _____

DATE: _____

REVISION: _____

DATE: _____

REVISION: _____

DATE: _____

ISSUE DATE: APRIL 18, 2022

CAD DWG FILE: ME201
DRAWN BY: BRESAN/MASRYA
CHECKED BY: RUSARN/MARHAR
DESIGNED BY: BRESAN/MASRYA


SHEET TITLE:
BLDG 17 ROOF PLANS -
MECHANICAL &
ELECTRICAL


SHEET NUMBER:

ME201

22 OF 29 SHEETS

04/18/2022

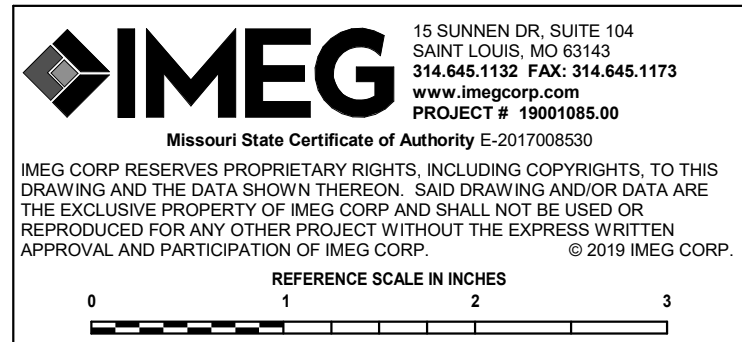


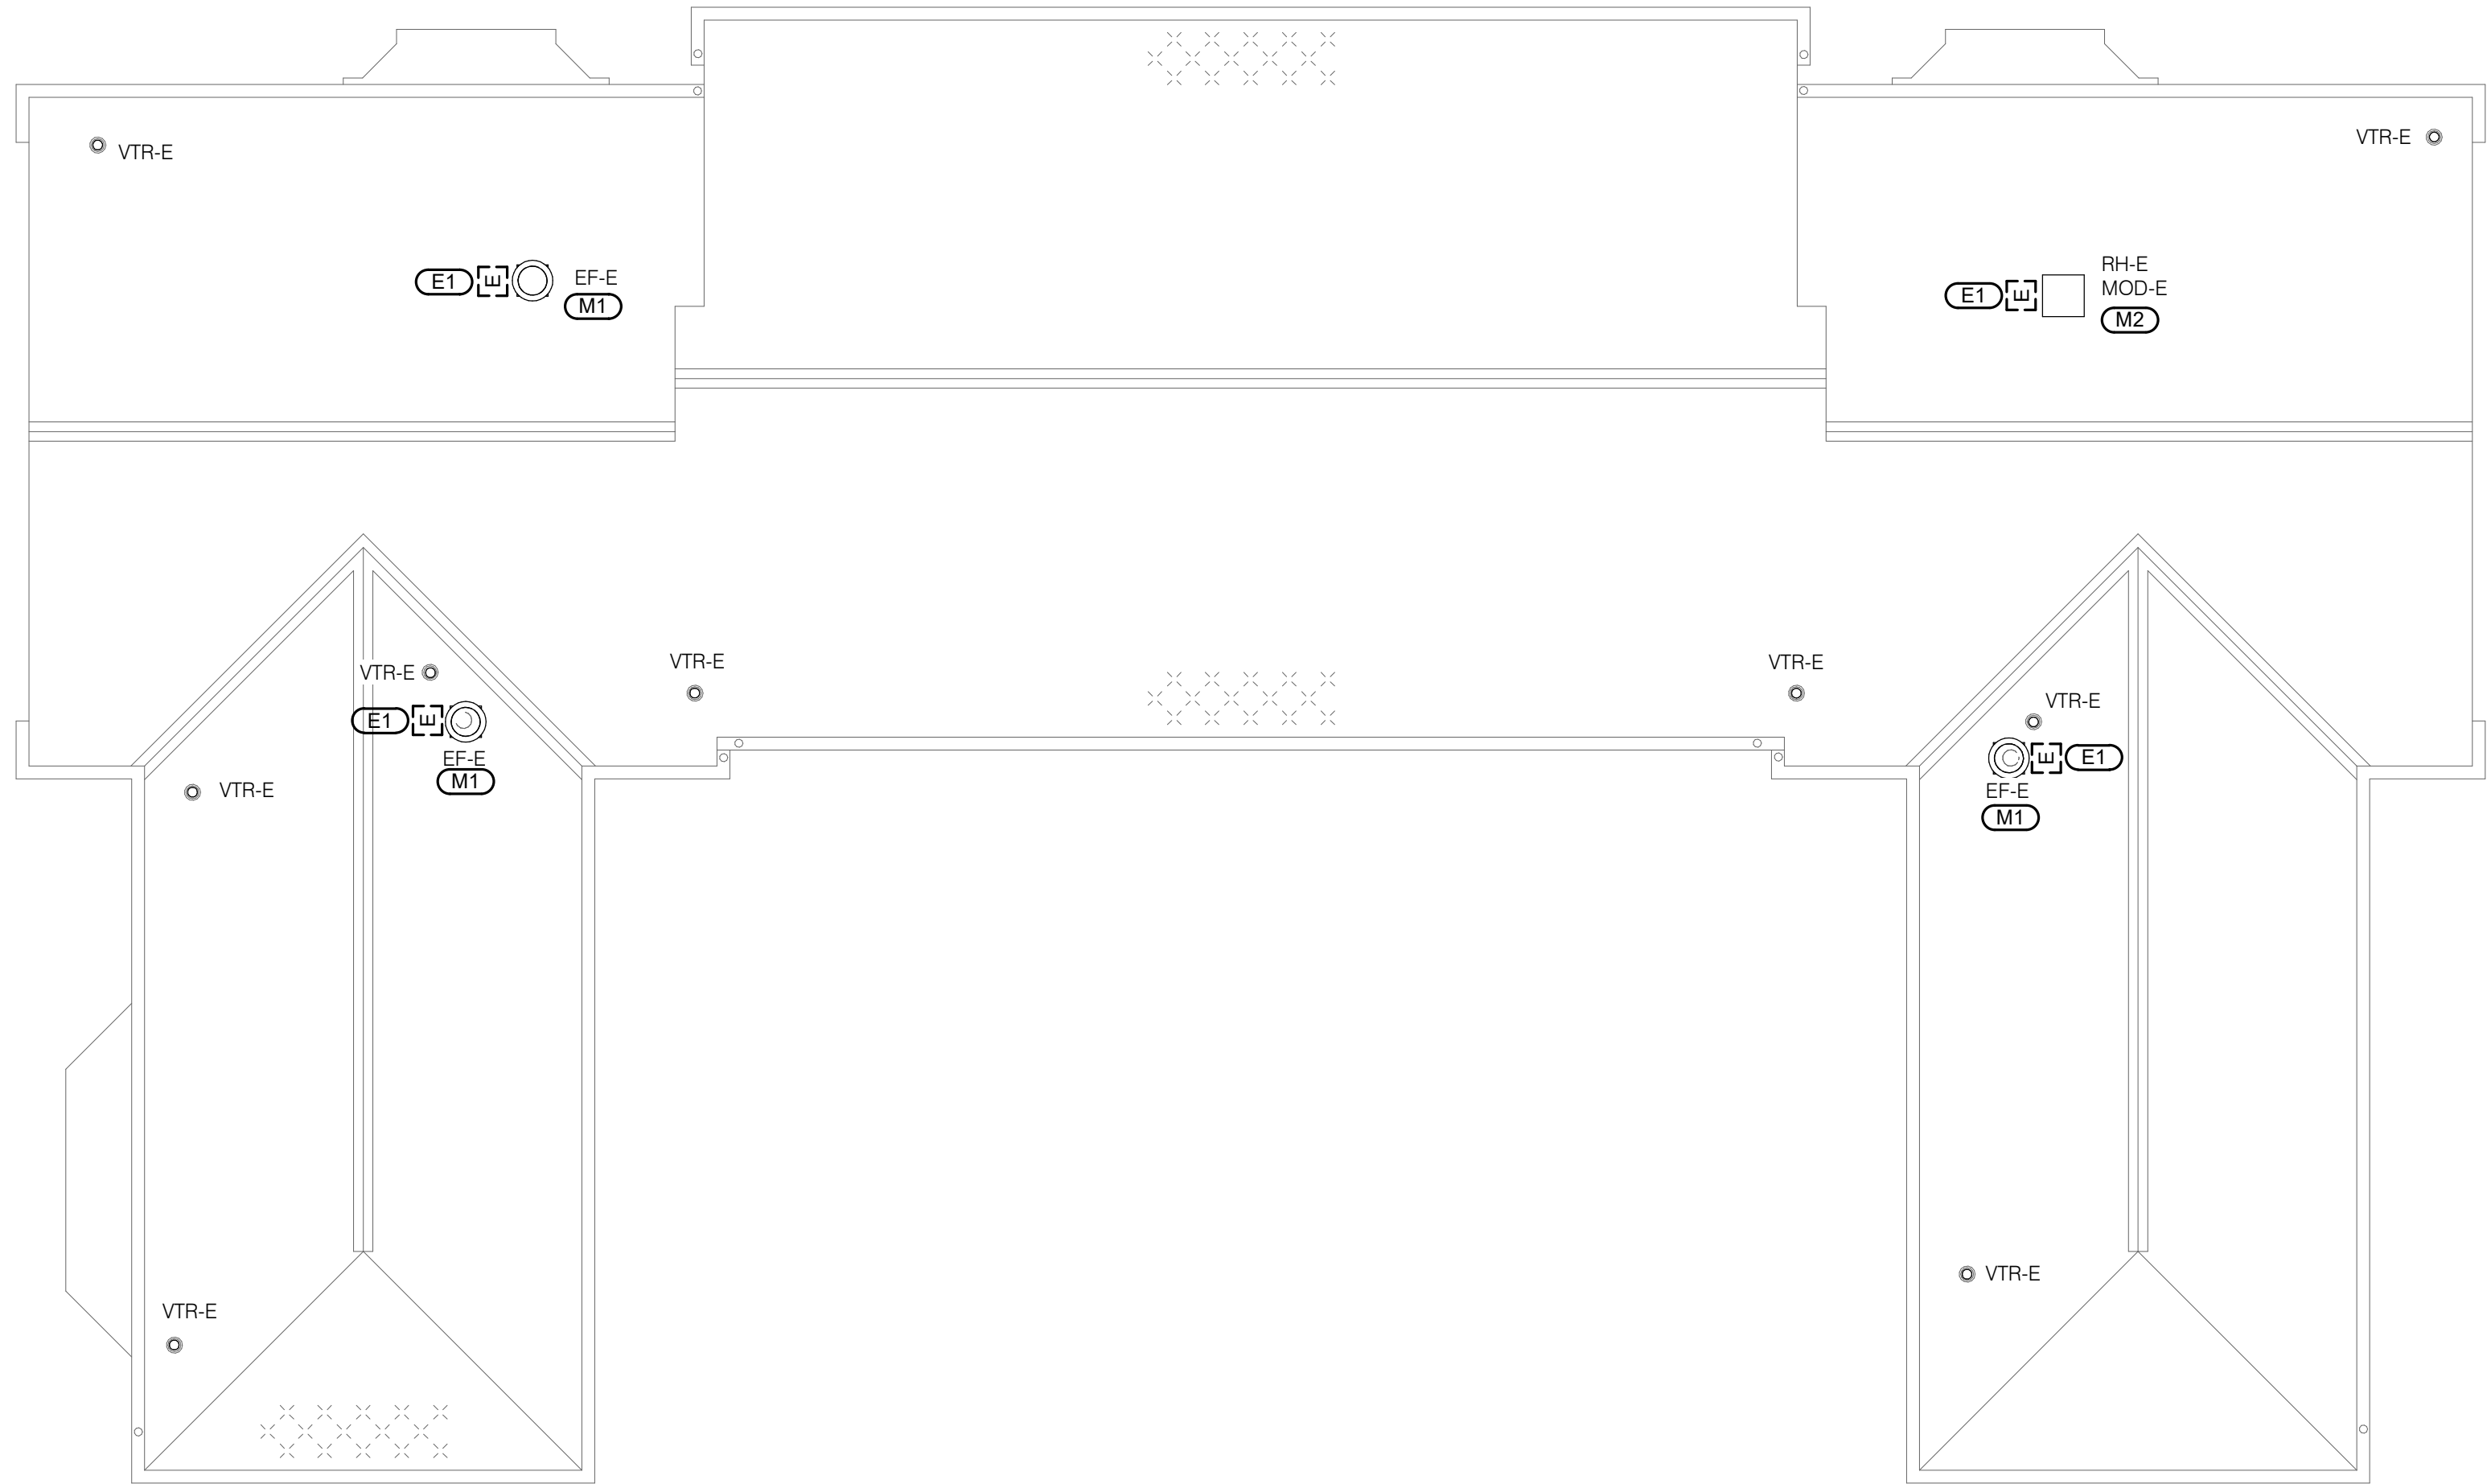

1

1/8" = 1'-0"

BLDG 18 ROOF PLAN - MECHANICAL & ELECTRICAL DEMOLITION

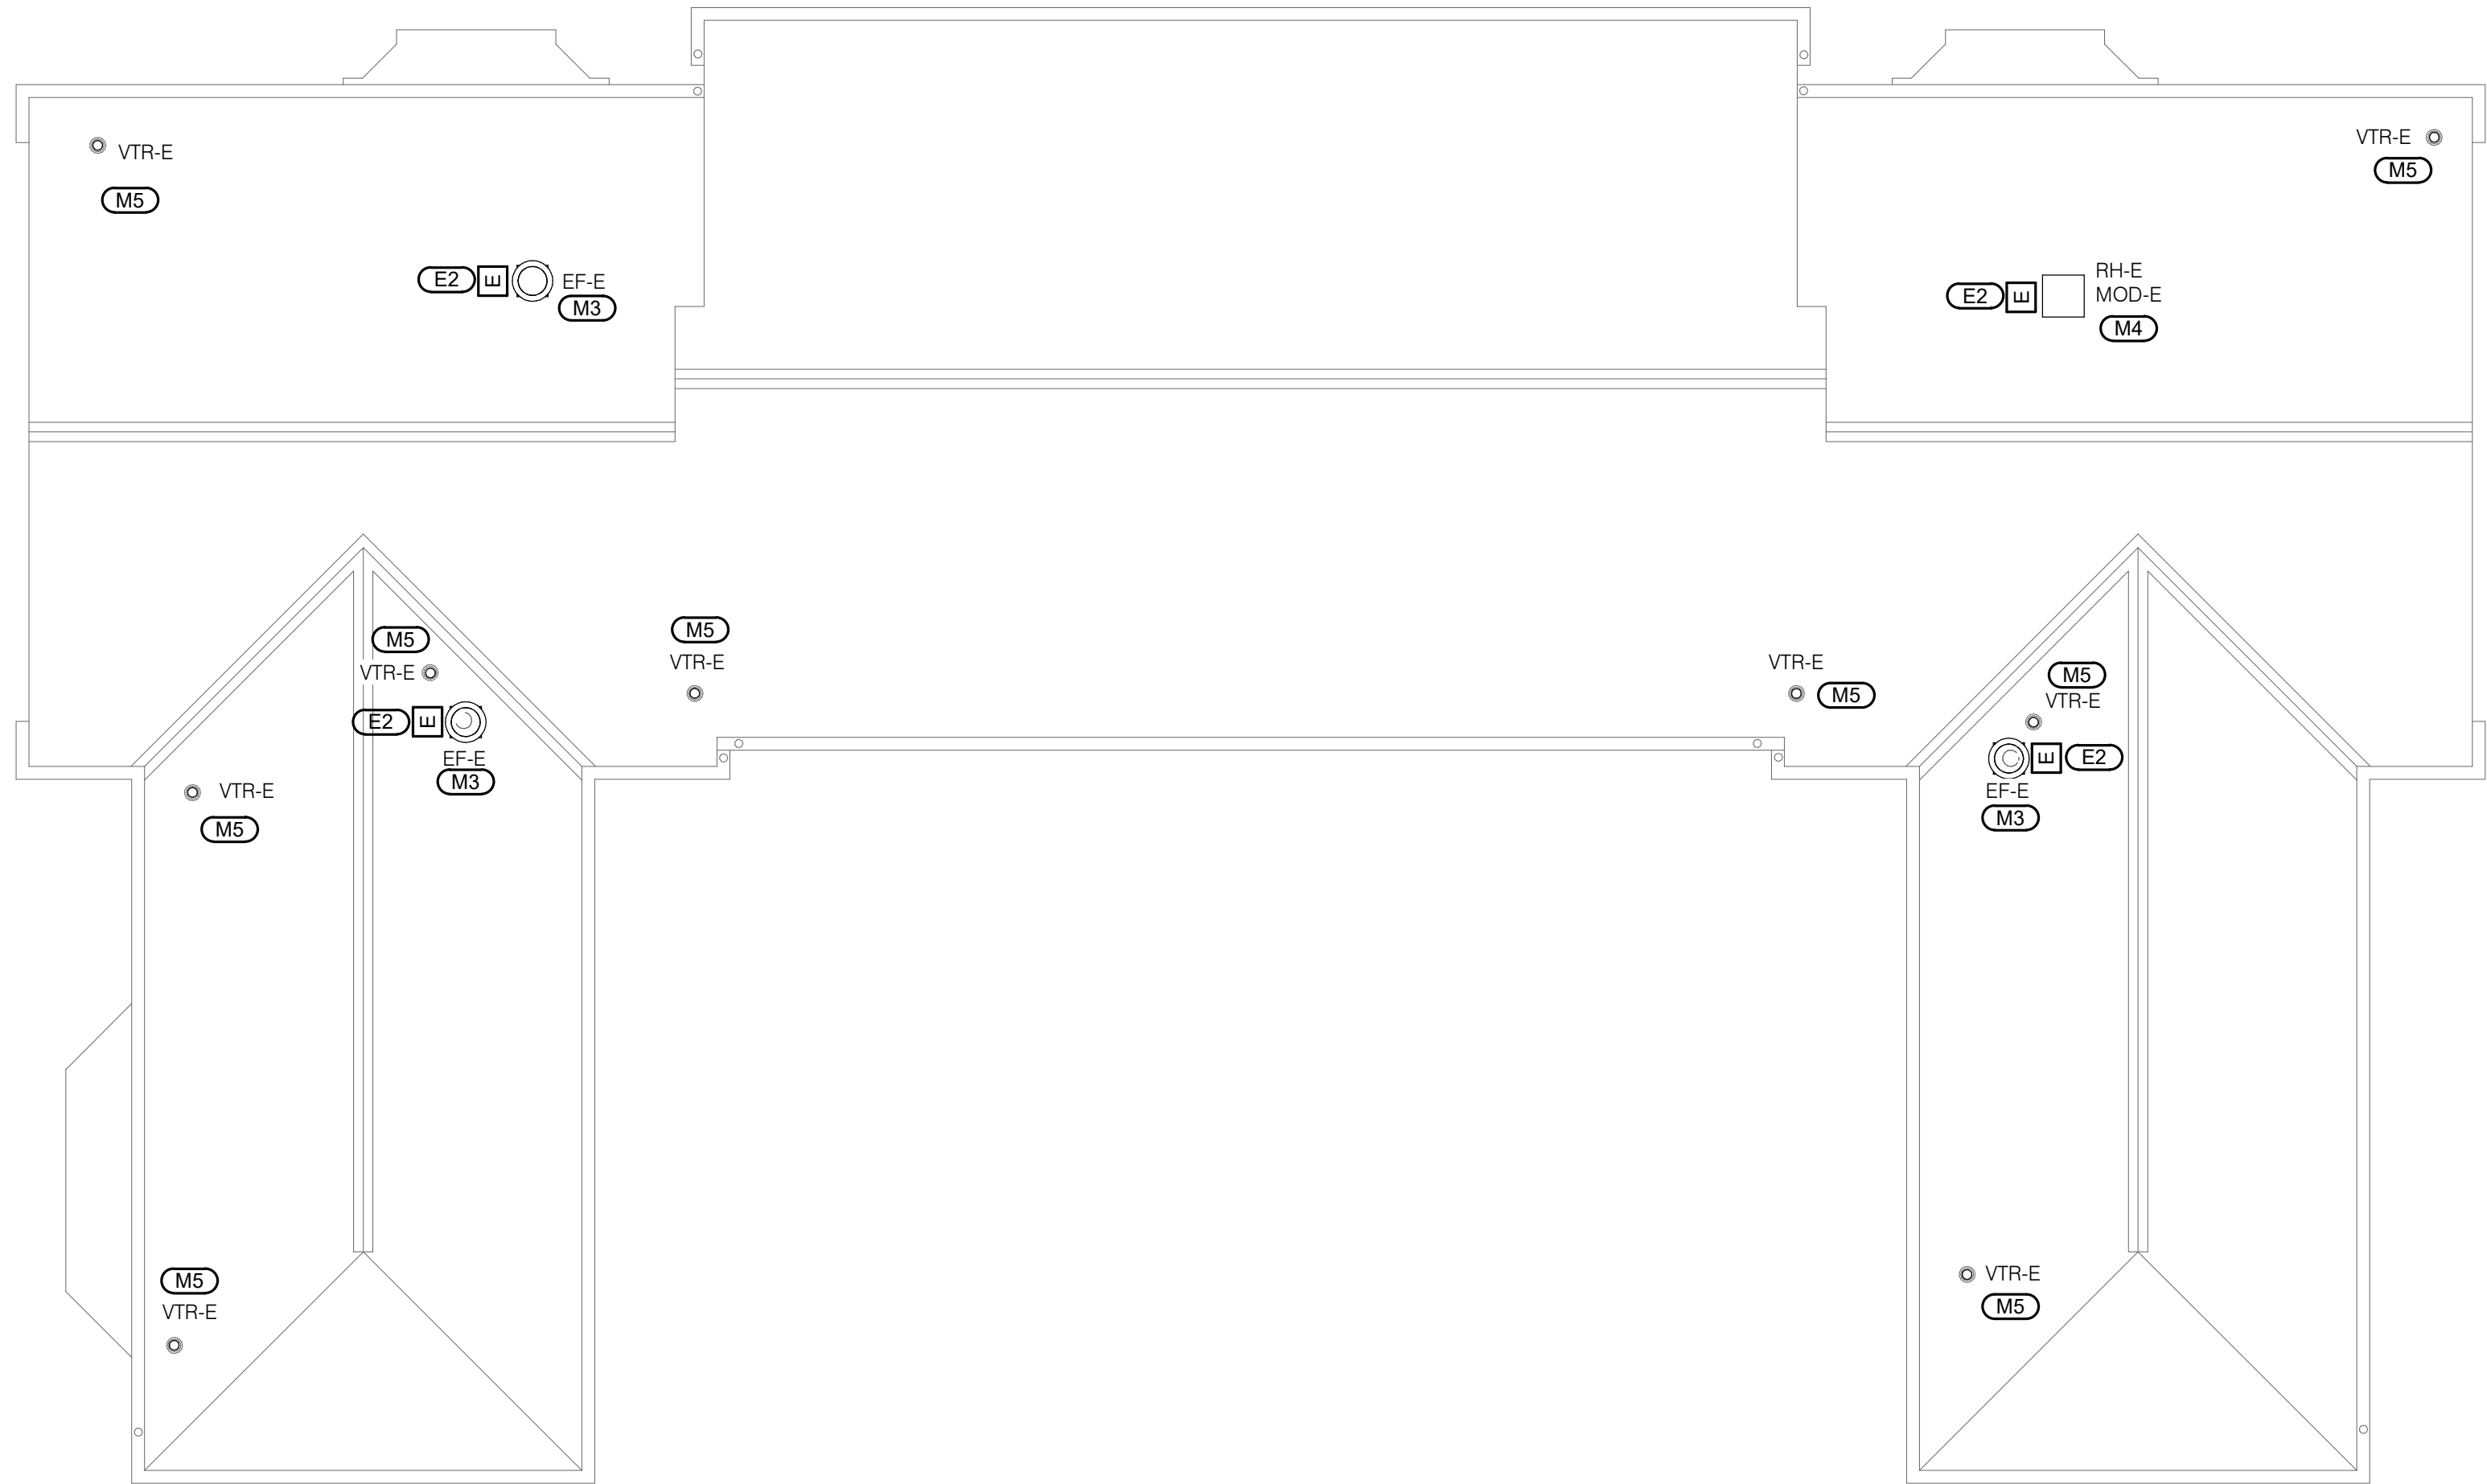

2

1/8" = 1'-0"

BLDG 18 ROOF PLAN - MECHANICAL & ELECTRICAL

- GENERAL SHEET NOTES:**
1. PERFORM A PRE-BALANCE OF ALL EQUIPMENT PRIOR TO DEMO. REFER TO SPECIFICATION SECTION 23 05 93 - TESTING, ADJUSTING, AND BALANCING FOR MORE INFORMATION.
 2. PROVIDE OPERATIONAL TESTING ON ALL HVAC EQUIPMENT AFTER REINSTALLATION.
 3. CONDITIONS SHOWN ARE BASED ON INFORMATION AVAILABLE FROM EXISTING DRAWINGS AND MEANS OF SITE INVESTIGATION. CONTRACTORS SHALL FIELD VERIFY ALL EXISTING CONDITIONS PRIOR TO BEGINNING WORK.
 4. COORDINATE WITH ALL TRADES PRIOR TO PERFORMING ANY WORK.
 5. NOTIFY OWNER OF ANY DAMAGED OR INOPERABLE EQUIPMENT PRIOR TO REMOVAL.

- MECHANICAL KEYNOTES:** **(M#)**
1. REMOVE EXISTING EXHAUST FAN AND STORE FOR PROPER FLASHING OF THE EXISTING EQUIPMENT CURB AND ROOF REPLACEMENT. PERFORM PREBALANCING ON FAN PRIOR TO REMOVAL. TEMPORARILY SEAL DUCT WHILE ROOF WORK IS OCCURING.
 2. REMOVE EXISTING ROOF HOOD AND ASSOCIATED MOTOR OPERATED DAMPER AND STORE FOR ROOF REPLACEMENT.
 3. REINSTALL EXISTING EXHAUST FAN ON EXISTING CURB. REBALANCE TO CFM MEASURED PRIOR TO REMOVAL. REFER TO 1/ME300 FOR ROOF MOUNTED EXHAUST FAN DETAIL.
 4. REINSTALL EXISTING ROOF HOOD AND ASSOCIATED MOTOR OPERATED DAMPER.
 5. PROVIDE NEW FLASHING AT EXISTING VENT PIPE FOR ROOF REPLACEMENT. REFER TO 3/ME300 FOR VENT PIPE FLASHING.

- ELECTRICAL KEYNOTES:** **(E#)**
1. PULL BACK CONDUCTORS AND CONDUIT TO ACCOMODATE ROOF REPLACEMENT. COORDINATE FINAL TERMINATION WITH MECHANICAL CONTRACTOR.
 2. REFEED ELECTRICALLY POWERED MECHANICAL EQUIPMENT.

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www.imegcorp.com
PROJECT # 19091085.00

Missouri State Certificate of Authority E-2017008030

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REFERENCE SCALE IN INCHES

0 1 2 3

STATE OF MISSOURI
MICHAEL L PARSON,
GOVERNOR



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**OFFICE OF ADMINISTRATION
DIVISION OF FACILITIES
MANAGEMENT,
DESIGN AND CONSTRUCTION**

**DEPARTMENT OF
CORRECTIONS**

**1012 WEST COLUMBIA ST.
FARMINGTON, MO 63640**

REPLACE ROOF SYSTEMS
MULTIPLE ASSETS
FARMINGTON
CORRECTIONAL CENTER

FARMINGTON, MISSOURI

PROJECT # C1922-01
SITE # 7008
ASSET # 9327008089,
9327008090, 9327008091, 9327008082
9327008081, 9327008080, 9327008079

REVISION: _____
DATE: _____
REVISION: _____
DATE: _____
REVISION: _____
DATE: _____

ISSUE DATE: APRIL 18, 2022


CAD DWG FILE: ME202
DRAWN BY: BRESAN/MASRYA
CHECKED BY: RUSARN/MARHAR
DESIGNED BY: BRESAN/MASRYA

SHEET TITLE:
BLDG 18 ROOF PLANS -
MECHANICAL &
ELECTRICAL
(ALTERNATE NO. 1)

SHEET NUMBER:

ME202


23 OF 29 SHEETS
04/18/2022

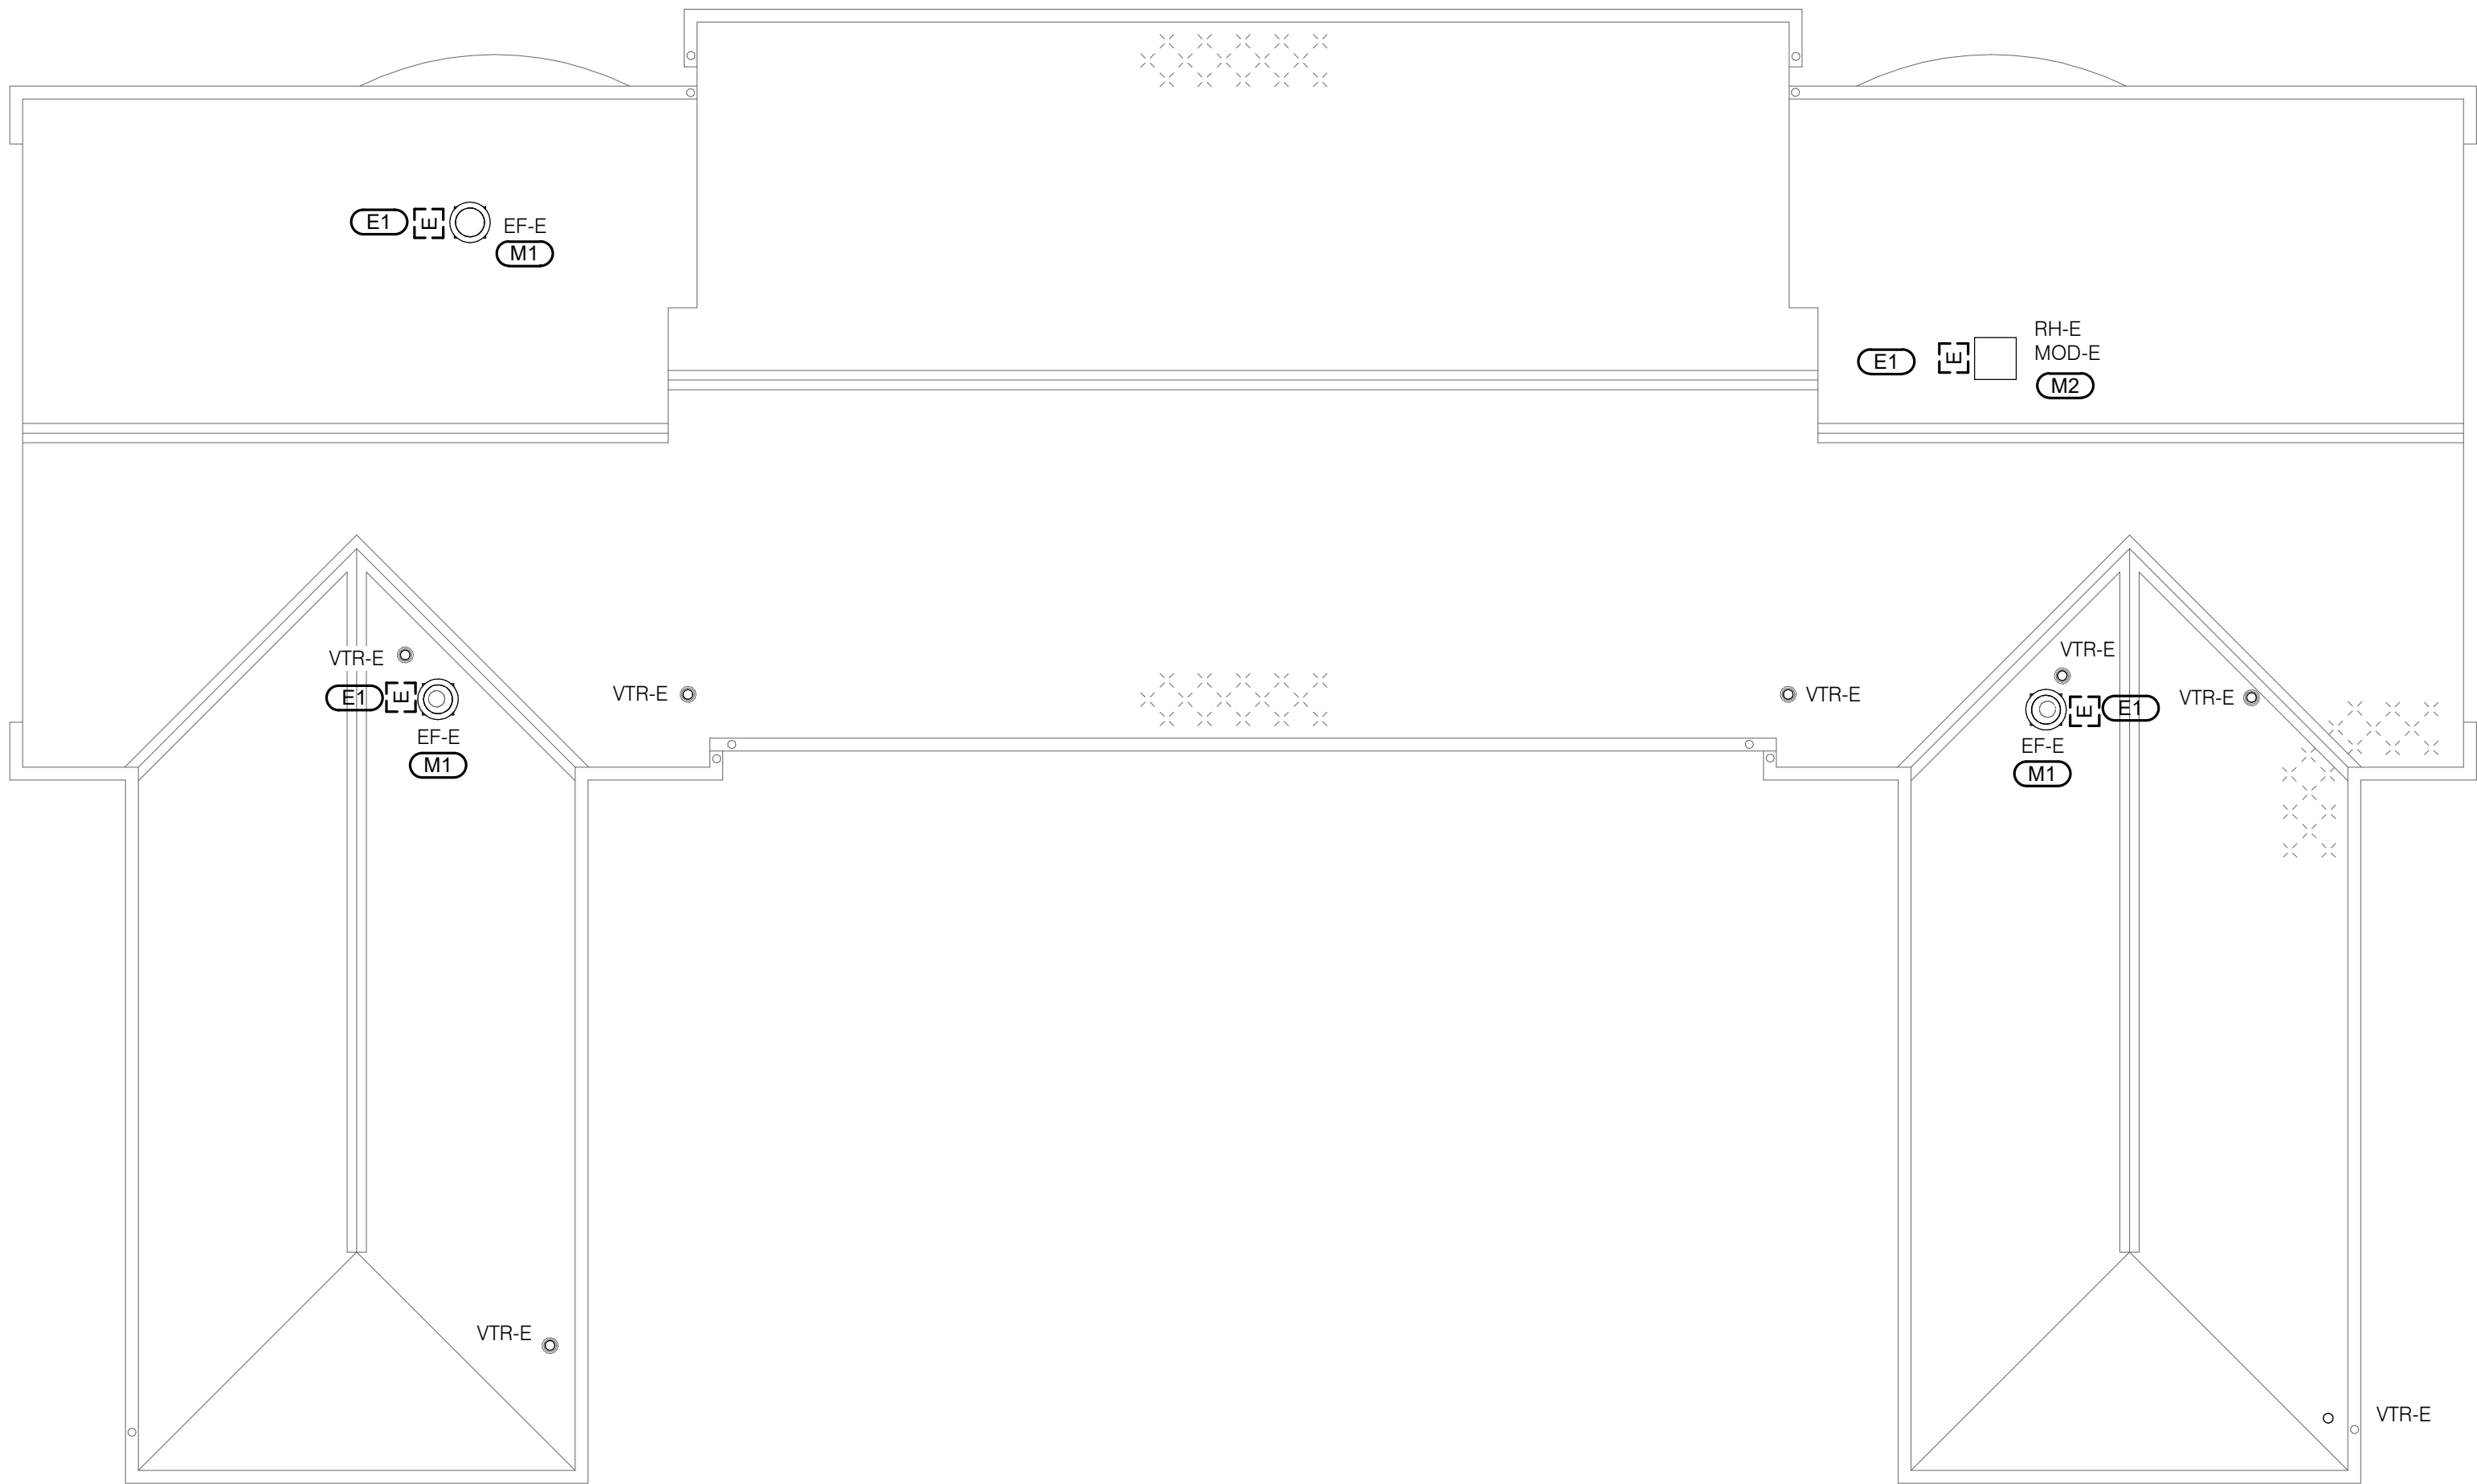

1

BLDG 19 ROOF PLAN - MECHANICAL & ELECTRICAL DEMOLITION

1/8" = 1'-0"

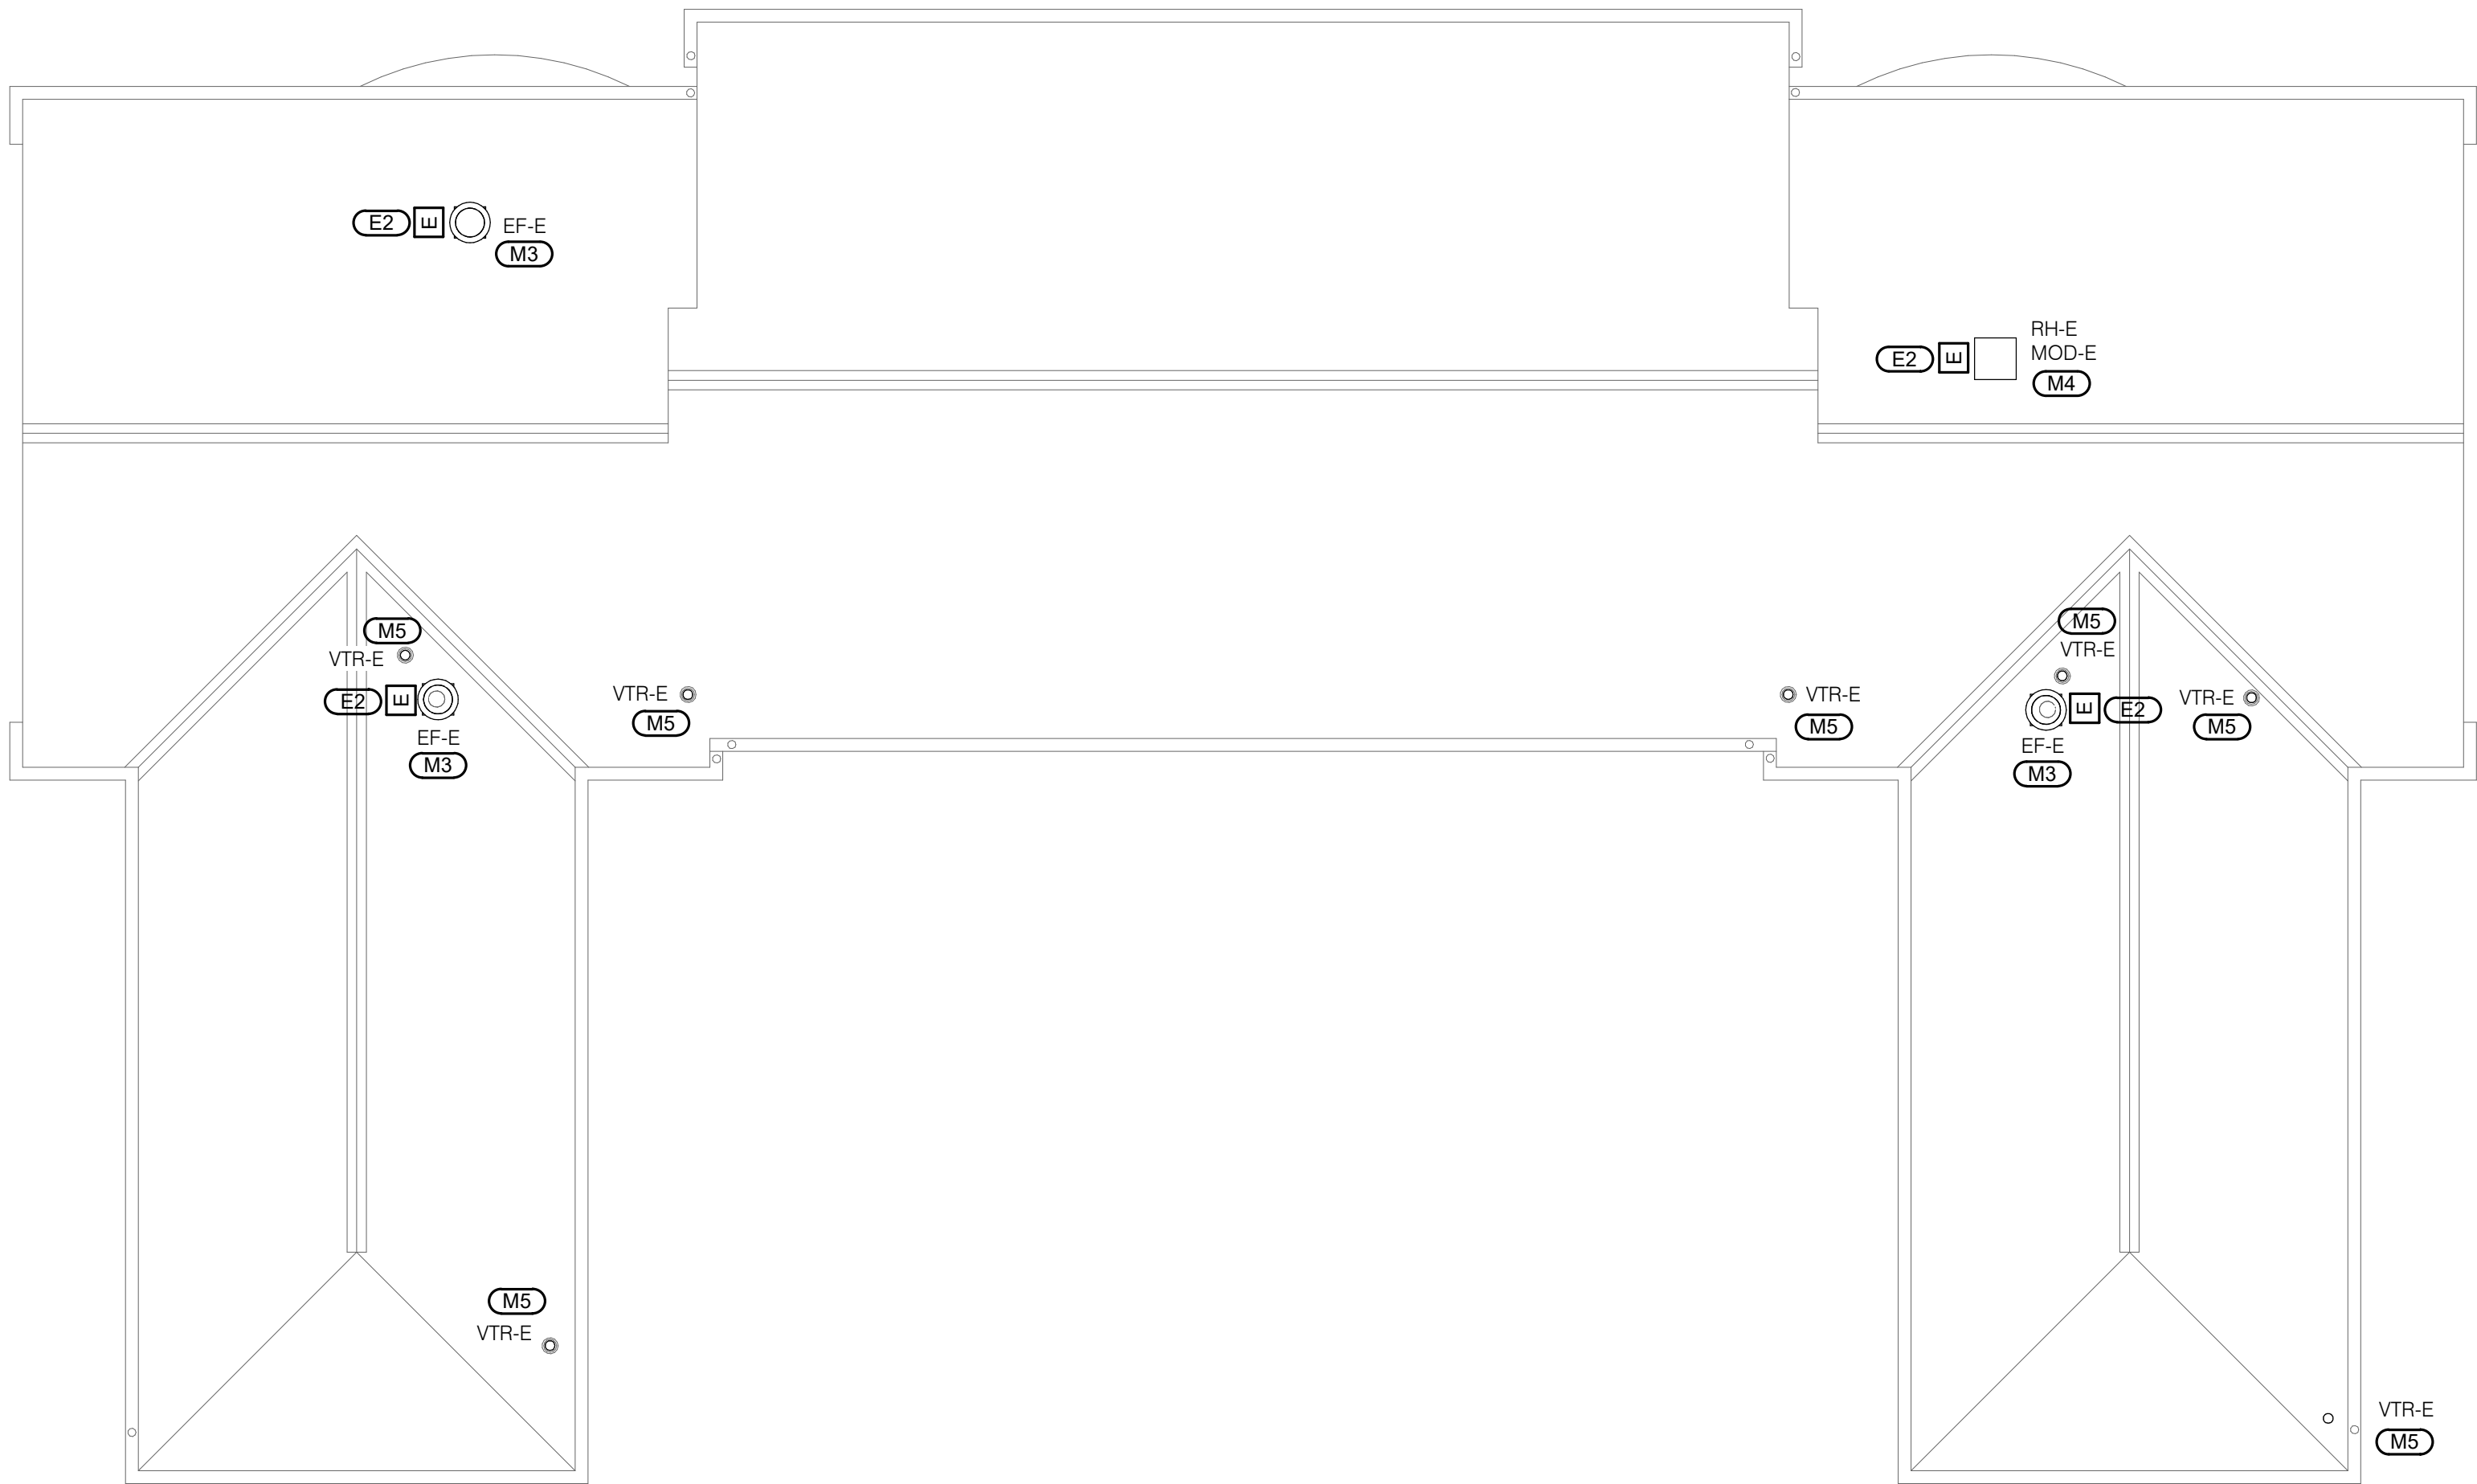

2

BLDG 19 ROOF PLAN - MECHANICAL & ELECTRICAL

1/8" = 1'-0"

GENERAL SHEET NOTES:

1. PERFORM A PRE-BALANCE OF ALL EQUIPMENT PRIOR TO DEMO. REFER TO SPECIFICATION SECTION 23 05 93 - TESTING, ADJUSTING, AND BALANCING FOR MORE INFORMATION.
2. PROVIDE OPERATIONAL TESTING ON ALL HVAC EQUIPMENT AFTER REINSTALLATION.
3. CONDITIONS SHOWN ARE BASED ON INFORMATION AVAILABLE FROM EXISTING DRAWINGS AND MEANS OF SITE INVESTIGATION. CONTRACTORS SHALL FIELD VERIFY ALL EXISTING CONDITIONS PRIOR TO BEGINNING WORK.
4. COORDINATE WITH ALL TRADES PRIOR TO PERFORMING ANY WORK.
5. NOTIFY OWNER OF ANY DAMAGED OR INOPERABLE EQUIPMENT PRIOR TO REMOVAL.

MECHANICAL KEYNOTES: (M#)

1. REMOVE EXISTING EXHAUST FAN AND STORE FOR PROPER FLASHING OF THE EXISTING EQUIPMENT CURB AND ROOF REPLACEMENT. PERFORM PREBALANCING ON FAN PRIOR TO REMOVAL. TEMPORARILY SEAL DUCT WHILE ROOF WORK IS OCCURING.
2. REMOVE EXISTING ROOF HOOD AND ASSOCIATED MOTOR OPERATED DAMPER AND STORE FOR ROOF REPLACEMENT.
3. REINSTALL EXISTING EXHAUST FAN ON EXISTING CURB. REBALANCE TO CFM MEASURED PRIOR TO REMOVAL. REFER TO 1/ME300 FOR ROOF MOUNTED EXHAUST FAN DETAIL.
4. REINSTALL EXISTING ROOF HOOD AND ASSOCIATED MOTOR OPERATED DAMPER. PROVIDE NEW FLASHING AT EXISTING VENT PIPE FOR ROOF REPLACEMENT. REFER TO 3/ME300 FOR VENT PIPE FLASHING.

ELECTRICAL KEYNOTES: (E#)

1. PULL BACK CONDUCTORS AND CONDUIT TO ACCOMODATE ROOF REPLACEMENT. COORDINATE FINAL TERMINATION WITH MECHANICAL CONTRACTOR.
2. REFEED ELECTRICALLY POWERED MECHANICAL EQUIPMENT.

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PROJECT # 19091085.00

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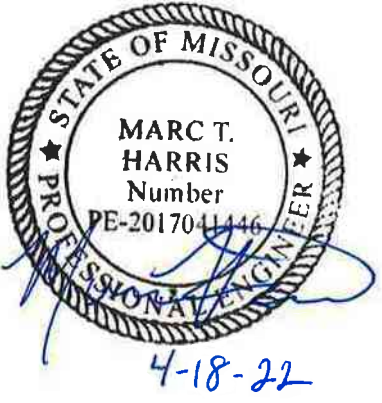
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FARMINGTON
CORRECTIONAL CENTER

FARMINGTON, MISSOURI

PROJECT # C1922-01
SITE # 7008
ASSET # 9327008089,
9327008090, 9327008091, 9327008082
9327008081, 9327008080, 9327008079

REVISION: _____
DATE: _____
REVISION: _____
DATE: _____
REVISION: _____
DATE: _____

ISSUE DATE: APRIL 18, 2022


CAD DWG FILE: ME203
DRAWN BY: BRESAN/MASRYA
CHECKED BY: RUSARN/MARHAR
DESIGNED BY: BRESAN/MASRYA

SHEET TITLE:
BLDG 19 ROOF PLANS -
MECHANICAL &
ELECTRICAL
(ALTERNATE NO. 2)

SHEET NUMBER:

ME203

24 OF 29 SHEETS
04/18/2022

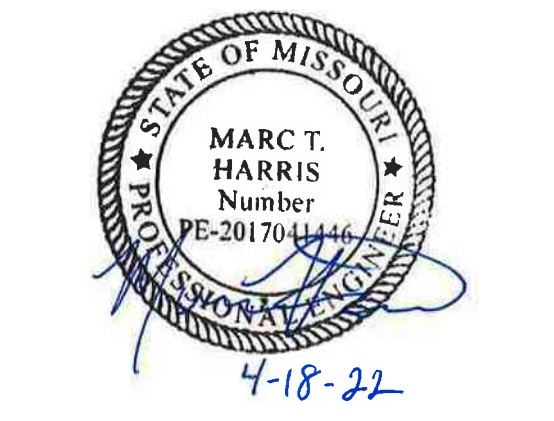

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**DEPARTMENT OF
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FARMINGTON
CORRECTIONAL CENTER

FARMINGTON, MISSOURI

PROJECT # C1922-01
SITE # 7008
ASSET # 9327008089,
9327008090, 9327008091, 9327008082
9327008081, 9327008080, 9327008079

REVISION: _____
DATE: _____
REVISION: _____
DATE: _____
REVISION: _____
DATE: _____
ISSUE DATE: APRIL 18, 2022

CAD DWG FILE: ME204
DRAWN BY: BRESAN/MASRYA
CHECKED BY: RUSARN/MARHAR
DESIGNED BY: BRESAN/MASRYA

SHEET TITLE:
BLDG 31 ROOF PLANS -
MECHANICAL &
ELECTRICAL
(ALTERNATE NO. 3)

SHEET NUMBER:



ME204

25 OF 29 SHEETS
04/18/2022

- GENERAL SHEET NOTES:**
1. PERFORM A PRE-BALANCE OF ALL EQUIPMENT PRIOR TO DEMO. REFER TO SPECIFICATION SECTION 23 05 93 - TESTING, ADJUSTING, AND BALANCING FOR MORE INFORMATION.
 2. PROVIDE OPERATIONAL TESTING ON ALL HVAC EQUIPMENT AFTER REINSTALLATION.
 3. CONDITIONS SHOWN ARE BASED ON INFORMATION AVAILABLE FROM EXISTING DRAWINGS AND MEANS OF SITE INVESTIGATION. CONTRACTORS SHALL FIELD VERIFY ALL EXISTING CONDITIONS PRIOR TO BEGINNING WORK.
 4. COORDINATE WITH ALL TRADES PRIOR TO PERFORMING ANY WORK
 5. NOTIFY OWNER OF ANY DAMAGED OR INOPERABLE EQUIPMENT PRIOR TO REMOVAL.


- MECHANICAL KEYNOTES:** (MR)
1. REMOVE EXISTING EXHAUST FAN AND STORE FOR PROPER FLASHING OF THE EXISTING EQUIPMENT CURB AND ROOF REPLACEMENT. PERFORM PREBALANCING ON FAN PRIOR TO REMOVAL. TEMPORARILY SEAL DUCT WHILE ROOF WORK IS OCCURRING.
 2. REINSTALL EXISTING EXHAUST FAN ON EXISTING CURB. REBALANCE TO CFM MEASURED PRIOR TO REMOVAL. REFER TO 1/ME300 FOR ROOF MOUNTED EXHAUST FAN DETAIL.
 3. REFER TO 7/ME300 DRIP PAN DETAIL AND 1/ME300 FOR ROOF MOUNTED EXHAUST FAN DETAIL.
 4. PROVIDE NEW FLASHING AT EXISTING VENT PIPE FOR ROOF REPLACEMENT. REFER TO 3/ME300 FOR VENT PIPE FLASHING.
 5. REMOVE EXISTING ATTIC FAN IN APPROXIMATELY THIS LOCATION BETWEEN THE ATTIC AND THE FLOOR BELOW. FAN IS MOUNTED ABOVE ATTIC ACCESS. REMOVE ALL SUPPORTS, HANGERS, ACCESSORIES, ETC.
 6. PROVIDE ANALOG TEMPERATURE SENSOR WITH DIAL WITH MINIMUM RANGE OF 80°F - 120°F. REFER TO 5/ME300 DAMPER AND EXHAUST FAN RELAY DETAIL.
 7. REFER TO 7/ME300 DRIP PAN DETAIL AND 1/ME500 METAL ROOF MOUNTED HOOD DETAIL FOR MOD AND ROOF HOOD INSTALLATION.


- ELECTRICAL KEYNOTES:** (EF)
1. PULL BACK CONDUCTORS AND CONDUIT TO ACCOMMODATE ROOF REPLACEMENT. COORDINATE FINAL TERMINATION WITH MECHANICAL CONTRACTOR.
 2. REFEED ELECTRICALLY POWERED MECHANICAL EQUIPMENT.
 3. PROVIDE NEW 120V CIRCUIT FROM NEAREST AVAILABLE 120V PANEL. PROVIDE 40A/1P CIRCUIT BREAKER WITHIN THE PANEL AND MATCH EXISTING MANUFACTURER AND SHORT CIRCUIT RATING OF CIRCUIT BREAKERS. CONTRACTOR SHALL PROVIDE 100 FEET OF 2#10, 1#10G IN 3/4" TO FAN AND 2#12, 1#12G IN 3/4" TO DAMPER. COORDINATE ROUTING AND PENETRATIONS WITH THE OWNER AS TO NOT DISTURB OPERATIONS AND PREVENT TAMPERING OF CIRCUIT FROM ANY TENANTS. EF-31 AND MOD-31 WILL SHARE THE SAME CIRCUIT FROM THE 120V PANELBOARD.
 4. DISCONNECT EXISTING ATTIC FAN IN APPROXIMATELY THIS LOCATION BETWEEN THE ATTIC AND THE FLOOR BELOW. FAN IS MOUNTED ABOVE ATTIC ACCESS. DEMO CONDUIT AND CONDUCTORS BACK TO SOURCE.

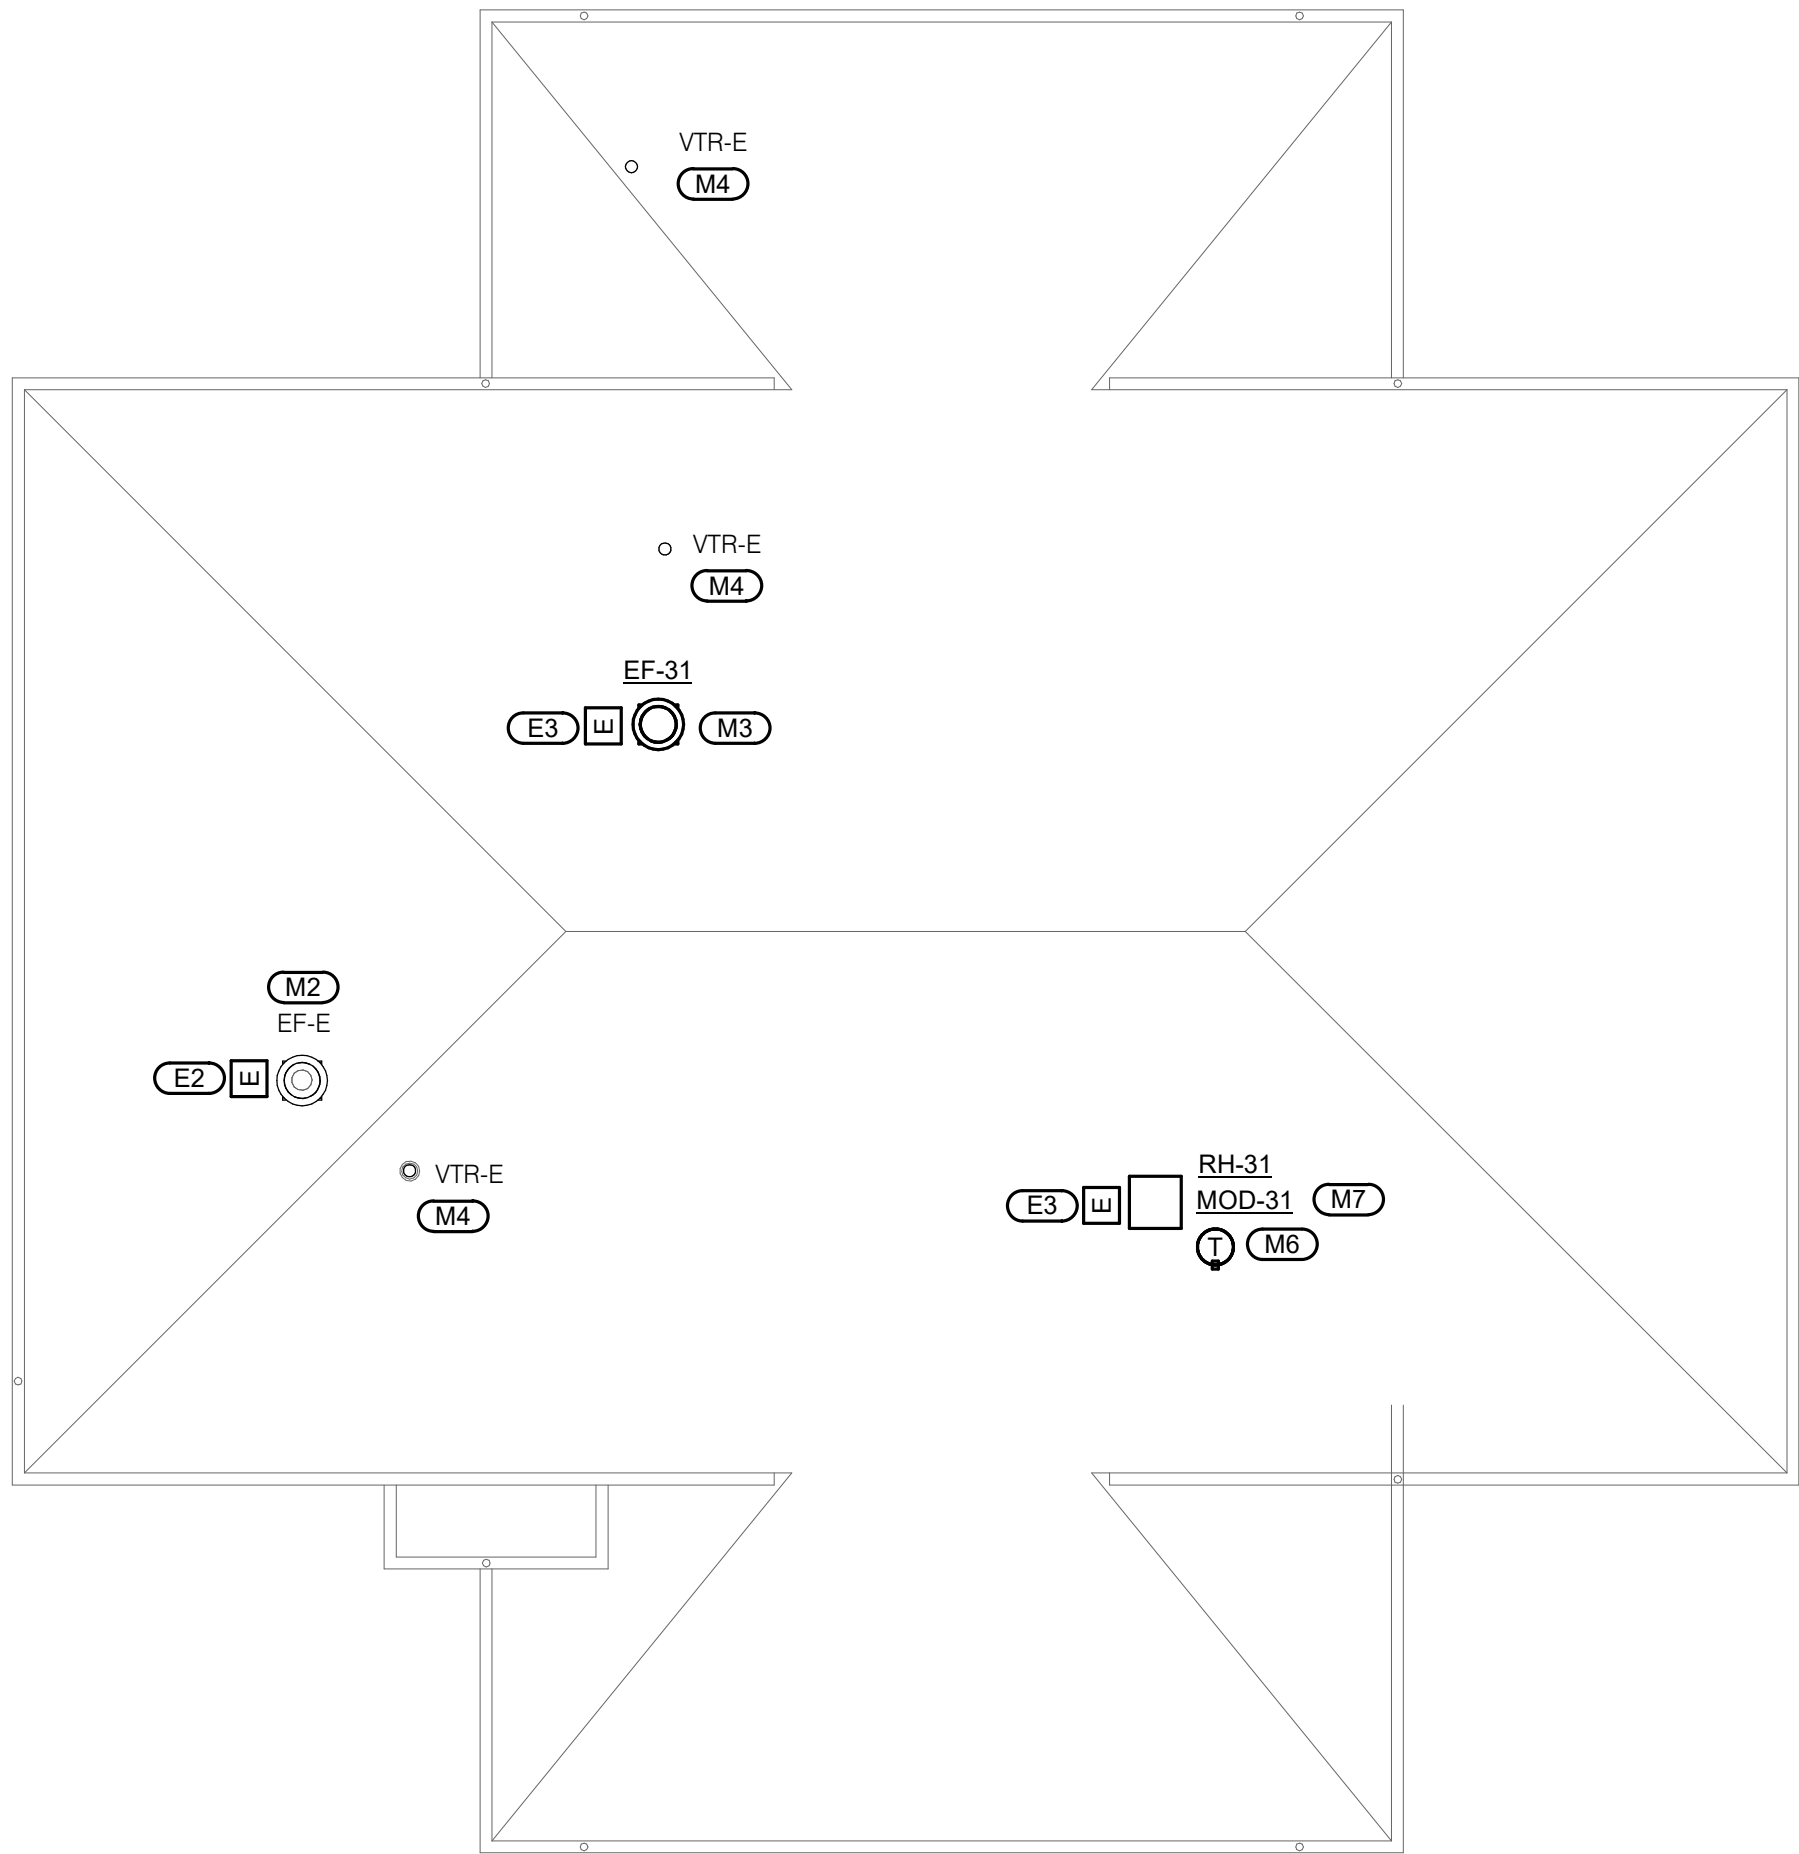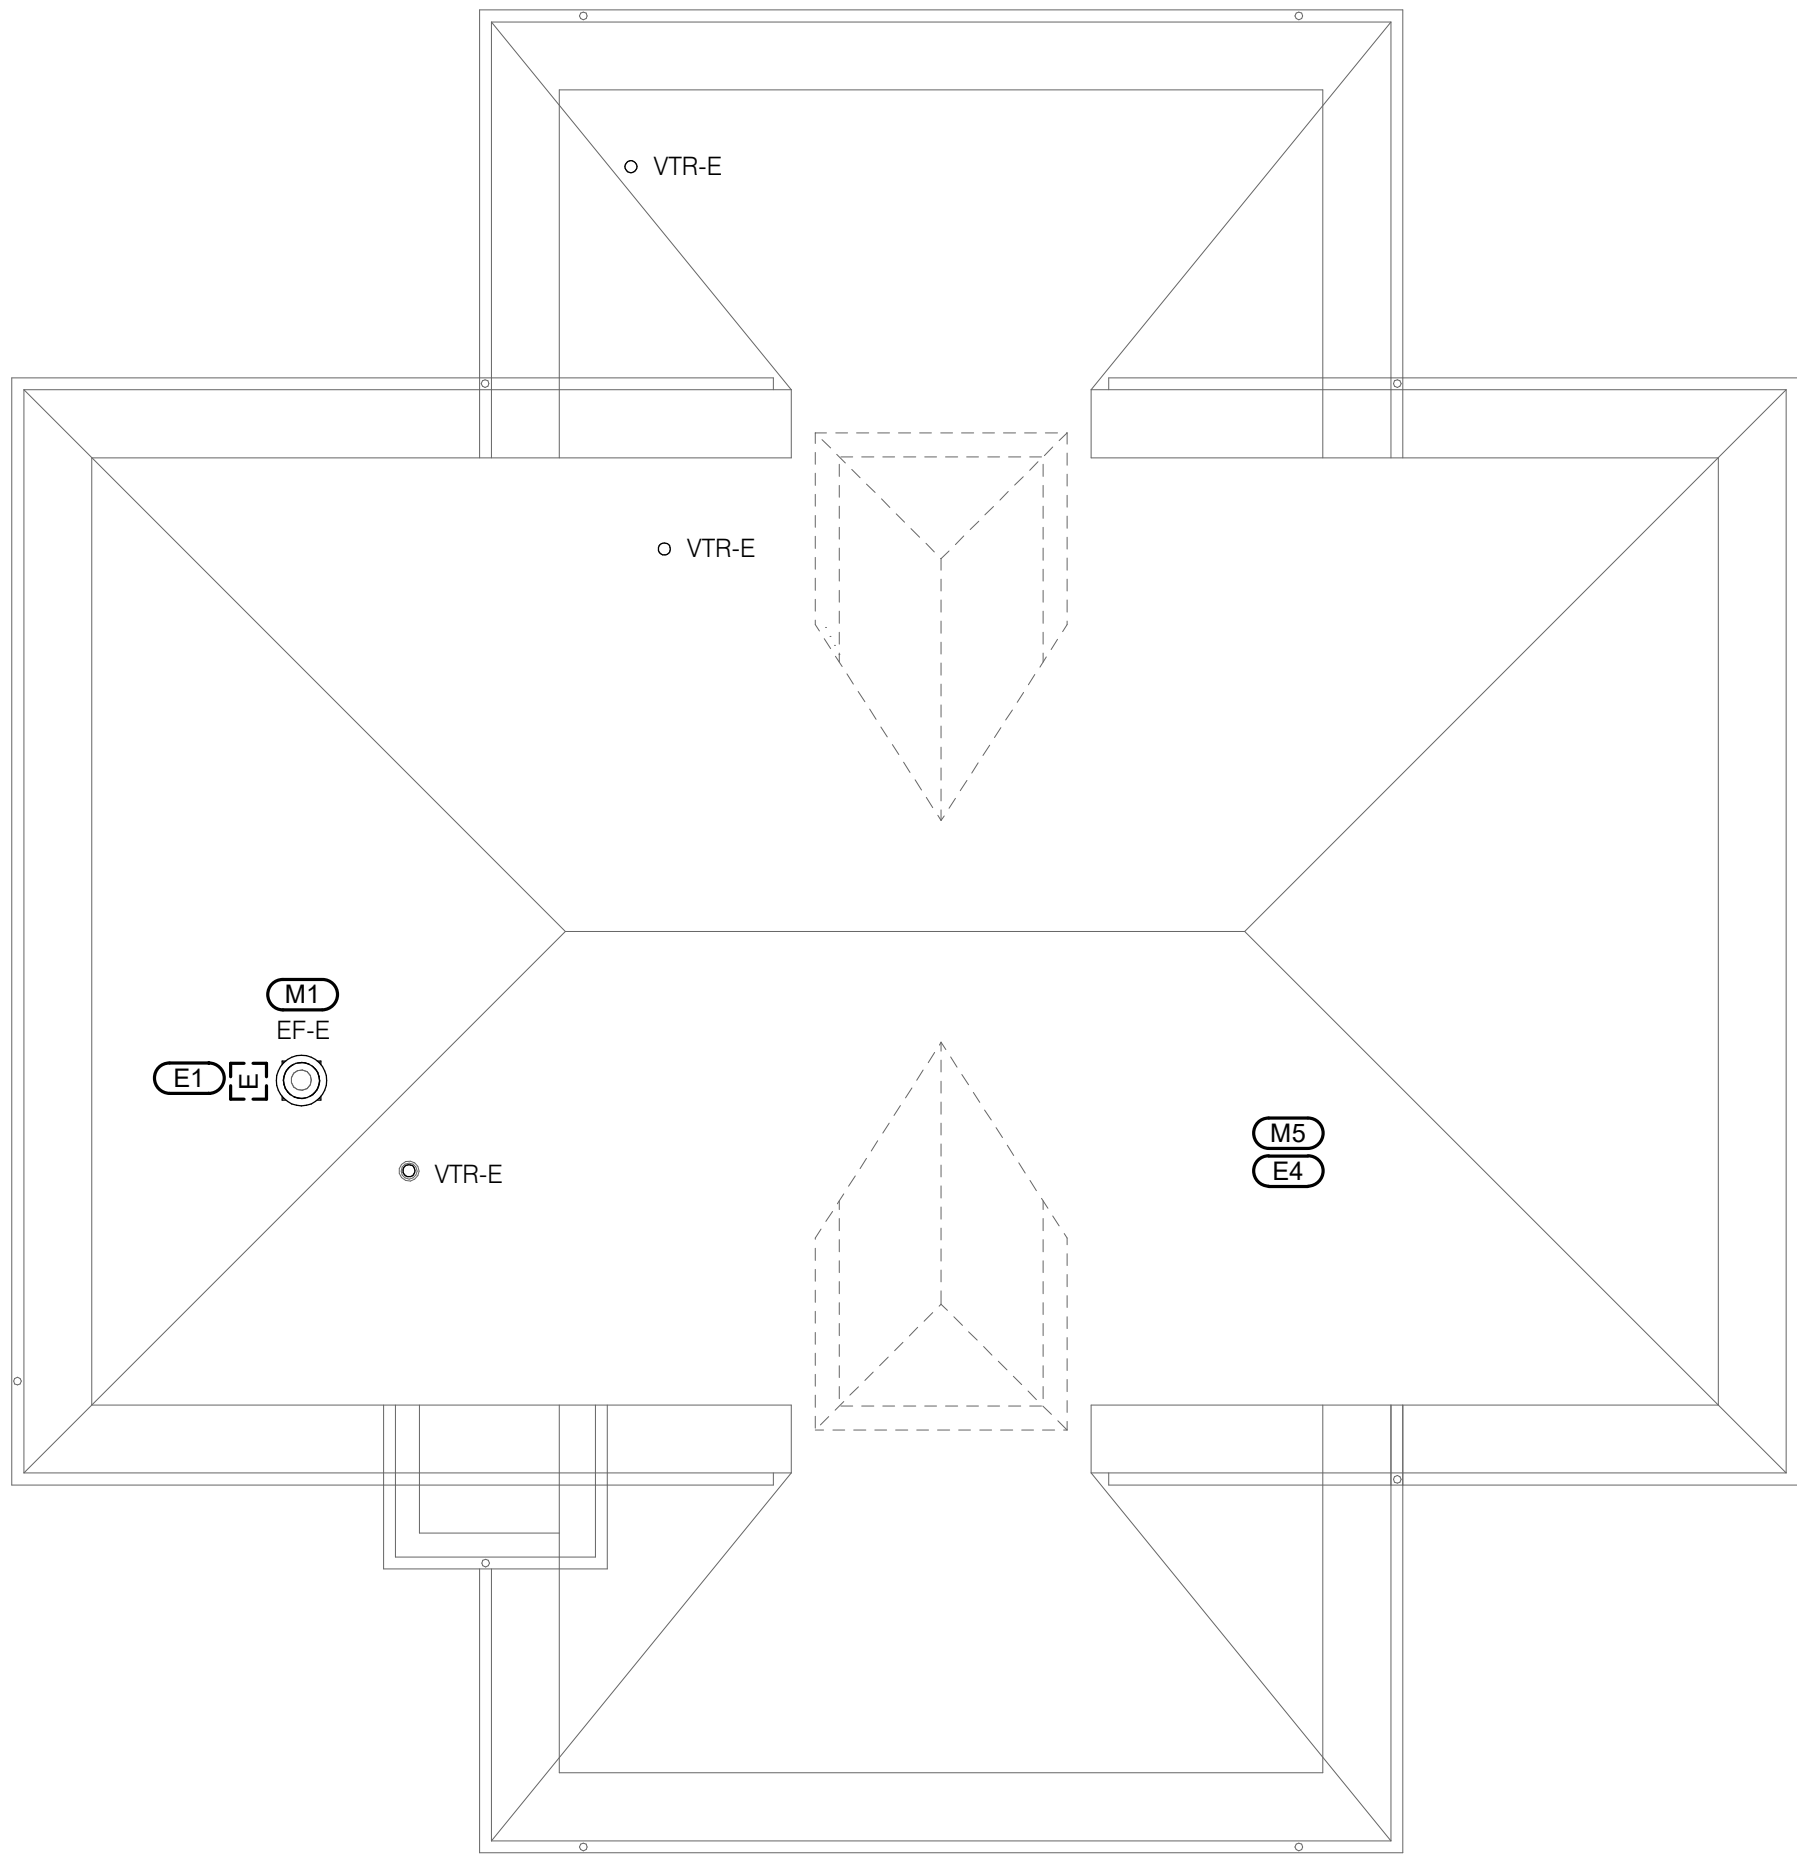


 **1** **BLDG 31 ROOF PLAN - MECHANICAL & ELECTRICAL DEMOLITION**
1/8" = 1'-0"

 **2** **BLDG 31 ROOF PLAN - MECHANICAL & ELECTRICAL**
1/8" = 1'-0"

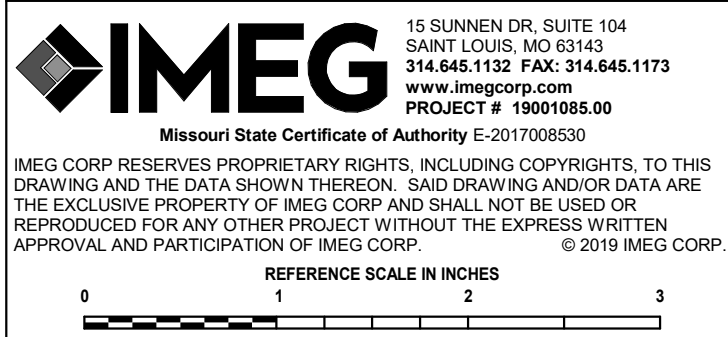

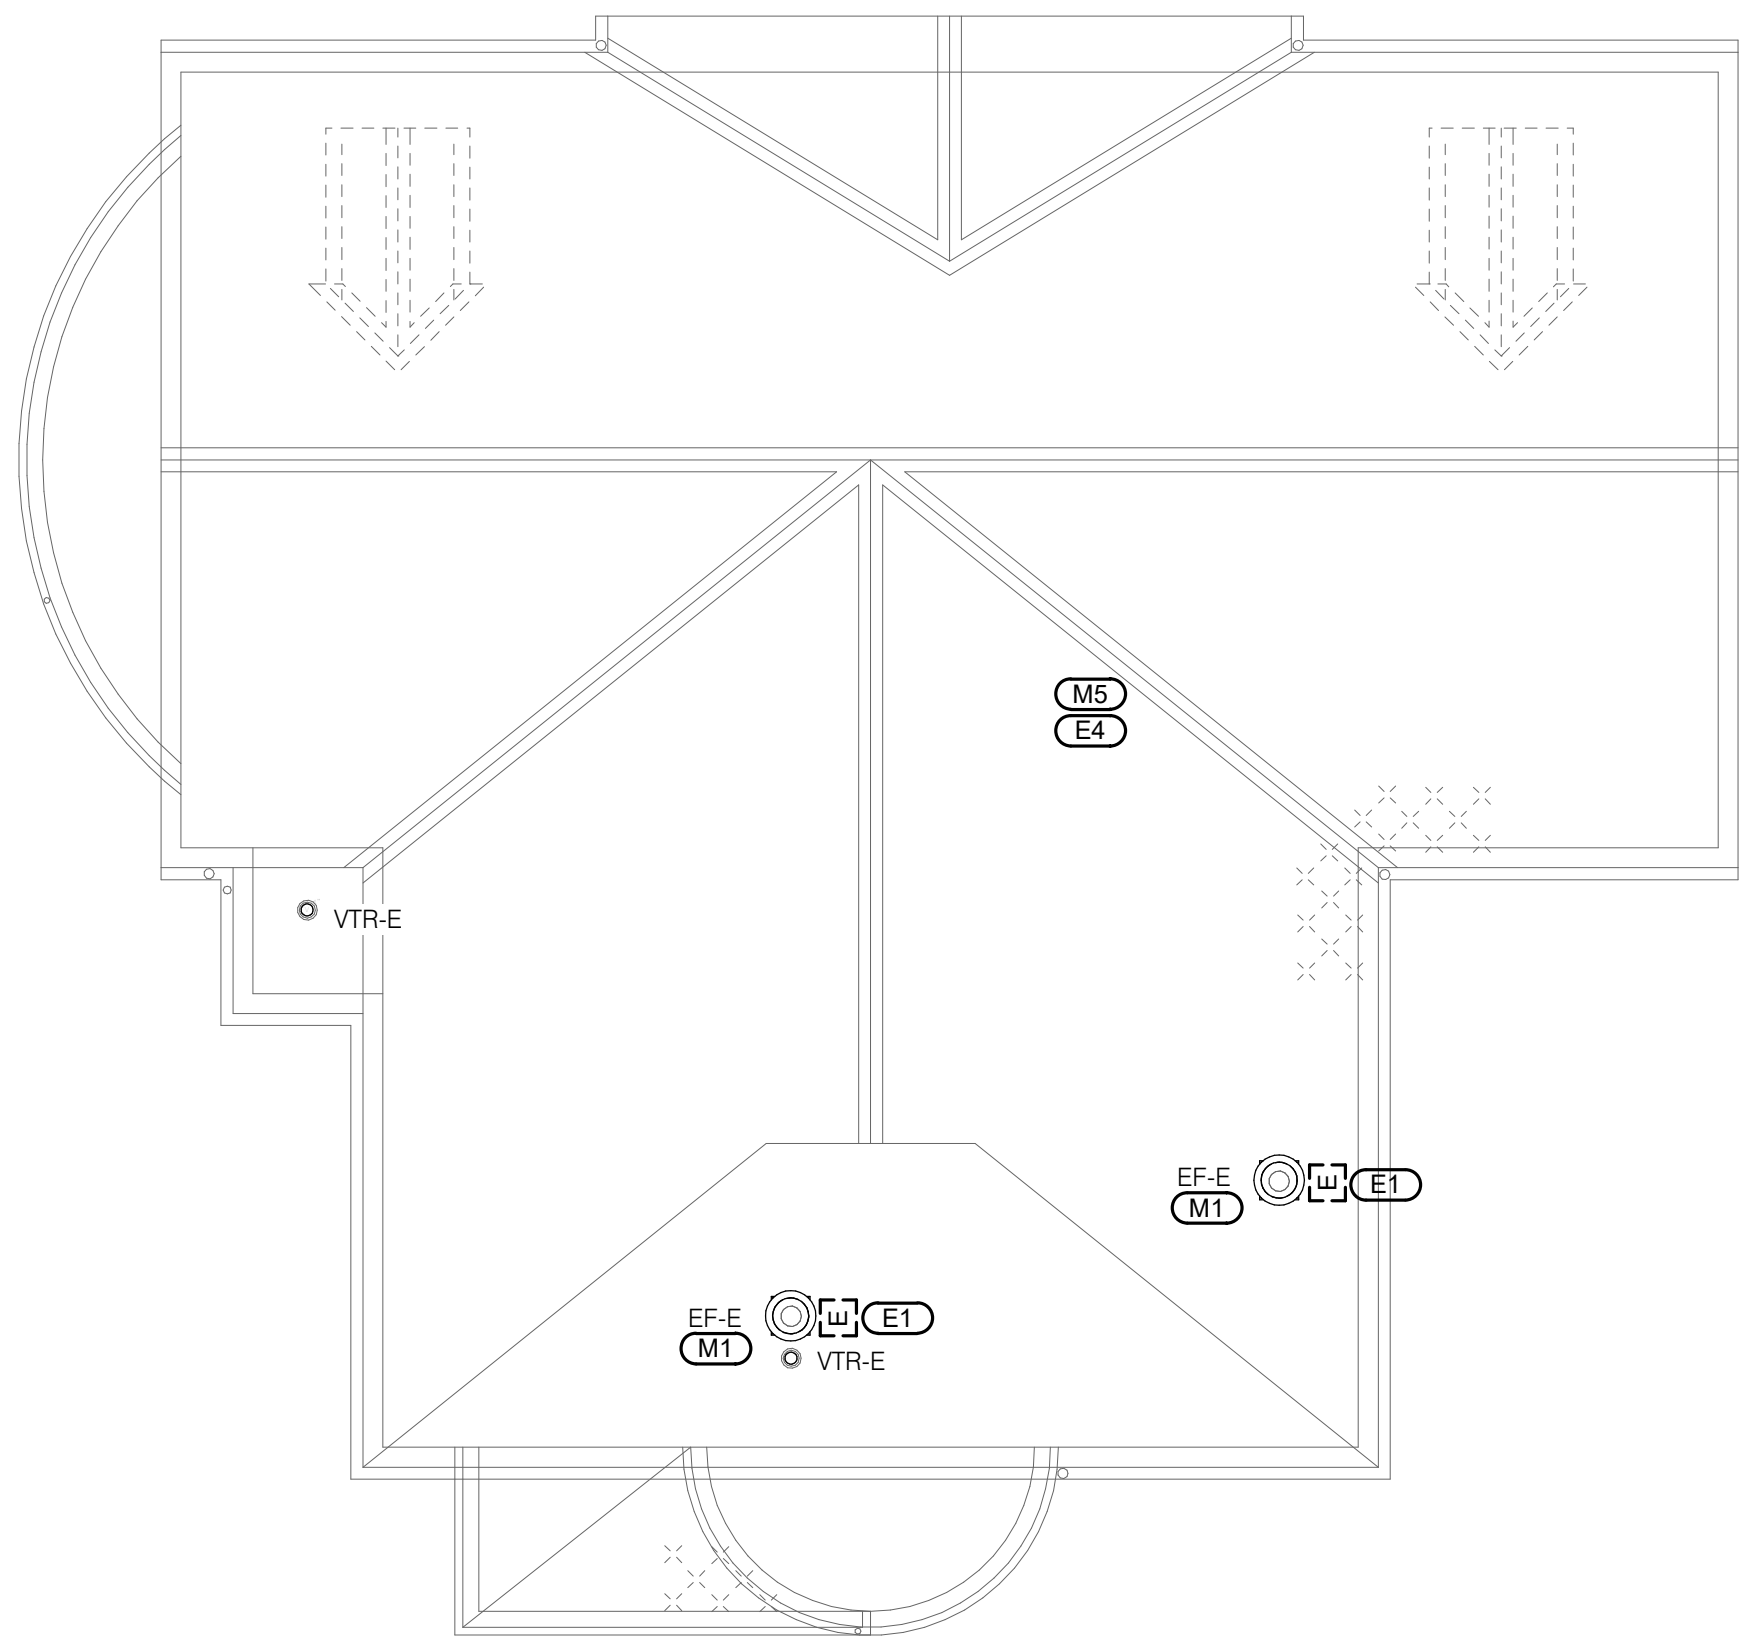

 **1** **BLDG 32 ROOF PLAN - MECHANICAL & ELECTRICAL DEMOLITION**
1/8" = 1'-0"

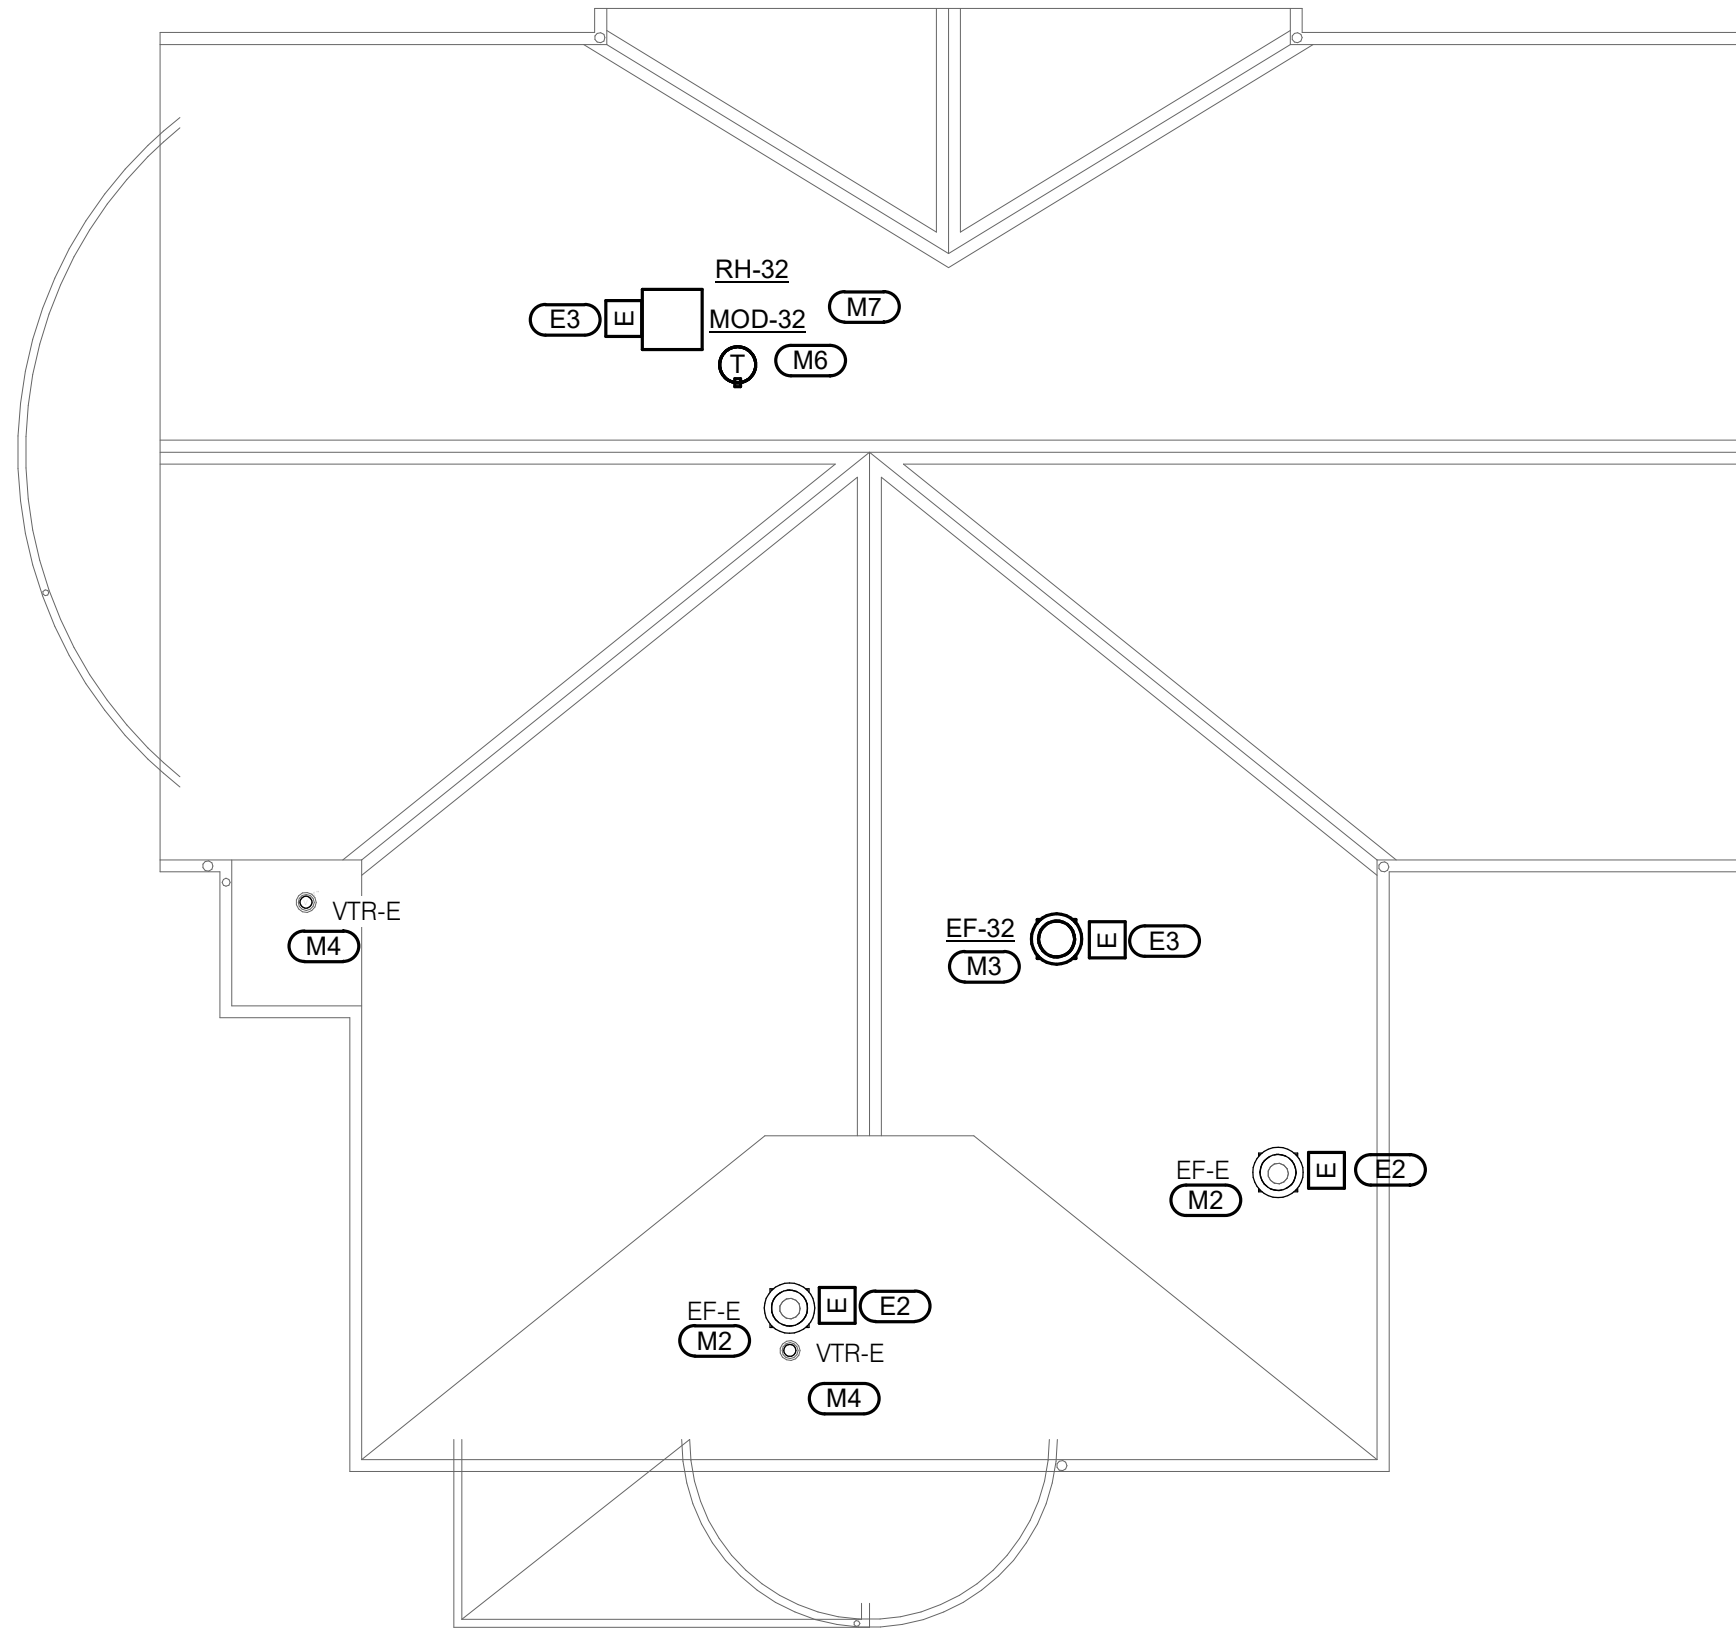

 **2** **BLDG 32 ROOF PLAN - MECHANICAL & ELECTRICAL**
1/8" = 1'-0"

- GENERAL SHEET NOTES:**
1. PERFORM A PRE-BALANCE OF ALL EQUIPMENT PRIOR TO DEMO. REFER TO SPECIFICATION SECTION 23 05 93 - TESTING, ADJUSTING, AND BALANCING FOR MORE INFORMATION.
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 4. COORDINATE WITH ALL TRADES PRIOR TO PERFORMING ANY WORK.
 5. NOTIFY OWNER OF ANY DAMAGED OR INOPERABLE EQUIPMENT PRIOR TO REMOVAL.

- MECHANICAL KEYNOTES: (M#)**
1. REMOVE EXISTING EXHAUST FAN AND STORE FOR PROPER FLASHING OF THE EXISTING EQUIPMENT CURB AND ROOF REPLACEMENT. PERFORM PREBALANCING ON FAN PRIOR TO REMOVAL. TEMPORARILY SEAL DUCT WHILE ROOF WORK IS OCCURRING.
 2. REINSTALL EXISTING EXHAUST FAN ON EXISTING CURB. REBALANCE TO CFM MEASURED PRIOR TO REMOVAL. REFER TO 1/ME300 FOR ROOF MOUNTED EXHAUST FAN DETAIL.
 3. REFER TO 7/ME300 DRIP PAN DETAIL AND 1/ME300 FOR ROOF MOUNTED EXHAUST FAN DETAIL.
 4. PROVIDE NEW FLASHING AT EXISTING VENT PIPE FOR ROOF REPLACEMENT. REFER TO 3/ME300 FOR VENT PIPE FLASHING.
 5. REMOVE EXISTING ATTIC FAN IN APPROXIMATELY THIS LOCATION BETWEEN THE ATTIC AND THE FLOOR BELOW. FAN IS MOUNTED ABOVE ATTIC ACCESS. REMOVE ALL SUPPORTS, HANGERS, ACCESSORIES, ETC.
 6. PROVIDE ANALOG TEMPERATURE SENSOR WITH DIAL WITH MINIMUM RANGE OF 80°F - 120°F. REFER TO 5/ME300 DAMPER AND EXHAUST FAN RELAY DETAIL.
 7. REFER TO 7/ME300 DRIP PAN DETAIL AND 1/ME500 METAL ROOF MOUNTED HOOD DETAIL FOR MOD AND ROOF HOOD INSTALLATION.

- ELECTRICAL KEYNOTES: (E#)**
1. PULL BACK CONDUCTORS AND CONDUIT TO ACCOMMODATE ROOF REPLACEMENT. COORDINATE FINAL TERMINATION WITH MECHANICAL CONTRACTOR.
 2. REFEED ELECTRICALLY POWERED MECHANICAL EQUIPMENT.
 3. PROVIDE NEW 120V CIRCUIT FROM NEAREST AVAILABLE 120V PANEL. PROVIDE 50A/1P CIRCUIT BREAKER WITHIN THE PANEL AND MATCH EXISTING MANUFACTURER AND SHORT CIRCUIT RATING OF CIRCUIT BREAKERS. PROVIDE 100 FEET OF 2#6, 1#10G IN 1" C TO FAN AND 2#12, 1#12G IN 3/4" C TO DAMPER. COORDINATE ROUTING AND PENETRATIONS WITH THE OWNER AS TO NOT DISTURB OPERATIONS AND PREVENT TAMPERING OF CIRCUIT FROM ANY TENANTS. EF-32 AND MOD-32 WILL SHARE THE SAME CIRCUIT FROM THE 120V PANELBOARD.
 4. DISCONNECT EXISTING ATTIC FAN IN APPROXIMATELY THIS LOCATION BETWEEN THE ATTIC AND THE FLOOR BELOW. FAN IS MOUNTED ABOVE ATTIC ACCESS. DEMO CONDUIT AND CONDUCTORS BACK TO SOURCE.

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PROJECT # 19001085.00

Missouri State Certificate of Authority E-2017008503

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**DEPARTMENT OF
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FARMINGTON, MO 63640**

**REPLACE ROOF SYSTEMS
MULTIPLE ASSETS
FARMINGTON
CORRECTIONAL CENTER**

FARMINGTON, MISSOURI

PROJECT # C1922-01
SITE # 7008
ASSET # 9327008089,
9327008090, 9327008091, 9327008082
9327008081, 9327008080, 9327008079

REVISION: _____
DATE: _____
REVISION: _____
DATE: _____
REVISION: _____
DATE: _____

ISSUE DATE: APRIL 18, 2022

CAD DWG FILE: ME205
DRAWN BY: BRESAN/MASRYA
CHECKED BY: RUSARN/MARHAR
DESIGNED BY: BRESAN/MASRYA

SHEET TITLE:
**BLDG 32 ROOF PLANS -
MECHANICAL &
ELECTRICAL**

SHEET NUMBER:

ME205

26 OF 29 SHEETS
04/18/2022

GENERAL SHEET NOTES:



1. PERFORM A PRE-BALANCE OF ALL EQUIPMENT PRIOR TO DEMO. REFER TO SPECIFICATION SECTION 23 05 93 - TESTING, ADJUSTING, AND BALANCING FOR MORE INFORMATION.
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4. COORDINATE WITH ALL TRADES PRIOR TO PERFORMING ANY WORK.
5. NOTIFY OWNER OF ANY DAMAGED OR INOPERABLE EQUIPMENT PRIOR TO REMOVAL.

MECHANICAL KEYNOTES: (M#)

1. REMOVE EXISTING EXHAUST FAN AND STORE FOR PROPER FLASHING OF THE EXISTING EQUIPMENT CURB AND ROOF REPLACEMENT. PERFORM PREBALANCING ON FAN PRIOR REMOVAL. TEMPORARILY SEAL DUCT WHILE ROOF WORK IS OCCURING.
2. REINSTALL EXISTING EXHAUST FAN ON EXISTING CURB. REBALANCE TO CFM MEASURED PRIOR TO REMOVAL. REFER TO 1/ME300 FOR ROOF MOUNTED EXHAUST FAN DETAIL.
3. REFER TO 7/ME300 DRIP PAN DETAIL AND 1/ME300 FOR ROOF MOUNTED EXHAUST FAN DETAIL.
4. PROVIDE NEW FLASHING AT EXISTING VENT PIPE FOR ROOF REPLACEMENT. REFER TO 3/ME300 FOR VENT PIPE FLASHING.
5. REMOVE EXISTING ATTIC FAN IN APPROXIMATELY THIS LOCATION BETWEEN THE ATTIC AND THE FLOOR BELOW. FAN IS MOUNTED ABOVE ATTIC ACCESS. REMOVE ALL SUPPORTS, HANGERS, ACCESSORIES, ETC.
6. PROVIDE ANALOG TEMPERATURE SENSOR WITH DIAL WITH MINIMUM RANGE OF 80°F - 120°F. REFER TO 5/ME300 DAMPER AND EXHAUST FAN RELAY DETAIL.
7. REFER TO 7/ME300 DRIP PAN DETAIL AND 1/ME500 METAL ROOF MOUNTED HOOD DETAIL FOR MOD AND ROOF HOOD INSTALLATION.

ELECTRICAL KEYNOTES: (E#)

1. PULL BACK CONDUCTORS AND CONDUIT TO ACCOMMODATE ROOF REPLACEMENT. COORDINATE FINAL TERMINATION WITH MECHANICAL CONTRACTOR.
2. REFEEED ELECTRICALLY POWERED MECHANICAL EQUIPMENT.
3. PROVIDE NEW 120V CIRCUIT FROM NEAREST AVAILABLE 120V PANEL. PROVIDE 50A/1P CIRCUIT BREAKER WITHIN THE PANEL AND MATCH EXISTING MANUFACTURER AND SHORT CIRCUIT RATING OF CIRCUIT BREAKERS. PROVIDE 100 FEET OF 2#6, 1#10G IN 1" C TO FAN AND 2#12, 1#12G IN 3/4" C TO DAMPER. COORDINATE ROUTING AND PENETRATIONS WITH THE OWNER AS TO NOT DISTURB OPERATIONS AND PREVENT TAMPERING OF CIRCUIT FROM ANY TENANTS. EF-33 AND MOD-33 WILL SHARE THE SAME CIRCUIT FROM THE 120V PANELBOARD.
4. DISCONNECT EXISTING ATTIC FAN IN APPROXIMATELY THIS LOCATION BETWEEN THE ATTIC AND THE FLOOR BELOW. FAN IS MOUNTED ABOVE ATTIC ACCESS. DEMO CONDUIT AND CONDUCTORS BACK TO SOURCE.

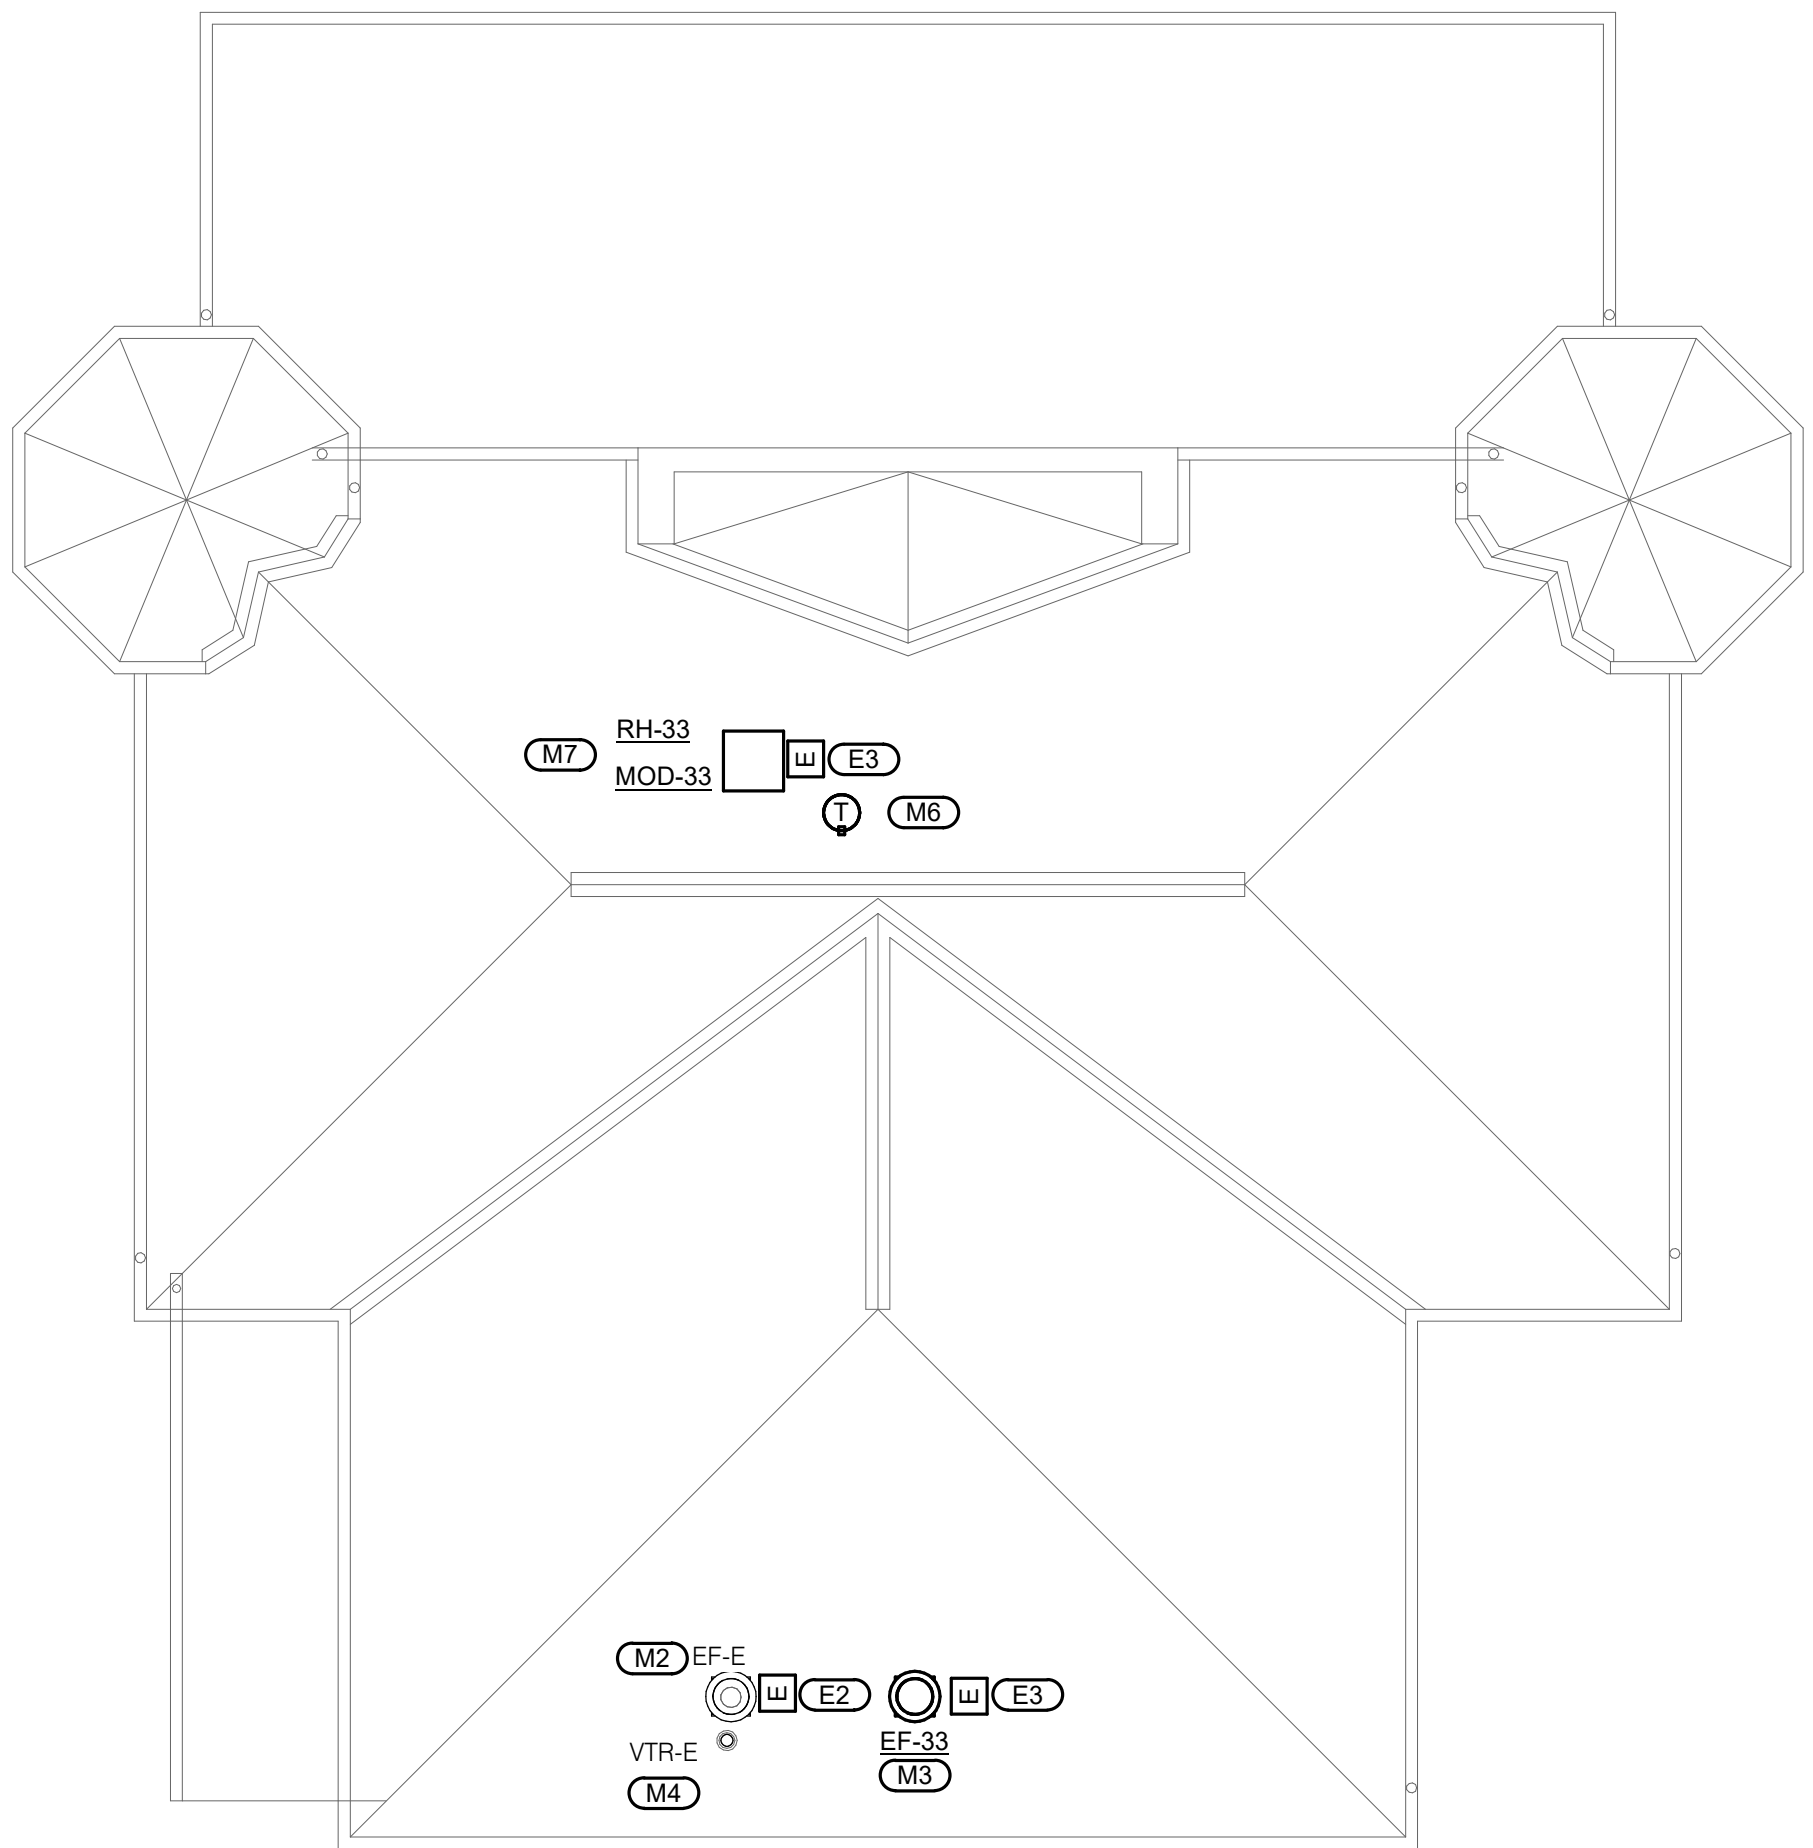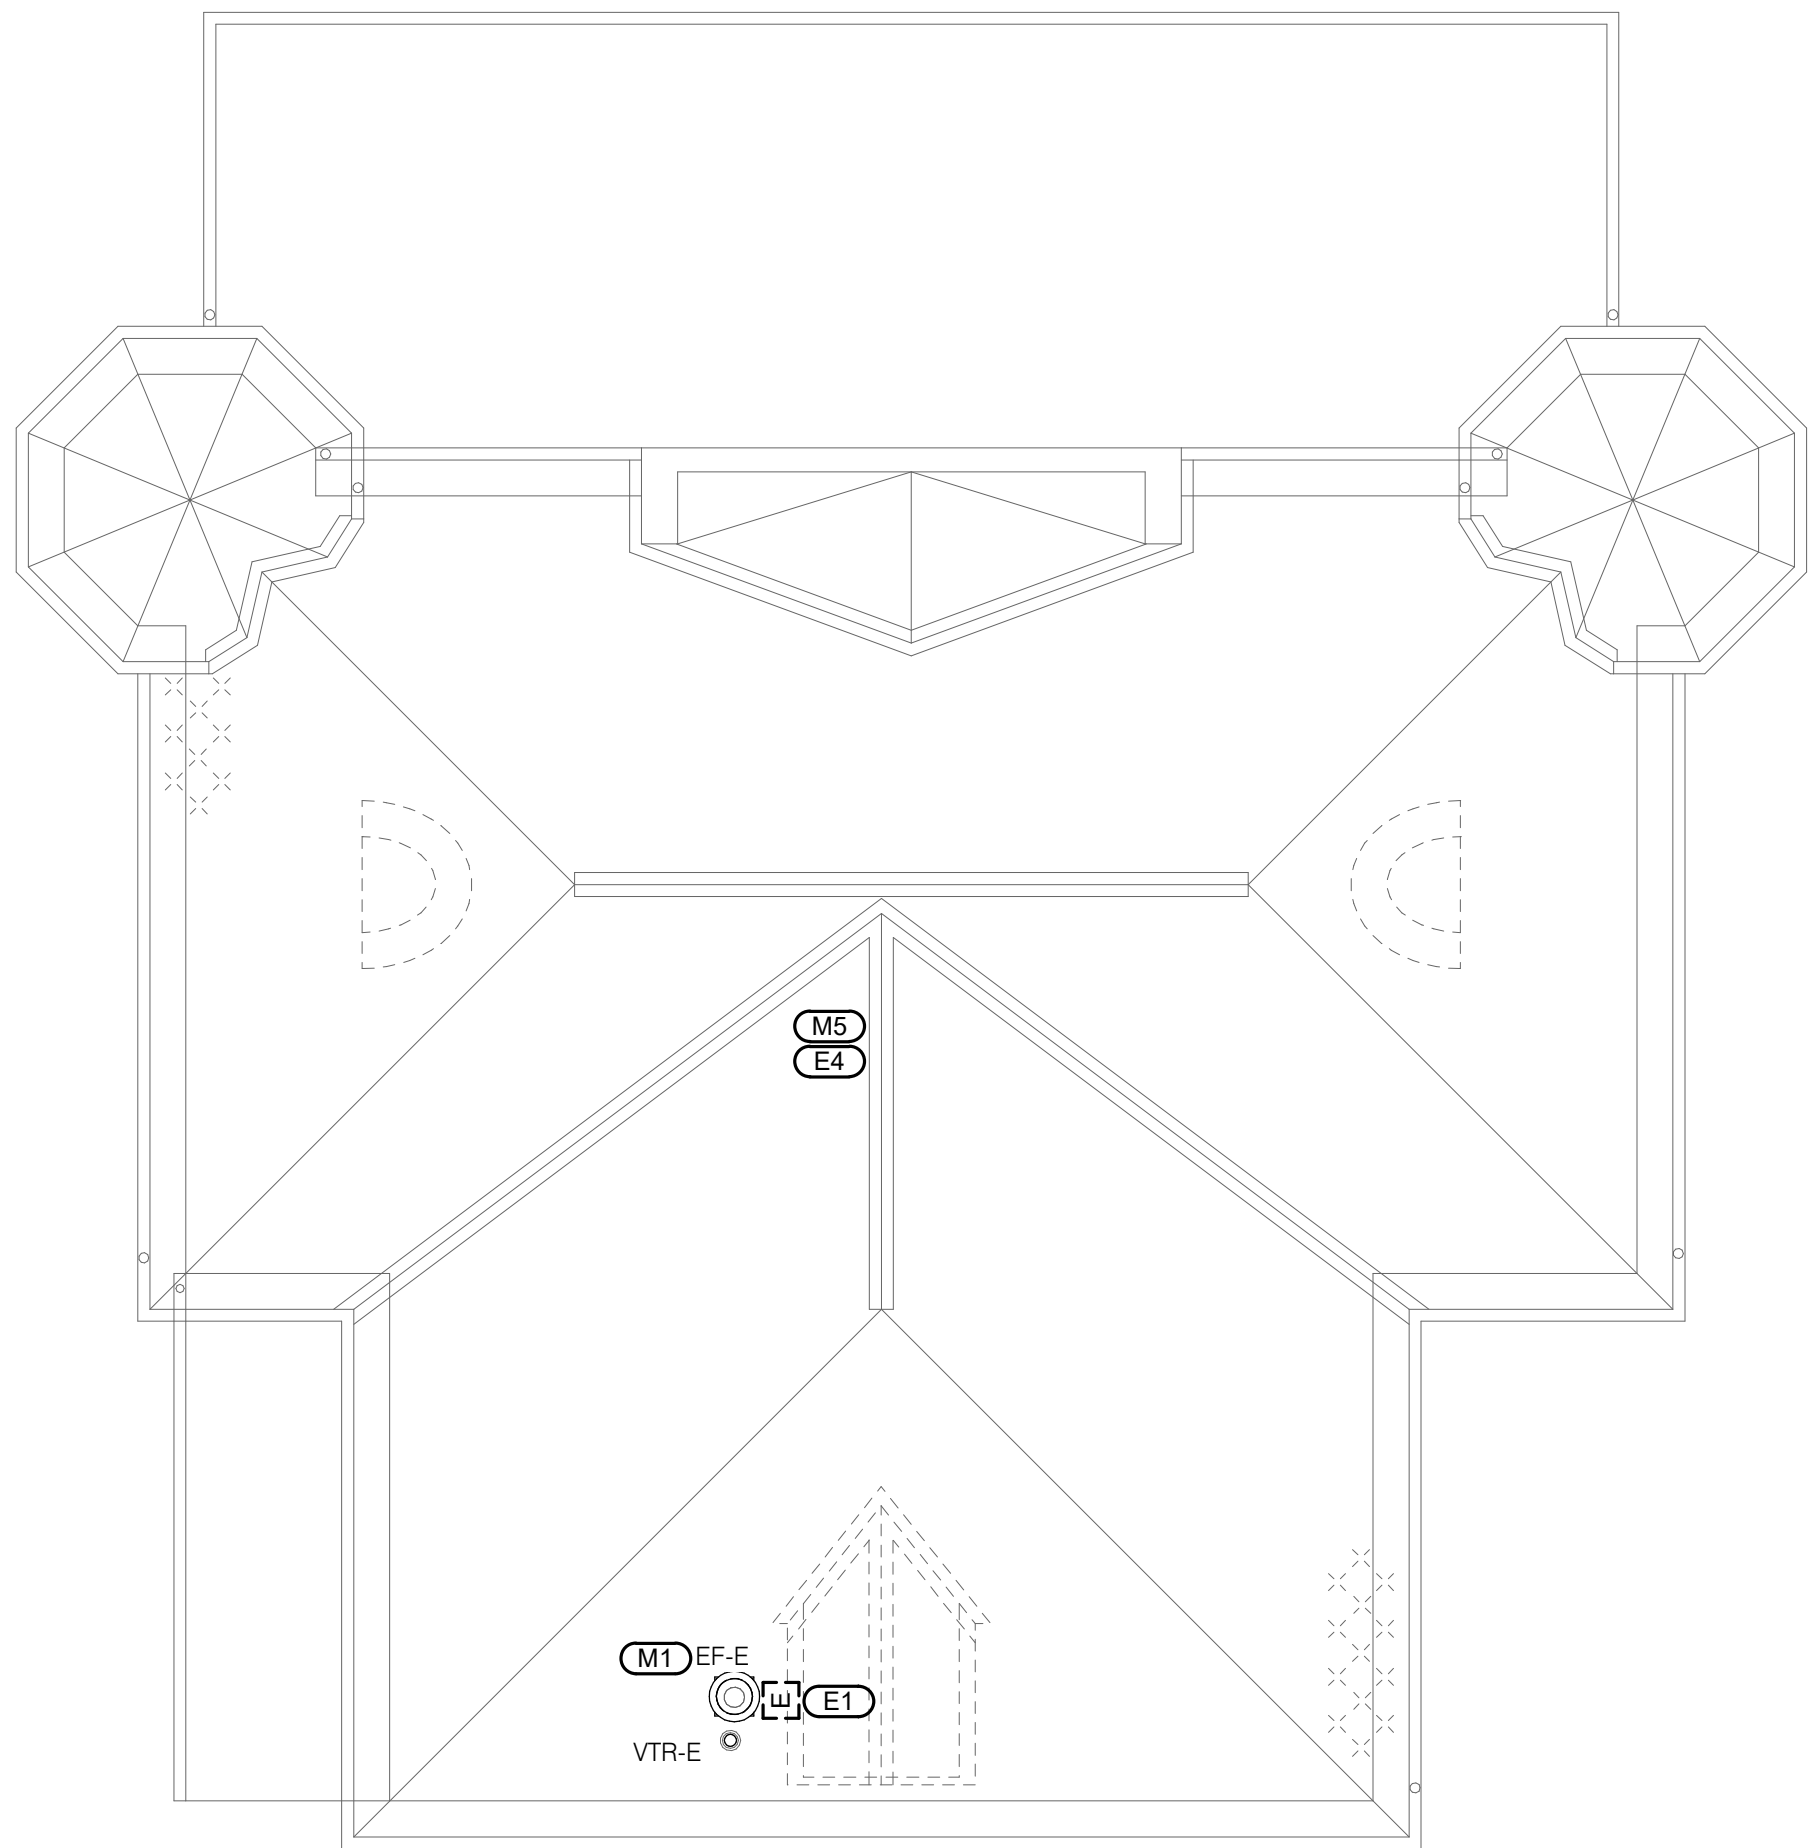

1

BLDG 33 ROOF PLAN - MECHANICAL & ELECTRICAL DEMOLITION

1/8" = 1'-0"



2

BLDG 33 ROOF PLAN - MECHANICAL & ELECTRICAL

1/8" = 1'-0"

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ARCHITECT

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ENGINEER

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15 SUNNEN, SUITE 104, ST. LOUIS, MO 63143

OFFICE OF ADMINISTRATION
DIVISION OF FACILITIES
MANAGEMENT,
DESIGN AND CONSTRUCTION
DEPARTMENT OF
CORRECTIONS

1012 WEST COLUMBIA ST.
FARMINGTON, MO 63640

REPLACE ROOF SYSTEMS
MULTIPLE ASSETS
FARMINGTON
CORRECTIONAL CENTER

FARMINGTON, MISSOURI

PROJECT # C1922-01
SITE # 7008
ASSET # 9327008089,
9327008090, 9327008091, 9327008082
9327008081, 9327008080, 9327008079

REVISION: _____
DATE: _____
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DATE: _____

ISSUE DATE: APRIL 18, 2022


CAD DWG FILE: ME206
DRAWN BY: BRESAN/MASRYA
CHECKED BY: RUSARN/MARHAR
DESIGNED BY: BRESAN/MASRYA

SHEET TITLE:
BLDG 33 ROOF PLANS -
MECHANICAL &
ELECTRICAL
(ALTERNATE NO. 4)

SHEET NUMBER:


ME206

27 OF 29 SHEETS
04/18/2022

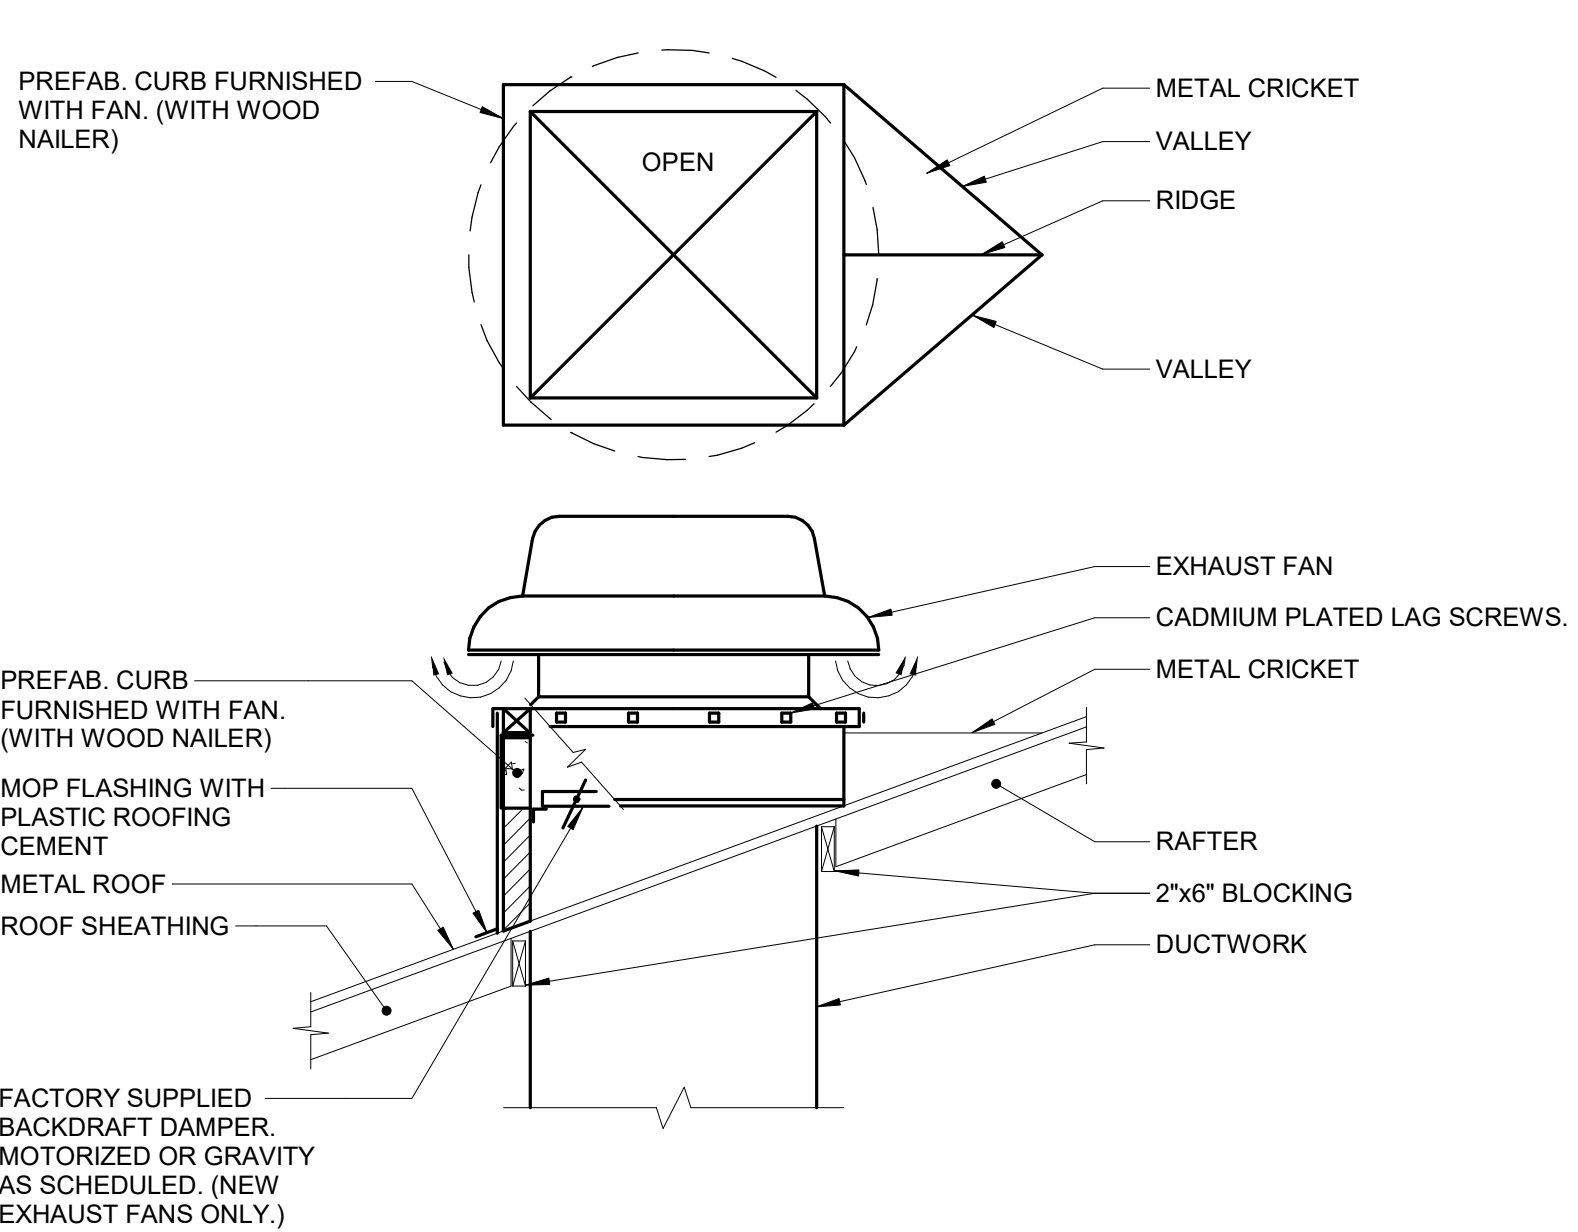


1 ROOF MOUNTED EXHAUST FAN

- NO SCALE
NOTES:
- ALL ROOF FLASHING SHALL BE PER ROOF MANUFACTURER'S RECOMMENDATIONS TO MAINTAIN WARRANTY. REFER TO ARCHITECTURAL DRAWINGS FOR MORE INFORMATION.
 - VERTICAL SEAMS SHALL BE CUT BACK A MINIMUM OF 2" FROM CRICKET.

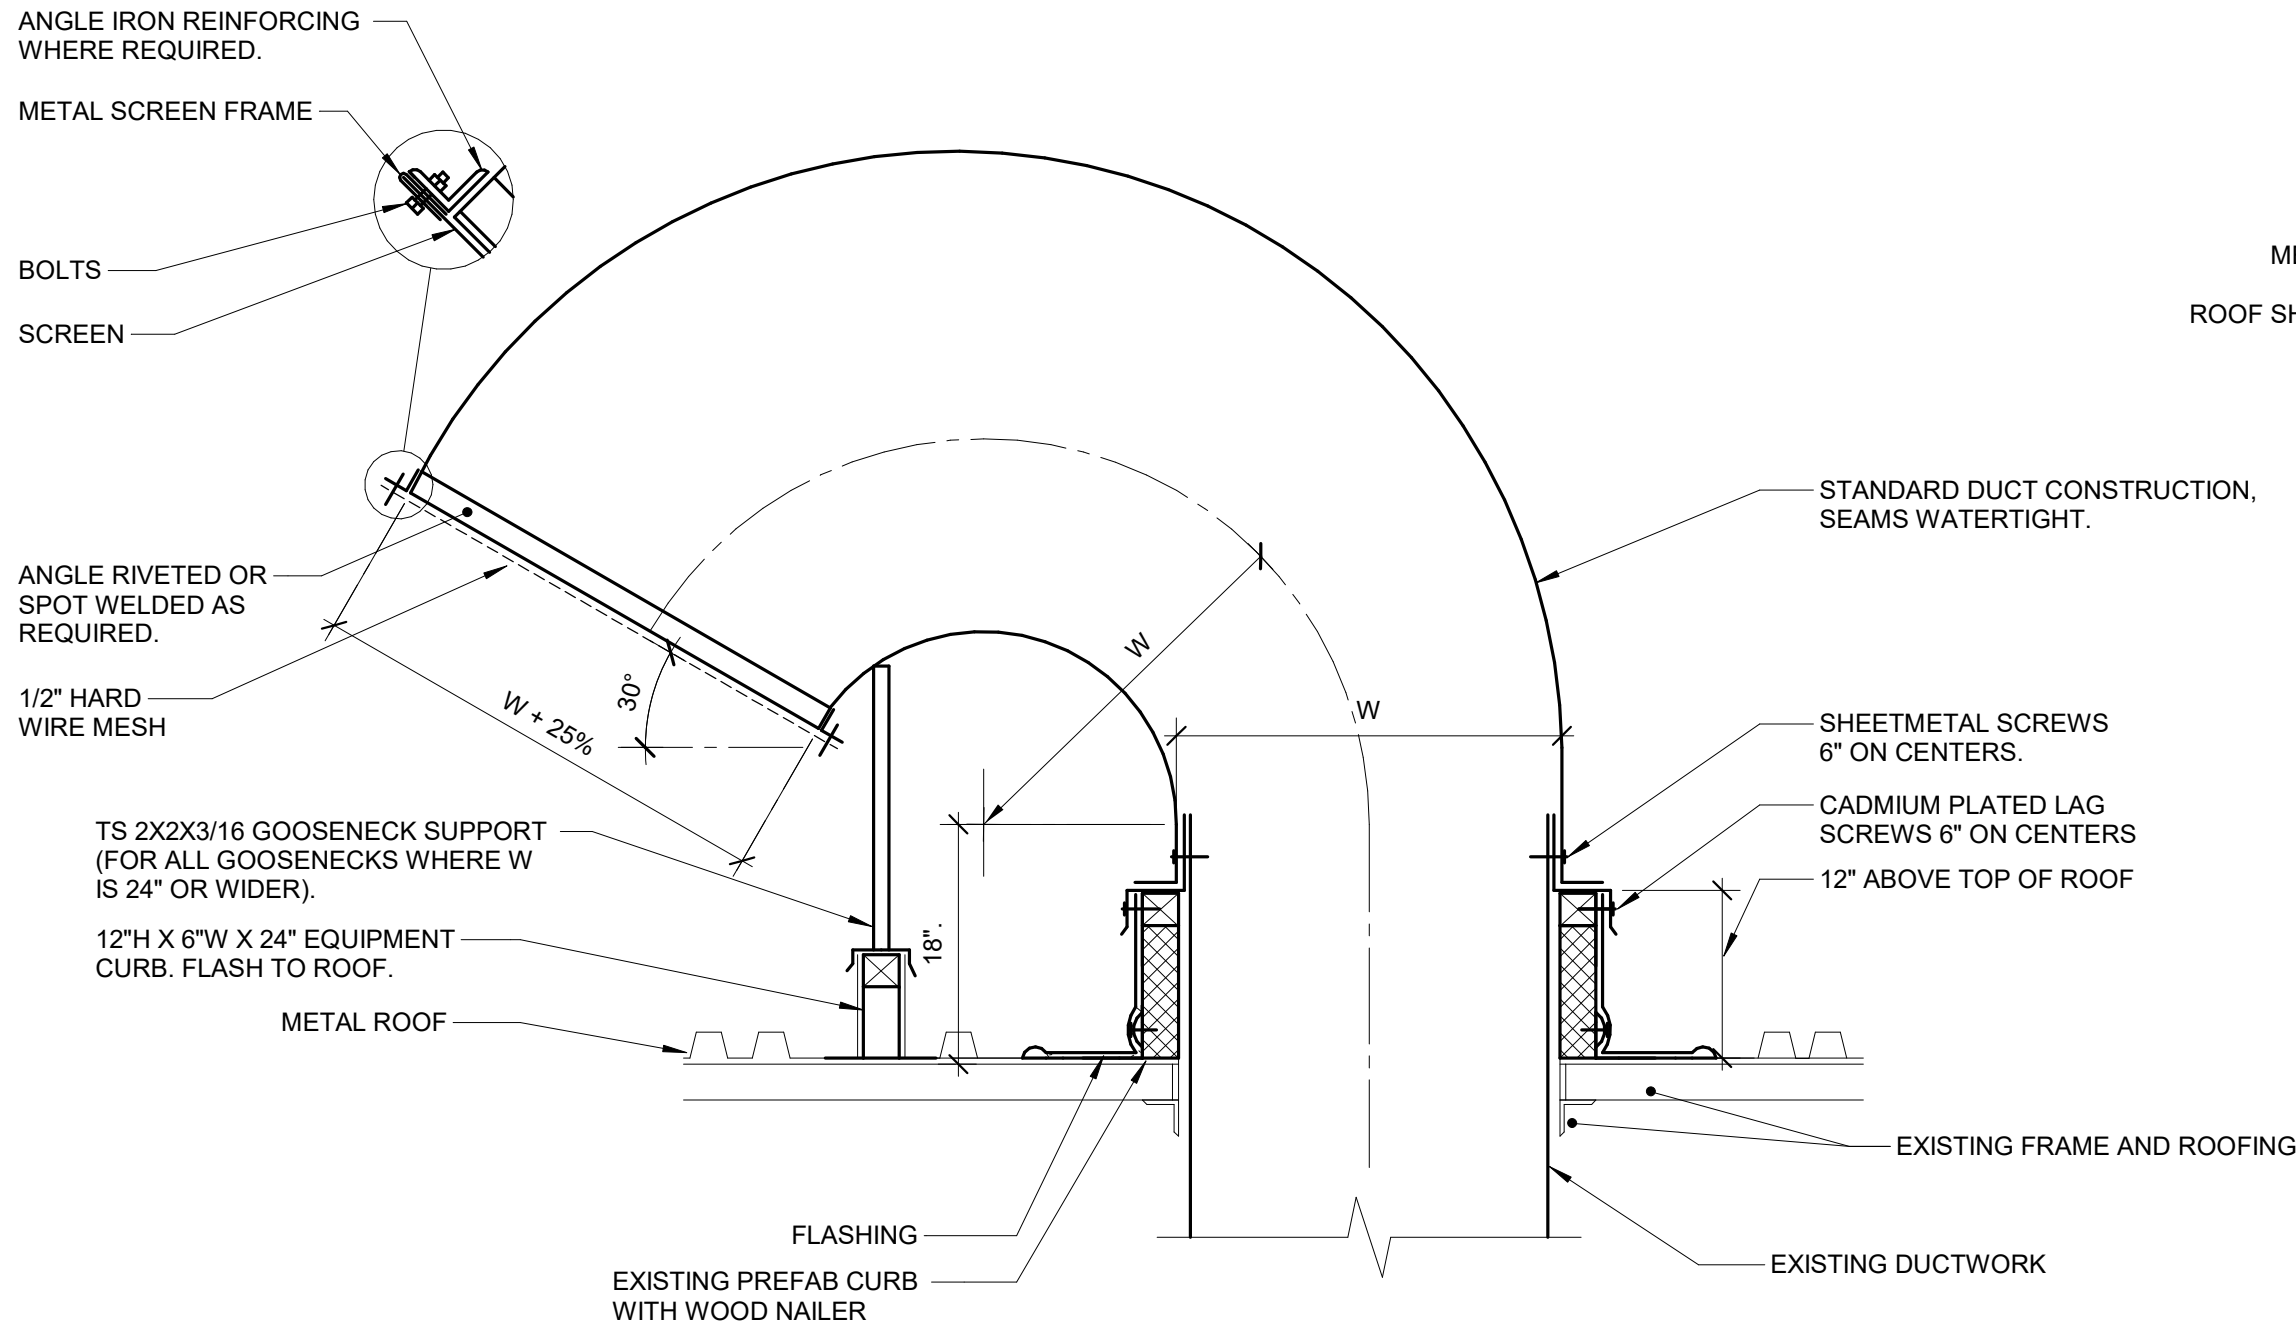

2 GOOSENECK DETAIL


- NO SCALE
NOTES:
- ALL ROOF FLASHING SHALL BE PER ROOF MANUFACTURER'S RECOMMENDATIONS TO MAINTAIN WARRANTY. REFER TO ARCHITECTURAL DRAWINGS FOR MORE INFORMATION.
 - DO NOT FASTEN CURB FLASHINGS TO ROOF CURB. CURB FLASHING TO MOVE WITH METAL ROOF PANEL SYSTEM DURING THERMAL EXPANSION AND CONTRACTION.

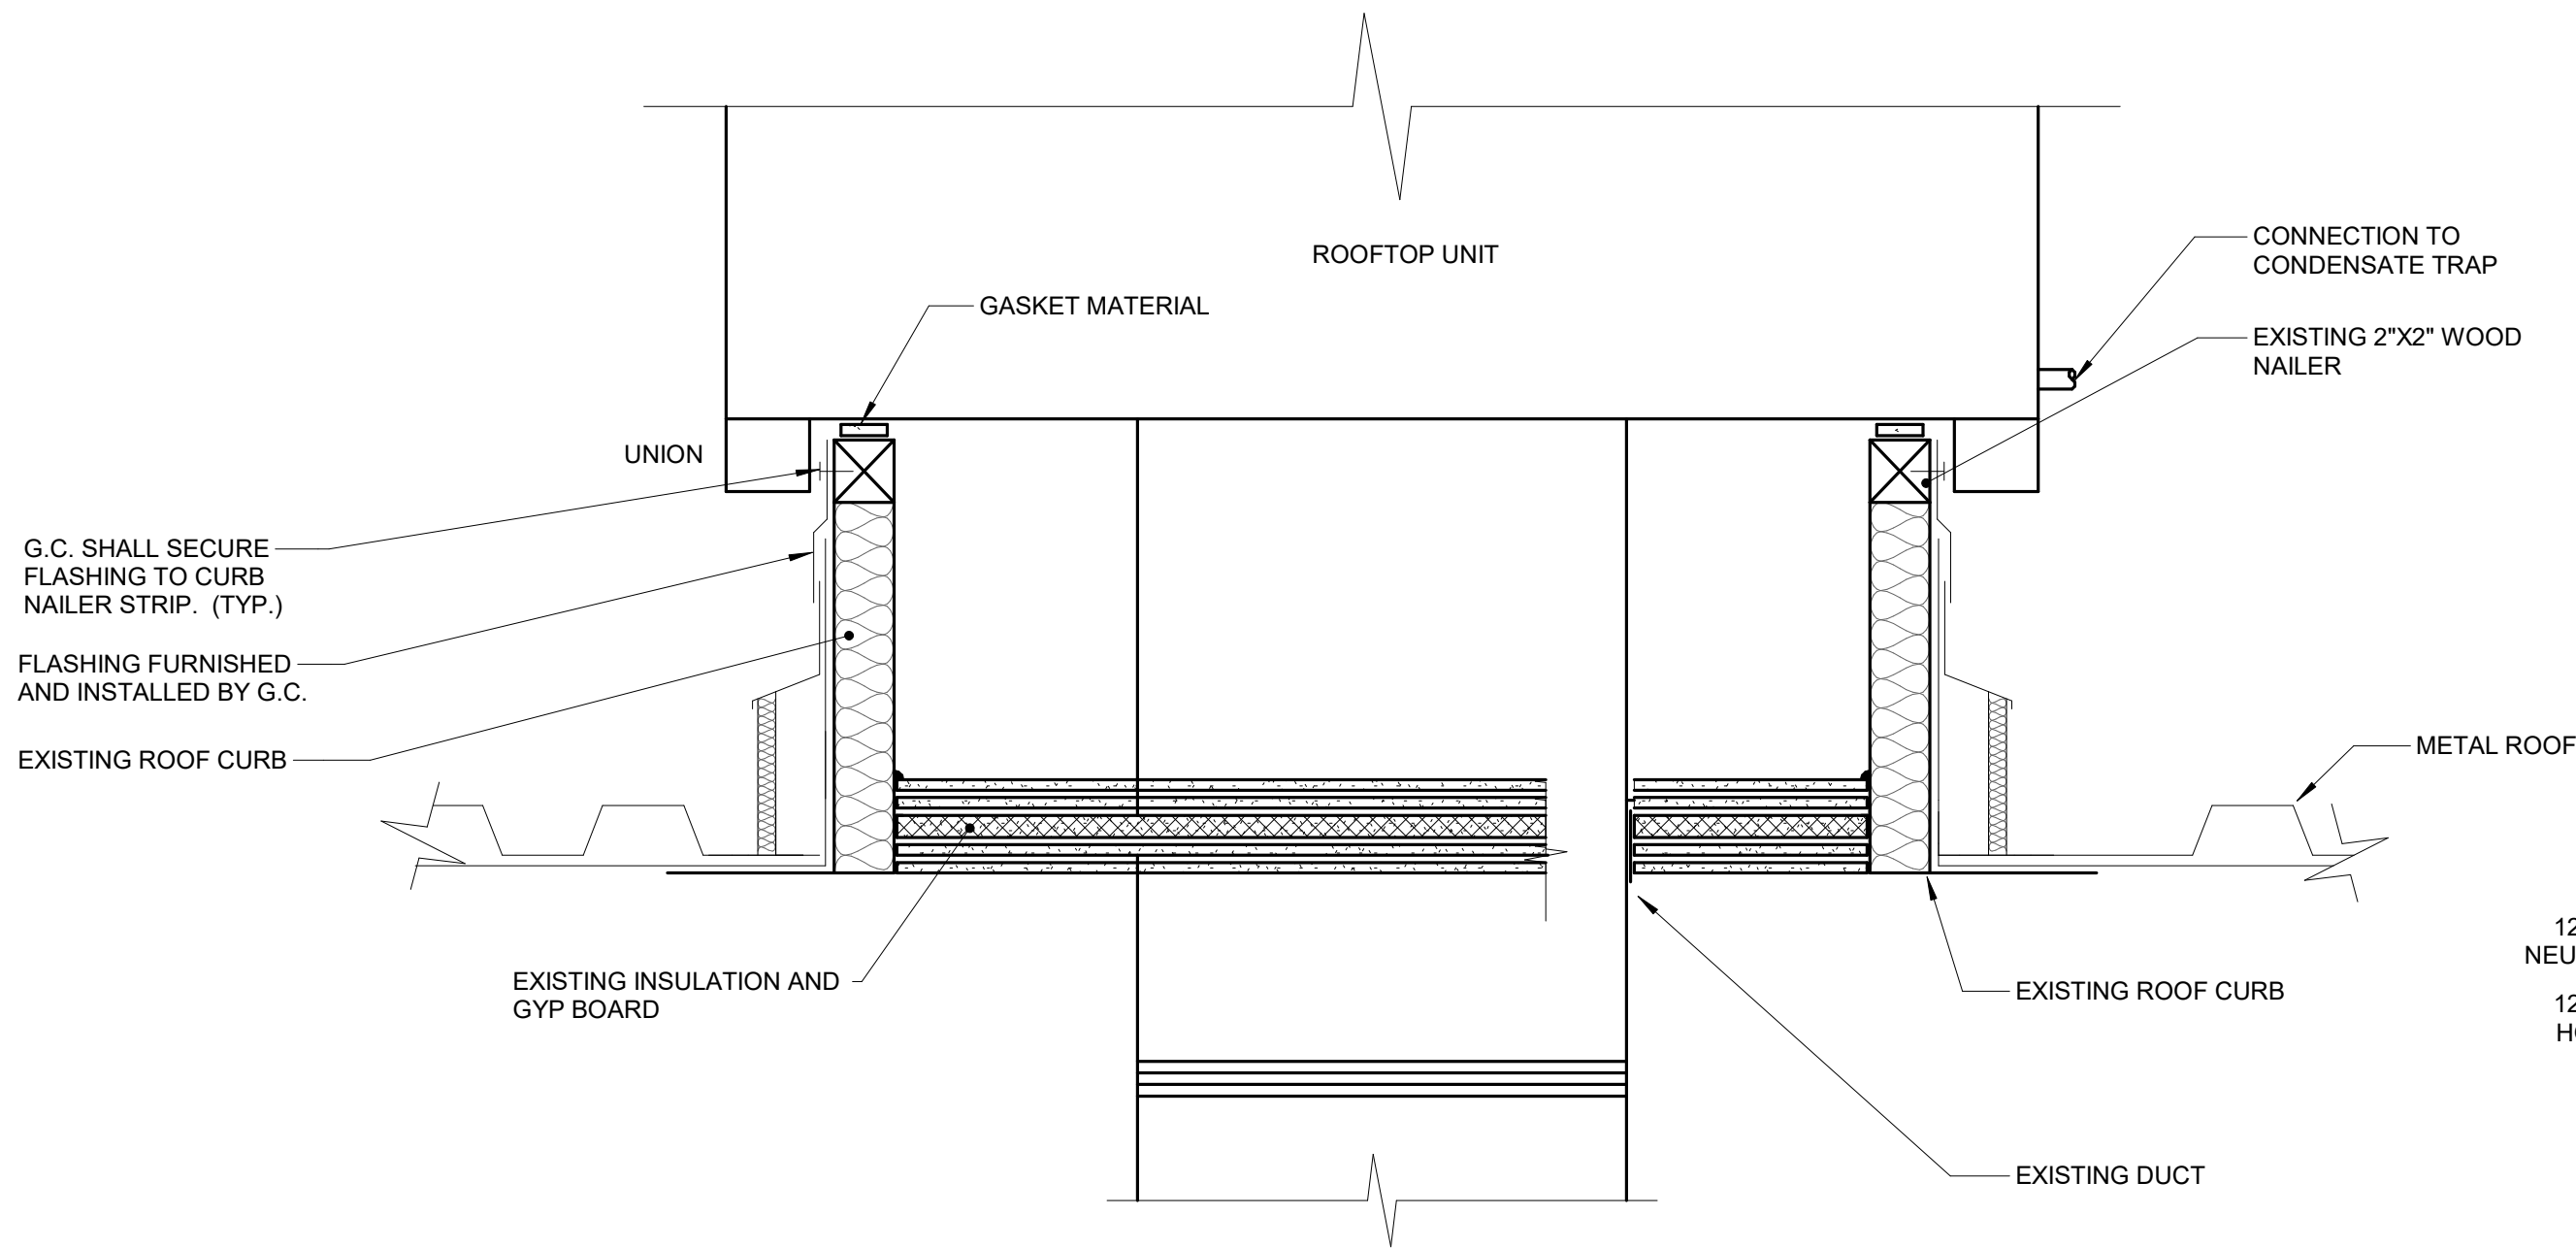

4 ROOFTOP UNIT DETAIL

- NO SCALE
NOTES:
- ALL ROOF FLASHING SHALL BE PER ROOF MANUFACTURER'S RECOMMENDATIONS TO MAINTAIN WARRANTY. REFER TO ARCHITECTURAL DRAWINGS FOR MORE INFORMATION.
 - DO NOT FASTEN CURB FLASHINGS TO ROOF CURB. CURB FLASHING TO MOVE WITH METAL ROOF PANEL SYSTEM DURING THERMAL EXPANSION AND CONTRACTION. ALLOW FOR REQUIRED THERMAL MOVEMENT BETWEEN CURB FLASHING AND ROOF MOUNTED UNIT AT BOTH TOP AND BOTTOM.

CONTROL SYMBOL LIST	
NOT ALL SYMBOLS MAY APPLY.	
SYMBOL:	DESCRIPTION:
ⓘ	THERMOSTAT
⚡	NORMALLY OPEN CONTACT
ACT	ACTUATOR
Ⓢ	RELAY COIL CONTACT

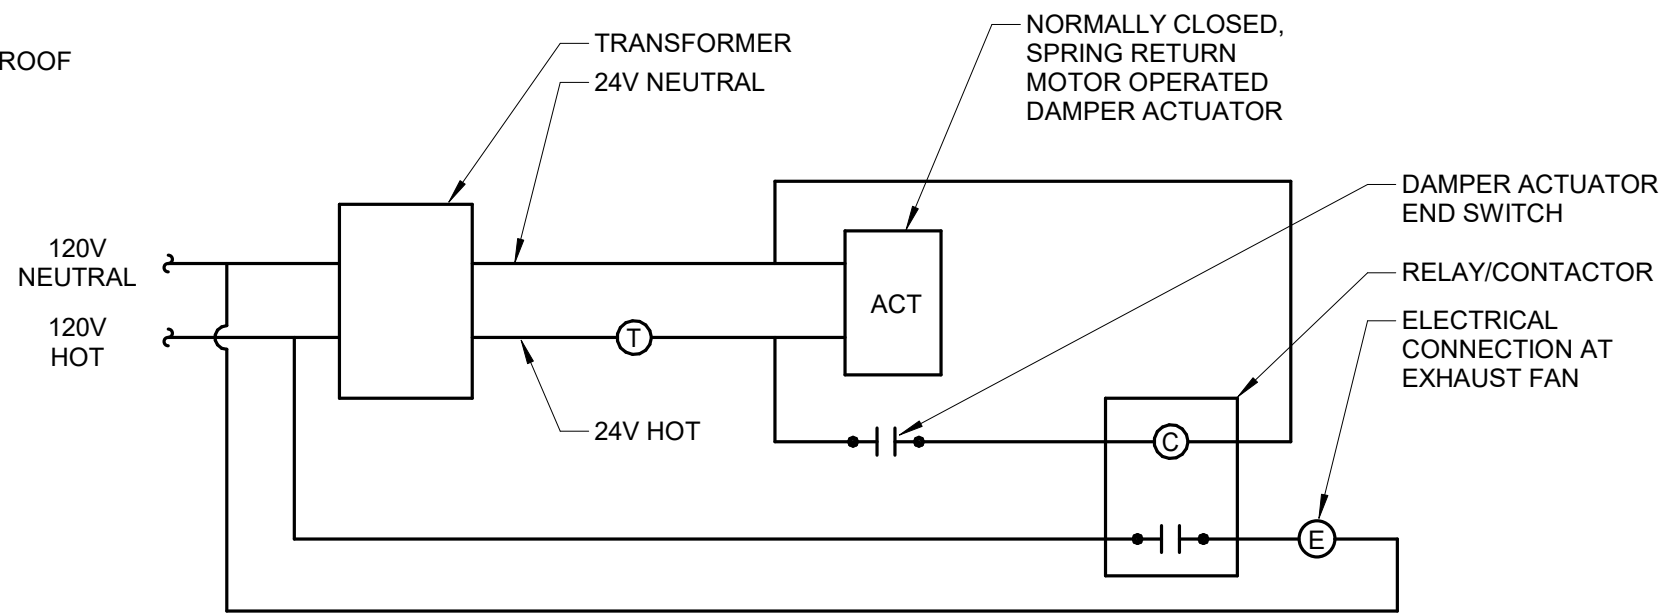


5 DAMPER & EXHAUST FAN RELAY

SEQUENCE OF OPERATION:


WHEN ROOM TEMPERATURE REACHES 115°F (ADJ.) THE MOTOR OPERATED DAMPER SHALL OPEN AND THE FAN SHALL RUN. WHEN ROOM TEMPERATURE READS 110°F (ADJ.) THE FAN SHALL DE-ENERGIZE AND THE MOTOR OPERATED DAMPER SHALL CLOSE.

- NOTES:
- CONTRACTOR SHALL PROVIDE ALL NECESSARY EQUIPMENT TO ALLOW OPERATIONAL SEQUENCE. COORDINATE WITH ELECTRICAL CONTRACTOR.

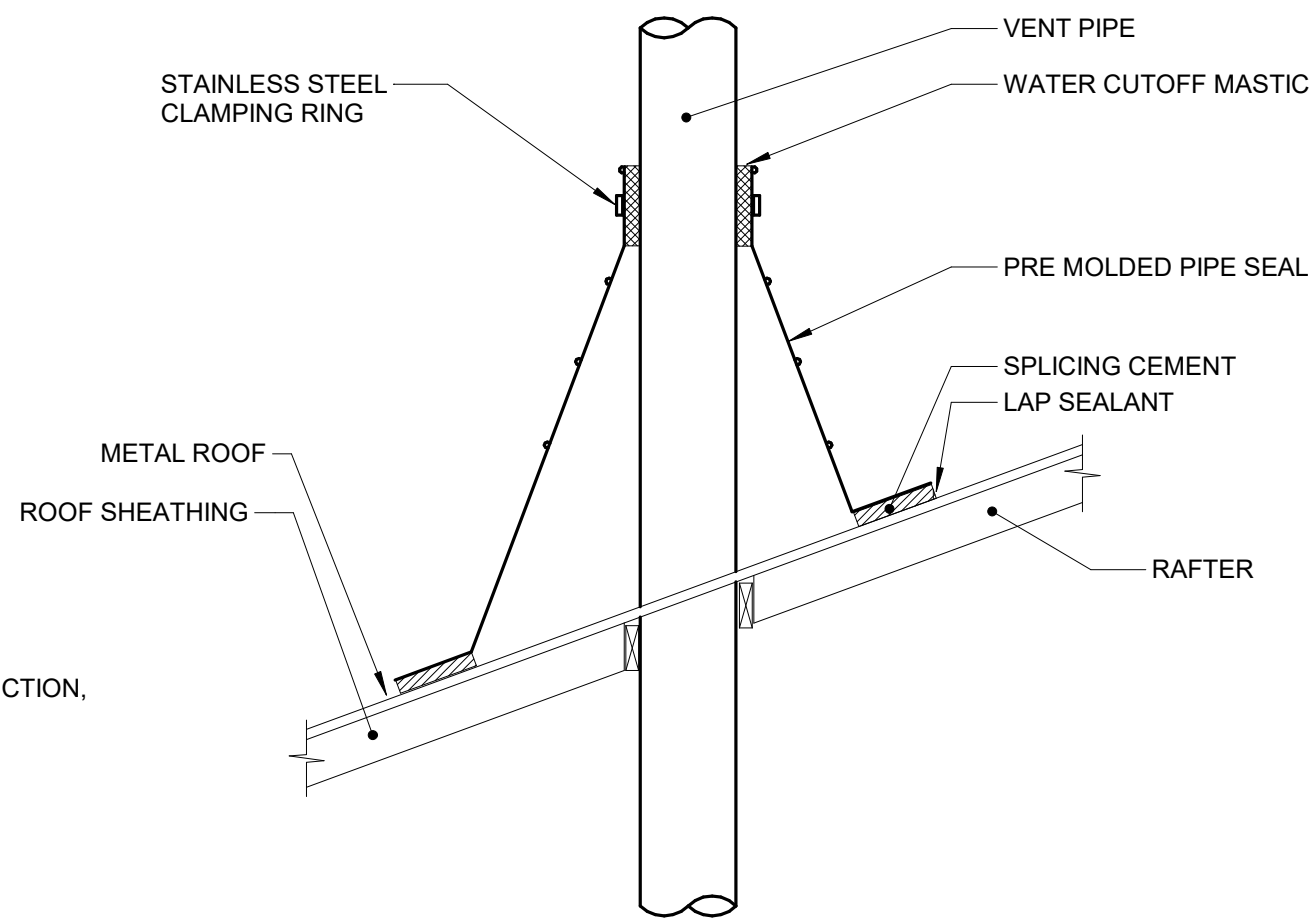


3 VENT PIPE FLASHING

- NO SCALE
NOTES:
- ALL ROOF FLASHING SHALL BE PER ROOF MANUFACTURER'S RECOMMENDATIONS TO MAINTAIN WARRANTY. REFER TO ARCHITECTURAL DRAWINGS FOR MORE INFORMATION.

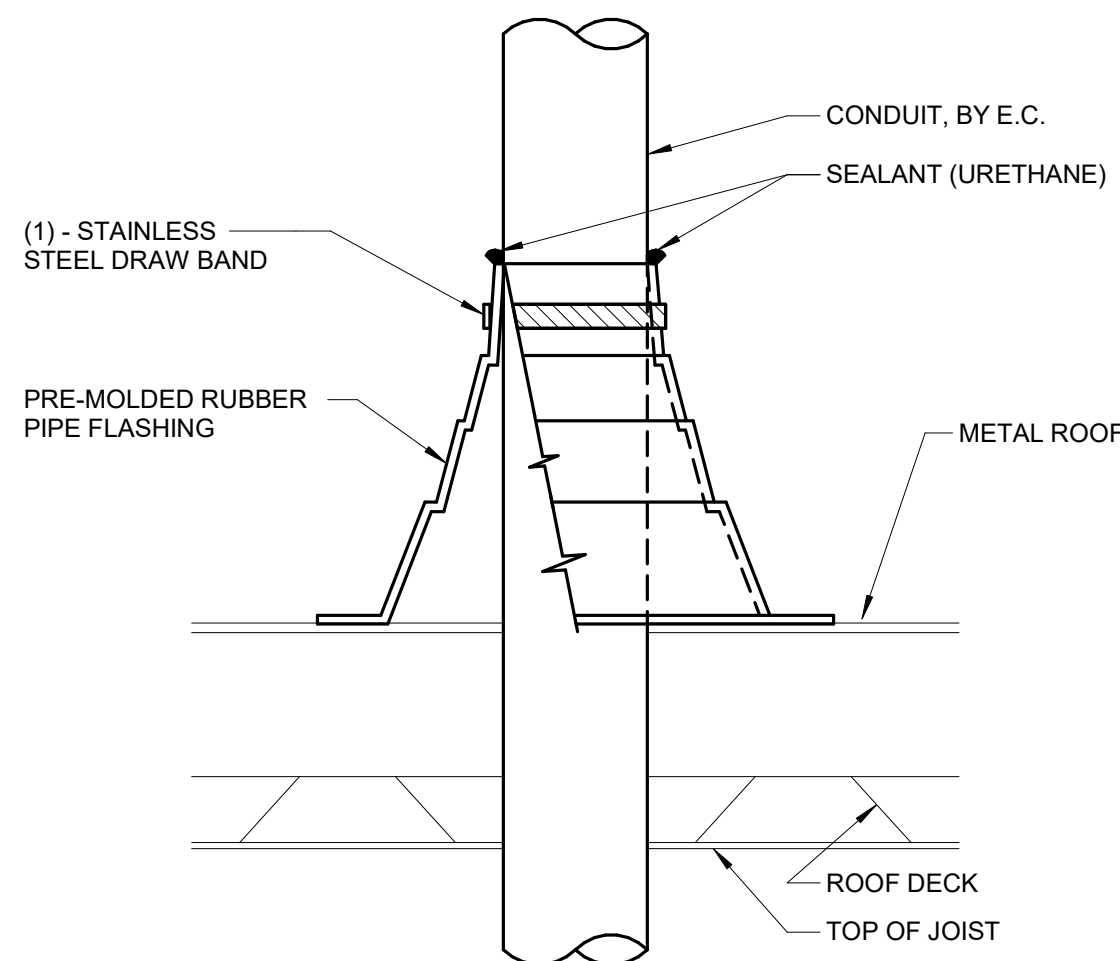

6 CONDUIT ROOF PENETRATION

- NO SCALE
NOTES:
- CONDUIT SHALL BE SUPPORTED WITHIN 24 INCHES ABOVE AND BELOW ROOF.
 - VERIFY FINAL REQUIREMENTS WITH GENERAL CONTRACTOR (G.C.) AND ROOFING INSTALLER PRIOR TO INSTALLATION. ALL ROOF FLASHING SHALL BE PER ROOF MANUFACTURER'S RECOMMENDATIONS TO MAINTAIN WARRANTY.

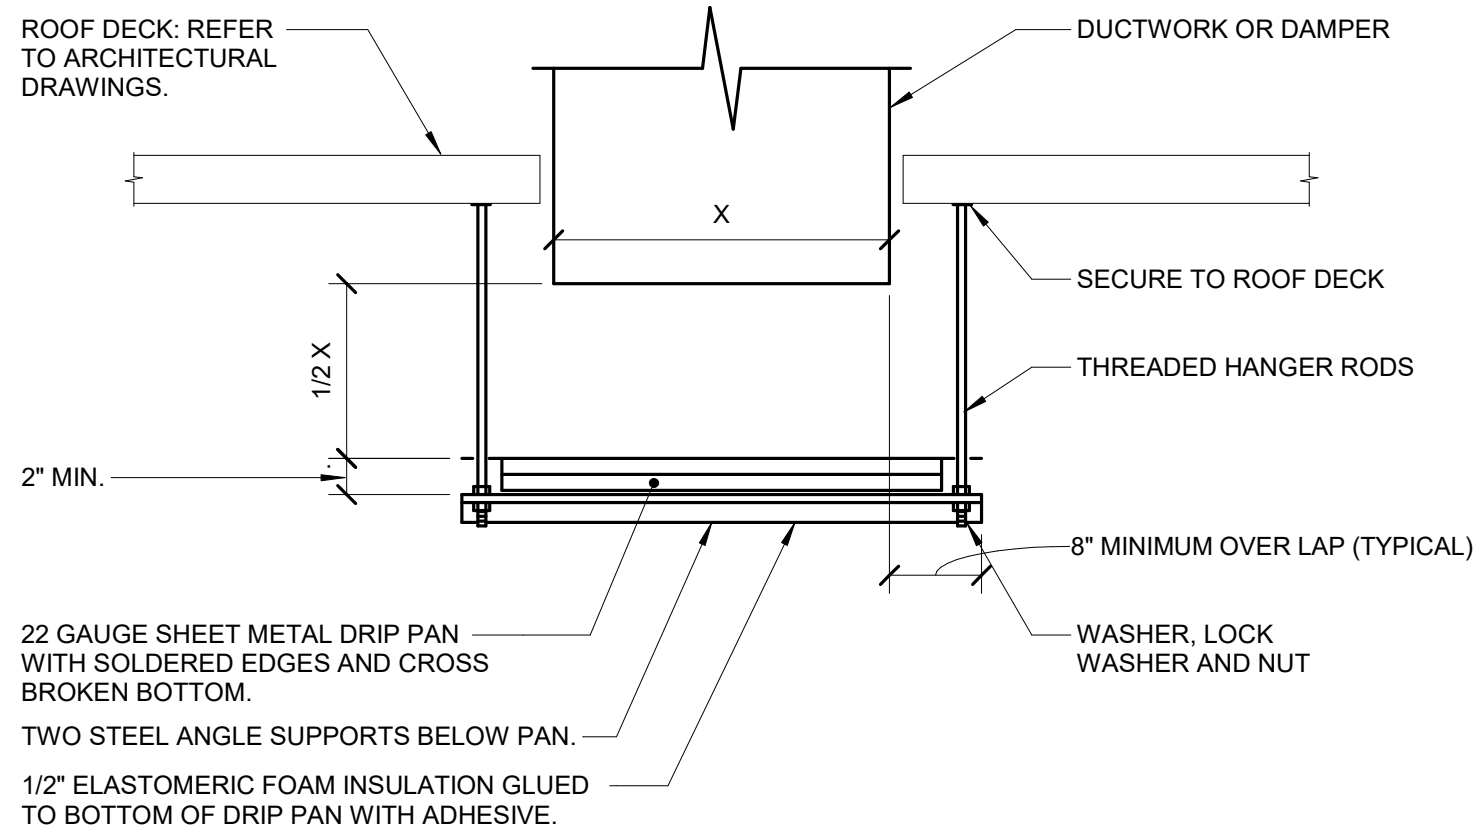

7 DRIP PAN DETAIL

IMEG
15 SUNNEN DR, SUITE 104
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314.645.1132 FAX: 314.645.1173
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PROJECT # 19091055.00

Missouri State Certificate of Authority E-2017008530

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REFERENCE SCALE IN INCHES
1 2 3

STATE OF MISSOURI
MICHAEL L PARSON,
GOVERNOR



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ISSUE DATE: APRIL 18, 2022

CAD DWG FILE: ME300
DRAWN BY: BRESAN/MASRYA
CHECKED BY: RUSARN/MARHAR
DESIGNED BY: BRESAN/MASRYA

SHEET TITLE:
MECHANICAL &
ELECTRICAL DETAILS
& DIAGRAMS

SHEET NUMBER:

ME300

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04/18/2022

SCHEDULE GENERAL NOTES	
KEY NAME	SCHEDULE GENERAL NOTES
A.	DISCONNECT AND CONTROLLER STARTER FURNISHED AND INSTALLED BY: MFR = MANUFACTURER EC = ELECTRICAL CONTRACTOR MC = FURNISHED BY MECHANICAL CONTRACTOR, INSTALLED BY ELECTRICAL CONTRACTOR MFR/EC = FURNISHED LOOSE BY MANUFACTURER INSTALLED BY ELECTRICAL CONTRACTOR ATC = AUTOMATIC TEMPERATURE CONTROL CONTRACTOR
B.	DISCONNECT TYPE: F = FUSED NF = NON-FUSED
C.	CONTROLLER STARTER TYPE: FV = FULL VOLTAGE WYE = WYE-DELTA SS = SOLID STATE (SOFT START) MS = MANUAL STARTER VFD = VARIABLE FREQUENCY DRIVE VFD/B = VARIABLE FREQUENCY DRIVE WITH BYPASS
D.	FAN RPM SHALL NOT EXCEED 110% OF SCHEDULED VALUE, WITH THE SCHEDULED WHEEL TYPE. SUBSTITUTION OF BI OR BIA FANS FOR FC IS ACCEPTABLE IF EFFICIENCY IS NOT LOWER.
E.	NO EQUIPMENT SHALL BE SELECTED ABOVE 90% OF MOTOR NAME PLATE RATING.
F.	MUST BE WITHIN +/- 10% OF SCHEDULED RPM.
G.	CURB TYPE: MFR = STANDARD CURB BY MANUFACTURER GC = BY GENERAL CONTRACTOR SAC = SOUND ATTENUATOR CURB


FAN SCHEDULE																						
NOTES: 1. MANUFACTURER IS BASIS OF DESIGN ONLY. REFERENCE SPECIFICATIONS FOR LIST OF APPROVED MANUFACTURERS.																						
TAG NAME	AREA SERVED	CFM	S.P. IN. W.C.	WHEEL DIA. INCHES	FAN RPM (NOTE F)	DRIVE TYPE	MAX. AMCA SONES	BACKDRAFT DAMPER TYPE	CURB TYPE (NOTE G)	ELECTRICAL										MANUFACTURER (NOTE 1)	MODEL	NOTES
										BHP	MHP	VOLTAGE	PHASES	DISCONNECT		CONTROLLER/STARTER						
														BY (NOTE A)	TYPE (NOTE B)	BY (NOTE A)	TYPE (NOTE C)	SCCR				
EF-31	BUILDING 31	3500	1.00	18	1222	BELT	17	MOTORIZED	MFR	1.1	1.5	115	1	MFR	F	MFR	FV	10,000	COOK	ACRU D	ALTERNATE #3	
EF-32	BUILDING 32	4750	1.00	19.5	1247	BELT	20	MOTORIZED	MFR	1.6	2	115	1	MFR	F	MFR	FV	10,000	COOK	ACRU D		
EF-33	BUILDING 33	4750	1.00	19.5	1247	BELT	20	MOTORIZED	MFR	1.6	2	115	1	MFR	F	MFR	FV	10,000	COOK	ACRU D	ALTERNATE #4	

MOTOR OPERATED DAMPER SCHEDULE

NOTES:
1.COORDINATE DAMPER ACTUATOR LOCATION AND MOUNTING REQUIREMENTS WITH TEMPERATURE CONTROL CONTRACTOR.

TAG NAME	AREA SERVED	SIZE		CFM		BLADE CONFIGURATION	BLADE ORIENTATION	INSULATED	ACTUATOR TYPE (NOTE 1)	ACTUATOR STYLE	POWER FAILURE POSITION	POSITIVE POSITION FEEDBACK REQUIRED	NOTES
		WIDTH	HEIGHT	MAX.	MIN.								
MOD-31	BUILDING 31	24	24	3500	0	OPPOSED	HORIZONTAL	Yes	ELECTRIC	TWO POSITION	NORMALLY CLOSED (NC)	Yes	ALTERNATE #3
MOD-32	BUILDING 32	28	28	4750	0	OPPOSED	HORIZONTAL	Yes	ELECTRIC	TWO POSITION	NORMALLY CLOSED (NC)	Yes	
MOD-33	BUILDING 33	28	28	4750	0	OPPOSED	HORIZONTAL	Yes	ELECTRIC	TWO POSITION	NORMALLY CLOSED (NC)	Yes	ALTERNATE #4


HOOD & LOUVERED PENTHOUSE SCHEDULE																	
NOTES: 1. PROVIDE INSULATED ROOF CURB SLOPED TO MATCH ROOF SLOPE. 2. PROVIDE INTEGRAL BIRDSCREEN. 3. MANUFACTURER IS BASIS OF DESIGN ONLY. REFERENCE SPECIFICATIONS FOR LIST OF APPROVED MANUFACTURERS.																	
TAG NAME	AREA SERVED	CFM	THROAT SIZE		THROAT VELOCITY (FT/MIN)	STATIC PRESSURE DROP (IN WC)	FREE AREA (FT ^2)	CONFIGURATION	DAMPER TYPE	CURB TYPE (NOTE A)	MAX. DIMENSIONS (IN)			WEIGHT (LB)	MANUFACTURER (NOTE 3)	MODEL	NOTES
			WIDTH	LENGTH							LENGTH	WIDTH	HEIGHT				
RH-31	BUILDING 31	3500	24	24	875	0.13	4	HOODED	MOD-31	MFR	39	52	21	82	GREENHECK	FGI	NOTES 1 & 2, ALTERNATE #3
RH-32	BUILDING 32	4750	28	28	875	0.13	5.4	HOODED	MOD-32	MFR	51	53	21	104	GREENHECK	FGI	NOTES 1 & 2
RH-33	BUILDING 33	4750	28	28	875	0.13	5.4	HOODED	MOD-33	MFR	51	53	21	104	GREENHECK	FGI	NOTES 1 & 2, ALTERNATE #4

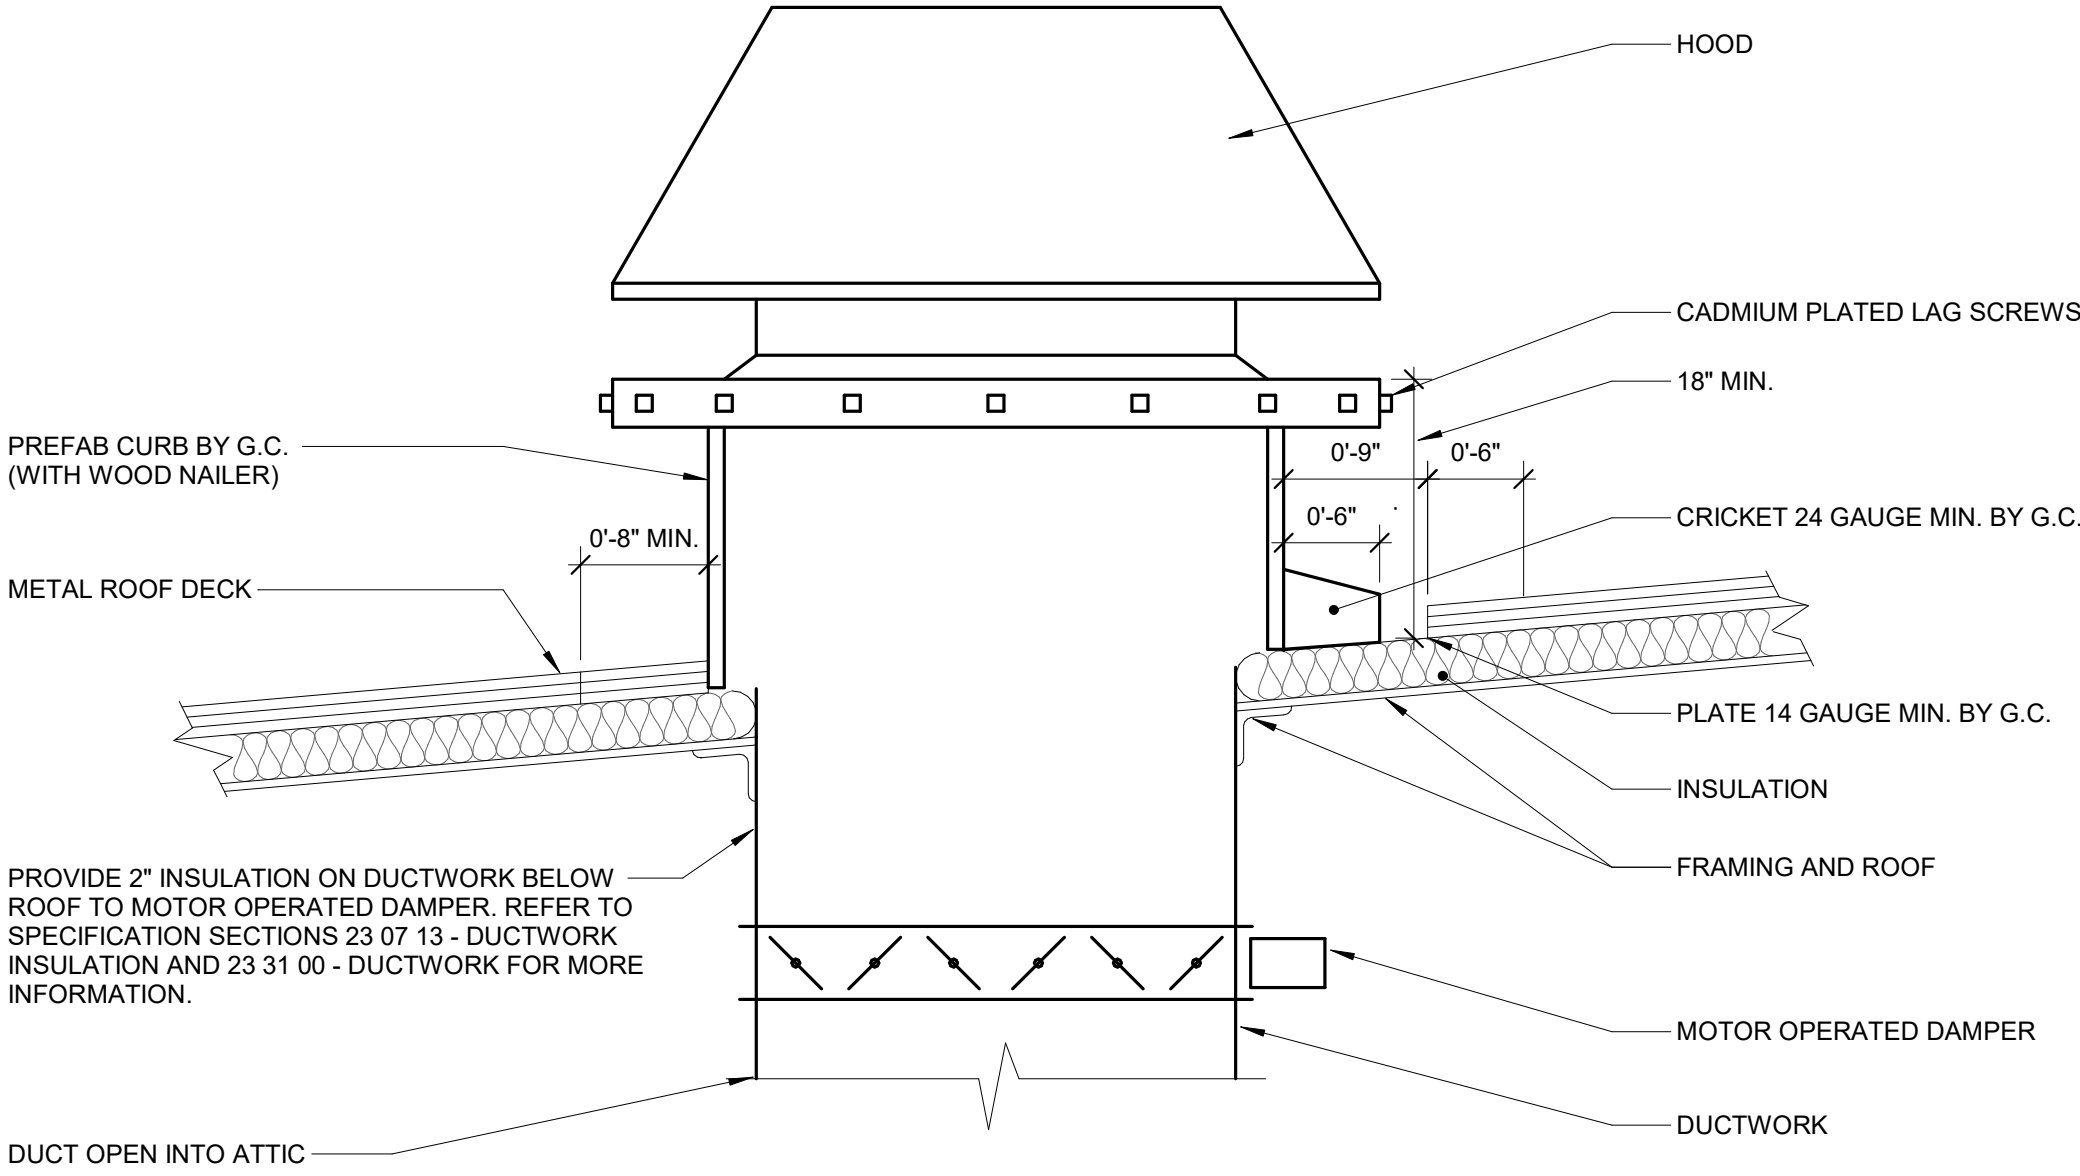

1

METAL ROOF MOUNTED HOOD

NO SCALE



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CAD DWG FILE: ME500
DRAWN BY: BRESAN/MASRYA
CHECKED BY: RUSARN/MARHAR
DESIGNED BY: BRESAN/MASRYA

SHEET TITLE:
MECHANICAL &
ELECTRICAL
SCHEDULES

SHEET NUMBER:

ME500

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