
# VOLUME 2 REPLACE BOILERS AND CONTROLS, POWER PLANT FARMINGTON CORRECTIONAL CENTER FARMINGTON, MISSOURI

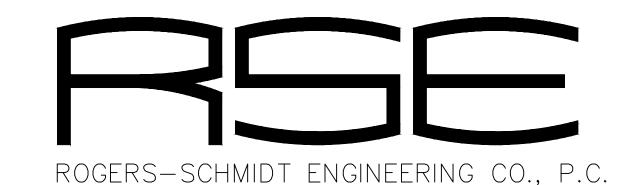

CONSULTING ENGINEERS
MISSOURI STATE CERTIFICATE
OF AUTHORITY #000408

OWNER: STATE OF MISSOURI

MICHAEL L. PARSON,

GOVERNOR

DEPARTMENT OF CORRECTIONS

PROJECT OFFICE OF ADMINISTRATION

MANAGEMENT: DIVISION OF FACILITIES MANAGEMENT,

DESIGN AND CONSTRUCTION

DESIGNER: ROGERS-SCHMIDT ENGINEERING CO., PC.

1736 WEST PARK CENTER DR.

SUITE 204


ST. LOUIS, 63026 PHONE: 636-600-1551


EMAIL: CBARTH@ROGERS-SCHMIDT.COM


PROJECT NUMBER: C2006-01

SITE NUMBER: 7008

ASSET NUMBER: POWER PLANT - 9327008094

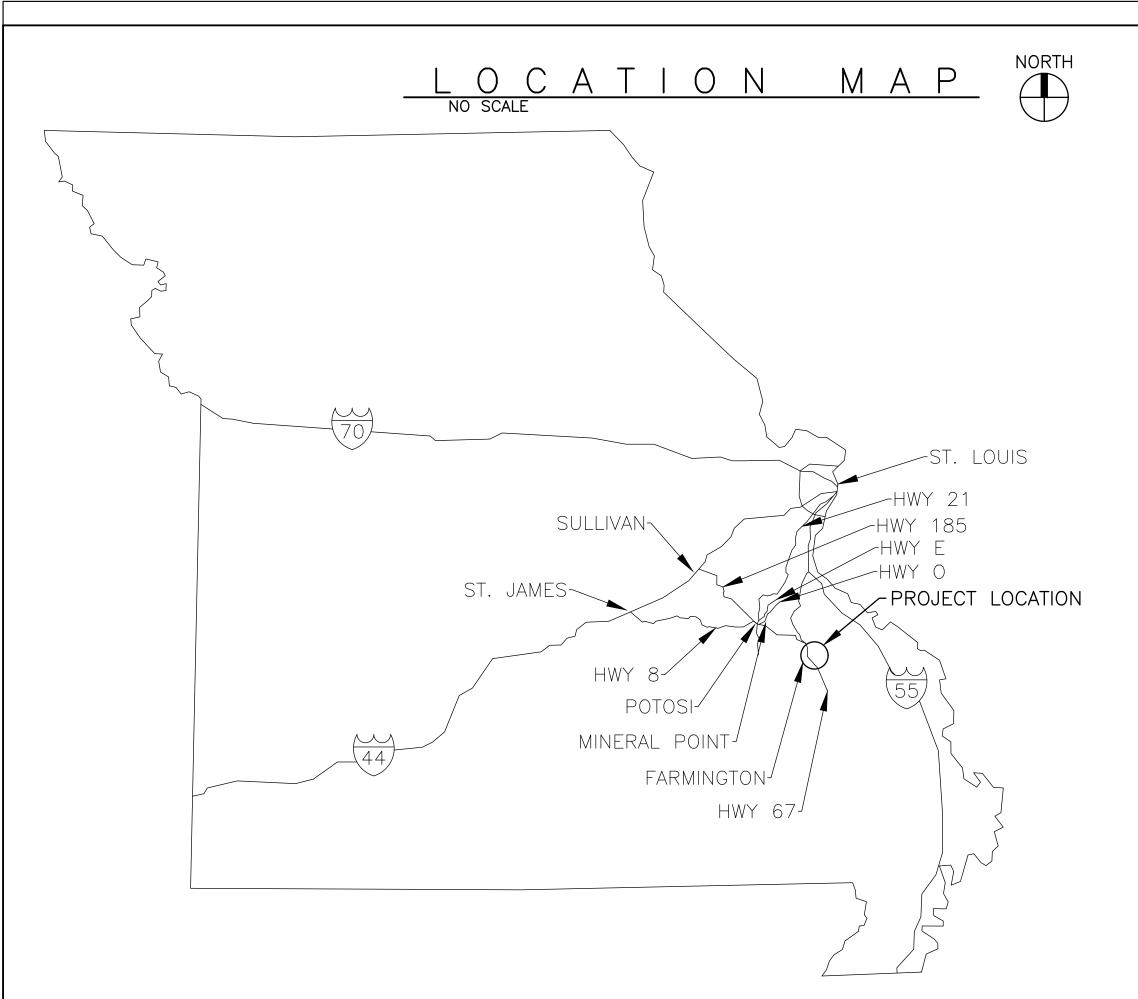

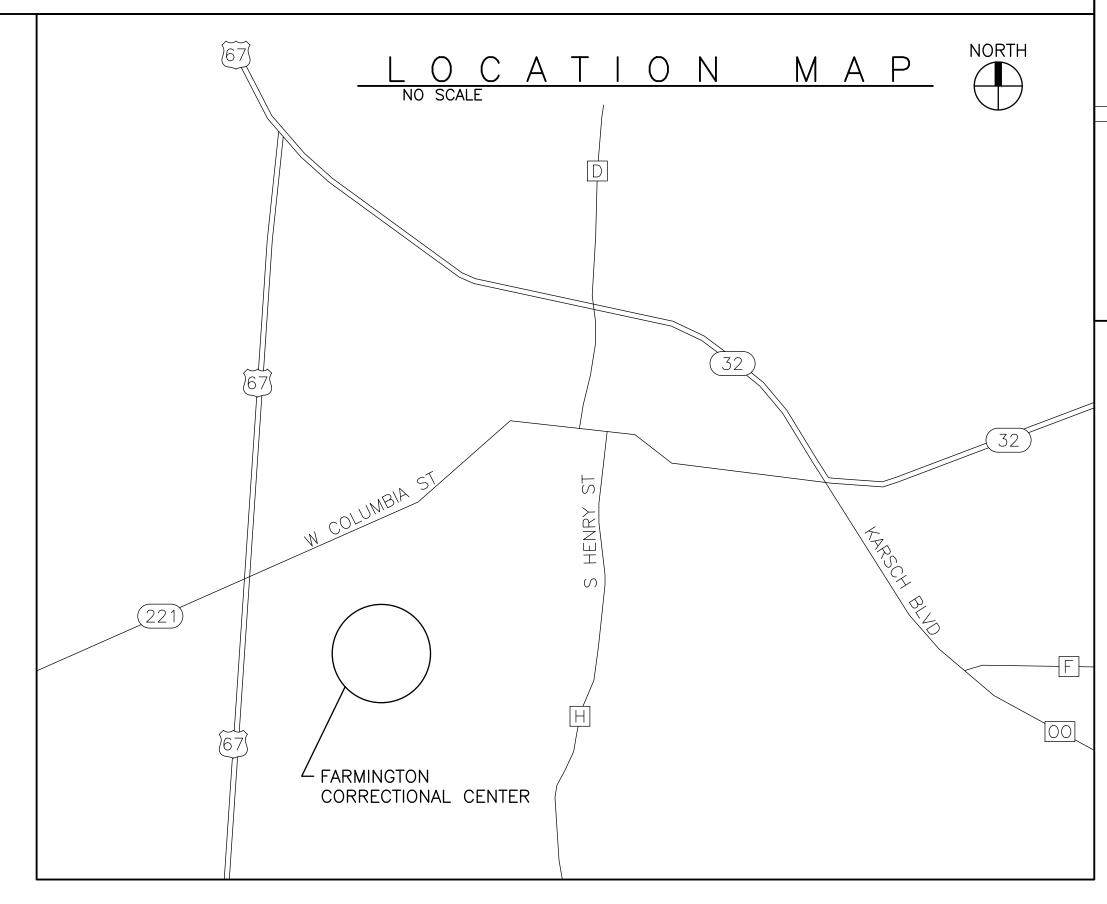

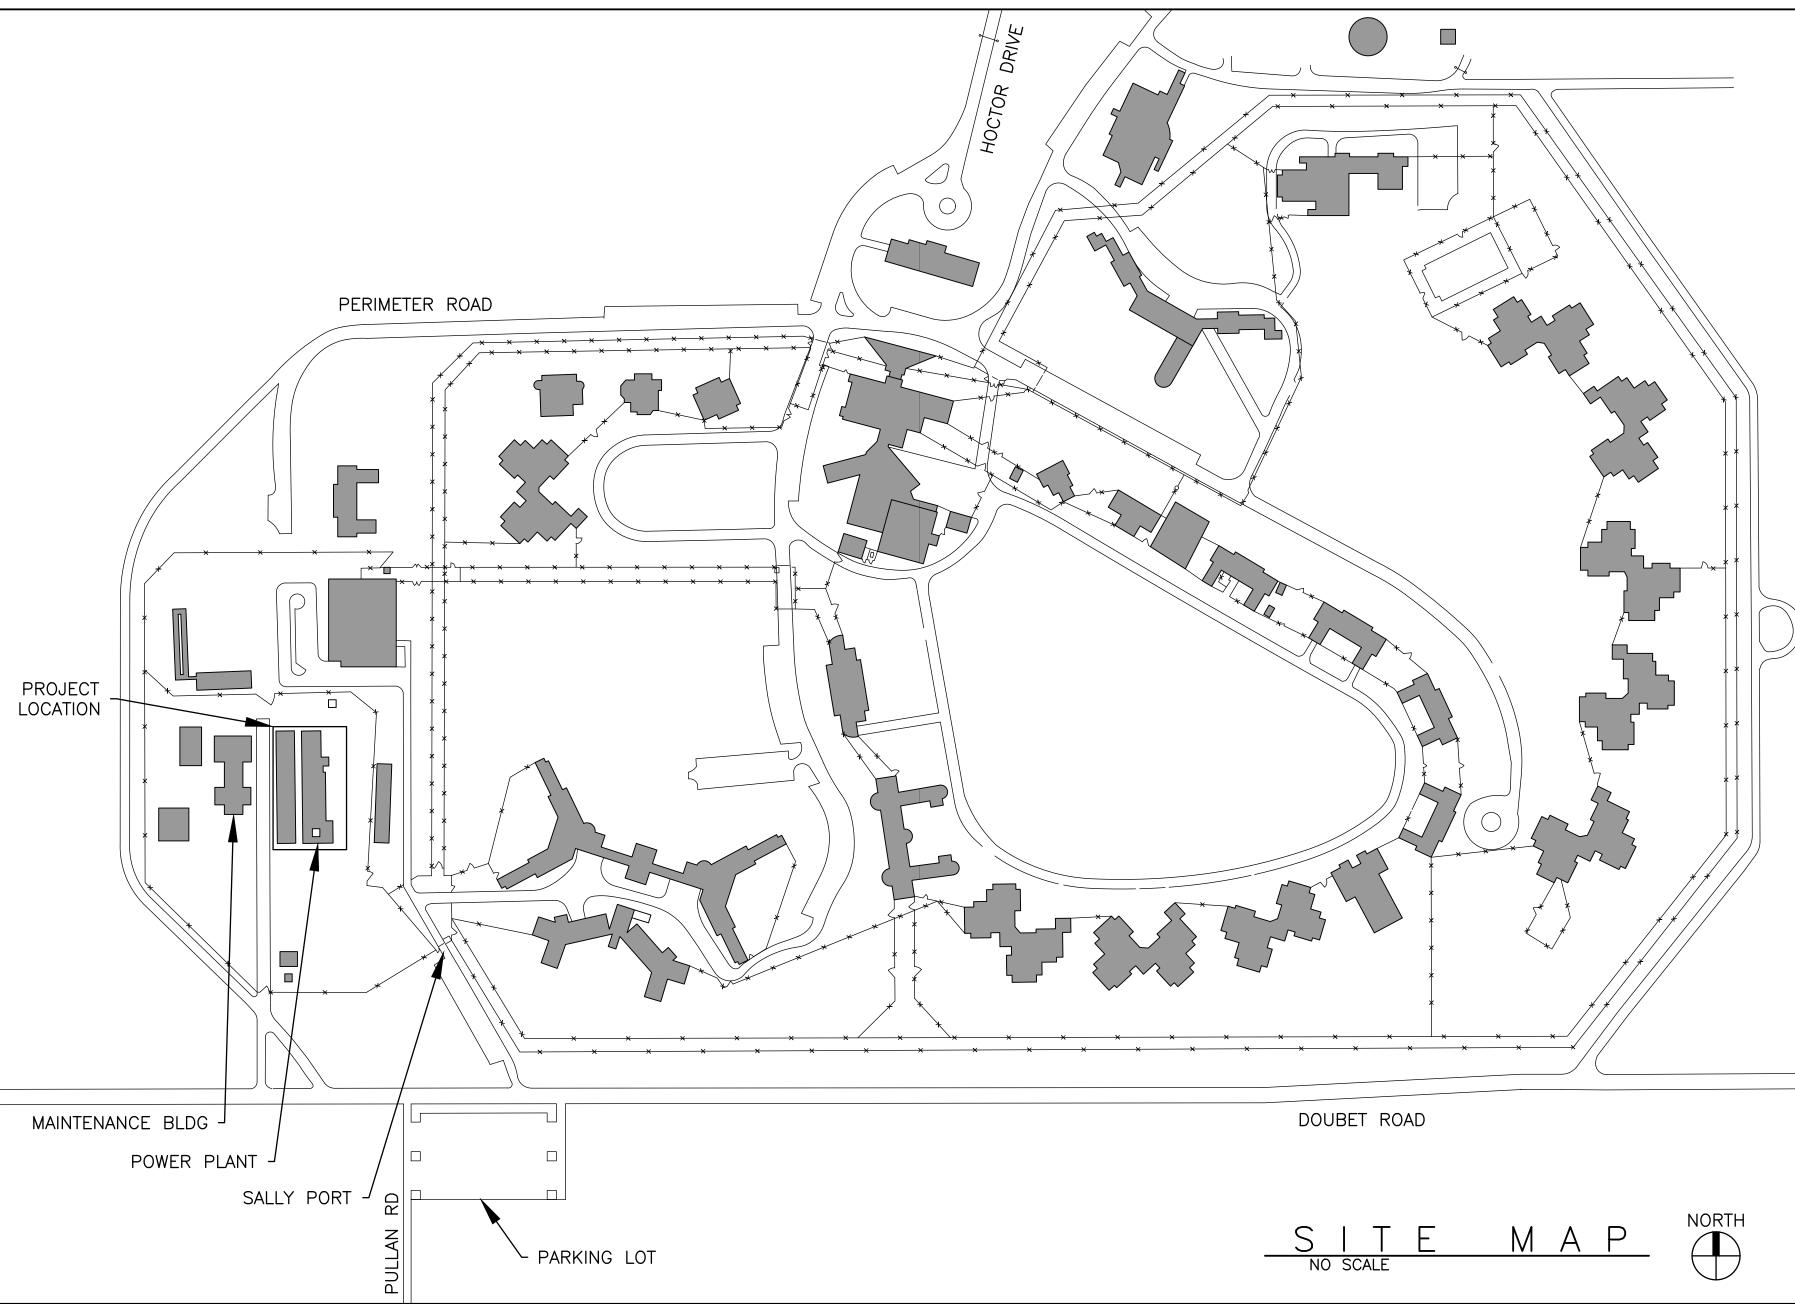

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OFFICE OF ADMINISTRATION DIVISION OF FACILITIES MANAGEMENT, DESIGN AND CONSTRUCTION

DEPARTMENT OF CORRECTIONS

VOLUME 2 -REPLACE BOILERS AND CONTROLS, POWER PLANT

FARMINGTON
CORRECTIONAL CENTER
1012 WEST COLUMBIA
STREET,
FARMINGTON, MO 63640

PROJECT # C2006-01 SITE # 7008 ASSET # 9327008094

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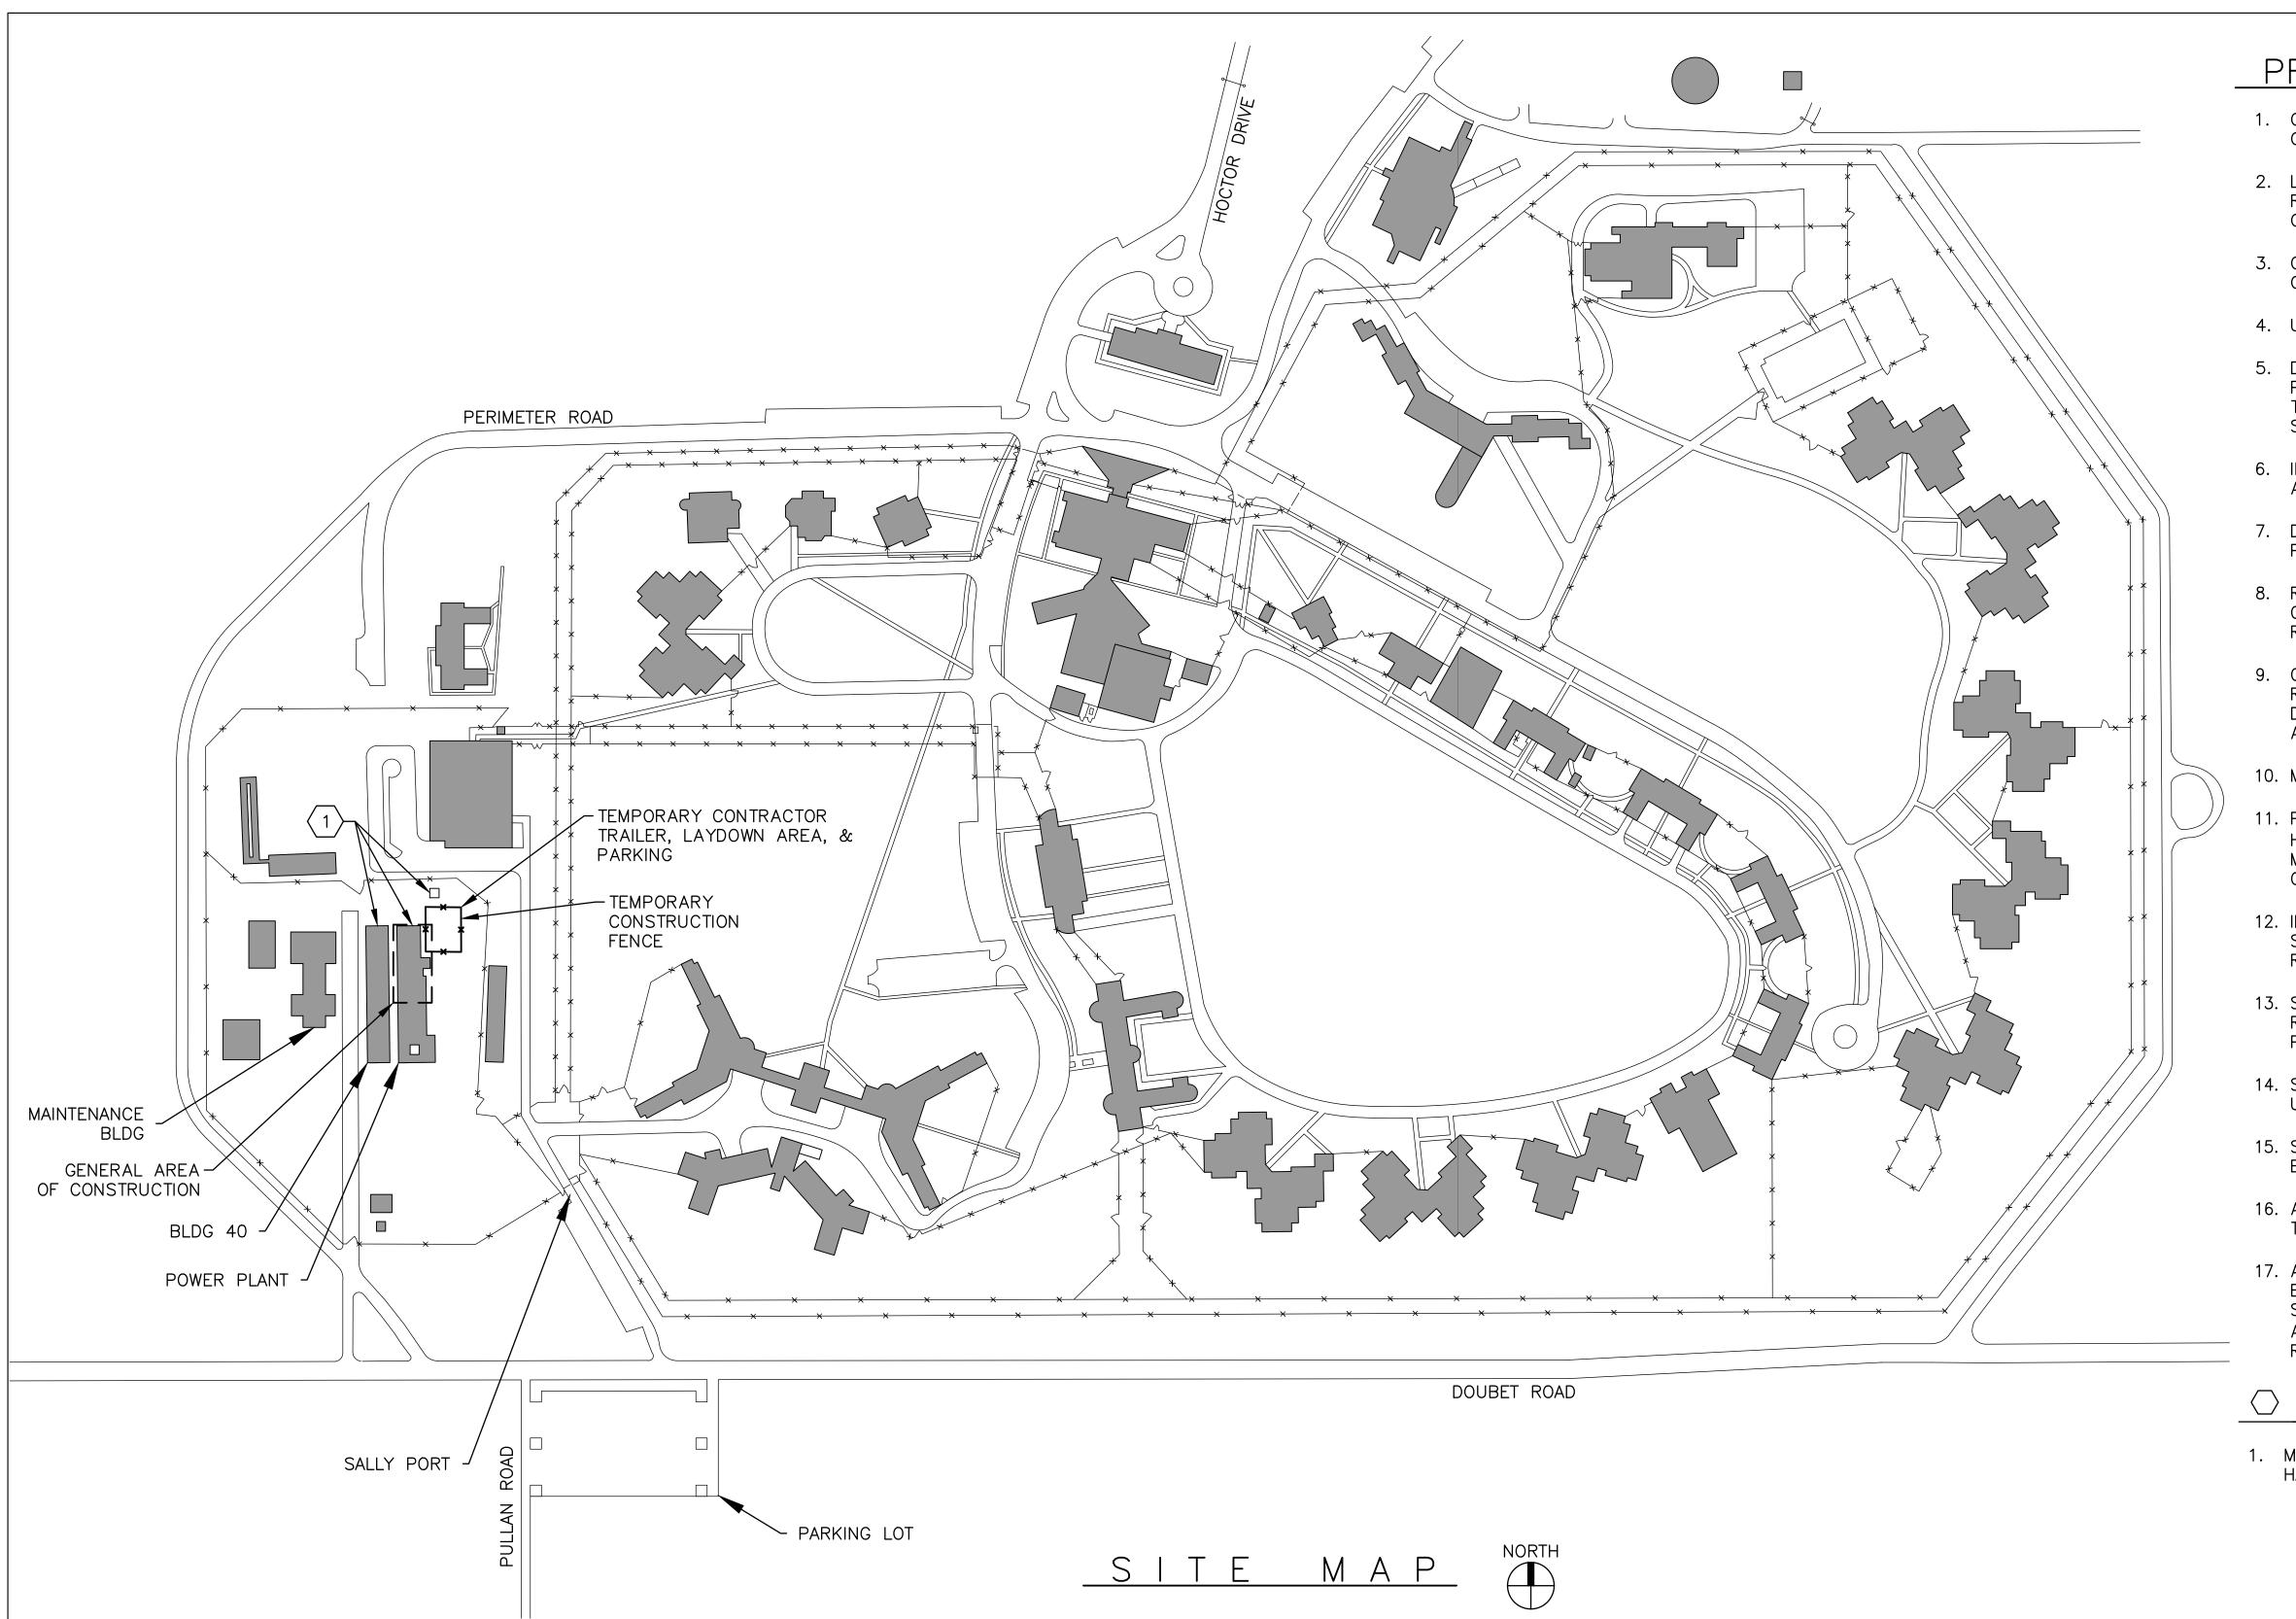
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SHEET TITLE:
SITE MAPS AND
DRAWING INDEX

SHEET NUMBER:

G-002



#### PROJECT GENERAL NOTES:

- 1. COORDINATE CONSTRUCTION FENCE, LAYDOWN AREA AND CONTRACTOR PARKING WITH CONSTRUCTION REPRESENTATIVE.
- 2. LAYDOWN AREA SHALL BE APPROVED BY THE CONSTRUCTION REPRESENTATIVE & RESTORED TO ORIGINAL CONDITION AFTER CONSTRUCTION IS COMPLETE.
- 3. CONTRACTOR SHALL NOT BLOCK ACCESS TO ANY MANHOLE OR VALVE BOX.
- 4. USE RUBBER TIRE EQUIPMENT IN PLANTED AREAS.
- 5. DO NOT STORE EQUIPMENT OR MATERIAL IN AREA OF TREES. PROTECT TREES FROM DAMAGE UNLESS NOTED OTHERWISE. TRIM TREES AS REQUIRED PRIOR TO CONSTRUCTION, SUBJECT TO APPROVAL OF CONSTRUCTION REPRESENTATIVE.
- 6. INSTALL CONSTRUCTION FENCING AROUND THE DRIP LINES OF ALL TREES IN WORK AREAS.
- 7. DOCUMENT EXISTING CONDITIONS WITH PHOTOGRAPHS PRIOR TO PROCEEDING.
- REPAIR ALL DAMAGE TO EXISTING FACILITIES CAUSED BY CONSTRUCTION TO SATISFACTION OF THE CONSTRUCTION REPRESENTATIVE. MATCH EXISTING CONSTRUCTION AND FINISH.
- 9. COMPLY WITH THE INTERNATIONAL FIRE CODE INCLUDING THE REQUIREMENTS FOR FIRE SAFETY DURING CONSTRUCTION AND DEMOLITION AND FOR WELDING AND OTHER HOT WORK. MAINTAIN A HOT WORK PROGRAM PERMIT SYSTEM.
- 10. MINIMIZE HOT WORK WITHIN THE BUILDING.
- 11. PROVIDE A FIRE WATCH FOR ALL DEMOLITION AND CONSTRUCTION HOT WORK (CUTTING, GRINDING, WELDING, SOLDERING, ETC.). MAINTAIN FIRE WATCH FOR AT LEAST 1 HOUR AFTER COMPLETION OF HOT WORK.
- 12. IDENTIFY & PROTECT ALL CONSTRUCTION AREAS WITH SIGNS AND SAFETY BARRIERS TO THE SATISFACTION OF THE CONSTRUCTION REPRESENTATIVE.
- 13. SECURE ALL CONSTRUCTION AREAS WITH BARRIERS & LOCKS AS REQUIRED TO PREVENT ACCESS BY RESIDENTS OR UNAUTHORIZED PERSONS AT ALL TIMES.
- 14. SECURE ALL MECHANICAL & ELECTRICAL ROOMS WHEN UNOCCUPIED.
- 15. SECURE ALL HAND TOOLS IN LOCKED TOOL BOXES & LOCK ALL EQUIPMENT WHEN NOT IN USE.
- 16. ALL UNSECURED MATERIAL, TOOLS, ETC. MUST BE REMOVED FROM THE FACILITY AT THE END OF EACH WORK DAY.
- 17. AVAILABLE INFORMATION INDICATES PROJECT WORK AREAS HAVE BEEN ABATED OF HAZARDOUS MATERIALS, EXCEPT FOR ITEMS SPECIFICALLY NOTED ON THE DEMOLITION DRAWINGS. ADDRESS ANY ADDITIONAL SUSPECTED HAZARDOUS MATERIALS WITH OWNER'S REPRESENTATIVE.

# OKEY NOTES:

1. MAINTAIN ACCESS TO BLDG 40, POWER PLANT, AND HAZARDOUS MATERIAL STORAGE.

#### CONSTRUCTION PHASING & SCHEDULING:

- 1. THE PROJECT SHALL BE COMPLETED AS NECESSARY TO PROVIDE UNINTERRUPTED OPERATION OF THE FACILITY. THE SEQUENCING, PHASING AND SCHEDULING OF ALL WORK SHALL BE DEPENDENT ON AND SUBJECT TO FACILITY OPERATIONS.
- 2. THE NATURE OF THIS PROJECT REQUIRES A HIGH LEVEL OF COORDINATION BY CONTRACTOR WITH OWNER.
- 3. ALL WORK SHALL BE SCHEDULED WITH THE CONSTRUCTION REPRESENTATIVE AND BE SUBJECT TO FACILITY APPROVAL PRIOR TO PROCEEDING.
- 4. THE PROJECT REQUIRES OUTAGES TO BUILDING SYSTEMS. CONTRACTOR SHALL COMPLETE ALL RELATED WORK TO THE MAXIMUM EXTENT POSSIBLE PRIOR TO THE START OF OUTAGES. CONTRACTOR SHALL HAVE ALL REQUIRED MATERIALS ON SITE PRIOR TO START OF OUTAGES.
- 5. TIE-INS TO BUILDING SYSTEMS SHALL BE MADE DURING APPROVED OUTAGES AND WORK SHALL BE DONE AROUND-THE-CLOCK UNTIL THE TIE-IN IS COMPLETED.

- 6. ANY OUTAGES OVER 4 HOURS IN DURATION WHICH AFFECT FIRE PROTECTION, FIRE ALARM, DEDICATED TELEPHONE, OR EMERGENCY MANAGEMENT SYSTEMS REQUIRE FIRE WATCHES. CONTRACTOR IS RESPONSIBLE FOR CONDUCTING FIRE WATCHES IN ALL AFFECTED AREAS.
- 7. OUTAGES SHALL BE COORDINATED WITH THE CONSTRUCTION REPRESENTATIVE AND ARE WEATHER DEPENDENT. CONTRACTOR SHALL NOTIFY CONSTRUCTION REPRESENTATIVE TWO (2) WEEKS IN ADVANCE OF DESIRED OUTAGE TIME. CONSTRUCTION REPRESENTATIVE WILL GIVE CONTRACTOR 72 HOURS ADVANCE NOTICE OF ACTUAL TIME FOR OUTAGE.
- 8. STEAM OUTAGES SHALL BE COMPLETED DURING ACCEPTABLE WEATHER CONDITIONS (ABOVE 50°F OUTDOOR AIR TEMPERATURE), UNLESS APPROVED OTHERWISE BY CONSTRUCTION REPRESENTATIVE.
- 9. EXISTING MAKE-UP WATER AND CONDENSATE SYSTEMS SHALL REMAIN IN SERVICE UNTIL NEW SYSTEMS ARE INSTALLED & READY FOR SERVICE & APPROVED FOR REMOVAL BY CONSTRUCTION REPRESENTATIVE. PHASE DEMOLITION & CONSTRUCTION AS REQUIRED.

- 10. LIMIT DEAERATOR, MAKE—UP WATER, CONDENSATE SYSTEM, AND ELECTRICAL OUTAGES TO NO MORE THAN 8 HOURS, UNLESS APPROVED OTHERWISE BY CONSTRUCTION REPRESENTATIVE.
- 11. ALL SITE CONSTRUCTION ACTIVITIES SHALL BE LIMITED TO 7:00 AM TO 3:30 PM ON MONDAY THRU FRIDAY, UNLESS APPROVED OTHERWISE IN ADVANCE BY CONSTRUCTION REPRESENTATIVE.
- 12. NO WORK IS TO TAKE PLACE ON WEEKENDS OR STATE OBSERVED HOLIDAYS UNLESS APPROVED IN WRITING IN ADVANCE BY CONSTRUCTION REPRESENTATIVE.

#### STATE OF MISSOURI MICHAEL L. PARSON, GOVERNOR



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OFFICE OF ADMINISTRATION DIVISION OF FACILITIES MANAGEMENT, DESIGN AND CONSTRUCTION

DEPARTMENT OF CORRECTIONS

VOLUME 2 -REPLACE BOILERS AND CONTROLS, POWER PLANT

FARMINGTON
CORRECTIONAL CENTER
1012 WEST COLUMBIA
STREET,
FARMINGTON, MO 63640

PROJECT # C2006-01 SITE # 7008 ASSET # 9327008094

REVISION:
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04/26/2023

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DRAWN BY: CLB
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DESIGNED BY: CLB


CONSTRUCTION
LIMITS, SCHEDULE
& PHASING

SHEET NUMBER:

G-003

03 OF 24 SHEETS

APRIL 26, 2023

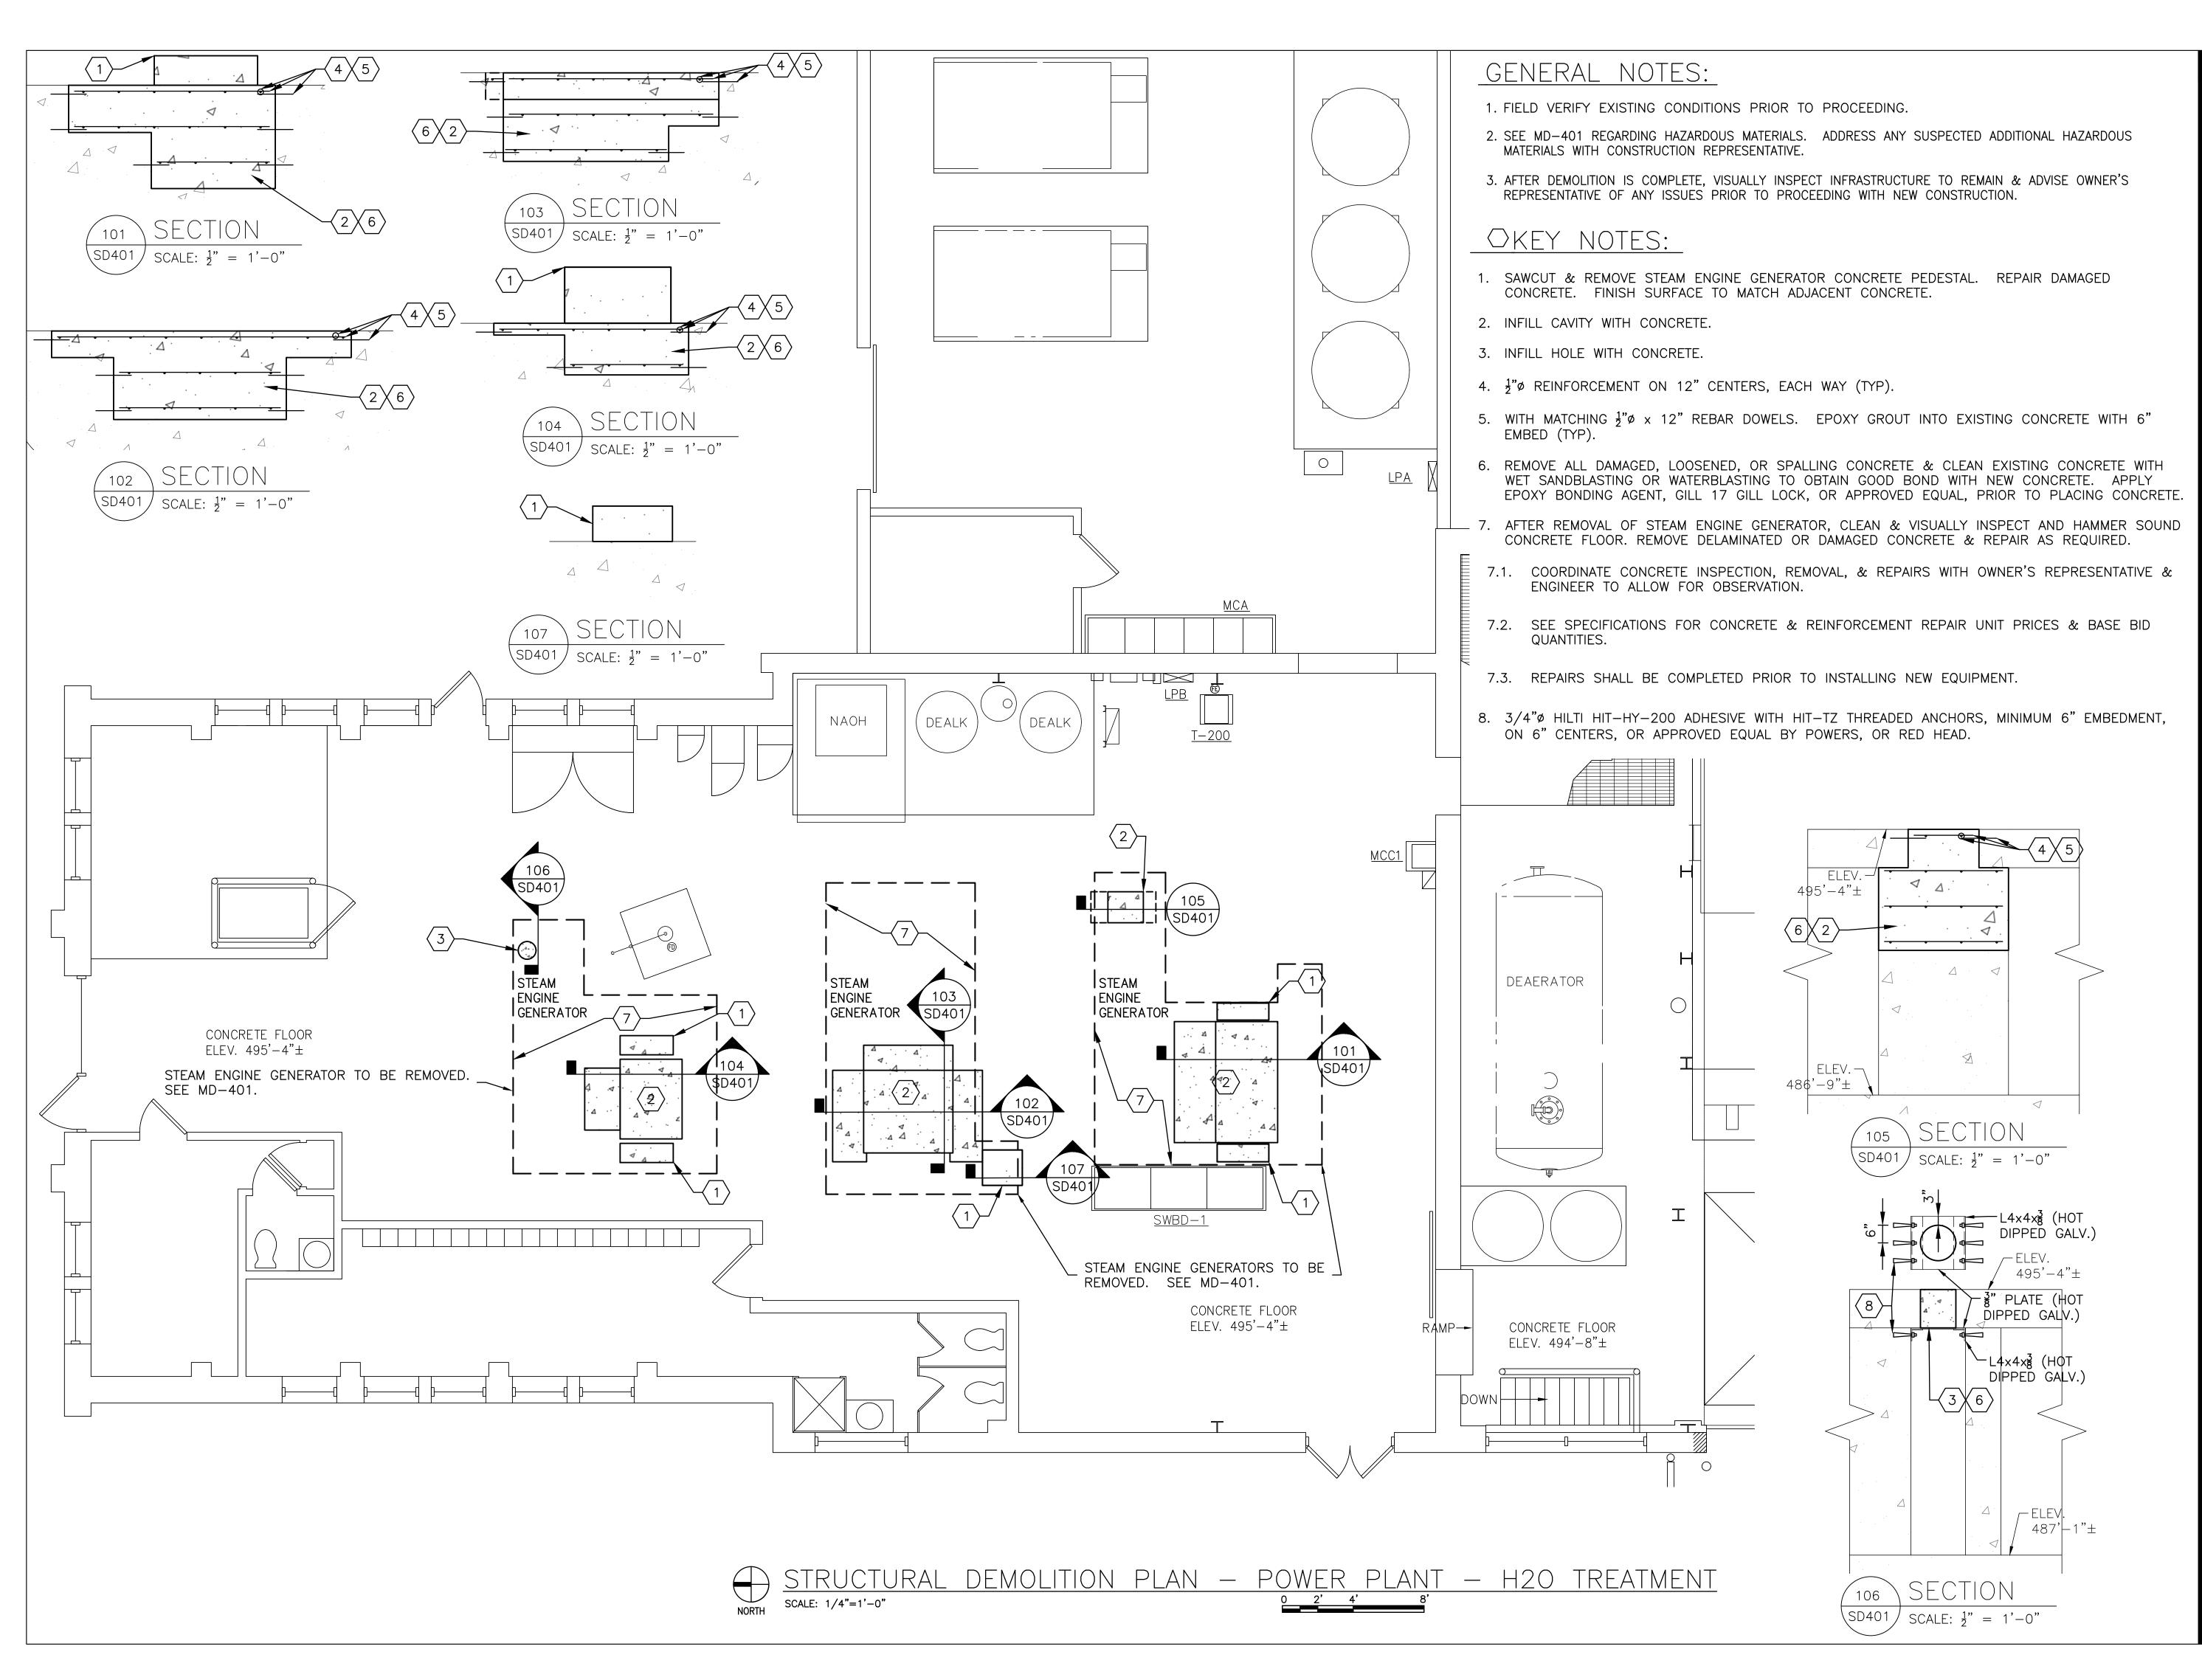



CHRISTOPHER L. BARTH Registered Professional Engineer MO # E-28880 Expires 12-31-2023

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OFFICE OF ADMINISTRATION DIVISION OF FACILITIES MANAGEMENT, DESIGN AND CONSTRUCTION

DEPARTMENT OF CORRECTIONS

VOLUME 2 -REPLACE BOILERS AND CONTROLS, POWER PLANT

FARMINGTON CORRECTIONAL CENTER 1012 WEST COLUMBIA STREET, FARMINGTON, MO 63640

PROJECT # C2006-01

9327008094 ASSET#

**REVISION: REVISION:** DATE:

**REVISION:** 

ISSUE DATE: 04/26/2023

CAD DWG FILE: C2007-01-9237-9327008094- SD-401.DWG

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DESIGNED BY: CLB

SHEET TITLE: STRUCTURAL

**DEMOLITION PLAN** - POWER PLANT -**H2O TREATMENT** 

SHEET NUMBER:

# 3. AFTER DEMOLITION IS COMPLETE, VISUALLY INSPECT INFRASTRUCTURE TO REMAIN & ADVISE OWNER'S REPRESENTATIVE OF ANY ISSUES PRIOR TO PROCEEDING WITH NEW CONSTRUCTION. SUMP FLOOR-ELEV. 490'-0"± OKEY NOTES: 1. AFTER REMOVAL OF STEAM ENGINE GENERATORS (ABOVE), VISUALLY INSPECT AND HAMMER SOUND CONCRETE BEAMS, COLUMNS, & WALLS IN BASEMENT. REMOVE DELAMINATED OR DAMAGED CONCRETE & REPAIR AS REQUIRED. 1.1. COORDINATE CONCRETE INSPECTION, REMOVAL, & REPAIRS WITH OWNER'S REPRESENTATIVE & ENGINEER TO ALLOW FOR OBSERVATION. 1.2. SEE SPECIFICATIONS FOR CONCRETE & REINFORCEMENT REPAIR UNIT PRICES & BASE BID QUANTITIES. 1.3. PROVIDE TEMPORARY SHORING OF BEAMS & FLOOR AS REQUIRED TO COMPLETE REPAIRS. CONCRETE FLOOR 1.4. LIMIT REPAIR AREA SIZE TO PREVENT COMPROMISING ELEV. 486'−9"± STABILITY OR STRENGTH OF STRUCTURE. 1.5. REPAIRS SHALL BE COMPLETED PRIOR TO INSTALLING NEW EQUIPMENT. $\bigcirc$ CONCRETE FLOOR ELEV. 487'-1"±

<u>STRUCTURAL DEMOLITION PLAN - POWER PLANT - BASEMENT</u>

NORTH SCALE: 1/4"=1'-0"

STATE OF MISSOURI MICHAEL L. PARSON, **GOVERNOR** 


**GENERAL NOTES:** 

CONSTRUCTION REPRESENTATIVE.

PROCEEDING.

1. FIELD VERIFY EXISTING CONDITIONS PRIOR TO

2. SEE MD-401 REGARDING HAZARDOUS MATERIALS. ADDRESS ANY SUSPECTED ADDITIONAL HAZARDOUS MATERIALS WITH

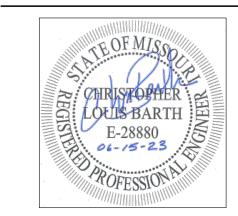

CHRISTOPHER L. BARTH Registered Professional Engineer MO # E-28880 Expires 12-31-2023

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OFFICE OF ADMINISTRATION DIVISION OF FACILITIES MANAGEMENT, DESIGN AND CONSTRUCTION

DEPARTMENT OF CORRECTIONS

VOLUME 2 -REPLACE BOILERS AND CONTROLS, POWER PLANT

FARMINGTON CORRECTIONAL CENTER 1012 WEST COLUMBIA STREET, FARMINGTON, MO 63640

PROJECT # C2006-01

ASSET # 9327008094

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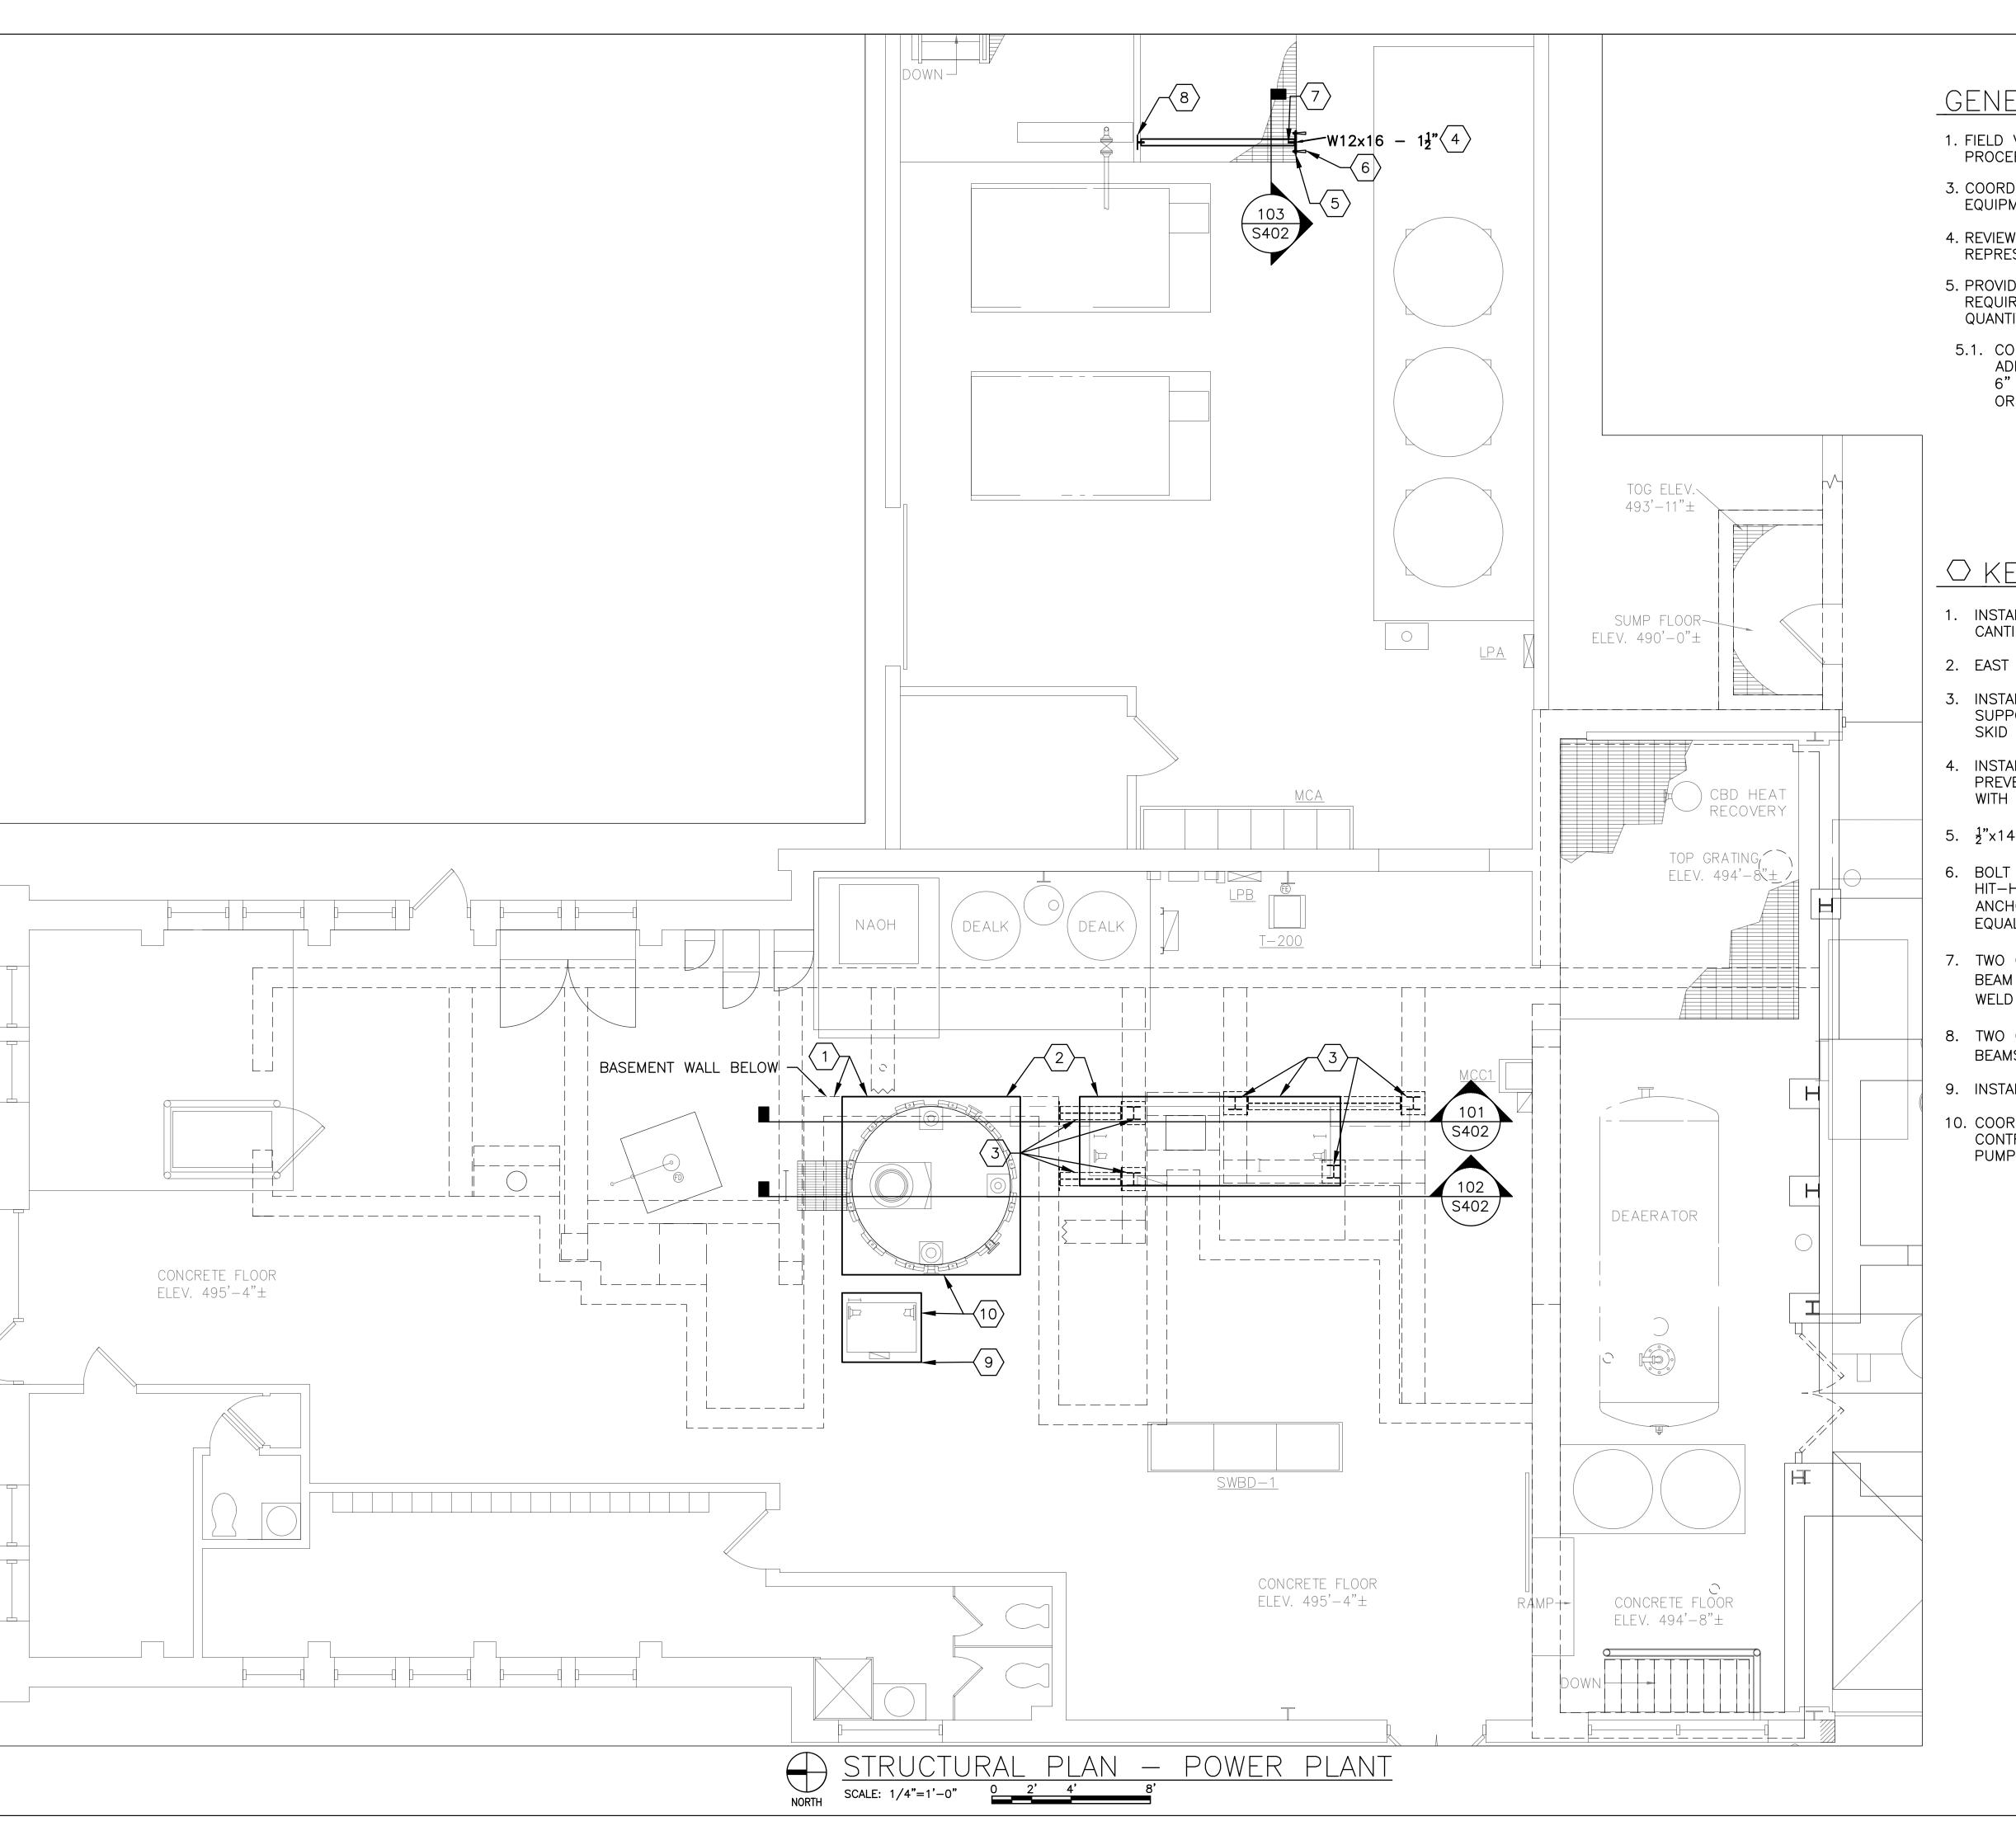
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CAD DWG FILE: C2007-01-9237-9327008094- SD-401.DWG

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DESIGNED BY: CLB SHEET TITLE:

STRUCTURAL DEMOLITION PLAN - POWER PLANT -

BASEMENT SHEET NUMBER:



- 1. FIELD VERIFY EXISTING CONDITIONS PRIOR TO PROCEEDING.
- 3. COORDINATE NEW EQUIPMENT PAD SIZE & LOCATION WITH EQUIPMENT PROVIDED.
- 4. REVIEW EQUIPMENT PAD LOCATIONS WITH OWNER'S REPRESENTATIVE PRIOR TO PROCEEDING.
- 5. PROVIDE ANCHOR BOLTS FOR NEW EQUIPMENT AS REQUIRED. COORDINATE LOCATIONS, SIZES, AND QUANTITIES WITH EQUIPMENT PROVIDED.
- 5.1. CONCRETE ANCHOR BOLTS TO BE HILTI HIT-HY-200 ADHESIVE WITH HIT-TZ THREADED ANCHORS, MINIMUM 6" EMBEDMENT, OR APPROVED EQUAL BY POWERS, OR RED HEAD.

## O KEY NOTES:

- INSTALL TANK PAD WEST OF BASEMENT WALL. DO NOT CANTILEVER PAD OVER UNSUPPORTED FLOOR.
- 2. EAST FACE OF RO PAD TO MATCH FACE OF TANK PAD.
- 3. INSTALL BEAMS & COLUMNS IN BASEMENT BELOW TO SUPPORT NEW EQUIPMENT. LOCATE BELOW NEW ROSKID CONCRETE HOUSEKEEPING PAD.
- 4. INSTALL NEW W12 FOR SUPPORT OF BACKFLOW PREVENTER & ASSOCIATED PIPE. COORDINATE LOCATION WITH PIPING CONTRACTOR.
- 5.  $\frac{1}{2}$ "x14"x14" PLATE WITH FOUR  $\frac{3}{4}$ "Ø ANCHOR BOLTS.
- 6. BOLT PLATE TO CONCRETE WITH FOUR ¾ p HILTI HIT—HY—200 ADHESIVE WITH HIT—TZ THREADED ANCHORS, MINIMUM 6 EMBEDMENT, OR APPROVED EQUAL BY POWERS, OR RED HEAD.
- 7. TWO CLIP ANGLES, THIS END =  $2L-4\times4\times\frac{5}{16}\times8\frac{1}{2}$ . BOLT TO BEAM WITH  $3-\frac{3}{4}$ " Ø A325-N BOLTS AT 3" CENTERS. WELD TO PLATE WITH  $\frac{5}{16}$ " FILLET WELD.
- 8. TWO CLIP ANGLES, THIS END =  $2L-4\times4X\frac{5}{16}\times8\frac{1}{2}$ . BOLT TO BEAMS WITH  $3-\frac{3}{4}$  Ø A325-N BOLTS AT 3" CENTERS.
- 9. INSTALL NEW PUMP PAD.
- 10. COORDINATE PAD HEIGHTS WITH MECHANICAL CONTRACTOR SO THAT PIPE CONNECTION ELEVATIONS AT PUMP & TANK ARE THE SAME.

#### STATE OF MISSOURI MICHAEL L. PARSON, GOVERNOR



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DEPARTMENT OF CORRECTIONS

VOLUME 2 REPLACE BOILERS AND
CONTROLS, POWER PLANT

FARMINGTON CORRECTIONAL CENTER 1012 WEST COLUMBIA STREET,

PROJECT # C2006-01

FARMINGTON, MO 63640

SITE # 7008 ASSET # 9327008094

REVISION:

REVISION: DATE: REVISION:

ISSUE DATE: <u>04/26/2023</u>

CAD DWG FILE: C2007-01-9237-9327008094- S-401.DWG

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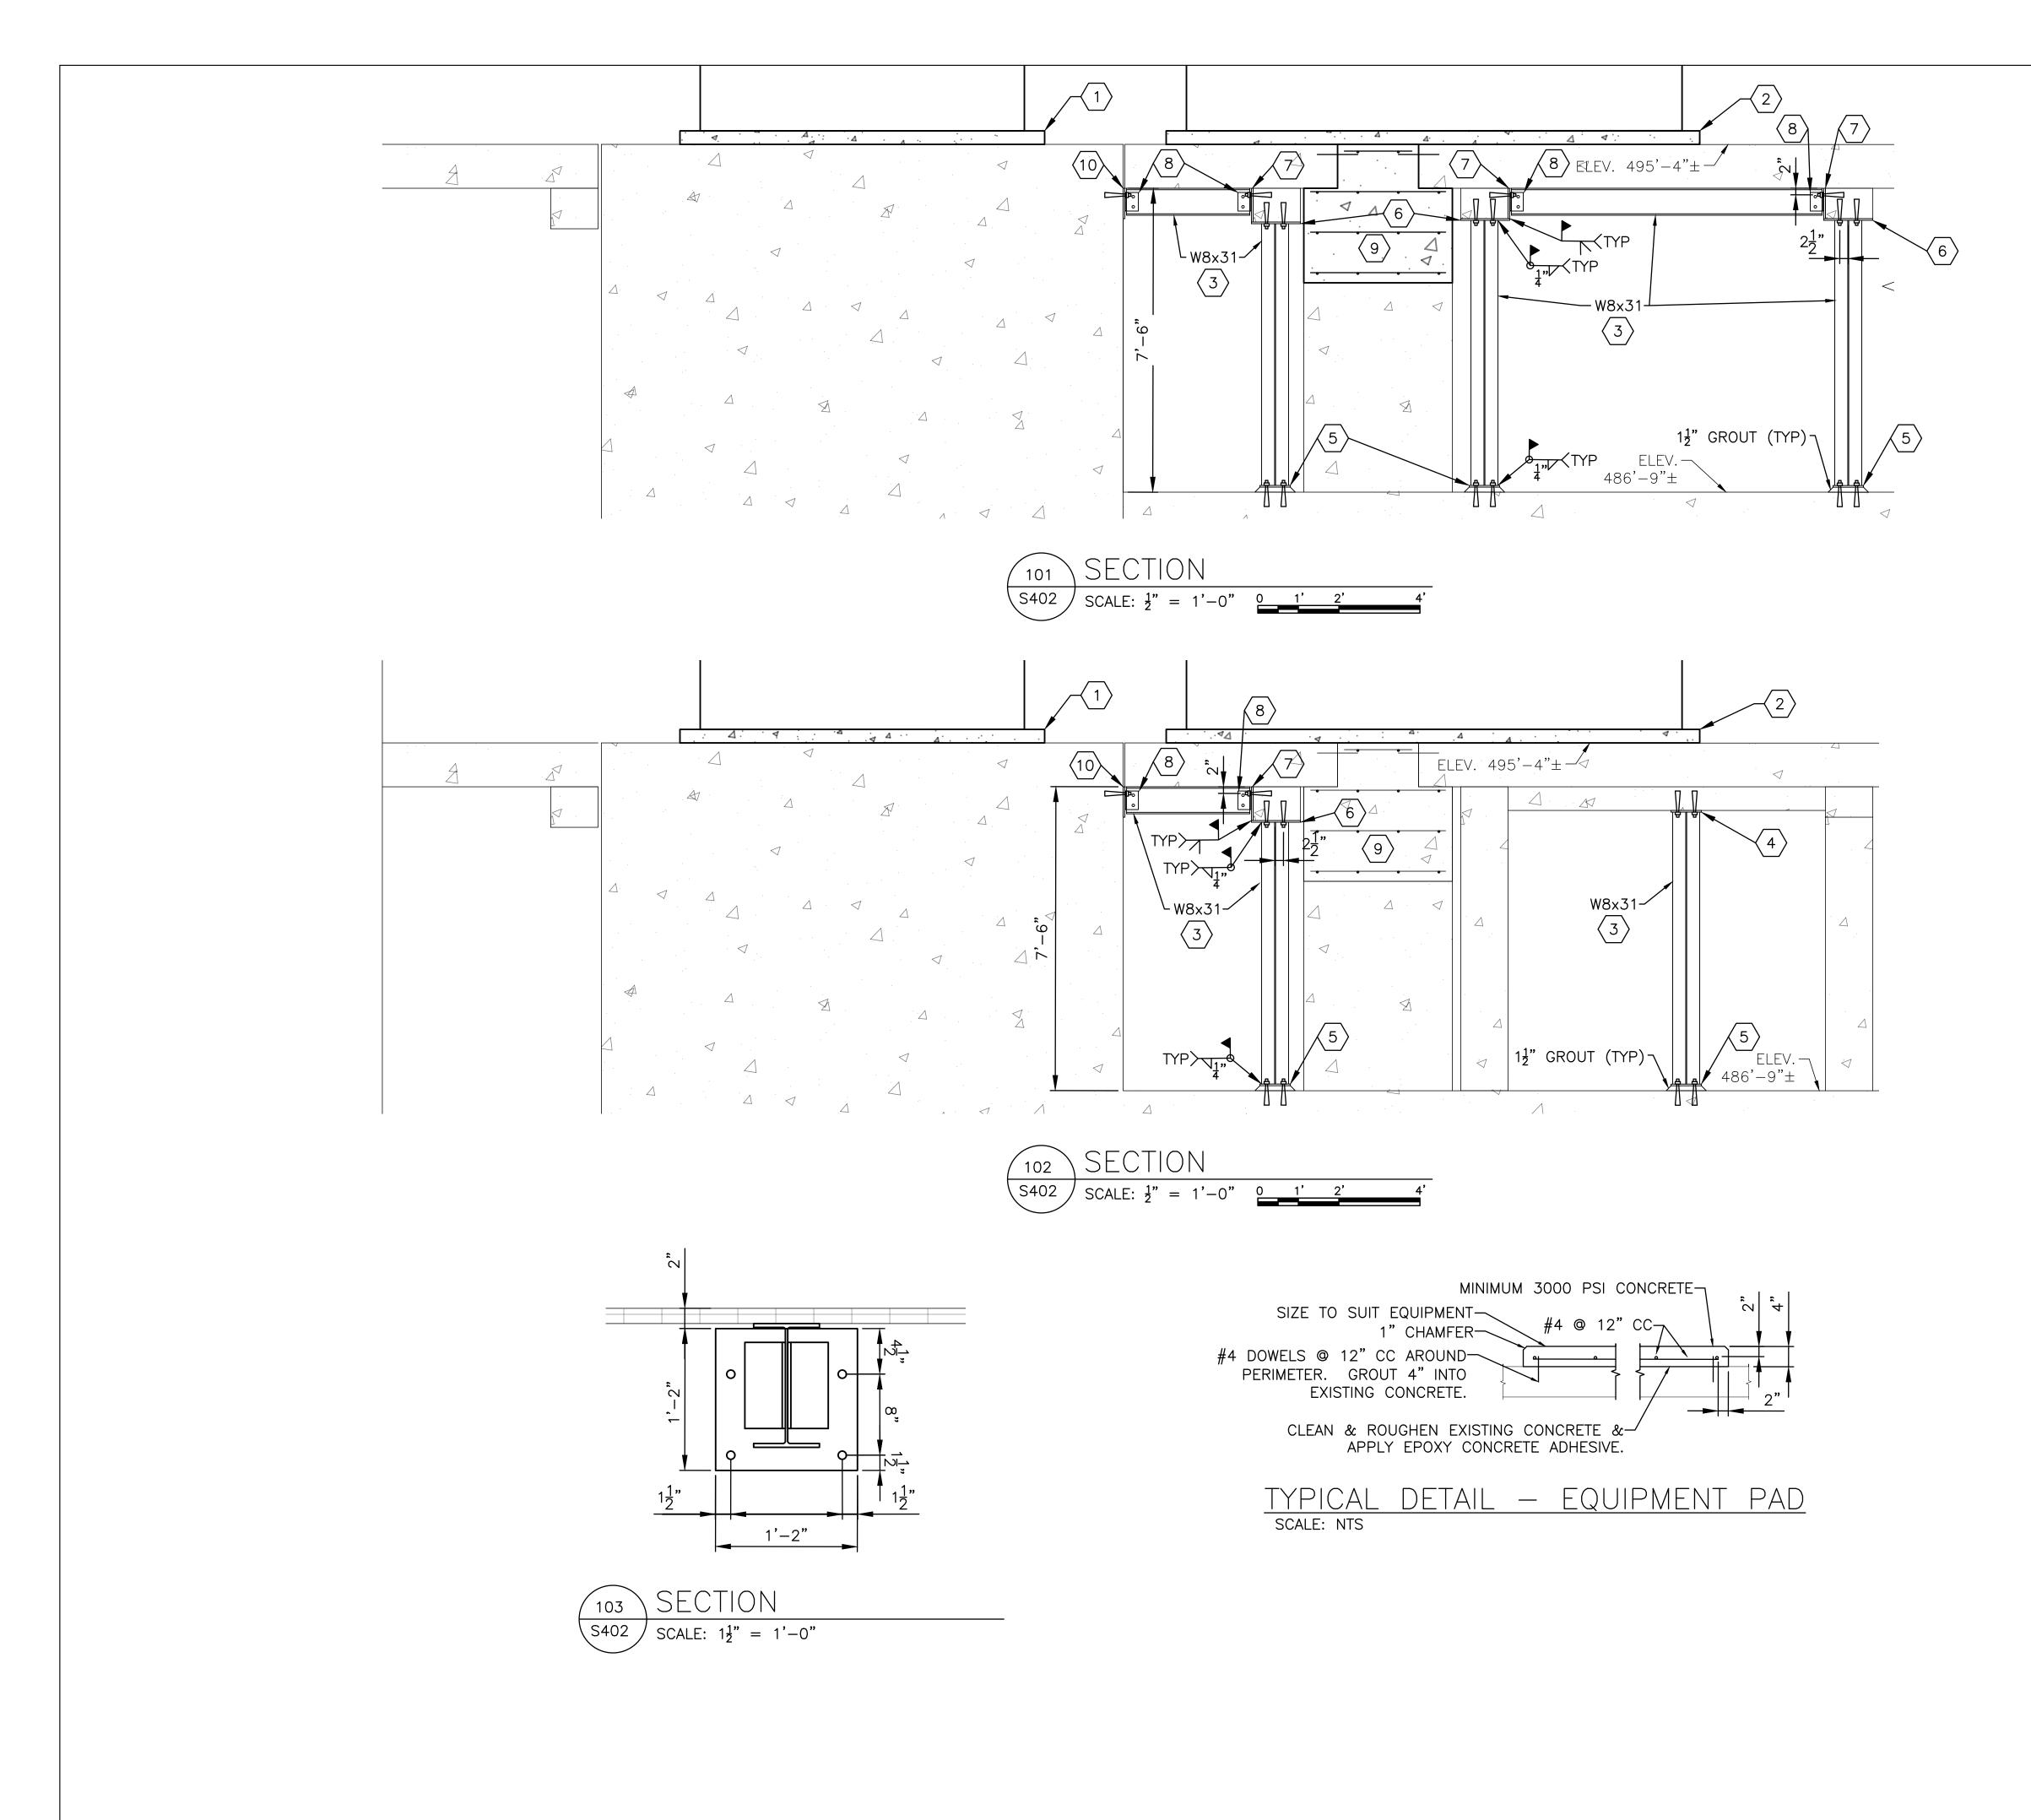
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SHEET TITLE:
STRUCTURAL
PLAN - POWER

PLANT - H2O TREATMENT

SHEET NUMBER:

S-40





CHRISTOPHER L. BARTH Registered Professional Engineer MO # E-28880 Expires 12-31-2023

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OF AUTHORITY #000408

# O KEY NOTES:

- 1. NEW RO TANK CONCRETE HOUSEKEEPING PAD. SEE TYPICAL DETAIL ON THIS SHEET.
- 2. NEW RO SKID CONCRETE HOUSEKEEPING PAD. SEE TYPICAL DETAIL ON THIS SHEET.
- 3. INSTALL BEAMS & COLUMNS IN BASEMENT TO SUPPORT NEW EQUIPMENT. LOCATE BELOW NEW RO SKID CONCRETE HOUSEKEEPING PAD.
- 4.  $\frac{1}{2}$ "x9"x14" PLATE WITH TWO  $\frac{3}{4}$ "Ø ANCHOR BOLTS ON 5" CENTERS.
- 5.  $\frac{1}{2}$ "X9"x9" PLATE WITH TWO  $\frac{3}{4}$ "Ø ANCHOR BOLTS ON 5" CENTERS.
- 6.  $\frac{1}{2}$ "X14"x14 $\frac{1}{2}$ " PLATE WITH TWO  $\frac{3}{4}$ "Ø ANCHOR BOLTS ON 5" CENTERS.
- 7.  $\frac{1}{2}$ "X14" PLATE WITH TWO  $\frac{3}{4}$ " ANCHOR BOLTS ON 10" CENTERS. HEIGHT TO MATCH EXISTING CONCRETE BEAM DEPTH.
- 8.  $L4\times4\times\frac{5}{16}\times5\frac{1}{2}$ ", EACH SIDE, EACH END, WITH TWO 3/4" A325-N BOLTS TO BEAM, 5 FILLET WELD TO PLATE.
- 9. CONCRETE INFILL. SEE SD DRAWINGS.
- 10.  $\frac{1}{2}$ "X14"x10" PLATE WITH TWO  $\frac{3}{4}$ "Ø ANCHOR BOLTS ON 10'

## GENERAL NOTES:

- 1. FIELD VERIFY EXISTING CONDITIONS PRIOR TO PROCEEDING.
- 3. COORDINATE NEW EQUIPMENT PAD SIZE & LOCATION WITH EQUIPMENT PROVIDED.
- 4. REVIEW EQUIPMENT PAD LOCATIONS WITH CONSTRUCTION REPRESENTATIVE PRIOR TO PROCEEDING.
- 5. CONCRETE ANCHOR BOLTS TO BE HILTI HIT-HY-200 ADHESIVE WITH HIT-TZ THREADED ANCHORS, MINIMUM 6" EMBEDMENT, OR APPROVED EQUAL BY POWERS, OR RED HEAD.
- 6. INSTALL TOP OF NEW BEAMS TIGHT TO BOTTOM OF EXISTING FLOOR. DRY PACK GROUT INTO GAPS BETWEEN BEAM AND FLOOR.

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VOLUME 2 -

REPLACE BOILERS AND CONTROLS, POWER PLANT

FARMINGTON CORRECTIONAL CENTER 1012 WEST COLUMBIA STREET, FARMINGTON, MO 63640

PROJECT # C2006-01 7008

9327008094 ASSET#

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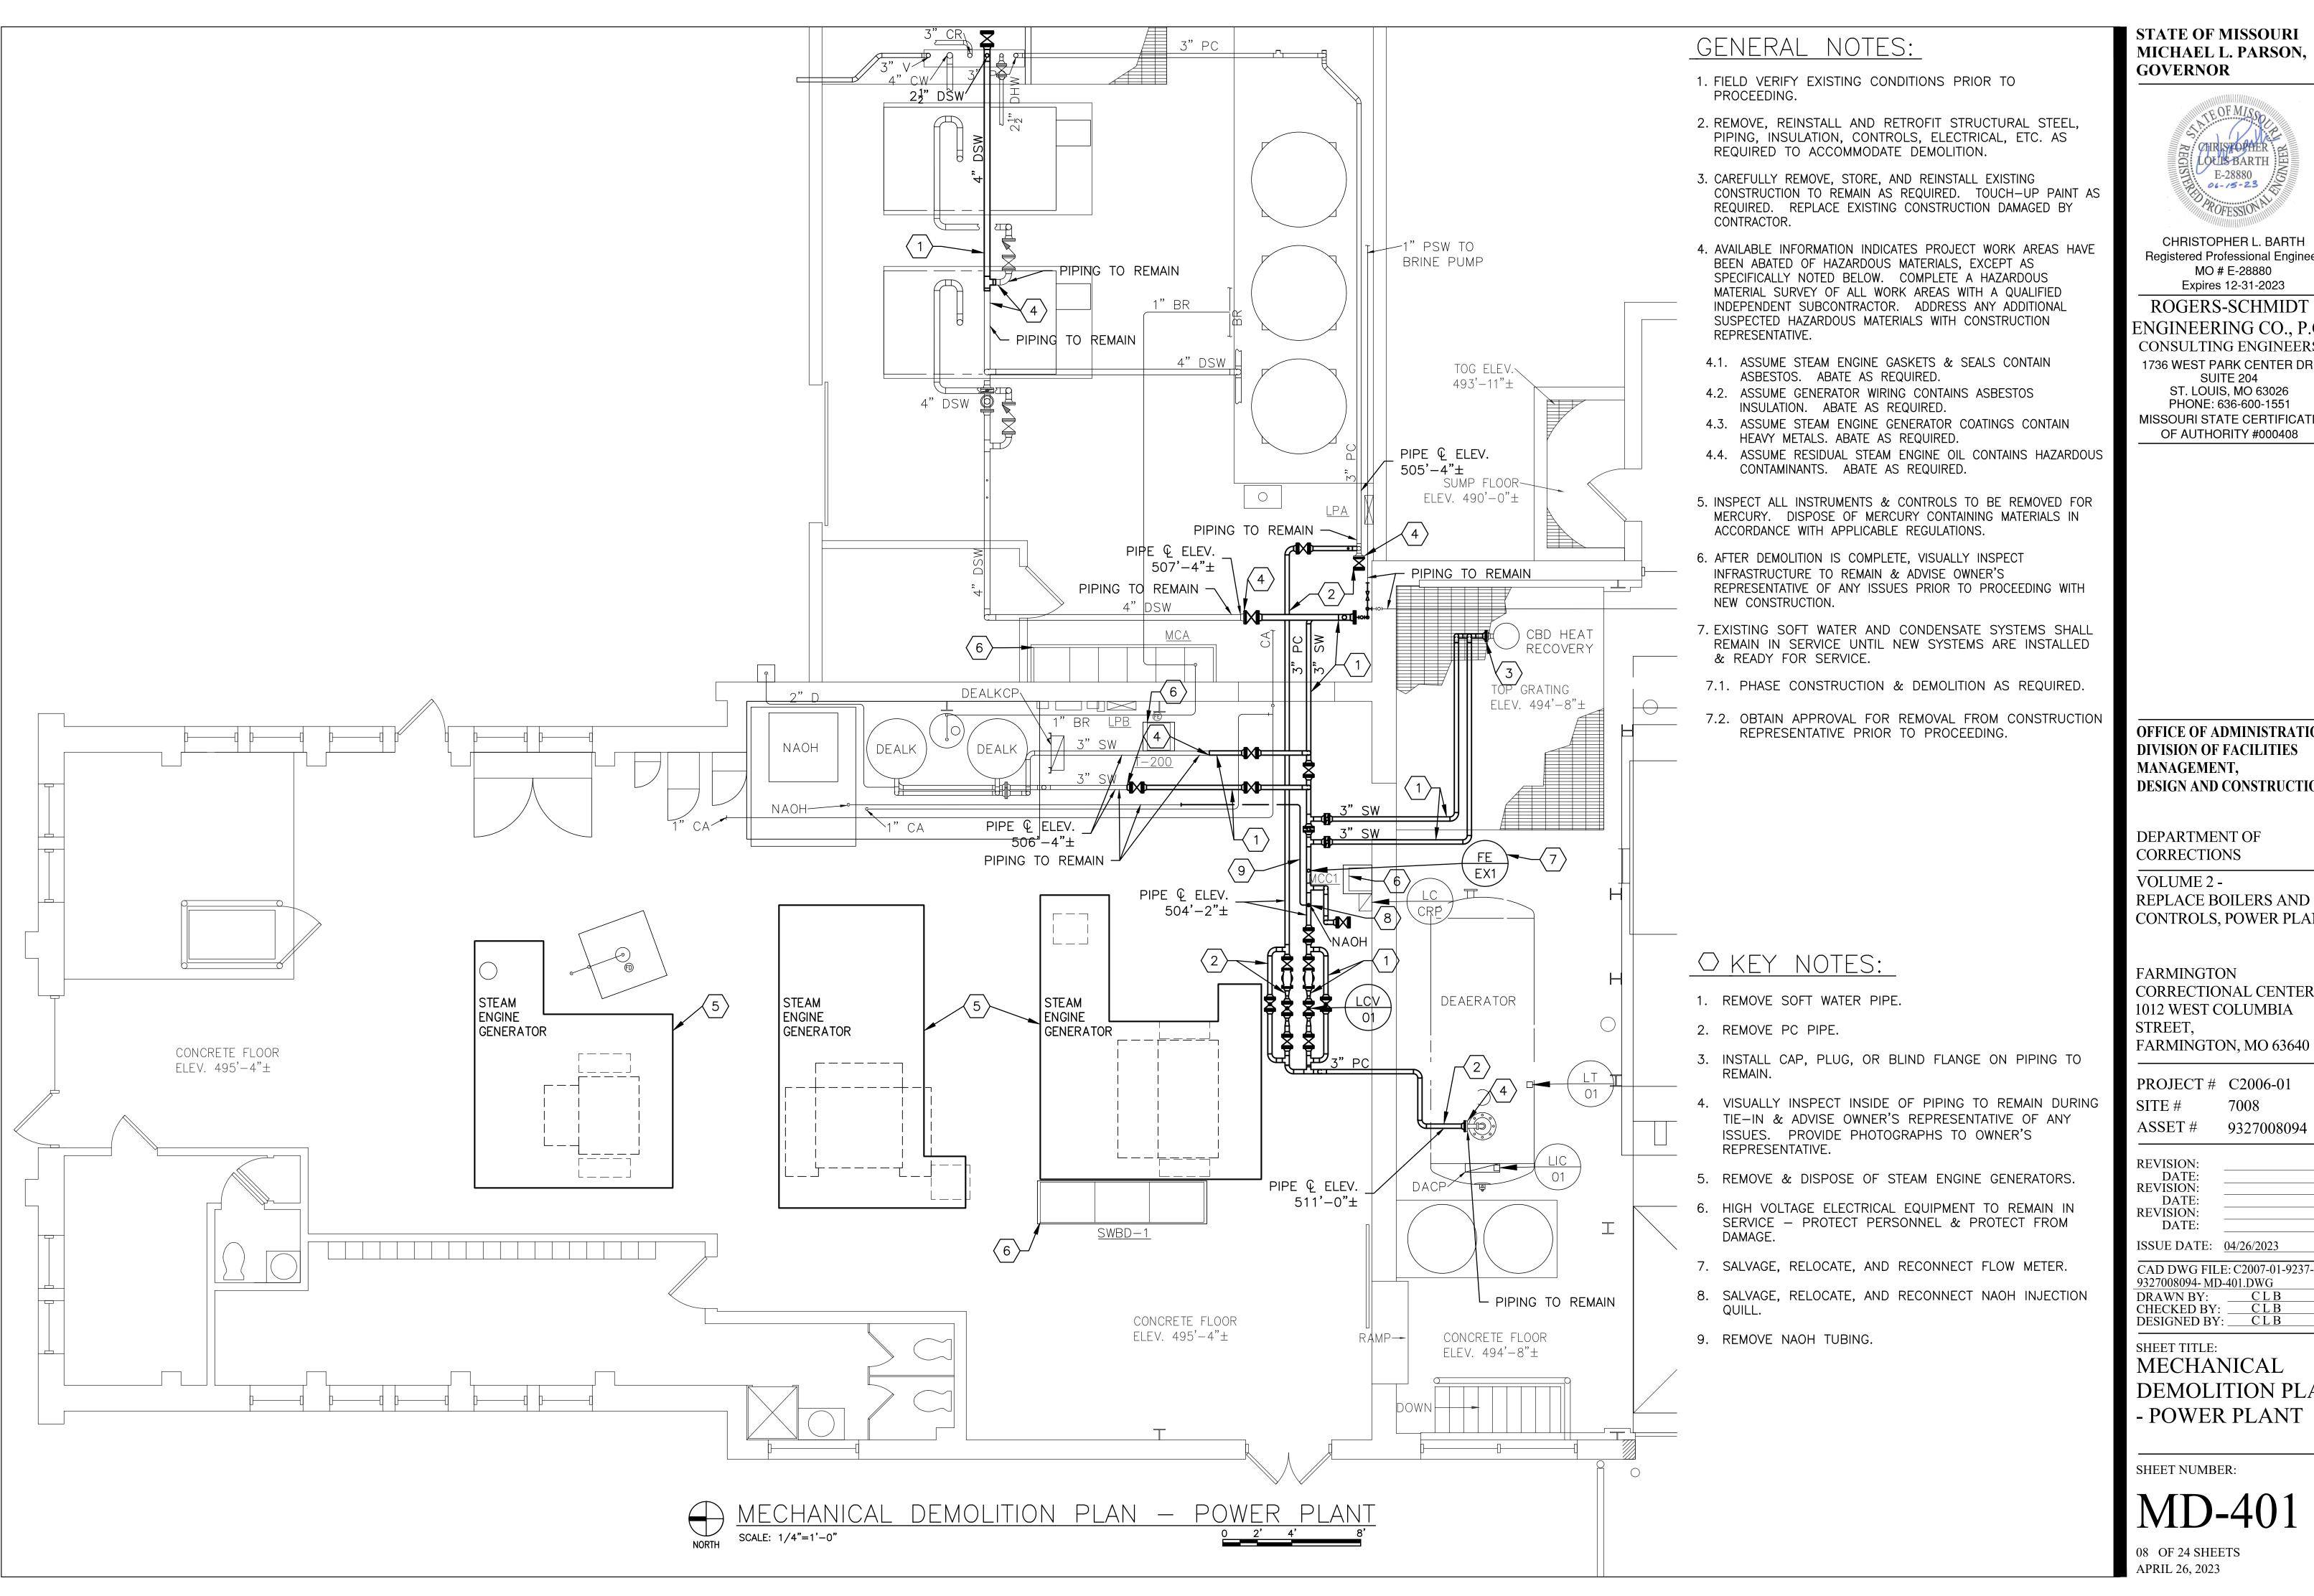
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CHECKED BY: CLB
DESIGNED BY: CLB

SHEET TITLE: STRUCTURAL SECTIONS & **DETAILS** 

SHEET NUMBER:





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OFFICE OF ADMINISTRATION DIVISION OF FACILITIES MANAGEMENT, **DESIGN AND CONSTRUCTION** 

DEPARTMENT OF CORRECTIONS

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REPLACE BOILERS AND CONTROLS, POWER PLANT

FARMINGTON CORRECTIONAL CENTER 1012 WEST COLUMBIA STREET,

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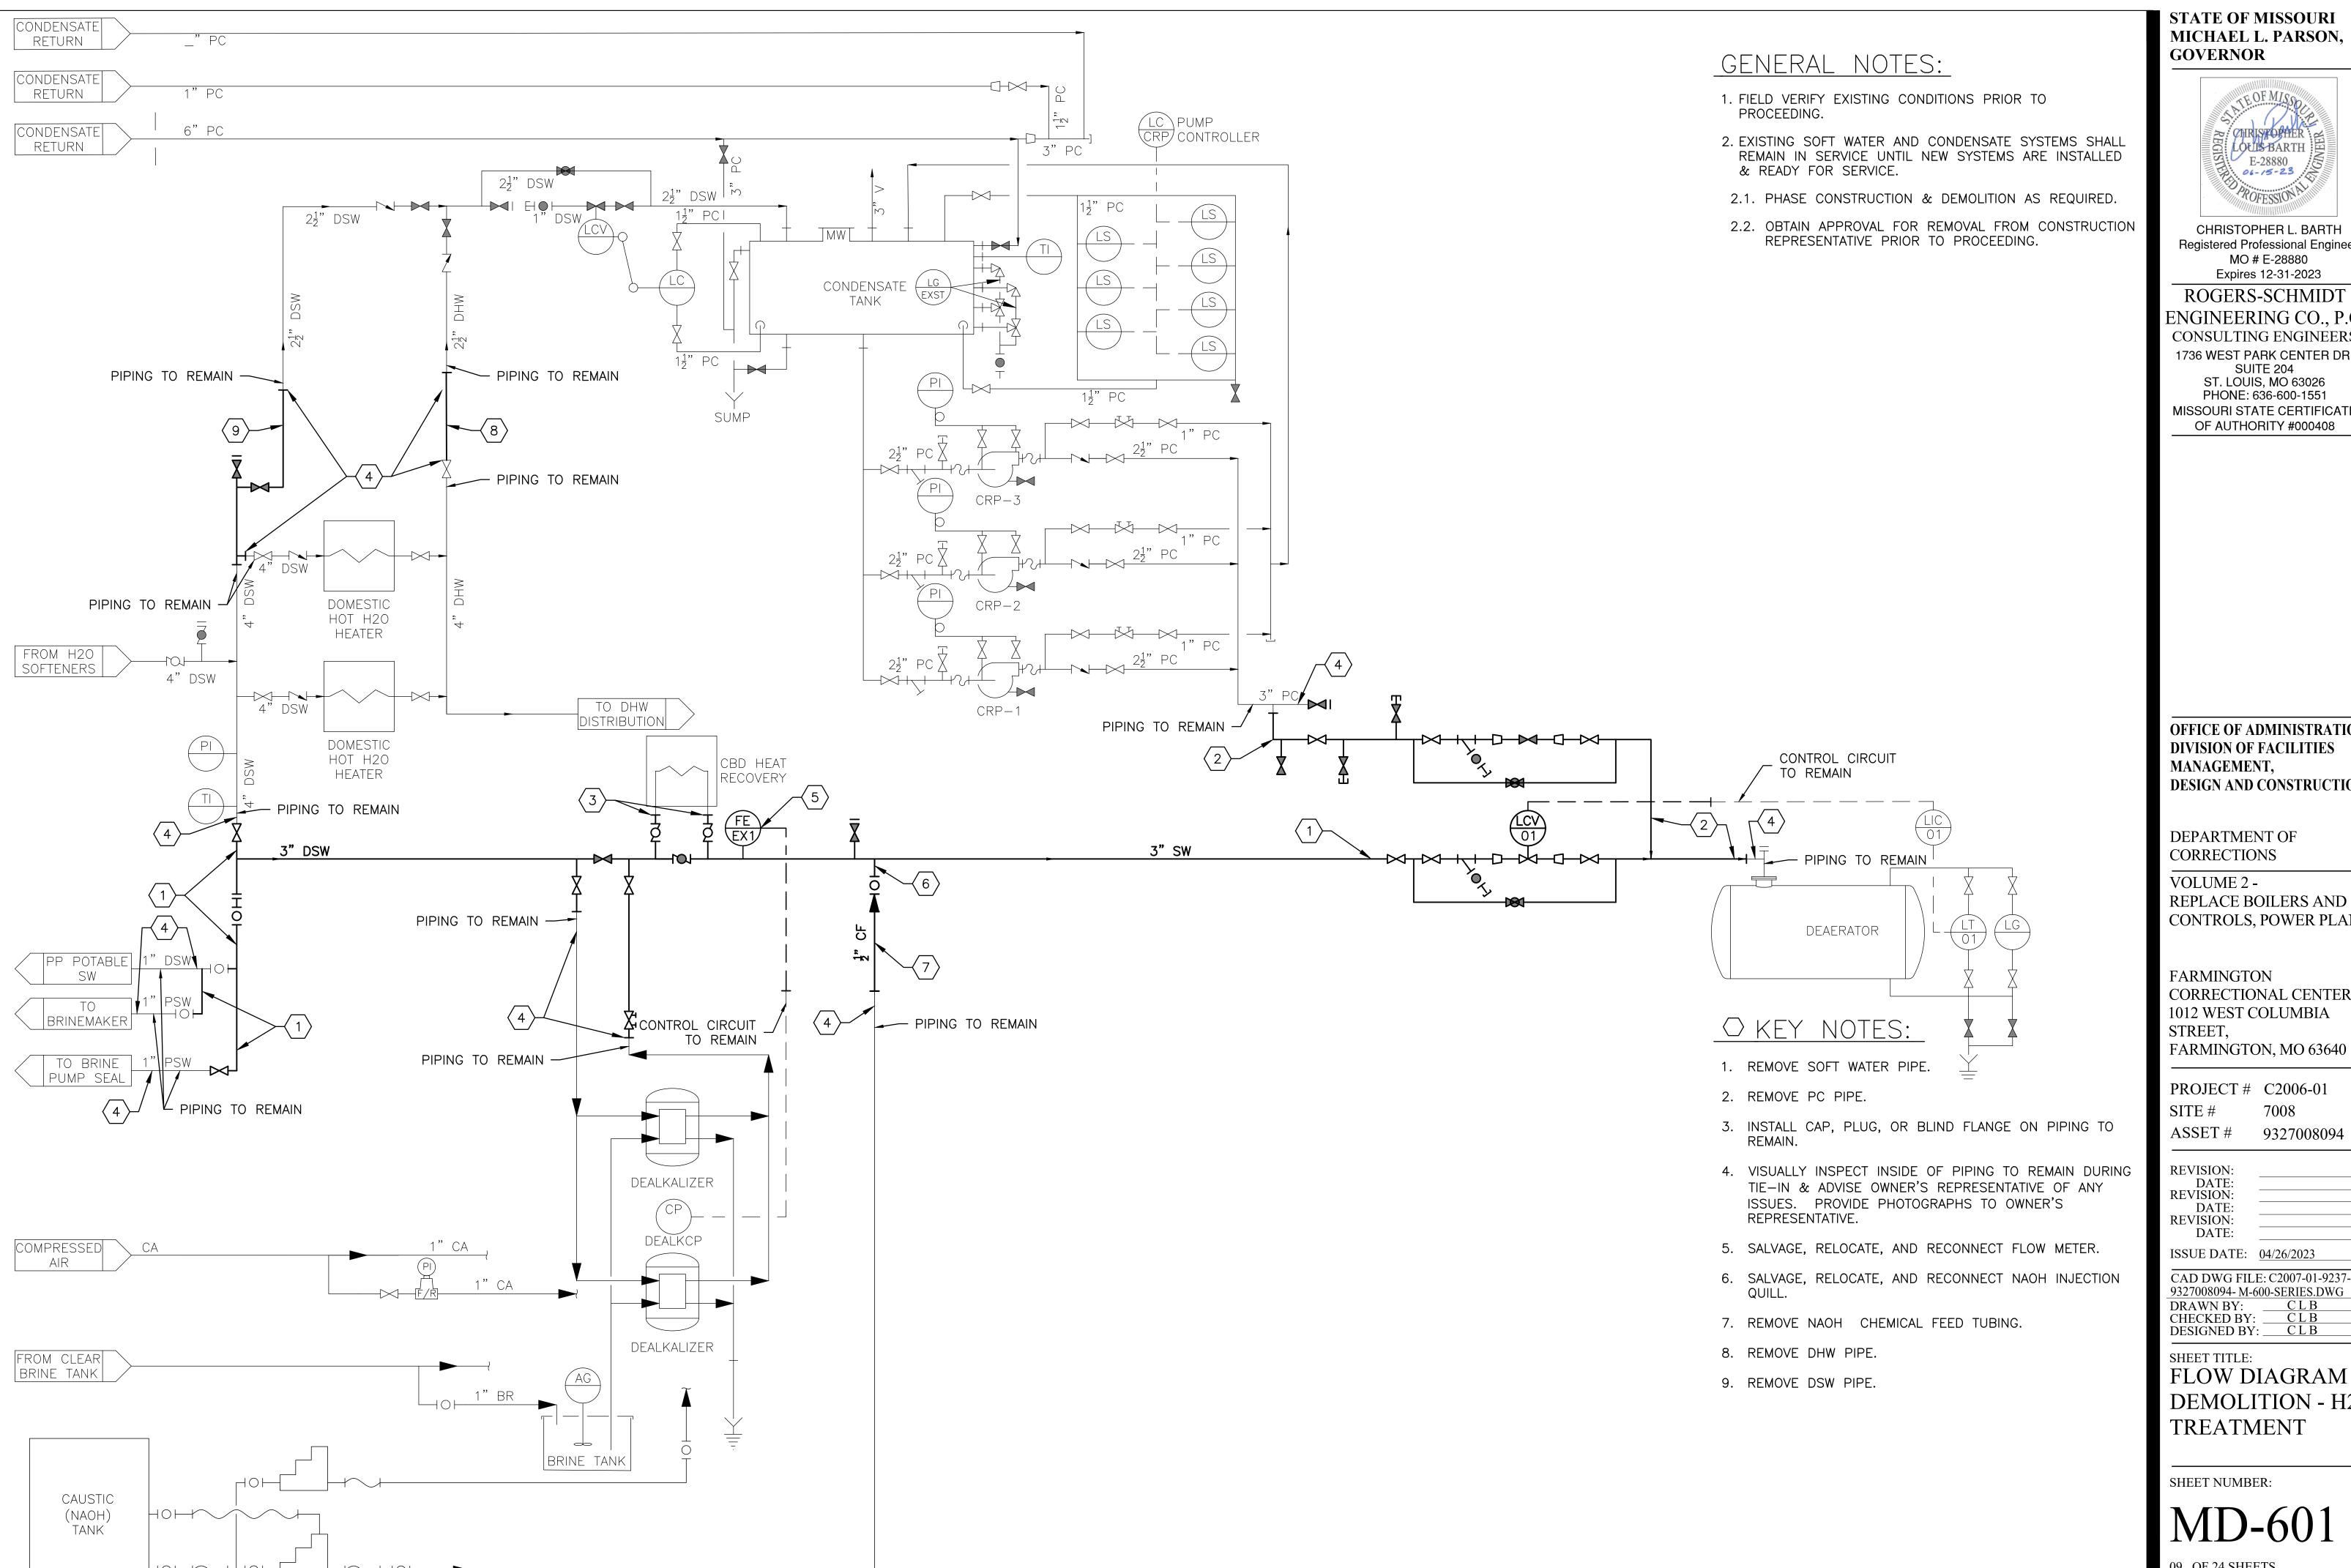
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CAD DWG FILE: C2007-01-9237-9327008094- MD-401.DWG DRAWN BY: CHECKED BY: CLB
DESIGNED BY: CLB

SHEET TITLE:

**MECHANICAL** DEMOLITION PLAN - POWER PLANT

SHEET NUMBER:





CHRISTOPHER L. BARTH Registered Professional Engineer MO # E-28880 Expires 12-31-2023

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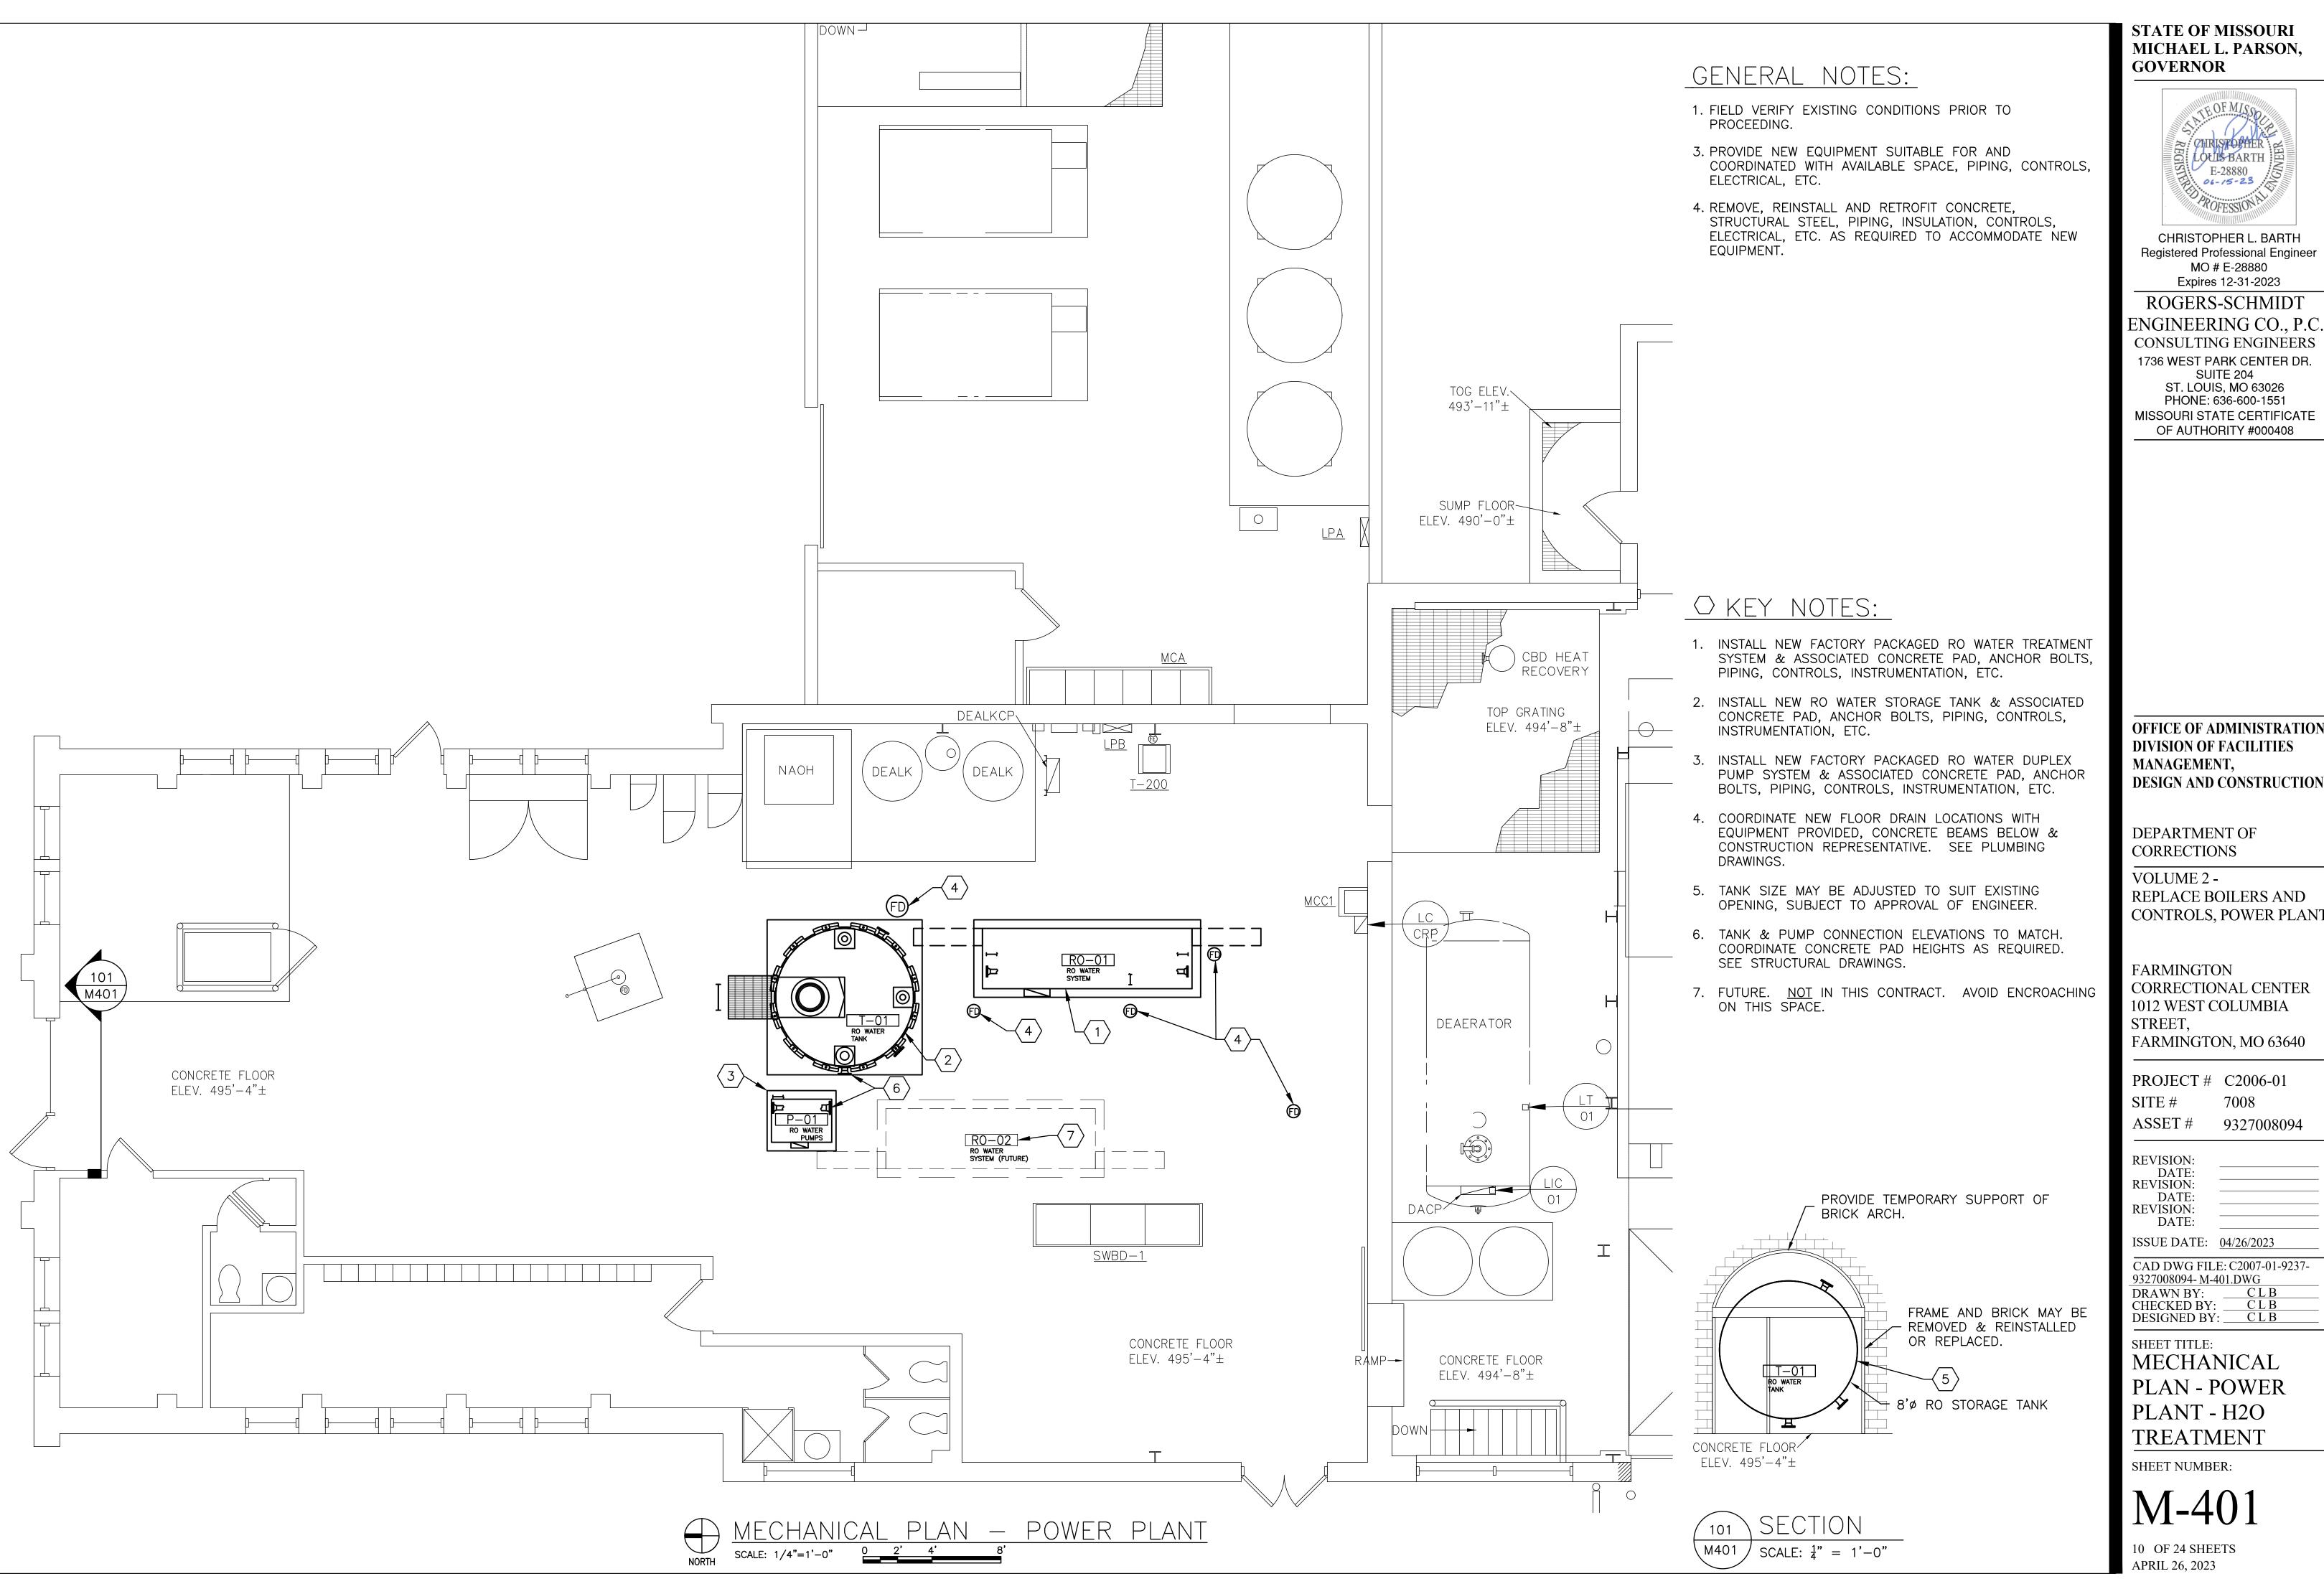
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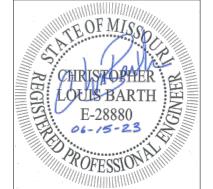
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9327008094- M-600-SERIES.DWG DRAWN BY: CLB
CHECKED BY: CLB
DESIGNED BY: CLB

SHEET TITLE: FLOW DIAGRAM -DEMOLITION - H2O



STATE OF MISSOURI MICHAEL L. PARSON,



CHRISTOPHER L. BARTH Registered Professional Engineer MO # E-28880

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REPLACE BOILERS AND CONTROLS, POWER PLANT

CORRECTIONAL CENTER 1012 WEST COLUMBIA

PROJECT # C2006-01


9327008094

ISSUE DATE: 04/26/2023


CAD DWG FILE: C2007-01-9237-

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CHECKED BY: CLB
DESIGNED BY: CLB

PLAN - POWER PLANT - H2O

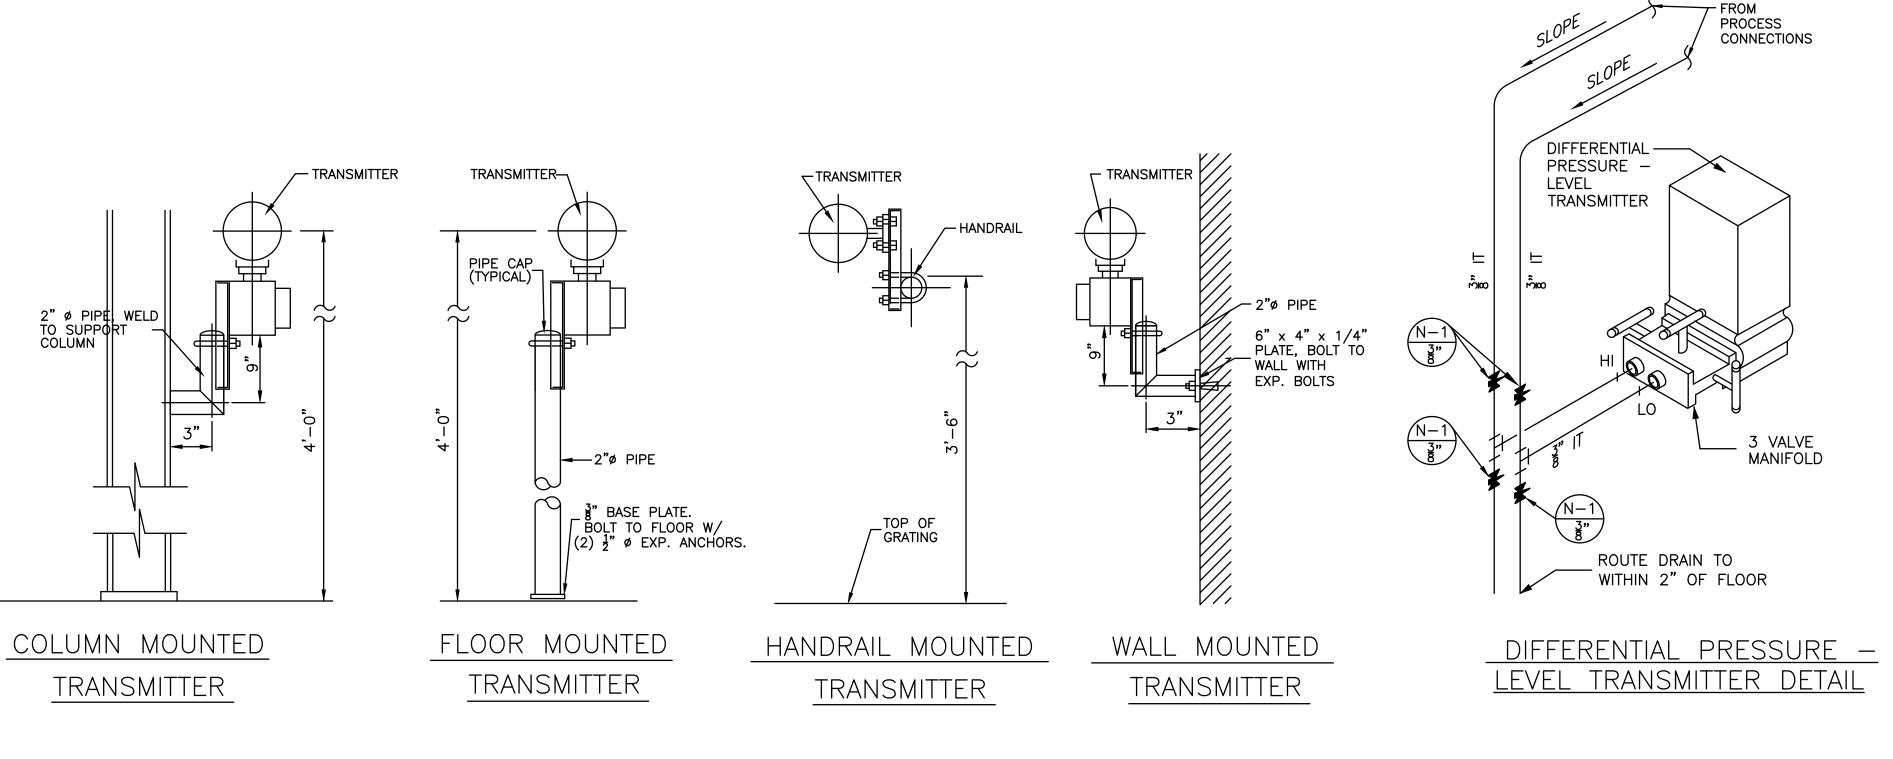




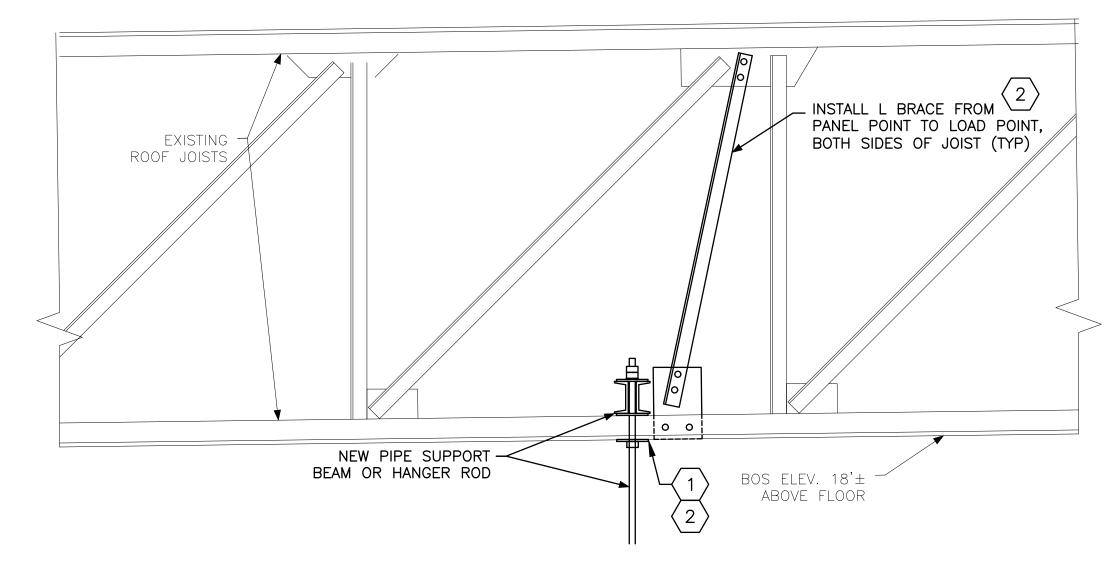


# EXISTING ROOF (2)

# NEW SUPPORT DETAIL NO SCALE

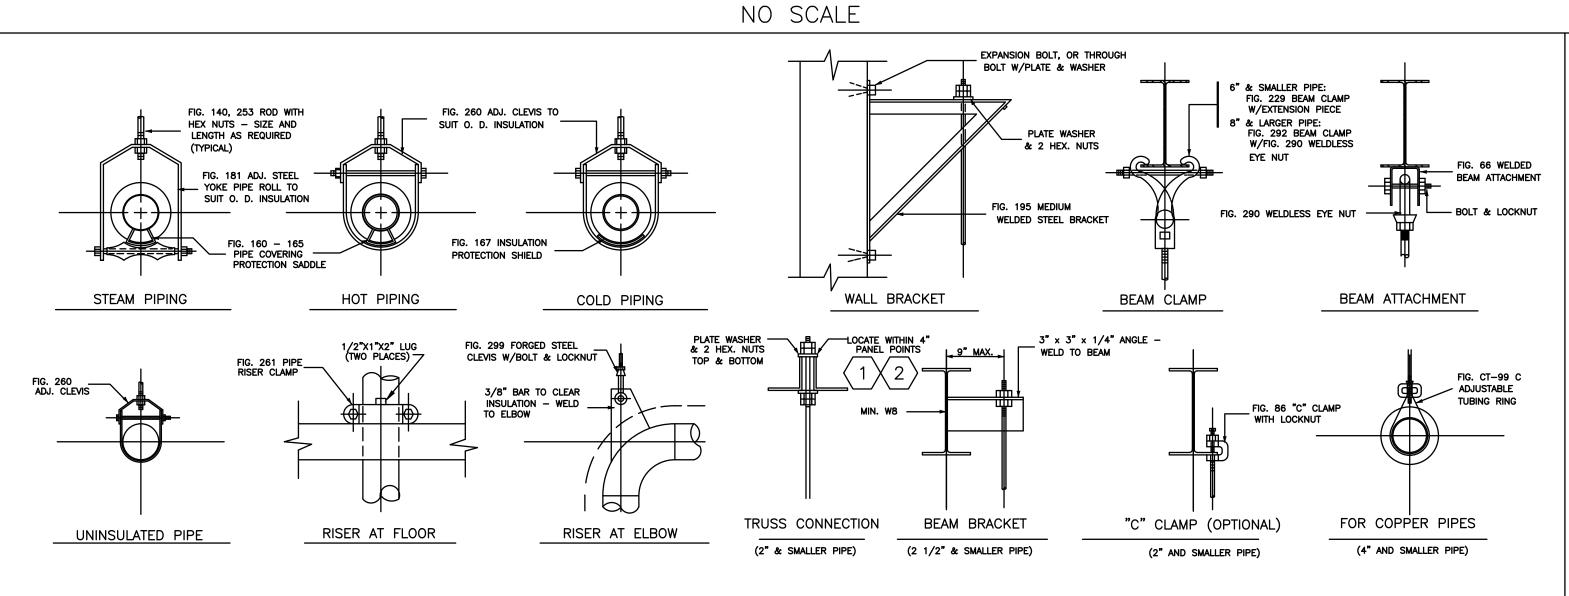

TYPICAL PIPE HANGERS AND SUPPORTS
NO SCALE

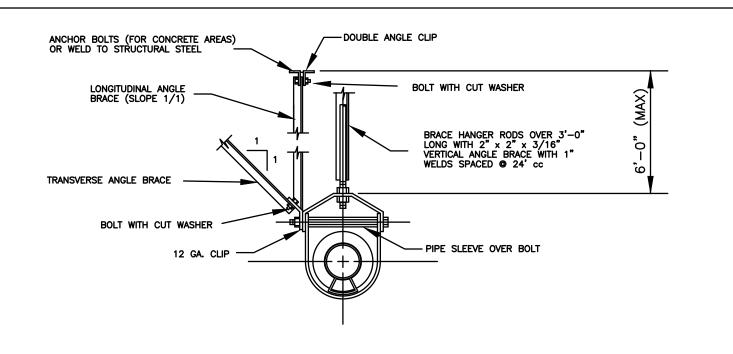

#### TYPICAL SEISMIC BRACING FOR PIPE HANGERS

		NO SCALE		
PIPE SIZE	ANGLE BRACE	BOLT SIZE	ANGLE CLIP	ANCHOR BOLT OR INSERT
2 1/2"	2" x 2" 16GA.	3/8"	3" x 3" x 1/4"	3/8"
3", 4"	2 1/2"x2 1/2" 16GA.	3/8"	3" x 3" x 1/4"	1/2"
5", 6"	2 1/2"x2 1/2" 16GA.	1/2"	5" x 3" x 1/2"	3/4"
8"	3" x 3" 12 GA.	5/8"	2-5" x 3" x 1/2"	2-5/8"
10"	3" x 3" 12 GA.	3/4"	2-5" x 3" x 1/2"	2-3/4"

#### GENERAL NOTES:

- FIELD VERIFY EXISTING CONDITIONS PRIOR TO PROCEEDING.
- 2. EXACT LOCATION OF NEW INSTRUMENTS TO BE DETERMINED BY CONTRACTOR. LOCATE FOR BEST OPERATION, ACCESS AND MAINTENANCE. VERIFY LOCATION WITH OWNER'S REPRESENTATIVE PRIOR TO INSTALLING DEVICES.

#### O KEY NOTES:

1. INSTALL L BRACE BETWEEN LOAD POINT & PANEL POINT, BOTH SIDES OF CHORD.

#### 2. <u>DELEGATED DESIGN</u>:

- 2.1. ALL NEW LOADS TO EXISTING ROOF TRUSSES & ASSOCIATED RETROFITS SHALL BE EVALUATED AND DESIGNED BY CONTRACTOR'S LICENSED MISSOURI PROFESSIONAL ENGINEER.
- 2.2. ASSUME NO INFORMATION IS AVAILABLE ON EXISTING ROOF STEEL. COMPLETE FIELD OBSERVATIONS AS REQUIRED.
- 2.3. EXISTING TRUSSES APPEAR TO BE CONSTRUCTED WITH RIVETS OR BOLTS.
- 2.4. PROVIDE SUBMITTAL OF PROPOSED PIPING SUPPORTS SEALED & SIGNED BY LICENSED MISSOURI PROFESSIONAL ENGINEER.
- 2.5. THE EXISTING ROOF TRUSSES APPEAR TO BE LIGHTLY LOADED WITH PIPING AND CONDUIT. THE NEW LOADS FROM PIPING (3" WATER PIPE = +/10 LB/FT) AND SMALL BORE CONDUIT ARE RELATIVELY SMALL. IT IS ANTICIPATED THAT THE EXISTING ROOF TRUSSES SHOULD BE ACCEPTABLE FOR THESE ADDITIONAL LOADS.
- 2.6. THE DESIGN INTENT IS FOR THE CONTRACTOR'S PROFESSIONAL ENGINEER TO:
- 2.6.1. COMPLETE A STRUCTURAL EVALUATION OF THE ROOF TRUSSES FOR EXISTING AND NEW GRAVITY LOADS IN ACCORDANCE WITH THE INTERNATIONAL EXISTING BUILDING CODE (LATEST EDITION).
- 2.6.2. ENSURE THAT THE NEW PIPING AND ELECTRICAL SUPPORTS CONNECT TO AND LOAD THE ROOF TRUSSES IN AN APPROPRIATE MANNER AND DO NOT DAMAGE THE TRUSSES.
- 2.7. DUE TO ITS AGE AND CONSTRUCTION, THE OWNER RECOGNIZES THAT THE EXISTING BUILDING WAS NOT DESIGNED FOR CURRENT SEISMIC LOADS. THERE IS NO DESIGN INTENT TO ADDRESS THIS ON THIS PROJECT.
- 2.8. IT IS ASSUMED THAT EVALUATION WILL CONCLUDE THAT THE ADDITIONAL LOADS ARE ACCEPTABLE.
- 2.9. IF THE EVALUATION CONCLUDES OTHERWISE, ADDITIONAL MEASURES WILL BE CONSIDERED THROUGH THE CONSTRUCTION CHANGE ORDER PROCESS. RETROFITS TO THE ROOF TRUSSES BEYOND THOSE INDICATED BY KEY NOTE 1 ARE NOT INCLUDED IN THE SCOPE OF WORK.

#### STATE OF MISSOURI MICHAEL L. PARSON, GOVERNOR



CHRISTOPHER L. BARTH
Registered Professional Engineer
MO # E-28880
Expires 12-31-2023

#### ROGERS-SCHMIDT ENGINEERING CO., P.C. CONSULTING ENGINEERS

1736 WEST PARK CENTER DR SUITE 204 ST. LOUIS, MO 63026 PHONE: 636-600-1551

MISSOURI STATE CERTIFICATE

OF AUTHORITY #000408

OFFICE OF ADMINISTRATION DIVISION OF FACILITIES MANAGEMENT, DESIGN AND CONSTRUCTION

DEPARTMENT OF CORRECTIONS

VOLUME 2 REPLACE BOILERS AND
CONTROLS, POWER PLANT

FARMINGTON
CORRECTIONAL CENTER
1012 WEST COLUMBIA
STREET,
FARMINGTON, MO 63640

PROJECT # C2006-01 SITE # 7008

ASSET # 9327008094

REVISION: DATE: REVISION: DATE:

**REVISION:** 

DATE: \_\_\_\_\_

ISSUE DATE: <u>04/26/2023</u>

CAD DWG FILE: C2007-01-9237-

9327008094- M-501.DWG

DRAWN BY: CLB

CHECKED BY: CLB

DESIGNED BY: CLB

SHEET TITLE:

MECHANICAL -

MECHANICAL -DETAILS

SHEET NUMBER:

M-50

	<u>VALVES</u>	<u></u> F	PIPING_	OPERATORS		
$\bowtie$	Gate Valve		Existing	(SOV)		
OI	Ball Valve		New Equipment	$\mathbb{X}$	Solenoid	
<b>X</b>	Globe Valve		New Piping	(MOV)	Motor	
	Check Valve	-	Flow			
<b>≫</b> I	Plug Valve	7	Strainer			
$\triangle$	Angle Valve		Reducer			
	Safety/Relief Valve	r.	Flexible Connector			
<u>~</u>	Hose End Valve		Quick Disconnect Coupling			
**	Knife Gate Valve	-3	Cap			
$X_{\square}$	Three Way Valve	$\bigcirc$	Mushroom Style Vent Cap			
×	Shading indicates normally closed	PT	Pressure			
	Anti-Siphon Valve		Transmitter			
		PI	Pressure Gauge with Cock			
		TI	Thermometer			
			Duplex Strainer			
			Positive Displacement Pump			
		T No.	Connection To Existing Plant Piping System			
			ldentification Symbol			
		FOS	Fuel Oil Return			
		FOR	Fuel Oil Condensate			
		D V	Drain Vent			

#### CONTROL & INSTRUMENTATION SYMBOLS Pressure Regulator Pneumatic Signal Instrument (Panel Mounted) Filter/Regulator With Gauge Electric Signal Future Filter Capillary Signal $\times \times \times \times$ Filter Regulator With Pressure Gauge Orifice Plate Lubricator Instrument (Line, or Local Mounted) INSTRUMENT IDENTIFICATION CODES PER ANSI/ISA-S5.1-1984 (R 1992) FIRST LETTER SUCCEEDING-LETTERS MEASURED OR INITIATING VARIABLE READOUT OR PASSIVE FUNCTION OUTPUT FUNCTION MODIFIER MODIFIER ANALYSIS ALARM USER'S CHOICE USER'S CHOICE USER'S CHOICE BURNER, COMBUSTION CONTROL USER'S CHOICE DIFFERENTIAL USER'S CHOICE SENSOR (PRIMARY ELEMENT) VOLTAGE RATIO(FRACTION) FLOW RATE GLASS, VIEWING DEVICE USER'S CHOICE HAND HIGH CURRENT(ELECTRICAL) INDICATE POWER TIME, TIME SCHEDULE TIME RATE OF CHANGE CONTROL STATION LIGHT LOW LEVEL MIDDLE, INTERMEDIATE MOMENTARY USER'S CHOICE USER'S CHOICE USER'S CHOICE USER'S CHOICE USER'S CHOICE ORIFICE, RESTRICTION

USER'S CHOICE

PRESSURE, VACUUM

QUANTITY

RADIATION SPEED, FREQUENCY

TEMPERATURE

MULTIVARIABLE

VIBRATION, MECHANICAL ANALYSIS WEIGHT, FORCE

UNCLASSIFIED

EVENT, STATE OR PRESENCE

POSITION, DIMENSION

	LEVEL CONTROL VALVES (LCV)											
TAG	SERVICE	INLET PRESS. (PSIG)	INLET TEMP. (°F)	OUTLET PRESS. (PSIG)	ΔP (PSI)	FLOW (PPH)	FLOW (GPM)	SIZE (INCHES)	FAIL-SAFE POSITION	REMARKS		
LCV-01	TREATED H20	60	60	50	10	87,545	175	2	CLOSED	316L SS BODY, 316L SS TRIM $\langle 1 \rangle$		
LCV-02	CONDENSATE	50	200	40	10	72,316	150	2	CLOSED	316L SS BODY, 316L SS TRIM		

SWITCH TRANSMIT

MULTIFUNCTION

VALVE, DAMPER LOUVER

UNCLASSIFIED

RELAY, COMPUTE, CONVERT

DRIVER, ACTUATOR, UNCLASSIFIED

FINAL CONTROL ELEMENT

MULTIFUNCTION

UNCLASSIFIED

LE	VEL TRANSM						
TAG	SERVICE	OPERATING PRESSURE PSIG	DIFFERENTIAL PRESSURE RANGE INCHES H20	OPERATING TEMPERATURE *F	TANK HEIGHT INCHES	H20 LEVEL SETPOINT INCHES	REMARKS
LIT-03	DEAERATOR	10	0-60	240	72	48 +/-	2

POINT (TEST) CONNECTION

RECORD

MULTIFUNCTION

WELL

UNCLASSIFIED

INTEGRATE OR TOTALIZE

SAFETY

X AXIS

Y AXIS

Z AXIS

#### GENERAL NOTES:

1. FIELD VERIFY EXISTING CONDITIONS PRIOR TO PROCEEDING.

#### O KEY NOTES:

- 1. LEVEL CONTROL VALVE TO BE SUITABLE FOR EXISTING SIGNAL FROM EXISTING DEAERATOR LEVEL CONTROLLER. FIELD VERIFY EXISTING CONTROL LOOP CONDITIONS PRIOR TO PROCEEDING. DOCUMENT & ADDRESS ISSUES, IF ANY, WITH ENGINEER PRIOR TO PROCEEDING.
- 2. FIELD VERIFY DIFFERENTIAL PRESSURE RANGE AND SETPOINT.
- 2.1. SETPOINT TO BE SET HALFWAY BETWEEN NORMAL WATER LEVEL AND DA OVERFLOW LEVEL.

**STATE OF MISSOURI** MICHAEL L. PARSON, **GOVERNOR** 



CHRISTOPHER L. BARTH Registered Professional Engineer MO # E-28880 Expires 12-31-2023

ROGERS-SCHMIDT ENGINEERING CO., P.C. CONSULTING ENGINEERS 1736 WEST PARK CENTER DR. SUITE 204 ST. LOUIS, MO 63026 PHONE: 636-600-1551 MISSOURI STATE CERTIFICATE

OF AUTHORITY #000408

OFFICE OF ADMINISTRATION DIVISION OF FACILITIES MANAGEMENT, DESIGN AND CONSTRUCTION

DEPARTMENT OF CORRECTIONS

VOLUME 2 -REPLACE BOILERS AND CONTROLS, POWER PLANT

FARMINGTON CORRECTIONAL CENTER 1012 WEST COLUMBIA STREET, FARMINGTON, MO 63640

PROJECT # C2006-01 SITE# 7008

ASSET # 9327008094

**REVISION: REVISION:** DATE: **REVISION:** 

DATE:

ISSUE DATE: 04/26/2023


CAD DWG FILE: C2007-01-9237-

9327008094- M-600.DWG DRAWN BY: CLB
CHECKED BY: CLB DESIGNED BY: CLB

SHEET TITLE:

MECHANICAL -SYMBOLS & SCHEDULES

SHEET NUMBER:

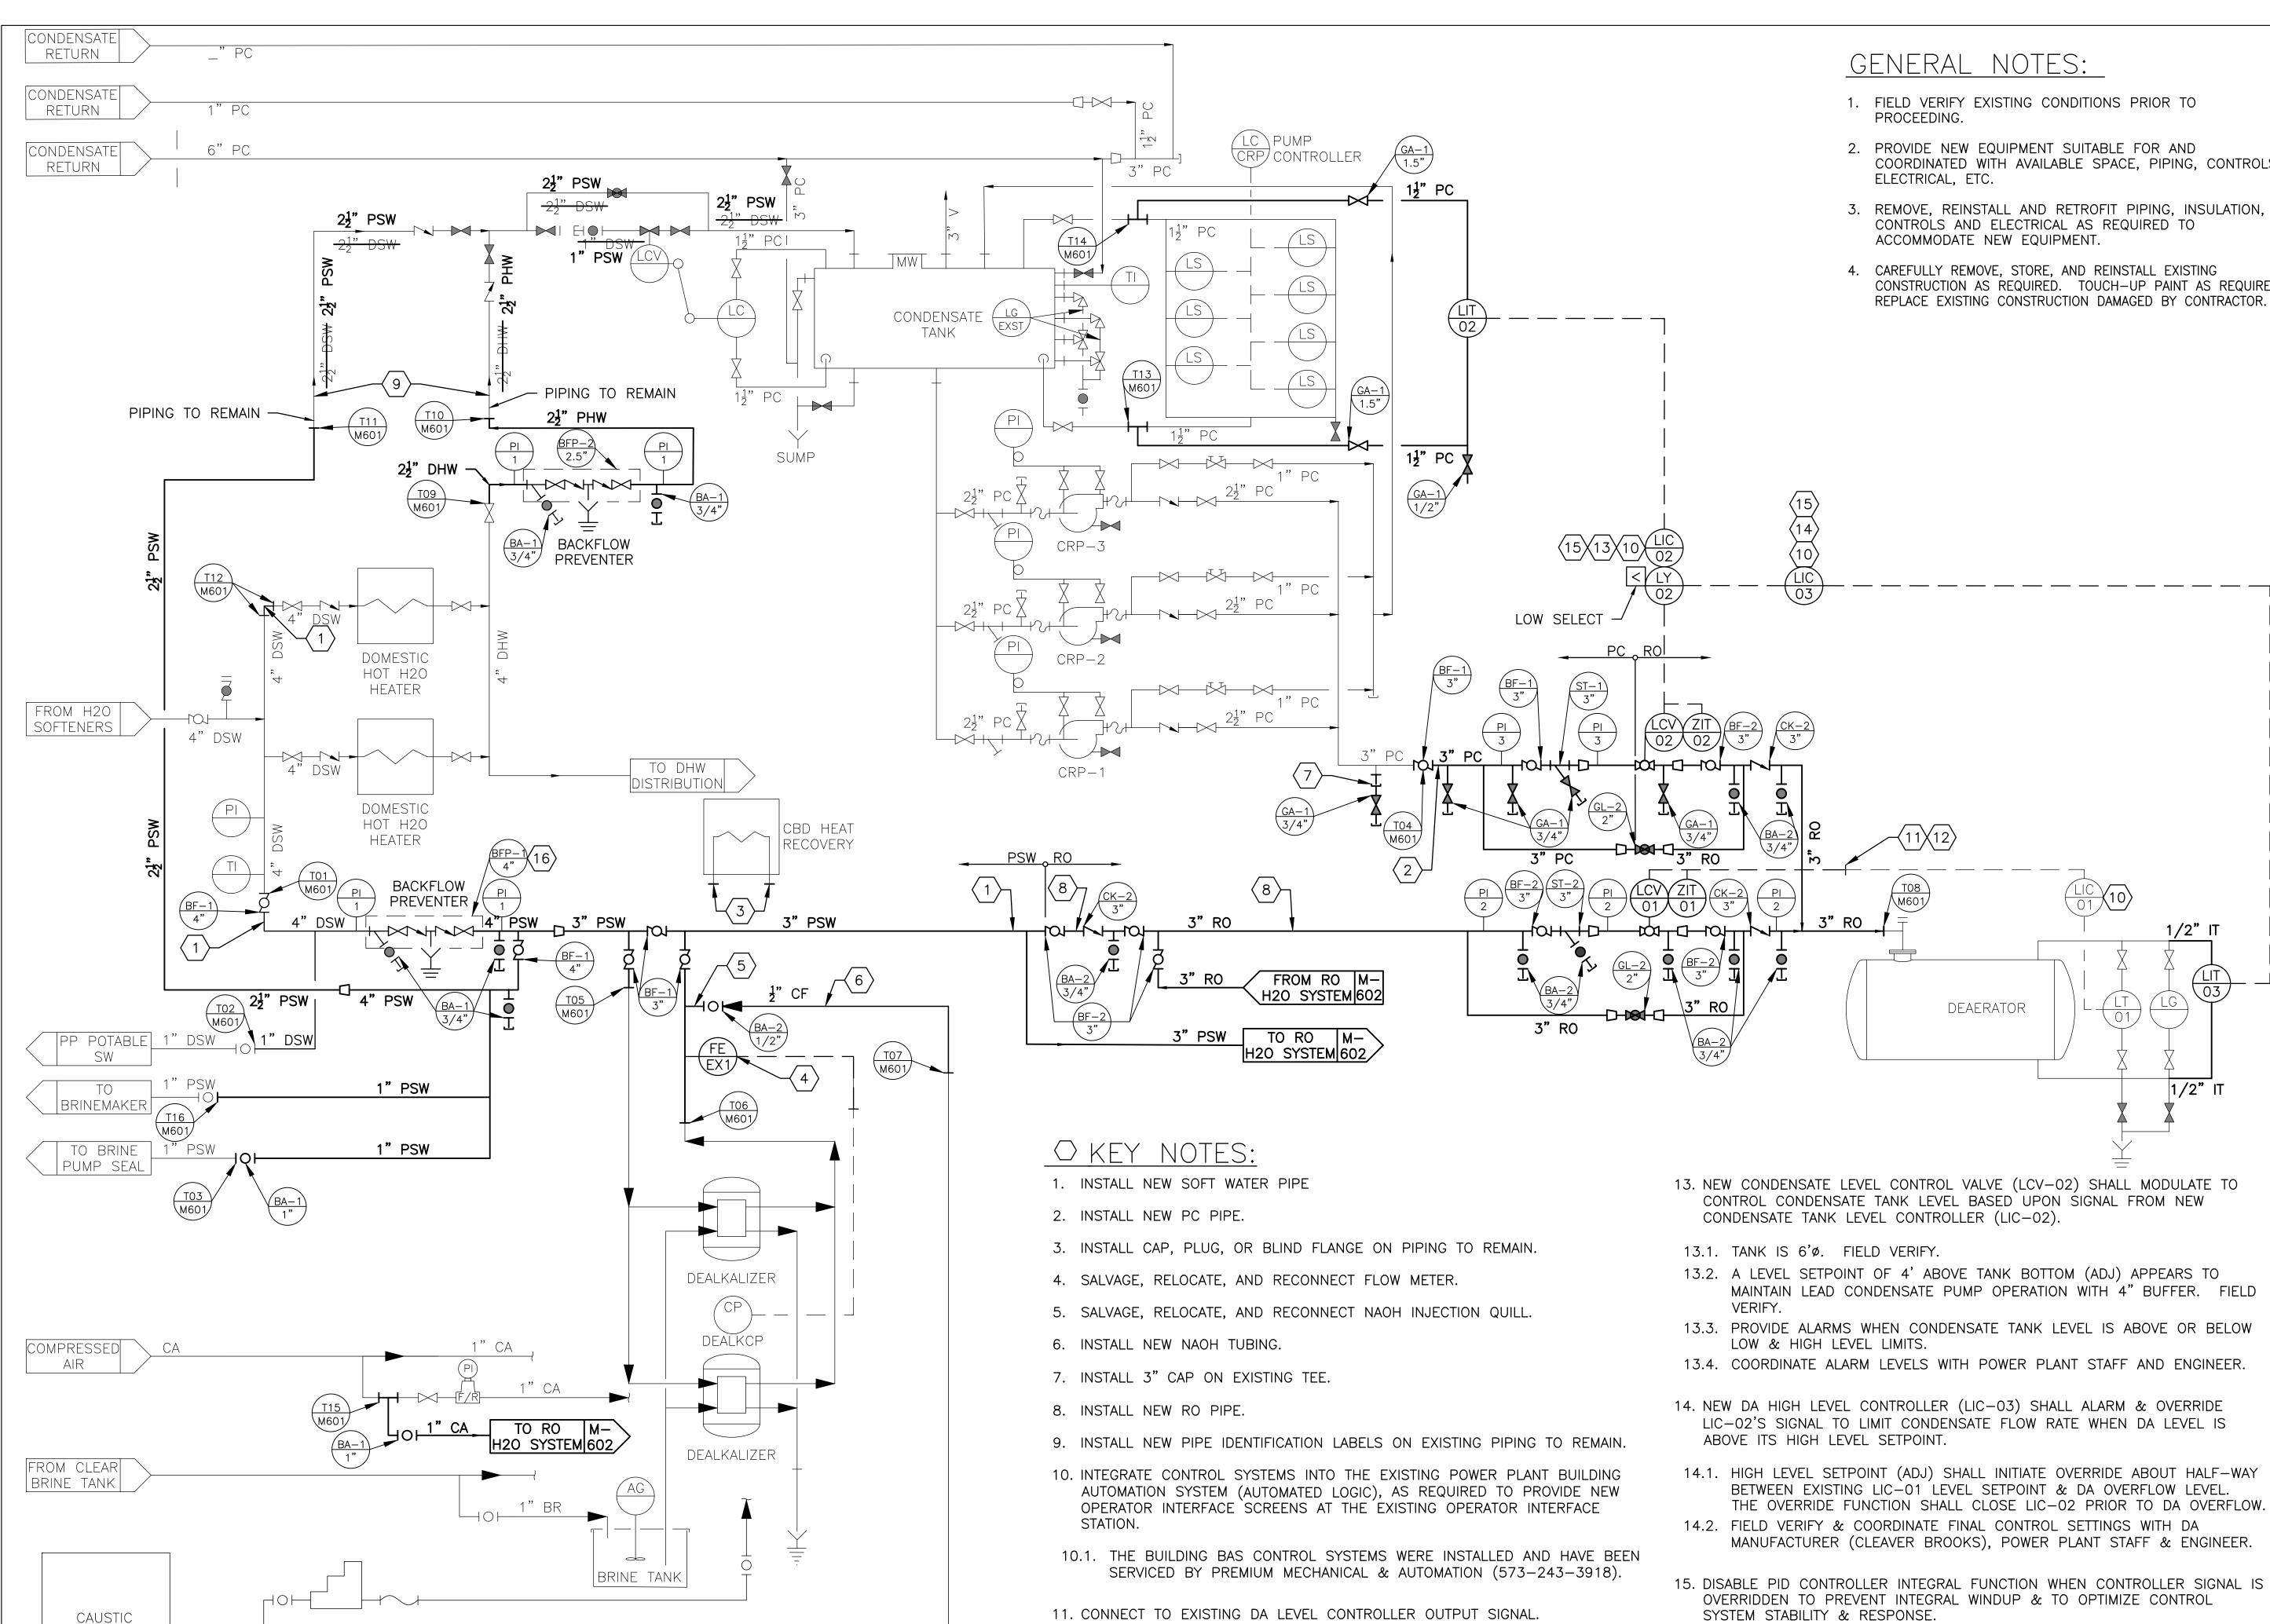

(NAOH)

TANK

#### GENERAL NOTES:

12. NEW MAKE-UP WATER LEVEL CONTROL VALVE (LCV-01) SHALL MODULATE TO 16. BACKFLOW PREVENTER, BFP-1, IS TO BE INSTALLED AS PART OF THE BASE

BID WORK. SEE VOLUME 1 BID DOCUMENTS.


CONTROL DA LEVEL BASED UPON THE SIGNAL FROM EXISTING DA LEVEL

CONTROLLER (LIC-01).

- 1. FIELD VERIFY EXISTING CONDITIONS PRIOR TO
- 2. PROVIDE NEW EQUIPMENT SUITABLE FOR AND COORDINATED WITH AVAILABLE SPACE, PIPING, CONTROLS,
- 3. REMOVE, REINSTALL AND RETROFIT PIPING, INSULATION, CONTROLS AND ELECTRICAL AS REQUIRED TO ACCOMMODATE NEW EQUIPMENT.
- CAREFULLY REMOVE, STORE, AND REINSTALL EXISTING CONSTRUCTION AS REQUIRED. TOUCH-UP PAINT AS REQUIRED. REPLACE EXISTING CONSTRUCTION DAMAGED BY CONTRACTOR.

MICHAEL L. PARSON, **GOVERNOR** 

**STATE OF MISSOURI** 

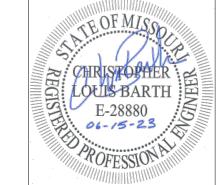

CHRISTOPHER L. BARTH Registered Professional Engineer MO # E-28880 Expires 12-31-2023

**ROGERS-SCHMIDT** ENGINEERING CO., P.C.

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OFFICE OF ADMINISTRATION **DIVISION OF FACILITIES** MANAGEMENT, **DESIGN AND CONSTRUCTION** 

DEPARTMENT OF CORRECTIONS

1/2" IT

1/2" IT

 $\frac{\text{LIT}}{03}$ 

VOLUME 2 -REPLACE BOILERS AND CONTROLS. POWER PLANT

FARMINGTON CORRECTIONAL CENTER 1012 WEST COLUMBIA STREET,

FARMINGTON, MO 63640

PROJECT # C2006-01

SITE#

9327008094 ASSET#

**REVISION: REVISION:** DATE:

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CAD DWG FILE: C2007-01-9237-9327008094- M-600-SERIES.DWG

DRAWN BY: CLB
CHECKED BY: CLB
DESIGNED BY: CLB

SHEET TITLE: FLOW DIAGRAM -H2O TREATMENT

SHEET NUMBER:

# O KEY NOTES:

- 1. INSTALL NEW FACTORY PACKAGED RO WATER SYSTEM & ASSOCIATED CONCRETE PAD, ANCHOR BOLTS, PIPING, CONTROLS, INSTRUMENTATION, ETC.
- 2. INSTALL NEW RO WATER STORAGE TANK & ASSOCIATED CONCRETE PAD, ANCHOR BOLTS, PIPING, CONTROLS, INSTRUMENTATION, ETC.
- 3. INSTALL NEW FACTORY PACKAGED RO WATER PUMPS & ASSOCIATED CONCRETE PAD, ANCHOR BOLTS, PIPING, CONTROLS, INSTRUMENTATION, ETC.
- 4. CHEMICAL INJECTION QUILLS SHALL BE PROVIDED WITH RO SYSTEM.
- 5. CHEMICAL PUMP CONTROL SHALL BE PROVIDED WITH RO SYSTEM.
- 6. CHEMICAL FEED SYSTEMS WILL BE FURNISHED BY OWNER'S WATER TREATMENT SERVICE COMPANY FOR INSTALLATION BY CONTRACTOR. COORDINATE AS REQUIRED.
- 6.1. ASSUME CHEMICAL FEED STATIONS WILL BE INSTALLED WITHIN 30' OF RO SKID.
- 7. TANK LEVEL CONTROL SYSTEM FURNISHED WITH RO SYSTEM. FIELD INSTALLED BY CONTRACTOR.
- 8. INTEGRATE CONTROL SYSTEMS INTO THE EXISTING POWER PLANT BUILDING AUTOMATION SYSTEM (AUTOMATED LOGIC), AS REQUIRED TO PROVIDE NEW OPERATOR INTERFACE SCREENS AT THE EXISTING OPERATOR INTERFACE STATION.
- 8.1. PROVIDE EQUIPMENT SYSTEM DISPLAYS WITH ALL AVAILABLE SYSTEM DATA, ALARMS, EVENT HISTORY, ETC. ON THE EXISTING POWER PLANT

#### OPERATOR INTERFACE STATION.

- 8.2. DUPLICATE THE EQUIPMENT SYSTEM OPERATOR INTERFACE SCREENS ON THE POWER PLANT'S OPERATOR INTERFACE STATION TO THE EXTENT POSSIBLE.
- 8.3. PROVIDE CRITICAL SYSTEM DATA COLLECTION, TRENDING, AND ARCHIVING TO POWER PLANT WORK STATION.
- 8.4. REMOTE EQUIPMENT SYSTEM CONTROL FROM THE POWER PLANT OPERATOR INTERFACE STATION IS NOT REQUIRED, BUT SHALL BE A CAPABILITY FOR FUTURE CONSIDERATON.
- 8.5. COMMUNICATION INTERFACE SHALL BE BACNET (WHICH IS PREFERRED)
  OR MODBUS WITH HARDWIRE MSTP OR TCP/IP PROTOCOL. FIELD
  VERIFY
- 9. THE BUILDING BAS CONTROL SYSTEMS WERE INSTALLED AND HAVE BEEN SERVICED BY PREMIUM MECHANICAL & AUTOMATION (573-243-3918).
- 10. CONNECT TO RO COMPRESSED AIR SYSTEM.
- 11. THE ARRAY SHOWN ON THIS P&ID DRAWING, IS FOR ILLUSTRATIVE PURPOSES ONLY. MANUFACTURER SHALL DETERMINE SYSTEM DESIGN & ARRAY SUBJECT TO SPECIFICATION COMPLIANCE AND ENGINEER'S APPROVAL.

#### GENERAL NOTES:

- 1. FIELD VERIFY EXISTING CONDITIONS PRIOR TO PROCEEDING.
- 2. PROVIDE NEW EQUIPMENT SUITABLE FOR AND COORDINATED WITH EXISTING CONDITIONS AND AVAILABLE SPACE.
- 3. CAREFULLY REMOVE, STORE, AND REINSTALL EXISTING CONSTRUCTION AS REQUIRED. TOUCH-UP PAINT AS REQUIRED. REPLACE EXISTING CONSTRUCTION DAMAGED BY CONTRACTOR.

STATE OF MISSOURI MICHAEL L. PARSON, GOVERNOR



CHRISTOPHER L. BARTH Registered Professional Engineer MO # E-28880 Expires 12-31-2023

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OFFICE OF ADMINISTRATION DIVISION OF FACILITIES MANAGEMENT, DESIGN AND CONSTRUCTION

DEPARTMENT OF CORRECTIONS

VOLUME 2 -REPLACE BOILERS AND CONTROLS, POWER PLANT

FARMINGTON
CORRECTIONAL CENTER
1012 WEST COLUMBIA
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FARMINGTON, MO 63640

PROJECT # C2006-01

ASSET # 9327008094

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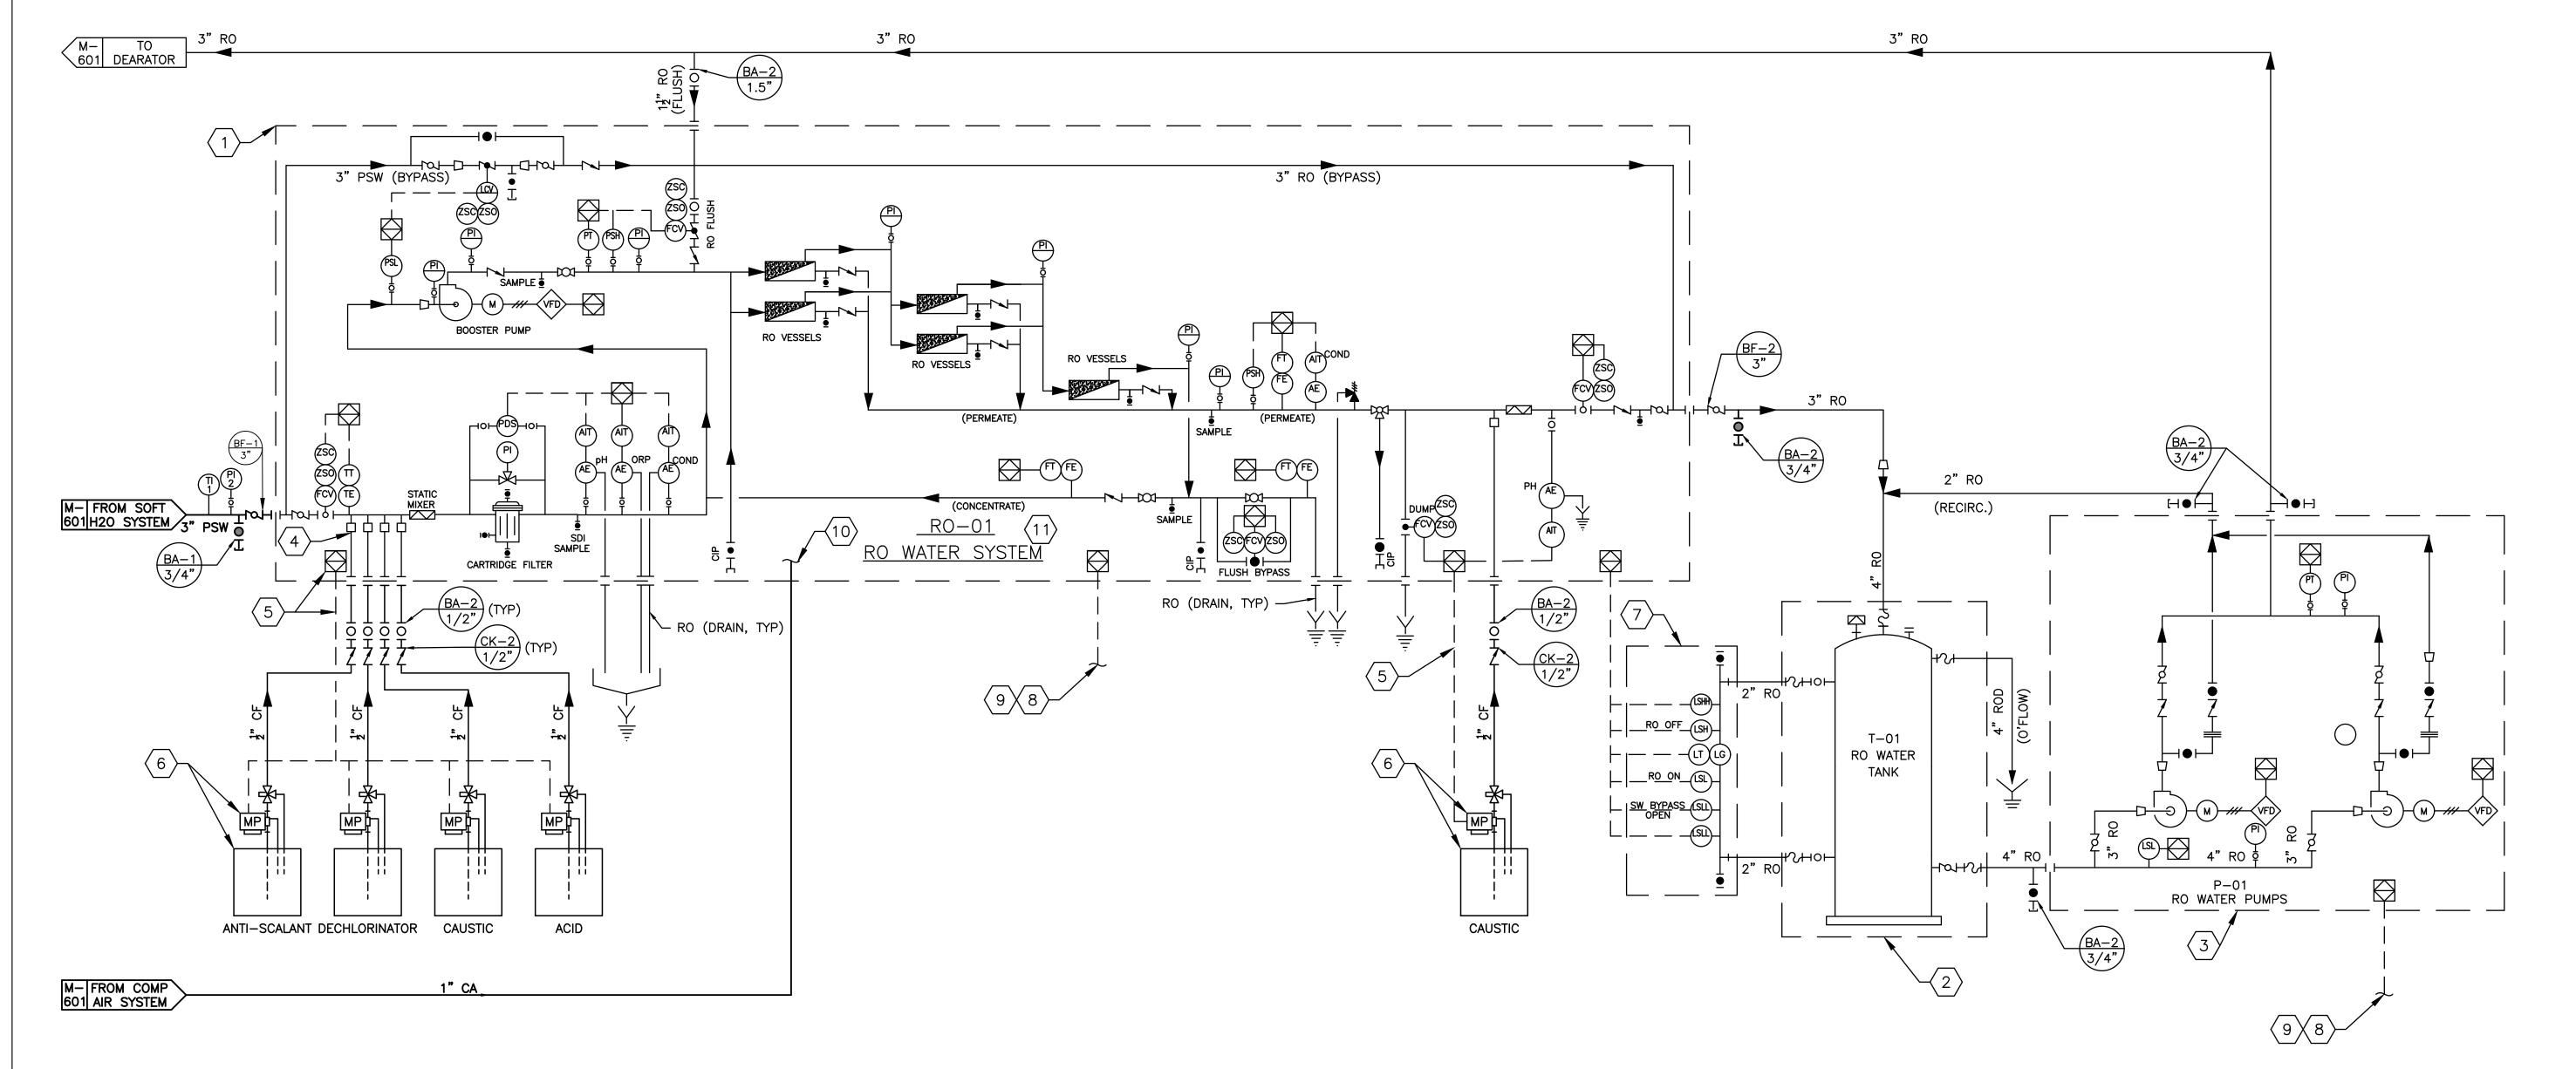
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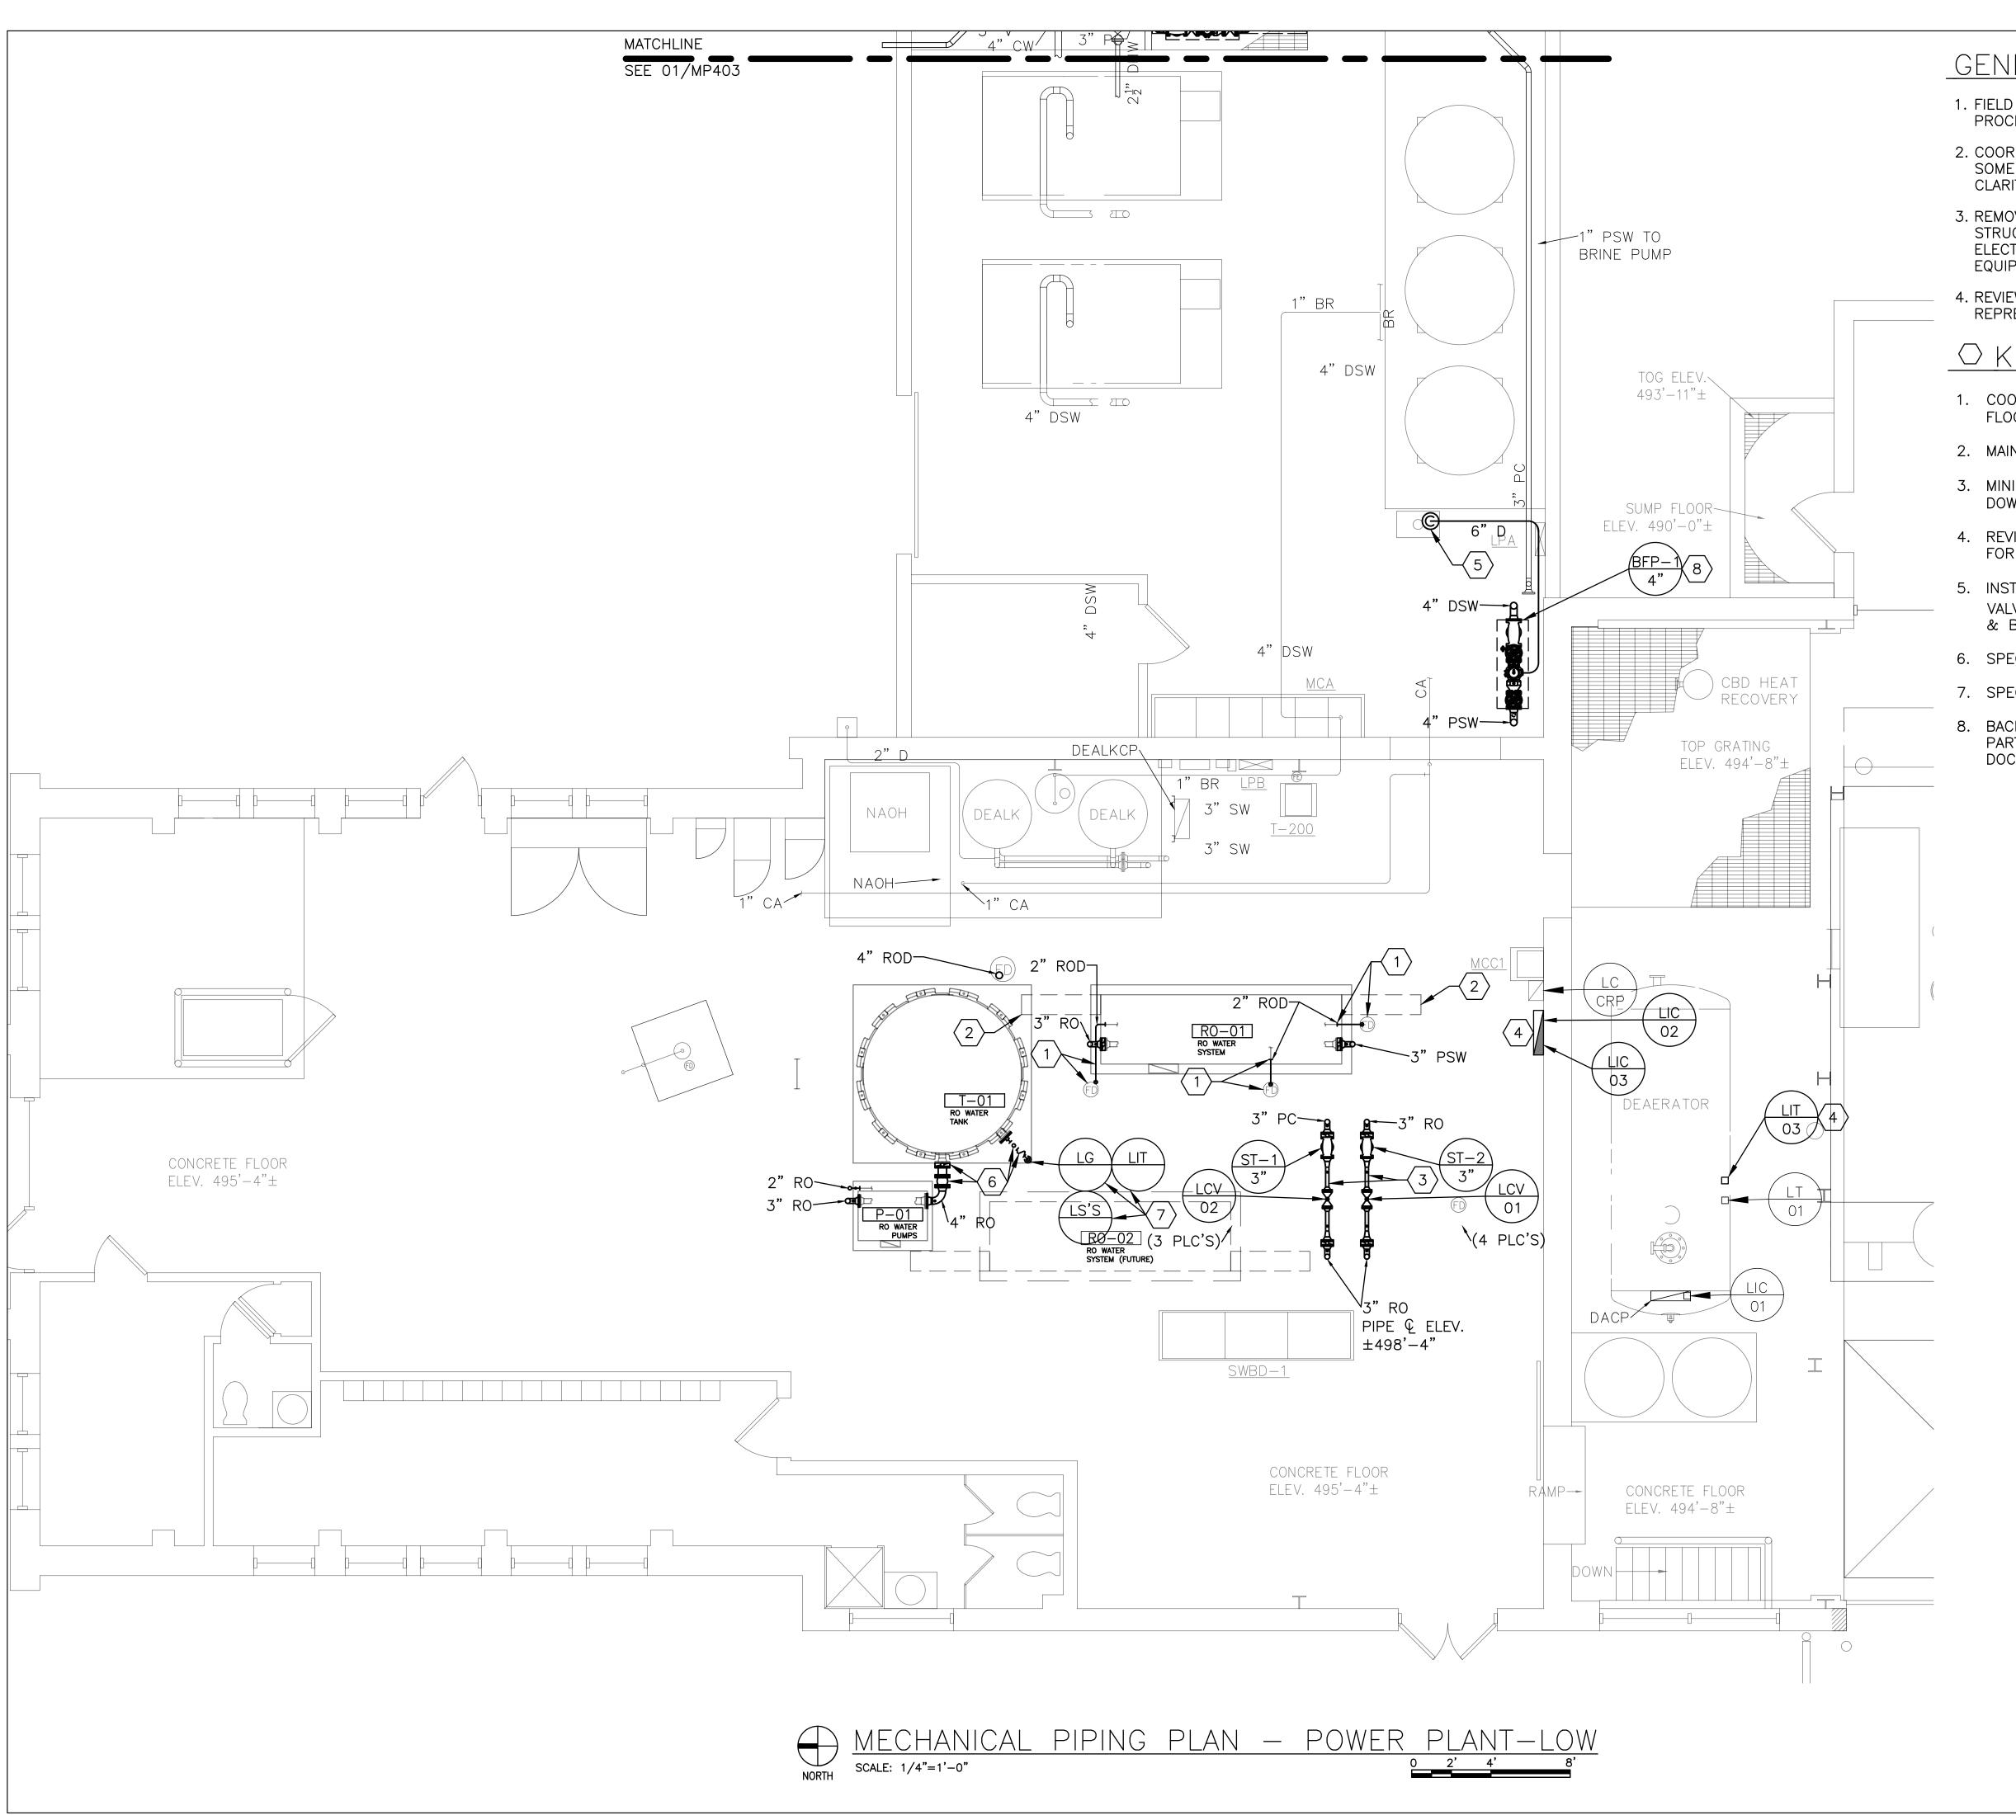
CAD DWG FILE: C2007-01-9237
9327008094- M-600-SERIES.DWG
DRAWN BY: CLB
CHECKED BY: CLB
DESIGNED BY: CLB

SHEET TITLE:
FLOW DIAGRAM RO WATER SYSTEM

SHEET NUMBER:

M-60





- 1. FIELD VERIFY EXISTING CONDITIONS PRIOR TO PROCEEDING.
- 2. COORDINATE PIPING INSTALLATION WITH FLOW DIAGRAMS. SOME PIPING COMPONENTS NOT SHOWN ON PLANS FOR CLARITY.
- 3. REMOVE, REINSTALL AND RETROFIT CONCRETE, STRUCTURAL STEEL, PIPING, INSULATION, CONTROLS, ELECTRICAL, ETC. AS REQUIRED TO ACCOMMODATE NEW EQUIPMENT & PIPING.
- 4. REVIEW PIPE ROUTING WITH CONSTRUCTION REPRESENTATIVE PRIOR TO PROCEEDING.

# O KEY NOTES:

- 1. COORDINATE DRAIN PIPE (ROD) SIZE & ROUTING AND FLOOR DRAIN LOCATIONS WITH RO SYSTEM PROVIDED.
- 2. MAINTAIN ACCESS FOR RO MEMBRANE REPLACEMENT.
- 3. MINIMUM OF 6 PIPE Ø'S STRAIGHT RUN UPSTREAM & DOWNSTREAM OF CONTROL VALVES.
- 4. REVIEW LOCATION WITH CONSTRUCTION REPRESENTATIVE FOR APPROVAL PRIOR TO PROCEEDING.
- 5. INSTALL 6" DRAIN (PVC, SCH 40) FROM BFP RELIEF VALVE TO DRAIN. SLOPE MINIMUM 1/2" PER FOOT. CUT & BAND OPENING IN GRATE.
- 6. SPECIFIED TO BE FURNISHED WITH TANK.
- 7. SPECIFIED TO BE FURNISHED WITH RO SYSTEM.
- 8. BACKFLOW PREVENTER, BFP-1, IS TO BE INSTALLED AS PART OF THE BASE BID WORK. SEE VOLUME 1 BID DOCUMENTS.

STATE OF MISSOURI MICHAEL L. PARSON, GOVERNOR



CHRISTOPHER L. BARTH Registered Professional Engineer MO # E-28880 Expires 12-31-2023

ROGERS-SCHMIDT ENGINEERING CO., P.C.

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1736 WEST PARK CENTER DR. SUITE 204 ST. LOUIS, MO 63026 PHONE: 636-600-1551 MISSOURI STATE CERTIFICATE OF AUTHORITY #000408

OFFICE OF ADMINISTRATION DIVISION OF FACILITIES MANAGEMENT, DESIGN AND CONSTRUCTION

DEPARTMENT OF CORRECTIONS

VOLUME 2 -REPLACE BOILERS AND CONTROLS, POWER PLANT

FARMINGTON CORRECTIONAL CENTER 1012 WEST COLUMBIA STREET, FARMINGTON, MO 63640

PROJECT # C2006-01

ASSET# 9327008094

**REVISION: REVISION: REVISION:** 

CAD DWG FILE: C2007-01-9237-9327008094- MP-401.DWG


DRAWN BY: CLB
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DESIGNED BY: CLB

SHEET TITLE:

MECHANICAL PIPING PLAN -POWER PLANT-LOW

SHEET NUMBER:

MP-401

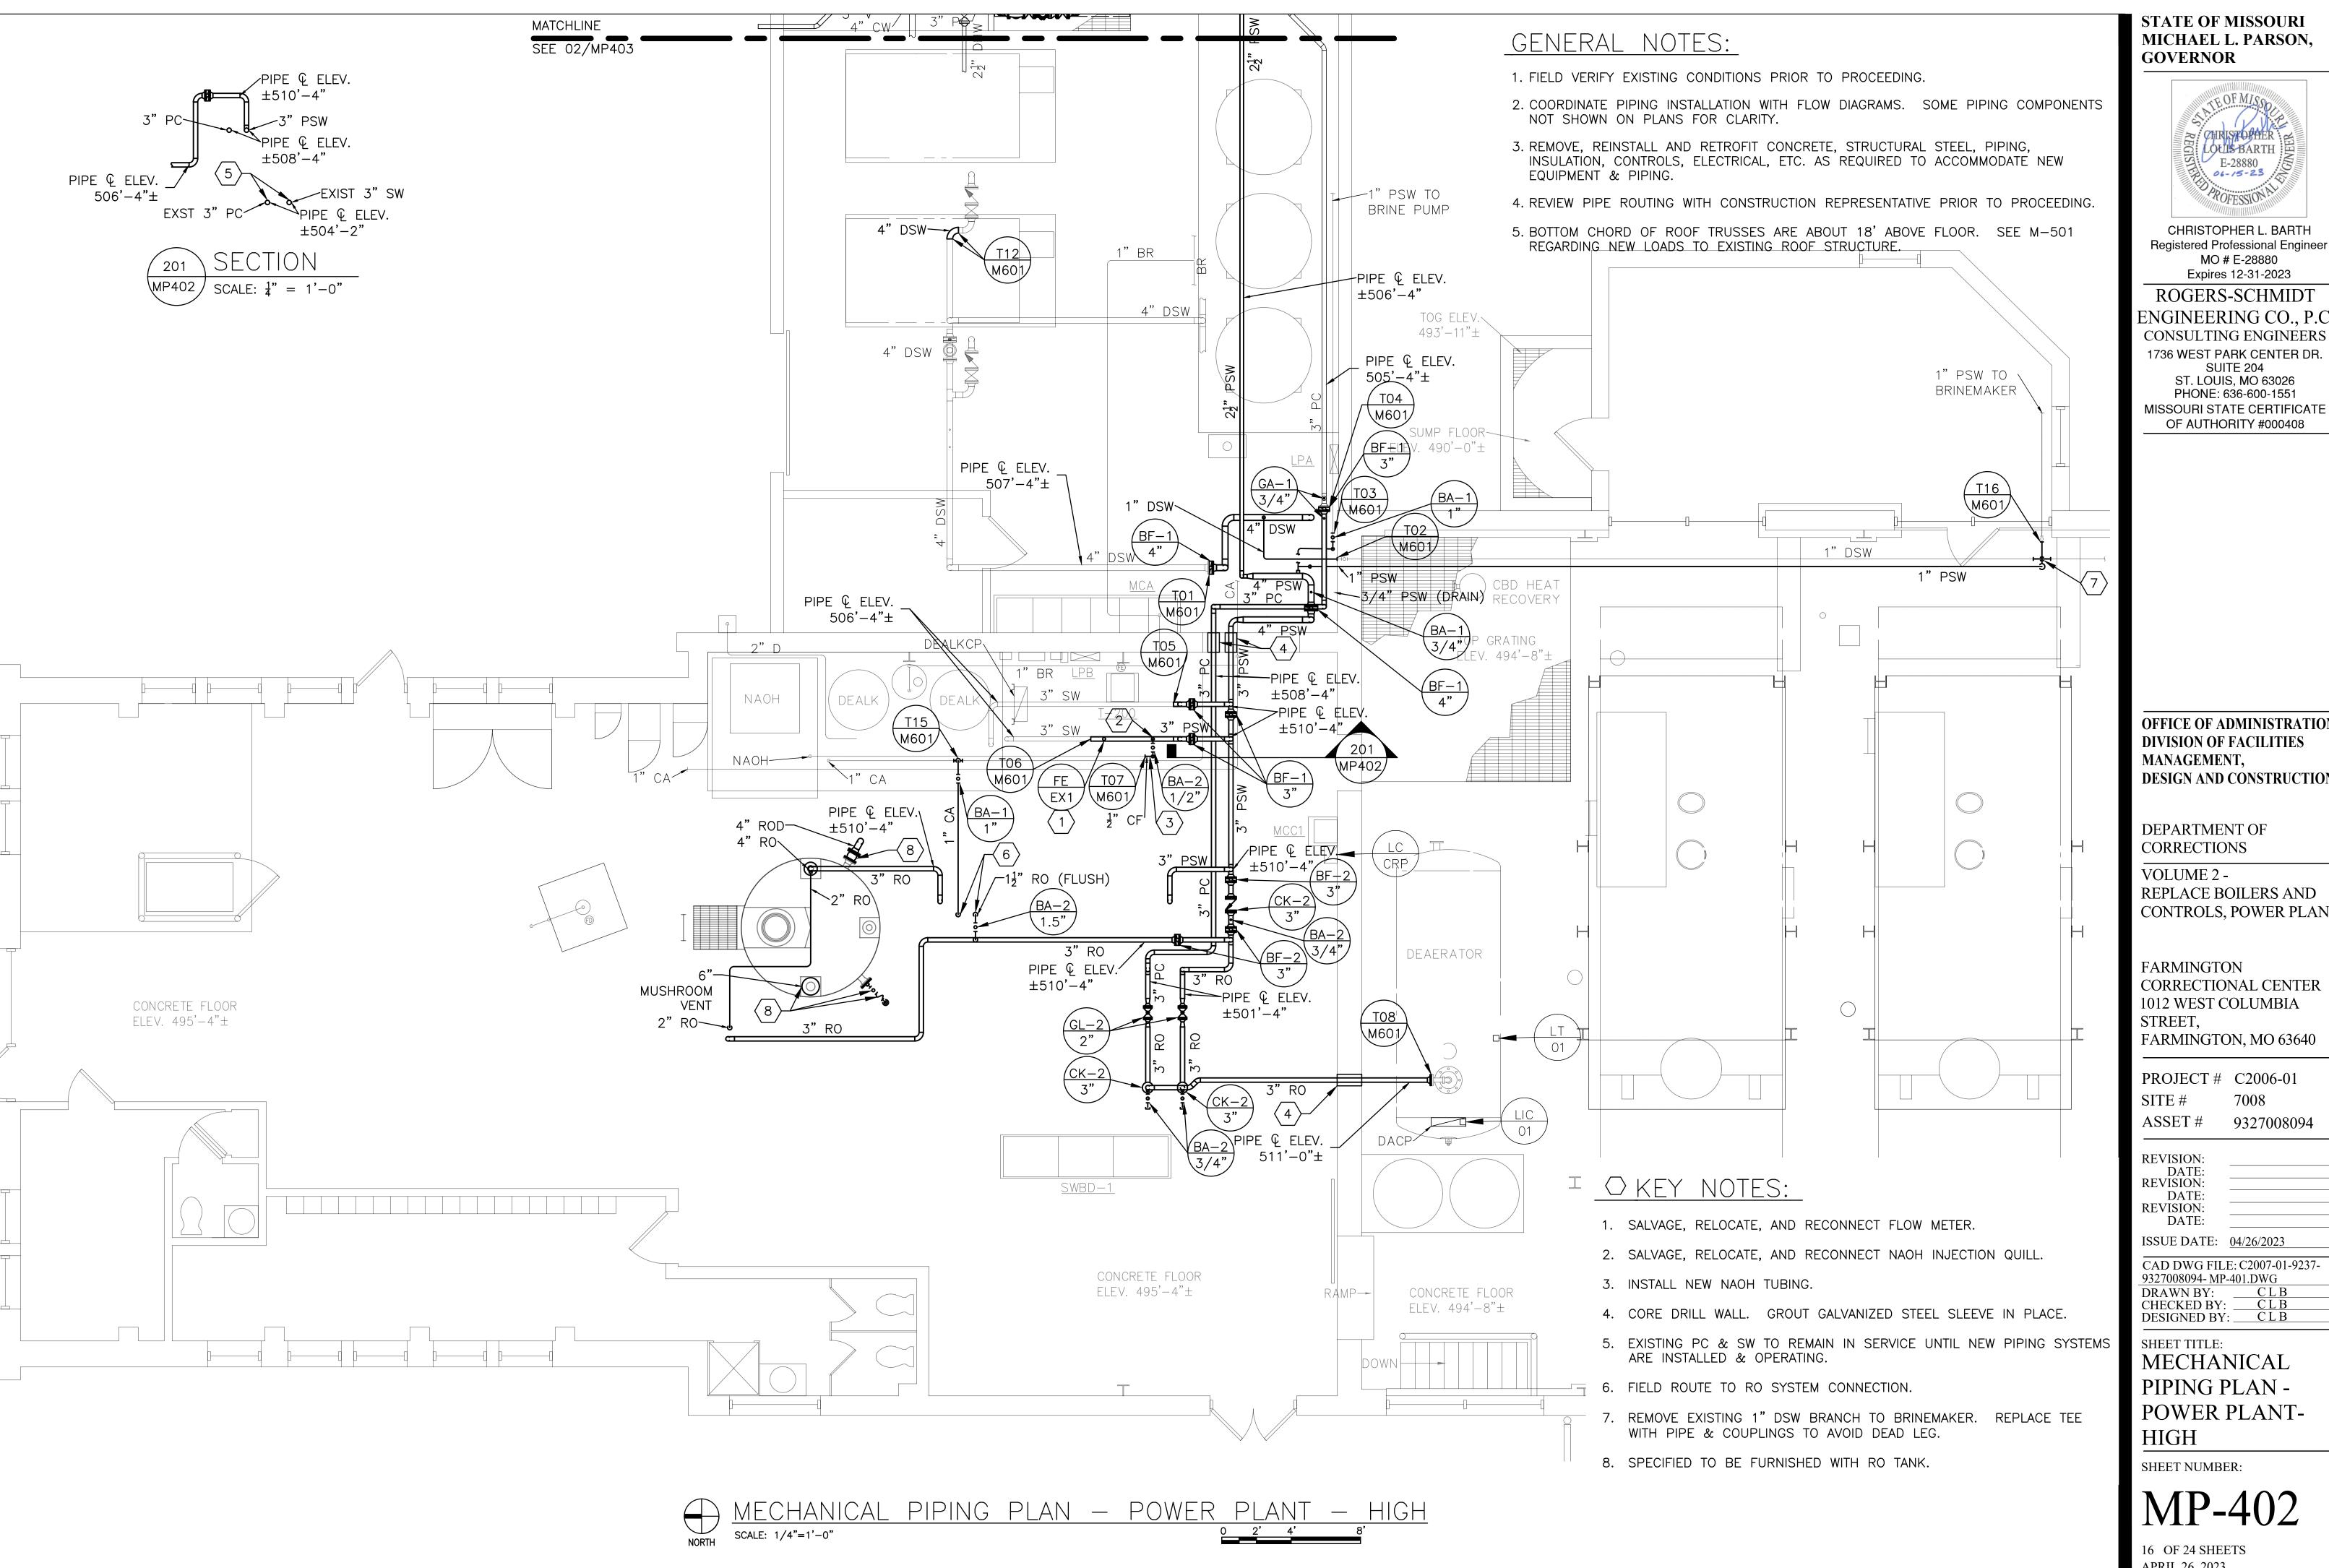



CHRISTOPHER L. BARTH Registered Professional Engineer MO # E-28880 Expires 12-31-2023

#### ROGERS-SCHMIDT ENGINEERING CO., P.C.

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OFFICE OF ADMINISTRATION DIVISION OF FACILITIES MANAGEMENT, DESIGN AND CONSTRUCTION

DEPARTMENT OF CORRECTIONS

VOLUME 2 -REPLACE BOILERS AND CONTROLS, POWER PLANT

FARMINGTON CORRECTIONAL CENTER 1012 WEST COLUMBIA STREET, FARMINGTON, MO 63640

PROJECT # C2006-01 7008

9327008094 ASSET#

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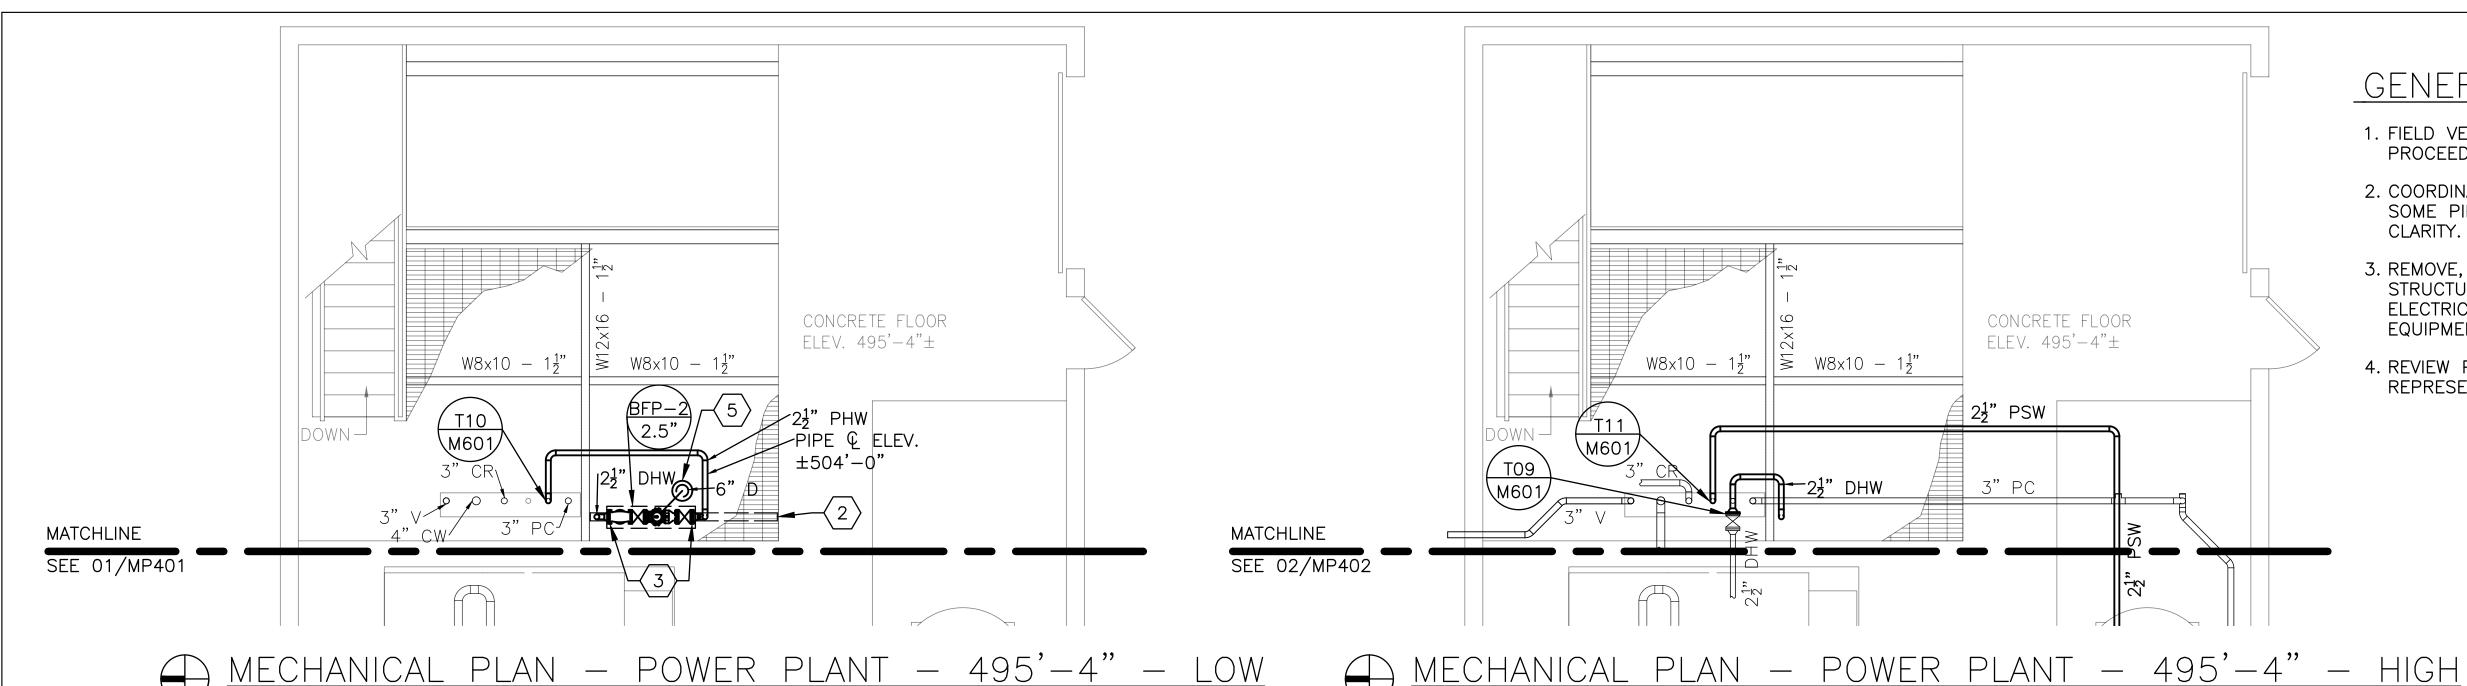
CAD DWG FILE: C2007-01-9237-9327008094- MP-401.DWG

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DESIGNED BY: CLB

MECHANICAL PIPING PLAN -POWER PLANT-

SHEET NUMBER:

MP-402



- 1. FIELD VERIFY EXISTING CONDITIONS PRIOR TO PROCEEDING.
- 2. COORDINATE PIPING INSTALLATION WITH FLOW DIAGRAMS. SOME PIPING COMPONENTS NOT SHOWN ON PLANS FOR CLARITY.
- 3. REMOVE, REINSTALL AND RETROFIT CONCRETE, STRUCTURAL STEEL, PIPING, INSULATION, CONTROLS, ELECTRICAL, ETC. AS REQUIRED TO ACCOMMODATE NEW EQUIPMENT & PIPING.
- 4. REVIEW PIPE ROUTING WITH CONSTRUCTION REPRESENTATIVE PRIOR TO PROCEEDING.

#### STATE OF MISSOURI MICHAEL L. PARSON, GOVERNOR



CHRISTOPHER L. BARTH Registered Professional Engineer MO # E-28880 Expires 12-31-2023

#### ROGERS-SCHMIDT ENGINEERING CO., P.C.


CONSULTING ENGINEERS

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PHONE: 636-600-1551
MISSOURI STATE CERTIFICATE

OF AUTHORITY #000408

# OKEY NOTES:

- 1. REVIEW LIT LOCATION WITH CONSTRUCTION REPRESENTATIVE FOR APPROVAL PRIOR TO PROCEEDING.
- 2. COORDINATE NEW W12 FOR SUPPORT OF BACKFLOW PREVENTER & ASSOCIATED PIPE WITH STRUCTURAL CONTRACTOR. SEE STRUCTURAL DRAWINGS.
- 3. DIELECTRIC CONNECTION.
- 4. PROVIDE SUITABLE SUPPORT & LATERAL BRACING.
- 5. INSTALL 6" DRAIN (PVC, SCH 40) FROM BFP RELIEF VALVE TO DRAIN. SLOPE MINIMUM 1" PER FOOT.
- 5.1. COORDINATE WITH NEW DRAIN LINE ADDITION INDICATED ON PLUMBING DRAWINGS.

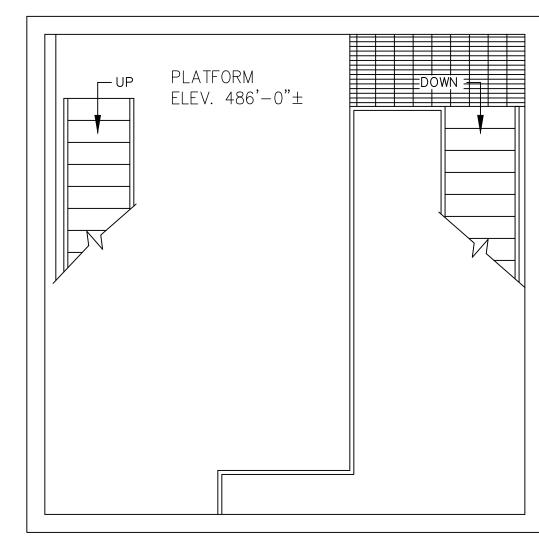

MECHANICAL PLAN — POWER PLANT — 486'—0"

SCALE: 1/4"=1'-0" 0 2' 4' 8'

# CONDENSATE RECEIVER T14 M601 1½" PC GA-1 1.5" CONCRETE FLOOR ELEV. 475'-4"±

MECHANICAL PLAN — POWER PLANT — 475'-4" — HIGH

SCALE: 1/4"=1'-0" 0 2' 4' 8'

OFFICE OF ADMINISTRATION DIVISION OF FACILITIES MANAGEMENT, DESIGN AND CONSTRUCTION

DEPARTMENT OF CORRECTIONS

VOLUME 2 REPLACE BOILERS AND
CONTROLS, POWER PLANT

FARMINGTON
CORRECTIONAL CENTER
1012 WEST COLUMBIA
STREET,
FARMINGTON, MO 63640

PROJECT # C2006-01

SITE # 7008 ASSET # 9327008094

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CAD DWG FILE: C2007-01-9237-9327008094- MP-401.DWG

DRAWN BY: CLB

CHECKED BY: CLB

DESIGNED BY: CLB


SHEET TITLE:

MECHANICAL PIPING PLANS -POWER PLANT -EAST

SHEET NUMBER:


MP-403

17 OF 24 SHEETS APRIL 26, 2023

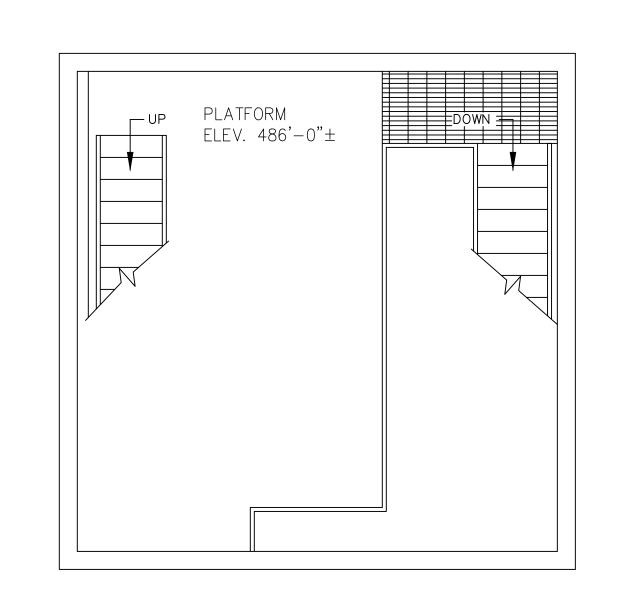


SCALE: 1/4"=1'-0"

MECHANICAL PLAN - POWER PLANT - 486'-0"

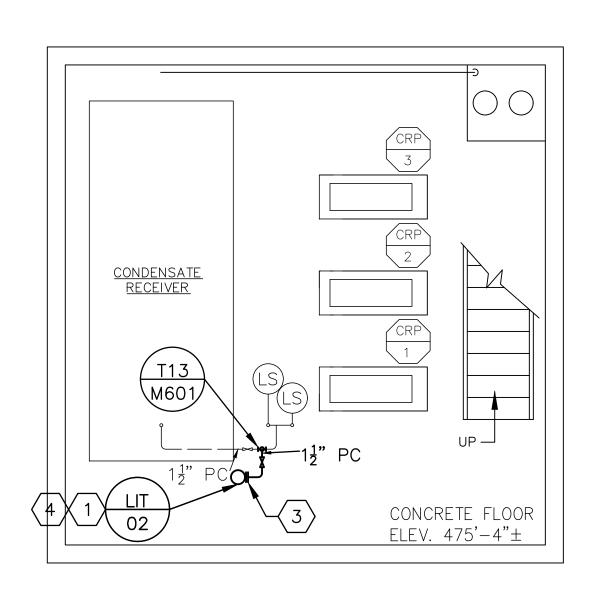

MECHANICAL PLAN - POWER PLANT - 475'-4" - LOW

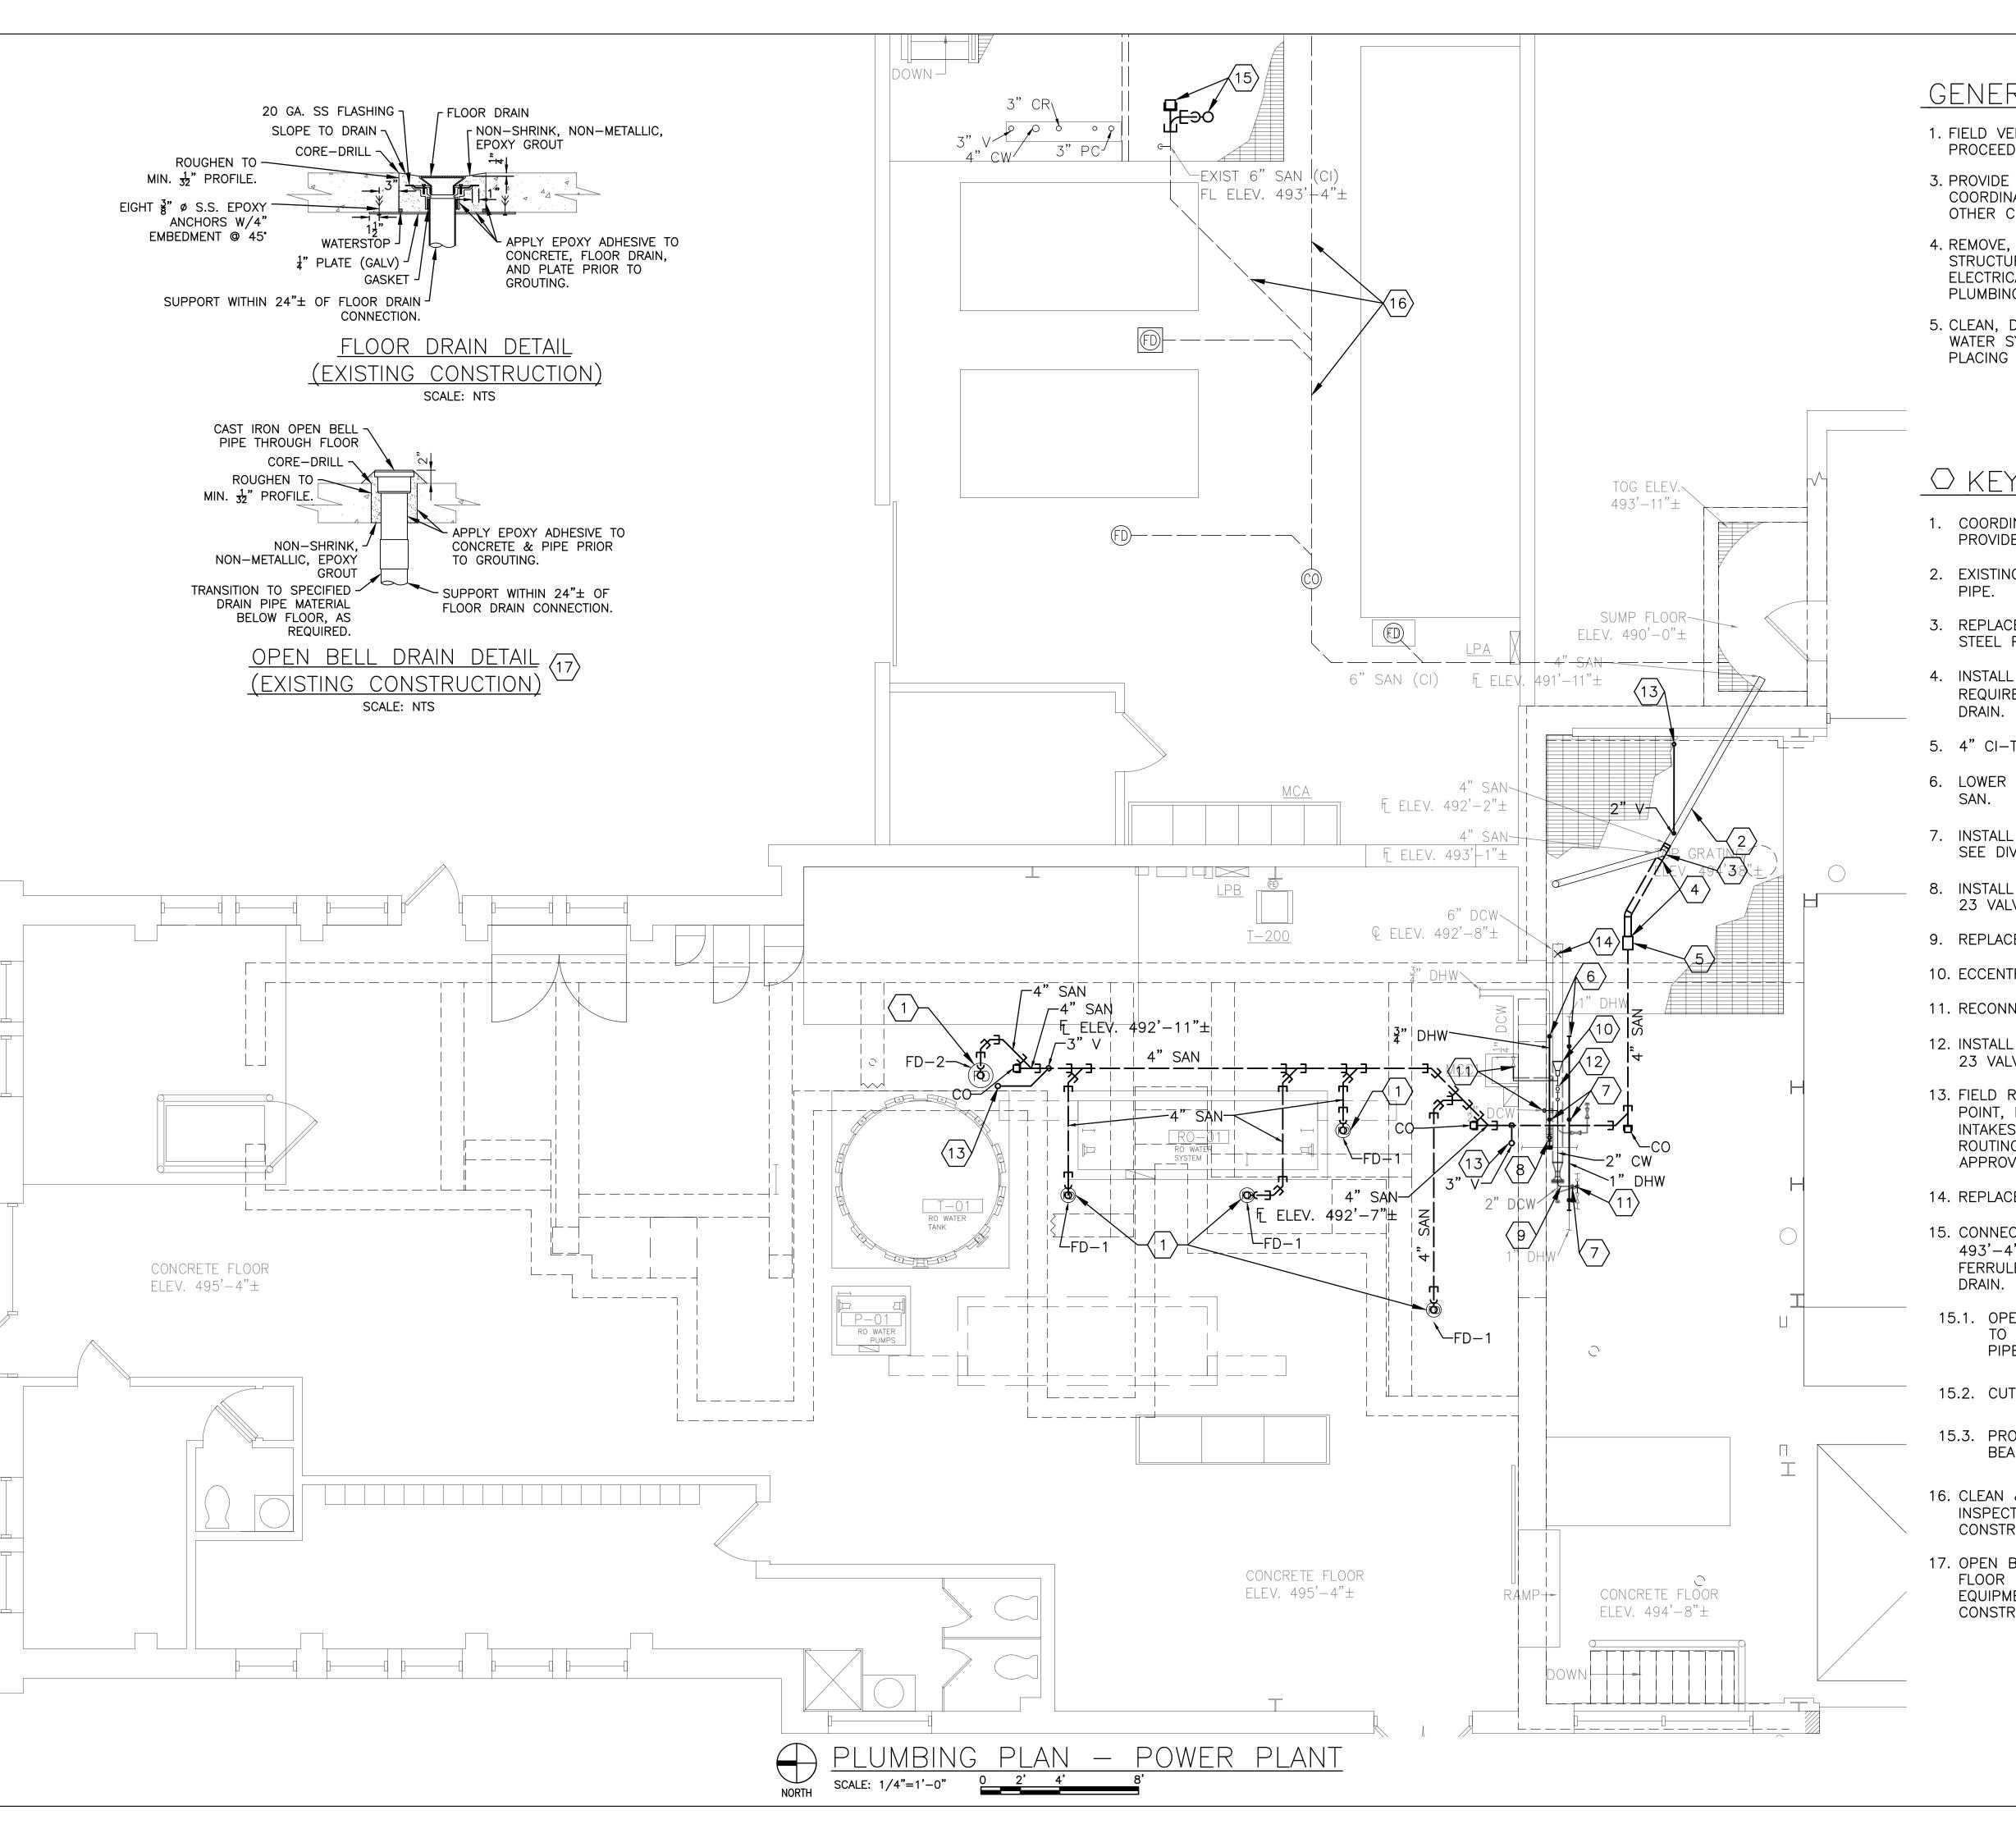


- 1. FIELD VERIFY EXISTING CONDITIONS PRIOR TO PROCEEDING.
- 3. PROVIDE NEW PLUMBING SYSTEMS SUITABLE FOR AND COORDINATED WITH NEW EQUIPMENT, AVAILABLE SPACE & OTHER CONSTRUCTION TRADES.
- 4. REMOVE, REINSTALL AND RETROFIT CONCRETE, STRUCTURAL STEEL, PIPING, INSULATION, CONTROLS, ELECTRICAL, ETC. AS REQUIRED TO ACCOMMODATE NEW PLUMBING.
- 5. CLEAN, DISINFECT, & FLUSH DOMESTIC COLD AND HOT WATER SYSTEMS WHICH ARE RETROFITED PRIOR TO PLACING INTO SERVICE.

# O KEY NOTES:

- 1. COORDINATE FLOOR DRAIN LOCATIONS WITH EQUIPMENT PROVIDED & PIPING SUBCONTRACTOR.
- 2. EXISTING 4" SANITARY DRAIN IS WELDED CARBON STEEL
- 3. REPLACE EXISTING 90° ELBOW WITH BUTT WELD CARBON STEEL PIPE TEE, SCHED. 40.
- 4. INSTALL NEW 4", SCHEDULE 40, CARBON STEEL PIPE AS REQUIRED TO CONNECT NEW 4", CAST IRON, SANITARY
- 5. 4" CI-TO-CS DRESSER TRANSITION COUPLING.
- 6. LOWER PIPE AS REQUIRED TO ACCOMMODATE NEW 4"
- 7. INSTALL NEW LOW POINT DRAIN VALVE BA-1- $\frac{1}{2}$ ". SEE DIV 23 VALVE SPECIFICATIONS.
- 8. INSTALL NEW ISOLATION VALVE BA- $1-\frac{3}{4}$ ". SEE DIV 23 VALVE SPECIFICATIONS.
- 9. REPLACE 6" DCW WITH 2" DCW.
- 10. ECCENTRIC REDUCERS WITH FLAT ON BOTTOM.
- 11. RECONNECT DCW BRANCH LINES TO NEW 2" DCW.
- 12. INSTALL NEW ISOLATION VALVE BA-1-2". SEE DIV 23 VALVE SPECIFICATIONS.
- 13. FIELD ROUTE VENTS TO SUITABLE EXTERIOR DISCHARGE POINT, MINIMUM 10' FROM BUILDING OPENINGS & AIR INTAKES. REVIEW VENT TERMINAL LOCATION & VENT ROUTING WITH CONSTRUCTION REPRESENTATIVE FOR APPROVAL PRIOR TO PROCEEDING.
- 14. REPLACE DETERIORATED 6" DCW PIPE HANGER.
- 15. CONNECT TO EXISTING 6" CI BELOW GRATING, FL = 493'-4"±. INSTALL NEW 6" SANITARY TEE, CLEAN-OUT FERRULE WITH BRASS PLUG, P-TRAP, & OPEN BELL
- 15.1. OPEN BELL DRAIN TO BE LOCATED ABOVE GRATING TO ACCOMMODATE NEW BACKFLOW PREVENTER DRAIN PIPE. SEE PIPING DRAWINGS.
- 15.2. CUT & BAND GRATING PENETRATION.
- 15.3. PROVIDE SUPPORTS AND SUPPLEMENTAL SUPPORT BEAMS AS REQUIRED.
- 16. CLEAN & INSPECT EXISTING 6" SAN. SUBMIT REPORT, INSPECTION VIDEO, & RECOMMENDATIONS TO CONSTRUCTION REPRESENTATIVE.
- 17. OPEN BELL DRAIN MAY BE SUBSTITUTED FOR FD-1 FLOOR DRAIN WHERE SERVICE IS PRIMARILY FOR RO-1 EQUIPMENT DRAINS, SUBJECT TO APPROVAL OF CONSTRUCTION REPRESENTATIVE & ENGINEER.

#### **STATE OF MISSOURI** MICHAEL L. PARSON, **GOVERNOR**

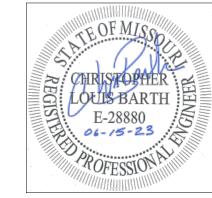

CHRISTOPHER L. BARTH Registered Professional Engineer MO # E-28880 Expires 12-31-2023

#### **ROGERS-SCHMIDT** ENGINEERING CO., P.C. **CONSULTING ENGINEERS**

1736 WEST PARK CENTER DR SUITE 204 ST. LOUIS, MO 63026 PHONE: 636-600-1551 MISSOURI STATE CERTIFICATE OF AUTHORITY #000408

OFFICE OF ADMINISTRATION DIVISION OF FACILITIES MANAGEMENT, **DESIGN AND CONSTRUCTION** 

DEPARTMENT OF CORRECTIONS

VOLUME 2 -

REPLACE BOILERS AND CONTROLS, POWER PLANT

FARMINGTON CORRECTIONAL CENTER 1012 WEST COLUMBIA STREET,

PROJECT # C2006-01

FARMINGTON, MO 63640

SITE# 7008

9327008094 ASSET#

**REVISION: REVISION:** DATE: **REVISION:** DATE:

ISSUE DATE: 04/26/2023

CAD DWG FILE: C2007-01-9237-9327008094- P-401.DWG DRAWN BY: CLB
CHECKED BY: CLB DESIGNED BY: \_\_\_\_CLB


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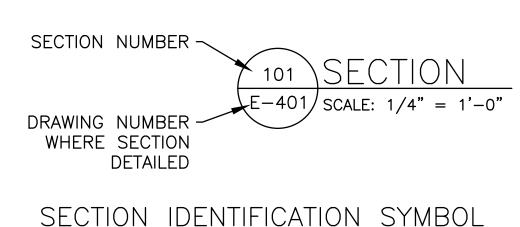
PLUMBING PLAN -POWER PLANT -**H2O TREATMENT** 

SHEET NUMBER:

#### **ELECTRICAL SYMBOLS GOVERNOR** PUSHBUTTON SWITCH AMPERE(S) FL FLOOR KEYNOTE; SPECIFICALLY REFERENCED TO WIRING CROSSING, CONNECTION ELECTRIC METER AN ITEM ON THE FIELD OF THE ABAND ABANDONED FM FREQUENCY METER POWER FACTOR CE OF MISS DRAWING. DIGITS IDENTIFY NOTE NUMBER. END-OF-LINE RESISTOR WIRING CROSSING, NO CONNECTION ALTERNATING CURRENT FOR FORWARD PILOT LIGHT **EOLR** BARRY D. CONDUIT EXPOSED AMP FUSE OR AMP FRAME FVNR FULL VOLTAGE NON REVERSING PNL PANEL FREINER EQUIPMENT CONNECTION 4' INDUSTRIAL OR STRIP LIGHT E-24220 ABOVE FINISHED FLOOR GAUGE PNLBD PANELBOARD CONDUIT OR CABLE TURNED DOWN 5-17-23 PROTECTIVE RELAYS OR PAIR AFG ABOVE FINISHED GRADE GALLON SELECTOR OR TOGGLE SWITCH EXIT SIGN — SINGLE FACE WALL MTD **—** GALV GALVANIZED CONDUIT OR CABLE TURNED UP AMPERE INTERRUPTING CAPACITY POTENTIAL TRANSFORMER (RMS SYMMETRICAL) BATTERY OPERATED EMERGENCY LIGHT PUSH-TO-TEST GENERATOR CONTROL PANEL NON-FUSIBLE DISCONNECT SWITCH BARRY D. FREINER CONDUIT BELOW GRADE OR IN FLOOR io 0 \_\_\_\_\_ AM AMMETER SCHEDULE 40 GROUND FAULT MANUAL PULL STATION POLYVINYLCHLORIDE CONDUIT MO # E-24220 ANNUN ANNUNCIATOR MEDIUM VOLTAGE FUSIBLE GROUND FAULT CIRCUIT FLEXIBLE CONDUIT OR CABLE Expires 12-31-2024 PWR POWER 0 LOAD-INTERUPTER SWITCH INTERRUPTER APPROX APPROXIMATELY HORN/STROBE ANNUNCIATOR, WALL-MTD **ROGERS-SCHMIDT** RAC RIGID ALUMINUM CONDUIT GROUND FAULT RELAY HOME RUN TO PANEL - SHORT AS AMMETER SWITCH FUSED SWITCH STROKES INDICATE PHASE OR SWITCHED RECPT RECEPTACLE GENERATOR REMOTE HEAT DETECTOR, CEILING-MTD ASSOC ASSOCIATED WIRES, LONG STROKE DENOTES NEUTRAL, ANNUNCIATOR PANEL \_\_\_\_\_\_ REQD REQUIRED ASSY ASSEMBLY LONG STROKE WITH DOT DENOTES FUSIBLE DISCONNECT SWITCH GALVANIZED RIGID STEEL CM ADDRESSABLE RELAY CONTROL MODULE REQMTS REQUIREMENTS GROUND. #12 AWG WIRES IN ≟"GRC SUITE 204 L\_\_\_\_\_J CONDUIT AT AMP TRIP UNLESS NOTED OTHERWISE. ST. LOUIS, MO 63026 GROUND ATS AUTOMATIC TRANSFER SWITCH PHONE: 636-600-1551 SMOKE DETECTOR, CEILING-MTD $\neg \Box \Box \neg$ **FUSE** REV REVERSE DISCONNECT SWITCH AUTO AUTOMATIC F = FUSIBLEOF AUTHORITY #000408 H-O-A HAND-OFF-AUTOMATIC NEUTRAL LINK/DUMMY FUSE FIRE EXTINGUISHER -0+-10-N = NON-FUSIBLEAVAIL AVAILABLE RMC RIGID METAL CONDUIT HORSEPOWER AMERICAN WIRE GAUGE REMOTE MONITORING PANEL JUNCTION BOX CIRCUIT BREAKER 0 0 FREQUENCY IN CYCLES PER BELOW FINISHED GRADE ROOT MEAN SQUARE $\langle \leftarrow \circ \rightarrow \rangle$ DRAW-OUT CIRCUIT BREAKER EXISTING CONTROL PANEL BREAKER I/O INPUT/OUTPUT SURGE ARRESTOR BLDG BUILDING INCLUDING $\mathcal{U}$ SURGE CAPACITOR NEW CONTROL PANEL TRANSFORMER $\bigcap$ BSMT BASEMENT INFORMATION SHORT CIRCUIT CURRENT TRANSFORMER (SHOWN WITH CONDUIT OR CONDUCTOR INS INSULATED EXISTING PANELBOARD SCHEDULE POLARITY MARKS, RATIO & QUANTITY) CIRCUIT BREAKER INSTRUMENT OR SHIELD OR SHIELDED POTENTIAL TRANSFORMER (SHOWN WITH INSTRUMENTATION SINGLE POLE SWITCH CIRCUIT CKT QUANTITY AND RATIO) SPEED OR SURGE PROTECTIVE JUNCTION BOX CNTRL CONTROL J-BOX CONTROL POWER TRANSFORMER 120V DUPLEX RECEPTACLE SELECTOR SWITCH OR STAINLESS COMB COMBINATION KILOAMPERE(S) 120V GROUND FAULT CIRCUIT KILOAMPERE INTERRUPTING CONC CONCRETE SHUNT TRIP HAND INTERRUPTER DUPLEX RECEPTACLE CAPACITY (RMS SYMMETRICAL) HAND-OFF-AUTOMATIC CONTROL PANEL STA STATION 120V DUPLEX RECEPTACLE W/ SELECTOR SWITCH THOUSAND CIRCULAR MIL(S) WEATHERPROOF COVER CONTROL POWER TRANSFORMER STL STEEL kV KILOVOLT(S) CONTROL RELAY STRD STRANDED **DIVISION OF FACILITIES** 120V DOUBLE DUPLEX RECEPTACLE kVA KILOVOLT-AMPERE(S) PILOT LIGHT. PUSH-TO-TEST CONDUIT SUPPORT OR CONTROL MANAGEMENT, SW SWITCH $\rightarrow$ (X X = LENS COLORkW KILOWATT(S) SPECIAL RECEPTACLE (AS NOTED) SWBD SWITCHBOARD CURRENT TRANSFORMER kWh KILOWATT-HOUR(S) SWGR SWITCHGEAR REMOTE CONTROL STATION STOP PUSHBUTTON CENTER LA LIGHTING ARRESTER SYM SYMMETRICAL DEPARTMENT OF CU COPPER LBCP LOAD BANK CONTROL PANEL CONTACTOR START PUSHBUTTON CORRECTIONS THERMOSTAT $-\circ$ $\circ$ D OR LIQUIDTIGHT FLEXIBLE METAL TB TERMINAL BLOCK CONDUIT VOLUME 2 -CONTROL RELAY NORMALLY CLOSED CONTACT 0-11-0 DIRECT CURRENT TC TOP OF CONCRETE LSH LEVEL SWITCH (HIGH) REPLACE BOILERS AND DAMPER CONTROL PANEL CONTROLS, POWER PLANT TDR TIME DELAY RELAY LONG TIME, SHORT TIME, EQUIPMENT GROUND FAULT NORMALLY OPEN CONTACT INSTANTANEOUS, GROUND FAULT DIAMETER TEFC TOTALLY ENCLOSED FAN COOLED LSL LEVEL SWITCH (LOW) MECHANICAL (KEY) INTERLOCK THERMAL OVERLOAD DISC DISCONNECT TEMP TEMPERATURE OR TEMPORARY **FARMINGTON** LTG LIGHTING TERM TERMINATION MOTOR OVERLOAD CONTACTS MOTOR STARTING CONTACTOR MOTOR STARTING CONTACTOR OR DISTRIBUTION PANEL THERMAL MAGNETIC CIRCUIT 1012 WEST COLUMBIA BREAKER DISCONNECT SWITCH MOTOR, X = HORSEPOWER**THERMOSTAT** STREET, mA MILLIAMPERE(S) TYP TYPICAL DWG DRAWING FARMINGTON, MO 63640 MAX MAXIMUM EXISTING COMBINATION MAGNETIC UNDERGROUND ELECTRIC TIME DELAY RELAY MOTOR STARTER EMERGENCY GENERATOR MCB MAIN CIRCUIT BREAKER UNINTERRUPTIBLE POWER PROJECT # C2006-01 NEW COMBINATION MAGNETIC ELEV ELEVATION MCC MOTOR CONTROL CENTER TIMING RELAY MOTOR STARTER SITE# 7008 ELEC ELECTRIC OR ELECTRICAL MCCB MOLDED CASE CIRCUIT BREAKER VOLT(S) SPD 9327008094 VARIABLE FREQUENCY AC MOTOR DRIVE ASSET# SURGE PROTECTIVE DEVICE EM EMERGENCY VA VOLT-AMPERE(S) MECH MECHANICAL EPM ELECTRONIC POWER METER VARIABLE FREQUENCY DRIVE S.A. MIN MINIMUM . \_ \_ \_ \_ \_ \_ . SURGE ARRESTER **REVISION: →** Hi COMBINATION MOTOR STARTER EPO EMERGENCY POWER OFF VOLTMETER DATE: MLO MAIN LUG ONLY L\_\_\_\_\_J **REVISION:** EQUIP EQUIPMENT VOLTMETER SWITCH GROUNDING ROD MOTOR STARTING DATE: **REVISION:** EXH EXHAUST MTD MOUNTED WATT(S), WIRE(S) OR WIDE **GENERATOR** DATE: EARTH GROUNDING CONNECTION EXIST EXISTING W/ WITH MV MEDIUM-VOLTAGE ISSUE DATE: 04/26/2023 FUSE OR FUSIBLE MVA MEGAVOLT-AMPERES WITH GROUND CHASSIS GROUNDING CONNECTION CAD DWG FILE: C2007-01-9237-LEVEL SWITCH $\sim 1$ FACP FIRE ALARM CONTROL PANEL 9327008094- E-001.DWG W/O WITHOUT NEUT DRAWN BY: MNS CHECKED BY: B D F FCI FAULTED CIRCUIT INDICATOR WHM WATTHOUR METER NORMALLY CLOSED FDR FEEDER DESIGNED BY: BDF WHMD WATTHOUR METER DEMAND N.O. NORMALLY OPENED SHEET TITLE: WM WATTMETER GENERAL ELECTRICAL NOTES: N/A NOT APPLICABLE ELECTRICAL WEATHERPROOF NATIONAL ELECTRICAL CODE A. THE CONTRACTOR SHALL PROVIDE ALL HOLES IN FLOORS AND WALLS AS REQUIRED FOR SYMBOLS, WW WIREWAY SECTION NUMBER SECTION NUMBER CONDUIT ROUTING. SEAL PENETRATIONS IN ACCORDANCE WITH THE SPECIFICATIONS. NON-FUSED

- B. COORDINATE EXACT LOCATIONS OF CONDUIT RUNS WITH EXISTING CONDITIONS AND WITH THE OWNER'S REPRESENTATIVE. INDICATE FINAL ROUTING OF ALL CONDUITS ON "AS BUILT" DRAWINGS.
- C. ALL INFORMATION CONTAINED ON THIS DRAWING APPLIES TO ED AND E SERIES DRAWINGS.
- D. THERE MAY BE SYMBOLS AND/OR ABBREVIATIONS SHOWN ON THIS SHEET THAT ARE NOT APPLICABLE TO THIS PROJECT.



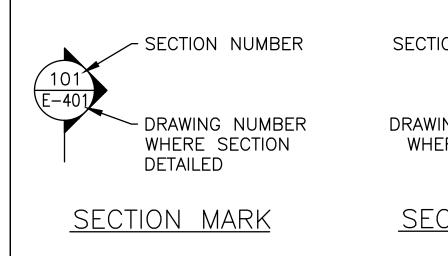

**ELECTRICAL ABBREVIATIONS** XFMR TRANSFORMER NEUTRAL GROUNDING RESISTOR Z IMPEDANCE NOT IN CONTRACT NOT TO SCALE DELTA OVERHEAD ELECTRIC NUMBER

PERCENT

Ø PHASE OR DIAMETER

OVERLOAD ELEMENT

POLE(S)

P/O PART OF

STATE OF MISSOURI MICHAEL L. PARSON,

Registered Professional Engineer


ENGINEERING CO., P.C. **CONSULTING ENGINEERS** 1736 WEST PARK CENTER DR MISSOURI STATE CERTIFICATE

OFFICE OF ADMINISTRATION DESIGN AND CONSTRUCTION

CORRECTIONAL CENTER

**ABBREVIATIONS &** GENERAL NOTES

SHEET NUMBER:

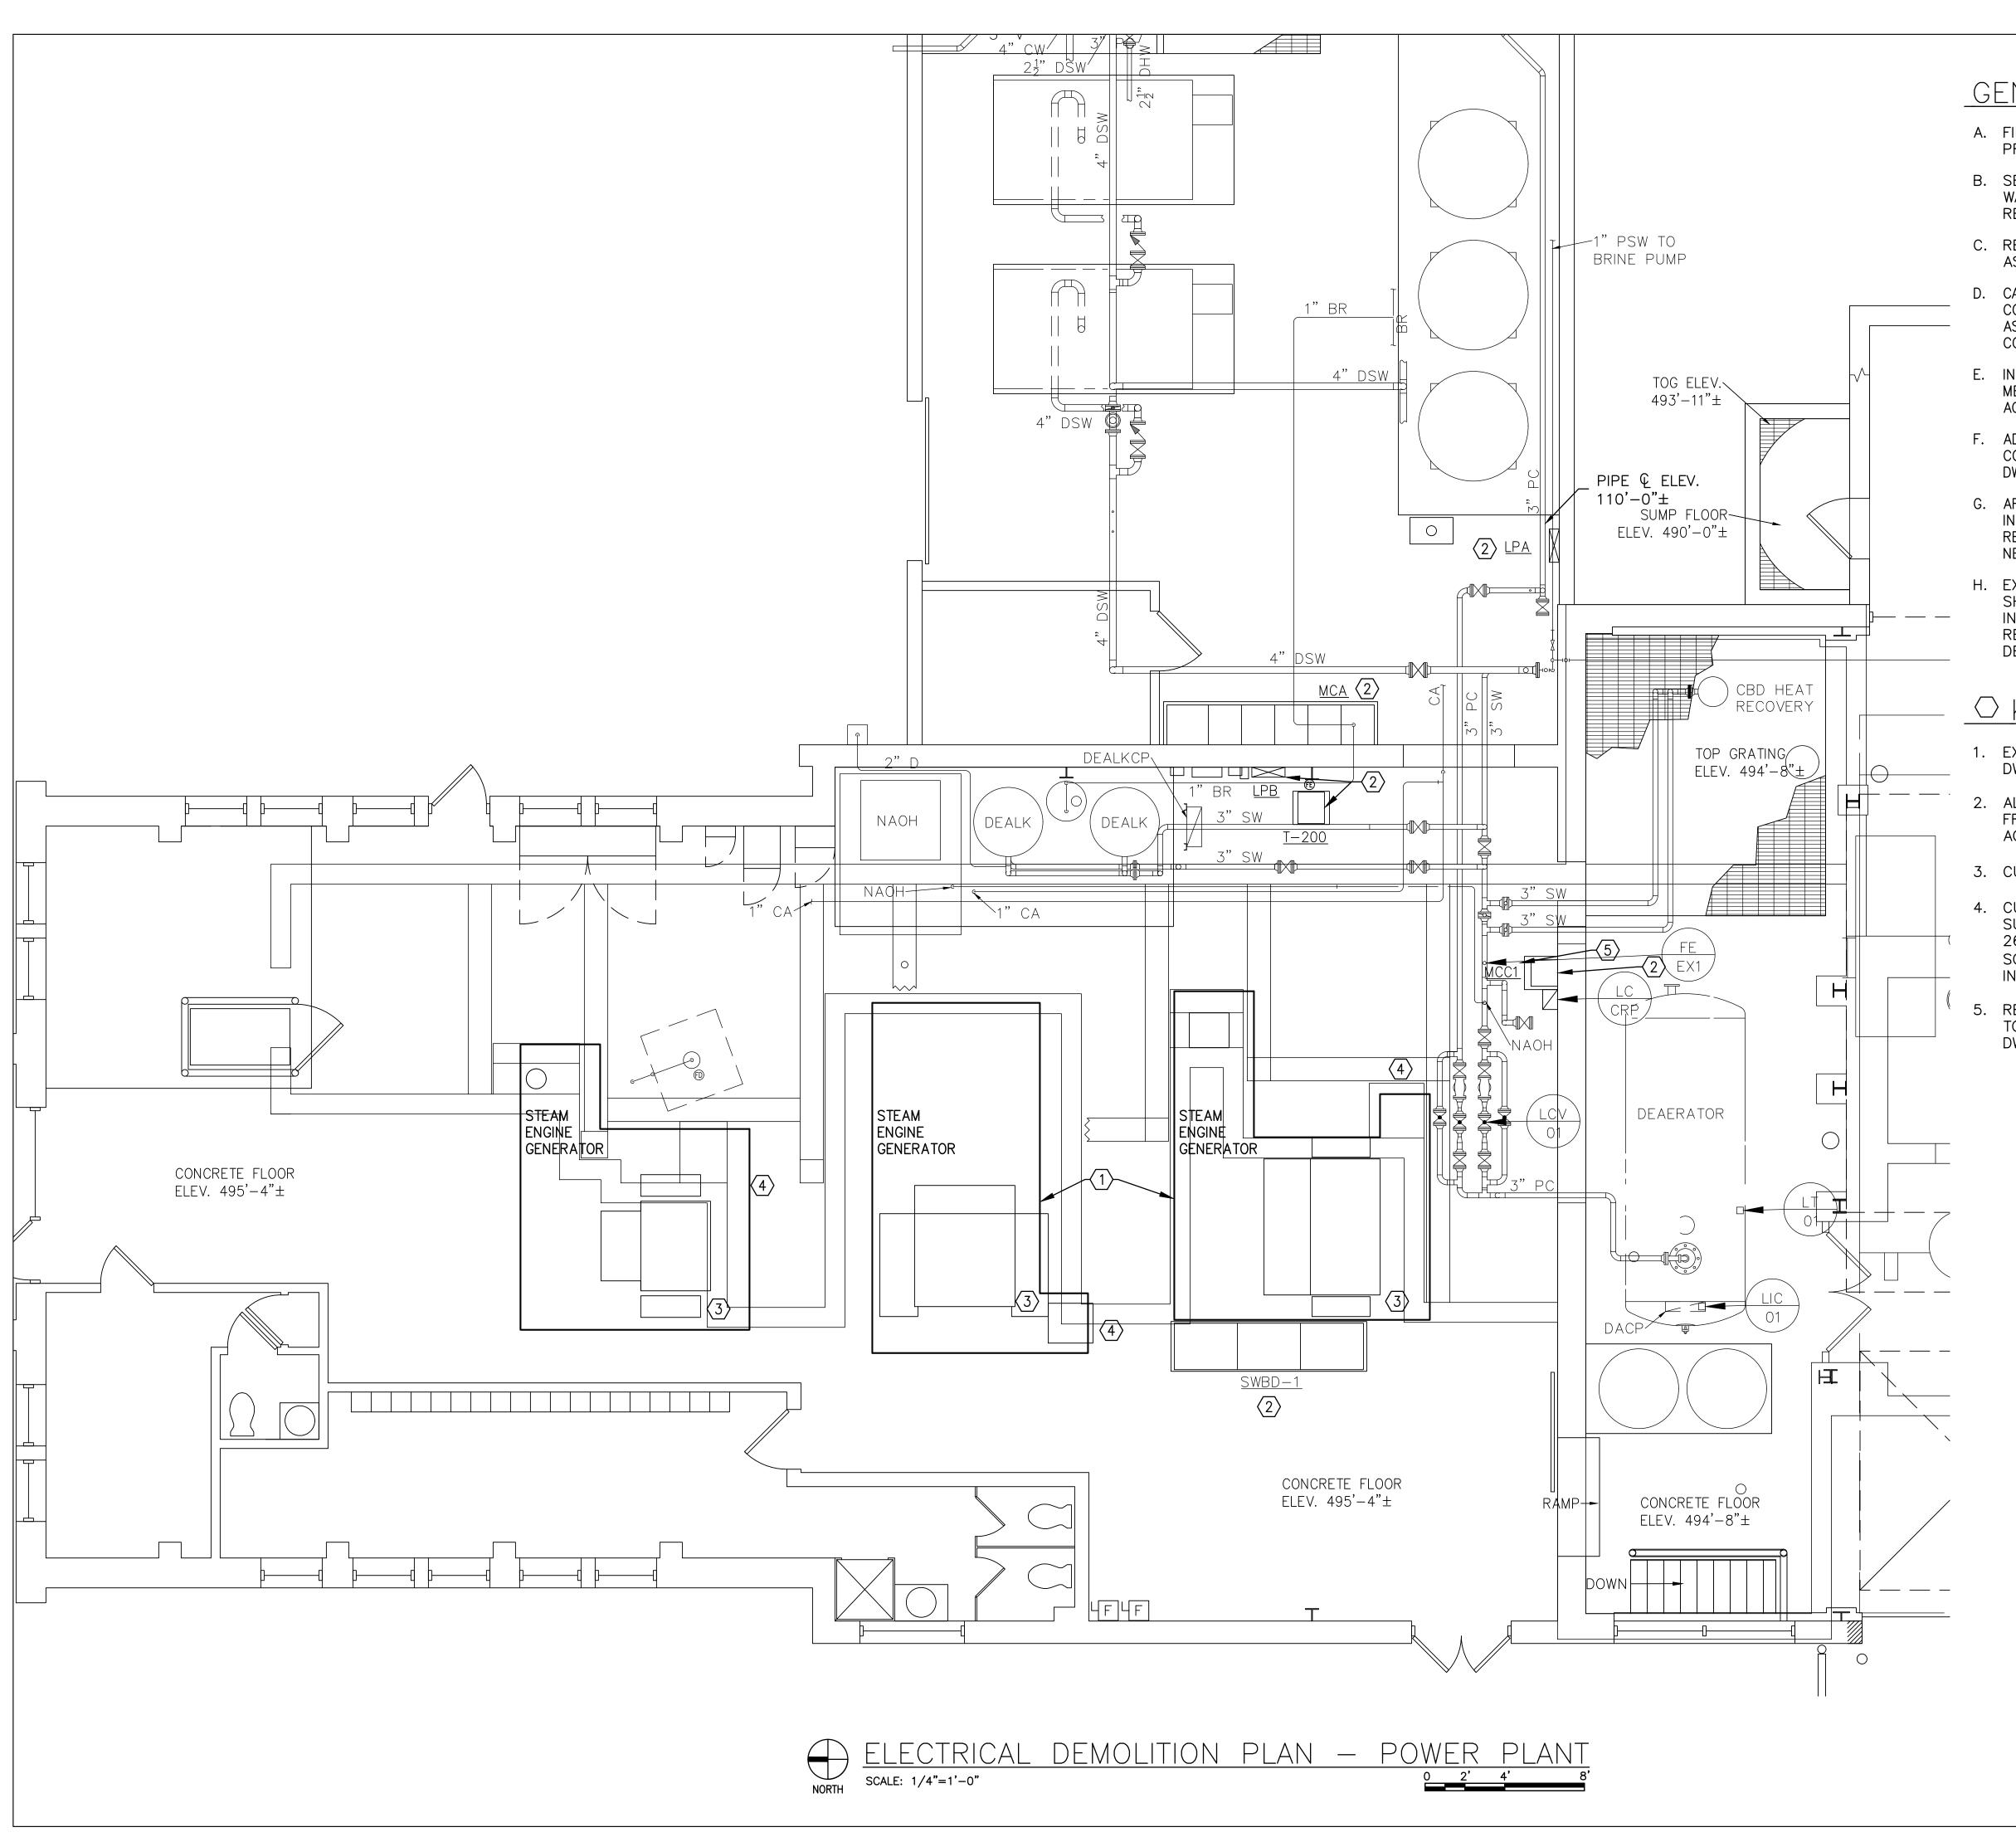

- A. FIELD VERIFY EXISTING CONDITIONS PRIOR TO PROCEEDING.
- B. SEAL & FIRESTOP ALL ABANDONED ROOF, FLOOR & WALL ELEC PENETRATIONS FOR 2 HOUR FIRE RESISTANCE RATING.
- C. REMOVE, REINSTALL AND RETROFIT CONTROLS & ELEC AS REQUIRED TO ACCOMMODATE DEMOLITION.
- D. CAREFULLY REMOVE, STORE, AND REINSTALL EXISTING
  CONSTRUCTION TO REMAIN AS REQUIRED. TOUCH—UP PAINT
  AS REQUIRED. REPLACE EXISTING CONSTRUCTION DAMAGED BY
  CONTRACTOR.
- E. INSPECT ALL INSTRUMENTS & CONTROLS TO BE REMOVED FOR MERCURY. DISPOSE OF MERCURY CONTAINING MATERIALS IN ACCORDANCE WITH APPLICABLE REGULATIONS.
- F. ADDRESS ANY OTHER SUSPECTED HAZARDOUS MATERIALS WITH CONSTRUCTION REPRESENTATIVE. SEE GENERAL NOTE 5 ON DWG MD-401.
- G. AFTER DEMOLITION IS COMPLETE, VISUALLY INSPECT INFRASTRUCTURE TO REMAIN & ADVISE CONSTRUCTION REPRESENTATIVE OF ANY ISSUES PRIOR TO PROCEEDING WITH NEW CONSTRUCTION.
- H. EXISTING MAKE—UP WATER AND CONDENSATE SYSTEMS SHALL REMAIN IN SERVICE UNTIL NEW SYSTEMS ARE INSTALLED & READY FOR SERVICE & APPROVED FOR REMOVAL BY CONSTRUCTION REPRESENTATIVE. PHASE DEMOLITION & CONSTRUCTION AS REQUIRED.

#### O KEY NOTES:

- EXIST STEAM ENGINE GENERATORS TO BE REMOVED. SEE DWG MD-401.
- 2. ALL EXIST ELEC EQUIP TO REMAIN IN SERVICE. PROTECT FROM DAMAGE DURING CONSTRUCTION AND MAINTAIN ACCESS TO FRONT OF EQUIP.
- 3. CUT OFF CONDUITS/CABLES/CONDUCTORS AT PIT WALL.
- 4. CUT OFF CONDUIT(S) & CONDUCTORS 2" BELOW SURFACE OF FLOOR PER SPECIFICATION SECTION 260505. REMOVE EXIST CONDUCTORS TO SOURCE/DESTINATION IF POSSIBLE. OTHERWISE ABAND IN PLACE.
- 5. REMOVE EXIST CONDUIT & WIRING FROM FLOW METER TO DELKCP. EXIST FLOW METER TO BE RELOCATED. SEE DWGS MD-401, MP-402 & E-401.

STATE OF MISSOURI MICHAEL L. PARSON, GOVERNOR



BARRY D. FREINER
Registered Professional Engineer
MO # E-24220
Expires 12-31-2024

ROGERS-SCHMIDT ENGINEERING CO., P.C. CONSULTING ENGINEERS

1736 WEST PARK CENTER DR.
SUITE 204
ST. LOUIS, MO 63026
PHONE: 636-600-1551
MISSOURI STATE CERTIFICATE
OF AUTHORITY #000408

OFFICE OF ADMINISTRATION
DIVISION OF FACILITIES
MANAGEMENT,
DESIGN AND CONSTRUCTION

DEPARTMENT OF CORRECTIONS

VOLUME 2 REPLACE BOILERS AND
CONTROLS, POWER PLANT

FARMINGTON
CORRECTIONAL CENTER
1012 WEST COLUMBIA
STREET,
FARMINGTON, MO 63640

PROJECT # C2006-01

SITE # 7008 ASSET # 9327008094

REVISION:
DATE:
REVISION:
DATE:
REVISION:

ISSUE DATE: 04/26/2023

CAD DWG FILE: C2007-01-9237-9327008094- ED-401.DWG

9327008094- ED-401.DWG

DRAWN BY: CLB/MNS

CHECKED BY: BDF


DESIGNED BY: BDF

SHEET TITLE:
ELECTRICAL

DEMOLITION PLAN
- POWER PLANT

SHEET NUMBER:

ED-401

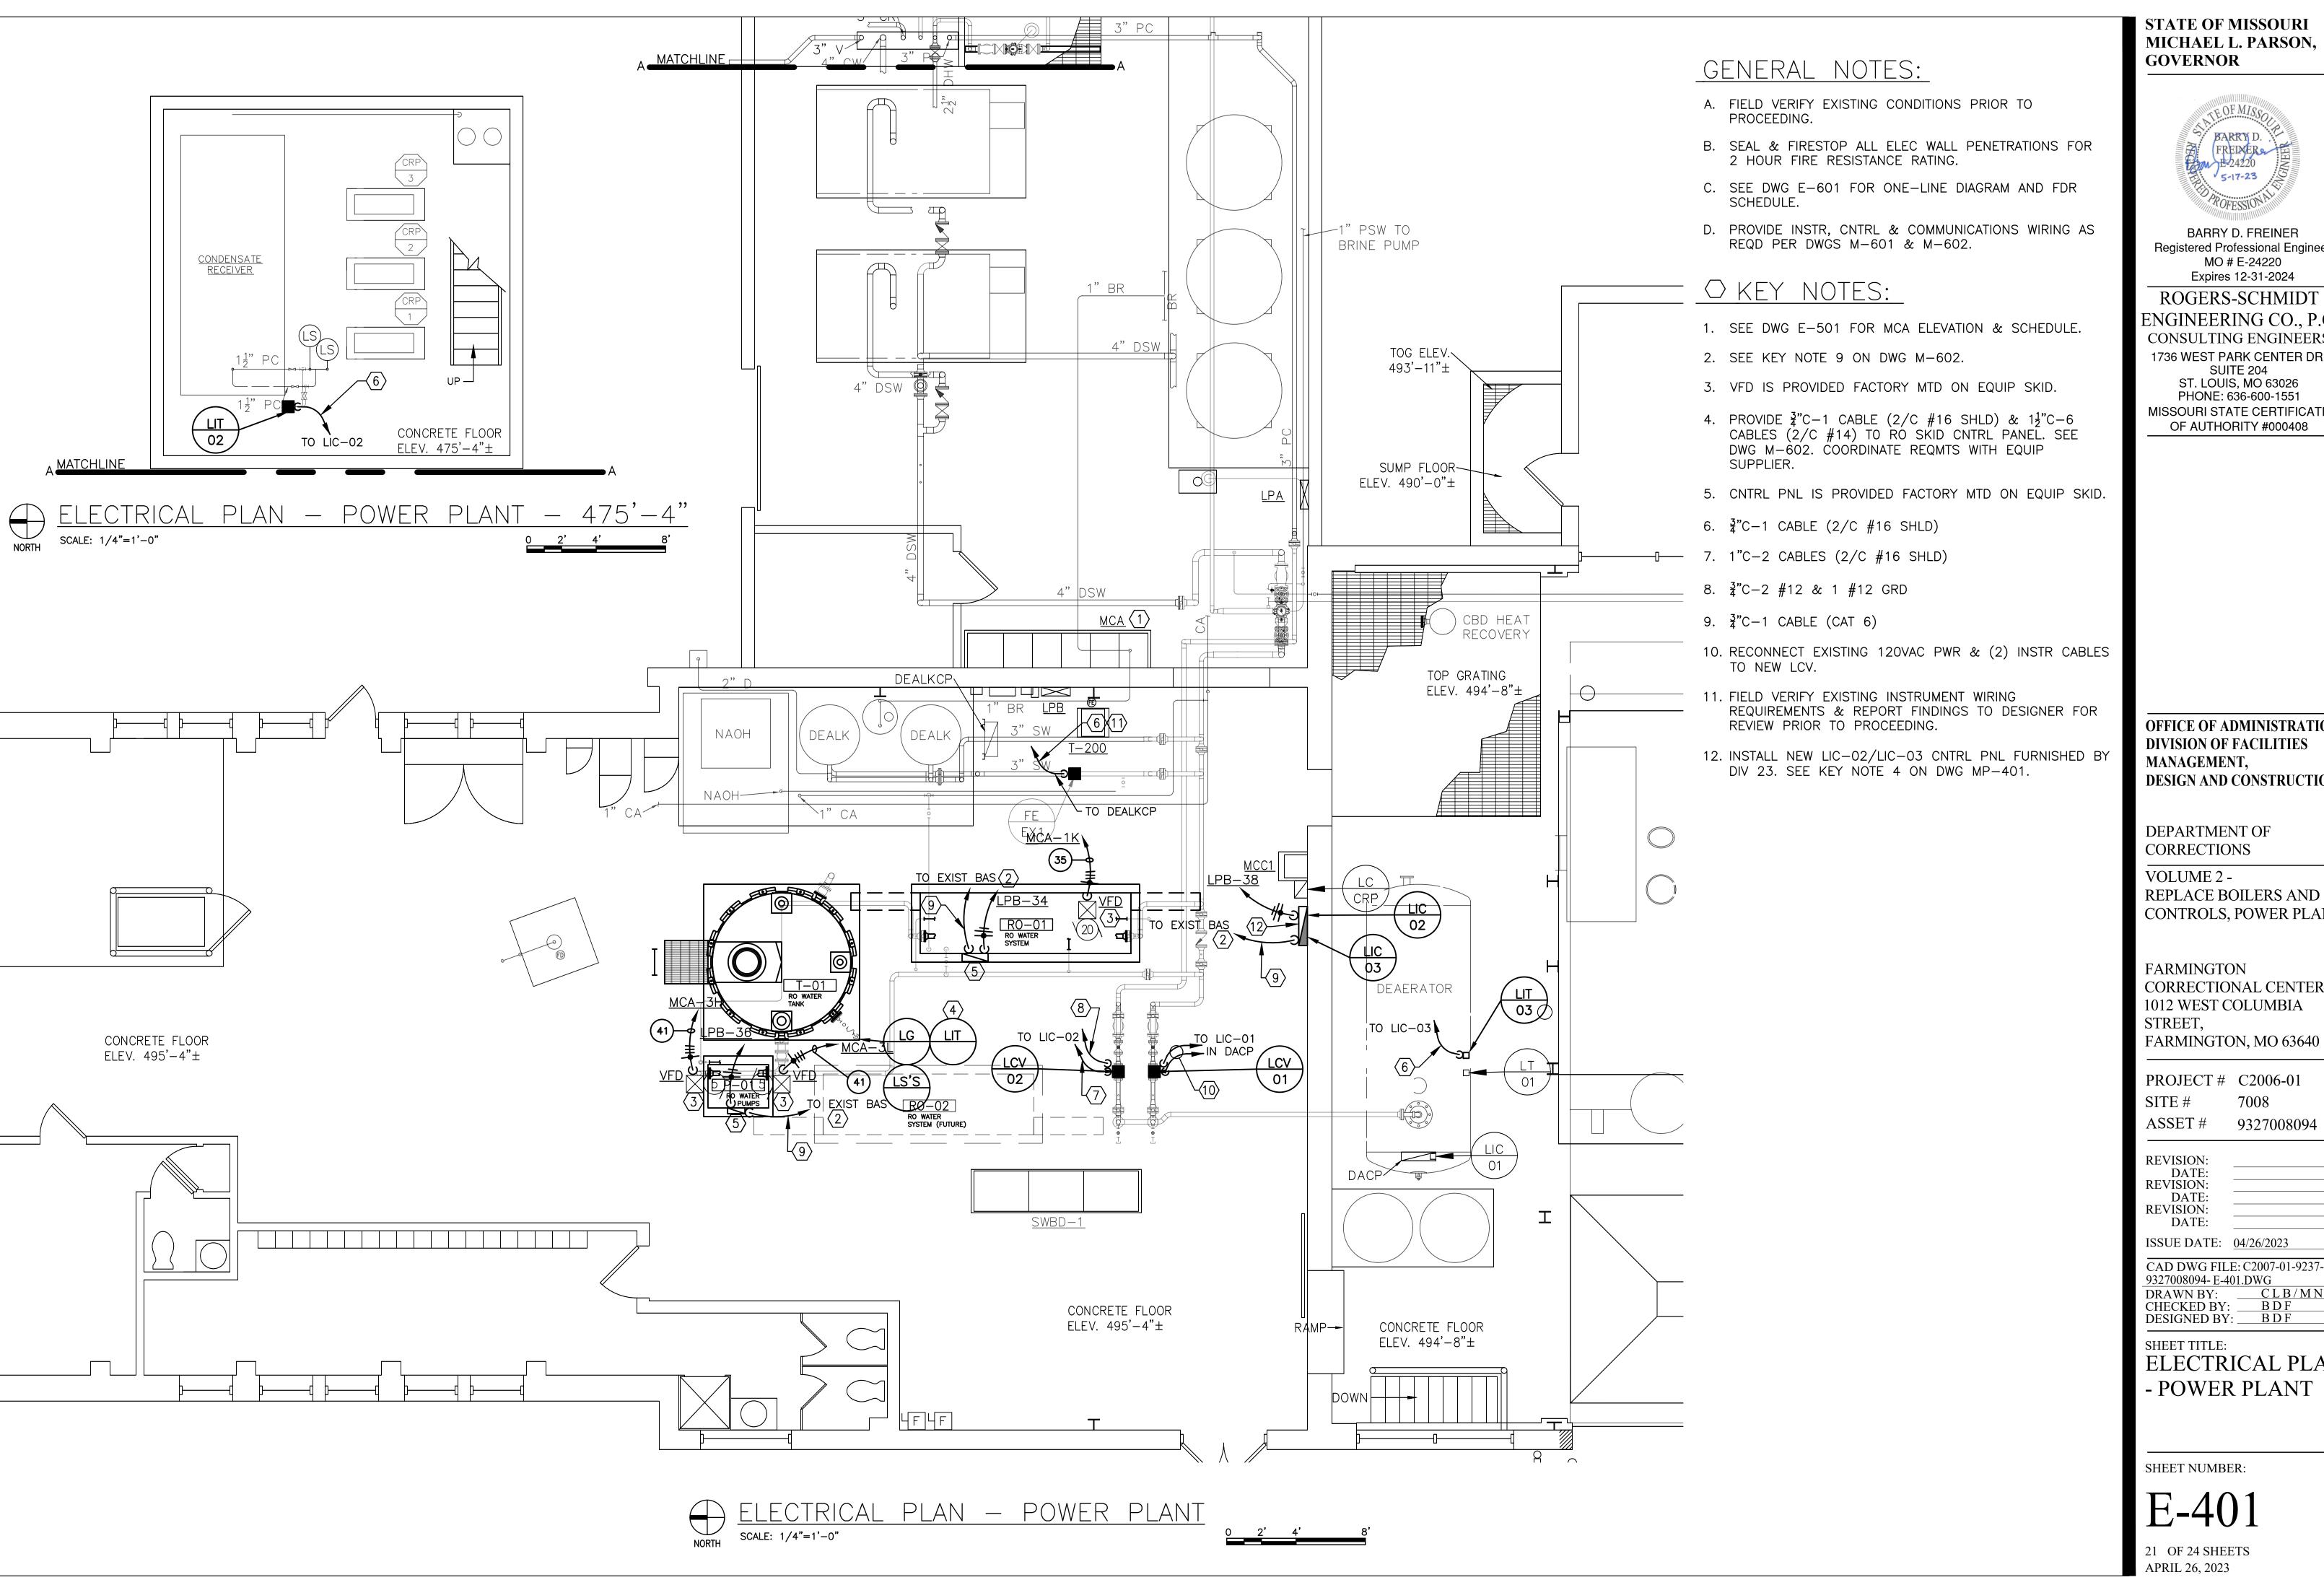



BARRY D. FREINER Registered Professional Engineer MO # E-24220 Expires 12-31-2024

#### ROGERS-SCHMIDT ENGINEERING CO., P.C.

CONSULTING ENGINEERS 1736 WEST PARK CENTER DR. SUITE 204 ST. LOUIS, MO 63026 PHONE: 636-600-1551 MISSOURI STATE CERTIFICATE

OFFICE OF ADMINISTRATION DIVISION OF FACILITIES MANAGEMENT, DESIGN AND CONSTRUCTION

DEPARTMENT OF CORRECTIONS

VOLUME 2 -REPLACE BOILERS AND CONTROLS, POWER PLANT

FARMINGTON CORRECTIONAL CENTER 1012 WEST COLUMBIA STREET,

PROJECT # C2006-01

7008 ASSET # 9327008094

**REVISION: REVISION:** 

**REVISION:** 

ISSUE DATE: 04/26/2023

CAD DWG FILE: C2007-01-9237-9327008094- E-401.DWG DRAWN BY: CLB/MNS
CHECKED BY: BDF
DESIGNED BY: BDF

SHEET TITLE:

ELECTRICAL PLAN - POWER PLANT

SHEET NUMBER:

# EXIST MOTOR CONTROL CENTER MCA SCHEDULE (WEST WALL OF CONDENSATE ROOM)

UNIT NUMBER	DESCRIPTION	
1D	ROOF VENTILATOR	
1H	SPARE	
1K	RO WATER SYSTEM PUMP #1 (EAST)	
1N	RO WATER SYSTEM PUMP # 2 (WEST) - FUTURE	
1V	SPARE FUSE STORAGE	
1X	SPACE	
2D	HOT WATER RETURN PUMP #2 (EAST)	
2H	HOT WATER RETURN PUMP #1 (WEST)	
2K	SPACE	
20	TRANSFORMER T200	
2S	SPACE	
2V	ZEOLITE PUMP #2	
2X	3-PHASE CAPACITOR	
3D	SPACE	
3H	TREATED WATER BOOSTER PUMP #1 (NORTH)	
3L	TREATED WATER BOOSTER PUMP #2 (SOUTH)	
3P	SPARE	
3T	SPARE	
3X	SPARE	
4D	SPACE	
4G	SPARE	
41	3-PHASE CAPACITOR	
4L	SPARE	
4N	3-PHASE CAPACITOR	
4Q	SPARE	
48	3-PHASE CAPACITOR	
4V	SPARE	
4X	3-PHASE CAPACITOR	
50	MAIN MOLDED CASE SWITCH	
5Q	SURGE ARRESTERS	
5T	TRANSFORMER T100	
5W	SUMP PUMPS FOR CONDENSATE ROOM	
5X	SPACE	
6X	AUTOMATIC TRANSFER SWITCH ATS3	

# (7X8) EXIST PANELBOARD LPB SCHEDULE (EAST WALL OF RO WATER SYSTEM AREA)

	1												1
	CKT		POLES		VOLT-A	MPERES	VOLT-AI	MPERES		ES		CKT	
	NO	AMPS	PO.	LOAD	ØA	ØB	ØA	ØB	LOAD	POLES	AMPS	NO	
$\langle 6 \rangle$	1	20	1	UNKNOWN LOAD	-		-		RO WATER SYSTEM ROOM LIGHTS	1	20	2	
	3	20	1	SOFTNER CONTROL		-		-	RO WATER SYSTEM ROOM LIGHTS	1	20	4	
	5	20	1	CONDENSATE PIT PUMPS	-		-		RO WATER SYSTEM ROOM LIGHTS	1	20	6	
	7	60	_	DANEL LD4		-		-	CONDENSATE CONTROL	1	20	8	
3	9	00	2	PANEL LP4	-		-		FACP	1	20	10	
$\rangle$	11	-00	_	DANEL LOC / DDINE DUMD		-		-	FIBER PANEL	1	20	12	
	13	60	2	PANEL LP5 / BRINE PUMP	-		-		EXIST RECEPTACLES	1	20	14	)
$\langle 6 \rangle$	15	20	1	PHOTOCELL		-		-	EXIST RECEPTACLES	1	20	16	<del> </del> <b>6</b>
_	17	20	1	DEALKALIZER	-		-		ASH TUNNEL LIGHTS	1	20	18	
	19	20	1	RECEPTACLES		-		-	BASEMENT LIGHTS	1	20	20	
	21	20	1	EXTERIOR LIGHTS	-		-		BASEMENT LIGHTS	1	20	22	$\left  \begin{array}{c} 6 \end{array} \right $
$\langle 6 \rangle$	23	20	1	RECEPTACLES		-		-	SUMP PUMP	1	20	24	
	25	20	1	EXTERIOR LIGHTS	-		-		SPARE OLD PANEL	1	20	26	6
·	27	20	1	CONDENSATE METER		-		-	RECEPTACLE PHONE HORN	1	20	28	
	29	20	1	SPARE	-		-		SPARE	1	20	30	
	31	20	1	SPARE		-		-	SPARE	1	20	32	
	33	20	1	SPARE	-		500		RO WATER SYS NO. 1 (EAST) - CNTRL PNL	1	15	34	
$\overline{4}$	35	20	1	SPARE		-		400	RO WATER PUMPS CNTRL PNL	1	15	36	$\sqrt{5}$
<b>_</b>	37	20	1	SPARE	-		200		COND TANK & DA LEVEL CNTRL PNL	1	15	38	
	39	20	1	SPARE		-		-	MAIN CEDVICE TO DADIO	2	100	40	/
	41	20	1	SPARE	-		-		MAIN SERVICE TO RADIO	2	100	42	
	t-			•					•				

700

400

200 AMP MCB, 120/240V-1Ø-3W, 42 CKT, 10kA

SIEMENS CAT. NO. P1A42QJ200CTS W/ TYPE BL CBs

NEMA TYPE 1 ENCLOSURE

# O KEY NOTES:

- 1. REPLACE ORANGE TAPE/IDENTIFY BΦ CONDUCTOR(S) WITH WHITE OR GRAY VINYL TAPE.
- 2. PROVIDE SOLID COPPER "DUMMY FUSE" LINK IN ΒΦ FUSE CLIPS.
- 3. PROVIDE ENGRAVED LAMINATED PLASTIC NAMEPLATE PER SPECIFICATION SECTION 260553:


SERVED FROM SWBD-1
IN RO WATER SYSTEM AREA
480V-3Φ-3W
GROUNDED B-PHASE


- 4. PROVIDE ENGRAVED LAMINATED NAMEPLATE PER SPECIFICATION SECTION 260553.
- 5. UTILIZE EXIST SPARE CB.
- 6. TRACE CKT AND PROVIDE DESCRIPTION THAT COMPLIES WITH NEC 408.4(A).
- 7. PROVIDE TYPEWRITTEN CKT DIRECTORY PER SPECIFICATION SECTION 260553.
- 8. PROVIDE ARC FLASH HAZARD WARNING LABEL PER SPECIFICATION SECTIONS 260553 & 260573.
- 9. IN ACCORDANCE WITH THE SPECIFICATIONS AND EQUIP WIRING SCHEMATICS.
- 10. VFD IS PROVIDED FACTORY MTD ON EQUIP SKID.

#### MOTOR CONTROL SCHEDULE MOTOR STARTER DATA MOTOR DATA DISCONNECT SWITCH DATA **EQUIPMENT NAME** N.O. REMARKS TAG 45 | VFD1 | 10 RO WATER SYSTEM PUMP NO. 1 - EAST | 20 | 460 | 3 | 27 | TEFC | RO WATER SYS AREA 9 3 VFD 60 AT MOTOR ON VFD $\langle 9 \rangle$ 12 VFD1 3 7.6 TEFC RO WATER SYS AREA AT MOTOR 30 ON VFD RO WATER PUMP NO. 1 - NORTH 5 | 460 | VFD 12 | VFD1 | (10) 3 7.6 TEFC RO WATER SYS AREA $\langle 9 \rangle$ RO WATER PUMP NO. 2 - SOUTH 30 VFD AT MOTOR ON VFD

600A

TOTAL NEW LOAD: 1100 VA

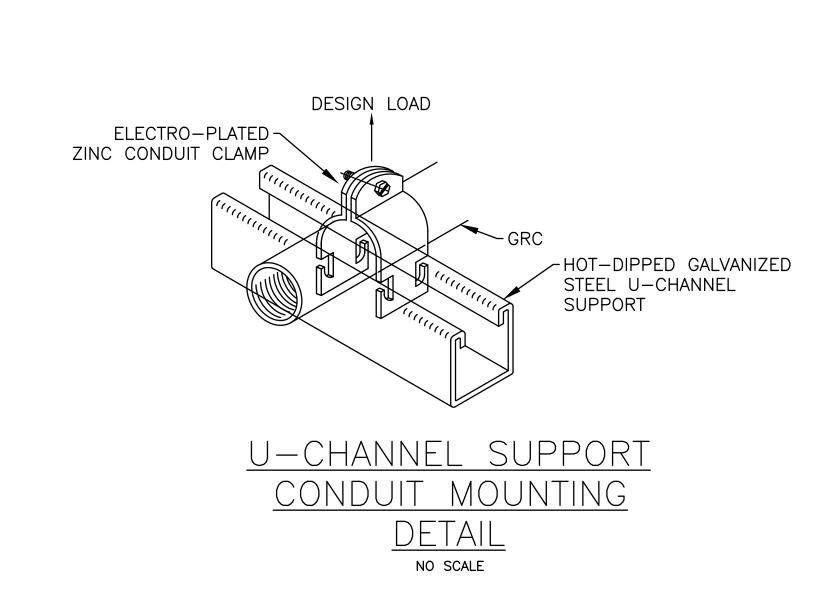

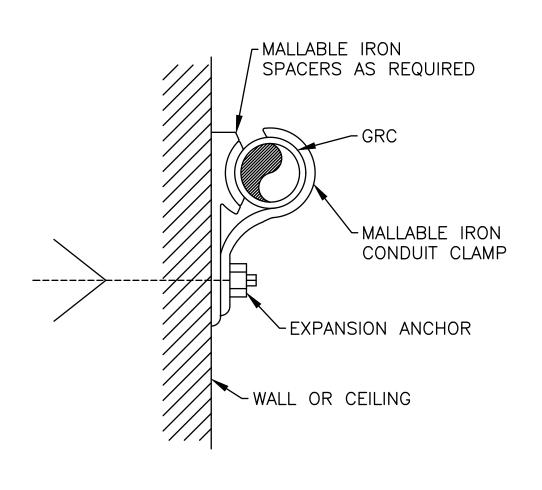

CONCRETE/MASONRY
WALL/CEILING CONDUIT
MOUNTING DETAIL
NO SCALE

SECTION 1	SECTION 2	SECTION 3	SECTION 4	SECTION 5	SECTION 6
WIREWAY  (8)	WIREWAY  (8)	WIREWAY  (3)(8)	WIREWAY  (8)	WIREWAY  (8)	WIREWAY  (8)
FVNR1 (1)(2) 1D	FVNR1 (1)(2) 2D	SPACE 3D	SPACE 4D		
FVNR1 (1)	FVNR1 (1)(2) 2H	FVNR2 (1)(2) 3H	60/3 (1) FS 4G CAP	400/3 MAIN MCS (1)	400/3 ATS (1)
60/3 FS 1K	SPACE 2K	FVNR2 (1)(2) 3L	60/3 (1) FS 4L		
60/3 FS 1N	100/3 FS 20	FVNR2	CAP 4N 60/3	50	
SPARE FUSE STORAGE	SPACE 2S	5P FVNR2 (1)	CAP 4S	SA 5Q 60/3 FS	
1 V	60/3 FS 2V	3T FVNR2 <b>(1)</b>	60/3 (1) FS 4V	1\(\frac{1}{2}\) 30/3 FS \(\frac{1}{2}\) 5W	
SPACE 1X WIREWAY	CAP 2X WIREWAY	3X 3X WIREWAY	CAP 4X WIREWAY	SPACE 5X WIREWAY	6X WIREWAY

E-501 SCALE: 1" = 1'-0"

600A

600A

600A

600A

600A

STATE OF MISSOURI MICHAEL L. PARSON, GOVERNOR



BARRY D. FREINER
Registered Professional Engineer
MO # E-24220
Expires 12-31-2024

ROGERS-SCHMIDT
ENGINEERING CO., P.C.
CONSULTING ENGINEERS
1736 WEST PARK CENTER DR.
SUITE 204
ST. LOUIS, MO 63026
PHONE: 636-600-1551
MISSOURI STATE CERTIFICATE
OF AUTHORITY #000408

OFFICE OF ADMINISTRATION
DIVISION OF FACILITIES
MANAGEMENT,
DESIGN AND CONSTRUCTION

DEPARTMENT OF CORRECTIONS

VOLUME 2 -REPLACE BOILERS AND CONTROLS, POWER PLANT

FARMINGTON
CORRECTIONAL CENTER
1012 WEST COLUMBIA
STREET,
FARMINGTON, MO 63640

PROJECT # C2006-01

ASSET # 9327008094

REVISION:
DATE:
REVISION:
DATE:
REVISION:
DATE:
DATE:

ISSUE DATE: 04/26/2023

CAD DWG FILE: C2007-01-92379327008094- E-501.DWG

DRAWN BY: MNS


CHECKED BY: BDF

DESIGNED BY: B D F

SHEET TITLE:
SCHEDULES,
DETAILS &
ELEVATIONS

SHEET NUMBER:

E-50

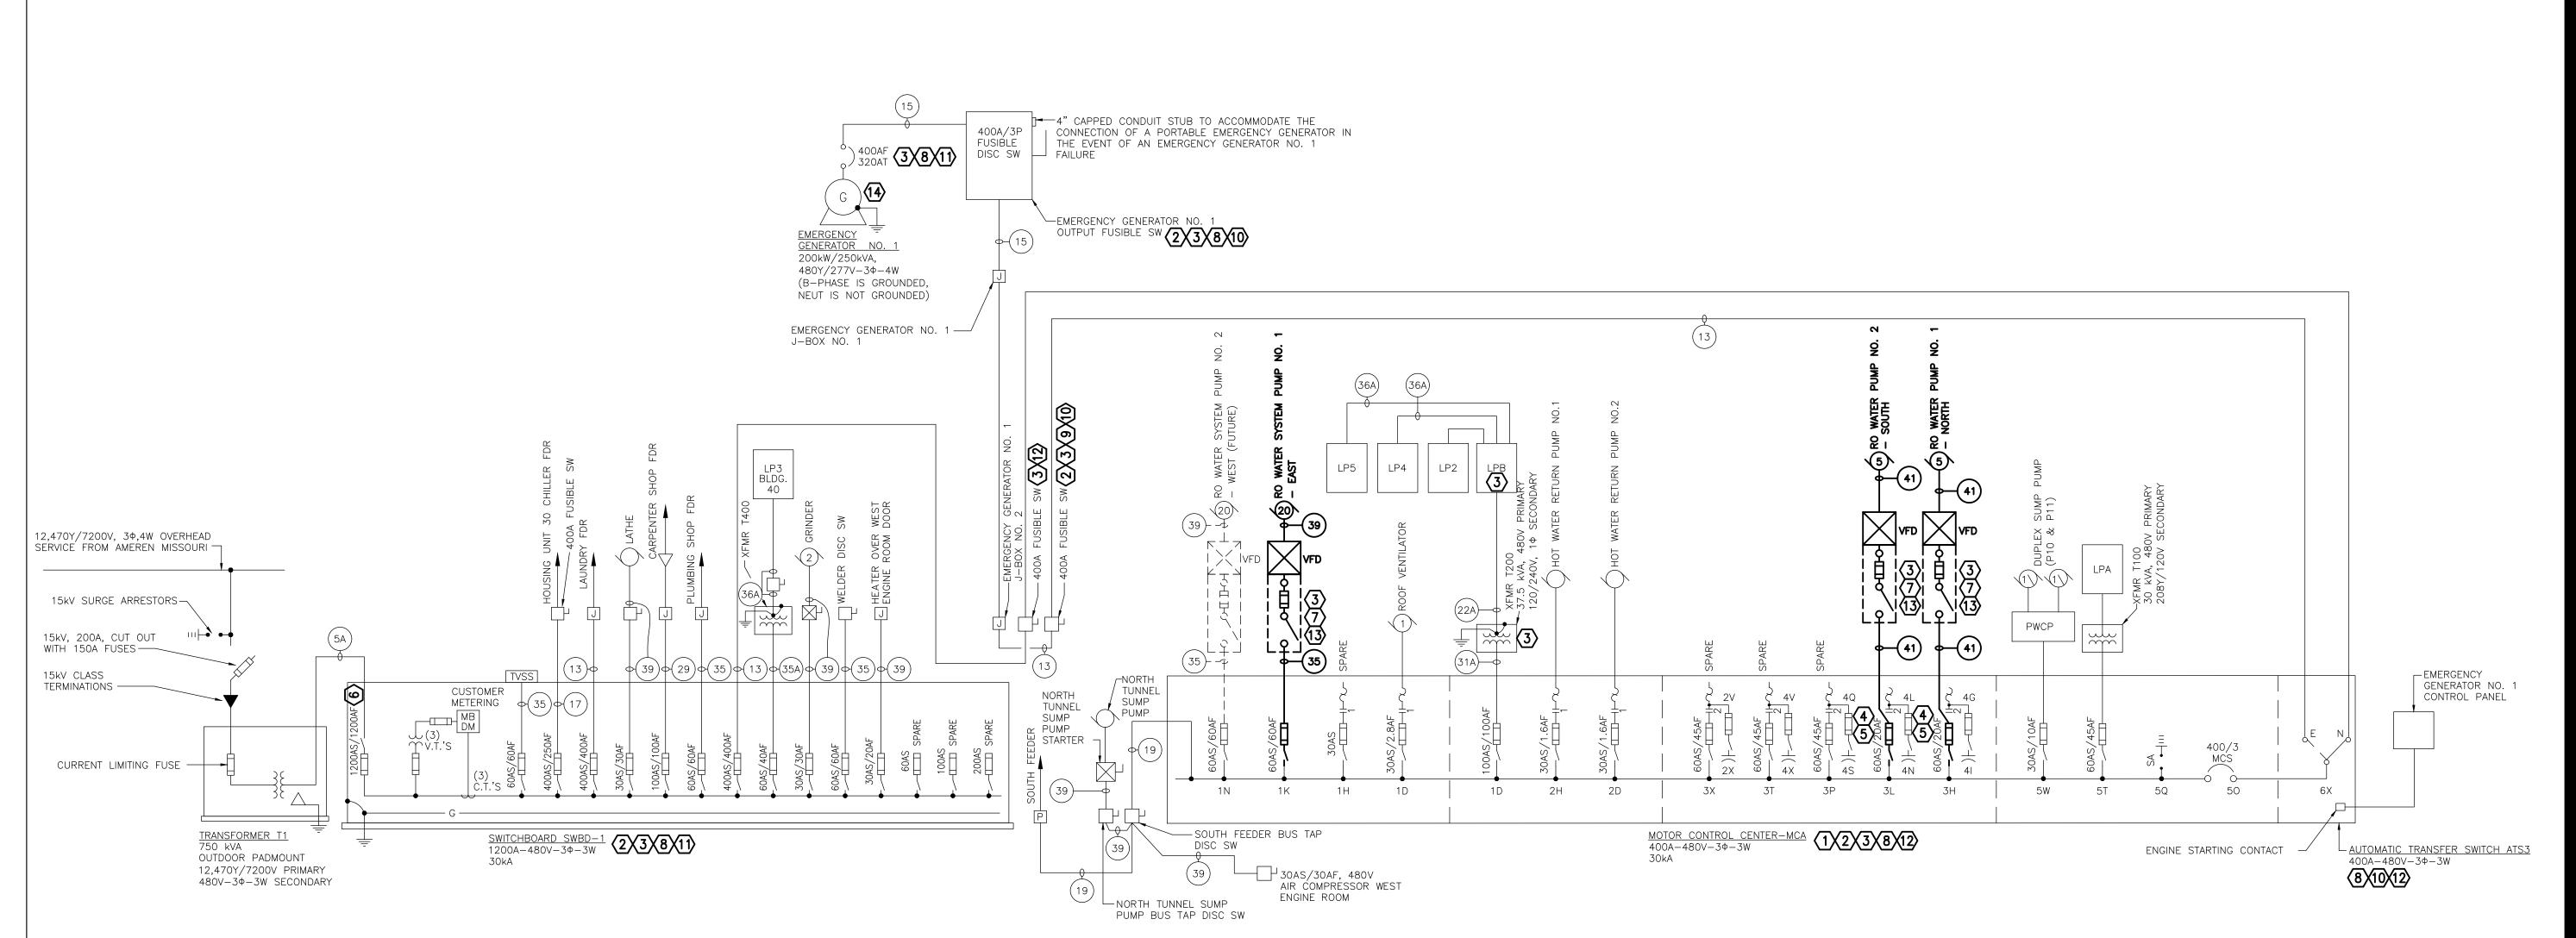

#### ONE-LINE DIAGRAM - NORTH NO SCALE

				FEEDE (all f		SCHE rs are co			
	[	PHASE	N	EUTRAL	GROUND		CONDUIT		
FEEDER NUMBER	TOTAL NO.	SIZE	TOTAL NO.	SIZE	TOTAL NO.	SIZE	TOTAL NO.	SIZE	2020NEC TABLE 310-16 86°F AMBIENT CONDUIT IN AIR NOMINAL AMPACITY BASED ON 75°C CONDUCTOR INSULATION
5A	12	350MCM	_	_	_	_	4	3"	1200A
13	3	500MCM	_	_	1	3	1	3"	400A
15	3	350MCM	_	_	1	4	1	3"	300A
17	3	250MCM	_	_	1	4	1	2 1/2"	250A
19	3	4/0	_	_	1	4	1	2"	225A
22A	2	3/0	1	3/ 0	1	6	1	2"	200A
29	3	2	_	_	1	6	1	1 1/4"	110A
31A	2	3	_	_	1	8	1	1 1/4"	100A
35	3	6	_	_	1	10	1	3/4"	60A
35A	2	6		_	1	10	1	3/4"	60A
36A	2	6	1	6	1	10	1	3/4"	60A
37	3	8	_	_	1	10	1	3/4"	50A
39	3	10	_	_	1	10	1	3/4"	30A
41	3	12	_	_	1	12	1	3/4"	20A

# OKEY NOTES:

- 1. SEE DWG E-501 FOR MCC-MCA ELEVATION & SCHEDULE.
- 2. GROUNDED BY SYSTEM. REPLACE EXIST FUSE WITH SOLID COPPER "DUMMY FUSE" PER SPECIFICATION SECTION 262813 IN BO FUSE CLIPS OF ALL FUSIBLE SWITCHES SERVING 3-PHASE LOADS.
- 3. PROVIDE ARC FLASH HAZARD WARNING LABEL(S) PER SPECIFICATION SECTIONS 260553 & 260573.
- 4. PROVIDE 60A TO 30A FUSE REDUCERS IN AP & CP FUSE CLIPS. DO NOT INSTALL FUSES IN PF CAPACITOR DISC SW.
- 5. REMOVE EXIST CONDUCTORS BETWEEN MOTOR CONTACTOR AND FUSIBLE DISC SW AND CONNECT MOTOR BRANCH CKT CONDUCTORS DIRECTLY TO LOAD SIDE OF DISC SW.
- 6. PROVIDE LABEL ON LINE SIDE OF MAIN FUSIBLE SWITCH INDICATING MAX AVAIL FAULT CURRENT. LABEL SHALL INDICATE DATE THE FAULT CURRENT CALCULATIONS WERE PERFORMED PER NEC 110.24(A).
- 7. PROVIDE SOLID COPPER "DUMMY FUSE" IN BO FUSE CLIPS PER SPECIFICATION SECTION 262813.
- 8. REMOVE ORANGE PHASE MARKING TAPE FROM EACH BO CONDUCTOR AND MARK WITH WHITE OR GRAY VINYL TAPE PER SPECIFICATION SECTION 260553.
- 9. REMOVE MARKING TAPE FROM EACH PHASE CONDUCTOR AND MARK PER SPECIFICATION SECTION 260553.

10. PROVIDE ENGRAVED LAMINATED PLASTIC NAMEPLATE PER SPECIFICATION SECTION 260553:

> SERVED FROM EMER GENERATOR NO. 1  $480V - 3\Phi - 3W$ GROUNDED B-PHASE

11. PROVIDE ENGRAVED LAMINATED PLASTIC NAMEPLATE WITH WHITE CHARACTERS ON A RED BACKGROUND PER SPECIFICATION SECTION 260553:

> 480V-3Ф-3W GROUNDED B-PHASE

12. PROVIDE ENGRAVED LAMINATED PLASTIC NAMEPLATE PER SPECIFICATION SECTION 260553:

> SERVED FROM SWBD-1  $480V - 3\Phi - 3W$ GROUNDED B-PHASE

13. PROVIDE ENGRAVED LAMINATED PLASTIC NAMEPLATE PER SPECIFICATION SECTION 260553:

> EQUIPMENT NAME SERVED FROM MCC-MCA 480V-3Φ-3W GROUNDED B-PHASE

14. CONFIRM THAT NEUTRAL CONDUCTOR IS CAPPED OFF IN ALTERNATOR CONNECTION BOX AND THAT THE GENERATOR NEUTRAL IS NOT BONDED TO GROUND. ADVISE DESIGNER IF THIS IS NOT THE CASE.

**STATE OF MISSOURI** MICHAEL L. PARSON, **GOVERNOR** 



BARRY D. FREINER Registered Professional Engineer MO # E-24220 Expires 12-31-2024

**ROGERS-SCHMIDT** ENGINEERING CO., P.C. CONSULTING ENGINEERS 1736 WEST PARK CENTER DR SUITE 204 ST. LOUIS, MO 63026 PHONE: 636-600-1551 MISSOURI STATE CERTIFICATE

OF AUTHORITY #000408

**OFFICE OF ADMINISTRATION DIVISION OF FACILITIES** MANAGEMENT, **DESIGN AND CONSTRUCTION** 

DEPARTMENT OF CORRECTIONS

VOLUME 2 -REPLACE BOILERS AND CONTROLS, POWER PLANT

FARMINGTON CORRECTIONAL CENTER 1012 WEST COLUMBIA STREET, FARMINGTON, MO 63640

PROJECT # C2006-01 7008

9327008094 **REVISION:** DATE:

ASSET#

**REVISION:** DATE: **REVISION:** DATE:

ISSUE DATE: <u>04/26/2023</u>


CAD DWG FILE: C2007-01-9237-

9327008094- E-601.DWG DRAWN BY: MNS
CHECKED BY: BDF DESIGNED BY: BDF

SHEET TITLE: ONE-LINE DIAGRAM -

SHEET NUMBER:

NORTH

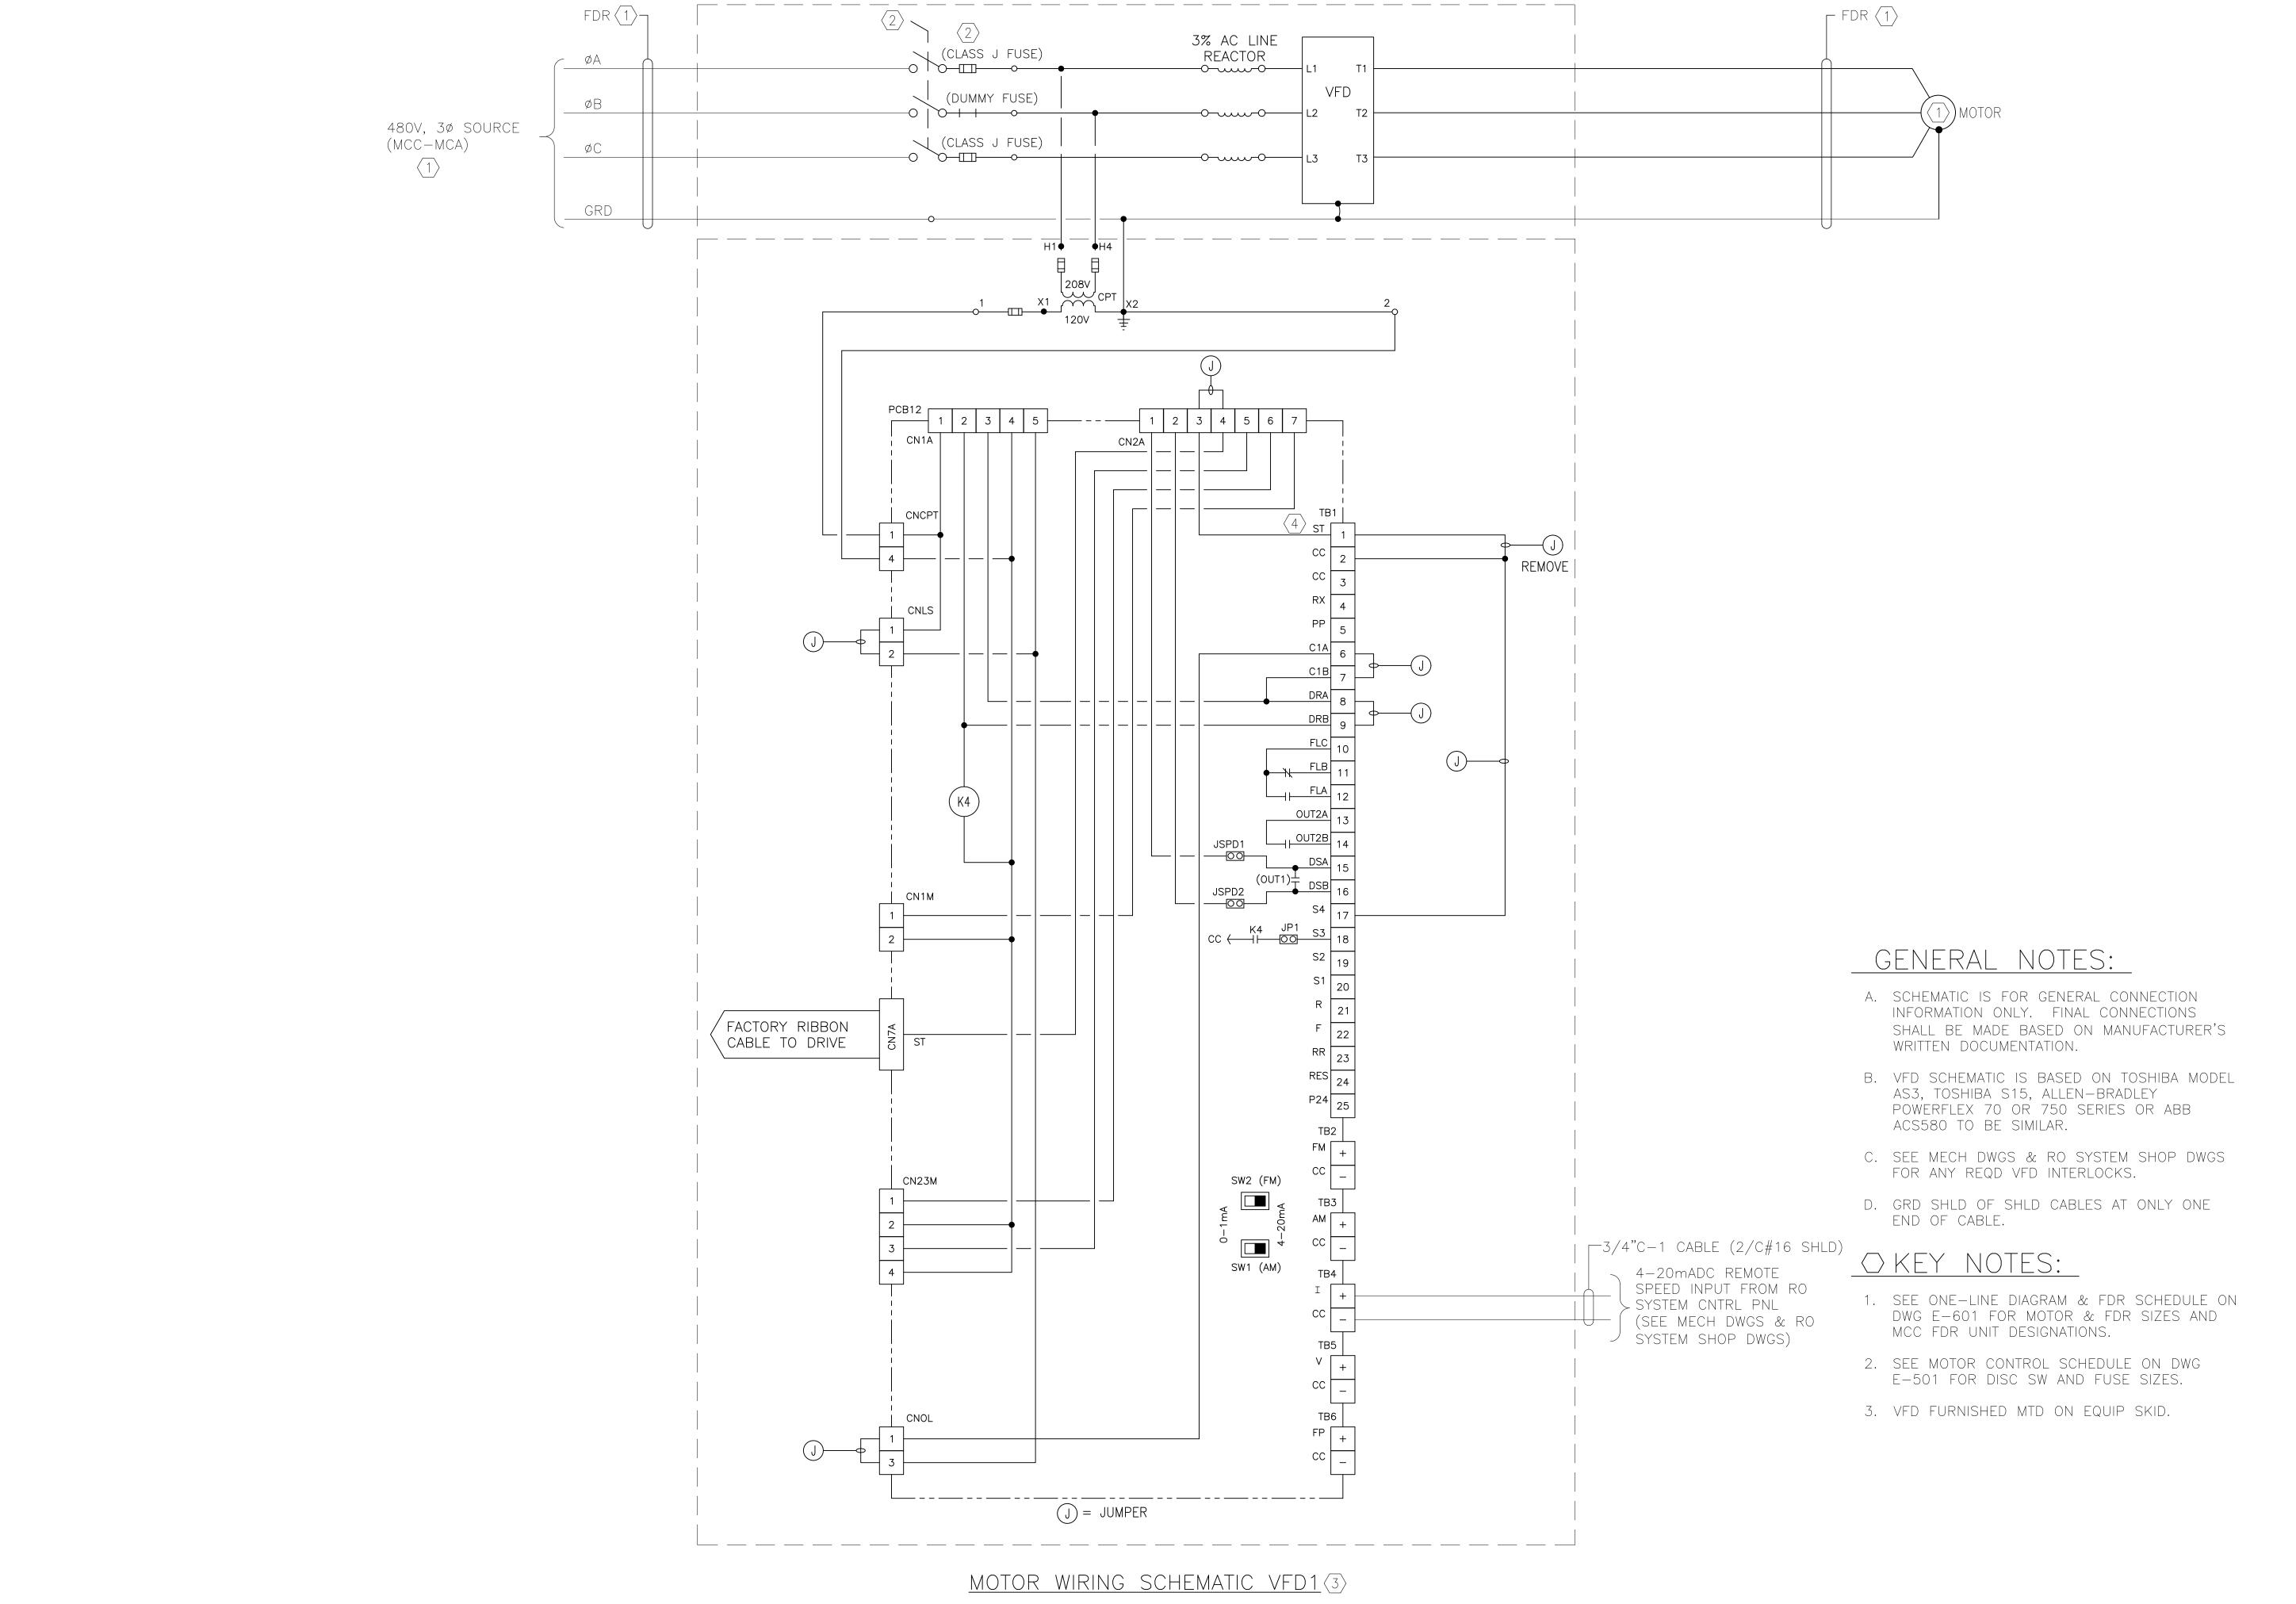



BARRY D. FREINER Registered Professional Engineer MO # E-24220 Expires 12-31-2024

#### **ROGERS-SCHMIDT** ENGINEERING CO., P.C.

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OFFICE OF ADMINISTRATION DIVISION OF FACILITIES MANAGEMENT, DESIGN AND CONSTRUCTION

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VOLUME 2 -REPLACE BOILERS AND CONTROLS, POWER PLANT

FARMINGTON CORRECTIONAL CENTER 1012 WEST COLUMBIA STREET, FARMINGTON, MO 63640

PROJECT # C2006-01

SITE# 7008 ASSET# 9327008094

**REVISION:** DATE: REVISION: DATE: **REVISION:** DATE:

ISSUE DATE: 04/26/2023

CAD DWG FILE: C2007-01-9237-9327008094- E-602.DWG

DRAWN BY: MNS
CHECKED BY: BDF
DESIGNED BY: BDF SHEET TITLE:

MOTOR WIRING SCHEMATIC

SHEET NUMBER: