### **ADDENDUM NO. 5**

### TO: PLANS AND SPECIFICATIONS FOR STATE OF MISSOURI

Replace Boilers and Controls Farmington Correctional Center Farmington, MO

**PROJECT NO.: C2006-01** 

Bid Opening Date: 1:30PM Thursday, October 12th, 2023 (Changed)

Bidders are hereby informed that the construction Plans and/or Specifications are modified as follows:

### VOLUME 1

### **SPECIFICATION CHANGES:**

None

### **DRAWING CHANGES:**

- 1. Volume 1 Drawing E3.2 Main Level South Electrical New Work
  - a. Revise per attached Revision A, dated 10/2/2023
- 2. Volume 1 Drawing E6.0 Electrical One Line Diagram and Schedules
  - a. Revise per attached Revision A, dated 10/2/2023

### **VOLUME 2**

### **SPECIFICATION CHANGES:**

None

### **DRAWING CHANGES:**

None


### **GENERAL COMMENTS:**

- 1. The Pre-Bid Meeting was be held Thursday, August 10<sup>th</sup>, 2023 at 10:30 AM followed by a walk-through of the facility.
- 2. Please contact Paul Girouard, Contract Specialist, at 573-751-4797 or <a href="mailto:Paul.Girouard@oa.mo.gov">Paul.Girouard@oa.mo.gov</a> for questions about bidding procedures and MBE\WBE\SDVE goals and submittal requirements.
- 3. All bids shall be submitted on the bid forms without additional terms and conditions, modifications, or stipulations. Each space on the bid forms shall be properly filled including a bid amount for the alternate. Failure to do so will result in rejection of the bid.
- 4. MBE/WBE/SDVE participation requirements can be found in DIVISION 00. The MBE/WBE/SDVE participation goals are 10%/10%/3%, respectively. All MBE, WBE, and MBE/WBE contractors, subcontractors, and suppliers must be certified by the State of Missouri, Office of Equal Opportunity. No other certifications from other Missouri certifying agencies will be accepted. If a bidder is unable to meet a participation goal, a Good Faith Effort Determination Form must be completed. Failure to complete this process will result in rejection of the bid.
- 5. The deadline for technical questions is October 4<sup>th</sup>, 2023 at noon.
- 6. Changes to, or clarification of, the bid documents are only made as issued in the addenda.
- 7. All correspondence with respect to this project must include the State of Missouri project number as indicated above.
- 8. Current Planholders list available online at: <a href="https://www.oafmdcplanroom.com/jobs/2077/planholders/c2006-01-replace-boilers-controls-farmington-correctional-center">https://www.oafmdcplanroom.com/jobs/2077/planholders/c2006-01-replace-boilers-controls-farmington-correctional-center</a>
- 9. Prospective Bidders contact American Document Solutions, 1400 Forum Blvd., Suite 7A, Columbia MO 65203, 573-446-7768 to order official plans and specifications.

### **Attachments:**

- 1. Volume 1 Drawing E3.2
- 2. Volume 1 Drawing E6.0

### **END ADDENDUM NO. 5**

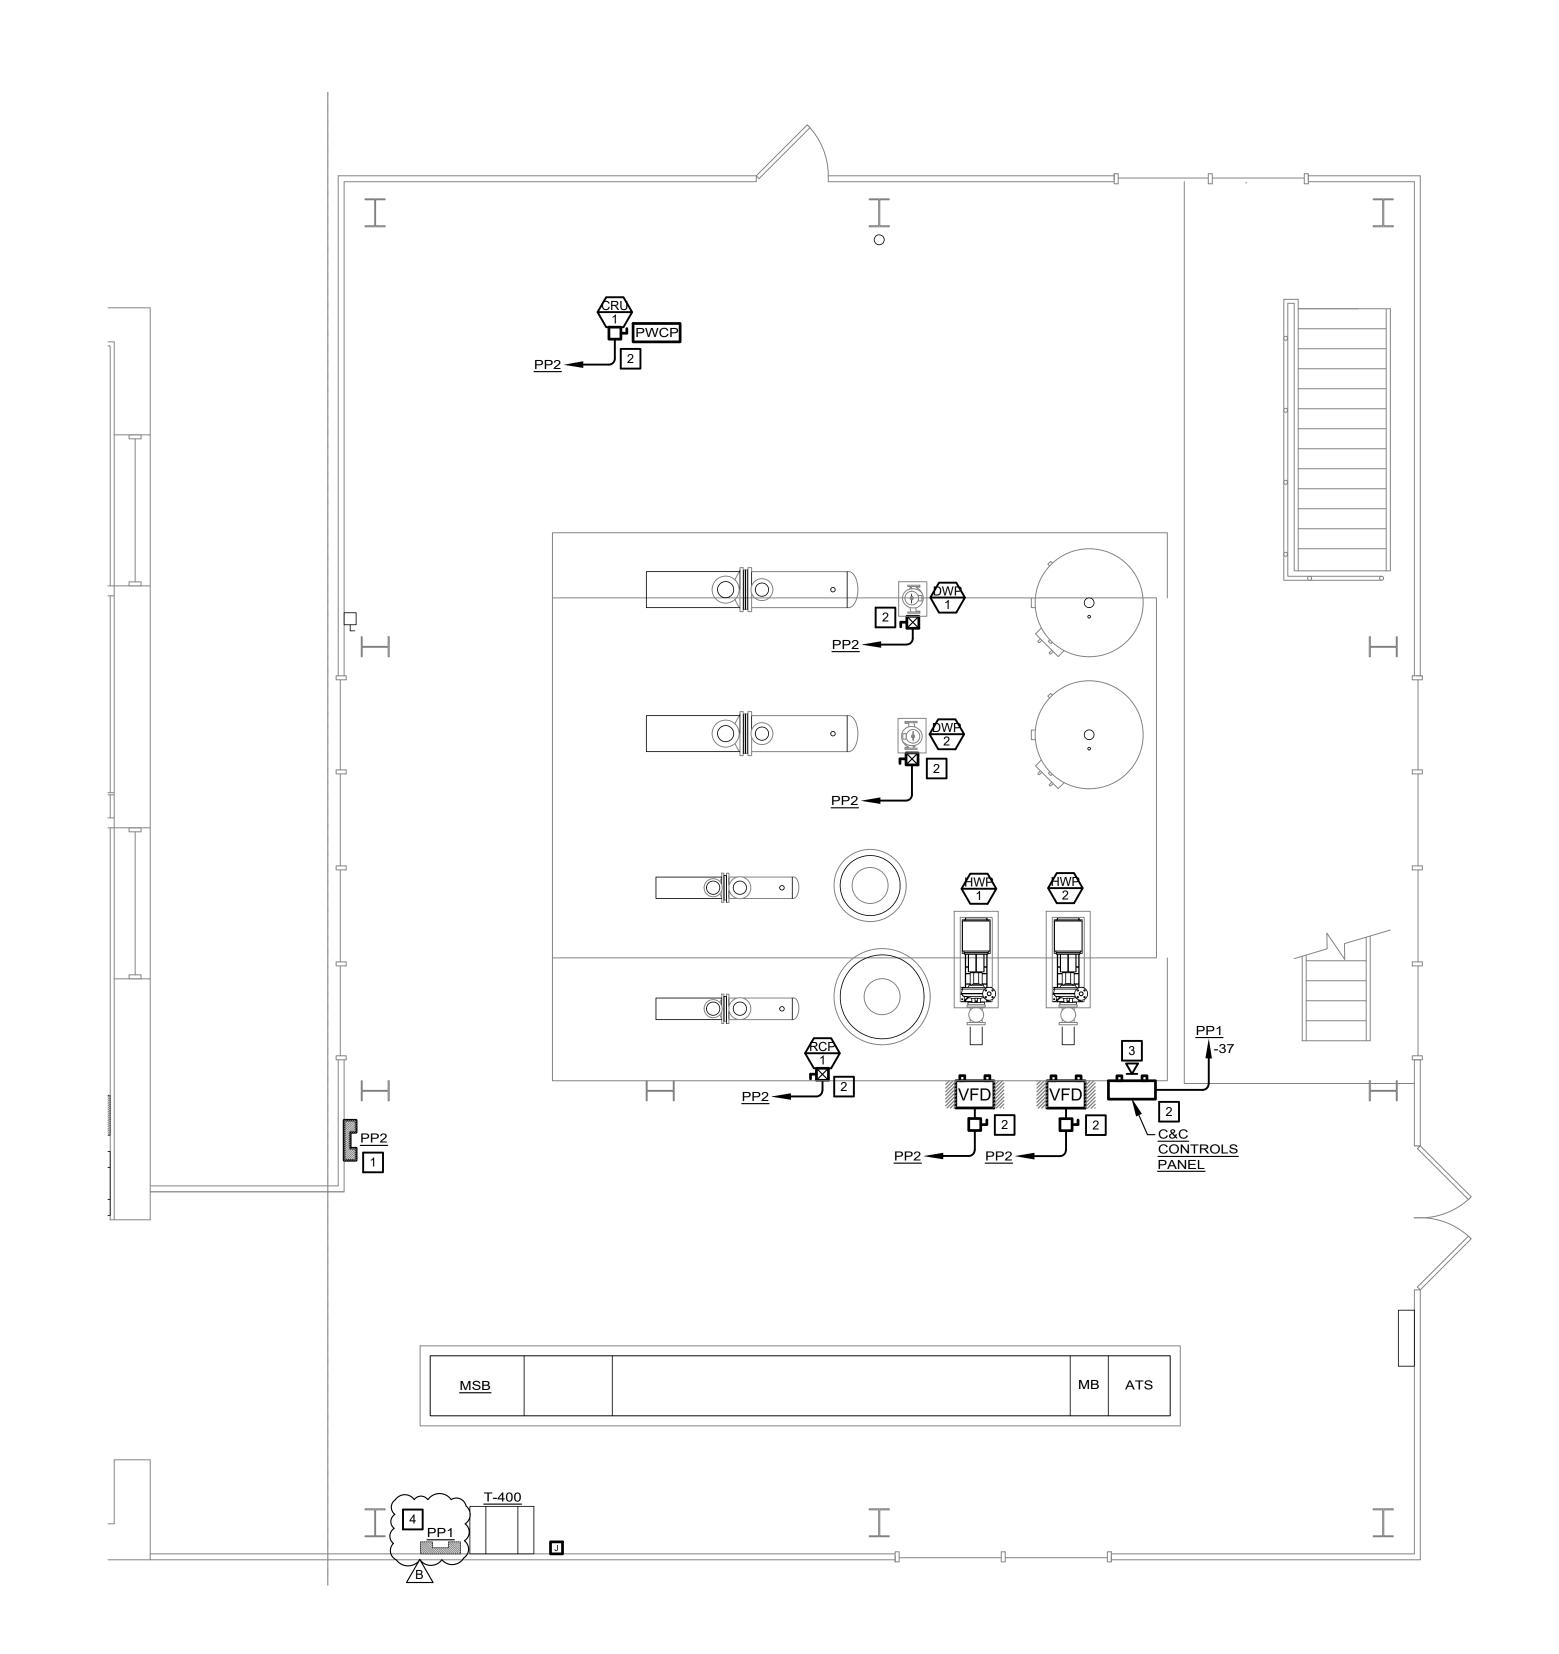

# N MAIN LEVEL - SOUTH ELECTRICAL - NEW WORK 1/4" = 1'

## KEYED NOTES:

- TURNISH AND INSTALL NEW 277/480V, 125A, 3Ø, 4W PANEL PP2. REFER TO ONE-LINE DIAGRAM ON SHEET E6.0 FOR MORE INFORMATION.
- FURNISH, CONSTRUCT, AND INSTALL UNISTRUT RACK OR MOUNTING EQUIPMENT FOR DISCONNECT AND CONTROLS.
- PROVIDE DATA RECEPTACLE FOR CONNECTION TO NEW CONTROLS PANEL. ROUTE TO DATA RACK LOCATED IN NORTH PLAN. SEE SHEET E3.0 FOR DATA RACK LOCATION. INTERCEPT AND REWORK EXISTING 100A CIRCUIT TO SALLY PORT FROM PANEL PP1. COORDINATE WITH UNDERGROUND UTILITY WORK.





MO Engineering Registration No. P-29111

# McClure ENGINEERING

1000 Clark Avenue Saint Louis, Missouri 63102 T 314-645-6232 MEP Engineers: McClure Engineering Professional Engineering Corporation Missouri State Certificate of Authority #000087

OFFICE OF ADMINISTRATION DIVISION OF FACILITIES MANAGEMENT, **DESIGN AND CONSTRUCTION** 

DEPARTMENT OF CORRECTIONS

BOILER UPGRADES

FARMINGTON CORRECTIONAL CENTER

1012 WEST COLUMBIA STREET FARMINGTON, MO 63640

PROJECT # C2006-01 FACILITY# 9327008094

REVISION: ADDENDUM #5
DATE: 10/02/2023
REVISION: DATE:
REVISION: DATE: DATE:

ISSUE DATE: 04/26/2023

DRAWN BY: AAC CHECKED BY: ESW DESIGNED BY: EMP


SHEET TITLE:

MAIN LEVEL SOUTH ELECTRICAL NEW WORK

SHEET NUMBER:

E3.2

30 OF 31 SHEETS 04/26/2023

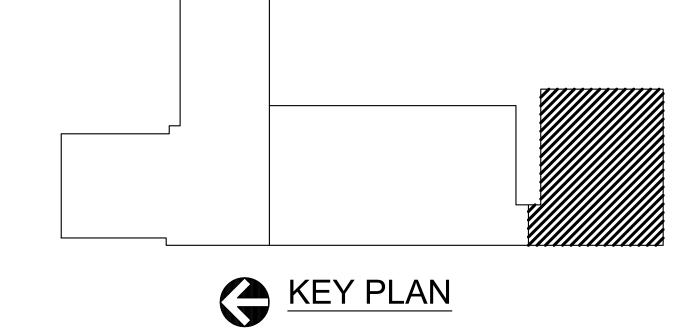

SWBD-1

**DEMOLITION WORK** 

d 400A

MAIN

SPARE SPARE SPARE

PARTIAL ONE-LINE DIAGRAM - MCA

DEMOLITION WORK - ONE-LINE DIAGRAM - MSB

MAIN SPARE SPARE SPARE

**NEW WORK** PARTIAL ONE-LINE DIAGRAM - MCA

# SWBD-1 **⊟** 60AS/

MECHANICAL-ELECTRICAL INTERFACE																					
EQUIPMENT				MOTOR DATA		BRANCH CIRCUIT DATA	SOURCE DATA			UNIT CONTROLS					ID		EQUIPMENT DISCONNECT				REMARKS
								ОСР				OCP								5	
EQUIP.		REF.		HP / (kW)	VOLTAGE /			TYPE <sup>3</sup> /	SWITCH/FUSE SIZE		STARTER		SWITCH/FUSE			SWITCH					
ID	DESCRIPTION	SHEET	LOCATION	/ (MCA) <sup>1</sup>	PHASE	FEEDER SIZE	SOURCE:	POLES	or CB TRIP	TYPE⁴	SIZE	TYPE <sup>3</sup>	or CB TRIP	NEMA RATING F I	;	SIZE	POLE	OCP SIZE	NEMA RATING	F I C	
HWP-1	HOT WATER PUMP	E3.2	BOILER PLANT SOUTH	15HP	480 / 3	(3) #10, (1) #10 GRD - 3/4"C	PP2	CB / 3	40	VFD	NA	NA	NA	1 E E	HWP-1	60A	3	40A	1	E E E	VFD PROVIDED BY DIVISION 26
HWP-2	HOT WATER PUMP	E3.2	BOILER PLANT SOUTH	15HP	480 / 3	(3) #10, (1) #10 GRD - 3/4"C	PP2	CB / 3	40	VFD	NA	NA	NA	1 E E	HWP-2	60A	3	40A	1	EEE	VFD PROVIDED BY DIVISION 26
BP-1	DOMESTIC WATER BOOSTER SKID	E3.0	BOILER PLANT NORTH	20HP	480 / 3	(3)#8, (1)#10 GRD - 3/4"C	MCA	FS / 3	60/40	VFD	NA	NA	NA	1 M M	BP-1	NA	NA	NA	NA	N N N	FACTORY-MOUNTED VFD
DWP-1	DOMESTIC WATER PUMP	E3.2	BOILER PLANT SOUTH	1.5HP	480 / 3	(3)#12, (1)#12 GRD - 3/4"C	PP2	CB / 1	20	COMB	0	FS	15A	1 E E	DWP-1	NA	NA	NA	NA NA	N N N	
DWP-2	DOMESTIC WATER PUMP	E3.2	BOILER PLANT SOUTH	1.5HP	480 / 3	(3)#12, (1)#12 GRD - 3/4"C	PP2	CB / 1	20	COMB	0	FS	15A	1 E E	DWP-2	NA	NA	NA	NA	N N N	
CRU-1	CONDENSATE RECEIVER	E3.2	BOILER PLANT SOUTH	4HP	480 / 3	(3) #12, (1) #12 GRD - 3/4"C	PP2	CB / 3	20	PWCP	NA	NA	NA	1 M M	CRU-1	30A	3	20A	1	EEE	
BF-1	BOILER FAN	E3.1	BOILER PLANT CENTRAL	75HP	480 / 3	(3)#1, (1)#6 GRD - 2"C	MSB	FS / 3	200/125	VFD	NA	NA	NA	1 M M	BF-1	200A	3	125A	1	EEE	VFD PROVIDED BY DIVISION 23
BF-2	BOILER FAN	E3.1	BOILER PLANT CENTRAL	100HP	480 / 3	(3)#2/0, (1)#6 GRD - 2"C	MSB	FS / 3	200/175	VFD	NA	NA	NA	1 M M	BF-2	200A	3	175A	1	E   E   E	VFD PROVIDED BY DIVISION 23
BF-3	BOILER FAN	E3.1	BOILER PLANT CENTRAL	75HP	480 / 3	(3)#1, (1)#6 GRD - 2"C	MSB	FS / 3	200/125	VFD	NA	NA	NA	1 M M	BF-3	200A	3	125A	1	EEE	VFD PROVIDED BY DIVISION 23
RCP-1	DOMESTIC HOT WATER RETURN PUMP	E3.1	BOILER PLANT SOUTH	3HP	480 / 3	(3)#12, (1)#12 GRD - 3/4"C	PP2	CB / 3	20A	COMB	0	FS	15A	1 EE	RCP-1	NA NA	NA NA	NA NA	NA NA	N N N	

UTILITY

SPARE

MSB - 277/480V, 1000A, 3Ø, 3W, 30kAIC

175AF

VFD

BF-2

125AF

60AF

60AF

PANELBOARD: PP2 **VOLTAGE**:

PHASE:

SHORT CIRCUIT:

LOAD

CRU-1

DWP-1

SPARE

SPARE

SPARE

SPARE

SPARE SPARE

SPARE

MAIN:

SPARE SPARE SPARE

 $\downarrow$  200AS/  $\downarrow$  200AS/  $\downarrow$  200AS/  $\downarrow$  60AS/  $\downarrow$  60AS/  $\downarrow$  100AS  $\downarrow$  100AS/  $\downarrow$  30AS/  $\downarrow$  30AS/  $\downarrow$  100AS/  $\downarrow$  100AS/  $\downarrow$  200AS/  $\downarrow$  200AS/  $\downarrow$  200AS/

STEAM

**HEATERS** 

**NEW WORK - ONE-LINE DIAGRAM - MSB** 

30AF

30AF

FUEL

PUMPS

T-300

100AF

100AF

#2

BKR POLES

40

20

20

20

20

Ph CKT

3 B 4

5 C 6

7 A 8

9 B 10

11 C 12

15 B 16

17 C 18 19 A 20 21 B 22

25 A 26

27 В 28

29 C 30

31 A 32 20 33 B 34 20 35 C 36 20 37 A 38 20 39 B 40 20

200AF

MCC-1

<u>PP2</u>

277/480V

125A 3Ø 3W

LOAD

HWP-2

RCP-1

SPARE

SPARE

SPARE

SPARE

SPARE

SPARE

SPARE

FIC<sup>5</sup>: (Furnished, Installed, Connected)

E Electrical Contractor

N Not Applicable

M Mechanical, Plumbing, Fire Protection Contractor, or Factory

100AF

DEAERATOR

480 V DELTA

14 K AIC

BKR

20

3P 3W

125 A

LOCATION: BOILER PLANT SOUTH

POLES

-- M SIEMENS

4300

HORSEPOWER IS SHOWN UNLESS KILOWATTS (kW) OR MINIMUM CIRCUIT AMPACITY (MCA) IS CALLED OUT

FS FUSED SWITCH CB CIRCUIT BREAKER NA NOT APPLICABLE

COMB Combination Magnetic Starter / Disconnect Switch or Circuit Breaker Magnetic Starter 2-speed 1-winding Magnetic Starter 2-speed 2-winding Magnetic Starter Manual Motor Starter Pre-wired Control Panel

Variable Frequency Drive Toggle Switch (horsepower rated) Relay in a Box Not Applicable

**GENERAL ONE-LINE NOTES:** 

- 1. ALL EQUIPMENT SHOWN AS THIN CONTINUOUS LIGHT LINE IS EXISTING EQUIPMENT TO REMAIN.
- 2. ALL EQUIPMENT SHOWN AS THICK DASHED HEAVY LINE IS EXISTING EQUIPMENT TO BE
- 3. ALL EQUIPMENT SHOWN AS THICK CONTINUOUS HEAVY LINE IS NEW EQUIPMENT.
- 4. COORDINATE ELECTRICAL SHUT-DOWNS WITH OWNER AND AMEREN.

### **GENERAL NOTES:**

REMOVED.

1. THIS FACILITY IS ON A 480V, GROUNDED B SYSTEM.

**ONE-LINE KEYED NOTES:** 

1 NOT USED

2 FURNISH AND INSTALL NEW FUSE SWITCH IN EXISTING MCA TO FEED NEW BOOSTER PUMP SKID. SEE PLANS SHEET E3.0 FOR MORE INFORMATION.

STATE OF MISSOURI MICHAEL L. PARSON, **GOVERNOR** 



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ISSUE DATE: 04/26/2023

DRAWN BY: AAC CHECKED BY: ESW DESIGNED BY: EMP

SHEET TITLE:

ELECTRICAL ONE-LINE DIAGRAM AND SCHEDULES

SHEET NUMBER:

E6.0

31 OF 31 SHEETS 04/26/2023