REPLACE FIRE ALARM SYSTEM, INFRASTRUCTURE NORTHEAST CORRECTIONAL CENTER (Bowling Green, Missouri)



8675 West 96th Street Overland Park, KS 66212 Phone: 816.333.4373 Fax: 913.722.3484

OWNER:

STATE OF MISSOURI

MICHAEL L. PARSON,

GOVERNOR

DEPARTMENT OF CORRECTIONS

PROJECT

OFFICE OF ADMINISTRATION

MANAGEMENT: DIVISION OF FACILITIES MANAGEMENT,

DESIGN AND CONSTRUCTION

DESIGNER:

FSC Inc

PROJECT NUMBER:

C2314-01

SITE NUMBER:

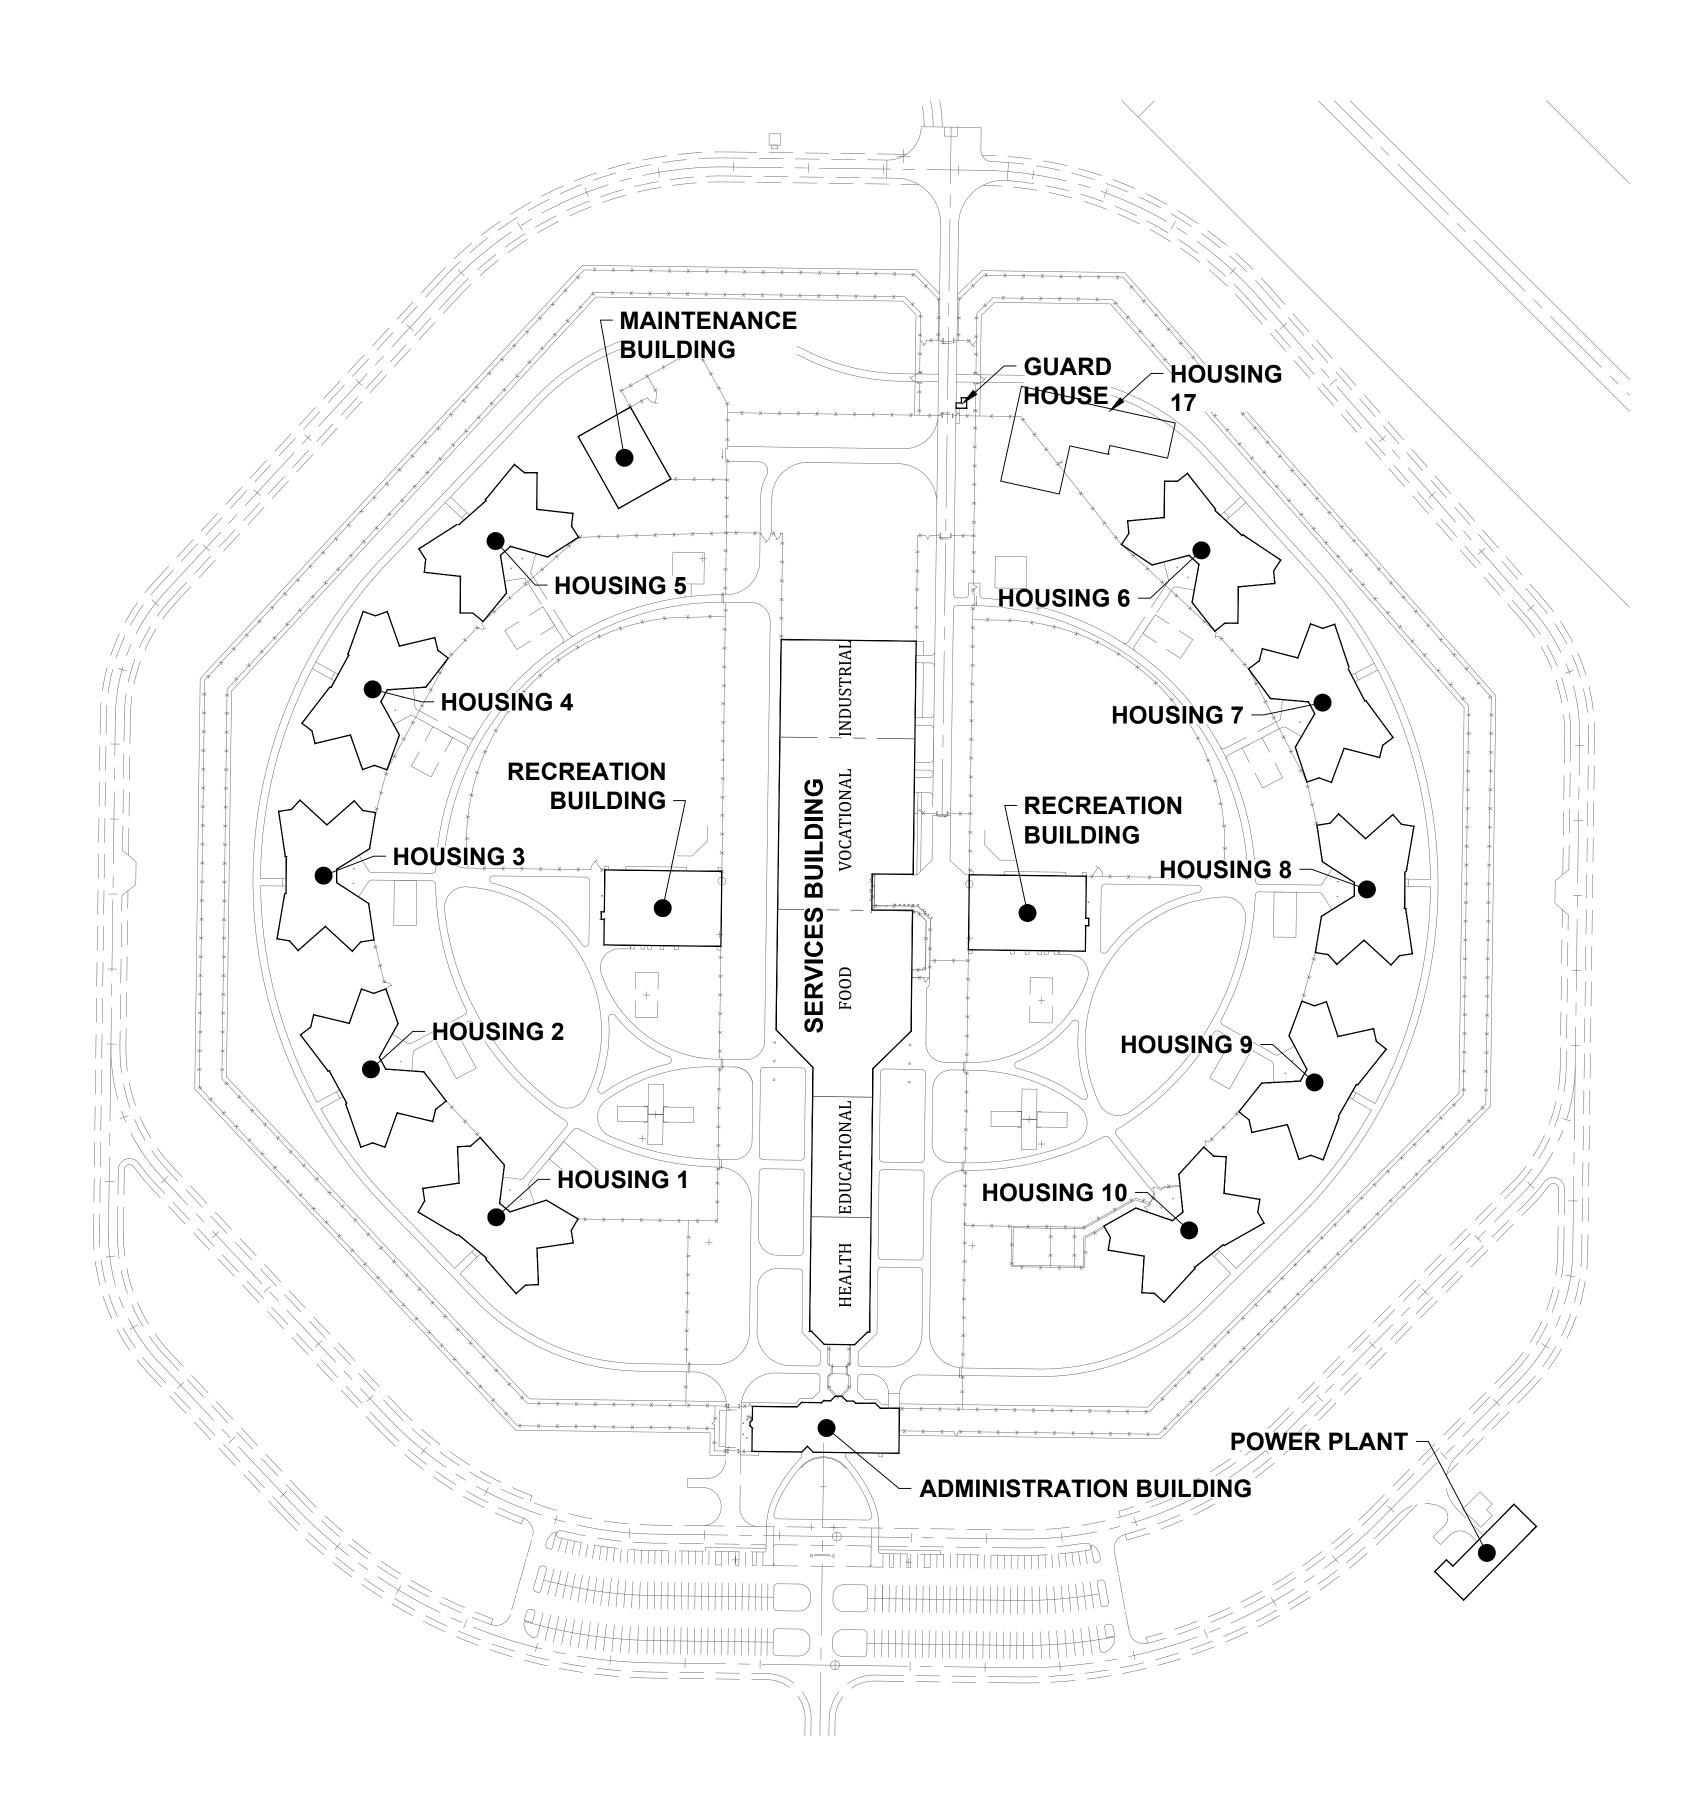
7017

INFRASTRUCTURE NUMBER:

9327017049

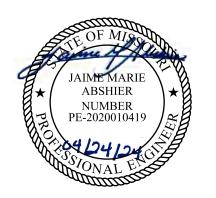
NE CORRECTIONAL CENTER

BOWLING GREEN, MISSOURI



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STATE OF MISSOURI MICHAEL L. PARSON, GOVERNOR



PROFESSIONAL SEAL



8675 W 96TH STREET OVERLAND PARK, KS. 6621 PHONE: 816.33.4373

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OFFICE OF
ADMINISTRATION
DIVISION OF FACILITIES
MANAGEMENT,
DESIGN AND
CONSTRUCTION

Replace Fire Alarm System, Infrastructure

Northeast Correctional center 13698 Airport Rd, Bowling Green, MO 63334

PROJECT # C2314-01 SITE # 7017 FACILITY # 9327017049

REVISION:
DATE:
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ISSUE DATE: 04/24/2024

CAD DWG FILE:

CAD DWG FILE: DRAWN BY: CHECKED BY: DESIGNED BY:

SHEET TITLE:

FIRE ALARM SITE PLAN

SHEET NUMBER:

FA-001

GENERAL NOTES

- ALL NOTES IN THIS DRAWINGS ARE INTEGRAL PART OF THE CONTRACT DOCUMENT AND MUST READ IN CONJUNCTION WITH ALL PACKAGE ELEMENTS (SPECIFICATIONS, LAYOUTS,...ETC.)
- INSTALLATION CONTRACTOR SHALL MAINTAIN A LEGIBLE AND ACCURATE SET OF AS-BUILT (MARKED-UP) DRAWINGS FOR RECORD DRAWING PURPOSES AND PROVIDE AS-BUILT PLANS TO FSC, INC. TO ALLOW PROPER RECORD KEEPING BY FSC INC. ENGINEERING DEPARTMENT.
- . INSTALLATION CONTRACTOR SHOULD BE FAMILIAR WITH CURRENT STANDARDS OF NFPA 72. NFPA 70. IBC. AND LOCAL CODE REQUIREMENTS. THIS INSTALLATION SHALL BE IN ACCORDANCE WITH THE APPLICABLE CODES, STANDARDS, LOCAL AMENDMENTS AND MANUFACTURER'S SPECIFICATIONS.
- . THE FIRE ALARM DRAWINGS ARE SCHEMATIC IN NATURE AND SHOW A MINIMAL QUANTITY OF DEVICES. DETERMINE THE FINAL QUANTITY AND LOCATION OF ALL DEVICES IN ACCORDANCE WITH THE SPECIFICATIONS, CONTRACT DRAWINGS, AND MANUFACTURER'S WRITTEN RECOMMENDATIONS TO BE COMPLIANT WITH ALL APPLICABLE CODES AND STANDARDS. PROVIDE ADDITIONAL DEVICES WHEN REQUIRED FOR A FULLY FUNCTIONING FIRE ALARM SYSTEM AS REQUIRED BY NFPA
- THE INSTALLATION OF THE FIRE ALARM SYSTEM SHALL NOT BEGIN UNTIL THE DRAWINGS HAVE BEEN REVIEWED AND APPROVED BY THE ENGINEER OF RECORD AND THE AUTHORITY HAVING JURISDICTION.
- IT IS THE CONTRACTOR'S RESPONSIBILITY TO CHECK LOCATIONS, DEPTHS, ELEVATIONS, AND SIZES OF THE EXISTING SYSTEMS THAT SHALL BE REPLACED. THE CONTRACTOR SHALL ASSUME SOME DEVIATIONS AND INCLUDE OFFSETS, ADDITIONAL WIRING, ETC. AT THE TIME OF BID, ALSO CONTRACTOR SHALL BE AWARE OF THE FULL EXISTING PROJECT / SYSTEM CONDITIONS AT TIME OF BID.
- FIRE ALARM SYSTEMS AND NETWORK SHALL BE NON-PROPRIETARY.
- B. CONTRACTOR SHALL BE RESPONSIBLE FOR PROVIDING ALL CONDUITS, BOXES, ETC. AND FIBER FROM THE FACU TO EACH BUILDING'S FIBER PATCH PANEL.
- CONTRACTOR SHALL BE RESPONSIBLE FOR ALL TERMINATIONS AND PROGRAMMING, INCLUDING FIBER MODULES (SINGLE MODE OR MULTIMODE) AND PROGRAMMING.
- 10. FIRE ALARM SEQUENCE OF OPERATION SHALL BE APPROVED BY THE STATE OF MO PRIOR TO CONFIGURATION.
- 11. A MONITOR SHALL BE LOCATED IN THE MAIN GUARD STATION, DEDICATED TO THE FA SYSTEM THAT ALLOWS SECURITY TO MONITOR EACH BUILDING AT A GLANCE. A TROUBLE OR ALARM IN ANY BUILDING OR FACU WILL ACTIVE A NONFICTION ON THE SCREEN AND PROVIDE AUDIBLE NOTIFICATION (SONALERT OR SIMILAR) THAT THERE IS AN ISSUE AT XX BUILDING.
- 12. THE CONTRACTOR IS RESPONSIBLE FOR CONNECTING AND INTEGRATING ALL FIRE ALARM UNITS INTO THE CAMPUS NETWORK. THE CONTRACTOR SHALL COORDINATE WITH THE INTERNAL SITE IT REPRESENTATIVES TO OBTAIN IP ADDRESSES AND OTHER REQUIRED INFORMATION FOR NETWORK PROGRAMMING. THE CONTRACTOR SHALL PROGRAM OR ENGAGE A SUBCONTRACTOR TO PROGRAM THE CAMPUS NETWORK SO ALL NEW FACUS REPORT THE MAIN FACU THAT IS TO BE LOCATED IN THE ADMINISTRATIVE BUILDING'S MAIN SECURITY OFFICE WHERE INDICATED ON THE DRAWINGS.
- 13. ENGAGE SPRINKLER CONTRACTOR AS NECESSARY TO REPLACE SPRINKLER MONITORING EQUIPMENT.
- 14. AC POWER FOR ALL FIRE ALARM CONTROL PANELS SHALL BE 120VAC, 50/60 HZ, 20 AMPS. WIRE SHALL BE MINIMUM 12 AWG WITH 600V INSULATION.
- 15. THE LOCATION OF THE DEDICATED BRANCH CIRCUIT DISCONNECTING MEANS SHALL BE PERMANENTLY IDENTIFIED AT THE CONTROL UNIT.

- 16. 120VAC CIRCUITS SHALL BE RUN IN SEPARATE CONDUIT.
- 17. ALL NON-POWER LIMITED WIRING SHALL HAVE A MINIMUM OF A 1/4" SEPARATION FROM POWER LIMITED WIRING.
- 18. ALL WIRING AND/OR CABLES SHALL BE ROUTED IN CONDUIT AND FIRE ALARM
- 19. TEE-TAPPING IS ONLY PERMISSIBLE ON CLASS 'B' SLC CIRCUITS.
- 20. ALL FIRE ALARM DEVICES AND WIRING SHALL BE PROPERLY LABELED WITH DEVICE AND WIRING IDENTIFICATION. RECOMMEND LABELING ALL DEVICES WITH A GOOD LABEL MAKER PRODUCT.
- 21. A BREAKER LOCK SHOULD BE INSTALLED AT THE ELECTRICAL PANEL ON THE BRANCH CIRCUIT FEEDING ANY FIRE ALARM PANEL. MUST BE IDENTIFIED BY RED AND LABELED AS SERVING THE FIRE ALARM SYSTEM.
- 22. SET STROBES TO CANDELA NOTED ON PLAN SHEET.
- 23. REFER TO DEVICE INSTALLATION SHEETS FOR BACK BOX REQUIREMENTS.
- 24. REFER TO DEVICE INSTALLATION SHEETS FOR REQUIREMENTS ON INSTALLING ALL EQUIPMENT.
- 25. ALL CIRCUITS SHALL BE IDENTIFIED AT TERMINAL AND JUNCTION LOCATIONS WHICH WILL HELP PREVENT UNINTENTIONAL SIGNALS TO OCCUR ON THE SYSTEM.
- 26. ALL WIRING CIRCUITS TO BE CHECKED FOR PROPER ELRD (END OF LINE RESISTOR DEVICE) READINGS. ALL GROUND FAULTS AND AND SHORTS SHALL BE ELIMINATED PRIOR TO FINAL ACCEPTANCE TESTING.
- 27. INTEGRITY OF CIRCUIT SHALL BE TESTED TO VERIFY THAT WHEN THE SYSTEM IS IN AN ENERGIZED STATE THE SYSTEM WILL FUNCTION PROPERLY.
- 28. ANY MODIFICATION MADE TO THE DEVICE LAYOUT, WIRING LAYOUT OR CONFIGURATION OF WIRING TO NOTIFICATION OR INITIATING DEVICES SHALL BE REVIEWED AND APPROVED BY AN FSC, INC. REPRESENTATIVE WHOSE DIRECT RESPONSIBILITY INCLUDES DESIGN AND ENGINEERING.
- 29. SMOKE DETECTORS SHALL NOT BE LOCATED IN A DIRECT AIR FLOW OR CLOSER THAN 3 FEET FROM AN AIR SUPPLY DIFFUSER OR RETURN AIR OPENING. SMOKE DETECTORS SHOULD BE LOCATED FARTHER AWAY FROM HIGH VELOCITY AIR
- 30. SMOKE DETECTORS SHALL BE SPACED AS INDICATED ON THE DRAWINGS AND FOLLOW THE SPACING REQUIREMENTS SPECIFIED IN NFPA 72. ANY CHANGES IN SMOKE DETECTOR LAYOUT DUE TO OBSTRUCTIONS IN THE CEILING SHALL BE REVIEWED AND APPROVED BY AN FSC, INC. REPRESENTATIVE WHOSE DIRECT RESPONSIBILITY INCLUDES DESIGN AND ENGINEERING.
- 31. FIRE SPRINKLER WATER FLOW AND VALVE TAMPER SWITCHES SHALL BE MONITORED BY THE FIRE ALARM SYSTEM (IF APPLICABLE).
- 32. AIR HANDLER UNITS THAT ARE GREATER THAN 2000 CFM SHALL BE EQUIPPED WITH A DUCT SMOKE DETECTOR IN THE RETURN DUCT. VERIFY LOCATION IN FIELD.
- 33. NOTIFICATION APPLIANCE CIRCUITS ARE TO BE 16 AWG 2 CONDUCTOR SOLID FPLR, FPLP, OR THHN WITH A MINIMUM OF 19 STRANDS AS REQUIRED. THHN WIRE MUST BE INSTALLED IN CONDUIT.
- 34. SIGNALING LINE CIRCUITS ARE TO BE 18AWG 2 CONDUCTOR SOLID FPLR, FPLP (PLENUM RATED) CABLE OR 16AWG OR 18AWG THHN WIRE (MUST BE 7 STRAND OR LESS) AS REQUIRED. THHN WIRE MUST BE INSTALLED IN CONDUIT.

- 35. AUDIO CIRCUITS ARE TO BE 14 AWG 2 CONDUCTOR SOLID SHIELDED TWISTED PAIR FPLR OR FPLP (PLENUM RATED) AS REQUIRED.
- 36. LIMIT NOTIFICATION APPLIANCE CIRCUIT WIRING TO THE SHORTEST POSSIBLE DISTANCE TO ACHIEVE CIRCUIT OPERATION.
- 37. ALL FIRE ALARM CABLE SHALL BE INSTALLED IN ACCORDANCE WITH ARTICLE 760 OF NFPA 70 NATIONAL ELECTRICAL CODE.
- 38. PLENUM RATED CABLE MUST BE INSTALLED IN ALL PLENUM AREAS. RISERS NOT IN CONDUIT MUST USE FPLP CABLE WHEN PENETRATING MORE THAN ONE FLOOR.
- 39. INPUT MODULE END OF LINE RESISTORS ARE BY MANUFACTURER INSTRUCTIONS.
- 40. NOTIFICATION APPLIANCE END OF LINE RESISTORS ARE BY MANUFACTURER INSTRUCTIONS. WHERE POSSIBLE, ALWAYS USE OEM SUPPLIED RESISTORS. WHERE OEM SUPPLIED RESISTORS ARE NOT AVAILABLE, USE RESISTOR COLOR CODE TO SELECT THE PROPER RESISTOR, MATCHING VALUES TO OEM SUPPLIED
- 41. A SMOKE DETECTOR SHALL BE PROVIDED ABOVE ALL FIRE ALARM CONTROL UNITS.
- 42. WALL MOUNT NOTIFICATION DEVICES SHALL BE INSTALLED AT 80" A.F.F. TO THE BOTTOM OF THE BOX.
- 43. MANUAL PULL STATIONS SHALL BE INSTALLED AT A MINIMUM 42" A.F.F. AND NOT GREATER THAN 48" TO THE OPERATING MECHANISM.
- 44. WHERE (2) OR MORE STROBES ARE VISIBLE THEY WILL BE SYNCHRONIZED.
- 45. ALL NEW REQUIRED CABLING SHALL HAVE INDEPENDENT SUPPORTS.
- 46. PROVIDE AUDIBILITY SOUND LEVEL OF 70 dBA THROUGHOUT THE AREA OF WORK.
- 47. CONTRACTOR SHALL COORDINATE WITH ALL OTHER MEP TRADES (MECHANICAL/ELECTRICAL/PLUMBING) FOR EXACT LOCATION OF CEILING / WALL MOUNTING OF FIRE ALARM DEVICES.
- 48. IT IS THE CONTRACTOR'S RESPONSIBILITY TO CONFIRM SPACES FOR SUSPENDED CEILINGS, DETECTORS ABOVE SUSPENDED CEILINGS SHALL CONFORM TO NFPA 72.
- 49. EXISTING DEVICES NOT REQUIRED BY THE APPLICABLE CODE WILL BE REPLACED AT A ONE-TO-ONE RATIO IN THEIR EXISTING LOCATIONS TO MAINTAIN THE EXISTING LEVEL OF PROTECTION THE SYSTEM WAS ORIGINALLY DESIGNED FOR.
- 50. EXISTING WIRING SHOWN IN THE DRAWINGS WAS PROVIDED BY THE STATE OF MISSOURI IN THE FORM OF AS BUILT DRAWINGS. IT IS THE CONTRACTOR'S RESPONSIBILITY TO VERIFY EXISTING WIRING.
- 51. WIRING NOT PROVIDED ON NEW WORK DRAWINGS FOR CLARITY. PLEASE REFER TO DEMO DRAWINGS FOR REFERENCE ASBUILT WIRE ROUTING INFORMATION PROVIDED BY OWNER. ROUTING TO BE VERIFIED BY THE CONTRACTOR.
- 52. FSC, INC. SHALL BE NOTIFIED OF COMMISSIONING OF THE SYSTEM AND SHALL BE PROVIDED ALL DOCUMENTATION WITH RESPECT TO SYSTEM COMMISSIONING AND AHJ ACCEPTANCE.
- 53. DESIGN IS IN ACCORDANCE WITH CODES AND STANDARDS LISTED AND THE AHJ OF THE STATE OF MISSOURI.
- NFPA 72 NATIONAL FIRE ALARM AND SIGNALING CODE 2022 UL STANDARD 864 - STANDARD FOR CONTROL UNITS AND ACCESSORIES FOR
- FIRE ALARM SYSTEMS UL STANDARD 268 - STANDARD FOR SMOKE DETECTORS FOR FIRE ALARM SYSTEMS
- NEC 70 NATIONAL ELECTRICAL CODE 54. WIRE GUARDS REQUIRED FOR SMOKE DETECTORS / OR NOTIFICATION APPLIANCES
- SHALL BE U.L LISTED, NON UL-LISTED GUARDS SHALL BE REMOVED AND REPLACED.

FIF	RE ALARM SYMBOL LEGEND
SYMBOL	DESCRIPTION
FACP	ADDRESSABLE FIRE ALARM CONTROL PANEL
NAC	12V 7AH BATTERY INTELLIGENT NOTIFICATION POWER SUPPLY
ANN	FIRE ALARM ANNUNCIATOR
(VDU)	VIDEO DISPLAY UNIT WITH LCD MONITOR, KEYBOARD, AND PRINTER
DBOX	FIRE ALARM DOCUMENT BOX
•	MANUAL PULL STATION
(§)	ADDRESSABLE SMOKE DETECTOR
<u>©</u>	ADDRESSABLE CARBON MONOXIDE DETECTOR
•	ADDRESSABLE HEAT DETECTOR
D	DUCT SMOKE DETECTOR
RT	REMOTE TEST STATION
CT	DUEL OR SINGLE INPUT MODULE(S)
CR	CONTROL MODULE
J	FIRE ALARM JUNCTION BOX
区	FIRE ALARM HORN STROBE
)	FIRE ALARM STROBE
H	FIRE ALARM HORN
B	FIRE ALARM WATERFLOW BELL
•	FIRE SPRINKLER RISER
s∳s	WATERFLOW SWITCH
Ŗ	TAMPER SWITCH
	END OF LINE RESISTOR

 $\times \# Y$ X: NO.OF WIRES, Y: AWG. SIZE

SMOKE DETECTOR MOUNTED ABOVE FACU ON SUSPENDED CEILING

FACU

2. J-BOX

6. MANUAL PULL STATION

9. HORN STROBE (WEATHERPROOF)

7. ALARM VALVE OS&Y

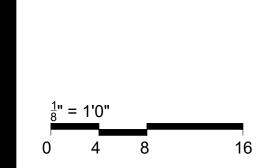
8. SMOKE DETECTOR

1. FIRE ALARM CONTROL UNIT

5. SUPERVISORY TAMPER SWITCH

3. WATER FLOW SWITCH 4. SPRINKLER ALARM VALVE

ABBREVIATION	DESCRIPTION
EX	EXISTING DEVICE
BAS	BUILDING AUTOMATION SYSTEM
R	RELOCATION OF EXISTING DEVICE
С	CEILING MOUNTED DEVICE
WG	END OF LINE
PC	PULL STATION COVER
WP	WEATHERPROOF DEVICE
EP	EXPLOSION PROOF DEVICE
dB	DECIBEL (UNIT FOR SOUND PRES
LF	LOW FREQUENCY
SB	SOUNDER BASE
НТ	HIGH TEMPERATURE
AHU	AIR HANDLING UNIT
RTU	ROOF TOP UNIT
TVSS	TRANSIENT VOLTAGE SURGE SU
UNO	UNLESS NOTED OTHERWISE
NIC	NOT IN CONTRACT
HVLS	HIGH VOLUME LOW SPEED
HVAC	HIGH VOLTAGE AIR CONDITIONE
AFF	ABOVE FINISHED FLOOR
NAC	NOTIFICATION APPLIANCE CIRC
SLC	SIGNALING LINE CIRCUIT
SBUS	SERIAL BUS
RDP	REMOTE DISPLAY
SPK	SPEAKER CIRCUIT
PWR	AUXILIARY POWER
FBUS	VOICE BUS
FDC	FIRE DEPARTMENT CONNECTION
NTS	NOT TO SCALE
EOL	END OF LINE
UG	UNDERGROUND
VAC	ALTERNATING CURRENT VOLTA
VDC	DIRECT CURRENT VOLTAGE
EMT	ELECTRICAL METALLIC TUBING
WG	WIRE GUARD



STATE OF MISSOURI

MICHAEL L. PARSON, **GOVERNOR**

NUMBER

PE-202001041

PROFESSIONAL SEAL

ENGINEERS, LLC

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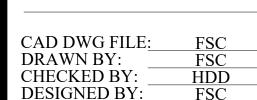
OFFICE OF ADMINISTRATION DIVISION OF FACILITIES MANAGEMENT, **DESIGN AND** CONSTRUCTION

Replace Fire Alarm System, Infrastructure

Northeast Correctional center 13698 Airport Rd, Bowling Green, MO 63334

PROJECT # C2314-01 7017 FACILITY # 9327017049

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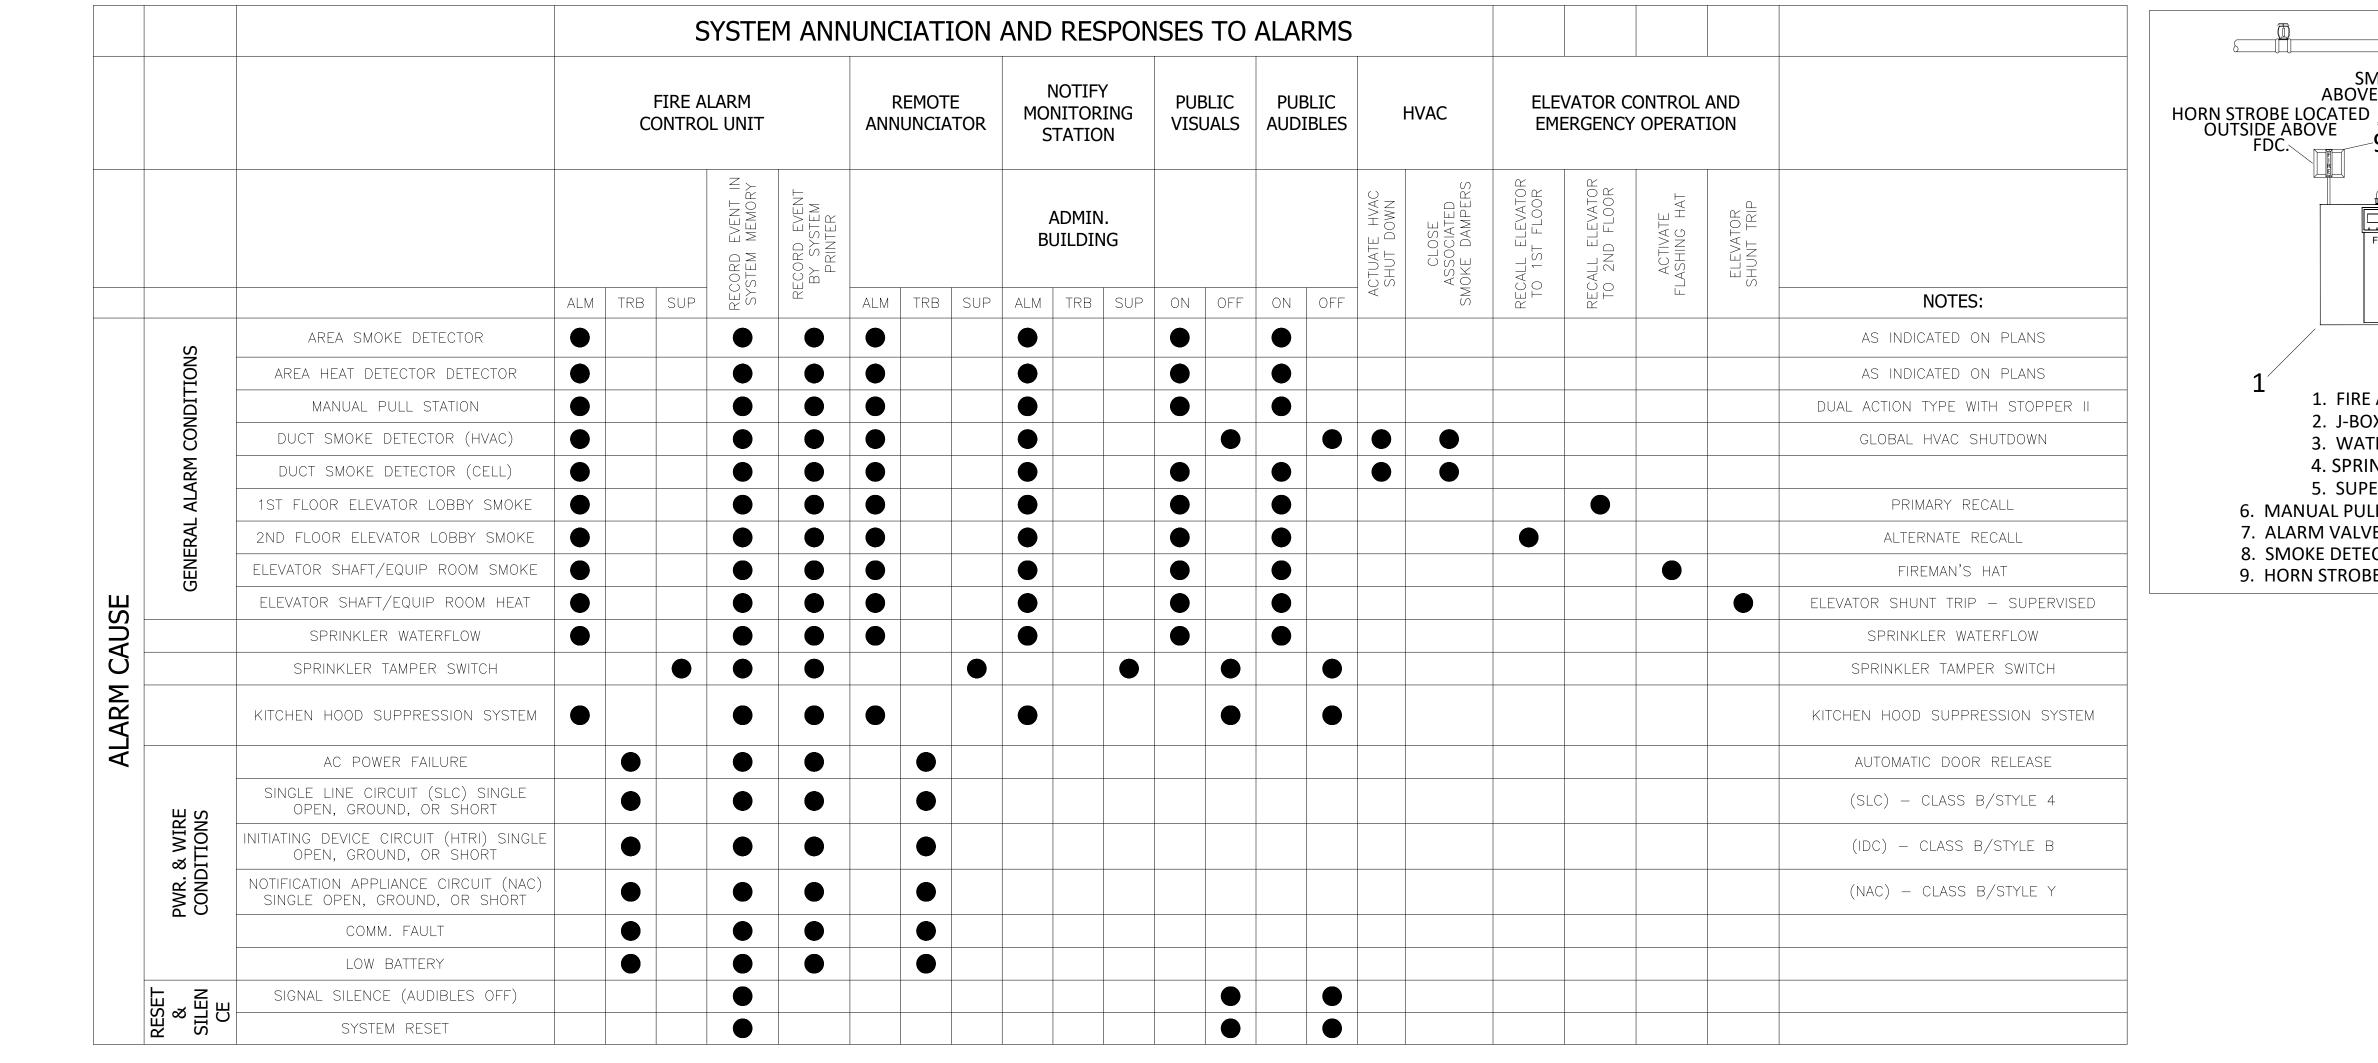
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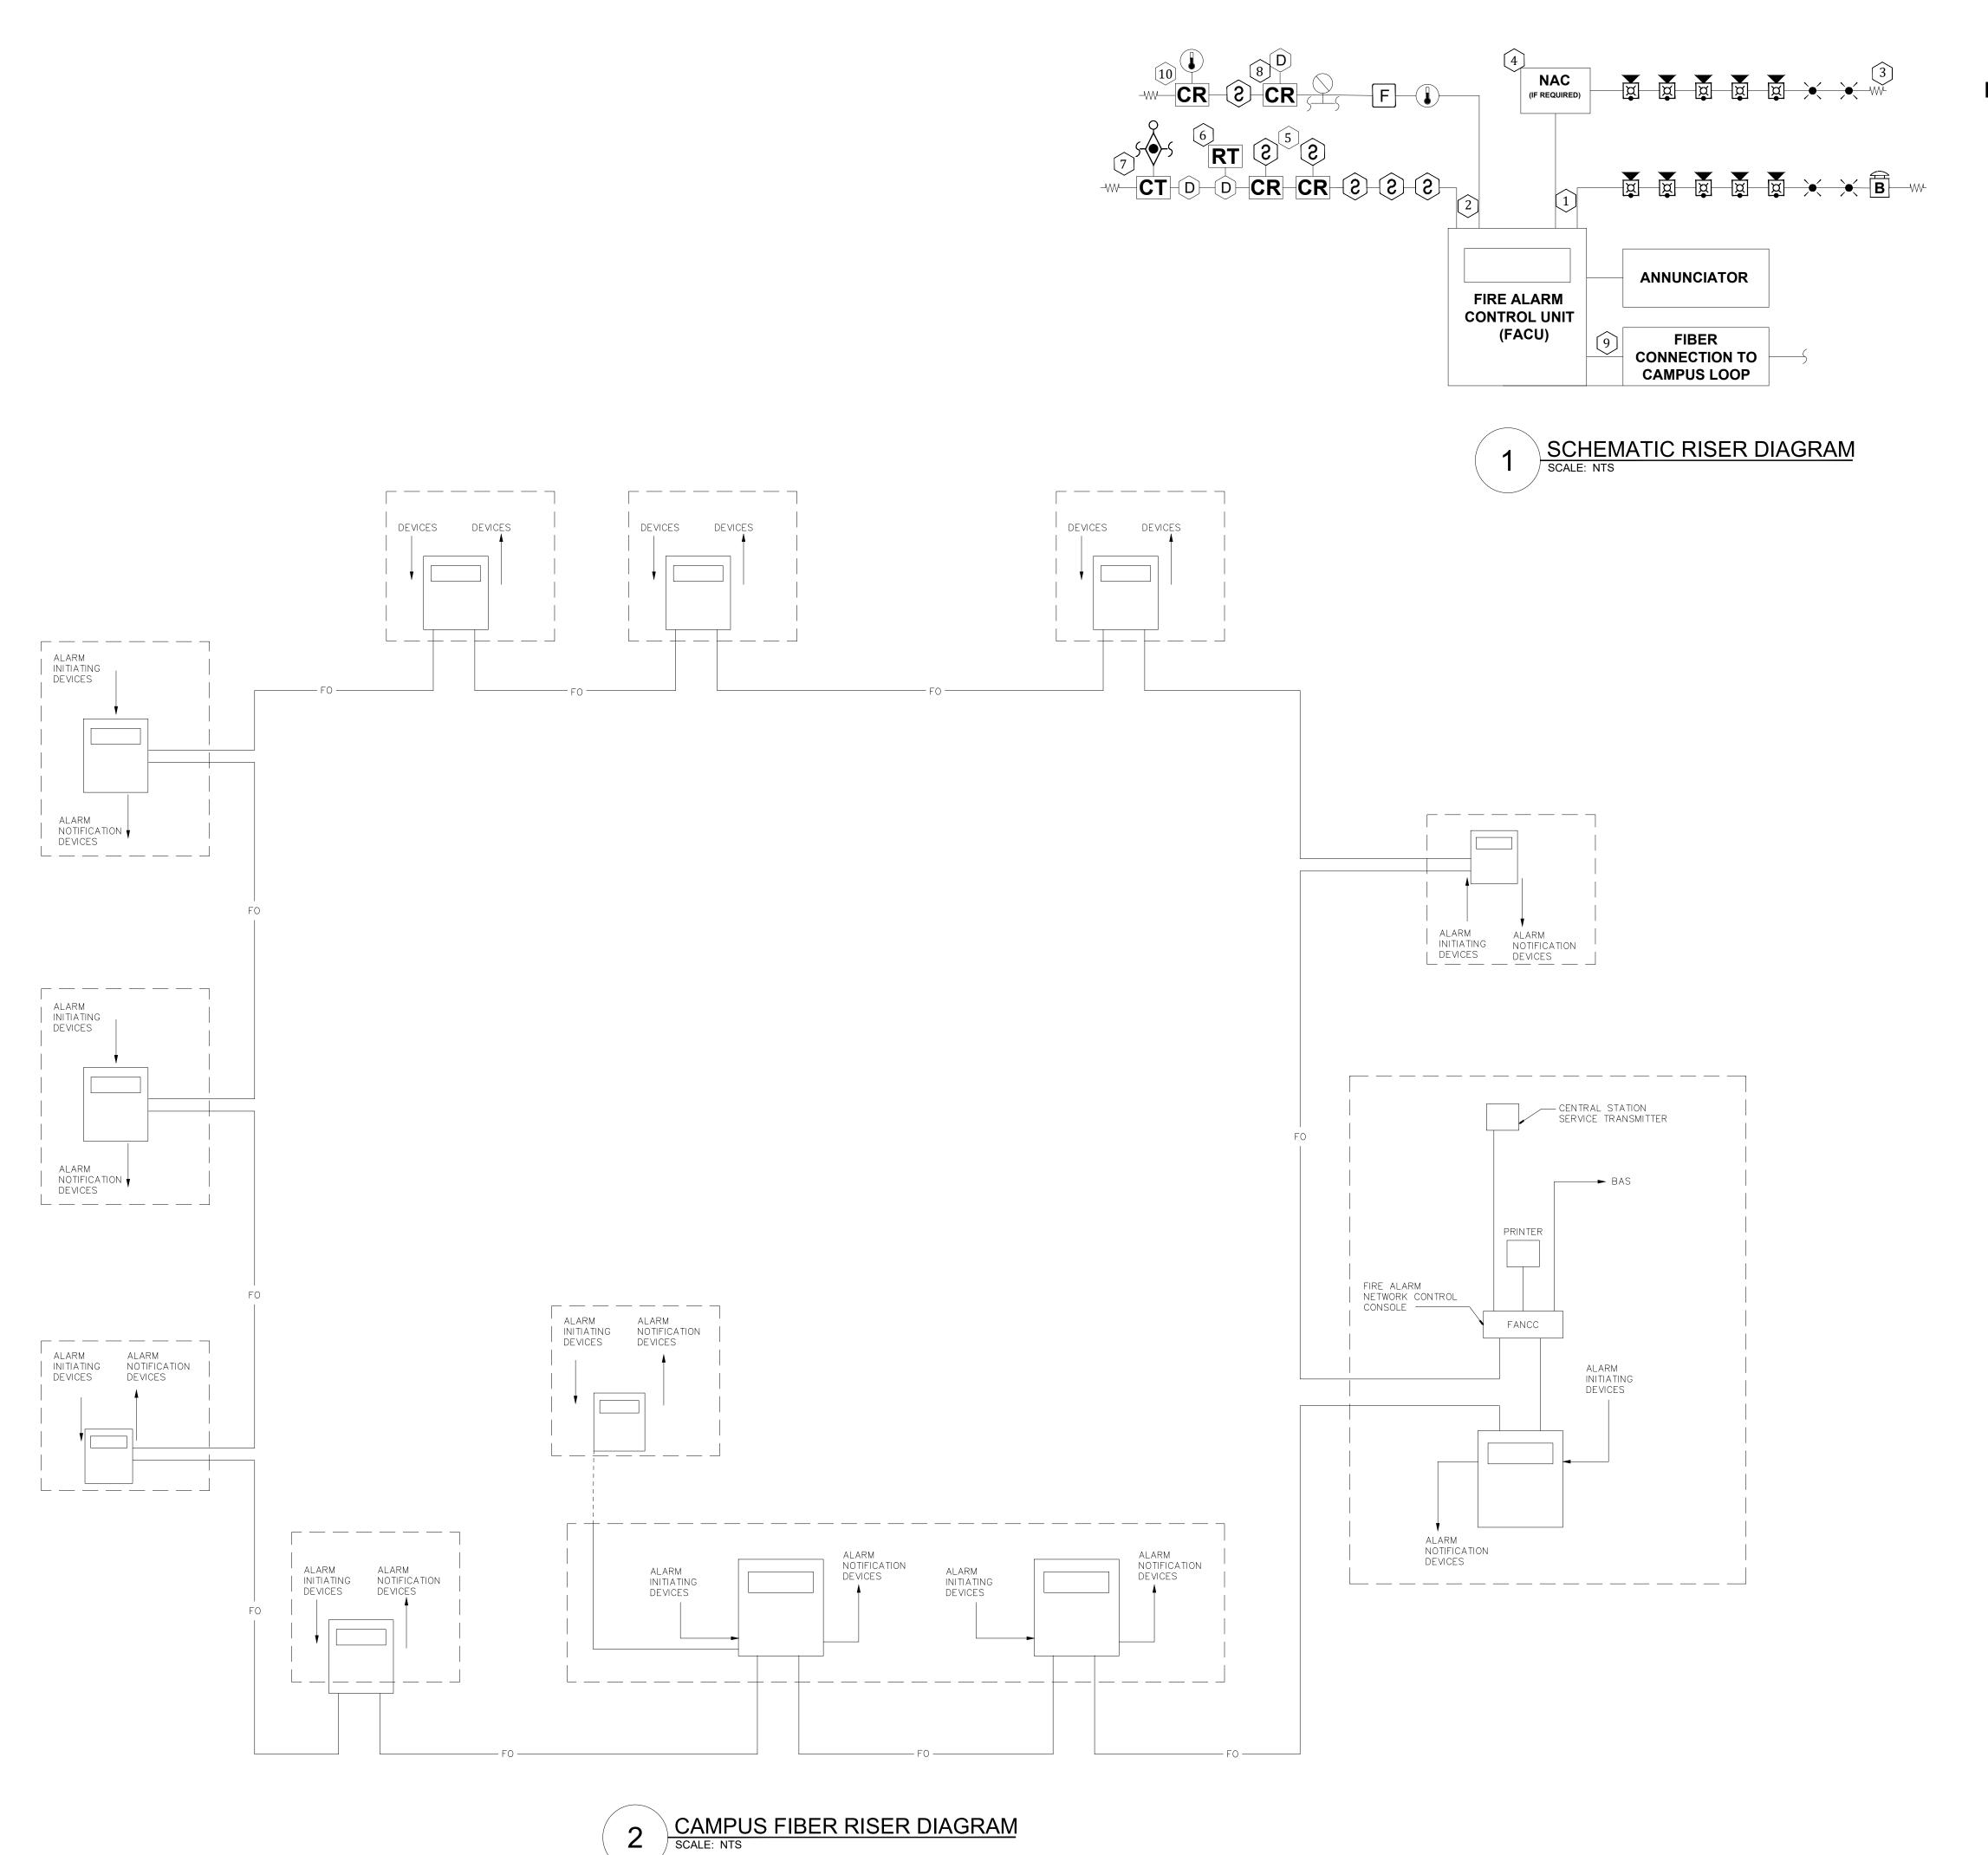
SHEET TITLE:

FIRE ALARM GENERAL NOTES, ABBREVIATIONS, **&LEGEND**

SHEET NUMBER:

FA-002

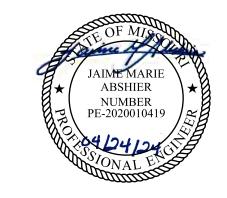




FIRE ALARM RISER KEYED NOTES

- 1 TYPICAL NAC CIRCUITS.
- (2) TYPICAL INITIATION DEVICE CIRCUITS.
- (3) TYPICAL END OF LINE RESISTOR.
- NOTIFICATION APPLIANCE CIRCUIT EXPANDER PANEL. PROVIDE QUANTITY AS NECESSARY. VERIFY LOCATION WITH OWNER PRIOR TO INSTALLATION.
- **S** WIRING TO ELEVATOR CONTROL.
- 6 PROVIDE A REMOTE TEST STATION FOR DUCT MOUNTED SMOKE DETECTORS NOT ACCESSIBLE FROM THE FINISHED FLOOR IN A SECURE LOCATION. VERIFY FINAL LOCATION WITH OWNER.
- 7 MONITOR MODULES FOR WATER FLOW SWITCH ON FIRE PROTECTION SYSTEM.
- 8 WIRING TO SMOKE DAMPER CONTROL.
- 9 CONNECT FACU TO FIBER BACKBONE OF CAMPUS NETWORK AT LOCATION PROVIDED WITHIN BUILDING.
- (10) WIRING TO ELEVATOR SHUNT TRIP.

STATE OF MISSOURI MICHAEL L. PARSON, GOVERNOR

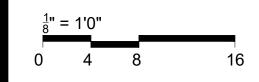


PROFESSIONAL SEAL



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NOTES: FOR FIRE ALARM GENERAL NOTES, REFER TO DWG# FA-002



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DRAWN BY: FSC
CHECKED BY: HDD
DESIGNED BY: FSC

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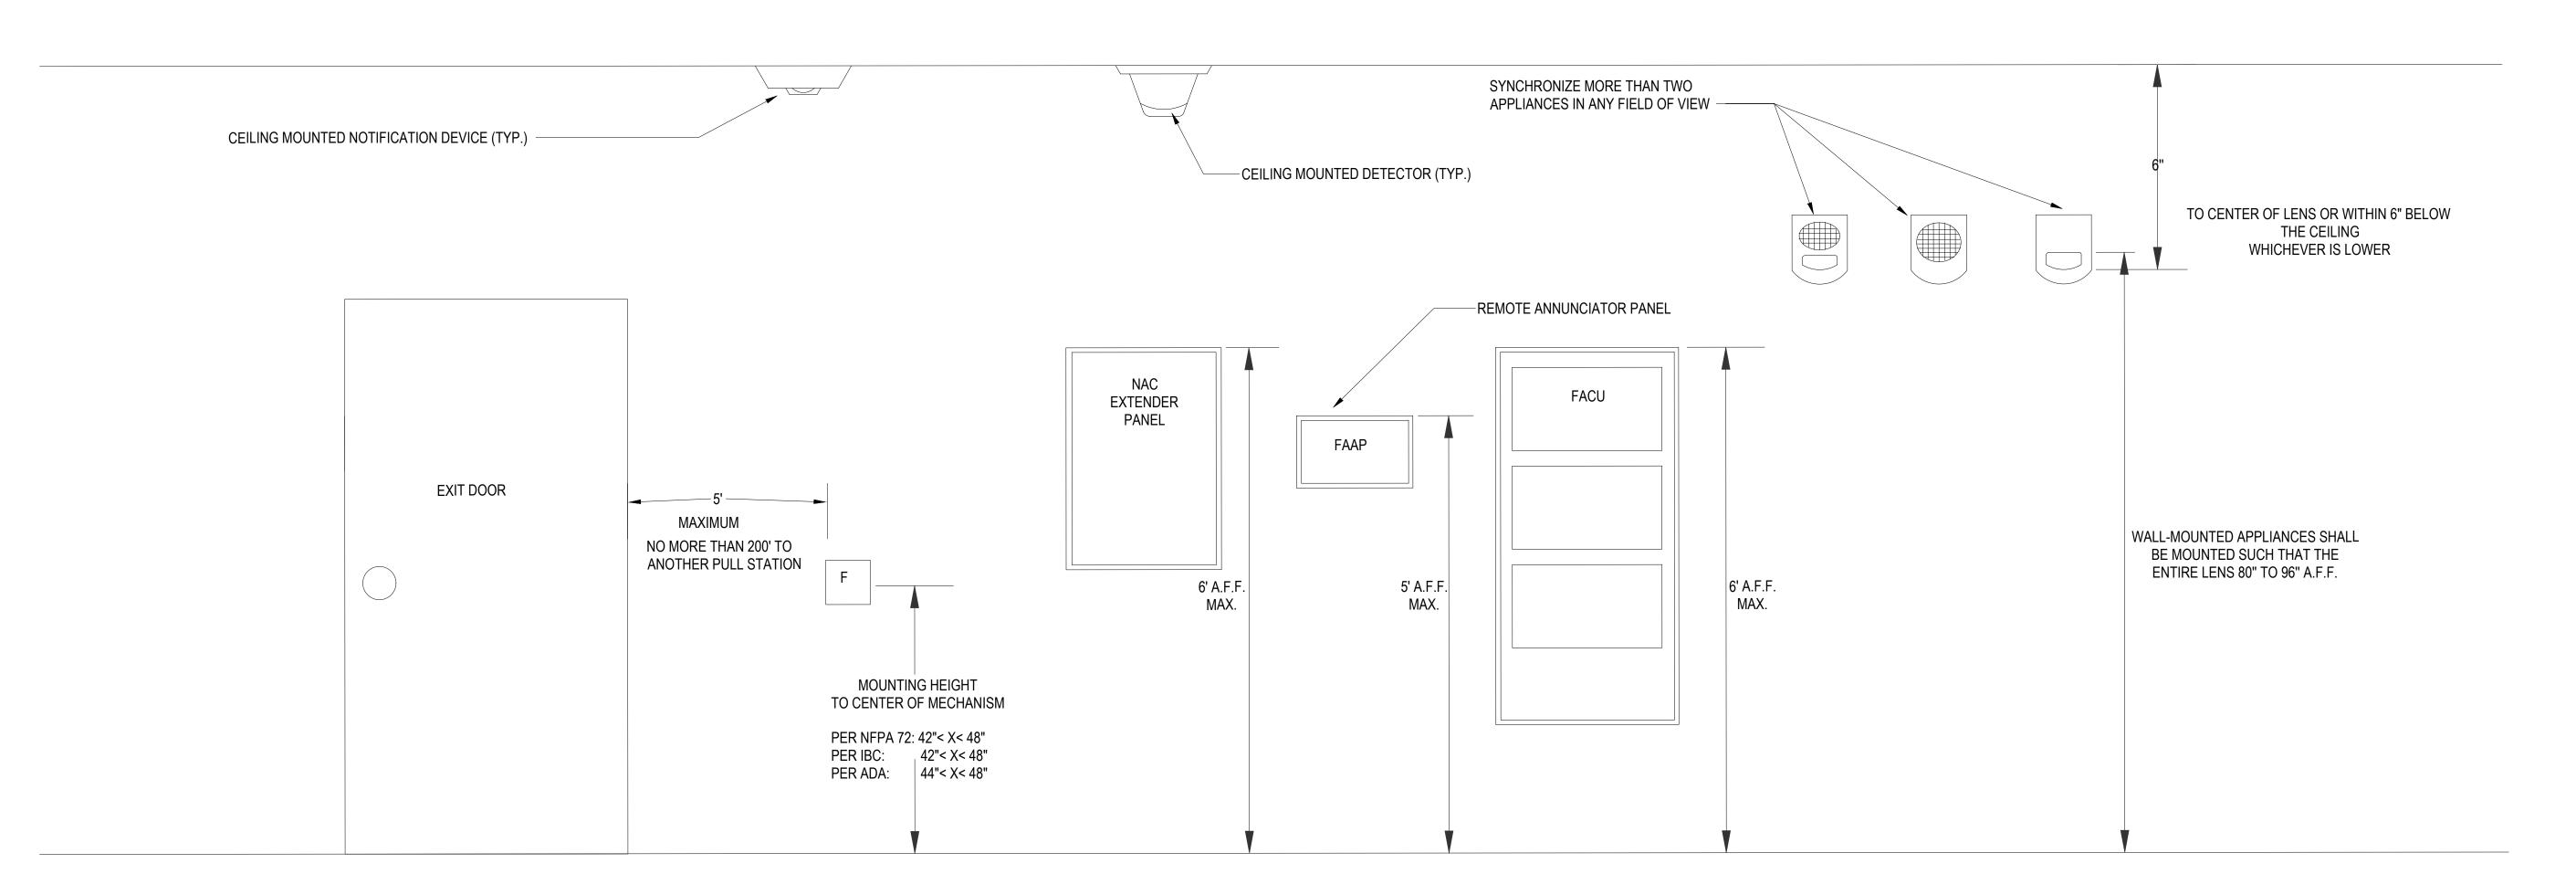
FIRE ALARM FIBER LOOP AND SCHEMATIC RISER

SHEET NUMBER:

FA-003

NOTES:

- 1. DO NOT INSTALL ANY EQUIPMENT OUTSIDE UNLESS IT IS LISTED FOR OUTDOOR USE.
- 2. FOR LOW CEILINGS WHERE THE MOUNTING HEIGHTS CAN NOT BE MET MOUNT THE INDICATED APPLIANCE (EX. HORN STROBES) 6" FROM THE CEILING.
- 3. ALL DEVICES AND APPLIANCE HEIGHTS SHOULD BE CONSISTENT FOR THE ENTIRE PROJECT.
- 4. THE FIRE PANEL SHALL HAVE A MINIMUM OF 3 FT CLEARANCE FROM THE FRONT OF THE CONTROL EQUIPMENT AND BE LOCATED IN A CLIMATE CONTROLLED AREA.
- 5. VERIFY ALL DIMENSIONS PROVIDED PER THE APPLICABLE STANDARDS AND SPECIFICATIONS FOR THE PROJECT.
 INSTALLATION MUST COMPLY WITH LOCAL REQUIREMENTS GOVERNING MINIMUM STANDARDS FOR THIS SYSTEM.



1 TYPICAL EQUIPMENT MOUNTING GUIDELINES
SCALE: NTS

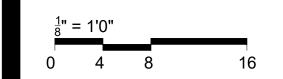
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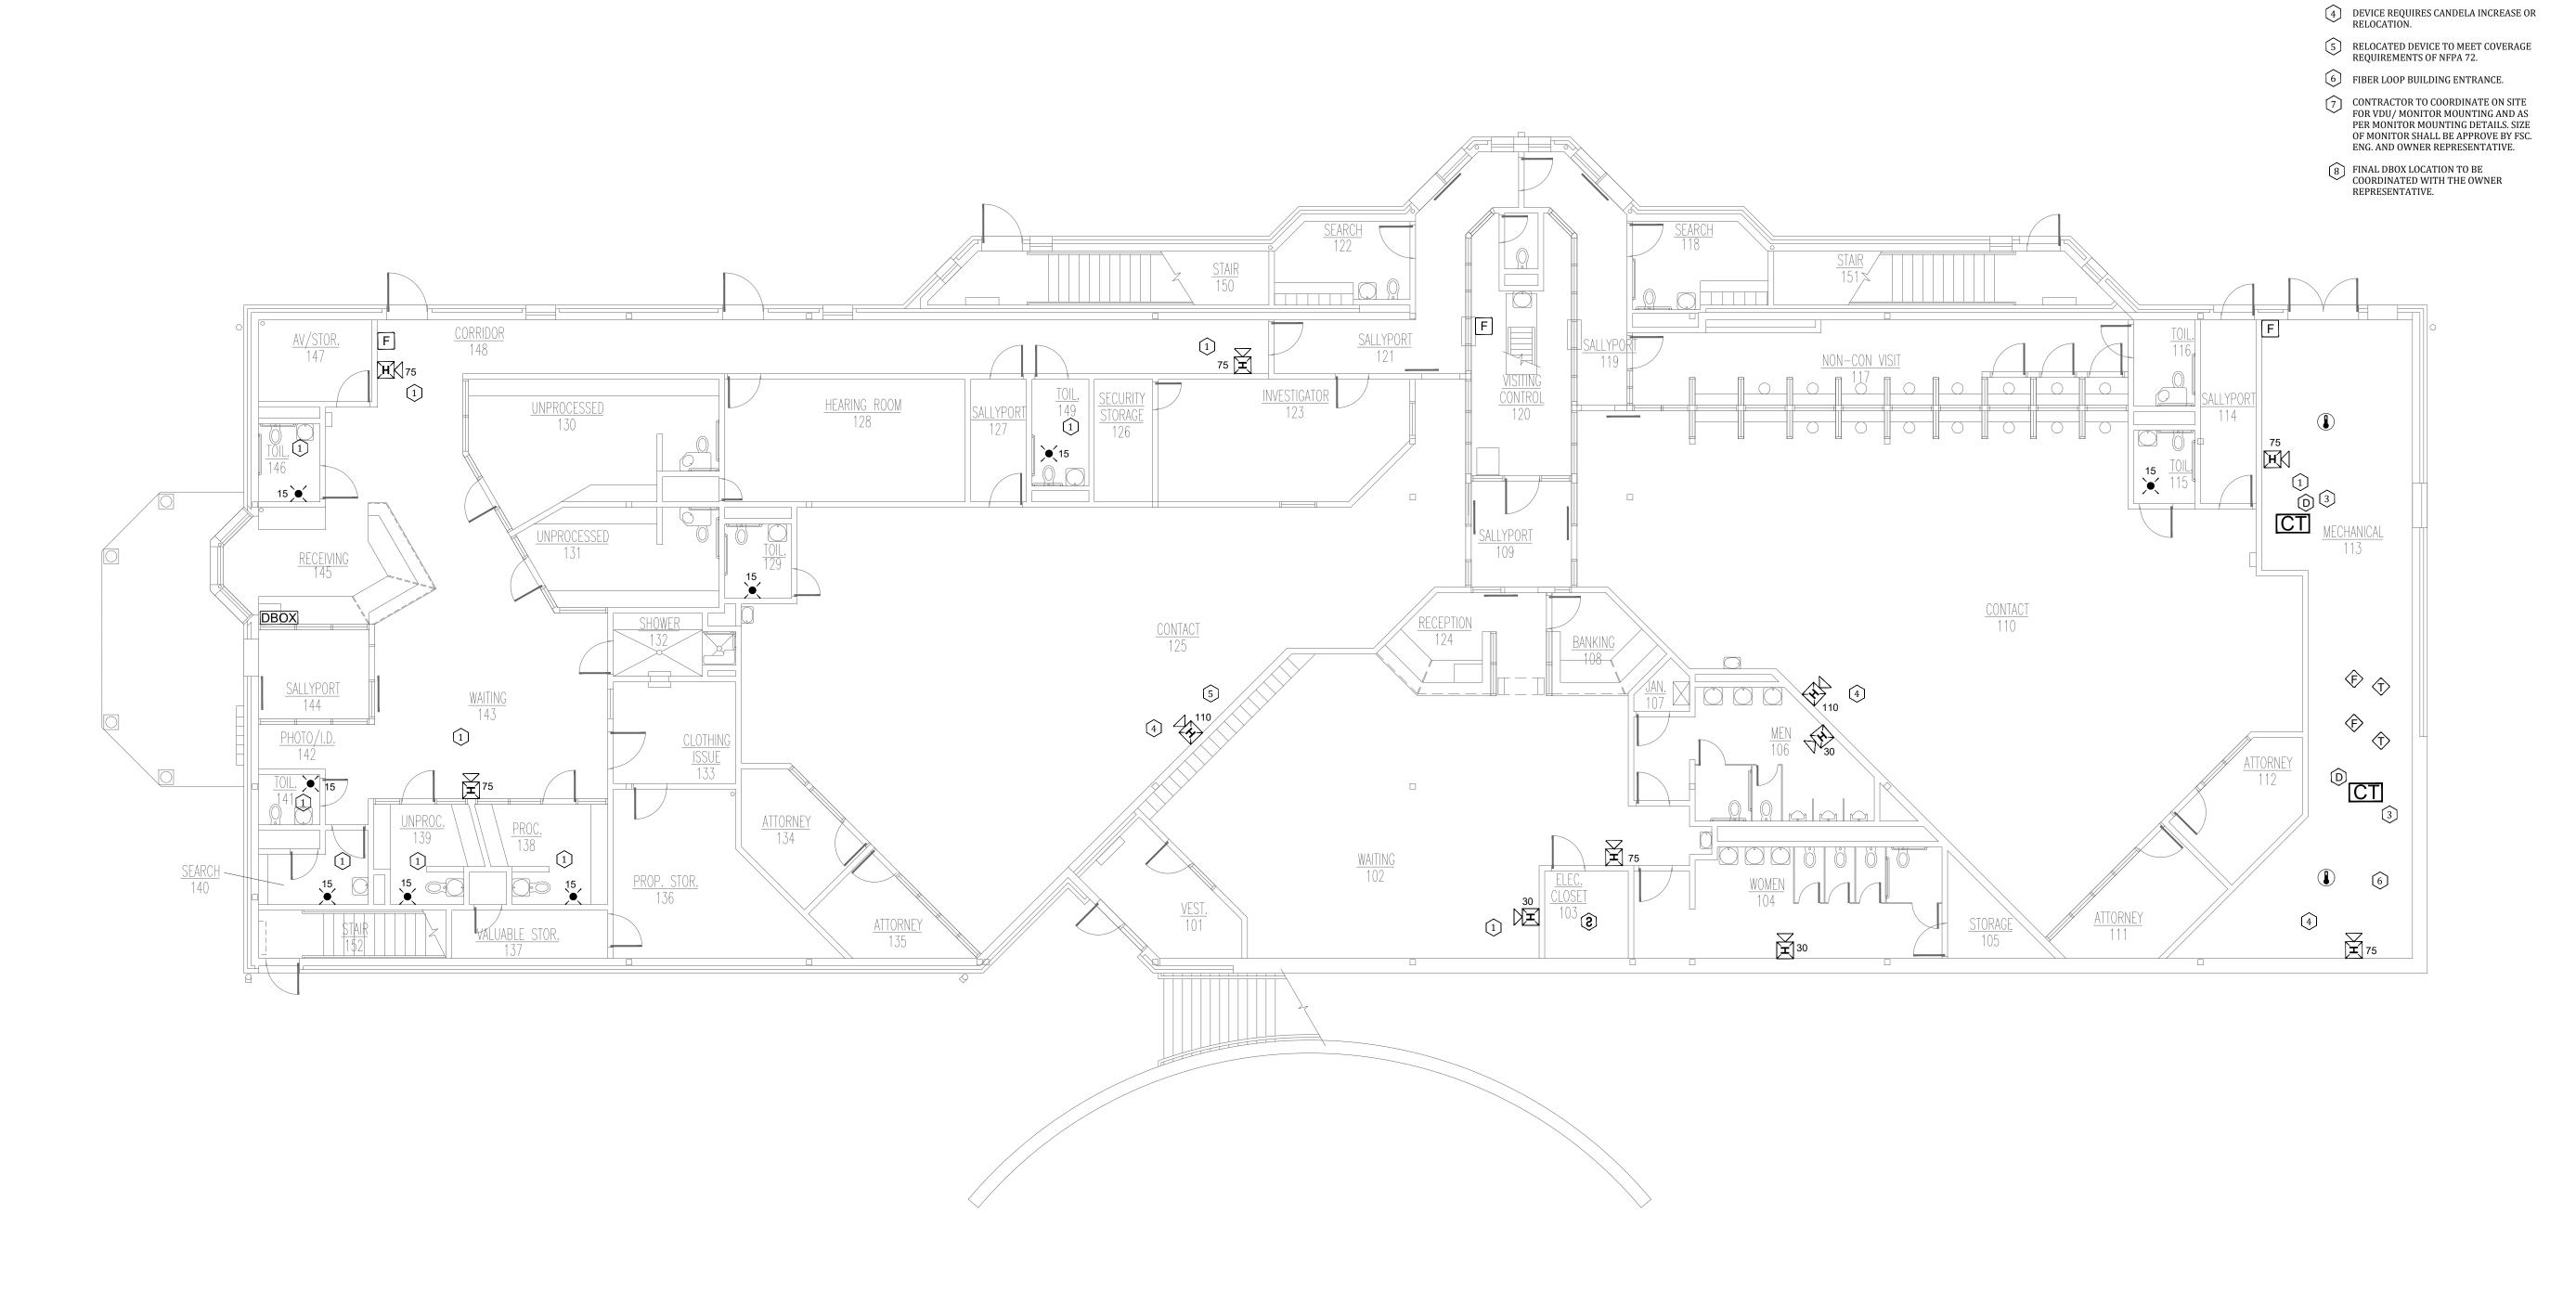
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DRAWN BY: FSC
CHECKED BY: HDD
DESIGNED BY: FSC

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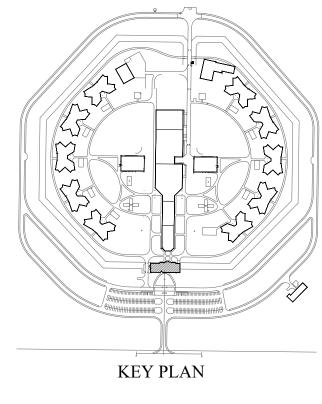
TYPICAL EQUIPMENT MOUNTING GUIDELINES

SHEET NUMBER:

FA-004



1 ADMINISTRATION BUILDING - FIRST FLOOR FIRE ALARM PLAN
SCALE: 1/8" = 1'-0"



ADMIN BUILDING PLAN NOTES:

BACK TO ADMIN FACU.

ADDED NOTIFICATION APPLIANCE TO MEET THE REQUIREMENTS OF NFPA 72.

FIRE ALARM CONTROL UNIT. TIE INTO CAMPUS FIBER NETWORK TO REPORT

ADDED CONTROL RELAY MODULE FOR HVAC SHUTDOWN.

STATE OF MISSOURI MICHAEL L. PARSON, GOVERNOR

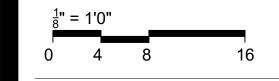


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NOTES: FOR FIRE ALARM GENERAL NOTES, REFER TO DWG# FA-002



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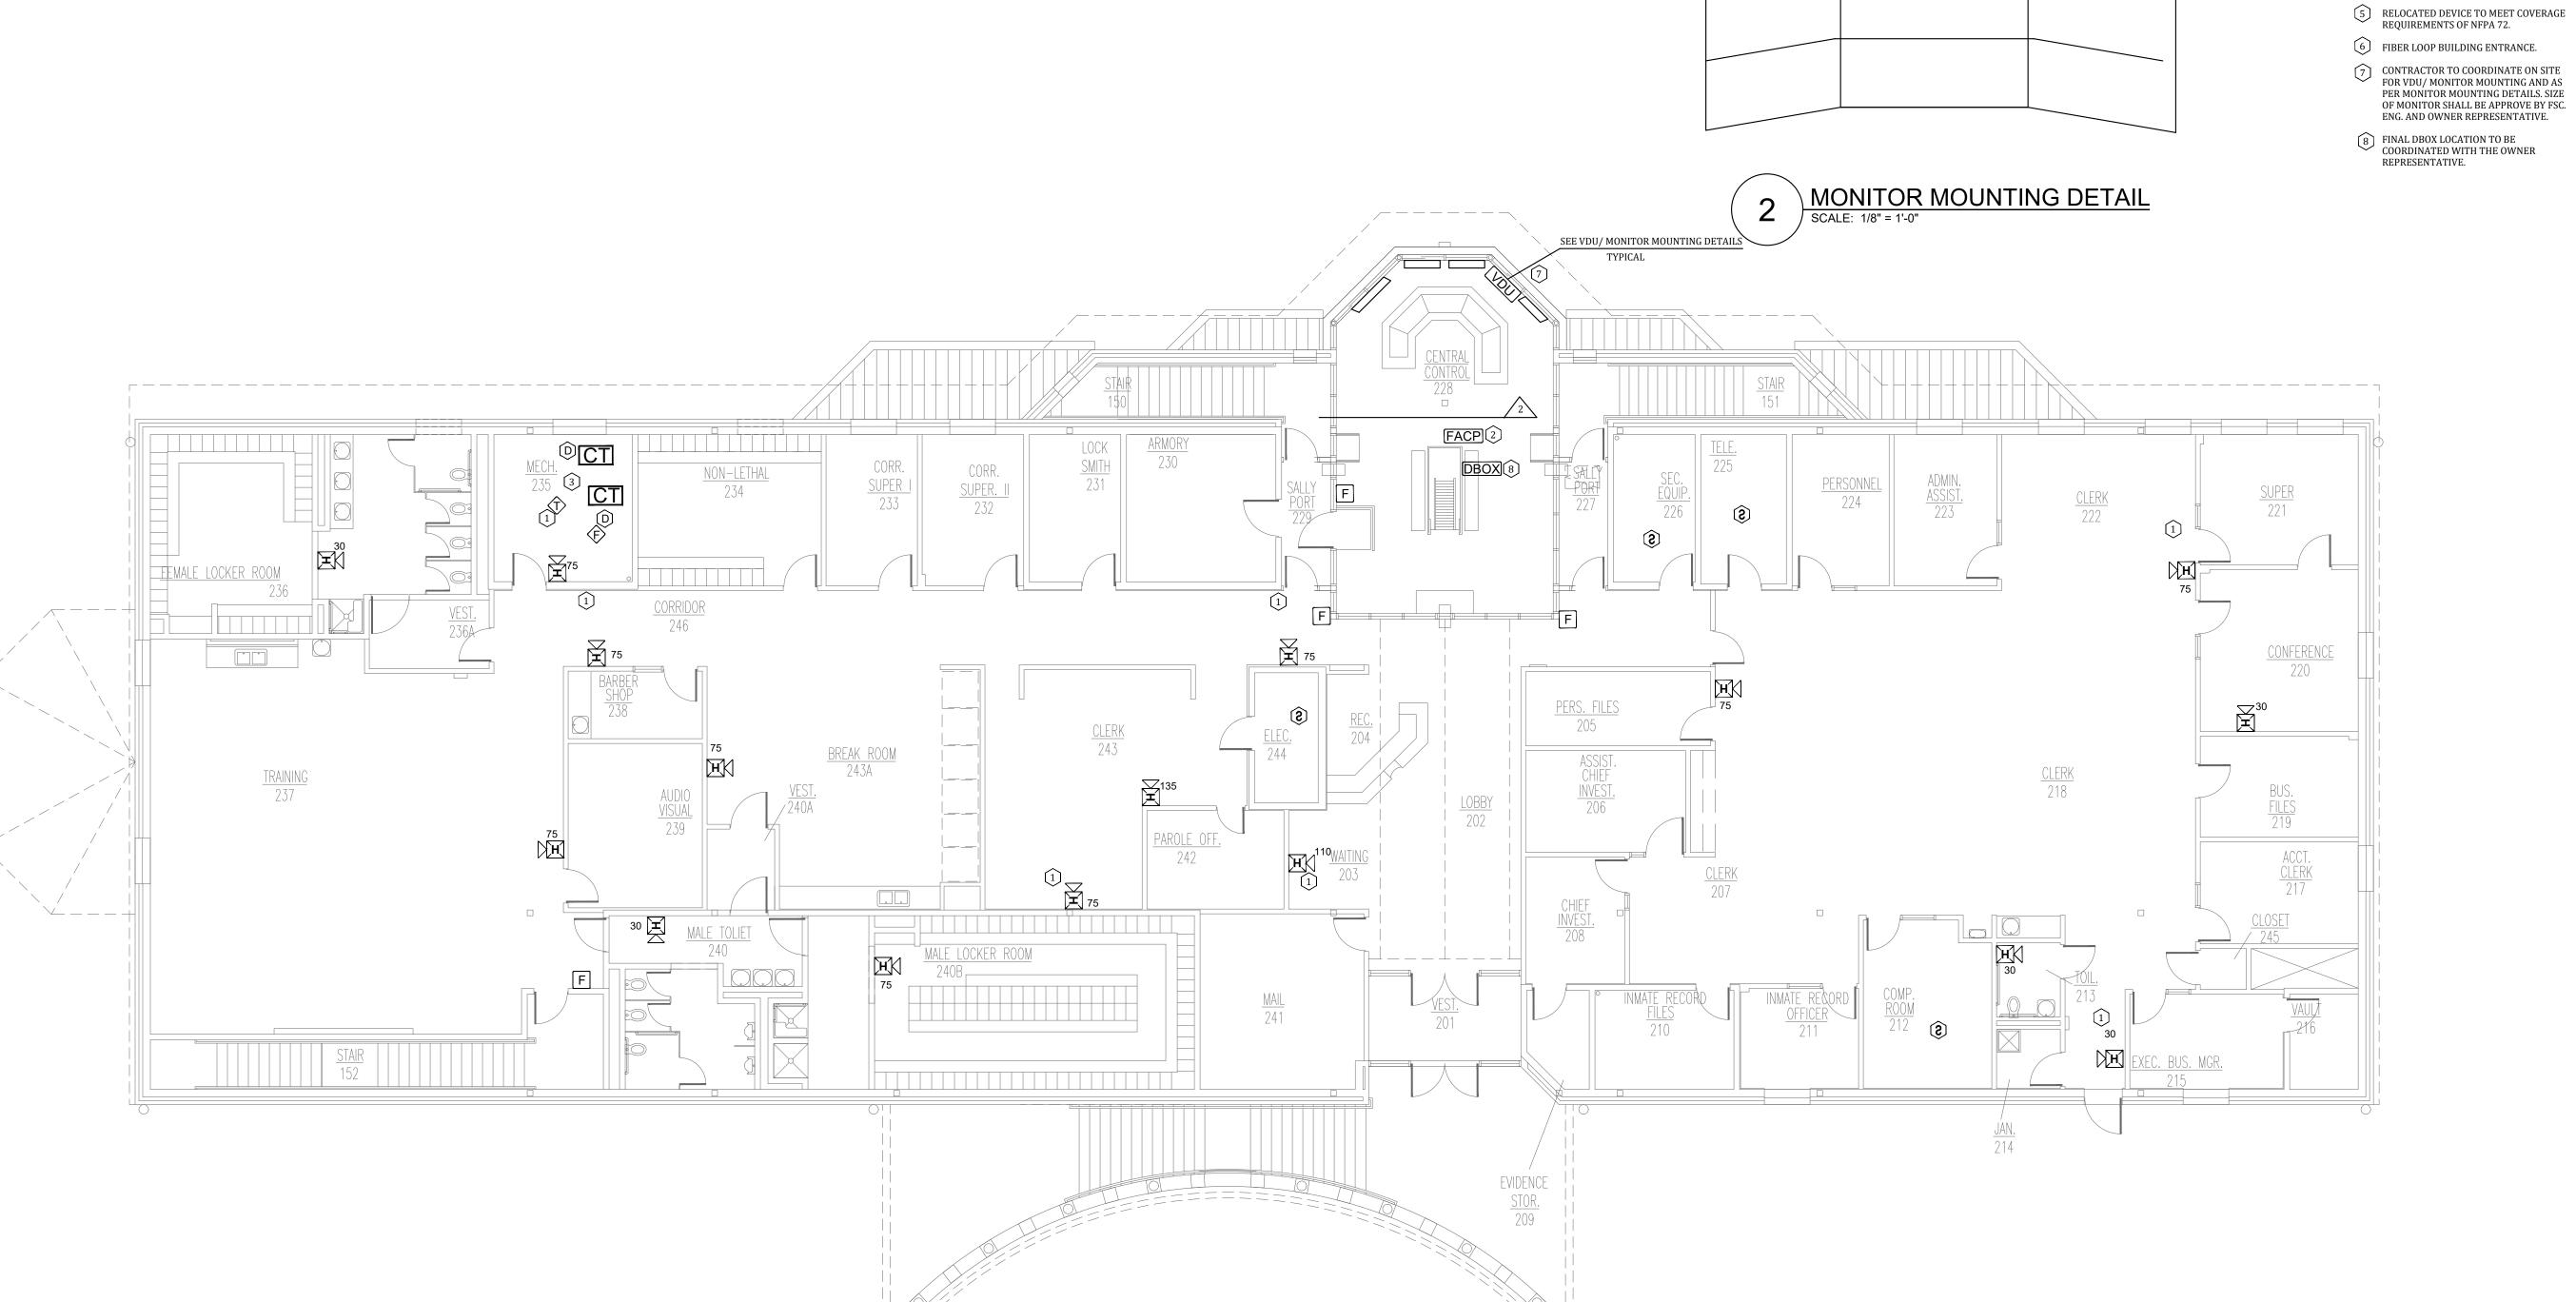
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DRAWN BY: FSC
CHECKED BY: HDD
DESIGNED BY: FSC

SHEET TITLE:

ADMINISTRATION
BUILDING - FIRST
FLOOR FIRE ALARM
PLAN

SHEET NUMBER: FA-100



ADMIN BUILDING PLAN NOTES:

EXISTING | EXISTING

CENTRAL CONTROL 228

| MONITOR || MONITOR | |

MONITOR |

EXISTING

MONITOR

- ADDED NOTIFICATION APPLIANCE TO MEET THE REQUIREMENTS OF NFPA 72.
- FIRE ALARM CONTROL UNIT. TIE INTO CAMPUS FIBER NETWORK TO REPORT BACK TO ADMIN FACU.
- ADDED CONTROL RELAY MODULE FOR HVAC SHUTDOWN.
- 4 DEVICE REQUIRES CANDELA INCREASE OR
- RELOCATION.
- 6 FIBER LOOP BUILDING ENTRANCE.
- (7) CONTRACTOR TO COORDINATE ON SITE FOR VDU/ MONITOR MOUNTING AND AS PER MONITOR MOUNTING DETAILS. SIZE OF MONITOR SHALL BE APPROVE BY FSC. ENG. AND OWNER REPRESENTATIVE.
- 8 FINAL DBOX LOCATION TO BE COORDINATED WITH THE OWNER

ENGINEERS, LLC 8675 W 96TH STREET OVERLAND PARK, KS. 66212

PROFESSIONAL SEAL

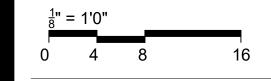
STATE OF MISSOURI MICHAEL L. PARSON, **GOVERNOR**

ABSHIER

NUMBER PE-2020010419

PHONE: 816.33.4373 FAX: 913.722.3484

FOR FIRE ALARM GENERAL NOTES, **REFER TO DWG# FA-002**



OFFICE OF ADMINISTRATION DIVISION OF FACILITIES MANAGEMENT, **DESIGN AND** CONSTRUCTION

Replace Fire Alarm System, Infrastructure

Northeast Correctional center 13698 Airport Rd, Bowling Green, MO 63334

PROJECT # C2314-01 7017 FACILITY # 9327017049

REVISION: DATE:_ REVISION:_

DATE: REVISION: DATE:

ISSUE DATE: 04/24/2024

CAD DWG FILE: DRAWN BY: CHECKED BY: DESIGNED BY:

SHEET TITLE:

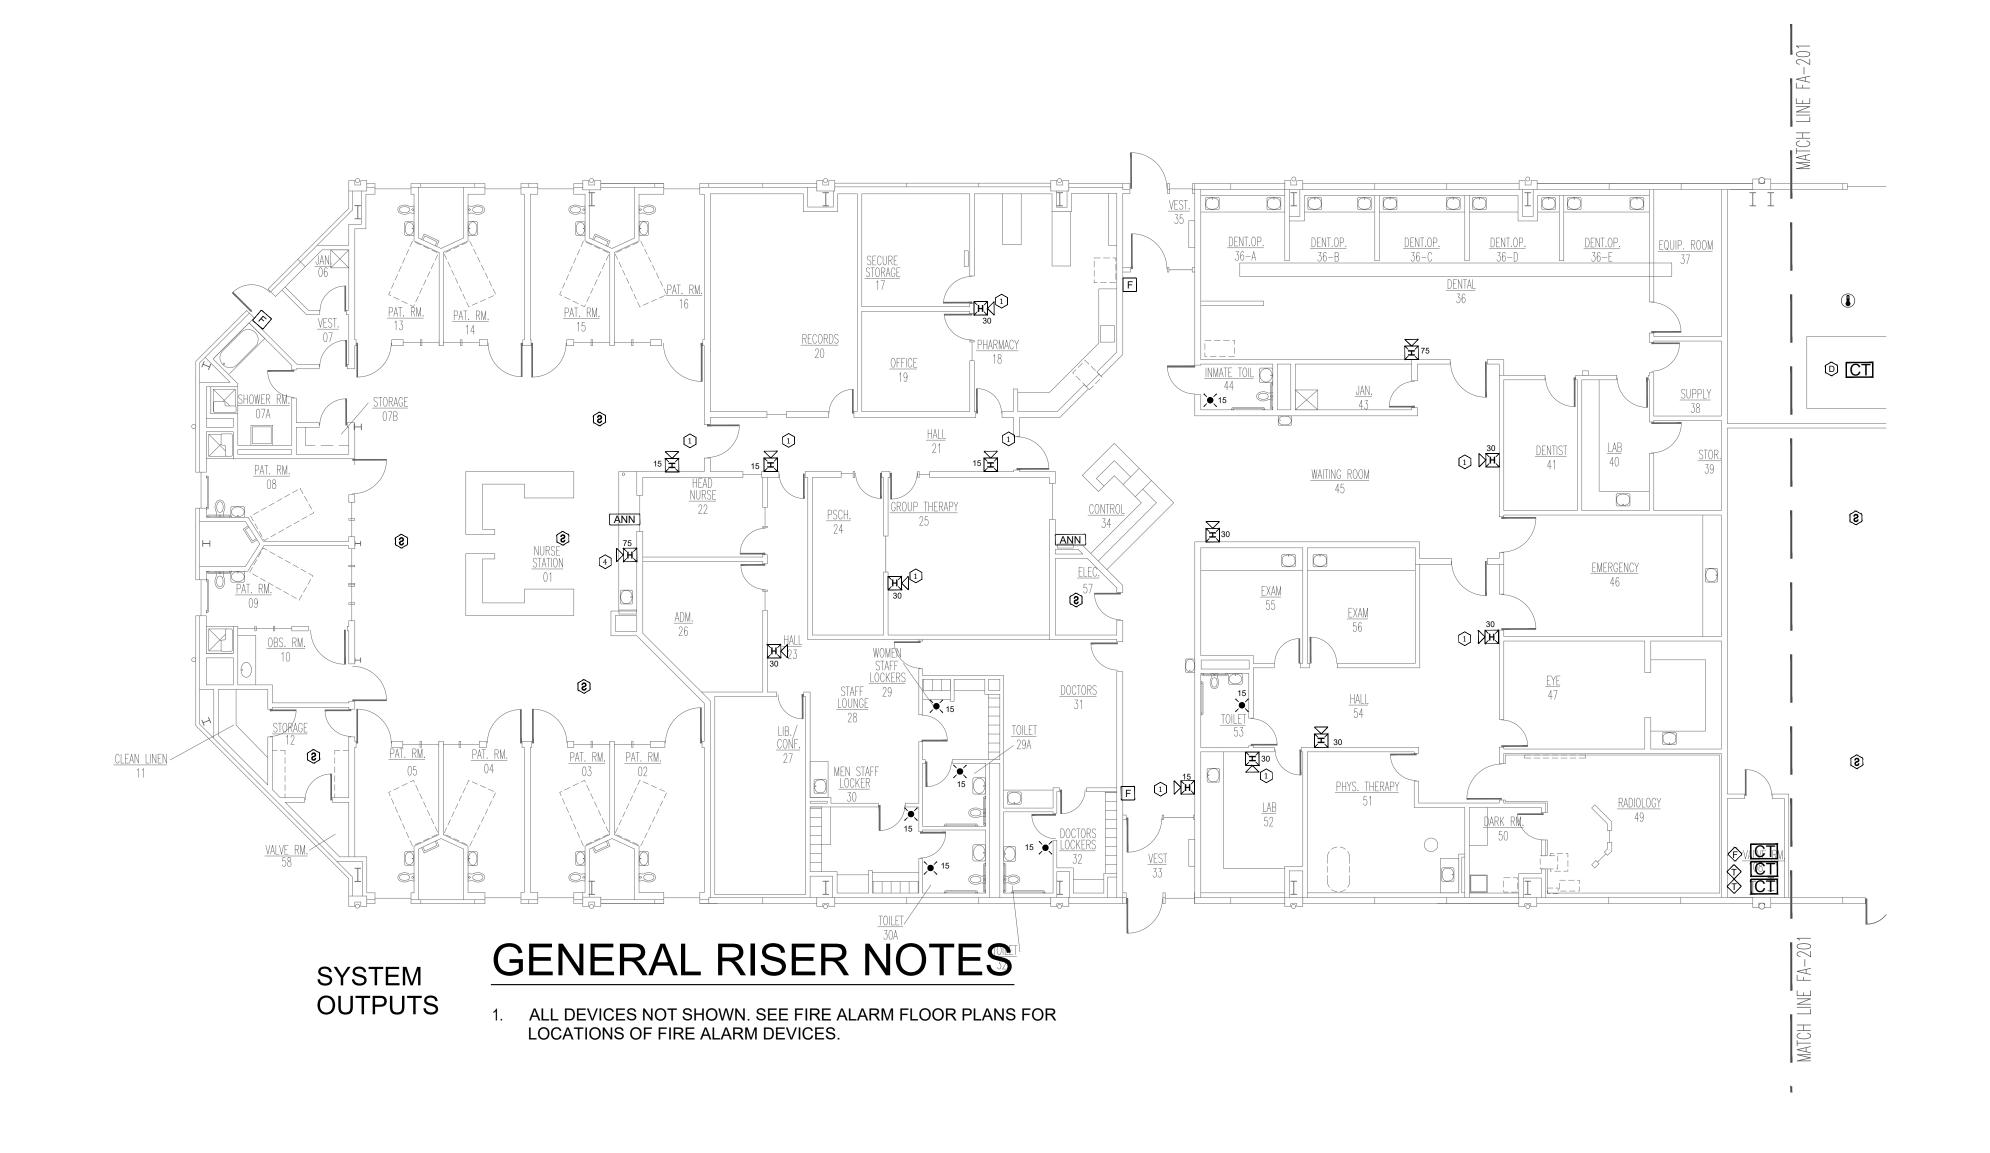
ADMINISTRATION BUILDING -SECOND FLOOR FIRE ALARM PLAN

SHEET NUMBER: FA-101

7 OF 31 SHEETS 04/24/2024

KEY PLAN

ADMINISTRATION BUILDING -SECOND FLOOR FIRE ALARM PLAN
SCALE: 1/8" = 1'-0"



SERVICES BUILDING - HEALTH - FIRE ALARM PLAN

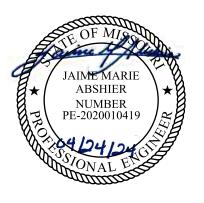
SCALE: 3/32" = 1'-0"

SERVICES BUILDING PLAN NOTES:

- DEVICE REQUIRES RELOCATION AND / OR CANDELA (CD) INCREASE TO MEET COVERAGE REQUIREMENTS OF NFPA 72. LOCATE DEVICE AS SHOWN AND ADJUST CANDELA AS NECESSARY.
- 6 PRE-ENGINEERED UL 300 KITCHEN
 HOOD SUPPRESSION SYSTEM, BASIS OF
 DESIGN CAPTIVEAIRE CORE FIRE
 PROTECTION SYSTEM KITCHEN HOOD SUPPRESSION SYSTEM SHALL BE MONITORED BY THE FIRE ALARM SYSTEM. REPRESENTATIVE FROM HOOD SUPPRESSION MANUFACTURER SHALL BE PRESENT AT SYSTEM TESTING AND PROVIDE TRAINING TO STATE OF MISSOURI STAFF.

- ADDED NOTIFICATION APPLIANCE TO MEET THE REQUIREMENTS OF NFPA 72.
- FIRE ALARM CONTROL UNIT. TIE INTO CAMPUS FIBER NETWORK TO REPORT BACK TO ADMIN FACU.
- 3 ADDED CONTROL RELAY MODULE FOR HVAC SHUTDOWN.
- CANDELA AS NECESSARY.
- 5 FIBER LOOP BUILDING ENTRANCE

STATE OF MISSOURI MICHAEL L. PARSON, **GOVERNOR**

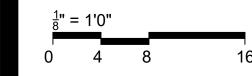


PROFESSIONAL SEAL



8675 W 96TH STREET OVERLAND PARK, KS. 66212 PHONE: 816.33.4373 FAX: 913.722.3484

FOR FIRE ALARM GENERAL NOTES,



REFER TO DWG# FA-002

OFFICE OF ADMINISTRATION DIVISION OF FACILITIES MANAGEMENT, **DESIGN AND** CONSTRUCTION

Replace Fire Alarm System, Infrastructure

Northeast Correctional center 13698 Airport Rd, Bowling Green, MO 63334

PROJECT # C2314-01 7017 FACILITY # 9327017049

REVISION: DATE:_ REVISION:_ DATE: REVISION: DATE:

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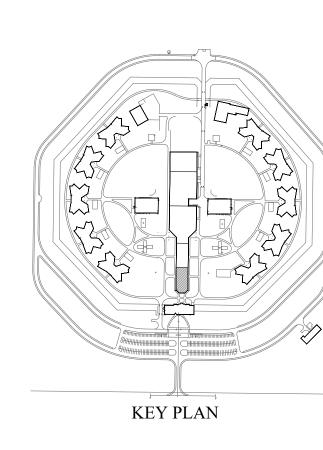
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SERVICES BUILDING - HEALTH - FIRE **ALARM PLAN**

SHEET NUMBER:

FA-200





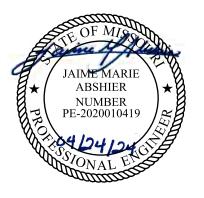
SERVICES BUILDING - EDUCATIONAL - FIRE ALARM PLAN
SCALE: 3/32" = 1'-0"

SERVICES BUILDING PLAN NOTES:

- ADDED NOTIFICATION APPLIANCE TO MEET THE REQUIREMENTS OF NFPA 72.
- 3 ADDED CONTROL RELAY MODULE FOR HVAC SHUTDOWN.
- DEVICE REQUIRES RELOCATION AND / OR CANDELA (CD) INCREASE TO MEET COVERAGE REQUIREMENTS OF NFPA 72. LOCATE DEVICE AS SHOWN AND ADJUST CANDELA AS INCRESSABLY.
- 5 FIBER LOOP BUILDING ENTRANCE
- PRE-ENGINEERED UL 300 KITCHEN
 HOOD SUPPRESSION SYSTEM, BASIS OF
 DESIGN CAPTIVEAIRE CORE FIRE
 PROTECTION SYSTEM KITCHEN HOOD SUPPRESSION SYSTEM SHALL BE MONITORED BY THE FIRE ALARM SYSTEM. REPRESENTATIVE FROM HOOD SUPPRESSION MANUFACTURER SHALL
 BE PRESENT AT SYSTEM TESTING AND
 PROVIDE TRAINING TO STATE OF
 MISSOURI STAFF.

- FIRE ALARM CONTROL UNIT. TIE INTO CAMPUS FIBER NETWORK TO REPORT BACK TO ADMIN FACU.
- CANDELA AS NECESSARY.

STATE OF MISSOURI MICHAEL L. PARSON, **GOVERNOR**

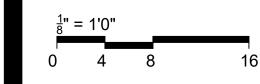


PROFESSIONAL SEAL



8675 W 96TH STREET OVERLAND PARK, KS. 66212 PHONE: 816.33.4373 FAX: 913.722.3484

FOR FIRE ALARM GENERAL NOTES, REFER TO DWG# FA-002



OFFICE OF ADMINISTRATION DIVISION OF FACILITIES MANAGEMENT, **DESIGN AND** CONSTRUCTION

Replace Fire Alarm System, Infrastructure

Northeast Correctional center 13698 Airport Rd, Bowling Green, MO 63334

PROJECT # C2314-01 7017 FACILITY # 9327017049

REVISION: DATE:_ REVISION:_ DATE: REVISION:

DATE: ISSUE DATE: 04/24/2024

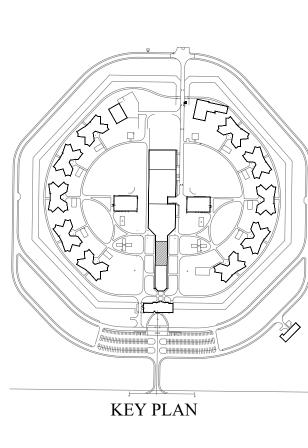
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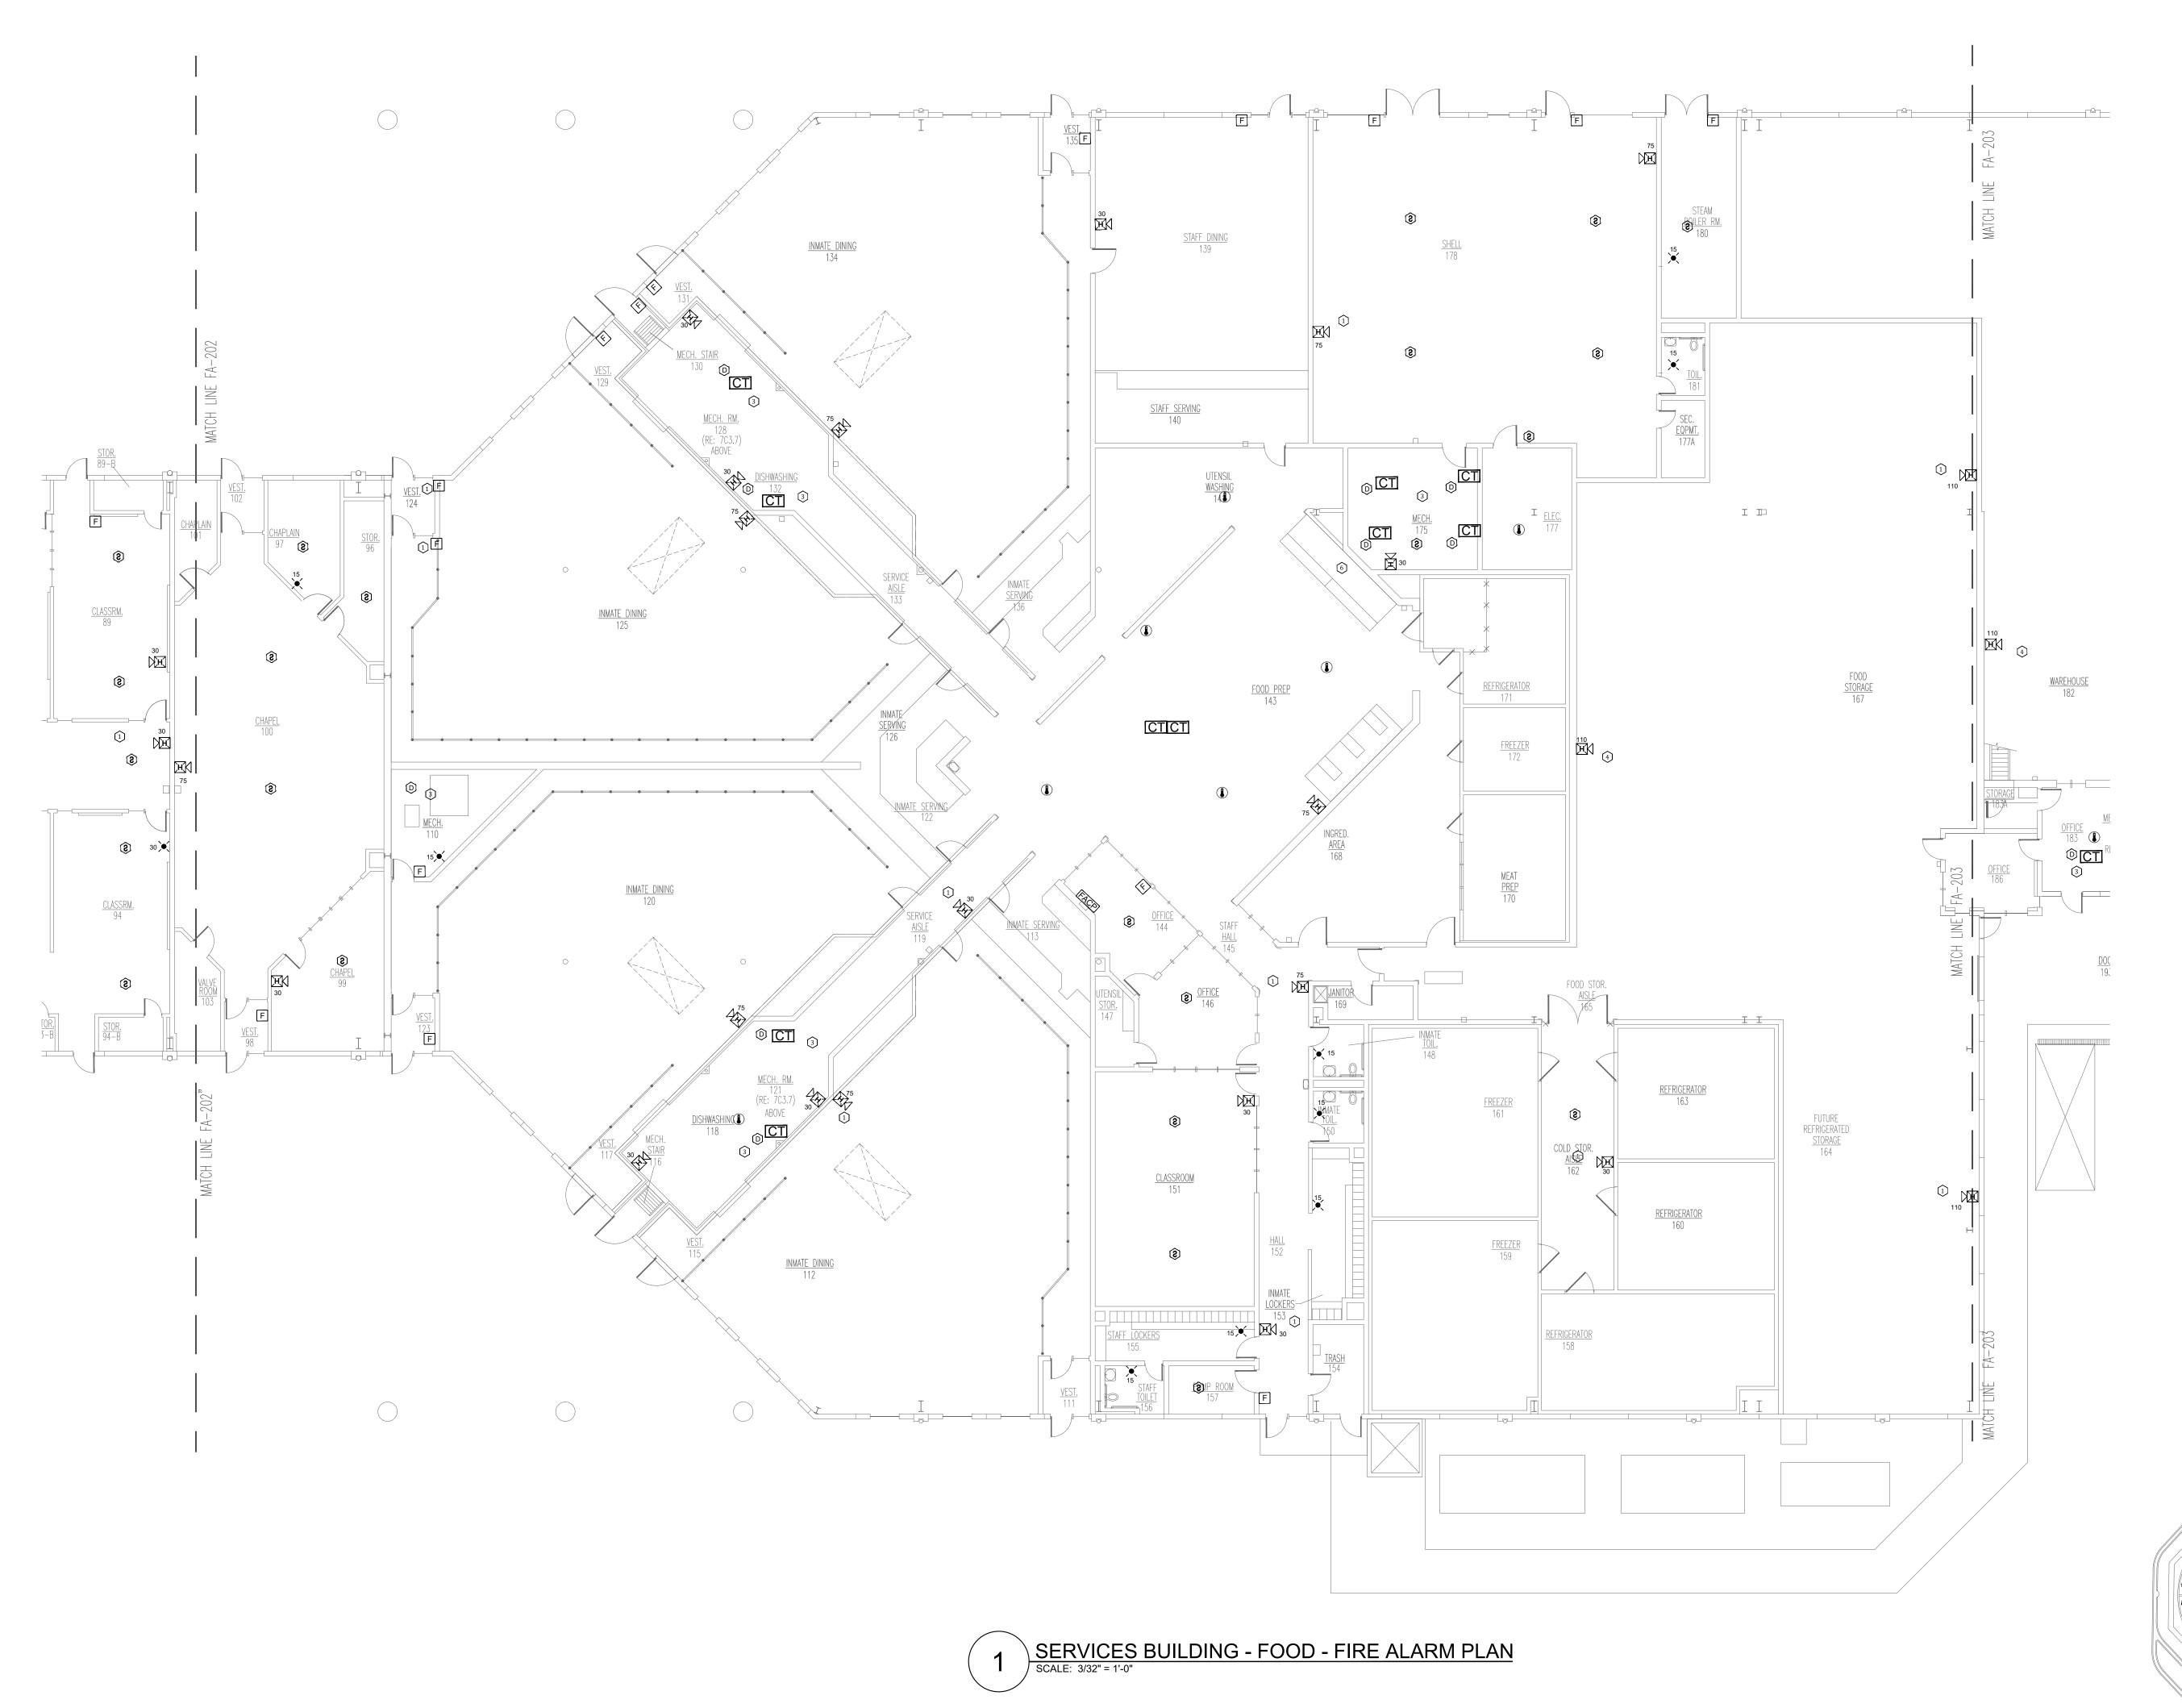
SHEET TITLE:

SERVICES BUILDING - EDUCATIONAL -FIRE ALARM PLAN

SHEET NUMBER:

FA-201





- ADDED NOTIFICATION APPLIANCE TO MEET THE REQUIREMENTS OF NFPA 72.
- 2 FIRE ALARM CONTROL UNIT. TIE INTO CAMPUS FIBER NETWORK TO REPORT BACK TO ADMIN FACU.
- 3 ADDED CONTROL RELAY MODULE FOR HVAC SHUTDOWN.
- SUPPRESSION SYSTEM SHALL BE MONITORED BY THE FIRE ALARM SYSTEM. REPRESENTATIVE FROM HOOD SUPPRESSION MANUFACTURER SHALL
 BE PRESENT AT SYSTEM TESTING AND
 PROVIDE TRAINING TO STATE OF
 MISSOURI STAFF.

SERVICES BUILDING PLAN NOTES:

- DEVICE REQUIRES RELOCATION AND / OR CANDELA (CD) INCREASE TO MEET COVERAGE REQUIREMENTS OF NFPA 72. LOCATE DEVICE AS SHOWN AND ADJUST CANDELA AS NECESSARY. CANDELA AS NECESSARY.
- 5 FIBER LOOP BUILDING ENTRANCE
- PRE-ENGINEERED UL 300 KITCHEN
 HOOD SUPPRESSION SYSTEM, BASIS OF
 DESIGN CAPTIVEAIRE CORE FIRE
 PROTECTION SYSTEM. KITCHEN HOOD

STATE OF MISSOURI MICHAEL L. PARSON, **GOVERNOR**

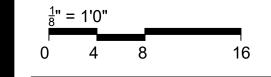


PROFESSIONAL SEAL



8675 W 96TH STREET OVERLAND PARK, KS. 66212 PHONE: 816.33.4373 FAX: 913.722.3484

FOR FIRE ALARM GENERAL NOTES, **REFER TO DWG# FA-002**



OFFICE OF ADMINISTRATION DIVISION OF FACILITIES MANAGEMENT, **DESIGN AND** CONSTRUCTION

Replace Fire Alarm System, Infrastructure

Northeast Correctional center 13698 Airport Rd, Bowling Green, MO 63334

PROJECT # C2314-01 7017 FACILITY # 9327017049

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CAD DWG FILE: DRAWN BY: CHECKED BY: DESIGNED BY:

SHEET TITLE:

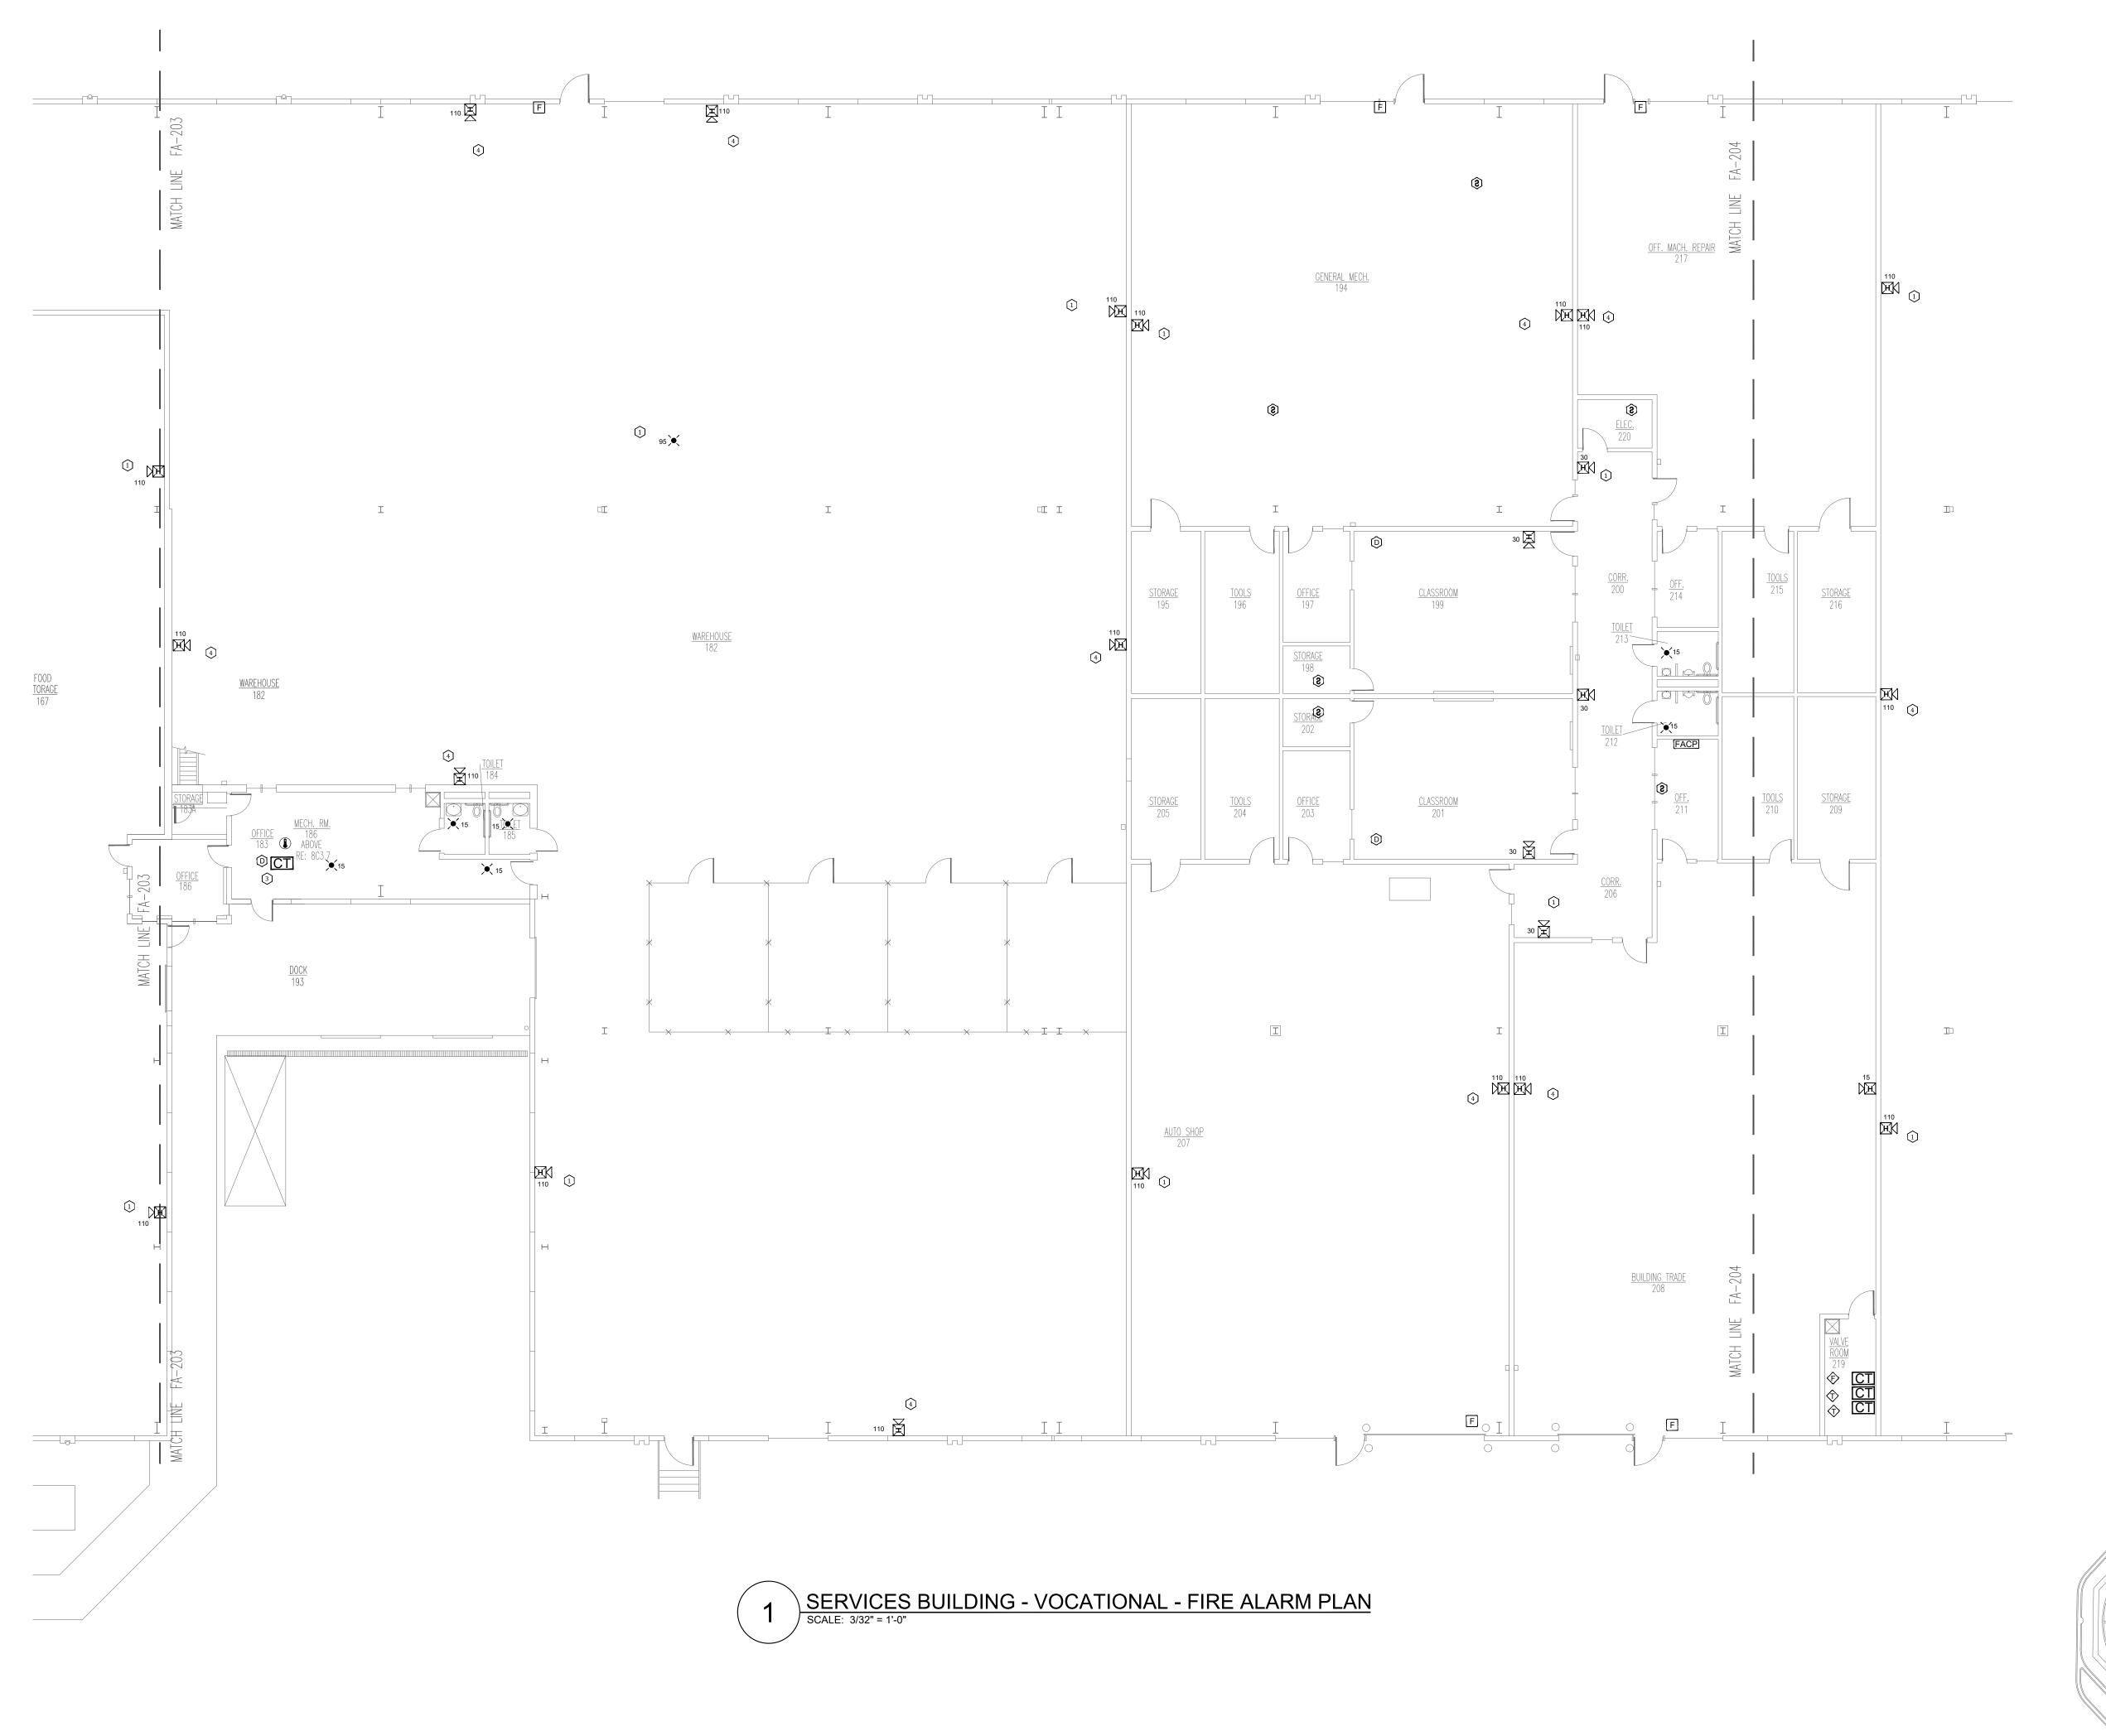
SERVICES BUILDING - FOOD - FIRE **ALARM PLAN**

SHEET NUMBER:

FA-202

10 OF 31 SHEETS 04/24/2024

KEY PLAN



SERVICES BUILDING PLAN NOTES:

- ADDED NOTIFICATION APPLIANCE TO MEET THE REQUIREMENTS OF NFPA 72.
- FIRE ALARM CONTROL UNIT. TIE INTO CAMPUS FIBER NETWORK TO REPORT BACK TO ADMIN FACU.
- 3 ADDED CONTROL RELAY MODULE FOR HVAC SHUTDOWN.
- DEVICE REQUIRES RELOCATION AND / OR CANDELA (CD) INCREASE TO MEET COVERAGE REQUIREMENTS OF NFPA 72. LOCATE DEVICE AS SHOWN AND ADJUST CANDELA AS NECESSARY.
- 5 FIBER LOOP BUILDING ENTRANCE
- PRE-ENGINEERED UL 300 KITCHEN
 HOOD SUPPRESSION SYSTEM, BASIS OF
 DESIGN CAPTIVEAIRE CORE FIRE
 PROTECTION SYSTEM. KITCHEN HOOD
 SUPPRESSION SYSTEM SHALL BE
 MONITORED BY THE FIRE ALARM
 SYSTEM. REPRESENTATIVE FROM HOOD
 SUPPRESSION MANUFACTURER SHALL
 BE PRESENT AT SYSTEM TESTING AND
 PROVIDE TRAINING TO STATE OF
 MISSOURI STAFF.

JAIME MARIE

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NUMBER

PE-2020010419

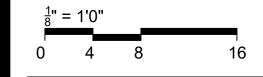
STATE OF MISSOURI MICHAEL L. PARSON, GOVERNOR

PROFESSIONAL SEAL



8675 W 96TH STREET OVERLAND PARK, KS. 66212 PHONE: 816.33.4373 FAX: 913.722.3484

NOTES: FOR FIRE ALARM GENERAL NOTES, REFER TO DWG# FA-002



OFFICE OF
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DESIGN AND
CONSTRUCTION

Replace Fire Alarm
System, Infrastructure

Northeast Correctional center 13698 Airport Rd, Bowling Green, MO 63334

PROJECT # C2314-01 SITE # 7017 FACILITY # 9327017049

REVISION:
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REVISION:
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REVISION:
DATE:

ISSUE DATE: 04/24/2024

CAD DWG FILE: FSC
DRAWN BY: FSC
CHECKED BY: HDD
DESIGNED BY: FSC

SHEET TITLE:

SERVICES BUILDING
- VOCATIONAL FIRE ALARM PLAN

SHEET NUMBER:

FA-203

KEY PLAN



SERVICES BUILDING PLAN NOTES:

- 3 ADDED CONTROL RELAY MODULE FOR HVAC SHUTDOWN.
- DEVICE REQUIRES RELOCATION AND / OR CANDELA (CD) INCREASE TO MEET COVERAGE REQUIREMENTS OF NFPA 72. LOCATE DEVICE AS SHOWN AND ADJUST CANDELA AS INCRESSABLY.
- 5 FIBER LOOP BUILDING ENTRANCE
- 6 PRE-ENGINEERED UL 300 KITCHEN
 HOOD SUPPRESSION SYSTEM, BASIS OF
 DESIGN CAPTIVEAIRE CORE FIRE
 PROTECTION SYSTEM KITCHEN HOOD SUPPRESSION SYSTEM SHALL BE MONITORED BY THE FIRE ALARM SYSTEM. REPRESENTATIVE FROM HOOD SUPPRESSION MANUFACTURER SHALL
 BE PRESENT AT SYSTEM TESTING AND
 PROVIDE TRAINING TO STATE OF
 MISSOURI STAFF.

- ADDED NOTIFICATION APPLIANCE TO MEET THE REQUIREMENTS OF NFPA 72.
- FIRE ALARM CONTROL UNIT. TIE INTO CAMPUS FIBER NETWORK TO REPORT BACK TO ADMIN FACU.
- CANDELA AS NECESSARY.

STATE OF MISSOURI MICHAEL L. PARSON, **GOVERNOR**

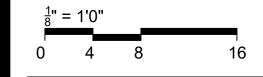


PROFESSIONAL SEAL



8675 W 96TH STREET OVERLAND PARK, KS. 66212 PHONE: 816.33.4373 FAX: 913.722.3484

FOR FIRE ALARM GENERAL NOTES, REFER TO DWG# FA-002



OFFICE OF ADMINISTRATION DIVISION OF FACILITIES MANAGEMENT, **DESIGN AND** CONSTRUCTION

Replace Fire Alarm System, Infrastructure

Northeast Correctional center 13698 Airport Rd, Bowling Green, MO 63334

PROJECT # C2314-01 7017 FACILITY # 9327017049

REVISION:	
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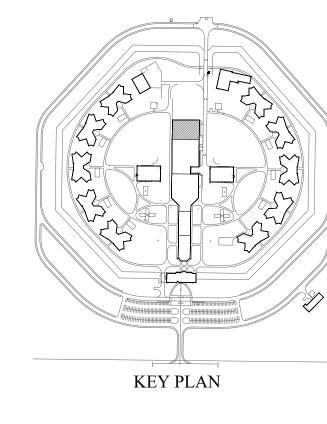
ISSUE DATE: 04/24/2024

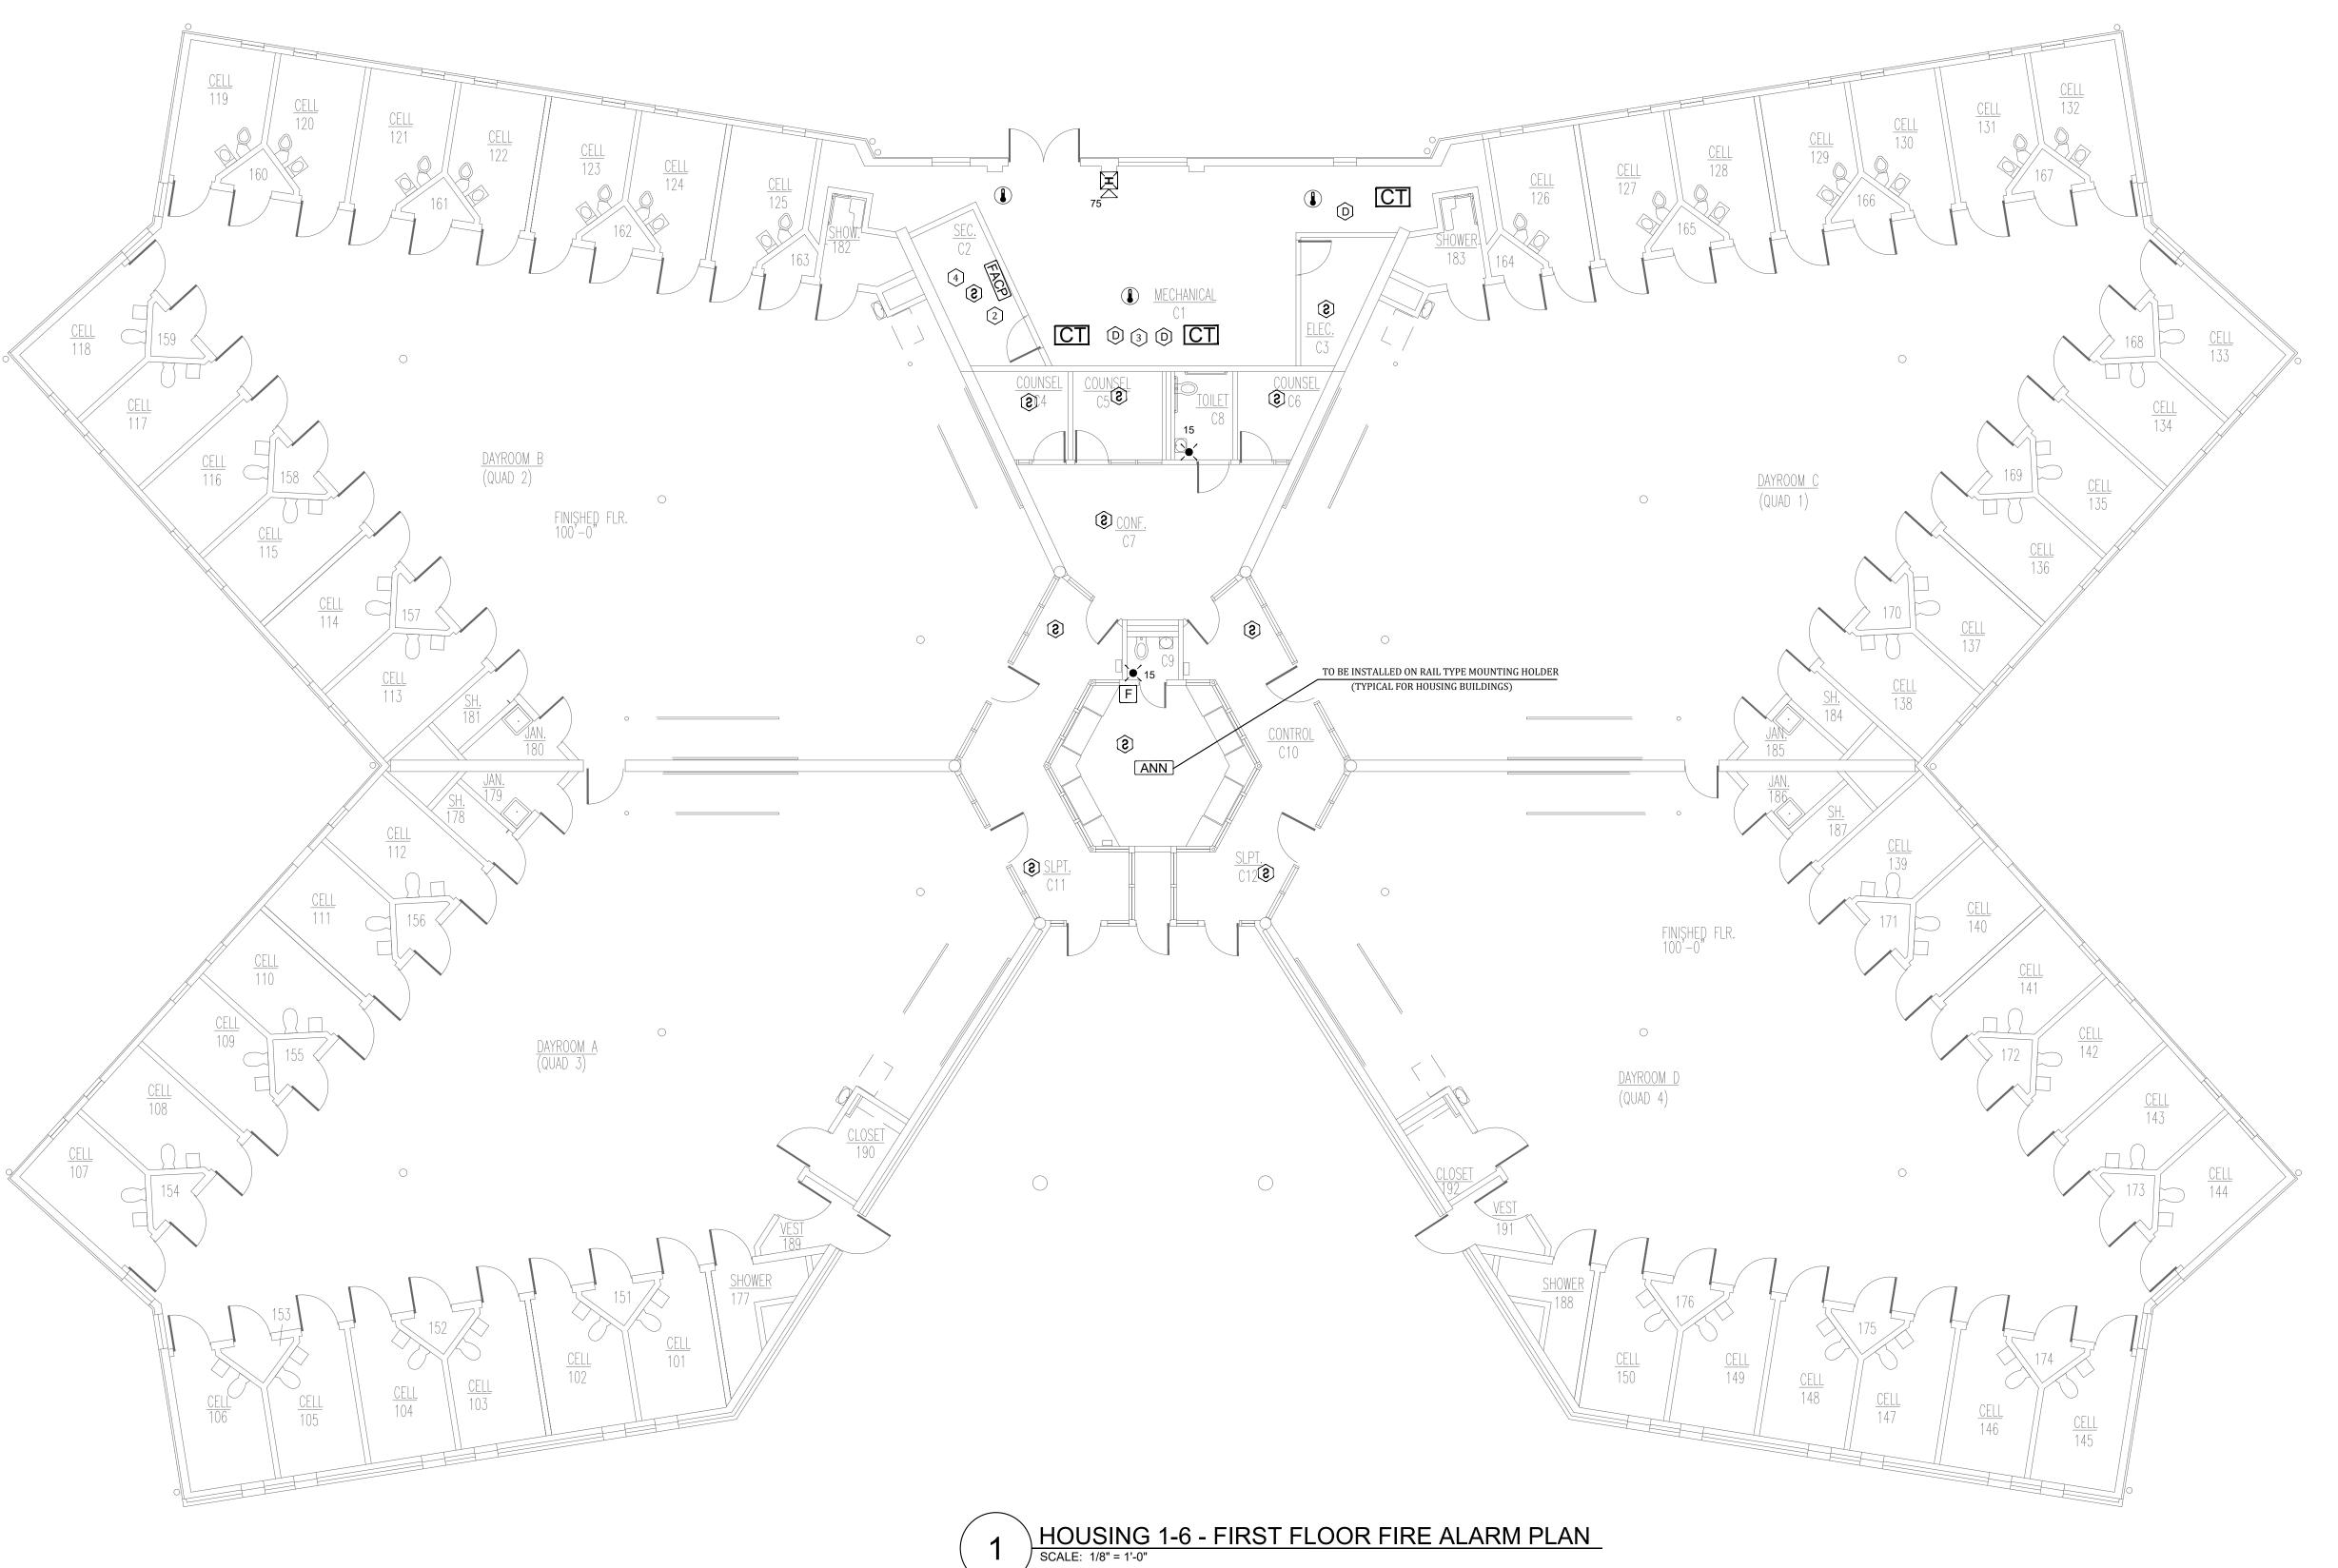
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DRAWN BY:	FSC
CHECKED BY:	HDD
DESIGNED BY:	FSC

SERVICES BUILDING - INDUSTRIAL -FIRE ALARM PLAN

SHEET NUMBER:

FA-204





HOUSING BUILDING PLAN NOTES:

- ADDED NOTIFICATION APPLIANCE TO MEET THE REQUIREMENTS OF NFPA 72.
- FIRE ALARM CONTROL UNIT. TIE INTO CAMPUS FIBER NETWORK TO REPORT BACK TO ADMIN FACU.
- 3 ADDED CONTROL RELAY MODULE FOR HVAC SHUTDOWN.
- 4 FIBER LOOP BUILDING ENTRANCE.



STATE OF MISSOURI MICHAEL L. PARSON,

GOVERNOR

PROFESSIONAL SEAL



8675 W 96TH STREET OVERLAND PARK, KS. 66212 PHONE: 816.33.4373 FAX: 913.722.3484

FOR FIRE ALARM GENERAL NOTES, REFER TO DWG# FA-002

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OFFICE OF **ADMINISTRATION** DIVISION OF FACILITIES MANAGEMENT, **DESIGN AND** CONSTRUCTION

Replace Fire Alarm System, Infrastructure

Northeast Correctional center 13698 Airport Rd, Bowling Green, MO 63334

PROJECT # C2314-01 7017 FACILITY # 9327017049

REVISION:_ DATE:_ REVISION:_ DATE:_ REVISION:_ DATE:_

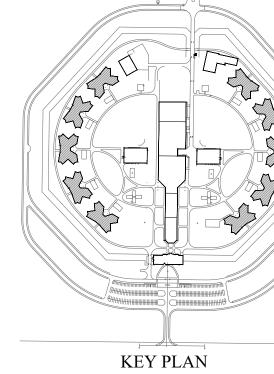
ISSUE DATE: 04/24/2024

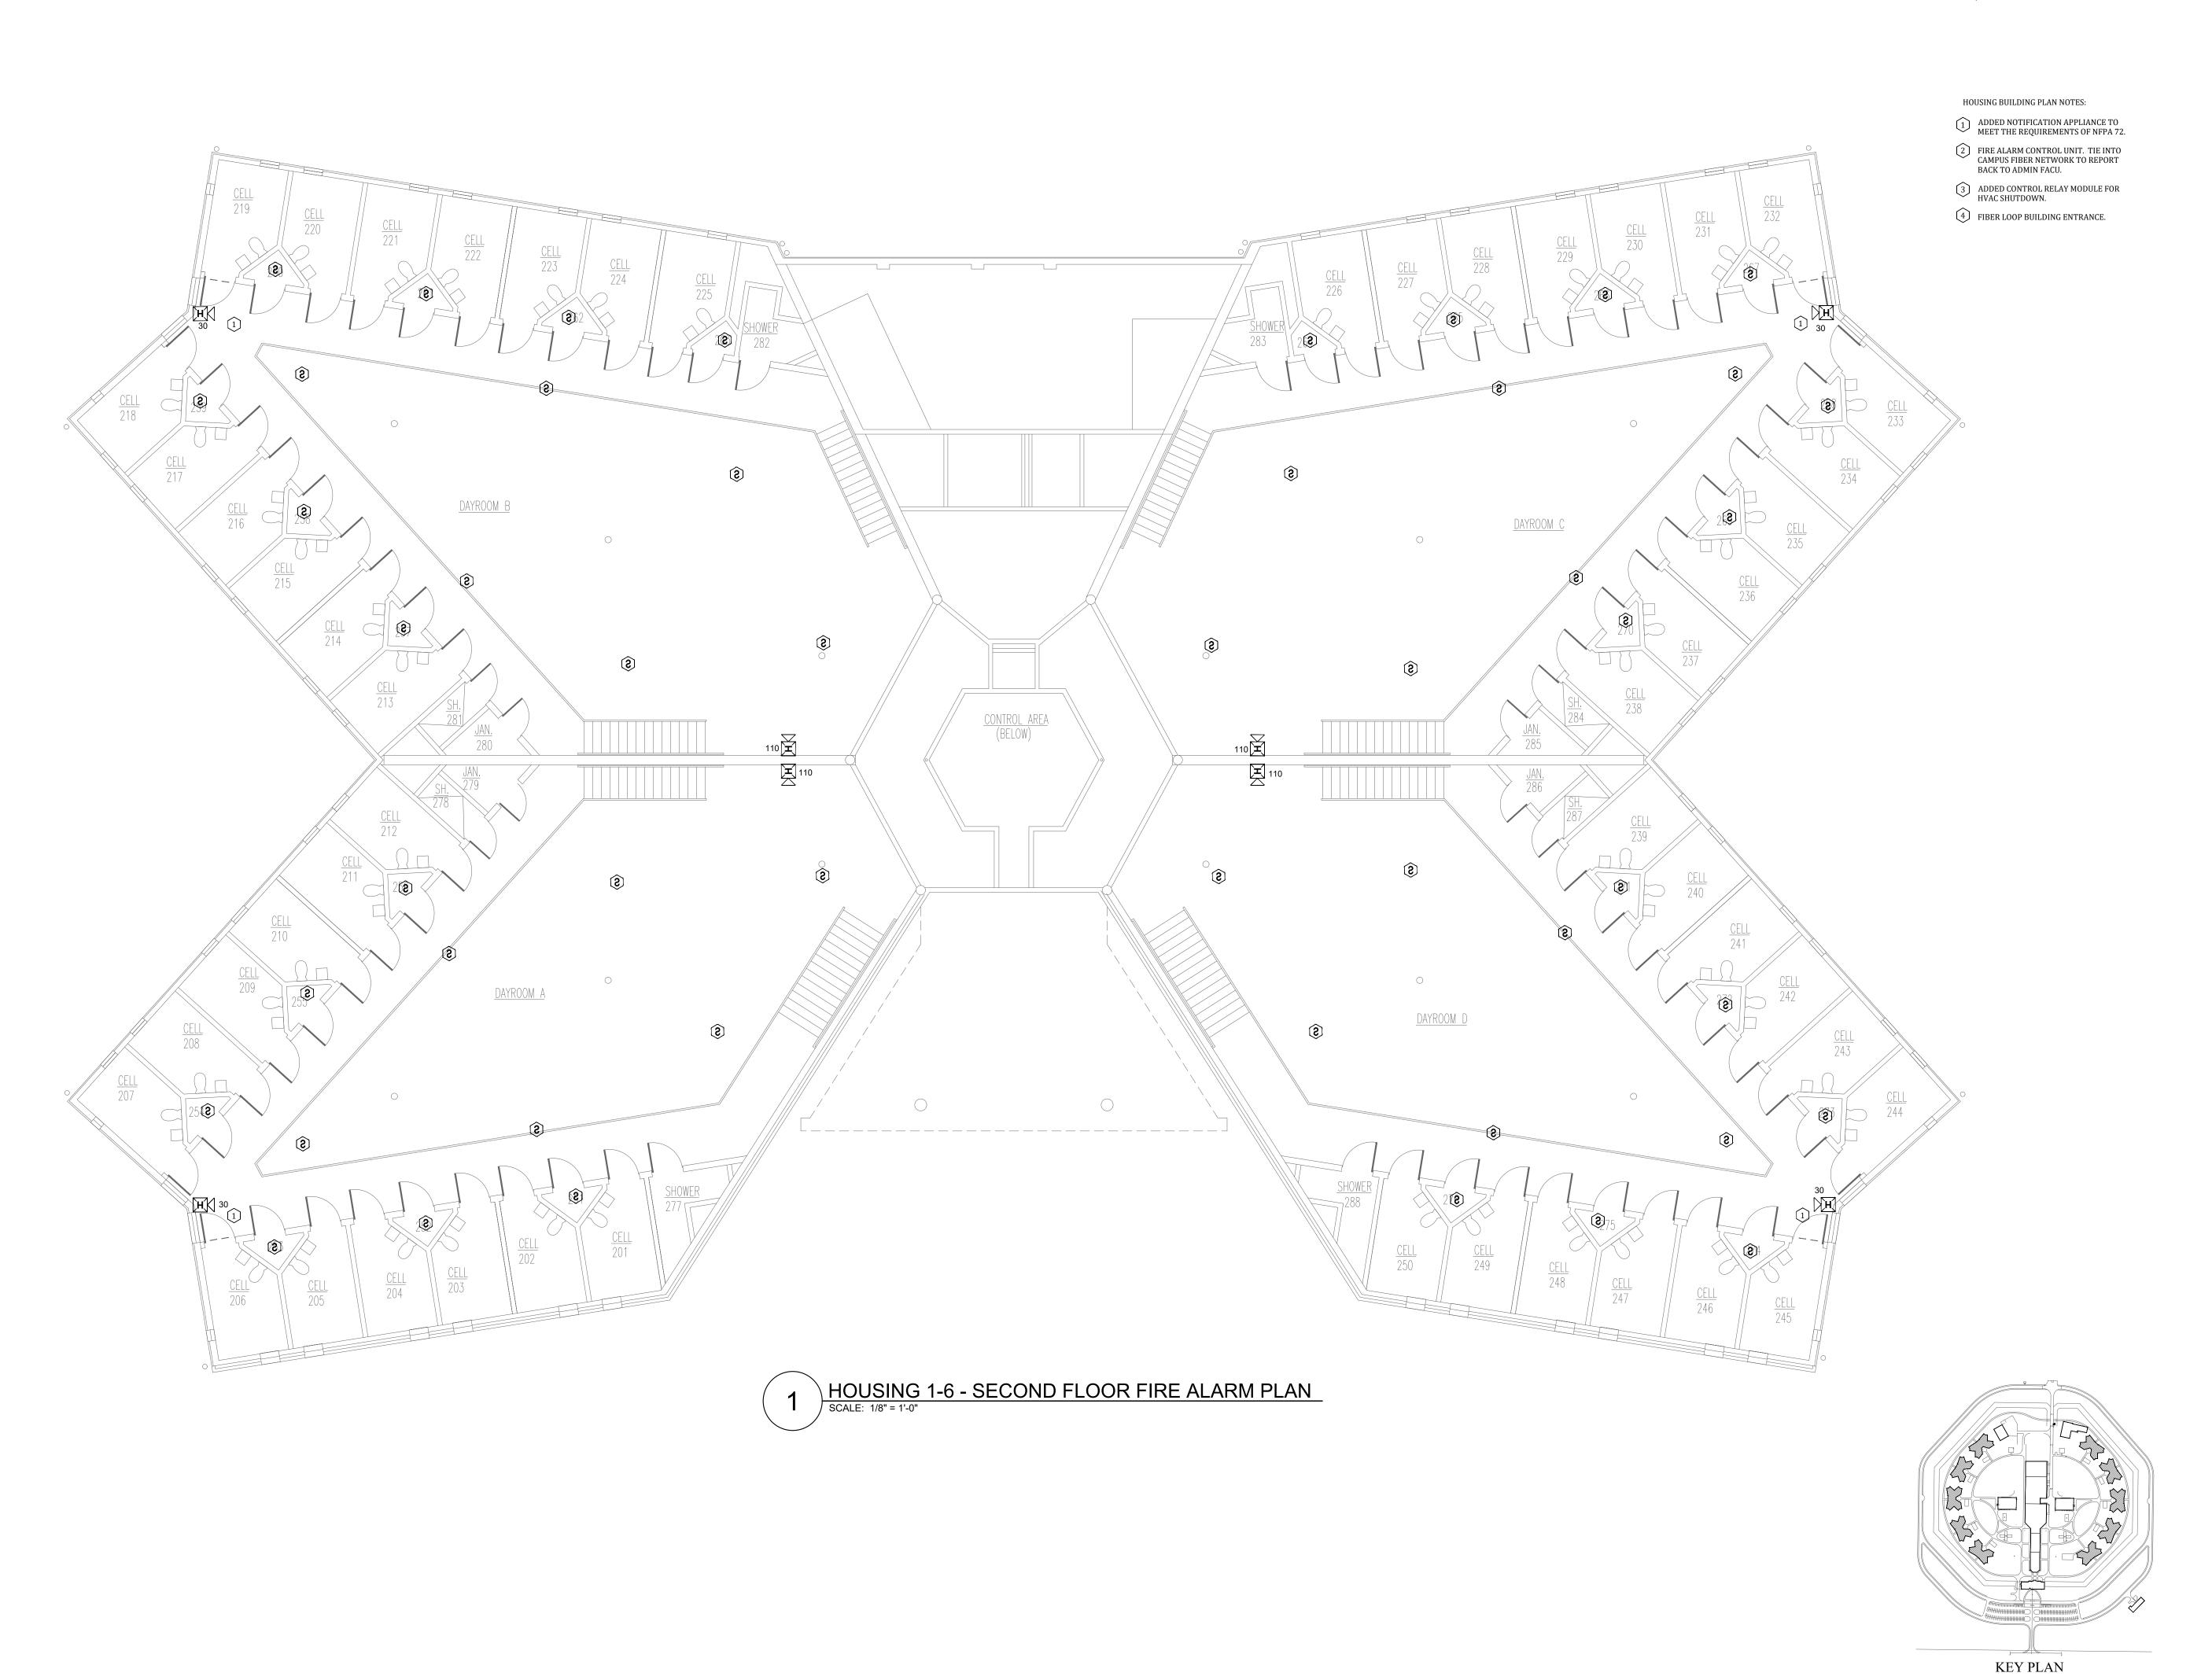
CAD DWG FILE:_ DRAWN BY: _ CHECKED BY: _ DESIGNED BY: _

SHEET TITLE:

HOUSING 1-10 -FIRST FLOOR FIRE **ALARM PLAN**

SHEET NUMBER: FA-300





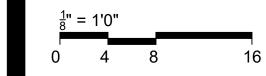


PROFESSIONAL SEAL



8675 W 96TH STREET OVERLAND PARK, KS. 66212 PHONE: 816.33.4373 FAX: 913.722.3484

NOTES: FOR FIRE ALARM GENERAL NOTES, REFER TO DWG# FA-002



OFFICE OF ADMINISTRATION DIVISION OF FACILITIES MANAGEMENT, DESIGN AND CONSTRUCTION

Replace Fire Alarm System, Infrastructure

Northeast Correctional center 13698 Airport Rd, Bowling Green, MO 63334

PROJECT # C2314-01 SITE # 7017 FACILITY # 9327017049

REVISION:	
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ISSUE DATE: 04/24/2024

CAD DWG FILE:	FSC
DRAWN BY:	FSC
CHECKED BY:	HDD
DESIGNED BY:	FSC

SHEET TITLE:

HOUSING 1-10 SECOND FLOOR FIRE ALARM PLAN

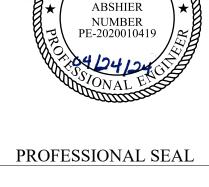
SHEET NUMBER: FA-301



RECREATION BUILDING - FIRE ALARM PLAN
SCALE: 1/8" = 1'-0"

RECREATION BUILDING PLAN NOTES:

- ADDED NOTIFICATION APPLIANCE TO MEET THE REQUIREMENTS OF NFPA 72.
- FIRE ALARM CONTROL UNIT. TIE INTO CAMPUS FIBER NETWORK TO REPORT BACK TO ADMIN FACU.
- 3 ADDED CONTROL RELAY MODULE FOR HVAC SHUTDOWN.
- 4 FIBER LOOP BUILDING ENTRANCE.



STATE OF MISSOURI MICHAEL L. PARSON, **GOVERNOR**



8675 W 96TH STREET OVERLAND PARK, KS. 66212 PHONE: 816.33.4373 FAX: 913.722.3484

FOR FIRE ALARM GENERAL NOTES, **REFER TO DWG# FA-002**



OFFICE OF ADMINISTRATION DIVISION OF FACILITIES MANAGEMENT, **DESIGN AND** CONSTRUCTION

Replace Fire Alarm System, Infrastructure

Northeast Correctional center 13698 Airport Rd, Bowling Green, MO 63334

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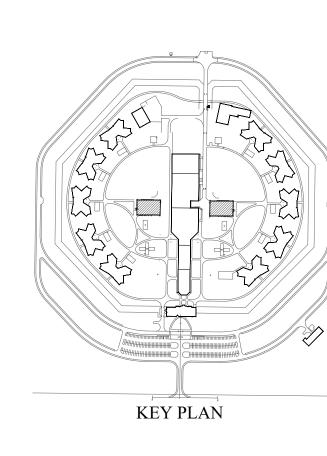
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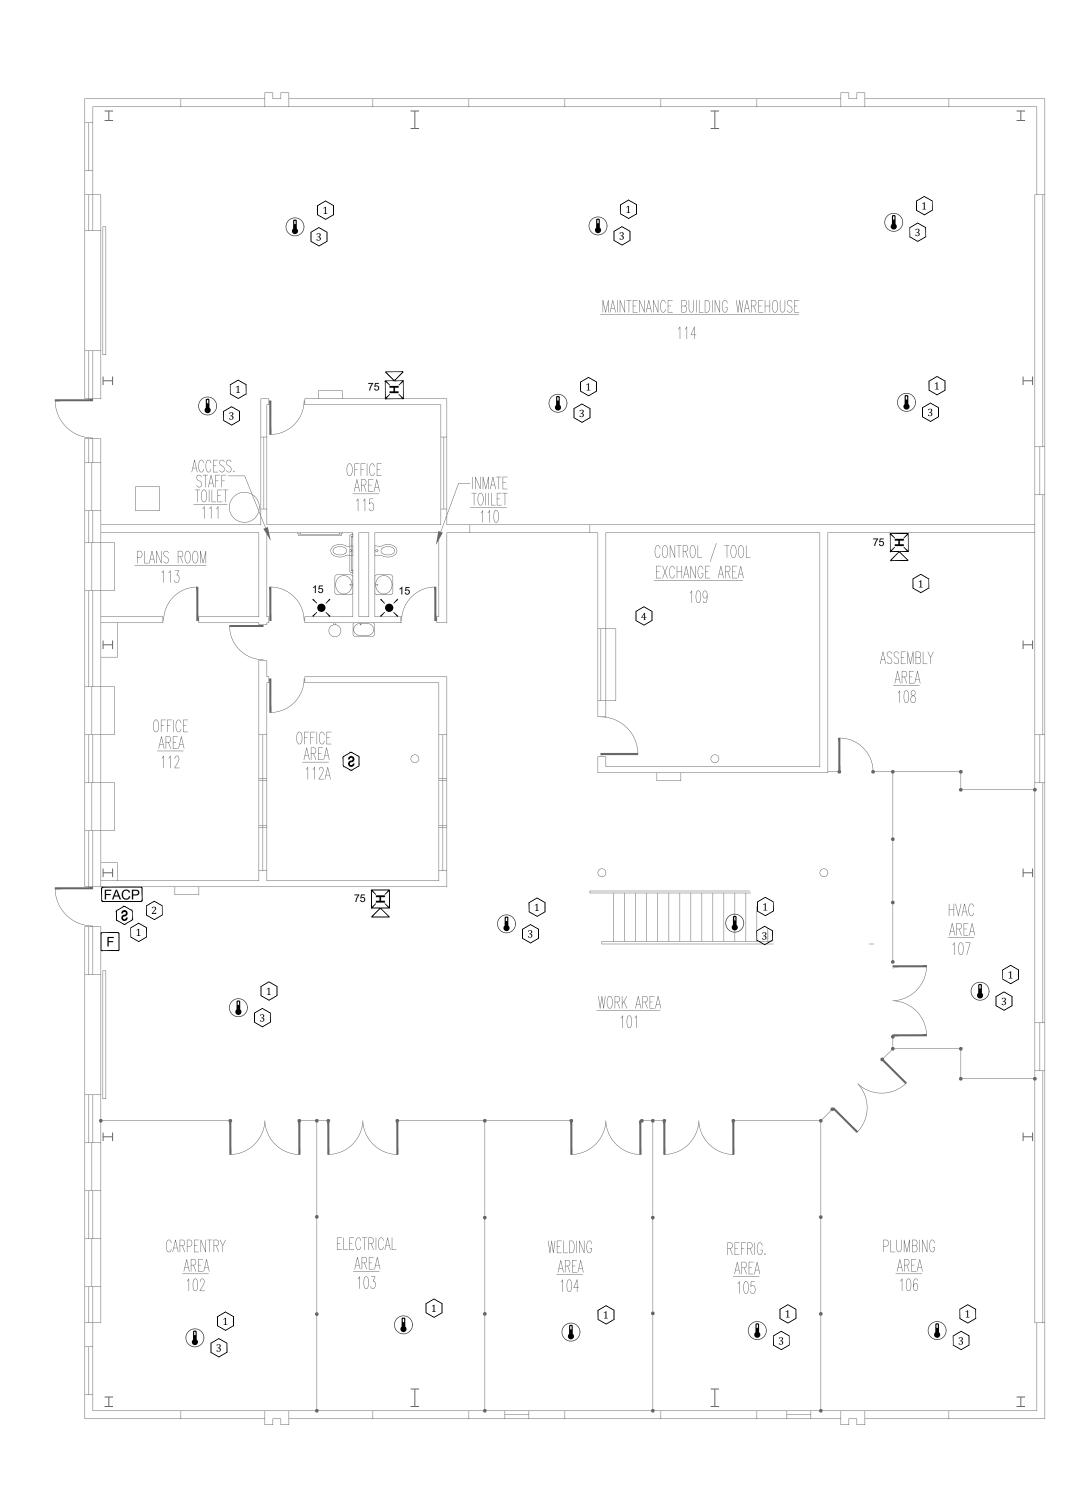
SHEET TITLE:

RECREATION BUILDING - FIRE **ALARM PLAN**

SHEET NUMBER:

FA-400

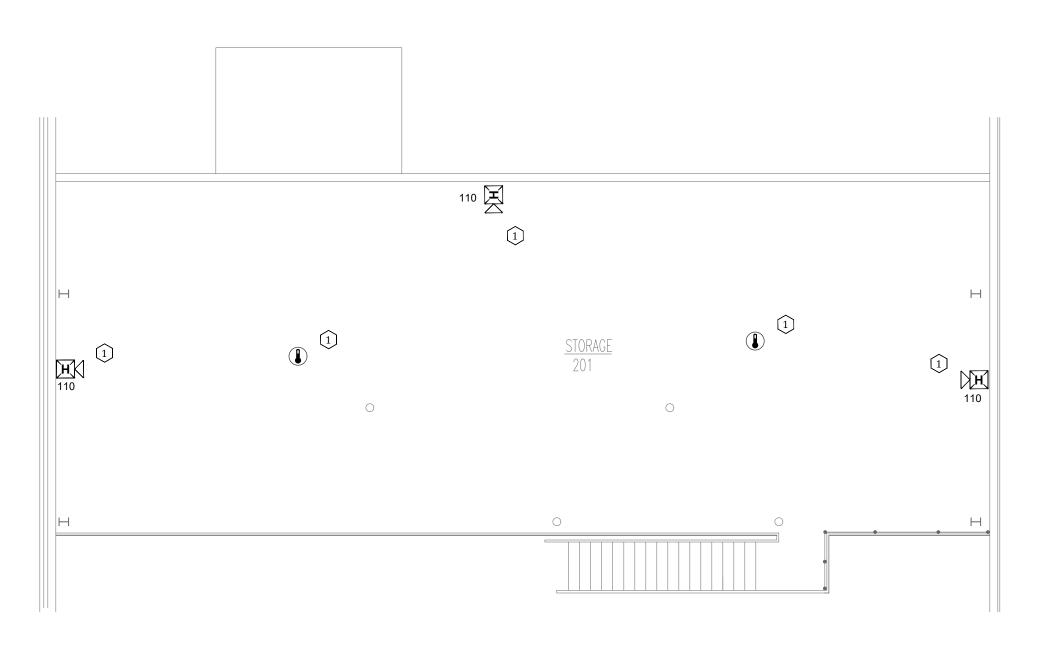




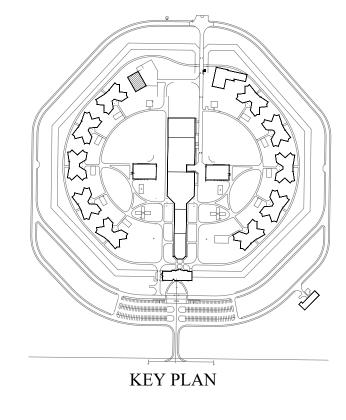
1 MAINTENANCE BUILDING - FIRST FLOOR FIRE ALARM PLAN
SCALE: 1/8" = 1'-0"

MAINTENANCE BUILDING PLAN NOTES:

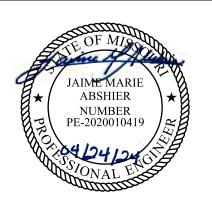
- ADDED NOTIFICATION APPLIANCE TO MEET THE REQUIREMENTS OF NFPA 72.
- 2 FIRE ALARM CONTROL UNIT. TIE INTO CAMPUS FIBER NETWORK TO REPORT BACK TO ADMIN FACU.
- 3 DEVICE CHANGED FROM SMOKE TO HEAT FOR OCCUPANCY.
- 4 FIBER LOOP BUILDING ENTRANCE.



2 MAINTENANCE BUILDING - SECOND FLOOR FIRE ALARM PLAN
SCALE: 1/8" = 1'-0"



STATE OF MISSOURI MICHAEL L. PARSON, GOVERNOR



PROFESSIONAL SEAL



8675 W 96TH STREET OVERLAND PARK, KS. 66212 PHONE: 816.33.4373 FAX: 913.722.3484

NOTES: FOR FIRE ALARM GENERAL NOTES, REFER TO DWG# FA-002



OFFICE OF
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DIVISION OF FACILITIES
MANAGEMENT,
DESIGN AND
CONSTRUCTION

Replace Fire Alarm
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Northeast Correctional center 13698 Airport Rd, Bowling Green, MO 63334

PROJECT # C2314-01 SITE # 7017 FACILITY # 9327017049

REVISION:
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ISSUE DATE: 04/24/2024

CAD DWG FILE: FSC

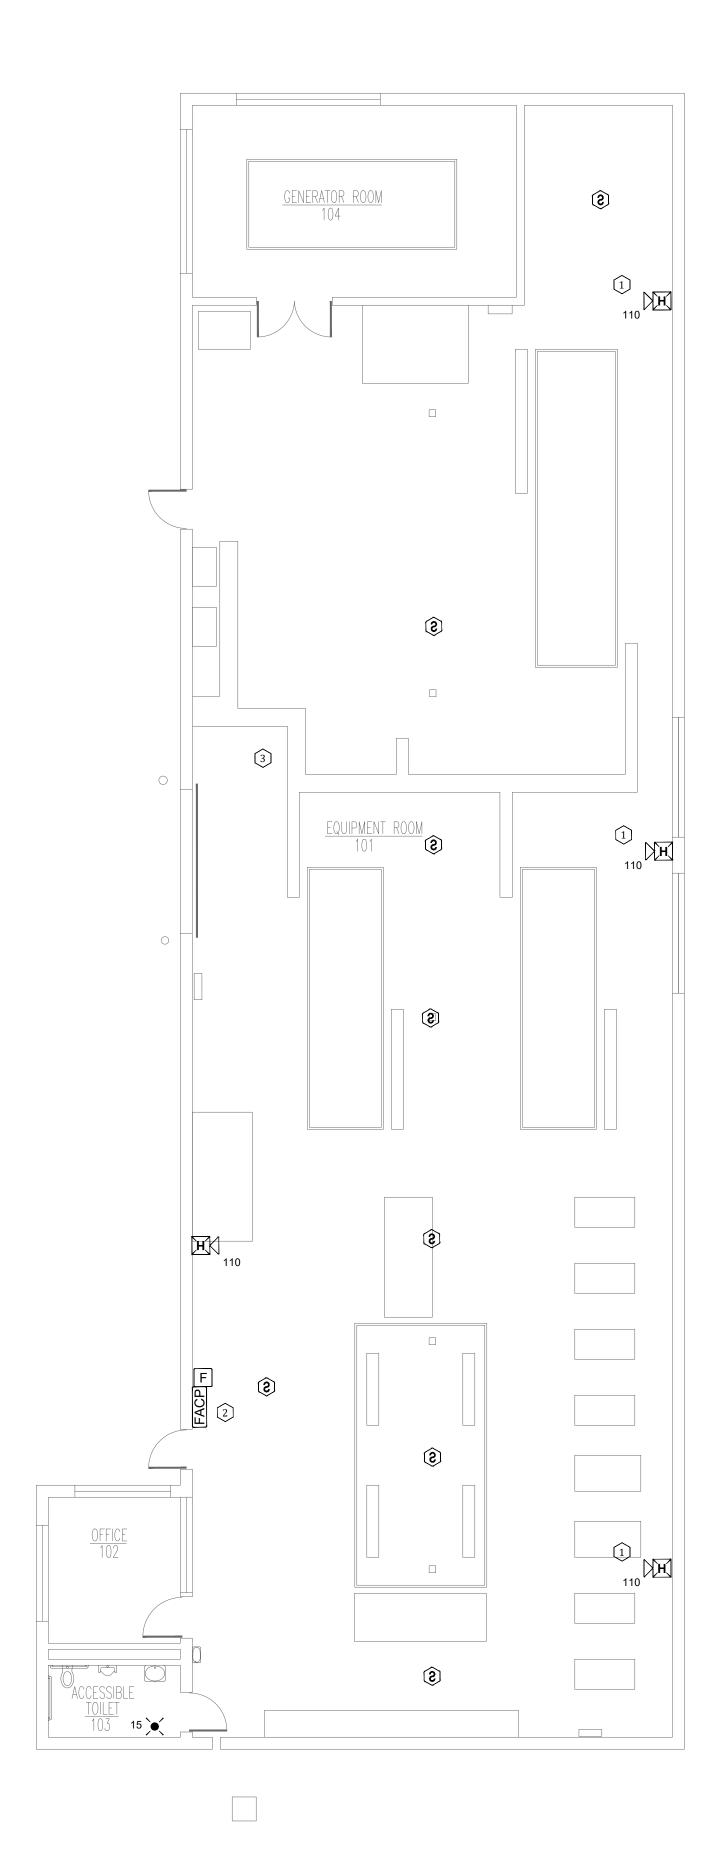
CAD DWG FILE: FSC
DRAWN BY: FSC
CHECKED BY: HDD
DESIGNED BY: FSC

SHEET TITLE:

MAINTENANCE
BUILDING-FIRST
AND SECOND FLOOR
FIRE ALARM PLANS

SHEET NUMBER:

FA-500



POWER PLANT FIRE ALARM PLAN
SCALE: 1/8" = 1'-0"

ADDED NOTIFICATION APPLIANCE TO MEET THE REQUIREMENTS OF NFPA 72.

- 2 FIRE ALARM CONTROL UNIT. TIE INTO CAMPUS FIBER NETWORK TO REPORT BACK TO ADMIN FACU.
- (3) FIBER LOOP BUILDING ENTRANCE.

POWER PLANT AND GUARD HOUSE BUILDING PLAN NOTES:



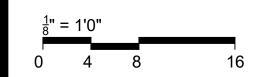
STATE OF MISSOURI MICHAEL L. PARSON, **GOVERNOR**

PROFESSIONAL SEAL



8675 W 96TH STREET OVERLAND PARK, KS. 66212 PHONE: 816.33.4373 FAX: 913.722.3484

FOR FIRE ALARM GENERAL NOTES, REFER TO DWG# FA-002



OFFICE OF ADMINISTRATION DIVISION OF FACILITIES MANAGEMENT, **DESIGN AND** CONSTRUCTION

Replace Fire Alarm System, Infrastructure

Northeast Correctional center 13698 Airport Rd, Bowling Green, MO 63334

PROJECT # C2314-01 7017 FACILITY # 9327017049

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CAD DWG FILE: DRAWN BY: CHECKED BY: DESIGNED BY:

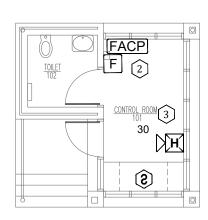
SHEET TITLE:

POWER PLANT AND GUARD HOUSE -FIRE ALARM PLANS

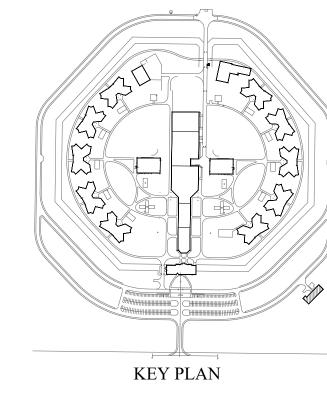
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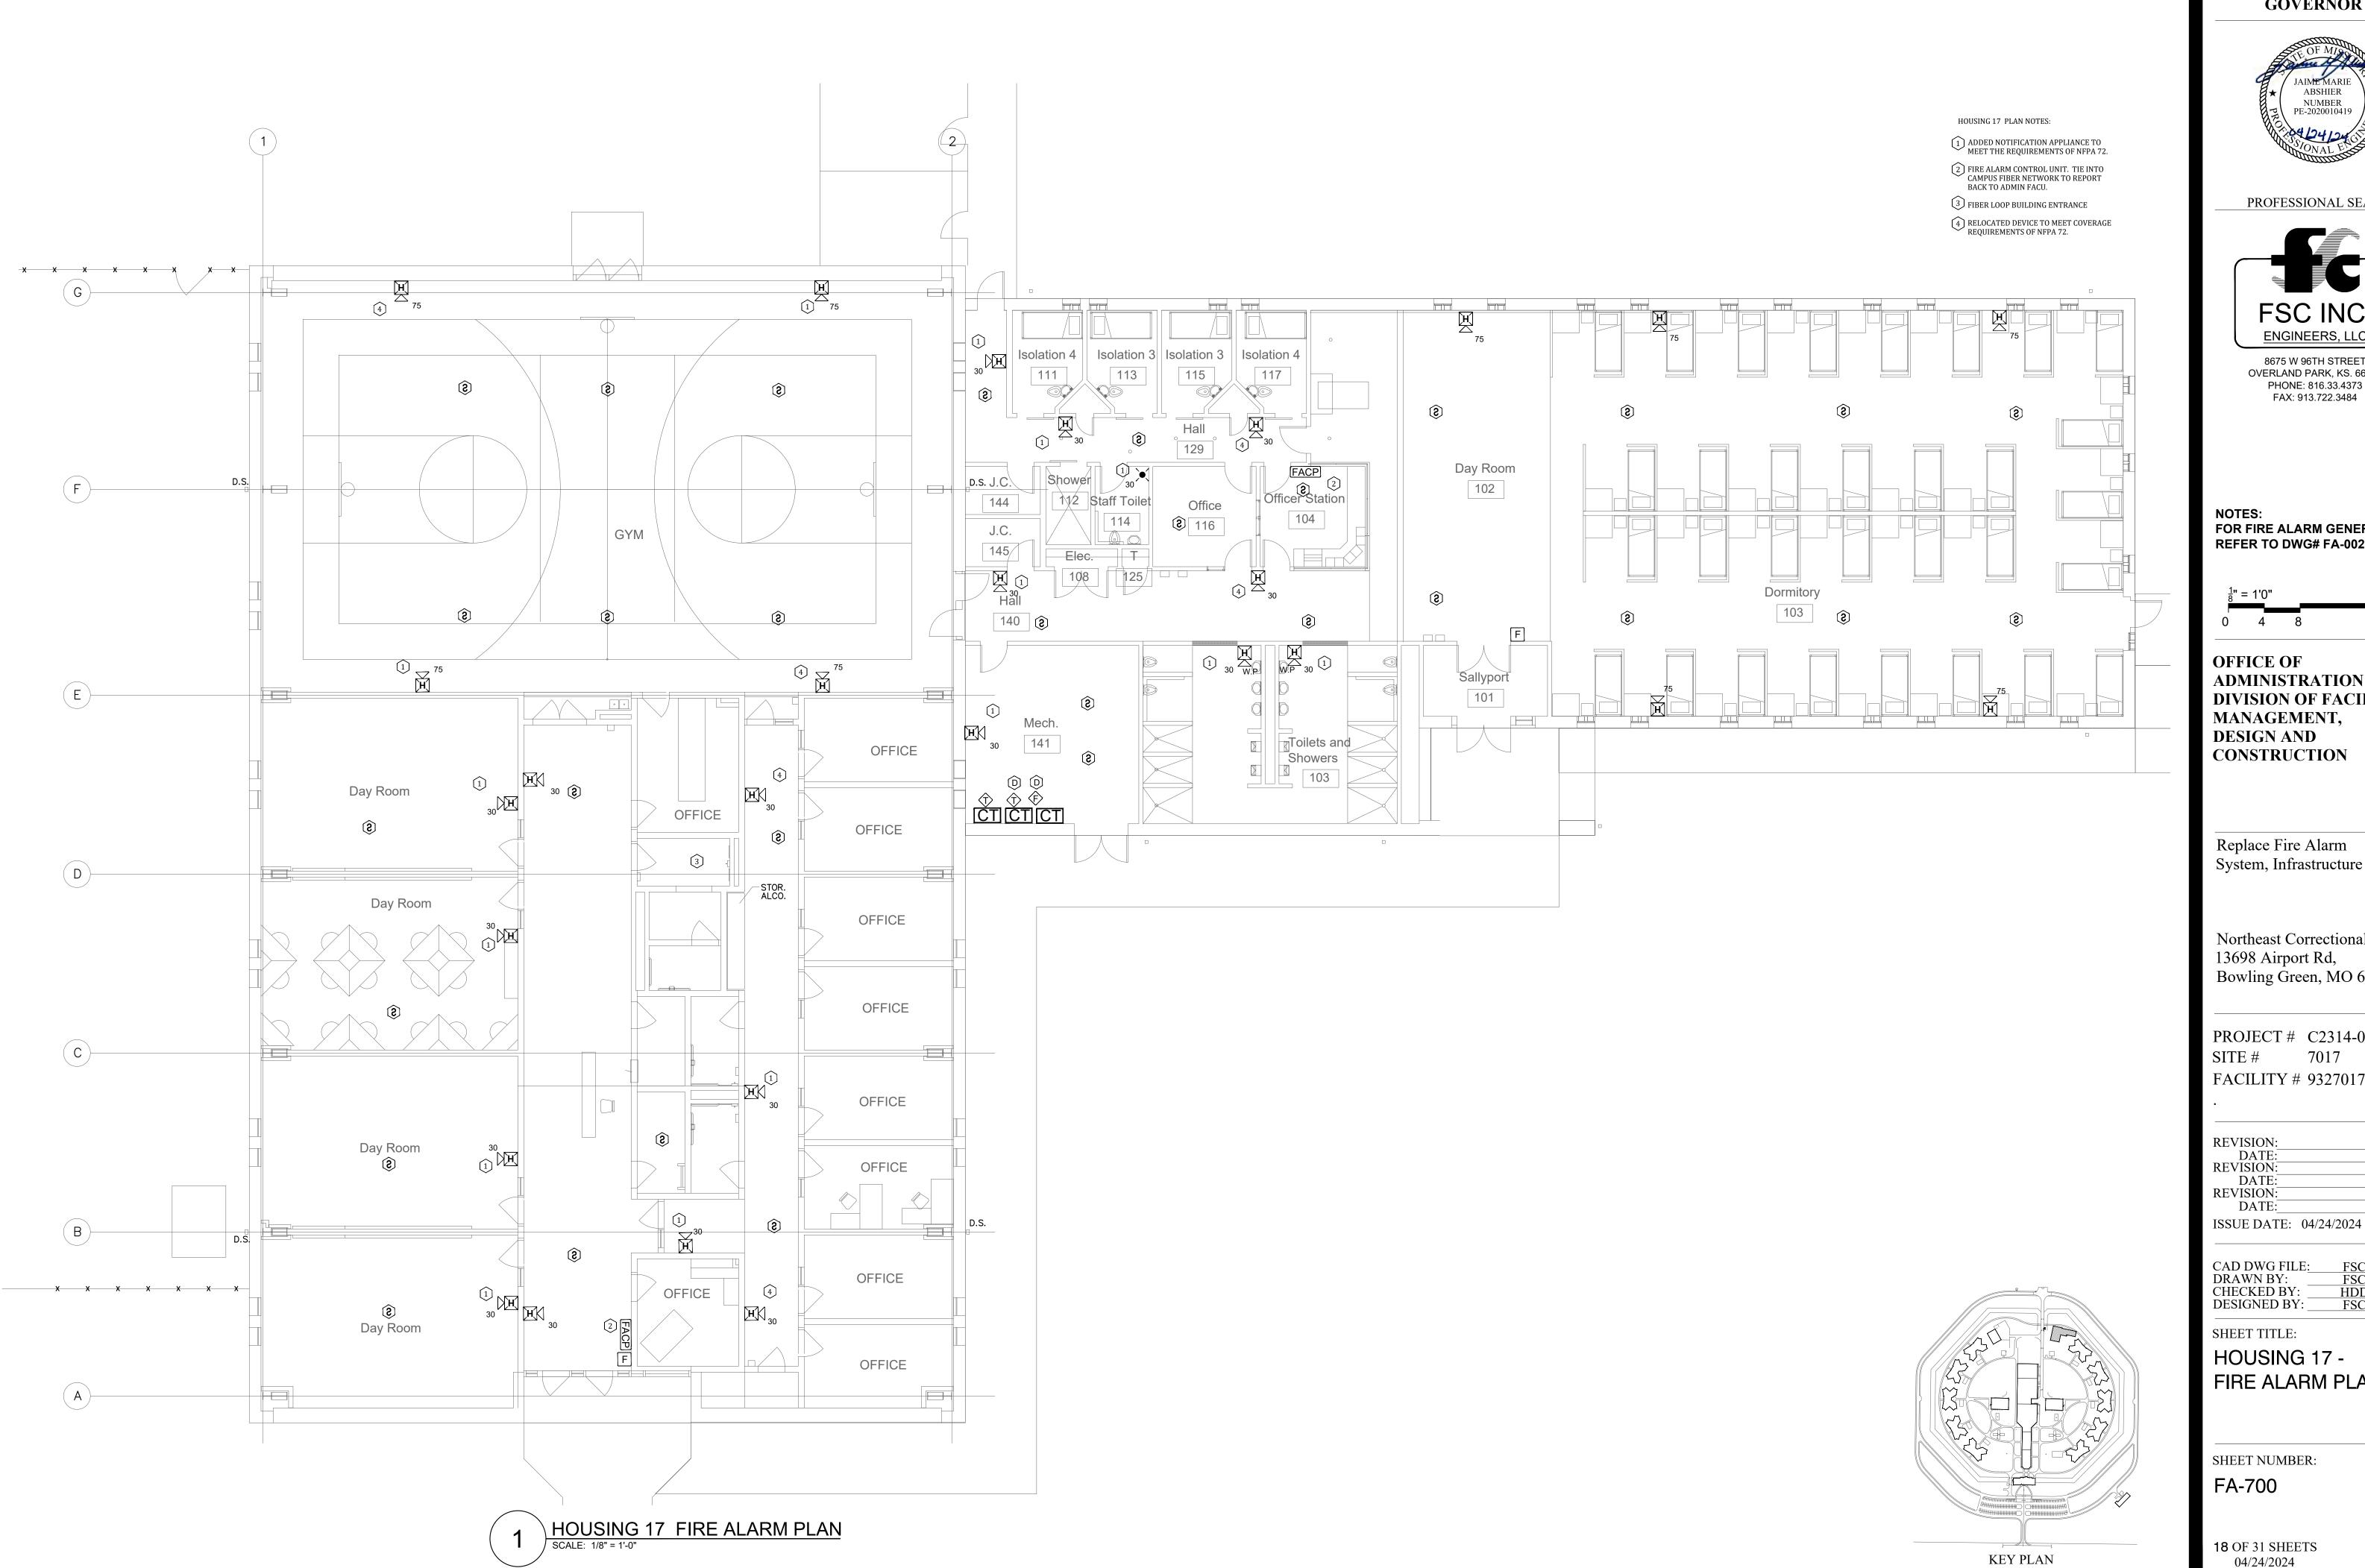
FA-600

17 OF 31 SHEETS 04/24/2024



GUARD HOUSE FIRE ALARM PLAN
SCALE: 1/8" = 1'-0"





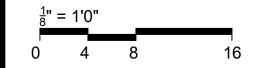


PROFESSIONAL SEAL



8675 W 96TH STREET OVERLAND PARK, KS. 66212 PHONE: 816.33.4373 FAX: 913.722.3484

FOR FIRE ALARM GENERAL NOTES, **REFER TO DWG# FA-002**



OFFICE OF ADMINISTRATION DIVISION OF FACILITIES MANAGEMENT, **DESIGN AND** CONSTRUCTION

Replace Fire Alarm System, Infrastructure

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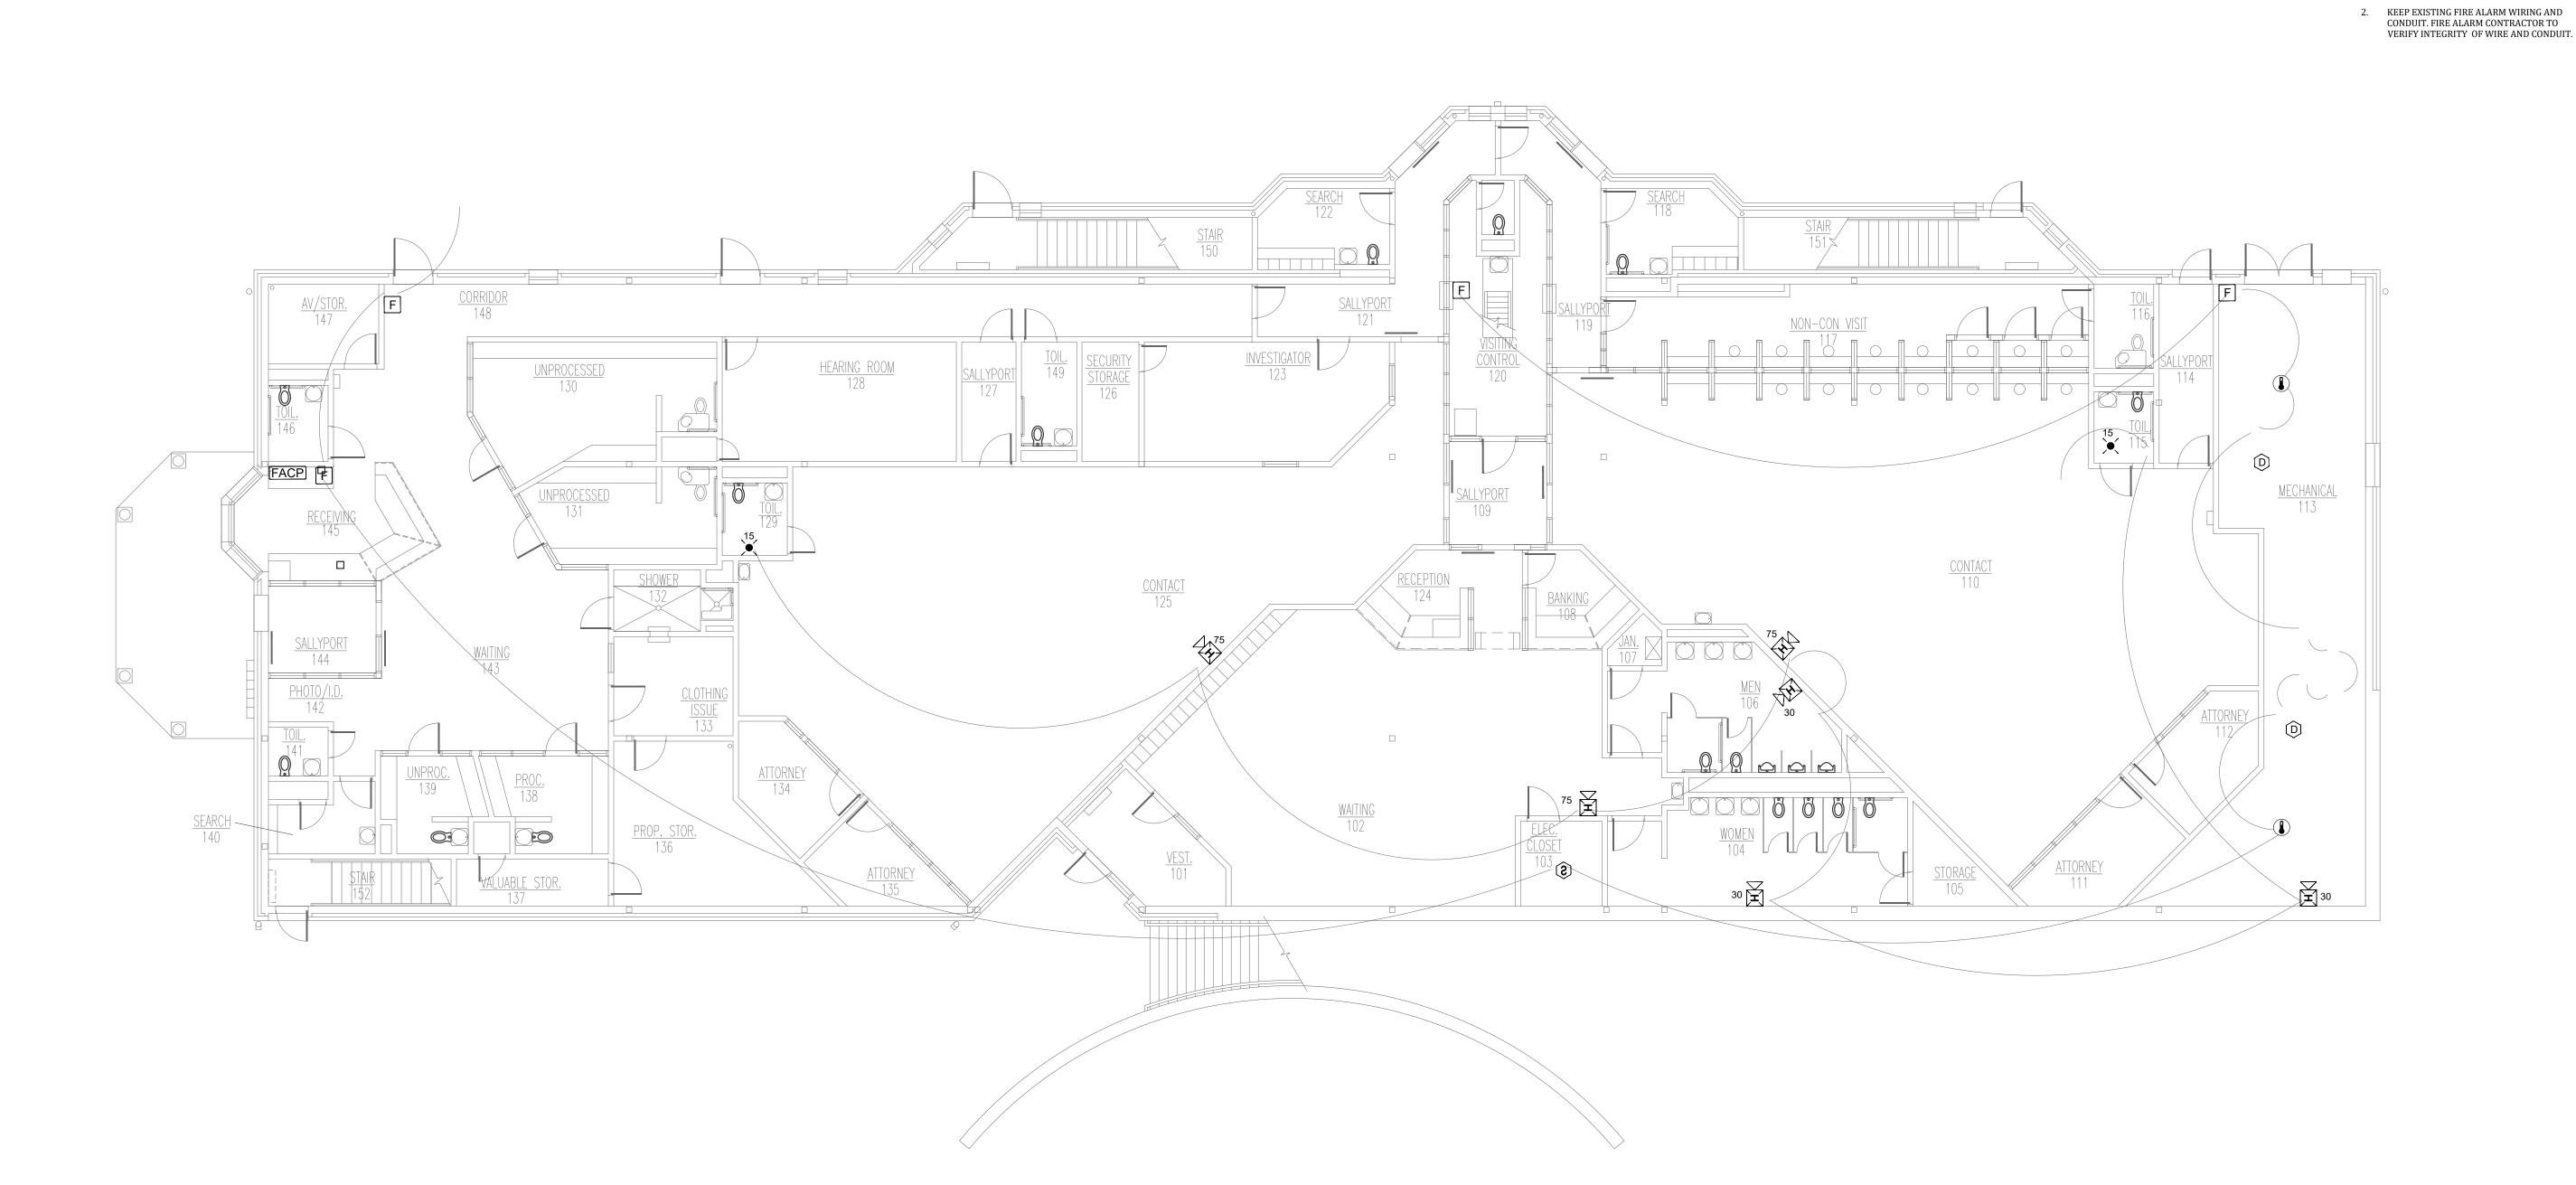
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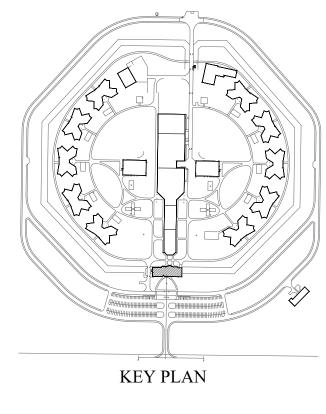
SHEET TITLE:

HOUSING 17 -FIRE ALARM PLANS

SHEET NUMBER:



1 ADMINISTRATION BUILDING - FIRST FLOOR DEMO FIRE ALARM PLAN
SCALE: 1/8" = 1'-0"



PLAN NOTES

1. DEMO ALL EXISTING FIRE ALARM DEVICES

STATE OF MISSOURI MICHAEL L. PARSON, GOVERNOR

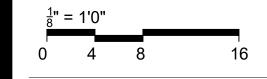


PROFESSIONAL SEAL



8675 W 96TH STREET OVERLAND PARK, KS. 66212 PHONE: 816.33.4373 FAX: 913.722.3484

NOTES: FOR FIRE ALARM GENERAL NOTES, REFER TO DWG# FA-002



OFFICE OF
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MANAGEMENT,
DESIGN AND
CONSTRUCTION

Replace Fire Alarm System, Infrastructure

Northeast Correctional center 13698 Airport Rd, Bowling Green, MO 63334

PROJECT # C2314-01 SITE # 7017 FACILITY # 9327017049

REVISION:
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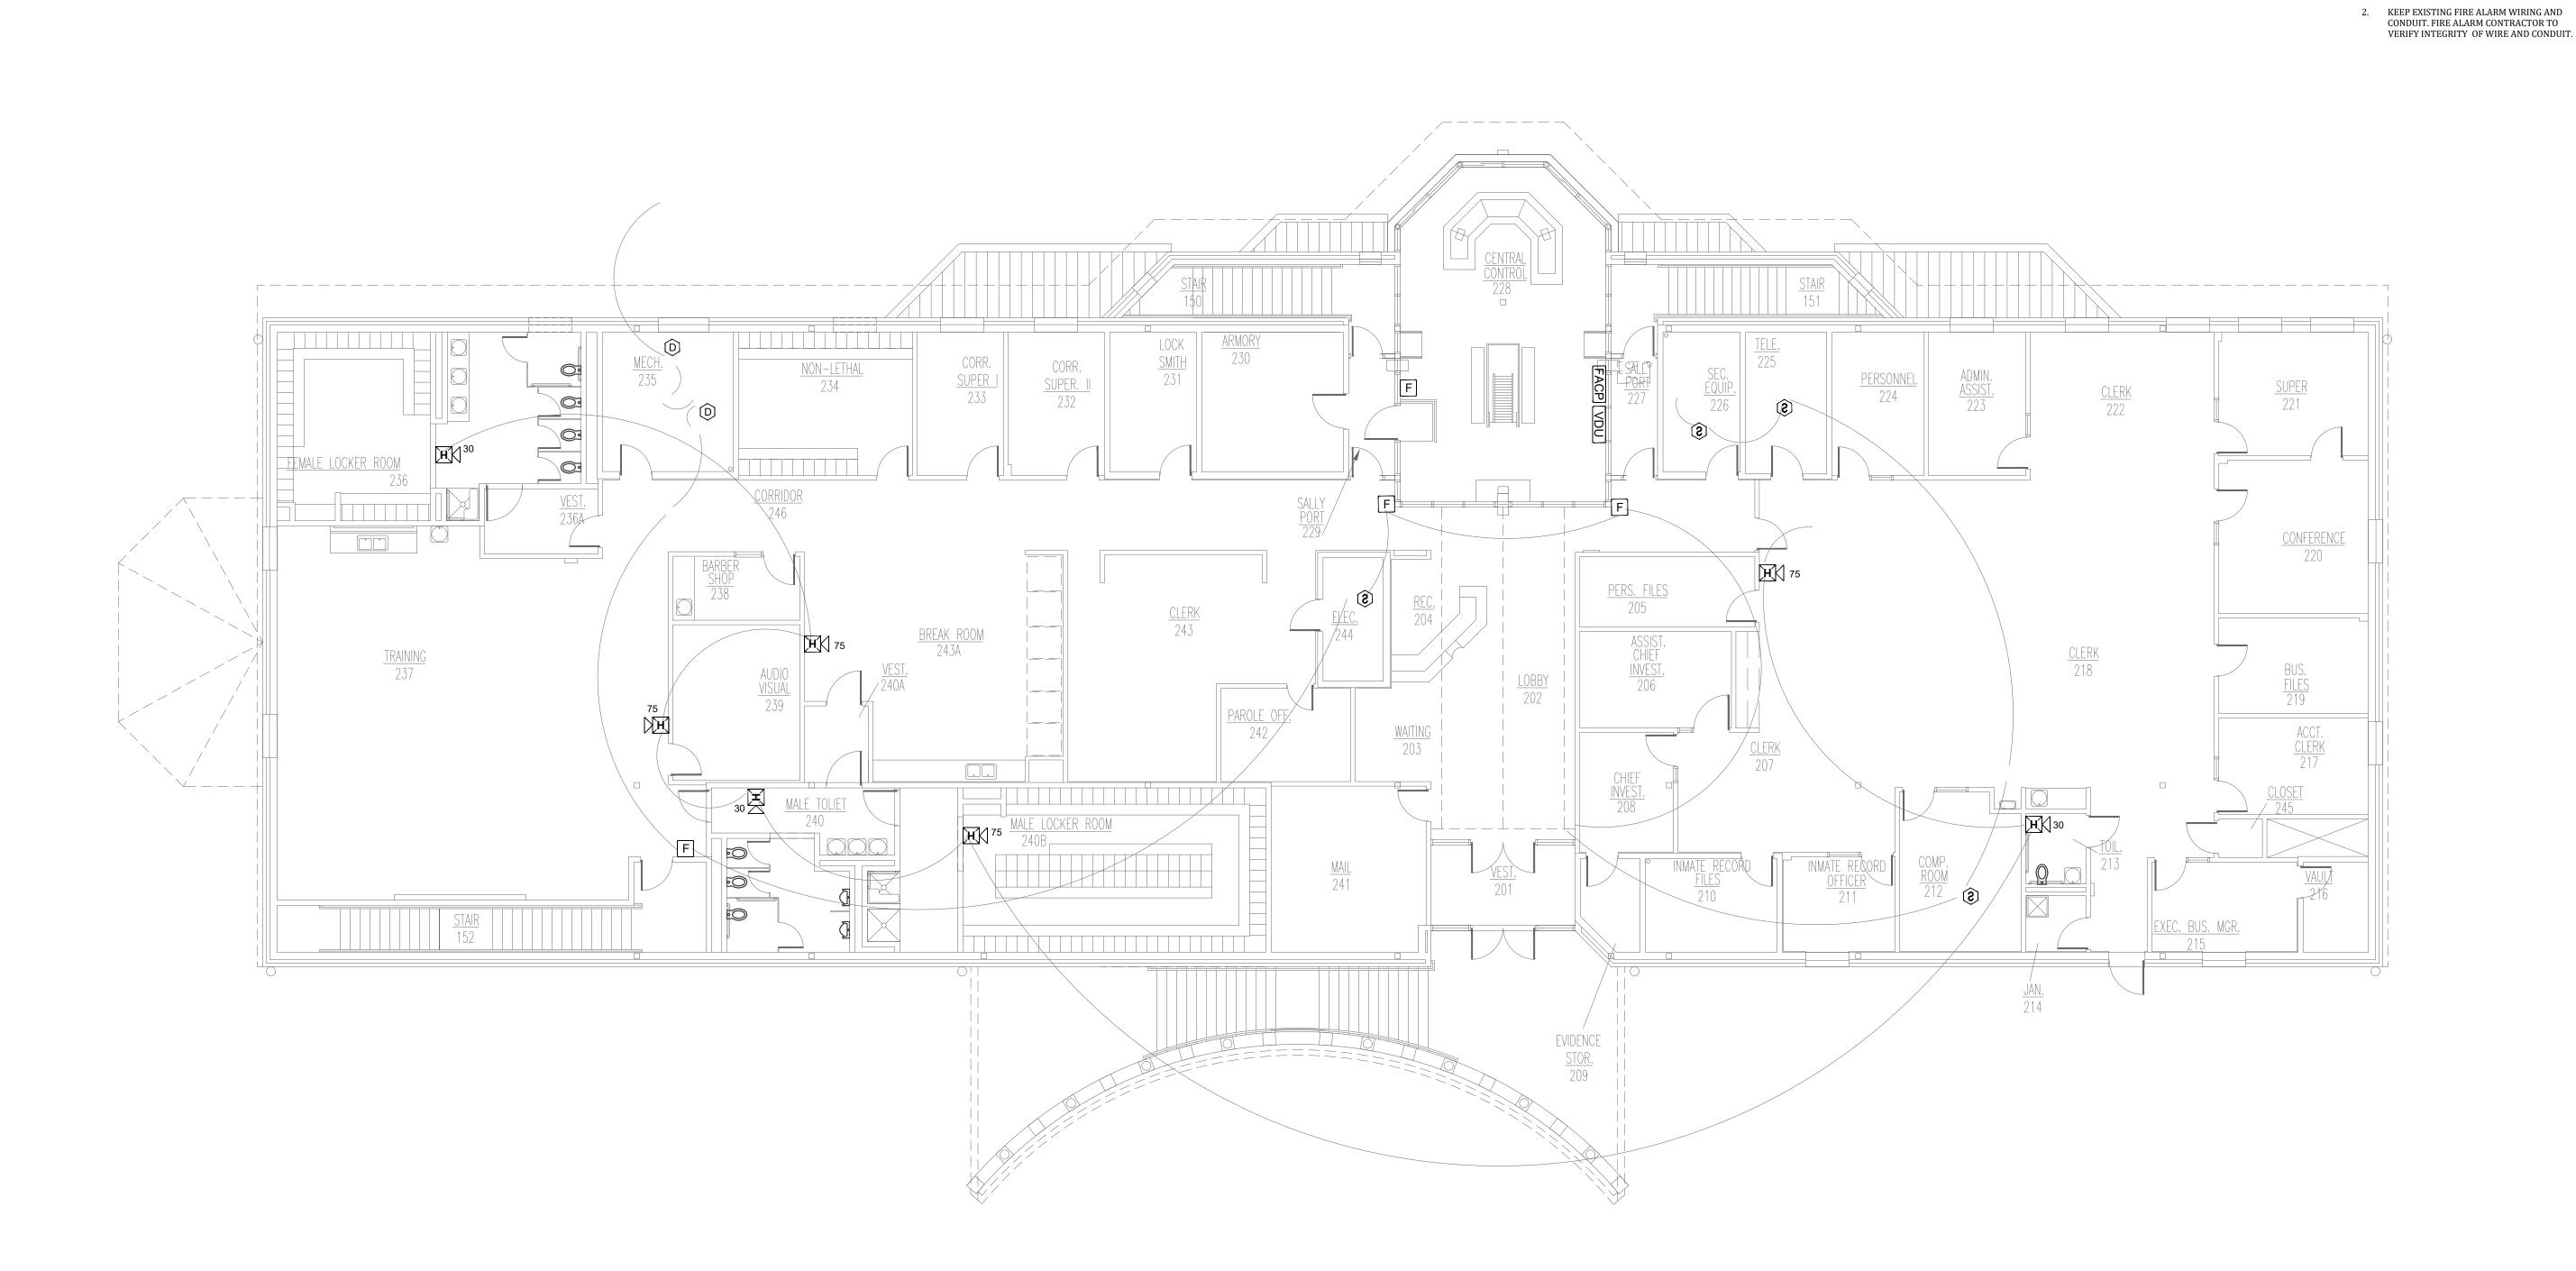
ISSUE DATE: 04/24/2024

CAD DWG FILE: FSC
DRAWN BY: FSC
CHECKED BY: HDD
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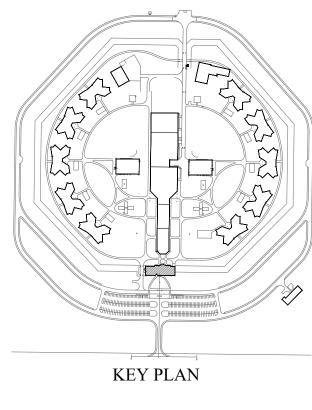
SHEET TITLE:

ADMINISTRATION
BUILDING - FIRST
FLOOR DEMO FIRE
ALARM PLAN

SHEET NUMBER: FAD-100



1 ADMINISTRATION BUILDING - DEMO SECOND FLOOR FIRE ALARM PLAN
SCALE: 1/8" = 1'-0"



PLAN NOTES

1. DEMO ALL EXISTING FIRE ALARM DEVICES

STATE OF MISSOURI MICHAEL L. PARSON, GOVERNOR

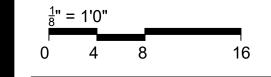


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DRAWN BY: FSC
CHECKED BY: HDD
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SHEET TITLE:

ADMINISTRATION
BUILDING - SECOND
FLOOR DEMO FIRE
ALARM PLAN

SHEET NUMBER:

FAD-101



PLAN NOTES

- 1. DEMO ALL EXISTING FIRE ALARM DEVICES
- 2. KEEP EXISTING FIRE ALARM WIRING AND CONDUIT. FIRE ALARM CONTRACTOR TO VERIFY INTEGRITY OF WIRE AND CONDUIT.



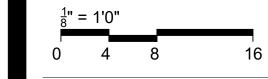


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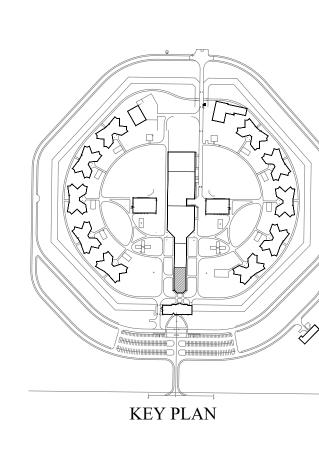
ISSUE DATE: 04/24/2024

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DRAWN BY: FSC
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DESIGNED BY: FSC

SHEET TITLE:

SERVICES BUILDING - HEALTH - DEMO FIRE ALARM PLAN

SHEET NUMBER: FAD-200

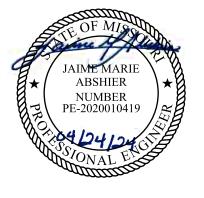




PLAN NOTES

- 1. DEMO ALL EXISTING FIRE ALARM DEVICES
- 2. KEEP EXISTING FIRE ALARM WIRING AND CONDUIT. FIRE ALARM CONTRACTOR TO VERIFY INTEGRITY OF WIRE AND CONDUIT.



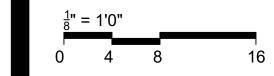


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NOTES: FOR FIRE ALARM GENERAL NOTES, REFER TO DWG# FA-002



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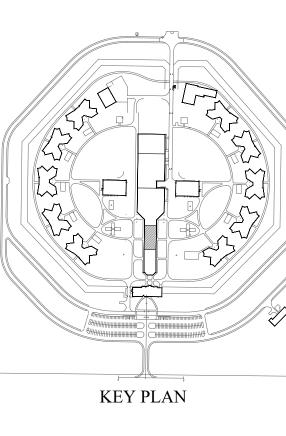
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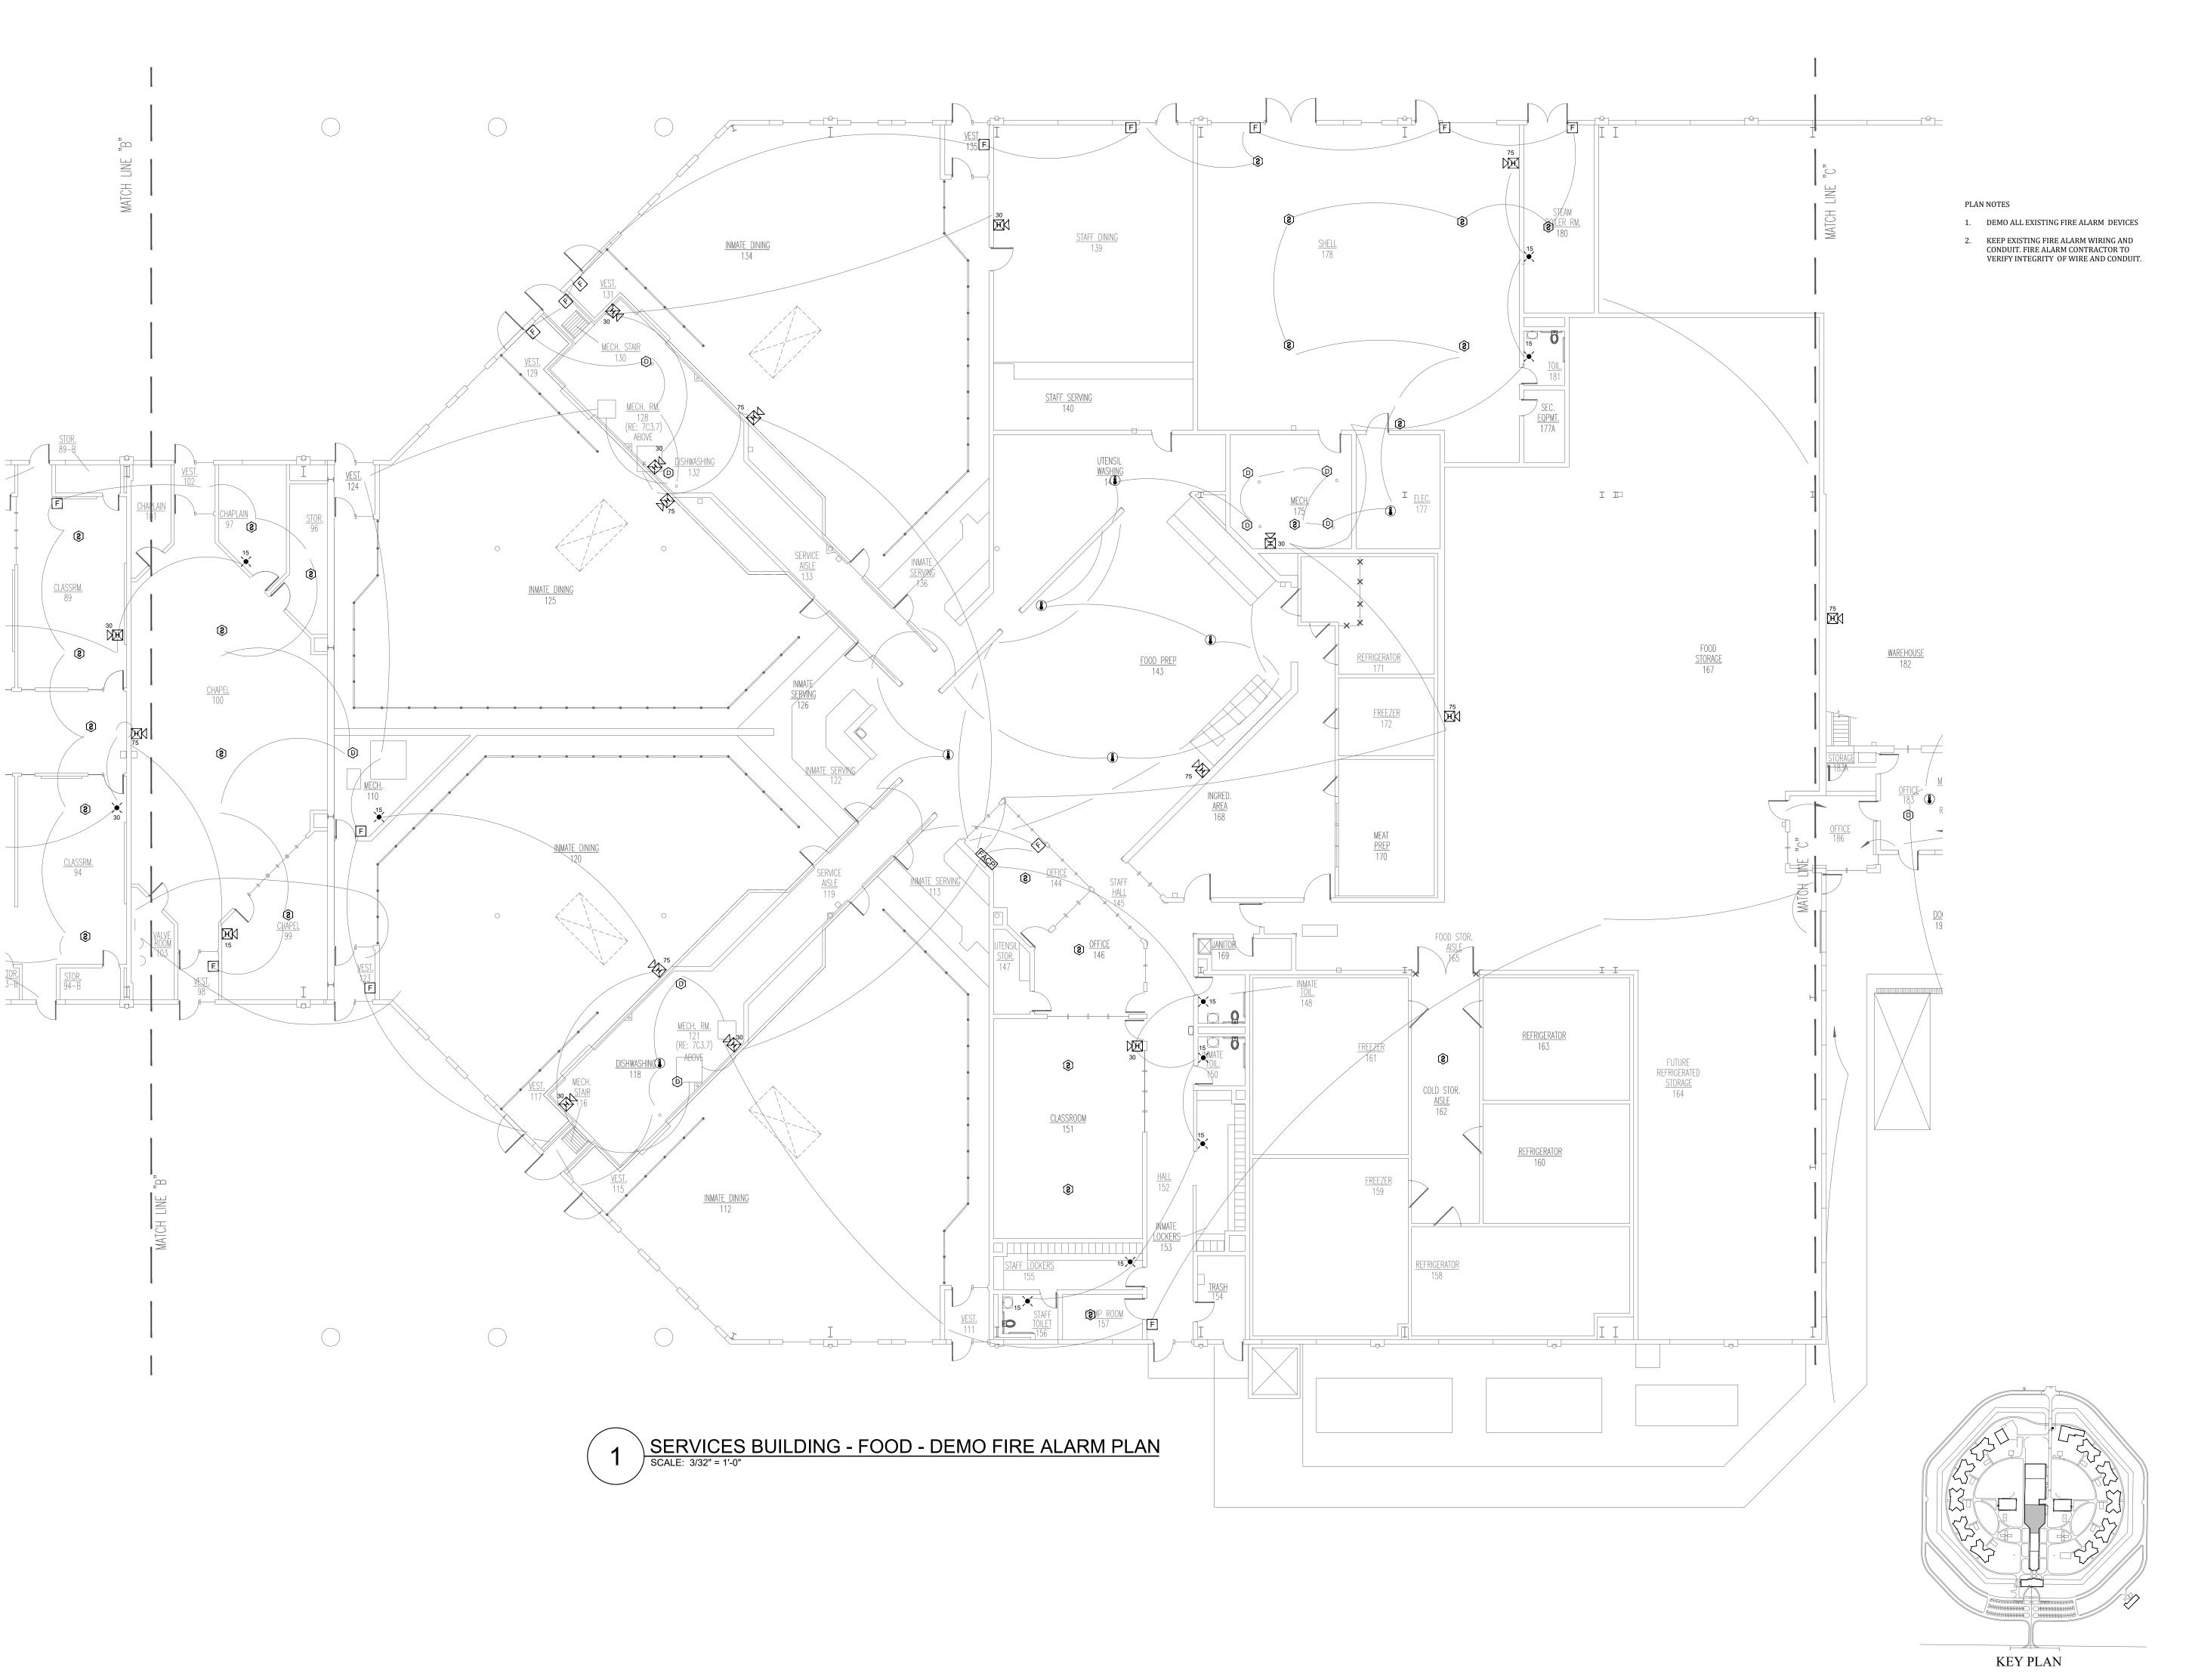
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SERVICES BUILDING
- EDUCATIONAL DEMO FIRE ALARM
PLAN

SHEET NUMBER:

FAD-201





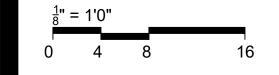


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NOTES: FOR FIRE ALARM GENERAL NOTES, REFER TO DWG# FA-002



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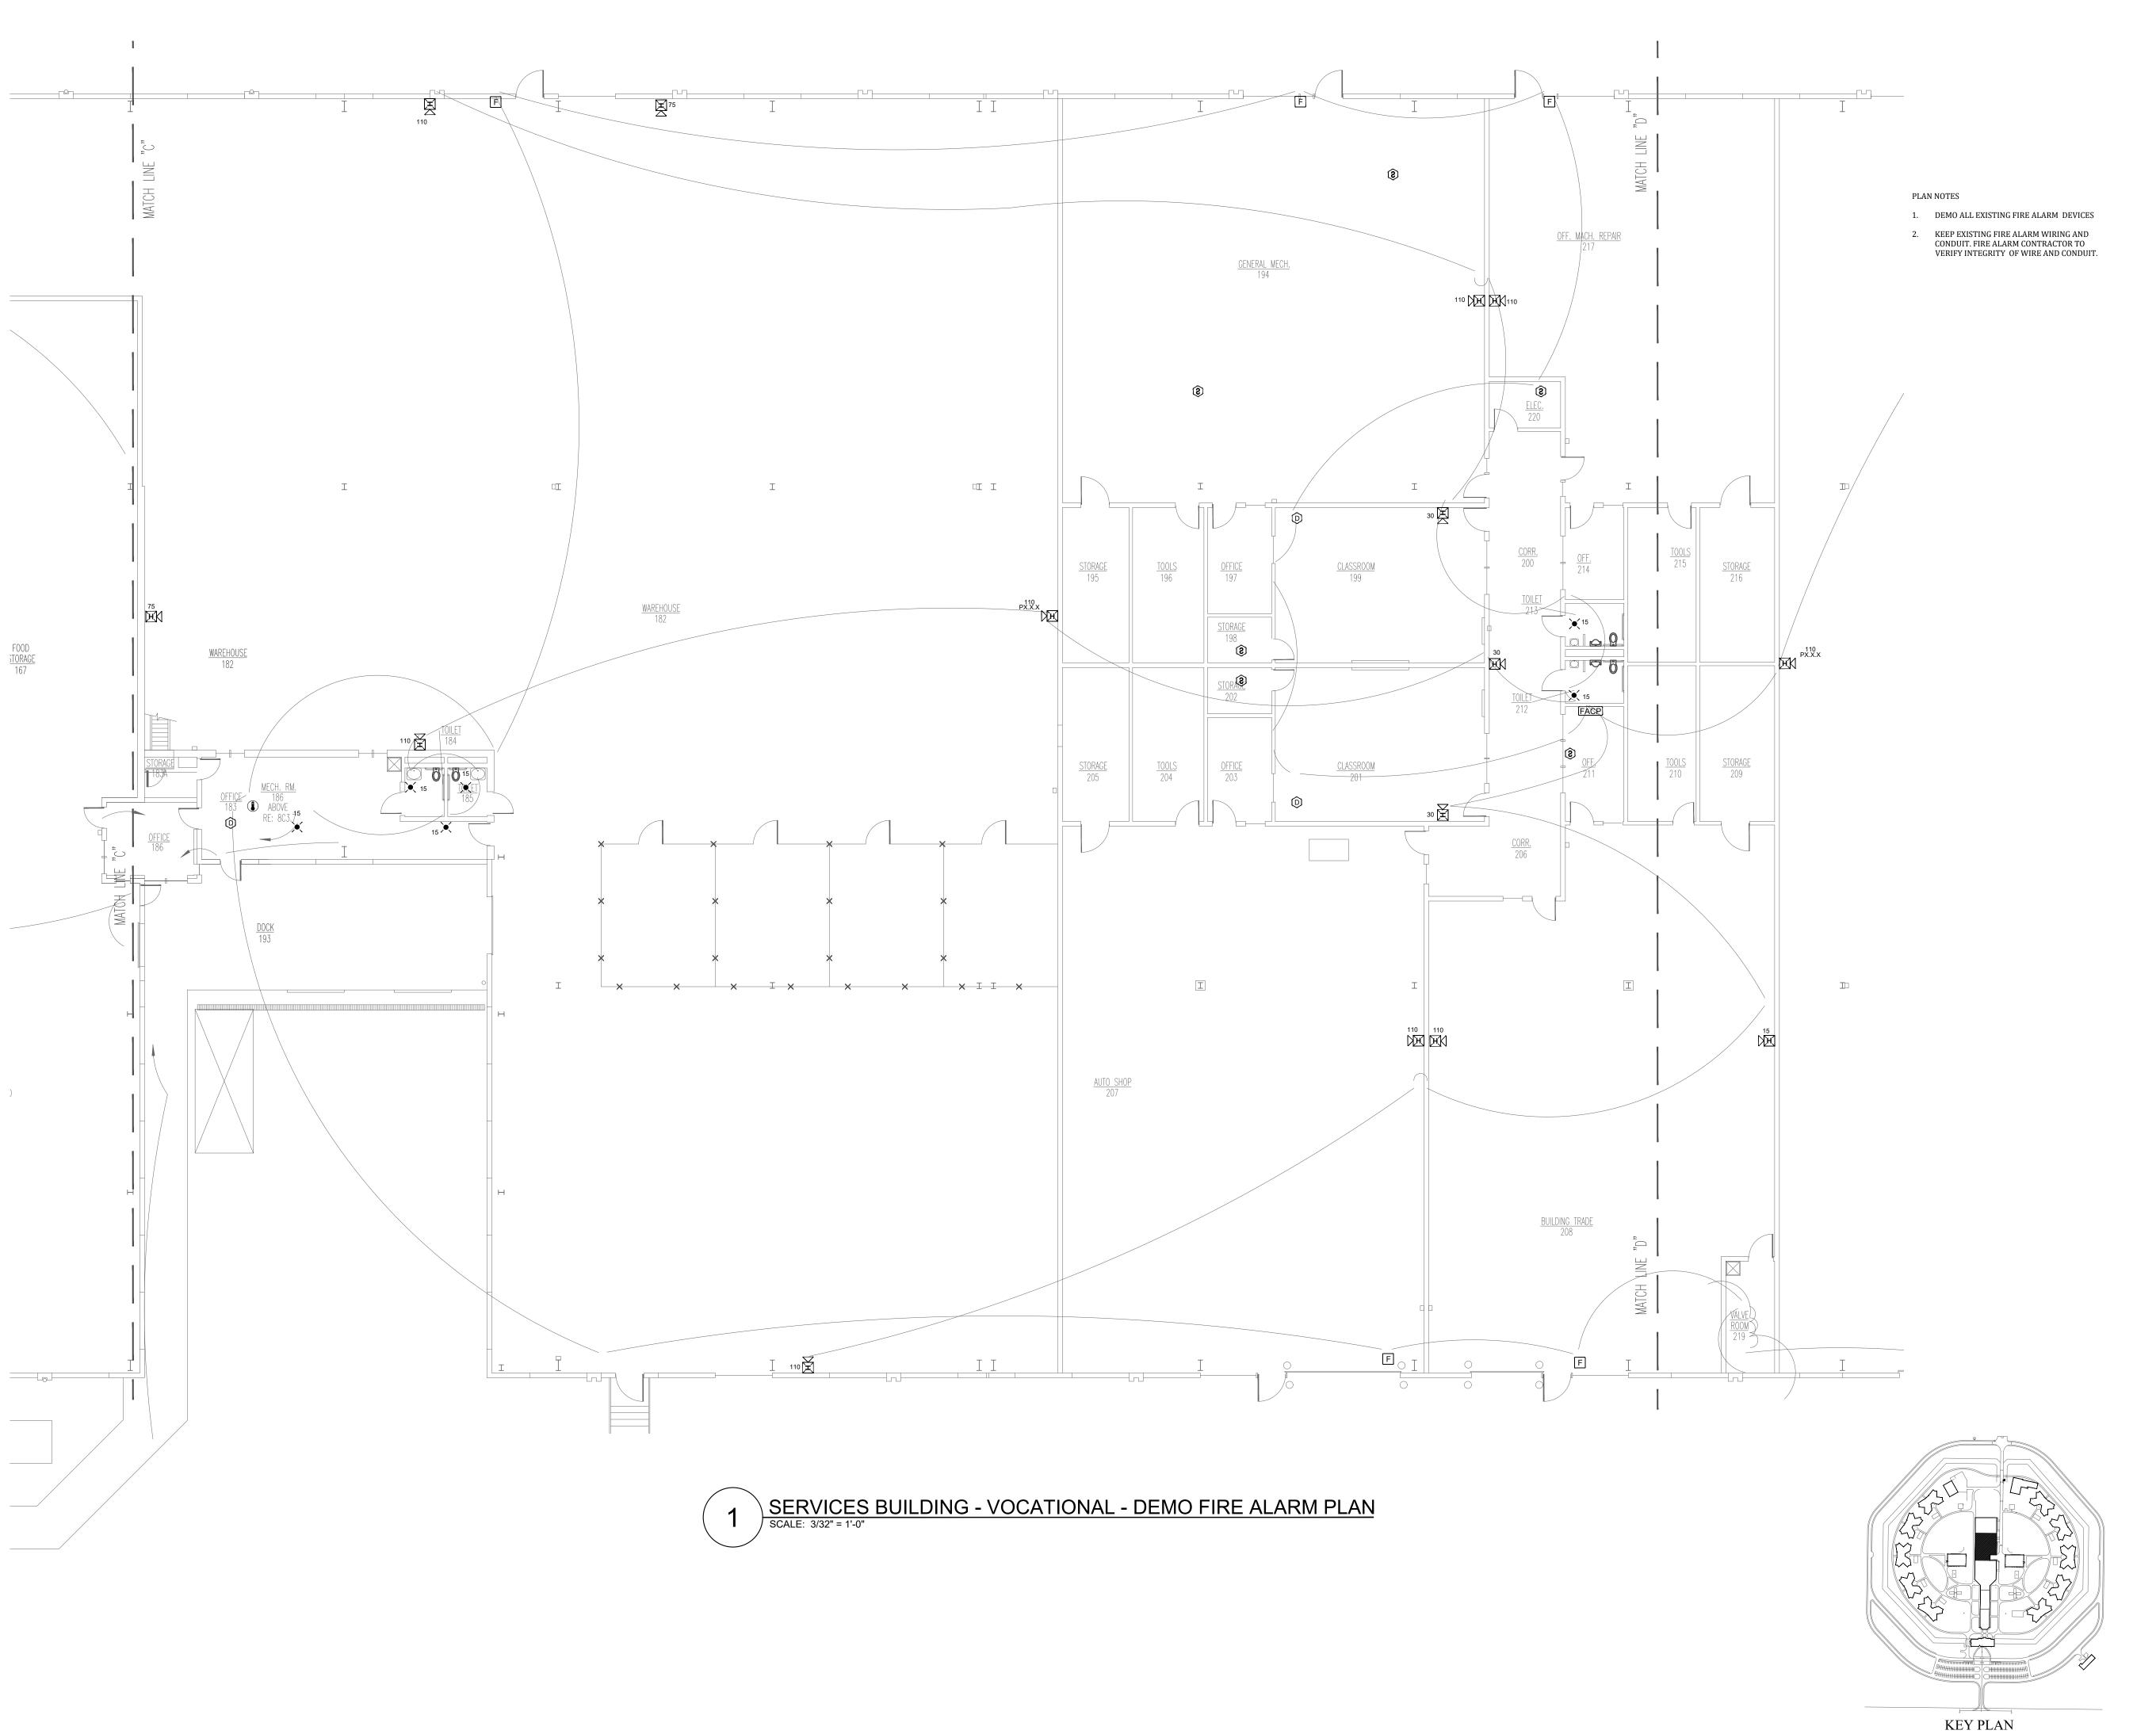
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DESIGNED BY: FSC

SHEET TITLE:

SERVICES BUILDING - FOOD - DEMO FIRE ALARM PLAN

SHEET NUMBER: FAD-202



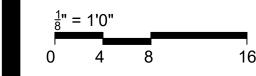


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NOTES: FOR FIRE ALARM GENERAL NOTES, REFER TO DWG# FA-002



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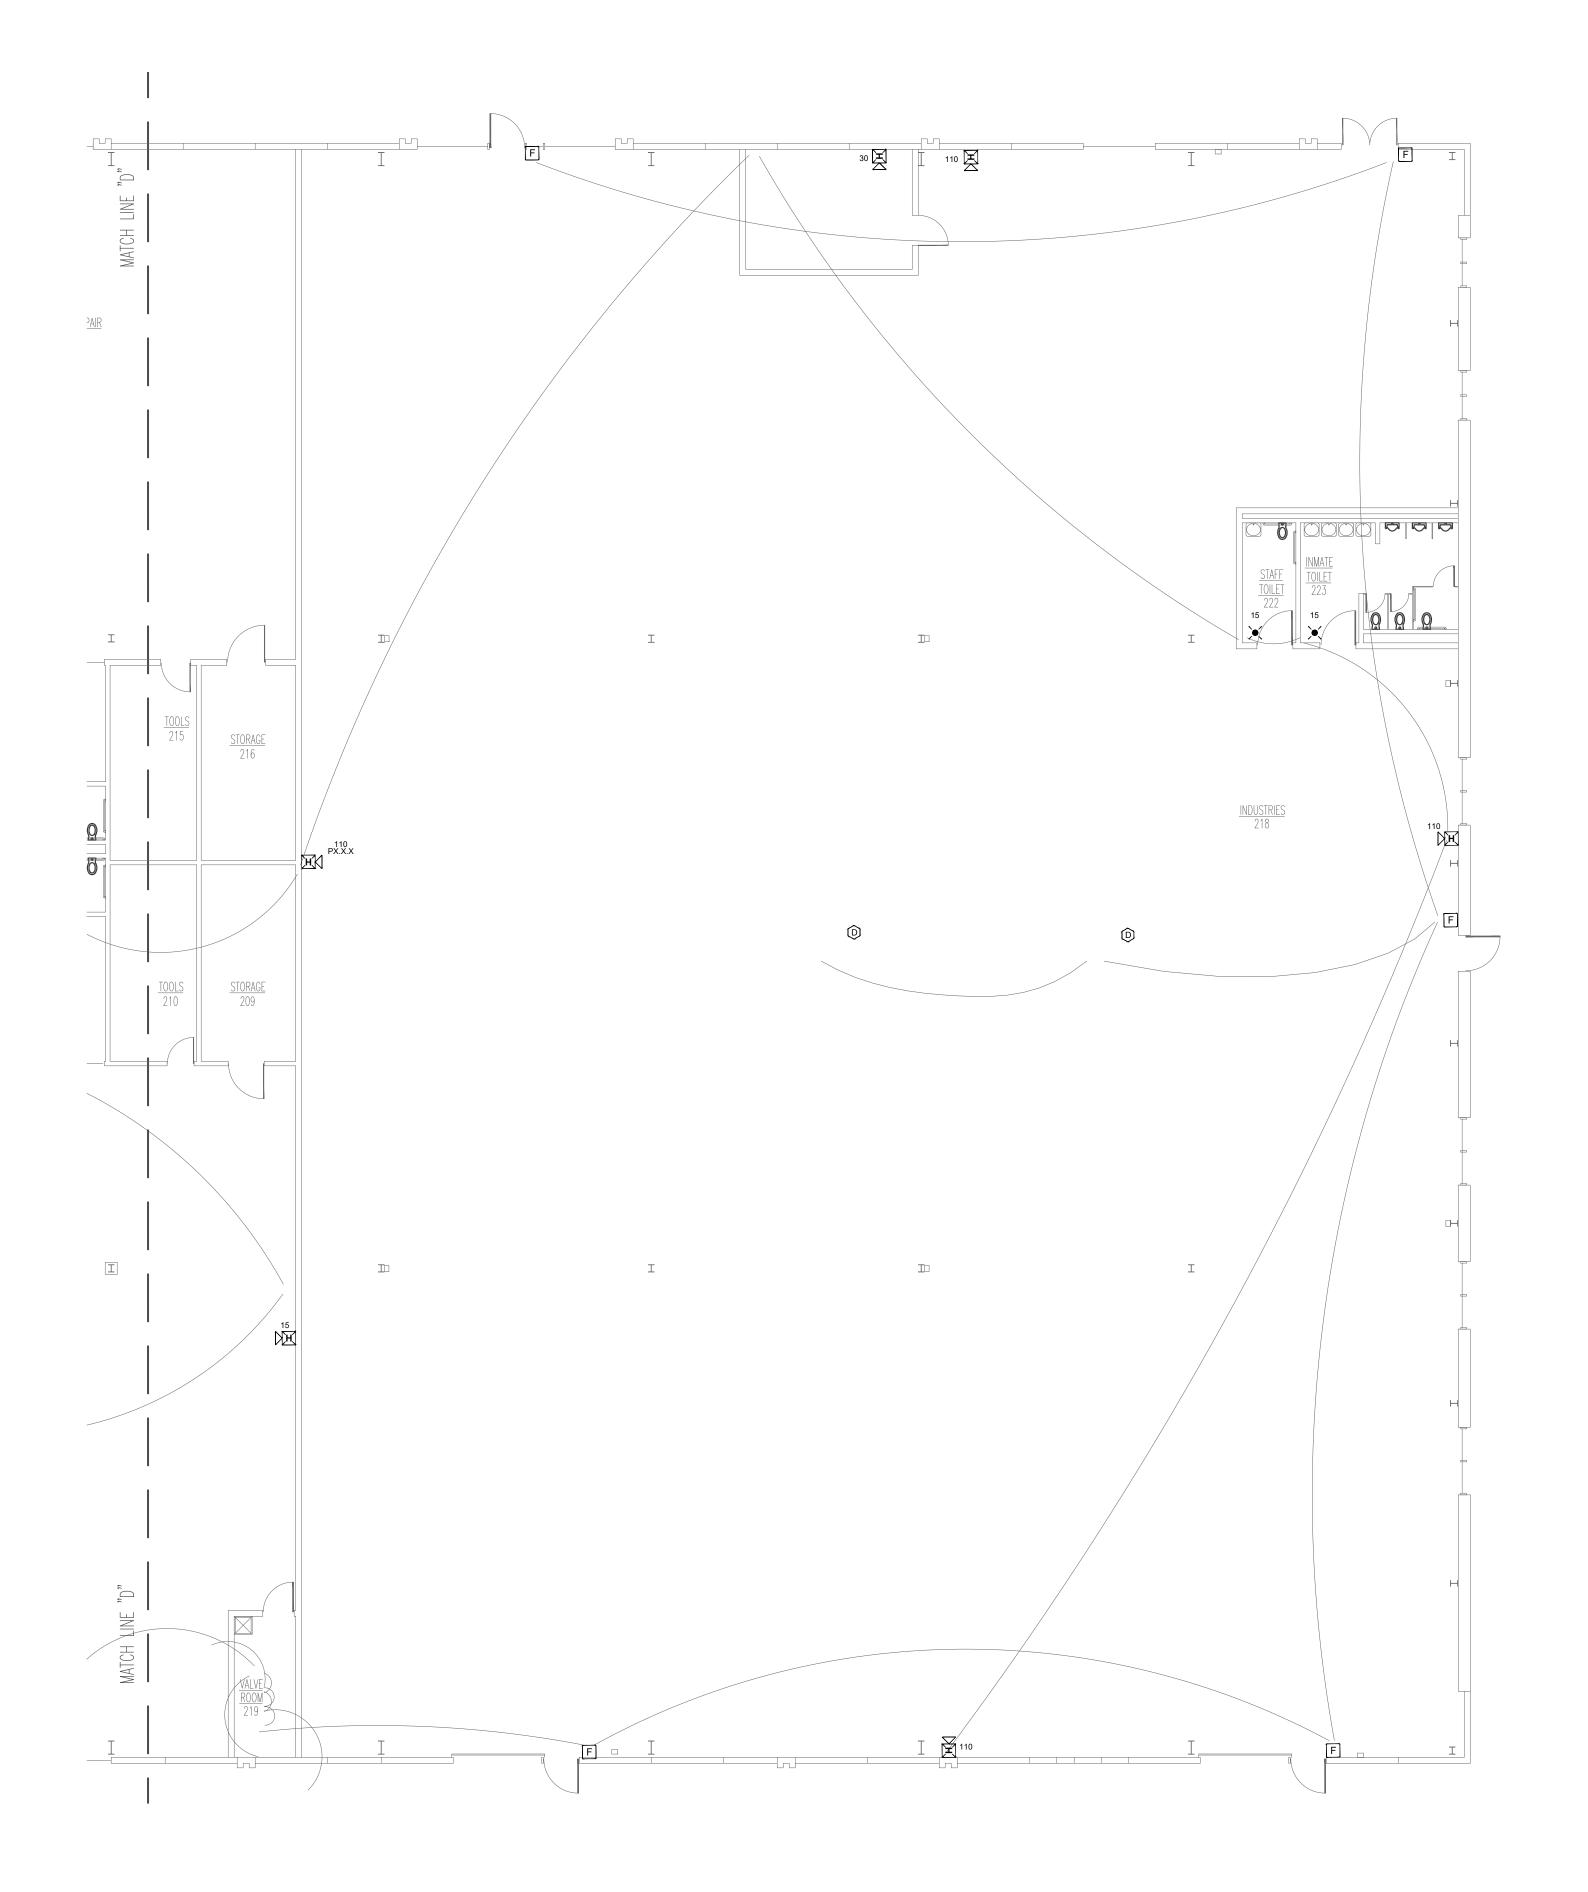
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CHECKED BY:	HDD
DESIGNED BY:	FSC

SHEET TITLE:

SERVICES BUILDING
- VOCATIONAL DEMO FIRE ALARM
PLAN

SHEET NUMBER:

FAD-203



SERVICES BUILDING - INDUSTRIAL - DEMO FIRE ALARM PLAN SCALE: 3/32" = 1'-0"

PLAN NOTES

- 1. DEMO ALL EXISTING FIRE ALARM DEVICES
- 2. KEEP EXISTING FIRE ALARM WIRING AND CONDUIT. FIRE ALARM CONTRACTOR TO VERIFY INTEGRITY OF WIRE AND CONDUIT.



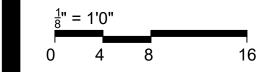


PROFESSIONAL SEAL



8675 W 96TH STREET OVERLAND PARK, KS. 66212 PHONE: 816.33.4373 FAX: 913.722.3484

FOR FIRE ALARM GENERAL NOTES, REFER TO DWG# FA-002



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Northeast Correctional center 13698 Airport Rd, Bowling Green, MO 63334

PROJECT # C2314-01 7017 FACILITY # 9327017049

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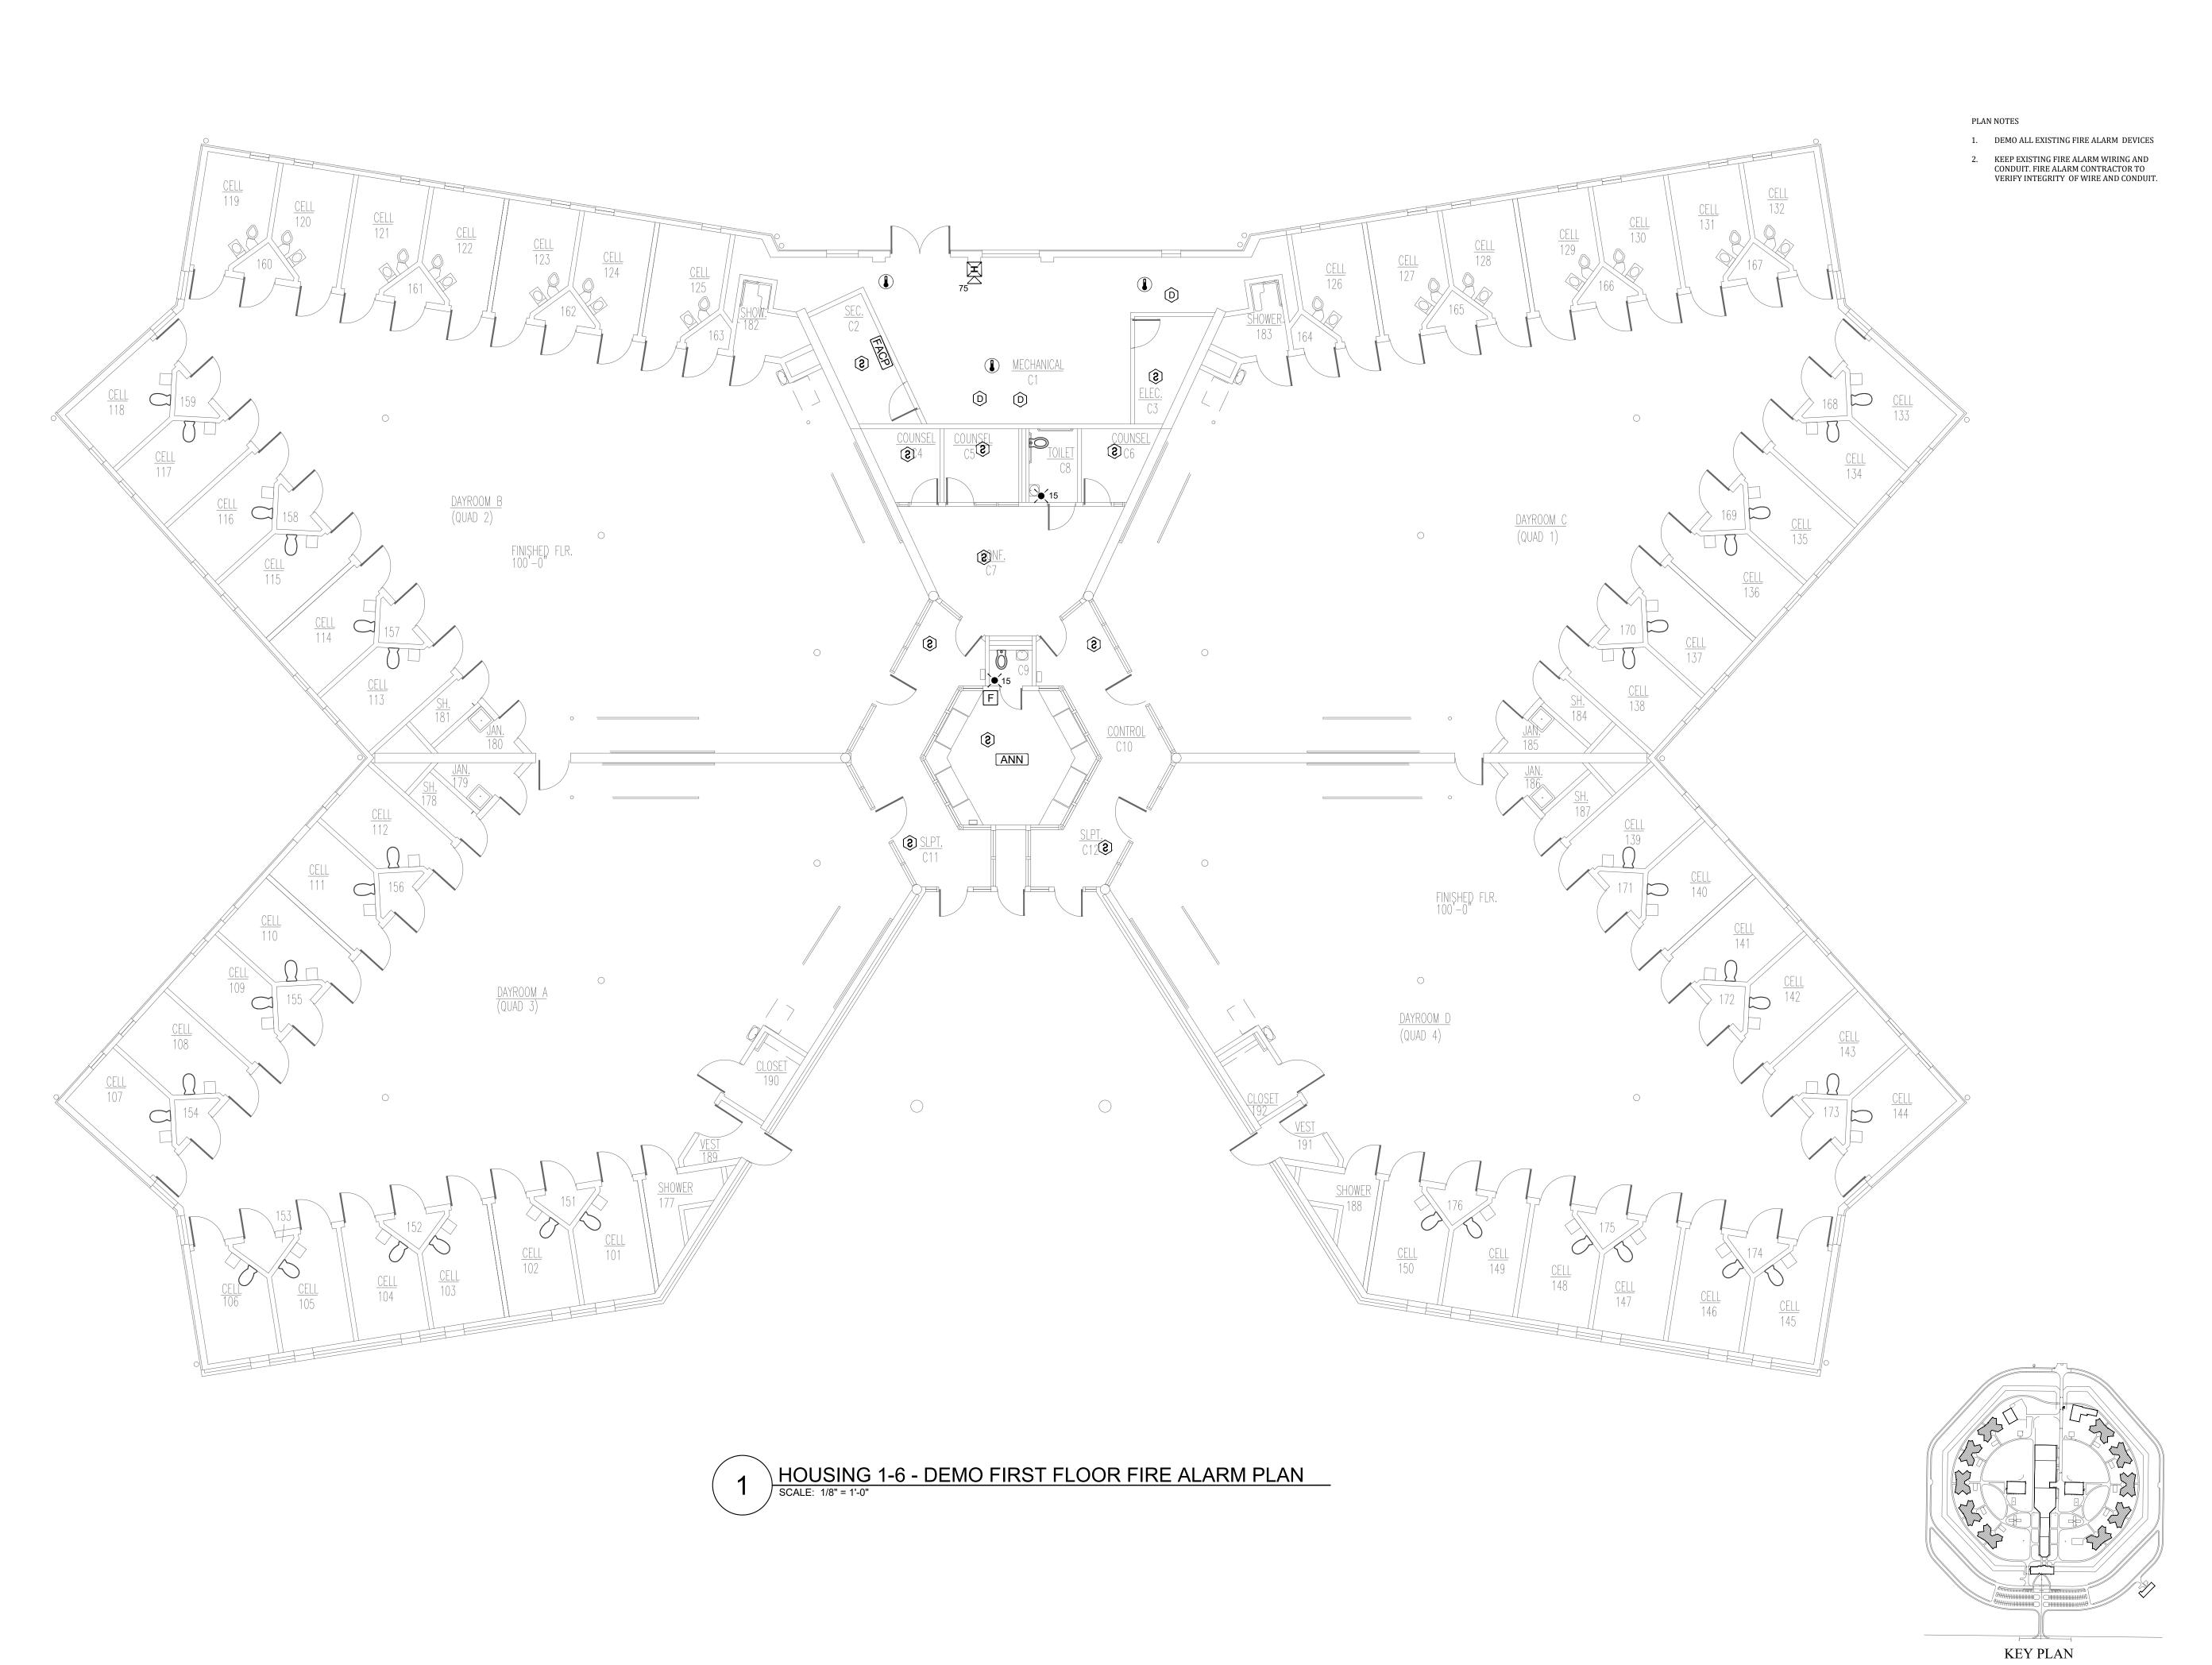
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SERVICES BUILDING - INDUSTRIAL -DEMO FIRE ALARM PLAN

SHEET NUMBER: FAD-204





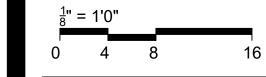


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NOTES: FOR FIRE ALARM GENERAL NOTES, REFER TO DWG# FA-002



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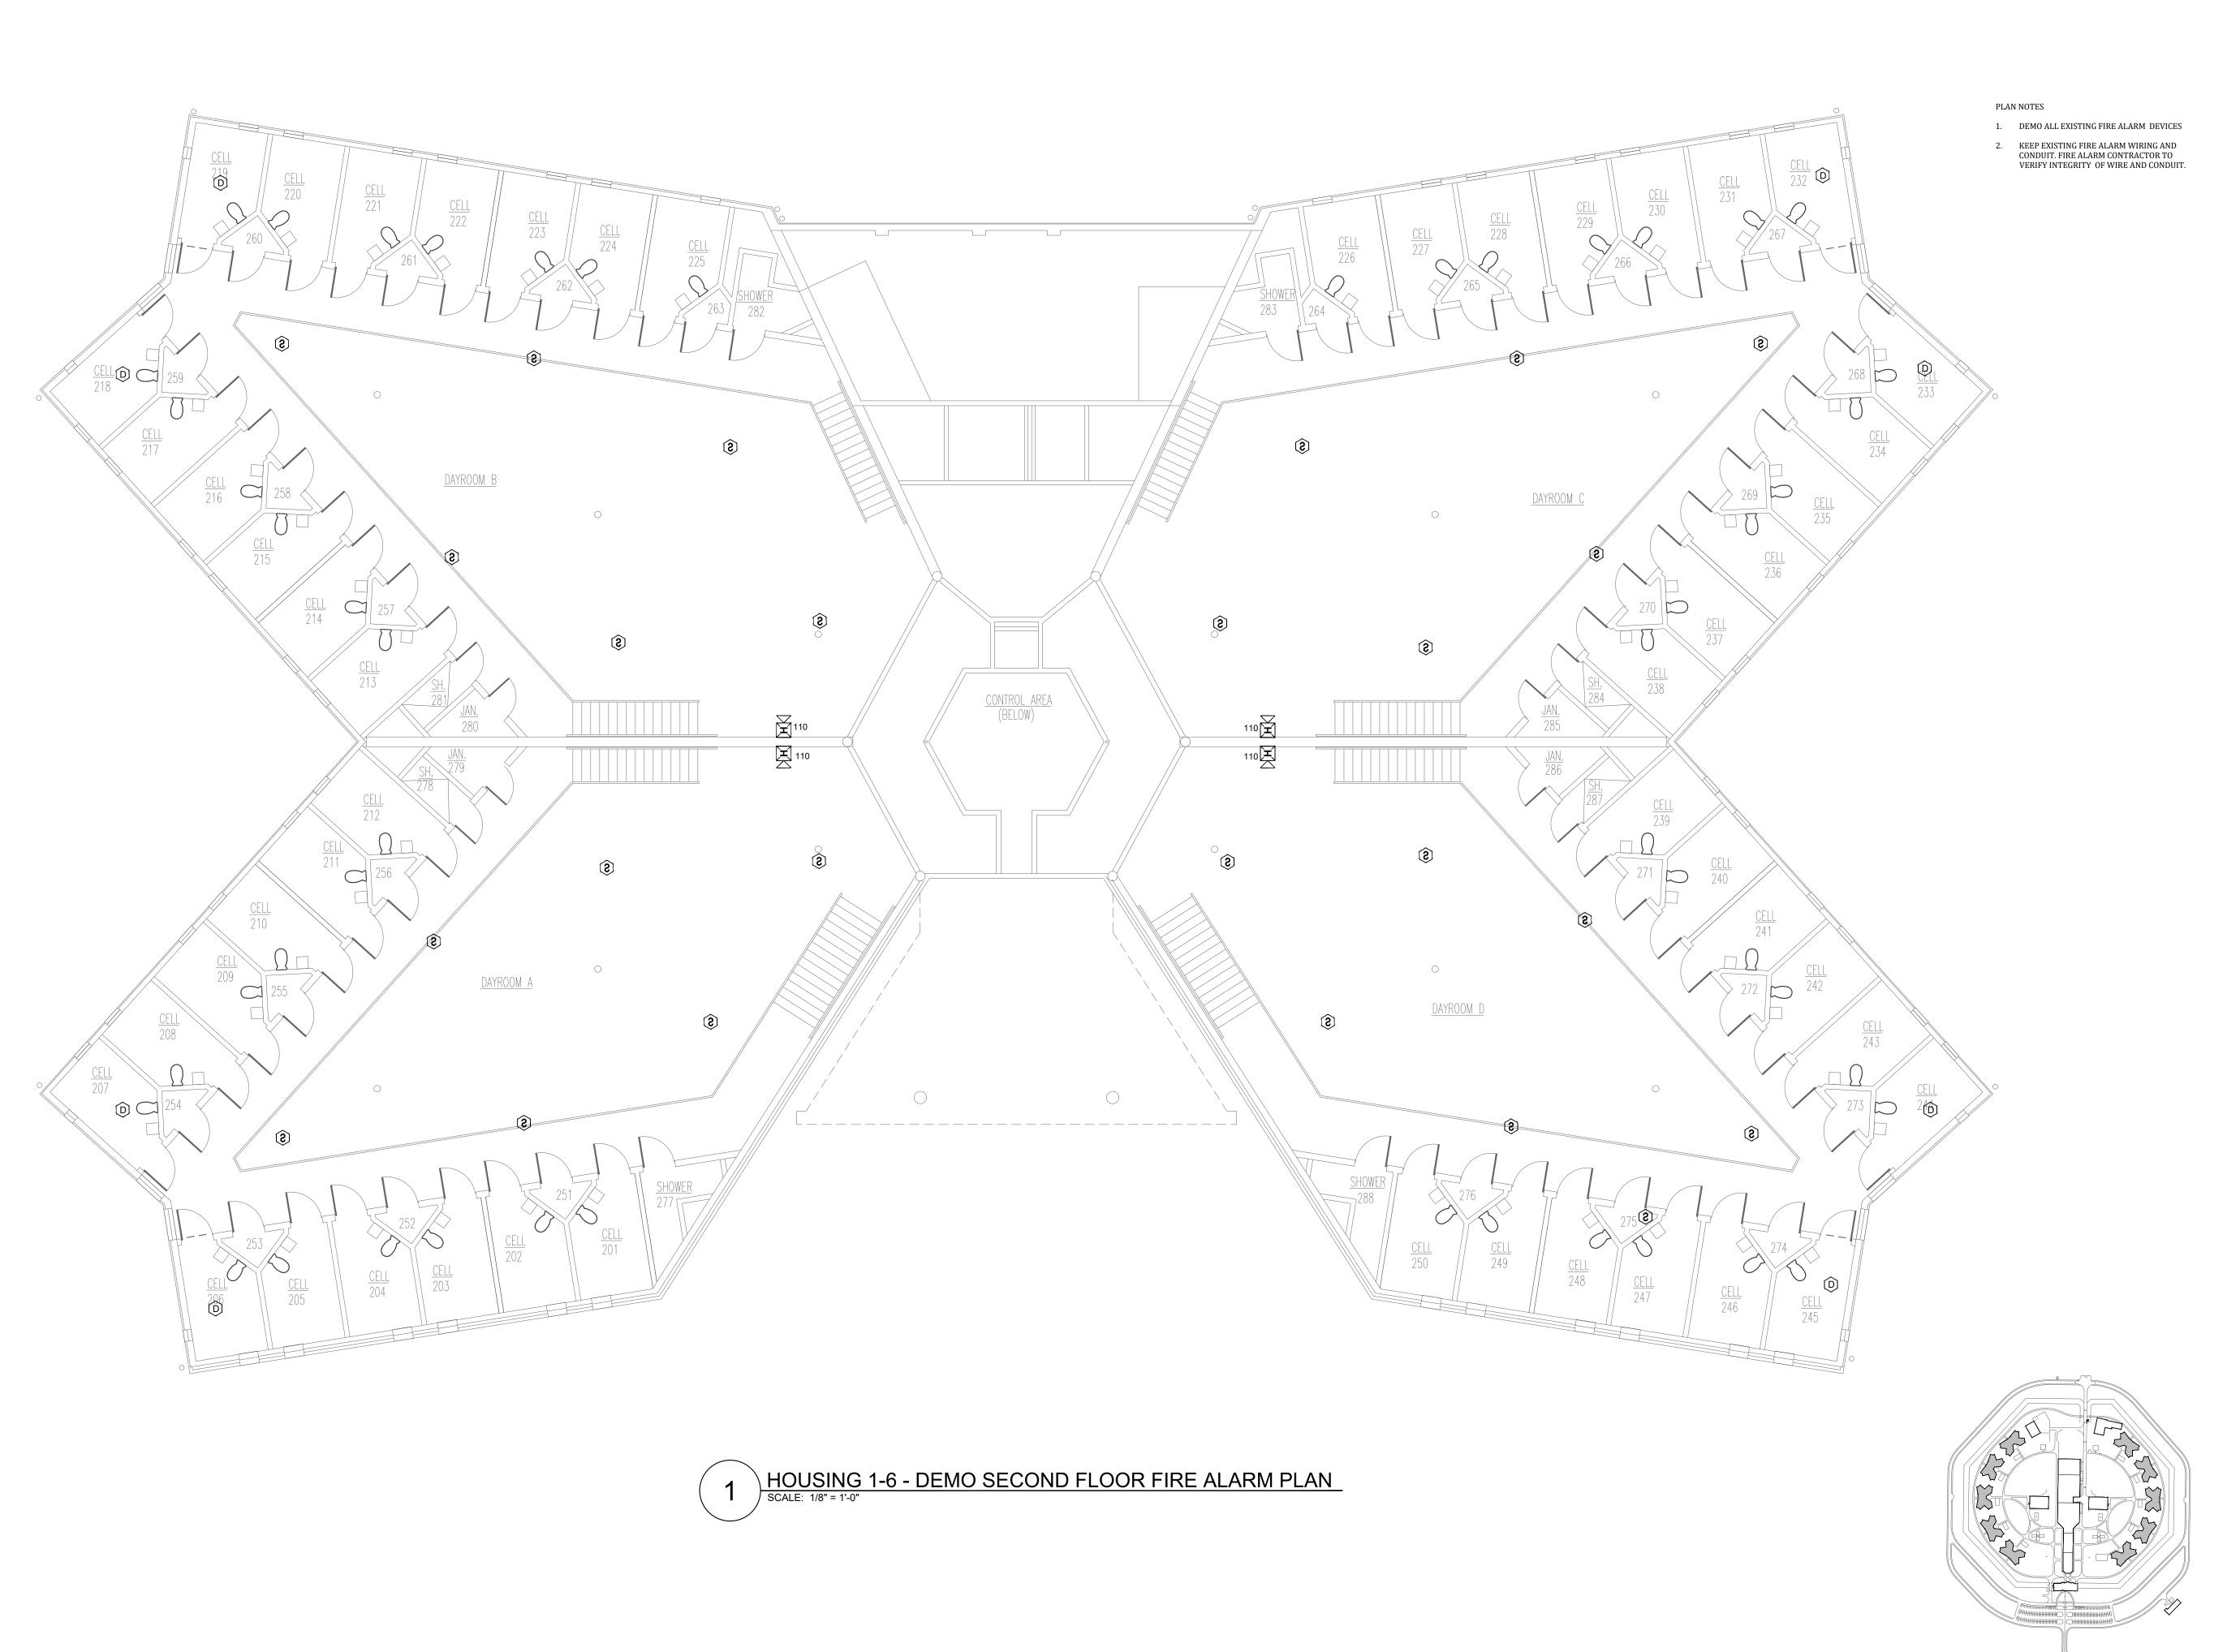
ISSUE DATE: 04/24/2024

CAD DWG FILE: FSC
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SHEET TITLE:

HOUSING 1-10 -FIRST FLOOR DEMO FIRE ALARM PLAN

SHEET NUMBER: FAD-300



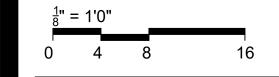


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NOTES: FOR FIRE ALARM GENERAL NOTES, REFER TO DWG# FA-002



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CAD DWG FILE: FSC
DRAWN BY: FSC
CHECKED BY: HDD
DESIGNED BY: FSC

SHEET TITLE:

HOUSING 1-10 -SECOND FLOOR DEMO FIRE ALARM PLAN

SHEET NUMBER:

FAD-301

27 OF 31 SHEETS 04/24/2024

KEY PLAN

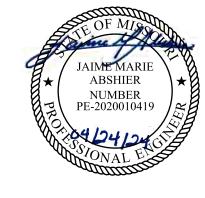


1 RECREATION BUILDING - DEMO FIRE ALARM PLAN
SCALE: 1/8" = 1'-0"

PLAN NOTES

- 1. DEMO ALL EXISTING FIRE ALARM DEVICES
- 2. KEEP EXISTING FIRE ALARM WIRING AND CONDUIT. FIRE ALARM CONTRACTOR TO VERIFY INTEGRITY OF WIRE AND CONDUIT.



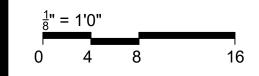


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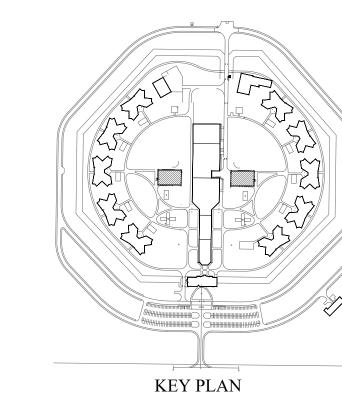
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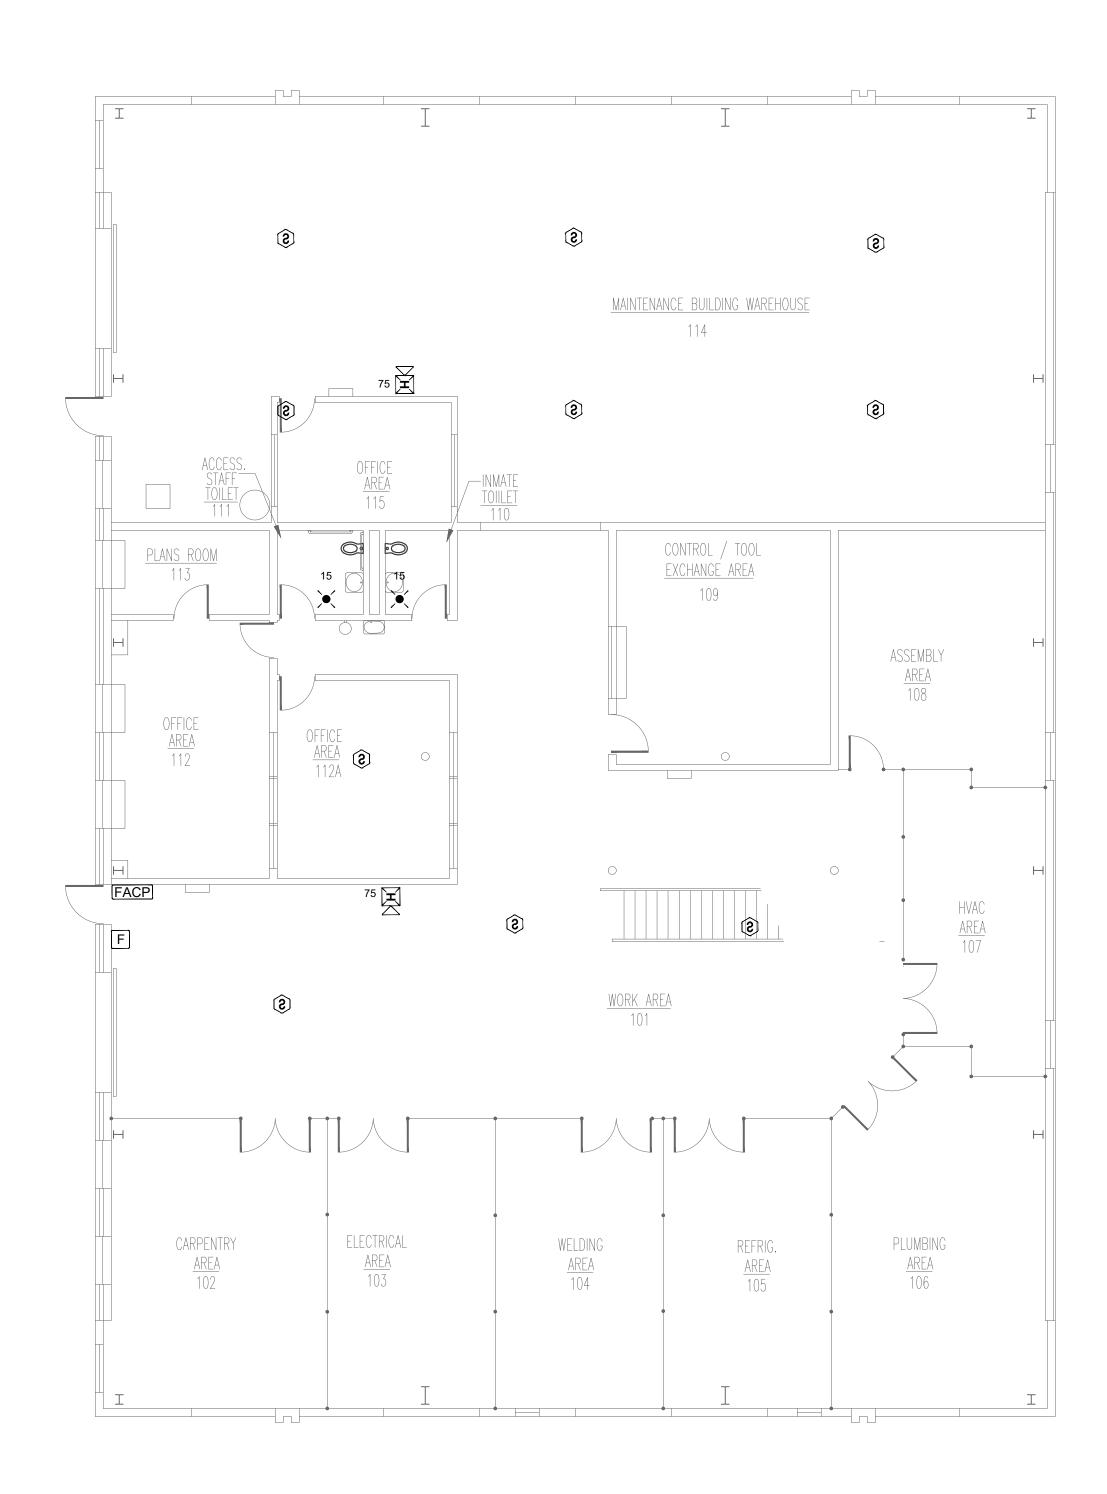
SHEET TITLE:

RECREATION BUILDING - DEMO FIRE ALARM PLAN

SHEET NUMBER:

FAD-400

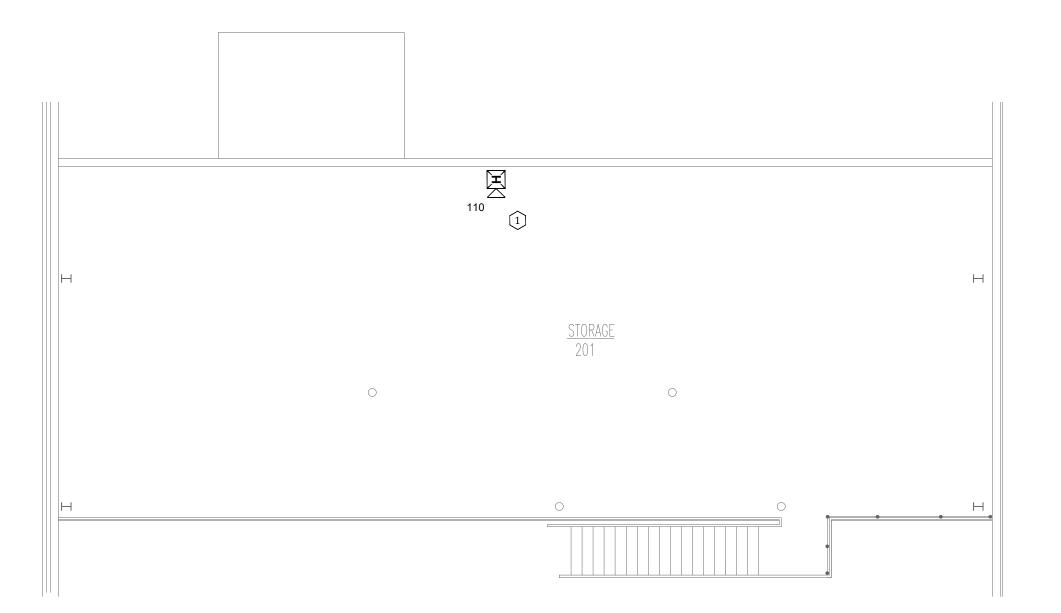




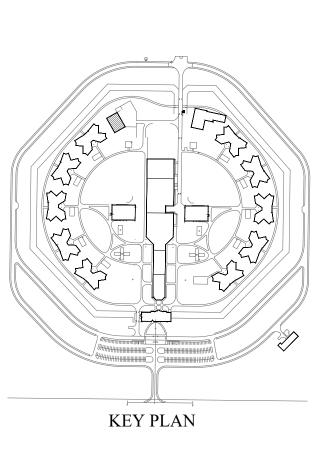
1 DEMO MAINTENANCE BUILDING - FIRST FLOOR FIRE ALARM PLAN
SCALE: 1/8" = 1'-0"

PLAN NOTES

- 1. DEMO ALL EXISTING FIRE ALARM DEVICES
- 2. KEEP EXISTING FIRE ALARM WIRING AND CONDUIT. FIRE ALARM CONTRACTOR TO VERIFY INTEGRITY OF WIRE AND CONDUIT.



2 DEMO MAINTENANCE BUILDING - SECOND FLOOR FIRE ALARM PLAN
SCALE: 1/8" = 1'-0"



STATE OF MISSOURI MICHAEL L. PARSON, GOVERNOR

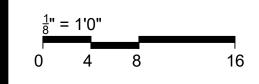


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NOTES: FOR FIRE ALARM GENERAL NOTES, REFER TO DWG# FA-002



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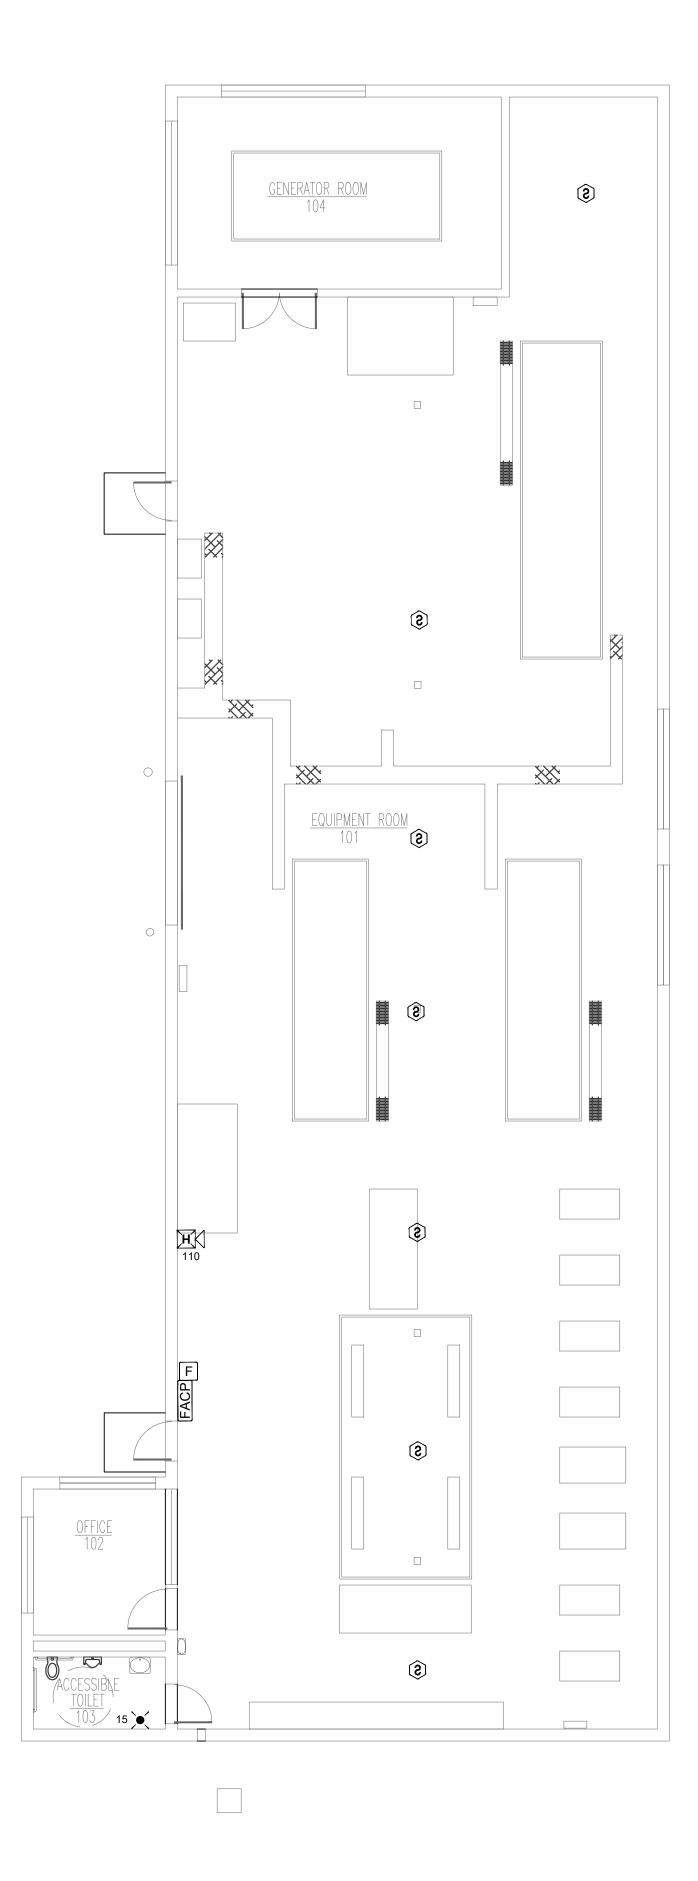
ISSUE DATE: 04/24/2024

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SHEET TITLE:

MAINTENANCE BUILDING-DEMO FIRST&SECOND FLOOR FIRE ALARM PLAN

SHEET NUMBER: FAD-500



1 DEMO POWER PLANT FIRE ALARM PLAN
SCALE: 1/8" = 1'-0"

PLAN NOTES

- 1. DEMO ALL EXISTING FIRE ALARM DEVICES
- 2. KEEP EXISTING FIRE ALARM WIRING AND CONDUIT. FIRE ALARM CONTRACTOR TO VERIFY INTEGRITY OF WIRE AND CONDUIT.



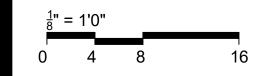


STATE OF MISSOURI MICHAEL L. PARSON, GOVERNOR

> NUMBER PE-2020010419

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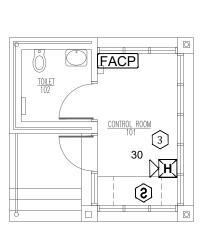
POWER PLANT AND GUARD HOUSE -DEMO FIRE ALARM PLANS

SHEET NUMBER:

FAD-600

30 OF 31 SHEETS 04/24/2024

KEY PLAN



2 DEMO GUARD HOUSE FIRE ALARM PLAN
SCALE: 1/8" = 1'-0"



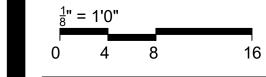


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CAD DWG FILE:	FSC
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SHEET TITLE:

HOUSING 17 -DEMO FIRE ALARM PLANS

SHEET NUMBER: FAD-700