
OZARK CORRECTIONAL CENTER UPGRADE HVAC FORDLAND, MISSOURI

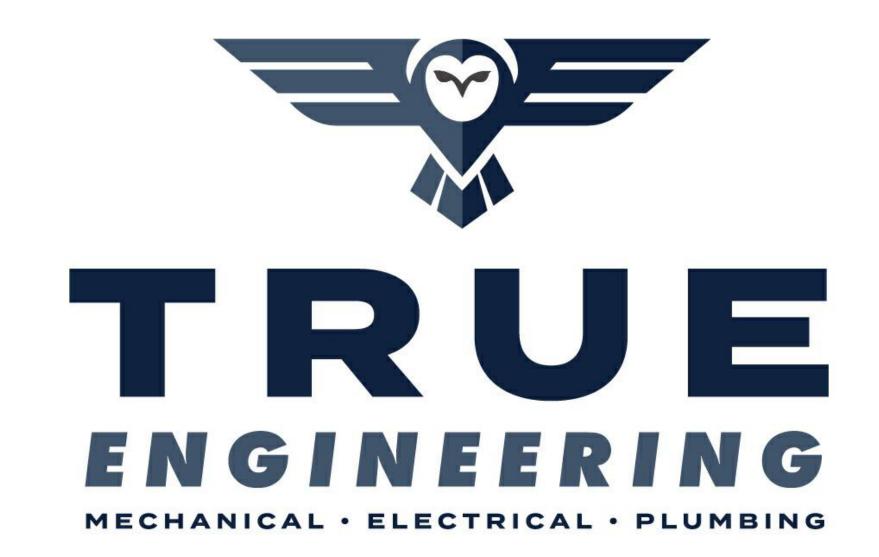

1200 E WOODHURST DR, STE P

SPRINGFIELD, MO 65804

417.708.7025

WWW.TRUE-MEP.COM

OWNER:

STATE OF MISSOURI

MIKE KEHOE, GOVERNOR

DEPARTMENT OF CORRECTIONS

PROJECT MANAGEMENT:

OFFICE OF ADMINISTRATION DIVISION OF FACILITIES

MANAGEMENT,


DESIGN AND CONSTRUCTION


DESIGNER: TRUE ENGINEERING GROUP, LLC

PROJECT NUMBER: C2324-01

SITE NUMBER: 7003

FACILITY NUMBER: 9327003081

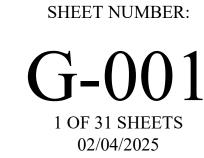

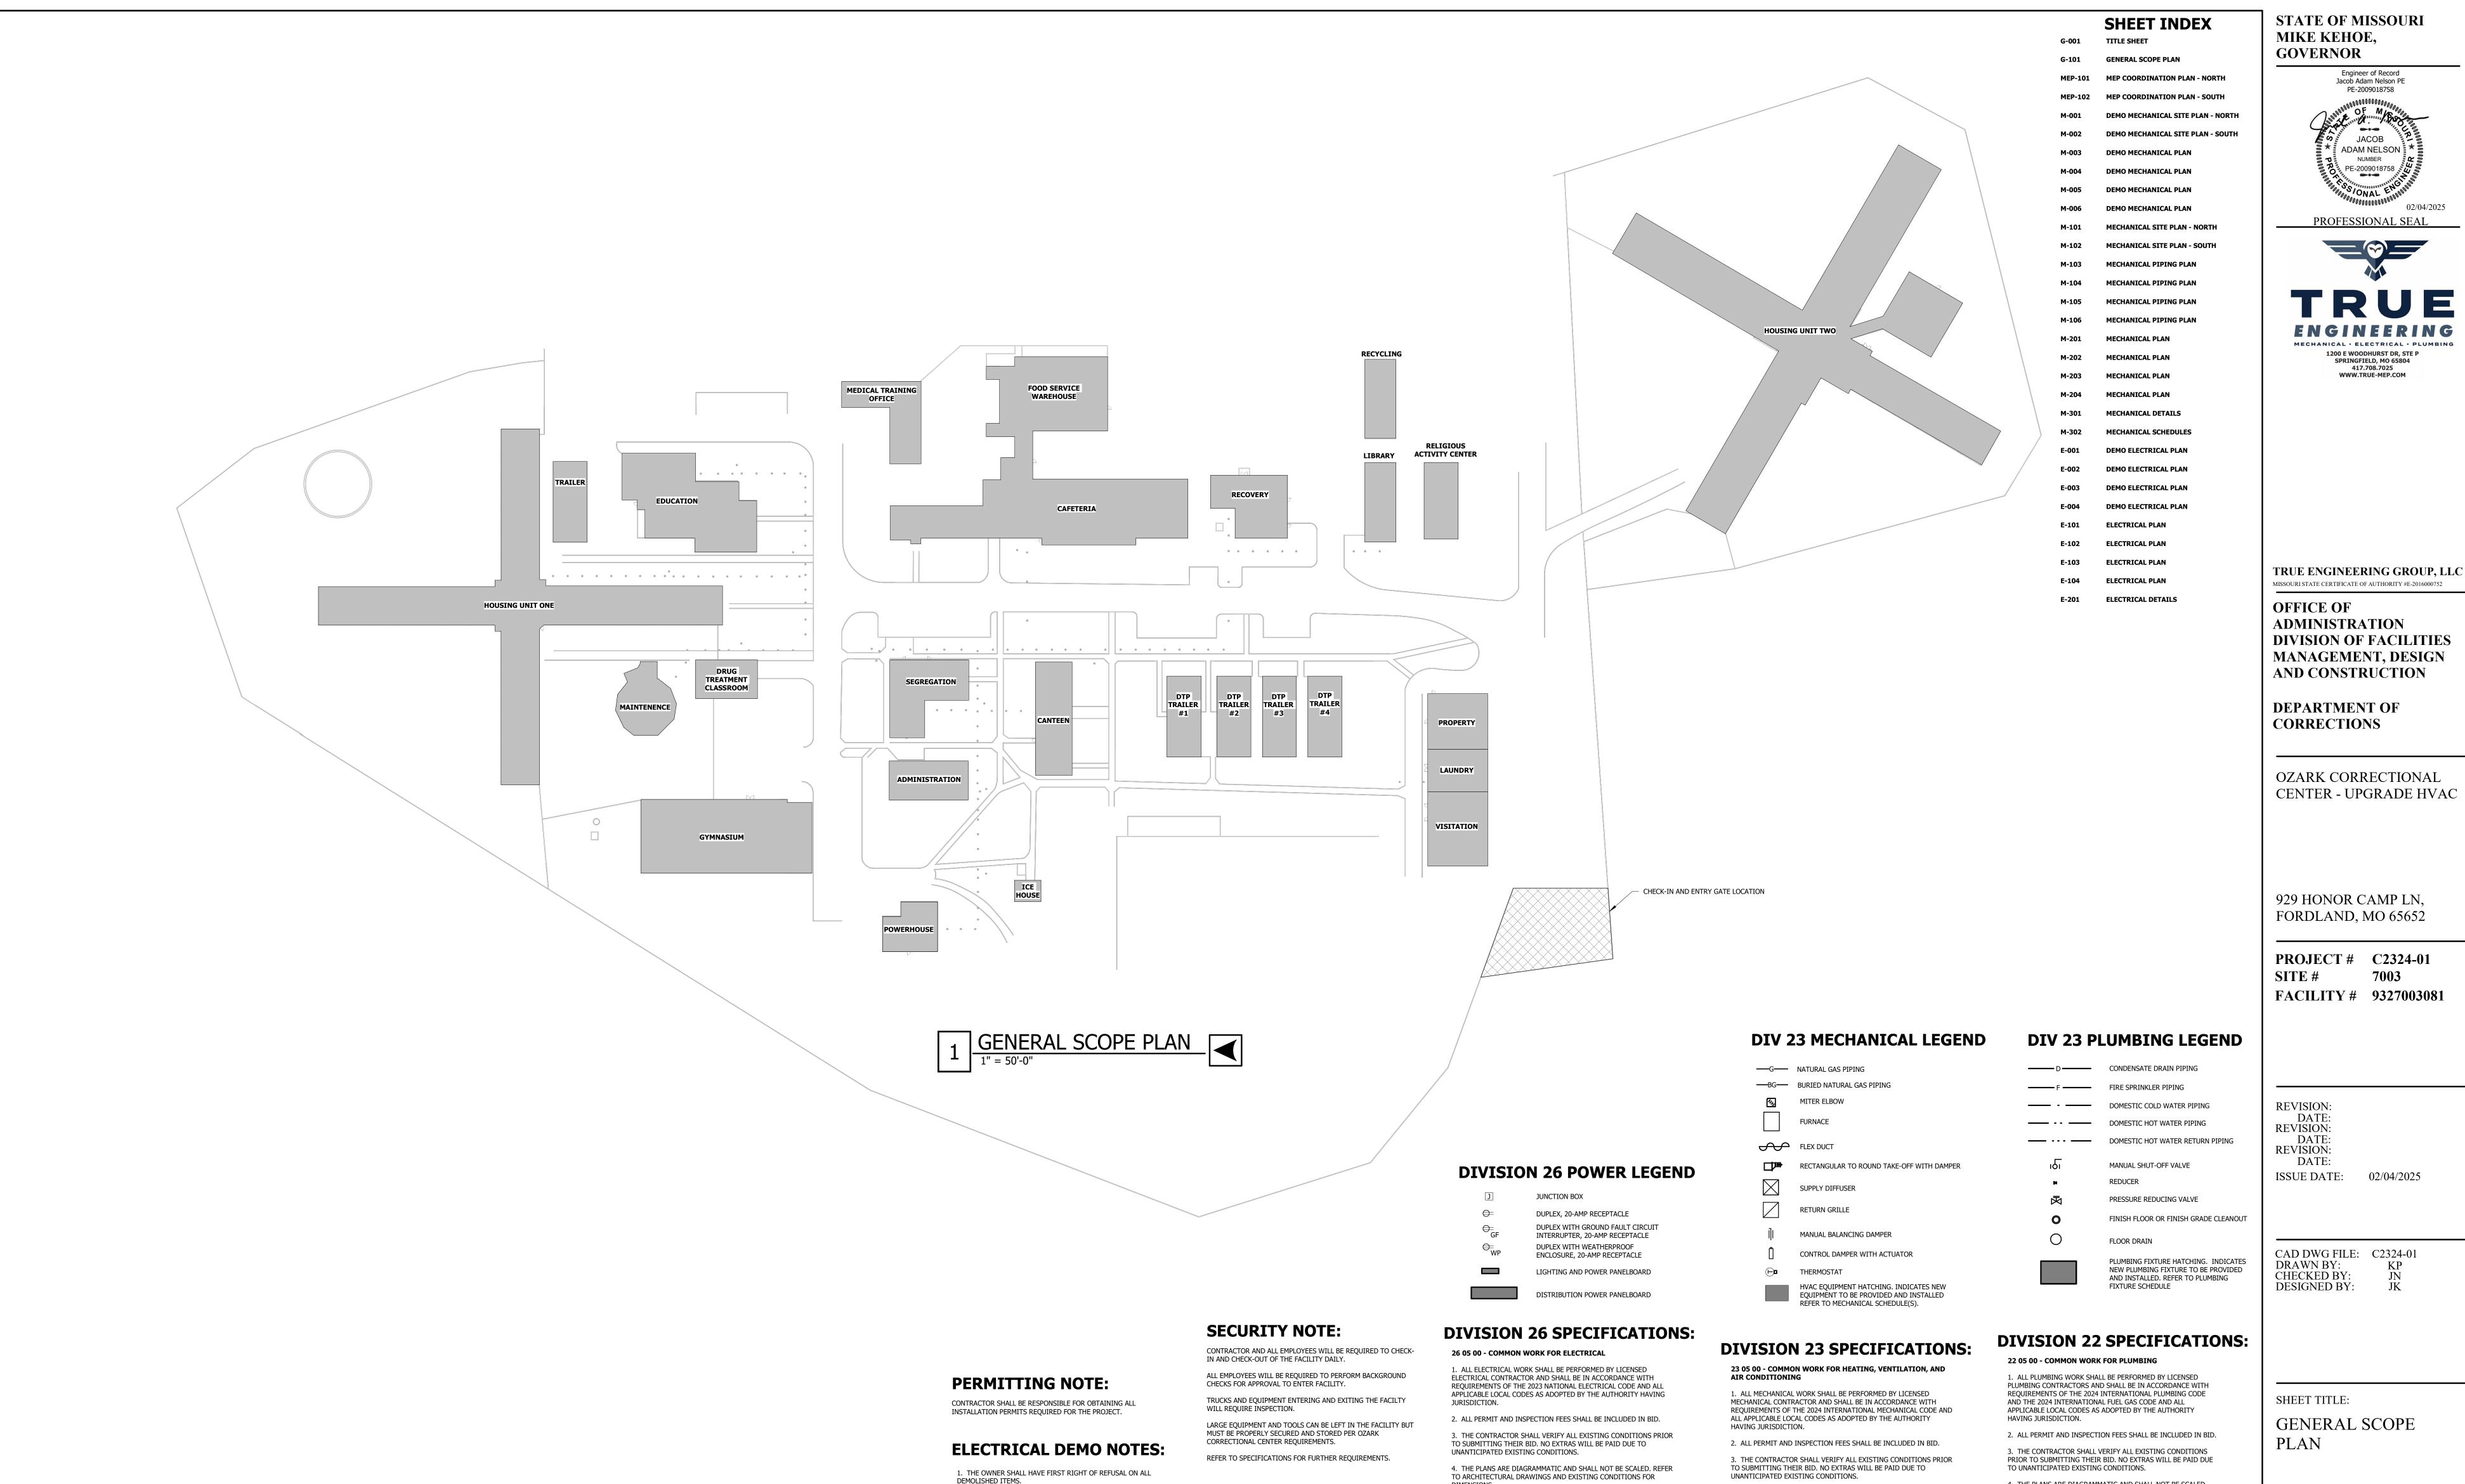

DEMOLISHED ITEMS. 2. THE CONTRACTOR SHALL FIELD VISIT THE SITE TO CONFIRM EXISTING CONDITIONS. 3. REMOVE CONDUIT, CONDUCTORS, SUPPORTS, ETC. BACK TO ELECTRICAL PANEL. 4. CONTRACTOR SHALL REPAIR ALL HOLES CREATED BY REMOVAL OF EXISTING ELECTRICAL EQUIPMENT.

1. THE OWNER SHALL HAVE FIRST RIGHT OF REFUSAL ON ALL

2. THE CONTRACTOR SHALL FIELD VISIT THE SITE TO CONFIRM

3. REMOVE SUPPORTS, ETC. ASSOCIATED WITH DEMOLISHED ITEMS.

4. CONTRACTOR SHALL REPAIR ALL HOLES CREATED BY REMOVAL

OF EXISTING MECHANICAL EQUIPMENT, DUCTWORK, AND PIPING.

DEMOLISHED ITEMS.

EXISTING CONDITIONS.

WORK SEQUENCE NOTE: MECHANICAL DEMO NOTES:

1. ALL NEW DOMECTIC HOT WATER SYSTEMS, FORCED AIR NATURAL GAS HEATING SYSTEMS, NATURAL GAS UNIT HEATERS, PACKAGED ROOFTOP UNITS, ELECTRIC HEATING SYSTEMS, AND BUILDING AUTOMATION SYSTEMS SHALL BE INSTALLED AND OPERATIONAL AS DESIGNED PRIOR TO DECOMMISIONING THE STEAM SYSTEM. 2. STEAM SYSTEM SHALL NOT BE DECOMMISIONED UNTIL AUTHORIZATION BY THE OWNER. CONTACT ENGINEER TO COORDINATE REQUIREMENTS PRIOR TO ANY DEMOLITION OF STEAM

OR CONDENSATE SYSTEMS.

3. REFER TO SPECIFICATION SECTION 01 10 00 - SUMMARY OF WORK FOR FURTHER WORK SEQUENCING REQUIREMENTS.

EXISTING GAS LOAD FOR EXISTING POWERHOUSE

NEW GAS LOAD FOR EXISTING POWERHOUSE 1. ADD 5 PSI SERVICE TO EXISTING GAS MAIN LOCATION. VERIFY EXISTING SERVICE PRESSURE. PROVIDE NEW GAS METER FOR NEW GAS LOAD. EXISTING METER SERVING THE POWERHOUSE SHALL

2. NEW GAS LOAD TOTALS A. HOUSING UNIT 1 = 1200 MBH B. HOUSING UNIT 2 = 1230 MBH C. CANTEEN = 90 MBH D. EDUCATION = 400 MBH E. GYM = 285 MBHF. MAINTENANCE = 210 MBH G. POWERHOUSE = 75 MBH

H. RECYCLING = 75 MBH

TOTAL = 3,565 MBH

DIMENSIONS.

5. CONDUIT/CONDUCTOR LAYOUTS ARE DIAGRAMMATIC. FIELD COORDINATE EXACT LOCATIONS AND ROUTINGS WITH STRUCTURE, PIPING, LIGHT FIXTURES, CONDUITS, ETC. 6. COOPERATE CLOSELY WITH ALL OTHER TRADES TO EXPEDITE

CONSTRUCTION AND AVOID INTERFERENCES AND CONFLICTS. BEFORE ANY PIPING, DUCTWORK, CONDUIT, ETC. IS INSTALLED, IT SHALL BE COORDINATED CAREFULLY BETWEEN ALL TRADES. 7. MAINTAIN ALL CLEARANCES REQUIRED BY ELECTRICAL EQUIPMENT. COORDINATE WITH MECHANICAL AND PLUMBING CONTRACTOR TO

ROUTE PIPING, DUCTWORK, ETC. ABOVE ELECTRICAL PANELS. ACCESSORIES, AND MATERIAL FURNISHED BY THEM FOR A PERIOD OF

4. THE PLANS ARE DIAGRAMMATIC AND SHALL NOT BE SCALED. REFER TO ARCHITECTURAL DRAWINGS AND EXISTING CONDITIONS

4. THE PLANS ARE DIAGRAMMATIC AND SHALL NOT BE SCALED. REFER

TO ARCHITECTURAL DRAWINGS AND EXISTING CONDITIONS FOR

5. DUCTWORK LAYOUTS ARE DIAGRAMMATIC. FIELD COORDINATE

6. COOPERATE CLOSELY WITH ALL OTHER TRADES TO EXPEDITE CONSTRUCTION AND AVOID INTERFERENCES AND CONFLICTS. BEFORE

COORDINATED CAREFULLY BETWEEN ALL TRADES.

FIXTURES, CONDUITS, ETC.

EXACT LOCATIONS AND ROUTINGS WITH STRUCTURE, PIPING, LIGHT

ANY PIPING, DUCTWORK, CONDUIT, ETC. IS INSTALLED, IT SHALL BE

7. MAINTAIN ALL CLEARANCES REQUIRED BY MECHANICAL EQUIPMENT.

COORDINATE WITH ELECTRICAL AND PLUMBING CONTRACTOR TO

MAINTAIN ALL CLEARANCES REQUIRED FOR EQUIPMENT. DO NOT

ACCESSORIES, AND MATERIAL FURNISHED BY THEM FOR A PERIOD OF

ROUTE PIPING, DUCTWORK, ETC. ABOVE ELECTRICAL PANELS.

8. THE CONTRACTOR SHALL GUARANTEE ALL EQUIPMENT,

9. REFER TO SPECIFICATION SECTIONS FOR ADDITIONAL

ONE YEAR FROM FINAL ACCEPTANCE AGAINST ALL DEFECTS.

FOR DIMENSIONS. 5. PIPING LAYOUTS ARE DIAGRAMMATIC. FIELD COORDINATE EXACT LOCATIONS AND ROUTINGS WITH STRUCTURE, DUCTWORK,

LIGHT FIXTURES, CONDUITS, ETC. 6. COOPERATE CLOSELY WITH ALL OTHER TRADES TO EXPEDITE CONSTRUCTION AND AVOID INTERFERENCES AND CONFLICTS. BEFORE ANY PIPING, DUCTWORK, CONDUIT, ETC. IS INSTALLED, IT SHALL BE COORDINATED CAREFULLY BETWEEN ALL TRADES.

7. MAINTAIN ALL CLEARANCES REQUIRED BY PLUMBING FOUIPMENT, COORDINATE WITH FLECTRICAL AND HVAC CONTRACTOR TO MAINTAIN ALL CLEARANCES REQUIRED FOR EQUIPMENT. DO NOT ROUTE PIPING, DUCTWORK, ETC. ABOVE ELECTRICAL PANELS.

DEFECTS. 9. REFER TO SPECIFICATION SECTIONS FOR ADDITIONAL REQUIREMENTS.

8. THE CONTRACTOR SHALL GUARANTEE ALL EQUIPMENT,

ACCESSORIES, AND MATERIALS FURNISHED BY THEM FOR A

PERIOD OF ONE YEAR FROM FINAL ACCEPTANCE AGAINST ALL

SHEET TITLE:

GENERAL SCOPE

02/04/2025

Engineer of Record Jacob Adam Nelson PE

PE-2009018758

ADAM NELSON NUMBER 🍃 PE-2009018758

SPRINGFIELD, MO 65804 417.708.7025 WWW.TRUE-MEP.COM

SHEET NUMBER:

2 OF 31 SHEETS 02/04/2025

GAS LOAD TABLE:

1. ALL EXISTING GAS LOADS FROM EXISTING POWERHOUSE SHALL REMAIN IN USE UNTIL CONSTRUCTION HAS BEEN COMPLETED.

MAINTAIN ALL CLEARANCES REQUIRED FOR EQUIPMENT. DO NOT REMAIN UNTIL STEAM SYSTEM HAS BEEN DECOMISSIONED.

8. THE CONTRACTOR SHALL GUARANTEE ALL EQUIPMENT, ONE YEAR FROM FINAL ACCEPTANCE AGAINST ALL DEFECTS. 9. COORDINATE LIGHT FIXTURE LOCATIONS WITH OWNER, STRUCTURE, AND OTHER TRADES PRIOR TO ROUGH-IN.


10. REFER TO SPECIFICATION SHEET SECTIONS FOR ADDITIONAL

ROOF	AND WALL TYPI	ES & ROOF WAR	RANTY
BUILDING	ROOF	EXTERIOR WALL	ROOF WARRANTY
HOUSING UNIT 1	PITCHED, SHINGLE	BRICK ON BLOCK	NO
HOUSING UNIT 2	PITCHED, SHINGLE	BRICK ON BLOCK	NO
CAFETERIA	PITCHED, METAL	BLOCK	YES
CANTEEN	PITCHED, SHINGLE	BLOCK	NO
EDUCATION	FLAT	BLOCK	NO
GYM	PITCHED, METAL	METAL	NO
MAINTENANCE	FLAT	METAL	NO
POWERHOUSE	FLAT, TPO	BLOCK	YES
RECOVERY	PITCHED, SHINGLE	BLOCK	NO
RECYCLING	PITCHED, METAL	METAL	NO
SEGREGATION	PITCHED, METAL	BLOCK	YES

ROOF	AND WALL TYPI	ES & ROOF WAR	RANTY
BUILDING	ROOF	EXTERIOR WALL	ROOF WARRANTY
HOUSING UNIT 1	PITCHED, SHINGLE	BRICK ON BLOCK	NO
HOUSING UNIT 2	PITCHED, SHINGLE	BRICK ON BLOCK	NO
CAFETERIA	PITCHED, METAL	BLOCK	YES
CANTEEN	PITCHED, SHINGLE	BLOCK	NO
EDUCATION	FLAT	BLOCK	NO
GYM	PITCHED, METAL	METAL	NO
MAINTENANCE	FLAT	METAL	NO
POWERHOUSE	FLAT, TPO	BLOCK	YES
RECOVERY	PITCHED, SHINGLE	BLOCK	NO
RECYCLING	PITCHED, METAL	METAL	NO
SEGREGATION	PITCHED, METAL	BLOCK	YES
VISITATION	PITCHED, SHINGLE	BLOCK	NO
	· ·	· ·	·

CEIL	ING LEGEND	
	GYPSUM OR OTHER HARD-LID CEILING	
	DV4 OD DV2 LAV IN CETLING	


OPEN TO STRUCTURE ABOVE

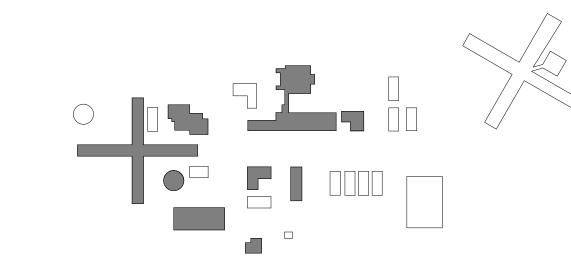

KEY PLAN


STATE OF MISSOURI MIKE KEHOE, **GOVERNOR**

Engineer of Record Jacob Adam Nelson PE

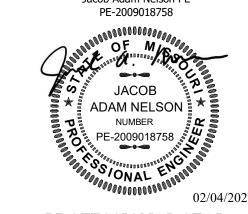

PROFESSIONAL SEAL MECHANICAL • ELECTRICAL • PLUMBING 1200 E WOODHURST DR, STE P SPRINGFIELD, MO 65804 417.708.7025 WWW.TRUE-MEP.COM

ROOF WARRANTY NOTE: CONTRACTOR SHALL BE RESPONSIBLE FOR MAINTAINING THE WARRANTY FOR ALL ROOFS REQUIRING NEW ROOF PENETRATIONS. REFER TO SPECIFICATIONS FOR ROOF WARRANTY INFORMATION.

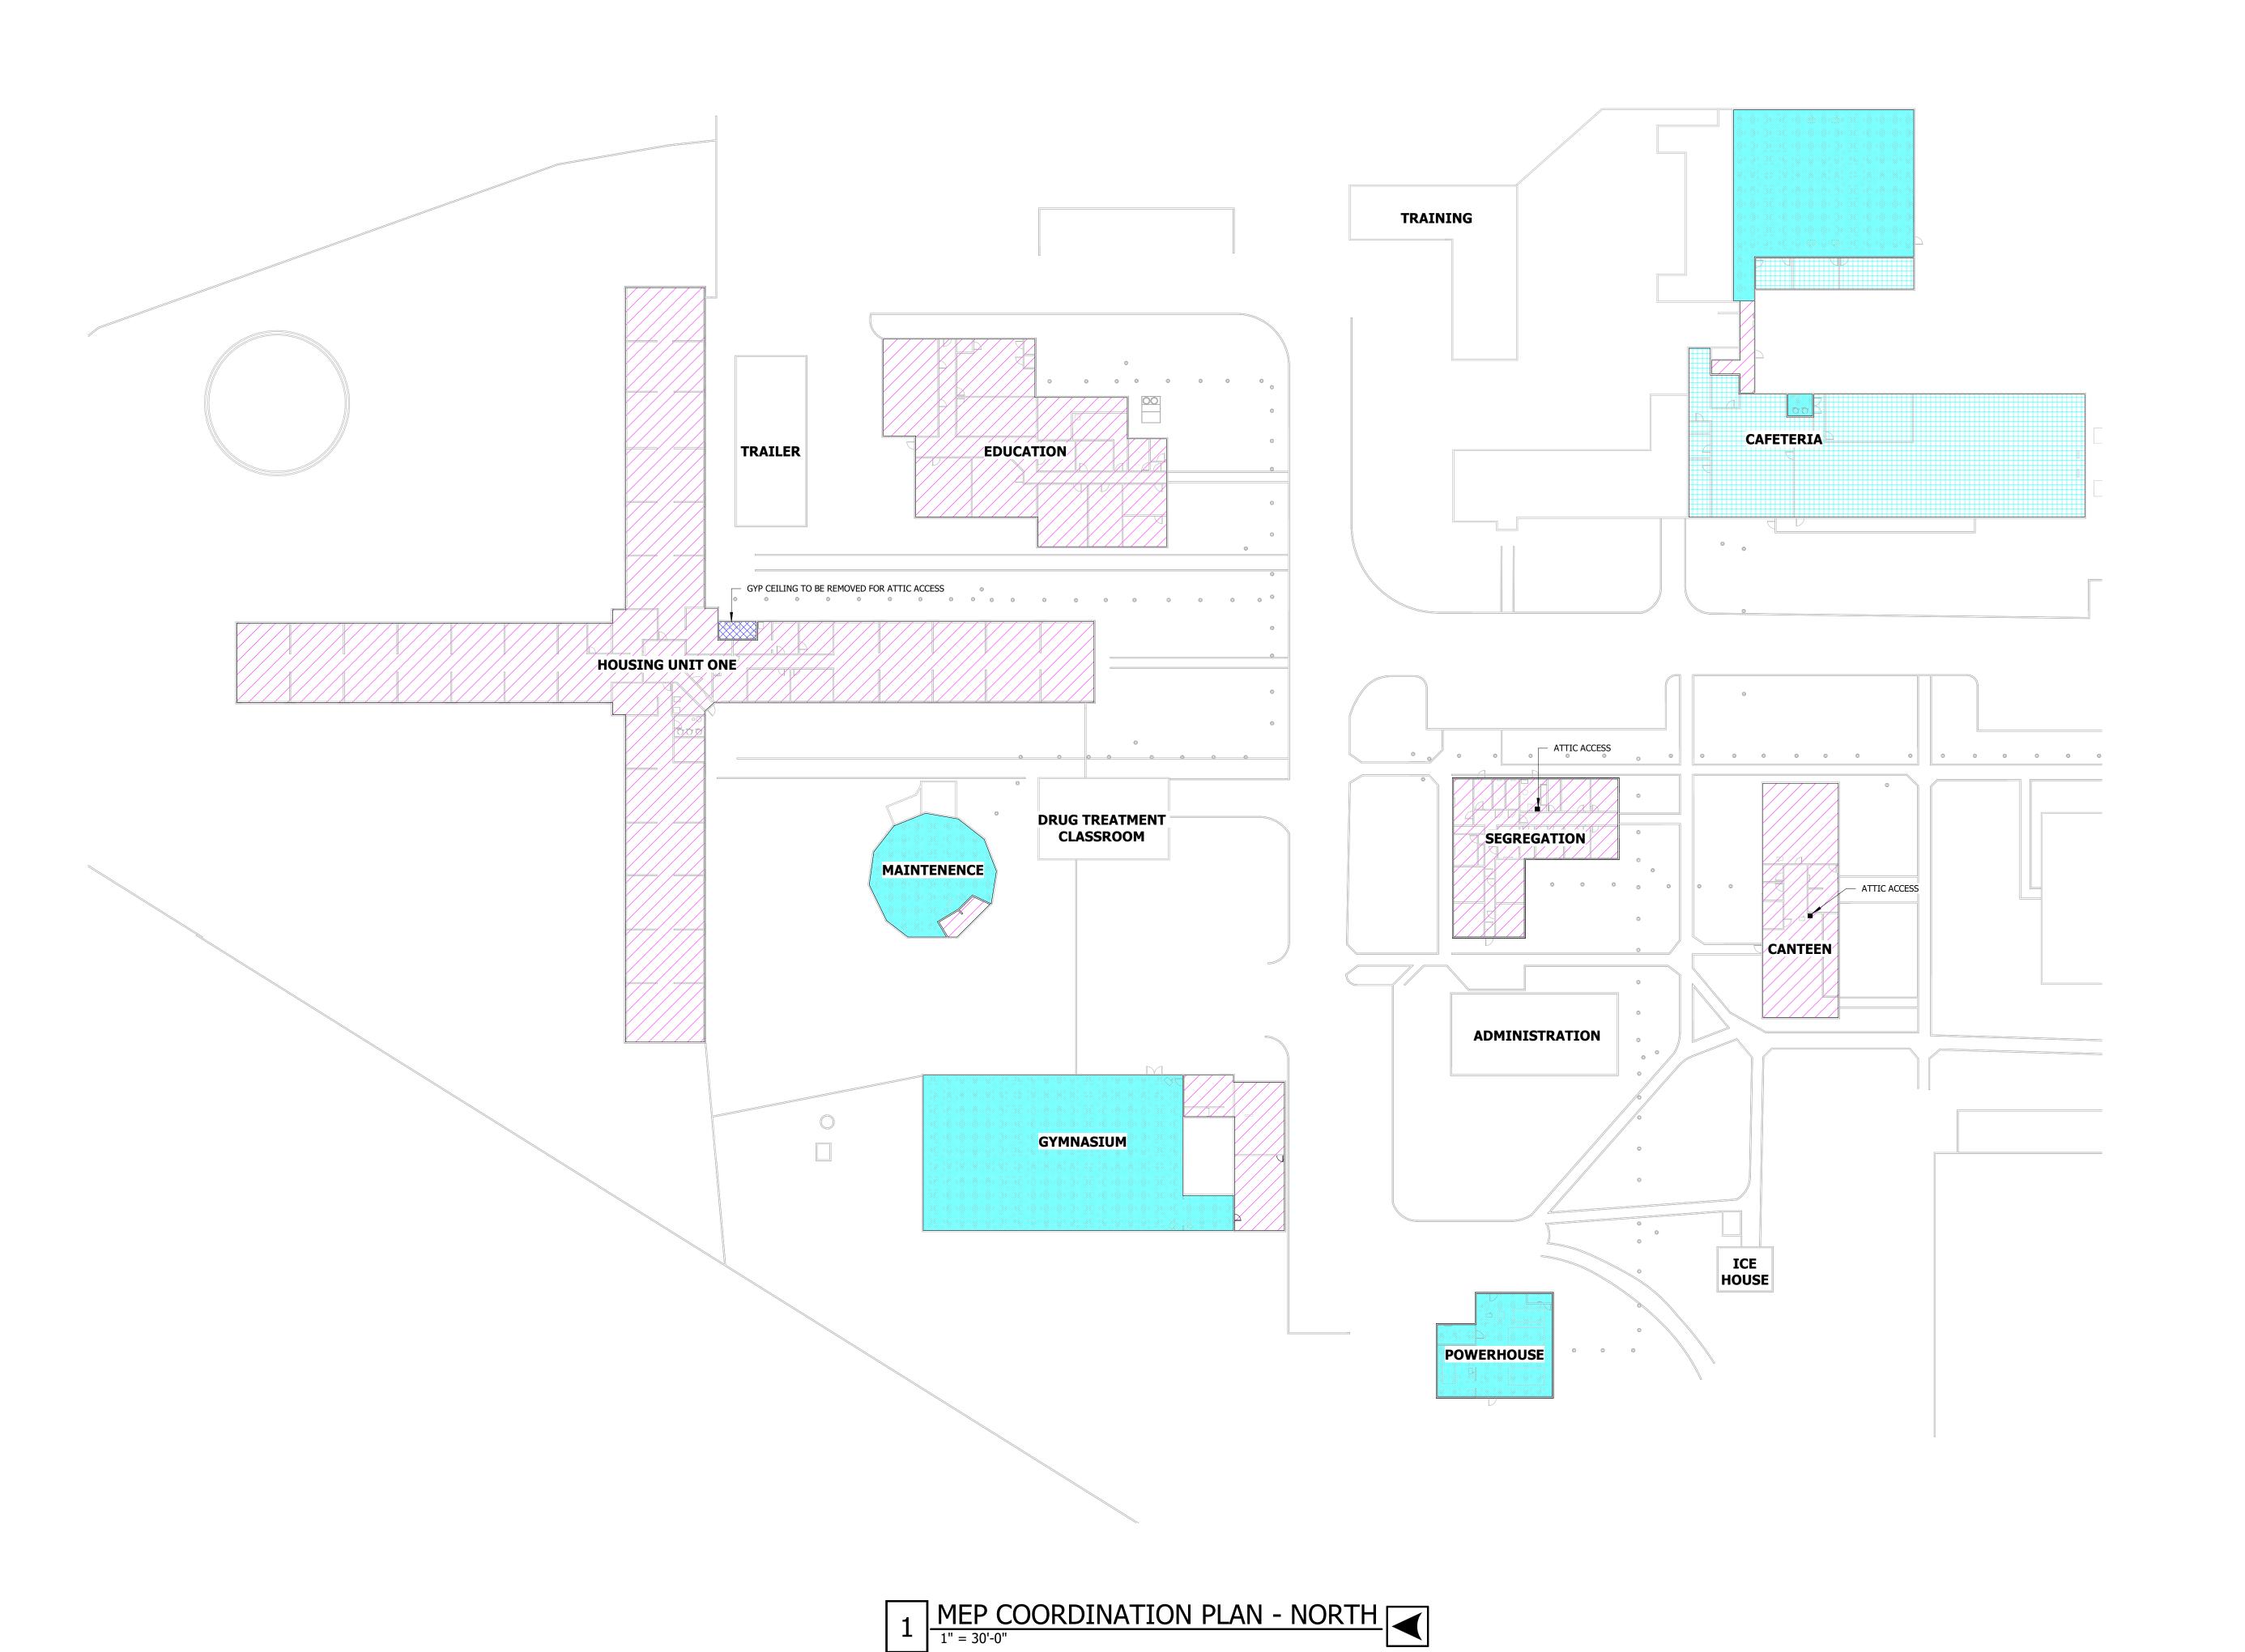

TRUE ENGINEERING GROUP, LLC MISSOURI STATE CERTIFICATE OF AUTHORITY #E-2016000752

OFFICE OF ADMINISTRATION DIVISION OF FACILITIES MANAGEMENT, DESIGN AND CONSTRUCTION

DEPARTMENT OF CORRECTIONS

OZARK CORRECTIONAL CENTER - UPGRADE HVAC

929 HONOR CAMP LN, FORDLAND, MO 65652

PROJECT # C2324-01 7003 FACILITY # 9327003081

REVISION:
DATE:
REVISION:
DATE:
REVISION:
DATE:

ISSUE DATE: 02/04/2025

CAD DWG FILE: C2324-01 DRAWN BY: KP CHECKED BY: JN DESIGNED BY: JK

SHEET TITLE: COORDINATION PLAN - NORTH

SHEET NUMBER:

MEP-101

ROOF	AND WALL TYPI	ES & ROOF WAR	RANTY
BUILDING	ROOF	EXTERIOR WALL	ROOF WARRANTY
HOUSING UNIT 1	PITCHED, SHINGLE	BRICK ON BLOCK	NO
HOUSING UNIT 2	PITCHED, SHINGLE	BRICK ON BLOCK	NO
CAFETERIA	PITCHED, METAL	BLOCK	YES
CANTEEN	PITCHED, SHINGLE	BLOCK	NO
EDUCATION	FLAT	BLOCK	NO
GYM	PITCHED, METAL	METAL	NO
MAINTENANCE	FLAT	METAL	NO
POWERHOUSE	FLAT, TPO	BLOCK	YES
RECOVERY	PITCHED, SHINGLE	BLOCK	NO
RECYCLING	PITCHED, METAL	METAL	NO
SEGREGATION	PITCHED, METAL	BLOCK	YES
VISITATION	PITCHED SHINGLE	BI OCK	NO


ROOF	AND WALL TYP	ES & ROOF WAR	RANTY
BUILDING	ROOF	EXTERIOR WALL	ROOF WARRANTY
HOUSING UNIT 1	PITCHED, SHINGLE	BRICK ON BLOCK	NO
HOUSING UNIT 2	PITCHED, SHINGLE	BRICK ON BLOCK	NO
CAFETERIA	PITCHED, METAL	BLOCK	YES
CANTEEN	PITCHED, SHINGLE	BLOCK	NO
EDUCATION	FLAT	BLOCK	NO
GYM	PITCHED, METAL	METAL	NO
MAINTENANCE	FLAT	METAL	NO
POWERHOUSE	FLAT, TPO	BLOCK	YES
RECOVERY	PITCHED, SHINGLE	BLOCK	NO
RECYCLING	PITCHED, METAL	METAL	NO
SEGREGATION	PITCHED, METAL	BLOCK	YES
VISITATION	PITCHED, SHINGLE	BLOCK	NO
	BUILDING HOUSING UNIT 1 HOUSING UNIT 2 CAFETERIA CANTEEN EDUCATION GYM MAINTENANCE POWERHOUSE RECOVERY RECYCLING SEGREGATION	BUILDING ROOF HOUSING UNIT 1 PITCHED, SHINGLE HOUSING UNIT 2 PITCHED, SHINGLE CAFETERIA PITCHED, METAL CANTEEN PITCHED, SHINGLE EDUCATION FLAT GYM PITCHED, METAL MAINTENANCE FLAT POWERHOUSE FLAT, TPO RECOVERY PITCHED, SHINGLE RECYCLING PITCHED, METAL SEGREGATION PITCHED, METAL	HOUSING UNIT 1 PITCHED, SHINGLE BRICK ON BLOCK HOUSING UNIT 2 PITCHED, SHINGLE BRICK ON BLOCK CAFETERIA PITCHED, METAL BLOCK CANTEEN PITCHED, SHINGLE BLOCK EDUCATION FLAT BLOCK GYM PITCHED, METAL METAL MAINTENANCE FLAT METAL POWERHOUSE FLAT, TPO BLOCK RECOVERY PITCHED, SHINGLE BLOCK RECYCLING PITCHED, METAL METAL SEGREGATION PITCHED, METAL BLOCK

CEIL	ING LEGEND
	GYPSUM OR OTHER HARD-LID CEILING
	2X4 OR 2X2 LAY-IN CEILING
	OPEN TO STRUCTURE ABOVE

KEY PLAN

STATE OF MISSOURI MIKE KEHOE, **GOVERNOR**


Engineer of Record Jacob Adam Nelson PE

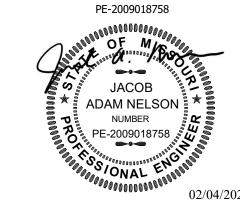



ROOF WARRANTY NOTE: CONTRACTOR SHALL BE RESPONSIBLE FOR MAINTAINING THE WARRANTY FOR ALL ROOFS REQUIRING NEW ROOF PENETRATIONS.

REFER TO SPECIFICATIONS FOR ROOF WARRANTY INFORMATION.

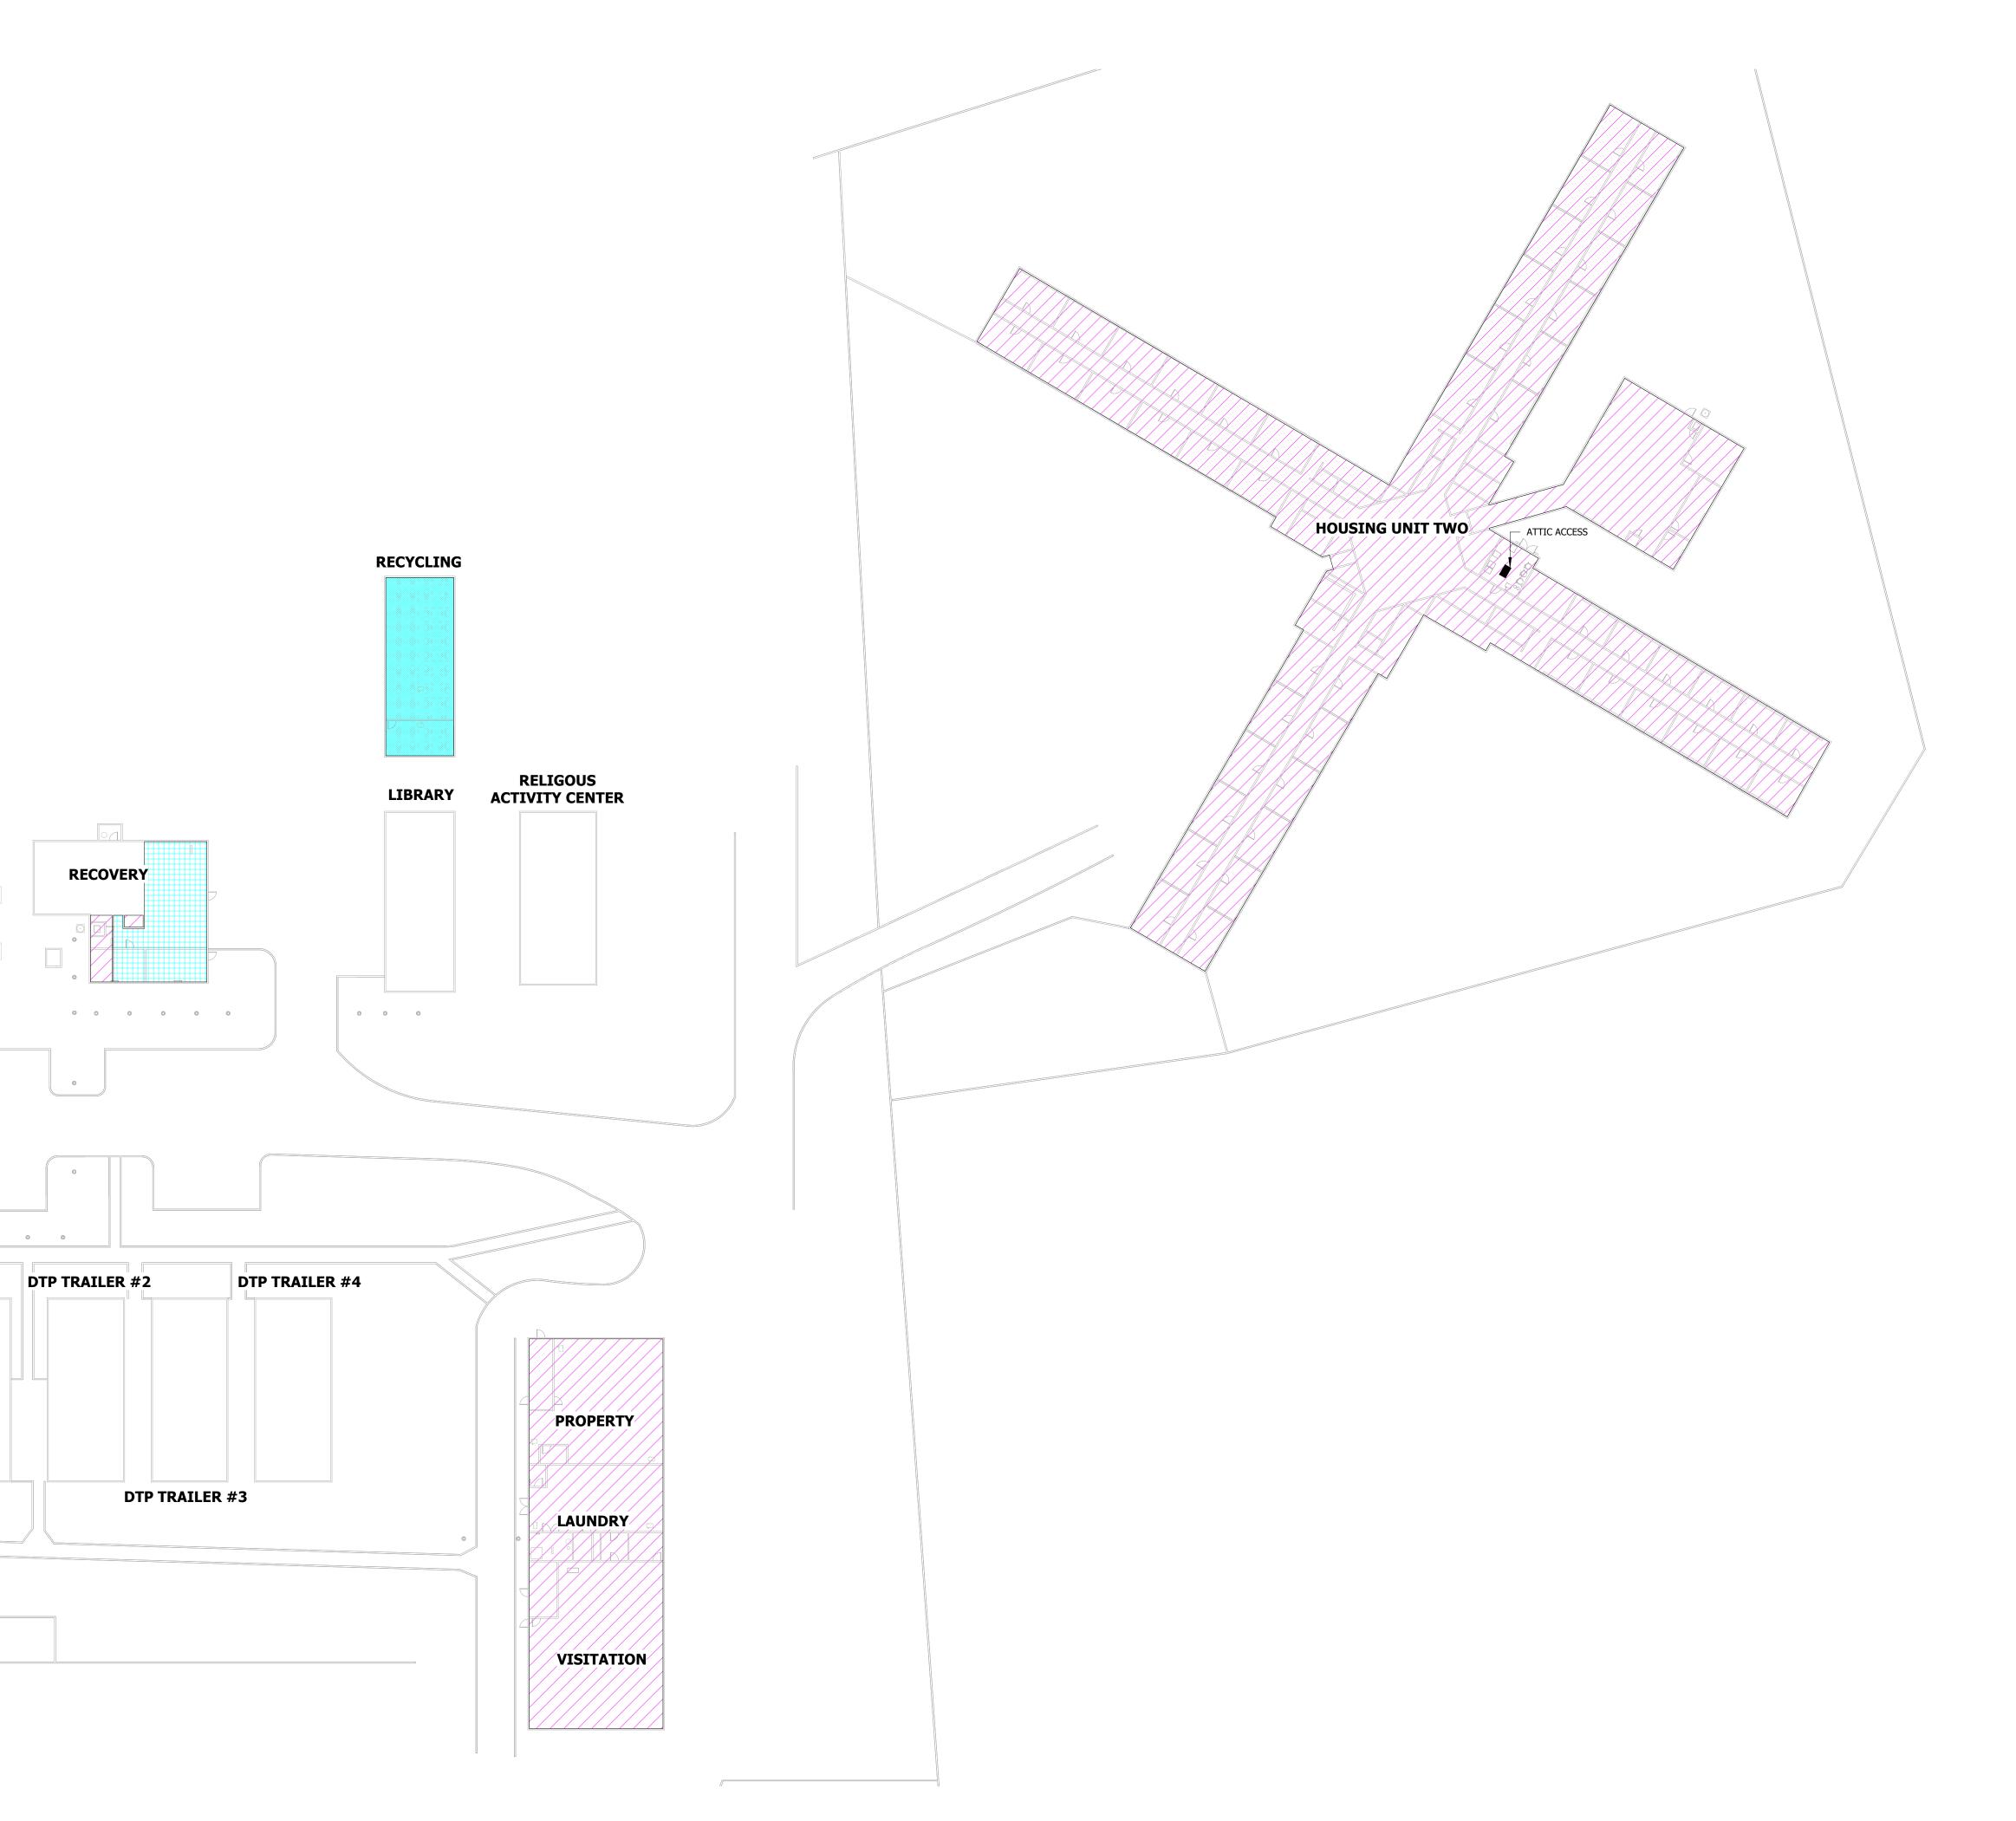

1 MEP COORDINATION PLAN - SOUTH 1" = 30'-0"

TRUE ENGINEERING GROUP, LLC MISSOURI STATE CERTIFICATE OF AUTHORITY #E-2016000752

OFFICE OF ADMINISTRATION DIVISION OF FACILITIES MANAGEMENT, DESIGN AND CONSTRUCTION

DEPARTMENT OF CORRECTIONS

OZARK CORRECTIONAL CENTER - UPGRADE HVAC

929 HONOR CAMP LN, FORDLAND, MO 65652

PROJECT # C2324-01 7003 SITE# FACILITY # 9327003081

REVISION:
DATE:
REVISION:
DATE:
REVISION:
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ISSUE DATE: 02/04/2025


CAD DWG FILE: C2324-01 DRAWN BY: JK CHECKED BY: JN DESIGNED BY: JK

SHEET TITLE: COORDINATION PLAN - SOUTH

SHEET NUMBER:

MEP-102

4 OF 31 SHEETS

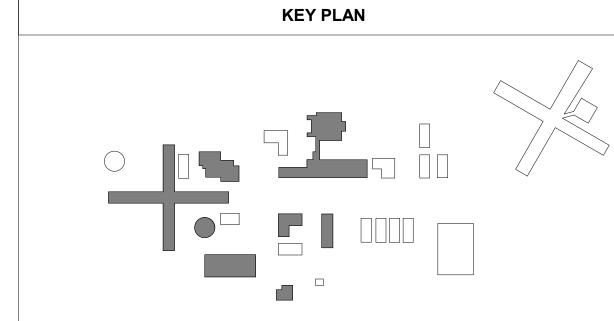


23.01 ABANDON IN PLACE EXISTING STEAM PIPING LOCATED ON STANDS. 23.02 EXISTING CONDENSATE PIPING LEAVING THE BUILDING SHALL REMAIN. ABANDON IN PLACE PIPING BELOWGROUND. EXISTING STEAM PIPING DOWN AND UNDERGROUND SHALL REMAIN.
 ABANDON PIPING IN PLACE.


 ABANDON IN PLACE EXISTING CONDENSATE RECEIVER PUMP.

STATE OF MISSOURI MIKE KEHOE, **GOVERNOR**

Engineer of Record Jacob Adam Nelson PE PE-2009018758

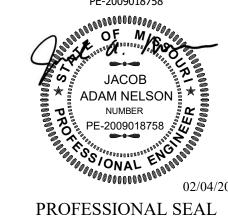



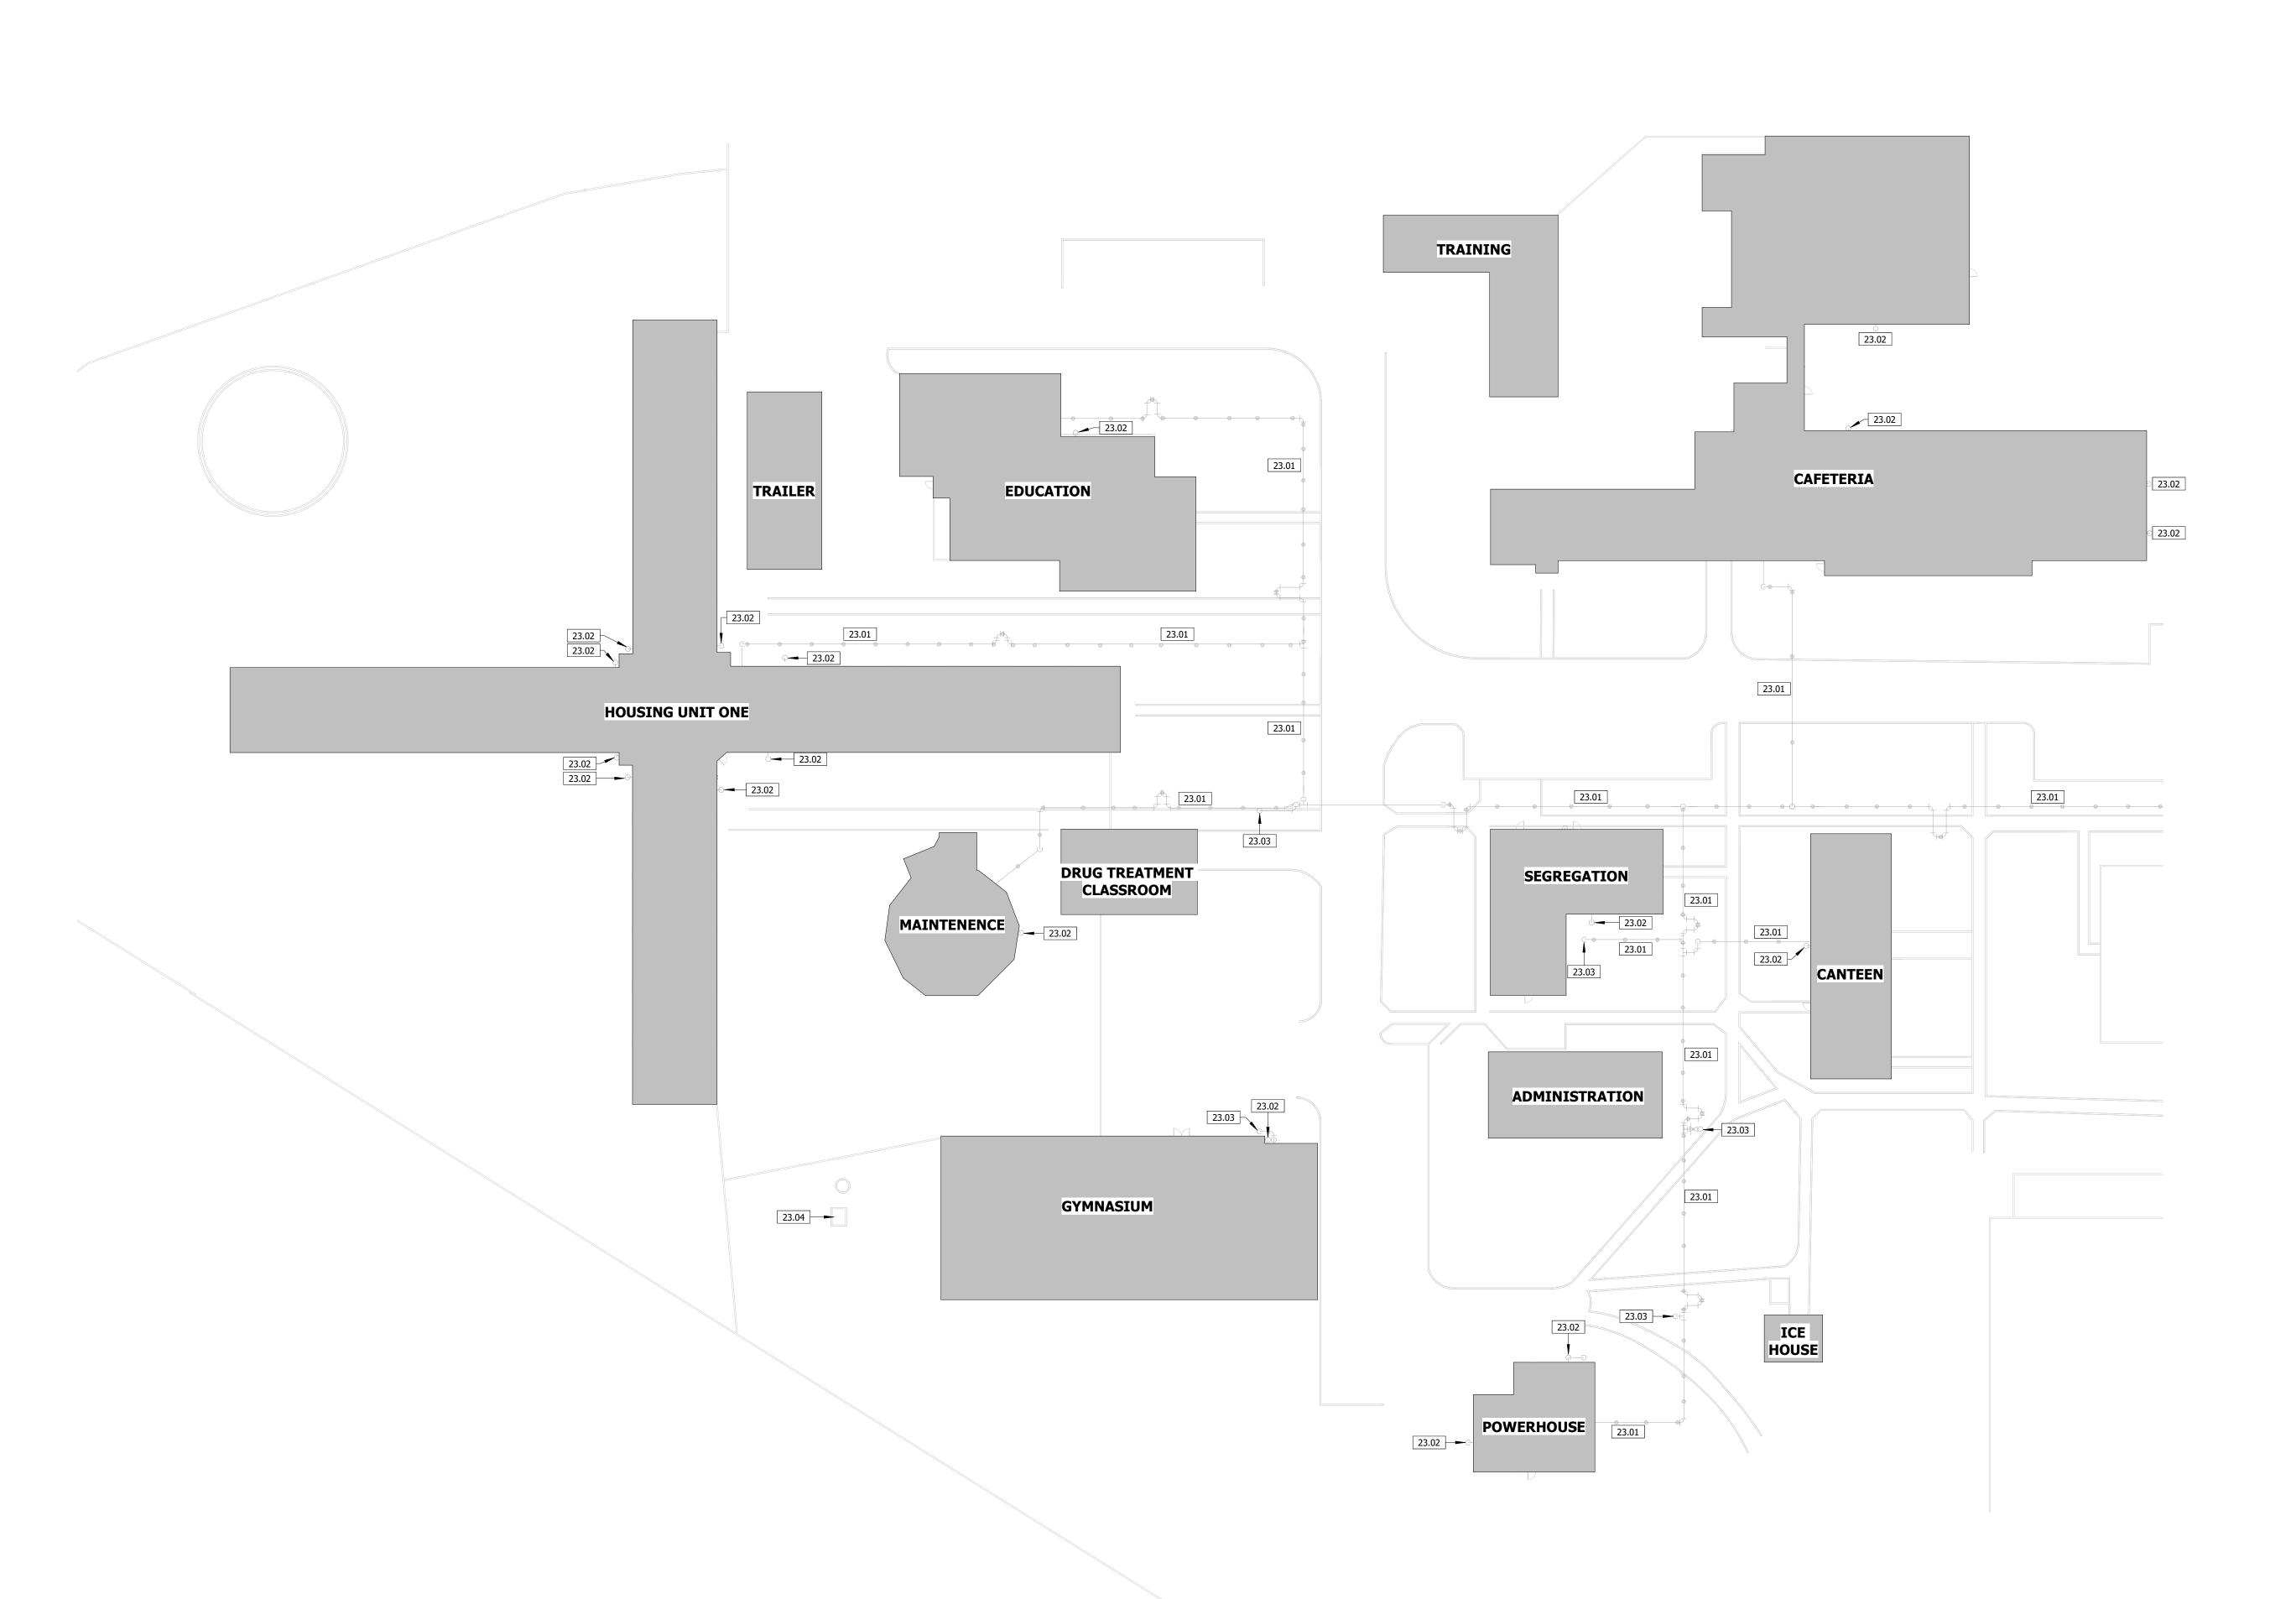

1 DEMO MECHANICAL SITE PLAN - NORTH

1" = 30'-0"

TRUE ENGINEERING GROUP, LLC MISSOURI STATE CERTIFICATE OF AUTHORITY #E-2016000752

OFFICE OF ADMINISTRATION DIVISION OF FACILITIES MANAGEMENT, DESIGN AND CONSTRUCTION

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OZARK CORRECTIONAL CENTER - UPGRADE HVAC

929 HONOR CAMP LN, FORDLAND, MO 65652

PROJECT # C2324-01 SITE# 7003 FACILITY # 9327003081

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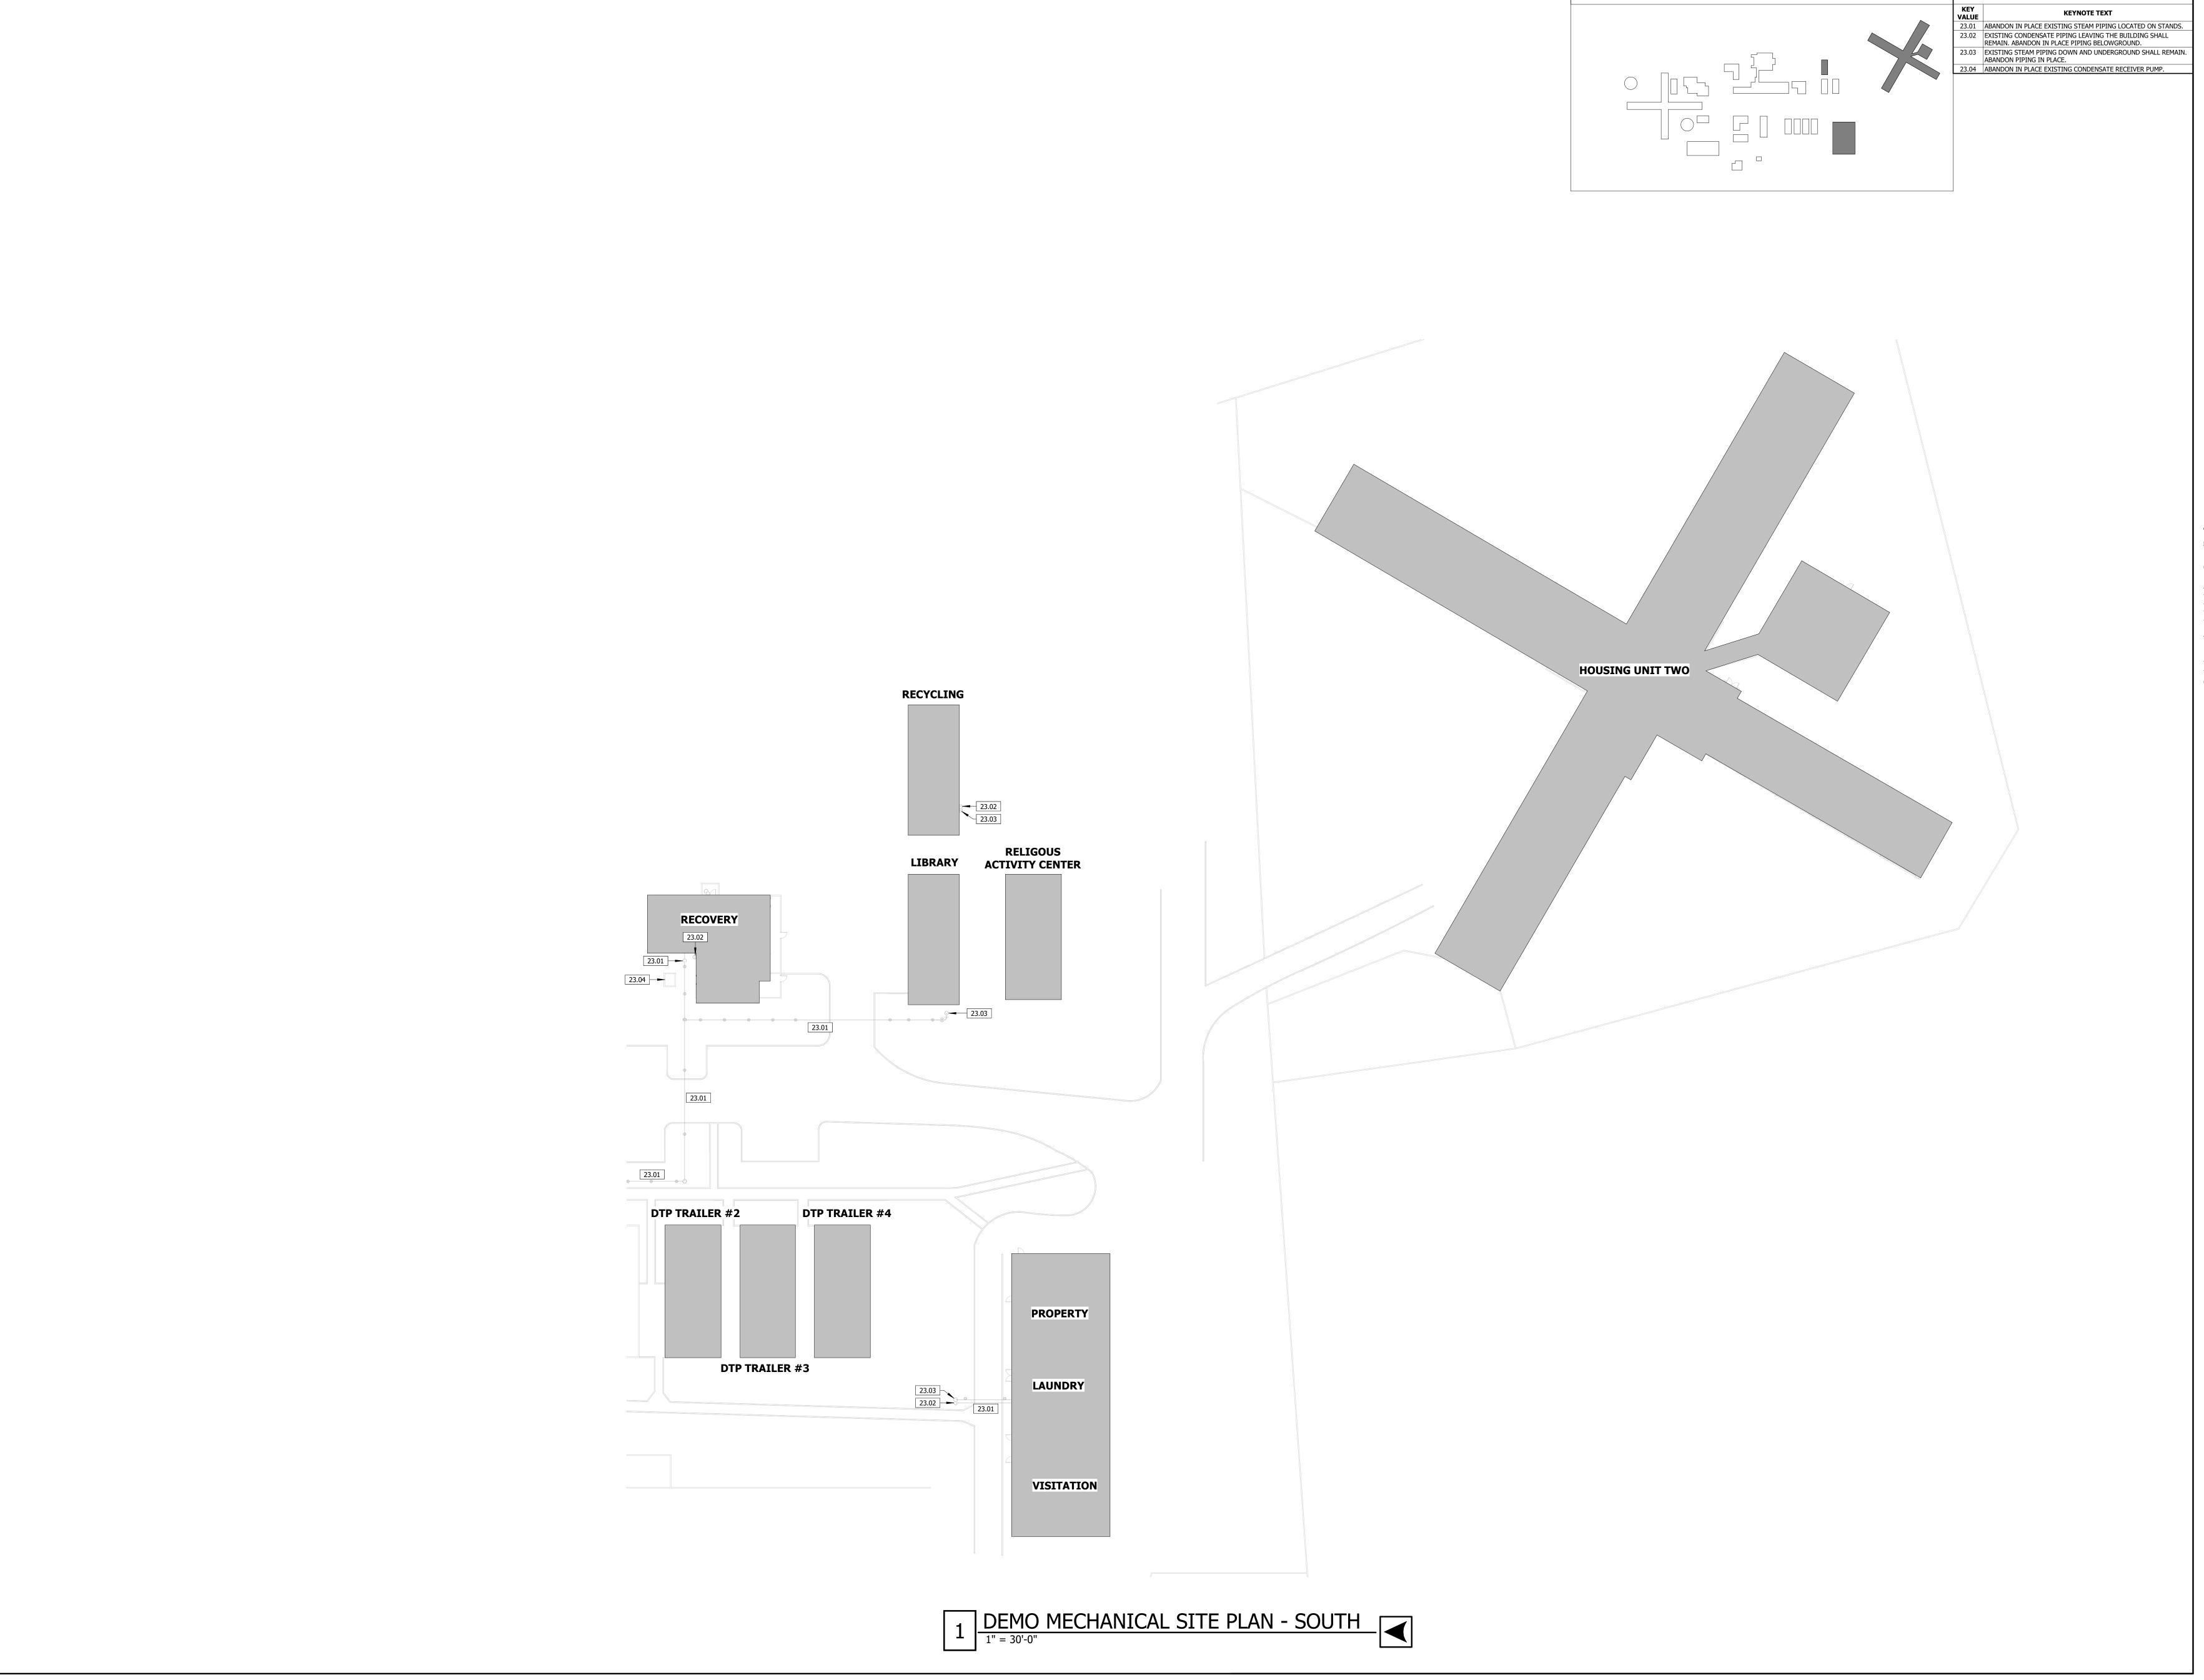
ISSUE DATE: 02/04/2025

CAD DWG FILE: C2324-01 DRAWN BY: JK CHECKED BY: JN DESIGNED BY: JK

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SHEET NUMBER:


M-001



KEY PLAN

STATE OF MISSOURI MIKE KEHOE, GOVERNOR

Engineer of Record Jacob Adam Nelson PE PE-2009018758

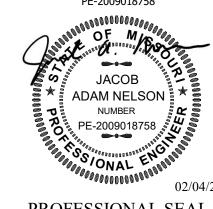



TRUE ENGINEERING GROUP, LLC
MISSOURI STATE CERTIFICATE OF AUTHORITY #E-2016000752

OFFICE OF ADMINISTRATION DIVISION OF FACILITIES MANAGEMENT, DESIGN AND CONSTRUCTION

DEPARTMENT OF CORRECTIONS

OZARK CORRECTIONAL CENTER - UPGRADE HVAC

929 HONOR CAMP LN, FORDLAND, MO 65652

PROJECT # C2324-01 SITE # 7003 FACILITY # 9327003081

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DATE:
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DATE:
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DATE:

DATE: 02/04/2025

CAD DWG FILE: C2324-01 DRAWN BY: JK CHECKED BY: JN DESIGNED BY: JK

SHEET TITLE:


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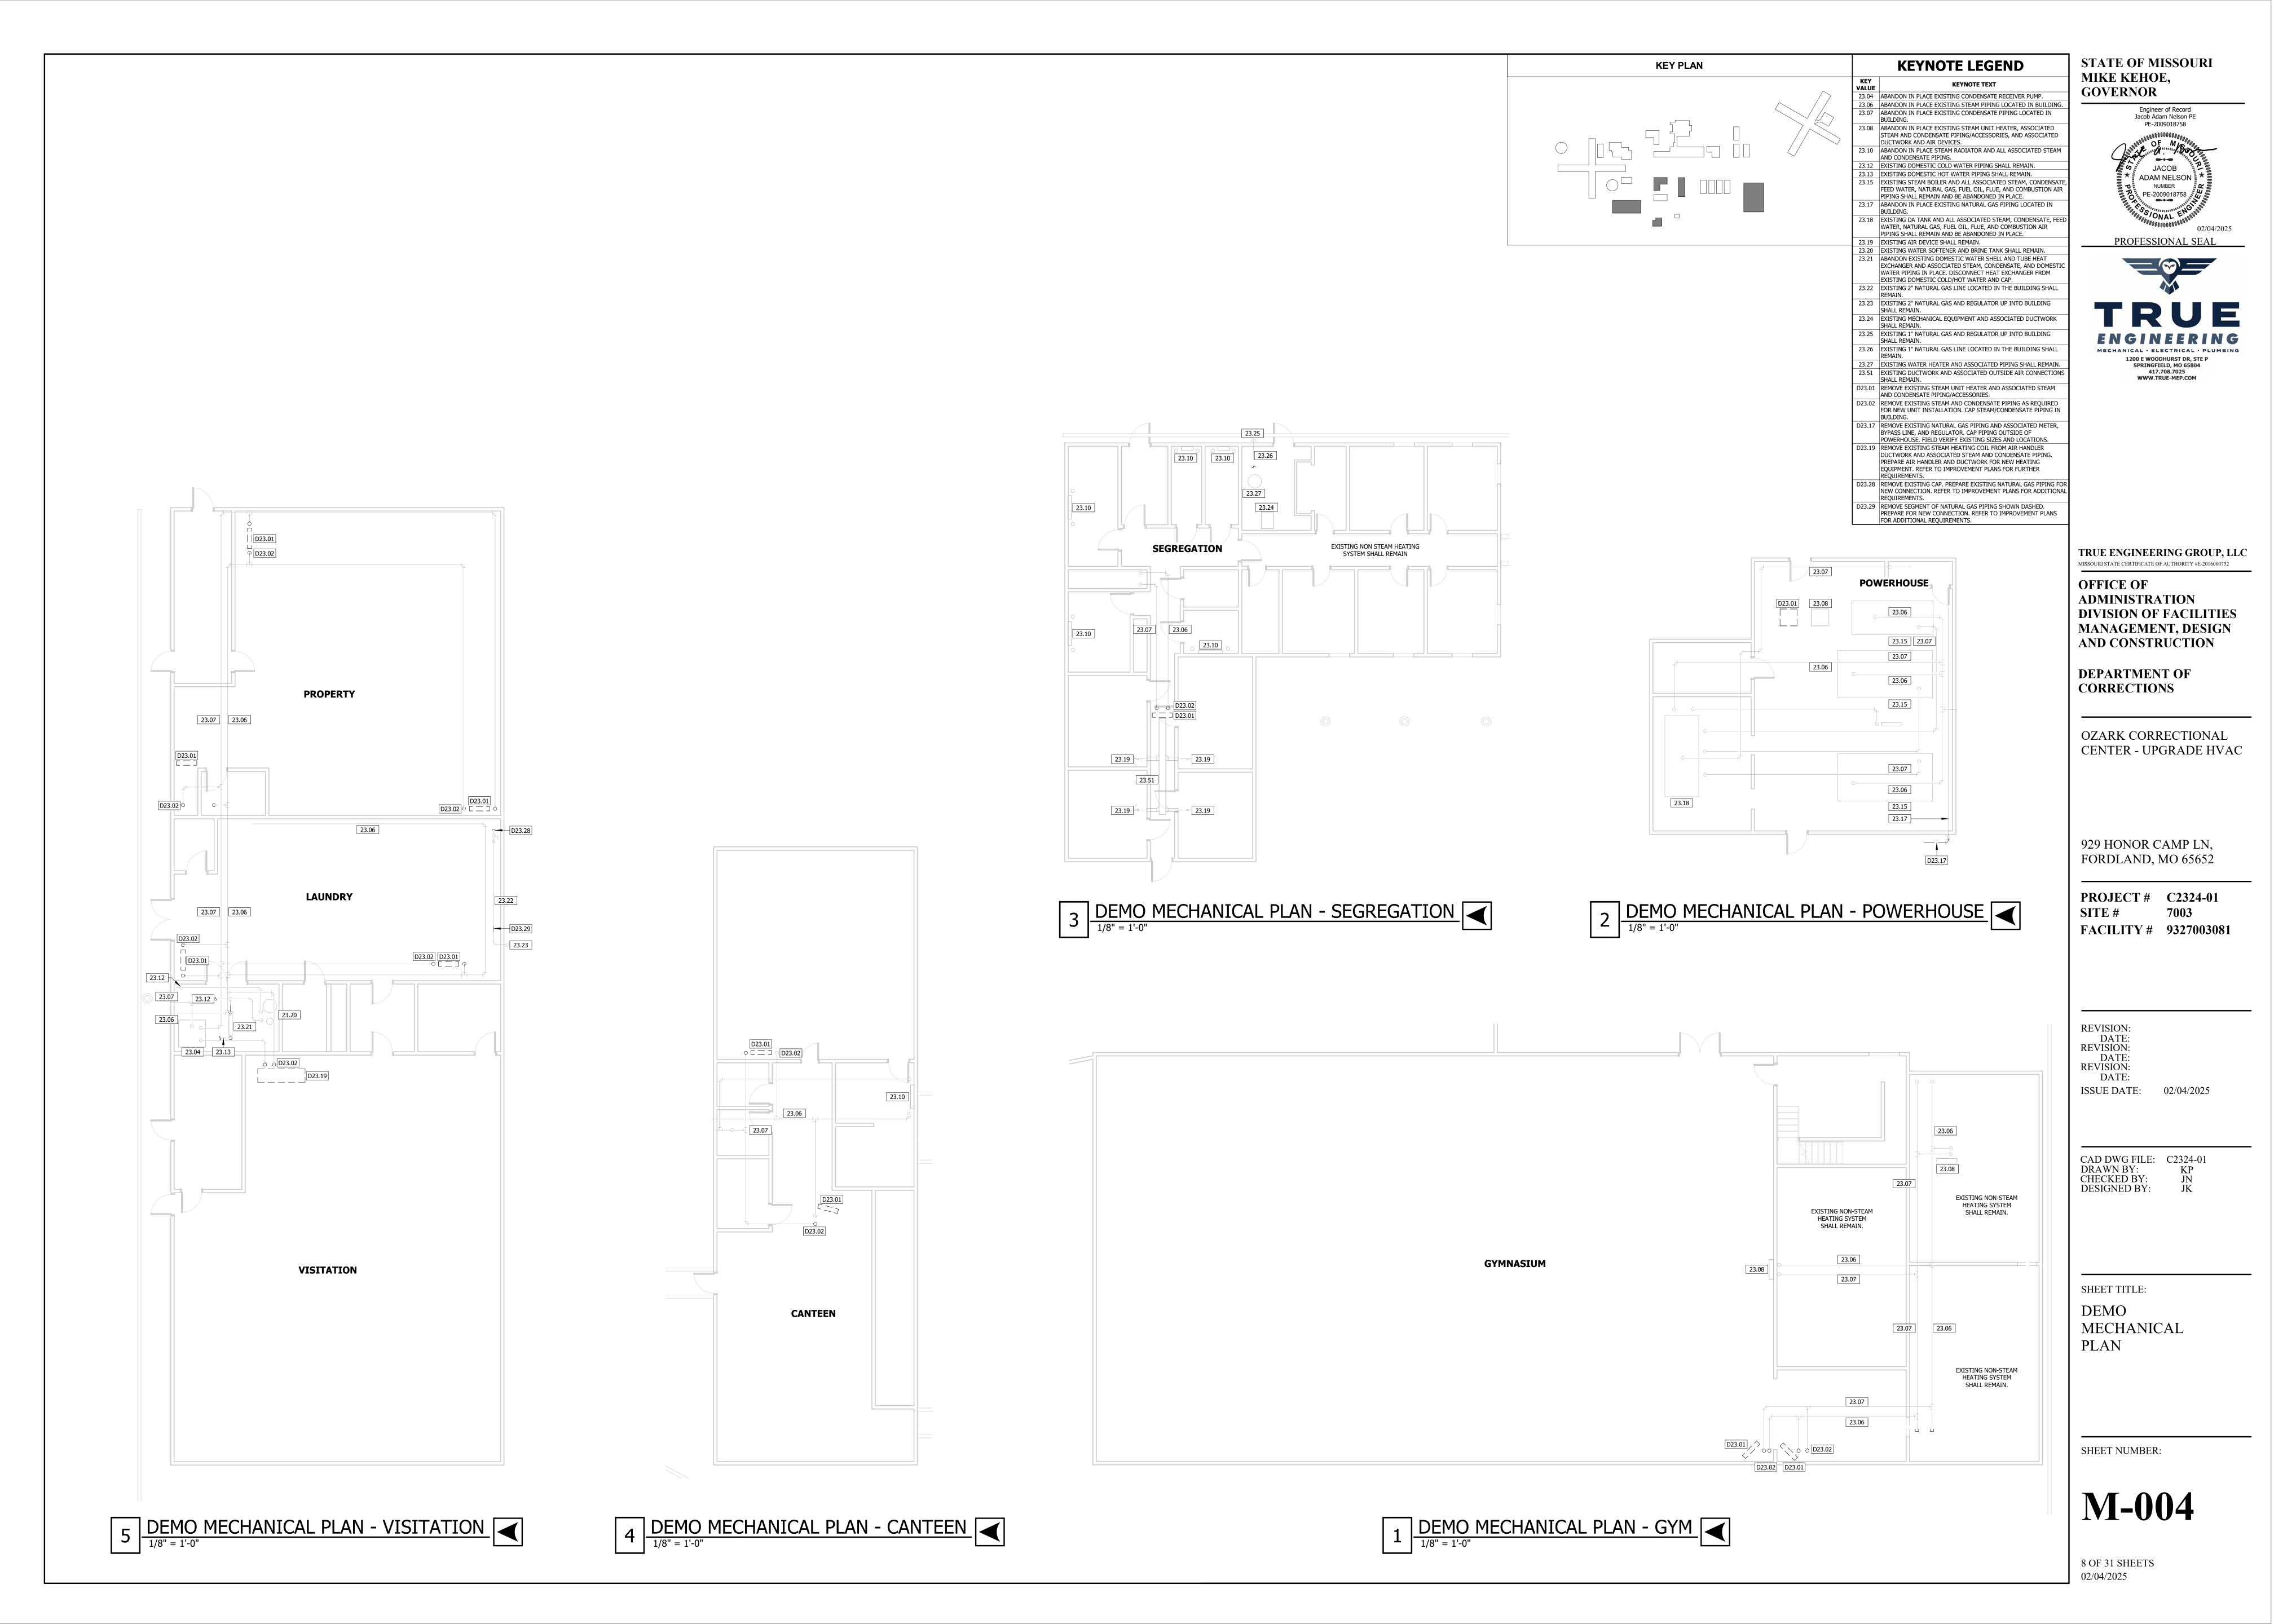
MECHANICAL


SITE PLAN
SOUTH

SHEET NUMBER:

M-002



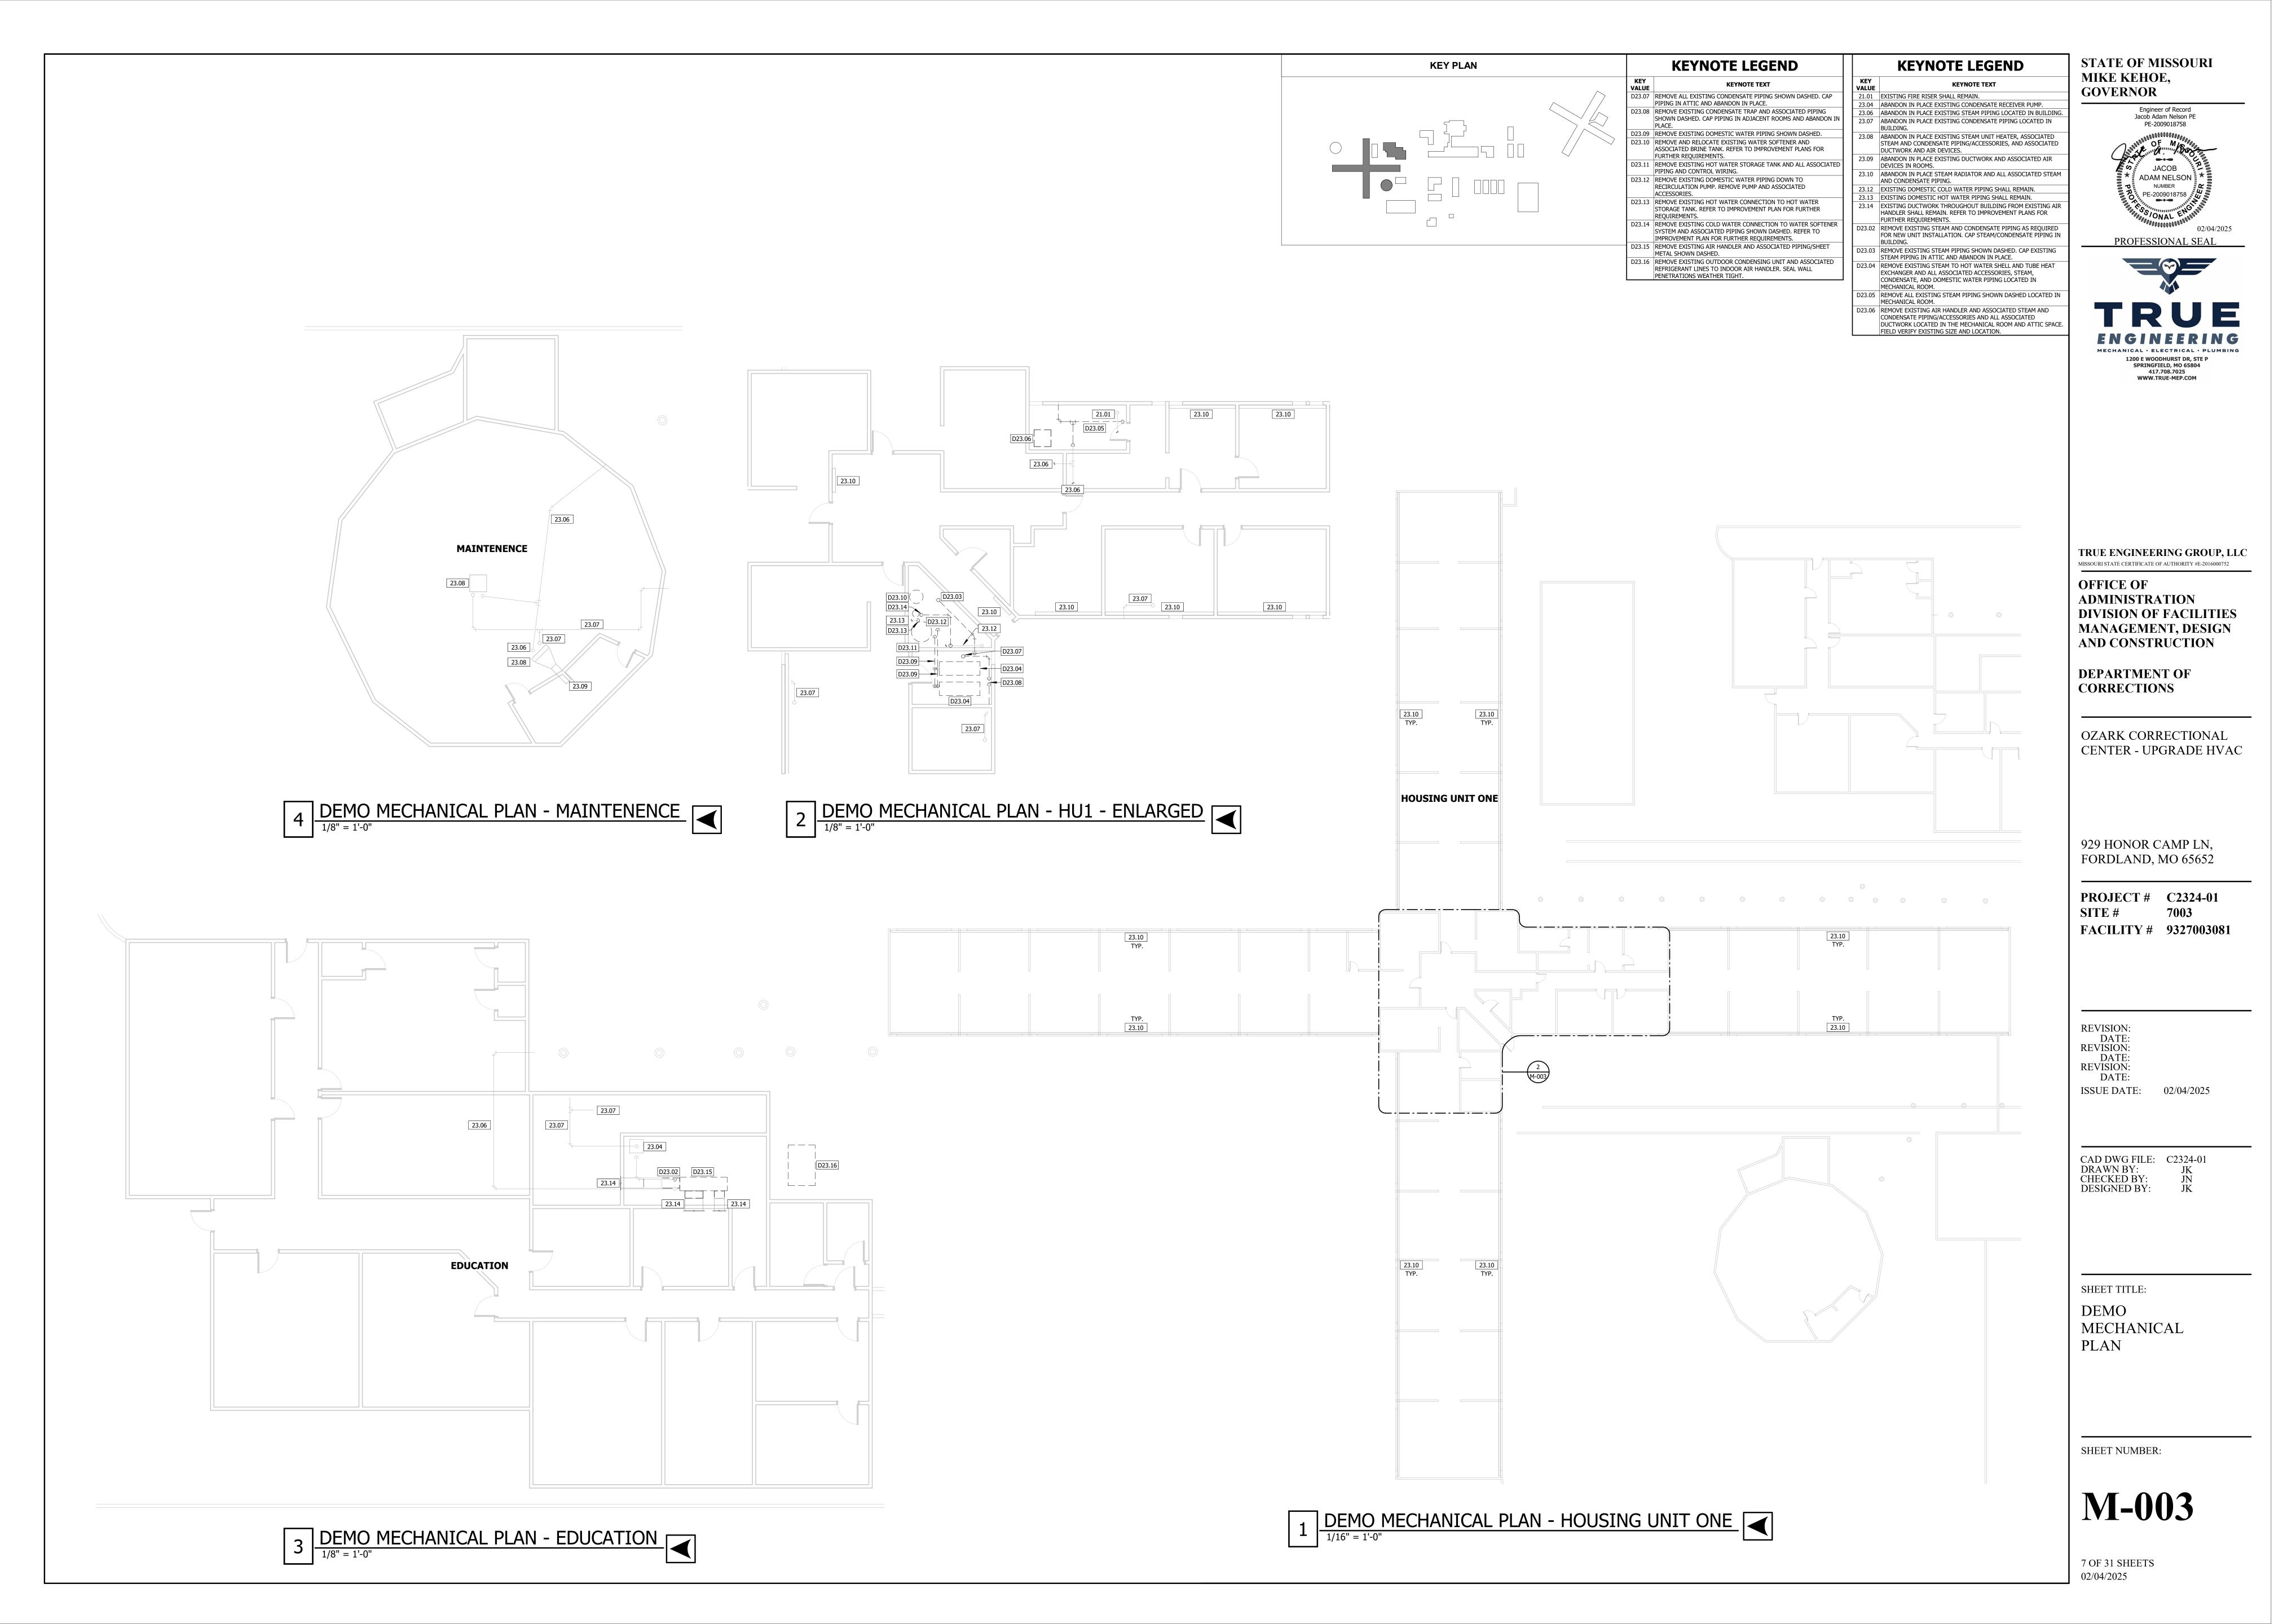

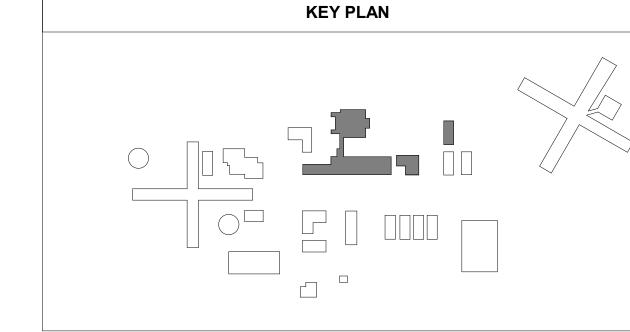

KEYNOTE LEGEND

KEY
VALUE
KEYNOTE TEXT

YALUE

23.06 ABANDON IN PLACE EXISTING STEAM PIPING LOCATED IN BUILDING.

23.07 ABANDON IN PLACE EXISTING CONDENSATE PIPING LOCATED IN BUILDING.

23.08 ABANDON IN PLACE EXISTING STEAM UNIT HEATER, ASSOCIATED STEAM AND CONDENSATE PIPING/ACCESSORIES, AND ASSOCIATED DUCTWORK AND AIR DEVICES.

STEAM AND CONDENSATE PIPING/ACCESSORIES, AND ASSOCIATED DUCTWORK AND AIR DEVICES.

23.10 ABANDON IN PLACE STEAM RADIATOR AND ALL ASSOCIATED STEAM AND CONDENSATE PIPING.

23.12 EXISTING DOMESTIC COLD WATER PIPING SHALL REMAIN.

23.13 EXISTING DOMESTIC HOT WATER PIPING SHALL REMAIN.

23.13 EXISTING DOMESTIC HOT WATER PIPING SHALL REMAIN.
 23.20 EXISTING WATER SOFTENER AND BRINE TANK SHALL REMAIN.
 23.24 EXISTING MECHANICAL EQUIPMENT AND ASSOCIATED DUCTWORK SHALL REMAIN.
 23.25 EXISTING 1" NATURAL GAS AND REGULATOR UP INTO BUILDING SHALL REMAIN.

23.27 EXISTING WATER HEATER AND ASSOCIATED PIPING SHALL REMAIN.
23.28 EXISTING AIR HANDLER COOLING COIL SHALL REMAIN. EXISTING AIR HANDLER IS A NORDYNE B5BM-X60K-C. FIELD VERIFY EXISTING COIL SIZE AND LOCATION.
23.29 EXISTING CONDENSING UNIT SHALL REMAIN. EXISTING UNIT IS A NORTEK JS4BD-060KA MODEL.
23.30 EXISTING 2.5" NATURAL GAS AND REGULATOR UP INTO BUILDING

AND CONDENSATE PIPING/ACCESSORIES.

REQUIREMENTS.

23.26 EXISTING 1" NATURAL GAS LINE LOCATED IN THE BUILDING SHALL

SHALL REMAIN.

23.31 EXISTING 2.5" NATURAL GAS LINE LOCATED IN THE BUILDING SHALL REMAIN.

D23.01 REMOVE EXISTING STEAM UNIT HEATER AND ASSOCIATED STEAM

D23.02 REMOVE EXISTING STEAM AND CONDENSATE PIPING AS REQUIRED FOR NEW UNIT INSTALLATION. CAP STEAM/CONDENSATE PIPING IN BUILDING.

D23.03 REMOVE EXISTING STEAM PIPING SHOWN DASHED. CAP EXISTING STEAM PIPING IN ATTIC AND ABANDON IN PLACE.

D23.04 REMOVE EXISTING STEAM TO HOT WATER SHELL AND TUBE HEAT

CONDENSATE, AND DOMESTIC WATER PIPING LOCATED IN MECHANICAL ROOM.

D23.05 REMOVE ALL EXISTING STEAM PIPING SHOWN DASHED LOCATED IN MECHANICAL ROOM.

D23.21 REMOVE EXISTING AIR HANDLER. PREPARE DUCTWORK FOR NEW INDOOR UNIT. REFER TO IMPROVEMENT PLAN FOR FURTHER

EXCHANGER AND ALL ASSOCIATED ACCESSORIES, STEAM,

TRUE

ENGINEERING

MECHANICAL · ELECTRICAL · PLUMBING

1200 E WOODHURST DR, STE P

SPRINGFIELD, MO 65804

417.708.7025

WWW.TRUE-MEP.COM

STATE OF MISSOURI

Engineer of Record Jacob Adam Nelson PE

PE-2009018758

JACOB

ADAM NELSON

NUMBER

PROFESSIONAL SEAL

PE-2009018758

MIKE KEHOE,

GOVERNOR

TRUE ENGINEERING GROUP, LLC
MISSOURI STATE CERTIFICATE OF AUTHORITY #E-2016000752

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CAD DWG FILE: C2324-01 DRAWN BY: KP CHECKED BY: JN DESIGNED BY: JK


SHEET TITLE:

DEMO
MECHANICAL
PLAN


SHEET NUMBER:

M-005

9 OF 31 SHEETS 02/04/2025

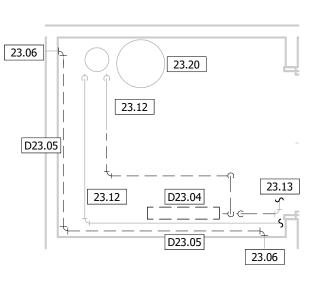


4 DEMO MECHANICAL PLAN - CAFETERIA - ENLARGED

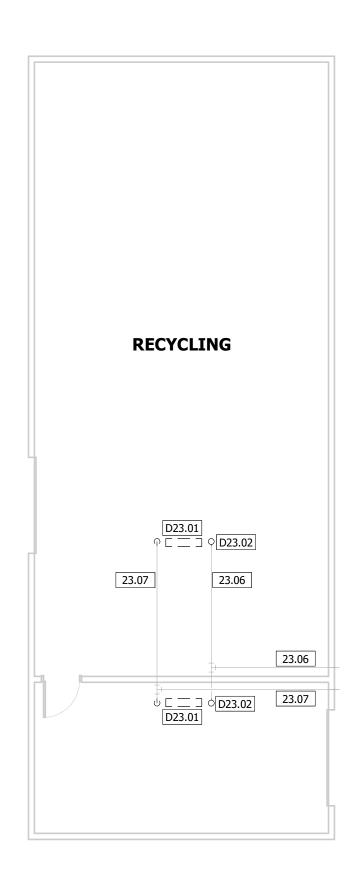


3 DEMO MECHANICAL PLAN - RECYCLING

1/8" = 1'-0"

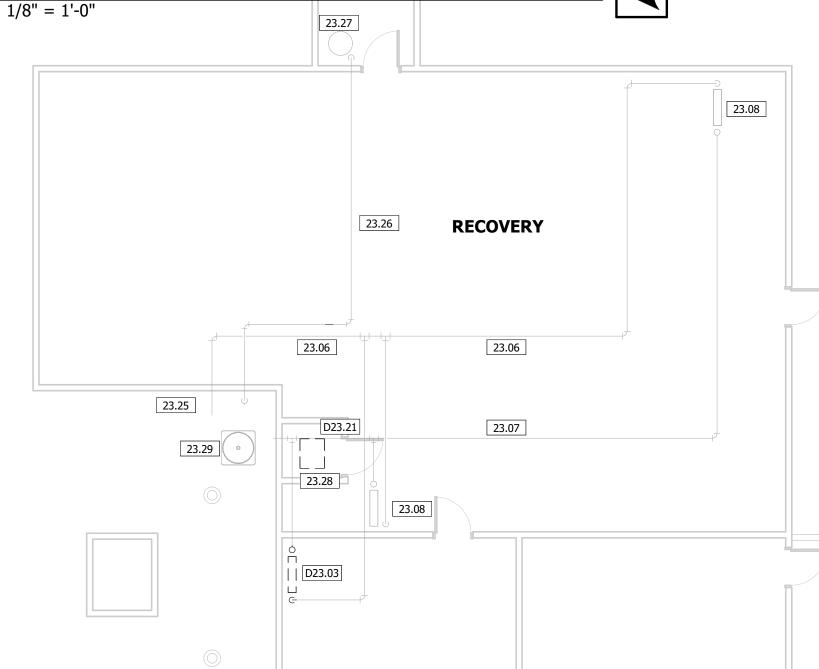


2 DEMO MECHANICAL PLAN - RECOVERY

1/8" = 1'-0"

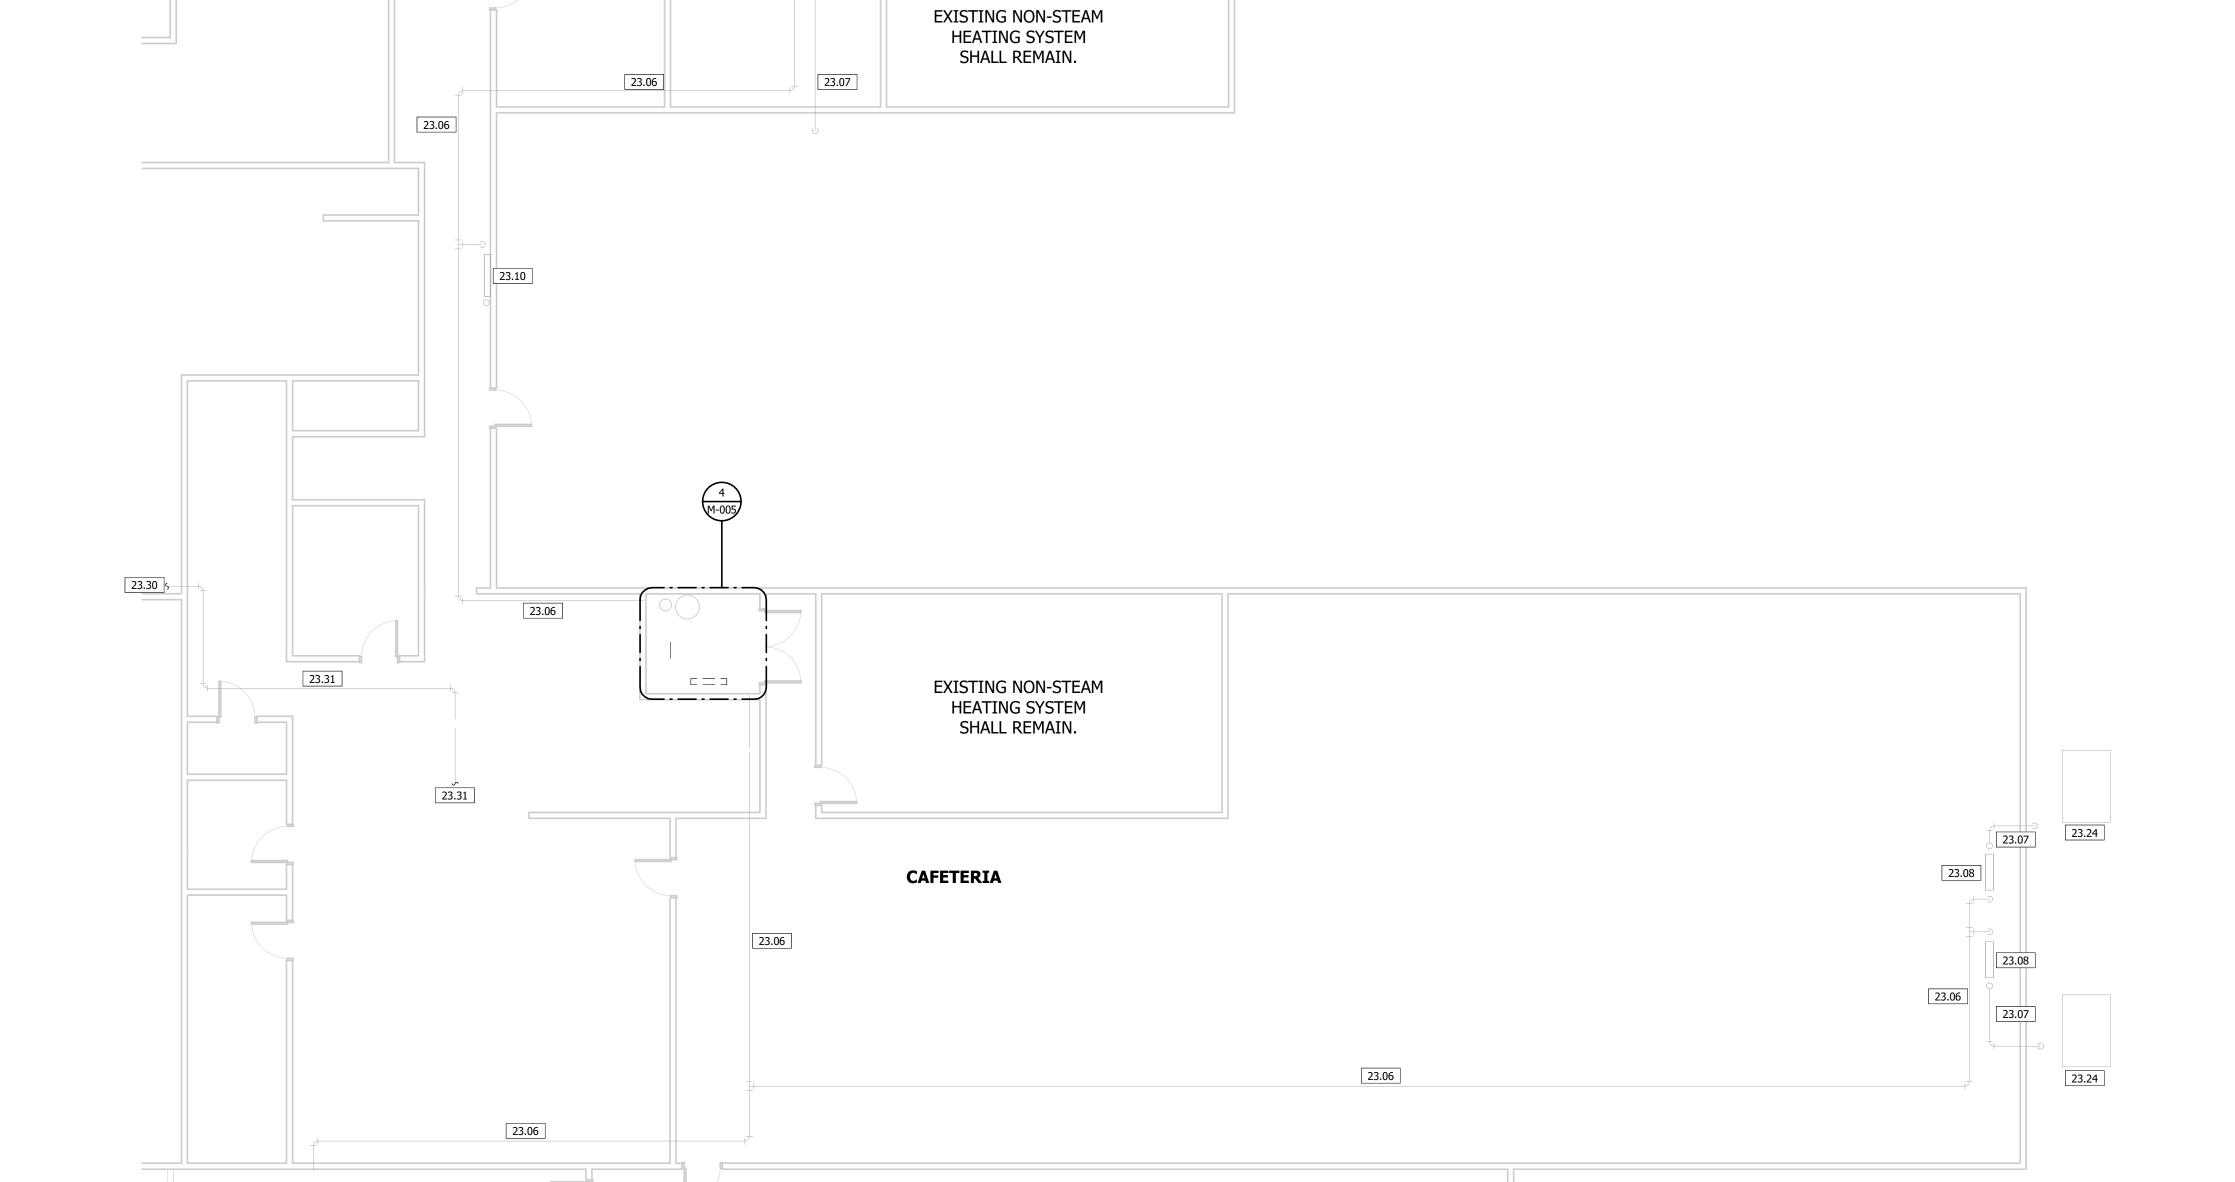

1 DEMO MECHANICAL PLAN - CAFETERIA 1/8" = 1'-0"

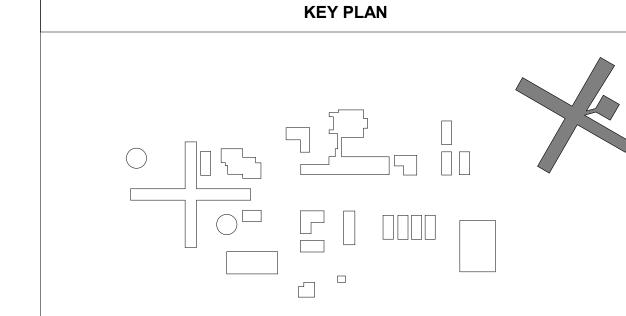

21.01 EXISTING FIRE RISER SHALL REMAIN.

3.12 EXISTING DOMESTIC COLD WATER PIPING SHALL REMAIN. .13 EXISTING DOMESTIC HOT WATER PIPING SHALL REMAIN. 23.32 EXISTING AIR HANDLER COOLING COIL SHALL REMAIN. EXISTING AIR HANDLER IS A WEATHER KING MODEL WH1T4821STANJA. FIELD VERIFY EXISTING COIL SIZE AND LOCATION.

3.33 EXISTING CONDENSING UNIT SHALL REMAIN. EXISTING UNIT IS A WEATHER KING MODEL WP1448AJ1NA. 23.34 ABANDON IN PLACE HYDRONIC RADIATOR AND ALL ASSOCIATED HYDRONIC HEATING PIPING. 23.99 EXISTING DOMESTIC HOT WATER RECIRCULATION PUMP SHALL

REMAIN. REFER TO IMPROVEMENT PLANS FOR FURTHER D23.04 REMOVE EXISTING STEAM TO HOT WATER SHELL AND TUBE HEAT EXCHANGER AND ALL ASSOCIATED ACCESSORIES, STEAM, CONDENSATE, AND DOMESTIC WATER PIPING LOCATED IN MECHANICAL ROOM.

D23.10 REMOVE AND RELOCATE EXISTING WATER SOFTENER AND ASSOCIATED BRINE TANK. REFER TO IMPROVEMENT PLANS FOR FURTHER REQUIREMENTS. D23.11 REMOVE EXISTING HOT WATER STORAGE TANK AND ALL ASSOCIATED PIPING AND CONTROL WIRING.

D23.12 REMOVE EXISTING DOMESTIC WATER PIPING DOWN TO RECIRCULATION PUMP. REMOVE PUMP AND ASSOCIATED D23.13 REMOVE EXISTING HOT WATER CONNECTION TO HOT WATER

STORAGE TANK. REFER TO IMPROVEMENT PLAN FOR FURTHER REQUIREMENTS. D23.14 REMOVE EXISTING COLD WATER CONNECTION TO WATER SOFTENER SYSTEM AND ASSOCIATED PIPING SHOWN DASHED. REFER TO IMPROVEMENT PLAN FOR FURTHER REQUIREMENTS.

D23.21 REMOVE EXISTING AIR HANDLER, PREPARE DUCTWORK FOR NEW INDOOR UNIT. REFER TO IMPROVEMENT PLAN FOR FURTHER REQUIREMENTS. D23.22 REMOVE ALL STEAM PIPING SHOWN DASHED LOCATED IN

MECHANICAL ROOM. CAP CONDENSATE PIPING IN ADJACENT ROOM AND ABANDON IN PLACE. D23.24 REMOVE EXISTING CONDENSATE RECEIVER PUMP AND ALL ASSOCIATED CONDENSATE PIPING/ACCESSORIES IN MECHANICAL

D23.25 REMOVE EXISTING HYDRONIC HEATING PUMP AND ALL ASSOCIATED HYDRONIC HEATING PIPING LOCATED IN MECHANICAL ROOM. CAP AND ABANDON HYDRONIC HEATING PIPING IS ADJACENT ROOM OR ATTIC SPACE. D23.26 REMOVE EXISTING STEAM TO HYDRONIC HEATING SHELL AND TUBE


ROOM. CAP CONDENSATE PIPING IN ADJACENT ROOM OR ATTIC

HEAT EXCHANGERS AND ALL ASSOCIATED HYDRONIC HEATING, STEAM, AND CONDENSATE PIPING LOCATED IN MECHANICAL ROOM. CAP AND ABANDON PIPING IS ADJACENT ROOM OR ATTIC SPACE. D23.27 REMOVE EXISTING AIR HANDLER AND ALL ASSOCIATED STEAM AND CONDENSATE PIPING AND DUCTWORK LOCATED IN MECHANICAL ROOM. CAP AND ABANDON PIPING IS ADJACENT ROOM OR ATTIC SPACE. REMOVE ALL EXISTING DUCTWORK IN ATTIC SPACE DIRECTLY
ABOVE MECHANICAL ROOM.

MIKE KEHOE, **GOVERNOR**

STATE OF MISSOURI

Engineer of Record Jacob Adam Nelson PE PE-2009018758

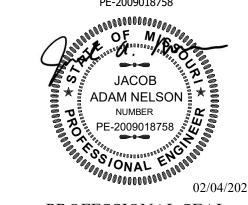



TRUE ENGINEERING GROUP, LLC MISSOURI STATE CERTIFICATE OF AUTHORITY #E-2016000752

OFFICE OF ADMINISTRATION DIVISION OF FACILITIES MANAGEMENT, DESIGN AND CONSTRUCTION

DEPARTMENT OF CORRECTIONS

OZARK CORRECTIONAL CENTER - UPGRADE HVAC

929 HONOR CAMP LN, FORDLAND, MO 65652

PROJECT # C2324-01 7003 FACILITY # 9327003081

REVISION:
DATE:
REVISION:
DATE:
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ISSUE DATE: 02/04/2025


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SHEET TITLE: **DEMO** MECHANICAL PLAN

SHEET NUMBER:

M-006


10 OF 31 SHEETS

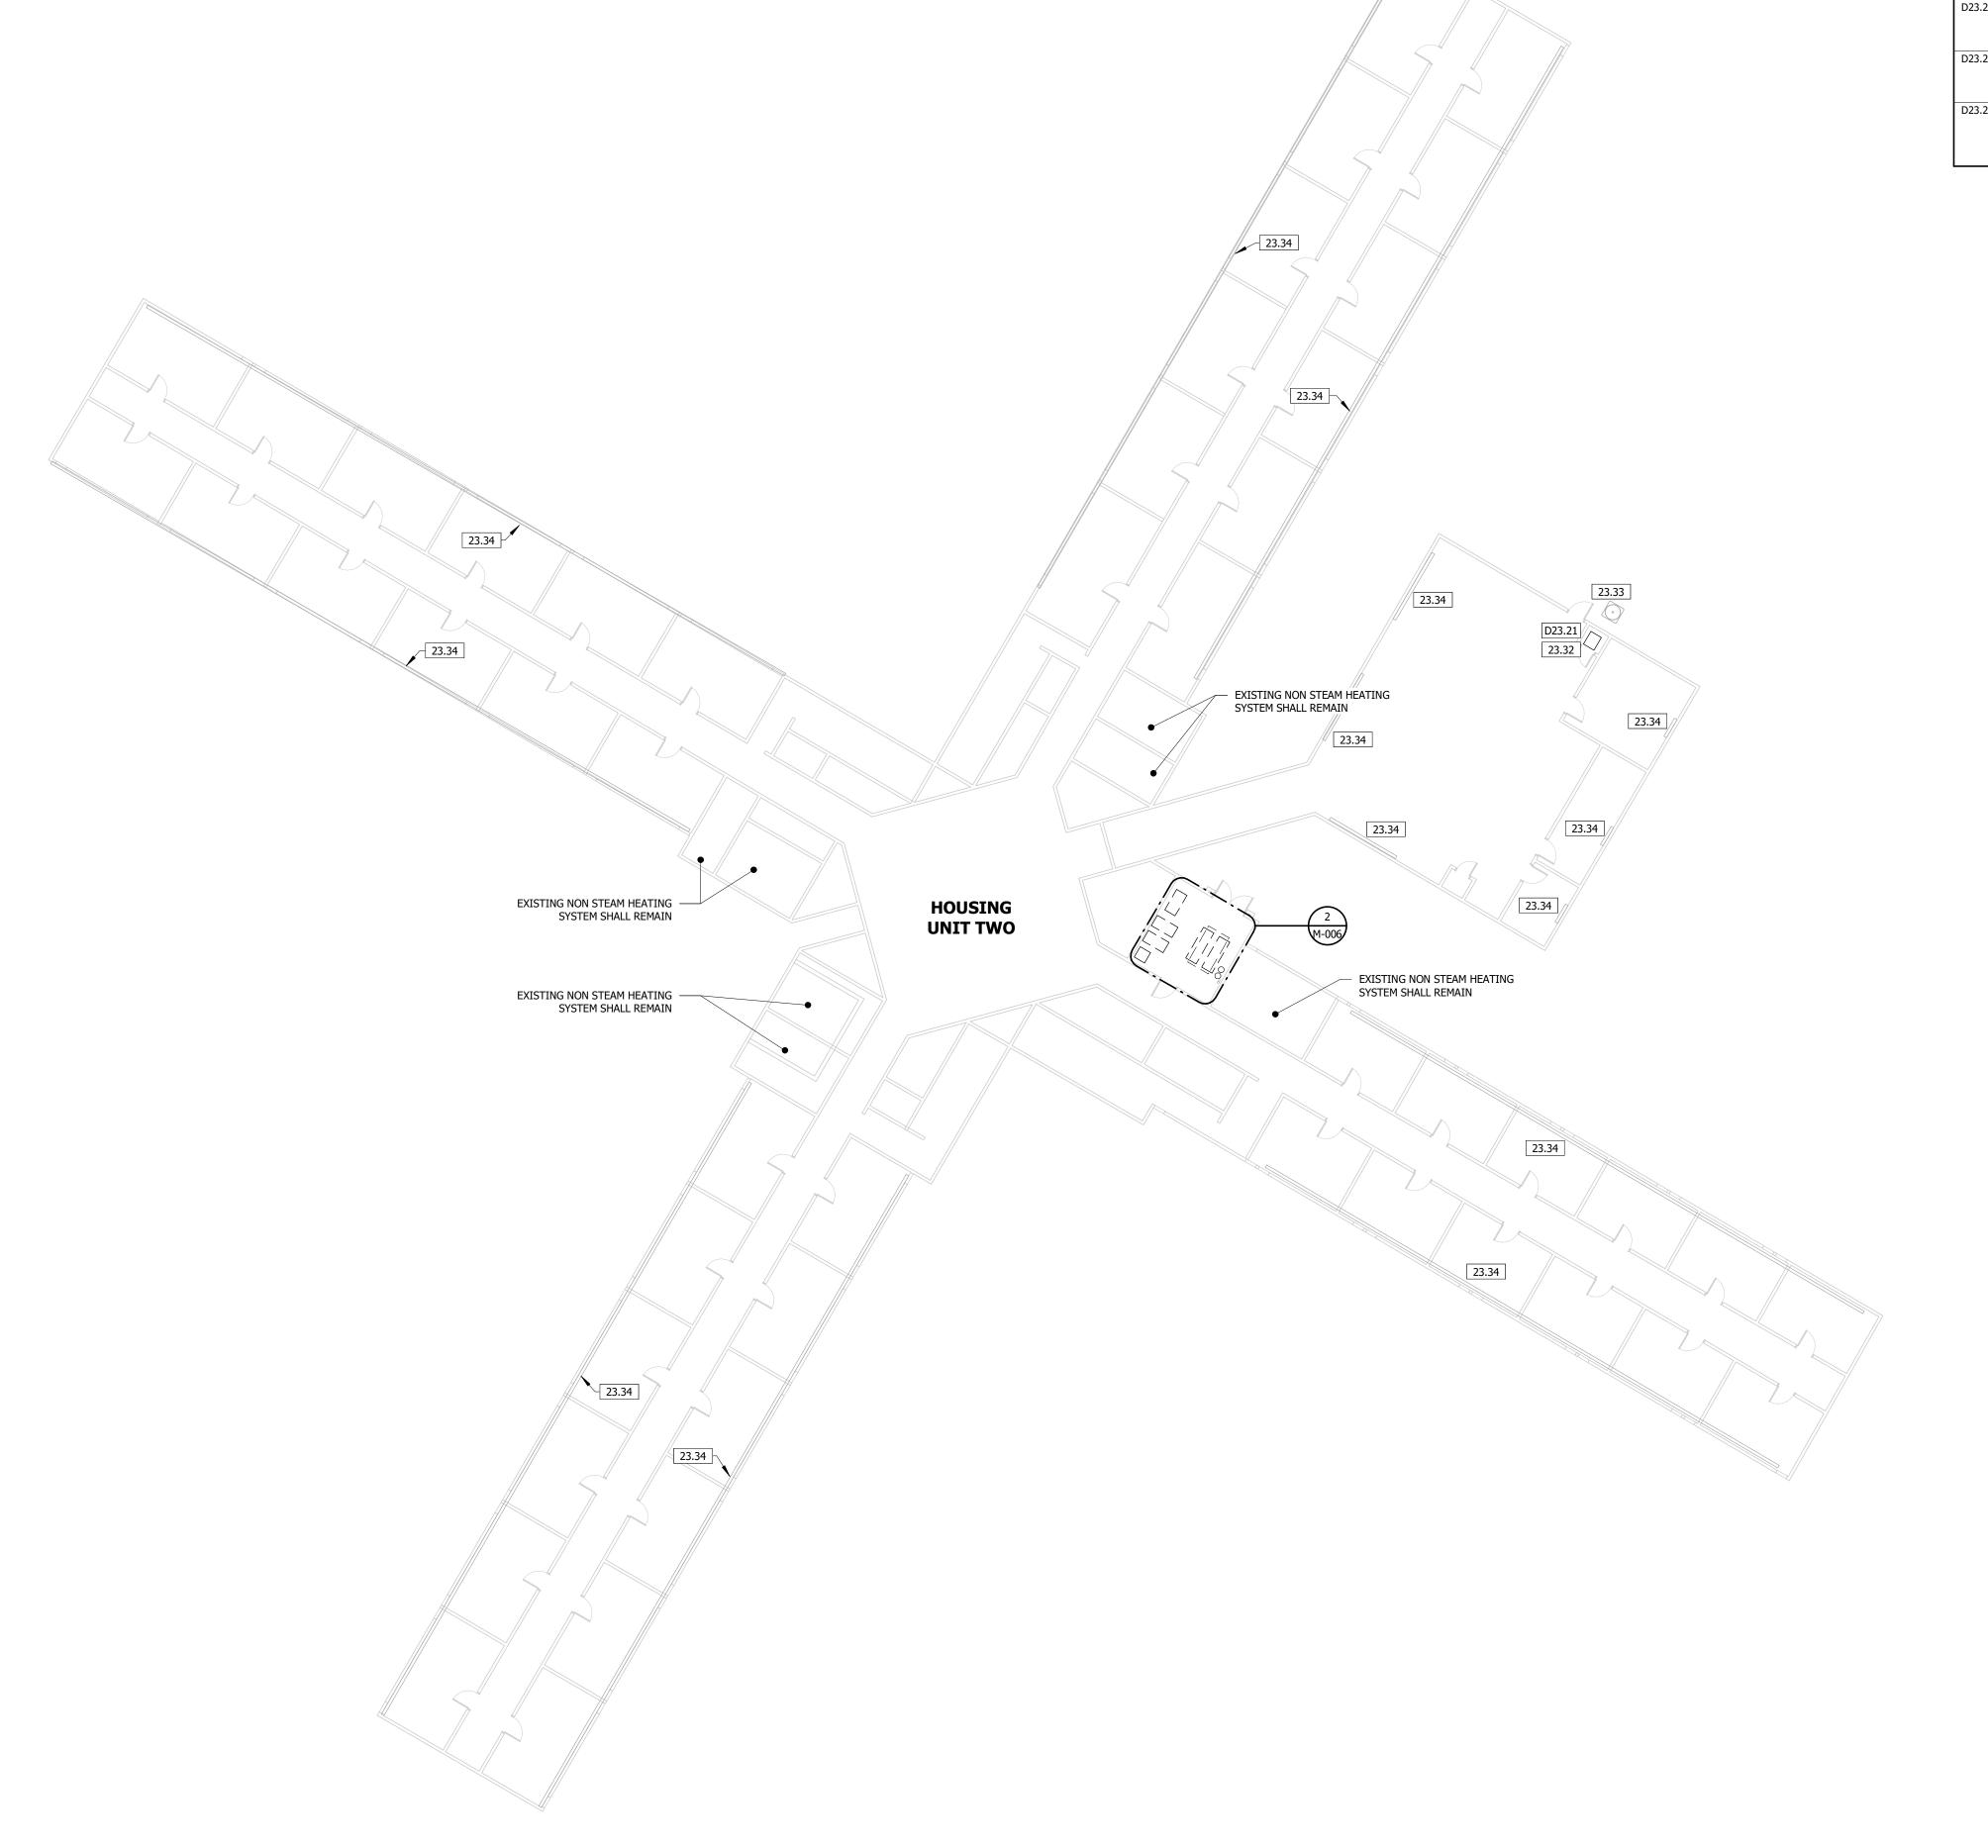

2 DEMO MECHANICAL PLAN - HU2 - ENLARGED

1/4" = 1'-0"

1 DEMO MECHANICAL PLAN - HOUSING UNIT TWO

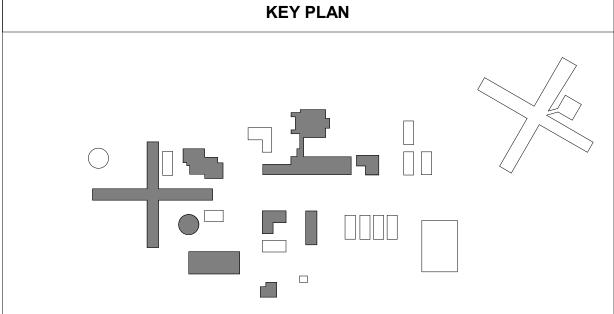

KEY VALUE 23 04 ARANDON IN DLACE EXISTING CONDEN

23.04 ABANDON IN PLACE EXISTING CONDENSATE RECEIVER PUMP.
23.59 CONNECT NEW 2.5" NATURAL GAS PIPE TO EXISTING GAS MAIN.
COORDINATE WITH UTILITY COMPANY FOR NEW METER.
23.63 0.75" NATURAL GAS PIPING UP. PROVIDE ACCESSIBLE SHUT-OFF
VALVE AND ASTM RATED RISER. CHANGE PIPE MATERIAL TO BLACK

VALVE AND ASTM RATED RISER. CHANGE PIPE MATERIAL TO BLACK IRON ABOVE GRADE. SEE ENLARGED PLAN FOR CONTINUATION INTO BUILDING.

23.64 0.5" NATURAL GAS PIPING UP. PROVIDE ACCESSIBLE SHUT-OFF VALVE AND ASTM RATED RISER. CHANGE PIPE MATERIAL TO BLACK

IRON. SEE ENLARGED PLAN FOR CONTINUATION INTO BUILDING.

23.65 2" NATURAL GAS PIPING DOWN. PROVIDE ACCESSIBLE SHUT-OFF VALVE AND ASTM RATED RISER. CHANGE PIPE MATERIAL TO NATURAL GAS RATED POLYETHYLENE PIPING UNDERGROUND.

23.66 0.75" NATURAL GAS PIPING DOWN. PROVIDE ACCESSIBLE SHUT-OFF VALVE AND ASTM RATED RISER. CHANGE PIPE MATERIAL TO NATURAL GAS RATED POLYETHYLENE PIPING UNDERGROUND.

23.67 SAW CUT EXISTING SIDEWALK WHERE NECESSARY BEFORE TRENCHING. PATCH AND REPAIR TO MATCH EXISTING.

23.70 2.5" NATURAL GAS PIPING. SEE ENLARGED PLAN FOR CONTINUATION.

23.82 1.5" NATURAL GAS PIPING UP. PROVIDE ACCESSIBLE SHUT-OFF VALVE AND ASTM RATED RISER. CHANGE PIPE MATERIAL TO BLACK IRON ABOVE GRADE. SEE ENLARGED PLAN FOR CONTINUATION INTO

BUILDING.

23.120 1" NATURAL GAS PIPING UP. PROVIDE ACCESSIBLE SHUT-OFF VALVE AND ASTM RATED RISER. CHANGE PIPE MATERIAL TO BLACK IRON ABOVE GRADE.

VALVE ON ALVE ON BEING ERING MECHANICAL · ELECTRICAL · PLUMBING 1200 E WOODHURST DR, STE P

SPRINGFIELD, MO 65804 417.708.7025 WWW.TRUE-MEP.COM

STATE OF MISSOURI

Engineer of Record Jacob Adam Nelson PE

PE-2009018758

JACOB

ADAM NELSON

NUMBER

PE-2009018758

MIKE KEHOE,

GOVERNOR

TRUE ENGINEERING GROUP, LLC
MISSOURI STATE CERTIFICATE OF AUTHORITY #E-2016000752

OFFICE OF ADMINISTRATION DIVISION OF FACILITIES MANAGEMENT, DESIGN AND CONSTRUCTION

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OZARK CORRECTIONAL CENTER - UPGRADE HVAC

929 HONOR CAMP LN, FORDLAND, MO 65652

PROJECT # C2324-01 SITE # 7003 FACILITY # 9327003081

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CAD DWG FILE: C2324-01 DRAWN BY: KP CHECKED BY: JN DESIGNED BY: JK


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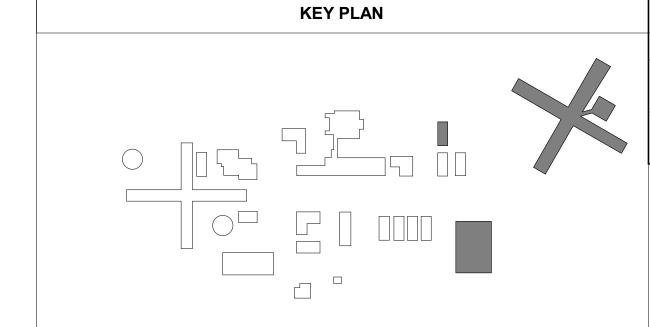
MECHANICAL

SITE PLAN -NORTH

SHEET NUMBER:

M-101



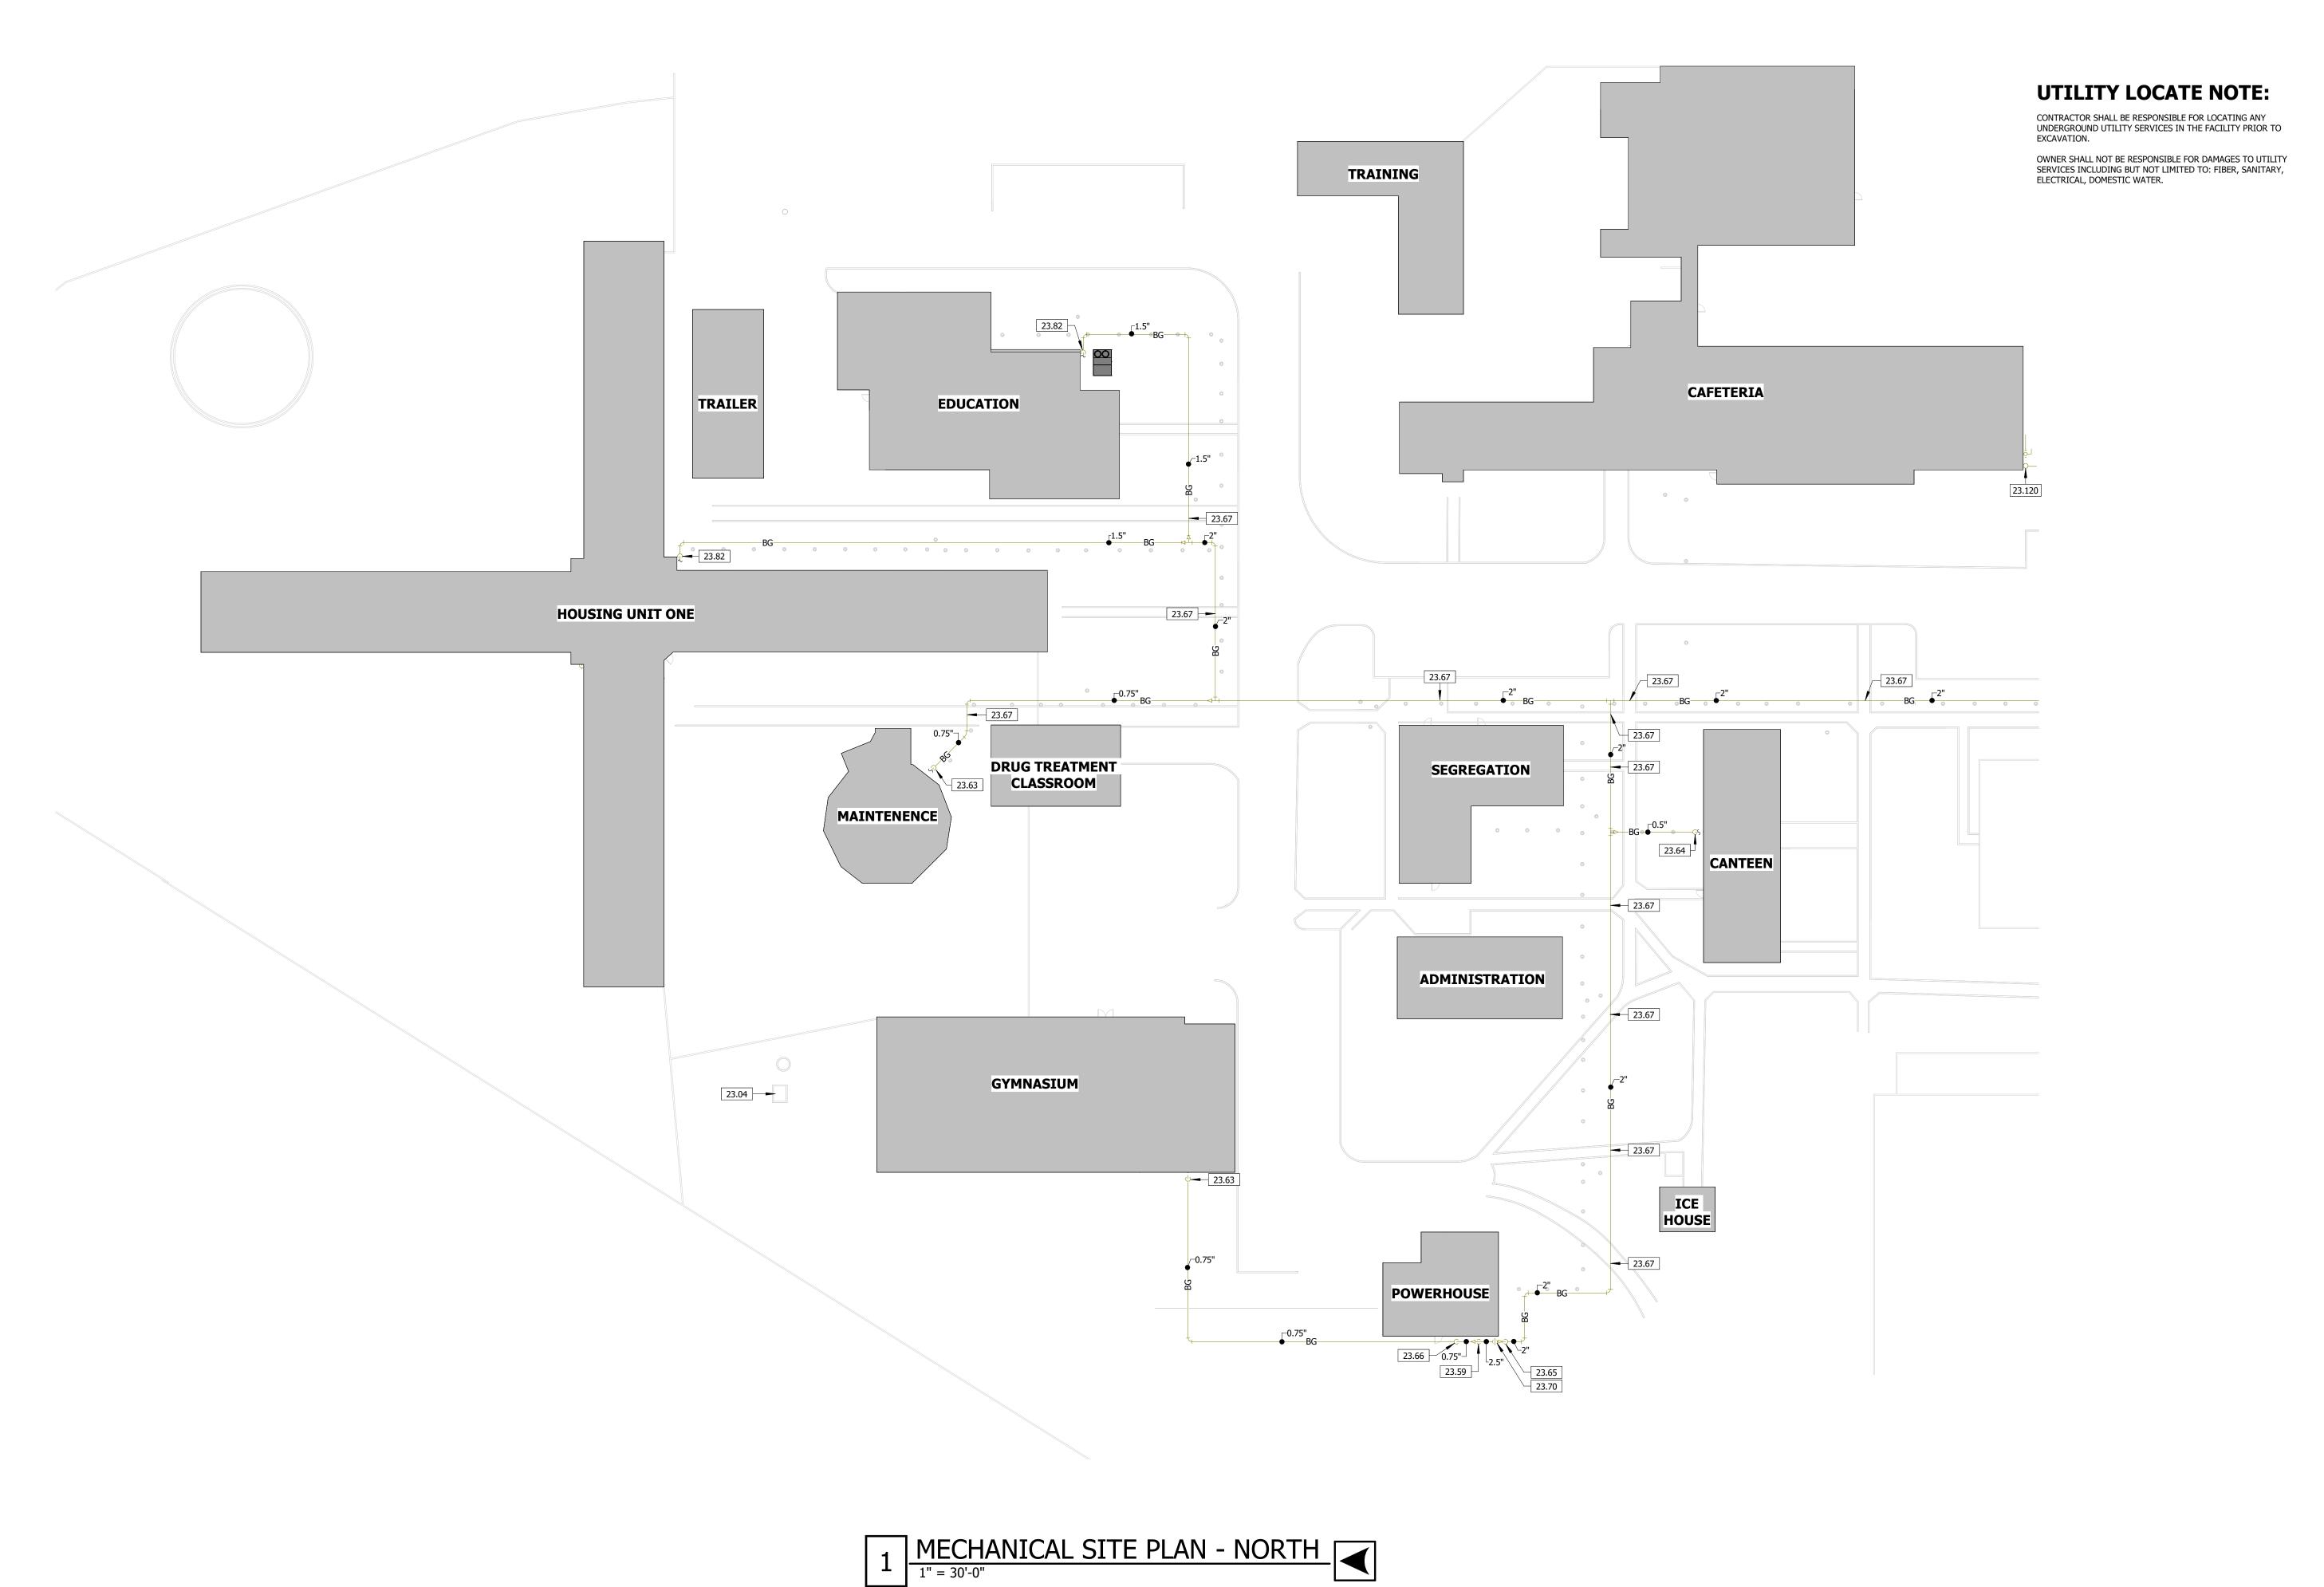

23.77 0.5" NATURAL GAS PIPING UP. PROVIDE ACCESSIBLE SHUT-OFF VALVE AND ASTM RATED RISER. CHANGE PIPE MATERIAL TO BLACK IRON ABOVE GRADE. SEE ENLARGED PLAN FOR CONTINUATION INTO 23.82

1.5" NATURAL GAS PIPING UP. PROVIDE ACCESSIBLE SHUT-OFF VALVE
AND ASTM RATED RISER. CHANGE PIPE MATERIAL TO BLACK IRON
ABOVE GRADE. SEE ENLARGED PLAN FOR CONTINUATION INTO

STATE OF MISSOURI MIKE KEHOE, **GOVERNOR**

Engineer of Record Jacob Adam Nelson PE PE-2009018758

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UTILITY LOCATE NOTE:

CONTRACTOR SHALL BE RESPONSIBLE FOR LOCATING ANY UNDERGROUND UTILITY SERVICES IN THE FACILITY PRIOR TO EXCAVATION.

OWNER SHALL NOT BE RESPONSIBLE FOR DAMAGES TO UTILITY SERVICES INCLUDING BUT NOT LIMITED TO: FIBER, SANITARY, ELECTRICAL, DOMESTIC WATER.

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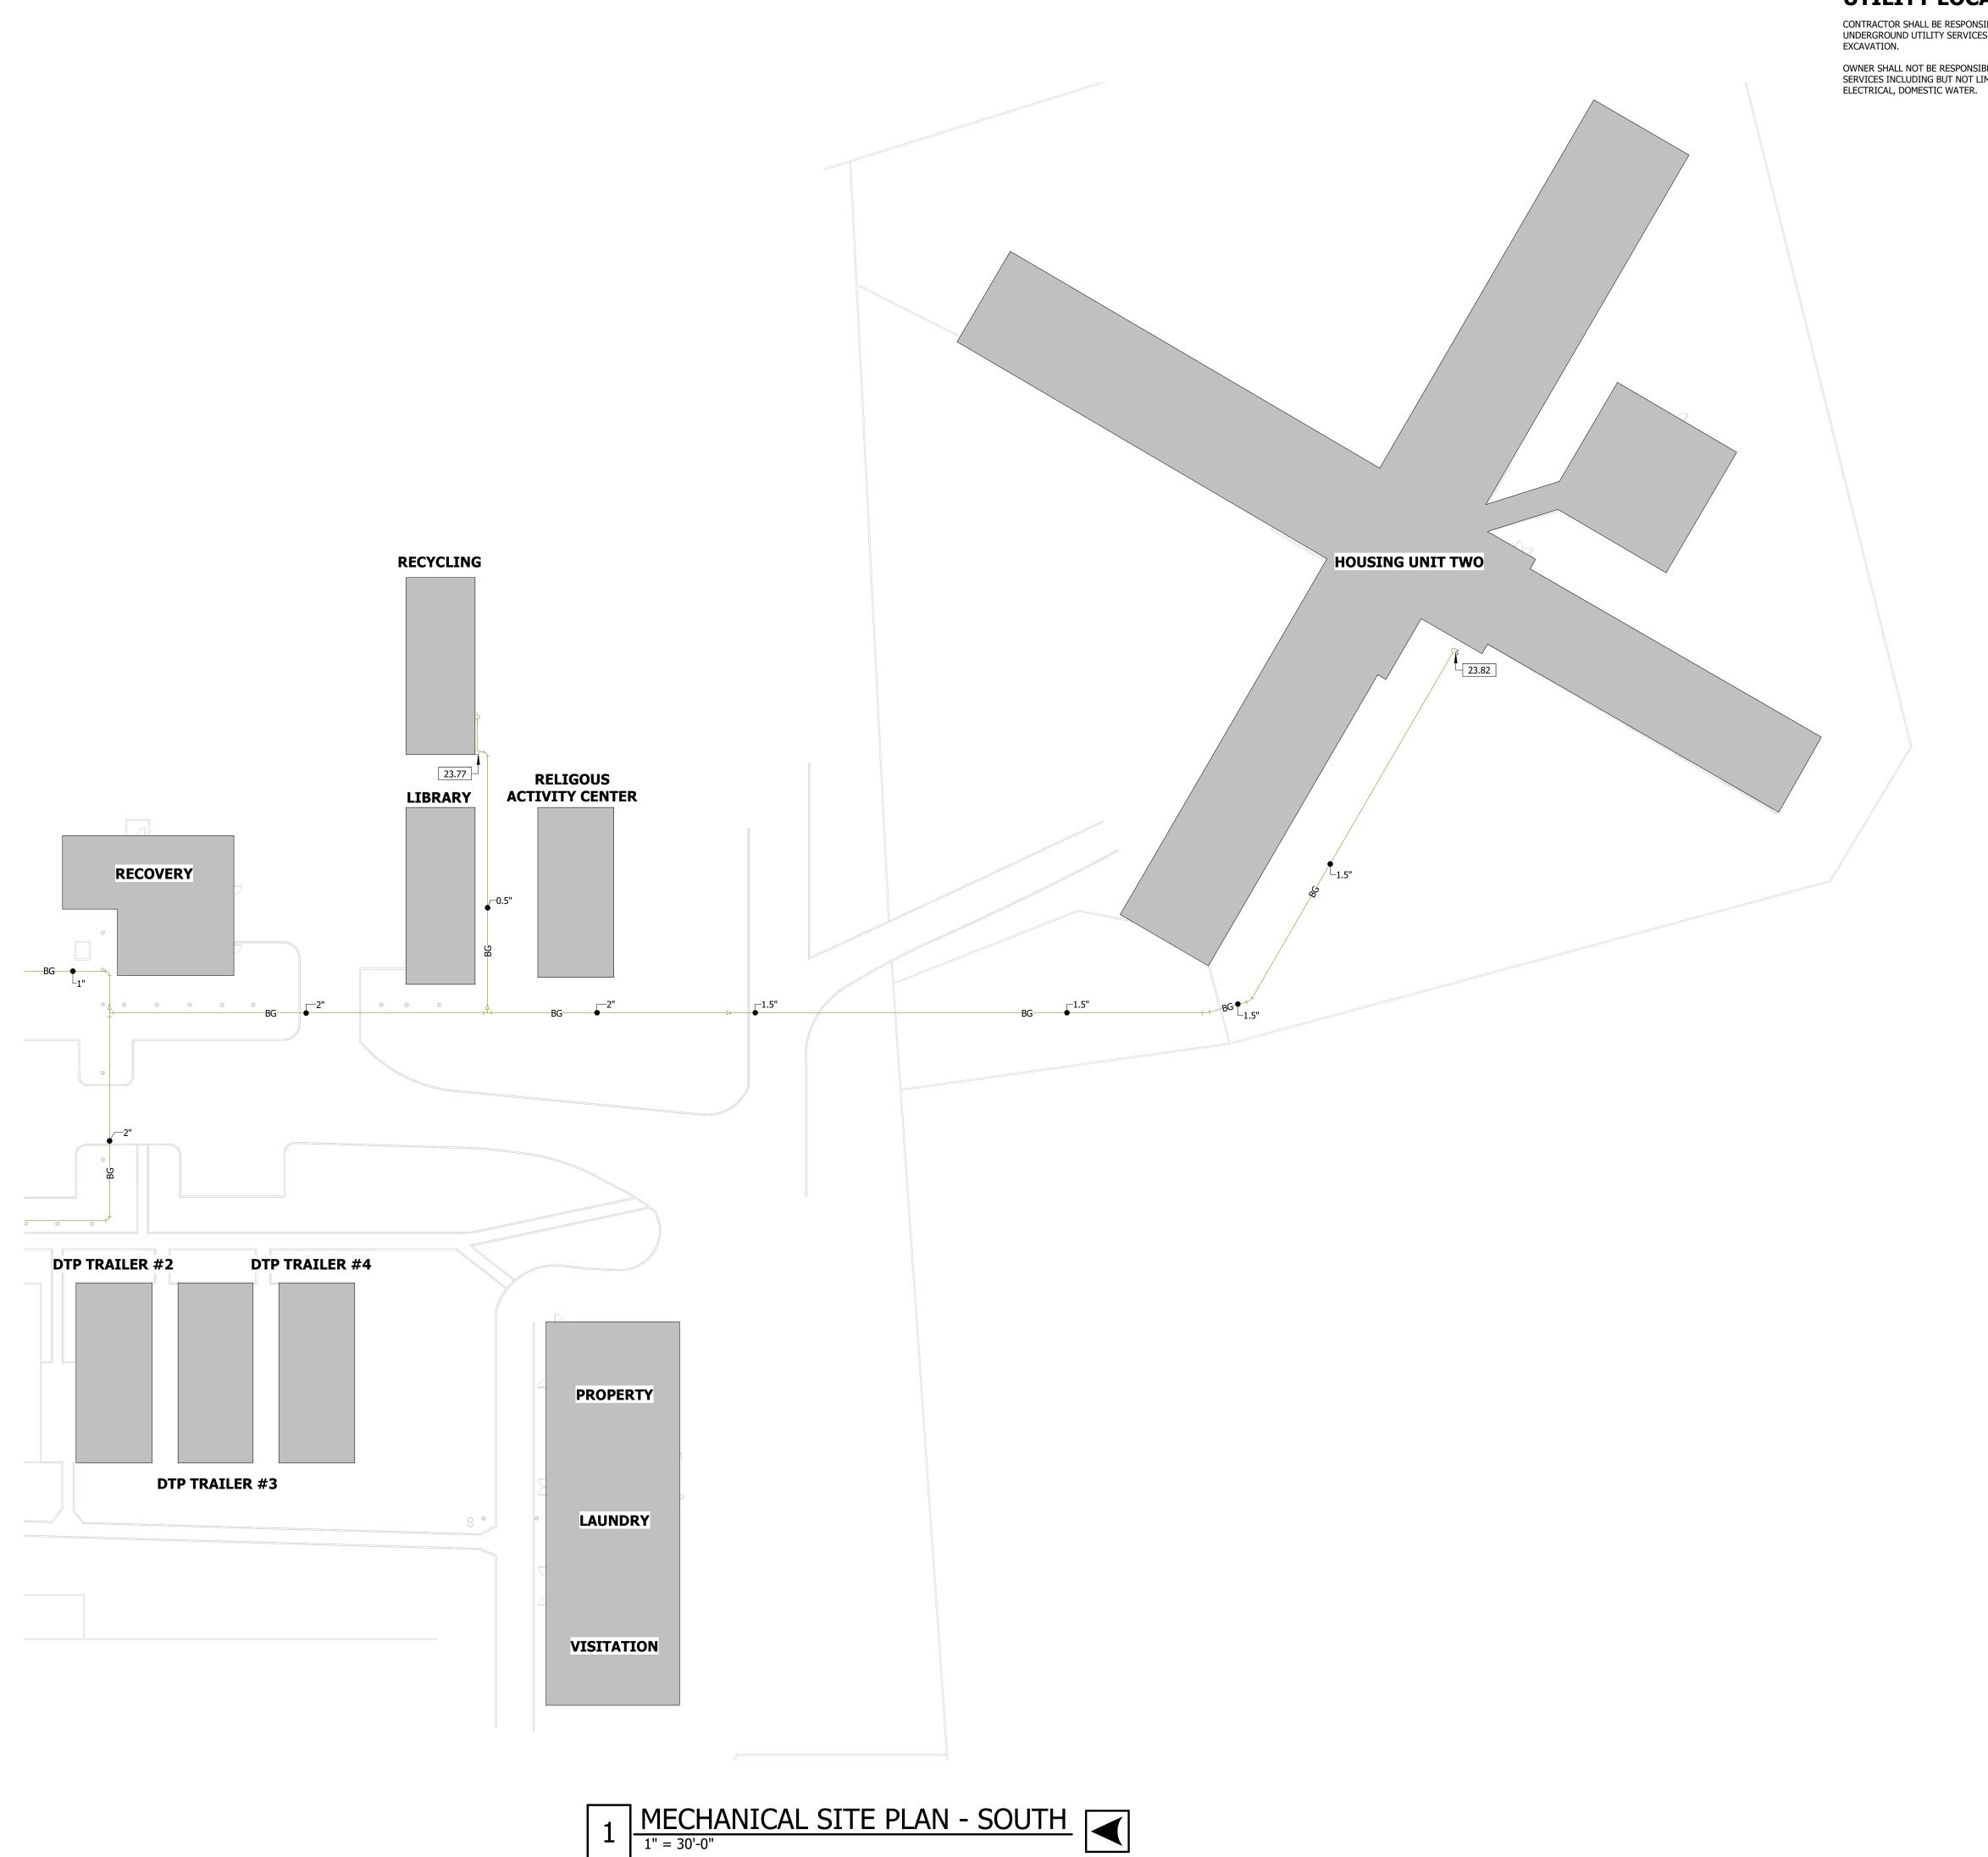
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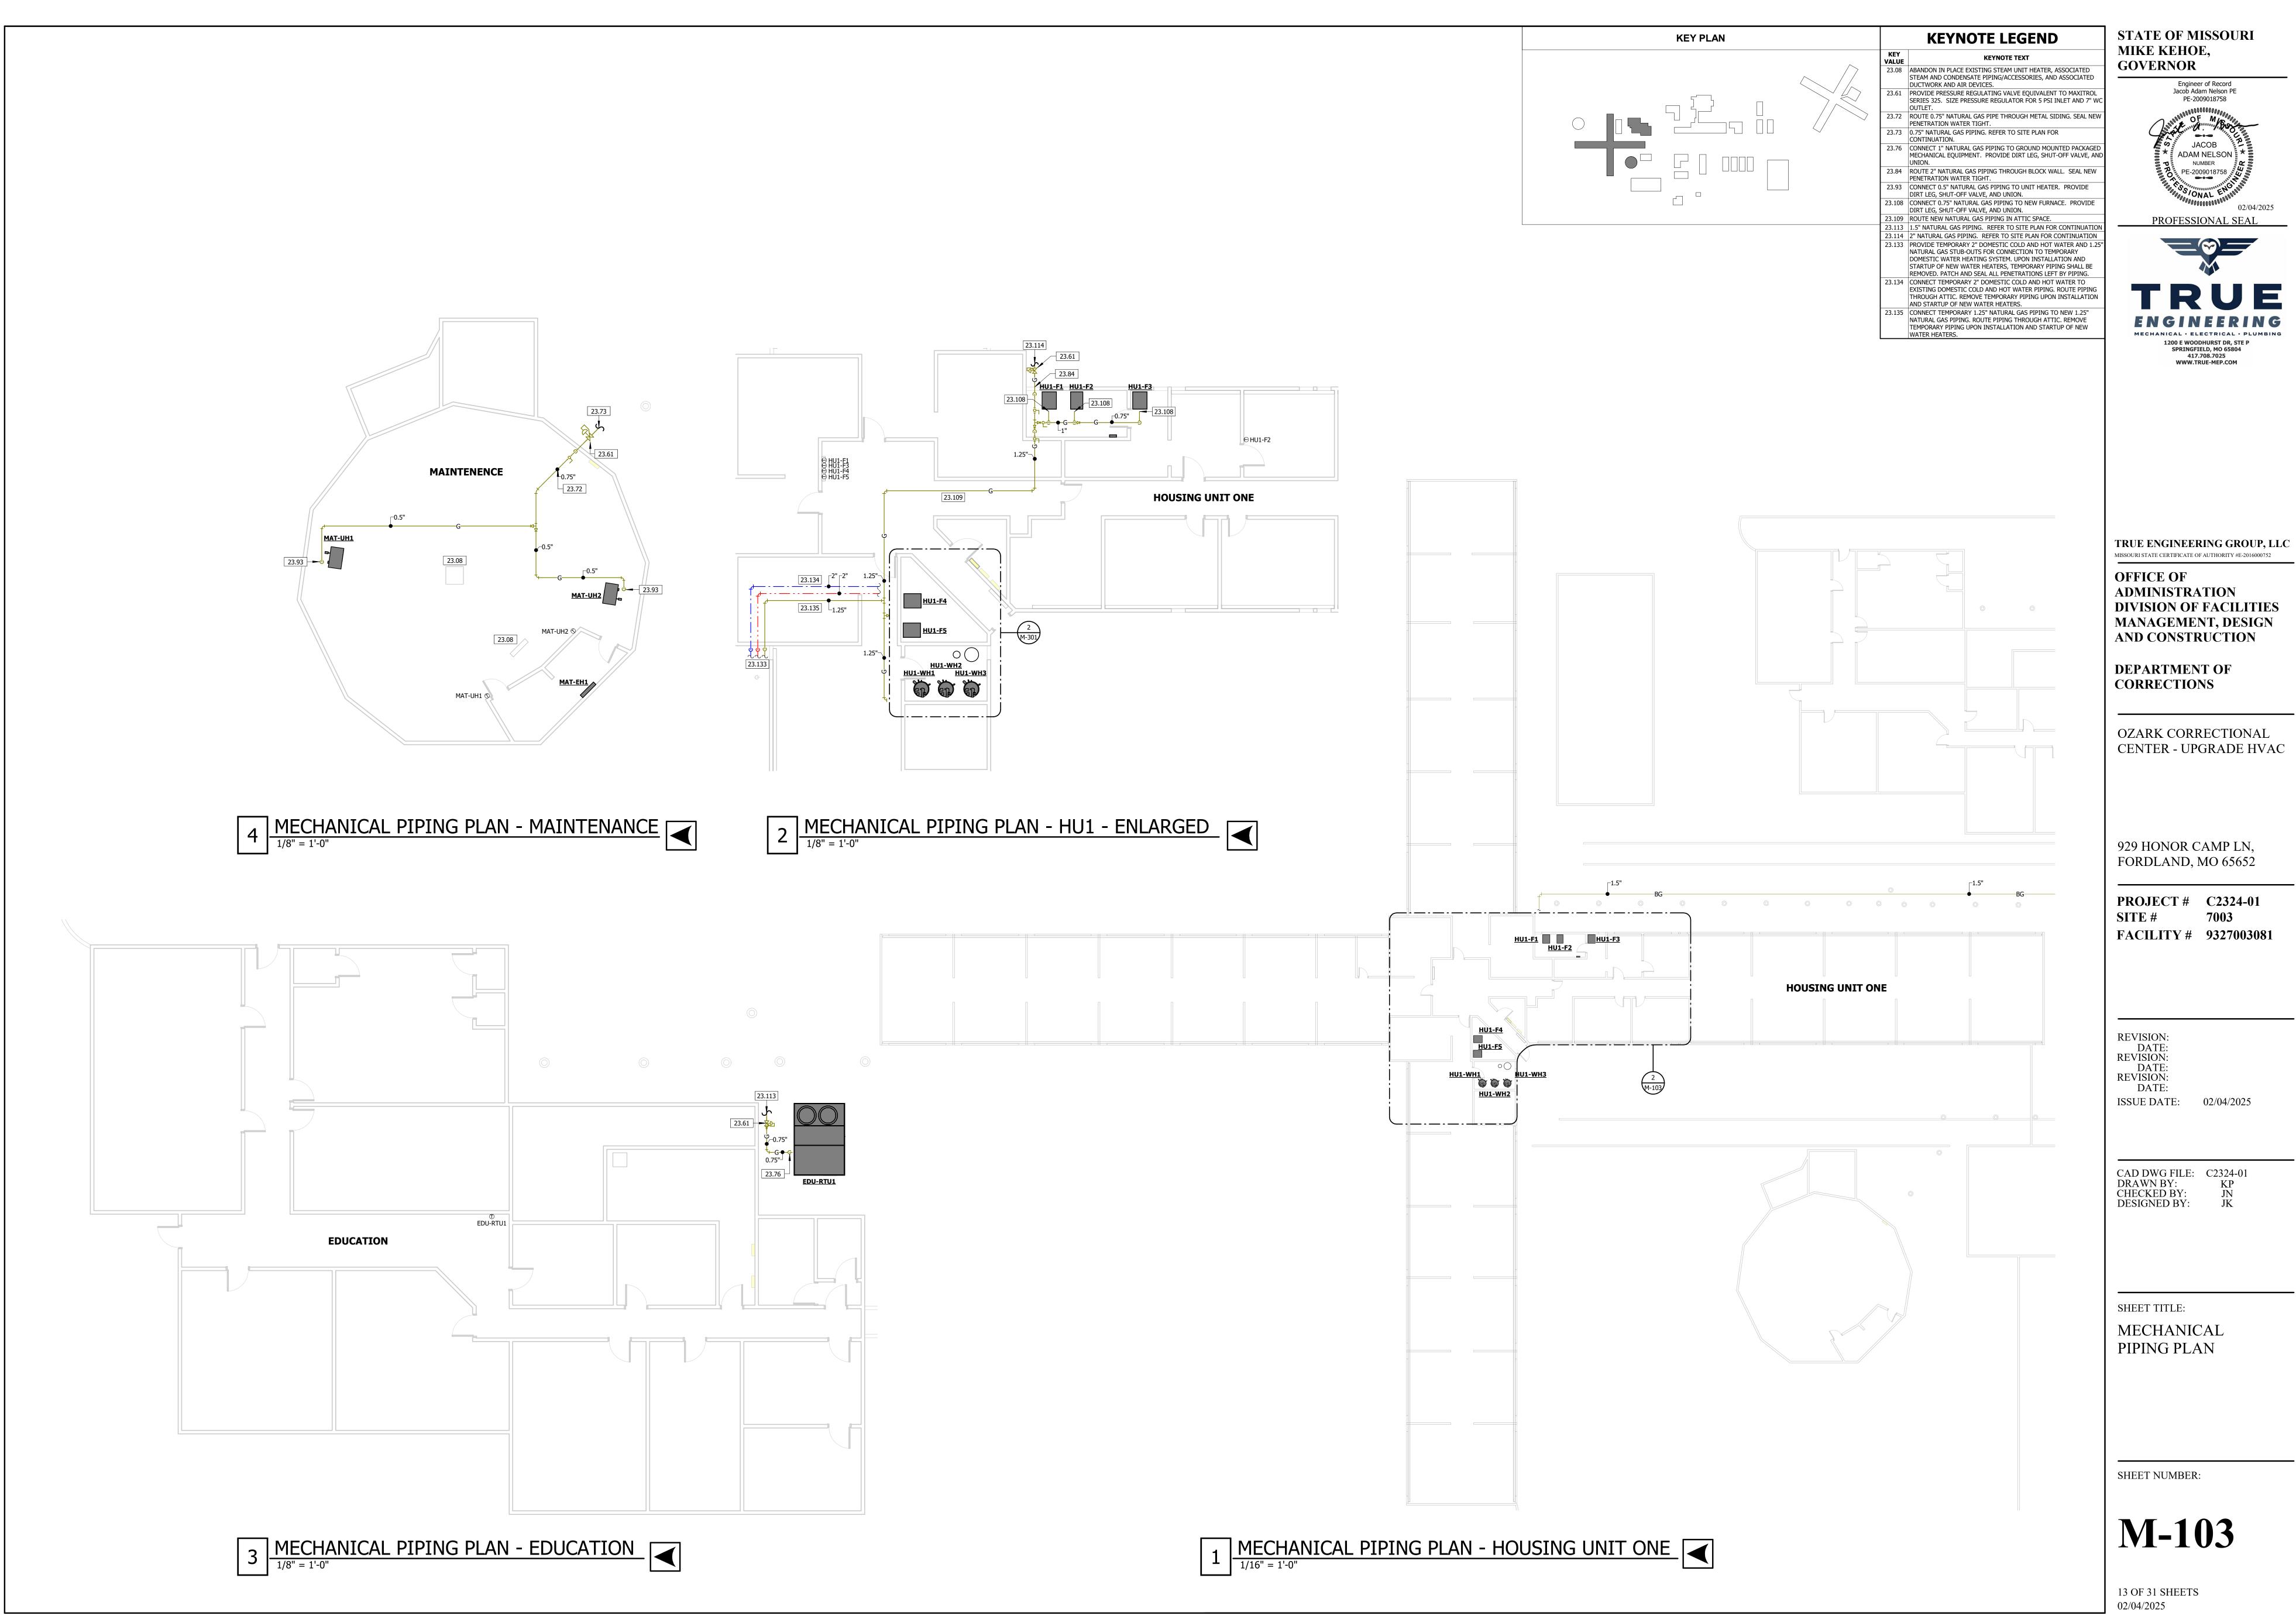
SHEET NUMBER:

SOUTH

M-102

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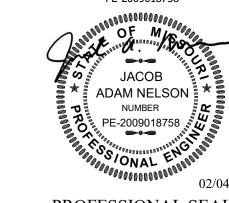


CENTER - UPGRADE HVAC



STATE OF MISSOURI
MIKE KEHOE,
GOVERNOR

Engineer of Record
Jacob Adam Nelson PE
PE-2009018758



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CAD DWG FILE: C2324-01
DRAWN BY: KP
CHECKED BY: JN
DESIGNED BY: JK

SHEET TITLE:

MECHANICAL

PIPING PLAN

SHEET NUMBER:

M-104

14 OF 31 SHEETS

5 MECHANICAL PIPING PLAN - VISITATION

1/8" = 1'-0"

PROPERTY

VISITATION


4 MECHANICAL PIPING PLAN - CANTEEN

1/8" = 1'-0"

CANTEEN

0.5" CAN-EH1

CAN-UH2

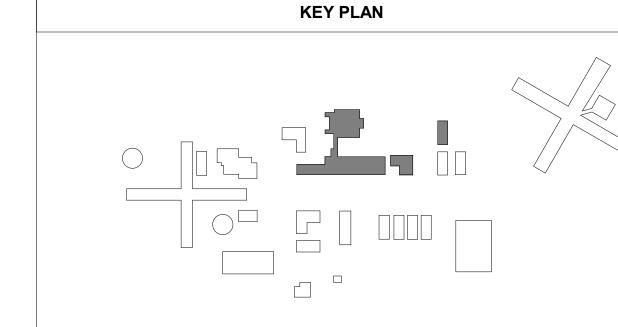

23.08 ABANDON IN PLACE EXISTING STEAM UNIT HEATER, ASSOCIATED STEAM AND CONDENSATE PIPING/ACCESSORIES, AND ASSOCIATED DUCTWORK AND AIR DEVICES.

23.25 EXISTING 1" NATURAL GAS AND REGULATOR UP INTO BUILDING SHALL REMAIN. 23.26 EXISTING 1" NATURAL GAS LINE LOCATED IN THE BUILDING SHALL

23.27 EXISTING WATER HEATER AND ASSOCIATED PIPING SHALL REMAIN. 23.29 EXISTING CONDENSING UNIT SHALL REMAIN. EXISTING UNIT IS A NORTEK JS4BD-060KA MODEL. 23.30 EXISTING 2.5" NATURAL GAS AND REGULATOR UP INTO BUILDING

SHALL REMAIN. 23.31 EXISTING 2.5" NATURAL GAS LINE LOCATED IN THE BUILDING SHALL 23.56 INSTALL NEW FURNACE IN PLACE OF EXISTING AIR HANDLER. RECONNECT EXISTING DUCTWORK AND EVAPORATOR COIL TO NEW FURNACE. PROVIDE NEW LINE SET FROM OUTDOOR UNIT TO INDOOR EVAPORATOR COIL.

SERIES 325. SIZE PRESSURE REGULATOR FOR 5 PSI INLET AND 7" WC 23.77 0.5" NATURAL GAS PIPING UP. PROVIDE ACCESSIBLE SHUT-OFF VALVE AND ASTM RATED RISER. CHANGE PIPE MATERIAL TO BLACK IRON ABOVE GRADE. SEE ENLARGED PLAN FOR CONTINUATION INTO

23.61 PROVIDE PRESSURE REGULATING VALVE EQUIVALENT TO MAXITROL

23.78 0.5" NATURAL GAS PIPING. REFER TO SITE PLAN FOR CONTINUATION. 23.79 ROUTE 0.5" NATURAL GAS PIPE THROUGH METAL SIDING. SEAL NEW OPENING WATER TIGHT.

23.93 CONNECT 0.5" NATURAL GAS PIPING TO UNIT HEATER. PROVIDE DIRT LEG, SHUT-OFF VALVE, AND UNION.

23.108 CONNECT 0.75" NATURAL GAS PIPING TO NEW FURNACE. PROVIDE

DIRT LEG, SHUT-OFF VALVE, AND UNION.

23.119 1" NATURAL GAS RATED POLYETHYLENE PIPING UNDERGROUND. 23.120 1" NATURAL GAS PIPING UP. PROVIDE ACCESSIBLE SHUT-OFF VALVE AND ASTM RATED RISER. CHANGE PIPE MATERIAL TO BLACK IRON ABOVE GRADE.

DIRT LEG, SHUT-OFF VALVE, AND UNION.

23.126 CONNECT NEW 2" NATURAL GAS PIPING TO EXISTING 2.5" NATURAL GAS. FIELD VERIFY EXISTING SIZE AND LOCATION.
23.127 ROUTE NEW NATURAL GAS PIPING ABOVE EXISTING LAY-IN CEILING.

UNIT. PROVIDE DIRT LEG, SHUT-OFF VALVE, AND UNION. 23.130 CONNECT NEW 1" NATURAL GAS PIPING TO EXISTING 1" PIPING. FIELD VERIFY EXISTING SIZE AND LOCATION.

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STATE OF MISSOURI

Engineer of Record Jacob Adam Nelson PE

PE-2009018758

JACOB

ADAM NELSON

NUMBER **ጆ** PE-2009018758 ,

PROFESSIONAL SEAL

MIKE KEHOE,

GOVERNOR

TRUE ENGINEERING GROUP, LLC MISSOURI STATE CERTIFICATE OF AUTHORITY #E-2016000752

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OZARK CORRECTIONAL CENTER - UPGRADE HVAC

929 HONOR CAMP LN, FORDLAND, MO 65652

PROJECT # C2324-01 7003 FACILITY # 9327003081

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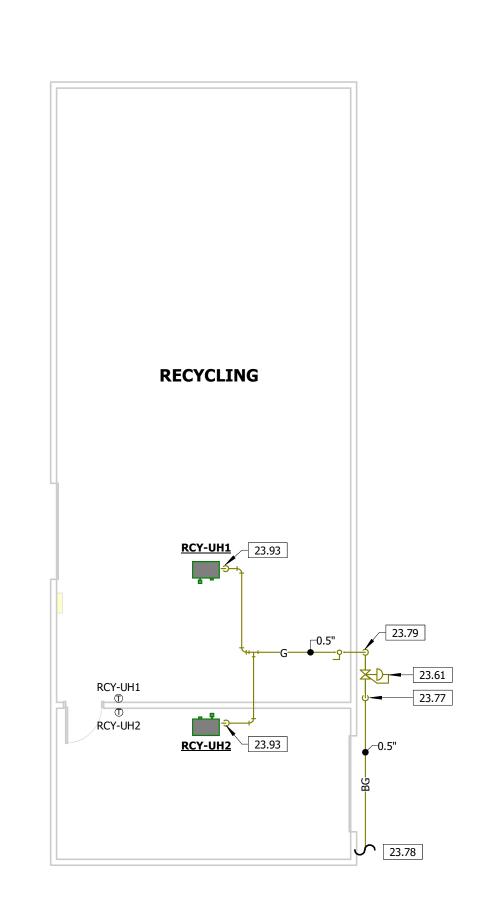
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PIPING PLAN


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M-105


15 OF 31 SHEETS








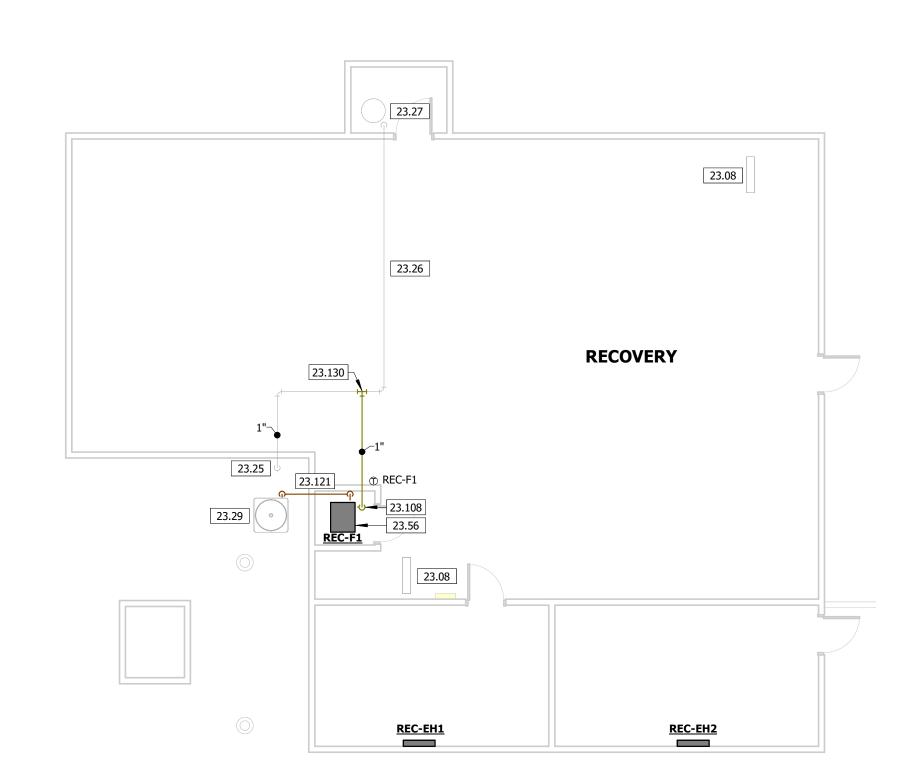

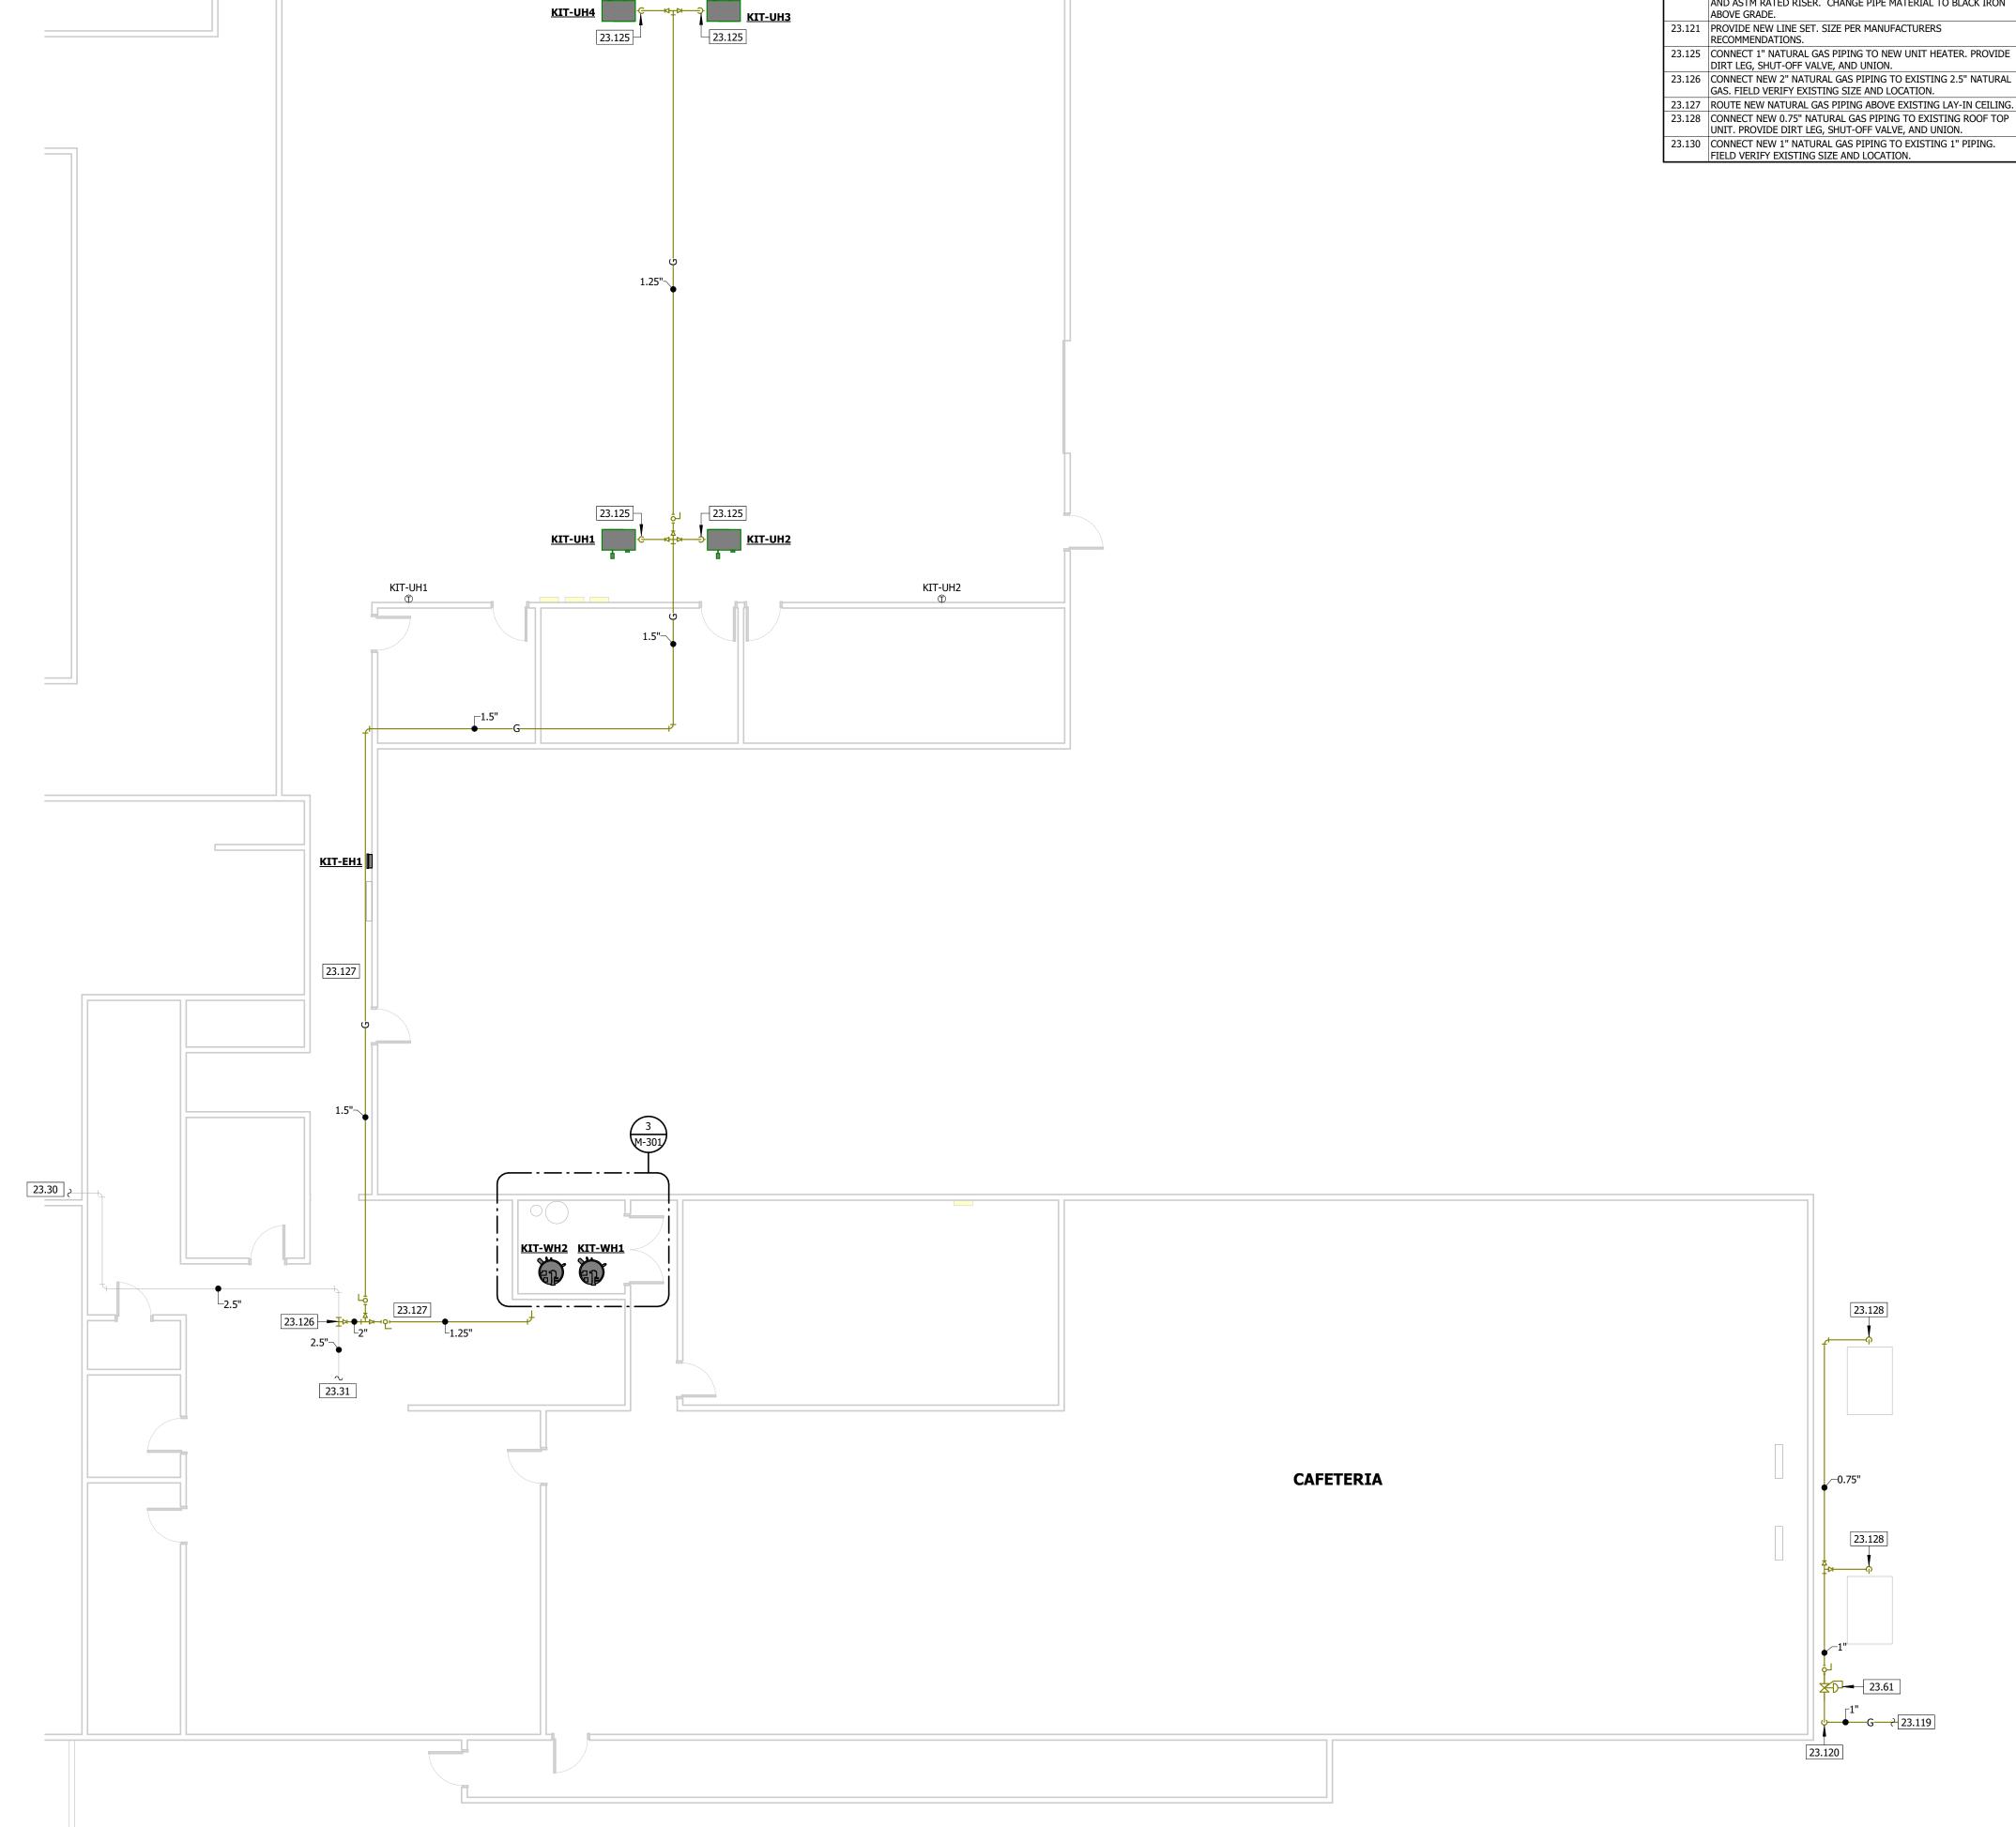

1 MECHANICAL PIPING PLAN - CAFETERIA

1/8" = 1'-0"

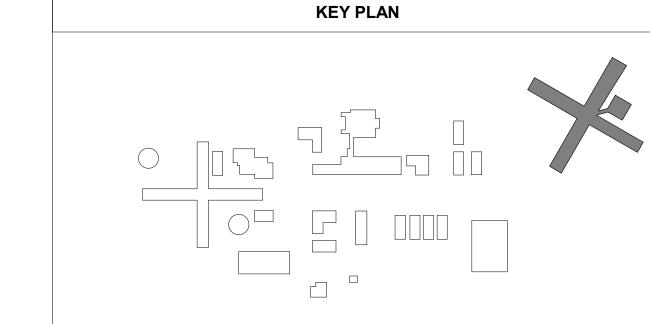

21.01 EXISTING FIRE RISER SHALL REMAIN.

23.10 ABANDON IN PLACE STEAM RADIATOR AND ALL ASSOCIATED STEAM AND CONDENSATE PIPING. 23.33 EXISTING CONDENSING UNIT SHALL REMAIN. EXISTING UNIT IS A WEATHER KING MODEL WP1448AJ1NA. 23.61 PROVIDE PRESSURE REGULATING VALVE EQUIVALENT TO MAXITROL SERIES 325. SIZE PRESSURE REGULATOR FOR 5 PSI INLET AND 7" WC

23.85 CONNECT NEW 2" COLD WATER TO RELOCATED WATER SOFTENER. 23.86 2" COLD AND HOT WATER DOWN TO NEW WATER HEATER. 23.87 CONNECT 0.5" CONDENSATE DRAIN TO NEW WATER HEATER.

23.88 1" DRAIN UP TO WATER HEATER TEMPERATURE AND PRESSURE RELIEF VALVE. PROVIDE AIR GAP. 23.89 TERMINATE 2" DRAIN AT EXISTING FLOOR DRAIN. 23.90 CONNECT NEW 2" COLD WATER TO EXISTING COLD WATER PIPING. FIELD VERIFY EXISTING SIZE AND LOCATION.

23.91 CONNECT NEW 2" TEMPERED WATER TO EXISTING HOT WATER

PIPING. FIELD VERIFY EXISTING SIZE AND LOCATION. 23.92 ROUTE PIPING BEHIND NEW EQUIPMENT. OFFSET SHOWN FOR 23.96 EXISTING HOT WATER RECIRCULATION PUMP AND UPSTREAM PIPING SHALL REMAIN. RECONNECT TO WATER HEATERS AND MASTER MIXING VALVE PER MANUFACTURERS RECOMMENDATIONS.

23.97 CONNECT NEW 0.75" COLD WATER TO EXISTING PIPING SERVING EXISTING WALL HYDRANT. 23.109 ROUTE NEW NATURAL GAS PIPING IN ATTIC SPACE. 23.113 1.5" NATURAL GAS PIPING. REFER TO SITE PLAN FOR CONTINUATION 23.116 CONNECT 1" NATURAL GAS PIPING TO NEW FURNACE. PROVIDE DIRT

LEG, SHUT-OFF VALVE, AND UNION.
23.117 1" NATURAL GAS PIPING DOWN. PROVIDE ACCESSIBLE SHUT-OFF VALVE AND ASTM RATED RISER. CHANGE PIPE MATERIAL TO NATURAL GAS RATED POLYETHYLENE PIPING UNDERGROUND. 23.118 CONNECT 1.25" NATURAL GAS PIPING TO NEW WATER HEATER. PROVIDE DIRT LEG, SHUT-OFF VALVE, AND UNION. 23.119 1" NATURAL GAS RATED POLYETHYLENE PIPING UNDERGROUND. 23.120 1" NATURAL GAS PIPING UP. PROVIDE ACCESSIBLE SHUT-OFF VALVE

23.121 PROVIDE NEW LINE SET. SIZE PER MANUFACTURERS

RECOMMENDATIONS. 23.122 ROUTE 2.5" NATURAL GAS PIPING THROUGH BLOCK WALL. SEAL NEW PENETRATION WATER TIGHT.

23.133 PROVIDE TEMPORARY 2" DOMESTIC COLD AND HOT WATER AND 1.25 NATURAL GAS STUB-OUTS FOR CONNECTION TO TEMPORARY DOMESTIC WATER HEATING SYSTEM, UPON INSTALLATION AND STARTUP OF NEW WATER HEATERS, TEMPORARY PIPING SHALL BE REMOVED. PATCH AND SEAL ALL PENETRATIONS LEFT BY PIPING. 23.136 CONNECT TEMPORARY 2" DOMESTIC COLD AND HOT WATER TO EXISTING DOMESTIC COLD AND HOT WATER PIPING. CONNECT 1.25" NATURAL GAS TO NEW NATURAL GAS PIPING. REMOVE TEMPORARY STATE OF MISSOURI MIKE KEHOE, **GOVERNOR**

Engineer of Record Jacob Adam Nelson PE PE-2009018758 JACOB ADAM NELSON NUMBER

PE-2009018758 PROFESSIONAL SEAL



TRUE ENGINEERING GROUP, LLC MISSOURI STATE CERTIFICATE OF AUTHORITY #E-2016000752

OFFICE OF ADMINISTRATION DIVISION OF FACILITIES MANAGEMENT, DESIGN AND CONSTRUCTION

DEPARTMENT OF CORRECTIONS

OZARK CORRECTIONAL CENTER - UPGRADE HVAC

929 HONOR CAMP LN, FORDLAND, MO 65652

PROJECT # C2324-01 7003 FACILITY # 9327003081

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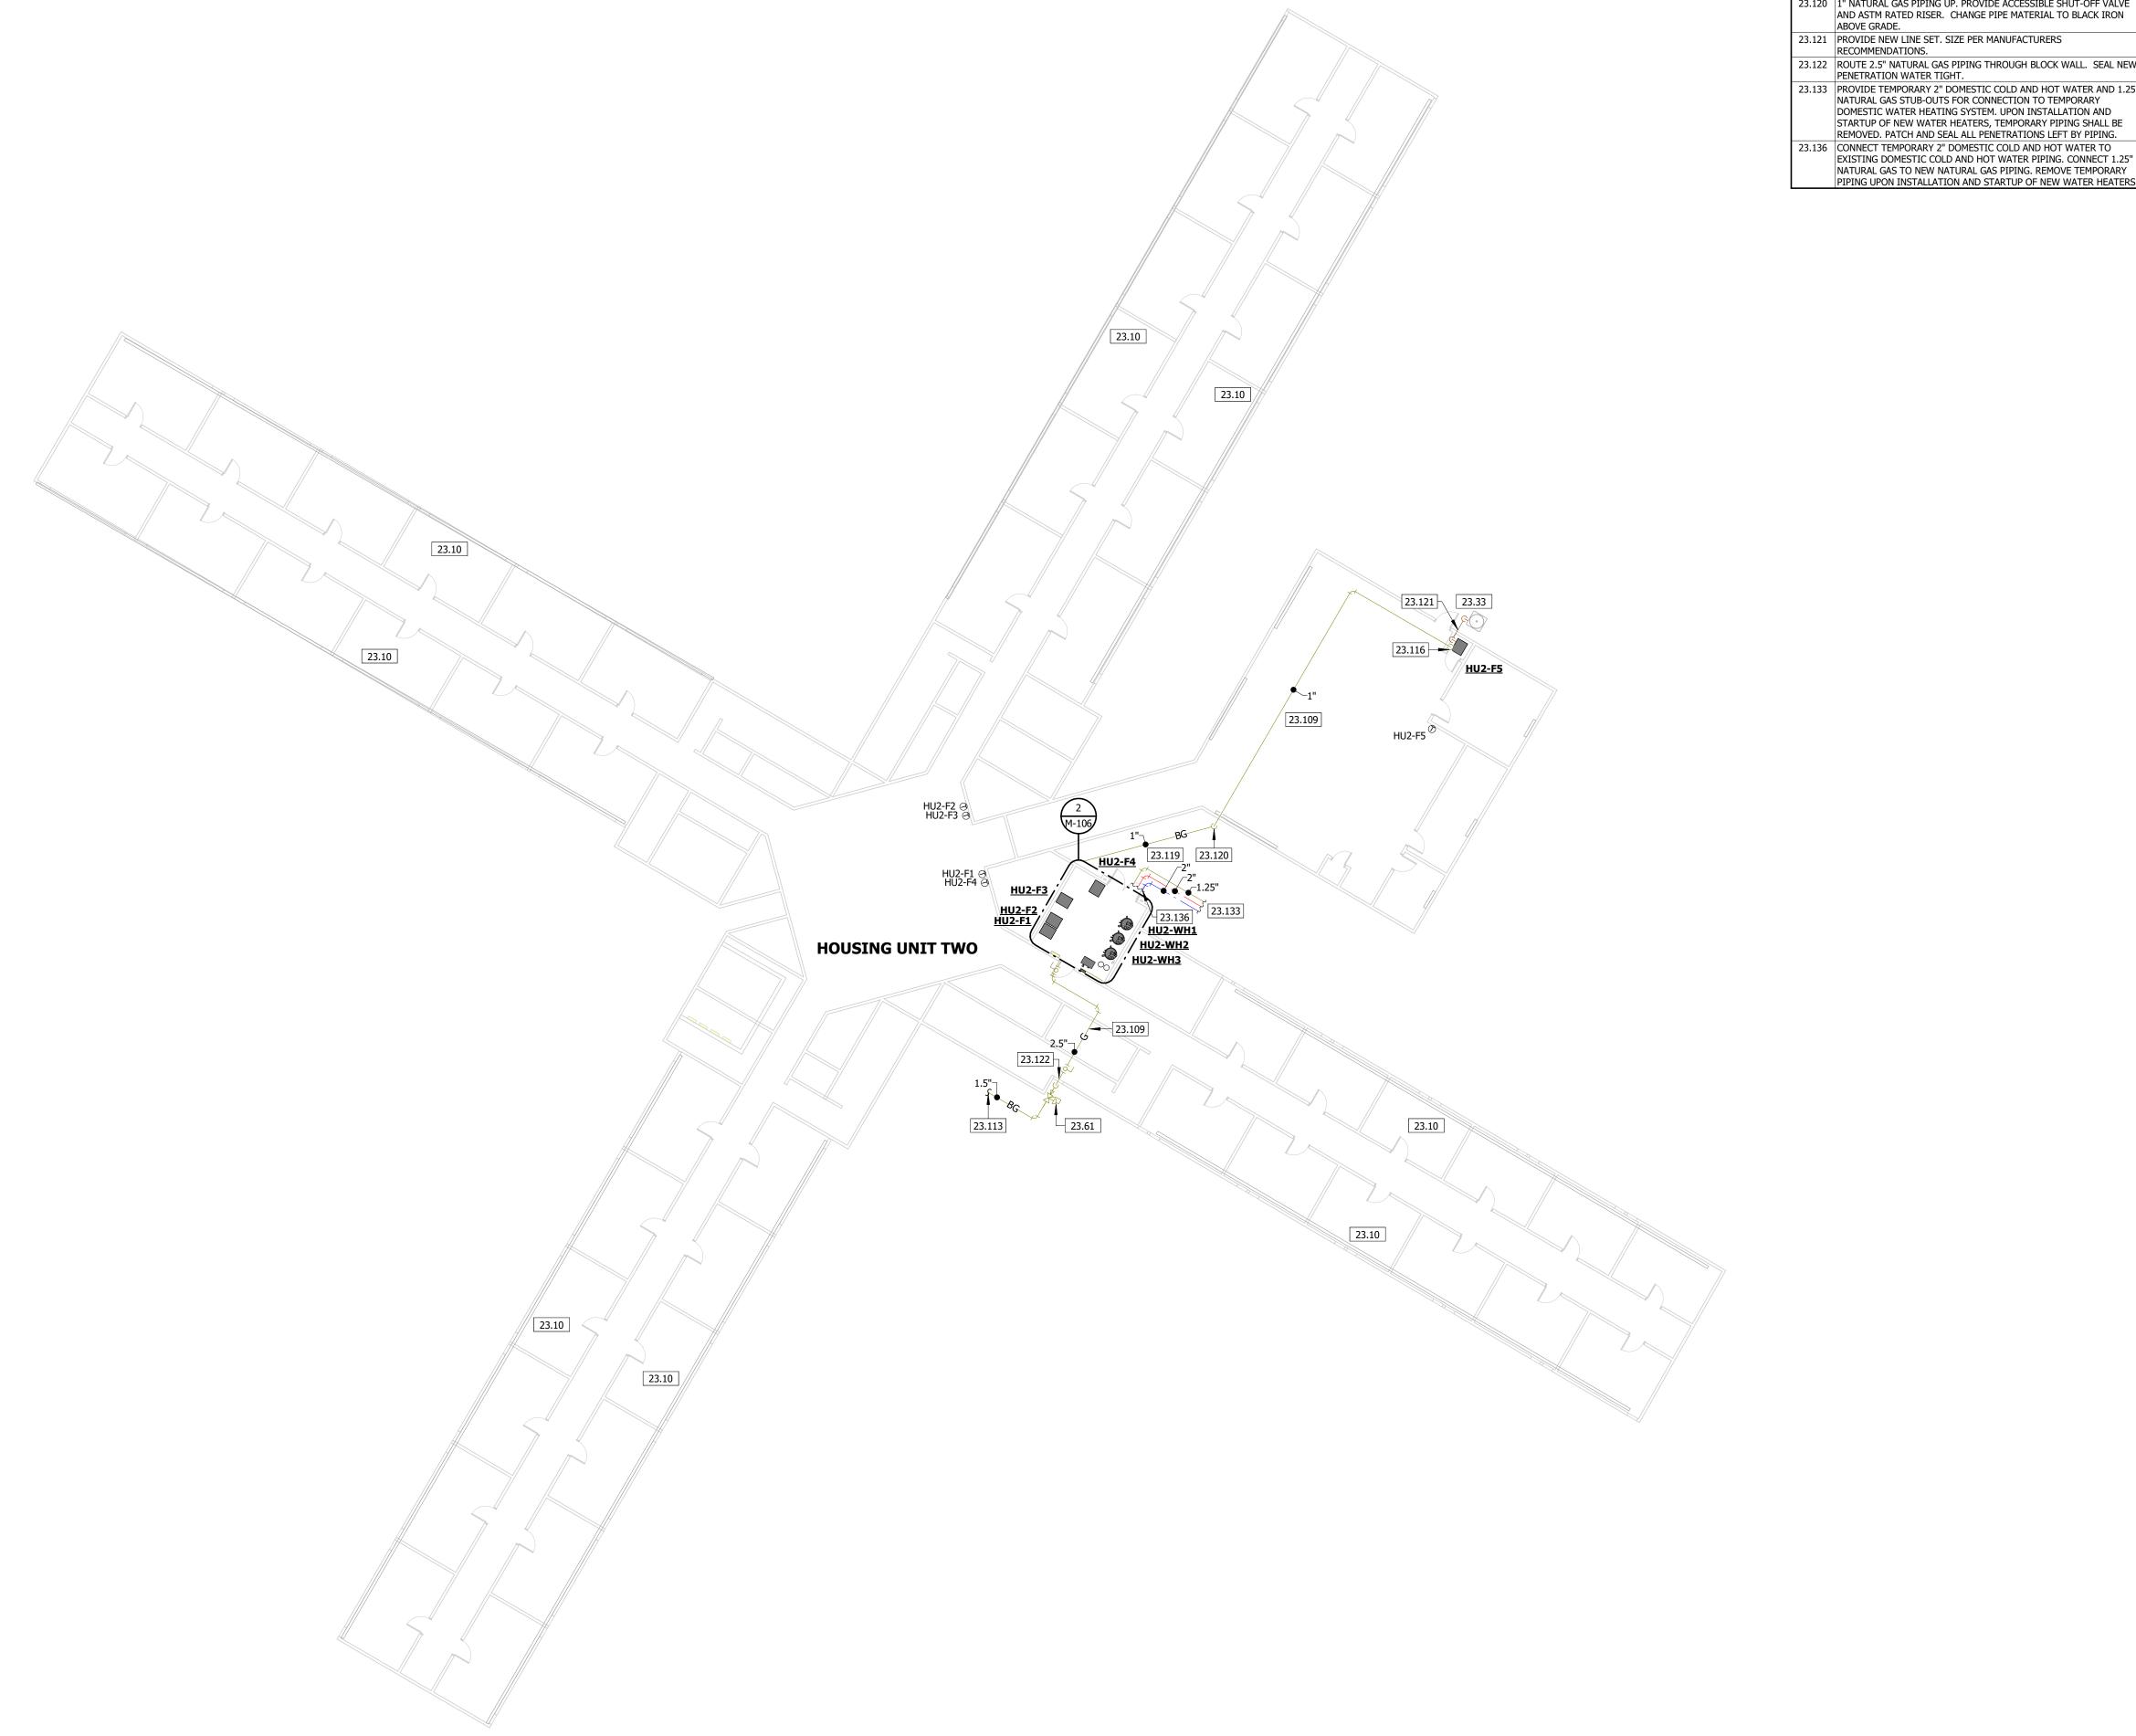
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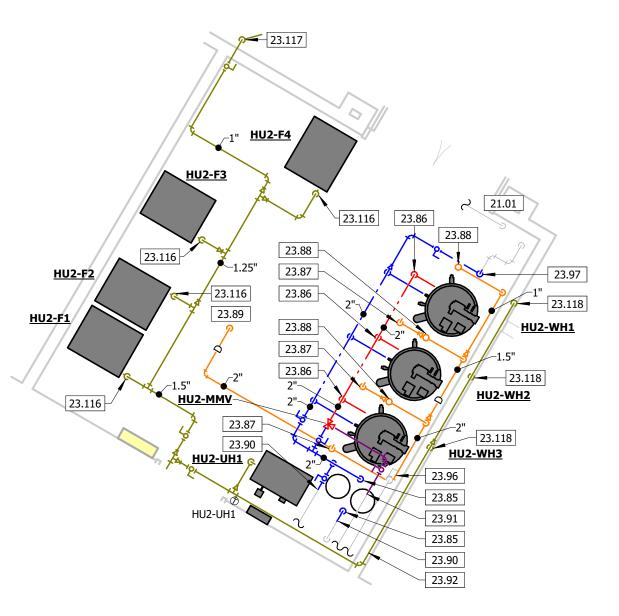
PIPING PLAN

SHEET NUMBER:

M-106

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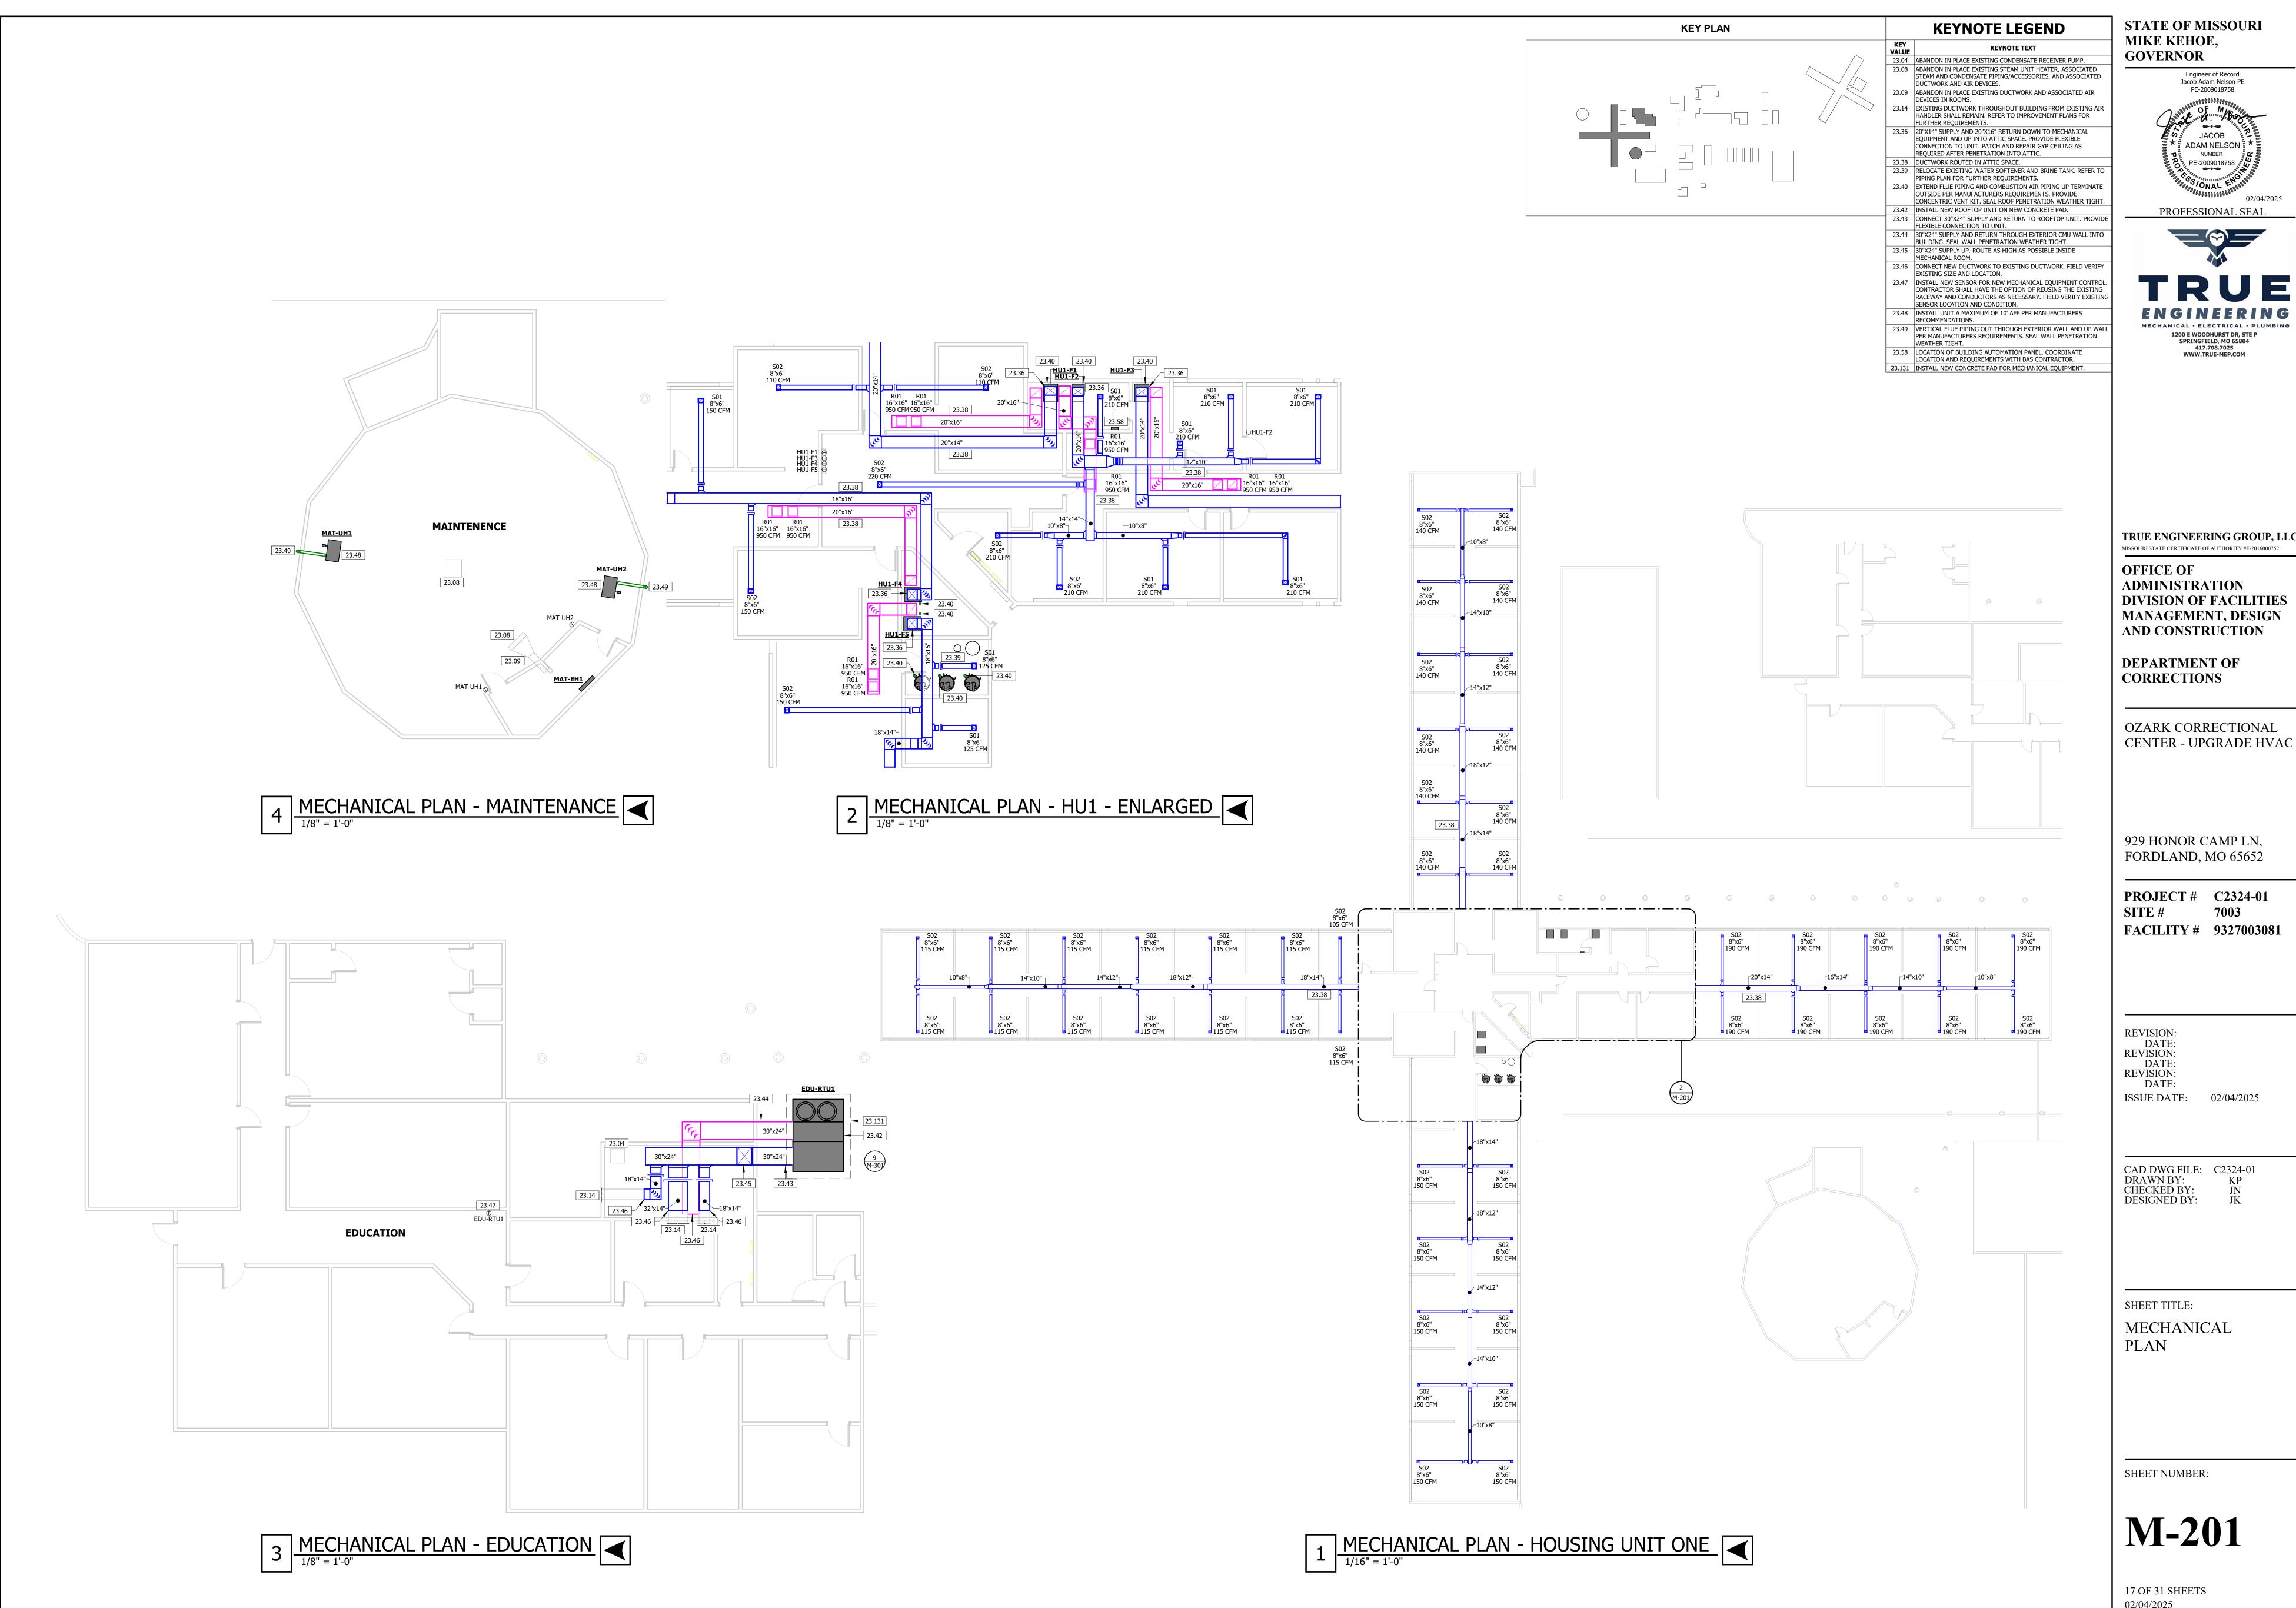




2 ENLARGED PIPING PLAN - HU2


1/4" = 1'-0"

1 MECHANICAL PIPING PLAN - HOUSING UNIT TWO



TRUE ENGINEERING GROUP, LLC

CENTER - UPGRADE HVAC

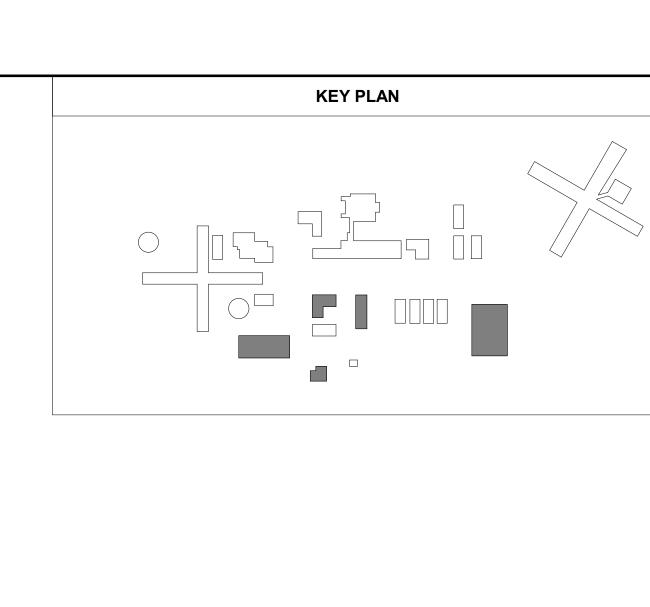

KEYNOTE LEGEND KEY KEYNOTE TEXT

23.04 ABANDON IN PLACE EXISTING CONDENSATE RECEIVER PUMP.

23.08 ABANDON IN PLACE EXISTING STEAM UNIT HEATER, ASSOCIATED STEAM AND CONDENSATE PIPING/ACCESSORIES, AND ASSOCIATED DUCTWORK AND AIR DEVICES.

23.10 ABANDON IN PLACE STEAM RADIATOR AND ALL ASSOCIATED STEAM AND CONDENSATE PIPING.

23.15 EXISTING STEAM BOILER AND ALL ASSOCIATED STEAM, CONDENSATE FEED WATER, NATURAL GAS, FUEL OIL, FLUE, AND COMBUSTION AIR PIPING SHALL REMAIN AND BE ABANDONED IN PLACE.

PIPING SHALL REMAIN AND BE ABANDONED IN PLACE.

23.18 EXISTING DA TANK AND ALL ASSOCIATED STEAM, CONDENSATE, FEED WATER, NATURAL GAS, FUEL OIL, FLUE, AND COMBUSTION AIR PIPING SHALL REMAIN AND BE ABANDONED IN PLACE.

23.20 EXISTING WATER SOFTENER AND BRINE TANK SHALL REMAIN.

23.21 ABANDON EXISTING DOMESTIC WATER SHELL AND TUBE HEAT EXCHANGER AND ASSOCIATED STEAM, CONDENSATE, AND DOMESTIC WATER PIPING IN PLACE. DISCONNECT HEAT EXCHANGER FROM

EXISTING DOMESTIC COLD/HOT WATER AND CAP.

23.24 EXISTING MECHANICAL EQUIPMENT AND ASSOCIATED DUCTWORK SHALL REMAIN.

23.27 EXISTING WATER HEATER AND ASSOCIATED PIPING SHALL REMAIN.

23.38 DUCTWORK ROUTED IN ATTIC SPACE.

23.40 EXTEND FLUE PIPING AND COMBUSTION AIR PIPING UP TERMINATE OUTSIDE PER MANUFACTURERS REQUIREMENTS. PROVIDE CONCENTRIC VENT KIT. SEAL ROOF PENETRATION WEATHER TIGHT.

CONCENTRIC VENT KIT. SEAL ROOF PENETRATION WEATHER TIGHT.

23.46 CONNECT NEW DUCTWORK TO EXISTING DUCTWORK. FIELD VERIFY EXISTING SIZE AND LOCATION.

23.47 INSTALL NEW SENSOR FOR NEW MECHANICAL EQUIPMENT CONTROL. CONTRACTOR SHALL HAVE THE OPTION OF REUSING THE EXISTING RACEWAY AND CONDUCTORS AS NECESSARY. FIELD VERIFY EXISTING SENSOR LOCATION AND CONDITION.

23.48 INSTALL UNIT A MAXIMUM OF 10' AFF PER MANUFACTURERS

RECOMMENDATIONS.

23.49 VERTICAL FLUE PIPING OUT THROUGH EXTERIOR WALL AND UP WALL PER MANUFACTURERS REQUIREMENTS. SEAL WALL PENETRATION WEATHER TIGHT.

23.50 VERTICAL FLUE PIPING UP THROUGH ROOF PER MANUFACTURERS REQUIREMENTS. SEAL ROOF PENETRATION WEATHER TIGHT.

23.51 EXISTING DUCTWORK AND ASSOCIATED OUTSIDE AIR CONNECTIONS


SHALL REMAIN.


23.52

20"X10" SUPPLY AND RETURN DOWN TO MECHANICAL EQUIPMENT AND UP INTO ATTIC SPACE. PROVIDE FLEXIBLE CONNECTION TO UNIT. PATCH AND REPAIR GYP CEILING AS REQUIRED AFTER PENETRATION INTO ATTIC.

UNIT. PATCH AND REPAIR GYP CEILING AS REQUIRED AFTER PENETRATION INTO ATTIC.

23.54 INSTALL NEW ELECTRIC DUCT HEATER IN EXISTING AIR HANDLER DUCTWORK PER MANUFACTURERS REQUIREMENTS. MODIFY SUPPLY DUCTWORK AS REQUIRED.

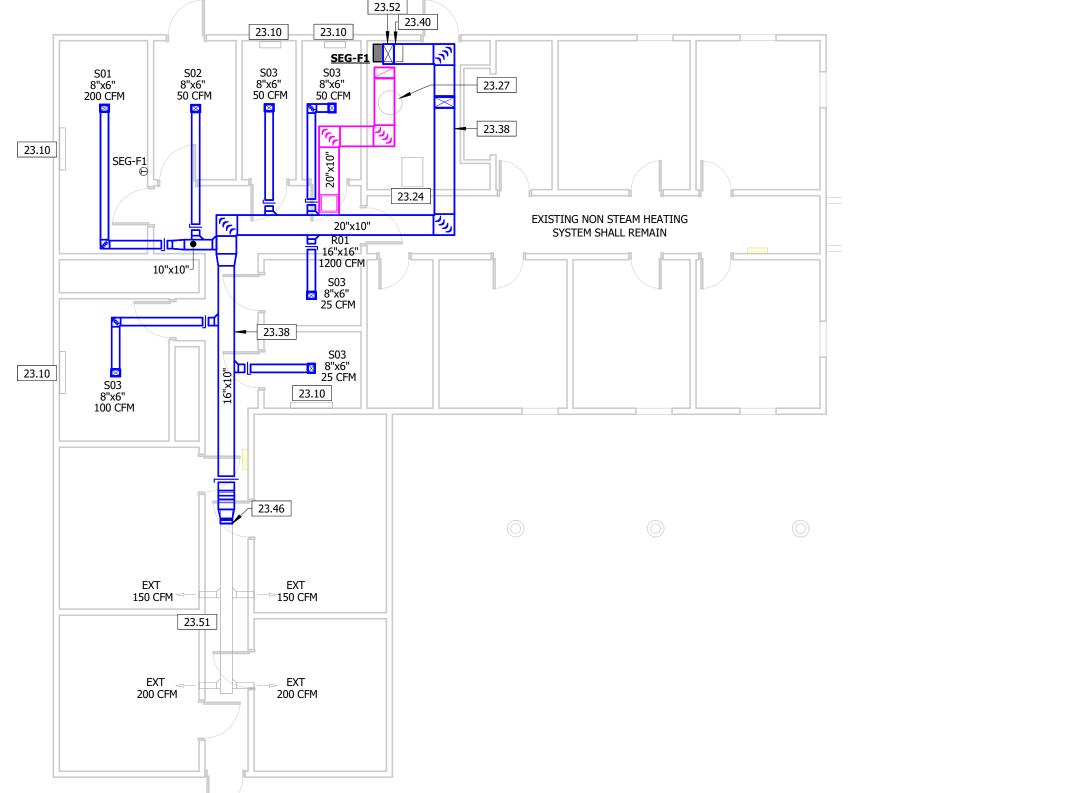

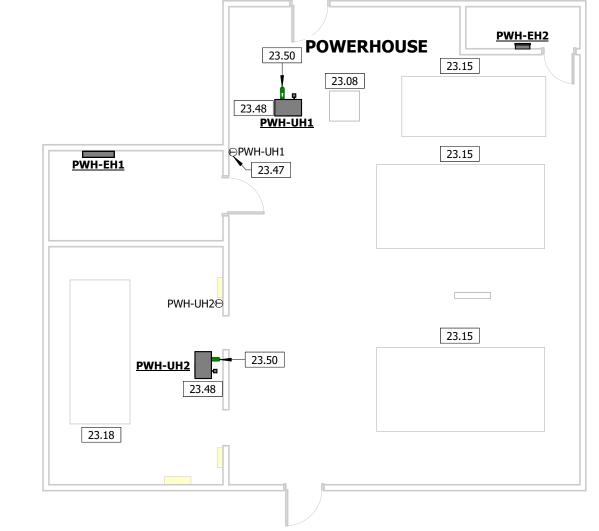

2 MECHANICAL PLAN - POWERHOUSE 1/8" = 1'-0"

929 HONOR CAMP LN,

STATE OF MISSOURI

Engineer of Record Jacob Adam Nelson PE

PE-2009018758

JACOB

ADAM NELSON

NUMBER

PROFESSIONAL SEAL

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PE-2009018758

MIKE KEHOE,

GOVERNOR

FORDLAND, MO 65652

PROJECT # C2324-01
SITE # 7003

FACILITY # 9327003081

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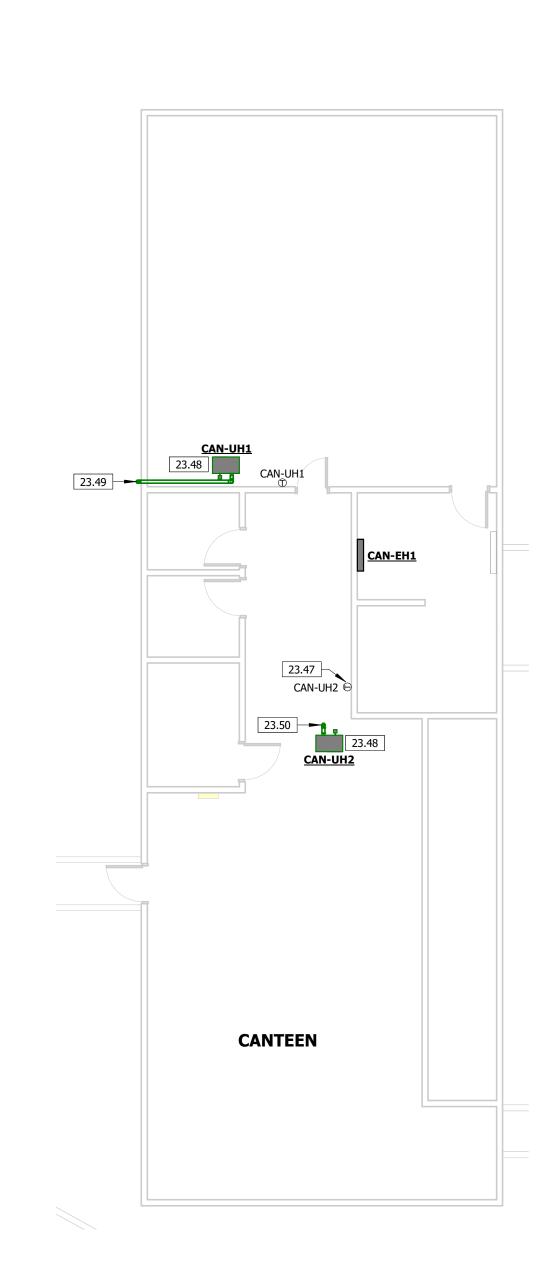
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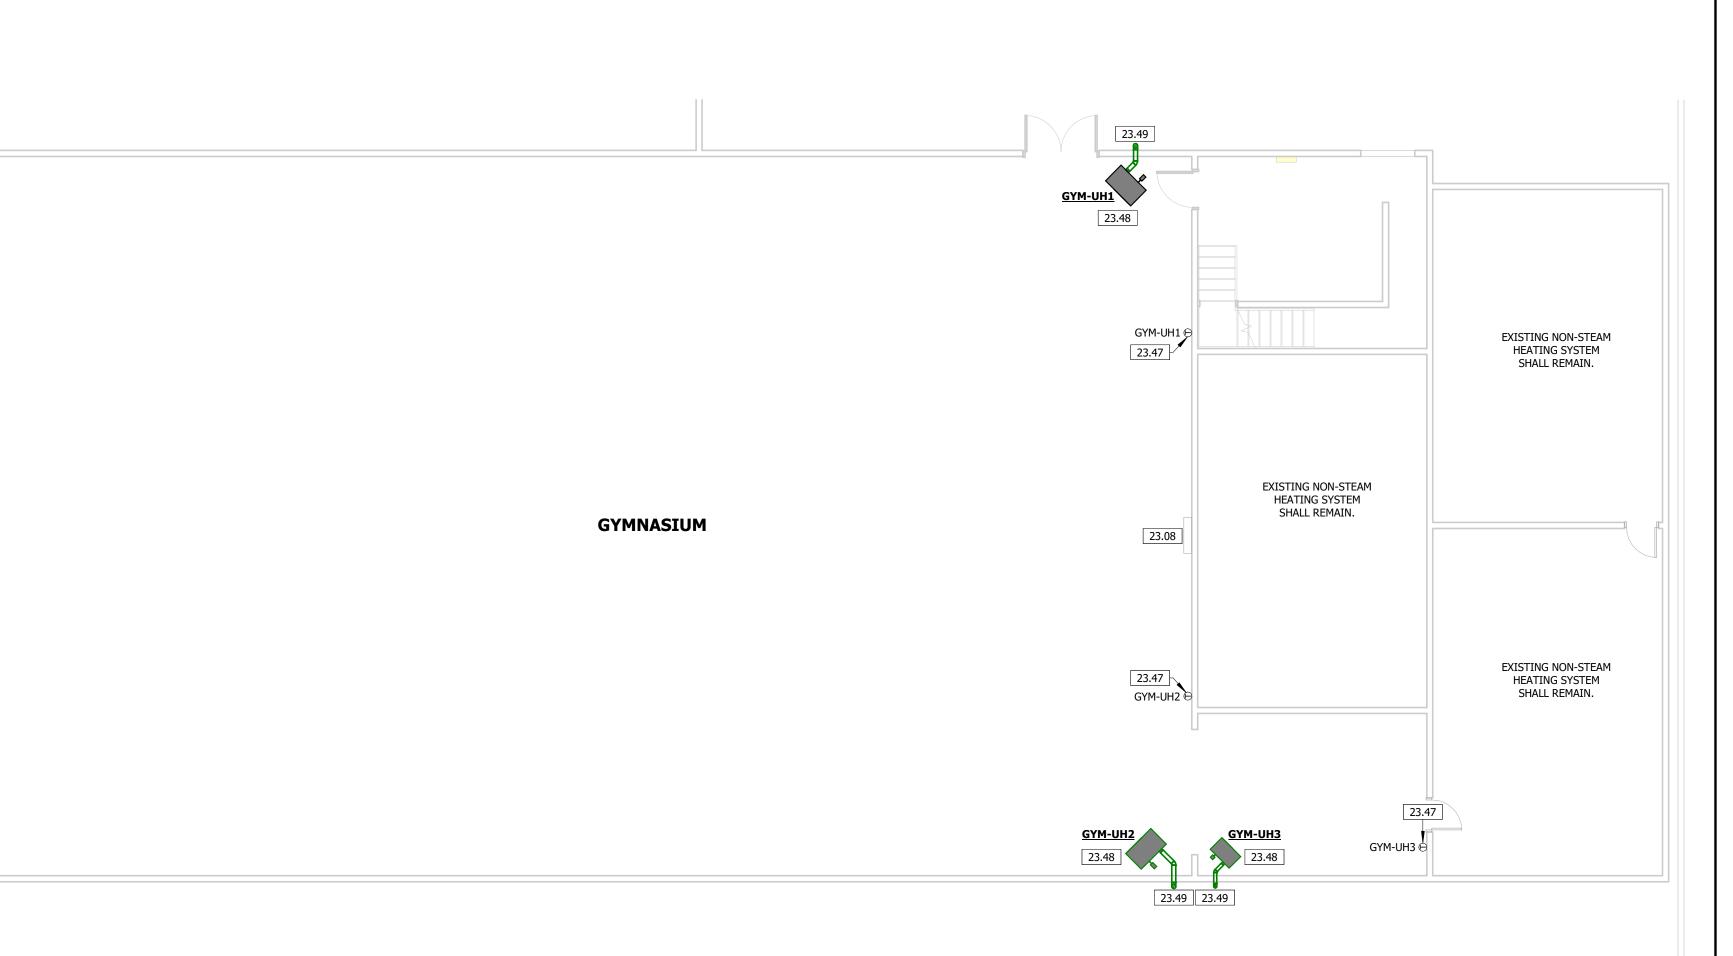
MECHANICAL
PLAN

SHEET NUMBER:

M-202

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VISITATION

PROPERTY

LAUNDRY

23.50 LDR-UH1

4 MECHANICAL PLAN - CANTEEN


1/8" = 1'-0"

3 MECHANICAL PLAN - SEGREGATION

1/8" = 1'-0"

1 MECHANICAL PLAN - GYM

1/8" = 1'-0"

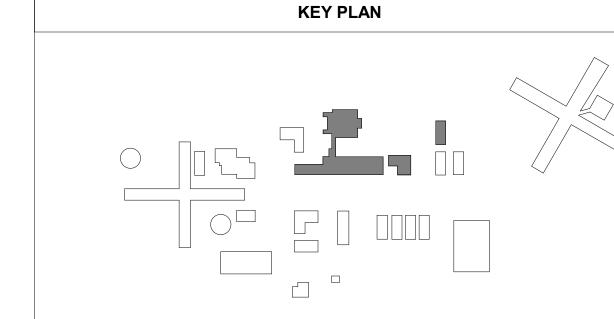

23.08 ABANDON IN PLACE EXISTING STEAM UNIT HEATER, ASSOCIATED STEAM AND CONDENSATE PIPING/ACCESSORIES, AND ASSOCIATED DUCTWORK AND AIR DEVICES. AND CONDENSATE PIPING.

23.10 ABANDON IN PLACE STEAM RADIATOR AND ALL ASSOCIATED STEAM 23.24 EXISTING MECHANICAL EQUIPMENT AND ASSOCIATED DUCTWORK SHALL REMAIN. 23.27 EXISTING WATER HEATER AND ASSOCIATED PIPING SHALL REMAIN.

23.29 EXISTING CONDENSING UNIT SHALL REMAIN. EXISTING UNIT IS A NORTEK JS4BD-060KA MODEL. 23.39 RELOCATE EXISTING WATER SOFTENER AND BRINE TANK. REFER TO PIPING PLAN FOR FURTHER REQUIREMENTS. 23.40 EXTEND FLUE PIPING AND COMBUSTION AIR PIPING UP TERMINATE OUTSIDE PER MANUFACTURERS REQUIREMENTS. PROVIDE CONCENTRIC VENT KIT. SEAL ROOF PENETRATION WEATHER TIGHT. 23.47 INSTALL NEW SENSOR FOR NEW MECHANICAL EQUIPMENT CONTROL. CONTRACTOR SHALL HAVE THE OPTION OF REUSING THE EXISTING RACEWAY AND CONDUCTORS AS NECESSARY. FIELD VERIFY EXISTING

SENSOR LOCATION AND CONDITION. 23.48 INSTALL UNIT A MAXIMUM OF 10' AFF PER MANUFACTURERS RECOMMENDATIONS. 23.49 VERTICAL FLUE PIPING OUT THROUGH EXTERIOR WALL AND UP WALL PER MANUFACTURERS REQUIREMENTS. SEAL WALL PENETRATION 23.50 VERTICAL FLUE PIPING UP THROUGH ROOF PER MANUFACTURERS

REQUIREMENTS. SEAL ROOF PENETRATION WEATHER TIGHT.

23.55 INSTALL UNIT IN SAME LOCATION AS EXISTING UNIT PER MANUFACTURERS RECOMMENDATIONS. 23.56 INSTALL NEW FURNACE IN PLACE OF EXISTING AIR HANDLER. RECONNECT EXISTING DUCTWORK AND EVAPORATOR COIL TO NEW FURNACE. PROVIDE NEW LINE SET FROM OUTDOOR UNIT TO INDOOR

EVAPORATOR COIL. 23.57 PROVIDE NEW SENSOR FOR FURNACE AND EXISTING CONDENSING UNIT. CONTRACTOR SHALL HAVE THE OPTION OF REUSING THE EXISTING RACEWAY AND CONDUCTORS AS NECESSARY. FIELD VERIFY EXISTING SENSOR LOCATION AND CONDITION.

STATE OF MISSOURI MIKE KEHOE, **GOVERNOR** Engineer of Record Jacob Adam Nelson PE PE-2009018758

JACOB ADAM NELSON NUMBER PE-2009018758

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TRUE ENGINEERING GROUP, LLC MISSOURI STATE CERTIFICATE OF AUTHORITY #E-2016000752

OFFICE OF ADMINISTRATION DIVISION OF FACILITIES MANAGEMENT, DESIGN AND CONSTRUCTION

DEPARTMENT OF CORRECTIONS

OZARK CORRECTIONAL CENTER - UPGRADE HVAC

929 HONOR CAMP LN, FORDLAND, MO 65652

PROJECT # C2324-01 7003 FACILITY # 9327003081

REVISION:
DATE:
REVISION:
DATE:
REVISION:
DATE:

ISSUE DATE: 02/04/2025


CAD DWG FILE: C2324-01 DRAWN BY: KP CHECKED BY: JN DESIGNED BY: JK

SHEET TITLE: MECHANICAL PLAN


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M-203


19 OF 31 SHEETS



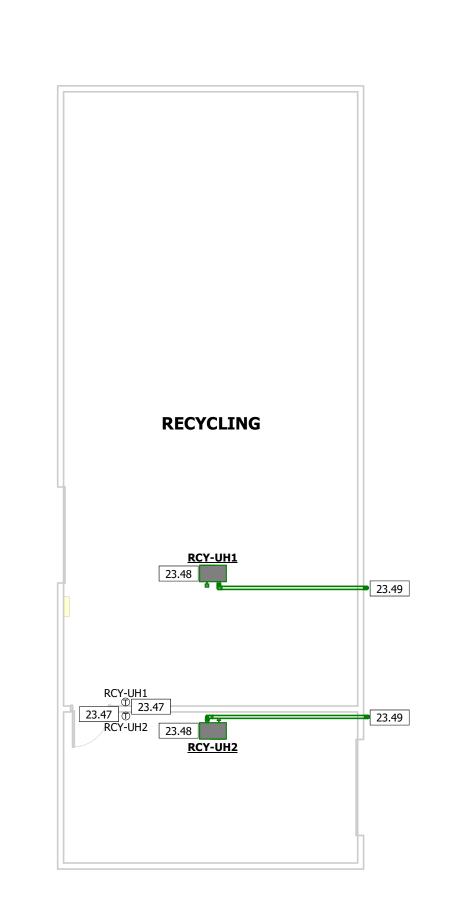




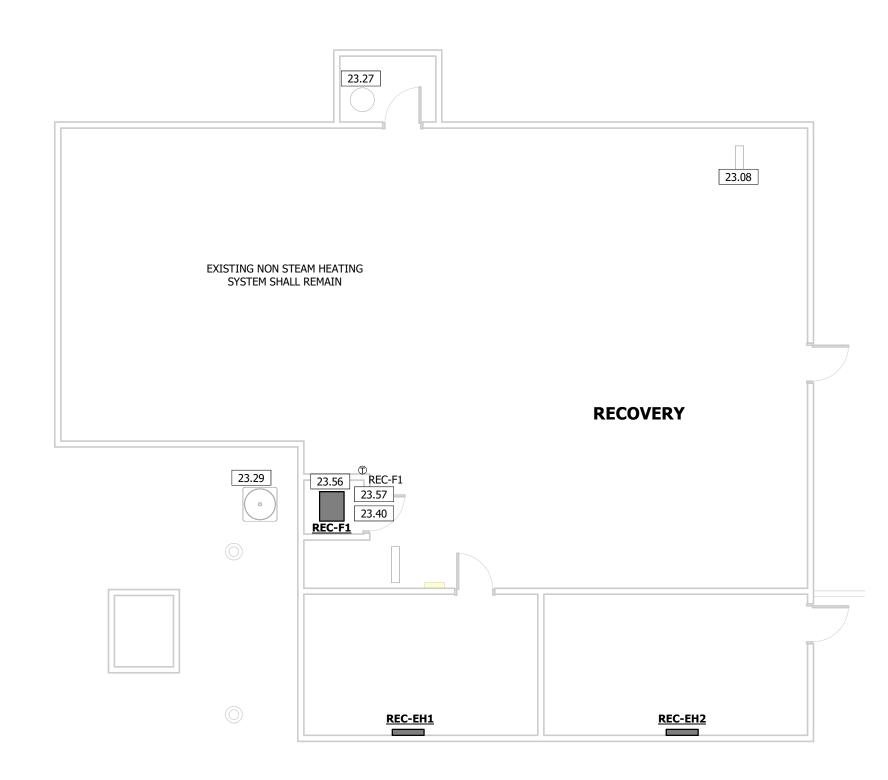

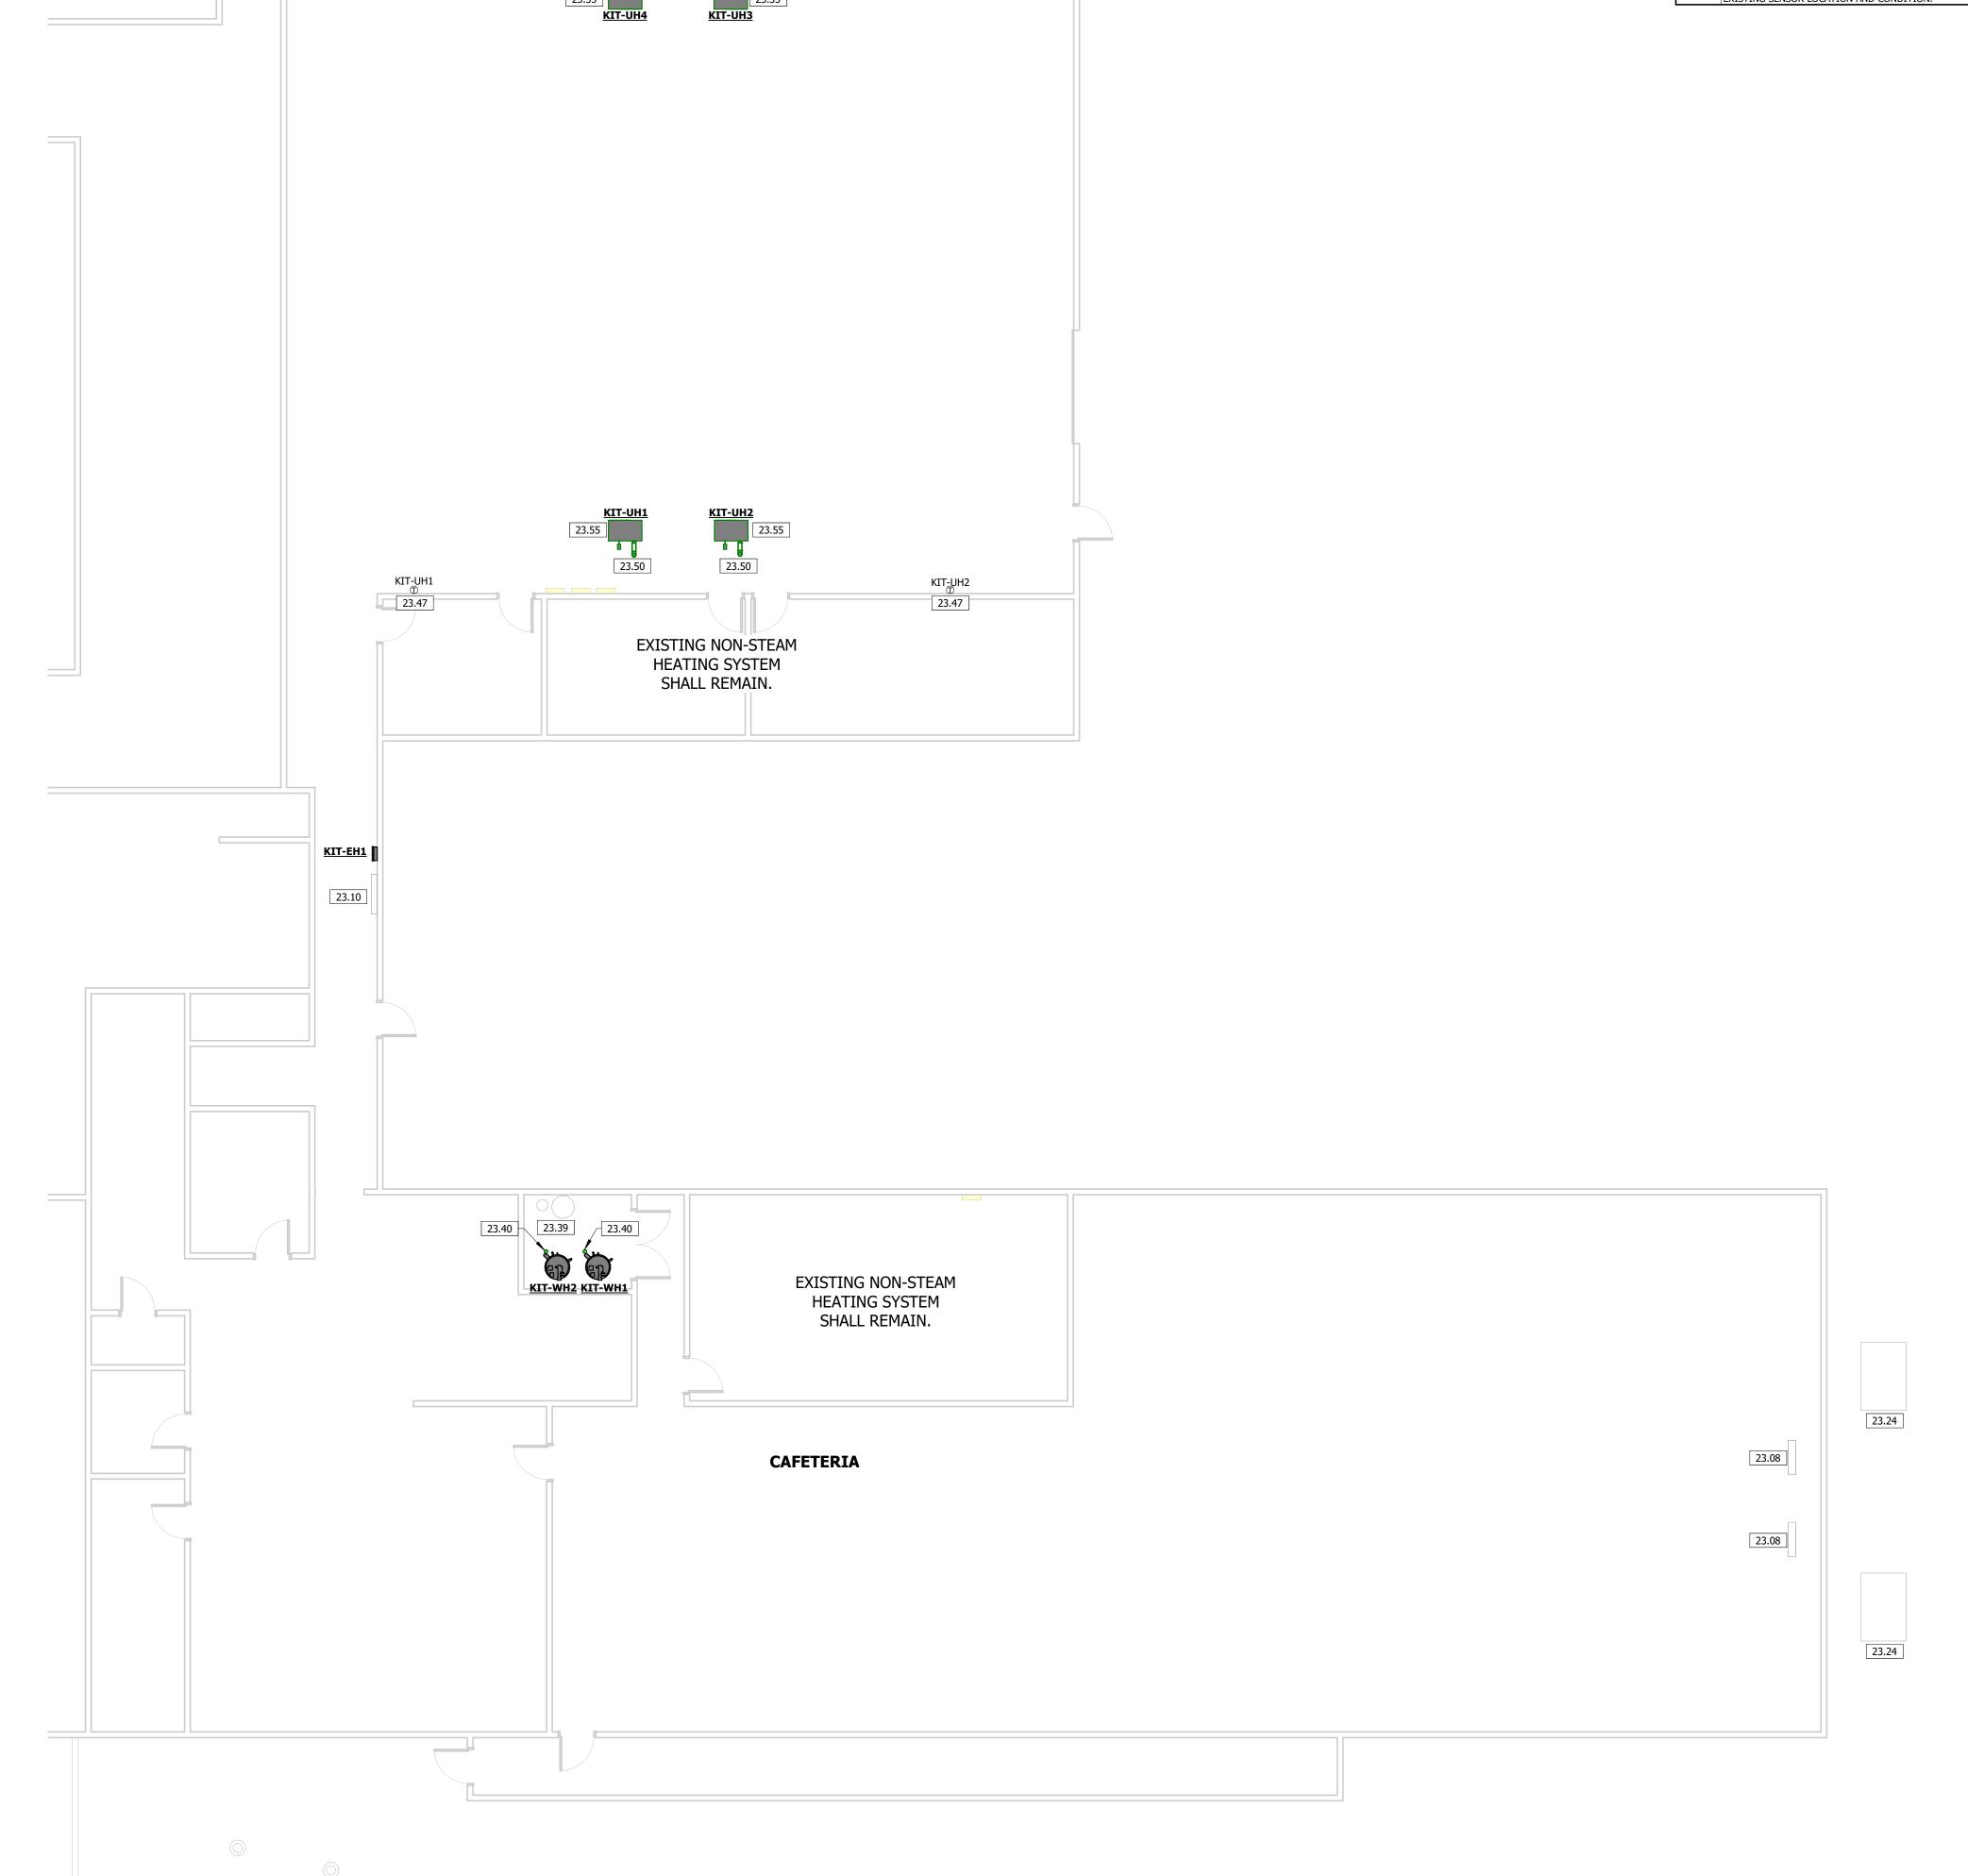

1 MECHANICAL PLAN - CAFETERIA

1/8" = 1'-0"

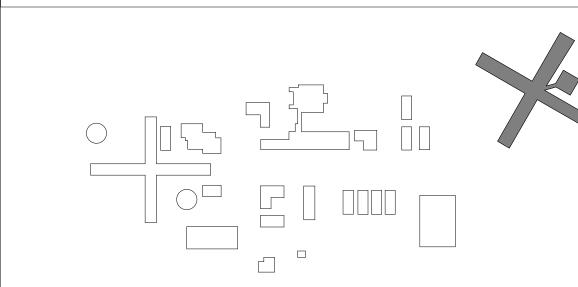

KEY PLAN

KEYNOTE LEGEND
KEYNOTE TEXT

KEY VALUE

23.33 EXISTING CONDENSING UNIT SHALL REMAIN. EXISTING UNIT IS A WEATHER KING MODEL WP1448AJ1NA.

23.38 DUCTWORK ROUTED IN ATTIC SPACE.

23.40 EXTEND FLUE PIPING AND COMBUSTION AIR PIPING UP TERMINATE OUTSIDE PER MANUFACTURERS REQUIREMENTS. PROVIDE CONCENTRIC VENT KIT. SEAL ROOF PENETRATION WEATHER TIGHT.

23.47 INSTALL NEW SENSOR FOR NEW MECHANICAL EQUIPMENT CONTROL.

23.47 INSTALL NEW SENSOR FOR NEW MECHANICAL EQUIPMENT CONTROL.
CONTRACTOR SHALL HAVE THE OPTION OF REUSING THE EXISTING
RACEWAY AND CONDUCTORS AS NECESSARY. FIELD VERIFY EXISTING
SENSOR LOCATION AND CONDITION.

23.48 INSTALL UNIT A MAXIMUM OF 10' AFF PER MANUFACTURERS

RECOMMENDATIONS.

23.50 VERTICAL FLUE PIPING UP THROUGH ROOF PER MANUFACTURERS REQUIREMENTS. SEAL ROOF PENETRATION WEATHER TIGHT.

23.56 INSTALL NEW FURNACE IN PLACE OF EXISTING AIR HANDLER. RECONNECT EXISTING DUCTWORK AND EVAPORATOR COIL TO NEW FURNACE. PROVIDE NEW LINE SET FROM OUTDOOR UNIT TO INDOOR

23.58 LOCATION OF BUILDING AUTOMATION PANEL. COORDINATE LOCATION AND REQUIREMENTS WITH BAS CONTRACTOR.

23.60 18"X16" SUPPLY AND 20"X16" RETURN DOWN TO MECHANICAL EQUIPMENT AND UP INTO ATTIC SPACE. PROVIDE FLEXIBLE CONNECTION TO UNIT. PATCH AND REPAIR GYP CEILING AS REQUIRED AFTER PENETRATION INTO ATTIC.

EVAPORATOR COIL.

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PROFESSIONAL SEAL

STATE OF MISSOURI

Engineer of Record Jacob Adam Nelson PE

PE-2009018758

MIKE KEHOE,

GOVERNOR

TRUE ENGINEERING GROUP, LLC
MISSOURI STATE CERTIFICATE OF AUTHORITY #E-2016000752

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929 HONOR CAMP LN, FORDLAND, MO 65652

PROJECT # C2324-01 SITE # 7003 FACILITY # 9327003081

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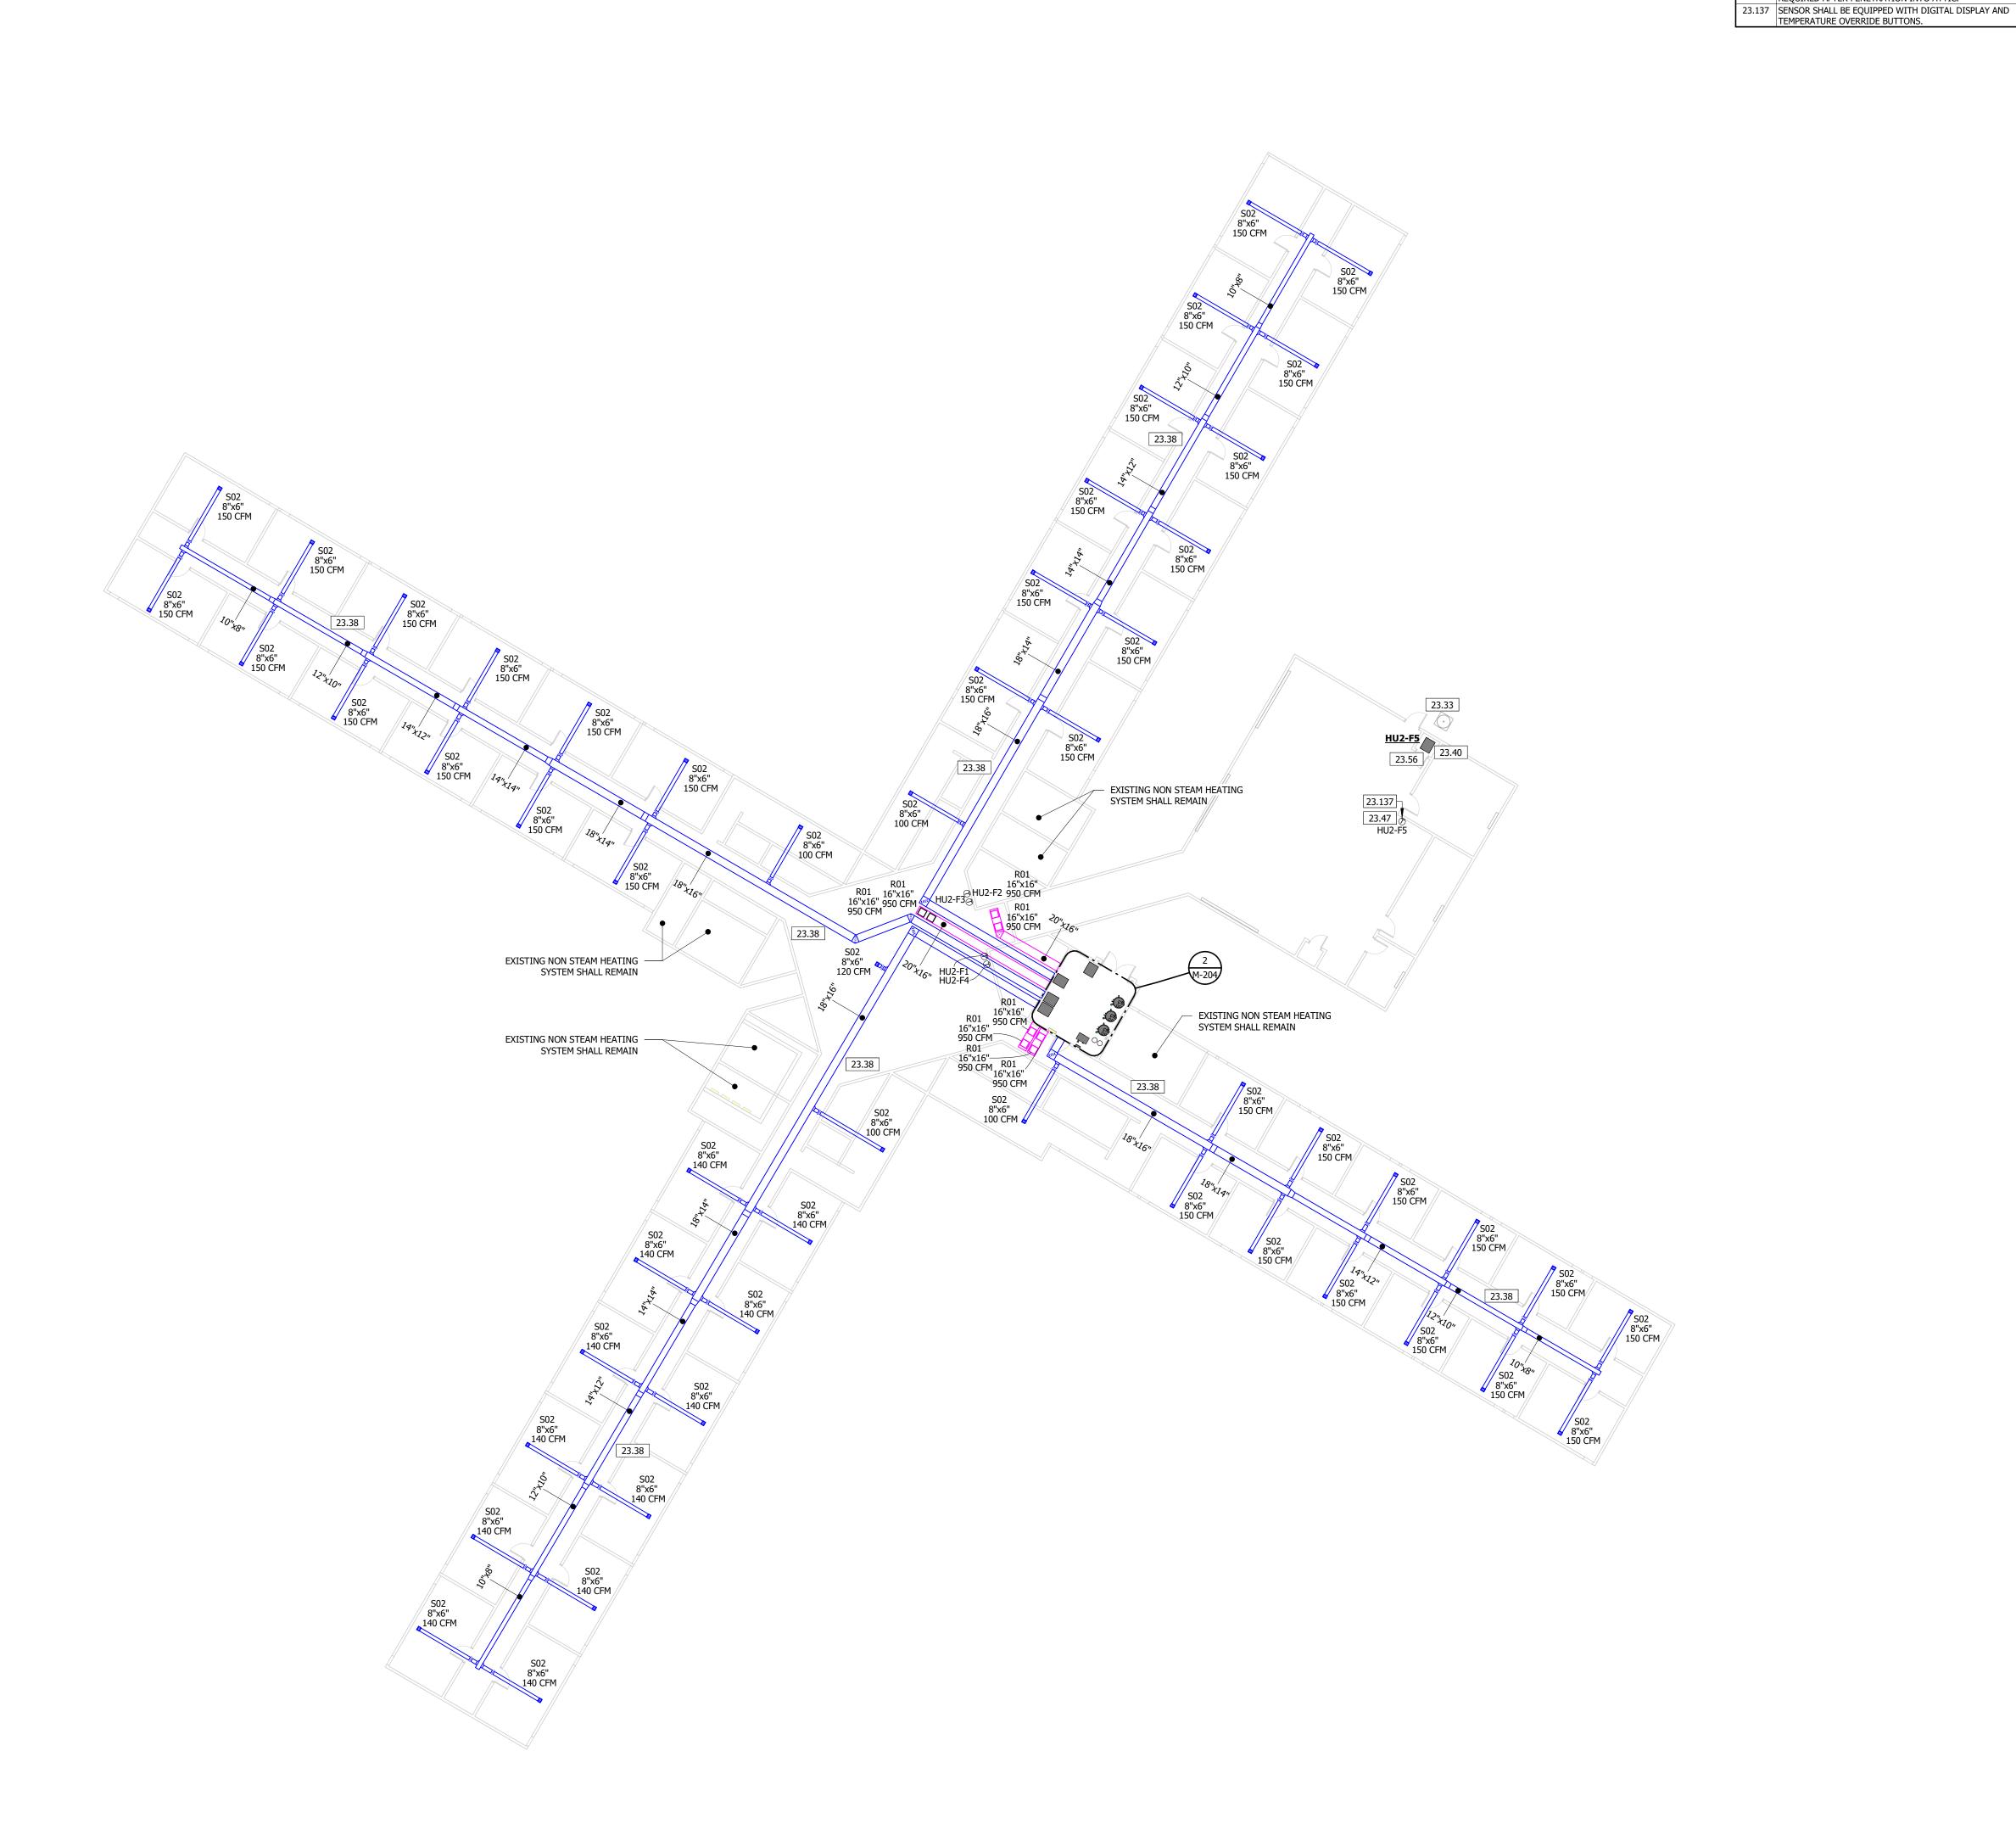
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MECHANICAL
PLAN

SHEET NUMBER:

M-204


20 OF 31 SHEETS 02/04/2025



2 MECHANICAL PLAN - HU2 - ENLARGED

1/4" = 1'-0"


1 MECHANICAL PLAN - HOUSING UNITS TWO

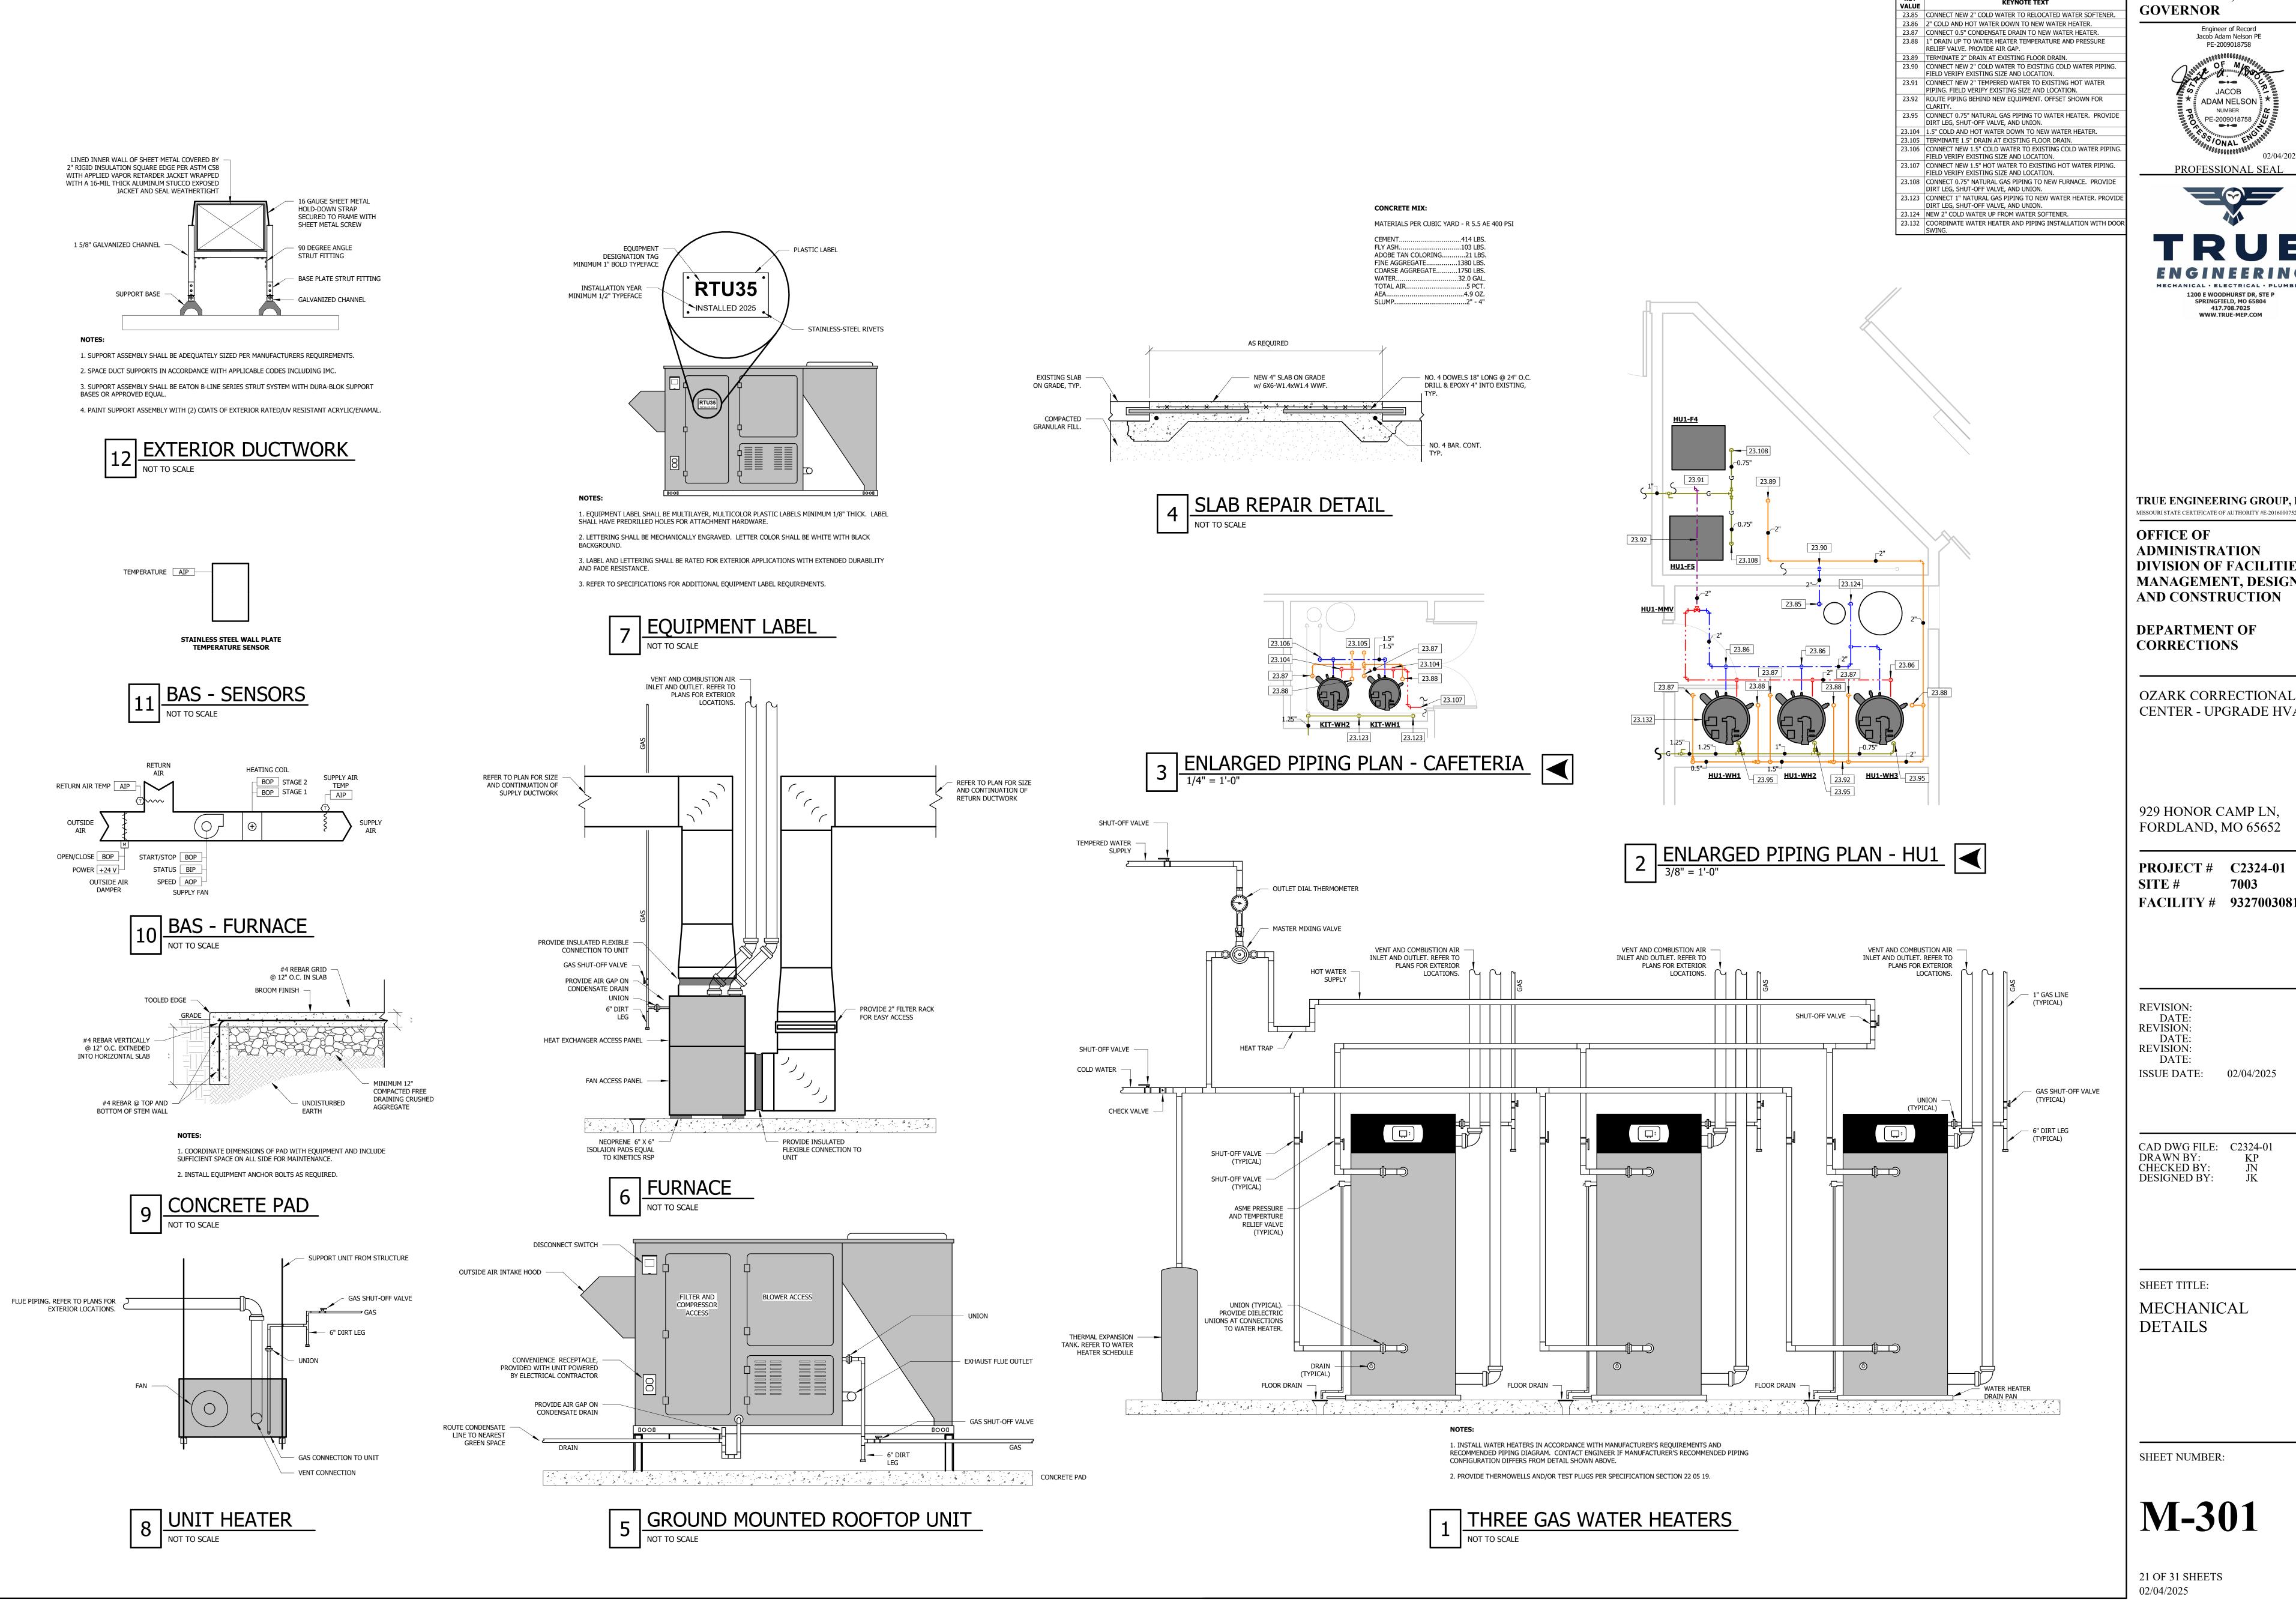

STATE OF MISSOURI MIKE KEHOE,

KEYNOTE LEGEND

GOVERNOR Jacob Adam Nelson PE PE-2009018758

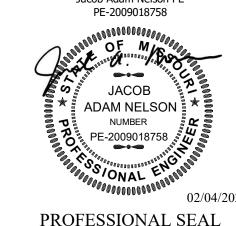



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929 HONOR CAMP LN, FORDLAND, MO 65652

PROJECT # C2324-01 7003 FACILITY # 9327003081

REVISION: DATE: **REVISION:** DATE: REVISION:

DATE: 02/04/2025 ISSUE DATE:

CAD DWG FILE: C2324-01 DRAWN BY: CHECKED BY: **DESIGNED BY:**

SHEET TITLE: **MECHANICAL DETAILS**

SHEET NUMBER:

M-301

		ELECT	RIC UNI	T HEAT	ER SC	CHEDUL	E
NOTES:							
1.	TAM	PER RESISTANT INTE	GRAL THERMOSTAT				
2.	SUR	FACE MOUNTED.					
3.	FACT	FORY INSTALLED EQU	JIPMENT DISCONNEC	TING MEANS.			
TYPE M	ARK	MANUFACTURER	MODEL NUMBER	ELEC (KW)	VOLTAGE	NOTES	EQUIVALENTS
CAN-E	H1	QMARK	EFQ6004	6.0	240/1	1,2,3	SEE SPECS
KIT-E	H1	QMARK	LFK151F	1.5	120/1	1,2,3	SEE SPECS
LDR-E	H1	QMARK	LFK151F	1.5	120/1	1,2,3	SEE SPECS
LDR-E	H2	QMARK	LFK151F	1.5	120/1	1,2,3	SEE SPECS
MAT-E	H1	QMARK	EFQ6008	6.0	208/1	1,2,3	SEE SPECS
PWH-E	H1	QMARK	EFQ6008	6.0	208/1	1,2,3	SEE SPECS
PWH-E	H2	QMARK	LFK151F	1.5	120/1	1,2,3	SEE SPECS
REC-E	H1	QMARK	EFQ6004	6.0	240/1	1,2,3	SEE SPECS
REC-E	H2	QMARK	EFQ6004	6.0	240/1	1,2,3	SEE SPECS

		KEC-	ETIZ QIMAKI	C EFQ00	,	240/1	1,2,3	SEE SPECS
		1	WATER	HEATER	SCHED	ULE		
NOTES:								
1.	PROVIDE THERMAL	EXPANSION TANK EQ	UIVALENT TO AMTR	OL MODEL ST-30VC-	DD. REFER TO GAS W	ATER HEATER DETA	IL FOR ADDITIONA	L REQUIREMENTS.
2.	DRAIN VALVE WITH	THREADED HOSE CO	NNECTION.					
3.	PRESSURE & TEMPE	RATURE RELIEF VALV	/E.					
4.	PROVIDE THERMAL	EXPANSION TANK EQ	UIVALENT TO AMTR	OL ST-12C-DD.				
TYPE MARK	MANUFACTURER	MODEL	GALLONS	GAS INPUT (MBH)	GAS OUTPUT (MBH)	VOLTAGE	NOTES	EQUIVALEN'
HU1-WH1	RHEEM	GHE100SS-200	100	199.9	194	120/1	1,2,3	SEE SPECS
HU1-WH2	RHEEM	GHE100SS-200	100	199.9	194	120/1	1,2,3	SEE SPECS
HU1-WH3	RHEEM	GHE100SS-200	100	199.9	194	120/1	1,2,3	SEE SPECS
HU2-WH1	RHEEM	GHE100SS-200	100	199.9	194	120/1	1,2,3	SEE SPECS
HU2-WH2	RHEEM	GHE100SS-200	100	199.9	194	120/1	1,2,3	SEE SPECS
HU2-WH3	RHEEM	GHE100SS-200	100	199.9	194	120/1	1,2,3	SEE SPECS
KIT-WH1	RHEEM	GHE100SS-130	100	130	126	120/1	1,2,3	SEE SPECS
KIT-WH2	RHEEM	GHE100SS-130	100	130	126	120/1	1,2,3	SEE SPECS
LDR-WH1	RHEEM	PROG29-30U RH63 EC1-1	29	30	27	120/1	2,3,4	SEE SPECS

			MIX	ING VA	LVE SCH	IEDULE			
NOTES:									
1.	PROVIDE OUTLET D	IAL THERMOMETER							
TYPE MARK	TYPE MANUFACTURED MODEL NUMBER INLET OUTLET TEMPERATURE MIN. FLOW MAX. PRESSURE NOTES FOLITY								EQUIVALENTS
HU1-MMV	LEONARD	TM-920-LF-DT	1.25"	1.25"	120	1	5	1	-
HU2-MMV	LEONARD	TM-920-LF-DT	1.25"	1.25"	120	1	5	1	-

			UNIT	HEATER	R SCI	HEDU	JLE					
NOTES:												
1.	WO STAGE THERMOSTAT (FIELD COORDINATE LOCATION WITH OWNER).											
2.	CHAIN HANGING SET	TAIN HANGING SET. TAINLESS STEEL FLEXIBLE GAS CONNECTOR.										
3.	STAINLESS STEEL ELL											
4.	4-POINT SUSPENSION											
5.	FULL FAN GUARD.	· · ·										
6.		NG KIT REFER TO PLA	NS FOR THE DISTA	NCE AND TERMINATIO	N REQUIRE	D SIZE PER	MANUFACTUR	FRS RECOMME	NDATIONS FOR DIST	TANCE		
	TWO STAGE NATURA		WOTOK THE DISTA	THE THE TENTH THE	MILOOINE	D. SIZE I EK	11/11/01/101	LICO RECOI II IEI	ND/(110NS 1 OK DIS)	7 II ICL		
			нел	TING								
TYPE MARK	MANUFACTURER	MODEL NUMBER	INPUT (MBH)	OUTPUT (MBH)	FLA	МОСР	VOLTAGE	WEIGHT	NOTES	EQUIVALENTS		
CAN-UH1	TRANE	GTNE-004	45	37.4	3.2	15	120/1	65	1,2,3,4,5,6,7	SEE SPECS		
CAN-UH2	TRANE	GTNE-004	45	37.4	3.2	15	120/1	65	1,2,3,4,5,6,7	SEE SPECS		
GYM-UH1	TRANE	GTNE-120	120	98.4	6.4	15	120/1	110	1,2,3,4,5,6,7	SEE SPECS		
GYM-UH2	TRANE	GTNE-120	120	98.4	6.4	15	120/1	110	1,2,3,4,5,6,7	SEE SPECS		
GYM-UH3	TRANE	GTNE-004	45	37.4	3.2	15	120/1	65	1,2,3,4,5,6,7	SEE SPECS		
HU2-UH1	TRANE	GTNE-003	30	24.9	3.2	15	120/1	60	1,2,3,4,5,6,7	SEE SPECS		
KIT-UH1	TRANE	GTNE-011	105	86.1	6.4	15	120/1	105	1,2,3,4,5,6,7	SEE SPECS		
KIT-UH2	TRANE	GTNE-011	105	86.1	6.4	15	120/1	105	1,2,3,4,5,6,7	SEE SPECS		
KIT-UH3	TRANE	GTNE-011	105	86.1	6.4	15	120/1	105	1,2,3,4,5,6,7	SEE SPECS		
KIT-UH4	TRANE	GTNE-011	105	86.1	6.4	15	120/1	105	1,2,3,4,5,6,7	SEE SPECS		
LDR-UH1	TRANE	GTNE-004	45	37.4	3.2	15	120/1	65	1,2,3,4,5,6,7	SEE SPECS		
LDR-UH2	TRANE	GTNE-004	45	37.4	3.2	15	120/1	65	1,2,3,4,5,6,7	SEE SPECS		
MAT-UH1	TRANE	GTNE-011	105	86.1	6.4	15	120/1	105	1,2,3,4,5,6,7	SEE SPECS		
MAT-UH2	TRANE	GTNE-011	105	86.1	6.4	15	120/1	105	1,2,3,4,5,6,7	SEE SPECS		
PRP-UH1	TRANE	GTNE-004	45	37.4	3.2	15	120/1	65	1,2,3,4,5,6,7	SEE SPECS		
PRP-UH2	TRANE	GTNE-004	45	37.4	3.2	15	120/1	65	1,2,3,4,5,6,7	SEE SPECS		
PRP-UH3	TRANE	GTNE-004	45	37.4	3.2	15	120/1	65	1,2,3,4,5,6,7	SEE SPECS		
PWH-UH1	TRANE	GTNE-004	45	37.4	3.2	15	120/1	65	1,2,3,4,5,6,7	SEE SPECS		
PWH-UH2	TRANE	GTNE-003	30	24.9	3.2	15	120/1	60	1,2,3,4,5,6,7	SEE SPECS		
RCY-UH1	TRANE	GTNE-004	45	37.4	3.2	15	120/1	65	1,2,3,4,5,6,7	SEE SPECS		
RCY-UH2	TRANE	GTNE-003	30	24.9	3.2	15	120/1	60	1,2,3,4,5,6,7	SEE SPECS		

			ELEC	TRIC DU	JCT HEA	ATER SC	HEDU	LE			
NOTES:											
1.	CONTROL PANEL D	ISCONNECTING SWIT	ΓCH, AND FULL BREA	K CONTACTOR.							
2.	CONTROL TRANSFO	ORMER.									
3.	AUTOMATIC THER	MAL CUTOUTS.									
4.	SCR CONTROL.										
5.	PROVIDE MAGNETI	C CONTACTOR.									
6.	PROGRAMMABLE 7	-DAY THERMOSTAT.									
TYPE	MANUEACTURER	MODEL NUMBER	AIRF	LOW	CT7E (WyU)		ELECTRIC	AL		NOTES	EQUITVALENTS
MARK	MANUFACIURER	MODEL NUMBER	VOLUME (CFM)	AIR VEL (FPM)	SIZE (WxH)	HEATING (KW)	VOLTAGE	MCA	МОСР	NOTES	EQUIVALENTS
VIS-EDH1	NEPTRONIC	DF-C100V	4000	600	48" X 20"	28.0	208/3	77.7	100	1,2,3,4,5,6	SEE SPECS


	AIR DEVICE SCHEDULE														
NOTES:															
1.	GRILLE/DIFFUSER NECK SHALL BE SAME SIZE AS BRANCH DUCTWORK UNLESS NOTED OTHERWISE ON PLAN.														
2.	DIFFUSER DISCHARGE AIR PATTERN SHALL BE 4-WAY UNLESS NOTED BY DIRECTION ON PLANS.														
3.	GRILLE/DIFFUSER SHALL BE FIELD PAINTABLE.														
4.	PROVIDE PLASTER FRAME ADAPTOR FOR LAYIN INTO GYPSUM CEILING.														
5.	COMPLIANT WITH ANTI-LIGATURE BUILDING CODE REGULATIONS. PROVIDE SECURITY BARS AND SHALL BE SUICIDE DETERRENT.														
6.	PROVIDE FACE COVER EQUIVALENT TO KRUEGER 1380.														
7.	FASTENERS SHALL BE TAMPER RESISTANT.														
TYPE MARK	SYTEM TYPE	MANUFACTURER	MODEL NUMBER	MODULE SIZE	FRAME	FINISH	DAMPER	MAX NC RATING	THROW (FT)	EXTERNAL STATIC (WC)	NOTES	EQUIVALENTS			
R01	RETURN	KRUEGER	S80	SEE PLAN	GYP	WHITE	-	30	-	0.08"	3,4,6,7	TITUS, PRICE			
S01	SUPPLY	KRUEGER	880	SEE PLAN	GYP	WHITE	-	30	-	0.1"	1,3,4,7	TITUS, PRICE			
S02	SUPPLY	KRUEGER	1380	SEE PLAN	GYP	WHITE	-	30	-	0.1"	1,3,4,7	TITUS, PRICE			
S03	SUPPLY	KRUEGER	13SD	SEE PLAN	GYP	WHITE	-	30	-	0.1"	1,5,7	TITUS, PRICE			

	FURNACE SCHEDULE															
NOTES:																
1.	STAINLESS STEEL H	EAT EXCHANGER.														
2.	PROVIDE ACCESSIBI	ROVIDE ACCESSIBLE FILTER RACK AND 1" FILTERS WITH MINIMUM MERV 8 RATING.														
3.	COMBUSTION INTAK	OMBUSTION INTAKE AND EXHAUST CONCENTRIC ROOF TERMINATION KIT.														
4.	2-STAGE GAS HEAT	STAGE GAS HEAT WITH CTM BLOWER MOTOR.														
5.	PROVIDE TERMINAL	ROVIDE TERMINAL STRIP FOR INTEGRATATION INTO BAS SYTEM. COORINATE REQUIREMENTS WITH BAS CONTRACTOR.														
6.	PROVIDE MANUFACT	ROVIDE MANUFACTURERS 7 DAY PROGRAMMABLE THERMOSTAT.														
TYPE MARK	MANUFACTURER	MODEL NUMBER	SUPPLY AIR (CFM)	OUTSIDE AIR (CFM)	EXTERNAL STATIC (WC)	ENTERING AIR DB	HEATING INPUT (MBH)	HEATING OUTPUT (MBH)	LEAVING AIR DB	MCA	МОСР	VOLTAGE	NOTES	EQUIVALENTS		
HU1-F1	TRANE	S9X2D120	1900	-	0.5"	60	120	115	90	6.0	15	120/1	1,2,3,4,5	SEE SPECS		
HU1-F2	TRANE	S9X2D120	1900	-	0.5"	60	120	115	90	6.0	15	120/1	1,2,3,4,5	SEE SPECS		
HU1-F3	TRANE	S9X2D120	1900	-	0.5"	60	120	115	90	6.0	15	120/1	1,2,3,4,5	SEE SPECS		
HU1-F4	TRANE	S9X2D120	1900	-	0.5"	60	120	115	90	6.0	15	120/1	1,2,3,4,5	SEE SPECS		
HU1-F5	TRANE	S9X2D120	1900	-	0.5"	60	120	115	90	6.0	15	120/1	1,2,3,4,5	SEE SPECS		
HU2-F1	TRANE	S9X2D120	1900	-	0.5"	60	120	115	90	6.0	15	120/1	1,2,3,4,5	SEE SPECS		
HU2-F2	TRANE	S9X2D120	1900	-	0.5"	60	120	115	90	6.0	15	120/1	1,2,3,4,5	SEE SPECS		
HU2-F3	TRANE	S9X2D120	1900	-	0.5"	60	120	115	90	6.0	15	120/1	1,2,3,4,5	SEE SPECS		
HU2-F4	TRANE	S9X2D120	1900	-	0.5"	60	120	115	90	6.0	15	120/1	1,2,3,4,5	SEE SPECS		
HU2-F5	TRANE	S9X2D120	1900	-	0.5"	60	120	115	90	6.0	15	120/1	1,2,3,4,5	SEE SPECS		
REC-F1	TRANE	S9X2D120	1900	-	0.5"	60	120	115	90	6.0	15	120/1	1,2,3,4,6	SEE SPECS		
SEG-F1	TRANE	S9X2D080	1200	-	0.5"	60	80	77	90	6.0	15	120/1	1,2,3,4,6	SEE SPECS		

	ROOFTOP UNIT SCHEDULE																				
NOTES:																					
1.	FILTER RACK. PROVI	DE A MINMUM MERV	8 FILTER.																		
2.	CRANKCASE HEATER	RANKCASE HEATER.																			
3.	SEE SPECS FOR WAR	SEE SPECS FOR WARRANTY INFORMATION.																			
4.	CONDENSER COIL HAIL GUARDS.																				
5.	OUTSIDE AIR HOOD	OUTSIDE AIR HOOD WITH 0-100% MODULATING OUTDOOR AIR ECONOMIZER.																			
6.	FACTORY MOUNTED	CTORY MOUNTED DISCONNECTS.																			
7.	STAINLESS STEEL HE	INLESS STEEL HEAT EXCHANGER WITH MINIMUM OF FOUR STAGES OF GAS HEAT.																			
8.	FACTORY INSTALLED	ACTORY INSTALLED, FACTORY POWERED GFCI RECEPTACLE.																			
9.	PROVIDE SPACE SEN	ISOR FOR TEMPERAT	URE AND HUMI	DITY CONTROL	UNIT SHALL BE	EQUIPPED WI	TH BACNET (CONTROLLER FO	R FUTURE CON	NECTION INTO	BAS SYSTEM										
10.	POWERED EXHAUST	•																			
11.	THREE STAGES OF C	OOLING WITH VARIA	ABLE SPEED FAI	NS TO MATCH C	COOLING LOAD.																
12.	HORIZONTAL DISCH	ARGE KIT. UNIT SHA	LL BE INSTALLE	ED ON 14" ROC	F CURB AND NE	W CONRETE PA	D.														
13.	HOT GAS REHEAT CO	OIL TO MAINTAIN 55	% RH.																		
TYPE MARK	MANUFACTURER	MODEL NUMBER	EER (SEER)	TONNAGE	SUPPLY AIR (CFM)	OUTSIDE AIR (CFM)	FAN (BHP)	EXTERNAL STATIC (WC)		ENTERING AIR WB	SENSIBLE (MBH)	TOTAL (MBH)	HEATING ENTERING AIR DB	HEATING INPUT (MBH)	HEATING OUTPUT (MBH)	LEAVING AIR DB	MCA	МОСР	VOLTAGE	NOTES	EQUIVALENTS
EDU-RTU1	TRANE	YSK180	10.8	15	6000	1000	(2) 3	0.75"	78.2	64.4	144.8	186.8	60	400	324	95	90.3	125	208/3	1 THRU 13	SEE SPECS

STATE OF MISSOURI MIKE KEHOE, **GOVERNOR**

Engineer of Record Jacob Adam Nelson PE PE-2009018758

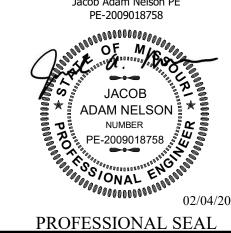



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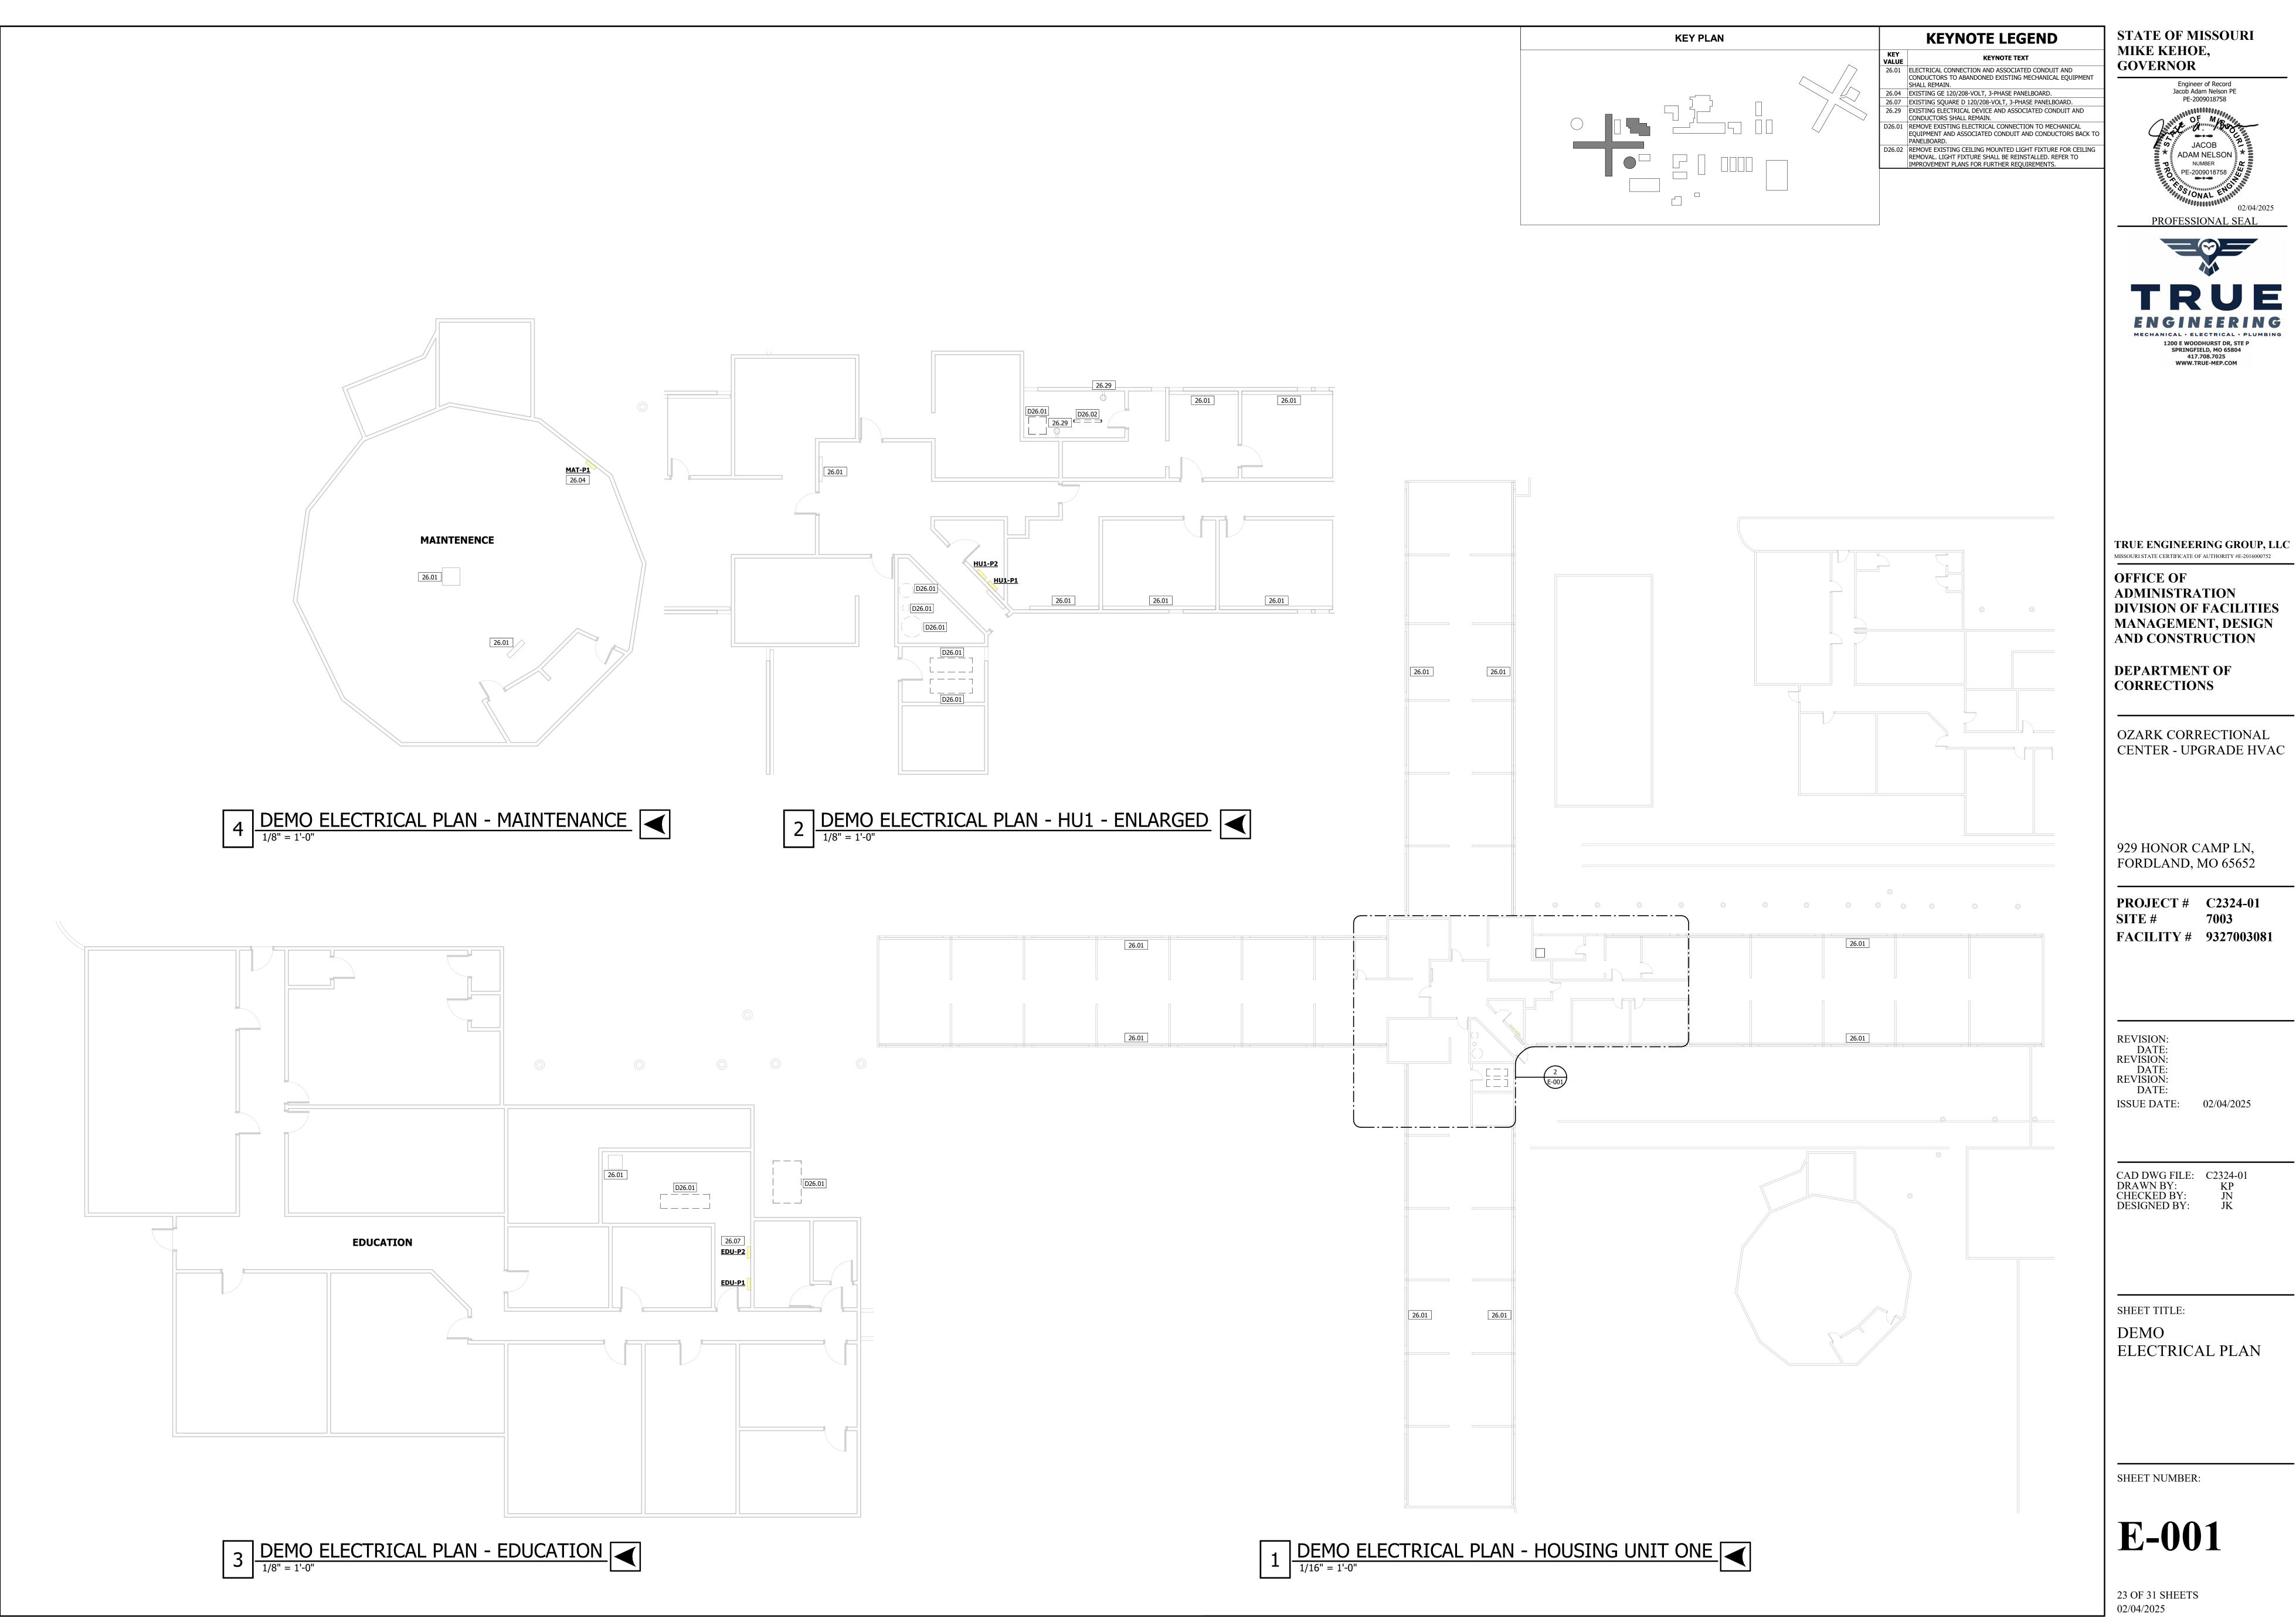
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REVISION:
DATE:

ISSUE DATE: 02/04/2025

CAD DWG FILE: C2324-01 DRAWN BY: KP CHECKED BY: JN DESIGNED BY: JK

SHEET TITLE: MECHANICAL SCHEDULES

SHEET NUMBER:





STATE OF MISSOURI MIKE KEHOE,


KEYNOTE LEGEND

KEY PLAN

GOVERNOR




TRUE ENGINEERING GROUP, LLC

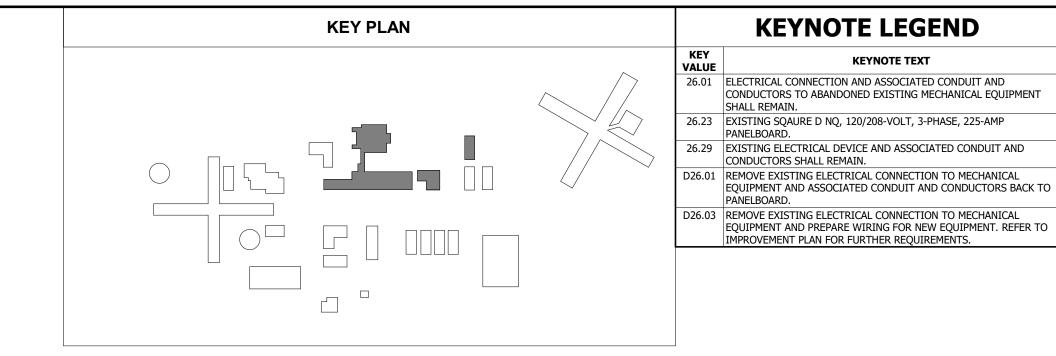

STATE OF MISSOURI **KEYNOTE LEGEND** MIKE KEHOE, **GOVERNOR**

Engineer of Record Jacob Adam Nelson PE

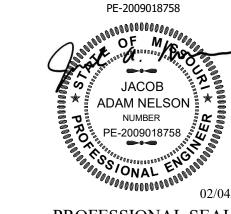



TRUE ENGINEERING GROUP, LLC MISSOURI STATE CERTIFICATE OF AUTHORITY #E-2016000752

OFFICE OF ADMINISTRATION DIVISION OF FACILITIES MANAGEMENT, DESIGN AND CONSTRUCTION

DEPARTMENT OF CORRECTIONS

OZARK CORRECTIONAL CENTER - UPGRADE HVAC

929 HONOR CAMP LN, FORDLAND, MO 65652

PROJECT # C2324-01 7003 FACILITY # 9327003081

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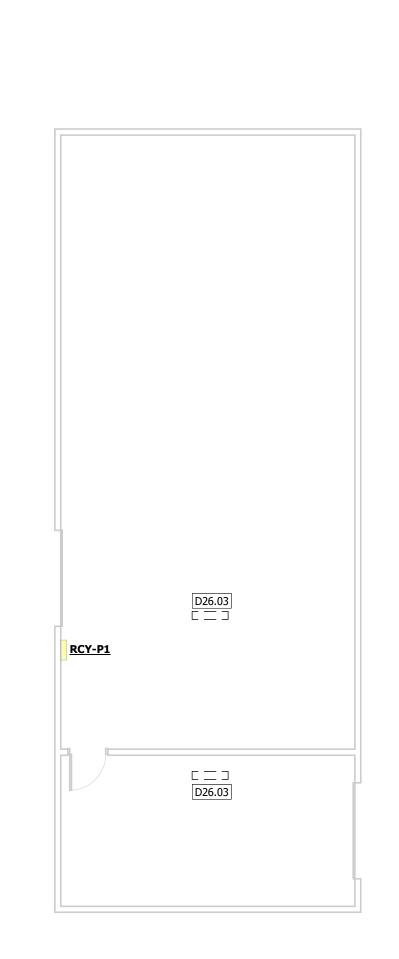
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DEMO ELECTRICAL PLAN


SHEET NUMBER:

E-003

25 OF 31 SHEETS





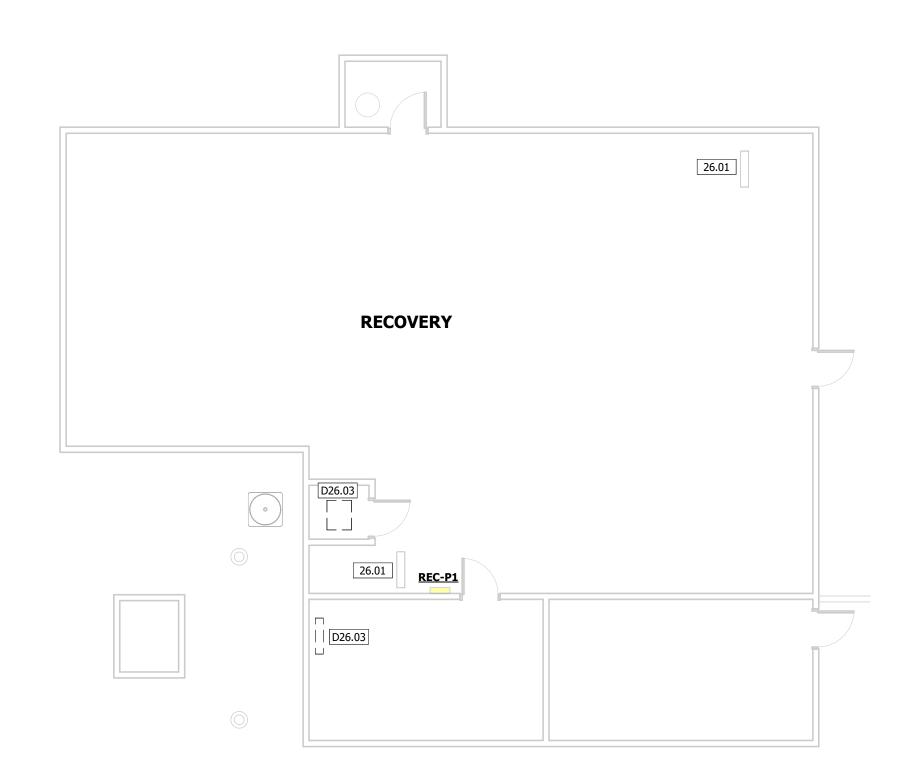

2 DEMO ELECTRICAL PLAN - RECOVERY



1 DEMO ELECTRICAL PLAN - CAFETERIA

1/8" = 1'-0"

KEY PLAN

KEYNOTE LEGEND
KEY VALUE
KEYNOTE TEXT

26.31 ELECTRICAL CONNECTION AND ASSOCIATED CONDUIT AND CONDUCTORS TO EXISTING MECHANICAL EQUIPMENT SHALL REMAIN.

D26.01 REMOVE EXISTING ELECTRICAL CONNECTION TO MECHANICAL EQUIPMENT AND ASSOCIATED CONDUIT AND CONDUCTORS BACK TO PANELBOARD.

D26.03 REMOVE EXISTING ELECTRICAL CONNECTION TO MECHANICAL EQUIPMENT AND PREPARE WIRING FOR NEW EQUIPMENT. REFER TO IMPROVEMENT PLAN FOR FURTHER REQUIREMENTS.

ADAM NELSON
NUMBER
PE-2009018758
02/04/2025
PROFESSIONAL SEAL

STATE OF MISSOURI

Engineer of Record Jacob Adam Nelson PE

PE-2009018758

MIKE KEHOE,

GOVERNOR

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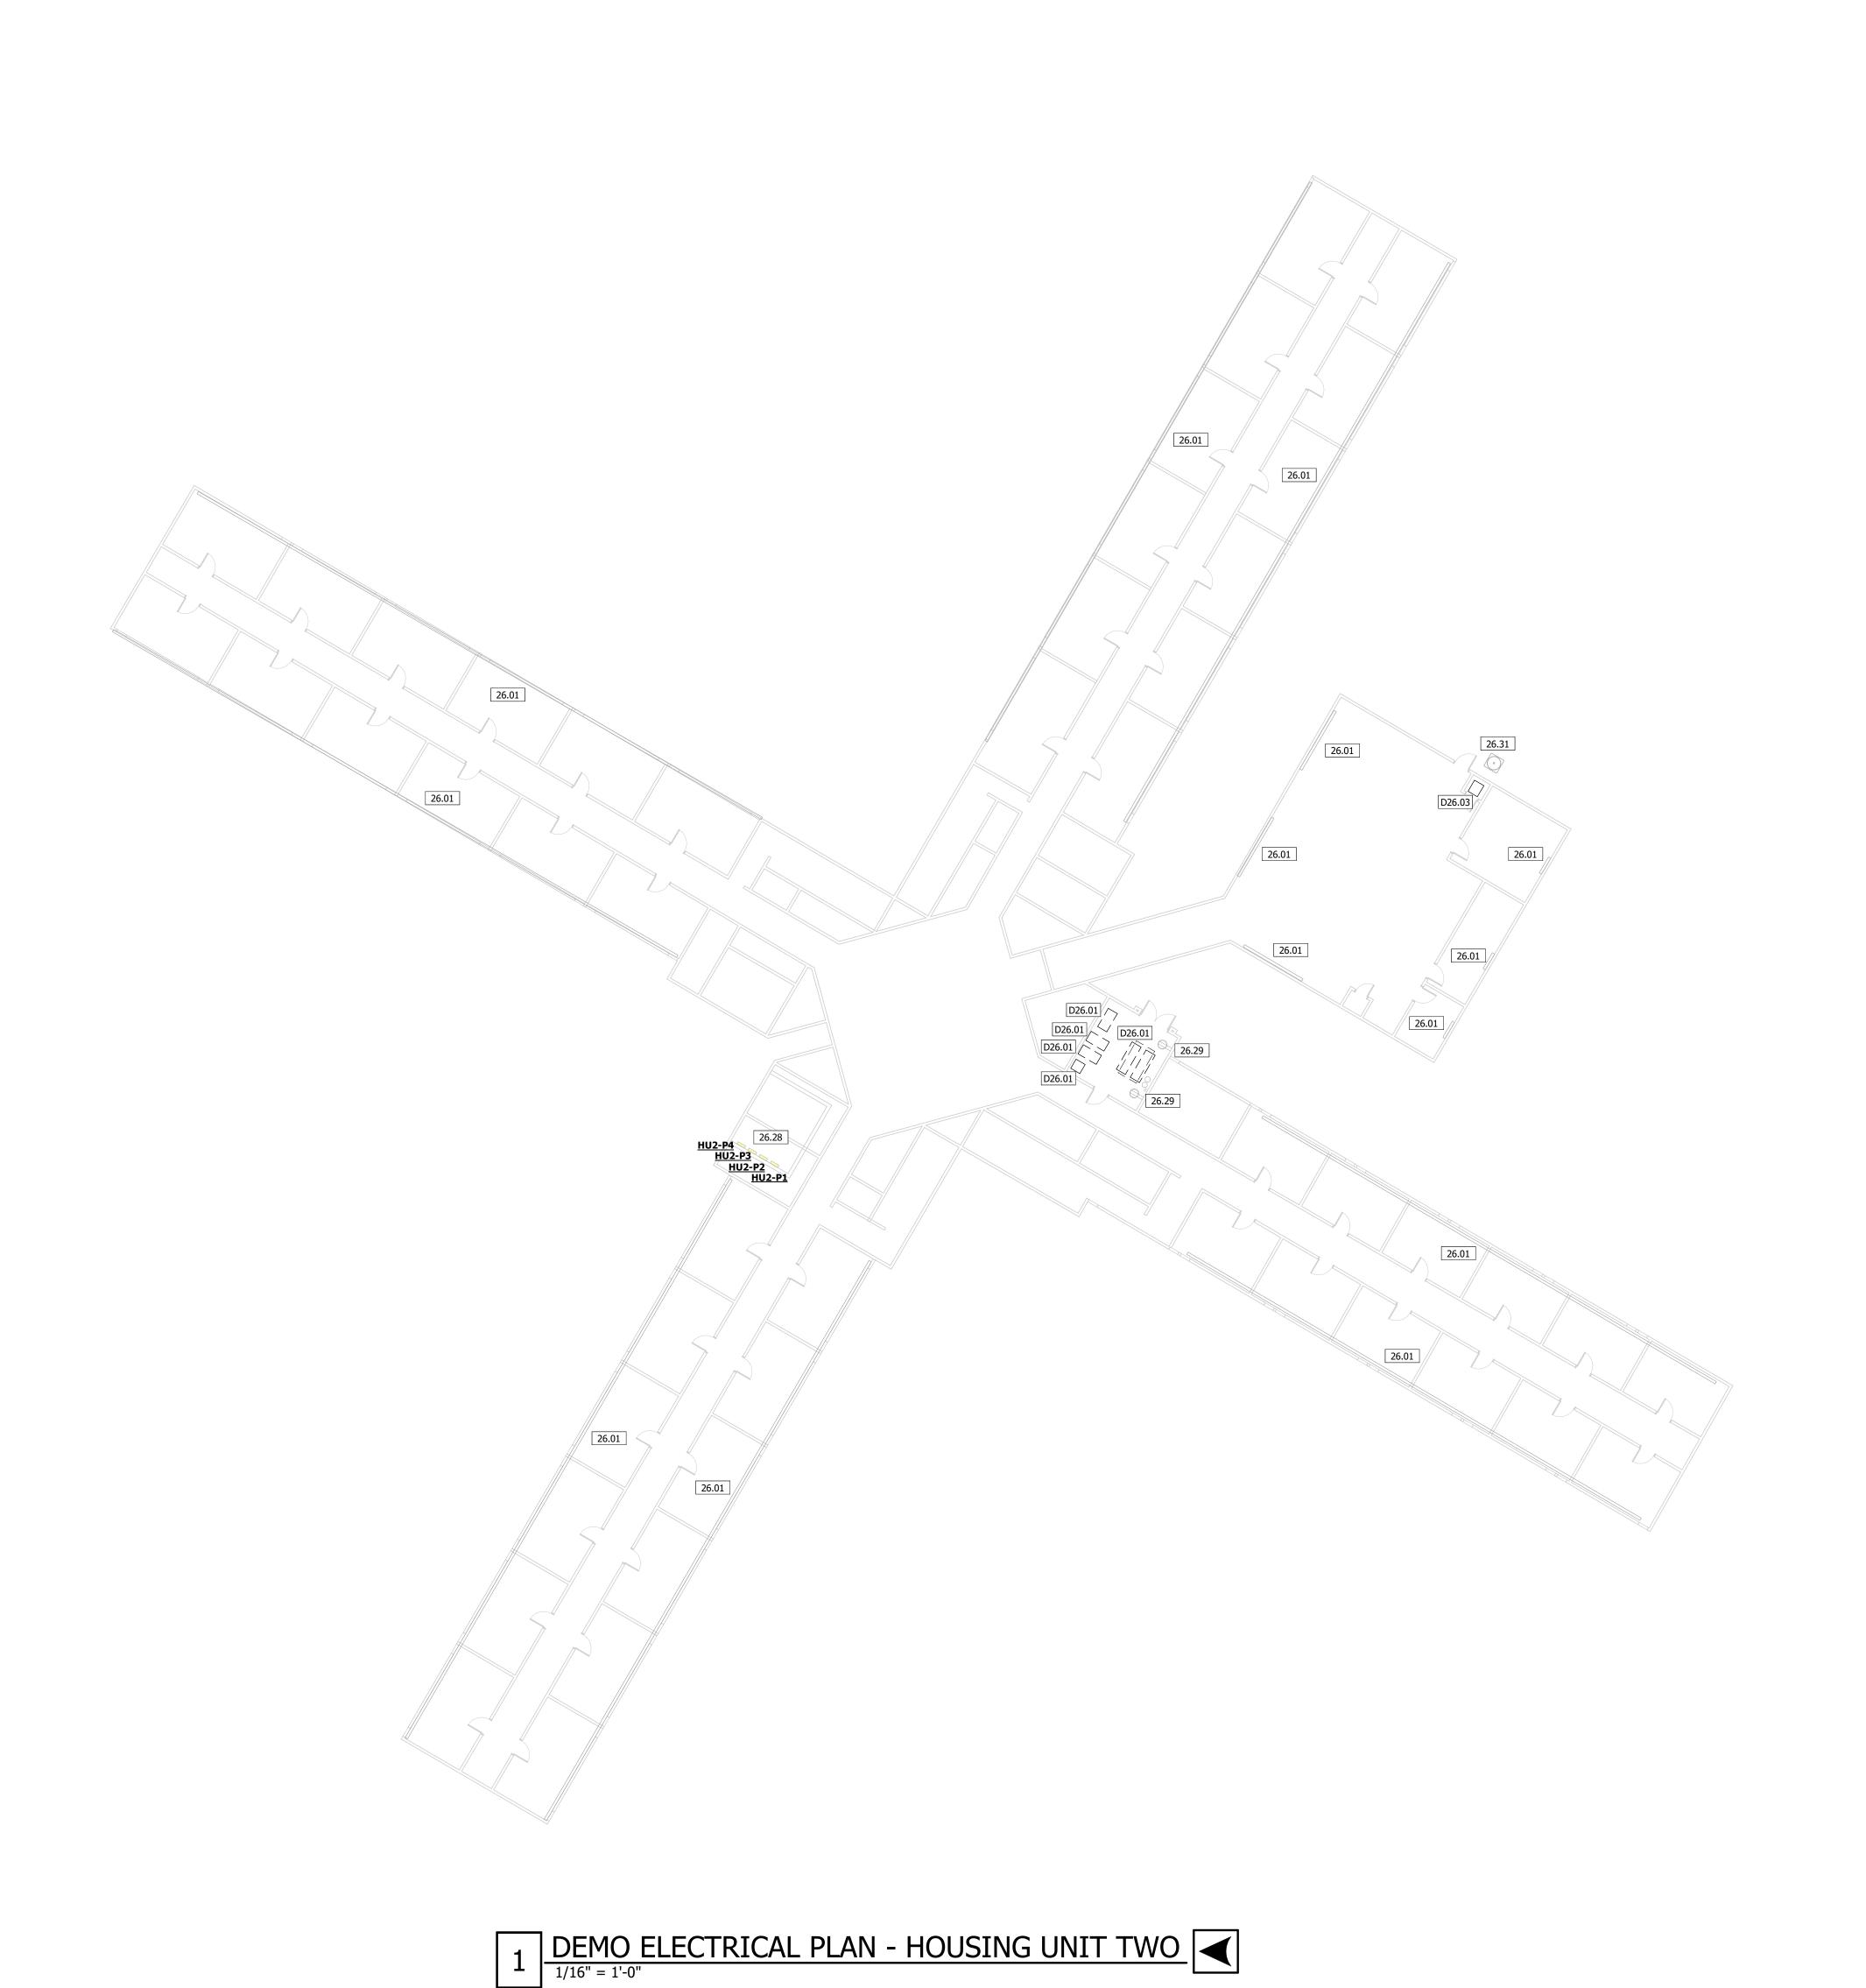
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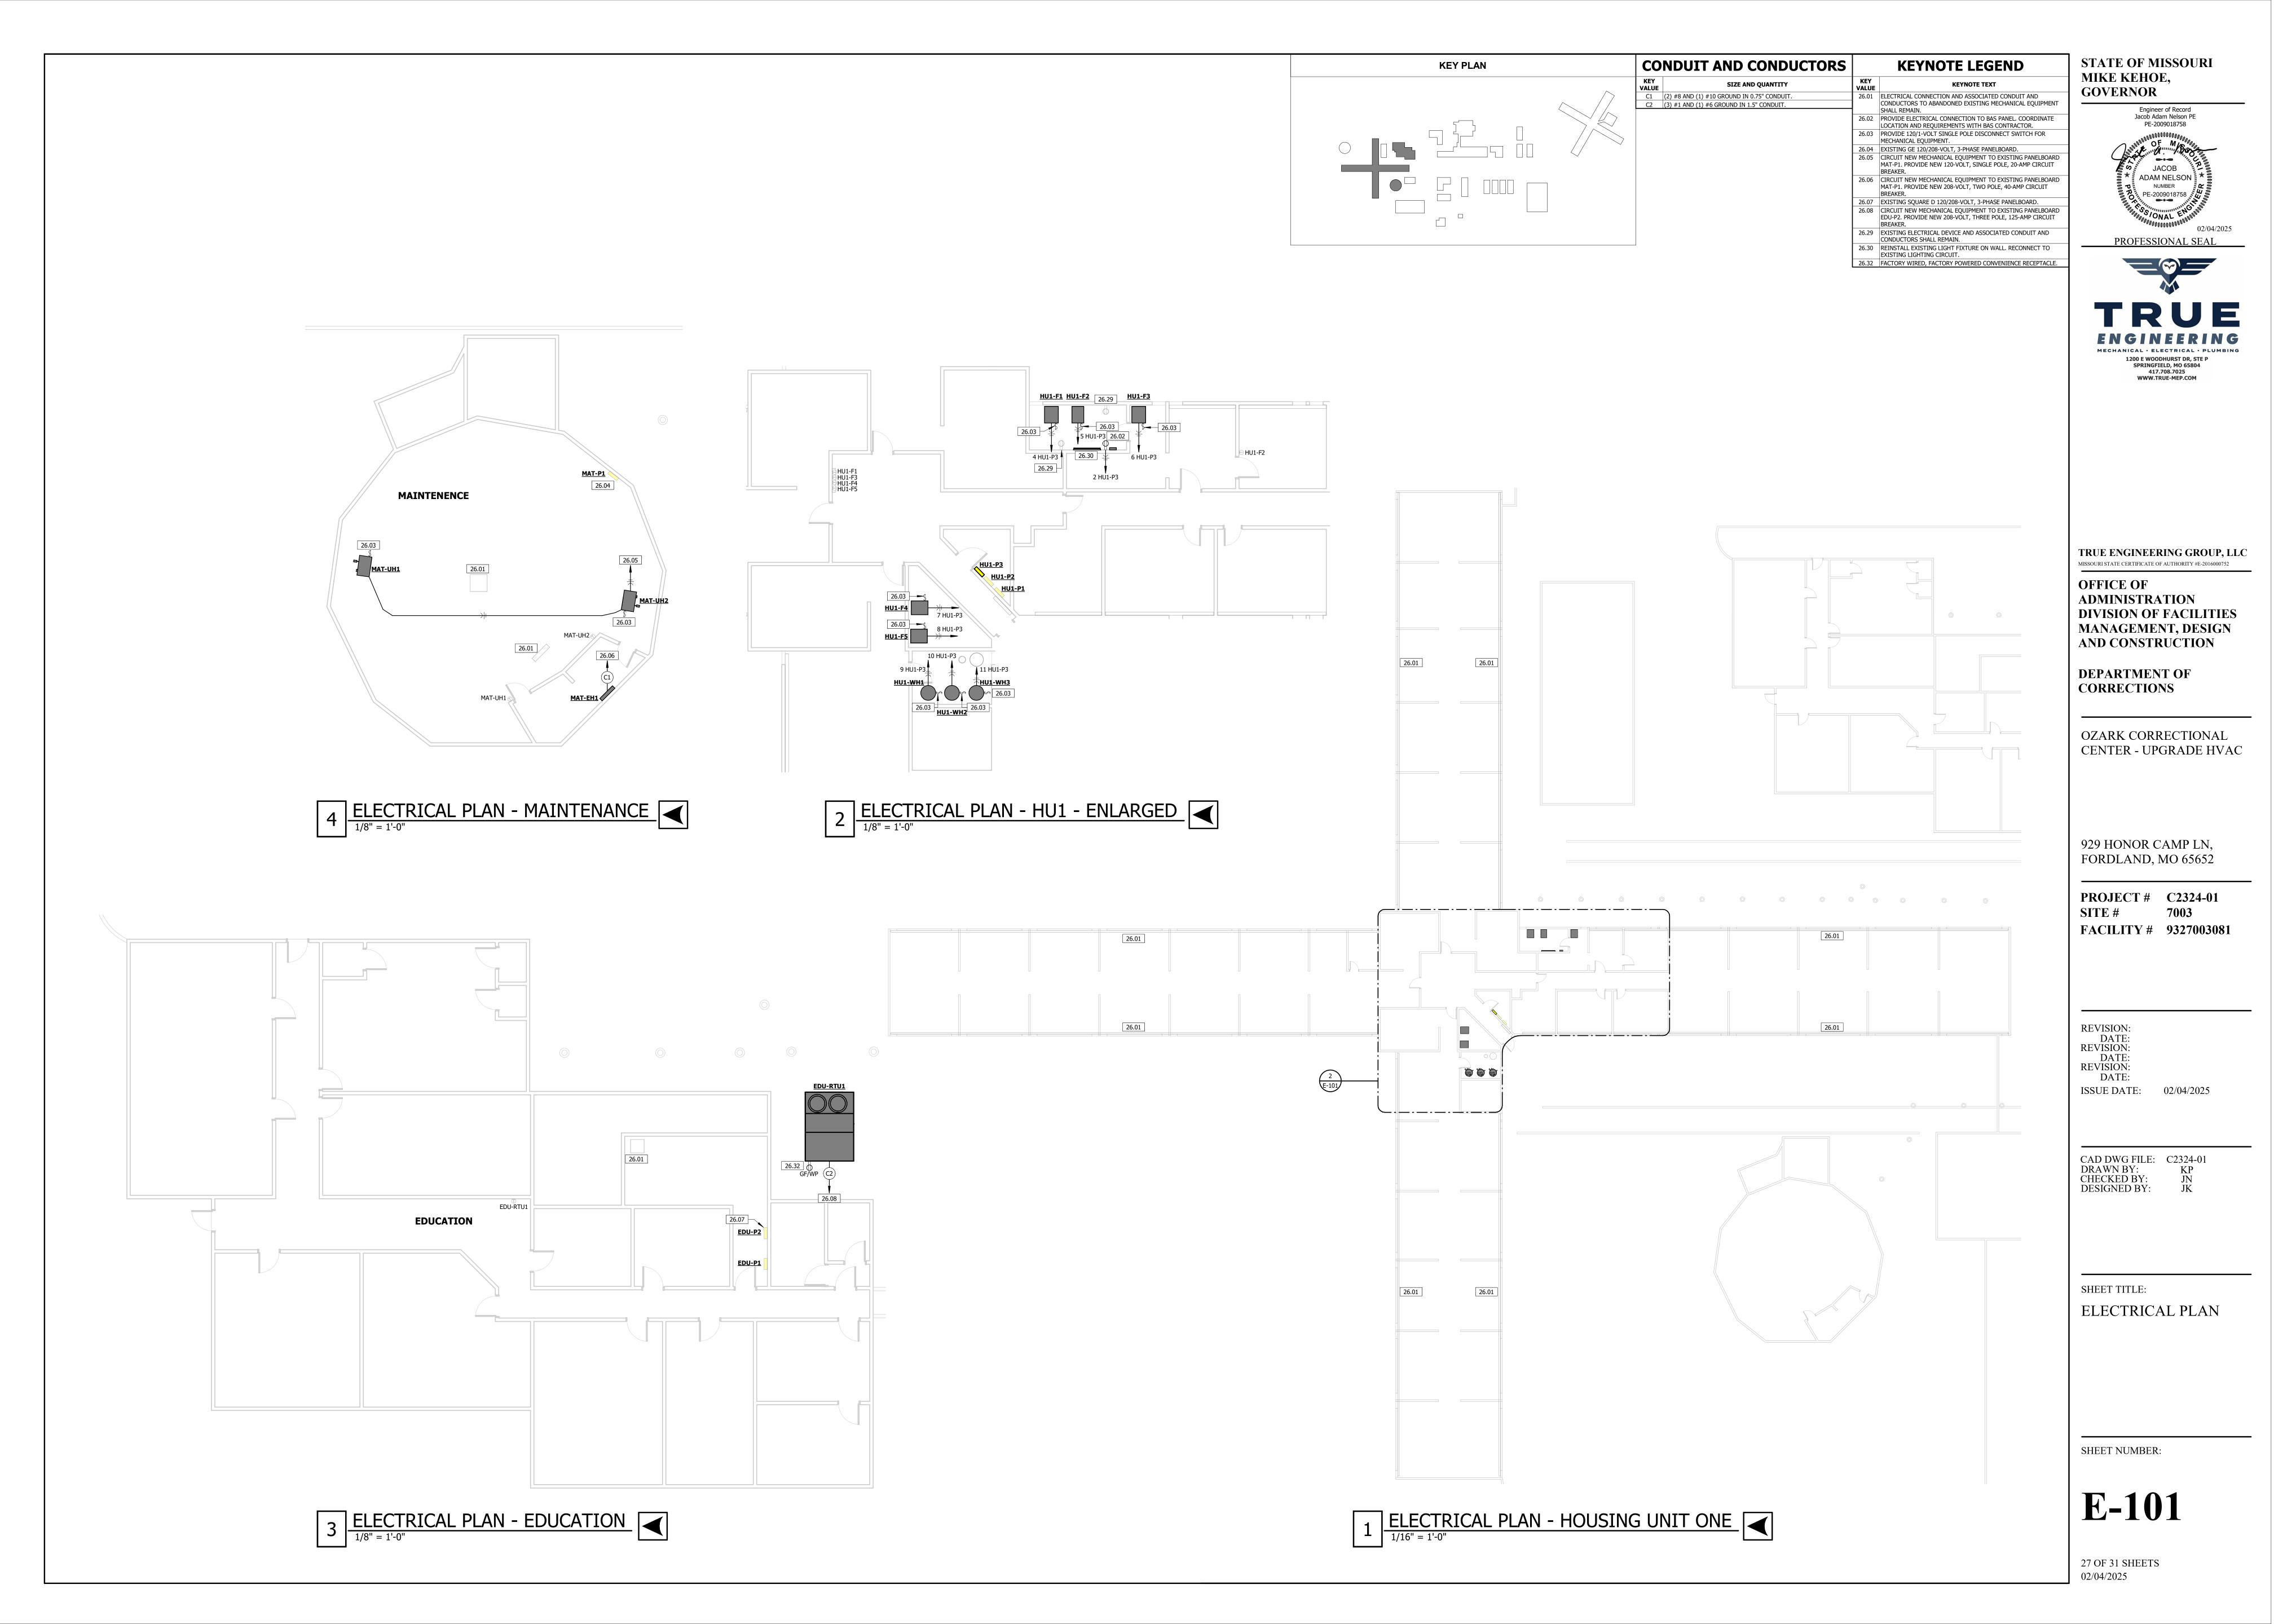
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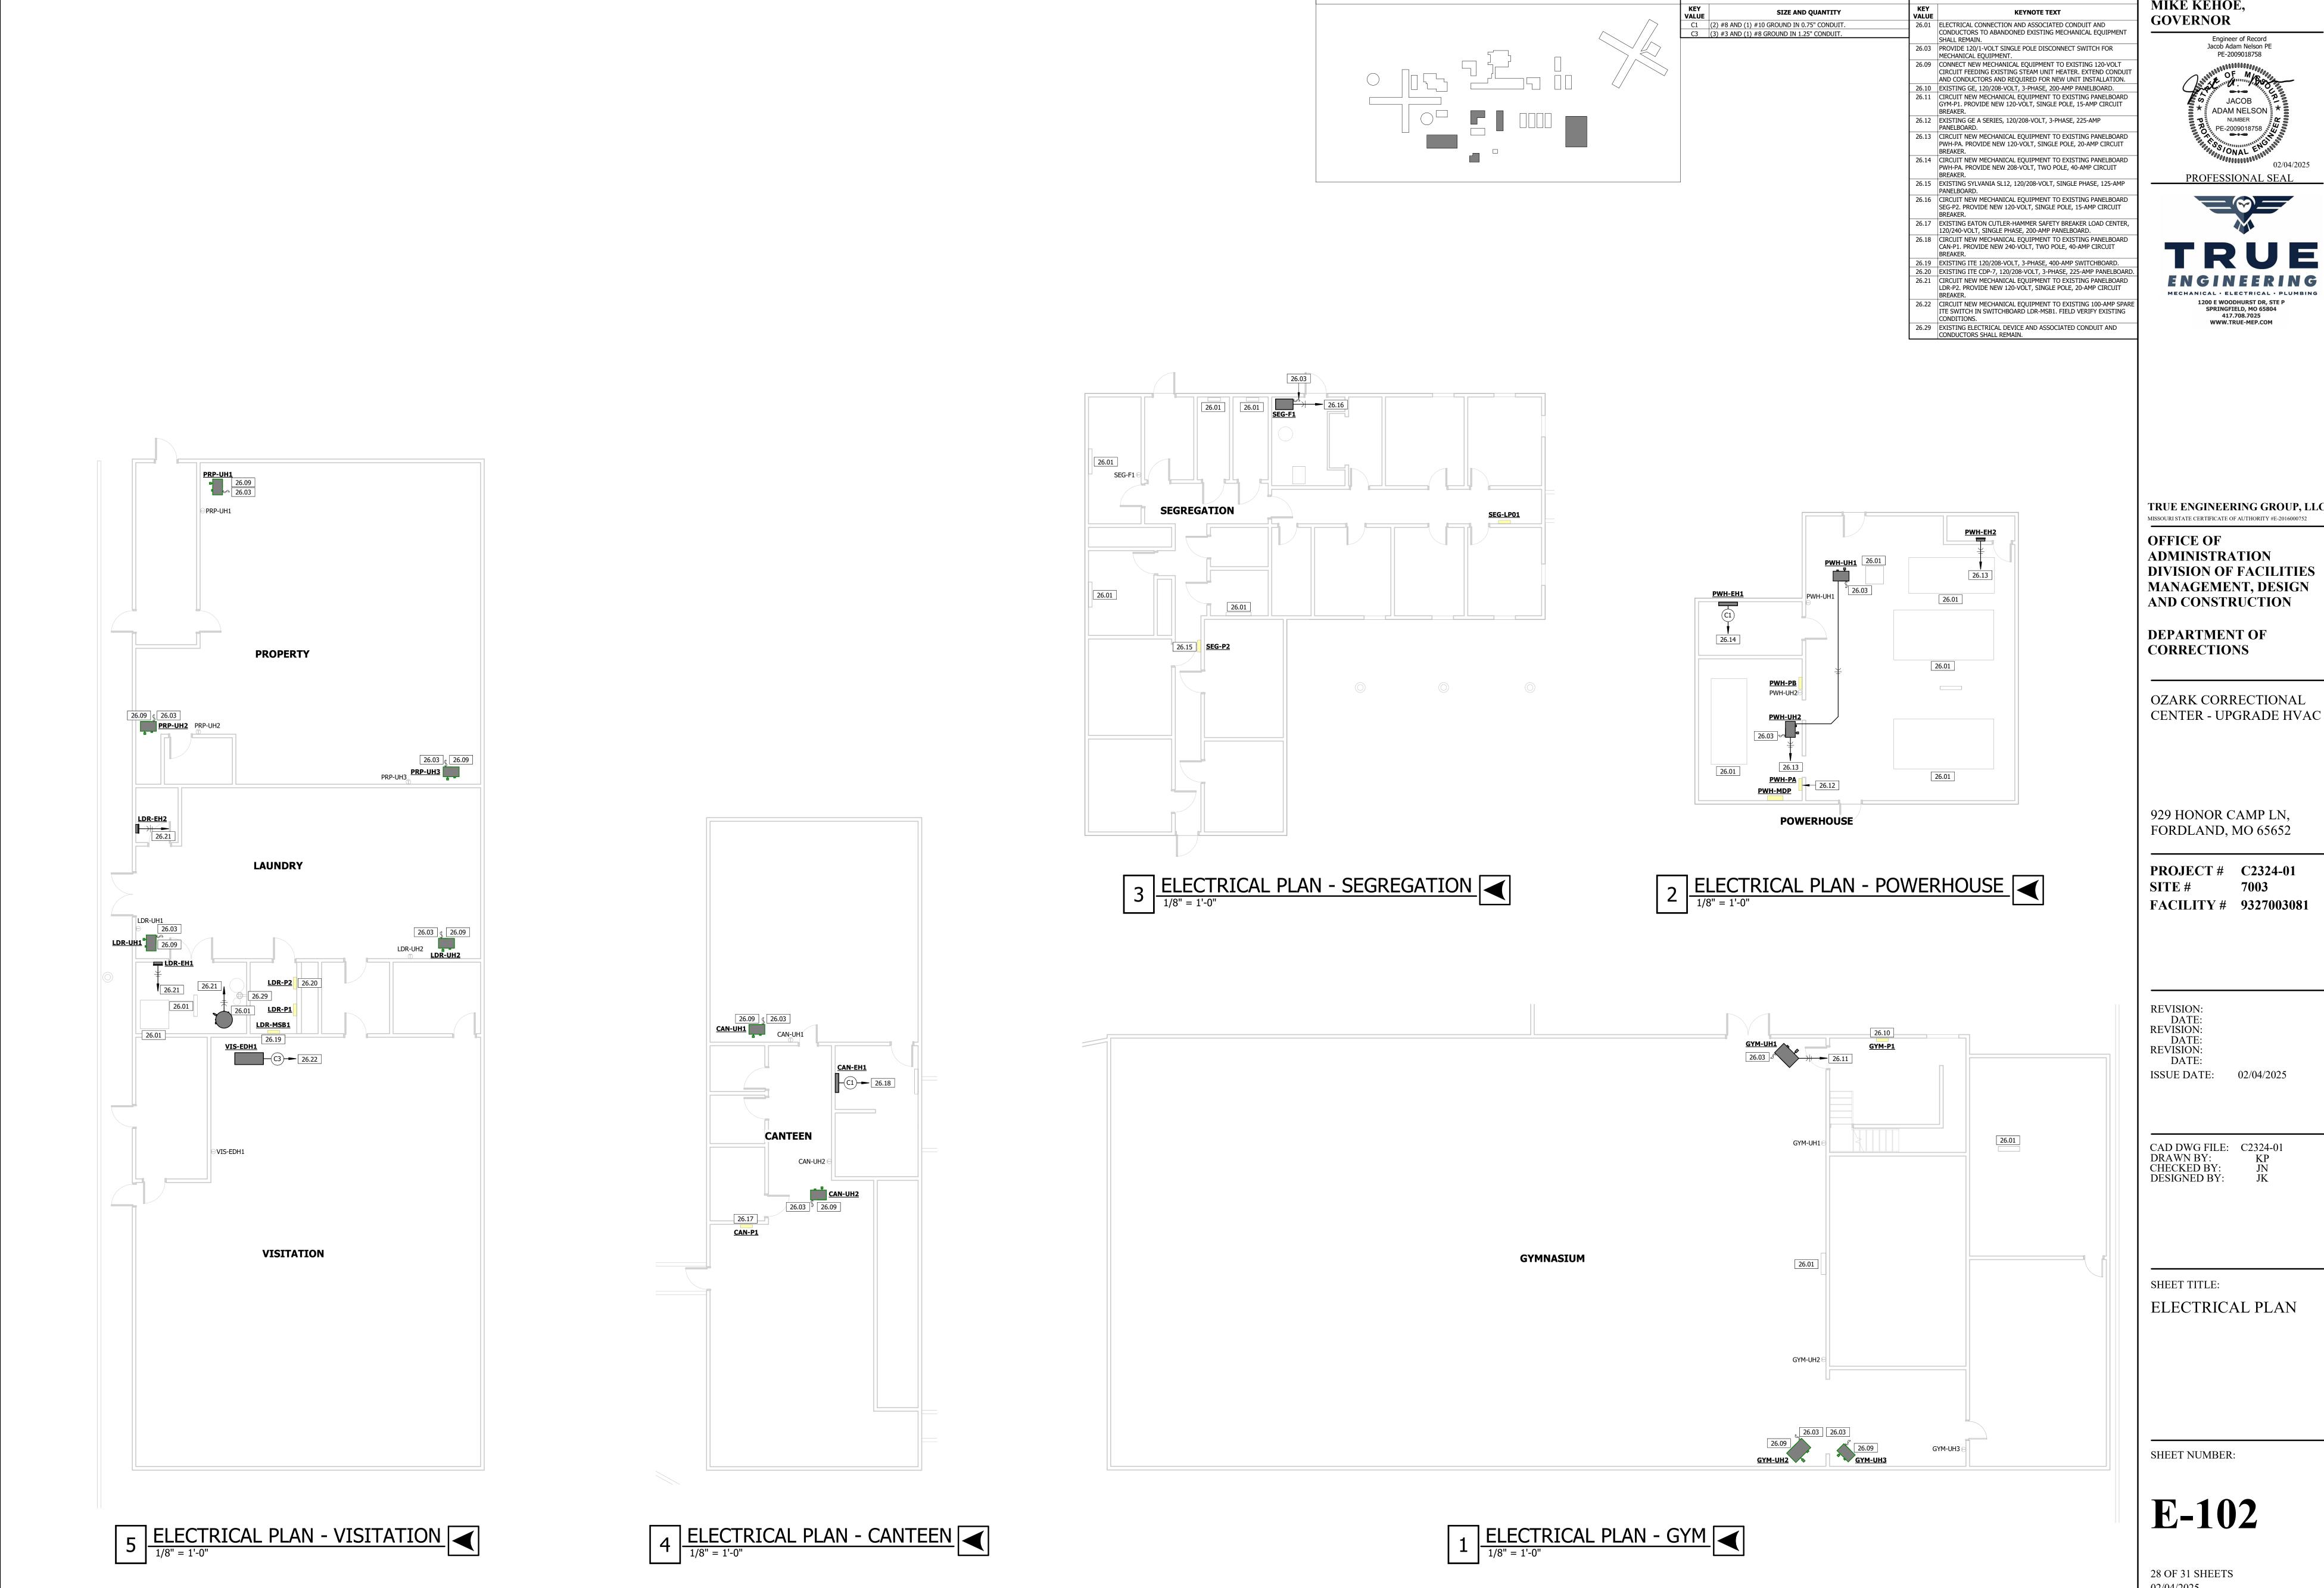
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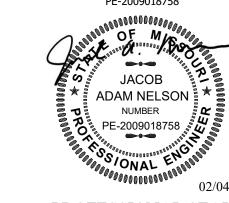
STATE OF MISSOURI MIKE KEHOE,

KEYNOTE LEGEND

CONDUIT AND CONDUCTORS

KEY PLAN

Engineer of Record Jacob Adam Nelson PE



PROFESSIONAL SEAL


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ADMINISTRATION DIVISION OF FACILITIES MANAGEMENT, DESIGN

OZARK CORRECTIONAL CENTER - UPGRADE HVAC

929 HONOR CAMP LN,

PROJECT # C2324-01 7003

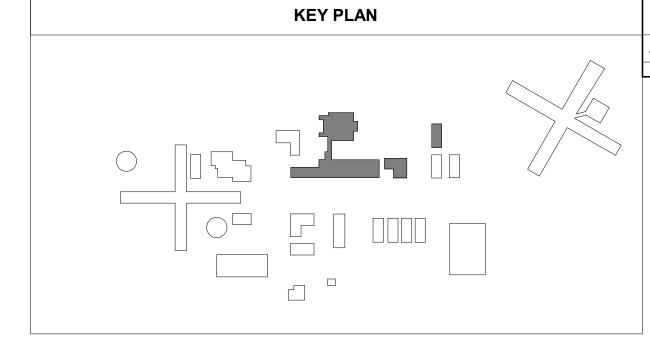

CONDUIT AND CONDUCTORS

KEY SIZE AND QUANTITY

C1 (2) #8 AND (1) #10 GROUND IN 0.75" CONDUIT.

KEYNOTE LEGEND

KEYNOTE TEXT

26.01 ELECTRICAL CONNECTION AND ASSOCIATED CONDUIT AND CONDUCTORS TO ABANDONED EXISTING MECHANICAL EQUIPMENT SHALL REMAIN.

26.03 PROVIDE 120/1-VOLT SINGLE POLE DISCONNECT SWITCH FOR MECHANICAL EQUIPMENT.

26.09 CONNECT NEW MECHANICAL FOLIPMENT TO EXISTING 120-VOLT

26.03 PROVIDE 120/1-VOLT SINGLE POLE DISCONNECT SWITCH FOR MECHANICAL EQUIPMENT.

26.09 CONNECT NEW MECHANICAL EQUIPMENT TO EXISTING 120-VOLT CIRCUIT FEEDING EXISTING STEAM UNIT HEATER. EXTEND CONDUIT AND CONDUCTORS AND REQUIRED FOR NEW UNIT INSTALLATION.

26.23 EXISTING SQAURE D NQ, 120/208-VOLT, 3-PHASE, 225-AMP PANELBOARD.

26.24 CIRCUIT NEW MECHANICAL EQUIPMENT TO EXISTING PANELBOARD

26.24 CIRCUIT NEW MECHANICAL EQUIPMENT TO EXISTING PANELBOARD KIT-P4. PROVIDE NEW 120-VOLT, SINGLE POLE, 20-AMP CIRCUIT BREAKER.

26.25 EXISTING EATON, 120/240-VOLT, SINGLE PHASE, 200-AMP PANELBOARD.

26.26 CONNECT NEW MECHANICAL EQUIPMENT TO EXISTING 120-VOLT CIRCUIT FEEDING EXISTING AIR HANDLER. EXTEND CONDUIT AND CONDUCTORS AS REQUIRED FOR NEW UNIT INSTALLATION.

26.27 CIRCUIT NEW MECHANICAL EQUIPMENT TO EXISTING PANELBOARD REC-P1. PROVIDE NEW 240-VOLT, TWO POLE, 40-AMP CIRCUIT BREAKER.

26.29 EXISTING ELECTRICAL DEVICE AND ASSOCIATED CONDUIT AND CONDUCTORS SHALL REMAIN.

Engineer of Record
Jacob Adam Nelson PE
PE-2009018758

OF M
JACOB
ADAM NELSON
NUMBER
PE-2009018758

PE-2009018758

02/04/2

PROFESSIONAL SEAL

STATE OF MISSOURI

MIKE KEHOE,

GOVERNOR

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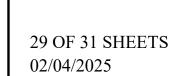
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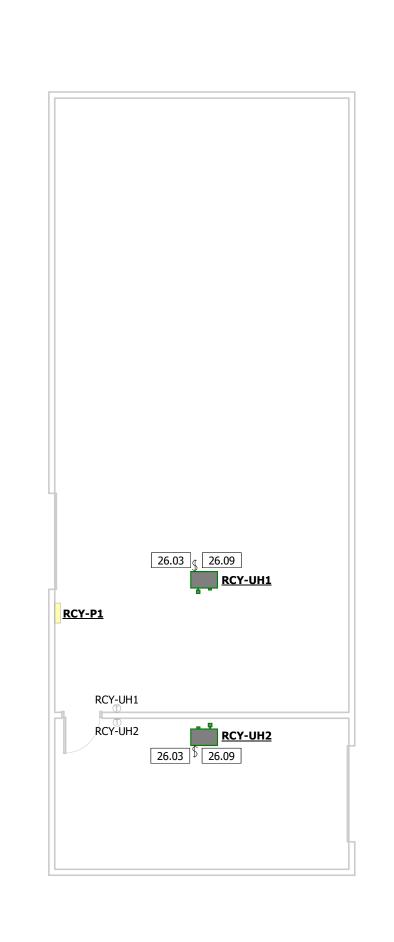
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ELECTRICAL PLAN


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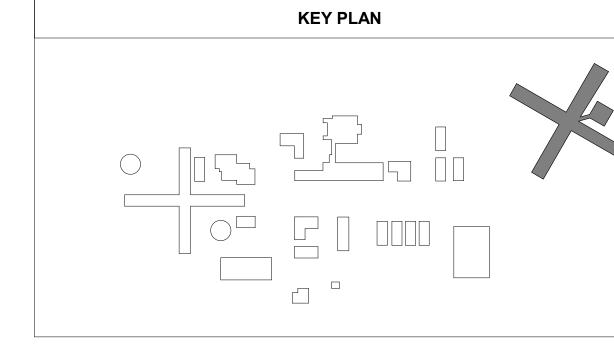








1 ELECTRICAL PLAN - CAFETERIA 1/8" = 1'-0"

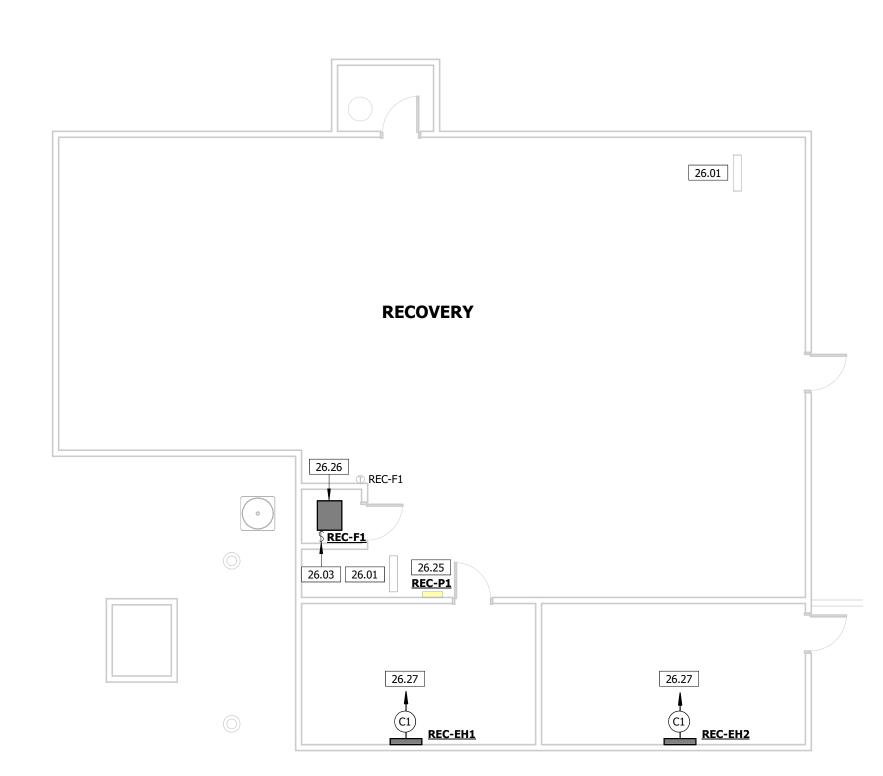


- 26.01 ELECTRICAL CONNECTION AND ASSOCIATED CONDUIT AND CONDUCTORS TO ABANDONED EXISTING MECHANICAL EQUIPMENT 26.02 PROVIDE ELECTRICAL CONNECTION TO BAS PANEL. COORDINATE LOCATION AND REQUIREMENTS WITH BAS CONTRACTOR.

 26.03 PROVIDE 120/1-VOLT SINGLE POLE DISCONNECT SWITCH FOR
- MECHANICAL EQUIPMENT. 26.26 CONNECT NEW MECHANICAL EQUIPMENT TO EXISTING 120-VOLT CIRCUIT FEEDING EXISTING AIR HANDLER. EXTEND CONDUIT AND CONDUCTORS AS REQUIRED FOR NEW UNIT INSTALLATION.

 26.28 EXISTING ITE CDP-7, 120/208-VOLT, 3-PHASE, 225-AMP PANELBOARD.

STATE OF MISSOURI MIKE KEHOE, **GOVERNOR**

Engineer of Record Jacob Adam Nelson PE PE-2009018758

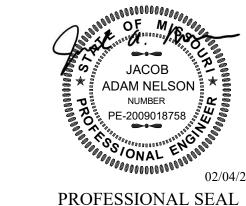



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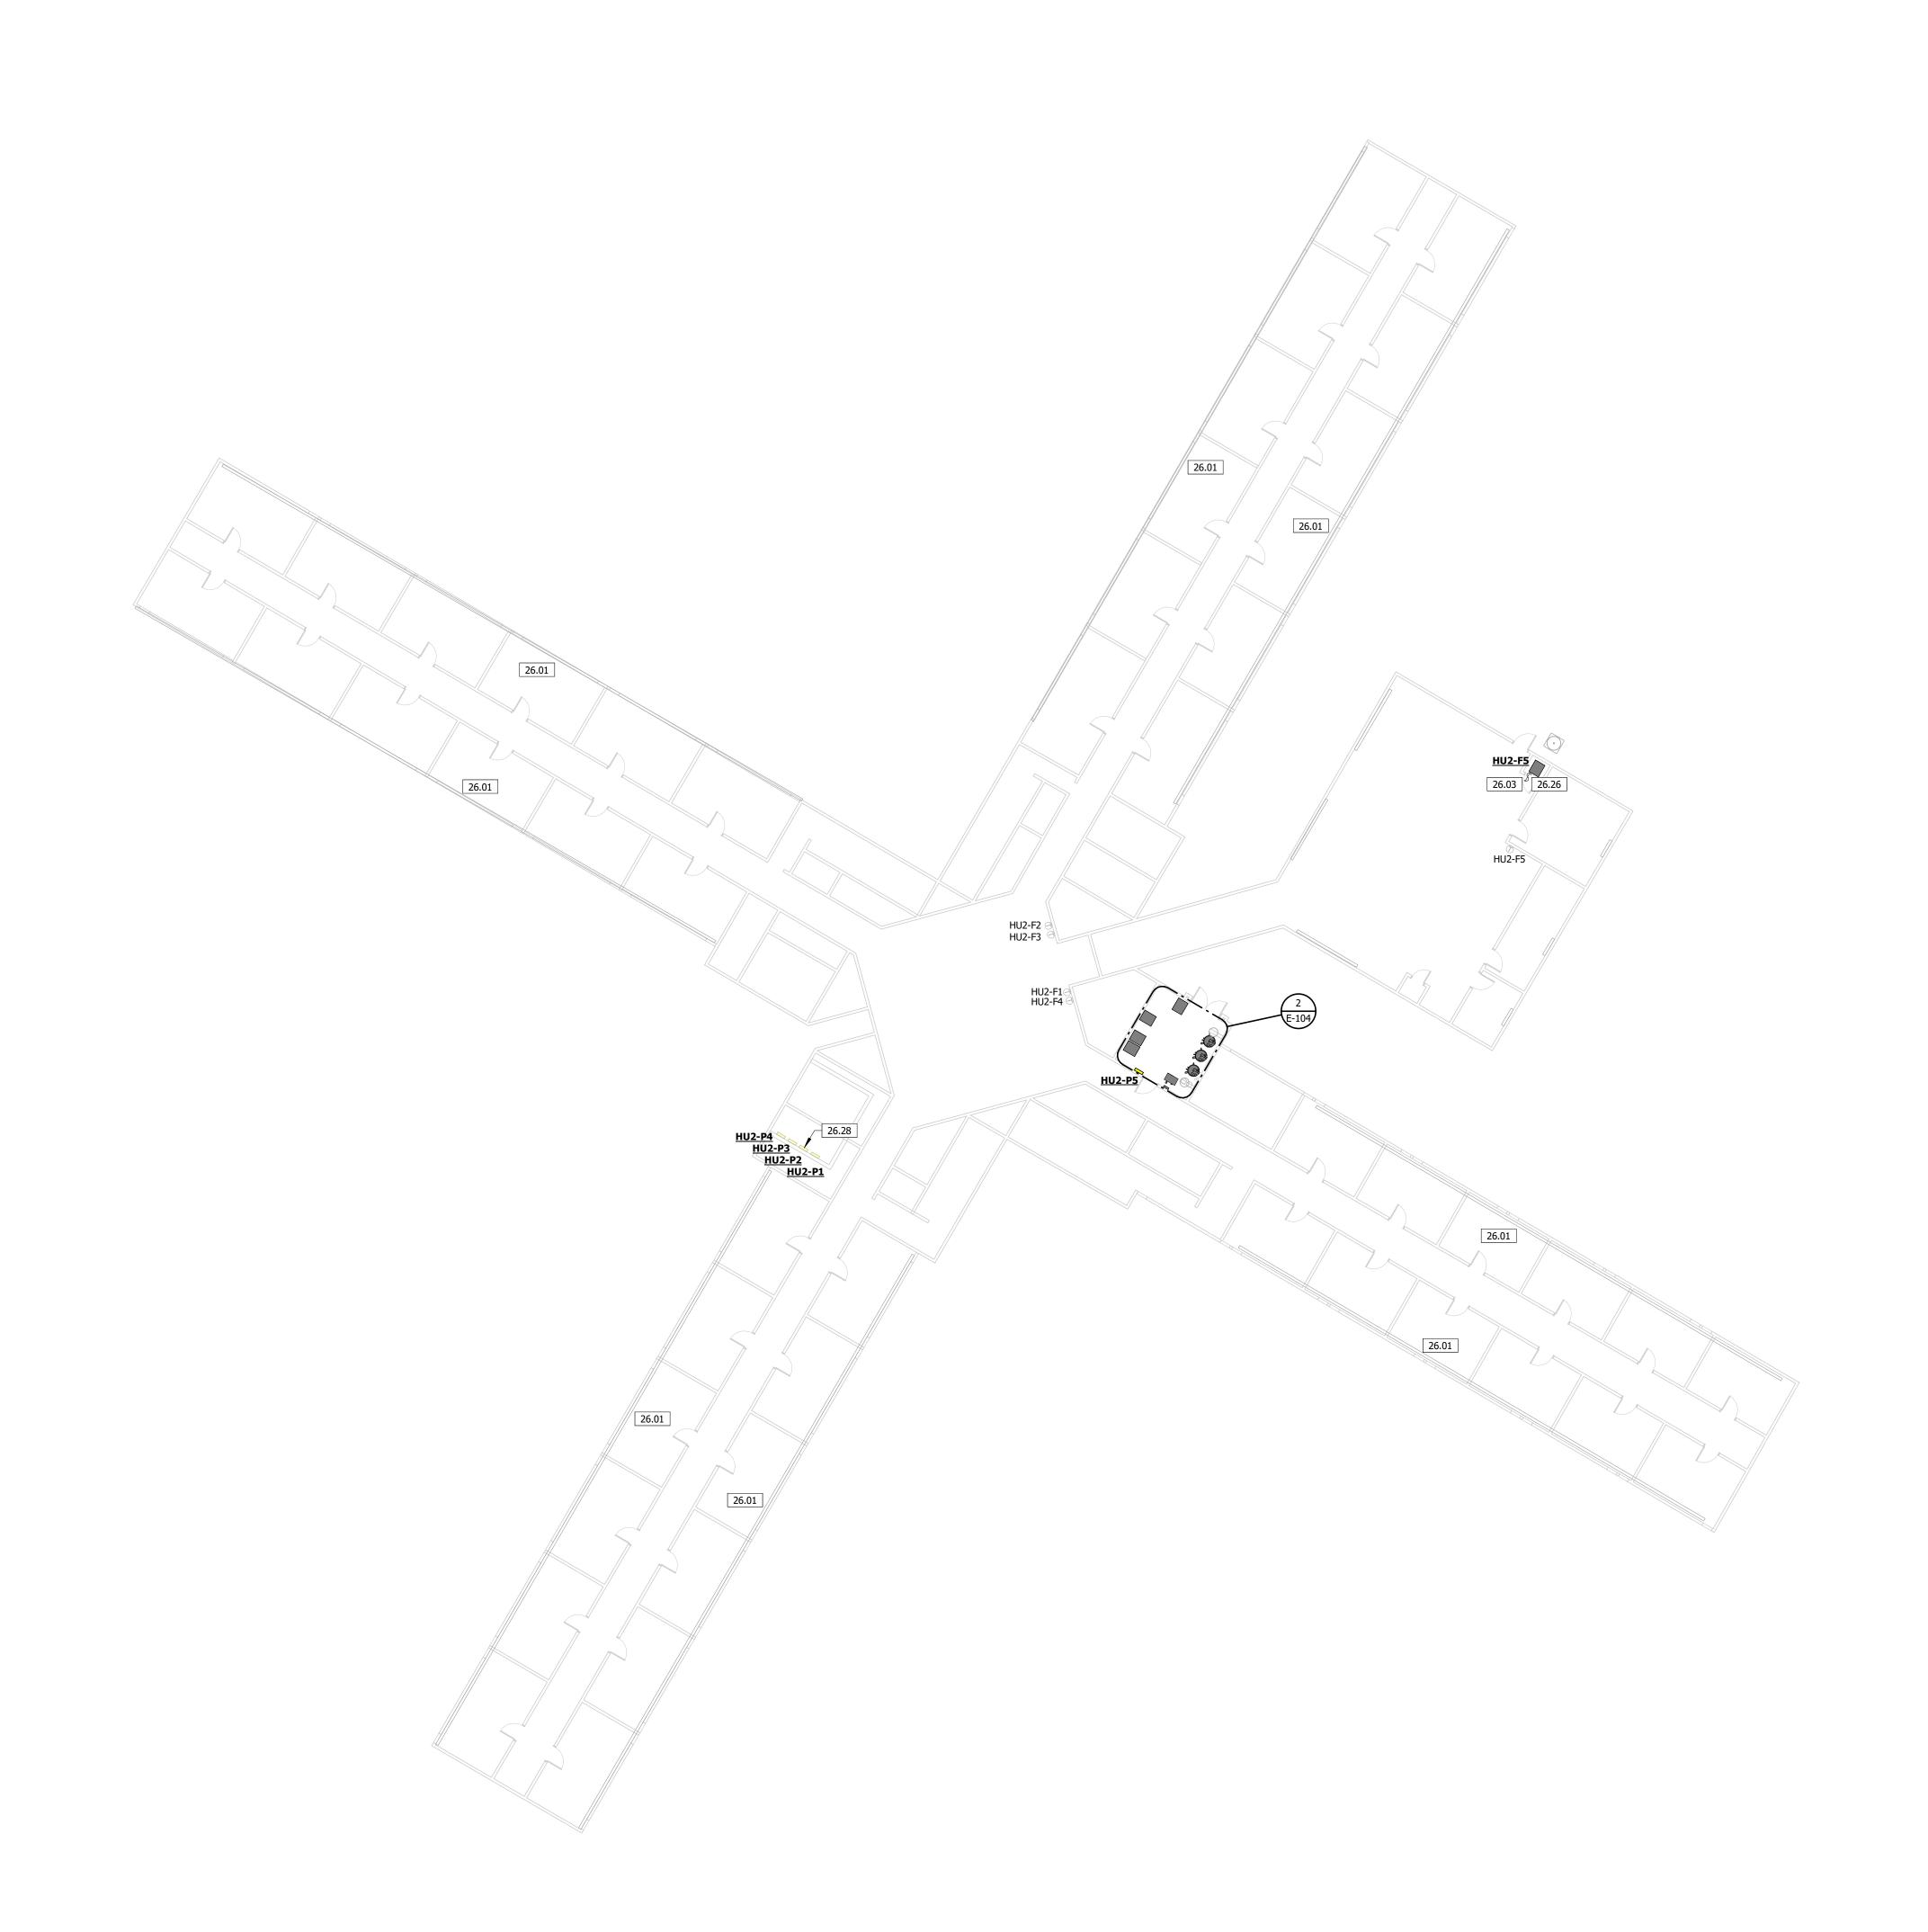
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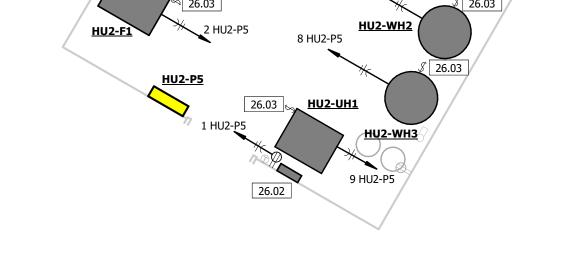
ELECTRICAL PLAN

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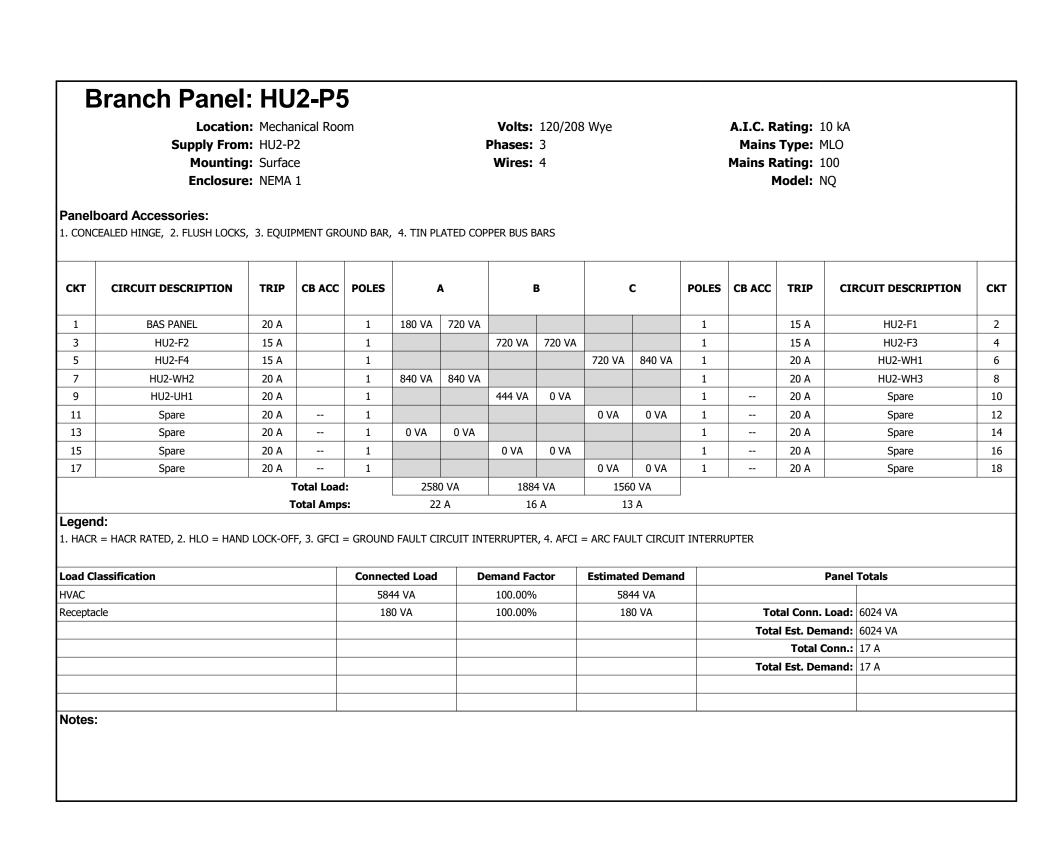
30 OF 31 SHEETS 02/04/2025







2 ELECTRICAL PLAN - HU2 - ENLARGED


1 ELECTRICAL PLAN - HOUSING UNIT TWO



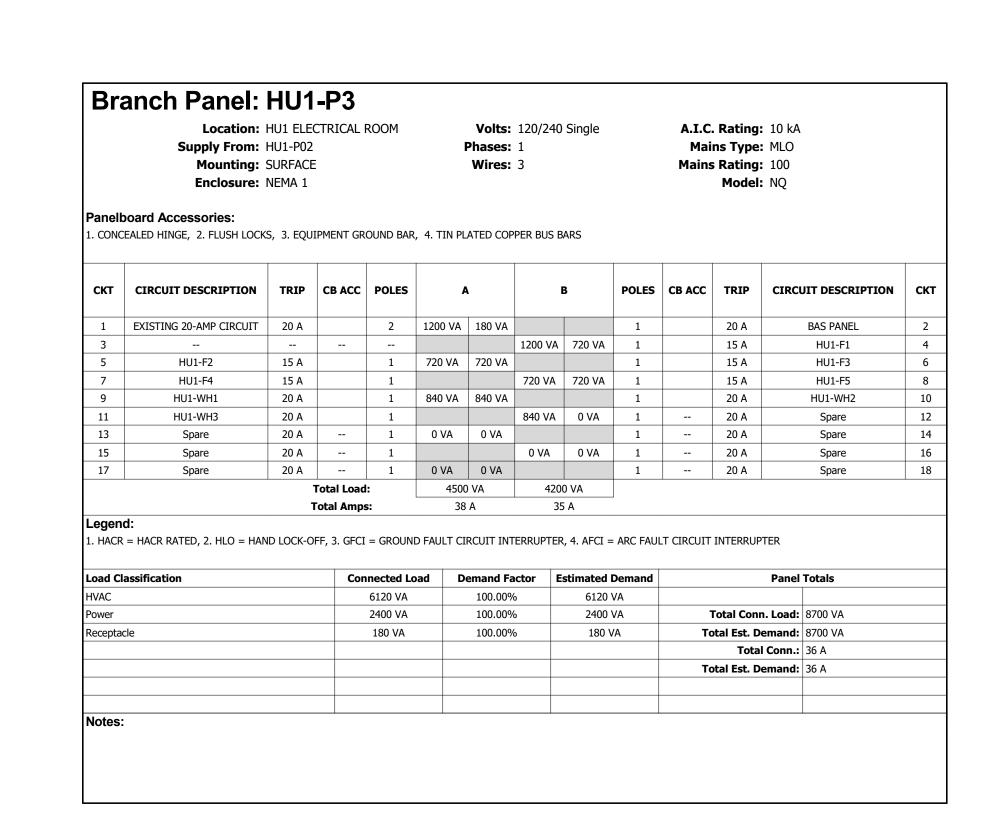

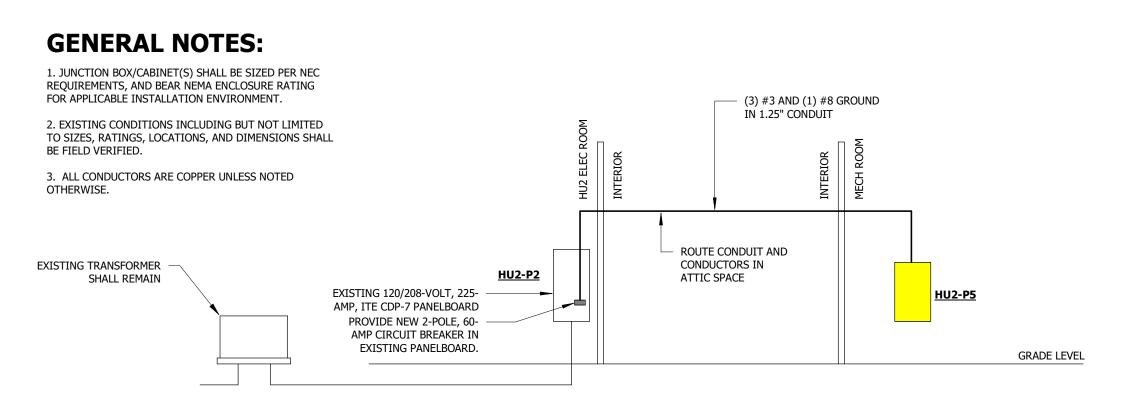

2 ELECTRICAL RISER - HOUSING UNIT 2
NOT TO SCALE

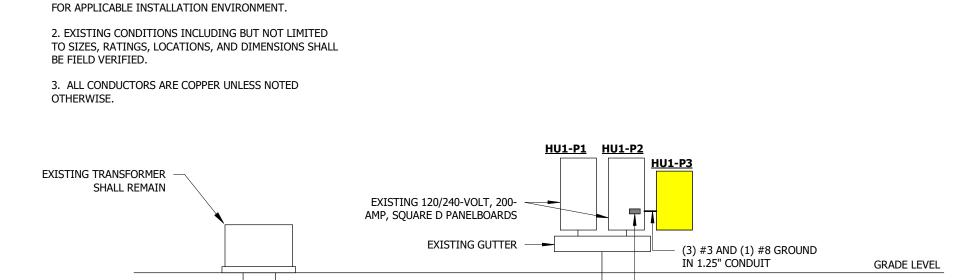

REMOVE EXISTING 20-AMP 2-POLE CIRCUIT BREAKER AND PROVIDE NEW 60-AMP, 2-POLE

PANEL SCHEDULES.

CIRCUIT BREAKER. RELOCATE EXISTING 20-AMP 2-

POLE CIRCUIT IN NEW PANEL "HU1-P3". REFER TO

1 ELECTRICAL RISER - HOUSING UNIT 1


NOT TO SCALE

GENERAL NOTES:

1. JUNCTION BOX/CABINET(S) SHALL BE SIZED PER NEC REQUIREMENTS, AND BEAR NEMA ENCLOSURE RATING

STATE OF MISSOURI MIKE KEHOE, **GOVERNOR**

Engineer of Record Jacob Adam Nelson PE

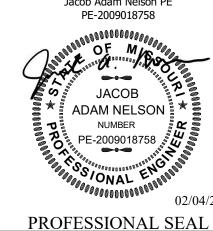



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DATE: ISSUE DATE: 02/04/2025

CAD DWG FILE: C2324-01 DRAWN BY: CHECKED BY: **DESIGNED BY:**

SHEET TITLE: ELECTRICAL **DETAILS**

SHEET NUMBER:

E-201