# REPLACE FIRE ALARM SYSTEM, INFRASTRUCTURE CHILLICOTHE CORRECTIONAL CENTER (Chillicothe, Missouri)



Overland Park, KS 66212 Phone: 816.333.4373 Fax: 913.722.3484

OWNER:

STATE OF MISSOURI MICHAEL L. PARSON,

GOVERNOR

DEPARTMENT OF CORRECTIONS

PROJECT

OFFICE OF ADMINISTRATION

MANAGEMENT: DIVISION OF FAC

DIVISION OF FACILITIES MANAGEMENT,

DESIGN AND CONSTRUCTION

DESIGNER:

FSC Inc

PROJECT NUMBER:

C2326-01


SITE NUMBER: ASSET NUMBER:

7030

9327030038

# CHILLICOTHE CORRECTIONAL CENTER

CHILLICOTHE, MISSOURI

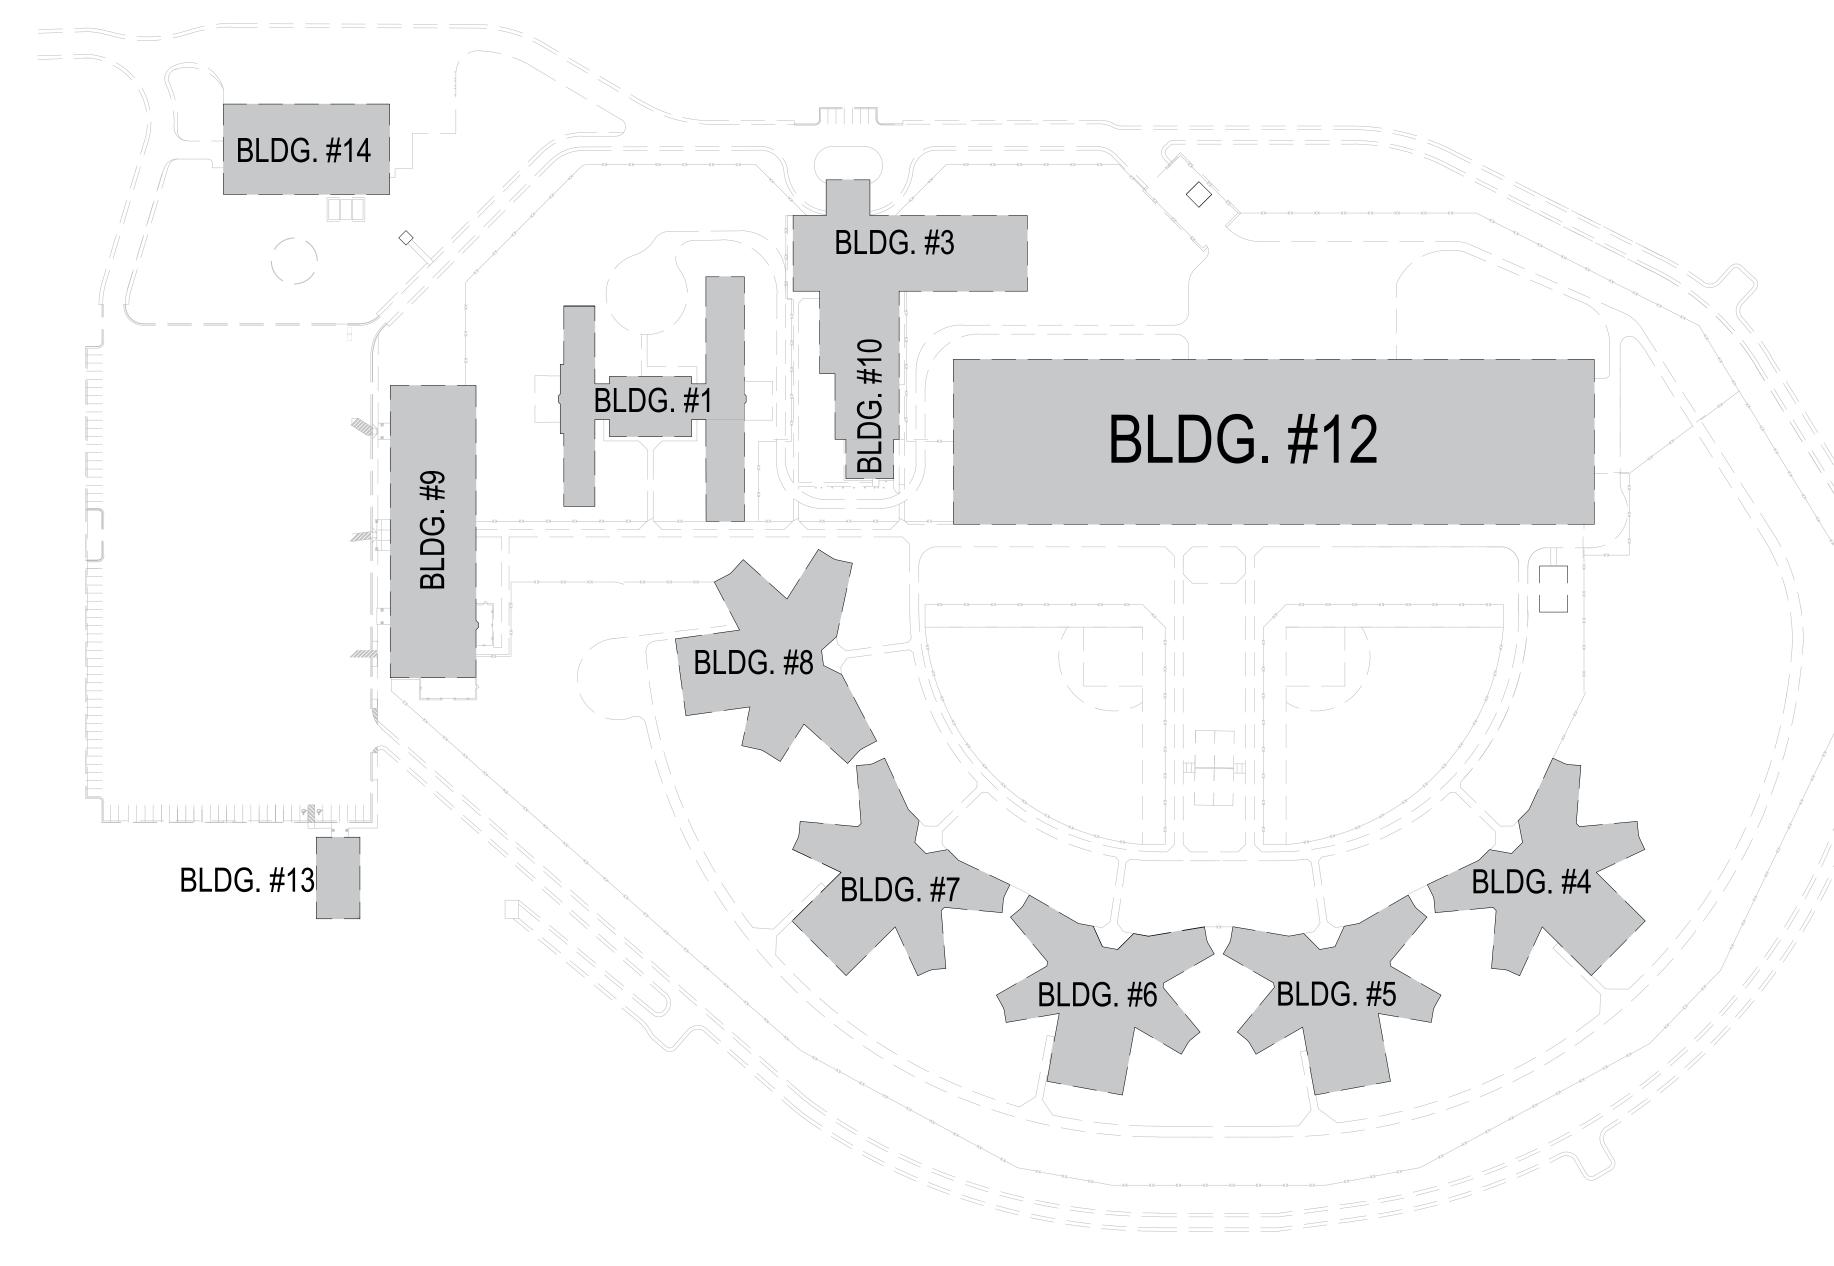

FIRE ALARM SITE PLAN
N.T.S.

NORTH

STATE OF MISSOURI MICHAEL L. PARSON, GOVERNOR



REFER TO FA-002 FOR FIRE ALARM GENERAL

SHEET NUMBER	SHEET NAME
FA-000	COVER SHEET
FA-001	FIRE ALARM SITE PLAN
FA-002	FIRE ALARM GENERAL NOTES, SYMBOLS, & ABBREVIATIONS
FA-003	FIRE ALARM SCHEMATIC DETAILS
FA-100	BUILDING #1 - FIRE ALARM PLAN
FA-200	BUILDING #3 & #10 - FIRE ALARM PLAN
FA-300	BUILDING #4 - #7 - FIRE ALARM PLAN
FA-400	BUILDING #8 - FIRE ALARM PLAN
FA-500	BUILDING #9, #13, & #14 - FIRE ALARM PLAN
FA-600	BUILDING #12 AREA A - FIRE ALARM PLAN
FA-601	BUILDING #12 AREA B - FIRE ALARM PLAN
FA-602	BUILDING #12 AREA C - FIRE ALARM PLAN
FAD-100	BUILDING #1 - FIRE ALARM DEMO PLAN
FAD-200	BUILDING #3 & #10 - FIRE ALARM DEMO PLAN
FAD-300	BUILDING #4 - #7 - FIRE ALARM DEMO PLAN
FAD-400	BUILDING #8 - FIRE ALARM DEMO PLAN
FAD-500	BUILDING #9, #13, & #14 - FIRE ALARM DEMO PLAN
FAD-600	BUILDING #12 AREA A - FIRE ALARM DEMO PLAN
FAD-601	BUILDING #12 AREA B - FIRE ALARM DEMO PLAN
FAD-602	BUILDING #12 AREA C - FIRE ALARM DEMO PLAN
	BUILDING LEGEND

**SHEET INDEX** 

#### BLDG# **BUILDING NAME** ADMINISTRATIVE SEGREGATION & MENTAL HEALTH BUILDING RECEPTION, DIAGNOSTIC & MEDICAL BUILDING HOUSING UNIT #1 **HOUSING UNIT #2** HOUSING UNIT - TREATMENT UNIT HOUSING UNIT - TRANSITIONAL UNIT HOUSING UNIT - STEP DOWN UNIT ADMINISTATION & VISITATION BUILDING 10 RECEPTION, DIAGNOSTIC & MEDICAL BUILDING 12 CENTRAL SERVICES BUILDING STAFF TRAINING BUILDING 13

CENTRAL PLANT / VEHICLE MAINTENANCE / STORAGE

14

15' 0 15 30 1/16"=1'-0"

OFFICE OF ADMINISTRATION DIVISION OF FACILITIES MANAGEMENT, DESIGN AND CONSTRUCTION

REPLACE FIRE ALARM SYSTEM, INFRASTRUCTURE CHILLICOTHE CORRECTIONAL CENTER

3151 LITTON ROAD CHILLICOTHE, MO 64601

PROJECT # C2326-01 SITE # 7030 ASSET # 9327030038


REVISION:
DATE:
REVISION:
DATE:
REVISION:
DATE:
REVISION:
DATE:
ISSUE DATE: 03/29/2024

CAD DWG FILE:C2326-01-FA-SIT-01
DRAWN BY: DB
CHECKED BY: JMA
DESIGNED BY: FSC

SHEET TITLE:

FIRE ALARM SITE PLAN

SHEET NUMBER: FA-001

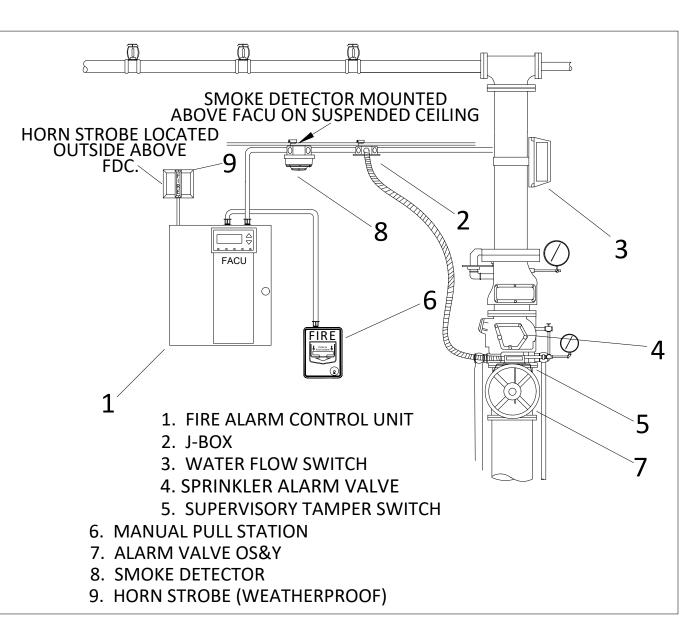

- 1. INSTALLATION CONTRACTOR SHALL MAINTAIN A LEGIBLE AND ACCURATE SET OF AS-BUILT (MARKED-UP) DRAWINGS FOR RECORD DRAWING PURPOSES AND PROVIDE AS-BUILT PLANS TO FSC, INC. TO ALLOW PEOPER RECORD KEEPING BY FSC INC. ENGINEERING DEPARTMENT.
- 2. INSTALLATION CONTRACTOR SHOULD BE FAMILIAR WITH CURRENT STANDARDS OF NFPA 72, NFPA 70, IBC, AND LOCAL CODE REQUIREMENTS. THIS INSTALLATION SHALL BE IN ACCORDANCE WITH THE APPLICABLE CODES, STANDARDS, LOCAL AMENDMENTS AND MANUFACTURER'S SPECIFICATIONS.
- 3. THE INSTALLATION OF THE FIRE ALARM SYSTEM SHALL NOT BEGIN UNTIL THE DRAWINGS HAVE BEEN REVIEWED AND APPROVED BY THE ENGINEER OR RECORD AND THE AUTHORITY HAVING JURISDICTION.
- 4. IT IS THE CONTRACTOR'S RESPONSIBILITY LOCATIONS, DEPTHS, ELEVATIONS, AND SIZES OF THE EXISTING SYSTEMS THAT SHALL BE REPLACED. THE CONTRACTOR SHALL ASSUME SOME DEVIATIONS AND INCLUDE OFFSETS, ADDITIONAL WIRING, ETC. AT THE TIME OF BID. CONTRACTOR SHALL BE AWARE OF THE FULL EXISTING PROJECT CONDITIONS AT TIME OF BID.
- 5. FIRE ALARM SYSTEMS AND NETWORK SHALL BE NON-PROPRIETARY.
- 6. CONTRACTOR SHALL BE RESPONSIBLE FOR PROVIDING ALL CONDUITS, BOXES, ETC. AND FIBER FROM THE FACU TO EACH BUILDING'S FIBER PATCH PANEL.
- 7. CONTRACTOR SHALL BE RESPONSIBLE FOR ALL TERMINATIONS AND PROGRAMMING. INCLUDING FIBER MODULES (SINGLE MODE OR MULTIMODE) AND PROGRAMMING.
- 8. CONTRACTOR SHALL INTERFACE WITH INTERNAL SITE IT SYSTEM TO ESTABLISH ANY ADDRESSES, ETC. TO COMPLETE THE SYSTEM.
- 9. ALL OF CAMPUS BUILDINGS AND FIRE ALARM (FA) SYSTEM STATUS. (SPEC: A MONITOR SHALL BE LOCATED IN THE MAIN GUARD STATION, DEDICATED TO THE FA SYSTEM THAT ALLOWS SECURITY TO MONITOR EACH BUILDING AT A GLANCE. A TROUBLE OR ALARM IN ANY BUILDING OR FACU WILL ACTIVE A NONFICTION ON THE SCREEN AND PROVIDE AUDIBLE NOTIFICATION ( SONALERT OR SIMILAR) THAT THERE IS AN ISSUE AT XX BUILDING.
- 10. THE CONTRACTOR IS RESPONSIBLE FOR CONNECTING AND INTEGRATING ALL FIRE ALARM UNITS INTO THE CAMPUS NETWORK. THE CONTRACTOR SHALL COORDINATE WITH THE STATE'S REPRESENTATIVES TO OBTAIN IP ADDRESSES AND OTHER REQUIRED INFORMATION FOR NETWORK PROGRAMMING. THE CONTRACTOR SHALL PROGRAM OR ENGAGE A SUBCONTRACTOR TO PROGRAM THE CAMPUS NETWORK SO ALL NEW FACPS REPORT THE MAIN FACU THAT IS TO BE LOCATED IN THE ADMINISTRATIVE BUILDING'S MAIN SECURITY OFFICE WHERE INDICATED ON THE
- 11. ENGAGE SPRINKLER CONTRACTOR AS NECESSARY TO REPLACE SPRINKLER MONITORING EQUIPMENT.
- 12. AC POWER FOR ALL FIRE ALARM CONTROL PANELS SHALL BE 120VAC, 50/60 HZ, 20 AMPS. WIRE SHALL BE MINIMUM 12 AWG WITH 600V INSULATION.
- 13. THE LOCATION OF THE DEDICATED BRANCH CIRCUIT DISCONNECTING MEANS SHALL BE PERMANENTLY IDENTIFIED AT THE CONTROL UNIT.
- 14. 120VAC CIRCUITS SHALL BE RUN IN SEPARATE CONDUIT
- 15. ALL NON-POWER LIMITED WIRING SHALL HAVE A MINIMUM OF A 1/4" SEPARATION FROM POWER LIMITED WIRING.
- 16. ALL WIRING AND/OR CABLES SHALL BE ROUTED IN CONDUIT AND FIRE ALARM RATED

- 17. TEE-TAPPING IS ONLY PERMISSIBLE ON CLASS 'B' SLC CIRCUITS.
- 18. ALL FIRE ALARM DEVICES AND WIRING SHALL BE PROPERLY LABELED WITH DEVICE AND WIRING IDENTIFICATION. RECOMMEND LABELING ALL DEVICES WITH A GOOD LABEL MAKER PRODUCT.
- 19. A BREAKER LOCK SHOULD BE INSTALLED AT THE ELECTRICAL PANEL ON THE BRANCH CIRCUIT FEEDING ANY FIRE ALARM PANEL. MUST BE IDENTIFIED BY RED AND LABELED AS SERVING THE FIRE ALARM SYSTEM.
- 20. SET STROBES TO CANDELA NOTED ON PLAN SHEET.
- 21. REFER TO DEVICE INSTALLATION SHEETS FOR BACK BOX REQUIREMENTS.
- 22. REFER TO DEVICE INSTALLATION SHEETS FOR REQUIREMENTS ON INSTALLING ALL EQUIPMENT.
- 23. ALL CIRCUITS SHALL BE IDENTIFIED AT TERMINAL AND JUNCTION LOCATIONS WHICH WILL HELP PREVENT UNINTENTIONAL SIGNALS TO OCCUR ON THE SYSTEM.
- 24. ALL WIRING CIRCUITS TO BE CHECKED FOR PROPER ELRD (END OF LINE RESISTOR DEVICE) READINGS. ALL GROUND FAULTS AND AND SHORTS SHALL BE ELIMINATED PRIOR TO FINAL ACCEPTANCE TESTING.
- 25. INTEGRITY OF CIRCUIT SHALL BE TESTED TO VERIFY THAT WHEN THE SYSTEM IS IN AN ENERGIZED STATE THE SYSTEM WILL FUNCTION PROPERLY.
- 26. ANY MODIFICATION MADE TO THE DEVICE LAYOUT, WIRING LAYOUT OR CONFIGURATION OF WIRING TO NOTIFICATION OR INITIATING DEVICES SHALL BE REVIEWED AND APPROVED BY AN FSC, INC. REPRESENTATIVE WHOSE DIRECT RESPONSIBILITY INCLUDES DESIGN AND ENGINEERING.
- 27. SMOKE DETECTORS SHALL NOT BE LOCATED IN A DIRECT AIR FLOW OR CLOSER THAN 3 FEET FROM AN AIR SUPPLY DIFFUSER OR RETURN AIR OPENING. SMOKE DETECTORS SHOULD BE LOCATED FARTHER AWAY FROM HIGH VELOCITY AIR SUPPLIES.
- 28. SMOKE DETECTORS SHALL BE SPACED AS INDICATED ON THE DRAWINGS AND FOLLOW THE SPACING REQUIREMENTS SPECIFIED IN NFPA 72. ANY CHANGES IN SMOKE DETECTOR LAYOUT DUE TO OBSTRUCTIONS IN THE CEILING SHALL BE REVIEWED AND APPROVED BY AN FSC, INC. REPRESENTATIVE WHOSE DIRECT RESPONSIBILITY INCLUDES DESIGN AND ENGINEERING.
- 29. FIRE SPRINKLER WATER FLOW AND VALVE TAMPER SWITCHES SHALL BE MONITORED BY THE FIRE ALARM SYSTEM (IF APPLICABLE).
- 30. AIR HANDLER UNITS THAT ARE GREATER THAN 2000 CFM SHALL BE EQUIPPED WITH A DUCT SMOKE DETECTOR IN THE RETURN DUCT. VERIFY LOCATION IN FIELD.
- 31.NOTIFICATION APPLIANCE CIRCUITS ARE TO BE 14AWG 2 CONDUCTOR SOLID FPLR, FPLP, OR THHN WITH A MIMIMUM OF 19 STRANDS AS REQUIRED. THHN WIRE MUST BE INSTALLED IN CONDUIT.
- 32.SIGNALING LINE CIRCUITS ARE TO BE 18AWG 2 CONDUCTOR SOLID FPLR, FPLP (PLENUM RATED) CABLE OR 16AWG OR 18AWG THHN WIRE (MUST BE 7 STRAND OR LESS) AS REQUIRED. THHN WIRE MUST BE INSTALLED IN CONDUIT.
- 33.AUDIO CIRCUITS ARE TO BE 14AWG 2 CONDUCTOR SOLID SHIELDED TWISTED PAIR FPLR OR FPLP (PLENUM RATED) AS REQUIRED.

- ARTICLE 760 OF NFPA 70 NATIONAL ELECTRICAL CODE.
- 37.PLENUM RATED CABLE MUST BE INSTALLED IN ALL PLENUM AREAS. MORE THAN ONE FLOOR.
- 38.INPUT MODULE END OF LINE RESISTORS ARE BY MANUFACTURER
- 39.NOTIFICATION APPLIANCE END OF LINE RESISTORS ARE BY MANUFACTURER INSTRUCTIONS. WHERE POSSIBLE, ALWAYS USE NOT AVAILABLE, USE RESISTOR COLOR CODE TO SELECT THE PROPER RESISTOR, MATCHING VALUES TO OEM SUPPLIED RESISTOR.
- BOTTOM OF THE BOX.

41. WALL MOUNT NOTIFICATION DEVICES SHALL BE INSTALLED AT 80" A.F.F. TO THE

- GREATER THAN 48" TO THE OPERATING MECHANISM.
- 43. WHERE (2) OR MORE STROBES ARE VISIBLE THEY WILL BE SYNCHRONIZED.

- 46. CONTRACTOR SHALL COORDINATE WITH ALL OTHER MEP TRADES MOUNTING OF FIRE ALARM DEVICES.
- MISSOURI IN THE FORM OF AS BUILT DRAWINGS. IT IS THE CONTRACTOR'S RESPONSIBILITY TO VERIFY EXISTING WIRING.
- 50. DESIGN IS IN ACCORDANCE WITH CODES AND STANDARDS LISTED AND THE AHJ OF THE STATE OF MISSOURI.
- FIRE ALARM SYSTEMS

- 34.DO NOT "T-TAP" NOPTIFICATION APPLIANCE CIRCUIT WIRING.
- 35.LIMIT NOTIFICATION APPLIANCE CIRCUIT WIRING TO THE SHORTEST POSSIBLE DISTANCE TO ACHIEVE CIRCUIT OPERATION.
- 36.ALL FIRE ALARM CABLE IS TO BE INSTALLED IN ACCORDANCE WITH
- RISERS NOT IN CONDUIT MUST USE FPLP CABLE WHEN PENETRATING
- INSTRUCTIONS.
- OEM SUPPLIED RESISTORS. WHERE OEM SUPPLIED RESISTORS ARE
- 40. A SMOKE DETECTOR SHALL BE PROVIDED ABOVE ALL FIRE ALARM CONTROL UNITS.
- 42. MANUAL PULL STATIONS SHALL BE INSTALLED AT A MINIMUN 42" A.F.F. AND NOT
- 44. ALL NEW REQUIRED CABLING SHALL HAVE INDEPENDENT SUPPORTS.
- 45. PROVIDE AUDIBILITY SOUND LEVEL OF 70 dBA THROUGHOUT THE AREA OF WORK.
- (MECHANICAL/ELECTRICAL/PLUMBING) FOR EXACT LOCATION OF CEILING / WALL
- 47. IT IS THE CONTRACTOR'S RESPONSIBILITY TO CONFIRM SPACES FOR SUSPENDED CEILINGS, DETECTORS ABOVE SUSPENDED CEILINGS SHALL CONFORM TO NFPA 72.
- 48. EXISTING WIRING SHOWN IN THE DRAWINGS WAS PROVIDED BY THE STATE OF
- 49. FSC, INC. SHALL BE NOTIFIED OF COMMISSIONING OF THE SYSTEM AND SHALL BE PROVIDED ALL DOCUMENTATION WITH RESPECT TO SYSTEM COMMISSIONING AND AHJ ACCEPTANCE.
- NFPA 72 NATIONAL FIRE ALARM AND SIGNALING CODE 2022 UL STANDARD 864 - STANDARD FOR CONTROL UNITS AND ACCESSORIES FOR
- UL STANDARD 268 STANDARD FOR SMOKE DETECTORS FOR FIRE ALARM SYSTEMS NEC 70 - NATIONAL ELECTRICAL CODE

#### FIRE ALARM SYMBOL **LEGEND** SYMBOL DESCRIPTION ADDRESSABLE FIRE ALARM CONTROL PANEL **FACU** 12V 7AH BATTERY NAC INTELLIGENT NOTIFICATION POWER SUPPLY

FIRE ALARM REMOTE EXTENDER PANEL

VIDEO DISPLAY UNIT WITH LCD MONITOR,

ADDRESSABLE CARBON MONOXIDE DETECTOR

FIRE ALARM ANNUNCIATOR

KEYBOARD, AND PRINTER

MANUAL PULL STATION

DUCT SMOKE DETECTOR

REMOTE TEST STATION

FIRE ALARM JUNCTION BOX

FIRE ALARM HORN STROBE

FIRE ALARM WATERFLOW BELL

FIRE ALARM

ABBREVIATIONS LEGEND

EXISTING DEVICE

END OF LINE

DESCRIPTION

BUILDING AUTOMATION SYSTEM

RELOCATION OF EXISTING DEVICE

CEILING MOUNTED DEVICE

PULL STATION COVER

LOW FREQUENCY

SOUNDER BASE

ROOF TOP UNIT

HIGH TEMPERATURE

AIR HANDLING UNIT

NOT IN CONTRACT

**UNLESS NOTED OTHERWISE** 

HIGH VOLUME LOW SPEED

ABOVE FINISHED FLOOR

SIGNALING LINE CIRCUIT

SERIAL BUS

VOICE BUS

NOT TO SCALE

END OF LINE

WIRE GUARD

UNDERGROUND

REMOTE DISPLAY

SPEAKER CIRCUIT **AUXILIARY POWER** 

HIGH VOLTAGE AIR CONDITIONER

NOTIFICATION APPLIANCE CIRCUIT

FIRE DEPARTMENT CONNECTION

ALTERNATING CURRENT VOLTAGE

DIRECT CURRENT VOLTAGE

ELECTRICAL METALLIC TUBING

WEATHERPROOF DEVICE

EXPLOSION PROOF DEVICE

DECIBLE (UNIT FOR SOUND PRESSURE)

TRANSIENT VOLTAGE SURGE SURPRESSOR

CONTROL MODULE

FIRE ALARM STROBE

FIRE ALARM HORN

FIRE SPRINKLER RISER

WATERFLOW SWITCH

TAMPER SWITCH

 $\times \# Y$  X: NO.OF WIRES, Y: AWG. SIZE

END OF LINE RESISTOR

ABBREVIATION

EX

BAS

WG

PC

WP

EP

LF

SB

HT

AHU

RTU

FIRE ALARM DOCUMENT BOX

ADDRESSABLE SMOKE DETECTOR

ADDRESSABLE SMOKE DETECTOR

ADDRESSABLE HEAT DETECTOR

DUEL OR SINGLE INPUT MODULE(S)

ANN

PAD

DBOX

**(S)** 

(co)

(§)<

(D)

CM



STATE OF MISSOURI

MICHAEL L. PARSON, **GOVERNOR** 

REFER TO FA-002 FOR FIRE ALARM GENERAL NOTES, SYMBOLS, & ABBREVIATIONS.



**OFFICE OF ADMINISTRATION DIVISION OF FACILITIES** MANAGEMENT, DESIGN AND CONSTRUCTION

REPLACE FIRE ALARM SYSTEM. INFRASTRUCTURE **CHILLICOTHE** 

3151 LITTON ROAD CHILLICOTHE, MO 64601

CORRECTIONAL CENTER

PROJECT # C2326-01 7030 SITE# 9327030038 ASSET#

REVISION:
DATE:
REVISION:
DATE:
REVISION:
DATE:


ISSUE DATE: 03/29/2024


CAD DWG FILE:C2326-01-FA-G-03 DRAWN BY: DB CHECKED BY: JMA DESIGNED BY: FSC

SHEET TITLE:

FIRE ALARM GENERAL NOTES, SYMBOLS, & **ABBREVIATIONS** 

SHEET NUMBER: FA-002

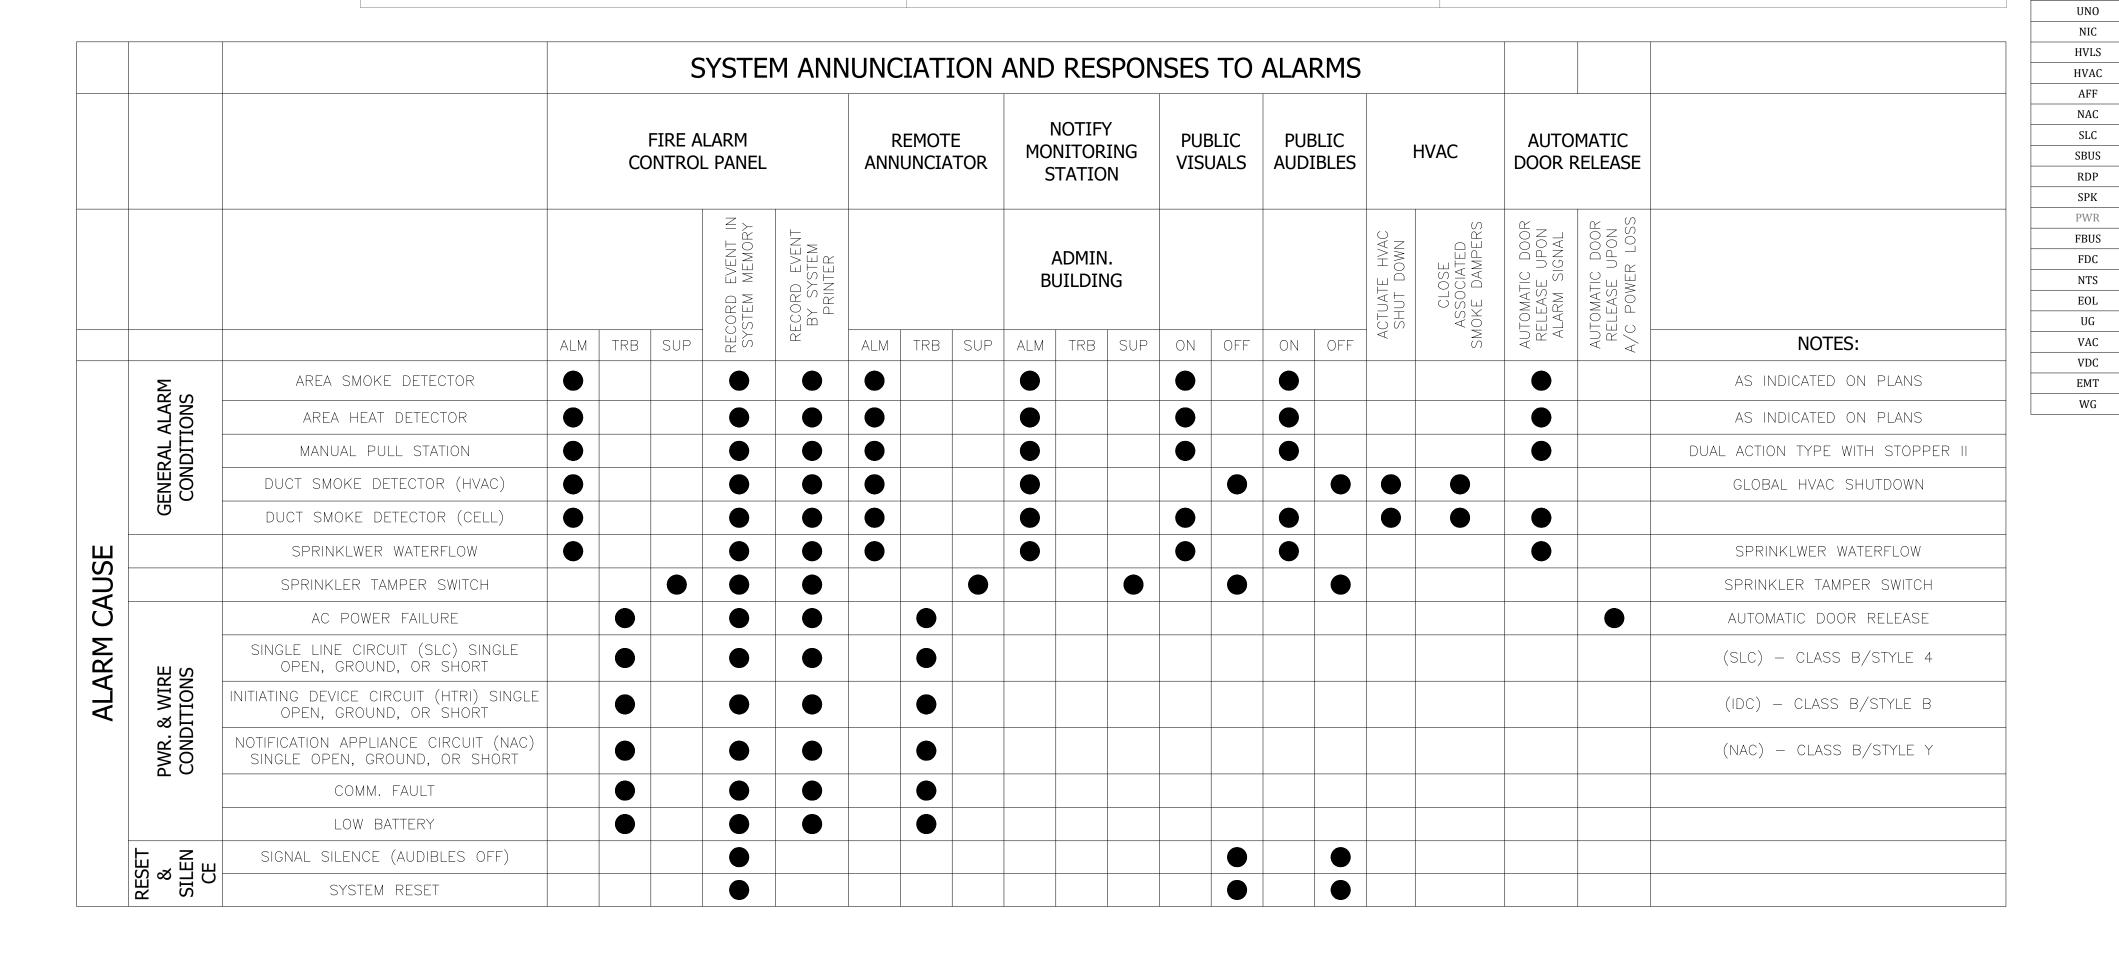


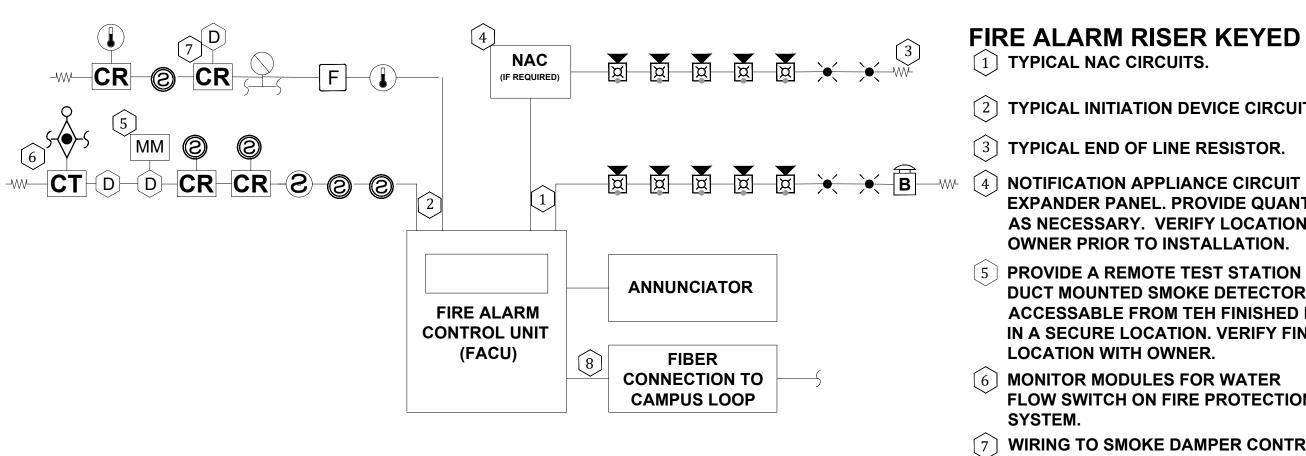

TYPICAL\_FIRE\_ALARM\_RISER\_DIAGRAM

#### FIRE ALARM RISER KEYED NOTES

- 1 TYPICAL NAC CIRCUITS.
- (2) TYPICAL INITIATION DEVICE CIRCUITS.
- (3) TYPICAL END OF LINE RESISTOR.
- EXPANDER PANEL. PROVIDE QUANTITY AS NECESSARY. VERIFY LOCATION WITH OWNER PRIOR TO INSTALLATION.
- 5 PROVIDE A REMOTE TEST STATION FOR **DUCT MOUNTED SMOKE DETECTORS NOT** ACCESSABLE FROM TEH FINISHED FLOOR IN A SECURE LOCATION. VERIFY FINAL LOCATION WITH OWNER.
- 6 MONITOR MODULES FOR WATER FLOW SWITCH ON FIRE PROTECTION SYSTEM.
- (7) WIRING TO SMOKE DAMPER CONTROL.
- (8) CONNECT FACP TO FIBER BACKBONE OF CAMPUS NETWORK AT LOCATION PROVIDED WITHIN BUILDING.

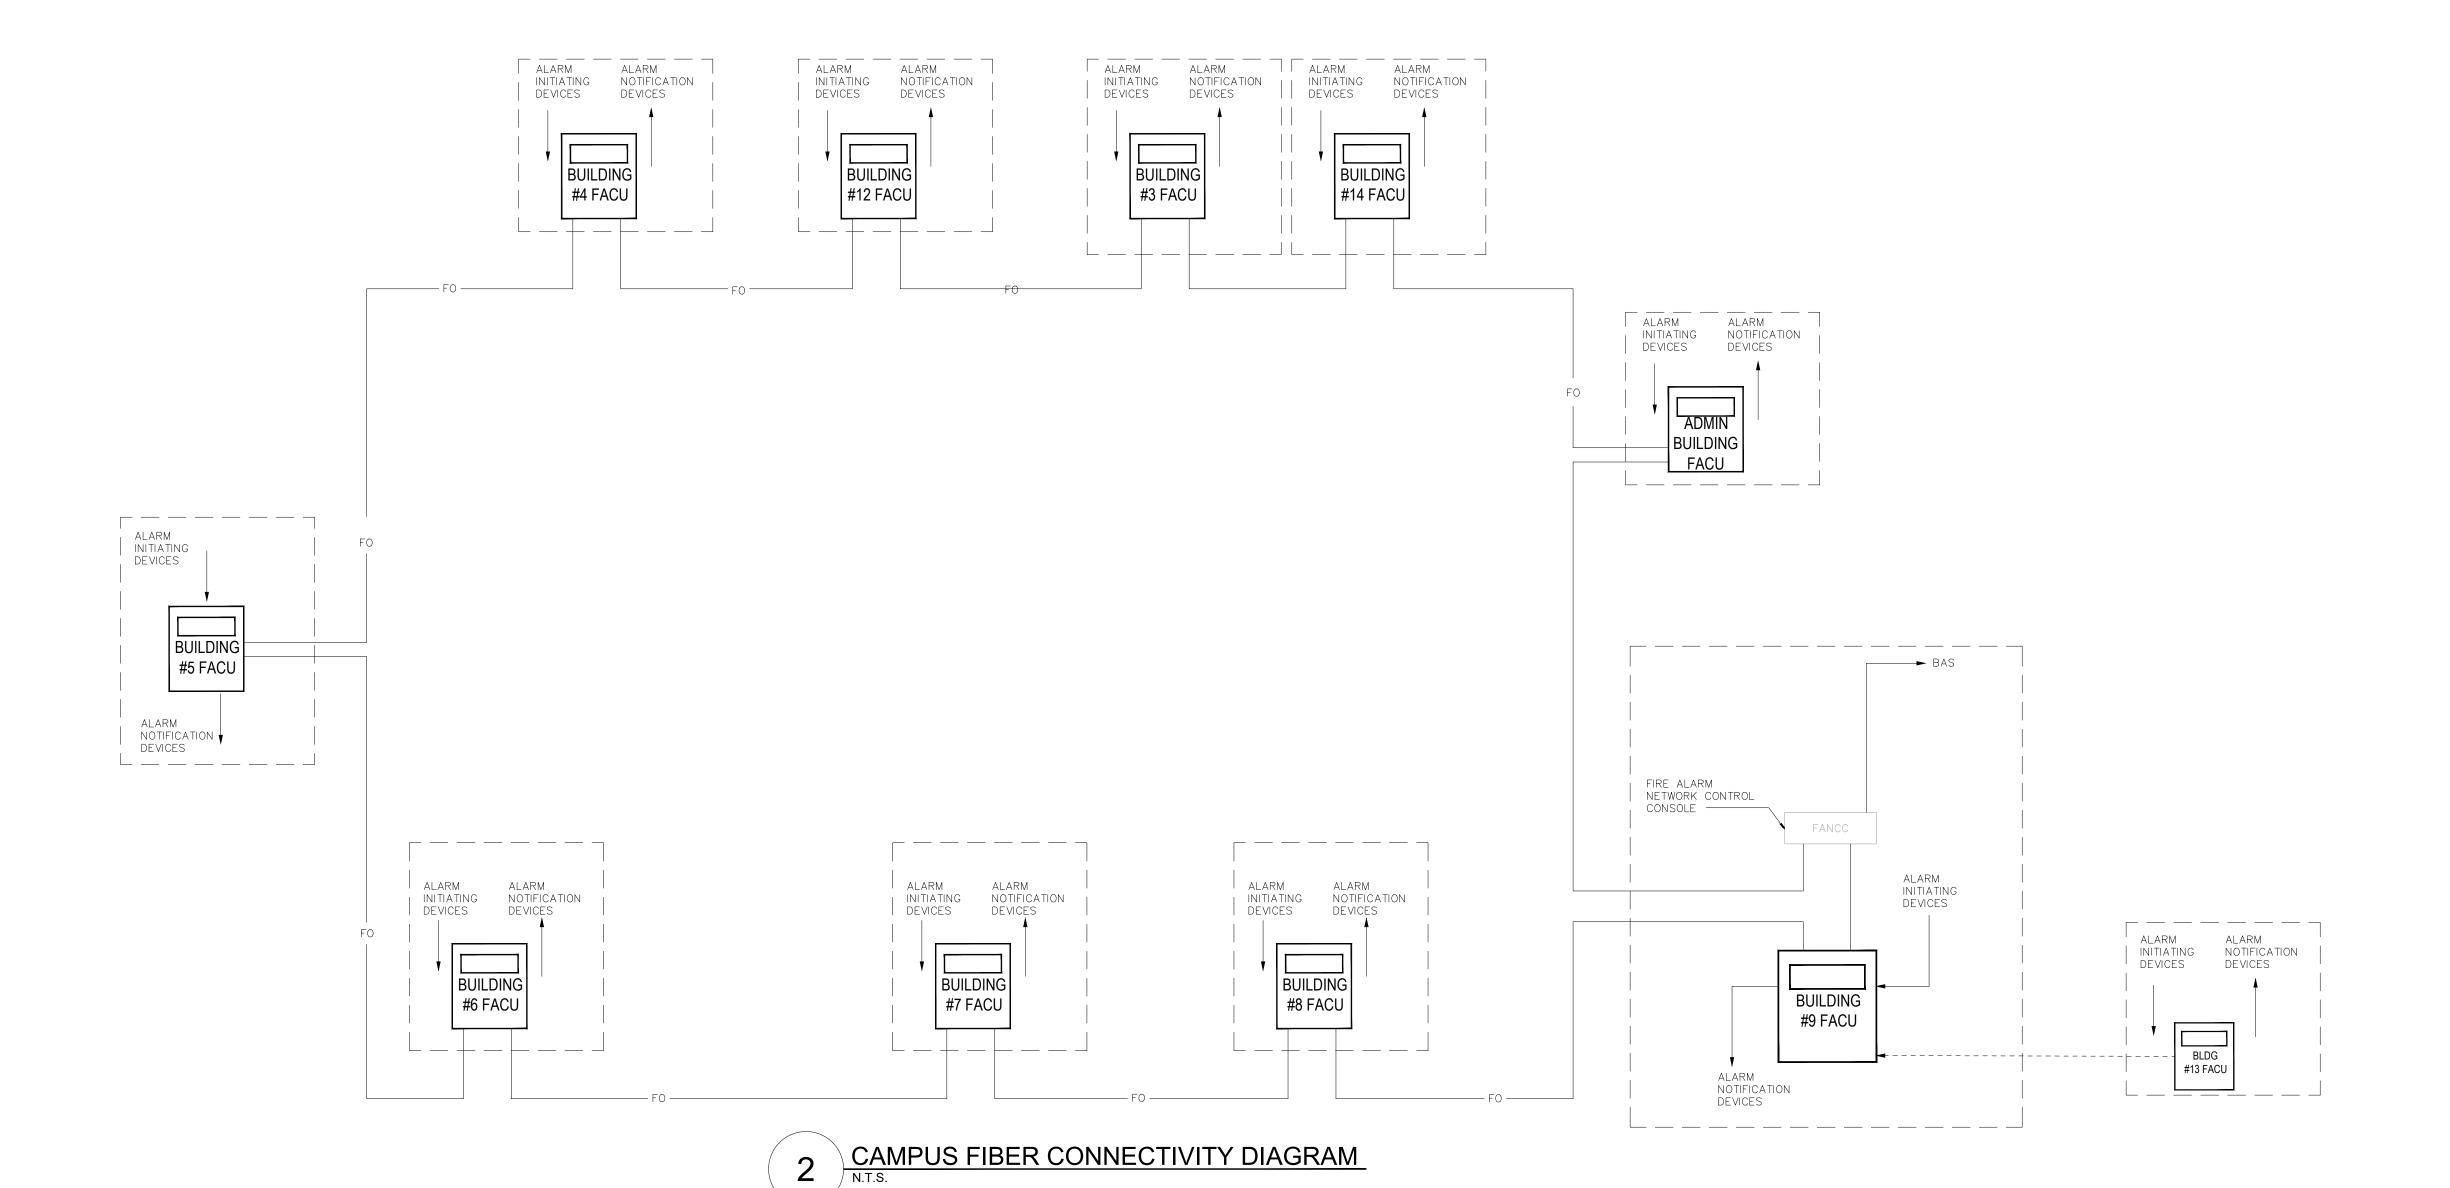

**GOVERNOR** 



STATE OF MISSOURI MICHAEL L. PARSON,

REFER TO FA-002 FOR FIRE ALARM GENERAL NOTES, SYMBOLS, & ABBREVIATIONS.



OFFICE OF ADMINISTRATION DIVISION OF FACILITIES MANAGEMENT, **DESIGN AND CONSTRUCTION** 

REPLACE FIRE ALARM SYSTEM, INFRASTRUCTURE **CHILLICOTHE** CORRECTIONAL CENTER

3151 LITTON ROAD CHILLICOTHE, MO 64601

PROJECT # C2326-01 7030 ASSET# 9327030038


**REVISION:** DATE: **REVISION:** DATE: **REVISION:** DATE: ISSUE DATE: 03/29/2024

CAD DWG FILE: C2326-01-FA-G-04
DRAWN BY: DB
CHECKED BY: JMA

DESIGNED BY: FSC SHEET TITLE: FIRE ALARM

SCHEMATIC DETAILS

SHEET NUMBER: FA-003

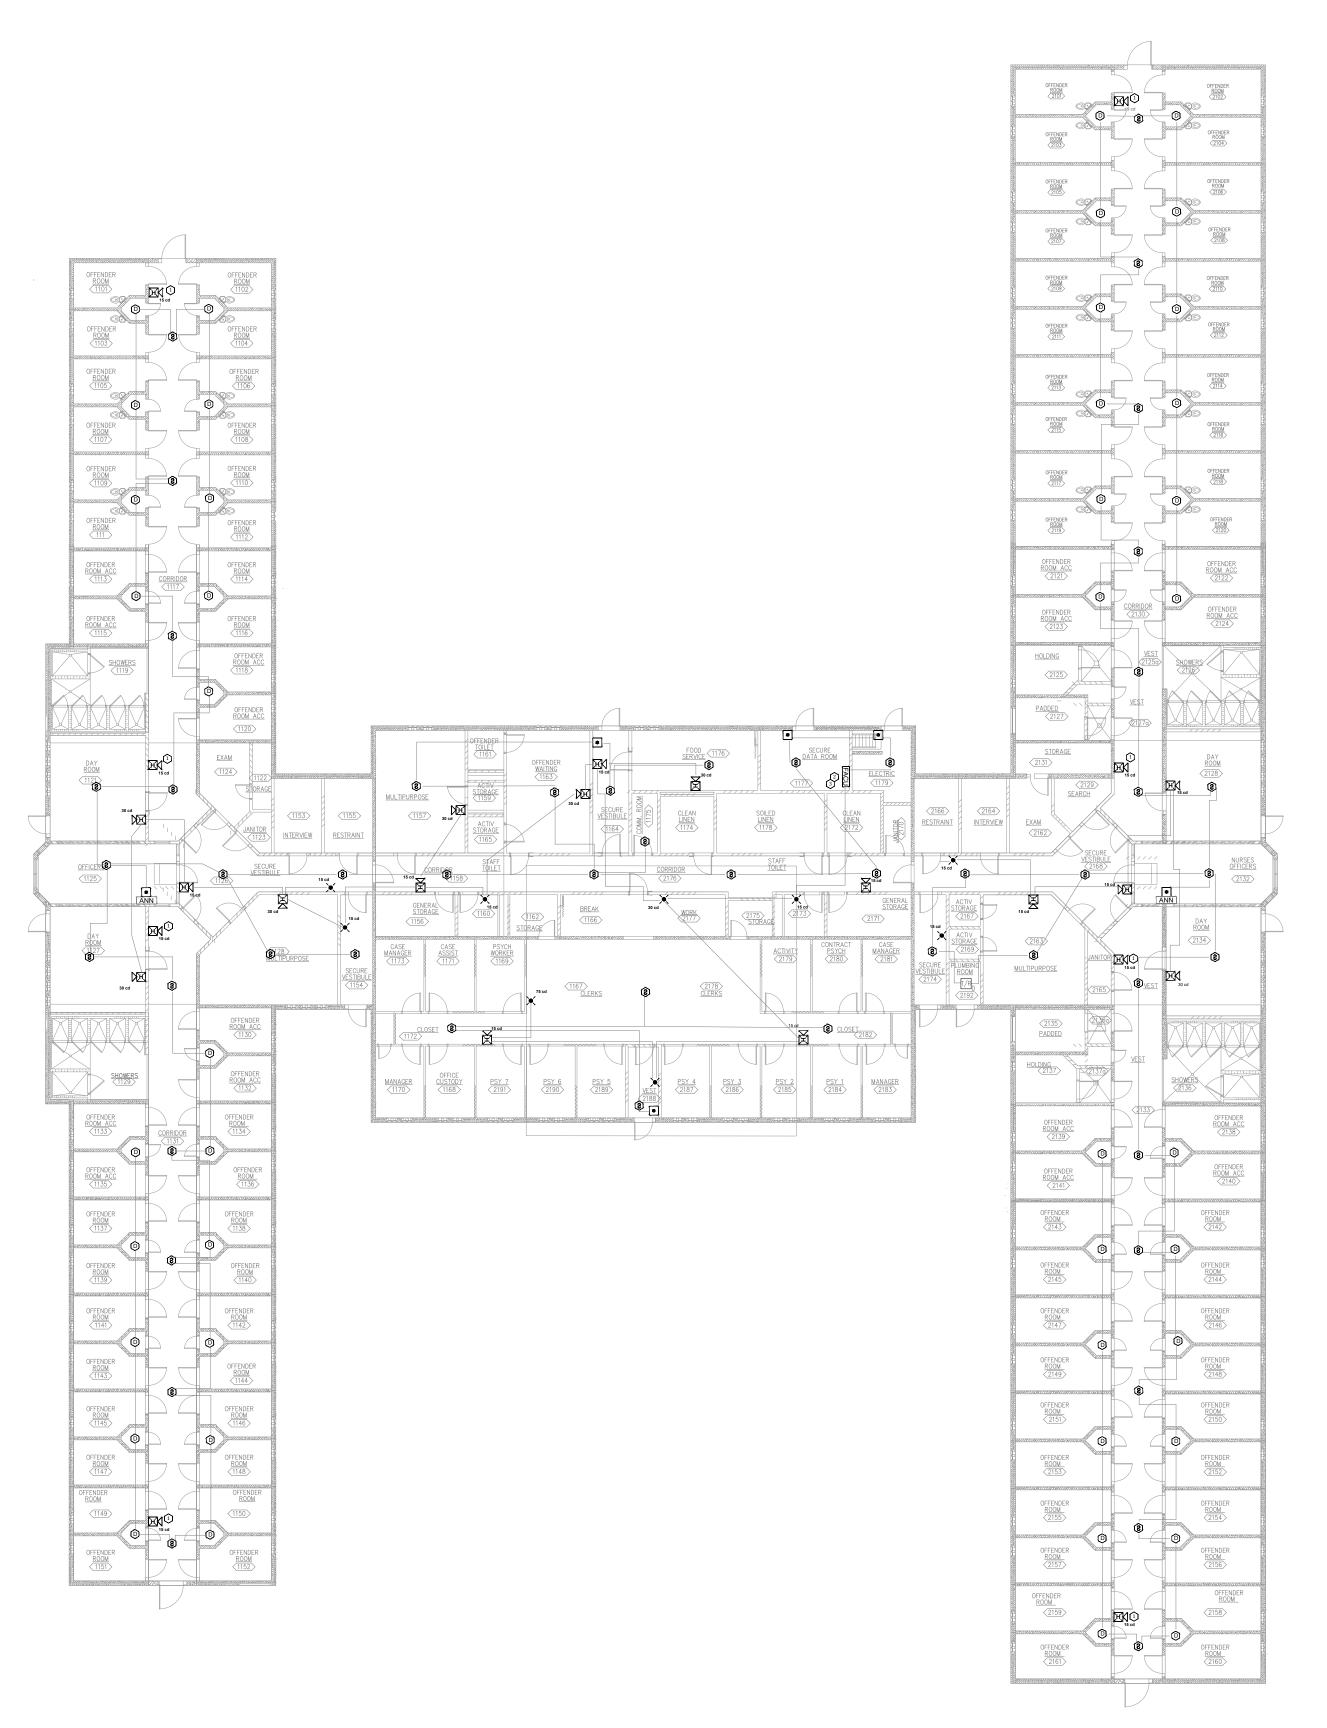

1 BUILDING #1 - FIRE ALARM PLAN
SCALE: 1/16" = 1'-0"



# **KEY NOTES**

- ADDED NOTIFICATION APPLIANCE TO MEET THE REQUIREMENTS OF NFPA 72
- FIRE ALARM CONTROL UNIT. TIE INTO CAMPUS FIBER NETWORK TO REPORT BACK TO ADMIN FACU.
- FIELD VERIFY EQUIPMENT BEING MONITORED AND/OR CONTROLLED BY THE FIRE ALARM SYSTEM. COORDINATE EXISTING CONDITIONS WITH OWNER FACILITIES MANAGEMENT.

#### STATE OF MISSOURI MICHAEL L. PARSON, GOVERNOR



EFER TO FA-002 FOR FIRE ALARM GENERAL



OFFICE OF ADMINISTRATION DIVISION OF FACILITIES MANAGEMENT, DESIGN AND CONSTRUCTION

REPLACE FIRE ALARM
SYSTEM,
INFRASTRUCTURE
CHILLICOTHE
CORRECTIONAL CENTER

3151 LITTON ROAD CHILLICOTHE, MO 64601

PROJECT # C2326-01 SITE # 7030 ASSET # 9327030038


REVISION:	
DATE:	
REVISION:	
DATE:	
REVISION:	
DATE:	
ISSUE DATE: 03/2	29/2024


CAD DWG FILE: C2326-01-FA-FP-105
DRAWN BY: DB
CHECKED BY: JMA
DESIGNED BY: FSC


SHEET TITLE:

BUILDING #1 - FIRE ALARM PLAN

SHEET NUMBER: FA-100

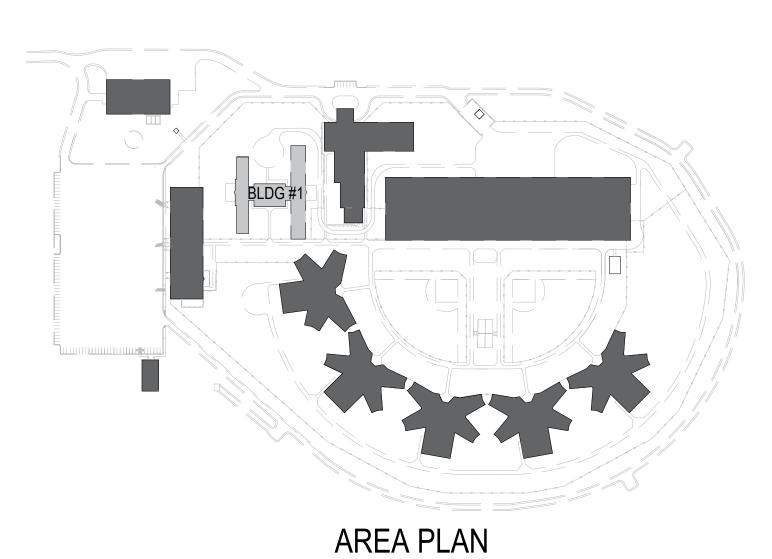

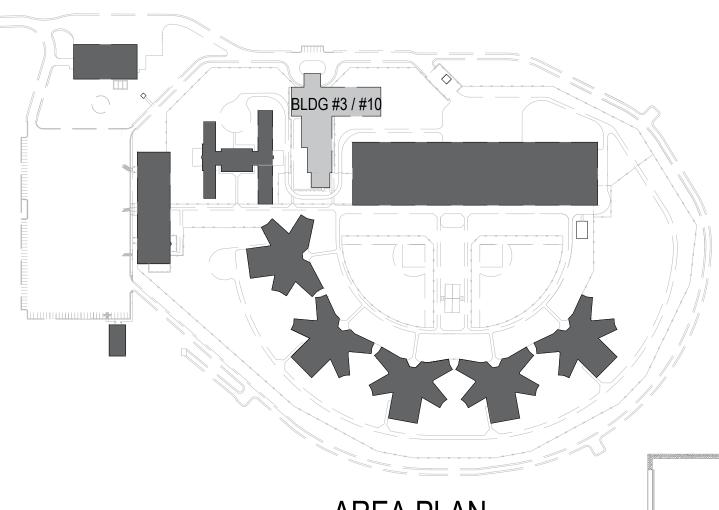


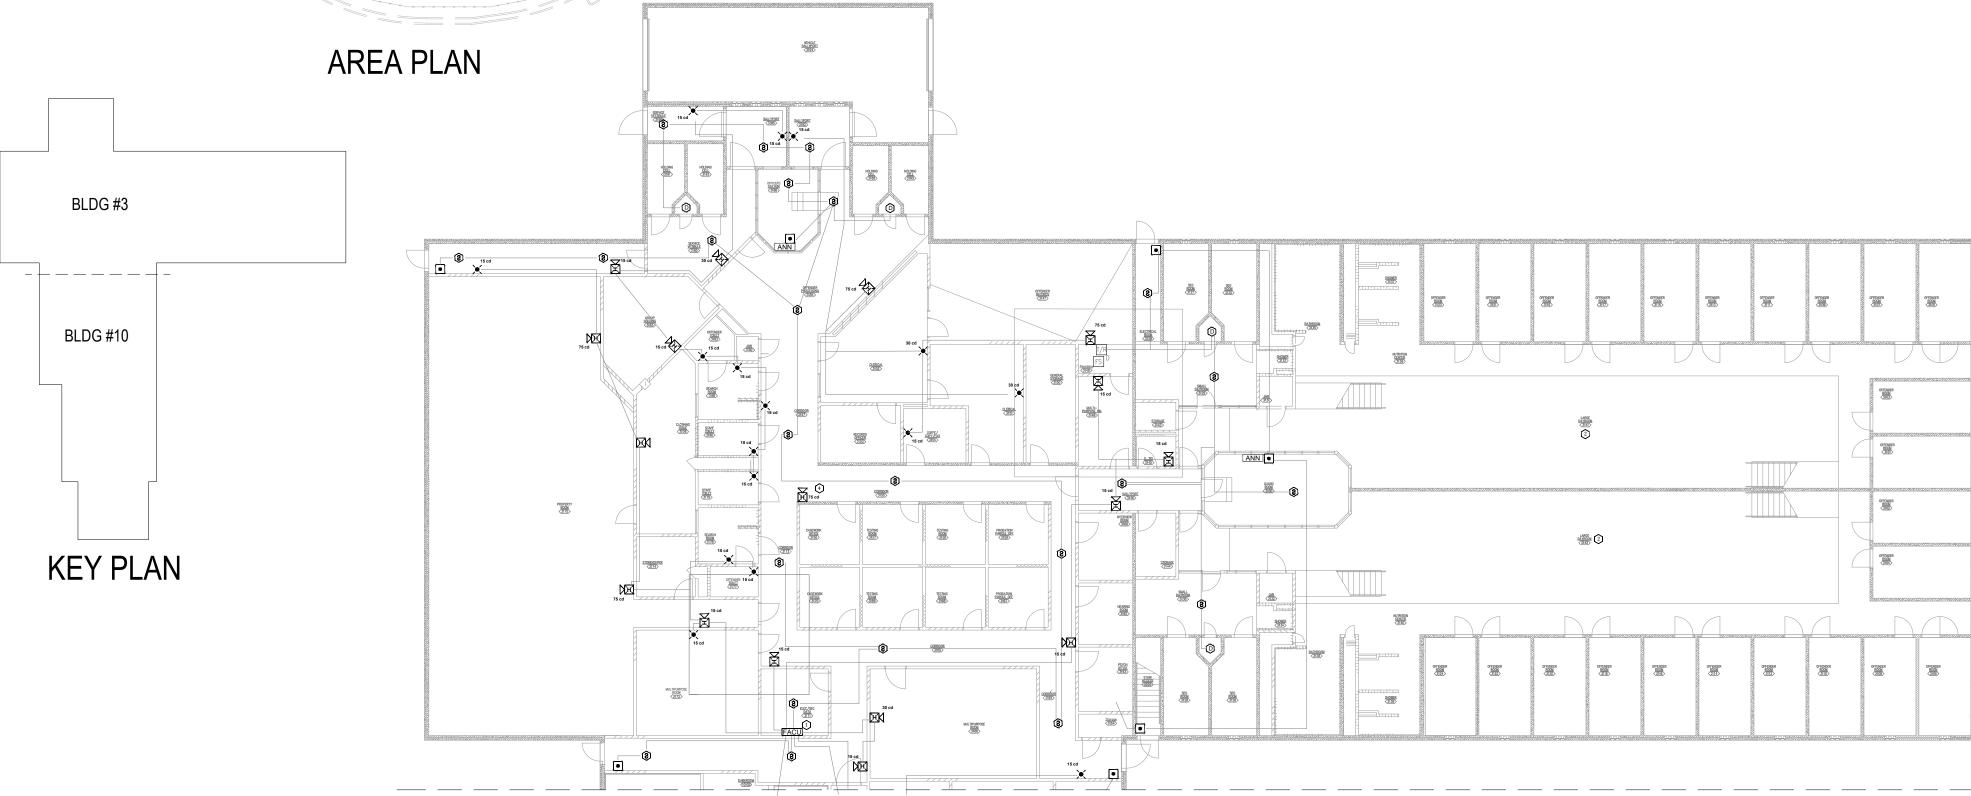

**REFER TO FA200 DETAIL 3** 

1 BUILDING #3 - FIRE ALARM FIRST FLOOR PLAN

SCALE: 1/16" = 1'-0"

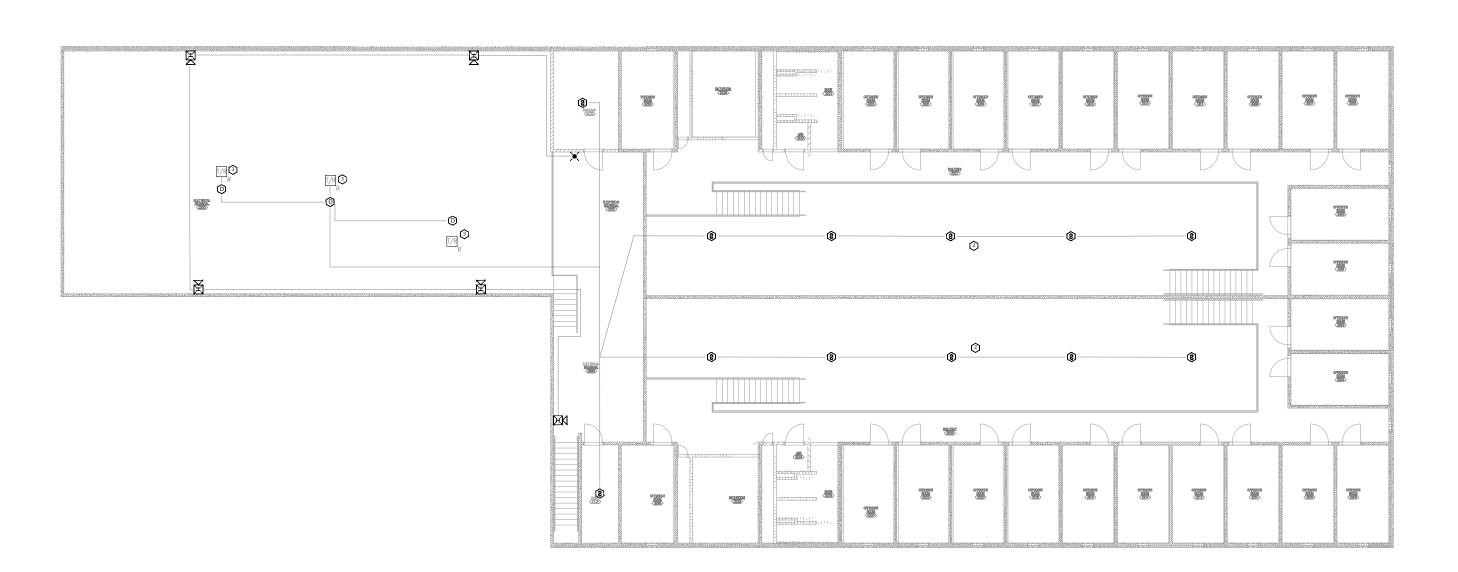


BUILDING #3 - FIRE ALARM SECOND FLOOR PLAN

SCALE: 1/16" = 1'-0"

# **KEY NOTES**

- 1 FIRE ALARM CONTROL UNIT. TIE INTO CAMPUS FIBER NETWORK TO REPORT BACK TO ADMIN FACU.
- NOTIFICATION NOT PRESENT IN THIS AREA PER NFPA 72
  SECTION 18.6 VISUAL NOTIFICATION IN PRIVATE MODE SHALL BE
  SUFFICIENT TO MEET THE INTENT OF THE USER. AREA IS UNDER
  SURVEILLANCE 24/7 WITH TRANIED STAFF TO EVACUATE OCCUPANT
  IF NEEDED. STAFF WILL BE NOTIFIED VIA ANNUNCIATOR AT THE 24/7
  MANNED STATION.
- FIELD VERIFY EQUIPMENT BEING MONITORED AND/OR CONTROLLED BY THE FIRE ALARM SYSTEM. COORDINATE EXISTING CONDITIONS WITH OWNER FACILITIES MANAGEMENT.
- 4 ADDED DETECTION APPLIANCE TO MEET THE REQUIREMENTS OF NFPA 72

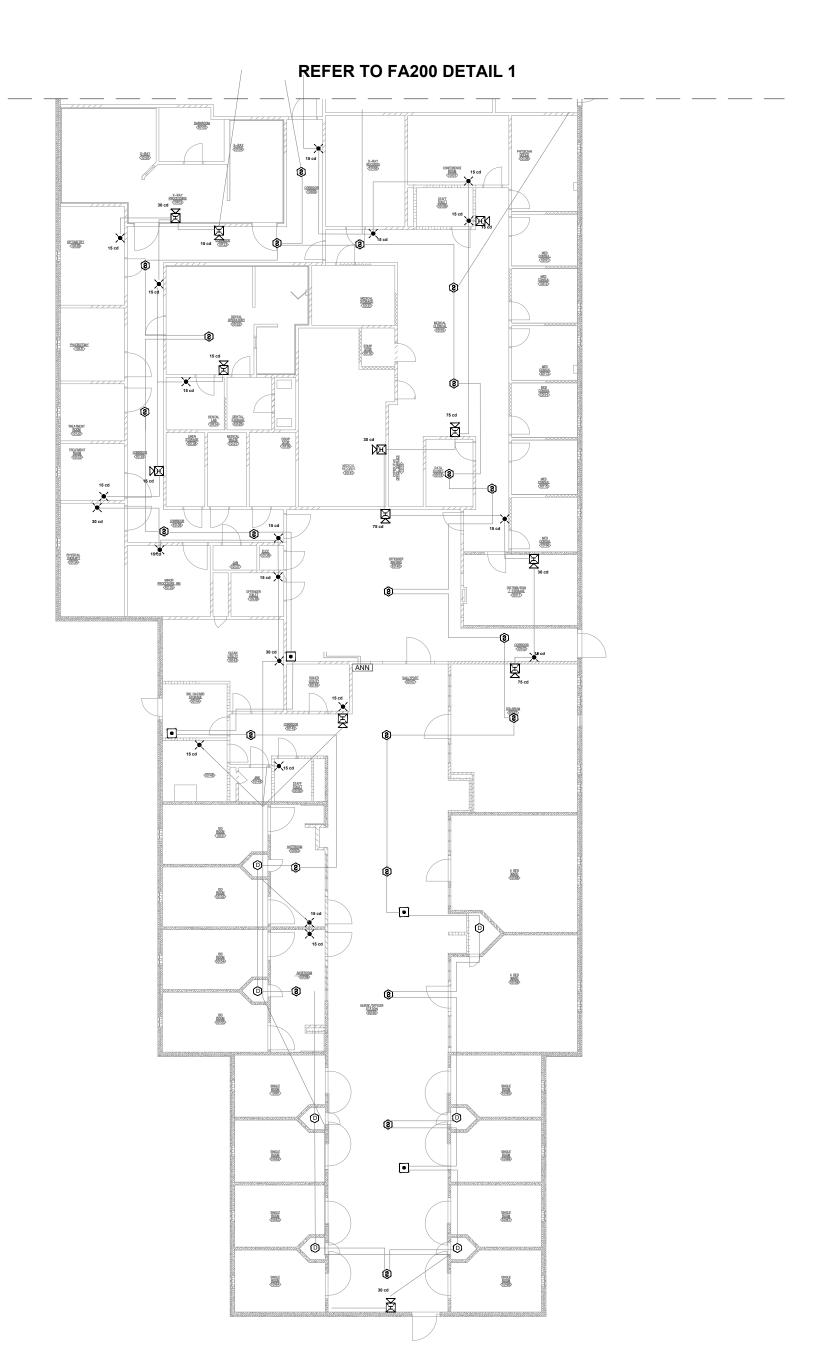

STATE OF MISSOURI MICHAEL L. PARSON, GOVERNOR



REFER TO FA-002 FOR FIRE ALARM GENERAL NOTES, SYMBOLS, & ABBREVIATIONS.



OFFICE OF ADMINISTRATION DIVISION OF FACILITIES MANAGEMENT, DESIGN AND CONSTRUCTION

REPLACE FIRE ALARM
SYSTEM,
INFRASTRUCTURE
CHILLICOTHE
CORRECTIONAL CENTER

3151 LITTON ROAD CHILLICOTHE, MO 64601

PROJECT # C2326-01 SITE # 7030 ASSET # 9327030038

REVISION:
DATE:
REVISION:
DATE:
REVISION:
DATE:
ISSUE DATE: 03/29/2024

CAD DWG FILE: C2326-01-FA-FP-106
DRAWN BY: DB
CHECKED BY: JMA
DESIGNED BY: FSC


SHEET TITLE:

BUILDINGS #3 & #10 -FIRE ALARM PLAN


SHEET NUMBER: FA-200

6 OF 20 SHEETS

NORTH

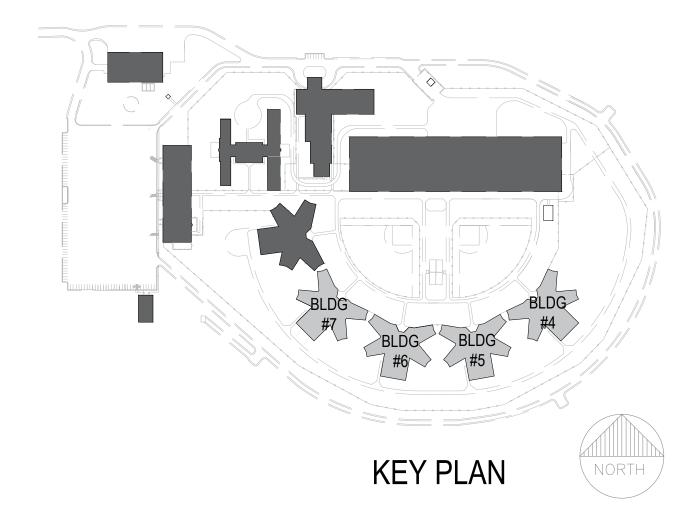

- 1 FIRE ALARM CONTROL UNIT. TIE INTO CAMPUS FIBER NETWORK TO REPORT BACK TO ADMIN FACU.
- 2 NOTIFICATION NOT PRESENT IN THIS AREA PER NFPA 72 SURVEILLANCE 24/7 WITH TRANIED STAFF TO EVACUATE OCCUPANTS IF NEEDED. STAFF WILL BE NOTIFIED VIA ANNUNCIATOR AT THE 24/7 MANNED STATION.
- 3 FIELD VERIFY EQUIPMENT BEING MONITORED AND/OR CONTROLLED BY THE FIRE ALARM SYSTEM. COORDINATE EXISTING CONDITIONS WITH OWNER FACILITIES MANAGEMENT.
- DUCT DETECTOR PROVIDED FOR MONITORING CELLS ON MEZZANINE LEVEL AND CELLS DIRECTLY BELOW ON 1ST FLOOR.

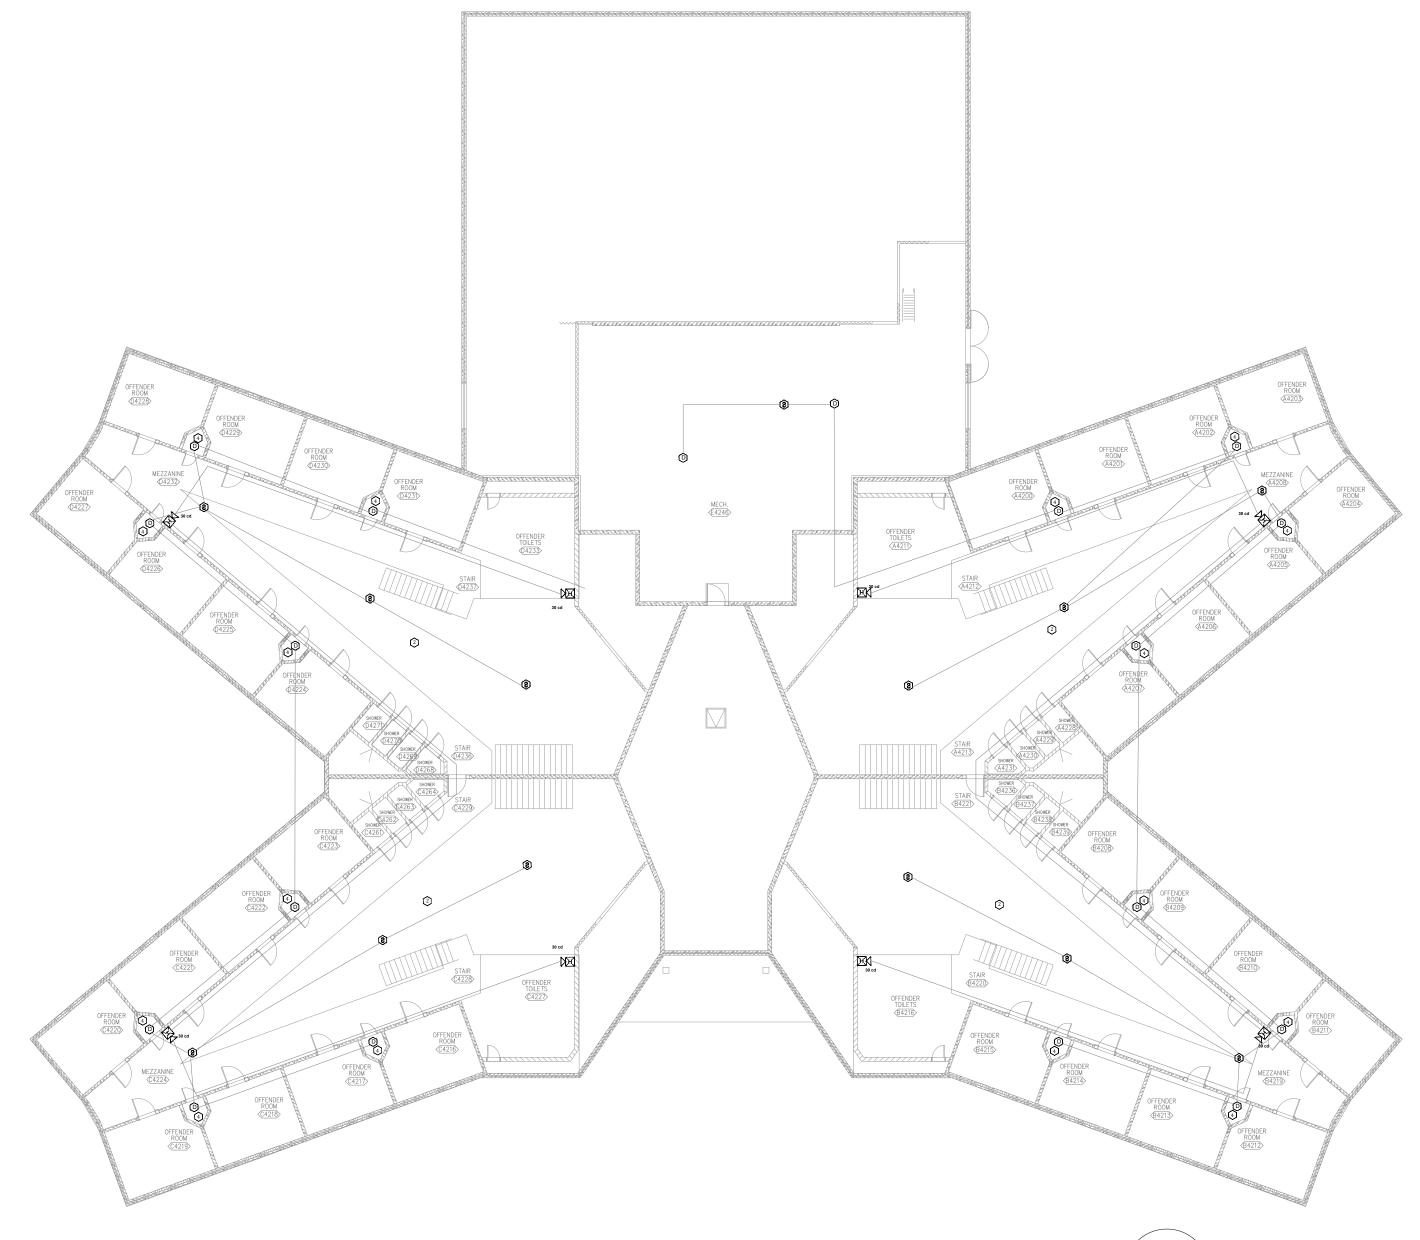

BUILDING #4 - #7 - FIRE ALARM SECOND FLOOR PLAN

STATE OF MISSOURI MICHAEL L. PARSON, **GOVERNOR** 



NOTES, SYMBOLS, & ABBREVIATIONS



OFFICE OF ADMINISTRATION **DIVISION OF FACILITIES** MANAGEMENT, **DESIGN AND CONSTRUCTION** 

REPLACE FIRE ALARM SYSTEM, INFRASTRUCTURE CHILLICOTHE **CORRECTIONAL CENTER** 

3151 LITTON ROAD CHILLICOTHE, MO 64601

PROJECT # C2326-01 7030 9327030038 ASSET#

**REVISION:** DATE: **REVISION:** DATE: **REVISION:** DATE:

ISSUE DATE: 03/29/2024


CAD DWG FILE: C2326-01-FA-FP-107
DRAWN BY: DB
CHECKED BY: JMA

DESIGNED BY: FSC SHEET TITLE:

BUILDING #4 - #7 -FIRE ALARM PLAN

SHEET NUMBER: FA-300


7 OF 20 SHEETS

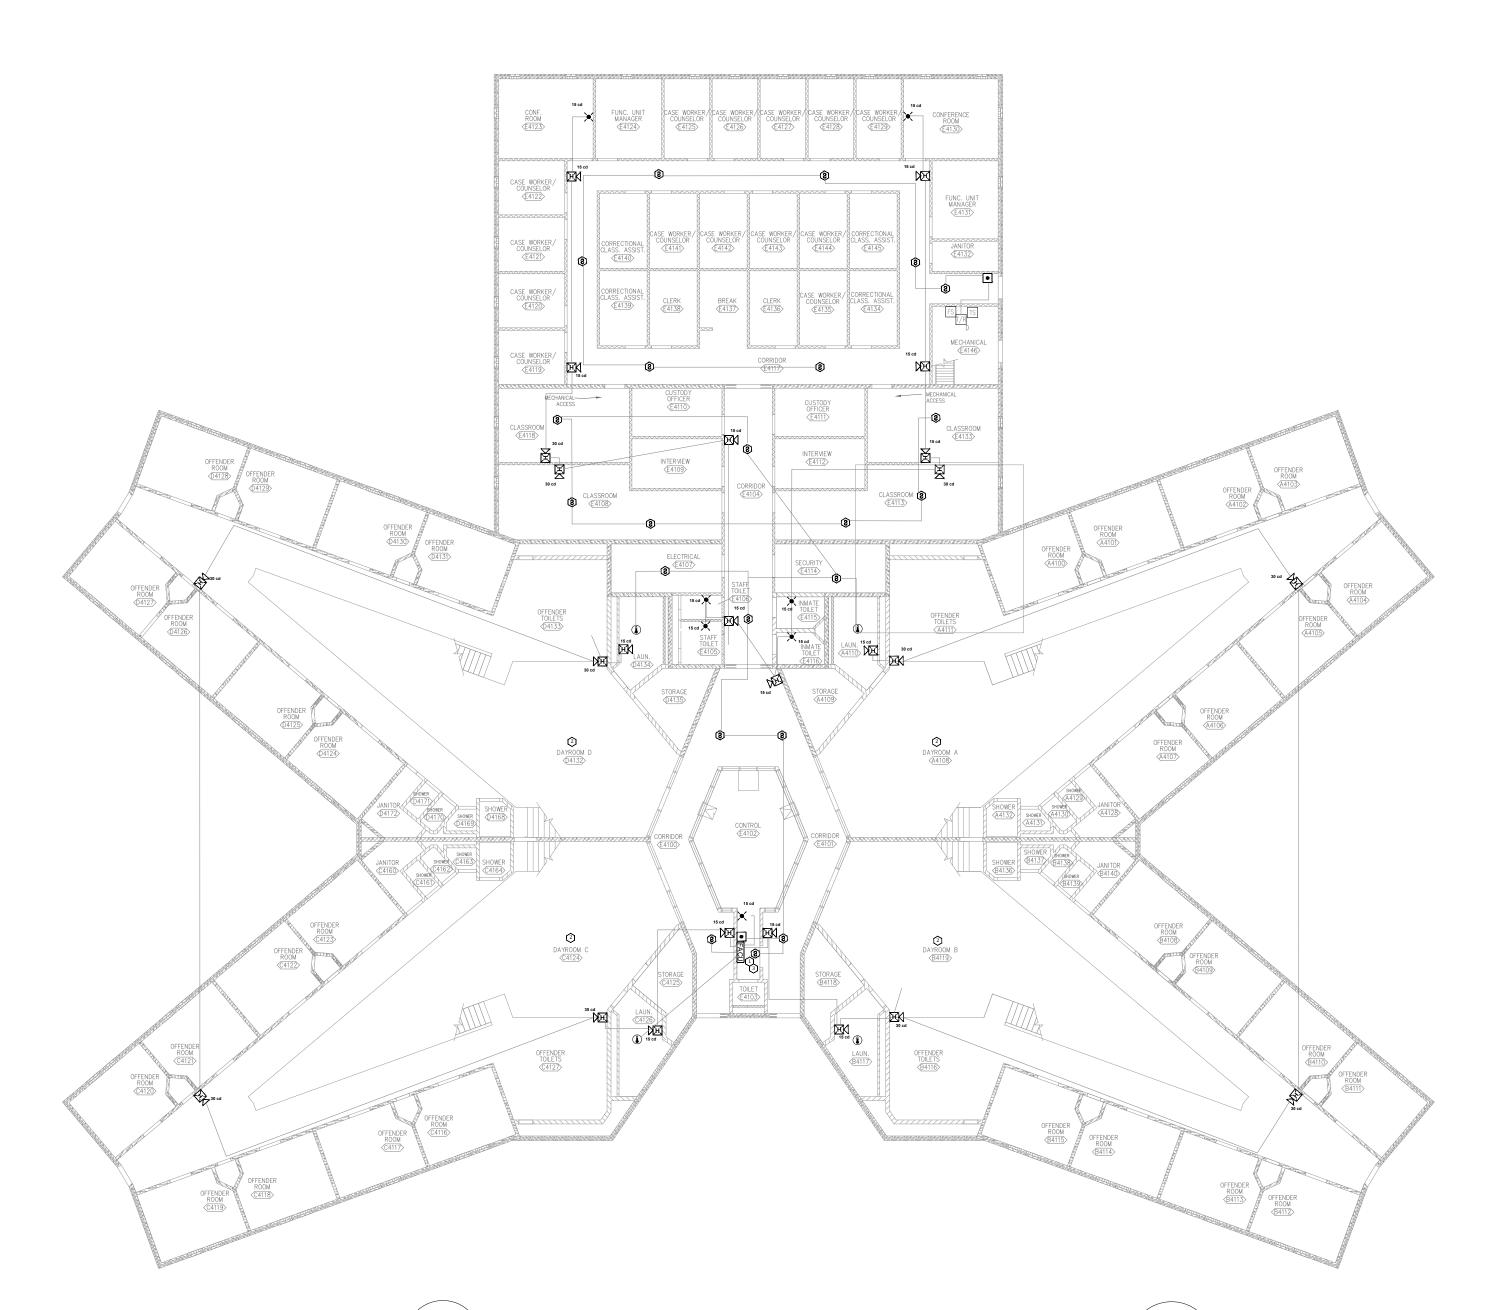

BUILDING #4 - #7 - FIRE ALARM FIRST FLOOR PLAN

TYPICAL FOR BUILDING #4 THROUGH BUILDING #7 NOTE: NORTH ARROW INDICATION FOR BUILDING #4, REFER TO KEY PLAN TO ORIENT NORTH FOR BUILDINGS #5-#7.


TYPICAL FOR BUILDING #4 THROUGH BUILDING #7 NOTE: NORTH ARROW INDICATION FOR BUILDING #4, REFER TO KEY PLAN TO ORIENT NORTH FOR BUILDINGS #5-#7.

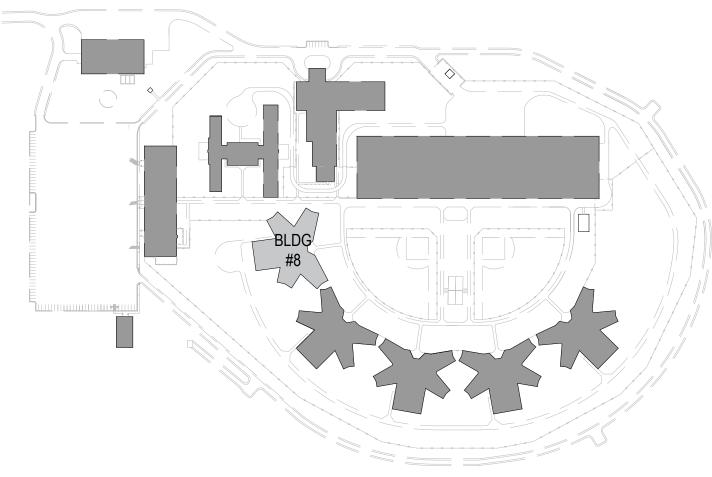

# AREA PLAN

# **KEY NOTES**

- 1 FIRE ALARM CONTROL UNIT. TIE INTO CAMPUS FIBER NETWORK TO REPORT BACK TO ADMIN FACU.
- NOTIFICATION NOT PRESENT IN THIS AREA PER NFPA 72
  SECTION 18.6 VISUAL NOTIFICATION IN PRIVATE MODE SHALL BE
  SUFFICIENT TO MEET THE INTENT OF THE USER. AREA IS UNDER
  SURVEILLANCE 24/7 WITH TRANIED STAFF TO EVACUATE OCCUPANTS
  IF NEEDED. STAFF WILL BE NOTIFIED VIA ANNUNCIATOR AT THE 24/7
  MANNED STATION.
- FIELD VERIFY EQUIPMENT BEING MONITORED AND/OR CONTROLLED BY THE FIRE ALARM SYSTEM. COORDINATE EXISTING CONDITIONS WITH OWNER FACILITIES MANAGEMENT.
- 4 DUCT DETECTOR PROVIDED FOR MONITORING CELLS ON MEZZANINE LEVEL AND CELLS DIRECTLY BELOW ON 1ST FLOOR.

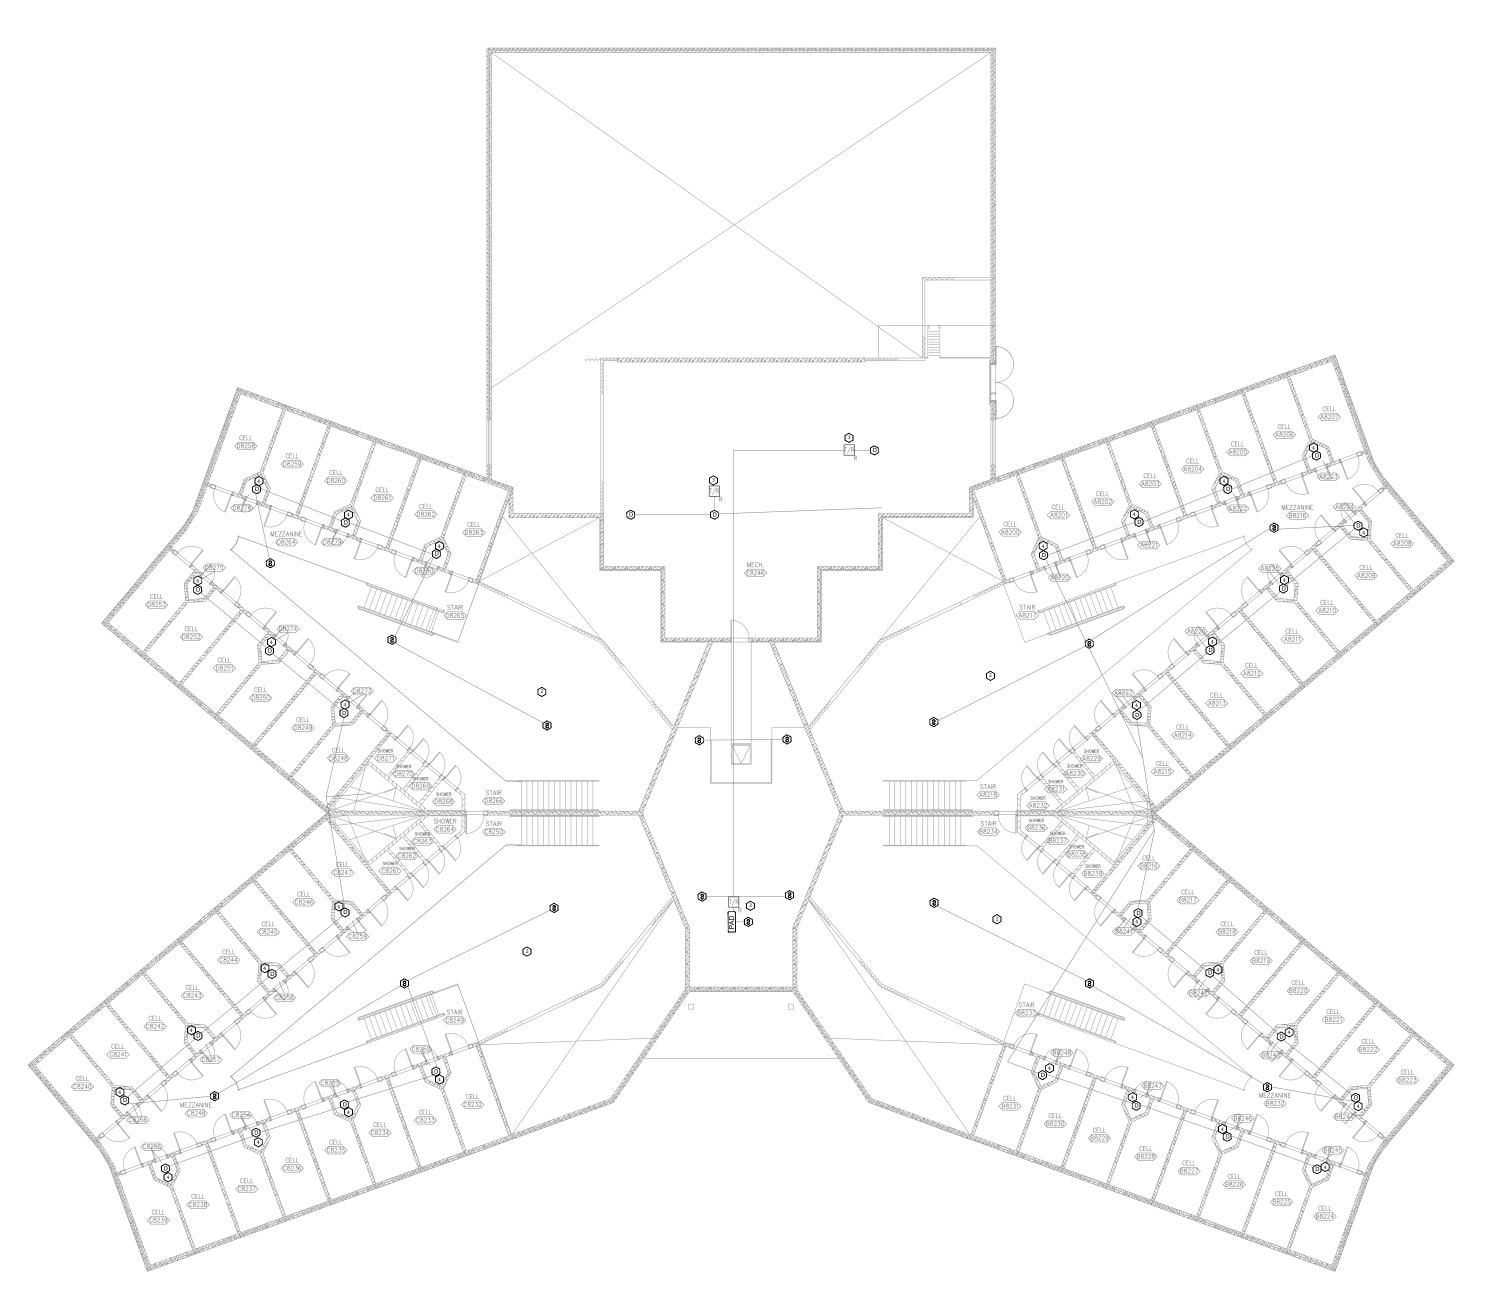

1 BUILDING #8 - FIRE ALARM FIRST FLOOR PLAN
SCALE: 1/16" = 1'-0"



2 BUILDING #8 - FIRE ALARM SECOND FLOOR PLAN
SCALE: 1/16" = 1'-0"



STATE OF MISSOURI MICHAEL L. PARSON, GOVERNOR



REFER TO FA-002 FOR FIRE ALARM GENERAL NOTES, SYMBOLS, & ABBREVIATIONS.



OFFICE OF ADMINISTRATION DIVISION OF FACILITIES MANAGEMENT, DESIGN AND CONSTRUCTION

REPLACE FIRE ALARM
SYSTEM,
INFRASTRUCTURE
CHILLICOTHE
CORRECTIONAL CENTER

3151 LITTON ROAD CHILLICOTHE, MO 64601


PROJECT # C2326-01 SITE # 7030 ASSET # 9327030038

REVISION:
DATE:
REVISION:
DATE:
REVISION:
DATE:
REVISION:
DATE:
ISSUE DATE: 03/29/2024


CAD DWG FILE: C2326-01-FA-FP-108
DRAWN BY: DB
CHECKED BY: JMA
DESIGNED BY: FSC

SHEET TITLE:
BUILDING #8 - FIRE
ALARM PLAN

SHEET NUMBER: FA-400

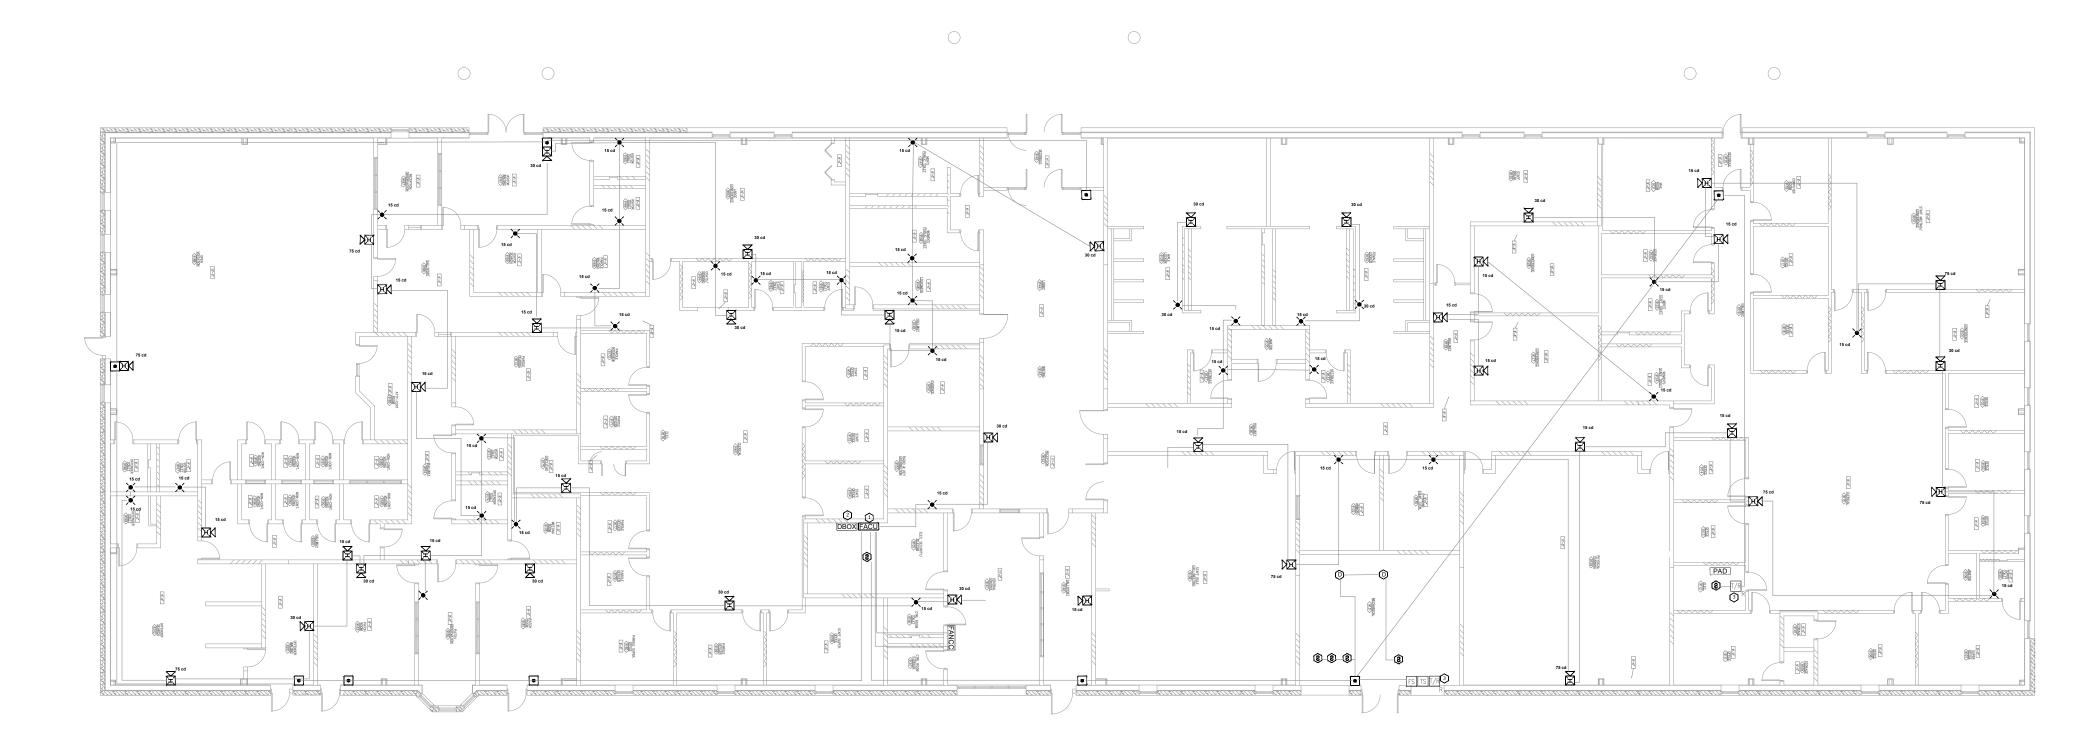



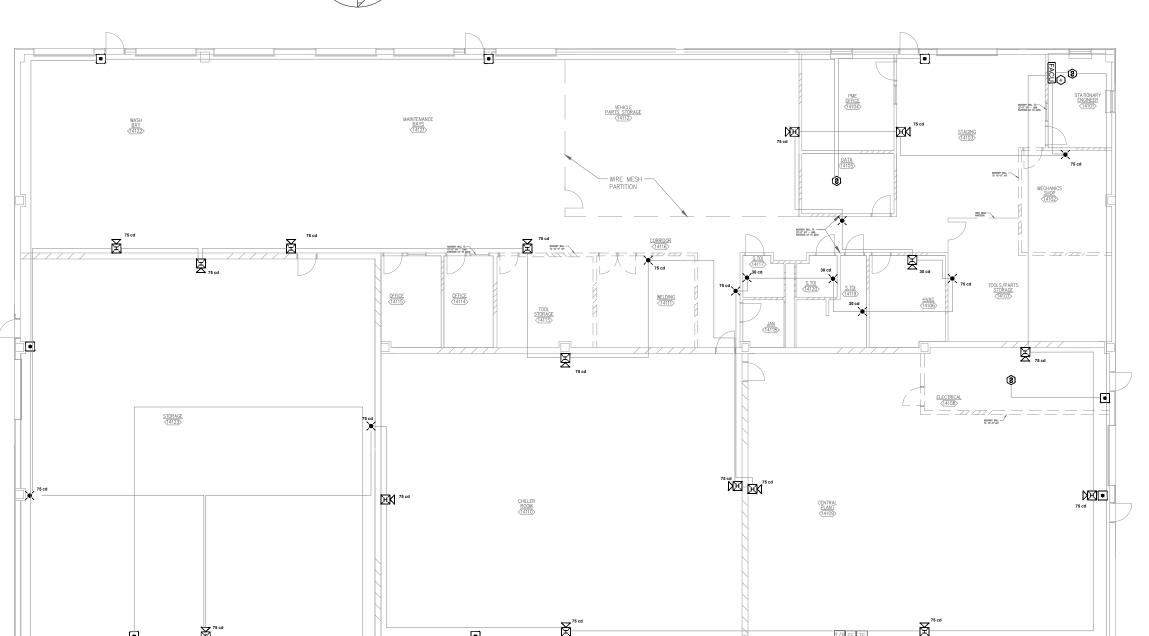

2 BUILDING #13 - FIRE ALARM PLAN

SCALE: 1/16" = 1'-0"



3 BUILDING #14 - FIRE ALARM PLAN

SCALE: 1/16" = 1'-0"



# **KEY NOTES**

- 1 FIRE ALARM PANELS LOCATED THROUGHOUT TO REPORT TO MAIN PANEL LOCATED HERE.
- 2 PROVIDE FIRE ALARM DOCUMENT BOX TO BEST SUIT THE SPACE. COORDINATE WITH OWNER FINAL TYPE AND MOUNTING LOCATION. PROVIDE TYPE INDICATED ON LEGEND OR SIMILAR.
- FIELD VERIFY EQUIPMENT BEING MONITORED AND/OR CONTROLLED BY THE FIRE ALARM SYSTEM. COORDINATE EXISTING CONDITIONS WITH OWNER FACILITIES MANAGEMENT.
- FIRE ALARM CONTROL UNIT. TIE INTO CAMPUS FIBER NETWORK TO REPORT BACK TO ADMIN FACU.





REFER TO FA-002 FOR FIRE ALARM GENERAL NOTES, SYMBOLS, & ABBREVIATIONS.



OFFICE OF ADMINISTRATION DIVISION OF FACILITIES MANAGEMENT, DESIGN AND CONSTRUCTION

REPLACE FIRE ALARM
SYSTEM,
INFRASTRUCTURE
CHILLICOTHE
CORRECTIONAL CENTER

3151 LITTON ROAD CHILLICOTHE, MO 64601


PROJECT # C2326-01 SITE # 7030 ASSET # 9327030038

REVISION:
DATE:
REVISION:
DATE:
REVISION:
DATE:
REVISION:
DATE:
ISSUE DATE: 03/29/2024

CAD DWG FILE: C2326-01-FA-FP-109
DRAWN BY: DB
CHECKED BY: JMA
DESIGNED BY: FSC

SHEET TITLE:
BUILDINGS #9, #13, &
#14 - FIRE ALARM
PLAN

SHEET NUMBER: FA-500

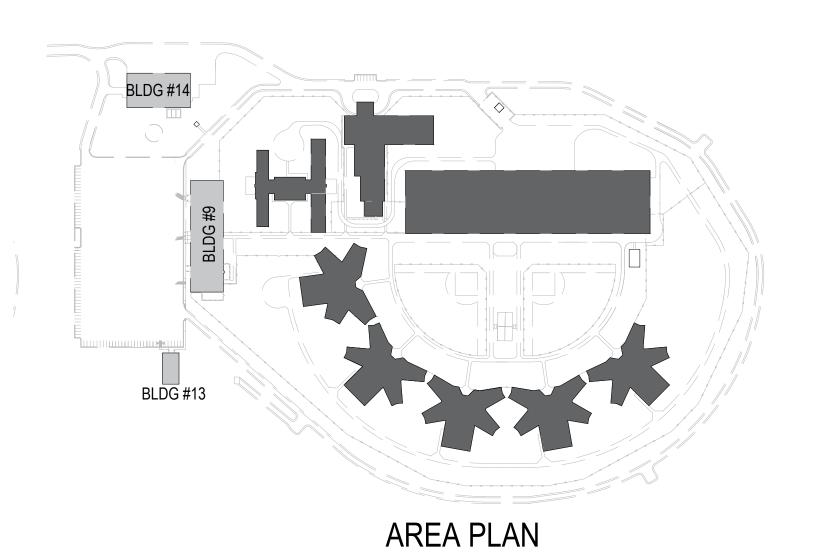


FIELD VERIFY EQUIPMENT AND QUANTITY BEING MONITORED AND/OR CONTROLLED BY THE FIRE ALARM SYSTEM.
COORDINATE EXISTING CONDITIONS WITH OWNER FACILITIES MANAGEMENT.





REFER TO FA-002 FOR FIRE ALARM GENERAL NOTES, SYMBOLS, & ABBREVIATIONS.

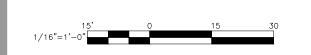

OFFICE OF ADMINISTRATION DIVISION OF FACILITIES MANAGEMENT, DESIGN AND CONSTRUCTION

# REPLACE FIRE ALARM SYSTEM, INFRASTRUCTURE CHILLICOTHE CORRECTIONAL CENTER

# 3151 LITTON ROAD CHILLICOTHE, MO 64601

9327030038

PROJECT # C2326-01 SITE # 7030

REVISION:
DATE:
REVISION:
DATE:
REVISION:

DATE: ISSUE DATE: 03/29/2024

ASSET#


CAD DWG FILE: C2326-01-FA-FP-110
DRAWN BY: DB
CHECKED BY: JMA
DESIGNED BY: FSC

SHEET TITLE:

BUILDING #12 AREA A
- FIRE ALARM PLAN

SHEET NUMBER: FA-600

10 OF 20 SHEETS

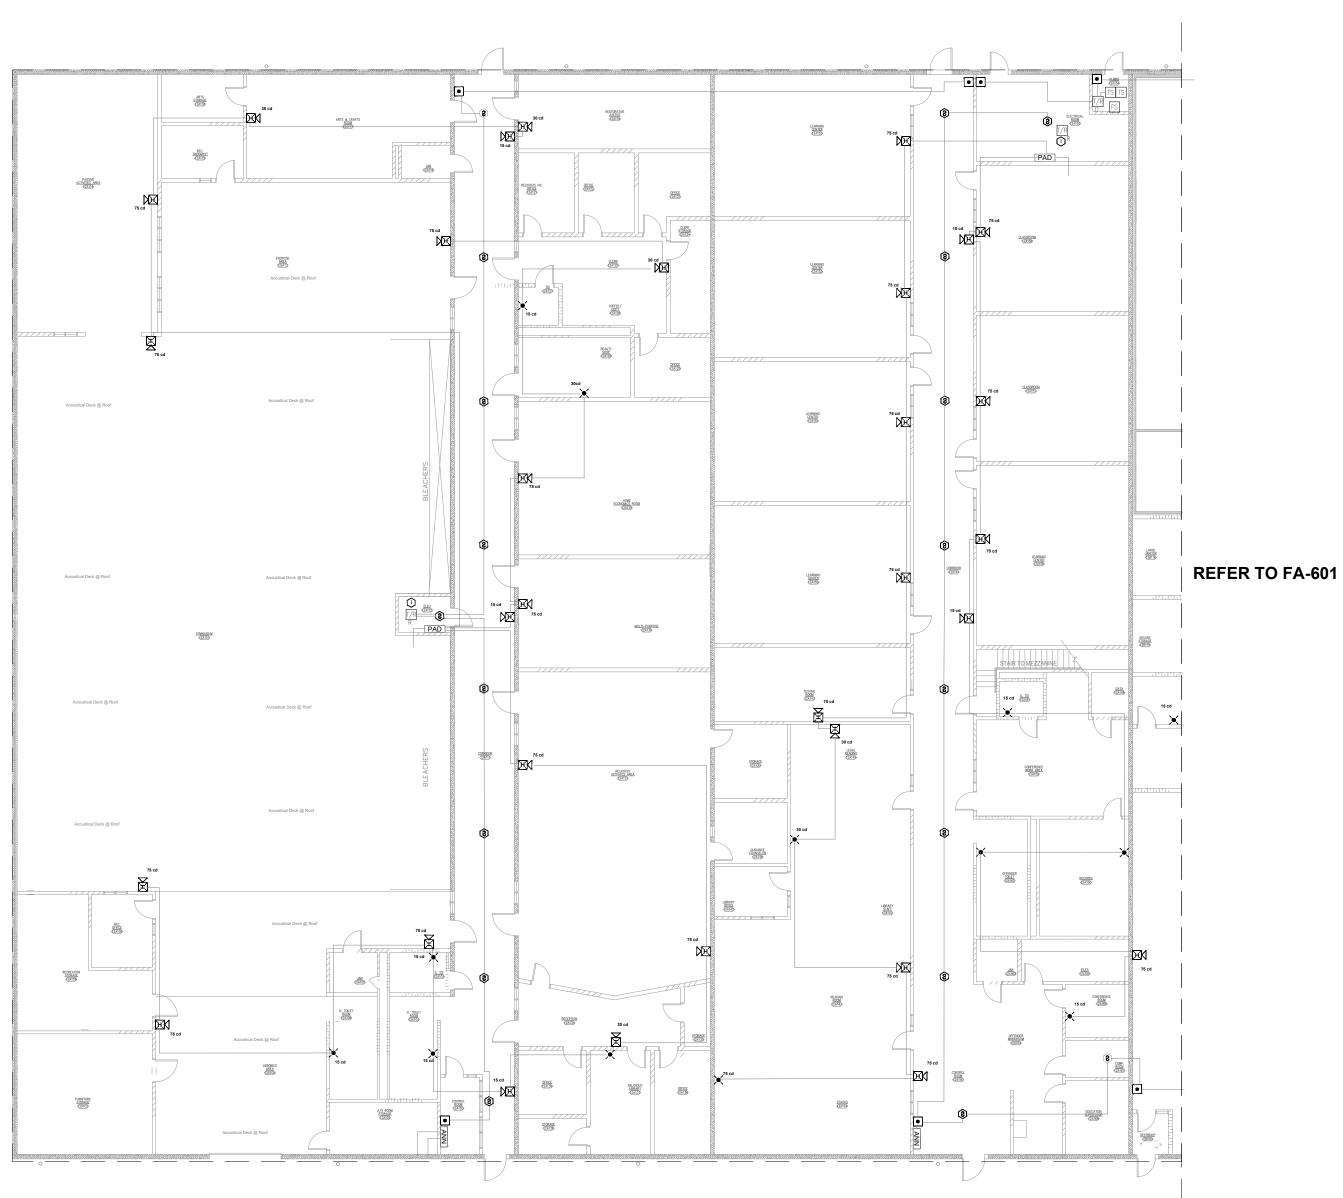

BUILDING #12 AREA A - FIRE ALARM PLAN

SCALE: 1/16" = 1'-0"


KEY PLAN

BLDG #12 AREA B SEE FA-601

BLDG #12 AREA A SEE FA-602

BLDG #12


AREA PLAN

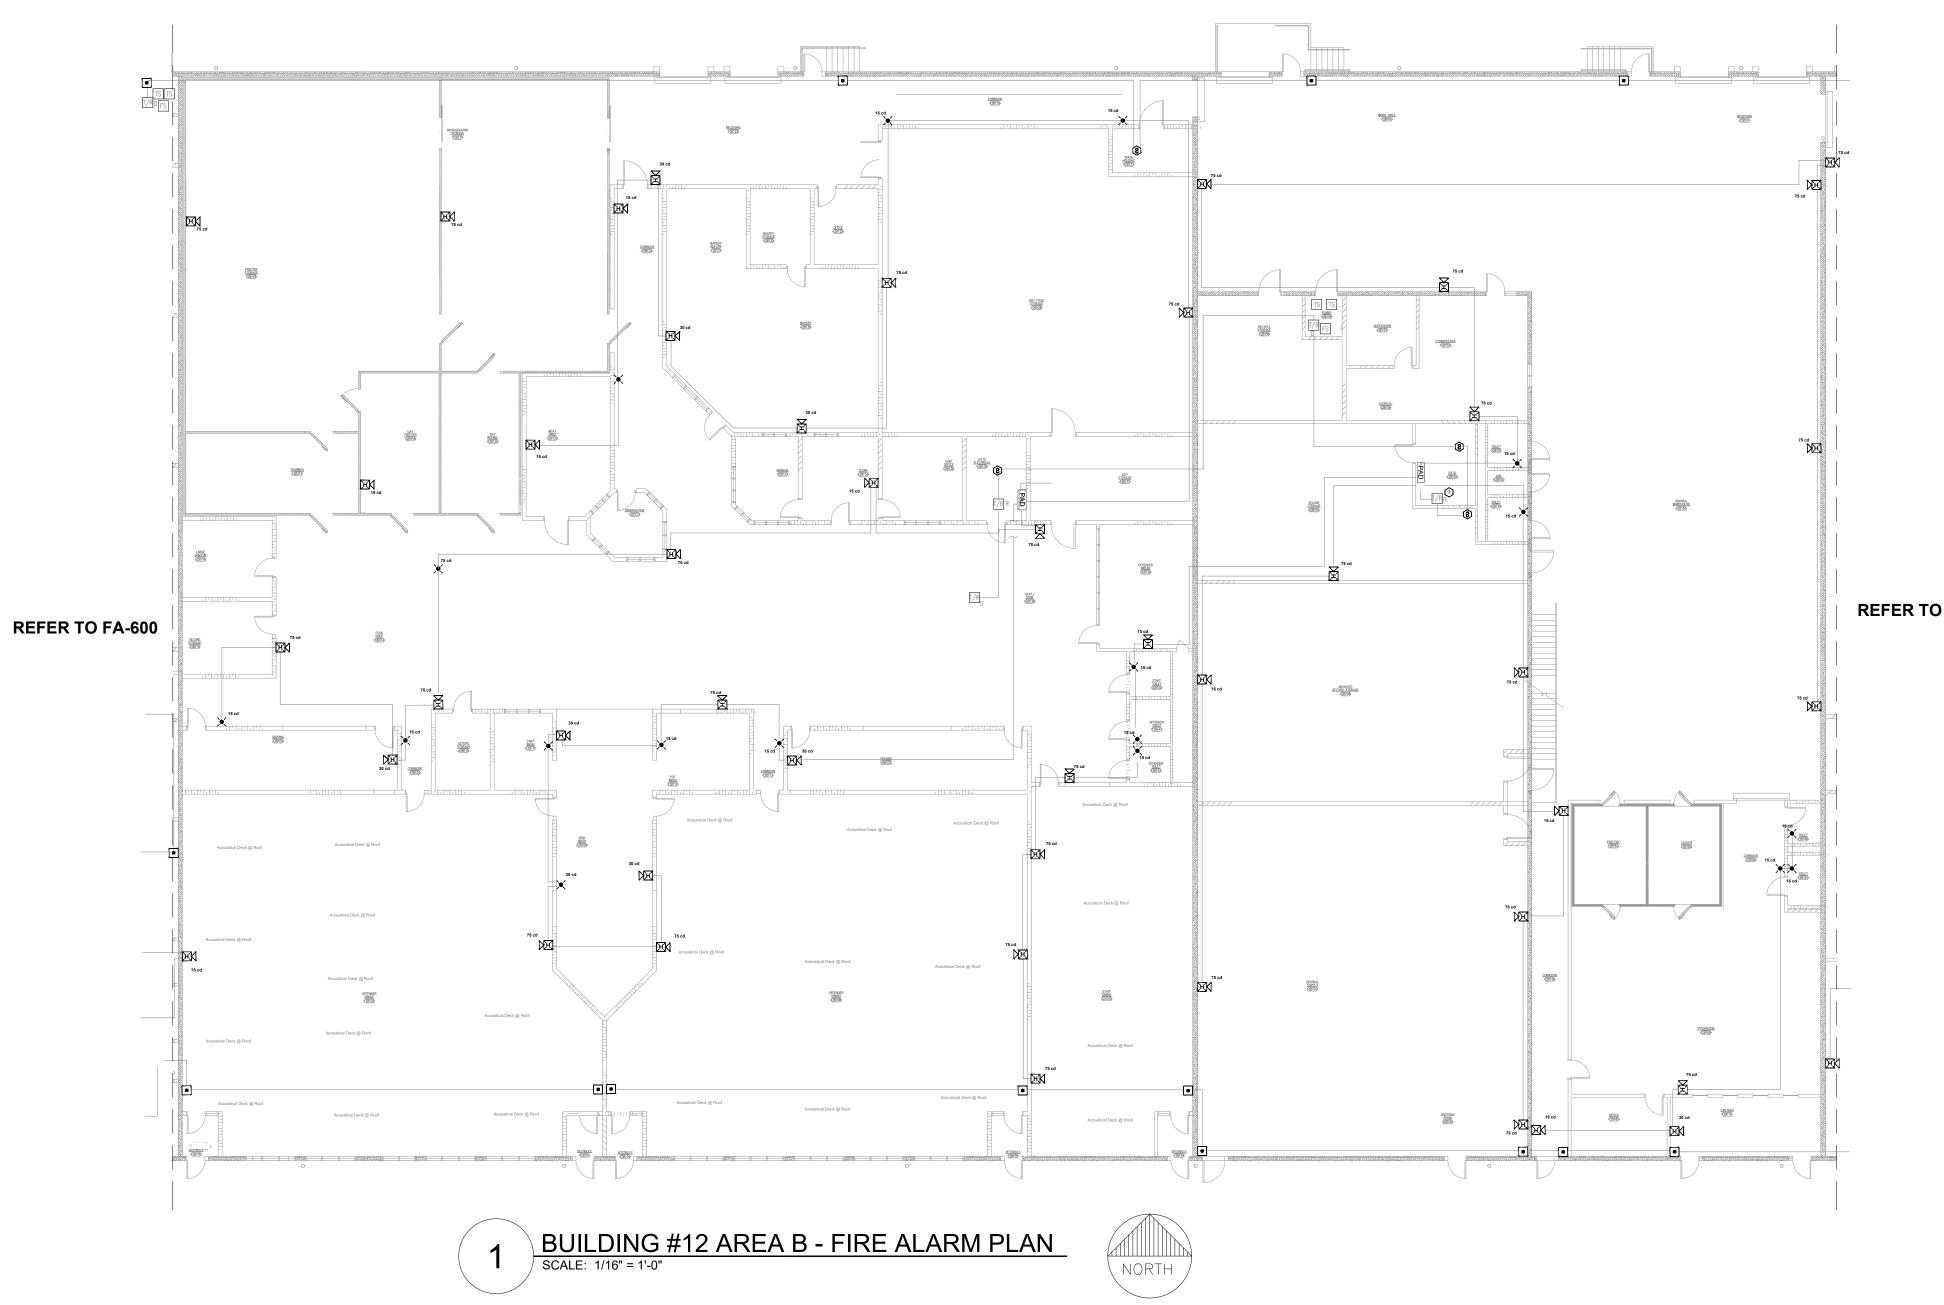

1 FIELD VERIFY EQUIPMENT AND QUANTITY BEING MONITORED AND/OR CONTROLLED BY THE FIRE ALARM SYSTEM. COORDINATE EXISTING CONDITIONS WITH OWNER FACILITIES MANAGEMENT.

**REFER TO FA-602** 

**KEY PLAN** 

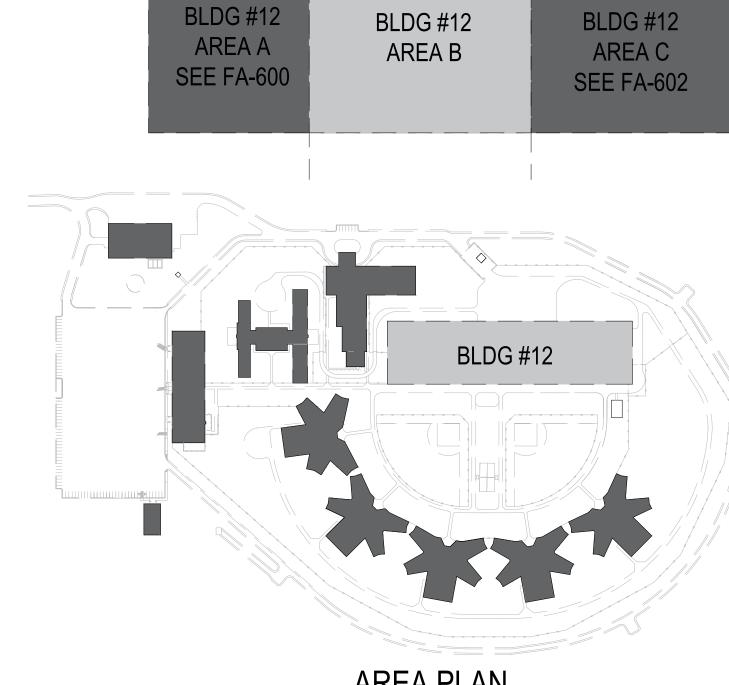

AREA PLAN

STATE OF MISSOURI MICHAEL L. PARSON, **GOVERNOR** 



REFER TO FA-002 FOR FIRE ALARM GENERAL NOTES, SYMBOLS, & ABBREVIATIONS.



OFFICE OF ADMINISTRATION **DIVISION OF FACILITIES** MANAGEMENT, **DESIGN AND CONSTRUCTION** 

REPLACE FIRE ALARM SYSTEM, INFRASTRUCTURE CHILLICOTHE CORRECTIONAL CENTER

3151 LITTON ROAD CHILLICOTHE, MO 64601

PROJECT # C2326-01 7030 SITE# ASSET# 9327030038


REVISION:\_ DATE:\_ REVISION:\_ DATE: REVISION: DATE: ISSUE DATE: 03/29/2024

CAD DWG FILE:C2326-01-FA-FP-111
DRAWN BY: DB
CHECKED BY: JMA
DESIGNED BY: FSC


SHEET TITLE:


BUILDING #12 AREA B - FIRE ALARM PLAN

SHEET NUMBER: FA-601

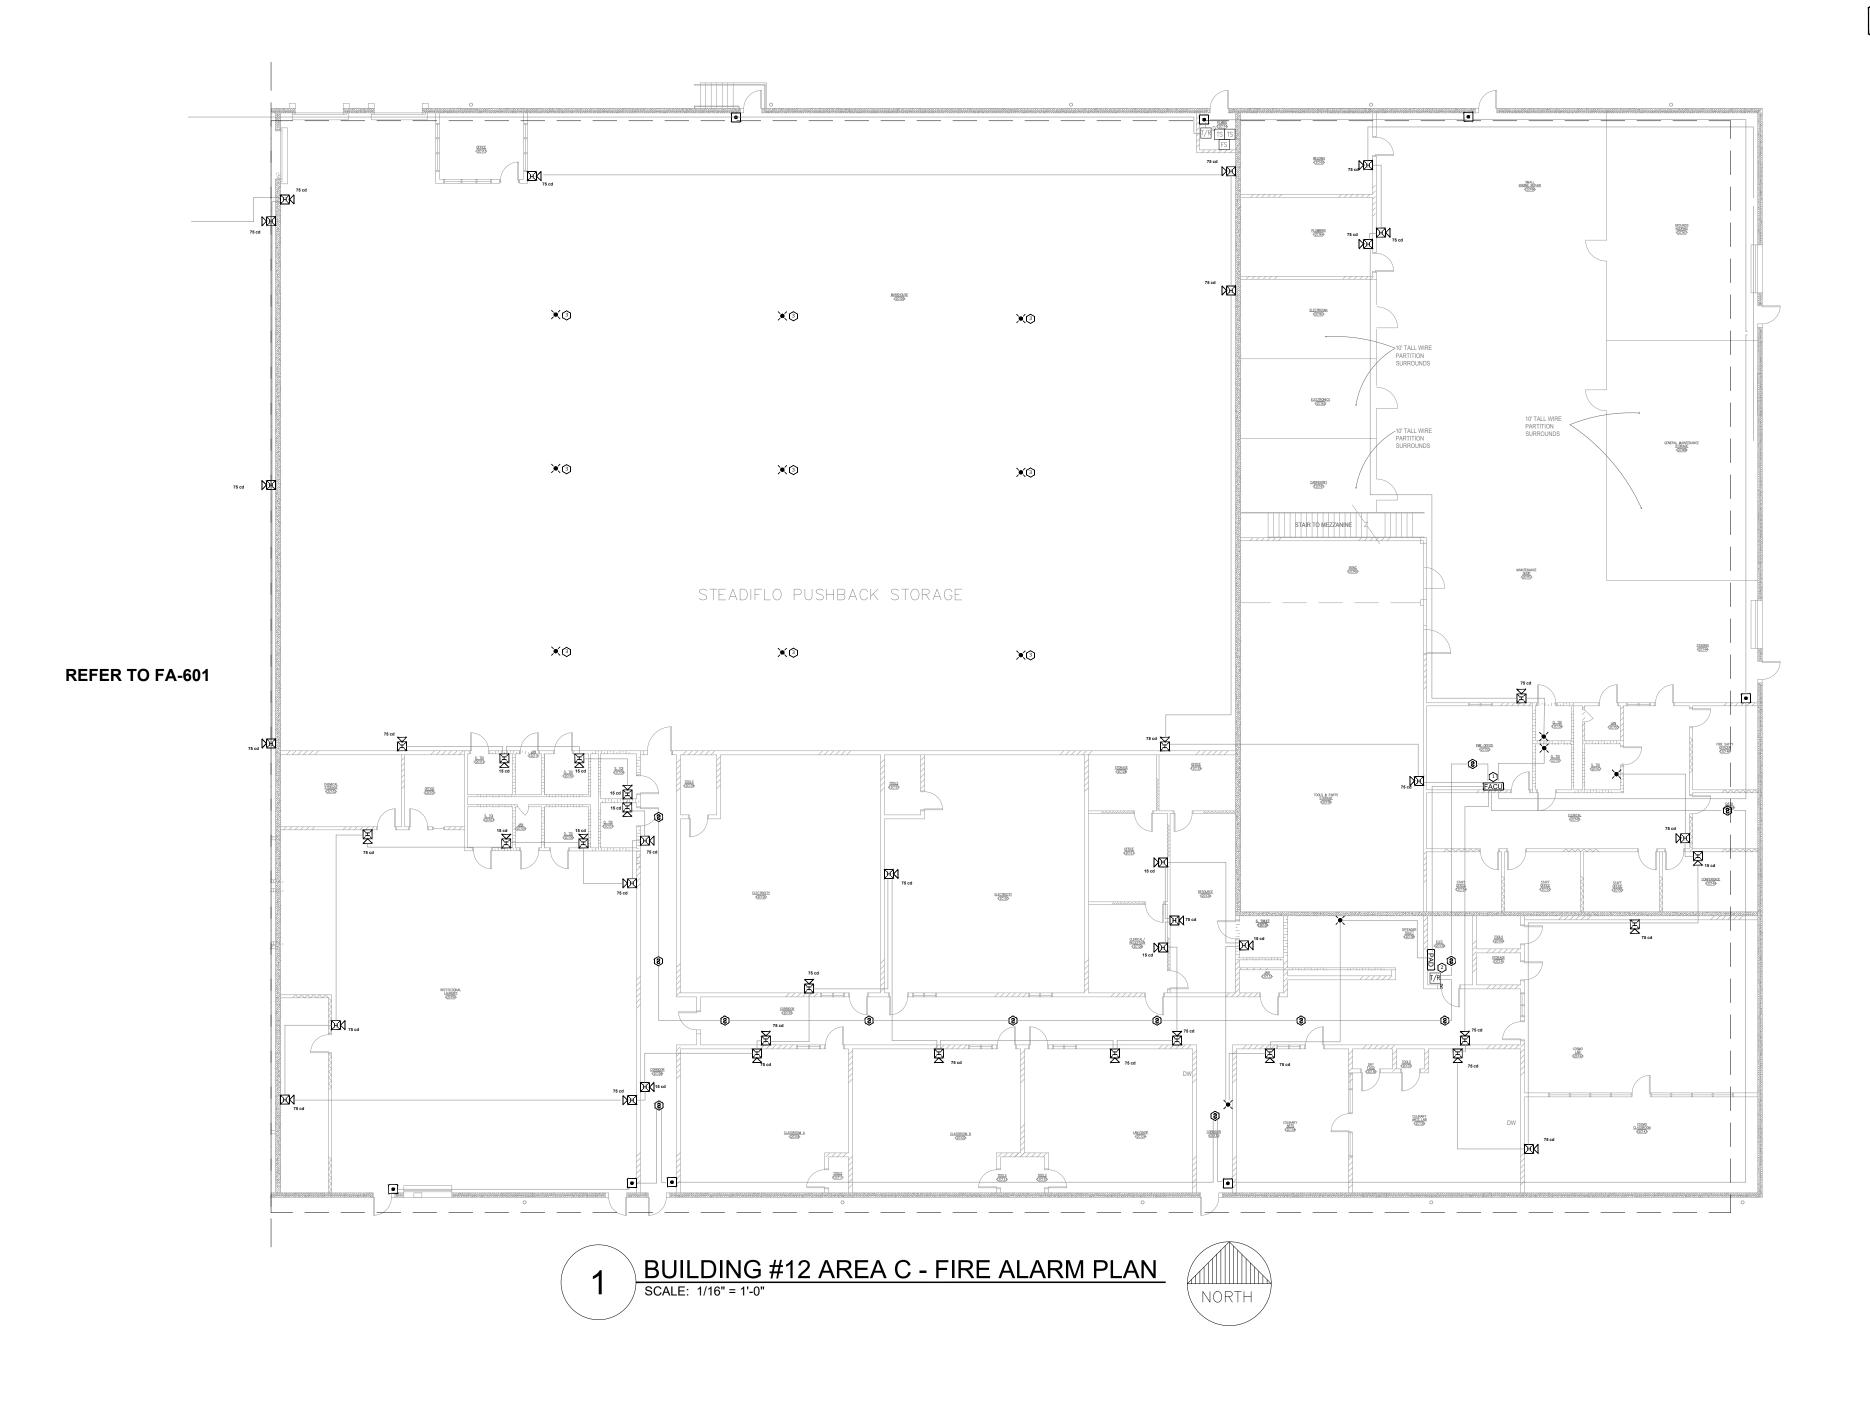

- 1 FIRE ALARM CONTROL UNIT. TIE INTO CAMPUS FIBER NETWORK TO REPORT BACK TO ADMIN FACU.
- 2 FIELD VERIFY EQUIPMENT AND QUANTITY BEING MONITORED AND/OR CONTROLLED BY THE FIRE ALARM SYSTEM.
  COORDINATE EXISTING CONDITIONS WITH OWNER FACILITIES MANAGEMENT.
- 3 ADDED NOTIFICATION APPLIANCE TO MEET THE REQUIREMENTS OF NFPA 72

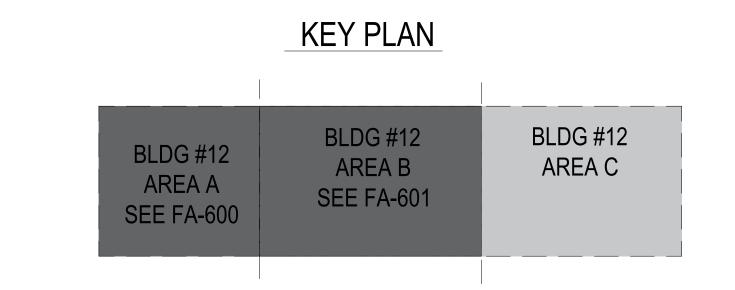

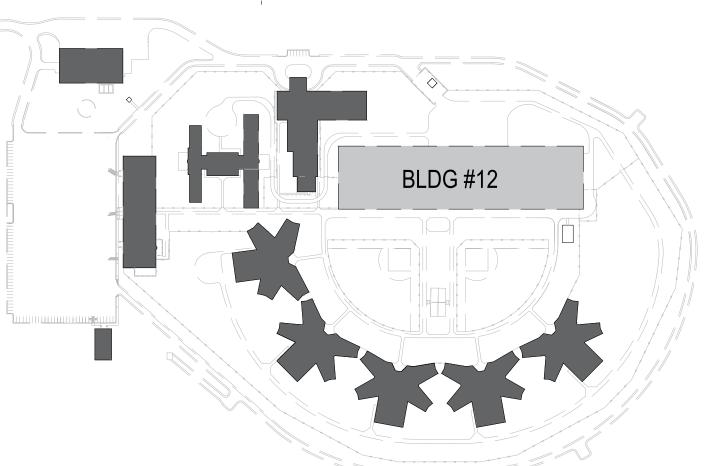


AREA PLAN

#### STATE OF MISSOURI MICHAEL L. PARSON, GOVERNOR



REFER TO FA-002 FOR FIRE ALARM GENERAL NOTES, SYMBOLS, & ABBREVIATIONS.

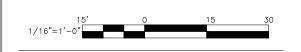

OFFICE OF ADMINISTRATION DIVISION OF FACILITIES MANAGEMENT, DESIGN AND CONSTRUCTION

REPLACE FIRE ALARM SYSTEM, INFRASTRUCTURE CHILLICOTHE CORRECTIONAL CENTER

3151 LITTON ROAD CHILLICOTHE, MO 64601

PROJECT # C2326-01 SITE # 7030 ASSET # 9327030038


REVISION:
DATE:
REVISION:
DATE:
REVISION:
DATE:
REVISION:
DATE:
ISSUE DATE: 03/29/2024

CAD DWG FILE: C2326-01-FA-FP-112
DRAWN BY: DB
CHECKED BY: JMA
DESIGNED BY: FSC

SHEET TITLE:

BUILDING #12 AREA C - FIRE ALARM PLAN

SHEET NUMBER: FA-602

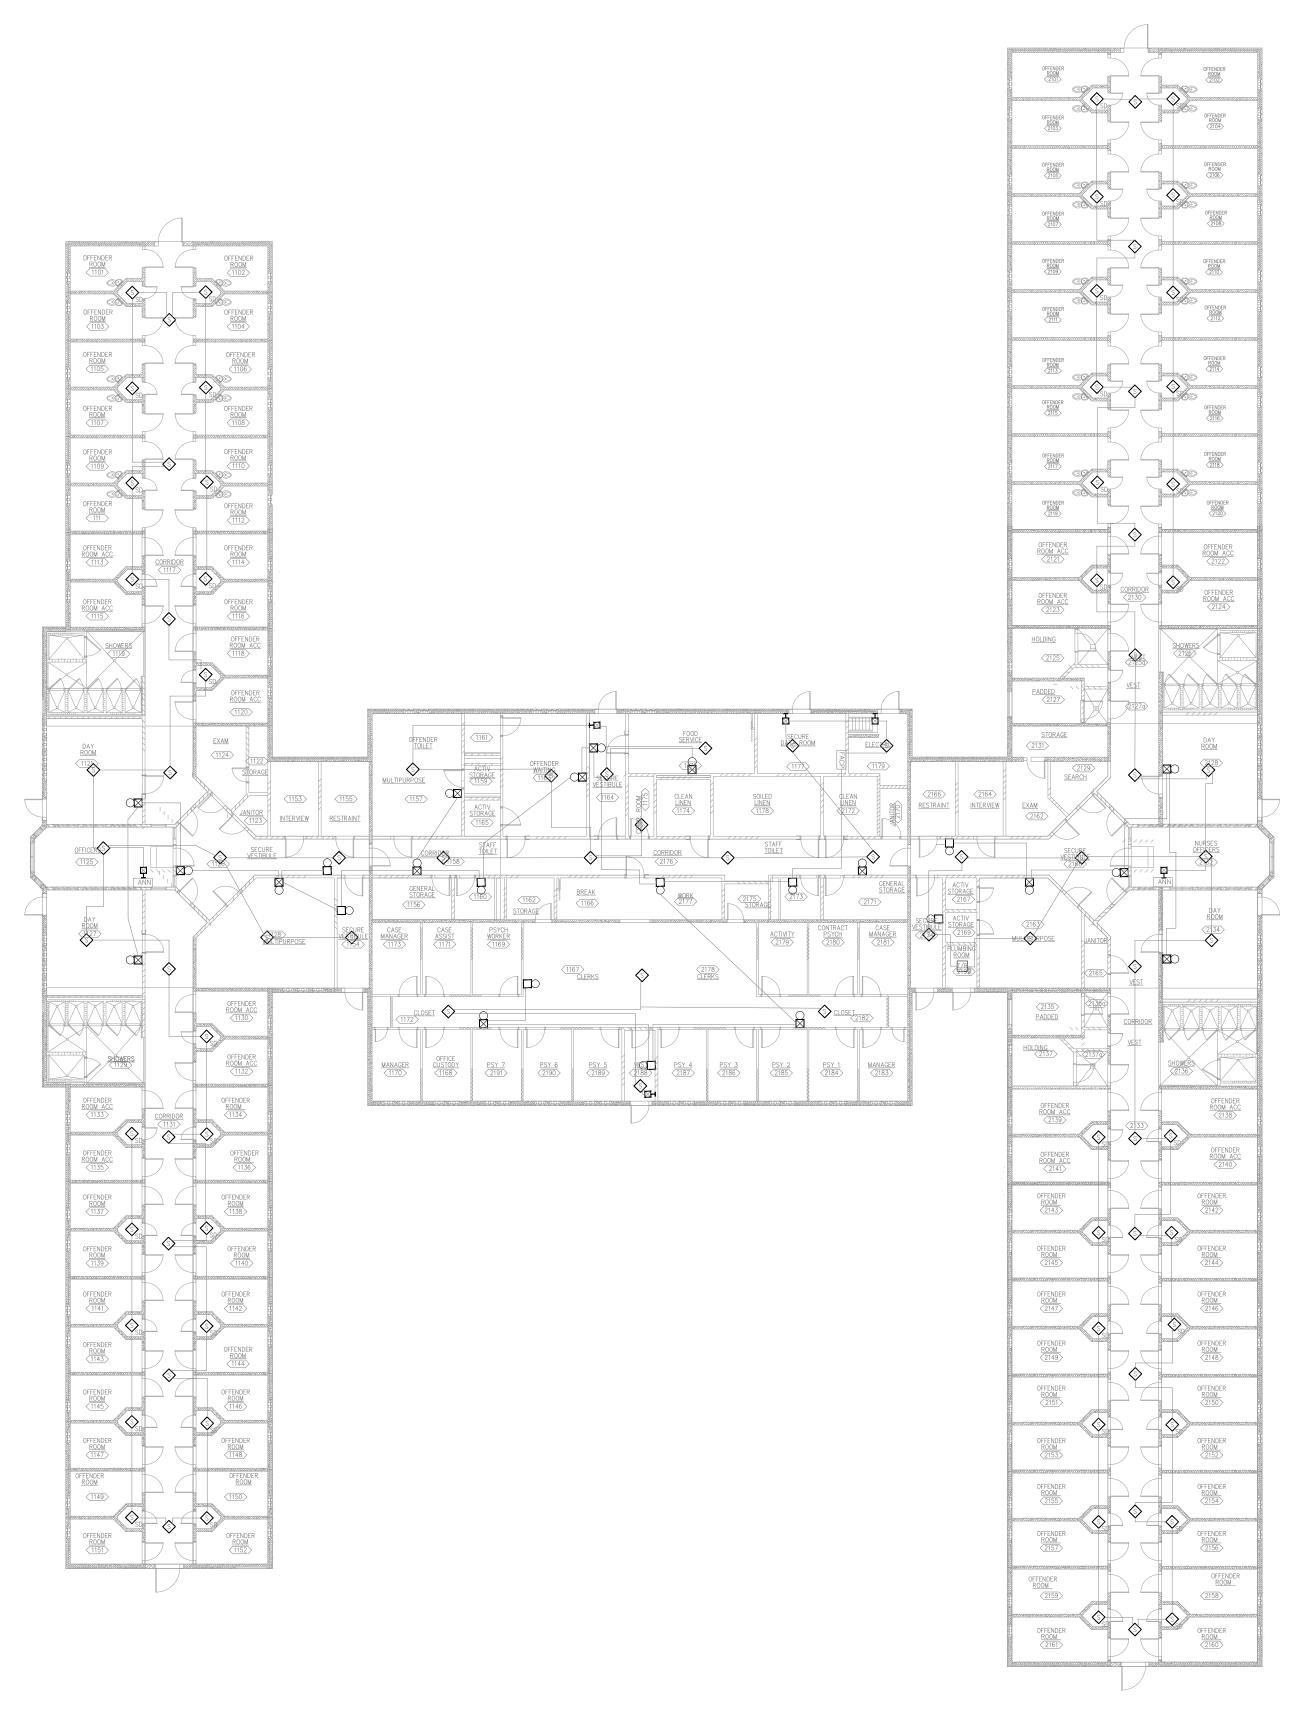

BUILDING #1 - FIRE ALARM DEMO PLAN

SCALE: 1/16" = 1'-0"



#### GENERAL NOTES

- 1. ALL NOTIFICATION AND DETECTION DEVICES ARE TO BE REPLACED. LOCATIONS TO BE MODIFIED AS NECESSARY TO MEET THE REQUIREMENTS OF NFPA 72. REFER TO NEW WORK DRAWINGS FOR ADDITIONAL INFORMATION.
- 2. ALL WIRING AND CONDUIT IN GOOD WORKING CONDITION MAY BE RE UTILIZED FOR NEW FIRE ALARM SYSTEM.

STATE OF MISSOURI MICHAEL L. PARSON, GOVERNOR



REFER TO FA-002 FOR FIRE ALARM GENERAL NOTES, SYMBOLS, & ABBREVIATIONS.



OFFICE OF ADMINISTRATION DIVISION OF FACILITIES MANAGEMENT, DESIGN AND CONSTRUCTION

REPLACE FIRE ALARM SYSTEM, INFRASTRUCTURE CHILLICOTHE CORRECTIONAL CENTER

3151 LITTON ROAD CHILLICOTHE, MO 64601

PROJECT # C2326-01 SITE # 7030 ASSET # 9327030038


REVISION:
DATE:
REVISION:
DATE:
REVISION:
DATE:
ISSUE DATE: 03/29/2024

CAD DWG FILE: C2326-01-FA-FP-113
DRAWN BY: DB
CHECKED BY: JMA
DESIGNED BY: FSC

SHEET TITLE:

BUILDING #1 - FIRE ALARM DEMO PLAN

SHEET NUMBER: FAD-100

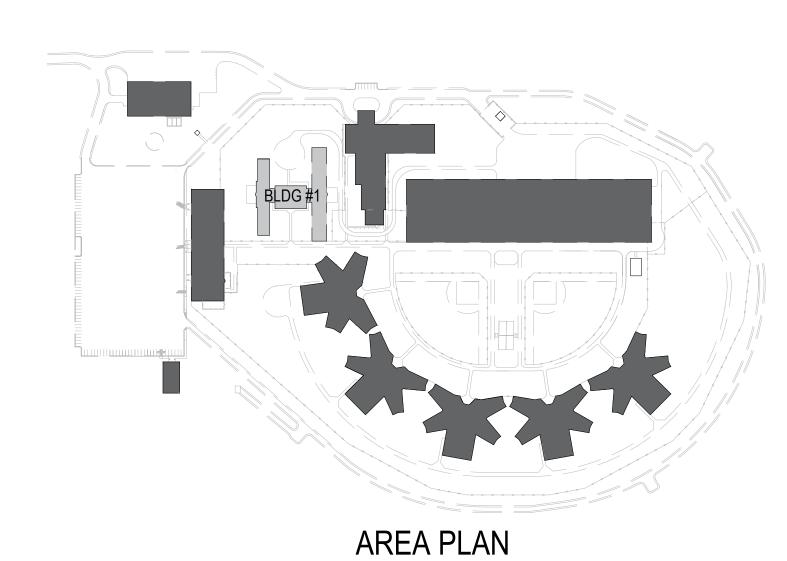

- 1. ALL NOTIFICATION AND DETECTION DEVICES ARE TO BE REPLACED. LOCATIONS TO BE MODIFIED AS NECESSARY TO MEET THE REQUIREMENTS OF NFPA 72. REFER TO NEW WORK
- 2. ALL WIRING AND CONDUIT IN GOOD WORKING CONDITION MAY BE

AREA PLAN




STATE OF MISSOURI

MICHAEL L. PARSON,

**GOVERNOR** 

REFER TO FA-002 FOR FIRE ALARM GENERAL NOTES, SYMBOLS, & ABBREVIATIONS.

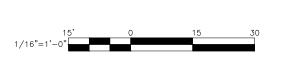

OFFICE OF ADMINISTRATION **DIVISION OF FACILITIES** MANAGEMENT, **DESIGN AND CONSTRUCTION** 

# REPLACE FIRE ALARM SYSTEM, INFRASTRUCTURE CHILLICOTHE

3151 LITTON ROAD CHILLICOTHE, MO 64601

9327030038

CORRECTIONAL CENTER

PROJECT # C2326-01 7030

**REVISION:** DATE: **REVISION:** DATE: REVISION:

ASSET#

DATE: ISSUE DATE: 03/29/2024


CAD DWG FILE: C2326-01-FA-FP-114
DRAWN BY: DB
CHECKED BY: JMA DESIGNED BY: FSC

SHEET TITLE:

BUILDING #3 & #10 -FIRE ALARM DEMO PLAN


SHEET NUMBER: FAD-200

14 OF 20 SHEETS

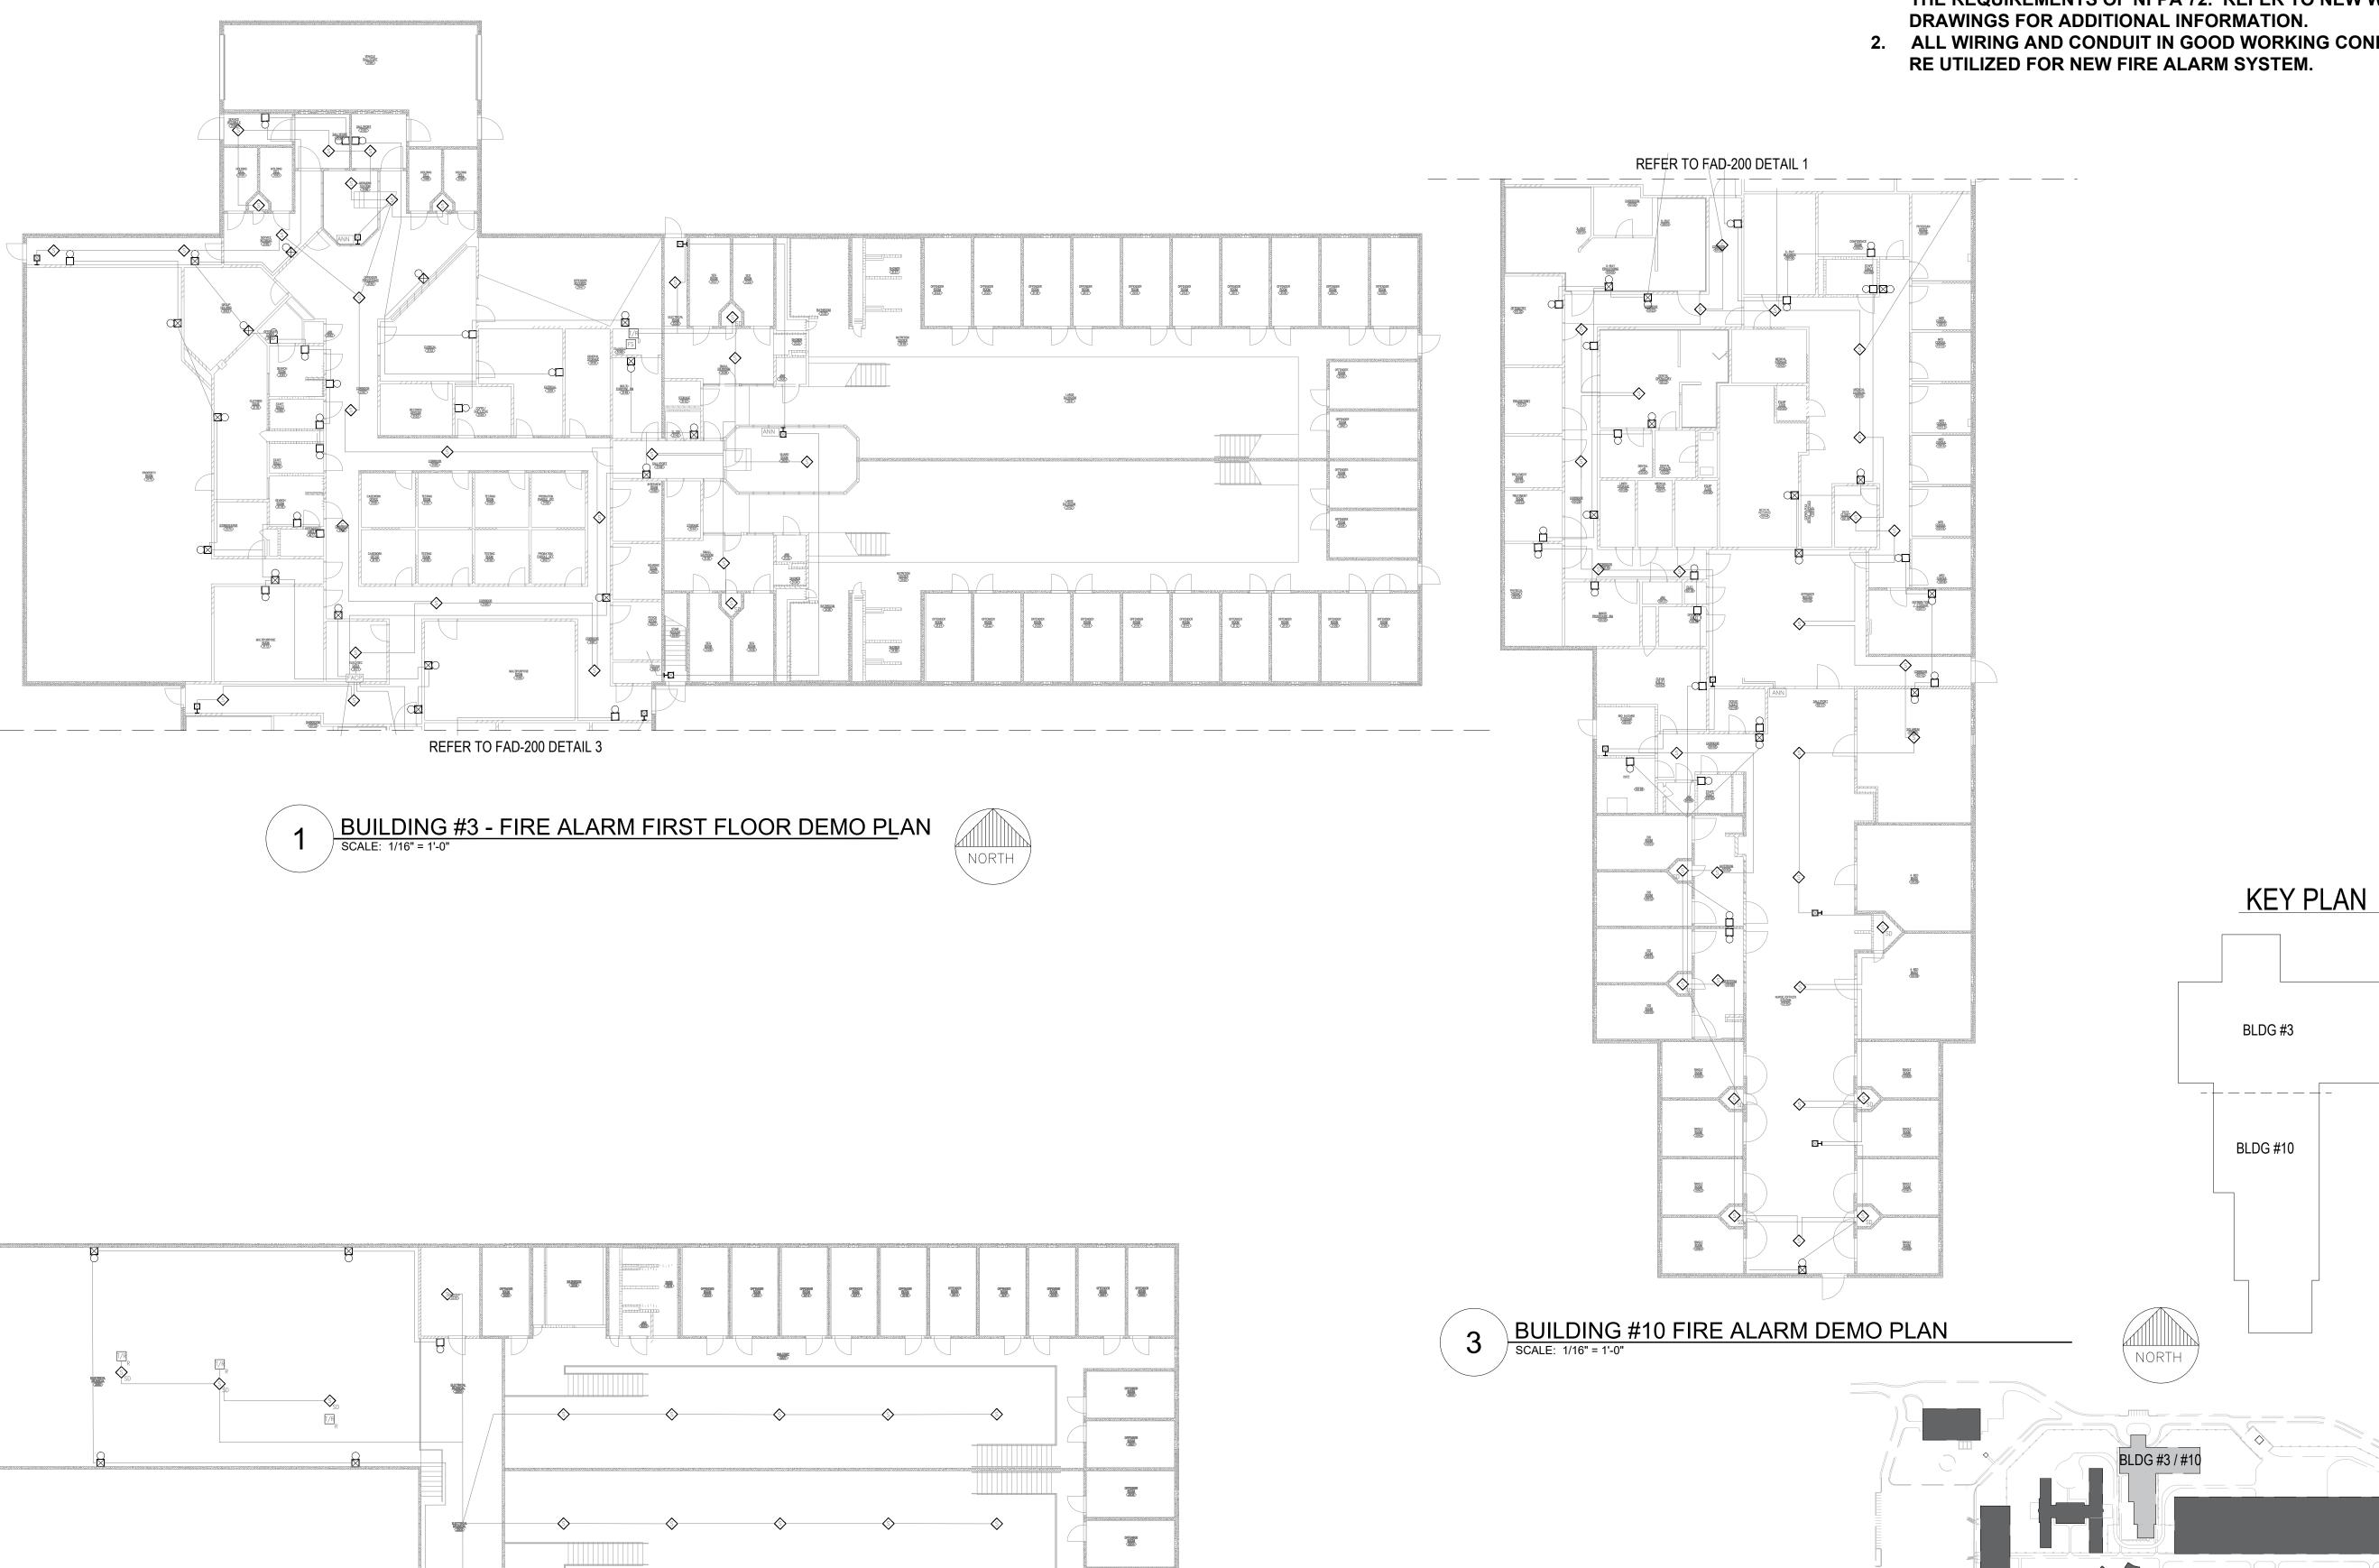


2 BUILDING #3 - FIRE ALARM SECOND FLOOR DEMO PLAN
SCALE: 1/16" = 1'-0"

- 1. ALL NOTIFICATION AND DETECTION DEVICES ARE TO BE REPLACED. LOCATIONS TO BE MODIFIED AS NECESSARY TO MEET THE REQUIREMENTS OF NFPA 72. REFER TO NEW WORK DRAWINGS FOR ADDITIONAL INFORMATION.
- 2. ALL WIRING AND CONDUIT IN GOOD WORKING CONDITION MAY BE RE UTILIZED FOR NEW FIRE ALARM SYSTEM.

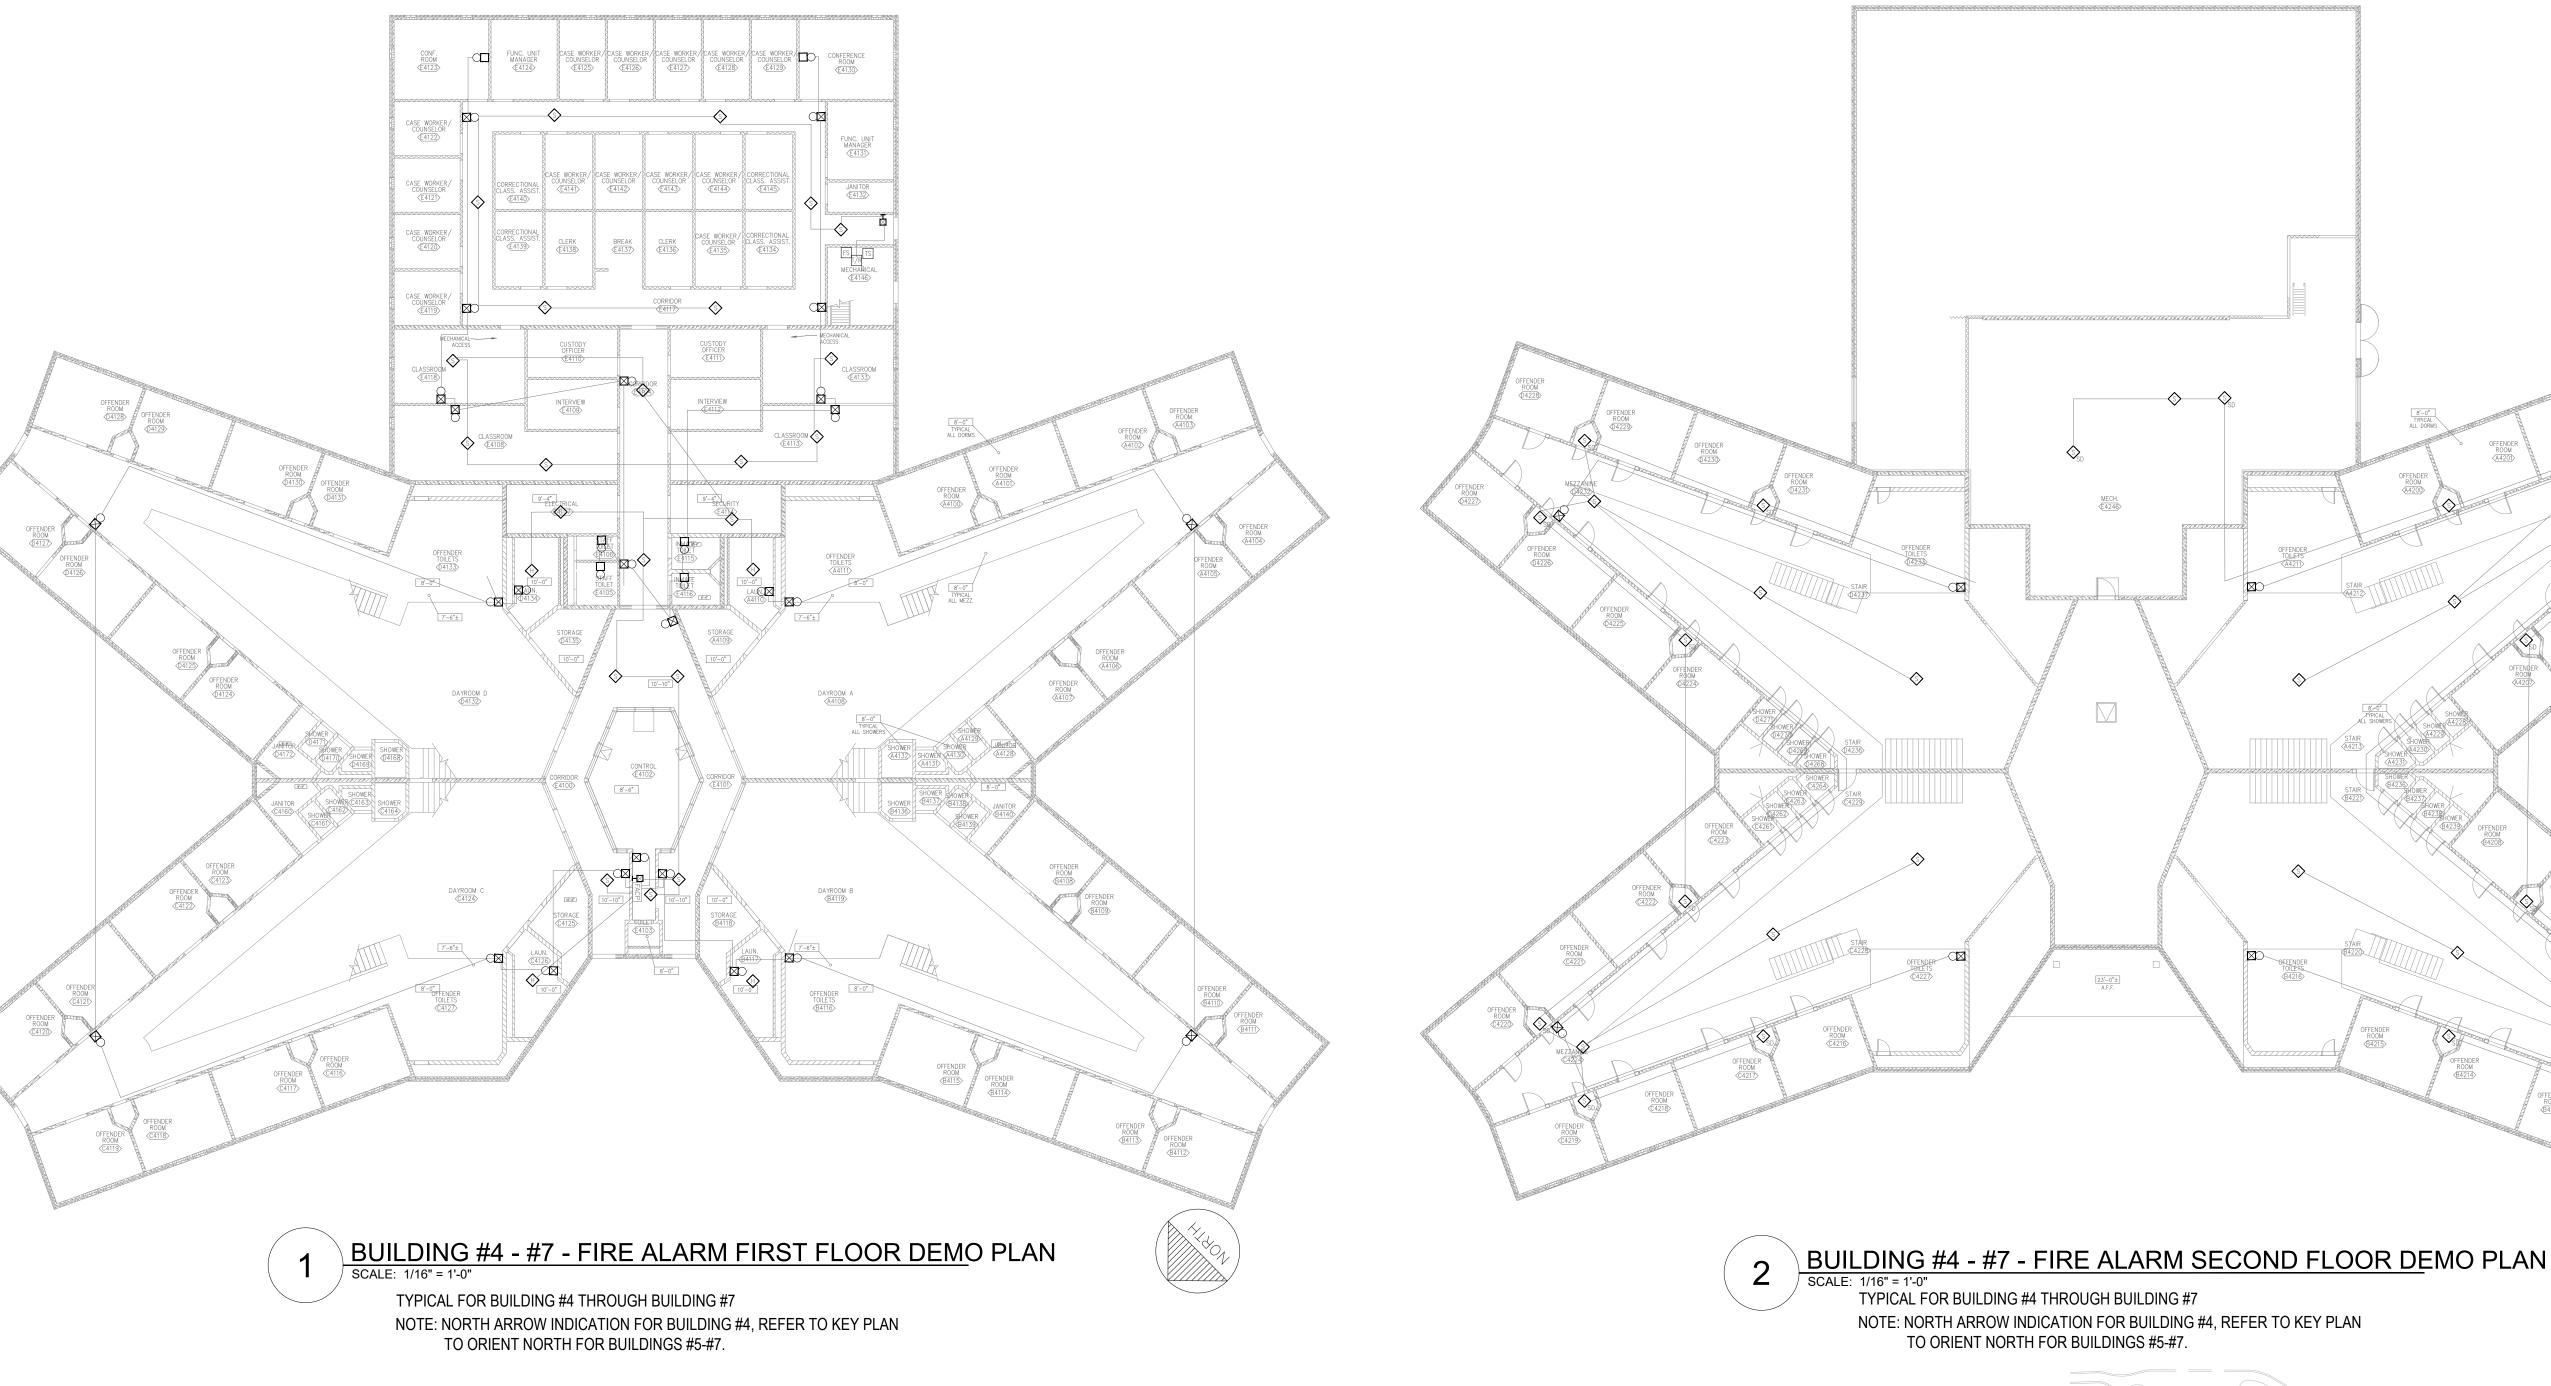

BUILDING #4 - #7 - FIRE ALARM SECOND FLOOR DEMO PLAN

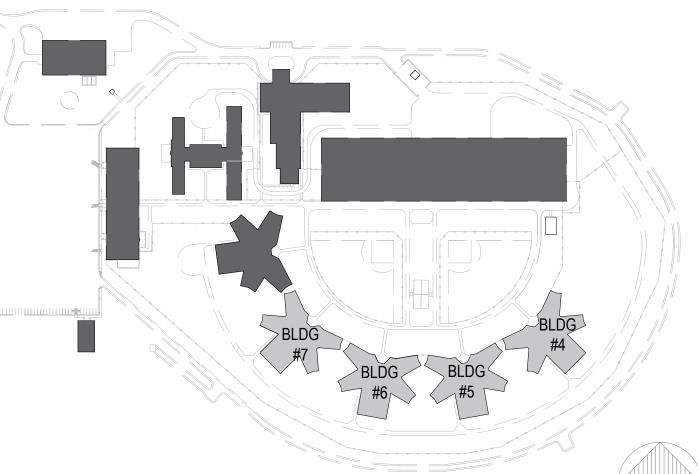

**KEY PLAN** 

STATE OF MISSOURI MICHAEL L. PARSON, **GOVERNOR** 



REFER TO FA-002 FOR FIRE ALARM GENERAL NOTES, SYMBOLS, & ABBREVIATIONS.



OFFICE OF ADMINISTRATION **DIVISION OF FACILITIES** MANAGEMENT, **DESIGN AND CONSTRUCTION** 

REPLACE FIRE ALARM SYSTEM, INFRASTRUCTURE CHILLICOTHE CORRECTIONAL CENTER

3151 LITTON ROAD CHILLICOTHE, MO 64601

PROJECT # C2326-01 7030 SITE# 9327030038 ASSET#

	REVISION:
	DATE:
	REVISION:
	DATE:
	REVISION:
	DATE:
	ISSUE DATE: 03/29/2024

CAD DWG FILE: C2326-01-FA-FP-115
DRAWN BY: DB
CHECKED BY: JMA DESIGNED BY: FSC


SHEET TITLE: BUILDING #4 - #7 -FIRE ALARM DEMO PLAN


SHEET NUMBER: FAD-300

**15** OF 20 SHEETS

NORTH

- 1. ALL NOTIFICATION AND DETECTION DEVICES ARE TO BE REPLACED. LOCATIONS TO BE MODIFIED AS NECESSARY TO MEET THE REQUIREMENTS OF NFPA 72. REFER TO NEW WORK DRAWINGS FOR ADDITIONAL INFORMATION.
- 2. ALL WIRING AND CONDUIT IN GOOD WORKING CONDITION MAY BE RE UTILIZED FOR NEW FIRE ALARM SYSTEM.

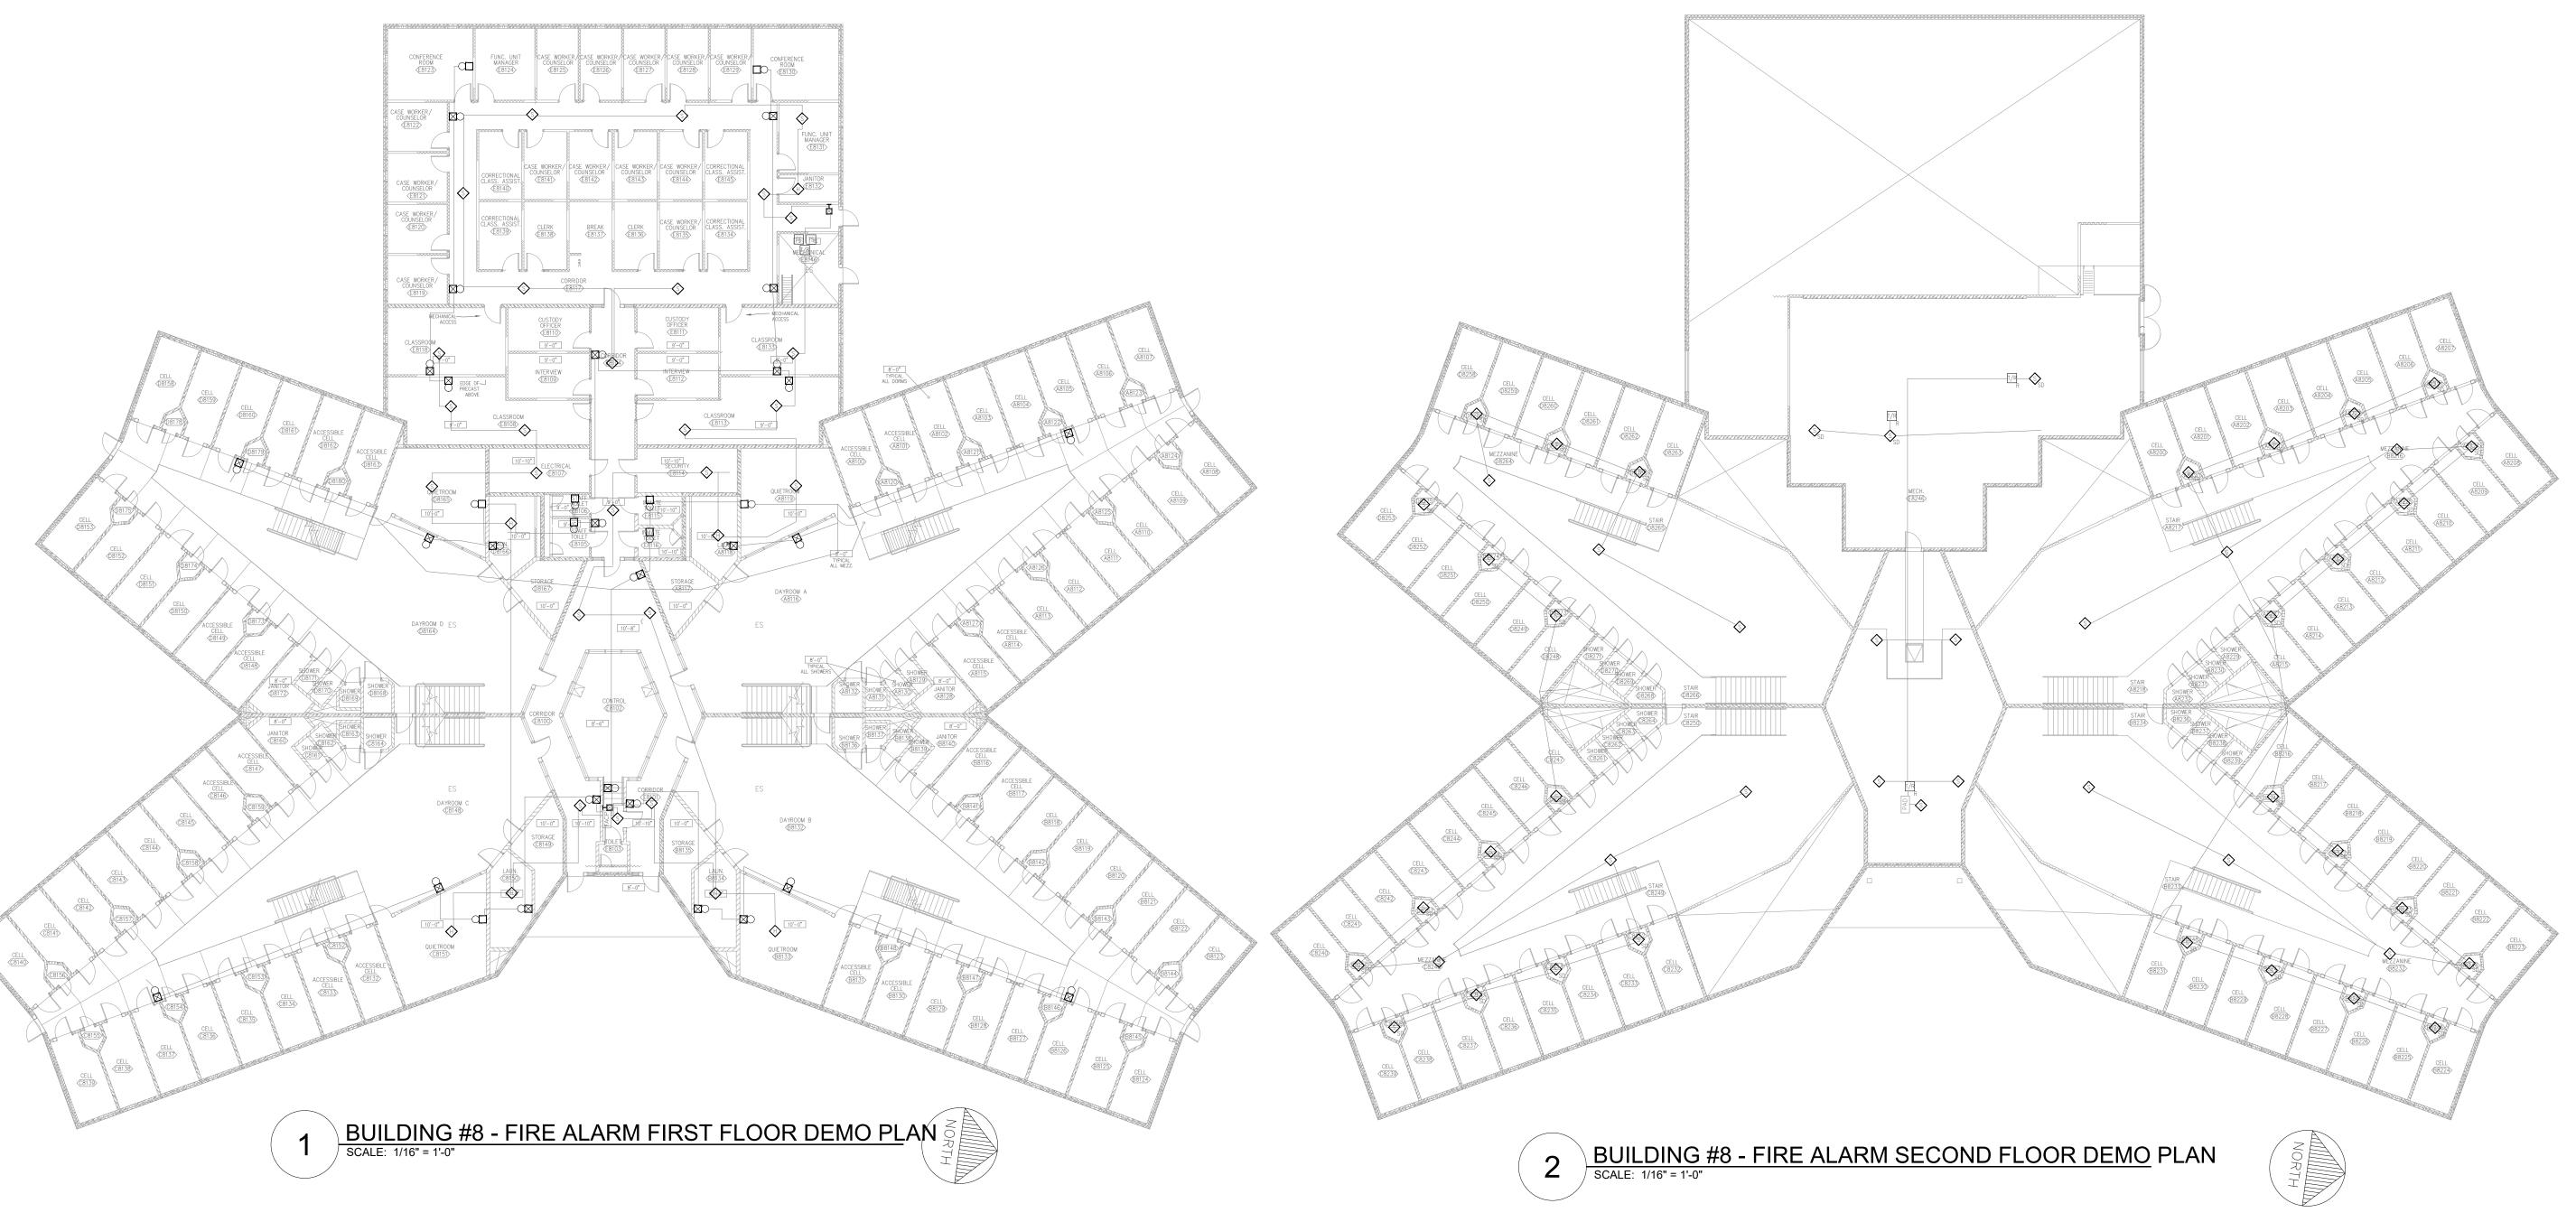

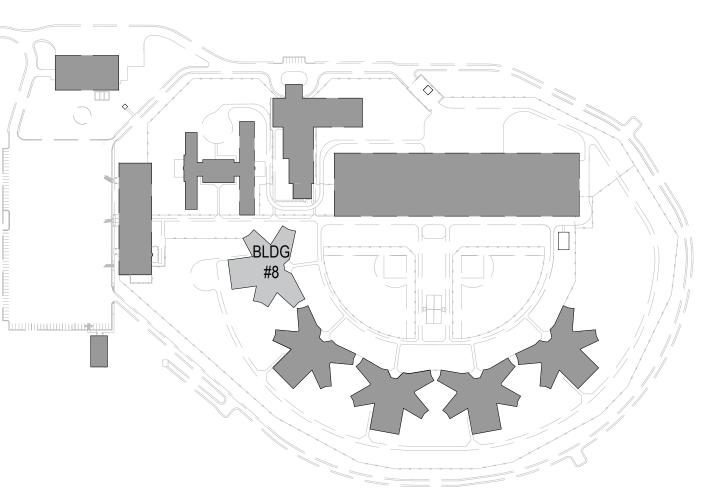

AREA PLAN

#### STATE OF MISSOURI MICHAEL L. PARSON, GOVERNOR



REFER TO FA-002 FOR FIRE ALARM GENERAL NOTES, SYMBOLS, & ABBREVIATIONS.



OFFICE OF ADMINISTRATION DIVISION OF FACILITIES MANAGEMENT, DESIGN AND CONSTRUCTION

REPLACE FIRE ALARM
SYSTEM,
INFRASTRUCTURE
CHILLICOTHE
CORRECTIONAL CENTER

3151 LITTON ROAD CHILLICOTHE, MO 64601


PROJECT # C2326-01 SITE # 7030 ASSET # 9327030038

ı	REVISION:
	DATE:
	REVISION:
-	DATE:
	REVISION:
	DATE:
	ISSUE DATE: 03/29/2024

CAD DWG FILE: C2326-01-FA-FP-116
DRAWN BY: DB
CHECKED BY: JMA
DESIGNED BY: FSC


SHEET TITLE:
BUILDING #8 - FIRE
ALARM DEMO PLAN

SHEET NUMBER: FAD-400

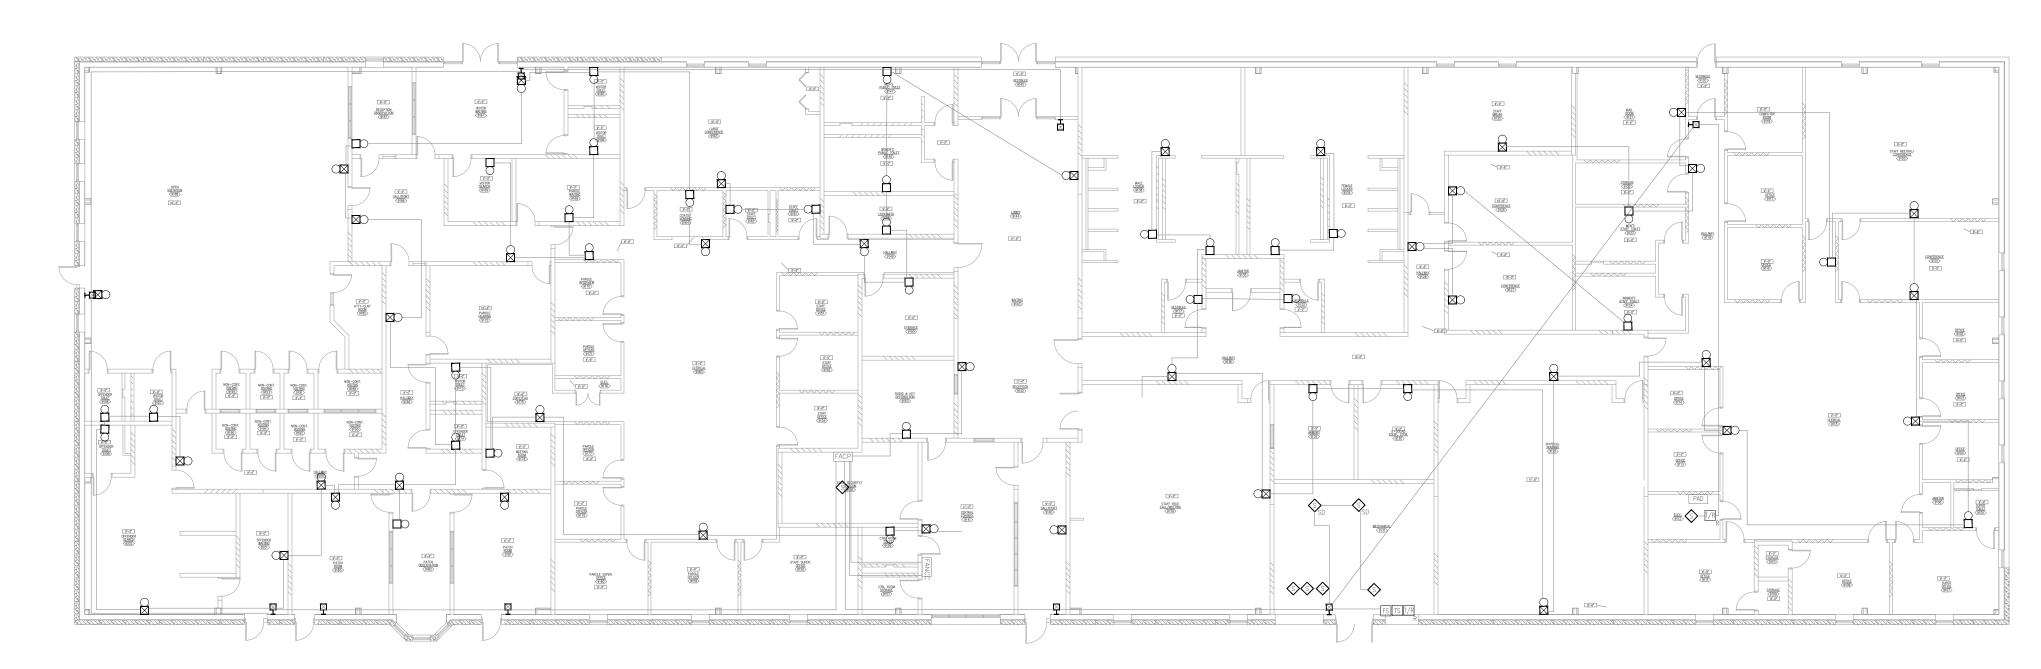






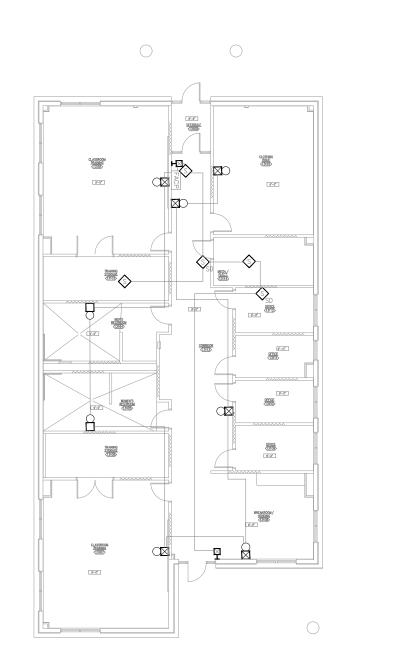





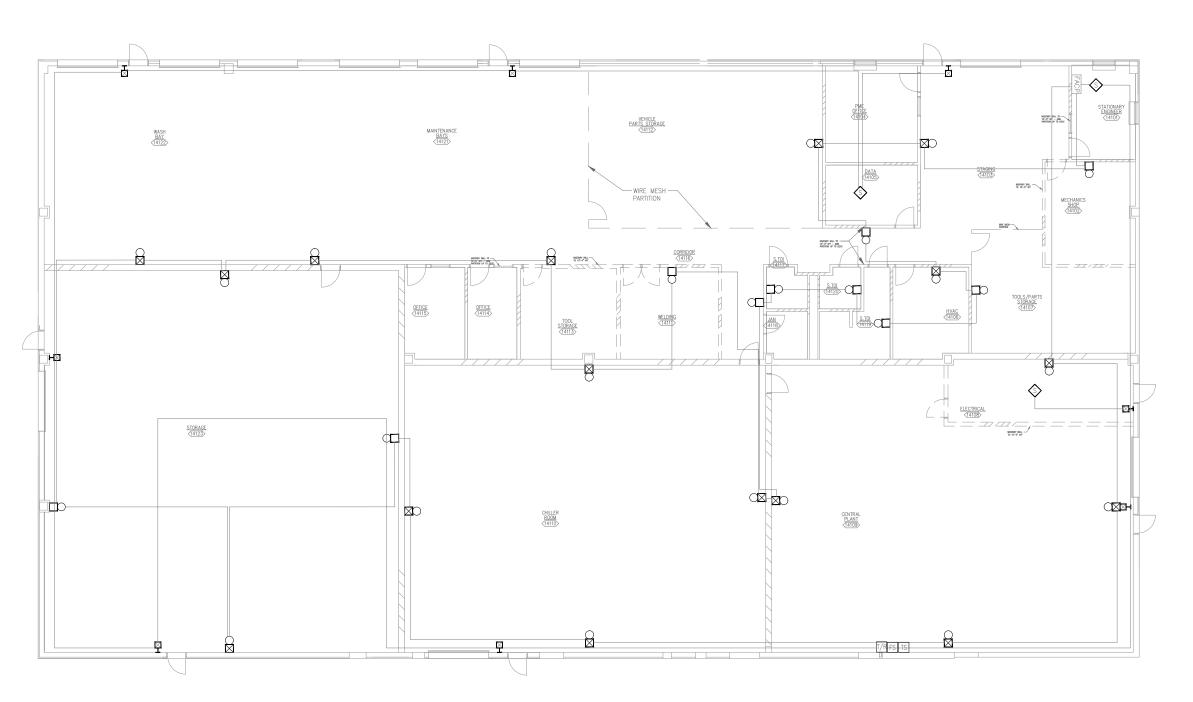

BUILDING #14 - FIRE ALARM DEMO PLAN

SCALE: 1/16" = 1'-0"

GENERAL NOTES

- 1. ALL NOTIFICATION AND DETECTION DEVICES ARE TO BE REPLACED. LOCATIONS TO BE MODIFIED AS NECESSARY TO MEET THE REQUIREMENTS OF NFPA 72. REFER TO NEW WORK DRAWINGS FOR ADDITIONAL INFORMATION.
- 2. ALL WIRING AND CONDUIT IN GOOD WORKING CONDITION MAY BE RE UTILIZED FOR NEW FIRE ALARM SYSTEM.

STATE OF MISSOURI MICHAEL L. PARSON, GOVERNOR



REFER TO FA-002 FOR FIRE ALARM GENERAL NOTES, SYMBOLS, & ABBREVIATIONS.



OFFICE OF ADMINISTRATION DIVISION OF FACILITIES MANAGEMENT, DESIGN AND CONSTRUCTION

REPLACE FIRE ALARM
SYSTEM,
INFRASTRUCTURE
CHILLICOTHE
CORRECTIONAL CENTER

3151 LITTON ROAD CHILLICOTHE, MO 64601


PROJECT # C2326-01 SITE # 7030 ASSET # 9327030038


REVISION:
DATE:
REVISION:
DATE:
REVISION:
DATE:
ISSUE DATE: 03/29/2024

CAD DWG FILE:C2326-01-FA-FP-117
DRAWN BY: DB
CHECKED BY: JMA
DESIGNED BY: FSC

SHEET TITLE:
BUILDING #9, #13, &
#14 - FIRE ALARM
DEMO PLAN

SHEET NUMBER: FAD-500

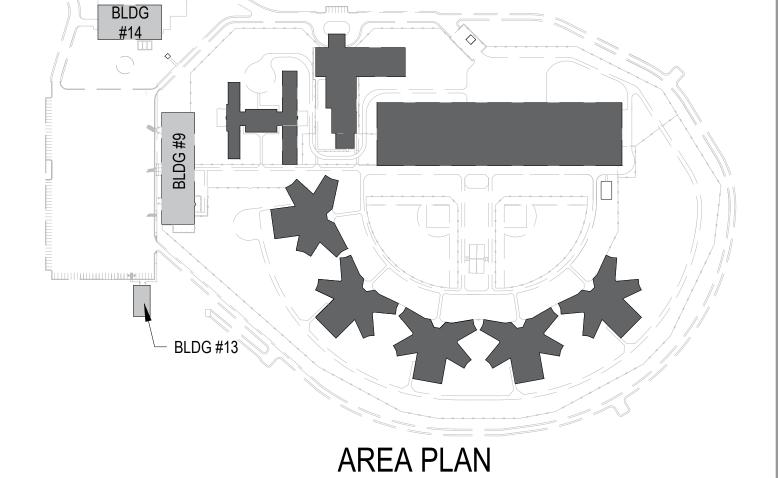

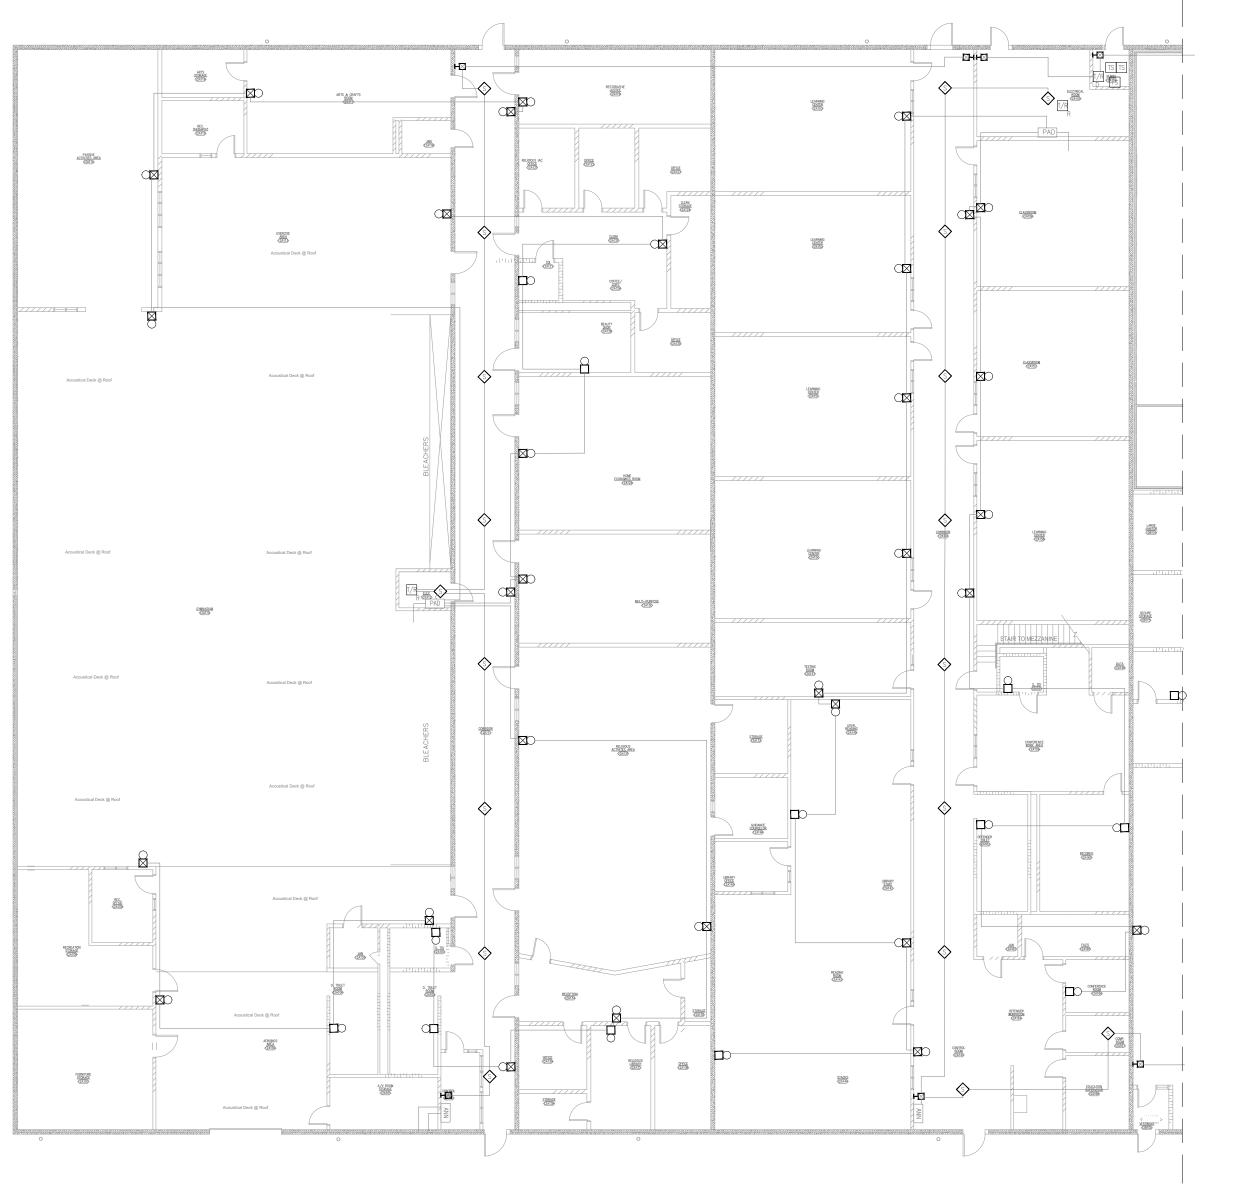

BUILDING #12 AREA A - FIRE ALARM DEMO PLAN

SCALE: 1/16" = 1'-0"



#### GENERAL NOTES

- 1. ALL NOTIFICATION AND DETECTION DEVICES ARE TO BE REPLACED. LOCATIONS TO BE MODIFIED AS NECESSARY TO MEET THE REQUIREMENTS OF NFPA 72. REFER TO NEW WORK DRAWINGS FOR ADDITIONAL INFORMATION.
- 2. ALL WIRING AND CONDUIT IN GOOD WORKING CONDITION MAY BE RE UTILIZED FOR NEW FIRE ALARM SYSTEM.

#### STATE OF MISSOURI MICHAEL L. PARSON, GOVERNOR



REFER TO FA-002 FOR FIRE ALARM GENERAL NOTES, SYMBOLS, & ABBREVIATIONS.



OFFICE OF ADMINISTRATION DIVISION OF FACILITIES MANAGEMENT, DESIGN AND CONSTRUCTION

REPLACE FIRE ALARM SYSTEM, INFRASTRUCTURE CHILLICOTHE CORRECTIONAL CENTER

# 3151 LITTON ROAD CHILLICOTHE, MO 64601

PROJECT # C2326-01 SITE # 7030 ASSET # 9327030038

	REVISION:
	DATE:
	REVISION:
	DATE:
	REVISION:
	DATE:
	ISSUE DATE: 03/29/2024

CAD DWG FILE: C2326-01-FA-FP-118
DRAWN BY: DB
CHECKED BY: JMA
DESIGNED BY: FSC

SHEET TITLE:
BUILDING #12 AREA A
- FIRE ALARM DEMO
PLAN


SHEET NUMBER: FAD-600

**18** OF 20 SHEETS


**KEY PLAN** 

BLDG #12
AREA B
SEE FAD-601

BLDG #12
AREA A
SEE FAD-602

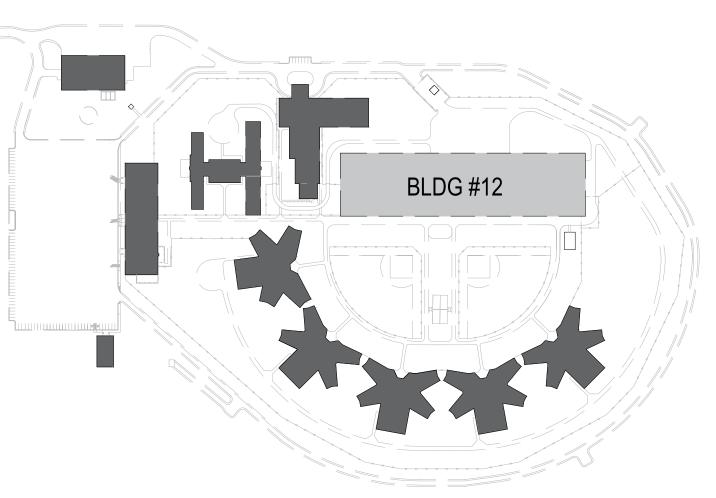

AREA PLAN

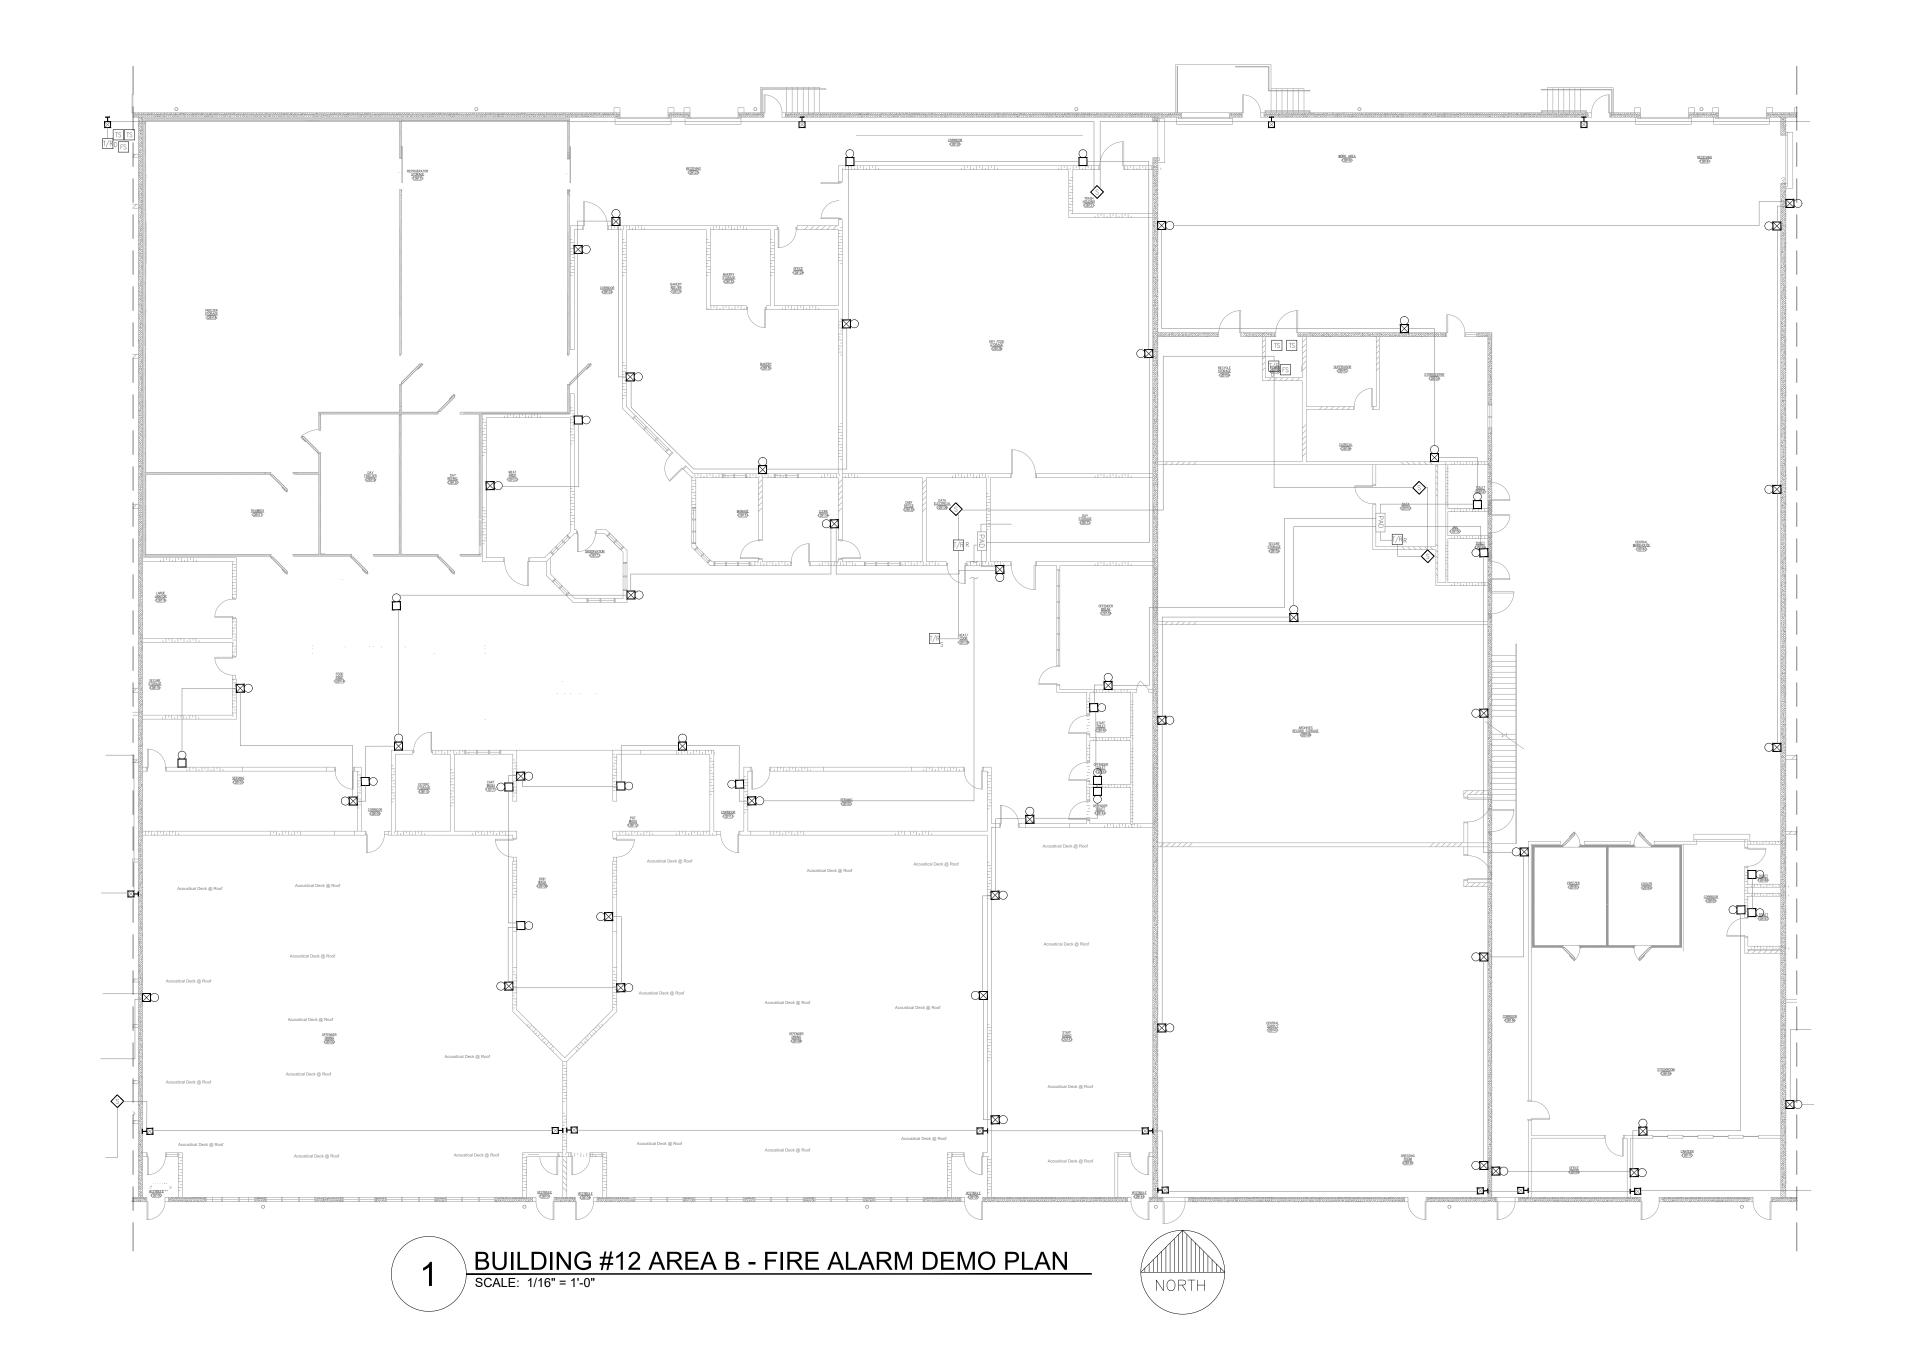

- 1. ALL NOTIFICATION AND DETECTION DEVICES ARE TO BE REPLACED. LOCATIONS TO BE MODIFIED AS NECESSARY TO MEET THE REQUIREMENTS OF NFPA 72. REFER TO NEW WORK DRAWINGS FOR ADDITIONAL INFORMATION.
- 2. ALL WIRING AND CONDUIT IN GOOD WORKING CONDITION MAY BE RE UTILIZED FOR NEW FIRE ALARM SYSTEM.

#### STATE OF MISSOURI MICHAEL L. PARSON, GOVERNOR



REFER TO FA-002 FOR FIRE ALARM GENERAL NOTES, SYMBOLS, & ABBREVIATIONS.



OFFICE OF ADMINISTRATION DIVISION OF FACILITIES MANAGEMENT, DESIGN AND CONSTRUCTION

REPLACE FIRE ALARM
SYSTEM,
INFRASTRUCTURE
CHILLICOTHE
CORRECTIONAL CENTER

3151 LITTON ROAD CHILLICOTHE, MO 64601

PROJECT # C2326-01 SITE # 7030 ASSET # 9327030038

REVISION:
DATE:
REVISION:
DATE:
REVISION:
DATE:
REVISION:

ISSUE DATE: 03/29/2024

CAD DWG FILE: C2326-01-FA-FP-125
DRAWN BY: DB
CHECKED BY: JMA
DESIGNED BY: FSC

SHEET TITLE:

BUILDING #12 AREA B
- FIRE ALARM DEMO
PLAN


SHEET NUMBER: FAD-601

19 OF 20 SHEETS




BLDG #12
AREA A
SEE FAD-600

BLDG #12
AREA B
AREA A
SEE FAD-602

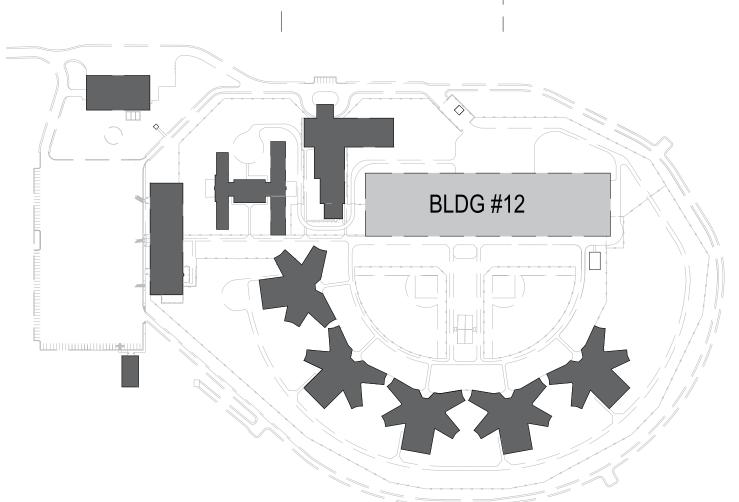

AREA PLAN

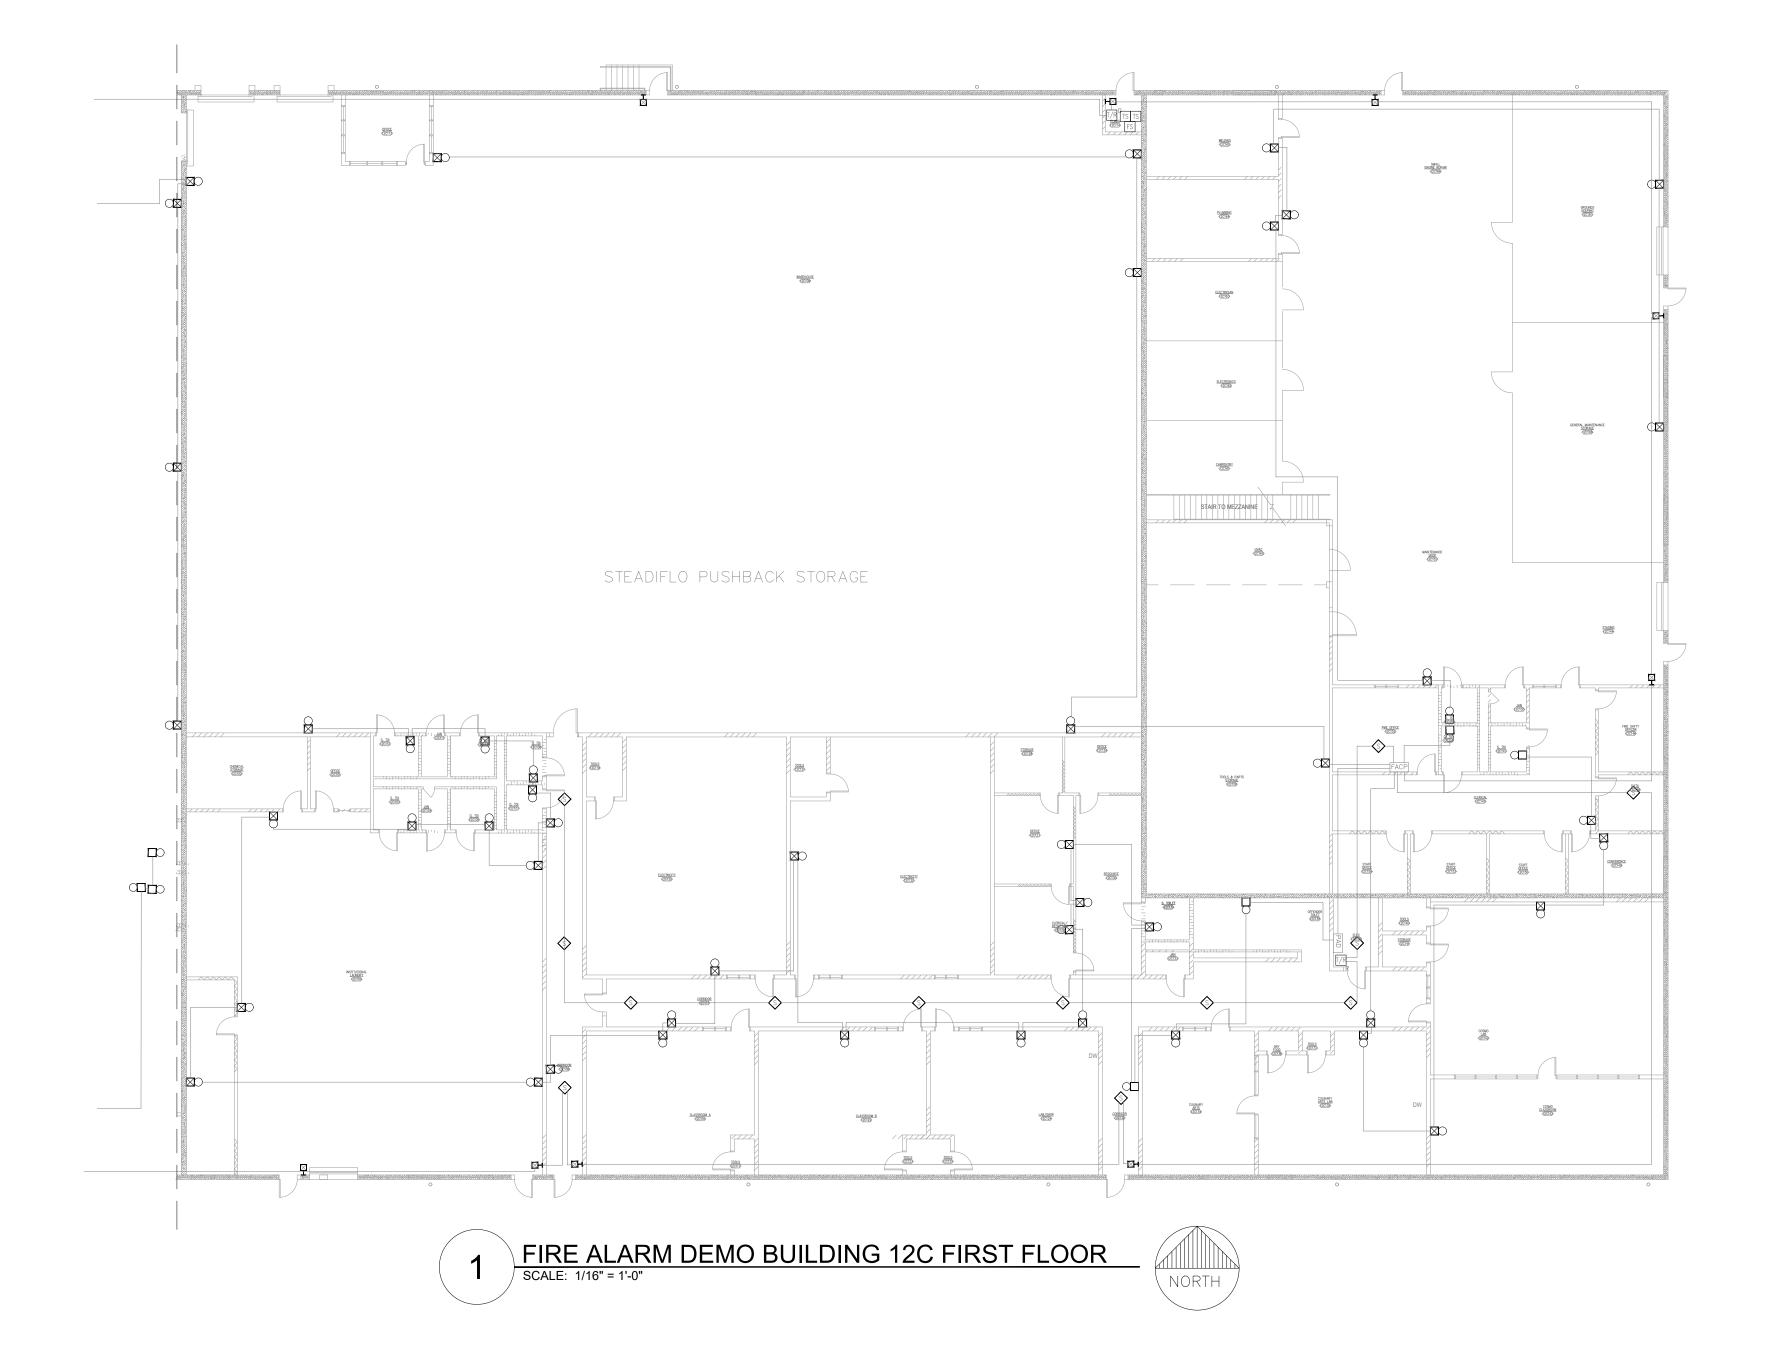

- 1. ALL NOTIFICATION AND DETECTION DEVICES ARE TO BE REPLACED. LOCATIONS TO BE MODIFIED AS NECESSARY TO MEET THE REQUIREMENTS OF NFPA 72. REFER TO NEW WORK DRAWINGS FOR ADDITIONAL INFORMATION.
- 2. ALL WIRING AND CONDUIT IN GOOD WORKING CONDITION MAY BE RE UTILIZED FOR NEW FIRE ALARM SYSTEM.

#### STATE OF MISSOURI MICHAEL L. PARSON, GOVERNOR



REFER TO FA-002 FOR FIRE ALARM GENERAL NOTES, SYMBOLS, & ABBREVIATIONS.



OFFICE OF ADMINISTRATION DIVISION OF FACILITIES MANAGEMENT, DESIGN AND CONSTRUCTION

REPLACE FIRE ALARM
SYSTEM,
INFRASTRUCTURE
CHILLICOTHE
CORRECTIONAL CENTER

# 3151 LITTON ROAD CHILLICOTHE, MO 64601

PROJECT # C2326-01 SITE # 7030 ASSET # 9327030038

REVISION:
DATE:
REVISION:
DATE:
REVISION:
DATE:
REVISION:
DATE:
ISSUE DATE: 03/29/2024

CAD DWG FILE: C2326-01-FA-FP-120 DRAWN BY: DB CHECKED BY: JMA DESIGNED BY: FSC

SHEET TITLE:
BUILDING #12 AREA C
- FIRE ALARM DEMO
PLAN

SHEET NUMBER: FAD-602


**20** OF 20 SHEETS



BLDG #12
AREA A
SEE FAD-600

BLDG #12
AREA B
SEE FAD-601

BLDG #12
AREA C

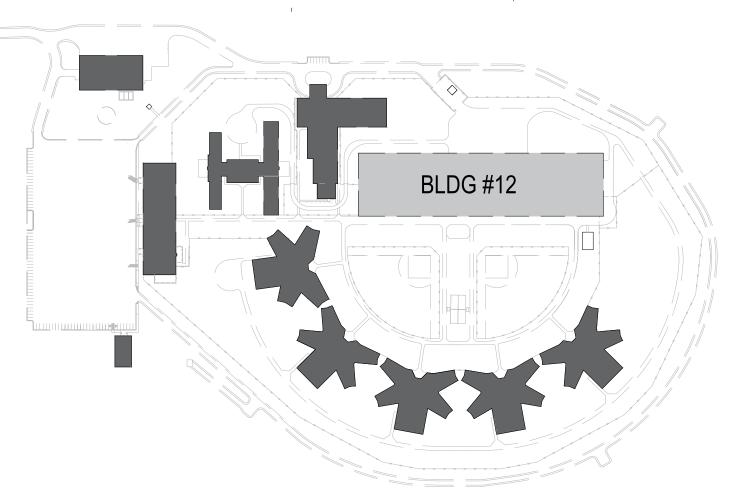

AREA PLAN