SERVICE GENERATOR, REPLACE ATS & RECONDITION SWITCHGEAR SOUTHEAST CORRECTIONAL CENTER CHARLESTON, MISSOURI



St. Louis6 South Old Orchard
St. Louis, MO 63119

+1 800.404.7677 hello@introba.com www.introba.com

OWNER:

STATE OF MISSOURI MICHAEL L. PARSON,

GOVERNOR

DEPARTMENT OF CORRECTIONS

PROJECT

OFFICE OF ADMINISTRATION

MANAGEMENT: DIVISION OF FACILITIES MANAGEMENT,

DESIGN AND CONSTRUCTION

DESIGNER:

TODD KUNO

PROJECT NUMBER:

C2329-01

SITE NUMBER: ASSET NUMBER:

7020 9327020021

LEGEND AND ABBREVIATIONS (SEE SPECIFICATIONS & SCHEDULES)

NOTES: 1. ALL SYMBOLS AND ABBREVIATIONS ARE NOT NECESSARILY USED ON THESE PLANS.

2. IN GENERAL, SYMBOLS SHOWN WITH LIGHT LINES DENOTE EXISTING WORK. SYMBOLS SHOWN WITH HEAVY LINES DENOTE NEW WORK.

DRAWING REFERENCES PLAN DETAIL REFERENCE TITLE KEYED NOTE DESIGNATION NORTH ARROW **ABBREVIATIONS** : ABOVE FINISHED FLOOR : CONDUIT : ELECTRICAL CONTRACTOR : EXISTING RELOCATED : EXISTING TO REMAIN : GENERAL CONTRACTOR GND : GROUND TYP. : TYPICAL U.O.N. : UNLESS OTHERWISE NOTED LINE TYPE LEGEND EXISTING TO REMAIN OR NEW WORK BY OTHERS (LIGHT, SOLID LINE) - NEW WORK BY THIS CONTRACTOR (DARK, SOLID LINE) _____ EXISTING TO BE REMOVED BY THIS CONTRACTOR (DARK, DASHED LINE, DEMOLITION PLANS) 2-HOUR FIRE RATED WALL POWER EQUIPMENT PANELBOARD (SURFACE) PANELBOARD (FLUSH)

GENERAL NOTES


- 1. MAKE ALL INSTALLATIONS IN ACCORDANCE WITH THE AMERICANS WITH DISABILITIES ACT ACCESSIBILITY GUIDELINES (ADAAG).
- 2. COORDINATE EXACT EQUIPMENT LOCATIONS WITH EXISTING CONDITIONS. EQUIPMENT LOCATIONS SHOWN ON ELECTRICAL PLANS ARE DIAGRAMMATICAL ONLY AND MIGHT NOT BE EXACT.
- 3. CONCEAL ALL CONDUIT IN WALLS, PARTITIONS, ABOVE CEILINGS, ETC. UNLESS OTHERWISE INDICATED ON THE PLANS OR IN THE SPECIFICATIONS. CONDUIT ROUTED IN MECHANICAL ROOMS, ELECTRICAL ROOMS, AND STORAGE ROOMS WITHOUT CEILINGS MAY BE ROUTED EXPOSED.
- 4. REPAIR ALL OPENINGS MADE IN EXISTING WALLS, PARTITIONS, ETC TO ACCOMMODATE WORK OF THIS DISCIPLINE TO MATCH THE SURROUNDING CONDITIONS, USING WORKERS QUALIFIED IN THE APPROPRIATE TRADE. APPROPRIATELY GROUT OR SEAL ALL CONDUITS THROUGH WALLS.
- 5. ALL MATERIALS USED TO SEAL PENETRATIONS OF FIRE RATED WALLS AND FLOORS MUST HAVE BEEN TESTED AND CERTIFIED AS A SYSTEM PER ASTM E814 STANDARDS FOR FIRE TESTS OF THROUGH—PENETRATION FIRESTOPS.
- 6. REPLACE OR REINSTALL ALL PORTIONS OF THE BUILDING (CEILING TILES, WALLS, ETC) REMOVED TO ACCOMMODATE THE INSTALLATION OF ANY FIRE ALARM DEVICE, EQUIPMENT, ETC., USING WORKERS QUALIFIED IN THE APPROPRIATE TRADE.
- 7. TAKE PHOTOS OF ANY EXISTING CEILING TILE OR WALLS THAT ARE DAMAGED PRIOR TO THE COMMENCEMENT OF WORK. ANY DAMAGED WALLS OR CEILING SUSPECTED OF BEING DAMAGED DURING THE CONSTRUCTION OF THIS PROJECT WILL BE REPLACED/REPAIRED BY CONTRACTOR.

GENERATOR TESTING

- GENERATOR SHALL BE TESTED PRIOR TO DEMO OF SWITCHGEAR RELAY, PLCS AND CONTROLS. THE CONTRACTOR IS RESPONSIBLE FOR DOCUMENTING THE AS FOUND CONDITIONS.
- 2. CONTRACTOR RESPONSIBLE FOR OPERATIONAL LOAD BANK SYSTEM TESTING OF GENERATOR AFTER INSTALLATION OF NEW SWITCHGEAR RELAY, PLCS AND CONTROLS.

DEMOLITION NOTES

- 1. REMOVE, CAP AND RELOCATE EQUIPMENT, DEVICES, CONDUIT, WIRE, ETC., AS SHOWN AND SPECIFIED ON DRAWINGS, AND AS MAY BECOME NECESSARY BECAUSE OF EXISTING FIELD CONDITIONS. FAILURE TO VISIT THE SITE AND TO TAKE ALL EXISTING CONDITIONS INTO ACCOUNT WILL NOT ALLOW FOR CHANGES TO THE SCOPE OF WORK.
- 2. MAINTAIN CIRCUIT CONTINUITY TO ALL EXISTING FIXTURES, EQUIPMENT, OUTLETS, ETC., TO REMAIN IN USE WHETHER NOTED ON THE PLANS OR NOT. FIELD VERIFY EXISTING ITEMS TO REMAIN IN USE. RECONNECT RACEWAYS AND WIRING FOR EXISTING CIRCUITS WHICH MUST BE RE—ROUTED OR WHICH ARE PARTIALLY ABANDONED TO POWER THE REMAINING OUTLETS ON THE CIRCUIT.
- 3. FOR ALL WORK SHOWN TO BE REMOVED DURING THE DEMOLITION PHASE, REMOVE ALL WIRING AND CABLES BACK TO THEIR SOURCE UNLESS NOTED OTHERWISE TO BE RE-USED FOR NEW WORK. REMOVE ALL UNUSED CONDUIT THAT IS EXPOSED OR ABOVE ACCESSIBLE CEILINGS WHICH IS AFFECTED BY OR IS IN THE AREA OF THE DEMOLITION WORK.
- 4. WHERE EQUIPMENT, DEVICES, CONDUIT, BOXES, AND SUPPORTING HARDWARE ARE REMOVED, PATCH AND FINISH THE SURFACE AS REQUIRED TO MATCH THE EXISTING, USING WORKERS QUALIFIED IN THE APPROPRIATE TRADE.
- 5. TAKE ALL REMOVED MATERIALS FROM THE PROJECT SITE, EXCEPT FOR THOSE TO BE RELOCATED, STORED, OR TURNED OVER TO THE USING AGENCY.
- ACCEPTANCE OF CONTRACT MEANS INSTALLER ACCEPTS EXISTING CONDITIONS.
 PROVIDE A BLANK COVER PLATE WHERE A FLUSH DEVICE IS BEING REMOVED
- 7. PROVIDE A BLANK COVER PLATE WHERE A FLUSH DEVICE IS BEING REMOVED FROM WALLS THAT ARE TO REMAIN. MATCH THE COLOR, MATERIAL AND FIRE RATING TO THE EXISTING SURFACE IN THE ROOM OR SPACE.
- 8. LEGALLY DISPOSE OF HAZARDOUS MATERIALS OR OTHER EQUIPMENT CONTAINING PCBS. COMPLY WITH ALL FEDERAL, STATE, AND LOCAL LAWS.
- 9. MODIFY EXISTING PANEL DIRECTORIES (OR REPLACE) FOR PANELBOARDS WHICH HAVE HAD ALTERATIONS TO THE CIRCUITS ORIGINATING THEREIN. DESCRIBE THE LOAD AND LOCATION. TYPE, DO NOT HAND LETTER NEW PANELBOARD DIRECTORIES.
- 10. PATCH OR FILL ANY EXPOSED GAP BETWEEN CONDUIT AND WALL WERE NEW HOLES ARE DRILLED IN EXISTING WALLS.
- 11. PAINT TO A MINIMUM OF 1 FT ALL SIDE OF PATCH OR REMOVED SURFACE

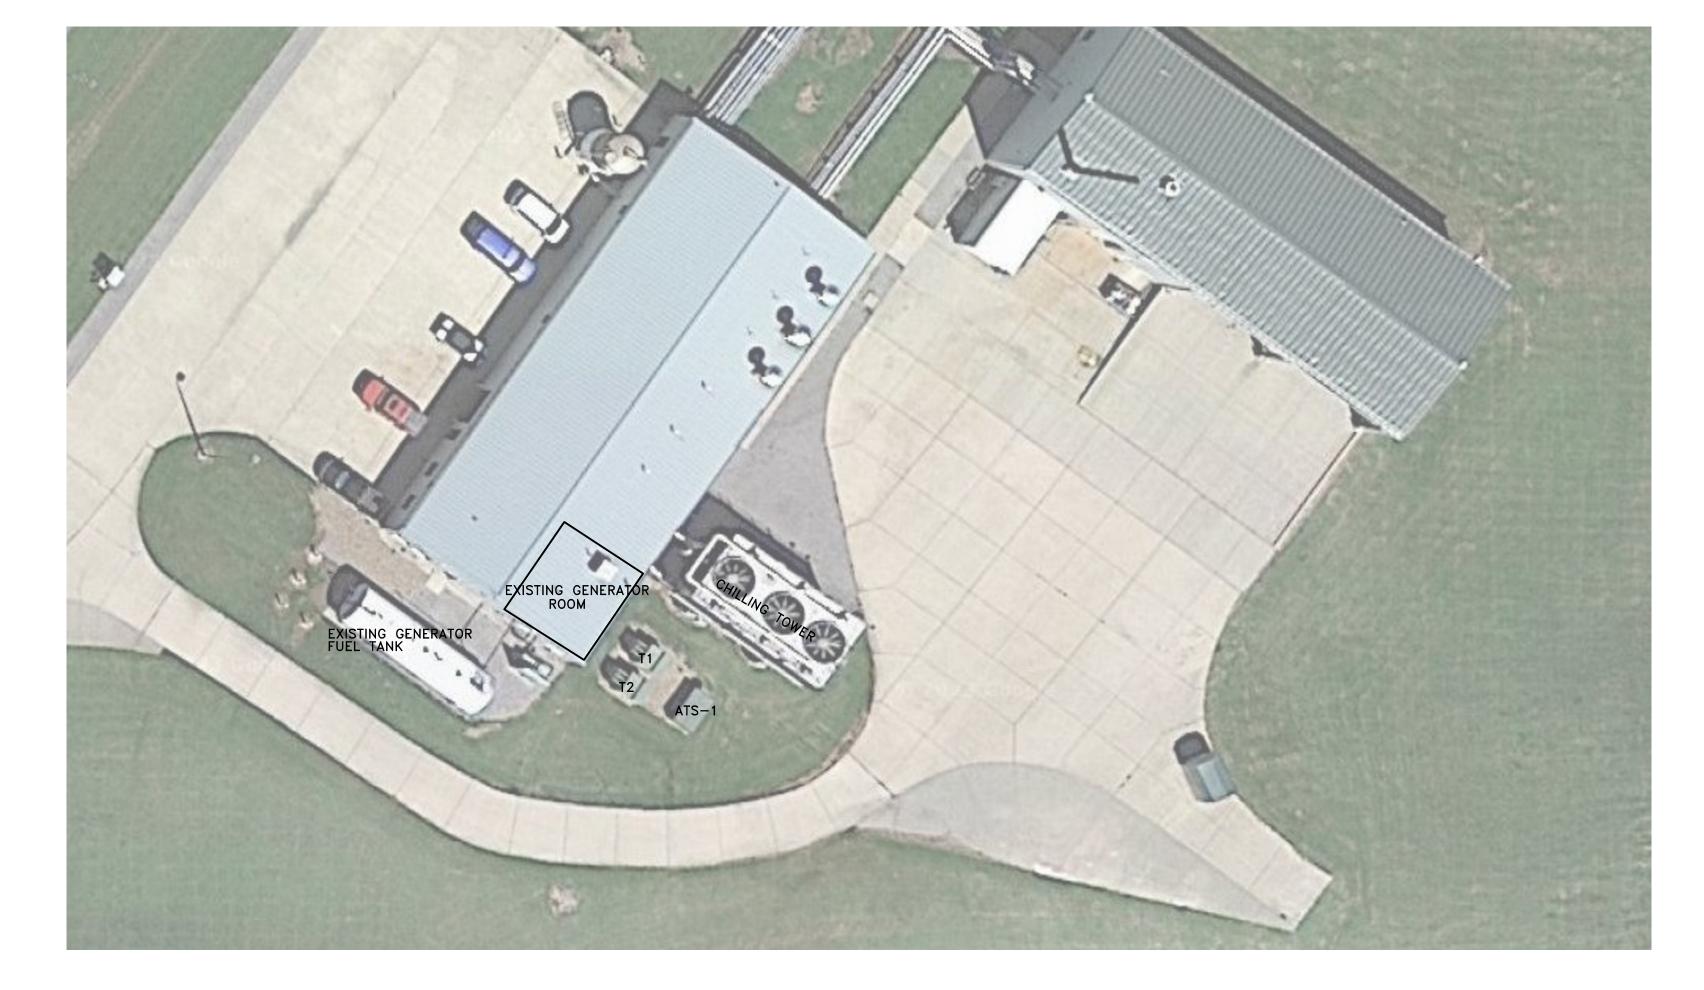

DRAWING INDEX

NUMBER TITLE

G-00

COVER SHEET

E-00 ELECTRICAL SYMBOLS AND LEGEND

E-10 DEMO ENLARGED ELECTRICAL PLAN
E-11 NEW WORK - ENLARGED ELECTRICAL PLAN

E-11 NEW WORK - ENLARGED ELECTF

E-60 DEMO CAMPUS ONE-LINE E-61 NEW WORK CAMPUS ONE-LINE

BASE BID / ALT BID

BASE BID: REPLACE GENERATOR MV METAL CLAD AND CONTROLS, GENERATOR BATTERY SYSTEM, AND

GENERATOR CONTROLLER.


ADD ALT 1: MAINTENANCE GENERATOR.

ADD ALT 2: MAINTENANCE G&W PAD MOUNT SWITCH.

ADD ALT 3: ADD LOAD CHILLER SHEDDING.

ADD ALT 4: ADD REMOTE GENERATOR ANNUNCIATOR PANEL.

STATE OF MISSOURI MICHAEL L. PARSON, GOVERNOR

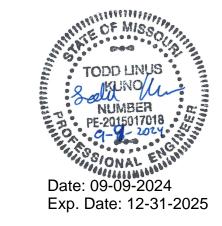



6 South Old Orchard St. Louis, MO 63119

+1 800.404.7677 hello@introba.com www.introba.com

OFFICE OF ADMINISTRATION DIVISION OF FACILITIES MANAGEMENT, DESIGN AND CONSTRUCTION

DEPARTMENT OF CORRECTIONS

SERVICE GENERATOR, REPLACE ATS AND RECONDITION SWITCHGEAR

SOUTHEAST CORRECTIONAL CENTER 300 PEDRO SIMMONS DR. CHARLESTON, MISSOURI

PROJECT # C2329-01

ASSET # 9327020021

REVISION:
DATE:
REVISION:
DATE:
REVISION:

DATE: ISSUE DATE: 09/09/2024

CAD DWG FILE:E-00
DRAWN BY: AO
CHECKED BY: GF
DESIGNED BY: TLK


SHEET TITLE:

ELECTRICAL
SYMBOLS AND
LEGEND

SHEET NUMBER:

E-00


02 OF 6 SHEETS 09/09/2024

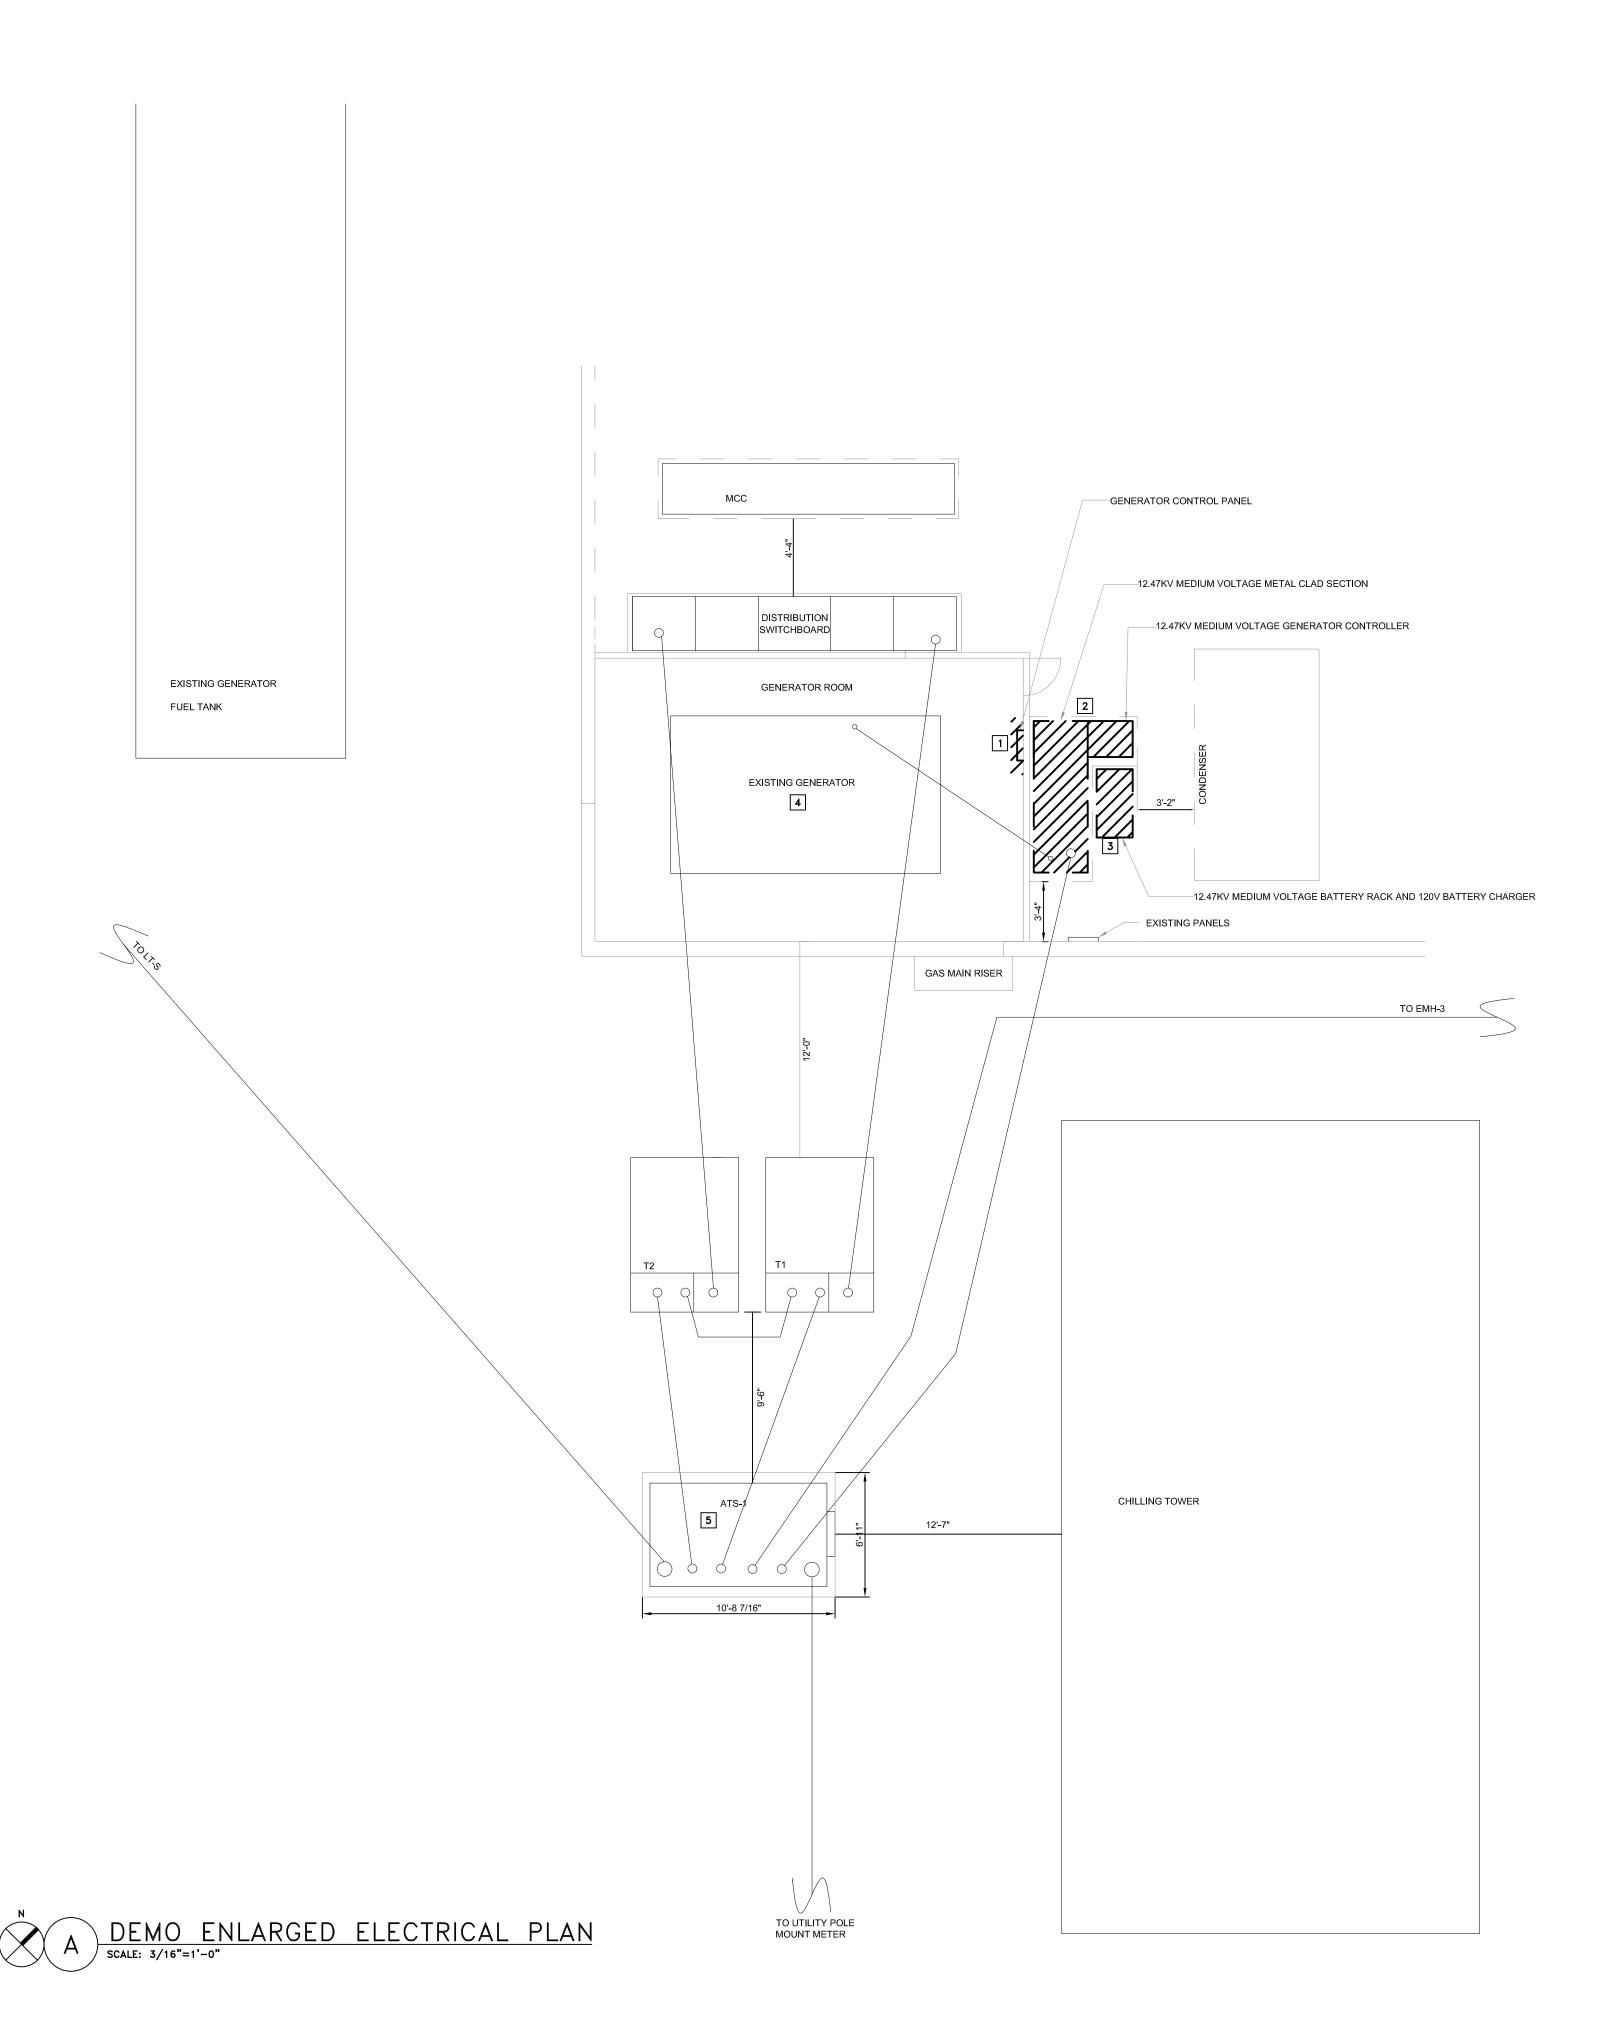

KEYED NOTES:

- . DEMO AND REPLACE GENERATOR CONTROL PANEL
- 2. DEMO AND REPLACE MEDIUM VOLTAGE GENERATOR METAL CLAD SWITCHGEAR AND CONTROL SECTION.
- 3. DEMO AND REPLACE MEDIUM VOLTAGE BATTERY RACK AND CHARGER.
- 4. PROVIDE MAINTENANCE FOR EXISTING GENERATOR UNDER ALT BID 1. REFER TO SPEC APPENDIX B FOR GENERATOR INSPECTION RECOMMENDED MAINTENANCE.
- 5. PROVIDE MAINTENANCE FOR EXISTING PAD MOUNT AIR INSULATED SWITCH UNDER ALT BID 2. REFER TO SPEC APPENDIX A FOR MANUFACTURE RECOMMENDED MAINTENANCE.

STATE OF MISSOURI MICHAEL L. PARSON, GOVERNOR

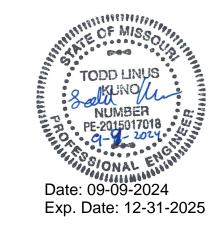



St. Louis 6 South Old Orchard St. Louis, MO 63119

+1 800.404.7677 hello@introba.com www.introba.com

OFFICE OF ADMINISTRATION DIVISION OF FACILITIES MANAGEMENT, DESIGN AND CONSTRUCTION

DEPARTMENT OF CORRECTIONS

SERVICE GENERATOR, REPLACE ATS AND RECONDITION SWITCHGEAR

SOUTHEAST CORRECTIONAL CENTER 300 PEDRO SIMMONS DR. CHARLESTON, MISSOURI

PROJECT # C2329-01 SITE # 7020 ASSET # 9327020021

REVISION:
DATE:
REVISION:
DATE:
REVISION:

ISSUE DATE: 09/09/2024

DATE:

CAD DWG FILE:E-10
DRAWN BY: AO
CHECKED BY: GF
DESIGNED BY: TLK

SHEET TITLE:


DEMO
ENLARGED
ELECTRICAL PLAN

SHEET NUMBER:

E-10

03 OF 6 SHEETS 09/09/2024


ID DOCUMENTS

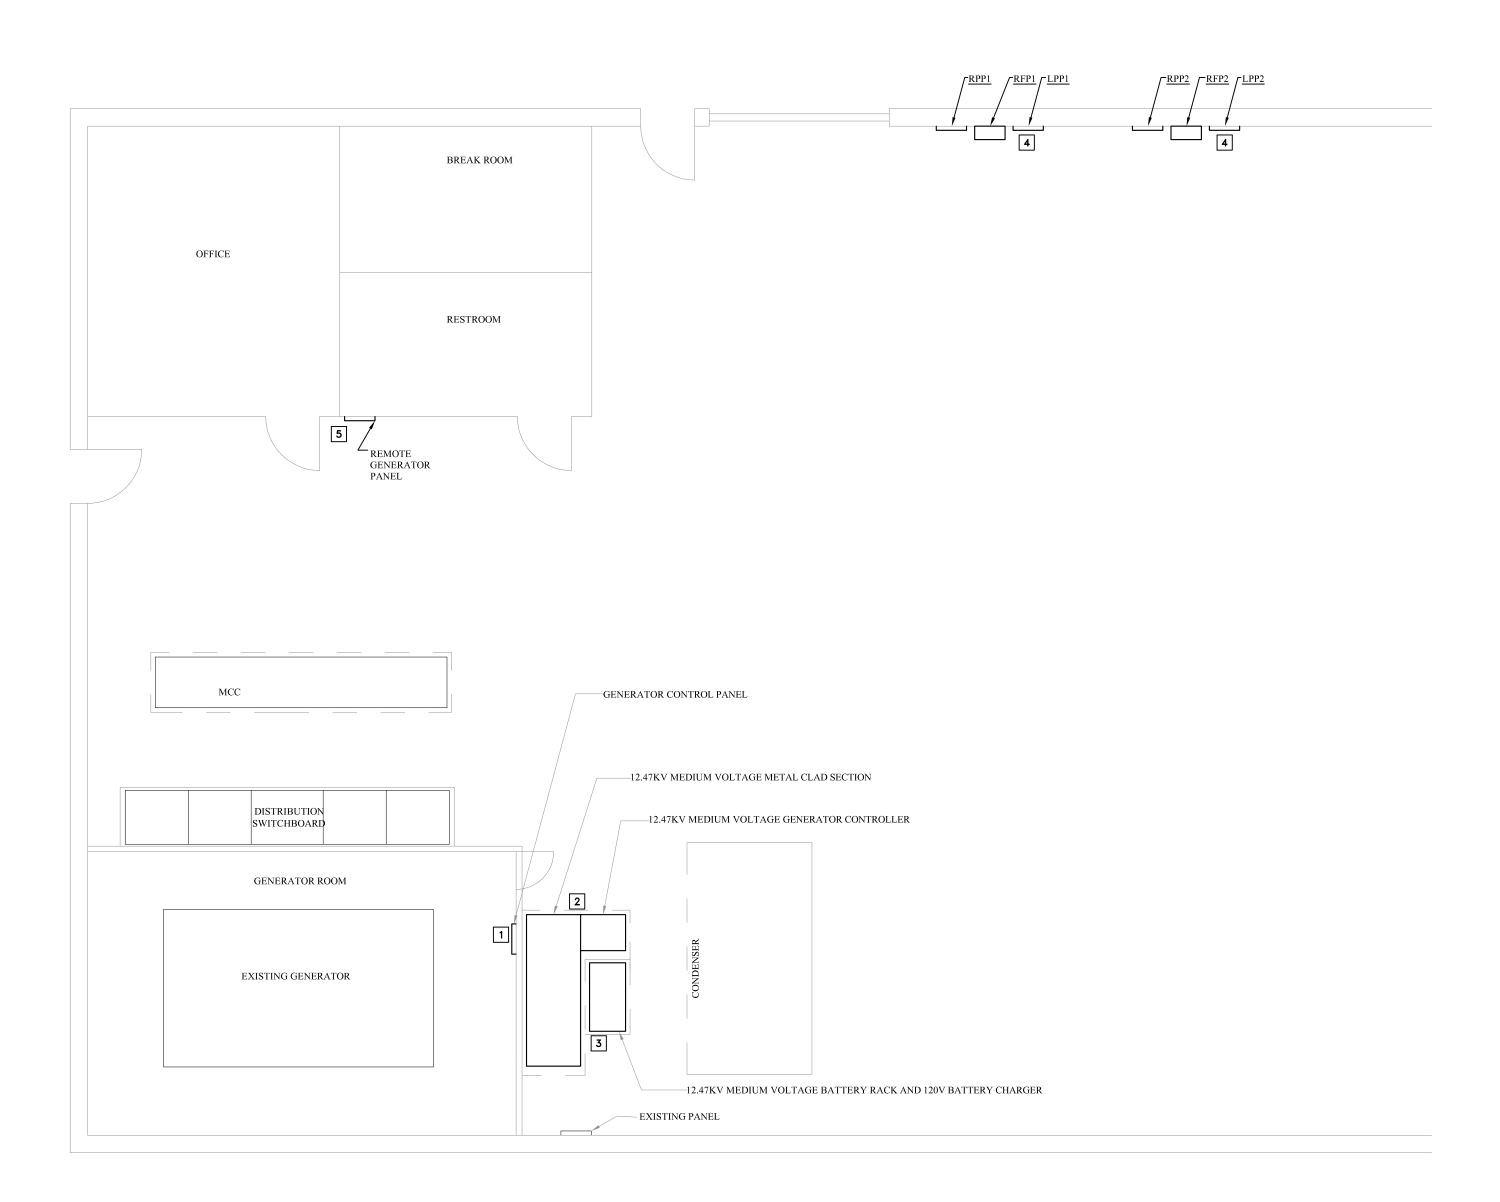

NEW WORK - ENLARGED ELECTRICAL PLAN SCALE: 3/16"=1'-0"




- PROVIDE NEW CAT EMCP 4.2 GENERATOR CONTROL PANEL.
- 2. PROVIDE NEW MEDIUM VOLTAGE GENERATOR METAL CLAD SECTION.
- 3. PROVIDE NEW DC RECTIFIER FOR MV RELAY AND CIRCUIT BREAKER. THE
- 4. CONNECT TO EXISTING CABLE FROM MEDIUM VOLTAGE GEAR.
- 5. PROVIDE NEW REMOTE GENERATOR PANEL UNDER ALTERNATE BID #4.

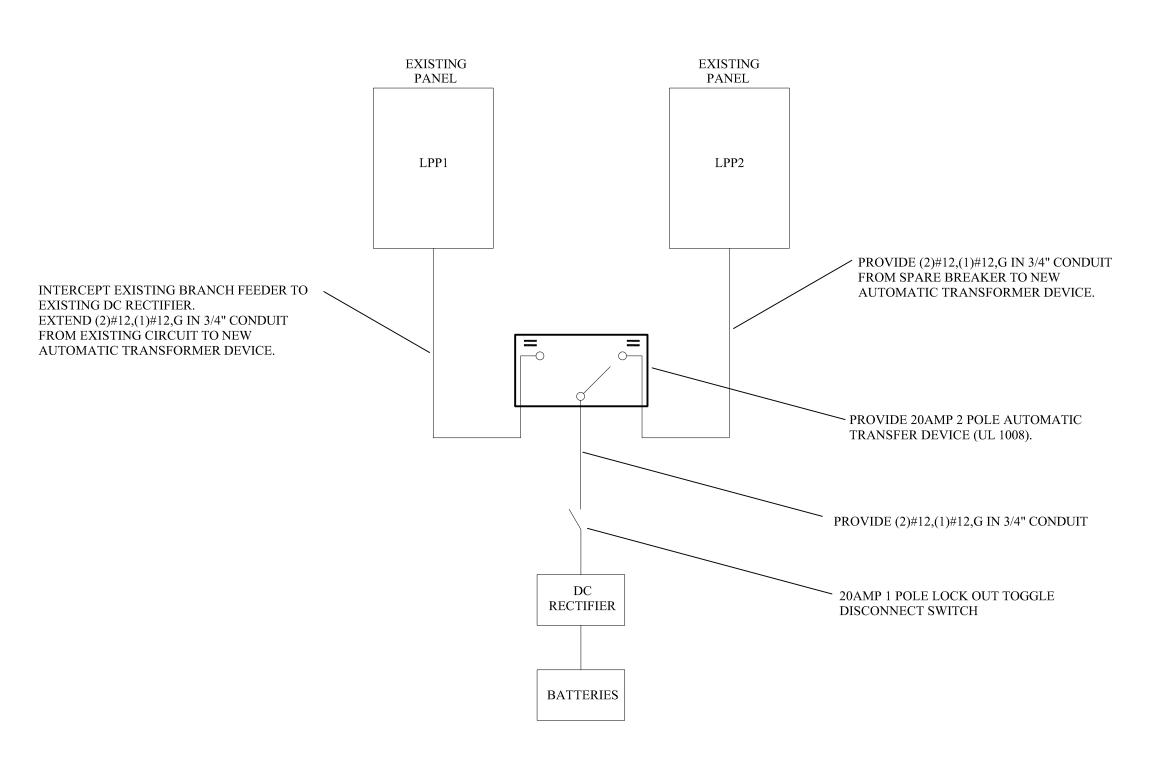

B DC RECTIFIER DETAIL

STATE OF MISSOURI MICHAEL L. PARSON, GOVERNOR

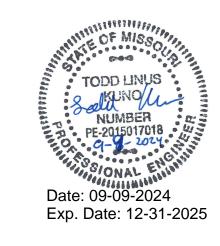



St. Louis
6 South Old Orchard
St. Louis, MO 63119
+1 800.404.7677
hello@introba.com
www.introba.com

OFFICE OF ADMINISTRATION DIVISION OF FACILITIES MANAGEMENT, DESIGN AND CONSTRUCTION

DEPARTMENT OF CORRECTIONS

SERVICE GENERATOR, REPLACE ATS AND RECONDITION SWITCHGEAR

SOUTHEAST CORRECTIONAL CENTER 300 PEDRO SIMMONS DR. CHARLESTON, MISSOURI

PROJECT # C2329-01 SITE # 7020 ASSET # 9327020021

REVISION:
DATE:
REVISION:
DATE:
REVISION:
DATE:
DATE:

ISSUE DATE: 09/09/2024

CAD DWG FILE:E-11
DRAWN BY: AO
CHECKED BY: GF
DESIGNED BY: TLK


SHEET TITLE:

NEW WORK -ENLARGED ELECTRICAL PLAN

SHEET NUMBER:


E-11

04 OF 6 SHEETS 09/09/2024

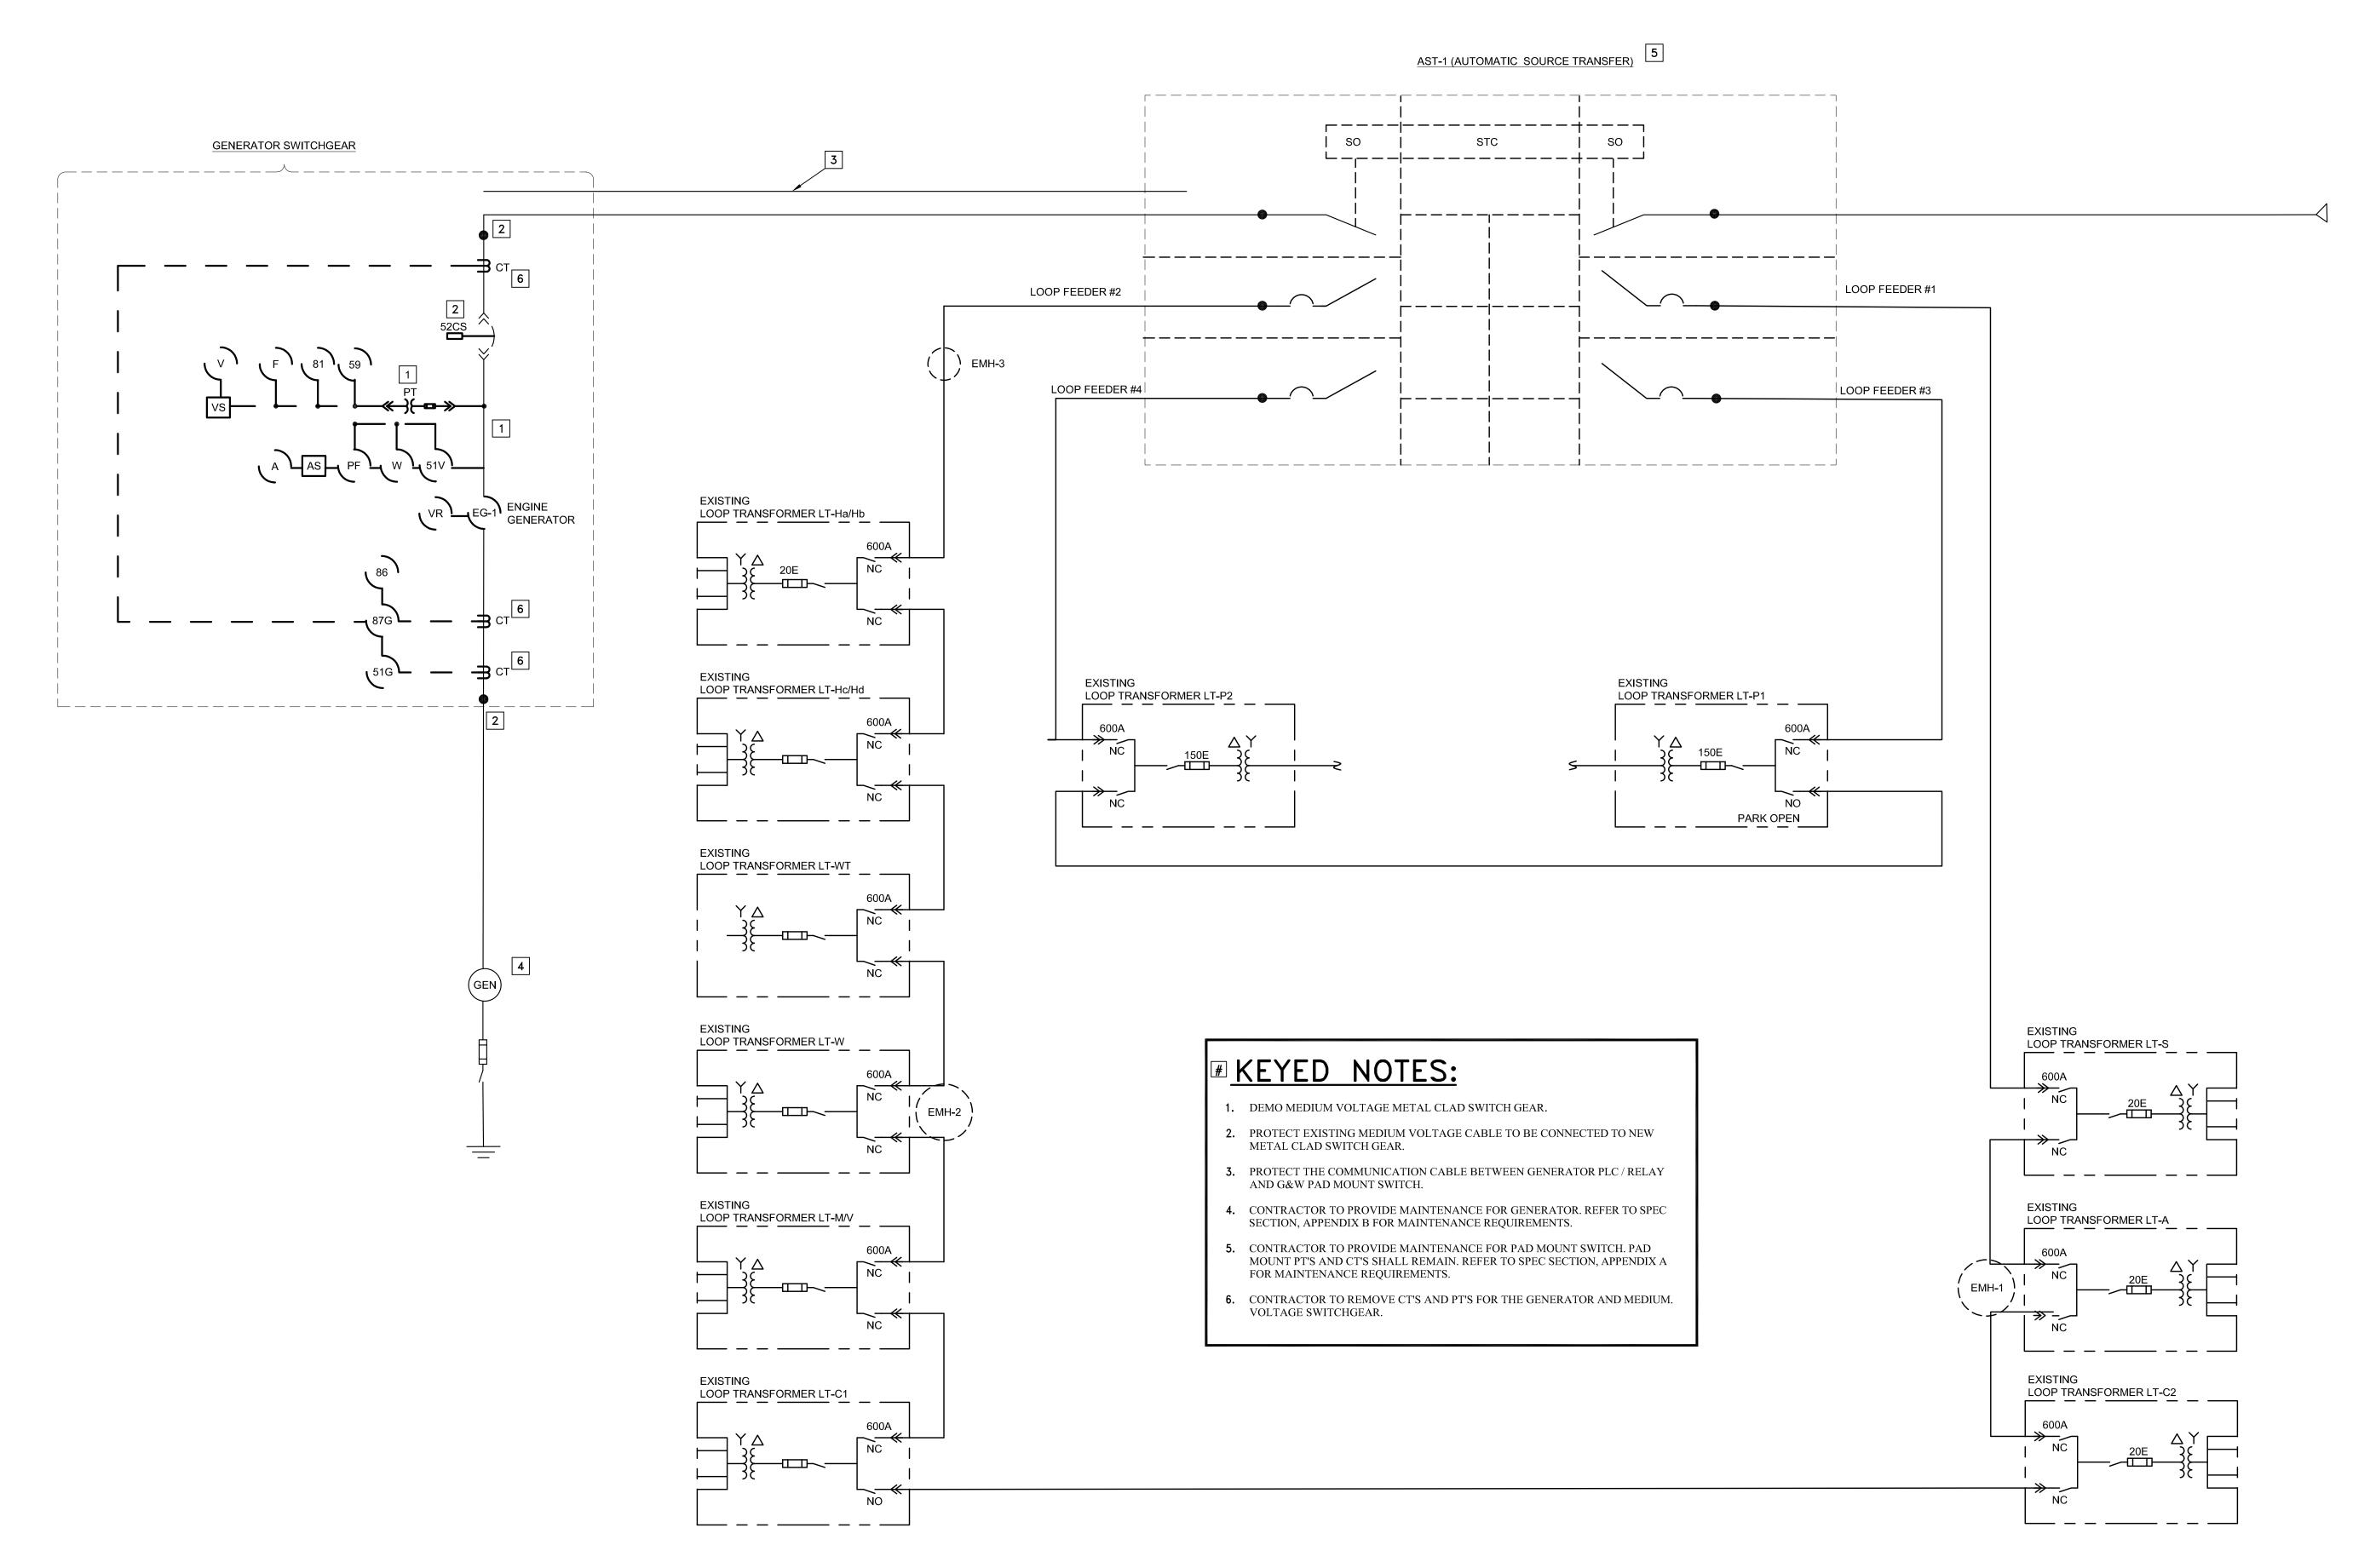

A DEMO CAMPUS ONE-LINE SCALE: NOT TO SCALE

STATE OF MISSOURI MICHAEL L. PARSON, GOVERNOR

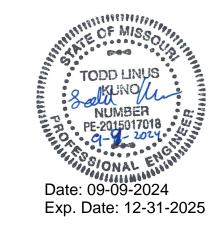



www.introba.com

St. Louis
6 South Old Orchard
St. Louis, MO 63119
+1 800.404.7677
hello@introba.com

OFFICE OF ADMINISTRATION DIVISION OF FACILITIES MANAGEMENT, DESIGN AND CONSTRUCTION

DEPARTMENT OF CORRECTIONS

SERVICE GENERATOR, REPLACE ATS AND RECONDITION SWITCHGEAR

SOUTHEAST CORRECTIONAL CENTER 300 PEDRO SIMMONS DR. CHARLESTON, MISSOURI

PROJECT # C2329-01 SITE # 7020 ASSET # 93270200

REVISION:
DATE:
REVISION:
DATE:
REVISION:
DATE:

ISSUE DATE: 09/09/2024

CAD DWG FILE:E-60
DRAWN BY: AO
CHECKED BY: GF
DESIGNED BY: TLK

SHEET TITLE:


DEMO
CAMPUS
ONE-LINE

SHEET NUMBER:


E-60

5 OF 6 SHEETS

BID DOCUMEN IS

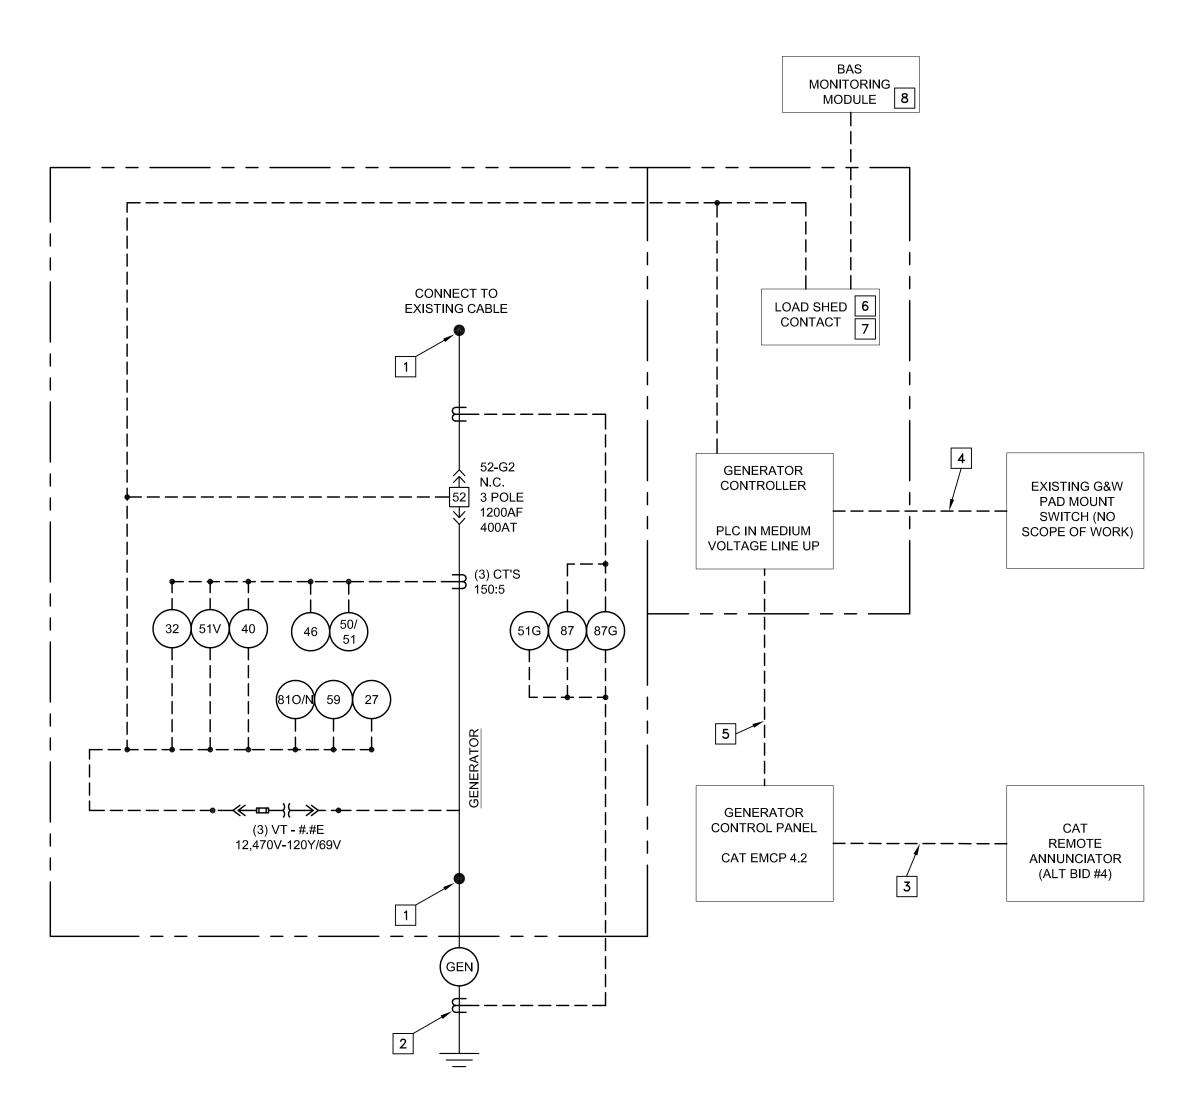

A NEW MEDIUM VOLTAGE ONE-LINE SCALE: NOT TO SCALE

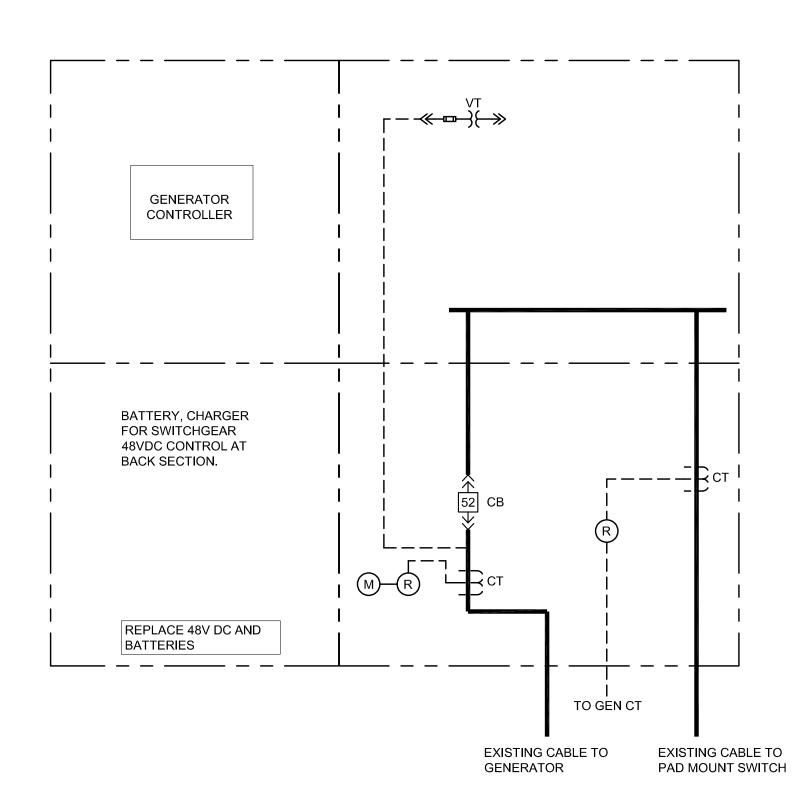

B NEW MEDIUM VOLTAGE DIAGRAM
SCALE: NOT TO SCALE

KEYED NOTES:

- CONTRACTOR TO EXTEND AND RECONNECT EXISTING CONDUCTORS TO NEW MEDIUM VOLTAGE SWITCH.
- 2. PROVIDE NEW CT AND CONTROL WIRE (DEMO EXISTING CT) FOR GENERATOR CURRENT DIFFERENTIAL.
- 3. PROVIDE COMMUNICATION CABLE IN 1" CONDUIT BETWEEN GENERATOR CONTROLLER AND REMOTE GENERATOR ANNUNCIATOR.
- 4. EXTEND EXISTING COMMUNICATION CABLE BETWEEN MEDIUM VOLTAGE GENERATOR PLC AND G&W SWITCH. NEW MEDIUM VOLTAGE RELAY AND PLC SHALL MAINTAIN EXISTING COMMUNICATION REQUIREMENTS FOR G&W SWITCH. REQUIREMENTS ARE LISTED ON THIS PAGE.
- 5. CONTRACTOR TO PROVIDE COMMUNICATION CABLE BETWEEN GENERATOR CONTROLLER AND MEDIUM VOLTAGE PLC CONTROLLER. CABLE SHALL BE INSTALLED IN EMT CONDUIT.
- 6. CONTRACTOR SHALL PROVIDE (6) DRY CONTACTS LEVELS OF LOAD SHED RELAYS FOR FUTURE USE. CONTROLLER AND RELAY SHALL BE CAPABLE CONTROLLING EACH RELAY INDEPENDENTLY OF THE OTHER RELAYS. PROGRAMING NOT REQUIRED UNDER BASE BID.
- 7. UNDER ALTERNATE BID #3, CONTRACTOR SHALL PROVIDE PROGRAMING FOR TWO LEVELS OF LOAD SHEDDING AND LOAD RESTORING BY GROUPING THE 6 CONTRACTOR IN THREE LEVELS OF PRIORITIES. PROGRAMMING SHALL INCLUDE BAS PROGRAMING AND GENERATOR EMCP 4.2.
- 7.1. PRIORITY 1 SHALL BE BASE LOADS AND NOT LOAD SHED.
 7.2. PRIORITY 3 SHALL LOAD SHED WHEN GENERATOR IS AT OR ABOVE 85% LOAD
- 7.3. PRIORITY 2 SHALL LOAD SHED WHEN GENERATOR IS AT OR ABOVE 85% LOAD FOR 3 MINUTES.
- 7.4. LOAD RESTORE SHALL ADD PRIORITY 2 AND 3 WHEN AT OR BELOW 60% FOR 5 MINUTES.
- 8. UNDER ALTERNATE BID #3, CONTRACTOR SHALL PROVIDE NEW BAS MONITORING MODULE. PROVIDE COMMUNICATION CABLES AND CONDUIT BETWEEN BAS MONITORING LOAD SHED CONTROLLER AND CABLES TO EACH CONTRACTOR TO LOAD CONTROLLER FOR EQUIPMENT TO BE SHED (ASSUME 100' FOR EACH CONTRACT). INCLUDE TIME FOR COORDINATION DISCUSSION WITH ENGINEER OF RECORD, FACILITY ENGINEER AND THE CONTRACTORS BAS AND SWITCHGEAR PROGRAMMER TO LOAD SHED LOAD RESTORED PRIORITY 2 AND 3 LOADS.

EXISTING ENGINE CONTROLS BETWEEN MEDIUM VOLTAGE SWITCH AND G&W PAD MOUNT

OUTPUT (FROM PAD MOUNT)
ENGINE START CONTACT
SWITCH IN NORMAL
SWITCH IN EMERGENCY
NORMAL SOURCE AVAILABLE

INPUT (FROM PAD MOUNT)


READY TO TRANSFER SIGNAL

CLOSED TRANSITION (CAP, LABEL WIRE)

OPEN TRANSITION

TEST MODE

STATE OF MISSOURI MICHAEL L. PARSON, GOVERNOR

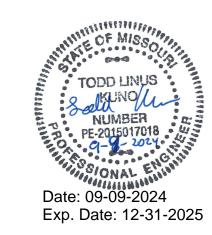



St. Louis 6 South Old Orchard St. Louis, MO 63119

+1 800.404.7677 hello@introba.com www.introba.com

OFFICE OF ADMINISTRATION DIVISION OF FACILITIES MANAGEMENT, DESIGN AND CONSTRUCTION

DEPARTMENT OF CORRECTIONS

SERVICE GENERATOR, REPLACE ATS AND RECONDITION SWITCHGEAR

SOUTHEAST CORRECTIONAL CENTER 300 PEDRO SIMMONS DR. CHARLESTON, MISSOURI

PROJECT # C2329-01 SITE # 7020 ASSET # 9327020021

REVISION:
DATE:
REVISION:
DATE:
REVISION:
DATE:
REVISION:
DATE:

ISSUE DATE: 09/09/2024

CAD DWG FILE:E-61
DRAWN BY: AO
CHECKED BY: GF
DESIGNED BY: TLK

SHEET TITLE:

NEW MEDIUM
VOLTAGE ONE-LINE
AND ELEVATION

SHEET NUMBER:

E-62

6 OF 6 SHEETS 09/09/2024