REPLACE SWITCHGEAR, POWER PLANT & MAINTENANCE BUILDING BONNE TERRE, MISSOURI



St. Louis 6 South Old Orchard St. Louis, MO 63119

+1 800.404.7677 hello@introba.com www.introba.com

OWNER:

STATE OF MISSOURI MICHAEL L. PARSON,

GOVERNOR

DEPARTMENT OF CORRECTIONS

PROJECT

OFFICE OF ADMINISTRATION

MANAGEMENT:

DIVISION OF FACILITIES MANAGEMENT,

DESIGN AND CONSTRUCTION

PROJECT PHASING

- 1. PHASE 1: RIGHT SIDE
- 1.1. PROVIDE TEMP 48VDC TO LEFT SIDE.
- 1.2. REMOVE DEMO BUS SECTION. REMOVE ADJACENT BUS TO ALLOW FOR REMOVAL OF BUS IN THE SECTION.
- 1.3. PROVIDE NEW BUS SECTION FOR A TIE-TIE CONFIGURATIONS.
- 1.4. DEMO EXISTING 48V DC RECTIFIER AND BATTERIES.
- 1.5. PROVIDE MASTER GENERATOR CONTROL.
- 1.6. NEW 48V DC RECTIFIER AND BATTERIES.
- 1.7. REPLACE RELAY, RELAY CONTROL WIRE, AND CIRCUIT BREAKERS
- 2. PHASE 2: LEFT SIDE
- 2.1. PROVIDE TEMPORARY 120V AC TO 48VDC RECTIFIER.
- 2.2. REPLACE RELAYS AND CIRCUIT BREAKER.
- 2.3. REMOVE TEMPORARY RECTIFIER.
- 3. 2MW TEMPORARY GENERATOR SHALL BE PROVIDED WHEN UTILITY SECTION ARE DE-ENERGIZED.
- 3.1. UTILITY SECTION CAN NOT BE DE-ENERGIZED WHEN SITE IS IN PEAK ELECTRICAL USAGE (JUNE, JULY, AUGUST)
- 3.2. PROVIDE ALL TEMPORARY POWER INCLUDING GENERATOR, FUEL, CABLES AND OVERCURRENT PROTECTION SO THE CAMPUS DOES NOT LOOSE POWER FOR MORE THAN THE TIME TO SWITCH BETWEEN UTILITY, SITE GENERATORS, LOOP SWITCHES OR TEMPORARY GENERATOR. THE ONLY EXCEPTION IS THE MAINTENANCE BUILDING WILL NEED A FEW HOURS OF DOWN TIME TO CONNECT TEMPORARY GENERATOR CABLES INTO THE PAD MOUNTED SWITCH SHOWN.

DESIGNER:

TODD KUNO

PROJECT NUMBER: C2330-01

SITE NUMBER:

7021

FACILITY NUMBER: 9327021024

DRAWING INDEX

NUMBER	TITLE
G-00	COVER SHEET
E-00 E-10 E-11 E-12	ELECTRICAL SYMBOLS AND LEGEND EXISTING SITE PLAN EXISTING MV SWITCHGEAR BUILDING ELECTRICAL ROOM
E-60 E-61 E-62	DEMO MV ONE-LINE AND ELEVATION PHASE 1: MV ONE-LINE AND ELEVATION PHASE 2: MV ONE-LINE AND ELEVATION

SHEET NUMBER:

01 OF 08 SHEETS MAY 24, 2024

LEGEND AND ABBREVIATIONS (SEE SPECIFICATIONS & SCHEDULES)

NOTES: 1. ALL SYMBOLS AND ABBREVIATIONS ARE NOT NECESSARILY USED ON THESE PLANS.
2. IN GENERAL, SYMBOLS SHOWN WITH LIGHT LINES DENOTE EXISTING WORK. SYMBOLS SHOWN WITH HEAVY LINES DENOTE NEW WORK.

GENERAL NOTES

- 1. MAKE ALL INSTALLATIONS IN ACCORDANCE WITH THE AMERICANS WITH DISABILITIES ACT ACCESSIBILITY GUIDELINES (ADAAG).
- 2. MOUNTING HEIGHTS INDICATED WITHIN PLANS AND SCHEDULES ARE DIMENSIONED TO THE CENTER LINE OF THE DEVICE, EQUIPMENT, ETC. UNLESS OTHERWISE NOTED.
- 3. COORDINATE EXACT EQUIPMENT LOCATIONS WITH EXISTING CONDITIONS. EQUIPMENT LOCATIONS SHOWN ON ELECTRICAL PLANS ARE DIAGRAMMATICAL ONLY AND MIGHT NOT BE EXACT.
- 4. REPAIR ALL OPENINGS MADE IN EXISTING WALLS, PARTITIONS, ETC TO ACCOMMODATE WORK OF THIS DISCIPLINE TO MATCH THE SURROUNDING CONDITIONS, USING WORKERS QUALIFIED IN THE APPROPRIATE TRADE. APPROPRIATELY GROUT OR SEAL ALL CONDUITS THROUGH WALLS.

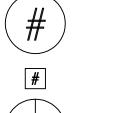
DEMOLITION NOTES

- I. REMOVE, CAP AND RELOCATE EQUIPMENT, DEVICES, CONDUIT, WIRE, ETC., AS SHOWN AND SPECIFIED ON DRAWINGS, AND AS MAY BECOME NECESSARY BECAUSE OF EXISTING FIELD CONDITIONS. FAILURE TO VISIT THE SITE AND TO TAKE ALL EXISTING CONDITIONS INTO ACCOUNT WILL NOT ALLOW FOR CHANGES TO THE SCOPE OF WORK.
- 2. FOR ALL WORK SHOWN TO BE REMOVED DURING THE DEMOLITION PHASE, REMOVE ALL WIRING AND CABLES BACK TO THEIR SOURCE UNLESS NOTED OTHERWISE TO BE RE-USED FOR NEW WORK. REMOVE ALL UNUSED CONDUIT THAT IS EXPOSED OR ABOVE ACCESSIBLE CEILINGS WHICH IS AFFECTED BY OR IS IN THE AREA OF THE DEMOLITION WORK.
- 3. WHERE EQUIPMENT, DEVICES, CONDUIT, BOXES, AND SUPPORTING HARDWARE ARE REMOVED, PATCH AND FINISH THE SURFACE AS REQUIRED TO MATCH THE EXISTING, USING WORKERS QUALIFIED IN THE APPROPRIATE TRADE.
- 4. TAKE ALL REMOVED MATERIALS FROM THE PROJECT SITE, EXCEPT FOR THOSE TO BE RELOCATED, STORED, OR TURNED OVER TO THE USING AGENCY.
- 5. ACCEPTANCE OF CONTRACT MEANS INSTALLER ACCEPTS EXISTING CONDITIONS.
- 6. PROVIDE A BLANK COVER PLATE WHERE A FLUSH DEVICE IS BEING REMOVED FROM WALLS THAT ARE TO REMAIN. MATCH THE COLOR, MATERIAL AND FIRE RATING TO THE EXISTING SURFACE IN THE ROOM OR SPACE.
- 7. LEGALLY DISPOSE OF HAZARDOUS MATERIALS OR OTHER EQUIPMENT CONTAINING PCBS. COMPLY WITH ALL FEDERAL, STATE, AND LOCAL LAWS.
- 8. PATCH OR FILL ANY EXPOSED GAP BETWEEN CONDUIT AND WALL WERE NEW HOLES ARE DRILLED IN EXISTING WALLS
- 9. PAINT TO A MINIMUM OF 1 FOOT ON ALL SIDES OF A PATCH OR REMOVED SURFACE FOR CONDUIT PENETRATIONS.

GENERATOR TESTING

- GENERATOR SHALL BE TESTED PRIOR TO DEMO OF SWITCHGEAR RELAY, PLCS AND CONTROLS. THE CONTRACTOR IS RESPONSIBLE FOR DOCUMENTING THE AS FOUND CONDITIONS.
- 2. CONTRACTOR RESPONSIBLE FOR OPERATIONAL LOAD BANK SYSTEM TESTING OF GENERATOR AFTER INSTALLATION OF NEW SWITCHGEAR RELAY, PLCS AND CONTROLS

DRAWING REFERENCES



PLAN DETAIL REFERENCE TITLE

KEYED NOTE DESIGNATION

PLAN NORTH

NORTH ARROW

ABBREVIATIONS

A.F.F : ABOVE FINISHED FLOOR
C : CONDUIT
E.C. : ELECTRICAL CONTRACTOR
ER : EXISTING RELOCATED
ETR : EXISTING TO REMAIN
E.D. : GENERAL CONTRACTOR

E.D. : GENERAL CONTRACTOR
GND : GROUND
TYP. : TYPICAL

LINE TYPE LEGEND

: UNLESS OTHERWISE NOTED

EXISTING TO REMAIN OR NEW WORK BY OTHERS
(LIGHT, SOLID LINE)

NEW WORK BY THIS CONTRACTOR
(DARK, SOLID LINE)

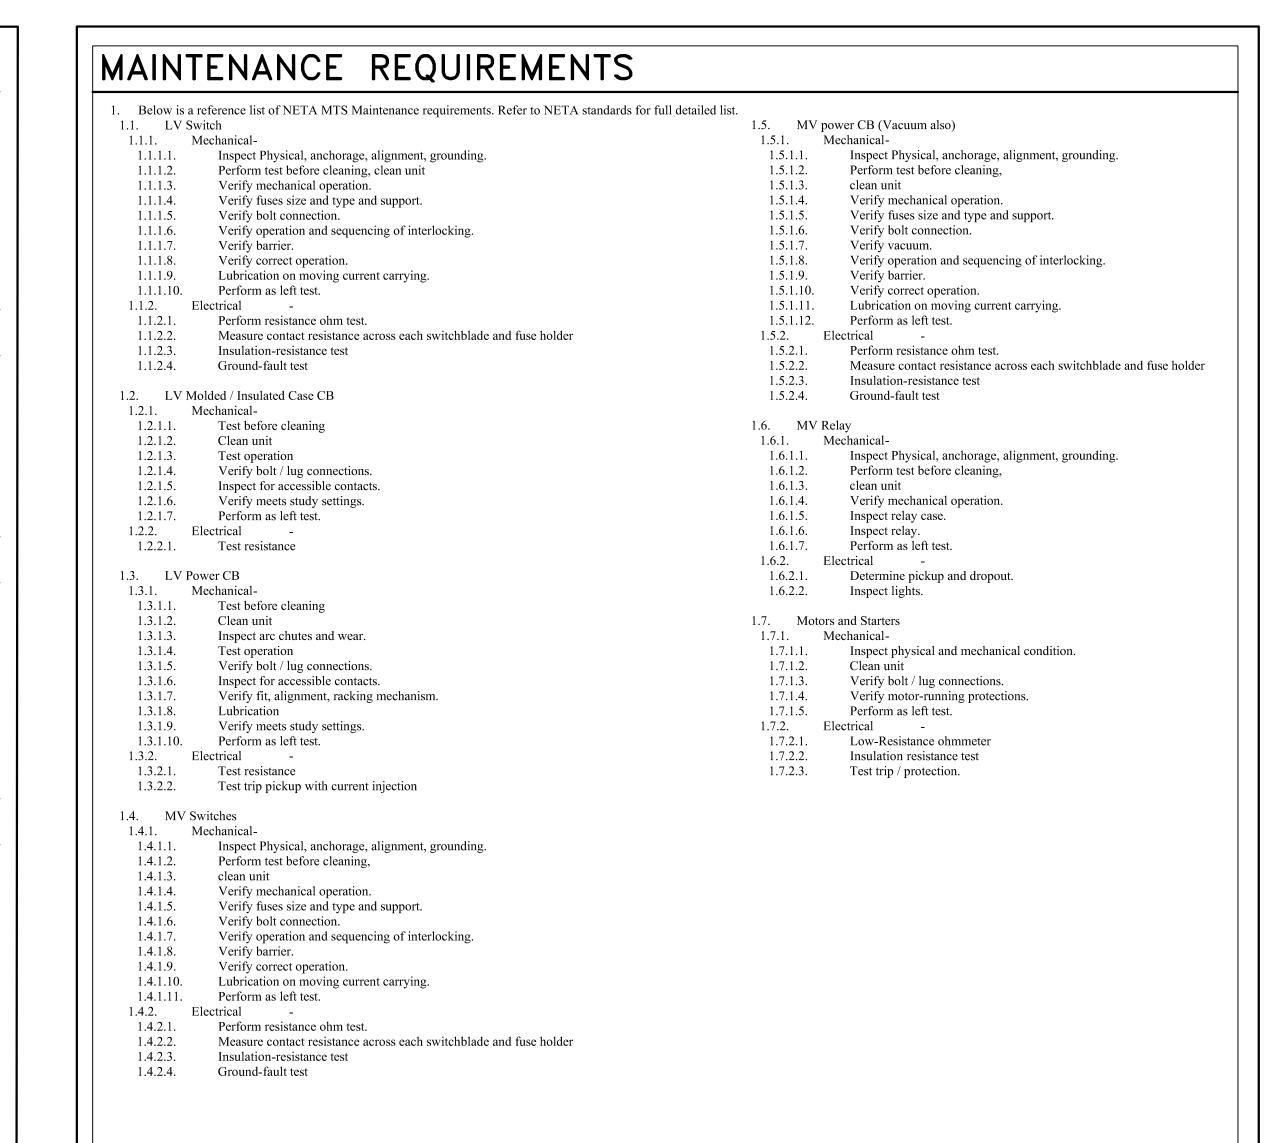
EXISTING TO BE REMOVED BY THIS CONTRACTOR
(DARK, DASHED LINE, DEMOLITION PLANS)

2-HOUR FIRE RATED WALL

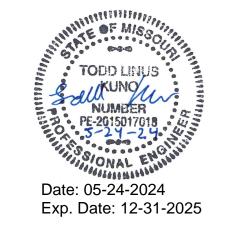
POWER EQUIPMENT

PANELBOARD (SURFACE)

PANELBOARD (FLUSH)



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PROJECT # C2330-01 SITE # 7021 FACILITY # 9327021024

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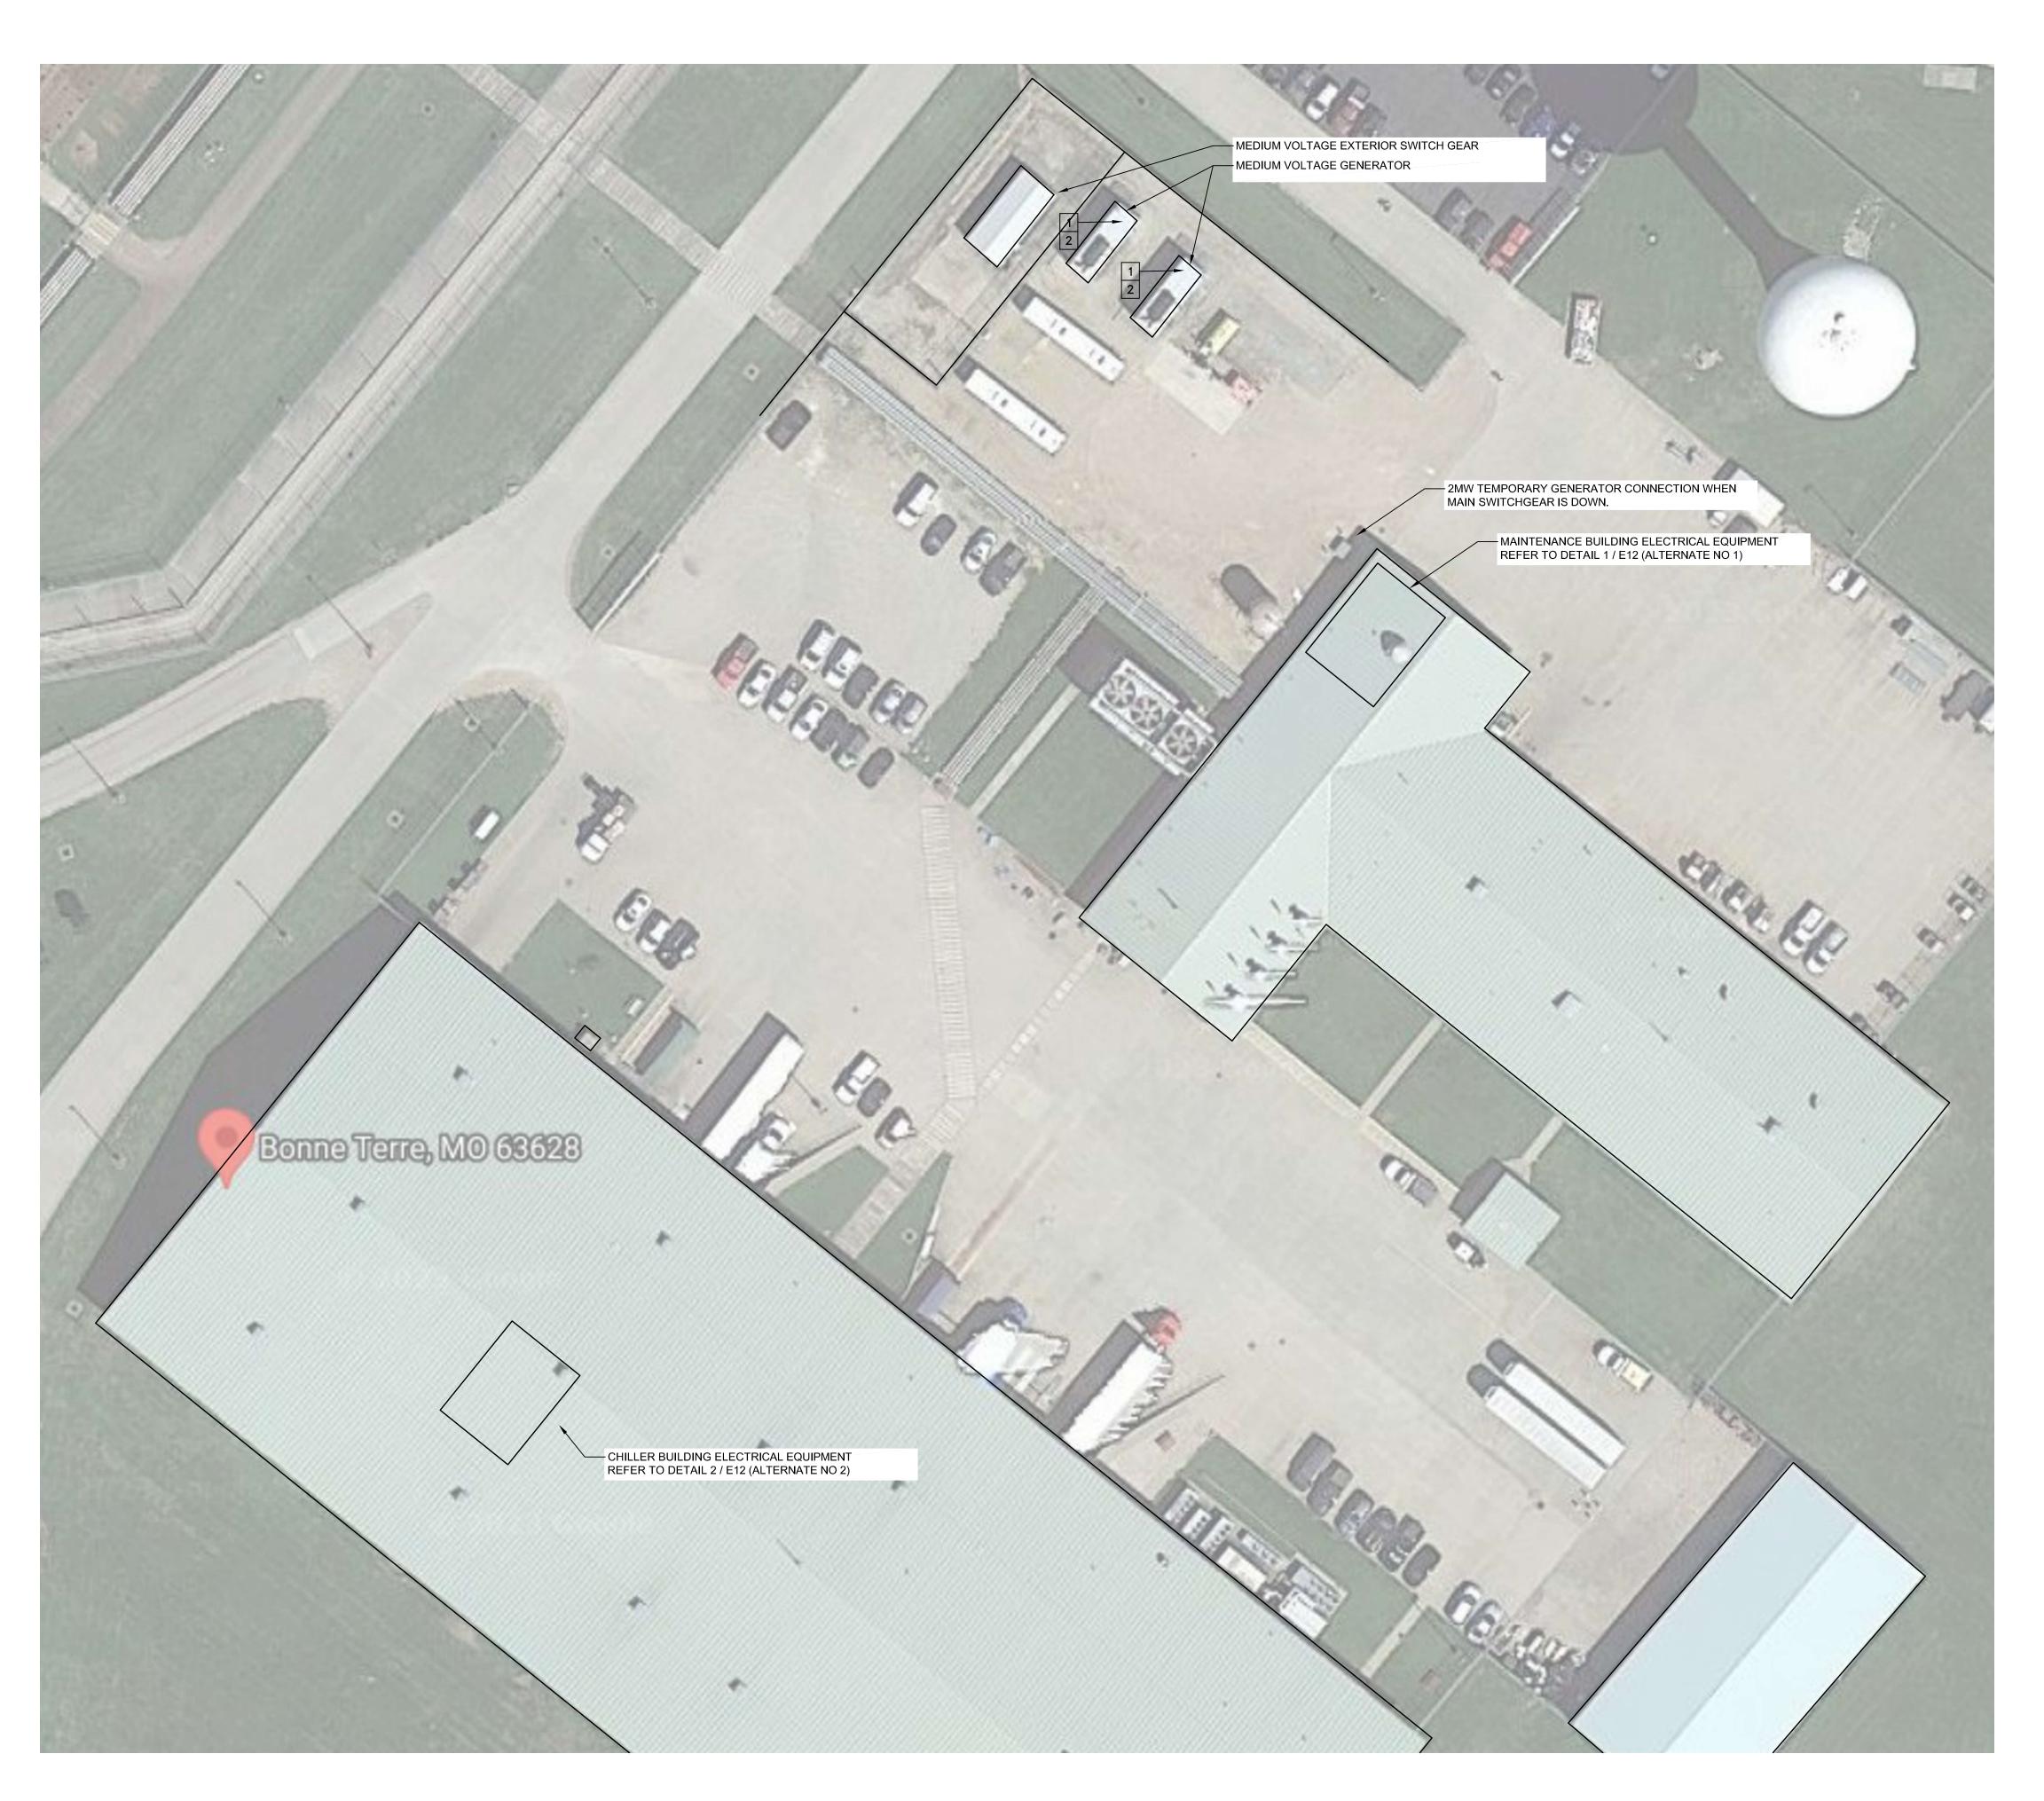
CAD DWG FILE:E-00
DRAWN BY: LB
CHECKED BY: GF
DESIGNED BY: TLK

SHEET TITLE:

ELECTRICAL SYMBOLS AND LEGEND

SHEET NUMBER:

E-00

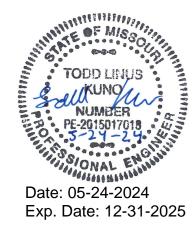




- # KEYED NOTES:

 1. CONTRACTOR TO REPLACE ALL EXISTING CAT EMCP 2 GENERATOR SET CONTROLLER. PROVIDE NEW EMCP 4 WITH UPGRADE KIT TO EXISTING GENERATOR(S) AND MODIFY GENERATOR SET AS REQUIRED FOR NEW CONTROLLER.
- CONTRACTOR TO REPLACE IN IT'S ENTIRETY, THE BATTERY SYSTEM, INCLUDING THE BATTERY CHARGER, BATTERIES, BATTERY SYSTEM CABLES. IN ADDITION, REMOVE IN ITS ENTIRETY THE EXISTING NOT IN USE, ABANDONED BATTERY SYSTEM.

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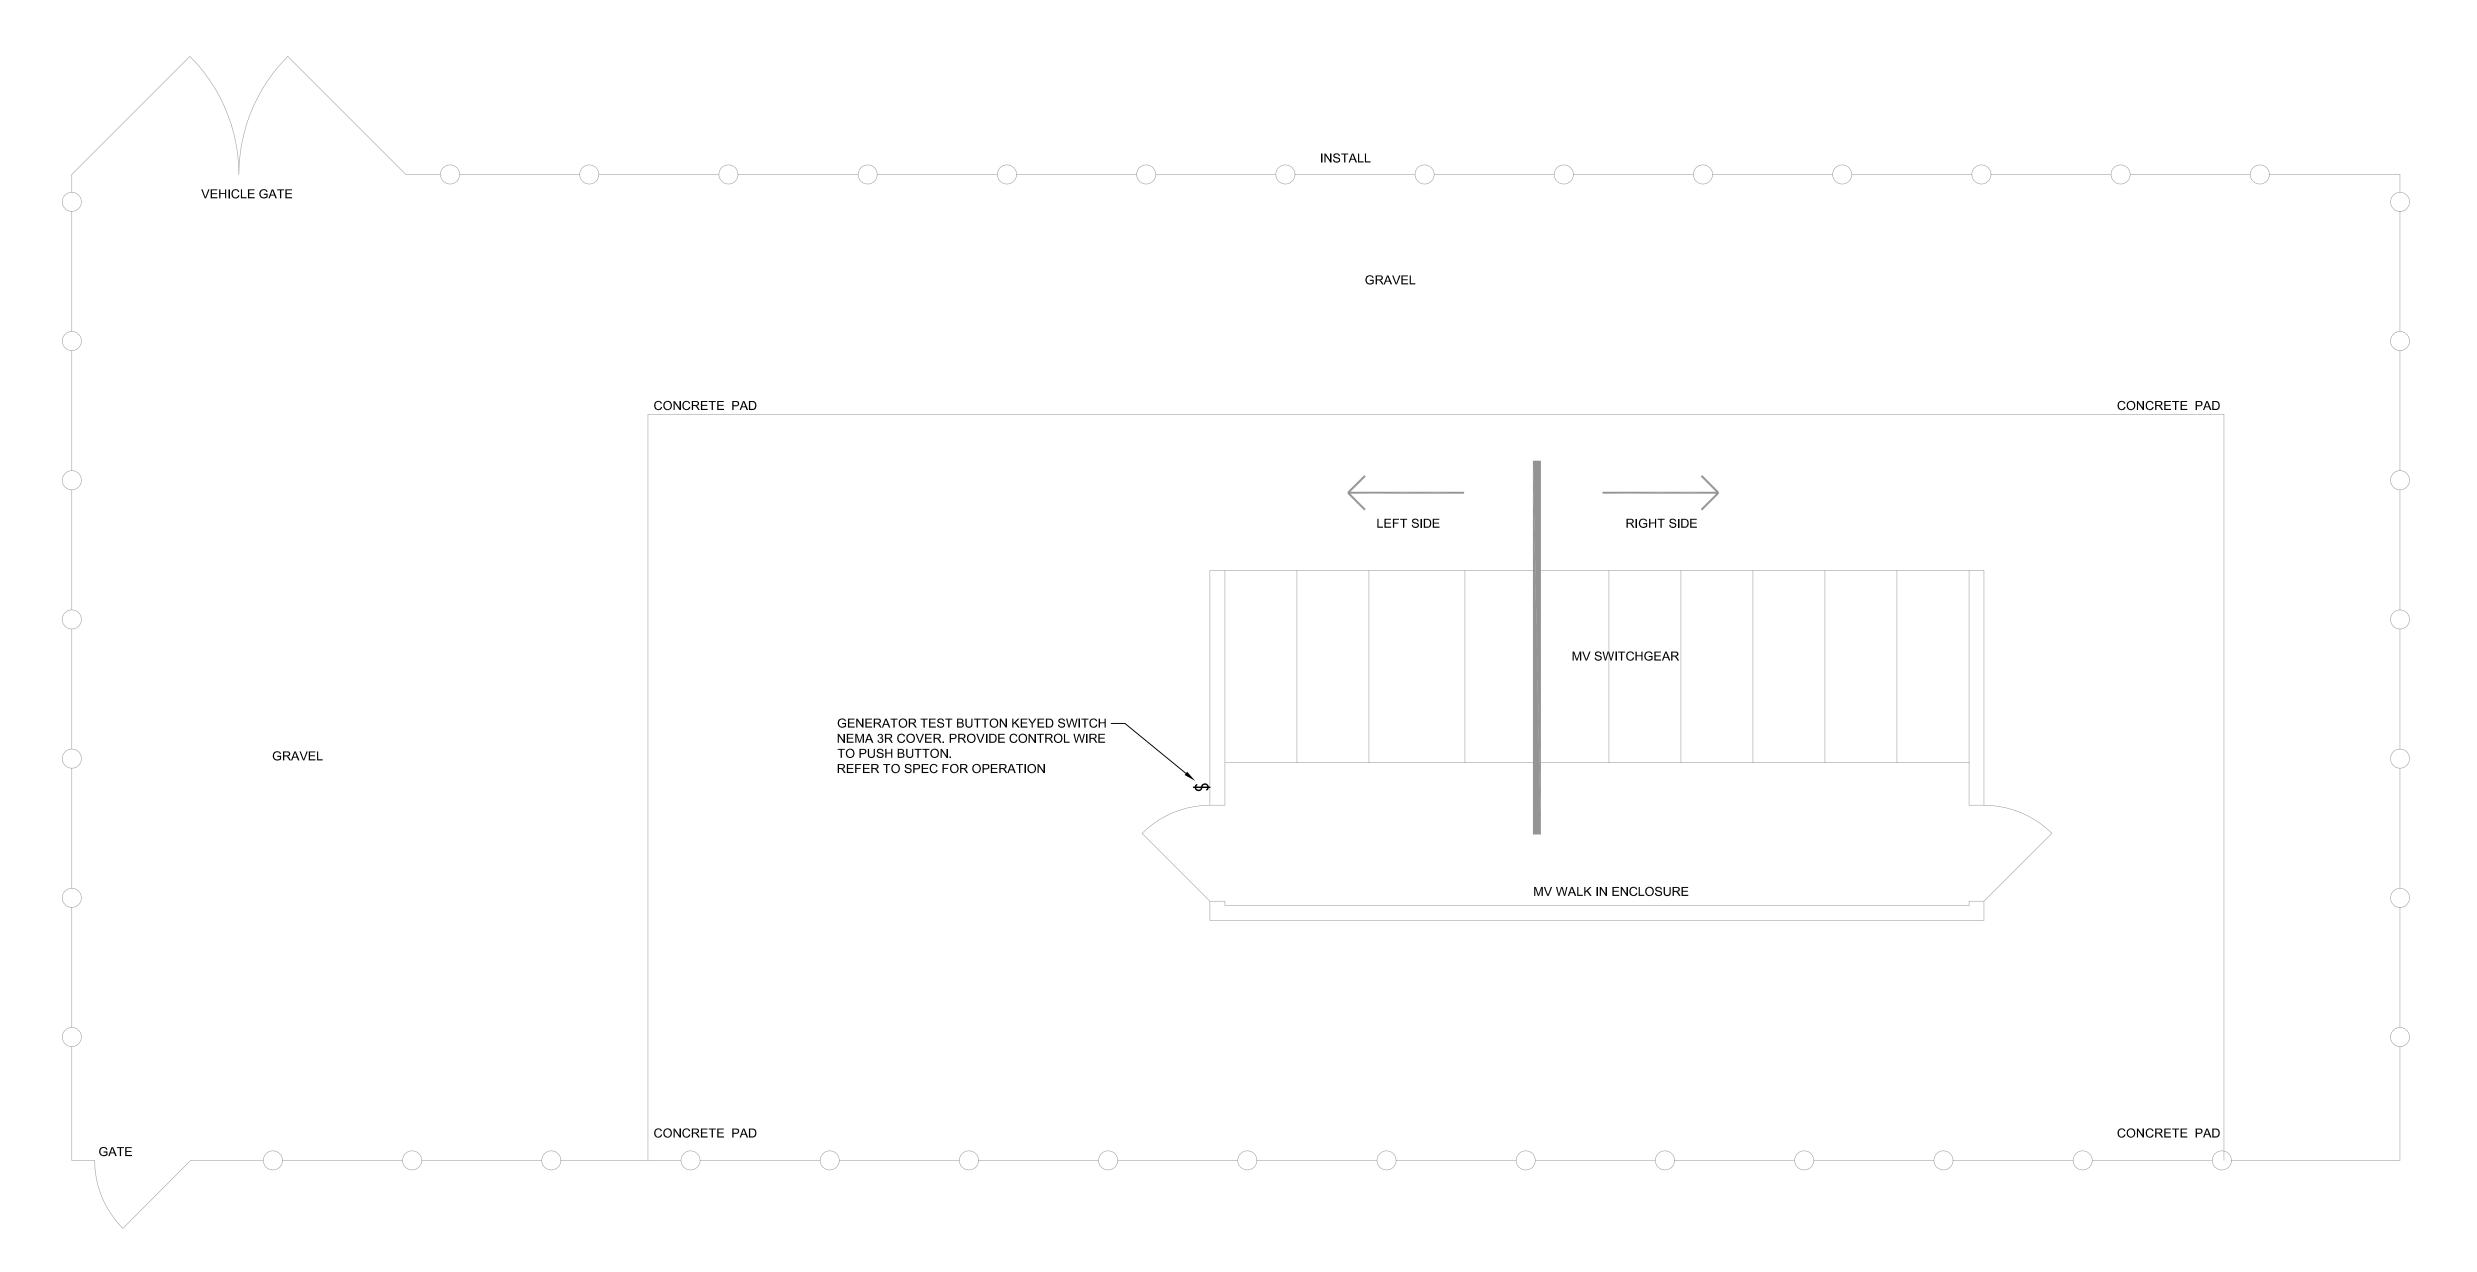
ISSUE DATE: 05/24/2024

CAD DWG FILE:E-10
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SHEET TITLE:

EXISTING SITE PLAN

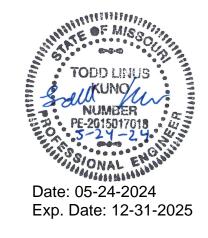
SHEET NUMBER:



EXISTING MEDIUM VOLTAGE SWITCHGEAR AREA PLAN

SCALE: 1/4" = 1' - 0"

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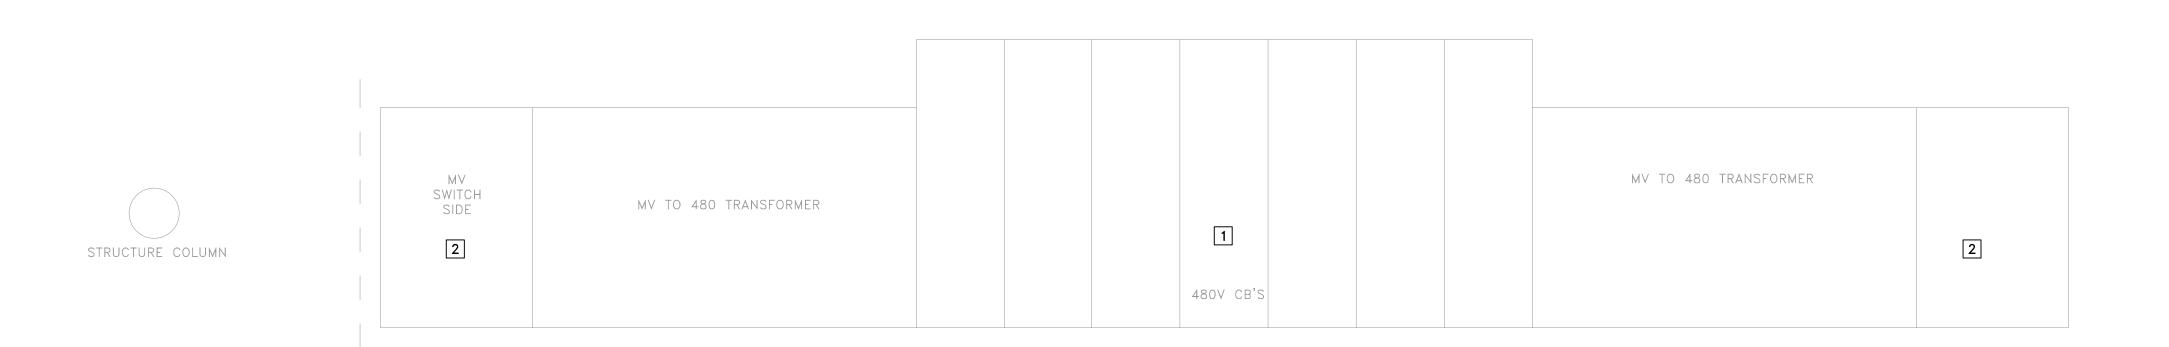
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DESIGNED BY: TLK

SHEET TITLE:

EXISTING MV SWITCHGEAR

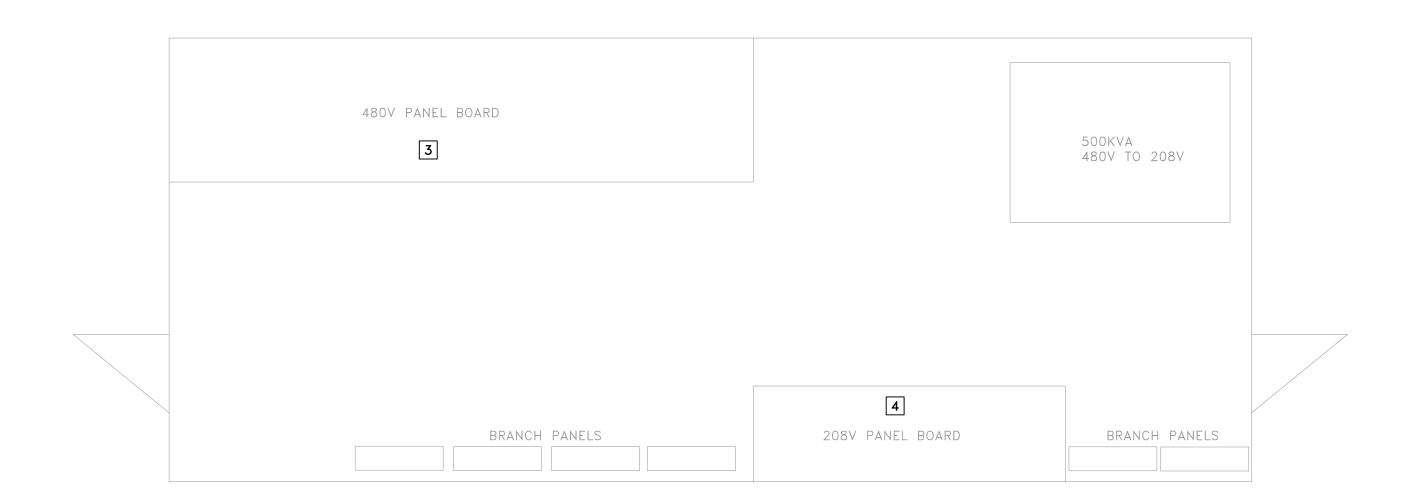
SHEET NUMBER:

E-11



EXISTING 480V EQUIPMENT

MAINTENANCE BUILDING (ALTERNATE 1) SCALE: 1/2" = 1' - 0"



CHILLER BUILDING ELECTRICAL ROOM

SCALE: 1/2" = 1' - 0" (ALTERNATE 2) **#** KEYED NOTES:

- 1. SCOPE SHALL BE UNDER ALTERNATIVE ADD BID #1. CONTRACTOR TO PROVIDE NETA MTS MAINTENANCE REQUIREMENTS ON ALL OPERABLE DEVICES. FOR SQUARE D, POWER ZONE III, SERIES 2 SWITCHGEAR. REFER TO TO SHEET E-00 FOR MAINTENANCE REQUIREMENTS. SEE BELOW FOR NUMBER AND SIZE OF DRAWOUT POWER CIRCUIT BREAKERS AND MOTOR STARTERS FOR CHILLER BLDG 480V SWGR.
- 2. SCOPE SHALL BE UNDER ALTERNATIVE ADD BID #1. CONTRACTOR TO PROVIDE NETA MTS MAINTENANCE REQUIREMENTS ON ALL OPERABLE DEVICES ON PRIMARY MEDIUM VOLTAGE SQUARE D, HVL LOAD CURRENT INTERRUPTER SWITCH. REFER TO SHEET E-00 FOR MAINTENANCE REQUIREMENTS. EACH SIDE HAS (1) 300AMP 15 KV METAL ENCLOSED FUSED SWITCHGEAR.
- SCOPE SHALL BE UNDER ALTERNATIVE ADD BID #2. CONTRACTOR TO PROVIDE NETA MTS MAINTENANCE REQUIREMENTS ON ALL OPERABLE DEVICES FOR SQUARE D, QED STYLE SWITCHBOARD, BOLTED PRESSURE SWITCH AND FUSED DISCONNECTS. REFER TO TO SHEET E-00 FOR MAINTENANCE REQUIREMENTS. SEE BELOW FOR NUMBER AND SIZE OF FUSE SWITCHES FOR ROOM 120B 480V.
- SCOPE SHALL BE UNDER ALTERNATIVE ADD BID #2. CONTRACTOR TO PROVIDE NETA MTS MAINTENANCE REQUIREMENTS ON ALL OPERABLE DEVICES SQUARE D, QED STYLE SWITCHBOARD, BOLTED PRESSURE SWITCH AND FUSED DISCONNECTS. REFER TO TO SHEET E-00 FOR MAINTENANCE REQUIREMENTS. SEE BELOW FOR NUMBER AND SIZE OF FUSE SWITCHES FOR ROOM 120B 208V.

CHILLER BLDG 480V SWGR 1

(3) 3200A FRAME

(2) 1600A FRAME

(6) 800A FRAME (8) 800A SPACE

ROOM 120B 480V 3

(1) 1600A FRAME

(7) 30A FRAME (2) 60A FRAME (6) 100A FRAME (3) 200A FRAME

(1) 400A FRAME

(1) 30A SPARE (4) 60A SPARE (1) 200A SPARE

(1) 800A SPARE

ROOM 120B 208V 4

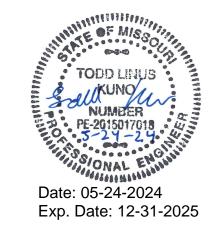
(1) 800A FRAME (2) 100A FRAME (1) 200A FRAME

(1) 400A FRAME (1) 600A FRAME (2) 60A SPARE

(2) 100A SPARE

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FACILITY # 9327021024

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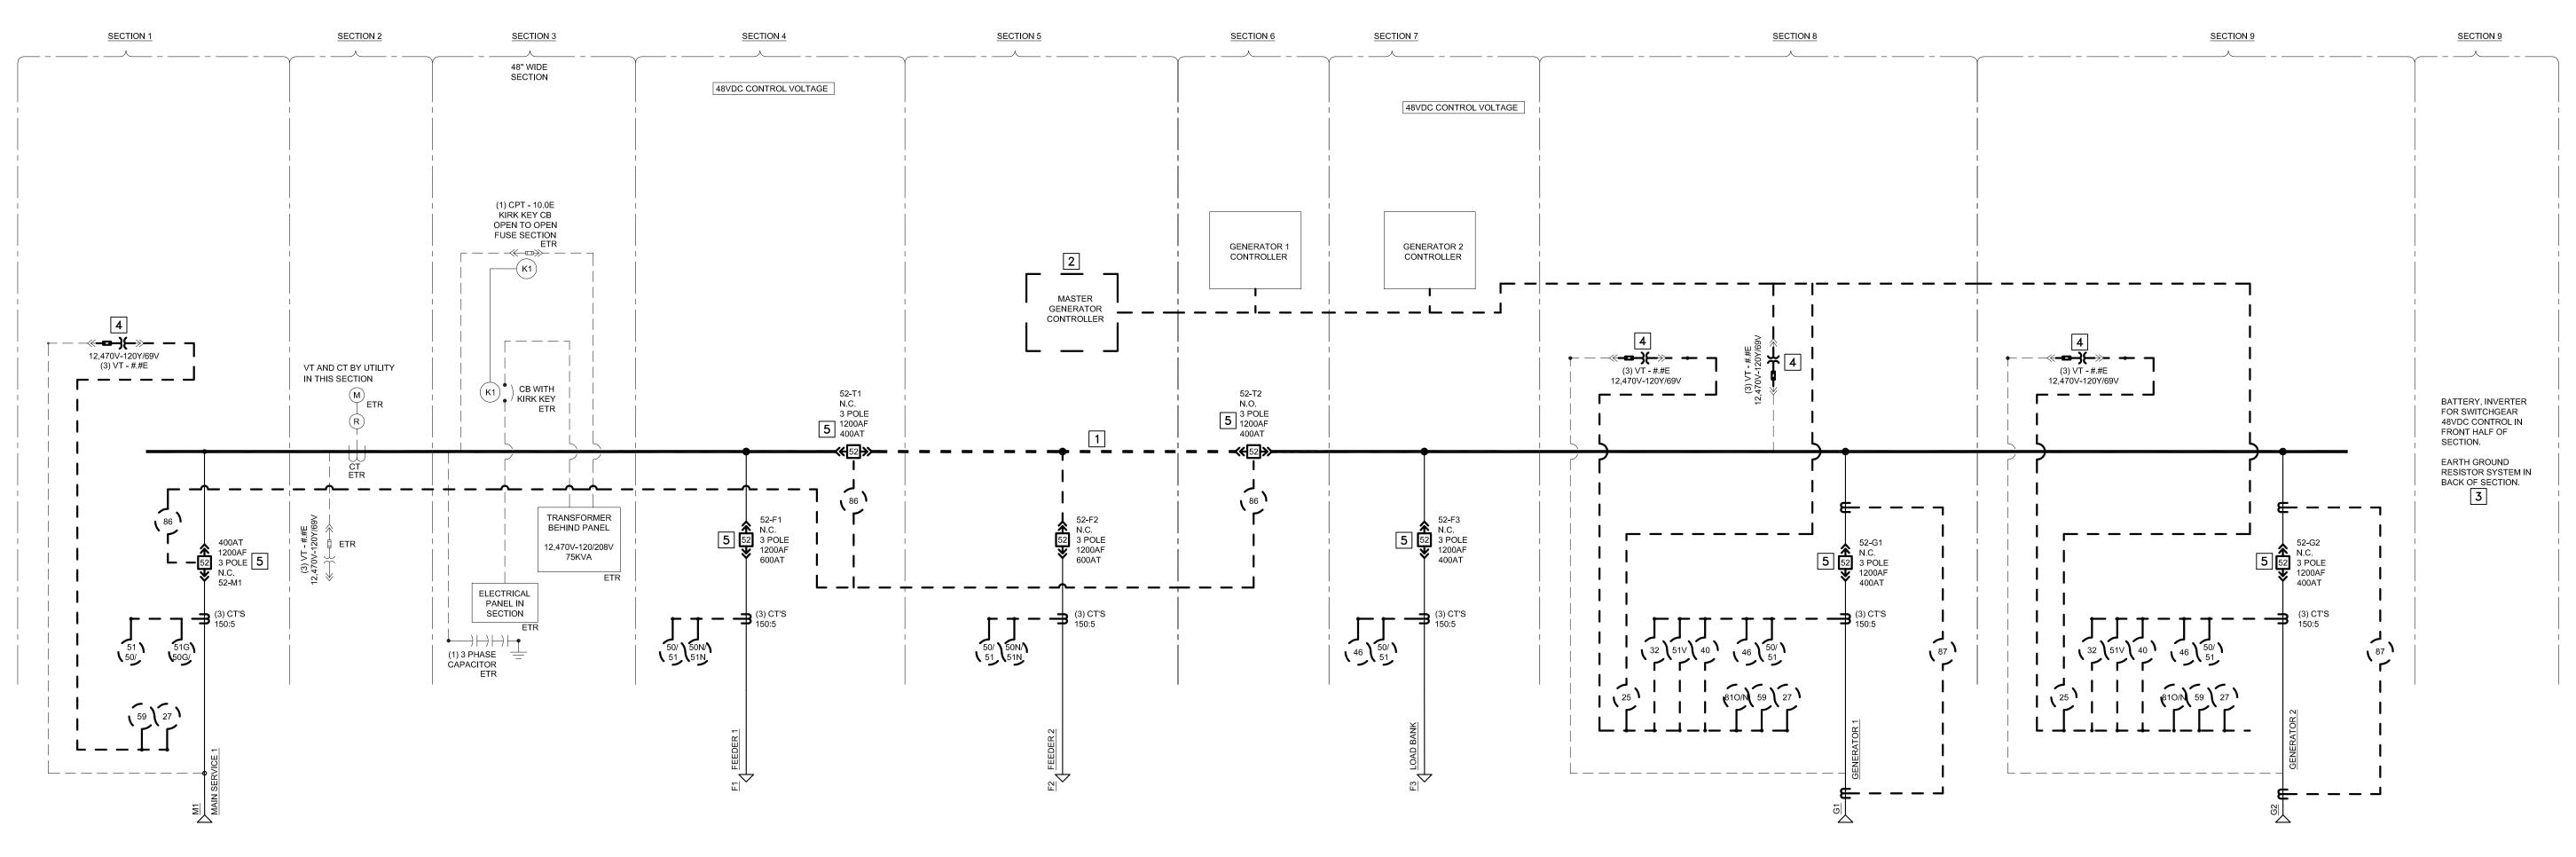
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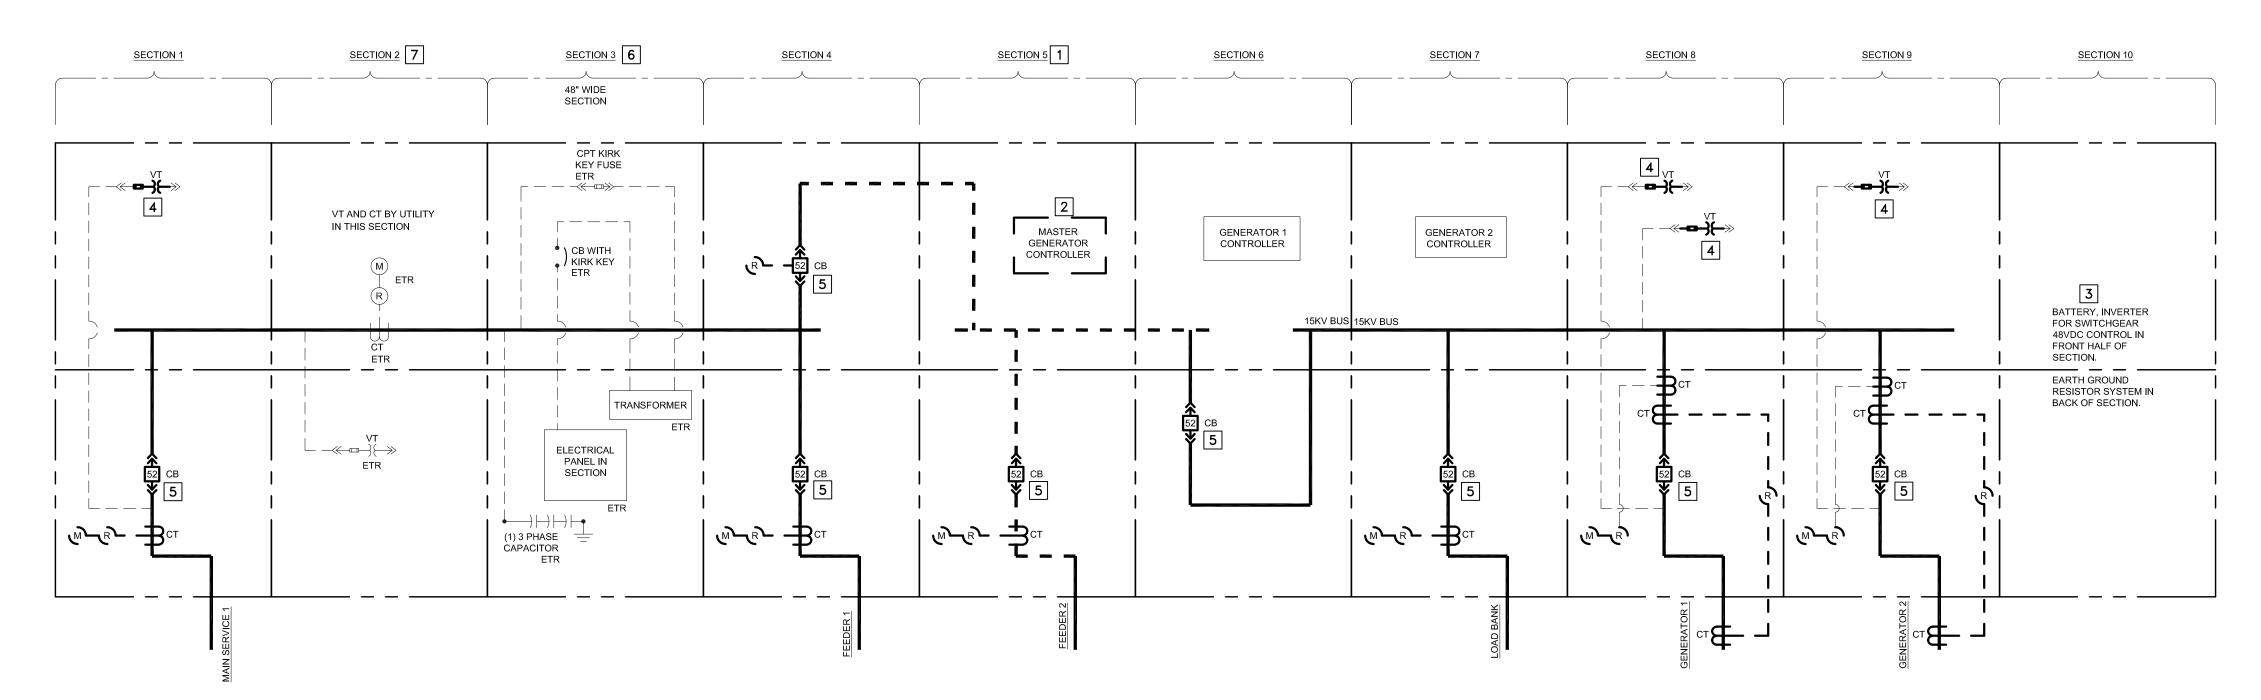
SHEET TITLE:

MAINTENANCE AND CHILLER BUILDING ELECTRICAL ROOM

SHEET NUMBER:



A EXISTING ONE-LINE SCALE: NO SCALE



KEYED NOTES:

- 1. DEMO BUS IN SECTION TO ALLOW FOR NEW TIE BREAKE
- 2. DEMO GENERATOR AND SWITCHGEAR MASTER CONTROLLER. (EXISTING SYSTEM IS PLC WOODWARD SYSTEM)
- 3. DEMO DC RECTIFIER AND BATTERIES.
- 4. DEMO AND PROVIDED NEW VT AND FUSES.
- 5. DEMO AND PROVIDE NEW 52 POWER CIRCUIT BREAKER CT'S AND RELAYS.
- 6. EXISTING PANEL BOARD, TRANSFORMER, CIRCUIT BREAKER AND KIRK KEY SHALL
- 7. NO MODIFICATIONS REQUIRED IN AMEREN SECTION.

B EXISTING DIAGRAM
SCALE: NO SCALE

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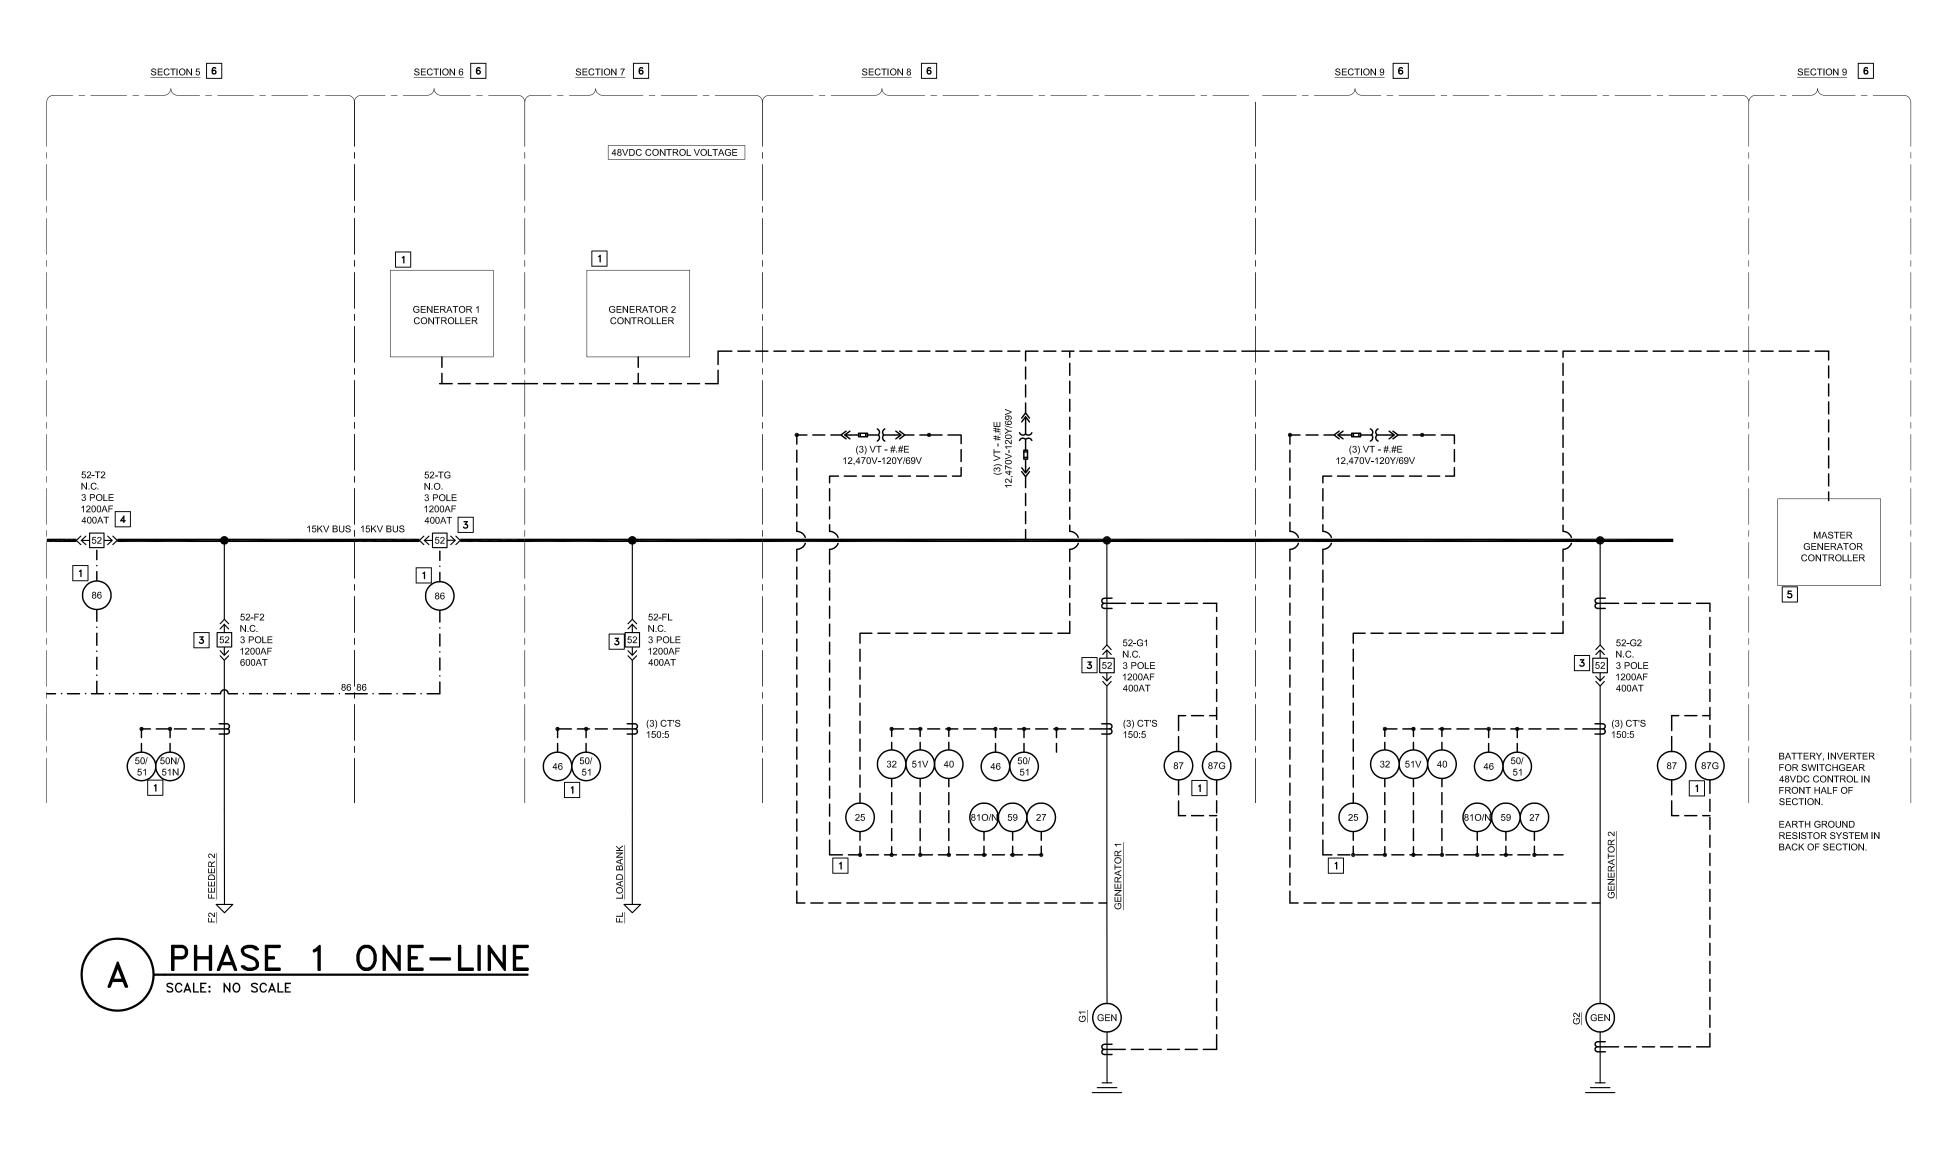
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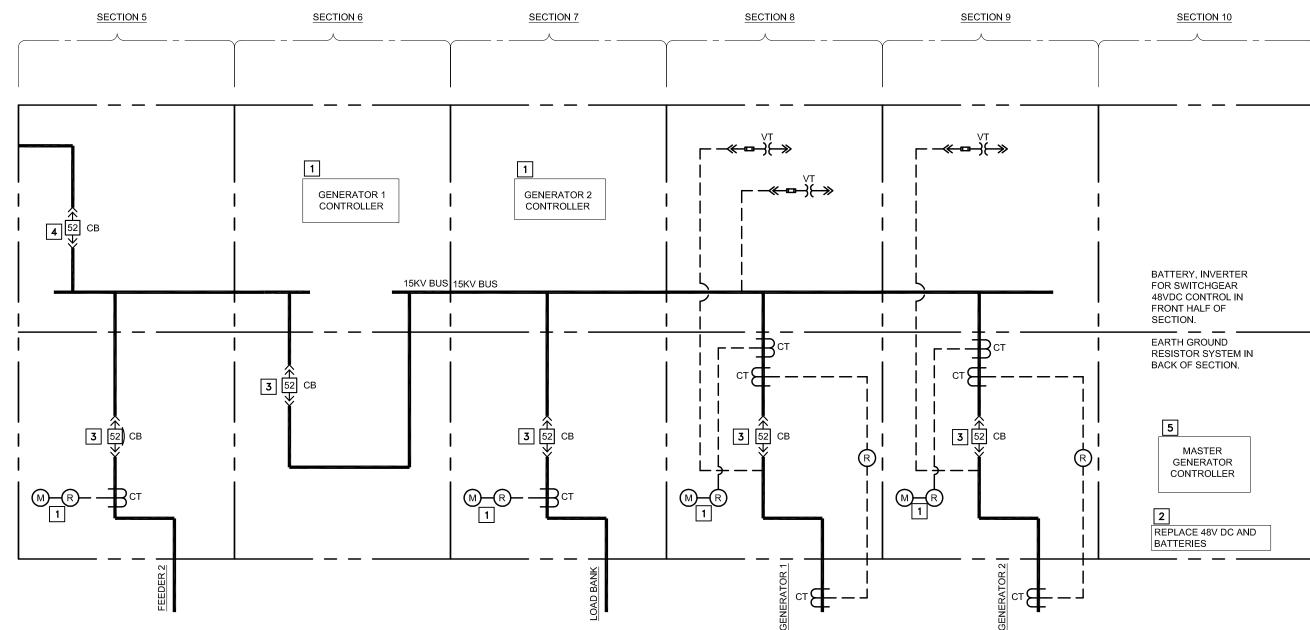
SHEET TITLE:

DEMO MV ONE-LINE AND ELEVATION

SHEET NUMBER:

E-60





PHASE 1 DIAGRAM SCALE: NO SCALE

RIGHT SIDE — PHASE 1: 1. PROVIDE TEMP 48VDC TO LEFT SIDE.

- REMOVE DEMO BUS SECTION. REMOVE ADJACENT BUS TO ALLOW FOR REMOVAL OF BUS IN THE SECTION.
- 3. PROVIDE NEW BUS SECTION FOR A TIE-TIE CONFIGURATION.
- 5. PROVIDE MASTER GENERATOR CONTROLLER. 6. NEW 48V DC RECTIFIER AND BATTERIES.
- 7. REPLACE RELAY, RELAY CONTROL WIRE, AND CIRCUIT BREAKERS.

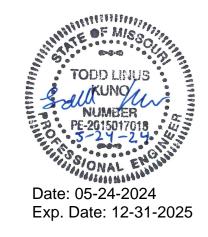
#KEYED NOTES:

- 2. REPLACE 48V DC AND BATTERIES.
- 3. REPLACE EXISTING DRAW OUT BREAKER.
- 4. REPLACE SECTION TO ALLOW FOR A TIE-TIE CONFIGURATION.
- 5. PROVIDE NEW MASTER GENERATOR PLC CONTROLLER IN SECTION 10. PROVIDE NEW BATTERY AND INVERTER TO SECTION 10 (SEE DRAWING B ON THIS SHEET)
- 6. PROVIDE NEW FRONT DOORS FOR BOTTOM AND TOP COMPARTMENT.



END SECTION TO BE MODIFIED FOR GENERATOR MASTER CONTROLLER

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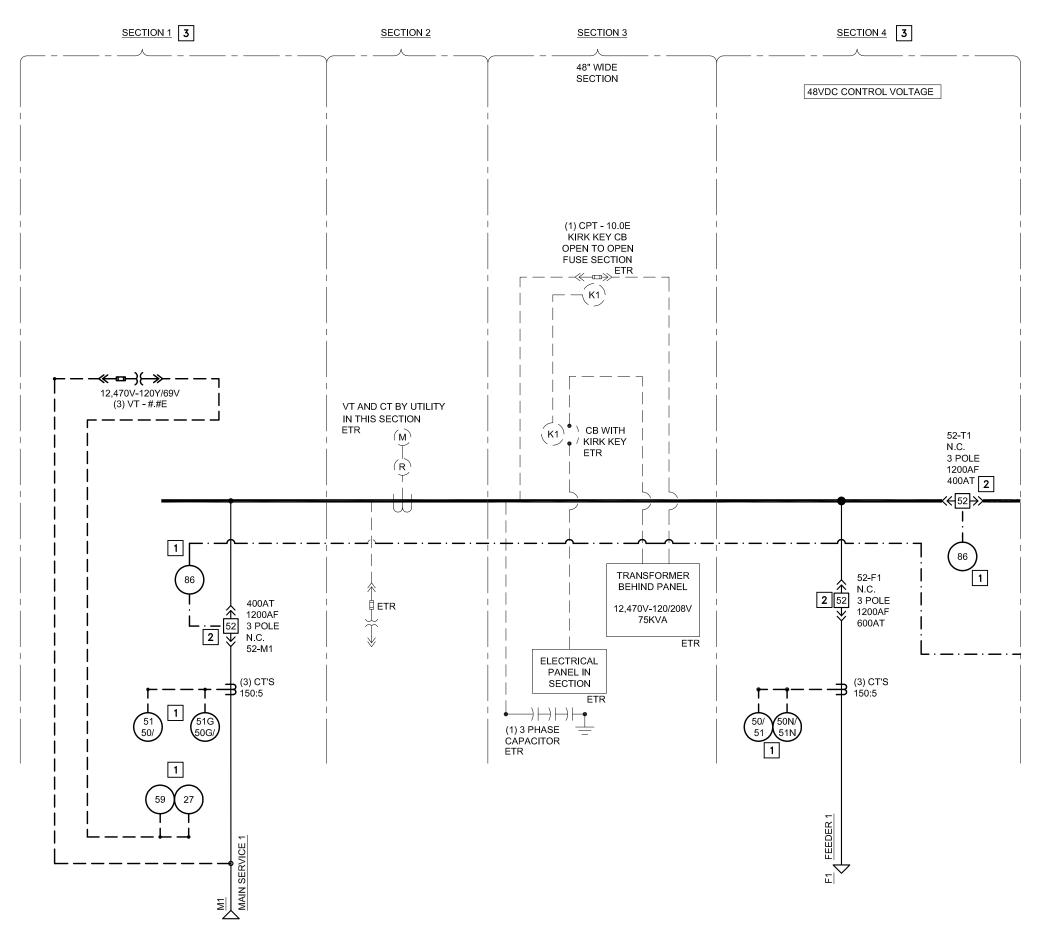
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SHEET TITLE:

PHASE 1: MV ONE-LINE AND **ELEVATION**

SHEET NUMBER:

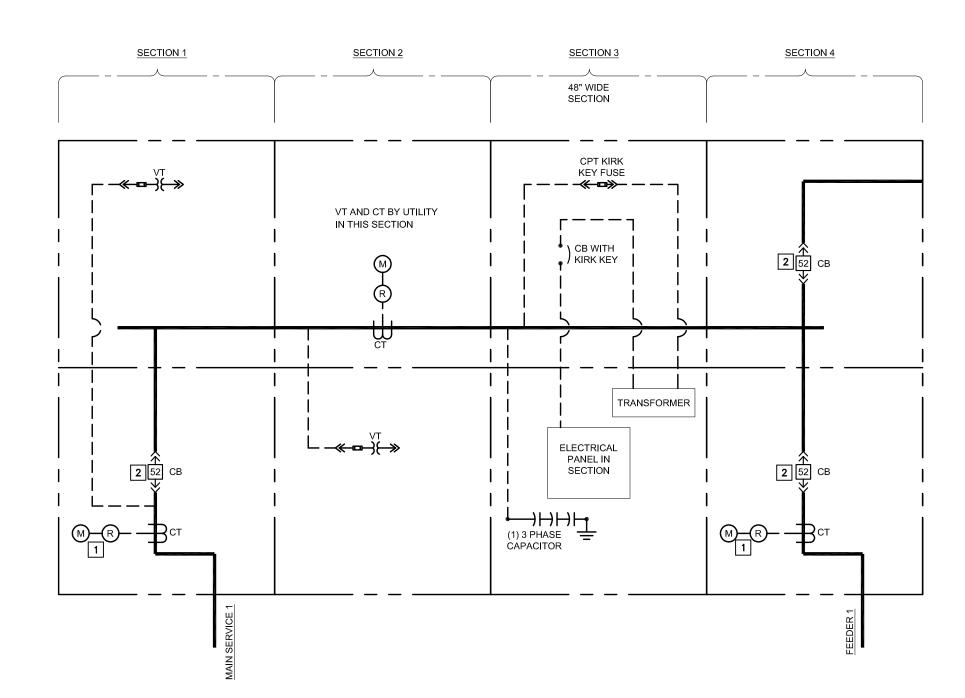


LEFT SIDE — PHASE 2:

1. PROVIDE TEMPORARY 120V AC TO 48VDC RECTIFIER.

2. REPLACE RELAYS AND CIRCUIT BREAKER. 3. REMOVE TEMPORARY RECTIFIER.

PHASE 2: ONE-LINE



PHASE 2: **DIAGRAM** SCALE: NO SCALE

KEYED NOTES:

2. REPLACE EXISTING DRAW OUT BREAKER.

3. PROVIDE NEW FRONT DOORS FOR BOTTOM AND TOP COMPARTMENT.

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SHEET TITLE:

PHASE 2: MV ONE-LINE AND ELEVATION

SHEET NUMBER: