ADDENDUM NO. 2

TO: PLANS AND SPECIFICATIONS FOR STATE OF MISSOURI

Upgrade Electrical and Restrooms, Grandstands Missouri State Fairgrounds Sedalia, Missouri PROJECT NO. F2304-01

Bid Opening Date is: 1:30 PM, Thursday, March 21st, 2024 (CHANGED)

Bidders are hereby informed that the Construction Plans and/or Specifications are modified as follows:

SPECIFICATION CHANGES:

- 1. As a change to specification section 011000 SUMMARY OF WORK, change paragraph 1.3-A-1 to the following:
 - a. Phase 1: Restroom remodel, structural repairs, Grandstand Stage Disconnect Replacement, and the Grandstand lighting replacement.
 - i. GC may choose to start work immediately after award and be substantially complete, ready for occupancy June 30, 2024.

Or

ii. GC may choose to start and complete all work in Phase 1 after the 2024 Missouri State Fair and be substantially complete, ready for occupancy by December 31, 2024.

The 2024 Missouri State Fair takes place August 8-18. GC may start work on August 26. If the GC accepts this option bathrooms must be available for events taking place between 9/20/2024 – 9/22/2024 and 10/5, 2024 – 10/12/2024

DRAWING GHANGES:

- 1. D-101
 - a. Please see the attached revised D-101 for revision to keynote #4.
- 2. E-101
 - a. Please see the attached revised E-101 with the addition of keynote #7
- 3. E-103
 - a. Please see the attached revised E-103 for a revision to keynote #1.
- 4. E-501
 - a. Please see the attached revised E-501 with additional information on the primary conduit and conductor tie in point.

GENERAL NOTE

- 1. All lighting dedicated to illuminating the track shall be existing to remain and not be included in this project.
- 2. No work shall take place on the racetrack. Any utility crossing of the racetrack shall be required to be bored underneath the racetrack at a minimum of 5'-0" below the lowest surface of the track where the crossing occurs. Any existing utilities underneath the racetrack that are to be abandoned shall be abandoned in place.

ATTACHMENTS:

- 1. D-101
- 2. E-101
- 3. E-103
- 4. E-501

March 13, 2024 END ADDENDUM NO. 2

DEMOLITION PLAN GENERAL NOTES:

- 1. SEE SHEETS E-501, E-502, E-601 & E-602 FOR ADDITIONAL ELECTRICAL
- NOTES, DETAILS, & SCHEDULES. 2. SEE SHEET M-501 FOR ADDITIONAL HVAC NOTES, DETAILS, &
- 3. SEE SHEET P-501 FOR ADDITIONAL PLUMBING NOTES, DETAILS, &
- SCHEDULES. 4. ALL EQUIPMENT LABELED 'EX' OR 'EXISTING' SHALL BE EXISTING TO REMAIN UNLESS OTHERWISE NOTED.

DEMOLITION PLAN KEY NOTES:

MORE DETAILS.

- (1) PHASE 2: DEMOLISH PANEL & PREP FOR NEW PANEL INSTALLATION.
- (2) PHASE 1: DEMOLISH HANGING PRESS BOX & ALL ASSOCIATED
- ELECTRICAL & HVAC EQUIPMENT & WIRING. (3) PHASE 3/ALTERNATE 1: DEMOLISH DISCONNECT.
- (4) PHASE 3/ALTERNATE 1: DEMOLISH CONDUIT AND CONDUCTORS. CONTRACTOR SHALL NOT DESTROY TRACK. ALL CONDUIT & 2
- (CONDUCTORS UNDER TRACK SHALL BE ABANDONED IN PLACE.)


 (5) PHASE 3/ALTERNATE 1: DEMOLISH PANEL & ROUTE EXISTING CIRCUITS THAT ARE TO REMAIN TO NEW PANEL CONNECTION LOCATED UNDER THE


ջEX

EXISTING

TRANSFORMER —

(6) PHASE 1: REPLACE EXISTING 600A DISCONNECT WITH NEW DOUBLE THROW 600A DISCONNECT. SEE STAGE POWER RISER (PHASE 1) FOR

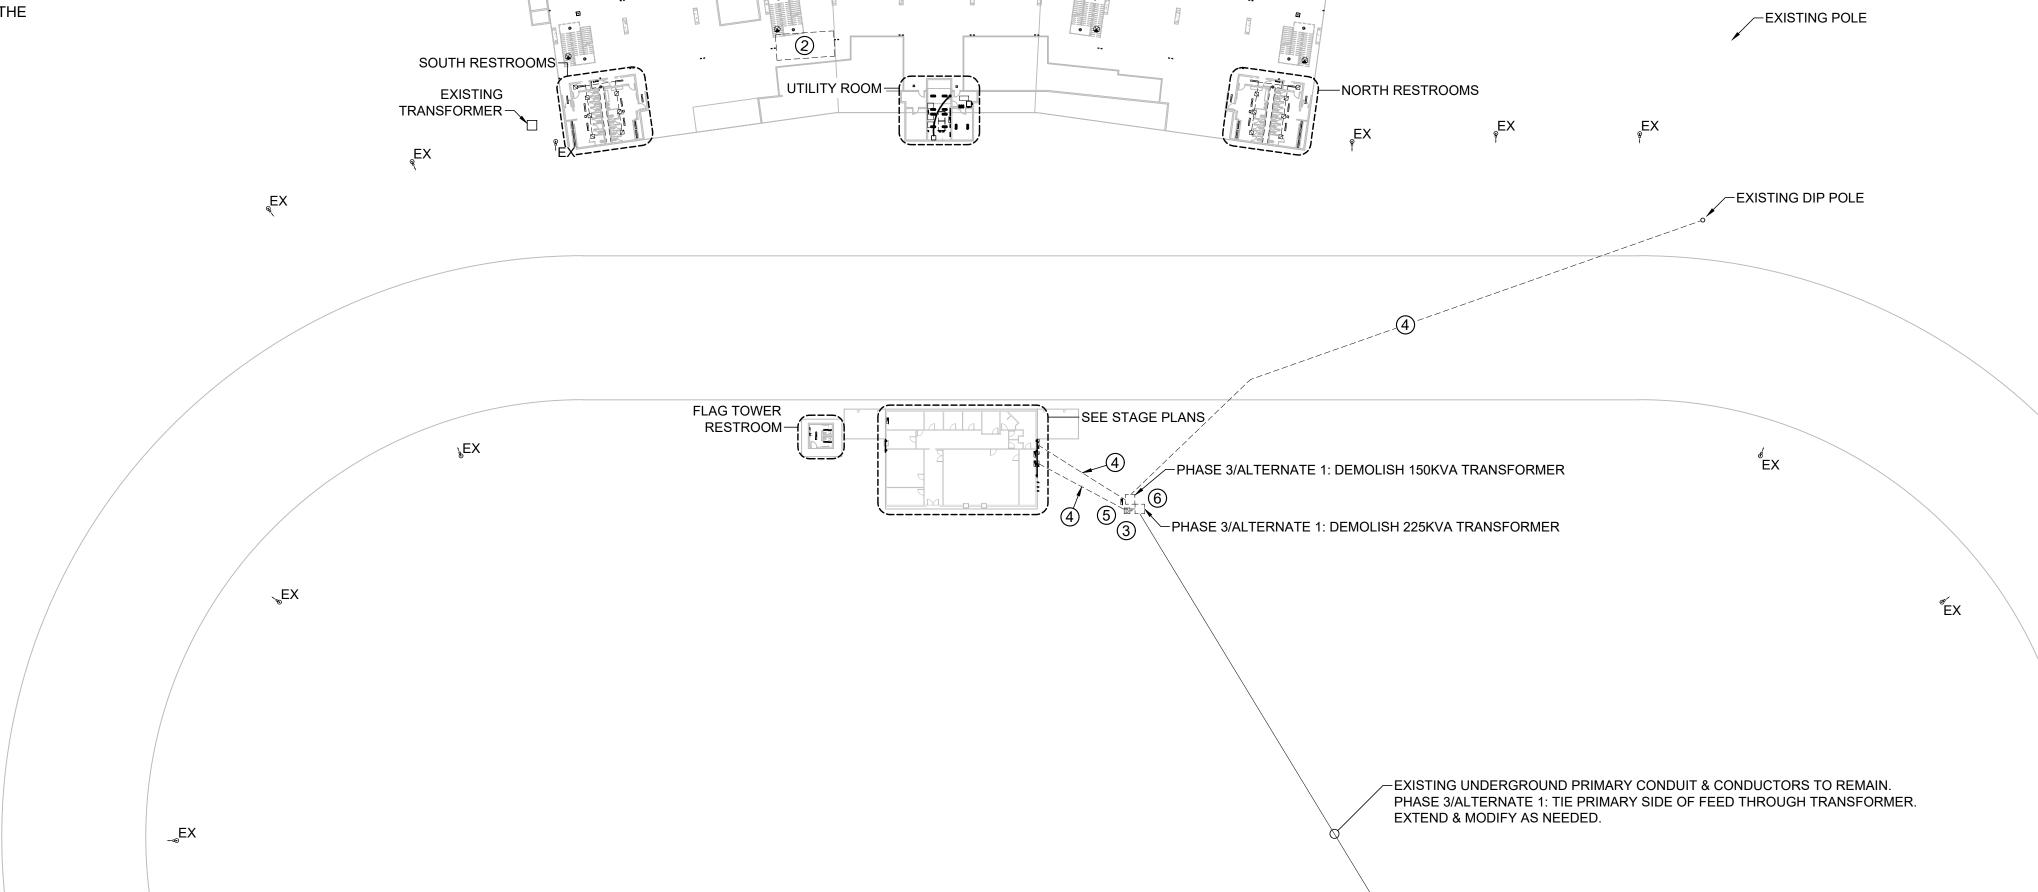

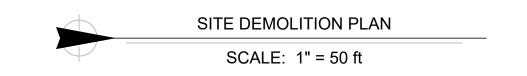

STATE OF MISSOURI MICHAEL L. PARSON, **GOVERNOR**



Keaton E. Leisinger, P.E. PE-2021035875



1806 West Broadway Boulevard Sedalia, MO 65301 660.829.9751



ENGINEERING 2400 BLUFF CREEK DR. STE. 101 COLUMBIA, MO 65203 573.234.4492

ENGINEERING CONSULTANTS 1000 W. Nifong Blvd., Bldg. 1. Columbia, Missouri 65202 (573) 447-0292 www.crockettengineering.com Crockett Engineering Consultants, LLC Missouri Certificate of Authority #2000151304

OFFICE OF ADMINISTRATION DIVISION OF FACILITIES MANAGEMENT DESIGN AND CONSTRUCTION

UPGRADE ELECTRICAL AND RESTROOMS, GRANDSTAND MISSOURI STATE **FAIRGROUNDS**

2503 W. 16TH ST. SEDALIA, MO 65301

PROJECT # T2304-01

ASSET # 3511501018 REVISION: ADDENDUM #2 DATE: 03 / 12 / 2024

REVISION: DATE:

EΧ

EXISTING

TRANSFORMER \ 1

SITE # 1501

REVISION: DATE:

ISSUE DATE: 11/29/2023

BID DOCUMENTS

CAD DWG FILE: F2304-01-D-FP-14.dwg
DRAWN BY: RXM
CHECKED BY: JAP
DESIGNED BY: KEL

SHEET TITLE:

SITE DEMOLITION PLAN

SHEET NUMBER:


POWER PLAN GENERAL NOTES:


- 1. SEE SHEETS E-501, E-502, E-601 & E-602 FOR ELECTRICAL NOTES, DETAILS, &
- SCHEDULES.
- 2. ALL EQUIPMENT LABELED "EX" OR "EXISTING" SHALL BE EXISTING TO REMAIN UNLESS OTHERWISE NOTED.

POWER PLAN KEY NOTES:

- (1) PHASE 1: PROVIDE & INSTALL NEW PANEL. SEE PANEL SCHEDULE &
- POWER RISER FOR MORE DETAILS.
- (2) EXISTING CONDUIT & CONDUCTORS TO REMAIN.
- 3 PHASE 2: PROVIDE & INSTALL NEW PANEL. SEE PANEL SCHEDULE & POWER RISER FOR MORE DETAILS.
- (4) PHASE 3/ALTERNATE 1: PROVIDE & INSTALL NEW 300kVA TRANSFORMER.
- (5) PHASE 3/ALTERNATE 1: SEE POWER RISER FOR CONDUIT & CONDUCTOR SIZE AND FURTHER INFORMATION.
- ⑥ PHASE 1: PROVIDE & INSTALL NEW 600A & 800A, 120/208Y, NEMA 3R,
- DOUBLE THROW DISCONNECTS. SEE STAGE POWER RISER (PHASE 1) FOR
- MORE INFORMATION.

 7 PHASE 3/ALTERNATE 1: PRIMARY CONDUIT & CONDUCTORS TO BE BORED UNDER TRACK AT MINIMUM OF 5 FT. DEEP. SEE POWER RISER FOR MORE DETAILS.

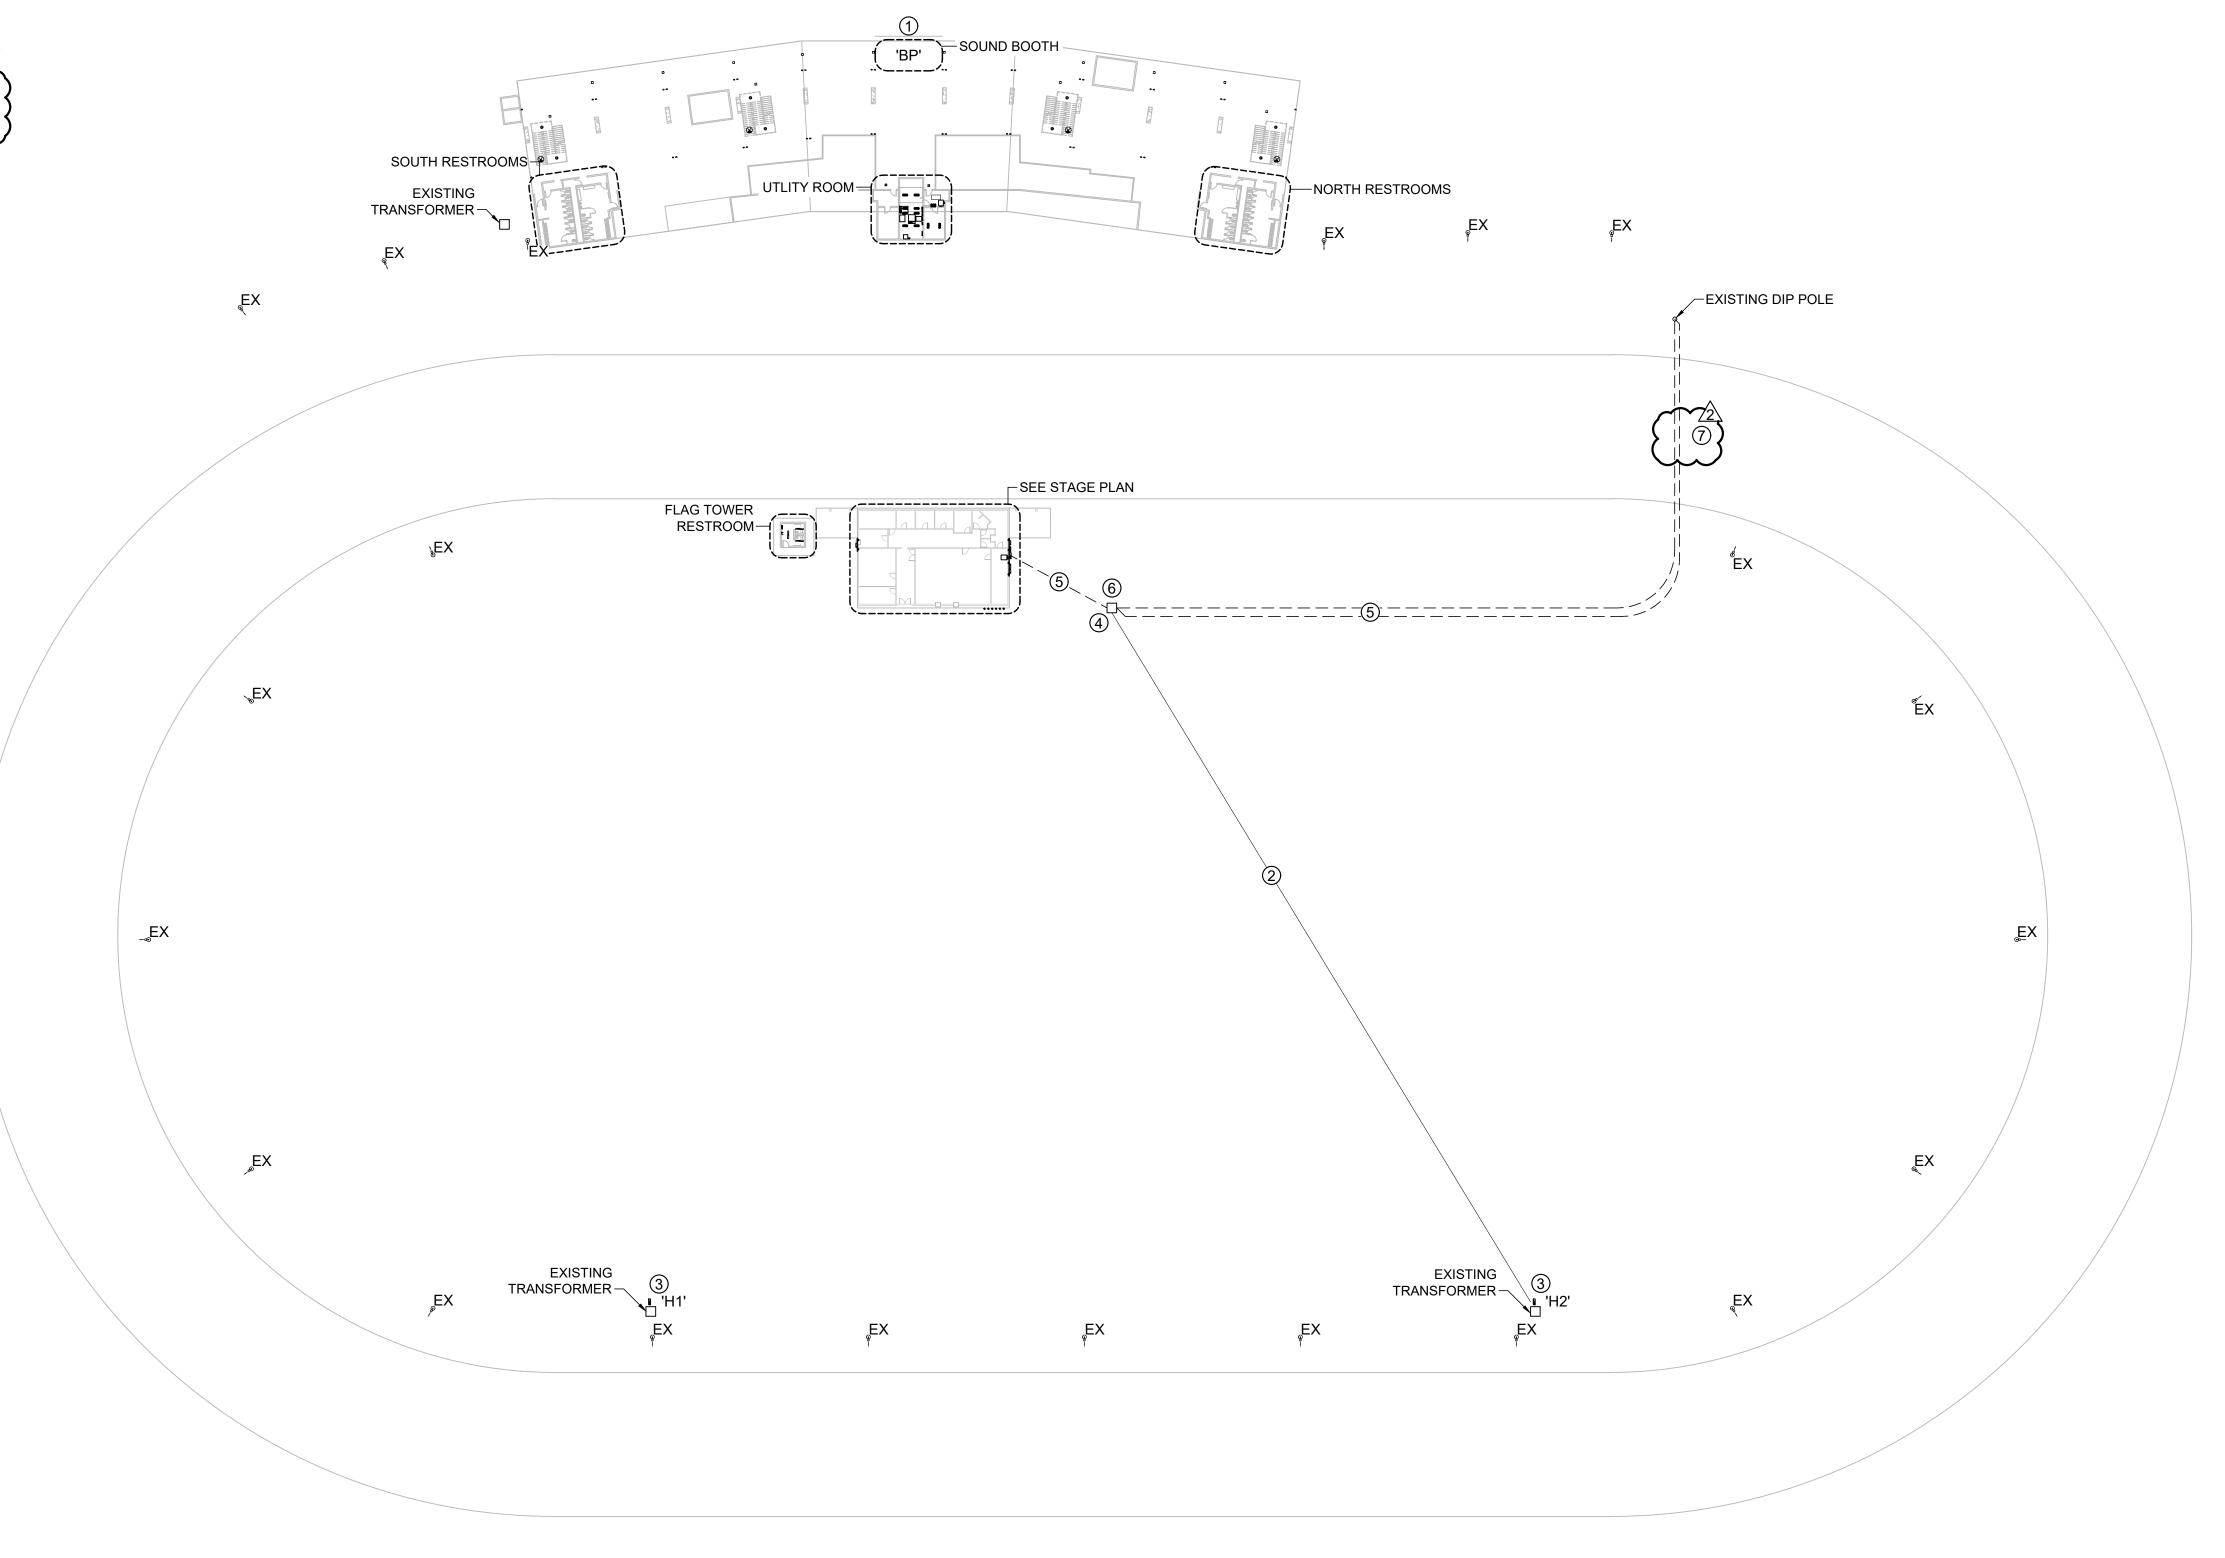

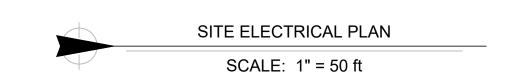

STATE OF MISSOURI MICHAEL L. PARSON, GOVERNOR



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CROCKETT

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Columbia, Missouri 65202
(573) 447-0292
www.crockettengineering.com
Crockett Engineering Consultants, LLC
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UPGRADE ELECTRICAL AND RESTROOMS, GRANDSTAND MISSOURI STATE FAIRGROUNDS

SEDALIA, MO 65301

PROJECT # T2304-01

ASSET # 3511501018

2503 W. 16TH ST.

REVISION: ADDENDUM #2 DATE: 03 / 12 / 2024

REVISION:_ DATE:_

SITE # 1501

REVISION:___ DATE:

ISSUE DATE: 11/29/2023

BID DOCUMENTS

CAD DWG FILE:F2304-01-E-FP-20.dwg
DRAWN BY: RXM
CHECKED BY: JAP
DESIGNED BY: KEL

SHEET TITLE:

SITE ELECTRICAL PLAN

SHEET NUMBER:

E-10

POWER PLAN SYMBOL LEGEND ____ CIRCUIT WIRING DATA / PHONE JACK BOX WITH 1" CONDUIT & PULL STRING) UP TO CEILING SPACE ——>PX-XX CIRCUIT TAG (STANDARD @ 18" AFF UNLESS NOTED OTHERWISE) JUNCTION BOX WIRELESS ACCESS POINT, CEILING MOUNTED RECEPTACLE FLOOR RECEPTACLE INDICATES MOUNTING HEIGHT TO BOTTOM OF BOX (STANDARD @ 18" AFF UNLESS NOTED OTHERWISE) FLOOR DATA "WP" = WEATHERPROOF OUTDOOR RECEPTACLE "AW" = ABOVE WINDOW RECEPTACLE DISCONNECT "AC" = ABOVE CEILING RECEPTACLE "EX" = EXISTING RECEPTACLE TO REMAIN FUSED DISCONNECT GFCI DUPLEX CONVENIENCE RECEPTACLE **FUSED SWITCH** 208V RECEPTACLE STARTER / DISCONNECT QUADPLEX CONVENIENCE RECEPTACLE TIE INTO EXISTING

USB OUTLET


WITH USB-A & USB-C CHARGING PORT

POWER PLAN GENERAL NOTES:

- 1. SEE SHEETS E-501, E-502, E-601 & E-602 FOR ELECTRICAL NOTES, DETAILS, & SCHEDULES.
- 2. ALL EQUIPMENT LABELED "EX" OR "EXISTING" SHALL BE EXISTING TO REMAIN UNLESS OTHERWISE NOTED.

POWER PLAN KEY NOTES:

1) PHASE 3/ALTERNATE 1: 50A NEMA 6-50R RECEPTACLE WITH BOX AND COVER MOUNTED TO BACK OF STAGE PLATFORM.

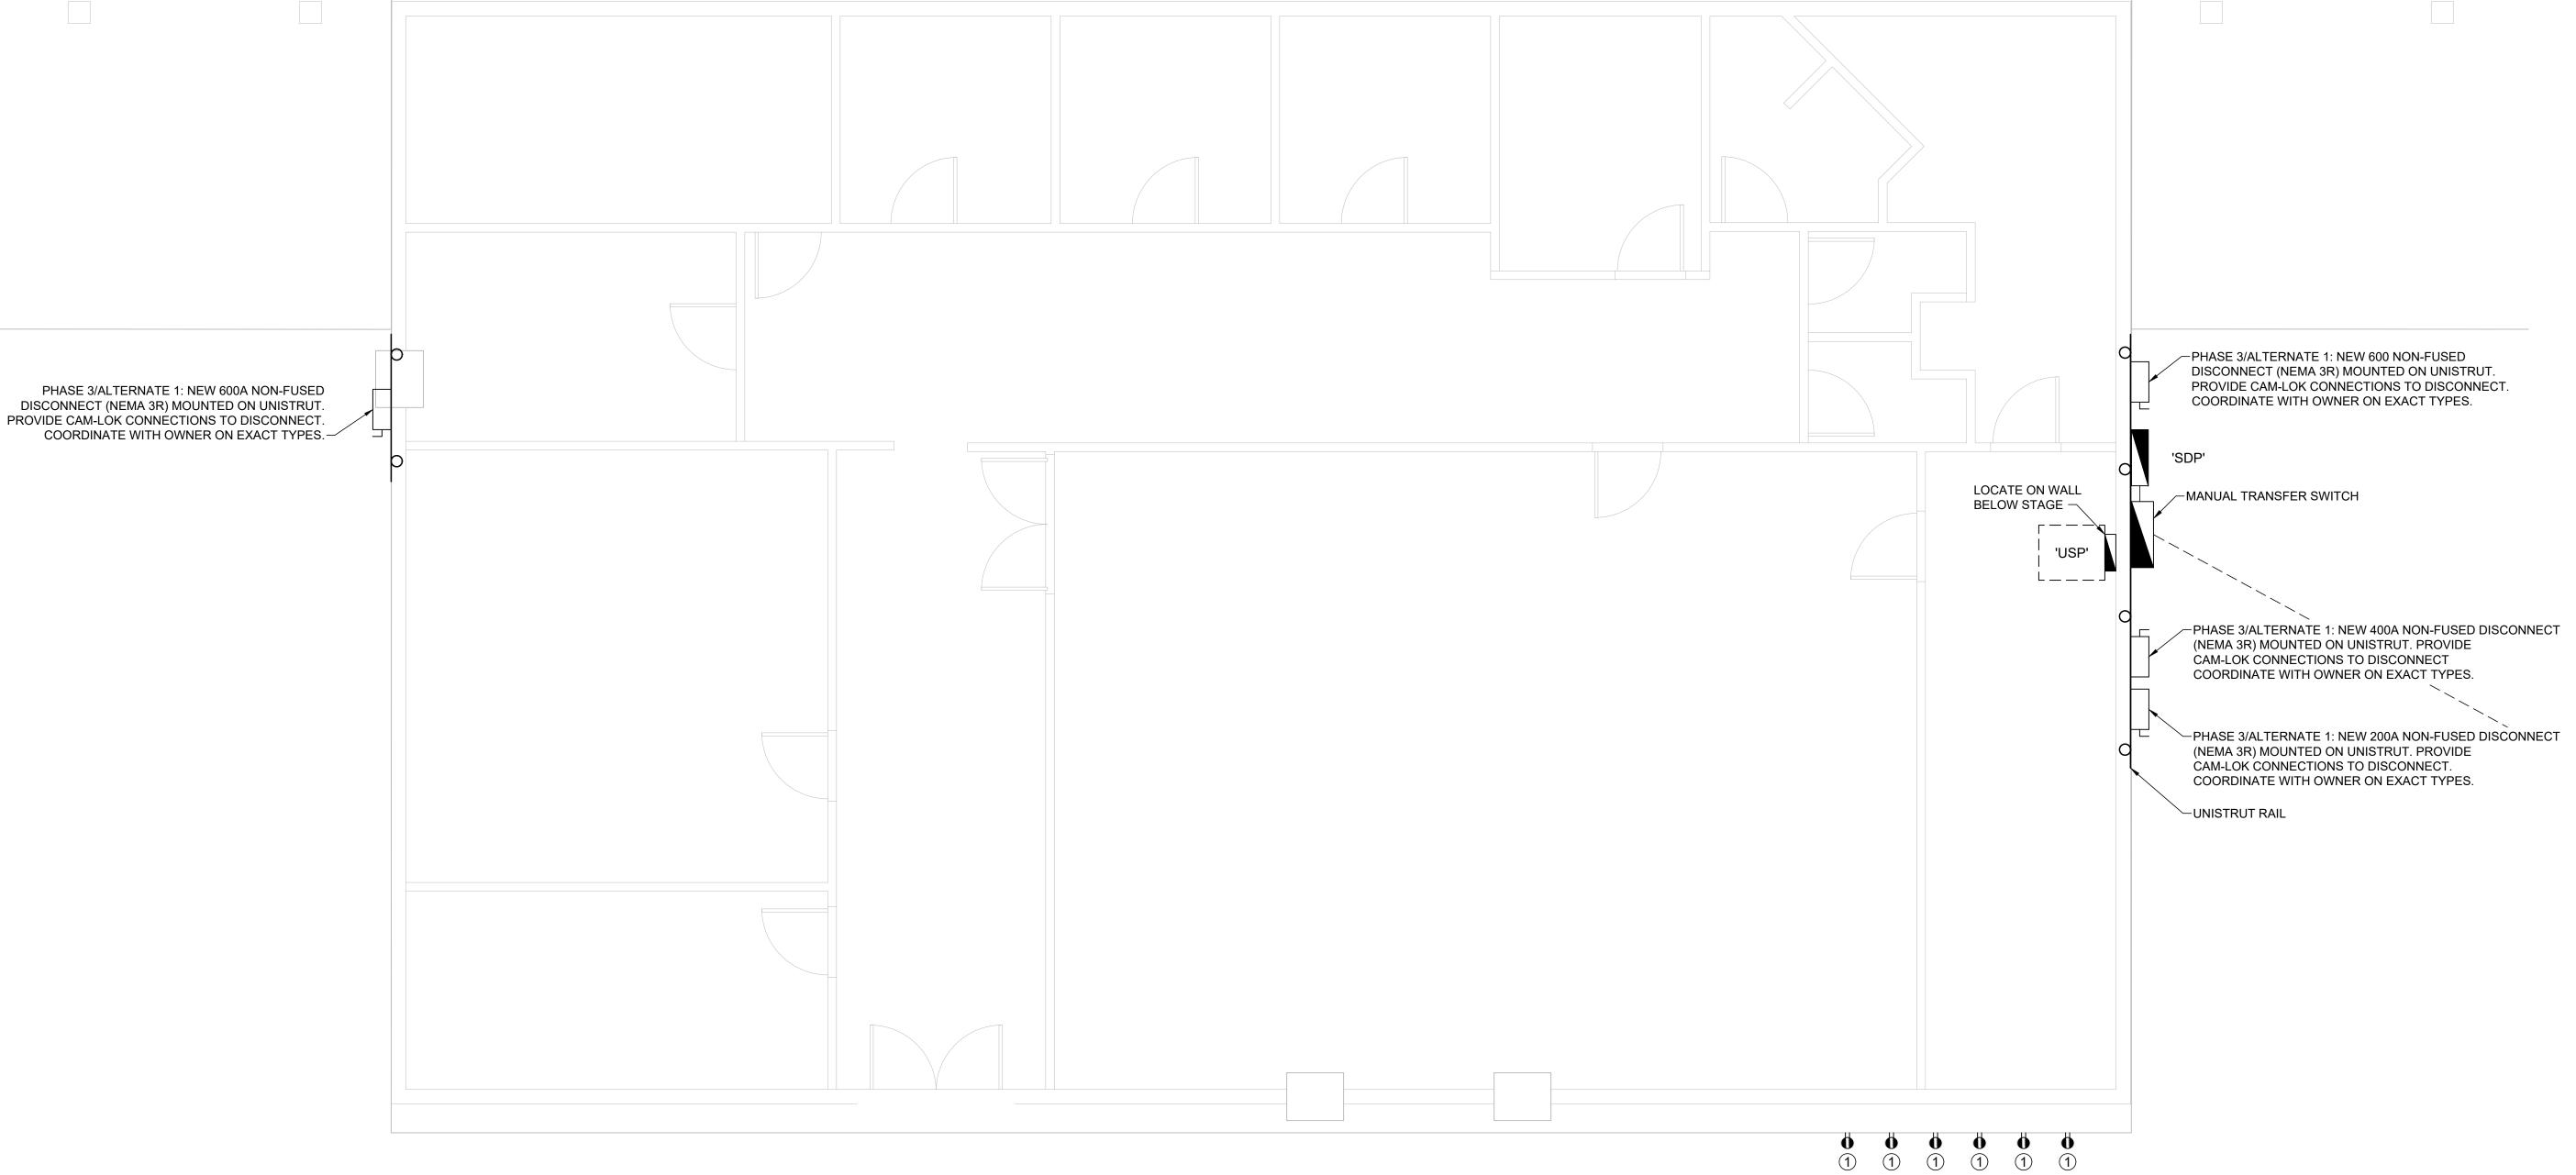


STAGE POWER PLAN

SCALE: 1/4" = 1'-0"

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UPGRADE ELECTRICAL AND RESTROOMS, GRANDSTAND

MISSOURI STATE FAIRGROUNDS 2503 W. 16TH ST. SEDALIA, MO 65301

PROJECT # T2304-01 SITE # 1501 ASSET # 3511501018

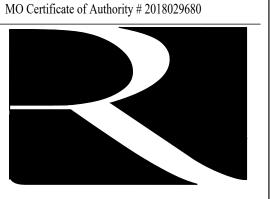REVISION: ADDENDUM #2 DATE: 03 / 12 / 2024

REVISION:_____DATE:

REVISION: _____ DATE: ____

ISSUE DATE: 11/29/2023

BID DOCUMENTS

CAD DWG FILE: F2304-01-E-FP-22.dwg
DRAWN BY: RXM
CHECKED BY: JAP
DESIGNED BY: KEL

SHEET TITLE:

ENLARGED STAGE POWER PLAN (PHASE 3 ALT. 1)

SHEET NUMBER:


E-103

POWER RISER GENERAL NOTES:


- 1. CONTRACTOR IS RESPONSIBLE FOR ANY CONDUIT & CONDUCTOR MODIFICATIONS & EXTENSIONS
- NECESSARY FOR A FULLY FUNCTIONAL ELECTRIC SYSTEM.
- 2. CONTRACTOR SHALL INCLUDE IN BID 1,000 FT OF #12 THHN, #10 THHN, AND #8 THHN.
- 3. CONTRACTOR SHALL ALSO INCLUDE IN BID 100 FT OF $\frac{3}{4}$ " AND 1" CONDUIT.
- 4. CONTRACTOR SHALL PROVIDE UNIT PRICE PER FOOT FOR #12 THHN, #10 THHN, AND #8 THHN IN $\frac{3}{4}$ " OR 1"

POWER RISER KEY NOTES:


- (1) EXISTING CONDUIT & CONDUCTORS TO REMAIN.
- (2) (2) 4" CONDUITS, EACH WITH (4) #350 CU & (1) #1 CU GRD.
- (3) 4" CONDUITS WITH (4) #500 CU & (1) #3 CU GRD.
- (4) 2 ½" CONDUITS WITH (4) #3/O CU & (1) #6 CU GRD.
- (5) (4) 4" CONDUITS WITH (4) #350 CU & (1) #3/O CU GRD.
- (6) (2) 4" CONDUITS WITH (4) #500 CU & (1) #2/O CU GRD.
- (7) PRIMARY CONDUCTORS SHALL MEET THE FOLLOWING SPECIFICATIONS. 3/0 URD CABLE, CLASS B STRAND, WITH A WATER BLOCKING STRAND FILLER TO SEAL AND FILL THE SPACE BETWEEN THE STRANDS, TO HAVE AN EXTENDED THERMO SETTING SEMI CONDUCTING CONDUCTOR SHIELD WHICH IS FREE STRIPPING FROM THE CONDUCTOR AND BONDED TO THE INSULATION, 220 MIL TREE RETARDANT UCC4202 OR BOREALIS 4212 INSULATION, EXTRUDED THERMOSETTING SEMI CONDUCTING INSULATION WITH CONTROLLED ADHESION TO THE INSULATION HAVING A REDUCED CONCENTRIC NEUTRAL OF 11-14AWG. BARE COPPER NEUTRAL WIRES & OVERALL ENCAPSULATING JACKET OF LINEAR LOW DENSITY POLYETHYLENE EXTRUDED TO FILL IN THE SPACE BETWEEN NEUTRAL WIRES, JACKET MUST BE FREE STRIPPING FROM THE UNDERLYING INSULATION SHIELD. CABLE TO BE TANDEM EXTRUDED & DRY CURED. CABLE TO BE CONSTRUCTED PER ICEA S-94-649, ICEA S-97-682 AND AEIC CS8.
- (8) FORMERLY POWER FOR HANGING ANNOUNCER BOOTH PANEL.
- (9) REPLACE EXISTING DISCONNECT WITH NEW 600A, 120/208Y, 3Ø, NEMA 3R, DOUBLE THROW DISCONNECT FOR STAND BY GENERATOR CONNECTION.
- (10) REPLACE EXISTING DISCONNECT WITH NEW 800A, 120/208Y, 3Ø, NEMA 3R, DOUBLE THROW DISCONNECT FOR STANDBY GENERATOR CONNECTION.
- (1) TRANSFORMER PRIMARY VOLTAGE 12470 GRD Y/ 7200.

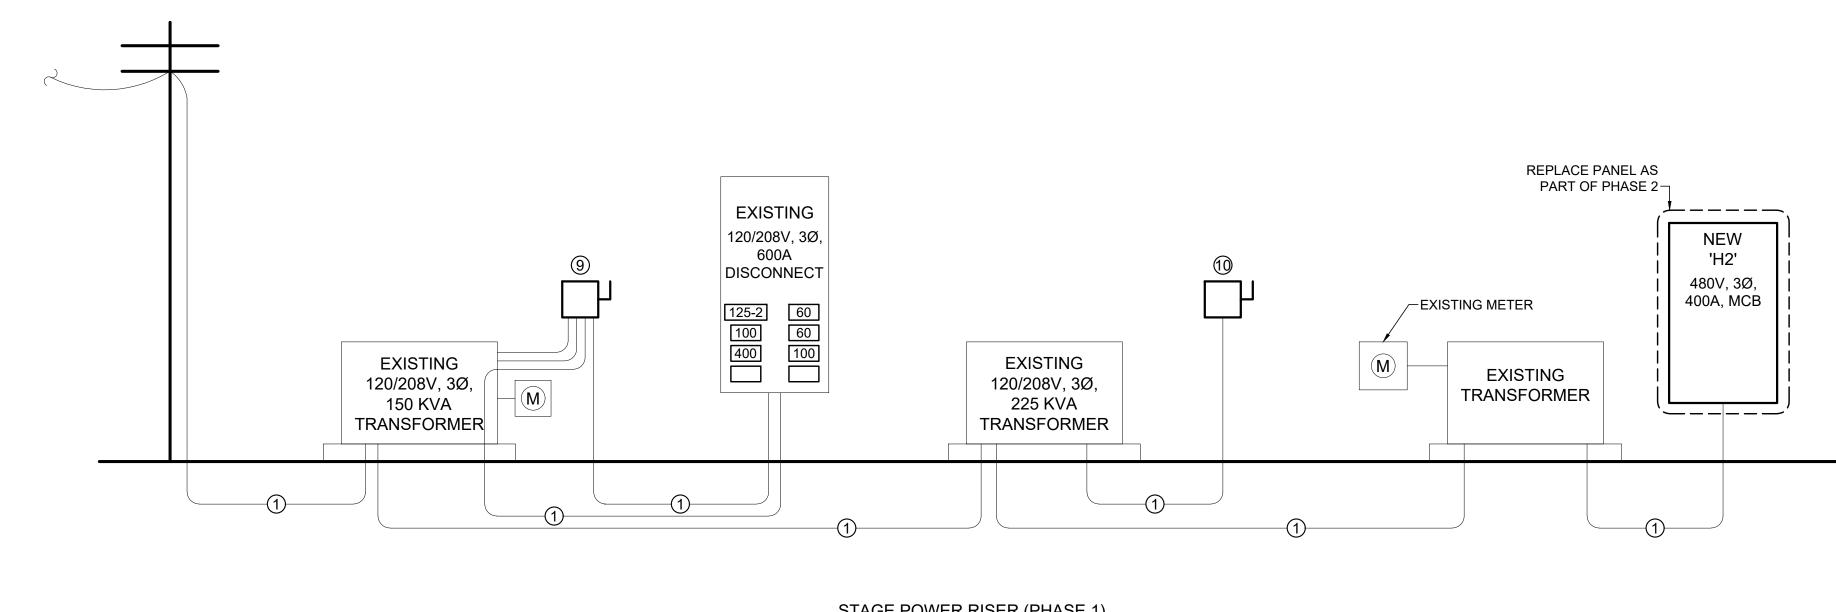

STAGE POWER RISER (PHASE 1

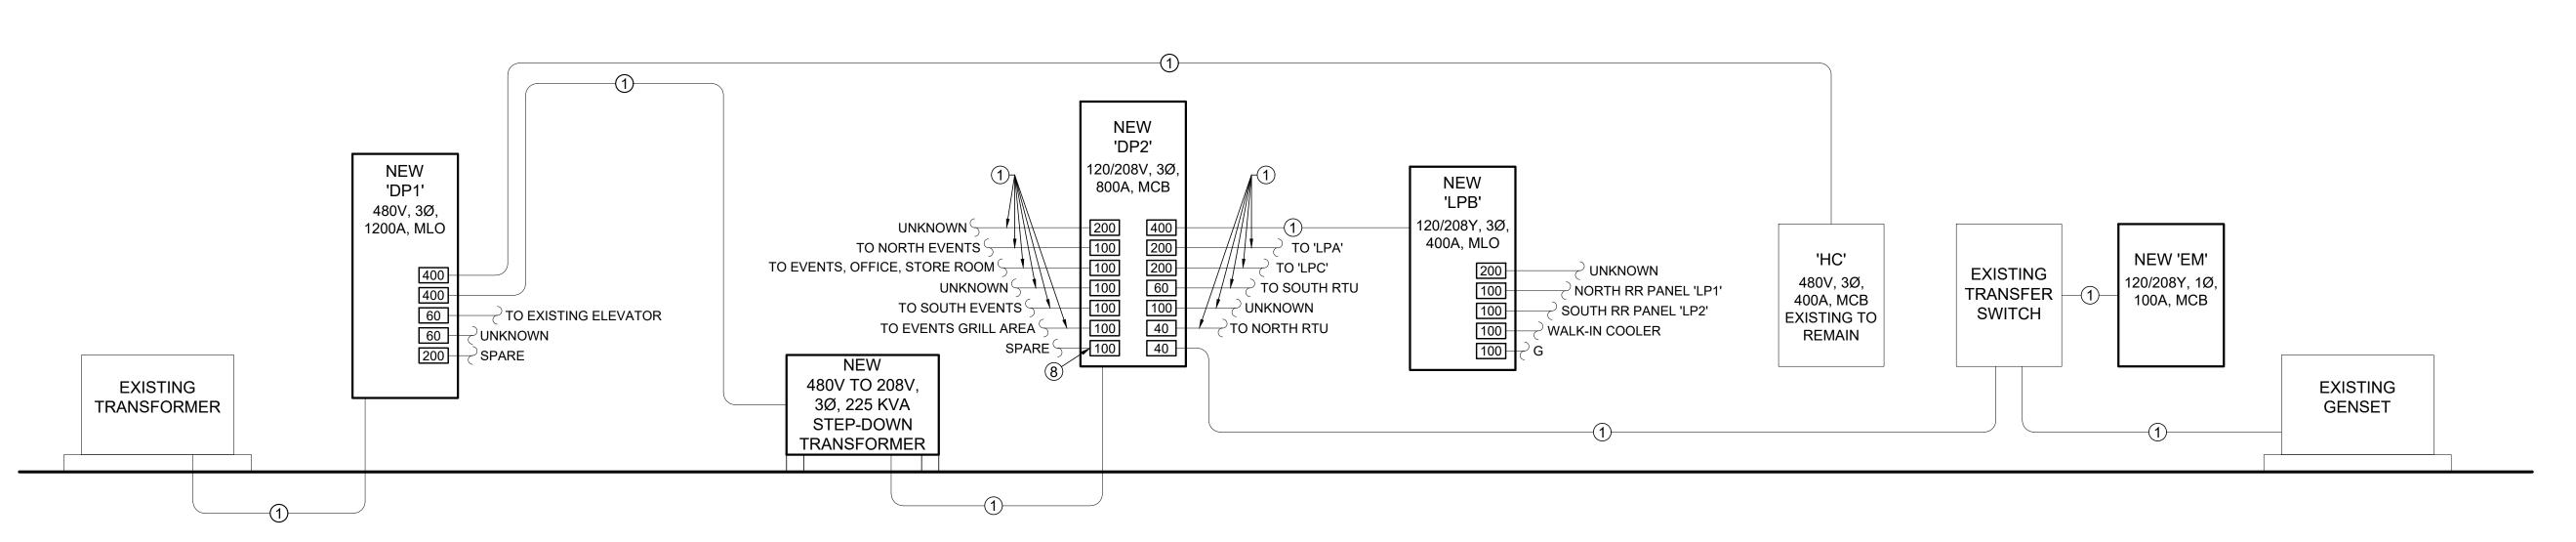

GRANDSTAND POWER RISER (PHASE 2)

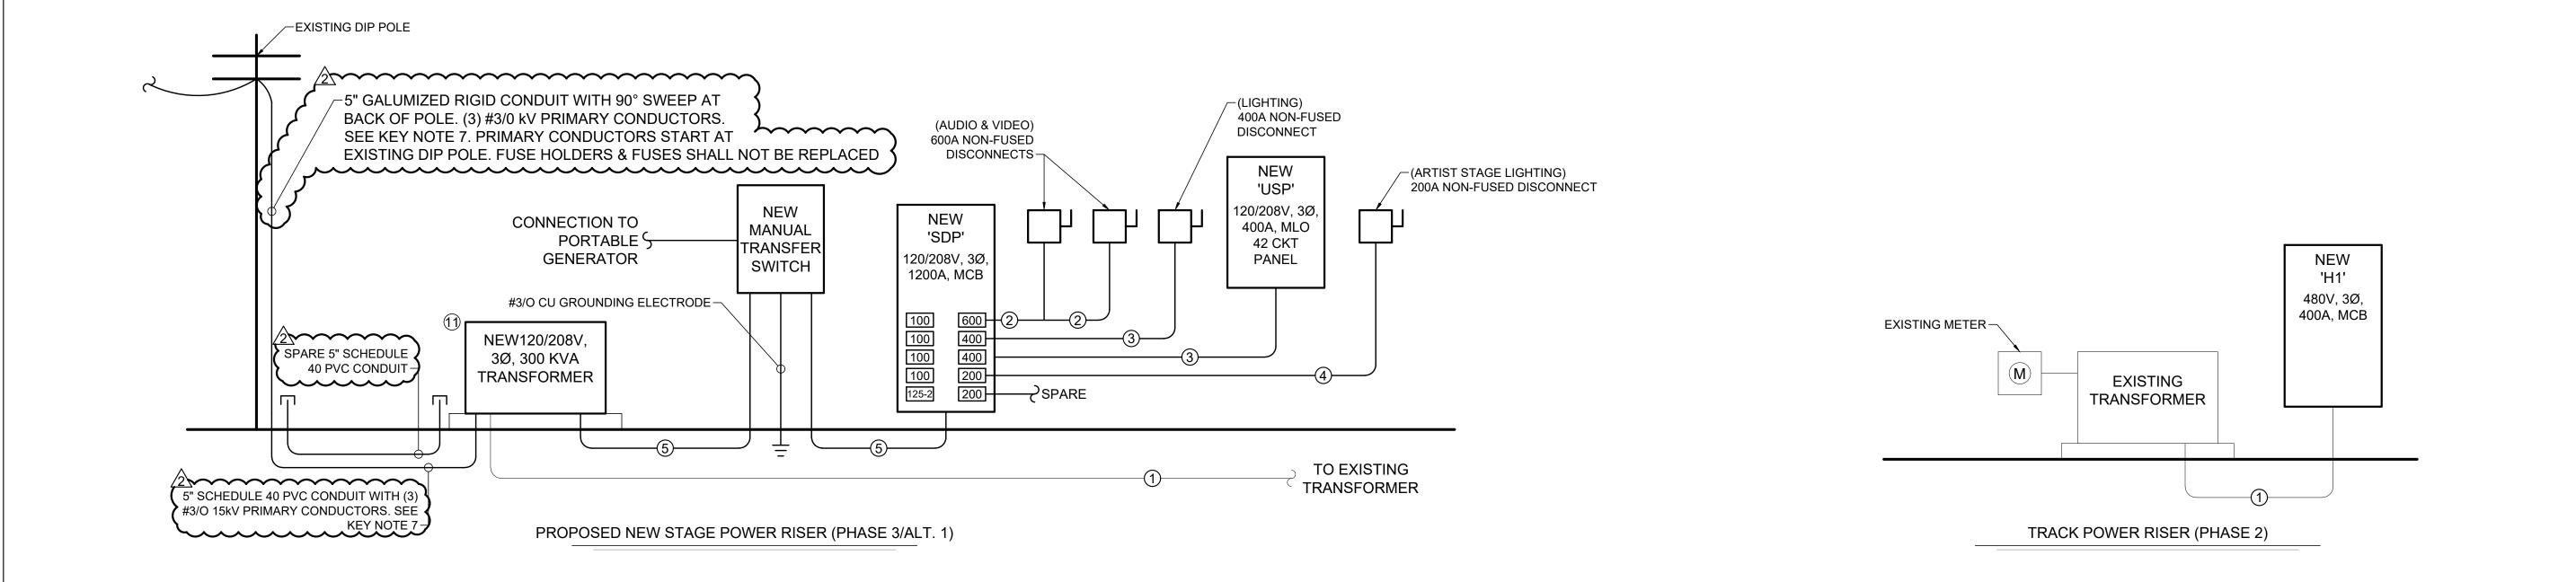

STATE OF MISSOURI MICHAEL L. PARSON, **GOVERNOR**



Keaton E. Leisinger, P.E.

PE-2021035875 MO Certificate of Authority # 2018029680



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PROJECT # T2304-01 SITE # 1501 ASSET # 3511501018

REVISION: ADDENDUM #1 DATE: 03 / 04 / 2024

REVISION: ADDENDUM #2 DATE: 03 / 12 / 2024

DATE:

ISSUE DATE: 11/29/2023

BID DOCUMENTS

CAD DWG FILE:F2304-01-E-DT-26.dwg DRAWN BY: RXM CHECKED BY: JAP DESIGNED BY: KEL

SHEET TITLE:

REVISION:

ELECTRICAL DETAILS

SHEET NUMBER: