ADDENDUM NO. 2

TO: PLANS AND SPECIFICATIONS FOR STATE OF MISSOURI

Interior & Exterior Renovations Missouri 4H Building Missouri State Fairgrounds Sedalia, Missouri Project No. F2407-01

Bid Opening Date: 1:30 PM, Thursday, October 30, (Not Changed)

Bidders are hereby informed that the construction Plans and/or Specifications are modified as follows:

SPECIFICATION CHANGES:

1. None

DRAWING CHANGES:

- 1. Sheet MEP2
 - a. REPLACE Sheet in its entirety
- 2. Sheet MEP3
 - a. REPLACE Sheet in its entirety
- 3. Sheet E101
 - a. REPLACE Sheet in its entirety
- 4. Sheet E102
 - a. REPLACE Sheet in its entirety
- 5. Sheet E501
 - a. REPLACE Sheet in its entirety
- 6. Sheet E601
 - a. REPLACE Sheet in its entirety
- 7. Sheet F101
 - a. REPLACE Sheet in its entirety
- 8. Sheet F102
 - a. REPLACE Sheet in its entirety

GENERAL COMMENTS:

1. None

ATTACHEMENTS:

- 1. Sheet MEP2
- 2. Sheet MEP3
- Sheet E101
 Sheet E102
- 5. Sheet E501
- 6. Sheet E601
- 7. Sheet F101
- 8. Sheet F102

October 23, 2025

END OF ADDENDUM NO. 2

TIE INTO EXISTING	 SEE HVAC PLANS FOR EQUIPMENT INFORMATION. UNDERGROUND CONDUIT AND CONDUCTORS FROM PAD MOUNT TRANSF SEE POWER RISER FOR FURTHER INFORMATION. NEW SANITARY PIPE. SEE CIVIL PLAN FOR CONTINUATION. SEE SHEET P-FURTHER DETAILS. NEW COMBINED DOMESTIC WATER AND FIRE SPRINKLER LINE CONNECT ESTIMATED SIZE SHALL BE 6", FIRE SPRINKLER CONTRACTOR & DESIGNE VERIFY PRIOR TO INSTALLATION. SEE CIVIL PLAN FOR CONTINUATION.
EXISTING BUILDING TO BE RENOVATED	
32-	

SITE UTILITY PLAN

SCALE: 1" = 20 ft

SITE PLAN SYMBOL LEGEND

---- Sanitary sewer piping

----- COLD WATER LINE

----- ELECTRIC

SITE UTILITIES PLAN GENERAL NOTES:

1. REFER TO CIVIL PLANS FOR EXACT UTILITY LOCATIONS, CONNECTIONS, DETAILS, ETC.

SITE UTILITIES PLAN KEY NOTES:

- FORMER.
- -101 FOR ~~~~~\\dot2
- TION;

ER SHALL لاستنا STATE OF MISSOURI MIKE KEHOE **GOVERNOR**




Keaton E. Leisinger, P.E. PE-2021035875

MO Certificate of Authority # 2018029680



SEDALTA, MO 65301 PHONE: 660 829 9751 FAX: 660 829 9752

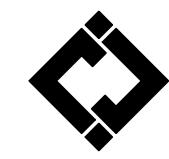

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www.crockettengineering.com
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#2000151304

OFFICE OF ADMINISTRATION DIVISION OF FACILITIES MANAGEMENT DESIGN AND CONSTRUCTION

INTERIOR & EXTERIOR RENOVATIONS, MISSOURI (4-H) BUILDING MISSOURI STATE FAIRGROUNDS 2503 W. 16TH ST SEDALIA, MO 65301

PROJECT # F2407-01 SITE # 1501

ASSET # 3511501028

REVISION: ADDENDUM 2 DATE: 10/23/2025



ISSUE DATE: 6/27/2025

BID DOCUMENTS

CAD DWG FILE:
DRAWN BY:
CHECKED BY:
DESIGNED BY:
KEL

SHEET TITLE:

SITE UTILITY PLAN

SHEET NUMBER:

MEP-2

VENT THROUGH ROOF

LOUVER & FAN

ROOF PLAN GENERAL NOTES:


- 1. REFER TO M500 AND/OR M600 SERIES SHEETS FOR ADDITIONAL HVAC NOTES, DETAILS, REQUIREMENTS, AND SCHEDULES.
- 2. HVAC CONTRACTOR SHALL REVIEW ALL PROJECT DOCUMENTS AND COORDINATE LOCATION OF ALL EQUIPMENT, DUCTWORK, REFRIGERANT PIPING, CONDENSATE PIPING, HANGERS / SUPPORTS, ETC. WITH PLUMBING AND ELECTRICAL TRADES BEFORE INSTALLATION OF ANY MATERIAL. ADDITIONAL COSTS ASSOCIATED WITH LACK OF COORDINATION WILL NOT BE REIMBURSED.

ROOF PLAN KEY NOTES:

1) VTR LOCATION. SEE PLUMBING PLANS FOR DETAILS.

(2) BASE BID: PROVIDE AND INSTALL LOUVER AND FAN ASSEMBLY IN EXISTING OPENING AS SHOWN. ELECTRICAL DISCONNECT SHALL BE MOUNTED INSIDE

- BUILDING ENVELOPE ADJACENT TO FAN ASSEMBLY. ALTERNATE #1: CONTRACTOR SHALL NOT PROVIDE AND INSTALL LOUVER AND FAN
- ASSEMBLY OR ASSOCIATED ELECTRICAL DISCONNECTS. SEE ARCHITECTURAL
- PLANS FOR SEALING OPENING.

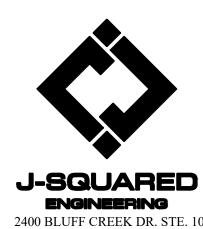

STATE OF MISSOURI

NUMBER ✓ PE-2021035875

MO Certificate of Authority # 2018029680

208 S. Lamine SEDALTA, MO 65301 PHONE: 660 829 9751 FAX: 660 829 9752

MIKE KEHOE

GOVERNOR

Keaton E. Leisinger, P.E.

PE-2021035875

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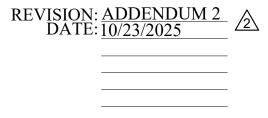
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INTERIOR & EXTERIOR RENOVATIONS, MISSOURI (4-H) **BUILDING** MISSOURI STATE FAIRGROUNDS 2503 W. 16TH ST SEDALIA, MO 65301

PROJECT # F2407-01 SITE # 1501

ASSET # 3511501028



ISSUE DATE: 6/27/2025

BID DOCUMENTS

CAD DWG FILE:
DRAWN BY:
CHECKED BY:
DESIGNED BY:
KEL


SHEET TITLE:

ROOF PLAN

SHEET NUMBER:

MEP-3

SHEET OF 48

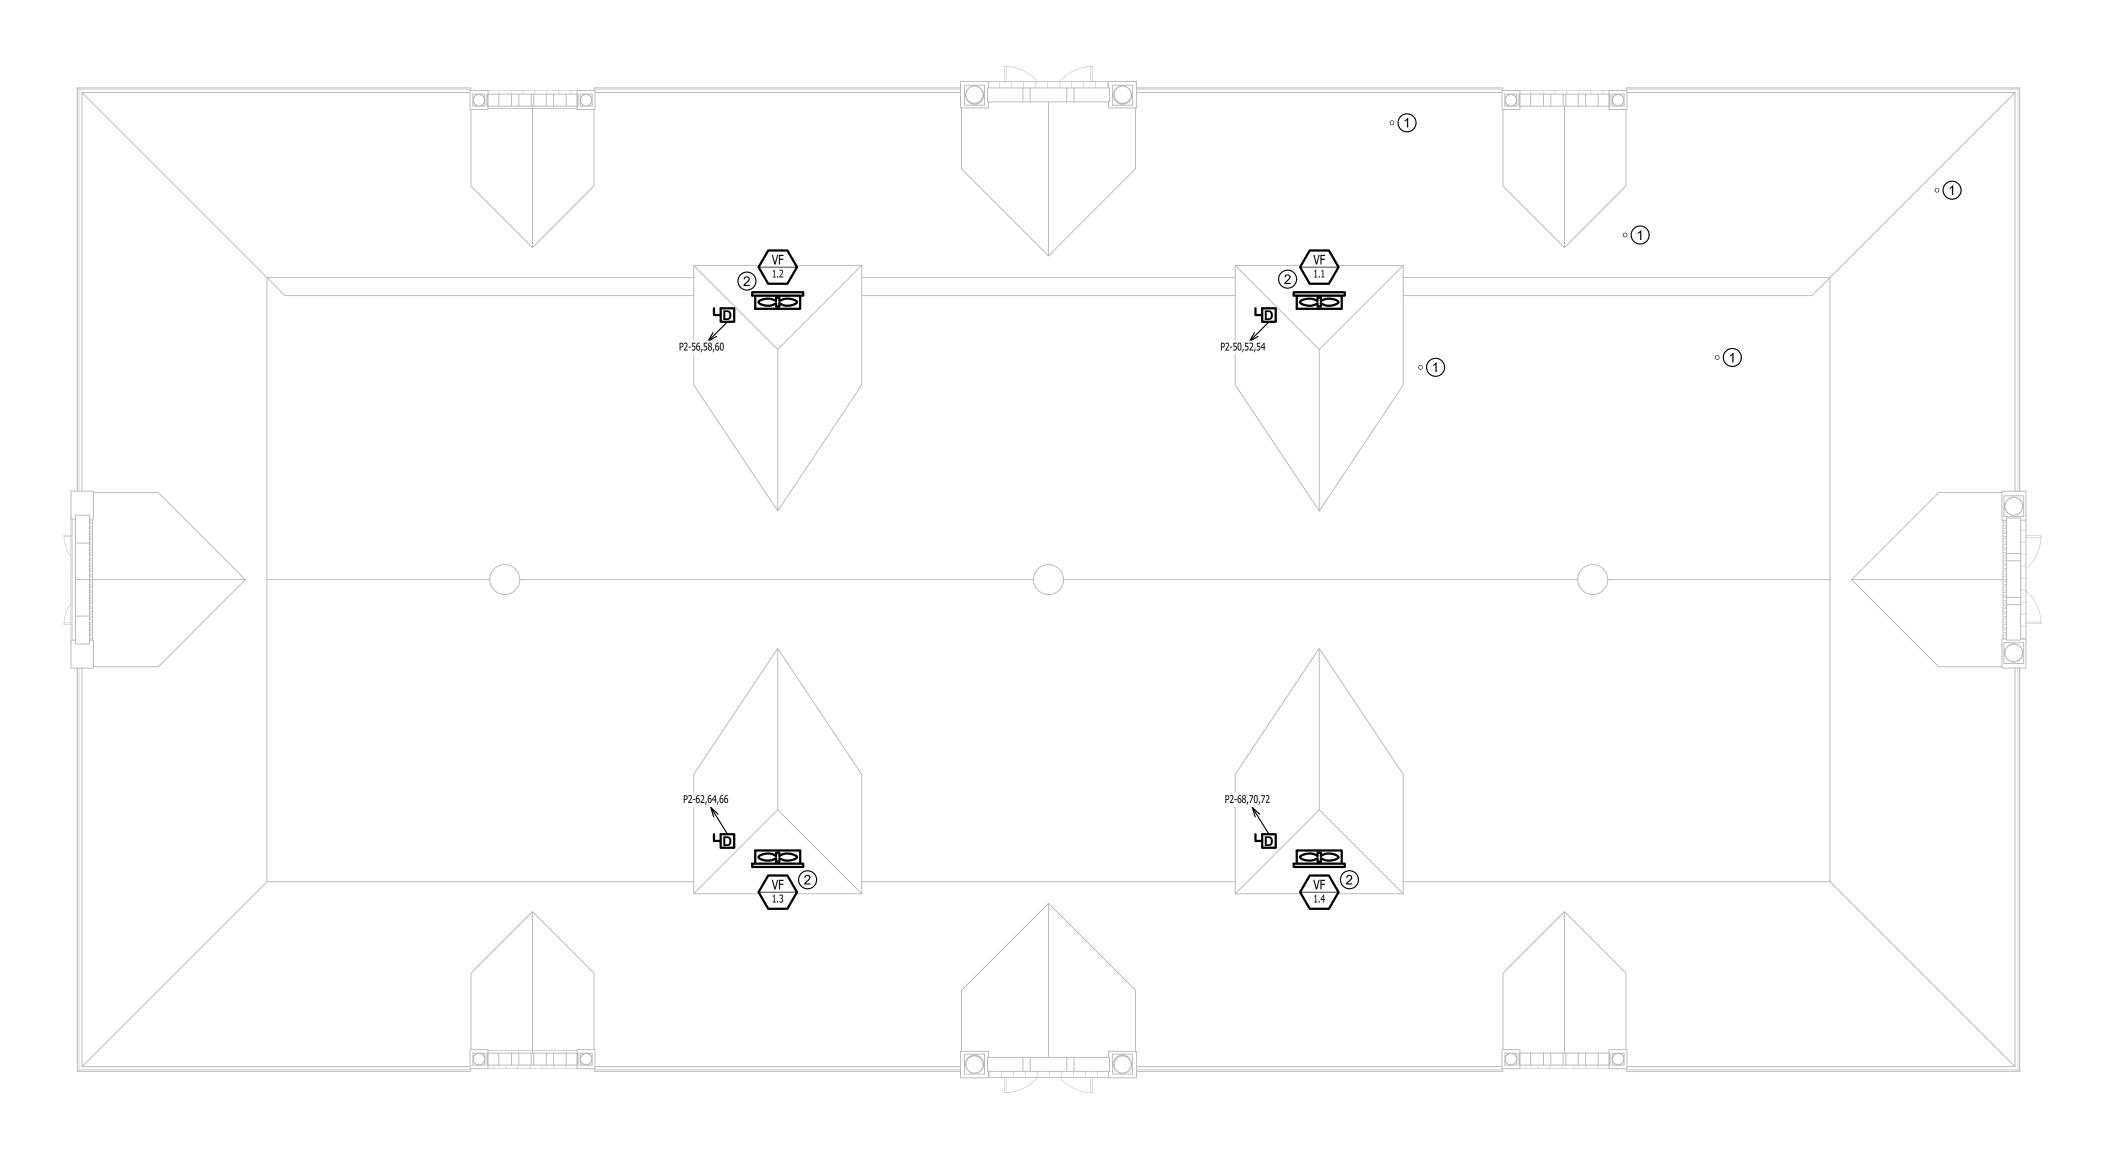

ROOF PLAN

SCALE: 1/8" = 1'-0"

POWER PLAN	I SYMBOL LEGEND		
	CIRCUIT WIRING	AP V	WIRELESS ACCESS POINT, CEILING MOUNTED
—> PX-XX	CIRCUIT TAG	lacksquare	FLOOR RECEPTACLE
J	JUNCTION BOX	T	FLOOR DATA
XX +42	RECEPTACLE	D	DISCONNECT
	 INDICATES MOUNTING HEIGHT TO BOTTOM OF BOX (STANDARD @ 18" AFF UNLESS NOTED OTHERWISE) "WP" = WEATHERPROOF OUTDOOR RECEPTACLE 	FD-	FUSED DISCONNECT
	"AW" = ABOVE WINDOW RECEPTACLE	FS-	FUSED SWITCH
	"AC" = ABOVE CEILING RECEPTACLE "EX" = EXISTING RECEPTACLE TO REMAIN	SD	STARTER / DISCONNECT
lacksquare	GFCI DUPLEX CONVENIENCE RECEPTACLE	\star	TIE INTO EXISTING
P	208V RECEPTACLE		
	QUADPLEX CONVENIENCE RECEPTACLE		
W	USB OUTLET WITH USB-A & USB-C CHARGING PORT		
T	DATA / PHONE JACK		

BOX WITH 1" CONDUIT & PULL STRING) UP TO CEILING SPACE

(STANDARD @ 18" AFF UNLESS NOTED OTHERWISE)

POWER PLAN GENERAL NOTES:


- 1. REFER TO E-500 AND/OR E-600 SERIES SHEETS FOR ADDITIONAL ELECTRICAL NOTES, DETAILS, REQUIREMENTS, AND SCHEDULES.
- 2. ELECTRICAL CONTRACTOR SHALL REVIEW ALL PROJECT DOCUMENTS AND COORDINATE LOCATION OF ALL ELECTRICAL EQUIPMENT, WIRING, HANGERS / SUPPORTS, ETC. WITH HVAC AND PLUMBING TRADES BEFORE INSTALLATION OF ANY MATERIAL. ADDITIONAL COSTS ASSOCIATED WITH LACK OF COORDINATION WILL NOT BE REIMBURSED.
- 3. CONTRACTOR SHALL PROVIDE ALTERNATE #1 PRICE FOR ANY ELECTRICAL MATERIALS AND LABOR ASSOCIATED WITH RTU-1 DETAILED ON THE PLANS.

POWER PLAN KEY NOTES:

- (1) UNDERGROUND CONDUIT AND CONDUCTORS FROM EXISTING PAD MOUNT TRANSFORMER LOCATED APPROXIMATELY 275FT AWAY. PLEASE SEE THE POWER RISER FOR FURTHER DETAILS.
- (2) POWER FOR AIR CURTAIN. COORDINATE WITH HVAC CONTRACTOR FOR FURTHER INFORMATION.
- (3) DEMOLISH EXISTING ELECTRICAL SERVICE AND ALL ASSOCIATED ELECTRICAL CONDUIT AND CONDUCTORS SERVING THE BUILDING. NEW ELECTRICAL SERVICE \
- (4) CONTRACTOR SHALL MOUNT UNITSTRUT RACK TO THE INSIDE OF THE

SHALL BE PROVIDED FROM THE WEST SIDE OF THE BUILDING.

- ENCLOSURE AND MOUNT CONDENSING UNIT DISCONNECTS TO UNISTRUT RACK.
- (5) CONTRACTOR SHALL MOUNT ROUTE CONDUIT TIGHT TO TOP OF BRICK WALL FROM THIS PANEL TO ELECTRICAL DEVICES.
- ············<u>/2</u> (6) BASE BID: J-BOX WITH PULL STRING.
- ALTERNATE #1: PROVIDE DISCONNECT FOR RTU POWER.
- (7) BASE BID: LOCATION OF SWITCH FOR ALL VENT FANS. PROVIDE CONTACTOR AS REQUIRED. COORDINATE SWITCH HEIGHT WITH OWNER PRIOR TO INSTALLATION. ALTERNATE #1: NO VENT FAN CONTROLS NEEDED.

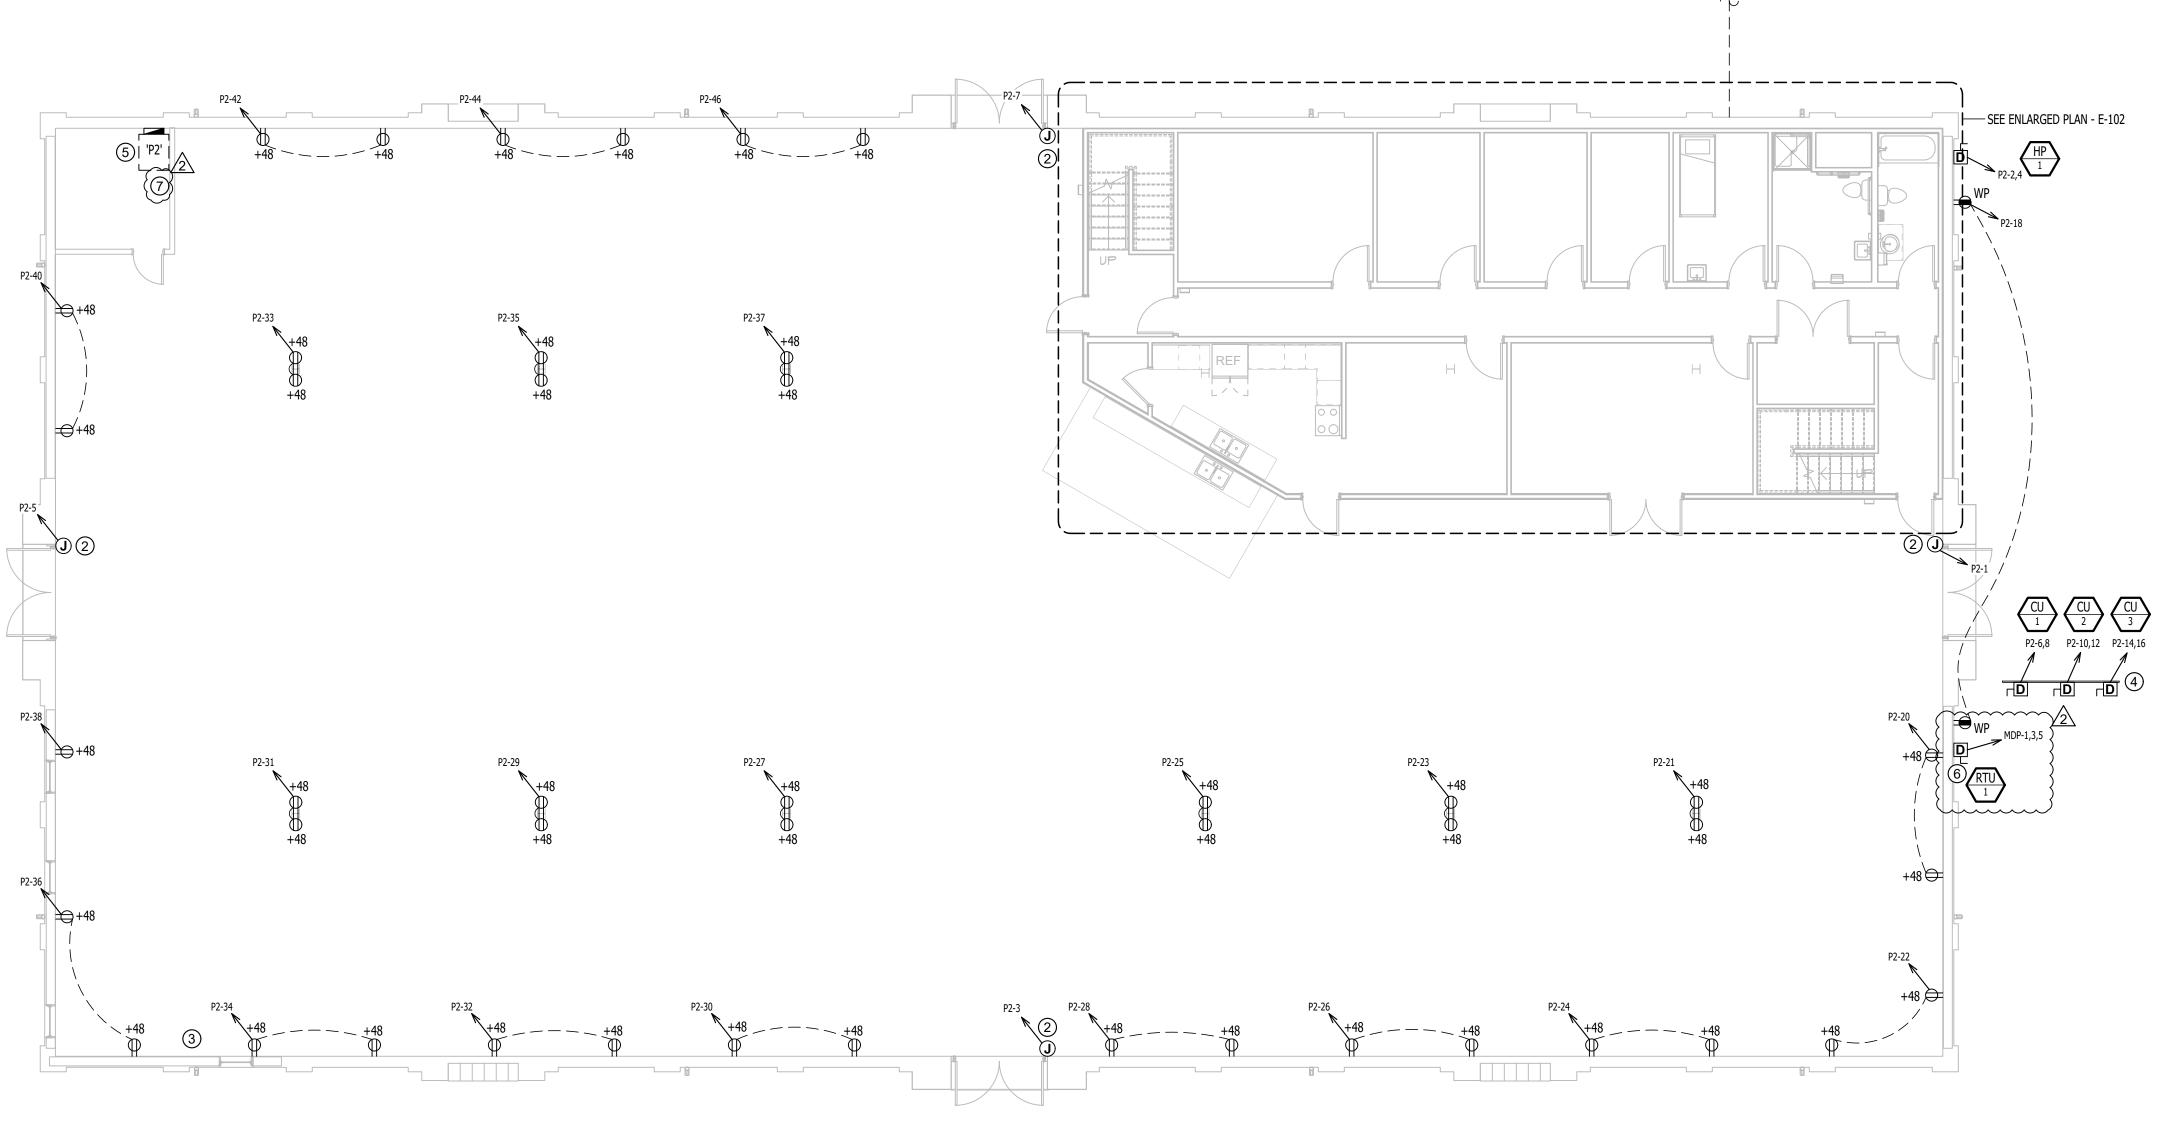

OVERALL POWER PLAN

SCALE: 1/8" = 1'-0"

STATE OF MISSOURI MIKE KEHOE **GOVERNOR**



Keaton E. Leisinger, P.E. PE-2021035875



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OFFICE OF ADMINISTRATION DIVISION OF FACILITIES MANAGEMENT DESIGN AND CONSTRUCTION

INTERIOR & EXTERIOR RENOVATIONS, MISSOURI (4-H) BUILDING MISSOURI STATE FAIRGROUNDS 2503 W. 16TH ST

SEDALIA, MO 65301 PROJECT # F2407-01 SITE # 1501

ASSET # 3511501028

REVISION: ADDENDUM 2 DATE: 10/23/2025



ISSUE DATE: 6/27/2025

BID DOCUMENTS

CAD DWG FILE:
DRAWN BY: RXM
CHECKED BY: JAP
DESIGNED BY: KEL

SHEET TITLE:

OVERALL POWER PLAN

SHEET NUMBER:

E-101

POWER PLAN SYMBOL LEGEND

____ CIRCUIT WIRING → PX-XX CIRCUIT TAG JUNCTION BOX RECEPTACLE INDICATES MOUNTING HEIGHT TO BOTTOM OF BOX (STANDARD @ 18" AFF UNLESS NOTED OTHERWISE) "WP" = WEATHERPROOF OUTDOOR RECEPTACLE "AW" = ABOVE WINDOW RECEPTACLE "AC" = ABOVE CEILING RECEPTACLE "EX" = EXISTING RECEPTACLE TO REMAIN GFCI DUPLEX CONVENIENCE RECEPTACLE 208V RECEPTACLE QUADPLEX CONVENIENCE RECEPTACLE USB OUTLET WITH USB-A & USB-C CHARGING PORT BOX WITH 1" CONDUIT & PULL STRING) UP TO CEILING SPACE (STANDARD @ 18" AFF UNLESS NOTED OTHERWISE) WIRELESS ACCESS POINT, CEILING MOUNTED FLOOR RECEPTACLE

DISCONNECT 120V SMOKE DETECTOR TIE INTO EXISTING

FLOOR DATA

lacksquare

POWER PLAN GENERAL NOTES:

1. REFER TO E-500 AND/OR E-600 SERIES SHEETS FOR ADDITIONAL ELECTRICAL

NOTES, DETAILS, REQUIREMENTS, AND SCHEDULES.

2. ELECTRICAL CONTRACTOR SHALL REVIEW ALL PROJECT DOCUMENTS AND COORDINATE LOCATION OF ALL ELECTRICAL EQUIPMENT, WIRING, HANGERS / SUPPORTS, ETC. WITH HVAC AND PLUMBING TRADES BEFORE INSTALLATION OF ANY MATERIAL. ADDITIONAL COSTS ASSOCIATED WITH LACK OF COORDINATION WILL NOT BE REIMBURSED.

3. ANY EXISTING ELECTRICAL EQUIPMENT, CIRCUITS, ETC. SHOWN IS FOR REFERENCE ONLY. ELECTRICAL CONTRACTOR TO FIELD VERIFY EXACT EQUIPMENT LOCATIONS, CONDITIONS, ETC. PRIOR TO BEGINNING WORK AND NOTIFY ENGINEER OF ANY DISCREPANCIES.

POWER PLAN KEY NOTES:

(1) COORDINATE RECEPTACLE LOCATION WITH RETICULATION PUMP LOCATION. COORDINATE WITH PLUMBING CONTRACTOR PRIOR TO ROUGH-IN.


(2) COORDINATE ELECTRIC HEATER POWER REQUIREMENTS WITH HVAC

CONTRACTOR PRIOR TO ROUGH-IN. (3) NEW STEPDOWN TRANSFORMER WITH EQUIPMENT PAD. SEE POWER RISER FOR


FURTHER DETAILS. (4) CONTRACTOR TO PROVIDE 2" CONDUIT CONNECTED TO TV JACK AND ROUTE TO

KITCHEN CLOSET WITH PULL STRING. SEE KEY NOTE #5 FOR LOCATION. (5) KITCHEN CLOSET LOCATION. OWNER TO PROVIDE TV INTEGRATION SYSTEM.

(6) CONTRACTOR TO PROVIDE 2" CONDUIT CONNECTED TO DATA JACK FOR OWNER PROVIDED SOUND SYSTEM CONNECTION AND ROUTE TO KITCHEN CLOSET WITH PULL STRING. SEE KEY NOT #5 FOR LOCATION.

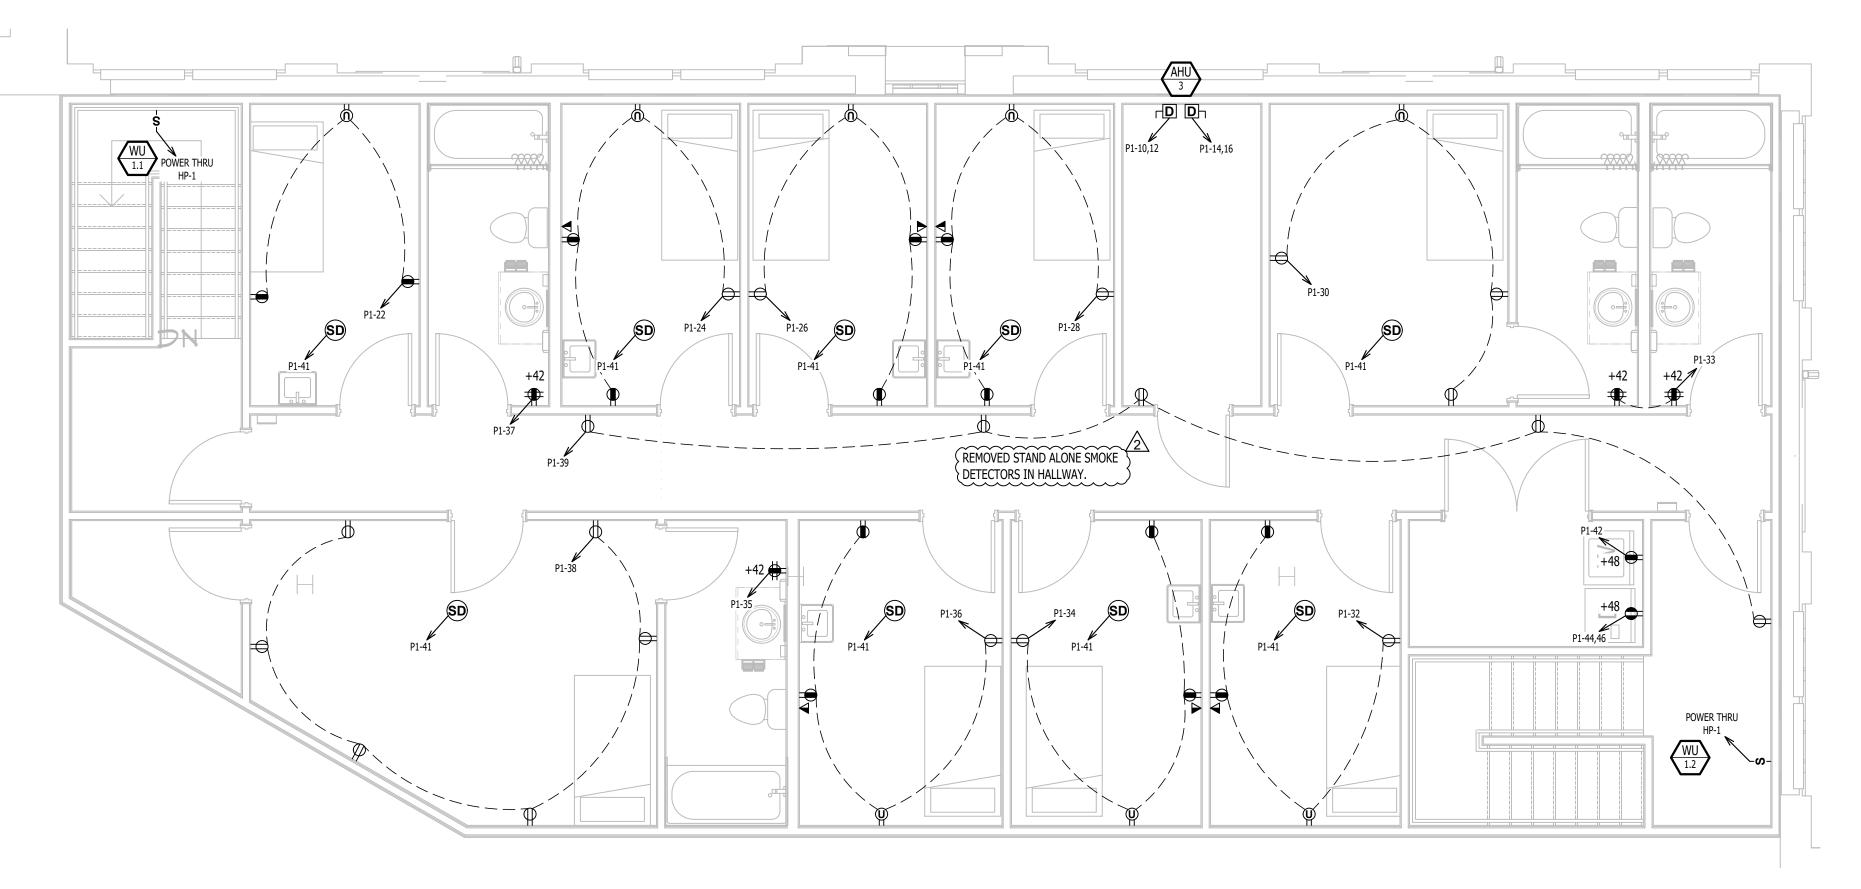

ENLARGED POWER PLAN - UPPER FLOOR SCALE: 1/4" = 1'-0"

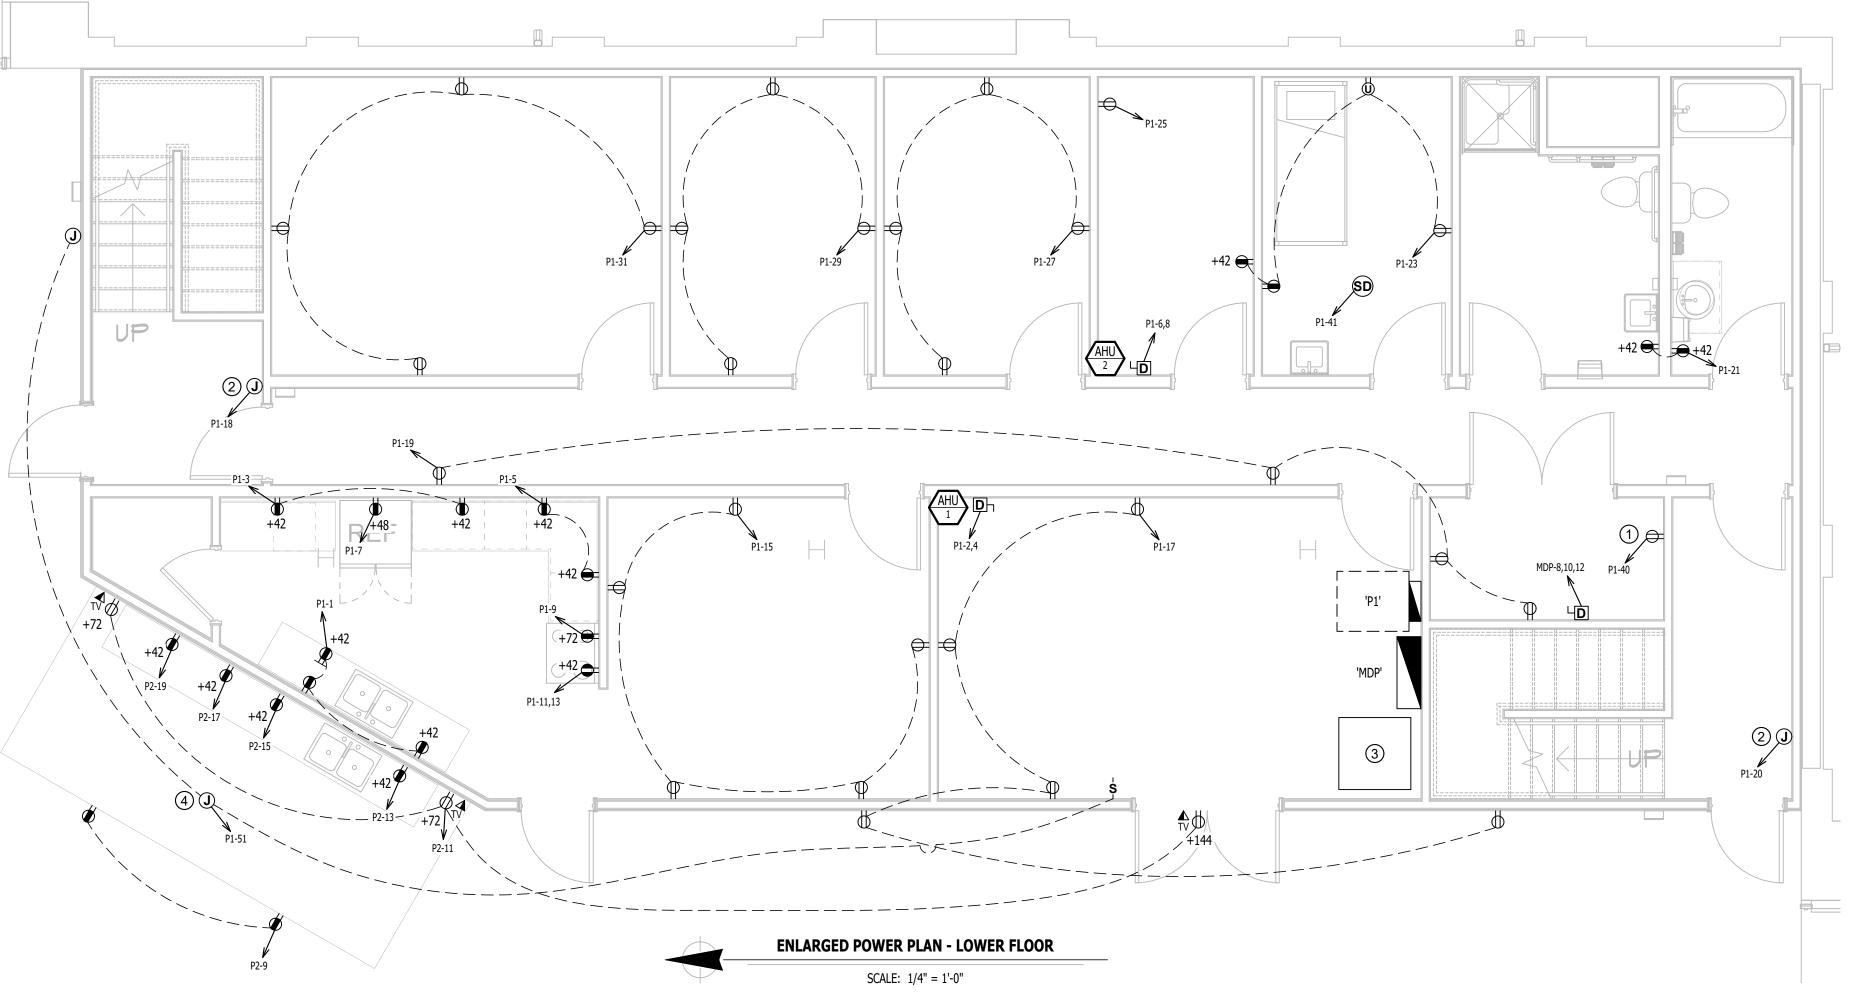


STATE OF MISSOURI MIKE KEHOE **GOVERNOR**



Keaton E. Leisinger, P.E. PE-2021035875



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OFFICE OF ADMINISTRATION DIVISION OF FACILITIES MANAGEMENT DESIGN AND CONSTRUCTION

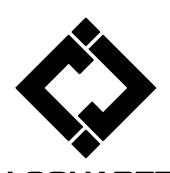
#2000151304

INTERIOR & EXTERIOR RENOVATIONS, MISSOURI (4-H) BUILDING MISSOURI STATE FAIRGROUNDS 2503 W. 16TH ST SEDALIA, MO 65301

PROJECT # F2407-01 SITE # 1501

ASSET # 3511501028

REVISION: ADDENDUM 2 DATE: 10/23/2025

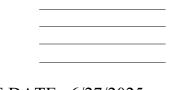

ISSUE DATE: 6/27/2025 **BID DOCUMENTS**


CAD DWG FILE: DRAWN BY: RXM CHECKED BY: JAP

DESIGNED BY: KEL SHEET TITLE:

> **ENLARGED POWER PLAN**


SHEET NUMBER:

E-102

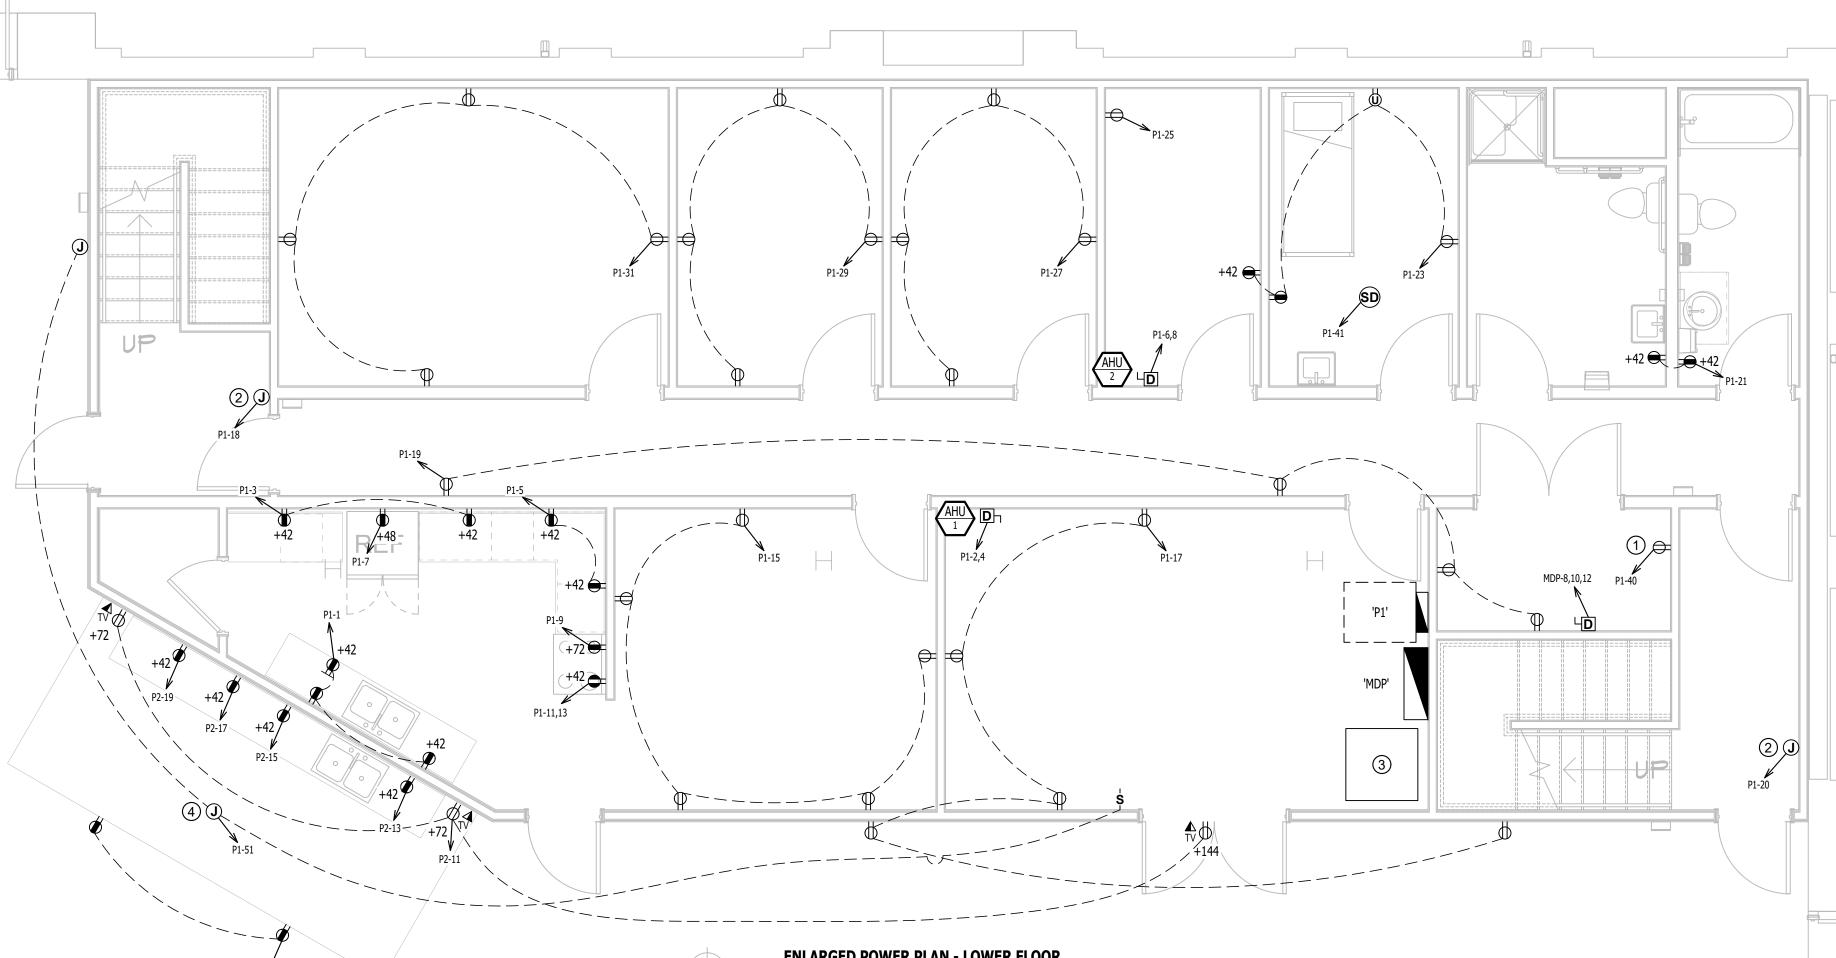



PAD MUST BE BUILT TO THE V-10 SPECIFICATION AND SUPPLIED BY THE VENDOR SHOWN BELOW. ALL PRIMARY AND SECONDARY CABLES MUST BE IN CONDUIT AND ENTER THE TRANSFORMER THROUGH DUCT AREA. ANY EXCAVATION UNDER THE PAD MUST BE BACKFILLED AND COMPACTED WITH REMOVABLE MATERIAL SUCH AS 1" CLEAN GRAVEL. NO CONDUITS ARE ALLOWED IN THE MIDDLE 10" OF DUCT AREA. CONDUITS MAY GO IN ANY DIRECTION FROM PAD. SIDE "A" MUST FACE AWAY FROM BUILDING OF OTHER OBSTRUCTIONS. OTHER SIDES MUST BE A MINIMUM OF 3' AWAY FROM ANY OBSTRUCTIONS. CENTERLINE OF TRANSFORMER MUST BE WITHIN 10' OF TRUCK ACCESSIBLE PAVEMENT. INSTALL 5/11 X 8' GROUND ROD AS SHOWN. BACKFILL MATERIAL AND PRIMARY CONDUITS MUST BE INSPECTED BY WATER & LIGHT DEPARTMENT BEFORE PAD IS SET IN PLACE. LIFTING ANCHOR HOLES MUST BE FILLED WITH NON-SHRINK GROUT BEFORE TRANSFORMER WILL BE SET.

PLEASE CALL (573) 874-6200 ANY EXCEPTIONS TO THE ABOVE REQUIREMENTS MUST BE APPROVED IN WRITING BY WATER AND LIGHT ENGINEERING DEPARTMENT BEFORE CONSTRUCTION.

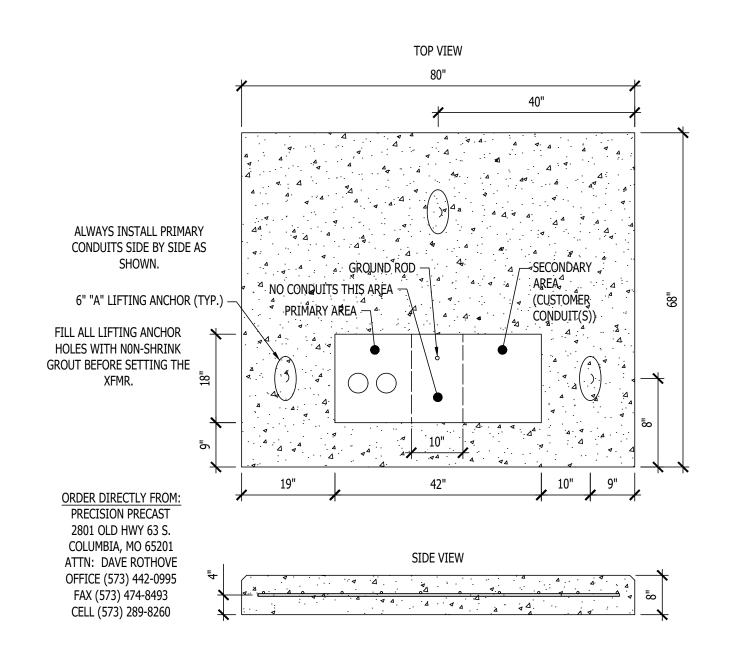

PRE-CAST: V-10 PAD DETAIL FOR 3PH 75-750 KVA TRANSFORMER

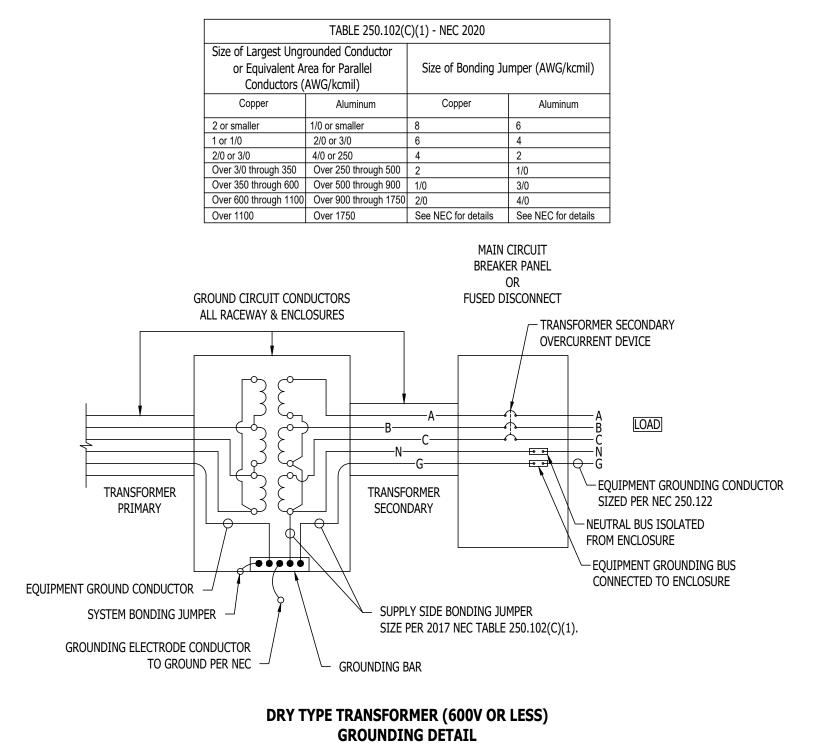

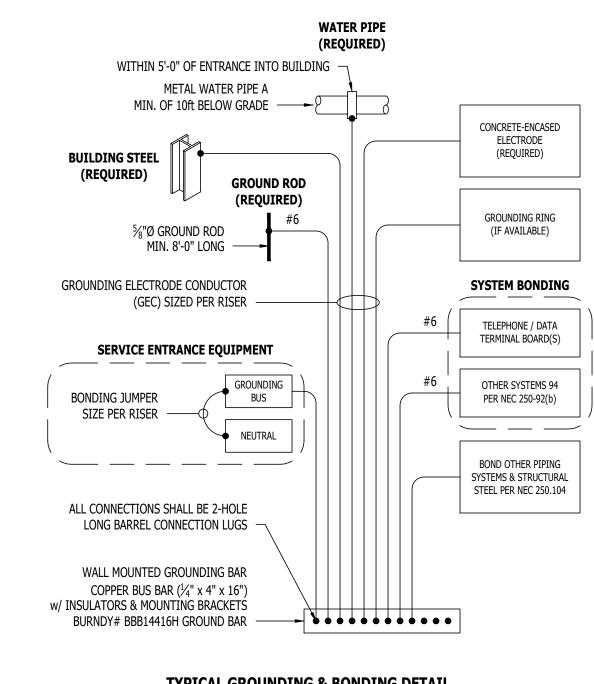

TYPICAL GROUNDING & BONDING DETAIL




POWER RISER GENERAL NOTES:

- 1. COORDINATE ALL CHANGES AND NEW SERVICE CONNECTIONS WITH MISSOURI
- STATE FAIR STAFF FOR STAGING AND OUTAGE TIMES. 2. SEE AERIAL PHOTO MARKUP FOR FURTHER INFORMATION.

POWER RISER KEY NOTES:

- (1) CONTRACTOR SHALL REMOVE EXISTING TRANSFORMER. DEMOLISH EXISTING TRANSFORMER PAD AND POUR NEW TRANSFORMER PAD PER TRANSFORMER PAD DETAIL AND REINSTALL EXISTING TRANSFORMER WITH NEW CONDUIT STUBBED UP WITHIN TRANSFORMER.
- (2) 4" PVC CONDUIT WITH (4) #500 CU. APPROXIMATELY 275FT OF CONDUIT AND CONDUCTOR LENGTH.
- (3) EXISTING CONDUIT AND CONDUCTORS TO REMAIN. RECONNECT TO TRANSFORMER ONCE TRANSFORMER IS REINSTALLED.
- $^{\circ}$ (4) BASE BID: 1 $\frac{1}{2}$ " CONDUIT WITH PULL STRING TO LOCATION RTU-1. SEE PLANS FOR DETAILS.
- ALTERNATE #1: 1 1/2" CONDUIT WITH (3) #3 CU. & (1) #8 CU. EQ GRD. ______
- (5) 112.5kVA, 480V, 3Ø TO 120/208V, 3Ø, NEMA 1 STEP DOWN TRANSFORMER.
- (6) 3" CONDUIT WITH (4) #3/0 CU. & (1) #6 EQ GRD.

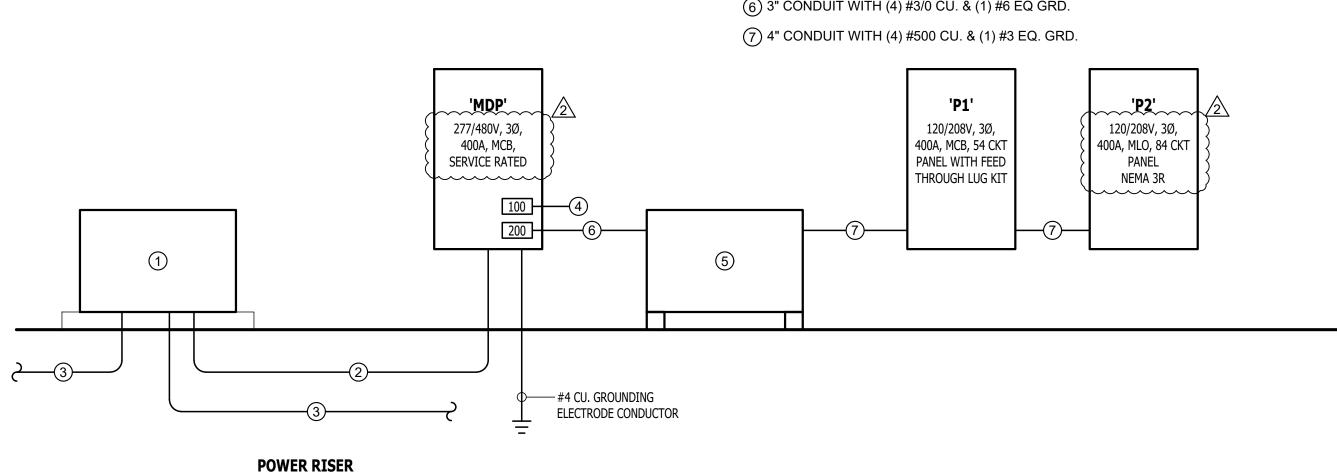


STATE OF MISSOURI MIKE KEHOE **GOVERNOR**



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PROJECT # F2407-01 SITE # 1501

ASSET # 3511501028

REVISION: ADDENDUM 2 DATE: 10/23/2025
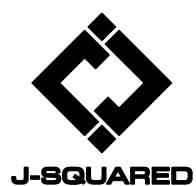
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BID DOCUMENTS

CAD DWG FILE: DRAWN BY: RXM CHECKED BY: JAP DESIGNED BY: KEL

SHEET TITLE:

ELECTRICAL DETAILS

SHEET NUMBER:

E-501

	LIGHT FIXTURE SCHEDULE											
TAG	MANUFACTURER (OR EQUAL)	MODEL NUMBER (OR EQUAL)	DESCRIPTION	CRI	VOLTA GE	WATTS	DIMMING	NOTES				
C1	HALO	SLDSL4069S1EMWR	4" ROUND LED CAN	SURFACE	635	3500	80	UNV	9	0-10V	CONTRACTOR SHALL SELECT OPITONS TO MATCH LIGHTING SCHEDULE VALUES.	
C2	LUMARK AP	CLCS15S-PC	LED CANOPY	SURFACE	3600	4000	70	UNV	24	0-10V	CONTRACTOR SHALL SELECT OPITONS TO MATCH LIGHTING SCHEDULE VALUES.	
E1	MULE	CWL-1-R-WH WITH R-ASRLED-2-WP	EXTR EXIT LIGHT WITH HEADS WITH EXTR RMT HD	WALL / CEILING	-	-	-	UNV	5	-	WITH RED LETTERS & REMOTE HEADS	
E2	SURE LITES	APX7RG	INTERIOR EXIT LIGHT	WALL / CEILING	-	-	-	UNV	1	-	WITH RED LETTERS	
E3	SURE LITES	APEL	EMERGENCY EGRESS LIGHT	WALL	-	_	-	UNV	1	-	MOUNT AT 8' A.F.F.	
HB1	METALUX	SPHB-2436SE-M-UNV-L84050-CD-SP1-U	LED HIGH BAY	CHAING HANG	24000	4000	80	UNV	162	0-10V	CONTRACTOR SHALL SELECT OPITONS TO MATCH LIGHTING SCHEDULE VALUES.	
HB1/EM	METALUX	SPHB-2436SE-M-UNV-L84050-CD-SP1-U-EL20WHV	LED HIGH BAY WITH BATTERY PACK	CHAING HANG	24000	4000	80	UNV	162	0-10V	CONTRACTOR SHALL SELECT OPITONS TO MATCH LIGHTING SCHEDULE VALUES.	
S1	WILLIAMS	FS-4-LS/8CS-DIM-UNV	4' LINEAR	WALL BRACKET	4800	3500	80	120	33	0-10V	CONTRACTOR SHALL SELECT OPITONS TO MATCH LIGHTING SCHEDULE VALUES.	
T1	METALUX	24FPSL2SCT3	2x4 LED FLAT PANEL	ACT GRID	4550	3500	80	120	40	0-10V	CONTRACTOR SHALL SELECT OPITONS TO MATCH LIGHTING SCHEDULE VALUES.	
T2	METALUX	22MMS-L3C3-UNV	2x2 LED FLAT PANEL	SURFACE	3500	3500	80	120	27	0-10V	CONTRACTOR SHALL SELECT OPITONS TO MATCH LIGHTING SCHEDULE VALUES.	
Т3	METALUX	14MMS-L3C3-UNV	1x4 LED FLAT PANEL	SURFACE	4900	3500	90	120	40	0-10V	CONTRACTOR SHALL SELECT OPITONS TO MATCH LIGHTING SCHEDULE VALUES.	
TK1	CONTECH	LT-12-B / (12)CTL9050F3CD-B	LED TRACK LIGHTING SYSTEM	WALL MOUNT	(12) 650	3500	90	120	240	120VAC	WITH TRACK LIMITER (240W) AND WALL MOUNT KIT #LA3609-B	
V1	WILLIAMS	75R-2-L25/835-DIM-UNV	2' LINEAR	WALL BRACKET	2400	3500	80	UNV	19	0-10V	MOUNT ABOVE MIRROR	

NOTES:

1. VERIFY LIGHT FIXTURE FINISHES WITH OWNER / ARCHITECT PRIOR TO INSTALLATION.

2. REFER TO ARCHITECTURAL REFLECTED CEILING PLAN FOR CEILING TYPES THROUGHOUT. COORDINATE EXACT MOUNTING DETAILS WITH GENERAL CONTRACTOR.

			r A	1 1 L	P2' S		VLL	T		
.		PECIFICATIONS	20					TOTAL CONNECTED L		
	DLTAGE: 120/208V 3-PH	NEMA RATING						PHASE "A" LOAD: 146.		
	A MPA CITY: 400A MLO PA NEL MOUNTING: SURFACE							PHASE "B" LOAD: 161.		
	RATING: 10kA			1		1	TT	PHASE "C" LOAD: 129.	_	
CUIT BER	DESCRI	PTION	BREAKER SIZE	AMPS	PHASE	AMPS	BREAKER SIZE	DESCRIPTION	CIRCUIT NUMBER	
	AIR CURTAI	N (SOUTH)	20-1	13	Α	27	40-2	MINI-SPLIT (HP-1, WU-1.1, & WU-1.2)	2	
	AIR CURTAI	N (WEST)	20-1	13	В	27	-	-	4	
	AIR CURTAI	N (NORTH)	20-1	13	С	14	25-2	CONDENSING UNIT (CU-1)	6	
	AIR CURTA	IN (EAST)	20-1	13	Α	14	-	-	8	
\neg	STAGE / GFG	CI RECEPT	20-1	3	В	14	25-2	CONDENSING UNIT (CU-2)	10	
L	STAGE / TV	RECEPTS	20-1	6	С	14	-		12	
3	STAGE / COUNTE		20-1	1.5	Α	18	30-2	CONDENSING UNIT (CU-3)	14	
5	STAGE / COUNTE		20-1	1.5	В	18	-		16	
7	STAGE / COUNTE	R GFCI RECEPT	20-1	1.5	С	1.5	20-1	OUTDOOR WP RECEPT	18	
9	STAGE / COUNTE		20-1	1.5	Α	3	20-1	EXHIBIT / WALL RECEPTS	20	
L	EXHIBIT / POI		20-1	3	В	3	20-1	EXHIBIT / WALL RECEPTS	22	
3	EXHIBIT / POI		20-1	3	С	3	20-1	EXHIBIT / WALL RECEPTS	24	
5	EXHIBIT / POI		20-1	3	A	3	20-1	EXHIBIT / WALL RECEPTS	26	
7	EXHIBIT / POI		20-1	3	В	3	20-1	EXHIBIT / WALL RECEPTS	28	
•	EXHIBIT / POI		20-1	3	C	3	20-1	EXHIBIT / WALL RECEPTS	30	
	EXHIBIT / POI		20-1	3	A	3	20-1	EXHIBIT / WALL RECEPTS	32	
3	EXHIBIT / POI		20-1	3	В	3	20-1	EXHIBIT / WALL RECEPTS	34	
5	EXHIBIT / POI		20-1	3	С	3	20-1	EXHIBIT / WALL RECEPTS	36	
7	EXHIBIT / POI		20-1	3	A	3	20-1	EXHIBIT / WALL RECEPTS	38	
	STAGE / SPEA		20-1	3	В	3	20-1	EXHIBIT / WALL RECEPTS	40	
	SPAI		20-1		C	3	20-1	EXHIBIT / WALL RECEPTS	42	
3	EXHIBIT STORAGE & DO		20-1	3	A	3	20-1	EXHIBIT / WALL RECEPTS	44	
5	EXHIBIT / I	· · · · · · · · · · · · · · · · · · ·	40-2	27	В	3	20-1	EXHIBIT / WALL RECEPTS	46	
7			-	27	С		20-1	SPARE	48	~~~~
•	SPAI	RF	20-1		A	7.8	15-3	VENT FAN (VF-1.1)	50	
Ĺ	SPAI		20-1		В	7.8	-		52	
3	SPAI		20-1		C	7.8	-		54	
5	SPAI		20-1		A	7.8	15-3	VENT FAN (VF-1.2)	56	
7	SPAI		20-1		В	7.8	-	-	58	
)	SPAI		20-1		С	7.8	-		60	BASE BID
1	SPAI		20-1		A	7.8	15-3	VENT FAN (VF-1.3)	62	— EXCLUDE I
3	SPAI		20-1		В	7.8	-		64	ALTERNAT
5	SPAI		20-1		C	7.8	-	-	66	
7	SPAI		20-1		A	7.8	15-3	VENT FAN (VF-1.4)	68	
•	SPA		20-1		В	7.8	-		70	
1	SPAI		20-1		С	7.8	-		72	
3	SPAI		20-1		A	7.0	20-1	SPARE	74	
5	SPAI		20-1		В		20-1	SPARE	76	
7	SPAI		20-1		С		20-1	SPARE	78	
)	SPAI		20-1		A		20-1	SPARE	80	
ľ	SPAI		20-1		В		20-1	SPARE	82	
3	SPAI		20-1		С		20-1	SPARE	84	

A: PANEL SHALL BE EQUAL TO SQUARE D MODEL "NQ"

B: ELECTRICIAN SHALL VERIFY EXACT EQUIPMENT OVERCURRENT PROTECTION REQUIREMENTS PRIOR TO PURCHASE & INSTALLATION OF EQUIPMENT.

υ.	ELECTRICIAN STATE VERILL EXACT EQUITIENT OVERCONCENT THOSE COLON REQUIREMENTS FRANK TO FORCE	, J L
C:	FTER COMPLETION OF WORK, ELECTRICAN SHALL PROVIDE A TYPE WRITTEN PANEL DIRECTORY IN NEW PANEL	

PA NEL SPECIFICATIONS									TOTAL CONNEC	TED LO	AD
VV	VOLTAGE: 480Y/277V 3-PH NEMA RATING: AMPACITY: 400A MCB PANEL MOUNTING:							PI	HASE "A" LOAD:	262.7	AMPS
AM								Р	PHASE "B" LOAD:	256.9	AMPS
AIC-RATING: 14kA CIRCUIT NUMBER DESCRIPTION								P	PHASE "C" LOAD:	243.6	AMPS
		PTION	DN BREAKER SIZE AMF		PHASE	AMPS	BREAKER SIZE	I DESCRIPTION			CIRCU NUMB
1	1 RTU-1		100-3	85	Α	159.7	200-3	STEPDOWN TRANSFORMER			2
3	3 -		-	85	В	153.9	-	-			4
5	5 -			85	С	140.6	-		-		6
7	7 SPACE				Α	18	30-3	WATER	R HEATER		8
9 SPACE				В	18	-		-		10	
11 SPACE					С	18	_		_		12

A: PANEL SHALL BE EQUAL TO SQUARE D "NF" SERIES FOR 480V

B: ELECTRICIAN SHALL VERIFY EXACT EQUIPMENT OVERCURRENT PROTECTION REQUIREMENTS PRIOR TO PURCHASE & INSTALLATION OF EQUIPMENT.

C: AFTER COMPLETION OF WORK, ELECTRICAN SHALL PROVIDE A TYPE WRITTEN PANEL DIRECTORY IN NEW PANEL.

			PA	NEL'	P1' S	CHED	ULE				
	PANEL S	SPECIFICATIONS							TOTAL CONNEC	TED LO	AD
VC	OLTAGE: 120/208V 3-PH	IG : 1						PHA SE "A" LOA D:	355.7	AMPS	
A MPA CITY: 400A MCB PA NEL MOUNTING:			IG: SURFACE						PHASE "B" LOAD:	343.8	AMPS
AIC-F	AIC-RATING: 10kA								PHASE "C" LOAD:	326.6	AMPS
CIRCUIT NUMBER	DESCR	IPTION	BREAKER SIZE	AMPS	PHASE	AMPS	BREAKER SIZE		DESCRIPTION		CIRCUI NUMBE
1	KITCHEN / COUNTER GFCI RECEPTS		20-1	4.5	Α	36	45-2	AIR HAN	IDLING UNIT (AHU-1)		2
3	KITCHEN / COUNT	ER GFCI RECEPTS	20-1	3	В	36	-		-		4
5	KITCHEN / COUNT	ER GFCI RECEPTS	20-1	3	С	36	45-2	AIR HAN	IDLING UNIT (AHU-2)		6
7	KITCHE	N / REF	20-1	5	Α	36	-	-			8
9	KITCHEN / RANGE HOOD		20-1	5	В	41	60-2	AIR HAN	IDLING UNIT (AHU-3)		10
11	KITCHEN /	RANGE **	50-2**	40	С	41	-		-		12
13	-		-	40	Α	18	25-2	AIR HAN	HANDLING UNIT (AHU-3)		14
15	OPEN / RECEPTS		20-1	7.5	В	18	-	-			16
17	STORAGE / RECEPTS		20-1	7.5	С	12.5	20-1	STAIR / WALL HEATER			18
19	CORRIDOR	/ RECEPTS	20-1	6	Α	12.5	20-1	STAIR / WALL HEATER			20
21	RESTROOM / (20-1	3	В	4.5	<u>20-1</u>	BED / RECEPTS			22
23	<u>BED 1 / </u>	<u>RECEPTS</u>	<u>20-1</u>	6	С	6	<u>20-1</u>	<u>B</u> i	ED / RECEPTS		24
25	FACP P	OWER	20-1	1.5	Α	6	<u>20-1</u>	<u>Bi</u>	ED / RECEPTS		26
27	OFFICE 2 /		20-1	6	В	6	<u>20-1</u>	<u>B</u> i	ED / RECEPTS		28
29	OFFICE 1 /		20-1	6	С	6	<u>20-1</u>	<u>Bi</u>	ED / RECEPTS		30
31	MEETING /		20-1	6	Α	6	<u>20-1</u>	<u>B</u> i	ED / RECEPTS		32
33	RESTROOM / 0		20-1	6	В	6	<u>20-1</u>	_	ED / RECEPTS		34
35	RESTROOM /		20-1	3	С	6	<u>20-1</u>	_	ED / RECEPTS		36
37	RESTROOM /		20-1	3	A	9	<u>20-1</u>		ED / RECEPTS		38
39	CORRIDOR		20-1	7.5	В	1.5	20-1		RCULATION PUMP		40
41	SMOKE DE		20-1	3	С	8	<u>20-1</u>		THES WASHER		42
43	SPA		20-1		Α	20	30-2**	CLO	THES DRYER **		44
45	FIRST FLOOR		<u>20-1</u>	11.1	В	20	-		-		46
47	SECOND FLOO		<u>20-1</u>	13.4	С		20-1		SPARE		48
49	SPA		20-1		A		20-1		SPARE		50
51	SPA		20-1		В		20-1		SPARE		52
53	SPA	ARE	20-1		С		20-1		SPARE		54

NOTES:

A: PANEL SHALL BE EQUAL TO SQUARE D MODEL "NQ"

- B: ELECTRICIAN SHALL VERIFY EXACT EQUIPMENT OVERCURRENT PROTECTION REQUIREMENTS PRIOR TO PURCHASE & INSTALLATION OF EQUIPMENT.
- C: AFTER COMPLETION OF WORK, ELECTRICAN SHALL PROVIDE A TYPE WRITTEN PANEL DIRECTORY IN NEW PANEL.
- D: CIRCUIT BREAKERS ABOVE SHOWN IN <u>BOLD UNDERLINED</u> TEXT SHALL BE ARC-FAULT CIRCUIT INTERUPTER (AFCI) PER 2020 NEC 210.12 E: CIRCUIT BREAKERS ABOVE SHOWN WITH "**" TEXT SHALL BE GROUND-FAULT CIRCUIT INTERUPTER (GFCI) PER 2020 NEC 210.8
- F: PER 2020 NEC SECTIONS 220.44 & 220.60 CALCULATED DEMAND LOAD FOR THIS PANEL IS EQUAL TO PHASE "A" = 302.6 A, PHASE "B" = 290.7 A, & PHASE "C" =277.5 A


STATE OF MISSOURI MIKE KEHOE GOVERNOR



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OFFICE OF ADMINISTRATION DIVISION OF FACILITIES MANAGEMENT DESIGN AND CONSTRUCTION

INTERIOR & EXTERIOR RENOVATIONS, MISSOURI (4-H) BUILDING MISSOURI STATE FAIRGROUNDS 2503 W. 16TH ST

SEDALIA, MO 65301 PROJECT # F2407-01

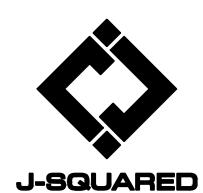SITE # 1501 ASSET # 3511501028

REVISION: <u>ADDENDUM 2</u> DATE: <u>10/23/2025</u>	<u>^</u>
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ISSUE DATE: 6/27/2025

BID DOCUMENTS

CAD DWG FILE:
DRAWN BY: RXM
CHECKED BY: JAP
DESIGNED BY: KEL

SHEET TITLE:

ELECTRICAL SCHEDULES

SHEET NUMBER:

E-601

FIRE PROTECTION PLAN SYMBOL LEGEND F MANUAL PULL STATION M MODULE O OUTPUT MODULE SD SMOKE DETECTOR S STROBE - CEILING MOUNT S STROBE - WALL MOUNT HIS HORN STROBE - WALL MOUNT HIS HORN STROBE - CEILING MOUNT SS SPEAKER STROBE - WALL MOUNT SS SPEAKER STROBE - CEILING MOUNT T TAMPER SWITCH WE WATER FLOW SWITCH

FIRE ALARM CONTROL PANEL

FIRE ALARM ANNUNCIATOR

FIRE PROTECTION PLAN GENERAL NOTES

- FIRE ALARM SYSTEM COMPONENTS SHOWN (IF APPLICABLE) ARE GENERAL AND SCHEMATIC IN NATURE. CONTRACTOR TO VERIFY EXACT DEVICE LOCATIONS AND REQUIREMENTS WITH FIRE ALARM SYSTEM DESIGNER OF RECORD PRIOR TO ROUGH-IN.
- FIRE ALARM CONTRACTOR SHALL PROVIDE DEFERRED SUBMITTAL PACKAGE FOR FIRE ALARM SYSTEM. SUBMITTAL SHALL INCLUDE BATTERY CALCULATIONS, VOLTAGE DROP CALCULATIONS, EQUIPMENT SPECIFICATIONS FOR DEVICES AND PANELS, ETC. DESIGN SHALL BE SEALED BY A QUALIFIED DESIGN PROFESSIONAL LICENSED BY THE STATE.
- 3. WHERE COMBINED FIRE & DOMESTIC WATER SUPPLY LINES ARE SHOWN ON PLANS, INSTALLING CONTRACTOR SHALL VERIFY WITH FIRE SPRINKLER CONTRACTOR THAT INCOMING LINE SIZE IS ADEQUATE FOR FIRE SUPPRESSION SYSTEM.
- 4. FIRE SPRINKLER CONTRACTOR TO PROVIDE DEFERRED SUBMITTAL PACKAGE FOR FIRE SPRINKLER SYSTEM. SUBMITTAL SHALL INCLUDE HYDRAULIC CALCULATIONS AND SPRINKLER SYSTEM DRAWINGS SEALED BY A QUALIFIED DESIGN PROFESSIONAL LICENSED BY THE STATE.
- 5. FIRE WATER FLOW DATA WAS NOT OBTAINED. CONTRACTOR MUST OBTAIN FIRE FLOW INFORMATION 10 DAYS AFTER INTENT TO AWARD IS GIVEN. IF FLOW IS INSUFFICIENT WITHOUT USE OF A FIRE PUMP, CONTRACTOR SHALL NOTIFY ARCHITECT AND ENGINEERING TEAM. IF NO NOTICE IS GIVEN AND A FIRE PUMP IS NEEDED, CONTRACTOR WILL BE RESPONSIBLE FOR ANY COST ASSOCIATED WITH FIRE PUMP.


STATE OF MISSOURI MIKE KEHOE GOVERNOR



Keaton E. Leisinger, P.E. PE-2021035875



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OFFICE OF ADMINISTRATION DIVISION OF FACILITIES MANAGEMENT DESIGN AND CONSTRUCTION

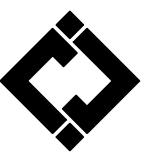INTERIOR & EXTERIOR RENOVATIONS, MISSOURI (4-H) BUILDING MISSOURI STATE FAIRGROUNDS 2503 W. 16TH ST SEDALIA, MO 65301

PROJECT # F2407-01 SITE # 1501

REVISION: ADDENDUM 2 DATE: 10/23/2025

ASSET # 3511501028

ISSUE DATE: 6/27/2025

BID DOCUMENTS

CAD DWG FILE:
DRAWN BY:
CHECKED BY:
DESIGNED BY:
KEL

SHEET TITLE:


OVERALL FIRE PROTECTION PLAN

SHEET NUMBER:

F-101

SHEET OF 48

FOR ESTIMATING PURPOSES ONLY. NOT FOR CONSTRUCTION.

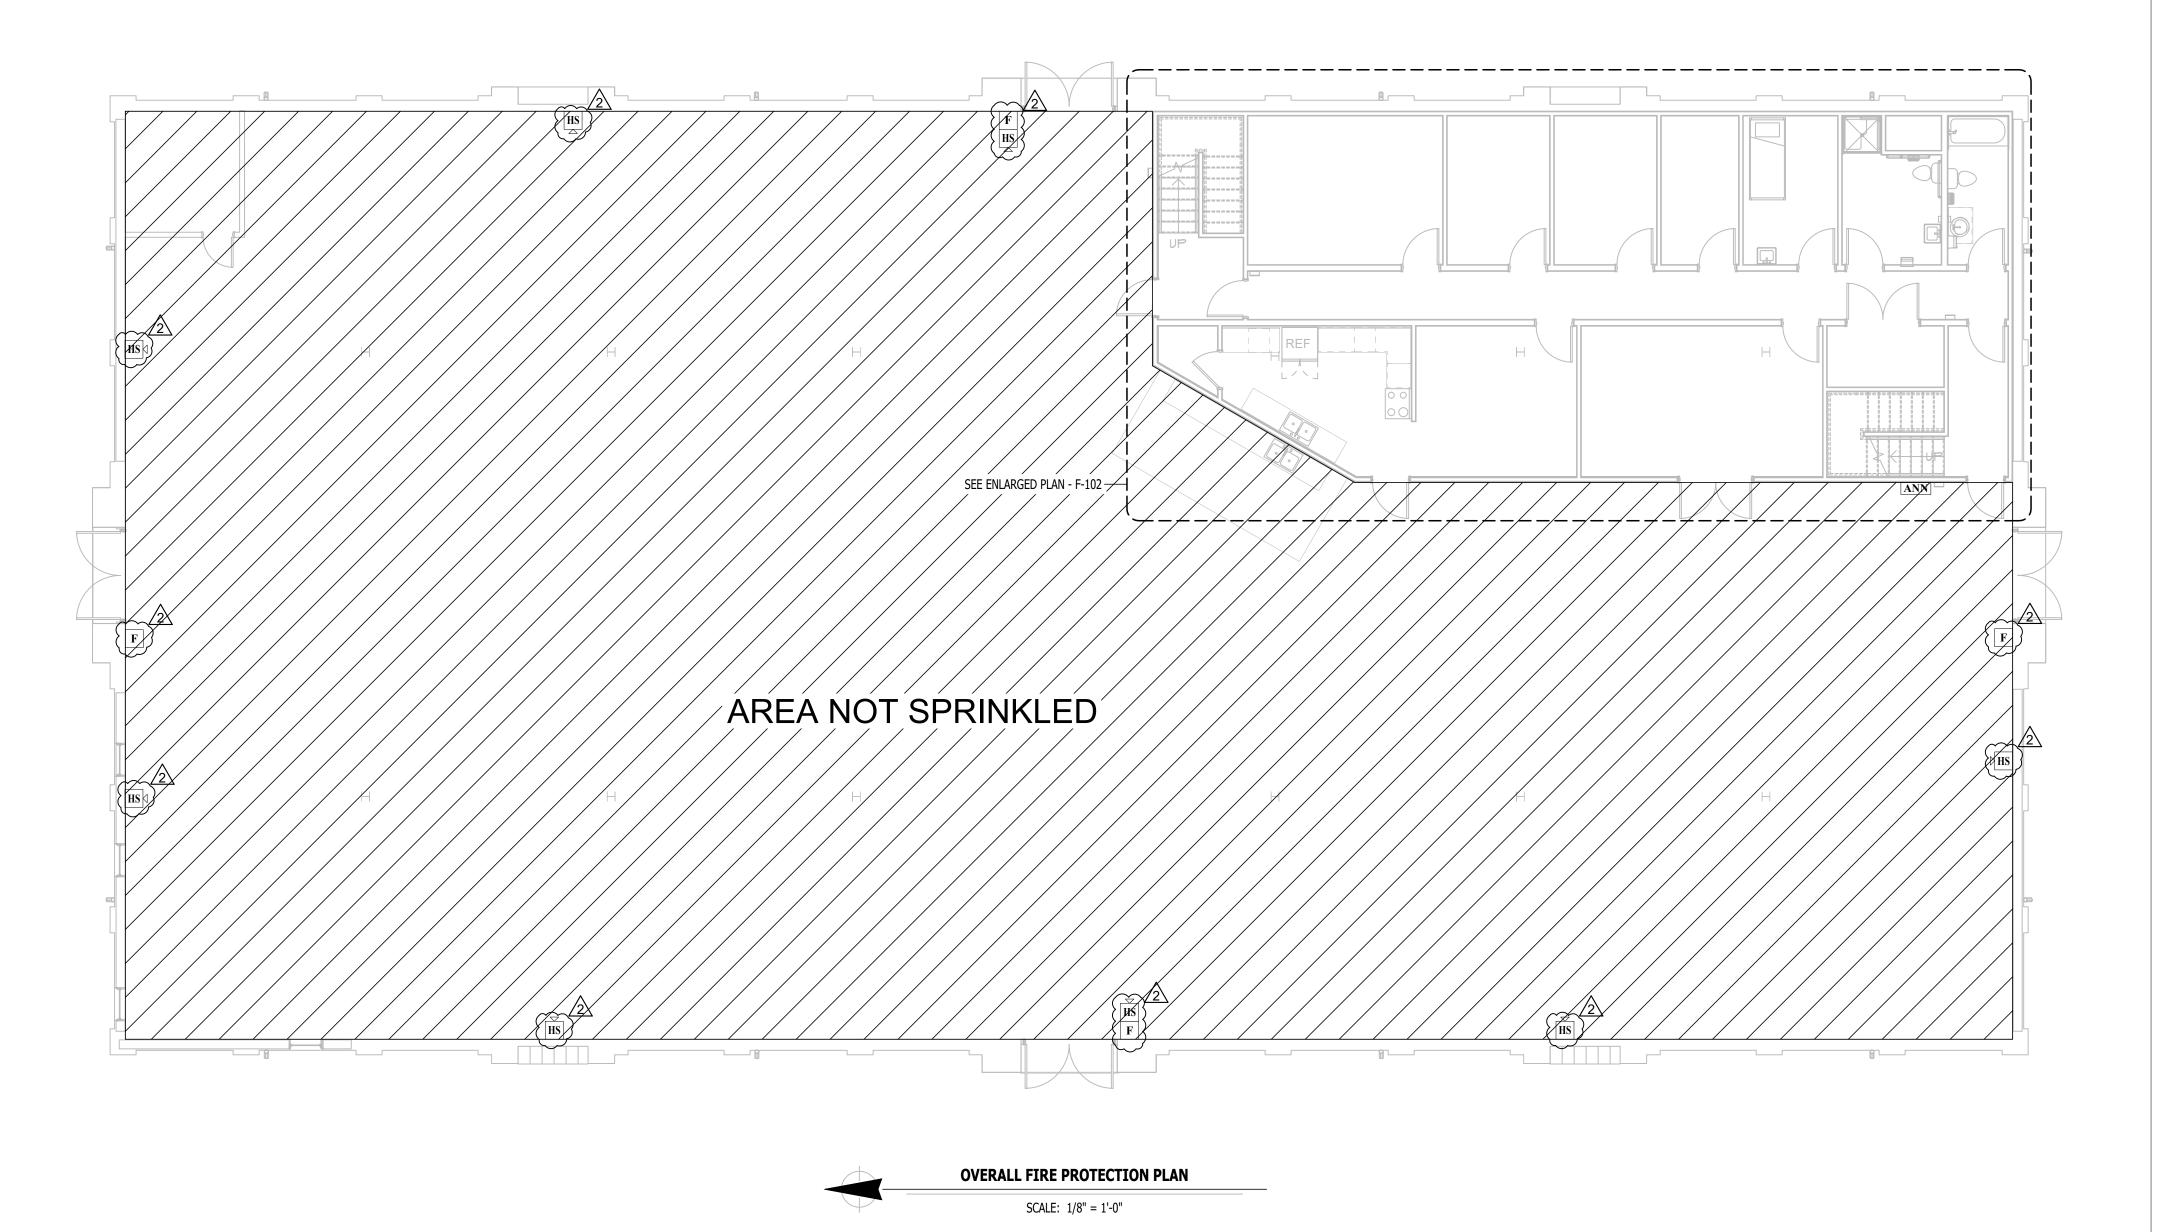



FIRE PROTECTION PLAN SYMBOL LEGEND MANUAL PULL STATION MODULE OUTPUT MODULE SMOKE DETECTOR STROBE - CEILING MOUNT STROBE - WALL MOUNT HORN STROBE - WALL MOUNT HORN STROBE - CEILING MOUNT SPEAKER STROBE - WALL MOUNT SPEAKER STROBE - CEILING MOUNT TAMPER SWITCH WATER FLOW SWITCH FIRE ALARM CONTROL PANEL FIRE ALARM ANNUNCIATOR FIRE PROTECTION PLAN GENERAL NOTES: FIRE ALARM SYSTEM. SUBMITTAL SHALL INCLUDE BATTERY CALCULATIONS,

- 1. FIRE ALARM SYSTEM COMPONENTS SHOWN (IF APPLICABLE) ARE GENERAL AND SCHEMATIC IN NATURE. CONTRACTOR TO VERIFY EXACT DEVICE LOCATIONS AND REQUIREMENTS WITH FIRE ALARM SYSTEM DESIGNER OF RECORD PRIOR TO
- 2. FIRE ALARM CONTRACTOR SHALL PROVIDE DEFERRED SUBMITTAL PACKAGE FOR VOLTAGE DROP CALCULATIONS, EQUIPMENT SPECIFICATIONS FOR DEVICES AND PANELS, ETC. DESIGN SHALL BE SEALED BY A QUALIFIED DESIGN PROFESSIONAL LICENSED BY THE STATE.
- 3. WHERE COMBINED FIRE & DOMESTIC WATER SUPPLY LINES ARE SHOWN ON PLANS, INSTALLING CONTRACTOR SHALL VERIFY WITH FIRE SPRINKLER CONTRACTOR THAT INCOMING LINE SIZE IS ADEQUATE FOR FIRE SUPPRESSION SYSTEM.
- 4. FIRE SPRINKLER CONTRACTOR TO PROVIDE DEFERRED SUBMITTAL PACKAGE FOR FIRE SPRINKLER SYSTEM. SUBMITTAL SHALL INCLUDE HYDRAULIC CALCULATIONS AND SPRINKLER SYSTEM DRAWINGS SEALED BY A QUALIFIED DESIGN PROFESSIONAL LICENSED BY THE STATE.

FIRE PROTECTION PLAN KEY NOTES:


1) FIRE SPRINKLER RISER AREA.

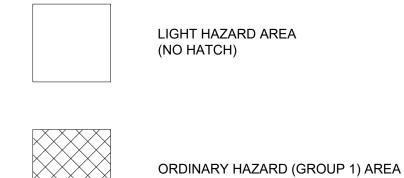

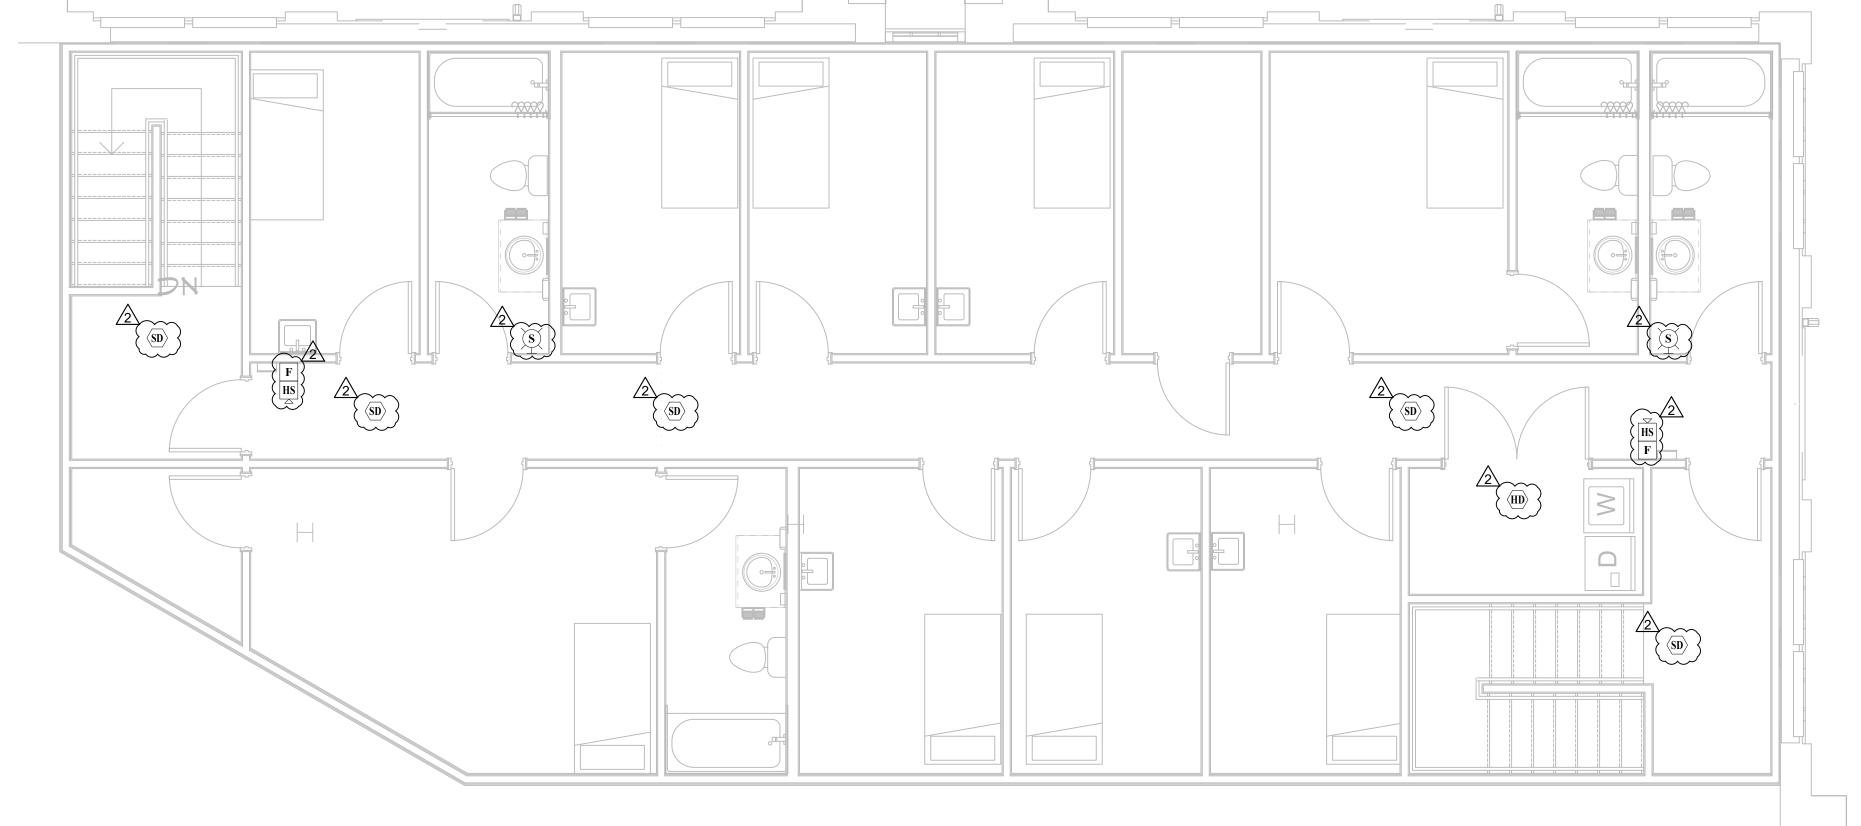

ENLARGED FIRE PROTECTION PLAN - UPPER FLOOR

SCALE: 1/4" = 1'-0"

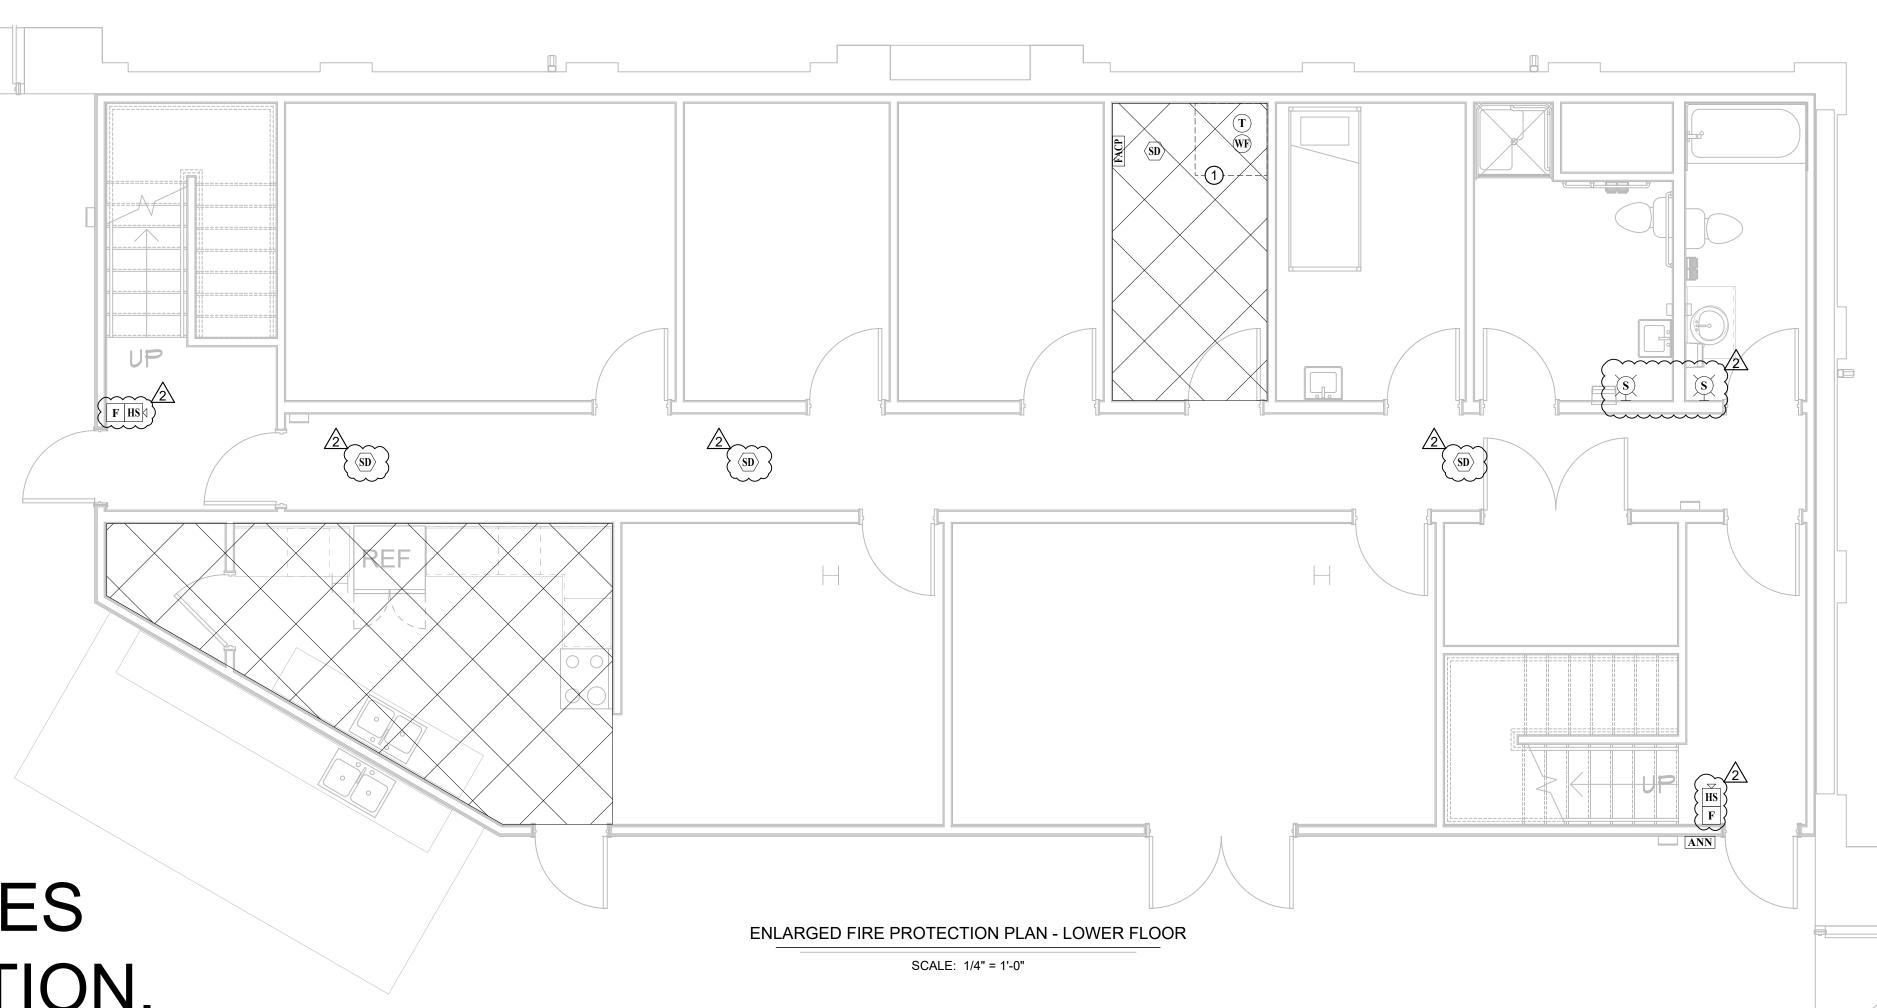

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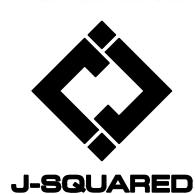
STATE OF MISSOURI MIKE KEHOE **GOVERNOR**



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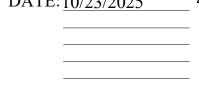
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PROJECT # F2407-01 SITE # 1501 ASSET # 3511501028



ISSUE DATE: 6/27/2025

BID DOCUMENTS

CAD DWG FILE:
DRAWN BY: RXM
CHECKED BY: JAP
DESIGNED BY: KEL

SHEET TITLE:

ENLARGED FIRE PROTECTION PLAN

SHEET NUMBER:

F-102