Addendum No. 01

TO: PLANS AND SPECIFICATIONS FOR:

Upgrade HVAC Controls Staples Building Southeast MO Mental Health Center Farmington, MO PROJECT NO. M2011-01

New Bid Opening Date: 1:30 PM, April 11, 2024 (CHANGED)

Bidders are hereby informed that the construction plans and/or specifications are modified as follows:

SPECIFICATION CHANGES:

- 1. Section 001116 INVITATION FOR BID
 - a. REVISE Paragraph 3.0-A as follows:

A. Until: 1:30 PM, April 11, 2024

DRAWING CHANGES:

Drawing M-001 MECHANICAL GENERAL NOTES

GENERAL NOTES

ADD: 18. "OR BE INSTALLED IN ALIGATURE/TAMPER PROOF ENCLOSURE."

ADD: 20: "CONTRACTOR IS NOT RESPONSIBLE FOR FURNISHING NEW PC WITHIN THE SCOPE OF THIS JOB. NEW CONTROLS SYSTEM SHALL BE INTERNET BASED. ALL CONNECTIONS MUST BE HARD WIRED. COORDINATE WITHOWNER'S I.T. DEPARTMENT TO ENSURE ALL CONNECTIONS ARE UP TO OWNER AND STATE STANDARDS. CONTACT THE HEAD OF FACILITIES AT SITE FOR COORDINATION."

ADD: 21: "CONNECTION TO FORENSIC'S BUILDING BAS IS OUTSIDE OF THE SCOPE OF WORK. DO NOT CONNECTING EXISTING ALERTON SYSTEM INTO NEW BAS."

GENERAL NOTES (HYDRONIC)

ADD: 2: "THE CONTRACTOR SHALL BE RESPONSIBLE FOR DRAINING, FILLING, AND VENTING (FOR ALL SYSTEMS OPENED BY CONTRACTOR) OF ALL HYDRONIC SYSTEMS IMPACTED BY THIS PROJECT. CHEMICALS SHALL BE PROVIDED BY WALTER LOUIS (STATE OF MISSOURI CHEMICAL PROVIDER) AND BE BOUGHT BY THE STATE DIRECTLY (NOT AT THE COST TOTHE CONTRACTOR), BUT THE CONTRACTOR SHALL BE REQUIRED TO MIX AND INCORPORATE CHEMICALS INTO ALL HYDRONIC SYSTEMS IMPACTED BY PROJECT.COORDINATE WITH OWNER CONTACT AT WALTER LOUIS FOR REQUIRED WATERTREATMENT SCOPE. CONTACT: NICK KISER, PHONE: 636-399-9388."

ADD: 3: "AS PER OWNER DISCUSSION, THERE IS NO GLYCOL IN THE HOT WATER HEATING LOOP. IF FIELD RESULTS SHOW DIFFERENT THAT AS STATED, CONTACT ENGINEER."

ADD: 4: "AS PER DISCUSSION WITH OWNER, THE CHILLED WATER SYSTEM IS 30% FOOD GRADEGLYCOL. CONTRACTOR SHALL FIELD VERIFY PERCENTAGE. IF THIS NUMBER IS DIFFERENT THAN THAT FOUND IN FIELD, CONTRACTOR SHALL CONTACT ENGINEER.

ADD: 5: "AFTER COMPLETION OF WORK IN EACH WARD, CONTRACTOR SHALL CLEAN HOT WATER STRAINER(S) IN MECHANICAL ROOM"

(ITEMS THAT DO NOT HAVE A HEADING FALL UNDER AN EXISTING HEADING) **ADD:** Boxed note highlighting the working days it will take staff to transition between wards. This reads as, "NOTE: FOR STAFF TO FULLY CHANGE RESIDENTS FROM ONE WARD TO ANOTHER, IT WAS REPORTED BY THE OWNER THAT THIS COULD BE COMPLETED IN TWO (2) WORKING DAYS. FOR EXAMPLE, IF WORK IS COMPLETED ON A FRIDAY BY THE CONTRACTOR, WORK CAN BESTARTED ON THE NEXT WARD ON THE WEDNESDAY OF THE FOLLOWING WEEK,. IF THE TRANSITION OF WARDS REQUIRES MORE TIME THAN TWO WORKING DAYS, THE CONTRACTOR SHALL CONTACT STATE CONSTRUCTION MANAGER."

ADD: Box note with the contact information for the fire alarm contractor. The contact is Hannah Smith with Johnson Controls. Her email is hannah.smith@JCI.com and her phone number is 314-320-9296.

2. <u>Drawing M-101 STAPLES PARTIAL MECHANICAL PLAN</u>
<u>STAPLES BUILDING – 1ST FLOOR PARTIAL MECHANICAL PLAN</u>

ADD: Damper sizes to all dampers on drawing

Keyed Notes

ADD: To end of note 10 "BID ALTERNATE #2: IF BID ALTERNATE # 2 IS APPROVED, INSTALL MODULATING TWO WAY VALVES IN PLACE OF THREE WAY VALVES UNLESS NOTED. CAP AND REMOVE BYPASS LINE.

ADD: 14. EXISTING ASU-7 AND 8 CONTROLLERS SHALL BE DEMOLISHED. NEW CONTROLLER SHALL BE INSTALLED IN PLACE OF EXISTING. CONNECT ALL POINTS BACK INTO CONTROLLER.

ADD: 15. BID ALTERNATE #2: INSTALL THREE WAY VALVE IN PLACE OF TWO WAY VALVE. INSTALL BALANCING VALVE IN RETURN AND BYPASS LINE.

3. <u>Drawing M-102 STAPLES PARTIAL MECHANICAL PLAN</u> <u>STAPLES BUILDING – 1ST FLOOR PARTIAL MECHANICAL PLAN</u>

ADD: Damper sizes to all dampers on drawing

KEYED NOTES

ADD: To end of note 2 "BID ALTERNATE #2: IF BID ALTERNATE # 2 IS APPROVED, INSTALL MODULATING TWO WAY VALVES IN PLACE OF THREE WAY VALVES UNLESS NOTED. CAP AND REMOVE BYPASS LINE.

ADD: 6. BID ALTERNATE #2: INSTALL THREE WAY VALVE IN PLACE OF TWO WAY VALVE. INSTALL BALANCING VALVE IN RETURN AND BYPASS LINE.

ADD: 7. EXISTING ASU-2 CONTROLLER SHALL BE DEMOLISHED. NEW CONTROLLER SHALL BE INSTALLED IN PLACE OF EXISTING. CONNECT ALL POINTS BACK INTO CONTROLLER.

4. <u>Drawing M-103 STAPLES PARTIAL MECHANICAL PLAN</u> KEYED NOTE

ADD: To end of note 2 "BID ALTERNATE #2: IF BID ALTERNATE # 2 IS APPROVED, INSTALL MODULATING TWO WAY VALVES IN PLACE OF THREE WAY VALVES UNLESS NOTED. CAP AND REMOVE BYPASS LINE.

ADD: 4. BID ALTERNATE #2: INSTALL THREE WAY VALVE IN PLACE OF TWO WAY VALVE. INSTALL BALANCING VALVE IN RETURN AND BYPASS LINE.

5. <u>Drawing M-104 STAPLES PARTIAL MECHANICAL PLAN</u> STAPLES BUILDING – 1ST FLOOR PARTIAL MECHANICAL PLAN

ADD: Damper sizes to all dampers on drawing

KEYED NOTE

ADD: To end of note 2 "BID ALTERNATE #2: IF BID ALTERNATE # 2 IS APPROVED, INSTALL MODULATING TWO WAY VALVES IN PLACE OF THREE WAY VALVES UNLESS NOTED. CAP AND REMOVE BYPASS LINE.

ADD: 5. BID ALTERNATE #2: INSTALL THREE WAY VALVE IN PLACE OF TWO WAY VALVE. INSTALL BALANCING VALVE IN RETURN AND BYPASS LINE

6. <u>Drawing M-105 STAPLES PARTIAL MECHANICAL PLAN</u> KEYED NOTE

ADD: To end of note 2 "BID ALTERNATE #2: IF BID ALTERNATE # 2 IS APPROVED, INSTALL MODULATING TWO WAY VALVES IN PLACE OF THREE WAY VALVES UNLESS NOTED. CAP AND REMOVE BYPASS LINE.

ADD: 4. BID ALTERNATE #2: INSTALL THREE WAY VALVE IN PLACE OF TWO WAY VALVE. INSTALL BALANCING VALVE IN RETURN AND BYPASS LINE

7. <u>Drawing M-106 STAPLES PARTIAL MECHANICAL PLAN</u> STAPLES BUILDING – 2ND FLOOR PARTIAL MECHANICAL PLAN

ADD: Damper sizes to all dampers on drawing

KEYED NOTE

ADD: To end of note 1 "BID ALTERNATE #2: IF BID ALTERNATE # 2 IS APPROVED, INSTALL MODULATING TWO WAY VALVES IN PLACE OF THREE WAY VALVES UNLESS NOTED. CAP AND REMOVE BYPASS LINE.

ADD: 5. BID ALTERNATE #2: INSTALL THREE WAY VALVE IN PLACE OF TWO WAY VALVE. INSTALL BALANCING VALVE IN RETURN AND BYPASS LINE

8. <u>Drawing M-107 STAPLES PARTIAL MECHANICAL PLAN</u> KEYED NOTE

ADD: To end of note 1 "BID ALTERNATE #2: IF BID ALTERNATE # 2 IS APPROVED, INSTALL MODULATING TWO WAY VALVES IN PLACE OF THREE WAY VALVES UNLESS NOTED. CAP AND REMOVE BYPASS LINE.

ADD: 3. BID ALTERNATE #2: INSTALL NEW DIFFERENTIAL PRESSURE SENSOR IN PIPING AT THIS LOCATION FOR CONTROL OF REHEAT PUMP.

ADD: 4. BID ALTERNATE #2: INSTALL THREE WAY VALVE IN PLACE OF TWO WAY VALVE. INSTALL BALANCING VALVE IN RETURN AND BYPASS LINE.

ADD: 5. EXISTING ASU – 4 CONTROLLER SHALL BE DEMOLISHED. NEW CONTROLLER SHALL BE ISNTALLED IN PLACE OF EXISTING. CONNECT ALL POINTS BACK INTO CONTROLLER.

(ITEMS THAT DO NOT HAVE A HEADING FALL UNDER AN EXISTING HEADING) **ADD**: DETAIL #2 WHICH SHOWS A PICTURE OF THE EXISTING ASU – 4

CONTROLLER.

9. <u>Drawing M-108 STAPLES PARTIAL MECHANICAL PLAN</u> KEYED NOTE

ADD: To end of note 1 "BID ALTERNATE #2: IF BID ALTERNATE # 2 IS APPROVED, INSTALL MODULATING TWO WAY VALVES IN PLACE OF THREE WAY VALVES UNLESS NOTED. CAP AND REMOVE BYPASS LINE.

ADD: 3. EXISTING ASU – 5 CONTROLLER SHALL BE DEMOLISHED. NEW CONTROLLER SHALL BE ISNTALLED IN PLACE OF EXISTING. CONNECT ALL POINTS BACK INTO CONTROLLER.

ADD: 4. EXISTING ASU – 6 CONTROLLER SHALL BE DEMOLISHED. NEW CONTROLLER SHALL BE ISNTALLED IN PLACE OF EXISTING. CONNECT ALL POINTS BACK INTO CONTROLLER.

ADD: 5. BID ALTERNATE #2: INSTALL THREE WAY VALVE IN PLACE OF TWO WAY VALVE. INSTALL BALANCING VALVE IN RETURN AND BYPASS LINE.

(ITEMS THAT DO NOT HAVE A HEADING FALL UNDER AN EXISTING HEADING) **ADD**: DETAIL #2 WHICH SHOWS A PICTURE OF THE EXISTING ASU – 5 AND 6 CONTROLLER

10. <u>Drawing M-109 STAPLES PARTIAL MECHANICAL PLAN</u>
STAPLES BUILDING – 2ND FLOOR PARTIAL MECHANICAL PLAN

ADD: Damper sizes to all dampers on drawing

KEYED NOTE

ADD: To end of note 2 "BID ALTERNATE #2: IF BID ALTERNATE # 2 IS APPROVED, INSTALL MODULATING TWO WAY VALVES IN PLACE OF THREE WAY VALVES UNLESS NOTED. CAP AND REMOVE BYPASS LINE.

ADD: 7. BID ALTERNATE #2: INSTALL THREE WAY VALVE IN PLACE OF TWO WAY VALVE. INSTALL BALANCING VALVE IN RETURN AND BYPASS LINE

11. <u>Drawing M-110 STAPLES PARTIAL MECHANICAL PLAN</u>
STAPLES BUILDING – 2ND FLOOR PARTIAL MECHANICAL PLAN

ADD: Damper sizes to all dampers on drawing

KEYED NOTE

ADD: To end of note 2 "BID ALTERNATE #2: IF BID ALTERNATE # 2 IS APPROVED, INSTALL MODULATING TWO WAY VALVES IN PLACE OF THREE WAY VALVES UNLESS NOTED. CAP AND REMOVE BYPASS LINE.

ADD: 6. BID ALTERNATE #2: INSTALL THREE WAY VALVE IN PLACE OF TWO WAY VALVE. INSTALL BALANCING VALVE IN RETURN AND BYPASS LINE

(ITEMS THAT DO NOT HAVE A HEADING FALL UNDER AN EXISTING HEADING) **ADD:** DETAIL #2 WHICH SHOWS A PICTURE EXISTING ASU – 1 CONTROL SCHEMATIC.

12. <u>Drawing M-601 MECHANICAL DETAILS</u>
Existing Cooling Coil Balancing Schedule

ADD: Valve size column

Existing Heating Coil Balancing Schedule

ADD: Valve size column

13. Drawing M-614 MECHANICAL AIR FLOW DIAGRAM – ASU 6 & 7

Existing TRU Schedule ADD: HW size column.

14. Drawing E-101 STAPLES PARTIAL ELECTRICAL PLAN

POWER GENERAL NOTES

ADD: I. "DASHED LINE INDICATES GROUPINGS FOR TRANSFORMER SERVICE."

POWER KEYED NOTES

ADD: "11. CONTROL TRANSFORMER TYPE: BOD - SQUARE-D 9070T100D19, TYPE-T, OR APPROVED EQUAL, 277V – PRIMARY, 24V-SECONDARY, 100VA, 1-PHASE. CONNECT (2) UNITS."

ADD: "12. CONTROL TRANSFORMER TYPE: BOD - SQUARE-D 9070T200D25, TYPE-T, EQUIVALENT - SIEMENS, EATON, OR APPROVED EQUAL), 277V - PRIMARY, 24V-SECONDARY, 200VA, 1-PHASE. CONNECT (4) UNITS."

15. <u>Drawing E-102 STAPLES PARTIAL ELECTRICAL PLAN</u>

POWER GENERAL NOTES

ADD: "I. DASHED LINE INDICATES GROUPINGS FOR TRANSFORMER SERVICE."

POWER KEYED NOTES

ADD: "8. CONTROL TRANSFORMER TYPE: BOD - SQUARE-D 9070T100D19, TYPE-T, OR APPROVED EQUAL, 277V – PRIMARY, 24V-SECONDARY, 100VA, 1-PHASE. CONNECT (2) UNITS."

ADD: "9. CONTROL TRANSFORMER TYPE: BOD - SQUARE-D 9070T200D25, TYPE-T, EQUIVALENT - SIEMENS, EATON, OR APPROVED EQUAL), 277V - PRIMARY, 24V-SECONDARY, 200VA, 1-PHASE. CONNECT (4) UNITS."

16. <u>Drawing E-103 STAPLES PARTIAL ELECTRICAL PLAN</u>

POWER GENERAL NOTES

ADD: "I. DASHED LINE INDICATES GROUPINGS FOR TRANSFORMER SERVICE."

POWER KEYED NOTES

ADD: "6. CONTROL TRANSFORMER TYPE: BOD - SQUARE-D 9070T100D19, TYPE-T, OR APPROVED EQUAL, 277V – PRIMARY, 24V-SECONDARY, 100VA, 1-PHASE. CONNECT (2) UNITS."

ADD: "7. CONTROL TRANSFORMER TYPE: BOD - SQUARE-D 9070T200D25, TYPE-T, EQUIVALENT - SIEMENS, EATON, OR APPROVED EQUAL), 277V - PRIMARY, 24V-SECONDARY, 200VA, 1-PHASE. CONNECT (4) UNITS."

17. Drawing E-104 STAPLES PARTIAL ELECTRICAL PLAN

POWER GENERAL NOTES

ADD: "I. DASHED LINE INDICATES GROUPINGS FOR TRANSFORMER SERVICE."

POWER KEYED NOTES

ADD: "6. CONTROL TRANSFORMER TYPE: BOD - SQUARE-D 9070T100D19, TYPE-T, OR APPROVED EQUAL, 277V – PRIMARY, 24V-SECONDARY, 100VA, 1-PHASE. CONNECT (2) UNITS."

ADD: "7. CONTROL TRANSFORMER TYPE: BOD - SQUARE-D 9070T200D25, TYPE-T,

EQUIVALENT – SIEMENS, EATON, OR APPROVED EQUAL), 277V – PRIMARY, 24V-SECONDARY, 200VA, 1-PHASE. CONNECT (4) UNITS."

18. <u>Drawing E-105 STAPLES PARTIAL ELECTRICAL PLAN</u>

POWER GENERAL NOTES

ADD: "I. DASHED LINE INDICATES GROUPINGS FOR TRANSFORMER SERVICE."

POWER KEYED NOTES

ADD: "6. CONTROL TRANSFORMER TYPE: BOD - SQUARE-D 9070T100D19, TYPE-T, OR APPROVED EQUAL, 277V – PRIMARY, 24V-SECONDARY, 100VA, 1-PHASE. CONNECT (2) UNITS."

ADD: "7. CONTROL TRANSFORMER TYPE: BOD - SQUARE-D 9070T200D25, TYPE-T, EQUIVALENT - SIEMENS, EATON, OR APPROVED EQUAL), 277V - PRIMARY, 24V-SECONDARY, 200VA, 1-PHASE. CONNECT (4) UNITS."

19. Drawing E-106 STAPLES PARTIAL ELECTRICAL PLAN

POWER GENERAL NOTES

ADD: "I. DASHED LINE INDICATES GROUPINGS FOR TRANSFORMER SERVICE."

POWER KEYED NOTES

ADD: "5. CONTROL TRANSFORMER TYPE: BOD - SQUARE-D 9070T100D19, TYPE-T, OR APPROVED EQUAL, 277V – PRIMARY, 24V-SECONDARY, 100VA, 1-PHASE. CONNECT (2) UNITS."

ADD: "6. CONTROL TRANSFORMER TYPE: BOD - SQUARE-D 9070T200D25, TYPE-T, EQUIVALENT - SIEMENS, EATON, OR APPROVED EQUAL), 277V - PRIMARY, 24V-SECONDARY, 200VA, 1-PHASE. CONNECT (4) UNITS."

20. Drawing E-107 STAPLES PARTIAL ELECTRICAL PLAN

POWER GENERAL NOTES

ADD: "I. DASHED LINE INDICATES GROUPINGS FOR TRANSFORMER SERVICE."

POWER KEYED NOTES

ADD: "4. CONTROL TRANSFORMER TYPE: BOD - SQUARE-D 9070T100D19, TYPE-T, OR APPROVED EQUAL, 277V – PRIMARY, 24V-SECONDARY, 100VA, 1-PHASE. CONNECT (2) UNITS."

ADD: "5. CONTROL TRANSFORMER TYPE: BOD - SQUARE-D 9070T200D25, TYPE-T, EQUIVALENT - SIEMENS, EATON, OR APPROVED EQUAL), 277V - PRIMARY, 24V-SECONDARY, 200VA, 1-PHASE. CONNECT (4) UNITS."

21. <u>Drawing E-108 STAPLES PARTIAL ELECTRICAL PLAN</u>

POWER GENERAL NOTES

ADD: "I. DASHED LINE INDICATES GROUPINGS FOR TRANSFORMER SERVICE."

POWER KEYED NOTES

ADD: "4. CONTROL TRANSFORMER TYPE: BOD - SQUARE-D 9070T100D19, TYPE-T, OR APPROVED EQUAL, 277V – PRIMARY, 24V-SECONDARY, 100VA, 1-PHASE. CONNECT (2) UNITS."

ADD: "5. CONTROL TRANSFORMER TYPE: BOD - SQUARE-D 9070T200D25, TYPE-T, EQUIVALENT - SIEMENS, EATON, OR APPROVED EQUAL), 277V - PRIMARY, 24V-SECONDARY, 200VA, 1-PHASE. CONNECT (4) UNITS."

22. <u>Drawing E-109 STAPLES PARTIAL ELECTRICAL PLAN</u>

POWER GENERAL NOTES

ADD: "I. DASHED LINE INDICATES GROUPINGS FOR TRANSFORMER SERVICE."

POWER KEYED NOTES

ADD: "6. CONTROL TRANSFORMER TYPE: BOD - SQUARE-D 9070T100D19, TYPE-T, OR APPROVED EQUAL, 277V – PRIMARY, 24V-SECONDARY, 100VA, 1-PHASE. CONNECT (2) UNITS."

ADD: "7. CONTROL TRANSFORMER TYPE: BOD - SQUARE-D 9070T200D25, TYPE-T, EQUIVALENT - SIEMENS, EATON, OR APPROVED EQUAL), 277V - PRIMARY, 24V-SECONDARY, 200VA, 1-PHASE. CONNECT (4) UNITS."

23. <u>Drawing E-110 STAPLES PARTIAL ELECTRICAL PLAN</u>

POWER GENERAL NOTES

ADD: "I. DASHED LINE INDICATES GROUPINGS FOR TRANSFORMER SERVICE."

POWER KEYED NOTES

ADD: "7. CONTROL TRANSFORMER TYPE: BOD - SQUARE-D 9070T100D19, TYPE-T, OR APPROVED EQUAL, 277V – PRIMARY, 24V-SECONDARY, 100VA, 1-PHASE. CONNECT (2) UNITS."

ADD: "8. CONTROL TRANSFORMER TYPE: BOD - SQUARE-D 9070T200D25, TYPE-T, EQUIVALENT - SIEMENS, EATON, OR APPROVED EQUAL), 277V - PRIMARY, 24V-SECONDARY, 200VA, 1-PHASE. CONNECT (4) UNITS."

GENERAL COMMENTS:

- The Pre-Bid meeting was held March 13, 2024 followed by an inspection of the project site.
- Bidders desiring to perform a site inspection should contact staff Brad Burgess at 573-218-6857
 Brad.Burgess@oa.mo.gov to schedule a time to enter the facility.
- Please contact Paul Girouard, 573-751-4797 <u>paul.girouard@oa.mo.gov</u> for questions about bidding procedures, MBE\WBE\SDVE Goals, and other submittal requirements.
- The deadline for technical questions is March 19,2024 at noon (12 pm).
- Changes to, or clarification of, the bid documents are only made as issued in the addenda.
- All correspondence with respect to this project must include the State of Missouri project number as indicated above.
- All bids shall be submitted on the bid form without additional terms and conditions, modifications, or stipulations. Each space on the bid form shall be properly filled including a bid amount for each alternate. Failure to do so will result in rejection of the bid.
- MBE/WBE/SDVE participation requirements can be found in DIVISION 00. The MBE/WBE/SDVE participation goals are 10%/10%/3%, respectively. Only certified firms as of the bid opening date can be used to satisfy the MBE/WBE/SDVE participation goals for this project. If a bidder is unable to meet a participation goal, a Good Faith Effort Determination Form must be completed. Failure to complete this process will result in rejection of the bid.

ATTACHMENTS:

Pre-bid sign in sheet

STAPLES PARTIAL MECHANICAL PLAN	M-101
STAPLES PARTIAL MECHANICAL PLAN	M-102
STAPLES PARTIAL MECHANICAL PLAN	M-103
STAPLES PARTIAL MECHANICAL PLAN	M-104
STAPLES PARTIAL MECHANICAL PLAN	M-105
STAPLES PARTIAL MECHANICAL PLAN	M-106
STAPLES PARTIAL MECHANICAL PLAN	M-107
STAPLES PARTIAL MECHANICAL PLAN	M-108
STAPLES PARTIAL MECHANICAL PLAN	M-109
STAPLES PARTIAL MECHANICAL PLAN	M-110
MECHANICAL DETAILS	M-601
MECHANICAL AIR FLOW DIAGRAM – ASU 6 & 7	M-614
MECHANICAL AIR FLOW DIAGRAM – ASU 6 & 7 STAPLES PARTIAL ELECTRICAL PLAN	M-614 E-101
STAPLES PARTIAL ELECTRICAL PLAN	E-101
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STAPLES PARTIAL ELECTRICAL PLAN	E-101 E-102 E-103 E-104 E-105 E-106 E-107

END OF ADDENDUM 01 March 20, 2024

Pre-Bid Meeting Attendance Sheet Upgrade HVAC Controls Southeast MO Mental Health Center Project #: M2011-01

Mar 13th, 2024 10:30 AM

Name & Title	Company Name & Type of Contracting	MBE/WBE/ SDVE Status	Phone	E-Mail Address of Attendee & E-Mail Address of Individual filling out Bid Documents
Shannon Thompson	State of Missouri		573-526-3166	
Project Manager	OA/FMDC	1 = 4	573-257-7137	Shannon.thompson@oa.mo.gov
Kevin Hultberg Construction Administrator	State of Missouri OA/FMDC		636-524-8528	kevin.hultberg@oa.mo.gov
Regina Raineri Architect	Casco Diversified Corperation		314-821-1100 Ext 145	regina.raineri@thecdeompanies.com
Tom Grassi	CASCO		314-443 - 7238	tom, grassi@ MEILING.com
Ryan Boatright	CASCO		314-882	ry an . boat right emelong com
Mee Stacy	Brockmiller		573-315- 6512	B: 2000 @ Brockmillercons truction.com

Pre-Bid Meeting Attendance Sheet Upgrade HVAC Controls Southeast MO Mental Health Center Project #: M2011-01 Mar 13th, 2024 10:30 AM

Name & Title	Company Name Type of Contracting	MBE/WBE/ SDVE Status	Phone	E-Mail Address of Attendee and E-Mail Address of Individual filling out Bid Documents
KEVIN SKAGGS	PREMIUM SOLUTIONS		(513)	Kskaggs @premiumbs;.com
SALES ENGINEER	CONTROLS & AUTOMATION		450-9632	
Brad Burgess	OA/FMDC		218-6857	Prenley@premiumbsi.com Brad. Burgess@OA.ma.gov
Andre Roberts HUAC Controls Supervison	Murphy Company		314.393.9051	aroberts Dmurphynet.com
YOM FLAKER ACCOUNT MGR	MURPHY COURALY		314-575-8669	+flaker@murphynetcon
Most White Account Mongo	Murphy Co.		(314) 466-7795	Muhite Emryphy net. com
Amy Luelobes	SMMHC		573. 218.6717	any. luebbers@dmh.nu.gov

Pre-Bid Meeting Attendance Sheet Upgrade HVAC Controls Southeast MO Mental Health Center Project #: M2011-01

Mar 13th, 2024 10:30 AM

Name & Title	Company Name Type of Contracting	MBE/WBE/ SDVE Status	Phone	E-Mail Address of Attendee and E-Mail Address of Individual filling out Bid Documents
Matthe Road	SMMHC		573-218-6789	matthew, road @ dmh.mo.gor
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GENERAL NOTES

- THESE PLANS ARE DIAGRAMMATIC IN NATURE SINCE THEY REFLECT ONLY THE AVAILABLE INFORMATION OBTAINED FROM EXISTING PLANS, SPECIFICATIONS, AND FIELD SURVEYS. THE EXACT LOCATION OF EXISTING DUCTWORK, PIPING, AND EQUIPMENT MAY DEVIATE FROM THE LOCATION INDICATED ON THE DRAWINGS. THE CONTRACTOR SHALL BE PREPARED TO MAKE SOME ALTERATIONS TO NEW AND/OR EXISTING SERVICES TO FIT ACTUAL JOB CONDITIONS.
- THE SPACE ALLOWED FOR MECHANICAL AND ELECTRICAL WORK ABOVE THE SUSPENDED CEILING IS CRITICAL AND REQUIRES COORDINATION BETWEEN TRADES. CONTRACTORS SHALL THOROUGHLY FAMILIARIZE THEMSELVES WITH THE EXISTING CONDITIONS PRIOR TO FABRICATION OR INSTALLATION OF ANY MATERIALS. DUCTWORK SHALL BE HUNG AS CLOSE AS POSSIBLE TO THE STRUCTURE ABOVE UNLESS INDICATED OTHERWISE. REWORK OF PIPING, DUCTWORK, EQUIPMENT LOCATION, CONDUIT, ETC. AS A RESULT OF POOR PLANNING, COORDINATION, OR SCHEDULING SHALL BE THE RESPONSIBILITY OF THE CONTRACTOR.
- 3. ANY HOLES LEFT IN EXISTING WALL CONSTRUCTION DUE TO DEMOLITION OR NEW WORK SHALL BE PATCHED TO MATCH EXISTING CONDITIONS.
- 4. PIPES/DUCTS/ETC. PENETRATING EXTERIOR WALLS AND ROOFS SHALL BE SEALED AND WEATHER PROOFED.
- THERMOSTATS & ROOM TEMPERATURE SENSORS SHALL BE MOUNTED AT 48" A.F.F. TO THE TOP OF THERMOSTAT UNLESS NOTED OTHERWISE. DO NOT MOUNT IN DIRECT SUNLIGHT OR NEAR HEAT PRODUCING FOLIPMENT
- 6. INSTALL H.V.A.C. SYSTEM IN ACCORDANCE WITH ALL STATE AND LOCAL CODES.
- 7. THE CONTRACTOR SHALL BE RESPONSIBLE FOR THE COORDINATION OF ANY FRAMING REVISIONS, EQUIPMENT LOCATIONS, ADDITION OF CONTROLS, ELECTRICAL CIRCUITING REVISIONS, ETC. THAT RESULT FROM USING EQUIPMENT OTHER THAN INDICATED ON THE DRAWINGS. APPROVAL OF THE SHOP DRAWINGS BY THE ENGINEER WILL NOT WAIVE THE CONTRACTOR OF THIS RESPONSIBILITY.
- 8. THE CONTRACTOR SHALL HAVE THE FINAL RESPONSIBILITY FOR MECHANICAL EQUIPMENT START UP AND TURN OVER TO THE OWNER. MANUFACTURER OF EQUIPMENT SHALL BE ON SITE DURING THE SYSTEM START UP.
- 9. ALL ITEMS INCLUDED ON THESE DRAWINGS AND THE SPECIFICATIONS
 SHALL BE INCLUDED IN THE CONTRACTOR'S BID. IF THE CONTRACTOR
 DOES NOT CLEARLY UNDERSTAND THESE PLANS OR IS NOT SURE OF
 THEIR MEANING, THE CONTRACTOR SHOULD OBTAIN THE ENGINEER'S
 WRITTEN EXPLANATION AND INTERPRETATION PRIOR TO BID TIME. THE
 CONTRACTOR WILL BE HELD TO THE INTERPRETATION OF THE ENGINEER.
- 10. IN THE EVENT THE CONTRACTOR DISCOVERS ANY POTENTIALLY HAZARDOUS MATERIALS (ASBESTOS, MOLD, MILDEW, ETC.), THE CONTRACTOR SHALL IMMEDIATELY NOTIFY THE OWNER'S REPRESENTATIVE AND THE ARCHITECT/ENGINEER OF RECORD, IN WRITING, OF THE CONCERNS AND/OR SUSPICIONS.
- 11. CAULK ALL PENETRATIONS THRU WALLS TO MINIMIZE SOUND TRANSMISSION THRU WALLS.
- 12. ANY DAMAGE TO THE SITE (SIDEWALKS, CURBS, ETC) OR TO THE BUILDING AS A RESULT OF WORK PERFORMED UNDER THIS CONTRACT SHALL BE FIXED BY THE CONTRACTOR AT NO ADDITIONAL COST TO THE OWNER.
- 13. CONTRACTOR WILL BE RESPONSIBLE FOR ALL CUTTING AND PATCHING OF ROOFS/WALLS/FLOORS AND CORE DRILLS REQUIRED TO COMPLETE THEIR RESPECTIVE WORK.
- 14. THE OWNER SHALL HAVE FIRST SALVAGE RIGHTS OF EQUIPMENT AND MATERIALS REMOVED. ALL EQUIPMENT AND MATERIALS NOT CLAIMED BY THE OWNER SHALL BE REMOVED FROM THE PREMISES BY THE CONTRACTORS.
- 15. THE CONTRACTOR SHALL BE RESPONSIBLE FOR PROVIDING ANY TEMPORARY FENCING AROUND THE LIFT SITE DURING LIFTS.
- 16. ALL EXISTING MECHANICAL EQUIPMENT, DUCTWORK, ETC. THAT SERVES SPACES NOT ON PLANS SHALL REMAIN AS IS. DO NOT DISCONNECT OR REMOVE ANY EQUIPMENT NOT SHOWN IN THESE PLANS.
- 17. REMOVE AND RE-INSTALL EXISTING LAY-IN CEILING AS REQUIRED TO COMPLETE ALL DEMOLITION AND NEW WORK. REPLACE CEILING TILES DAMAGED DURING CONSTRUCTION WITH NEW TILES MATCHING EXISTING.
- 18. ALL WORK THAT SHALL LEAVE EQUIPMENT EXPOSED TO PATIENTS SHALL BE LIGATURE AND TAMPER PROOF OR BE INSTALLED IN A LIGATURE/TAMPER PROOF ENCLOSURE. CONTRACTOR SHALL COORDINATE WORK WITH OWNER TO SET UP WORK TIMES AS A REPRESENTATIVE OF THE OWNER MUST BE ACCOMPANYING THE CONTRACTORS AT ALL TIME.
- 19. WORKING TIMES WITHIN PATIENT WARDS SHALL BE SET AT A MAXIMUM OF 8 HOURS STRAIGHT. WORK WITHIN PATIENT WARDS MUST BE COORDINATED WITH THE ACTING MAINTENANCE SUPERVISOR AT LEAST ONE WEEK PRIOR TO START OF WORK. ALL TOOLS, ACCESSORIES, MATERIALS, ETC OWNED BY CONTRACTOR TO COMPLETE WORK MUST BE REMOVED PRIOR TO THE END OF THE MAXIMUM 8 HOUR WORKING TIME PERIOD. NO MATERIALS, TOOLS, ACCESSORIES, ETC SHALL BE LEFT WITHIN OCCUPIED WARDS. WHERE PATIENTS ARE NOT PRESENT, ALL EQUIPMENT, MATERIALS, ACCESSORIES, ETC MUST BE KEPT WITH
- 20. CONTRACTOR IS NOT RESPONSIBLE FOR FURNISHING NEW PC ON THE SCOPE OF THIS JOB. NEW CONTROLS SYSTEM SHALL BE INTERNET BASED. ALL CONNECTIONS MUST BE HARD WIRED. COORDINATE WITH OWNER'S I.T. DEPARTMENT TO ENSURE ALL CONNECTIONS ARE UP TO OWNER AND STATE STANDARDS. CONTACT THE HEAD OF FACILITIES AT SITE FOR COORDINATION.

SECURED ROOMS OR BOXES.


21. CONNECTION TO FORENSIC'S BUILDING BAS IS OUTSIDE OF SCOPE OF WORK. DO NOT CONNECT EXISTING ALERTON SYSTEM INTO NEW BAS.

GENERAL NOTES (AIR SIDE)

- ALL DUCTWORK SHALL BE CONSTRUCTED AND INSTALLED PER THE LATEST VERSION OF THE S.M.A.C.N.A. H.V.A.C. DUCT CONSTRUCTION STANDARDS, UNLESS SPECIFIED MORE STRINGENTLY IN THESE CONSTRUCTION DOCUMENTS. MINIMUM DUCT GAUGE SHALL BE 24.
- NOT ALL OF THE ACCESS DOORS IN THE DUCT SYSTEMS OR PLENUMS ARE SHOWN.
 PROVIDE ACCESS DOORS IN ALL DUCT SYSTEMS OR PLENUMS WHERE REQUIRED TO
 ACCESS AND MAINTAIN MOTORIZED OR AUTOMATIC DAMPER BLADES AND LINKAGES.
- FLEXIBLE DUCT RUNOUTS TO AIR DEVICES SHALL NOT EXCEED 5'-0" IN LENGTH. FLEXIBLE RUNOUTS SHALL BE TRIMMED TO THE MINIMUM LENGTH NECESSARY TO MAKE THE CONNECTION.
- WHERE DAMPER ACTUATORS ARE MOUNTED TO DUCTWORK OR PLENUMS PROVIDE A HEAVY GAGE BASE PLATE, ANGLE STIFFENERS, OR MOUNTING AS REQUIRED TO ELIMINATE DEFLECTION OF DUCTWORK DURING ACTUATOR OPERATION.
- ALL DAMPER ACTUATORS FOR DUCT SYSTEMS OR EQUIPMENT THAT COMMUNICATES DIRECTLY WITH THE OUTDOORS SHALL BE SPRING RETURN TYPE TO CLOSE IN THE EVENT OF A POWER FAILURE.
- 6. AREAS ABOVE THE CEILING SERVE AS A RETURN AIR PLENUM. ALL MATERIALS EXPOSED IN THE PLENUM SHALL HAVE A 25/50 SMOKE/FLAME SPREAD RATING.
- 7. CONTRACTOR SHALL BALANCE EACH AREA OF COMPLETED WORK. THE CONTRACTOR SHALL BALANCE SUPPLY, RETURN, AND EXHAUST AIR FLOWS AT EACH AIR DEVICE AFFECTED BY RENOVATION TO QUANTITY INDICATED ON THE DRAWINGS.
- 8. ALL NEW DUCT CONNECTIONS TO EXISTING DUCTWORK SHALL BE SEALED AIRTIGHT.

GENERAL NOTES (HYDRONIC)

- 1. THE CONTRACTOR SHALL COORDINATE SYSTEM SHUT-DOWNS, INCLUDING CHILLED WATER AND HEATING WATER SYSTEM SHUT-DOWNS, WITH THE OWNER. PROVIDE A MINIMUM ONE WEEK NOTICE PRIOR TO ANY SYSTEM SHUT-DOWN.
- 2. THE CONTRACTOR SHALL BE RESPONSIBLE FOR DRAINING, FILLING, AND VENTING (FOR ALL SYSTEMS OPENED BY CONTRACTOR) OF ALL HYDRONIC SYSTEMS IMPACTED BY THIS PROJECT. CHEMICALS SHALL BE PROVIDED BY WALTER LOUIS (STATE OF MISSOURI CHEMICAL PROVIDER) AND BE BOUGHT BY THE STATE DIRECTLY (NOT AT THE COST TO THE CONTRACTOR), BUT THE CONTRACTOR SHALL BE REQUIRED TO MIX AND INCORPORATE CHEMICALS INTO ALL HYDRONIC SYSTEMS IMPACTED BY PROJECT. COORDINATE WITH OWNER CONTACT AT WALTER LOUIS FOR REQUIRED WATER TREATMENT SCOPE. CONTACT: NICK KISER, PHONE: 636-399-9388.
- AS PER OWNER DISCUSSION, THERE IS NO GLYCOL IN THE HOT WATER HEATING LOOP. IF
- AS PER DISCUSSION WITH OWNER, THE CHILLED WATER SYSTEM IS 30% FOOD GRADE GLYCOL. CONTRACTOR SHALL FIELD VERIFY PERCENTAGE. IF THIS NUMBER IS DIFFERENT THAN THAT FOUND IN FIELD, CONTRACTOR SHALL CONTACT ENGINEER.
- AFTER COMPLETION OF WORK IN EACH WARD, CONTRACTOR SHALL CLEAN HOT WATER

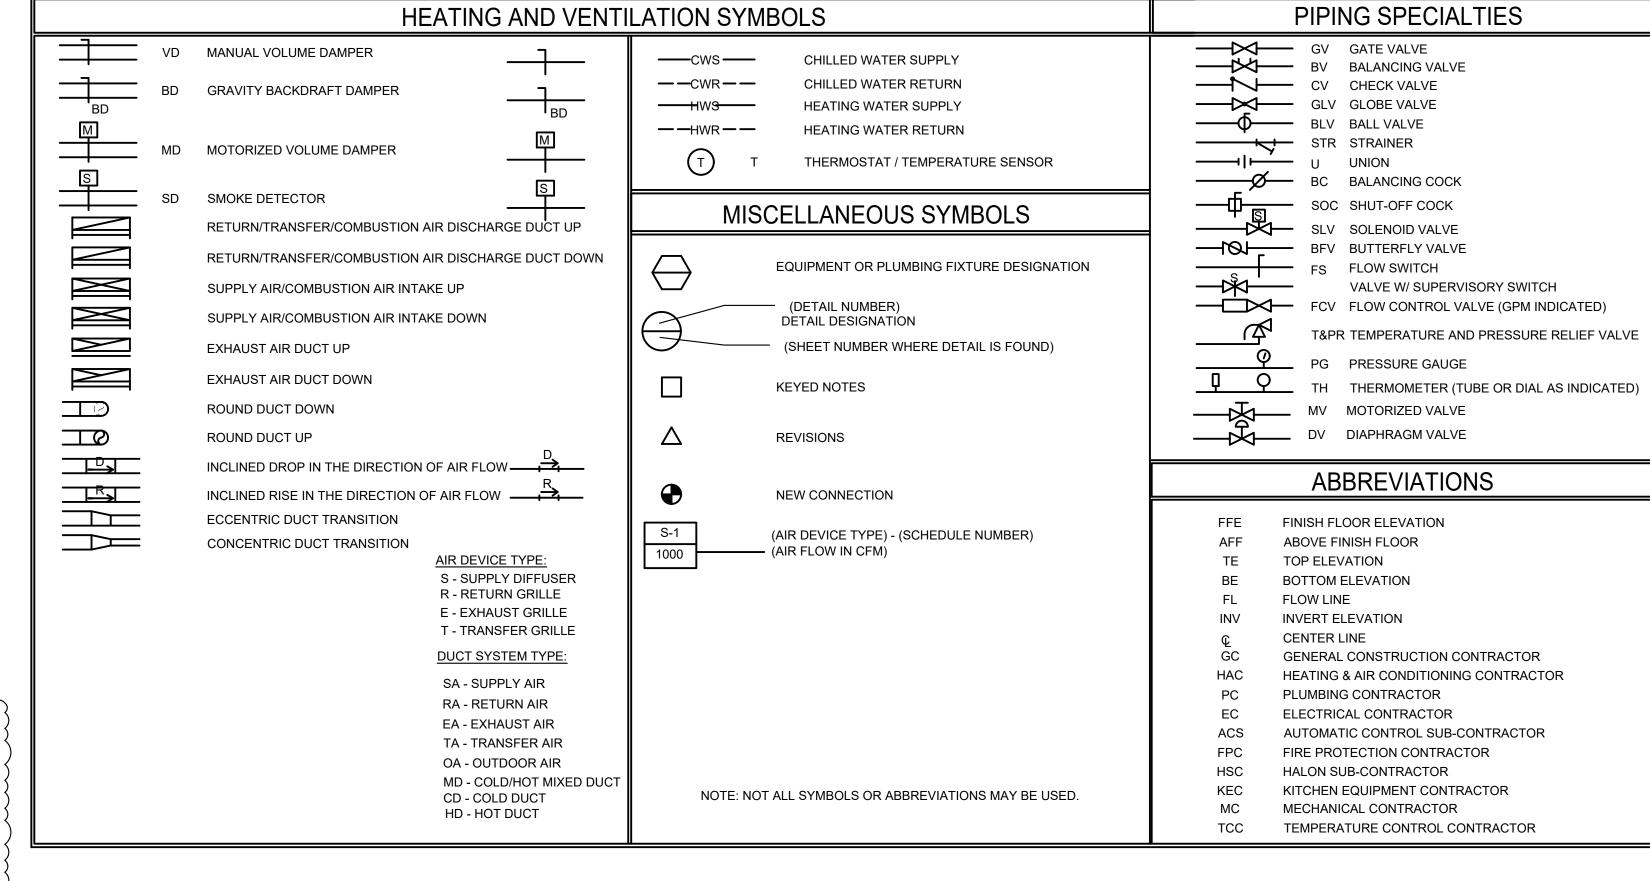

GENERAL NOTES (DEMOLITION)

- THESE PLANS ARE DIAGRAMMATIC IN NATURE. SINCE THEY REFLECT ONLY THE AVAILABLE INFORMATION OBTAINED FROM EXISTING PLANS, SPECIFICATIONS, AND FIELD SURVEYS. THE EXACT LOCATION OF EXISTING DUCTWORK, PIPING, AND EQUIPMENT MAY DEVIATE FROM THE LOCATION INDICATED ON THESE DRAWINGS. THE CONTRACTOR SHALL BE PREPARED TO MAKE SOME ALTERATIONS TO NEW AND/OR EXISTING SERVICES TO FIT ACTUAL JOB CONDITIONS.
- OWNER HAS FIRST RIGHT OF REFUSAL FOR ALL EQUIPMENT BEING REMOVED. CONTRACTOR TO DISPOSE OF EQUIPMENT BEING REMOVED BUT NOT RETAINED BY OWNER.
- WHEN REMOVING AND DEMOLISHING A PNEUMATIC AIR LINE OR CONNECTION TO A PIECE OF EQUIPMENT, CONTRACTOR SHALL CUT AND CAP AIR LINE WITH AN AIR TIGHT SEAL. COMPRESSED AIR SHALL REMAIN ACTIVE UNTIL THE END OF THE PROJECT TO ALLOW FOR BUILDING OPERATIONS TO CONTINUE. CONTRACTOR SHALL BE RESPONSIBLE FOR ANY REPAIRS THAT THEIR WORK CAUSES TO THE EXISTING SYSTEM THAT IMPEDES THE OPERATION OF THE BUILDING. COMPRESSED AIR LINES SHALL BE ABANDONED IN PLACE AT THE COMPLETION OF THE PROJECT.

GENERAL NOTES (ROOF PROTECTION)


- 1. THE CONTRACTOR SHALL NOTIFY THE OWNER'S REPRESENTATIVE A MINIMUM OF ONE WEEK PRIOR TO THE BEGINNING OF WORK THAT INVOLVES ACTIVITY ON THE ROOF.
- 2. TRAFFIC OVER THE EXISTING ROOF SURFACES SHALL BE KEPT TO AN ABSOLUTE MINIMUM.
- THE CONTRACTOR AND THE OWNER'S REPRESENTATIVE SHALL INSPECT THE EXPOSED ROOFING MEMBRANE SYSTEM PRIOR TO THE START OF CONSTRUCTION. ANY PREVIOUS DAMAGE OR DEFECTS OF THE ROOFING SYSTEM SHALL BE DOCUMENTED BY WRITING AND/OR PHOTOGRAPHS.
- THE CONTRACTOR SHALL PLACE MINIMUM OF 48" WIDE, 1/2" THICK APPROVED PROTECTION BOARDS (1 LAYER) MADE OF CONSTRUCTION GRADE PLYWOOD (ORIENTED STRAND BOARD WILL BE ACCEPTABLE) OVER ALL MEMBRANE ROOFING THAT WILL HAVE CONSTRUCTION TRAFFIC. THIS ROOF PROTECTION SHALL BE PROVIDED FOR THE ENTIRE AREA WITHIN THE LIMITS OF THE WORK. SUCH PROTECTION SHALL ALSO BE PROVIDED IN THE FORM OF A WALKWAY FROM THE ROOF ACCESS DOOR TO THE PROTECTED CONSTRUCTION AREA.
- STORAGE OF MATERIALS ON EXISTING ROOF WILL NOT BE ALLOWED.
- THE CONTRACTOR SHALL REMOVED DAILY ALL PROJECT DEBRIS FROM ALL ROOFING SURFACES.
- THE CONTRACTOR SHALL ADVISE THE OWNER WHEN WORK ON THE ROOF IS COMPLETE AND THE PROTECTION BOARDS HAVE BEEN REMOVED. THE CONTRACTOR AND THE OWNER SHALL EXAMINE ALL ROOF SURFACES WHERE WORK HAS OCCURRED AND WILL REPAIR ALL DEFECTS NOT PREVIOUSLY DOCUMENTED.
- CONTRACTOR SHALL BE RESPONSIBLE FOR ANY DAMAGE TO THE BUILDING.
 ROOF, STRUCTURAL FRAMING, ETC. INCURRED DURING CONSTRUCTION.
- THE CONTRACTOR SHALL VERIFY WARRANTY OF THE EXISTING MEMBRANE ROOFING SYSTEM. THE CONTRACTOR SHALL UTILIZE A LICENSED APPLICATOR OF THE EXISTING ROOFING SYSTEM TO PERFORM ALL ROOFING WORK AND TO REPAIR ANY AND ALL DAMAGE. UPON COMPLETION, THE CONTRACTOR SHALL OBTAIN A LETTER FROM THE ROOF MANUFACTURER STATING THAT THE EXISTING WARRANTY REMAINS IN FULL FORCE AND EFFECT.

FIRE ALARM COORDINATION SHALL BE DONE THROUGH EXISTING FIRE

ALARM VENDOR.
COMPANY: JOHNSON CONTROLS
CONTACT: HANNAH SMITH
EMAIL: HANNAH.SMITH@JCI.COM
PHONE: 314-320-9296

NOTE: FOR STAFF TO FULLY CHANGE RESIDENTS FROM ONE WARD TO ANOTHER, IT WAS REPORTED BY THE OWNER THAT THIS COULD BE COMPLETED IN TWO (2) WORKING DAYS. FOR EXAMPLE, IF WORK IS COMPLETED ON A FRIDAY BY THE CONTRACTOR, WORK CAN BE STARTED ON THE NEXT WARD ON THE WEDNESDAY OF THE FOLLOWING WEEK,. IF THE TRANSITION OF WARDS REQUIRES MORE TIME THAN TWO WORKING DAYS, THE CONTRACTOR SHALL CONTACT STATE CONSTRUCTION MANAGER.

STATE OF MISSOURI MICHAEL L. PARSON, GOVERNOR

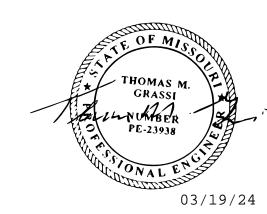

THOMAS M. GRASSI
License Number: E-23938
Expiration Date: 12/31/24
PROFESSIONAL SEAL
CASCO Diversified Corporation

MO Certificate of Authority #000329 Arch

MO Certificate of Authority #000613 Eng.

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DESIGN AND
CONSTRUCTION

DEPARTMENT OF MENTAL HEALTH

UPGRADE HVAC CONTROLS

STAPLES BUILDING 1010 W COLUMBIA ST. FARMINGTON, MISSOURI 63640

PROJECT # M2011-01 SITE # 7354

6517354012

REVISION: ADDENDUM #1
DATE: 03/19/24

ASSET#

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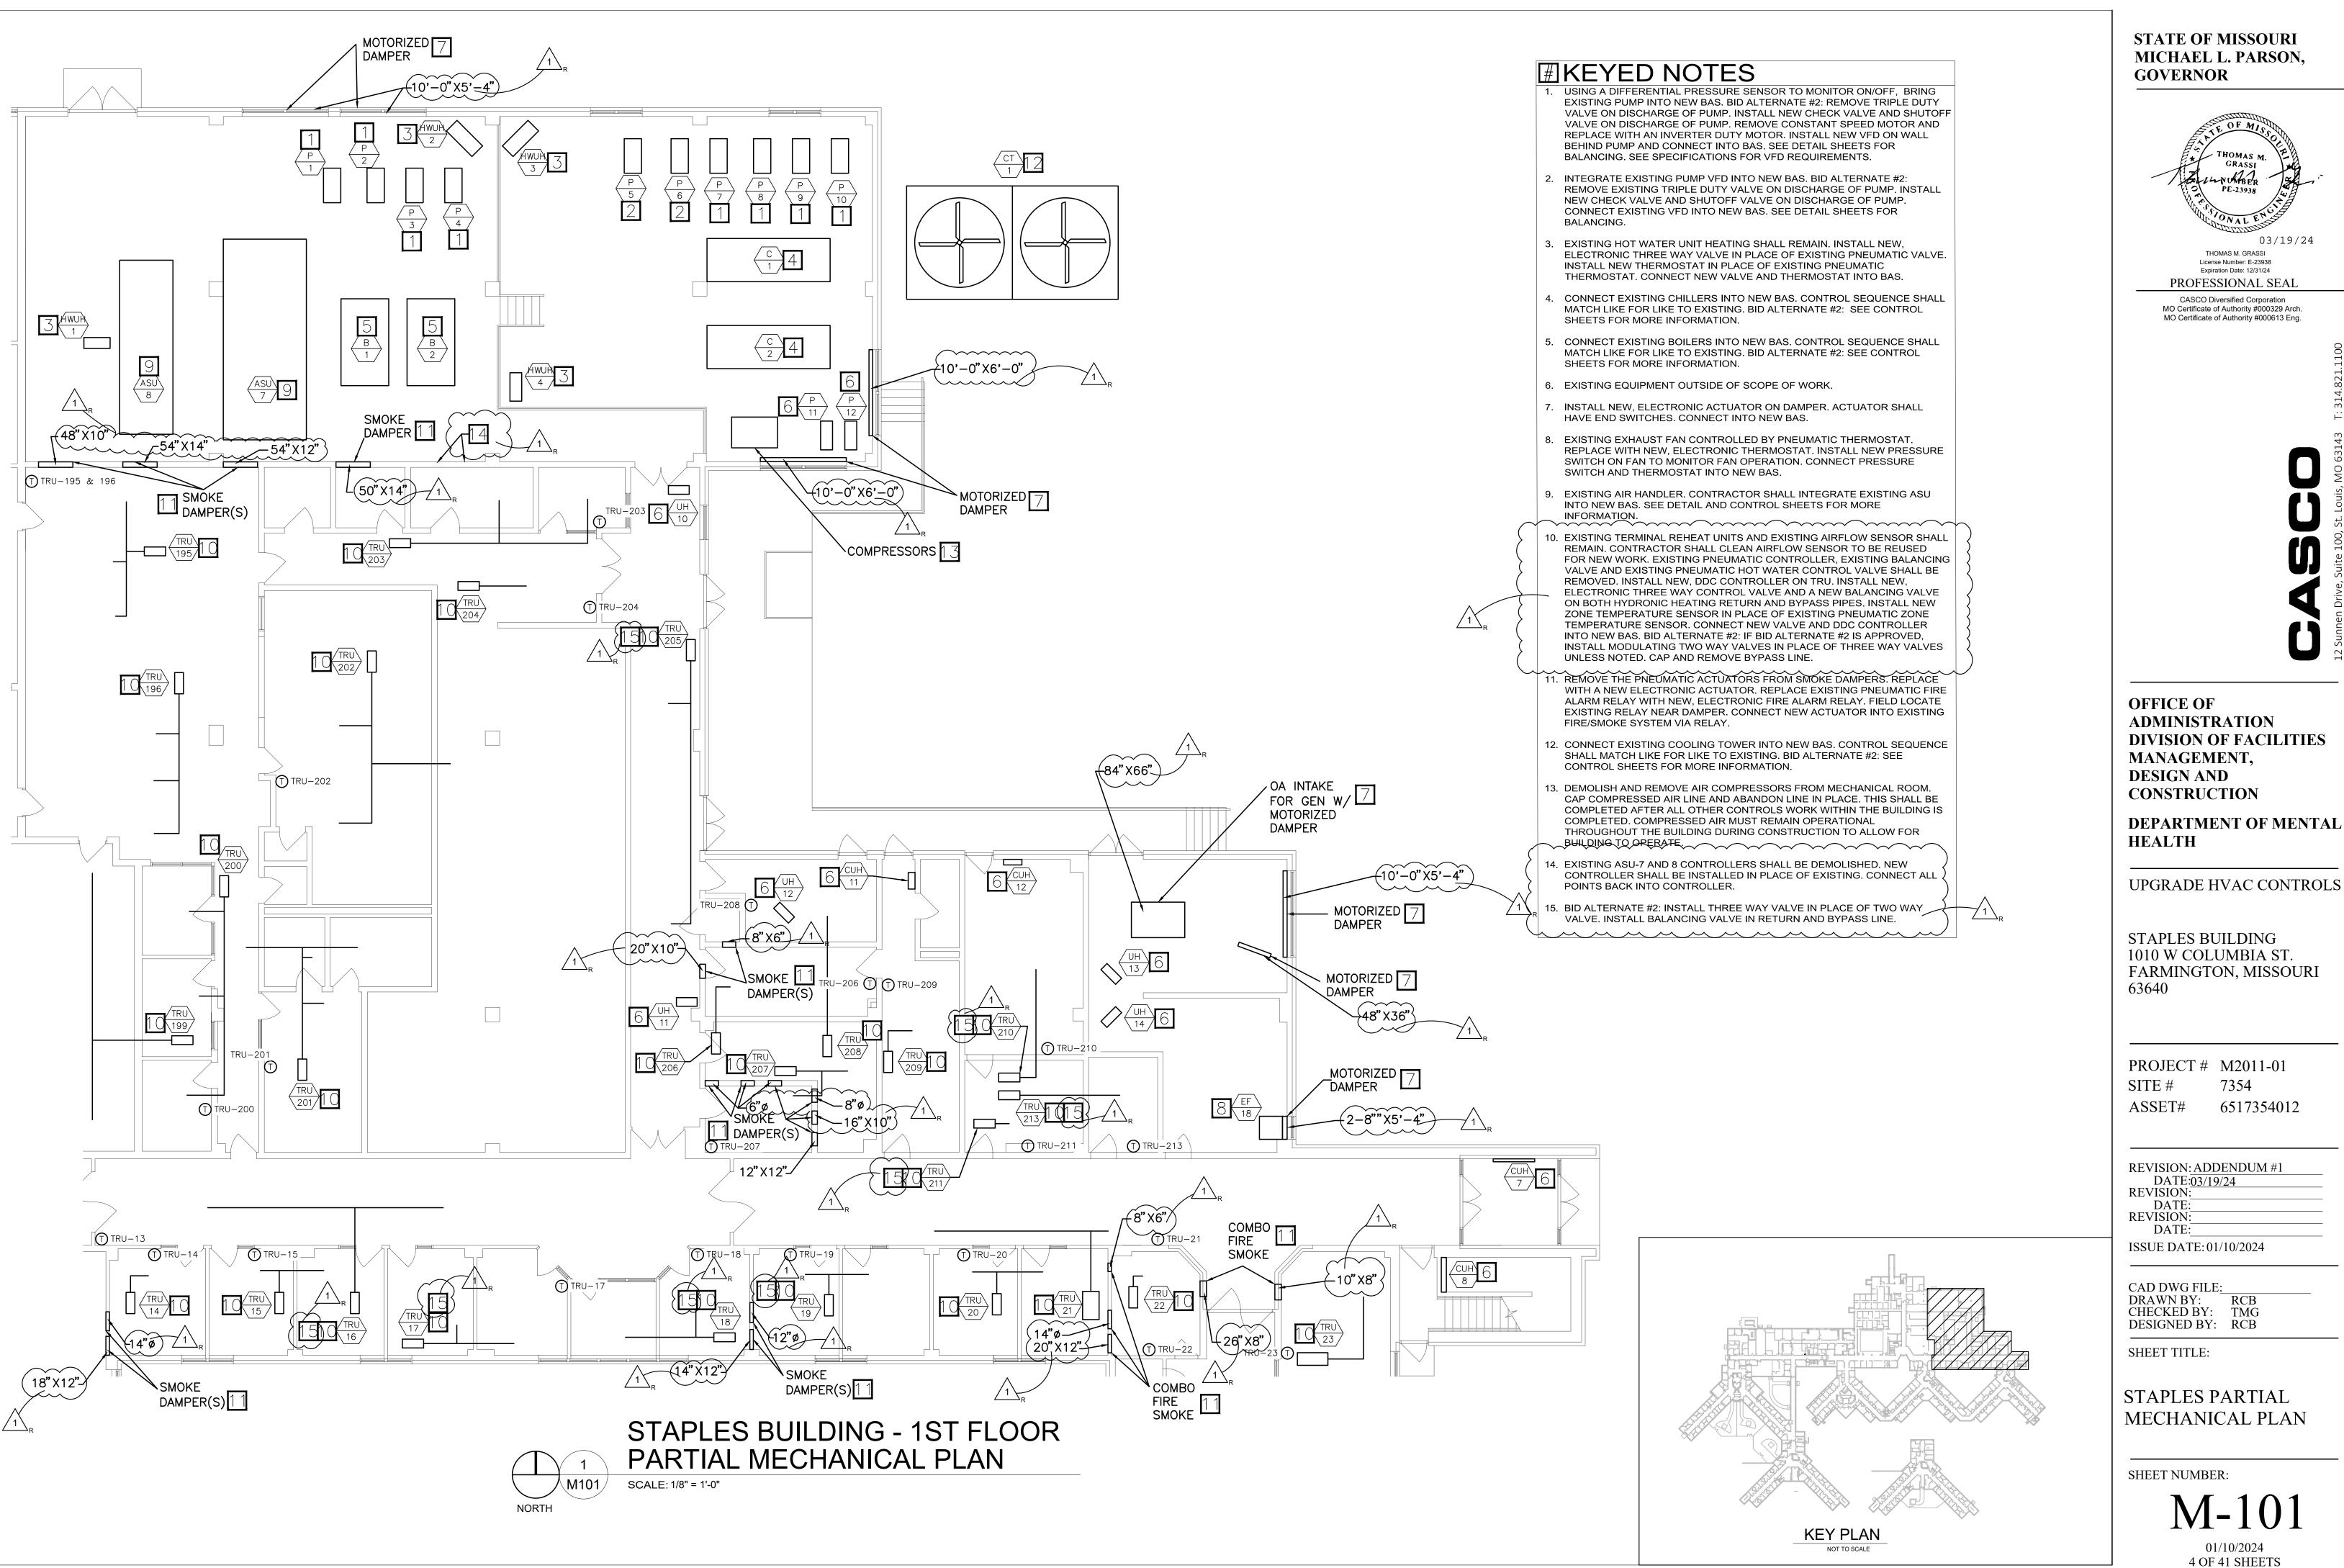
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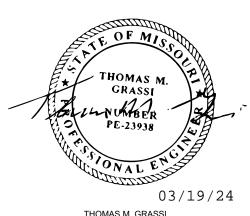
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MECHANICAL GENERAL NOTES

SHEET NUMBER:







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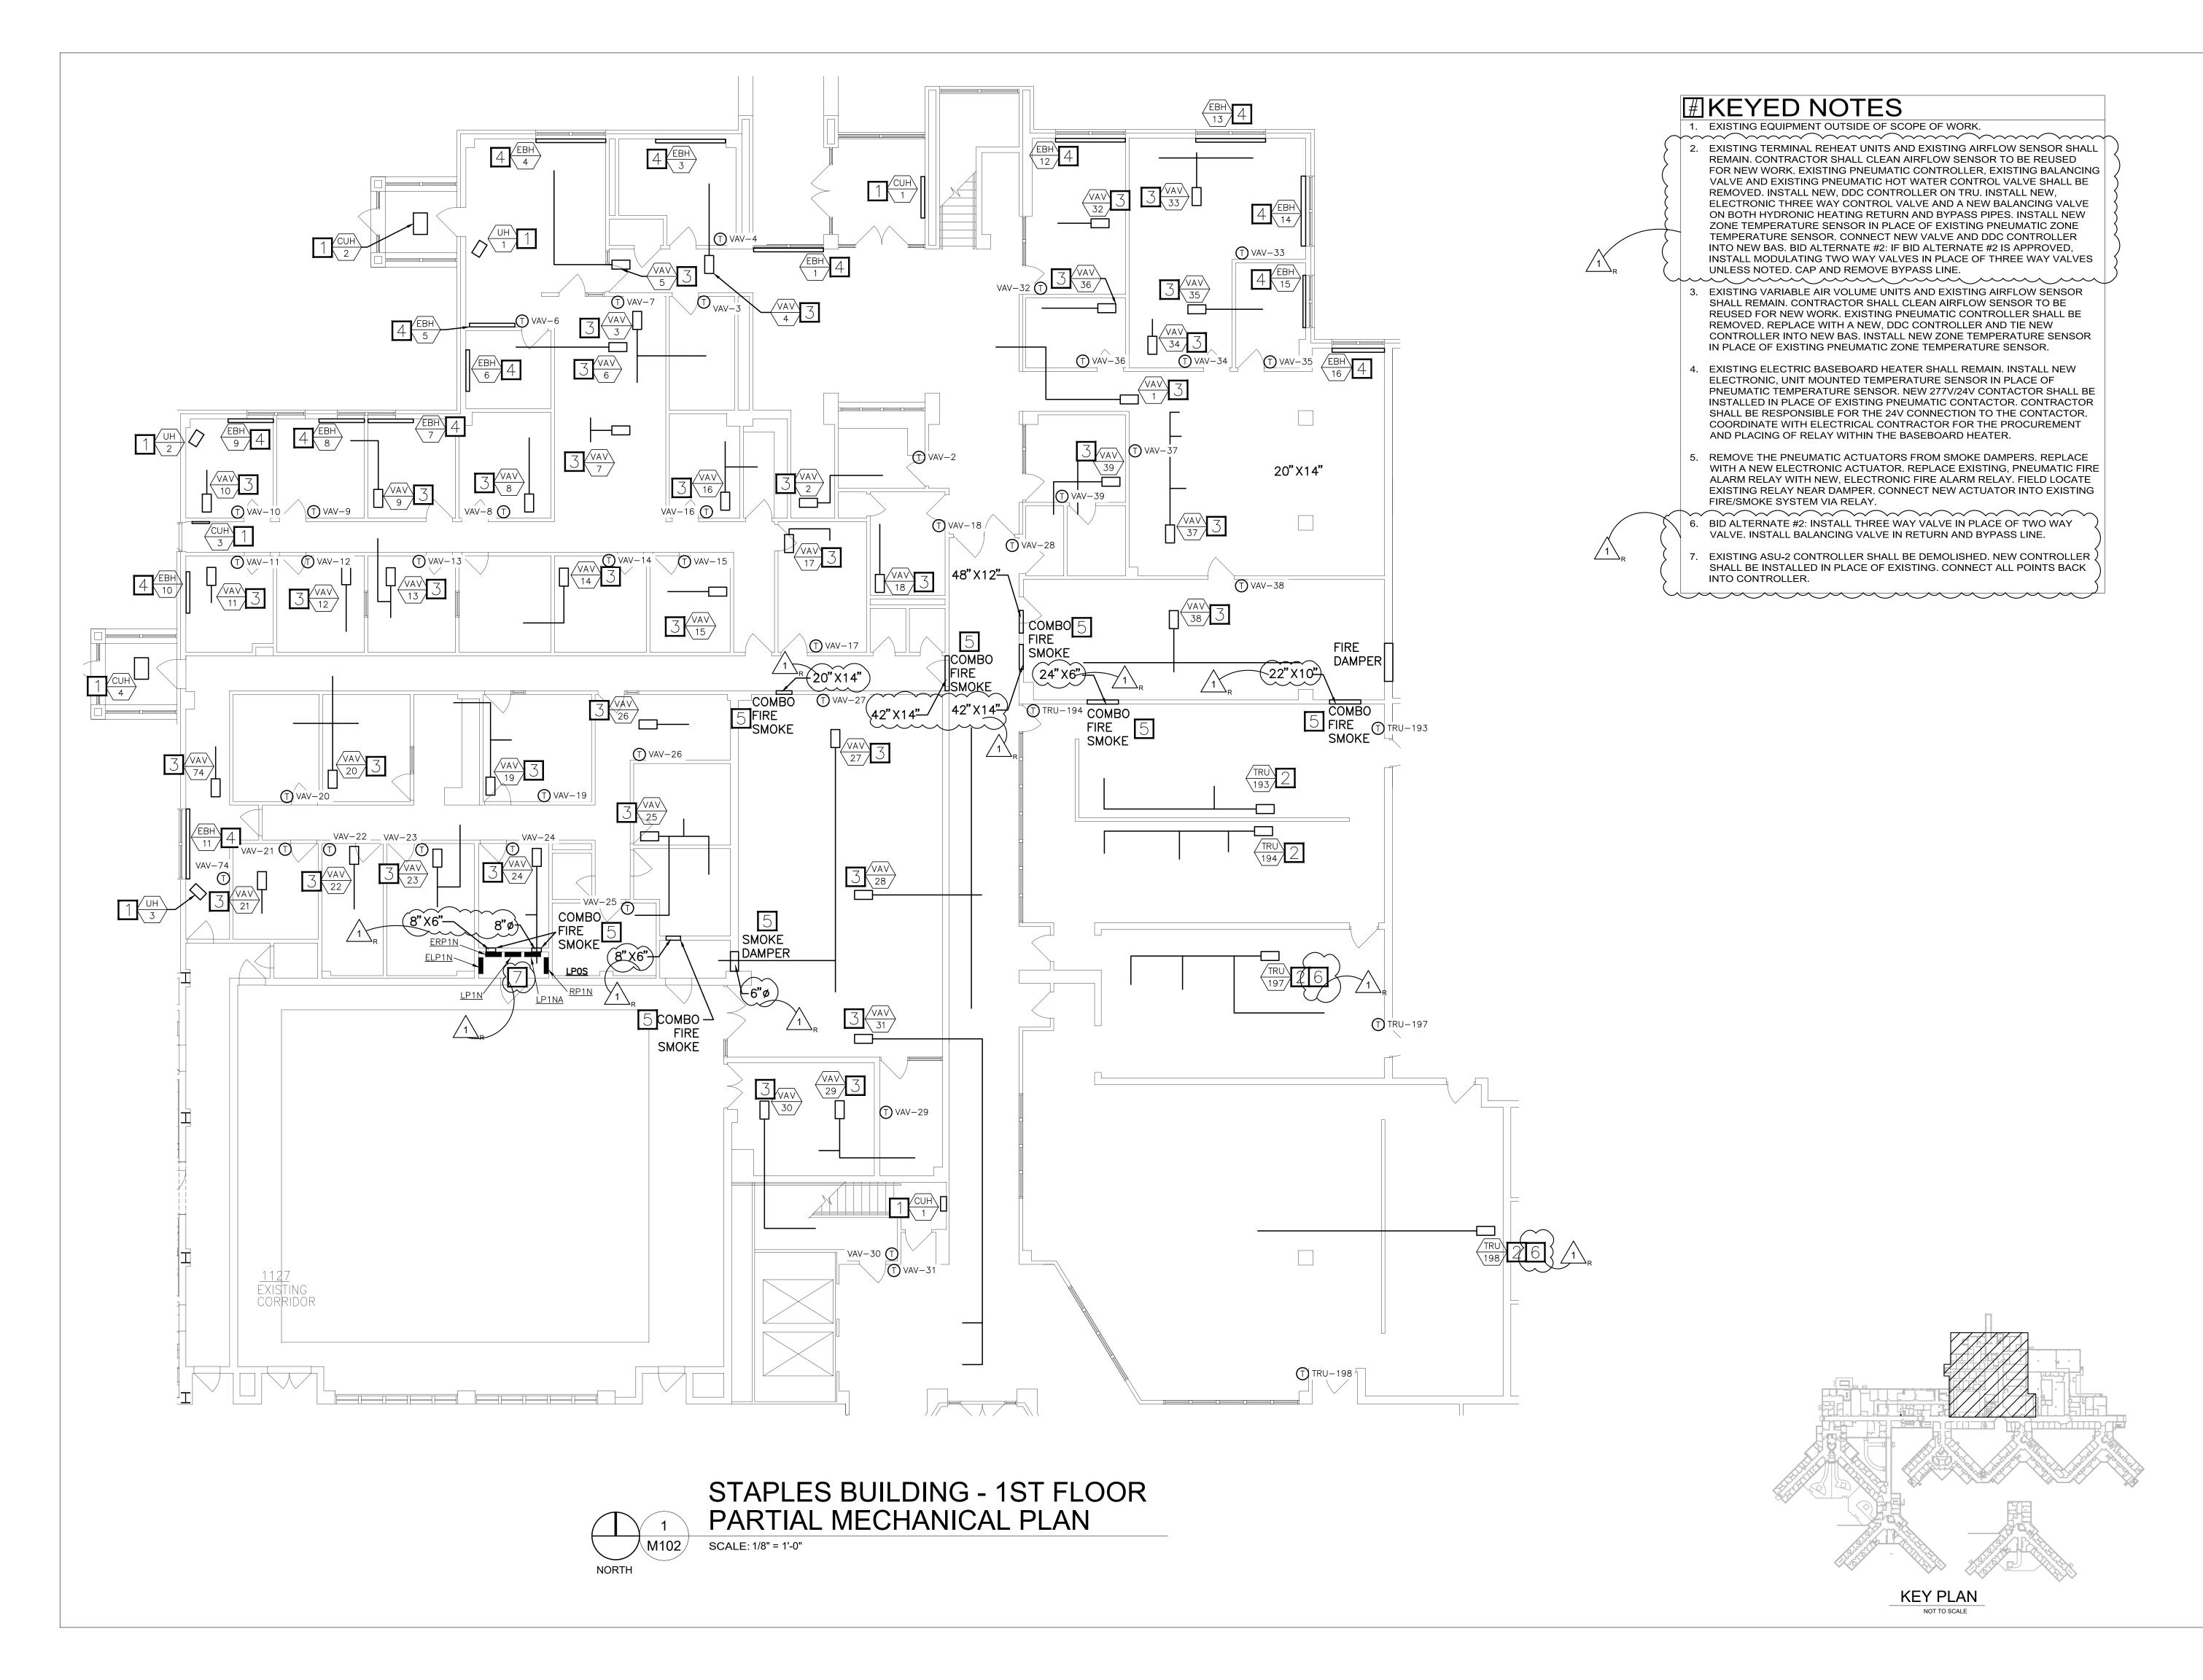
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STAPLES PARTIAL MECHANICAL PLAN

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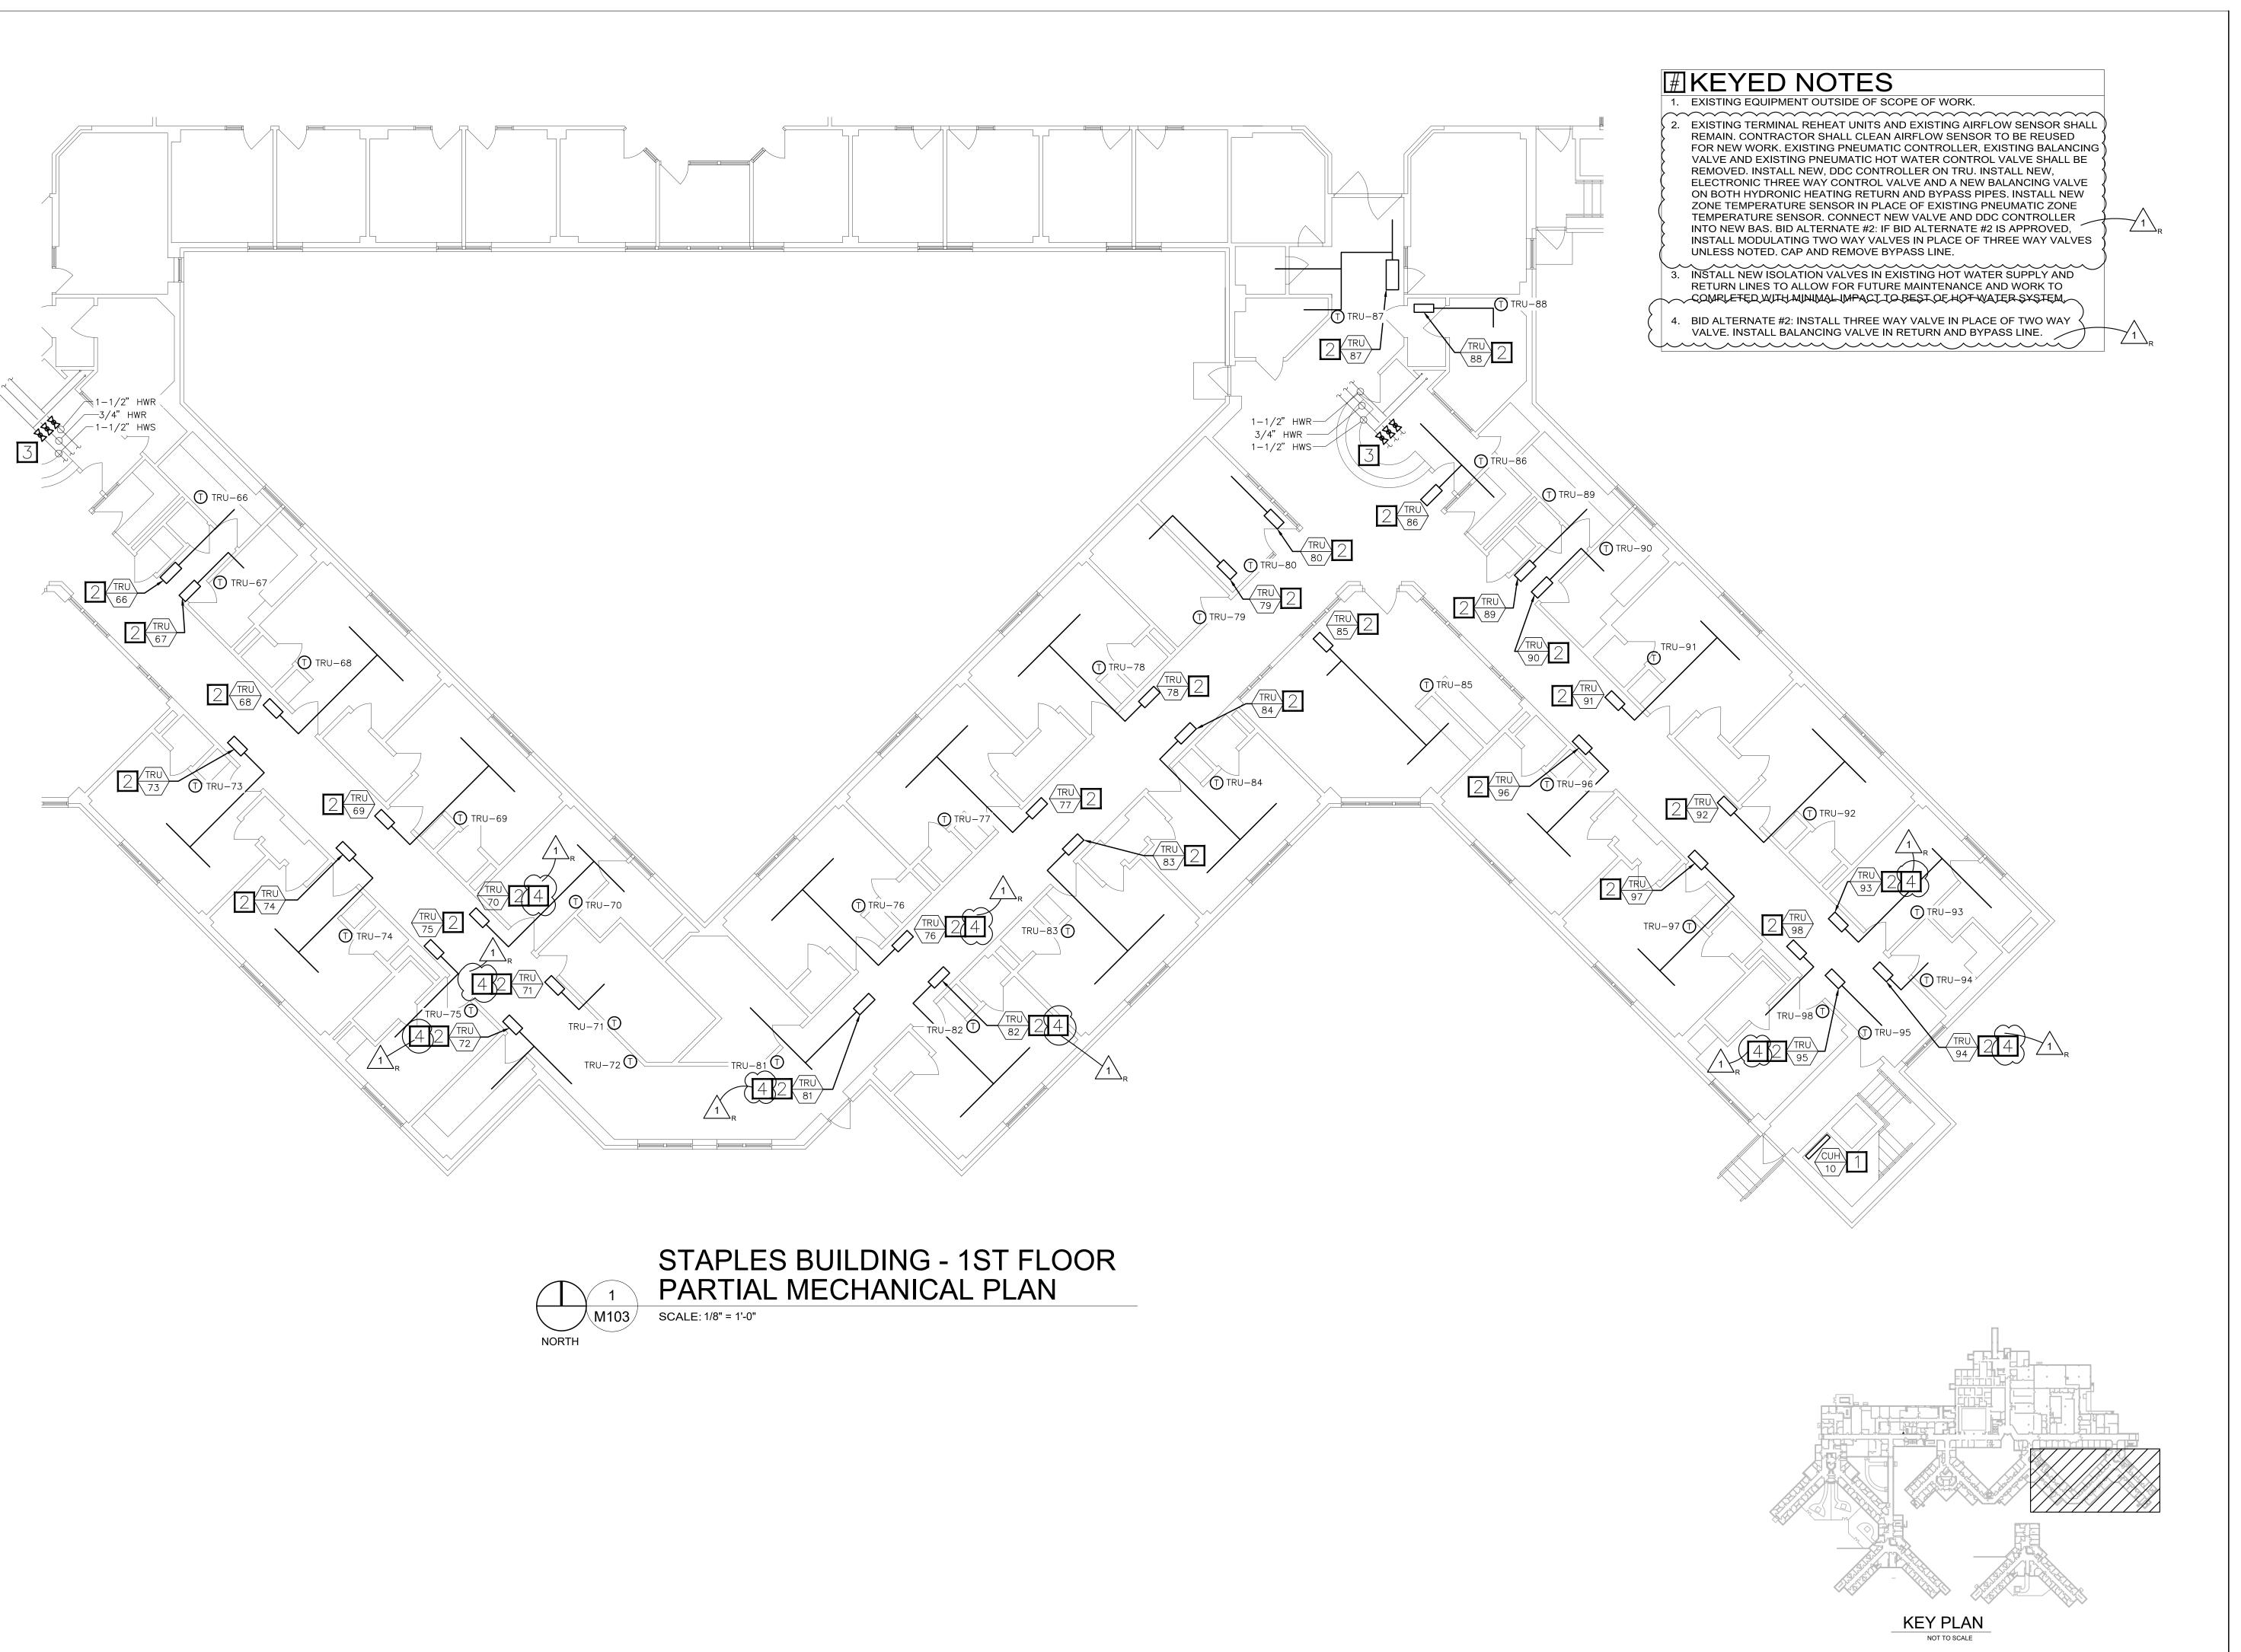
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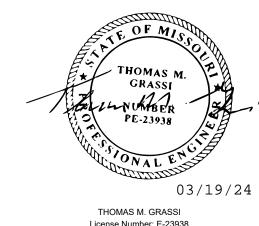
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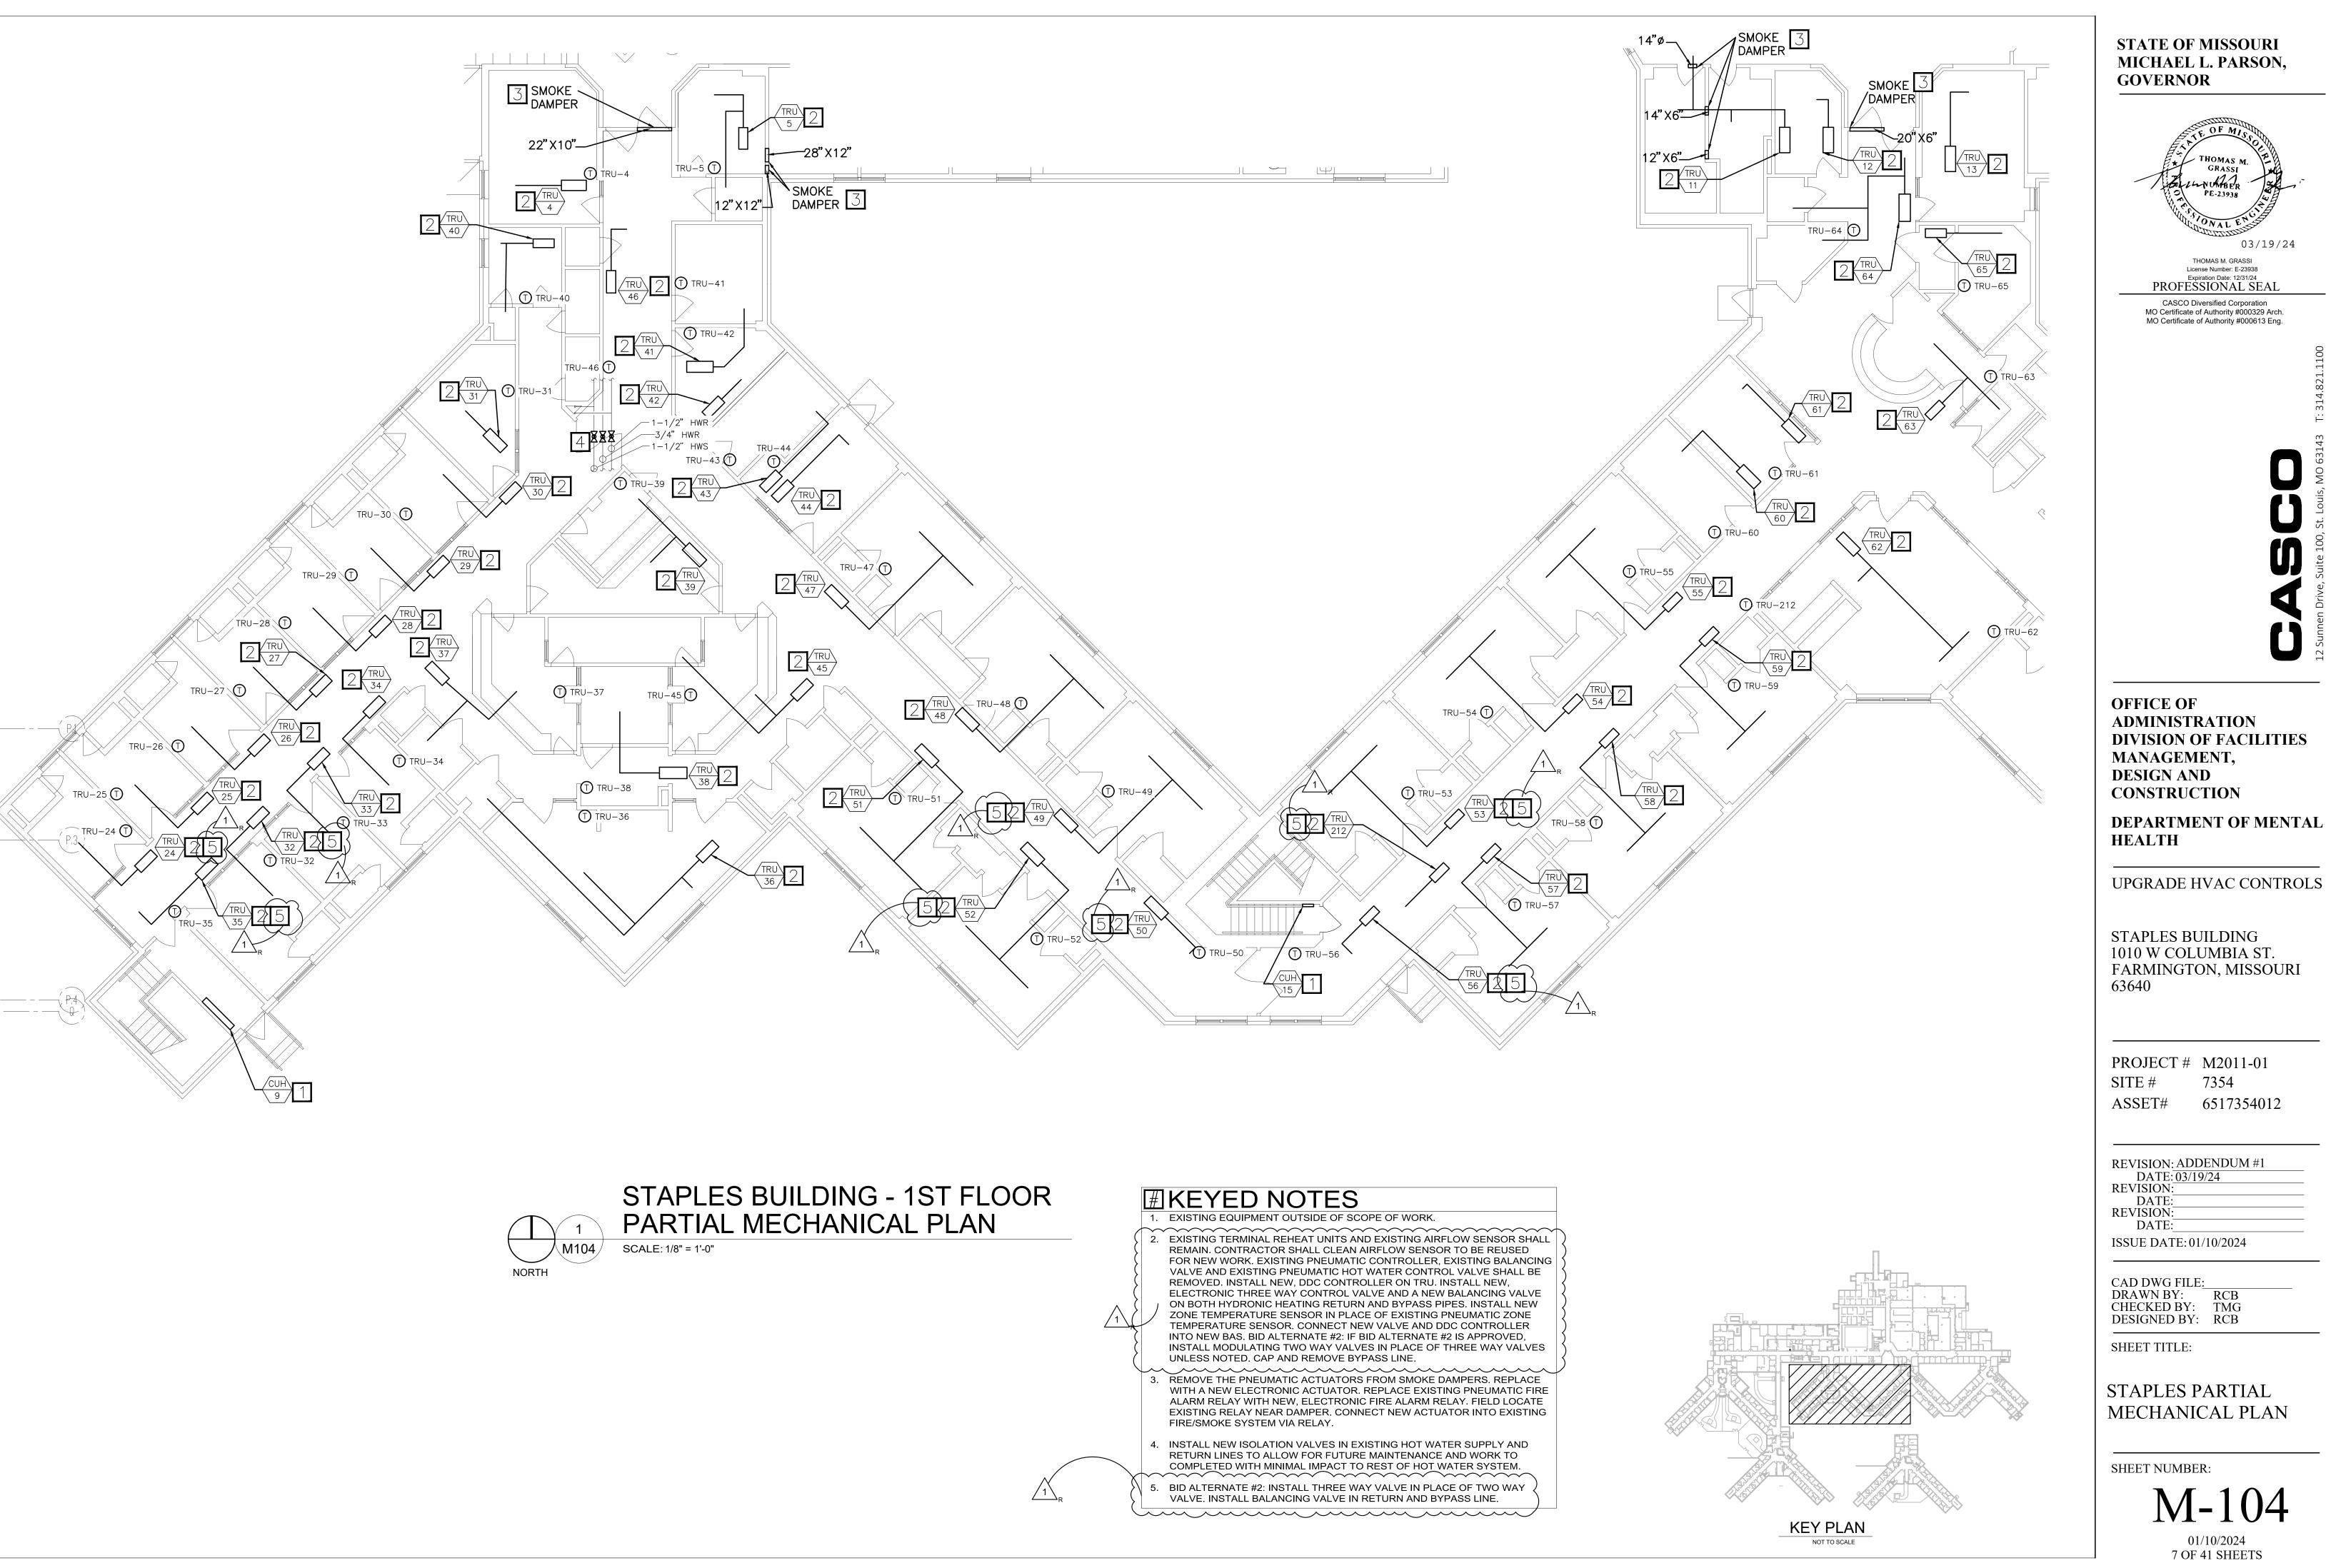
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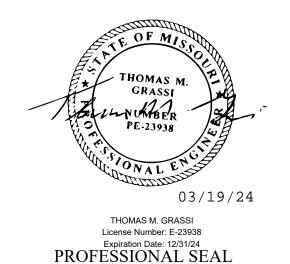
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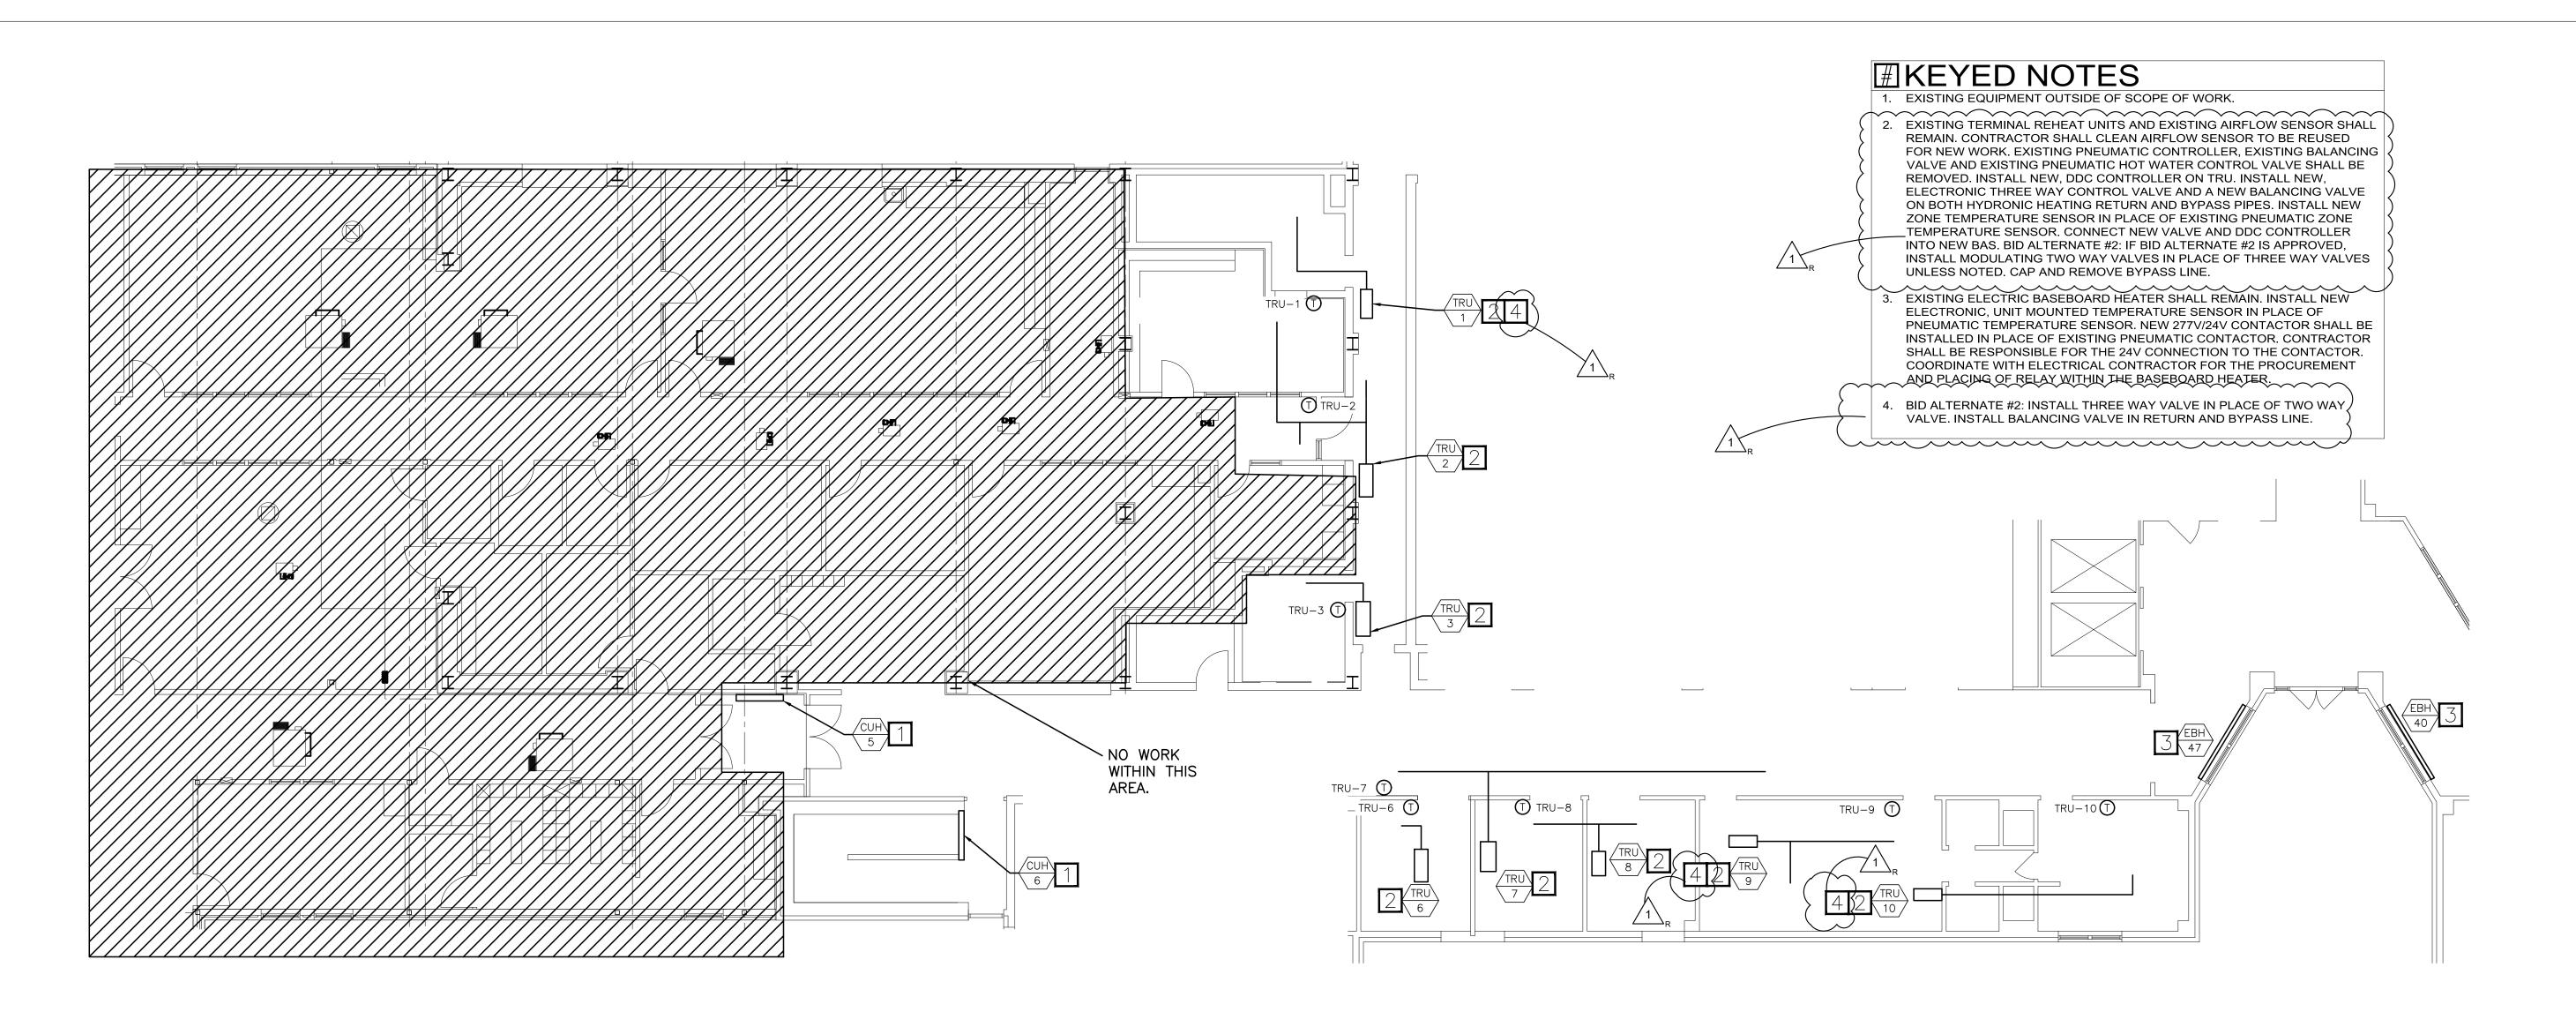
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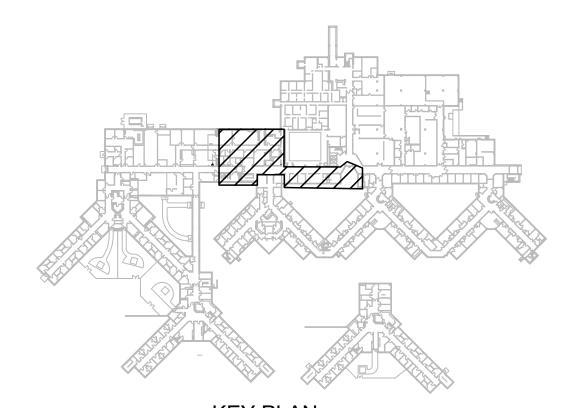
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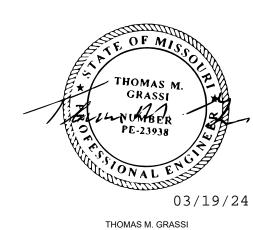
STAPLES BUILDING - 1ST FLOOR PARTIAL MECHANICAL PLAN SCALE: 1/8" = 1'-0"



KEY PLAN

NOT TO SCALE

STATE OF MISSOURI MICHAEL L. PARSON, **GOVERNOR**



THOMAS M. GRASSI License Number: E-23938 Expiration Date: 12/31/24
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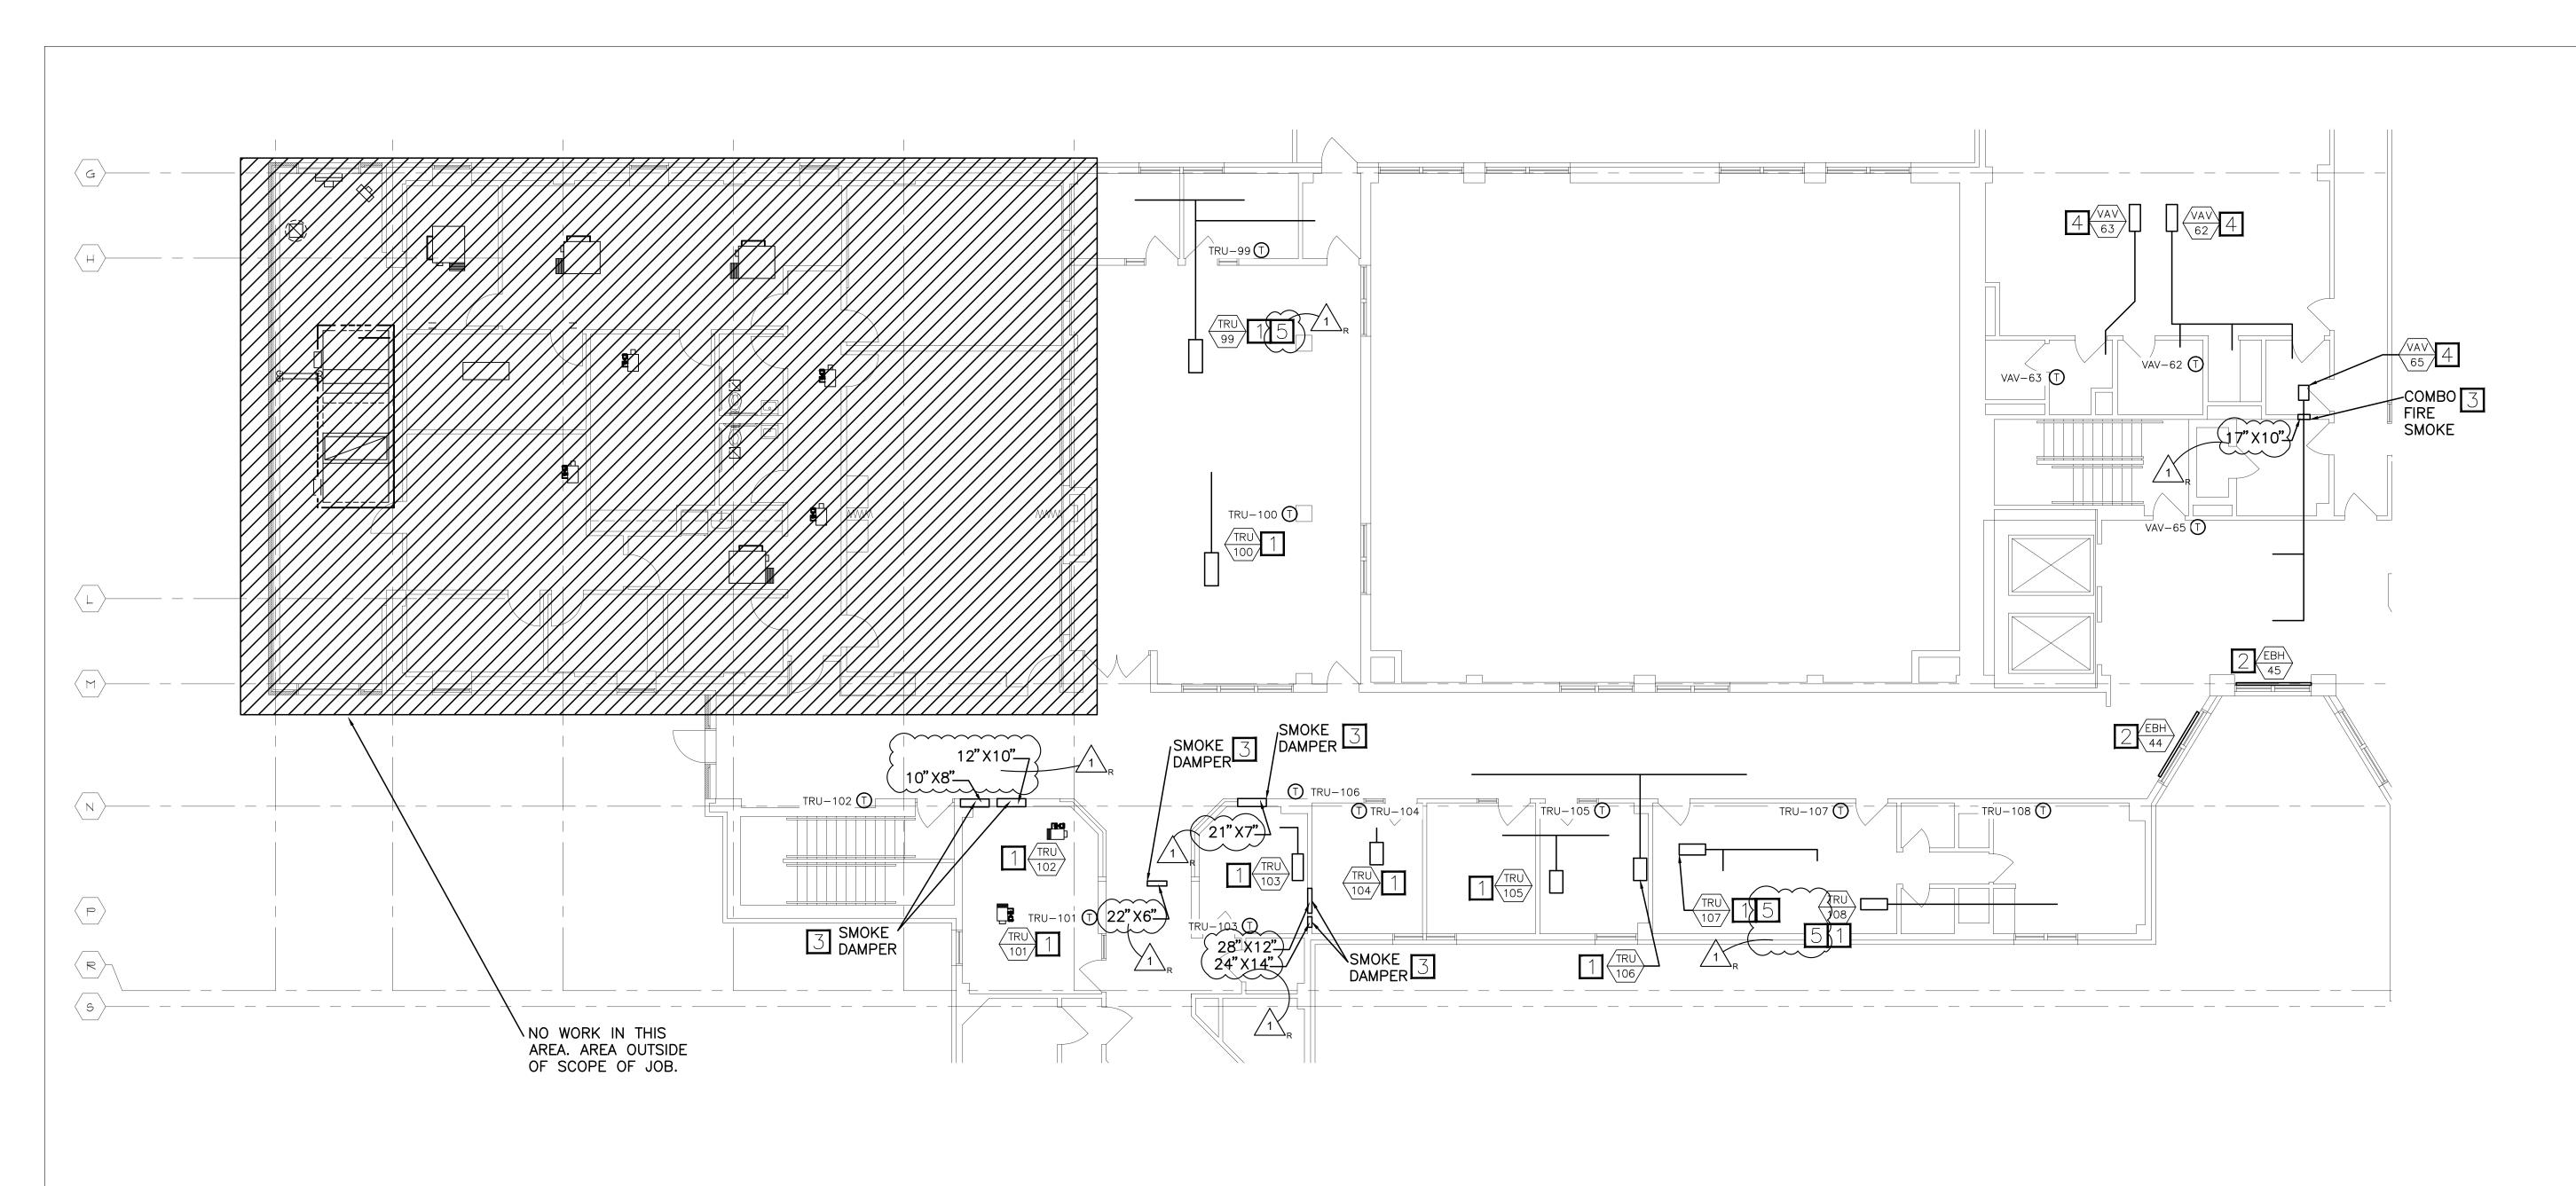
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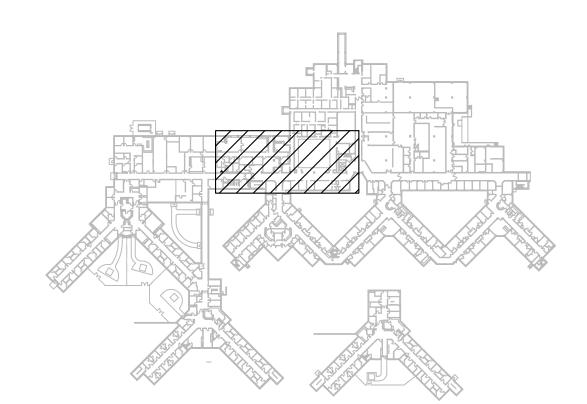
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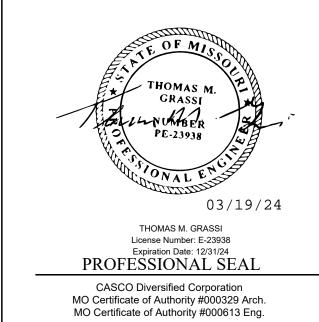


#KEYED NOTES

1. EXISTING TERMINAL REHEAT UNITS AND EXISTING AIRFLOW SENSOR SHALL REMAIN. CONTRACTOR SHALL CLEAN AIRFLOW SENSOR TO BE REUSED FOR NEW WORK. EXISTING PNEUMATIC CONTROLLER, EXISTING BALANCING VALVE AND EXISTING PNEUMATIC HOT WATER CONTROL VALVE SHALL BE REMOVED. INSTALL NEW, DDC CONTROLLER ON TRU. INSTALL NEW, ELECTRONIC THREE WAY CONTROL VALVE AND A NEW BALANCING VALVE ON BOTH HYDRONIC HEATING RETURN AND BYPASS PIPES. INSTALL NEW ZONE TEMPERATURE SENSOR IN PLACE OF EXISTING PNEUMATIC ZONE TEMPERATURE SENSOR. CONNECT NEW VALVE AND DDC CONTROLLER INTO NEW BAS. BID ALTERNATE #2: IF BID ALTERNATE #2 IS APPROVED, INSTALL MODULATING TWO WAY VALVES IN PLACE OF THREE WAY VALVES UNLESS NOTED. CAP AND REMOVE BYPASS LINE. EXISTING ELECTRIC BASEBOARD HEATER SHALL REMAIN. INSTALL NEW ELECTRONIC, UNIT MOUNTED TEMPERATURE SENSOR IN PLACE OF PNEUMATIC TEMPERATURE SENSOR. NEW 277V/24V CONTACTOR SHALL BE INSTALLED IN PLACE OF EXISTING PNEUMATIC CONTACTOR. CONTRACTOR SHALL BE RESPONSIBLE FOR THE 24V CONNECTION TO THE CONTACTOR. COORDINATE WITH ELECTRICAL CONTRACTOR FOR THE PROCUREMENT AND PLACING OF RELAY WITHIN THE BASEBOARD HEATER. REMOVE THE PNEUMATIC ACTUATORS FROM SMOKE DAMPERS. REPLACE WITH A NEW ELECTRONIC ACTUATOR. REPLACE EXISTING PNEUMATIC FIRE ALARM RELAY WITH NEW, ELECTRONIC FIRE ALARM RELAY. FIELD LOCATE EXISTING RELAY NEAR DAMPER. CONNECT NEW ACTUATOR INTO EXISTING FIRE/SMOKE SYSTEM VIA RELAY. EXISTING VARIABLE AIR VOLUME UNITS AND EXISTING AIRFLOW SENSOR SHALL REMAIN. CONTRACTOR SHALL CLEAN AIRFLOW SENSOR TO BE REUSED FOR NEW WORK. EXISTING PNEUMATIC CONTROLLER SHALL BE REMOVED. REPLACE WITH A NEW, DDC CONTROLLER AND TIE NEW CONTROLLER INTO NEW BAS. INSTALL NEW ZONE TEMPERATURE SENSOR IN PLACE OF EXISTING PNEUMATIC ZONE TEMPERATURE SENSOR. BID ALTERNATE #2: INSTALL THREE WAY VALVE IN PLACE OF TWO WAY VALVE. INSTALL BALANCING VALVE IN RETURN AND BYPASS LINE.



STATE OF MISSOURI MICHAEL L. PARSON, GOVERNOR



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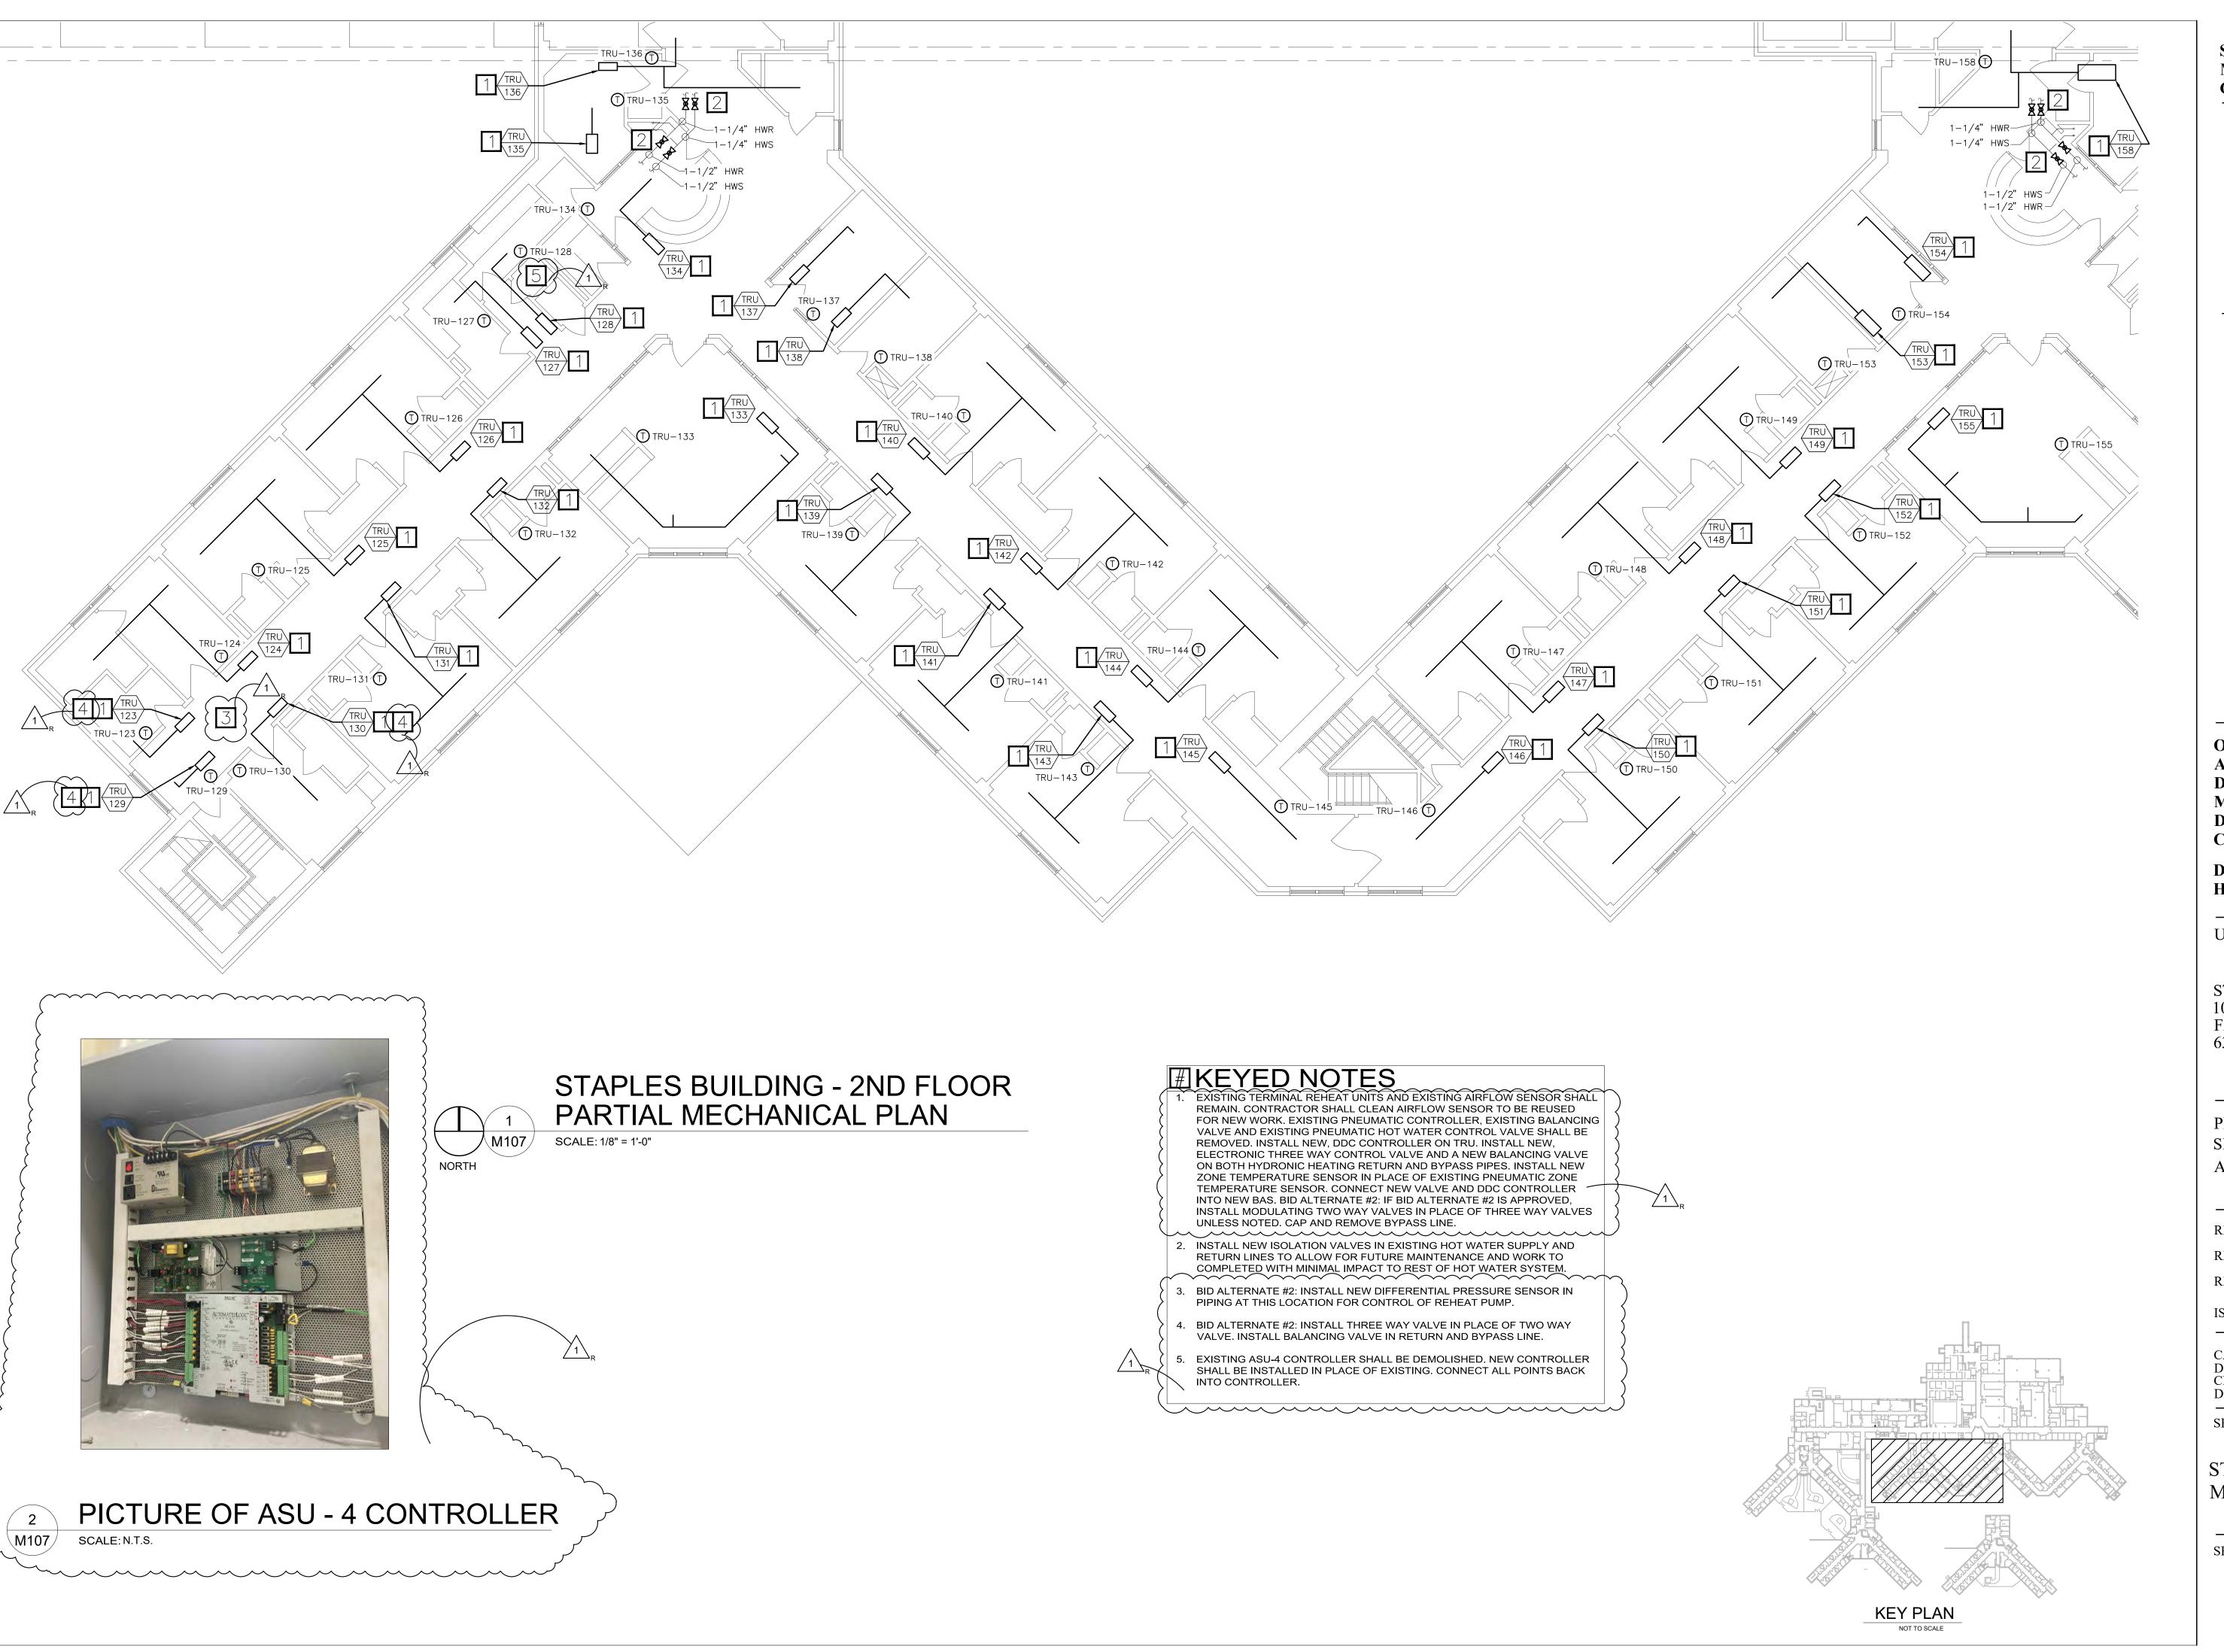
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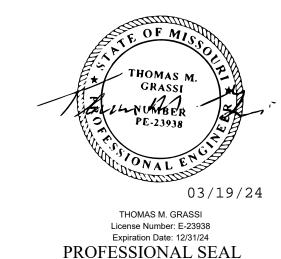
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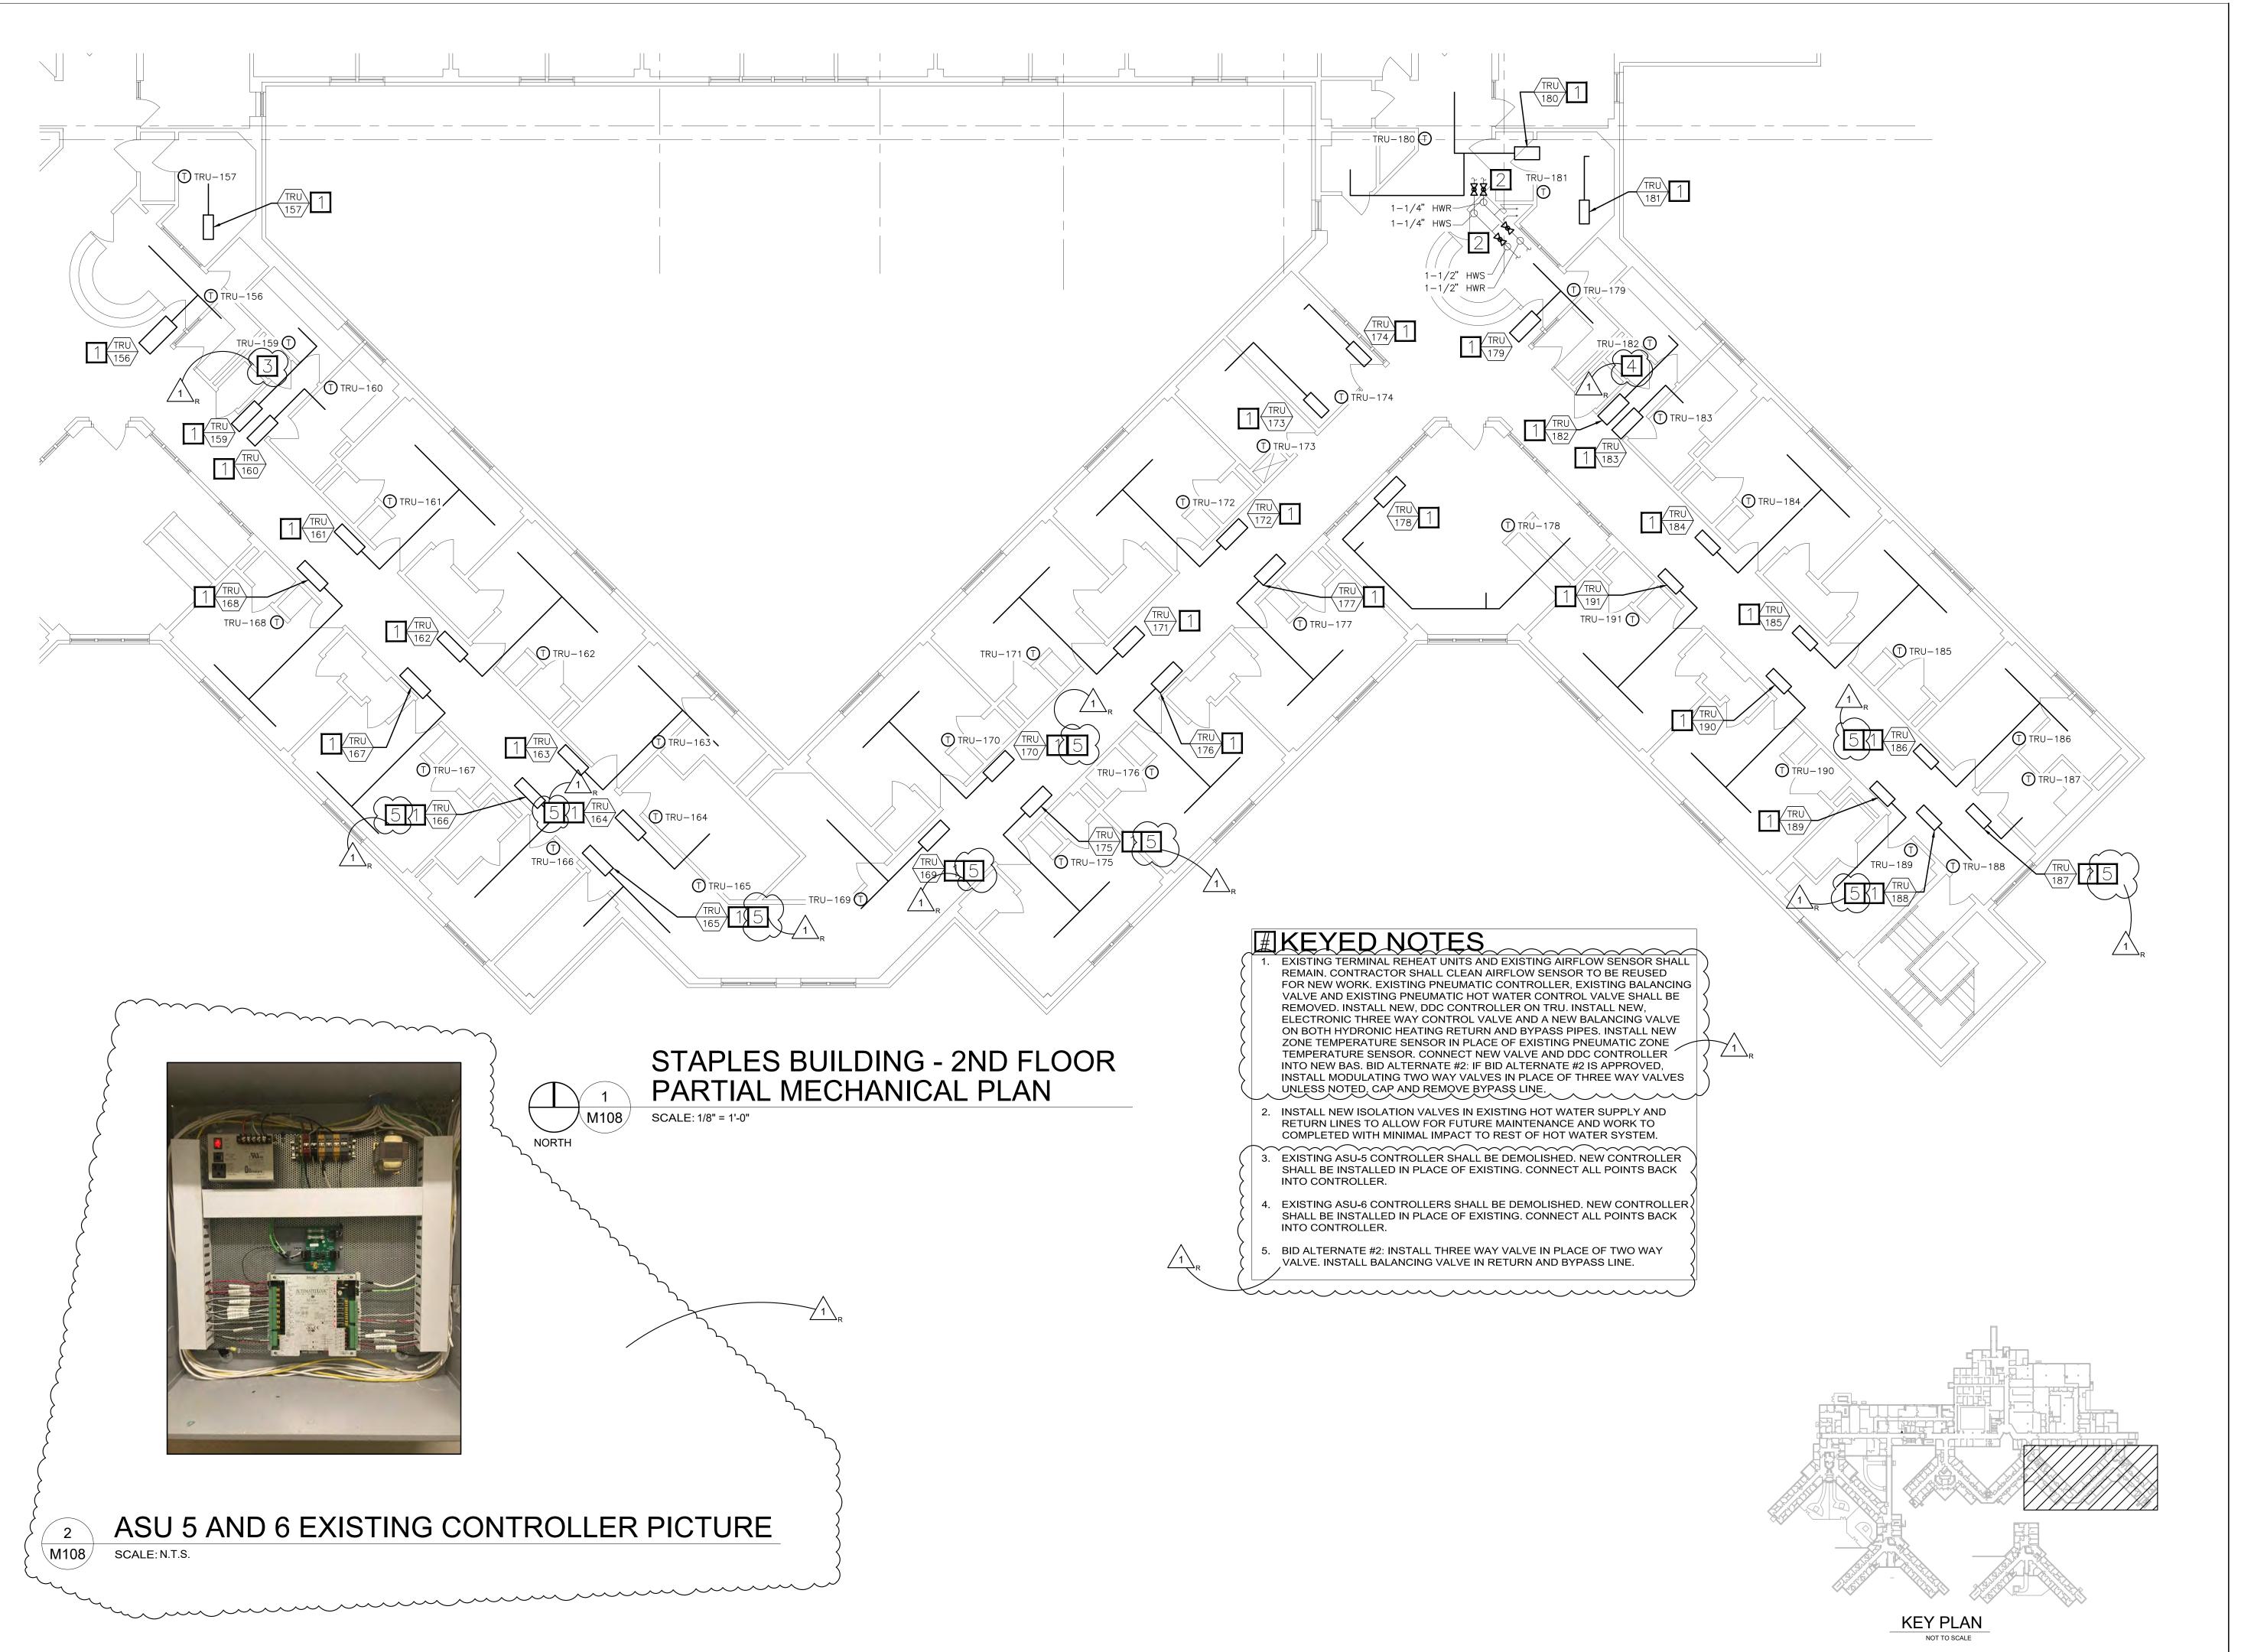
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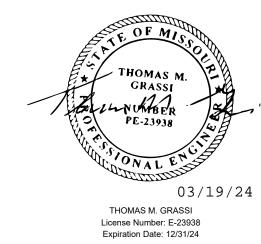
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M-107





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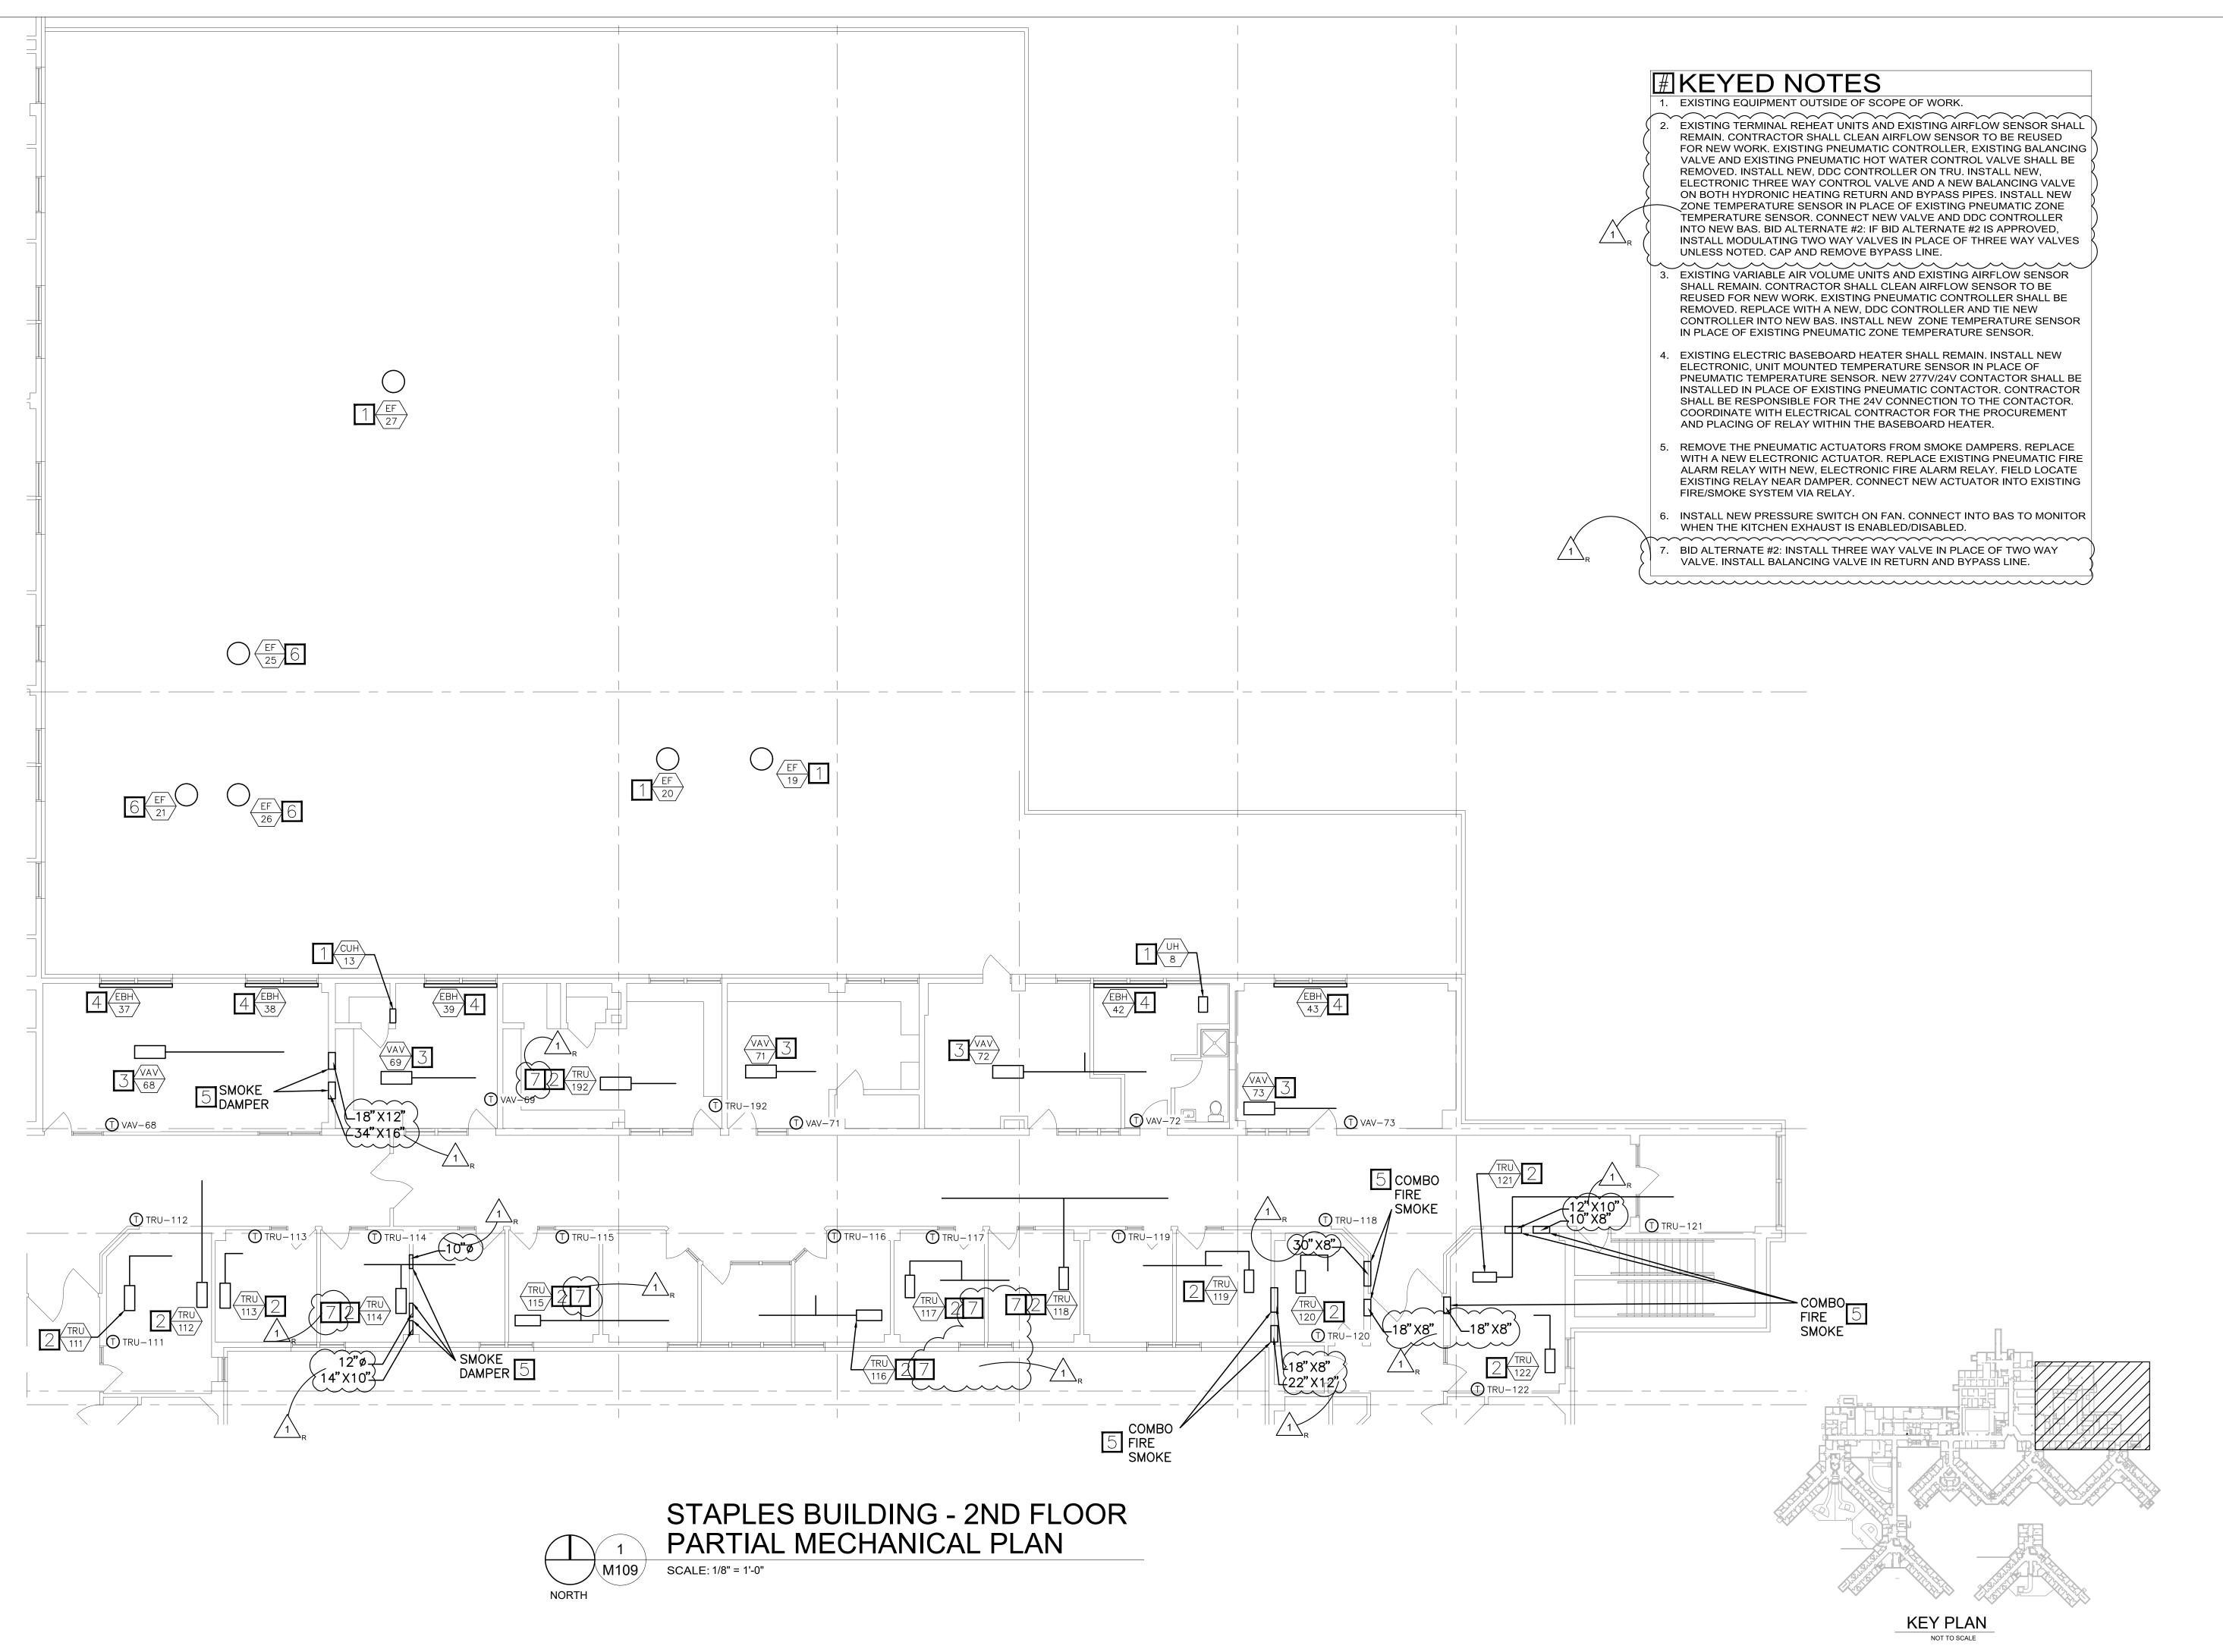
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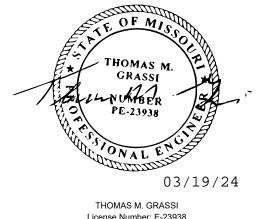
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M-108





THOMAS M. GRASSI
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OFFICE OF ADMINISTRATION DIVISION OF FACILITIES MANAGEMENT, DESIGN AND CONSTRUCTION

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SITE # 7354 ASSET# 6517354012

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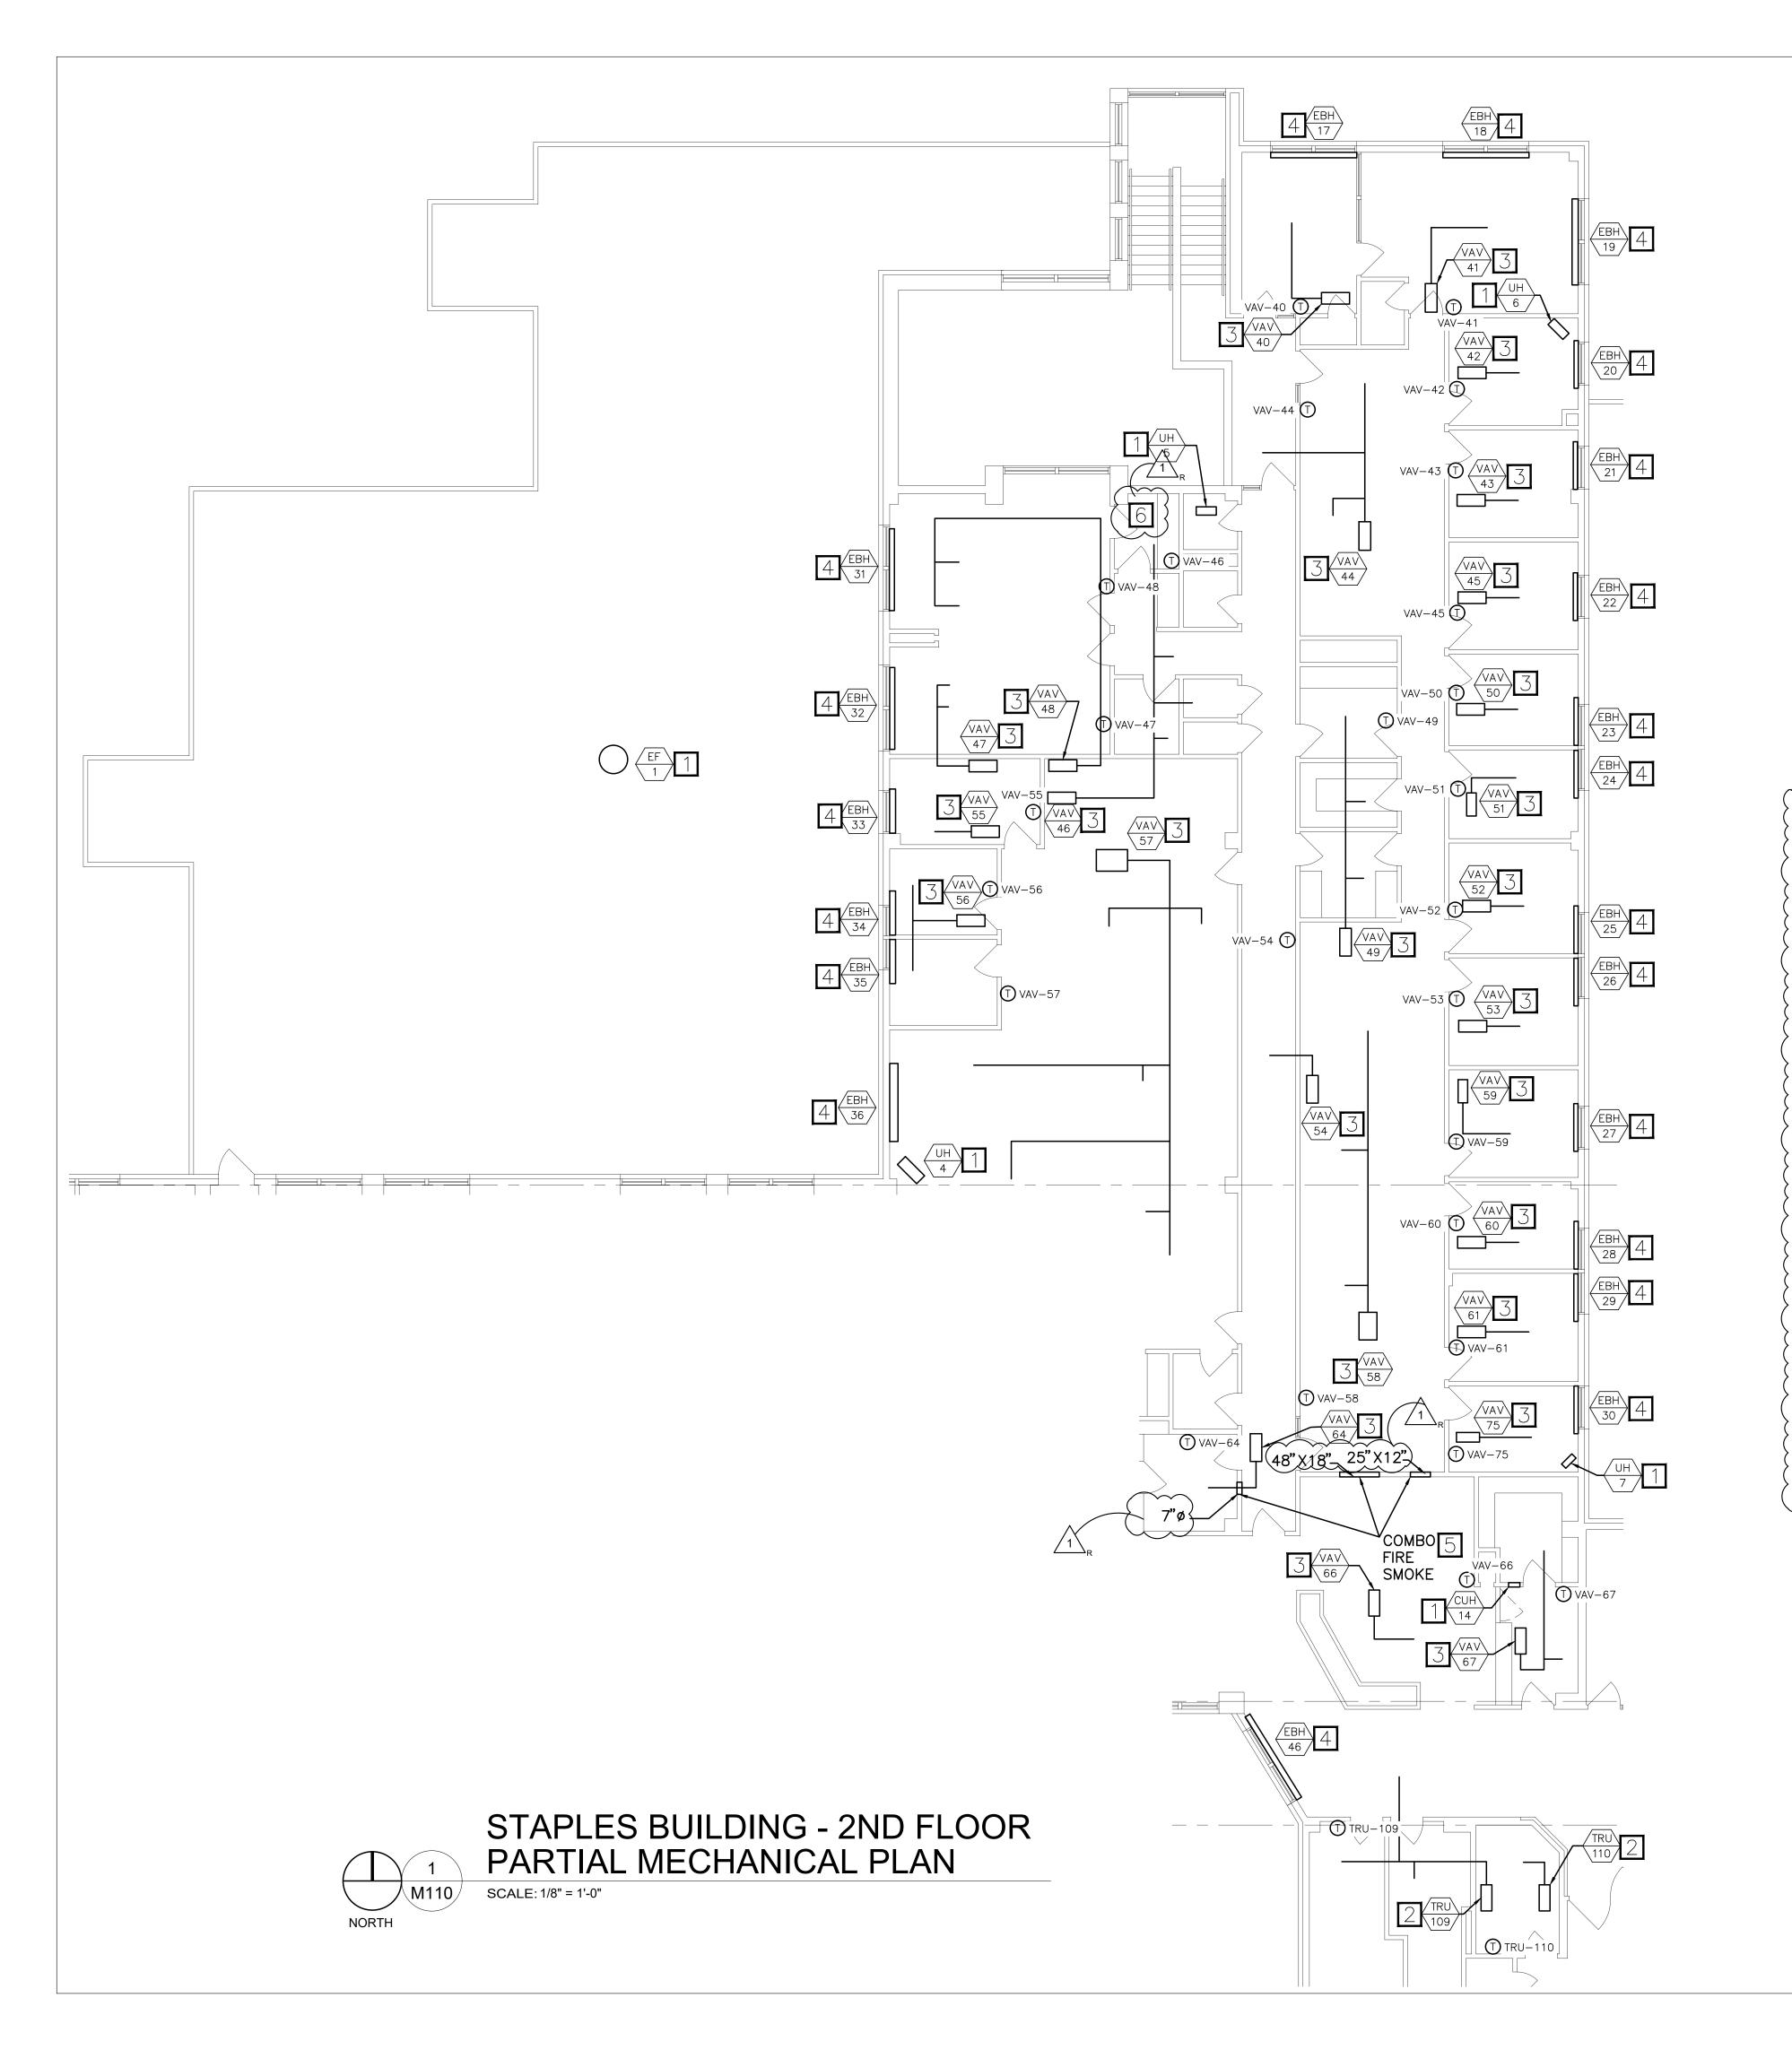
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M-109



⊞KEYED NOTES


EXISTING TERMINAL REHEAT UNITS AND EXISTING AIRFLOW SENSOR SHALL REMAIN. CONTRACTOR SHALL CLEAN AIRFLOW SENSOR TO BE REUSED FOR NEW WORK. EXISTING PNEUMATIC CONTROLLER, EXISTING BALANCING VALVE AND EXISTING PNEUMATIC HOT WATER CONTROL VALVE SHALL BE ELECTRONIC THREE WAY CONTROL VALVE AND A NEW BALANCING VALVE ON BOTH HYDRONIC HEATING RETURN AND BYPASS PIPES. INSTALL NEW ZONE TEMPERATURE SENSOR IN PLACE OF EXISTING PNEUMATIC ZONE TEMPERATURE SENSOR. CONNECT NEW VALVE AND DDC CONTROLLER INTO NEW BAS. BID ALTERNATE #2: IF BID ALTERNATE #2 IS APPROVED, INSTALL MODULATING TWO WAY VALVES IN PLACE OF THREE WAY VALVES UNLESS NOTED. CAP AND REMOVE BYPASS LINE.

EXISTING VARIABLE AIR VOLUME UNITS AND EXISTING AIRFLOW SENSOR SHALL REMAIN. CONTRACTOR SHALL CLEAN AIRFLOW SENSOR TO BE REUSED FOR NEW WORK. EXISTING PNEUMATIC CONTROLLER SHALL BE REMOVED. REPLACE WITH A NEW, DDC CONTROLLER AND TIE NEW CONTROLLER INTO NEW BAS. INSTALL NEW ZONE TEMPERATURE SENSOR IN PLACE OF EXISTING PNEUMATIC ZONE TEMPERATURE SENSOR.

4. EXISTING ELECTRIC BASEBOARD HEATER SHALL REMAIN. INSTALL NEW ELECTRONIC, UNIT MOUNTED TEMPERATURE SENSOR IN PLACE OF INSTALLED IN PLACE OF EXISTING PNEUMATIC CONTACTOR. CONTRACTOR SHALL BE RESPONSIBLE FOR THE 24V CONNECTION TO THE CONTACTOR. COORDINATE WITH ELECTRICAL CONTRACTOR FOR THE PROCUREMENT AND PLACING OF RELAY WITHIN THE BASEBOARD HEATER.


REMOVE THE PNEUMATIC ACTUATORS FROM SMOKE DAMPERS. REPLACE WITH A NEW ELECTRONIC ACTUATOR. REPLACE EXISTING PNEUMATIC FIRE ALARM RELAY WITH NEW, ELECTRONIC FIRE ALARM RELAY. FIELD LOCATE EXISTING RELAY NEAR DAMPER. CONNECT NEW ACTUATOR INTO EXISTING FIRE/SMOKE SYSTEM VIA RELAY.

EXISTING ASU-1 CONTROLLER SHALL BE DEMOLISHED. NEW CONTROLLER SHALL BE INSTALLED IN PLACE OF EXISTING. CONNECT ALL POINTS BACK INTO CONTROLLER.

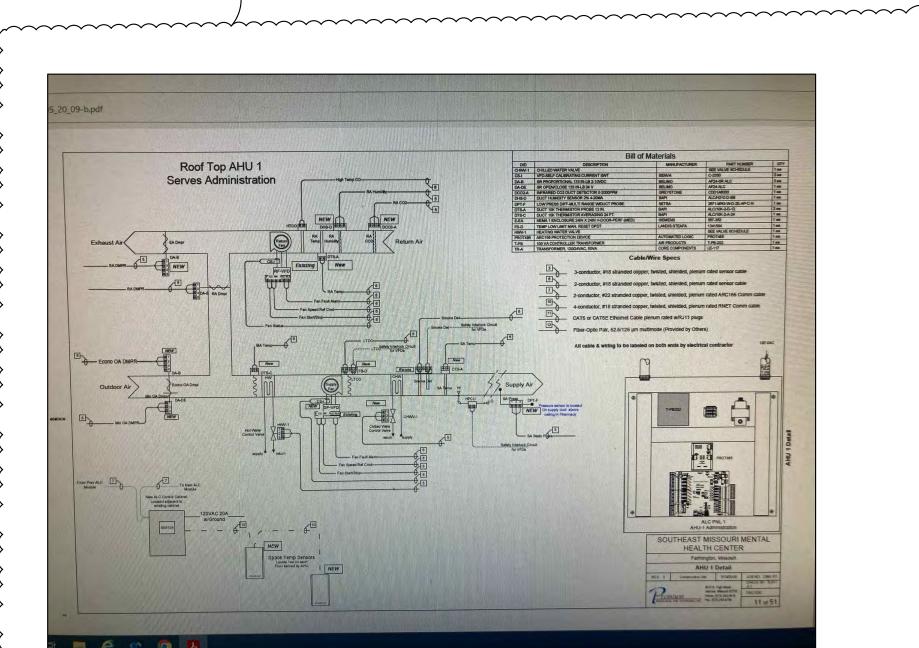

M110 SCALE: N.T.S.


ASU - 1 EXISTING CONTROL SCHEMATIC

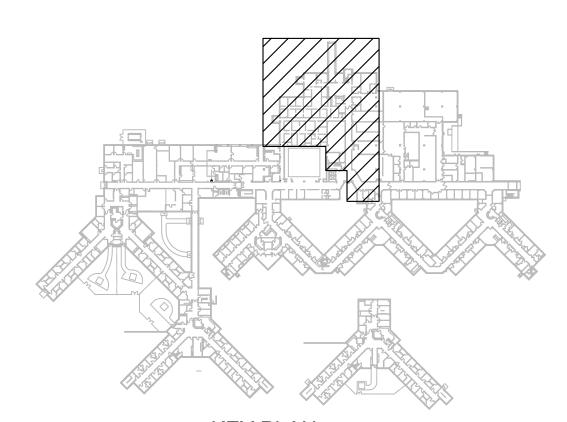

KEY PLAN

NOT TO SCALE

STATE OF MISSOURI MICHAEL L. PARSON, **GOVERNOR**

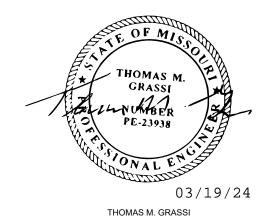

License Number: E-23938 Expiration Date: 12/31/24 PROFESSIONAL SEAL

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DEPARTMENT OF MENTAL HEALTH

UPGRADE HVAC CONTROLS

STAPLES BUILDING 1010 W COLUMBIA ST. FARMINGTON, MISSOURI

PROJECT # M2011-01 SITE# 7354

6517354012

REVISION: ADDENDUM #1
DATE: 03/19/24
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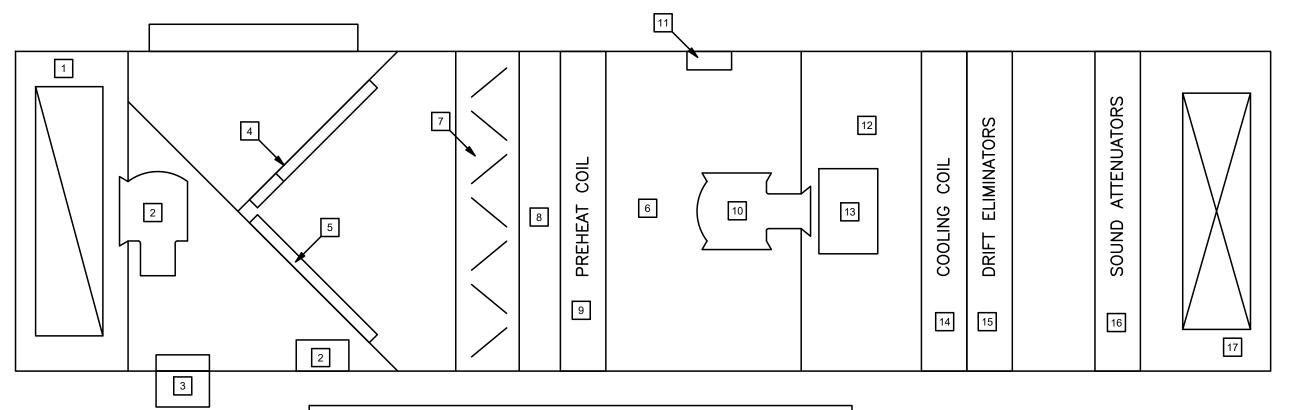
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DESIGNED BY: RCB


SHEET TITLE:

STAPLES PARTIAL MECHANICAL PLAN

SHEET NUMBER:





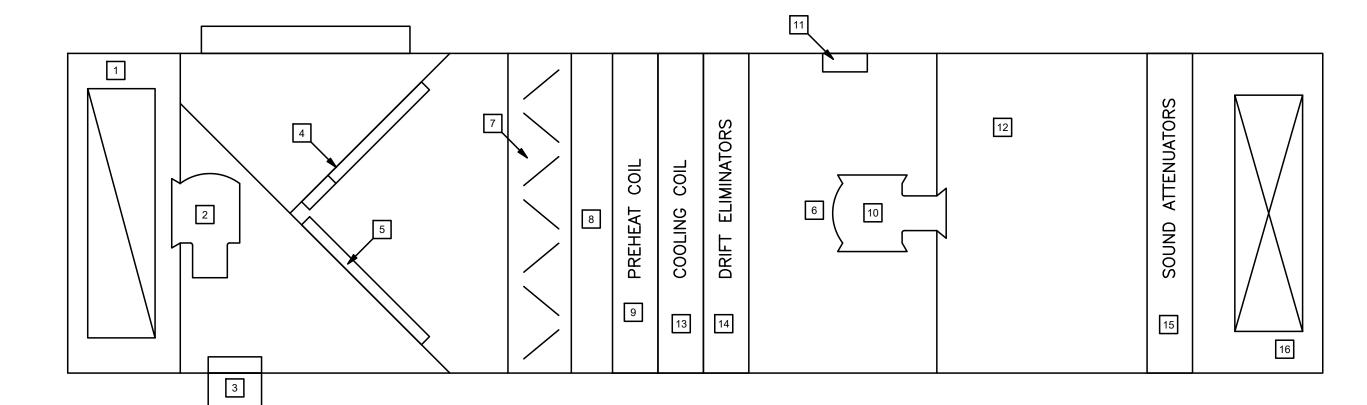

KEYED NOTES

REPLACE EXISTING CO2, TEMPERATURE, AND HUMIDITY SENSOR AND TIE

2. EXISTING RETURN FAN SHALL REMAIN. EXISTING CONSTANT SPEED MOTOR

SHALL BE REMOVED AND REPLACE WITH AN INVERTER DUTY MOTOR. INSTALL NEW VFD TO CONTROL FAN AND TIE VFD INTO NEW BAS. SEE

INTO NEW BAS. EXISTING SMOKE DETECTOR SHALL REMAIN. INSTALL NEW

LOW PRESSURE SWITCH FOR THE RETURN FAN WITHIN RETURN SECTION OF

SPECIFICATIONS FOR VFD REQUIREMENTS. COORDINATE WITH EC. INSTALL A

NEW, LOW PRESSURE SAFETY SWITCH NEAR INLET SIDE OF RETURN. (BID

3. EXISTING RELIEF DAMPER SHALL REMAIN. ADJUST ACTUATORS AND REPAIR

OUTSIDE AIR AND ECONOMIZER) TO ALLOW DAMPERS TO FULLY OPEN AND

DAMPER AS REQUIRED. TIE EXISTING ACTUATOR INTO NEW BAS.

STATIONS TO OUTSIDE AIR STREAM. CONNECT INTO BAS.

4. EXISTING OA DAMPER. ADJUST ACTUATORS AND REPAIR DAMPERS (MIN

CLOSE. TIE ACTUATORS INTO NEW BAS. ADD NEW FLOW MEASURING

5. EXISTING RETURN AIR DAMPERS. ADJUST ACTUATOR AND REPAIR DAMPER TO ALLOW DAMPERS TO FULLY OPEN AND CLOSE. TIE ACTUATOR INTO NEW

6. INSTALL NEW LOW PRESSURE SAFETY SWITCH IN THE CABINET NEAR INLET OF SUPPLY FAN. CONNECT INTO OTHER SAFETIES TO SHUTDOWN FAN.

ACROSS FILTERS. TIE DIFFERENTIAL PRESSURE MONITOR INTO NEW BAS TO

8. REPLACE EXISTING AVERAGING MIXING AIR TEMPERATURE SENSOR. TIE NEW

9. EXISTING PREHEAT COIL SHALL REMAIN. REMOVE THREE WAY VALVE WITHIN

CABINET AND REPLACE WITH A NEW, THREE WAY VALVE. INSTALL NEW,

TEMPERATURE SENSOR. INSTALL NEW, AIR TEMPERATURE SENSOR WITHIN

CABINET SPACE TO MONITOR DISCHARGE AIR TEMPERATURE SENSOR FROM COIL. CONNECTION NEW CONTROL VALVE AND SENSORS INTO NEW BAS.

ENTERING WATER TEMPERATURE SENSOR AND NEW, LEAVING WATER

10. EXISTING SUPPLY FAN SHALL REMAIN. REMOVE EXISTING, CONSTANT VOLUME MOTOR AND REPLACE WITH AN INVERTER DUTY MOTOR. SEE

11. INSTALL NEW VFD FOR THE SUPPLY FAN. CONNECT VFD INTO EXIST

12. REPLACE EXISTING HIGH PRESSURE SAFETY SWITCH WITH NEW, HIGH

13. EXISTING COOLING COIL SHALL REMAIN. REMOVE EXISTING THREE WAY

INSTALL NEW ENTERING WATER TEMPERATURE SENSOR AND LEAVING

WATER TEMPERATURE SENSORS. TIE NEW CONTROL VALVE AND NEW

FREEZESTAT WITH NEW FREEZESTAT AND TIE INTO EXISTING SAFETY

TEMPERATURE SENSOR AND REPLACE WITH A NEW, AVERAGING SENSOR

OVER OPENING INTO SUPPLY DUCT DROP. CONNECT NEW, AVERAGING

14. EXISTING DRIFT ELIMINATOR SHALL REMAIN. REPLACE EXISTING

16. EXISTING SUPPLY AIR CABINET SECTION. REMOVE SINGLE POINT

15. EXISTING SOUND ATTENUATOR SHALL REMAIN. NO WORK.

STAPLES BUILDING -

THE AIR HANDLER.

SENSOR INTO NEW BAS.

SCALE: N. T. S.

∖M601*/*

TEMPERATURE SENSORS INTO NEW BAS.

PRESSURE SAFETY SWITCH. CONNECT INTO EXISTING SAFETY CIRCUIT OF

CONTROL VALVE AND REPLACE WITH A NEW, THREE WAY CONTROL VALVE.

SPECIFICATIONS FOR VFD REQUIREMENTS. COORDINATE WITH EC. (BID

7. EXISTING FILTERS. INSTALL NEW, DIFFERENTIAL PRESSURE MONITOR


AVERAGING MIXING AIR TEMPERATURE SENSOR INTO NEW BAS.

ALLOW MAINTENANCE TO OBSERVE LOADING OF FILTERS.

KEYED NOTES

- 1. REPLACE EXISTING CO2, TEMPERATURE, AND HUMIDITY SENSOR AND TIE INTO NEW BAS. EXISTING SMOKE DETECTOR SHALL REMAIN. INSTALL NEW LOW PRESSURE SWITCH FOR THE RETURN FAN WITHIN RETURN SECTION OF CABINET.
- 2. EXISTING RETURN FAN AND RETURN FAN VFD. FAN SHALL REMAIN. EXISTING VFD SHALL BE REMOVED AND REPLACED WITH A NEW VFD. SEE SPECIFICATIONS FOR VFD REQUIREMENTS. COORDINATE WITH EC. TIE NEW VFD INTO NEW BAS. REMOVE INLET GUIDE VANES FROM FAN. INSTALL A NEW, LOW PRESSURE SAFETY SWITCH NEAR INLET SIDE OF RETURN.
- 3. EXISTING RELIEF DAMPER SHALL REMAIN. ADJUST ACTUATOR AND REPAIR DAMPER AS REQUIRED. TIE EXISTING ACTUATOR INTO NEW BAS.
- 4. EXISTING OA DAMPER. ADJUST ACTUATORS AND REPAIR DAMPER (MIN OUTSIDE AIR AND ECONOMIZER) TO ALLOW DAMPERS TO FULLY OPEN AND CLOSE. TIE ACTUATORS INTO NEW BAS. ADD NEW FLOW MEASURING STATIONS TO OUTSIDE AIR STREAM. CONNECT INTO BAS.
- 5. EXISTING RETURN AIR DAMPERS. ADJUST ACTUATOR AND REPAIR DAMPER TO ALLOW DAMPERS TO FULLY OPEN AND CLOSE. TIE ACTUATOR INTO NEW BAS.
- 6. INSTALL NEW LOW PRESSURE SAFETY SWITCH IN THE CABINET NEAR INLET OF SUPPLY FAN. CONNECT INTO OTHER SAFETIES TO SHUTDOWN FAN.
- 7. EXISTING FILTERS. INSTALL NEW, DIFFERENTIAL PRESSURE MONITOR ACROSS FILTERS. TIE DIFFERENTIAL PRESSURE MONITOR INTO NEW BAS TO ALLOW MAINTENANCE TO OBSERVE LOADING OF FILTERS.
- 8. REPLACE EXISTING AVERAGING MIXING AIR TEMPERATURE SENSOR. TIE NEW AVERAGING MIXING AIR TEMPERATURE SENSOR INTO NEW BAS.
- 9. EXISTING PREHEAT COIL SHALL REMAIN. REMOVE THREE WAY VALVE WITHIN CABINET AND REPLACE WITH A NEW, THREE WAY VALVE. INSTALL NEW, ENTERING WATER TEMPERATURE SENSOR AND NEW, LEAVING WATER TEMPERATURE SENSOR. INSTALL NEW, AIR TEMPERATURE SENSOR WITHIN CABINET SPACE TO MONITOR DISCHARGE AIR TEMPERATURE SENSOR FROM COIL. CONNECTION NEW CONTROL VALVE AND SENSORS INTO NEW BAS.
- 10. EXISTING SUPPLY FAN SHALL REMAIN. REMOVE INLET GUIDE VANES FROM FAN.
- 11. EXISTING SUPPLY FAN VFD SHALL REMAIN. CONNECT EXISTING VFD INTO
- 12. REPLACE EXISTING HIGH PRESSURE SAFETY SWITCH AND FREEZESTAT WITH NEW, HIGH PRESSURE SAFETY SWITCH AND FREEZESTAT. CONNECT INTO EXISTING SAFETY LOOP OF THE AIR HANDLER AND BAS.
- 13. EXISTING, ABANDONED HUMIDIFIER. NO WORK.
- 14. EXISTING COOLING COIL SHALL REMAIN. REMOVE EXISTING THREE WAY CONTROL VALVE AND REPLACE WITH A NEW, THREE WAY CONTROL VALVE. INSTALL NEW ENTERING WATER TEMPERATURE SENSOR AND LEAVING WATER TEMPERATURE SENSORS. TIE NEW CONTROL VALVE AND NEW TEMPERATURE SENSORS INTO NEW BAS.
- 15. EXISTING DRIFT ELIMINATOR SHALL REMAIN. NO WORK.
- 16. EXISTING SOUND ATTENUATOR SHALL REMAIN. NO WORK.
- 17. EXISTING SUPPLY AIR CABINET SECTION. REMOVE SINGLE POINT TEMPERATURE SENSOR AND REPLACE WITH A NEW, AVERAGING SENSOR OVER OPENING INTO SUPPLY DUCT DROP. CONNECT NEW, AVERAGING SENSOR INTO NEW BAS.

STAPLES BUILDING -ASU-1 WORK TO BE DONE - BID ALTERNATE #1

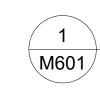

SCALE: N. T. S.

EXIST	EXISTING AIR HANDLER AIRFLOW BALANCING SCHEDULE (BID ALT#1)								
TAG		SUPPLYF	AN	RETURN FAN					
	CFM	HP	TSP(INW.C.)	CFM	HP	TSP(INW.C.)			
ASU-1	26000	50	8	20800	15	2.5			
ASU-2	6500	5	2.5	6500	3	2			
ASU-4	24800	50	8	17300	15	2			
ASU-5	21300	50	8	16200	15	2			
ASU-6	21500	50	8	16200	15	2			
ASU-7	15150	25	6	10530	3	3			
ASU-8	8805	10	4	-	-	-			

E SP	VALVE SIZE	LWT(F)	EWT(F)	LATWB(F)	LATDB(F)	EATWB(F)	EAT DB (F)	CFM	UNIT
) 48	4"	55 (4 5	54	55	65.6	89	26000	ASU-1
\ 40	2"	55	4 5	54	55	64.1	77	6500	ASU-2
20	4"	55 (4 5	54	55	67.2	81	24800	ASU-4
(16	4"	55 (45	54	55	66.4	75	21300	ASU-5
{16	4"	55	45	54	55	66.4	75	21500	ASU-6
3 16	4"	55 (4 5	54	55	71	81	15150	ASU-7
711	3"	55	45	54	55	78	95	8805	ASU-8
\mathcal{I}									


\frown		EXISTING HEATING COIL BALANCING SCHEDULE (BID ALT#1)								
E GPM	UNIT	TYPE	CFM	EAT(F)	LAT(F)	EWT(F)	LWT(F)	VALVESIZE) GPM	
485	ASU-1	PREHEAT	26000	58	95	200	160	2-1/2"	14	
₹40	ASU-2	PREHEAT	6500	66.5	100	200	160 (1-1/2"	12	
205	ASU-8	PREHEAT	8805	50	80	200	160	2"	15	
)164	ASU-8	REHEAT	8805	-10	50	200	160 >	1-1/2"	28	
₹165)	
)168										
(114						, /				
)						/ ₁ \				

ASU-2 WORK TO BE DONE - BID ALTERNATE #1 & #3

$\sim\sim$						
/ALVESIZE) GPM			(BID ALT	ERNATE #2)	
2-1/2"	14		TAG	GPM	FTOFHEAT	HP
1-1/2"	12	1	P-1	160	70	7.5
2"	15	1	P-2	160	70	7.5
1-1/2"	28	1	P-3	260	110	20
	/ 	ı	P-4	260	110	20
			P-5	1200	105	50
			P-6	1200	105	50
			P-7	600	50	7.5
			P-8	600	50	7.5
			P-9	750	70	20
			P-10	750	70	20

EXISTING PUMP BALANCING SCHEDULE

STATE OF MISSOURI MICHAEL L. PARSON, GOVERNOR

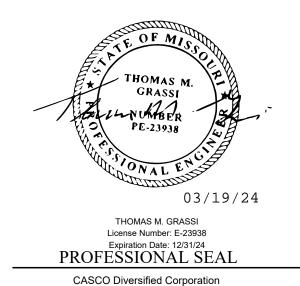

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nen Drive, Suite 100, St. Louis, MO 63143 T

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HEALTH

DEPARTMENT OF MENTAL

UPGRADE HVAC CONTROLS

STAPLES BUILDING 1010 W COLUMBIA ST. FARMINGTON, MISSOURI

PROJECT # M2011-01 SITE # 7354

6517354012

REVISION: ADDENDUM #1 DATE: 03/19/24

REVISION:

DATE:

REVISION:

DATE:

ASSET#


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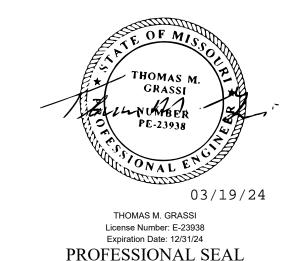
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MECHANICAL DETAILS

SHEET NUMBER:





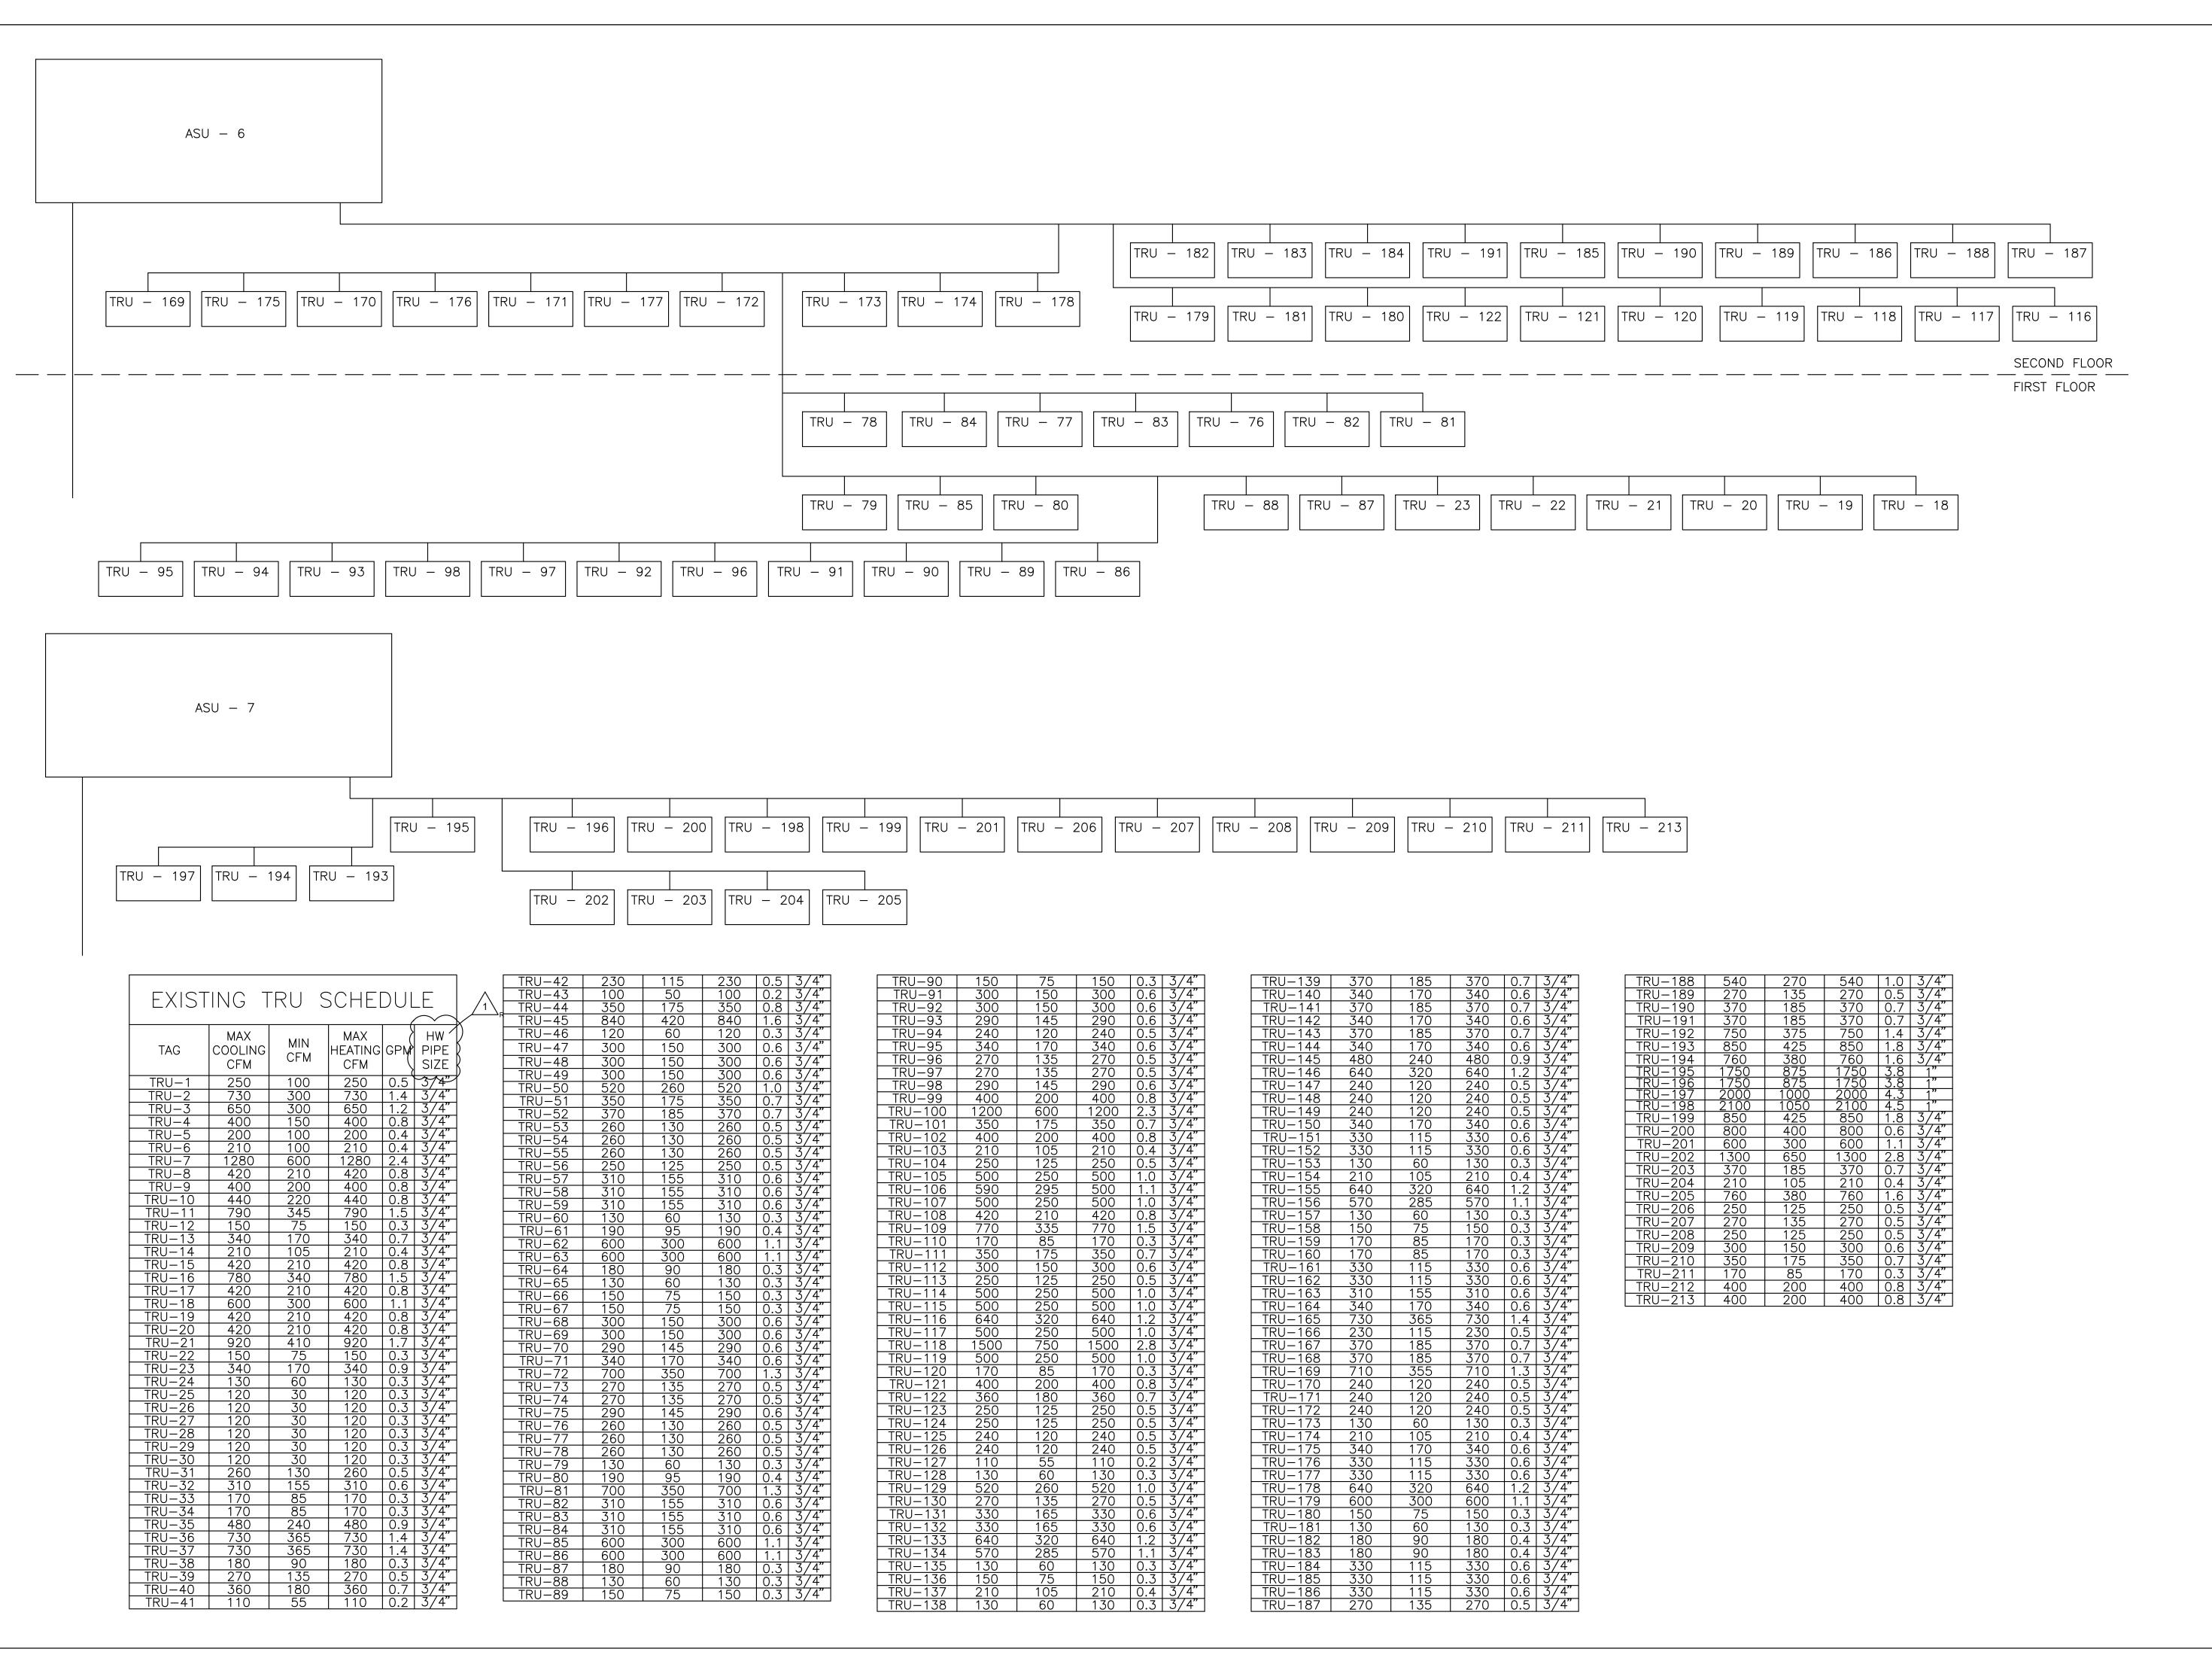

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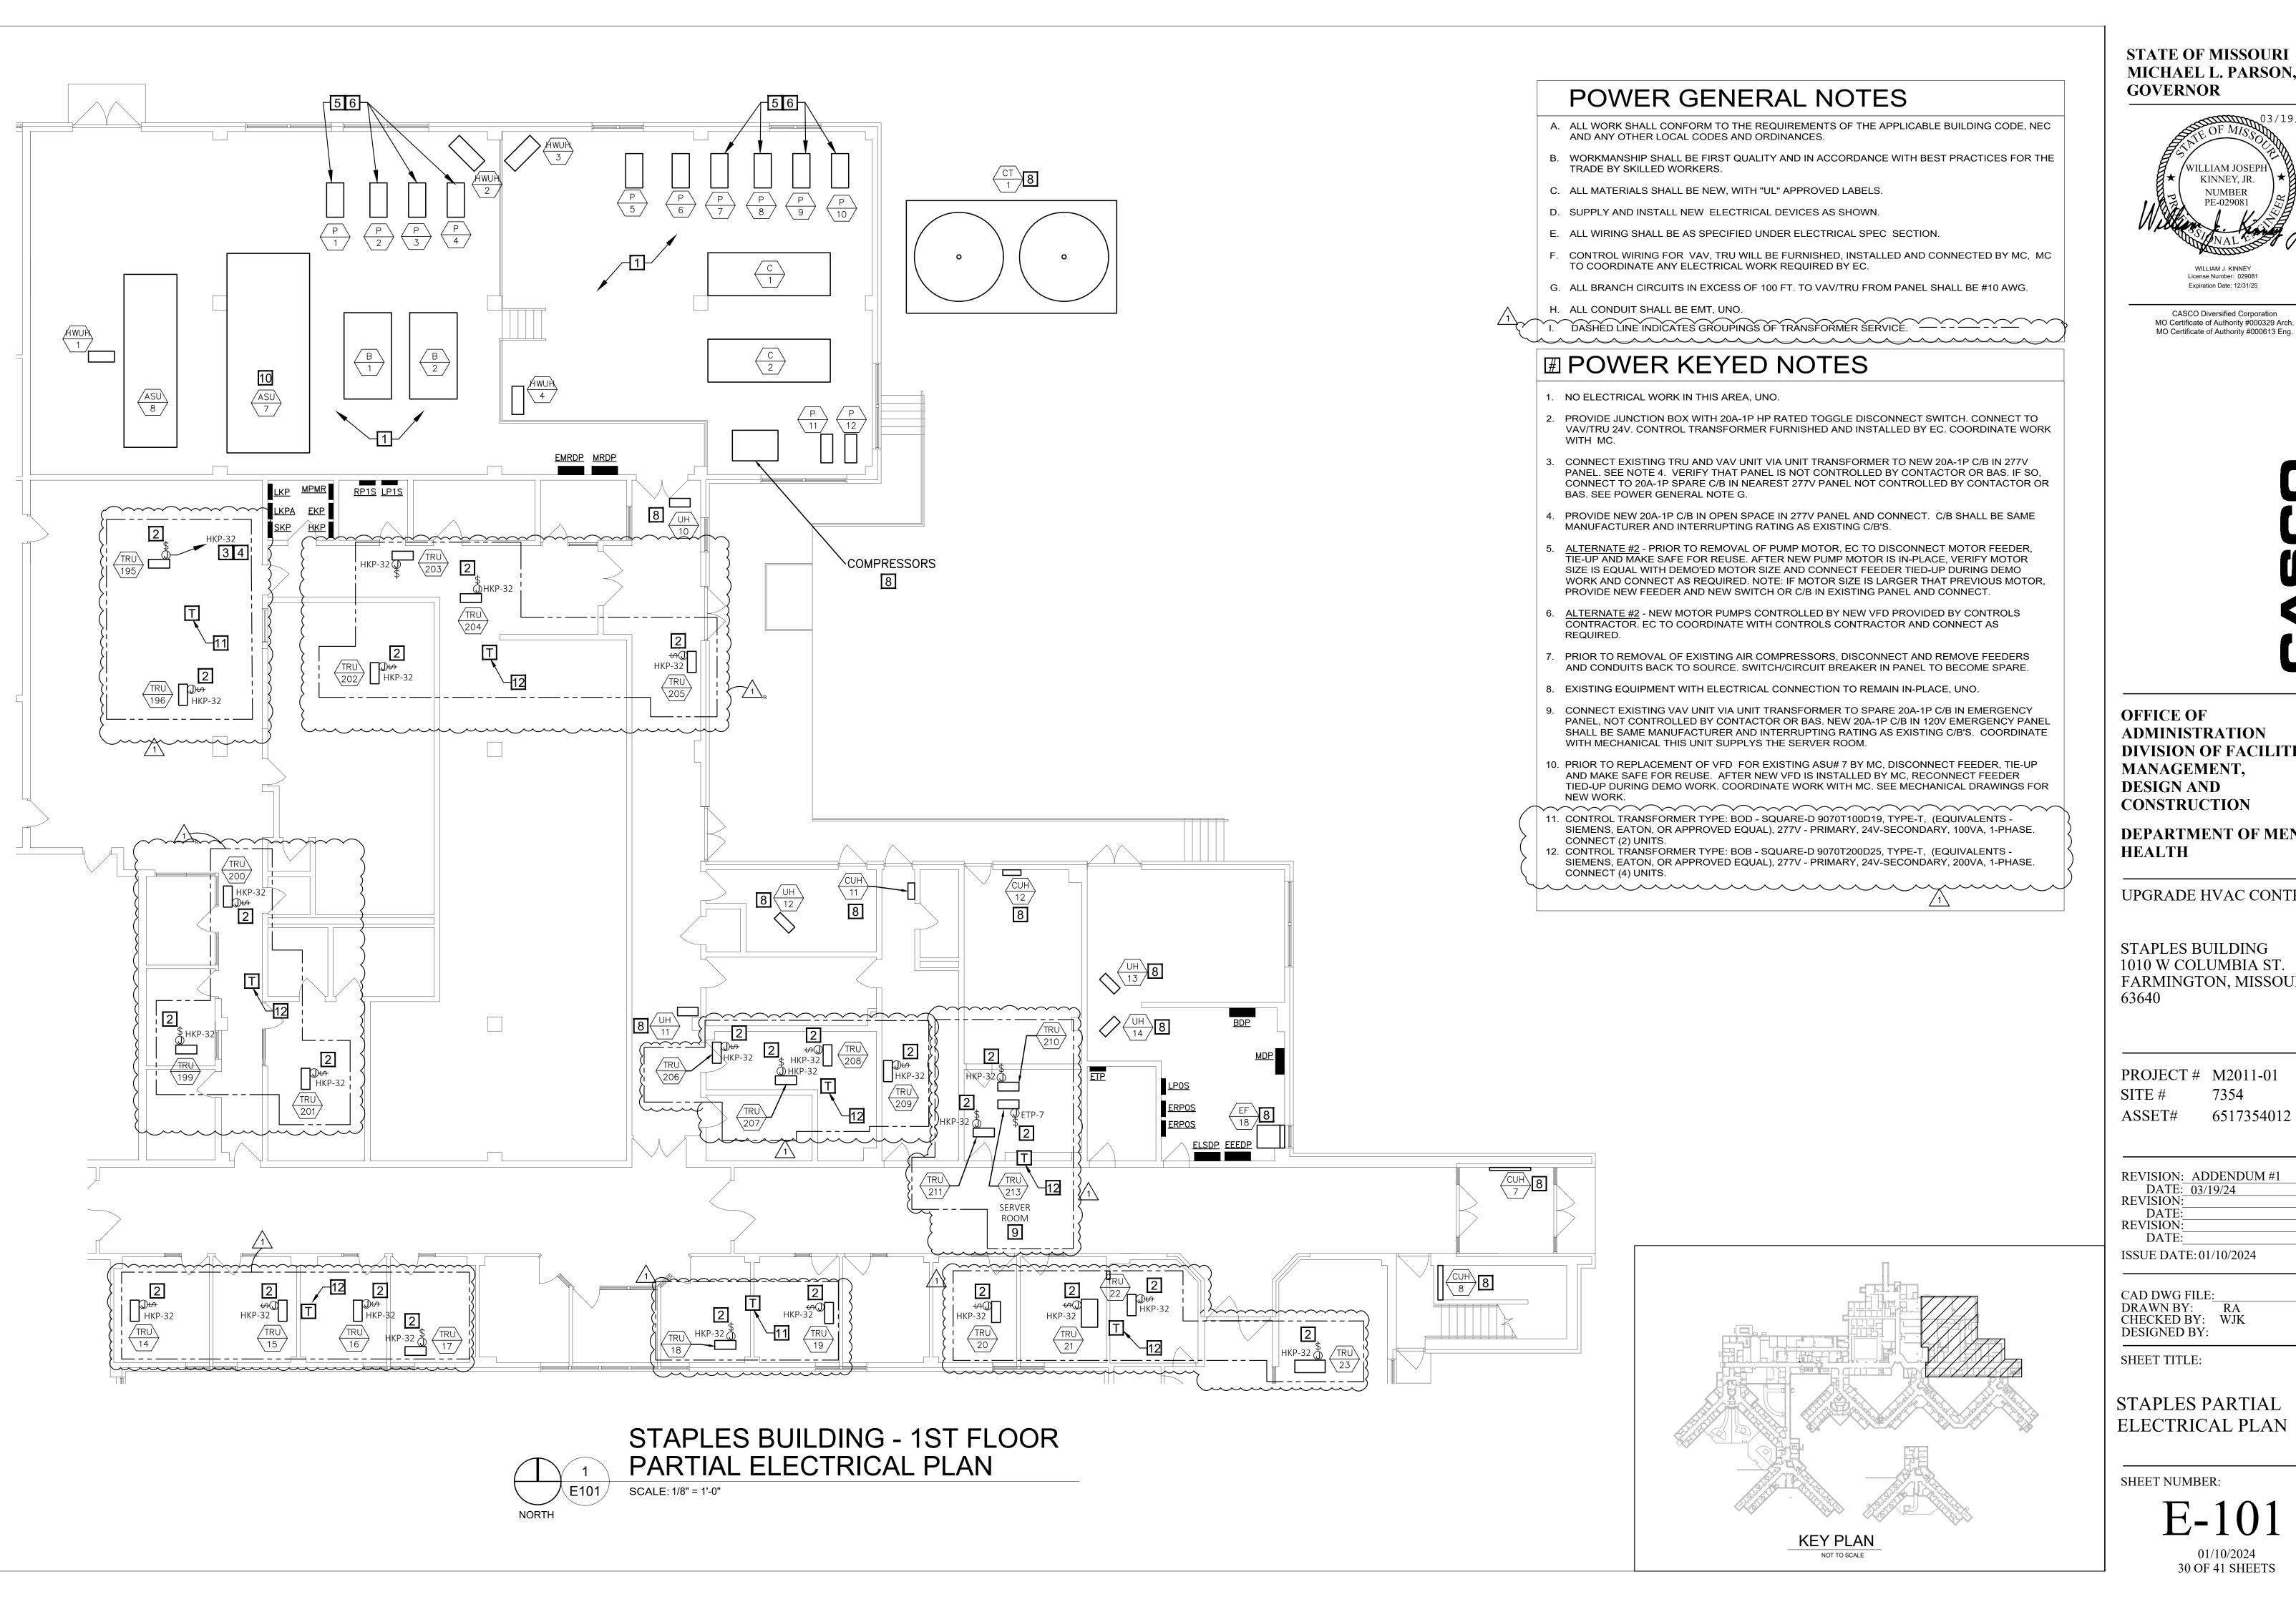
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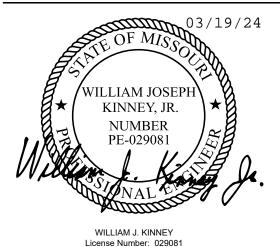
MECHANICAL AIR FLOW DIAGRAM -ASU 6 & 7

SHEET NUMBER:

M-614

01/10/2024 28 OF 41 SHEETS





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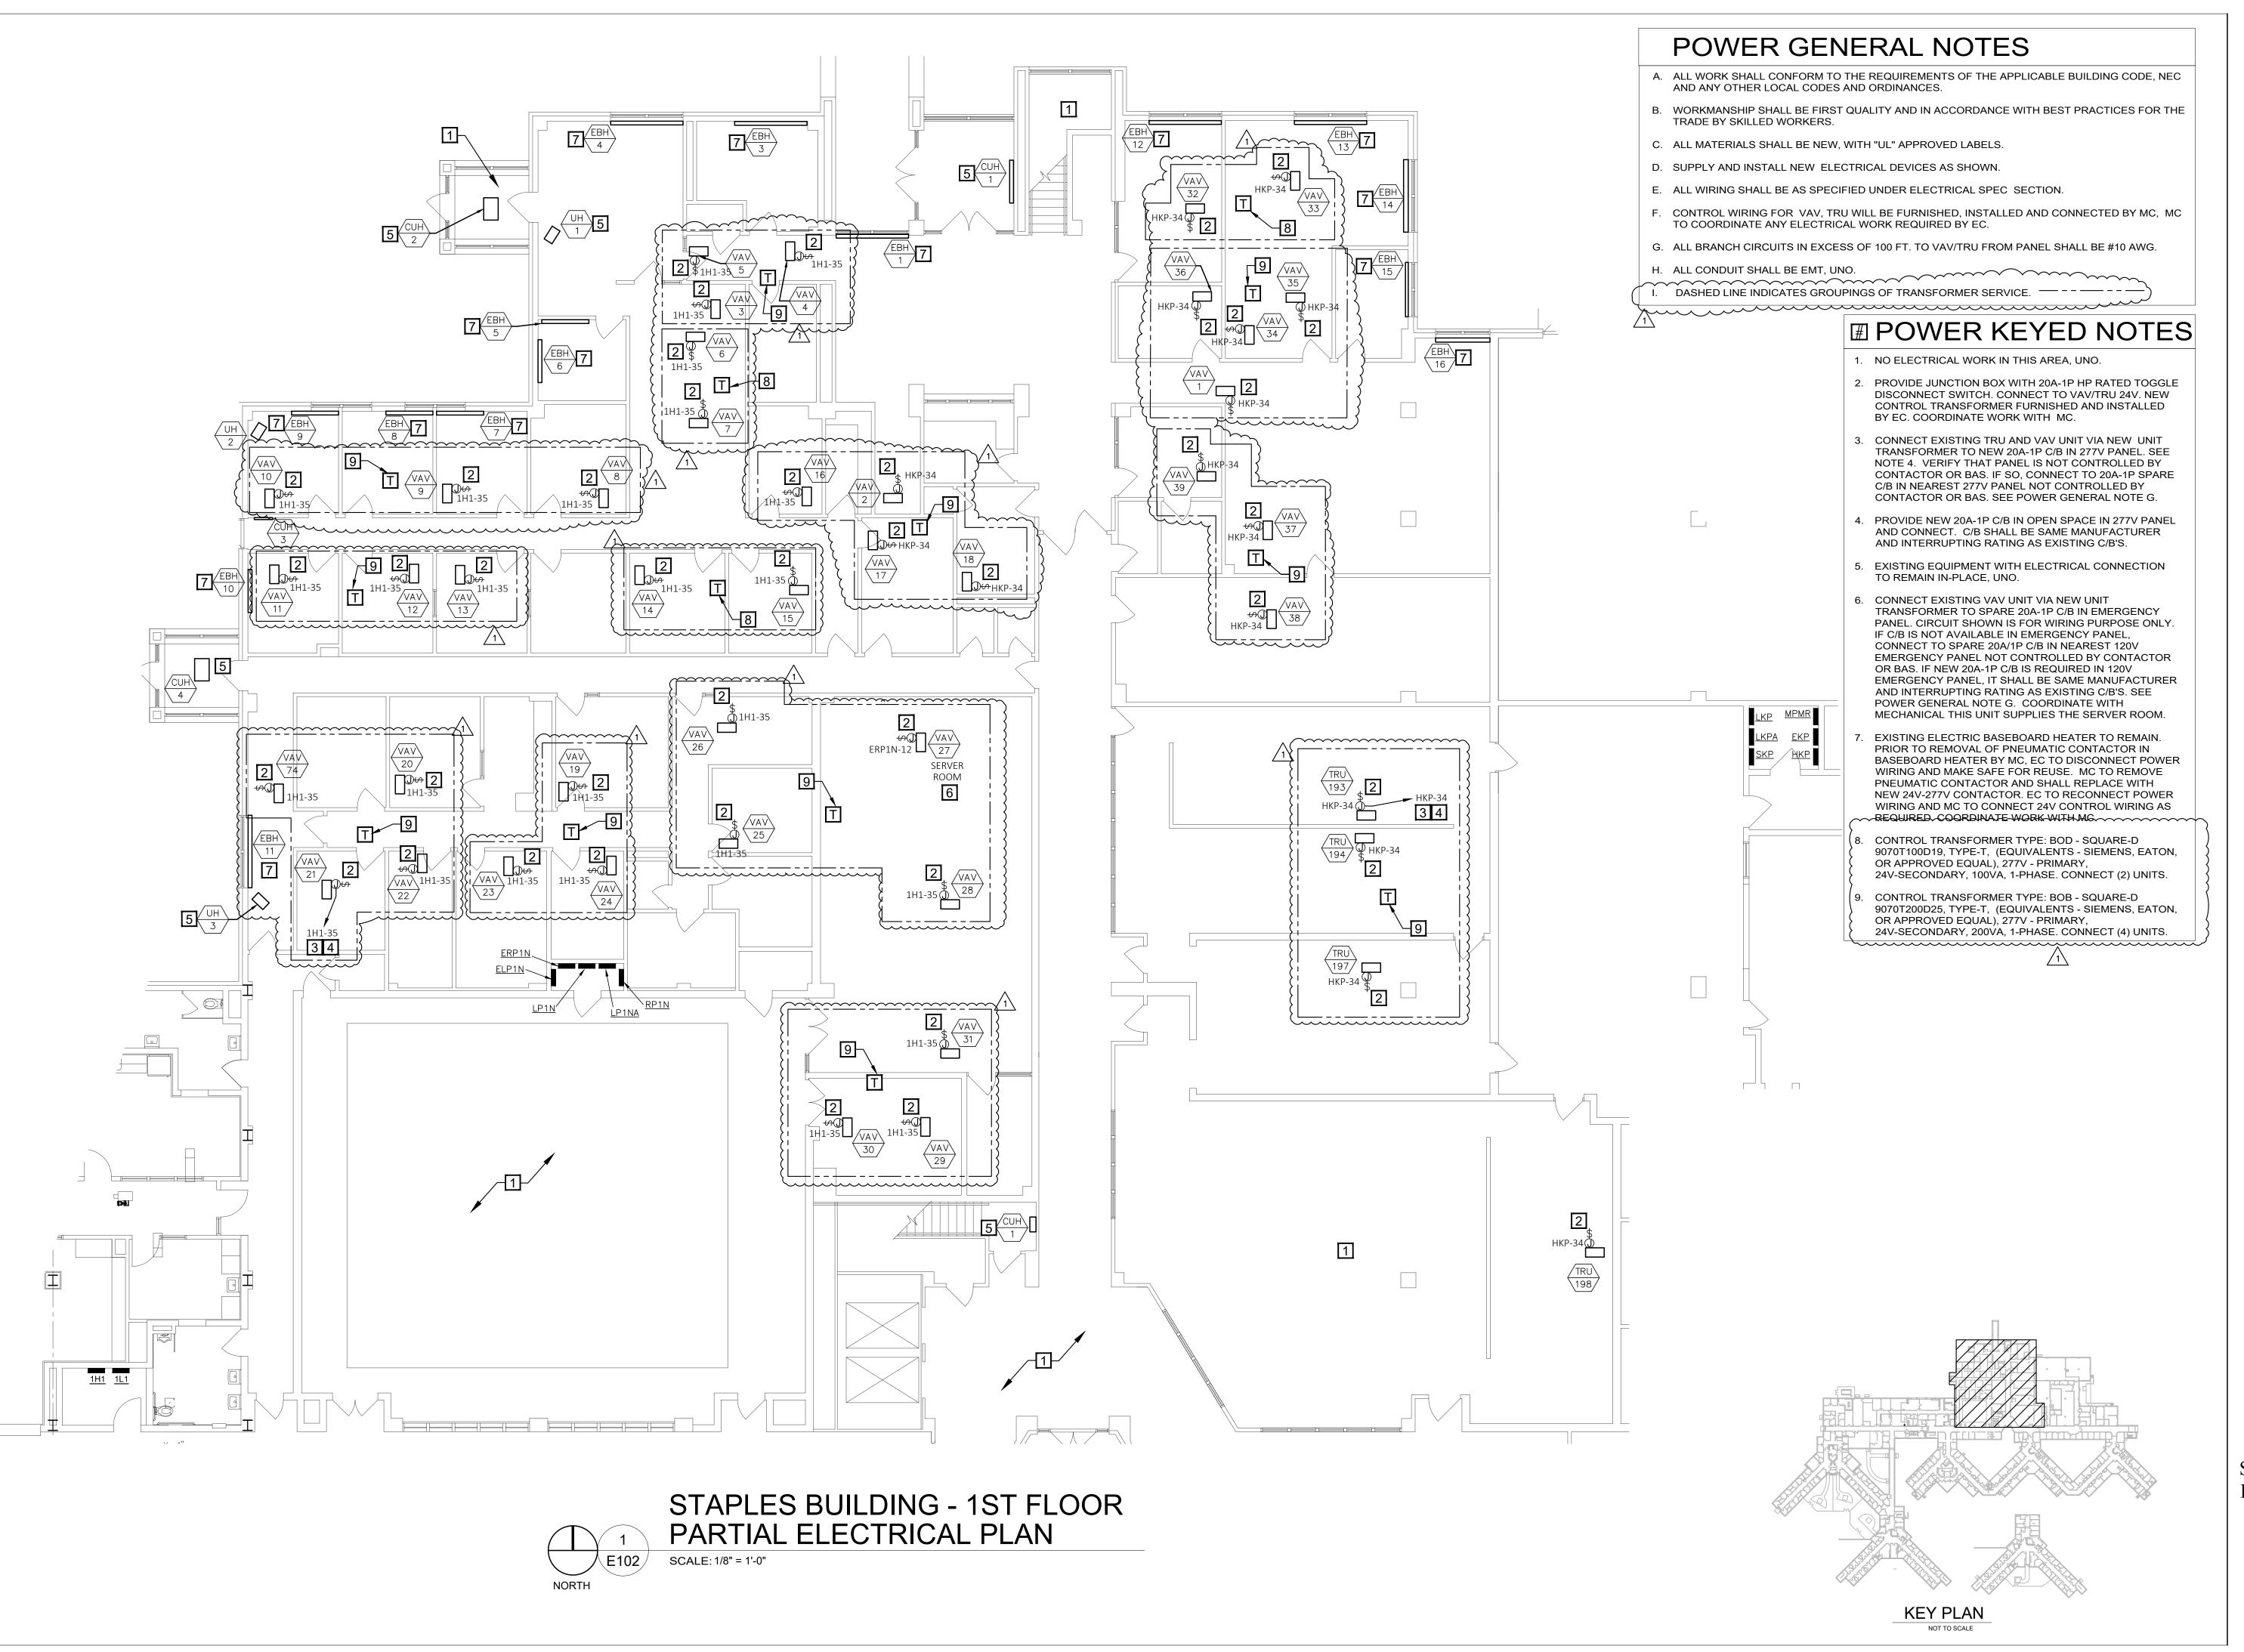
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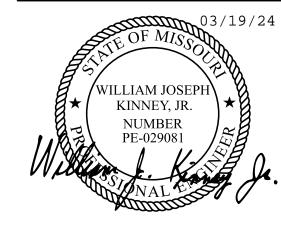
SHEET TITLE:

STAPLES PARTIAL ELECTRICAL PLAN

SHEET NUMBER:

E-101





WILLIAM J. KINNEY License Number: 029081 Expiration Date: 12/31/25

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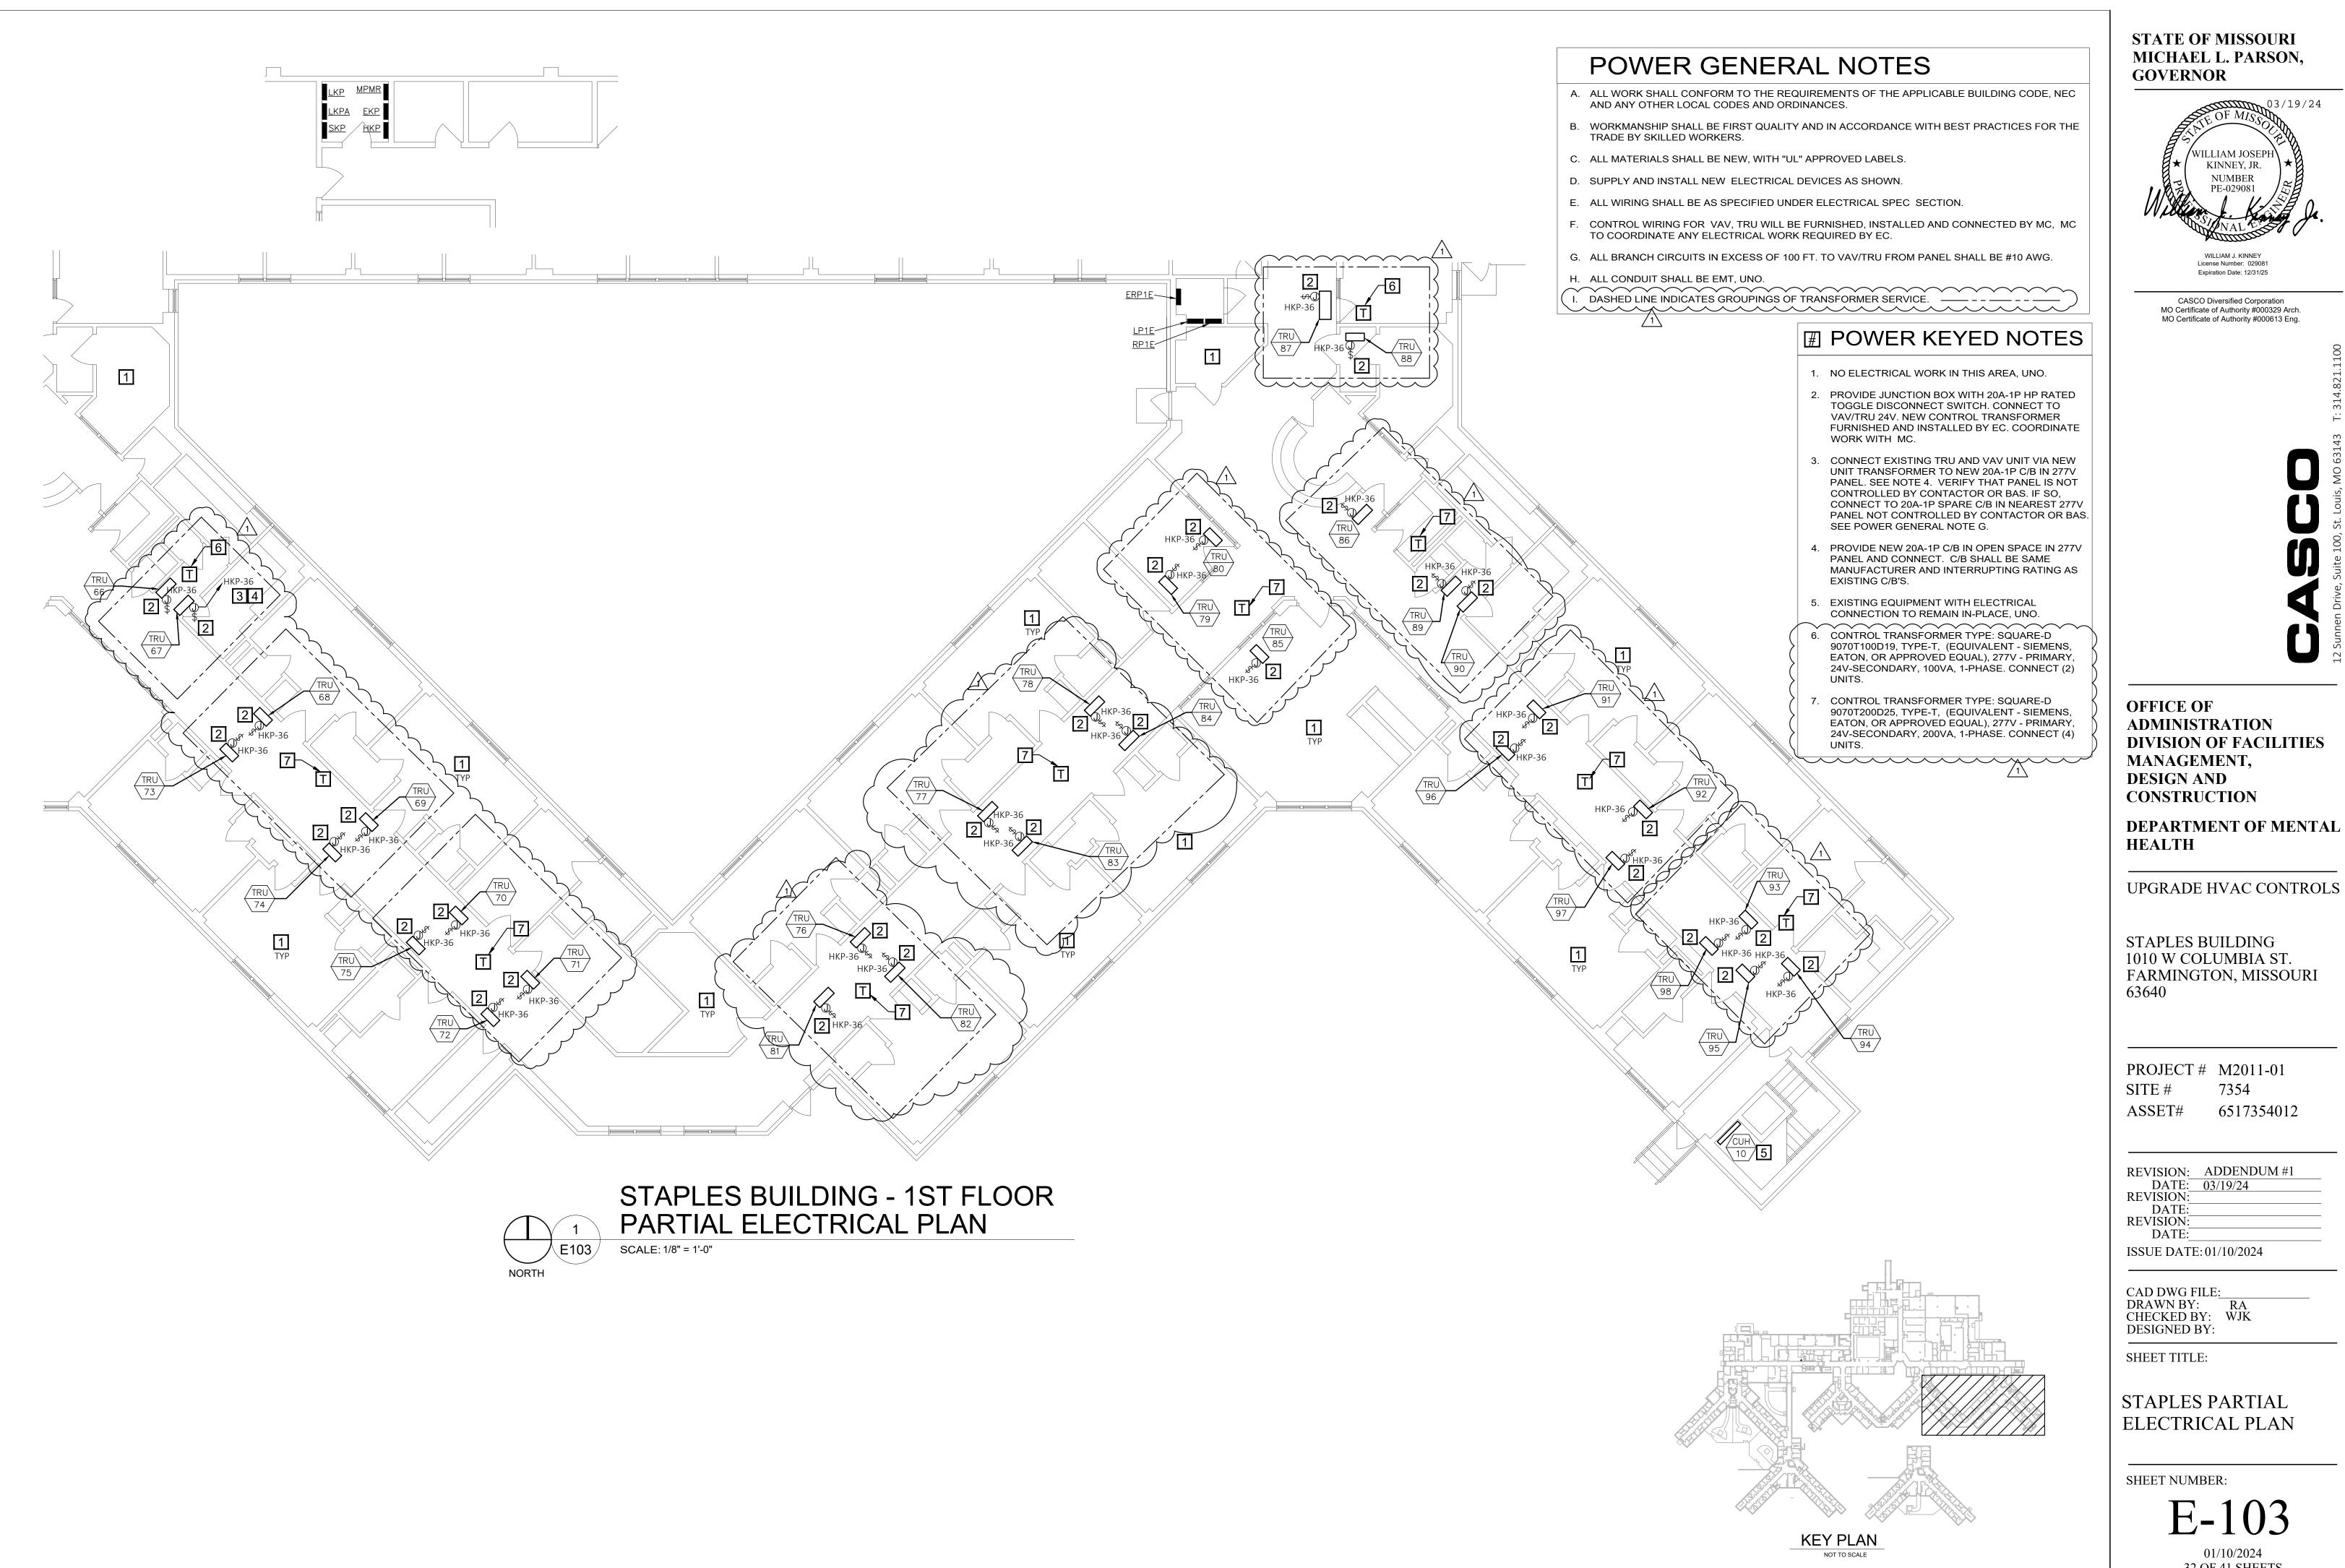
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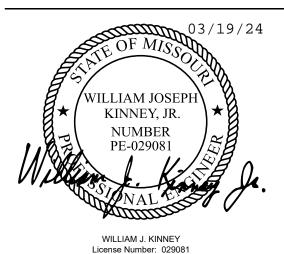
STAPLES PARTIAL ELECTRICAL PLAN

SHEET NUMBER:

E-102

09/07/23 31 OF 40 SHEETS





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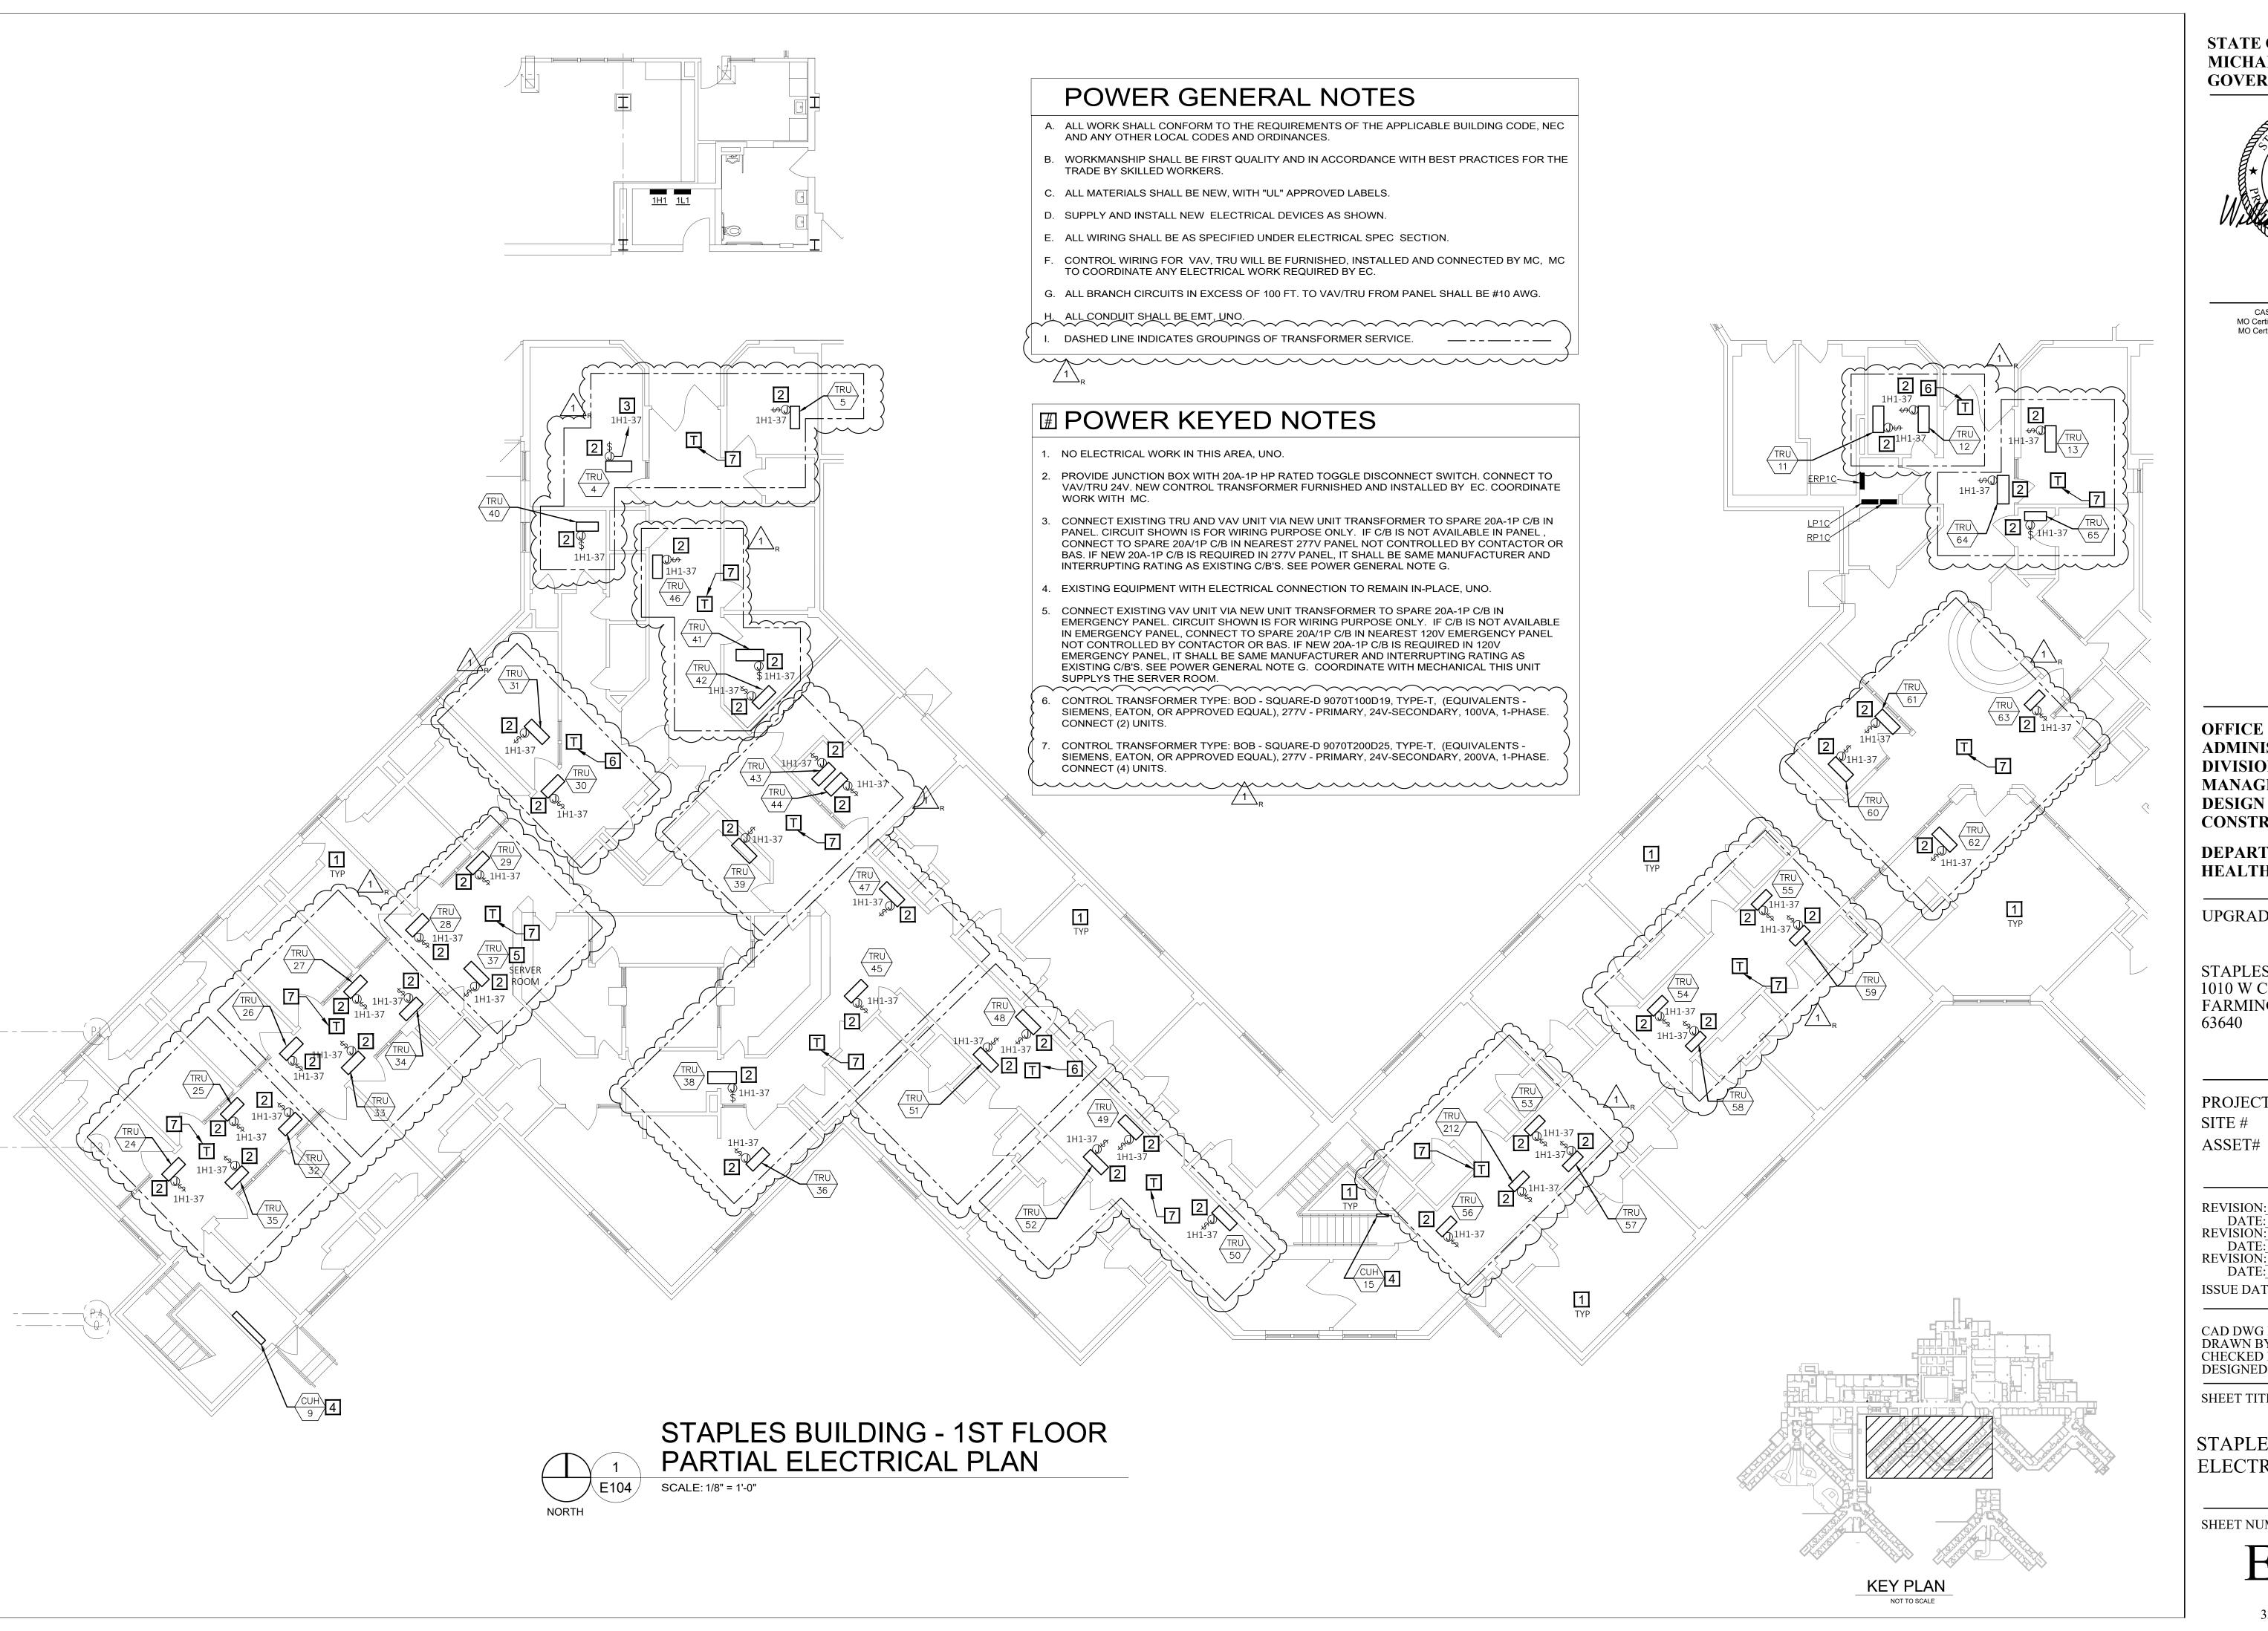
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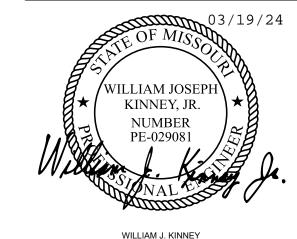
STAPLES PARTIAL ELECTRICAL PLAN

SHEET NUMBER:

E-103

01/10/2024 32 OF 41 SHEETS





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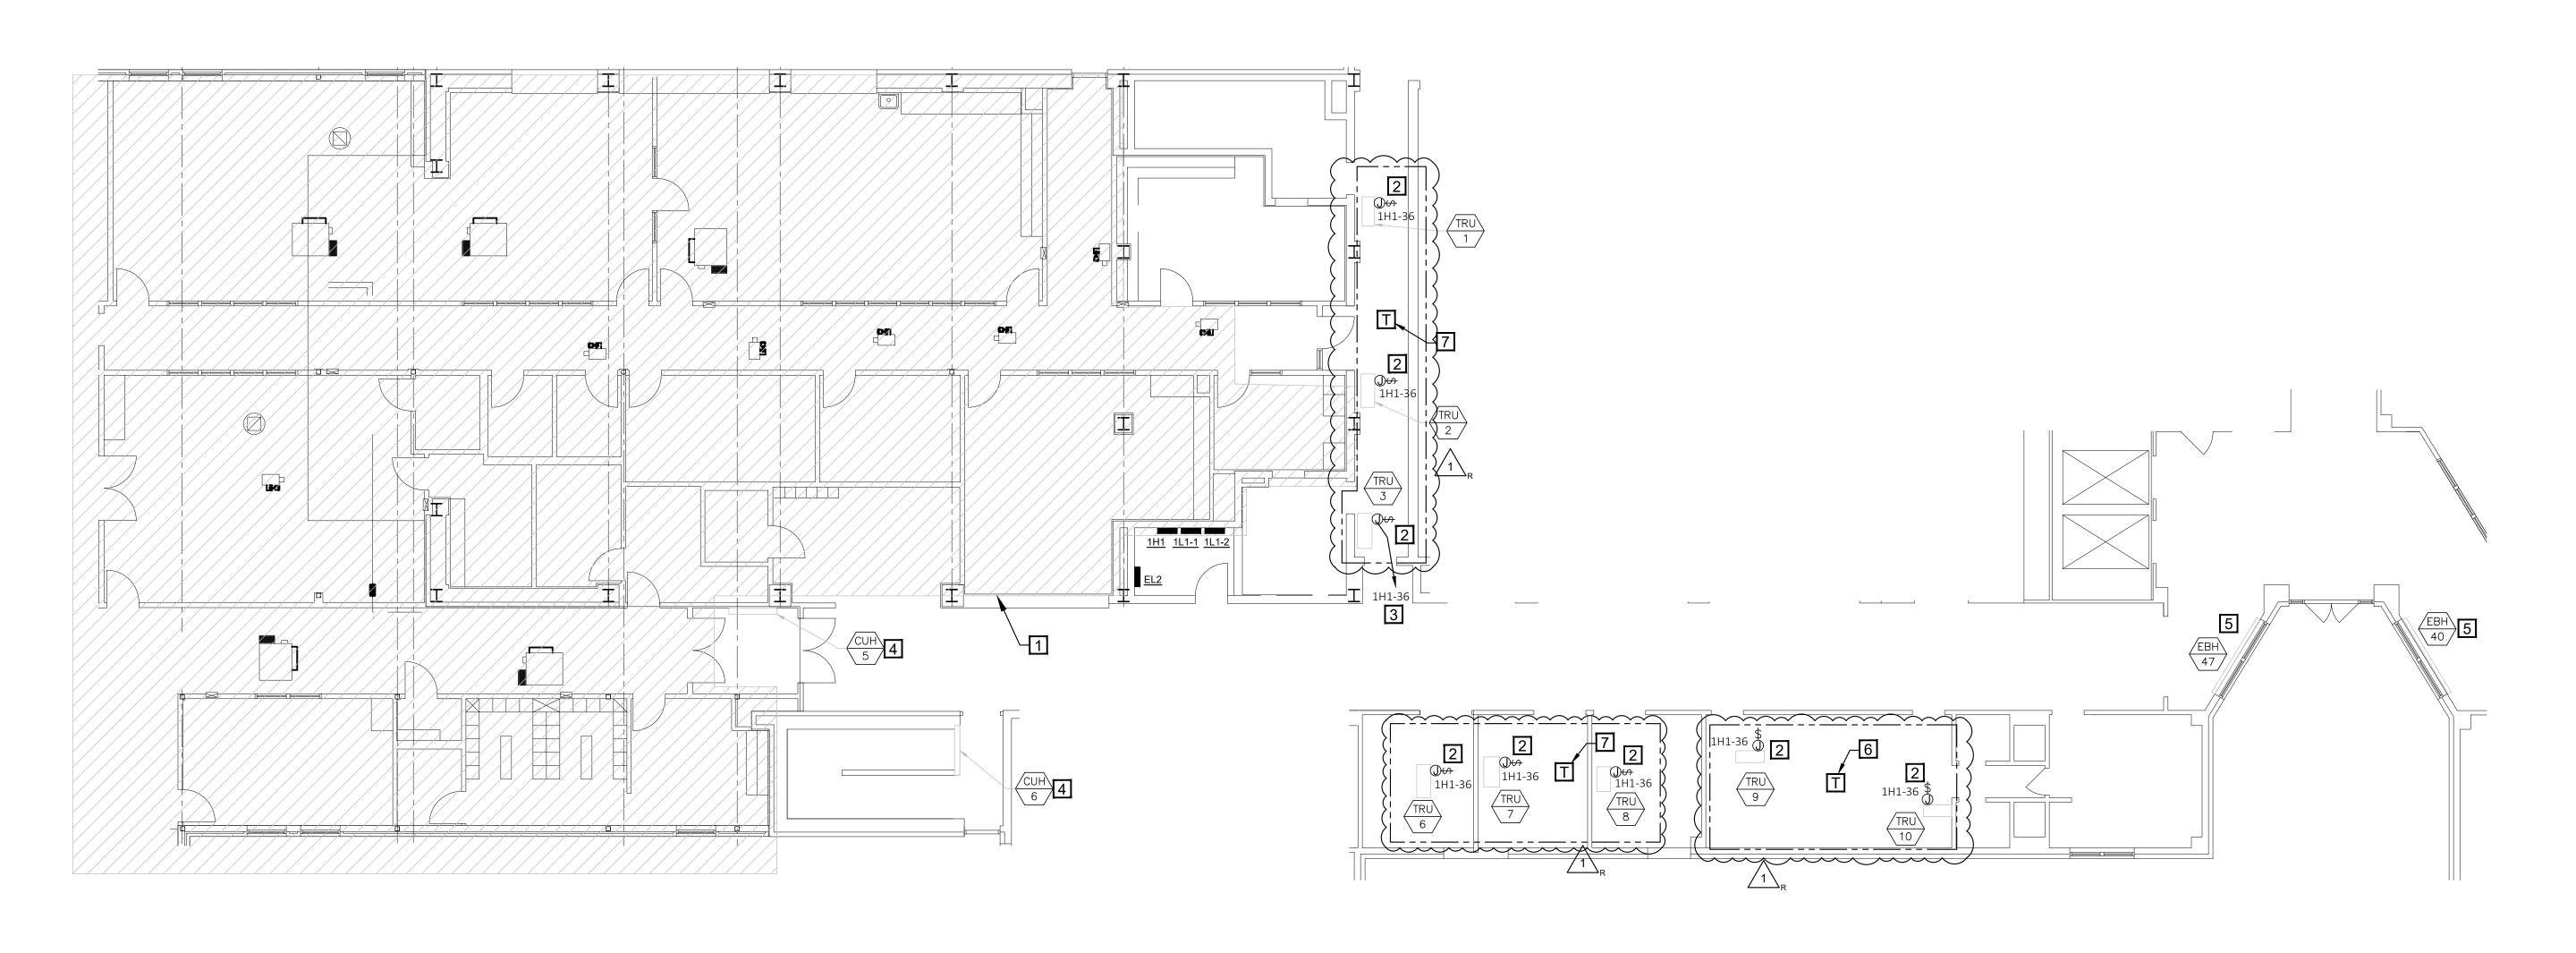
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STAPLES PARTIAL ELECTRICAL PLAN

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E-104

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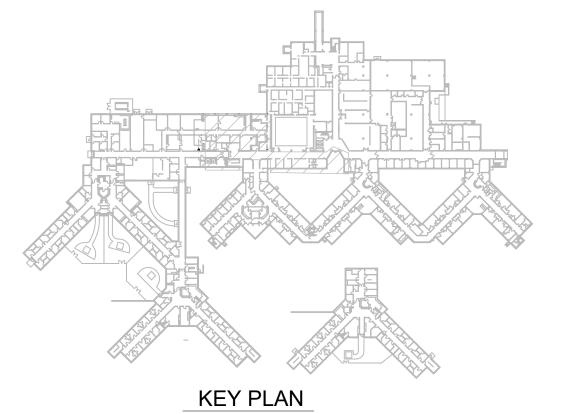
POWER GENERAL NOTES

- A. ALL WORK SHALL CONFORM TO THE REQUIREMENTS OF THE APPLICABLE BUILDING CODE, NEC AND ANY OTHER LOCAL CODES AND ORDINANCES.
- B. WORKMANSHIP SHALL BE FIRST QUALITY AND IN ACCORDANCE WITH BEST PRACTICES FOR THE TRADE BY SKILLED WORKERS.
- C. ALL MATERIALS SHALL BE NEW, WITH "UL" APPROVED LABELS.
- D. SUPPLY AND INSTALL NEW ELECTRICAL DEVICES AS SHOWN.
- E. ALL WIRING SHALL BE AS SPECIFIED UNDER ELECTRICAL SPEC SECTION.
- F. CONTROL WIRING FOR VAV, TRU WILL BE FURNISHED, INSTALLED AND CONNECTED BY MC, MC TO COORDINATE ANY ELECTRICAL WORK REQUIRED BY EC.
- G. ALL BRANCH CIRCUITS IN EXCESS OF 100 FT. TO VAV/TRU FROM PANEL SHALL BE #10 AWG.
- H. ALL CONDUIT SHALL BE EMT, UNO. DASHED LINE INDICATES GROUPINGS OF TRANSFORMER SERVICE. — - - — - - —


POWER KEYED NOTES

- 1. NO ELECTRICAL WORK IN THIS AREA, UNO.
- 2. PROVIDE JUNCTION BOX WITH 20A-1P HP RATED TOGGLE DISCONNECT SWITCH. CONNECT TO VAV/TRU 24V. NEW CONTROL TRANSFORMER FURNISHED AND INSTALLED BY EC. COORDINATE
- 3. CONNECT EXISTING TRU AND VAV UNIT VIA NEW UNIT TRANSFORMER TO SPARE 20A-1P C/B IN PANEL. CIRCUIT SHOWN IS FOR WIRING PURPOSE ONLY. IF C/B IS NOT AVAILABLE IN PANEL, CONNECT TO SPARE 20A/1P C/B IN NEAREST 277V PANEL NOT CONTROLLED BY CONTACTOR OR BAS. IF NEW 20A-1P C/B IS REQUIRED IN 277V PANEL, IT SHALL BE SAME MANUFACTURER AND INTERRUPTING RATING AS EXISTING C/B'S. SEE POWER GENERAL NOTE G.
- 4. EXISTING EQUIPMENT WITH ELECTRICAL CONNECTION TO REMAIN IN-PLACE, UNO.
- 5. EXISTING ELECTRIC BASEBOARD HEATER TO REMAIN. PRIOR TO REMOVAL OF PNEUMATIC CONTACTOR IN BASEBOARD HEATER BY MC, EC TO DISCONNECT POWER WIRING AND MAKE SAFE FOR REUSE. MC TO REMOVE PNEUMATIC CONTACTOR AND SHALL REPLACE WITH NEW 24V-277V CONTACTOR. EC TO RECONNECT POWER WIRING AND MC TO CONNECT 24V CONTROL WIRING AS REQUIRED. COORDINATE WORK WITH MC.
- CONTROL TRANSFORMER TYPE: BOD SQUARE-D 9070T100D19, TYPE-T, (EQUIVALENTS -SIEMENS, EATON, OR APPROVED EQUAL), 277V - PRIMARY, 24V-SECONDARY, 100VA, 1-PHASE. CONNECT (2) UNITS.
- CONTROL TRANSFORMER TYPE: BOB SQUARE-D 9070T200D25, TYPE-T, (EQUIVALENTS -SIEMENS, EATON, OR APPROVED EQUAL), 277V - PRIMARY, 24V-SECONDARY, 200VA, 1-PHASE. CONNECT (4) UNITS.





STATE OF MISSOURI MICHAEL L. PARSON, **GOVERNOR**

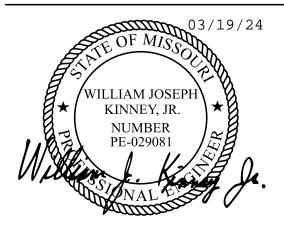

WILLIAM J. KINNEY License Number: 029081 Expiration Date: 12/31/25

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ADMINISTRATION DIVISION OF FACILITIES MANAGEMENT, **DESIGN AND CONSTRUCTION**

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DEPARTMENT OF MENTAL

UPGRADE HVAC CONTROLS

STAPLES BUILDING 1010 W COLUMBIA ST. FARMINGTON, MISSOURI 63640

PROJECT # M2011-01

SITE# 7354 ASSET# 6517354012

REVISION: ADDENDUM #1 DATE: 03/19/24

REVISION: DATE:

REVISION: DATE:


ISSUE DATE: 01/10/2024

CAD DWG FILE: DRAWN BY: RA CHECKED BY: WJK DESIGNED BY:

SHEET TITLE:

STAPLES PARTIAL ELECTRICAL PLAN

SHEET NUMBER:

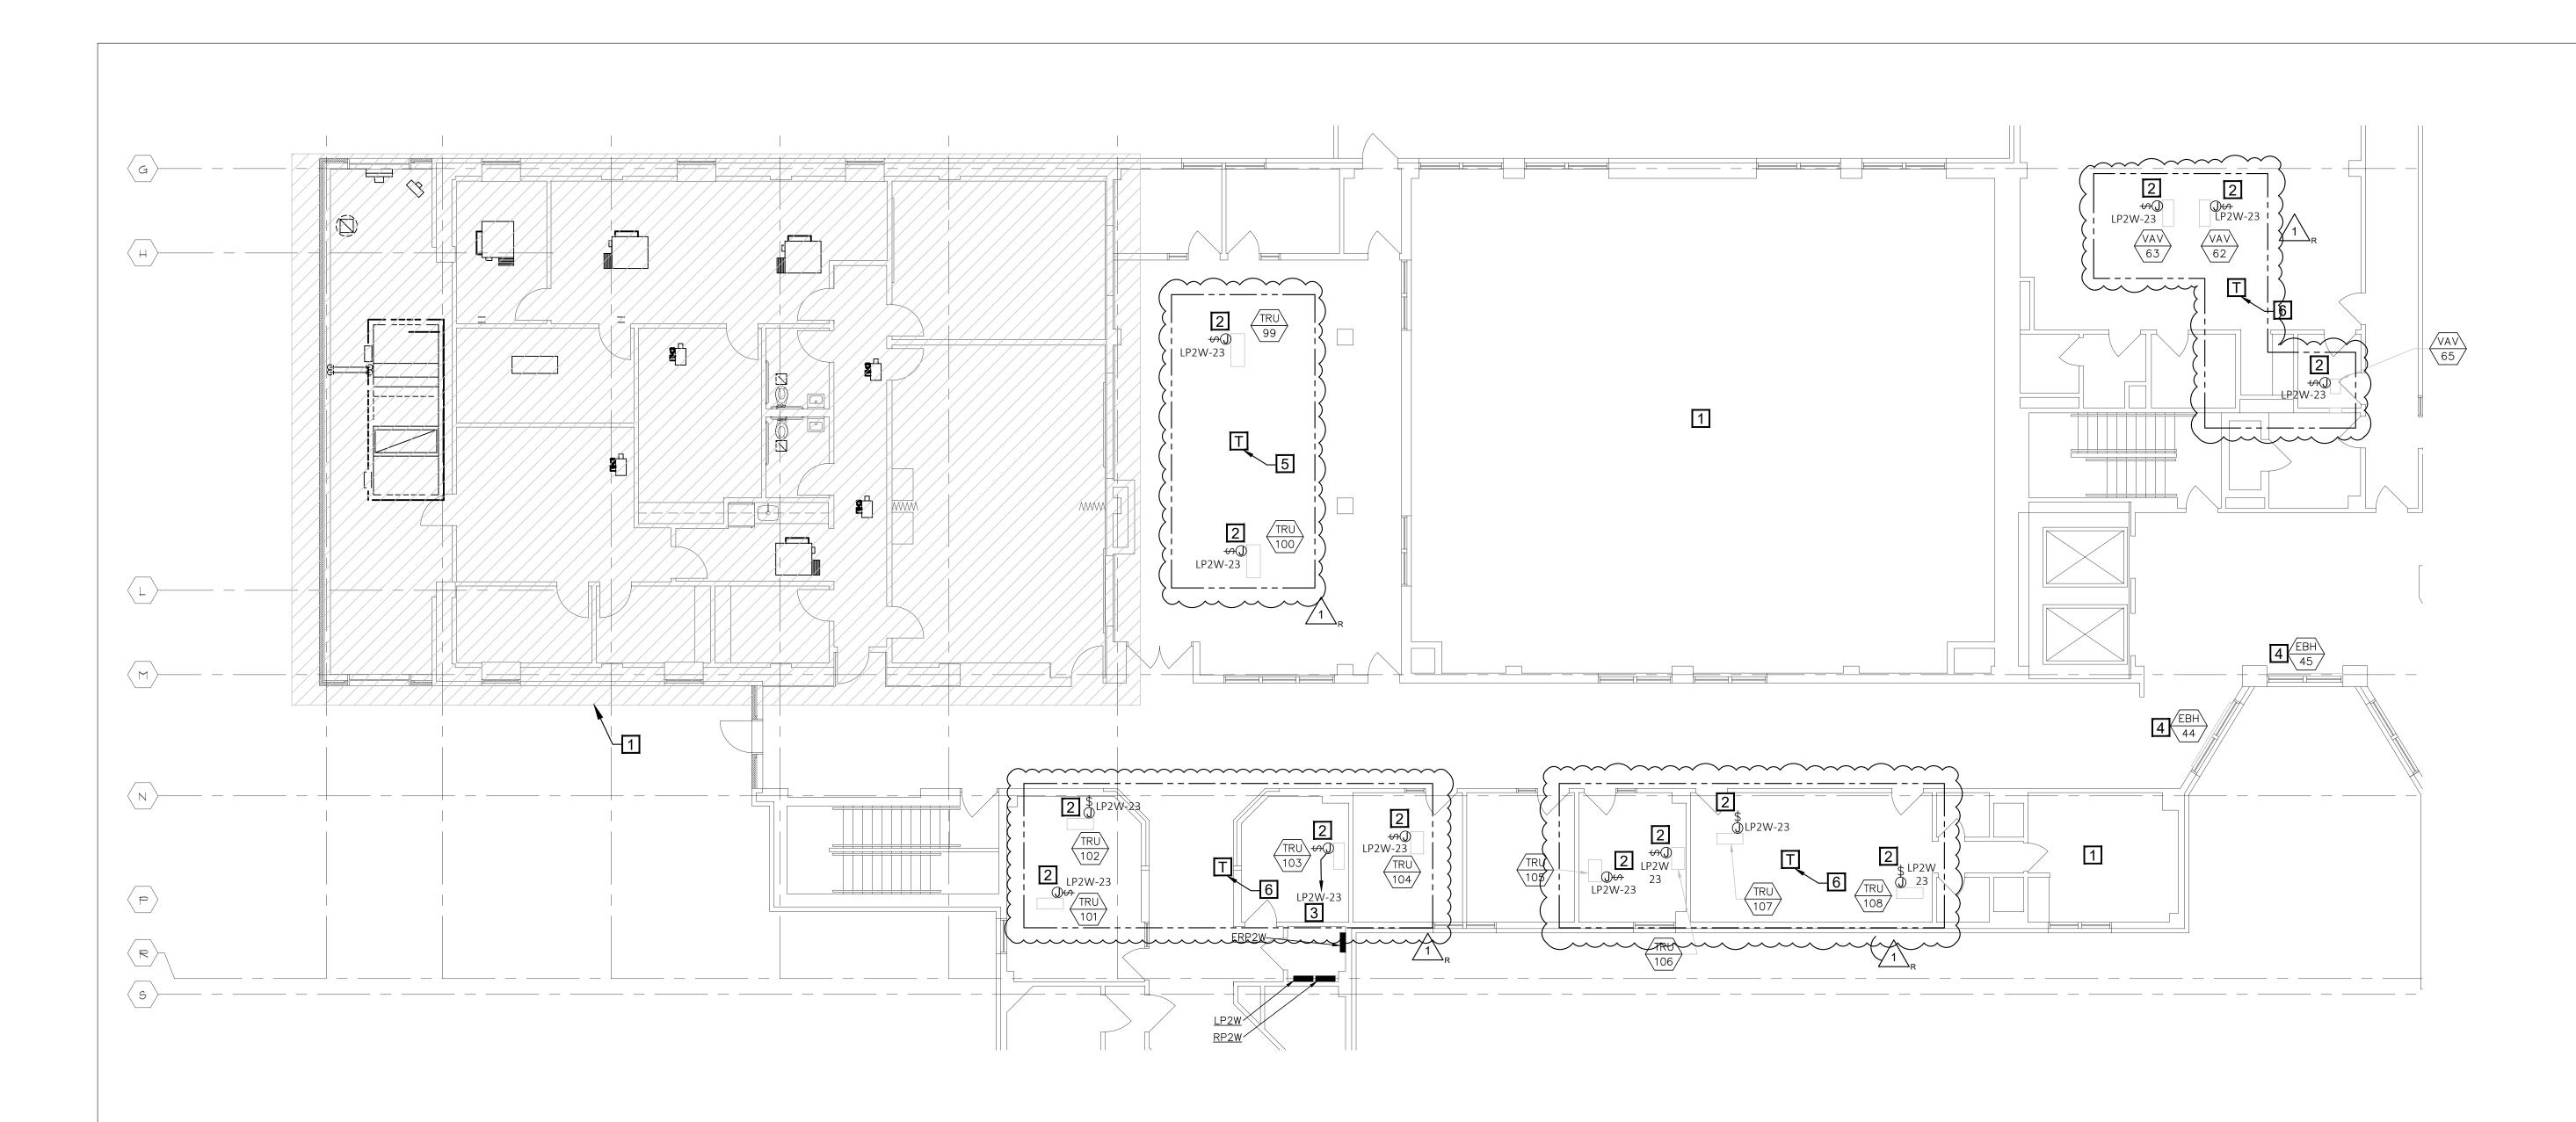


STAPLES BUILDING - 2ND FLOOR PARTIAL ELECTRICAL PLAN SCALE: 1/8" = 1'-0"

POWER GENERAL NOTES


- A. ALL WORK SHALL CONFORM TO THE REQUIREMENTS OF THE APPLICABLE BUILDING CODE, NEC AND ANY OTHER LOCAL CODES AND ORDINANCES.
- B. WORKMANSHIP SHALL BE FIRST QUALITY AND IN ACCORDANCE WITH BEST PRACTICES FOR THE TRADE BY SKILLED WORKERS.
- C. ALL MATERIALS SHALL BE NEW, WITH "UL" APPROVED LABELS.
- D. SUPPLY AND INSTALL NEW ELECTRICAL DEVICES AS SHOWN.
- E. ALL WIRING SHALL BE AS SPECIFIED UNDER ELECTRICAL SPEC SECTION.
- F. CONTROL WIRING FOR VAV, TRU WILL BE FURNISHED, INSTALLED AND CONNECTED BY MC, MC TO COORDINATE ANY ELECTRICAL WORK REQUIRED BY EC.
- G. ALL BRANCH CIRCUITS IN EXCESS OF 100 FT. TO VAV/TRU FROM PANEL SHALL BE #10 AWG.
- H. ALL CONDUIT SHALL BE EMT, UNO. DASHED LINE INDICATES GROUPINGS OF TRANSFORMER SERVICE.

POWER KEYED NOTES

- 1. NO ELECTRICAL WORK IN THIS AREA, UNO.
- PROVIDE JUNCTION BOX WITH 20A-1P HP RATED TOGGLE DISCONNECT SWITCH. CONNECT TO VAV/TRU 24V. NEW CONTROL TRANSFORMER FURNISHED AND INSTALLED BY EC. COORDINATE WORK WITH MC.
- CONNECT EXISTING TRU AND VAV UNIT VIA NEW UNIT TRANSFORMER TO SPARE 20A-1P C/B IN PANEL. CIRCUIT SHOWN IS FOR WIRING PURPOSE ONLY. IF C/B IS NOT AVAILABLE IN PANEL, CONNECT TO SPARE 20A/1P C/B IN NEAREST 277V PANEL NOT CONTROLLED BY CONTACTOR OR BAS. IF NEW 20A-1P C/B IS REQUIRED IN 277V PANEL, IT SHALL BE SAME MANUFACTURER AND INTERRUPTING RATING AS EXISTING C/B'S. SEE POWER GENERAL NOTE G.
- EXISTING ELECTRIC BASEBOARD HEATER TO REMAIN. PRIOR TO REMOVAL OF PNEUMATIC CONTACTOR IN BASEBOARD HEATER BY MC, EC TO DISCONNECT POWER WIRING AND MAKE SAFE FOR REUSE. MC TO REMOVE PNEUMATIC CONTACTOR AND SHALL REPLACE WITH NEW 24V-277V CONTACTOR. EC TO RECONNECT POWER WIRING AND MC TO CONNECT 24V CONTROL WIRING AS REQUIRED. COORDINATE WORK WITH MC.
- 5. CONTROL TRANSFORMER TYPE: BOD - SQUARE-D 9070T100D19, TYPE-T, (EQUIVALENTS -SIEMENS, EATON, OR APPROVED EQUAL), 277V - PRIMARY, 24V-SECONDARY, 100VA, 1-PHASE. CONNECT (2) UNITS.
- 6. CONTROL TRANSFORMER TYPE: BOB SQUARE-D 9070T200D25, TYPE-T, (EQUIVALENTS -SIEMENS, EATON, OR APPROVED EQUAL), 277V - PRIMARY, 24V-SECONDARY, 200VA, 1-PHASE.

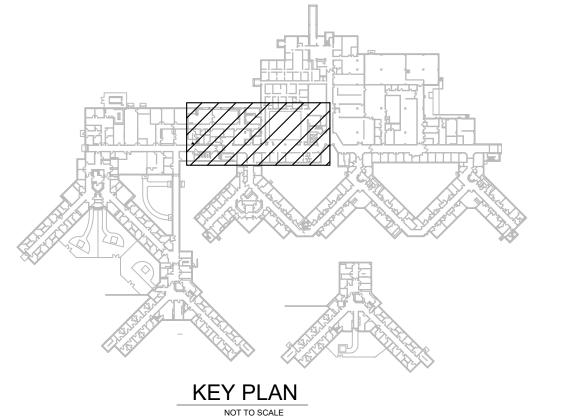

STATE OF MISSOURI MICHAEL L. PARSON, **GOVERNOR**

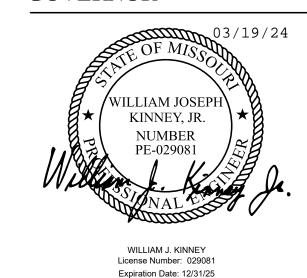

CASCO Diversified Corporation
MO Certificate of Authority #000329 Arch. MO Certificate of Authority #000613 Eng.

OFFICE OF ADMINISTRATION DIVISION OF FACILITIES MANAGEMENT, **DESIGN AND CONSTRUCTION**

DEPARTMENT OF MENTAL HEALTH

UPGRADE HVAC CONTROLS

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6517354012

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STAPLES PARTIAL ELECTRICAL PLAN

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STAPLES BUILDING - 2ND FLOOR PARTIAL ELECTRICAL PLAN

SCALE: 1/8" = 1'-0"

POWER GENERAL NOTES


- A. ALL WORK SHALL CONFORM TO THE REQUIREMENTS OF THE APPLICABLE BUILDING CODE, NEC AND ANY OTHER LOCAL CODES AND ORDINANCES.
- B. WORKMANSHIP SHALL BE FIRST QUALITY AND IN ACCORDANCE WITH BEST PRACTICES FOR THE TRADE BY SKILLED WORKERS.
- C. ALL MATERIALS SHALL BE NEW, WITH "UL" APPROVED LABELS.
- D. SUPPLY AND INSTALL NEW ELECTRICAL DEVICES AS SHOWN.
- E. ALL WIRING SHALL BE AS SPECIFIED UNDER ELECTRICAL SPEC SECTION.
- F. CONTROL WIRING FOR VAV, TRU WILL BE FURNISHED, INSTALLED AND CONNECTED BY MC, MC TO COORDINATE ANY ELECTRICAL WORK REQUIRED BY EC.
- G. ALL BRANCH CIRCUITS IN EXCESS OF 100 FT. TO VAV/TRU FROM PANEL SHALL BE #10 AWG.
- H. ALL CONDUIT SHALL BE EMT, UNO.
- DASHED LINE INDICATES GROUPINGS OF TRANSFORMER SERVICE. — - - - — - - —

POWER KEYED NOTES

- 1. NO ELECTRICAL WORK IN THIS AREA, UNO.
- 2. PROVIDE JUNCTION BOX WITH 20A-1P HP RATED TOGGLE DISCONNECT SWITCH. CONNECT TO VAV/TRU 24V. NEW CONTROL TRANSFORMER FURNISHED AND INSTALLED BY EC. COORDINATE
- CONNECT EXISTING TRU AND VAV UNIT VIA NEW UNIT TRANSFORMER TO SPARE 20A-1P C/B IN PANEL. CIRCUIT SHOWN IS FOR WIRING PURPOSE ONLY. IF C/B IS NOT AVAILABLE IN PANEL, CONNECT TO SPARE 20A/1P C/B IN NEAREST 277V PANEL NOT CONTROLLED BY CONTACTOR OR BAS. IF NEW 20A-1P C/B IS REQUIRED IN 277V PANEL, IT SHALL BE SAME MANUFACTURER AND INTERRUPTING RATING AS EXISTING C/B'S. SEE POWER GENERAL NOTE G.
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KEY PLAN

STATE OF MISSOURI MICHAEL L. PARSON, **GOVERNOR**

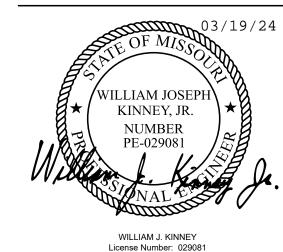

CASCO Diversified Corporation
MO Certificate of Authority #000329 Arch.
MO Certificate of Authority #000613 Eng.

Expiration Date: 12/31/25

OFFICE OF ADMINISTRATION DIVISION OF FACILITIES MANAGEMENT, **DESIGN AND CONSTRUCTION**

UPGRADE HVAC CONTROLS

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PROJECT # M2011-01 SITE# 7354

6517354012

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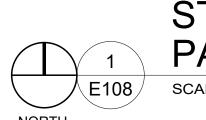
CAD DWG FILE: DRAWN BY: RA CHECKED BY: WJK DESIGNED BY:

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STAPLES PARTIAL ELECTRICAL PLAN

SHEET NUMBER:





STAPLES BUILDING - 2ND FLOOR PARTIAL ELECTRICAL PLAN

SCALE: 1/8" = 1'-0"


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POWER KEYED NOTES


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KEY PLAN

STATE OF MISSOURI MICHAEL L. PARSON, GOVERNOR



CASCO Diversified Corporation
MO Certificate of Authority #000329 Arch.
MO Certificate of Authority #000613 Eng.

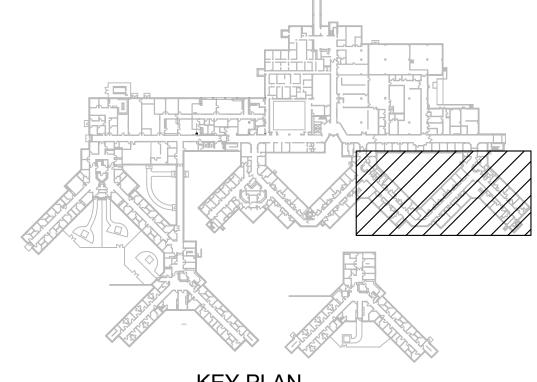12 Supper Drive Suite 100 St Touis MO 63143

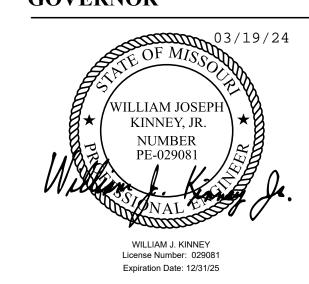ADMINISTRATION
DIVISION OF FACILITIES
MANAGEMENT,
DESIGN AND
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OFFICE OF

HEALTH

DEPARTMENT OF MENTAL

UPGRADE HVAC CONTROLS

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DRAWN BY: RA
CHECKED BY: WJK
DESIGNED BY:

SHEET TITLE:

STAPLES PARTIAL MECHANICAL PLAN

SHEET NUMBER:

E-108

01/10/2024 37 OF 41 SHEETS


POWER GENERAL NOTES


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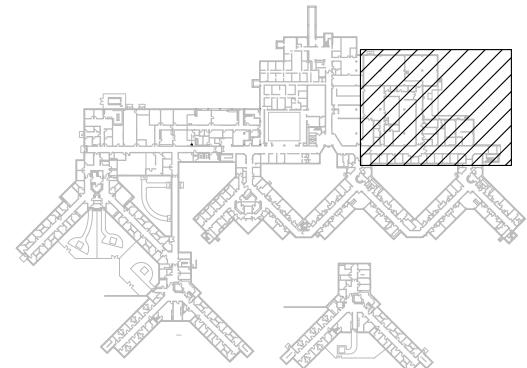
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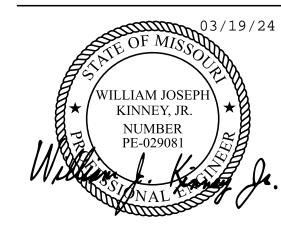
STAPLES BUILDING - 2ND FLOOR PARTIAL ELECTRICAL PLAN SCALE: 1/8" = 1'-0"



KEY PLAN

NOT TO SCALE

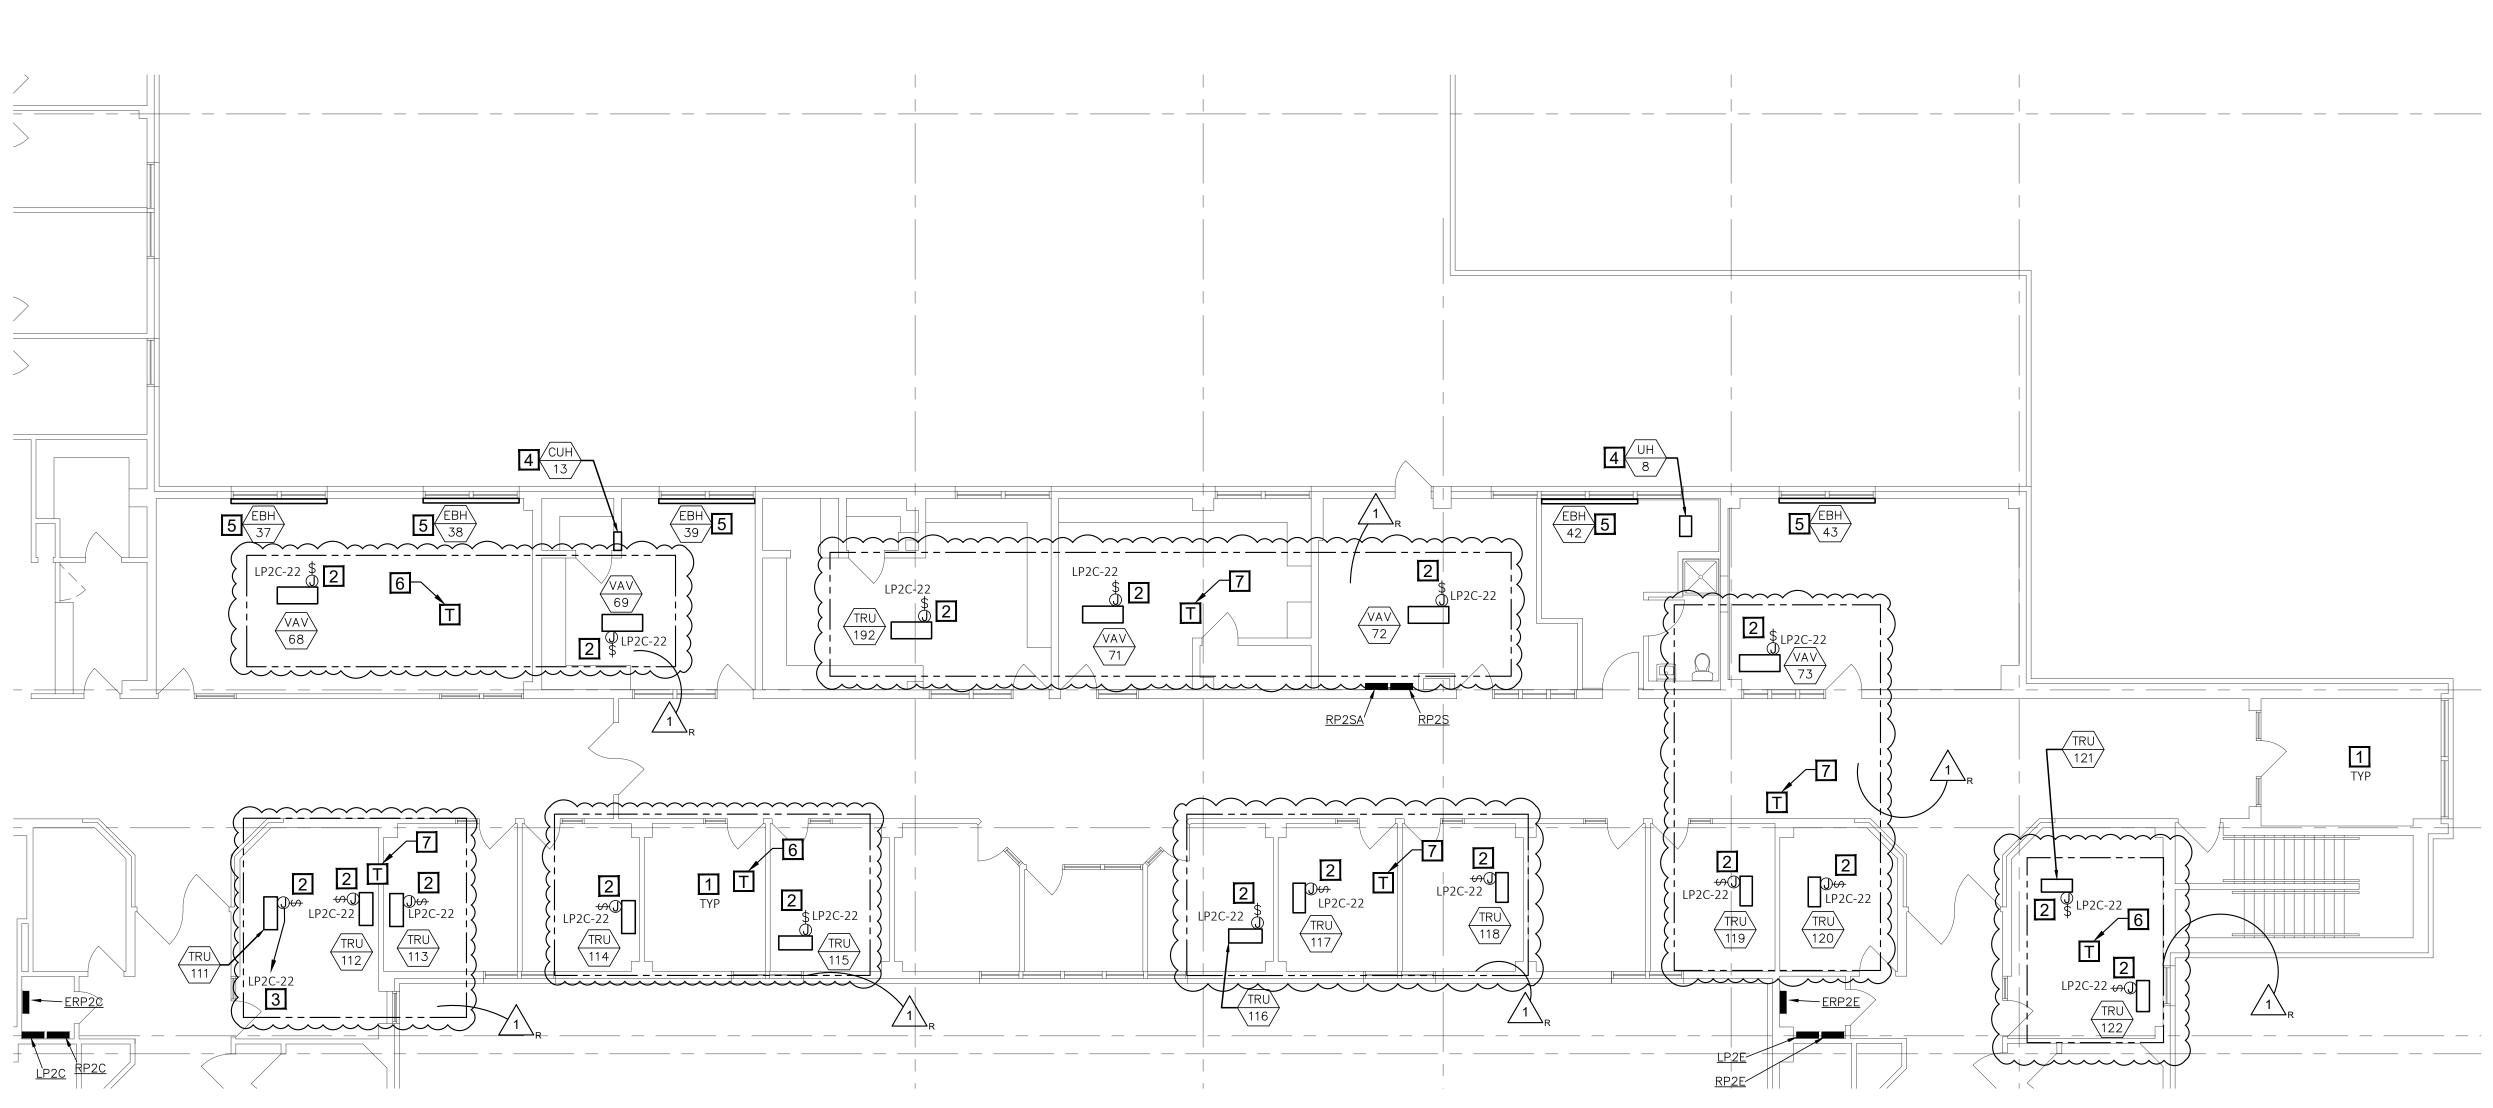STATE OF MISSOURI MICHAEL L. PARSON, **GOVERNOR**

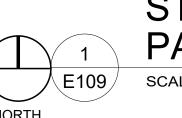

License Number: 029081 PROFESSIONAL SEAL

CASCO Diversified Corporation MO Certificate of Authority #000329 Arch. MO Certificate of Authority #000613 Eng.

OFFICE OF ADMINISTRATION DIVISION OF FACILITIES MANAGEMENT, **DESIGN AND** CONSTRUCTION

DEPARTMENT OF MENTAL

HEALTH

UPGRADE HVAC CONTROLS

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6517354012

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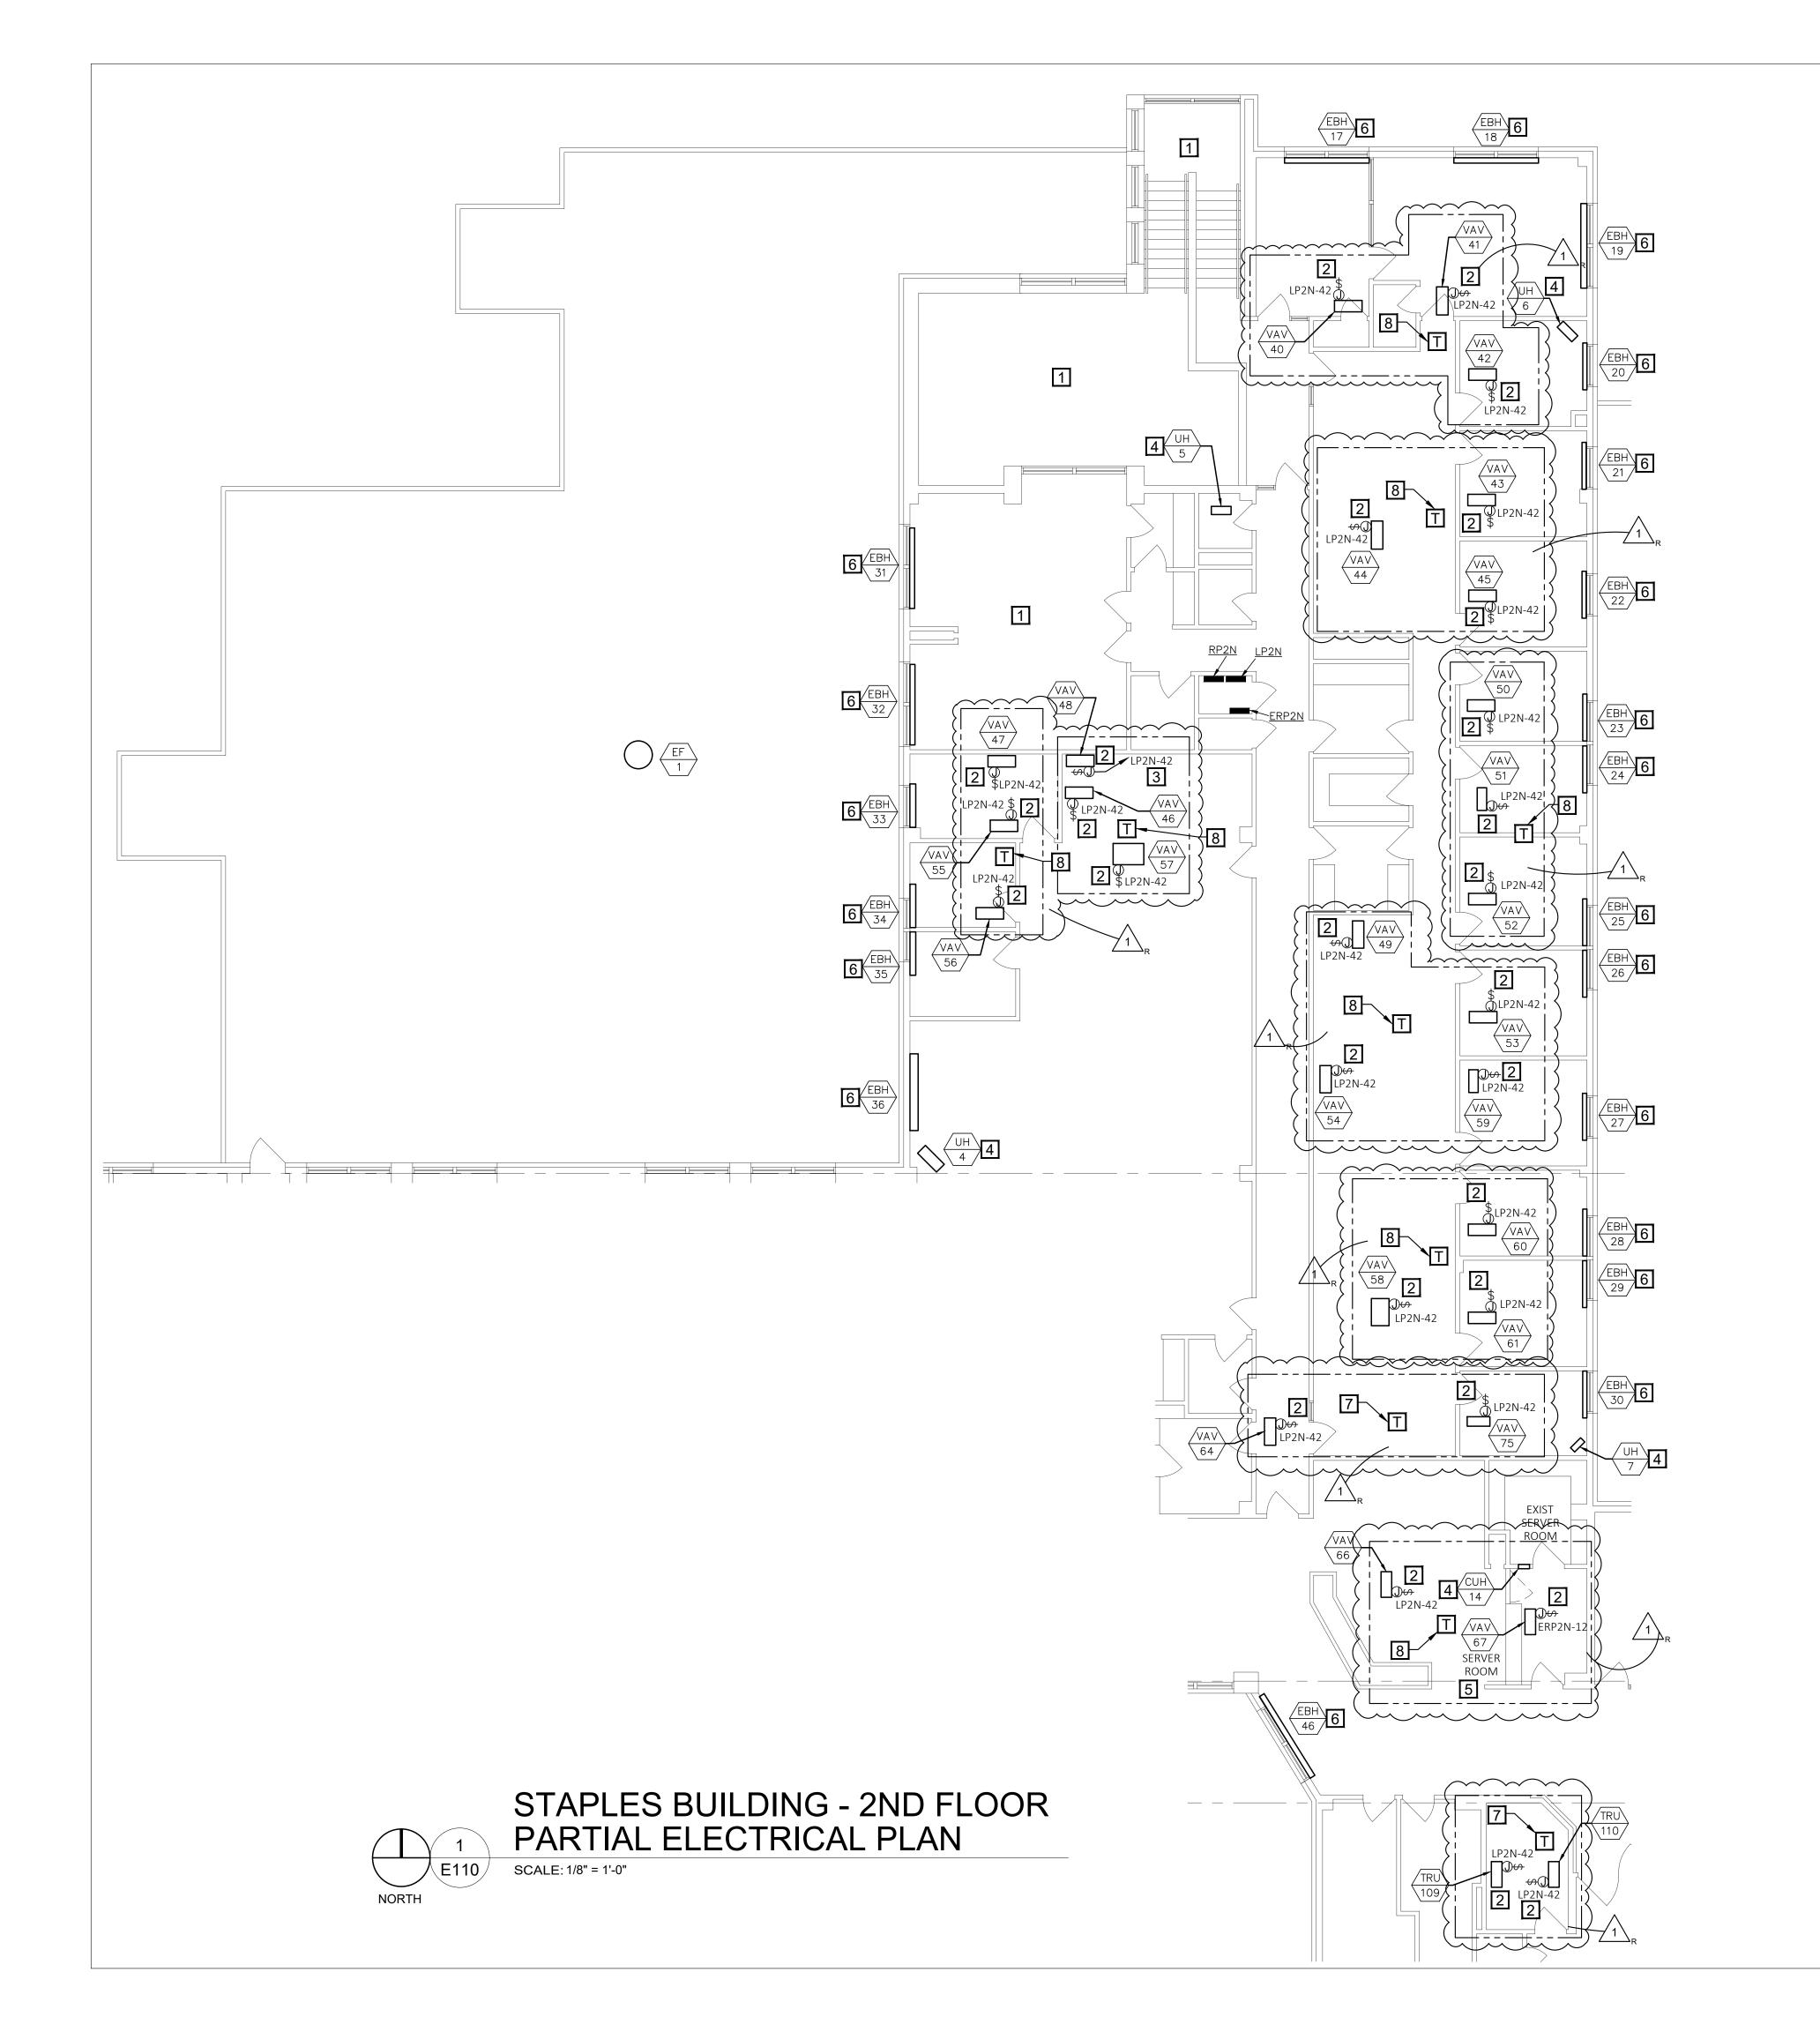
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STAPLES PARTIAL ELECTRICAL PLAN

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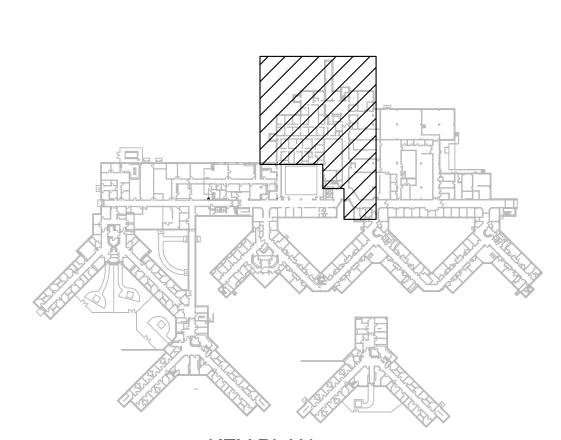
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DASHED LINE INDICATES GROUPINGS OF TRANSFORMER SERVICE. — - - - — - - -

POWER KEYED NOTES


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- 4. EXISTING EQUIPMENT WITH ELECTRICAL CONNECTION TO REMAIN IN-PLACE, UNO.
- 5. CONNECT EXISTING VAV UNIT VIA NEW UNIT TRANSFORMER TO SPARE 20A-1P C/B IN EMERGENCY PANEL. CIRCUIT SHOWN IS FOR WIRING PURPOSE ONLY. IF C/B IS NOT AVAILABLE IN EMERGENCY PANEL, CONNECT TO SPARE 20A/1P C/B IN NEAREST 120V EMERGENCY PANEL NOT CONTROLLED BY CONTACTOR OR BAS. IF NEW 20A-1P C/B IS REQUIRED IN 120V EMERGENCY PANEL, IT SHALL BE SAME MANUFACTURER AND INTERRUPTING RATING AS EXISTING C/B'S. SEE POWER GENERAL NOTE G. COORDINATE WITH MECHANICAL THIS UNIT SUPPLYS THE SERVER ROOM.
- 6. EXISTING ELECTRIC BASEBOARD HEATER TO REMAIN. PRIOR TO REMOVAL OF PNEUMATIC CONTACTOR IN BASEBOARD HEATER BY MC, EC TO DISCONNECT POWER WIRING AND MAKE SAFE FOR REUSE. MC TO REMOVE PNEUMATIC CONTACTOR AND SHALL REPLACE WITH NEW 24V-277V CONTACTOR. EC TO RECONNECT POWER WIRING AND MC TO CONNECT 24V CONTROL WIRING AS REQUIRED. COORDINATE WORK WITH MC.
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KEY PLAN

NOT TO SCALE

STATE OF MISSOURI MICHAEL L. PARSON, GOVERNOR



WILLIAM J. KINNEY
License Number: 029081
Expiration Date: 12/31/25
PROFESSIONAL SEAL

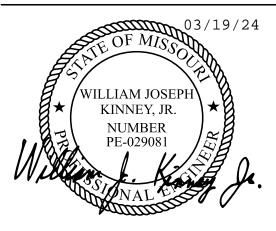CASCO Diversified Corporation MO Certificate of Authority #000329 Arch. MO Certificate of Authority #000613 Eng.

2 Sunnen Drive, Suite 100, St. Louis, MO 63143

DIVISION OF FACILITIES MANAGEMENT,
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STAPLES PARTIAL ELECTRICAL PLAN

SHEET NUMBER:

E-110