REPLACE COOLING TOWERS SAINT LOUIS FORENSIC TREATMENT CENTER - NORTH SAINT LOUIS, MISSOURI

OWNER: STATE OF MISSOURI

MICHAEL L. PARSON,

GOVERNOR

DEPARTMENT OF

OFFICE OF ADMINISTRATION

PROJECT OFFICE OF ADMINISTRATION

DIVISION OF FACILITIES MANAGEMENT, MANAGEMENT:

DESIGN AND CONSTRUCTION

DESIGNER: BERNHARD TME

Mechanical / Plumbing / Electrical

PROJECT NUMBER: M2015-01

SITE NUMBER:

7391

6517391002 ASSET NUMBER:

DRAWING SET - SHEET LIST INDEX

GENERAL:

G-001 COVER SHEET / SHEET LIST INDEX

MECHANICAL SHEETS:

M-001 SYMBOLS AND ABBREVIATION

MD-101 PARTIAL ROOF PLAN - COOLING TOWER DEMOLITION MD-102 PARIAL FIRST FLOOR PLAN - MAIN MECHANICAL DEMOLITION

MD-201 CONDENSER WATER DEMOLITION FLOW DIAGRAM

M-101 PARTIAL ROOF PLAN - COOLING TOWER NEW WORK PARIAL FIRST FLOOR PLAN - MAIN MECHANICAL NEW WORK

M-201 MODIFIED CONDENSER WATER FLOW DIAGRAM M-202 CONDENSER WATER POINTS LIST SCHEDULE

M-203 SCHEDULES AND DETAILS

ELECTRICAL SHEETS:

E-001 SYMBOLS AND ABBREVIATION

ED-101 PARTIAL ROOF PLAN - COOLING TOWER DEMOLITION ED-102 PARIAL FIRST FLOOR PLAN - MAIN MECHANICAL DEMOLITION

E-101 PARTIAL ROOF PLAN - COOLING TOWER NEW WORK E-102 PARIAL FIRST FLOOR PLAN - MAIN MECHANICAL NEW WORK

STATE OF MISSOURI MICHAEL L. PARSON, **GOVERNOR**

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OFFICE OF ADMINISTRATION **DIVISION OF FACILITIES** MANAGEMENT, **DESIGN AND CONSTRUCTION**

DEPARTMENT OF MENTAL HEALTH

REPLACE COOLING TOWERS SAINT LOUIS FORENSIC TREATMENT CENTER - NORTH SAINT LOUIS, MISSOURI

PROJECT # M2015-01 SITE# 7391 ASSET # 6517391002

REVISION REVISION DATE **REVISION**

CAD DWG FILE: M2015-01 G-001.DWG DRAWN BY: CHECKED BY: EGU

ISSUE DATE: 02/14/2023

SHEET TITLE:

COVER SHEET

DESIGNED BY: NJS

SHEET NUMBER:

G-001

SHEET 1 OF 15 FEBRUARY 14, 2023

PLUMBING SYMBOLS

SANITARY SEWER BELOW GRAD
SANITARY SEWER ABOVE GRAD
STORM SEWER BELOW GRADE
STORM SEWER ABOVE GRADE
SLOPE IN DIRECTION OF ARROY (SEE PLANS FOR % OF SLOPE)
VENT
COLD WATER
HOT WATER
HOT WATER CIRCULATING

MECHANICAL SYMBOLS AND ABBREVIATIONS

ABV ABOVE AD ACCESS DOOR AFF ABOVE FINISHED FLOOR AHU AIR HANDLING UNIT ALT ALTERNATE AP ACCESS PANEL APPROX APPROXIMATE AS AIR SEPARATOR AUTO AUTOMATIC AV AIR VENT BHP BRAKE HORSEPOWER BLDG BUILDING BM BEAM	GPM GV HGR HOA HP HTG HWR HWS HX ID LAT LWT MAX	GALLONS PER MINUTE GAUGE VALVE HANGER HAND OFF AUTO HORSEPOWER HEATING HEATING WATER RETURN HEATING WATER SUPPLY HEAT EXCHANGER INSIDE DIAMETER LEAVING AIR TEMPERATURE LEAVING WATER TEMPERATURE MAXIMUM	CWS ————————————————————————————————————	CWS	CONDENSER WATER SUPPLY CONDENSER WATER RETURN CHILLED WATER SUPPLY CHILLED WATER RETURN GRAVITY DRAIN PIPE HEATING WATER SUPPLY
BOD BOTTOM OF DUCT BOP BOTTOM OF PIPE BOT BOTTOM BSMT BASEMENT BTU BRITISH THERMAL UNIT BTUH BRITISH THERMAL UNIT PER HO BV BALANCE VALVE CF CHEMICAL FEED CH CHILLER CHV CHECK VALVE CLG CEILING COM COMMON CONC CONCRETE COND CONDENSATE CWR CONDENSER WATER RETURN CWS CONDENSER WATER SUPPLY CT COOLING TOWER CTE CONTROL VALVE CHWR CHILLED WATER RETURN	MBH MPC MECH MIN NC NIC NO NOM NTS OPNG P PD PR PR RA REQ'D REV RF RH	BTU x 1000 MECHANICAL PIPE COUPLING MECHANICAL MINIMUM NORMALLY CLOSED NOT IN CONTRACT NORMALLY OPEN NOMINAL NOT TO SCALE OPENING PUMP PRESSURE DROP PRESSURE REGULATOR PRESSURE REDUCING VALVE REDUCER RETURN AIR REQUIRED REVISION RETURN FAN RELATIVE HUMIDITY	HWR ————————————————————————————————————	HWR————————————————————————————————————	HEATING WATER RETURN BALANCE VALVE CHECK VALVE TWO WAY CONTROL VALVE THREE WAY CONTROL VALVE HI FLANGE CONNECTION OR BLIND FLANGE PIPE FLOW METER MECHANICAL PIPE COUPLING PIPE FLEX CONNECTION PRESSURE REGULATING VALVE PRESSURE REDUCING VALVE
CHWS CHILLED WATER SUPPLY DDC DIRECT DIGITAL CONTROL DIA DIAMETER DIS DISCHARGE DN DOWN DP DIFFERENTIAL PRESSURE DR DRAIN LINE DV DRAIN VALVE DWG DRAWING EAT ENTERING AIR TEMPERATURE EC ELECTRIC CONTRACTOR EF EXHAUST FAN EFF EFFICIENCY EQUIP EQUIPMENT EWT ENTERING WATER TEMPERATURI ET EXPANSION TANK EX EXISTING EXH EXHAUST AIR F FLANGE CONNECTION F DEGREE FAHRENHEIT FC FLEXIBLE CONNECTION FLR FLOOR FRD FIRE RATED DAMPER	RM RPM RTU RV SEC SP SPEC STR SUC SUD SV T TB TH TSP TW TYP U UH VFD WTR W/ W/o	ROOM REVOLUTIONS PER MINUTE ROOF TOP UNIT RELIEF VALVE SECTION STATIC PRESSURE SPECIFICATIONS STRAINER SUCTION SUCTION DIFFUSER SERVICE VALVE THERMOSTAT TESTING AND BALANCING THERMOMETER TOTAL STATIC PRESSURE THERMOMETER WELL TYPICAL UNION UNIT HEATER VARIABLE FREQUENCY DRIVE WATER WITH WITHOUT	ER ————————————————————————————————————		 ■ ECCENTRIC PIPE REDUCER ■ PIPE REDUCER ■ STRAINER ■ STEAM TRAP ■ SERVICE VALVE ■ TRIPLE DUTY VALVE PIPE AIR VENT ■ PIPE CAP DRAIN VALVE ■ DIRECTION OF FLOW IN PIPE GAUGE WITH GAUGE VALVE ■ GAUGE VALVE
		UCTWORK VED VORK OR PIPING TING EQUIPMENT DESIGNATION	RBPB RV U TH TH DN		REDUCED PRESSURE BACKFLOW PREVEN RELIEF VALVE UNION THERMOMETER THERMOMETER WELL PIPE LINE, TURNED DOWN
1	(CONTRACTOR SHALL F KEYED NOTE DESIGNATI DEMOLITION KEYED NOT EQUIPMENT TYPE EQUIPMENT DESIGNATION EQUIPMENT NUMBER	E DESIGNATION	UP		PIPE LINE, TURNED UP PIPE RUNOUT OFF THE BOTTOM PIPE RUNOUT OFF THE TOP PUMP SYMBOL PUMP SYMBOL w/ SUCTION DIFFUSER

GENERAL DEMOLITION AND NEW WORK NOTES:

- 1. REMOVE EQUIPMENT, PIPING AND DUCTWORK AS INDICATED INCLUDING HANGERS, RODS, BRACKETS, ANCHOR BOLTS, SEISMIC BRACES AND CABLES AND OTHER ASSOCIATED SUPPORTS, BASES, ACCESSORIES AND SPECIALTIES.
- 2. CAP ALL OPEN ENDS OF EXISTING PIPE THAT REMAIN IN SERVICE. WHERE PIPING IS REMOVED TO EXISTING SERVICE VALVES, CAP SERVICE VALVES USING CAP, PLUGS, OR BLIND FLANGES.
- 3. PATCH HOLES IN WALLS AND PARTITIONS WHERE PIPING AND DUCTWORK ARE REMOVED. WALL AND PARTITION PATCHES SHALL MATCH EXISTING CONSTRUCTION AND FIRE RATING INCLUDING LEVEL OF SURFACE FINISH. PATCH CLAY TILE AND BRICK WALLS, FULL THICKNESS WITH BRICK AND/OR MASONRY PRODUCTS. PATCHES EXPOSED TO VIEW SHALL BE PAINTED TO MATCH SURROUNDINGS.
- 4. PATCH HOLES IN FLOOR WHERE PIPING AND DUCTWORK ARE REMOVED. PROVIDE CONCRETE OR GROUT INFILL WITH REINFORCING STEEL. PROVIDE FORMS AS REQUIRED. SURFACE FINISH AND FIRE RATING SHALL MATCH EXISTING SURROUNDINGS.
- 5. THE PLANS INDICATE, GENERALLY, THE DESIGN AND ARRANGEMENT OF DUCTWORK, PIPING, EQUIPMENT, AND ACCESSORIES, AND ARE DIAGRAMMATIC IN NATURE. THE EXACT LOCATION OF THESE ITEMS IS SUBJECT TO CHANGE DUE TO FIELD CONDITIONS WHICH SHALL BE VERIFIED BY THE CONTRACTOR. IF REQUIRED, THESE CHANGES SHALL BE MADE IN COMPLIANCE WITH THE INTERNATIONAL PLUMBING AND MECHANICAL CODES, AND WITHOUT ADDITIONAL COST TO THE OWNER.
- 6. EQUIPMENT SHALL BE INSTALLED, AND ADEQUATE CLEARANCES FOR MAINTENANCE AND REPLACEMENT SHALL BE PROVIDED, IN ACCORDANCE WITH THE MANUFACTURERS INSTALLATION INSTRUCTIONS AND RECOMMENDATIONS.
- 7. IT IS THE CONTRACTOR'S RESPONSIBILITY TO LOCATE SHUT-OFF VALVES REQUIRED FOR TIE-INS AND TO ISOLATE AND DRAIN PIPING TO BE DEMOLISHED. THE SHUT-OFF DATE AND DURATION OF SHUT-OFF PERIOD SHALL BE APPROVED BY OWNER PRIOR TO SHUT OFF.
- 8. CONTRACTOR SHALL PROTECT ALL EXISTING FLOOR, WALL AND CEILING SURFACES IN AREAS OF WORK AND EQUIPMENT AND PERSONNEL ACCESS. CONTRACTOR SHALL PROVIDE PLASTIC FLOOR PROTECTION FILM AND MASONITE RIGID BOARDS FOR FINISHED FLOOR IN AREAS OF WORK AND ACCESS INCLUDING CORRIDORS AND TOILETS. CONTRACTOR SHALL REPAIR OR REPLACE DAMAGED FLOOR, WALL AND CEILING SURFACES AND BUILDING COMPONENTS.
- 9. CONTRACTOR SHALL PATCH EXISTING FIRE RESISTIVE MATERIAL WHERE HANGERS, BRACKETS, SUPPORTS, CLIPS, ANCHORS, EQUIPMENT, WALLS, ETC. ARE REMOVED OR INSTALLED AS PART OF THIS PROJECT. FIRE RESISTIVE MATERIAL SHALL BE COMPATIBLE AND OF EQUAL FIRE RATED PROTECTION AND THICKNESS OF EXISTING MATERIAL.
- 10. MAINTAIN MINIMUM ELECTRICAL CLEARANCES ABOVE AND IN FRONT OF ALL ELECTRICAL PANELS AND EQUIPMENT. SEE ELECTRICAL PLANS.

STATE OF MISSOURI MICHAEL L. PARSON, GOVERNOR

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DEPARTMENT OF MENTAL HEALTH

REPLACE COOLING TOWERS SAINT LOUIS FORENSIC TREATMENT CENTER - NORTH SAINT LOUIS, MISSOURI

PROJECT # M2015-01 SITE # 7391

ASSET#

REVISION:
DATE:
REVISION:
DATE:
REVISION:
DATE:

ISSUE DATE: 02/14/2023

6517391002

CAD DWG FILE: M2015-01 M-001.DWG
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CHECKED BY: EGU

DESIGNED BY: NJS


SHEET TITLE:

SYMBOLS AND ABBREVIATIONS

SHEET NUMBER:

M-00

SHEET 2 OF 15 FEBRUARY 14, 2023

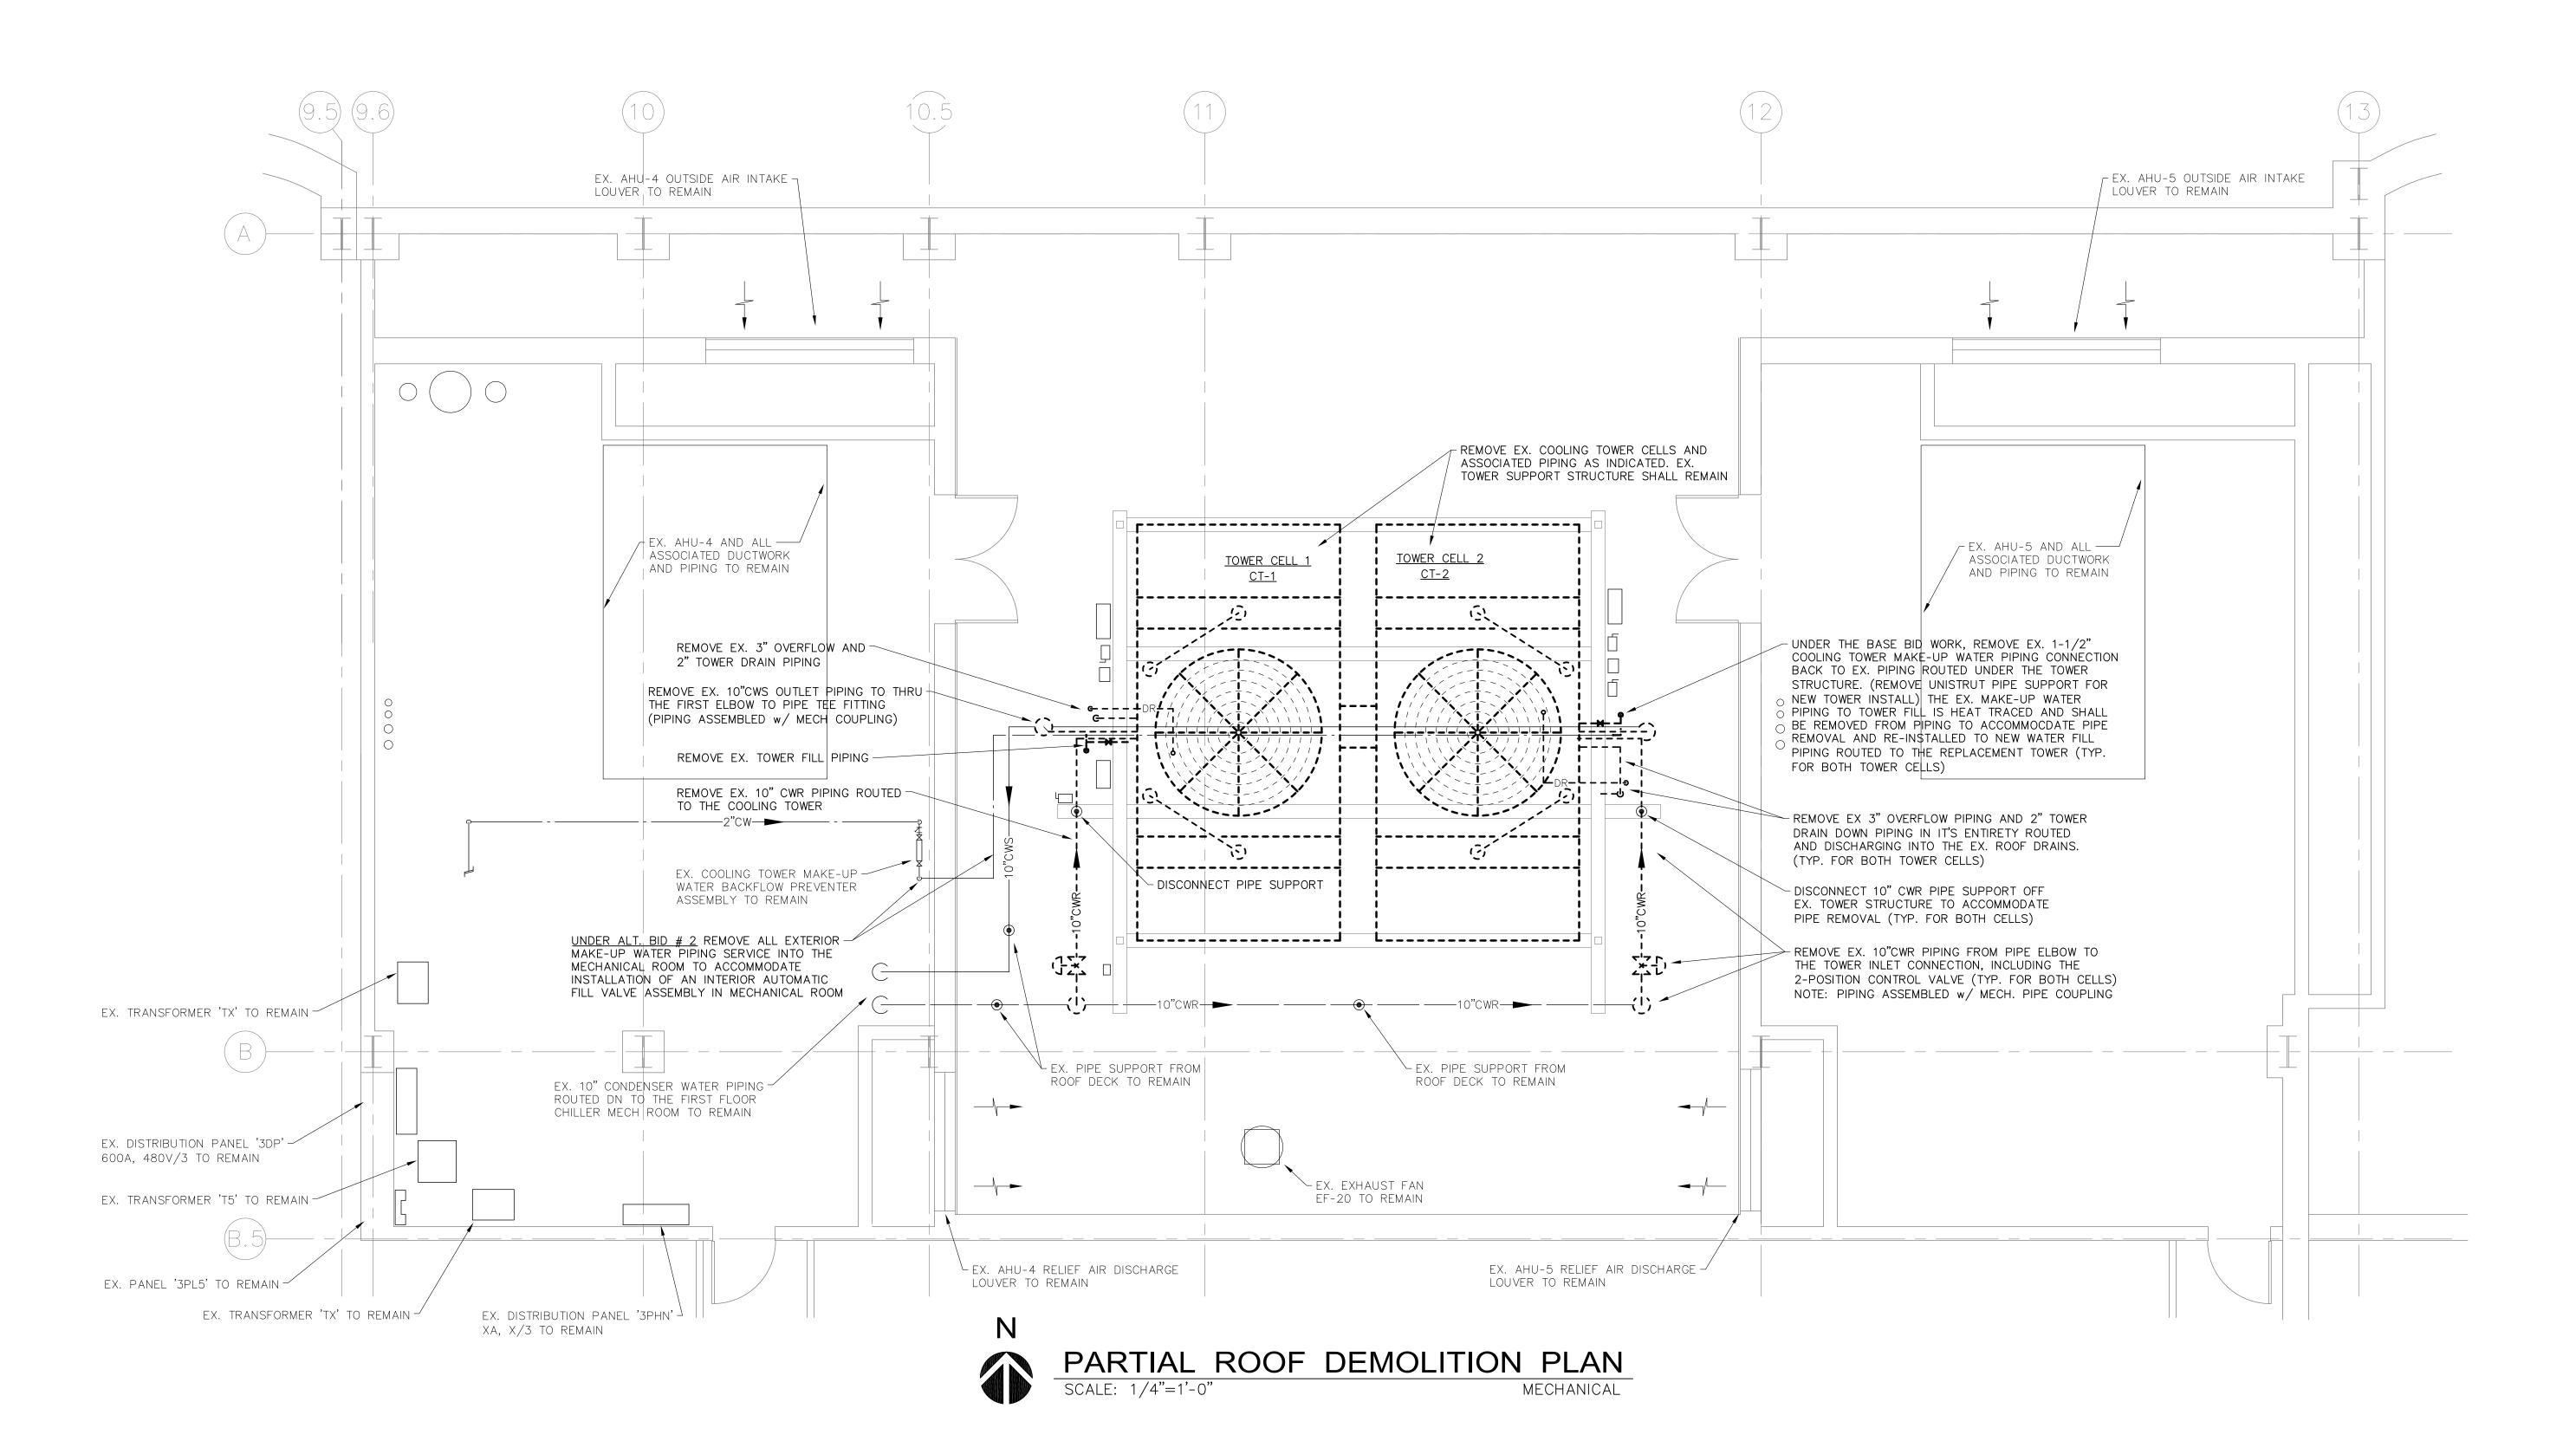

M2015-01 MD-101.dwg, ., 2/14/2023 11:40 AM, jmor

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DEPARTMENT OF MENTAL HEALTH

REPLACE COOLING TOWERS
SAINT LOUIS FORENSIC
TREATMENT CENTER - NORTH
SAINT LOUIS, MISSOURI

PROJECT # M2015-01 SITE # 7391

SITE # 7391 ASSET # 6517391002

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CAD DWG FILE: M2015-01 MD-101.DWG
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DESIGNED BY: NJS

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SHEET TITLE:

PARTIAL ROOF DEMOLITION PLAN

SHEET NUMBER:

MD-10

SHEET 3 OF 15 FEBRUARY 14, 2023

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REVISION:
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DESIGNED BY: NJS

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ASSET#


PARTIAL FIRST FLR. PLAN - MAIN EQUIP. ROOM DEMO

SHEET NUMBER:

MD-102

SHEET 4 OF 15 FEBRUARY 14, 2023

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EXISTING CONDENSER WATER DEMOLITION FLOW DIAGRAM NO SCALE
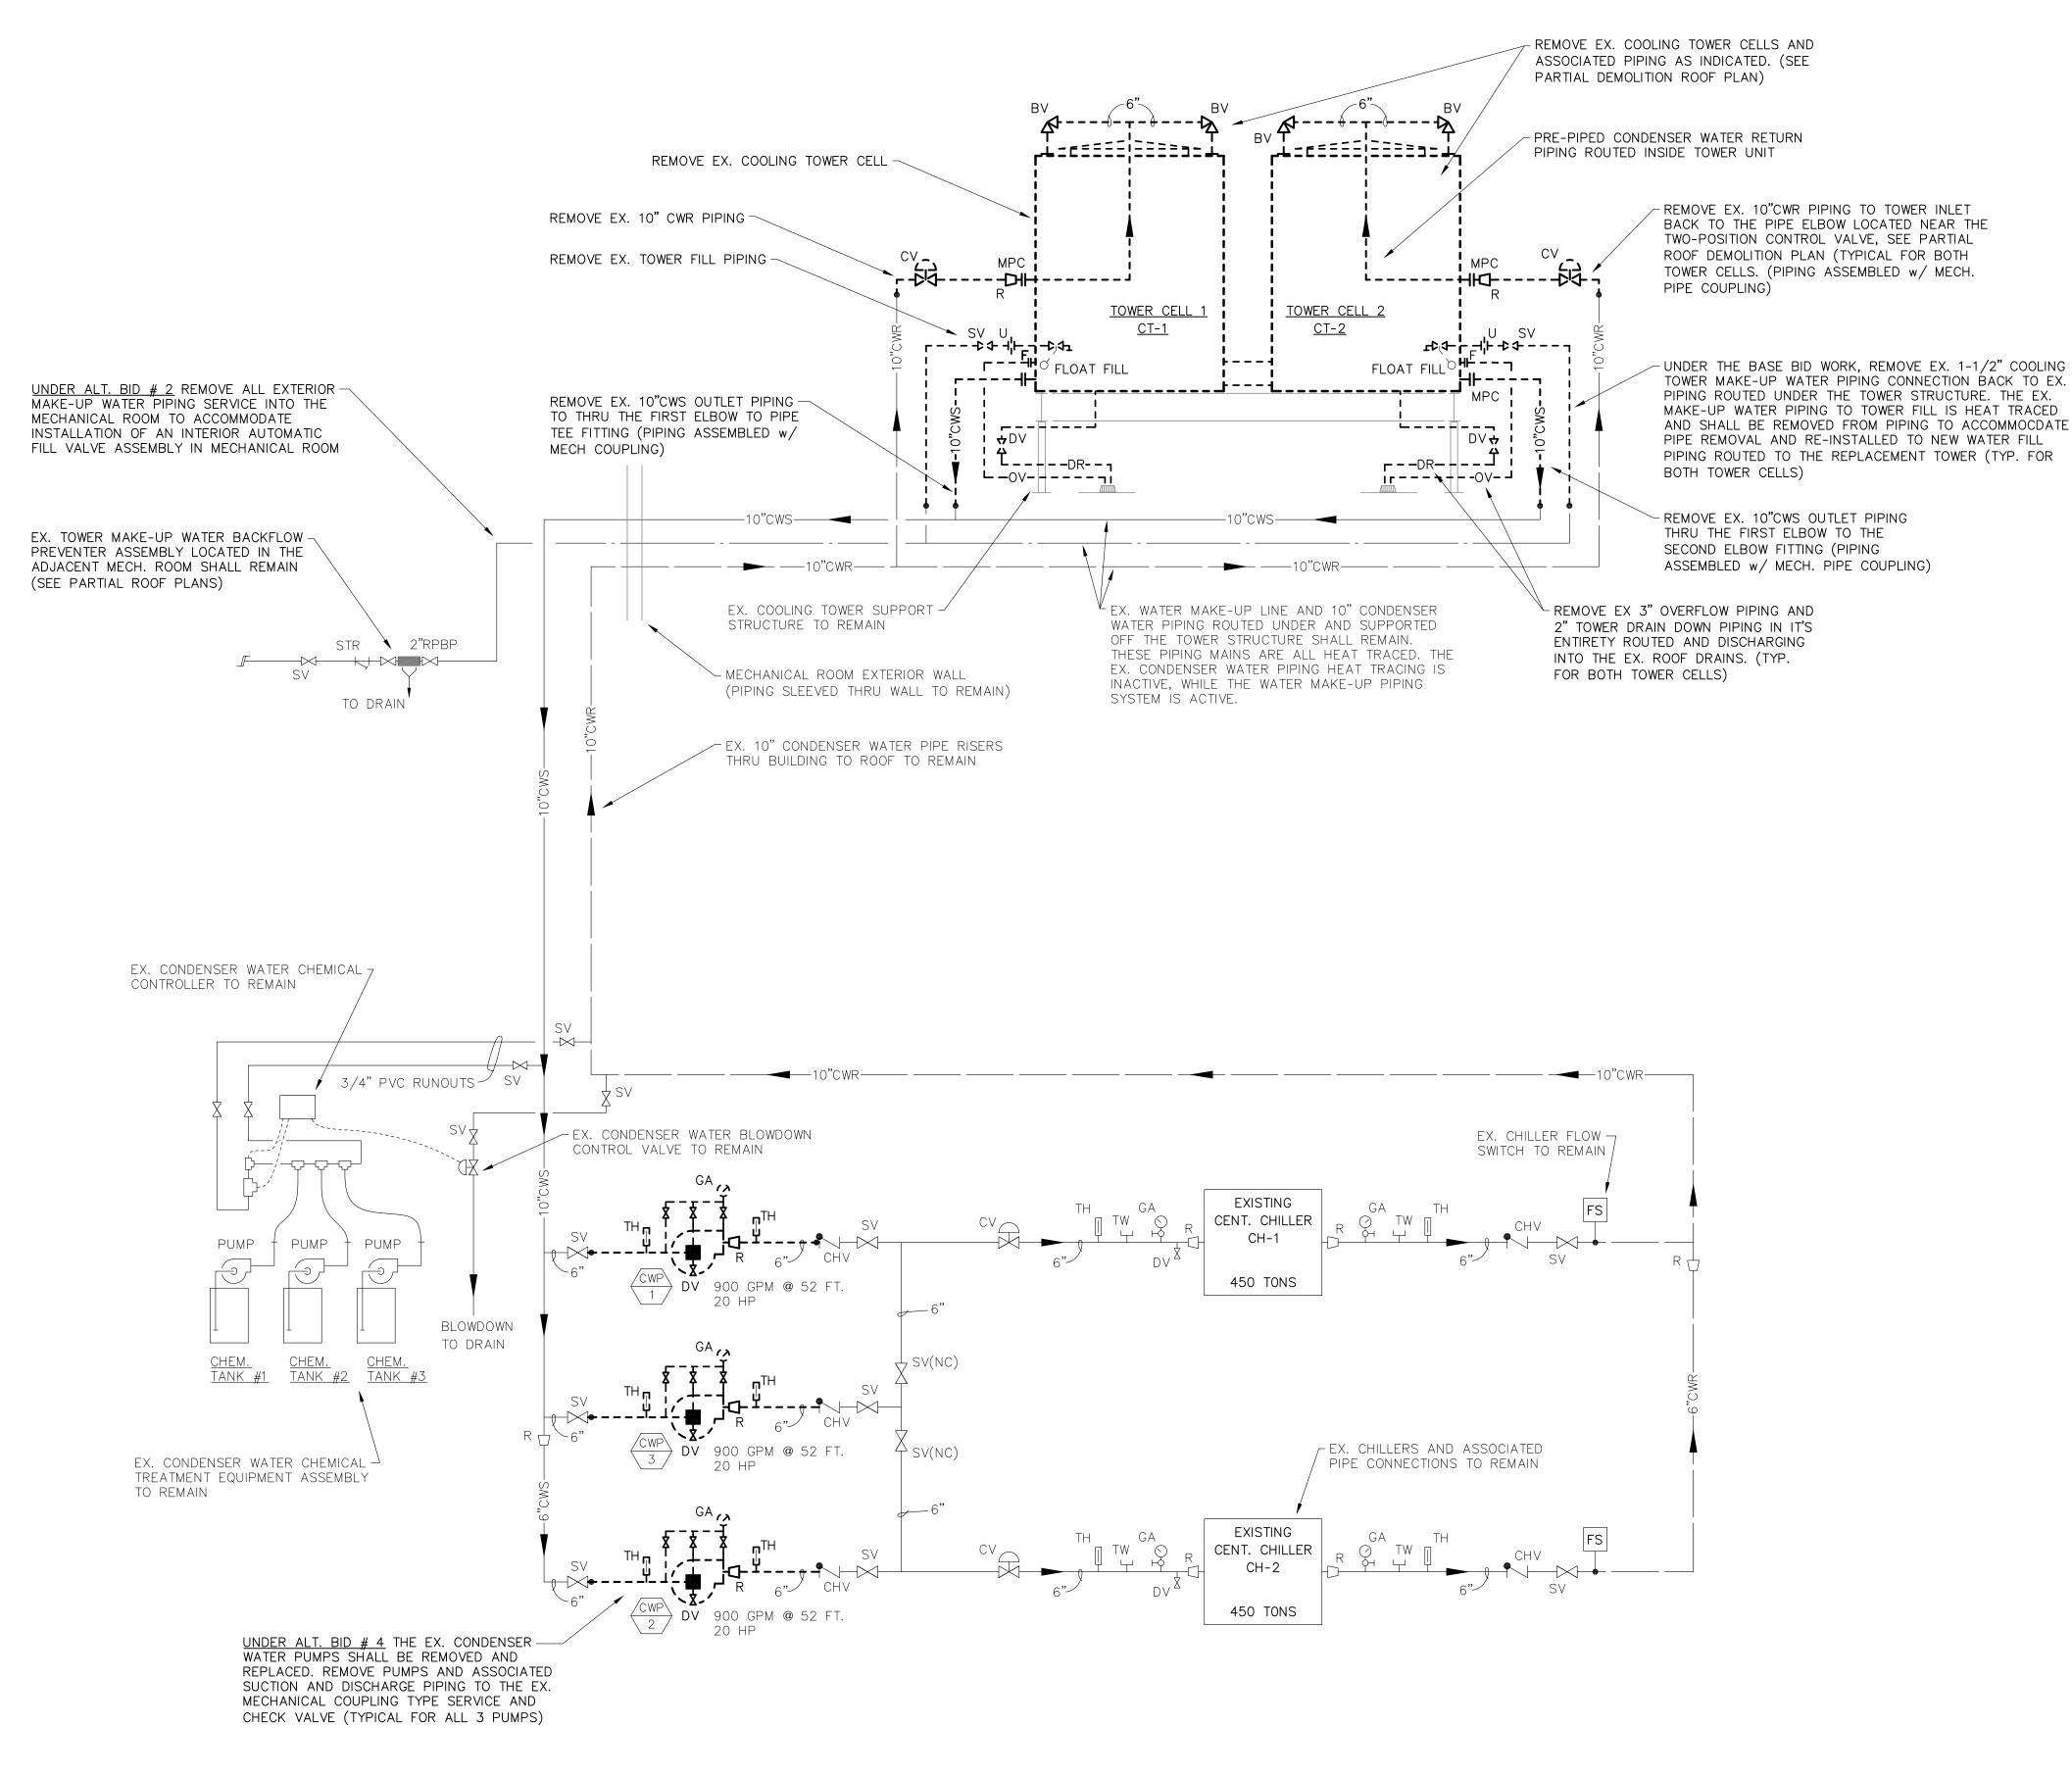
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DATE:
REVISION:

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DATE:

CAD DWG FILE: M2015-01 MD-201.DWG
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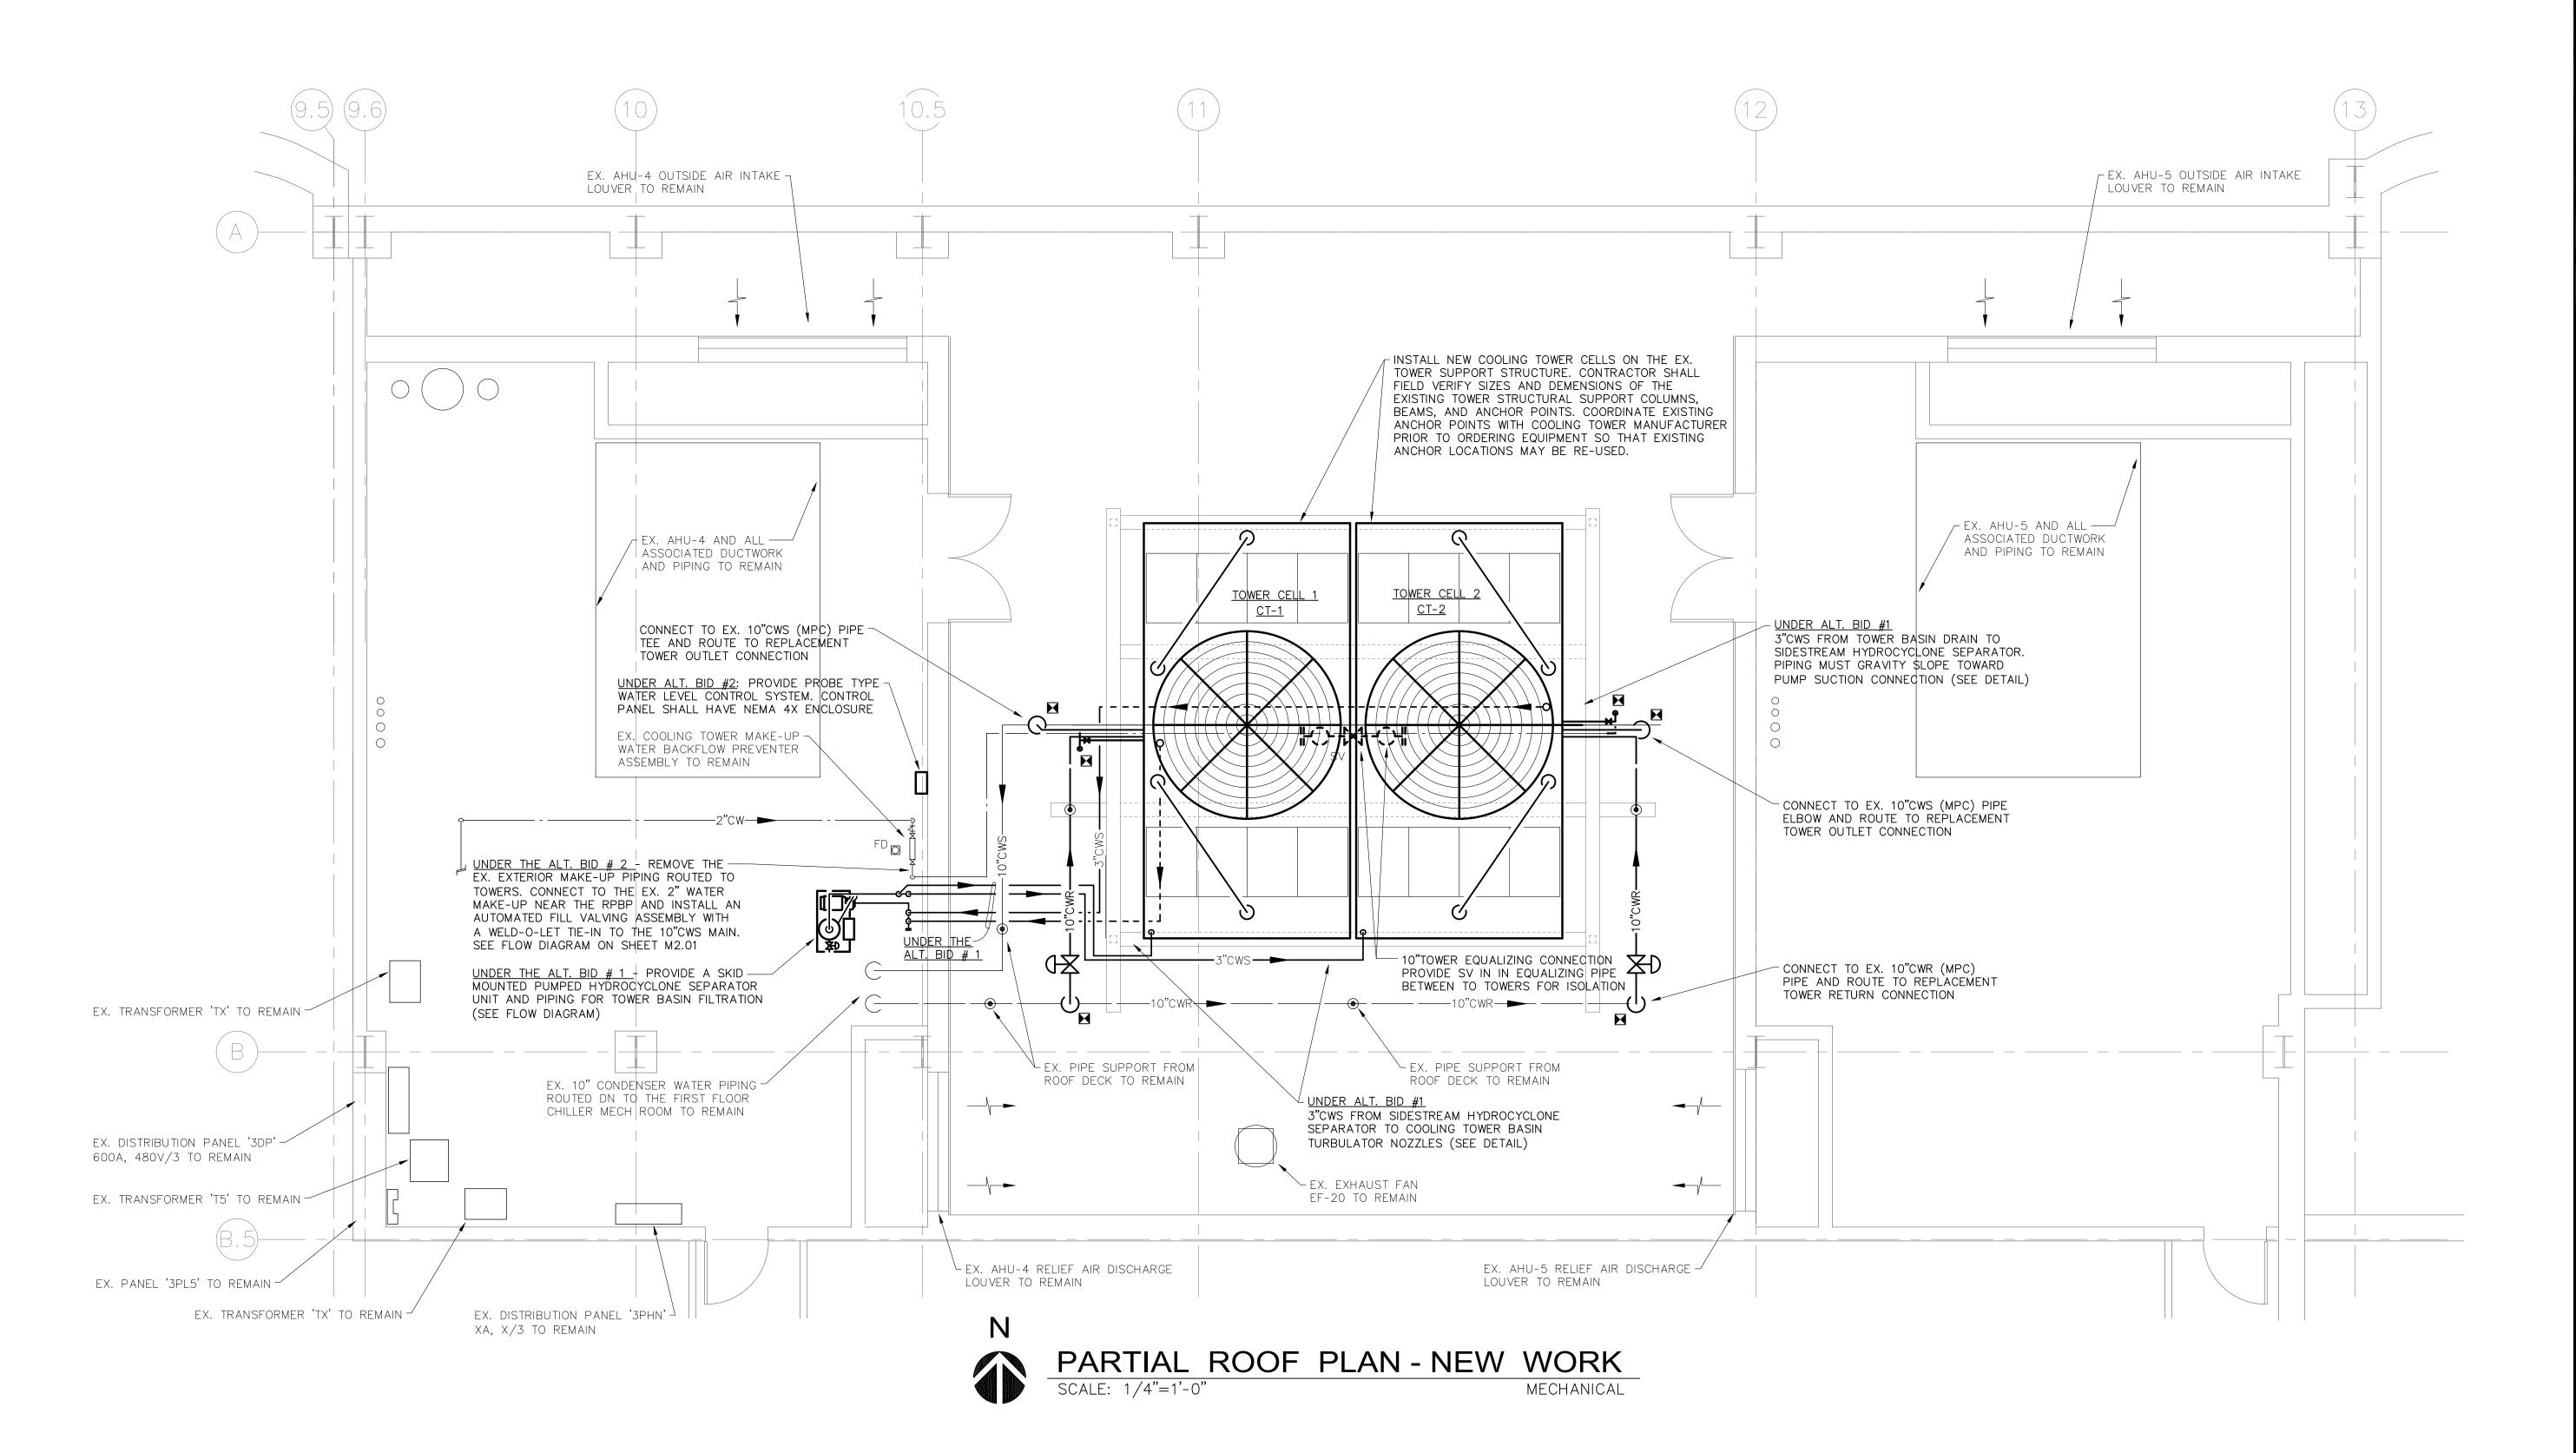
ASSET #

EX. CONDENSER
WATER DEMOLITION
FLOW DIAGRAM

SHEET NUMBER:

MD-20

SHEET 5 OF 15 FEBRUARY 14, 2023



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DEPARTMENT OF MENTAL HEALTH

REPLACE COOLING TOWERS
SAINT LOUIS FORENSIC
TREATMENT CENTER - NORTH
SAINT LOUIS, MISSOURI

PROJECT # M2015-01 SITE # 7391

ASSET # 6517391002

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PARTIAL ROOF PLAN - NEW WORK

ISSUE DATE: 02/14/2023

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M-101

SHEET 6 OF 15 FEBRUARY 14, 2023

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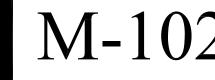
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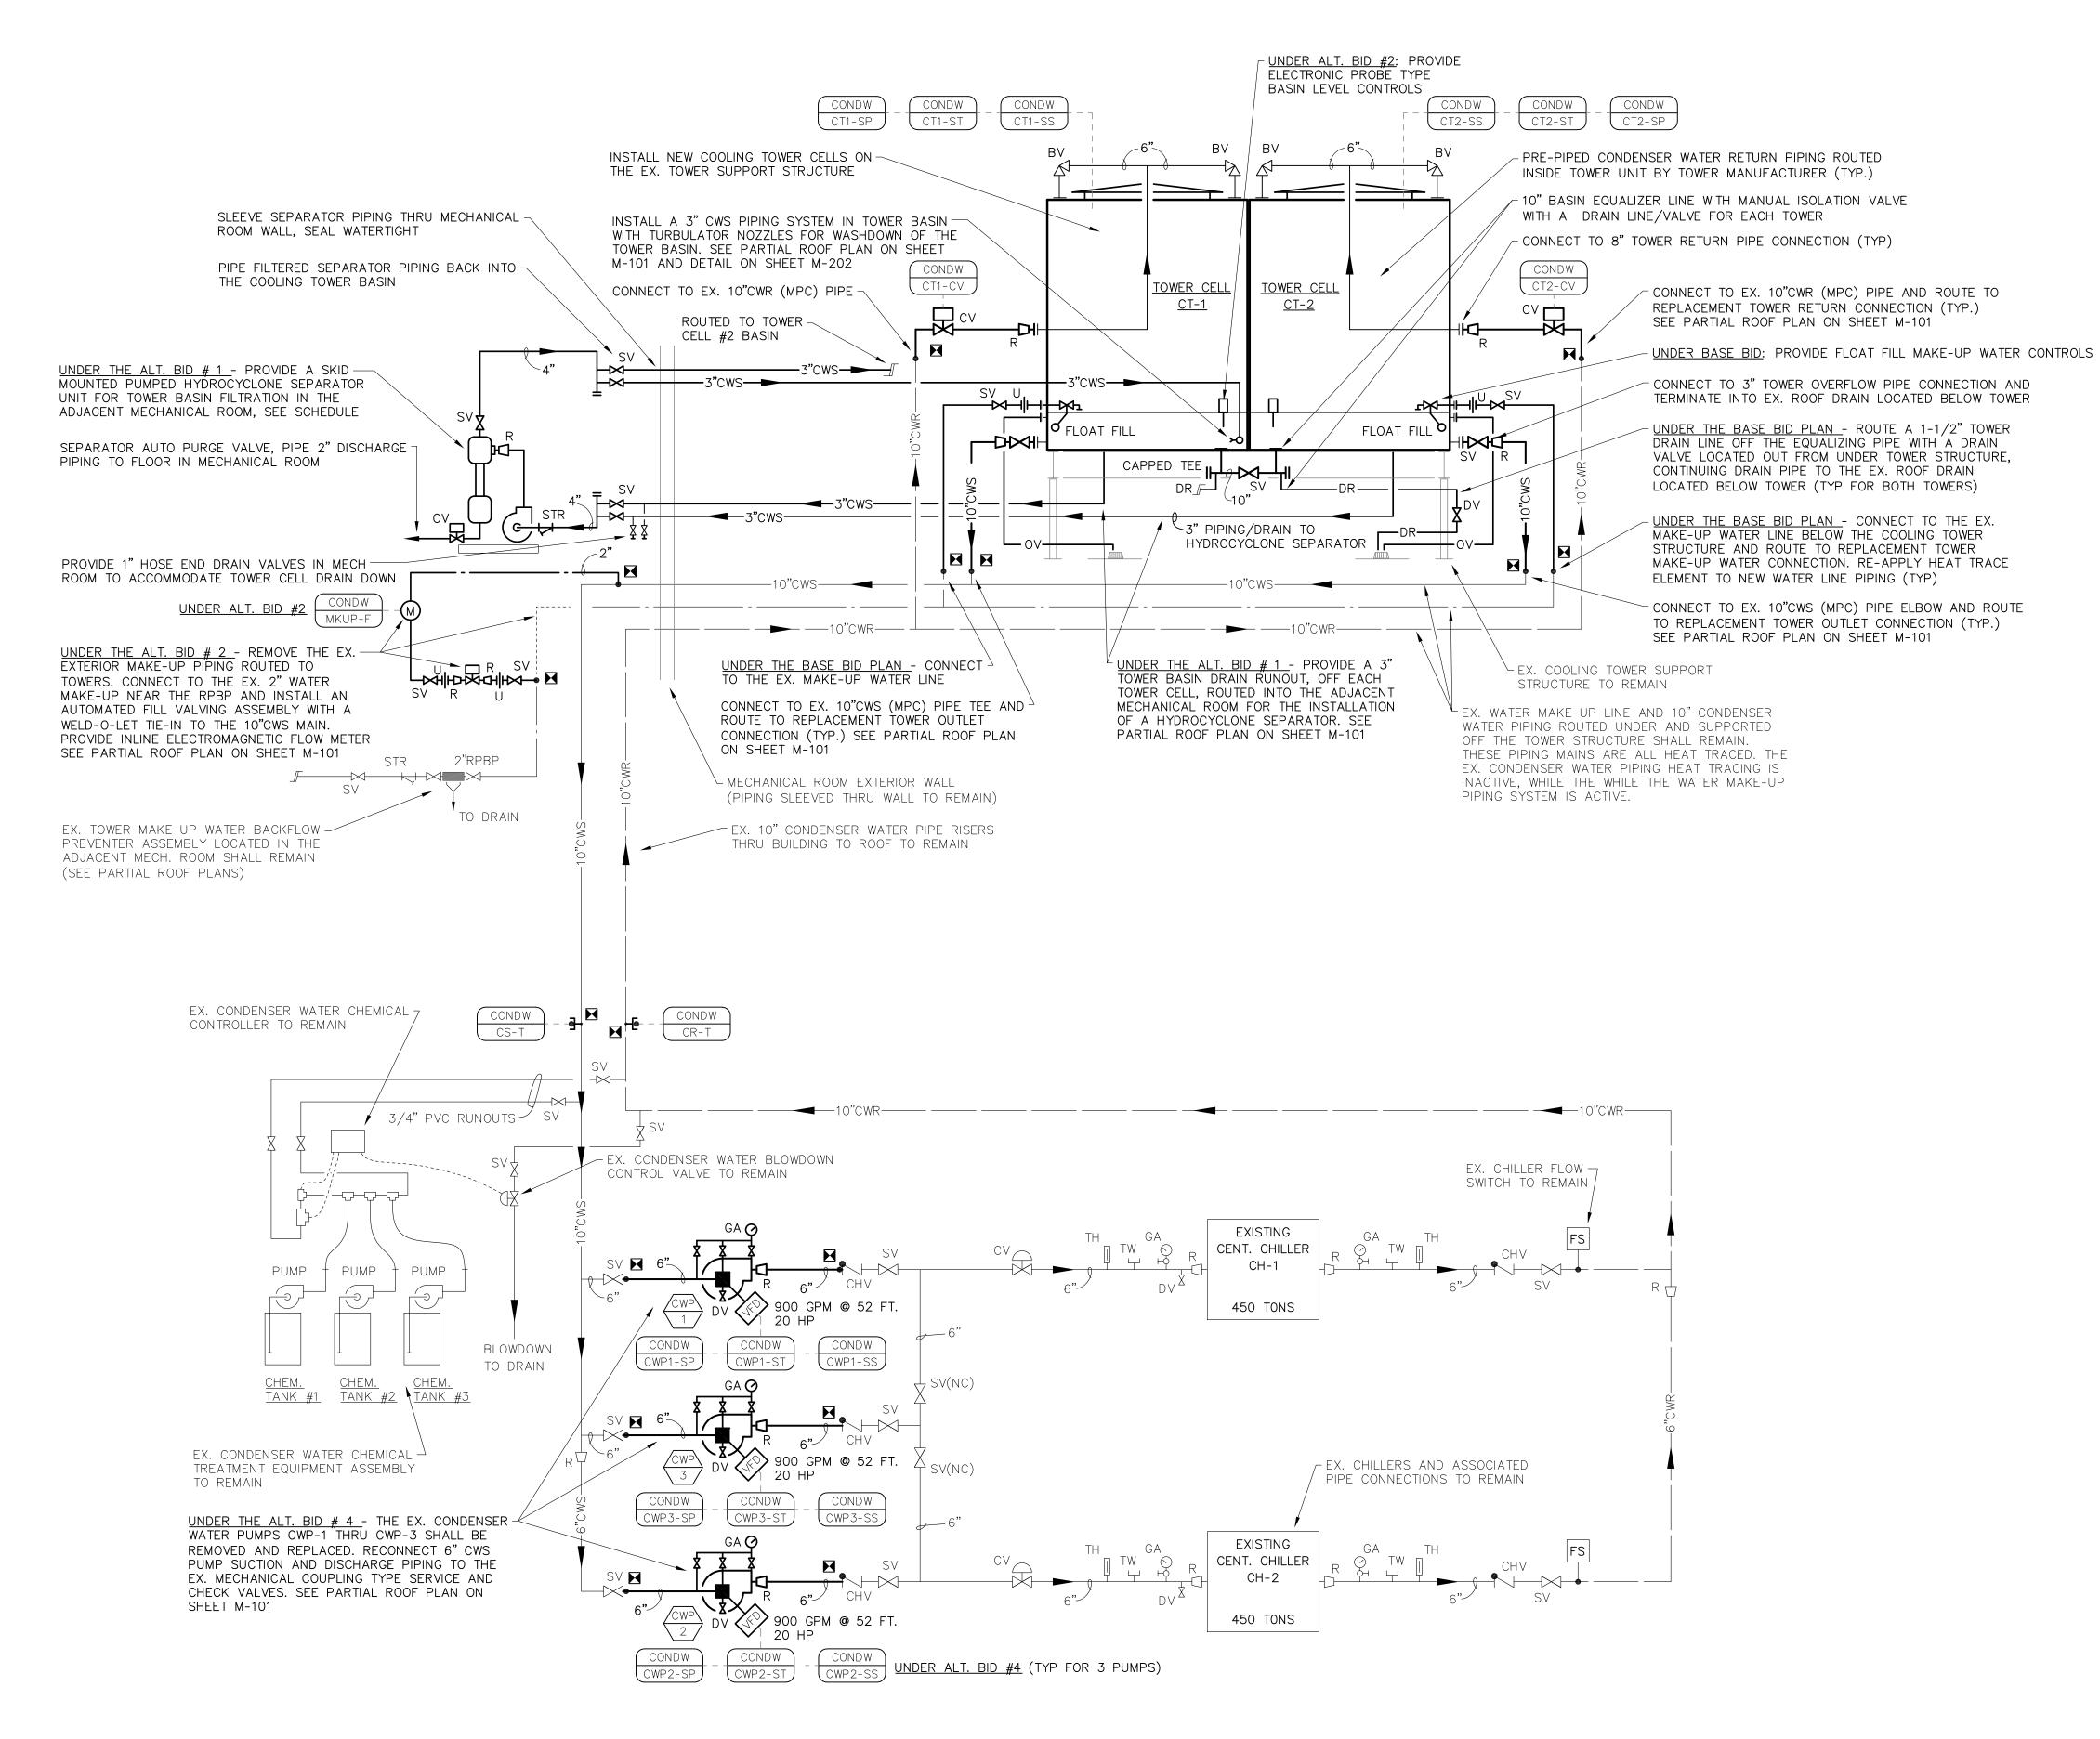
ASSET#

PARTIAL FIRST FLR. PLAN - MAIN EQUIP. ROOM - NEW WORK

SHEET NUMBER:



SHEET 7 OF 15 FEBRUARY 14, 2023



MODIFIED CONDENSER WATER FLOW DIAGRAM NO SCALE

PATE:____

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OFFICE OF ADMINISTRATION

DESIGN AND CONSTRUCTION

REPLACE COOLING TOWERS

TREATMENT CENTER - NORTH

SAINT LOUIS FORENSIC

SAINT LOUIS, MISSOURI

PROJECT # M2015-01

7391

6517391002

DIVISION OF FACILITIES

MANAGEMENT,

DEPARTMENT OF MENTAL HEALTH

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GOVERNOR

DATE: REVISION DATE:

REVISION

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ASSET #

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SHEET TITLE:

MODIFIED
CONDENSER WATER
FLOW DIAGRAM

SHEET NUMBER:

M-201

SHEET 8 OF 15 FEBRUARY 14, 2023

POINT	NAME		POI				ALARM	TREN	ID	FIELD DEVICE DESCRIPTION				
POINT ESIGNATION	CONTROLLER NAME	INPUT OUTPUT TYPE	DESCRIPTION	TYPE	SET POINT	UNITS NOW LONG TO STREET T	ADJUST SELECT	THRESHOLD	FREQUENC	Y ARCHIVE	INSTRUMENT TYPE	SIGNAL	RANGE	NOTES
CT1-SS	CONDW	DO	COOLING TOWER FAN START/STOP COMMAND	COMMAND	-	ON/OFF X	OVERRIDE -	-	X COS	1 WEEK	RELAY	CONTACT	ON/OFF	;
CT1-ST	CONDW	DI	COOILING TOWER FAN STATUS	STATUS	-	RUNNING/NOT RUNNING X	OVERRIDE X	START=OFF=WHEN CMD=ON	x cos	1 WEEK	CURRENT SENSING RELAY	CONTACT	OPEN/CLOSED	1
CT1-SPD	CONDW	AO	COOLING TOWER FAN SPEED COMMAND	COMMAND	-	% SPEED X	OVERRIDE -	-	X 15 MIN.	1 WEEK	DIRECT CONNECTION TO VFD	4-20 MA	0 TO 100%	1
CT2-SS	CONDW	DO	COOLING TOWER FAN START/STOP COMMAND	COMMAND	-	ON/OFF X	OVERRIDE -	-	X COS	1 WEEK	RELAY	CONTACT	ON/OFF	1
CT2-ST	CONDW	DI	COOILING TOWER FAN STATUS	STATUS	-	RUNNING/NOT RUNNING X	OVERRIDE X	START=OFF=WHEN CMD=ON	x cos	1 WEEK	CURRENT SENSING RELAY	CONTACT	OPEN/CLOSED	1
CT2-SPD	CONDW	AO	COOLING TOWER FAN SPEED COMMAND	COMMAND	-	% SPEED X	OVERRIDE -	-	X 15 MIN.	1 WEEK	DIRECT CONNECTION TO VFD	4-20 MA	0 TO 100%	1
CWP1-SS	CONDW	DO	CONDENSER WATER PUMP CWP-1 START/STOP COMMAND	COMMAND	-	ON/OFF X	OVERRIDE -	-	X COS	1 WEEK	RELAY	CONTACT	ON/OFF	ALTERNATE BID #4
CWP1-ST	CONDW	DI	CONDENSER WATER CWP-1 PUMP STATUS	STATUS	-	RUNNING/NOT RUNNING X	OVERRIDE X	START=OFF=WHEN CMD=ON	X COS	1 WEEK	CURRENT SENSING SWITCH	CONTACT	OPEN/CLOSED	ALTERNATE BID #4
CWP1-SPD	CONDW	AO	CONDENSER WATER PUMP CWP-1 SPEED COMMAND	COMMAND	-	% SPEED X	OVERRIDE -	-	X 15 MIN.	1 WEEK	DIRECT CONNECTION TO VFD	4-20 MA	0 TO 100%	ALTERNATE BID #4
CWP2-SS	CONDW	DO	CONDENSER WATER PUMP CWP-2 START/STOP COMMAND	COMMAND	-	ON/OFF X	OVERRIDE -	-	X COS	1 WEEK	RELAY	CONTACT	ON/OFF	ALTERNATE BID #4
CWP2-ST	CONDW	DI	CONDENSER WATER CWP-2 PUMP STATUS	STATUS	-	RUNNING/NOT RUNNING X	OVERRIDE X	START=OFF=WHEN CMD=ON	X COS	1 WEEK	CURRENT SENSING SWITCH	CONTACT	OPEN/CLOSED	ALTERNATE BID #4
CWP2-SPD	CONDW	AO	CONDENSER WATER PUMP CWP-2 SPEED COMMAND	COMMAND	-	% SPEED X	OVERRIDE -	-	X 15 MIN.	1 WEEK	DIRECT CONNECTION TO VFD	4-20 MA	0 TO 100%	ALTERNATE BID #4
CWP3-SS	CONDW	DO	CONDENSER WATER PUMP CWP-3 START/STOP COMMAND	COMMAND	-	ON/OFF X	OVERRIDE -	-	X COS	1 WEEK	RELAY	CONTACT	ON/OFF	ALTERNATE BID #4
CWP3-ST	CONDW	DI	CONDENSER WATER CWP-3 PUMP STATUS	STATUS	-	RUNNING/NOT RUNNING X	OVERRIDE X	START=OFF=WHEN CMD=ON	X COS	1 WEEK	CURRENT SENSING SWITCH	CONTACT	OPEN/CLOSED	ALTERNATE BID #4
CWP3-SPD	CONDW	AO	CONDENSER WATER PUMP CWP-3 SPEED COMMAND	COMMAND	-	% SPEED X	OVERRIDE -	-	X 15 MIN.	1 WEEK	DIRECT CONNECTION TO VFD	4-20 MA	0 TO 100%	ALTERNATE BID #4
CT-CV	CONDW	DO	COOLING TOWER CT-1 ISOLATION CONTROL VALVE	COMMAND	-	OPEN/CLOSE X	OVERRIDE -	-	X COS	1 WEEK	ELECTRIC CONTROL VALVE ACTUATOR	CONTACT	OPEN/CLOSE	1
CT-CV	CONDW	DO	COOLING TOWER CT-2 ISOLATION CONTROL VALVE	COMMAND	-	OPEN/CLOSE X	OVERRIDE -	-	x cos	1 WEEK	ELECTRIC CONTROL VALVE ACTUATOR	CONTACT	OPEN/CLOSE	1
CS1-T	CONDW	Al	CONDENSER WATER SUPPLY TEMPERATURE	TEMPERATURE	-	DEGREES F X	OVERRIDE -		X 15 MIN.	1 WEEK RI	GID RTD OR THERMISTOR TEMPERATURE SENSOR WITH THERMOWELL	OHMS	-30 TO 250 F	1
CR1-T	CONDW	Al	CONDENSER WATER RETURN TEMPERATURE	TEMPERATURE	-	DEGREES F X	OVERRIDE -	-	X 15 MIN.	1 WEEK RI	GID RTD OR THERMISTOR TEMPERATURE SENSOR WITH THERMOWELL	OHMS	-30 TO 250 F	1
MKUP-F	CONDW	Al	CONDENSER MAKE-UP WATER FLOW	FLOW	-	GPM X	OVERRIDE -	-	X 15 MIN.	1 WEEK	ELECTROMAGNETIC FLOW METER WITH TRANSMITTER	4-20MA	0-100 GPM	ALTERNATE BID #2

POINTS LIST SYMBOLS AND ABBREVIATIONS POINTS LIST NOTES

DI DIGITAL INPUT TO BAS
DO DIGITAL OUTPUT TO BAS
AI ANALOG INPUT TO BAS
AO ANALOG OUTPUT TO BAS
NET NETWORKED POINTS

HW HARD WIRED INTERLOCK/SAFETY
COS CHANGE OF STATE

STATE OF MISSOURI MICHAEL L. PARSON, GOVERNOR

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DEPARTMENT OF MENTAL HEALTH

REPLACE COOLING TOWERS SAINT LOUIS FORENSIC TREATMENT CENTER - NORTH SAINT LOUIS, MISSOURI

PROJECT # M2015-01 SITE# 7391 ASSET # 6517391002

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ISSUE DATE: 02/14/2023


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DESIGNED BY: NJS

SHEET TITLE:


CONDENSER WATER POINTS LIST SCHEDULE

SHEET NUMBER:

SHEET 9 OF 15 FEBRUARY 14, 2023

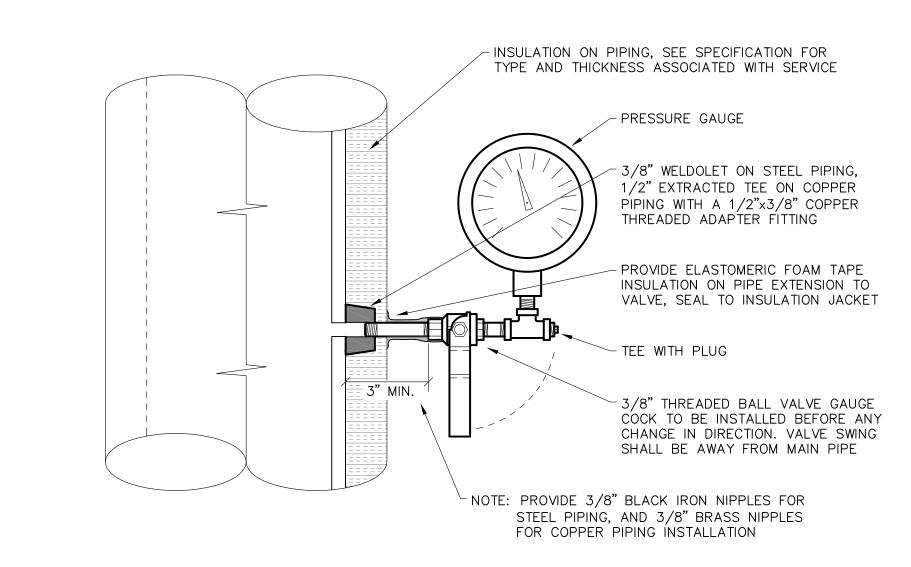


PRESSURE GAUGE INSTALLATION DETAIL NO SCALE

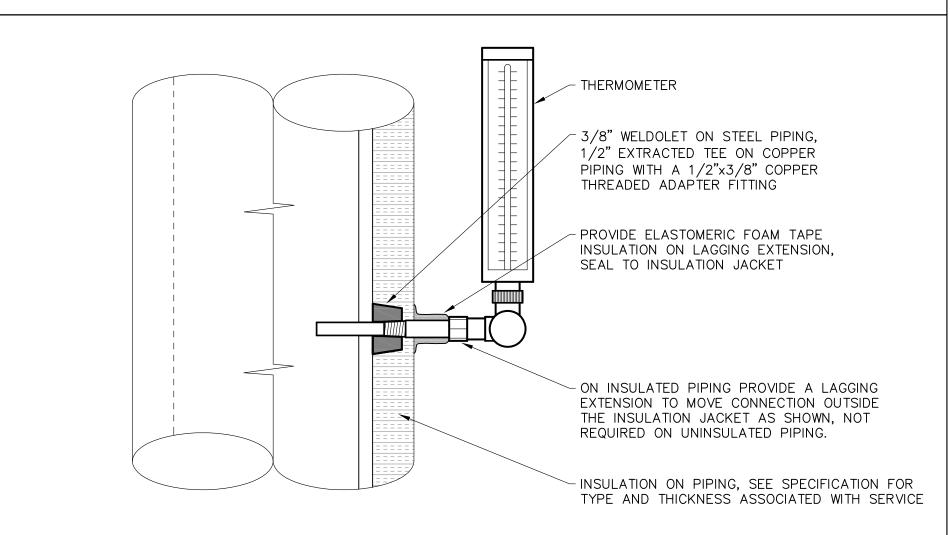

THERMOMETER INSTALLATION DETAIL

NO SCALE

NOTE: COORDINATE THERMOMETER STEM LENGTH, INSERTION LENGTH AND LAGGING EXTENSION LENGTH WITH PIPE SIZE AND INSULATION REQUIREMENTS

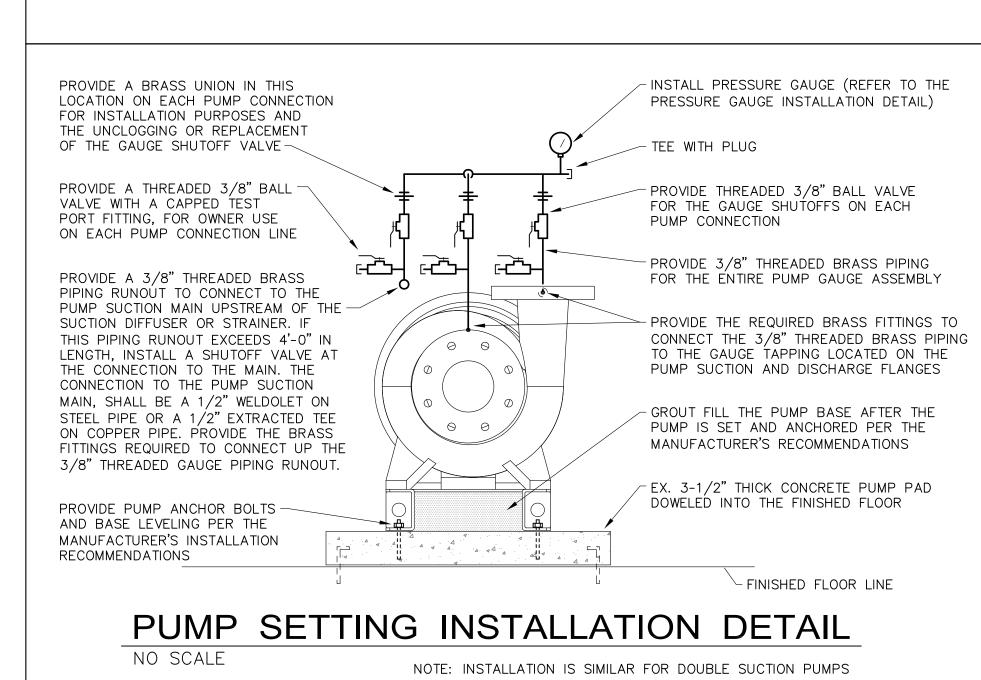

	COOLING TOWER SCHEDULE															
TOWED		WATER FLOW FATERAGE LEAVING AMBIENT WET MAXIMUM NO.771 E	MAXIMUM NOT					FR FLOW DUE ENTERNG LEAVING AMBIENT WET MAXIMUM NOZZLES AP MOTOR DATA				———— MAXIMUM NO77				
TOWER DESIGNATION	MANUFACTURER / MODEL NUMBER	WATER FLOW (GPM)	BHP	ENTERNG WATER (°F)	LEAVING WATER (*F)	AMBIENT WET BULB (*F)	STATIC LIFT (FEET)	STATIC LIFT		(PSI)	НР	RPM	VOLTS/PH	VFD	REMARKS	
CT-1 & 2	MARLEY NC8405PAN	1800	11.92(x2)	100	85	78	12.3	-	15(x2)	1800	480/3	YES	NOTE 1 & 2			
NOTE 1. UNE	DER BASE BID: PROVIDE TOWERS WITH 304	STAINLESS STEE	L HOT & C	COLD BASINS, GA	LVANIZED STEEL	STRUCTURAL CO	OMPONENTS, FF	RP CASING PAN	IELS &	AIR INL	ET LOUVERS	, PVC	FILL & DRIFT			

ELIMINATORS, AND MECHANICAL FLOAT VALVE FOR BASIN LEVEL (MAKE-UP WATER) CONTROL.

NOTE 2. UNDER ALTERNATE BID #3: ALL STRUCTURAL STEEL COMPONENTS SHALL BE CONSTRUCTED FROM 304 STAINLESS STEEL

	PUMP SCHEDULE (ALT. BID #4)													
511145	PUMP DATA						MOTOR DATA							
PUMP DESIGNATION	SERVICE	MANUFACTURER MODEL NUMBER	LOCATION		WATER FLOW (GPM)	HEAD (FEET)	IMPELLER DIA. (IN)	NPSHA (FEET)	HP	RPM	VOLTS/PH	VFD	REMARKS	
CWP-1	CONDENSER WATER PUMP	B & G e-1510 5BD	MECH ROOM	BASE MOUNTED	14.4	900	50	8.375	-	15	1715	480/3	YES	ALT. BID # 4
CWP-2	CONDENSER WATER PUMP	B & G e-1510 5BD	MECH ROOM	BASE MOUNTED	14.4	900	50	8.375	-	15	1715	480/3	YES	ALT. BID # 4
CWP-3	CONDENSER WATER PUMP	B & G e-1510 5BD	MECH ROOM	BASE MOUNTED	14.4	900	50	8.375	-	15	1715	480/3	YES	ALT. BID # 4

	SEPARATOR SCHEDULE (ALT. BID #1)										
		MANUFACTURER LOCA				PUMP MOTOR DATA					
DESIGNATION	SERVICE	MODEL NUMBER	LOCATION	TYPE	WATER FLOW (GPM)	HP	RPM	VOLTS/PH	VFD	REMARKS	
S-1	CONDENSER WATER SYSTEM	EVOQUA LCS340	MECH ROOM	SIDESTREAM HYDROCYCLONE SEPARATOR	260	7.5	1800	480/3	NO	NOTE 1, 2, & 4	

NOTE 1. PROVIDE WITH CONTROL PANEL, SEPARATOR CONTROL VALVE AND AUTO PURGE CONTROL VALVE

NOTE 2. PROVIDE WITH 1/4" TURBULATOR NOZZLES (28 PER BASIN)

NOTE 3. PROVIDE WITH STAINLESS STEEL SKID BASE

NOTE 4. PROVIDE WITH CIRCULATING PUMP.

A	2"	2" 0	
-3.°CWS			1/4" CWS TURBULATOR NOZZLES
	2"	2"	(TYP). PROVIDE 7 NOZZLES ON EACH LATERAL PIPE RUN
SV 3"CWS 3"CWS	3"	3"	CONNECT FILTER PUMP SUCTION TO BASIN DRAIN CONNECTION (TYP)
cv3"cws3"cws	- - - - - - - - - -		∠ 2" CWS INTERNAL PIPING IN
STR STR			THE BOTTOM OF BASIN (TYP)
UNDER THE ALT. BID # 1 - PROVIDE A SKID	2"	2"	
MOUNTED PUMPED HYDROCYCLONE SEPARATOR UNIT FOR TOWER BASIN FILTRATION IN THE ADJACENT MECHANICAL ROOM, SEE SCHEDULE ABOVE AND CONDENSER WATER FLOW DIAGRAM	2"	2"——	
	2"	2"	

COOLING TOWER BASIN TURBULATOR PIPING DETAIL NO SCALE

STATE OF MISSOURI MICHAEL L. PARSON, **GOVERNOR**

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OFFICE OF ADMINISTRATION DIVISION OF FACILITIES MANAGEMENT, DESIGN AND CONSTRUCTION

DEPARTMENT OF MENTAL HEALTH

REPLACE COOLING TOWERS SAINT LOUIS FORENSIC TREATMENT CENTER - NORTH SAINT LOUIS, MISSOURI

PROJECT # M2015-01 SITE# 7391

6517391002

REVISION: DATE: **REVISION** DATE: REVISION DATE:

ISSUE DATE: 02/14/2023

CAD DWG FILE: M2015-01 M-203.DWG DRAWN BY: CHECKED BY: EGU

DESIGNED BY: NJS


SHEET TITLE:

ASSET #

SCHEDULES AND **DETAILS**

SHEET NUMBER:

SHEET 10 OF 15 FEBRUARY 14, 2023

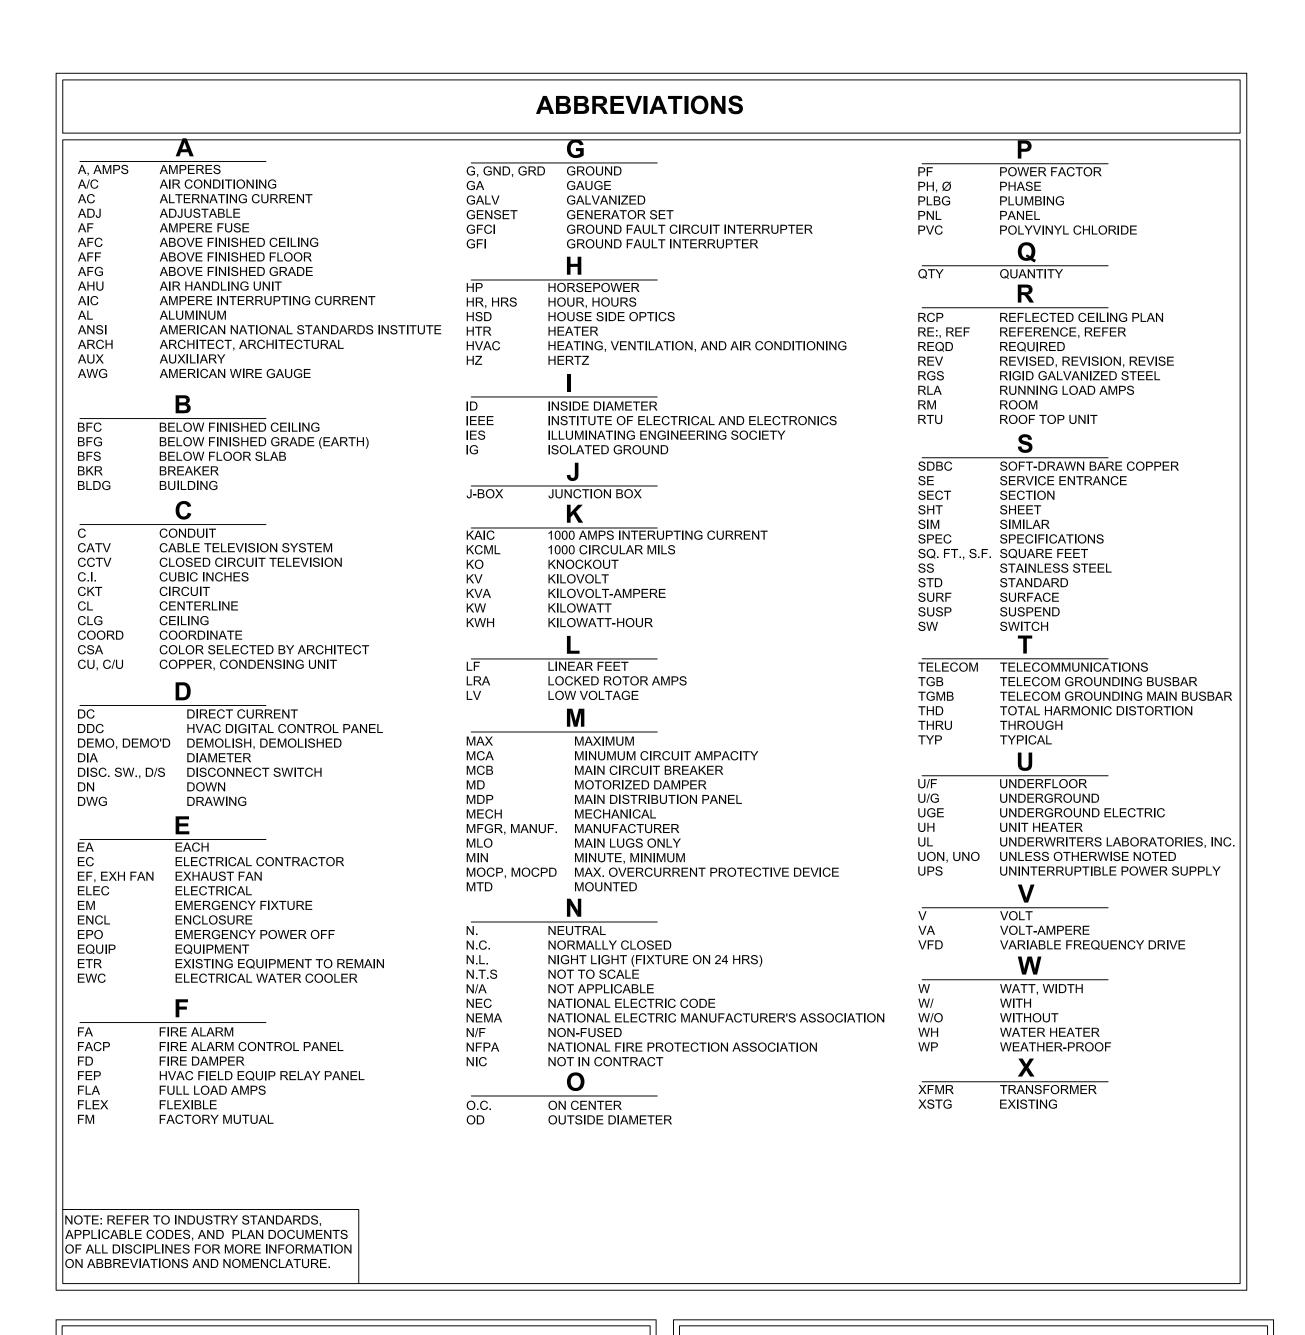


GENERAL NOTES

- 1. EACH CIRCUIT SHALL HAVE AN EQUIPMENT GROUNDING CONDUCTOR, AND MULTI-WIRE CIRCUITS OF DIFFERENT PHASES MAY SHARE EQUIPMENT GROUND CONDUCTOR. EQUIPMENT GROUND CONDUCTOR SIZE SHALL NOT BE LESS THAN #12 AWG OR AS INDICATED ON THE DRAWINGS.
- 2. ALL CONDUCTORS #10 AND SMALLER SHALL BE SOLID COPPER, AND ALL CONDUCTORS #8 AND LARGER SHALL BE STRANDED COPPER USING BOLTED LUGS AT TERMINALS.
- 3. MINIMUM CONDUIT SIZE SHALL BE 3/4" UNLESS OTHERWISE NOTED.
- 4. ALL WIRING DEVICES SHALL BE INSTALLED PLUMB, SQUARE, AND TRUE; AND ALL DEVICES INSTALLED AT A SINGLE LOCATION SHALL BE ALIGNED.
- 5. MINIMUM WIRE SIZE SHALL BE #12 AWG UNLESS OTHERWISE SPECIFIED.
- 6. ALL WORK SHALL COMPLY WITH THE 2020 EDITION OF THE NATIONAL ELECTRICAL CODE. CONTRACTOR SHALL REFER TO THE EQUIPMENT DRAWINGS AND DETAILS FOR EXACT LOCATIONS OF ALL WIRING DEVICES.
- 7. ALL CONDUIT SHALL BE INSTALLED AS HIGH AS POSSIBLE (MOUNT TO BOTTOM OF STRUCTURE) TO AVOID CONFLICTS WITH DUCTWORK AND PIPING. THE ELECTRICAL CONTRACTOR SHALL COORDINATE INSTALLATION WITH THE MECHANICAL CONTRACTOR.
- 8. ON THREE PHASE, FOUR WIRE SYSTEMS, DO NOT USE A COMMON NEUTRAL.MORE THAN THREE CIRCUITS IN ANY ONE CONDUIT IS NOT ALLOWED WITHOUT WRITTEN PERMISSION FROM THE ENGINEER.

GENERAL DEMOLITION NOTES

- 1. ALL EXISTING BRANCH CIRCUITS NOT USED SHALL BE REMOVED BACK TO PANEL. THE CIRCUIT BREAKERS SHALL BE LABELED AS SPARE, AND EXISTING CONDUIT SHALL REMAIN FROM PANEL TO ABOVE ACCESSIBLE CEILING SPACE.
- 2. THIS CONTRACTOR SHALL BE RESPONSIBLE FOR ALL DEMOLITION IN AREAS OF RENOVATION. ALL WIRING DEVICES, LIGHT FIXTURES, WIRE, AND CONDUIT THAT IS TO BE REMOVED SHALL BE STORED, AS DIRECTED BY THE OWNER, OR RELOCATED, AS SHOWN ON THE NEW FLOOR PLANS. APPROPRIATE MEASURES SHALL BE TAKEN TO ASSURE CONTINUITY OF EXISTING CIRCUITS WHERE REQUIRED. ALL OUTAGES WHICH MAY RESULT SHALL BE COORDINATED WITH THE OWNER PRIOR TO THE WORK.
- 3. THE ELECTRICAL CONTRACTOR SHALL BE RESPONSIBLE FOR UPDATING SCHEDULES IN ALL ELECTRICAL PANELS THAT ARE AFFECTED BY THIS WORK. UPDATED SCHEDULES ARE TO BE TYPEWRITTEN.
- 4. THE ELECTRICAL CONTRACTOR SHALL BE RESPONSIBLE FOR MARKING ALL SWITCHES, RECEPTACLES, AND FIXED EQUIPMENT WITH THE BRANCH CIRCUIT PANEL NAME AND NUMBER SERVING EACH DEVICE.

	SYMBOLS SCHEDULE									
SYMBOL	DESCRIPTION	SYMBOL	DESCRIPTION	SYMBOL	DESCRIPTION					
	BRANCH CIRCUIT HOMERUN - PANEL & CIRCUIT NUMBER INDICATED	GFI/WP	DUPLEX RECEPTACLE - GROUND FAULT INTERRUPTING AND WEATHER-PROOF TYPES AS INDICATED ON PLANS	4	NONFUSED DISCONNECT SWITCH - SIZE NOTED ON PLAN					
	EMERGENCY CIRCUIT IN CONDUIT	(J)	FLOOR MOUNTED JUNCTION BOX	₩	COMBINATION MOTOR STARTER AND DISCONNECT SWITCH					
_	SURFACE MOUNTED PANEL BOARD	I	CEILING MOUNTED JUNCTION BOX	4	FUSED DISCONNECT					
	FLOOR MOUNTED TRANSFORMER	(i)	ELECTRIC MOTOR SYMBOL							

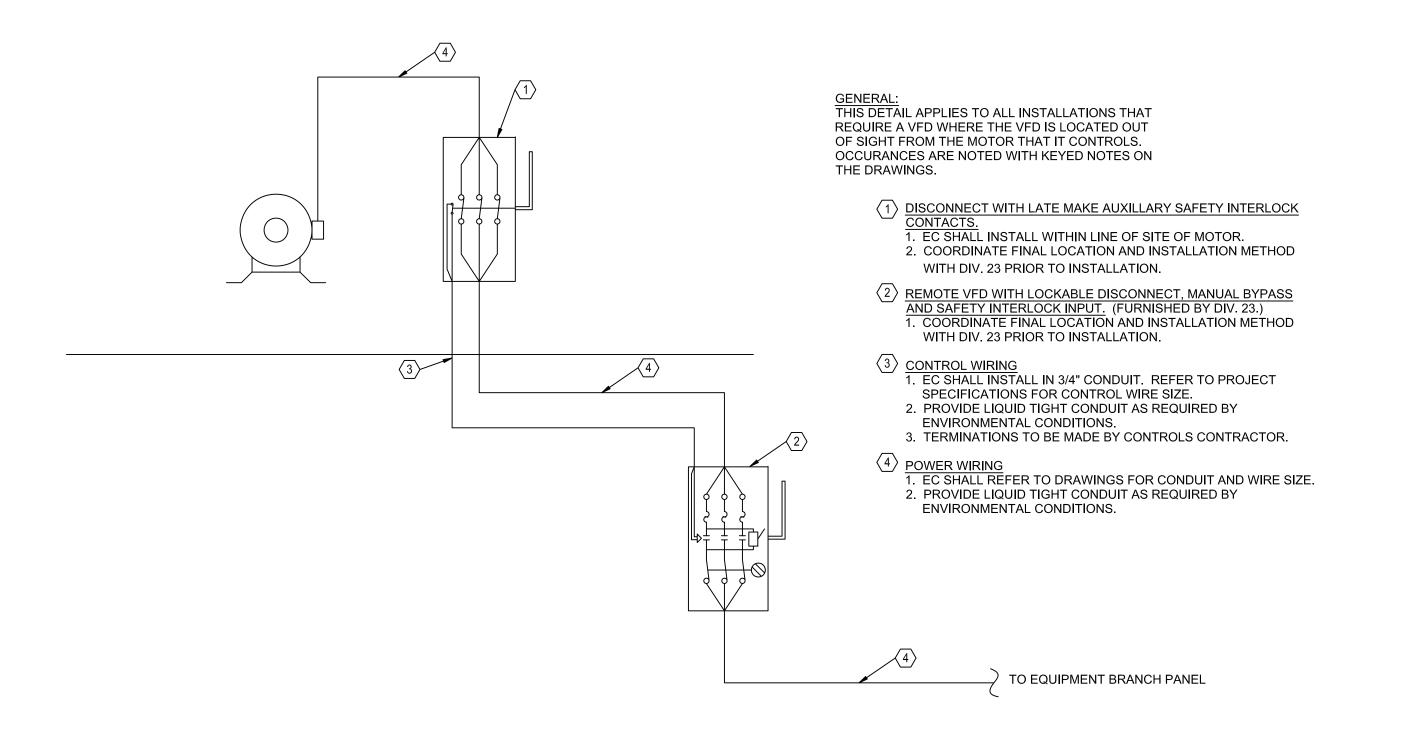

VFD DISCONNECT DETAIL

SCALE: NONE

STATE OF MISSOURI MICHAEL L. PARSON, GOVERNOR

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DEPARTMENT OF MENTAL HEALTH

REPLACE COOLING TOWERS
SAINT LOUIS FORENSIC
TREATMENT CENTER - NORTH

SAINT LOUIS, MISSOURI

PROJECT # M2015-01 SITE # 7391

6517391002

REVISION:_______DATE:_____REVISION:

DATE:
REVISION:
DATE:
USSUE DATE: 02/14/2023

CAD DWG FILE: M2015-01 E-001.DWG
DRAWN BY: VUP
CHECKED BY: VUP
DESIGNED BY: GDL

SHEET TITLE:


ASSET #

SYMBOLS, ABBREVIATIONS AND DETAILS

SHEET NUMBER:

E-001

SHEET 11 OF 15 FEBRUARY 14, 2023

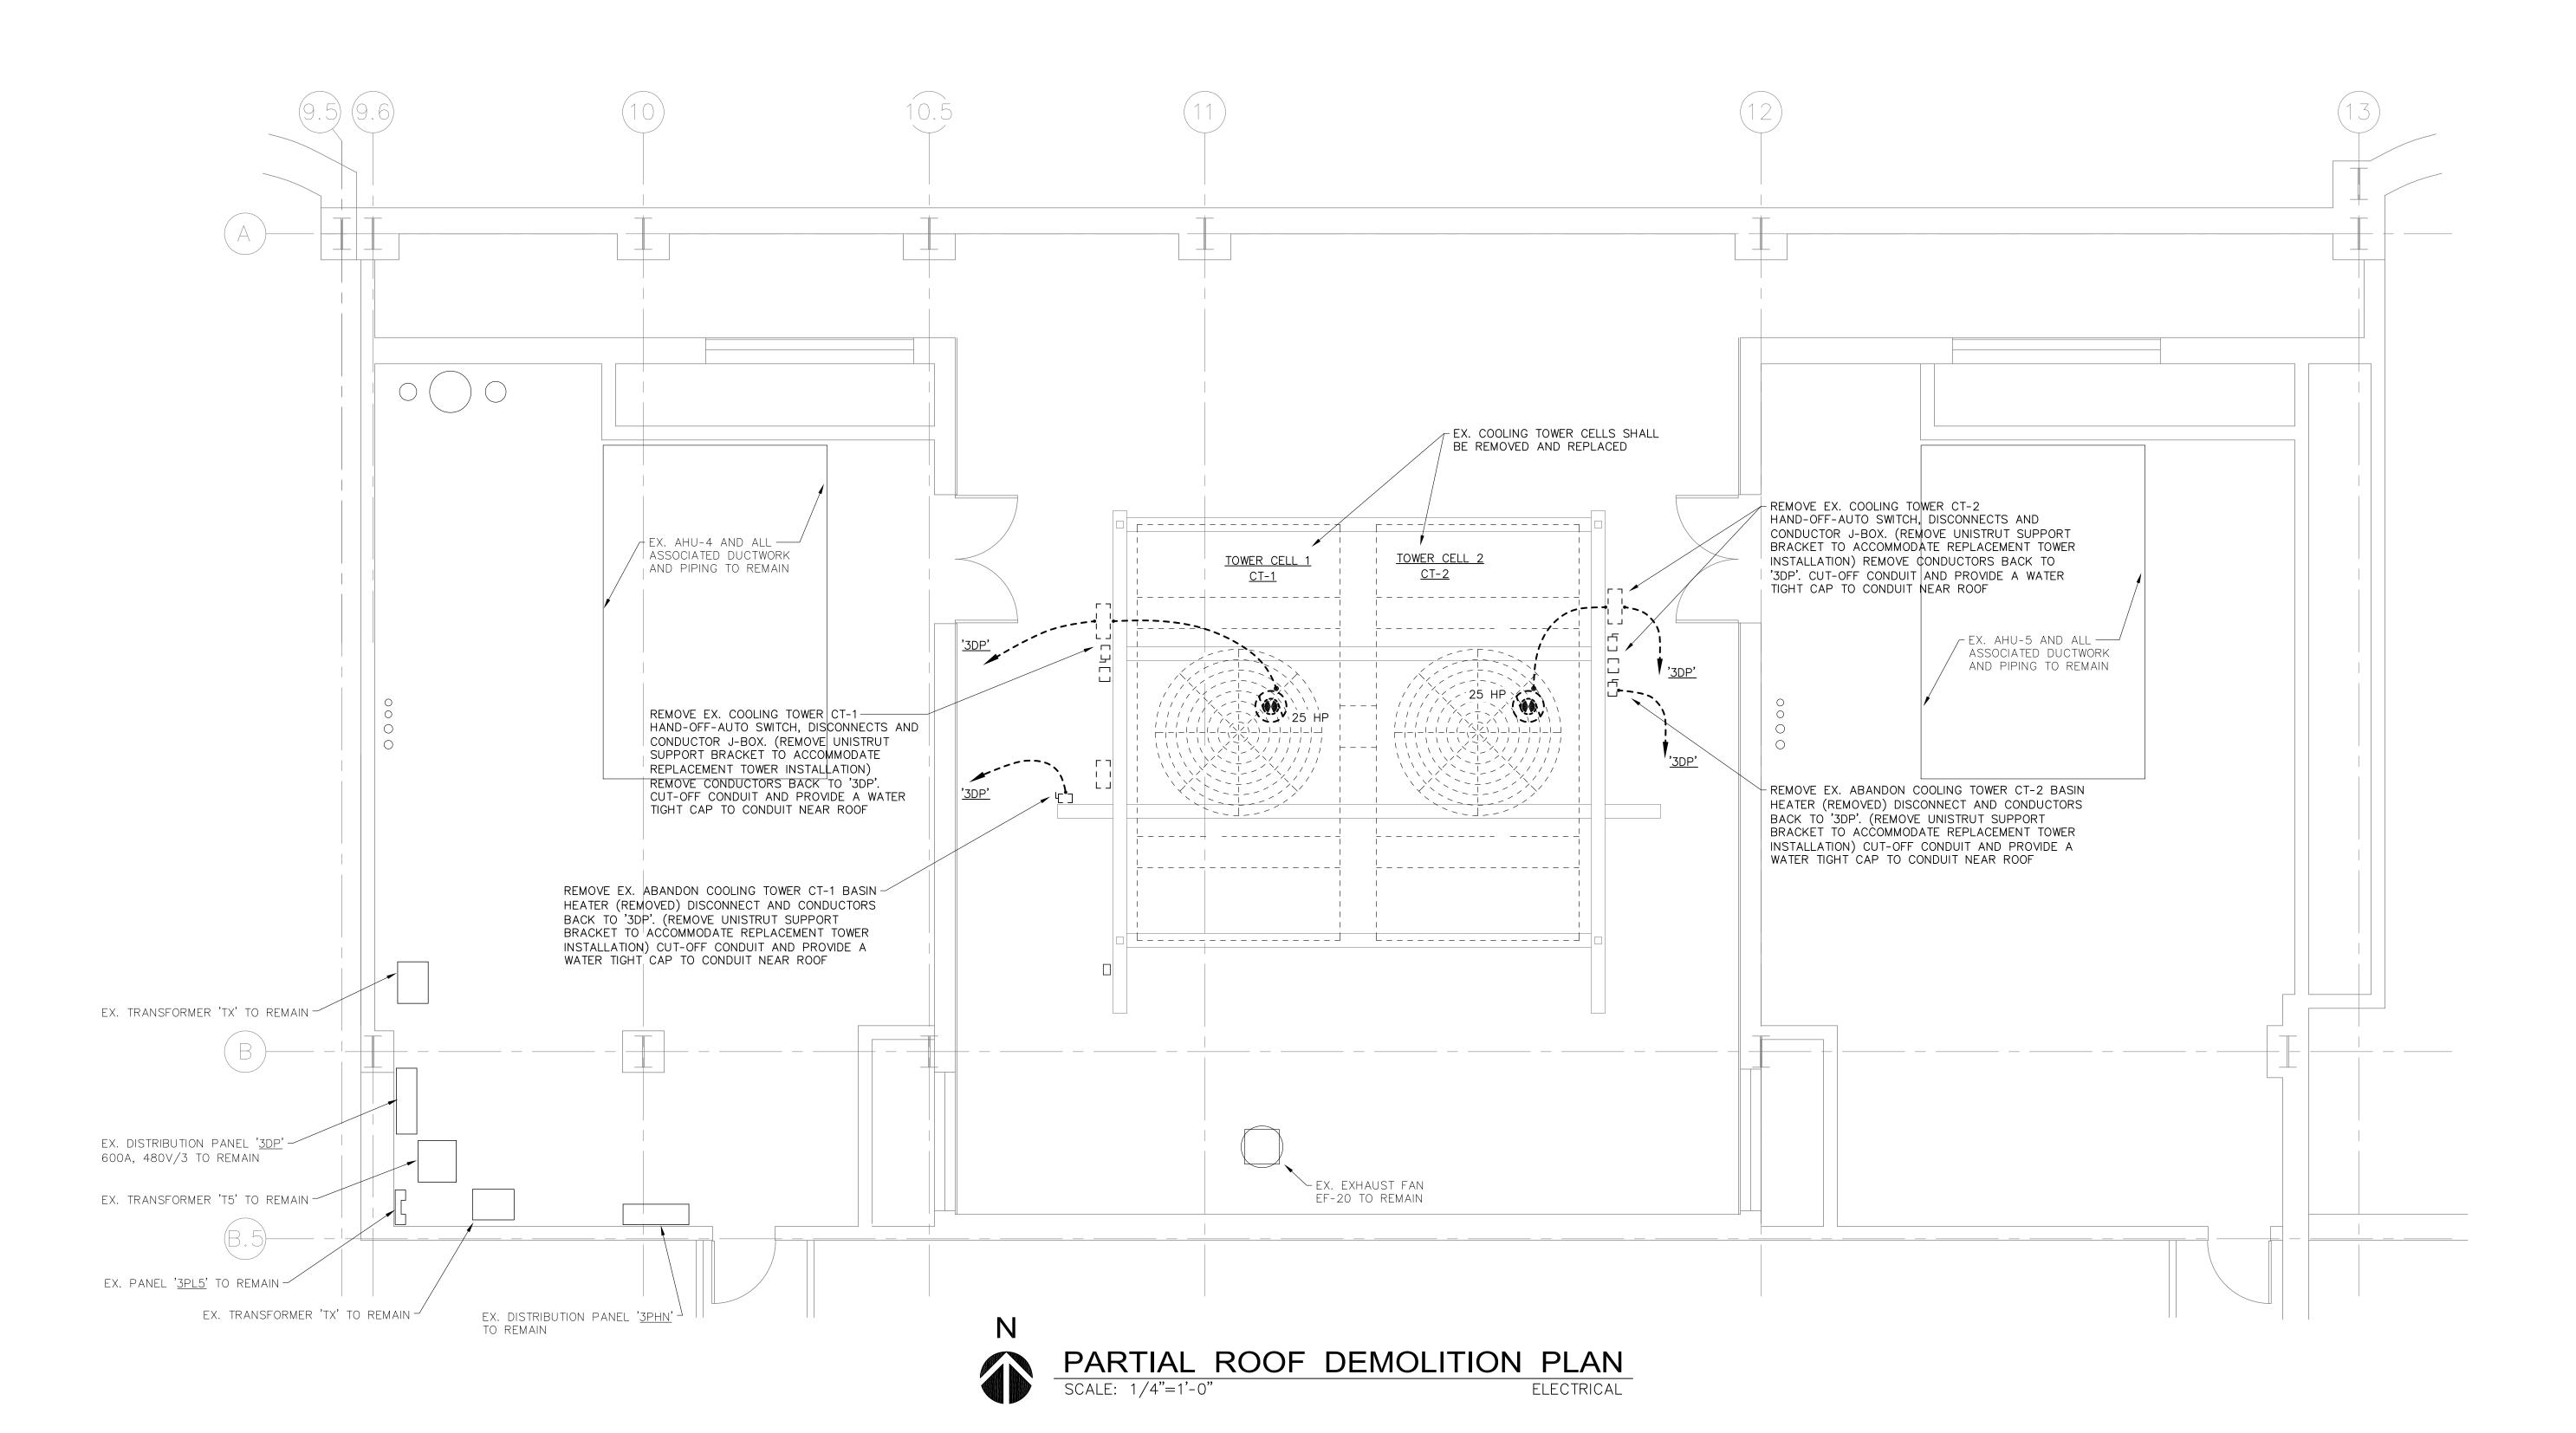

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PROJECT # M2015-01 7391

6517391002 ASSET#

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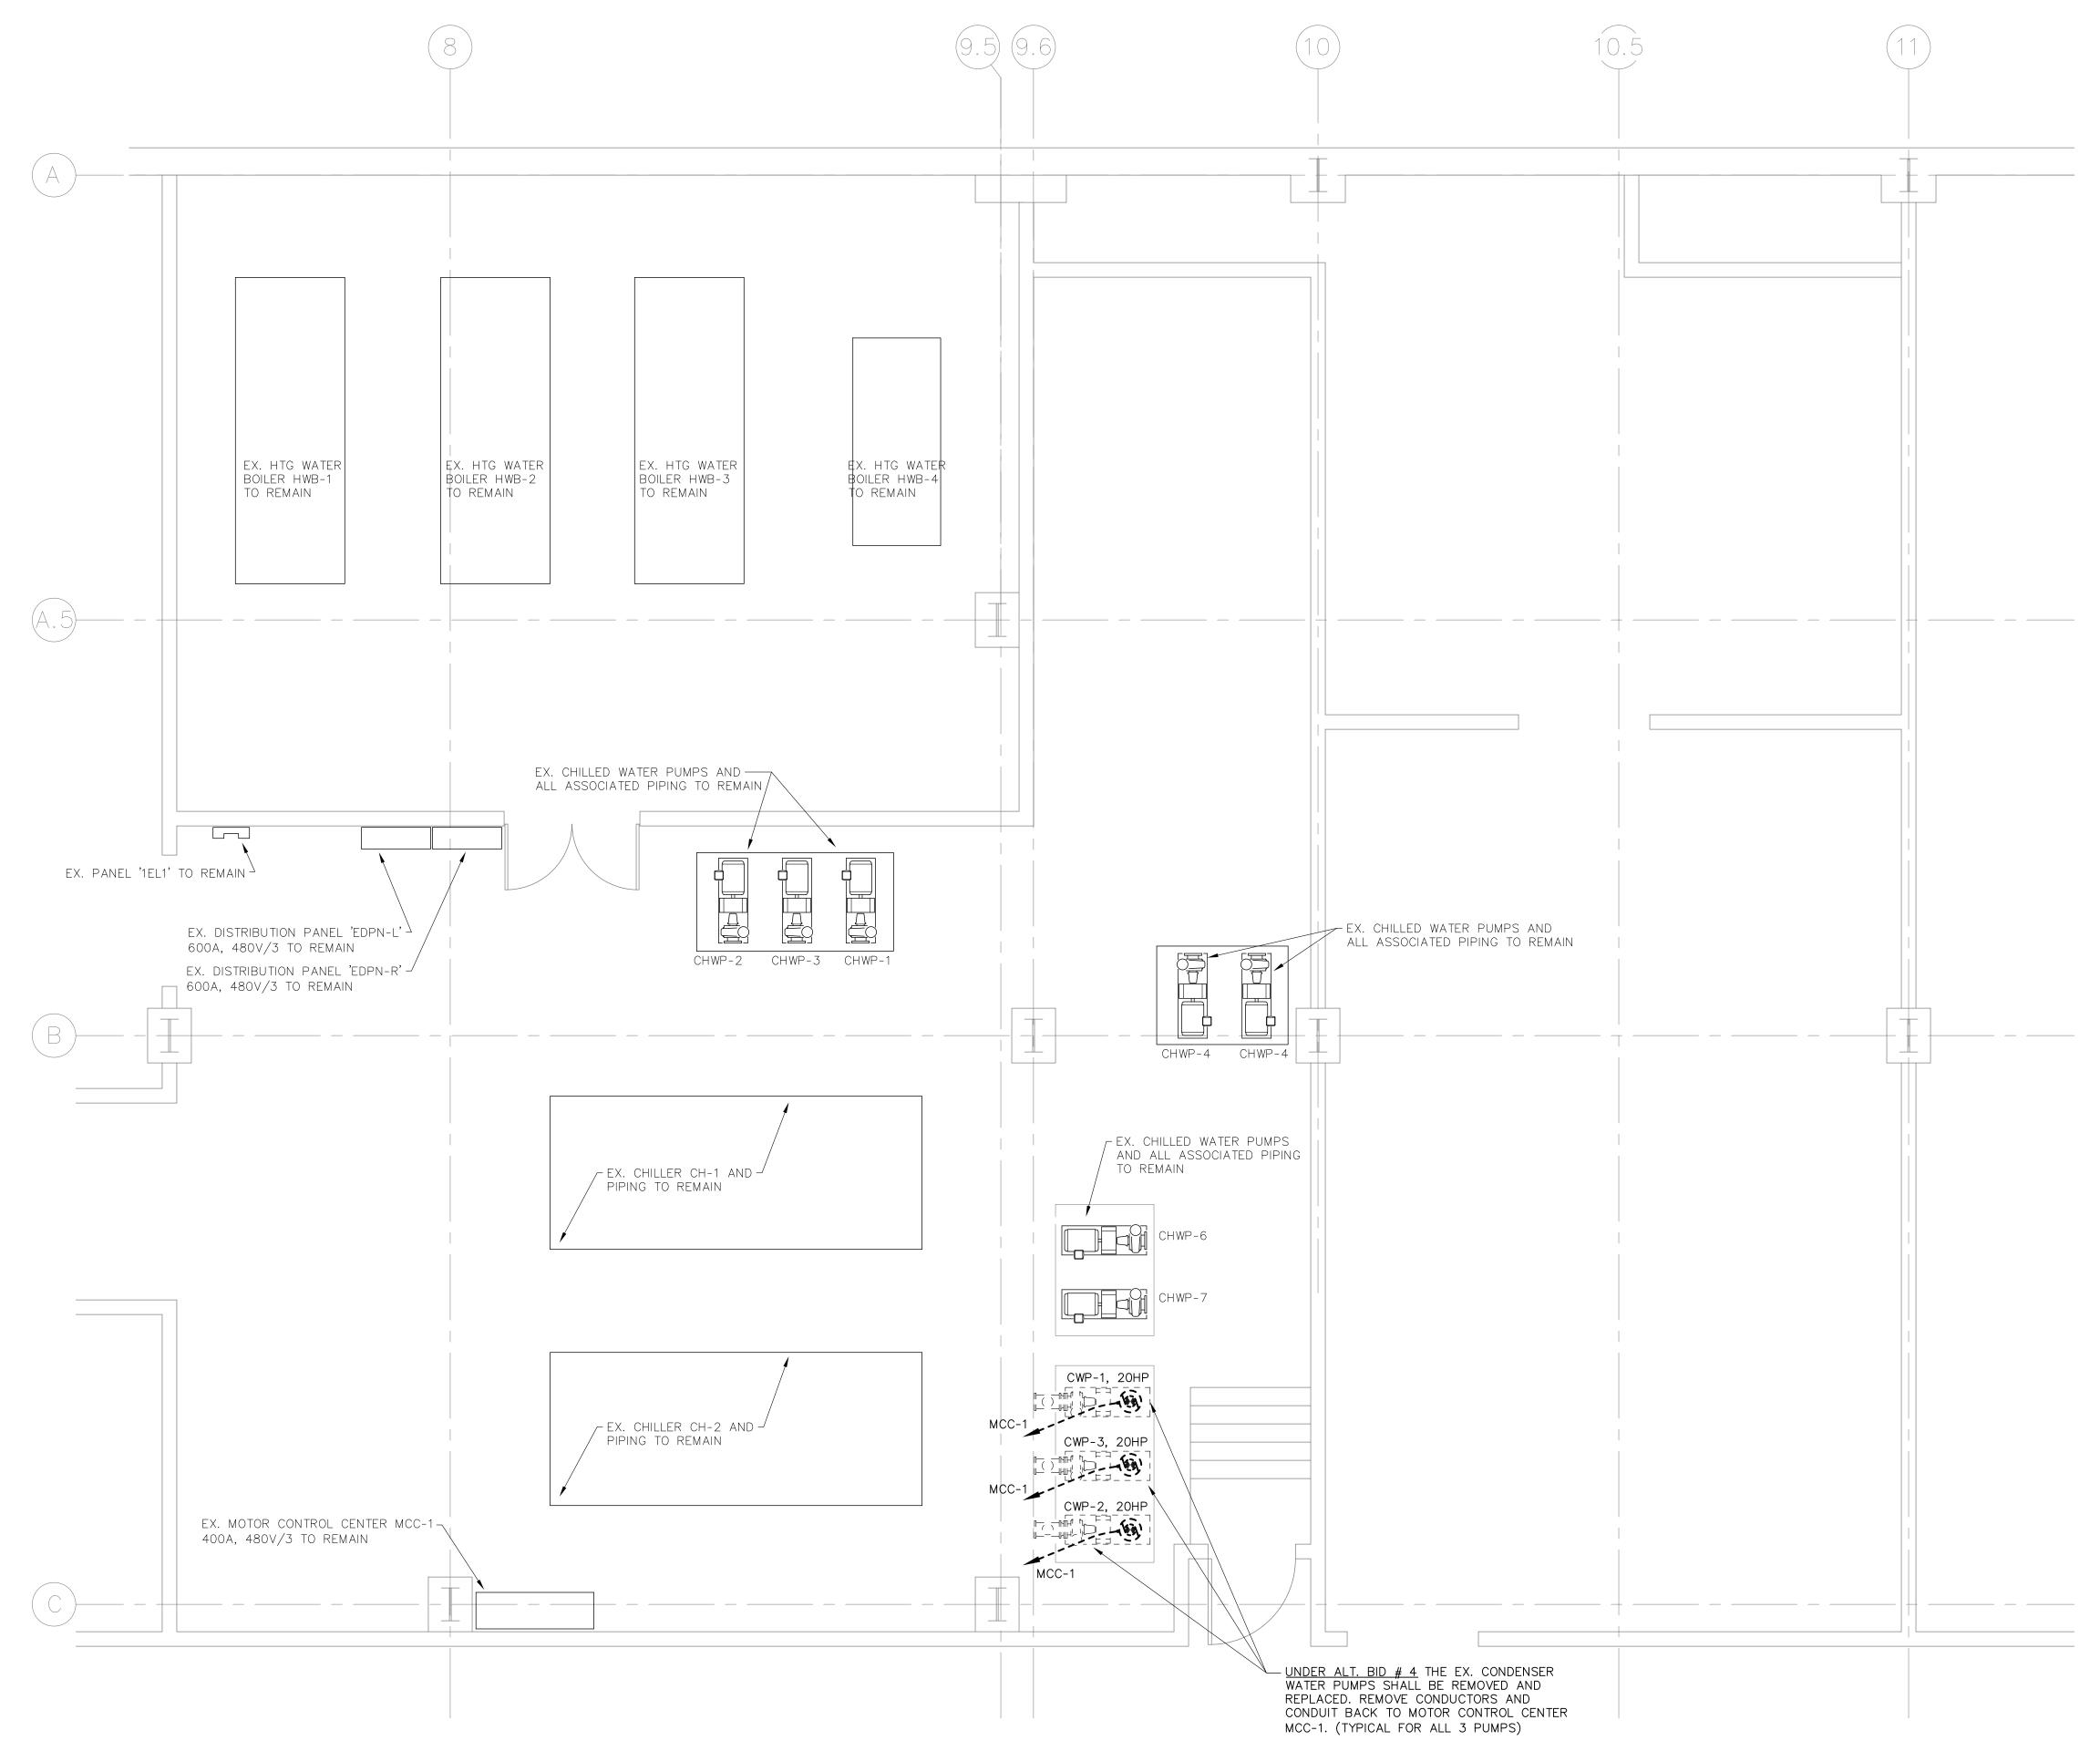
CAD DWG FILE: M2015-01 ED-101.DWG
DRAWN BY: JBM
CHECKED BY: VUP DESIGNED BY: GDL

SHEET TITLE:

PARTIAL ROOF **DEMOLITION PLAN**

SHEET NUMBER:

SHEET 12 OF 15 FEBRUARY 14, 2023





PARTIAL FIRST FLOOR PLAN - MAIN MECHANICAL DEMOLITION SCALE: 1/4"=1'-0"

ELECTRICAL (ALT BID # 4)

STATE OF MISSOURI MICHAEL L. PARSON, **GOVERNOR**

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REVISION:

ASSET#

DATE: REVISION DATE: **REVISION:** DATE:

ISSUE DATE: 02/14/2023

CAD DWG FILE: M2015-01 ED-102.DWG
DRAWN BY: JBM
CHECKED BY: VUP DESIGNED BY: GDL


SHEET TITLE:

PARTIAL FIRST FLR. PLAN - MAIN EQUIP. ROOM DEMO

SHEET NUMBER:

ED-102

SHEET 13 OF 15 FEBRUARY 14, 2023

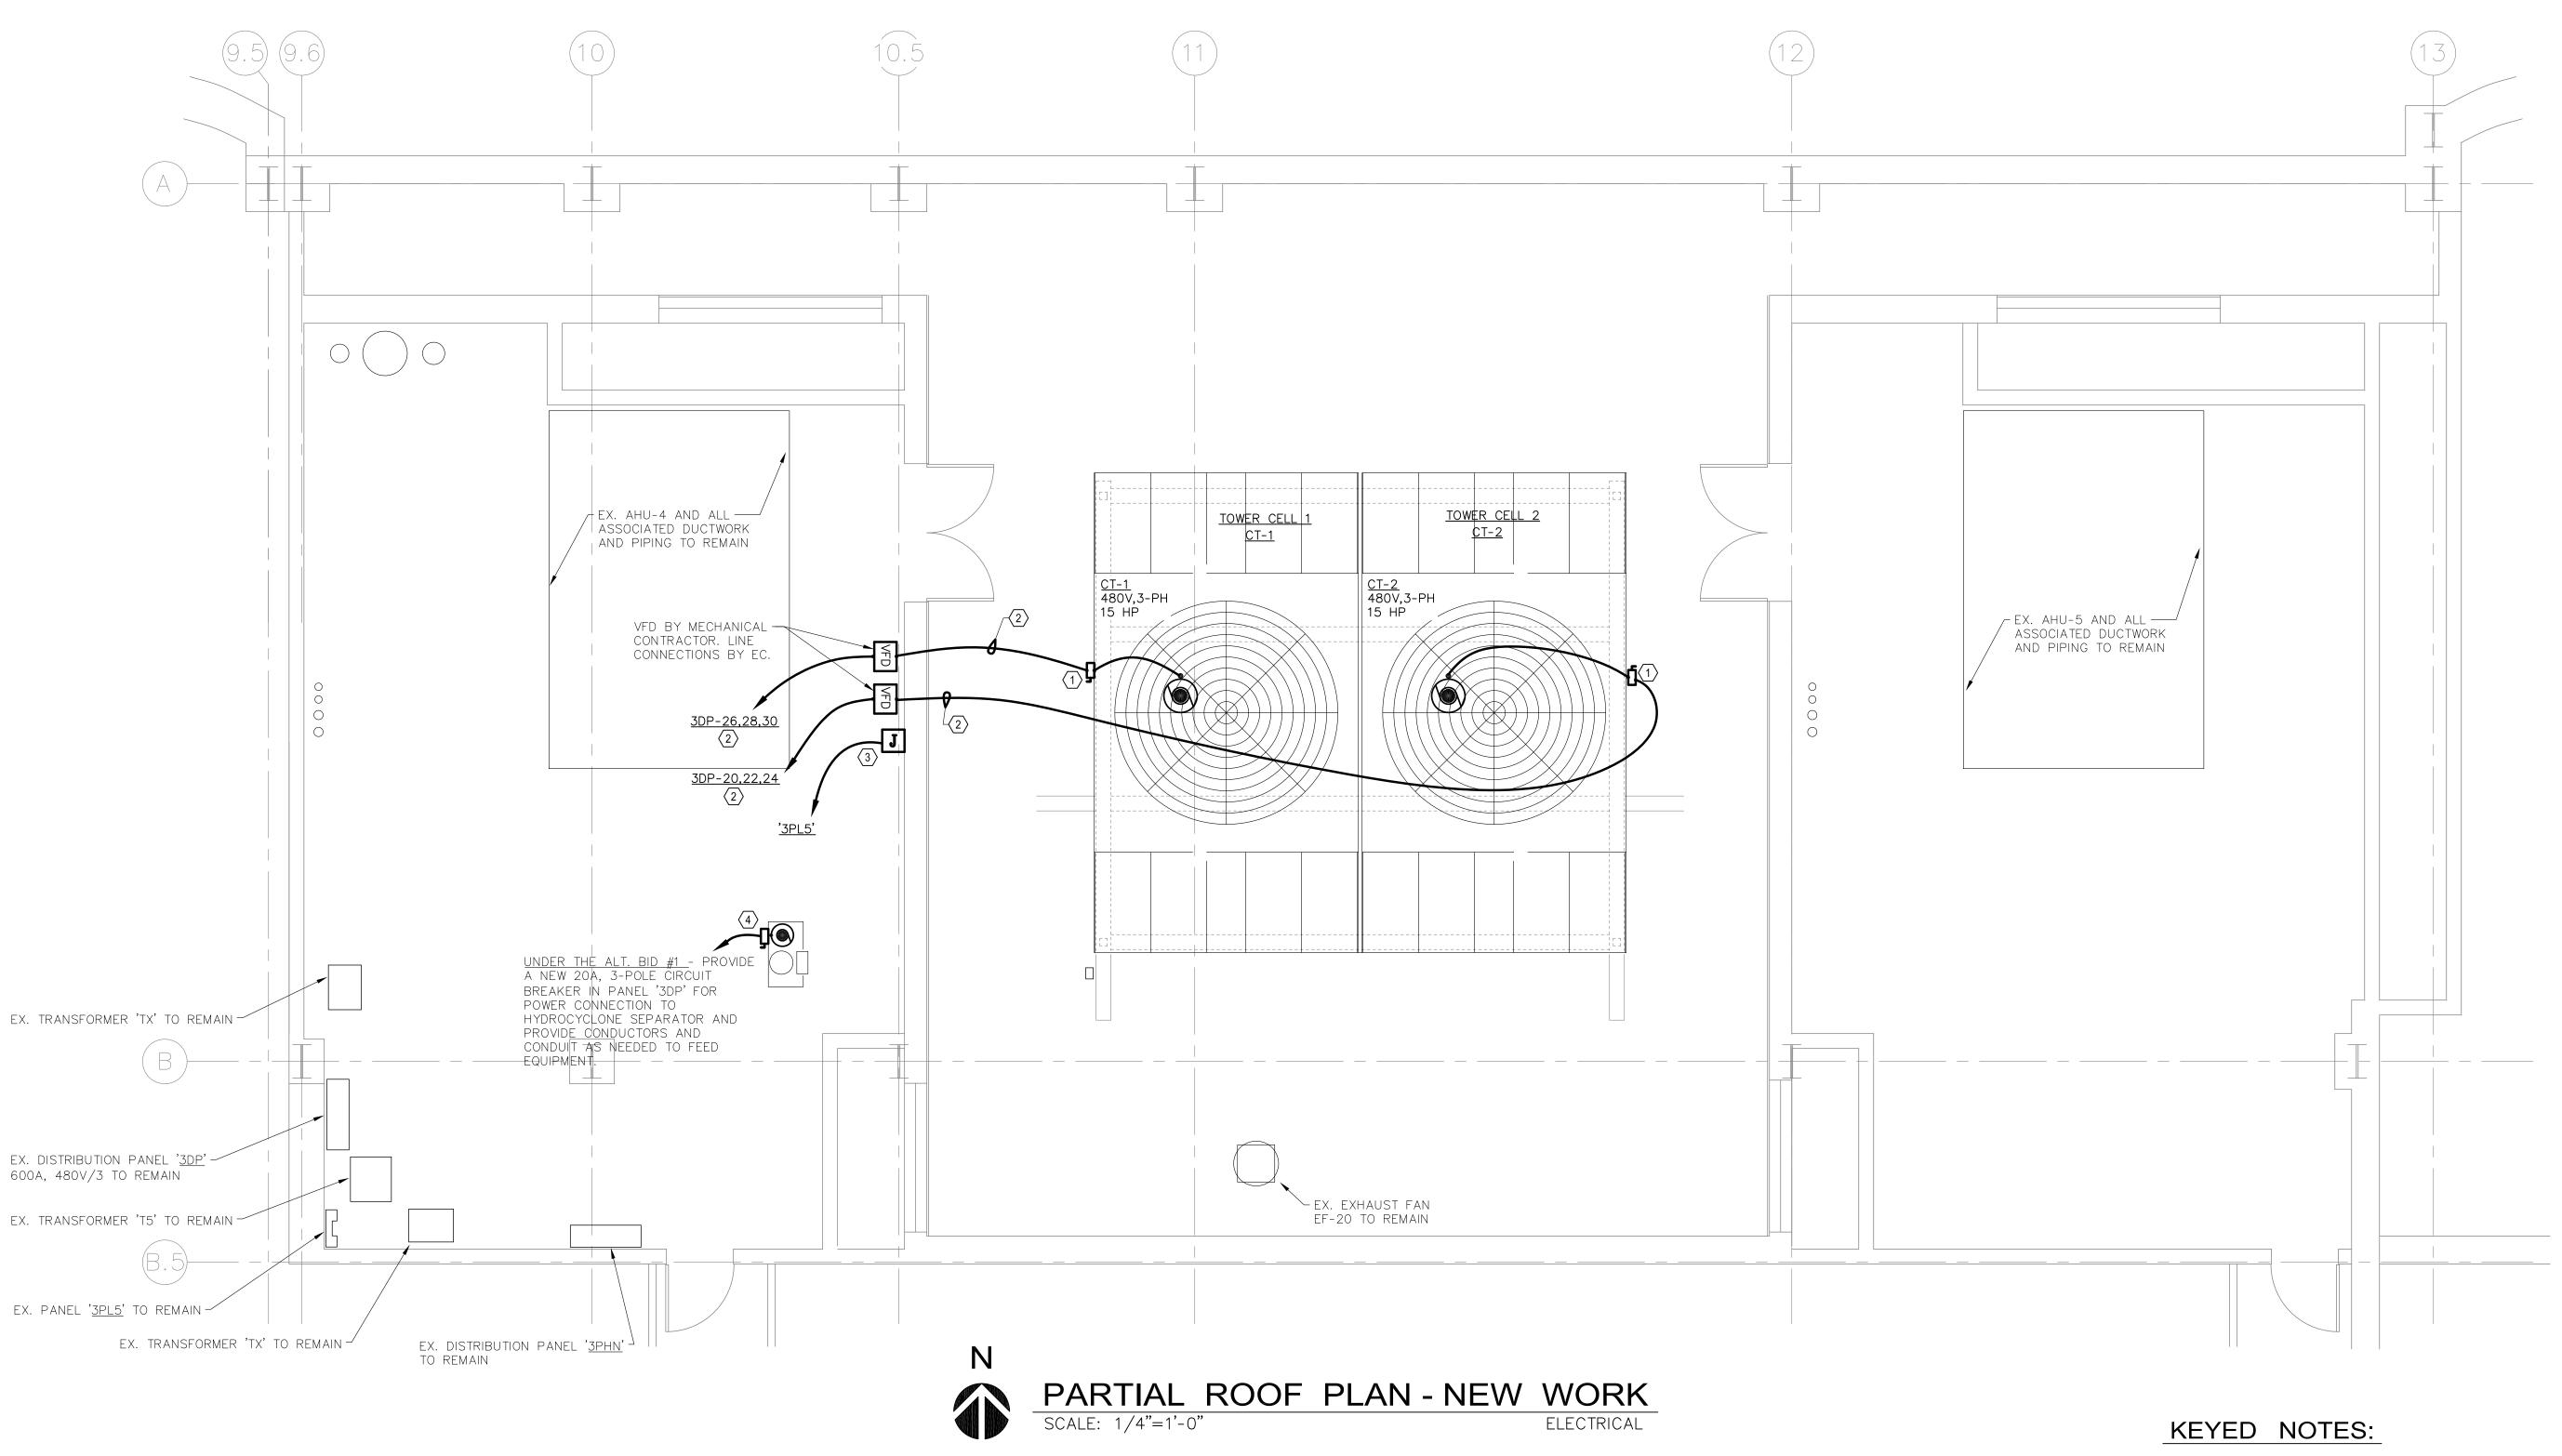

- PROVIDE A 600V, 60A, 3P, NEMA-3X, HEAVY DUTY REMOTE NON-FUSED DISCONNECT SWITCH. REFER TO REMOTE VFD/DISCONNECT DETAIL 01 ON SHEET E-001. COORDINATE EXACT LOCATION WITH MECHANICAL CONTRACTOR
- REPLACE THE EXISTING 70A BREAKER FEEDING THE EXISTING COOLING TOWERS WITH A NEW 50A, 3P BREAKER. PROVIDE (3)#10, (1)#10G, CONDUCTORS IN EXISTING CONDUIT. EXTEND CONDUIT AS NEEDED TO CONNECT TO NEW TOWERS. REFER TO DETAIL 01 ON SHEET E-001.
- 3 UNDER ALT. BID #2 PROVIDE 120V/1PH, POWER CONNECTION TO ELECTRONIC WATER CONTROL SYSTEM. CONNECT TO THE NEXT AVAILABLE CIRCUIT IN PANEL '3PL5' WITH 1-POLE, 20A CIRCUIT BREAKER.
- UNDER ALT. BID#1 PROVIDE A 30A, 3P, NEMA-1, HEAVY DUTY NON-FUSED DISCONNECT SWITCH. COORDINATE EXACT LOCATION WITH MECHANICAL CONTRACTOR.

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CAD DWG FILE: M2015-01 E-101.DWG
DRAWN BY: JBM
CHECKED BY: VUP
DESIGNED BY: GDL

SHEET TITLE:


ASSET#

PARTIAL ROOF PLAN - NEW WORK

SHEET NUMBER:

E-101

SHEET 14 OF 15 FEBRUARY 14, 2023

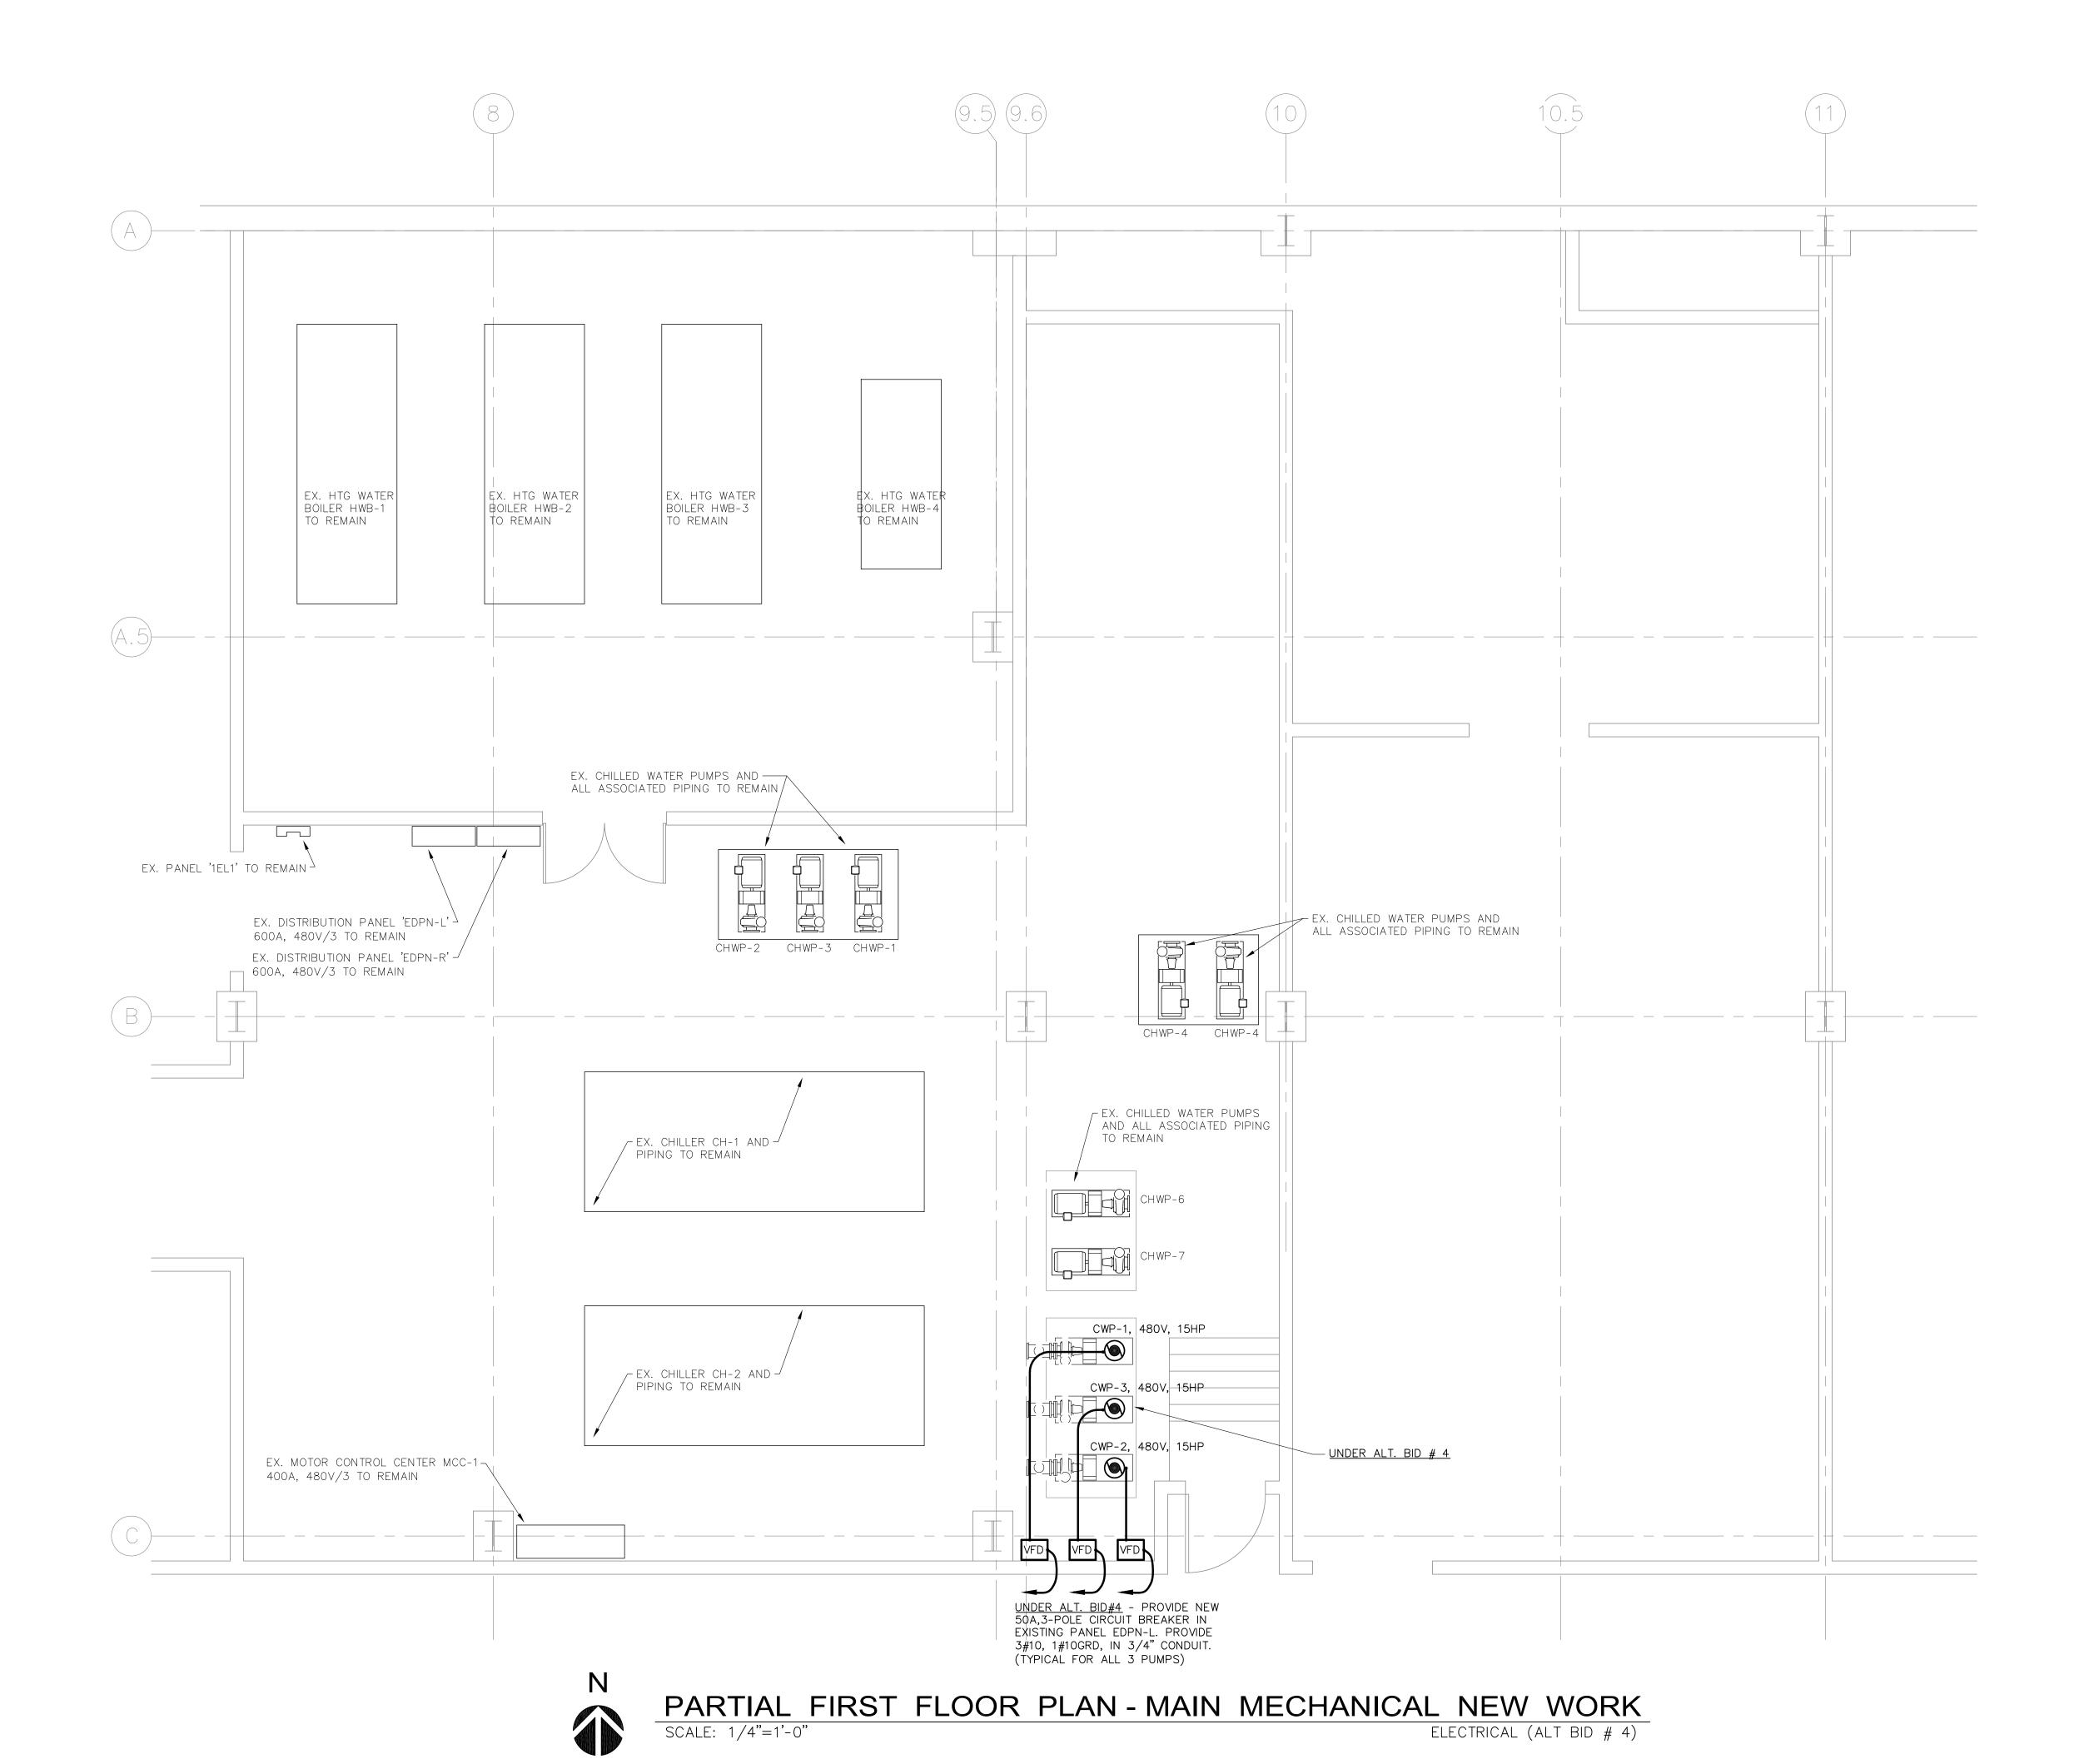

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PROJECT # M2015-01 SITE # 7391

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CAD DWG FILE: M2015-01 E-102.DWG
DRAWN BY: JBM
CHECKED BY: VUP
DESIGNED BY: GDL

SHEET TITLE:

ASSET#

PARTIAL FIRST FLR.
PLAN - MAIN EQUIP.
ROOM NEW WORK

SHEET NUMBER:

E-102

SHEET 15 OF 15 FEBRUARY 14, 2023

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