Anti-Ligature Upgrades, Multiple Assets Fulton State Hospital (Fulton, Missouri)



OWNER:

STATE OF MISSOURI MICHAEL L. PARSON,

GOVERNOR

DEPARTMENT OF Mental Health

PROJECT

OFFICE OF ADMINISTRATION

MANAGEMENT: DIVI

DIVISION OF FACILITIES MANAGEMENT,

DESIGN AND CONSTRUCTION

DESIGNER:

Architect: L2e Solutions

Engineer: Astral Engineers

PROJECT NUMBER:


M2312-001

SITE NUMBER:

7352

FACILITY NUMBER: 6517352026

6517352027 6517352031 6517352057

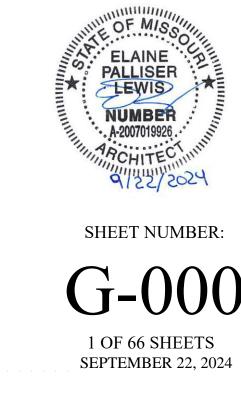





STANDARD NOTATION



NORTH

NORTH ARROW

DETAIL CUT, DETAIL TITLE, DETAIL NUMBER/ BUILDING TYPE SHEET NUMBER/ BUILDING NUMBER SECTION CUT:



KEYED NOTE, PLANS



KEYED NOTE, DEMOLITION PLANS



REVISION NOTE

---- DEMOLITION ITEM, ON DEMO PLANS

PARTITION TYPE

CODE INFORMATION

(ICC) INTERNATIONAL BUILDING CODE (2021 EDITION) (ICC) INTERNATIONAL EXISTING BUILDING CODE (2021 EDITION) (NFPA) NATIONAL FIRE PROTECTION ASSOCIATION 70 (2021 EDITION) (NFPA) NATIONAL FIRE PROTECTION ASSOCIATION 101 LIFE SAFETY CODE (2021 EDITION) 2021 ICC INTERNATIONAL ENERGY CONSERVATION CODE NATIONAL ELECTRICAL CODE (2023 EDITION) INTERNATIONAL MECHANICAL CODE (2021 EDITION) INTERNATIONAL PLUMBING CODE (2021 EDITION) ENERGY CONSERVATION CODE - ASHRAE 90.1 (2022 EDITION)

PROJECT INFORMATION:


GUHLEMAN BUILDING WEST (6517352027) - TWO STORY BUILDING GUHLEMAN BUILDING EAST (6517352026) - TWO STORY BUILDING HEARNES BUILDING (6517352031) - SINGLE STORY BUILDING NIXON BUILDING (6517352057) - SINGLE STORY BUILDING

STANDARD ARCHITECTURAL ABBREVIATIONS

В.	ANCHOR BOLT	(E)	EXISTING ITEM	JAN.	JANITOR	REINF.	REINFORCED, REINFORCING
COUS.	ACOUSTIC	EA.	EACH	JT.	JOINT	REQ'D	REQUIRED
.С.Т.	ACOUSTIC TILE CEILING	E.J.	EXPANSION JOINT	01.	001111	REV.	REVISION, REVERSED
NDJ.	ADJUSTABLE, ADJACENT	ELEC.	ELECTRICAL	L.P.	LIGHT POLE	R.T.	RUBBER TILE
v.F.F.	ABOVE FINISHED FLOOR	ELEV.	ELEVATION, ELEVATOR	L.I .	LIGITI I OLL	11.1.	NODDEN TILL
	ALTERNATE	ENG.	ENGINEER	MAC	MACONDV	S&P	SHELF AND POLE
LT.				MAS.	MASONRY		
LUM.	ALUMINUM	E.P.	ELECTRIC PANEL	MAX.	MAXIMUM	SC	SOLID CORE
RCH.	ARCHITECT	EQ.	EQUAL	M.E.	MATCH EXISTING	SCHD.	SCHEDULE
		EQUIP.	EQUIPMENT	MECH.	MECHANICAL	SECT.	SECTION
3C	BASE CABINET	E.W.C.	ELECTRIC WATER COOLER	MFGR.	MANUFACTURER	SEP.	SEPARATE, SEPARATION
3D.	BOARD	EXIST.	EXISTING	M.H.	MAN HOLE	SHT.	SHEET
BET.	BETWEEN	EXP.	EXPOSED, EXPANSION	MIN.	MINIMUM	SHTG.	SHEATHING
BLDG.	BUILDING	EXT.	EXTERIOR	MISC.	MISCELLANEOUS	SIM.	SIMILAR
BLKG.	BLOCKING			MLDG.	MOULDING	SPCS.	SPACES
3M.	BEAM	F	FILLER PANEL	M.O.	MASONRY OPENING	SPEC.	SPECIFICATION(S)
3.0.	BY OTHERS	F.D.	FLOOR DRAIN	MTD.	MOUNTED	SQ.	SQUARE
30T.	BOTTOM	FDTN.	FOUNDATION	MTL.	METAL	STL.	STEEL
BRG.	BEARING	F.E.	FIRE EXTINGUISHER	MTRL.	MATERIAL	STOR.	STORAGE
,,,,,,,,,,,,,,,,,,,,,,,,,,,,,,,,,,,,,,,		F.H.	FIRE HYDRANT	WITT CE.	WO TETADAE	STRUCT.	STRUCTURE, STRUCTURAL
,	CENTERLINE	FIN.	FINISH	(N)	NEW ITEM	S.V.	SHEET VINYL
ZAB.	CABINET	FLR.	FLOOR	N.I.C.	NOT IN CONTRACT	J.V.	SHEEL VIIVIE
	CABINET	FLUOR.	FLUORESCENT	No.	NUMBER	T&G	TONGUE AND GROOVE
CEM.							
).J.	CONTROL JOINT	F.P.H.B.	FREEZE PROOF HOSE BIBB	NOM., (\pm)	NOMINAL	T/	TOP OF
CLG.	CEILING	F.R.	FIRE RATED	N.T.S.	NOT TO SCALE	TERR.	TERRAZZO
CLOS.	CLOSET	F.R.T.	FIRE RETARDANT TREATED		011 0511750	THRESH.	THRESHOLD
CLR.	CLEAR	FT.	FOOT, FEET	O.C.	ON CENTER	THRU	THROUGH
C.M.U.	CONCRETE MASONRY UNIT	FTG.	FOOTING	O.D.	OUTSIDE DIAMETER	TPO	THERMOPLASTIC OLEFIN MEMBRANE ROOFING
COL.	COLUMN			OPNG.	OPENING	TYP.	TYPICAL
COMP.	COMPACTED, COMPRESSIBLE	GA.	GAUGE	OPP.	OPPOSITE		
CONC.	CONCRETE	GALV.	GALVANIZED			U.L.	UNDERWRITERS LABORATORY
CONST.	CONSTRUCTION	G.C.	GENERAL CONTRACTOR	P.LAM.	PLASTIC LAMINATE	U.N.O.	UNLESS OTHERWISE NOTED
CONT.	CONTINUOUS	GR.	GRADE	PLYWD.	PLYWOOD		
ORR.	CORRIDOR	GYP.	GYPSUM	PT.	PAINT	V.B.	VAPOR BARRIER, VANITY
PT.	CARPET			P.V.C.	POLY-VINYL CHLORIDE		BASE
C.R.C.	COLD ROLLED CHANNEL	HC	HOLLOW CORE, HANDICAPPED	PV.T.	PAVER TILE	V.C.T.	VINYL COMPOSITION TILE
D.T.	CERAMIC TILE	HDWR.	HARDWARE	1 1111	1711211 1122	VEST.	VESTIBULE
· · · ·	OLIVIANIO TIEL	H.M.	HOLLOW METAL			VERT.	VERTICAL
)	DRYER	HORIZ.	HORIZONTAL	Q.T.	QUARRY TILE	V L I \ I \	VEITHORE
)B	DRAWER BASE	HR.	HOUR	Q.I.	QUANTI TILL	W	WASHER
EMO.	DEMOLITION DEMOLITION	HT.	HEIGHT	(D)	RELOCATED ITEM		WITH
				(R)		W/	
ET.	DETAIL	H.V.A.C.	HEATING, VENTILATION, AND	R.	RISER, RADIUS	WC	WALL CABINET
).F.	DRINKING FOUNTAIN		AIR CONDITIONING	R.B.	RESILIENT BASE	WD.	WOOD
)IA., (ø)	DIAMETER		INICHIATED	R.D.	ROOF DRAIN	W.H.	WATER HEATER
ISP.	DISPENSER		INSULATED	R.O.	ROUGH OPENING	WOLM.	WOLMANIZED
)S	DOWNSPOUT	I.D.	INTERIOR DIAMETER	REC.	RECESSED	WP.	WATERPROOF(ING)
WG.	DRAWING	INSUL.	INSULATION	REF.	REFRIGERATOR	W.T.	WOOD TILE
		INIT	INITEDIAD			\A/ \A/ E	WELDED WIDE EXDDIC

INTERIOR

NOTE: NOT ALL SYMBOLS AND/OR ABBREVIATIONS MAY BE USED

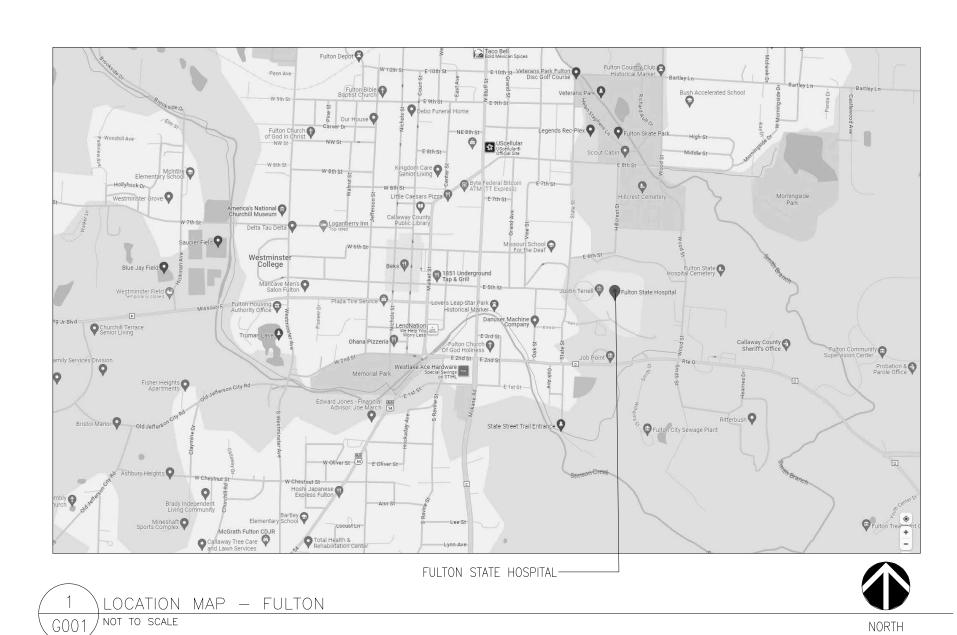

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NORTH

W.W.F. WELDED WIRE FABRIC

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PATCH/PAINT EXISTING ADJACENT PARTITIONS.

ALTERNATES:

ALTERNATE #1: REMOVE EXISTING FIRE HOSE CABINET AND REPLACE WITH NEW LIGATURE RESISTANT CABINET PATCH/PAINT EXISTING BLOCK PARTITIONS AT NEW CABINET LOCATION. ALTERNATE #2: REMOVE EXISTING LOCKER SYSTEM AND INSTALL NEW LIGATURE RESISTANT LOCKER SYSTEM

STATE OF MISSOURI MICHAEL L PARSON, **GOVERNOR**





STATE OF MISSOURI CERTIFICATE OF AUTHORITY #2018019473

ASTRAL ENGINEERS

NORTH

OFFICE OF ADMINISTRATION DIVISION OF FACILITIES MANAGEMENT, **DESIGN AND CONSTRUCTION**

DEPARTMENT OF MENTAL HEALTH

ANTI-LIGATURE UPGRADES MULTIPLE ASSETS FULTON STATE HOSPITAL FULTON, MISSOURI

PROJECT #	M2312-01
SITE#	7352
ASSET#	6517352026

6517352027

6517352031

6517352057 **REVISION:-**DATE: REVISION: -DATE: -REVISION: -DATE: -


ISSUE DATE: 9-22-2024

CAD DWG FILE:G-001 DRAWN BY: CHECKED BY: El DESIGNED BY: EL

SHEET TITLE:

PROJECT INFORMATION

SHEET NUMBER:

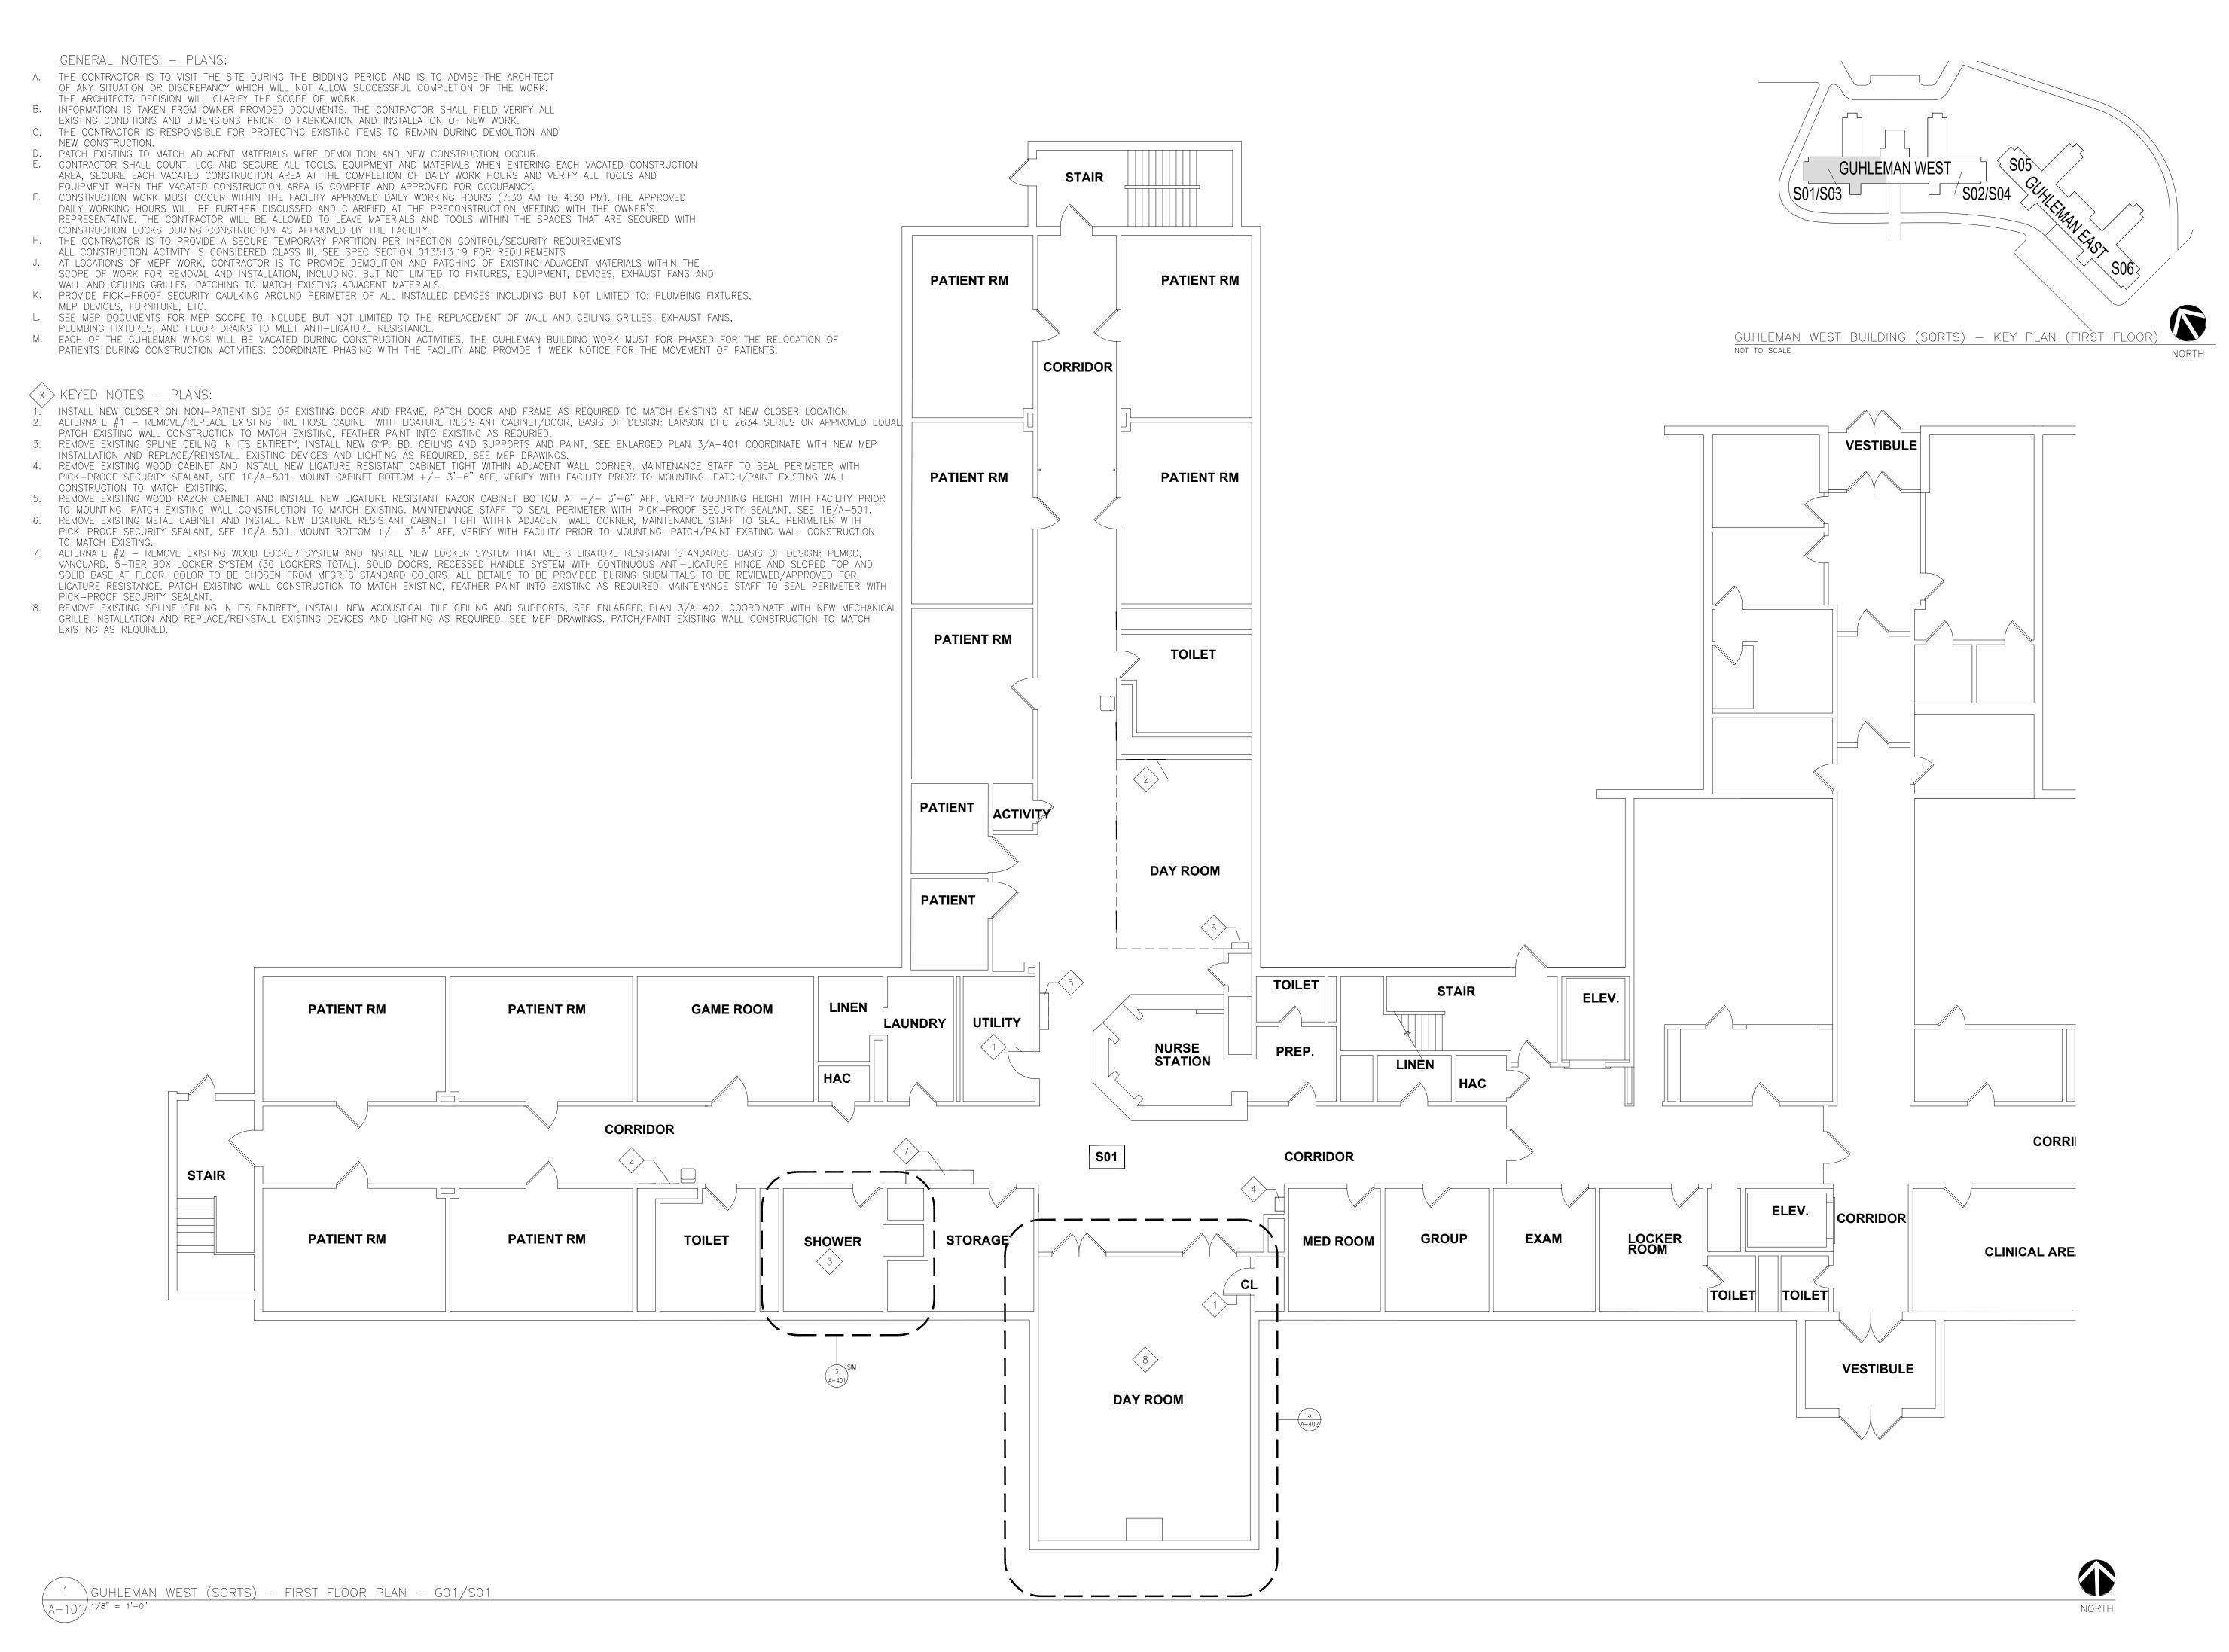





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DEPARTMENT OF MENTAL HEALTH

ANTI-LIGATURE UPGRADES MULTIPLE ASSETS FULTON STATE HOSPITAL FULTON, MISSOURI

PROJECT # M2312-01 SITE # 7352 ASSET # 6517352026

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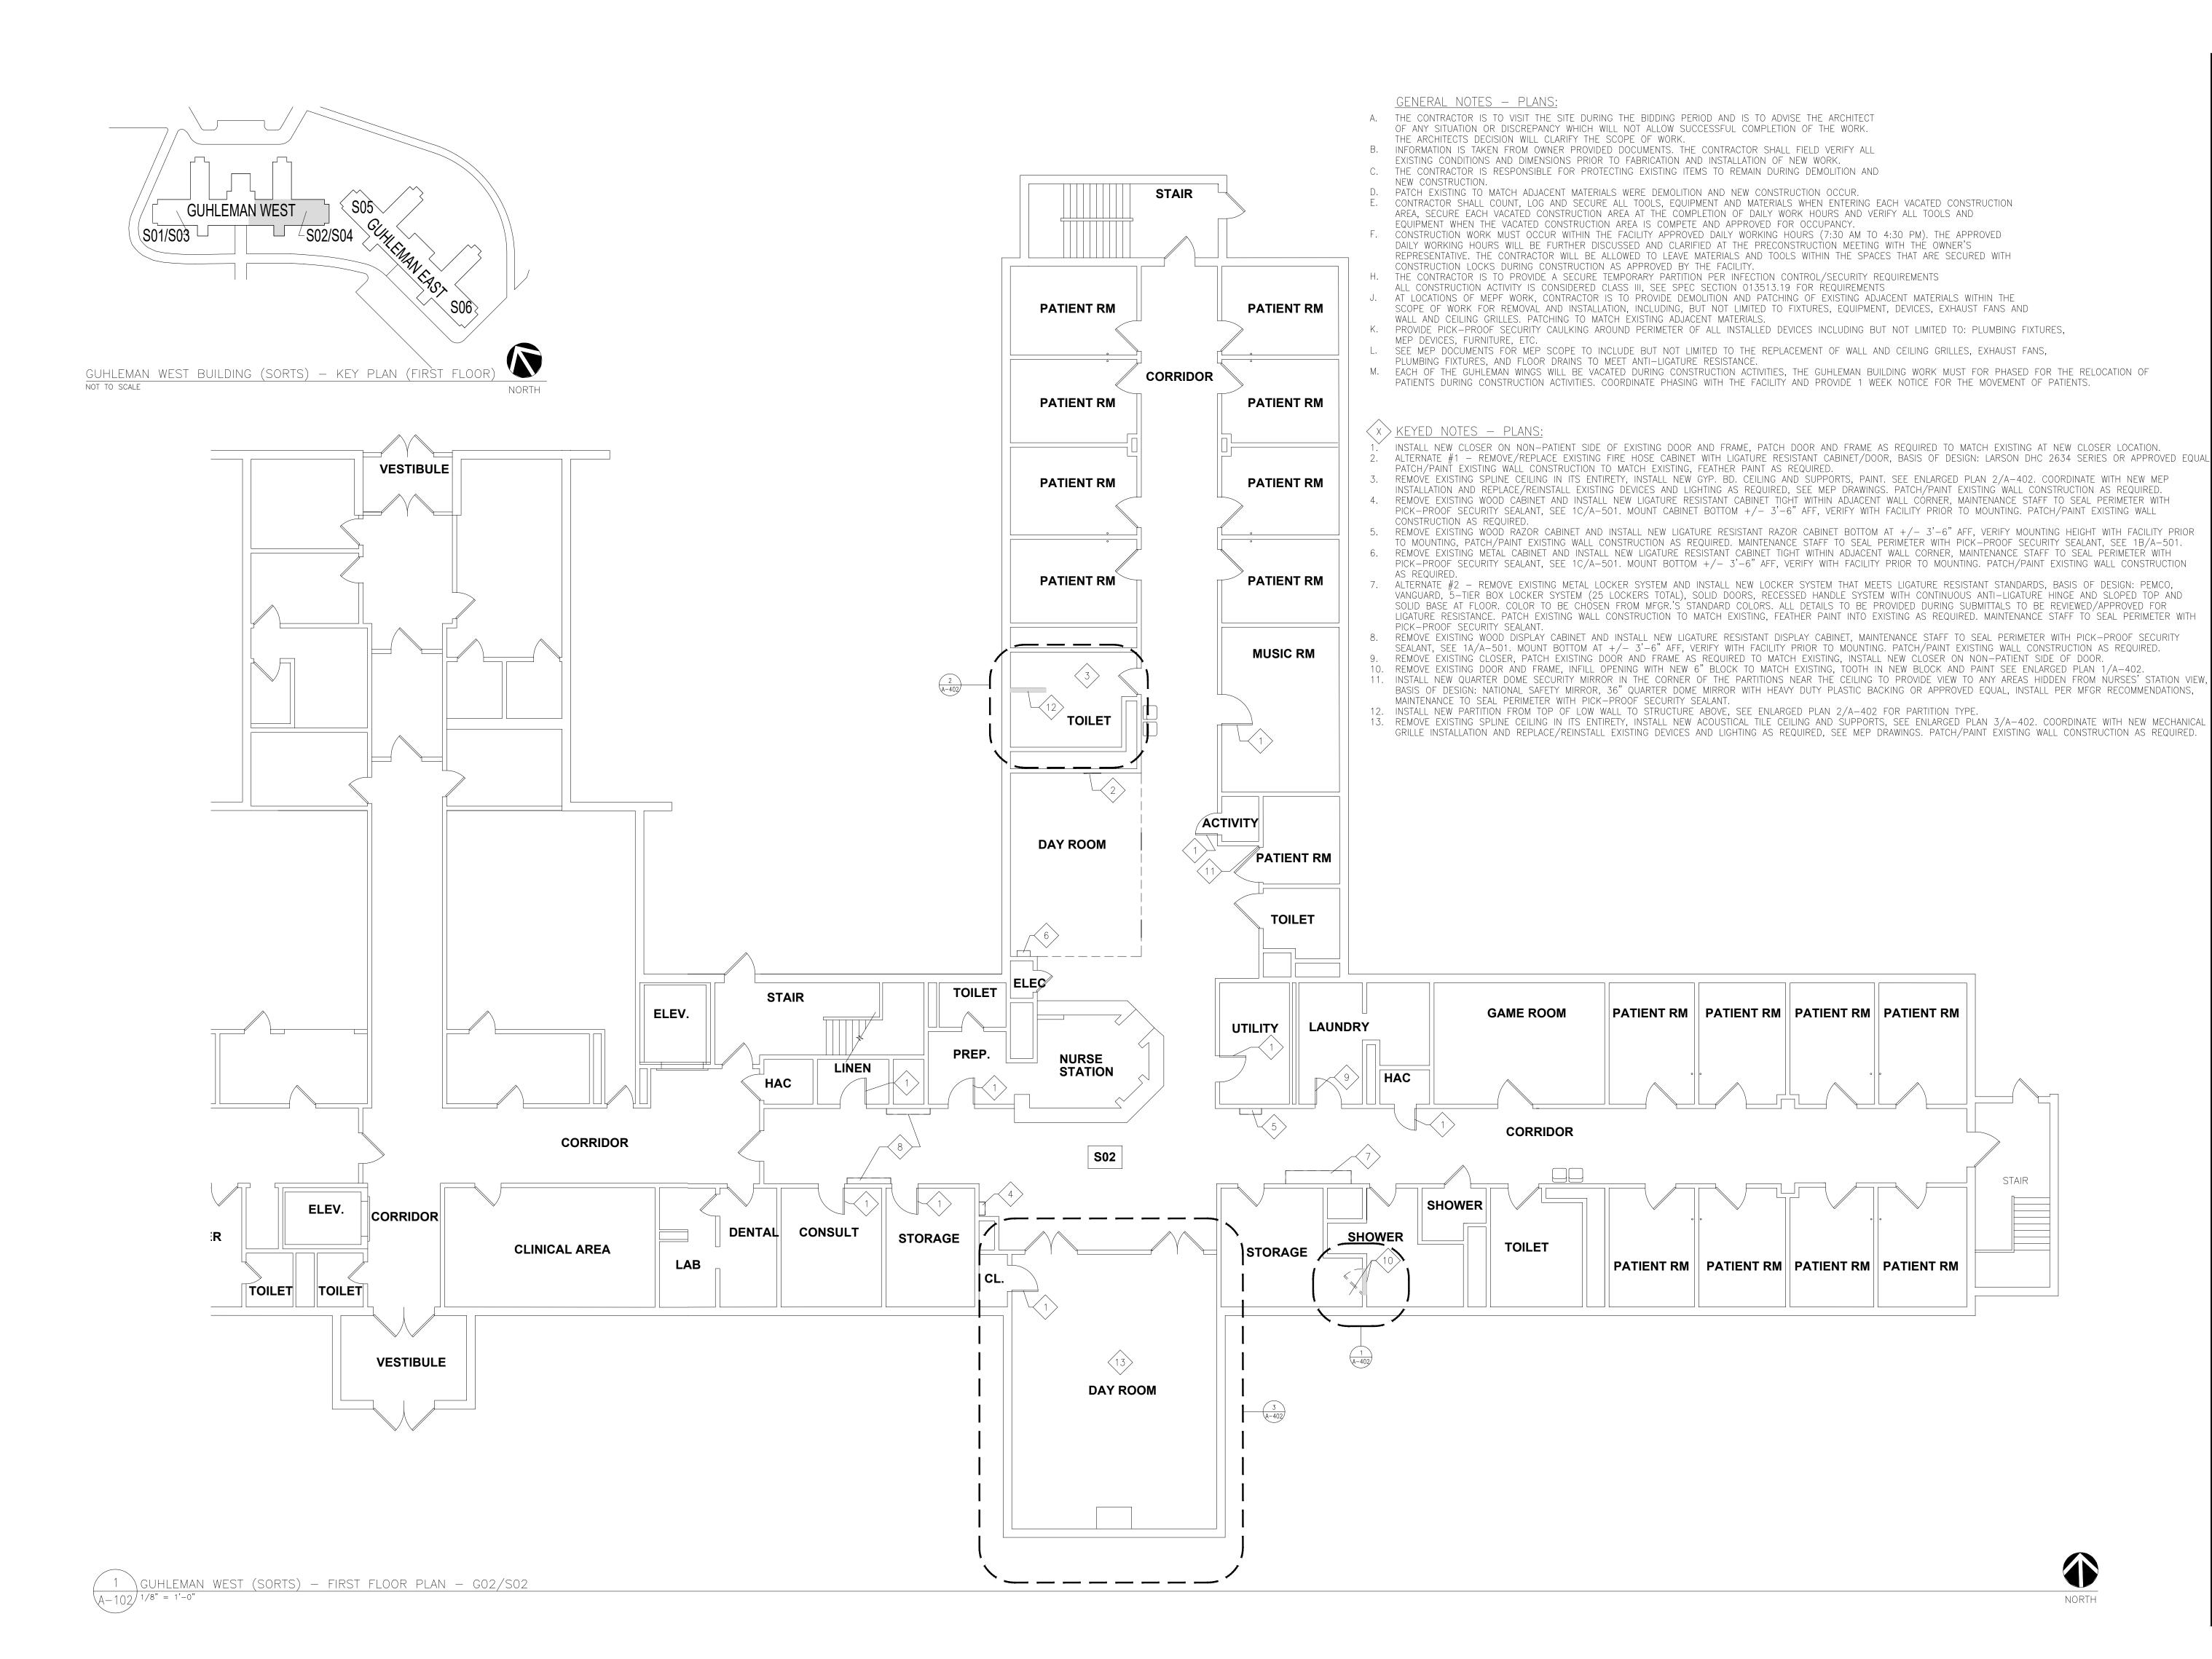
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DRAWN BY: EL
CHECKED BY: EL
DESIGNED BY: EL

SHEET TITLE:

GUHLEMAN BLDG. WEST (SORTS) FIRST FLR - G01/S01

SHEET NUMBER:

A-10







STATE OF MISSOURI CERTIFICATE OF AUTHORITY #2018019473

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ANTI-LIGATURE UPGRADES MULTIPLE ASSETS FULTON STATE HOSPITAL FULTON, MISSOURI

PROJECT # M2312-01 SITE # 7352 ASSET # 6517352026

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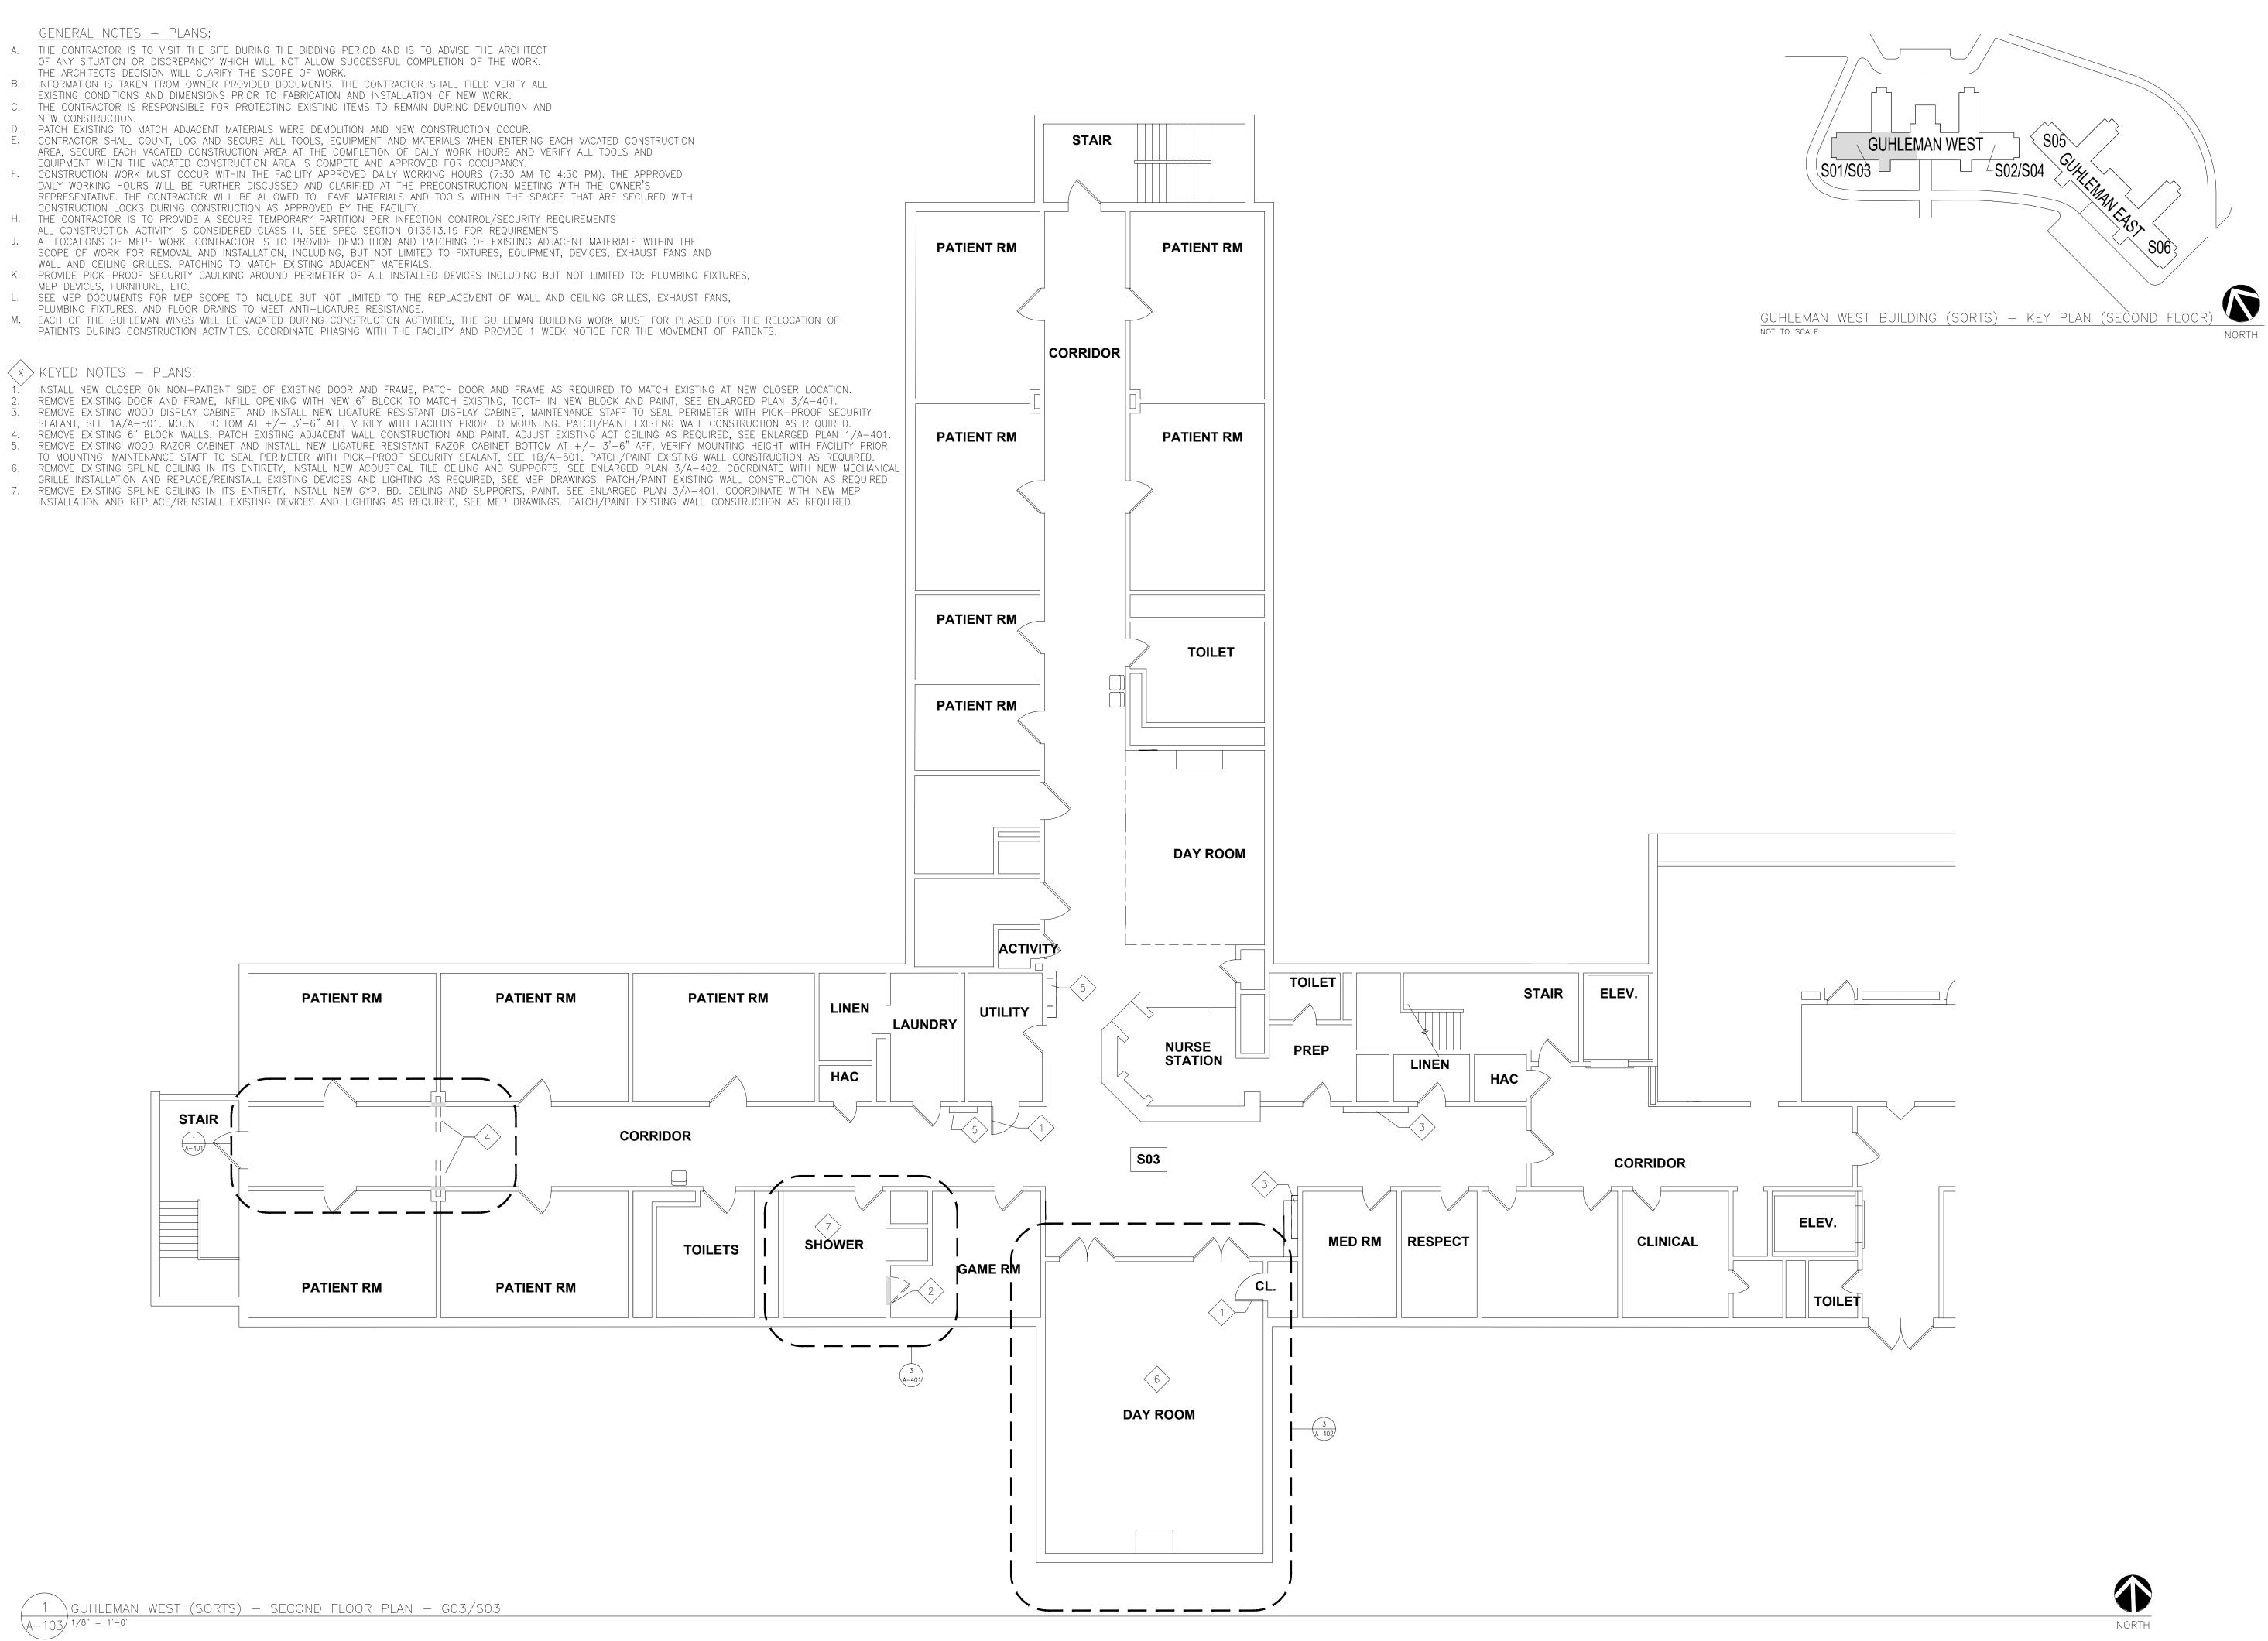
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SHEET TITLE:

GUHLEMAN BLDG. WEST (SORTS) FIRST FLR - G02/S02

SHEET NUMBER:

A-102







STATE OF MISSOURI CERTIFICATE OF AUTHORITY #2018019473

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DEPARTMENT OF MENTAL HEALTH

ANTI-LIGATURE UPGRADES MULTIPLE ASSETS FULTON STATE HOSPITAL FULTON, MISSOURI

PROJECT # M2312-01 SITE # 7352 ASSET # 6517352026

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ISSUE DATE: 9-22-2024

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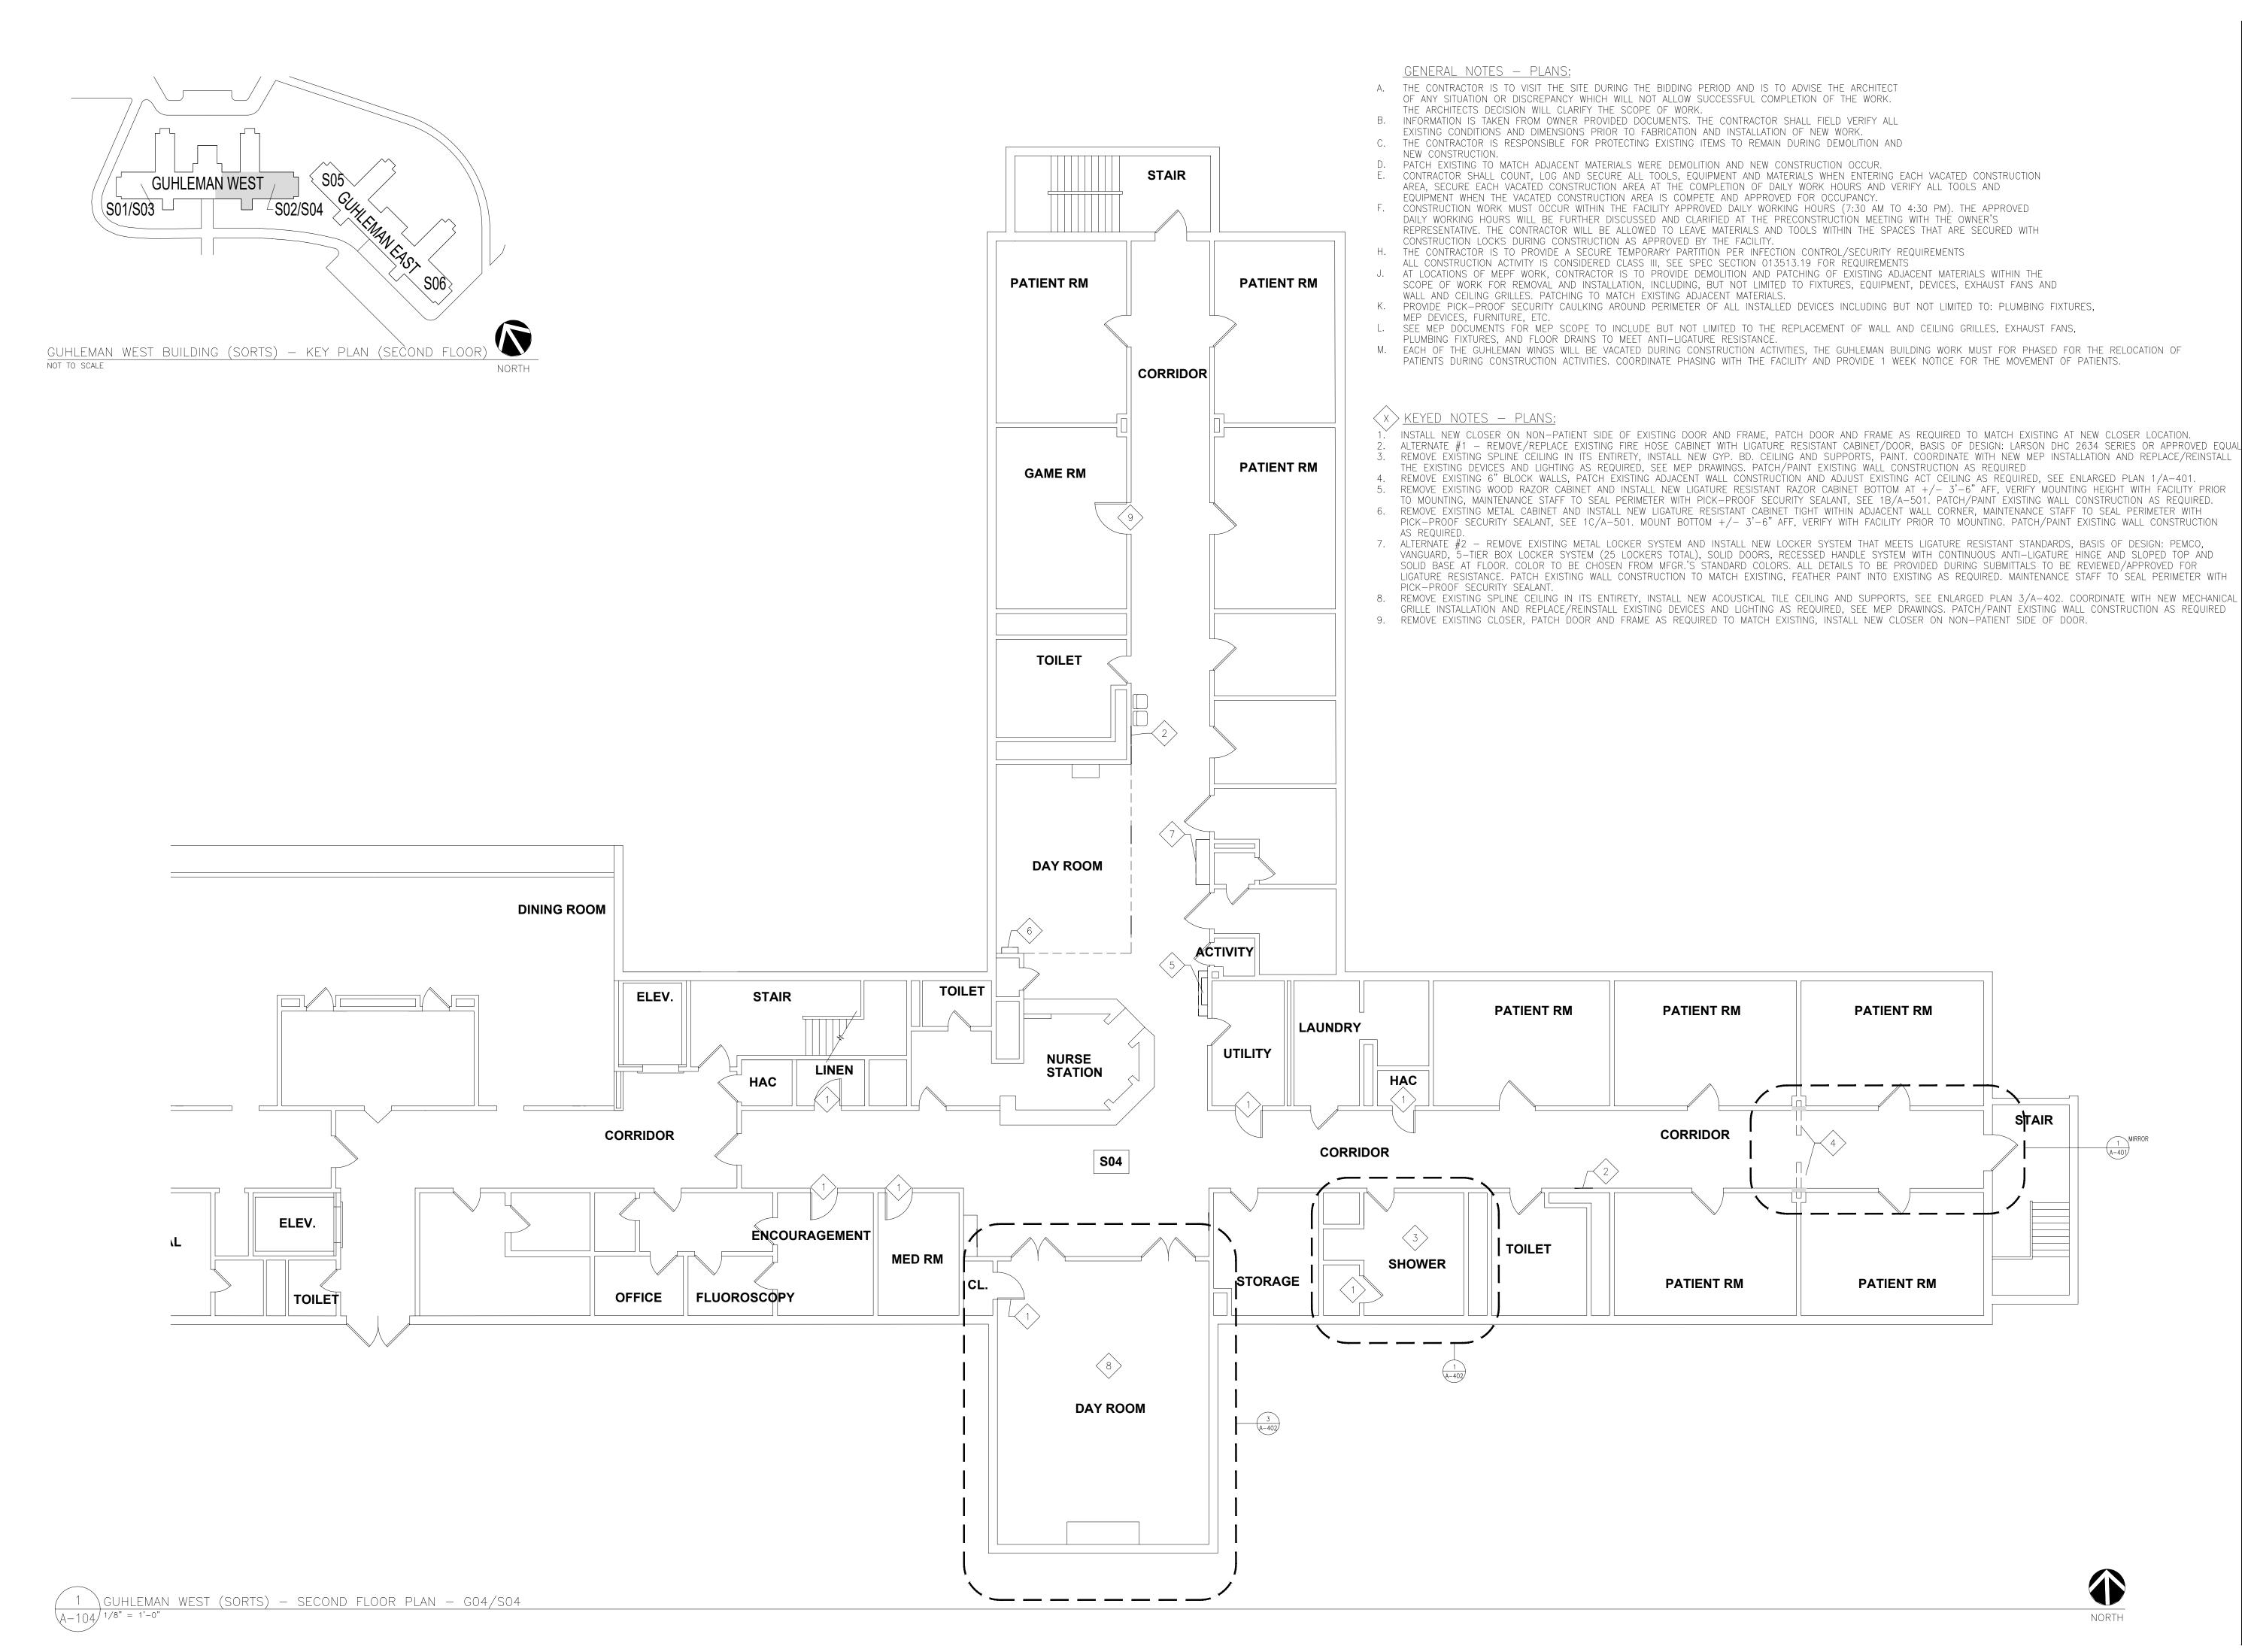
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SHEET TITLE:

GUHLEMAN BLDG.
WEST (SORTS)
SECOND FLR - G03/S03

SHEET NUMBER:

A-103







STATE OF MISSOURI CERTIFICATE OF AUTHORITY #2018019473

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DEPARTMENT OF MENTAL HEALTH

ANTI-LIGATURE UPGRADES MULTIPLE ASSETS FULTON STATE HOSPITAL FULTON, MISSOURI

PROJECT # M2312-01 SITE # 7352 ASSET # 6517352026

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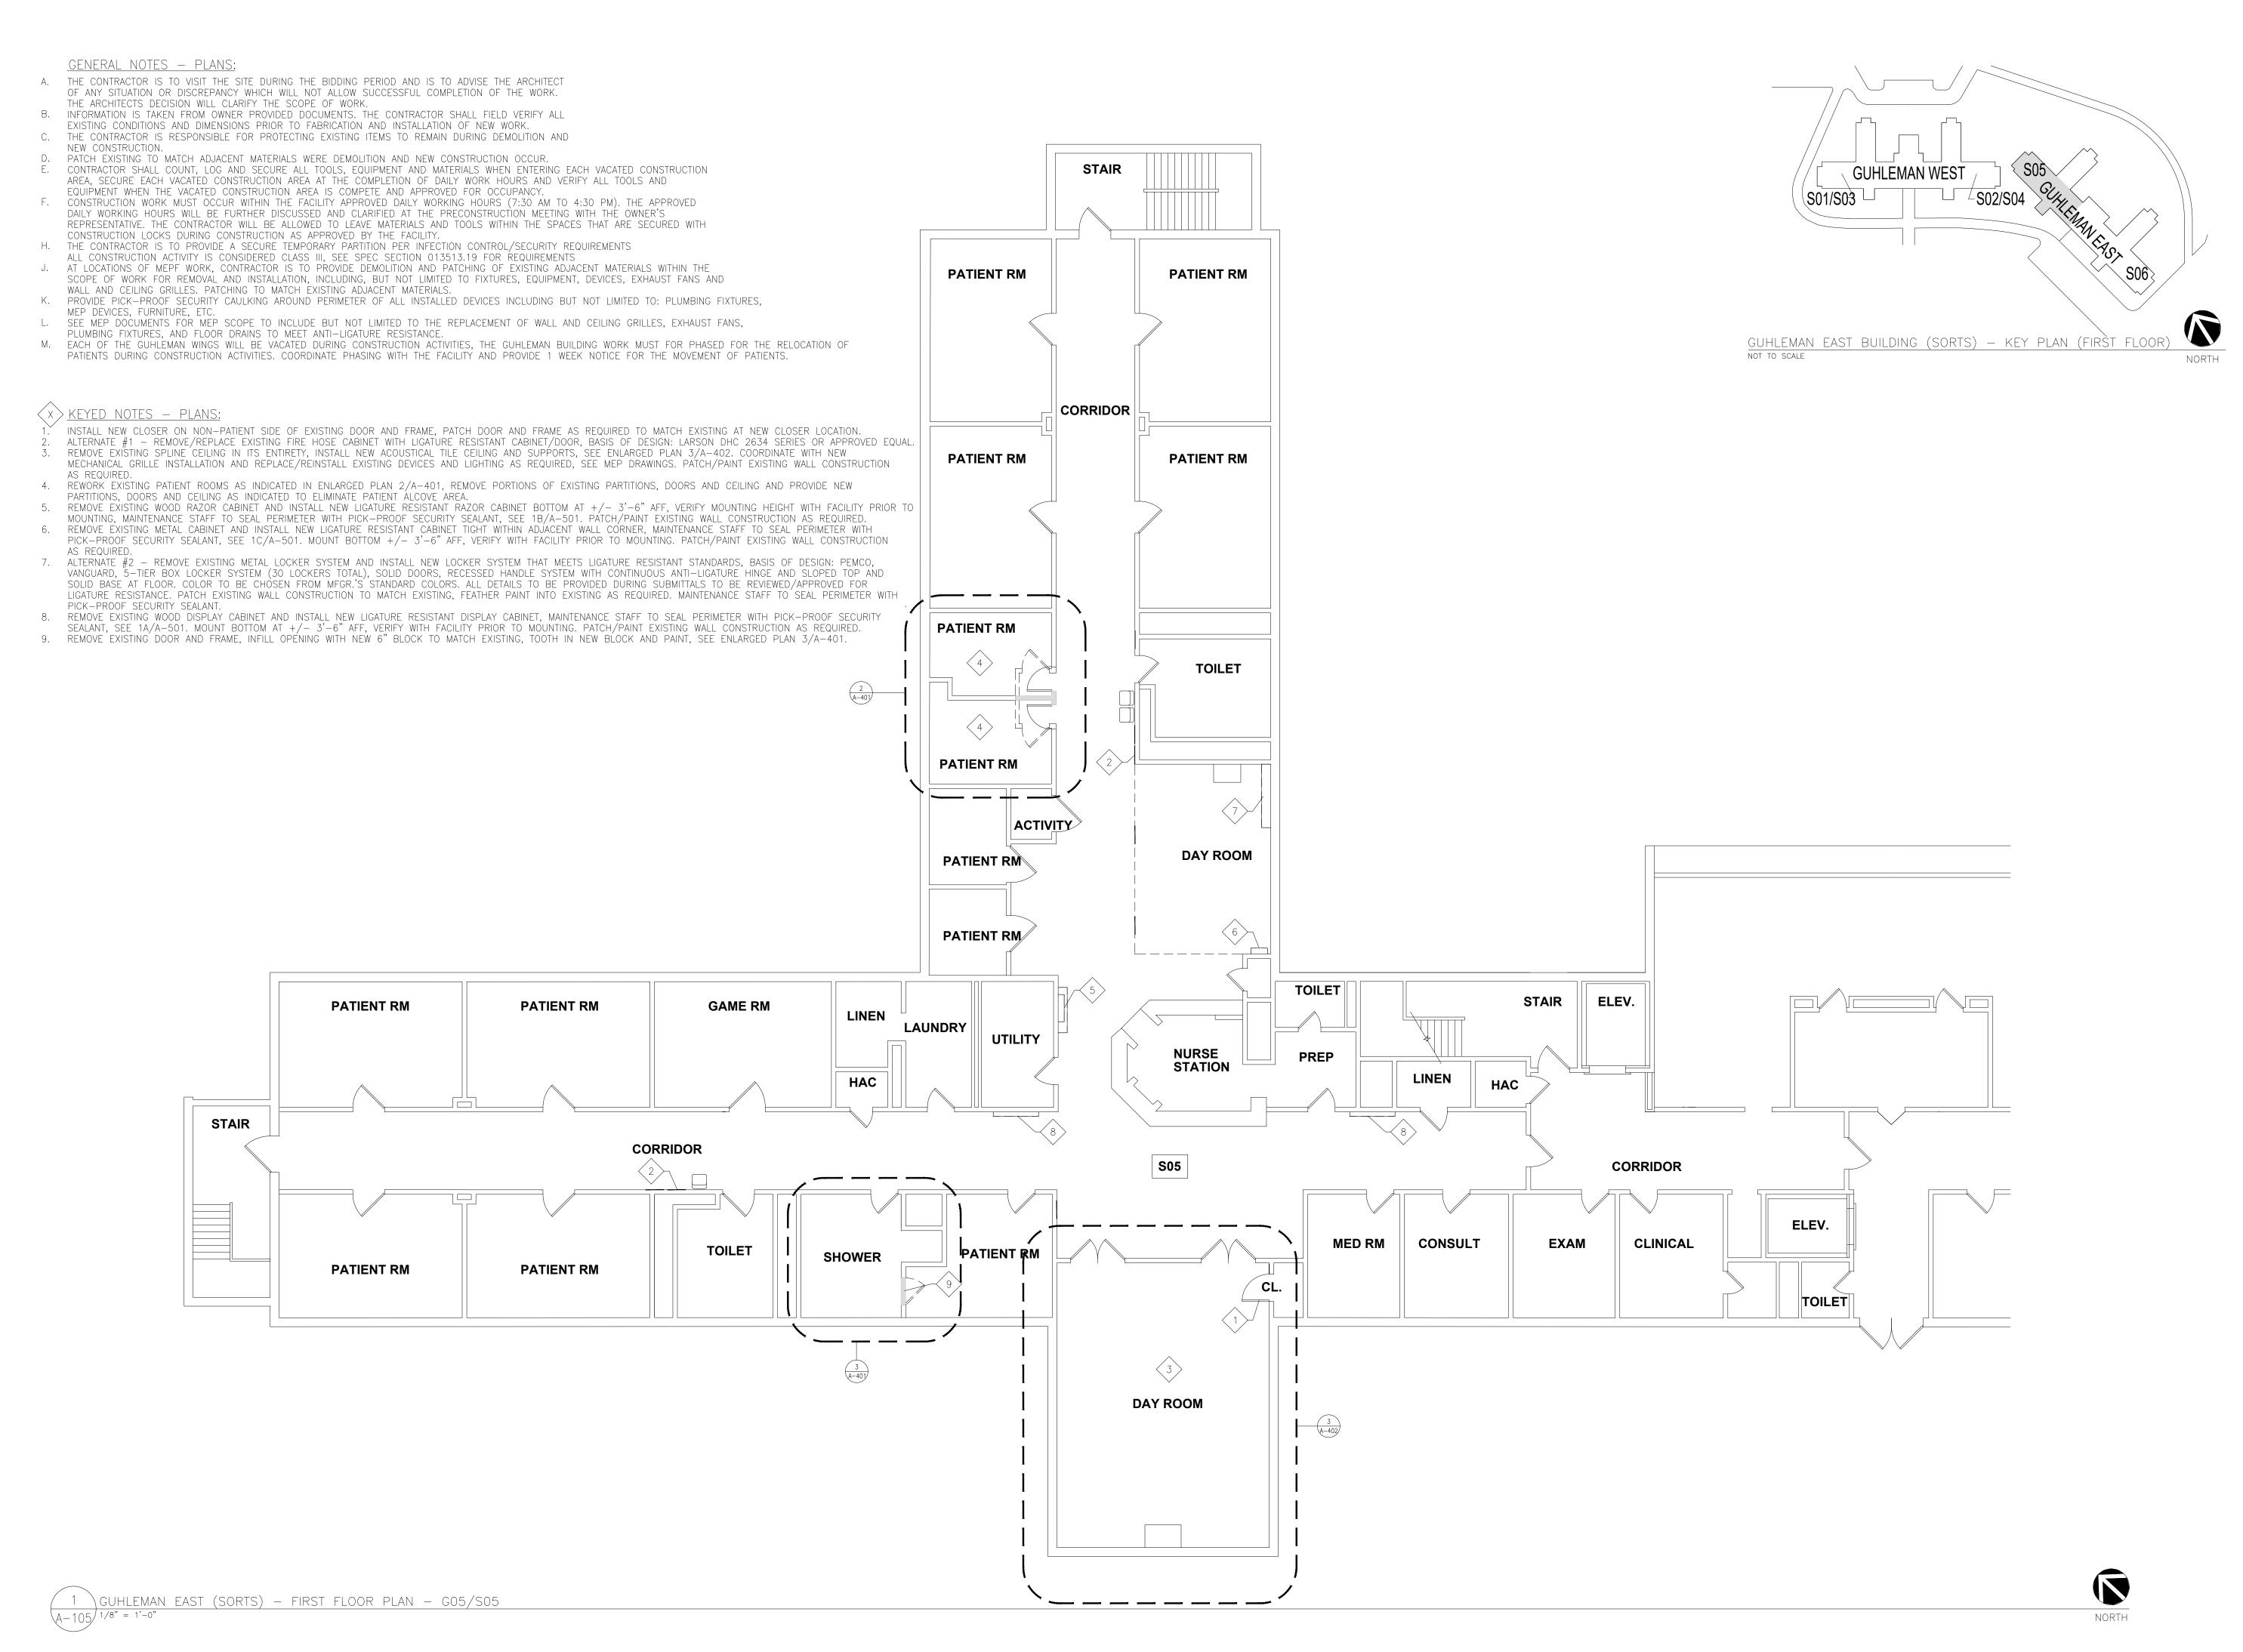
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DESIGNED BY: EL

SHEET TITLE:

GUHLEMAN BLDG. WEST (SORTS) SECOND FLR - G04/S04

SHEET NUMBER:

A-104







STATE OF MISSOURI CERTIFICATE OF AUTHORITY #2018019473

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1 O DON 190, INTINCITO COCAMINICA (NE 1901)	11/27

DIVISION OF FACILITIES MANAGEMENT, DESIGN AND CONSTRUCTION

OFFICE OF ADMINISTRATION

DEPARTMENT OF MENTAL HEALTH

ANTI-LIGATURE UPGRADES MULTIPLE ASSETS FULTON STATE HOSPITAL FULTON, MISSOURI

PROJECT # M2312-01 SITE # 7352 ASSET # 6517352027

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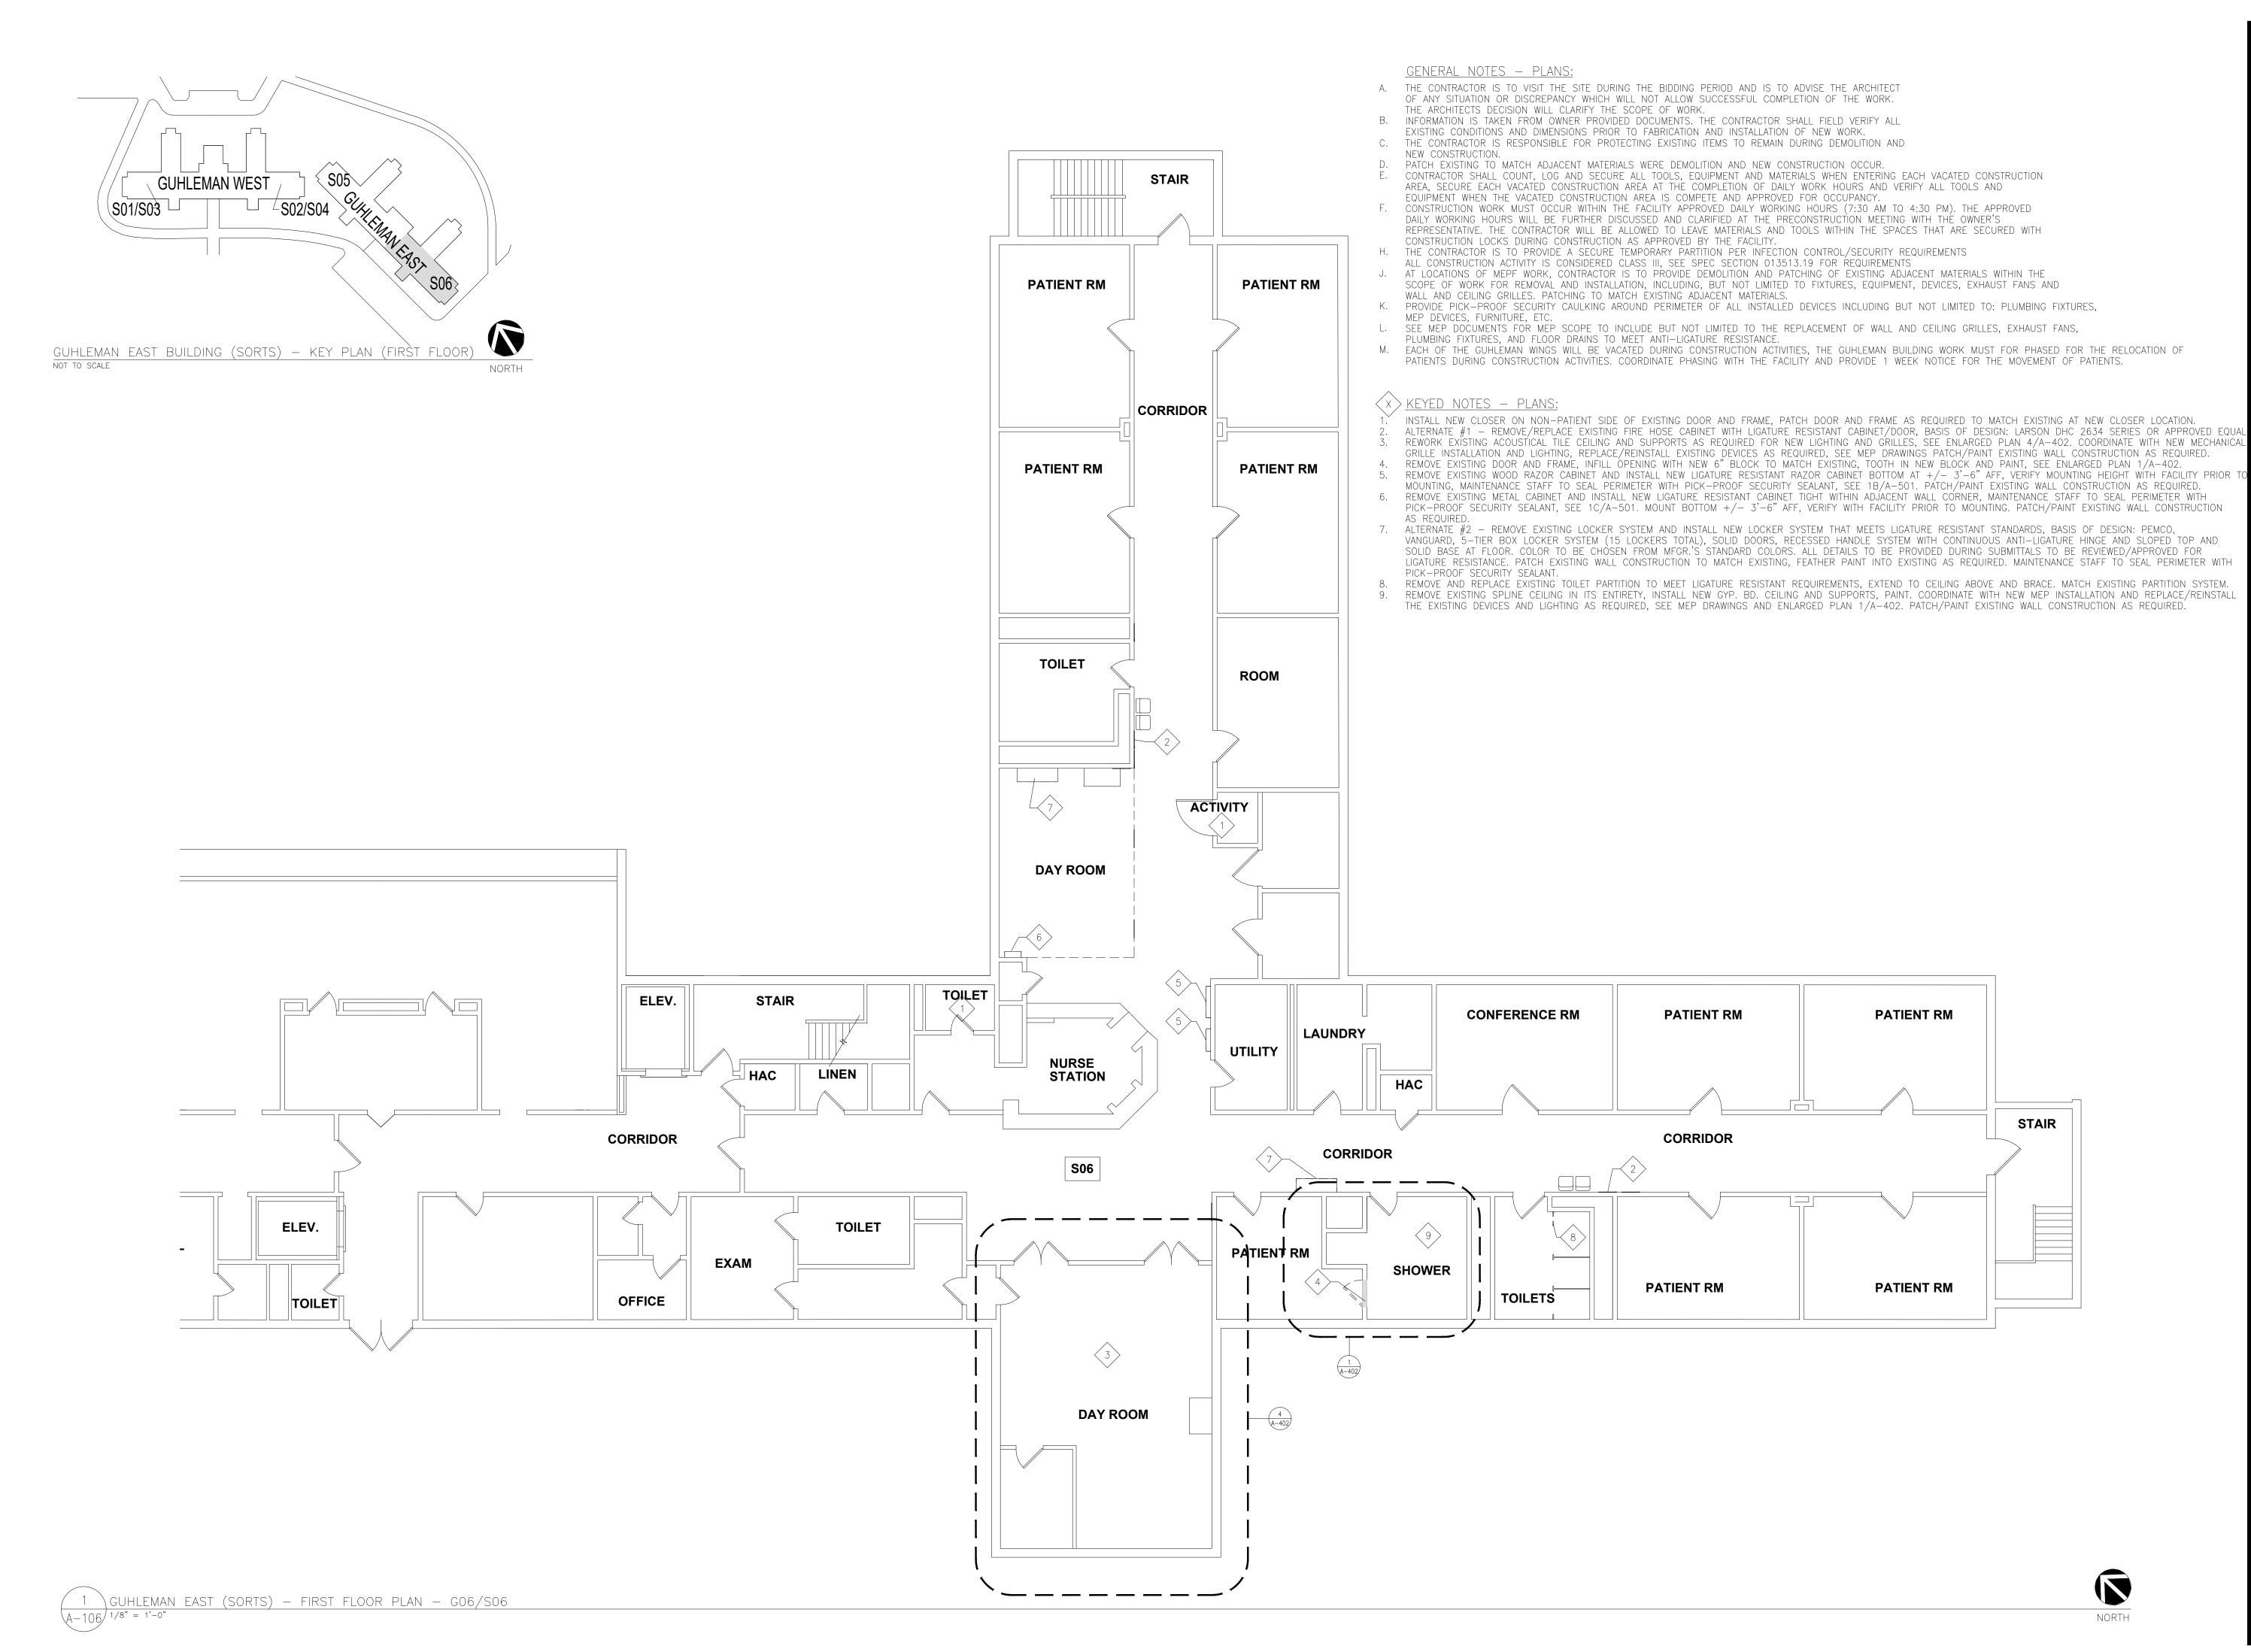
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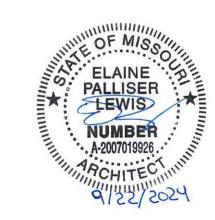
SHEET TITLE:

GUHLEMAN BLDG. EAST (SORTS) FIRST FLR - G05/S05

SHEET NUMBER:

A-105







STATE OF MISSOURI CERTIFICATE OF AUTHORITY #2018019473

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DEPARTMENT OF MENTAL HEALTH

ANTI-LIGATURE UPGRADES MULTIPLE ASSETS FULTON STATE HOSPITAL FULTON, MISSOURI

PROJECT # M2312-01 SITE # 7352 ASSET # 6517352027

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ISSUE DATE: 9-22-2024


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DRAWN BY: EL
CHECKED BY: EL
DESIGNED BY: EL

SHEET TITLE:

GUHLEMAN BLDG. EAST (SORTS) FIRST FLR - G06/S06

SHEET NUMBER:

A-106

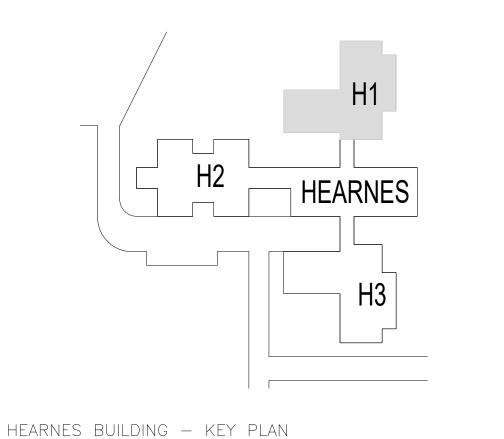

GENERAL NOTES - PLANS:

A. THE CONTRACTOR IS TO VISIT THE SITE DURING THE BIDDING PERIOD AND IS TO ADVISE THE ARCHITECT OF ANY SITUATION OR DISCREPANCY WHICH WILL NOT ALLOW SUCCESSFUL COMPLETION OF THE WORK.

THE ARCHITECTS DECISION WILL CLARIFY THE SCOPE OF WORK. B. INFORMATION IS TAKEN FROM OWNER PROVIDED DOCUMENTS. THE CONTRACTOR SHALL FIELD VERIFY ALL

EXISTING CONDITIONS AND DIMENSIONS PRIOR TO FABRICATION AND INSTALLATION OF NEW WORK.

THE CONTRACTOR IS RESPONSIBLE FOR PROTECTING EXISTING ITEMS TO REMAIN DURING DEMOLITION AND NEW CONSTRUCTION.

PATCH EXISTING TO MATCH ADJACENT MATERIALS WERE DEMOLITION AND NEW CONSTRUCTION OCCUR. E. CONTRACTOR SHALL COUNT, LOG AND SECURE ALL TOOLS, EQUIPMENT AND MATERIALS WHEN ENTERING EACH VACATED CONSTRUCTION AREA, SECURE EACH VACATED CONSTRUCTION AREA AT THE COMPLETION OF DAILY WORK HOURS AND VERIFY ALL TOOLS AND

EQUIPMENT WHEN THE VACATED CONSTRUCTION AREA IS COMPETE AND APPROVED FOR OCCUPANCY. THE CONTRACTOR IS TO PROVIDE A SECURE TEMPORARY PARTITION PER INFECTION CONTROL/SECURITY REQUIREMENTS ALL CONSTRUCTION ACTIVITY IS CONSIDERED CLASS III, SEE SPEC SECTION 013513.19 FOR REQUIREMENTS

G. AT LOCATIONS OF MEPF WORK, CONTRACTOR IS TO PROVIDE DEMOLITION AND PATCHING OF EXISTING ADJACENT MATERIALS WITHIN THE SCOPE OF WORK FOR REMOVAL AND INSTALLATION, INCLUDING, BUT NOT LIMITED TO FIXTURES, EQUIPMENT, DEVICES, EXHAUST FANS AND WALL AND CEILING GRILLES. PATCHING TO MATCH EXISTING ADJACENT MATERIALS.

H. PROVIDE PICK-PROOF SECURITY CAULKING AROUND PERIMETER OF ALL INSTALLED DEVICES INCLUDING BUT NOT LIMITED TO: PLUMBING FIXTURES, MEP DEVICES, FURNITURE, ETC.

J. SEE MEP DOCUMENTS FOR MEP SCOPE TO INCLUDE BUT NOT LIMITED TO THE REPLACEMENT OF WALL AND CEILING GRILLES, EXHAUST FANS, PLUMBING FIXTURES, AND FLOOR DRAINS TO MEET ANTI-LIGATURE RESISTANCE.

MUST BE COUNTED, LOGGED, SECURED AND REMOVED FROM THE HEARNES BUILDING UPON THE END OF EACH CONSTRUCTION DAY.


K. CONSTRUCTION IN THE HEARNES BUILDING WILL NEED TO BE PHASED AND COORDINATED WITH FACILITY STAFF AND MUST BE COMPLETED BETWEEN THE HOURS OF 9:00 AND 3:30. STAFF WILL REMOVE PATIENTS FROM THE AREA DURING THOSE HOURS ONLY AND PATIENTS WILL RETURN AT 3:30. TOOLS

(x) KEYED NOTES - PLANS:

REMOVE EXISTING CLOSER, PATCH DOOR AND FRAME AS REQUIRED TO MATCH EXISTING, INSTALL NEW CLOSER ON NON-PATIENT SIDE OF DOOR. PATCH EXISTING WALLS WHERE EXISTING WATER COOLERS WERE REMOVED/REPLACED, PATCH/PAINT TO MATCH EXISTING.

REMOVE EXISTING WOOD DISPLAY CABINET AND INSTALL NEW LIGATURE RESISTANT DISPLAY CABINET, MAINTENANCE STAFF TO SEAL PERIMETER WITH PICK-PROOF SECURITY SEALANT, SEE 1A/A-501. MOUNT BOTTOM AT +/-3'-6'' AFF, VERIFY WITH FACILITY PRIOR TO MOUNTING. PATCH/PAINT EXISTING

WALL CONSTRUCTION AS REQUIRED. VANGUARD, 5-TIER BOX LOCKER SYSTEM (25 LOCKERS TOTAL), SOLID DOORS, RECESSED HANDLE SYSTEM WITH CONTINUOUS ANTI-LIGATURE HINGE AND SLOPED TO AND SOLID BASE AT FLOOR. COLOR TO BE CHOSEN FROM MFGR.'S STANDARD COLORS. ALL DETAILS TO BE PROVIDED DURING SUBMITTALS TO BE REVIEWED/APPROV FOR LIGATURE RESISTANCE. PATCH EXISTING WALL CONSTRUCTION TO MATCH EXISTING, FEATHER PAINT INTO EXISTING AS REQUIRED. MAINTENANCE STAFF TO SEAL

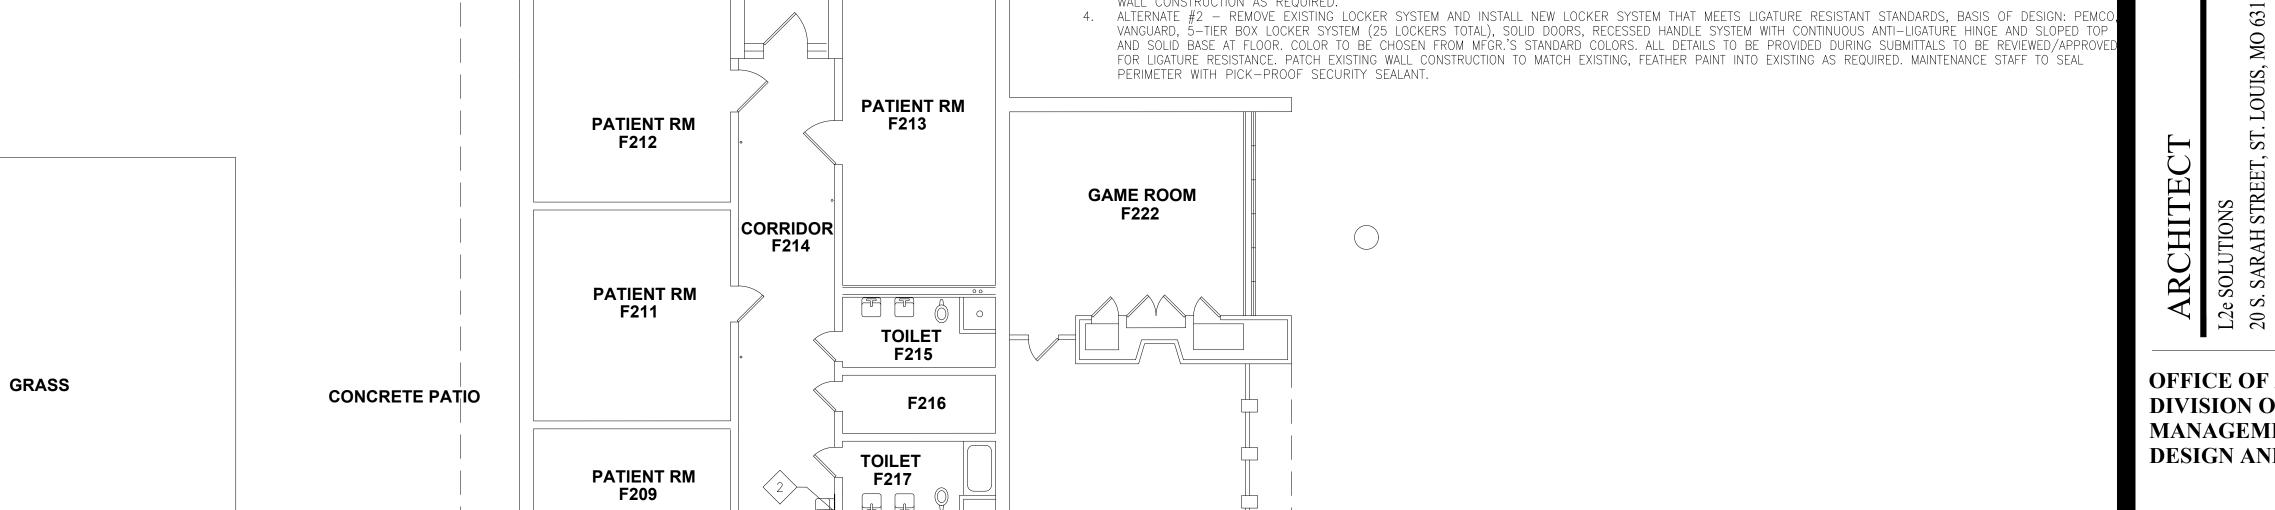

TOILET F218 **PATIENT RM DAY ROOM** HAC F221 F223 **MECH** F205 PATIENT RM PATIENT RM F202 PATIENT RM PATIENT RM DAY ROOM F219 F201 TOILET F206 TOILET **ENTRY** F220 **NURSE STATION CORRIDOR** F187

TOILET F194 | FA F200 MED RM TOILET F189 F193A PATIENT RM PATIENT RM F198 PATIENT RM F196 CORRIDOR F192 F185

F186 F184 F168

STATE OF MISSOURI MICHAEL L PARSON, **GOVERNOR**





STATE OF MISSOURI CERTIFICATE OF AUTHORITY #2018019473

ASTRAL ENGINEERS	L2e SOLUTIONS 20 S. SARAH STREET, ST. LOUIS, MO 63108
	ASTRAL ENGINEERS

OFFICE OF ADMINISTRATION **DIVISION OF FACILITIES** MANAGEMENT, **DESIGN AND CONSTRUCTION**

DEPARTMENT OF MENTAL HEALTH

ANTI-LIGATURE UPGRADES MULTIPLE ASSETS FULTON STATE HOSPITAL FULTON, MISSOURI

PROJECT # M2312-01 7352 6517352031

REVISION:-	
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ISSUE DATE: 9-22-2024	

CAD DWG FILE: A-FP-07 DRAWN BY: CHECKED BY: E DESIGNED BY: EL

SHEET TITLE:

HEARNES BLDG. - H01


SHEET NUMBER:

9 OF 66 SHEETS

SEPTEMBER 22, 2024

PATIENT RM

F199

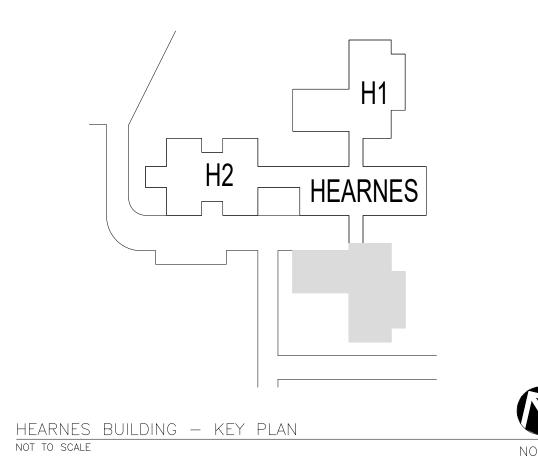


GENERAL NOTES - PLANS:

- A. THE CONTRACTOR IS TO VISIT THE SITE DURING THE BIDDING PERIOD AND IS TO ADVISE THE ARCHITECT OF ANY SITUATION OR DISCREPANCY WHICH WILL NOT ALLOW SUCCESSFUL COMPLETION OF THE WORK.
- THE ARCHITECTS DECISION WILL CLARIFY THE SCOPE OF WORK. B. INFORMATION IS TAKEN FROM OWNER PROVIDED DOCUMENTS. THE CONTRACTOR SHALL FIELD VERIFY ALL
- EXISTING CONDITIONS AND DIMENSIONS PRIOR TO FABRICATION AND INSTALLATION OF NEW WORK.
- THE CONTRACTOR IS RESPONSIBLE FOR PROTECTING EXISTING ITEMS TO REMAIN DURING DEMOLITION AND NEW CONSTRUCTION.
- D. PATCH EXISTING TO MATCH ADJACENT MATERIALS WERE DEMOLITION AND NEW CONSTRUCTION OCCUR. E. CONTRACTOR SHALL COUNT, LOG AND SECURE ALL TOOLS, EQUIPMENT AND MATERIALS WHEN ENTERING EACH VACATED CONSTRUCTION AREA, SECURE EACH VACATED CONSTRUCTION AREA AT THE COMPLETION OF DAILY WORK HOURS AND VERIFY ALL TOOLS AND EQUIPMENT WHEN THE VACATED CONSTRUCTION AREA IS COMPETE AND APPROVED FOR OCCUPANCY.
- F. THE CONTRACTOR IS TO PROVIDE A SECURE TEMPORARY PARTITION PER INFECTION CONTROL/SECURITY REQUIREMENTS ALL CONSTRUCTION ACTIVITY IS CONSIDERED CLASS III, SEE SPEC SECTION 013513.19 FOR REQUIREMENTS
- G. AT LOCATIONS OF MEPF WORK, CONTRACTOR IS TO PROVIDE DEMOLITION AND PATCHING OF EXISTING ADJACENT MATERIALS WITHIN THE SCOPE OF WORK FOR REMOVAL AND INSTALLATION, INCLUDING, BUT NOT LIMITED TO FIXTURES, EQUIPMENT, DEVICES, EXHAUST FANS AND WALL AND CEILING GRILLES. PATCHING TO MATCH EXISTING ADJACENT MATERIALS.
- H. PROVIDE PICK-PROOF SECURITY CAULKING AROUND PERIMETER OF ALL INSTALLED DEVICES INCLUDING BUT NOT LIMITED TO: PLUMBING FIXTURES, MEP DEVICES, FURNITURE, ETC.
- J. SEE MEP DOCUMENTS FOR MEP SCOPE TO INCLUDE BUT NOT LIMITED TO THE REPLACEMENT OF WALL AND CEILING GRILLES, EXHAUST FANS, PLUMBING FIXTURES, AND FLOOR DRAINS TO MEET ANTI-LIGATURE RESISTANCE.
- K. CONSTRUCTION IN THE HEARNES BUILDING WILL NEED TO BE PHASED AND COORDINATED WITH FACILITY STAFF AND MUST BE COMPLETED BETWEEN THE HOURS OF 9:00 AND 3:30. STAFF WILL REMOVE PATIENTS FROM THE AREA DURING THOSE HOURS ONLY AND PATIENTS WILL RETURN AT 3:30. TOOLS MUST BE COUNTED, LOGGED, SECURED AND REMOVED FROM THE HEARNES BUILDING UPON THE END OF EACH CONSTRUCTION DAY.

(x) KEYED NOTES - PLANS:

REMOVE EXISTING CLOSER, PATCH DOOR AND FRAME AS REQUIRED TO MATCH EXISTING, INSTALL NEW CLOSER ON NON-PATIENT SIDE OF DOOR. 2. PATCH EXISTING WALLS WHERE EXISTING WATER COOLERS WERE REMOVED/REPLACED, PATCH/PAINT TO MATCH EXISTING.

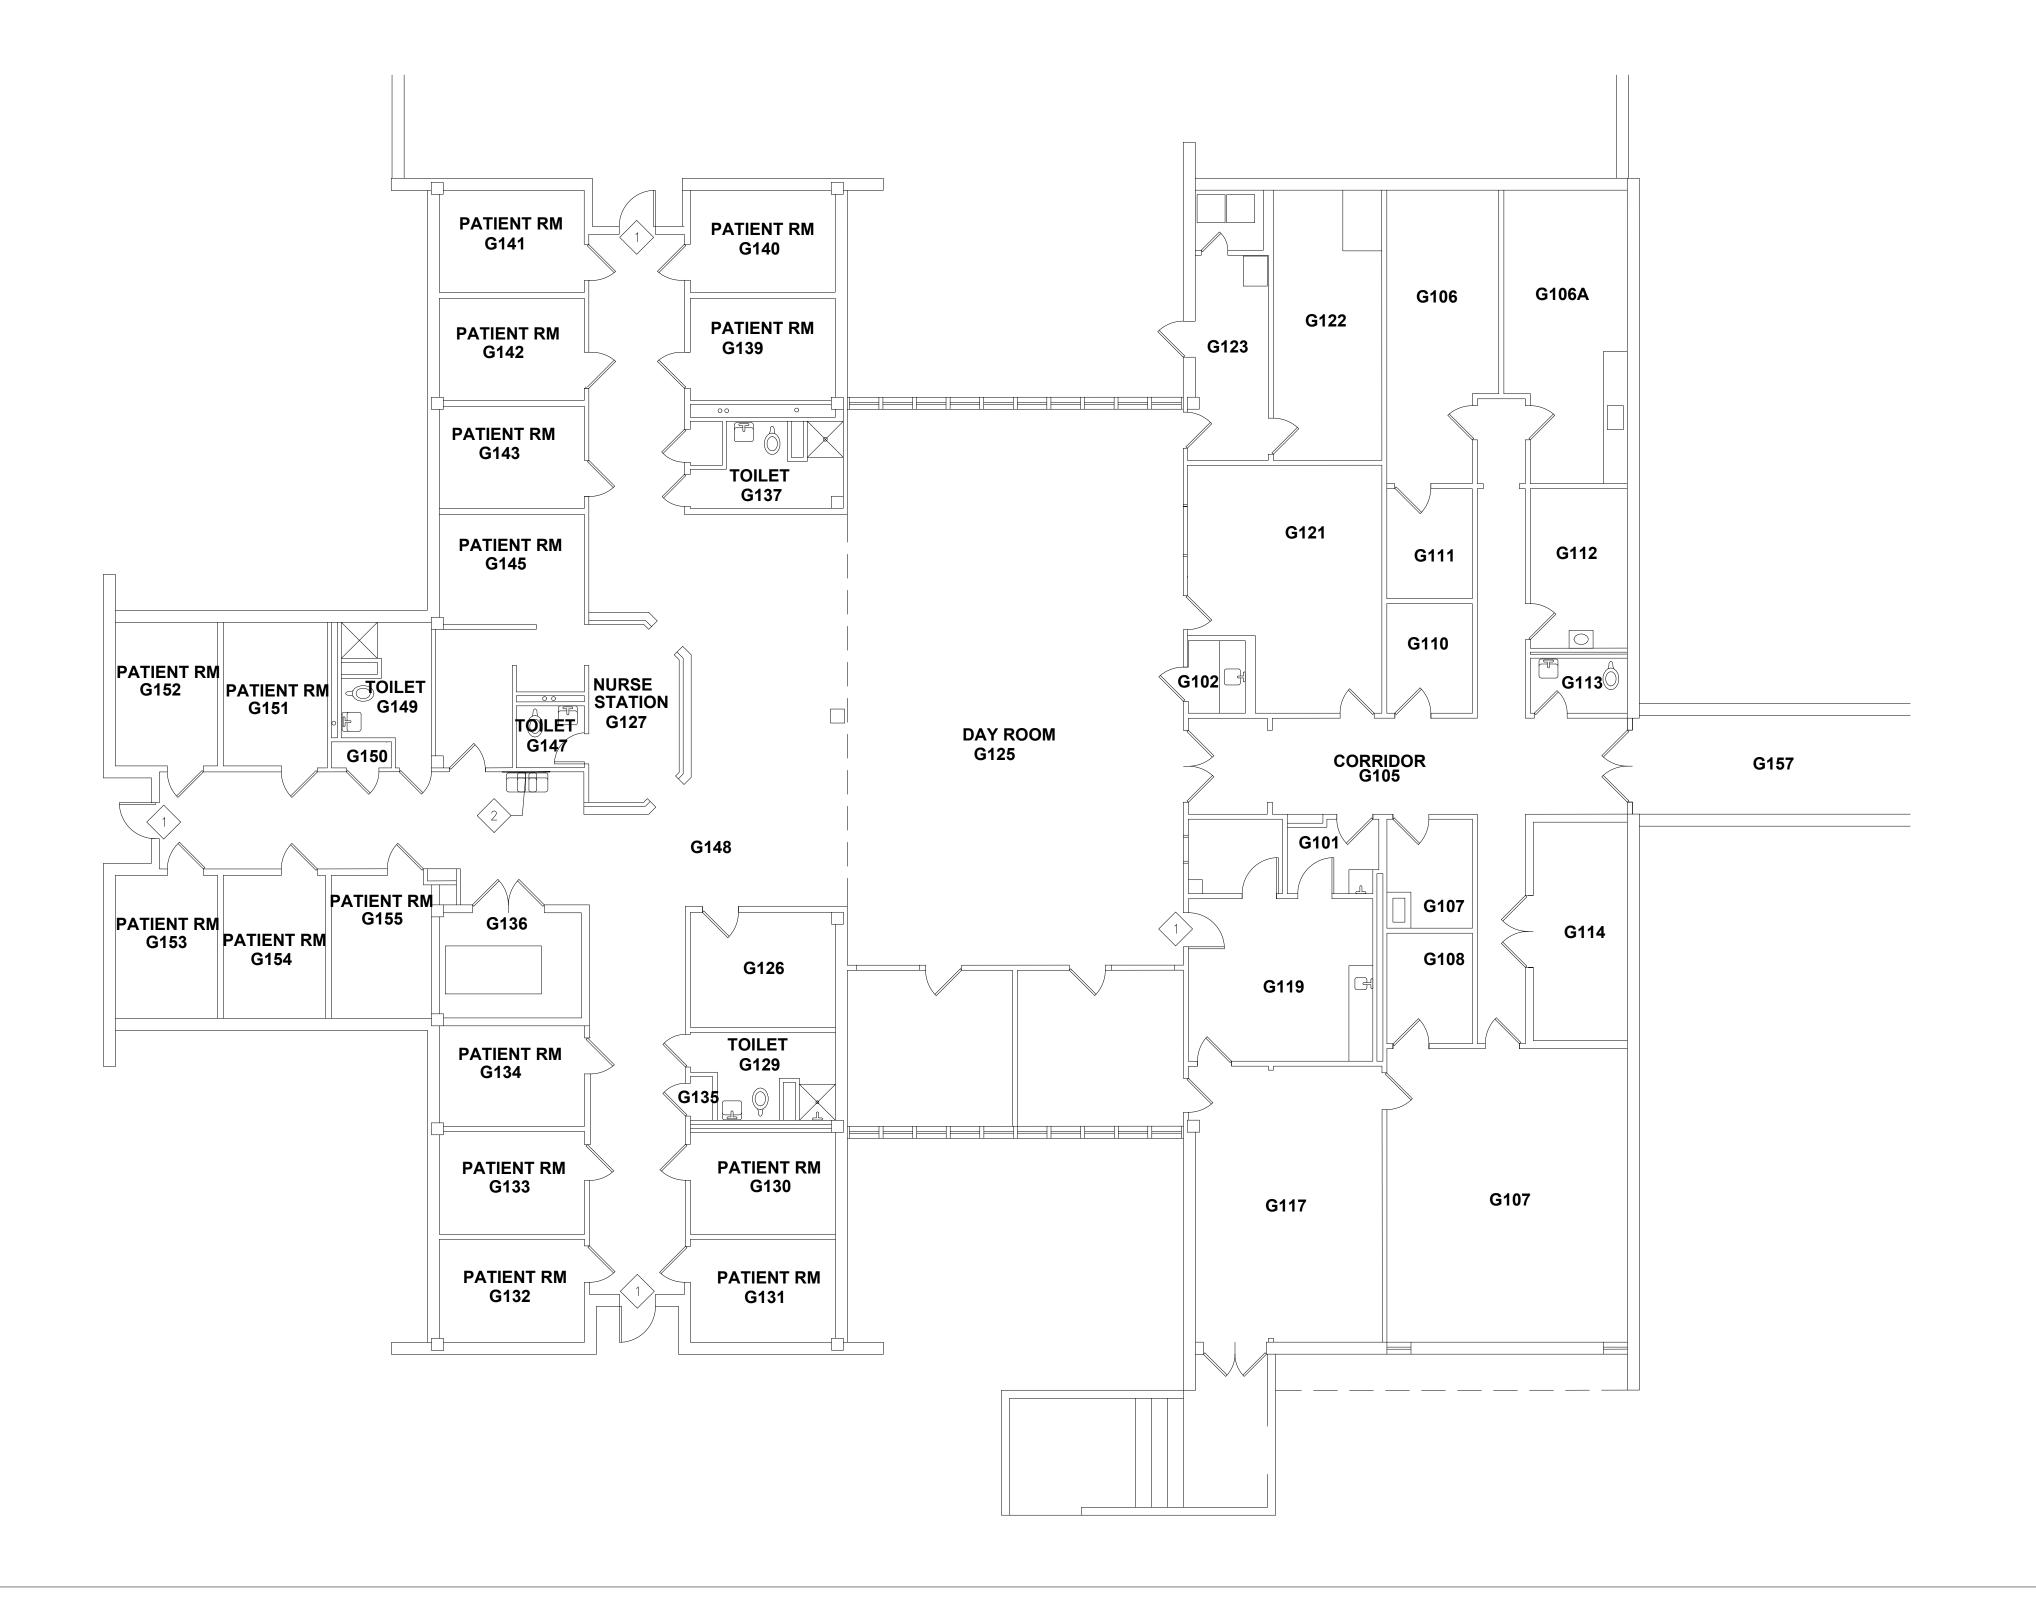



STATE OF MISSOURI MICHAEL L PARSON, **GOVERNOR**





STATE OF MISSOURI CERTIFICATE OF AUTHORITY #2018019473

L2e SOLUTIONS 20 S. SARAH STREET, ST. LOUIS, MO 63108
ASTRAL ENGINEERS

OFFICE OF ADMINISTRATION DIVISION OF FACILITIES MANAGEMENT, **DESIGN AND CONSTRUCTION**

DEPARTMENT OF MENTAL HEALTH

ANTI-LIGATURE UPGRADES MULTIPLE ASSETS FULTON STATE HOSPITAL FULTON, MISSOURI

PROJECT # M2312-01 7352 6517352031

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ISSUE DATE: 9-22-2024

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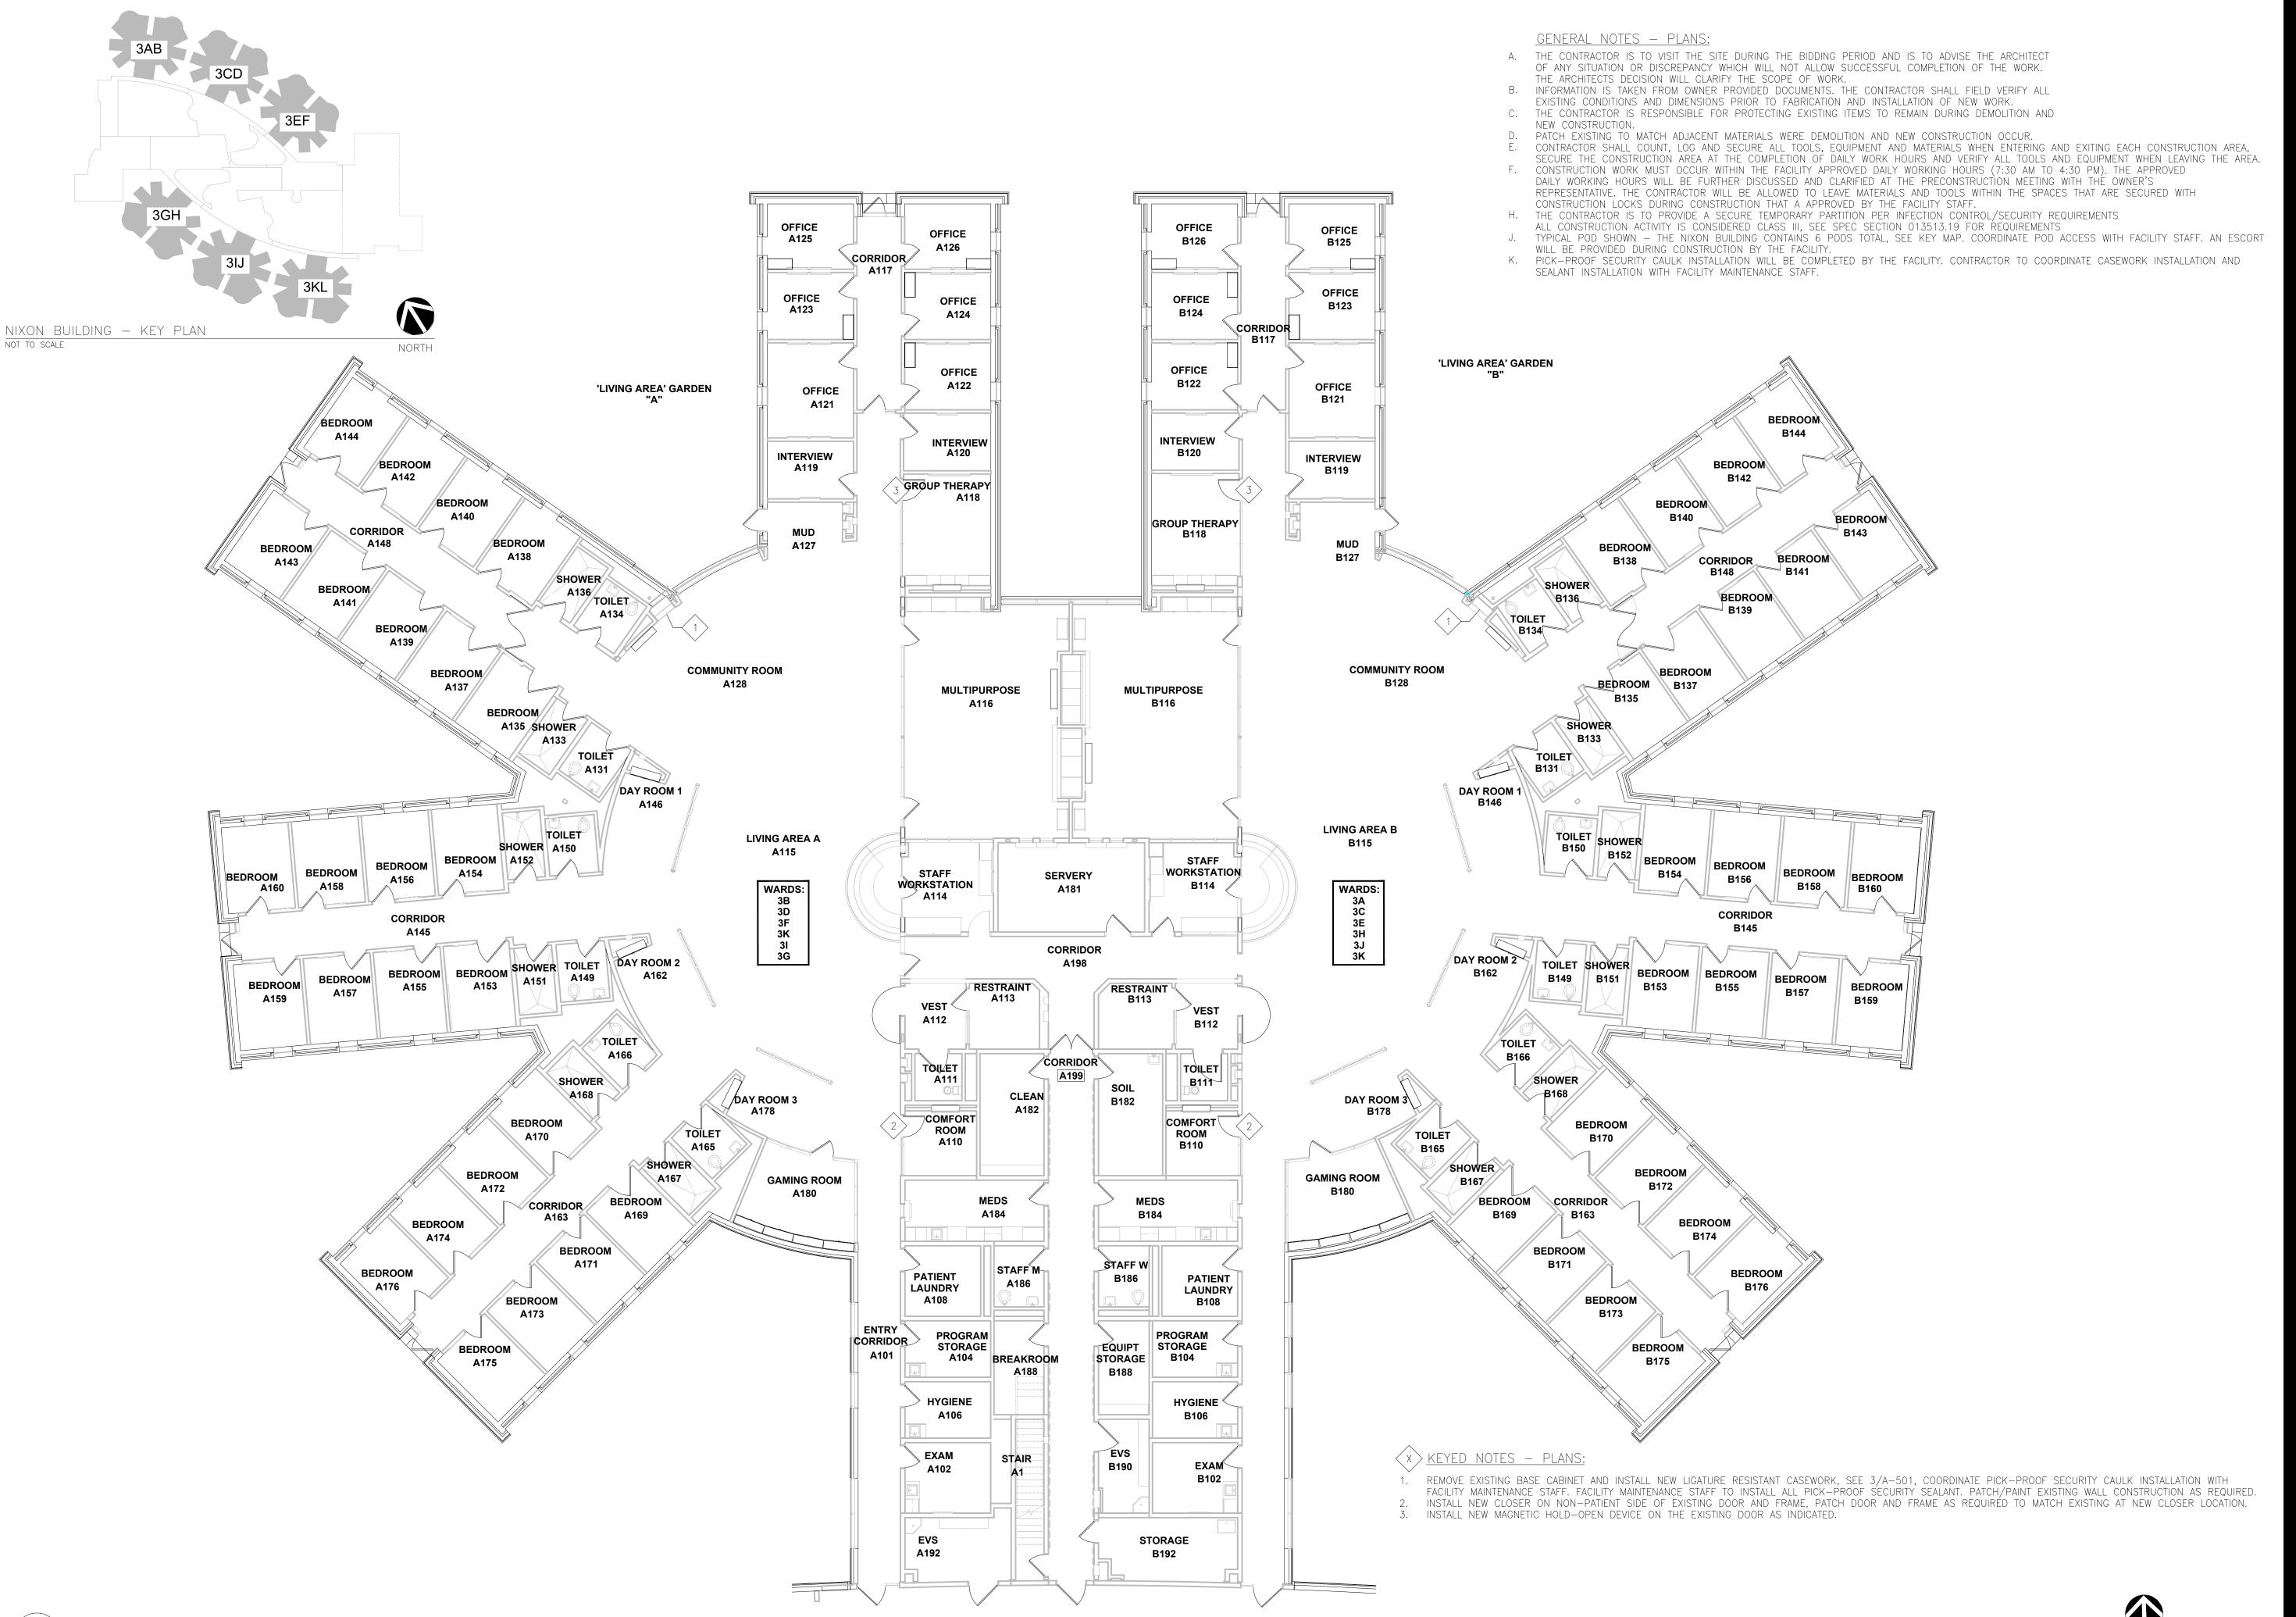
SHEET TITLE:

HEARNES BLDG. - H02

SHEET NUMBER:

10 OF 66 SHEETS

SEPTEMBER 22, 2024







STATE OF MISSOURI CERTIFICATE OF AUTHORITY #2018019473

L2e SOLUTIONS 20 S. SARAH STREET, ST. LOUIS, MO 63108

OFFICE OF ADMINISTRATION DIVISION OF FACILITIES MANAGEMENT, DESIGN AND CONSTRUCTION

DEPARTMENT OF MENTAL HEALTH

ANTI-LIGATURE UPGRADES MULTIPLE ASSETS FULTON STATE HOSPITAL FULTON, MISSOURI

PROJECT # M2312-01 SITE # 7352 ASSET # 6517352057

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ISSUE DATE: 9-22-2024	

CAD DWG FILE:A-FP-09
DRAWN BY: EL
CHECKED BY: EL
DESIGNED BY: EL

SHEET TITLE:

NIXON BLDG - PODS

SHEET NUMBER:

A-109
11 OF 66 SHEETS

SEPTEMBER 22, 2024

GENERAL NOTES - REFLECTED CEILING PLAN

- COR/AE CONSULTANT TO APPROVE CEILING GRID INSTALALTION PRIOR TO CEILING PAD INSTALLATION.
- SEE 1/A-601 FOR ACOUSTICAL TILE CEILING BRACING DETAILS. COORDINATE CEILING GRID INSTALLATION WITH EXISTING CONDITIONS AND MEP, SEE MEP DRAWINGS
- FOR NEW DEVICE LOCATIONS AND REINSTALLATION OF EXISTING DEVICES. WHERE EXISTING DEVICES ARE TO BE REMOVED AND REINSTALLED IN NEW CEILING, FIELD VEIFY
- DEVICE LOCATIONS PRIOR TO REMOVAL, SEE MEP FOR NEW DEVICE LOCATIONS. E. NEW CEILINGS ARE TO BE LOCATED AT EXISTING CEILING HEIGHT UNLESS NOTED OTHERWISE

GENERAL SYMBOLS - REFLECTED CEILING PLAN LIGHT FIXTURES, SEE ELECTRICAL DRAWINGS

MECHANICAL DIFFUSER, SEE MECHANICAL DRAWINGS


EXHAUST FAN, SEE MECHANICAL DRAWINGS

GENERAL NOTES

- A. THE CONTRACTOR IS TO VISIT THE SITE DURING THE BIDDING PERIOD AND IS TO ADVISE THE ARCHITECT OF ANY SITUATION OR DISCREPANCY WHICH WILL NOT ALLOW SUCCESSFUL
- COMPLETION OF THE WORK. THE ARCHITECTS DECISION WILL CLARIFY THE SCOPE OF WORK. INFORMATION IS TAKEN FROM OWNER PROVIDED DOCUMENTS AND FIELD VISITS. THE CONTRACTOR SHALL FIELD VERIFY ALL EXISTING CONDITIONS AND DIMENSIONS PRIOR TO FABRICATION AND INSTALLATION OF NEW WORK.
- THE CONTRACTOR IS RESPONSIBLE FOR PROTECTING EXISTING ITEMS TO REMAIN DURING DEMOLITION AND NEW CONSTRUCTION. PATCH EXISTING TO MATCH ADJACENT MATERIALS WHERE DEMOLITION AND NEW
- CONSTRUCTION OCCUR. FACILITY BUILDINGS ARE TO REMAIN OCCUPIED AND FUNCTIONAL DURING DEMOLITION AND CONSTRUCTION, CONTRACTOR TO PROVIDE SAFETY BARRIERS AS REQUIRED TO SEPARATE CONSTRUCTION AREAS FROM THE BUILDING OCCUPANTS DURING DEMOLITION AND CONSTRUCTION.

DIMENSIONS SHOWN ON EXISTING PARTITIONS ARE +/-, CONTRACTOR TO FIELD VERIFY. SEE SHEET A-501 FOR PARTITION TYPE DETAILS. SEE SHEET A-601 FOR DOOR SCHEDULED AND DETAILS.


> **CORRIDOR** CORRIDOR

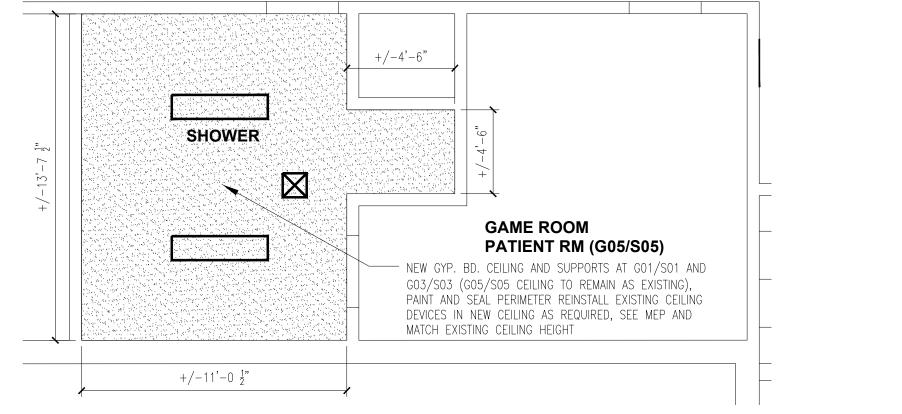

CORRIDOR

SHOWER **GAME ROOM** PATIENT RM (G05/S05) NOTE: PATCH/PAINT EXISTING SHOWER ROOM PARTITIONS AS REQUIRED AFTER CEILING REMOVAL NEW CMU $3'-0" \times 7'-0"$ INFILL TO MATCH AND INSTALLATION EXISTING, ALIGN AND TOOTH INTO EXISTING PARTITION, PAINT TO MATCH EXISTING, BOTH SIDES, FEATHER PAINT INTO EXISTING FINISH (INFILL WORK NOT REQUIRED AT G01/S01)

PATIENT RM

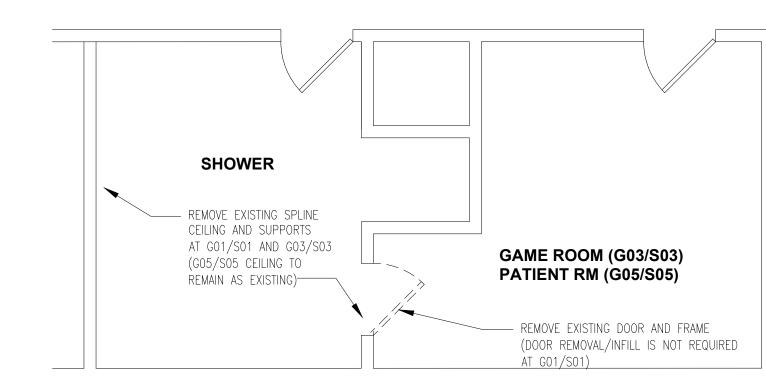

DEMOLITION PLAN

GENERAL NOTES - DEMOLITION

PROTECT ITEMS TO REMAIN AS EXISTING.

CONTRACTOR IS TO PROTECT ITEMS TO REMAIN DURING DEMOLITION.

FIELD VERIFY EXISTING CEILING HEIGHT PRIOR TO REMOVAL OF CEILING.

FIELD VERIFY EXISTING CEILING DEVICES TO BE REMOVED AND REINSTALLED PRIOR TO DEMOLITION.

NEW CEILINGS ARE TO BE LOCATED AT EXISTING CEILING HEIGHT UNLESS NOTED OTHERWISE.

REFLECTED CEILING PLAN - G01/S01 AND G03/S03 ONLY (G05/S05 TO REMAIN AS EXISTING)

<u>FLOOR PLAN</u>

<u>FLOOR PLAN</u>

3 \ GUHLEMAN WEST/EAST (SORTS) - SECOND FLOOR ENLARGED PLANS - G03/S03, FIRST FLOOR ENLARGED PLANS - G01/S01 AND G05/S05 $\Delta - 401 / 1/4" = 1\overline{'-0"}$

PATIENT RM NEW GYP. BD. CEILING AND SUPPORTS, PAINT TO MATCH EXISTING AND SEAL PERIMETER REINSTALL EXISTING CEILING

DEVICES IN NEW CEILING AS REQUIRED, SEE MEP AND MATCH EXISTING CEILING HEIGHT CORRIDOR PARTITION TYPES PATIENT RM

IS COMPLETE

PARTITIONS AS REQUIRED AFTER CEILING REMOVAL #001 - NEW 3'-0"x6'-8" WOOD DOOR AND INSTALLATION IN HOLLOW METAL FRAME, SEE A-601 FOR DOOR SCHEDULE AND DETAILS - PATCH FLOOR TO MATCH EXISTING AS REQUIRED AFTER REMOVAL OF PARTITIONS EXISTING FLOOR IS A TERRAZZO FINISH → CORRIDOR NEW 6" CMU PARTITION TO MATCH EXISTING, ALIGN ABUSE RESISTANT GYP BD. ON ALIGN WITH EXISTING AND PROVIDE STEEL 3 § METAL STUDS AT 16 ON PLATE LINTEL TO SUPPORT EXISTING CMU AT CENTER, ALIGN FLUSH WITH EXISTING EACH DOOR OPENING/MTL FRAME LOCATION PARTITION, SEAL PARTITION AT CMU PARTITION LOCATIONS, PAINT TO MATCH EXISTING. PAINT ENTIRE PARTITION. PATIENT RM NEW AND EXISTING - SEE A-501 FOR - #002 - NEW 3'-0"x6'-8" WOOD DOOR NOTE: PATCH/PAINT IN HOLLOW METAL FRAME, SEE A-601 EXISTING PATIENT ROOM FOR DOOR SCHEDULE AND DETAILS PARTITIONS AS REQUIRED AFTER CEILING REMOVAL AND INSTALLATION

NOTE: PATCH/PAINT

FXISTING PATIENT ROOM

- REMOVE EXISTING DOORS, FRAMES, AND PORTION OF EXISTING GYP. BD. PARTITION AS REQUIRED FOR NEW PATIS +/-4'-0" PATIENT RM ROOM DESIGN REMOVE PORTION OF EXIST. CMU PARTITION FOR THE DOORS AND FRAMES, SUPPORT EXISTING CMU AS REQUIRED DURING DEMOLITION - REMOVE EXISTING MTL FRAME AND PORTION OF CMU PARTITION AS INDICATED, SUPPORT EXISTING CMU AS **PATIENT RM** REQUIRED DURING DEMOLITION \Rightarrow REMOVE PORTION OF EXIST. CMU PARTITION FOR THE - REMOVE EXISTING SPLINE INSTALLATION OF NEW DOORS AND FRAMES, SUPPORT EXISTING CMU AS REQUIRED DURING DEMOLITION **CORRIDOR** DEMOLITION PLAN

EXISTING ACT CEILING TO REMAIN AS EXISTING IN CORRIDOR AREA

NORTH

2 \GUHLEMAN EAST (SORTS) - FIRST FLOOR ENLARGED PLANS - G05/S05

REFLECTED CEILING PLAN

NEW ACT CEILING AS REQUIRED TO MATCH EXISTING, REINSTALL EXISTING **PATIENT RM** CEILING DEVICES IN NEW CEILING AS REQUIRED - EXISTING CEILING IS 2'X4' **PATIENT RM** NEW & GYP. BOARD ON 6" METAL ACT CEILING PADS, MATCH EXISTING STUDS AT 16" O.C. SOFFIT CEILING HEIGHT, +/- 9'-0", FIELD CONSTRUCTION TO SUPPORT NEW AND EXISTING CEILING GRID <u>EXTEND SOFFIT 2"</u> BELOW EXISTING CEILING HEIGHT +/- 8'-10", PAINT TO MATCH EXISTING CORRIDOR PARTITIONS CORRIDOR PATIENT RM PATIENT RM SUPPORT EXISTING CEILING GRID TO REMAIN AS REQUIRED UNTIL SOFFIT

PATIENT RM **PATIENT RM** GRIND SMOOTH AND PATCH AREA - GRIND SMOOTH AND PATCH EXISTING OF FLOOR WHERE PARTITION PARTITION TO MATCH EXISTING AT WAS REMOVE TO MATCH EXISTING -LOCATION CMU PARTITION WAS REMOVED, EXISTING FLOOR IS A TERRAZZO FINISH PATCH/PAINT TO MATCH EXISTING CORRIDOR PARTITIONS FEATHER PAINT INTO EXISTING FOR SEAMLESS FINISH NOTE: PATCH/PAINT CORRIDOR EXISTING CORRIDOR PARTITIONS AS REQUIRED AFTER CEILING REMOVAL AND INSTALLATION PATIENT RM PATIENT RM FLOOR PLAN

PATIENT RM PATIENT RM $+/-19'-8\frac{1}{2}"$ - REMOVE EXISTING BLOCK WALL - REMOVE EXISTING ACT CEILING AND SUPPORTS AS AND METAL FRAME IN ITS ENTIRETY, REQUIRED TO REWORK CEILING AT LOCATION OF SUPPORT EXISTING ACT CEILING AS PARTITION TO BE REMOVED. REMOVE EXISTING REQUIRED DURING PARTITION DEVICES AS REQUIRED TO BE REINSTALLED INTO REMOVAL PRIOR TO NEW SOFFIT NEW ACT CEILING, SEE MEP ---CONSTRUCTION **CORRIDOR PATIENT RM** PATIENT RM

DEMOLITION PLAN

NORTH

NORTH

STATE OF MISSOURI MICHAEL L PARSON,

GOVERNOR

PALLISER LEWIS



STATE OF MISSOURI CERTIFICATE OF AUTHORITY #2018019473

OFFICE OF ADMINISTRATION DIVISION OF FACILITIES MANAGEMENT, **DESIGN AND CONSTRUCTION**

DEPARTMENT OF MENTAL HEALTH

ANTI-LIGATURE UPGRADES MULTIPLE ASSETS FULTON STATE HOSPITAL FULTON, MISSOURI

PROJECT # M2312-01 7352 6517352026

DEVICION.
REVISION:-
DATE: -
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ISSUE DATE: 9-22-2024
CAD DWG FILE:A-EL-01
DRAWN BY: EL
CHECKED BY: EL
DESIGNED BY: EL

ENLARGED PLANS

SHEET NUMBER:

SHEET TITLE:

12 OF 66 SHEETS

SEPTEMBER 22, 2024

1 \GUHLEMAN WEST (SORTS) - SECOND FLOOR ENLARGED PLANS - G03/S03. G04/S04

REFLECTED CEILING PLAN

GENERAL NOTES - REFLECTED CEILING PLAN

- COR/AE CONSULTANT TO APPROVE CEILING GRID INSTALALTION PRIOR TO CEILING PAD INSTALLATION.
- SEE 1/A-601 FOR ACOUSTICAL TILE CEILING BRACING DETAILS. COORDINATE CEILING GRID INSTALLATION WITH EXISTING CONDITIONS AND MEP, SEE MEP DRAWINGS

CORRIDOR

DAY ROOM

+/- 23'-5"

CORRIDOR

SHOWER

SUPPORTS AT GO4/SO4 AND

SEAL PERIMETER

<u>+/-11'-0 1"</u>

G06/S06 (G02/S02 CEILING TO

REMAIN AS EXISTING), PAINT AND

- FOR NEW DEVICE LOCATIONS AND REINSTALLATION OF EXISTING DEVICES. WHERE EXISTING DEVICES ARE TO BE REMOVED AND REINSTALLED IN NEW CEILING, FIELD VEIFY
- DEVICE LOCATIONS PRIOR TO REMOVAL, SEE MEP FOR NEW DEVICE LOCATIONS. E. NEW CEILINGS ARE TO BE LOCATED AT EXISTING CEILING HEIGHT UNLESS NOTED OTHERWISE

GENERAL SYMBOLS - REFLECTED CEILING PLAN

LIGHT FIXTURES, SEE ELECTRICAL DRAWINGS MECHANICAL DIFFUSER, SEE MECHANICAL DRAWINGS

EXHAUST FAN, SEE MECHANICAL DRAWINGS


GENERAL NOTES

- A. THE CONTRACTOR IS TO VISIT THE SITE DURING THE BIDDING PERIOD AND IS TO ADVISE THE ARCHITECT OF ANY SITUATION OR DISCREPANCY WHICH WILL NOT ALLOW SUCCESSFUL
- COMPLETION OF THE WORK. THE ARCHITECTS DECISION WILL CLARIFY THE SCOPE OF WORK. INFORMATION IS TAKEN FROM OWNER PROVIDED DOCUMENTS AND FIELD VISITS. THE CONTRACTOR SHALL FIELD VERIFY ALL EXISTING CONDITIONS AND DIMENSIONS PRIOR
- TO FABRICATION AND INSTALLATION OF NEW WORK. THE CONTRACTOR IS RESPONSIBLE FOR PROTECTING EXISTING ITEMS TO REMAIN DURING DEMOLITION AND NEW CONSTRUCTION.
- PATCH EXISTING TO MATCH ADJACENT MATERIALS WHERE DEMOLITION AND NEW CONSTRUCTION OCCUR.
- FACILITY BUILDINGS ARE TO REMAIN OCCUPIED AND FUNCTIONAL DURING DEMOLITION AND CONSTRUCTION, CONTRACTOR TO PROVIDE SAFETY BARRIERS AS REQUIRED TO SEPARATE CONSTRUCTION AREAS FROM THE BUILDING OCCUPANTS DURING DEMOLITION AND CONSTRUCTION. DIMENSIONS SHOWN ON EXISTING PARTITIONS ARE +/-, CONTRACTOR TO FIELD VERIFY.

CORRIDOR

DAY ROOM

SEE SHEET A-501 FOR PARTITION TYPE DETAILS. SEE SHEET A-601 FOR DOOR SCHEDULED AND DETAILS.

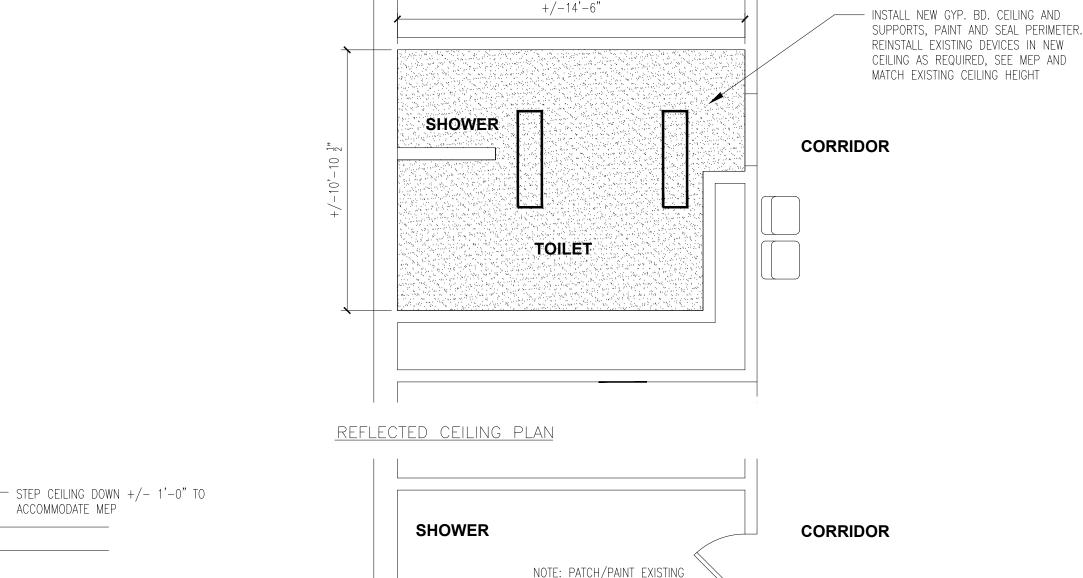

GENERAL NOTES - DEMOLITION


PROTECT ITEMS TO REMAIN AS EXISTING.


CONTRACTOR IS TO PROTECT ITEMS TO REMAIN DURING DEMOLITION.


FIELD VERIFY EXISTING CEILING HEIGHT PRIOR TO REMOVAL OF CEILING.


FIELD VERIFY EXISTING CEILING DEVICES TO BE REMOVED AND REINSTALLED PRIOR TO DEMOLITION.

NEW CEILINGS ARE TO BE LOCATED AT EXISTING CEILING HEIGHT UNLESS NOTED OTHERWISE.

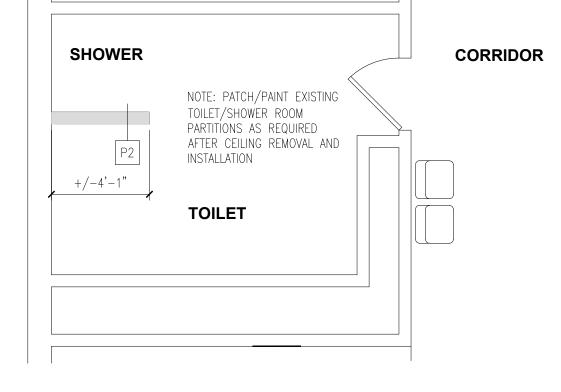

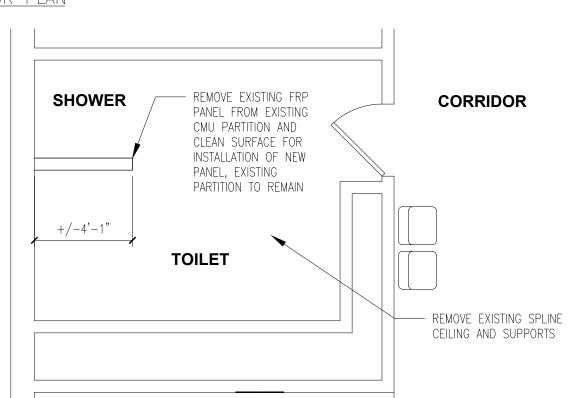

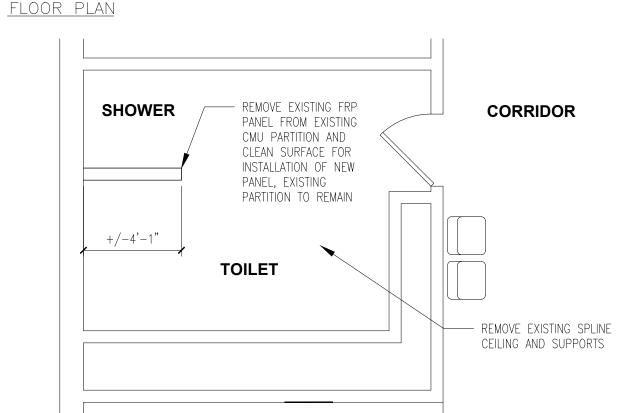

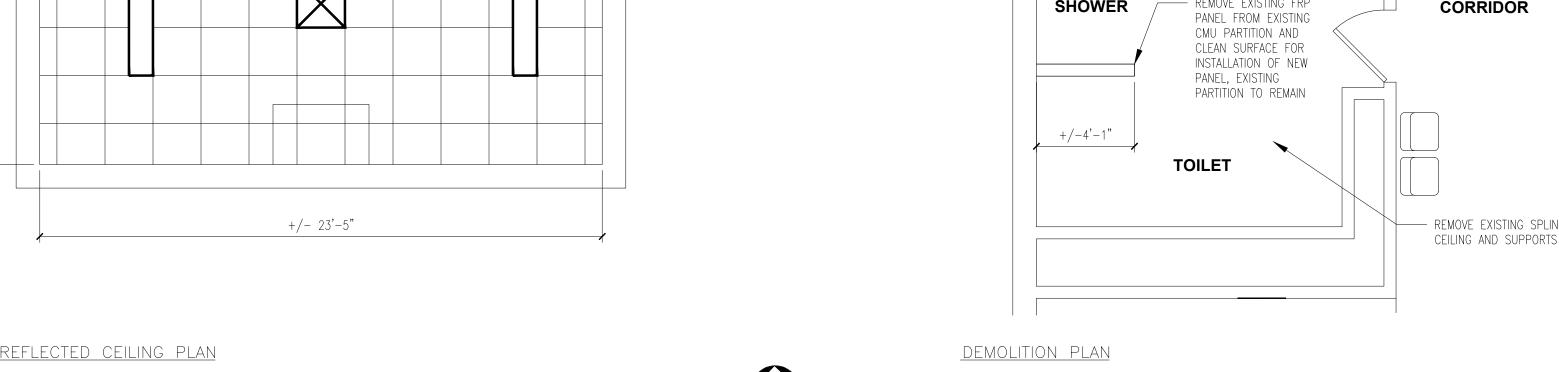

- REMOVE EXISTING SPLINE CEILING, SUPPORTS

AND CEILING DEVICES AS REQUIRED (RETAIN

DEVICES FOR REINSTALLATION, SEE MEP),

INSTALL NEW ACOUSTICAL TILE CEILING AND

AND COORDINATE DEVICE LOCATIONS. NEW

- NOTE: PATCH/PAINT EXISTING DAY ROOM

PARTITIONS AS REQUIRED AFTER CEILING

REMOVAL AND INSTALLATION

HEIGHT.

CEILING TO BE INSTALLED AT EXISTING CEILING

SUPPORTS, REINSTALL EXISTING DEVICES IN NEW

CEILING CONSTRUCTION AS REQUIRED, SEE MEP

REFLECTED CEILING PLAN

STORAGE (G02/S02)

PATIENT RM (G06/S06)

4 \DAY ROOM REFLECTED CEILING PLAN - G06/S06

+/-4'-0"

- STEP CEILING DOWN +/- 1'-0" TO

REMOVE EXISTING SPLINE CEILING, SUPPORTS

AND CEILING DEVICES AS REQUIRED (RETAIN

DEVICES FOR REINSTALLATION, SEE MEP),

INSTALL NEW ACOUSTICAL TILE CEILING AND

AND COORDINATE DEVICE LOCATIONS. NEW

NOTE: PATCH/PAINT EXISTING DAY ROOM

PARTITIONS AS REQUIRED AFTER CEILING

REMOVAL AND INSTALLATION

SUPPORTS, REINSTALL EXISTING DEVICES IN NEW

CEILING CONSTRUCTION AS REQUIRED, SEE MEP

CEILING TO BE INSTALLED AT EXISTING CEILING

ACCOMMODATE MEP

LOCKERS, SEE ALTERNATE NO 2 FOR SCOPE CORRIDOR NOTE: PATCH/PAINT EXISTING SHOWER ROOM STORAGE (G02/S02) PARTITIONS AS REQUIRED AFTER CEILING REMOVAL PATIENT RM (G06/S06) AND INSTALLATION **SHOWER**

FLOOR PLAN

LOCKERS, SEE ALTERNATE NO 2 FOR SCOPE CORRIDOR STORAGE (G02/S02) SHOWER PATIENT RM (G06/S06) REMOVE EXISTING SPLINE CEILING AND SUPPORTS AT G04/S04 AND G06/S06 (G02/S02 CEILING TO REMAIN AS EXISTING) — REMOVE EXISTING DOOR AND FRAME (DOOR REMOVAL/INFILL NOT REQUIRED AT GO4/SO4)

EXISTING, ALIGN AND TOOTH INTO EXISTING PARTITION, PAINT TO MATCH EXISTING, BOTH SIDES, FEATHER PAINT INTO EXISTING FINISH (INFILL WORK NOT REQUIRED AT GO4/SO4)

 \longrightarrow NEW CMU 3'-0" \times 7'-0" INFILL TO MATCH

REFLECTED CEILING PLAN - G04/S04 AND G06/S06 ONLY (G02/S02 CEILING TO REMAIN AS EXISTING)

DEMOLITION PLAN

NORTH

ASSET# 6517352026

REVISION: DATE: REVISION: DATE: REVISION: -DATE: -ISSUE DATE: 9-22-2024 CAD DWG FILE: A-EL-01 DRAWN BY: CHECKED BY: \overline{E} DESIGNED BY: EL

STATE OF MISSOURI

MICHAEL L PARSON,

ELAINE

PALLISER

LEWIS

Concepts to Architecture

STATE OF MISSOURI CERTIFICATE OF AUTHORITY #2018019473

OFFICE OF ADMINISTRATION

DESIGN AND CONSTRUCTION

DIVISION OF FACILITIES

ANTI-LIGATURE UPGRADES

FULTON STATE HOSPITAL

MANAGEMENT,

DEPARTMENT OF

MENTAL HEALTH

MULTIPLE ASSETS

FULTON, MISSOURI

PROJECT # M2312-01

- 7352

GOVERNOR

SHEET TITLE:

ENLARGED PLANS


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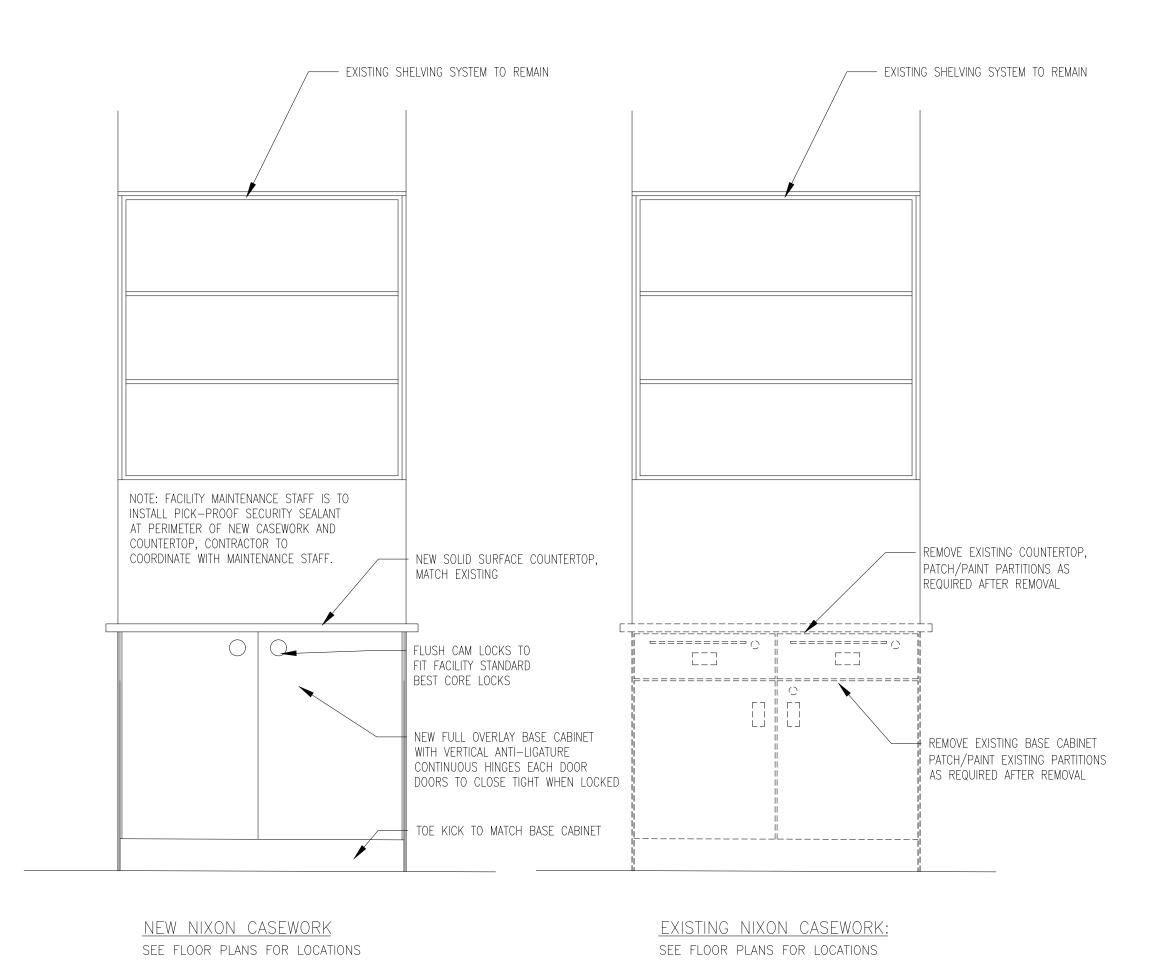
13 OF 66 SHEETS

SEPTEMBER 22, 2024

GUHLEMAN WEST/EAST (SORTS) - FIRST FLOOR ENLARGED PLANS - G02/S02, G06/S06

A-402 1/4" = 1'-0"



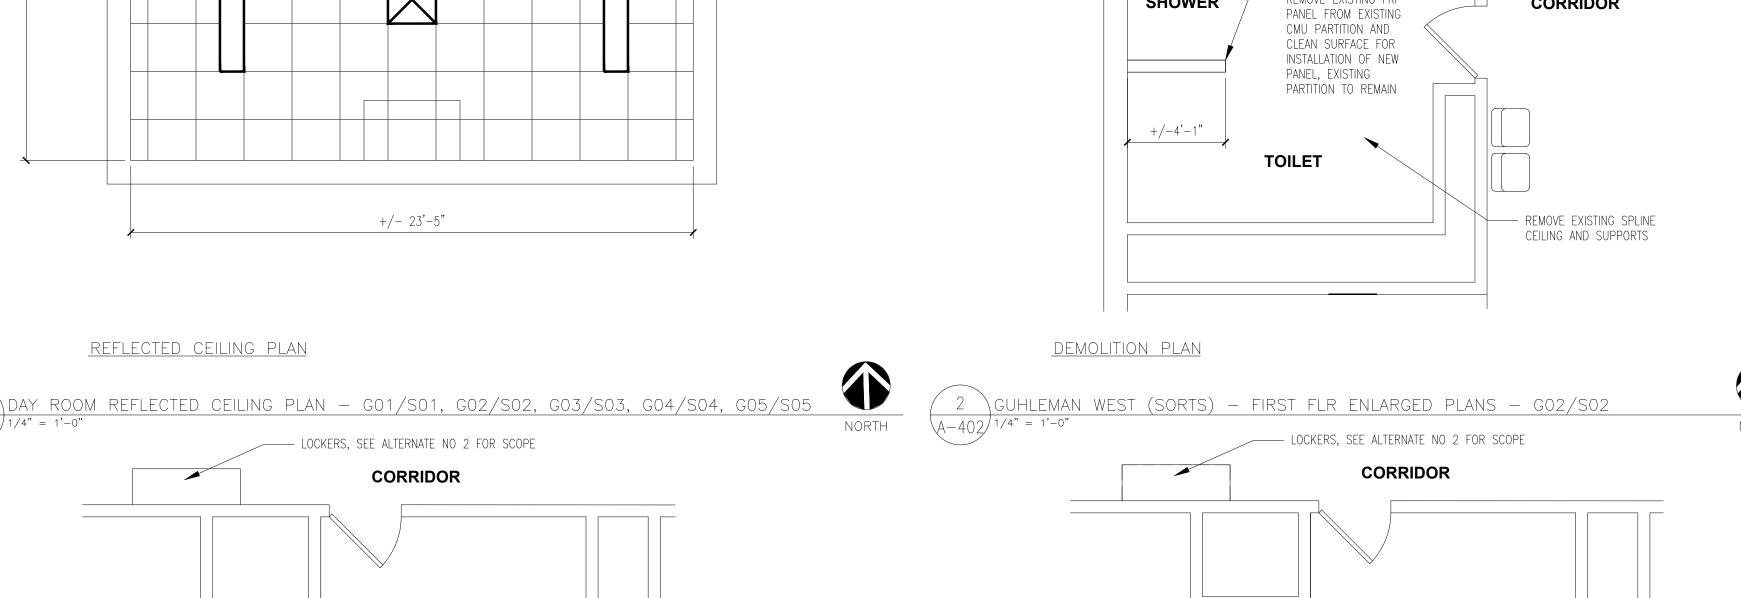


— EXISTING STRUCTURE ABOVE, — EXISTING STRUCTURE ABOVE, FIELD VERIFY FIELD VERIFY - 3 🖁 METAL STUDS AT 16" O.C. 3 § METAL STUDS AT 16 O.C. METAL RUNNER TOP AND BOTTOM METAL RUNNER TOP AND BOTTOM PROVIDE SLIP TRACK AT EXISTING PROVIDE SLIP TRACK AT EXISTING STRUCTURE FOR MOVEMENT STRUCTURE FOR MOVEMENT - NEW GYP. BD. CEILING, MATCH EXISTING AT LOCATION OF NEW PARTITION AS REQUIRED CEILING HEIGHT — NEW GYP. BD. CEILING AND SUPPORTS AT - FRP PANEL ON ½" CEMENT BOARD, WRAP NEW PATIENT SIDE, PAINT AND SEAL AT EXISTING FRP DOWN EXISTING CMU BLOCK PARTITION PARTITIONS, MATCH EXISTING CEILING HEIGHT AND AROUND ALL SIDES, SEAL PERIMETER WITH PICK-PROOF SEALANT. - PROVIDE SOUND BATTS AT NEW PARTITION NEW FRP PANELS, REMOVE EXISTING FRP. LOCATIONS WRAP PARTITION IN ITS ENTIRETY ALL SIDES TOILET SIDE AND SEAL PERIMETER WITH PICK-PROOF SEALANT, PROVIDE FLUSH CORNER CORRIDOR SIDE ACCESSORIES AND SEAL TIGHT, OVERLAP SHOWER SIDE EXISTING CMU AND NEW CEMENT BOARD PATIENT SIDE WITH FRP, PANEL CONNECTIONS MUST BE TIGHT AND FLUSH → §" TYPE X ABUSE RESISTANT GYP. BD. BOTH SIDES, PAINT TO MATCH EXISTING — EXISTING NOM. 6" CMU PARTITION — SEAL FRP TO FLOORING WITH PICK-PROOF SEALANT ALL SIDES, HOLD TIGHT WITH NO GAPS — SEAL PERIMETER TIGHT WITH PICK-PROOF SEALANT TO MATCH EXISTING P1 P2 GENERAL NOTES - PLANS:

A. SEE FLOOR PLANS FOR PARTITION LOCATIONS

A. SEE FLOOR PLANS FOR PARTITION LOCATIONS

A SEE FLOOR PLANS FOR PARTITION LOCATIONS

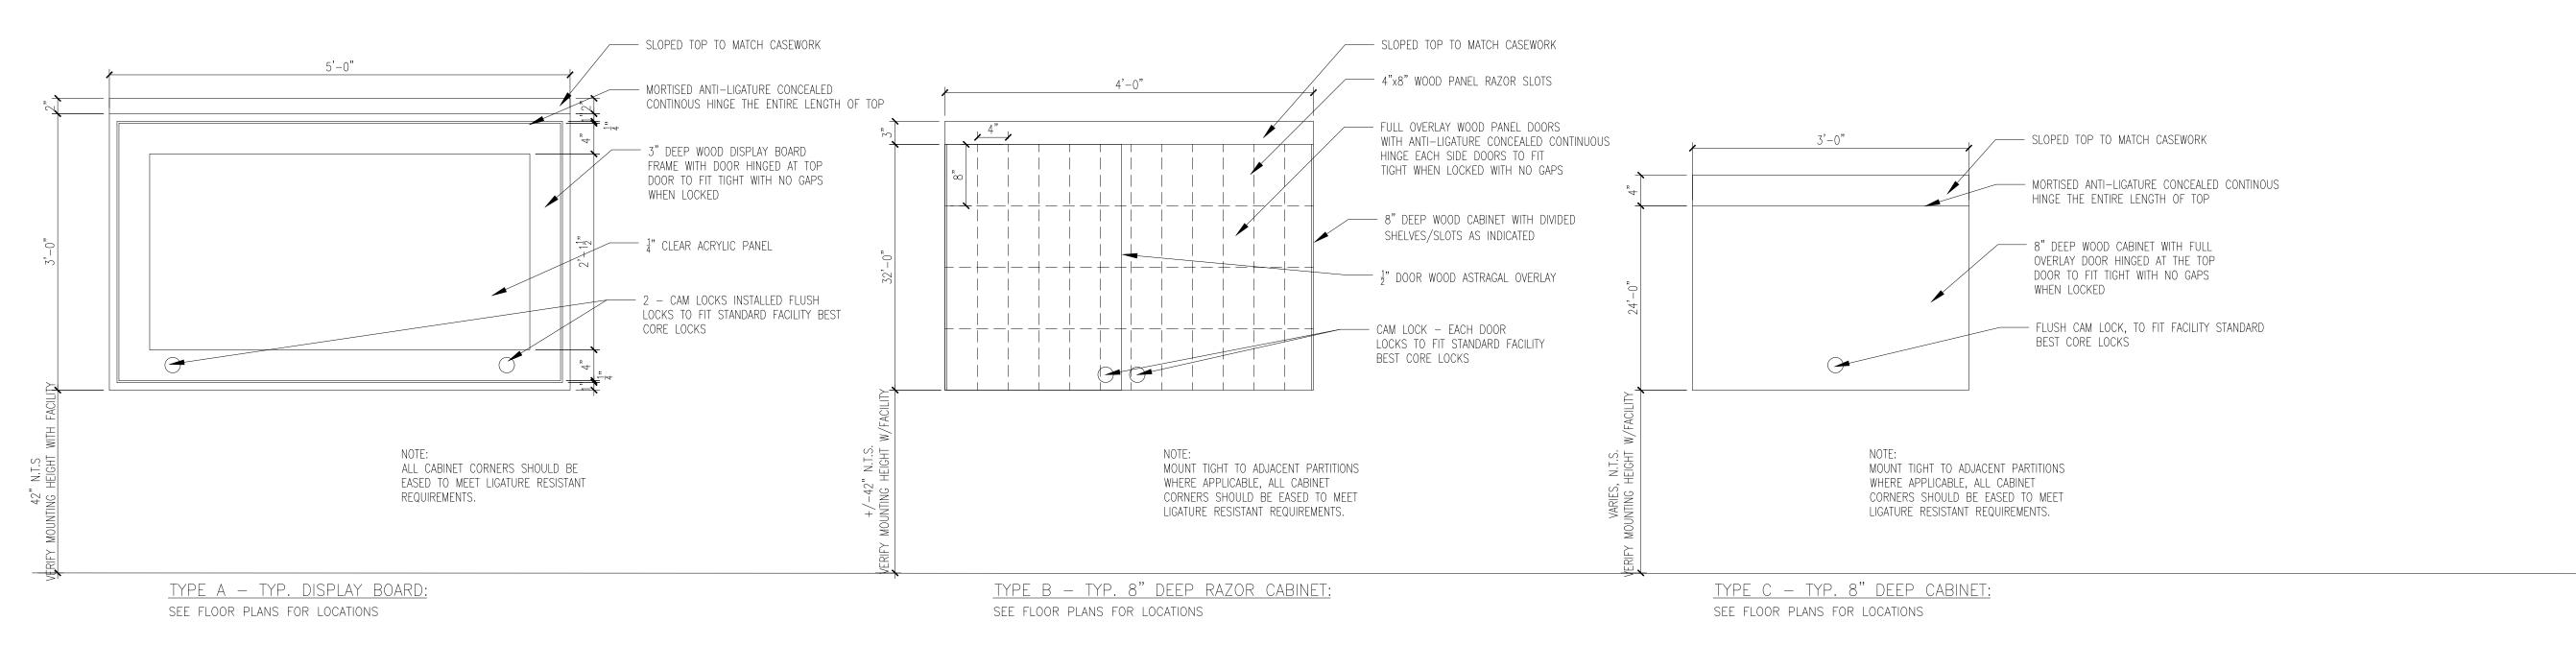



STATE OF MISSOURI MICHAEL L PARSON, GOVERNOR





STATE OF MISSOURI CERTIFICATE OF AUTHORITY #2018019473

L2e SOLUTIONS 20 S. SARAH STREET, ST. LOUIS, MO 63108
ENGINEER - MEP
ASTRAL ENGINEERS
OCTIONAL AND AND STANDARD AND VOIL OF

OFFICE OF ADMINISTRATION DIVISION OF FACILITIES MANAGEMENT, DESIGN AND CONSTRUCTION

DEPARTMENT OF MENTAL HEALTH

ANTI-LIGATURE UPGRADES MULTIPLE ASSETS FULTON STATE HOSPITAL FULTON, MISSOURI

PROJECT #	M2312-01
SITE#	7352
ASSET #	6517352026 6517352027

REVISION: DATE: REVISION: DATE: REVISION: DATE: -

ISSUE DATE: 9-22-2024

6517352031 6517352057


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DRAWN BY: EL
CHECKED BY: EL
DESIGNED BY: EL


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INTERIOR ELEVATIONS AND DETAILS

SHEET NUMBER:


A-50



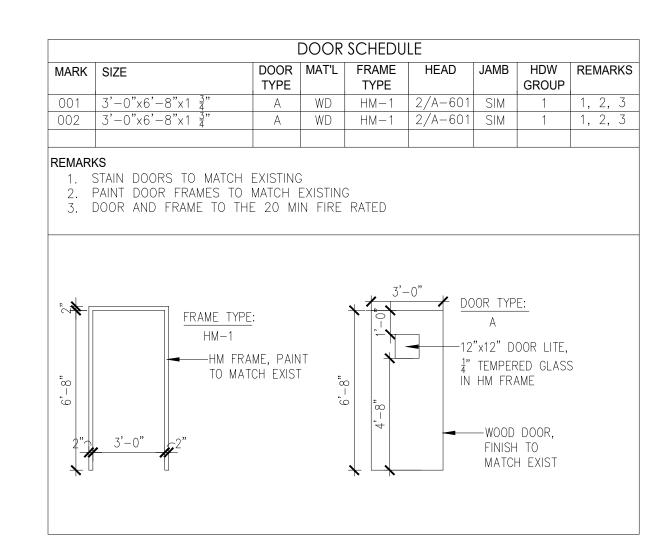

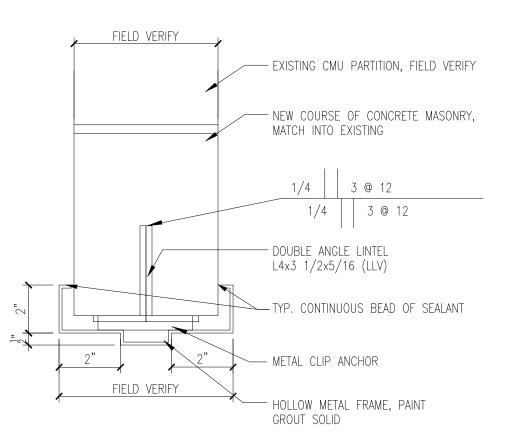NOTE: EXISTING MASONRY WALL TO BE SHORED AS REQUIRED FOR INSTALLATION OF NEW LINTEL



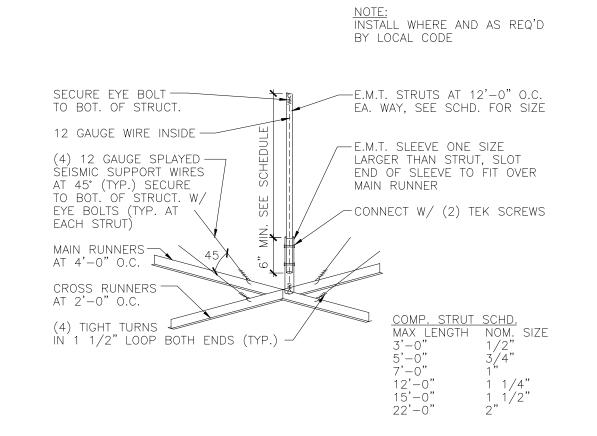



STATE OF MISSOURI MICHAEL L PARSON, GOVERNOR





STATE OF MISSOURI CERTIFICATE OF AUTHORITY #2018019473

ARCHITECT L2e SOLUTIONS 20 S. SARAH STREET, ST. LOUIS, MO 63108	ENGINEER - MEP ASTRAL ENGINEERS
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OFFICE OF ADMINISTRATION DIVISION OF FACILITIES MANAGEMENT, DESIGN AND CONSTRUCTION

DEPARTMENT OF MENTAL HEALTH

ANTI-LIGATURE UPGRADES MULTIPLE ASSETS FULTON STATE HOSPITAL FULTON, MISSOURI

PROJECT #	M2312-01
SITE#	7352
ASSET #	6517352026 6517352027
	6517352031
	6517352057

:A-DT-02
EL
EL
EL

SHEET TITLE:

DETAILS

SHEET NUMBER:

A-60

ELECTRICAL	SYMBOLS:
LINETYPE/SYMBOL	DESCRIPTION
#	DUPLEX CONVENIENCE RECEPTACLE 20A, 125V
#	QUAD CONVENIENCE RECEPTACLE 20A, 125V
IJ	JUNCTION BOX - FLUSH WALL MOUNT
J	JUNCTION BOX - FLUSH CEILING MOUNT/IN CEILING SPACE
	JUNCTION BOX - FLUSH FLOOR MOUNT
	ELECTRICAL SURFACE MOUNT BRANCH CIRCUIT PANELBOARD
	ELECTRICAL RECESSED MOUNT BRANCH CIRCUIT PANELBOARD
s_M	MOTOR RATED SWITCH
SD	CEILING-MOUNT SMOKE DETECTOR (EXISTING)
SP	CEILING-MOUNT SMOKE DETECTOR (EXISTING)
	CEILING-MOUNT CCTV CAMERA (EXISTING)
4 <u>_</u>	CEILING-MOUNT EGRESS LIGHT (EXISTING)
NOTES:	V.

- NOT ALL SYMBOLS MAY APPLY.
- SEE SPECS AND DRAWINGS FOR SPECIFIC COMPONENT REQUIREMENTS. STANDARD RECEPTACLE SHALL BE 20A, 125V OTHERWISE NEMA CONFIGURATION
- SHALL BE NOTED ON EACH OUTLET & RECEPTACLE. ALL OUTLETS & RECEPTACLES SHALL BE FLUSH MOUNT UNLESS OTHERWISE NOTED ON EACH RECEPTACLE. S=SURFACE MOUNT.
- # = CIRCUIT NUMBER PLACED NEXT TO EACH RECEPTACLE. WP = WEATHER PROOF PLACED NEXT TO EACH RECEPTACLE ACCORDINGLY.




"#" =CIRCUIT NUMBER DESIGNATION

"x" = TYPE OF RECEPTACLE BASED ON ACRONYM

ACRONYMS: "C" = CONTROLLED VIA PLUG LOAD CONTROL TYPE "GFCI" = GROUND FAULT CIRCUIT INTERRUPTER TYPE "TP" = TAMPERPROOF TYPE "EG" = ELECTRONIC GRADE TYPE "AFCI" = ARC FAULT CIRCUIT INTERRUPTER TYPE

FLECTRICAL ABBREVIATIONS:

ELECTRICAL ABBREVIATIONS.		
ABBREVIATION	DESCRIPTION	
AFG	ABOVE FINISHED GRADE	
FBO	FURNISHED BY OTHERS	
FF	FINISHED FLOOR	
UNO	UNLESS NOTED OTHERWISE	
+XX	DIMENSIONED HEIGHT ABOVE FINISHED FLOOR	
-XX	DIMENSIONED HEIGHT BELOW FINISHED FLOOR	
1P	ONE POLE	
1W	ONE WIRE	
2P	TWO POLE	
2W	TWO WIRE	
3P	THREE POLE	
3W	THREE WIRE	
ADJ	ADJUSTABLE	
AF	AMP FRAME	
AFC	AVAILABLE FAULT CURRENT	
AFCI	ARC FAULT CURRENT INTERRUPTER	
AIC	AMPERES INTERRUPTING CAPACITY	
AT	AMP TRIP	
CB	CIRCUIT BREAKER	
CKT	CIRCUIT	
DISC	DISCONNECT	
DN	DOWN	
EM	EQUIPMENT POWERED WITH EMERGENCY SOURCE	
FLA	FULL LOAD AMPS	
FSD	FIRE SMOKE DAMPER	
FT,'	FOOT OR FEET	
GFCI	GROUND FAULT CIRCUIT INTERRUPTER	
IN., "	INCH OR INCHES	
J-BOX	JUNCTION BOX	
KVA	KILOVOLT AMPERE	
KW	KILOWATT	
LTG	LIGHTING	
MAX	MAXIMUM	
MCB	MAIN CIRCUIT BREAKER	
MIN	MINIMUM	
MLO	MAIN LUGS ONLY	
N/A	NOT APPLICABLE	
NIC	NOT IN CONTRACT	
NO., #	NUMBER	
NTS	NOT TO SCALE	
SD	SMOKE DAMPER	
SPEC	SPECIFICATION	
TYP	TYPICAL	
WP	WEATHERPROOF	

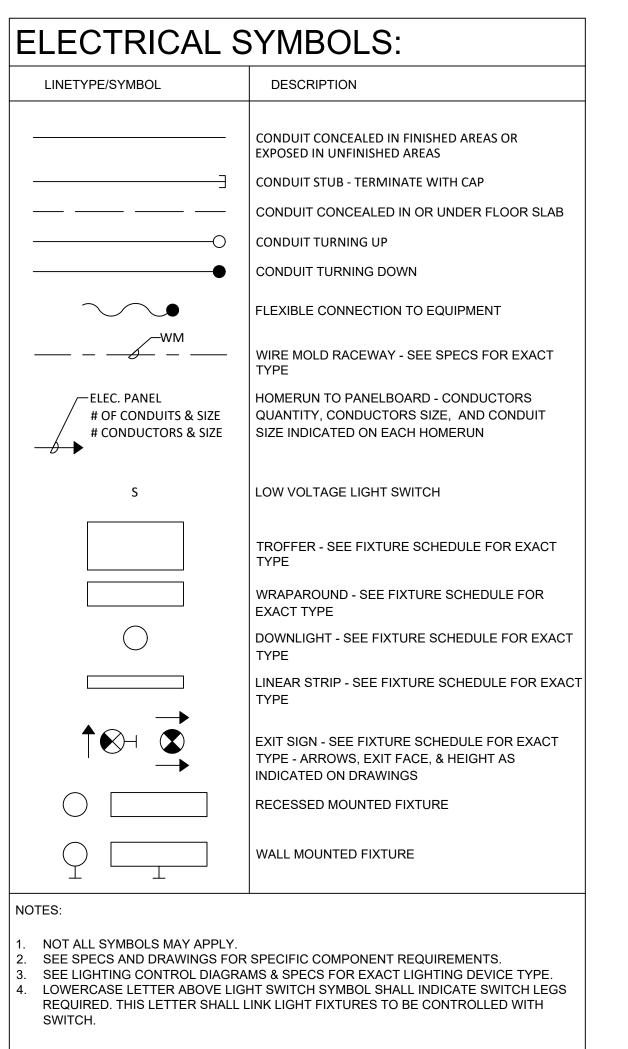

"a" = SWITCH LEG/SWITCH CONTROL "x" = TYPE OF SWITCH BASED ON ACRONYM

> THE LEFT KEY OPERATED

ARE ON

"1" = CIRCUIT NUMBER

WITH TIMER

OFF POSITION

"a" = SWITCH LEG/SWITCH CONTROL

EMERGENCY POWER SOURCE.

CONTROLLING LIGHT FIXTURE.

SHOWN ON ELECTRICAL PLANS.

"xx" = STANDARD FIXTURE MOUNTING HEIGHT SEE

ARCHITECT DRAWINGS WHEN HEIGHT IS NOT

STANDARD LUMINAIRE PROVIDING EMERGENCY LIGHTING

-FIXTURE POWERED WITH INTEGRAL BATTERY OR EXTERIOR

INTEGRAL OCCUPANCY SENSOR

HORIZONTALLY MOUNTED, WITH ON POSITION TO

KEY OPERATED WITH PILOT LIGHT ON WHEN LIGHTS

TO CONTROL PROJECTION SCREEN "G" = GLOWS IN

"A" = STANDARD FIXTURE TYPE. REFER TO FIXTURE SCHEDULE

THIS LOWERCASE LETTER SHALL LINK LIGHT SWITCH

ACRONYMS:

+xx AFF

5:	S)
	1a A
	+xx Al

GENERAL NOTES:

- INSTALLATION SHALL COMPLY WITH ALL APPLICABLE CODES, STANDARDS, AND MANUFACTURER'S INSTALLATION REQUIREMENTS.
- REVIEW ALL PROJECT DOCUMENTS INCLUDING SPECS AND DRAWINGS PERTAINING TO ALL DISCIPLINES PRIOR TO SUBMITTING A BID. SUBMIT PRE-BID REQUEST FOR INFORMATION FOR ITEMS IN QUESTION AND/OR CONFLICTS FOUND.
- DRAWINGS SHOW THE DESIGN INTENT DIAGRAMMATICALLY. THEY DO NOT SHOW THE EXACT UTILITY ROUTING NOR EVERY ELBOW, OFFSET, ETC. WHERE REQUIRED, THE CONTRACTOR SHALL MAKE ADJUSTMENTS TO THEIR SYSTEMS TO AVOID CONFLICT WITH THE STRUCTURE AND OTHER DISCIPLINES. THE COST FOR SUCH
- OBTAIN AND PAY FOR ALL PERMITS REQUIRED FOR WORK PERFORMED.
- OBTAIN UTILITY PURVEYOR REQUIREMENTS PRIOR TO PURCHASING EQUIPMENT OR PERFORMING WORK.
- THE CONTRACTOR TEAM SHALL LEAD THE SUBCONTRACTORS IN PROVIDING A
- PROVIDE FIRESTOPPING FOR ALL UTILITY PENETRATIONS THRU FIRE-RATED
- COORDINATE FRAMING REQUIREMENTS FOR ACCESS PANELS AND EQUIPMENT/PANEL SUPPORTS PRIOR TO SUBMITTING BID.
- THE CONTRACTOR IS RESPONSIBLE FOR VERIFYING THE CORRECTION OF CONSTRUCTION DEFICIENCIES LISTED ON THE JOB SITE OBSERVATION REPORT. RETURN THE JOB SITE OBSERVATION REPORT TO A/E WITH DEFICIENCIES SIGNED OFF. PROVIDE PHOTOGRAPHIC AND/OR VIDEO EVIDENCE OF CORRECTED DEFICIENCIES IF REQUESTED BY THE ENGINEER.
- PROVIDE CLOSEOUT DOCUMENTATION UPON COMPLETION OF PROJECT. SEE GENERAL REQUIREMENTS SPEC FOR ADDITIONAL INFORMATION.

- COMPONENTS SHALL BE CLEANED PRIOR TO OWNER TURNOVER.
- THE SCHEDULED EQUIPMENT SHALL BE USED AS THE BASIS OF DESIGN. MODEL NUMBERS ARE PROVIDED FOR REFERENCE ONLY. EQUIPMENT SHALL MEET SPECIFIED PERFORMANCE. THE CONTRACTOR SHALL IDENTIFY ALL SELECTED OPTIONS IN THE SUBMITTAL.
- CONTRACTOR SHALL BE RESPONSIBLE FOR ALL COSTS INCURRED AS A RESULT. STRUCTURAL MODIFICATIONS FOR INCREASED WEIGHT AND, ELECTRICAL EQUIPMENT, WIRING, CONDUIT, AND BREAKER CHANGES FOR DIFFERENT ELECTRICAL REQUIREMENTS.
- AND CLEANING REQUIREMENTS.
- BUILDING MOVEMENT WHERE CONDUIT OR RACEWAY CROSSES BUILDING
- 6. PAINT INTERIOR EXPOSED CONDUIT/RACEWAYS, PULL BOXES, AND ASSOCIATED HANGERS/SUPPORTS LOCATED IN OCCUPIED SPACES TO MATCH THE SURROUNDING ARCHITECTURAL COLOR SCHEME. PAINT EXTERIOR CONDUIT/RACEWAYS, PULL BOXES, AND ASSOCIATED HANGERS/SUPPORTS ADJACENT TO EXTERIOR WALL TO MATCH WALL COLOR. FINAL COLORS SHALL BE APPROVED BY THE ARCHITECT AND ENGINEER. SEE SPEC SECTION 26 0500 FOR ADDITIONAL REQUIREMENTS.
- PROVIDE IDENTIFICATION FOR CONDUIT/RACEWAYS, PULL BOXES, AND EQUIPMENT PER SPEC SECTION 26 0553.
- . CONDUIT/RACEWAY SHALL NOT PASS THRU NOR UNDER DATA ROOMS, ELEVATOR MACHINE ROOMS, ELEVATOR HOISTWAYS, SKYLIGHTS, AND ROOF ACCESS HATCHES.
- BOXES HAVE BEEN LOCATED IN CONCEALED AREAS. ACCESS PANEL SIZE SHALL BE LARGE ENOUGH TO ACCESS EACH PULL BOX.
- AND LIGHTING DEVICES WITH MECHANICAL AND FIRE PROTECTION, AND FIRE ALARM
- SHALL BE SEPARATED BY 24". OPENINGS SHALL BE FIRESTOPPED WITH THE SPECIFIED MATERIAL.
- EQUIPMENT, THEY SHALL BE OF THE SAME MANUFACTURER AND DESIGN AS THE EXISTING BREAKERS AND SHALL BE OF THE SIZES INDICATED.

RENOVATION NOTES:

- DEMOLITION WORK SHALL BE PERFORMED AS DESCRIBED WITHIN SPEC SECTION 26 0505 AND THE DRAWINGS.
- THE CONTRACTOR SHALL VISIT THE SITE PRIOR TO BID SUBMISSION TO VERIFY ALL FIELD CONDITIONS INCLUDING BUT NOT LIMITED TO THE FOLLOWING: A. LOCATIONS OF EXISTING ELECTRICAL SYSTEMS. B. LOCATIONS OF ARCHITECTURAL, STRUCTURAL, MECHANICAL, PLUMBING, TECHNOLOGY, FIRE PROTECTION, AND FIRE ALARM SYSTEMS. C. EXISTING SURFACES WHICH REQUIRE ALTERING. D. EXISTING MAIN SWITCHGEAR CONDITIONS.
- TO SHUTDOWN. EXACT SHUTDOWN TIME AND PROCEDURE SHALL BE COORDINATED WITH OWNER AT LEAST 96 HOURS PRIOR TO SHUTDOWN.
- HANGERS, SUPPORTS, AND ACCESSORIES.
- CONTRACTOR SHALL CONFIRM THAT ONCE POWER IS RESTORED, (E) ELECTRICAL DEVICES DOWNSTREAM OF REPLACED DEVICES ARE OPERATIONAL WITH ADEQUATE

- ADJUSTMENTS SHALL BE INCLUDED IN THE BID.
- COORDINATED SET OF SHOP DRAWINGS. SEE GENERAL REQUIREMENTS SPEC FOR ADDITIONAL INFORMATION.

ELECTRICAL NOTES:

- ELECTRICAL WORK SHALL BE CONSTRUCTED IN A PROFESSIONAL MANNER.
- IF A CONTRACTOR PROVIDES EQUIPMENT OTHER THAN THE BASIS OF DESIGN, THAT THAT INCLUDES, BUT IS NOT LIMITED TO, AGENCY FEES FOR REVIEW OF CHANGES,
- SEE SPEC SECTIONS 26 0533 AND FOR CONDUIT/RACEWAY SYSTEM INSTALLATION
- PROVIDE CONDUIT OR RACEWAY EXPANSION JOINT THAT ACCOMMODATES THE
- PULL BOXES SHALL BE ACCESSIBLE. PROVIDE KEYED ACCESS PANELS WHERE PULL
- 10. ELECTRICAL CONTRACTOR SHALL COORDINATE LOCATION OF LIGHTING FIXTURES
- 11. CONTRACTOR SHALL VERIFY U.L. LISTING AND PROCEED WITH FINAL CONNECTION.
- 12. ELECTRICAL OUTLETS INSTALLED ON OPPOSITE SIDES OF FIRE-RATED ASSEMBLIES
- 13. WHERE NEW CIRCUIT BREAKERS ARE TO BE ADDED TO EXISTING ELECTRICAL

- NOTIFY OWNER OF REQUIRED SYSTEM SHUTDOWNS AT LEAST TWO WEEKS PRIOR
- WHEN ELECTRICAL CONDUIT OR EQUIPMENT ARE NOTATED TO BE PERMANENTLY REMOVED THEIR ASSOCIATED COMPONENTS SHALL ALSO BE REMOVED INCLUDING
- . COORDINATE THE DISCONNECTION AND REMOVAL OF THE POWERED SYSTEMS WITH THE OTHER TRADES WHEN REMOVING POWERED EQUIPMENT.
- 3. REPAIR EXISTING FLOORS, WALLS, AND CEILINGS IN ALTERED AREAS TO MATCH EXISTING. SEE ARCHITECTURAL PLANS FOR FINISH DETAILS IN REMODEL AREAS.
- ELECTRICAL CONTINUITY.

ELECTRICAL SHEET INDEX:

SHEET NUMBER	SHEET NAME
E-001	ELECTRICAL COVERSHEET
E-101	ELECTRICAL GUHLEMAN WEST BUILDING - FIRST FLOOR - G1 - DEMO
E-102	ELECTRICAL GUHLEMAN WEST BUILDING - FIRST FLOOR - G2 - DEMO
E-103	ELECTRICAL GUHLEMAN WEST BUILDING - SECOND FLOOR - G3 - DEMO
E-104	ELECTRICAL GUHLEMAN WEST BUILDING - SECOND FLOOR - G4 - DEMO
E-105	ELECTRICAL GUHLEMAN EAST BUILDING - FIRST FLOOR - G5 - DEMO
E-106	ELECTRICAL GUHLEMAN EAST BUILDING - FIRST FLOOR - G6 - DEMO
E-107	ELECTRICAL HEARNES BUILDING - H1 - DEMO
E-108	ELECTRICAL HEARNES BUILDING - H2 - DEMO
E-109	ELECTRICAL GUHLEMAN WEST BUILDING - FIRST FLOOR - G1 - REMODEL
E-110	ELECTRICAL GUHLEMAN WEST BUILDING - FIRST FLOOR - G2 - REMODEL
E-111	ELECTRICAL GUHLEMAN WEST BUILDING - SECOND FLOOR - G3 - REMODEL
E-112	ELECTRICAL GUHLEMAN WEST BUILDING - SECOND FLOOR - G4 - REMODEL
E-113	ELECTRICAL GUHLEMAN EAST BUILDING - FIRST FLOOR - G5 - REMODEL
E-114	ELECTRICAL GUHLEMAN EAST BUILDING - FIRST FLOOR - G6 - REMODEL
E-115	ELECTRICAL HEARNES BUILDING - H1 - REMODEL
E-116	ELECTRICAL HEARNES BUILDING - H2 - REMODEL
E-601	ELECTRICAL SCHEDULES

CODES AND STANDARDS:

EDITION	REFERENCE CODE/STANDARD
2010	AMERICANS WITH DISABILITIES ACT (ADAAG)
2021	INTERNATIONAL BUILDING CODE, (IBC)
2023	NATIONAL ELECTRICAL CODE, (NEC)
2021	INTERNATIONAL MECHANICAL CODE, (IMC)
2021	INTERNATIONAL PLUMBING CODE, (IPC)
2021	NATIONAL LIFE SAFETY CODE, (NFPA 101)
2022	ENERGY EFFICIENCY STANDARD, (ASHRAE 90.1)


NFPA-NATIONAL FIRE PROTECTION AGENCY

(X)

GENERAL LEG	END:
SYMBOL	DESCRIPTION
## ####	DETAIL CALL-OUT SYMBOL
###-#	EQUIPMENT TAG
#>	KEYNOTE SYMBOL
•	POINT OF CONNECTION DISCONNECTION
####	SECTION CUT CALL-OUT SYMBOL
####	ENLARGED PLAN CALL-OUT SYMBOL
LINETYPE	DESCRIPTION
	EXISTING TO REMAIN
	EXISTING TO BE REMOVED
	NEW CONSTRUCTION
(E)	EXISTING TO REMAIN

EXISTING TO BE REMOVED

STATE OF MISSOURI MICHAEL L PARSON, **GOVERNOR**

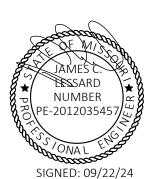



STATE OF MISSOURI CERTIFICATE OF AUTHORITY #2018019473

OFFICE OF ADMINISTRATION DIVISION OF FACILITIES MANAGEMENT,

ANTI-LIGATURE UPGRADES MULTIPLE ASSETS FULTON STATE HOSPITAL

DESIGN AND CONSTRUCTION

PROJECT # M2312-01 7352 SITE#

FULTON, MISSOURI

ASSET # 6517352026, 6517352027, 6517352031

REVISION: DATE: **REVISION:** DATE: **REVISION:** DATE:

ISSUE DATE: 09/22/24


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SHEET TITLE: ELECTRICAL **COVERSHEE**

SHEET NUMBER:

SEPTEMBER 22, 2024

SHEET 16 OF 66



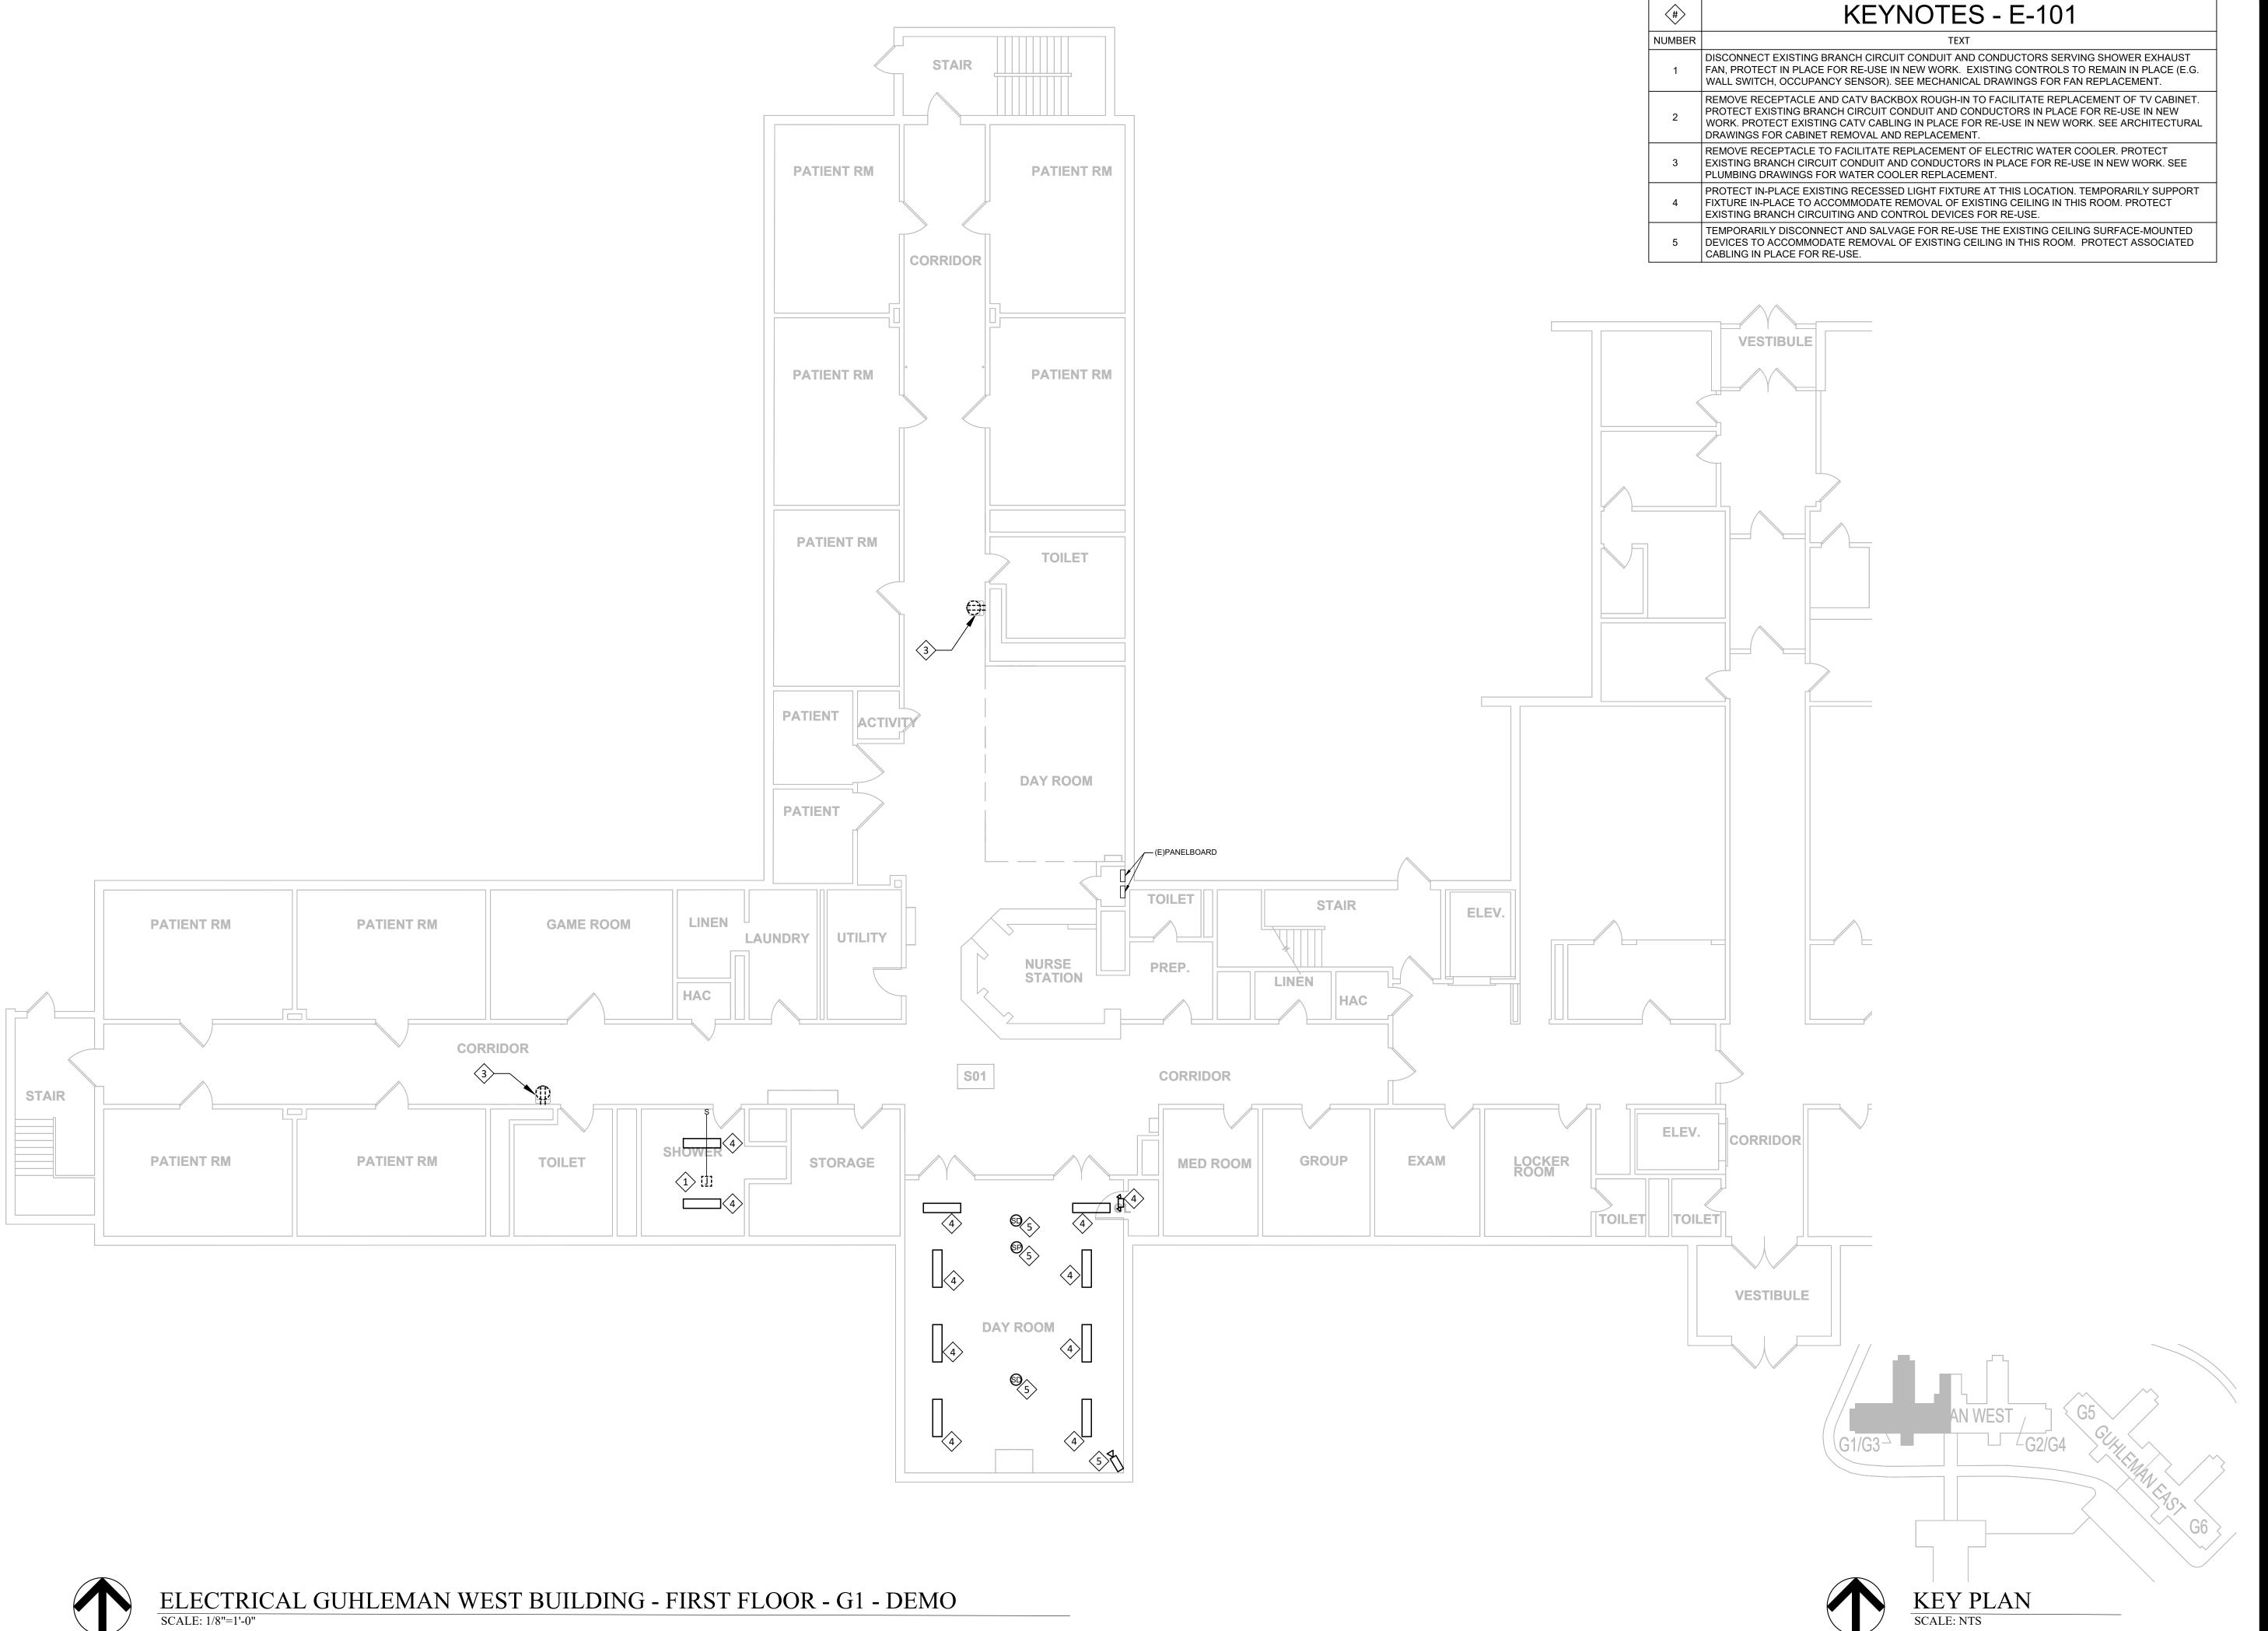



STATE OF MISSOURI CERTIFICATE OF AUTHORITY #2018019473

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ANTI-LIGATURE UPGRADES MULTIPLE ASSETS FULTON STATE HOSPITAL FULTON, MISSOURI

PROJECT # M2312-01 SITE # 7352 ASSET # 6517352027

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DATE:
REVISION:
DATE:
REVISION:
DATE:
ISSUE DATE: 09/22/24


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DESIGNED BY: JCL


SHEET TITLE:

ELECTRICAL
GUHLEMAN WEST
BUILDING - FIRST
FLOOR - G1 - DEMO
SHEET NUMBER:

E-101

SHEET 17 OF 66 SEPTEMBER 22, 2024

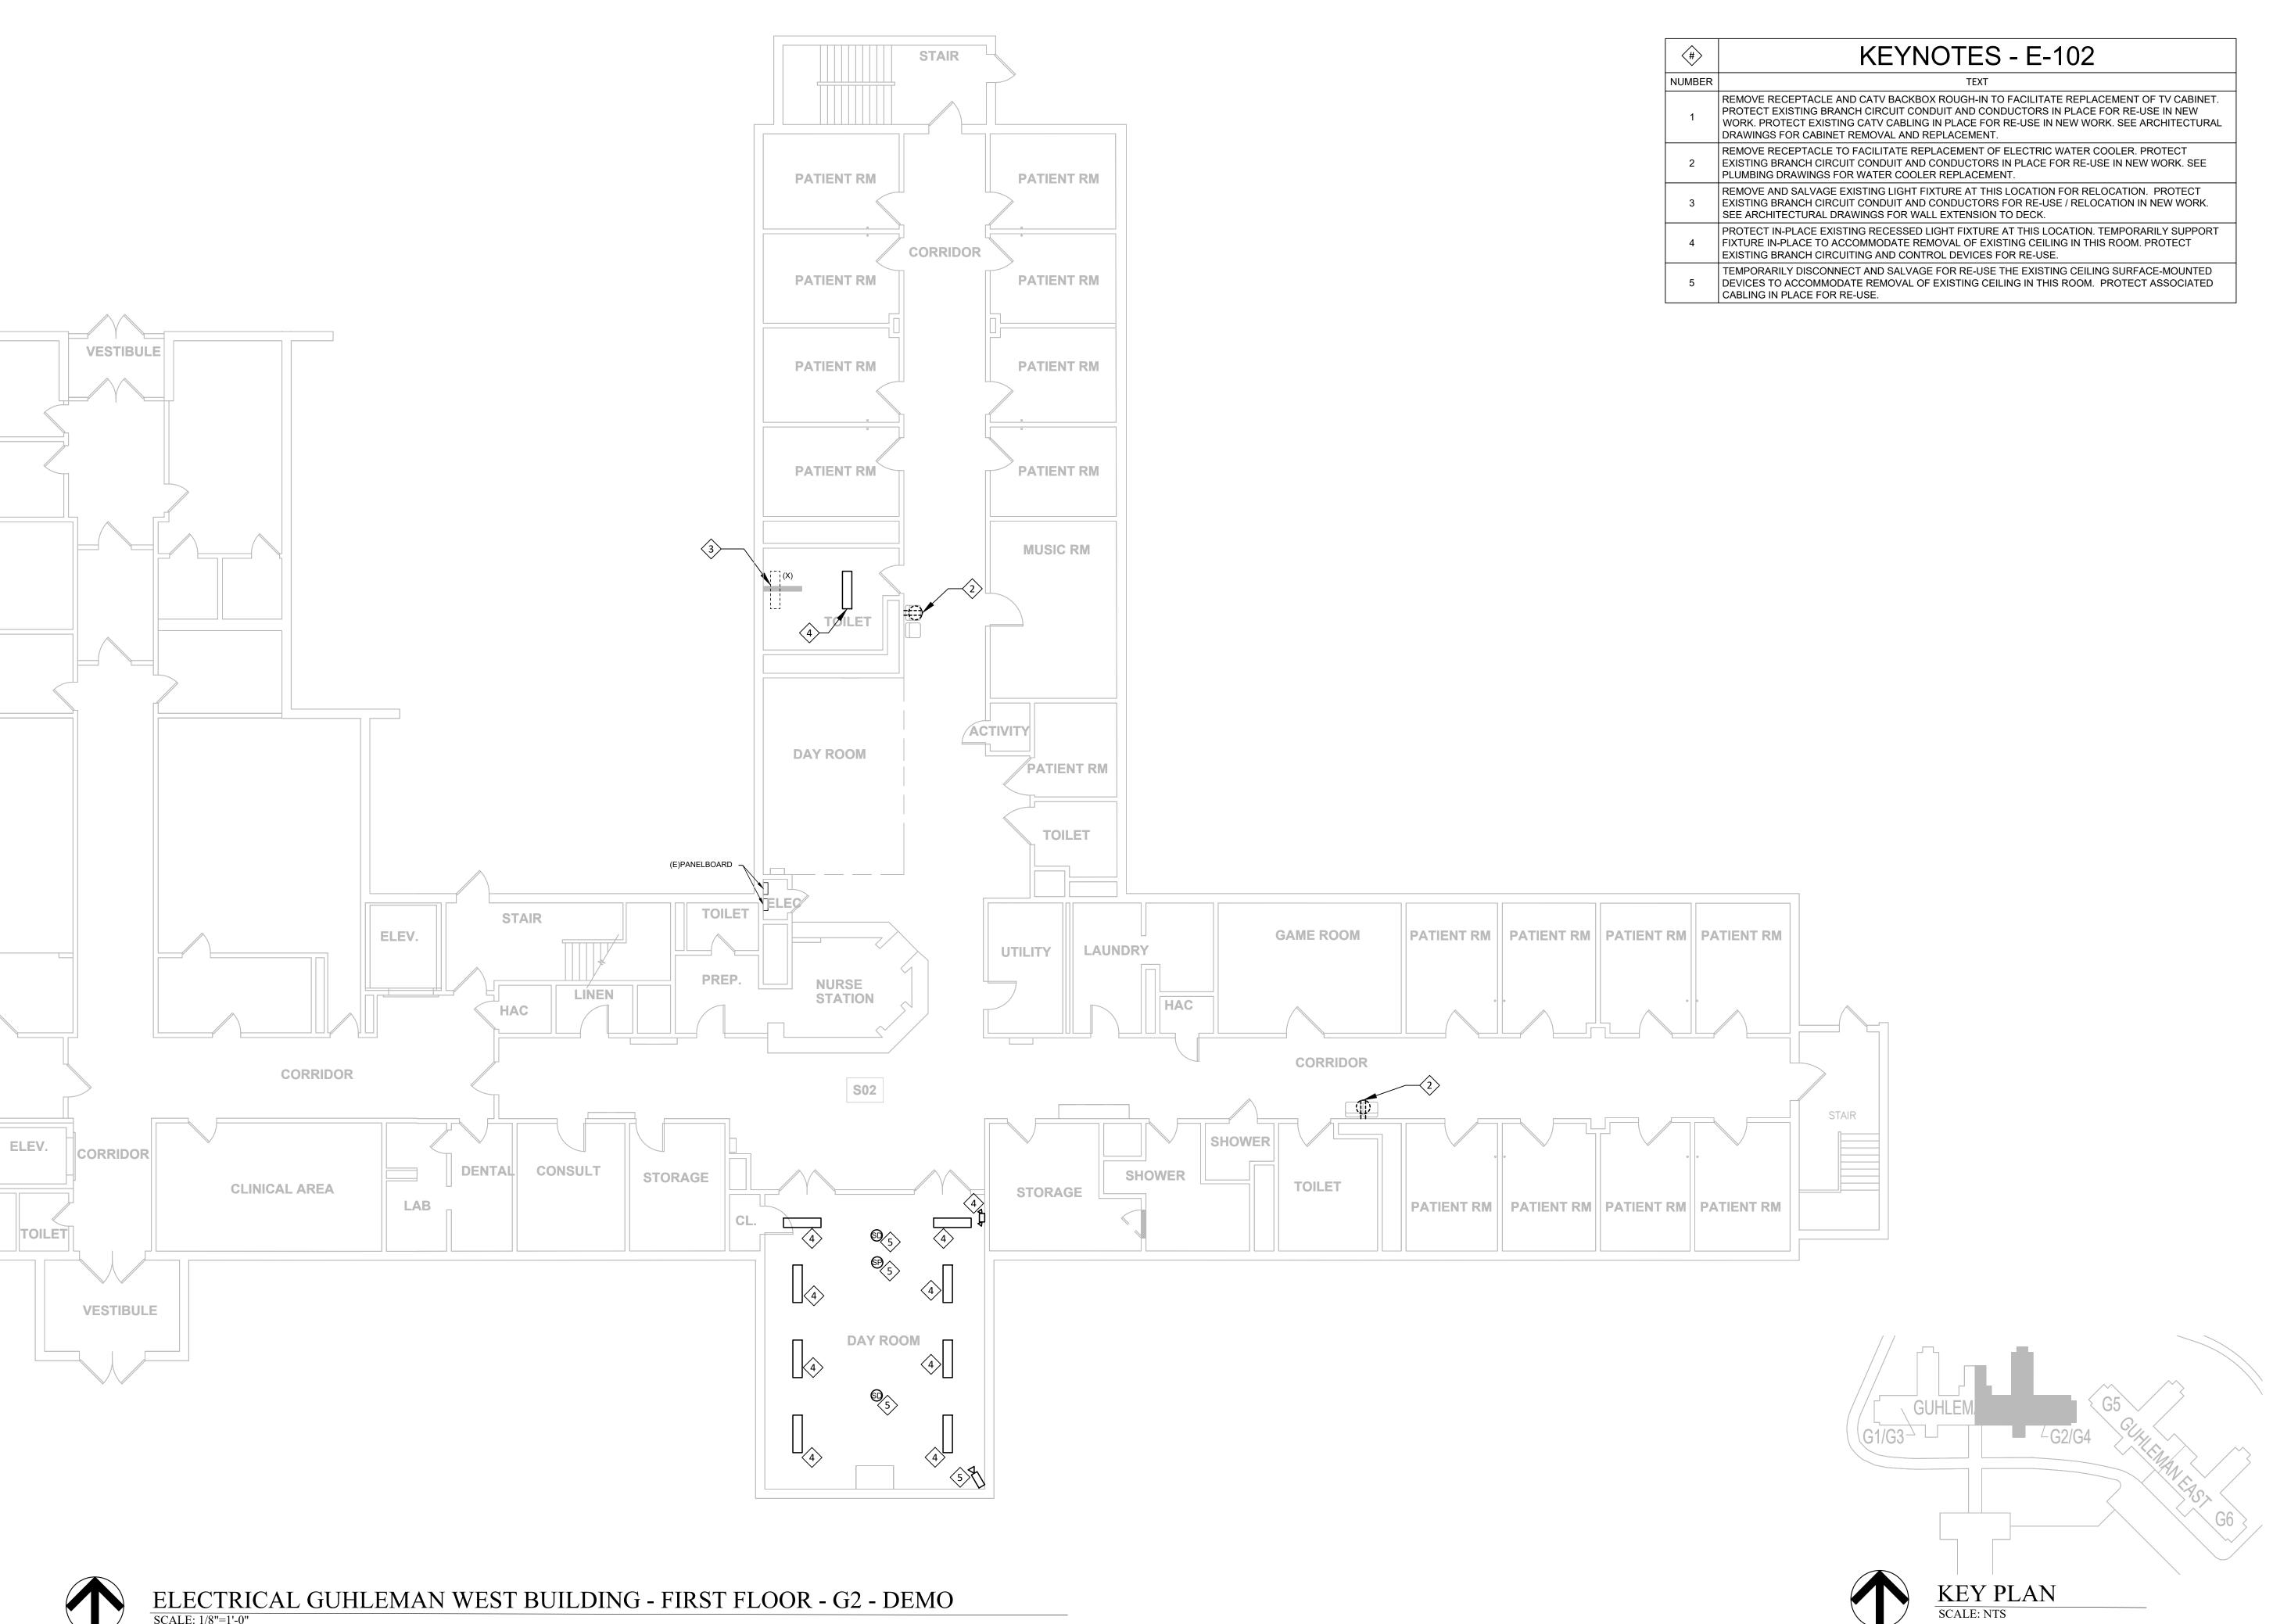

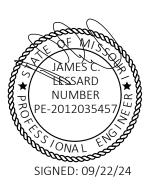



STATE OF MISSOURI CERTIFICATE OF AUTHORITY #2018019473

OFFICE OF ADMINISTRATION DIVISION OF FACILITIES MANAGEMENT, DESIGN AND CONSTRUCTION

ANTI-LIGATURE UPGRADES MULTIPLE ASSETS FULTON STATE HOSPITAL FULTON, MISSOURI

PROJECT # M2312-01 7352 ASSET # 6517352027


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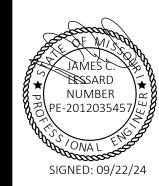
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DRAWN BY: RUM
CHECKED BY: JCL DESIGNED BY: JC

SHEET TITLE:

ELECTRICAL GUHLEMAN WEST BUILDING - FIRST FLOOR - G2 - DEMO SHEET NUMBER:

SHEET 18 OF 66 SEPTEMBER 22, 2024



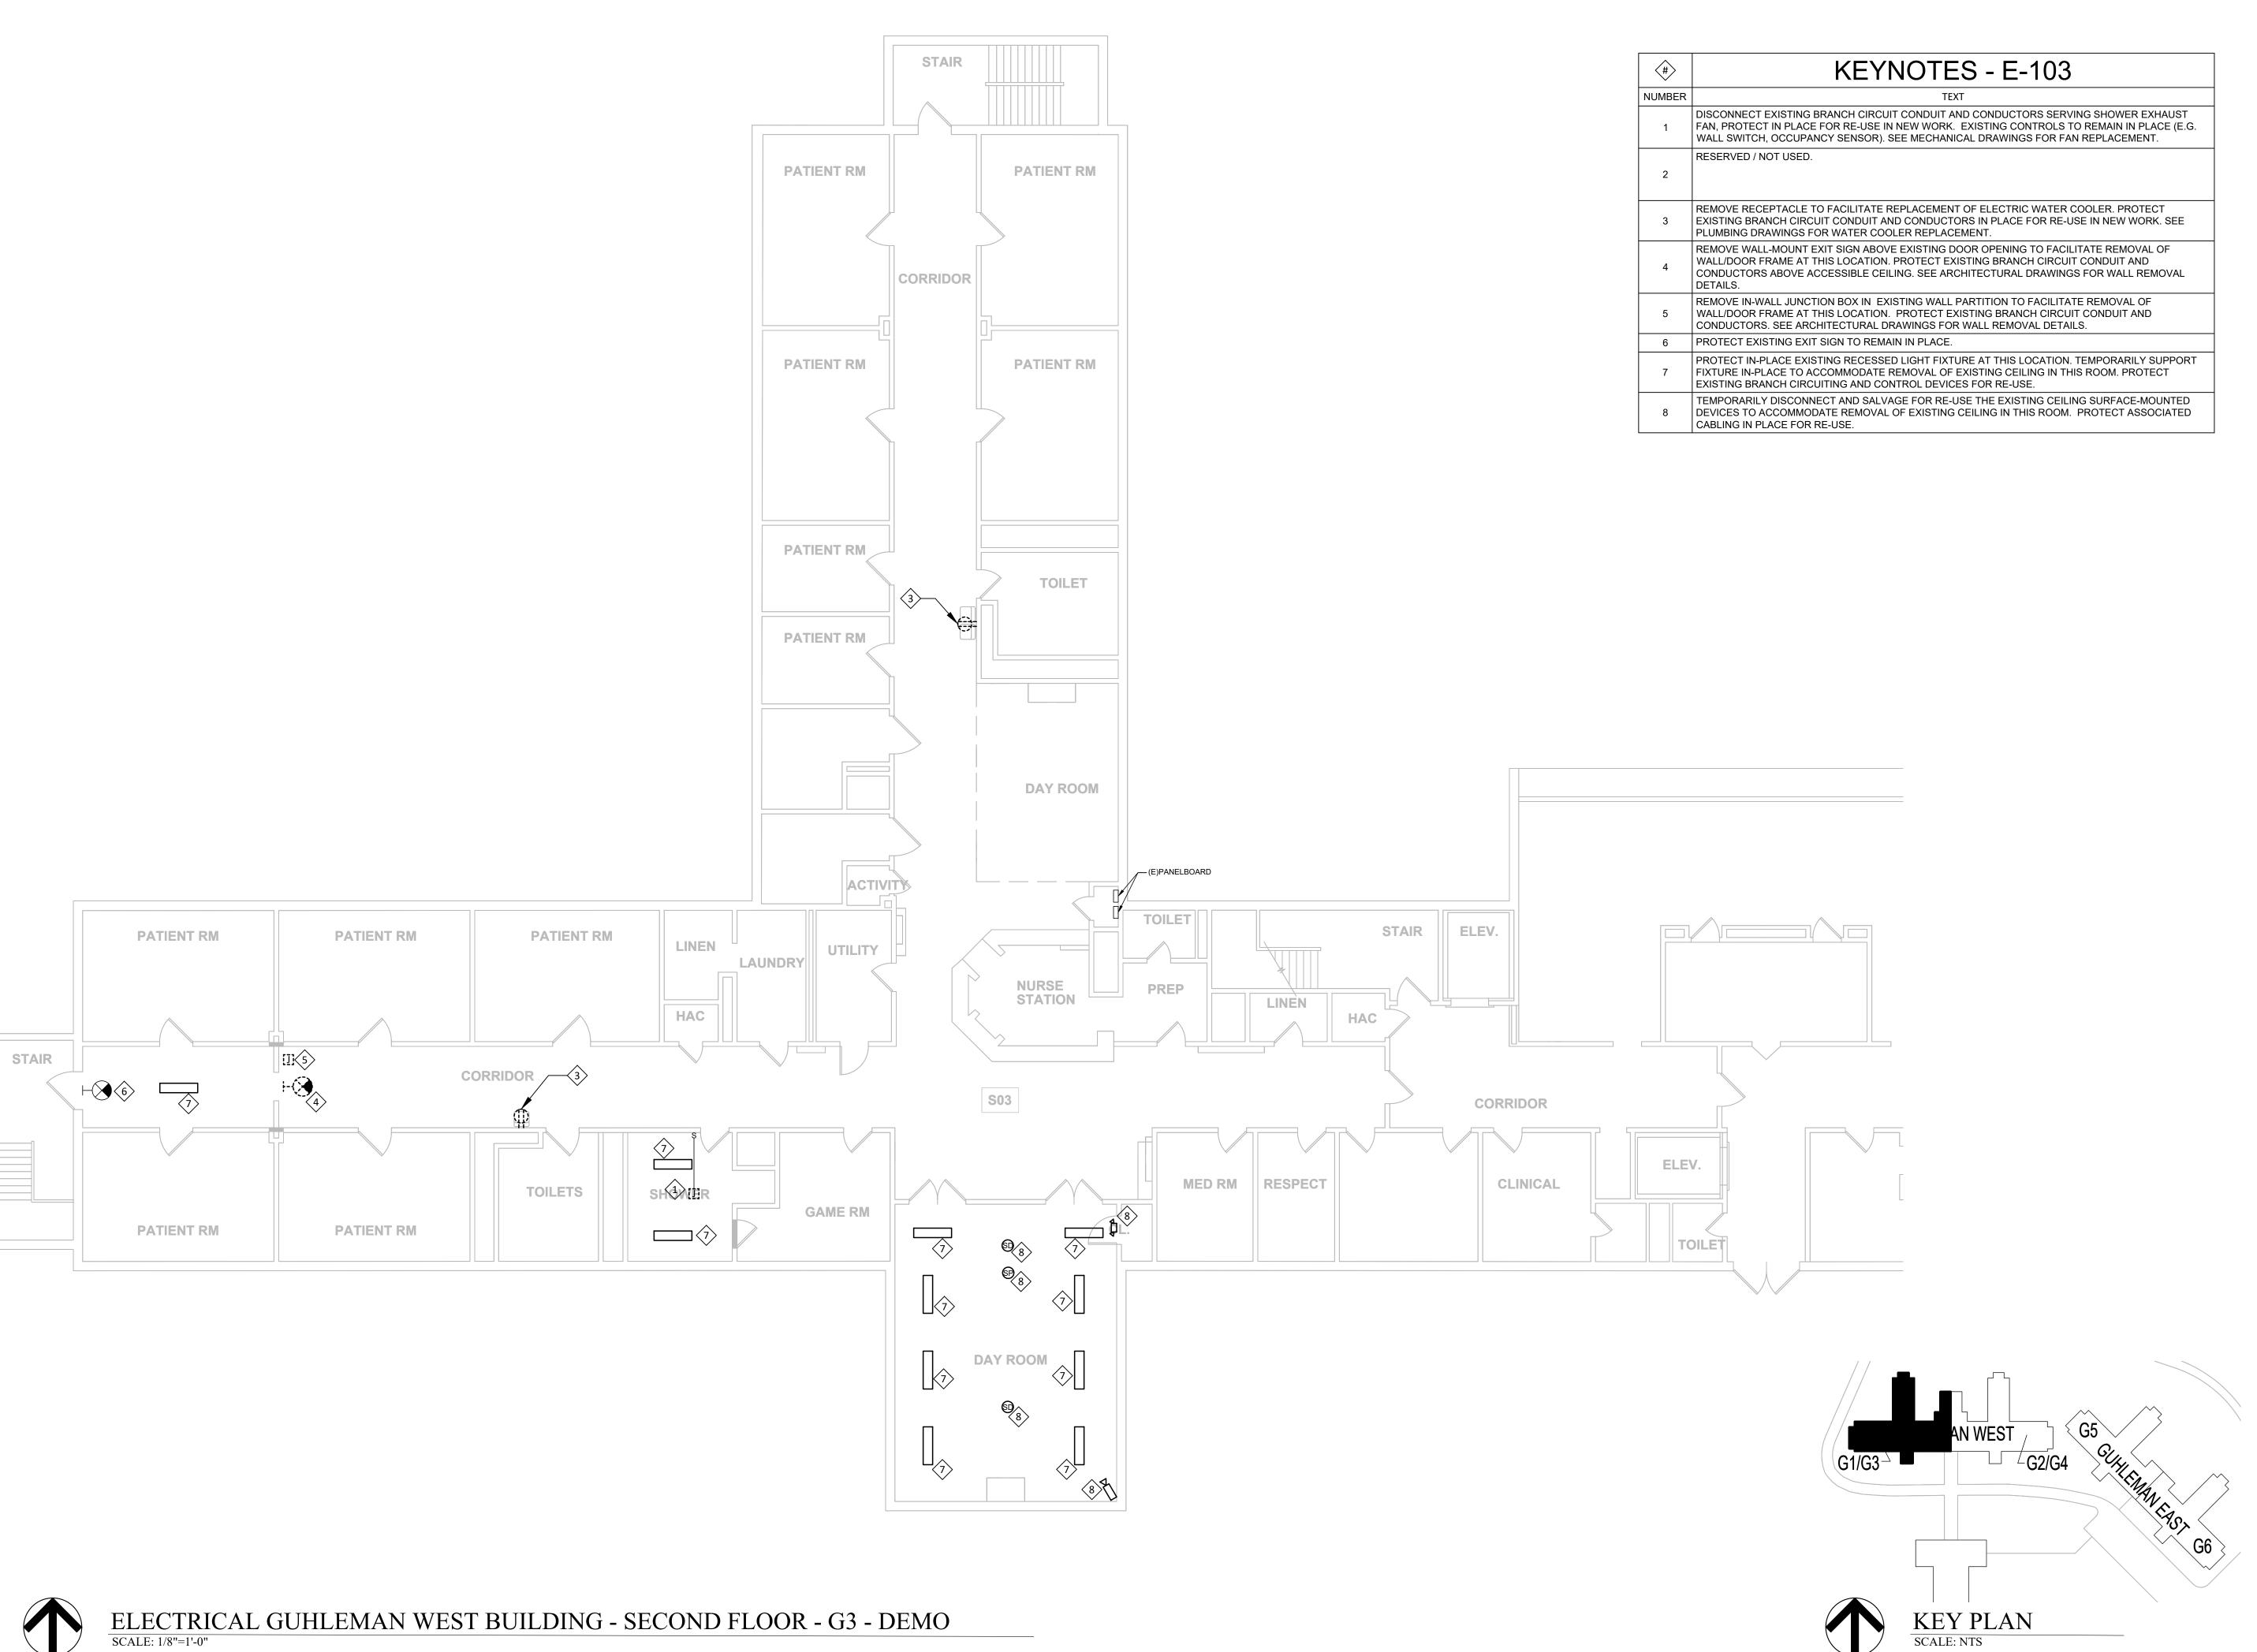



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ANTI-LIGATURE UPGRADES MULTIPLE ASSETS FULTON STATE HOSPITAL FULTON, MISSOURI

PROJECT # M2312-01 SITE # 7352 ASSET # 6517352027

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DATE:
REVISION:
DATE:
REVISION:
DATE:
ISSUE DATE: 09/22/24


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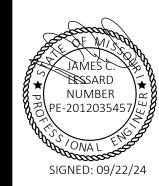
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ELECTRICAL
GUHLEMAN WEST
BUILDING - SECOND
FLOOR - G3 - DEMO

SHEET NUMBER:

E-103

SHEET 19 OF 66 SEPTEMBER 22, 2024



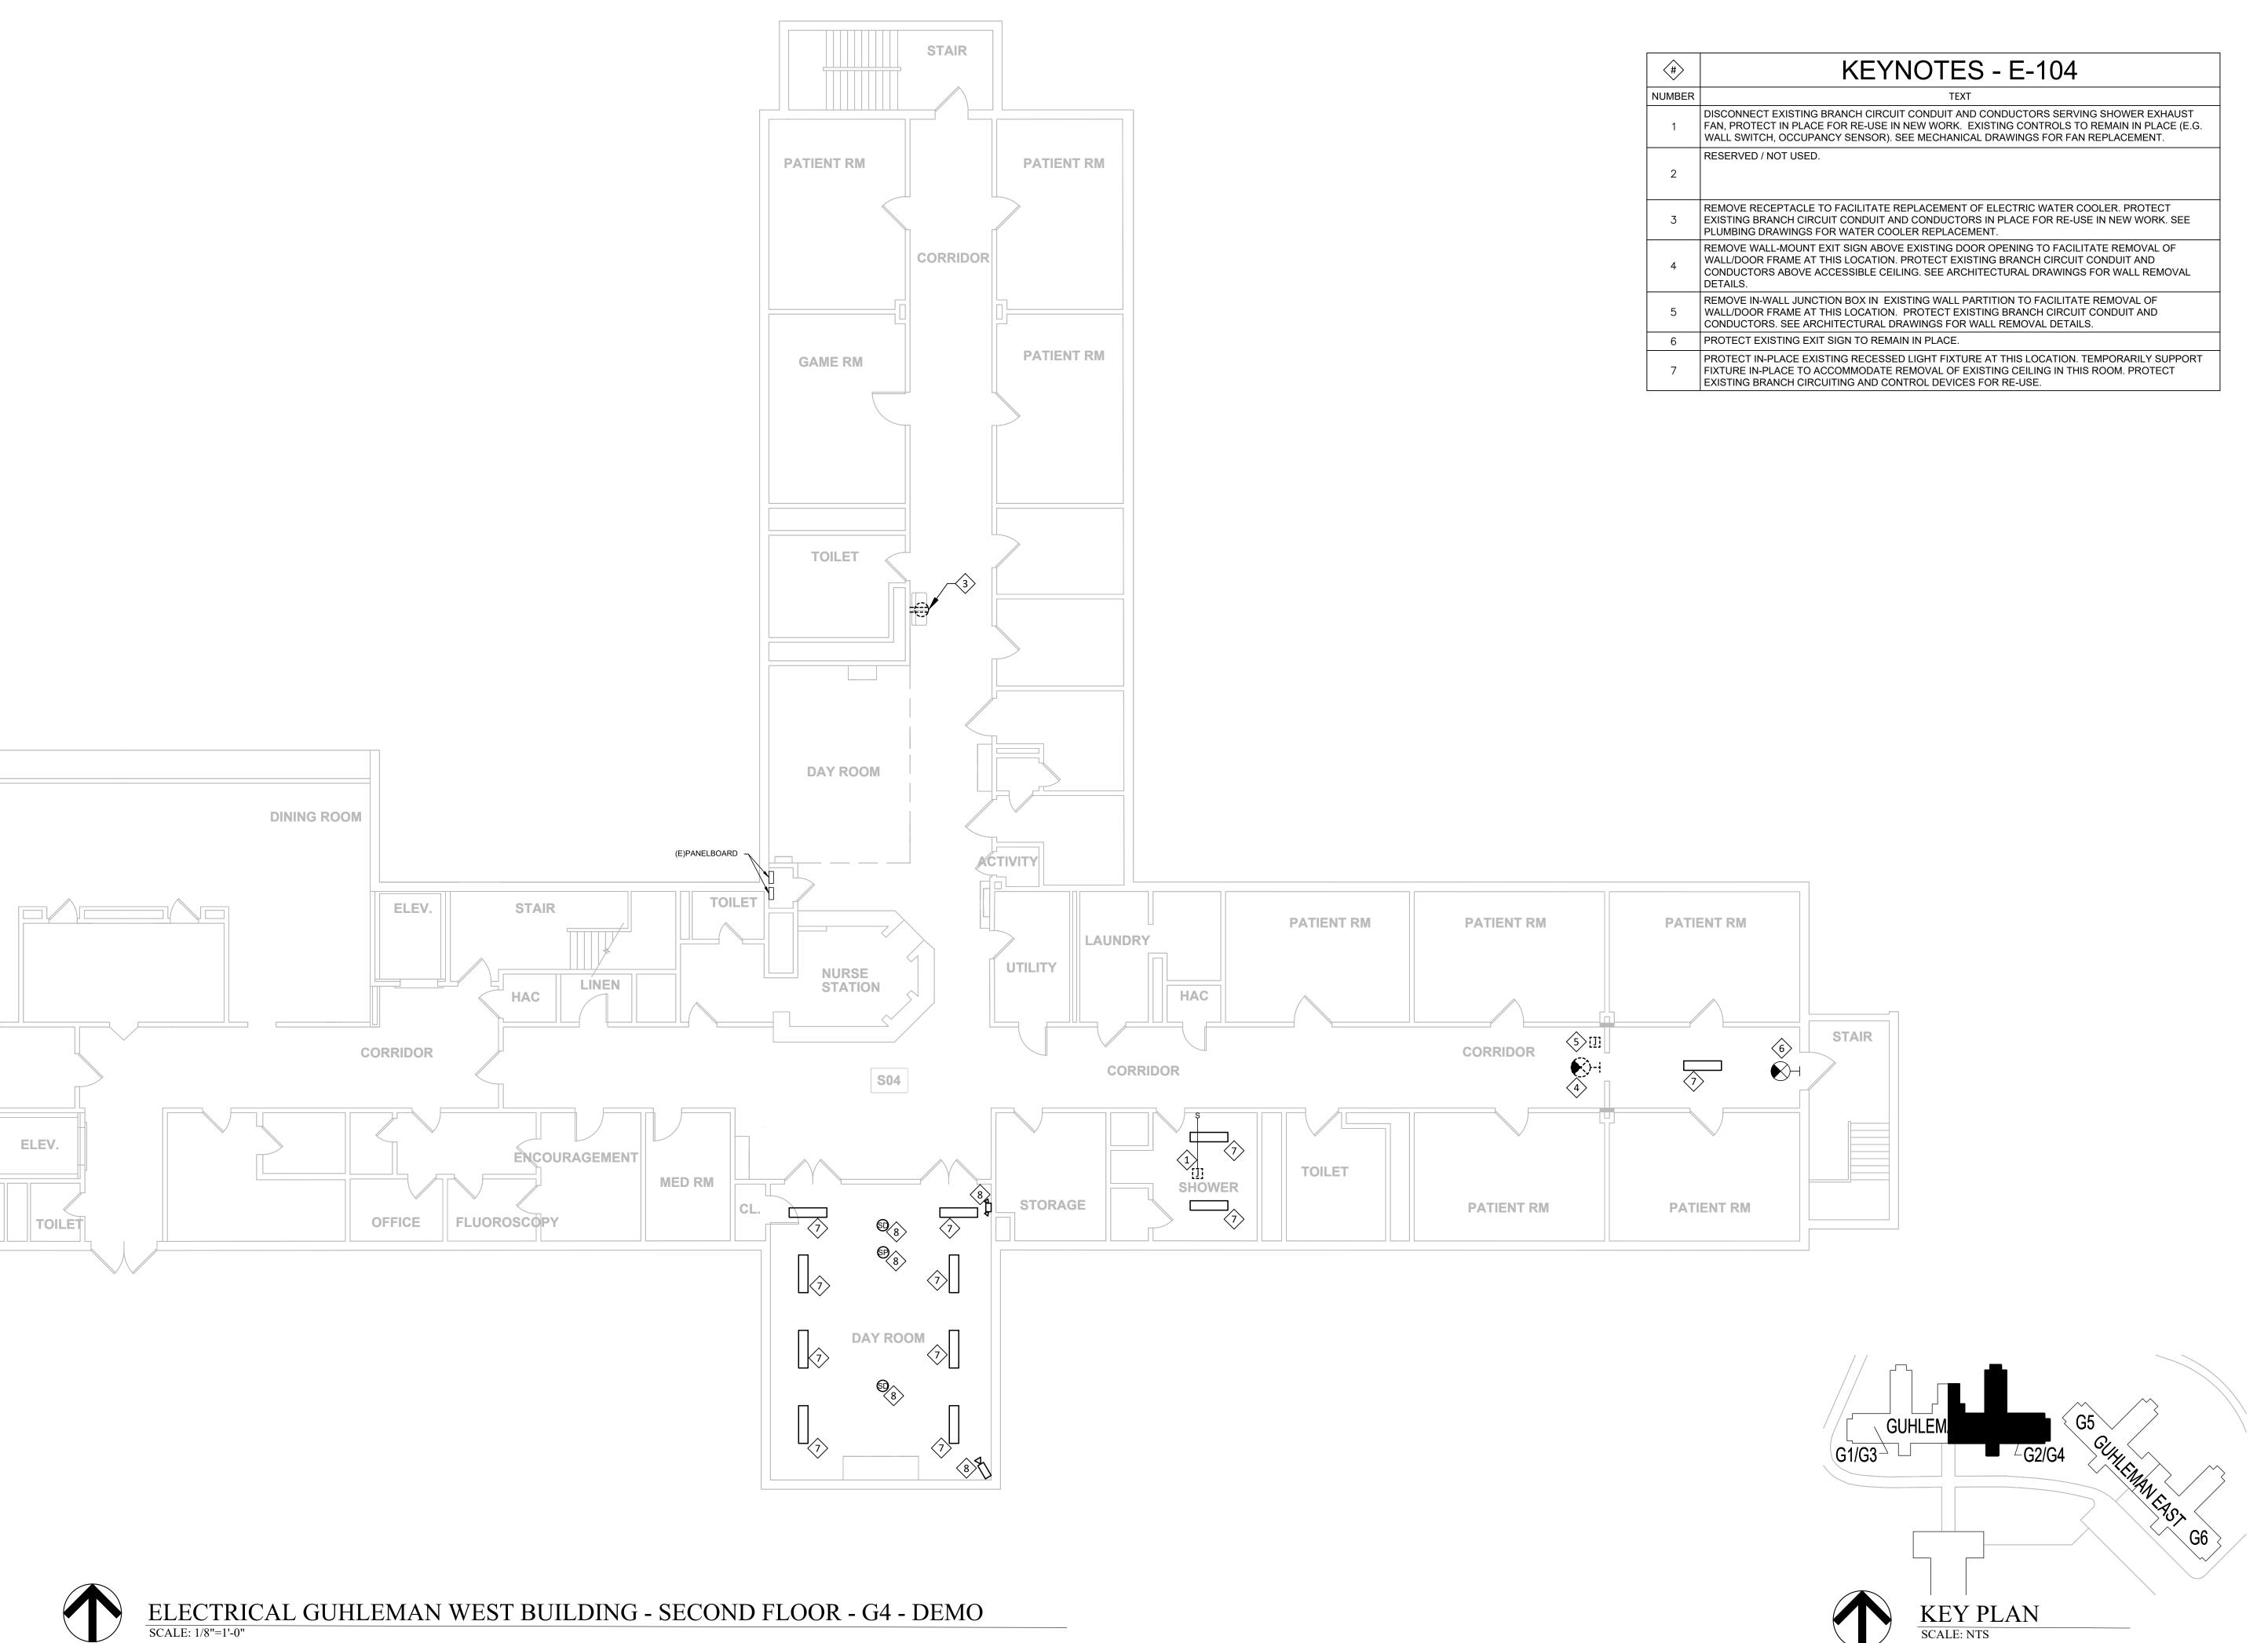



STATE OF MISSOURI CERTIFICATE OF AUTHORITY #2018019473

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ANTI-LIGATURE UPGRADES MULTIPLE ASSETS FULTON STATE HOSPITAL FULTON, MISSOURI

PROJECT # M2312-01 SITE # 7352 ASSET # 6517352027


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DATE:
ISSUE DATE: 09/22/24


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DRAWN BY: RUM
CHECKED BY: JCL
DESIGNED BY: JCL

SHEET TITLE:
ELECTRICAL
GUHLEMAN WEST
BUILDING - SECOND
FLOOR - G4 - DEMO
SHEET NUMBER:

E-104

SHEET 20 OF 66 SEPTEMBER 22, 2024

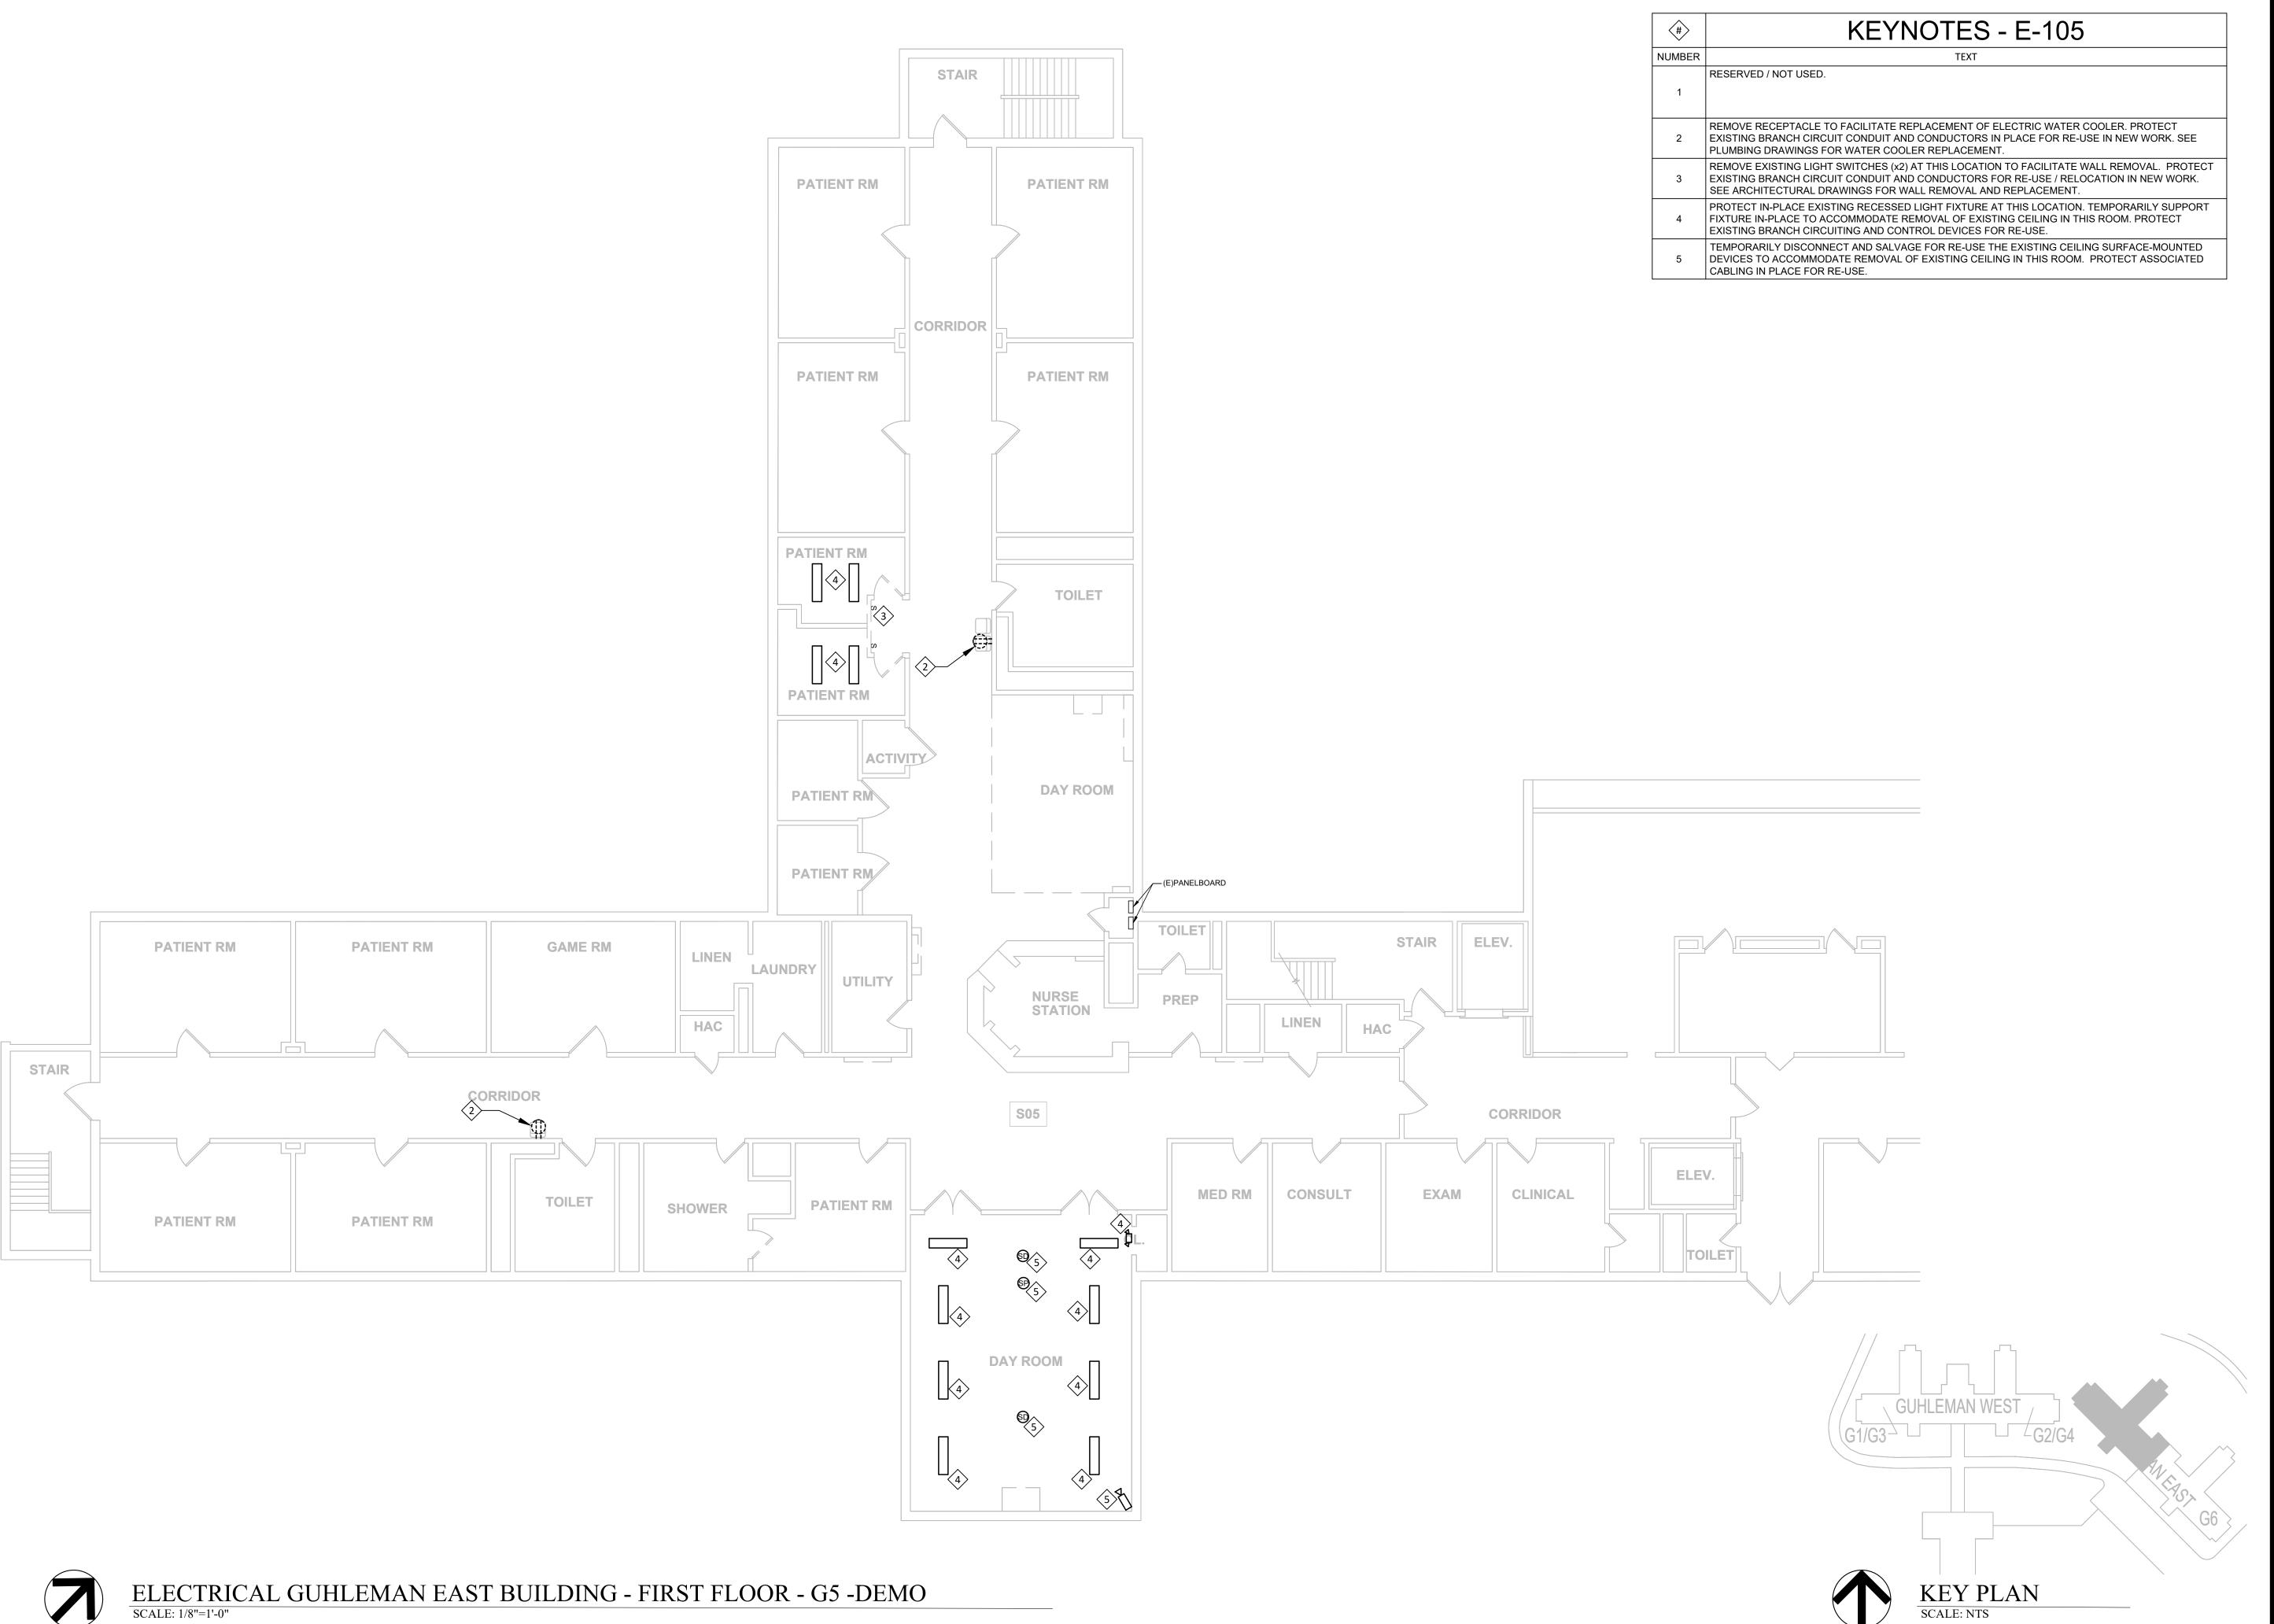

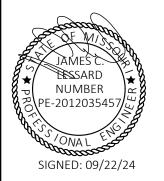



STATE OF MISSOURI CERTIFICATE OF AUTHORITY #2018019473

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ANTI-LIGATURE UPGRADES MULTIPLE ASSETS FULTON STATE HOSPITAL FULTON, MISSOURI

PROJECT # M2312-01 SITE # 7352 ASSET # 6517352026

REVISION:
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REVISION:
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REVISION:
DATE:
ISSUE DATE: 09/22/24

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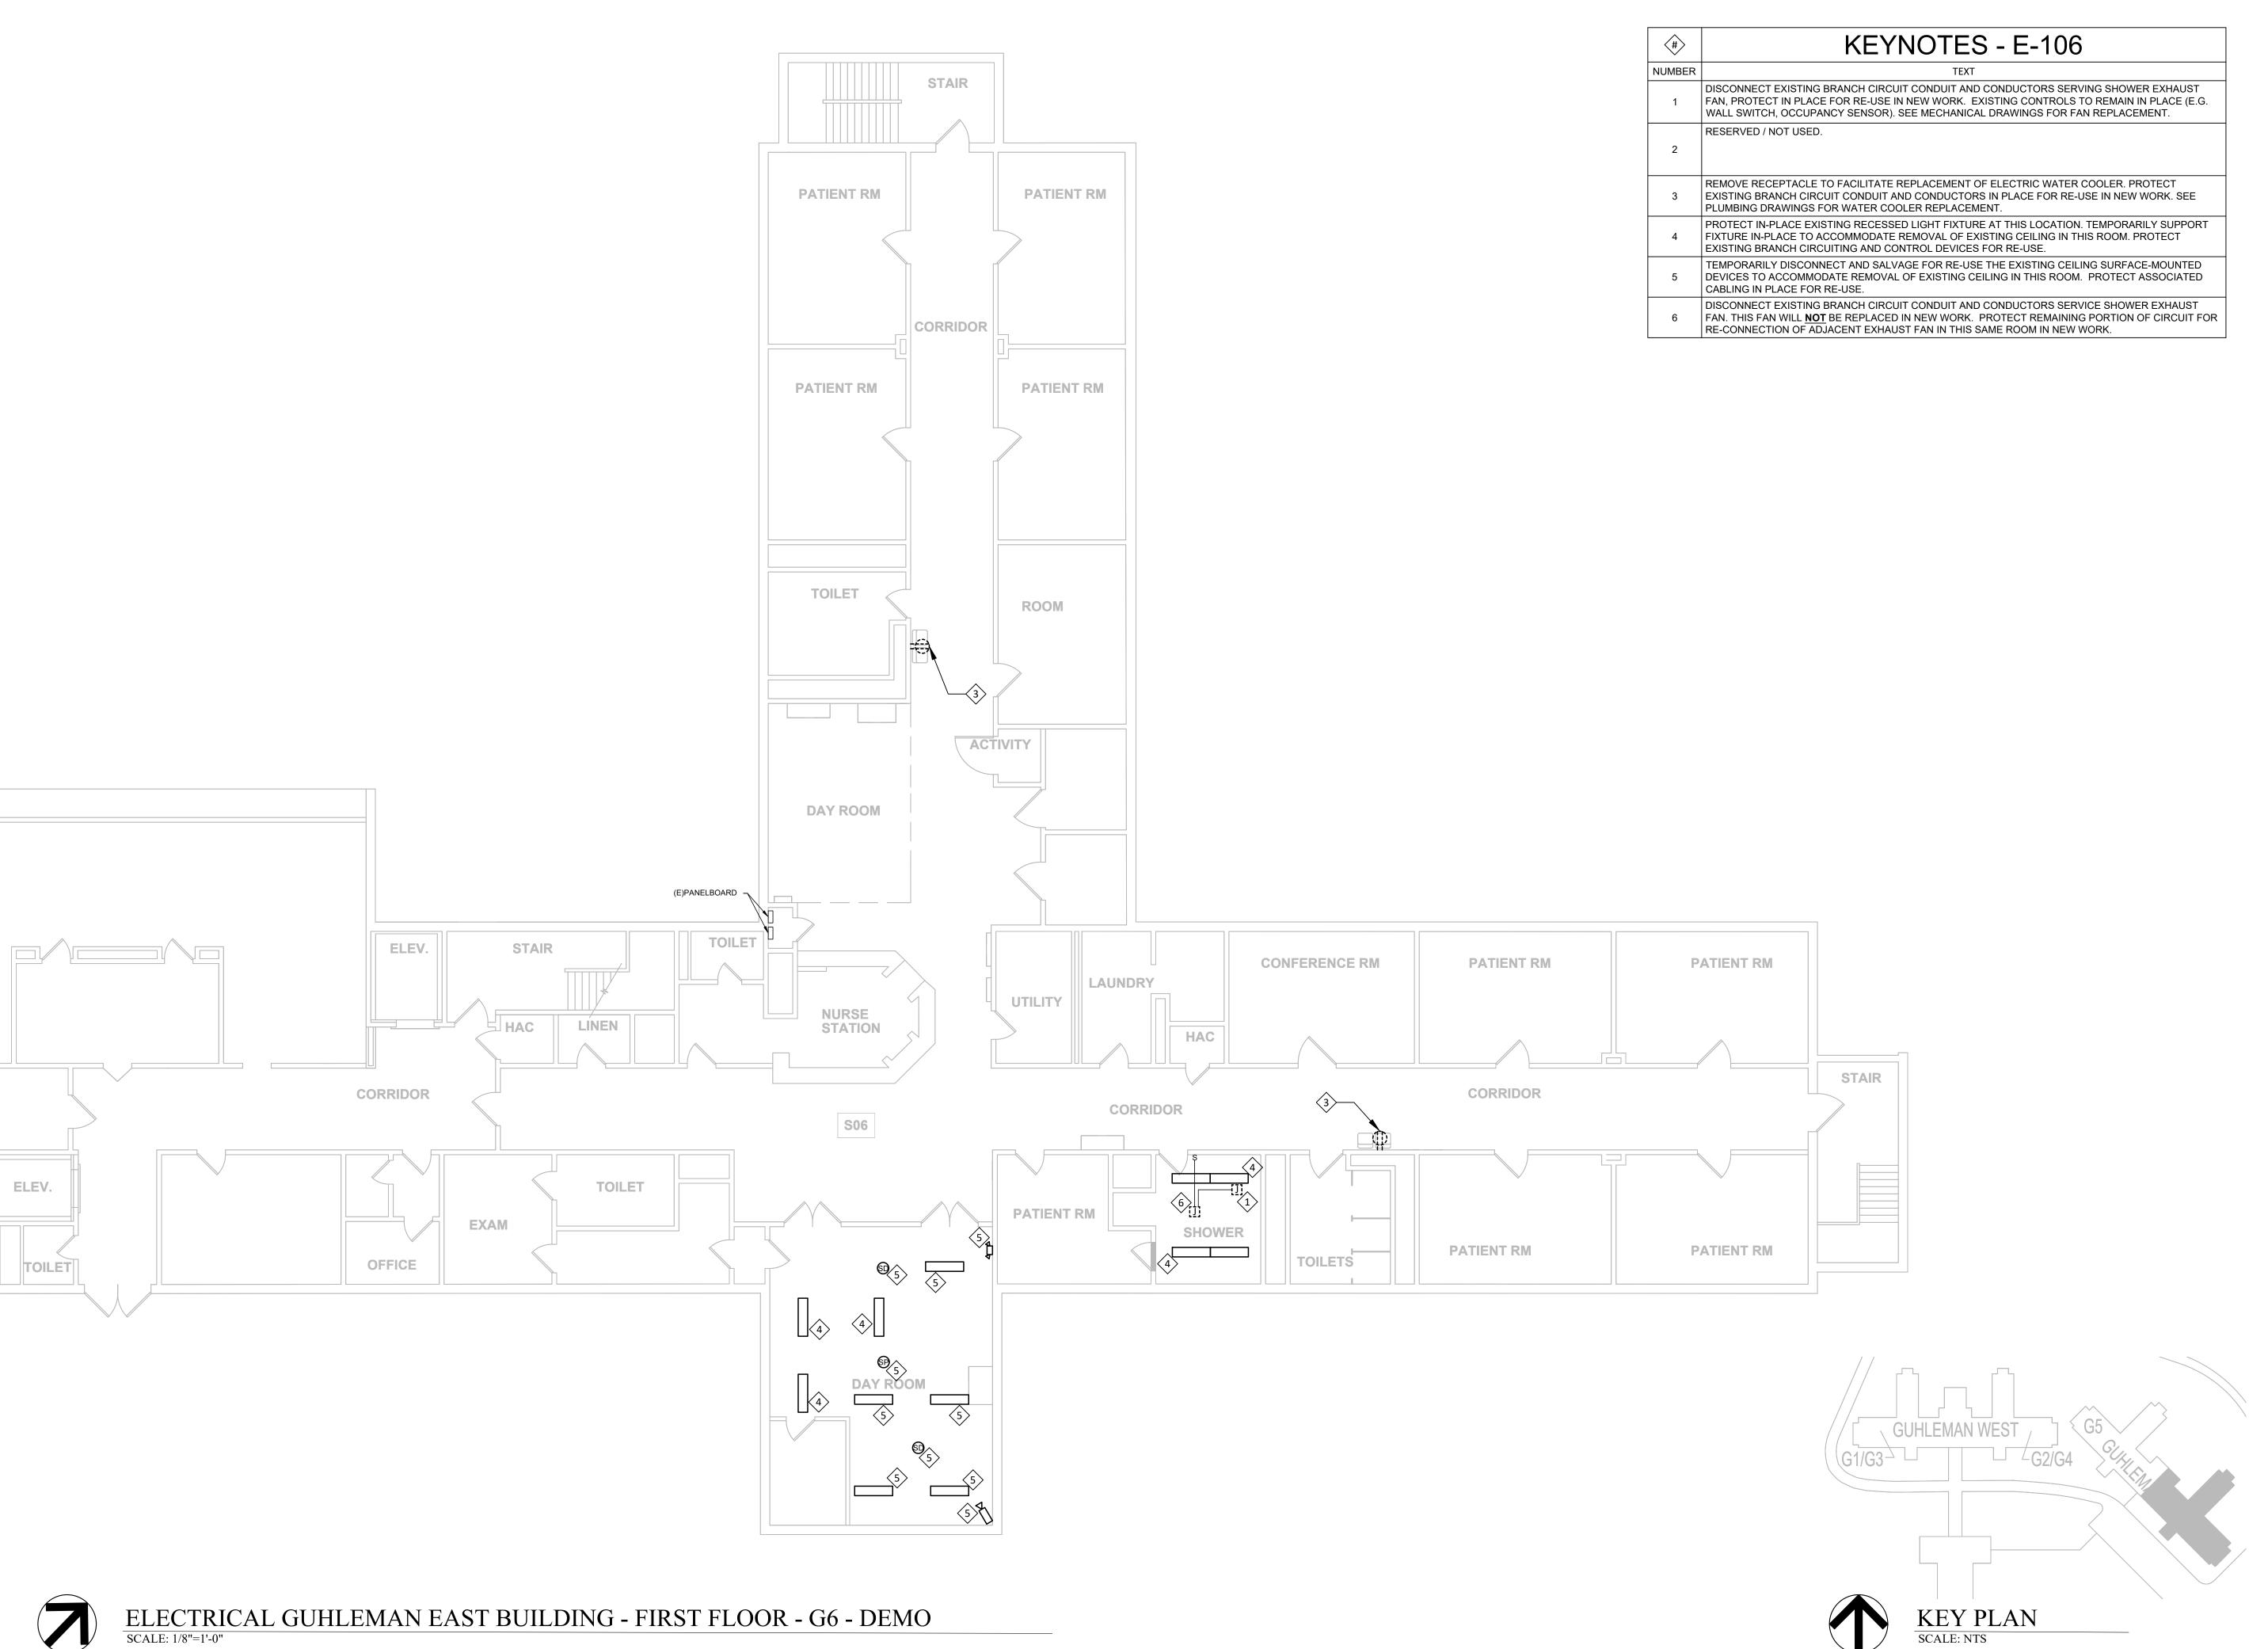
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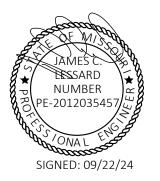
ELECTRICAL
GUHLEMAN EAST
BUILDING - FIRST
FLOOR - G5 - DEMO

E-105

SHEET 21 OF 66 SEPTEMBER 22, 2024

SHEET NUMBER:







STATE OF MISSOURI CERTIFICATE OF AUTHORITY #2018019473

ENGINEERS
O BOX 190, RANCHO CUCAMONGA, CA 91

ENGINEERS

ENGINEER - STRUCT

OFFICE OF ADMINISTRATION DIVISION OF FACILITIES MANAGEMENT, DESIGN AND CONSTRUCTION

ANTI-LIGATURE UPGRADES MULTIPLE ASSETS FULTON STATE HOSPITAL FULTON, MISSOURI

PROJECT # M2312-01 SITE # 7352 ASSET # 6517352026

REVISION:
DATE:
REVISION:
DATE:
REVISION:
DATE:
REVISION:
DATE:
USSUE DATE: 09/22/24

CAD DWG FILE:E-DP-01
DRAWN BY: RUM
CHECKED BY: JCL
DESIGNED BY: JCL


SHEET TITLE:
ELECTRICAL
GUHLEMAN EAST
BUILDING - FIRST
FLOOR - G6


SHEET NUMBER:

E-106


SHEET 22 OF 66 SEPTEMBER 22, 2024

#	KEYNOTES - E-107
NUMBER	TEXT
1	RESERVED / NOT USED.
2	REMOVE RECEPTACLE TO FACILITATE REPLACEMENT OF ELECTRIC WATER COOLER. PROTECT EXISTING BRANCH CIRCUIT CONDUIT AND CONDUCTORS IN PLACE FOR RE-USE IN NEW WORK. SEE PLUMBING DRAWINGS FOR WATER COOLER REPLACEMENT.

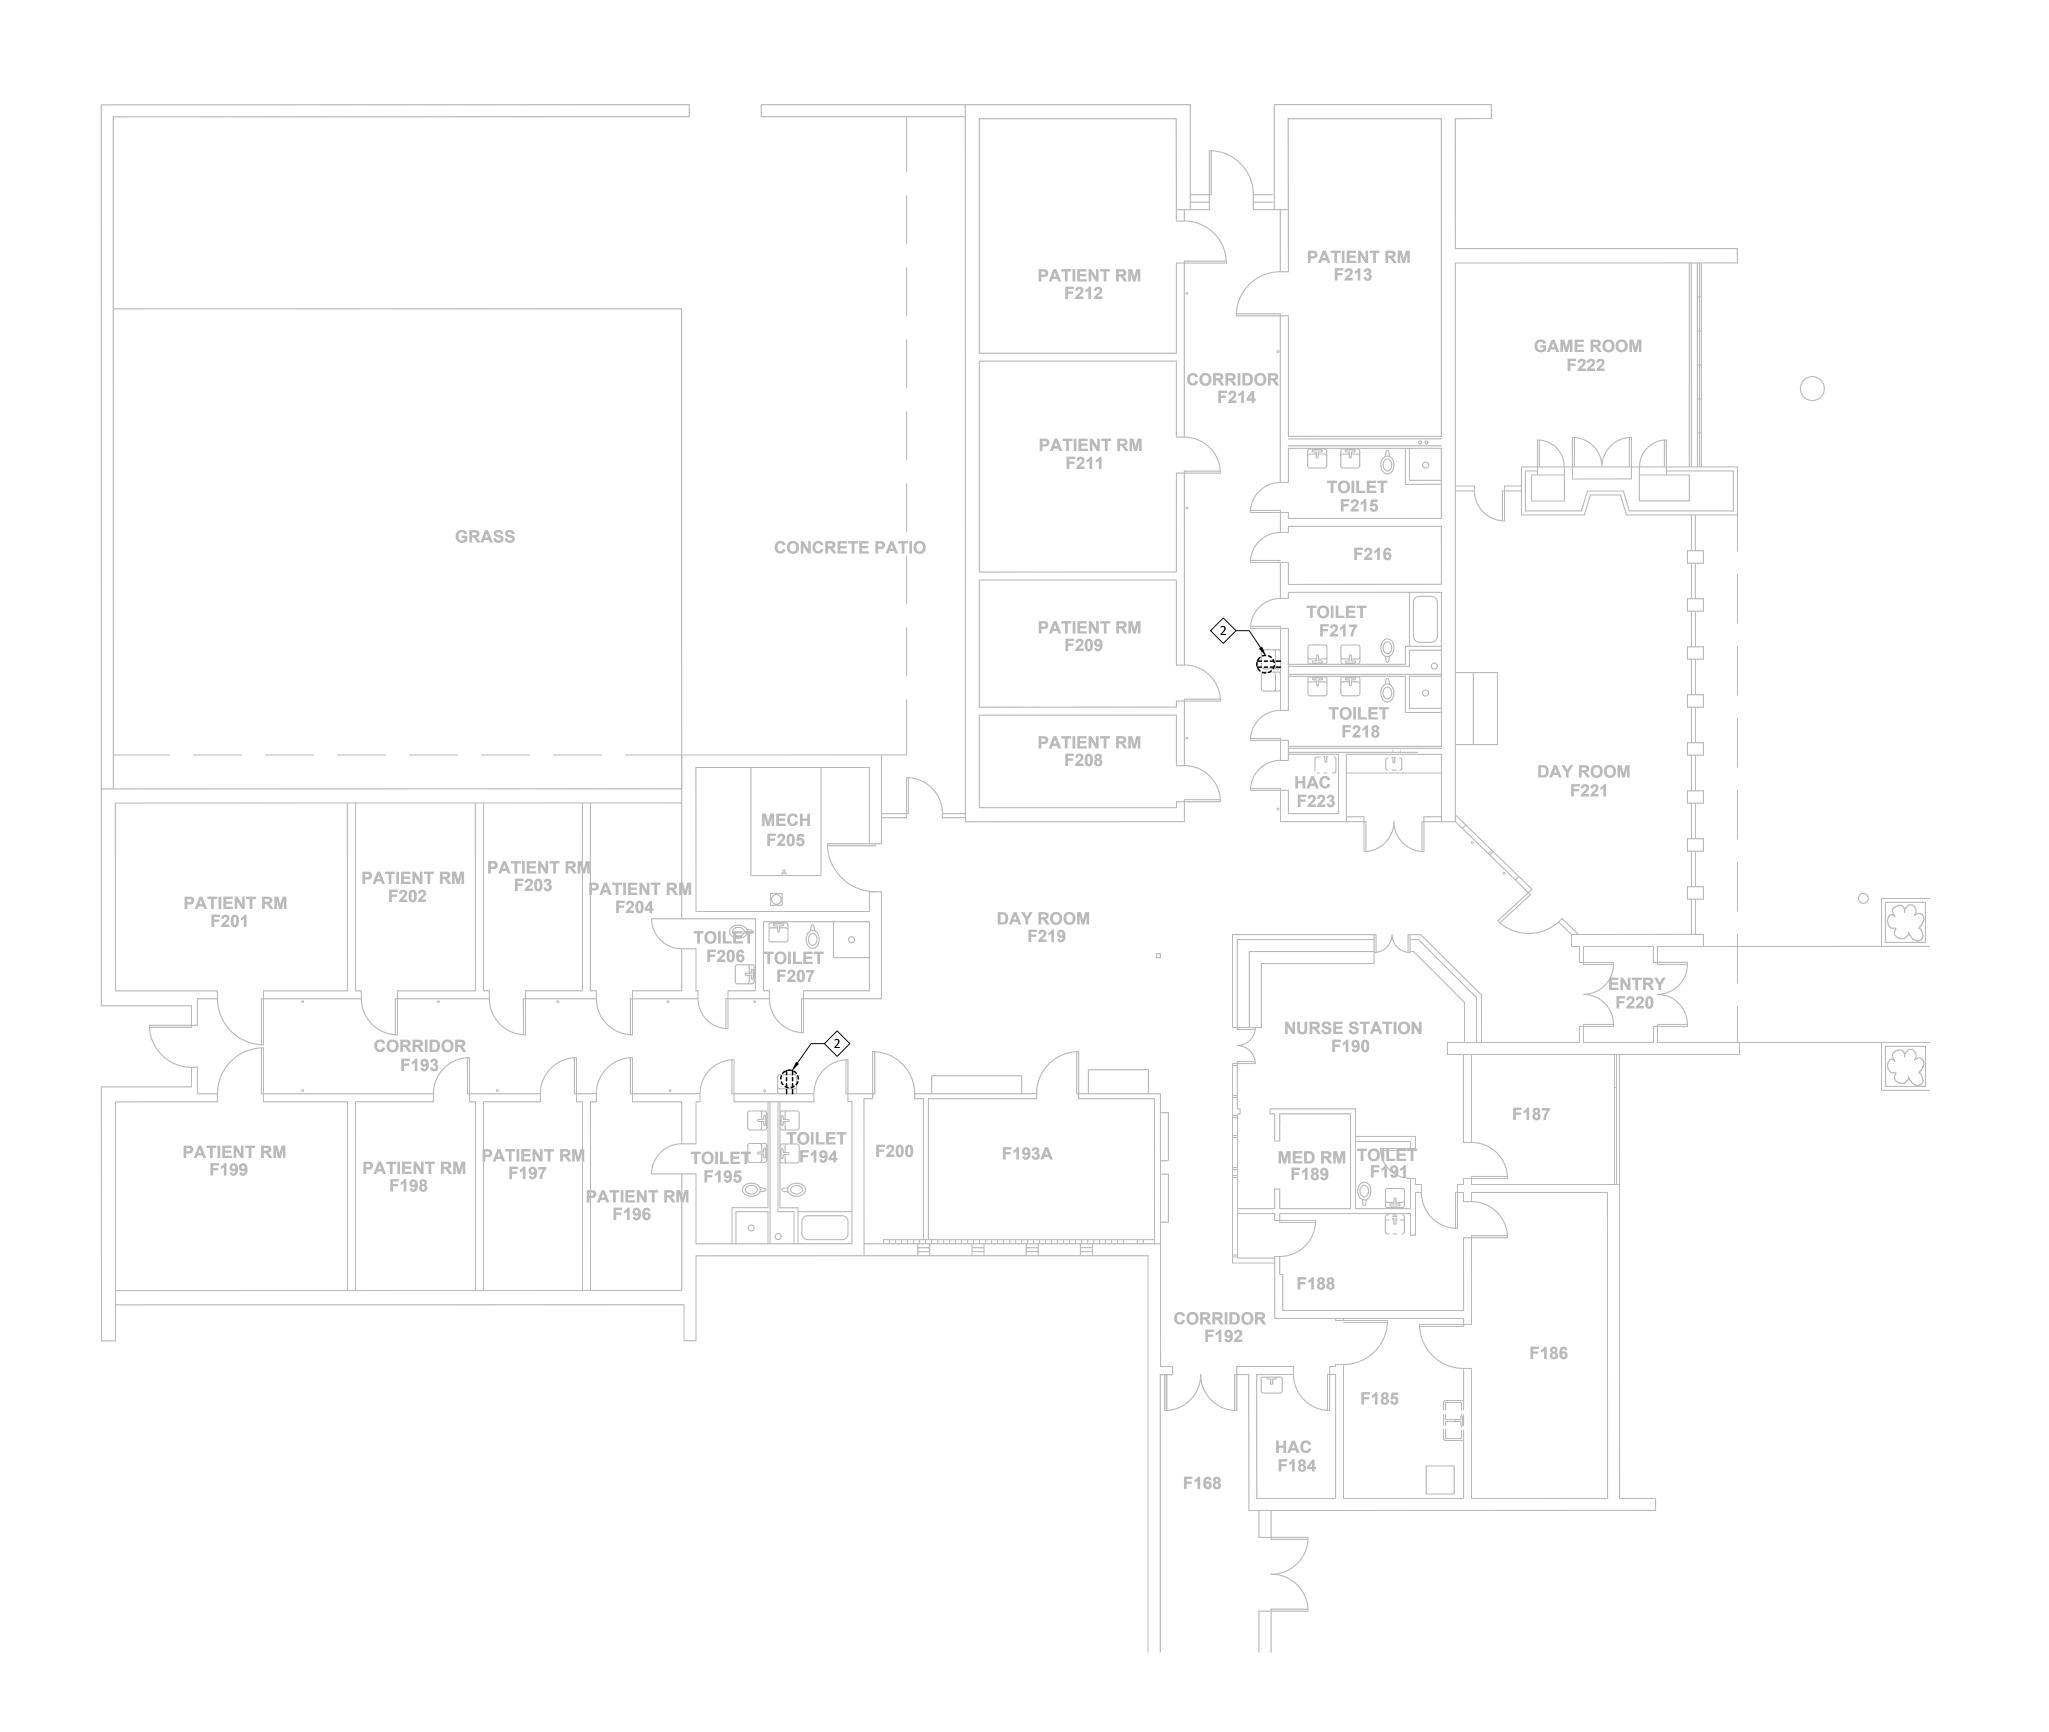

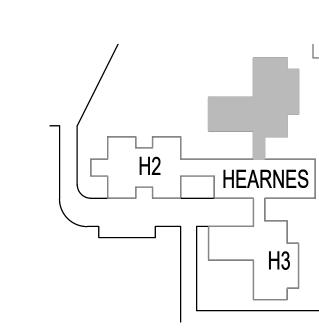



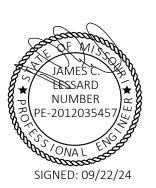



STATE OF MISSOURI CERTIFICATE OF AUTHORITY #2018019473

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ANTI-LIGATURE UPGRADES MULTIPLE ASSETS FULTON STATE HOSPITAL FULTON, MISSOURI

PROJECT # M2312-01 SITE # 7352 ASSET # 6517352031

REVISION:
DATE:
REVISION:
DATE:
REVISION:
DATE:
REVISION:
DATE:
ISSUE DATE: 09/22/24

CAD DWG FILE:E-DP-01
DRAWN BY: RUM
CHECKED BY: JCL
DESIGNED BY: JCL


SHEET TITLE:
ELECTRICAL
HEARNES BUILDING H1 - DEMO


SHEET NUMBER:

E-107

SHEET 23 OF 66 SEPTEMBER 22, 2024



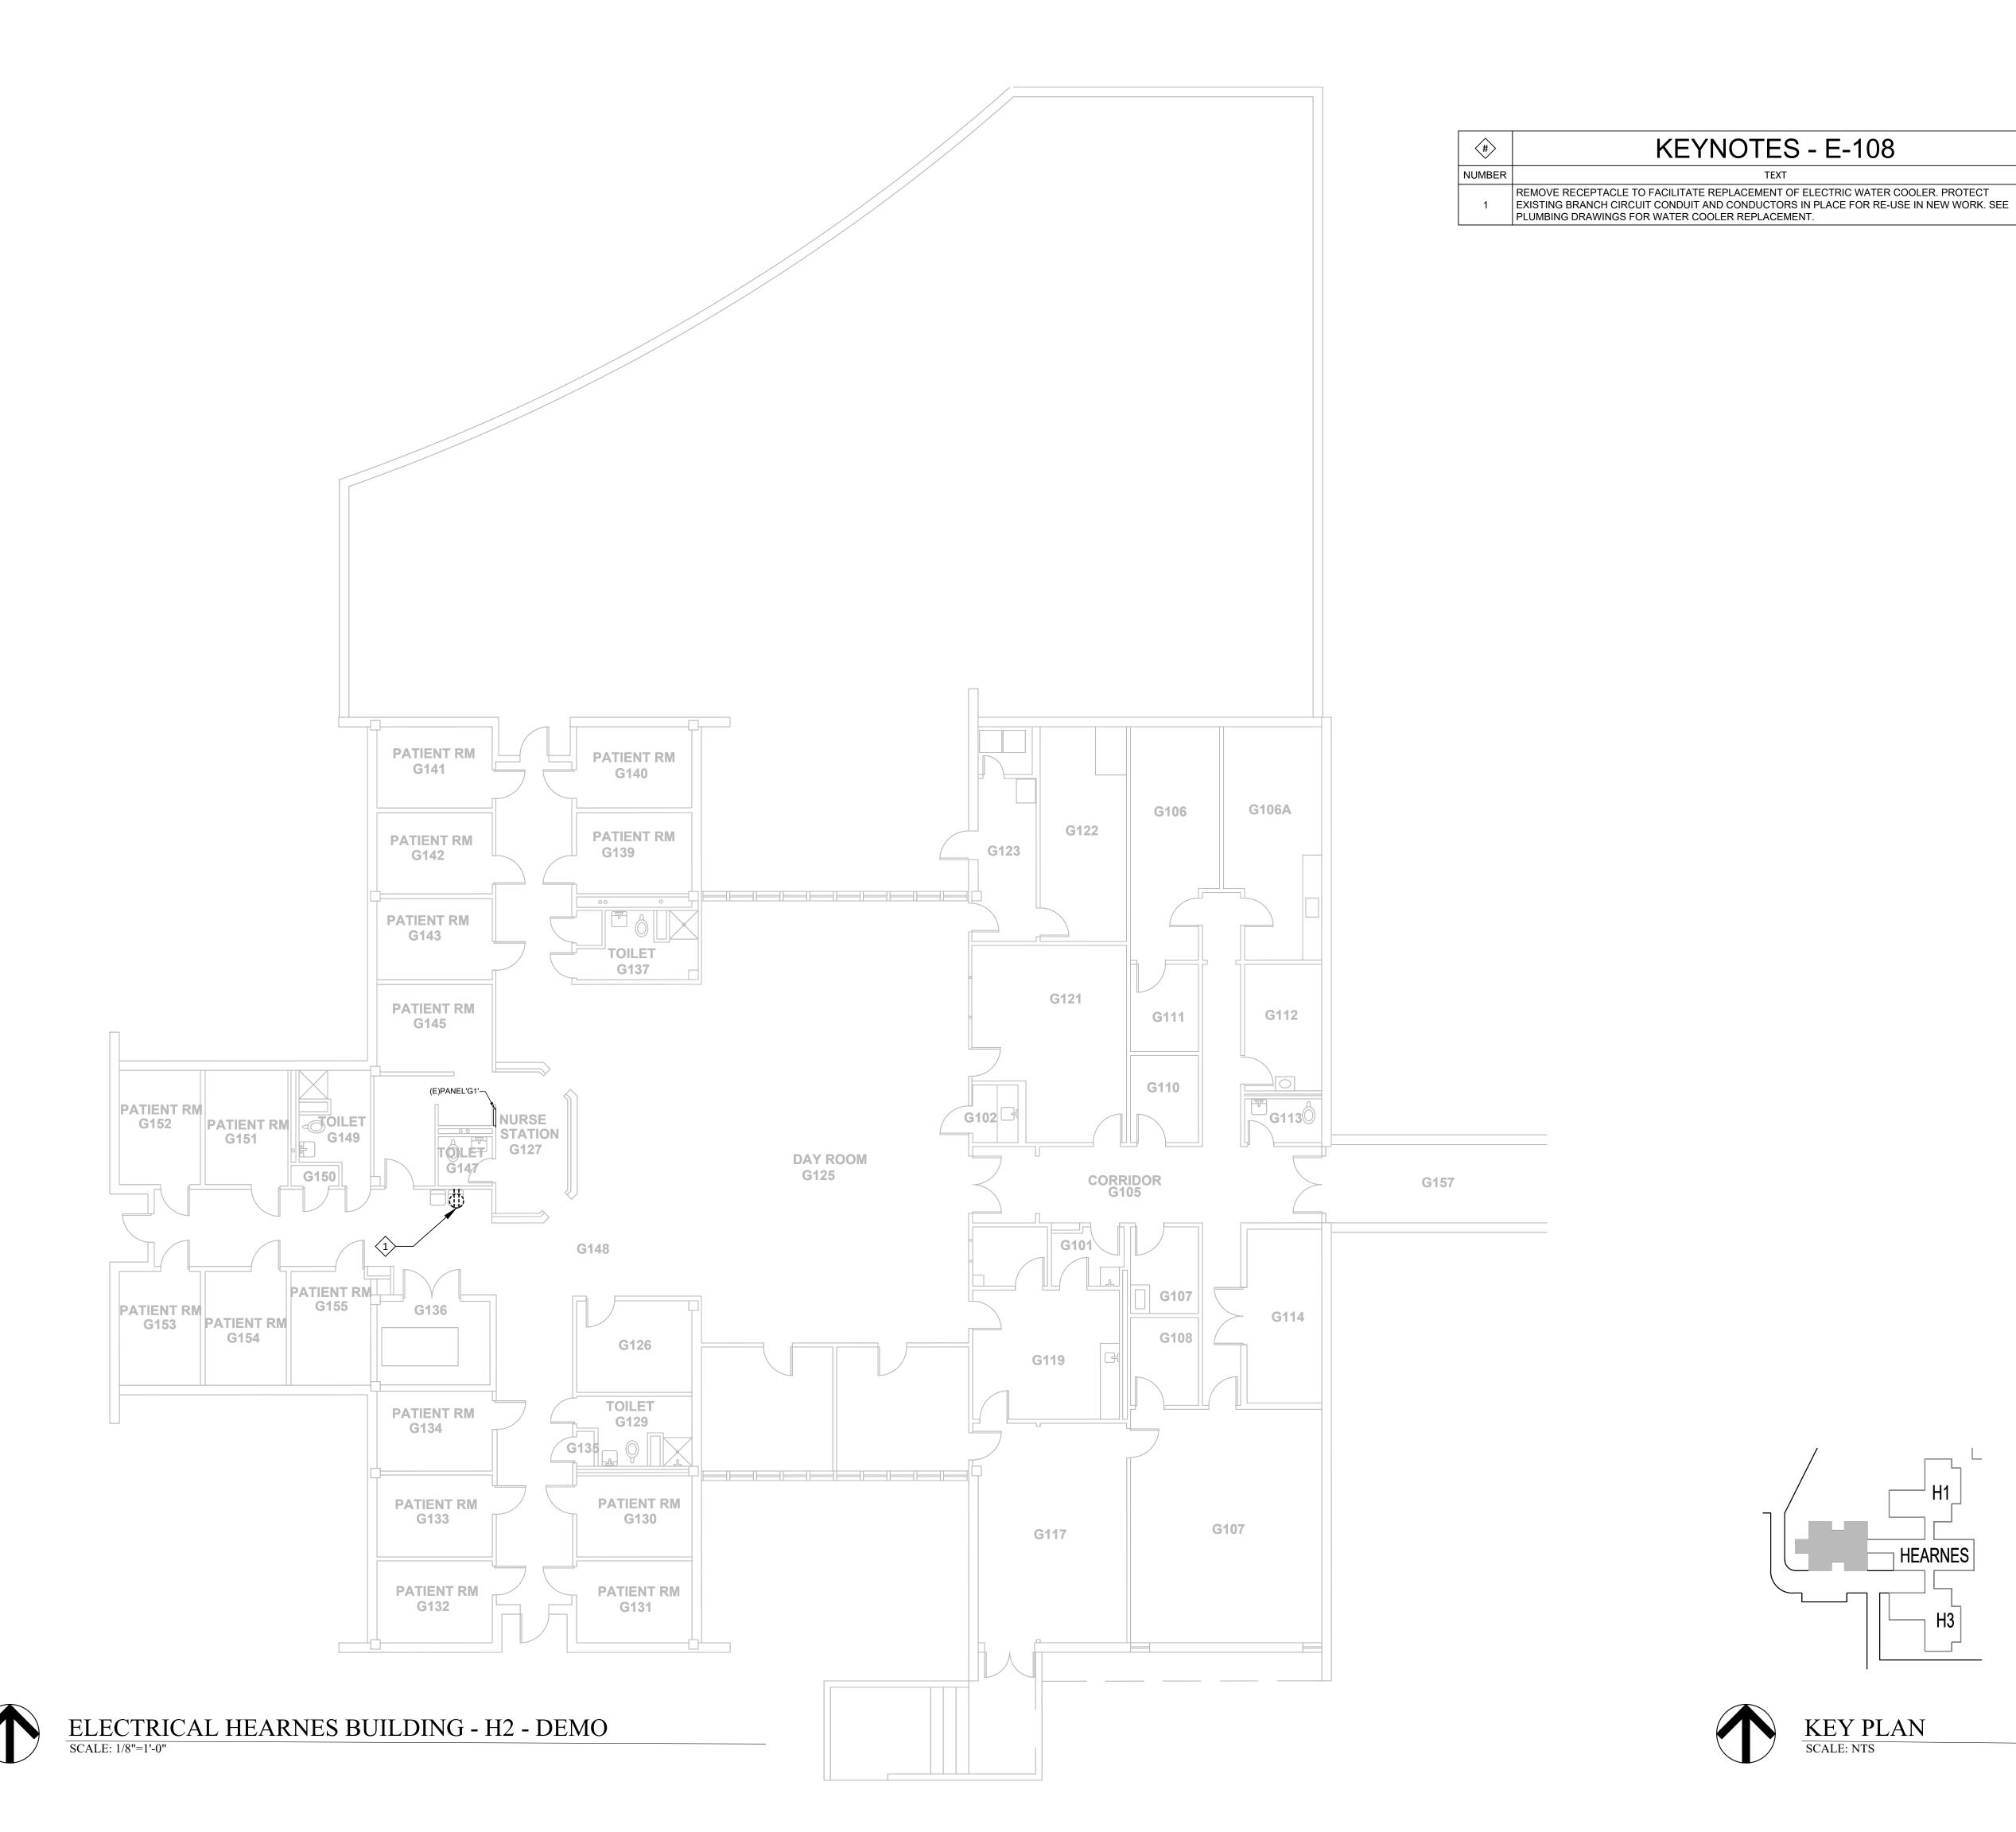

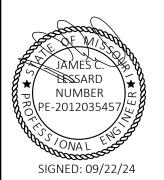



STATE OF MISSOURI CERTIFICATE OF AUTHORITY #2018019473

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ANTI-LIGATURE UPGRADES MULTIPLE ASSETS FULTON STATE HOSPITAL FULTON, MISSOURI

PROJECT # M2312-01 SITE # 7352 ASSET # 6517352031

REVISION:
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REVISION:
DATE:
REVISION:
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REVISION:
DATE:
ISSUE DATE: 09/22/24


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DRAWN BY: RUM
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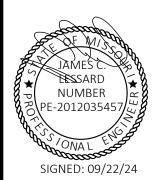
SHEET TITLE:
ELECTRICAL
HEARNES BUILDING H2 - DEMO

SHEET NUMBER:

E-108

SHEET 24 OF 66 SEPTEMBER 22, 2024



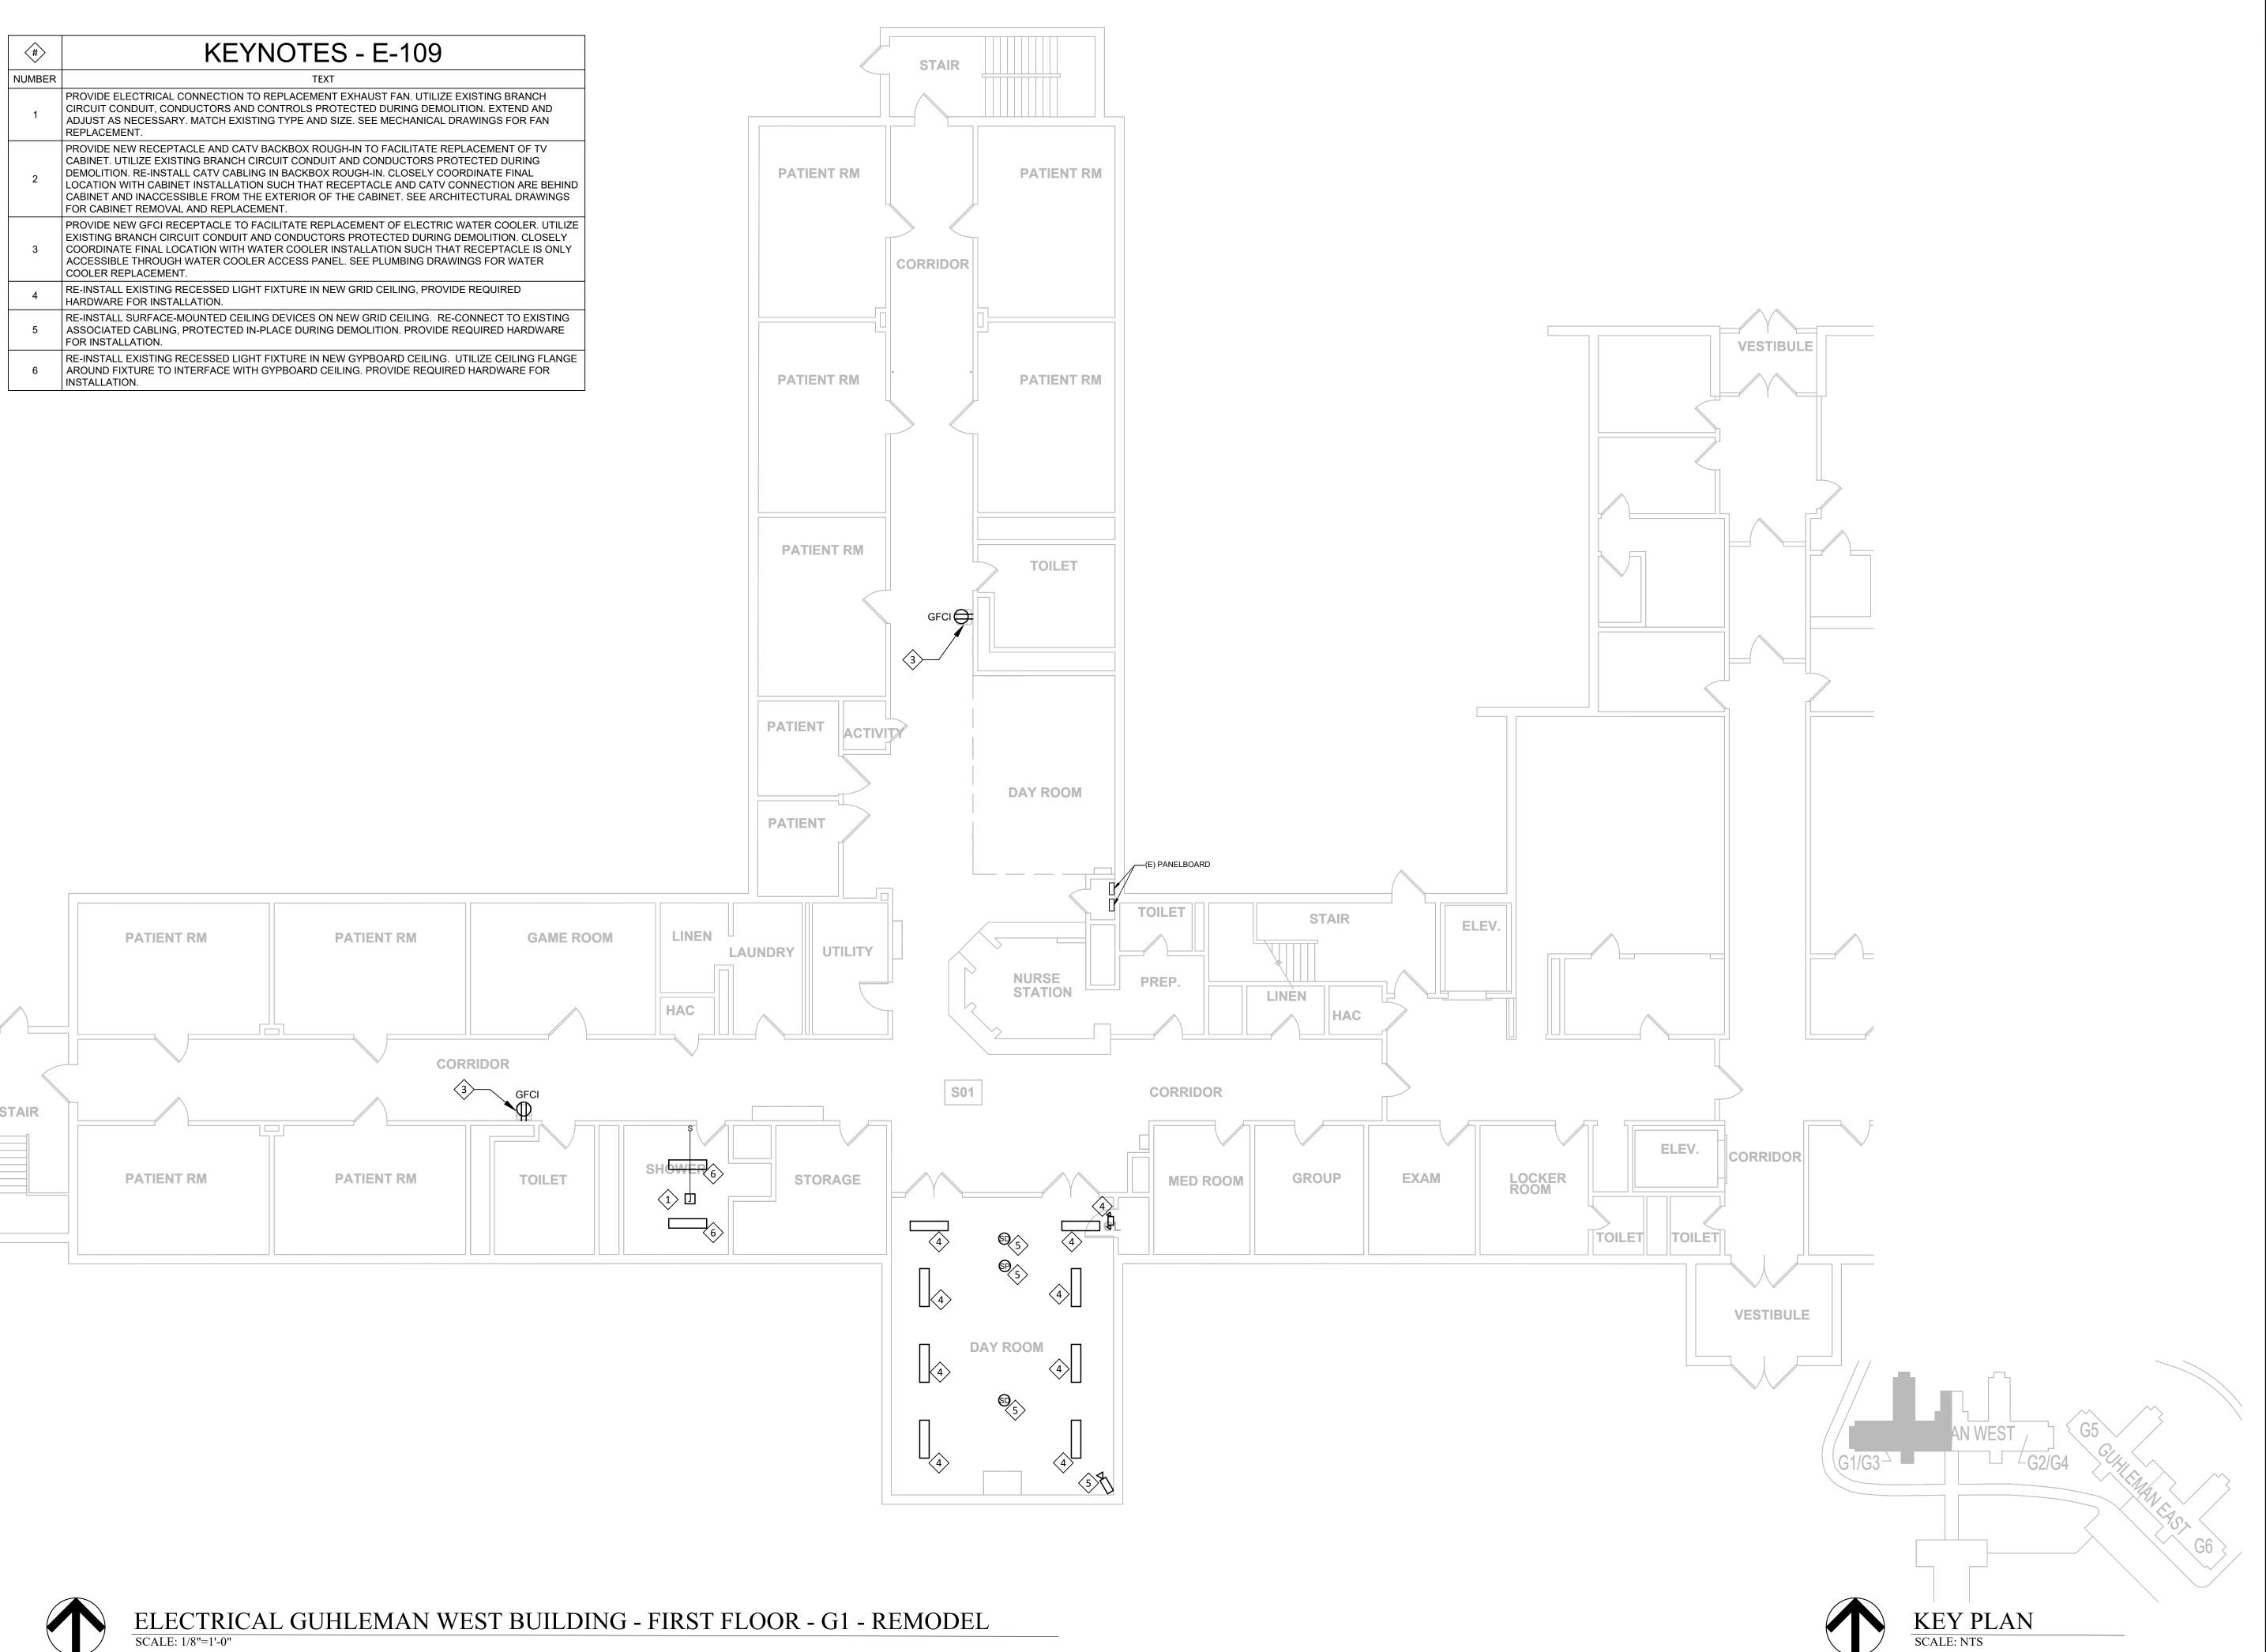



STATE OF MISSOURI CERTIFICATE OF AUTHORITY #2018019473

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ANTI-LIGATURE UPGRADES MULTIPLE ASSETS FULTON STATE HOSPITAL FULTON, MISSOURI

PROJECT # M2312-01 SITE # 7352 ASSET # 6517352027


REVISION:
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REVISION:
DATE:
ISSUE DATE: 09/22/24

CAD DWG FILE:E-FP-01
DRAWN BY: RUM
CHECKED BY: JCL
DESIGNED BY: JCL

SHEET TITLE:
ELECTRICAL
GUHLEMAN WEST
BUILDING - FIRST
FLOOR - G1 - REMODEL
SHEET NUMBER:


E-109

SHEET 25 OF 66 SEPTEMBER 22, 2024

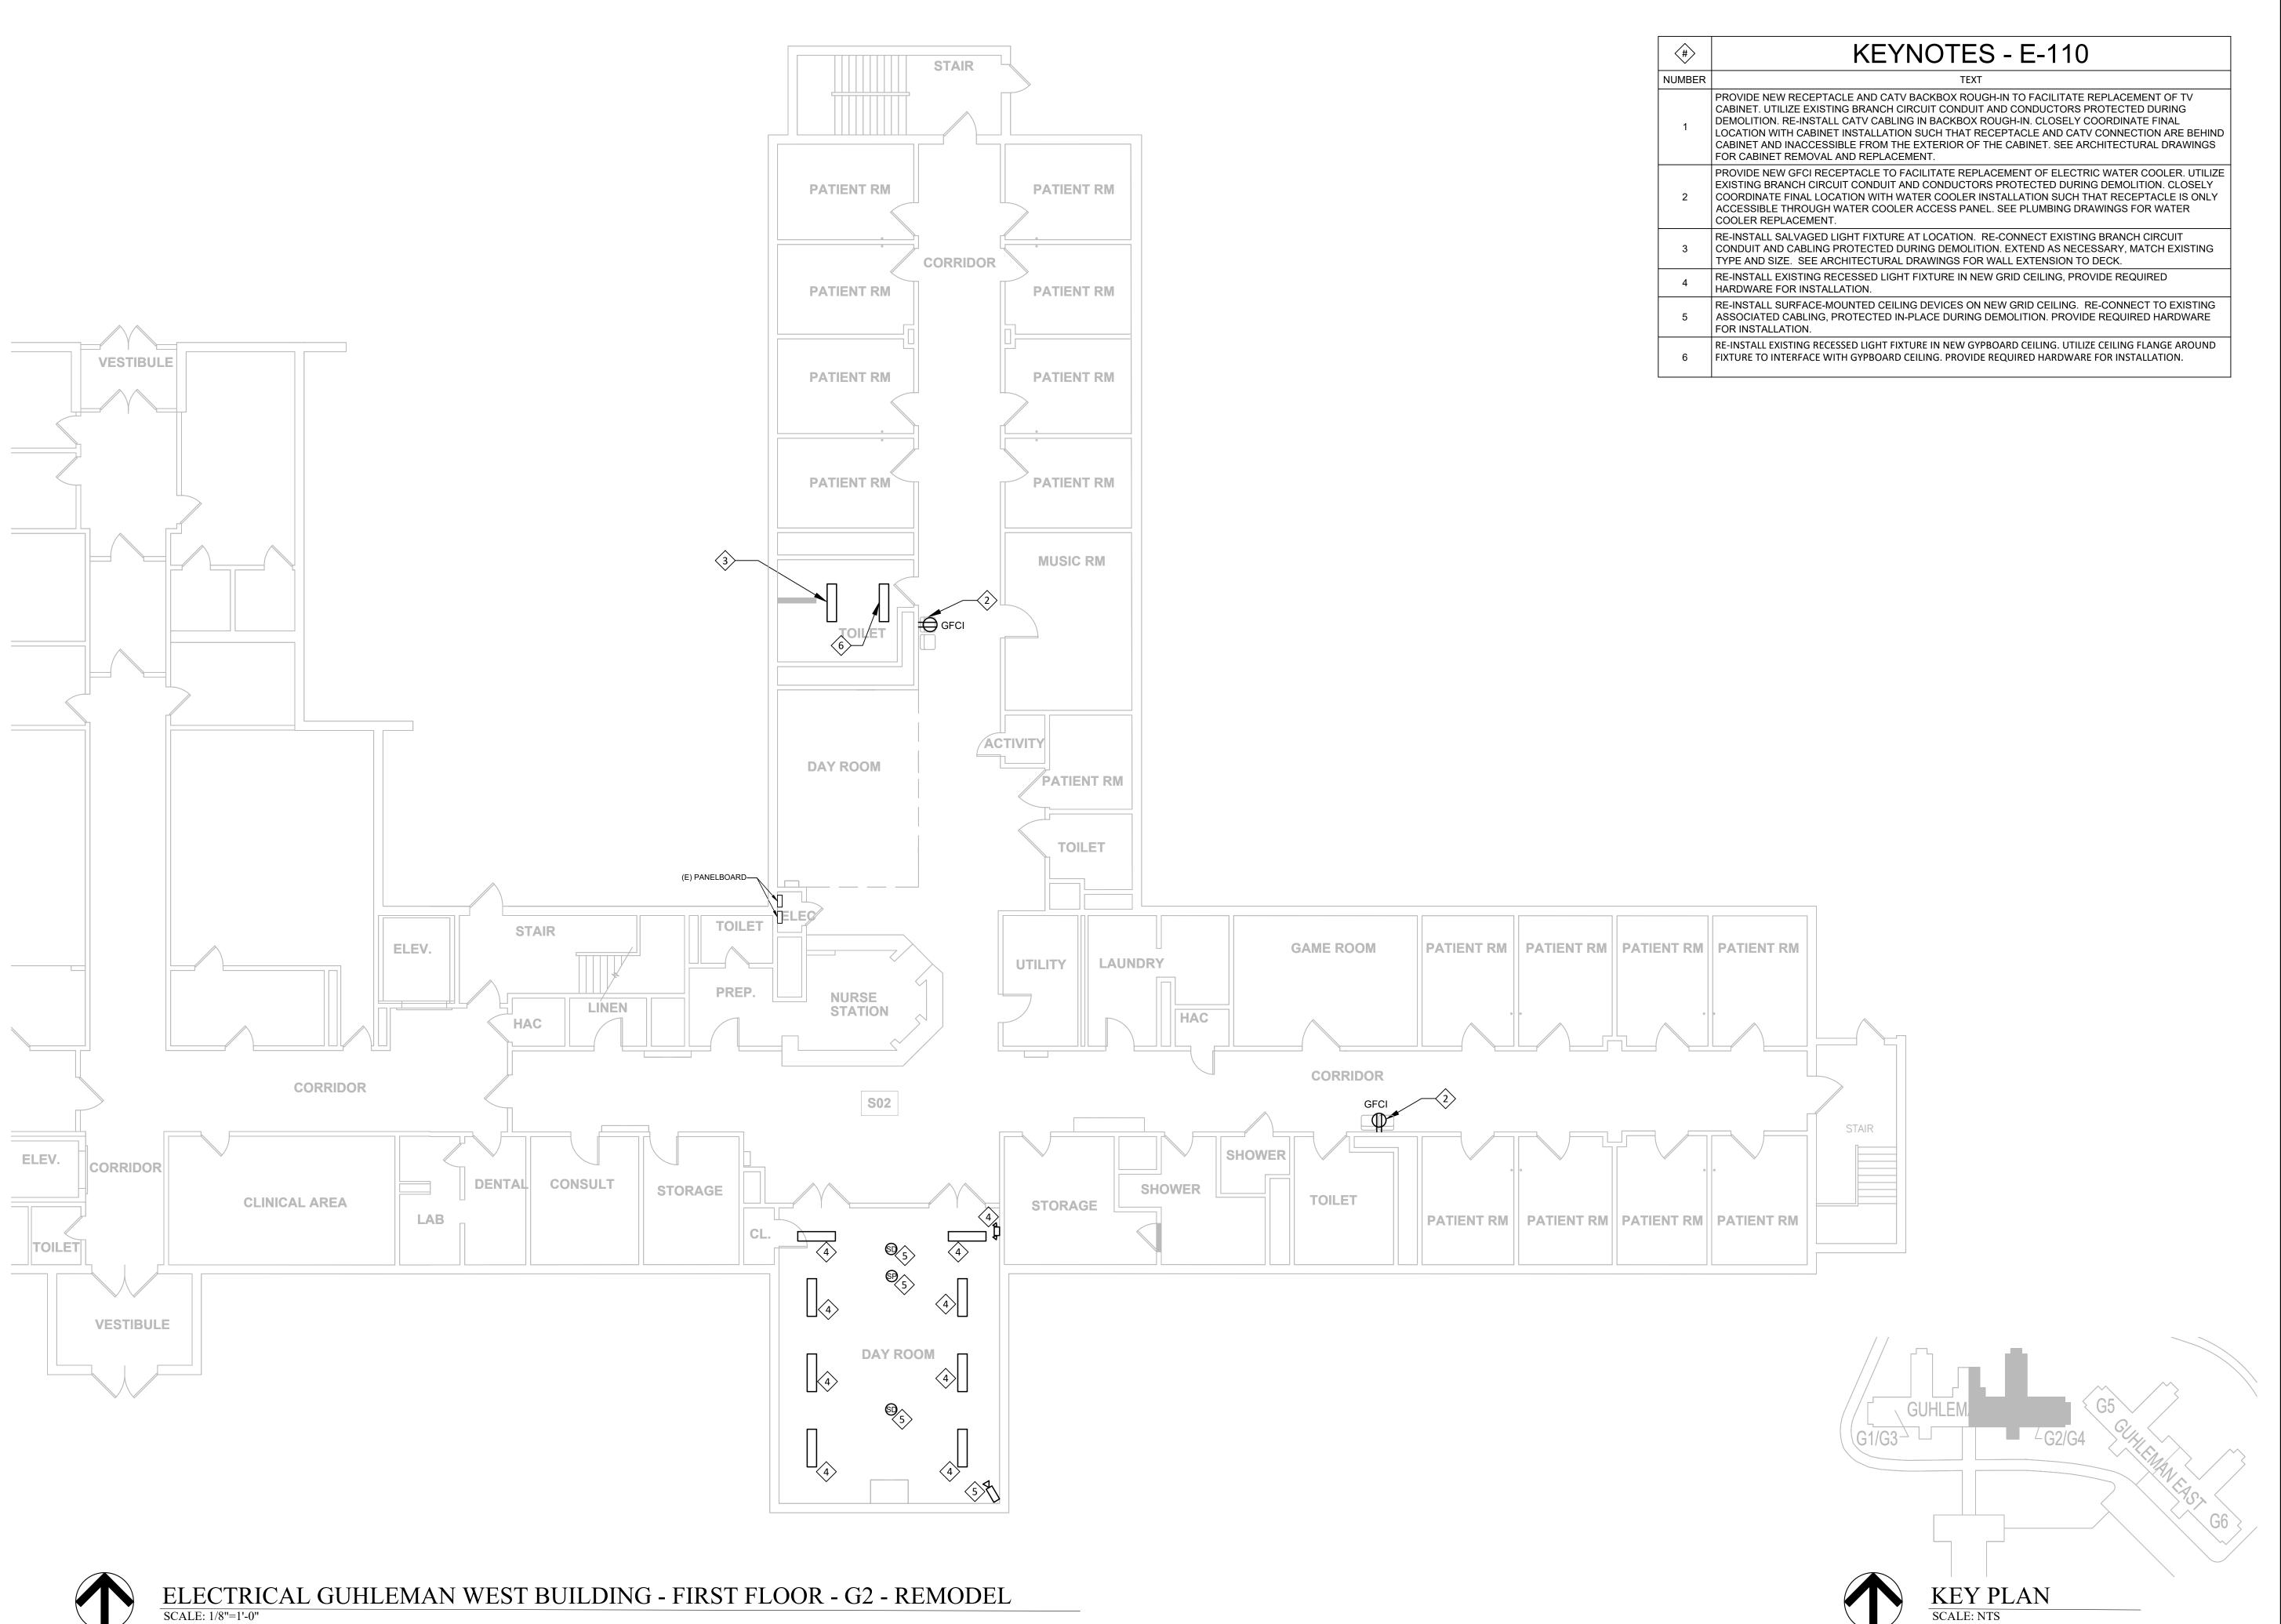

SCALE: 1/8"=1'-0"

STATE OF MISSOURI MICHAEL L PARSON, **GOVERNOR**

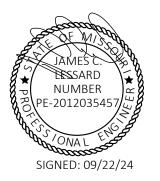



STATE OF MISSOURI CERTIFICATE OF AUTHORITY #2018019473

OFFICE OF ADMINISTRATION DIVISION OF FACILITIES MANAGEMENT, DESIGN AND CONSTRUCTION

ANTI-LIGATURE UPGRADES MULTIPLE ASSETS FULTON STATE HOSPITAL FULTON, MISSOURI

PROJECT # M2312-01 7352 ASSET # 6517352027

REVISION:
DATE:
REVISION:
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REVISION:
DATE:
ISSUE DATE: 09/22/24


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DRAWN BY: RUM
CHECKED BY: JCL DESIGNED BY: JC


SHEET TITLE:

ELECTRICAL **GUHLEMAN WEST BUILDING - FIRST** FLOOR - G2 - REMODEL

SHEET 26 OF 66 SEPTEMBER 22, 2024

SHEET NUMBER:

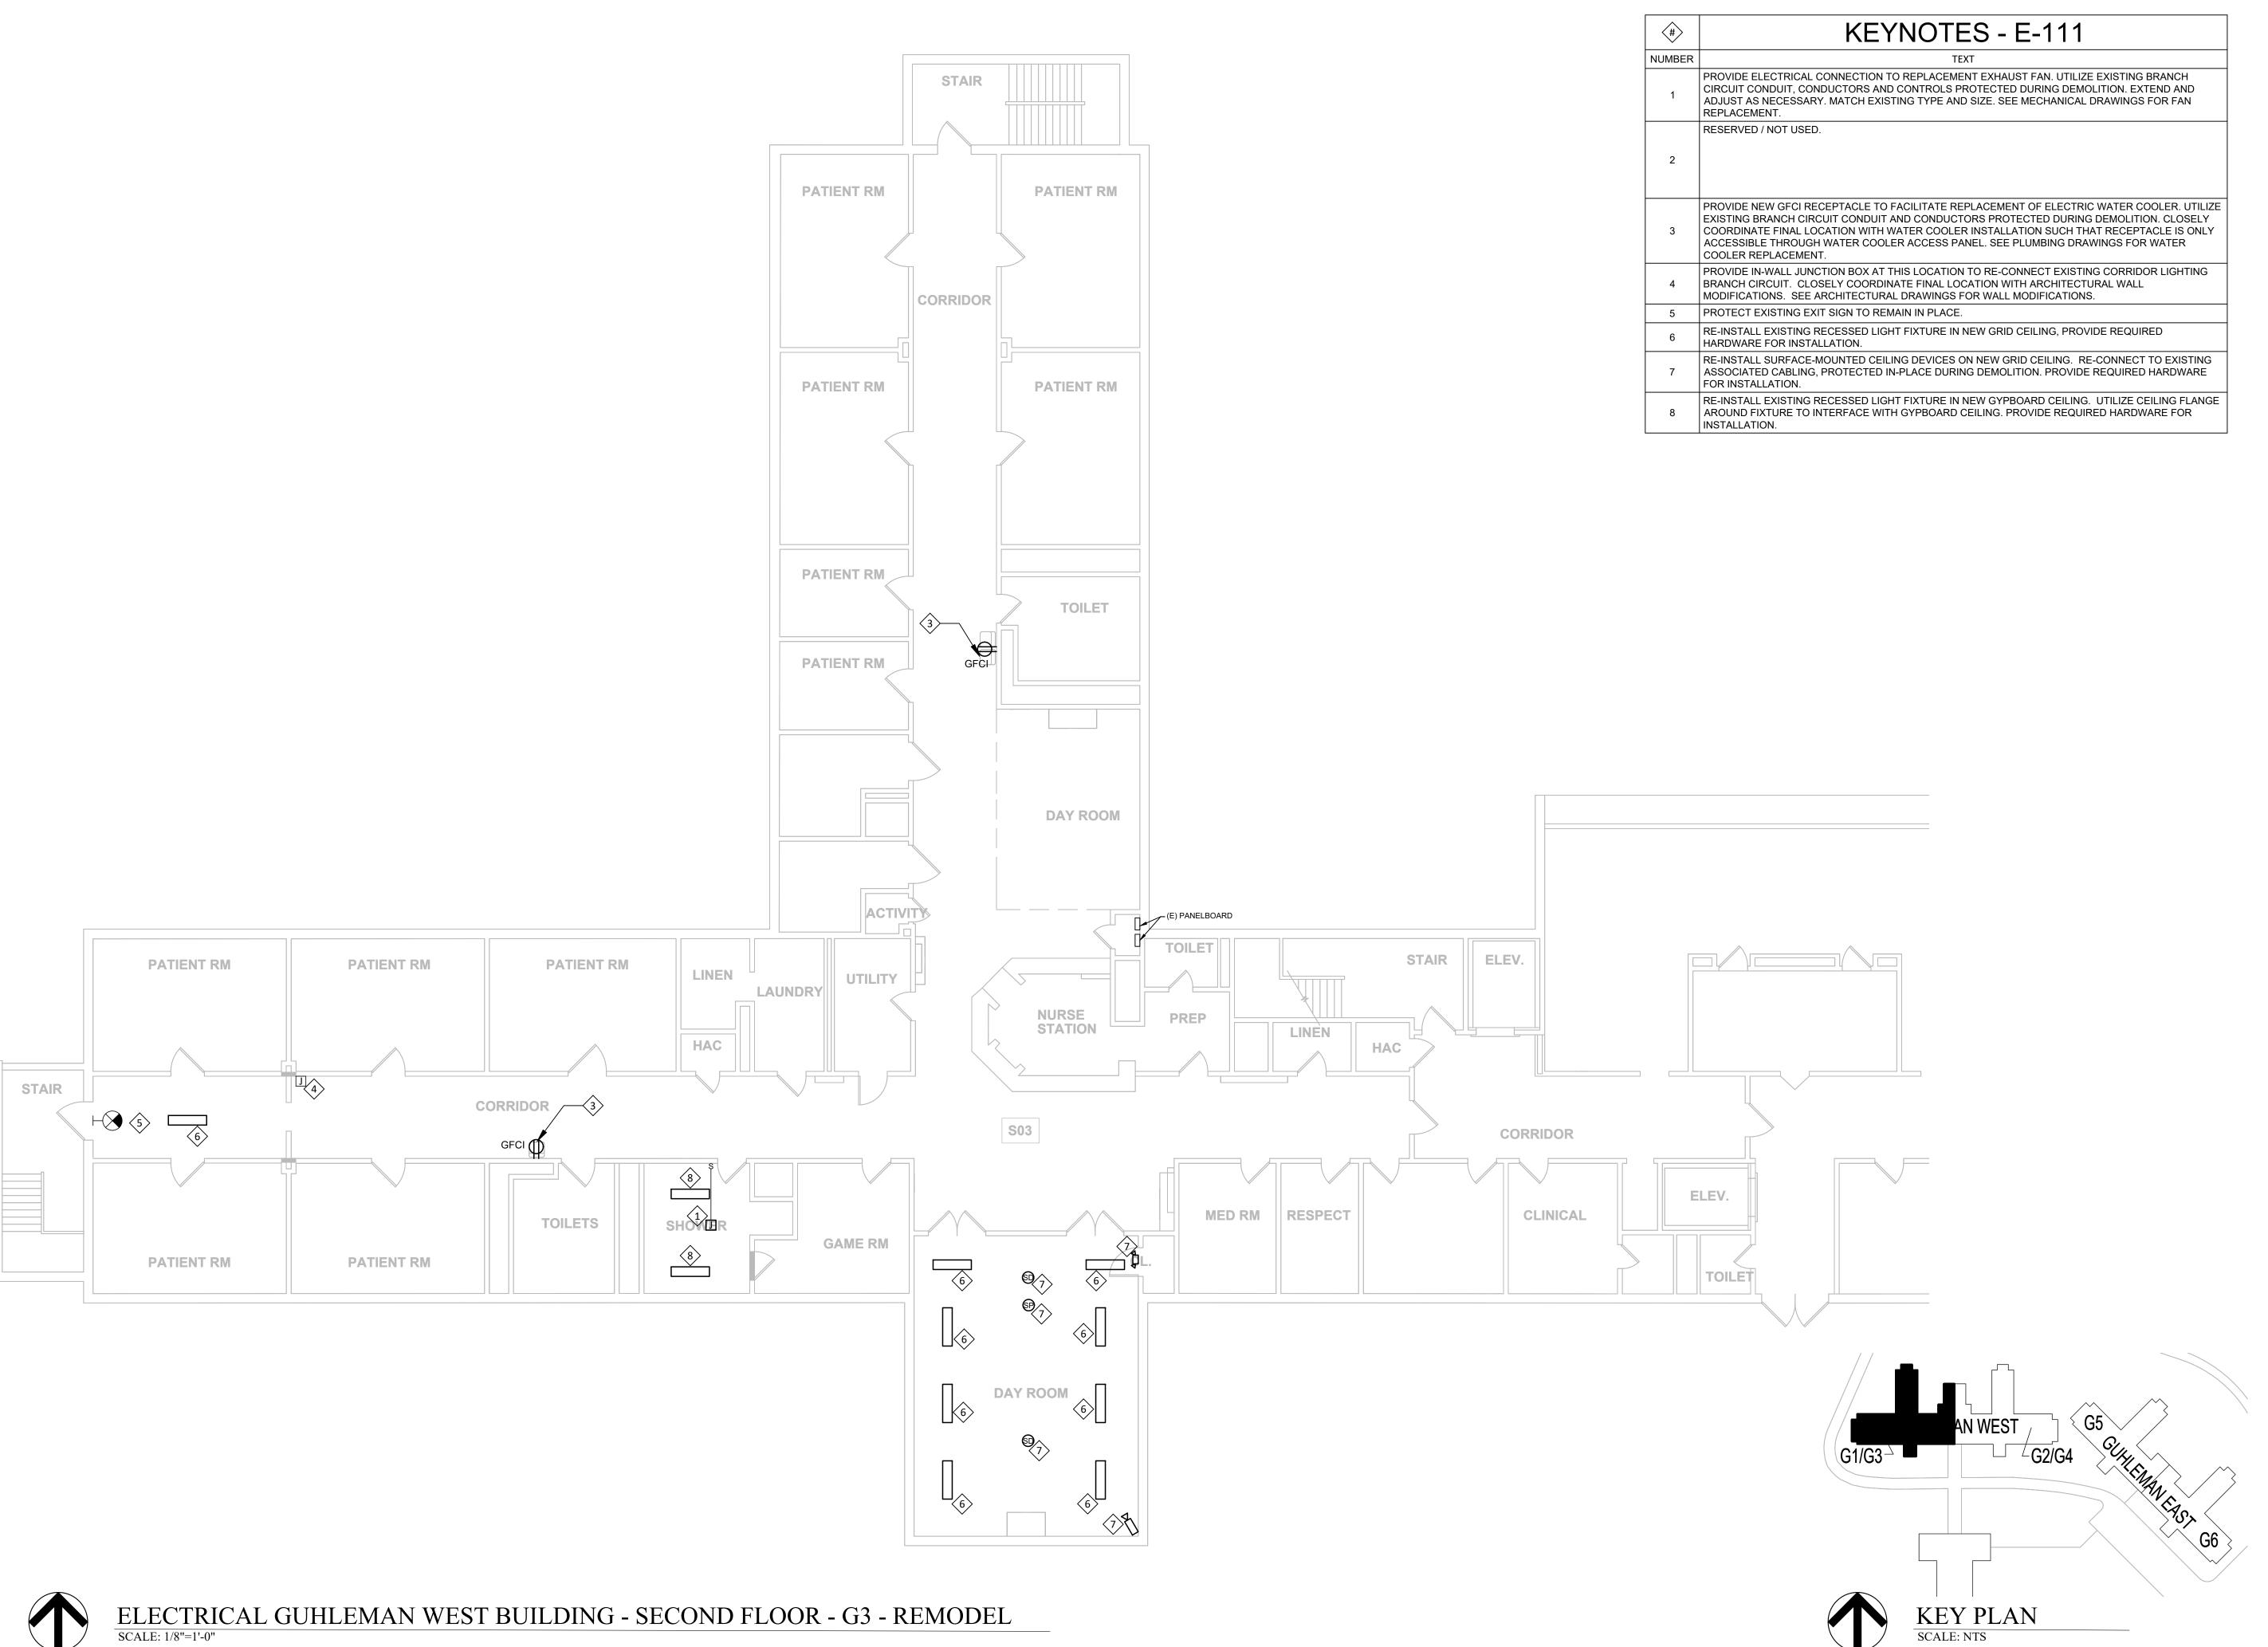

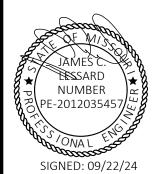



STATE OF MISSOURI CERTIFICATE OF AUTHORITY #2018019473

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OFFICE OF ADMINISTRATION DIVISION OF FACILITIES MANAGEMENT, DESIGN AND CONSTRUCTION

ANTI-LIGATURE UPGRADES MULTIPLE ASSETS FULTON STATE HOSPITAL FULTON, MISSOURI

PROJECT # M2312-01 SITE # 7352 ASSET # 6517352027

REVISION:
DATE:
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DATE:
ISSUE DATE: 09/22/24


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DRAWN BY: RUM
CHECKED BY: JCL
DESIGNED BY: JCL


SHEET TITLE:
ELECTRICAL
GUHLEMAN WEST
BUILDING - SECOND
FLOOR - G3 - REMODEL

SHEET NUMBER:



SEPTEMBER 22, 2024

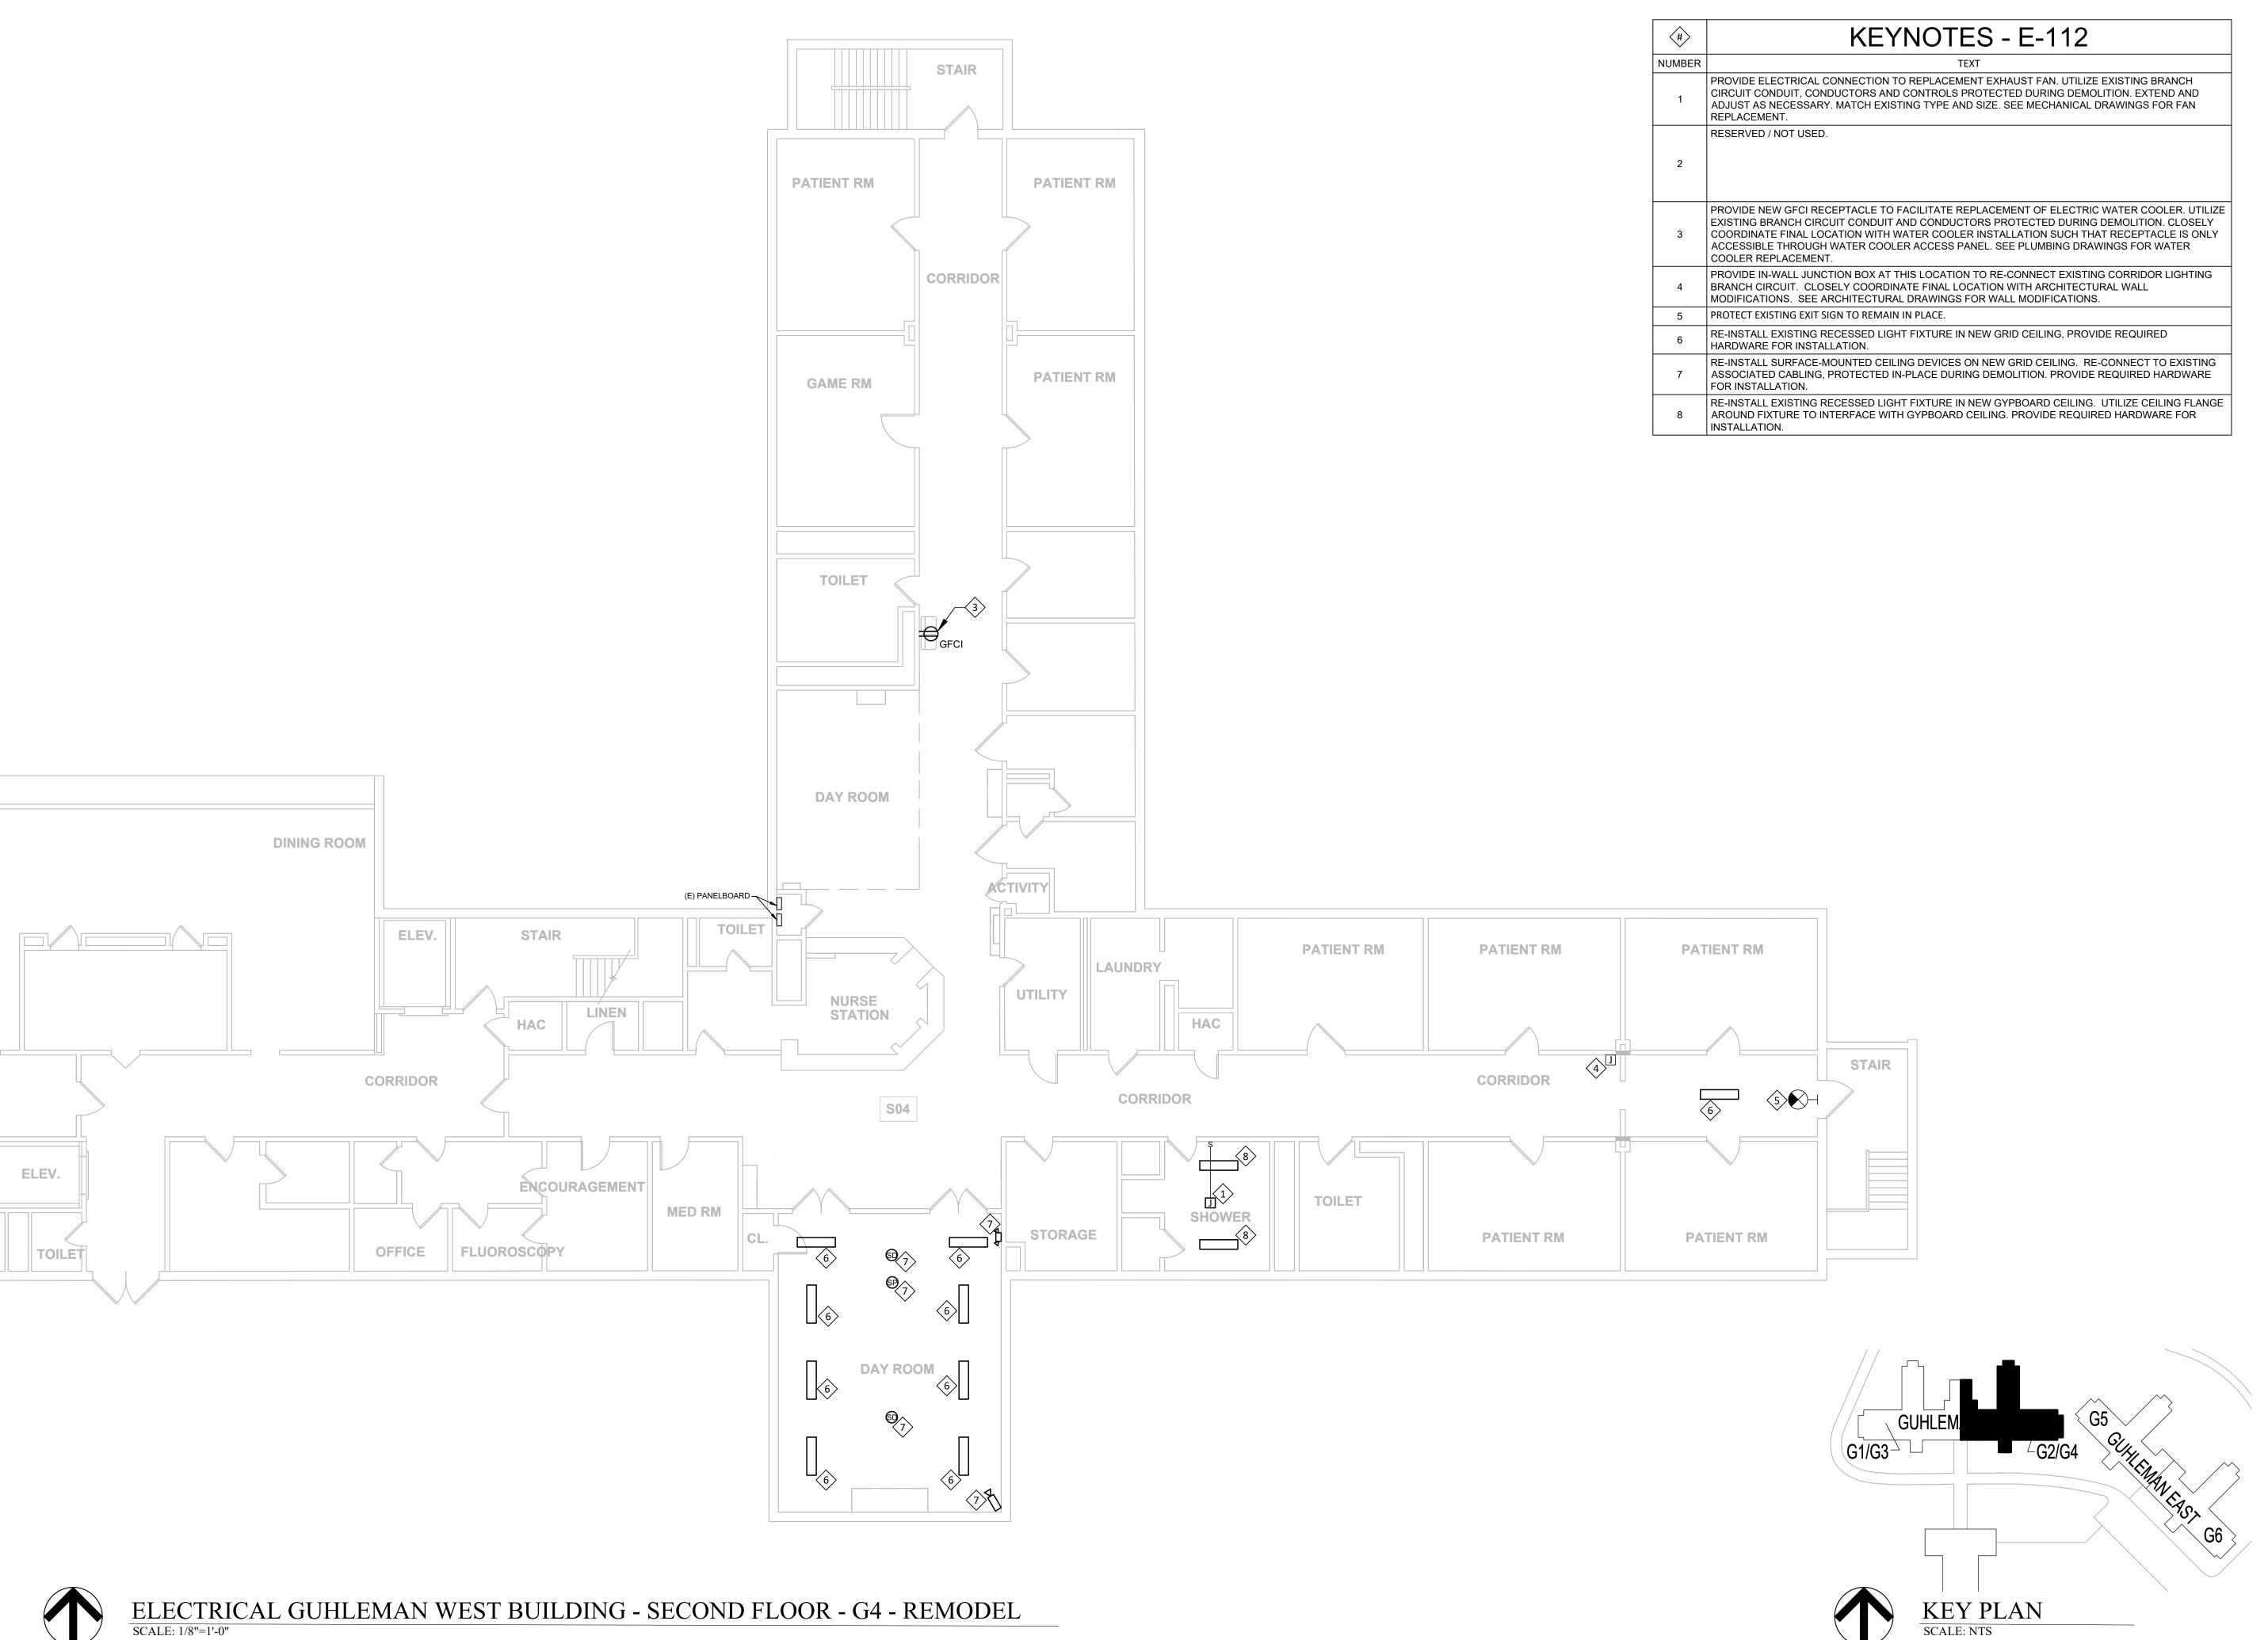

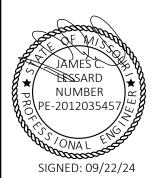



STATE OF MISSOURI CERTIFICATE OF AUTHORITY #2018019473

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OFFICE OF ADMINISTRATION DIVISION OF FACILITIES MANAGEMENT, DESIGN AND CONSTRUCTION

ANTI-LIGATURE UPGRADES MULTIPLE ASSETS FULTON STATE HOSPITAL FULTON, MISSOURI

PROJECT # M2312-01 SITE # 7352 ASSET # 6517352027

REVISION:
DATE:
REVISION:
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REVISION:
DATE:
ISSUE DATE: 09/22/24


CAD DWG FILE:E-FP-01
DRAWN BY: RUM
CHECKED BY: JCL
DESIGNED BY: JCL


SHEET TITLE:
ELECTRICAL
GUHLEMAN WEST
BUILDING - SECOND

FLOOR - G4 - REMODEL SHEET NUMBER:

E-112

SHEET 28 OF 66 SEPTEMBER 22, 2024

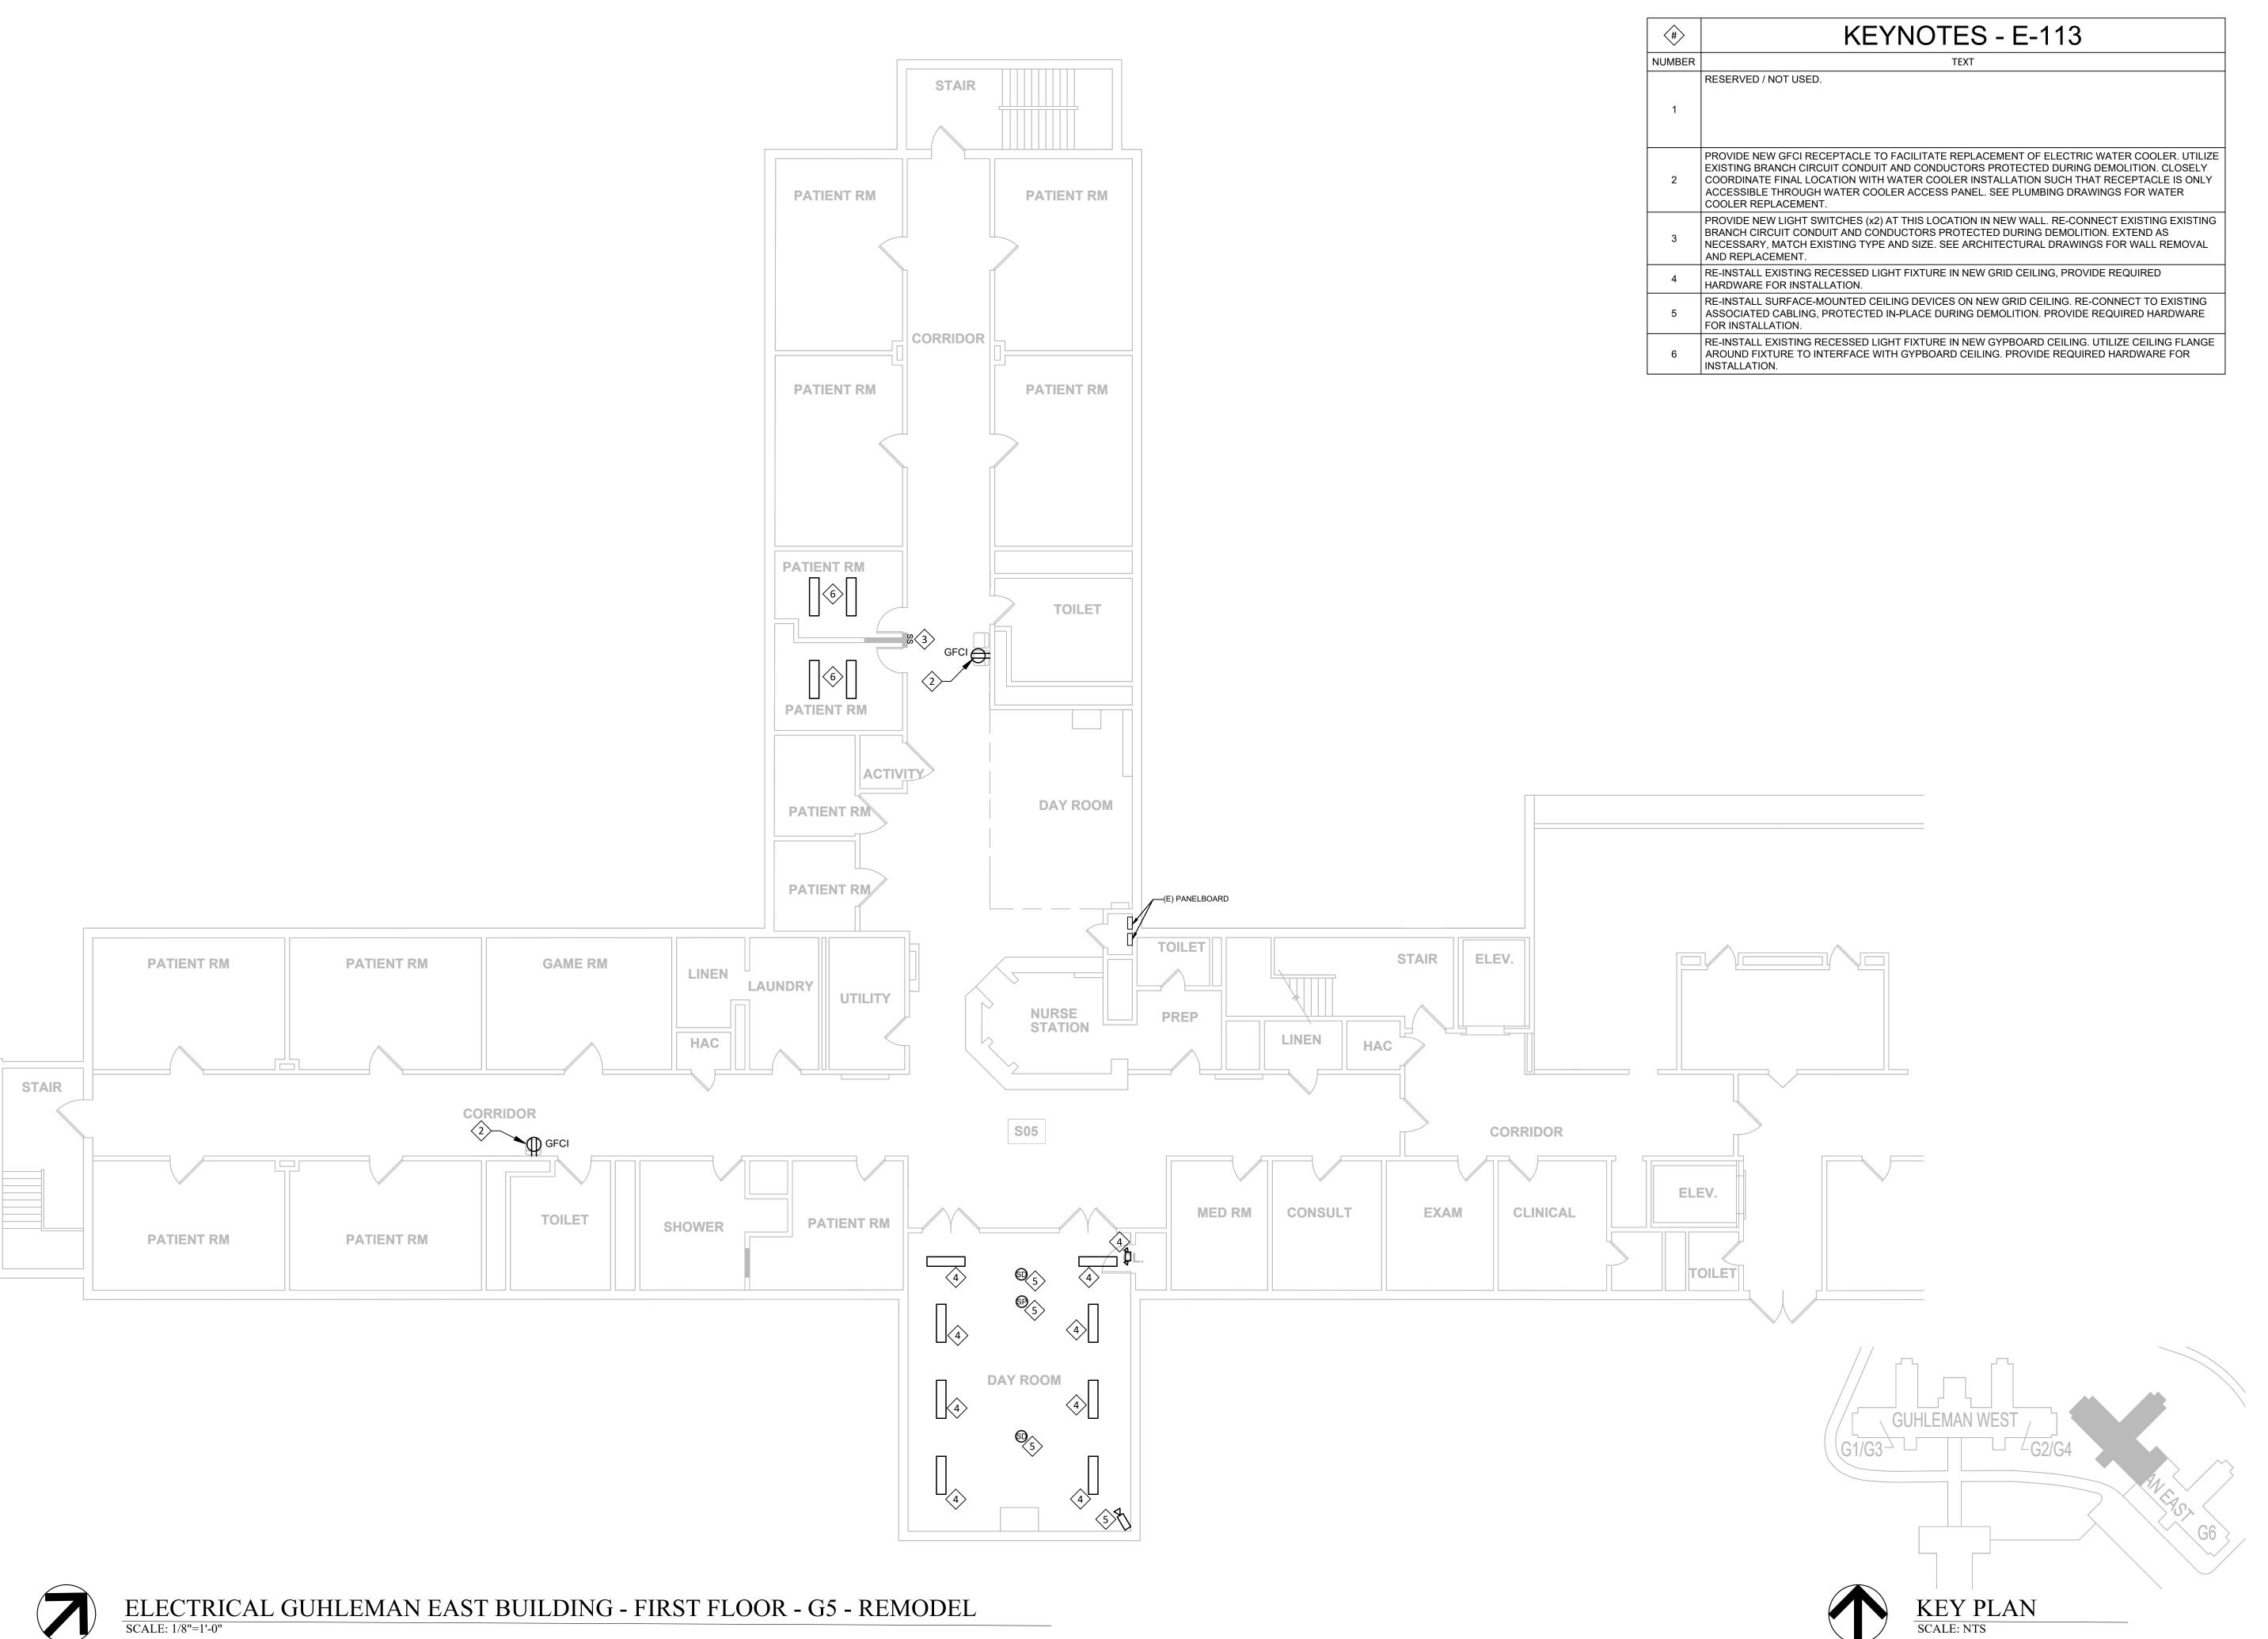

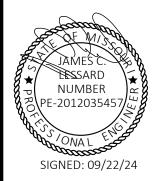



STATE OF MISSOURI CERTIFICATE OF AUTHORITY #2018019473

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OFFICE OF ADMINISTRATION DIVISION OF FACILITIES MANAGEMENT, DESIGN AND CONSTRUCTION

ANTI-LIGATURE UPGRADES MULTIPLE ASSETS FULTON STATE HOSPITAL FULTON, MISSOURI

PROJECT # M2312-01 SITE # 7352 ASSET # 6517352026

REVISION:
DATE:
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REVISION:
DATE:
ISSUE DATE: 09/22/24


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CHECKED BY: JCL


CHECKED BY: JCL
DESIGNED BY: JCL
SHEET TITLE:

ELECTRICAL
GUHLEMAN EAST
BUILDING - FIRST
FLOOR - G5 - REMODEL
SHEET NUMBER:

E-113

SHEET 29 OF 66 SEPTEMBER 22, 2024

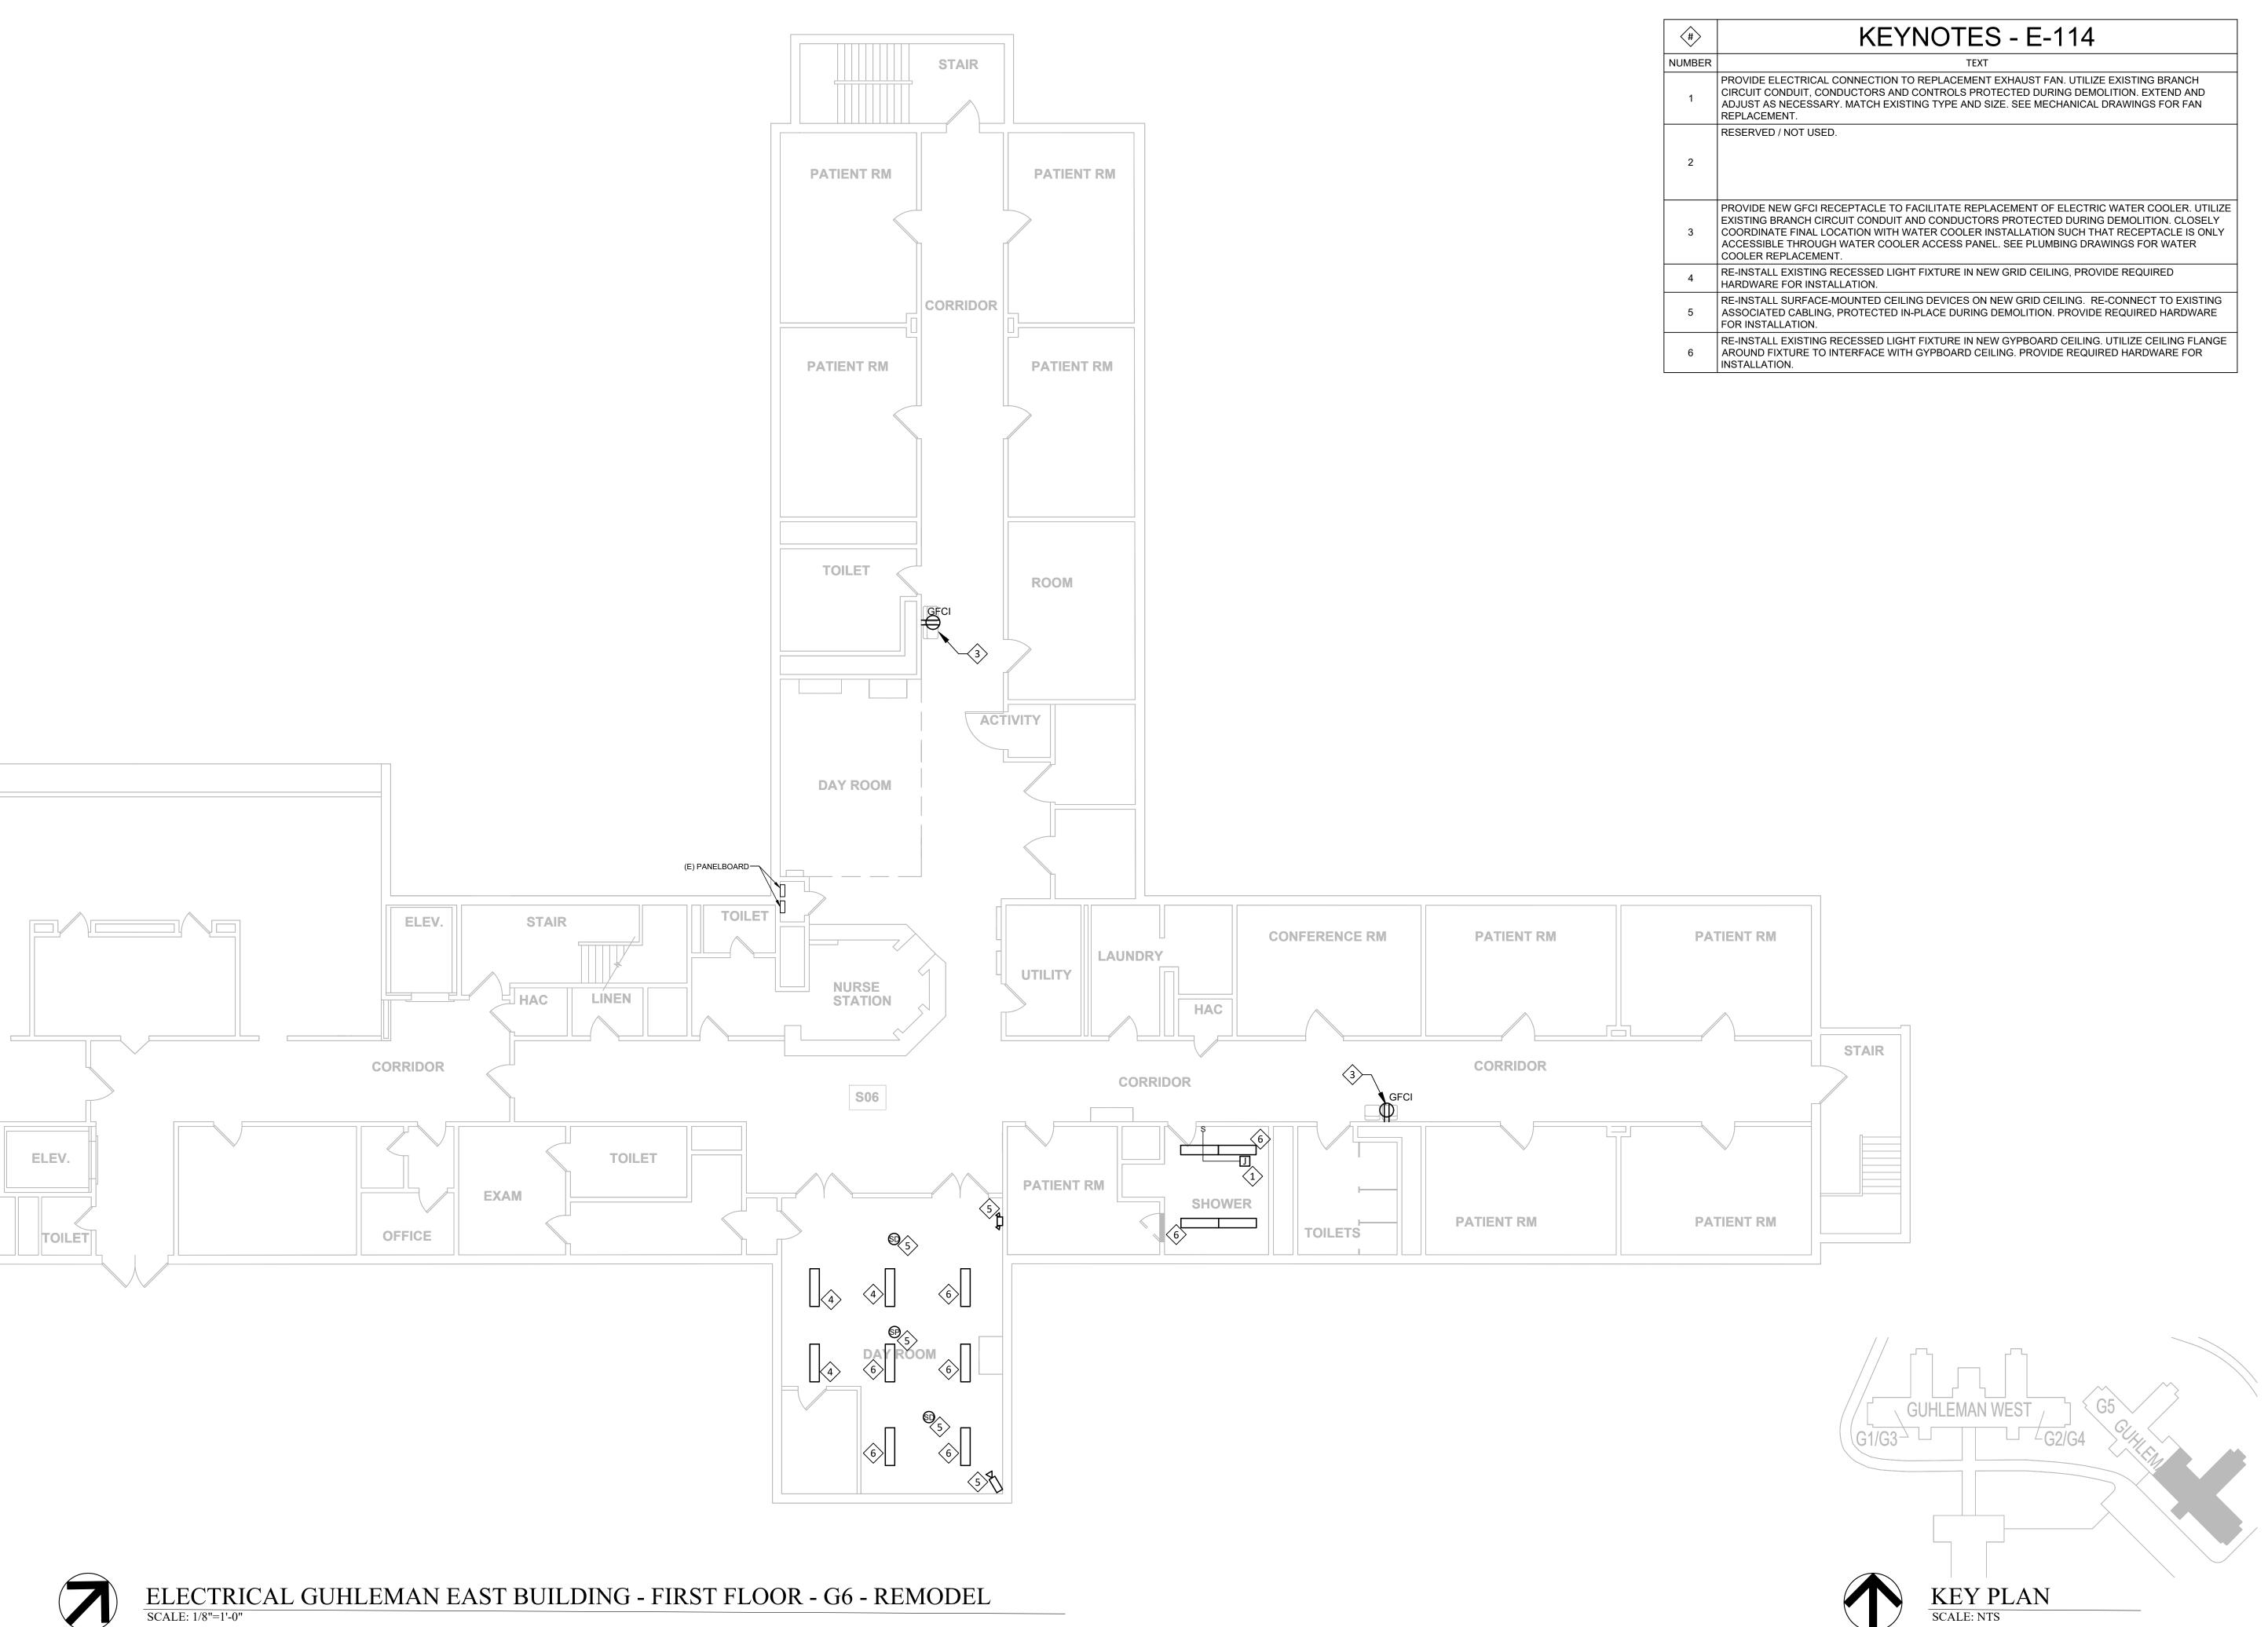

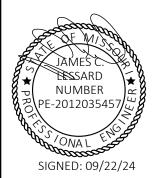



STATE OF MISSOURI CERTIFICATE OF AUTHORITY #2018019473

OFFICE OF ADMINISTRATION DIVISION OF FACILITIES MANAGEMENT, **DESIGN AND CONSTRUCTION**

ANTI-LIGATURE UPGRADES MULTIPLE ASSETS FULTON STATE HOSPITAL FULTON, MISSOURI

PROJECT # M2312-01 7352 ASSET # 6517352026

REVISION:	
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ISSUE DATE: 09/22/24	

CAD DWG FILE:E-FP-01
DRAWN BY: RUM
CHECKED BY: JCL


DESIGNED BY: JC SHEET TITLE:


ELECTRICAL GUHLEMAN EAST BUILDING - FIRST FLOOR - G6 - REMODEL SHEET NUMBER:

SHEET 30 OF 66 SEPTEMBER 22, 2024

ELECTRICAL GUHLEMAN EAST BUILDING - FIRST FLOOR - G6 - REMODEL

	#	KEYNOTES - E-115
NU	JMBER	TEXT
	1	RESERVED / NOT USED.
	2	PROVIDE NEW GFCI RECEPTACLE TO FACILITATE REPLACEMENT OF ELECTRIC WATER COOLER. UTILIZE EXISTING BRANCH CIRCUIT CONDUIT AND CONDUCTORS PROTECTED DURING DEMOLITION. CLOSELY COORDINATE FINAL LOCATION WITH WATER COOLER INSTALLATION SUCH THAT RECEPTACLE IS ONLY ACCESSIBLE THROUGH WATER COOLER ACCESS PANEL. SEE PLUMBING DRAWINGS FOR WATER COOLER REPLACEMENT.

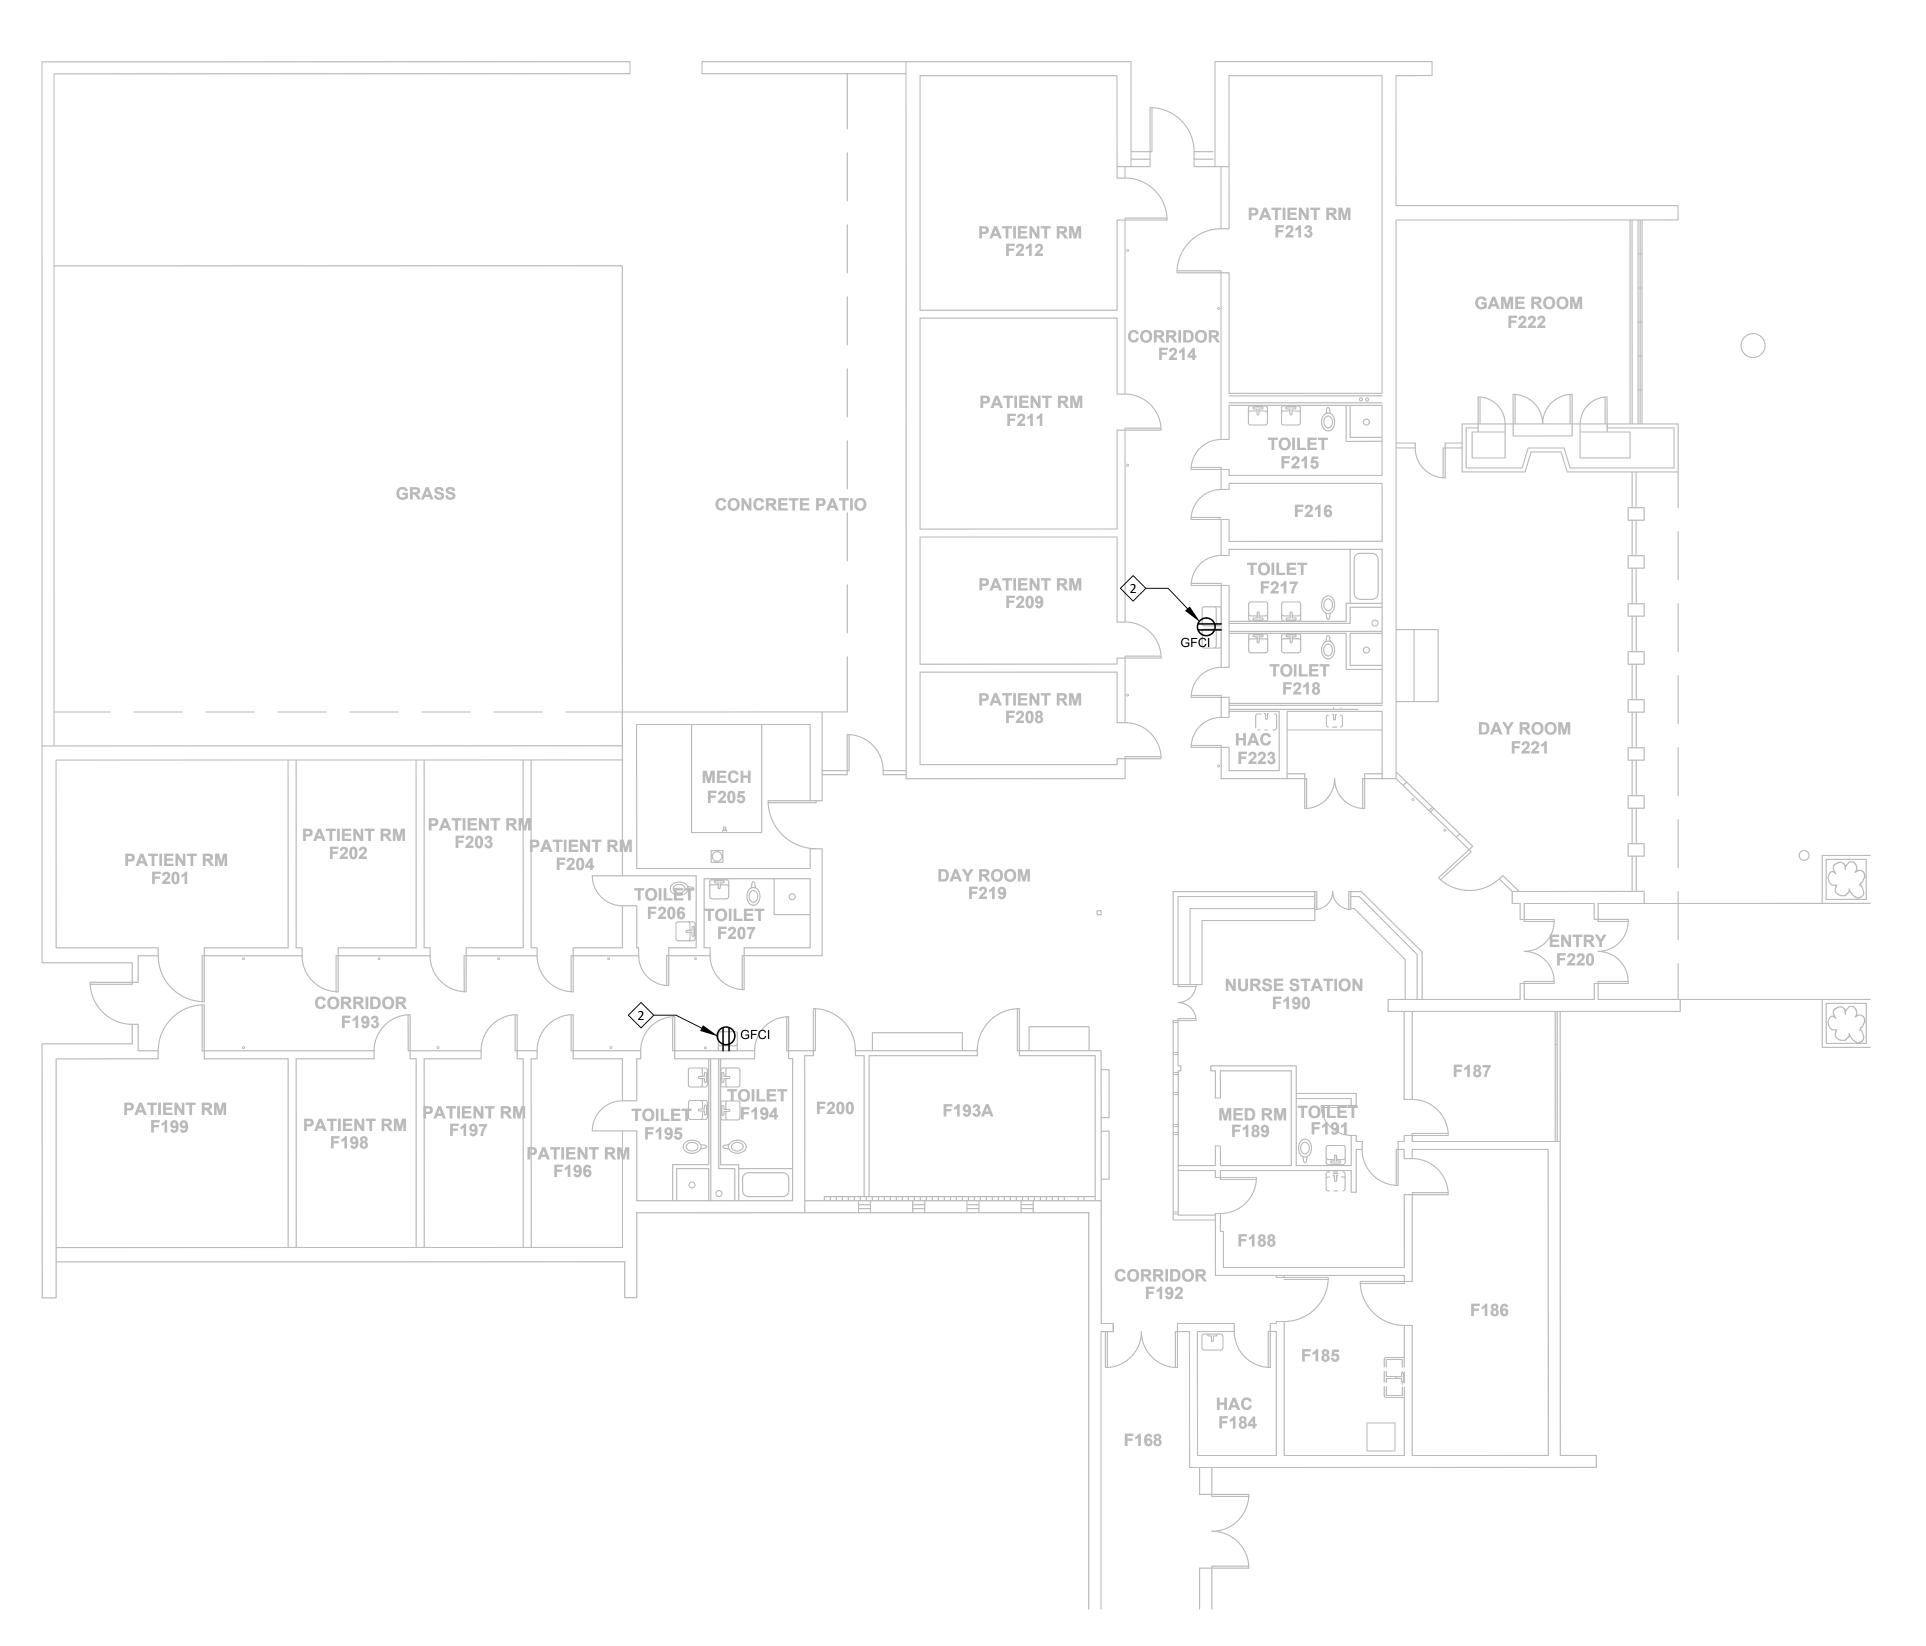

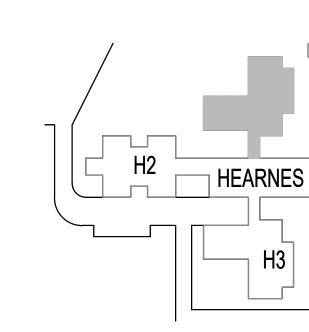




KEY PLAN

SCALE: NTS

STATE OF MISSOURI MICHAEL L PARSON, GOVERNOR

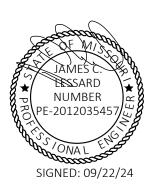



STATE OF MISSOURI CERTIFICATE OF AUTHORITY #2018019473

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ANTI-LIGATURE UPGRADES MULTIPLE ASSETS FULTON STATE HOSPITAL FULTON, MISSOURI

PROJECT # M2312-01 SITE # 7352 ASSET # 6517352031

REVISION:
DATE:
REVISION:
DATE:
REVISION:
DATE:
ISSUE DATE: 09/22/24

CAD DWG FILE:E-FP-01
DRAWN BY: RUM
CHECKED BY: JCL
DESIGNED BY: JCL


SHEET TITLE:
ELECTRICAL
HEARNES BUILDING H1 - REMODEL


SHEET NUMBER:

E-115

SHEET 31 OF 66 SEPTEMBER 22, 2024



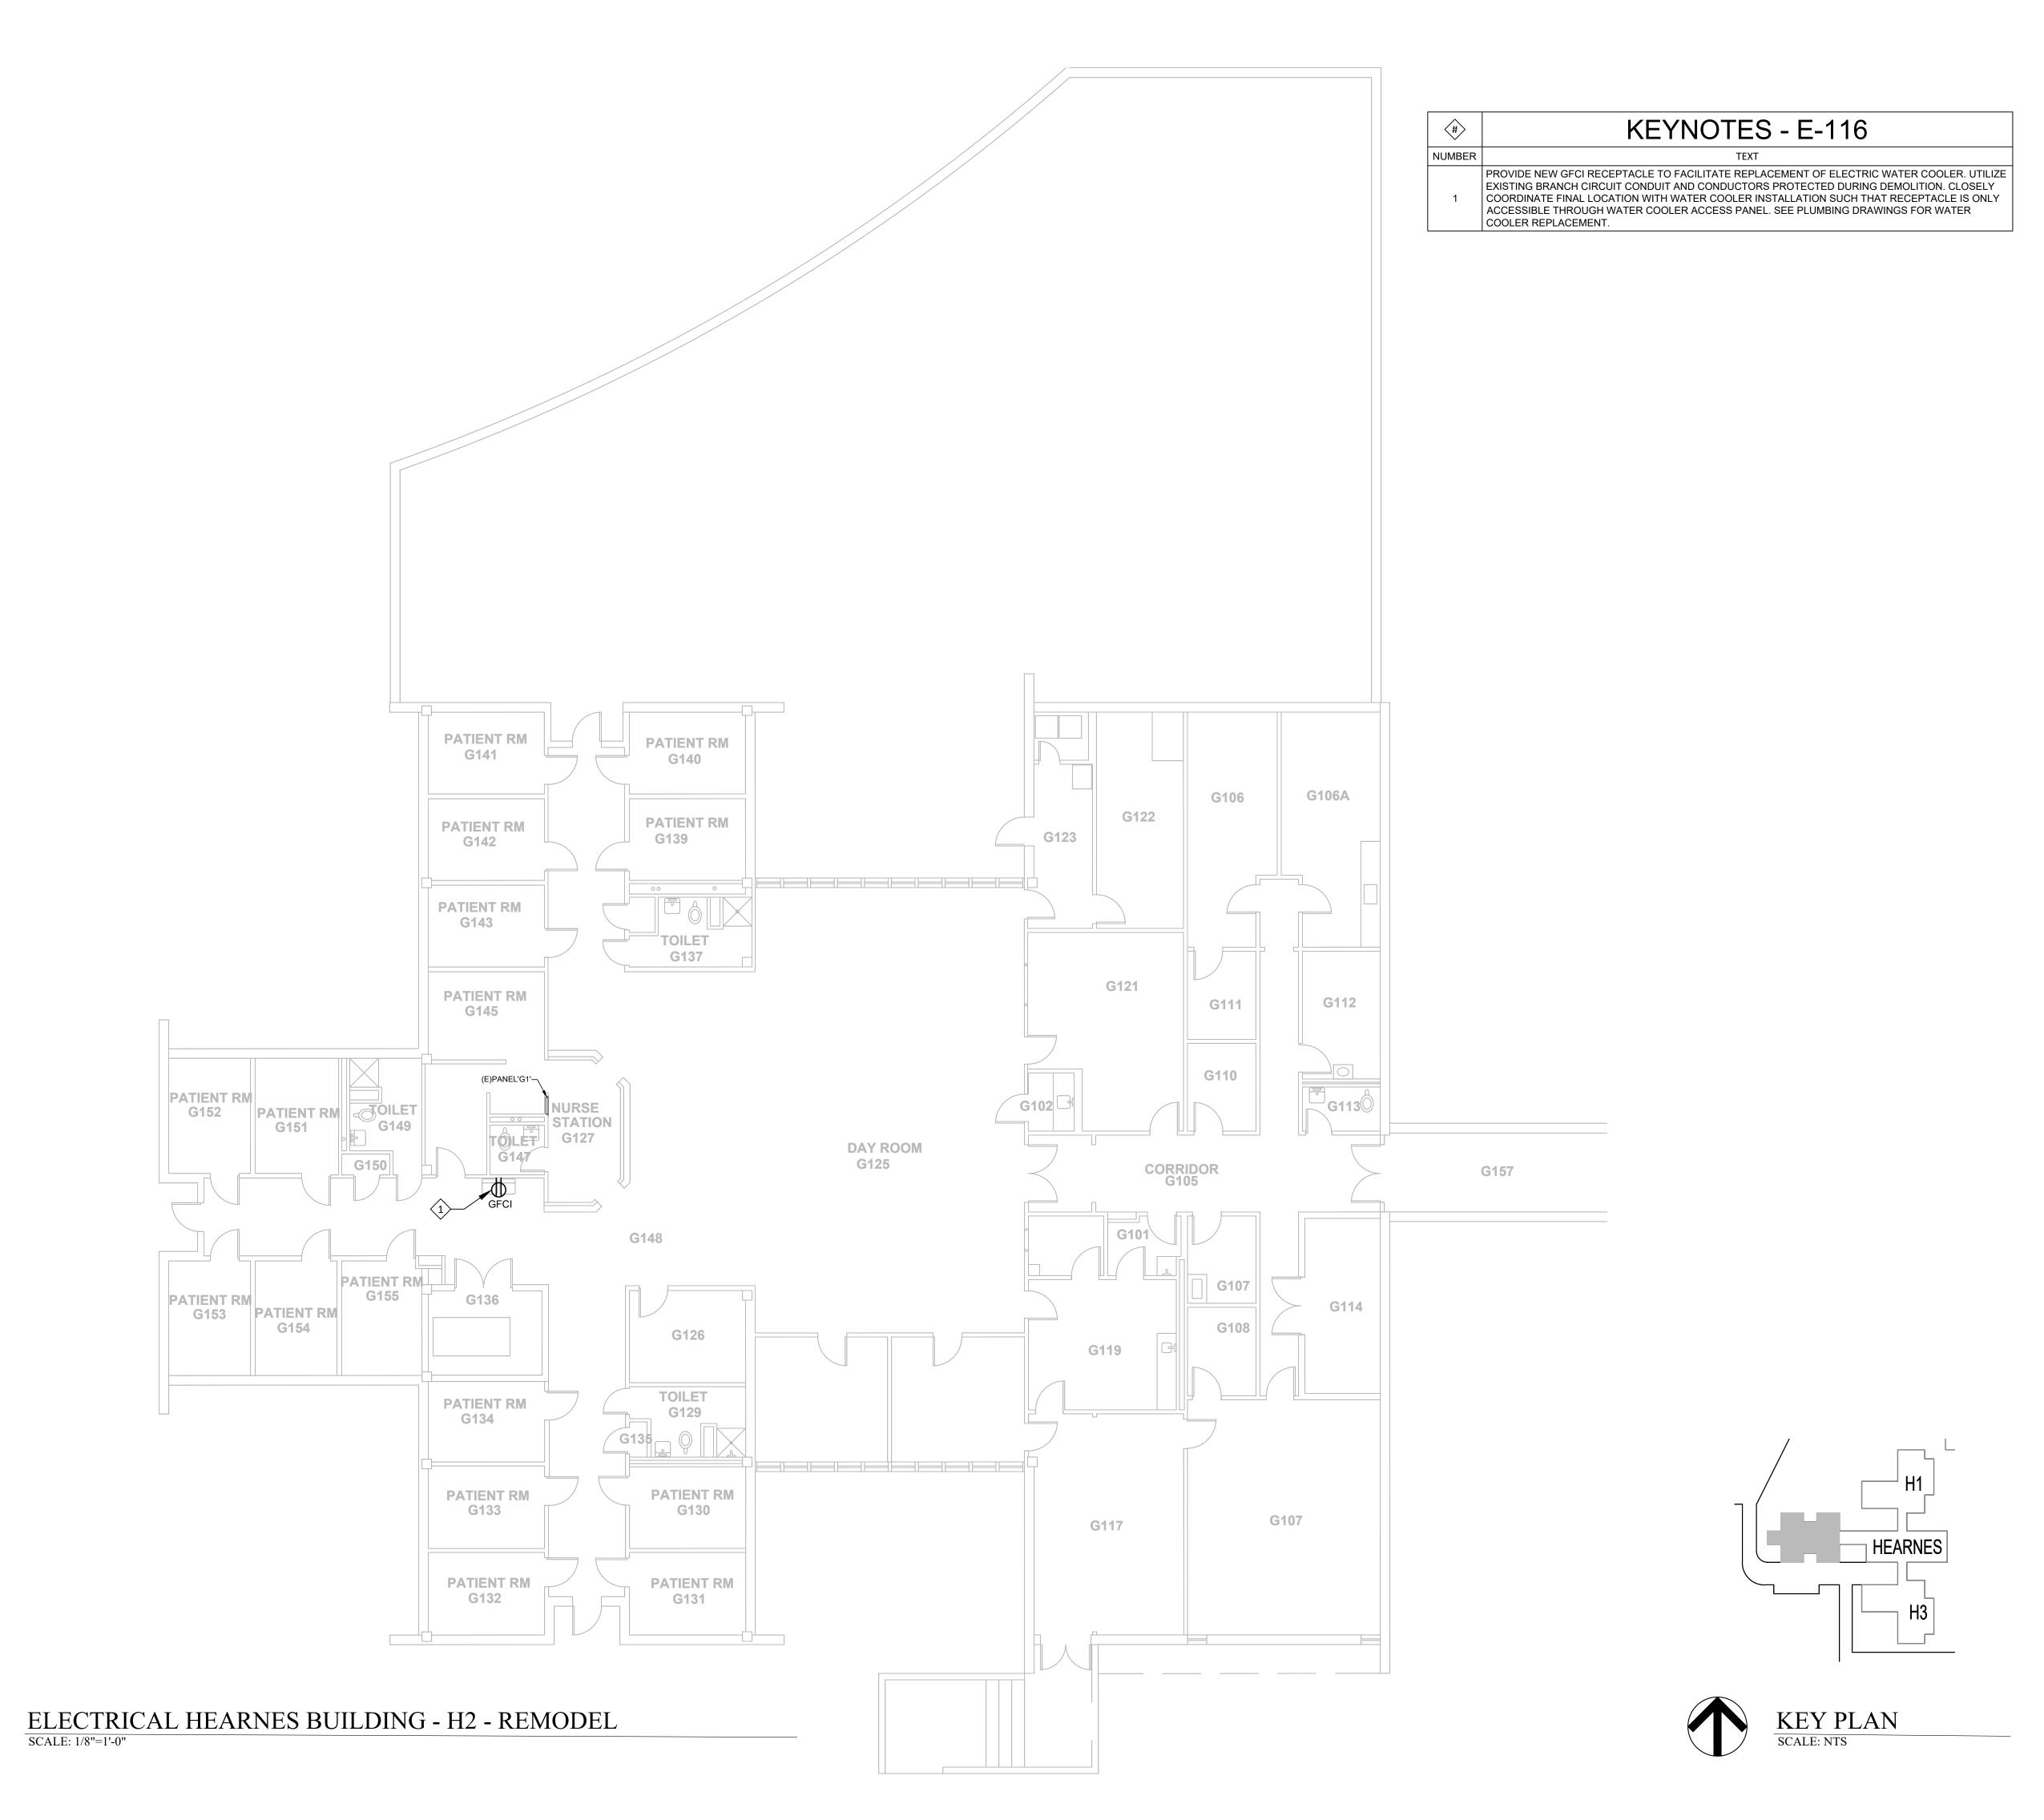

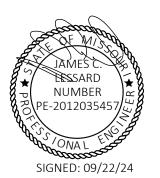



STATE OF MISSOURI CERTIFICATE OF AUTHORITY #2018019473

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OFFICE OF ADMINISTRATION DIVISION OF FACILITIES MANAGEMENT, DESIGN AND CONSTRUCTION

ANTI-LIGATURE UPGRADES MULTIPLE ASSETS FULTON STATE HOSPITAL FULTON, MISSOURI

PROJECT # M2312-01 SITE # 7352 ASSET # 6517352031

REVISION:
DATE:
REVISION:
DATE:
REVISION:
DATE:
ISSUE DATE: 09/22/24

CAD DWG FILE:E-FP-01
DRAWN BY: RUM
CHECKED BY: JCL
DESIGNED BY: JCL


SHEET TITLE:
ELECTRICAL
HEARNES BUILDING H2 - REMODEL

SHEET NUMBER:

E-116

SHEET 32 OF 66 SEPTEMBER 22, 2024

	LIGHTING FIXTURE SCHEDULE															
	LAMP:		E	BALLAS	T TYPE:				MOUNTING:							
	ED LIGHT EMITTING DIODE	С	-10V	0-10V DIMMING				CL CEILING SURFACE						F	R FLANGED RECESSED	
	FL FLUORESCENT		DMX	DIGITAL MULTIPLEX				RERE				RECESSED			Ş	SP SUSOENDED
	HL HALOGEN	EB ELECTRONIC BALLAST				CV				COVE			S	SUSURFACE		
	HPS HIGH PRESSURE	S HIGH PRESSURE EM EMERGENCY BATTERY				PL POLE							l	C UNDER CABINER		
	IN INCANDESCENT ELV ELECTRONIC LOW VOLTAGE				WL WALL											
	O OTHER (SEE DESC)				P PERIMETER											
T40	<u>.</u>			DIMEN	SIONS				ELECTRICA	\L	•					
TAG NAME	DESCRIPTION	LENG	гн '	WIDTH	DEAPTH	HEIGHT	LAMP	BALLAST TYPE	VOLTAGE	VA	LUMENS	CRI	MOUNTING	ι	DIST./MANUF.	DETAIL REFERENCE
F1 RECESSED ANTI-LIGATURE T 1X4 LED FIXTURE . NOTES: COORDINATE LIGHT FIXTURE FRAME TYPE WITH CEILING CONSTRUCTION.		ING 4' - (" 1	1' - 0"	0' - 1 1/8"		LED	0-10V	MV	50 VA	5500 LN	1 4K		NEW STA APPROVE	R 37M14 SERIES OR ED EQUAL	REFER TO MANUFACTURER CUTSHEET.

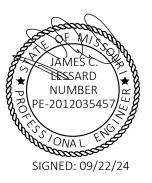



STATE OF MISSOURI CERTIFICATE OF AUTHORITY #2018019473

MO 63108	•	
LEET, ST. LOUIS, N	S - MEF	
REET	EF	

L2e SOLUTIONS
20 S. SARAH STREET, ST. I
ENGINEER - N

OFFICE OF ADMINISTRATION DIVISION OF FACILITIES MANAGEMENT, DESIGN AND CONSTRUCTION

ANTI-LIGATURE UPGRADES MULTIPLE ASSETS FULTON STATE HOSPITAL FULTON, MISSOURI

PROJECT # M2312-01 SITE # 7352

ASSET # 6517352026, 6517352027, 6517352031

REVISION:
DATE:
REVISION:
DATE:
REVISION:
DATE:
ISSUE DATE: 09/22/24

CAD DWG FILE:E-601
DRAWN BY: RUM
CHECKED BY: JCL
DESIGNED BY: JCL

SHEET TITLE:
ELECTRICAL
SCHEDULES

SHEET NUMBER:

E-601

SHEET 33 OF 66 SEPTEMBER 22, 2024

MECHANICAL SYMBOLS:

LINETYPE/SYMBOL DIFFUSER BLANKOFF

INLET (IN.)/CFM

RECTANGULAR FOUR-WAY OUTLET, SUPPLY DIFFUSER

DIFFUSER/GRILLE TAG **DIRECTION OF AIRFLOW**

ACCESS PANEL OR ROOF HATCH

. NOT ALL SYMBOLS MAY APPLY.

2. SEE SPECS AND DRAWINGS FOR SPECIFIC COMPONENT REQUIREMENTS.

MECHANICAL ABBREVIATIONS:

ABBREVIATION	DESCRIPTION
EA	EXHAUST AIFOR RELIEF AIR
MA	MAKEUP AIR
OA	OUTSIDE AIR
RA	RETURN AIR
SA	SUPPLY AIR
TA	TRANSFER AIR
ADJ	ADJUSTABLE
AFF	ABOVE FINISHED FLOOR
AMB	AMBIENTTEMPERATURE
BD	BACKDRAFT DAMPER
DIA, Ø	DIAMETER
DN	DOWN
DTR	DOWN THRU ROOF
EAT	ENTERING AIR TEMPERATURE
EGE	EXISTING EXHAUST AIR GRILLE
FT, '	FOOT OR FEET
GA	GAGE OR GAUGE
GR	GRAINS
HD	HEAD (PRESSURE)
ID	DIAMETER, INSIDE
IN., "	INCH OR INCHES
LAT	LEAVING AIR TEMPERATURE
LF	LINEAR FOOT OR LINEAR FEET
MAX	MAXIMUM
MIN	MINIMUM
N/A	NOT APPLICABLE
NC	NORMALLY CLOSED
NIC	NOT IN CONTRACT
NO	NORMALLY OPEN
NO.,#	NUMBER
NTS	NOT TO SCALE
OD	DIAMETER, OUTSIDE
PD	PRESSURE DROP
PPM	PARTS PER MILLION
RGE	EXISTING RETURN AIR GRILLE
RH	RELATIVE HUMIDITY
RPM	REVOLUTIONS PER MINUTE
RTU	ROOFTOP UNIT
SDE	EXISTING SUPPLY AIR DIFFUSER
SP	STATIC PRESSURE
SPEC	SPECIFICATION
TAB	TESTING, ADJUSTING, AND BALANCING
TG	TRANSFER GRILLE
TSP	TOTAL STATIC PRESSURE
TU	TERMINAL UNIT
TYP	TYPICAL
UTR	UP THRU ROOF
VAV	VARIABLE AIR VOLUME
VFD	VARIABLE FREQUENCY DRIVE
WB	WET-BULB TEMPERATURE

- . NOT ALL ABBREVIATIONS MAY APPLY.
- MECHANCIAL SCHEDULES CONTAIN EQUIPMENT TAG ABBREVIATIONS THAT ARE HEREBY INCORPORATED INTO THE ABBREVIATION LIST.
- B. SEE OTHER DISCIPLINE DRAWINGS WITHIN THE CONSTRUCTION DOCUMENTS FOR ABBREVIATIONS NOT DEFINED ABOVE OR IN MECHANICAL SCHEDULES.

GENERAL NOTES:

- INSTALLATION SHALL COMPLY WITH ALL APPLICABLE CODES, STANDARDS, AND MANUFACTURER'S INSTALLATION REQUIREMENTS.
- REVIEW ALL PROJECT DOCUMENTS INCLUDING SPECS AND DRAWINGS PERTAINING TO ALL DISCIPLINES PRIOR TO SUBMITTING A BID. SUBMIT PRE-BID REQUEST FOR INFORMATION FOR ITEMS IN QUESTION AND/OR CONFLICTS FOUND.
- DRAWINGS SHOW THE DESIGN INTENT DIAGRAMMATICALLY. THEY DO NOT SHOW THE EXACT UTILITY ROUTING NOR EVERY ELBOW, OFFSET, ETC. WHERE REQUIRED, THE CONTRACTOR SHALL MAKE ADJUSTMENTS TO THEIR SYSTEMS TO AVOID CONFLICT WITH THE STRUCTURE AND OTHER DISCIPLINES. THE COST FOR SUCH ADJUSTMENTS SHALL BE INCLUDED IN THE BID.
- OBTAIN AND PAY FOR ALL PERMITS REQUIRED FOR WORK PERFORMED.
- THE CONTRACTOR TEAM SHALL LEAD THE SUBCONTRACTORS IN PROVIDING A COORDINATED SET OF SHOP DRAWINGS. SEE GENERAL REQUIREMENTS SPEC FOR
- COORDINATE FRAMING REQUIREMENTS FOR ACCESS PANELS AND EQUIPMENT/PANEL SUPPORTS WITH THE CONTRACTOR PRIOR TO SUBMITTING BID.
- THE CONTRACTOR IS RESPONSIBLE FOR VERIFYING THE CORRECTION OF CONSTRUCTION DEFICIENCIES LISTED ON THE JOB SITE OBSERVATION REPORT. RETURN THE JOB SITE OBSERVATION REPORT TO A/E WITH DEFICIENCIES SIGNED OFF. PROVIDE PHOTOGRAPHIC AND/OR VIDEO EVIDENCE OF CORRECTED DEFICIENCIES IF REQUESTED BY THE ENGINEER.
- PROVIDE CLOSEOUT DOCUMENTATION UPON COMPLETION OF PROJECT. SEE GENERAL REQUIREMENTS SPEC FOR ADDITIONAL INFORMATION.
- RECYCLE AND/OR SALVAGE FOR REUSE A MINIMUM OF 65% OF THE NONHAZARDOUS CONSTRUCTION AND DEMOLITION WASTE. UTILIZE A WASTE MANAGEMENT COMPANY THAT CAN PROVIDE VERIFIABLE DOCUMENTATION THAT THE PERCENTAGE OF CONSTRUCTION AND DEMOLITION WASTE MATERIAL DIVERTED FROM THE LANDFILL COMPLIES WITH CODE. SEE GENERAL REQUIREMENTS SPEC FOR ADDITIONAL INFORMATION.

MECHANICAL NOTES:

- MECHANICAL WORK SHALL BE CONSTRUCTED IN A PROFESSIONAL MANNER. COMPONENTS SHALL BE CLEANED PRIOR TO OWNER TURNOVER.
- THE SCHEDULED EQUIPMENT SHALL BE USED AS THE BASIS OF DESIGN. MODEL NUMBERS ARE PROVIDED FOR REFERENCE ONLY. EQUIPMENT SHALL MEET SPECIFIED PERFORMANCE. THE CONTRACTOR SHALL IDENTIFY ALL SELECTED OPTIONS IN THE SUBMITTAL.
- IF A CONTRACTOR PROVIDES EQUIPMENT OTHER THAN THE BASIS OF DESIGN, THAT CONTRACTOR SHALL BE RESPONSIBLE FOR ALL COSTS INCURRED AS A RESULT. THAT INCLUDES, BUT IS NOT LIMITED TO, AGENCY FEES FOR REVIEW OF CHANGES, STRUCTURAL MODIFICATIONS FOR INCREASED WEIGHT, AND ELECTRICAL EQUIPMENT, WIRING, CONDUIT, AND BREAKER CHANGES FOR DIFFERENT ELECTRICAL REQUIREMENTS.
- COORDINATE POWER REQUIREMENTS WITH THE CONTRACTOR PRIOR TO PROVIDING SUBMITTALS TO THE ENGINEER.
- . SEE SPEC SECTION 23 3100 FOR DUCT INSTALLATION, AND TESTING REQUIREMENTS.
- INSULATION SHALL BE PROVIDED CONTINUOUS THROUGHOUT THE DUCTWORK SYSTEM INCLUDING AT HANGERS/SUPPORTS, FITTINGS, AND ACCESSORIES. OPENINGS SHALL BE PROVIDED TO ALLOW FOR VALVE HANDLE OPERATION AND ACCESS. INSULATION THICKNESS SHALL MEET THE LISTED ENERGY CODE MINIMUM REQUIREMENTS. SEE SPEC SECTION 23 0713 FOR SYSTEMS REQUIRING INSULATION AND ADDITIONAL INSTALLATION REQUIREMENTS.

RENOVATION NOTES:

- DEMOLITION WORK SHALL BE PERFORMED AS DESCRIBED WITHIN SPEC SECTION 23 0505 AND THE DRAWINGS.
- . THE CONTRACTOR SHALL VISIT THE SITE PRIOR TO BID SUBMISSION TO VERIFY ALL FIELD CONDITIONS INCLUDING BUT NOT LIMITED TO THE FOLLOWING:
- A. LOCATIONS OF EXISTING MECHANICAL SYSTEMS.
- B. LOCATIONS OF ARCHITECTURAL, STRUCTURAL, ELECTRICAL, PLUMBING,
- TECHNOLOGY, FIRE PROTECTION, AND FIRE ALARM SYSTEMS. C. EXISTING SURFACES WHICH REQUIRE ALTERING.
- NOTIFY OWNER OF REQUIRED SYSTEM SHUTDOWNS AT LEAST TWO WEEKS PRIOR TO SHUTDOWN. EXACT SHUTDOWN TIME AND PROCEDURE SHALL BE COORDINATED WITH OWNER AT LEAST 96 HOURS PRIOR TO SHUTDOWN.
- WHEN DUCTWORK IS NOTATED TO BE PERMANENTLY REMOVED THEIR ASSOCIATED COMPONENTS SHALL ALSO BE REMOVED INCLUDING HANGERS, SUPPORTS, AND ACCESSORIES.
- COORDINATE THE DISCONNECTION AND REMOVAL OF POWERED SYSTEMS WITH THE CONTRACTOR. WHEN REMOVING POWERED MECHANICAL EQUIPMENT.
- REPAIR WALLS, AND CEILINGS IN ALTERED AREAS TO MATCH EXISTING. SEE ARCHITECTURAL PLANS FOR FINISH DETAILS IN REMODEL AREAS.
- TAB CONTRACTOR SHALL BALANCE SUPPLY AIR AND EXHAUST AIR GRILLES TO VALUES SHOWN ON DRAWINGS. SUBMIT TAB REPORT TO A/E FOR REVIEW. SEE SPEC SECTION 23 0593 FOR ADDITIONAL INFORMATION.

MECHANICAL SHEET INDEX:

Sheet Number	Sheet Name
M-001	MECHANICAL COVER SHEET
M-101	MECHANICAL GUHLEMAN WEST BUILDING - FIRST FLOOR - G1 - DEMO
M-102	MECHANICAL GUHLEMAN WEST BUILDING - FIRST FLOOR - G2 - DEMO
M-103	MECHANICAL GUHLEMAN WEST BUILDING - SECOND FLOOR - G3 - DEMO
M-104	MECHANICAL GUHLEMAN WEST BUILDING - SECOND FLOOR - G4 - DEMO
M-105	MECHANICAL GUHLEMAN EAST BUILDING - FIRST FLOOR - G5 - DEMO
M-106	MECHANICAL GUHLEMAN EAST BUILDING - FIRST FLOOR - G6 - DEMO
M-107	MECHANICAL GUHLEMAN WEST BUILDING - FIRST FLOOR - G1 - REMODEL
M-108	MECHANICAL GUHLEMAN WEST BUILDING - FIRST FLOOR - G2 - REMODEL
M-109	MECHANICAL GUHLEMAN WEST BUILDING - SECOND FLOOR - G3 - REMOD
M-110	MECHANICAL GUHLEMAN WEST BUILDING - SECOND FLOOR - G4 - REMOD
M-111	MECHANICAL GUHLEMAN EAST BUILDING - FIRST FLOOR - G5 - REMODEL
M-112	MECHANICAL GUHLEMAN EAST BUILDING - FIRST FLOOR - G6 - REMODEL
M-601	MECHANICAL SCHEDULES/DETAILS

CODES AND STANDARDS: EDITION REFERENCE CODE/STANDARD AMERICANS WITH DISABILITIES ACT (ADAAG) 2010 2021 INTERNATIONAL BUILDING CODE, (IBC) 2023 NATIONAL ELECTRICAL CODE, (NEC) INTERNATIONAL MECHANICAL CODE, (IMC) 2021 INTERNATIONAL PLUMBING CODE, (IPC)

NATIONAL LIFE SAFETY CODE, (NFPA 101)

ENERGY EFFICIENCY STANDARD, (ASHRAE 90.1)


NFPA-NATIONAL FIRE PROTECTION AGENCY

2021

GENERAL LEGEND:

SYMBOL	DESCRIPTION
####	DETAIL CALL-OUT SYMBOL
###-#	EQUIPMENT TAG
#>	KEYNOTE SYMBOL
•	POINT OF CONNECTION OR DISCONNECTION
####	SECTION CUT CALL-OUT SYMBOL
####	ENLARGED PLAN CALL-OUT SYMBOL
LINETYPE	DESCRIPTION
	EXISTING TO REMAIN
	EXISTING TO BE REMOVED
	NEW CONSTRUCTION
(E)	EXISTING TO REMAIN
(X)	EXISTING TO BE REMOVED

STATE OF MISSOURI MICHAEL L PARSON, **GOVERNOR**

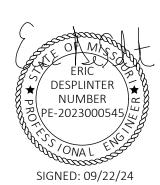



STATE OF MISSOURI CERTIFICATE OF AUTHORITY #2018019473

OFFICE OF ADMINISTRATION **DIVISION OF FACILITIES** MANAGEMENT, **DESIGN AND CONSTRUCTION**

ANTI-LIGATURE UPGRADES MULTIPLE ASSETS FULTON STATE HOSPITAL FULTON, MISSOURI

PROJECT # M2312-01 7352 ASSET # 6517352026, 6517352027,

6517352031

REVISION: DATE: **REVISION:** DATE: **REVISION:** DATE:

ISSUE DATE: 09/22/24


CAD DWG FILE:M-001 DRAWN BY: CHECKED BY: EMD DESIGNED BY: BST

SHEET TITLE:

MECHANICAL COVER SHEET

SHEET NUMBER:

SHEET 34 OF 66 **SEPTEMBER 22, 2024**

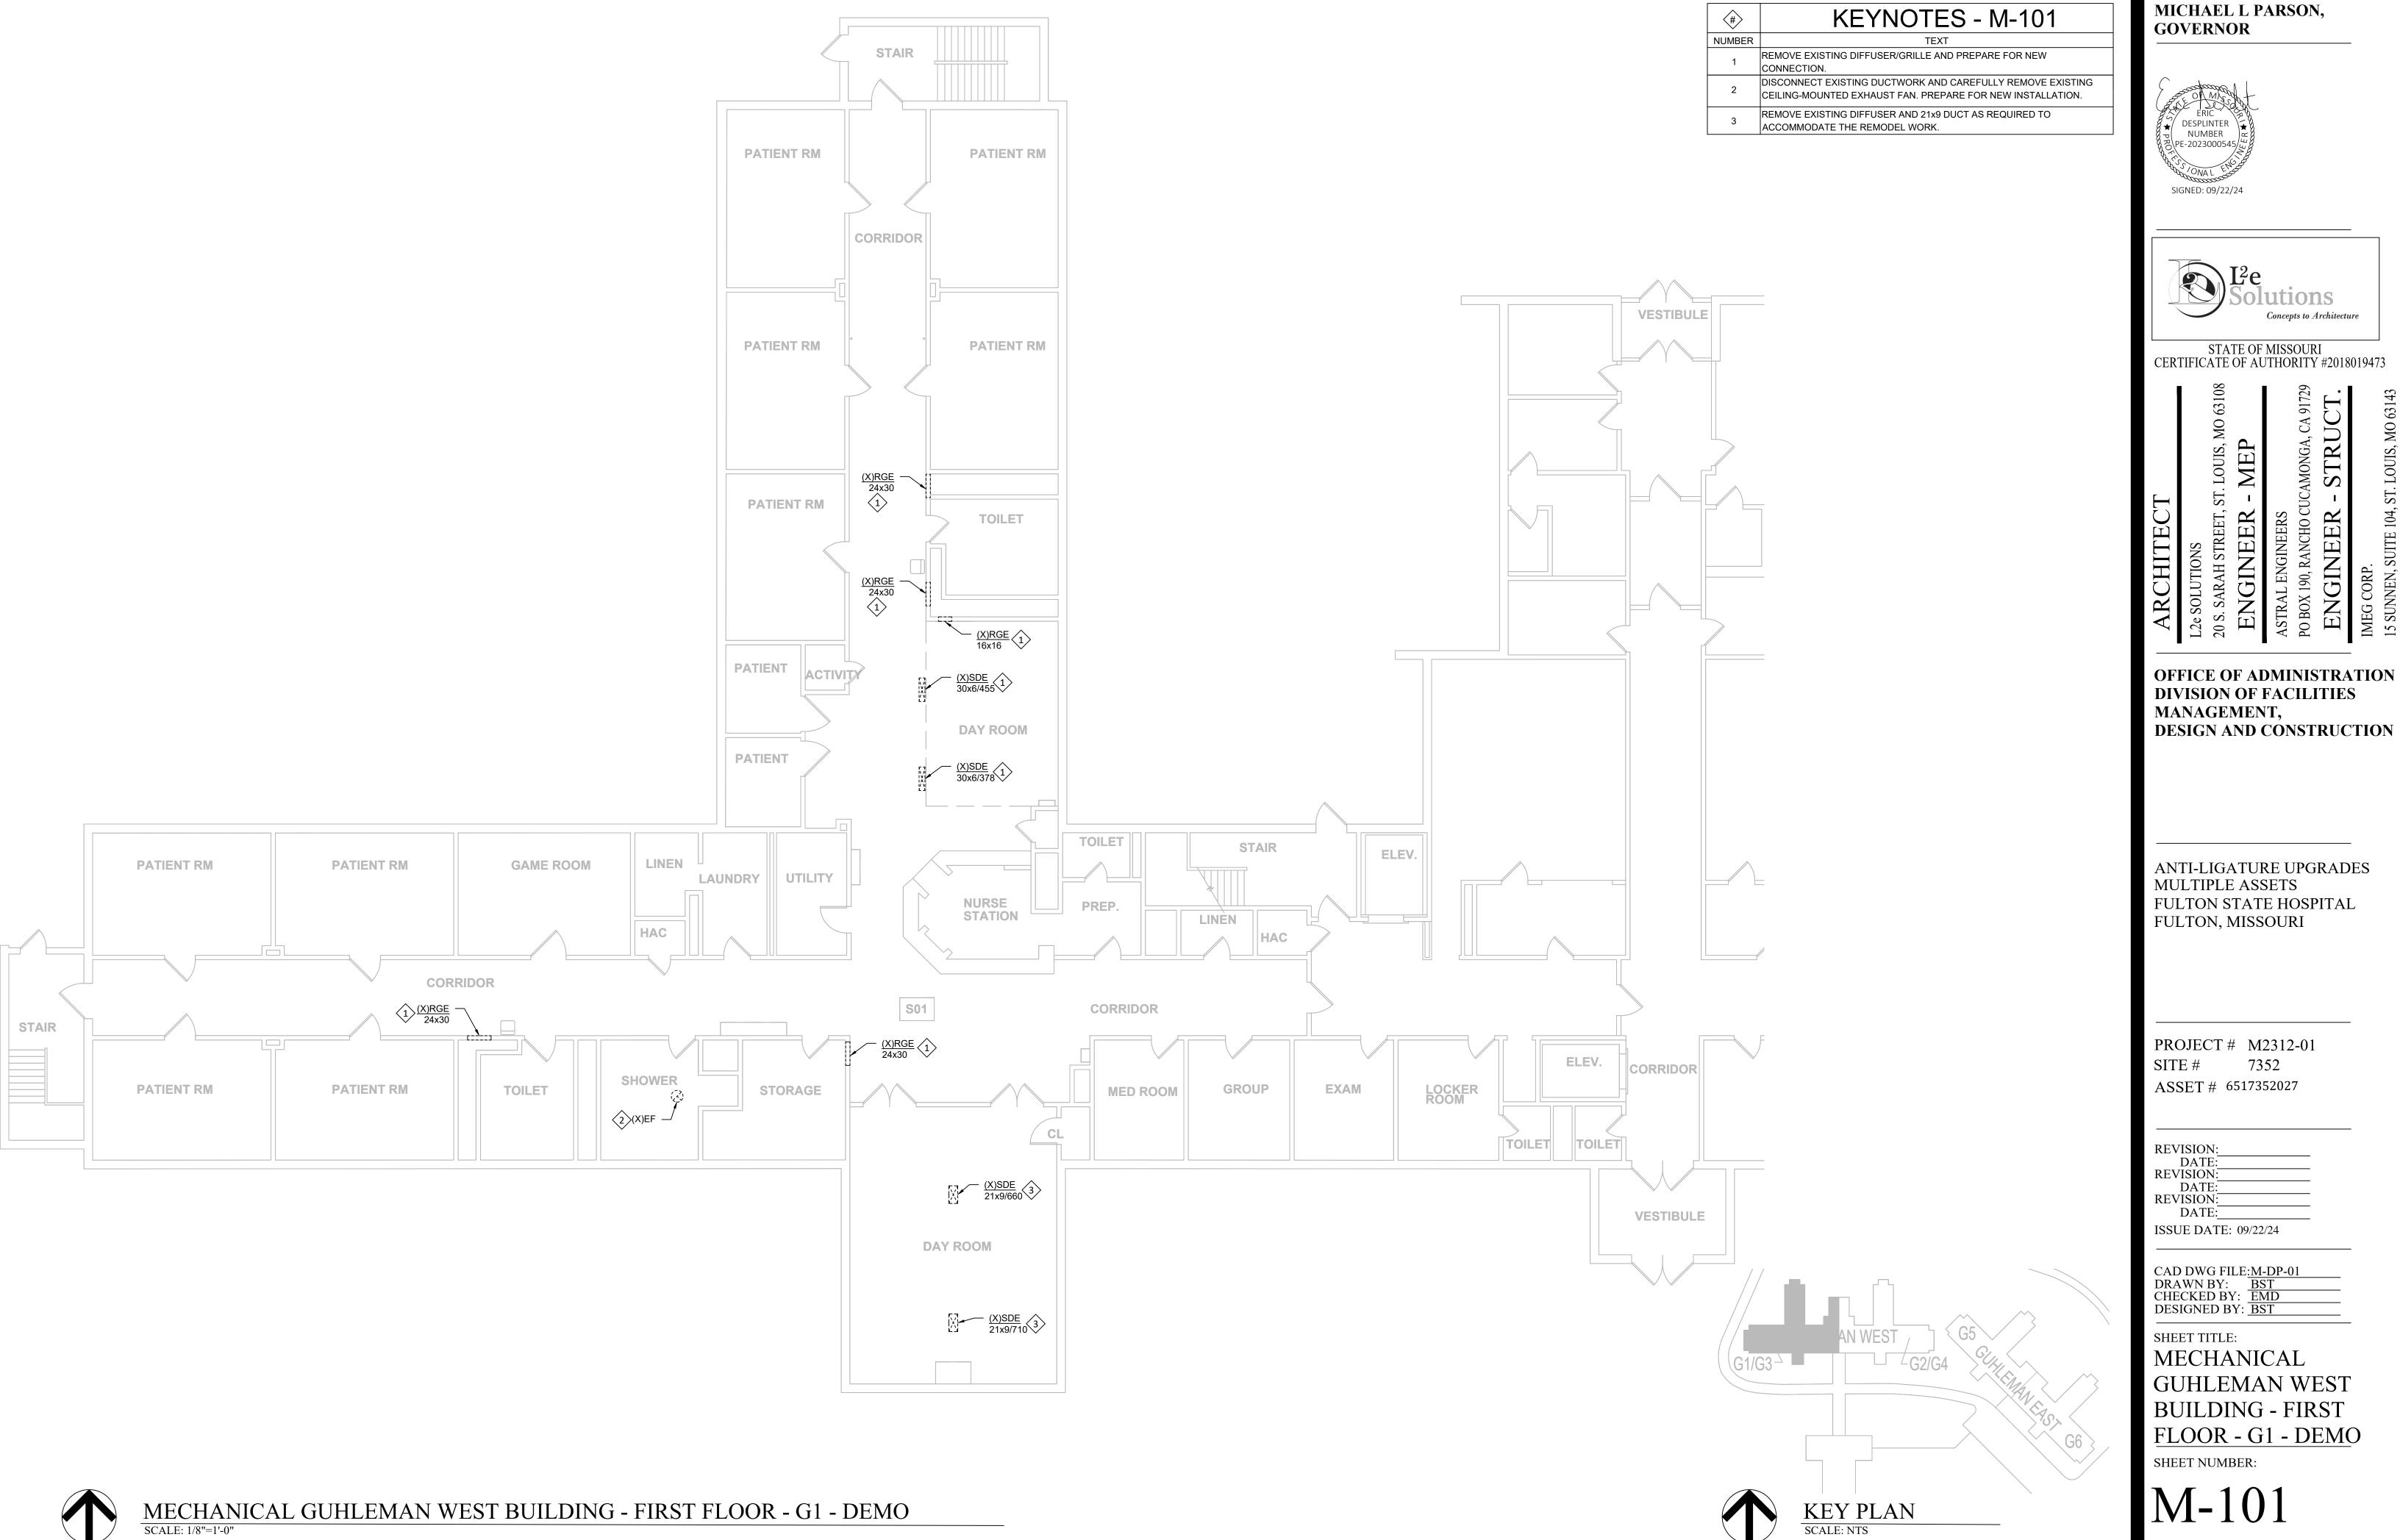


STATE OF MISSOURI MICHAEL L PARSON,



DIVISION OF FACILITIES **DESIGN AND CONSTRUCTION**

GUHLEMAN WEST BUILDING - FIRST

SHEET 35 OF 66 SEPTEMBER 22, 2024

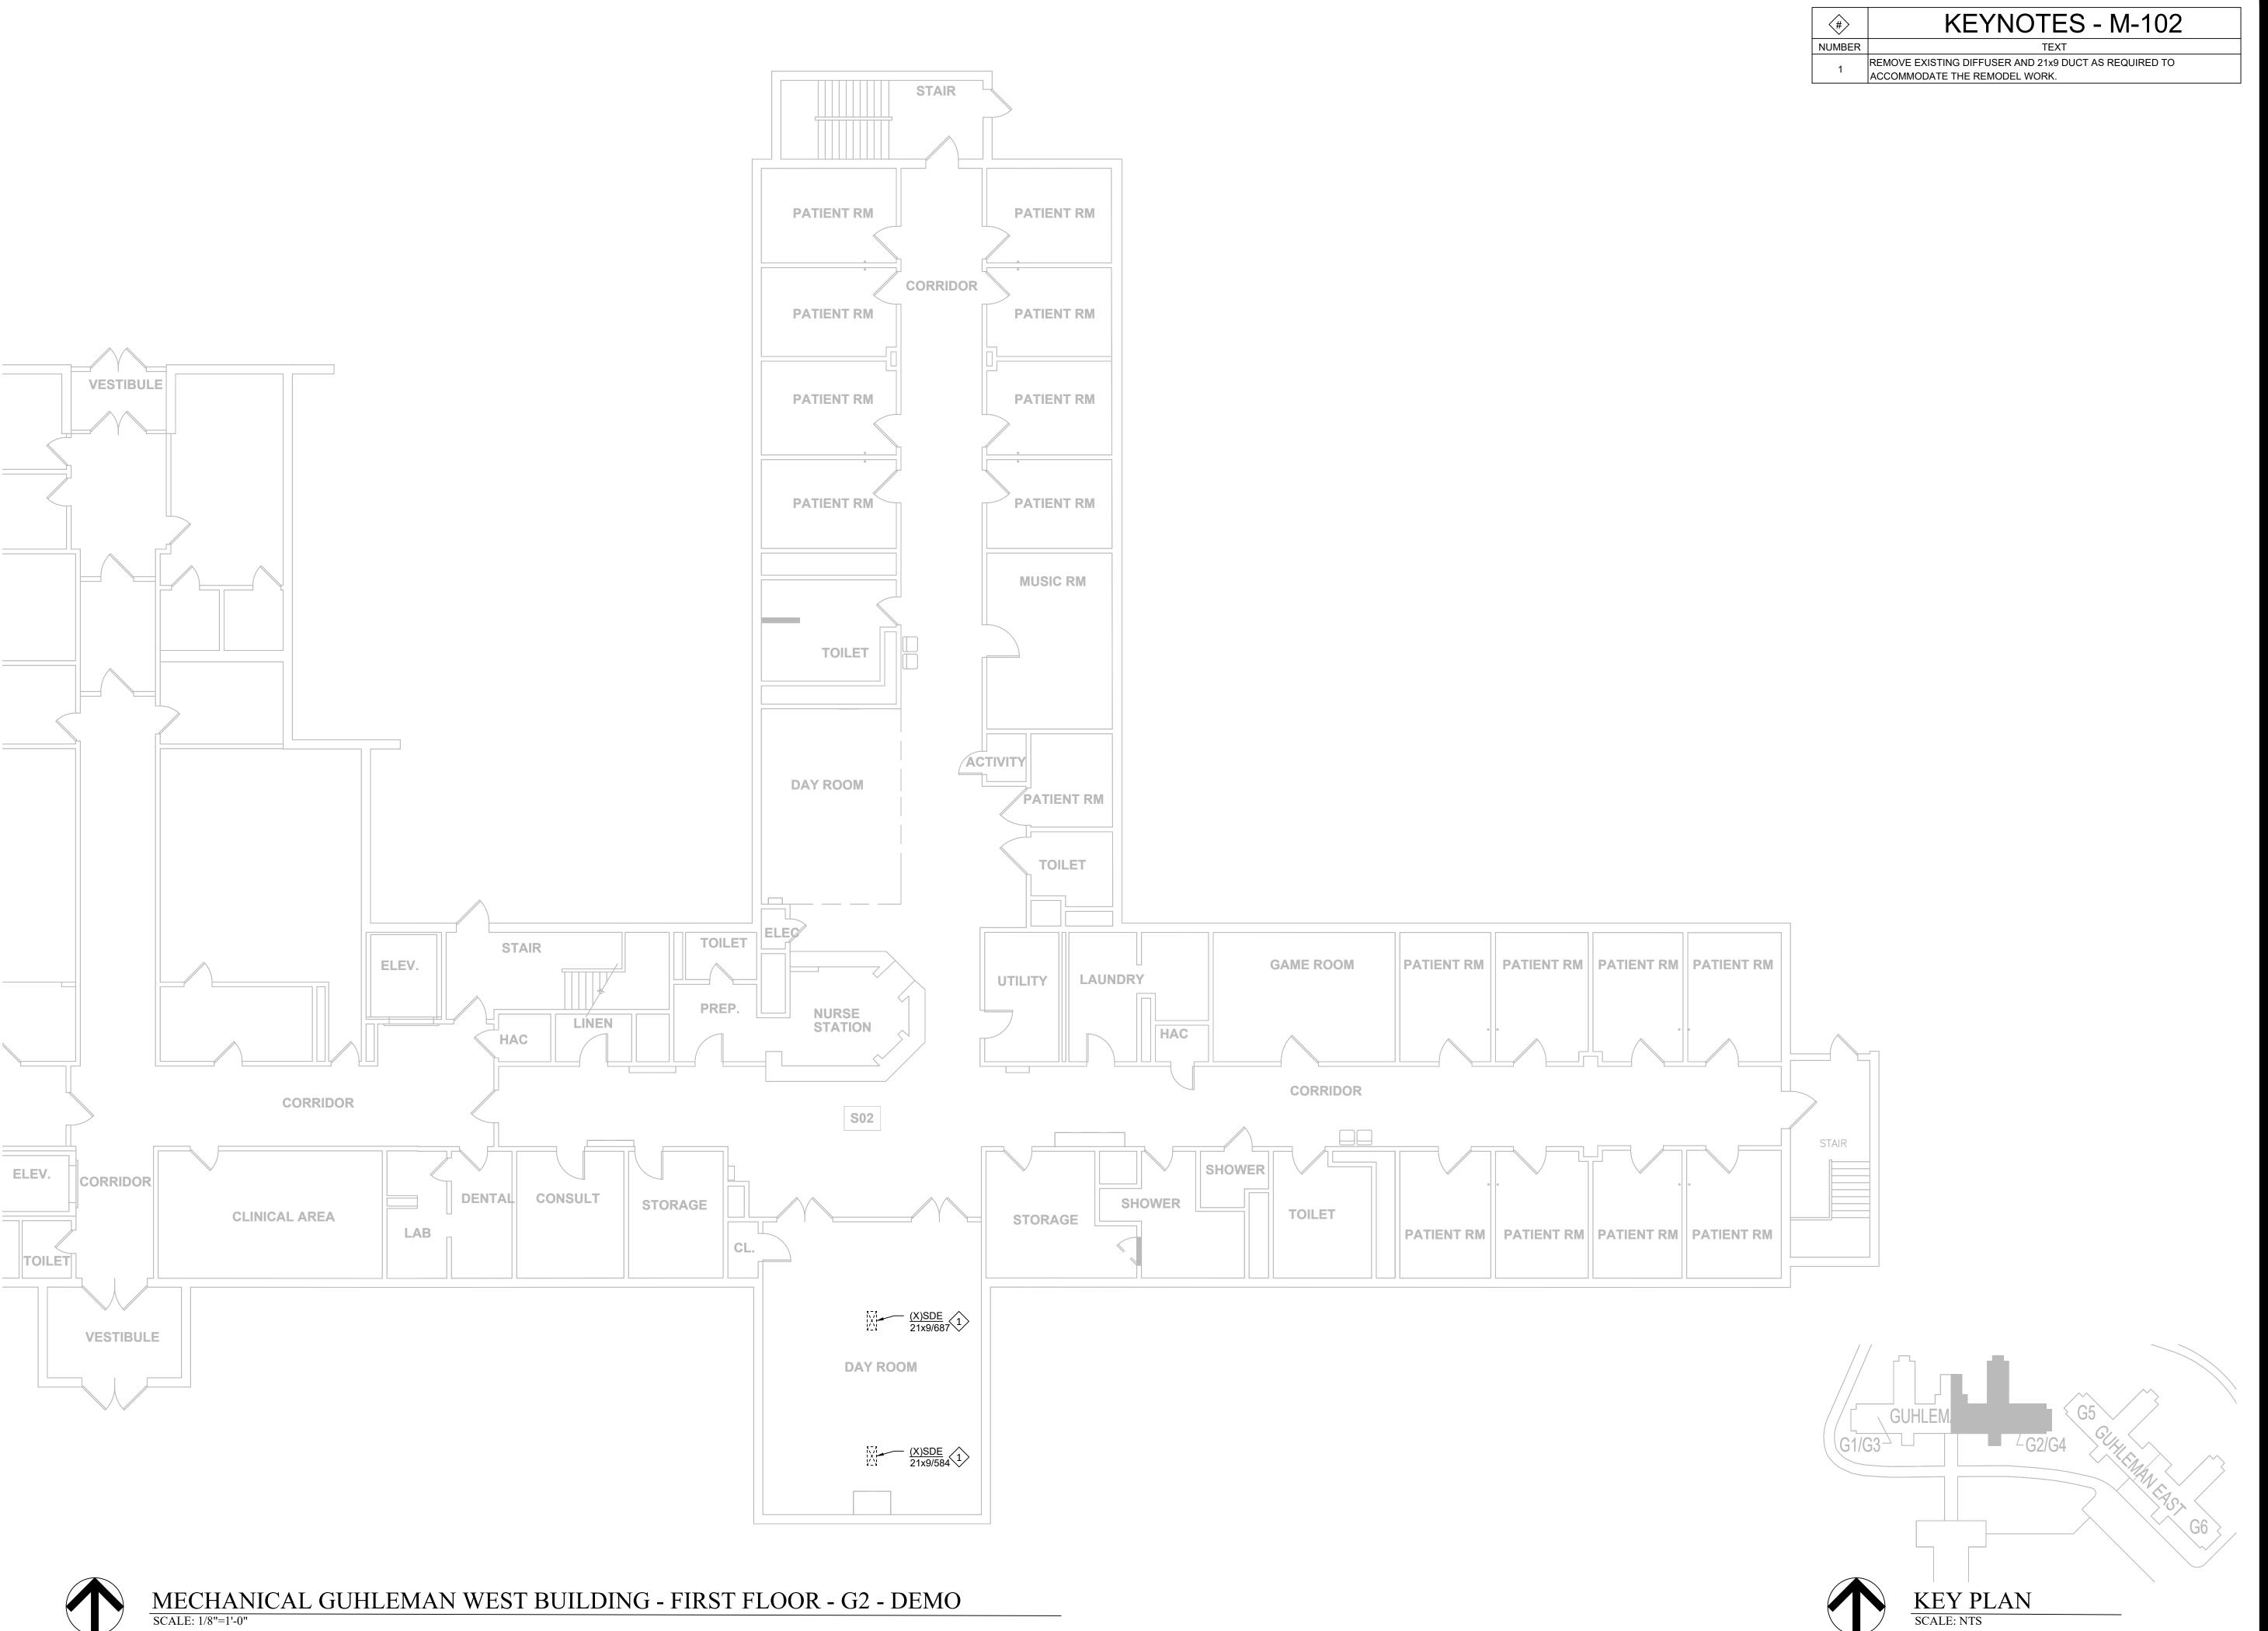





STATE OF MISSOURI CERTIFICATE OF AUTHORITY #2018019473

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OFFICE OF ADMINISTRATION DIVISION OF FACILITIES MANAGEMENT, DESIGN AND CONSTRUCTION

ANTI-LIGATURE UPGRADES MULTIPLE ASSETS FULTON STATE HOSPITAL FULTON, MISSOURI

PROJECT # M2312-01 SITE # 7352 ASSET # 6517352027

REVISION:
DATE:
REVISION:
DATE:
REVISION:
DATE:
REVISION:
DATE:
ISSUE DATE: 09/22/24

CAD DWG FILE:M-DP-01
DRAWN BY: BST
CHECKED BY: EMD
DESIGNED BY: BST

SHEET TITLE:

MECHANICAL

GUHLEMAN WEST


BUILDING - FIRST


FLOOR - G2 - DEMO

SHEET NUMBER:

M-102

SHEET 36 OF 66 SEPTEMBER 22, 2024

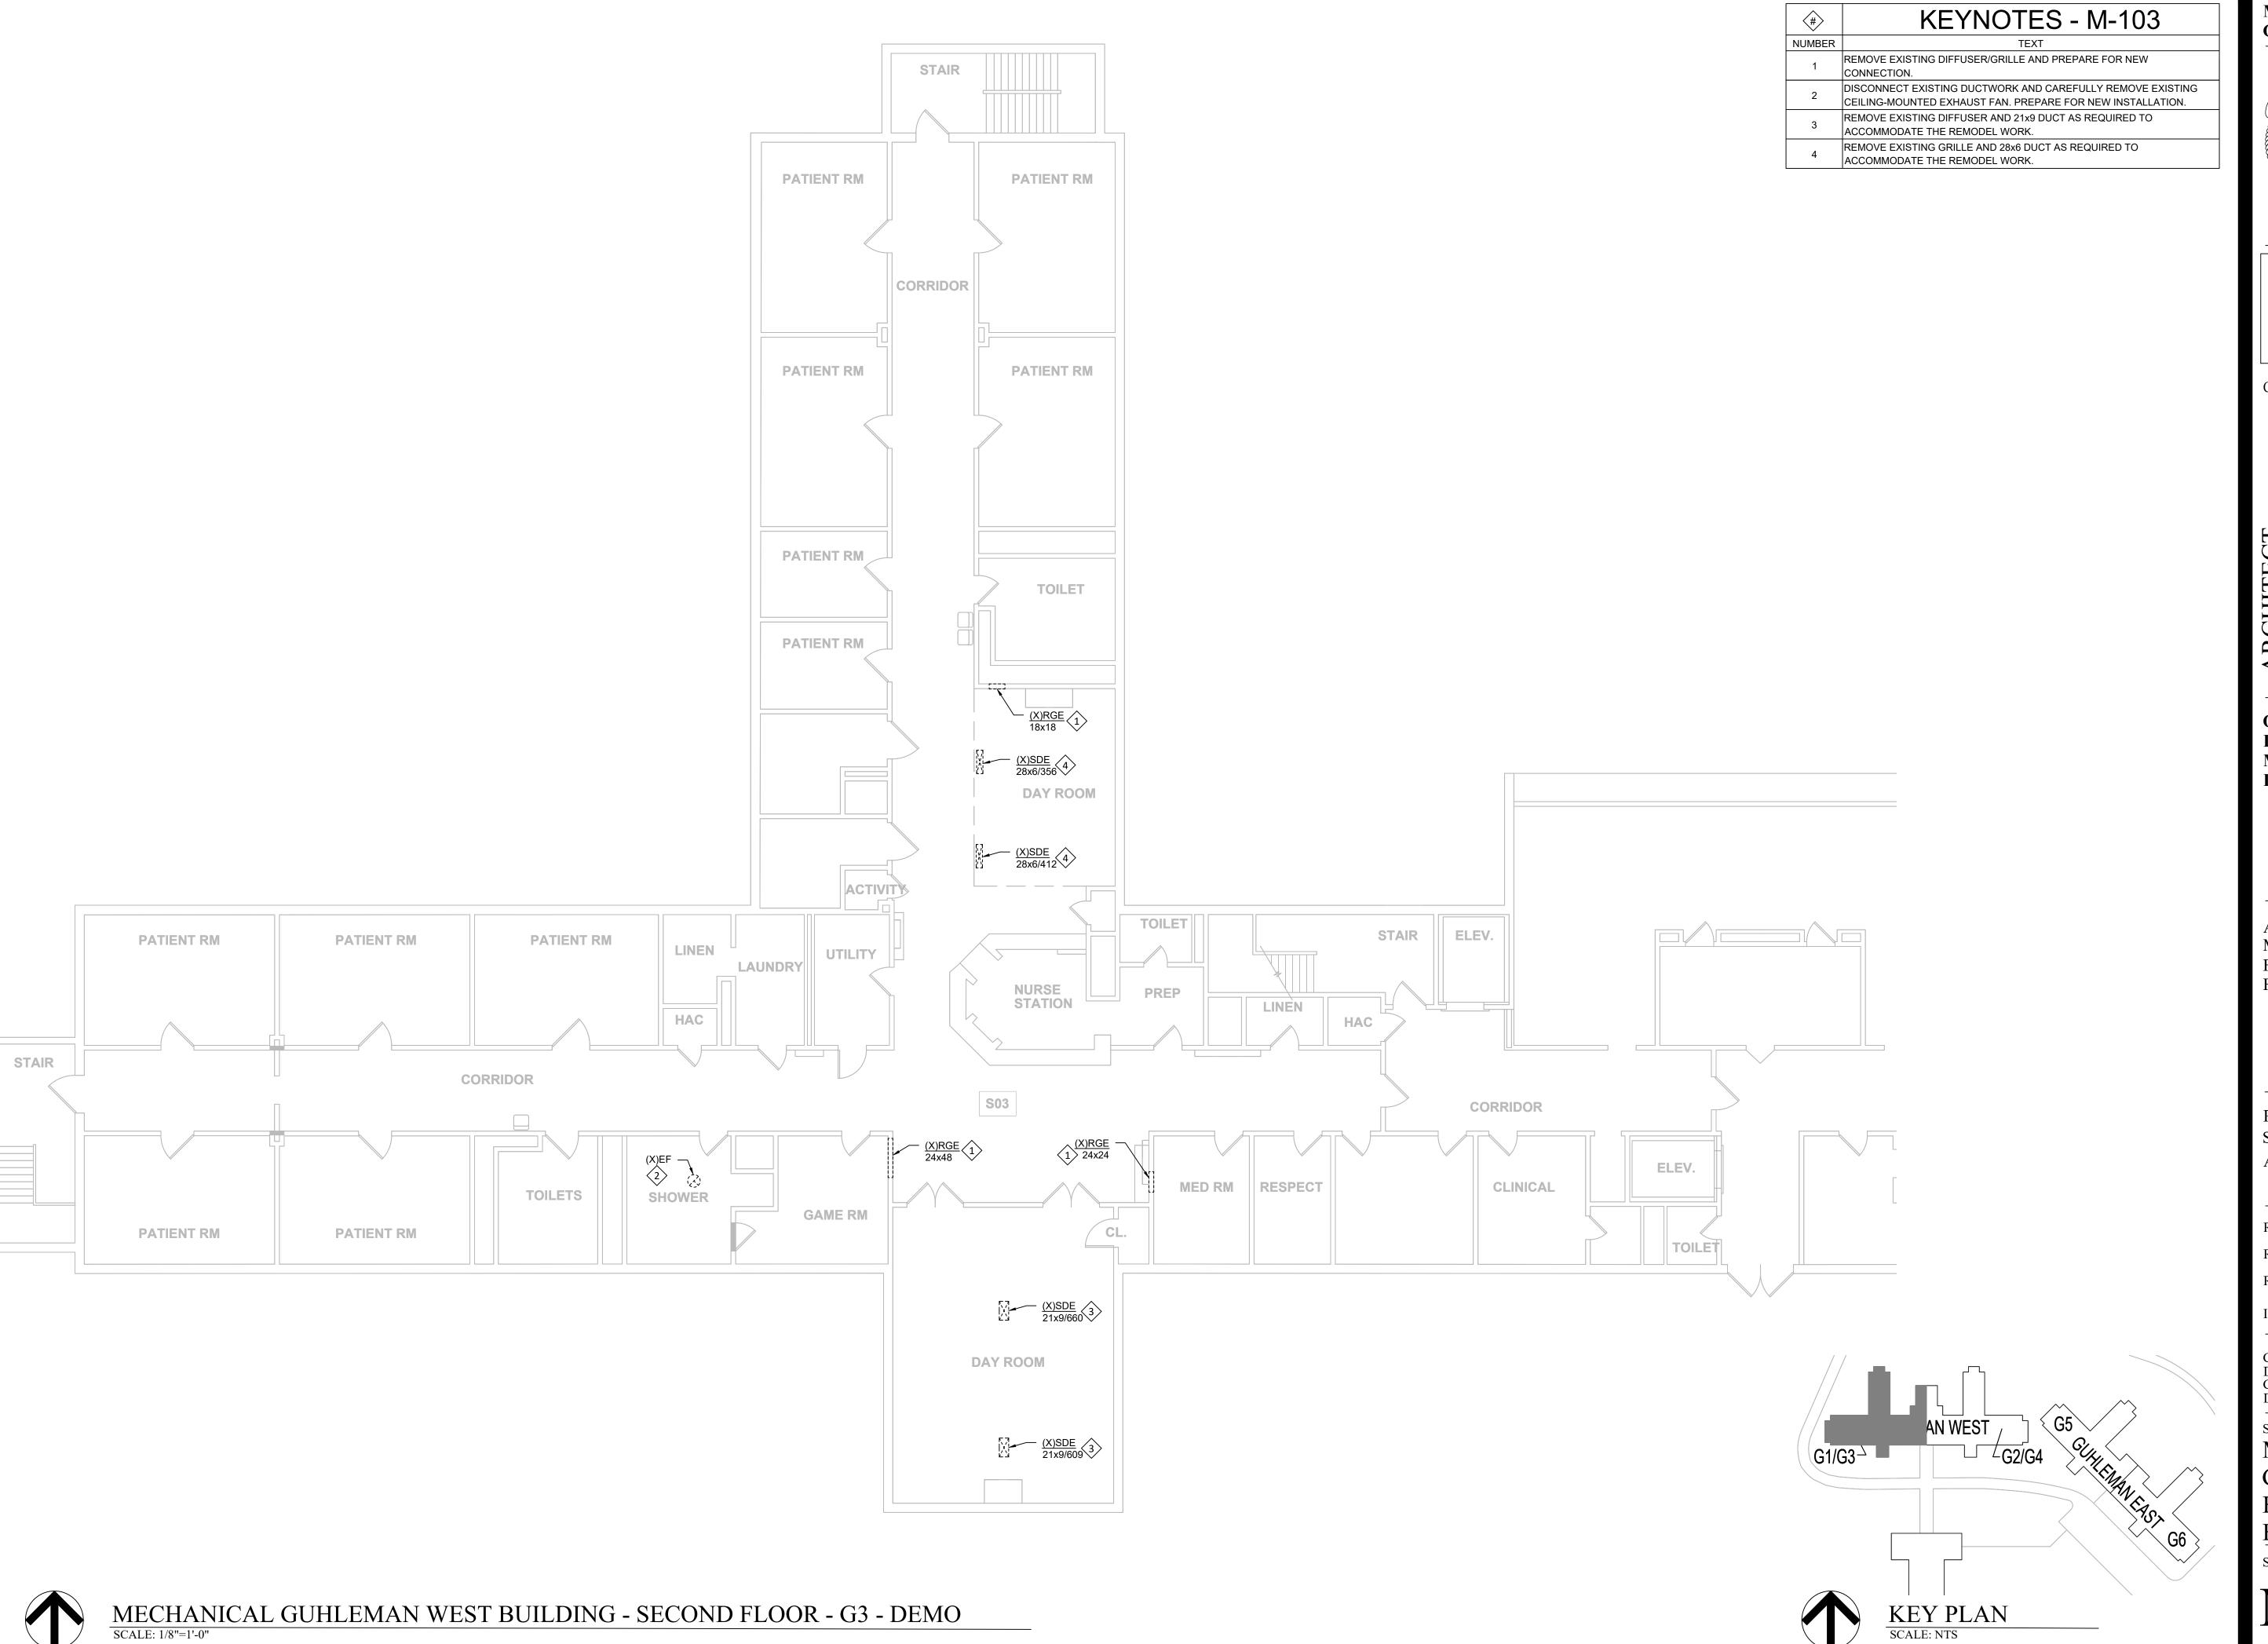

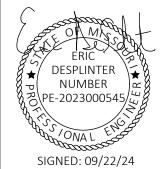



STATE OF MISSOURI CERTIFICATE OF AUTHORITY #2018019473

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ANTI-LIGATURE UPGRADES MULTIPLE ASSETS FULTON STATE HOSPITAL FULTON, MISSOURI

PROJECT # M2312-01 SITE # 7352 ASSET # 6517352027

REVISION:	
DATE:	
REVISION:	
DATE:	
REVISION:	
DATE:	
ISSUE DATE: 09/22/24	

CAD DWG FILE:M-DP-01
DRAWN BY: BST
CHECKED BY: EMD
DESIGNED BY: BST


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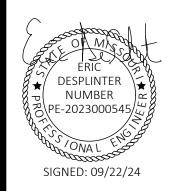
MECHANI

MECHANICAL
GUHLEMAN WEST
BUILDING - SECOND
FLOOR - G3 - DEMO
SHEET NUMBER:

M-103

SHEET 37 OF 66 SEPTEMBER 22, 2024



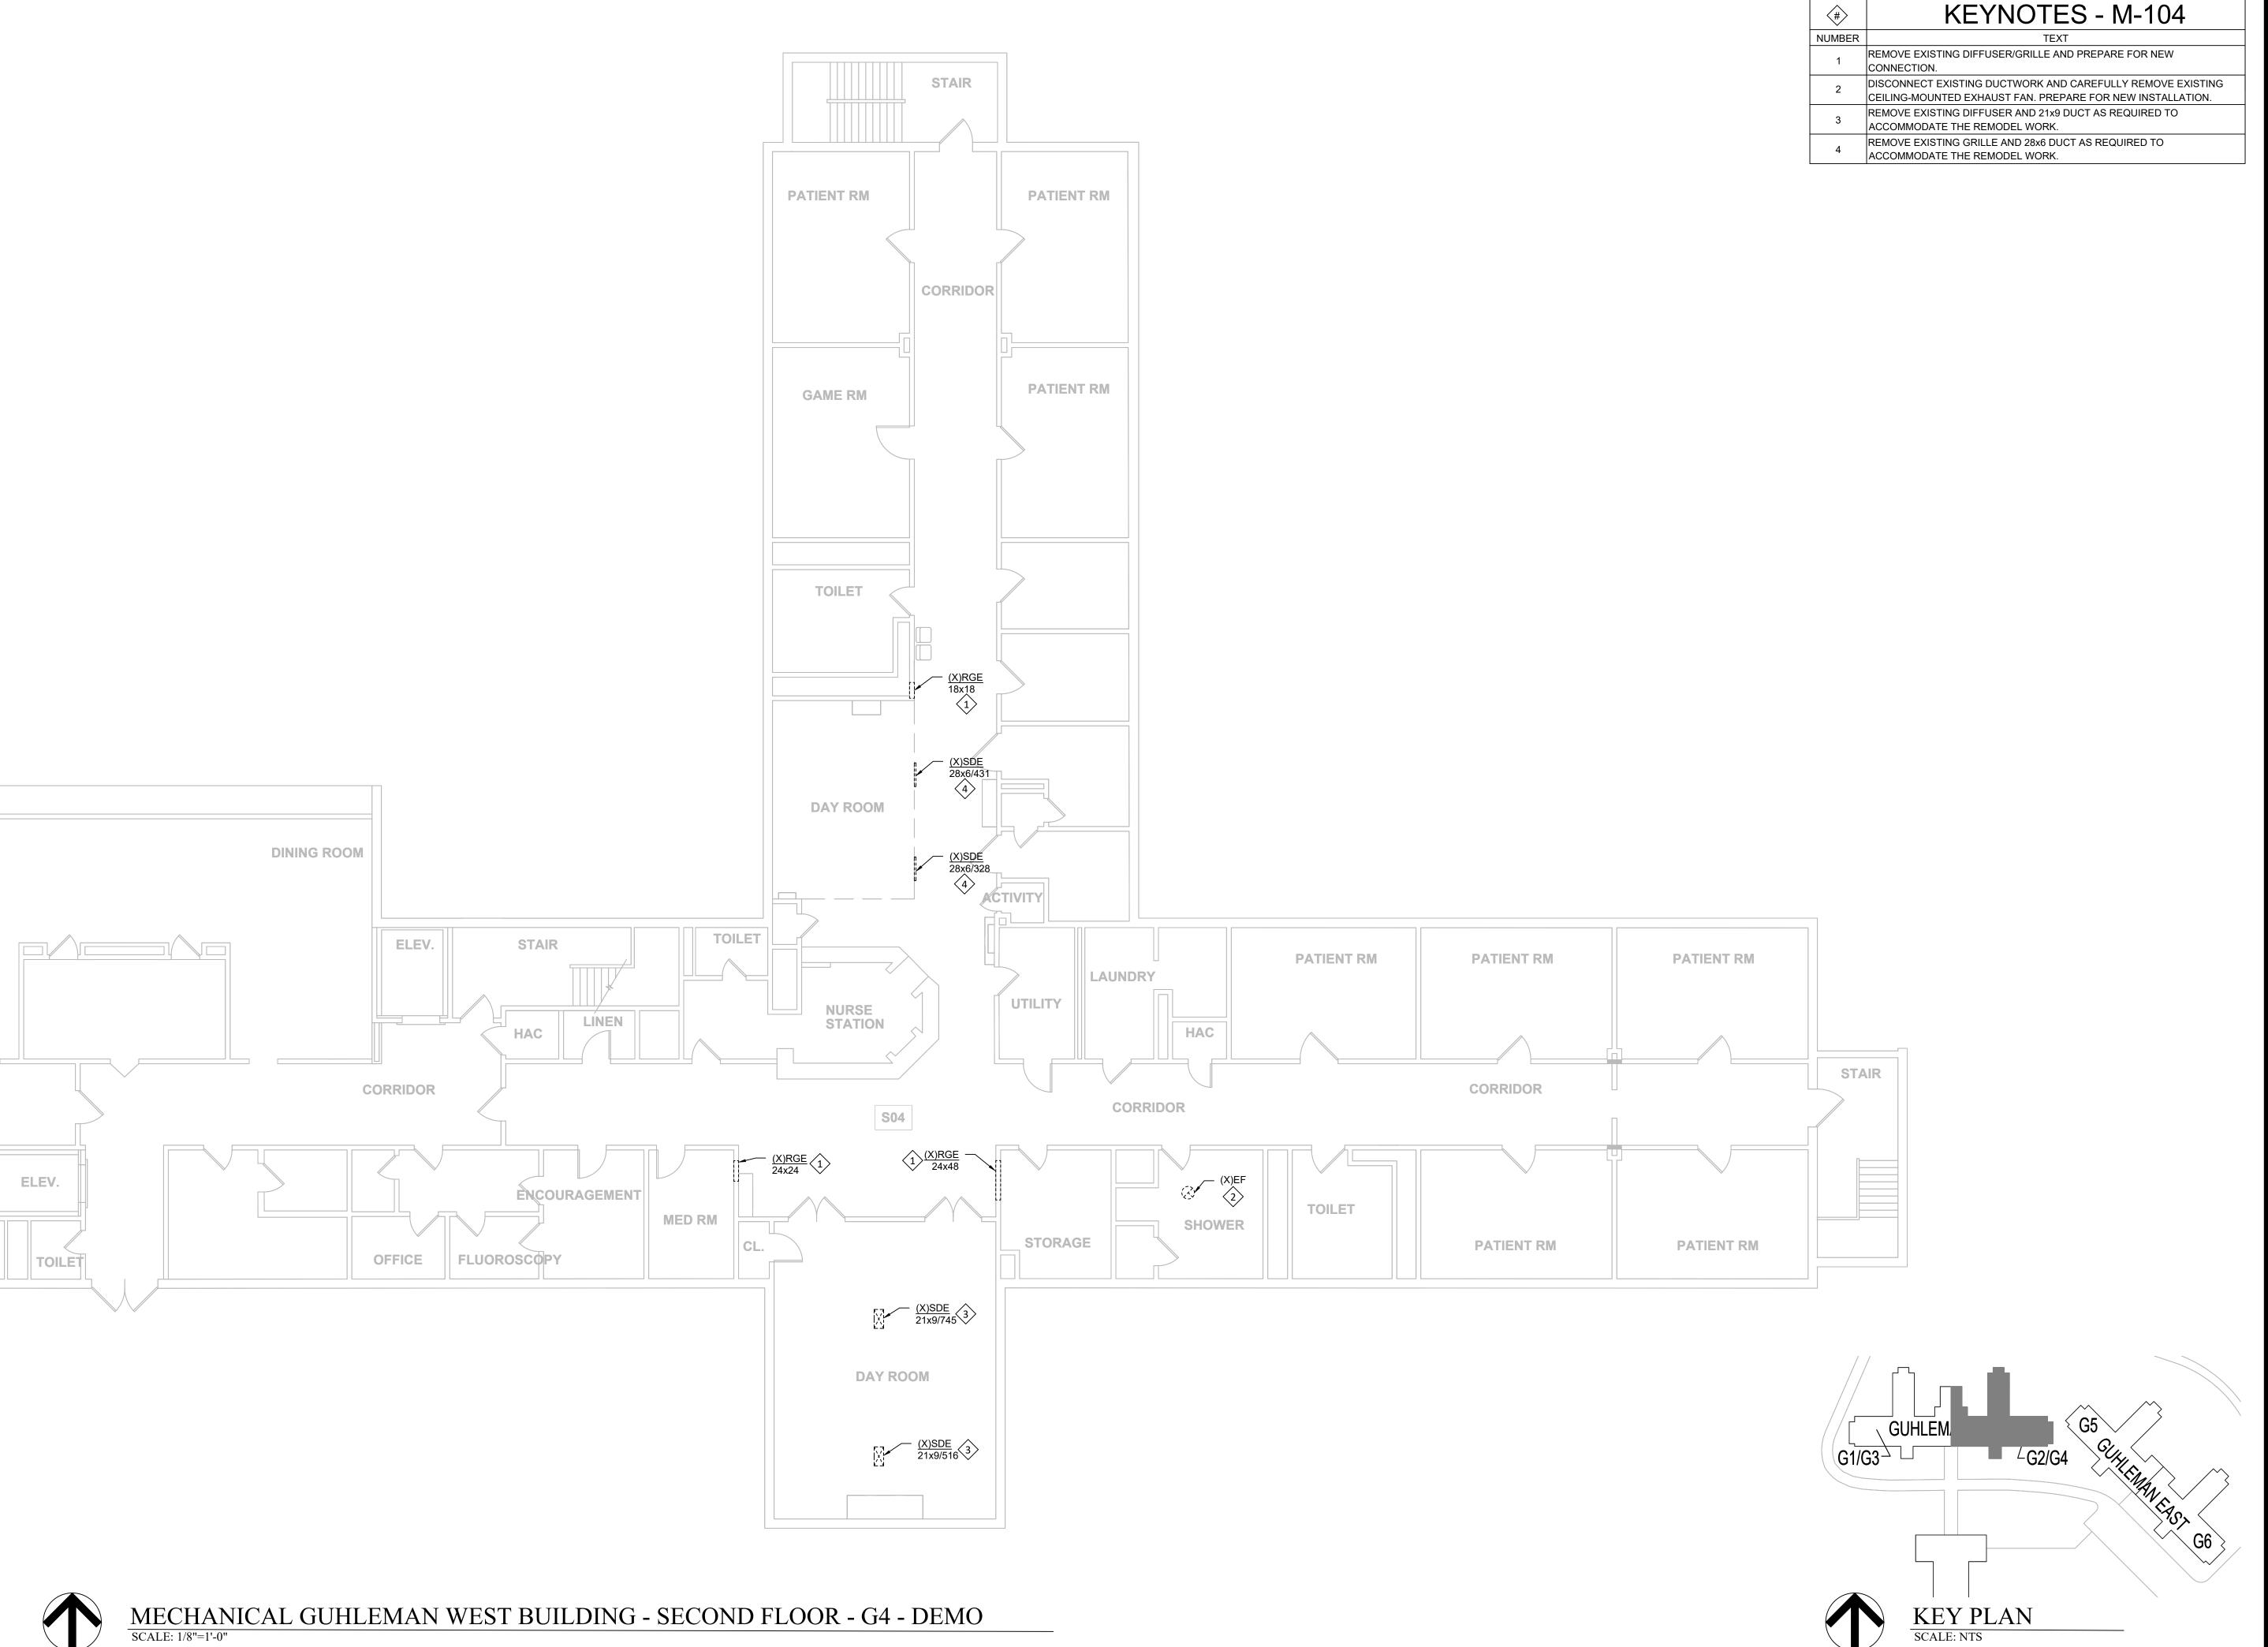



STATE OF MISSOURI CERTIFICATE OF AUTHORITY #2018019473

OFFICE OF ADMINISTRATION DIVISION OF FACILITIES MANAGEMENT, **DESIGN AND CONSTRUCTION**

ANTI-LIGATURE UPGRADES MULTIPLE ASSETS FULTON STATE HOSPITAL FULTON, MISSOURI

PROJECT # M2312-01 7352 ASSET # 6517352027


REVISION: DATE: **REVISION:** DATE: REVISION: DATE: ISSUE DATE: 09/22/24

CAD DWG FILE:M-DP-01
DRAWN BY: BST
CHECKED BY: EMD
DESIGNED BY: BST

SHEET TITLE: MECHANICAL GUHLEMAN WEST BUILDING - SECOND FLOOR - G4 - DEMO

SHEET 38 OF 66 SEPTEMBER 22, 2024

SHEET NUMBER:

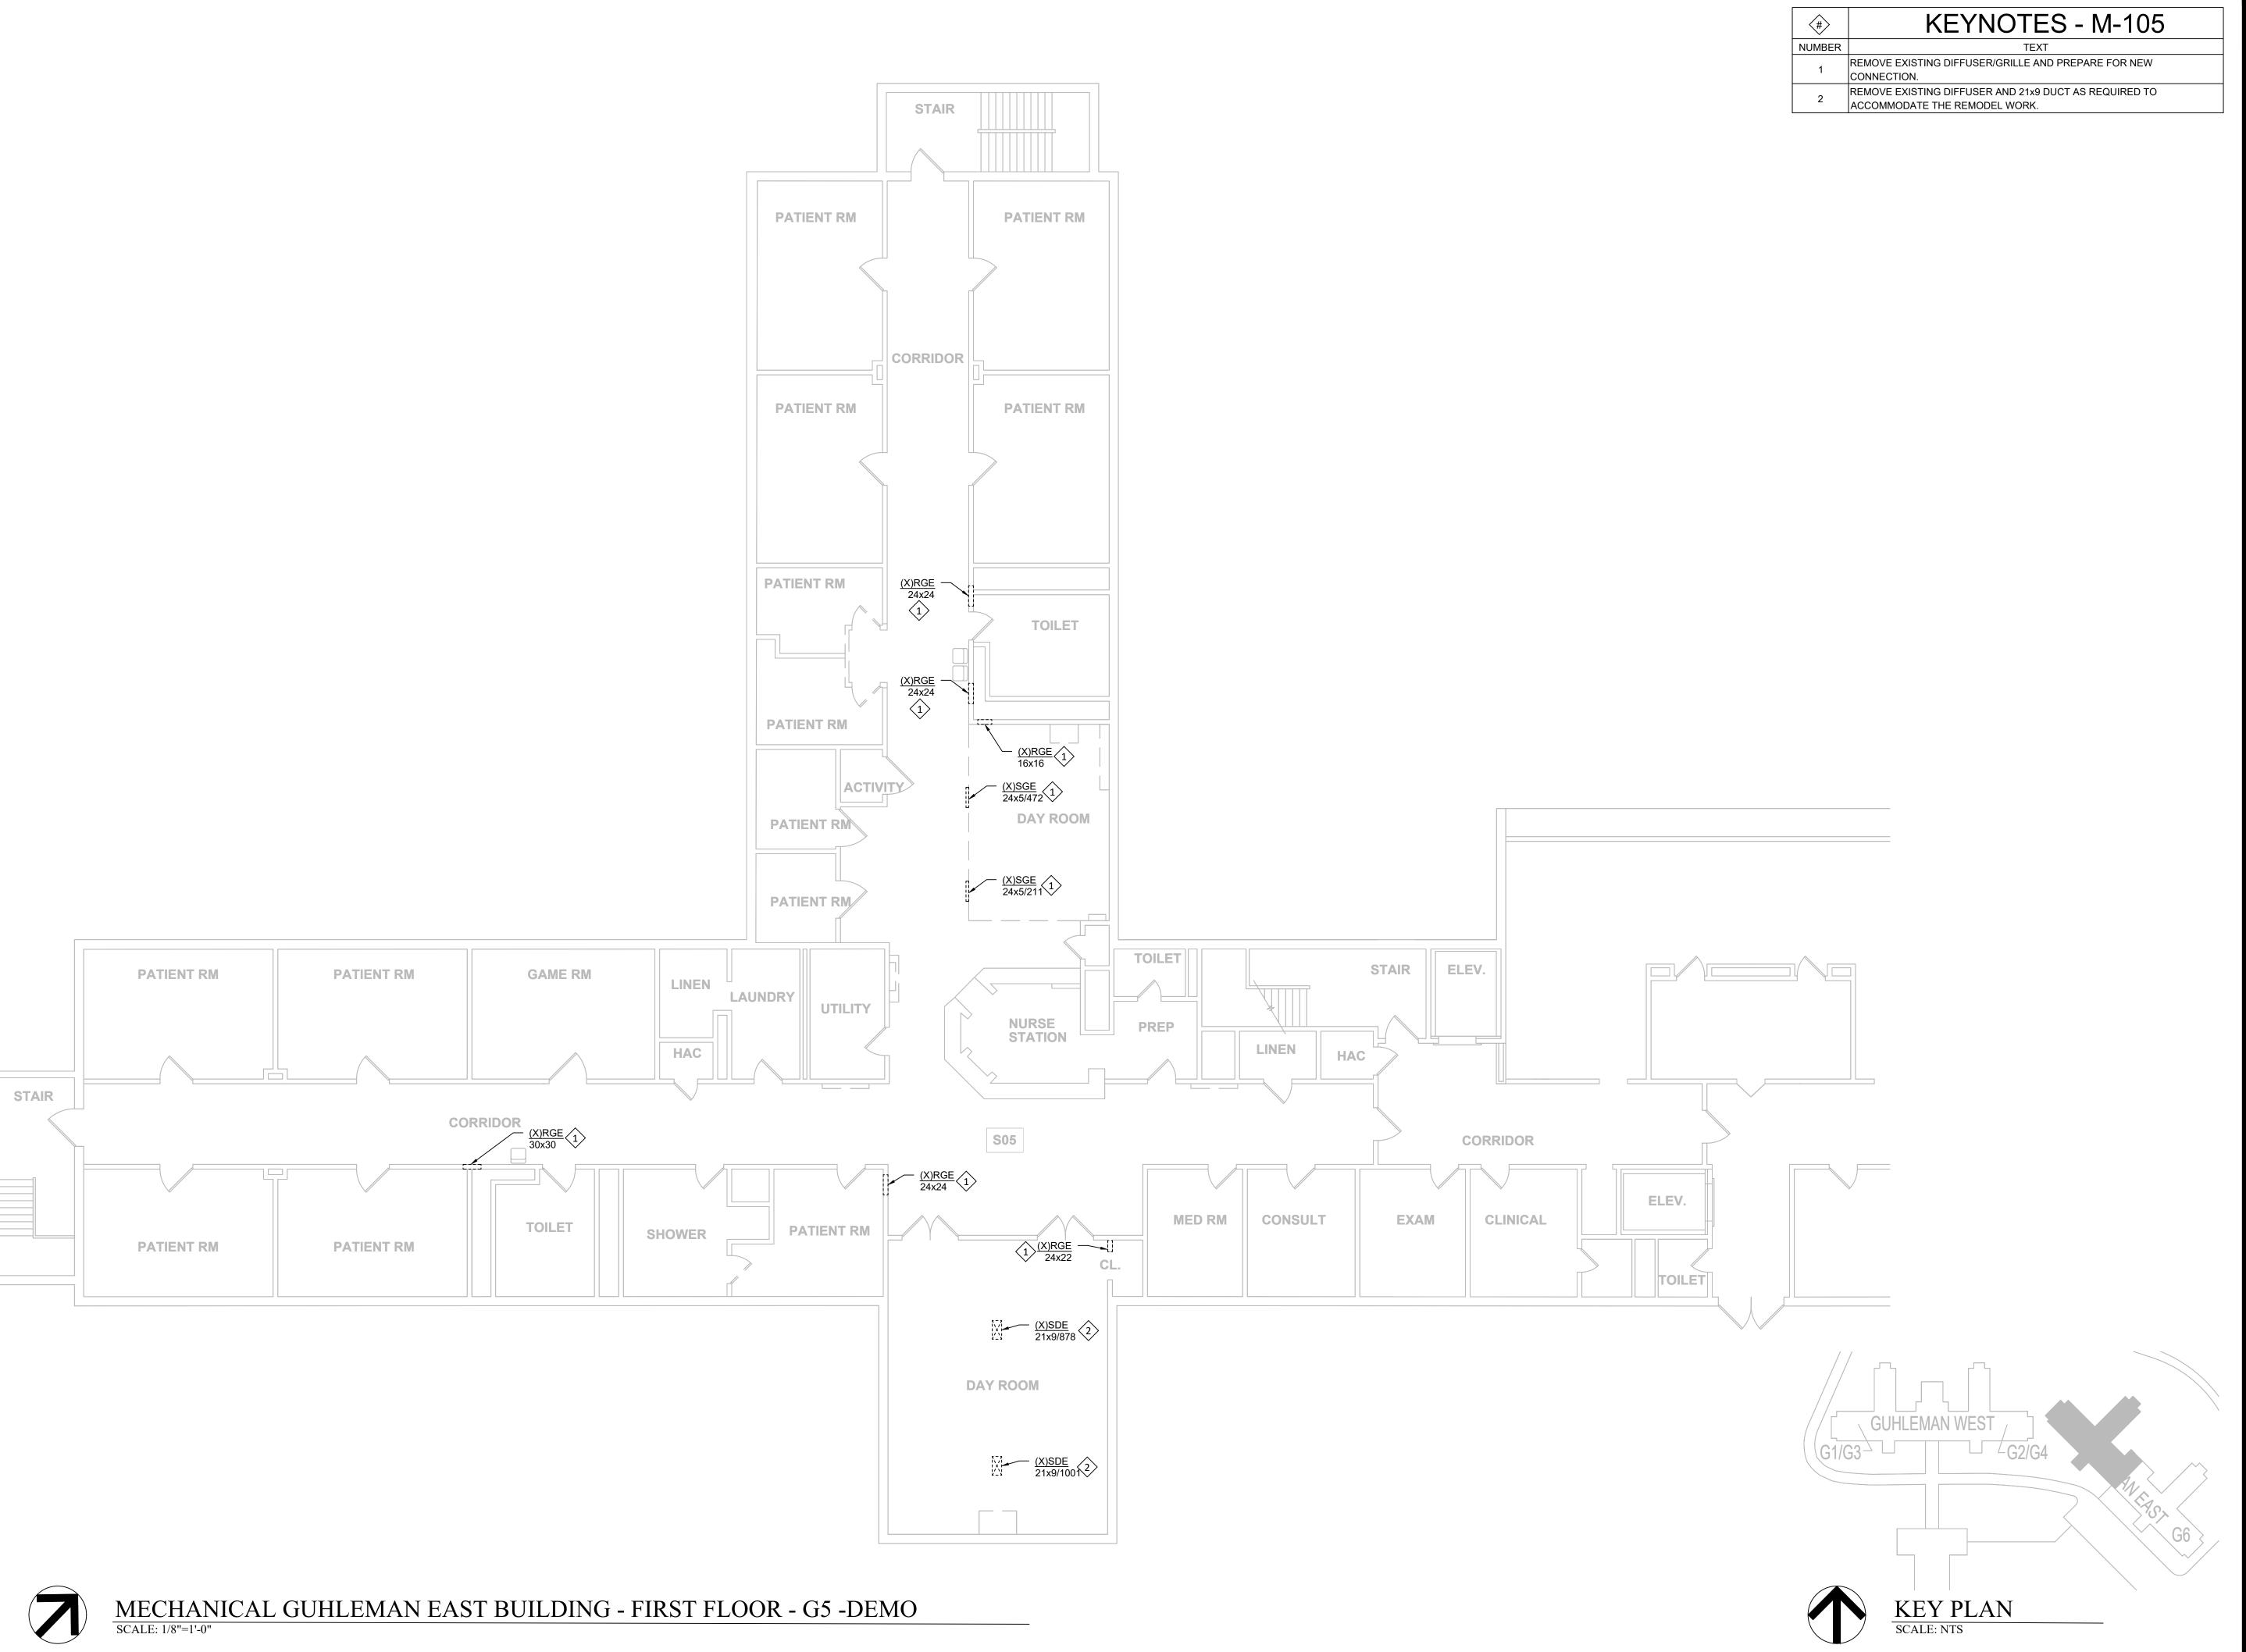





STATE OF MISSOURI CERTIFICATE OF AUTHORITY #2018019473

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OFFICE OF ADMINISTRATION DIVISION OF FACILITIES MANAGEMENT, DESIGN AND CONSTRUCTION

ANTI-LIGATURE UPGRADES MULTIPLE ASSETS FULTON STATE HOSPITAL FULTON, MISSOURI

PROJECT # M2312-01 SITE # 7352 ASSET # 6517352026

REVISION:
DATE:
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REVISION:
DATE:
ISSUE DATE: 09/22/24

CAD DWG FILE:M-DP-01
DRAWN BY: BST
CHECKED BY: EMD
DESIGNED BY: BST

SHEET TITLE:

MECHANICAL

GUHLEMAN EAST


BUILDING - FIRST

FLOOR - G5 - DEMO

SHEET NUMBER:

M-105

SHEET 39 OF 66 SEPTEMBER 22, 2024

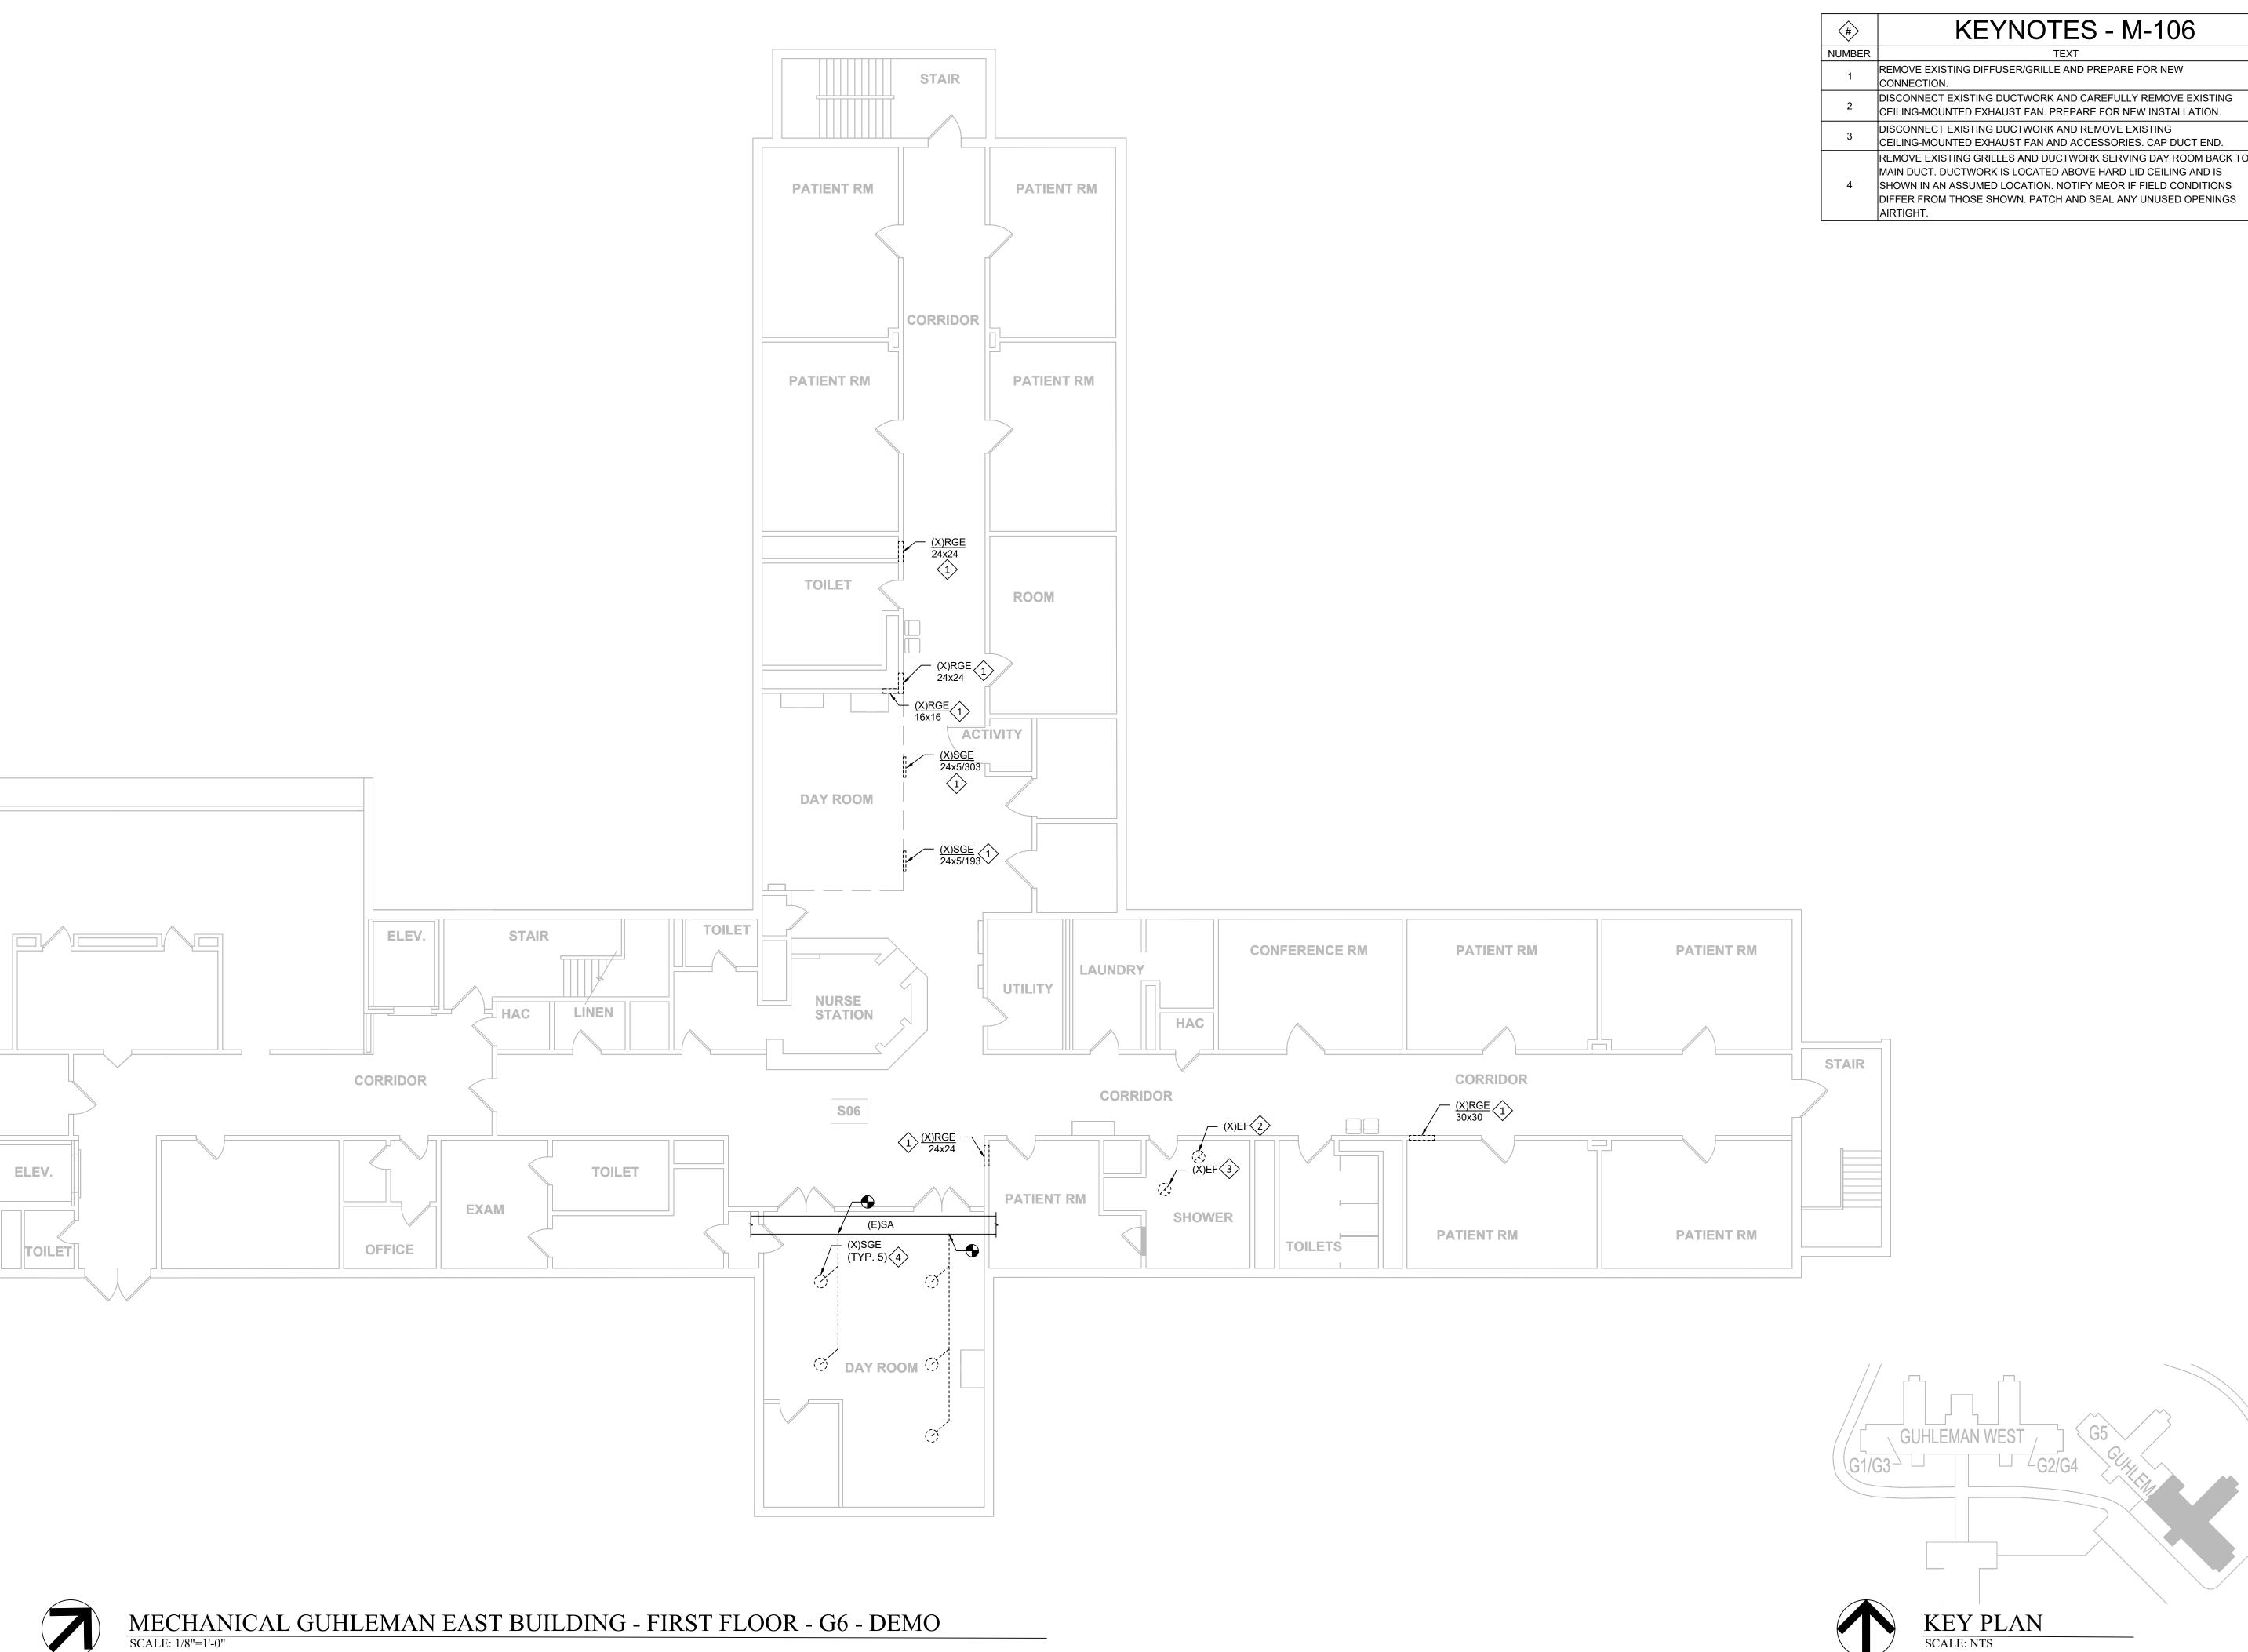


KEYNOTES - M-106

REMOVE EXISTING DIFFUSER/GRILLE AND PREPARE FOR NEW

DISCONNECT EXISTING DUCTWORK AND CAREFULLY REMOVE EXISTING CEILING-MOUNTED EXHAUST FAN. PREPARE FOR NEW INSTALLATION.

DISCONNECT EXISTING DUCTWORK AND REMOVE EXISTING

MAIN DUCT. DUCTWORK IS LOCATED ABOVE HARD LID CEILING AND IS SHOWN IN AN ASSUMED LOCATION. NOTIFY MEOR IF FIELD CONDITIONS DIFFER FROM THOSE SHOWN. PATCH AND SEAL ANY UNUSED OPENINGS STATE OF MISSOURI MICHAEL L PARSON, **GOVERNOR**

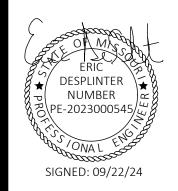



STATE OF MISSOURI CERTIFICATE OF AUTHORITY #2018019473

OFFICE OF ADMINISTRATION DIVISION OF FACILITIES MANAGEMENT, **DESIGN AND CONSTRUCTION**

ANTI-LIGATURE UPGRADES MULTIPLE ASSETS FULTON STATE HOSPITAL FULTON, MISSOURI

PROJECT # M2312-01 7352 ASSET # 6517352026


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ISSUE DATE: 09/22/24

CAD DWG FILE:M-DP-01
DRAWN BY: BST
CHECKED BY: EMD
DESIGNED BY: BST

SHEET TITLE: MECHANICAL GUHLEMAN EAST BUILDING - FIRST FLOOR - G6 - DEMO

SHEET NUMBER:

SHEET 40 OF 66 SEPTEMBER 22, 2024

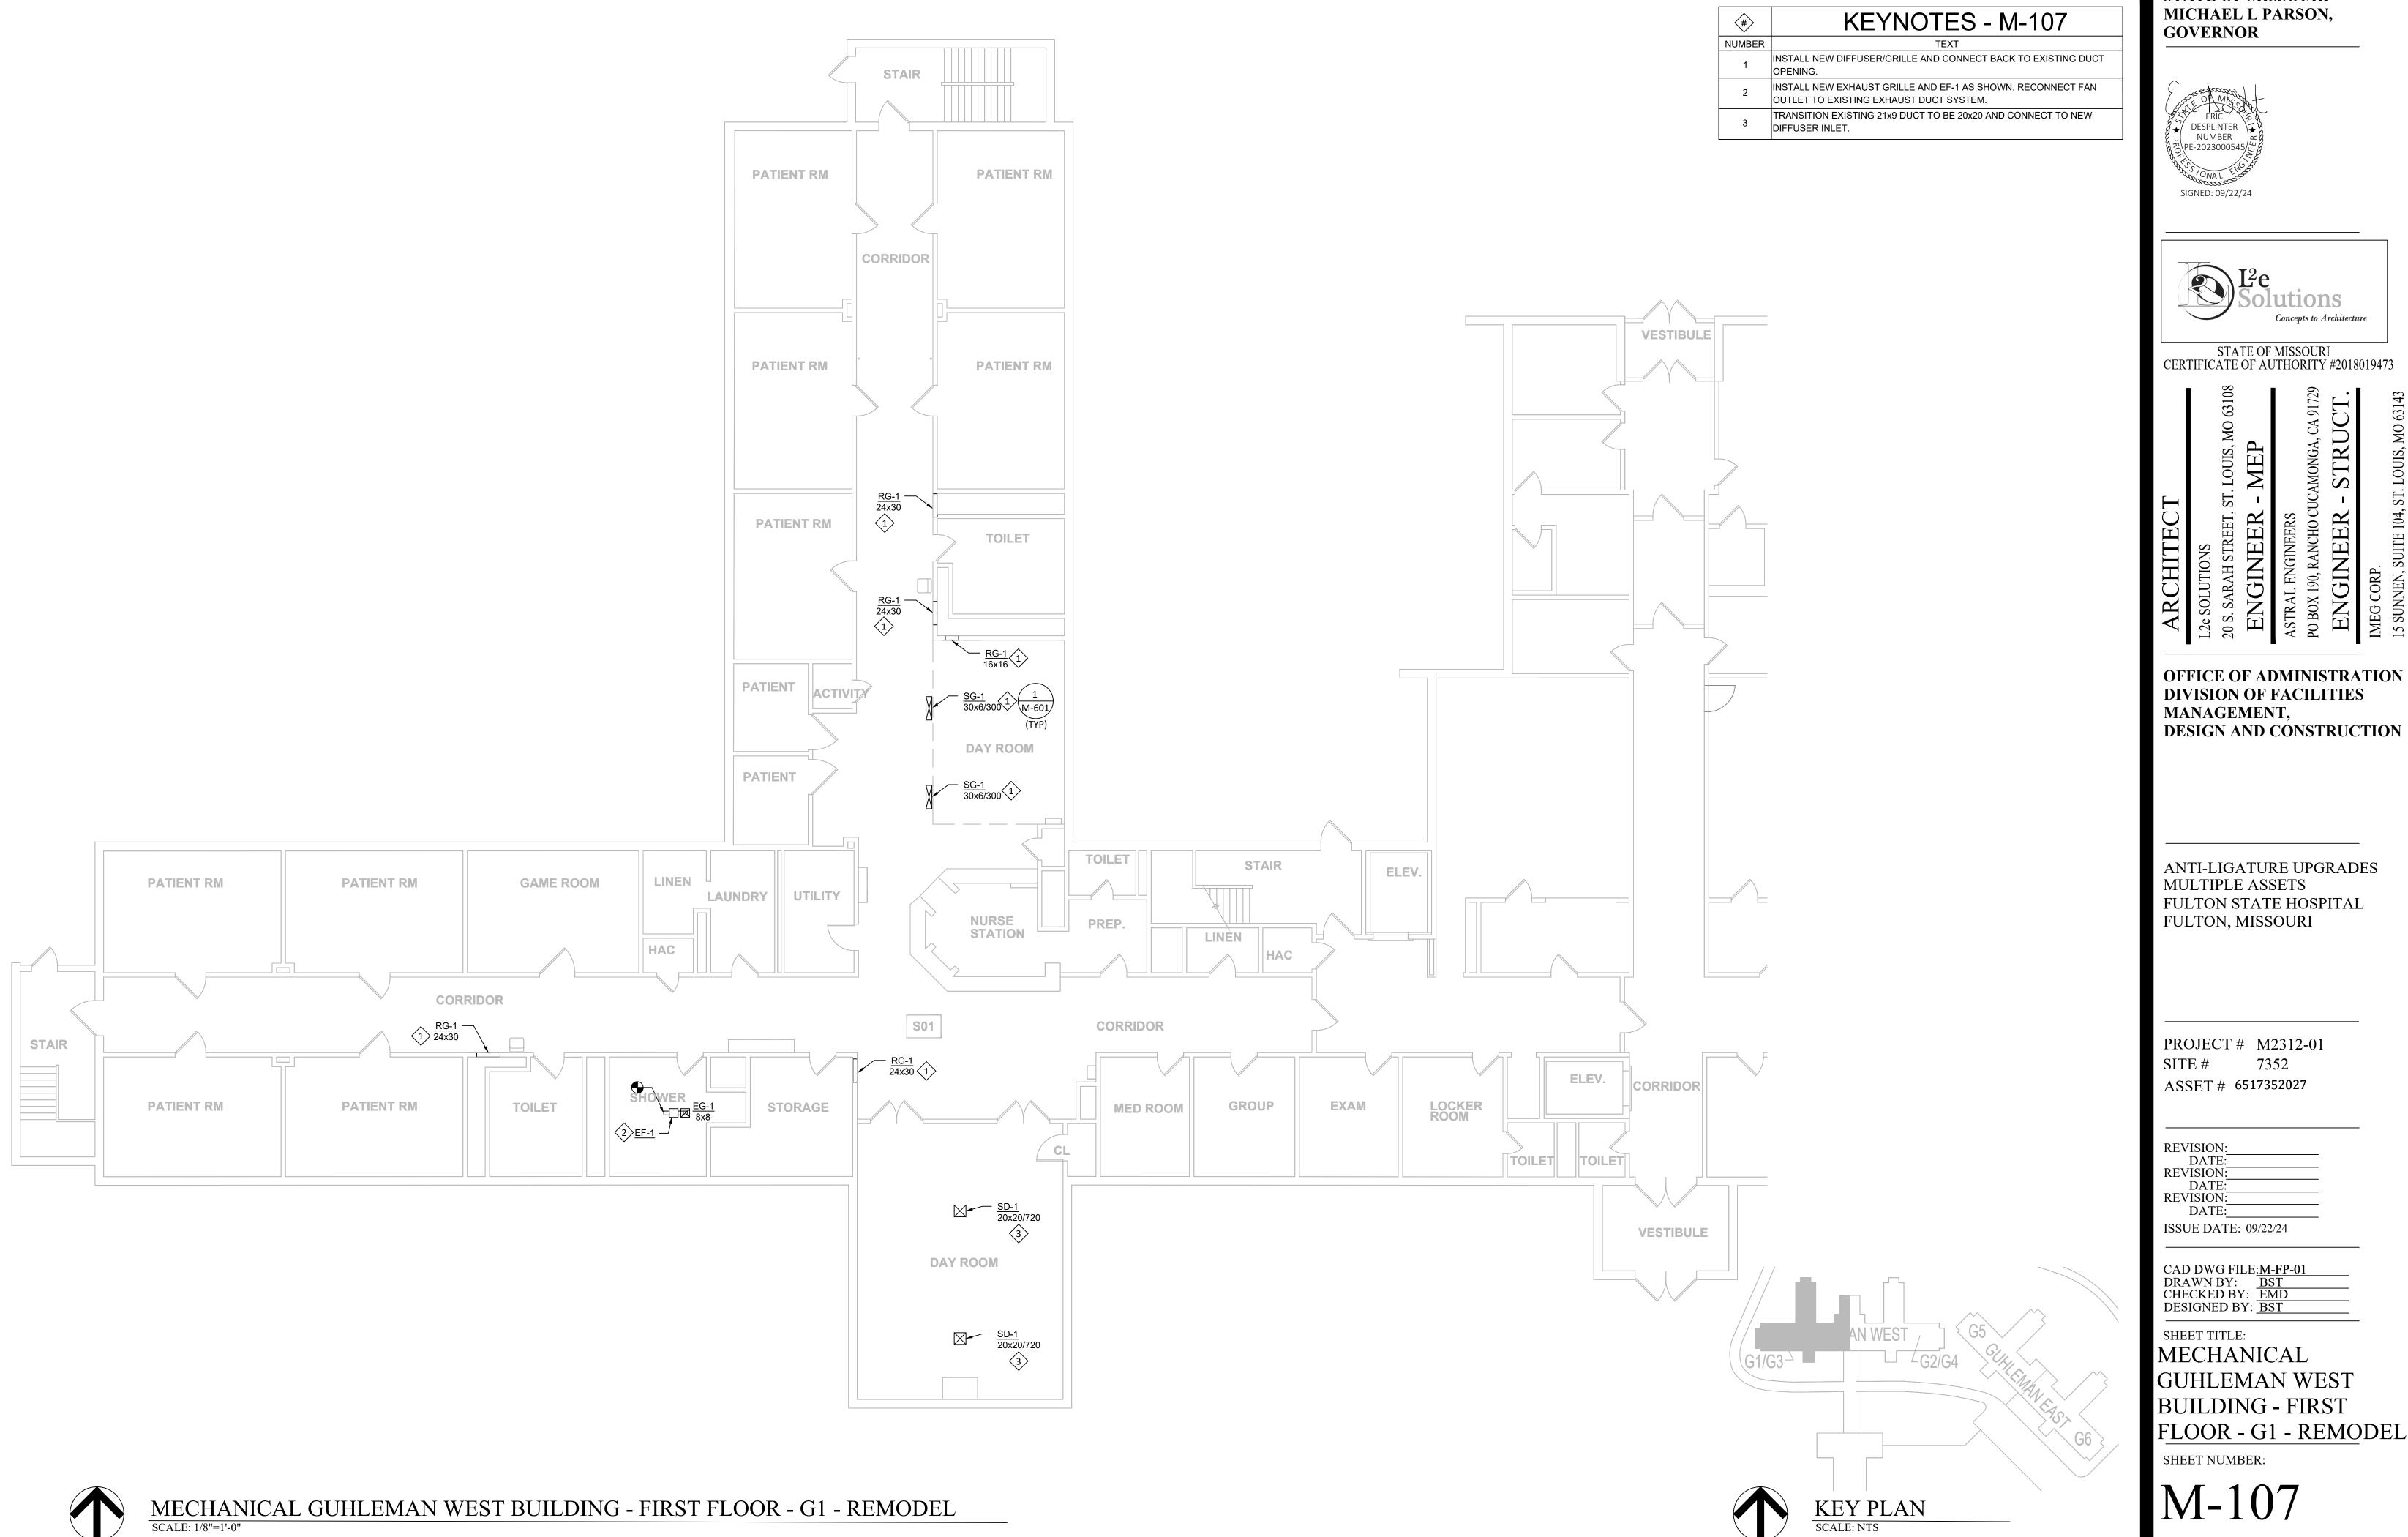


STATE OF MISSOURI MICHAEL L PARSON,



DESIGN AND CONSTRUCTION

FLOOR - G1 - REMODEL

SHEET 41 OF 66 SEPTEMBER 22, 2024

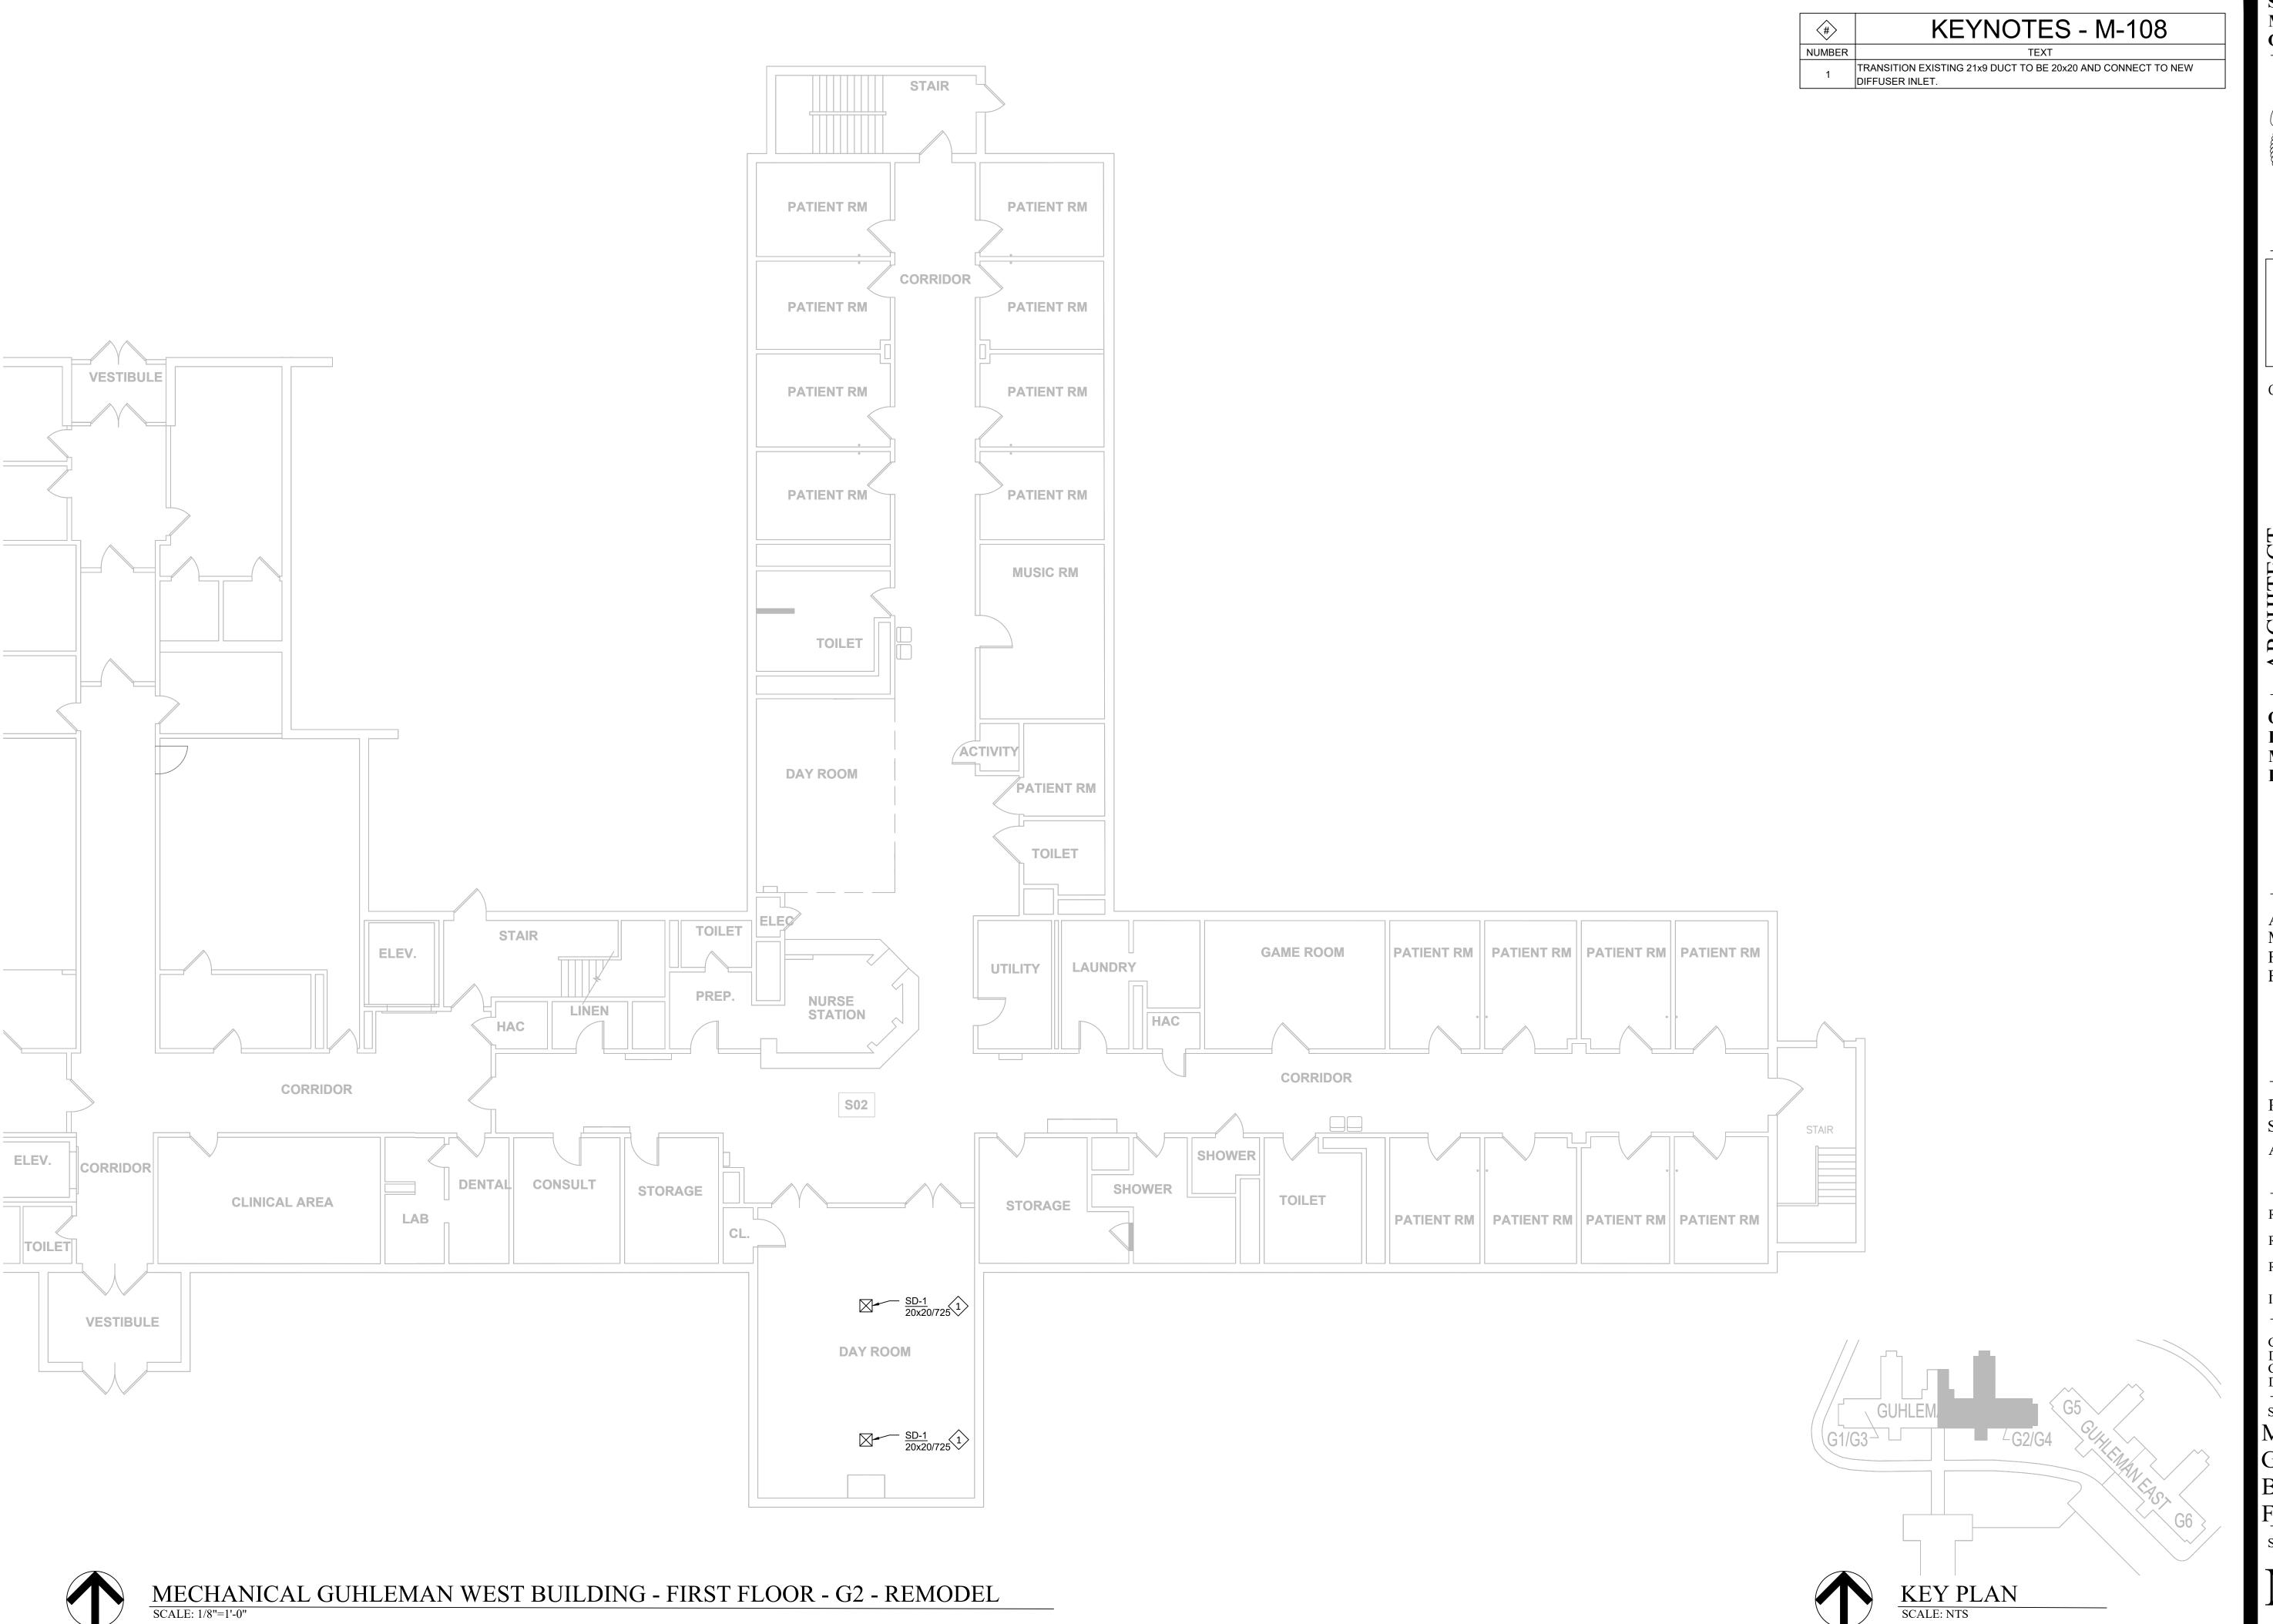





STATE OF MISSOURI CERTIFICATE OF AUTHORITY #2018019473

OFFICE OF ADMINISTRATION DIVISION OF FACILITIES MANAGEMENT, **DESIGN AND CONSTRUCTION**

ANTI-LIGATURE UPGRADES MULTIPLE ASSETS FULTON STATE HOSPITAL FULTON, MISSOURI

PROJECT # M2312-01 7352 ASSET # 6517352027


REVISION: DATE: **REVISION:** REVISION: DATE: ISSUE DATE: 09/22/24

CAD DWG FILE:M-FP-01
DRAWN BY: BST
CHECKED BY: EMD DESIGNED BY: BST

SHEET TITLE:

MECHANICAL GUHLEMAN WEST **BUILDING - FIRST** FLOOR - G2 - REMODEL SHEET NUMBER:

SHEET 42 OF 66 SEPTEMBER 22, 2024

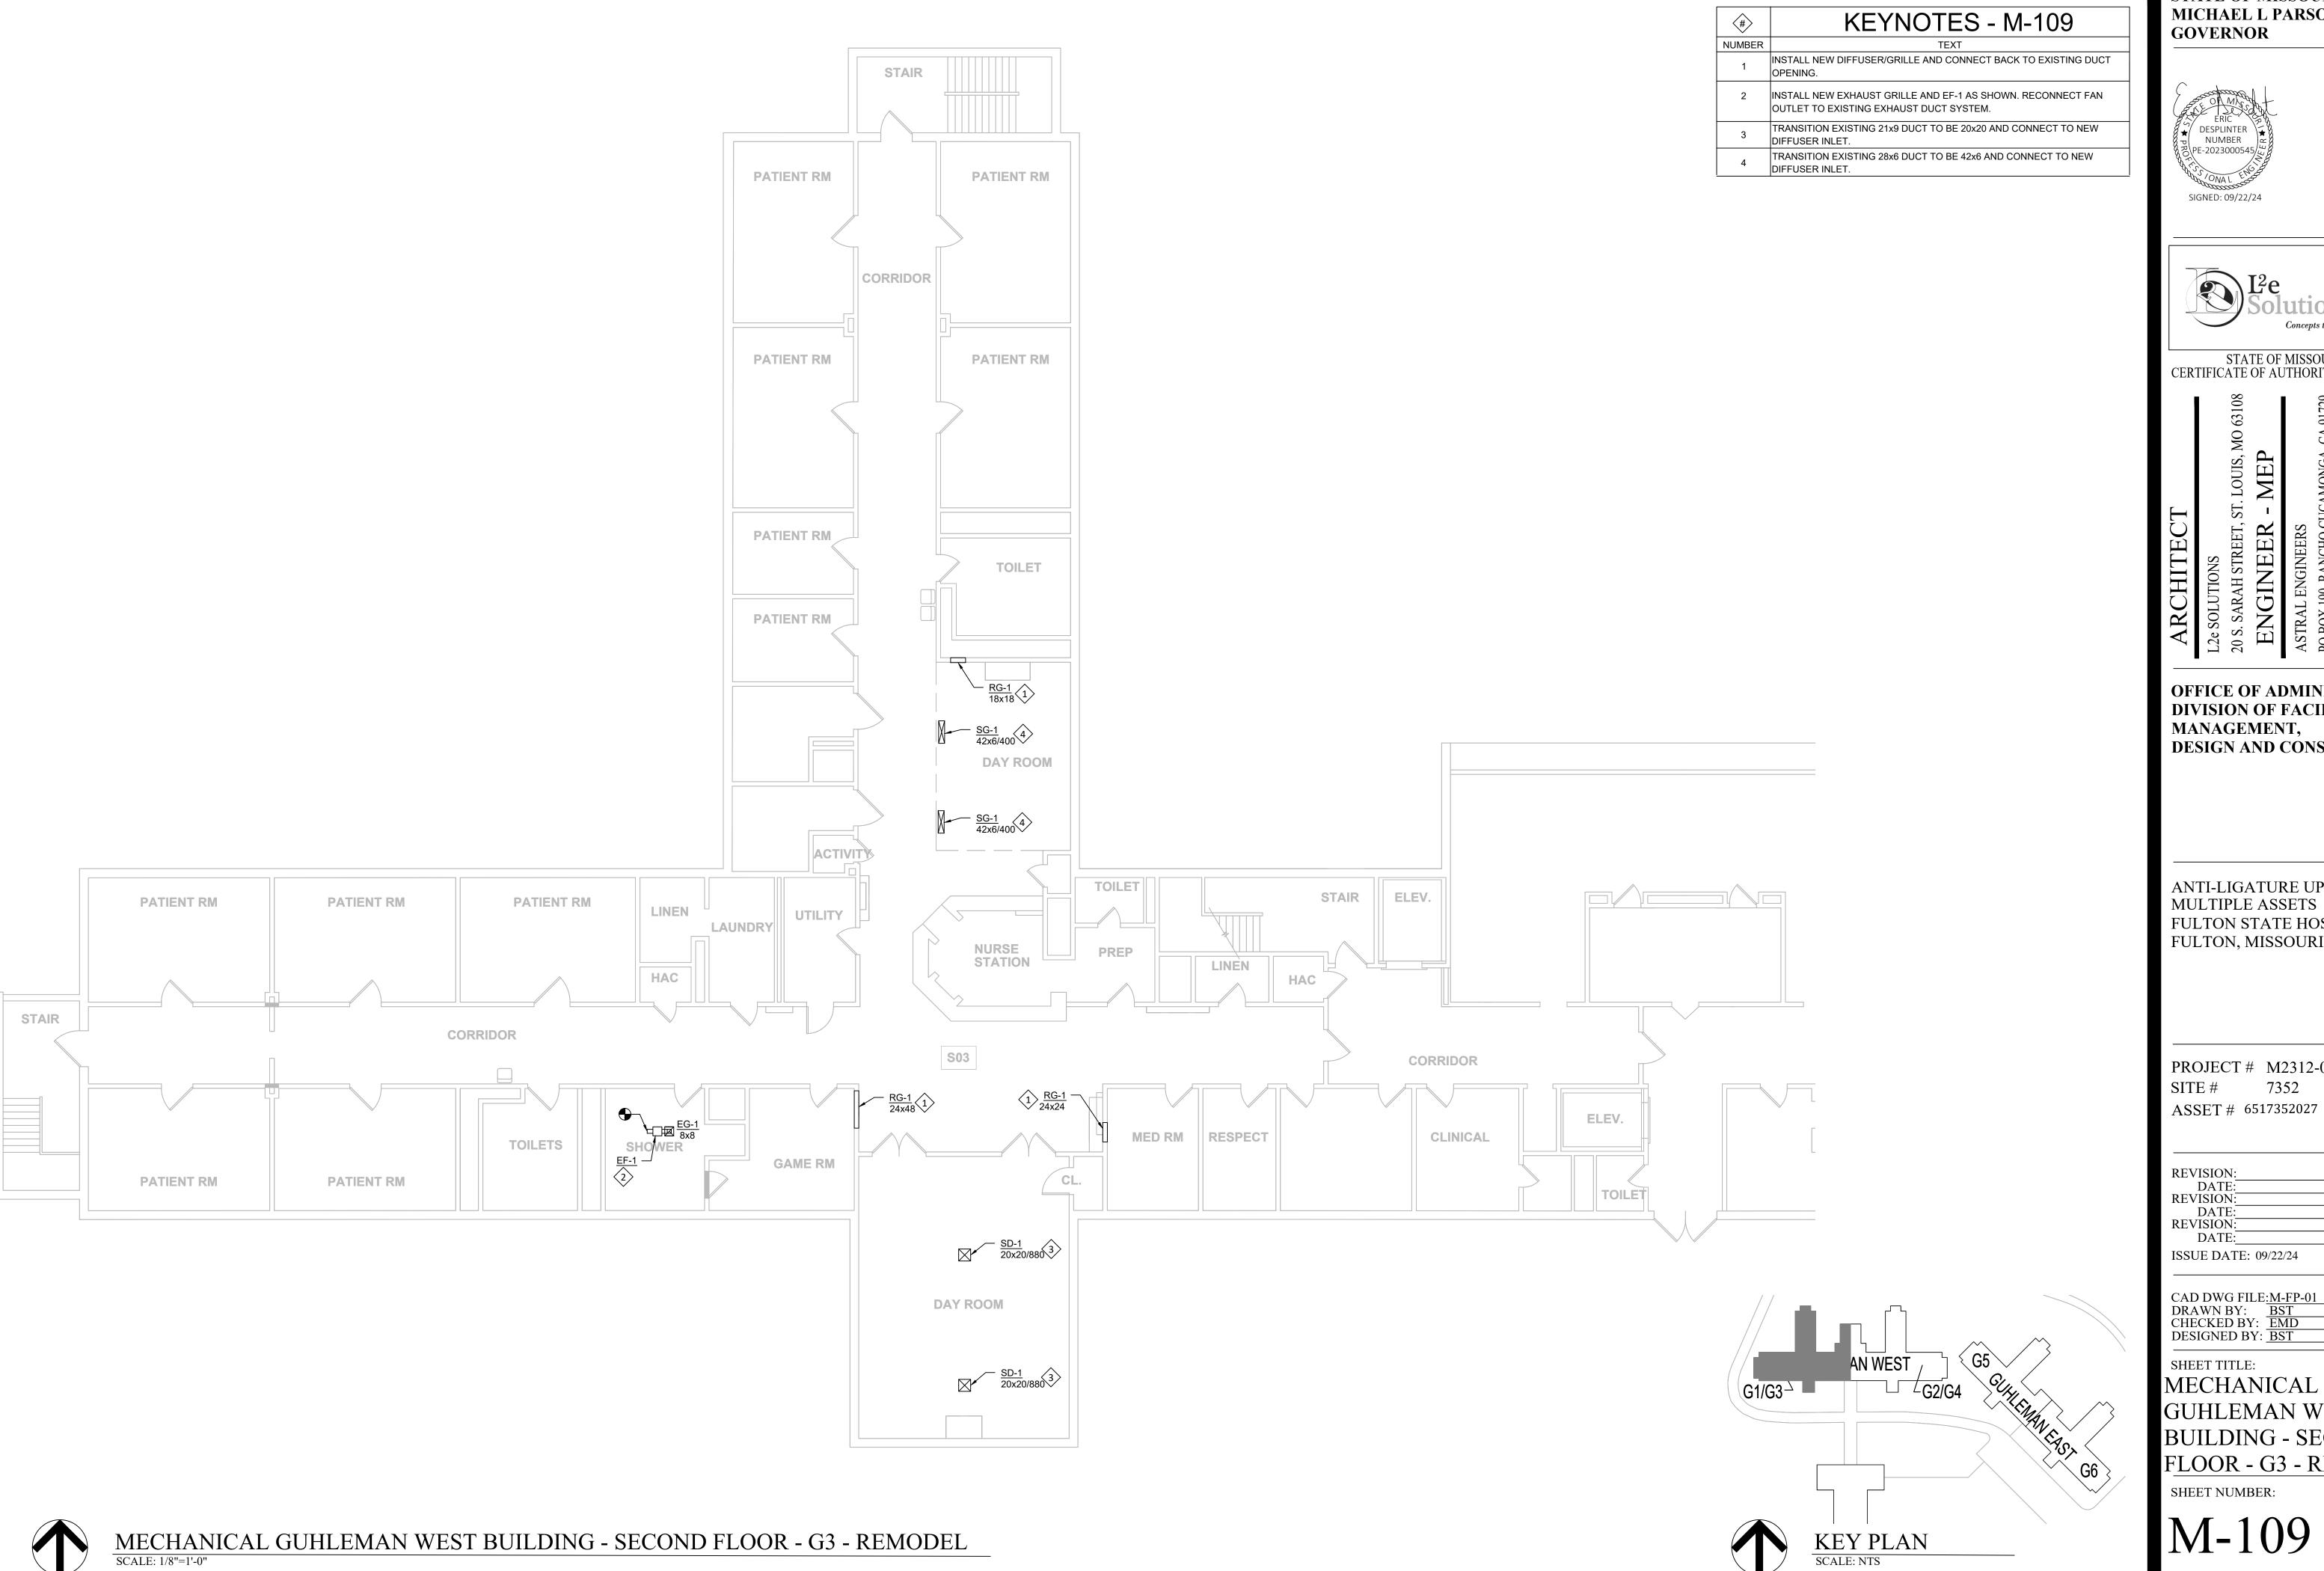

STATE OF MISSOURI MICHAEL L PARSON,



STATE OF MISSOURI CERTIFICATE OF AUTHORITY #2018019473

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OFFICE OF ADMINISTRATION DIVISION OF FACILITIES DESIGN AND CONSTRUCTION

ANTI-LIGATURE UPGRADES MULTIPLE ASSETS FULTON STATE HOSPITAL FULTON, MISSOURI


PROJECT # M2312-01 7352


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CAD DWG FILE:M-FP-01
DRAWN BY: BST
CHECKED BY: EMD
DESIGNED BY: BST

GUHLEMAN WEST BUILDING - SECOND FLOOR - G3 - REMODEL

SHEET 43 OF 66 SEPTEMBER 22, 2024



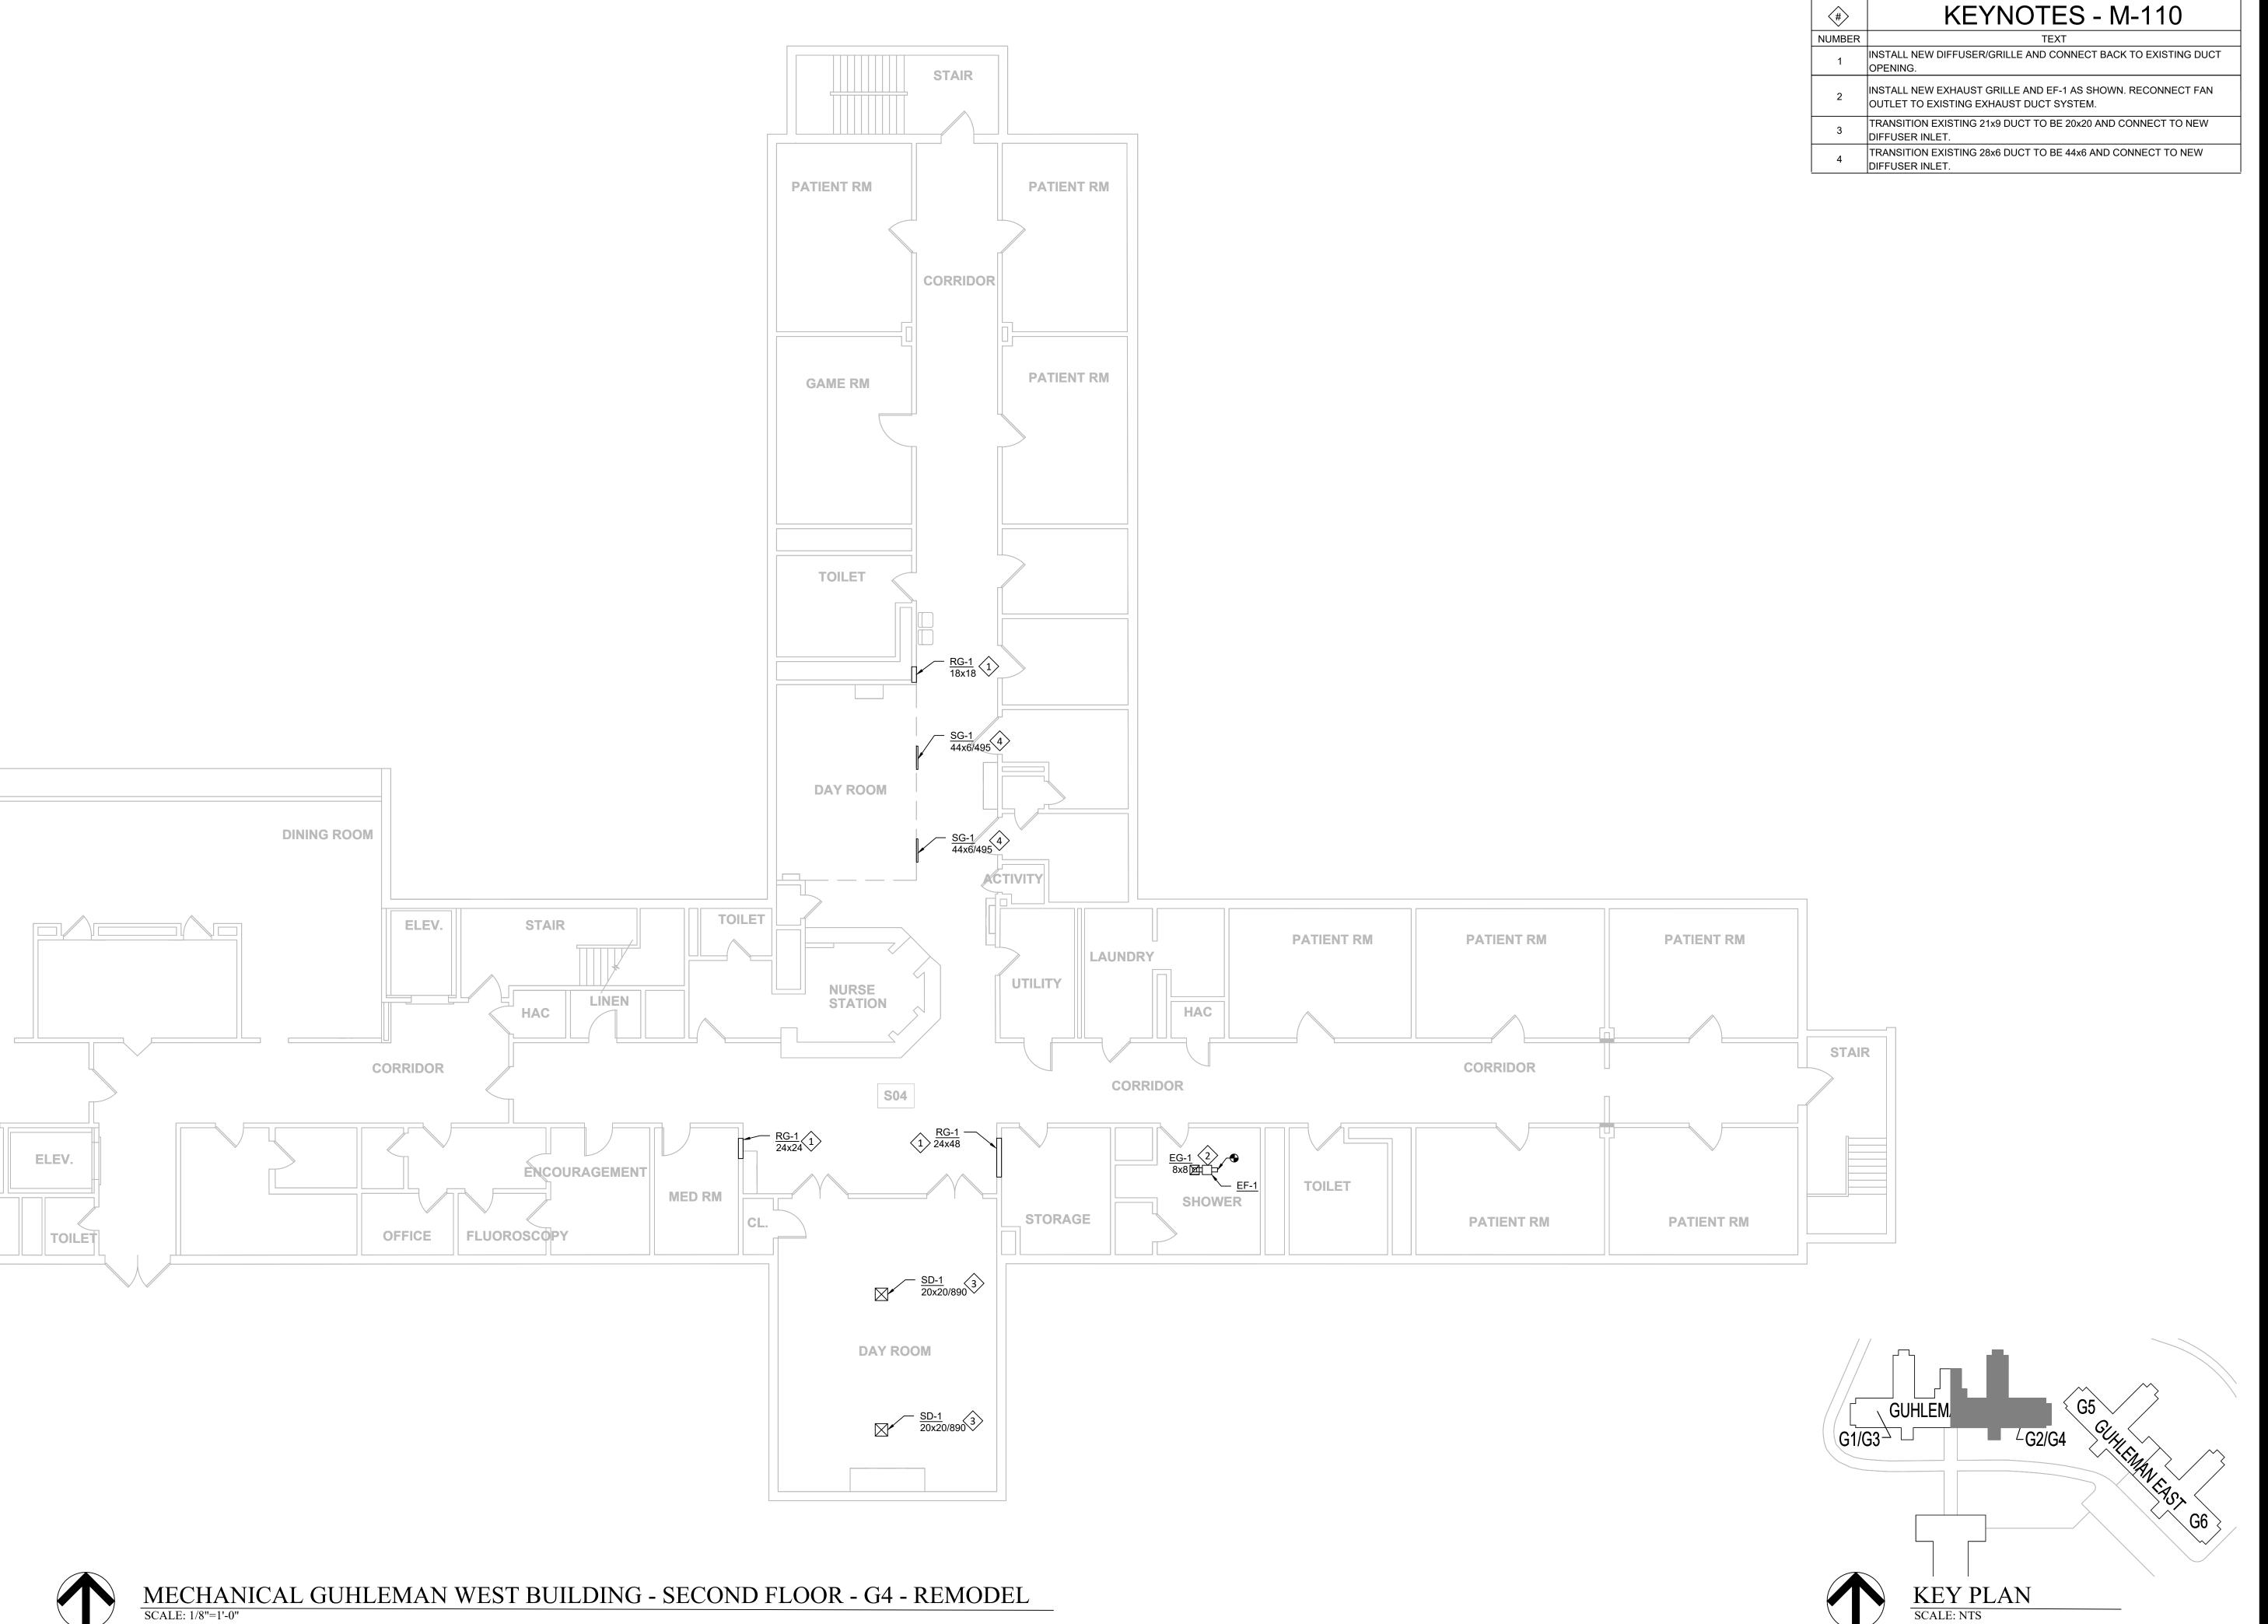

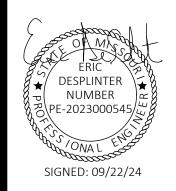

STATE OF MISSOURI CERTIFICATE OF AUTHORITY #2018019473

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OFFICE OF ADMINISTRATION DIVISION OF FACILITIES MANAGEMENT, DESIGN AND CONSTRUCTION

ANTI-LIGATURE UPGRADES MULTIPLE ASSETS FULTON STATE HOSPITAL FULTON, MISSOURI

PROJECT # M2312-01 SITE # 7352 ASSET # 6517352027

REVISION:
DATE:
REVISION:
DATE:
REVISION:
DATE:
ISSUE DATE: 09/22/24

CAD DWG FILE:M-FP-01
DRAWN BY: BST
CHECKED BY: EMD
DESIGNED BY: BST


SHEET TITLE:

MECHANICAL GUHLEMAN WEST BUILDING - SECOND FLOOR - G4 - REMODEL

SHEET NUMBER:

M-110

SHEET 44 OF 66 SEPTEMBER 22, 2024

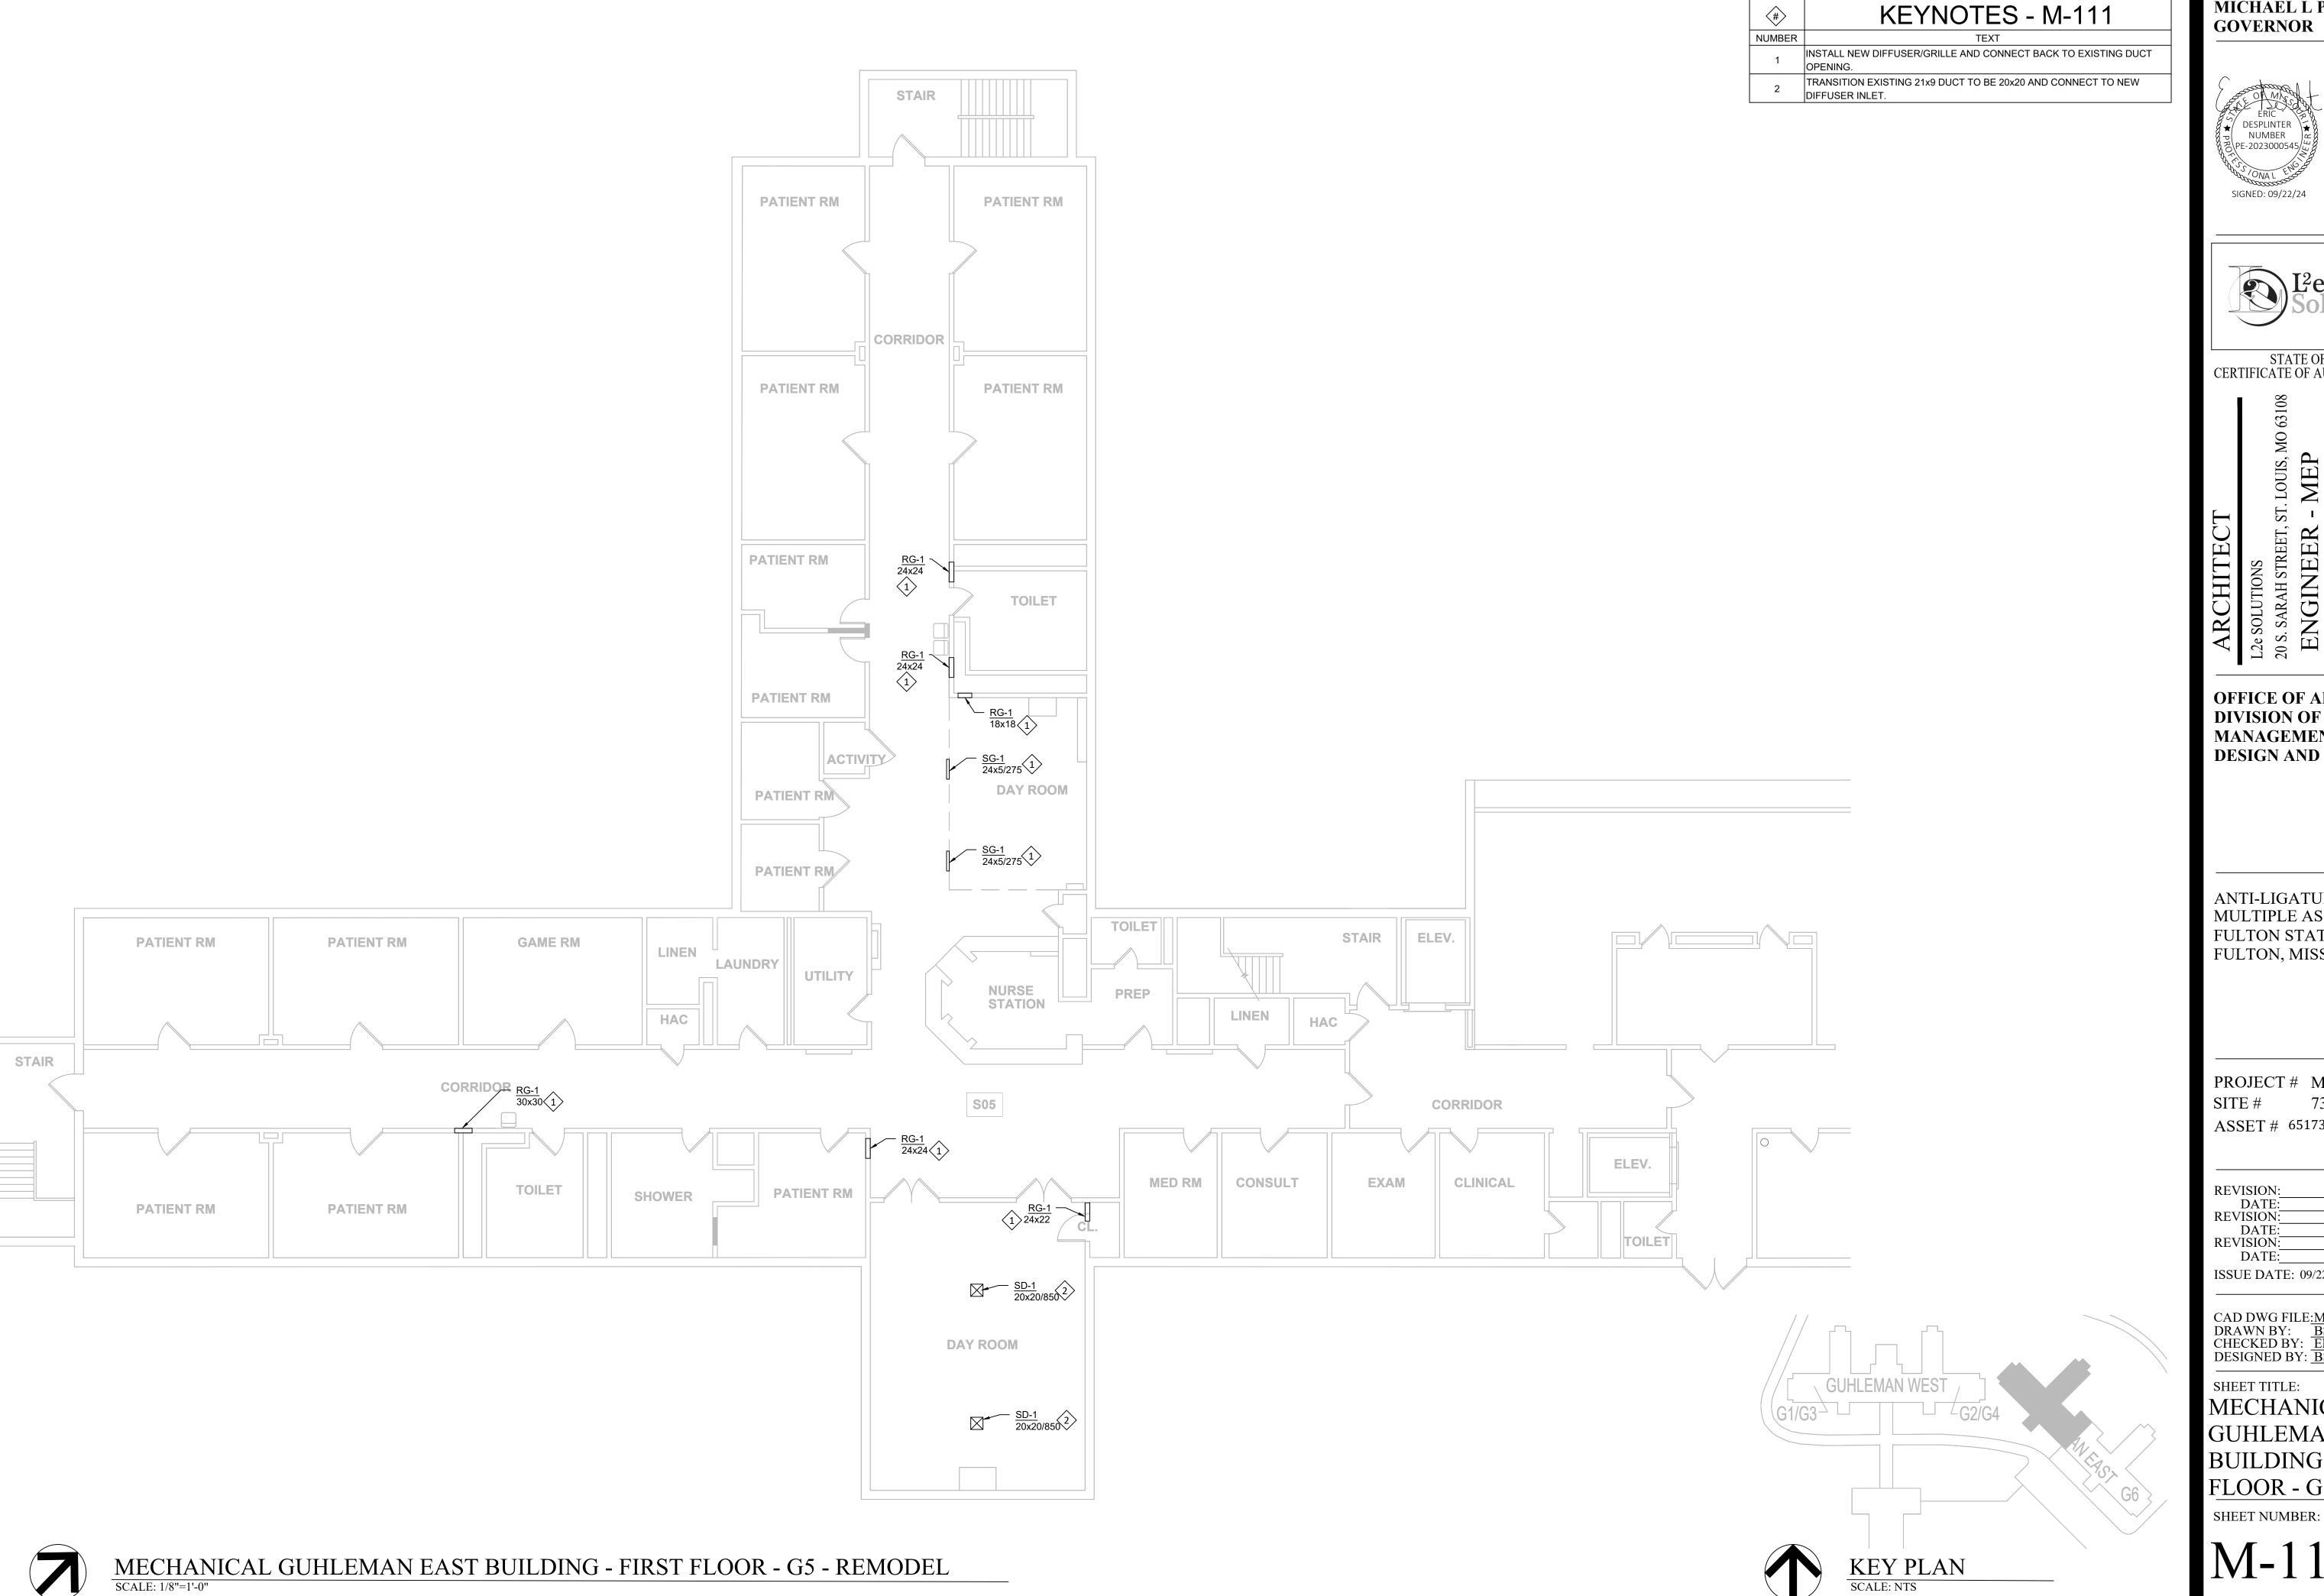





STATE OF MISSOURI CERTIFICATE OF AUTHORITY #2018019473

OFFICE OF ADMINISTRATION DIVISION OF FACILITIES MANAGEMENT, DESIGN AND CONSTRUCTION

ANTI-LIGATURE UPGRADES MULTIPLE ASSETS FULTON STATE HOSPITAL FULTON, MISSOURI

PROJECT # M2312-01 7352 ASSET # 6517352026


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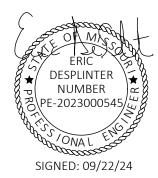
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DRAWN BY: BST
CHECKED BY: EMD DESIGNED BY: BST

SHEET TITLE:

MECHANICAL GUHLEMAN EAST BUILDING - FIRST FLOOR - G5 - REMODEL

SHEET 45 OF 66 SEPTEMBER 22, 2024



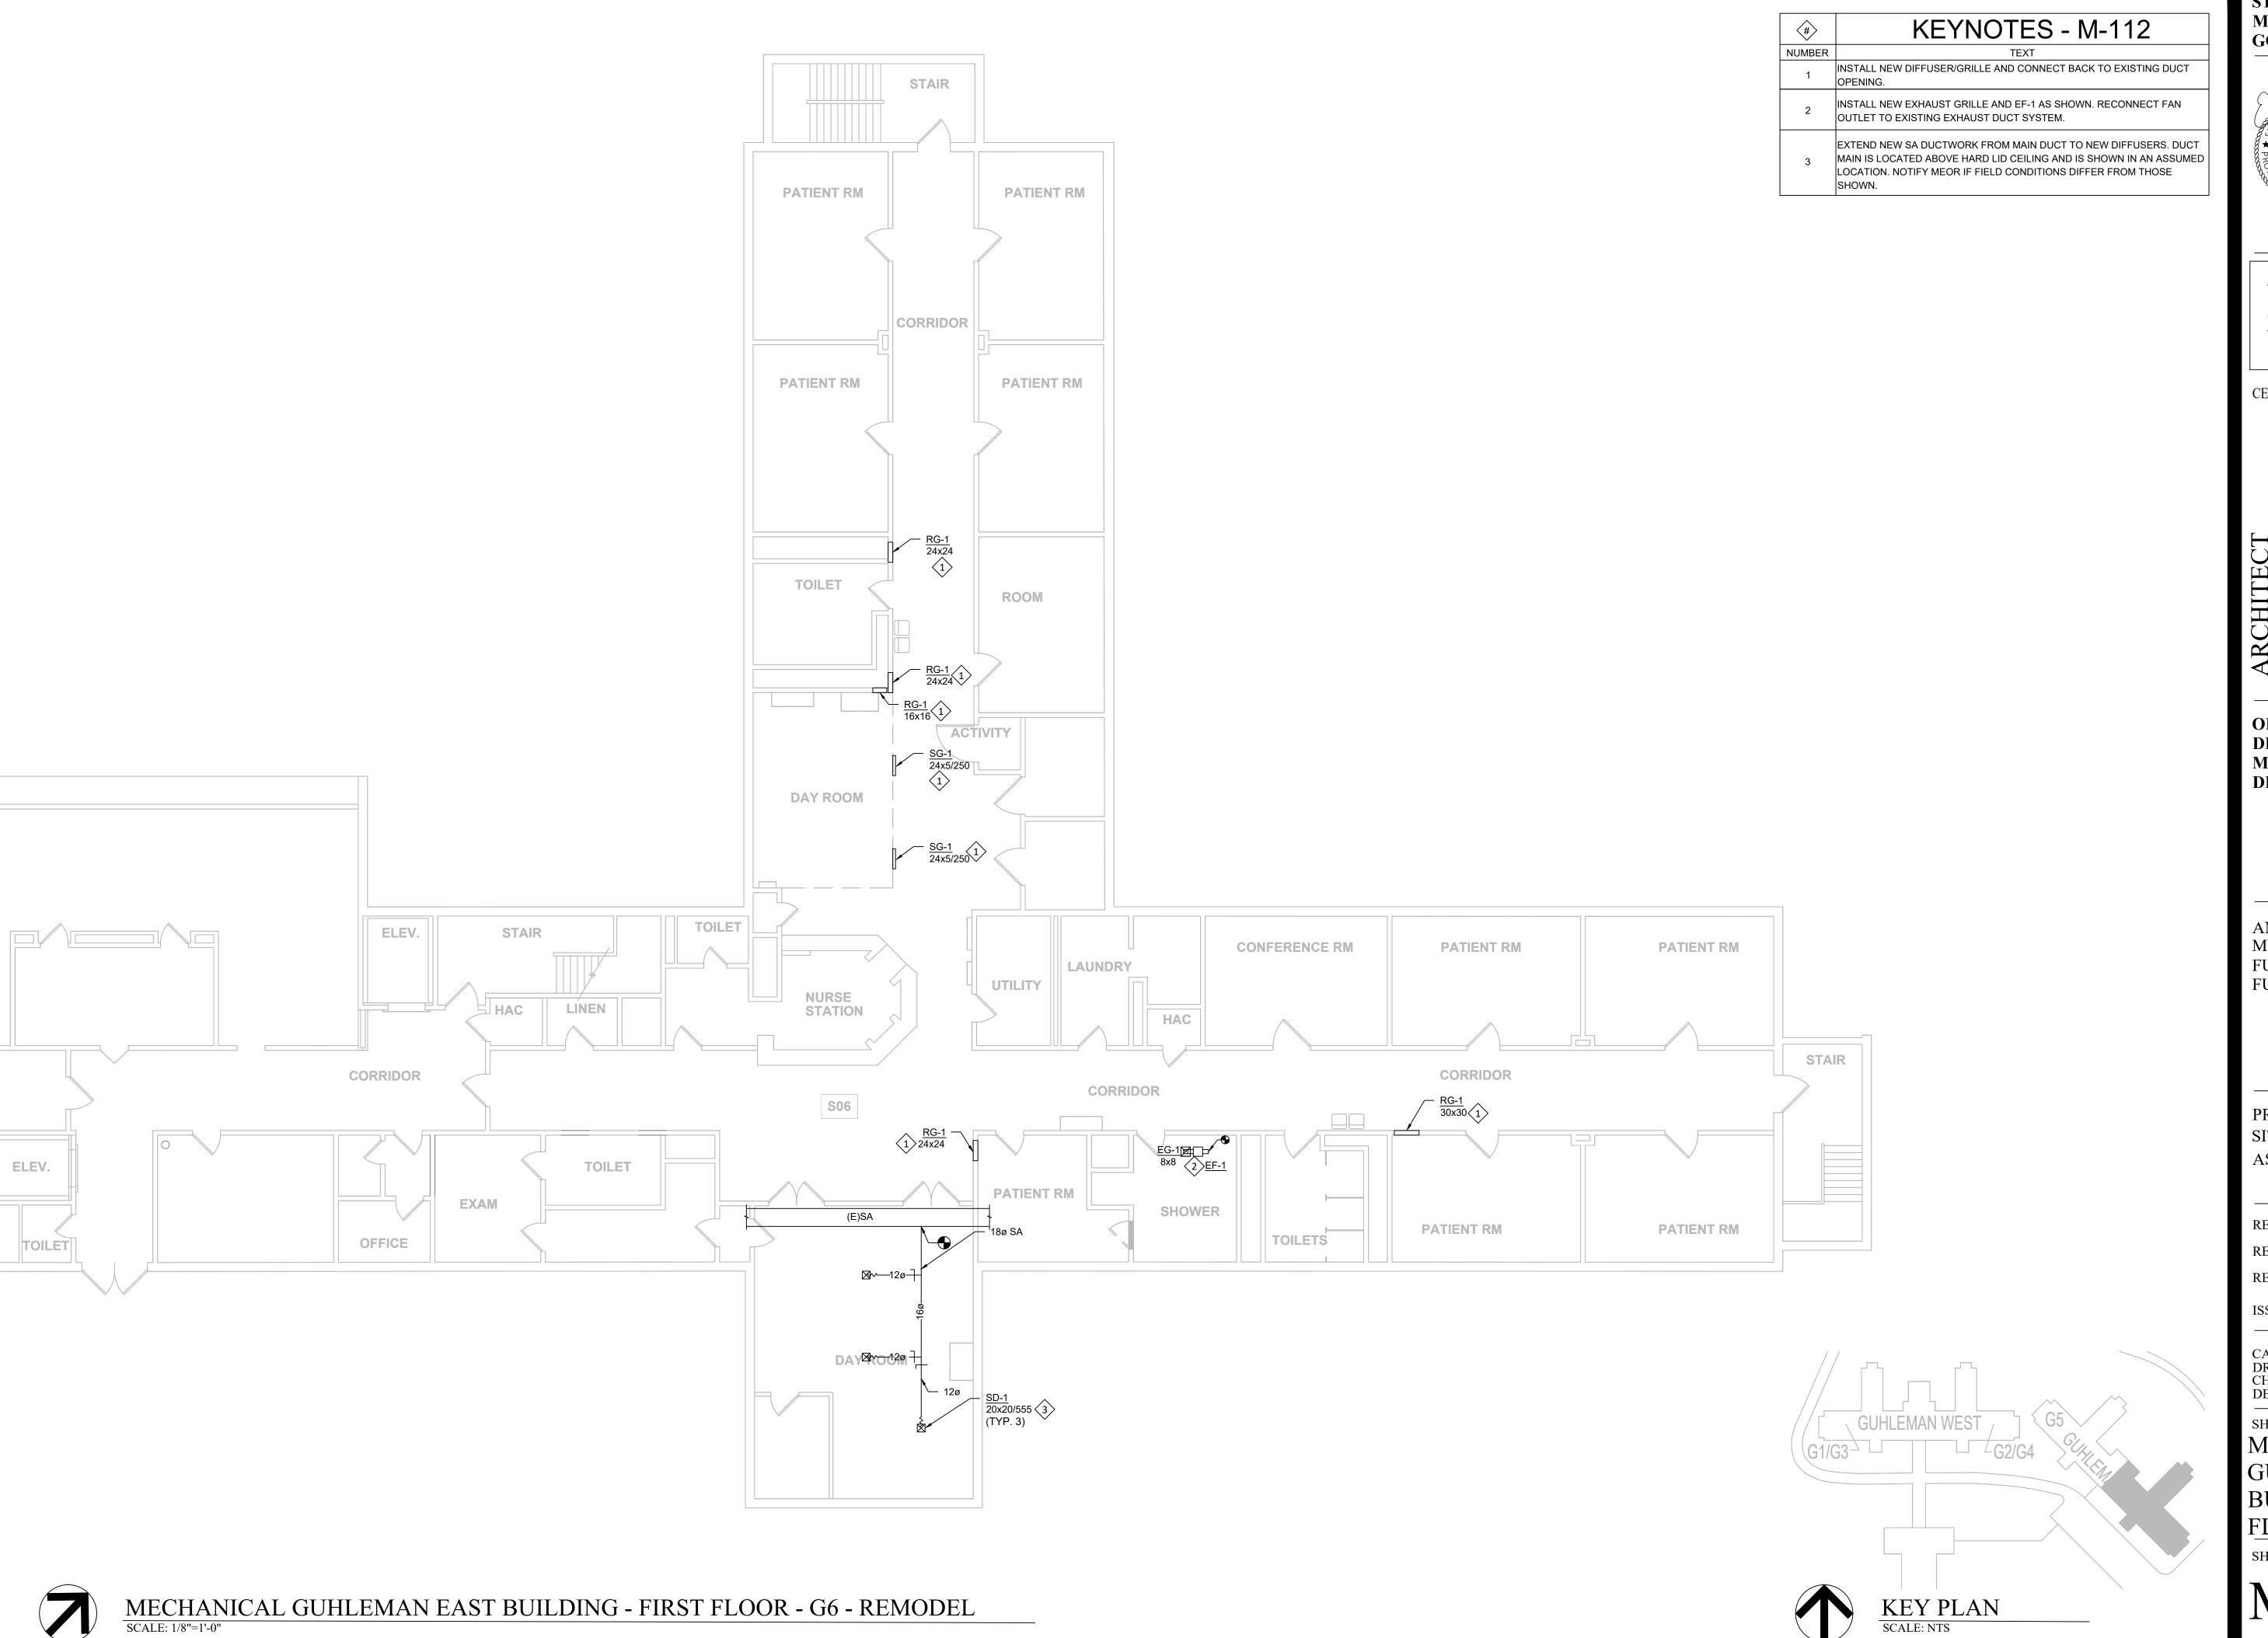



STATE OF MISSOURI CERTIFICATE OF AUTHORITY #2018019473

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ANTI-LIGATURE UPGRADES MULTIPLE ASSETS FULTON STATE HOSPITAL FULTON, MISSOURI

PROJECT # M2312-01 SITE # 7352 ASSET # 6517352026

REVISION:
DATE:
REVISION:
DATE:
REVISION:
DATE:
ISSUE DATE: 09/22/24

CAD DWG FILE:M-FP-01
DRAWN BY: BST
CHECKED BY: EMD
DESIGNED BY: BST

SHEET TITLE:

MECHANICAL

GUHLEMAN EA

GUHLEMAN EAST
BUILDING - FIRST
FLOOR - G6 - REMODEL
SHEET NUMBER:

M-112

SHEET 46 OF 66 SEPTEMBER 22, 2024

GRILLE-REGISTER-DIFFUSER SCHEDULE							
NOTES: 1. SEE SPEC SECTION 23 3700 FOR ADDITIONAL INFORMATION. 2. CONTRACTOR SHALL SELECT PROPER MOUNTING BASED ON INSTALLATION SURFACE TYPE. 3. SEE FLOOR PLANS FOR NECK SIZE. 4. CONTRACTOR SHALL FIELD VERIFY ALL SIZES AND QUANTITIES PRIOR TO ORDERING.							
TAG NAME	TYPE	FACE SIZE (IN.)	MATERIAL	FINISH	MANUFACTURER	MODEL	NOTES
SD-1	MODULAR CORE W/ S-STYLE ANTI LIGATURE	NECK SIZE + 3"	STEEL	WHITE	ANEMOSTAT	SV432	1, 2, 3, 4
SG-1	45 DEGREE DEFLECTION SLEEVED SECURITY	NECK SIZE + 2"	STEEL	WHITE	CARNES	RSPA41	1, 2, 3, 4
RG-1	0 DEGREE DEFLECTION WITH HOLES	NECK SIZE + 2"	STEEL	WHITE	CARNES	RSPA51	1, 2, 3, 4

12x12


FAN SCHEDULE															
NOTES: 1. PROVIDE GRAVITY BACKDRAFT DAMPER. ELECTRICAL															
			1						ELECTRICAL		I	I			
TAG NAME	AREA SERVED	CFM	S.P. IN. W.C.	DRIVE TYPE	MAX AMCA SONES	VOLTAGE	PHASE	W	DISCO	 CONTROLLER/STAR BY (NOTE A) TYPE (N	——— (LBS)	MANUFACTURER	MODEL	ANCHORAGE DETAIL	NOTES

WHITE BESAFEPRO EG420 1, 2, 3, 4


S	CHEDU	LE GENERAL NOTES					
	ABBREVIATION	DESCRIPTION					
		PROVIDED BY					
TE A	E.C.	ELECTRICAL CONTRACTOR					
NOTE	M.C.	MECHANICAL CONTRACTOR					
	MFR MANUFACTURER						
<u>a</u>		DISCONNECT TYPE					
NOTE	F	FUSED					
Z	NF	NON-FUSED					
		STARTER TYPE					
	ECM	ELECTRONICALLY COMMUTATED MOTOR					
О	FV	FULL VOLTAGE					
NOTE	MS	MANUAL STARTER					
_	SS	SOFT STARTER					
	VFD	VARIABLE FREQUENCY DRIVE					
	VFD/B	VARIABLE FREQUENCY DRIVE WITH BYPASS					

LIGATURE RESISTANT GRILLE W/ HOLES

NOTES:							
1. SEE SPEC SECTION 23 0713 FOR							
NO INSULATION IS REQUIRED C SERVES UNLESS OTHERWISE NO				OCCUPI	ED SPF	ICE IH	ATTI
DUCT APPLICATION	INSULAT	INSTALLED MIN R-VALUE			NOTES	NOTES	
	GLASS FIBER FLEXIBLE WRAP	NONE	0	4.2	8		
NTERIOR							
SUPPLY AIR	Χ			Х		2	
RETURN AIR		Х	Х				
NTERIOR OR EXTERIOR							
GENERAL EXHAUST AIR		Х	Х				

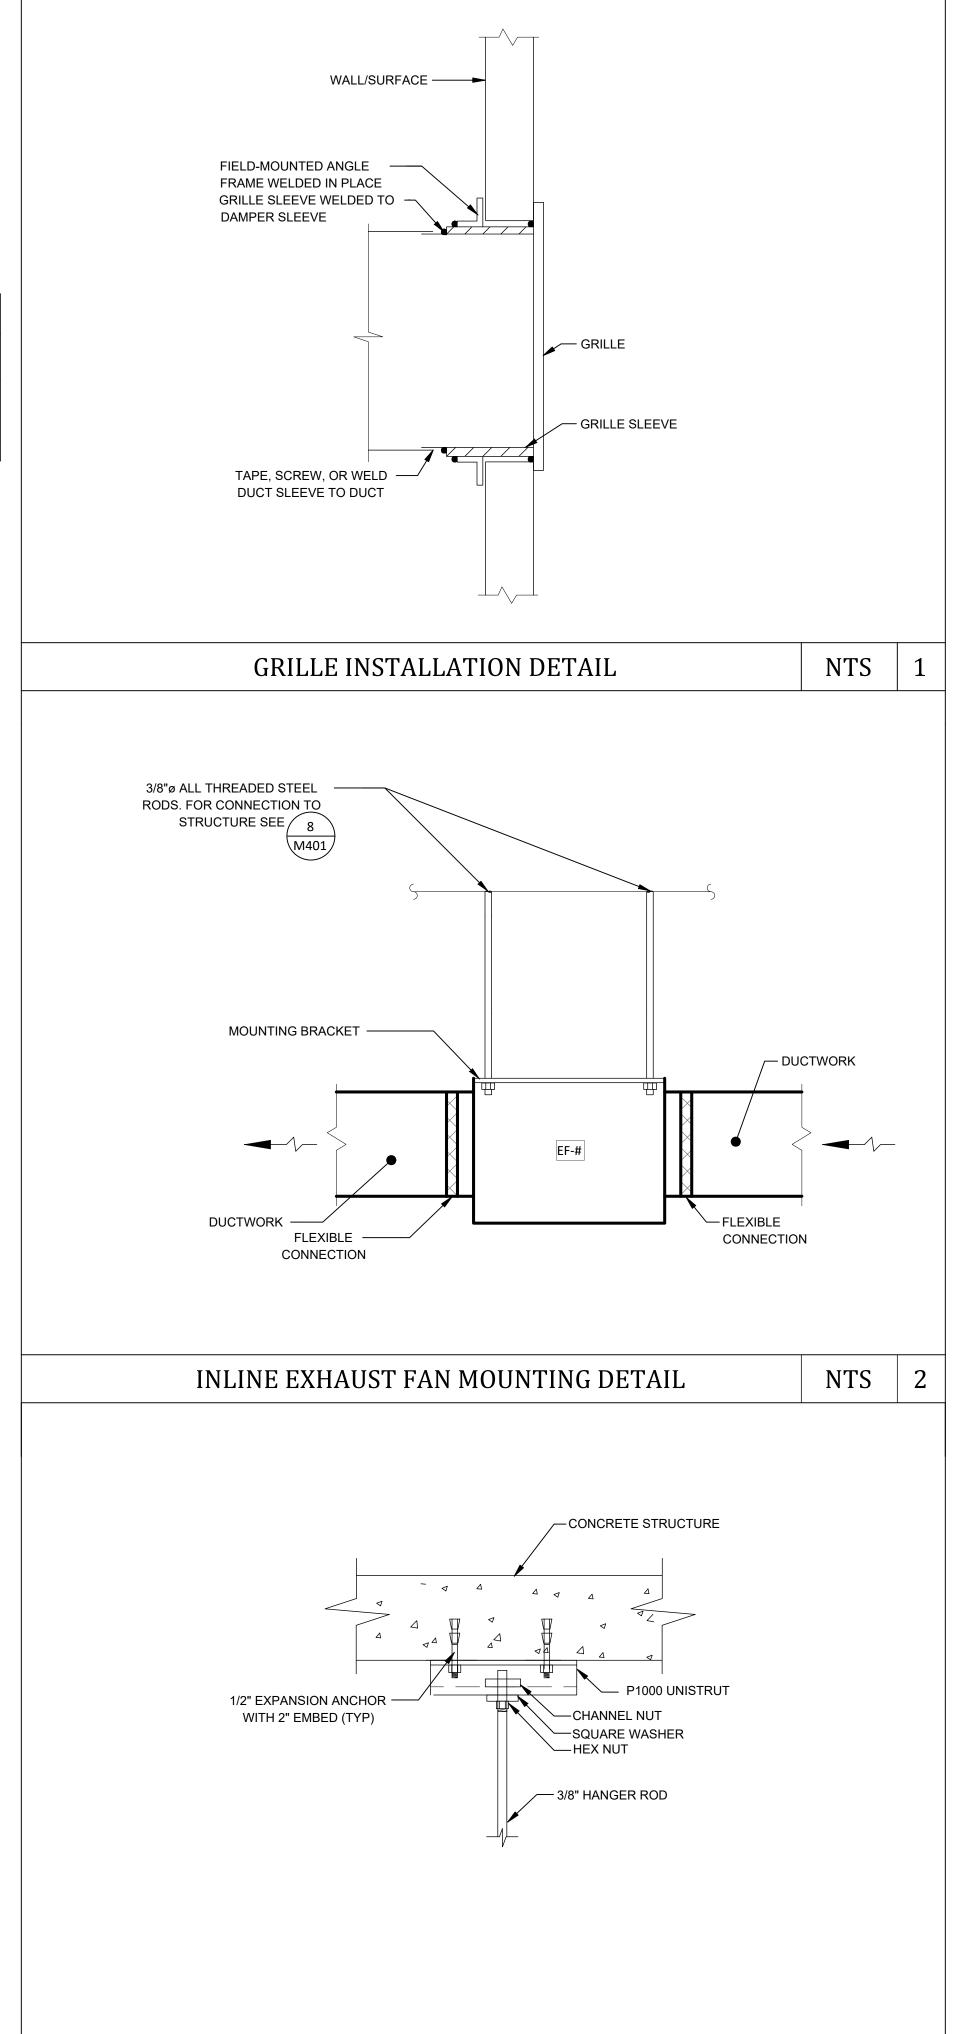

ATTACHMENT TO STRUCTURE

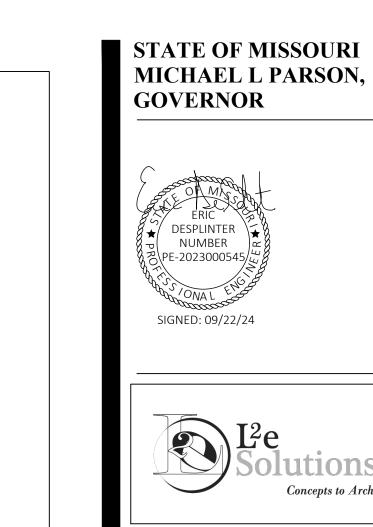

STATE OF MISSOURI
CERTIFICATE OF AUTHORITY #2018019473

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O BOX 190, RANCHO CUCAMONGA, CA 917
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OFFICE OF ADMINISTRATION DIVISION OF FACILITIES MANAGEMENT, DESIGN AND CONSTRUCTION

ANTI-LIGATURE UPGRADES MULTIPLE ASSETS FULTON STATE HOSPITAL FULTON, MISSOURI

PROJECT # M2312-01 SITE # 7352 ASSET # 6517352026, 6517352027

REVISION:
DATE:
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ISSUE DATE: 09/22/24

CAD DWG FILE:M-601
DRAWN BY: BST
CHECKED BY: EMD
DESIGNED BY: BST


SHEET TITLE:
MECHANICAL
SCHEDULES/DETAILS

SHEET NUMBER:

M-601

SHEET 47 OF 66 SEPTEMBER 22, 2024

NTS 3

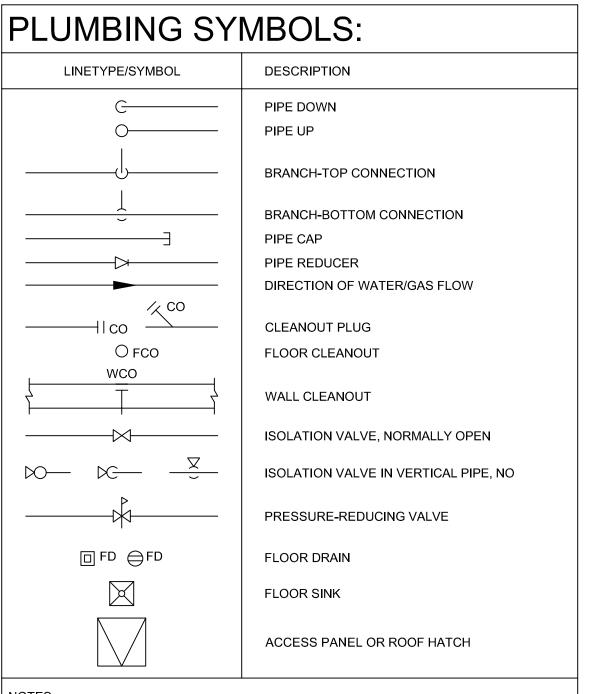

OTES:

NOT ALL SYMBOLS MAY APPLY.

SEE SPECS AND DRAWINGS FOR SPECIFIC COMPONENT REQUIREMENTS.

PLUMBING ABBREVIATIONS:

ABBREVIATION	DESCRIPTION
CW HW HWR	POTABLE COLD WATER POTABLE HOT WATER SUPPLY (120°F), UNLESS NOTED OTHERWISE POTABLE HOT WATER RECIRCULATING (120°F), UNLESS NOTED OTHERWISE VENT
AFF DF DIA, Ø DN EL ECM FPS FT, ' GA GAL HD HT ID IE IN., " LF MAX MIN N/A NIC NO NO., # NTS OD PPM PSI RPM	ABOVE FINISHED FLOOR DRINKING FOUNTAIN/ELECTRIC WATER COOLER DIAMETER DOWN ELEVATION ELECTRONICALLY COMMUTATED MOTOR FEET PER SECOND FOOT OR FEET GAGE OR GAUGE GALLONS HEAD (PRESSURE) HEIGHT DIAMETER, INSIDE INVERT ELEVATION BELOW FINISHED FLOOR INCH OR INCHES LINEAR FOOT OR FEET MAXIMUM MINIMUM NOT APPLICABLE NOT IN CONTRACT NORMALLY OPEN NUMBER NOT TO SCALE DIAMETER, OUTSIDE PARTS PER MILLION POUNDS PER SQUARE INCH REVOLUTIONS PER MINUTE
SPEC	SPECIFICATION

NOTES:

- NOT ALL ABBREVIATIONS MAY APPLY.
- 2. PLUMBING MATERIAL LIST/PLUMBING SCHEDULES CONTAIN EQUIPMENT TAG
- ABBREVIATIONS THAT ARE HEREBY INCORPORATED INTO THE ABBREVIATION LIST.

 3. SEE OTHER DISCIPLINE DRAWINGS WITHIN THE CONSTRUCTION DOCUMENTS FOR

ABBREVIATIONS NOT DEFINED ABOVE OR IN PLUMBING MATERIAL LIST/PLUMBING

SCHEDULES.

PLUMBING SYSTEMS:

LINETYPE/SYMBOL	DESCRIPTION
	POTABLE COLD WATER
	POTABLE HOT WATER SUPPLY (120°F)A
SAN	SOIL, WASTE, OR SANITARY SEWER
	VENT

NOTES:

- 1. NOT ALL SYMBOLS MAY APPLY.
- 2. SEE SPECS AND DRAWINGS FOR SPECIFIC COMPONENT REQUIREMENTS.

RENOVATION NOTES:

- 1. DEMOLITION WORK SHALL BE PERFORMED AS DESCRIBED WITHIN SPEC SECTION 220505 AND THE DRAWINGS.
- THE CONTRACTOR SHALL VISIT THE SITE PRIOR TO BID SUBMISSION TO VERIFY ALL FIELD CONDITIONS INCLUDING BUT NOT LIMITED TO THE FOLLOWING:

 LOCATIONS OF EXISTING PLUMBING SYSTEMS.
 LOCATIONS OF ARCHITECTURAL, STRUCTURAL, MECHANICAL, ELECTRICAL,
 - TECHNOLOGY, FIRE PROTECTION, AND FIRE ALARM SYSTEMS.

 C. EXISTING SURFACES WHICH REQUIRE ALTERING.

 D. INVERTS OF EXISTING DRAINAGE PIPING VIA CLEANOUT DEPTHS.
- 3. SCAN/X-RAY POST TENSION SLABS PRIOR TO ALTERATION. SHOP DRAWINGS SHALL REFLECT REBAR AND TENSION CABLE LOCATIONS. OPENINGS SHALL BE COORDINATED WITH THE STRUCTURAL ENGINEER PRIOR TO PERFORMING ANY
- 4. NOTIFY OWNER OF REQUIRED SYSTEM SHUTDOWNS AT LEAST TWO WEEKS PRIOR TO SHUTDOWN. EXACT SHUTDOWN TIME AND PROCEDURE SHALL BE COORDINATED WITH OWNER AT LEAST 96 HOURS PRIOR TO SHUTDOWN.
- WHEN PIPING, EQUIPMENT, OR FIXTURES ARE NOTATED TO BE PERMANENTLY REMOVED THEIR ASSOCIATED COMPONENTS SHALL ALSO BE REMOVED INCLUDING HANGERS, SUPPORTS, AND ACCESSORIES.
- 6. COORDINATE THE DISCONNECTION AND REMOVAL OF POWERED SYSTEMS
 WHEN REMOVING POWERED PLUMBING EQUIPMENT.
- 7. REPAIR EXISTING FLOORS, WALLS, AND CEILINGS IN ALTERED AREAS TO MATCH EXISTING. SEE ARCHITECTURAL PLANS FOR FINISH DETAILS IN REMODEL AREAS.
- 8. THE CONTRACTOR SHALL NEATLY SAW CUT SECTIONS OF THE CONCRETE TO ACCESS THE WORK BELOW GRADE. REMOVE PORTIONS OF DEMOLISHED CONCRETE FROM THE SITE. REPAIR THE EXISTING SLAB PER PLUMBING/STRUCTURAL DETAILS WITHIN THE DRAWING SET.

GENERAL NOTES:

ADJUSTMENTS SHALL BE INCLUDED IN THE BID.

- 1. INSTALLATION SHALL COMPLY WITH ALL APPLICABLE CODES, STANDARDS, AND MANUFACTURER'S INSTALLATION REQUIREMENTS.
- REVIEW ALL PROJECT DOCUMENTS INCLUDING SPECS AND DRAWINGS PERTAINING TO ALL DISCIPLINES PRIOR TO SUBMITTING A BID. SUBMIT PRE-BID REQUEST FOR INFORMATION FOR ITEMS IN QUESTION AND/OR CONFLICTS FOUND.
- DRAWINGS SHOW THE DESIGN INTENT DIAGRAMMATICALLY. THEY DO NOT SHOW THE EXACT UTILITY ROUTING NOR EVERY ELBOW, OFFSET, ETC. WHERE REQUIRED, THE CONTRACTOR SHALL MAKE ADJUSTMENTS TO THEIR SYSTEMS TO AVOID CONFLICT WITH THE STRUCTURE AND OTHER DISCIPLINES. THE COST FOR SUCH
- . OBTAIN AND PAY FOR ALL PERMITS REQUIRED FOR WORK PERFORMED.
- 5. OBTAIN UTILITY PURVEYOR REQUIREMENTS PRIOR TO PURCHASING EQUIPMENT OR PERFORMING WORK.
- PROVIDE A COORDINATED SET OF SHOP DRAWINGS. SEE GENERAL REQUIREMENTS SPEC FOR ADDITIONAL INFORMATION.
- PROVIDE FIRESTOPPING FOR ALL UTILITY PENETRATIONS THRU FIRE-RATED ASSEMBLIES
- COORDINATE FRAMING REQUIREMENTS FOR ACCESS PANELS AND EQUIPMENT/PANEL SUPPORTS PRIOR TO SUBMITTING BID.
- THE CONTRACTOR IS RESPONSIBLE FOR VERIFYING THE CORRECTION OF CONSTRUCTION DEFICIENCIES LISTED ON THE JOB SITE OBSERVATION REPORT. RETURN THE JOB SITE OBSERVATION REPORT TO A/E WITH DEFICIENCIES SIGNED OFF. PROVIDE PHOTOGRAPHIC AND/OR VIDEO EVIDENCE OF CORRECTED DEFICIENCIES IF REQUESTED BY THE ENGINEER.
- 10. PROVIDE CLOSEOUT DOCUMENTATION UPON COMPLETION OF PROJECT. SEE GENERAL REQUIREMENTS SPEC FOR ADDITIONAL INFORMATION.
- 11. RECYCLE AND/OR SALVAGE FOR REUSE A MINIMUM OF 65% OF THE NONHAZARDOUS CONSTRUCTION AND DEMOLITION WASTE. UTILIZE A WASTE MANAGEMENT COMPANY THAT CAN PROVIDE VERIFIABLE DOCUMENTATION THAT THE PERCENTAGE OF CONSTRUCTION AND DEMOLITION WASTE MATERIAL DIVERTED FROM THE LANDFILL COMPLIES WITH CODE. SEE GENERAL REQUIREMENTS SPEC FOR ADDITIONAL INFORMATION.

PLUMBING NOTES:

- 1. PLUMBING WORK SHALL BE CONSTRUCTED IN A PROFESSIONAL MANNER. ENSURE FIXTURES, EQUIPMENT, AND ASSOCIATED COMPONENTS ARE INSTALLED LEVEL AND PLUMB. SEALANT BETWEEN FIXTURES AND SURFACES SHALL BE EVEN AND NEAT. COMPONENTS SHALL BE CLEANED PRIOR TO OWNER TURNOVER.
- 2. THE PLUMBING MATERIAL LIST SHALL BE USED AS THE BASIS OF DESIGN. MODEL NUMBERS ARE PROVIDED FOR REFERENCE ONLY. MATERIALS SHALL MEET DESCRIPTION OF SPECIFIED ITEMS. THE CONTRACTOR SHALL IDENTIFY ALL SELECTED OPTIONS IN THE SUBMITTAL.
- 3. IF THE CONTRACTOR PROVIDES EQUIPMENT OTHER THAN THE BASIS OF DESIGN, THEY ARE RESPONSIBLE FOR ALL COSTS INCURRED AS A RESULT. THAT INCLUDES, BUT IS NOT LIMITED TO, AGENCY FEES FOR REVIEW OF CHANGES, STRUCTURAL MODIFICATIONS FOR INCREASED WEIGHT, AND ELECTRICAL EQUIPMENT, WIRING CONDUIT, AND BREAKER CHANGES FOR DIFFERENT ELECTRICAL REQUIREMENTS.
- ENGINEER.
- 5. PLUMBING FIXTURE HEIGHTS SHALL BE OBTAINED FROM ARCHITECTURAL ELEVATION DRAWINGS. PROVIDE ROUGH-INS ACCORDINGLY.
- 6. SEE SPEC SECTION 221005, FOR PIPE SYSTEM INSTALLATION, TESTING, CLEANING, AND DISINFECTION REQUIREMENTS.
- 7. PIPE, PIPE FITTINGS, FIXTURES, AND EQUIPMENT INTENDED TO DISPENSE WATER FOR HUMAN CONSUMPTION SHALL MEET NSF 61 LEAD FREE REQUIREMENTS, A MAX OF .25 WEIGHTED AVERAGE OF LEAD CONTENT.
- 8. PAINT INTERIOR EXPOSED PIPING, VALVES, AND ASSOCIATED HANGERS/SUPPORTS LOCATED IN OCCUPIED SPACES TO MATCH THE SURROUNDING ARCHITECTURAL COLOR SCHEME. PAINT EXTERIOR PIPING, VALVES, AND ASSOCIATED HANGERS/SUPPORTS ADJACENT TO EXTERIOR WALL TO MATCH WALL COLOR. PAINT ROOFTOP GAS PIPING AND VALVES TO MATCH ROOF COLOR. FINAL COLORS SHALL BE APPROVED BY THE ARCHITECT AND ENGINEER. SEE SPEC SECTION 220500 FOR ADDITIONAL REQUIREMENTS.
- PROVIDE IDENTIFICATION FOR PIPING, VALVES, AND EQUIPMENT PER SPEC SECTION 220553.
- 10. INSULATION SHALL BE PROVIDED CONTINUOUS THROUGHOUT THE PIPING SYSTEM INCLUDING AT HANGERS/SUPPORTS, PIPE FITTINGS, VALVES, AND ACCESSORIES. OPENINGS SHALL BE PROVIDED TO ALLOW FOR VALVE HANDLE OPERATION AND ACCESS. INSULATION THICKNESS SHALL MEET THE LISTED ENERGY CODE MINIMUM REQUIREMENTS. SEE SPEC SECTION 220719 FOR SYSTEMS REQUIRING INSULATION AND ADDITIONAL INSTALLATION REQUIREMENTS.
- 11. VALVES SHALL BE ACCESSIBLE. PROVIDE KEYED ACCESS PANELS WHERE VALVES HAVE BEEN LOCATED IN CONCEALED AREAS. ACCESS PANEL SIZE SHALL BE LARGE ENOUGH TO ACCESS EACH VALVE AND FOR FULL VALVE OPERATION.
- 12. CLEANOUTS SHALL BE PROVIDED PER PLUMBING CODE REQUIREMENTS. IN ADDITION, PROVIDE CLEANOUTS AT LAVATORIES. CLEANOUTS SHALL BE INSTALLED IN ACCESSIBLE LOCATIONS.
- 13. WATER HAMMER ARRESTORS SHALL BE PROVIDED AT QUICK-CLOSING VALVES INCLUDING FLUSH VALVES, EQUIPMENT, AND AUTOMATIC FAUCETS. PROVIDE ACCESS PANELS WHERE ARRESTORS HAVE BEEN INSTALLED IN CONCEALED SPACES. SEE DETAILS AND PLUMBING MATERIAL LIST FOR ADDITIONAL REQUIREMENTS.
- 14. TRAP PRIMERS AND SUPPLY LINES SHALL BE PROVIDED AT EQUIPMENT AND FIXTURE DRAINS NOT RECEIVING REGULAR DISCHARGE. PROVIDE ACCESS PANELS WHERE PRIMERS HAVE BEEN INSTALLED IN CONCEALED SPACES. SEE DETAILS AND PLUMBING MATERIAL LIST FOR ADDITIONAL REQUIREMENTS.

PLUMBING SHEET INDEX:

Sheet Number	Sheet Name
P-001	PLUMBING COVER SHEET
P-101	PLUMBING GUHLEMAN WEST BUILDING - FIRST FLOOR - G1 - DEMO
P-102	PLUMBING GUHLEMAN WEST BUILDING - FIRST FLOOR - G2 - DEMO
P-103	PLUMBING GUHLEMAN WEST BUILDING - SECOND FLOOR - G3 - DEMO
P-104	PLUMBING GUHLEMAN WEST BUILDING - SECOND FLOOR - G4 - DEMO
P-105	PLUMBING GUHLEMAN EAST BUILDING - FIRST FLOOR - G5 - DEMO
P-106	PLUMBING GUHLEMAN EAST BUILDING - FIRST FLOOR - G6 - DEMO
P-107	PLUMBING HEARNES BUILDING - H1 - DEMO
P-108	PLUMBING HEARNES BUILDING - H2 - DEMO
P-109	PLUMBING GUHLEMAN WEST BUILDING - FIRST FLOOR - G1 - REMODEL
P-110	PLUMBING GUHLEMAN WEST BUILDING - FIRST FLOOR - G2 - REMODEL
P-111	PLUMBING GUHLEMAN WEST BUILDING - SECOND FLOOR - G3 - REMODEL
P-112	PLUMBING GUHLEMAN WEST BUILDING - SECOND FLOOR - G4 - REMODEL
P-113	PLUMBING GUHLEMAN EAST BUILDING - FIRST FLOOR - G5 - REMODEL
P-114	PLUMBING GUHLEMAN EAST BUILDING - FIRST FLOOR - G6 - REMODEL
P-115	PLUMBING HEARNES BUILDING - H1 - REMODEL
P-116	PLUMBING HEARNES BUILDING - H2 - REMODEL
P-501	PLUMBING DETAILS
P-601	PLUMBING SCHEDULES

CODES AND STANDARDS:

EDITION	REFERENCE CODE/STANDARD
2010	AMERICANS WITH DISABILITIES ACT (ADAAG)
2021	INTERNATIONAL BUILDING CODE, (IBC)
2023	NATIONAL ELECTRICAL CODE, (NEC)
2021	INTERNATIONAL MECHANICAL CODE, (IMC)
2021	INTERNATIONAL PLUMBING CODE, (IPC)
2021	NATIONAL LIFE SAFETY CODE, (NFPA 101)
2022	ENERGY EFFICIENCY STANDARD, (ASHRAE 90.1)

NFPA-NATIONAL FIRE PROTECTION AGENCY

GENERAL LEGEND:

SYMBOL	DESCRIPTION
####	DETAIL CALL-OUT SYMBOL
###-#	EQUIPMENT TAG
#>	KEYNOTE SYMBOL
•	POINT OF CONNECTION DISCONNECTION
####	SECTION CUT CALL-OUT SYMBOL
####	ENLARGED PLAN CALL-OUT SYMBOL
LINETYPE	DESCRIPTION
	EXISTING TO REMAIN
	EXISTING TO BE REMOVED

(E) EXISTING TO BE REMOVED

STATE OF MISSOURI MICHAEL L PARSON, GOVERNOR





STATE OF MISSOURI

ST. LOUIS, MO 63108

- MEP

UCAMONGA, CA 91729

- STRUCT.

- STRUCT.

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OFFICE OF ADMINISTRATION DIVISION OF FACILITIES MANAGEMENT, DESIGN AND CONSTRUCTION

ANTI-LIGATURE UPGRADES MULTIPLE ASSETS FULTON STATE HOSPITAL FULTON, MISSOURI

PROJECT # M2312-01 SITE # 7352

ASSET # 6517352026, 6517352027 6517352031

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ISSUE DATE: 09/22/24


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DRAWN BY: PSK
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DESIGNED BY: RSS

SHEET TITLE:
PLUMBING
COVERSHEE

SHEET NUMBER:

P-00

SHEET 48 OF 66 SEPTEMBER 22, 2024

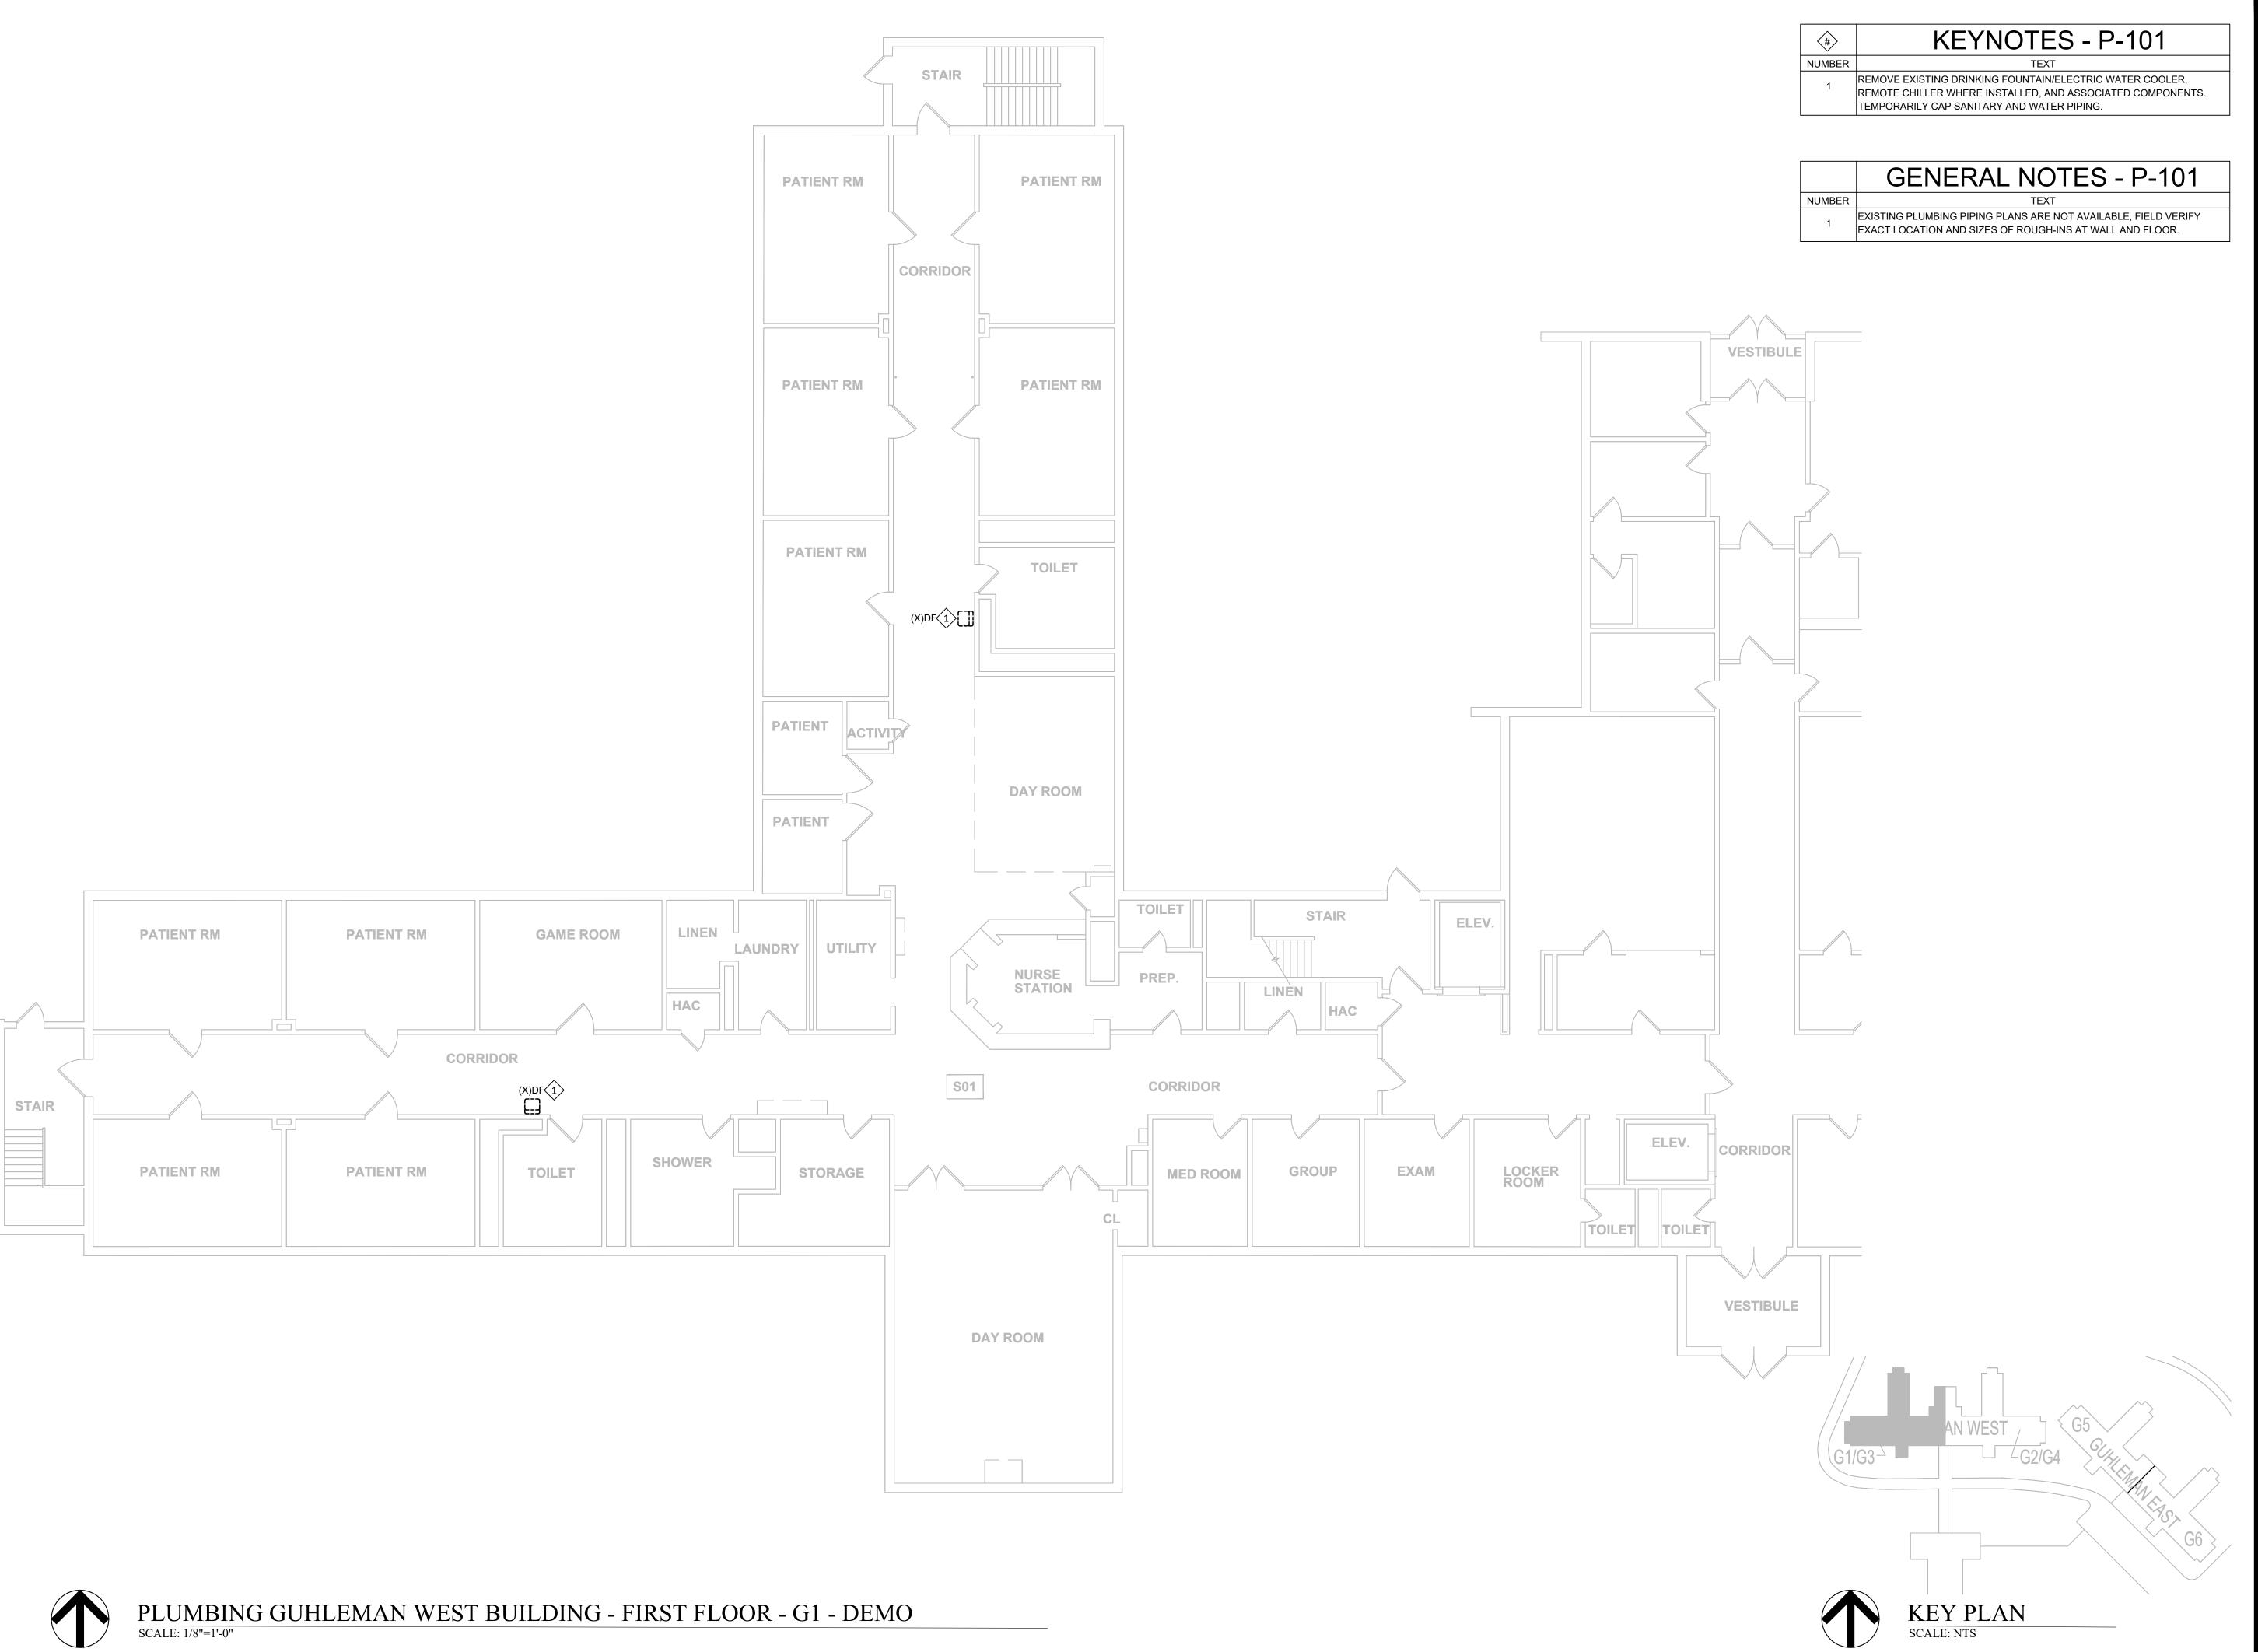





STATE OF MISSOURI CERTIFICATE OF AUTHORITY #2018019473

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ANTI-LIGATURE UPGRADES MULTIPLE ASSETS FULTON STATE HOSPITAL FULTON, MISSOURI

PROJECT # M2312-01 SITE # 7352 ASSET # 6517352027


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DATE:
ISSUE DATE: 09/22/24

CAD DWG FILE:P-DP-01
DRAWN BY: PSK
CHECKED BY: RSS
DESIGNED BY: RSS

SHEET TITLE:
PLUMBING
GUHLEMAN WEST
BUILDING - FIRST
FLOOR - G1 - DEMO
SHEET NUMBER:

P-101

SHEET 49 OF 66 SEPTEMBER 22, 2024

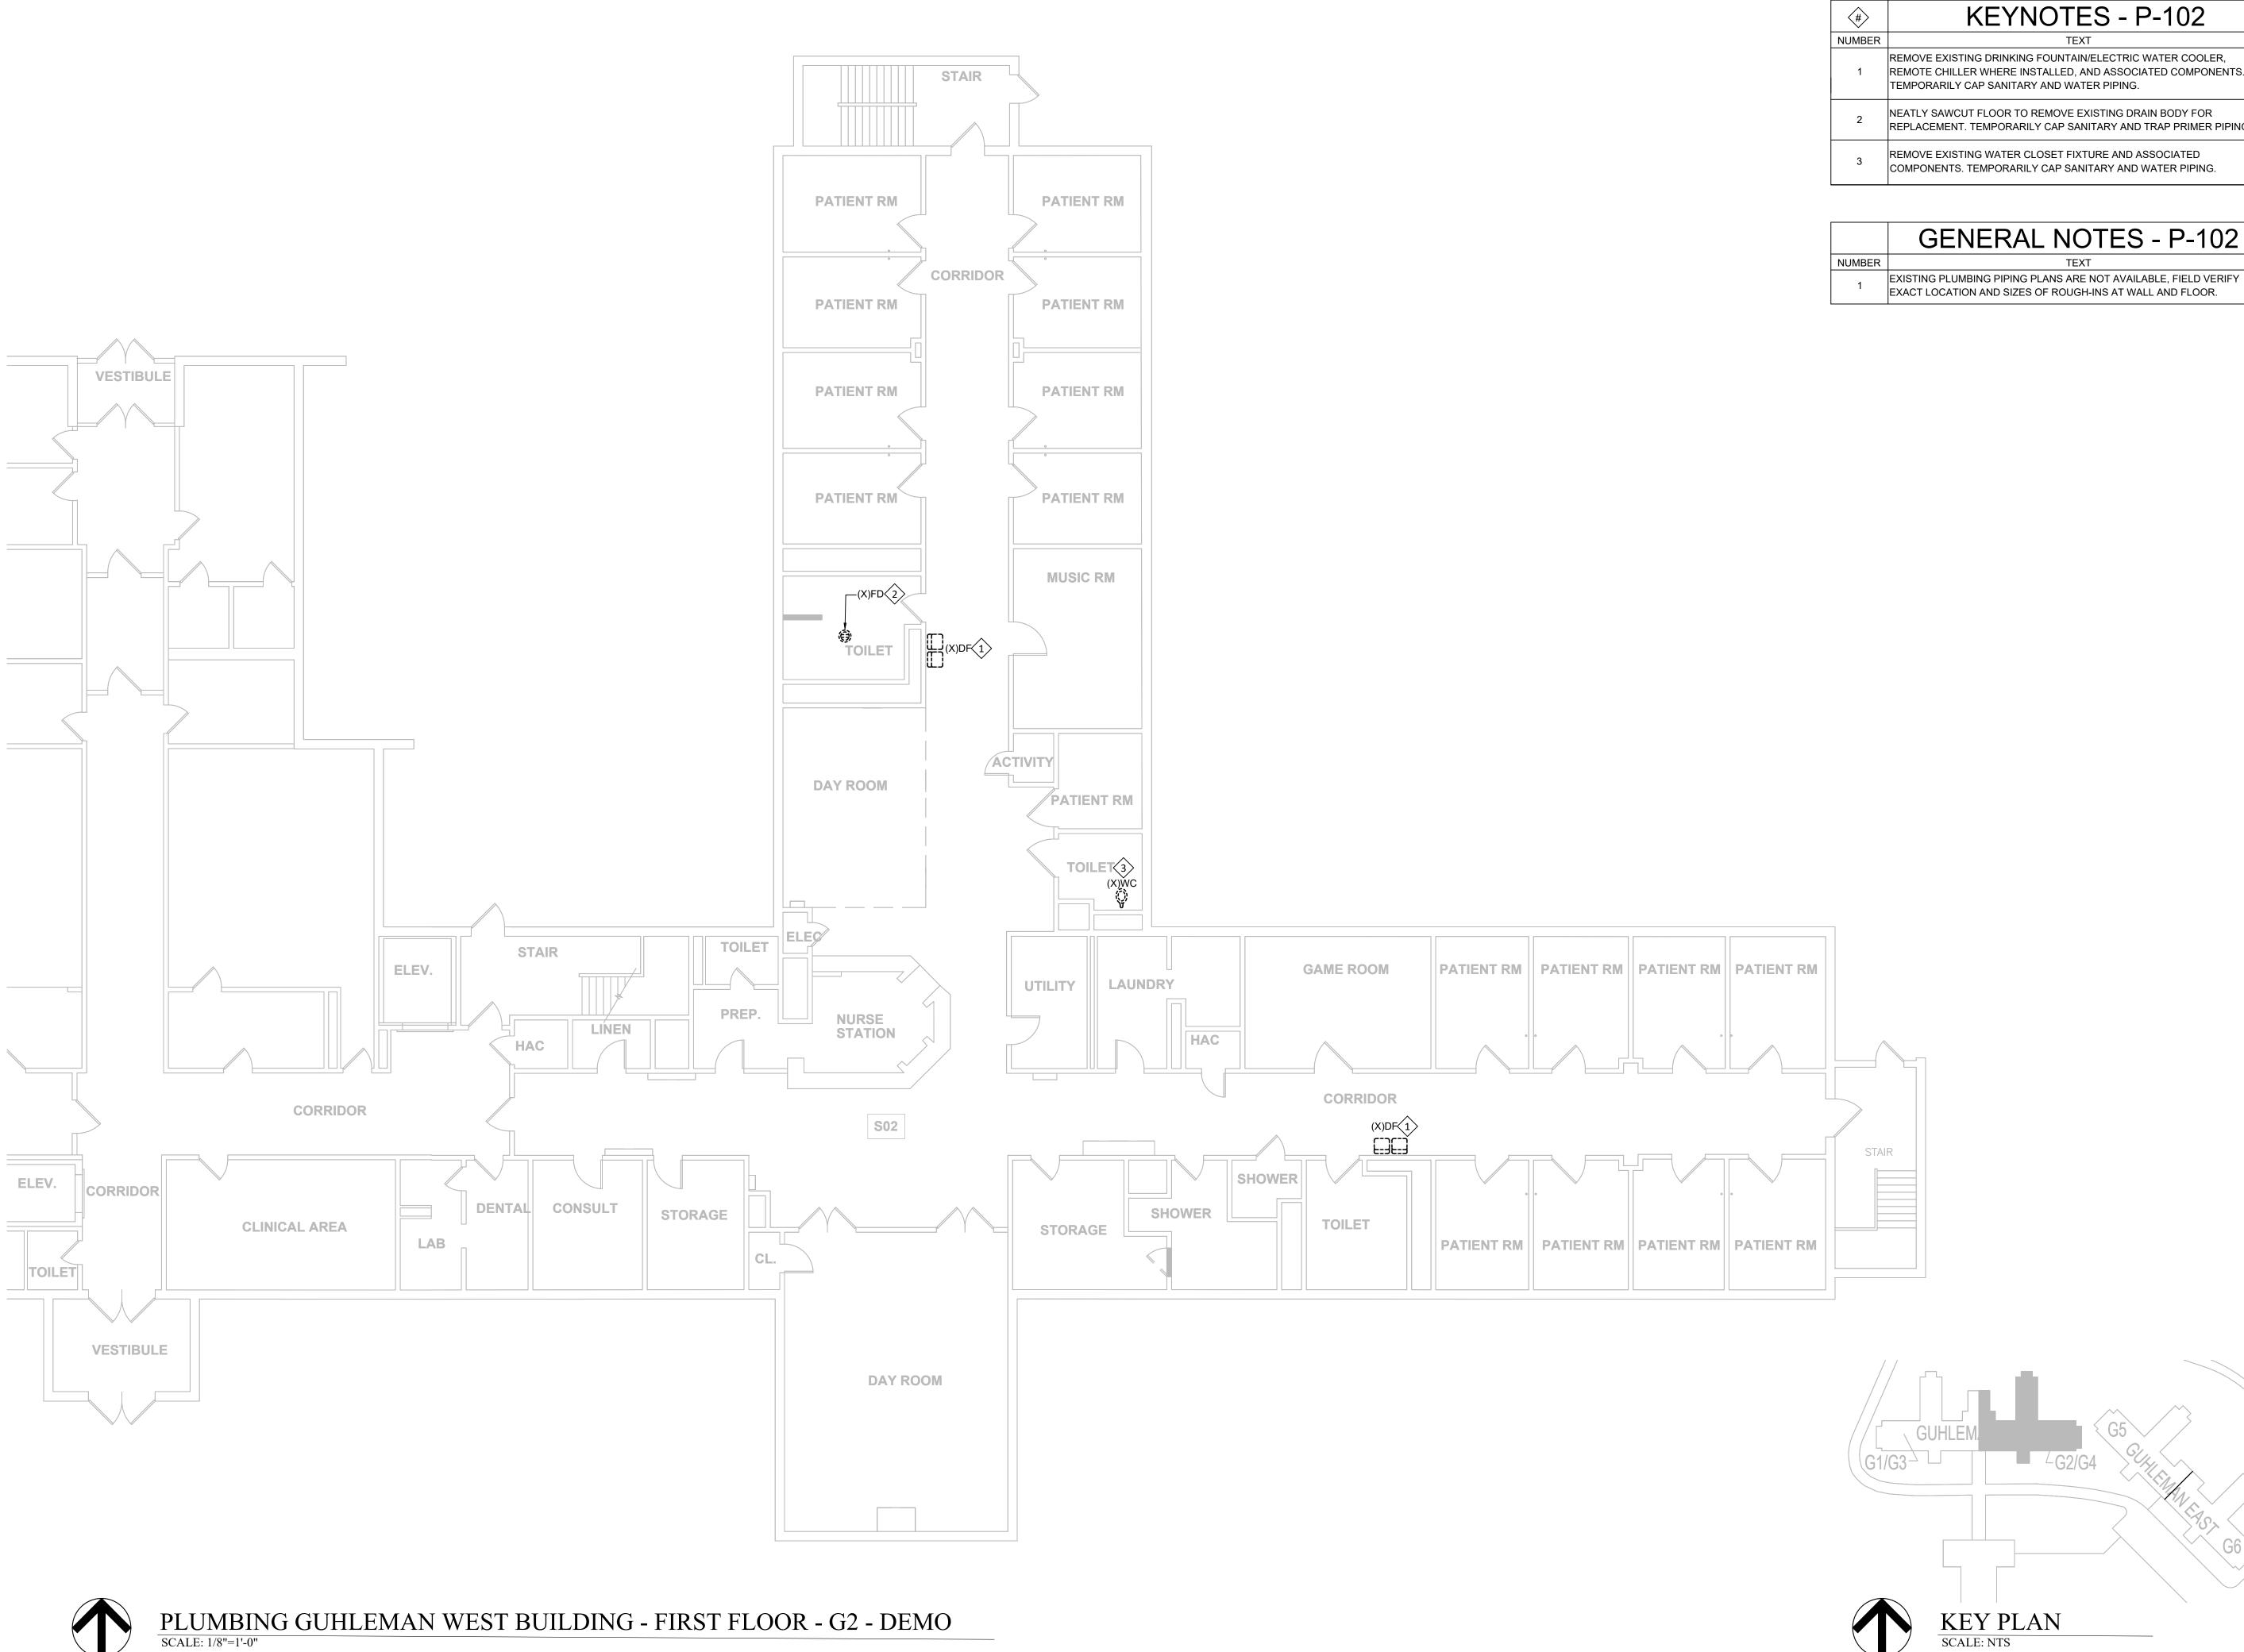

KEYNOTES - P-102 REMOVE EXISTING DRINKING FOUNTAIN/ELECTRIC WATER COOLER, REMOTE CHILLER WHERE INSTALLED, AND ASSOCIATED COMPONENTS. TEMPORARILY CAP SANITARY AND WATER PIPING. NEATLY SAWCUT FLOOR TO REMOVE EXISTING DRAIN BODY FOR EPLACEMENT, TEMPORARILY CAP SANITARY AND TRAP PRIMER PIPING. REMOVE EXISTING WATER CLOSET FIXTURE AND ASSOCIATED

GENERAL NOTES - P-102

STATE OF MISSOURI MICHAEL L PARSON,

GOVERNOR

DESPLINTER NUMBER

SIGNED: 09/22/24

STATE OF MISSOURI CERTIFICATE OF AUTHORITY #2018019473

OFFICE OF ADMINISTRATION DIVISION OF FACILITIES MANAGEMENT, DESIGN AND CONSTRUCTION

ANTI-LIGATURE UPGRADES MULTIPLE ASSETS FULTON STATE HOSPITAL FULTON, MISSOURI

PROJECT # M2312-01 7352 ASSET # 6517352027


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SHEET TITLE: PLUMBING GUHLEMAN WEST BUILDING - FIRST FLOOR - G2 - DEMO

SHEET 50 OF 66 SEPTEMBER 22, 2024

SHEET NUMBER:





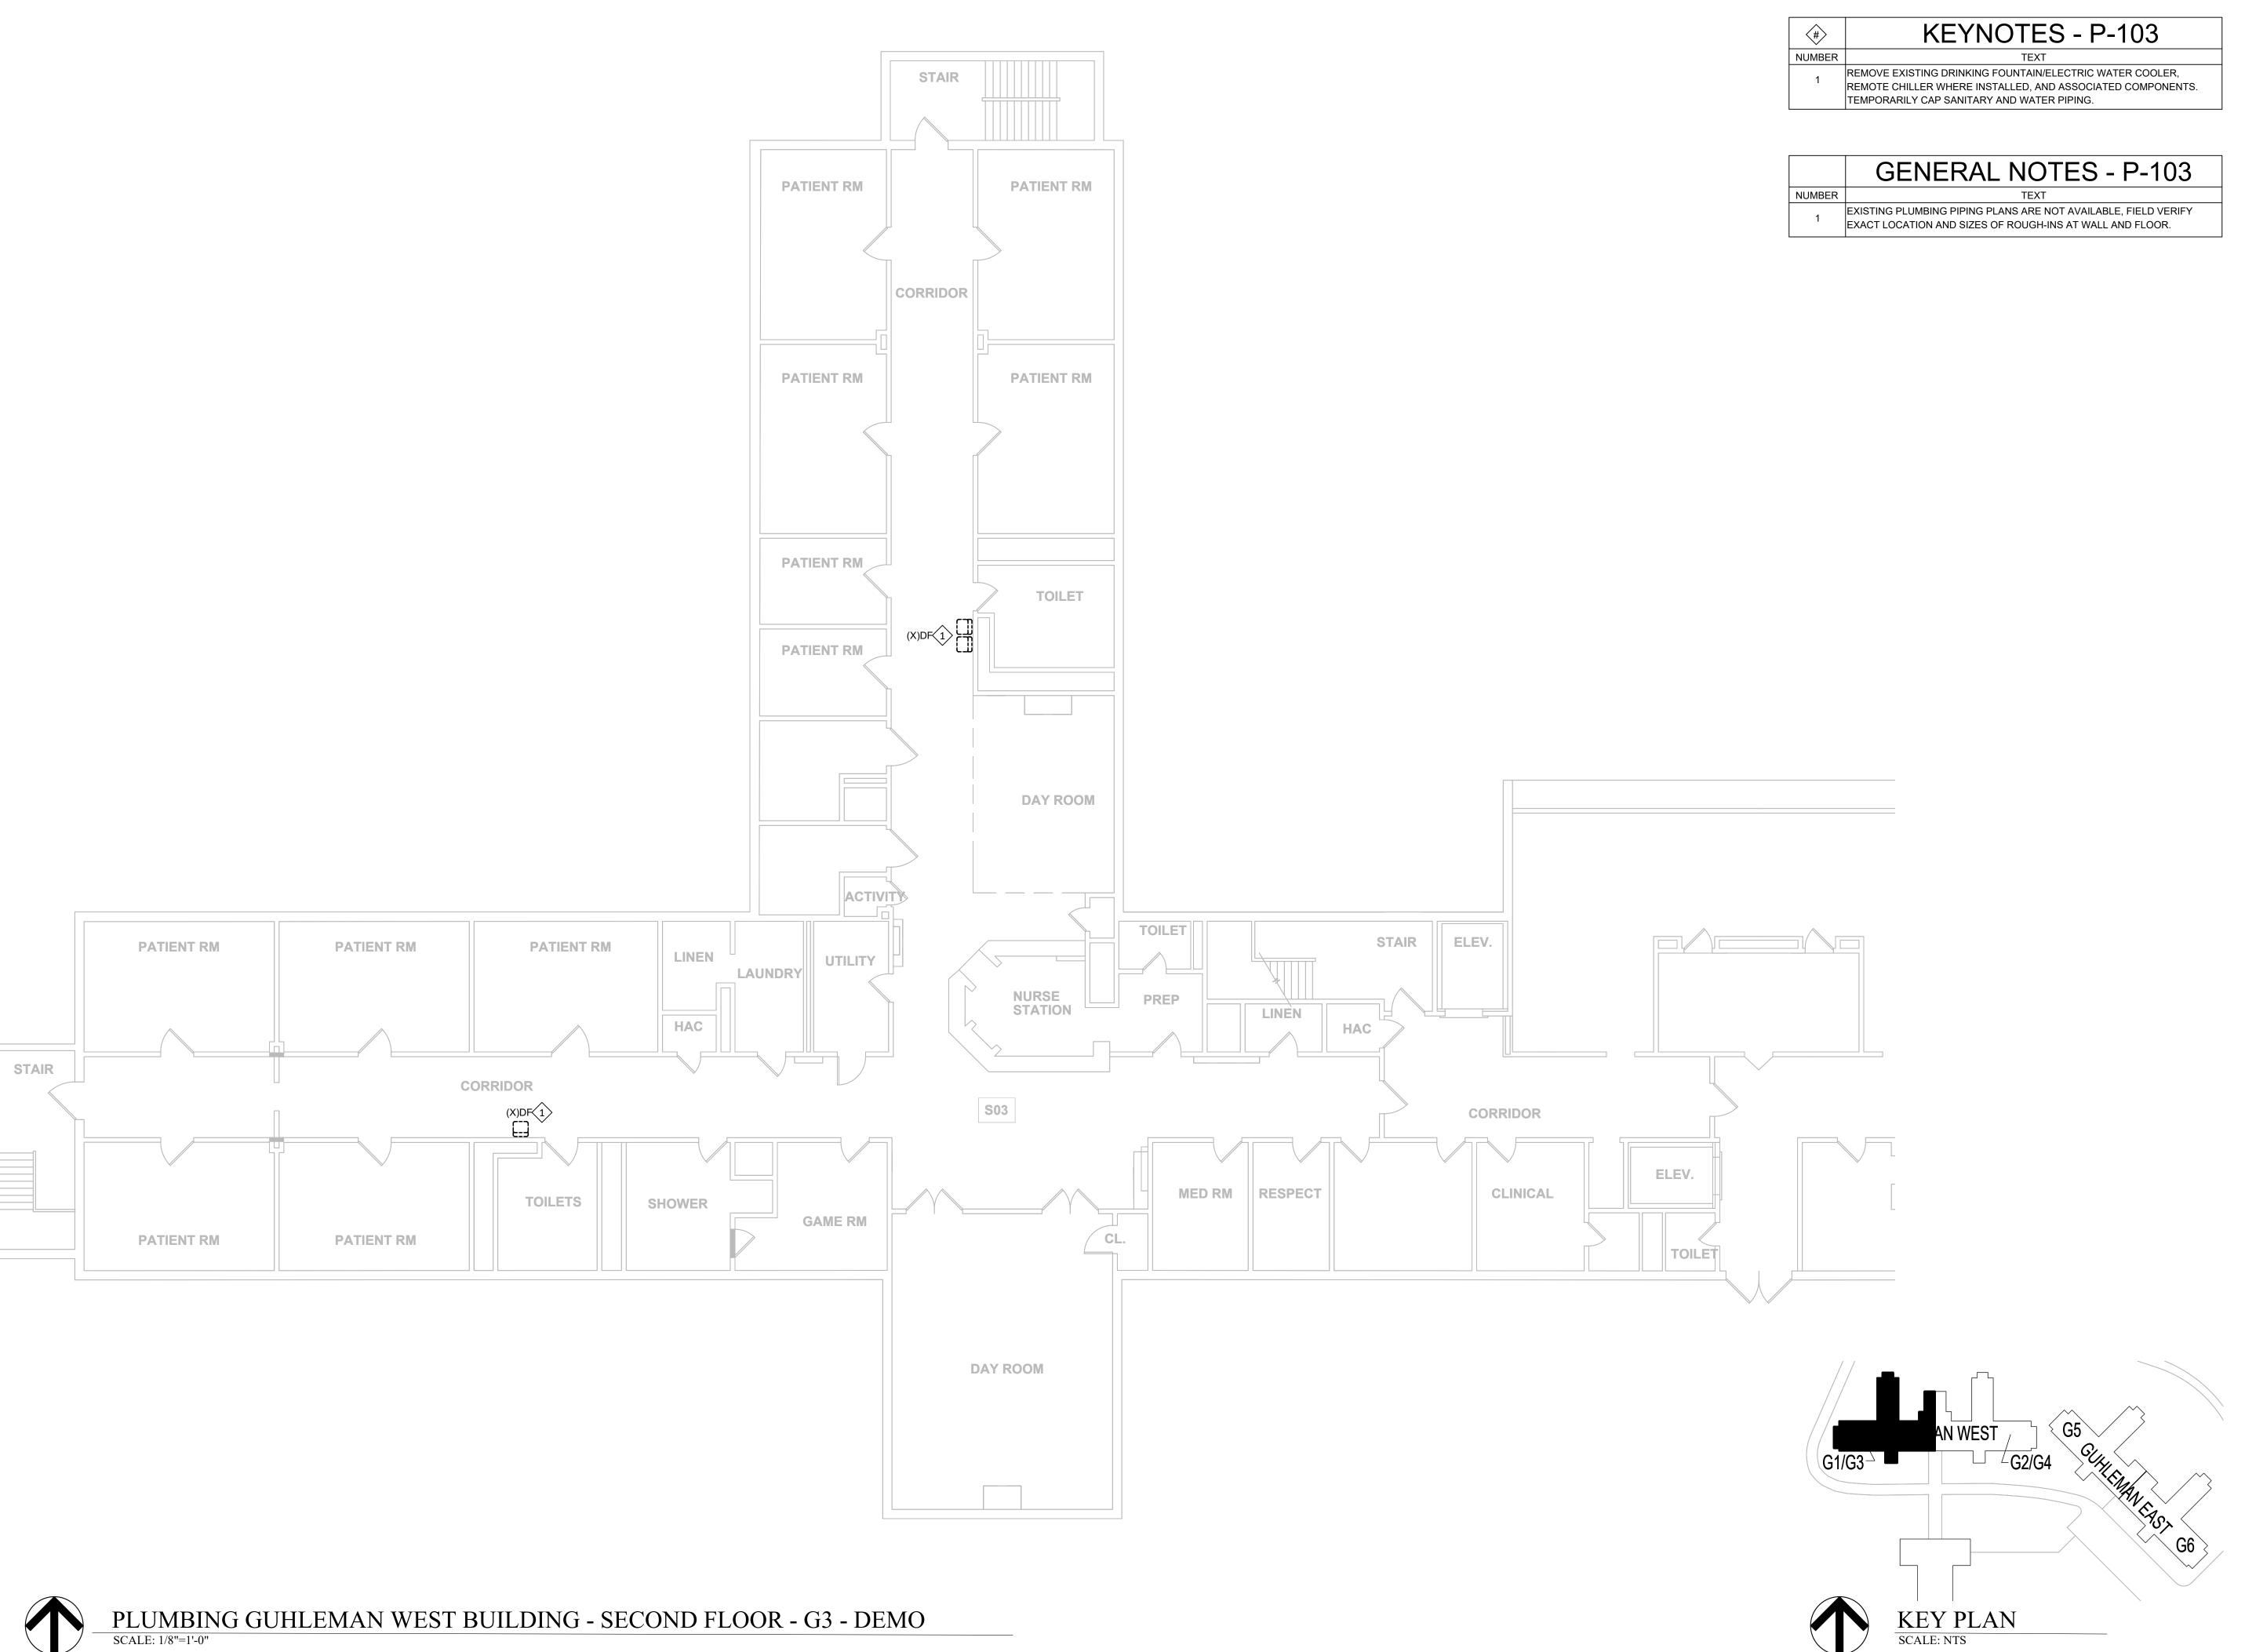

STATE OF MISSOURI CERTIFICATE OF AUTHORITY #2018019473

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ANTI-LIGATURE UPGRADES MULTIPLE ASSETS FULTON STATE HOSPITAL FULTON, MISSOURI

PROJECT # M2312-01 SITE # 7352 ASSET # 6517352027

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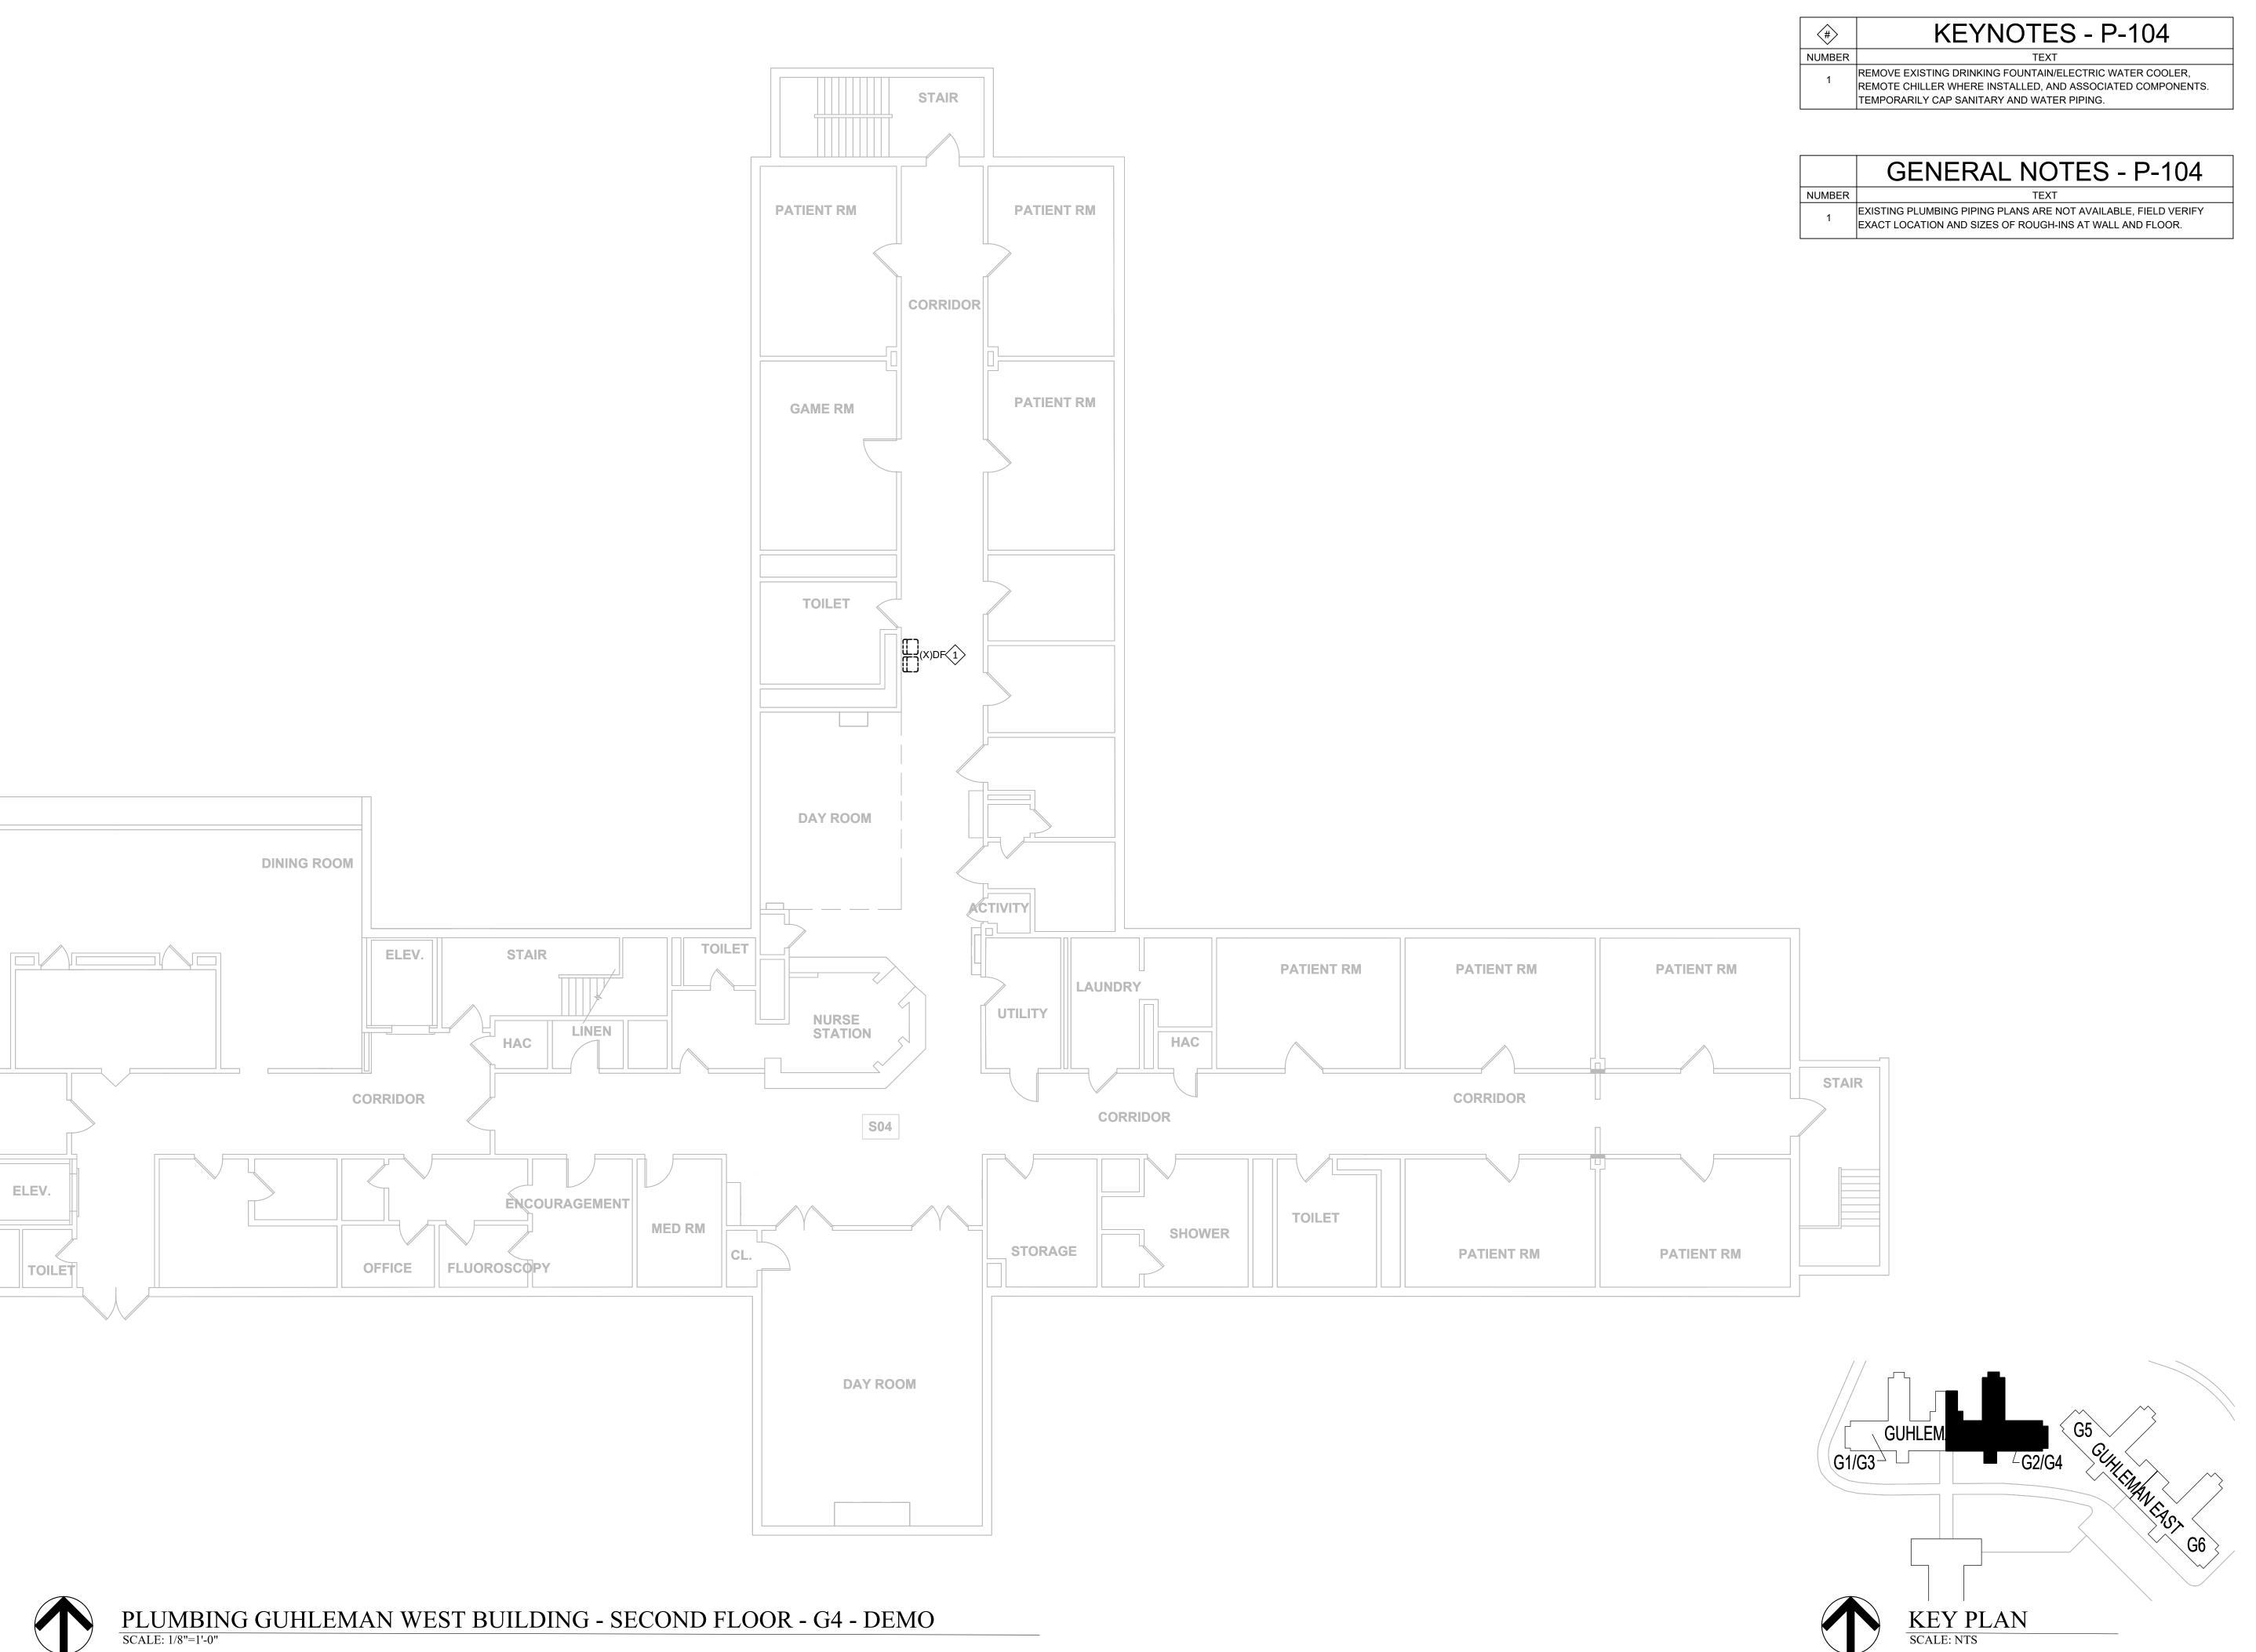
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SHEET TITLE:
PLUMBING
GUHLEMAN WEST
BUILDING - SECOND
FLOOR - G3 - DEMO

P-103

SHEET 51 OF 66 SEPTEMBER 22, 2024

SHEET NUMBER:







STATE OF MISSOURI CERTIFICATE OF AUTHORITY #2018019473

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ANTI-LIGATURE UPGRADES MULTIPLE ASSETS FULTON STATE HOSPITAL FULTON, MISSOURI

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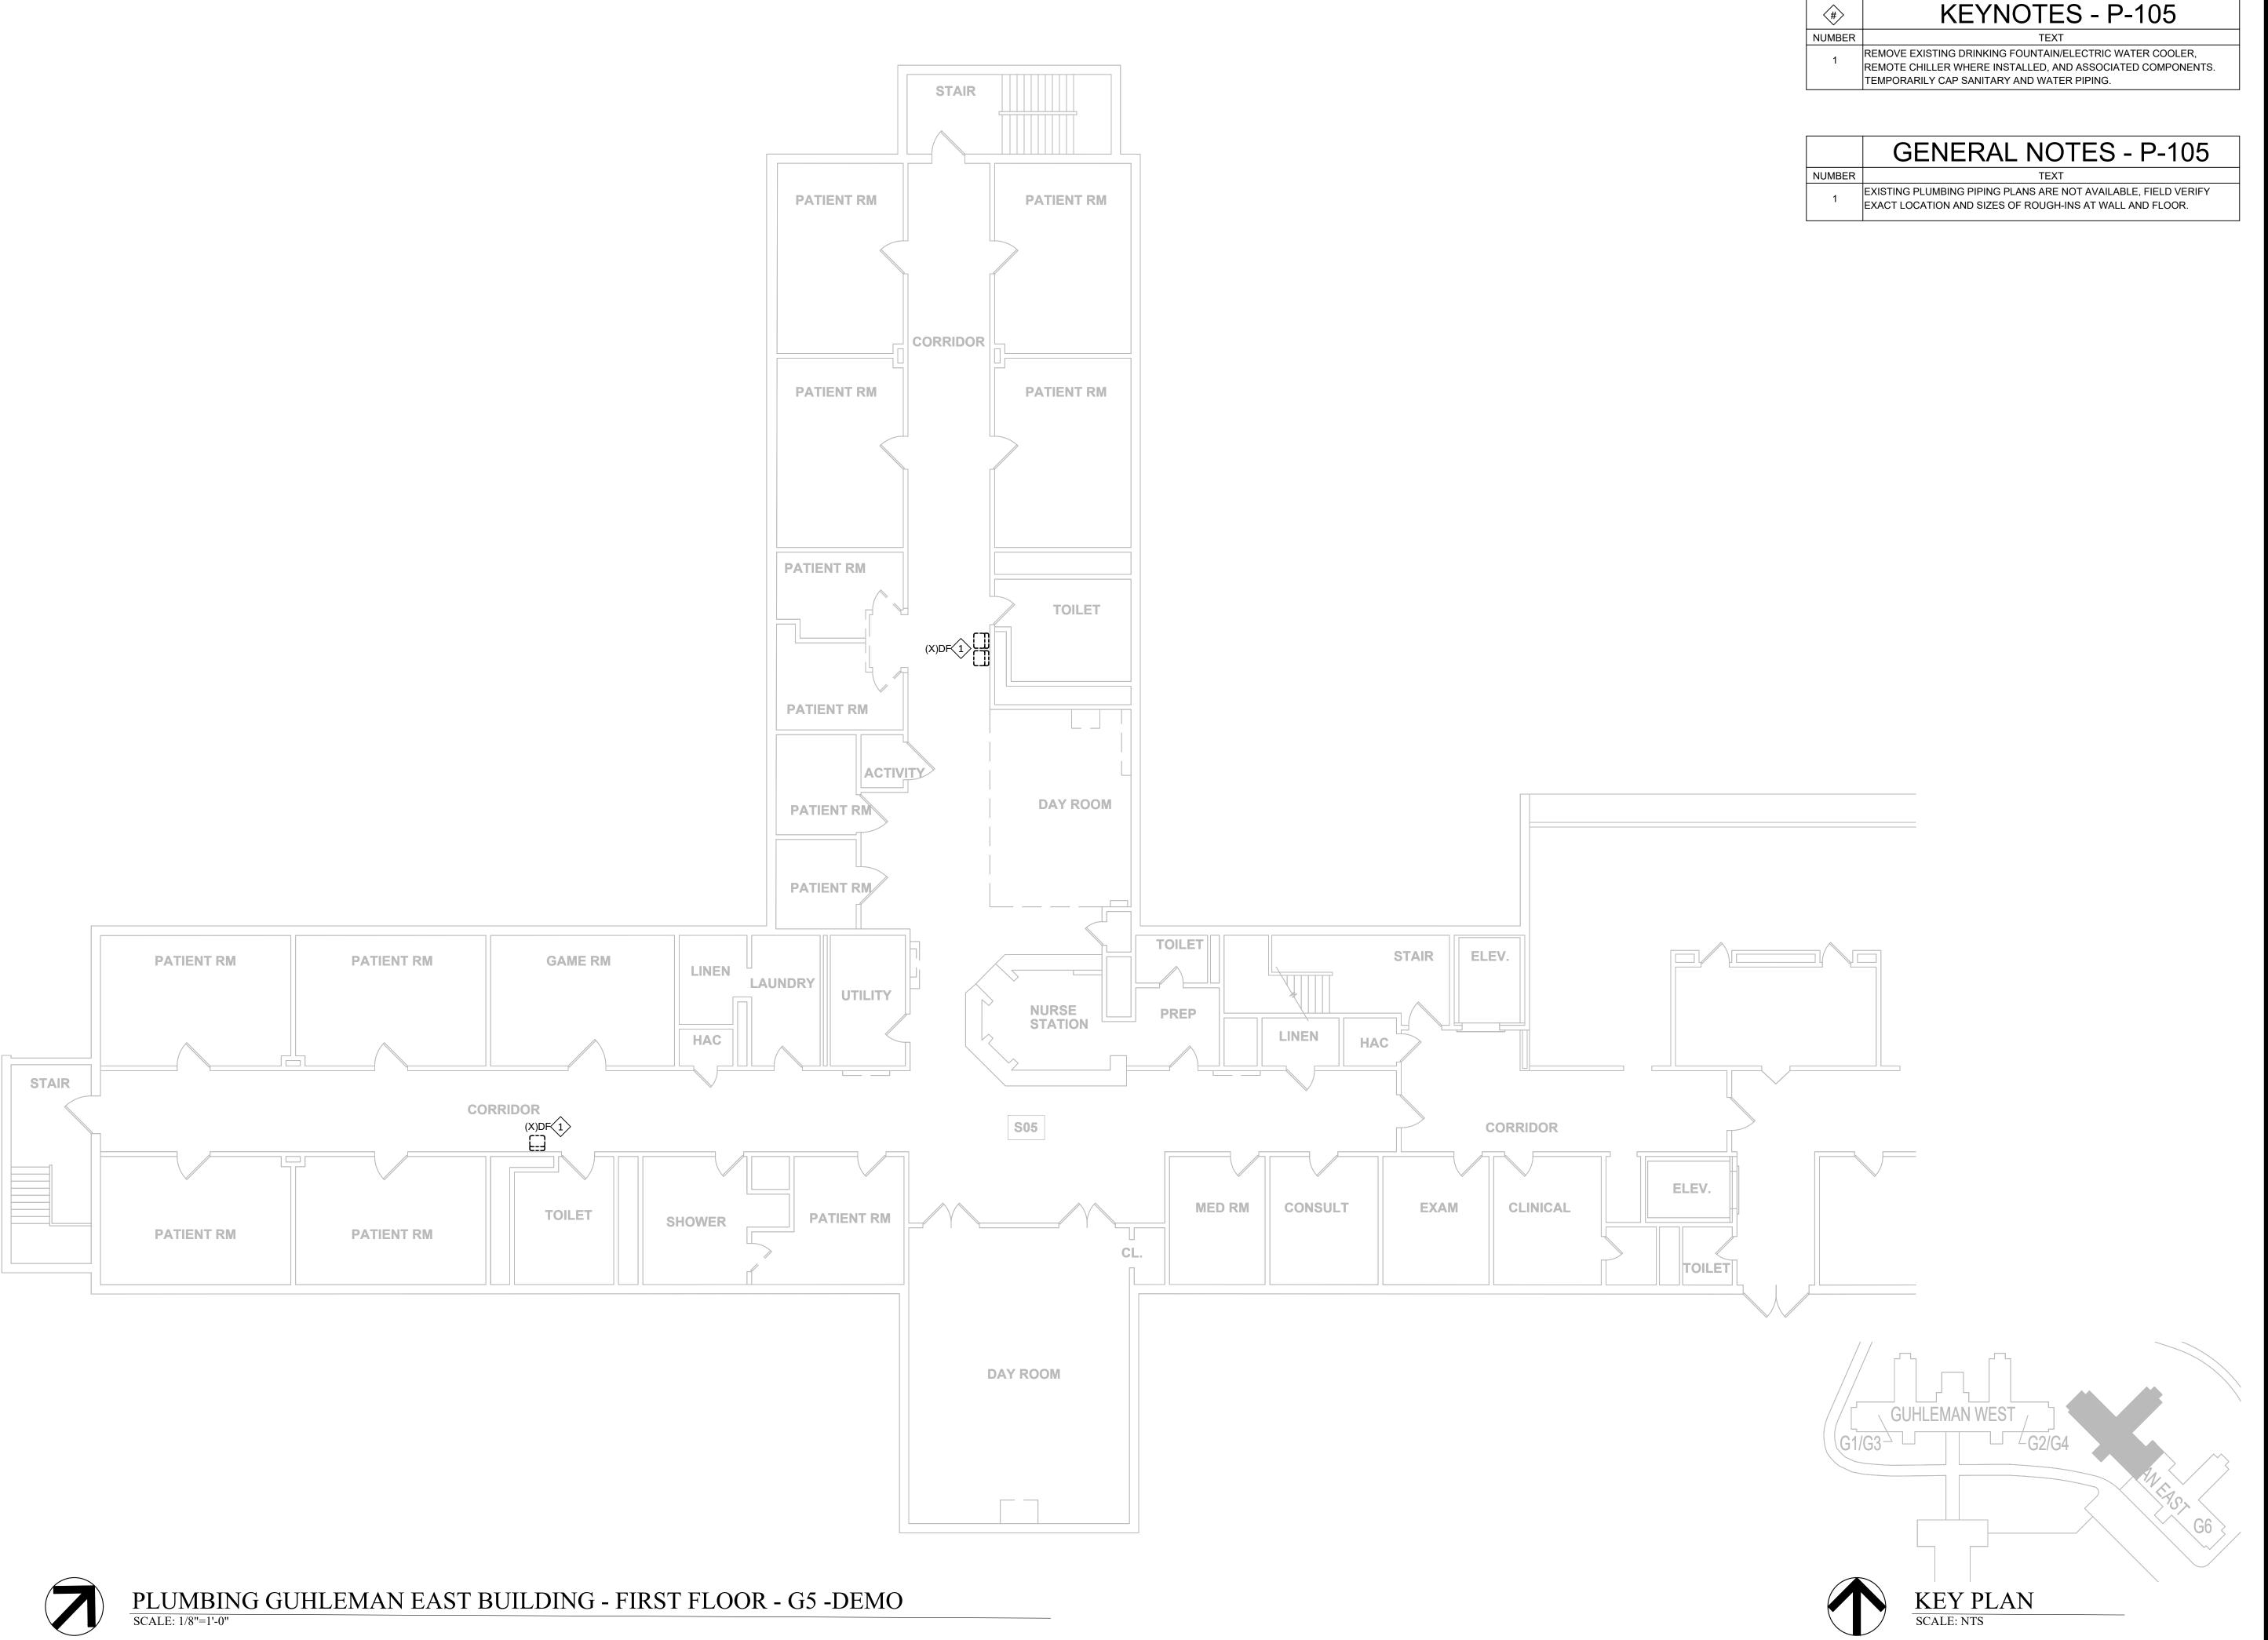
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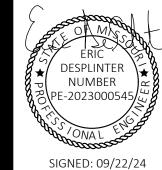
SHEET TITLE:
PLUMBING
GUHLEMAN WEST
BUILDING - SECOND
FLOOR - G4 - DEMO

SHEET NUMBER:

P-104

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STATE OF MISSOURI CERTIFICATE OF AUTHORITY #2018019473

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OFFICE OF ADMINISTRATION DIVISION OF FACILITIES MANAGEMENT, DESIGN AND CONSTRUCTION

ANTI-LIGATURE UPGRADES MULTIPLE ASSETS FULTON STATE HOSPITAL FULTON, MISSOURI

PROJECT # M2312-01 SITE # 7352 ASSET # 6517352026


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SHEET TITLE:
PLUMBING
GUHLEMAN EAST
BUILDING - FIRST
FLOOR - G5 - DEMO
SHEET NUMBER:

P-105

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STATE OF MISSOURI CERTIFICATE OF AUTHORITY #2018019473

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ANTI-LIGATURE UPGRADES MULTIPLE ASSETS FULTON STATE HOSPITAL FULTON, MISSOURI

PROJECT # M2312-01 7352 ASSET # 6517352026

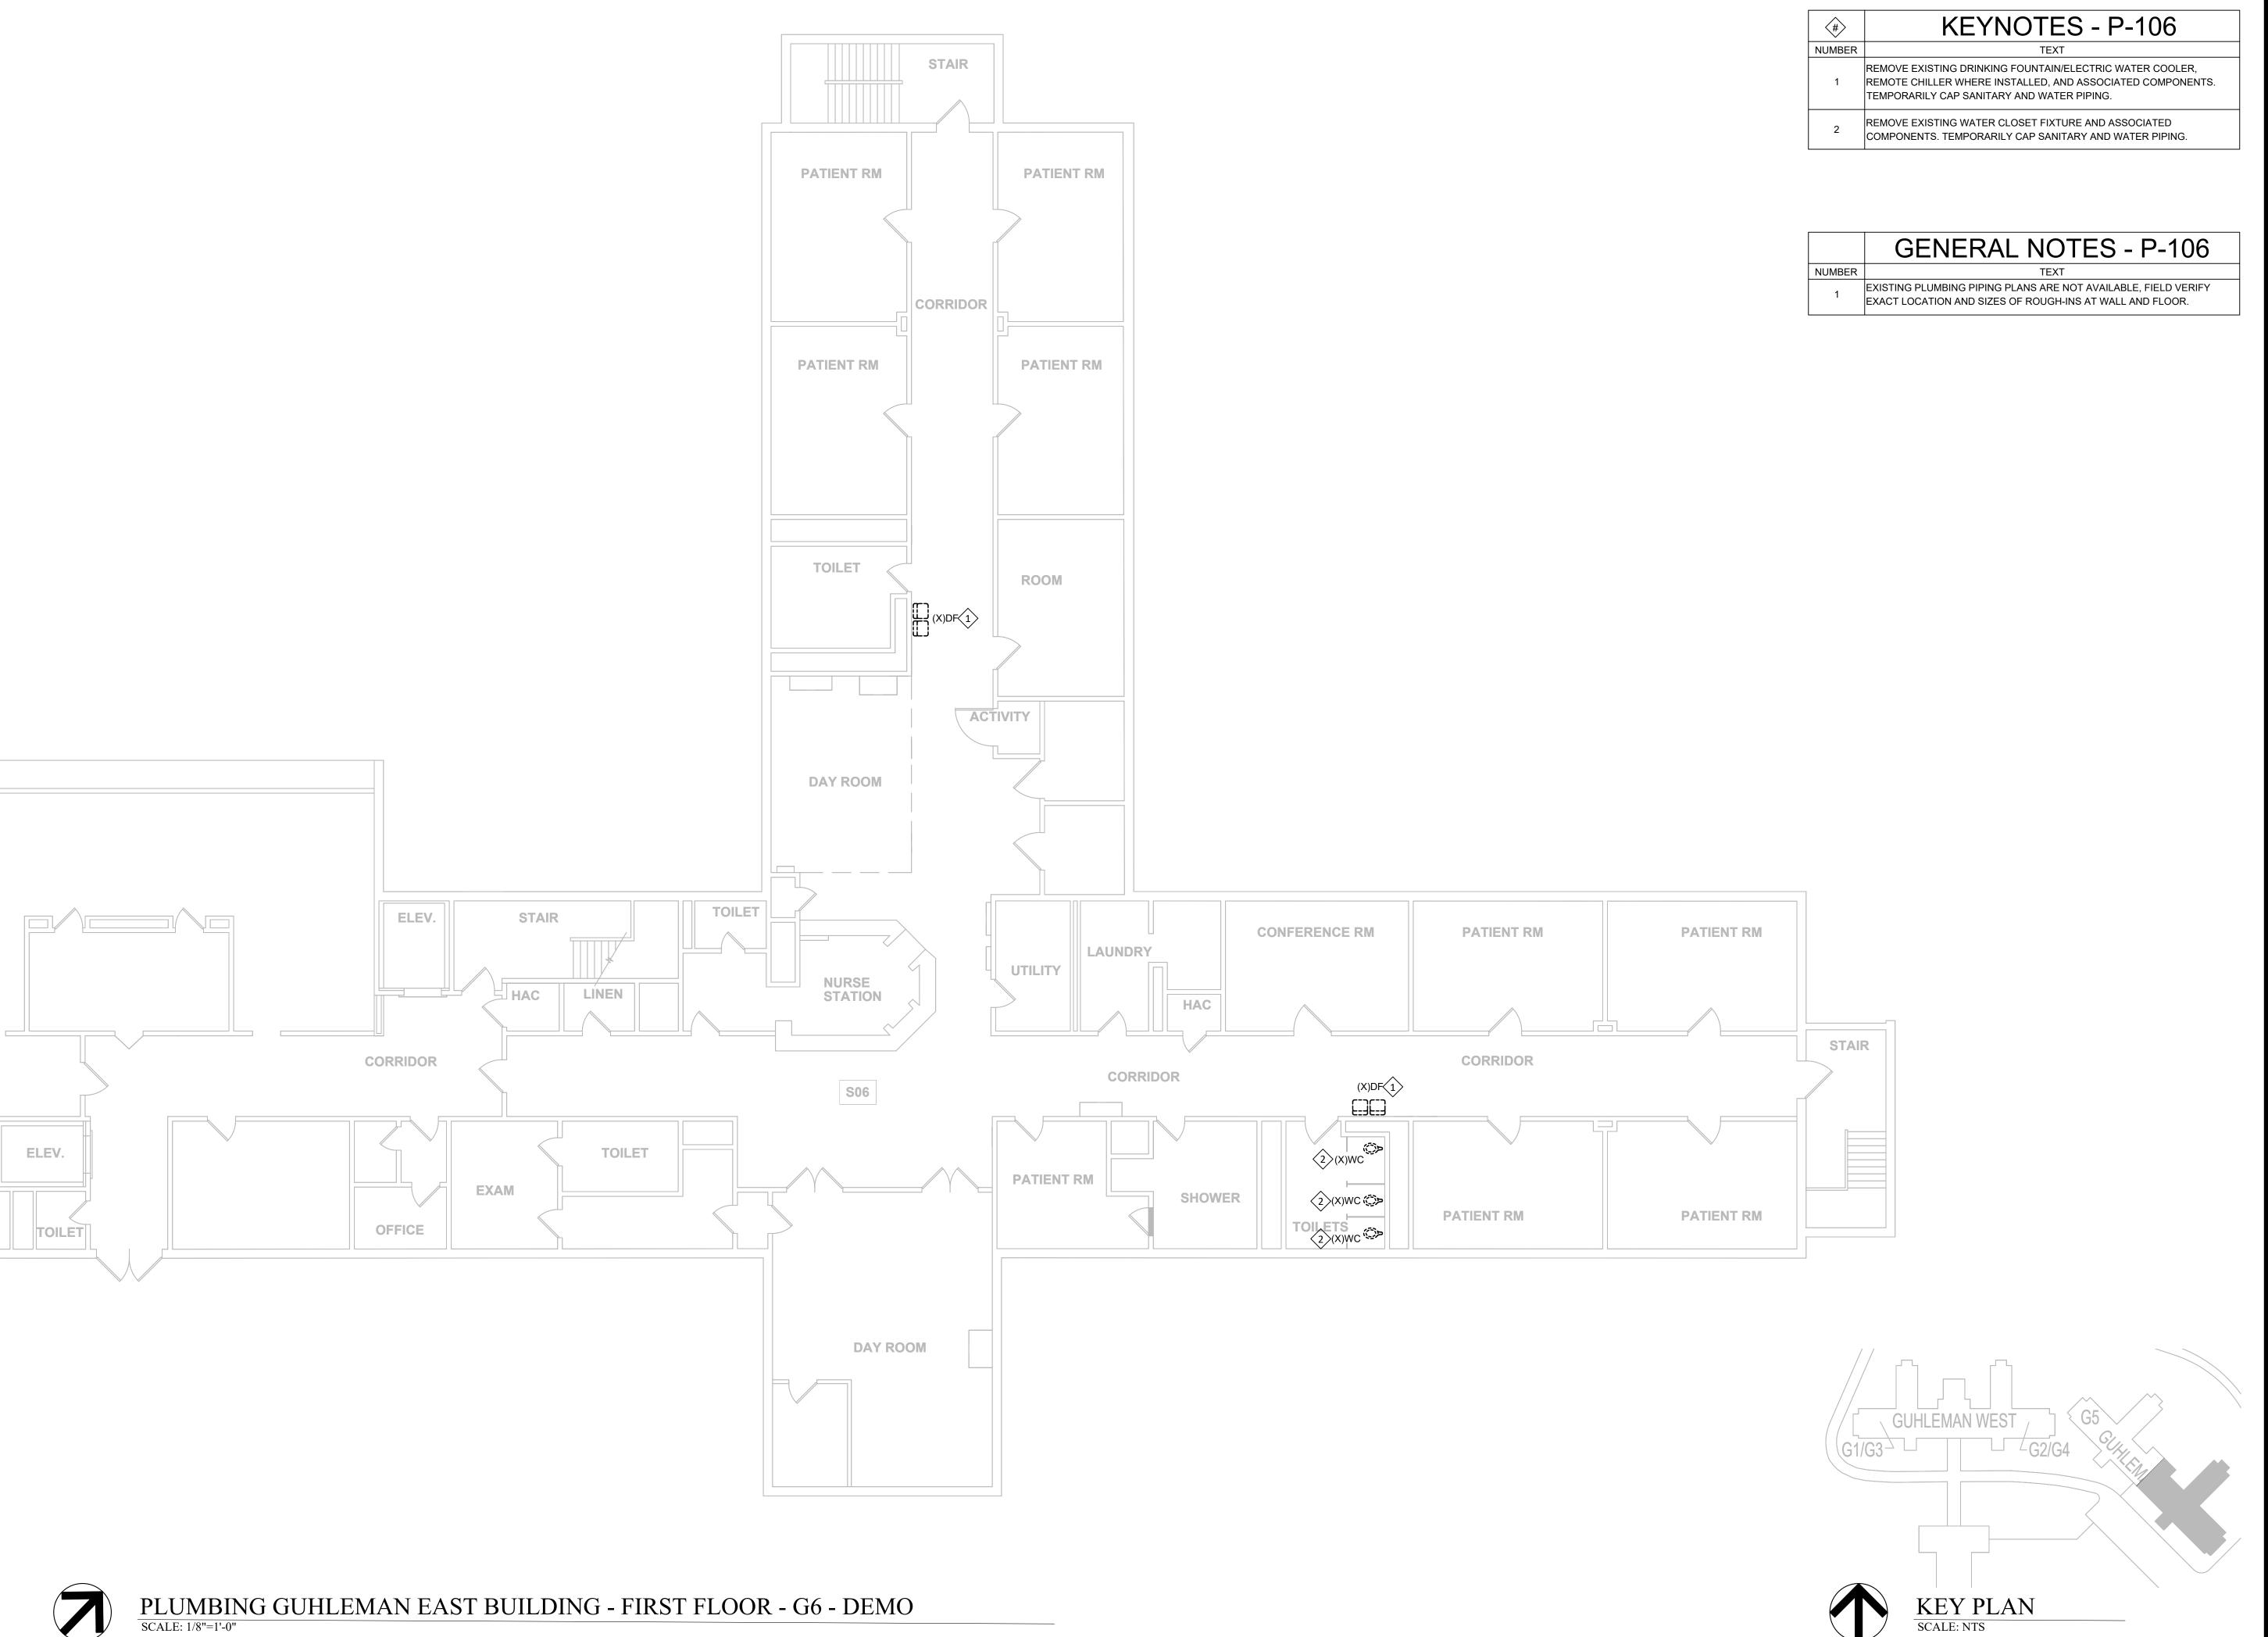
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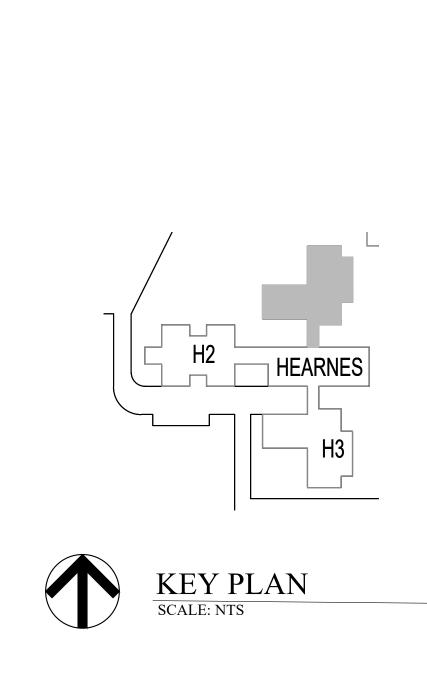
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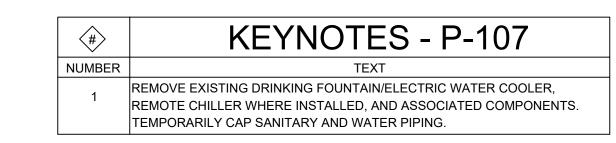
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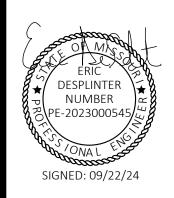
PLUMBING HEARNES BUILDING - H1 - DEMO
SCALE: 1/8"=1'-0"





	GENERAL NOTES - P-107
NUMBER	TEXT
	EXISTING PLUMBING PIPING PLANS ARE NOT AVAILABLE, FIELD VERIFY EXACT LOCATION AND SIZES OF ROUGH-INS AT WALL AND FLOOR.

STATE OF MISSOURI MICHAEL L PARSON, GOVERNOR

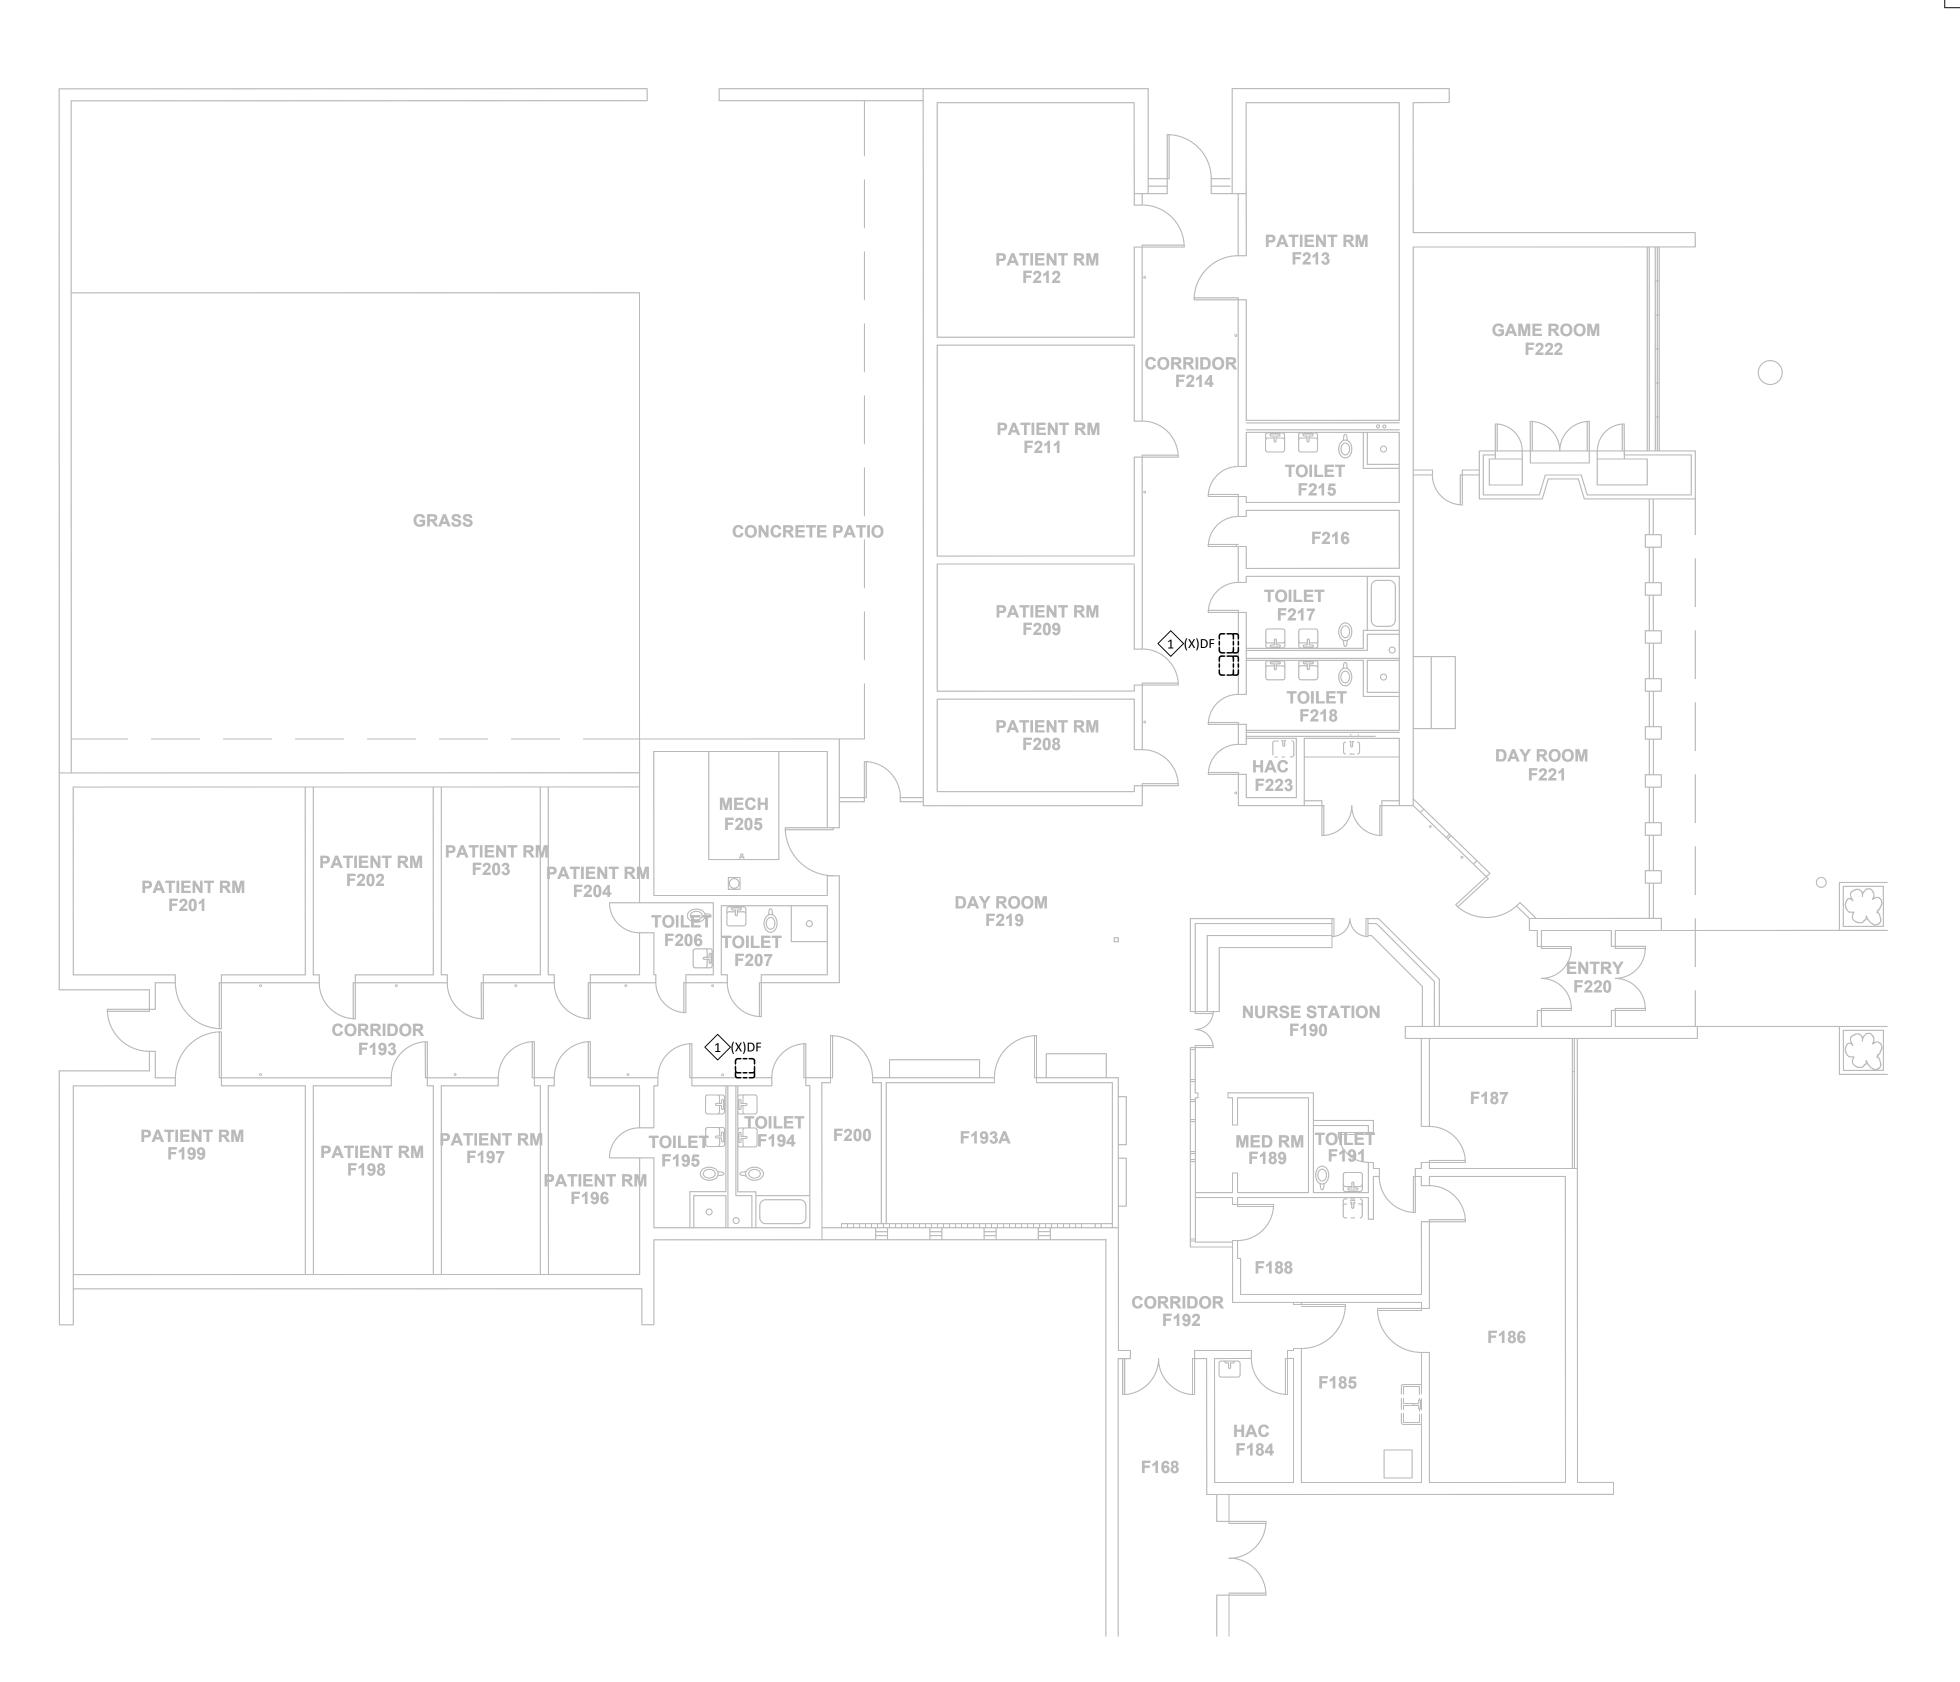



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ANTI-LIGATURE UPGRADES MULTIPLE ASSETS FULTON STATE HOSPITAL FULTON, MISSOURI

PROJECT # M2312-01 SITE # 7352 ASSET # 6517352031

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ISSUE DATE: 09/22/24

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CHECKED BY: RSS
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PLUMBING HEARNES
BUILDING - H1 - DEMO

SHEET NUMBER:


P-107

SHEET 55 OF 66 SEPTEMBER 22, 2024





	GENERAL NOTES - P-108
NUMBER	TEXT
	EXISTING PLUMBING PIPING PLANS ARE NOT AVAILABLE, FIELD VERIFY EXACT LOCATION AND SIZES OF ROUGH-INS AT WALL AND FLOOR.

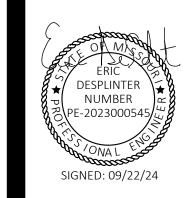



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ANTI-LIGATURE UPGRADES MULTIPLE ASSETS FULTON STATE HOSPITAL FULTON, MISSOURI

PROJECT # M2312-01 SITE # 7352 ASSET # 6517352031

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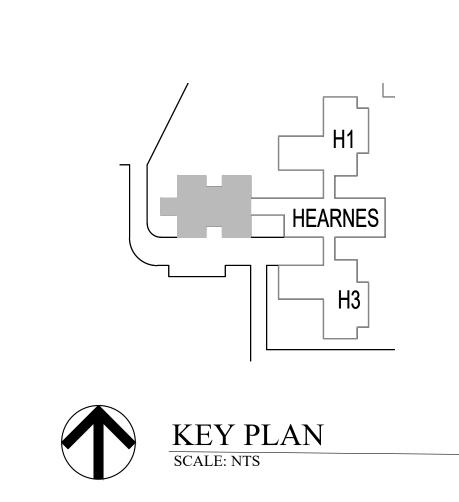
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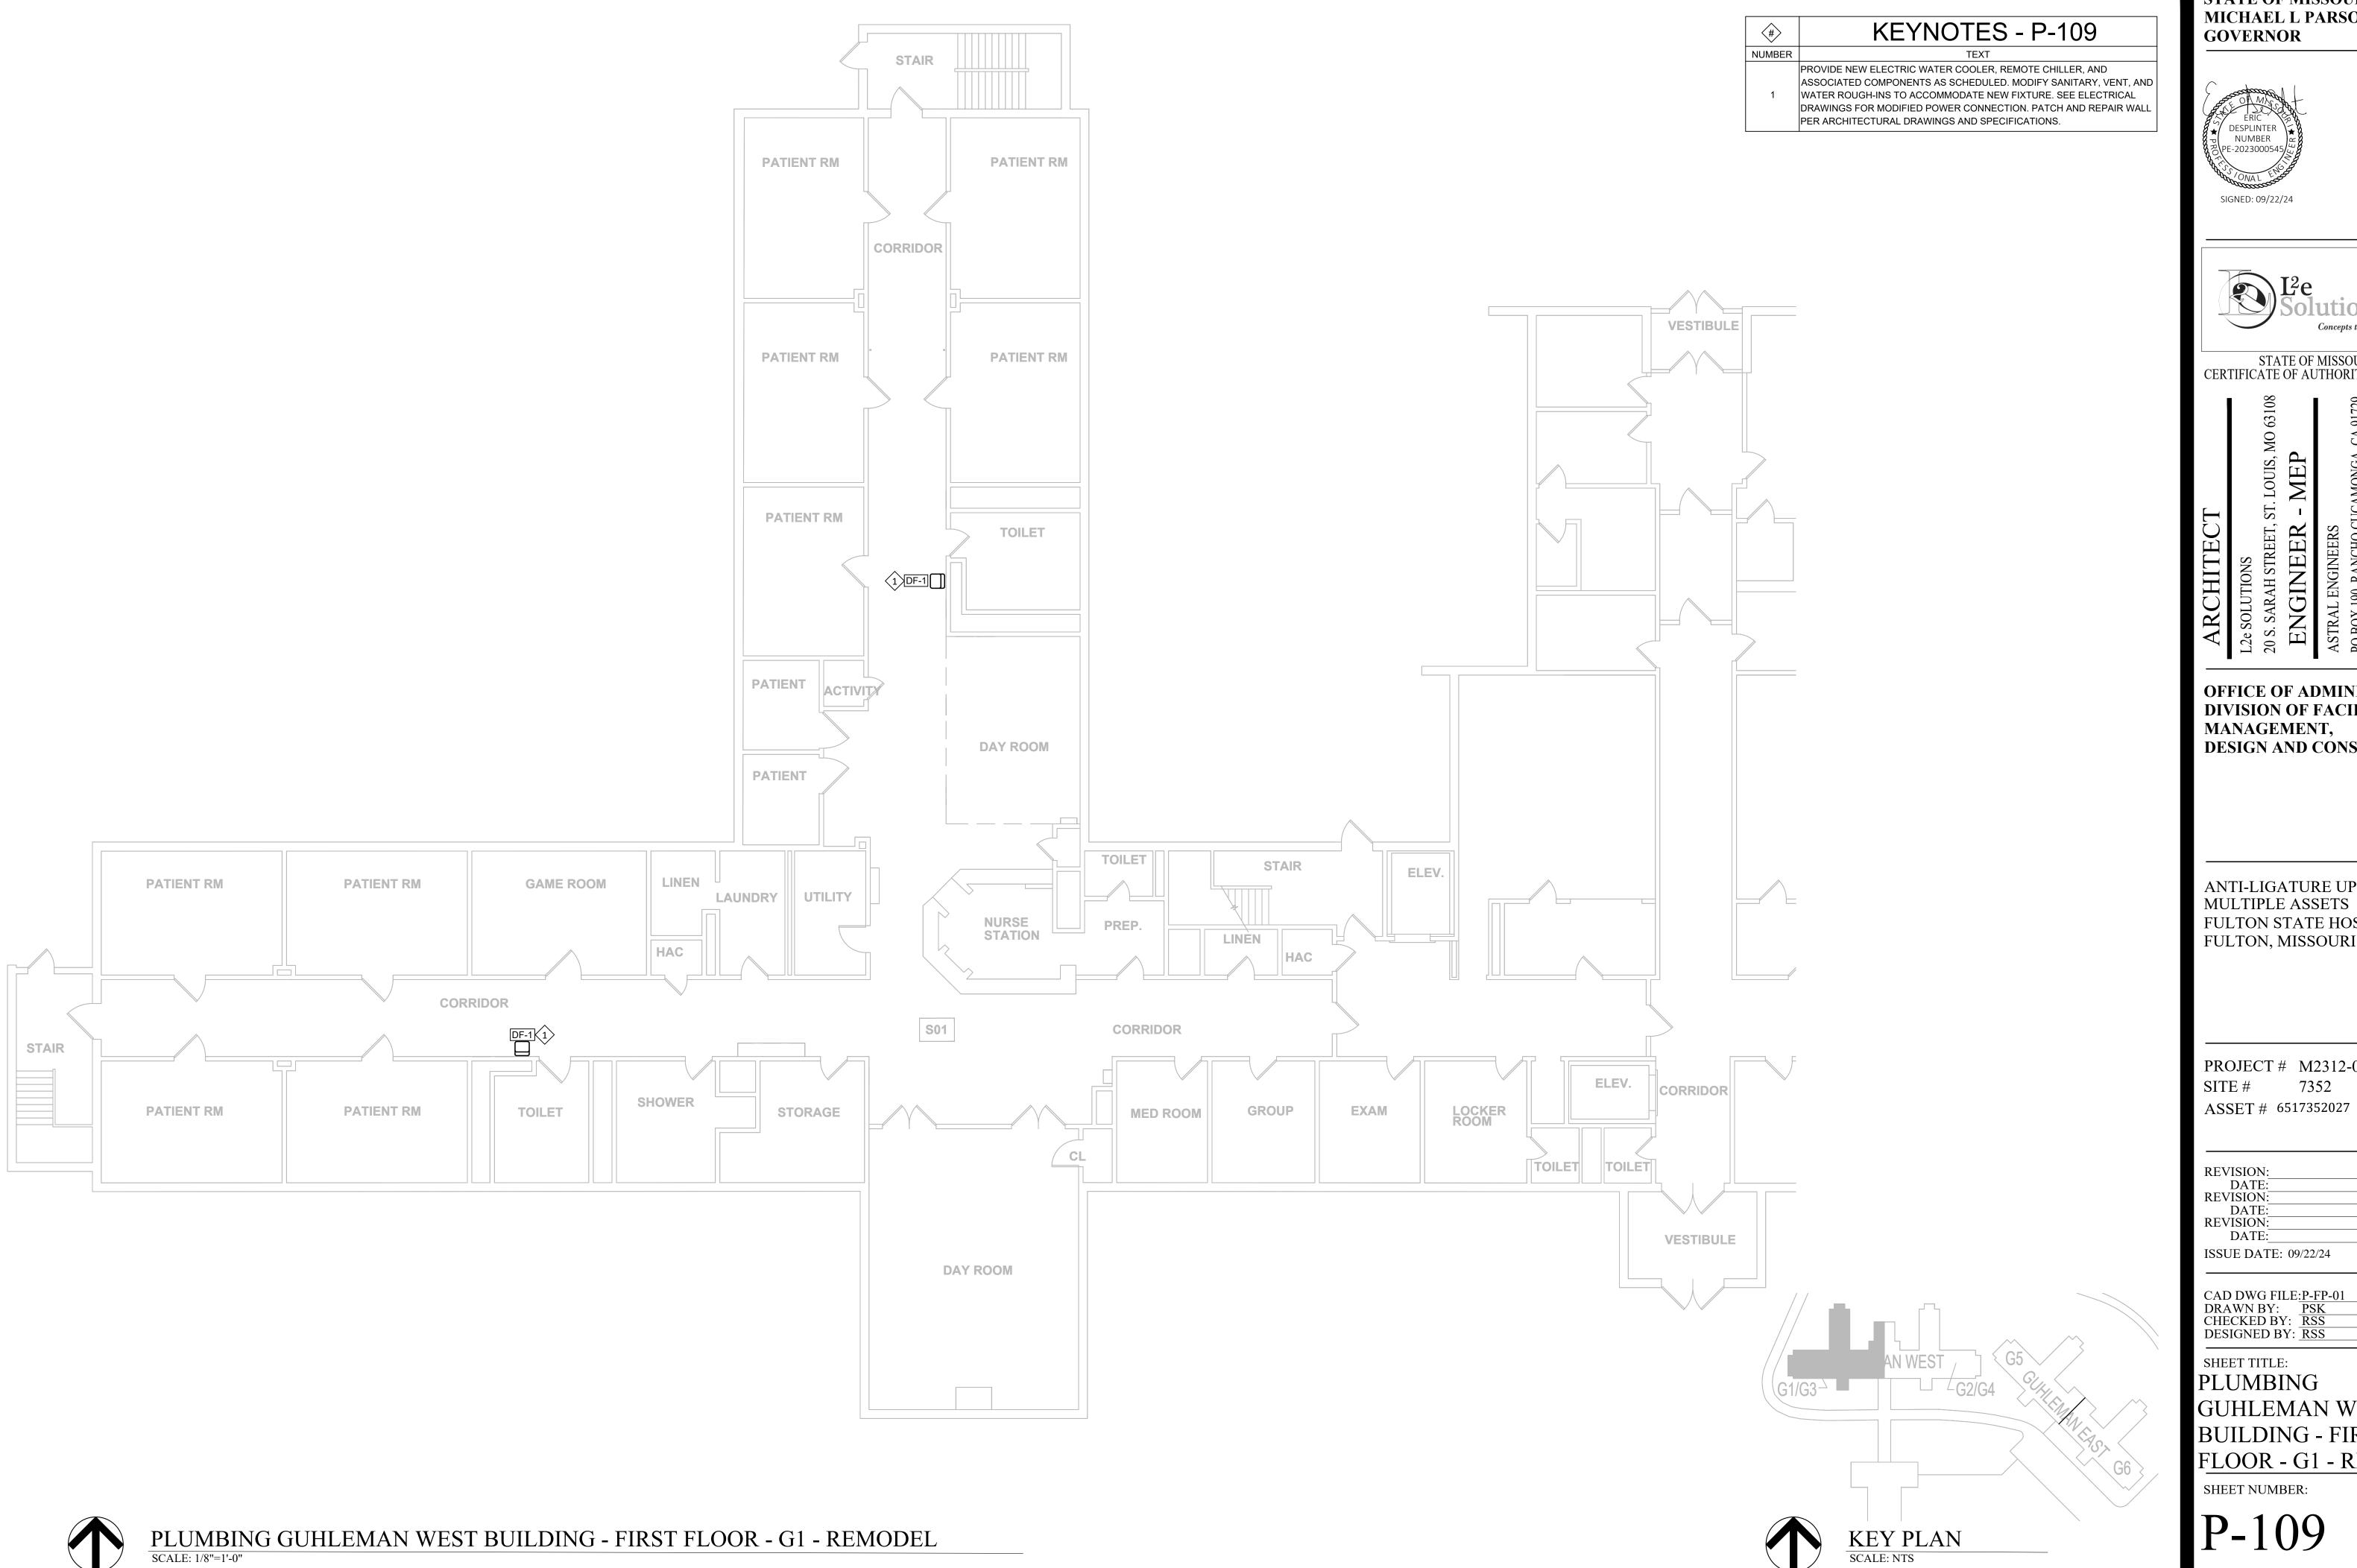
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PLUMBING HEARNES
BUILDING - H2 - DEMO

SHEET NUMBER:

P-108

SHEET 56 OF 66 SEPTEMBER 22, 2024





STATE OF MISSOURI MICHAEL L PARSON,



STATE OF MISSOURI CERTIFICATE OF AUTHORITY #2018019473

OFFICE OF ADMINISTRATION DIVISION OF FACILITIES **DESIGN AND CONSTRUCTION**


ANTI-LIGATURE UPGRADES MULTIPLE ASSETS FULTON STATE HOSPITAL FULTON, MISSOURI

PROJECT # M2312-01

GUHLEMAN WEST **BUILDING - FIRST** FLOOR - G1 - REMODEL

SHEET 57 OF 66 SEPTEMBER 22, 2024



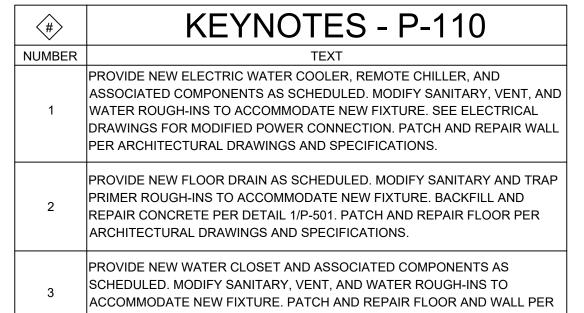



SIGNED: 09/22/24



STATE OF MISSOURI CERTIFICATE OF AUTHORITY #2018019473

OFFICE OF ADMINISTRATION DIVISION OF FACILITIES MANAGEMENT, DESIGN AND CONSTRUCTION

ANTI-LIGATURE UPGRADES MULTIPLE ASSETS FULTON STATE HOSPITAL FULTON, MISSOURI

PROJECT # M2312-01 7352 ASSET # 6517352027

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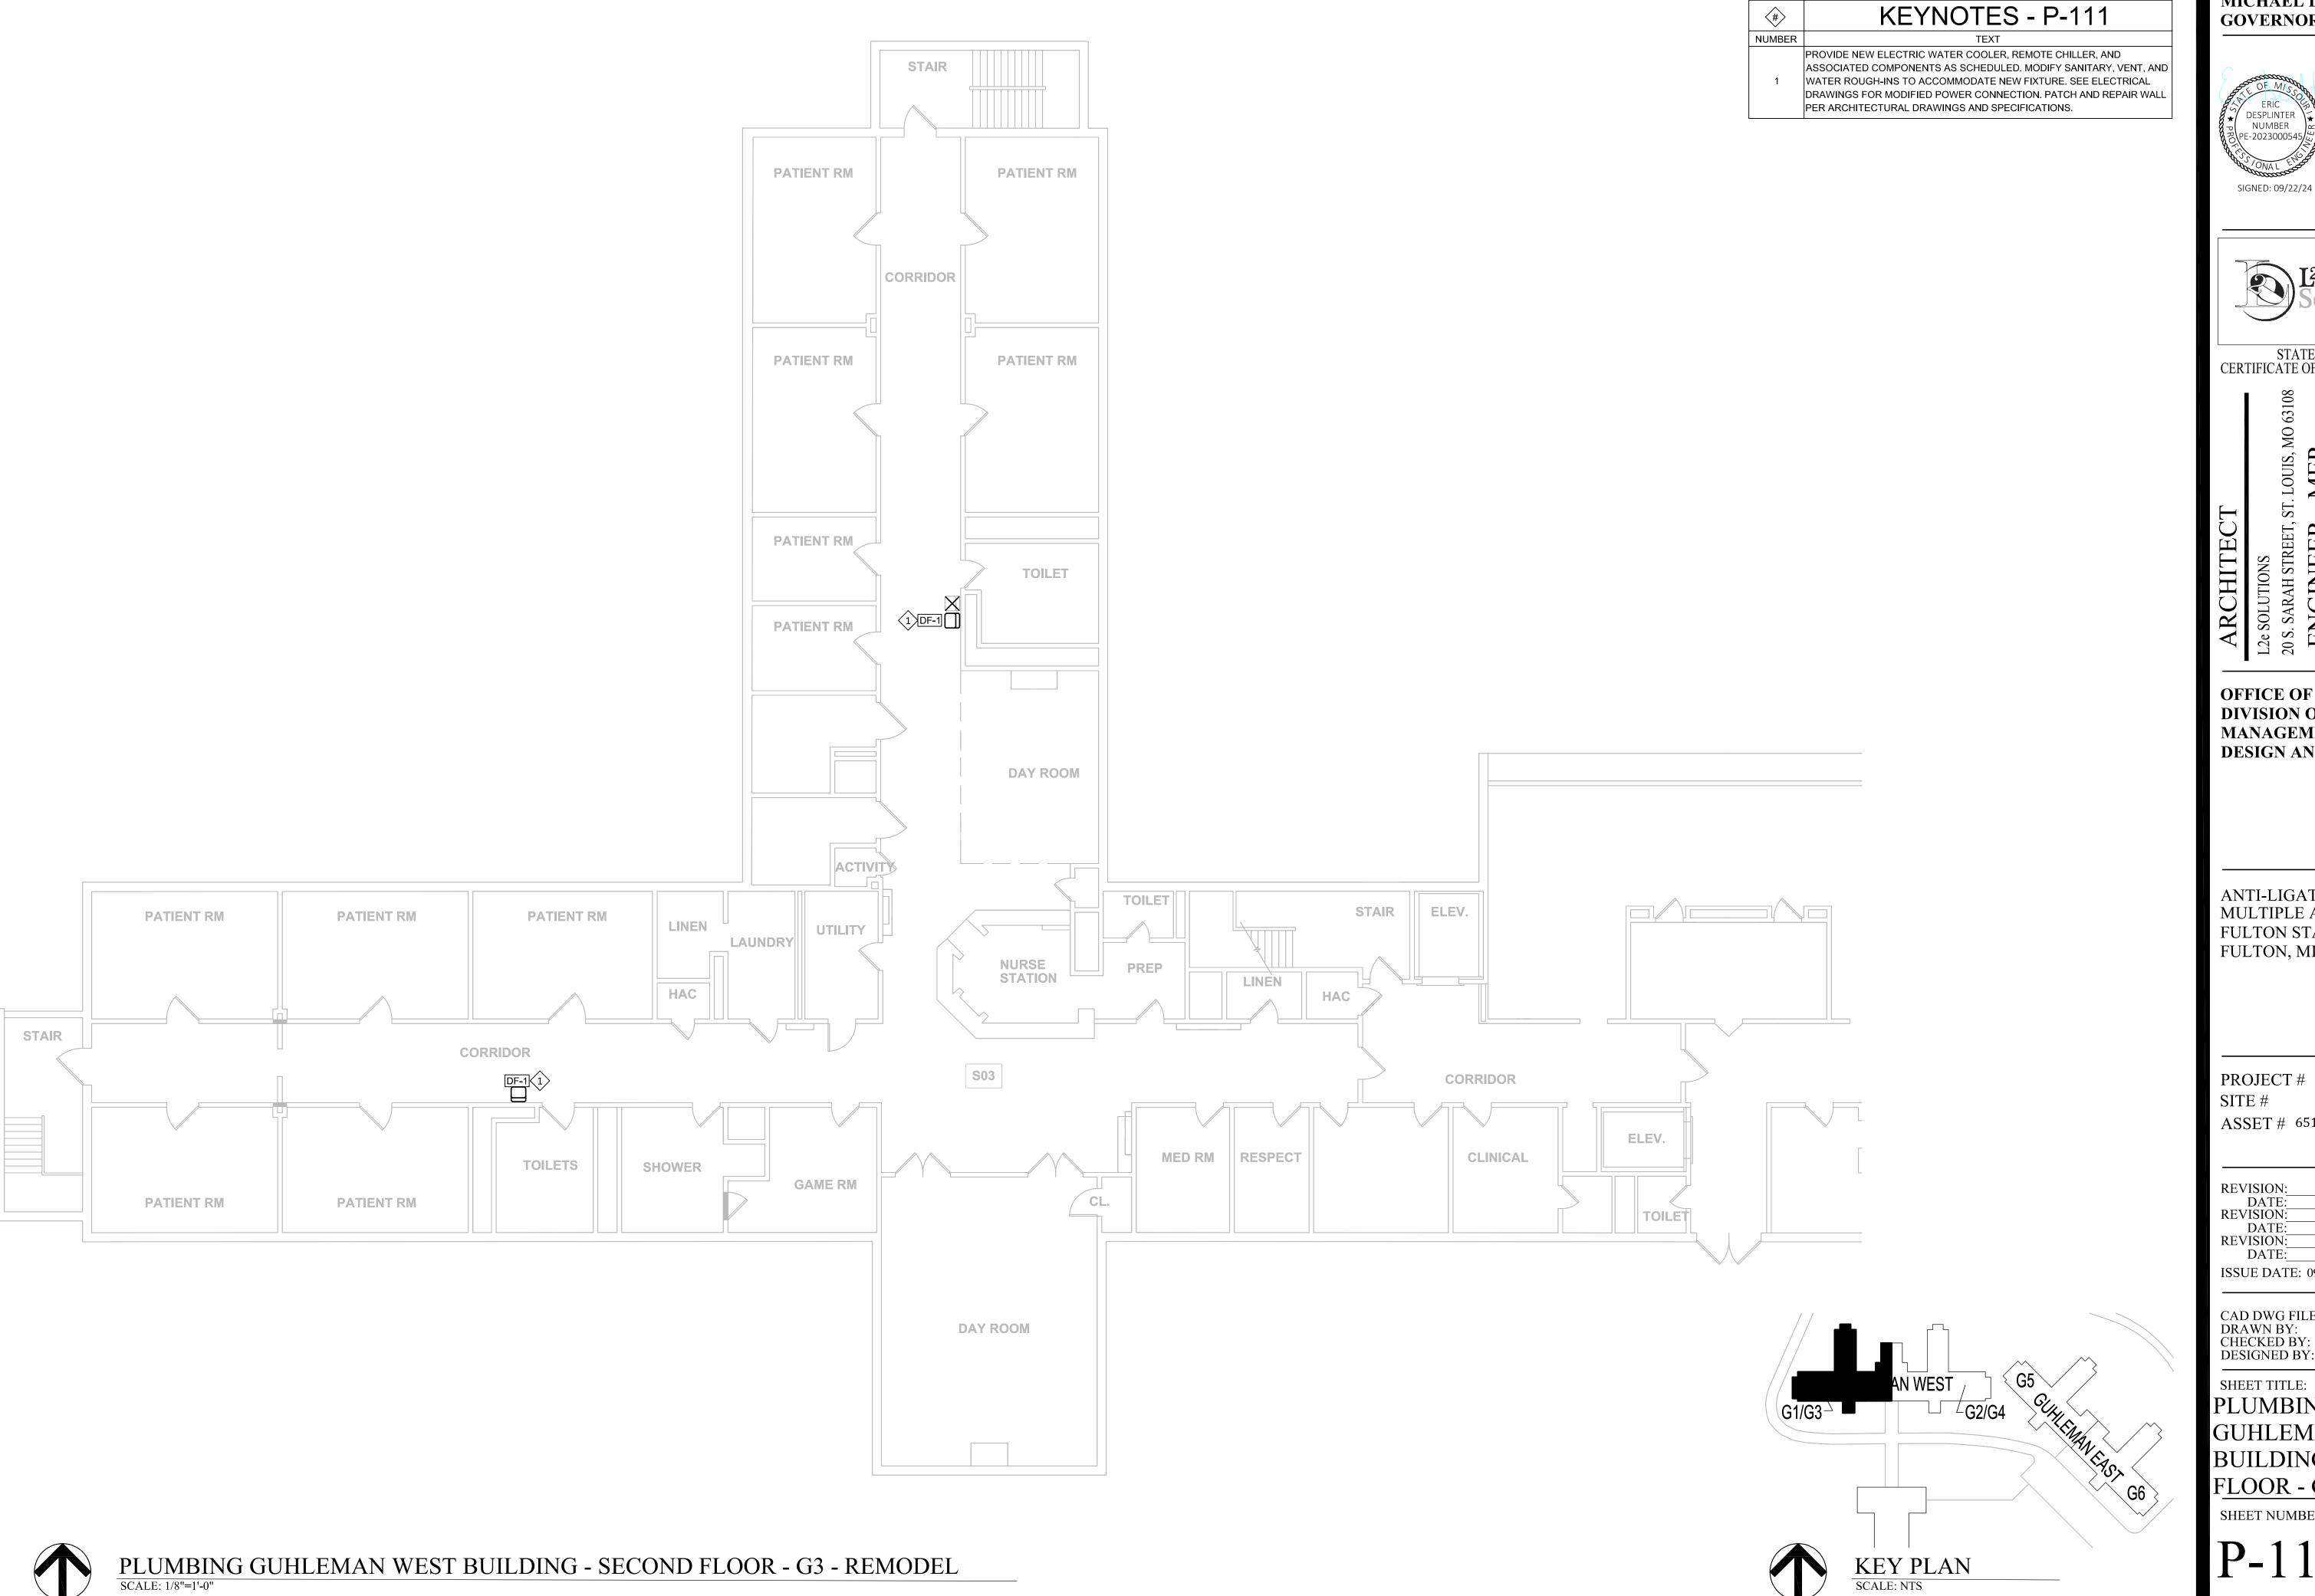
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DESIGNED BY: RSS SHEET TITLE:

SHEET NUMBER:

PLUMBING GUHLEMAN WEST **BUILDING - FIRST** FLOOR - G2 - REMODEL

SHEET 58 OF 66 SEPTEMBER 22, 2024







STATE OF MISSOURI CERTIFICATE OF AUTHORITY #2018019473

OFFICE OF ADMINISTRATION DIVISION OF FACILITIES MANAGEMENT, DESIGN AND CONSTRUCTION

ANTI-LIGATURE UPGRADES MULTIPLE ASSETS FULTON STATE HOSPITAL FULTON, MISSOURI

PROJECT # M2312-01 7352 ASSET # 6517352027

ISSUE DATE: 09/22/24


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SHEET TITLE: PLUMBING GUHLEMAN WEST BUILDING - SECOND FLOOR - G3 - REMODEL

SHEET NUMBER:

SEPTEMBER 22, 2024





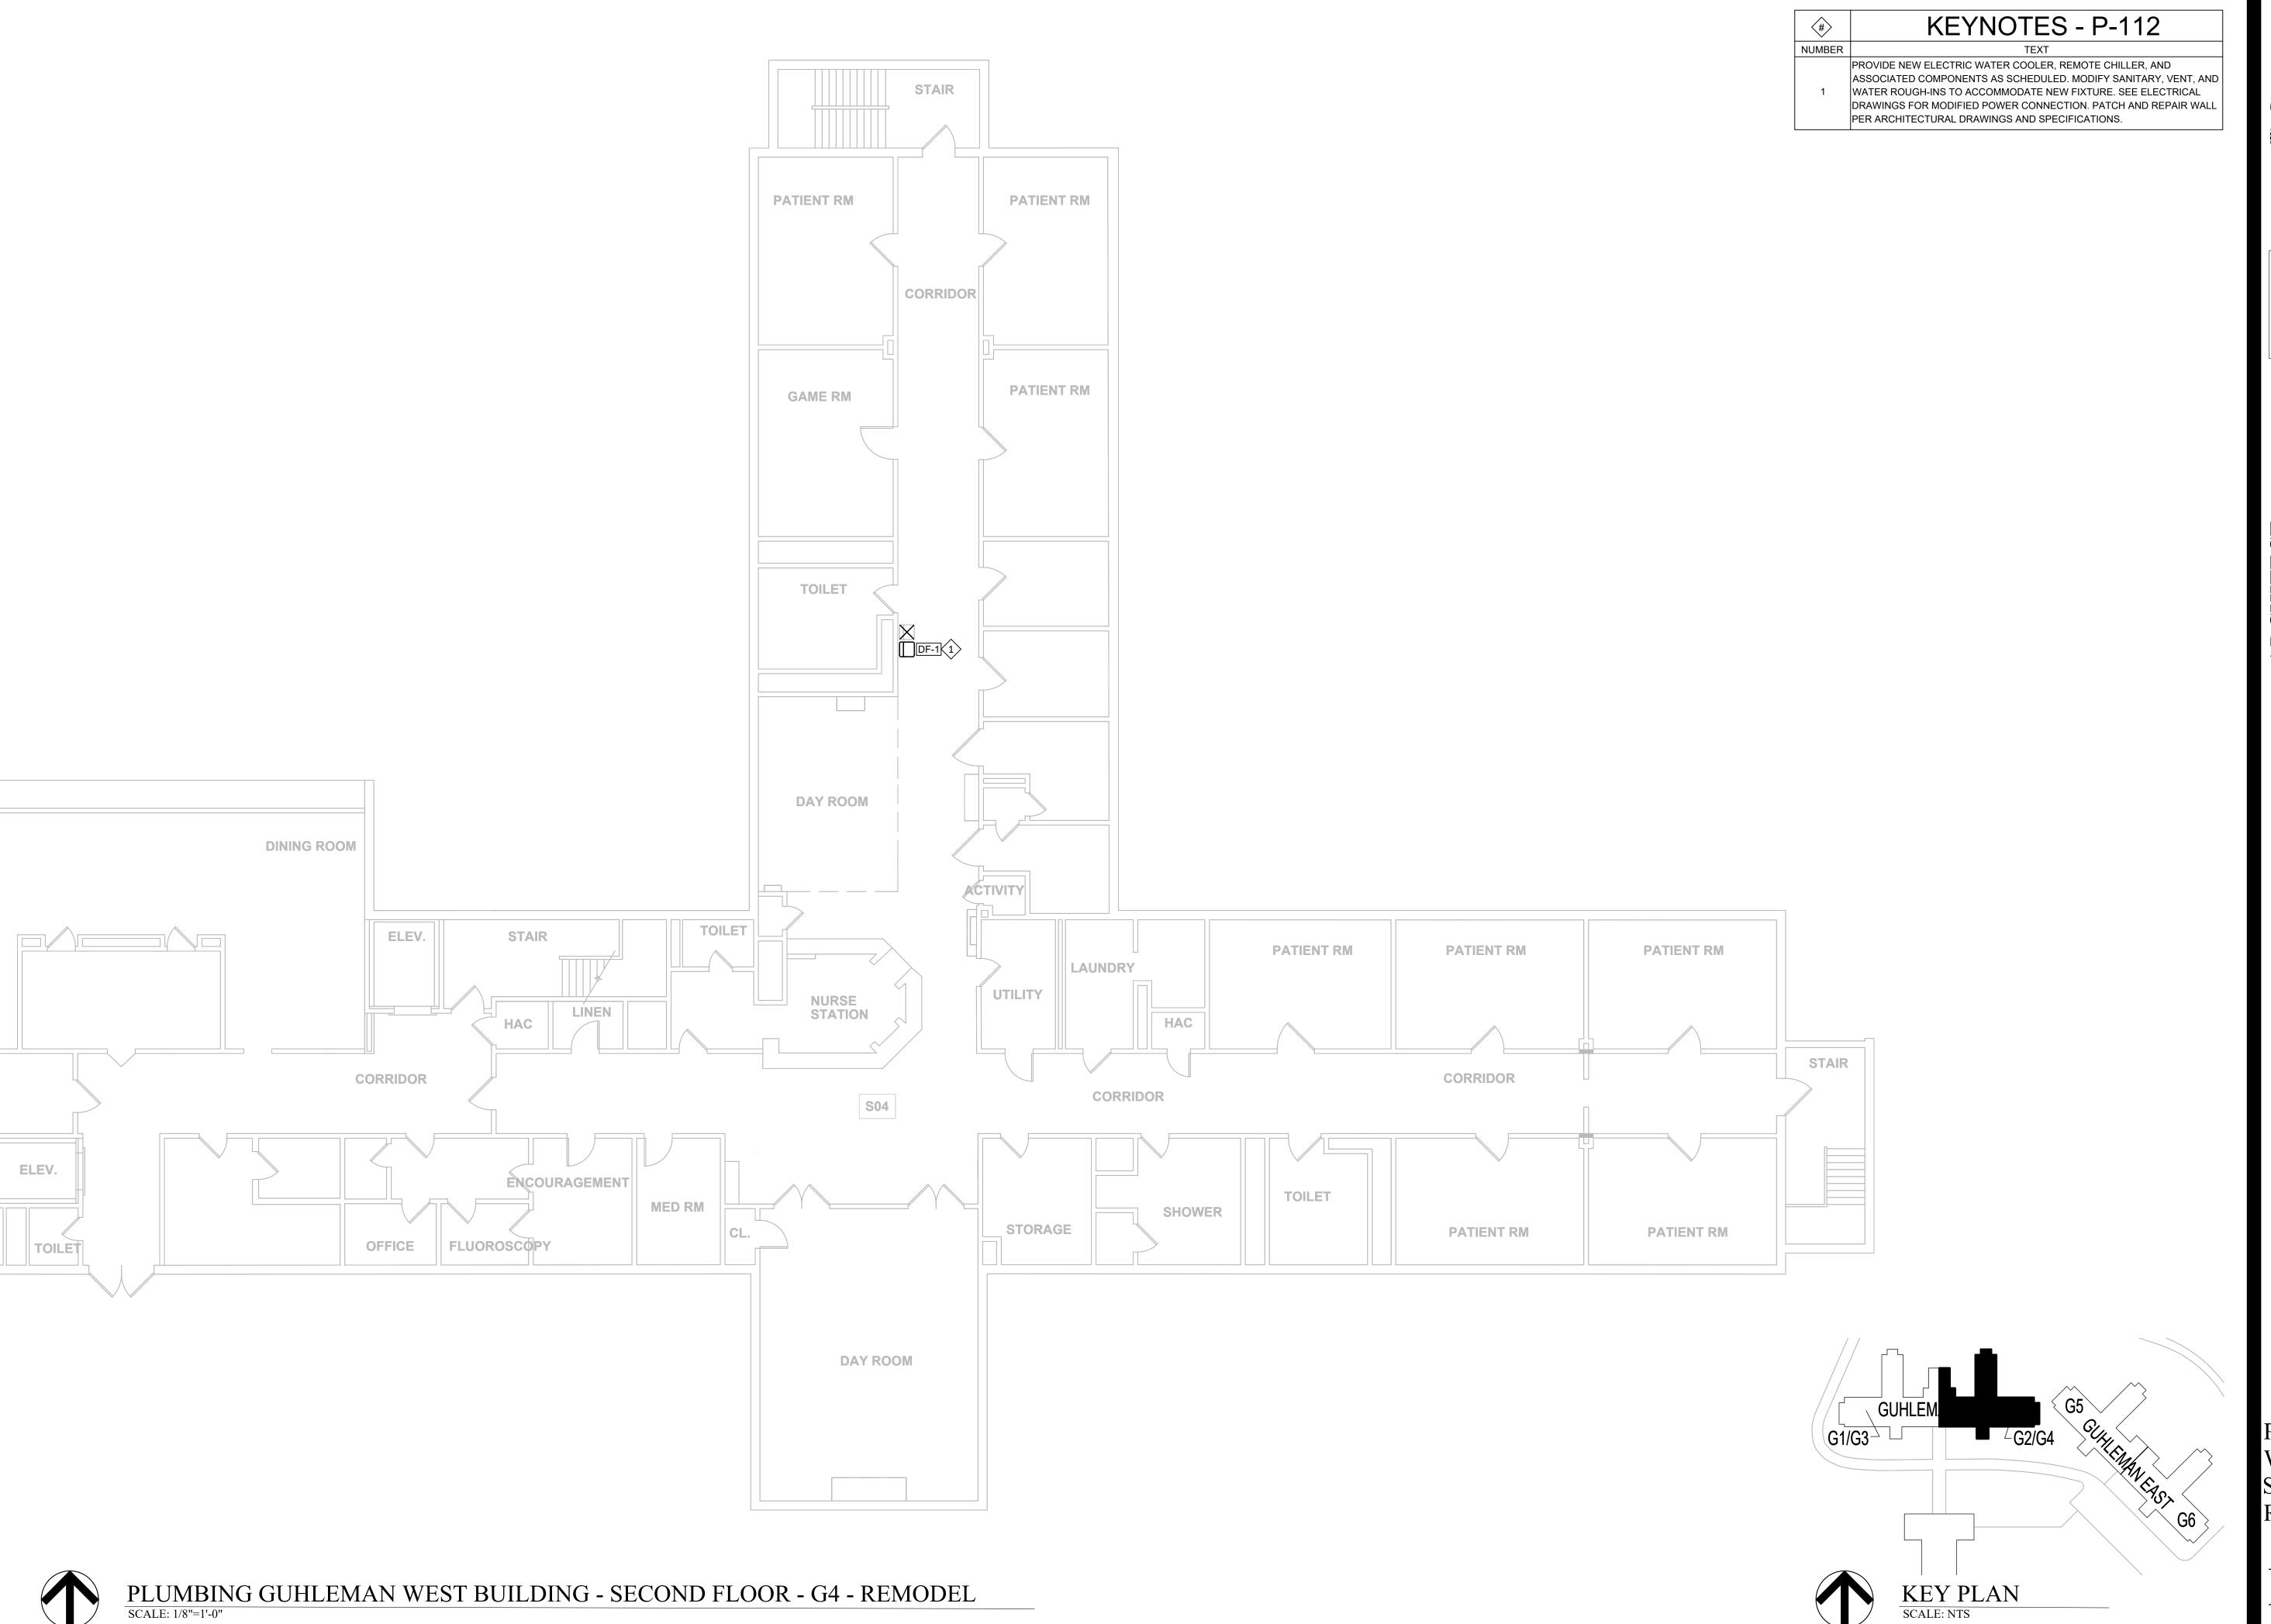



STATE OF MISSOURI CERTIFICATE OF AUTHORITY #2018019473

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ANTI-LIGATURE UPGRADES MULTIPLE ASSETS FULTON STATE HOSPITAL FULTON, MISSOURI

PROJECT # M2312-01 SITE # 7352 ASSET # 6517352027


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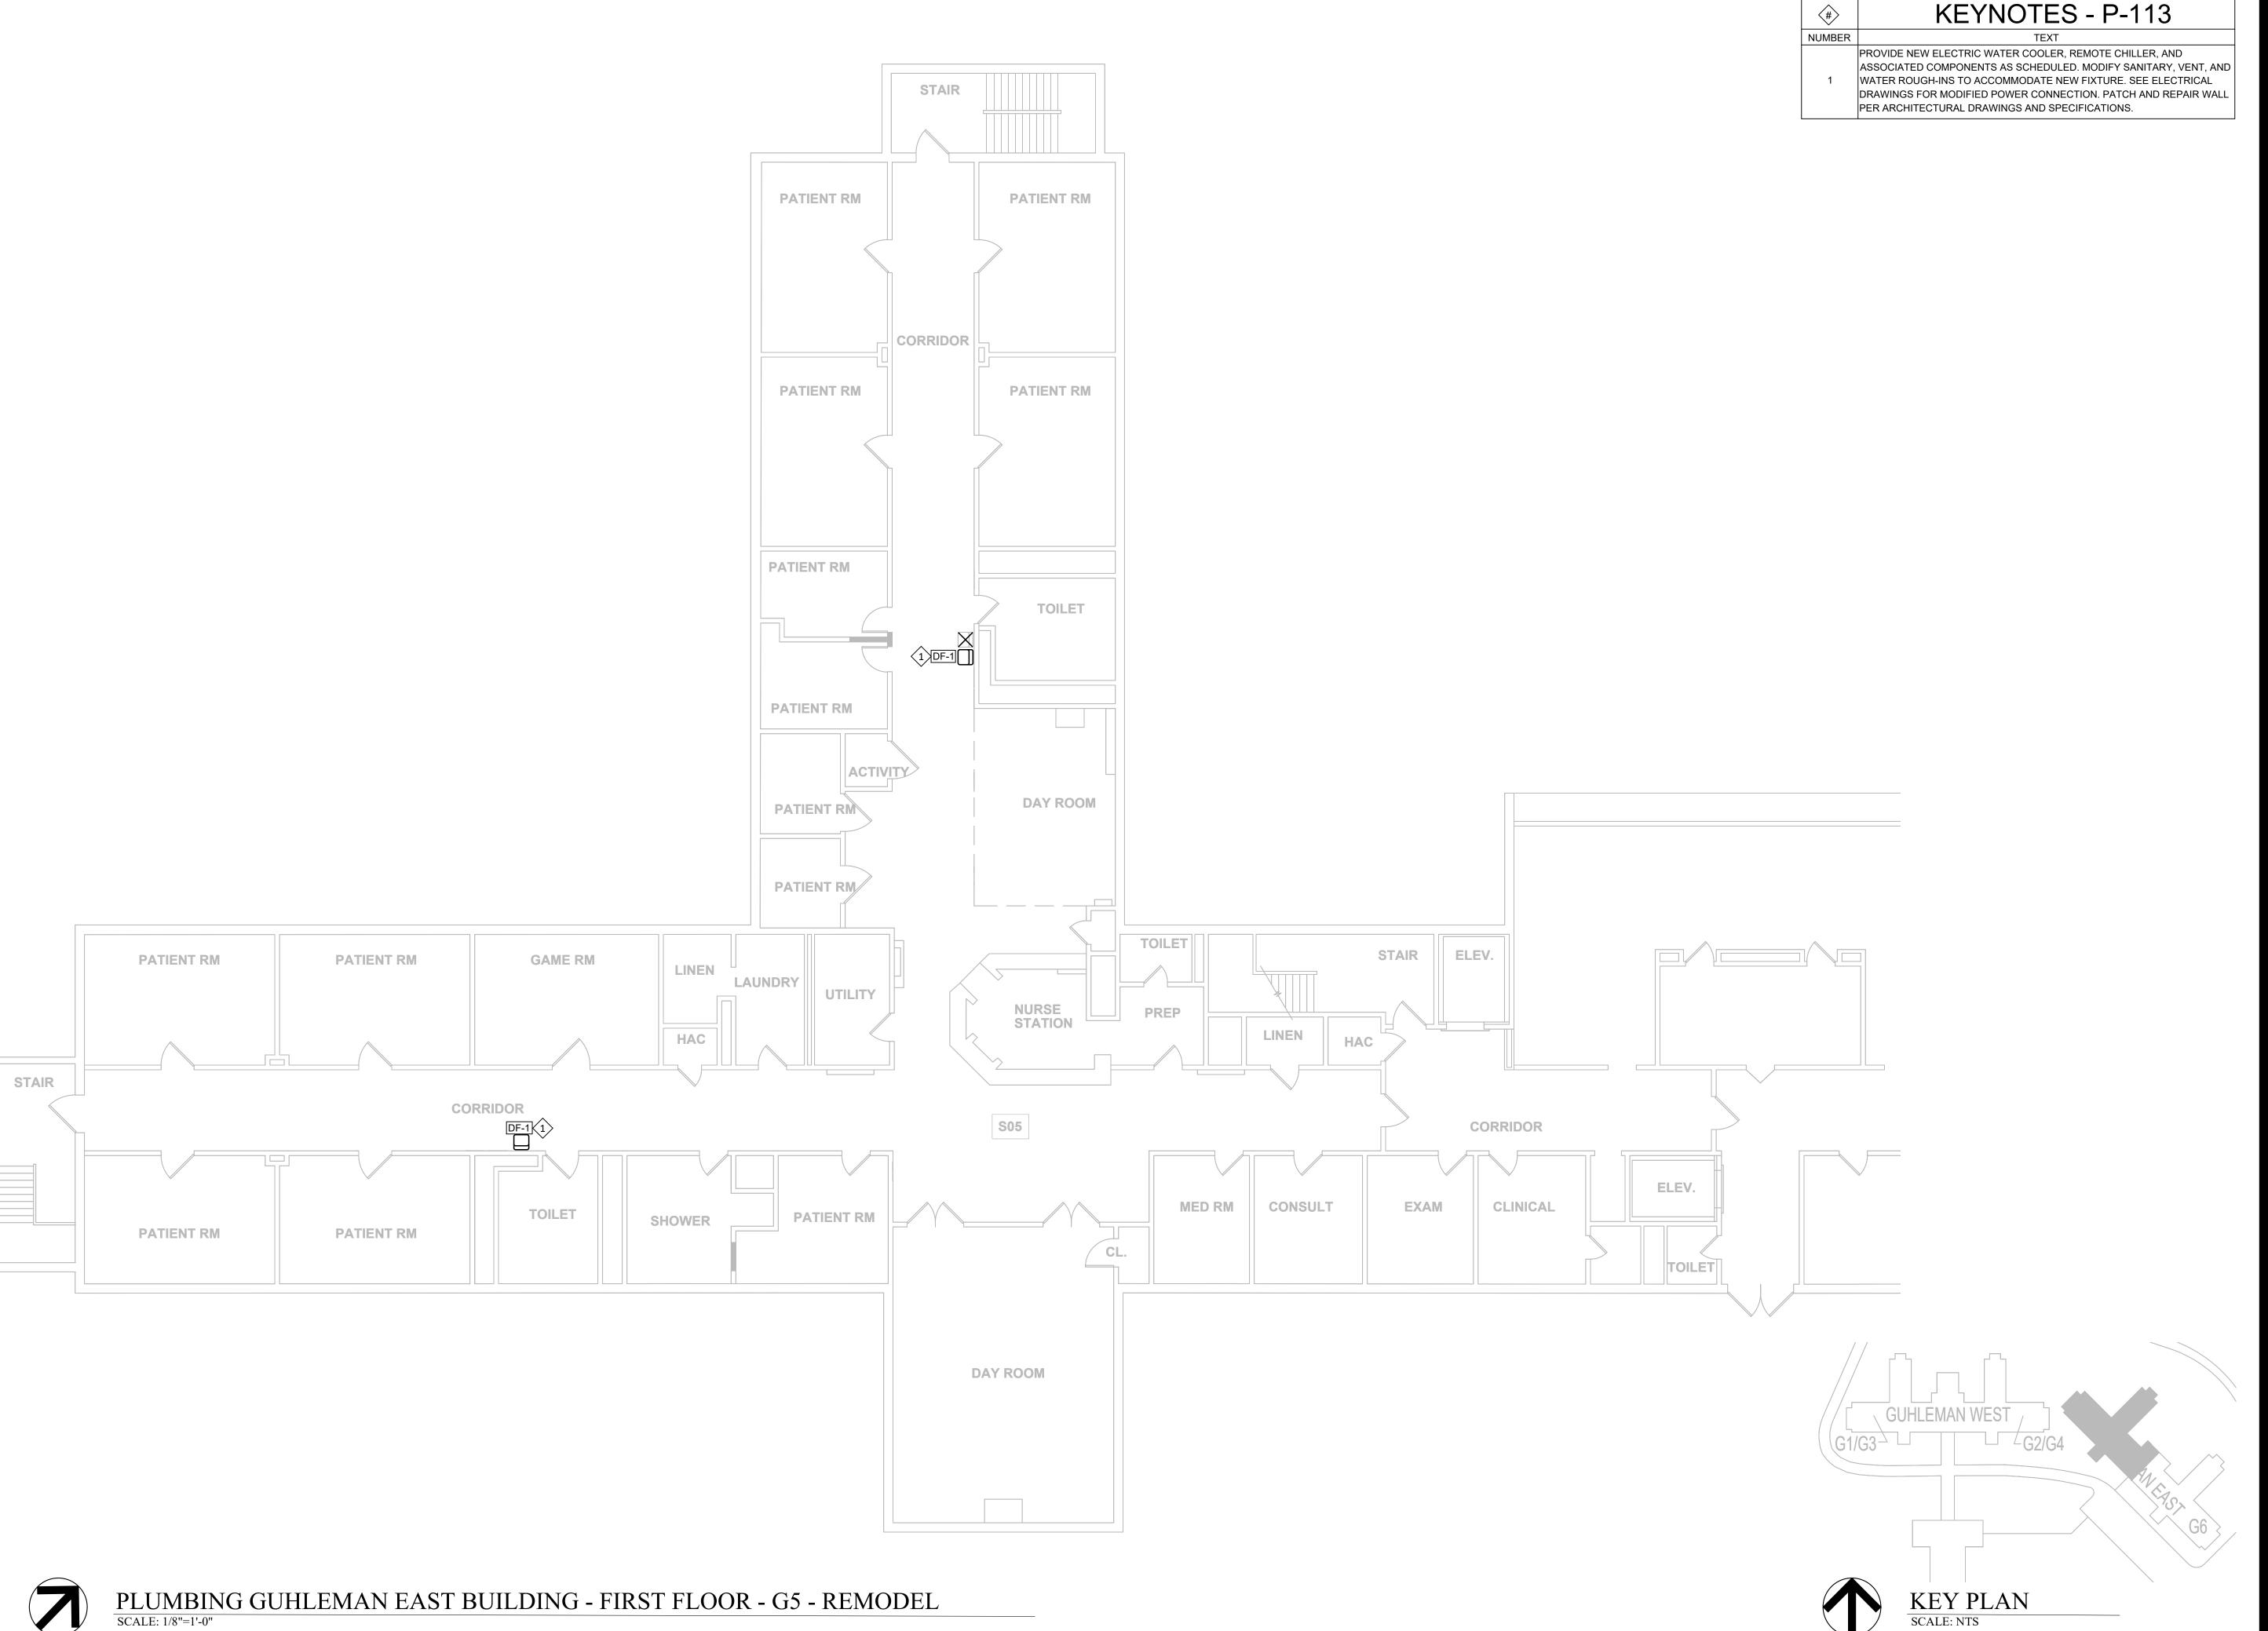
SHEET TITLE:
PLUMBING GUHLEMAN
WEST BUILDING -

SECOND FLOOR - G4 - REMODEL

SHEET NUMBER:



SHEET 60 OF 66 SEPTEMBER 22, 2024

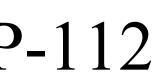





STATE OF MISSOURI CERTIFICATE OF AUTHORITY #2018019473

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ANTI-LIGATURE UPGRADES MULTIPLE ASSETS FULTON STATE HOSPITAL FULTON, MISSOURI

PROJECT # M2312-01 SITE # 7352 ASSET # 6517352026

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ISSUE DATE: 09/22/24


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DRAWN BY: PSK
CHECKED BY: RSS
DESIGNED BY: RSS

SHEET TITLE:
PLUMBING
GUHLEMAN EAST
BUILDING - FIRST
FLOOR - G5 - REMODEL

SHEET NUMBER:

P-113

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SIGNED: 09/22/24

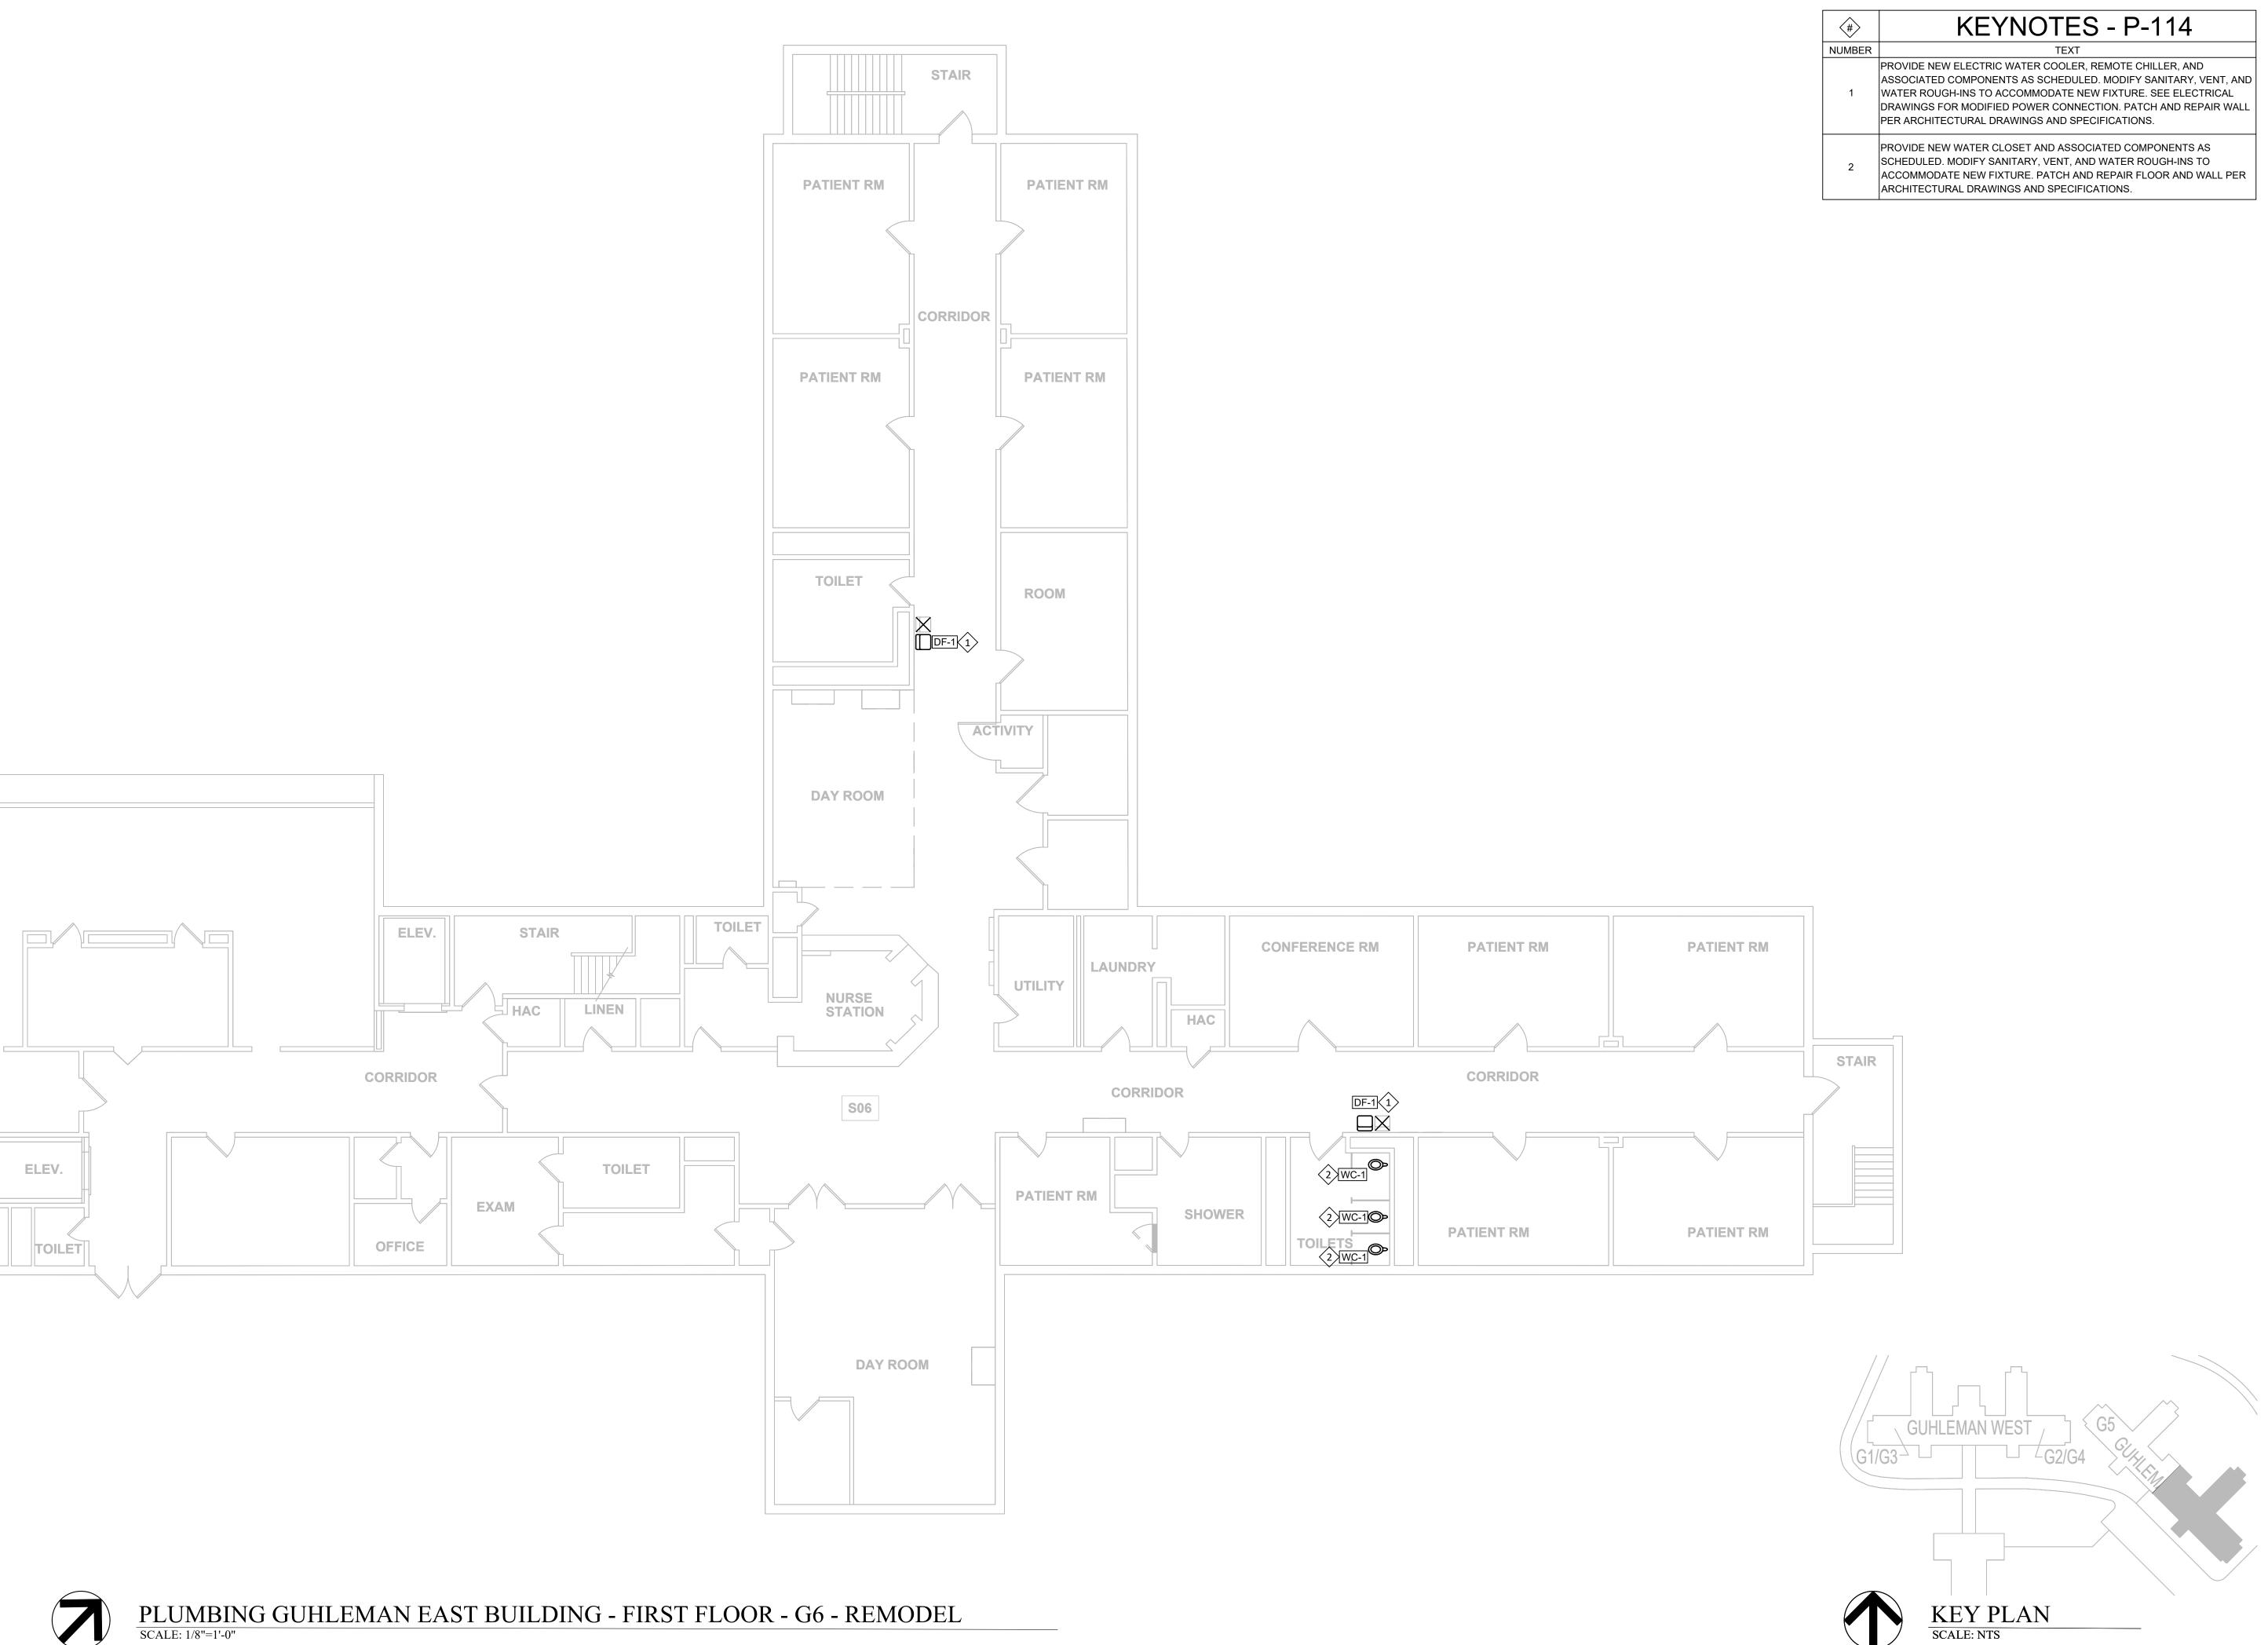

STATE OF MISSOURI CERTIFICATE OF AUTHORITY #2018019473

OFFICE OF ADMINISTRATION DIVISION OF FACILITIES MANAGEMENT, **DESIGN AND CONSTRUCTION**

ANTI-LIGATURE UPGRADES MULTIPLE ASSETS FULTON STATE HOSPITAL FULTON, MISSOURI

PROJECT # M2312-01 7352 ASSET # 6517352026


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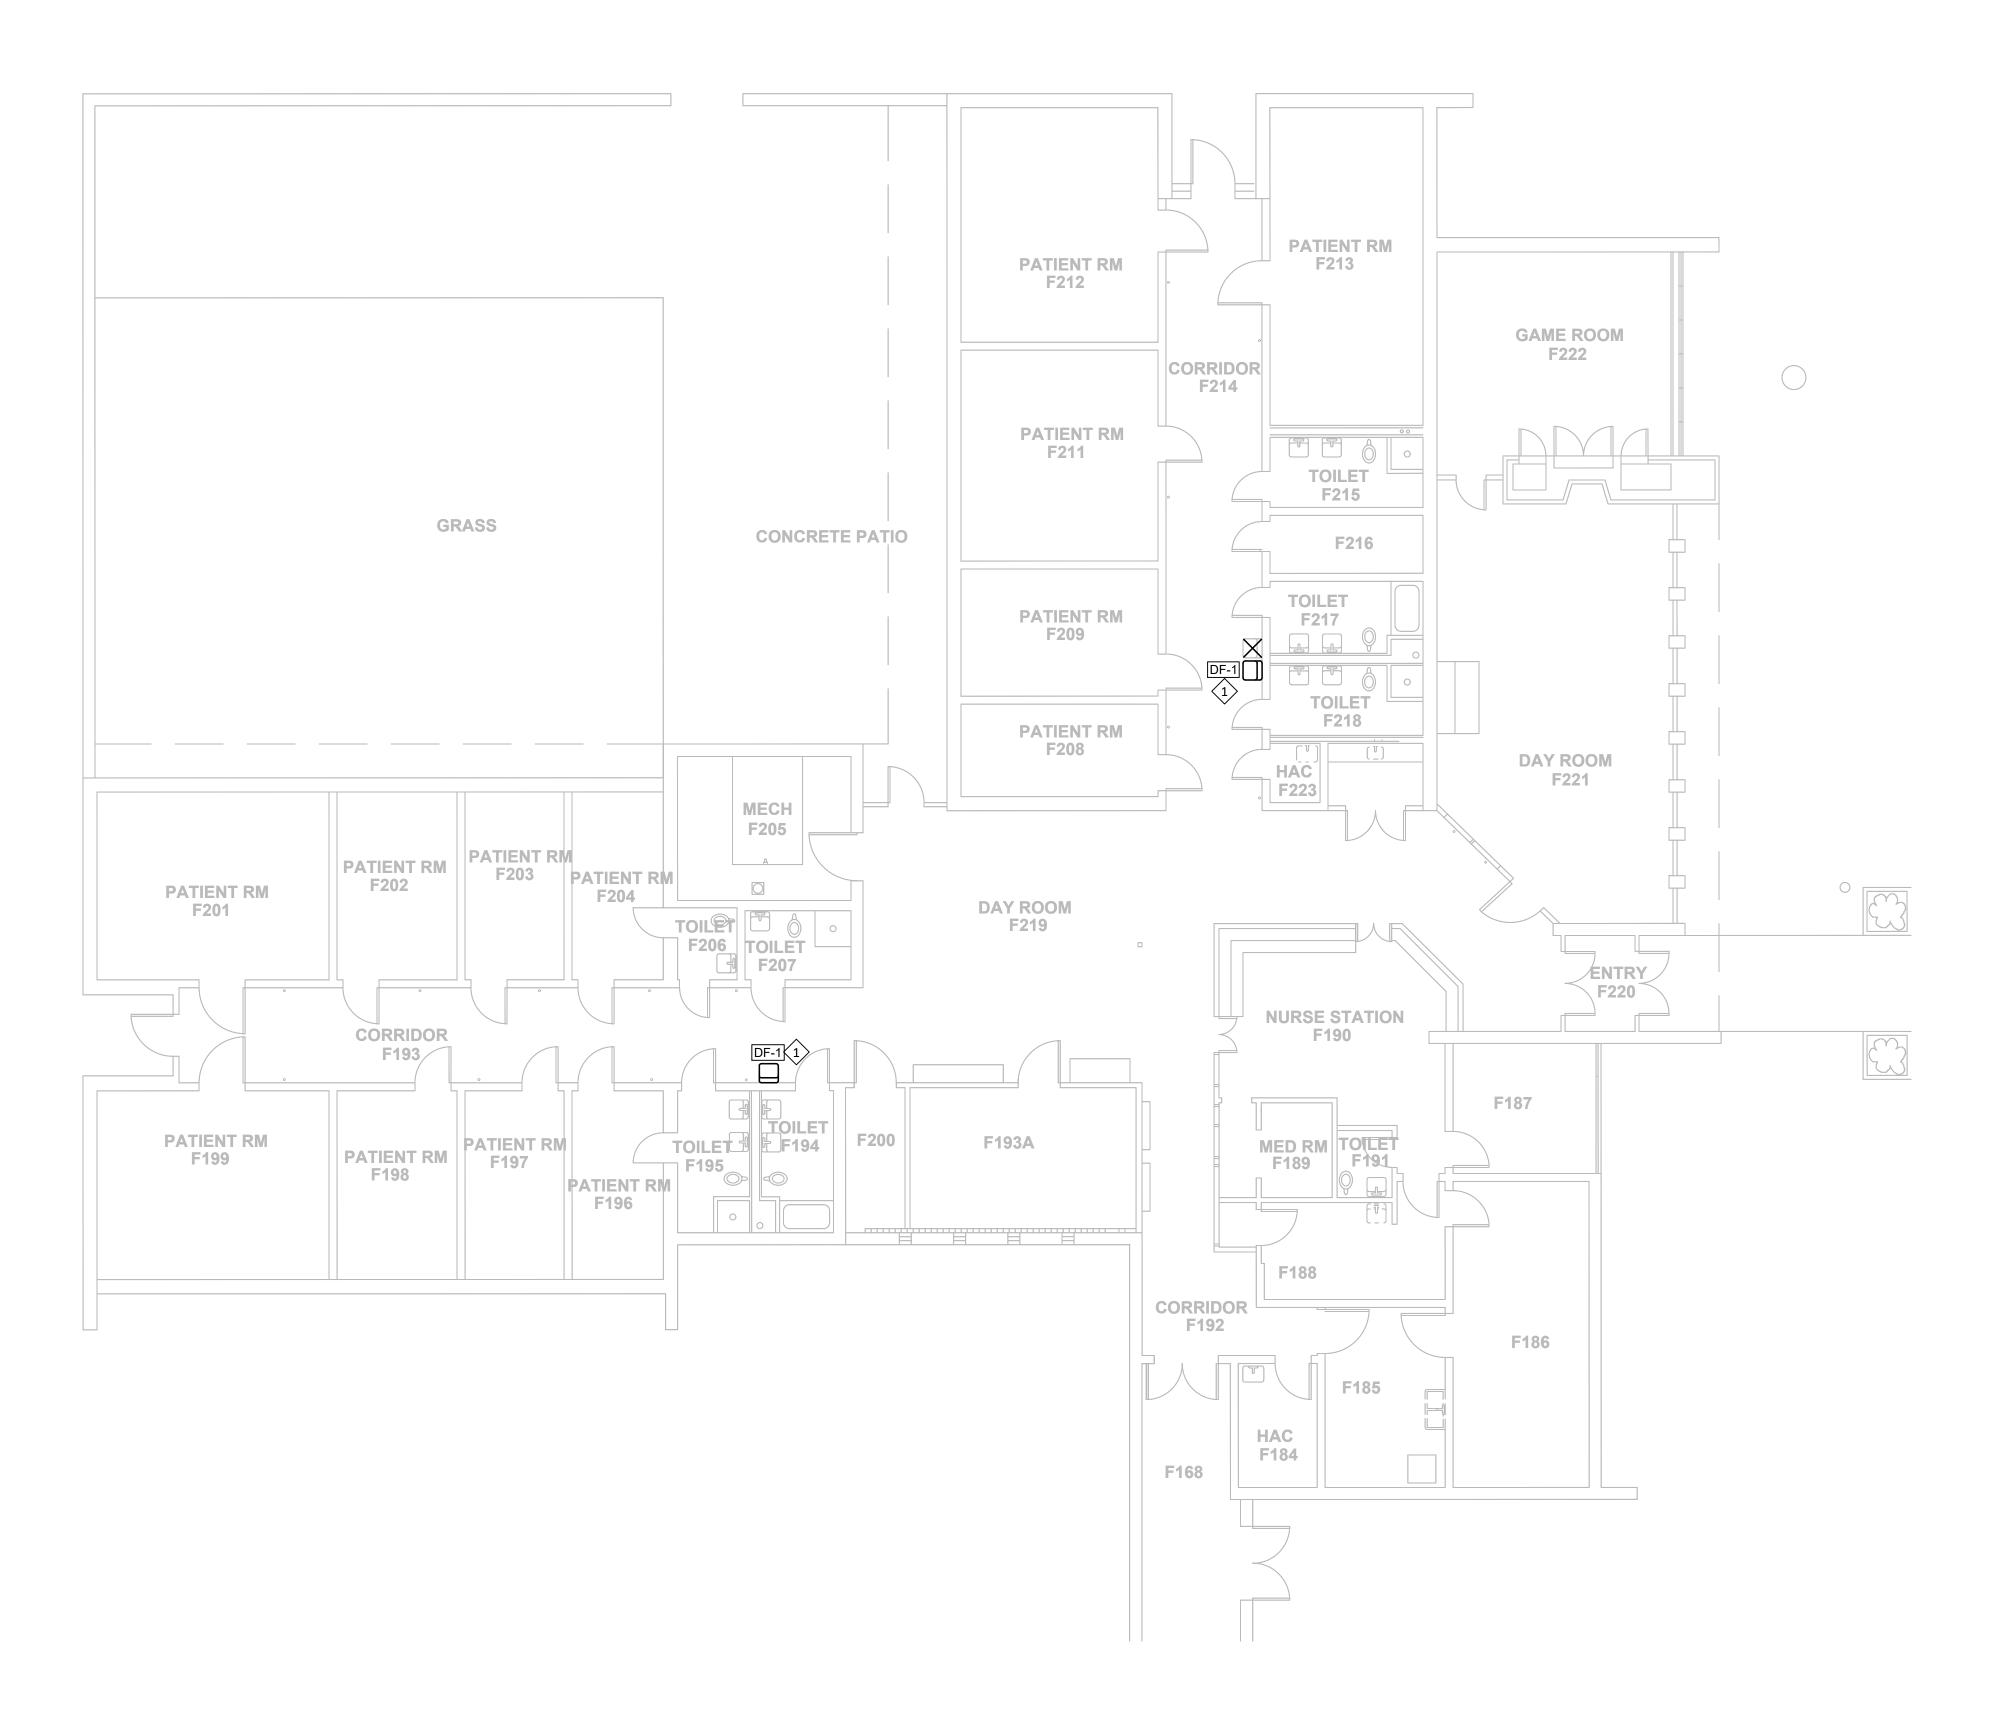
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PLUMBING GUHLEMAN **EAST BUILDING - FIRST** FLOOR - G6 - REMODEL


SHEET NUMBER:



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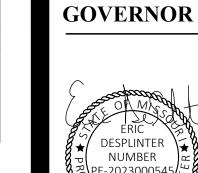


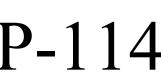

PER ARCHITECTURAL DRAWINGS AND SPECIFICATIONS.

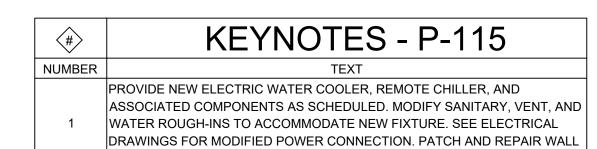H2

KEY PLAN
SCALE: NTS





STATE OF MISSOURI MICHAEL L PARSON,



STATE OF MISSOURI CERTIFICATE OF AUTHORITY #2018019473

20 S. SARAH STREET, ST. LOUIS, MO 63108
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PO BOX 190, RANCHO CUCAMONGA, CA 91729
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ANTI-LIGATURE UPGRADES MULTIPLE ASSETS FULTON STATE HOSPITAL FULTON, MISSOURI


PROJECT	# M2312-0
SITE#	7352
ASSET #	6517352031

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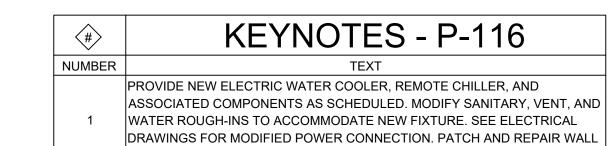
SHEET TITLE: PLUMBING HEARNES BUILDING - H1 -REMODEL

SHEET NUMBER:




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PER ARCHITECTURAL DRAWINGS AND SPECIFICATIONS.

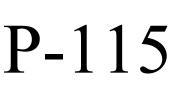



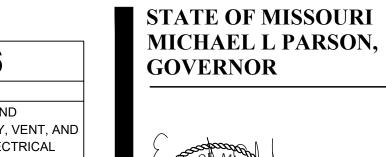

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20 S. SARAH STREET, ST. LOUIS, MO 63	ENGINEER - MEP	ASTRAL ENGINEERS	PO BOX 190, RANCHO CUCAMONGA, CA 91	ENGINEER - STRUCT	MEGCOBB
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PROJECT # M2312-01 SITE # 7352 ASSET # 6517352031

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CHECKED BY: RSS
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SHEET TITLE:
PLUMBING HEARNES
BUILDING - H2 REMODEL


SHEET NUMBER:

KEY PLAN
SCALE: NTS



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STATE OF MISSOURI CERTIFICATE OF AUTHORITY #2018019473

SINEER - MEP

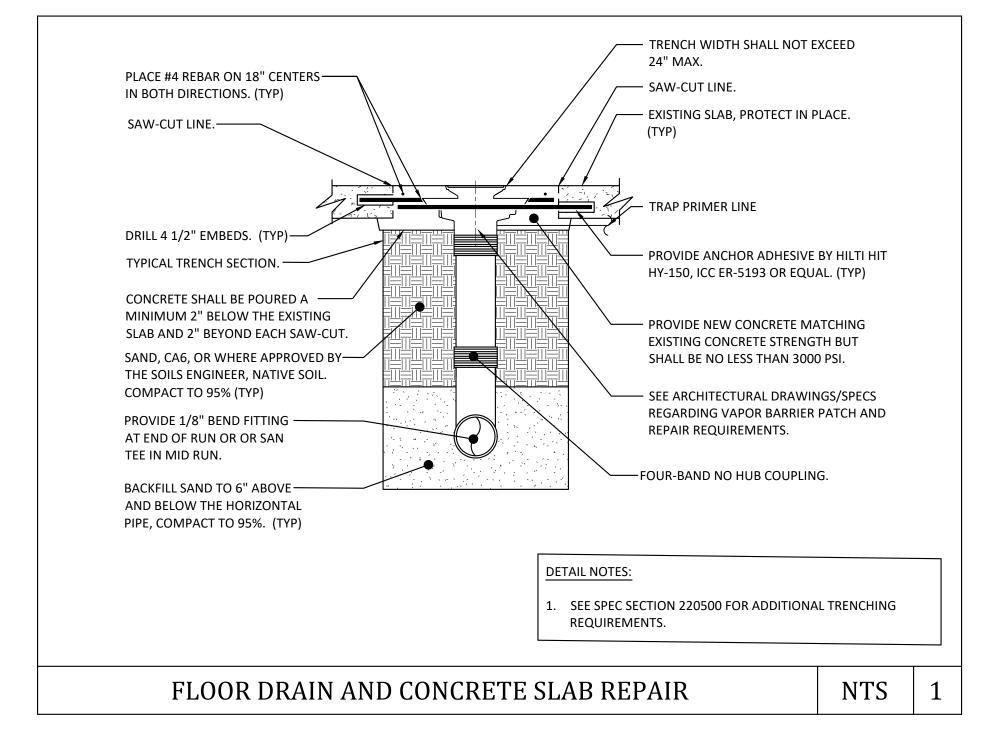ENGINEERS

SINEERS

SINEER - STRUCT.

L2e SOLUTION SOLUTION

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ANTI-LIGATURE UPGRADES MULTIPLE ASSETS FULTON STATE HOSPITAL FULTON, MISSOURI

PROJECT # M2312-01 SITE # 7352

ASSET # 6517352026, 6517352027, 6517352031

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ISSUE DATE: 09/22/24

CAD DWG FILE:P-501
DRAWN BY: PSK
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SHEET TITLE:
PLUMBING DETAILS

SHEET NUMBER:

P-50

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PLUMBING MATERIAL LIST				
SYMBOL	DESCRIPTION	MANUFACTURER AND MODEL		
DF-1	DRINKING FOUNTAIN/ELECTRIC WATER COOLER: ACCESSIBLE WALL MOUNTED LIGATURE RESISTANT SINGLE BASIN CONSTRUCTED OF 16 GA 304 STAINLESS STEEL WITH WHITE POWDER COAT FINISH, BOTTOM ENCLOSURE CONSTRUCTED OF 18 GA TYPE 304 STAINLESS STEEL WITH WHITE POWDER COAT FINISH, HANDS FREE SENSOR OPERATED BUBBLER, AND REMOTE CHILLER. PROVIDE COMPLETE WITH CONCEALED MOUNTING PLATE.	BASIN: WHITEHALL WHBF6-BAT-MC-WF1 (LESS BOTTLE FILLER) OR EQUAL. REMOTE CHILLER: WHITEHALL A9100080-A		
	LISTINGS: ADA & ANSI A117.1, NSF/ANSI 61 & 372 LISTED. POWER REQUIREMENTS: BUBBLER: 120VAC PLUG-IN TRANSFORMER OR OPTIONAL BATTERY OPERATED SENSOR. CHILLER: 115VAC/60HZ, 4.6 AMPS	BASIN MOUNTING PLATE: 'MC' CONCEALED MOUNTING CARRIER OR EQUAL.		
FD-1	FLOOR DRAIN: 9" CAST IRON BODY WITH FLASHING COLLAR, 6" ADJUSTABLE LIGATURE RESISTANT ROUND STRAINER HEAD, COMPLETE WITH TRAP PRIMER CONNECTION AND VANDAL PROOF SCREWS. 2" OUTLET.	WHITEHALL 'WHFDV-6RD-2NH' OR EQUAL.		
WC-1	WATER CLOSET: ACCESSIBLE FLOOR MOUNTED BACK SPUD SINGLE PIECE ELONGATED BOWL WITH INTEGRAL SEAT, WHITE VITREOUS CHINA. ACCOMMODATES 1.1 - 1.6 GPF FLUSH VALVES. 17" SEAT HEIGHT. PROVIDE BACKING PLATE/CARRIER PER MANUFACTUER INSTRUCTIONS. LISTINGS: ASME A112.19.2 / CSA B45.1	BOWL: AS HURON 3341.001 OR EQUAL. FLUSH VALVE: SLOAN ROYAL 611-1.28-L/C9A		
I	FLUSH VALVE: MANAUL OPERATED CONCEALED FLUSH VALVE, 1.28 GPF, ROUGH BRASS FINISH, REAR SPUD CONNECTION, SINGLE FLUSH, LESS PUSH BOTTON.			





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OFFICE OF ADMINISTRATION DIVISION OF FACILITIES MANAGEMENT, DESIGN AND CONSTRUCTION

ANTI-LIGATURE UPGRADES MULTIPLE ASSETS FULTON STATE HOSPITAL FULTON, MISSOURI

PROJECT # M2312-01 SITE # 7352

ASSET # 6517352026, 6517352027, 6517352031

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ISSUE DATE: 09/22/24

CAD DWG FILE:P-601
DRAWN BY: PSK
CHECKED BY: RSS
DESIGNED BY: RSS

SHEET TITLE:
PLUMBING
SCHEDULES

SHEET NUMBER:

P-60

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