#### Addendum No. 04

#### TO: PLANS AND SPECIFICATIONS FOR STATE OF MISSOURI

Elevator Replacement Governor's Mansion Jefferson City, MO Project No: O2036-01

Bid Opening Date: 1:30 PM, Tuesday, January 17, 2023 (Changed with Addendum 03)

Bidders are hereby informed that the construction Plans and/or Specifications are modified as follows:

#### **SPECIFICATION CHANGES:**

NONE

#### **DRAWING CHANGES:**

#### 1. <u>Drawing A101:</u>

- a. Revise details 01, 02, 03, and 04 to show
  - a. Estimated location of existing masonry chimney.
  - b. Wall and ceiling demolition necessary to install guide rail bracing

#### 2. Drawing A102:

- a. Revise detail 01 to show
  - 1) Estimated location of existing masonry chimney
  - 2) New plan detail at northeast elevator shaft wall and guide rail at estimated location of existing masonry chimney
  - 3) New plan detail callout added at southwest elevator shaft wall and quide rail
- b. Revise detail 03 to show
  - 1) Location of C-channel guide rail supports at northeast elevator shaft wall, and update the referenced plan detail
  - 2) Add section detail callout where C-channel guide rail support attaches to shaft sidewall in north corner.
  - 3) Revised hoist beam

#### 3. <u>Drawing A104:</u>

a. Revise detail 03 to show plan detail location at the southwest wall of the elevator shaft at wood stud wall construction.

- b. Revise detail 04 to show section cut callout to existing detail 02/A104.
- c. Revise detail 05 to show:
  - 1) Revised to indicate new hoist beam construction and space plates
  - 2) Left side of detail indicates southwest elevator shaft wall guide rail, which will stop below the hoist beam
  - 3) Extended detail to show northeast elevator shaft wall guide rail, which will provide support of the hoist beam at this side of the shaft
- d. Add detail 08 to show guide rail support at the northeast elevator shaft wall
- e. Add detail 09 to show attachment of guide rail support at the north elevator shaft corner


#### **GENERAL:**


NONE

#### **ATTACHMENTS:**

- 1. A101 Add 04 Revision (1 Page)
- 2. A102 Add 04 Revision (1 Page)
- 3. A104 Add 04 Revision (1 Page)

**END OF ADDENDUM 04** 

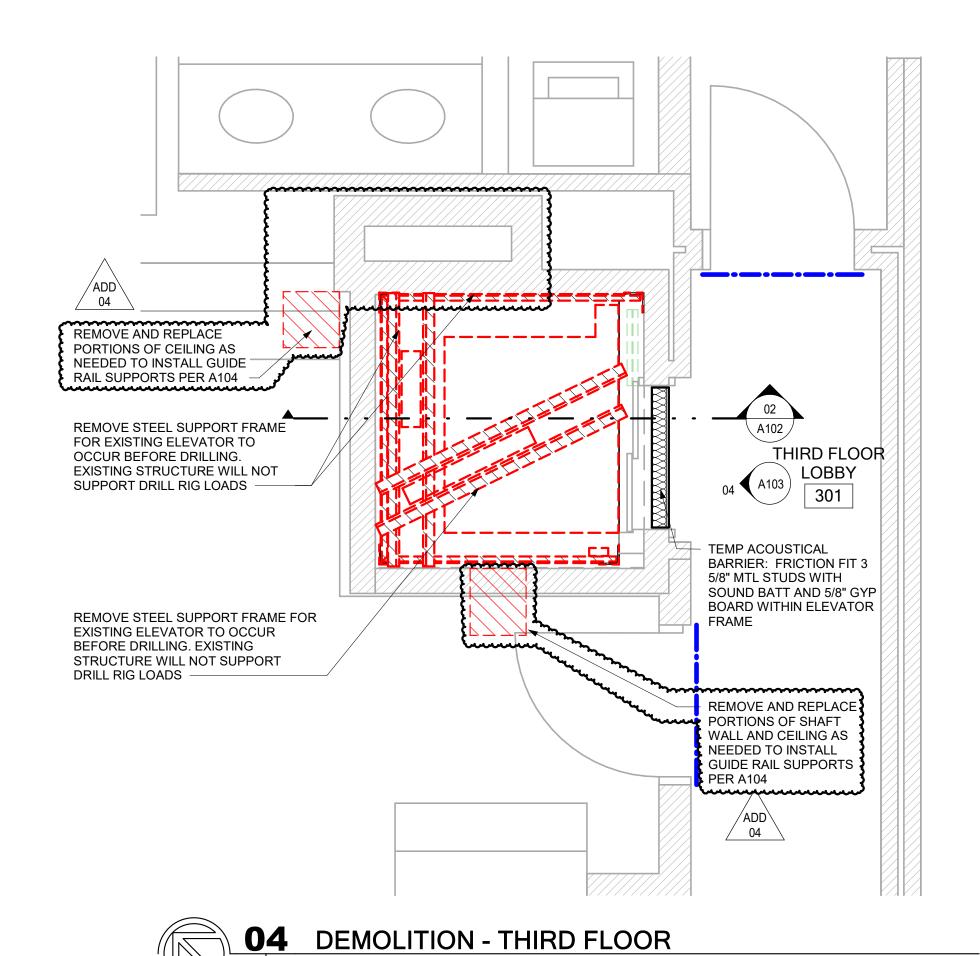

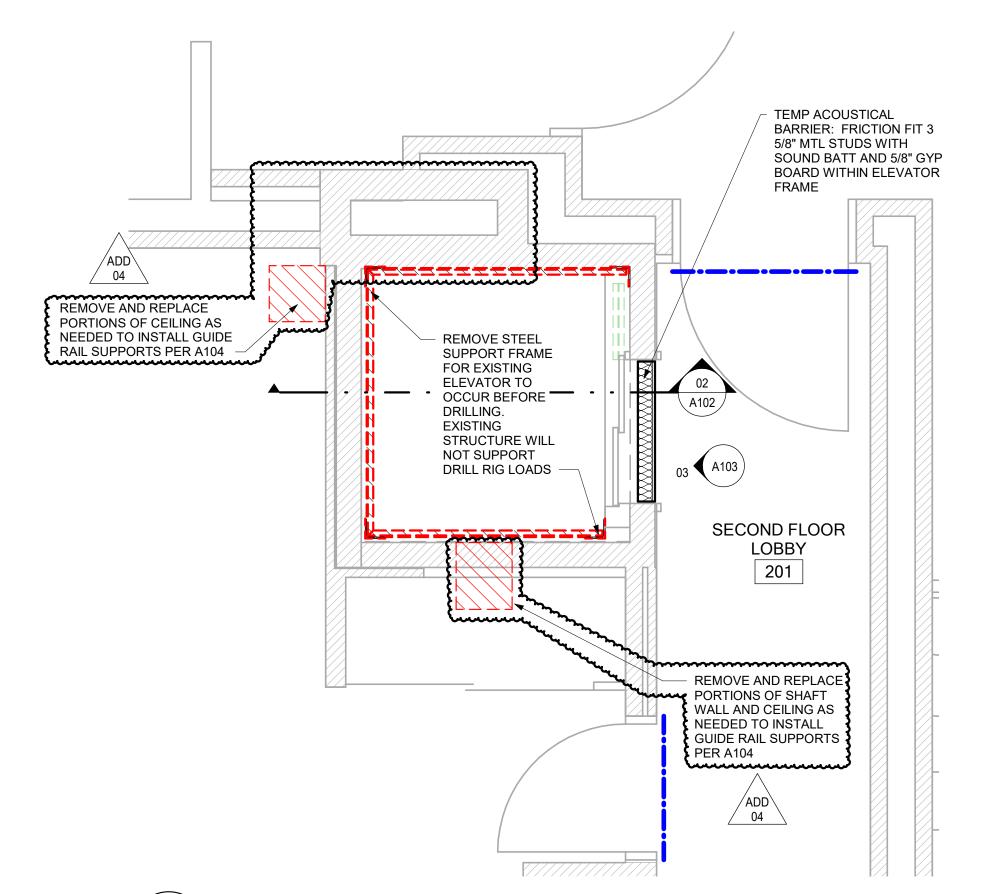



**BASEMENT** 

LOBBY

REMOVE 30" X 30" CONC

SLAB TO ACCOMODATE DRILLING OF JACK HOLE

REMOVE AND REPLACE

PORTIONS OF SHAFT

WALL AND CEILING AS NEEDED TO INSTALL

GUIDE RAIL SUPPORTS

PER A104

**03** DEMOLITION - SECOND FLOOR

# DUST PARTITION LEGEND

6 MIL. FIRE-RATED POLY BARRIER FROM FLOOR TO CEILING WITH 24" OVERLAP AT ROOM ENTRANCE FOR CONTRACTOR ACCESS.


1/4" THK MASONITE TO COVER DOOR AND FRAME AND SEAL WITH BLUE PAINTER'S .TAPE.

6 MIL. FIRE-RATED POLY BARRIER FROM FLOOR TO CEILING TO PROTECT WALLS FROM DUST ACCUMULATION. CUT AROUND OPENINGS AS NEEDED.

## **GENERAL NOTES - DEMOLITION**


 REMOVE WALLS INDICATED BY THE FOLLOWING LINETYPE (UNLESS NOTED OTHERWISE):

HEPA FILTERED EXHAUST OVER
EXISTING WALL TO CEILING OUTSIDE
OF PROJECTS LIMITS. DISCHARGE
AIR TO BE ATTACHED TO A 24" X 24"
LAY-IN DIFFUSER.

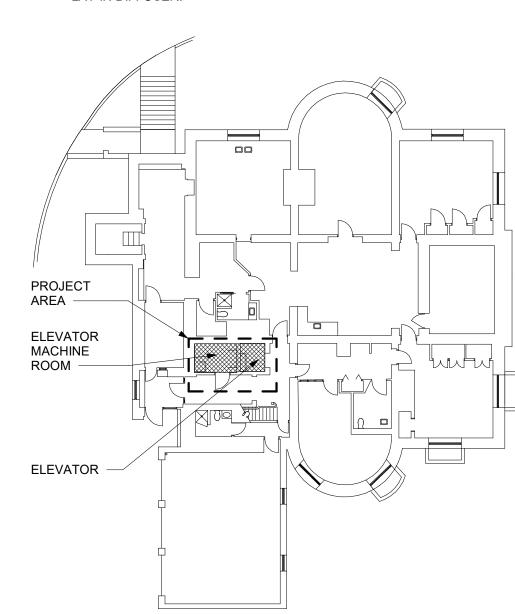



**KEY PLAN**1" = 20'-0"

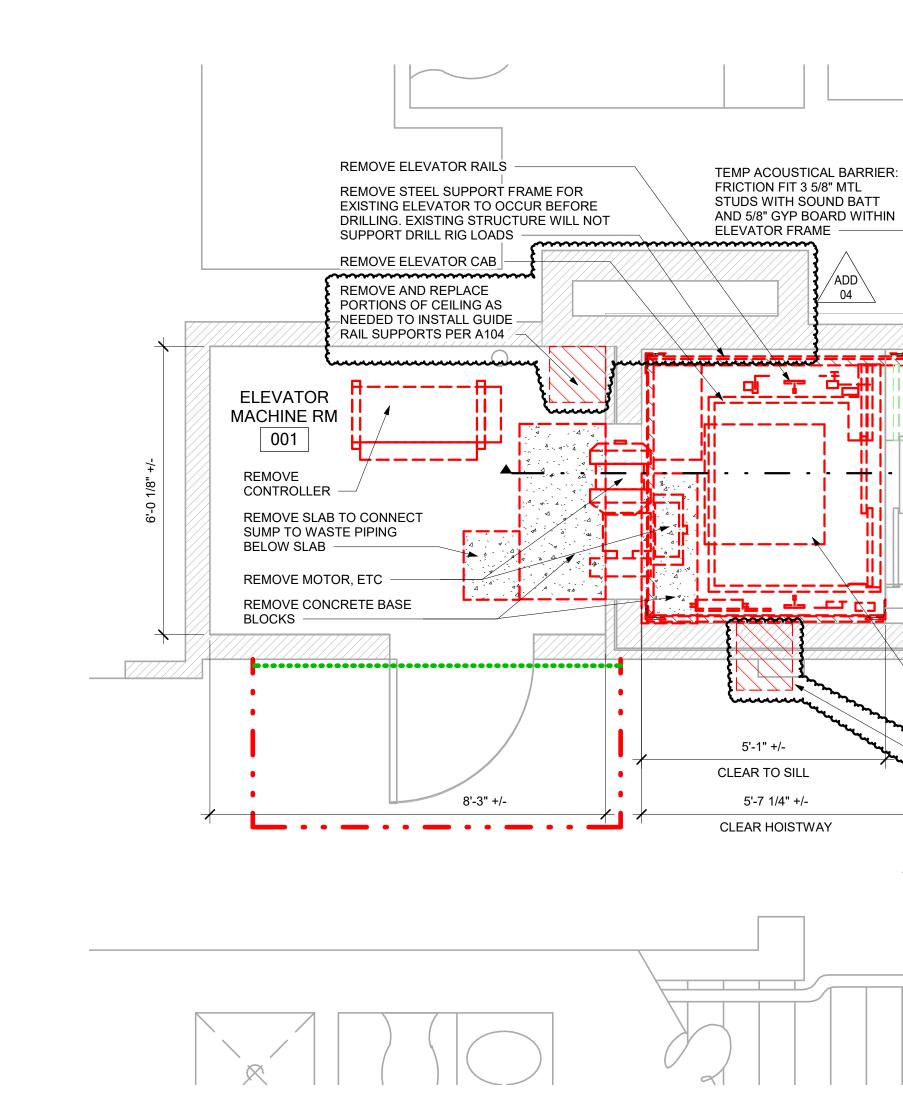



01 DEMOLITION - BASEMENT



REMOVE STEEL

FOR EXISTING

**ELEVATOR TO** 

DRILLING.

**EXISTING** 

SUPPORT FRAME

OCCUR BEFORE

STRUCTURE WILL

DRILL RIG LOADS

NOT SUPPORT

A102

<sub>02</sub> **(** A103)

FIRST FLOOR

LOBBY

101

BOARD WITHIN ELEVATOR

REMOVE AND REPLACE

PORTIONS OF SHAFT

NEEDED TO INSTALL
GUIDE RAIL SUPPORTS

PER A104

WALL AND CEILING AS

TEMP ACOUSTICAL
BARRIER: FRICTION FIT 3
5/8" MTL STUDS WITH
SOUND BATT AND 5/8" GYP

<u>/ 04</u> `

REMOVE AND REPLACE

PORTIONS OF CEILING AS

NEEDED TO INSTALL GUIDE

RAIL SUPPORTS PER A104



STATE OF MISSOURI

MIKE PARSON,

**GOVERNOR** 

Architecture

Interior Design

Planning
Sustainability

2801 Woodard Drive, Suite 103 Columbia, MO 65202 573.443.1407

www.soa-inc.com

Missouri Certificate of Authority Number: 000826

STRUCTURAL ENGINEER:
Allstate Consultants LLC

3312 Lemone Industrial Boulevard Columbia, MO 65201 (573) 875-8799

MEP ENGINEER: IMEG Corp. 1600 Baltimore, Suite 300 Kansas City, MO, 64108 (816) 842-8437

ELEVATOR CONSULTANT: ATIS Elevator Consulting 211 3rd Street Valley Park, MO, 63088 (314) 668-7396

OFFICE OF
ADMINISTRATION
DIVISION OF FACILITIES
MANAGEMENT,
DESIGN AND
CONSTRUCTION

ELEVATOR REPLACEMENT

GOVERNOR'S MANSION

Jefferson City, Missouri

PROJECT # O2036-01 SITE # 0001 FACILITY # 05005 BID DOCUMENTS

| DATE      |
|-----------|
| 1/10/2023 |
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ISSUE DATE: 10/28/2022

CAD DWG FILE:
DRAWN BY: KMT
CHECKED BY: NBB
DESIGNED BY: SOA

SHEET TITLE:

DEMOLITION FLOOR PLAN AND ROOF PLAN

SHEET NUMBER:

AIUI SHEET 3 OF 14 ISSUE DATE: 10/28/2022

# **EXISTING ROOF EXISTING ROOF HATCH -**HATCH TO REMAIN FROM INSIDE SHAFT, WELD HATCH IN CLOSED POSITION AT 3 NON-HINGE SIDES ROOF 167'-8 1/2" \_\_\_\_\_\_ 2) C8X11.5 HOIST BEAM A104 COLUMN BRACE LOCATION REF A104 CONNECTOR PLATES THIRD FLOOR 148'-2 1/2" COLUMN BRACE LOCATION REF 08/A104 REMOVE STEEL SUPPORT FRAME FOR EXISTING ELEVATOR / 04 <sup>\</sup> COLUMN BRACE A104 / SECOND FLOOR 129'-9 3/4" SECOND FLOOR 129'-9 3/4" **ELEVATOR** TEMP ACOUSTICAL BARRIER: FRICTION FIT 3 COLUMN BRACE LOCATION REF 5/8" MTL STUDS WITH SOUND BATT AND 5/8" GYP BOARD WITHIN ELEVATOR FRAME, TYP ON EACH FIRST FLOOR 111'-5 1/4" FIRST FLOOR 111'-5 1/4" REMOVE STEEL SUPPORT FRAME ELEVATOR CAB FOR EXISTING ELEVATOR BEYOND -OPENING FOR PIPES, MAINTAIN FIRE RATING CONCRETE AFTER INSTALL BASE BLOCKS BASEMENT 100'-0" BASEMENT 100'-0" 10" THICK OVERBUILT SLAB W/ #5'S @ 12" O.C. EA WAY TOP &

CYLINDER IN

BOREHOLE

**03** HOISTWAY SECTION NORTH

A102 A102 1/4" = 1'-0"




- FIELD VERIFY ALL DIMENSIONS. IF DIMENSIONS VARY SIGNIFICANTLY NOTIFY THE ARCHITECT
- 2. ALL DIMENSIONS TO FACE OF EXISTING FINISH OR FACE OF METAL STUDS UNLESS NOTED OTHERWISE
- WHERE PENETRATIONS OF EXISTING SHAFT WALLS EXIST DUE TO WIRING, ETC. TO BE RELOCATED, REPLASTER 8. TO RESTORE FIRE INTEGRITY OF
- SEAL ALL NEW AND EXISTING PENETRATIONS IN EXISTING SHAFT WALL WITH FIRE CAULKING
- HOISTWAY ENTRANCE JAMBS ARE BEING RETAINED AND NEED TO BE PROPERLY FIRE GROUTED.


CONTRACTOR TO COORDINATE FINAL LADDER DESIGN AND LOCATION WITH ELEVATOR


INSTALLER TO AVOID INTERFERENCE AND MEET CODE REQUIREMENTS. WHERE PIPES, CONDUIT, ETC HAVE BEEN REMOVED, DRAFTSTOP ANY HOLES THAT ARE LEFT REMAINING. FOLLOW INFECTION CONTROL

PRECAUTIONS IN ALL AREAS WHERE WORK IS BEING PERFORMED. REFERENCE SITE SECURITY AND HEALTH REQUIREMENTS (OA) SECTION OF PROJECT MANUAL FOR MORE DETAILS.

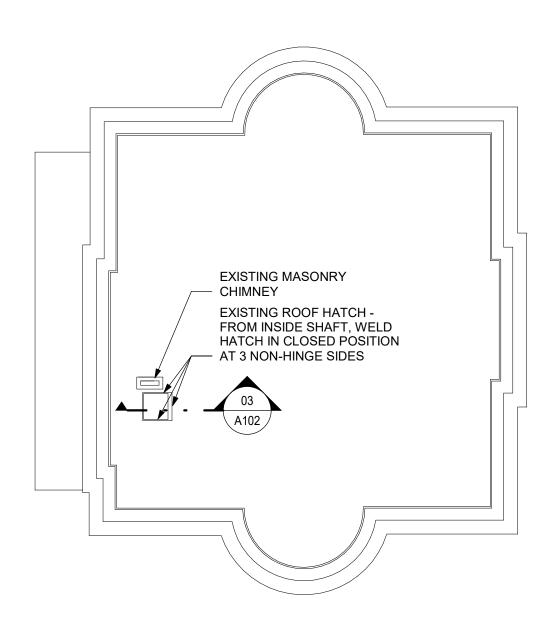




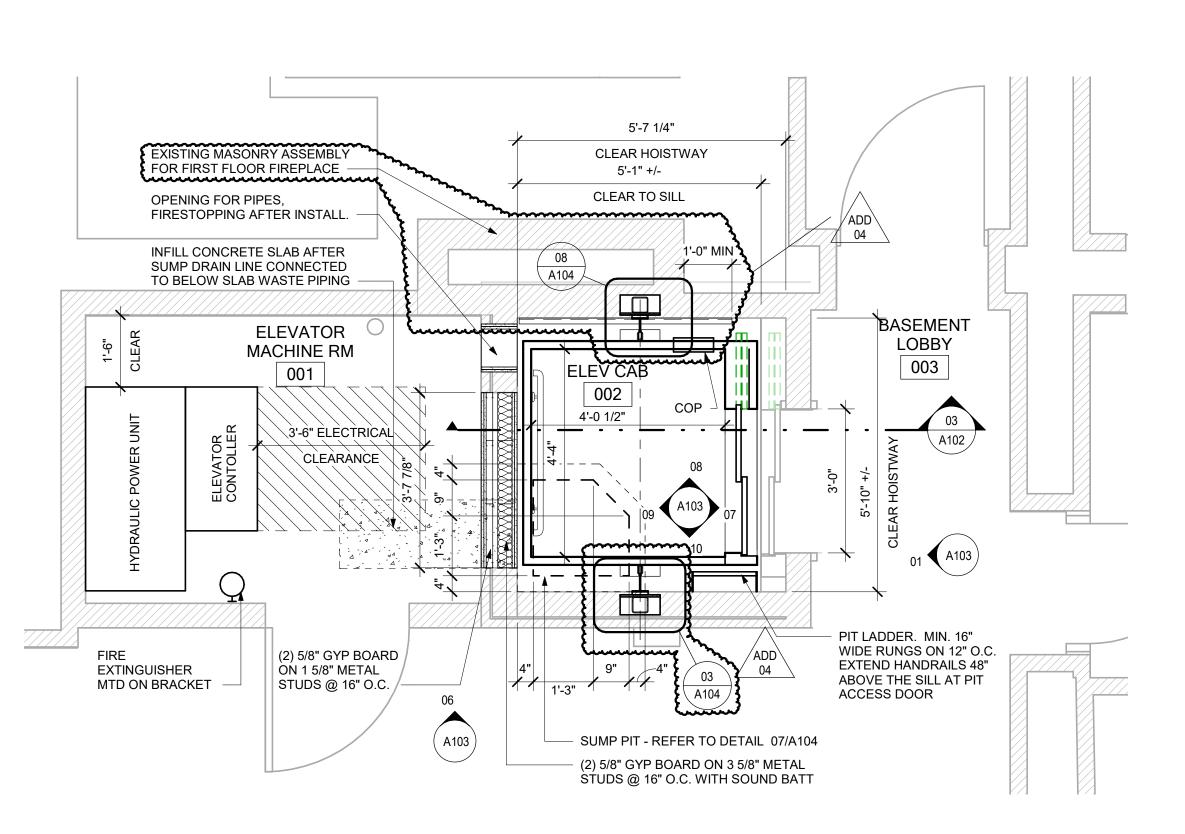

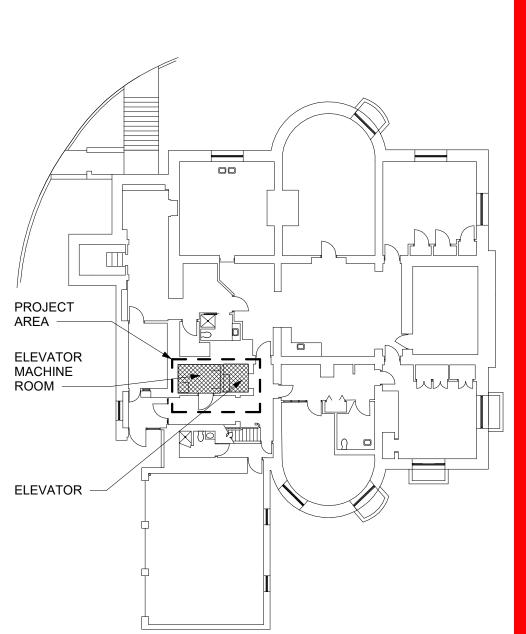

**02** DEMO HOISTWAY SECTION NORTH A101 A102 1/4" = 1'-0"



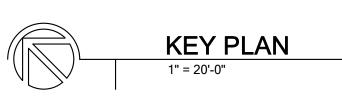



STATE OF MISSOURI

MARIE

Jennifer M. Hedrick - Architect

MIKE PARSON,

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| REVISION | DATE      |  |
|----------|-----------|--|
| ADD 04   | 1/10/2023 |  |
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ISSUE DATE: 10/28/2022

CAD DWG FILE:
DRAWN BY: KMT
CHECKED BY: NBB
DESIGNED BY: SOA

SHEET TITLE:

FLOOR PLAN, ROOF PLAN, AND HOISTWAY SECTIONS

SHEET NUMBER:

SHEET 4 OF 14 ISSUE DATE: 10/28/2022

**01** NEW WORK - BASEMENT

# **STRUCTURAL NOTES:**

- Reinforced Concrete (Division 3):
- A. Design codes Building Code Requirements for Reinforced Concrete (ACI 318), latest adoption.
- B. Material strengths
- Concrete compressive strength (fc) at 28 days:
- a. All concrete 4,000 psi
- 2. Slump a. Slump
- All concrete 2" to 4"
- Reinforcing steel a Bars and ties ASTM A615, Grade 60 (Fy=60ksi)
- Placement of concrete and reinforcement shall be in accordance with ACI and CRSI standards. Lap or dowel continuous bars with Class B splices per ACI 318 unless noted otherwise. Lap or dowel
- bars 50 bar diameters minimum. Reinforcing shown on details is for concept only, follow CRSI
- placement and cover requirements unless noted otherwise. Furnish the following concrete cover at reinforcing bars unless shown otherwise on the drawings:
- a. Slab 3" cover at bottom and sides. Provide 2" cover at top. Maximum aggregate size shall not exceed 3/4 the concrete cover (i.e. 3/4" max aggregate for 1" cover.

(2) SOLID BLOCKING AT

EACH SIDE JOIST

**EXISTING FLOOR** 

**OUT MEMBER IF** 

HTT4 BY SIMPSON

STRONG TIE OR EQ.

∖ A104 🏿

1'-0" MAX COPING LENGTH

**08** RAIL SUPPORT - PLAN DETAIL - NORTHEAST WALL

05

A104

**03** COL AND BP AT RAIL - PLAN DETAIL - SOUTHWEST WALL

REQUIRED

**09** NORTH GUIDE RAIL BRACING

A102 A104 3" = 1'-0"

**EXISTING** 

PLASTER

**ELEVATOR RAIL** 

BASEPLATE, AND

ATTACHMENT BY

**MANUFACTURER** 

ELEVATOR CAB

A102 A104 3" = 1'-0"

**HOLLO-BOLT BY** 

LINDAPTER OR

EQUIVALENT, SIZE

AND SPACING BY

MANUFACTURER

**ELEVATOR** 

A102 A104 3" = 1'-0"

**ELEVATOR** 

SHELL

JOIST - PROVIDE (2) 2X

**BLOCKING TO BUILD** 

SPACE

EXISTING (2) 2X

MC12X10.6

1/4" X 8" BENT PLATE W/

(2) 5/8" DIA. THRU BOLTS

CÉNTERED ON CHANNEL

SOLID BLOCKING AT EA

1/4" CAP PLATE

HSS 4X4X1/4"

COLUMN

SIDE OF ANCHORS

**EXISTING PLASTER** 

**EXISTING STUD WALL** 

**EXISTING MASONRY** 

CHIMNEY AT NORTH

(2) 5/8"x3" EMBED EPOXY

SPACING PER ELEVATOR

MFG. VERIFY ANCHORS DO

NOT PENETRATE EXISTING

PL 4" X 10" X THICKNESS

REQUIRED. SPACING TO

MATCH ELEVATOR RAIL

MC12X10.6 - COPE AT GUIDE

RAIL AS NEEDED. PROVIDE

(4) 5/8" DIA X 6-1/2" EMBED

DISTANCE & 8" SPACING

**ÉPOXY ANCHORS W 2" EDGE** 

**VERT & HORIZ AT MASONRY** 

WALLS PAST THE CHIMNEY

GROUT CORES SOLID AT

ANCHOR LOCATIONS. SEE

WALL. EXTEND PLATE AS

REQUIRED AND WELD TO

WELD 8" LONG AT EA SIDE.

CHANNEL W/ 1/4" FILLET

NOTE ONLY (1) PLATE IS

REQUIRED AT CHANNEL

**ELEVATOR CAB SHELL** 

**ELEVATOR RAIL AND** 

PL 4" X 10" X THICKNESS

REQUIRED, SPACING TO

MATCH ELEVATOR RAIL

ATTACHMENT BY

MANUFACTURER

**ELEVATOR** 

ATTACHMENT

LATH PATCH

3/4" PLASTER AND

EXISTING PLASTER

(2) 5/8"x8" EMBED

**EPOXY ANCHORS** 

2x4 WD BLOCKING FOR

EXISTING 2x6 WD STUD

HSS 4x4x1/4 COLUMN, VERIFY SIZE DOES NOT CONFLICT WITH RAIL BOLT GAUGE

**EXISTING PLASTER** 

PL 5" x 5/8" x 0'-10"

PLASTER AND LATH PATCH

DETAILS 01 & 04 FOR

ATTACHMENT TO STUD

-12" MIN PAST CHIMNEY

ANCHORS VERTICAL

CLAY FLUE

ATTACHMENT

### 2. Structural Steel (Division 5):

B. Material Strengths:


- A. Design Code: Specifications for the Design, Fabrication and Erection of Structural Steel for Buildings (AISC), latest adoption.
- Structural Steel Rolled Wide Flange Shapes ASTM A992, Grade 50 (Fy=50ksi)
- 2. Angles, channels, plates (including tread plate), and bars ASTM A36 (Fy=36ksi)
- Structural steel HSS tubing ASTM A500, Grade C (Fy=50ksi) Connection bolts ASTM F3125 Grade A325, Type 1, ASTM A563 heavy hex carbon-steel nuts and ASTM F436 hardened carbon-
- Adhesive/epoxy anchors ASTM F1554, Grade 36 (Fy=36ksi) Welds E70XX (Fexx=70ksi) electrodes per AWS D1.1 - steel
- C. Notes: All structural steel shall be fabricated and erected according to the specifications of The American Institute of Steel Construction
- (AISC), latest adoption. Steel shop drawings shall include erection plans showing connections, beam elevations and splices.
- Structural steel shall be shipped with standard shop primer. See architectural specifications for primer and paint coating (if required).
- Bolts shall be placed at 3" spacing, 1 1/4" edge distance, standard gage, and thru standard holes unless noted otherwise.
- Shop connections may be welded or bolted using 3/4" (A325) diameter bolts. Field connections shall be bolted using 3/4" (A325) diameter bolts.
- 6. All structural steel shop and field welding shall be completed by an AWS certified welder.
- Field cutting of structural members (including holes) and member splices (field or shop splices) will not be permitted unless shown on the shop drawings and without written authorization of architect/engineer.


## D. Post-installed anchors -- screw anchors


- Post-installed anchors shall only be used where specified on the construction documents. The contractor shall obtain approval from the engineer prior to installing post-installed anchors in place of missing or misplaced cast-in-place anchors. Care shall be taken in placing post-installed anchors to avoid conflicts with existing rebar. Holes shall be drilled (hammer drilled in concrete and core drilled in masonry) and cleaned in accordance with the manufacturer's written instructions. For horizontal or vertically inclined anchor orientation carrying sustained tension loads, the installer must be certified by an ACI/CRSI Adhesive Anchor Installer Certification program. See general notes for substitution requests.
- a. Concrete anchors
  - Adhesive/epoxy anchors for use in cracked and uncracked concrete, Simpson Strong-Tie "AT-XP" or equivalent (tested in accordance with ACI 355.4 and ICC-
  - a. Design bond strength has been based on cracked concrete, ACI 355.4 temperature Category B and installations into dry holes into concrete that has cured for at least 21 days.
- b. Masonry anchors
- 1. Adhesive/epoxy anchors for use in solid-grouted concrete masonry, Simpson Strong-Tie "AT-XP" or equivalent (tested in accordance with ICC-ES AC58)
- 3. Wood Framing Rough Carpentry, Wood Products, and Wood Trusses (Division 6):

# À. Design codes:

- National Design Specification for Wood Construction (NDS), latest
- Install rough carpentry work to comply with American Institute of Timber Construction (AITC), Timber Construction (TC) Manual, latest adoption and recommendations of the product manufacturer. B. Material Strengths:
- All wood stick framing shall be Southern Pine, No. 2 Grade (graded inder SPIB rules) or better.
- 2. Lumber for miscellaneous uses may be "standard" grade lightframing-size lumber of any species for support of other construction, including rooftop equipment and support bases, cant strips, bucks, nailers, blocking, furring, grounds, stripping and similar members.
- Fasteners:
- a. Nails, wire, brads, and staples: ASTM F547
- All nails shall be common wire nails unless notes otherwise. Nails shall be driven so that heads are flush with the wood surface. Over or under driven nails will not be acceptable. Nail sizes on drawings shall be as shown unless noted otherwise.
  - 16d. 0.162" shank diameter. 3 1/2" length
  - 10d, 0.148" shankdiameter, 3" length 8d, 0.131" shank diameter, 2 1/2" length
- 6d. 0.113" shank diameter, 2" length
- Bolts: ASTM A307, Grade A. or ASTM A36.

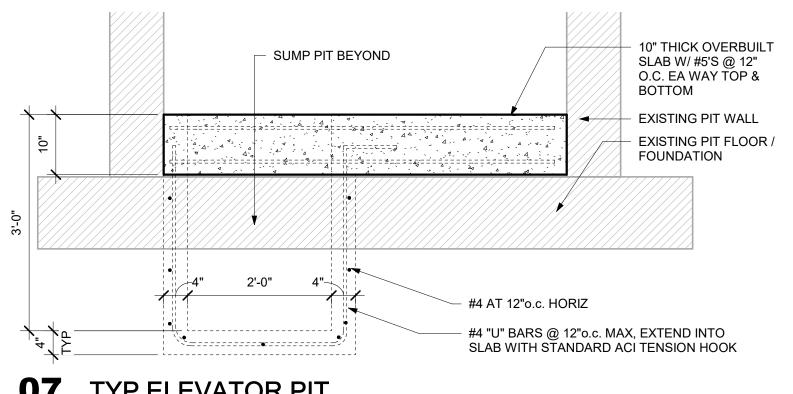

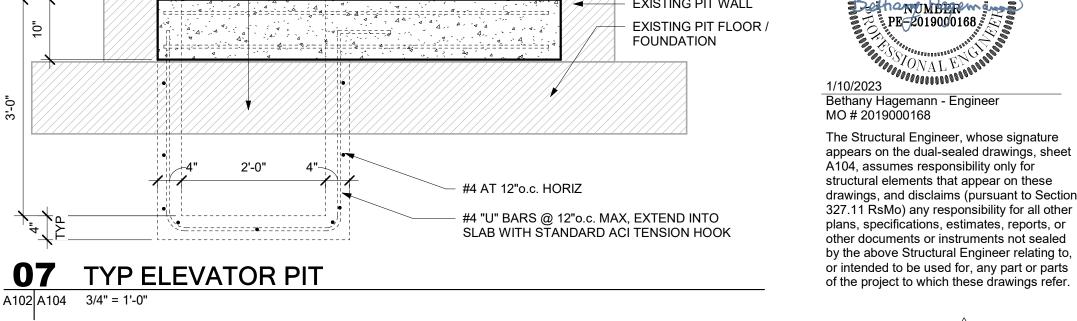

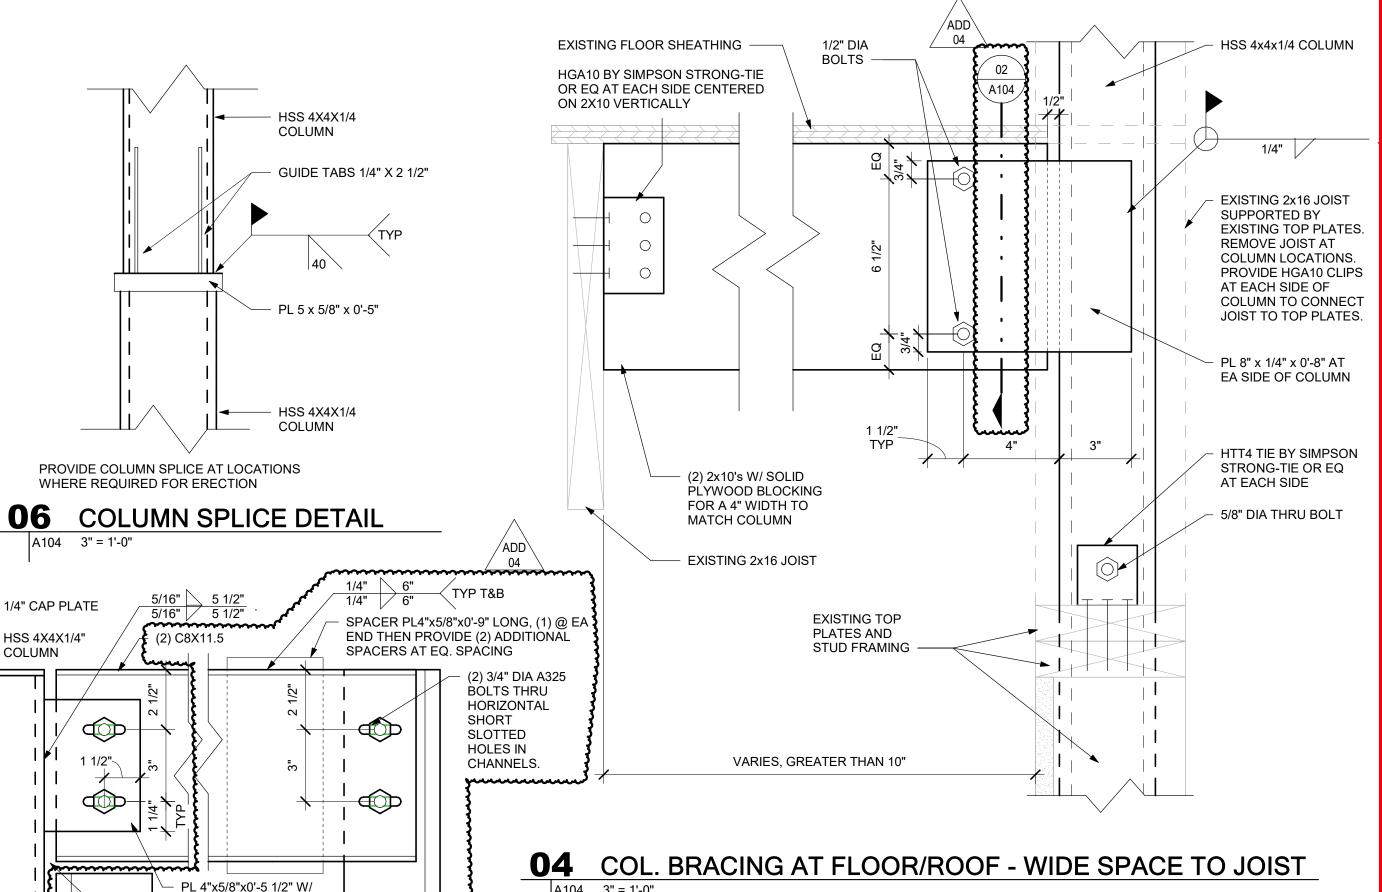

HGA10 BY SIMPSON

STRONG-TIE OR EQ AT

EACH SIDE CENTERED

ON 2X10 VERTICALLY -

**EXISTING FLOOR** 

SHEATHING

BETHANY

HAGEMANN


**ALLSTATE** CONSULTANTS

3312 Lemone Industrial Blvd

Columbia, MO 65201

phone: 573.875.8799

fax: 573.875.8850

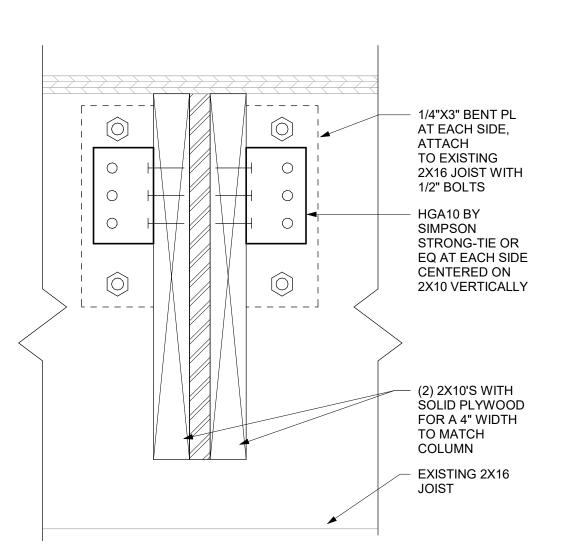

(2) 3/4" DIA A325 BOLTS

THRU HORIZONTAL

SHORT SLOTTED

- SOUTH GUIDE RAIL


NORTH GUIDE RAIL

HSS AND HOIST BEAM CONNECTION

HOLES IN PLATE.

1/2" GAP



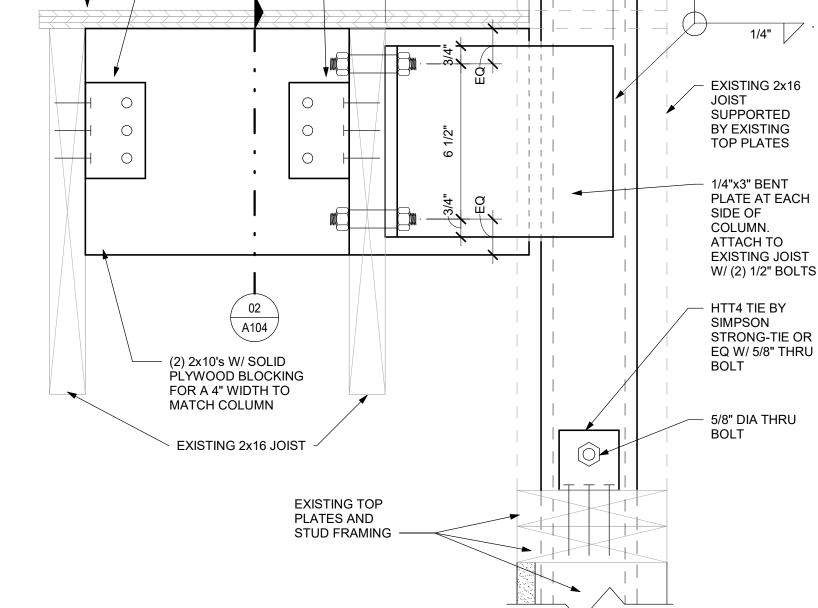

VARIES 10" OR LESS

**01** COL. BRACING AT FLOOR/ROOF - NARROW SPACE TO JOIST

STATE OF MISSOURI STRUCTURAL ENGINEER: MIKE PARSON, **GOVERNOR** 





Architecture Interior Design

Planning Sustainability

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HSS 4x4x1/4

COLUMN

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> REVISION ADD 04 1/10/2023

ISSUE DATE: 10/28/2022

CAD DWG FILE: DRAWN BY: KMT CHECKED BY: NBB DESIGNED BY: SOA

SHEET TITLE: **DETAILS AND** 

STRUCTURAL NOTES

SHEET NUMBER: SHEET 6 OF 14 ISSUE DATE: 10/28/2022