# ELEVATOR REPLACEMENT GOVERNOR'S MANSION Jefferson City



Simon Oswald Associate, Inc.

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2801 Woodard Drive, Suite 103

Columbia, MO 65202

573.443.1407

Architecture Interior Design Planning Sustainability

OWNER: STATE OF MISSOURI

MICHAEL L. PARSON,

GOVERNOR

PROJECT STATE OF MISSOURI

MANAGMENT: OFFICE OF ADMINISTRATION

DIVISION OF FACILITIES MANAGEMENT,

DESIGN AND CONSTRUCTION

DESIGNER: Jennifer M. Hedrick - Architect


PH#: (573)443-1407

PROJECT NUMBER: 02036-01
SITE NUMBER: 0001
FACILITY NUMBER: 05005


MISSOURI STATE CERTIFICATE OF AUTHORITY


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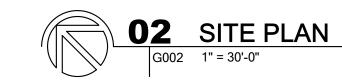


### **GENERAL NOTES & SYMBOLS**

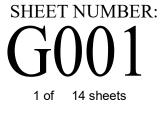

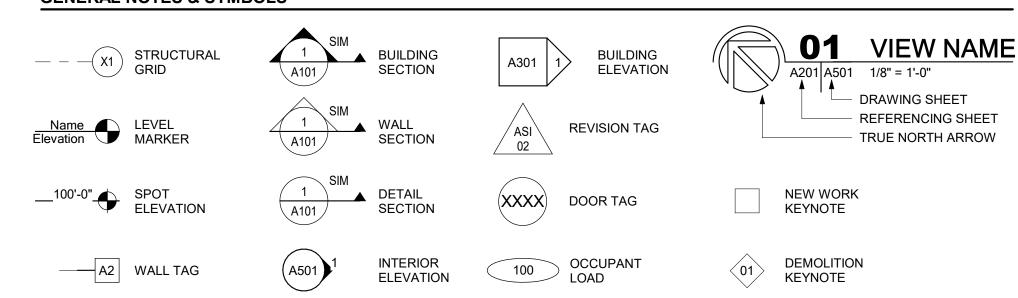

E CAPITOL AVE

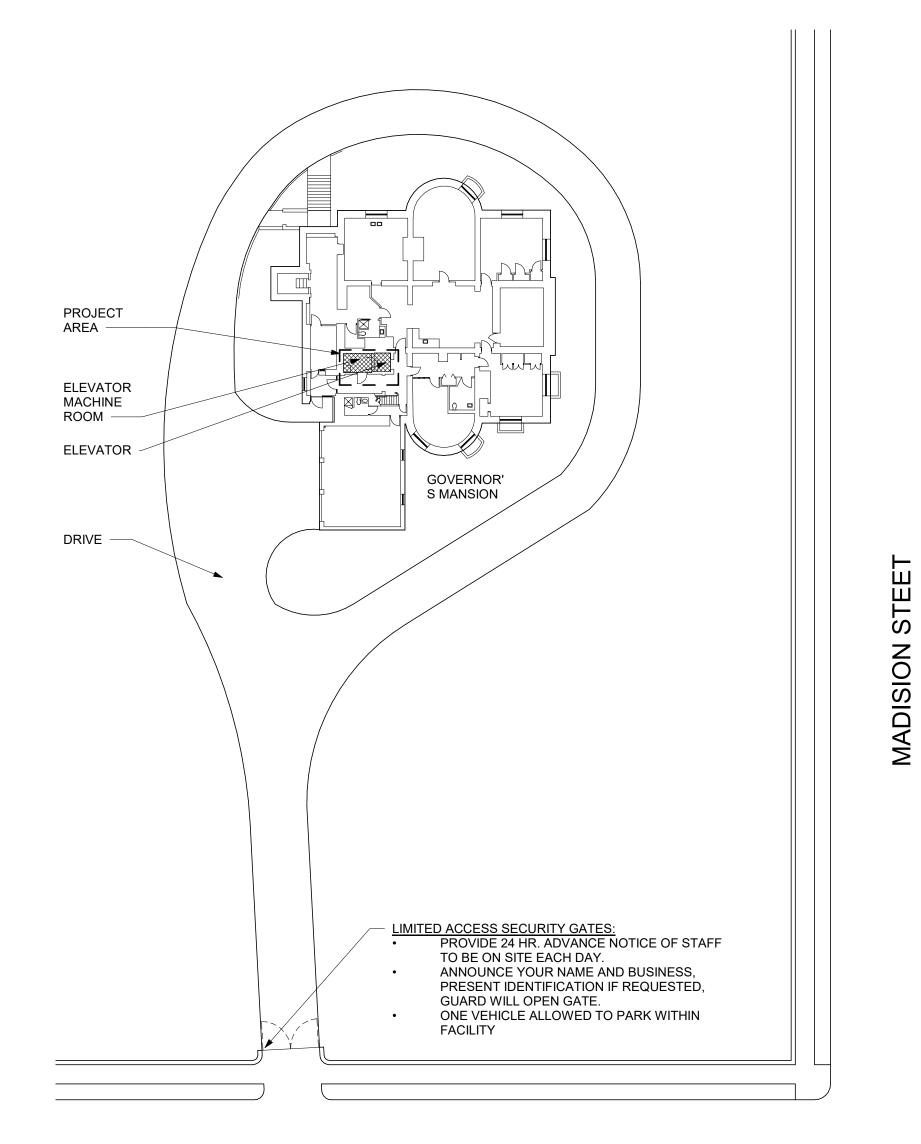

### SHEET LIST

### GENERAL

G001 **COVER SHEET** 

SHEET INDEX AND LOCATION MAPS

### **ARCHITECTURAL**

DEMOLITION FLOOR PLAN AND ROOF PLAN

A102 FLOOR PLAN, ROOF PLAN, AND HOISTWAY SECTIONS

INTERIOR ELEVATIONS, CAB DETAILS, & ROOM FINISH SCHEDULE

### MECHANICAL

**SHEET LIST** 

PM000 Plumb/Mech General Notes, Symbols & Abbreviations

PM100 Plumbing and Mechanical Plans

PME600 Plumbing and Mechanical Schedules & Details

### **ELECTRICAL**

E000 Electrical Symbols and General Notes

E100 Electrical Plans EL100 Lighting Plans

Fire Alarm Plans E601 Electrical Riser

DETAILS AND STRUCTURAL NOTES

### INFECTION CONTROL REQUIRMENTS

- Isolate HVAC system in area where work is being done to prevent contamination of duct system.
- Complete all critical barriers or implement control cube method before construction begins.
- Maintain negative air pressure within work site utilizing HEPA equipped air filtration units for exhaust. · Seal holes, pipes, conduits, and punctures appropriately.
- Provide walk-off mats at entrance to work area. Replace used mats with new mats as needed or required.
- Do not remove barriers from work area until project is completed. At the completion of the project carefully remove barriers to minimize spreading of dust and debris associated with construction.
- Contain construction waste before transport in tightly covered containers.
- Cover transport receptacle or carts; tape covering.
- Remove isolation of HVAC system (in areas where work is being performed) at completion of job.
- limits within 18" of ceiling line.

### \*\* LAY-DOWN AND STAGING AREA WILL BE PROVIDED ON OTHER STATE PROPERTY. **INDOOR SPACE CAN BE PROVIDED AS**

### **CODE & ZONING INFORMATION**

### **APPLICABLE CODES:**

**BUILDING CODE:** 2018 IBC MECHANICAL CODE: 2018 IMC PLUMBING CODE: 2018 IPC ELECTRICAL CODE:

2017 NEC FIRE CODE: 2018 IFC

ACCESSIBILITY: ADAAG & ANSI 117-1 **ELEVATOR CODE:** ASME A17.1-2004 SAFETY CODE FOR ELEVATORS AND ESCALATORS UP TO AND INCLUDING THE A17.1A-2016 ADDENDA AND THE A17.1S-2016 SUPPLEMENT.


LOCAL FIRE DEPARTMENT: CITY OF JEFFERSON CITY FIRE DEPARTMENT LOCAL BUILDING CODE JURISDICTION: STATE OF MISSOURI


### GENERAL INFORMATION:

USE GROUP: RESIDENTIAL (R) / BUSINESS (B) CONSTRUCTION TYPE: III B

### **LIFE SAFETY FEATURES:**

FIRE ALARMS THROUGHOUT - BATTERY BACKUP

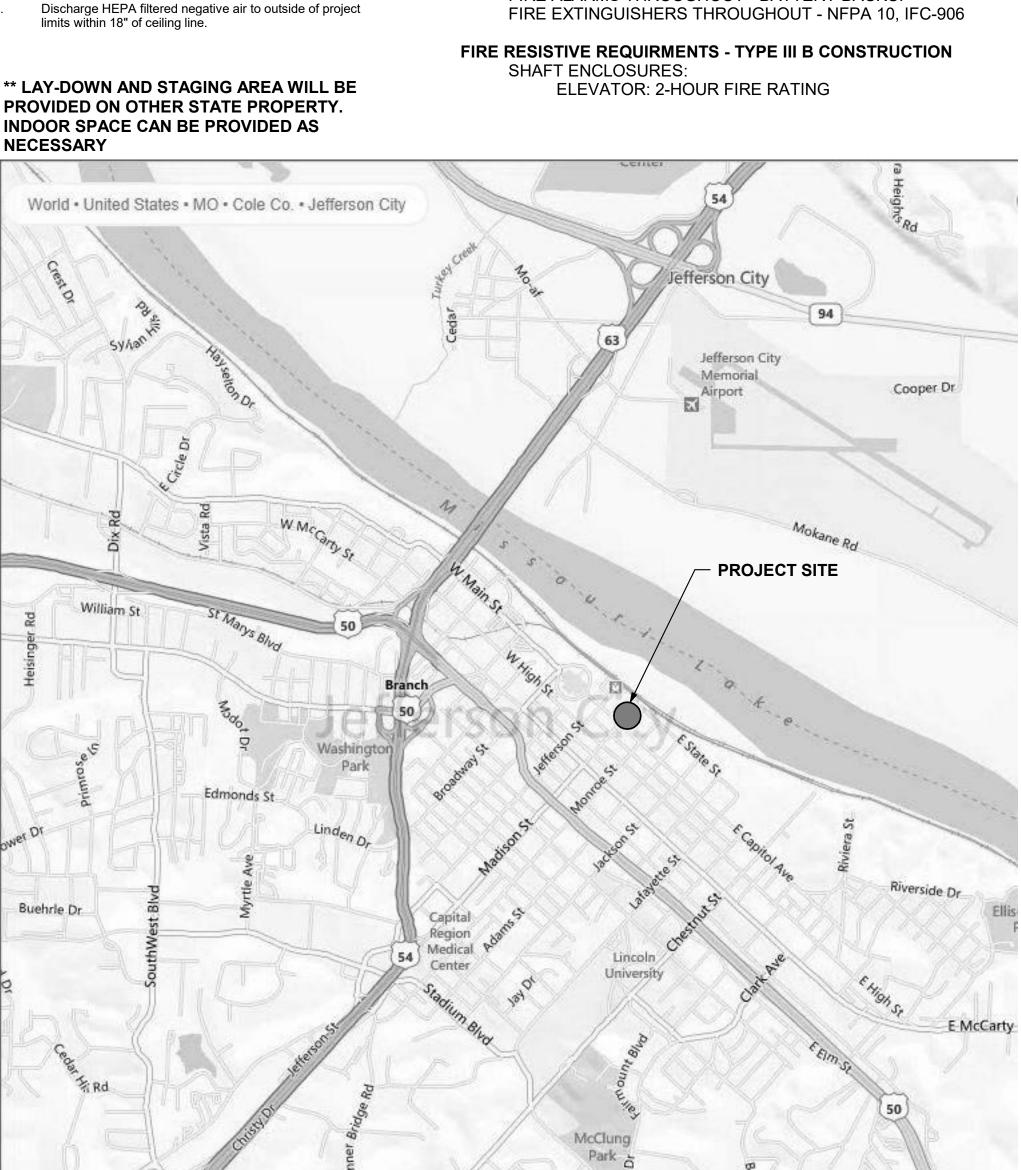

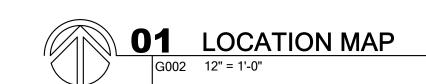

### STATE OF MISSOURI MIKE PARSON, **GOVERNOR**





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### STRUCTURAL ENGINEER:

Allstate Consultants LLC 3312 Lemone Industrial Boulevard Columbia, MO 65201

MEP ENGINEER: IMEG Corp. 1600 Baltimore, Suite 300

(573) 875-8799

### Kansas City, MO, 64108 (816) 842-8437 ELEVATOR CONSULTANT: ATIS Elevator Consulting

211 3rd Street Valley Park, MO, 63088 (314) 668-7396

### **OFFICE OF ADMINISTRATION DIVISION OF FACILITIES** MANAGEMENT, **DESIGN AND CONSTRUCTION**


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PROJECT # O2036-01 SITE # 0001 FACILITY # 05005

BID DOCUMENTS




ISSUE DATE: 10/28/2022


CAD DWG FILE:
DRAWN BY: KMT
CHECKED BY: NBB
DESIGNED BY: SOA

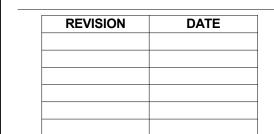SHEET TITLE:

SHEET INDEX AND LOCATION MAPS

SHEET NUMBER:

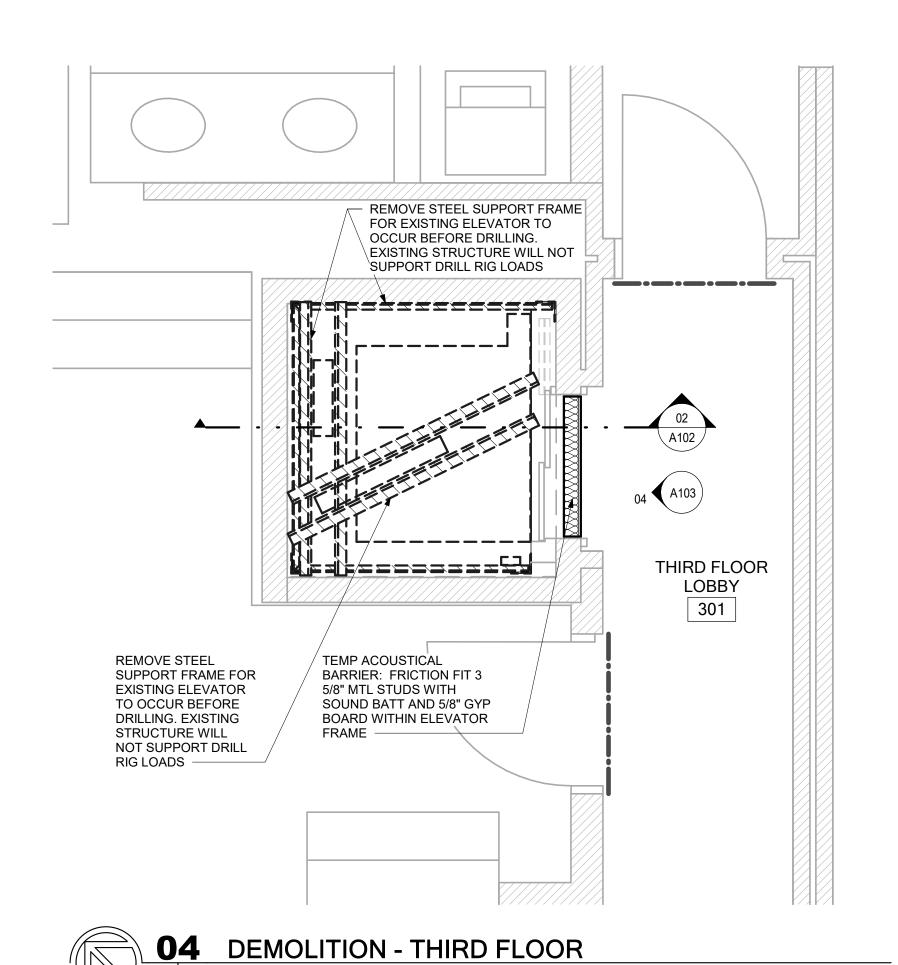

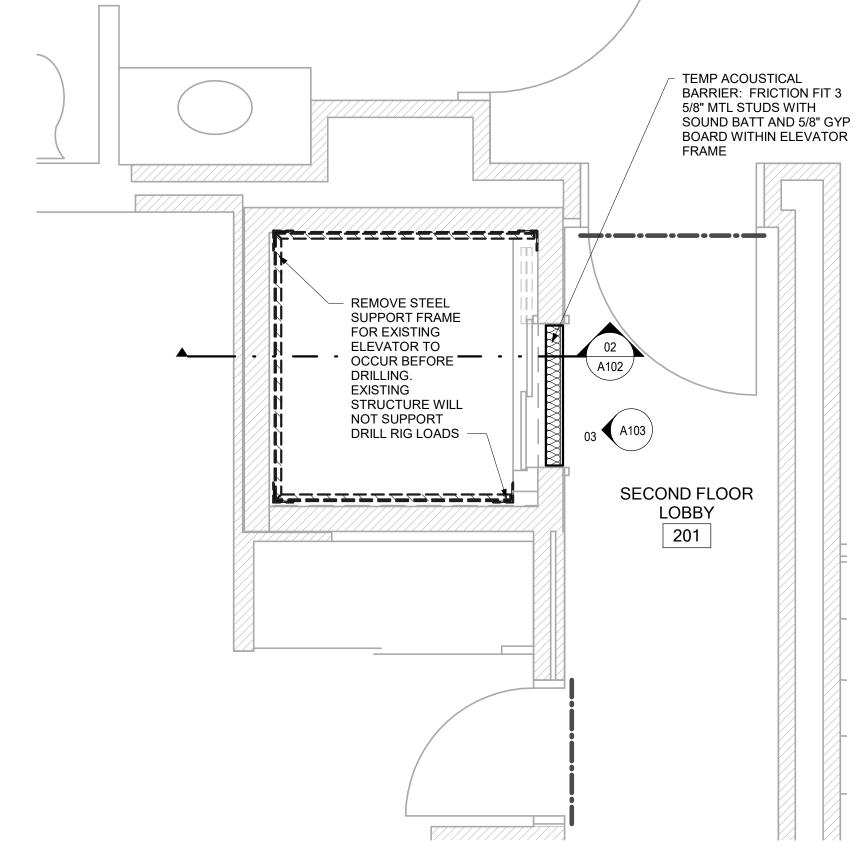



BASEMENT

LOBBY

TEMP ACOUSTICAL BARRIER: FRICTION FIT

3 5/8" MTL STUDS WITH SOUND BATT AND 5/8"

GYP BOARD WITHIN

**ELEVATOR FRAME** 

<u>Krtrrazzzzzzzzzzzz</u>

**03** DEMOLITION - SECOND FLOOR

### **DUST PARTITION LEGEND**

6 MIL. FIRE-RATED POLY BARRIER FROM FLOOR TO CEILING WITH 24" OVERLAP AT ROOM ENTRANCE FOR CONTRACTOR -ACCESS. - - - - -

1/4" THK MASONITE TO COVER DOOR AND FRAME AND SEAL WITH BLUE PAINTER'S


6 MIL. FIRE-RATED POLY BARRIER FROM FLOOR TO CEILING TO PROTECT WALLS FROM DUST ACCUMULATION. CUT AROUND OPENINGS AS NEEDED. •••••

### **GENERAL NOTES - DEMOLITION**

REMOVE WALLS INDICATED BY THE FOLLOWING LINETYPE (UNLESS NOTED OTHERWISE):

c==========

HEPA FILTERED EXHAUST OVER EXISTING WALL TO CEILING OUTSIDE OF PROJECTS LIMITS. DISCHARGE AIR TO BE ATTACHED TO A 24" X 24" LAY-IN DIFFUSER.

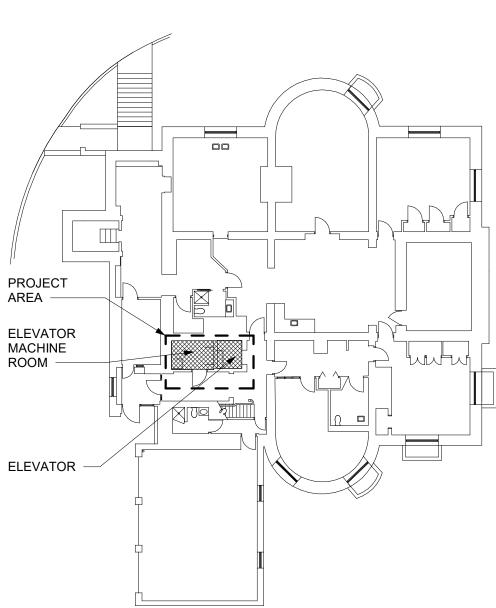



**01** DEMOLITION - BASEMENT

REMOVE ELEVATOR RAILS

SUPPORT DRILL RIG LOADS

REMOVE ELEVATOR CAB

**ELEVATOR** MACHINE RM

001

CONTROLLER -

**BELOW SLAB** 

**BLOCKS** 

REMOVE SLAB TO CONNECT

SUMP TO WASTE PIPING


REMOVE MOTOR, ETC

REMOVE CONCRETE BASE

REMOVE

REMOVE STEEL SUPPORT FRAME FOR

EXISTING ELEVATOR TO OCCUR BEFORE DRILLING. EXISTING STRUCTURE WILL NOT

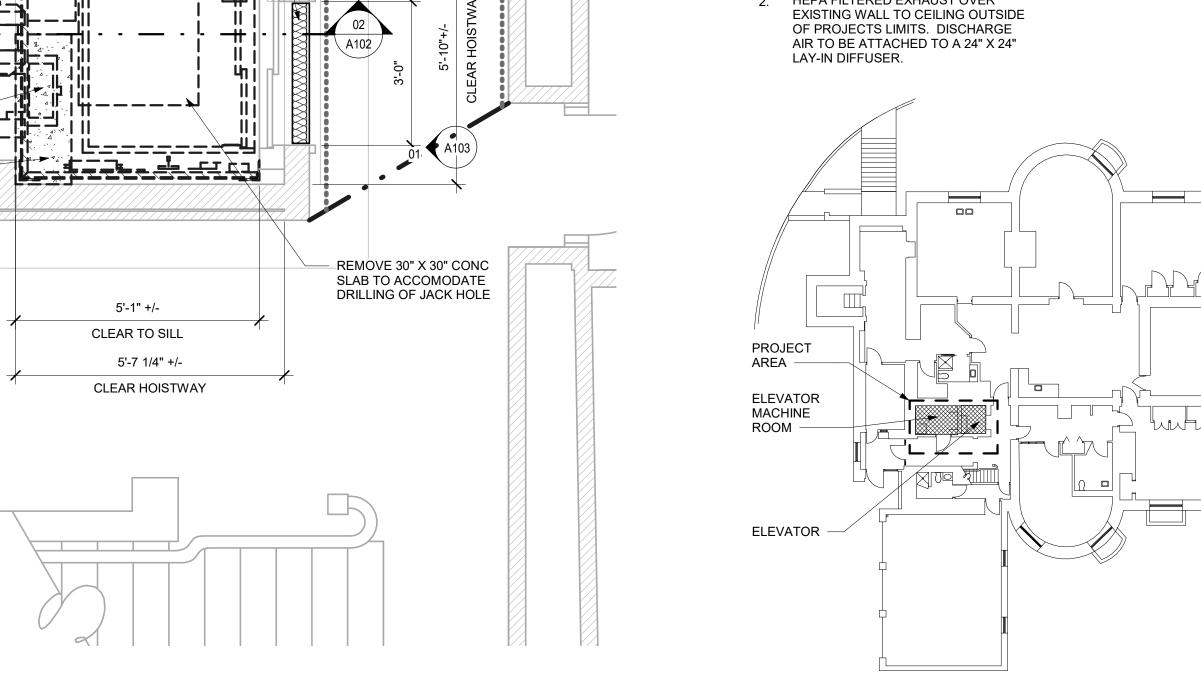



REMOVE STEEL

FOR EXISTING **ELEVATOR TO** 

DRILLING.

**EXISTING** 

SUPPORT FRAME

OCCUR BEFORE

STRUCTURE WILL

DRILL RIG LOADS

TEMP ACOUSTICAL BARRIER: FRICTION FIT 3

SOUND BATT AND 5/8" GYP

**BOARD WITHIN ELEVATOR** 

5/8" MTL STUDS WITH

NOT SUPPORT

∖ A102 /ˈ

02 A103

FIRST FLOOR

LOBBY

101



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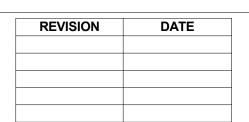
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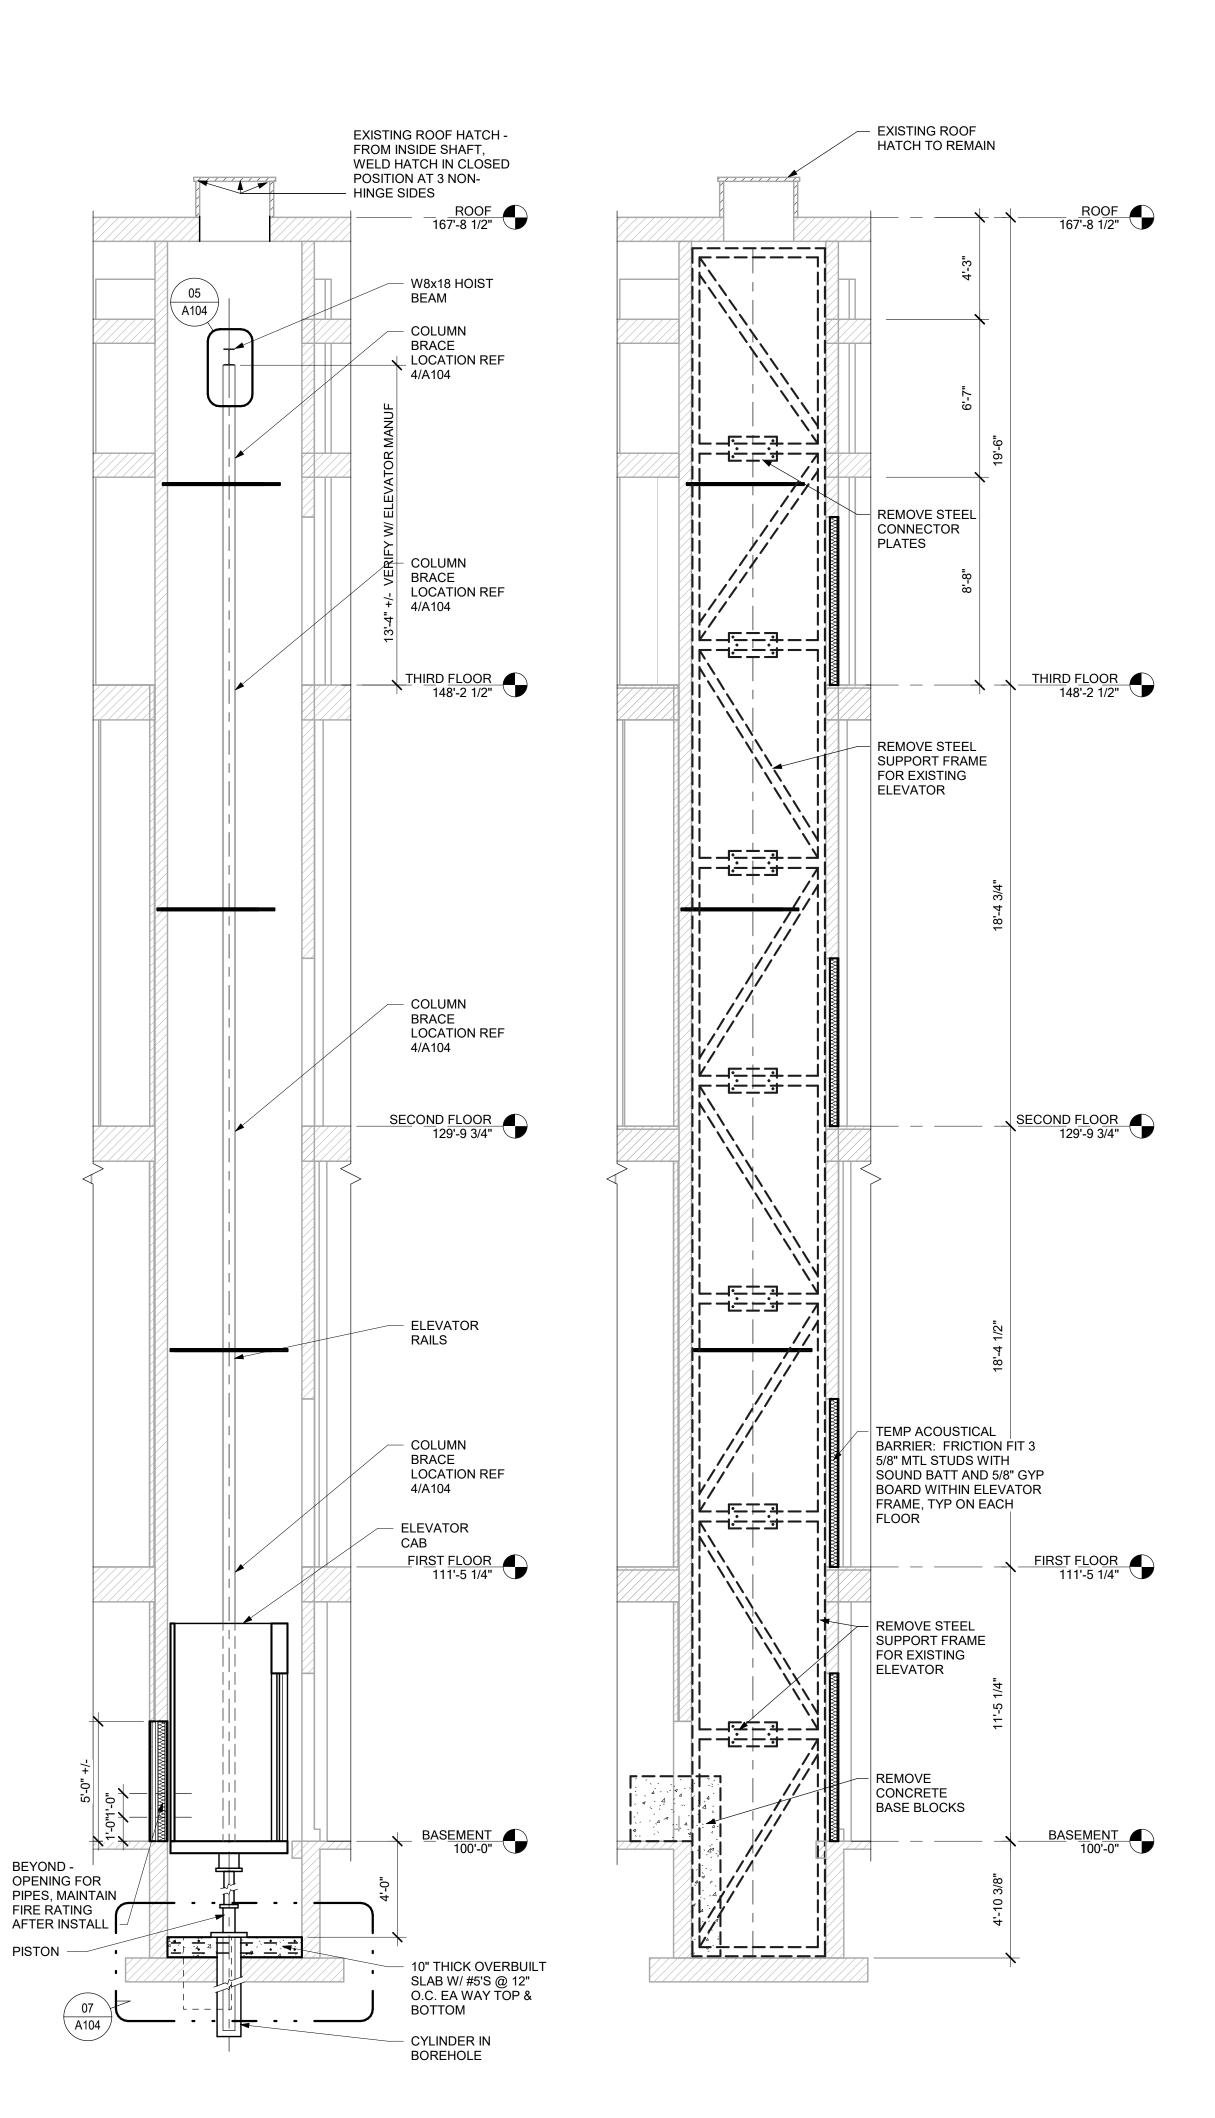
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CAD DWG FILE:
DRAWN BY: KMT
CHECKED BY: NBB DESIGNED BY: SOA

SHEET TITLE:

**DEMOLITION** FLOOR PLAN AND **ROOF PLAN** 

SHEET NUMBER:



**03** HOISTWAY SECTION NORTH

A102 A102 1/4" = 1'-0"

### **NEW WORK GENERAL NOTES**

- FIELD VERIFY ALL DIMENSIONS. IF DIMENSIONS VARY SIGNIFICANTLY NOTIFY THE ARCHITECT
- 2. ALL DIMENSIONS TO FACE OF EXISTING FINISH OR FACE OF METAL STUDS UNLESS NOTED OTHERWISE
- 3. WHERE PENETRATIONS OF EXISTING SHAFT WALLS EXIST DUE TO WIRING, ETC. TO BE RELOCATED, REPLASTER 8. TO RESTORE FIRE INTEGRITY OF PARTITION
- 4. SEAL ALL NEW AND EXISTING PENETRATIONS IN EXISTING SHAFT WALL WITH FIRE CAULKING
- 5. HOISTWAY ENTRANCE JAMBS ARE BEING RETAINED AND NEED TO BE PROPERLY FIRE GROUTED.

CONTRACTOR TO COORDINATE FINAL LADDER DESIGN AND LOCATION WITH ELEVATOR INSTALLER TO AVOID INTERFERENCE AND MEET CODE REQUIREMENTS. WHERE PIPES, CONDUIT, ETC HAVE BEEN REMOVED, DRAFTSTOP ANY

HOLES THAT ARE LEFT REMAINING.

FOLLOW INFECTION CONTROL
PRECAUTIONS IN ALL AREAS WHERE
WORK IS BEING PERFORMED.
REFERENCE SITE SECURITY AND

HEALTH REQUIREMENTS (OA)

MORE DETAILS.

SECTION OF PROJECT MANUAL FOR



STATE OF MISSOURI

MARIE

Jennifer M. Hedrick - Architect

License No. A-5419

MIKE PARSON,

**GOVERNOR** 

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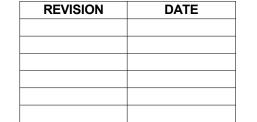
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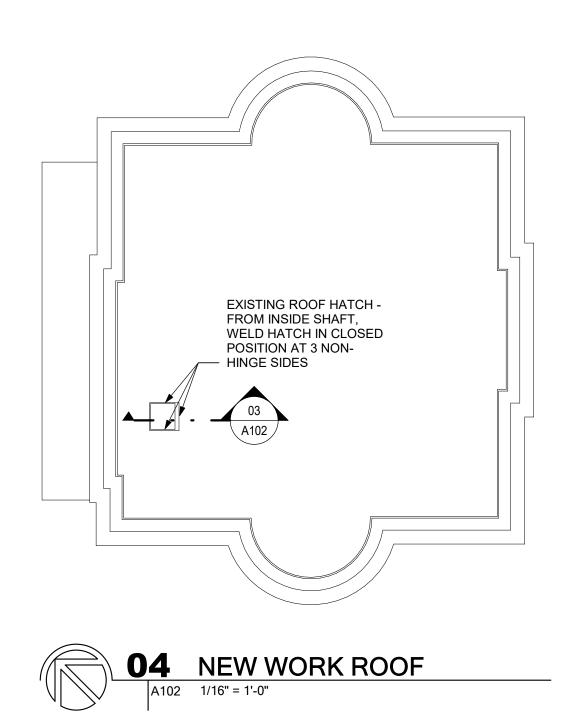
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SHEET TITLE:

FLOOR PLAN, ROOF PLAN, AND HOISTWAY SECTIONS

SHEET NUMBER:

A 1 0 2 SHEET 4 OF 14 ISSUE DATE: 10/28/2022



PROJECT AREA —


**ELEVATOR** 

ELEVATOR -


**KEY PLAN** 

1" = 20'-0"

MACHINE ROOM —

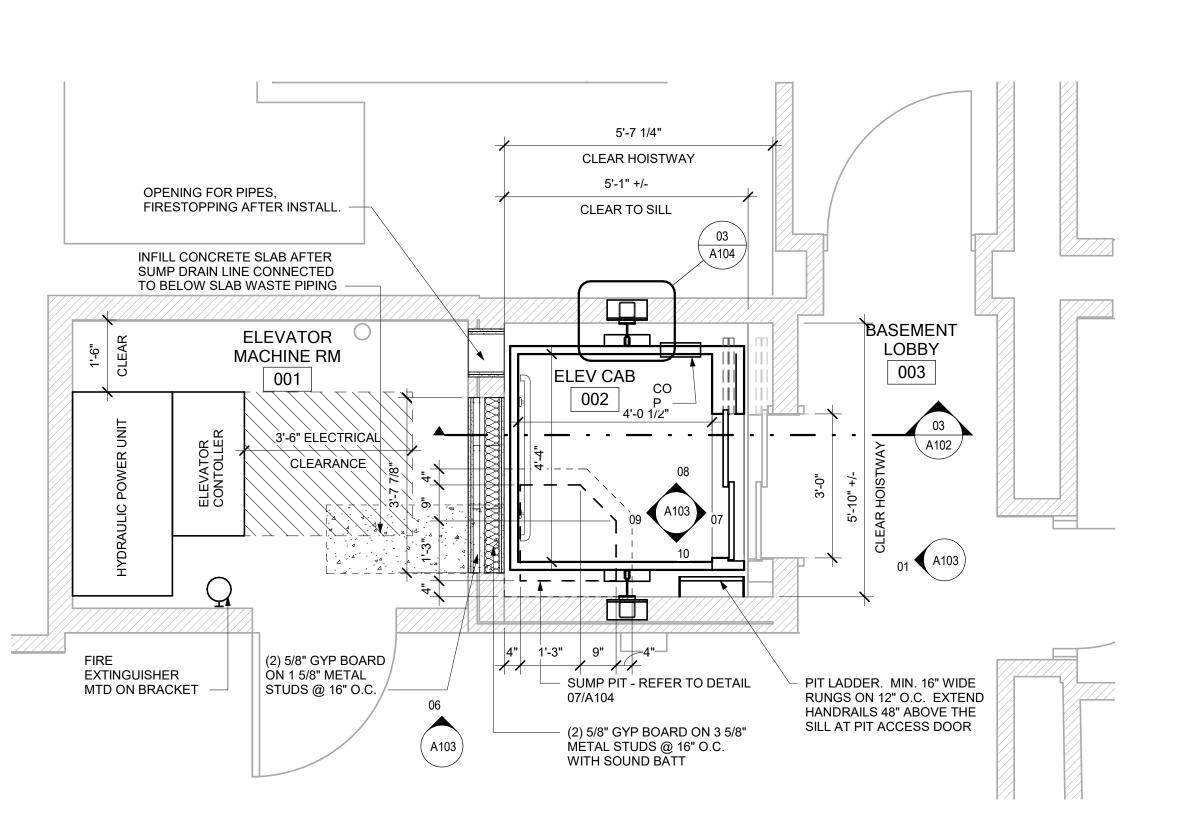



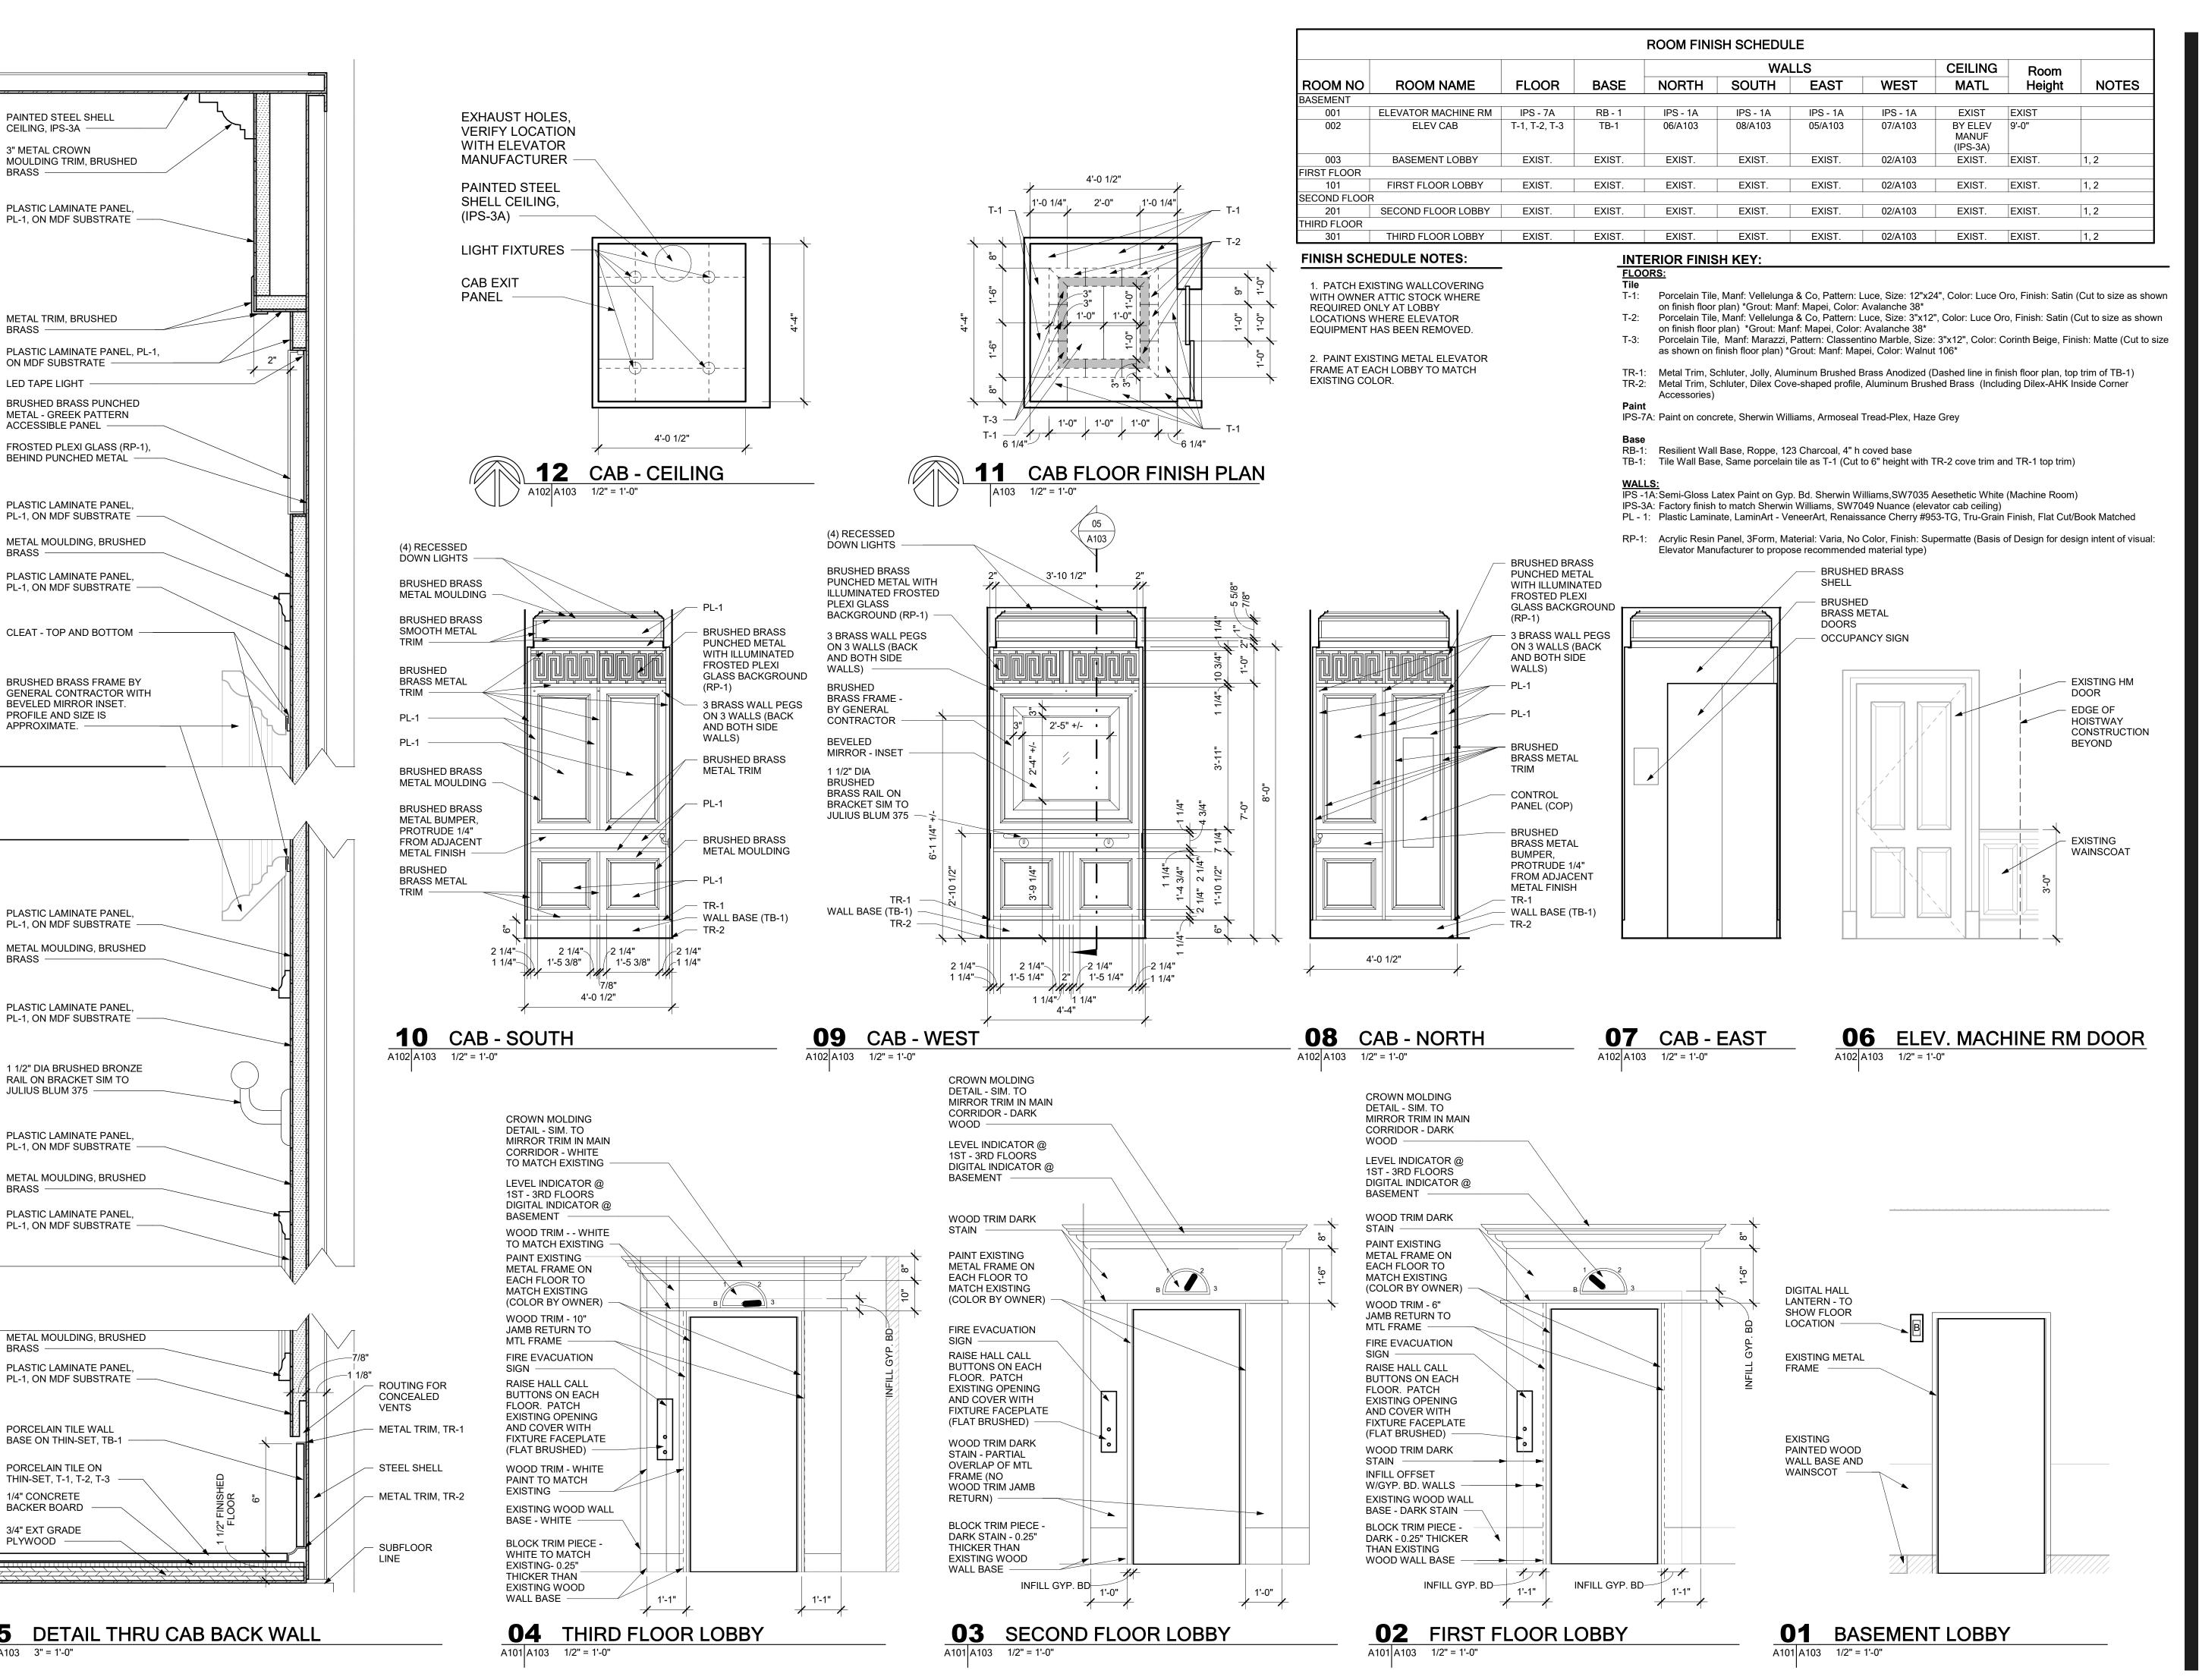

**STATE OF MISSOURI** MIKE PARSON, **GOVERNOR** 





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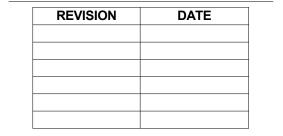
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CAD DWG FILE DRAWN BY: KMT CHECKED BY: NBB DESIGNED BY: SOA

SHEET TITLE:

**INTERIOR** ELEVATIONS, CAB DETAILS, & ROOM FINISH SCHEDULE

SHEET NUMBER:

SHEET 5 OF 14 ISSUE DATE: 10/28/2022

- 1. Reinforced Concrete (Division 3):
  - A. Design codes Building Code Requirements for Reinforced Concrete (ACI 318), latest adoption. B. Material strengths
    - 1) Concrete compressive strength (fc) at 28 days:
  - a. All concrete 4,000 psi 2) Slump
  - a. Slump

) All concrete 2" to 4" 3) Reinforcing steel a Bars and ties ASTM A615, Grade 60 (Fy=60ksi)


- 1) Placement of conctete and reinforcement shall be in accordance with ACI and CRSI standards. Lap or dowel continuous bars with Class B splices per ACI 318 unless noted
  - otherwise. Lap or dowel bars 50 bar diameters minimum. 2) Reinforcing showen on details is for concept only, follow CRSI placement and cover
  - requirements unless noted otherwise. 3) Furnish the following concrete cover at reinforcing bars unless shown otherwise on the
  - a. Slab 3" cover at bottom and sides. Provide 2" cover at top.
  - 4) Maximum aggregate size shall not exceed 3/4 the concrete cover (i.e. 3/4" max aggregate for

### 2. Structural Steel (Division 5):


- A. Design Code: Specifications for the Design, Fabrication and Erection of Structural Steel for Buildings (AISC), latest adoption.
- B. Material Strengths:
  - 1) Structural Steel Rolled Wide Flange Shapes ASTM A992, Grade 50 (Fy=50ksi)
  - 2) Angles, channels, plates (including tread plate), and bars ASTM A36 (Fy=36ksi)
  - 3) Structural steel HSS tubing ASTM A500, Grade C (Fy=50ksi)
  - 4) Connection bolts ASTM F3125 Grade A325, Type 1, ASTM A563 heavy hex carbon-steel nuts and ASTM F436 hardened carbon-steel washers
  - 5) Adhesive/epoxy anchors ASTM F1554, Grade 36 (Fy=36ksi)
  - 6) Welds E70XX (Fexx=70ksi) electrodes per AWS D1.1 steel
- C. Notes 1) All structural steel shall be fabricated and erected according to the specifications of The
  - American Institute of Steel Construction (AISC), latest adoption. 2) Steel shop drawings shall include erection plansshowing connections, beam elevations and
  - 3) Structural steel shall be shipped with standard shop primer. See architectural specifications for primer and paint coating (if required).
  - 4) Bolts shall be placed at 3" spacing, 1 1/4" edge distance, standard gage, and thru standard
  - holes unless noted otherwise. 5) Shop connections may be welded or bolted using 3/4" (A325) diameter bolts. Field
  - connections shall be bolted using 3/4" (A325) diameter bolts.
  - 6) All structural steel shop and field welding shall be completed by an AWS certified welder. 7) Field cutting of structural members (inculding holes) and member splices (field or shop splices) will not be permitted unless shown on the shop drawings and without written
- 3. Wood Framing Rough Carpentry, Wood Products, and Wood Trusses (Division 6):

authorization of architect/engineer.

- A. Design codes:
  - 1) National Design Specification for Wood Construction (NDS), latest adoption. 2) Install rough carpentry work to comply with American Institute of Timber Construction (AITC). Timber Construction (TC) Manual, latest adoption and recommendations of the product
- manufacturer. B. Material Strengths:
  - 1) All wood stick framing shall be Southern Pine, No. 2 Grade (graded inder SPIB rules) or
  - 2) Lumber for miscellaneous uses may be "standard" grade light-framing-size lumber of any species for support of other construction, including rooftop equipment and support bases, cant strips, bucks, nailers, blocking, furring, grounds, stripping and similar members. 3) Fasteners:
  - a. Nails, wire, brads, and staples: ASTM F547
  - b. All nails shall be common wire nails unless notes otherwise. Nails shall be driven so that heads are flush with the wood surface. Over or under driven nails will not be acceptable. Nail sizes on drawings shall be as shown unless noted otherwise.
    - i) 16d, 0.162" shank diameter, 3 1/2" length
    - ii) 10d, 0.148" shankdiameter, 3" length
  - iii) 8d, 0.131" shank diameter, 2 1/2" length iv) 6d, 0.113" shank diameter, 2" length
  - c. Bolts: ASTM A307. Grade A. or ASTM A36.

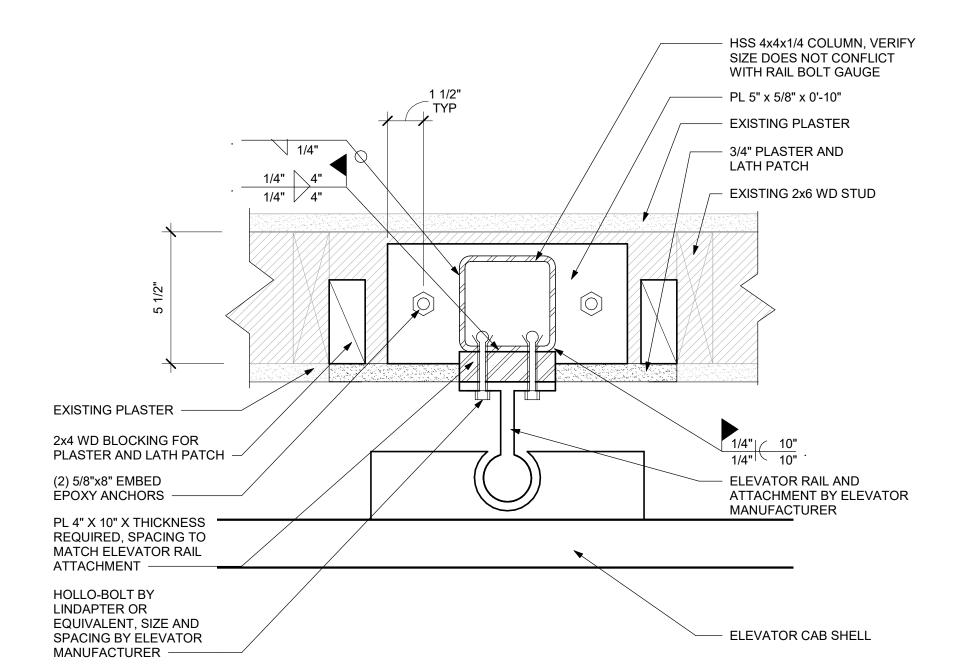


**03** COL BASEPLATE AND COL AT RAIL SUPPORT PLAN DETAIL

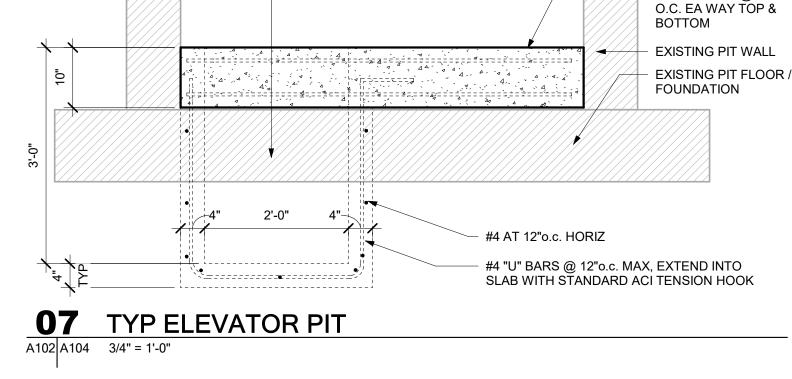

SUMP PIT BEYOND


10" THICK OVERBUILT

SLAB W/ #5'S @ 12"

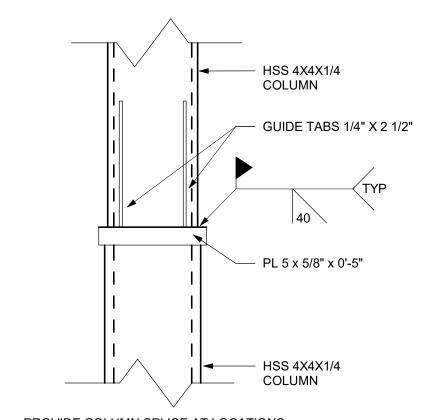


PROVIDE COLUMN SPLICE AT LOCATIONS WHERE REQUIRED FOR ERECTION

# **06** COLUMN SPLICE DETAIL

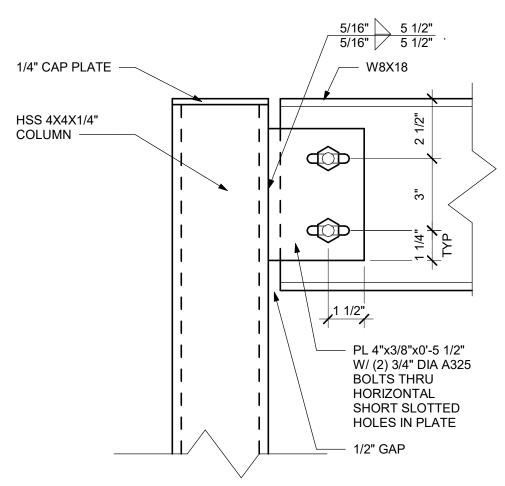

HSS AND HOIST BEAM CONNECTION A102 A104 3" = 1'-0"

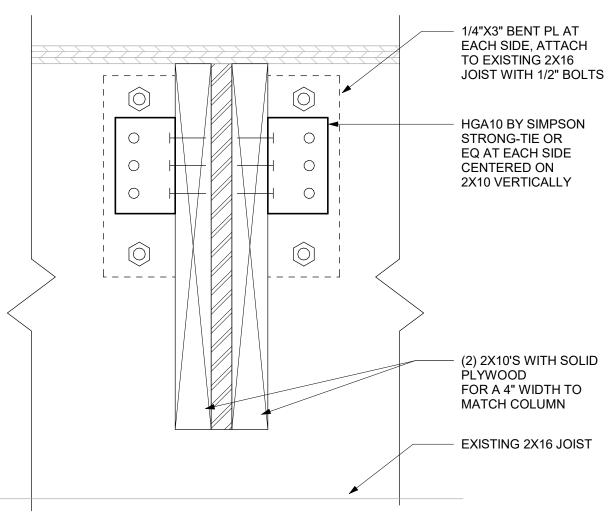


**02** COLUMN BRACING BLOCKING DETAIL A104 A104 3" = 1'-0"








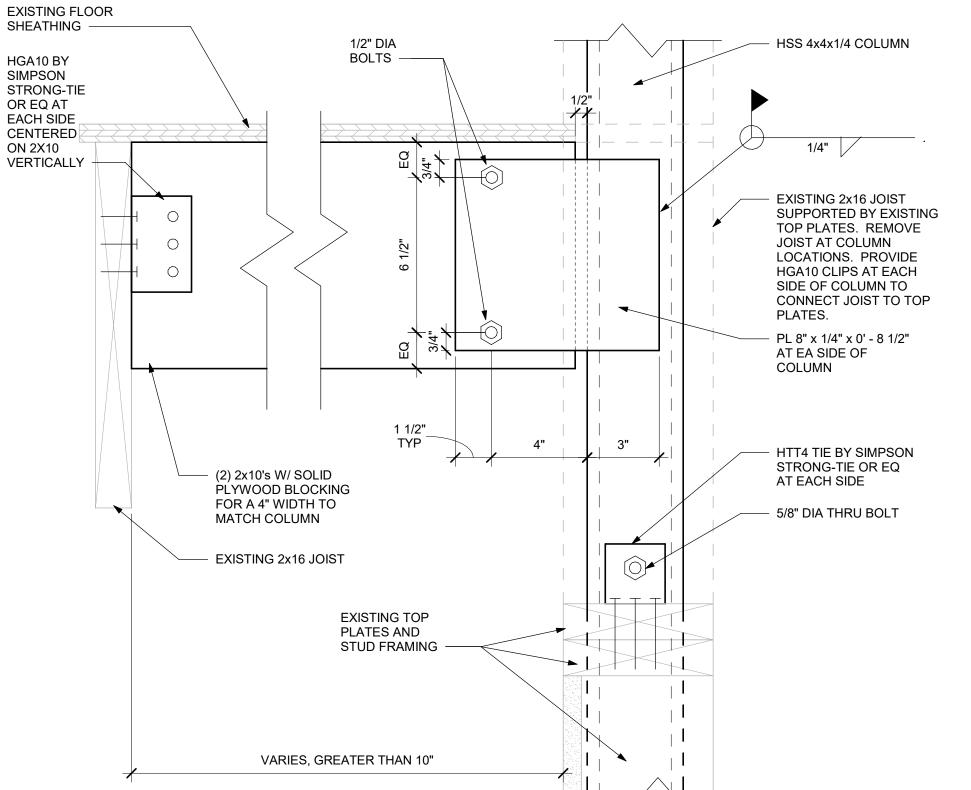

**04** COLUMN BRACING DETAIL AT FLOOR/ROOF - WIDE SPACE TO JOIST

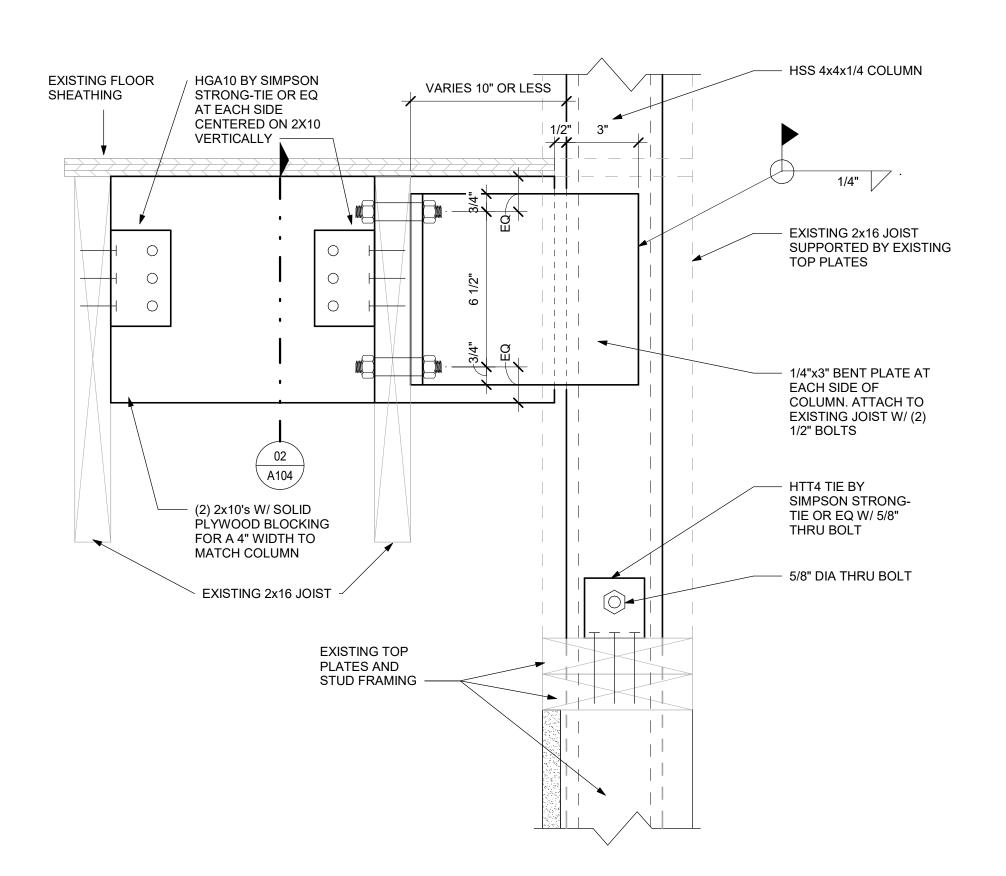

**01** COLUMN BRACING DETAIL AT FLOOR/ROOF - NARROW SPACE TO JOIST



Bethany Hagemann - Engineer MO # 2019000168

The Structural Engineer, whose signature appears on the dual-sealed drawings, sheet A104, assumes responsibility only for structural elements that appear on these drawings, and disclaims (pursuant to Section 327.11 RsMo) any responsibility for all other plans, specifications, estimates, reports, or other documents or instruments not sealed by the above Structural Engineer relating to, or intended to be used for, any part or parts of the project to which these drawings refer.

Architecture Interior Design

**STRUCTURAL ENGINEER:** 

Missouri Certificate of Authority Number: 000826

STATE OF MISSOURI

JENNIFE

MARIE

Jennifer M. Hedrick - Architect

License No. A-5419

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REVISION

ISSUE DATE: 10/28/2022

CAD DWG FILE: DRAWN BY: KMT CHECKED BY: NBB DESIGNED BY: SOA

SHEET TITLE:

**DETAILS AND** STRUCTURAL NOTES

SHEET NUMBER:

SHEET 6 OF 14 ISSUE DATE: 10/28/2022

	ABBREVIATIONS		ABBREVIATIONS
ABBREV.	DESCRIPTION	ABBREV.	DESCRIPTION
AAV	AUTOMATIC AIR VENT	GA	GAUGE
ABAN ABV	ABANDON ABOVE	GAL V	GALLON GAL VANIZED
AC	AIR CONDITIONING UNIT	GRD	GROUND
ACC	AIR COOLED CONDENSER	GPM	GALLON PER MINUTE
ACU AD	AIR COOLED CONDENSING UNIT  ACCESS DOOR	GSNK GSNK	GRILLE GOOSENECK
AF	AFTER FILTER	HC	HEATING COIL
AFF AHU	ABOVE FINISHED FLOOR	HX	HEAT EXCHANGER
AMB	AIR HANDLING UNIT  AMBIENT	HP HORIZ	HORIZONTAL HORSEPOWER
APPROX	APPROXIMATE	HP	HIGH PRESSURE
ARCH AS	ARCHITECTURAL  AIR SEPARATOR	HPT HTG	HIGH POINT  HEATING
ATM	ATMOSPHERE	HZ	HERTZ
ATMV	ATMOSPHERIC VENT	//V	INCHES
AWT BDD	AVERAGE WATER TEMPERATURE  BACKDRAFT DAMPER	LAT	KILOWATT  LEAVING AIR TEMPERATURE
BFWP	BOILER FEED WATER PUMP	LB	POUND
BFW	BOILER FEED WATER	LD	LINEAR DIFFUSER
BHP BLDG	BRAKE HORSEPOWER BUILDING	LWBT LWBT	LEAVING DRY BULB TEMPERATURE  LEAVING WET BULB TEMPERATURE
BLWDN	BLOWDOWN	LWT	LEAVING WATER TEMPERATURE
BS	BLOWDOWN SEPARATOR	M	MOTORIZED DAMPER
BLR BLW	BOILER BELOW	MAT MAX	MIXED AIR TEMPERATURE  MAXIMUM
BM BM	BEAM	MBTU	BRITISH THERMAL UNIT (1000)
BOT	BOTTOM	MCC	MOTOR CONTROL CENTER
BOD BSMT	BOTTOM OF DUCT  BASEMENT	MECH MEZZ	MECHANICAL MEZZANINE
BTU	BRITISH THERMAL UNIT	MIN	MINIMUM
BTUH	BTU PER HOUR	MISC	MISCELLANEOUS
C C/C	CONVERTER  CENTER TO CENTER	NA NC	NOT APPLICABLE  NORMALLY CLOSED
CC	COOLING COIL	NO	NORMALLY OPEN
CF CF14	CUBIC FEET DEP MINUTE	NTS	NOT TO SCALE
CFM CFP	CUBIC FEET PER MINUTE  CHEMICAL FEED PUMP	OA OC	OUTSIDE AIR ON CENTER
СН	CHILLER	OD	OUTSIDE DIAMETER
CJ CL	CONSTRUCTION JOINT CENTER LINE	OPNG OPWT	OPENING  OPERATING WEIGHT
CLG	CEILING	P	PUMP
CLR	CLEAR	PA	PIPE ANCHOR
CO COL	CLEANOUT COLUMN	PCF PEN	POUNDS PER CUBIC FOOT  PENETRATION
CONC	CONCRETE	PERF	PERFORATOR
COND	CONDENSATE	PL	PLATE
CONDR CONN	CONDENSOR CONNECTION	PRV PSIA	PRESSURE REDUCING VALVE  POUNDS PER SQUARE INCH (ABSOLUTE)
CONT	CONTINUATION/CONTINUOUS	PSIG	POUNDS PER SQUARE INCH (GAUGE)
CONV	CONVECTOR	RA	RETURN AIR
COP CP	COEFFICIENT OF PERFORMANCE  CONTROL PANEL	RD RET	RETURN DIFFUSER RETURN
CPF	CHEMICAL POT FEEDER	RF	RETURN FAN
CRP	CONDENSATE RETURN PUMP	RG	RETURN GRILLE
CT CU FT	COOLING TOWER  CUBIC FEET	RH RHC	RELATIVE HUMIDITY  REHEAT COIL
CU IN	CUBIC INCHES	RPM	REVOLUTIONS PER MINUTE
DB DEC	DRY BULB	S	STEAM TRAP
DEG DEMO	DEGREE FAHRENHEIT  DEMOLITION	SA SD	SUPPLY AIR SUPPLY DIFFUSER
DET	DETAIL	SF	SUPPLY FAN
DIA DIM	DIAMETER  DIMENSION	SG SP	SUPPLY GRILLE STATIC PRESSURE
DLV DLV	DOOR LOUVER	SQ FT	SQUARE FEET
DMPR	DAMPER	SRV	SAFETY RELIEF VALVE
DN DR	DOWN DRAIN	SS SST	STEAM SEPARATOR STAINLESS STEEL
DWG DWG	DRAWNG	ST	SOUND ATTENUATOR
EX	EXISTING	STL	STEEL
EA EAT	EACH ENTERING AIR TEMPERATURE	STM STRUCT	STEAM STRUCTURAL
EDBT	ENTERING DRY BULB TEMPERATURE	TEMP	TEMPERATURE
EF	EXHAUST FAN	TFA TER	TO FLOOR ABOVE
EFF EJ	EFFICIENCY EXPANSION JOINT	TFB TG	TO FLOOR BELOW  TRANSFER GRILLE
ELEC	ELECTRICAL	THK	THICK
ELEV	ELEVATION	TNL	TUNNEL
ENT EQ	ENTERING FOUAL	UFD UFD	TYPICAL  UNDERFLOOR DUCT
ET	EXPANSION TANK	UG	UNDERGROUND
EXH	EXHAUST	UON	UNLESS OTHERWISE NOTED
EXP EXT	EXPANSION EXTERIOR	VA V VB	VARIABLE AIR VOLUME  VACUUM BREAKER
EWBT	ENTERING WET BULB TEMPERATURE	VD VB	VOLUME DAMPER
EWT	ENTERING WATER TEMPERATURE	VFD	VARIABLE FREQUENCY DRIVE
FA FCV	FACE AREA FLOW CONTROL VALVE	VIF W/	VERIFY IN FIELD WITH
FD	FIRE DAMPER	W/   WB	WET BULB
FF	FINAL FILTER	WC	WATER COLUMN
FFA FER	FROM FLOOR ABOVE	WF WG	WATER FILTER
FFB	FROM FLOOR BELOW  FULL LOAD AMP	WG WMS	WATER GAUGE WIRE MESH SCREEN
FLA	FLOW MEASURING DEVICE	W/O	WITHOUT
FLA FMD		□ WT	WEIGHT
FMD FPM	FEET PER MINUTE	<del></del>	
FMD	FEET PER MINUTE  FIRE AND SMOKE DAMPER  FLOW SENSING SMITCH	WS	WATER SOFTENER
FMD FPM FSD	FIRE AND SMOKE DAMPER	<del></del>	

# MECHANICAL SHEET METAL SYMBOLS EXISTING DUCTWORK TO REMAIN EXISTING DUCTWORK TO BE REMOVED NEW DUCTWORK HAND DAMPER IN DUCT HAND DAMPER IN CONCEALED DUCT W/ CONCEALED DAMPER ACTUATOR HUMIDIFIER IN DUCT FIRE DAMPER WITH HINGED ACCESS DOOR (B) DENOTES 'B' STYLE DAMPER SMOKE DAMPER WITH HINGED ACCESS DOOR COMBINATION FIRE/SMOKE DAMPER WITH HINGED ACCESS DOOR RECTANGULAR TO ROUND BRANCH CONNECTION FROM MAIN DUCT RECTANGULAR TO ROUND BRANCH CONNECTION FROM MAIN DUCT WITH HAND DAMPER IN ROUND SECTION RECTANGULAR TO ROUND TRANSITION RECTANGULAR TO ROUND TRANSITION WITH HAND DAMPER CEILING SUPPLY OUTLET. (A) DENOTES DIFFUSER TYPE. (300) DENOTES CFM. SEE SCHEDULE FOR SIZE. ARROWS INDICATE DIRECTION OF THROW. NO ARROWS (A) 300 INDICATE 4-WAY THROW. CEILING SUPPLY OUTLET WITH FLEXIBLE DUCT CONNECTION. **→** ₩ **→** (A) DENOTES DIFFUSER TYPE. (300) DENOTES CFM. SEE SCHEDULE FOR FACE SIZE AND FLEXIBLE DUCT (NECK) SIZE. ARROWS INDICATE DIRECTION OF THROW. NO ARROWS INDICATE 4-WAY THROW. CEILING RETURN OR EXHAUST GRILLE. (A) DENOTES GRILLE TYPE. (300) DENOTES CFM. SEE SCHEDULE FOR SIZE. (A) 300 WALL SUPPLY GRILLE. A DENOTES GRILLE TYPE. (600) DENOTES CFM. SEE SCHEDULE FOR SIZE. WALL RETURN OR EXHAUST GRILLE. (A) DENOTES GRILLE TYPE. (600) DENOTES CFM. SEE SCHEDULE FOR SIZE. VARIABLE AIR VOLUME BOX VARIABLE AIR VOLUME BOX WITH REHEAT COIL RECTANGULAR DUCT TRANSITION IN SINGLE LINE DUCTWORK RECTANGULAR TO ROUND TRANSITION IN SINGLE LINE DUCTWORK CEILING RETURN GRILLE WITH LINED BOOT ABOVE FINISH CEILING — FREE AREA OF BOOT = 2/3 OF GRILLE FACE. (A) DENOTES GRILLE TYPE. (300) DENOTES CFM. SEE DIFFUSER SCHEDULE FOR SIZE. LINED RETURN AIR BOOT WITH TURNING VANES ABOVE CEILING - SIZE OF BOOT IS INDICATED ON DRAWINGS

### MECHANICAL PIPING SYMBOLS ----- EXISTING PIPING TO REMAIN — — — EXISTING PIPING TO BE REMOVED ----- NEW PIPING — HWS — HOT WATER SUPPLY — HWR — HOT WATER RETURN — LPS — STEAM SUPPLY (LOW PRESSURE) — LPR — STEAM RETURN (LOW PRESSURE) - MPS - STEAM SUPPLY (MEDIUM PRESSURE) — MPR — STEAM RETURN (MEDIUM PRESSURE) — HPS — STEAM SUPPLY (HIGH PRESSURE) — HPR — STEAM RETURN (HIGH PRESSURE) --- SV --- STEAM RELIEF VENT — CWS — CHILLED WATER SUPPLY --- CWR --- CHILLED WATER RETURN — CHS — CHILLED/HOT WATER SUPPLY — CHR — CHILLED/HOT WATER RETURN —— SWS —— SECONDARY WATER SUPPLY ----- SWR ---- SECONDARY WATER RETURN --- TS --- COOLING TOWER SUPPLY ---- TR ---- COOLING TOWER RETURN ---- RS ---- REFRIGERANT SUCTION PIPING ---- RL ---- REFRIGERANT LIQUID PIPING ---- HG ---- HOT GAS PIPING — GS — GLYCOL SUPPLY PIPING ---- GR ---- GLYCOL RETURN PIPING ---- PD ---- PUMP DISCHARGE ----- CD ----- CONDENSATE DRAIN PIPING -----CDS----- CONDENSER WATER SUPPLY —— SMS —— SNOW MELTING SYSTEM SUPPLY 7 THERMOSTAT HUMIDISTAT CONNECTION - NEW TO EXISTING FLOAT AND THERMOSTATIC TRAP <del>------+♥+------</del> SHUT-OFF VALVE GLOBE VALVE — +♥+ CHECK VALVE (SWING OR CUSHION) ───**♥** CONTROL VALVE ───<del>+♥+</del> LUBRICATED PLUG COCK ───────── SOLENOID VALVE PRESSURE RELIEF VALVE → PRESSURE REDUCING VALVE PIPE ANCHOR → DIRECTION OF FLOW IN PIPES DIRECTION OF PITCH IN PIPES ────────────────────────── RISE AND DROP IN PIPING

BRANCH PIPING CONNECTION (TOP OF PIPE)

BRANCH PIPING CONNECTION (BOTTOM OF PIPE)

*WELDED ELBOW* 

EXPANSION JOINT

# PLUMBING SYMBOLS

——c—	COLD WATER PIPING
— — н —	HOT WATER PIPING
—— ——НС—	HOT WATER CIRCULATING PIPING
	VENT PIPING
	WASTE PIPING
SW	SAFE WASTE PIPING
—— DS ——	DOWNSPOUT PIPING
—— EDS ——	
—— G ——	GAS PIPING
—— FOS ——	FUEL OIL SUPPLY PIPING
—— FOR ——	FUEL OIL RETURN PIPING
—— A ——	
— — A — —	ACID VENT PIPING
DI	
sc	SOFT COLD WATER PIPING
RO	
——ETO——	ETHYLENE OXIDE PIPING
—— PD ——	PUMP DISCHARGE
—— TW ——	TEMPERED WATER PIPING
DW	
—— CA ——	
>-(CA)	COMPRESSED AIR OUTLET
co	CLEANOUT
FCO	FLUSH CLEANOUT
Ø RD	ROOF DRAIN
	EMERGENCY ROOF DRAIN
Ø FD	FLOOR DRAIN
Ø FFD	FLOOR DRAIN WITH FUNNEL
Ø 11 D Ø SFD	SAFE WASTE FLOOR DRAIN
-0+ HB	HOSE BIBB
-0+ WH	WALL HYDRANT
	VENT THRU ROOF
	SHUT-OFF VALVE
	BALANCING VALVE
	GLOBE VALVE (SWING OR CUSHION)
<u> </u>	CHECK VALVE (SWING OR CUSHION)  CONTROL VALVE
₩	LUBRICATED PLUG COCK
∑\ ∑\	SOLENOID VALVE
	PRESSURE RELIEF VALVE  PRESSURE REDUCING VALVE
———·	
	WYE STRAINER
	UNION
	PIPE ANCHOR
	FLOW ELEMENTS

→ DIRECTION OF FLOW IN PIPES

DIRECTION OF PITCH IN PIPES

*WELDED ELBOW* 

BRANCH PIPING CONNECTION (BOTTOM OF PIPE)

EXPANSION JOINT

# TEMPERATURE CONTROLS SYMBOLS

	PNEUMATIC PIPING
	ELECTRIC WIRING
<del>////</del>	PARALLEL BLADE DAMPER
<del>/ \                                   </del>	OPPOSED BLADE DAMPER
<u></u>	HUMIDIFIER
<b>\( \lambda \)</b>	AVERAGE SENSING ELEMENT
	AIR FLOW PROBE
$\Box$	DAMPER ACTUATOR
$\bigcirc$	3-1/2" DIAL THERMOMETER
	ROOM THERMOSTAT
$\boxtimes$	MOTOR STARTER
(W)	WARM UP
DP	DIFFERENTIAL PRESSURE SWITCH
ES	END SWITCH
HL	HIGH LIMIT SWITCH
HS	HUMIDITY SENSOR
HX	HEAT EXCHANGER
SD	SMOKE DETECTOR
SP	STATIC PRESSURE SENSOR
TS	TEMPERATURE SENSOR
<b>VFD</b>	VARIABLE FREQUENCY DRIVE
VS	VELOCITY SENSOR
<b>A</b>	LOCATED IN CONTROL CABINET
$\triangle$	LOCATED ON CONTROL CABINET DOOR
Al	ANALOG INPUT
AO	ANALOG OUTPUT
С	COMMON
DA	DIRECT ACTING
DDC	DIRECT DIGITAL CONTROL
DI	DIGITAL INPUT
DO	DIGITAL OUTPUT
NC	NORMALLY CLOSED
NO	NORMALLY OPEN
POF	PROOF OF FLOW
RA	REVERSE ACTING
S/S	START/STOP

CURRENT RELAY

# GENERAL MECHANICAL NOTES

- THE LOCATION OF ALL STRUCTURAL OPENINGS SHALL BE AS INDICATED ON THE MECHANICAL, STRUCTURAL AND ARCHITECTURAL DRAWINGS. COORDINATE EXACT SIZES OF OPENINGS REQUIRED.
- 2. ALL EQUIPMENT SHALL BE INSTALLED IN STRICT ACCORDANCE WITH THE EQUIPMENT MANUFACTURER'S RECOMMENDATIONS. PROVIDE ALL FITTINGS, TRANSITIONS, DAMPERS, VALVES AND OTHER DEVICES REQUIRED FOR A COMPLETE WORKABLE
- 3. ALL DUCTWORK SHALL BE CONSTRUCTED, ERECTED AND TESTED IN ACCORDANCE WITH THE MOST RESTRICTIVE OF LOCAL REGULATIONS, PROCEDURES DETAILED IN THE ASHRAE HANDBOOK OF FUNDAMENTALS, OR THE APPLICABLE STANDARDS ADOPTED BY THE SHEET METAL AND AIR CONDITIONING CONTRACTORS NATIONAL ASSOCIATION.
- 4. DUCT AND PLENUM SIZES INDICATED ON THE DRAWINGS ARE SHEET METAL
- 5. CONTRACTOR SHALL FIELD VERIFY CLEARANCE ABOVE THE CEILING AND NOTIFY THE ENGINEER ABOUT POSSIBLE CONFLICTS.
- 6. DRAWINGS ARE DIAGRAMMATIC AND INDICATE GENERAL ARRANGEMENT OF SYSTEMS AND WORK INCLUDED. FOLLOW DRAWINGS IN LAYING OUT WORK AND CHECK DRAWINGS OF OTHER TRADES RELATING TO WORK TO VERIFY SPACE IN WHICH WORK WILL BE INSTALLED. MAINTAIN HEADROOM AND SPACE CONDITIONS AT ALL TIMES.
- 7. IT IS THE RESPONSIBILITY OF THIS CONTRACTOR TO COORDINATE ALL WORK WITH ALL OTHER TRADES. THE SHOP DRAWINGS PREPARED BY THIS CONTRACTOR SHALL INDICATE SPACE ALLOWANCES FOR ALL WORK OF ALL OTHER TRADES AND SHALL BE SIGNED OFF BY ALL OTHER CONTRACTORS.
- 8. CONTRACTOR SHALL COMPLY WITH ALL APPLICABLE BUILDING CODE REQUIREMENTS AND PROVIDE ALL REQUIRED CONTROLLED INSPECTIONS FOR HIS WORK.
- 9. PROVIDE ESCUTCHEONS AND SEALING OF ALL PENETRATIONS OF FIRE SEPARATIONS IN ACCORDANCE WITH THE BUILDING CODE AND DETAIL DRAWINGS.
- 10. CONTRACTOR SHALL VERIFY ON—SITE ALL CONDITIONS AND MEASUREMENTS SHOWN ON CONTRACT DRAWINGS.
- 11. MECHANICAL CONTRACTOR IS RESPONSIBLE TO FURNISH DISCONNECT SWITCHES AND MOTOR STARTERS FOR ALL HVAC EQUIPMENT. FOR INSTALLATION AND WIRING, MECHANICAL CONTRACTOR SHALL COORDINATE WITH DIVISION 23.
- 12. WHERE EQUIPMENT AND/OR PIPING AND/OR DUCTWORK IS NOTED TO BE DEMOLISHED, COORDINATE WITH GENERAL CONTRACTOR PRIOR TO REMOVAL OR ENSURE THAT REMOVAL OR EQUIPMENT FALLS WITHIN PRESENT CONSTRUCTION LIMITS AND SCOPE OF WORK
- 13. ALL STORED AND/OR PARTIALLY INSTALLED SHEET METAL, PIPING, AND EQUIPMENT SHALL BE PROTECTED FROM WEATHER. CONTRACTOR SHALL COVER OPEN ENDS AT END OF WORK DAY.


### PLUMBING GENERAL NOTES:

- 1. ALL MATERIALS AND WORKMANSHIP SHALL CONFORM TO ALL APPLICABLE LOCAL CODES AND REGULATIONS.
- 2. DRAWINGS ARE DIAGRAMMATIC AND INDICATE GENERAL ARRANGEMENT OF SYSTEMS AND WORK INCLUDED. FOLLOW DRAWINGS IN LAYING OUT WORK AND CHECK DRAWINGS OF OTHER TRADES RELATING TO WORK TO VERIFY SPACE IN WHICH WORK WILL BE INSTALLED. MAINTAIN HEADROOM AND SPACE CONDITIONS AT ALL TIMES.
- COORDINATE PLUMBING SYSTEMS WITH WORK OF ALL OTHER TRADES PRIOR TO ANY FABRICATION OR INSTALLATION. PROVIDE ALL FITTINGS, OFFSETS AND

TRANSITIONS AS REQUIRED FOR A COMPLETE WORKABLE INSTALLATION.

- 4. ALL EQUIPMENT SHALL BE INSTALLED IN STRICT ACCORDANCE WITH THE EQUIPMENT MANUFACTURER'S RECOMMENDATIONS AND APPLICABLE CODES. PROVIDE ALL FITTINGS, TRANSITIONS, VALVES AND OTHER DEVICES REQUIRED FOR A COMPLETE WORKABLE INSTALLATION.
- 5. MAINTENANCE LABEL SHALL BE AFFIXED TO ALL PLUMBING EQUIPMENT AND A MAINTENANCE MANUAL SHALL BE PROVIDED TO OWNER.
- 6. WHERE EQUIPMENT AND/OR PIPING IS NOTED TO BE DEMOLISHED, COORDINATE WITH GENERAL CONTRACTOR PRIOR TO REMOVAL TO ENSURE THAT REMOVAL OF EQUIPMENT FALLS WITHIN PRESENT CONSTRUCTION LIMITS AND SCOPE OF WORK.
- 7. PLUMBING CONTRACTOR IS RESPONSIBLE TO FURNISH DISCONNECT SWITCHES AND MOTOR STARTERS FOR ALL PLUMBING EQUIPMENT. FOR INSTALLATION AND WIRING, PLUMBING CONTRACTOR SHALL COORDINATE WITH ELECTRICAL SPECIFICATIONS

STATE OF MISSOURI MIKE PARSON, GOVERNOR

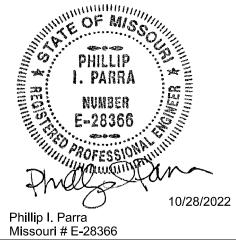



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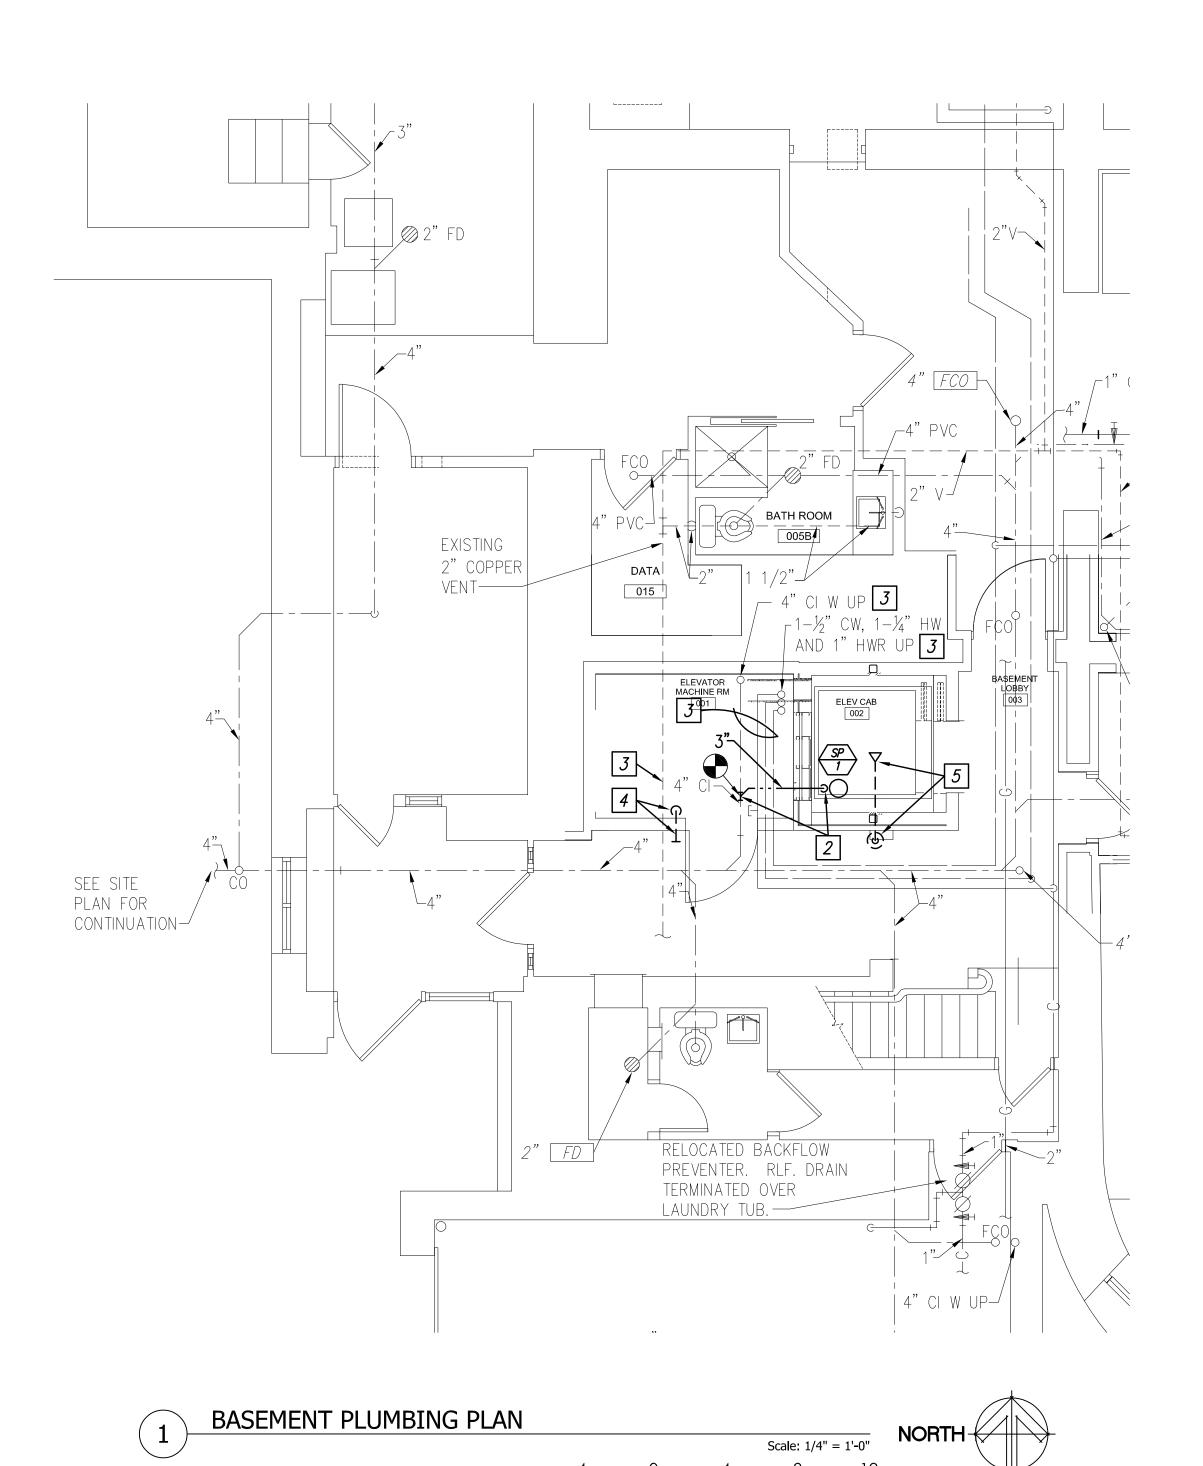
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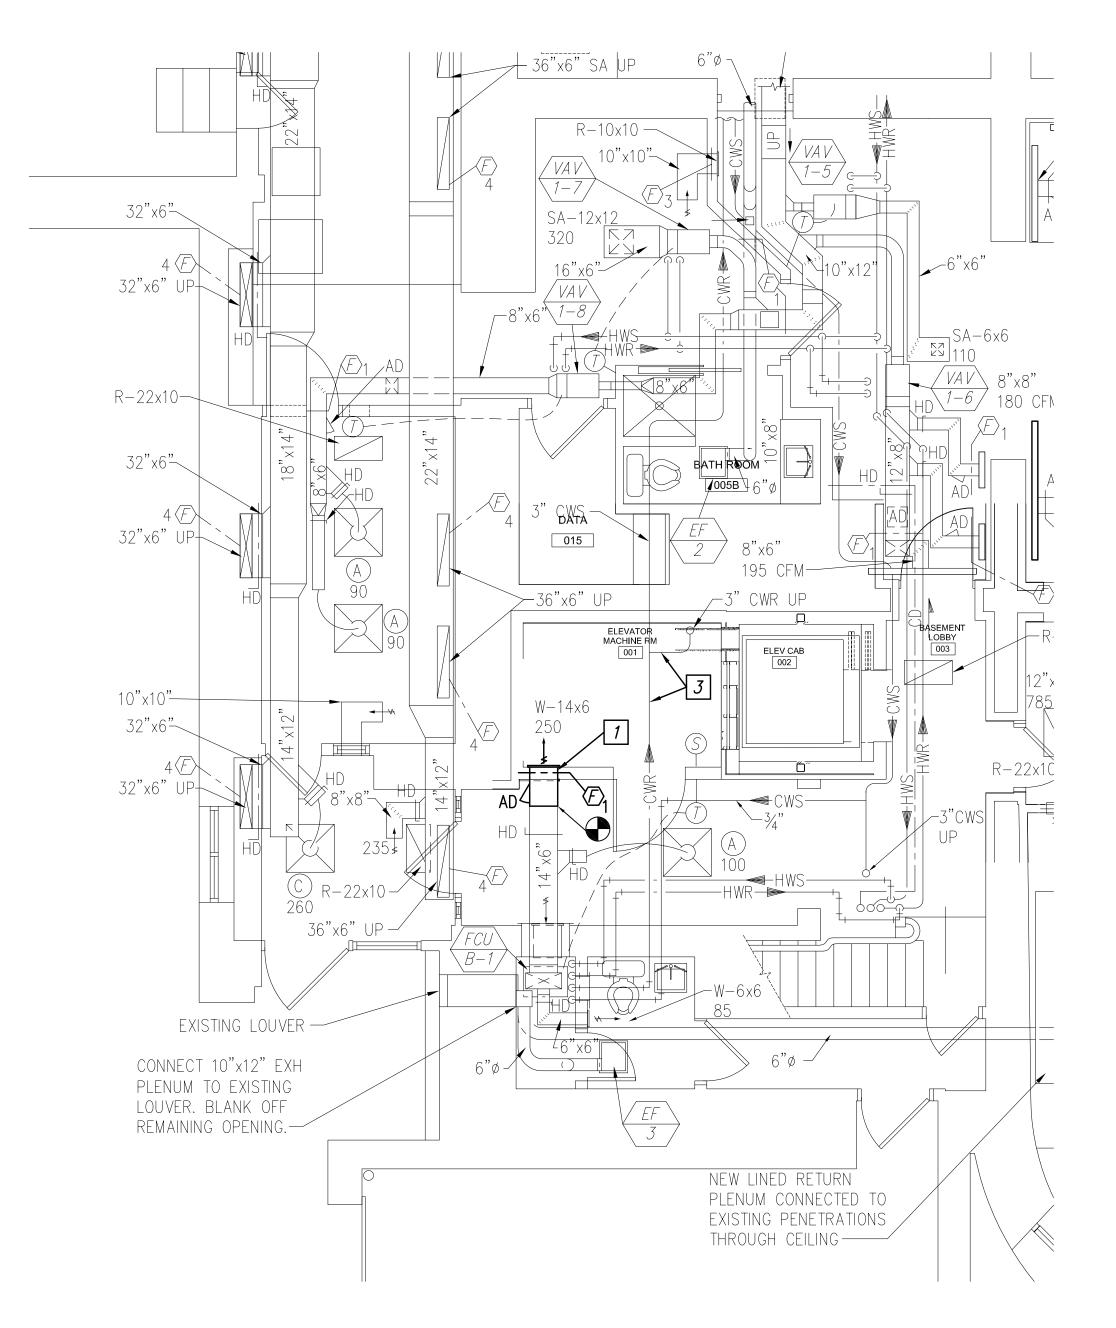
SHEET TITLE:

PLUMB/MECH
GENERAL NOTES,
SYMBOLS &
ABBREVIATIONS

SHEET NUMBER:

PM000 SHEET 7 OF 14 ISSUE DATE: 10/28/2022








1. THIS IS A HISTORIC BUILDING AND ALL DUCTWORK, PIPING & WIRING SHALL BE RUN CONCEALED FROM VIEW & <u>ALL</u> ROUTING SHALL BE APPROVED BY ARCHITECT BEFORE INSTALLATION. COORDINATE WHERE EXISTING FINISH MATERIALS NEED TO BE REMOVED FOR INSTALLATION AND PATCH TO MATCH EXISTING.

### **KEYED NOTES:**

- DISCONNECT & REMOVE SECTION OF EXISTING SUPPLY DUCT AS REQUIRED TO INSTALL GRILL ACCESS HAND DAMPER. CLEAN AND SALVAGE SUPPLY GRILLE FOR REINSTALLATION.
- 2 3"PD DOWN TO SUMP PUMP IN PIT. ROUTE PIPING BELOW SLAB AND CONNECT TO EXISTING 4" C.I. WASTE MAIN.
- 3 EXISTING PIPING AND ASSOCIATED DRIP PANS BELOW TO REMAIN.
- 4 DISCONNECT & REMOVE EXISTING 3/4" COLD WATER LINE & ASSOCIATED SUPPORTS. CAP AT MAIN IN THE CORRIDOR.
- DISCONNECT & REMOVE EXISTING DRY CHEMICAL FIRE EXTINGUISHING SYSTEM LOCATED IN 3RD FLOOR UTILITY ROOM INCLUDING CYLINDER, HEADS, PIPING, CONTROL PANEL & INITIATING DEVICES PATCH SHAFT PENETRATIONS.

### STATE OF MISSOURI MIKE PARSON, GOVERNOR

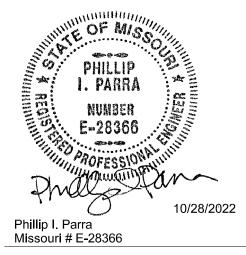



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SHEET 8 OF 14


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SP #	SUMP PUMP SCHEDULE												
					PUMP		PUMP	MOTOR DAT	TΑ		MOTOR CONTROL DATA		
MARK	AREA SERVED	MANUFACTURER	MODEL	GPM	HEAD (FT.)	MIN HP	RPM	VOLTS	PHASE	STARTER/DISC. SWITCH	LOCAL CONTROL DEVICES @ STARTER	MISC. CONTROL & DEVICES	REMARKS
SP-1	ELEVATOR SHAFT	ZOELLER	N152	50	16	0.4	3450	120 V	1			PROVIDE WITH ALARM PANEL AND 8245 LEVEL CONTROL FLOAT.	PROVIDE WITH 24"x24"x36" DEEP CONCRETE PIT IN ELEVATOR SHAFT. PROVIDE WITH 300 PSF RATED SQUARE FIBERGLASS GRATE FOR LID. SYSTEM TO INCLUDE CHECK VALVE AT PUMP DISCHARGE, GATE VALVE AND UNION FOR SERVICING.

NOTES:

- 1. PUMP SHALL BE PROVIDED W/OIL SENSOR TO DISABLE PUMP IF HYDRAULIC FLUID IS DETECTED AND SHALL ALARM AT BUILDING MANAGEMENT SYSTEM.
- 2. ALARM PANEL TO BE NEMA 4X RATED, WITH INDICATOR LIGHT AND AUDIBLE LOCAL ALARM, AUXILIARY DRY


	FIRE AND SMOKE DAMPER SCHEDULE										
PLAN MARK	TYPE	MANUFACTURER	MODEL	OPERATOR	NOTES						
F-1	GRILLE ACCESS FD	RUSKIN	DIBD2GA	165° FUSIBLE LINK							

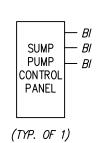

### **SUMP PUMP MONITORING**

BMS shall monitor high water alarm and pump status for the sump pump. Connect to FCU B-1 or other nearest controller with spare inputs.


SUMP PUMPS P	OIN	ITS	8 L	.IS	T			
SYSTEM		HAR[ POI	)WAR NTS	E	SO	FTWA	4 <i>RE</i>	GRAPHIC
POINT NAME	A/	40	BI	ВО	SCHEDULE	TREND	ALARM	SHOW ON GF
SUMP PUMP STATUS			Х				Х	Х
SUMP OIL DETECTION ALARM			Х				Х	Х
SUMP HIGH WATER ALARM STATUS			Х				Х	Х

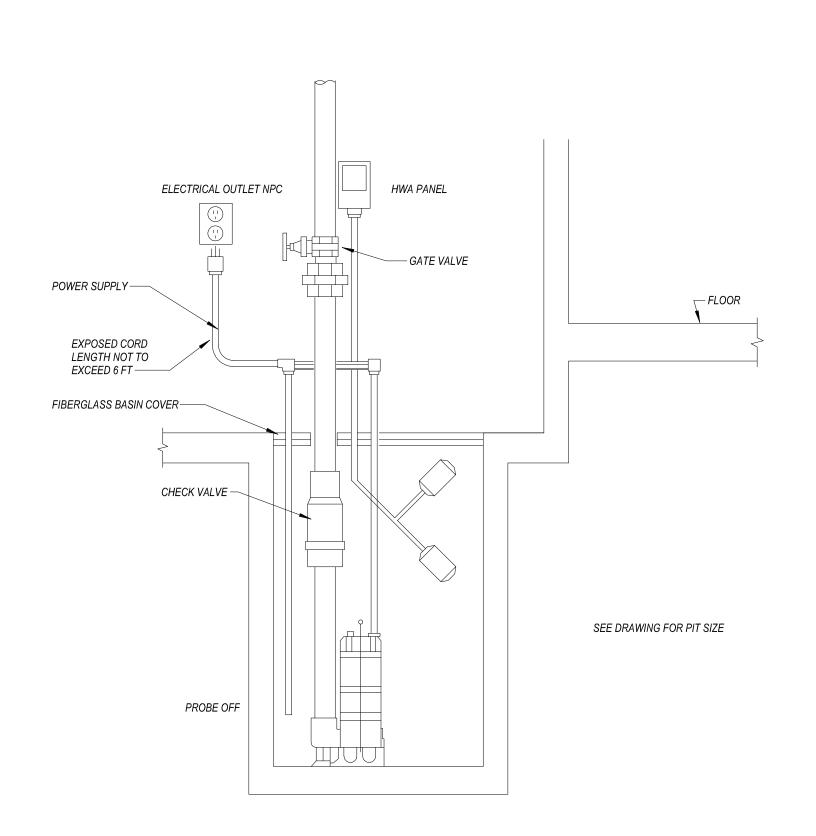



Scale: N.T.S.

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DETAILS
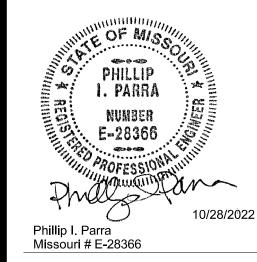
# **ELECTRICAL SYMBOLS LIST**

(ALL MAY NOT APPLY)

### **POWER SYMBOLS**

- HOMERUN TO SOURCE AS NOTED

  CONDUIT IN WALL OR CEILING CONSTRUCTION WITH ONE PHASE WIRE, ONE NEUTRAL WIRE AND ONE GROUND WIRE
- CONDUIT IN FLOOR OR BELOW GRADE CONSTRUCTION WITH ONE PHASE WIRE, ONE NEUTRAL WIRE AND ONE GROUND WIRE

  CONDUIT WITH WIRING (TWO PHASE WIRES, NEUTRAL
- AND GROUND WIRE)

  CONDUIT WITH #10 WIRE THROUGHOUT ENTIRE CIRCUIT
- CONDUIT WITH #10 WIRE THROUGHOUT ENTIRE CIRCUIT

  PARTIAL CIRCUIT, HOMERUN TO SOURCE AS NOTED

  LOW VOLTAGE WIRING
- PANELBOARD (DOUBLE LINE INDICATES
- FRONT OF PANELBOARD)

  ——□□□ MOTOR STARTER
- 4 DISCONNECTING SWITCH
- 452 COMB. MOTOR STARTER AND DISC. SWITCH
- NF NF DENOTES NON-FUSED

  MOTOR CONNECTION
- TRANSFORMER
- DUPLEX CONVENIENCE RECEPTACLE
- HEAVY DUTY OUTLET WITH NEMA
  6-20R CONFIGURATION
  - ⊕: CONVENIENCE RECEPTACLE MOUNTED HORIZONTALLY

GROUND FAULT CIRCUIT INTERRUPTER

- NUMBER INDICATES MOUNTING HEIGHT OF DEVICE (CENTER LINE ABOVE FLOOR) IF OTHER THAN SPECIFIED HEIGHT
- JUNCTION BOX
- WALL MOUNTED JUNCTION BOX
- Junction box mounted over ceiling
- -T<sub>F</sub> ELECTRIC THERMOSTAT WALL MOUNTED
- ] BUSHING AT END OF CONDUIT
- INDICATES DEVICE THAT SHALL BE MOUNTED ABOVE OR BELOW ARCHITECTURAL CASEWORK. CONTRACTOR SHALL REFER TO ARCHITECTURAL DETAILS AND ELEVATIONS AND COORDINATE EXACT LOCATION OF DEVICE. WHERE DEVICES ARE NOT SHOWN IN ARCHITECTURAL DETAILS, CONTRACTOR SHALL CONFIRM EXACT MOUNTING LOCATION WITH ARCHITECT.
- EM INDICATES LIGHT OR DEVICE CONNECTED TO EMERGENCY POWER OR FURNISHED WITH A BATTERY PACK CONNECTED TO A NON—
- EX EXISTING DEVICE, LIGHT, OR CONDUIT & WIRE

SWITCHED HOT WIRE

- TO REMAIN

  N NEW DEVICE IN EXISTING OUTLET BOX
- NL INDICATES NIGHT LIGHT FIXTURE CONNECTED TO A NON-SWITCHED HOT WIRE
- R EXISTING DEVICE, LIGHT, OR CONDUIT & WIRE TO BE REMOVED
- RB EXISTING DEVICE OR LIGHT TO BE REMOVED
- WITH BLANK COVER ON OUTLET BOX
  RL EXISTING DEVICE OR LIGHT RELOCATED
- RN EXISTING DEVICE OR LIGHT TO BE REMOVED AND
- OUTLET BOX REUSED FOR NEW DEVICE OR LIGHT

  RAINTIGHT DEVICE NEMA 3R
- TP TAMPER-PROOF DEVICE
- WP WEATHER-PROOF DEVICE
- VUH VERTICAL UNIT HEATER. REFER TO DETAIL FOR ALL WIRING REQUIRED. REFER TO FLOOR PLANS FOR LOCATIONS.

### FIRE ALARM SYMBOLS

- S SMOKE DETECTOR
- SMOKE DETECTOR ELEVATOR LOBBY
- H HEAT DETECTOR
- DOOR HOLDER WALL MOUNTED
- VA VISUAL/AUDIBLE ALARM NUMBER INDICATES
  CANDELA OUTPUT, LACK OF NUMBER INDICATES
  15/75 CANDELA OUTPUT
- 15/75 CANDELA OUTPUT

  VA VISUAL ALARM NUMBER INDICATES CANDELA
  OUTPUT, LACK OF NUMBER INDICATES
- 15/75 CANDELA OUTPUT

  FIRE ALARM CONTROL PANEL (DOUBLE LINE
- INDICATES FRONT OF PANEL)

  FIRE ALARM ANNUNCIATOR (DOUBLE LINE INDICATES FRONT OF PANEL)
- ADDRESSABLE INTERFACE MODULE
- ADDRESSABLE INTERFACE MODULE WITH RELAY

### LIGHTING SYMBOLS

- CEILING MOUNTED FLUORESCENT LIGHT FIXTURE
- WALL MOUNTED FLUORESCENT LIGHT FIXTURE
- -+ SINGLE POLE SWITCH

### **COMMUNICATION SYMBOLS**

- TELEPHONE OUTLET WITH 3/4" CONDUIT
- INTO ACCESSIBLE CEILING SPACE

  DATA OUTLET WITH 3/4" CONDUIT INTO ACCESSIBLE CEILING SPACE
- ← TELEPHONE/DATA OUTLET WITH 3/4" CONDUIT
- INTO ACCESSIBLE CEILING SPACE

  ■48 WALL MOUNTED TELEPHONE OUTLET NUMBER
- INDICATES HEIGHT ABOVE FINISHED FLOOR

  —(TV) TELEVISION OUTLET

### **GENERAL NOTES**

(THESE NOTES APPLY TO ALL ELECTRICAL SHEETS)

- 1. A MAXIMUM OF SIX(6) CURRENT CARRYING WIRES SHALL BE INSTALLED IN ANY ONE(1) CONDUIT. ALL BRANCH CIRCUITS EXCEPT MOTOR CIRCUITS SHALL BE INSTALLED WITH A DEDICATED NEUTRAL
- COORDINATE ALL WORK WITH OTHER TRADES. OFFSET PANELS, LIGHTS, RECEPTACLES AND CONDUIT AS REQUIRED. APPROVAL MUST BE OBTAINED FROM ARCHITECT PRIOR TO OFFSETTING ANY DEVICE OR EQUIPMENT.
- 3. CONTRACTOR SHALL COORDINATE ALL SHUT DOWNS WITH OWNER. NO SHUT DOWNS SHALL BE PERFORMED WITHOUT RECEIVING PRIOR APPROVAL FROM OWNER.
- 4. NO CONDUIT OR DEVICES IN FINISHED AREAS SHALL BE SURFACE MOUNTED. CONTRACTOR SHALL RECESS OR CONCEAL CONDUITS AND DEVICES AS REQUIRED. WHERE WALL TRENCHING IS REQUIRED, SAME SHALL BE APPROVED BY ARCHITECT.
- 5. CONTRACTOR SHALL GAIN APPROVAL FROM ARCHITECT PRIOR TO INSTALLING ANY SURFACE MOUNTED
- 6. CONTRACTOR SHALL RE-LABEL AND UPDATE SCHEDULES IN ALL EXISTING TO REMAIN PANELBOARDS AT THE COMPLETION OF THE PROJECT. PROVIDE NEW TYPED DIRECTORIES FOR EXISTING PANELBOARDS TO REFLECT ALL WORK DONE AS PART OF THIS PROJECT.
- 7. ALL EXISTING CONDUIT AND WIRING BEING CONNECTED TO NEW WORK THAT IS NOT IN COMPLIANCE WITH THE NEC SHALL BE CORRECTED AS REQUIRED.
- 8. AFTER COMPLETION OF NEW WORK REMOVE ALL TEMPORARY EQUIPMENT, CONDUIT, AND WIRING NOT REQUIRED TO REMAIN.
- 9. CONTRACTOR SHALL FIELD VERIFY ALL EXISTING CONDITIONS PRIOR TO BEGINNING ANY WORK.
- 10. ALL EXISTING ITEMS REMOVED DURING DEMOLITION SHALL BE TURNED OVER TO OWNER. THE CONTRACTOR SHALL BE RESPONSIBLE FOR MOVING THE ITEMS TO A STORAGE LOCATION AS DETERMINED BY THE OWNER. ANY ITEMS THAT ARE NOT TO BE KEPT BY THE OWNER SHALL BE DISPOSED OF BY THE CONTRACTOR. COORDINATE AS REQUIRED.
- 11. ALL CONDUITS SHALL BE HELD AS HIGH AND AS TIGHT AS POSSIBLE TO THE STRUCTURE SUPPORTING THE FLOOR ABOVE AREA WHERE INSTALLATION OCCURS. COORDINATE WITH OTHER TRADES AS REQUIRED.
- 12. COORDINATE THE ROUTING OF ALL CONDUITS WITH OTHER TRADES. MAKE OFFSETS AS REQUIRED. FURNISH AND INSTALL JUNCTION AND PULL BOXES AS REQUIRED. ROUTING SHOWN ON PLANS IS DIAGRAMMATIC.
- 13. CONTRACTOR SHALL REROUTE, RELOCATE, OR REMOVE ANY CONDUIT, FIXTURES, OR OTHER EXISTING ELECTRICAL DEVICES AS REQUIRED FOR NEW WORK. MAINTAIN AND RESTORE POWER TO ALL EXISTING DEVICES BEING SERVED IN UNDISTURBED AREAS, AND DEVICES THAT ARE SHOWN AS EXISTING TO REMAIN
- 14. ALL CIRCUITS FROM EXISTING—TO—REMAIN PANELBOARDS THAT HAVE THEIR ENTIRE LOAD REMOVED AND ARE NOT REQUIRED TO BE REUSED TO SERVE NEW LOADS, AS SHOWN ON NEW WORK DRAWINGS, SHALL HAVE THEIR CONDUIT AND WIRE REMOVED BACK TO THEIR PANELBOARD AND THEIR ASSOCIATED BREAKER SHALL BE LABELED AS A SPARE. CONDUIT THAT IS LOCATED IN THE FLOOR SLAB OR ABOVE INACCESSIBLE CEILING SHALL BE ABANDONED IN PLACE; HOWEVER, ALL CONDUCTORS SHALL BE REMOVED.
- 15. DISCONNECT AND REMOVE ALL EXISTING ELECTRICAL DEVICES, LIGHT FIXTURES, ELECTRICAL EQUIPMENT SHOWN DARK AND DASHED ON THE DEMOLITION PLANS. DEVICES SHOWN LIGHT ARE EXISTING TO
- 16. THE CONTRACTOR SHALL VERIFY THE OPERATION OF ALL DEVICES THAT ARE EXISTING TO REMAIN. ALL NON-OPERATIONAL DEVICES SHALL BE CORRECTED OR REPLACED AS REQUIRED. REPLACE ALL DAMAGED AND MISSING COVERPLATES IN AREAS OF NEW WORK AS REQUIRED.
- 17. ALL CONDUIT, WIRING, DEVICES AND EQUIPMENT TO BE REMOVED MAY NOT BE SHOWN. HOWEVER, ALL ITEMS NOT REQUIRED TO REMAIN SHALL BE REMOVED.
- 18. THE CONTRACTOR SHALL MATCH THE RATINGS AND CHARACTERISTICS OF ALL NEW CIRCUIT BREAKERS BEING FURNISHED TO THAT OF THE EXISTING BREAKERS IN EXISTING PANELBOARDS UNLESS NOTED OTHERWISE
- 19. MC CABLE WILL BE ALLOWED FOR ALL INTERIOR POWER WIRING INSTALLED CONCEALED OR ABOVE 7'-6". SAME SHALL BE RAN IN A NEAT MANNER AND SUPPORTED PROPERLY.

20. ALL NEW CONVENIENCE RECEPTACLES SHALL BE OF THE TAMPER RESISTANT TYPE.

SCHEDULE OF LIGHTING FIXTURES

APPROVED MANUFACTURER
TYPE AND MODEL

A WILLIAMS-96 SERIES LED ACRYLIC LENS AND FIBERGLASS HOUSING.

SCHEDULE OF LIGHTING FIXTURES

LED/ SOURCE

BALLAST/ DRIVER


MOUNTING VOLTAGE WATTAGE

INTEGRAL 3500 K CCT, 6500 LUMENS DELIVER DELIVERD, MIN. 80 CRI

WILLIAMS-96 SERIES LED ACRYLIC LENS AND FIBERGLASS HOUSING.

# ELECTRICAL SYMBOLS LIST AND GENERAL NOTES

### STATE OF MISSOURI MIKE PARSON, GOVERNOR

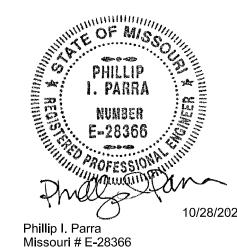



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Planning

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DIVISION OF FACILITIES
MANAGEMENT,
DESIGN AND
CONSTRUCTION

MANSION ELEVATOR REPLACEMENT

GOVERNOR'S MANSION

Jefferson City, Missouri

PROJECT # O2036-01 SITE # 0001 FACILITY # 0505

REVISION DATE

BID DOCUMENTS

ISSUE DATE: 10/28/2022

CAD DWG FILE:
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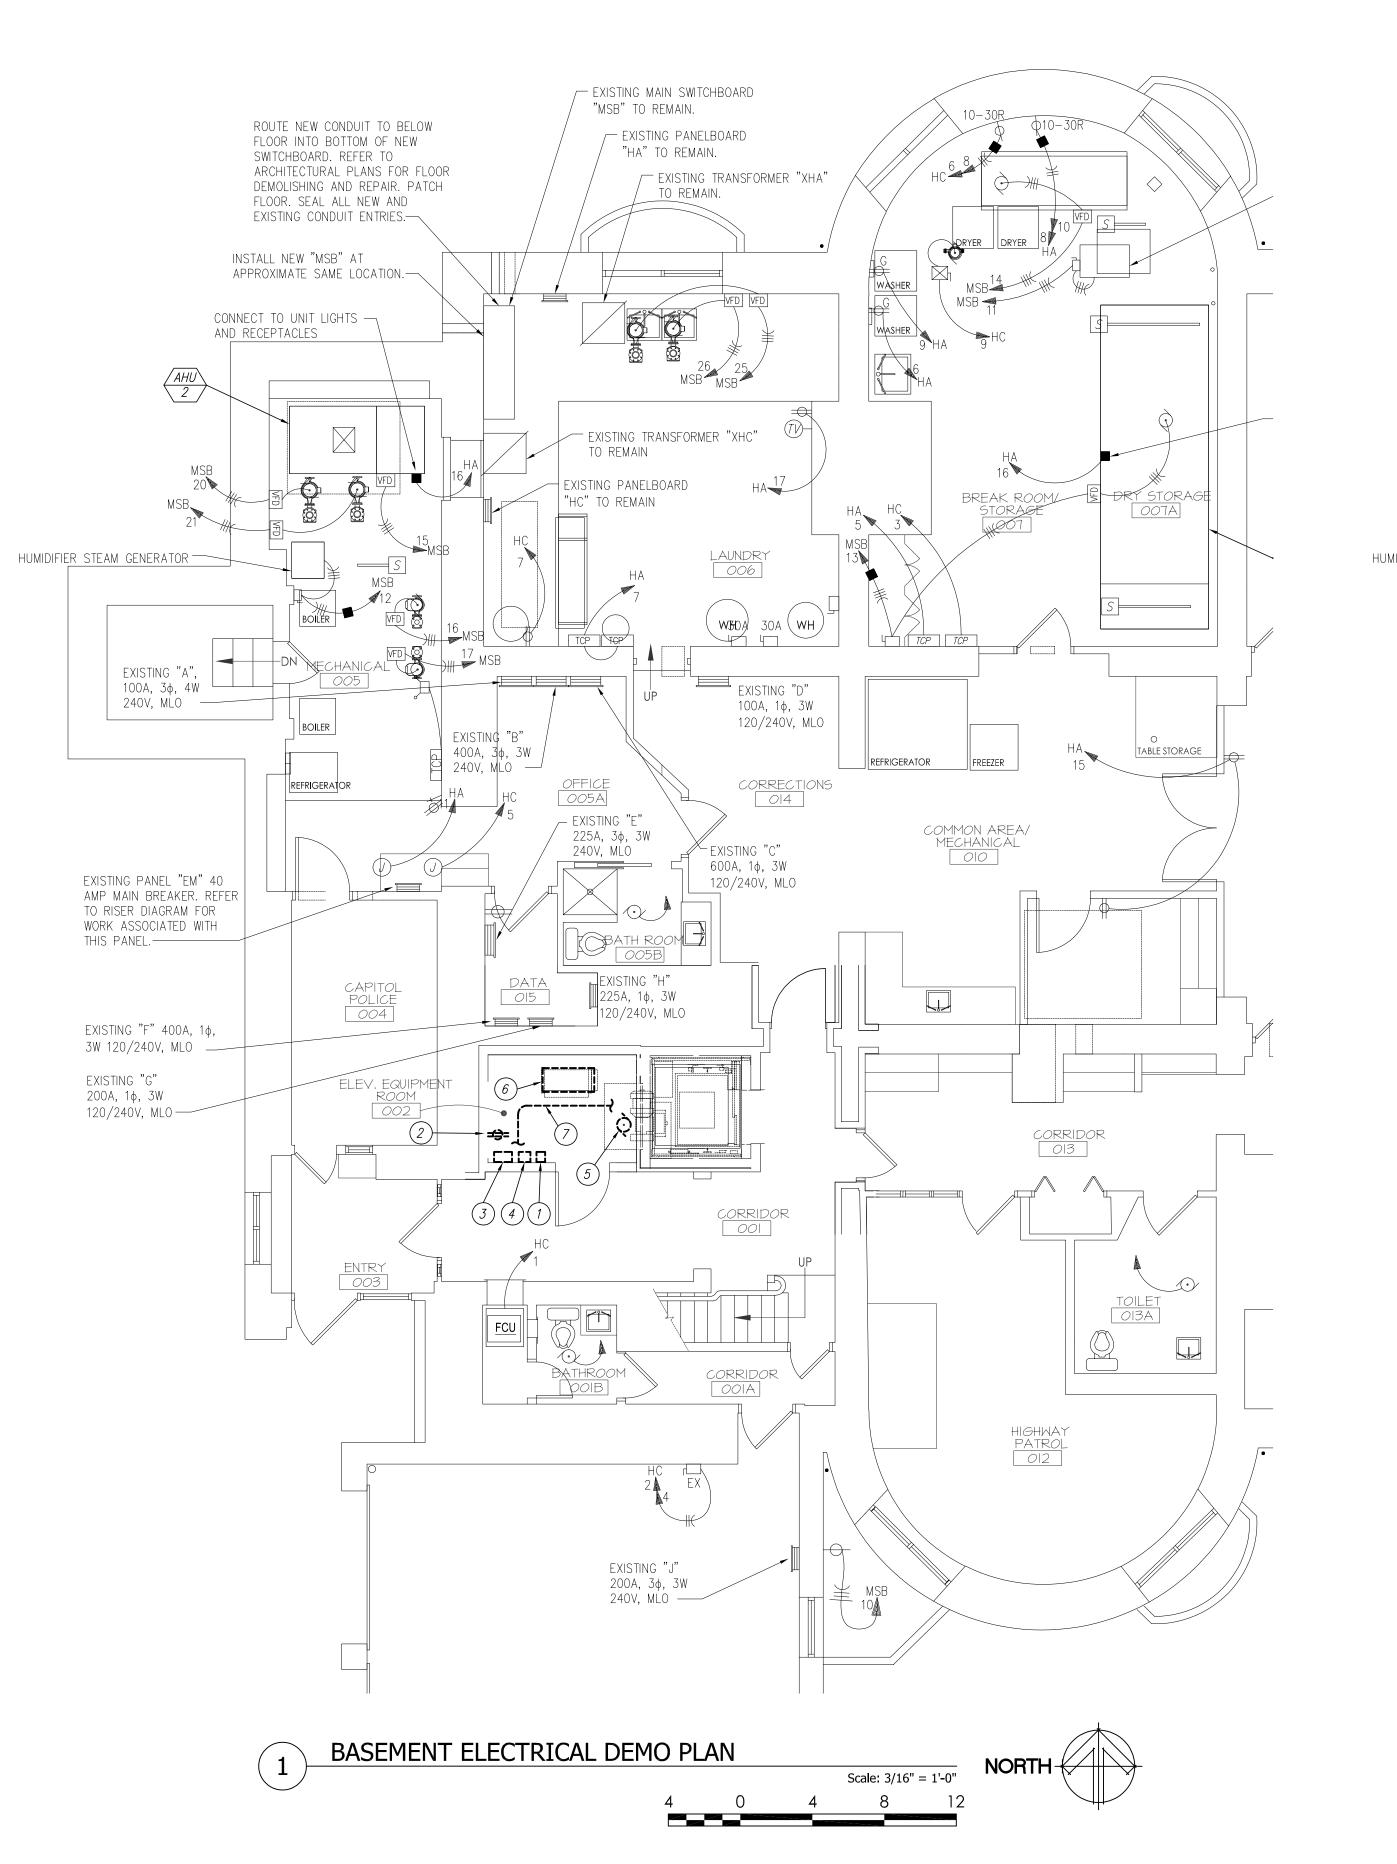
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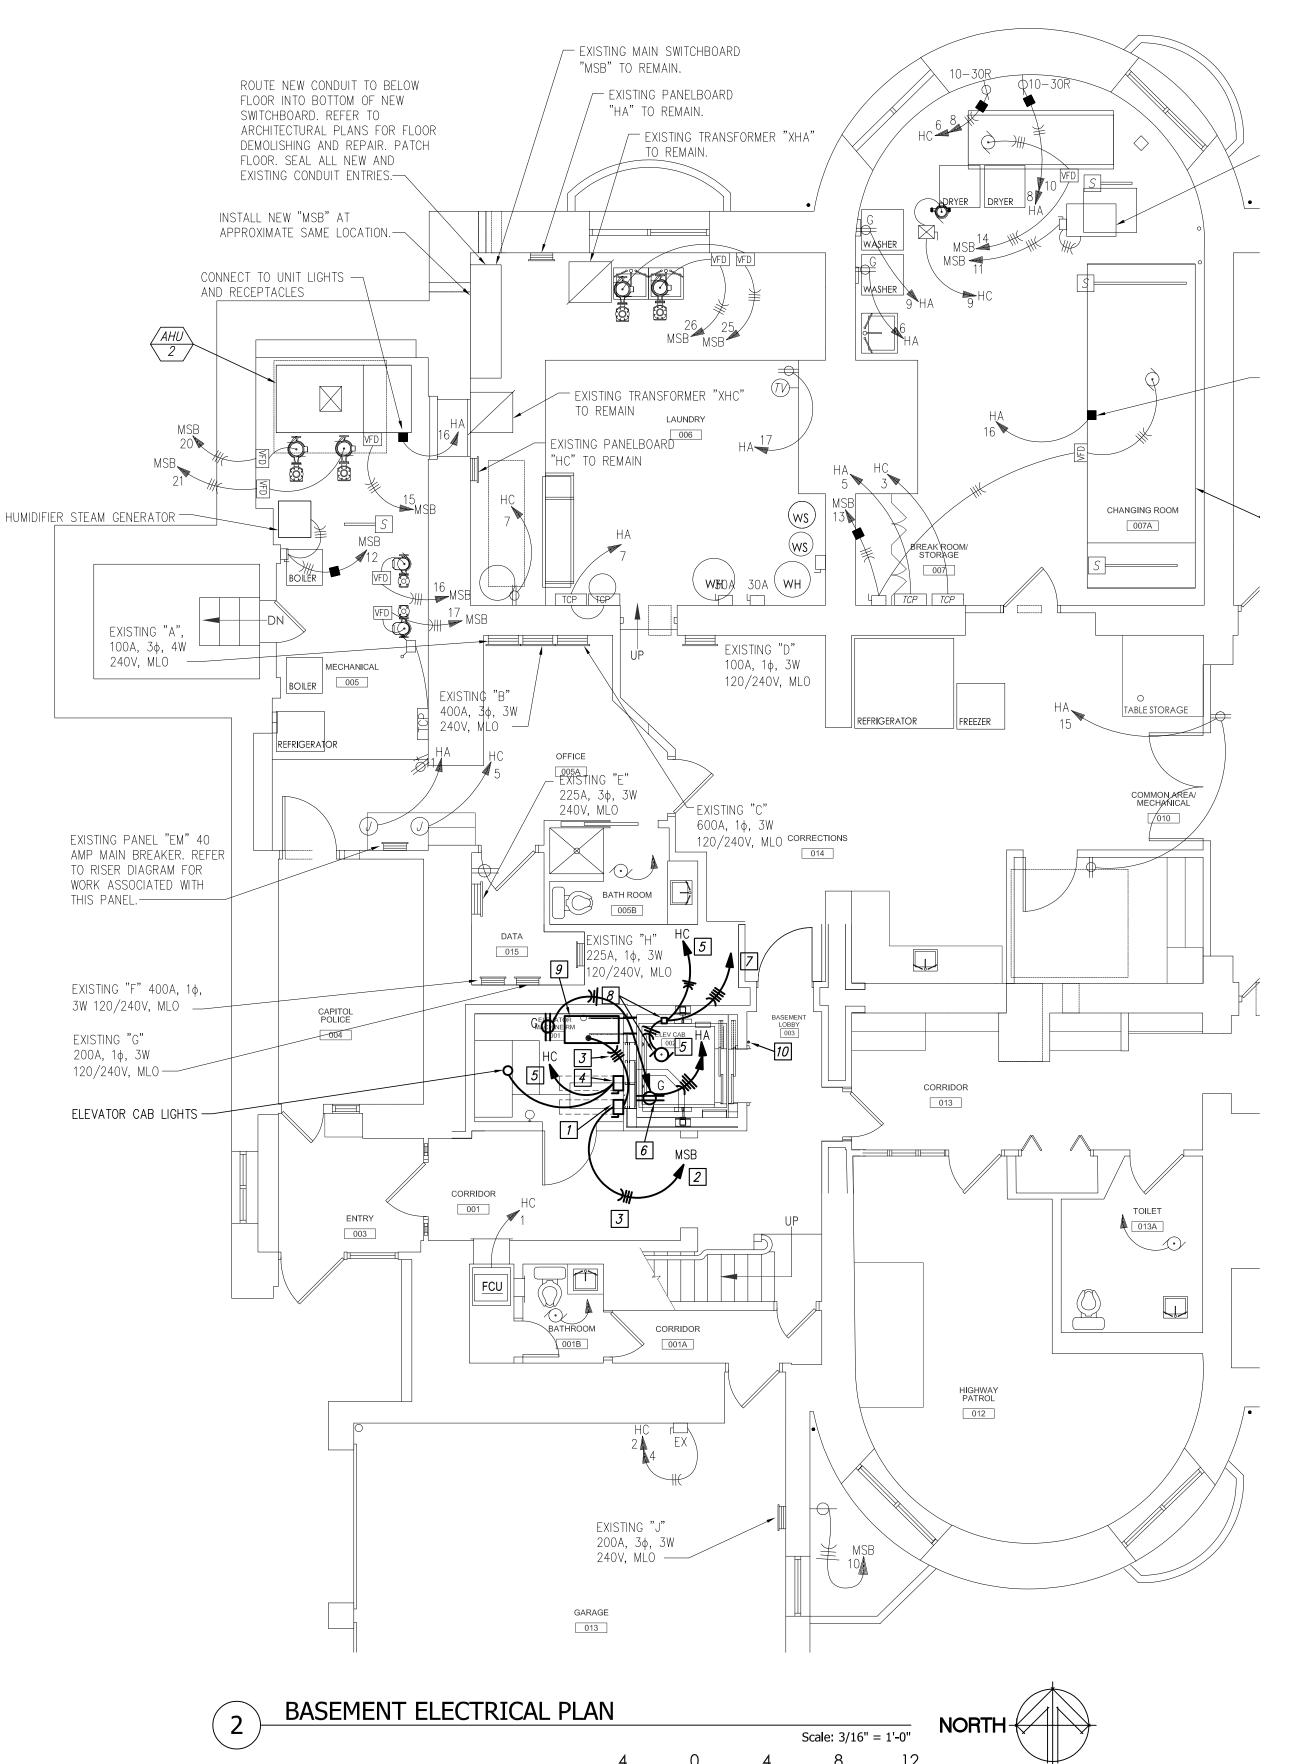
ELECTRICAL SYMBOLS AND GENERAL

NOTES

SHEET NUMBER:

E000
SHEET 10 OF 14





- WHERE ANY NEW CONNECTION IS MADE TO AN EXISTING CIRCUIT THE FOLLOWING SHALL OCCUR. THE ELECTRICAL CONTRACTOR SHALL TAKE AND RECORD THE LOAD ON THE EXISTING CIRCUIT PRIOR TO MAKING ANY NEW CONNECTION. NEW LOAD SHALL ONLY BE CONNECTED ONCE IT IS DETERMINED THAT NEW LOAD WILL NOT OVERLOAD EXISTING
- WORK SHOWN LIGHTLY IS EXISTING TO REMAIN. WORK SHOWN DARK IS NEW TO BE FURNISHED AND INSTALLED BY


# **DEMO KEYED NOTES:**

- 1) DISCONNECT AND REMOVE EXISTING CONDUIT AND WIRE.
- DISCONNECT AND REMOVE EXISTING CONVENIENCE RECEPTACLE AND ALL ASSOCIATED CONDUIT AND WIRE NOT REQUIRED TO REMAIN.
- 3 DISCONNECT AND REMOVE ABANDONED TELEPHONE BOX. REMOVE ALL ASSOCIATED CABLING NOT REQUIRED TO REMAIN. FIELD VERIFY CABLING TO BE REMOVED WITH
- (4) DISCONNECT AND REMOVE EXISTING ELEVATOR DISCONNECT AND ALL ASSOCIATED CONDUIT AND WIRE NOT REQUIRED
- 5 DISCONNECT AND REMOVE EXISTING ELEVATOR MOTOR AND ALL ASSOCIATED CONDUIT AND WIRE NOT REQUIRED TO
- (6) DISCONNECT AND REMOVE EXISTING ELEVATOR CONTROLLER AND ALL ASSOCIATED CONDUIT AND WIRE NOT REQUIRED
- (7) DISCONNECT AND REMOVE ABANDONED TELEPHONE WIRING FROM EXISTING WIREWAY NOT REQUIRED TO REMAIN. FIELD VERIFY CABLING TO BE REMOVED WITH OWNER.

# **KEYED NOTES:**

- 1 LOCKABLE 200 AMP, 3-POLE FUSIBLE DISCONNECT SWITCH FOR CONNECTION TO ELEVATOR CONTROLLER. FUSE AT
- 2 EXTEND AND CONNECT TO NEW 125 AMP, 3-POLE SHUNT
- TRIP BREAKER IN "MSB".
- $\boxed{3}$  2 1 W, 1 #6 GND IN 1  $\frac{1}{2}$ " C. 4 LOCKABLE 30 AMP, 1-POLE FUSIBLE DISCONNECT SWITCH.
- 5 FURNISH AND INSTALL 20 AMP, 1-POLE CIRCUIT BREAKER FOR EACH NEW CIRCUIT. MOUNT CIRCUIT BREAKER IN AVAILABLE SPACE IN PANEL. NEW CIRCUIT BREAKER SHALL MATCH CHARACTERISTICS OF EXISTING CIRCUIT
- 6 COORDINATE MOUNTING LOCATION SO THAT SAME DOES NOT INTERFERE WITH TRAVEL OF ELEVATOR.
- 7 FURNISH AND INSTALL CONDUIT AND WIRING FOR LOW VOLTAGE CABLING CONNECTION OF SUMP PIT ALARMS WITH BUILDING MANAGEMENT SYSTEM. COORDINATE CONDUIT SIZE AND LOCATION WITH BMS INSTALLER. REFERENCE MECHANICAL DRAWINGS FOR MORE INFORMATION.
- 8 FURNISH AND INSTALL POWER TO SUMP PUMP AND CONTROL PANEL PER MANUFACTURERS INSTALLATION INSTRUCTIONS AND RECOMMENDATIONS. COORDINATE MOUNTING LOCATION WITH ELEVATOR TRAVEL.
- 9 FURNISH AND INSTALL PHONE LINE CONNECTION TO ELEVATOR CONTROLLER. COORDINATE CONNECTION WITH ELEVATOR INSTALLER.
- 10 COORDINATE CONNECTION TO ELEVATOR EMERGENCY POWER JEWEL INDICATOR LIGHT. FURNISH AND INSTALL ALL CONDUIT AND WIRING AS REQUIRED TO EXTERIOR EMERGENCY TRANSFER SWITCH. REFER TO RISER DIAGRAM.

### STATE OF MISSOURI MIKE PARSON, **GOVERNOR**

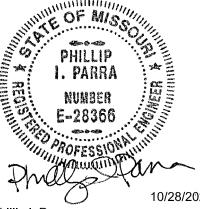



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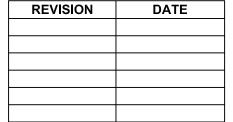
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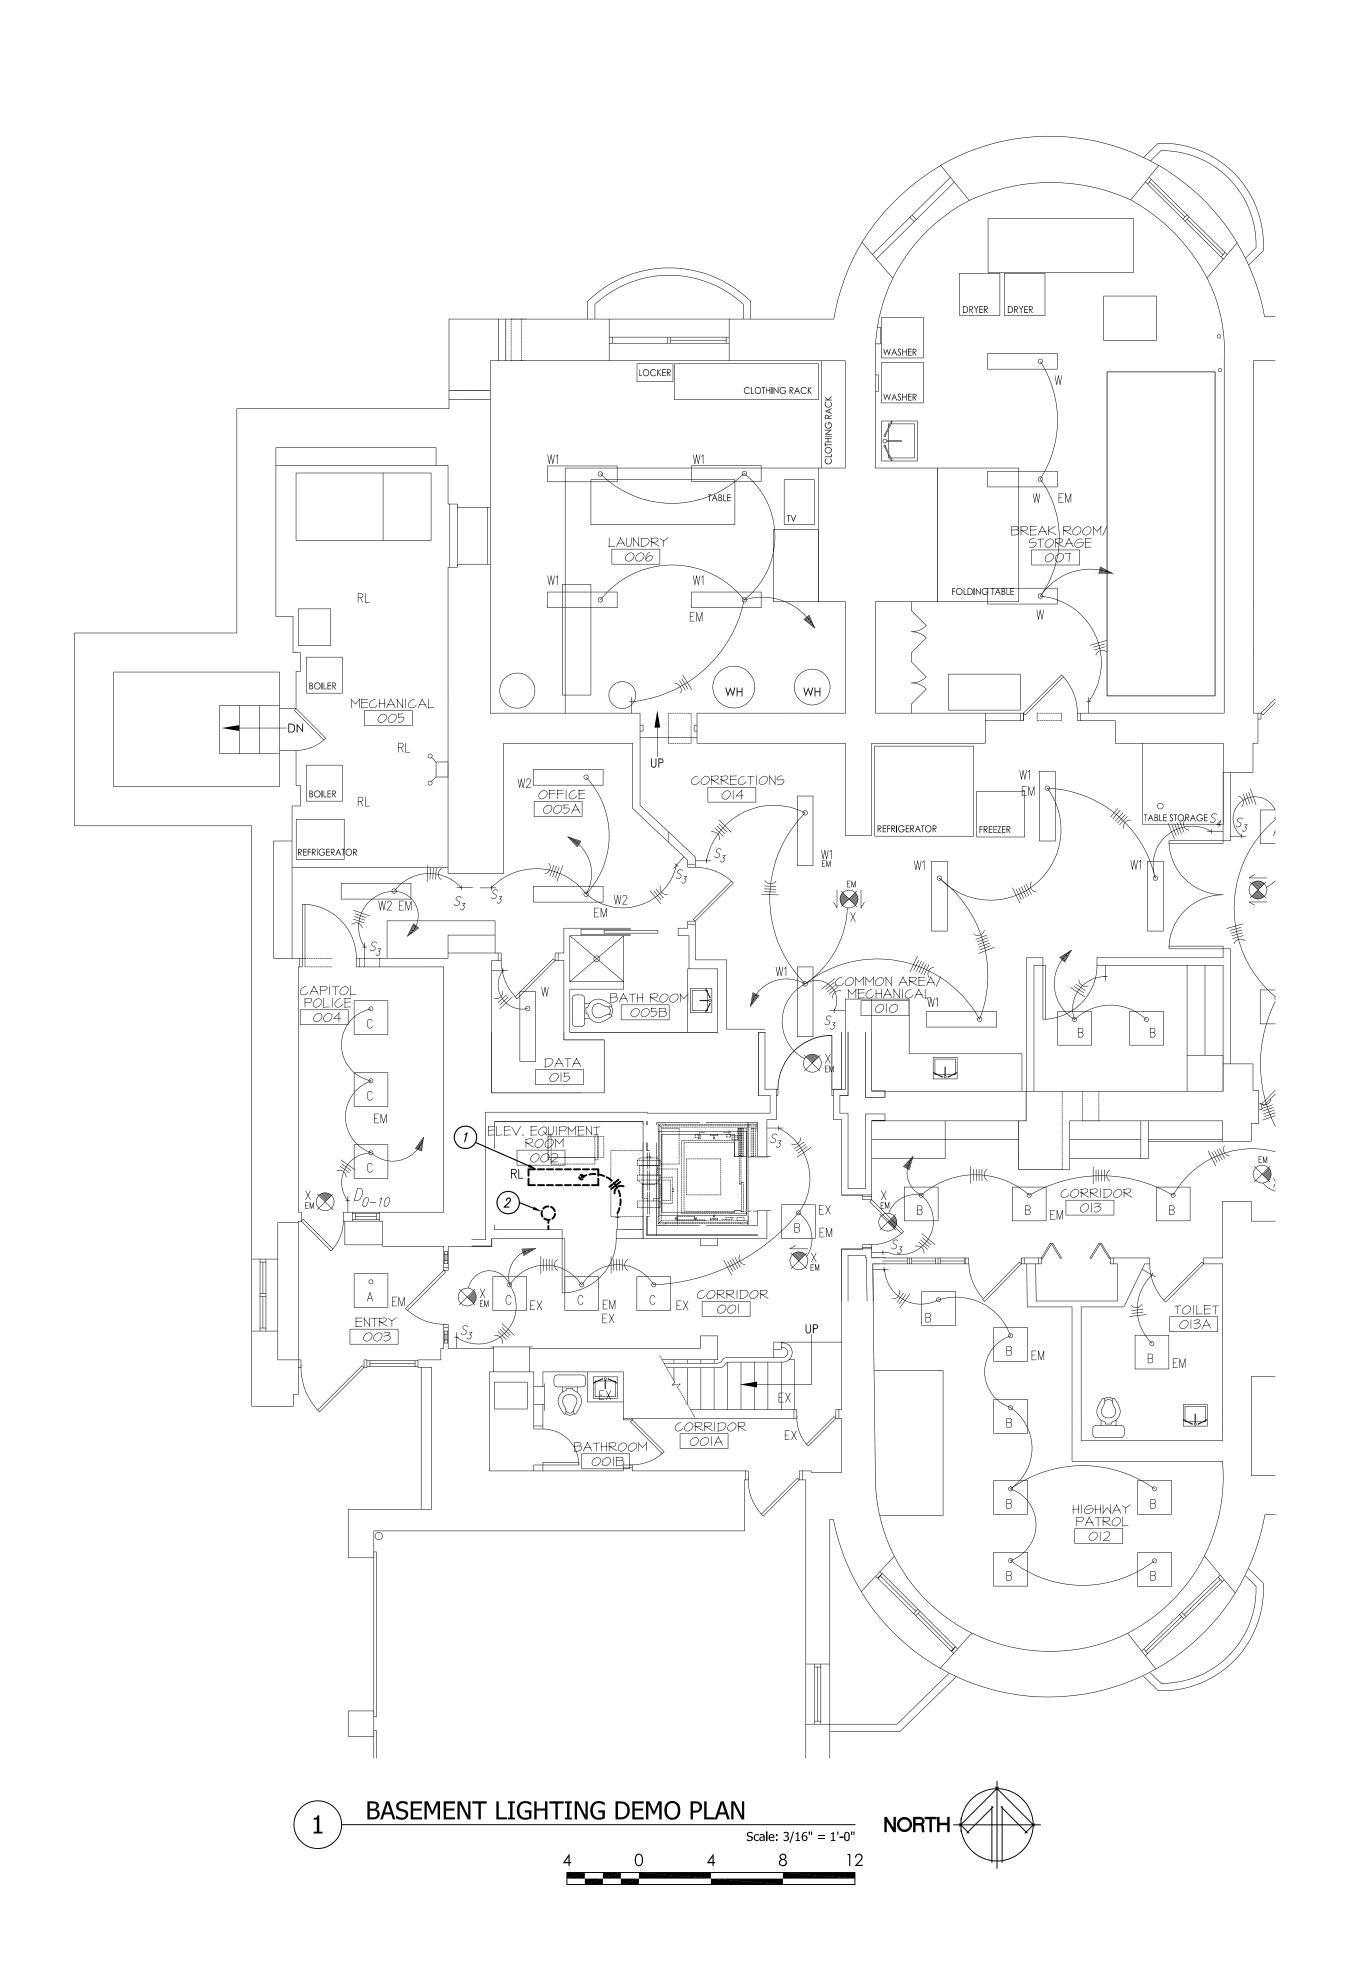
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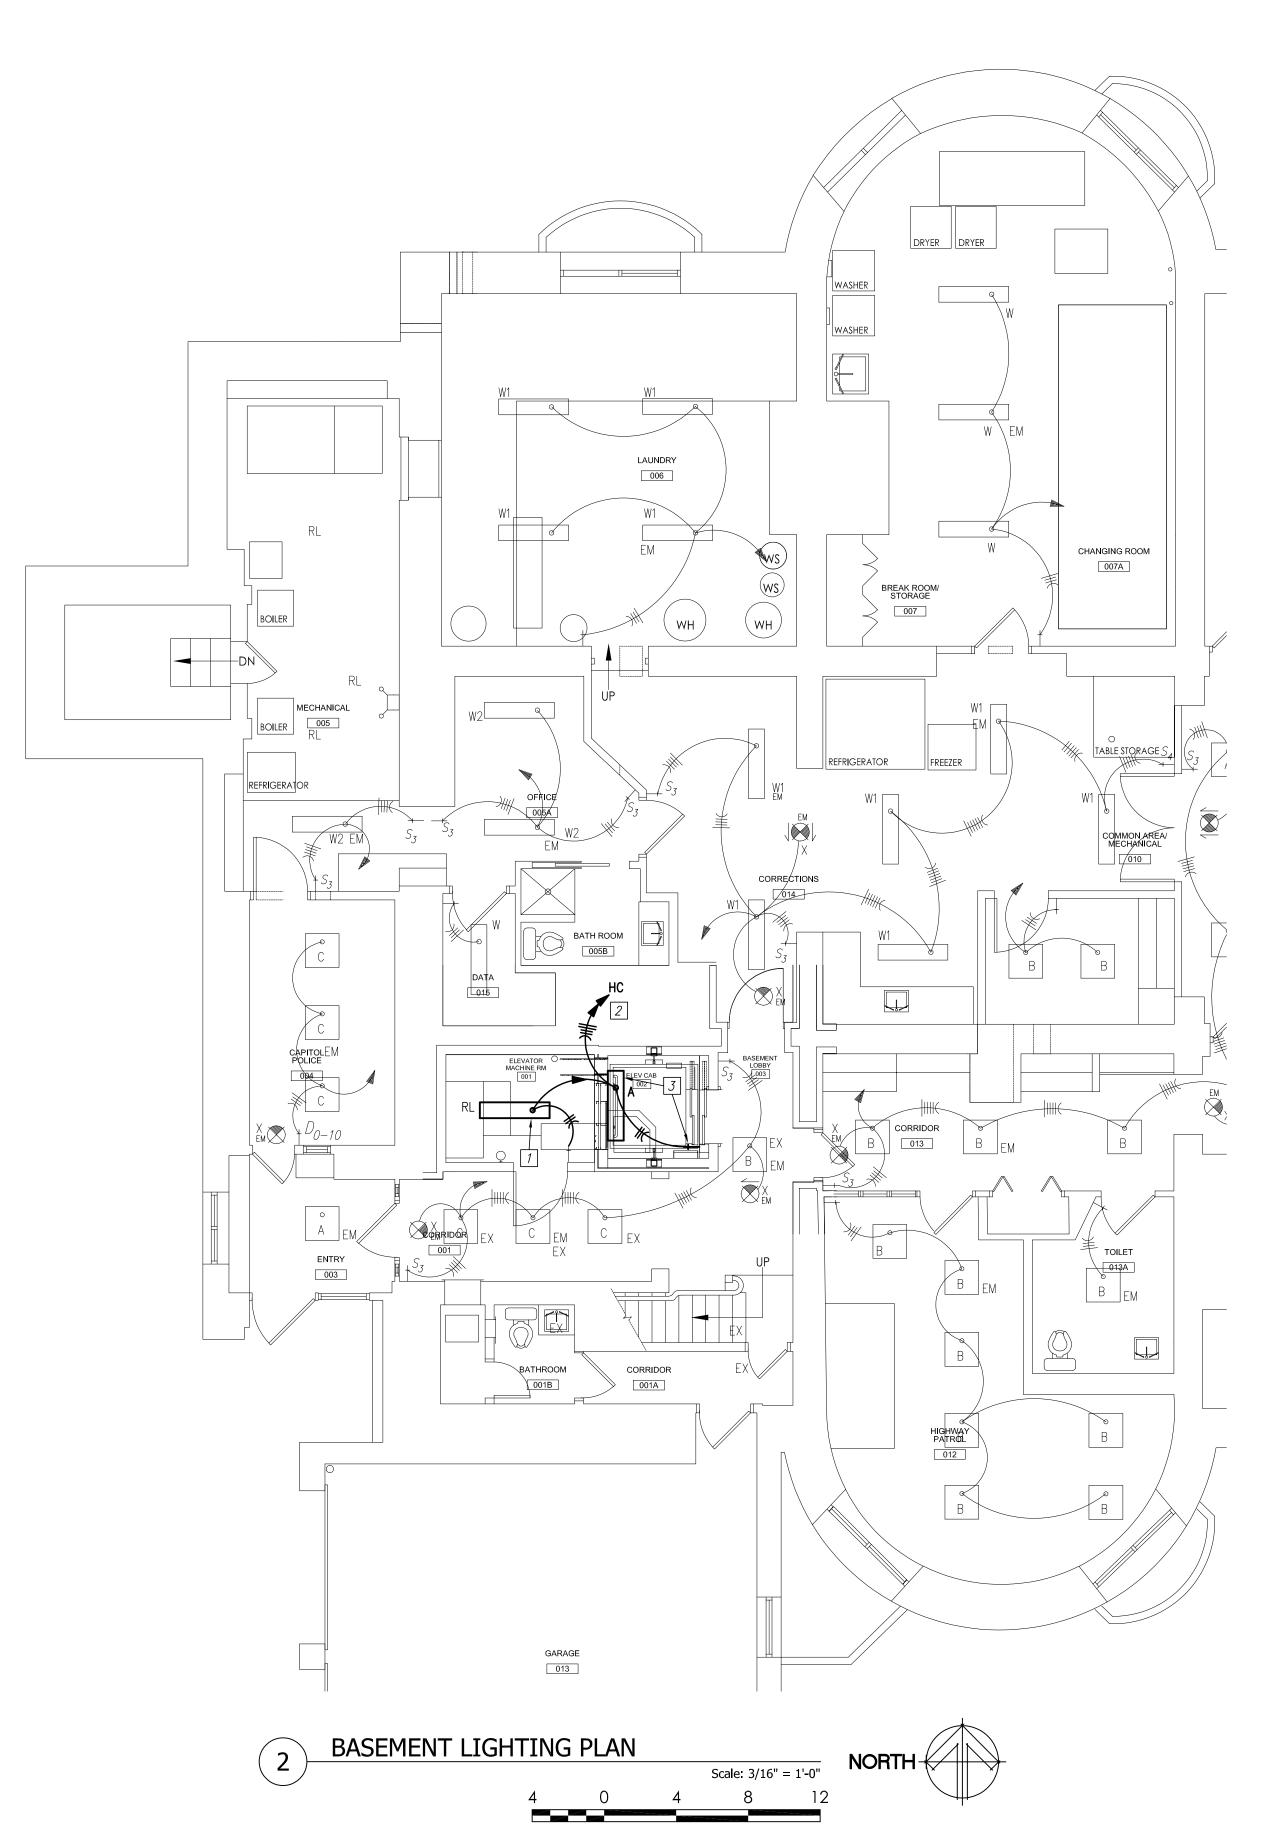
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ELECTRICAL **PLANS** 

SHEET NUMBER:

SHEET 11 OF 14 ISSUE DATE: 10/28/2022





WORK SHOWN LIGHTLY IS EXISTING TO REMAIN. WORK SHOWN DARK IS NEW TO BE FURNISHED AND INSTALLED BY CONTRACTOR.


### **DEMO KEYED NOTES:**

- DISCONNECT, REMOVE, RELOCATE AND RECONNECT EXISTING LIGHT FIXTURE AS REQUIRED FOR INSTALLATION OF NEW ELEVATOR EQUIPMENT.
- DISCONNECT AND REMOVE EXISTING LIGHT FIXTURE.

# **KEYED NOTES:**

- 1 REINSTALL EXISTING LIGHT FIXTURE.
- 7 FURNISH AND INSTALL 20 AMP, 1—POLE CIRCUIT BREAKER FOR EACH NEW CIRCUIT. MOUNT CIRCUIT BREAKER IN AVAILABLE SPACE IN PANEL. NEW CIRCUIT BREAKER SHALL MATCH CHARACTERISTICS OF EXISTING CIRCUIT BREAKERS.
- 3 COORDINATE MOUNTING LOCATION SO THAT SAME DOES NOT INTERFERE WITH TRAVEL OF ELEVATOR.

STATE OF MISSOURI MIKE PARSON, **GOVERNOR** 

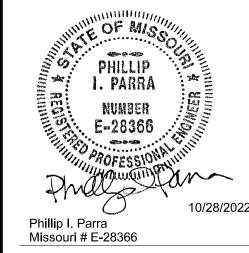



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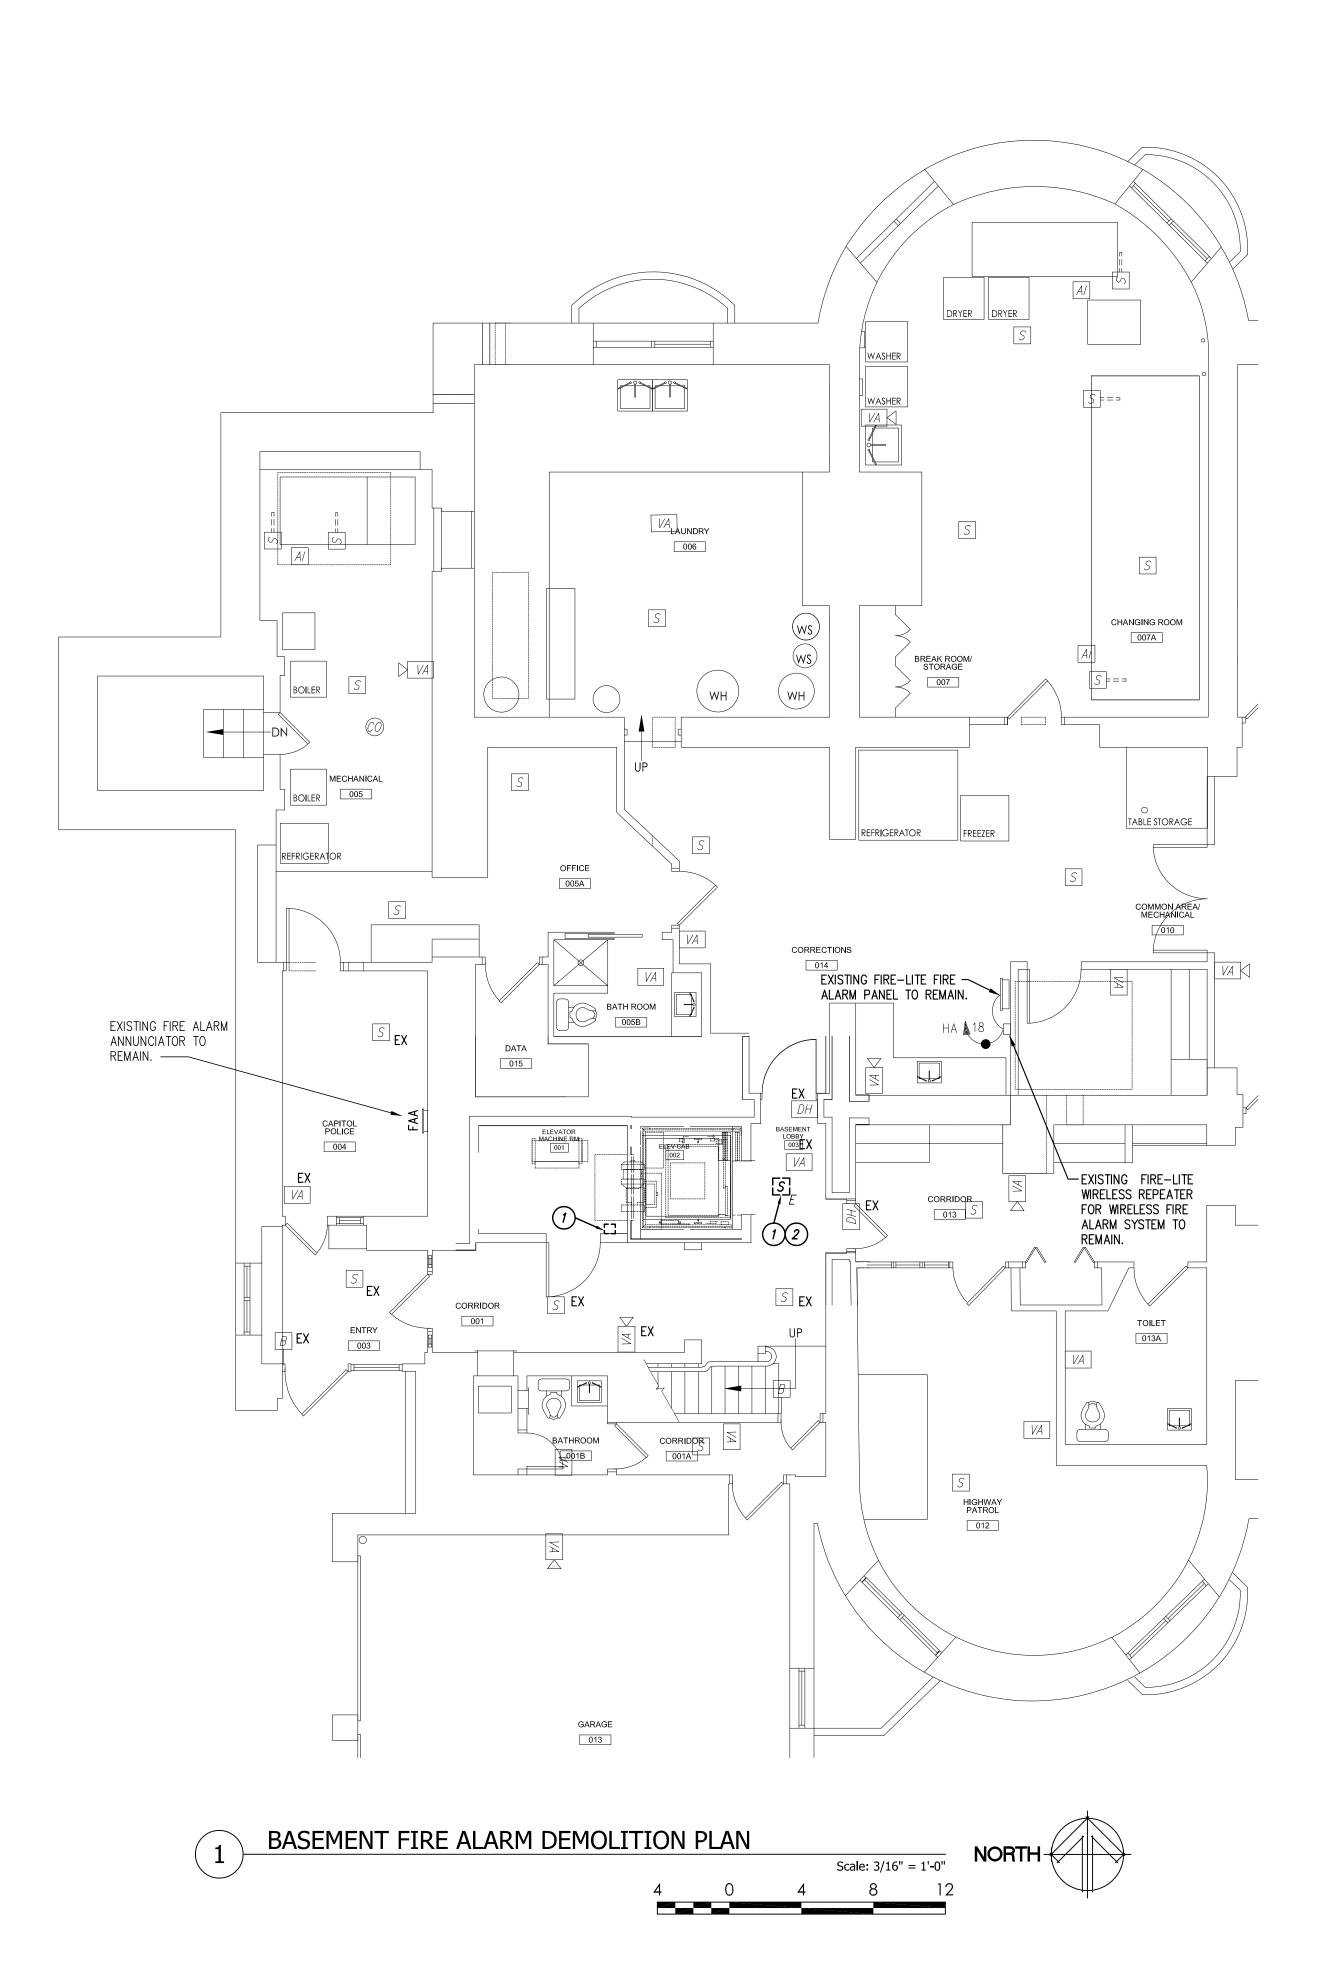
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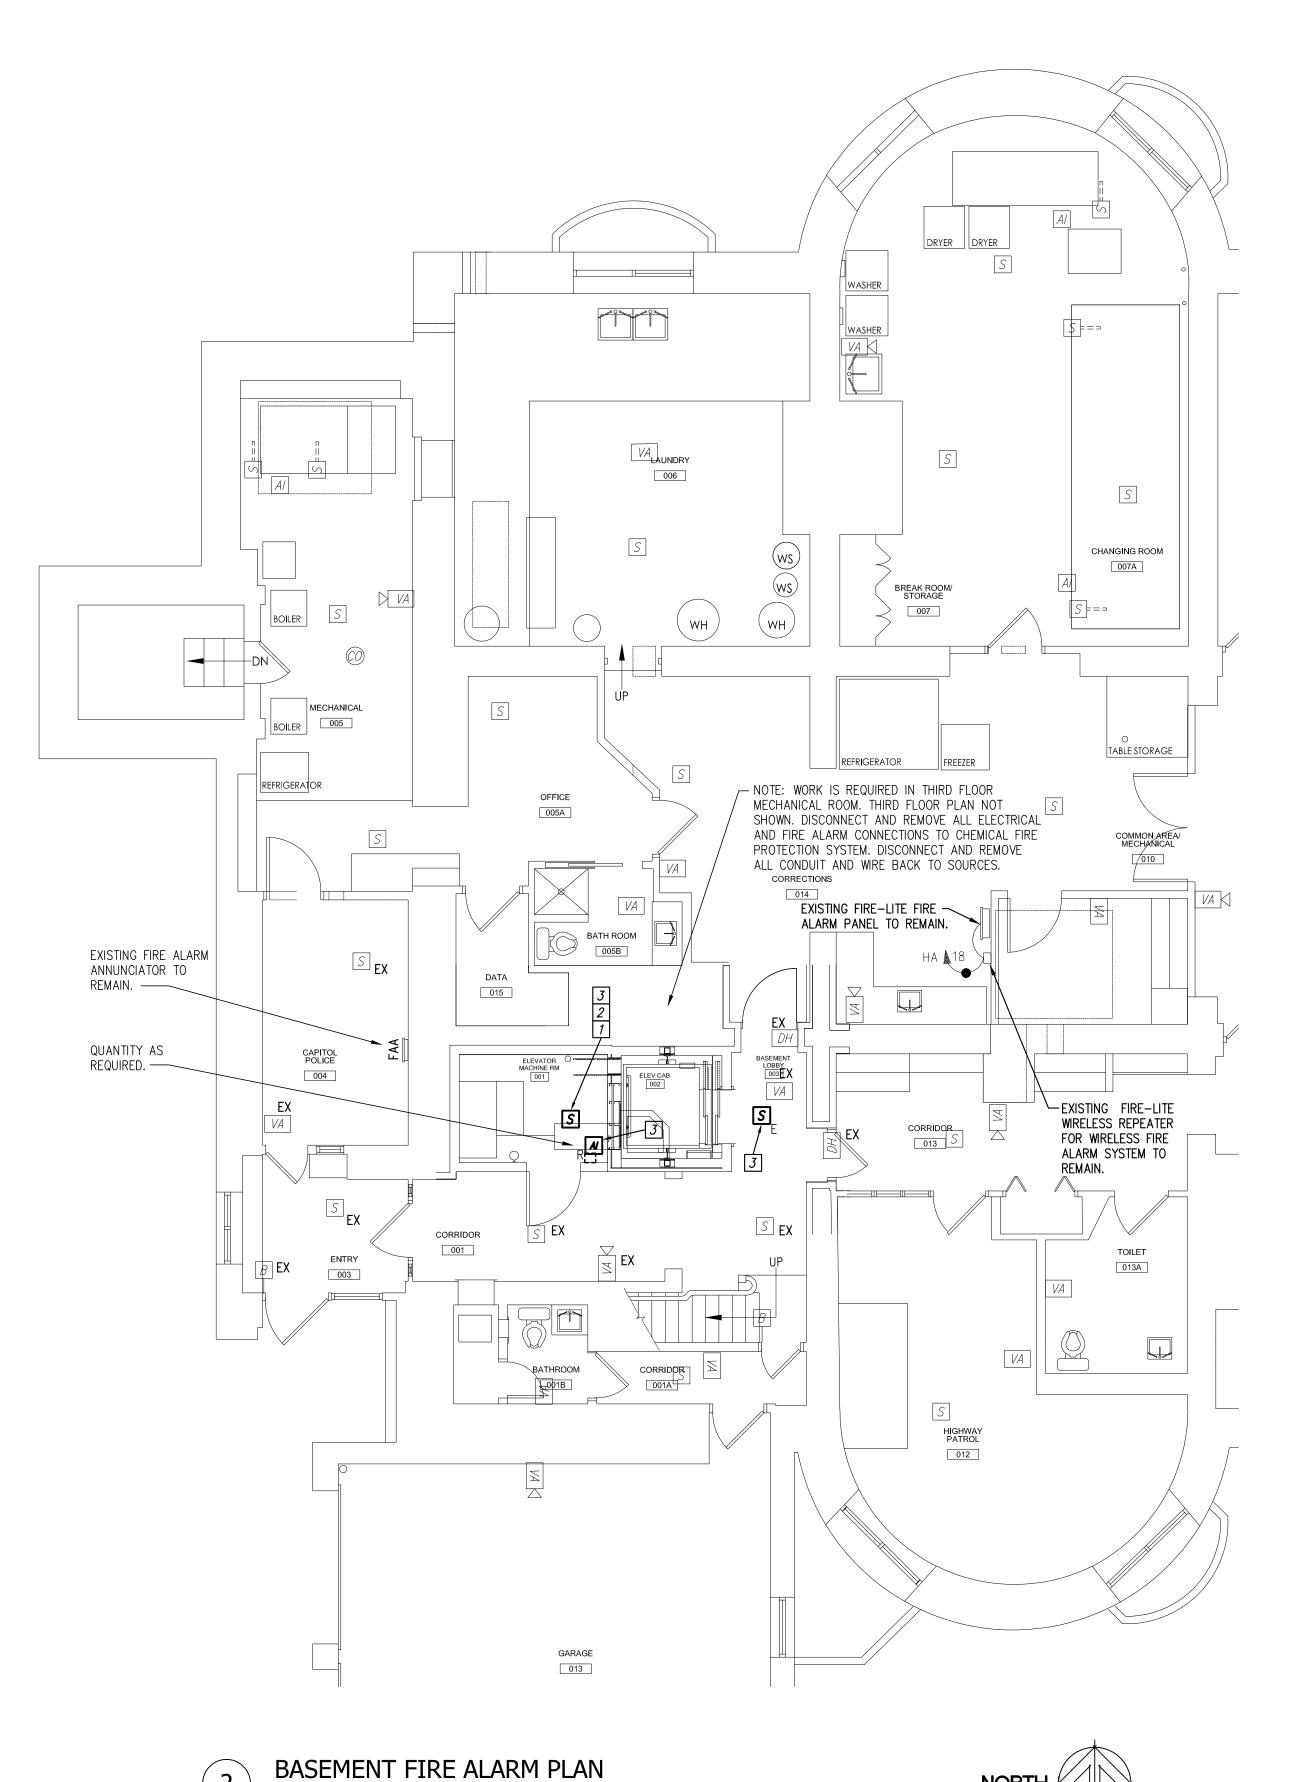
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CAD DWG FILE:
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CHECKED BY: PIP
DESIGNED BY: PIP

SHEET TITLE: LIGHTING PLANS

SHEET NUMBER: SHEET 12 OF 14 ISSUE DATE: 10/28/2022





Scale: 3/16" = 1'-0"

### **GENERAL NOTES:**

### **DEMO KEYED NOTES:**

- DISCONNECT AND REMOVE EXISTING DEVICE AS REQUIRED FOR NEW ELEVATOR INSTALLATION. IT IS ACCEPTABLE TO REUSE EXISTING DEVICE.
- 2 ELEVATOR LOBBIES ON 1ST, 2ND AND 3RD FLOOR ARE NOT SHOWN. INCLUDE SIMILAR REWORK AS SHOWN ON

### **KEYED NOTES:**


- T FURNISH AND INSTALL NEW FIRE-LITE DEVICE IN LOCATION OF EXISTING JUNCTION BOX AND CONDUIT. MAKE ALL CONNECTIONS AS REQUIRED AT DEVICE LOCATION AND NEW FIRE-LITE PANEL LOCATED IN
- SIGNAL 1: WHEN A SMOKE SENSOR IS ACTIVATED IN ANY OF THE ELEVATOR LOBBIES WITH EXCEPTION OF THE MAIN FIRE ACCESS FLOOR B LOBBY.
- SIGNAL 2: WHEN A SMOKE SENSOR IS ACTIVATED IN THE ELEVATOR MACHINE ROOM AREA OF THE MAIN FIRE ACCESS FLOOR B LOBBY.
- SIGNAL 3: WHEN A SMOKE SENSOR IS ACTIVATED AT THE ELEVATOR MACHINE ROOM.
- REWORK OR PROVIDE NEW AS NEEDED ON 1ST, 2ND AND 3RD FLOOR.

- 1. ALL SMOKE DETECTORS SHALL BE KEPT A MINIMUM 36" AWAY FROM SUPPLY OR RETURN AIR DIFFUSERS.
- 2. WORK SHOWN LIGHTLY IS EXISTING TO REMAIN. WORK SHOWN DARK IS NEW TO BE FURNISHED AND INSTALLED BY CONTRACTOR.
- THIS SHEET AND AS REQUIRED.

- 2 FURNISH AND INSTALL NEW FIRE-LITE SMOKE DETECTOR.
- 3 REINSTALL EXISTING DEVICE. THE EXISTING FIRE ALARM SYSTEM SHALL BE MODIFIED SUCH THAT THE SYSTEM WORKS IN CONJUNCTION WITH THE NEW ELEVATOR'S FIREMAN'S PHASE I RECALL OPERATION. THERE SHALL BE A NEW SMOKE DETECTOR INSTALLED IN THE ELEVATOR MACHINE ROOM. THE FOLLOWING SIGNALS SHALL BE PROVIDED TO THE ELEVATOR CONTROLLER IN THE ELEVATOR MACHINE ROOM.

- FOURTH RELAY FOR ELEVATOR SHUNT TRIP BREAKER CONTROL.

### STATE OF MISSOURI MIKE PARSON, **GOVERNOR**

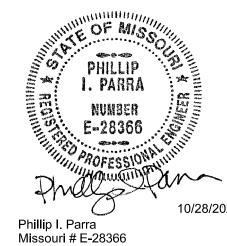

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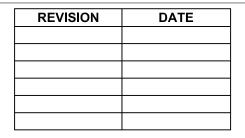
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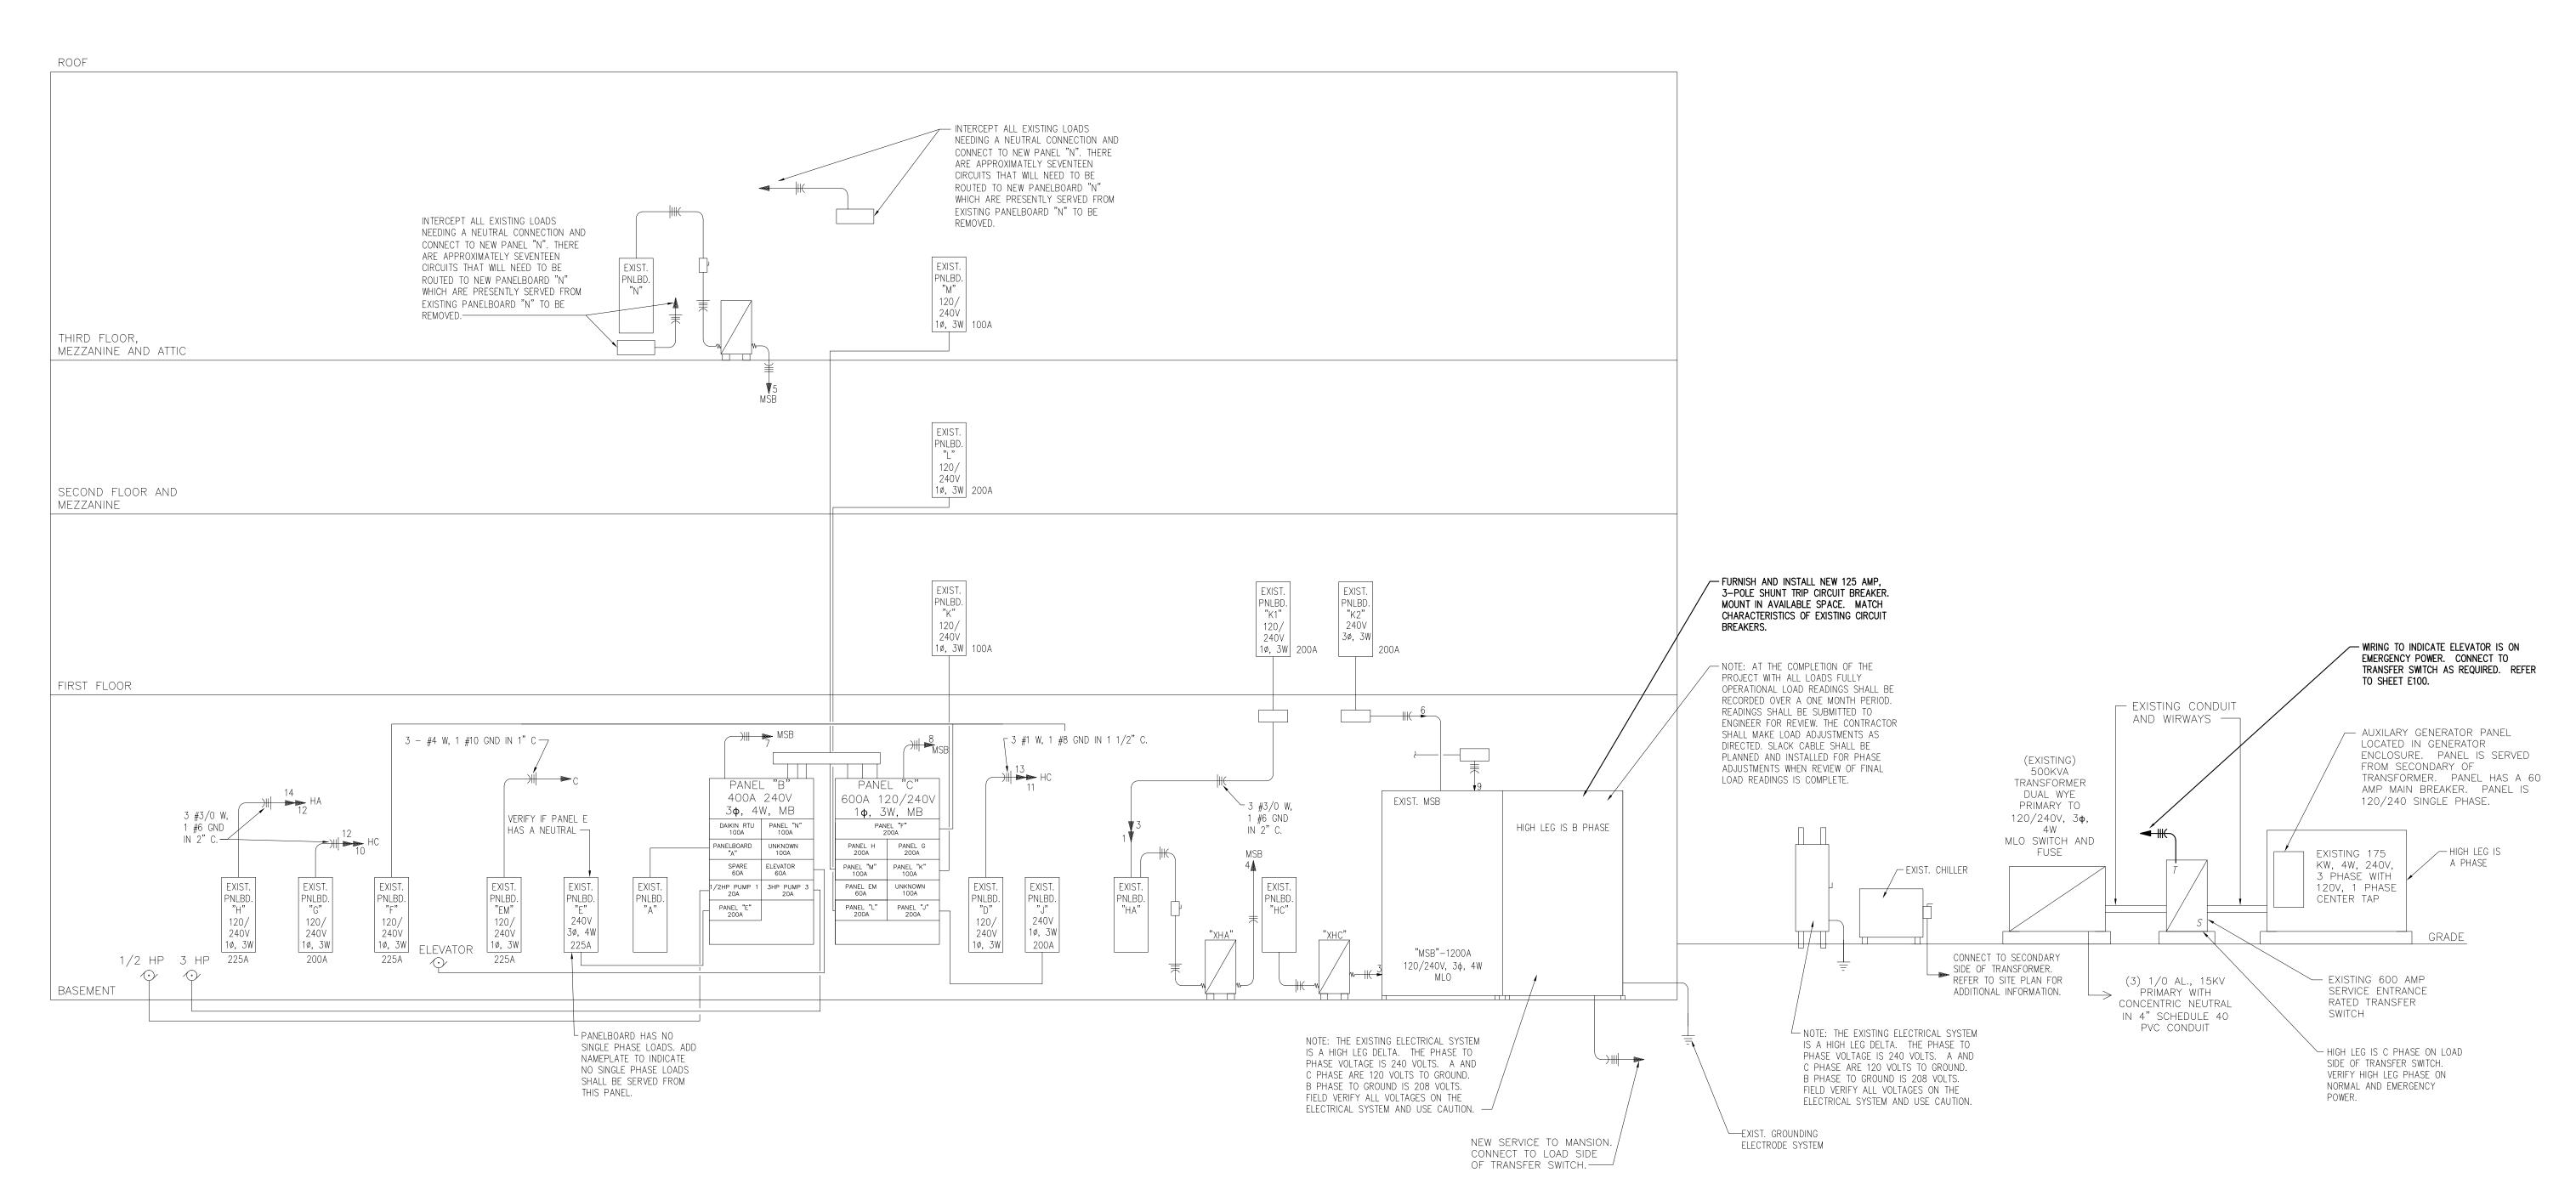
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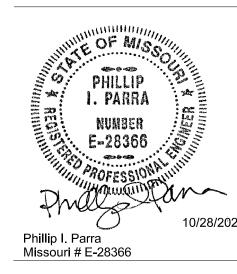
. WORK SHOWN LIGHTLY IS EXISTING TO REMAIN. WORK SHOWN DARK IS NEW TO BE FURNISHED AND INSTALLED BY CONTRACTOR.



NEW ELECTRICAL RISER DETAIL

Scale: NOT TO SCALE

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SHEET TITLE: ELECTRICAL

RISER

SHEET NUMBER: