# MULTIPURPOSE BUILDING RENOVATION MISSOURI DEPARTMENT OF AGRICULTURE


# NEW MADRID, MISSOURI

**OWNER:** 

STATE OF MISSOURI MIKE L. PARSON, GOVERNOR

MISSOURI AGRICULTURE DEPARTMENT

PROJECT MANAGEMENT: OFFICE OF ADMINISTRATION, DIVISION OF FACILITIES MANAGEMENT, **DESIGN & CONSTRUCTION** 

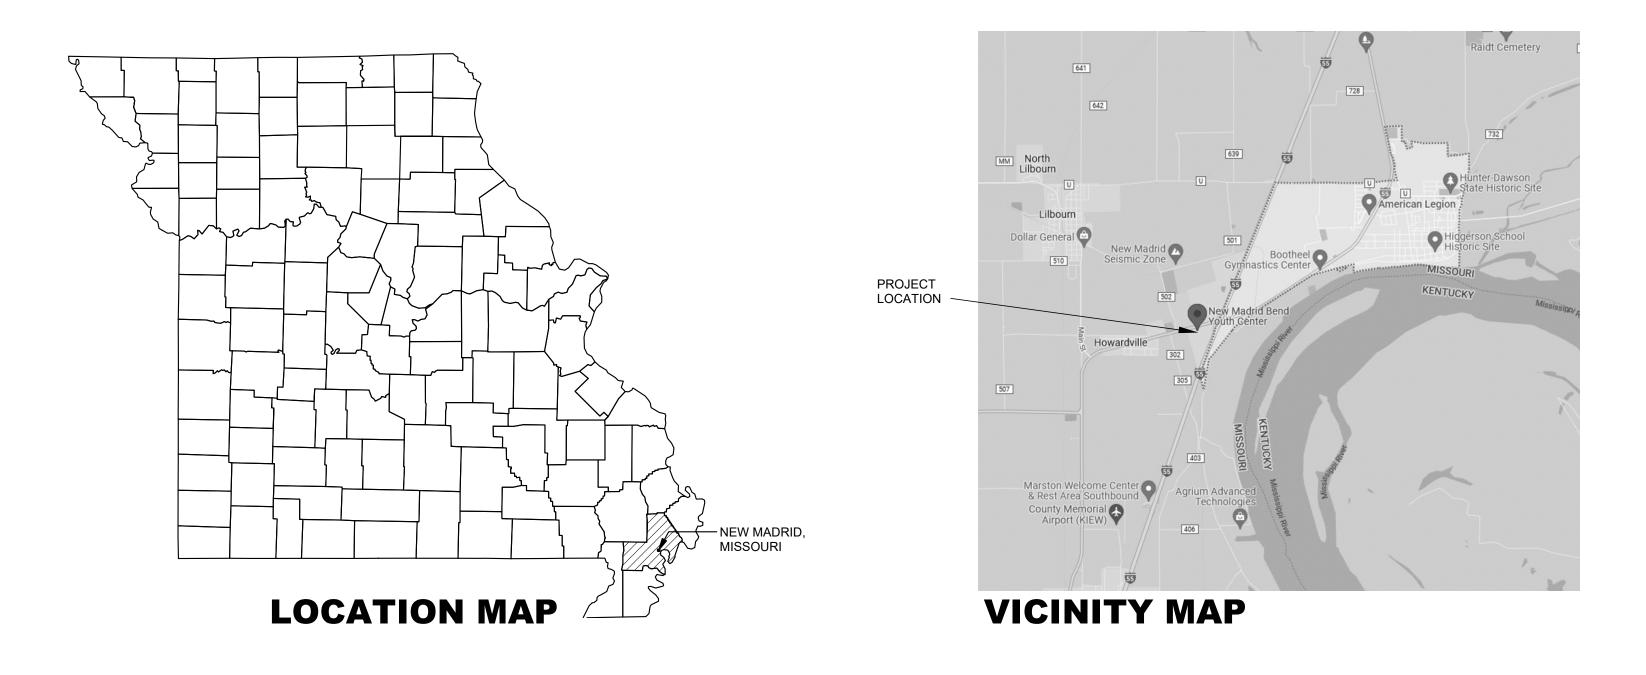

**DESIGNER**:

**PROJECT NUMBER:** 

SITE NUMBER:

ASSET NUMBER:

PWArchitects, Inc.

O2233-01

7711

8877711007



Peckham & Wright Architects, Inc., d.b.a. **PWArchitects**, Inc. 2120 Forum Blvd., Ste. 101 Columbia, Missouri 65203 PWArchitects.com | 573.449.2683

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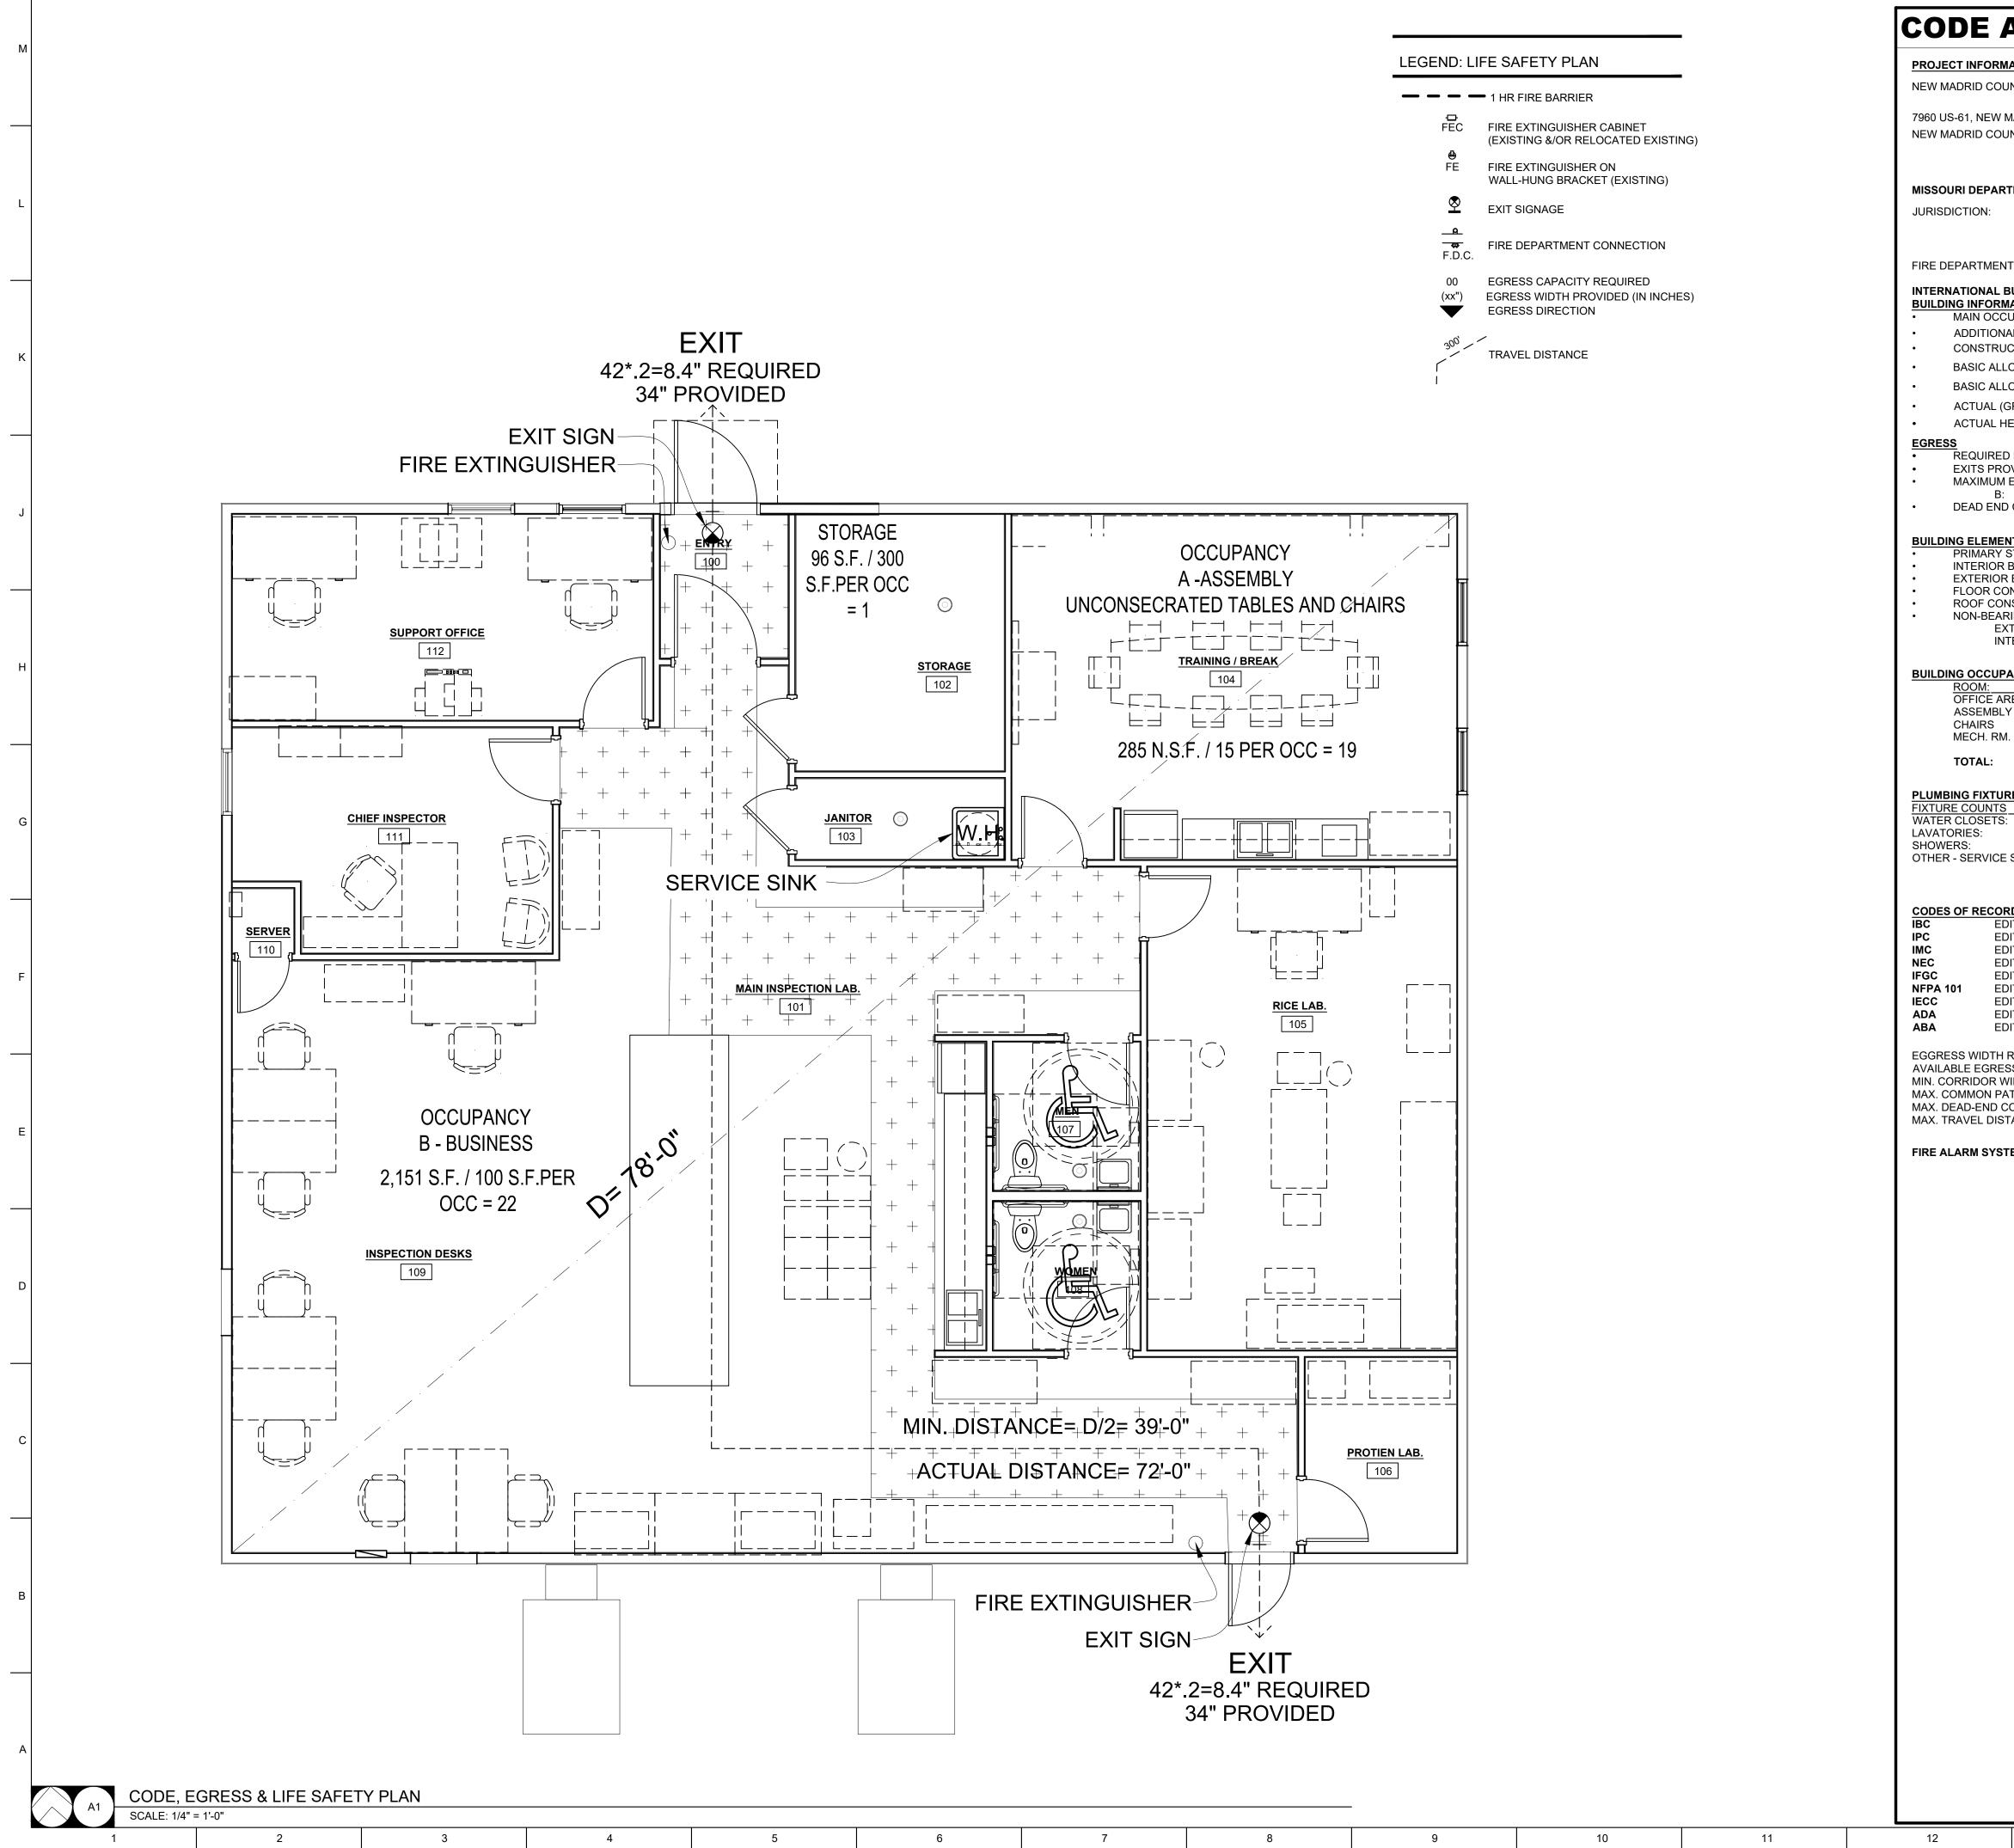
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COVER SHEET, INDEX OF DRAWINGS & LOCATION MAP

G-001 01 OF 23 SHEETS



ANALYSIS S	SUN	<b>MAR</b>	Y	
IATION: JNTY FAMILY SERVICES SITE				
MADRID, MO 63869				
TMENT OF AGRICULTURE OFFICE MISSOURI OFFICE OI MANAGEMENT, DESI MISSOURI DEPARTM AGRICULTURE T: NEW MADRID FIRE D	F ADMIN GN & CC ENT OF	ISTRATION - FAI		
BUILDING CODE (IBC) <u>MATION</u> CUPANCY TYPE (304.1): AL (MIXED) OCCUPANCIES (CHAPT ICTION TYPE (TABLE 601):		B (BUSINESS		
OWABLE AREA (TABLE 506.2): OWABLE HEIGHT (TABLE 504.3 & 5 GROSS) BUILDING AREA: IEIGHT:	504.4):	19,000 S.F. 3-STORIES / 5 3,097 S.F. 1-STORY / 18'		
D EXITS PER STORY (TABLE 1006.3 DVIDED IN DESIGN: EXIT ACCESS TRAVEL DISTANCE D CORRIDOR LENGTH (SECTION 10	(TABLE 1	<b>300 FEET</b>	EED 20 F	EET
NTS FIRE-RESISTANCE RATING RE STRUCTURAL FRAME:		0-HOI	JRS	
BEARING WALLS: R BEARING WALLS: DNSTRUCTION: NSTRUCTION: RING WALLS & PARTITIONS		0-HOU 0-HOU 0-HOU 0-HOU	JRS JRS	
(TERIOR: TERIOR:		0-HOI 0-HOI		
REA 1/100	G.S.F.	AREA 2,151 S.F. 285 S.F.	<u>OCC.</u> 22 OC	CUPANTS
		285 S.F. 96 S.F.	1 OCC	CUPANTS UPANT CUPANTS
RES         OCCUPANCY B           (42 OCC.)           1/25 OCC = 2			2	TOTAL PROVIDED
1/40 OCC = 2 - SINK: - (exception e)			2 - 1	2 0 1
<b>RD:</b> DITION: 2018 DITION: 2018 DITION: 2018 DITION: 2017 DITION: 2018 DITION: 2015 DITION: 2018 DITION: 2018 DITION: 2010 DITION: 2015				
REQ'D (TABLE 7.3.3.1): SS WIDTH: VIDTH: ATH OF TRAVEL (SECT. 38.2.5.3.1): CORRIDORS (SECTION 38.2.5.2.1): TANCE (SECTION 38.2.6.1):	42 OC 68" 84" 100 Fl 20 FE 200 F	ET	"/OCC. =	8.4"
TEM:		NFPA 70, 72 & UI ABLE EXTINGU		01 QUIP. PER NFPA
12		14	I	15


13

14

15

# **STATE OF MISSOURI** MICHAEL L. PARSON, GOVERNOR 02/27/202 Peckham & Wright Architects, Inc., d.b.a. PWArchitects, Inc. 2120 Forum Blvd., Ste. 101 Columbia, Missouri 65203 PWArchitects.com | 573.449.2683 ckham & Wright Architects an Arc Missouri State Certificate of Authority No. 000244 **OFFICE OF** ADMINISTRATION **DIVISION OF** FACILITIES MANAGEMENT, **DESIGN AND** CONSTRUCTION O2233-01 -MULTIPURPOSE BUILDING for MDA USE NEW MADRID STATE OFFICE BUILDING NEW MADRID, MISSOURI PROJECT # 02233-01 7711 SITE # 8877711007 ASSET # **REVISION:** DATE **REVISION:** DATE **REVISION**: DATE: ISSUE DATE: 02/27/2023 CAD DWG FILE: DRAWN BY: CHECKED BY: $\underline{EM}$ DESIGNED BY: EM SHEET TITLE: LIFE SAFETY PLAN & CODE ANALYSIS SHEET NUMBER: G-002 OF 23 SHEETS 02/27/2023



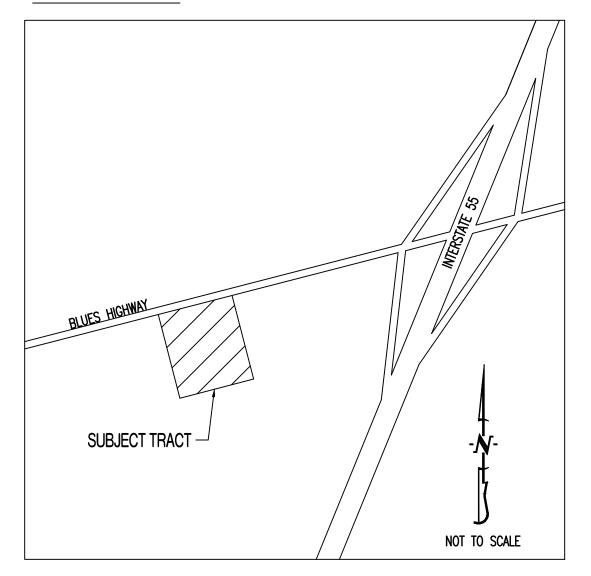

# PROJECT BENCHMARK:

TBM #1 - CHISELED + TOP FLANGE BOLT OF FH ELEVATION = 299.18

## FLOOD PLAIN STATEMENT:

THIS TRACT IS LOCATED IN ZONE X UNSHADED - AREAS DETERMINED TO BE OUTSIDE THE 1% ANNUAL CHANCE FLOOD AS SHOWN ON THE FEMA F.I.R.M. PANEL #2902560005B, DATED JUNE 15, 1979.

## UTILITY COMPANIES:

2

LOCATES: MISSOURI ONE CALL INC. 1022 B NORTHEAST DRIVE JEFFERSON CITY, MO 65109 1-800-344-7483

1



WATER/SANITARY: WATER AND SEWER DEPARTMENT 560 MOTT STREET NEW MADRID, MO 63869 573-748-2458

EXISTING UTILITIES SHOWN FOR REFERENCE ONLY. CONTRACTOR SHALL COORDINATE LOCATES (HORIZONTAL AND VERTICAL) PRIOR TO ANY EXCAVATION.

FROM THE EXCAVATION.

A GEOTECHNICAL EVALUATION OF THE SUBSURFACE SOIL, GROUNDWATER CONDITIONS, AND A SLOPE STABILITY ANALYSIS HAS NOT BEEN PERFORMED BY THIS ENGINEER. THE OWNER SHALL SATISFY THEMSELVES OF ALL GEOTECHNICAL CONDITIONS PRIOR TO ANY CONSTRUCTION.

ANY FILL PLACEMENT WITHIN STREET RIGHT-OF-WAY SHALL BE INSPECTED BY THE CITY OF NEW MADRID.

ALL SLOPES ARE 3:1 OR FLATTER UNLESS OTHERWISE NOTED.

ALL DISTURBED AREAS WITHIN THE "LIMITS OF DISTURBANCE" SHALL BE FINE GRADED, SEEDED, AND MULCHED.

STABILIZED.

ALL EXCAVATION WITHIN THE STREET RIGHT-OF-WAY SHALL BE BACKFILLED PER CURRENT CITY OF NEW MADRID SPECIFICATIONS. ALL SANITARY SEWER PIPE TO BE 4" PVC SDR 35 UNLESS OTHERWISE NOTED.

### GENERAL NOTES:

ALL STREET, STORM DRAIN, AND SANITARY SEWER CONSTRUCTION TO BE IN ACCORDANCE WITH THE CITY OF NEW MADRID SPECIFICATIONS AND STANDARDS.

CONTRACTOR WILL BE RESPONSIBLE FOR PLACEMENT AND MAINTENANCE OF TRAFFIC CONTROL DEVICES NECESSARY TO COMPLETE THEIR PORTION OF WORK. THE DEVICES AND METHODS EMPLOYED WILL COMPLY WITH THE CURRENT VERSION OF THE MANUAL ON UNIFORM TRAFFIC CONTROL DEVICES.

ALL EXCAVATION TO BE IN ACCORDANCE WITH SECTIONS 319.010-319.050, REVISED STATUTES OF THE STATE OF MISSOURI. SUCH COMPLIANCE SHALL NOT, HOWEVER, EXCUSE ANY PERSON MAKING ANY EXCAVATION FROM DOING SO IN A CAREFUL AND PRUDENT MANNER, NOR SHALL IT EXCUSE SUCH PERSON FROM LIABILITY FOR ANY DAMAGE OR INJURY TO UNDERGROUND UTILITIES RESULTING

ALL LAND DISTURBANCE ACTIVITIES SHALL BE IN ACCORDANCE WITH THE CITY OF NEW MADRID CODE OF ORDINANCES.

IT IS THE INTENT OF THESE PLANS TO COMPLY WITH THE REQUIREMENTS OF THE MODNR CLEAN WATER COMMISSION.

THE CONTRACTOR IS RESPONSIBLE FOR MAINTAINING ALL EROSION CONTROL DEVICES AND REMOVING THEM ONCE THE SITE IS

ALL SEWERLINES SHALL BE CONSTRUCTED AT LEAST 10 FEET HORIZONTALLY, EDGE TO EDGE, FROM ANY WATERLINE AND AT LEAST 24 INCHES VERTICALLY BETWEEN THE OUTSIDE LIMITS OF THE SANITARY SEWER AND WATERLINE. FOR CONDITIONS OTHER THAN THOSE IDENTIFIED ABOVE, CONTACT THE ENGINEER FOR SPECIFIC INSTRUCTIONS.

ALL SEWER GREATER THAN 15 FEET IN DEPTH SHALL BE A MINIMUM OF SDR 26.

ALL LATERAL LINES SHALL HAVE TRACER WIRE INSTALLED.

TOTAL DISTURBED AREA ON SITE = 0.15 AC.

	REVISION KEY				2
REV #	DATE	COMMENTS	CE 0	CE 1	CE 2
	1–31–2023	ORIGINAL SUBMITTAL	X	Х	Х


SHEET INDEX: CE 0 - COVERSHEET


CE1-SITE/UTILITY PLAN CE 2 - DETAILS

## LEGEND OF SYMBOLS:


	EXISTING CURB
	PROPOSED CURB
	EXISTING STRUCTURE
— — w — —	EXISTING WATERLINE
——————————————————————————————————————	EXISTING OVERHEAD ELECTRIC
— — s — —	EXISTING SANITARY SEWER
s	PROPOSED SANITARY SEWER
·····XXX······	EXISTING MINOR CONTOUR
— — —XXX— — —	EXISTING MAJOR CONTOUR
	EXISTING SIGNS
Ø	EXISTING POWER POLE
$\bowtie$	EXISTING WATER VALVE
Ą	EXISTING FIRE HYDRANT
$\bigcirc$	MANHOLE
— —	EXISTING SANITARY SEWER LATERA
•	PROPOSED SANITARY SEWER LATE
AC	EXISTING AIR CONDITIONER
¤	EXISTING LIGHT POLE
$\rightarrow$	EXISTING GUY WIRE


14

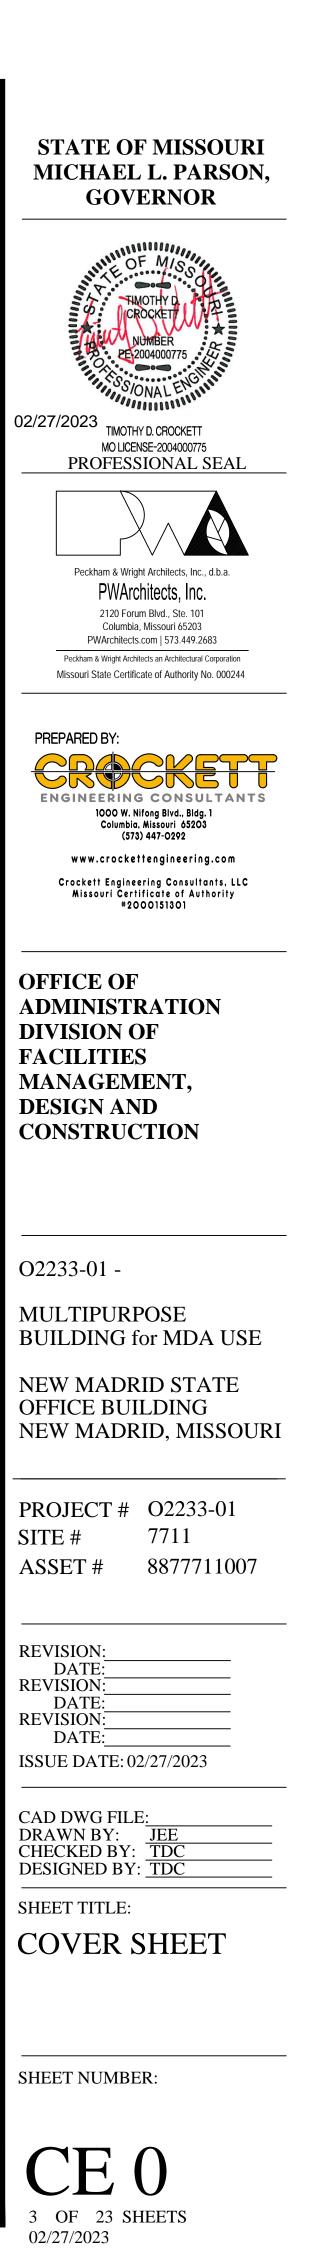

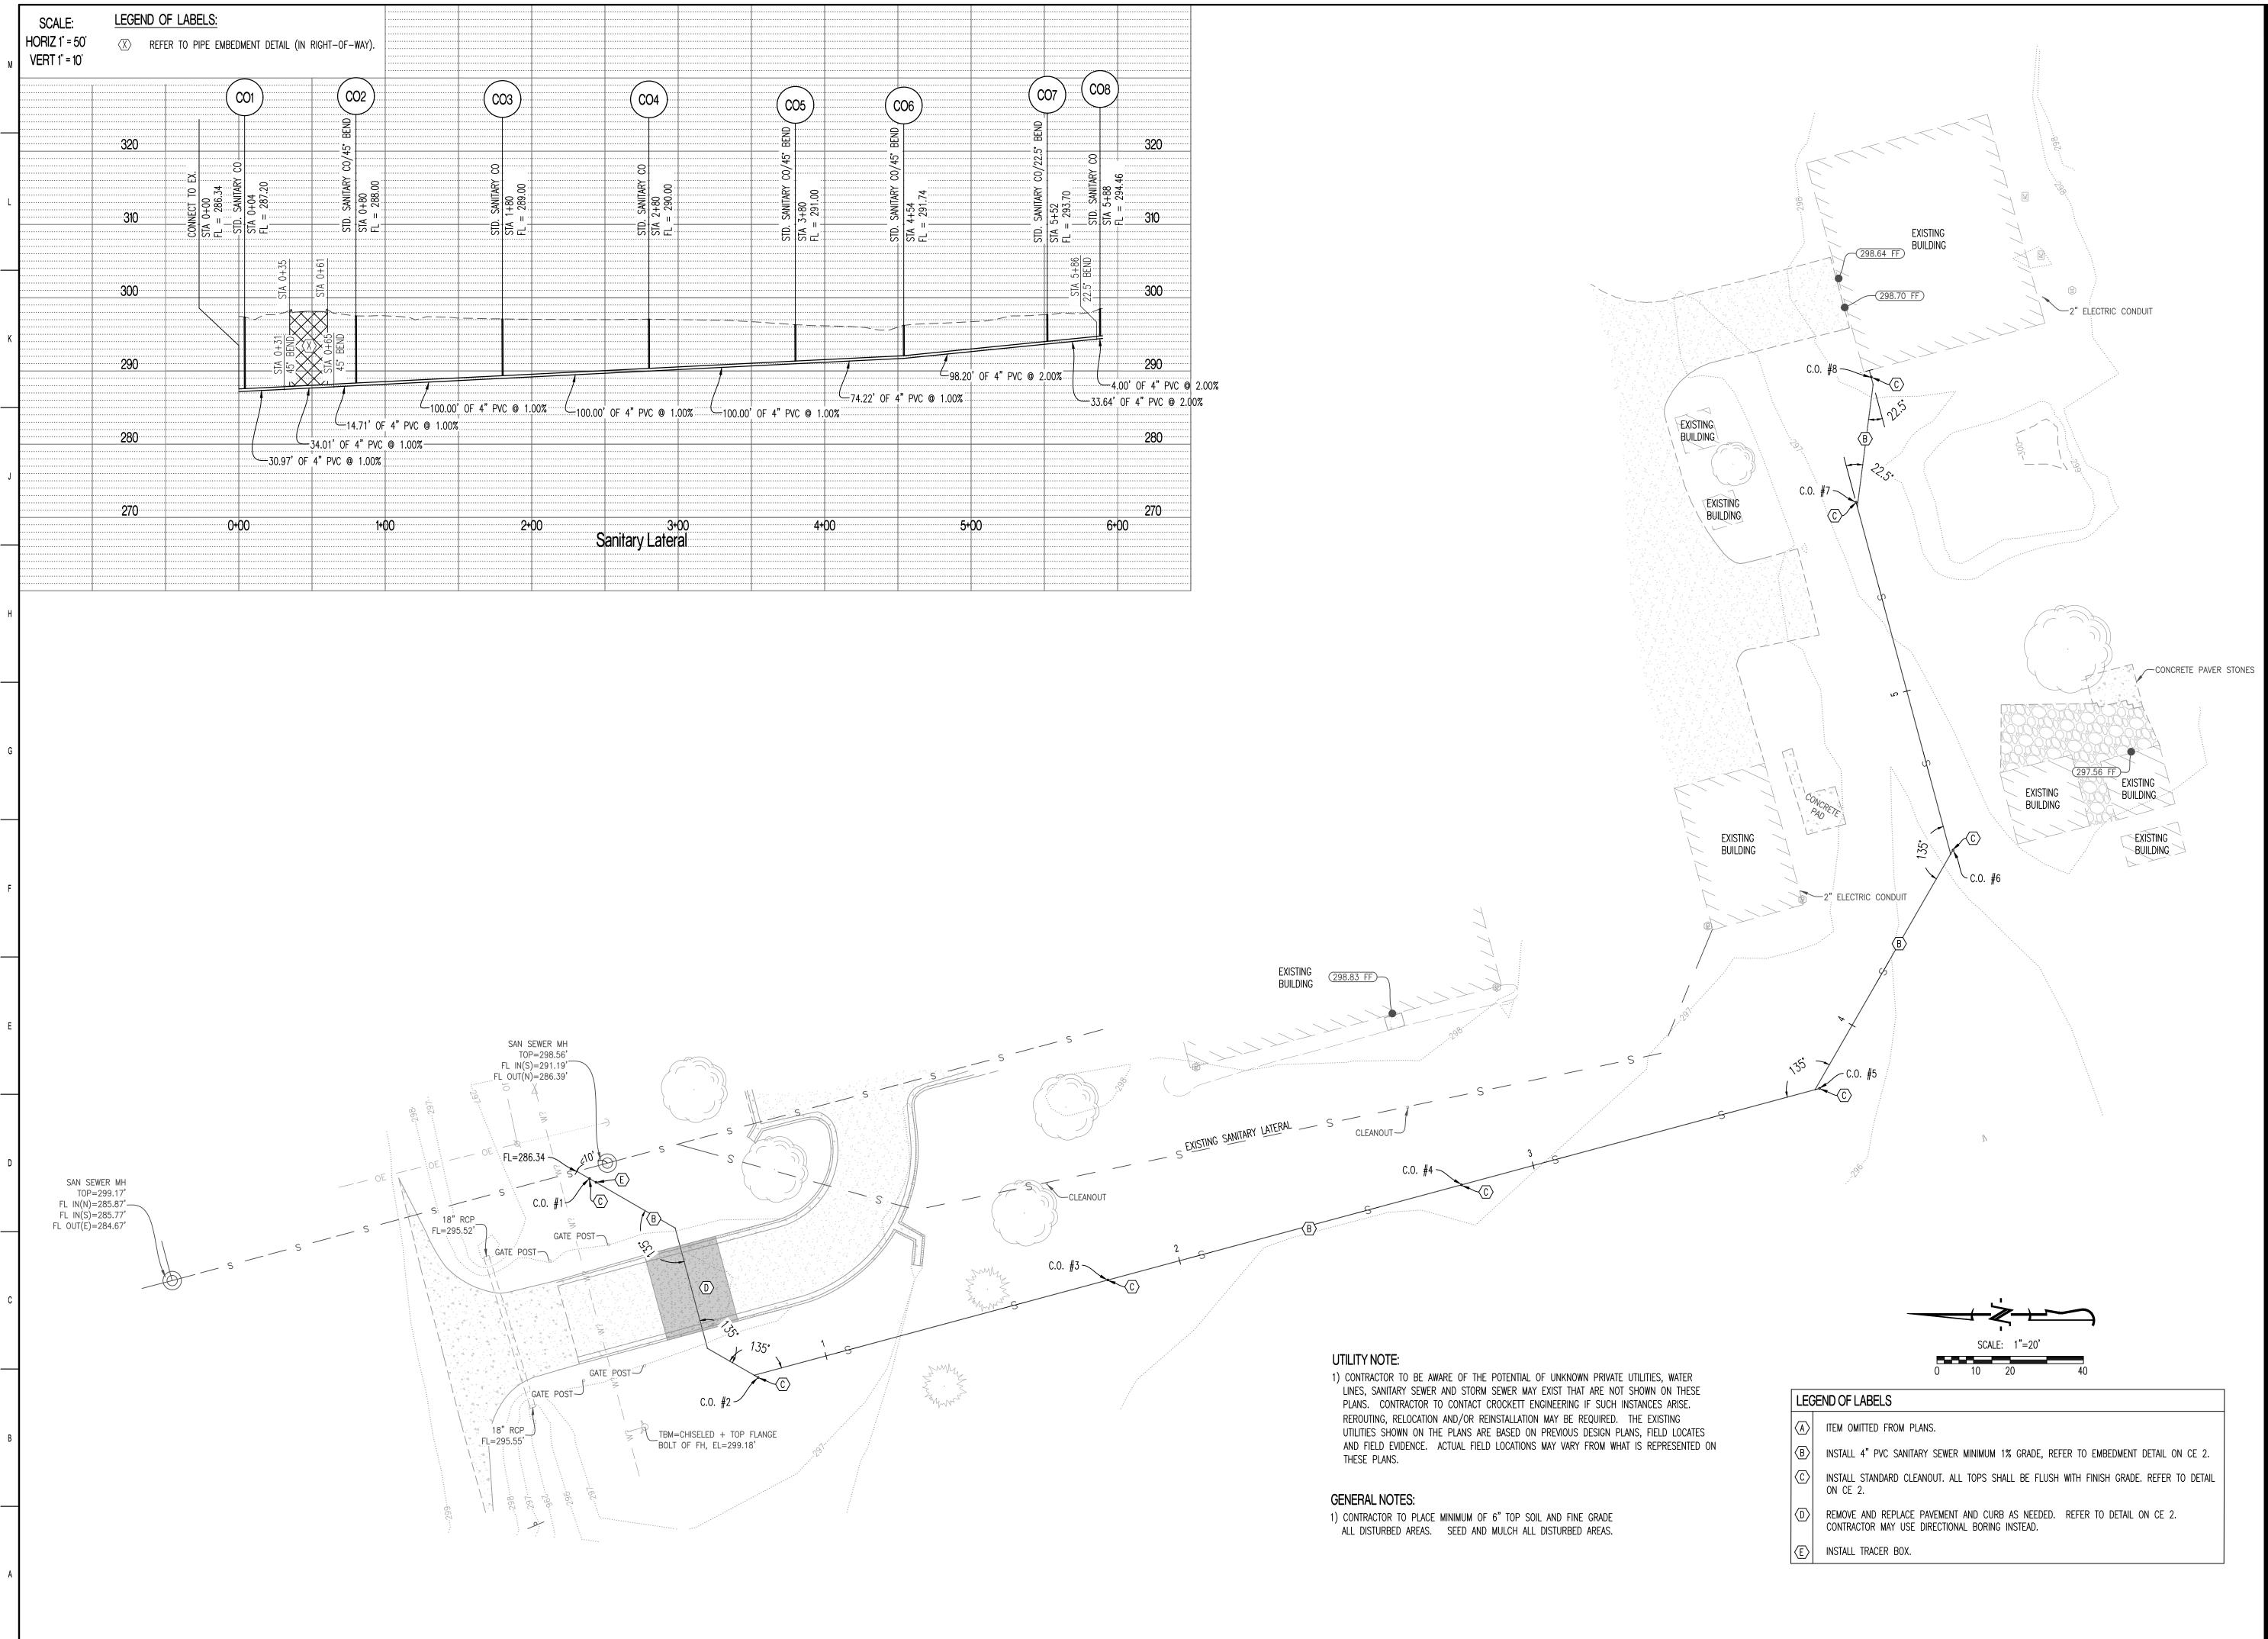

STATE OF MISSOURI MICHAEL L. PARSON, GOVERNOR
02/27/2023 TIMOTHY D. CROCKETT MO LICENSE-2004000775 PROFESSIONAL SEAL
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PREPARED BY: COOV. Nifong Bivd., Bidg. 1 Columbia, Missouri 65203 (573) 447-0292 Www.crockettengineering.com Crockett Engineering Consultants, LLC Missouri Certificate of Authority *2000151301
OFFICE OF ADMINISTRATION DIVISION OF FACILITIES MANAGEMENT, DESIGN AND CONSTRUCTION
O2233-01 - MULTIPURPOSE BUILDING for MDA USE NEW MADRID STATE OFFICE BUILDING NEW MADRID, MISSOURI
PROJECT #O2233-01SITE #7711ASSET #8877711007
REVISION: DATE: REVISION: DATE: REVISION: DATE: DATE: ISSUE DATE: 02/27/2023
CAD DWG FILE: DRAWN BY: JEE CHECKED BY: TDC DESIGNED BY: TDC SHEET TITLE: SITE / UTILITY PLAN
SHEET NUMBER:
CE 1 4 OF 23 SHEETS 02/27/2023

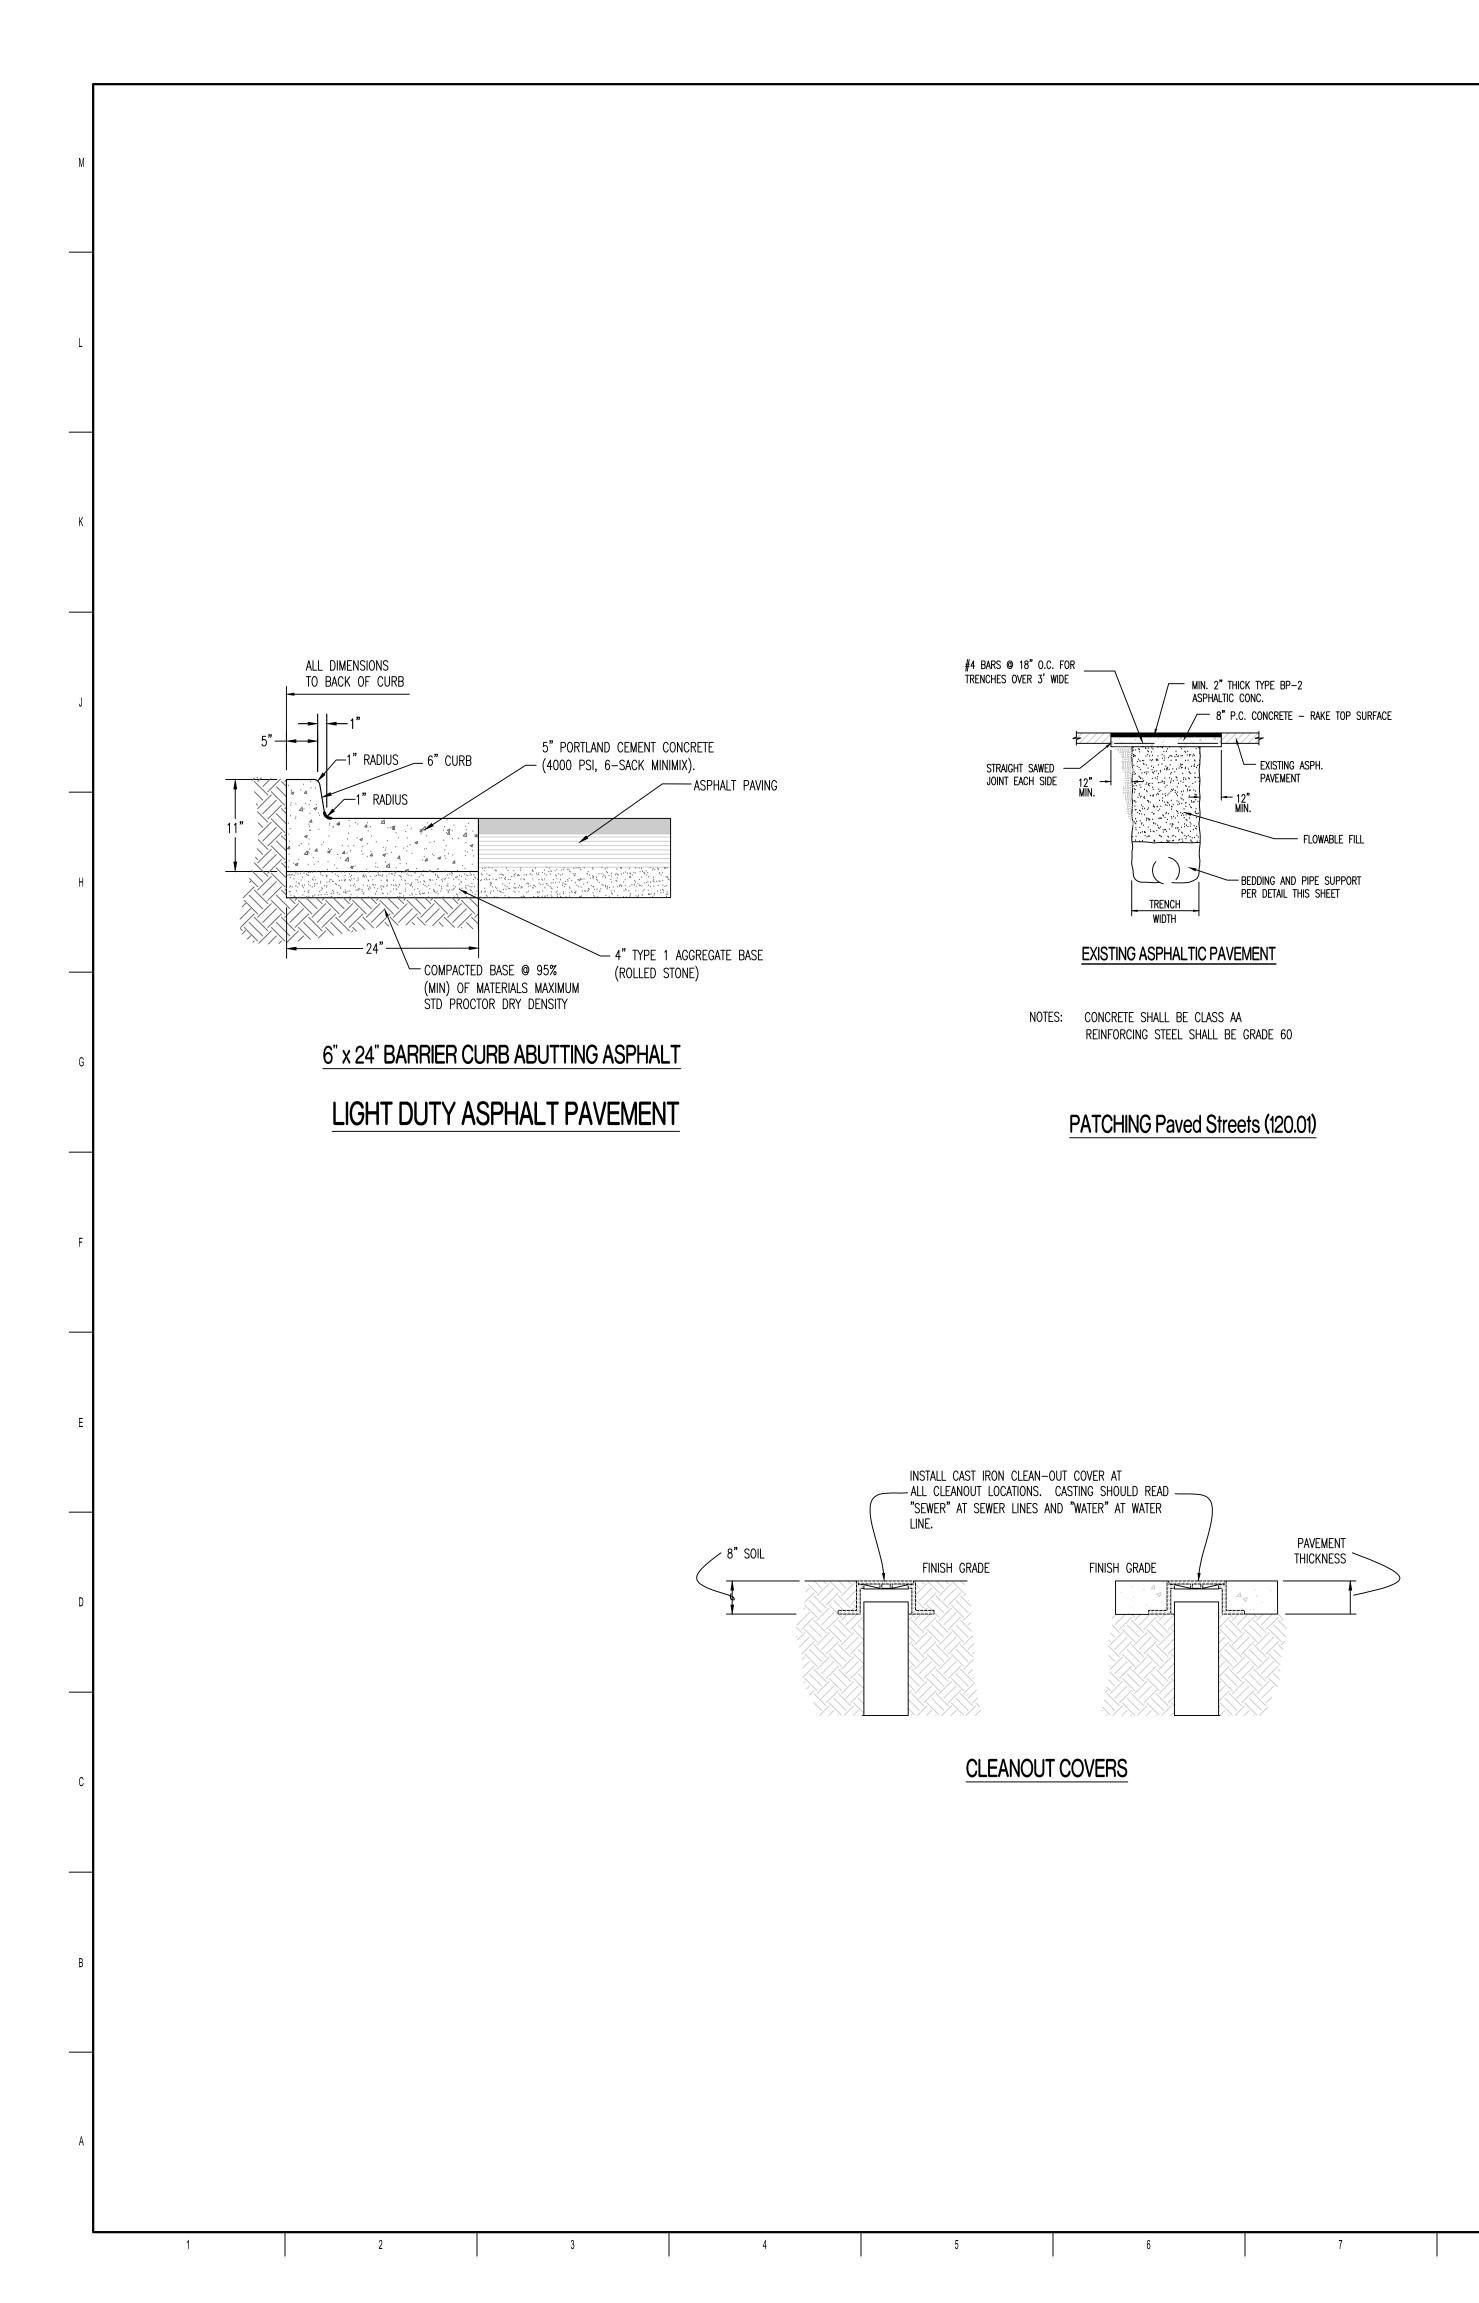


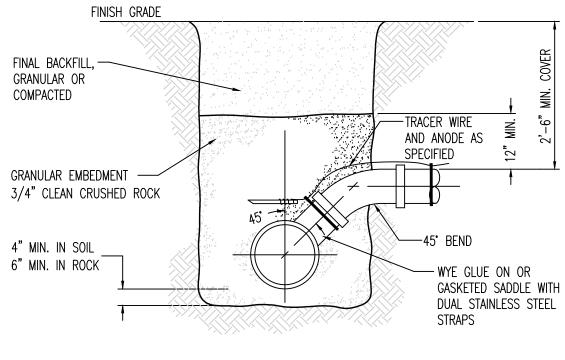




NOTES: 1. VCP PIPES SHALL NOT BE TAPPED. REPLACE SECTION OF VCP WITH PVC AND FITTING.


STANDARD SERVICE CONNECTION DETAIL (13)

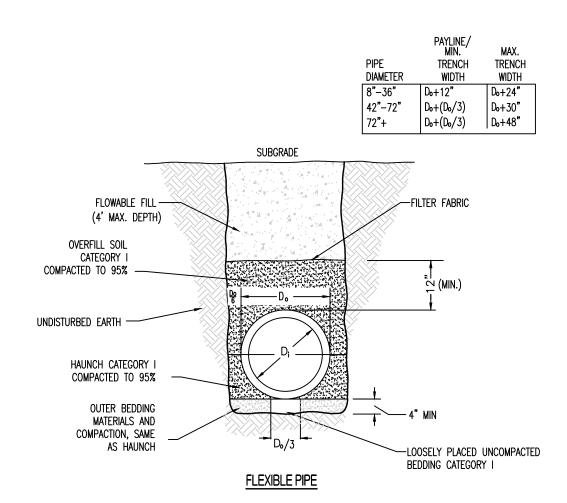

### PIPE EMBEDMENT (UNDER PAVEMENT)

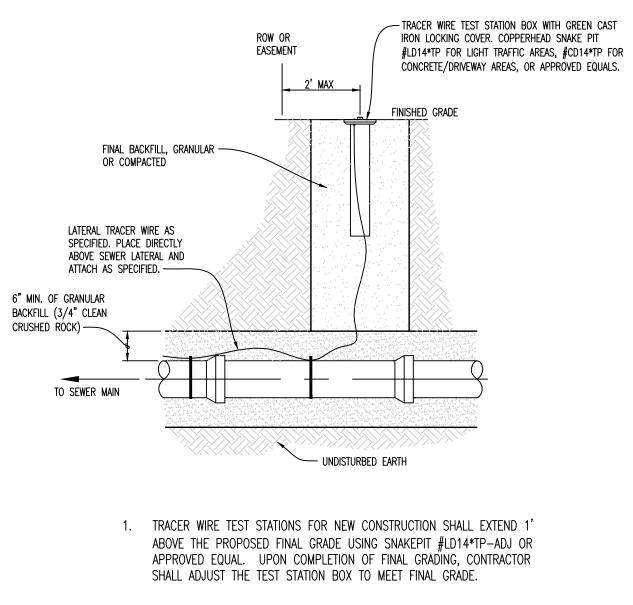




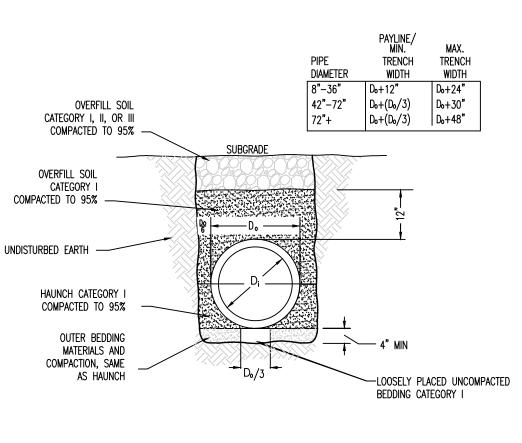

FLEXIBLE PIPE



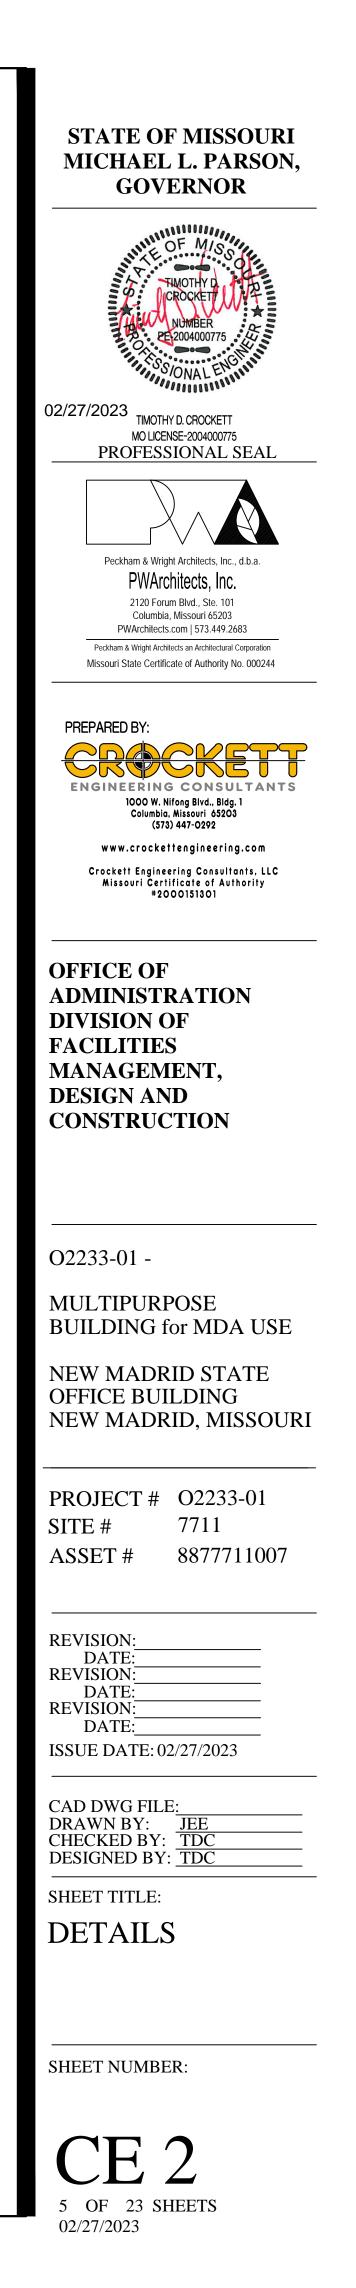

#### ABBREVIATIONS

1

2

3

А		F		Ν		
A ABV.	ABOVE	FAB.	FABRICATE / FABRICATION		NRC	NOISE REDUCTION COEFFICIE
A.F.F.	ABOVE FINISHED FLOOR	F.O.W.	FAC OF WALL		NOM.	NOMINAL
ACOUST		F.M.	FACTORY MUTUAL		N.	NORTH
ACT	ACOUSTICAL CEILING TILE	FT.	FEET / FOOT		N/A	NOT APPLICABLE
ADD.	ADDITION / ADDENDUM	F.V.			N.I.C. N.T.S.	NOT IN CONTRACT NOT TO SCALE
ADJ.		FIN.	FINISHED / FINISH		NO.	NUMBER
A/C		F.A. FACP	FIRE ALARM FIRE ALARM CONTROL PANEL		NO.	NOMBER
ALT. AL. / ALU	ALTERNATE /I. ALUMINUM	FACP F.E.B.	FIRE EXTINGUISHER BRACKET	0		
AL. / ALU AWG	AMERICAN WIRE GAUGE	F.E.C.	FIRE EXTINGUISHER CABINET		OCC.	OCCUPANT / OCCUPANCY
ANG	AMERICAN WITH DISABILITIES ACT	F.H.	FIRE HYDRANT		0.C.	ON-CENTER
A.B.	ANCHOR BOLT	F.P.	FIRE PROTECTION / FIRE PROOF /		OPNG.	OPENING
A.B.	ANCHOR BOLT		FIRE PROOFING		OPP.	OPPOSITE
APPROX	APPROXIMATE	F.R.	FIRE-RATED		O.D.	OVERALL / OUTSIDE DIMENSIC
ARCH.	ARCHITECT / ARCHITECURAL	FLR.	FLOOR		O.H.	OVERHEAD / OVERHANG
ASPH.	ASPHALT	F.D.	FLOOR DRAIN			
AUTO.	AUTOMATIC	FLG.	FLOORING	Р		
AVG.	AVERAGE	FLUOR.	FLUORESCENT		PT.	PAINT
		FTG.	FOOTING		PTD.	PAINTED
В		FDN.			PR.	PAIR
BSMT.	BASEMENT	FURN. FUT.	FURNITURE / FURNISH FUTURE		PTN. / PART. PVMT.	PAVEMENT
BM.	BEAM	101.	TOTORE		PERF.	PERFORATED
BRG.	BEARING	G			PERIM.	PERIMETER
B.M.	BENCH MARK	GALV.	GALVANIZED / GALVALUME		PERM.	PERMANENT
BTWN. BLK.	BETWEEN BLOCK	GA.	GAUGE		PERP.	PERPENDICULAR
BLK. BLKG.	BLOCKING	G.C.	GENERAL CONTRACTOR		PH.	PHASE / PHASED
BERG. BD.	BOARD	GL.	GLASS		PLAS.	PLASTIC
B.O.	BOTTOM OF	GLAZ.	GLAZING		PLAM	PLASTIC LAMINATE
B.O. BRZ	BRONZE	GOVT.	GOVERNMENT		PLMG. /	PLUMBING
BRZ BLDG.	BUILDING	G.B.	GRAB BAR		PLUMB.	
BLDG. B.U.	BUILT-UP	GYP.	GYPSUM		PLYWD.	PLYWOOD
5.0.					PVC	POLYVINYL CHLORIDE
С		Н			PORC.	PORCELAIN
CAB.	CABINET	HDW	HARDWARE		P.C.F.	POUNDS PER CUBIC FOOT
CPT	CARPET	HDWD.	HARDWOOD		P.L.F.	POUNDS PER LINEAR FOOT
C.I.P.	CAST IN PLACE	HTG.	HEATING		P.S.F.	POUNDS PER SQUARE FOOT
CLG.	CEILING	HVAC	HEATING, VENTILATING & AIR		P.S.I.	POUNDS PER SQUARE INCH
C	CENTER LINE		CONDITIONING		PWR.	POWER
СТ	CERAMIC TILE	HVY.	HEAVY		P.C.	PRE CAST
C.O.	CLEAN OUT	HT.	HEIGHT		PRE-ENG.	PRE-ENGINEERED
CLR.	CLEAR / CLEARANCE	H.	HIGH		PRE-FIN.	PRE-FINISHED
CLO.	CLOSET	H.C.	HOLLOW CORE		PROJ.	PROJECT / PROJECTION
COL.	COLUMN	HM	HOLLOW METAL		PL	PROPERTY LINE
COMB.	COMBINATION	HORZ. /	HORIZONTAL			
CONC.	CONCRETE	HOR.		Q		
CMU	CONCRETE MASONRY UNIT	H.W.	HOT WATER HEATER		QTY.	QUANTITY
COND.	CONDITION / CONDENSER	HR.	HOUR		QT	QUARRY TILE
CONF.	CONFERENCE					
CONST.	CONSTRUCTION	I		R		
CD	CONSTRUCTION DOCUMENT(S)	ID IN.	IDENTIFICATION INCH / INCHES		R.	RADIUS / RISER(S)
CONT.	CONTINUAL / CONTINUOUS				RECEPT.	RECEPTION
CONTR.	CONTRACTOR	INCL.	INCLUDE / INCLUDED		RE:	REFERENCE
C.J.	CONTROL / CONSTRUCTION JOINT	I.D.			RCP	REFLECTED CEILING PLAN
CU	COPPER	INST.	INSTRUCTIONS / INSTALL / INSTALLATION		REF.	REFRIGERATOR
CORR.	CORRIDOR	INSUL.	INSULATION / INSULATED		REG.	<b>REGULATION / REGISTERED</b>
CU. FT.	CUBIC FEET	INT.	INTERIOR		REINF.	REINFORCED / REINFORCEME
CFM	CUBIC FEET PER MINUTE				RMV.	REMOVE
CU. YD.	CUBIC YARD	J			REQD.	REQUIRED
		JAN.	JANITOR		RET.	RETURN
D		JT.	JOINT		RA REV.	RETURN AIR REVERSE / REVERSED / REVIS
DK.	DARK	JST.	JOIST		REV.	REVERSE / REVERSED / REVIS
D.	DEEP / DEPTH	JCT.	JUNCTION		R.H.	RIGHT HAND
DEMO	DEMOLITION				R.O.W.	RIGHT OF WAY
DTL.	DETAIL	K			RTU	ROOF TOP UNIT
DIAG.	DIAGONAL / DIAGONALLY	KIT.	KITCHEN		RM.	ROOM
DIA.	DIAMETER				R.O.	ROUGH OPENING
DIM.	DIMENSION	L			R.S.	ROUGH SAWN
D.W.		LAM.	LAMINATE		RB	RUBBER / RESILIENT BASE
DISP.	DISPENSER / DISPLAY	LVL	LAMINATED VENEER LUMBER			
DIV.		LAT.	LATERAL	S		
DOC.	DOCUMENT(S) / DOCUMENTED	LAV.	LAVATORY		SAN.	SANITARY
DR.		L.H.	LEFT HAND		S.S.	SANITARY SEWER / SERIVCE S
DBL.	DOUBLE	LT.	LIGHT			STAINLESS STEEL
DN.		LED	LIGHT EMITTING DIODE		SCHED.	SCHEDULE
DS.		LTG.	LIGHTING		SCRN.	SCREEN / SCREENED
DWG. D.F.	DRAWING DRINKING FOUNTAIN	LIN.	LINE / LINEAR		SECT.	SECTION
D.F. d	PENNY	L.F.	LINEAR FEET		SHTG.	SHEATHING
u	I LININI	LINO	LINOLEUM		SHT.	SHEET
E		LOC.	LOCATION / LOCATE		SIM.	SIMILAR
EA.	EACH	LG.	LONG/LENGTH		SC.	SOLID CORE
E.W.	EACH WAY	LB.	POUND / POUNDS		SCWD.	SOLID CORE WOOD DOOR
E.	EAST				SSM	SOLID SURFACE MATERIAL
ELECT. /	ELECTRICAL	М			STC	SOUND TRANSMISSION CLASS
ELEC.		M.H.			S.	SOUTH
EL.	ELEVATION	MFR.	MANUFACTURED / MANUFACTURER		SPKR.	SPEAKER
ELEV.	ELEVATOR	MFG.	MANUFACTURING		SPEC.	SPECIFICATION(S)
ENCL.	ENCLOSE / ENCLOSED / ENCLOSURE	MAS.	MASONRY		SQ.	SQUARE
EQ.	EQUAL	M.O.	MASONRY OPENING		S.F. / SF	SQUARE FEET
EQUIP.	EQUIPMENT	MATL.	MATERIAL		SQ. IN.	
EST.	ESTIMATE	MAX.	MAXIMUM		SQ. YD.	SQUARE YARD
EXIST.	EXISTING	MECH.	MECHANICAL		S.&V.	STAIN AND VARNISH
EXP.	EXPANSION / EXPOSED	MED.	MEDIUM		STD.	STANDARD
E.J.	EXPANSION JOINT	MEMB.	MEMBRANE		STL.	STEEL
EXT.	EXTERIOR	MTL.	METAL		SL	STEEL LINE
E.I.F.S.	EXTERIOR INSULATED FINISH	М.	METER(S)		STOR.	STORAGE
	SYSTEM	MM.	MILLIMETER(S)		SD	STORM DRAIN / SMOKE DETEC
		MIN.	MINIMUM			SUPPLY DUCT / SOAP DISPENS
		MIR.	MIRROR		ST.	STREET
		MISC.	MISCELLANEOUS		STRUCT.	STRUCTURAL / STRUCTURE
		MONG	MISSOURI NATIONAL GUARD		SUSP.	SUSPENDED
		MOD.	MODULAR / MODIFY		SYM.	SYMMETIRCAL
			MODULAR / MODIFY MOUNTED MULTIPLE		SYM. SYS.	SYMMETIRCAL SYSTEM

5

4

		SYMBOLS LEGEND
т		DRAWING BULLET W
TEL.	TELEPHONE	
TV	TELEVISION	
TEMP.	TEMPORARY / TEMPERATURE	
THK.	THICK	
THRU	THROUGH	
TOIL.	TOILET	sc sc
T.&G.	TONGUE AND GROOVE	
T.&B.	TOP AND BOTTOM	
T.O.		
T.O.C.	TOP OF CURB	DRAWING BULLET W
T.O.W.	TOP OF WALL	
TS.	TRANSITION STRIP / TUBE STEEL	
Τ.	TREAD(S)	
TYP.	TYPICAL	A2 DI
		A1 A100 SC
U		
U.N.O.	UNLESS NOTED OTHERWISE	
V		
		ELEVATION BULLETS
V.B.	VAPOR BARRIER	
VTR	VENT THROUGH ROOF	AO
VERT. /	VERTICAL	
VER.		
VEST.	VESTIBULE	ONE ELEVATION
VCT	VINYL COMPOSITION TILE	SCOPE OF WORK BL
N		
W.C.	WATER CLOSET	
WP	WEATHERPROOF	
WT.	WEIGHT	DOOR MARK BULLET
W.W.F.	WELDED WIRE FABRIC	
W.W.M.	WELDED WIRE MESH	(000A)
W.	WEST / WIDE / WIDTH	
WIN.	WINDOW	WINDOW MARK BULI
W/	WITH	
W/O	WITHOUT	
WD.	WOOD	$\langle A \rangle$
WB	WOOD BASE	
<		REVISION NOTE BUL
XFER		
Х	TYPE X	
,		GENERAL NOTE BUL
YD.	YARD	
TD.		
		BENCHMARK BULLE
		• 000.OO'
		+**** FLOOR
		TEOOK

MATERIAL LEGEND

LARGE SC
BRICK MASONRY UNIT
CONCRETE MASONRY UNIT
CONCRETE
GYPSUM BOARD
GROUTED AREA OF: CMU/CAVITY/DOOR FRAME
MISCELLANEOUS ITEMS: AS NOTED ON EACH SHEET
INSULATION
ROOF SHINGLES
CONTINUOUS WOOD FRAMING
WOOD BLOCKING
PLYWOOD
EXISTING BUILDING

SMOKE DETECTOR /	
SOAP DISPENSER	


OLS LEGEND	
DRAWING BULLET WITH NORTH ARROW	
	GRID REFERENCE
DRAWING TITLE	
SCALE: X/X" = 1'-0"	ARCH. SCALE
DRAWING BULLET WITHOUT NORTH ARROW	
A2 DRAWING TITLE	GRID REFERENCE
A1 A2 DRAWING TITLE A1 A100 SCALE: X/X" = 1'-0"	ARCH. SCALE
	PAGE FIRST REFERENCED (IF APPLICABLE)
ELEVATION BULLETS	PLAN / ELEVATION DETAIL BULLET
A0 GRID REFERENCE	$\langle  \rangle$
A000 SHEET NUMBER	GRID REFERENCE
SCOPE OF WORK BULLET	
	A100 SHEET NUMBER
	SECTION BULLET
(000A)	GRID REFERENCE
	A1 ALWAYS ON TOP
	SHEET NUMBER
$\langle \mathbf{A} \rangle$	NORTH ARROW
GENERAL NOTE BULLET	
	COLUMN LINE BULLETS
BENCHMARK BULLET	
000.00'	$(\mathbf{A}) - \cdots - \cdots -$
***** FLOOR	SPOT ELEV. BULLETS
WALL PARTITION (TYPE) FLAG	TC - TOP OF CURB TG -
A	TOP OF GRADE TW - TOP OF GRADE TW - TOP OF WALL TP - TOP OF PAVING
	₩ ₩×
RIAL LEGEND	
RIAL LEGEND	
LARGE SCALE SMALL SCALE	
BRICK PLAN,	
MASONRY UNIT	
CONCRETE PLAN,	
CONCRETE PLAN, SECTIO	N
GYPSUM PLAN,	
BOARD SECTION	
GROUTED AREA OF: CMU/CAVITY/DOOR FRAME	 N
MISCELLANEOUS ITEMS: AS NOTED ON EACH SHEET	ECTION,
INSULATION PLAN, SECTIO	
ROOF PLAN, SHINGLES ELEVAT	
CONTINUOUS PLAN, WOOD FRAMING SECTIO	 N
WOOD PLAN, BLOCKING SECTIO	
PLYWOOD PLAN, SECTIO	
EXISTING PLAN, BUILDING SECTIO	

# **STATE OF MISSOURI** MICHAEL L. PARSON, GOVERNOR 02/27/202 Peckham & Wright Architects, Inc., d.b.a. PWArchitects, Inc. 2120 Forum Blvd., Ste. 101 Columbia, Missouri 65203 PWArchitects.com | 573.449.2683 ckham & Wright Architects an Arc Missouri State Certificate of Authority No. 000244 **OFFICE OF** ADMINISTRATION **DIVISION OF** FACILITIES MANAGEMENT, **DESIGN AND** CONSTRUCTION O2233-01 -MULTIPURPOSE BUILDING for MDA USE NEW MADRID STATE OFFICE BUILDING NEW MADRID, MISSOURI PROJECT # 02233-01 7711 SITE # ASSET # 8877711007 **REVISION:** DATE REVISION: DATE: REVISION: DATE: ISSUE DATE: 02/27/2023 CAD DWG FILE: DRAWN BY: <u>LC</u> CHECKED BY: <u>EM</u> DESIGNED BY: <u>EM</u> SHEET TITLE: SYMBOLS, ABBREVIATIONS AND NOTES SHEET NUMBER: A-001 OF 23 SHEETS 6

02/27/2023

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- DEMO AND REMOVE ALL EXISTING  $\left\{ 1 \right\}$ BROADLOOM GLUE DOWN CARPET FLOORING AND RUBBER COVE BASE 2 DEMO AND REMOVE ALL EXISTING
- VINYL PLANK FLOORING AND RUBBER COVE BASE  $\langle 3 \rangle$  DEMO AND REMOVE EXISTING SINK,
- TOILET, HAND DRYER, PLUMBING AND ACCESSORIES
- 4 DEMO AND REMOVE EXISTING HOLLOW CORE WOOD DOOR AND WOOD FRAME
- 5 DEMO AND REMOVE EXISTING INSULATED HOLLOW METAL DOOR AND FRAME
- 6 DEMO AND REMOVE EXISTING INSULATED OVERHEAD GARAGE DOOR, HARDWARE AND TRACK
- 7 DEMO AND REMOVE EXISTING INTERIOR WOOD STUD AND GYPSUM BOARD WALLS
- $\left( 8 \right)$  DEMO AND REMOVE ALL EXISTING WOOD FRAMED STAIRS, RAILINGS AND WALLS
- (9) DEMO AND REMOVE ALL EXISTING FIRE ALARM SYSTEM, EXIT LIGHTS AND CONDUIT
- (10) DEMO AND REMOVE ALL EXISTING MEZZANINE FLOOR FRAMING
- (11) DEMO AND REMOVE EXISTING THROUGH WALL AIR CONDITIONING UNIT
- 12 DEMO AND REMOVE EXISTING WINDOW GLAZING AND FRAME
- (13) REMOVE AND SALVAGE TO OWNER EXISTING WINDOW WALL MOUNTED BASKETBALL GOALS, BACKBOARDS, FRAMES AND WALL PADDING
- (14) SAW CUT, DEMO AND REMOVE EXISTING CONCRETE SLAB AS REQUIRED FOR NEW PLUMBING PIPE AND FIXTURE INSTALLATION. SEE MEP
- (15) DEMO OR REMOVE WALL EXISTING GYPSUM BOARD OR PAINTED WOOD WALL SHEATHING ON THE EXTERIOR WALLS

- (16) DEMO OR REMOVE EXISTING DOUBLE HUNG VINYL WINDOW
- 17 DEMO OR REMOVE EXISTING WALL AS REQUIRED FOR NEW WINDOWS
- (18) DEMO OR REMOVE EXISTING METAL SIDING AS REQUIRED FOR NEW CANOPY INSTALLATION
- (19) REMOVE ALL EXISTING FLOOR COATINGS, CLEAN AND PREPARE NEW AND EXISTING FLOOR SLABS FOR NEW SEALED CONCRETE
- GENERAL NOTES
- THE GENERAL CONTRACTOR IS RESPONSIBLE FOR THE FOLLOWING:
- 1. PROVIDING DUST, NOISE AND SAFETY BARRIERS
- 2. CAPPING OFF ALL UTILITY SERVICES

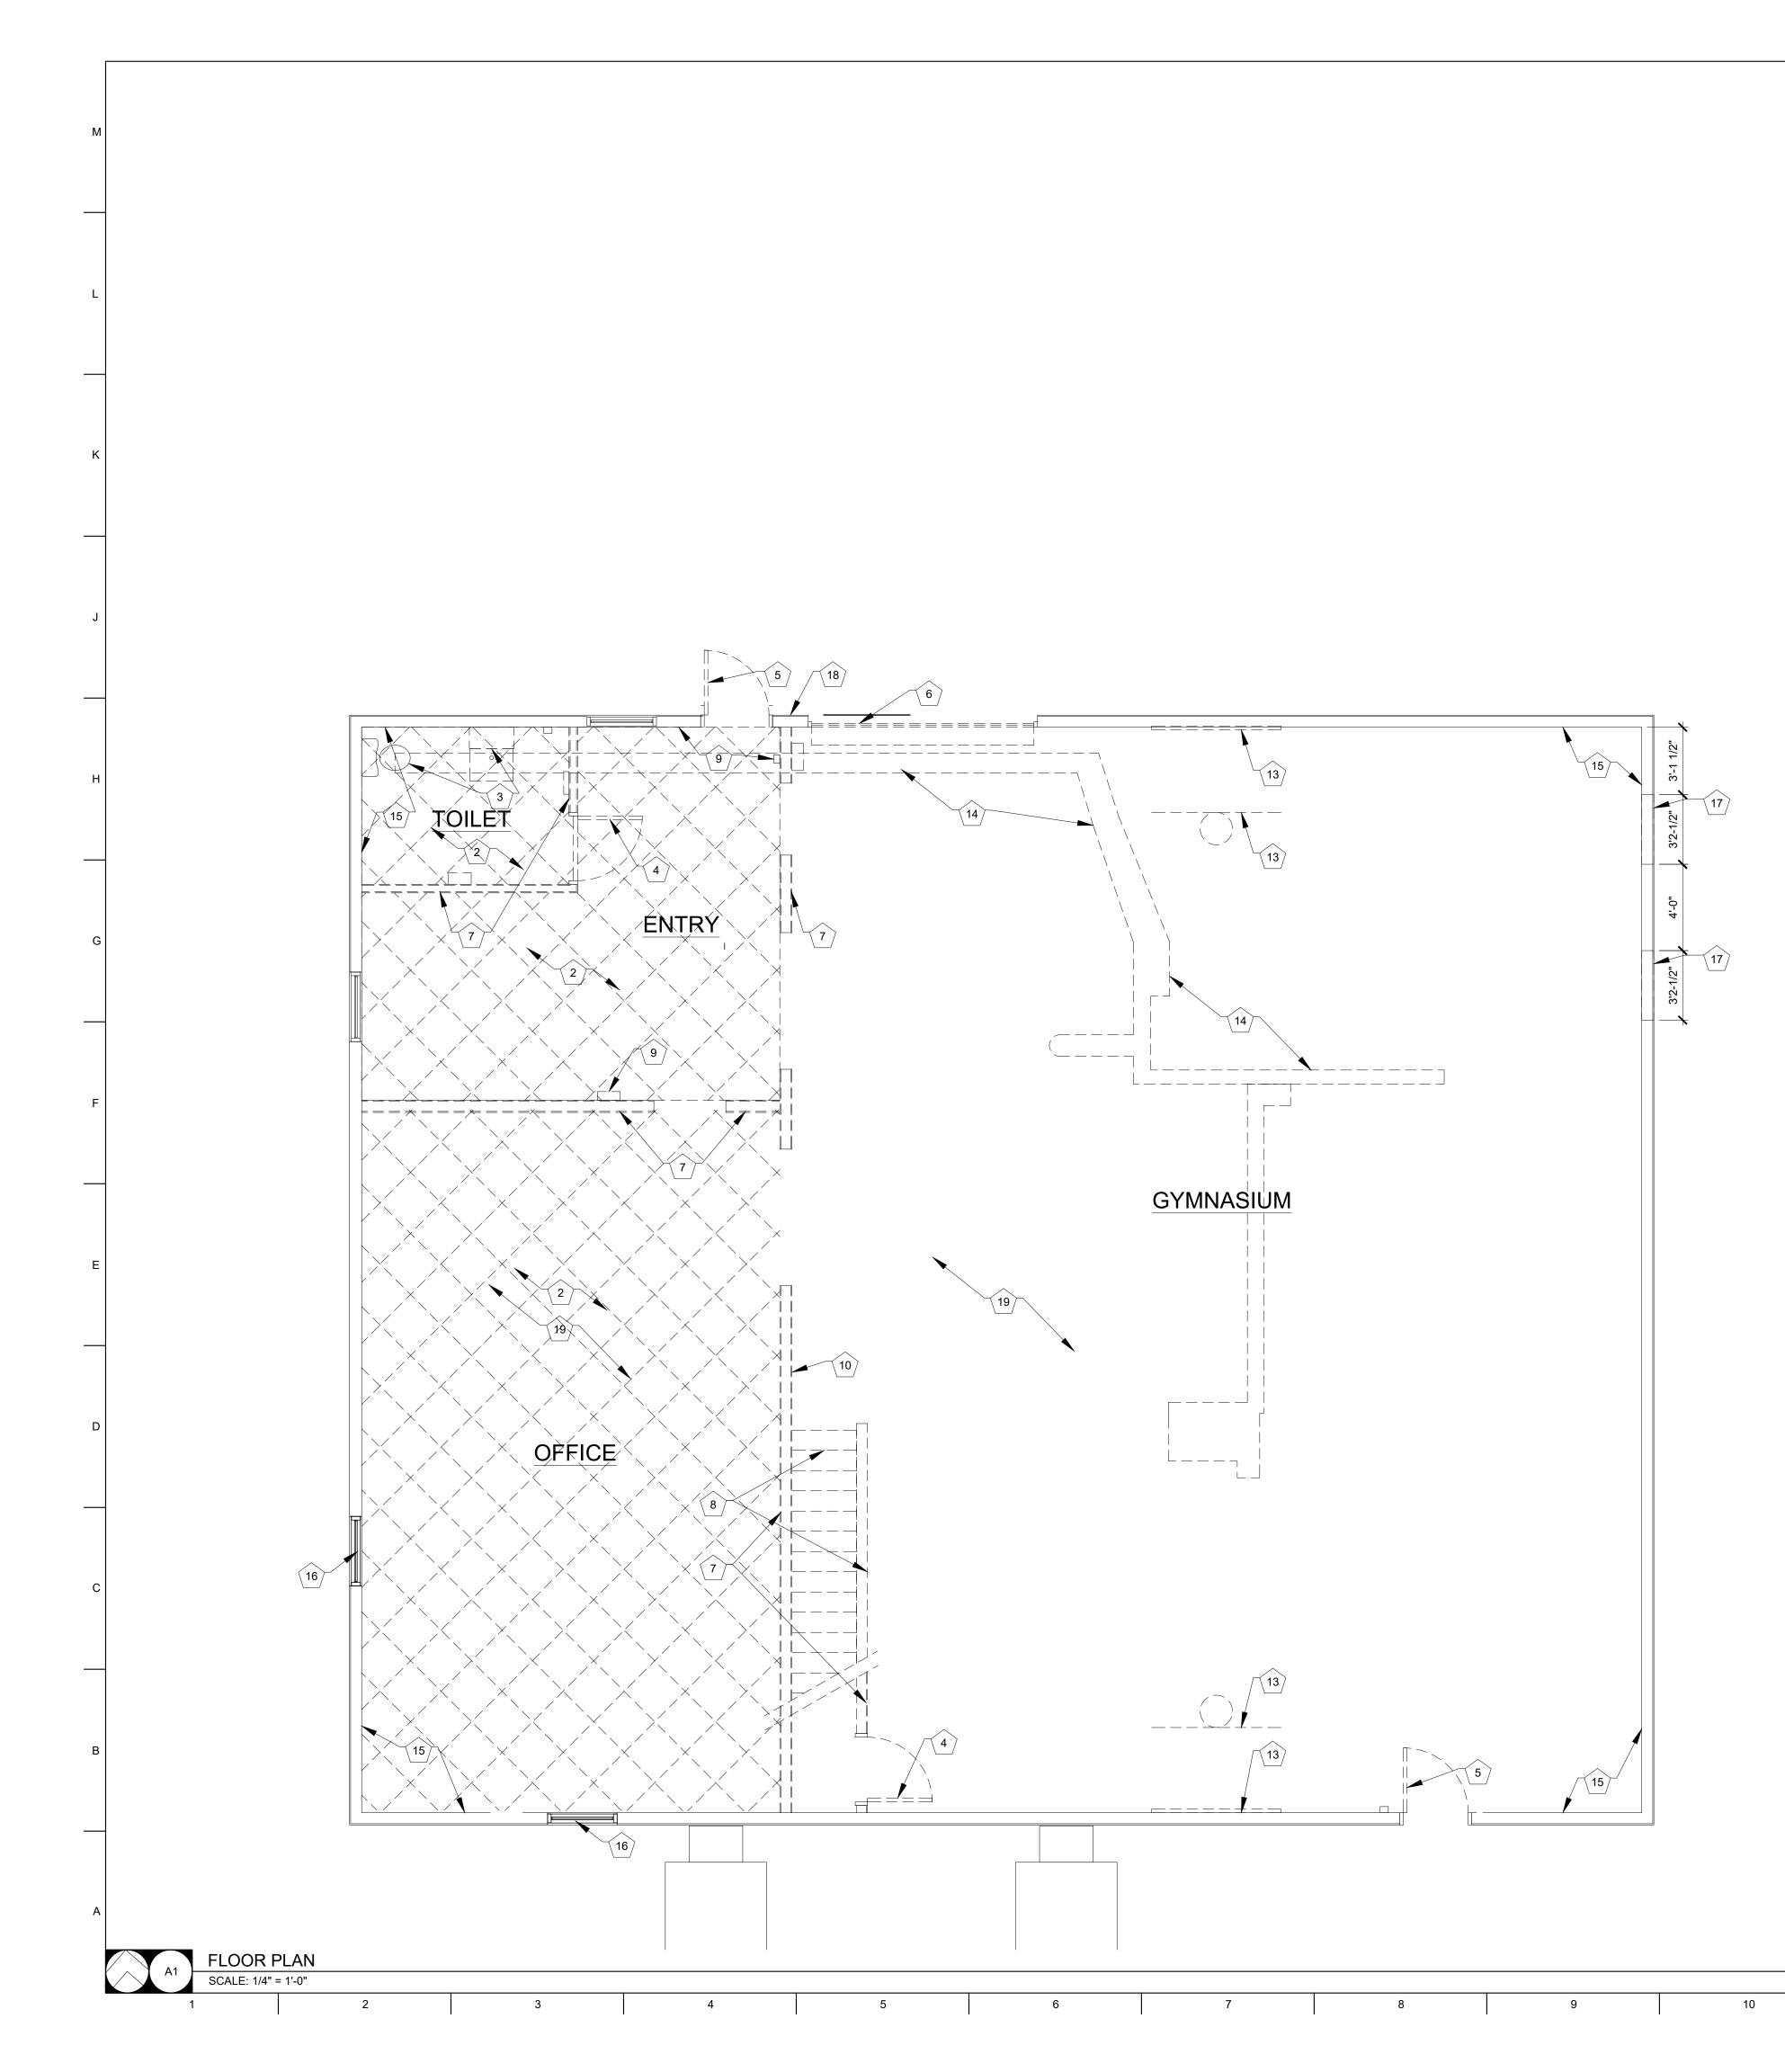REQUIRED BY THE ARCHITECT

3. CAREFULLY REMOVING AND SAVING ITEMS THAT CAN BE REUSED OR RETURNED TO THE OWNER.

4. PROPERLY SHORING UP ALL STRUCTURES, WHETHER DIRECTED BY STRUCTURAL ENGINEER OR NOT.

5. PROTECTING ALL ITEMS AND FINISHES TO REMAIN, OR REPLACING SUCH ITEMS AND FINISHES DAMAGED DURING DEMOLITION AS

6. CLEANING UP ALL SURFACES ADJOINING DEMOLITION WORK TO PREPARE FOR NEW WORK BY OTHER TRADES, INCLUDING REMOVAL OF ALL ANCHORS, BRACKETS, FASTENERS, BLOCKING, ETC. THAT MAY INTERFERE WITH NEW WORK

7. MAINTAINING WATERPROOFING AND SECURITY OF BUILDINGS.

8. LEAVING ALL AREAS OF DEMOLITION READY FOR NEW WORK.


9. NOTIFYING ARCHITECT OF ANY ITEMS NOT NOTED FOR REMOVAL THAT WILL INTERFERE WITH NEW WORK.

10. MAINTAINING ACCESS TO AND EXITS FROM BUILDINGS AS REQUIRED BY OWNER AND CODE OFFICIALS.

11. REFER TO CIVIL DRAWINGS FOR ADDITIONAL REQUIRED DEMOLITION WORK.

12. REFER TO MECHANICAL, ELECTRICAL, AND PLUMBING DRAWINGS FOR ADDITIONAL REQUIRED DEMOLITION WORK.

13. FIELD VERIFY ALL DIMENSIONS AND CONDITIONS PRIOR TO EXECUTING ANY WORK. NOTIFY ARCHITECT OF ANY DIMENSIONS OR WORK DIFFERING FROM THAT SHOWN, FOR CLARIFICATION BY THE ARCHITECT PRIOR TO PROCEEDING WITH WORK.

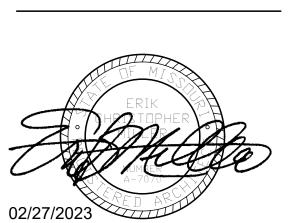

**STATE OF MISSOURI** 

MICHAEL L. PARSON,

GOVERNOR



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**OFFICE OF** ADMINISTRATION **DIVISION OF** FACILITIES MANAGEMENT, **DESIGN AND** CONSTRUCTION

#### O2233-01 -

MULTIPURPOSE BUILDING for MDA USE

NEW MADRID STATE OFFICE BUILDING NEW MADRID, MISSOURI

PROJECT # 02233-01 SITE # ASSET #

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ISSUE DATE: 02/27/2023


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SHEET TITLE: DEMOLITION PLANS

#### SHEET NUMBER:

**D-101** OF 23 SHEETS 02/27/2023



MEZZANINE DEMOLITION PLAN

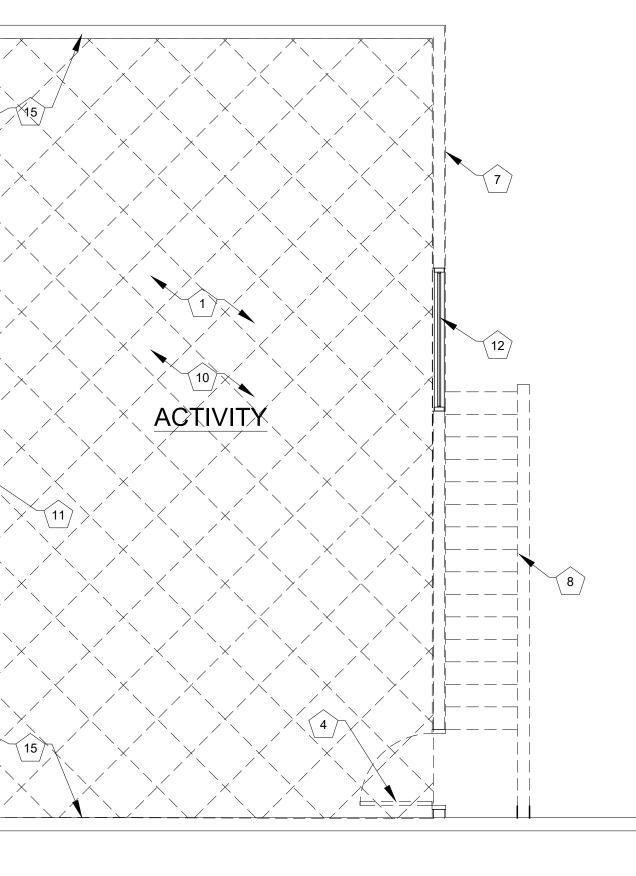
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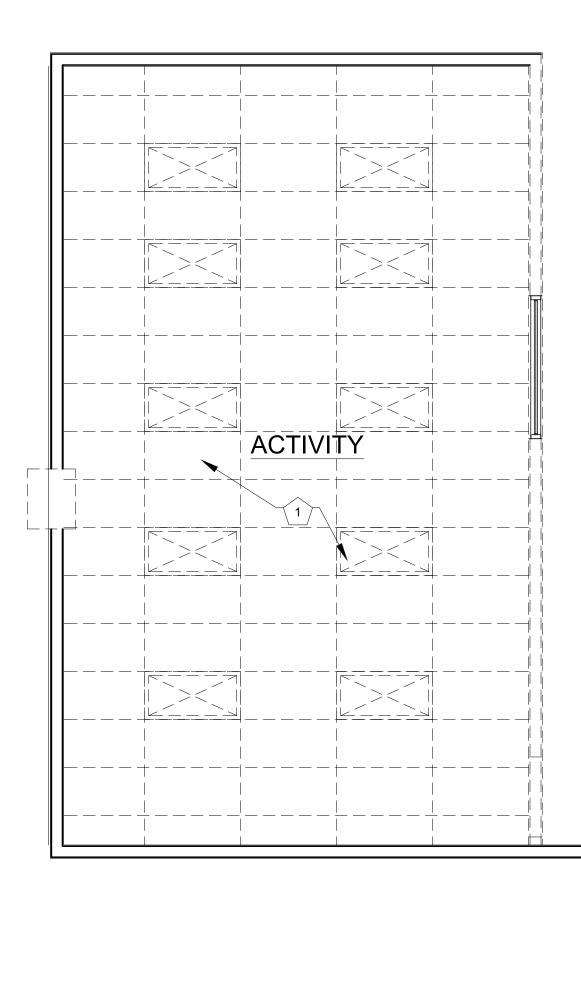
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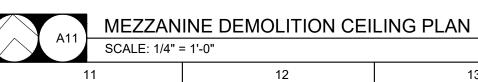
SCALE: 1/4" = 1'-0"

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KEY NOTES

(1) DEMO AND REMOVE ALL EXISTING 2X4 ACOUSTIC CEILING TILE, GRID, LIGHTS, DIFFUSERS AND HANGERS

2 DEMO AND REMOVE ALL EXISTING WOOD STUD FRAMING AND GYPSUM BOARD BATHROOM CEILING, LIGHT AND FAN

3 REMOVE EXISTING LIGHTS AND SALVAGE TO OWNER

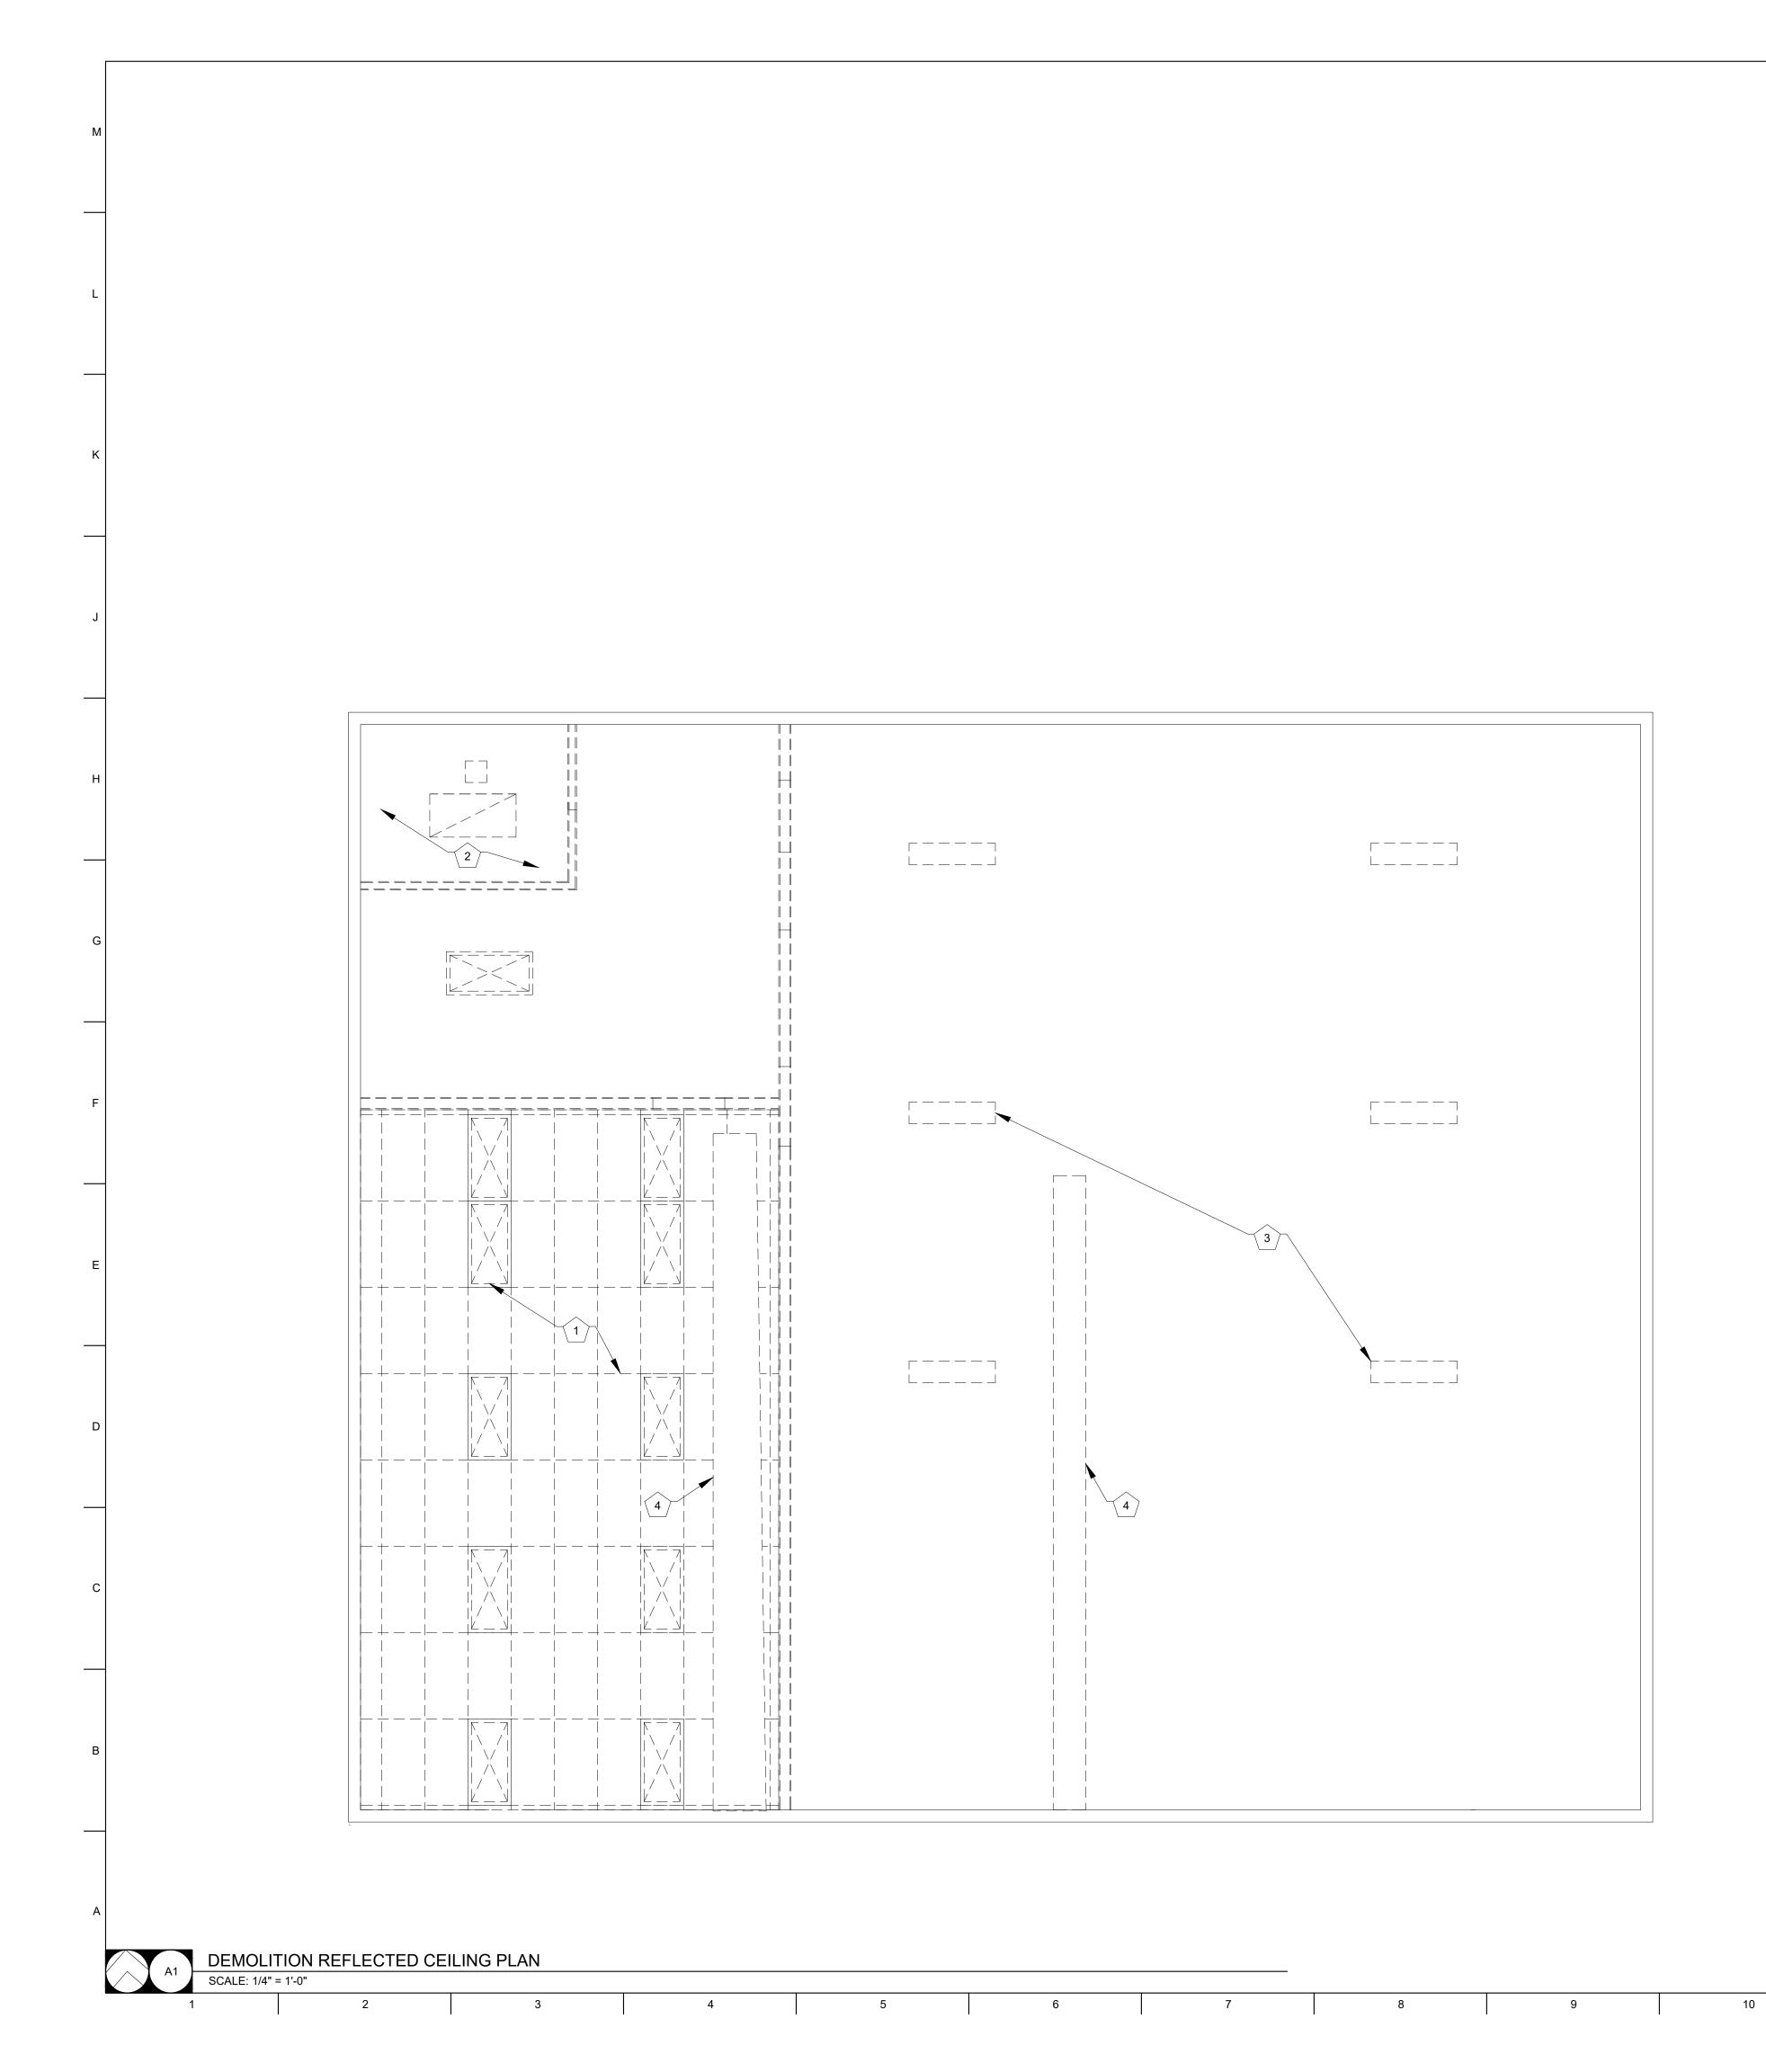4 DEMO AND REMOVE ALL EXISTING METAL AND FABRIC DUCT WORK

GENERAL DEMOLITION NOTES

THE GENERAL CONTRACTOR IS RESPONSIBLE FOR THE FOLLOWING:

1. PROVIDING DUST, NOISE AND SAFETY BARRIERS

2. CAREFULLY REMOVING AND SAVING ITEMS THAT CAN BE REUSED OR RETURNED TO THE OWNER.

3. PROTECTING ALL ITEMS AND FINISHES TO REMAIN, OR REPLACING SUCH ITEMS AND FINISHES DAMAGED DURING DEMOLITION AS

REQUIRED BY THE ARCHITECT

4. CLEANING UP ALL SURFACES ADJOINING DEMOLITION WORK TO PREPARE FOR NEW WORK BY OTHER TRADES, INCLUDING REMOVAL OF ALL ANCHORS, BRACKETS, FASTENERS, BLOCKING, ETC. THAT MAY INTERFERE WITH NEW WORK

5. MAINTAINING WATERPROOFING AND SECURITY OF BUILDINGS.

6. LEAVING ALL AREAS OF DEMOLITION READY FOR NEW WORK.

7. NOTIFYING ARCHITECT OF ANY ITEMS NOT NOTED FOR REMOVAL THAT WILL INTERFERE WITH NEW WORK.

8. MAINTAINING ACCESS TO AND EXITS FROM BUILDINGS AS REQUIRED BY OWNER AND CODE OFFICIALS.

#### **STATE OF MISSOURI** MICHAEL L. PARSON, GOVERNOR





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**OFFICE OF** ADMINISTRATION **DIVISION OF** FACILITIES MANAGEMENT, **DESIGN AND** CONSTRUCTION

#### O2233-01 -

MULTIPURPOSE BUILDING for MDA USE

NEW MADRID STATE OFFICE BUILDING NEW MADRID, MISSOURI

PROJECT # 02233-01 SITE # ASSET #

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ISSUE DATE: 02/27/2023


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SHEET TITLE: DEMOLITION **CEILING PLANS** 

SHEET NUMBER:

D-102 OF 23 SHEETS 8 02/27/2023

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THE GENERAL CONTRACTOR IS RESPONSIBLE FOR

1. PROVIDING DUST, NOISE AND SAFETY BARRIERS

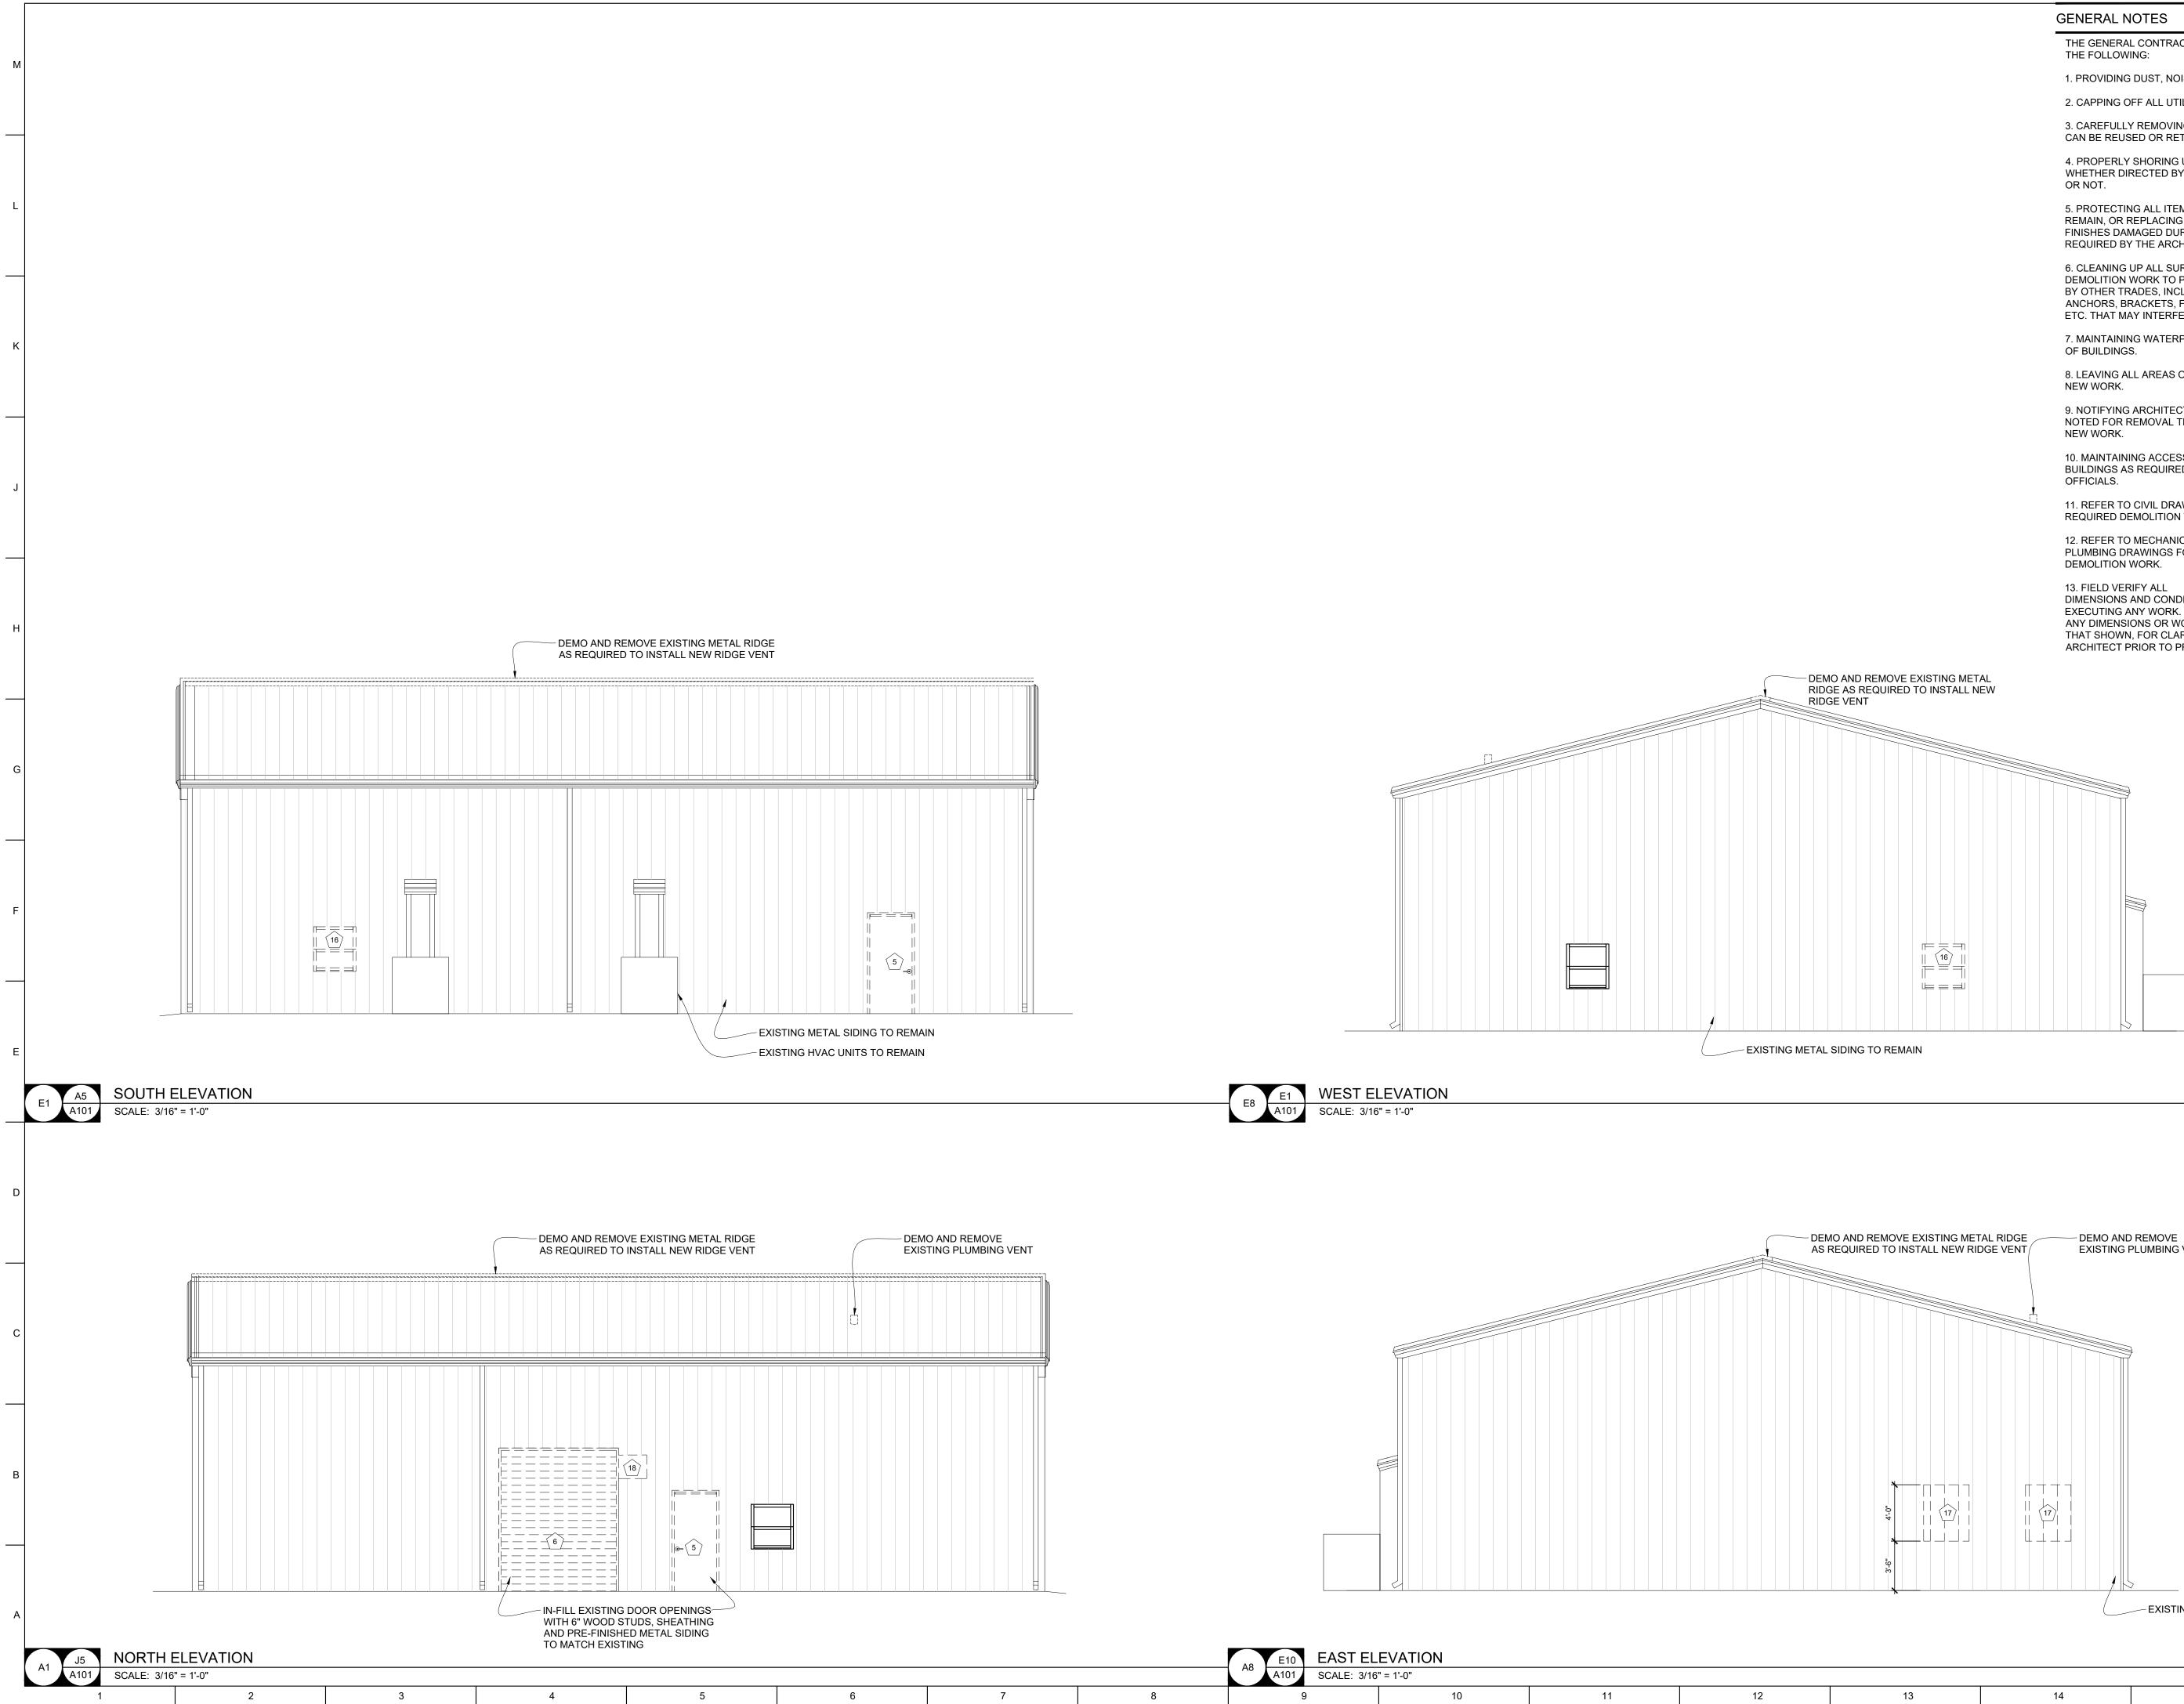2. CAPPING OFF ALL UTILITY SERVICES

3. CAREFULLY REMOVING AND SAVING ITEMS THAT CAN BE REUSED OR RETURNED TO THE OWNER.

4. PROPERLY SHORING UP ALL STRUCTURES, WHETHER DIRECTED BY STRUCTURAL ENGINEER

5. PROTECTING ALL ITEMS AND FINISHES TO REMAIN, OR REPLACING SUCH ITEMS AND FINISHES DAMAGED DURING DEMOLITION AS REQUIRED BY THE ARCHITECT

6. CLEANING UP ALL SURFACES ADJOINING DEMOLITION WORK TO PREPARE FOR NEW WORK BY OTHER TRADES, INCLUDING REMOVAL OF ALL ANCHORS, BRACKETS, FASTENERS, BLOCKING, ETC. THAT MAY INTERFERE WITH NEW WORK

7. MAINTAINING WATERPROOFING AND SECURITY

8. LEAVING ALL AREAS OF DEMOLITION READY FOR

9. NOTIFYING ARCHITECT OF ANY ITEMS NOT NOTED FOR REMOVAL THAT WILL INTERFERE WITH

10. MAINTAINING ACCESS TO AND EXITS FROM BUILDINGS AS REQUIRED BY OWNER AND CODE

11. REFER TO CIVIL DRAWINGS FOR ADDITIONAL REQUIRED DEMOLITION WORK.


12. REFER TO MECHANICAL, ELECTRICAL, AND PLUMBING DRAWINGS FOR ADDITIONAL REQUIRED

DIMENSIONS AND CONDITIONS PRIOR TO EXECUTING ANY WORK. NOTIFY ARCHITECT OF ANY DIMENSIONS OR WORK DIFFERING FROM THAT SHOWN, FOR CLARIFICATION BY THE ARCHITECT PRIOR TO PROCEEDING WITH WORK.

DEMO AND REMOVE EXISTING METAL RIDGE DEMO AND REMOVE AS REQUIRED TO INSTALL NEW RIDGE VENT EXISTING PLUMBING VENT
EXISTING METAL SIDING TO REMAIN

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#### **STATE OF MISSOURI** MICHAEL L. PARSON, GOVERNOR



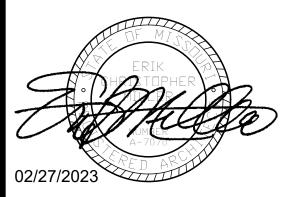

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**OFFICE OF** ADMINISTRATION **DIVISION OF** FACILITIES MANAGEMENT, **DESIGN AND** CONSTRUCTION

#### O2233-01 -

MULTIPURPOSE BUILDING for MDA USE

NEW MADRID STATE OFFICE BUILDING NEW MADRID, MISSOURI

PROJECT # 02233-01 SITE # 7711 ASSET # 8877711007

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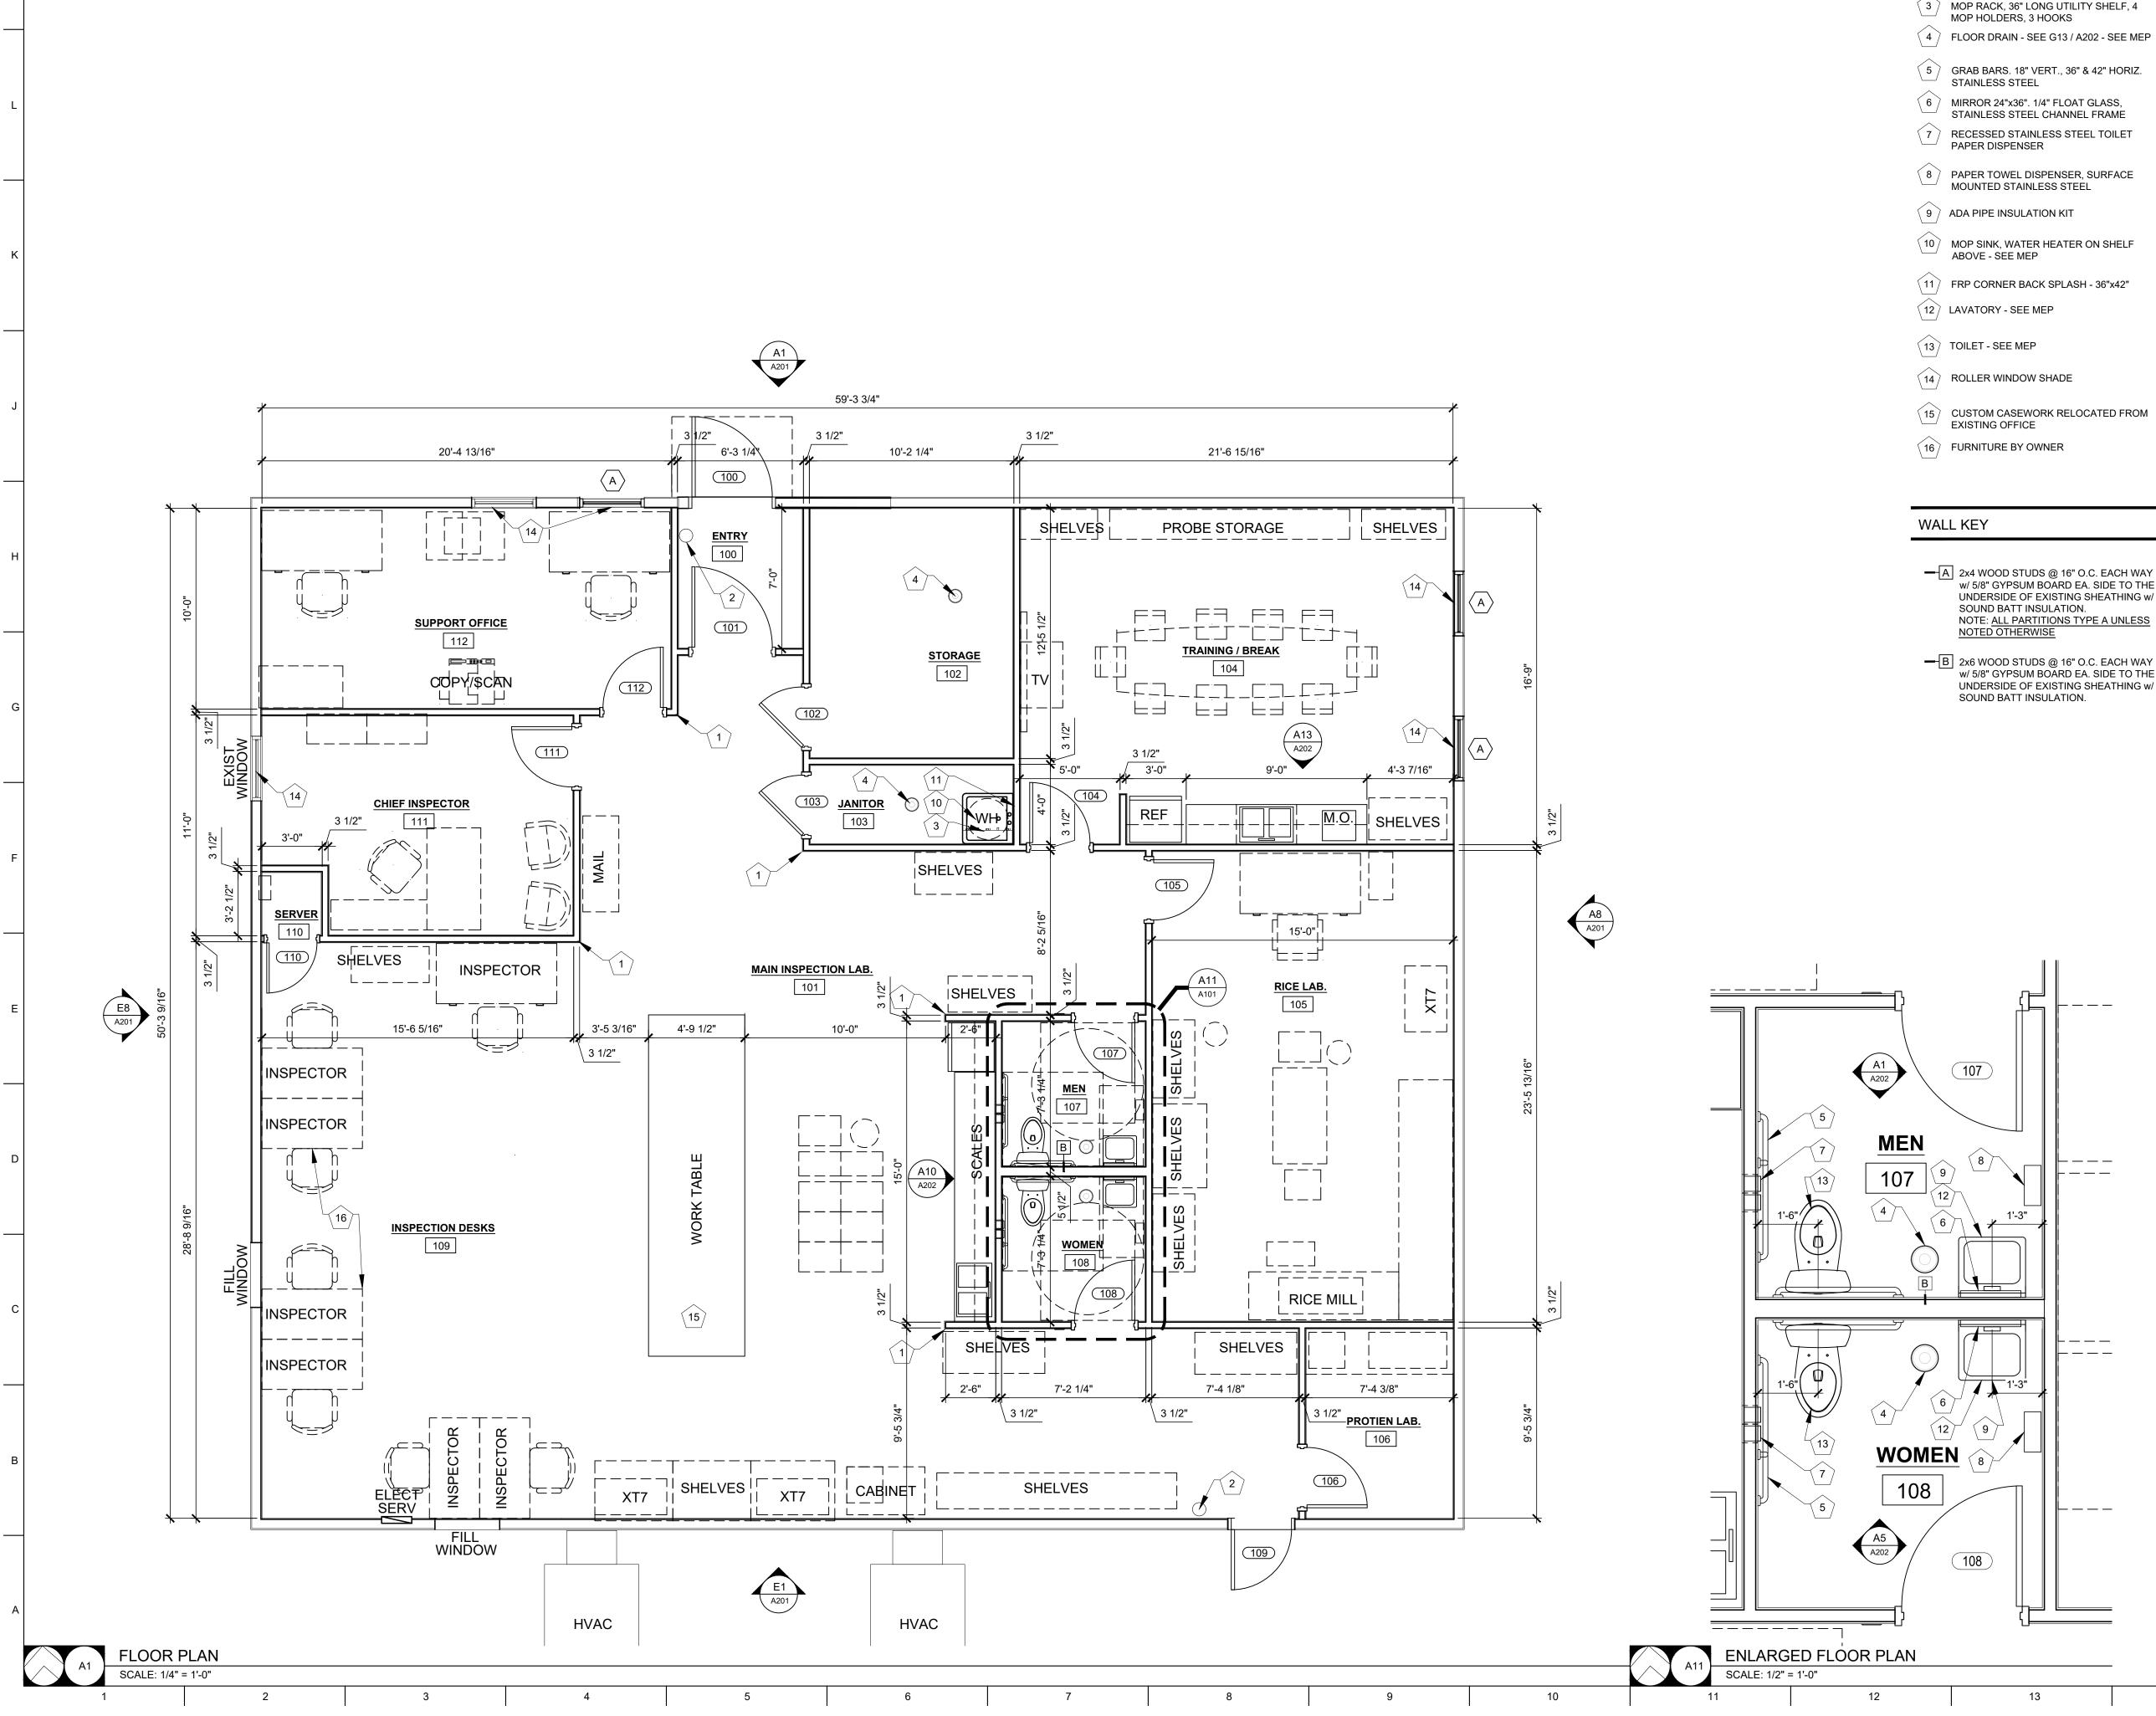
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SHEET TITLE: DEMOLITION ELEVATIONS

#### SHEET NUMBER:

D-201 OF 23 SHEETS 9 02/27/2023



ΈY	NOTES
1	CORNER GUARD
2	WALL MOUNTED FIRE EXTINGUISHER
3	MOP RACK, 36" LONG UTILITY SHELF, 4 MOP HOLDERS, 3 HOOKS
4	FLOOR DRAIN - SEE G13 / A202 - SEE MEP
5	GRAB BARS. 18" VERT., 36" & 42" HORIZ. STAINLESS STEEL
6	MIRROR 24"x36". 1/4" FLOAT GLASS, STAINLESS STEEL CHANNEL FRAME
7	RECESSED STAINLESS STEEL TOILET PAPER DISPENSER
8	PAPER TOWEL DISPENSER, SURFACE MOUNTED STAINLESS STEEL
9	ADA PIPE INSULATION KIT
10	MOP SINK, WATER HEATER ON SHELF ABOVE - SEE MEP
11)	FRP CORNER BACK SPLASH - 36"x42"
12)	LAVATORY - SEE MEP
13	TOILET - SEE MEP
14	ROLLER WINDOW SHADE
15	CUSTOM CASEWORK RELOCATED FROM EXISTING OFFICE

- w/ 5/8" GYPSUM BOARD EA. SIDE TO THE UNDERSIDE OF EXISTING SHEATHING w/ NOTE: ALL PARTITIONS TYPE A UNLESS
- B 2x6 WOOD STUDS @ 16" O.C. EACH WAY w/ 5/8" GYPSUM BOARD EA. SIDE TO THE UNDERSIDE OF EXISTING SHEATHING w/

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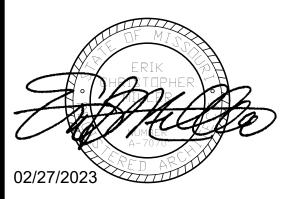
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1. FIELD VERIFY ALL DIMENSIONS AND CONDITIONS PRIOR TO EXECUTING ANY WORK. NOTIFY ARCHITECT OF ANY DIMENSIONS OR WORK DIFFERING FROM THAT SHOWN, FOR CLARIFICATION BY THE ARCHITECT PRIOR TO PROCEEDING WITH WORK.

GENERAL FLOOR PLAN NOTES

- 2. VERIFY ALL ROUGH OPENINGS FOR DOORS, WINDOWS, EQUIPMENT, & OTHER "BUILT-IN" ITEMS PRIOR TO EXECUTION OF ANY WORK AFFECTED BY SAME.
- 3. LOCATE DOOR OPENINGS WHICH ARE NOT DIMENSIONED OTHERWISE, CENTERED IN WALL AND 6" FROM FINISH WALL TO FINISH JAMB.
- 4. COORDINATE ALL FLOOR DRAINS AND OTHER REFERENCED MECHANICAL, ELECTRICAL, OR PLUMBING ITEMS W/ M.E.P.
- 5. COORDINATE ALL REQUIRED UTILITIES WITH EQUIPMENT MANUFACTURER.
- 6. ALL DIMENSIONS ARE TO FACE OF STUD UNLESS OTHERWISE NOTED.
- 7. DO NOT SCALE DRAWINGS WHERE DIMENSIONAL DISCREPANCIES ARE ENCOUNTERED NOTIFY ARCHITECT PRIOR TO PROCEEDING WITH THE WORK.
- 8. COORDINATE HEIGHTS OF OUTLETS & SWITCHING WITH ALL ARCHITECTURAL ITEMS. SEE M/E DRAWINGS FOR LOCATIONS.
- 9. SEE INTERIOR ELEVATIONS FOR ADDITIONAL KEY NOTED ITEMS NOT LABELED IN PLAN.







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#### O2233-01 -

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NEW MADRID STATE OFFICE BUILDING NEW MADRID, MISSOURI

PROJECT # 02233-01 SITE # ASSET #

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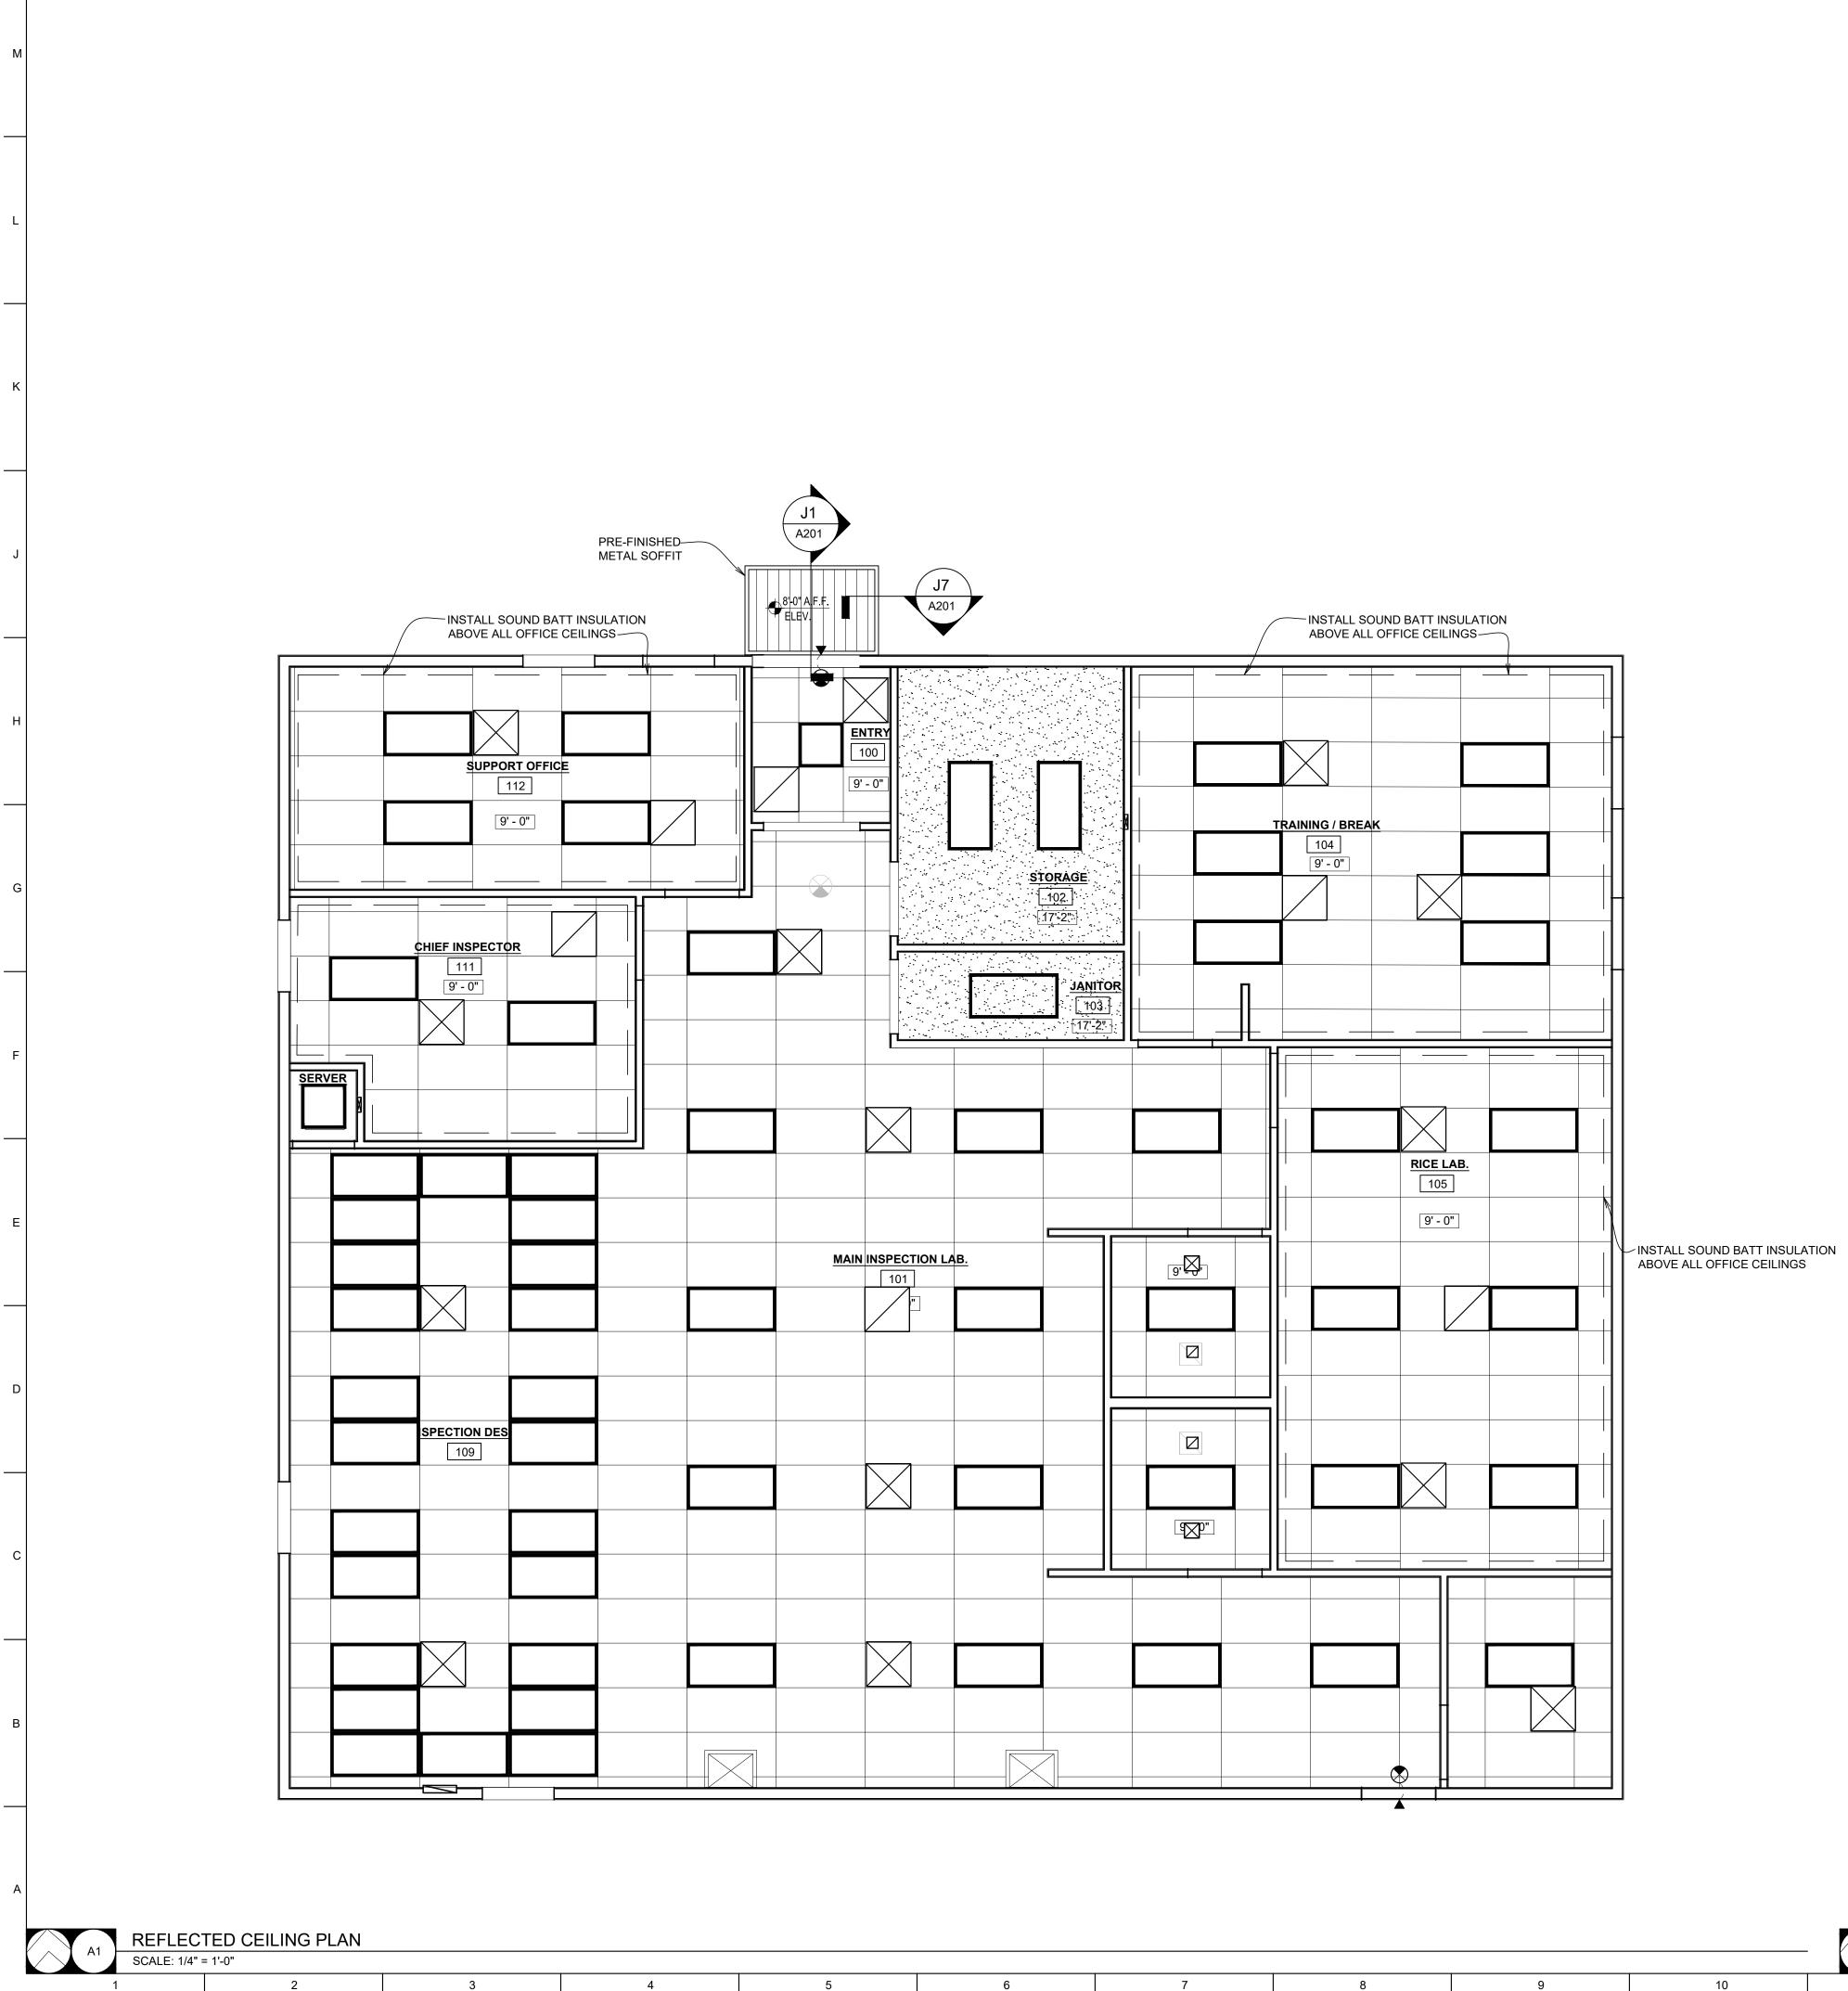
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ISSUE DATE: 02/27/2023

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SHEET TITLE: FLOOR PLAN

SHEET NUMBER:

A-101 OF 23 SHEETS 10 02/27/2023




REFLECTED CEILING PLAN - UNDERSIDE OF TRUSS SCALE: 1/4" = 1'-0" 12 11

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#### GENERAL REF. CEILING PLAN NOTES

- 1. FIELD VERIFY ALL DIMENSIONS AND CONDITIONS PRIOR TO EXECUTING ANY WORK. NOTIFY ARCHITECT OF ANY DIMENSIONS OR WORK DIFFERING FROM THAT SHOWN, FOR CLARIFICATION BY THE ARCHITECT PRIOR TO PROCEEDING WITH WORK.
- 2. VERIFY ALL ROUGH OPENINGS FOR DOORS, WINDOWS, EQUIPMENT, & OTHER "BUILT-IN" ITEMS PRIOR TO EXECUTION OF ANY WORK AFFECTED BY SAME.
- 3. COORDINATE ALL REQUIRED UTILITIES WITH EQUIPMENT MANUFACTURER.
- 4. DO NOT SCALE DRAWINGS WHERE DIMENSIONAL DISCREPANCIES ARE ENCOUNTERED NOTIFY ARCHITECT PRIOR TO PROCEEDING WITH THE WORK.
- 5. COORDINATE ALL LIGHT FIXTURES, EQUIPMENT, GRILL AND VENTS WITH MEP DRAWINGS.

#### CEILING MATERIAL LEGEND

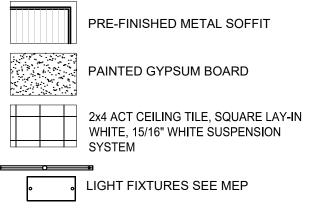


MECHANICAL UNITS FLUSH MOUNTED SEE MEP  $\bowtie$ 

INSTALL ADDITIONAL 8D NAILS SO THAT ALL EXISTING OSB PANELS ARE FASTENED @ 12" O.C. IN TRUSS DIRECTION. INSTALL SIGA WIGLUV 60 EXTERIOR AIR SEALING TAPE: 2-1/4" WIDE ON ALL SEAMS								
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						<u>+</u> /[		

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#### **STATE OF MISSOURI** MICHAEL L. PARSON, GOVERNOR



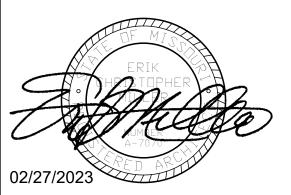

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**OFFICE OF** ADMINISTRATION **DIVISION OF** FACILITIES MANAGEMENT, **DESIGN AND** CONSTRUCTION

#### O2233-01 -

MULTIPURPOSE BUILDING for MDA USE

NEW MADRID STATE OFFICE BUILDING NEW MADRID, MISSOURI

PROJECT # 02233-01 SITE # 7711 ASSET # 8877711007

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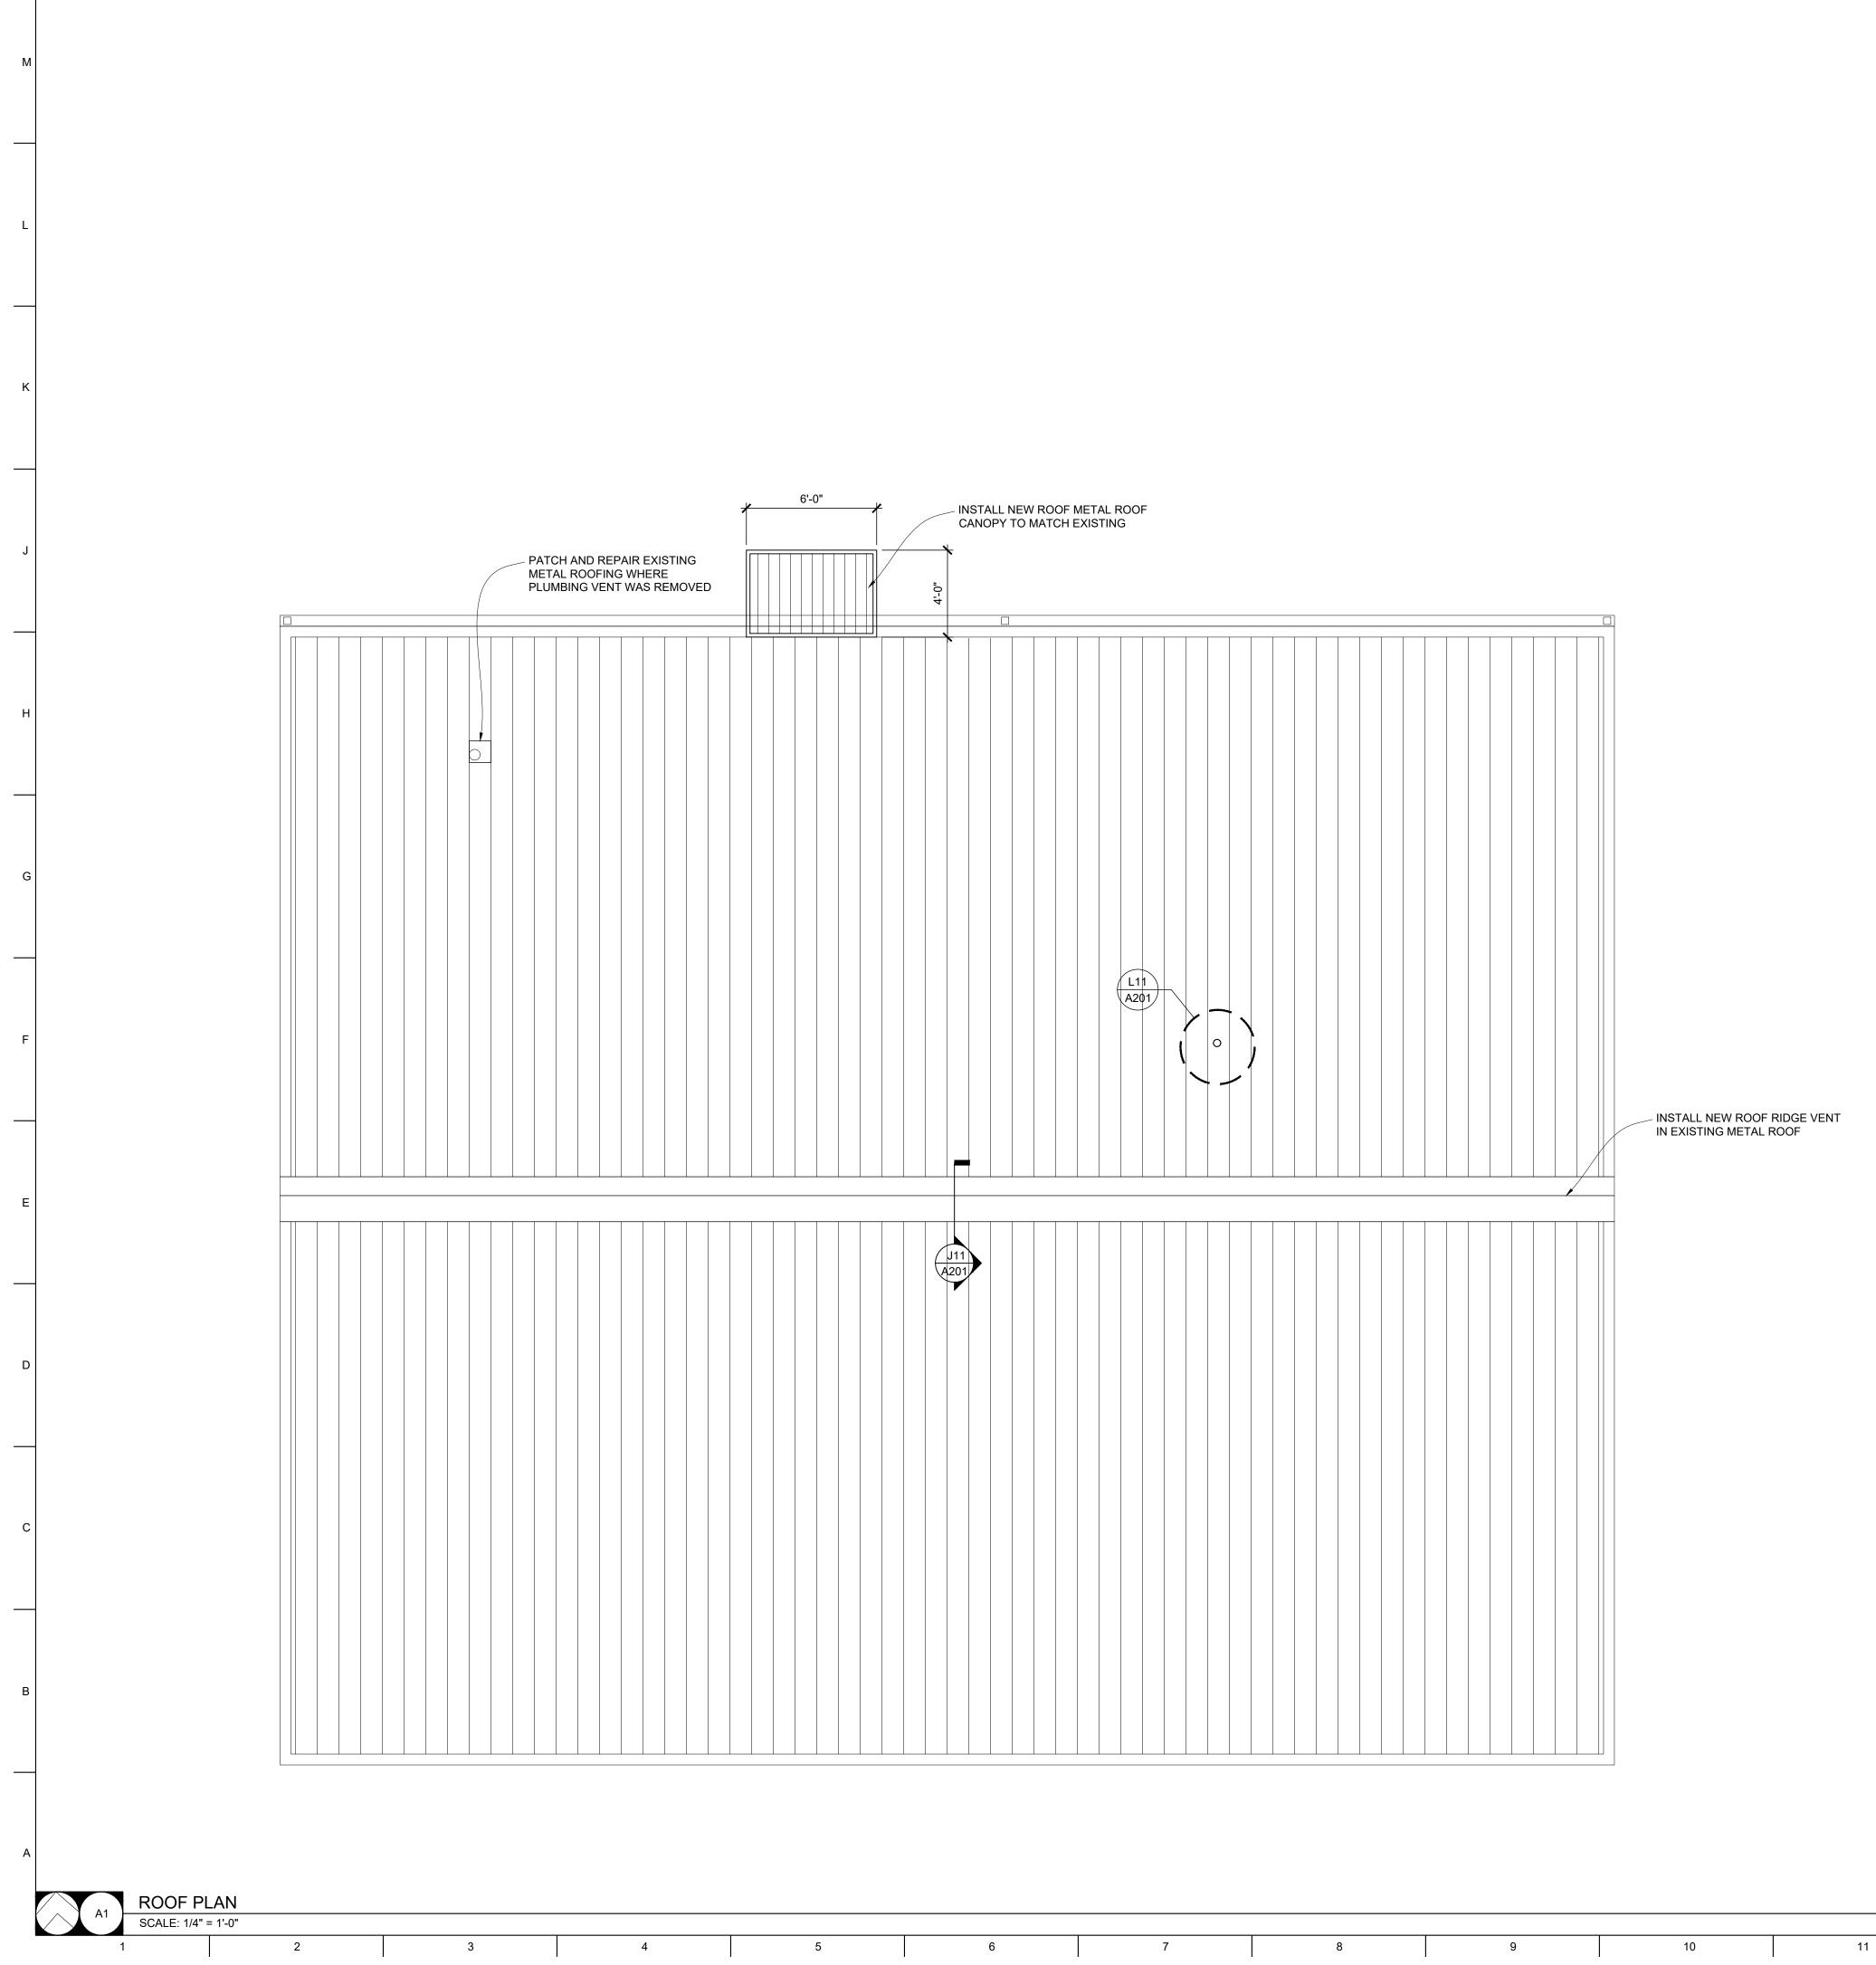
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CHECKED BY:	EM
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SHEET TITLE: REFLECTED CEILING PLAN


SHEET NUMBER:

A-102 11 OF 23 SHEETS 02/27/2023



- 1. ANY ROOFING DETAILS NOT SHOWN SHALL BE DONE IN ACCORDANCE W/ ROOFING FABRICATOR OR INSTALLER APPROVED DETAILS.
- 2. COORDINATE ALL ROOF PENETRATIONS WITH MECHANICAL, PLUMBING & ELECTRICAL WORK. PROVIDE ALL BLOCKINGS, FLASHINGS, CURBS & OTHER RELATED ITEMS AS REQUIRED FOR PROPER INSTALLATION OF MECHANICAL, PLUMBING & ELECTRICAL ITEMS. COMPLY WITH REQUIREMENTS OF NRCA &/OR SMACNA. NOTIFY ARCHITECT OF FABRICATOR OR INSTALLER REQUIREMENTS THAT DIFFER FROM THE REFERENCED STANDARDS.
- 3. INSTALL ALL ROOFING AND FLASHINGS IN ACCORDANCE WITH REQUIREMENTS OF ROOFING MANUFACTURER'S INSTALLATION INSTRUCTIONS.
- 4. INSTALL SEALANT TAPE BETWEEN ALL NON-SOLDERED CONNECTIONS OF FLASHINGS, GUTTERS, DOWNSPOUTS AND OTHER AREAS TO MAKE WATER-TIGHT ROOF & FLASHINGS.
- 5. THE INTENT OF THE ROOF PLANS & DETAILS IS TO ACHIEVE A COMPLETE & PROPER WATER-TIGHT INSTALLATION, REGARDLESS IF A DETAIL IS OR IS NOT SHOWN.

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CAD DWG FILE: DRAWN BY: LC CHECKED BY: EM DESIGNED BY: EM

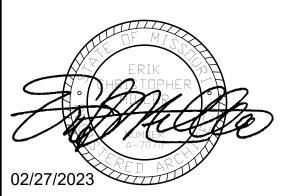SHEET TITLE: ROOF PLAN

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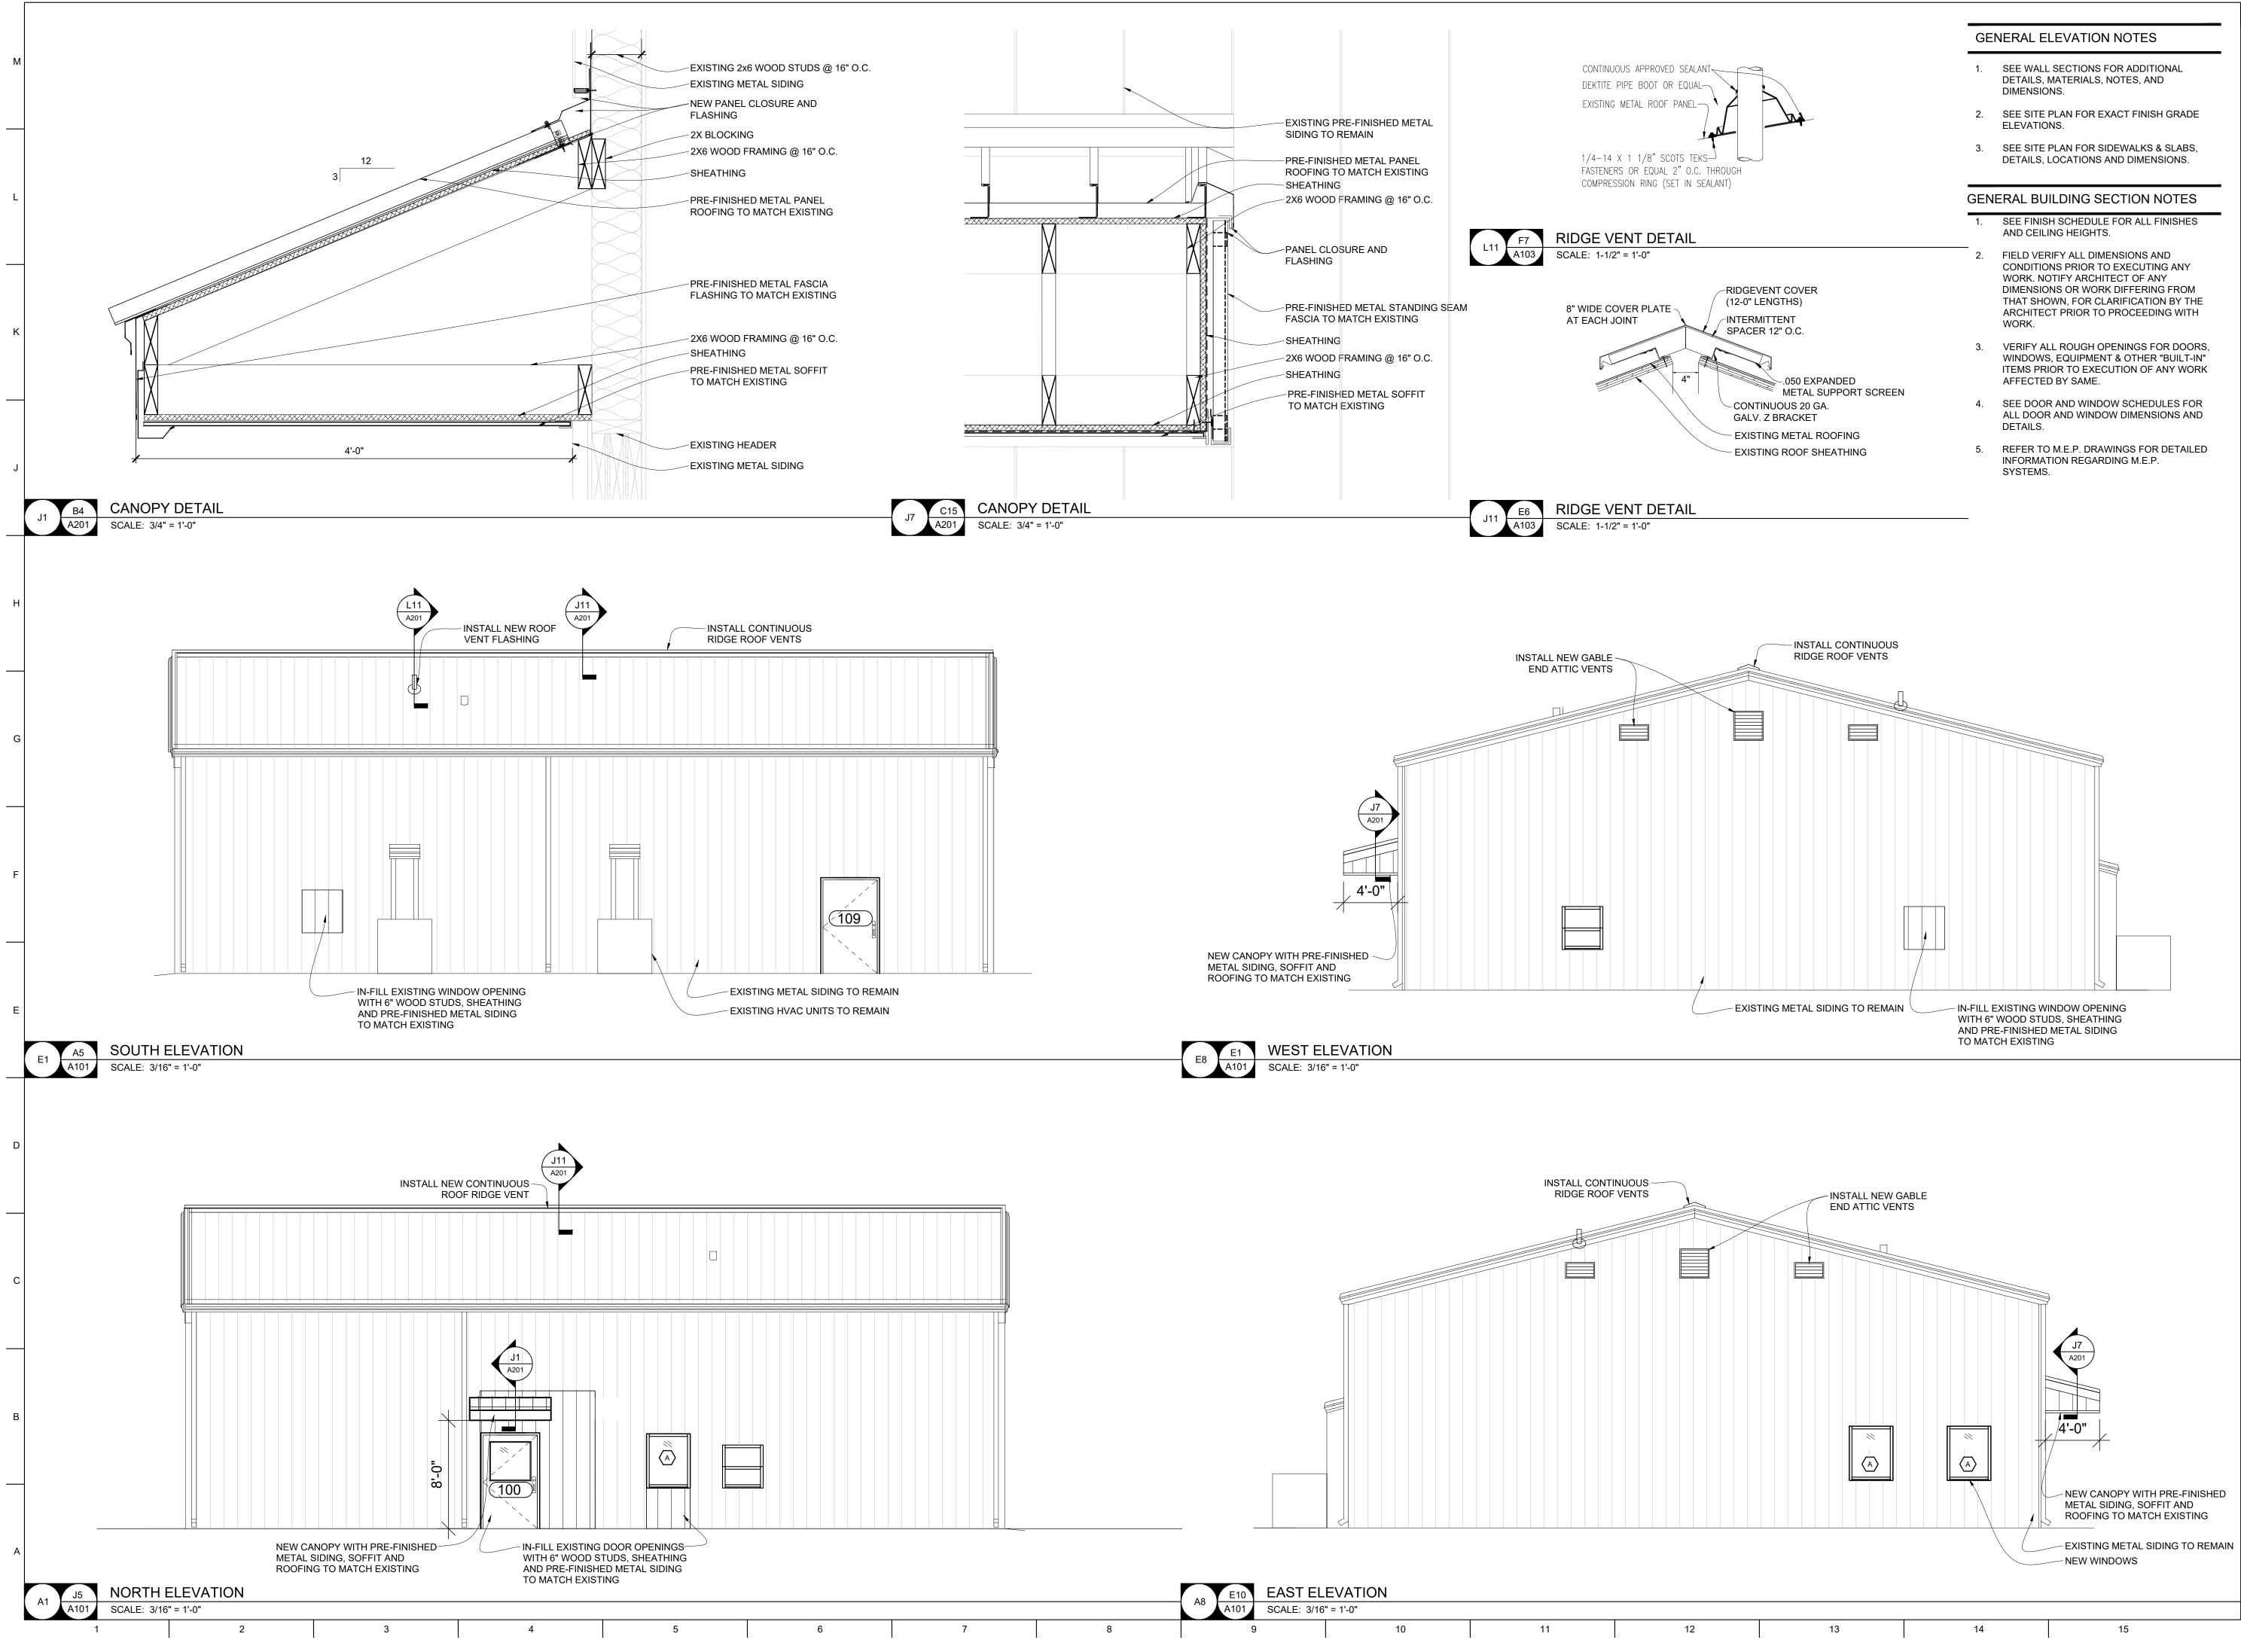
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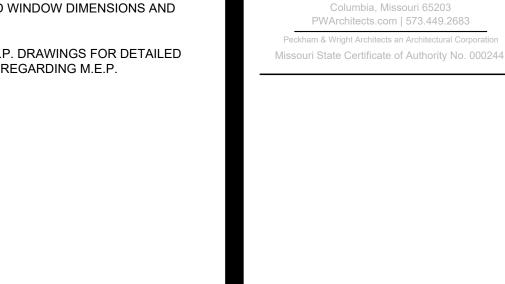
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A-103 12 OF 23 SHEETS 02/27/2023





**OFFICE OF** ADMINISTRATION **DIVISION OF** FACILITIES MANAGEMENT, **DESIGN AND** CONSTRUCTION

**STATE OF MISSOURI** 

MICHAEL L. PARSON,

GOVERNOR

Peckham & Wright Architects, Inc., d.b.a.

2120 Forum Blvd., Ste, 101

PWArchitects, Inc.

02/27/202

#### O2233-01 -

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PROJECT # 02233-01 7711 SITE # ASSET #

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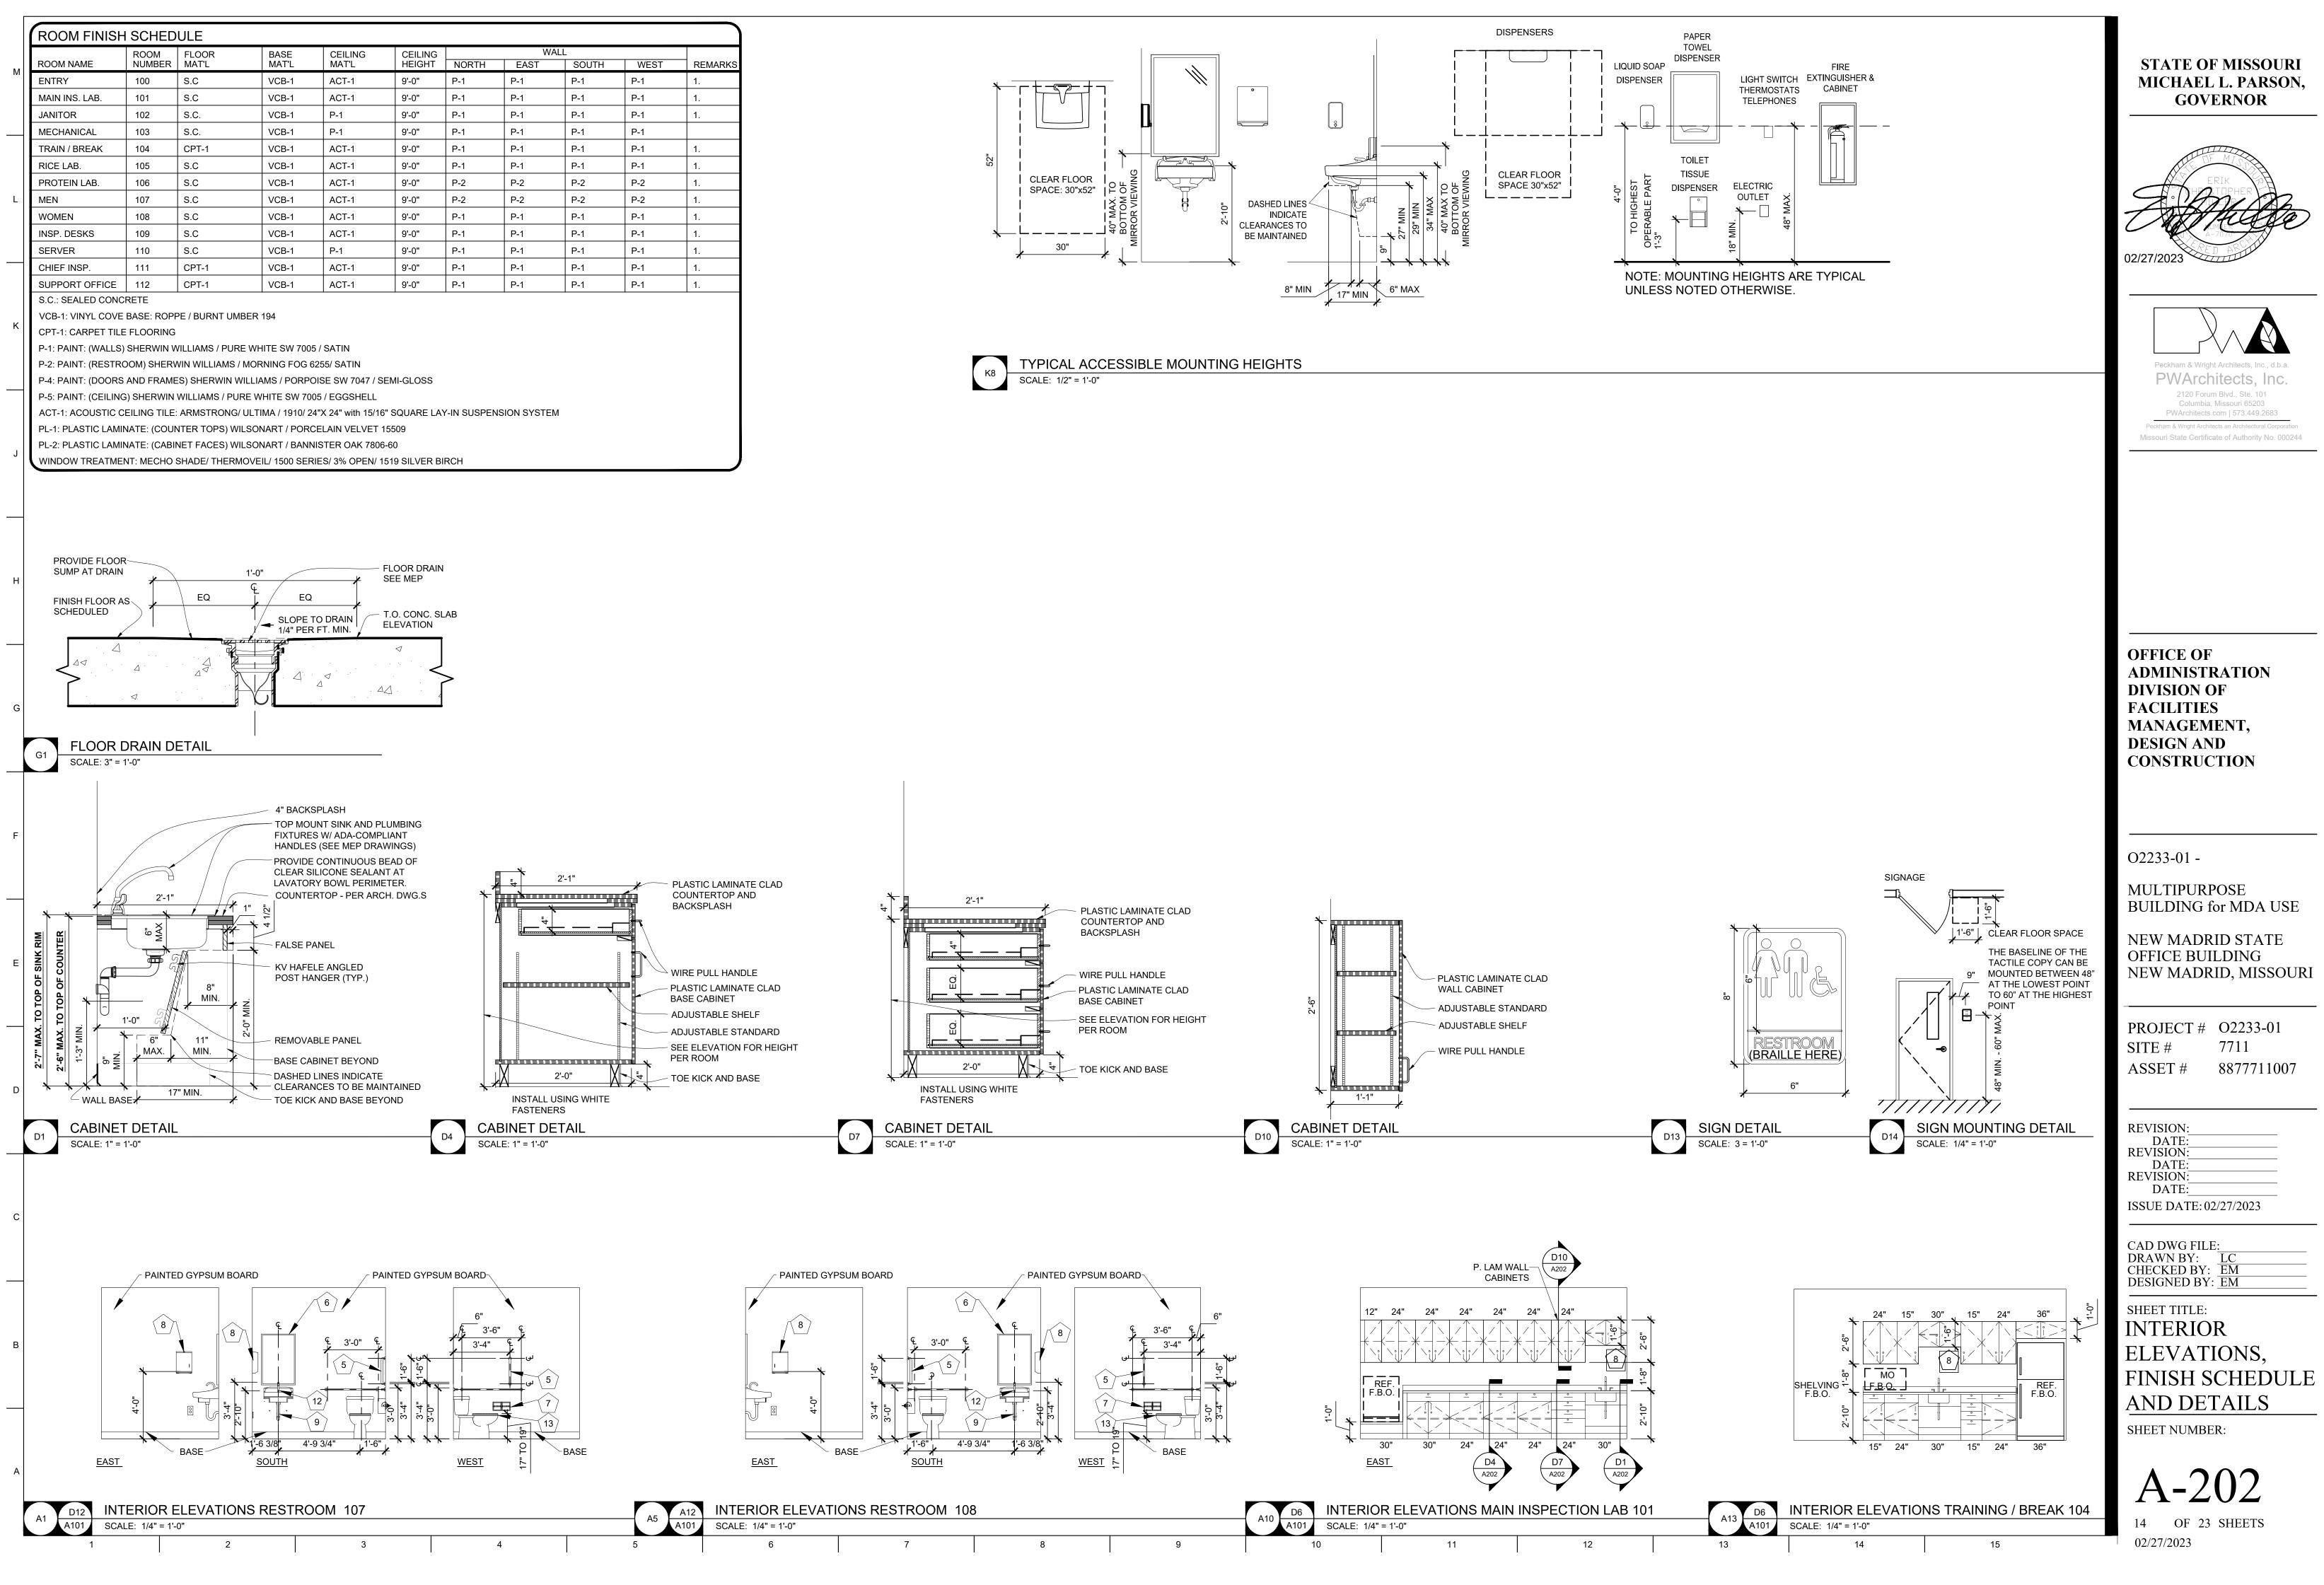
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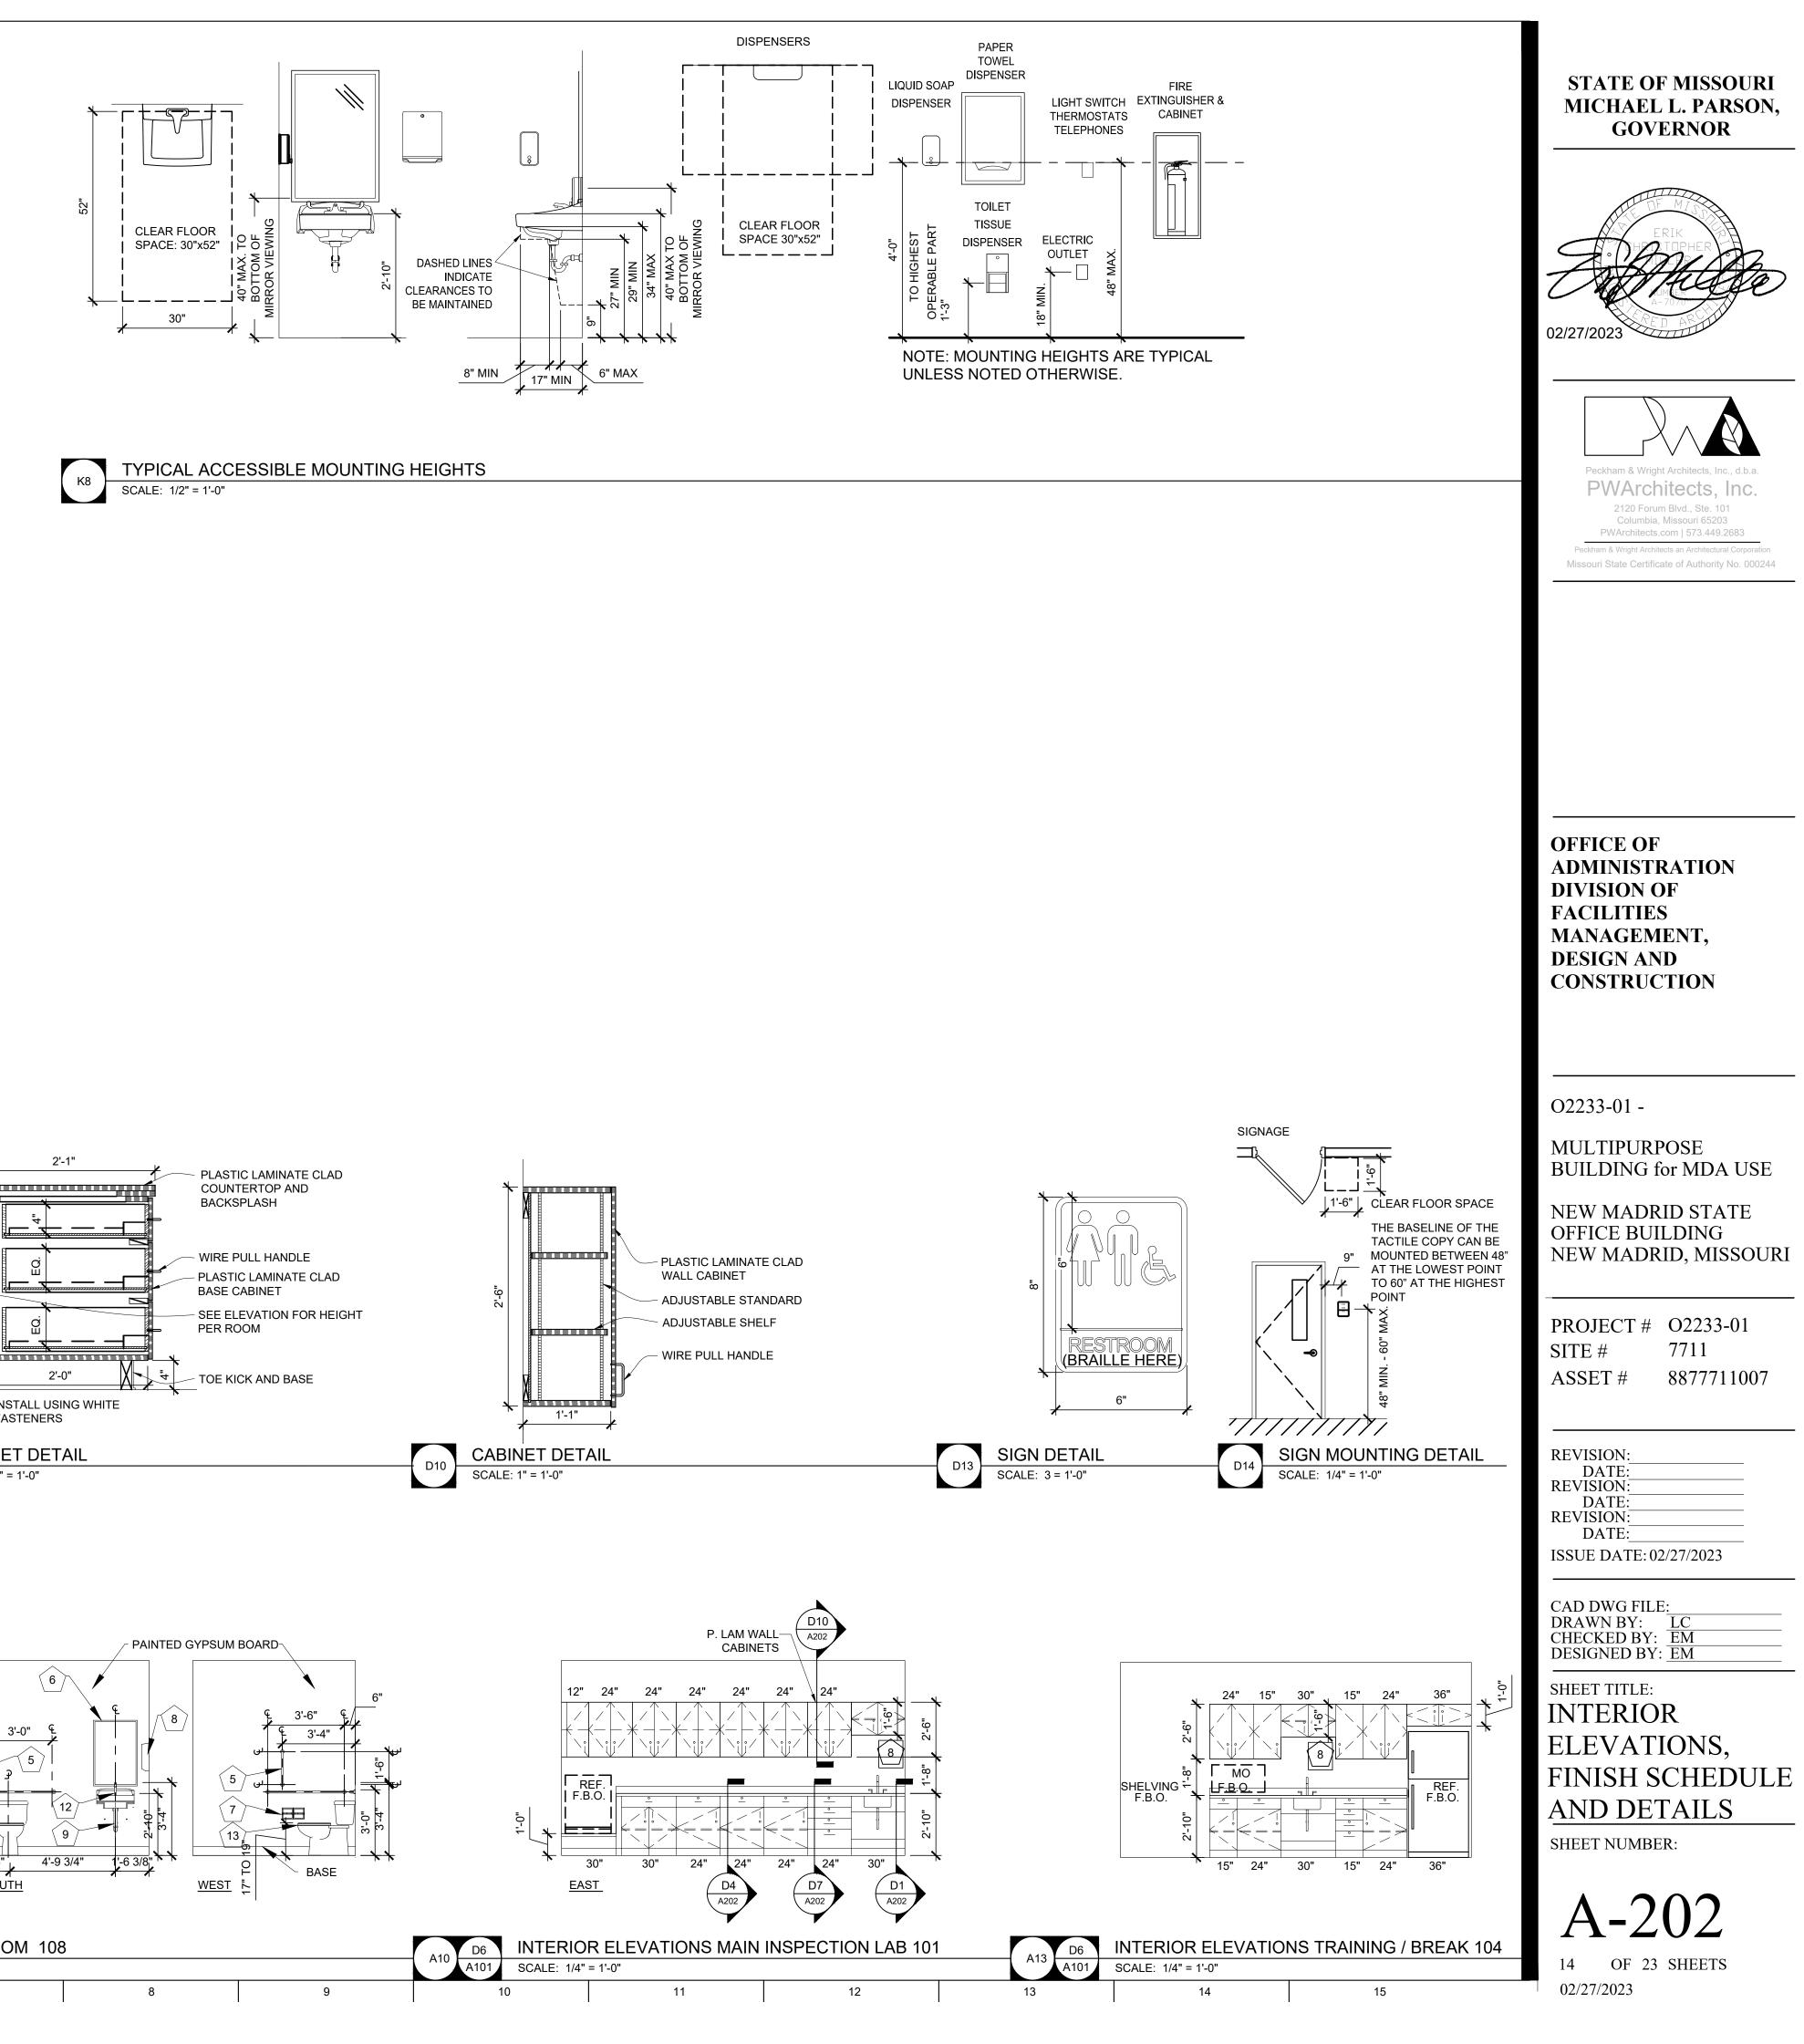
SHEET TITLE: EXTERIOR **ELEVATIONS** 

DESIGNED BY: EM

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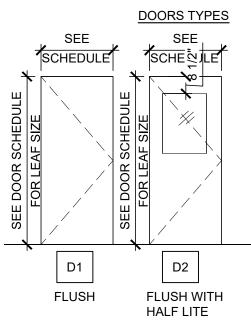
A-201 OF 23 SHEETS 13 02/27/2023







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										GEI	NERAL DOOR DETAIL NOTES	
DOOR SO	DOOR LEAF SIZE W X H		FRAME S				DETAILS		FIRE RATING HARDWARE	1.	FIELD VERIFY ALL DIMENSIONS AND CONDITIONS PRIOR TO EXECUTING ANY WORK. NOTIFY ARCHITECT OF ANY DIMENSIONS OR WORK DIFFERING FROM THAT SHOWN, FOR CLARIFICATION BY THE	STATE OF MISSOURI MICHAEL L. PARSON,
FIRST FLOOR 100 101 102 103 104 105	4'-0" x 7'-0" 4'-0" x 7'-0" 3'-0" x 7'-0" 3'-0" x 7'-0" 3'-0" x 7'-0" 3'-0" x 7'-0"	CI     CI     CI       CI     CI     CI       CI     CI     CI       NSULATED HOLLOW METAL	4'-4" x 7'-2" 4'-4" x 7'-2" 3'-4" x 7'-2" 3'-4" x 7'-2" 3'-4" x 7'-2" 3'-4" x 7'-2"	FRAME ELEVATION     1     1     1	ALUMINUM HOLLOW METAL WOOD	SILL A11 / A601 A13 / A601 A13 / A601 A13 / A601 A13 / A601 A13 / A601	A13 / A601 A13 / A601 A13 / A601 A13 / A601	A13 / A601 A13 / A601 A13 / A601 A13 / A601	1 1 1 2 2 2 3 3 3	2. 3. 4.	ARCHITECT PRIOR TO PROCEEDING WITH WORK. VERIFY ALL ROUGH OPENINGS FOR DOORS, WINDOWS, EQUIPMENT, & OTHER "BUILT-IN" ITEMS PRIOR TO EXECUTION OF ANY WORK AFFECTED BY SAME. LOCATE DOOR OPENINGS IN METAL STUD WALLS WHICH ARE NOT DIMENSIONED OTHERWISE, CENTERED IN WALL AND 6" FROM FINISH WALL TO FINISH JAMB. SEE DOOR SCHEDULE FOR DOOR DIMENSIONS AND DETAILS.	GOVERNOR RIK DERIK DERIK RIK RIK RIK RIK RIK RIK RIK RIK RIK
106       107       108       109       110       111       112	3'-0" x 7'-0"	D2 D1 D1 D1 D1 D2 D2 D2	3'-4" x 7'-2" 3'-4" x 7'-2" 3'-4" x 7'-2" 3'-4" x 7'-2" 3'-4" x 7'-2" 3'-4" x 7'-2" 3'-4" x 7'-2"	1 1 1 1 1 1 1 1		A13 / A601 A13 / A601 A13 / A601 A13 / A601	A13 / A601 A13 / A601 A13 / A601 A13 / A601 A11 / A601 A13 / A601	A13 / A601 A13 / A601 A13 / A601 A13 / A601 A11 / A601 A13 / A601	3       4       4       5       2       3		WINDOW TYPES	Peckham & Wright Architects, Inc., d.b.a. <b>POVACCIENTS, Inc.</b> 2120 Forum Blvd., Ste. 101 Columbia, Missouri 65203 PWArchitects.com   573.449.2683 Peckham & Wright Architects an Architectural Corporation Missouri State Certificate of Authority No. 000244
SEE SCHEDULE EOR LEAF SIZE	DOORS TYPES SEE SCHE ILE JUE BUILT SCHE ILE JUE BUILT D2 FLUSH WITH HALF LITE		RAME TYPES 2" 2" SEE SCH F1								A8 $A601$ $B$ $A8$ $A601$ $B$ $A8$ $A601$ $B$ $A8$ $A601$ $B$ $C$	OFFICE OF ADMINISTRATION DIVISION OF FACILITIES
	BATT INSULATION 6" WOOD STUDS @ 16" WITH 5/8" GYP BOARD	O.C.										DESIGN AND CONSTRUCTION 02233-01 - MULTIPURPOSE BUILDING for MDA USE NEW MADRID STATE OFFICE BUILDING NEW MADRID, MISSOURI
	HEADER VERTICAL RIB METAL SIDING WITH HEAD TRII BACKER ROD WITH COI SEALANT EACH SIDE, T WINDOW FRAME WITH INSULATED GLAZING VERTICAL RIB METAL S WITH CLOSURE TRIM BATT INSULATION BACKER ROD WITH COI SEALANT EACH SIDE, T WINDOW FRAME WITH INSULATED GLAZING METAL J-MOULD WITH CONTINUOUS BEAD OF	NTINUOUS YP. 1" SIDING NTINUOUS YP. 1"	SEE			HEAD GYPS RUBE TOOL SIDE BASE	UM BOARD ER CLOSU ED SEALAN FLASHING R - SEE SCH	RE NT EA.			METAL STUD 18 GA. RUNNER PNG. 4'-1" TO 8'-0"	PROJECT #       O2233-01         SITE #       7711         ASSET #       8877711007         REVISION:
INDOW DET		1" - SHING HDING	— A11 —		SILL	META HOLL FRAM DOUE GYPS TOOL T TOOL T DOOF POSI TO DI THRE BED ( EXPA	L PANEL S OW METAL IE BLE 2X6 STU UM BOARD ED SEALAN C SEE SCH TIVE SLOPE RAIN SHOLD SET OF SEALAN NSION JOIN ATE UNDER SHOLD	DOOR JD NT HEDULE E T IN FULL T NT R	5/8" $7$ $7$ $7$ $7$ $7$ $7$ $7$ $7$ $7$ $7$	METAL STUD H - CONTINUOUS SE (BOTH SIDES AND - 5/8" GYPSUM B - DOUBLE METAL - HOLLOW METAL FRAME WITH FRA ANCHORS (MIN 3 - SEE PLAN FOR THICKNESS AILS - 14	ALANT D BOTTOM) OARD L STUDS DOOR ME PER JAMB)	SHEET TITLE: DOOR AND WINDOW SCHEDULE AND DETAILS SHEET NUMBER: A-601 15 OF 23 SHEETS 02/27/2023





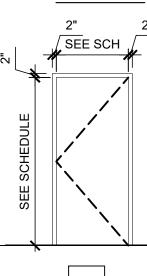
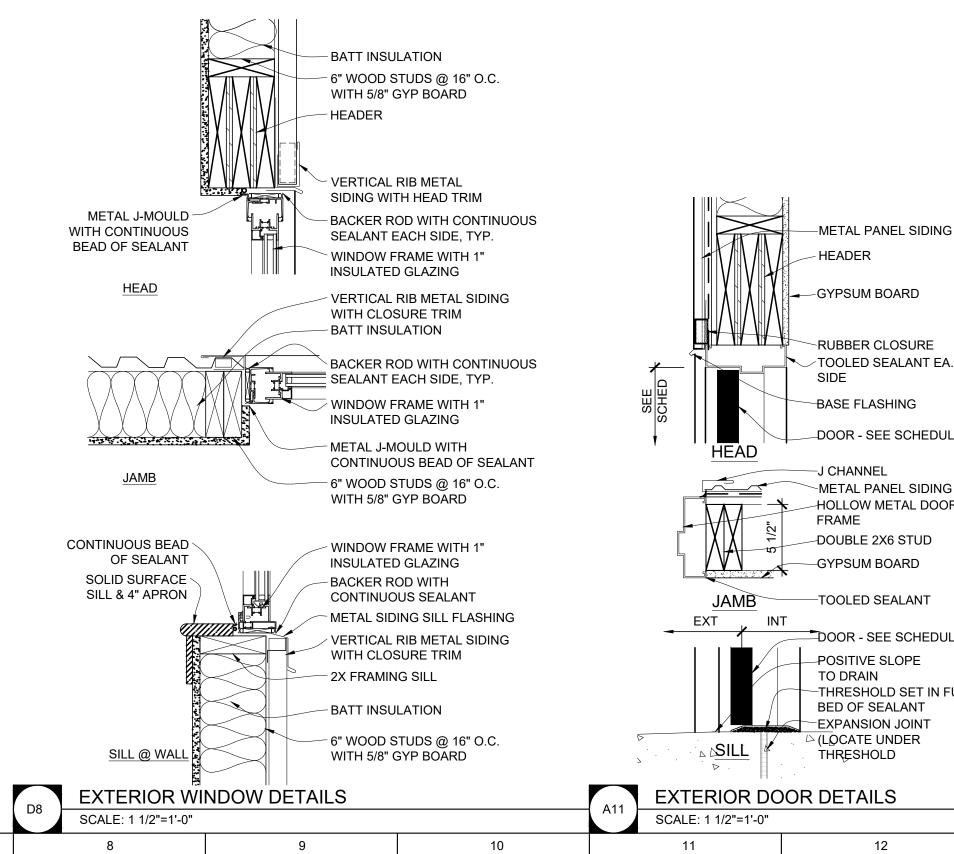
#### HVAC PLAN SYMBOL LEGEND

<u> </u>	EQUIPMENT TYPE (REFER TO EQUIPMENT SCHEDULE)
\_#/	EQUIPMENT REFERENCE NUMBER
<u> </u>	DIFFUSER/GRILLE TYPE (REFER TO SCHEDULE)
#	CUBIC FEET PER MINUTE (CFM) / FACE SIZE
	SUPPLY DUCTWORK
	RETURN DUCTWORK
	EXHAUST DUCTWORK
	OUTSIDE AIR DUCTWORK
~~~~~~	FLEX DUCT
	VENT / COMBUSTION AIR
$\left  \right\rangle$	TIE INTO EXISTING
	SUPPLY DIFFUSER (HATCH INDICATES "NO FLOW ZONE")
	RETURN DIFFUSER
<b></b>	BALANCE DAMPER
Σ	MOTORIZED DAMPER
<b>0</b>	CEILING RADIATION DAMPER
<b>Ľ</b>	FIRE RATED DAMPER
<b>o</b>	SMOKE DAMPER
1	THERMOSTAT
CO2	CO2 DETECTOR
(DS)	RETURN DUCT SMOKE DETECTOR WIRED TO FAN STARTER TO SHUT UNIT(S) DOWN AND SEND ALARM SIGNAL TO FIRE ALARM SYSTEM (IF PRESENT) OR TO REMOTE SOUNDER LOCATED IN AN OCCUPIED SPACE (EQUAL TO SYSTEM SENSOR #D4120)
<b>(3</b> )	REMOTE SOUNDER WIRED TO RETURN DUCT SMOKE DETECTOR (EQUAL TO SYSTEM SENSOR #MHW)

#### HVAC PLAN GENERAL NOTES:

1. SEE SHEET M-501 FOR ADDITIONAL HVAC NOTES, DETAIL, AND SCHEDULES. 2. ALL MECHANICAL EQUIPMENT INSTALLED ON ROOF MUST BE AT LEAST 24" ABOVE ROOF DECK TO ALLOW FOR FUTURE ROOF REPLACEMENT.


#### HVAC PLAN KEY NOTES:

- (1) EF-1 TO BE CONTROLLED THRU TIME CLOCK.
- (2) CONTRACTOR TO ADD OUTSIDE AIR & ECONOMIZER KIT WITH BAROMETRIC RELIEF SIZED AT 100% OF FLOW. CONTROL TO BE ADJUSTABLE FIXED POINT SET AT 65°F.
- (3) PROVIDE ALTERNATE BID TO REPLACE EXISTING GROUND MOUNTED RTU WITH NEW. SEE RTU SCHEDULE ON SHEET M501.
- (4) ELBOW SUPPLY AND RETURN DUCTWORK UP INSIDE ENCLOSURE ON OUTSIDE OF BUILDING TO ENTER ROOM ABOVE CEILING.

#### GENERAL MEP SPECIFICATIONS

- 1. IT IS THE RESPONSIBILITY OF THE CONTRACTOR TO REVIEW AND UNDERSTAND ALL DRAWINGS AND SPECIFICATIONS IN THE CONTRACT DOCUMENTS. EACH CONTRACTOR IS RESPONSIBLE FOR ALL WORK ASSOCIATED WITH HIS TRADE REGARDLESS OF WHERE THE WORK IS DEPICTED IN THE DRAWINGS OR SPECIFICATIONS.
- 2. THE LAYOUT OF SYSTEMS SHOWN ON PLANS ARE APPROXIMATE AND WILL NEED TO BE COORDINATED IN FIELD. THE CONTRACTOR SHALL INCLUDE THIS COORDINATION IN HIS SCOPE AND INCLUDE ALL COSTS OF MODIFYING THE LAYOUT AS REQUIRED IN HIS BID.
- PRODUCE A COMPLETE AND FULLY OPERATIONAL SYSTEM UNLESS STATED OTHERWISE ON PLANS.
- 4. ALL MATERIALS TO BE NEW, FIRST CLASS, AND INSTALLED PER MANUFACTURE'S PUBLISHED INSTRUCTIONS 5. ALL WORK SHALL BE PERFORMED IN COMPLIANCE WITH LOCALLY ADOPTED CODES AND
- ORDINANCES. 6. CONTRACTOR IS RESPONSIBLE FOR COORDINATING EQUIPMENT LOCATIONS AND SYSTEM
- ROUTING WITH OTHER TRADES PRIOR TO INSTALLATION. 7. CONTRACTOR TO GUARANTEE ALL MATERIALS AND WORKMANSHIP FOR A PERIOD OF ONE YEAR
- FROM THE DATE THE PROJECT IS TURN OVER TO THE OWNER, UNLESS NOTED OTHERWISE. 8. CONTRACTOR IS TO INCLUDE IN THEIR SCOPE THE COST OF ALL PERMITS, INSPECTIONS,
- METERING, AND TAPS ASSOCIATED WITH THEIR WORK. 9. CONTRACTOR IS RESPONSIBLE FOR ALL EXCAVATION, CUTTING, CORING, PATCHING, AND
- BACKFILL REQUIRED TO COMPLETE THEIR WORK, UNLESS NOTED OTHERWISE. 10. THESE PLANS ARE NOT TO BE SCALED. SEE ARCHITECTURAL PLANS FOR DIMENSIONS. WHERE THERE IS A CONFLICT BETWEEN ARCHITECTURAL DIMENSIONS AND MEP DIMENSION, ARCHITECTURAL SHALL GOVERN.
- 11. SEE DISCIPLINE SHEETS FOR ADDITIONAL DISCIPLINE SPECIFIC SPECIFICATIONS.

3. THE CONTRACTOR IS RESPONSIBLE FOR PROVIDING ALL NECESSARY PARTS AND LABOR TO

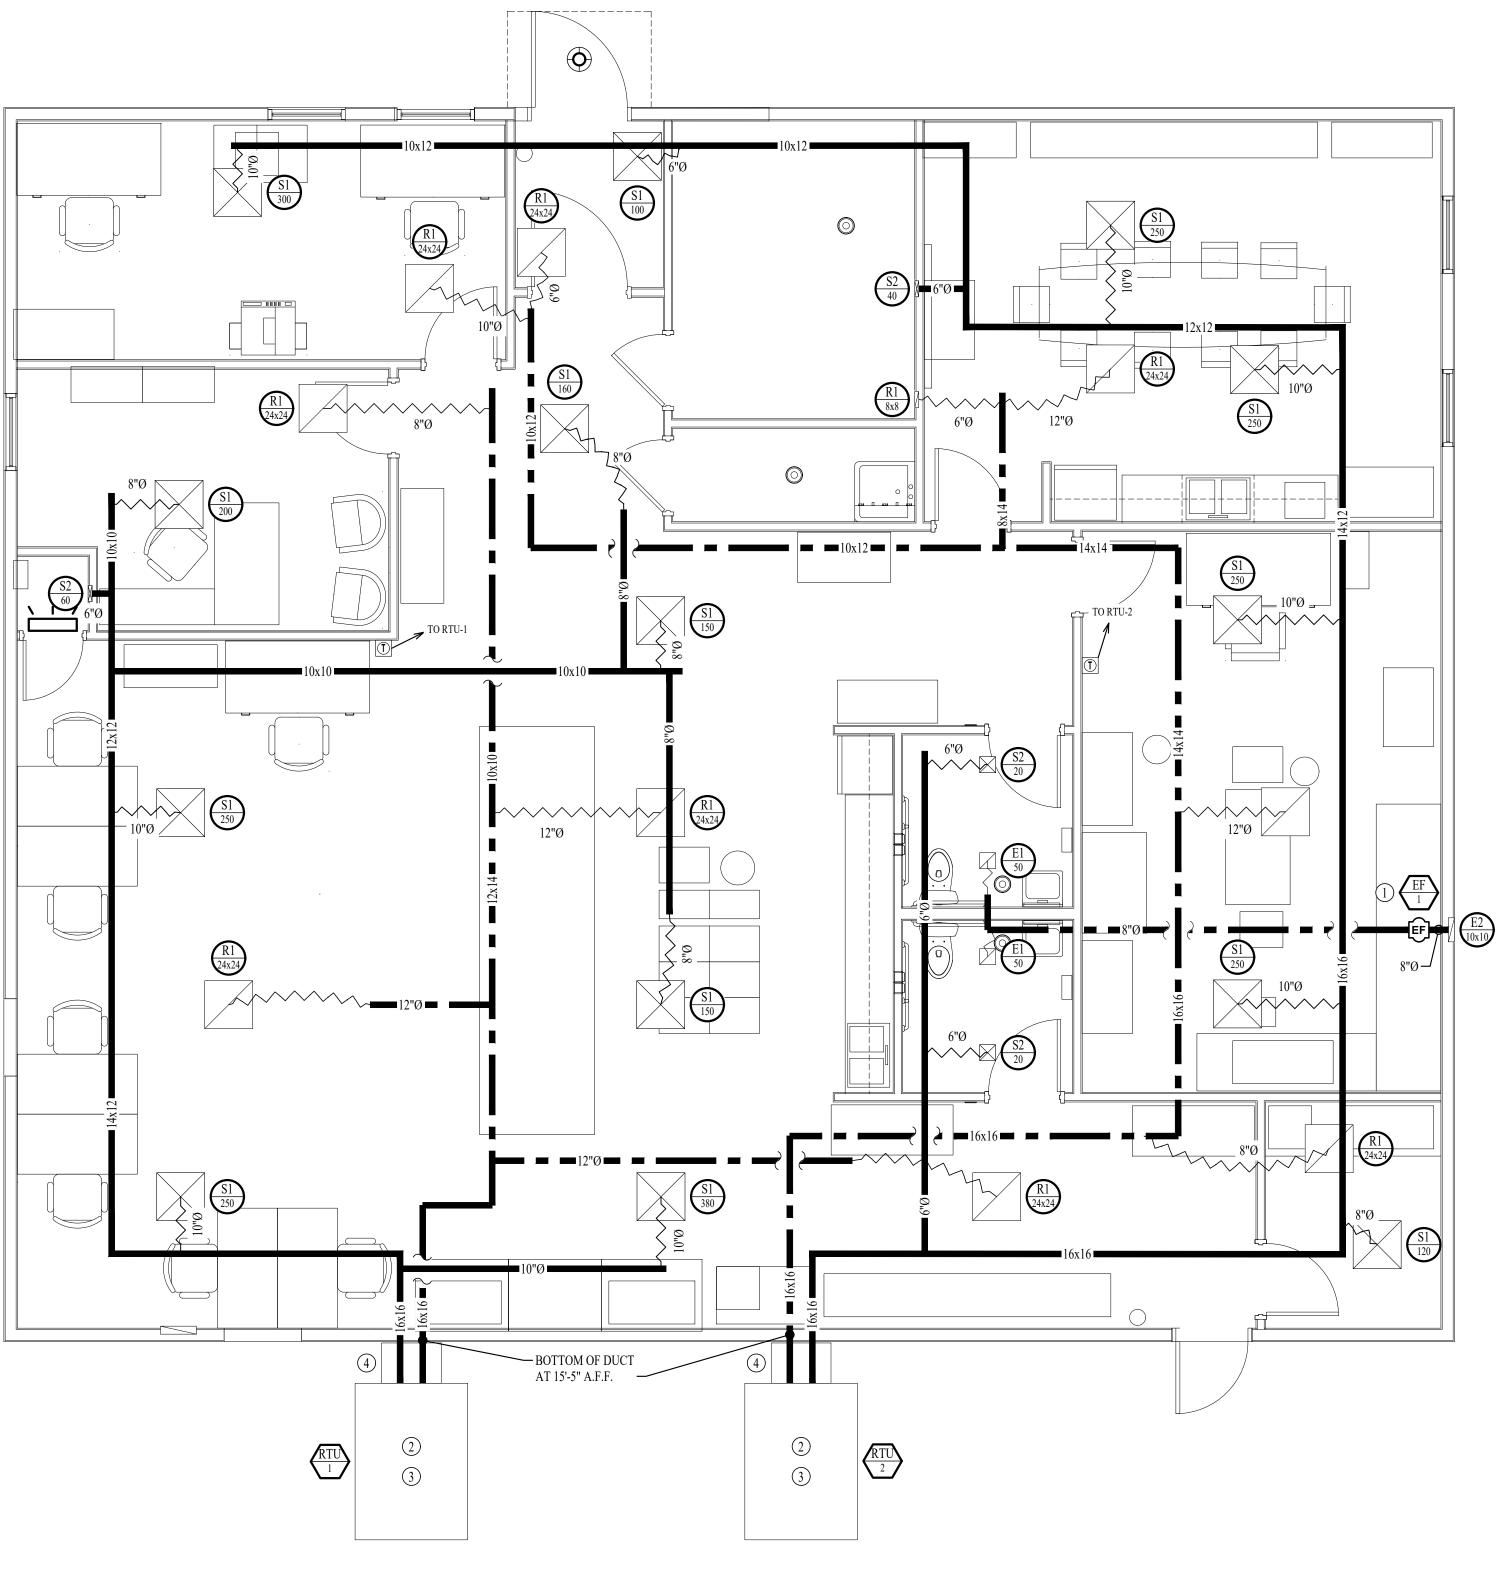

HVAC PLAN SCALE: 1/4" = 1'-0"



CHECKED BY:	
DESIGNED BY: _	
SHEET TITLE:	


HVAC PLAN


## SHEET NUMBER:

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#### HVAC SPECIFICATIONS

- 1. EQUIPMENT 1.1. ALL EQUIPMENT MUST PROVIDE THE PERFORMANCE SPECIFIED ON PLANS. WHERE SPECIFIC MAKES AND MODELS ARE INDICATED ON PLAN, CONTRACTOR TO PROVIDE MODEL
- INDICATED OR APPROVED EQUAL. 1.2. CONTRACTOR TO SUPPLY SUBMITTALS FOR ALL EQUIPMENT FOR REVIEW BY ARCHITECT
- AND ENGINEER PRIOR TO PURCHASE,
- 1.3. ALL EXTERIOR REFRIGERANT COILS TO BE PROTECTED BY FACTORY EQUIPPED HAIL GUARDS.
- 1.4. REFRIGERANT PIPING TO BE ACR COPPER OR TYPE L COPPER.
- 2. DUCTWORK 2.1. DUCTWORK TO BE GALVANIZED STEEL, SEAL CLASS B, CONSTRUCTED PER SMACNA
- STANDARDS.
- 2.2. 26 GA. MINIMUM UP TO 16" DUCT, 24 GA. UP TO 20", 22 GA. UP TO 24", 20 GA. UP TO 28", AND 18 GA. UP TO 36".
- 2.3. TURNING VANES TO BE PROVIDED AND INSTALLED AT ALL 90° BENDS AND TEES. 2.4. DUCT DIMENSIONS LISTED ARE TO INTERIOR OF DUCT LINER.
- 2.5. BALANCE DAMPERS MUST BE PROVIDED TO ALLOW ADJUSTMENT AT EACH AIR TERMINAL.
- 2.5.1. WHERE BRANCH TAKEOFF IS ACCESSIBLE (ABOVE LAY-IN CEILING OR EXPOSED DUCT), THE BALANCE DAMPER IS TO BE INSTALLED AT TAKEOFF. 2.5.2. WHERE TAKEOFF IS INACCESSIBLE (IN ATTIC OR SOFFIT), THE BALANCE DAMPER IS TO
- BE LOCATED SO IT IS ACCESSIBLE FROM FACE OF AIR DEVICE. 2.6. HVAC CONTRACTOR RESPONSIBLE FOR ALL DUCTWORK TRANSITIONS AND FITTINGS AS
- REQUIRED FOR FINAL CONNECTIONS TO HVAC EQUIPMENT.
- 3. INSULATION 3.1. DUCTWORK
- 3.1.1. SEE "TYPICAL DUCT INSULATION DIAGRAM" FOR INSTALLATION SPECIFIC
- REQUIREMENTS. EXTERNAL DUCT WRAP TO INCLUDE VAPOR BARRIER. EQUAL TO 'JOHNS MANVILLE 3.1.2. MICROLITE' WITH FSK JACKET.
- 4. WORKMANSHIP
- 4.1. COORDINATE WITH OTHER TRADES SO THAT HVAC EQUIPMENT AND DUCT WORK DOES NOT BLOCK REQUIRED ACCESS OR CLEARANCE TO EQUIPMENT.
- 4.2. ALL HVAC EQUIPMENT IS TO BE INSTALLED PER MANUFACTURER'S PUBLISHED RECOMMENDATIONS.
- 4.3. ALL EQUIPMENT TO BE INSTALLED LEVEL AND PLUMB.
- 4.4. ROOFTOP MOUNTED RTUS TO BE INSTALLED ON CURBS PER MANUFACTURES INSTRUCTIONS. 4.5. GRADE MOUNTED RTUS, CONDENSING UNITS, AND HEAT PUMPS TO BE INSTALLED ON 4" REINFORCED CONCRETE PAD EXTENDING 4" BEYOND EACH EDGE OF THE EQUIPMENT, OR A MANUFACTURER APPROVED PRE-MANUFACTURED BASE.



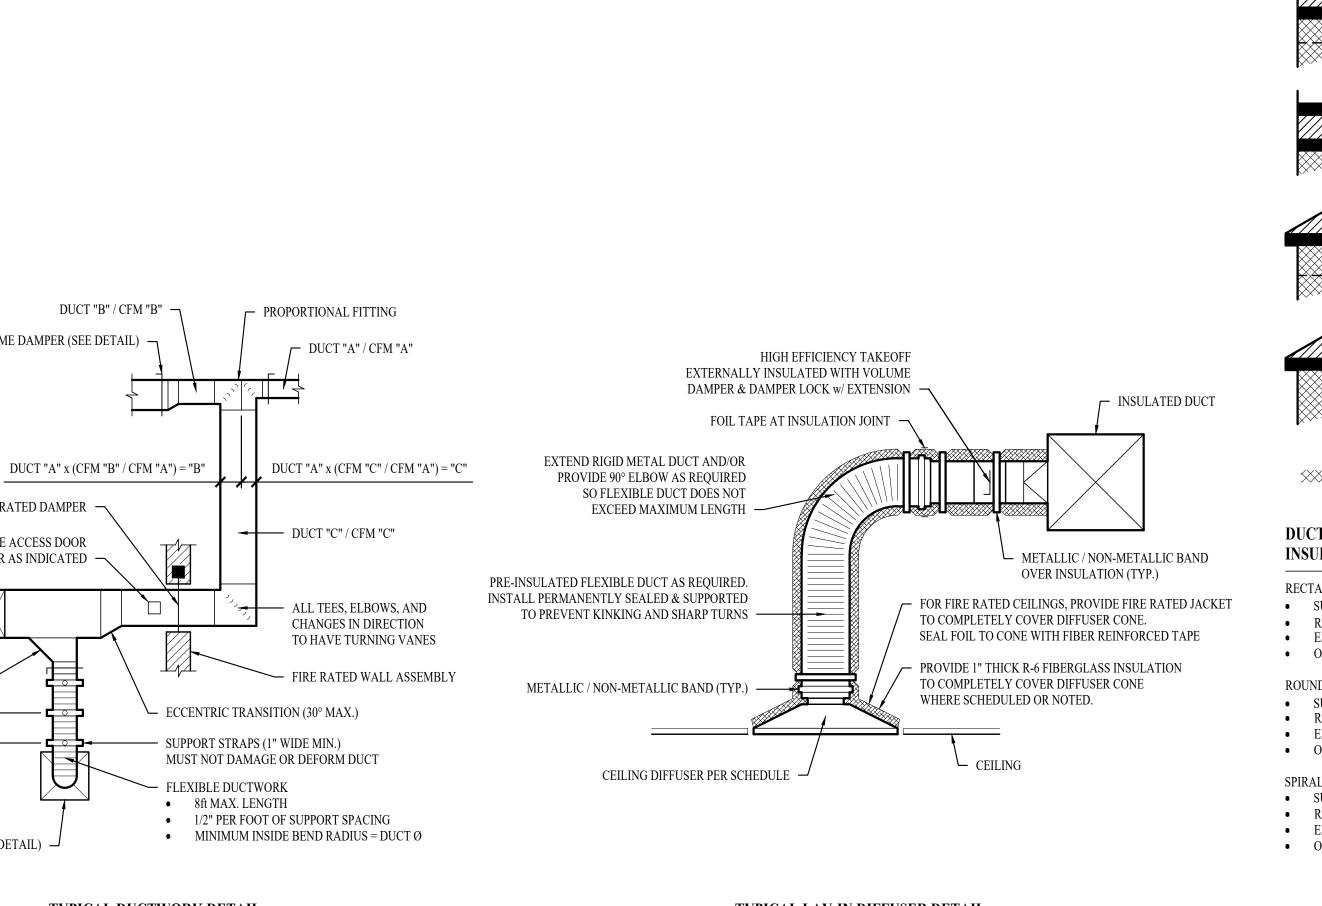

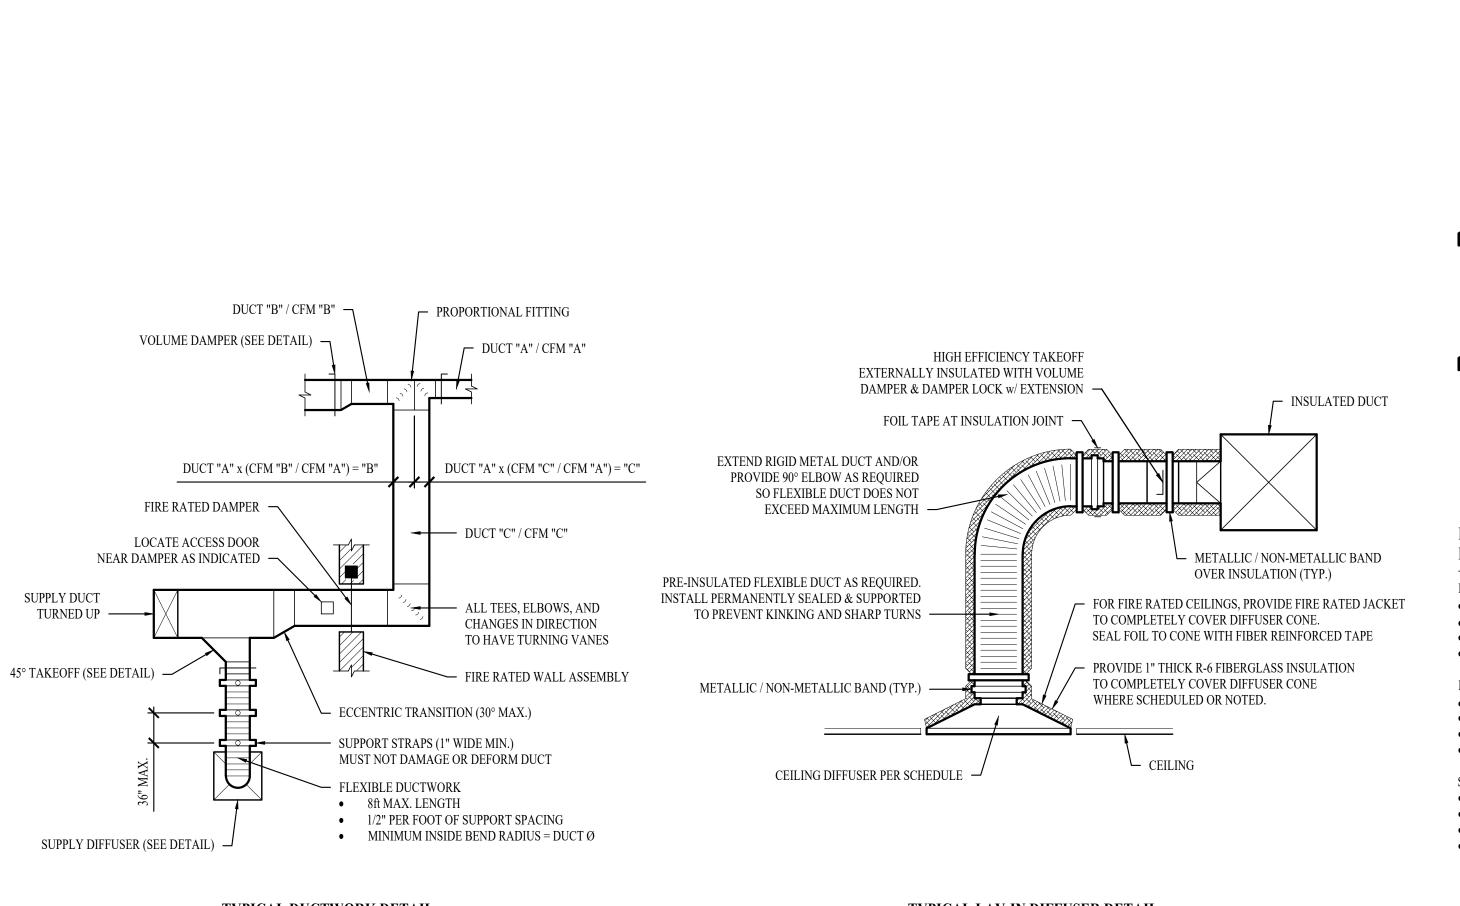TYPICAL DUCTWORK DETAIL

# **RTU SCHEDULE - ALTERNATE #1**

					KIU SC	IILDUL								
TAC	EQUIPMENT	SIZE	ORIENTATION	TOTAL AIRFLOW	OA AIRFLOW	GAS H	EATING	(IA		LING VB, OA: 95 DB)	FLECTRICAL		NOTES	
TAG	DESCRIPTION	(TONS)	ORIENTATION	(CFM)	MAX/MIN (CFM)	INPUT (kBTU)	OUTPUT (kBTU)	SENSIBLE (KBTU)	TOTAL (KBTU)	MIN. EFFICIENCY	VOLTS / PHASE	MCA	ОСР	NOTES
RTU-1	ROOF TOP UNIT	4	SIDE DISCHARGE	1600	180	108	88	35.0	46.0	14 SEER	208/1	26.9	40	1,2,3,4
RTU-2	ROOF TOP UNIT	4	SIDE DISCHARGE	1600	180	108	88	35.0	46.0	14 SEER	208/1	26.9	40	1,2,3,4
NOTES.														

NOTES

1. PROVIDE AND INSTALL 7 DAY PROGRAMABLE THERMOSTAT. COORDINATE EXACT MOUNTING LOCATION WITH OWNER. 2. WITH FACTORY HAIL GUARD.

3. WITH FACTORY INSTALLED DISCONNECT.

4. ECONOMIZER WITH BAROMETRIC RELIEF SIZED AT 100% OF FLOW. CONTROL TO BE ADJUSTABLE FIXED POINT SET AT 65°F. ECONOMIZER TO BE IECC COMPLIANT WITH FAULT DETECTION AND NOTIFICATION.


			EXHAUS	ST FAN	SCHED	ULE			
TAG	EQUIPMENT TYPE	MANUFACTURER	MODEL	MODEL FLO		ELECTRICAL			NOTES
IAG	EQUIPMENT TYPE	(OR EQUAL)	(OR EQUAL)	CFM	S.P.	VOLT/PH	MCA	OCP	NOTES
<b>EF-1</b>	INLINE EXHAUST FAN	SOLER & PALAU	TD-SILENT	100	3/8	120/1	1	15	1,2
NOTES:									

1. WITH BACKDRAFT DAMPER

2. WITH SPEED CONTROLLER

	AIR DEVICE SCHEDULE										
TAG	SERVICE	MANUFACTURER (OR EQUAL)	MODEL (OR EQUAL)	SIZE	COLOR/ FINISH	NOTES					
S1	SUPPLY	PRICE	SPD	24x24	WHITE	SEE PLANS FOR AIRFLOW					
S2	SUPPLY	PRICE	520	8x8	WHITE	SEE PLANS FOR AIRFLOW					
R1	RETURN	PRICE	80	SEE PLANS	WHITE						
E1	EXHAUST	PRICE	530	8x8	WHITE	SEE PLANS FOR AIRFLOW					
E2	EXHAUST	POTTORFF	EFD-445	SEE PLANS	WHITE						
NOTES:	. VERIFY AIR I	DEVICE FINISHES WITH C	WNER/ARCHITEC	F PRIOR TO IN	ISTALLATION	V					

TYPICAL LAY-IN DIFFUSER DETAIL

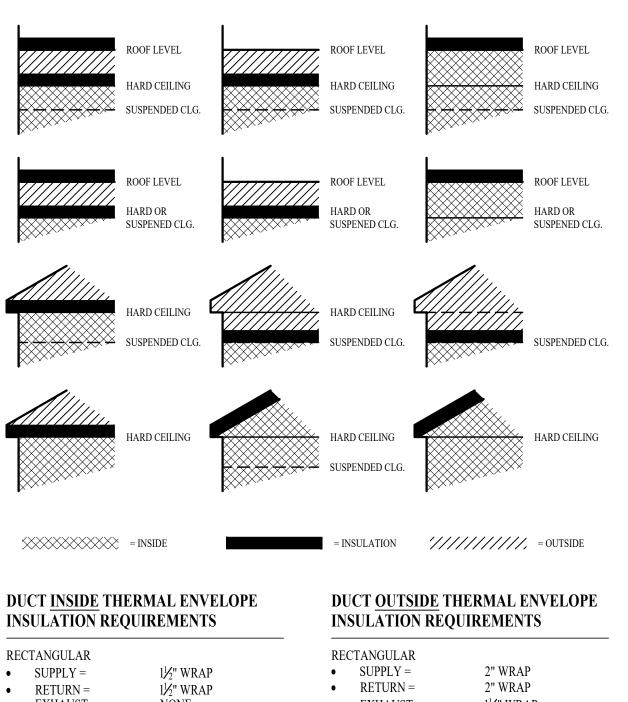


SUPPLY =	1 <sup>1</sup> / <sub>2</sub> " WRAP	• SUPPLY =	2" WRAP
RETURN =	$1\frac{1}{2}$ " WRAP	• RETURN =	2" WRAP
EXHAUST =	NONE	• EXHAUST =	1 <sup>1</sup> / <sub>2</sub> " WRAP
OUTSIDE AIR =	2" WRAP	• OUTSIDE AIR =	NONE
۱D		ROUND	
SUPPLY =	1½" WRAP	• SUPPLY =	2" WRAP
RETURN =	NONE	• RETURN =	2" WRAP
EXHAUST =	NONE	• EXHAUST =	1½" WRAP
OUTSIDE AIR =	2" WRAP	• OUTSIDE AIR =	NONE
٨L		SPIRAL	
SUPPLY =	NONE	• SUPPLY =	2" WRAP
RETURN =	NONE	• RETURN =	2" WRAP
EXHAUST =	NONE	• EXHAUST =	1 <sup>1</sup> / <sub>2</sub> " WRAP
OUTSIDE AIR =	2" WRAP	• OUTSIDE AIR =	NONE

TYPICAL BUILDING INTERIOR DUCT INSULATION DIAGRAM

STATE OF MISSOURI MICHAEL L. PARSON, GOVERNOR
James Watson, P.E. James Watson, P.E. James Watson, P.E. PE-2015017071 BMO Certificate of Authority # 2018029680
Peckham & Wright Architects, Inc., d.b.a. <b>PWArchitects, Inc.</b> 2120 Forum Blvd., Ste. 101 Columbia, Missouri 65203 PWArchitects.com   573.449.2683 Peckham & Wright Architects an Architectural Corporation Missouri State Certificate of Authority No. 000244
J-SQUARED ENGINEERING OFFICE OF
ADMINISTRATION DIVISION OF FACILITIES MANAGEMENT, DESIGN AND CONSTRUCTION
O2233-01 - MULTIPURPOSE BUILDING for MDA USE
NEW MADRID STATE OFFICE BUILDING NEW MADRID, MO
PROJECT # 02233-01 SITE # 7711 ASSET # 8877711007
REVISION: DATE: REVISION: DATE: REVISION: DATE: DATE: ISSUE DATE: 02/27/2023
CAD DWG FILE: J20720 DRAWN BY: DET CHECKED BY: JPW DESIGNED BY: TAW SHEET TITLE:
HVAC DETAILS & SCHEDULES
sheet number: $M-501$
17 OF 23 SHEETS 02 / 27 / 2023

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#### POWER PLAN SYMBOL LEGEND

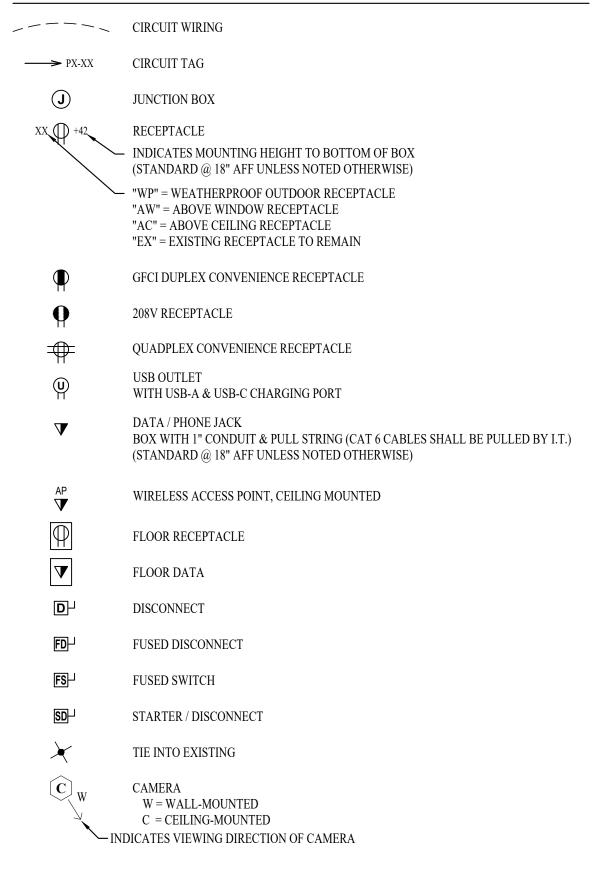


#### POWER PLAN GENERAL NOTES:


1. SEE SHEET E501 FOR ADDITIONAL ELECTRICAL NOTES, DETAILS, & SCHEDULES.

#### POWER PLAN KEY NOTES:

- (1) RECEPTACLE IN CABINET. ROUTE CONDUIT TIGHT TO CABINET DIVIDERS.
- (2) COORDINATE EXACT LOCATION OF RECEPTACLES FOR WATER HEATER WITH PLUMBER.
- (3) WIRE EF-1 TO TIMECLOCK TO OPERATE DURING OCCUPIED HOURS. WIRE TO CIRCUIT P1-20.

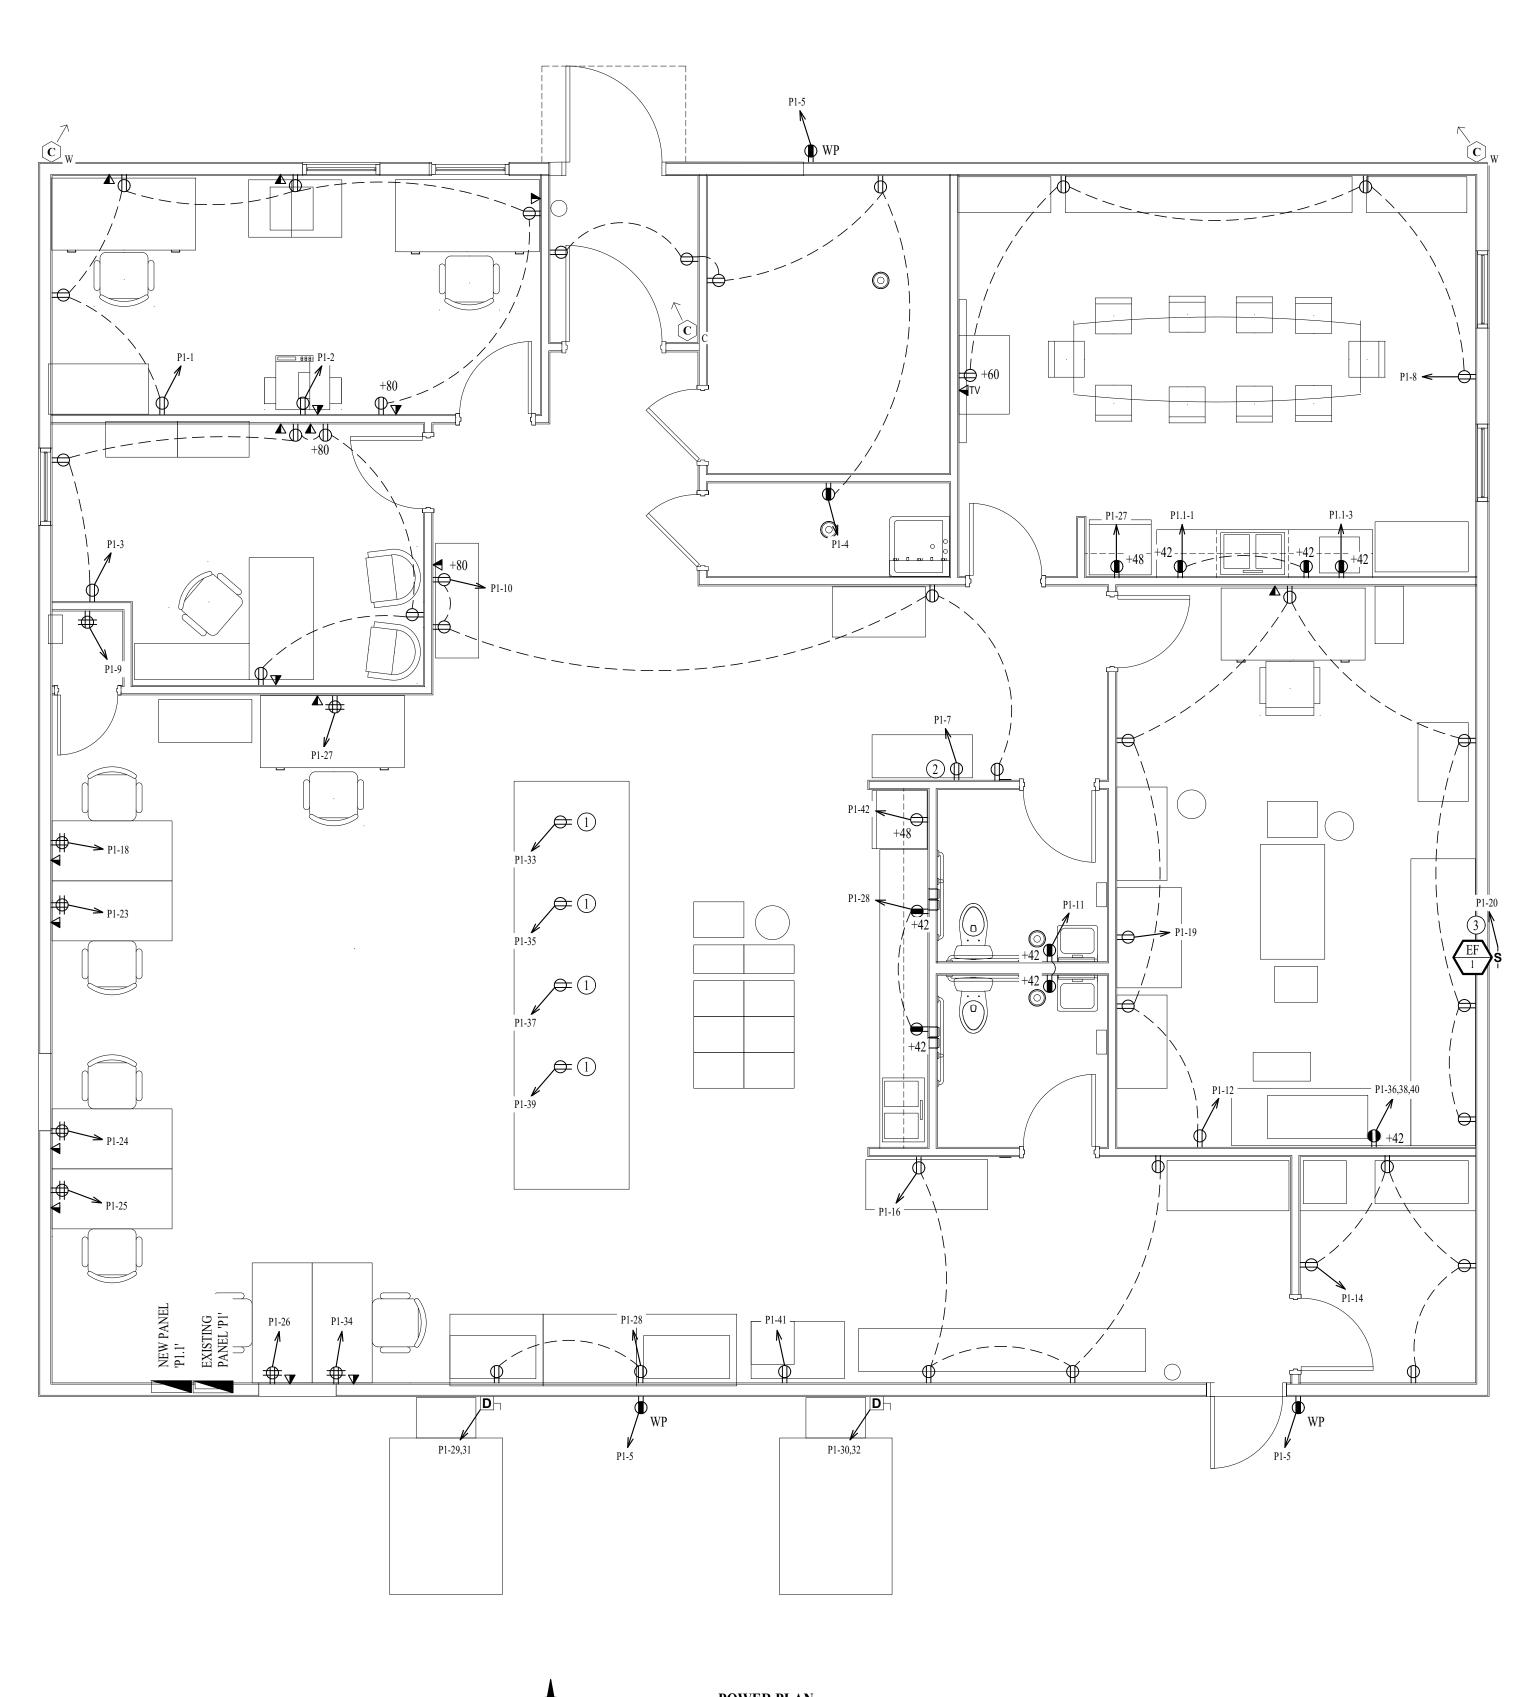


**POWER PLAN** SCALE: 1/4" = 1'-0"

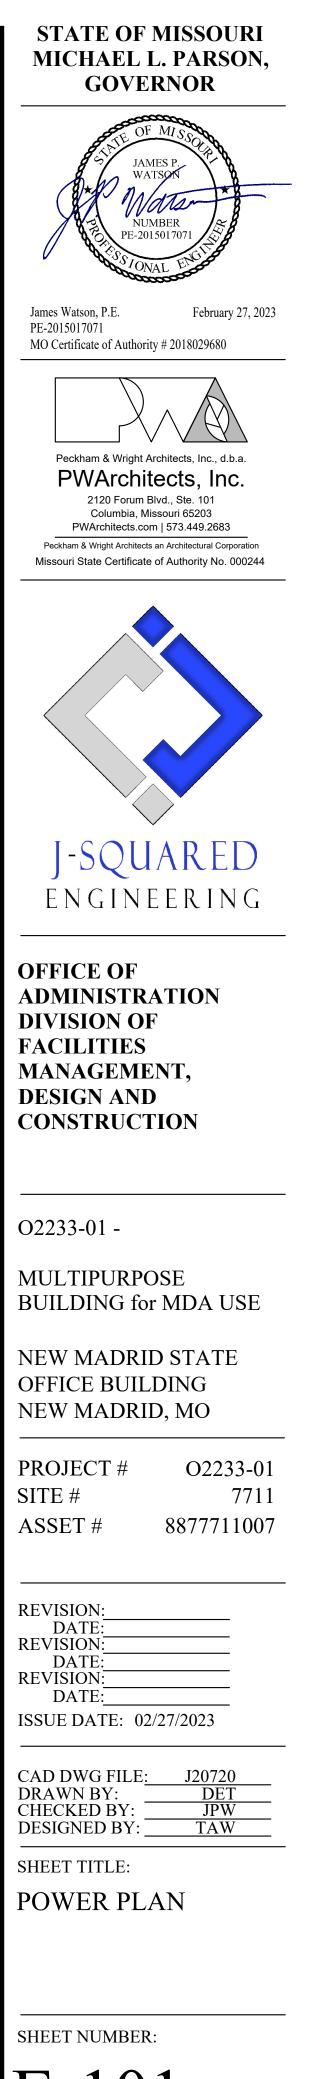

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#### LIGHTING PLAN SYMBOL LEGEND

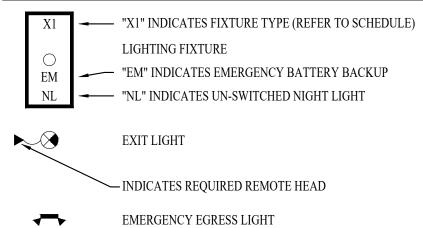

#### EMERGENCY EGRESS LIGHT

#### SWITCH (WALL MOUNTED)

- SWITCH TYPE: • 3 = 3-WAY
- 4 = 4-WAY
- OP = PASSIVE INFRARED OCCUPANCY SENSOR • OU = ULTRASONIC OCCUPANCY SENSOR
- OT = DUAL-TECHNOLOGY OCCUPANCY SENSOR
- VP = PASSIVE INFRARED VACANCY SENSOR
- VU = ULTRASONIC VACANCY SENSOR
- VT = DUAL-TECHNOLOGY VACANCY SENSOR
- M = MOMENTARY SWITCH
- SS = SCENE SWITCH
- DIMMER SWITCH (WALL MOUNTED)

#### SWITCH TYPE:

• SEE "SWITCH (WALL MOUNTED)" FOR TYPE DESIGNATIONS

### Switch type: SWITCH (CEILING MOUNTED)

• SEE "SWITCH (WALL MOUNTED)" FOR TYPE DESIGNATIONS

#### PP POWER PACK


- OCCUPANCY SENSOR
- AUTO FULL-ON (OR 50% IF NOTED) AUTOMATICALLY TURN OFF LIGHTING AFTER 20 MINUTES WITHOUT
- OCCUPANT DETECTION
- WITH MANUAL OVERRIDE CONTROL (IF NOTED)

#### VACANCY SENSOR

- MANUAL FULL-ON AUTOMATICALLY TURN OFF LIGHTING AFTER 20 MINUTES WITHOUT
- OCCUPANT DETECTION
- WITH MANUAL OVERRIDE CONTROL (IF NOTED)

#### LIGHTING PLAN GENERAL NOTES:

- 1. SEE SHEET E501 FOR ADDITIONAL ELECTRICAL NOTES, DETAILS, & SCHEDULES. 2. OCCUPANCY / VACANCY SENSOR QUANTITIES AND GENERAL LOCATIONS SHOWN FOR REFERENCE ONLY. CONTRACTOR TO PROVIDE AND INSTALL SENSOR WITH SPACING PER MANUFACTURER SPECIFICATIONS AND INCLUDE ADDITIONAL SENSORS IF NECESSARY. CEILING-MOUNTED SENSORS SHALL BE INSTALLED WITHIN MANUFACTURE'S ACCEPTABLE MOUNTING HEIGHT RANGE.
- 3. EXISTING LIGHT FIXTURES SHALL BE SALVAGED & RETURNED TO OWNER.

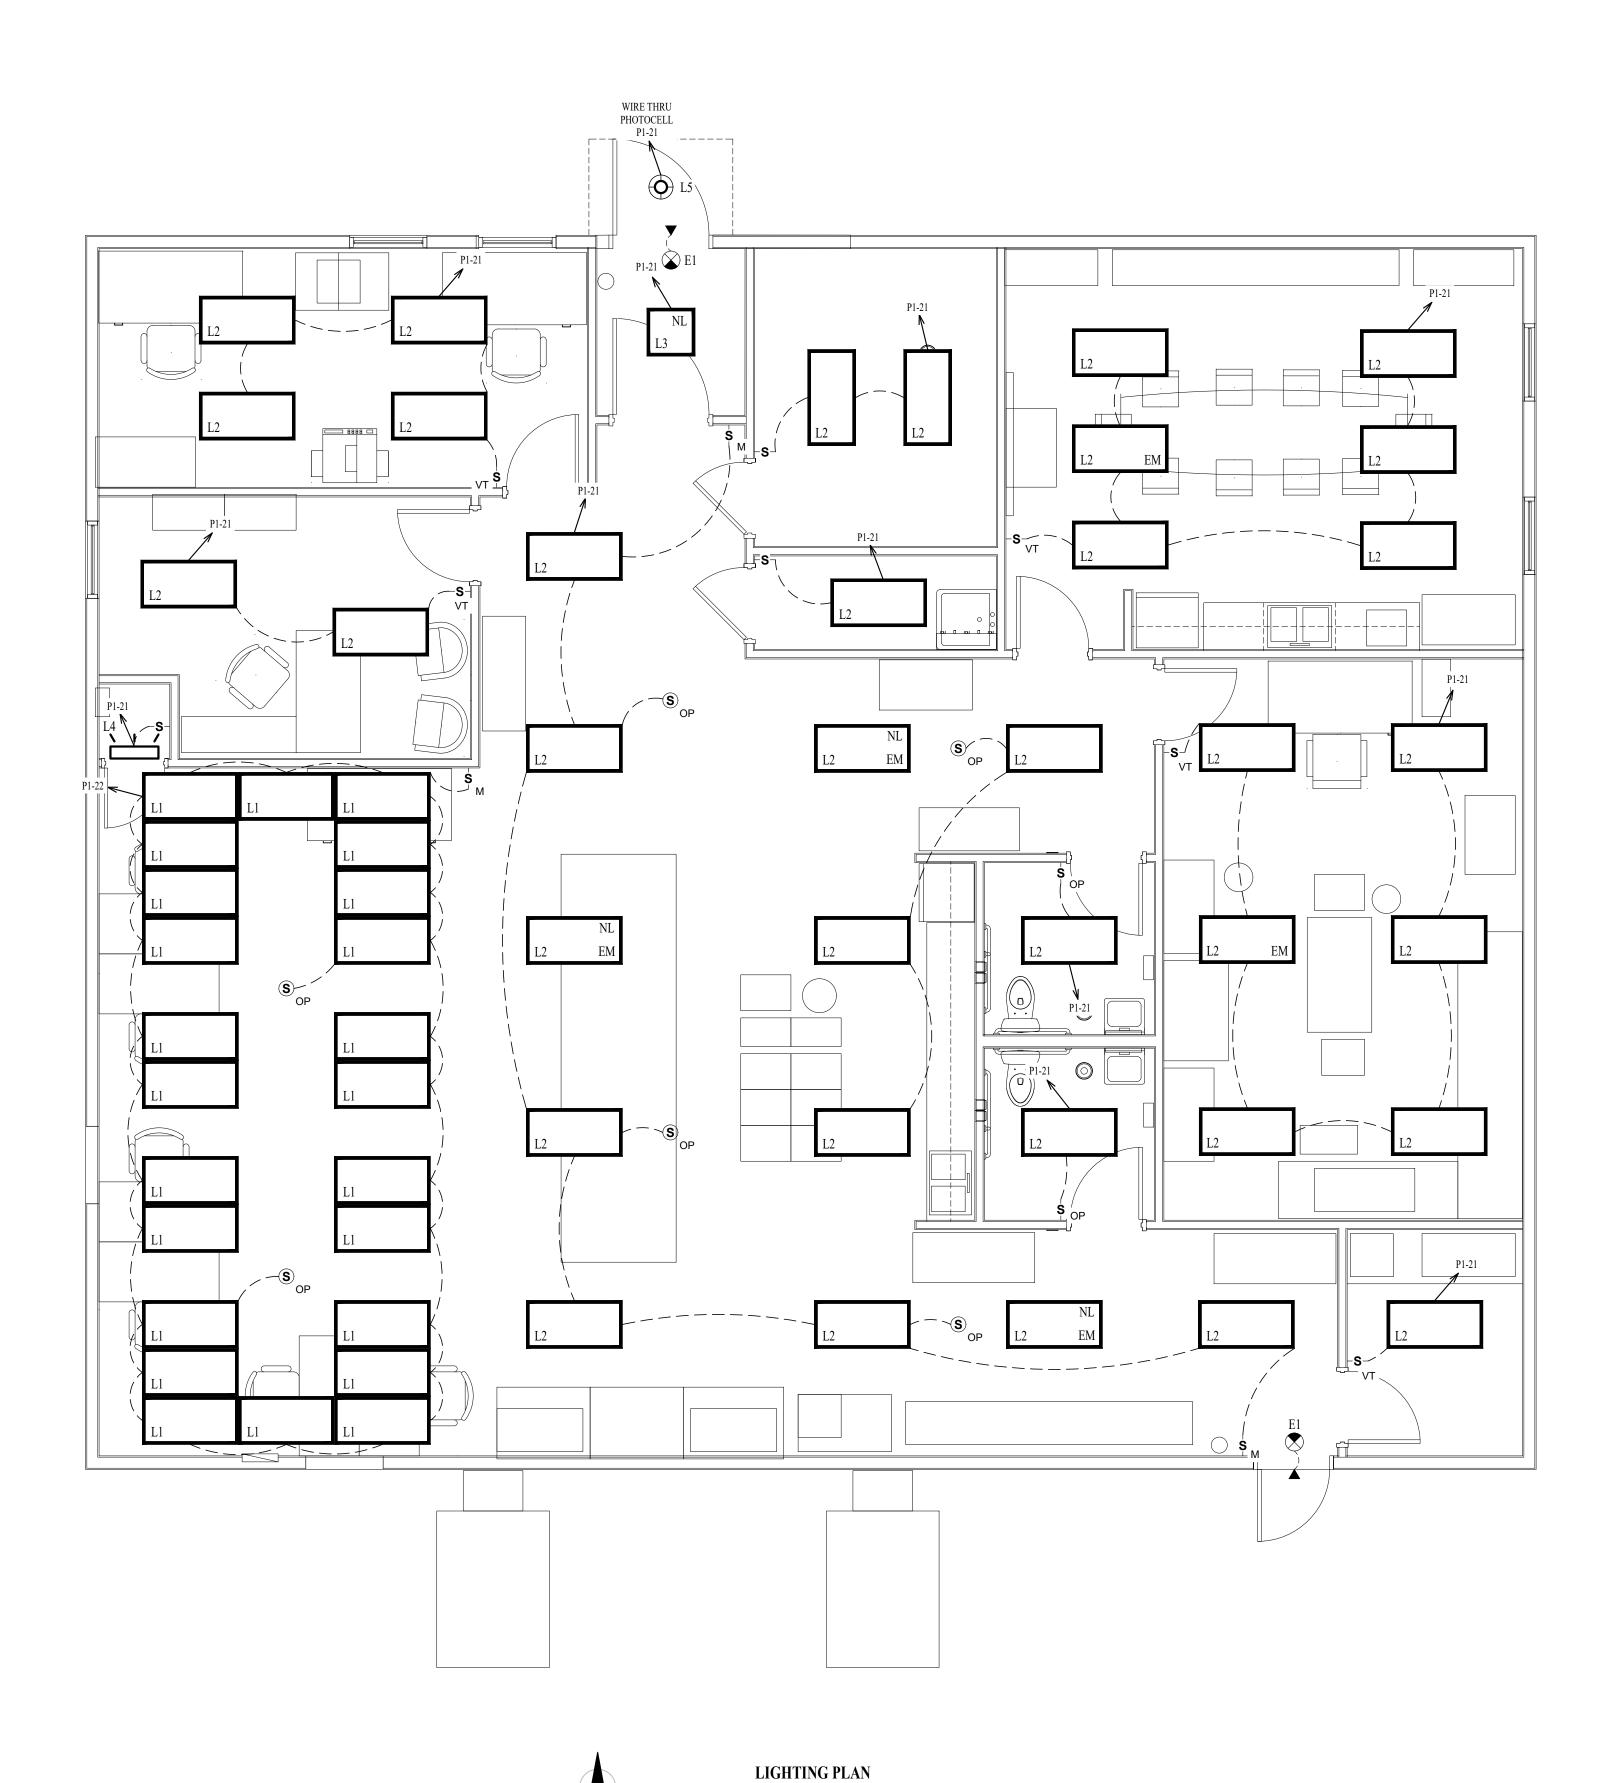

SCALE: 1/4" = 1'-0"

STATE OF MISSOURI MICHAEL L. PARSON, GOVERNOR	
JAMES P. WATSON NUMBER PE-2015017071	
James Watson, P.E. February 27, 2023 PE-2015017071 MO Certificate of Authority # 2018029680	_
Peckham & Wright Architects, Inc., d.b.a. <b>PWArchitects, Inc.</b> , d.b.a. 2120 Forum Blvd., Ste. 101 Columbia, Missouri 65203 PWArchitects.com   573.449.2683 Peckham & Wright Architects an Architectural Corporation Missouri State Certificate of Authority No. 000244	
J-SQUARED Engineering	
ADMINISTRATION DIVISION OF FACILITIES MANAGEMENT, DESIGN AND CONSTRUCTION	
D2233-01 - MULTIPURPOSE BUILDING for MDA USE	
NEW MADRID STATE OFFICE BUILDING NEW MADRID, MO	
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REVISION: DATE: REVISION: DATE: REVISION: DATE: DATE: SSUE DATE: 02/27/2023	
CAD DWG FILE: J20720 DRAWN BY: DET CHECKED BY: JPW	
DESIGNED BY: JPW TAW	
CHECKED BY: JPW DESIGNED BY: TAW SHEET TITLE: LIGHTING PLAN	

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#### ELECTRICAL SPECIFICATIONS

#### 1. GENERAL

- 1.1. THE ENTIRE ELECTRICAL SYSTEM SHALL BE CONTINUOUSLY GROUNDED. EVERY BRANCH
- CONDUIT SHALL INCLUDE A GREEN GROUND CONDUCTOR SIZED PER NEC. 1.2. ARC-FAULT CIRCUITS SHALL BE RUN WITH A DEDICATED NEUTRAL AS REQUIRED BY
- MANUFACTURER.
- 1.3. PROVIDE PERMANENT ARC-FLASH LABEL AFFIXED TO EVERY DISCONNECT AND PANEL. 1.4. PROVIDE TYPE WRITTEN PANEL SCHEDULE FOR EACH PANEL.
- 2. MATERIALS

2.1. DEVICES

- 2.1.1. CONTRACTOR TO PROVIDE J-BOXES, COVER PLATES, AND ANY ACCESSORIES REQUIRED TO PROVIDE A COMPLETE SYSTEM. SEE ARCHITECTURAL PLANS FOR DEVICE COLORS.
- 2.1.1. DUPLEX RECEPTACLES SHALL BE TAMPER RESISTANT, 20 AMP, EQUAL TO LEVITON
- CR20. 2.1.2. TOGGLE WALL SWITCHES SHALL BE EQUAL TO LEVITON CS120-2
- 2.1.3. DIMMER SWITCHES SHALL BE TESTED WITH FIXTURES AND LAMPS FOR

COMPATIBILITY. 3. EMERGENCY LIGHTING

3.1. THE BRANCH CIRCUIT FEEDING THE EMERGENCY FIXTURE SHALL BE THE SAME BRANCH CIRCUIT AS THAT SERVING THE NORMAL LIGHTING IN THE AREA AND CONNECTED AHEAD OF ANY LOCAL SWITCHES.

	LIGHT FIXTURE SCHEDULE									
TAG	MANUFACTURER (OR EQUAL)	MODEL NUMBER (OR EQUAL)	DESCRIPTION	MOUNTING	LUMEN OUTPUT	CCT (°K)	CRI	VOLTS	WATTS	NOTES
L1	METALUX	2GR8332	3-LAMP 2x4 T8 LIGHT	ACT GRID	5400	6500	95	120	54	WITH (3) NORTHLUX T8 LAMPS, MODEL: 4024.65
L2	METALUX	24FP4740C	2x4 LED FLAT PANEL	ACT GRID	4556	4000	80	120	41	WITH 'FPSURF24' MOUNTING KIT WHERE REQUIRED
L3	METALUX	22FP4240C	2x2 LED FLAT PANEL	SURFACE	4567	4000	80	120	39	WITH 'FPSURF24' MOUNTING KIT
L4	METALUX	2BCLED-LD4-20SL-F-UNV-L835-CD1-U	2' WALL BRACKET	WALL BRACKET	2000	3500	85	UNV	23	
L5	HALO	SMD14R-20-9S-WH-E	14" ROUND SURFACE DOWNLIGHT	SURFACE	2090	4000	95	UNV	27	
E1	SURE LITES	APCH7R WITH APWR2	INTERIOR EXIT LIGHT WITH EXTERIOR REMOTE HEAD	CEILING	-	-	-	UNV	1	WITH RED LETTERS
NOTES: 1.										

VOLTAGE		PANEL SIZE		MOUNTING		AIC RATING		
	120/208	120/208					PHASE "A" LOAD	120.3
		225A I	MCB	RECESSED		22,000	PHASE "B" LOAD	84.8
	NEMA RATING: 1						PHASE "C" LOAD	98.3
CIRCUIT NUMBER	DESCRIPTION	BREAKER SIZE	AMPS	PHASE	AMPS	BREAKER SIZE	DESCRIPTION	CIRCUI NUMBE
1	SUPPORT OFFICE RECEPTACLES	20-1	7.5	А	12	20-1	SUPPORT OFFICE PRINTER	2
3	CHIEF INSPECTOR RECEPTACLES	20-1	7.5	В	6	20-1	LOBBY/JANITORIAL RECEPTACLES	4
5	EXTERIOR RECEPTACLES	20-1	3	С		20-1	SPARE	
7	WATER HEATER	20-1	12.5	А	6	20-1	BREAK ROOM RECEPTACLES	
9	SERVER ROOM RECEPTACLE	20-1	3	В	9	20-1	NORTH MAIN INSPECTION LAB RECEPTACLES	
11	RESTROOM RECEPTACLES	20-1	3	С	10.5	20-1	RICE LAB RECEPTACLES	12
13	SUB PANEL P1.1	60-3		А	6	20-1	PROTEIN LAB RECEPTACLES	14
15	-	-		В	10.5	20-1	SOUTH MAIN INSPECTION LAB RECEPTACLES	16
17	-	-		С	3	20-1	INSPECTION DESK RECEPTACLE	18
19	INSPECTION DESK RECEPTACLE	20-1	3	А	1	15-1	EF-1	20
21	OFFICE LIGHTING	20-1	13	В	10.8	20-1	INSPECTION DESK LIGHTING	22
23	INSPECTION DESK RECEPTACLE	20-1	3	С	3	20-1	INSPECTION DESK RECEPTACLE	24
25	INSPECTION DESK RECEPTACLE	20-1	3	А	3	20-1	INSPECTION DESK RECEPTACLE	26
27	REFRIGERATOR	20-1	5	В	3	20-1	COUNTERTOP OUTLETS	28
29	RTU-1	40-2	26.9	С	26.9	40-2	RTU-2	30
31	/	/	26.9	А	26.9	/	/	32
33	INSPECTION LAB WORKBENCH RECEPTACLE	20-1	1.5	В	3	20-1	INSPECTION DESK RECEPTACLE	34
35	INSPECTION LAB WORKBENCH RECEPTACLE	20-1	1.5	С	11	20-3	RICE MILL	36
37	INSPECTION LAB WORKBENCH RECEPTACLE	20-1	1.5	А	11	-	-	38
39	INSPECTION LAB WORKBENCH RECEPTACLE	20-1	1.5	В	11	-	-	40
	INSPECTION LAB WORKBENCH RECEPTACLE	20-1	1.5	С	5	20-1	REFRIGERATOR	42

		P	ANEL	P1.1' SC	HEDUI			
	VOLTAGE	PANEI	L SIZE	MOU	NTING	AIC RATING		
120/208				RECESSED			PHASE "A" LOAD	3
		100 N	MLO			22,000	PHASE "B" LOAD	5
	NEMA RATING: 1						PHASE "C" LOAD	0
CIRCUIT NUMBER	<b>DESCRIPTION</b>	BREAKER SIZE	AMPS	PHASE	AMPS	BREAKER SIZE	DESCRIPTION	CIRCU NUMB
1	COUNTERTOP CONF ROOM	20-1	3	А		20-1	SPARE	2
3	CONF ROOM MICROWAVE	20-1	5	В		20-1	SPARE	4
5				С		20-1	SPARE	6
7				А		20-1	SPARE	8
9				В		20-1	SPARE	10
11				С		20-1	SPARE	12
13				А		20-1	SPARE	14
15				В		20-1	SPARE	16
17				С		20-1	SPARE	18
19				А		20-1	SPARE	20
21				В		20-1	SPARE	22
23				С		20-1	SPARE	24
25				А		20-1	SPARE	26
27				В		20-1	SPARE	28
29				С		20-1	SPARE	30

C: AFTER COMPLETION OF WORK, ELECTRICAN SHALL PROVIDE A TYPE WRITTEN PANEL DIRECTORY IN NEW PANEL.

C: AFTER COMPLETION OF WORK, ELECTRICAN SHALL PROVIDE A TYPE WRITTEN PANEL DIRECTORY IN NEW PANEL.

STATE OF MISSOURI MICHAEL L. PARSON, GOVERNOR
NUMBER PE-2015017071
James Watson, P.E.       February 27, 2023         PE-2015017071       MO Certificate of Authority # 2018029680         Image: Construction of Authority # 2018029680       Image: Construction of Authority # 2018029680       Image: Constructing Authority # 2018029680
J-SQUARED ENGINEERING OFFICE OF ADMINISTRATION DIVISION OF FACILITIES MANAGEMENT, DESIGN AND CONSTRUCTION
O2233-01 - MULTIPURPOSE BUILDING for MDA USE NEW MADRID STATE OFFICE BUILDING NEW MADRID, MO
PROJECT #       O2233-01         SITE #       7711         ASSET #       8877711007         REVISION:
CAD DWG FILE: J20720 DRAWN BY: DET CHECKED BY: JPW DESIGNED BY: TAW

SHEET TITLE: ELECTRICAL DETAILS & SCHEDULES

SHEET NUMBER:

E-501 20 OF 23 SHEETS 02 / 27 / 2023

#### SANITARY SEWER PLAN SYMBOL LEGEND

	SANITARY SEWER PIPING
	VENT PIPING
o	PIPING TURNED DOWN / TURNED UP
$\boldsymbol{\lambda}$	TIE INTO EXISTING


#### SANITARY SEWER PLAN GENERAL NOTES:

1. SEE SHEET P501 FOR ADDITIONAL PLUMBING NOTES, DETAILS, & SCHEDULES.

#### SANITARY SEWER PLAN KEY NOTES:

(1) SEE CIVIL FOR CONTINUATION.

(2) INSTALL HUB DRAIN (HD) IN WALL FOR DRAIN FROM WATER HEATER.

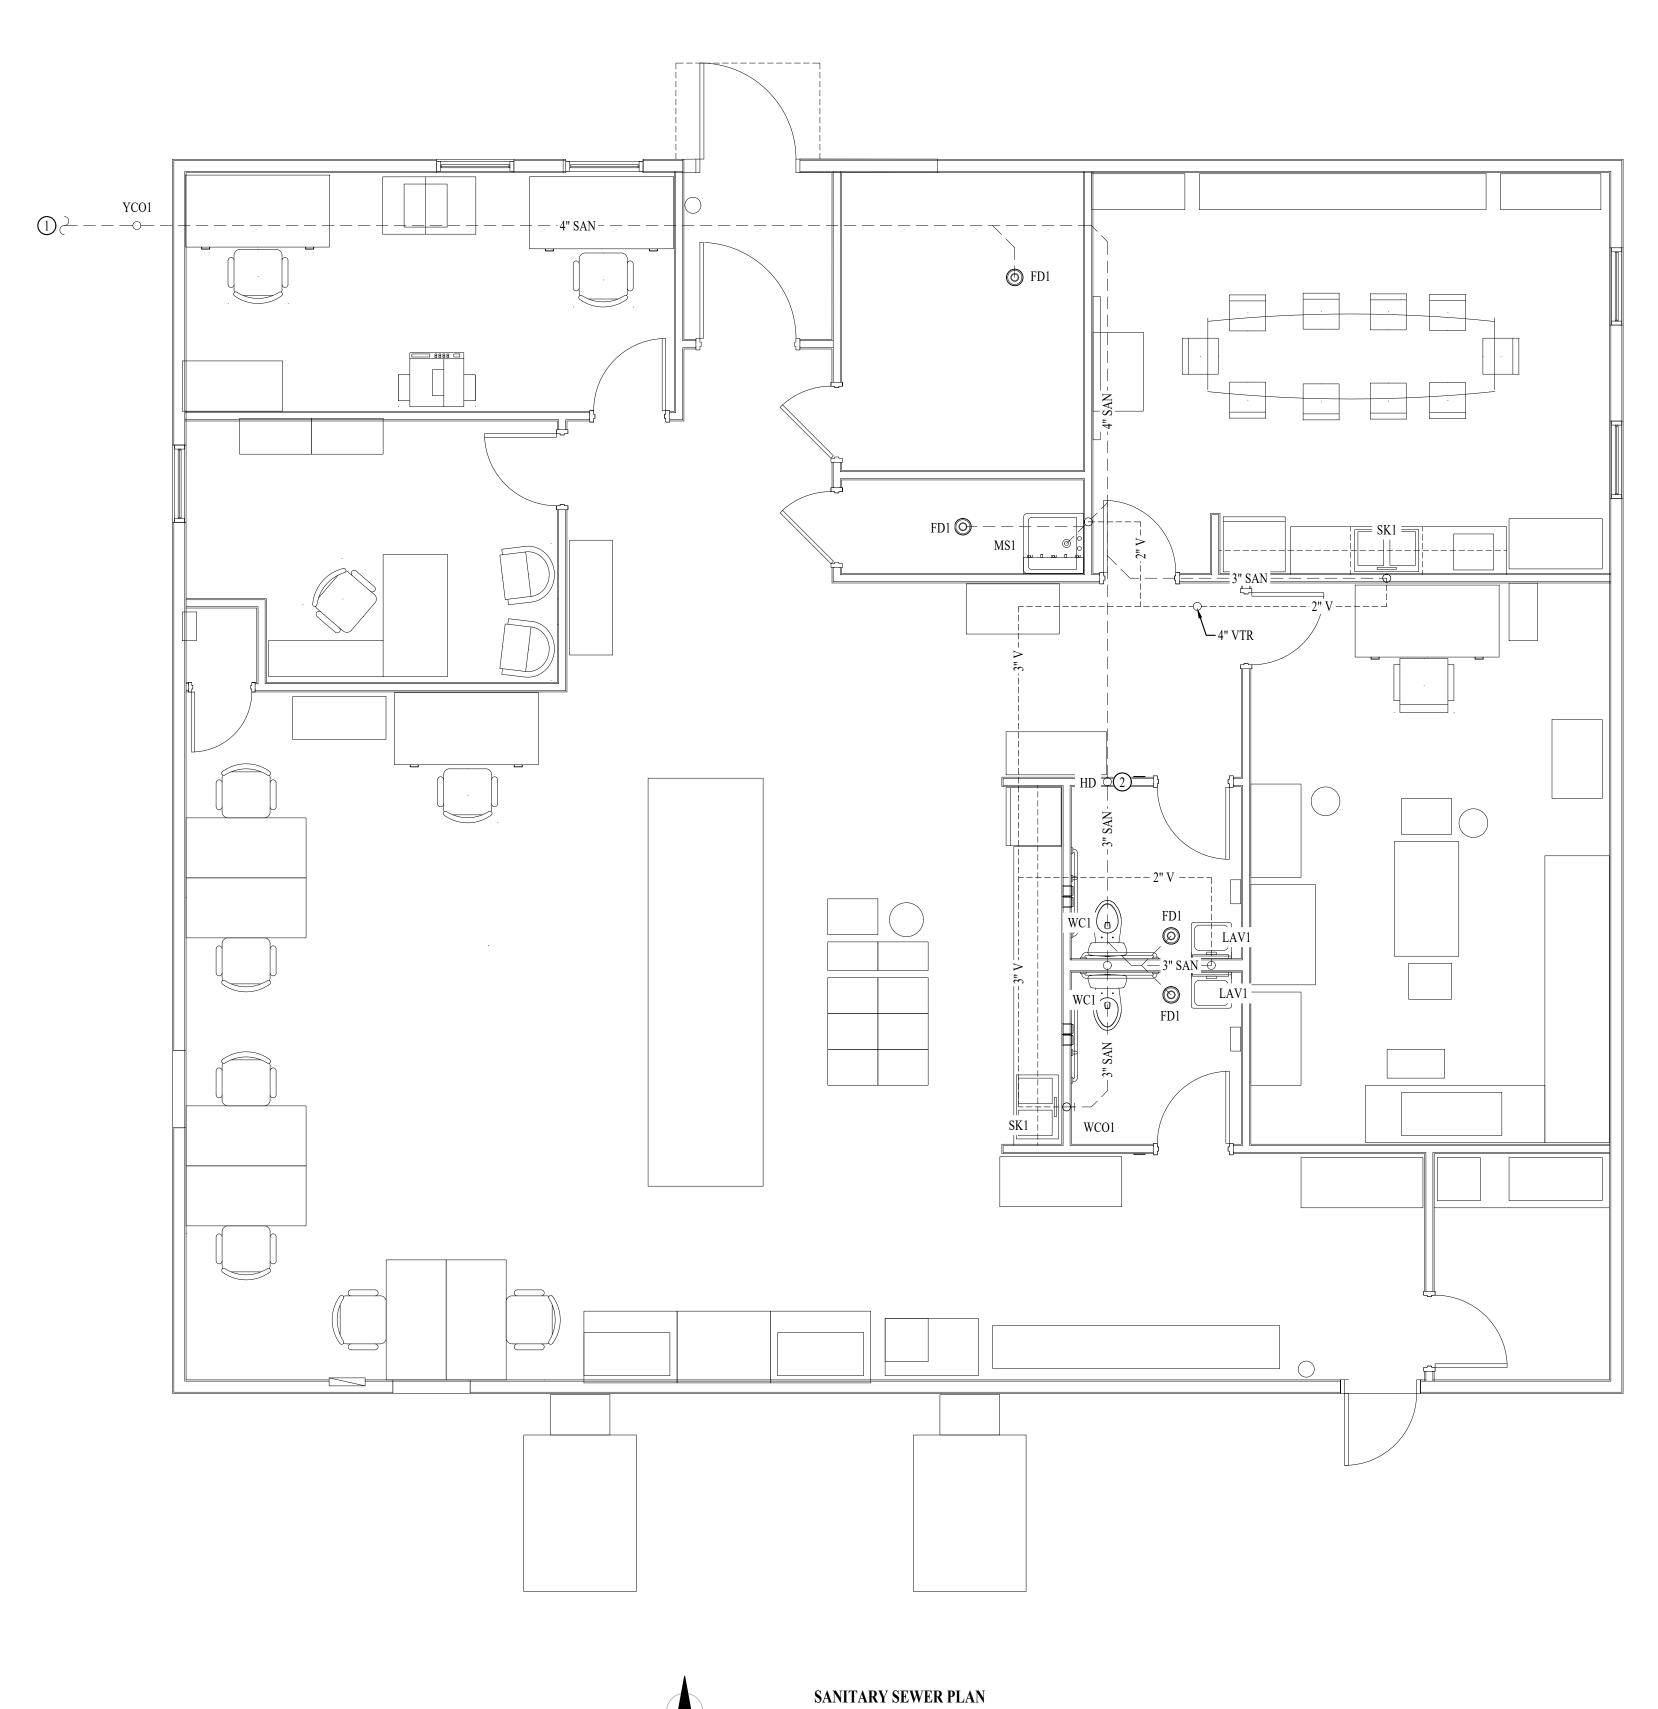

SANTIARY SEWER FL SCALE: 1/4" = 1'-0"

21 OF 23 SHEETS 02 / 27 / 2023

#### WATER & GAS PLAN SYMBOL LEGEND

 _	 COLD WATER LINE


- ----- HOT WATER RECIRCULATION LINE
  - WATER METER
  - VALVE
  - Image: PUMP
- PIPING TURNED DOWN / TURNED UP
- TIE INTO EXISTING

#### WATER & GAS PLAN GENERAL NOTES:

1. SEE SHEET P501 FOR ADDITIONAL PLUMBING NOTES, DETAILS, & SCHEDULES.

#### WATER & GAS PLAN KEY NOTES:

(1) CONTRACTOR TO VERIFY EXACT LOCATION OF SERVICE ENTRANCE INTO SPACE AND SIZE OF EXISTING SERVICE. UPSIZE SERVICE IF NECESSARY.

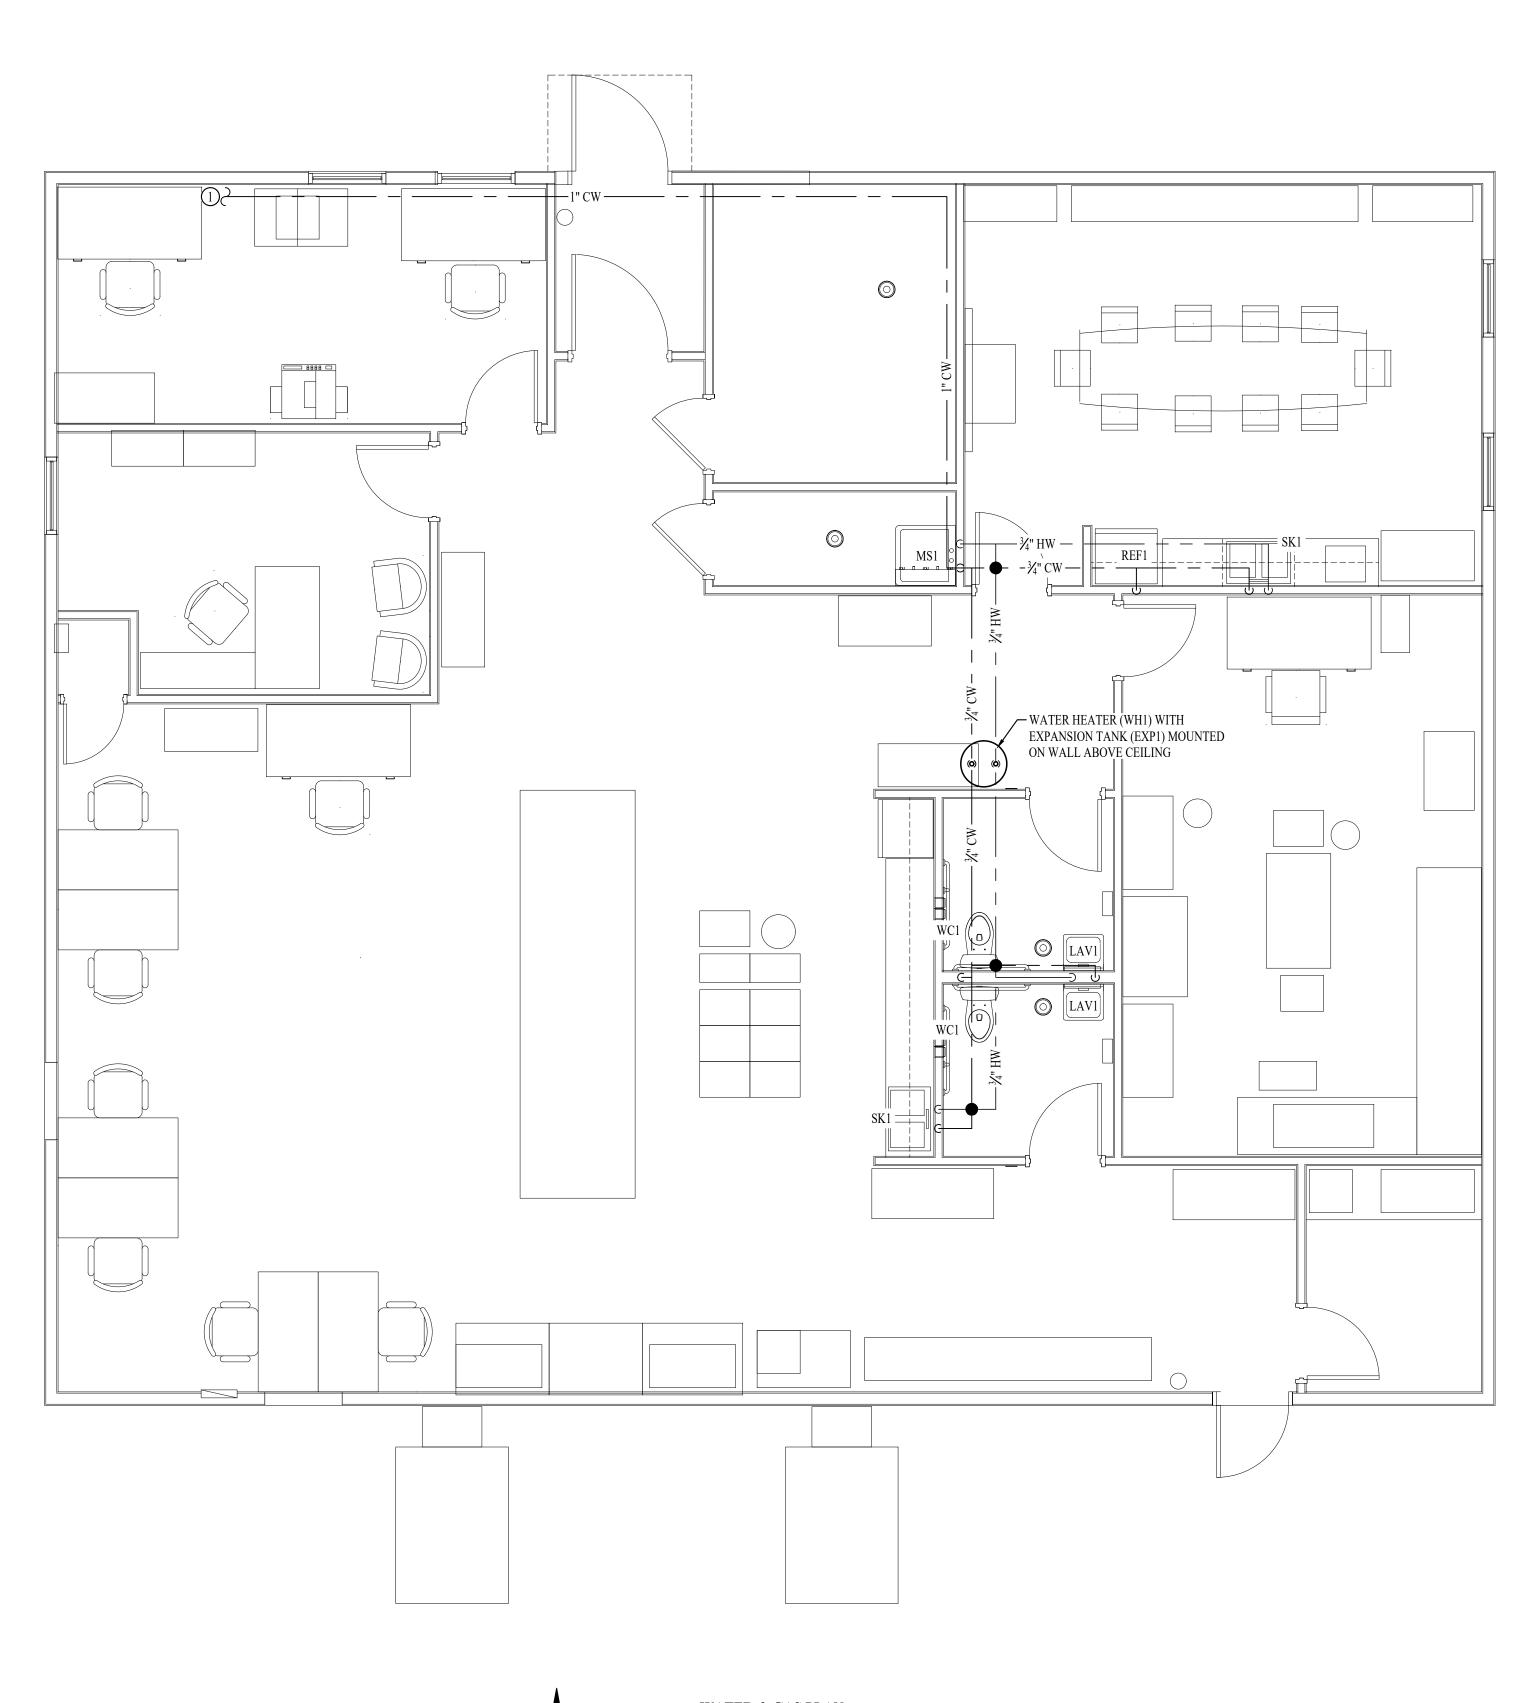

**WATER & GAS PLAN** SCALE: 1/4" = 1'-0"

STATE OF MISSOURI MICHAEL L. PARSON, GOVERNOR	
STATE OF MISSOR	-
NUMBER PE-2015017071	<u>in da appan</u> en
James Watson, P.E. February 27, 202 PE-2015017071 MO Certificate of Authority # 2018029680	23
Peckham & Wright Architects, Inc., d.b.a. <b>PWArchitects</b> , Inc., d.b.a. 2120 Forum Blvd., Ste. 101 Columbia, Missouri 65203 PWArchitects.com   573.449.2683 Peckham & Wright Architects an Architectural Corporation Missouri State Certificate of Authority No. 000244	
J-SQUARED Engineering	
DIVISION OF FACILITIES	
MANAGEMENT, DESIGN AND	
MANAGEMENT, DESIGN AND CONSTRUCTION D2233-01 - MULTIPURPOSE	
MANAGEMENT, DESIGN AND CONSTRUCTION D2233-01 - MULTIPURPOSE BUILDING for MDA USE NEW MADRID STATE OFFICE BUILDING	
MANAGEMENT, DESIGN AND CONSTRUCTION D2233-01 - MULTIPURPOSE BUILDING for MDA USE NEW MADRID STATE OFFICE BUILDING NEW MADRID, MO PROJECT # 02233-01 SITE # 7711	1
MANAGEMENT, DESIGN AND CONSTRUCTION D22233-01 - MULTIPURPOSE BUILDING for MDA USE NEW MADRID STATE DFFICE BUILDING NEW MADRID, MO PROJECT # 02233-01 SITE # 7711 ASSET # 8877711002 REVISION: DATE: REVISION: DATE: REVISION: REVISION: DATE: REVISION: DATE: REVISION: DATE: REVISION: DATE: REVISION: DATE: REVISION: DATE: REVISION: DATE: REVISION: DATE: REVISION: DATE: REVISION: DATE: REVISION: DATE: REVISION: DATE: REVISION: DATE: DATE: REVISION: DATE: DATE: D	1
MANAGEMENT, DESIGN AND CONSTRUCTION D22233-01 - MULTIPURPOSE BUILDING for MDA USE NEW MADRID STATE OFFICE BUILDING NEW MADRID, MO PROJECT # 02233-01 SITE # 7711 ASSET # 8877711002 REVISION: DATE: REVISION: DATE: DATE: 1
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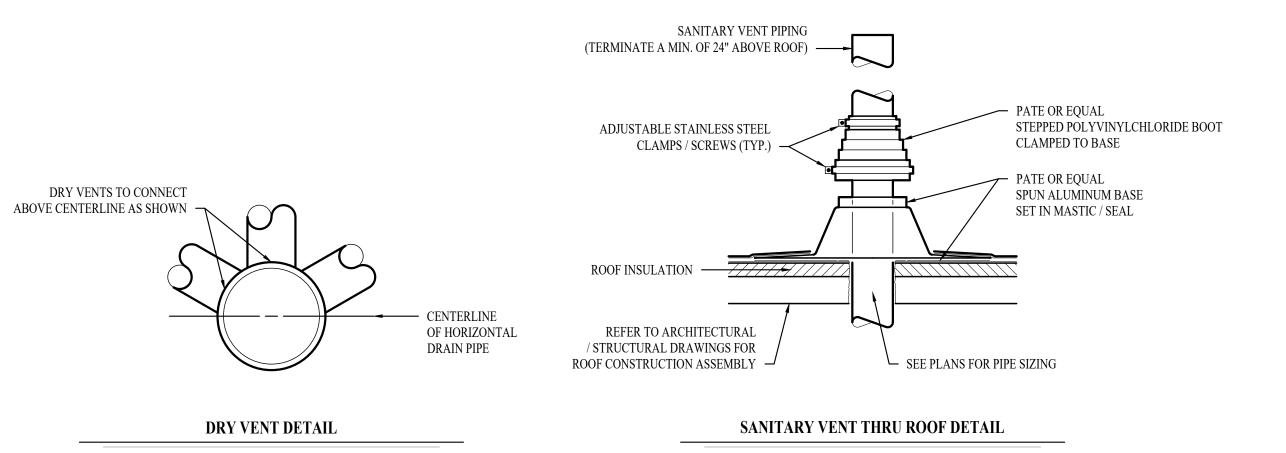
22 OF 23 SHEETS 02 / 27 / 2023


#### PLUMBING SPECIFICATIONS

1. GE	NERAL
1.1.	PLUMBING CONTRACTOR IS RESPONSIBLE TO PROVIDE ALL ESCUTCHEONS, $ arrow4$ TURN STOPS,
	P-TRAPS, AND SUPPLY LINES TO PROVIDE A COMPLETE SYSTEM AT EACH FIXTURE
	INDICATED ON PLANS UNLESS NOTED OTHERWISE.
	NITARY
2.1.	BELOW AND ABOVE GRADE WASTE AND VENT PIPING IN BUILDING TO BE SOLID CORE SCH.
	40 PVC DWV.
2.2.	
2.3.	
	WRAP LISTED FOR USE AS SUCH AN ASSEMBLY.
2.4.	ALL VENT PIPE TERMINATIONS ARE TO BE LOCATED EITHER 10' HORIZONTALLY OR 3' ABOVE
<b>1</b> DO	MECHANICAL AIR INTAKE LOCATIONS.
-	MESTIC WATER
3.1.	DOMESTIC WATER PIPING TO BE EITHER COPPER OR PEX. WHERE PEX PIPING IS USED, IT
	SHALL BE INCREASED ONE PIPE SIZE FROM WHAT IS INDICATED ON PLANS FOR ALL PORTIONS OF THE SYSTEM.
3.2.	PEX-A MAY BE INSTALLED AT SIZES INDICATED ON PLANS IF AN ENGINEERED PLAN IS
5.2.	SUBMITTED SHOWING ACCEPTABLE PRESSURE DROPS AND FLUID VELOCITIES, APPROVAL
	MUST BE GRANTED PRIOR TO PURCHASE AND INSTALLATION.
3.3.	COPPER WATER PIPING BELOW GRADE SHALL BE TYPE "K". BELOW GRADE JOINTS SHALL BE
5.5.	SILVER SOLDERED. THERE SHALL BE NO JOINTS IN WATER PIPING LOCATED BENEATH
	BUILDING SLAB.
3.4.	COPPER WATER PIPING ABOVE GRADE SHALL BE TYPE "L".
3.5.	PROVIDE WATER HAMMER ARRESTORS AT ALL QUICK-CLOSE VALVES. FIXTURES
0.01	REQUIRING WATER HAMMER ARRESTORS INCLUDE BUT ARE NOT LIMITED TO FLUSH
	VALVES, SENSOR FAUCETS, AND WASHING MACHINE BOXES. AIR CHAMBERS ARE NOT
	ACCEPTABLE.
3.6.	DOMESTIC WATER PIPING INSULATION
3.6.1.	ALL HW PIPING, WHETHER COPPER OR PEX, SHALL BE INSULATED WITH PLENUM
	RATED CLOSED CELL ELASTOMERIC INSULATION. FOR PIPING LESS THAN $1\frac{1}{2}$ ",
	INSULATION THICKNESS TO BE 1". FOR PIPING 1/2" OR GREATER, INSULATION
	THICKNESS SHALL BE 1//".
3.6.2.	
	ELASTOMERIC INSULATION. CW PEX NEED NOT BE INSULATED UNLESS NOTED
	OTHERWISE.

TAG	<b>DES CRIPTION</b>	MANUFACTURER (OR EQUAL)	MODEL (OR EQUAL)	NOTES
EXP1	EXPANSION TANK	WATTS	PLT-5	
FD1	FLOOR DRAIN	ZURN	Z415-BZ	WITH Z1072 TRAP SEAL
HD	HUB DRAIN	-	Ξ	
LAV1	LAVATORY (WALL HUNG W/MANUAL FAUCET)	AMERICAN STANDARD	0355.012	WITH ZURN Z81104-XL FAUCET, 1/4 TURN STOPS, BRAIDED STAINLESS STEEL SUPPLIES, AND TRUBRO LAV GUARD 2
MS1	MOP SINK	FIAT	MSB2424	WITH ZURN Z843M1 FAUCET WITH WALL HOOK
REF1	REFRIGERA TOR BOX	SOUIX CHIEF	696-G1000	
SK1	DOUBLE COMPARTMENT SINK (33x22x7)	ELKAY	CR3322	WITH TWO HANDLED ZURN Z871C4-XL FAUCET
WC1	WATER CLOSET - ADA HEIGHT - TANK	AMERICAN STANDARD	215AA.004	WITH CHURCH 9500SSCT SELF SUSTAINING SEAT, STAINLESS BRAIDED SUPPLIAND 1/4 TURN SHUT-OFF.
WCO1	WALL CLEAN OUT	-	-	
WH1	WATER HEATER	RUUD	EGSP20	20 GALLON, 120V, 1500W
YCO1	YARD CLEAN OUT	ZURN	Z1400	

			Y PIPING	SCITLI	PIPING
ТҮРЕ	TYPICAL ABBREVIATION	WAS TE CONNECTION	VENT CONNECTION	COLD WATER CONNECTION	HOT WATER CONNECTION
DRINKING FOUNTAIN	DF	1-1/2"	1-1/4"	1/2"	-
FLOOR DRAIN	FD	3"	2"	-	-
HAND / HAIR SINK	HS / SK	2"	1-1/4"	1/2"	1/2"
HOSE BIBB	HB	-	-	3/4"	-
LAVATORY	LAV	1-1/2"	1-1/4"	1/2"	1/2"
MOP SINK	MS	3"	1-1/2"	1/2"	1/2"
ICE MAKER OUTLET BOX	REF	-	-	1/2"	-
SHOWER	SH	3"	1-1/2"	1/2"	1/2"
URINAL	UR	2"	1-1/4"	3/4"	-
WATER CLOSET (FLUSH TANK)	WC	3"	2"	1/2"	-
WATER CLOSET (FLUSH VALVE)	WC	3"	2"	1"	-



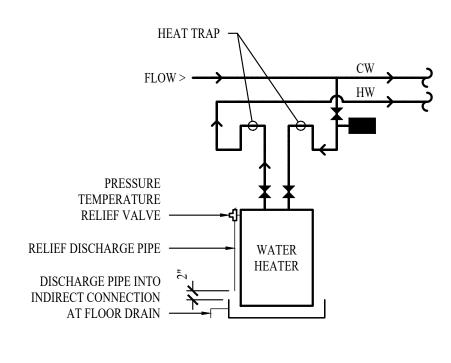

WATER HEATER DETAIL

STATE OF MISSOURI MICHAEL L. PARSON, GOVERNOR
NUMBER PE-2015017071
James Watson, P.E. February 27, 2023 PE-2015017071 MO Certificate of Authority # 2018029680
Peckham & Wright Architects, Inc., d.b.a. <b>PWArchitects, Inc.</b> 2120 Forum Blvd., Ste. 101 Columbia, Missouri 65203 PWArchitects.com   573.449.2683 Peckham & Wright Architects an Architectural Corporation Missouri State Certificate of Authority No. 000244
J-SQUARED Engineering
OFFICE OF ADMINISTRATION DIVISION OF FACILITIES MANAGEMENT, DESIGN AND CONSTRUCTION
O2233-01 -
MULTIPURPOSE BUILDING for MDA USE
NEW MADRID STATE OFFICE BUILDING NEW MADRID, MO
PROJECT # 02233-01 SITE # 7711 ASSET # 8877711007
REVISION: DATE: REVISION: DATE: REVISION: DATE:
ISSUE DATE: 02/27/2023
CAD DWG FILE: J20720 DRAWN BY: DET CHECKED BY: JPW DESIGNED BY: TAW
SHEET TITLE: PLUMBING DETAILS &

DETAILS & SCHEDULES

SHEET NUMBER:

**P-501** 23 OF 23 SHEETS 02 / 27 / 2023