VOLUME 3 REPLACE HVAC, STRUCTURAL REPAIRS, & REPLACE ROOF

GEORGE WASHINGTON CARVER STATE OFFICE BUILDING JEFFERSON CITY, MISSOURI

OWNER:

STATE OF MISSOURI MICHAEL L. PARSON,

GOVERNOR


OFFICE OF ADMINISTRATION

PROJECT

OFFICE OF ADMINISTRATION

DIVISION OF FACILITIES MANAGEMENT, MANAGEMENT:

DESIGN AND CONSTRUCTION

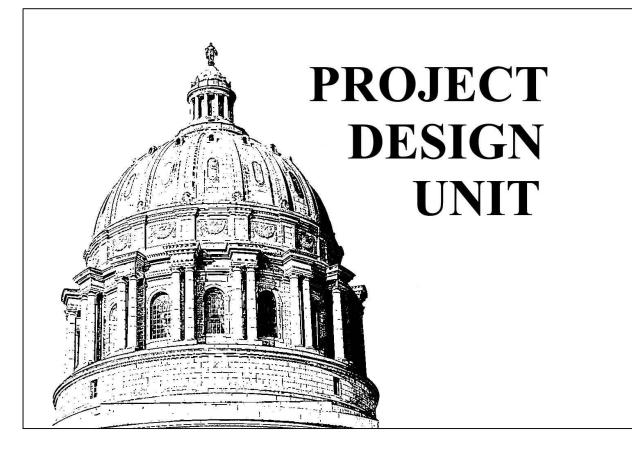

SHEET LIST:

G-001 - COVERSHEET A-100 - EXISTING ROOF PLAN A-101 - ROOF PLAN

A-102 - ELEVATIONS A-103 - DETAILS

DESIGNER:

STATE OF MISSOURI - OFFICE OF ADMINISTRATION

DIVISION OF FACILITIES MANAGEMENT DESIGN AND CONSTRUCTION: 301 W. HIGH STREET,

JEFFERSON CITY, MO. 65102

PROJECT NUMBER:

O2440-01

SITE NUMBER:

1010

ASSET NUMBER:

3101010001

SHEET NUMBER:

G-0011 OF 5 SHEETS JUNE 14, 2024



PHOTO ANTENNA POLE, GUY WIRES, AND

CONCRETE BASE TO BE REMOVED.

PHOTO NOT TO SCALE MASONRY CHIMNEY AND

VENTILATOR TO REMAIN.



PHOTO NOT TO SCALE

ROOF DIVIDER WALL, SATELLITE DISH SUPPORTS, ELEVATOR PENTHOUSE, AND ROOF HATCH.



PHOTO LOW ROOF WITH EQUIPMENT

AND EXISTING ROOF LADDER.



TO BE REPLACED.

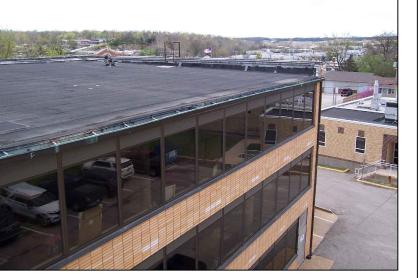






PHOTO NOT TO SCALE

ROOF AND GUTTERS ON EAST END OF BUILDING.



G PHOTO NOT TO SCALE

ROOF AND GUTTERS ON WEST END OF BUILDING.

STATE OF MISSOURI MICHAEL L. PARSON, **GOVERNOR**



Brad M. Schaefer - Architect MO# A-2009027294

Office of Administration

Division of Facilities Management Design and Construction Project Design Unit

Office of Administration Division of Facilities Management **Design and Construction**

PROJECT:

Replace HVAC, Structural Repairs, and Replace Roof - Volume 3

3101010001

LOCATION:

George Washington Carver State Office Building 1616 Missouri Boulevard Jefferson City, MO 65109

PROJECT # O2440-01 1010

ISSUE DATE: 06/14/2024 **REVISION:**

DATE: REVISION: DATE: REVISION: DATE:

ASSET#

CAD DWG FILE: O2440-01

DRAWN BY: MLB

CHECKED BY: BMS DESIGNED BY: MLB


SHEET TITLE:

VOLUME 3

EXISTING ROOF PLAN

SHEET NUMBER:

14 June 2024

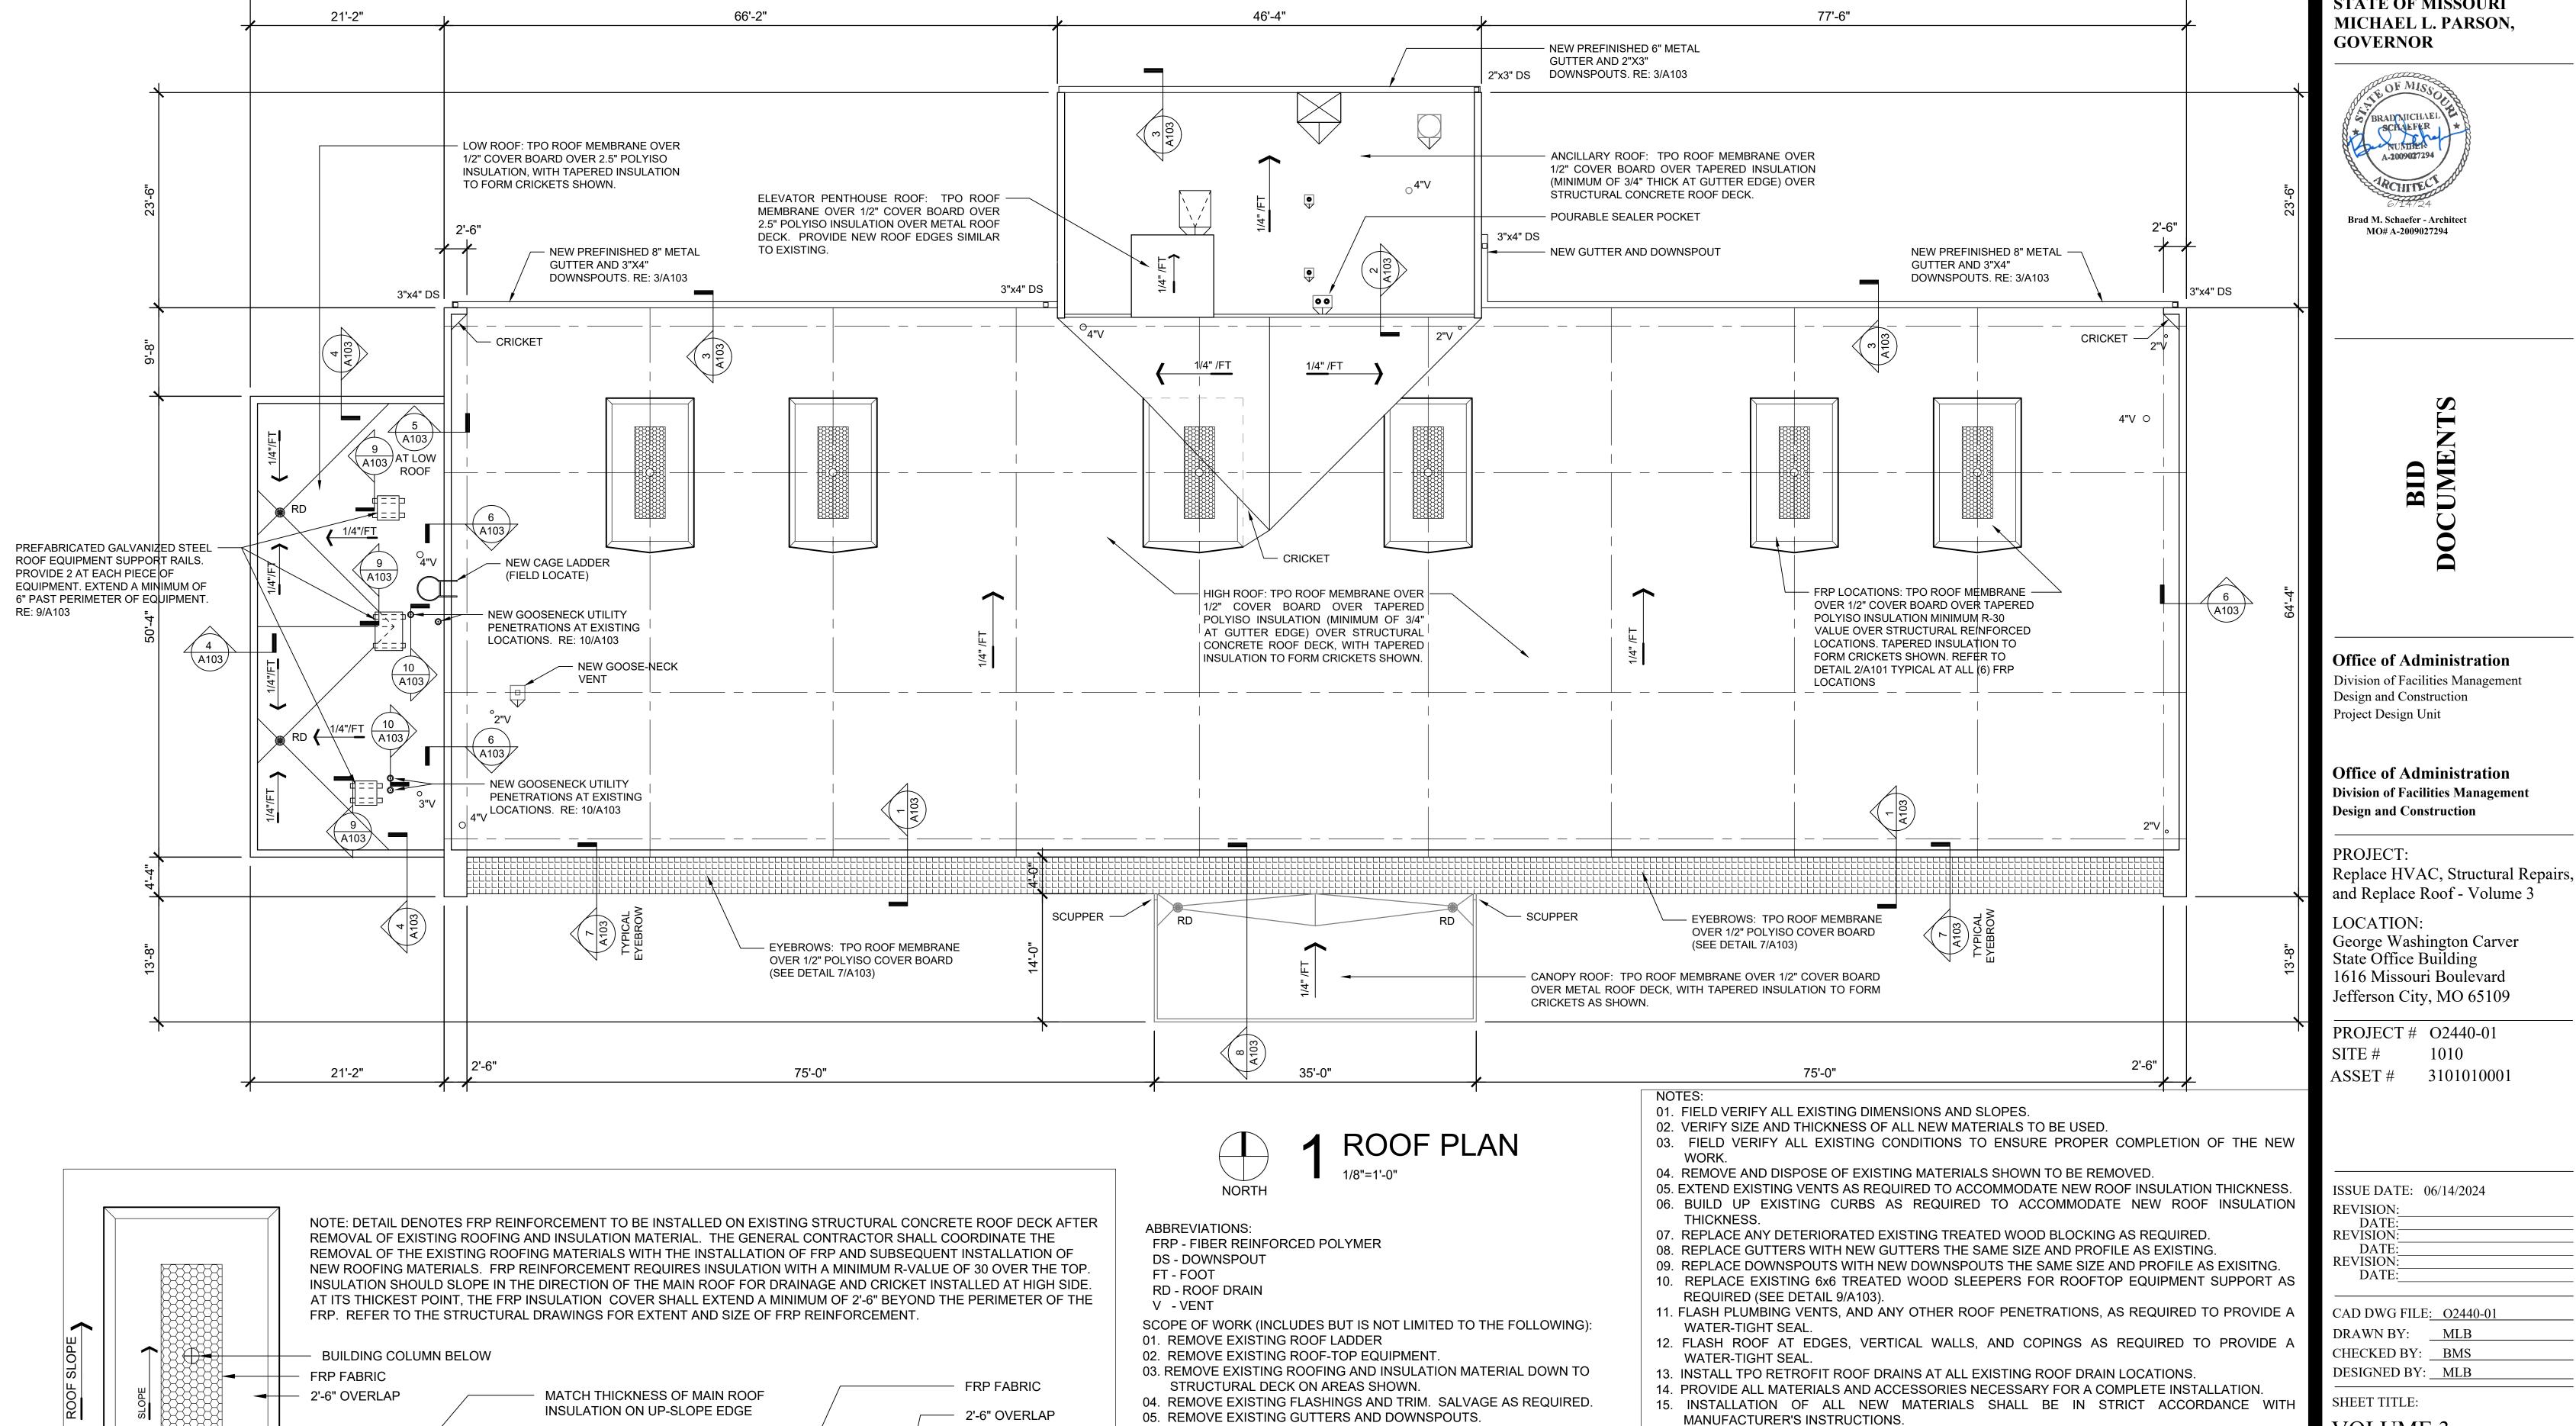

06. PREPARE ROOF AS REQUIRED TO RECEIVE NEW ROOF SYSTEM.

EXTEND VENTS AS REQUIRED FOR NEW WORK.

11. INSTALL NEW GUTTERS AND DOWNSPOUTS.

13. RESEAL ALL JOINTS IN EXISTING STONE COPING.

12. INSTALL TPO RETROFIT ROOF DRAINS

14. REINSTALL ROOF-TOP EQUIPMENT.

15. INSTALL NEW CAGE LADDER.

AND TRIM WHERE SHOWN.

08. COORDINATE NEW ROOFING WITH INSTALLATION OF FRP

16. INSTALL INSULATION ON EXISTING REFRIGERANT PIPING.

07. INSTALL BLOCKING, CONSTRUCT DIVIDER WALL, EXTEND CURBS, AND

REINFORCEMENT AS DEFINED IN VOLUME 2 OF THE PROJECT.

10. INSTALL NEW FLASHINGS AND TRIM. REINSTALL EXISTING FLASHINGS

09. INSTALL NEW INSULATION, COVER BOARD, AND TPO MEMBRANE.

BEVEL EXPOSED EDGE

45 DEGREES

2'-6"

ROOF SLOPE

TRP REINFORCEMENT

CRICKET AT

HIGH SIDE

OVERLAP

2'-6"

STATE OF MISSOURI

VOLUME 3 **ROOF PLAN**

SHEET NUMBER:

16. CONSTRUCT NEW WORK SUCH THAT IT BLENDS SEAMLESSLY WITH EXISTING CONDITIONS.

18. STORE MATERIALS ONLY IN APPROVED AREAS ON THE SITE.

LEFT WITH THE OWNER.

EXTERIOR REFRIGERATE PIPE.

17. DO NOT IMPEDE THE OPERATION OF THE FACILITY IN ANY MANNER WHILE CONSTRUCTION IS

19. THOROUGHLY CLEAN ROOFS AND SITE UPON COMPLETION OF ROOFING WORK. PICK UP AND

20. REPAIR ANY DAMAGE MADE TO THE BUILDINGS AND GROUNDS BY CONSTRUCTION ACTIVITIES.

SUPPORTS AT MINIMUM OF 5'-0" SPACING AND AT CORNERS OF PIPING CONNECTIONS.

21. PROVIDE ROOF PIPING SURFACE MOUNTED SUPPORTS AT ANY EXPOSED ROOF PIPING. ROOF

22. INSULATE ALL REFRIGERANT PIPES WITH 0.75 INCH THICK FLEXIBLE ELASTOMERIC CELLULAR


PROPERLY DISPOSE OF ALL FASTENERS, DEBRIS, AND EXTRA MATERIAL NOT MEANT TO BE

SUPPORTS SHALL BE SURFACE MOUNTED WITH CHANNEL MOUNTED CLIPS. LOCATE


INSULATION THAT COMPLIES WITH ASTM C534 GRADE 1. INSTALL ALUMINUM JACKET TO ANY

14 June 2024


3 OF 5 SHEETS

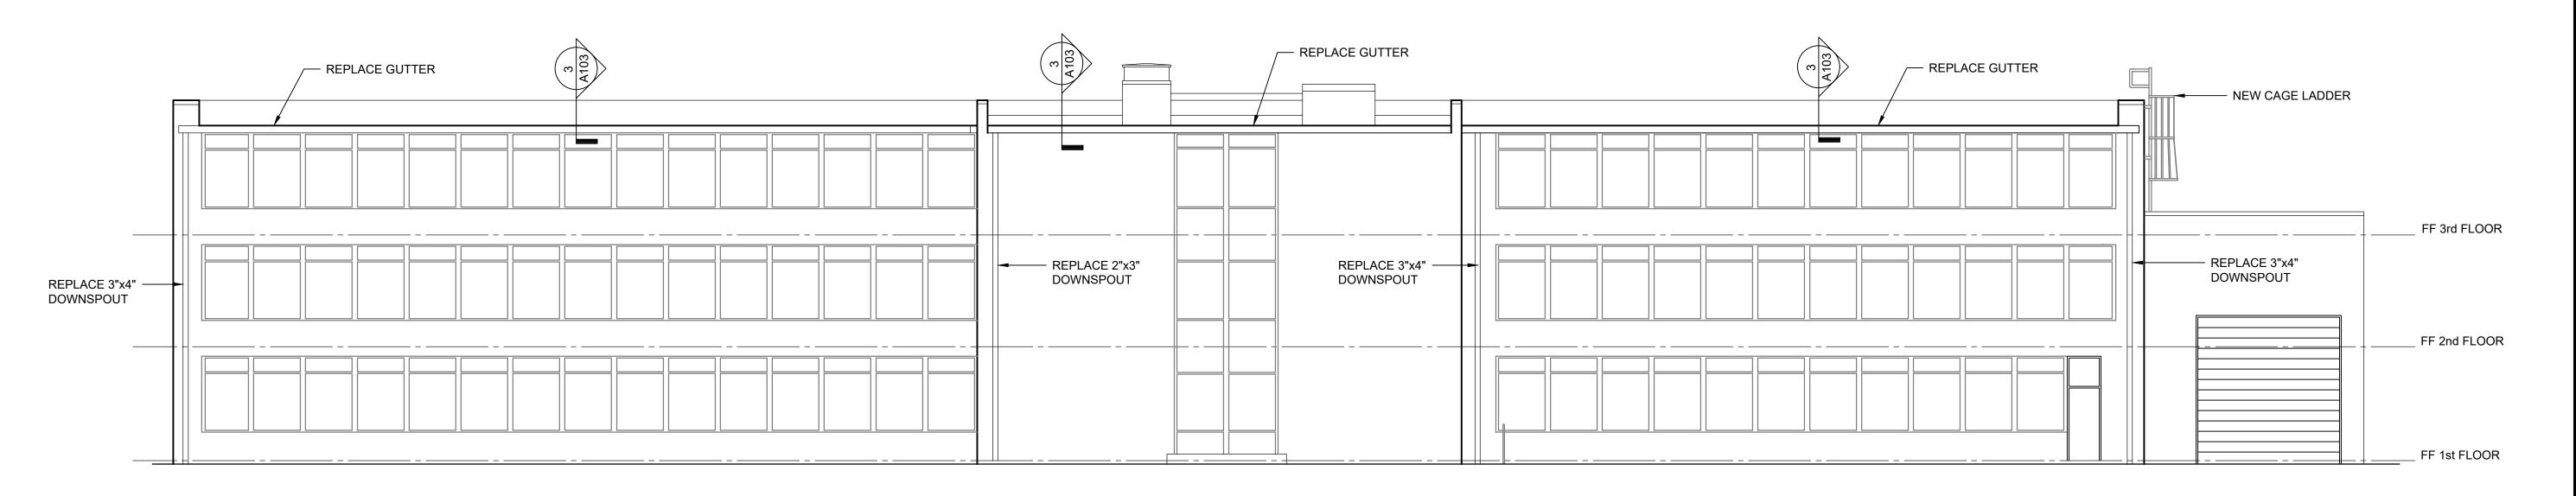

1 NORTH ELEVATION

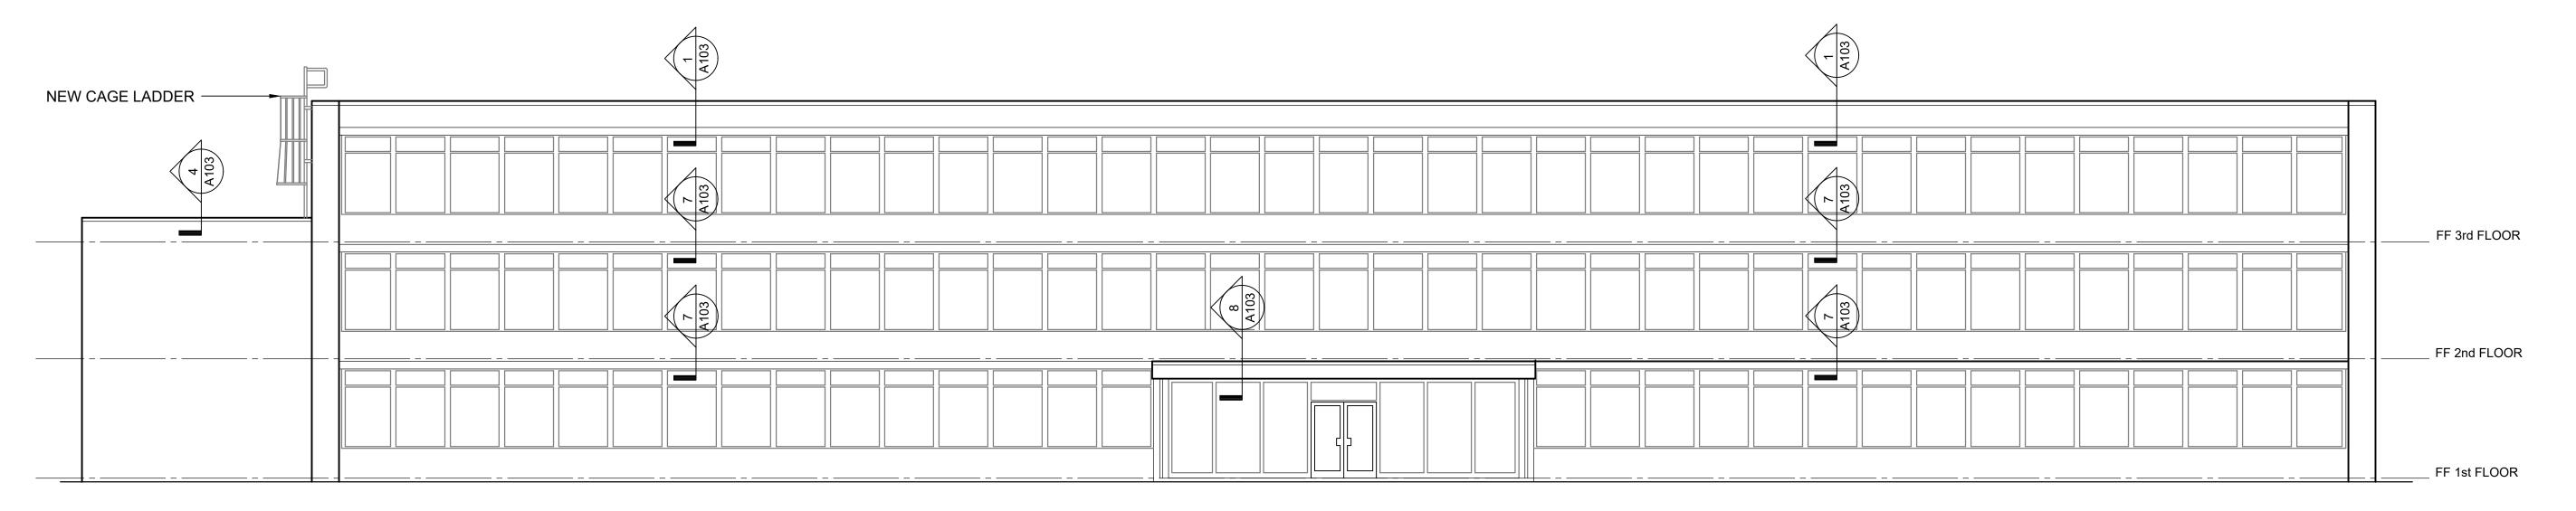

2 SOUTH ELEVATION 1/8" = 1'-0"

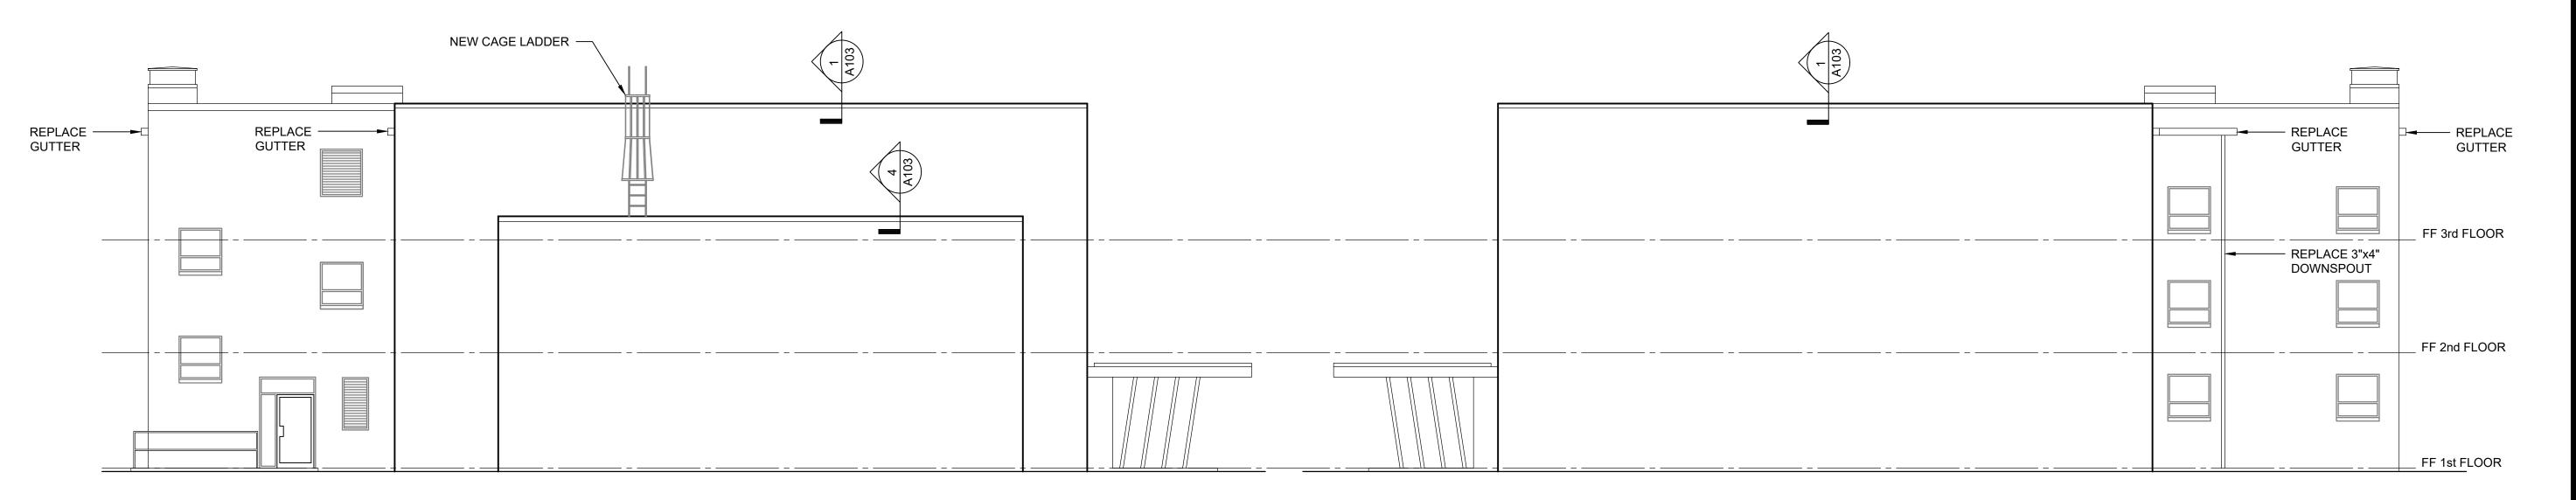

3 WEST ELEVATION

1/8" = 1'-0"

4 EAST ELEVATION

1/8" = 1'-0"

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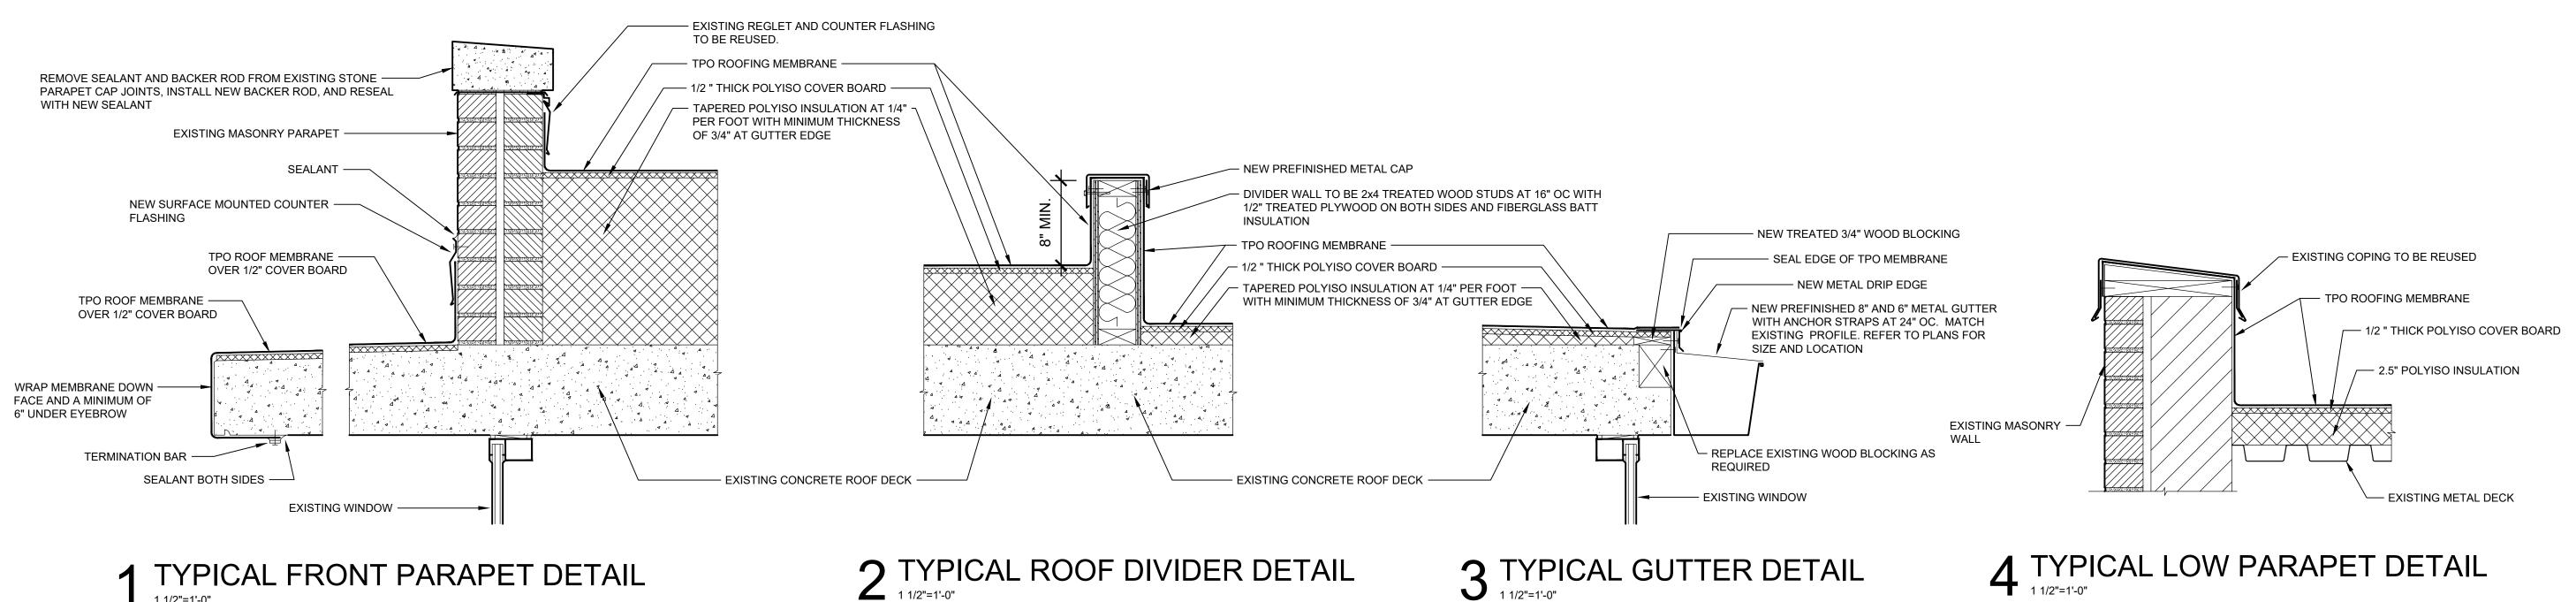
PROJECT # O2440-01 ASSET # 3101010001

ISSUE DATE: 06/14/2024
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CAD DWG FILE: O2440-01
DRAWN BY: MLB
CHECKED BY: BMS
DESIGNED BY: MLB

SHEET TITLE: VOLUME 3

ELEVATIONS

SHEET NUMBER:



EXISTING MASONRY WALL -EXISTING REGLET AND COUNTER -FLASHING TO BE REUSED TPO ROOFING MEMBRANE -1/2 " THICK POLYISO COVER BOARD -2.5" POLYISO INSULATION —

EXISTING METAL DECK

1 TYPICAL FRONT PARAPET DETAIL

REMOVE SEALANT AND BACKER ROD FROM EXISTING STONE PARAPET CAP JOINTS, INSTALL NEW BACKER ROD, AND RESEAL WITH NEW SEALANT EXISTING REGLET AND COUNTER FLASHING TO BE REUSED TPO ROOFING MEMBRANE — 1/2 " THICK POLYISO COVER BOARD — TAPERED POLYISO INSULATION — AT 1/4" PER FOOT WITH MINIMUM THICKNESS OF 3/4" AT GUTTER EXISTING CONCRETE ROOF DECK -

EXISTING MASONRY WALL NEW SURFACE MOUNTED COUNTER -FLASHING TPO ROOF MEMBRANE -OVER 1/2" COVER BOARD EXISTING CONCRETE **EYEBROW** WRAP MEMBRANE DOWN -FACE AND A MINIMUM OF 6" UNDER EYEBROW TERMINATION BAR — SEALANT BOTH SIDES — EXISTING WINDOW ——


NOTE: TYPICAL EYEBROW DETAIL AT FLOORS TWO AND THREE ON THE SOUTH ELEVATION OF THE BUILDING

5 TYPICAL VERTICAL WALL DETAIL


6 TYPICAL HIGH PARAPET DETAIL

1 1/2"=1'-0"

7 TYPICAL EYEBROW DETAIL
1 1/2"=1'-0"

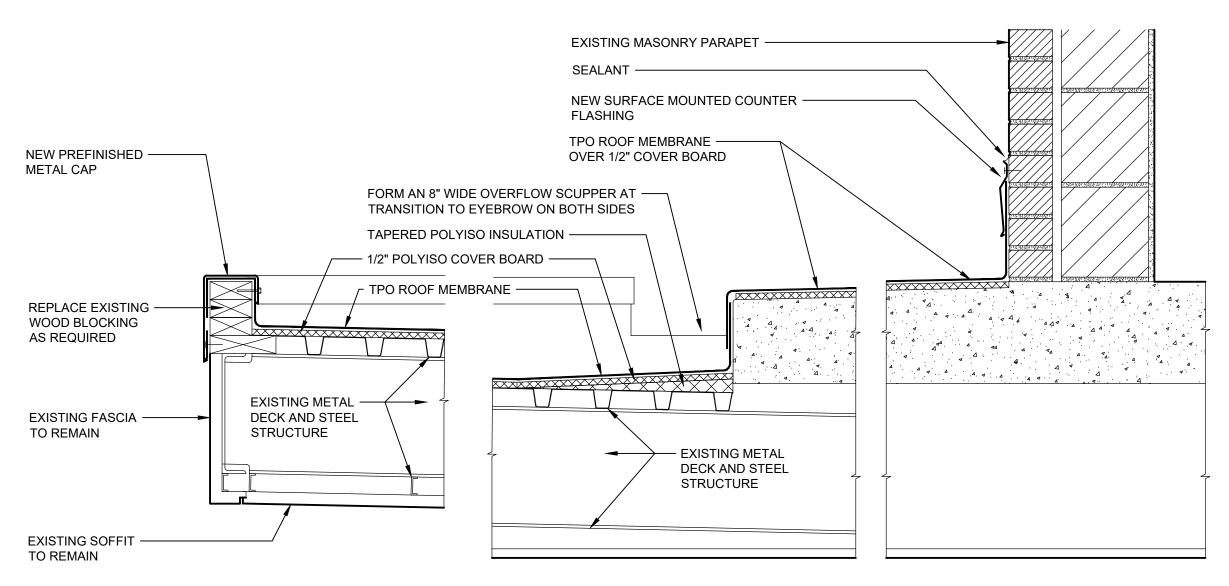


8 CANOPY DETAIL

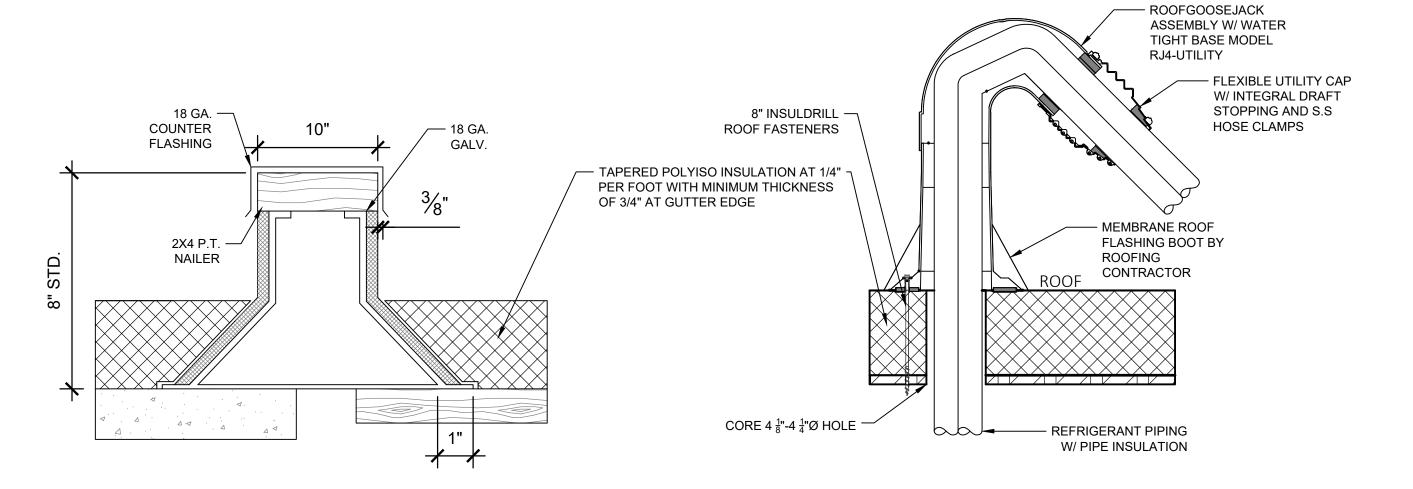

9 EQUIPMENT SUPPORT DETAIL

10 ROOF PIPE PENETRATION DETAIL

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CHECKED BY: BMS DESIGNED BY: MLB

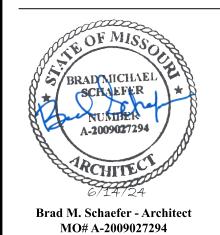SHEET TITLE:

VOLUME 3 DETAILS

SHEET NUMBER:

14 June 2024