
RENOVATE WOMENS LOCKER ROOM ACADEMY PHYSICAL TRAINING BUILDING, MSHP GENERAL HEADQUARTERS COMPLEX

OWNER:

STATE OF MISSOURI MICHAEL L. PARSON, GOVERNOR

PROJECT MANAGEMENT:

OFFICE OF ADMINISTRATION DIVISION OF FACILITIES MANAGEMENT, DESIGN AND CONSTRUCTION

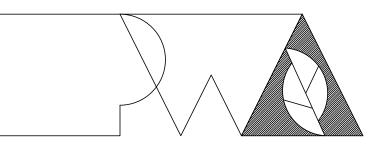

Peckham & Wright Architects, Inc., d.b.a.

PWArchitects, Inc.

2120 Forum Blvd., Ste 101 Columbia, Missouri 65203 Ph:(573) 449-2683 Fax:(573) 442-6213

DESIGNER:

PROJECT NUMBER: R2402-01

 SITE NUMBER:
 6001


 ASSET NUMBER:
 8136001003

PWArchitects, Inc. 2120 Forum Blvd., Ste. 101 Columbia, Missouri 65203



sheet number: G-001

1 OF 17 SHEETS JULY 23, 2024

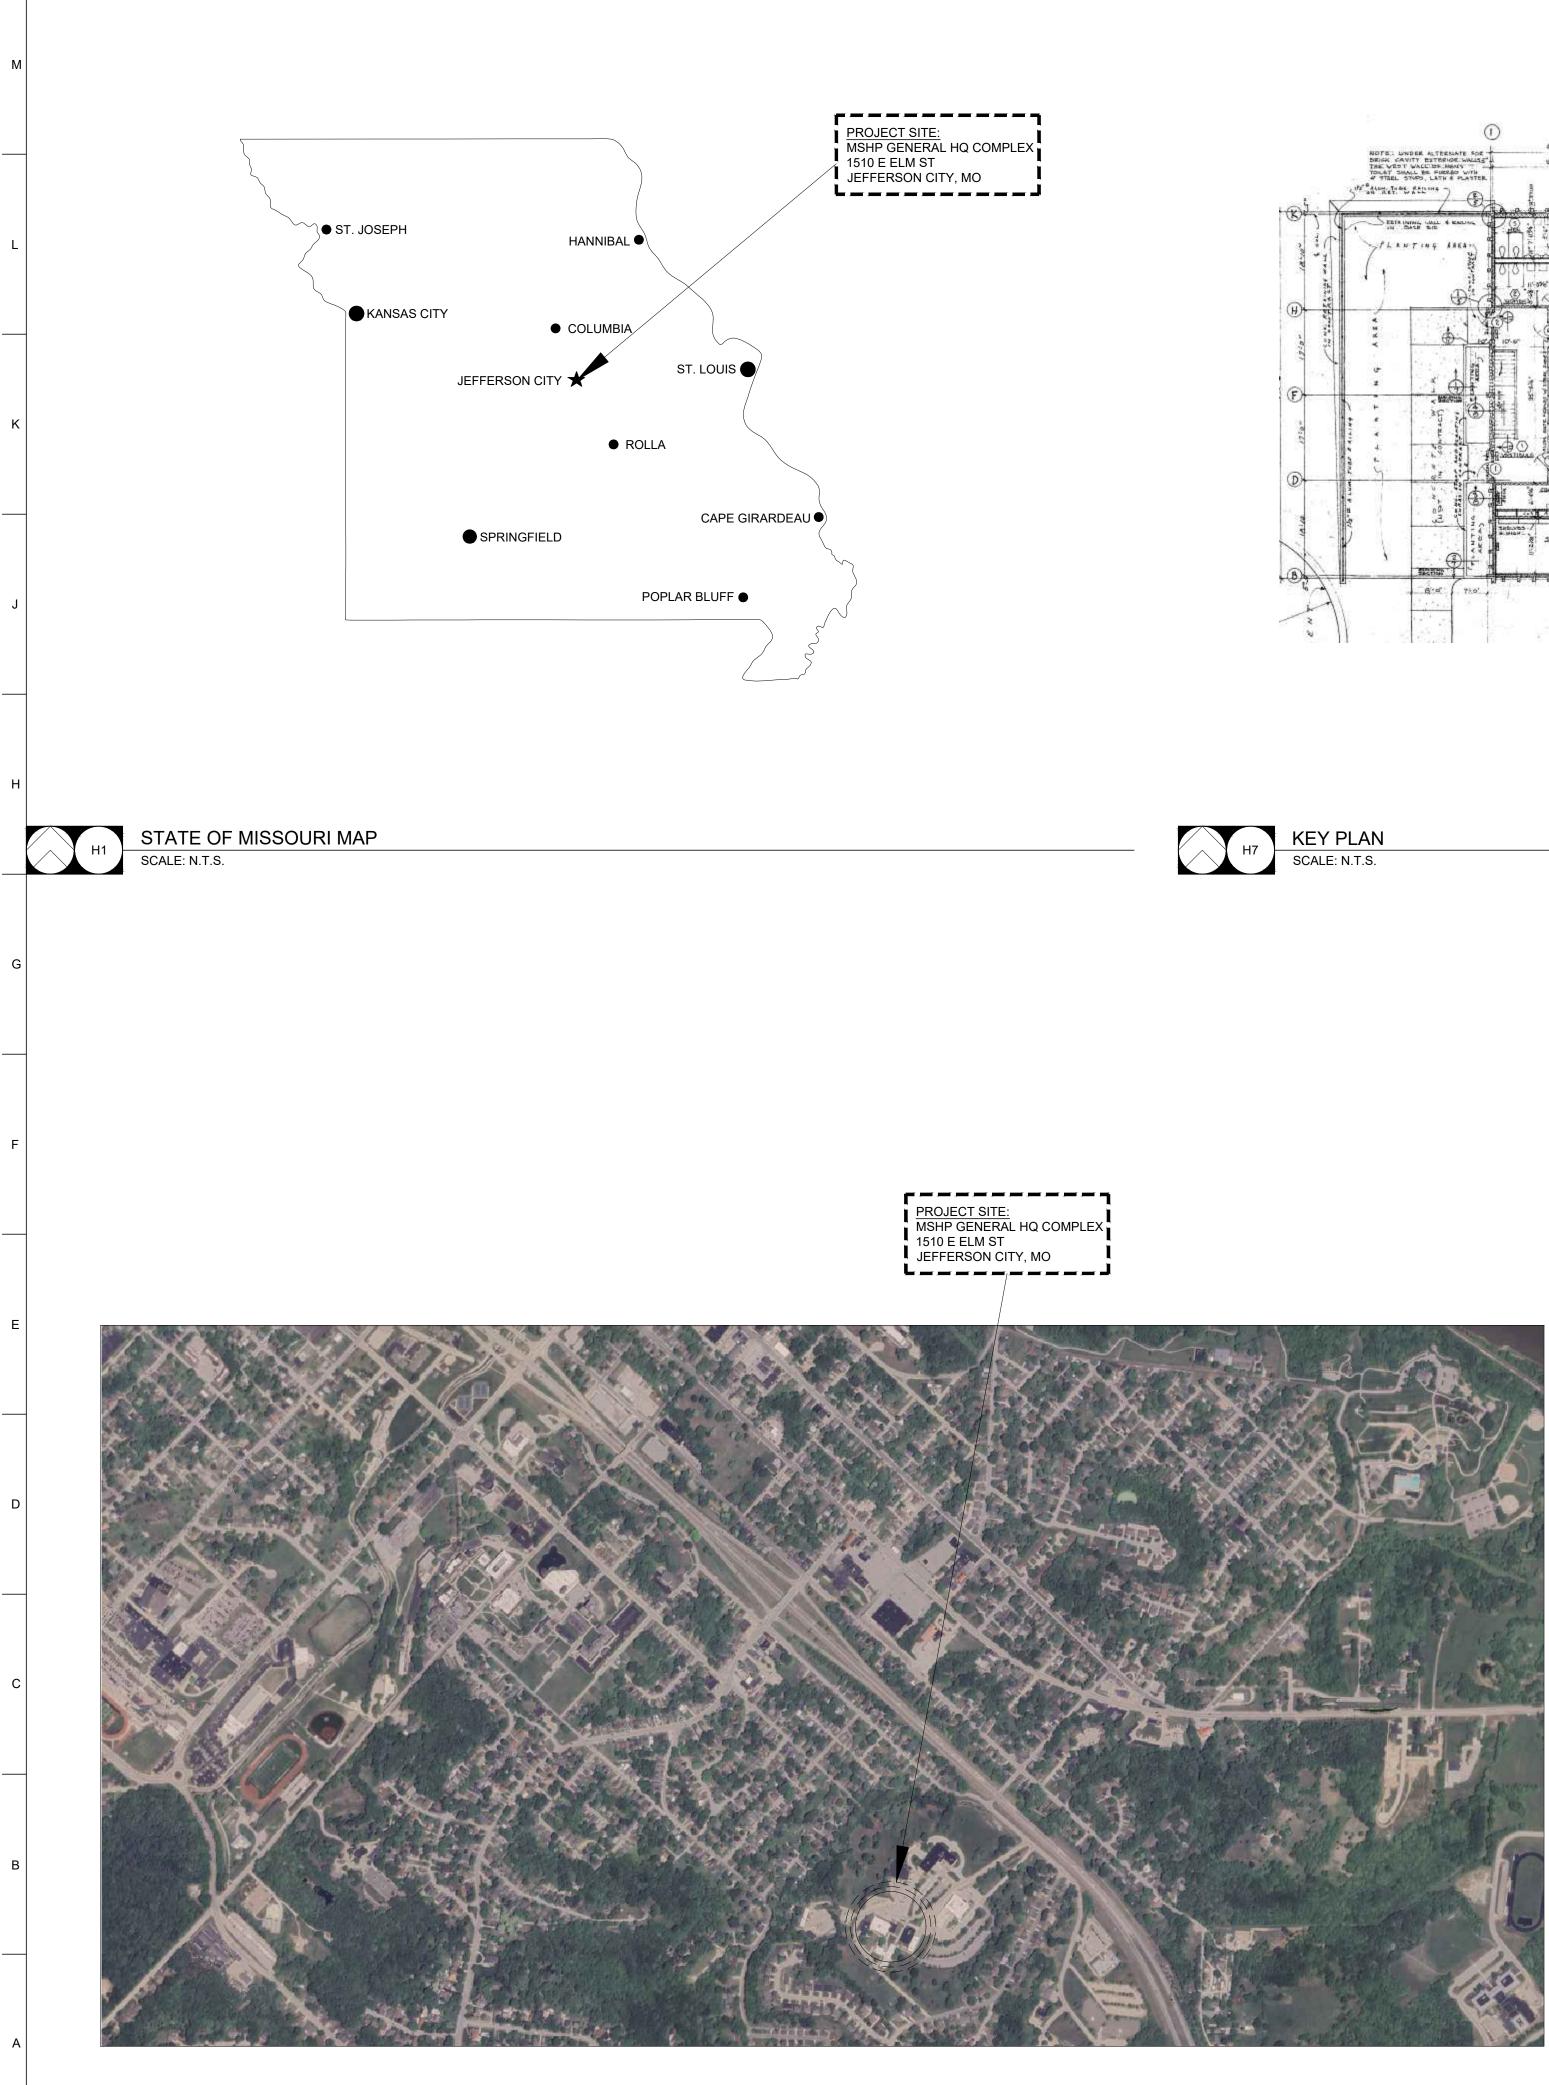




LOCATION MAP SCALE: N.T.S.

2 3 5 4

6

7

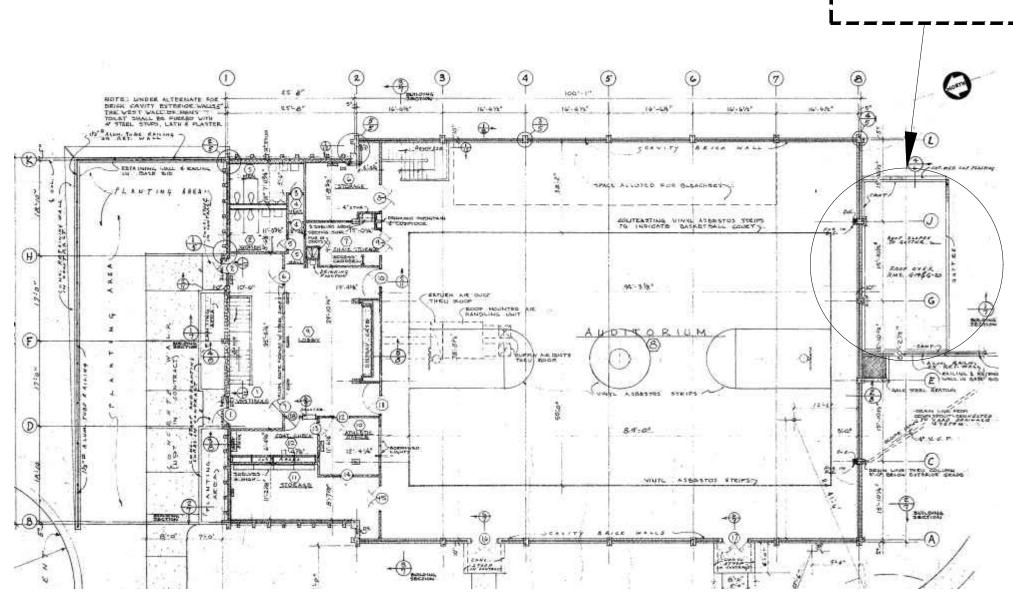

DRAWING BULLET WITH NORTH ARROW



GRID REFERENCE
 DRAWING TITLE

 SCALE: X/X" = 1'-0"

ARCH. SCALE DRAWING BULLET WITHOUT NORTH ARROW GRID REFERENCE A2 DRAWING TITLE ARCH. SCALE A100 SCALE: X/X" = 1'-0" PAGE FIRST REFERENCED (IF APPLICABLE) PLAN/ELEVATION DETAIL BULLET ELEVATION BULLETS $\overline{}$ - GRID REFERENCE A0 🕂 A000 — SHEET NUMBER ONE ELEVATION くし SCOPE OF WORK BULLET A1 A100 SHEET NUMBER SECTION BULLET DOOR MARK BULLET GRID REFERENCE
 ALWAYS ON TOP (000A) A1XA100 FINISH MARK BULLET - SHEET NUMBER $\langle 9 \rangle$ NORTH ARROW **REVISION NOTE BULLET** GENERAL NOTE BULLET COLUMN LINE BULLETS $\langle 1 \rangle$ (1)BENCHMARK BULLET 000.00' ***** FLOOR SPOT ELEV. BULLETS TC - TOP OF CURB TG -TOP OF GRADE TW -TOP OF WALL TP - TOP OF PAVING NE ETS



8

10

13

14

15

GOVERNOR

Peckham & Wright Architects, Inc., d.b.a. PWArchitects, Inc.

2120 Forum Blvd., Ste. 101 Columbia, Missouri 65203

PWArchitects.com | 573.449.2683 kham & Wright Architects an Architectural Corporatio

Missouri State Certificate of Authority No. 000244

09/17/2024

STATE OF MISSOURI MICHAEL L. PARSON,

LIST OF DRAWINGS

G-001	COVER SHEET
G-101	INDEX SHEET
D-100	DEMOLITION PLANS
A-101	FLOOR PLAN-NOTES, FLOOR PLAN DIMENSIONS
A-102	REFLECTED CEILING & FLOOR FINISH PLANS
A-103	FLOOR PLAN-RAMP FRAMING AND SUB-FLOOR FILL
A-201	INTERIOR ELEVATIONS, SCHEDULES, DETAILS
A-301	SECTION DETAILS
A-302	SECTION DETAILS
A-601	DOOR SCHEDULE AND DOOR DETAILS
MD-101	MEP DEMOLITION PLAN
M-101	HVAC PLAN
M-501	HVAC DETAILS & SCHEDULES
E-101	POWER PLAN
E-102	LIGHTING PLAN
E-501	ELECTRICAL DETAILS & SCHEDULES
P-101	PLUMBING PLANS

H13

PROJECT LOCATION

WITHIN BUILDING

DRAWING INDEX SCALE: NTS

LARGE S	CALE	SMALL SCALE	
CONCRETE			
GYPSUM BOARD			
RESINOUS COATING			
FOAM INSULATION	$\begin{array}{c} \\ \\ \\ \\ \\ \\ \\ \\ \\ \\ \\ \\ \\ \\ \\ \\ \\ \\ \\$		
MISCELLANEOUS ITEMS: AS NOTED ON EACH SHEET			
BATT INSULATION			
ASPEN PANELING			
VINYL TILES			
CERAMIC TILE			

E13 MATERIAL LEGEND SCALE: NTS

OFFICE OF ADMINISTRATION **DIVISION OF** FACILITIES MANAGEMENT, **DESIGN AND** CONSTRUCTION

RENOVATE WOMENS LOCKER ROOM, ACADEMY PHYSICAL TRAINING BUILDING

MSHP GENERAL HEAD-QUARTERS COMPLEX 1510 E ELM ST JEFFERSON CITY, MO

PROJECT # R2402-01 6001 SITE # ASSET # 8136001003

REVISION: DATE: REVISION: DATE: **REVISION:** DATE:

ISSUE DATE: 09/17/2024


CAD DWG FILE:R2402-CD DRAWN BY: <u>AB/EM</u> CHECKED BY: <u>EM</u> DESIGNED BY: AB/EM

SHEET TITLE:

INDEX SHEET

SHEET NUMBER:

G-101 2 OF 17 SHEETS 09/17/2024

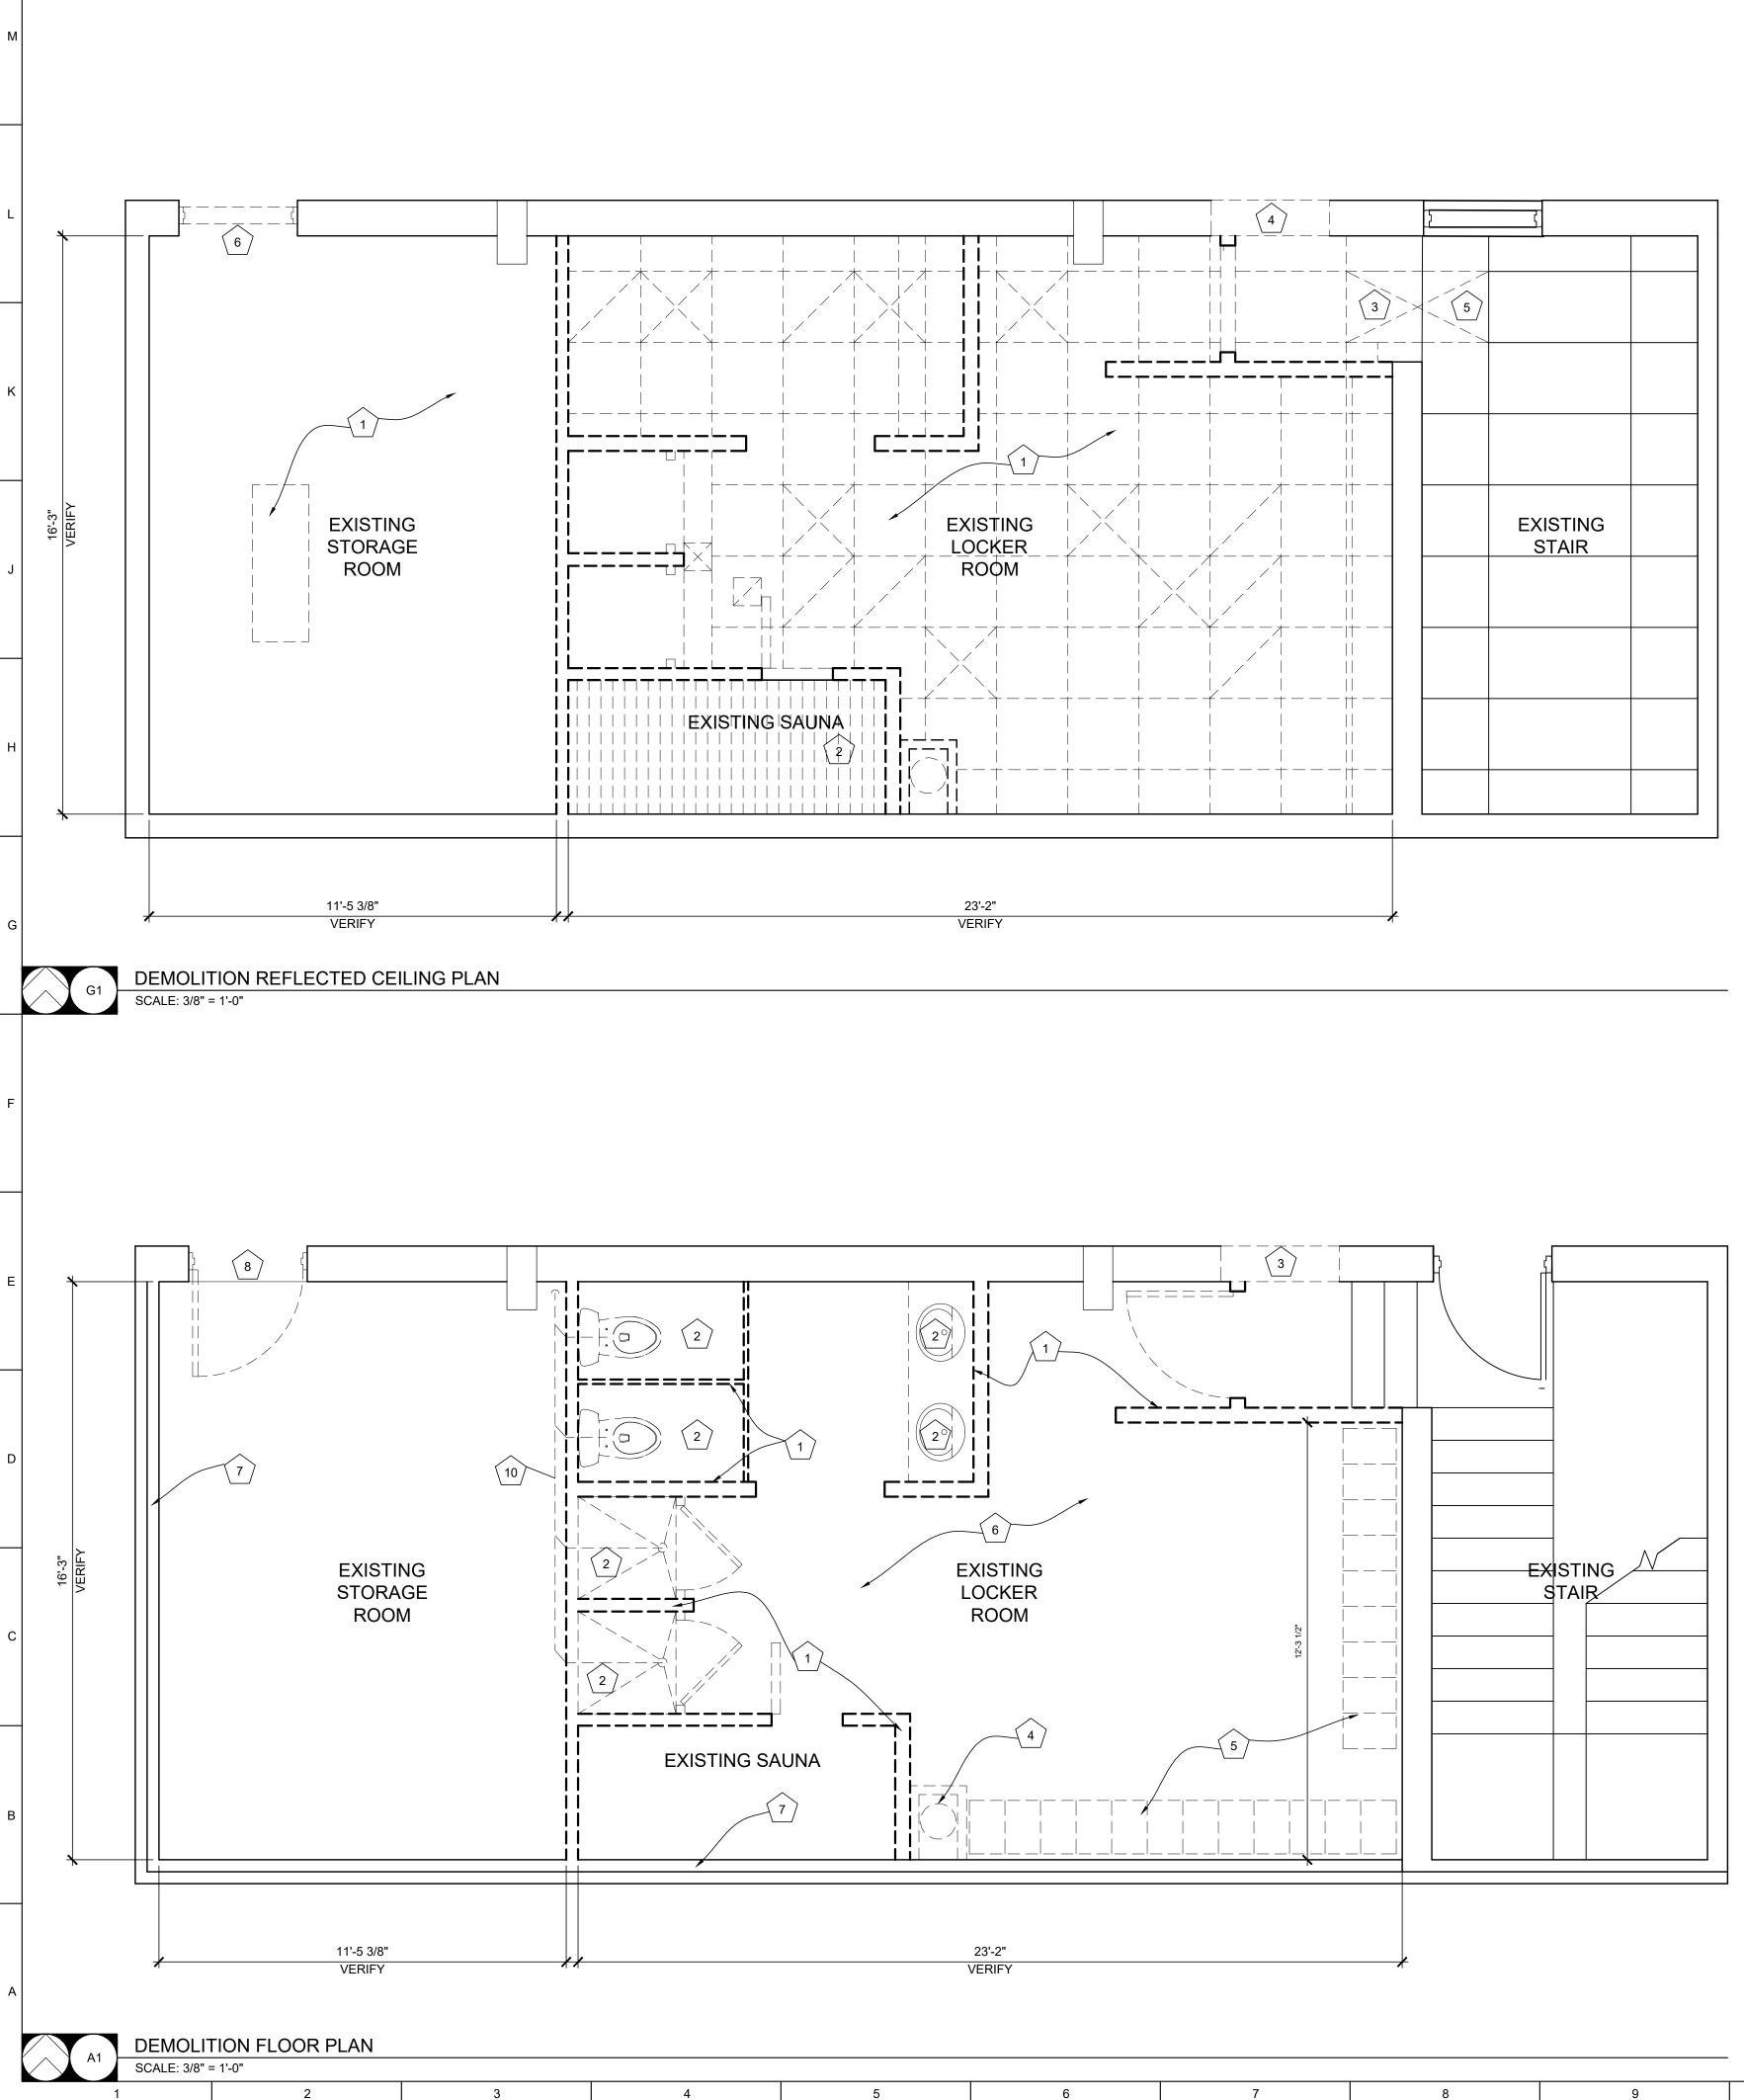

			}	
	⁻ 		5	
└────┴───┤ │ └───			^	
		 		EXISTING STAIR
		 - +		

	DEMO CEILING PLAN NOTES	
	DEMO EXISTING SUSPENDED CEILING FIXTURES AND ATTACHED ELECTRICA - SEE MEP DRAWINGS.	IS, LI
2	DEMO EXISTING SAUNA	
3	DEMO AND SALVAGE EXISTING LIGHT RELOCATE IN EXISTING STAIR	FIXT

- DEMO EXISTING MASONRY FOR NEW DOOR INSTALLATION-SALVAGE MASONRY TO GREATEST EXTENT POSSIBLE FOR RE-INSTALLATION AT DOORS
- \rangle DEMO EXISTING SUSPENDED CEILING AS **REQUIRED TO MODIFY INSTALLATION FOR** NEW CONFIGURATION-SEE REFLECTED CEILING PLAN
- 6 DEMO EXISTING HM DOOR AND FRAME

- DEMO FLOOR PLAN SCOPE OF WORK NOTES
- $\begin{pmatrix} 1 \end{pmatrix}$ DEMO EXISTING PARTITIONS, TYP.
- DEMO EXISTING PLUMBING FIXTURES, SUPPLY & ² WASTE PIPING - SEE MEP DRAWINGS FOR EXTENTS
- DEMO EXISTING MASONRY FOR NEW DOOR INSTALLATION-MAINTAIN COURSING-VERIFY DIMENSIONS WITH FLOOR PLAN
- 4 DEMO EXISTING CHASE AND FLUE-SEE CONCRETE SPEC FOR FLOOR FILL
- 5 DEMO EXISTING LOCKERS-SAVE TO OWNER
- 6 DEMO EXISTING ELECTRICAL FIXTURES & WIRING SEE MEP
- $\overrightarrow{7}$ DEMO EXISTING BATT INSULATION IN \sim EXISTING EXTERIOR WALLS
- (8) DEMO EXISTING HM DOOR AND FRAME
- DEMO EXISTING LIGHTS, ELECTRICAL WIRING ⁹ AND BOXES THROUGHOUT
- DEMO EXISTING PLUMBING AS 10 REQUIRED-SEE MEP DRAWINGS AND SPECS

10

GHT
EVICES

XTURE

GENERAL DEMOLITION NOTES

- 1. FIELD VERIFICATION: INFORMATION CONTAINED IN THESE DRAWINGS IS BASED ON EXISTING DOCUMENTS & FIELD OBSERVATIONS. THE INFORMATION CONTAINED HERE-IN MAY REQUIRE ADJUSTMENTS OR MODIFICATIONS TO CONFORM WITH EXISTING CONDITIONS. THESE DRAWINGS CONVEY THE DESIGN INTENT ONLY.
- 2. FIELD VERIFY ALL DIMENSIONS AND CONDITIONS PRIOR TO EXECUTING ANY WORK. NOTIFY OWNER'S REPRESENTATIVE OF ANY DIMENSIONS OR WORK DIFFERING FROM THAT SHOWN FOR CLARIFICATION BY THE OWNER'S REPRESENTATIVE PRIOR TO PROCEEDING WITH THE WORK.
- 3. PROVIDE PROTECTION OVER LOWER EXTERIOR DOORS, WINDOWS, OTHER OPENINGS, AND OTHER CONSTRUCTION TO REMAIN DURING CONSTRUCTION. PROTECT PEDESTRIAN TRAFFIC BY COVERED WALKWAY.
- 4. LEAVE AREA CLEAN AND FREE OF DEBRIS AT THE END OF EACH DAY.
- 5. ALL DIMENSIONS ARE TO FACE OF STUD OR MASONRY - UNLESS OTHERWISE NOTED.
- 6. DEMOLISH AND REMOVE ALL EXISTING BUILDING ELEMENTS AS NOTED AND THOSE THAT WOULD INTERFERE WITH THE INSTALLATION OF NEW WORK. VERIFY WITH OWNER'S REPRESENTATIVE REMOVAL OF ANY ITEMS NOT NOTED FOR DEMOLITION. 6.1. REMOVE ALL CEILING TREATMENTS
- WHERE REQUIRED. REMOVE ALL FLOOR COVERINGS DOWN 6.2. TO CONCRETE SUBSTRATE WHERE REQUIRED; PATCH & REPAIR WHERE DAMAGED, USE PATCHING MATERIALS COMPATIBLE WITH FLOOR POLISHING TO ENSURE MATCH WITH ADJACENT SURFACES, TO PROVIDE SMOOTH LEVEL SURFACE SUITABLE FOR NEW FLOORING.
- 7. COORDINATE DEMOLITION WORK W/ THAT SHOWN ON PLUMBING DEMOLITION, MECHANICAL DEMOLITION, & ELECTRICAL DEMOLITION SHEETS. AT REMOVED PIPES, DUCTS, & CABLES, WHERE EXISTING OPENING WILL NOT BE REUSED, INFILL & PATCH NEW OPENING W/ MATERIALS MATCHING ADJACENT WALL CONSTRUCTION; COORDINATE W/ STRUCTURAL DRAWINGS FOR INFILL @ EXISTING MASONRY WALLS.

STATE OF MISSOURI MICHAEL L. PARSON, GOVERNOR





Peckham & Wright Architects, Inc., d.b.a. PWArchitects, Inc. 2120 Forum Blvd., Ste. 101 Columbia, Missouri 65203 PWArchitects.com | 573.449.2683

. ckham & Wright Architects an Architectura Vissouri State Certificate of Authority No. 000244

OFFICE OF ADMINISTRATION **DIVISION OF** FACILITIES MANAGEMENT, **DESIGN AND** CONSTRUCTION

RENOVATE WOMENS LOCKER ROOM, ACADEMY PHYSICAL TRAINING BUILDING

MSHP GENERAL HEAD-QUARTERS COMPLEX 1510 E ELM ST JEFFERSON CITY, MO

PROJECT #	R2402-01
SITE #	6001
ASSET #	8136001003

REVISION: DATE: **REVISION**: DATE: **REVISION:** DATE:

ISSUE DATE: 09/17/2024

CAD DWG FILE:R2402-CD DRAWN BY: <u>AB/EM</u> CHECKED BY: <u>EM</u> DESIGNED BY: AB/EM

SHEET TITLE: DEMOLITION PLANS

SHEET NUMBER:


D-101 3 OF 17 SHEETS 09/17/2024

12

13

14

15

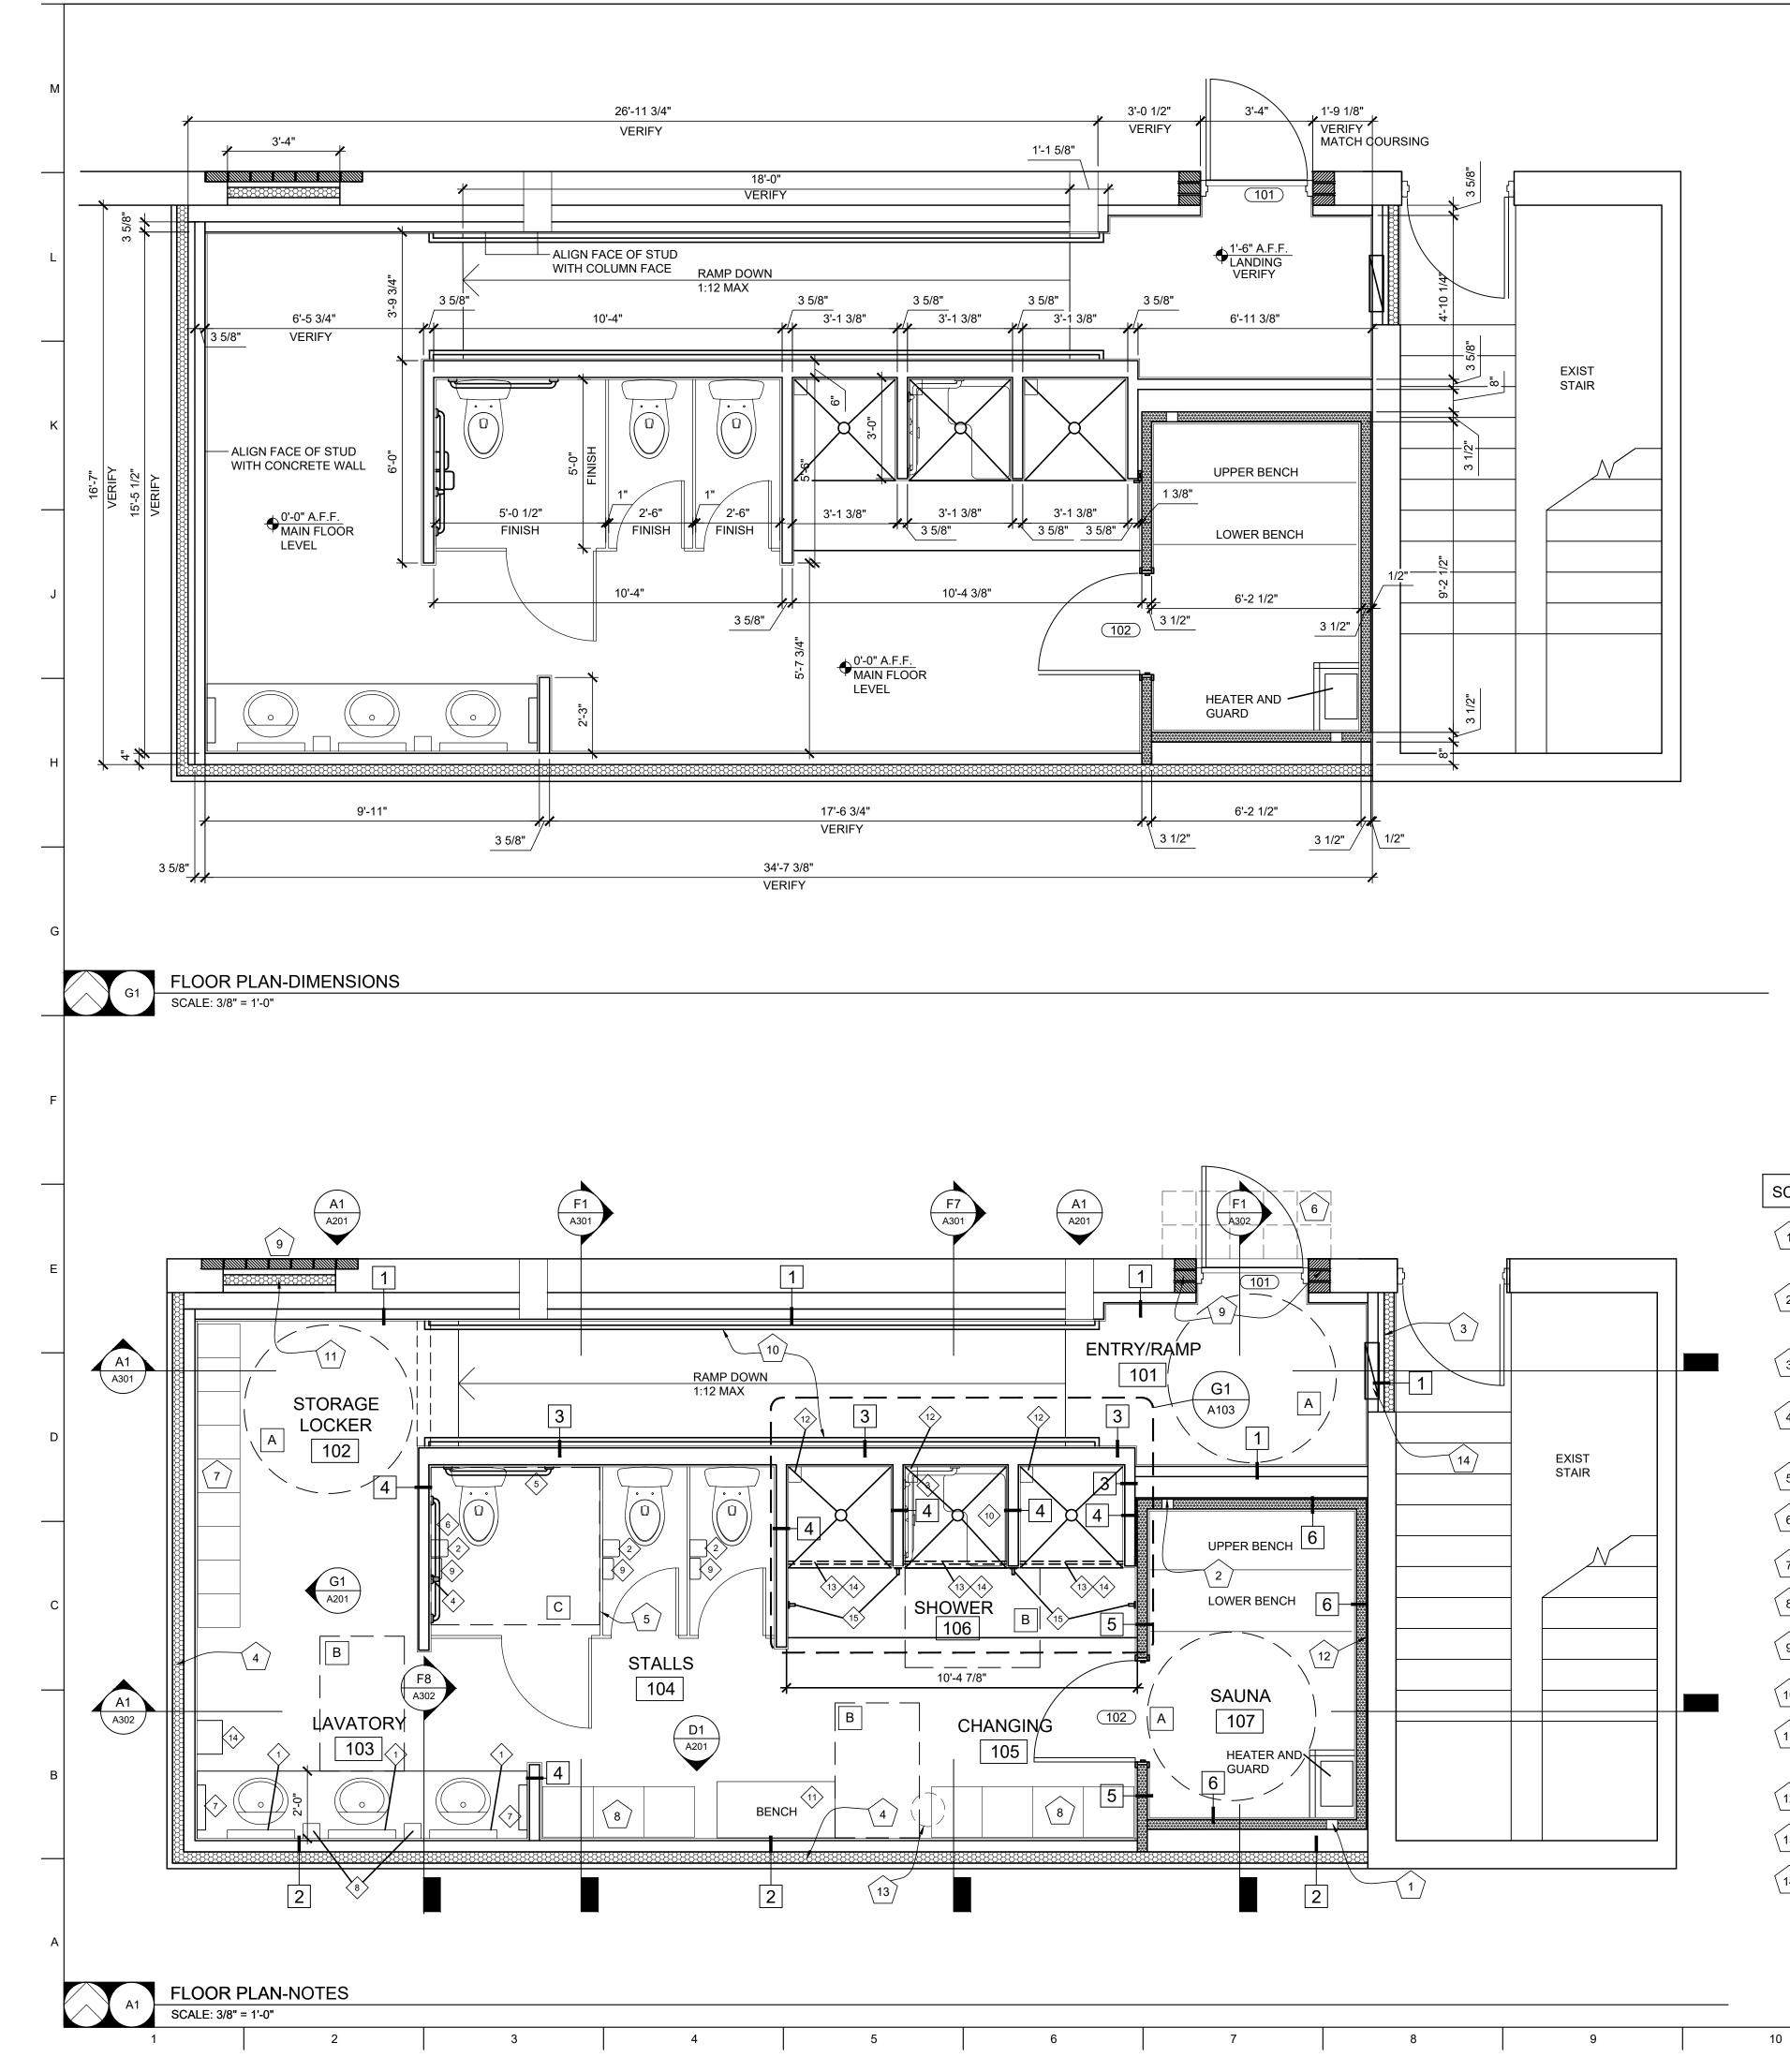

Y
N
B
Т
B
B
B
B
K C
G
B
B
S
A S 1: C
B
B
B
B B

*MODEL PROVIDED AS BASIS OF DESIGN - SEE SPECIFICATIONS PROVIDE WALL BLOCKING / REINFORCING AS REQUIRED FOR ACCESSORY INSTALLATION AND MOUNTING.

PBO = PROVIDED BY OWNER

• **PBC** = PROVIDED BY CONTRACTOR • **IBC** = INSTALLED BY CONTRACTOR

ACCESSIBLE CLEAR FLOOR SPACE REQUIREMENTS NOTE ITEM Α 5'-0" DIAMETER CLEAR FLOOR TURNING SPACE В 30" X 48" CLEAR FLOOR SPACE С 56" X 60" MIN. CLEAR FLOOR SPACE AROUND WATER CLOSET

SCOPE-OF-WORK NOTES	PARTITIC
SAUNA INLET VENT - FINAL LOCATION AND SIZE TO BE DETERMINED BY SAUNA MANUFACTURER	1
2 SAUNA EXHAUST VENT - FINAL LOCATION AND SIZE TO BE DETERMINED BY SAUNA MANUFACTURER	2
3 INFILL EXISTING OPENING WITH STEEL STUDS & GYPSUM BOARD - ALIGN FINISHES	3
4 FILL STUD CAVITIES FOR EXTERIOR WALLS WITH CLOSED CELL SPRAY FOAM INSULATION - FLOOR TO UNDERSIDE OF ROOF DECK.	
5 INSTALL OVERHEAD BRACED TOILET PARTITIONS	4
6 INSTALL NEW VCT FLOORING TO MATCH EXISTING - TOOTH INTO EXISTING.	5
7 SOLID PLASTIC STORAGE LOCKERS. 12 X 15 X 6'-0" EACH-2-TIER	
8 SOLID PLASTIC CHANGING LOCKERS. 18 X 18 X 6'-0" EACH 1-TIER	6
9 TOOTH IN MASONRY TO ACCOMMODATE INSTALLATION OF SALVAGED/NEW BRICK VENEER	
1-1/2" DIA HANDRAIL - MOUNT AT 34" A.F.F.	
11 INFILL EXISTING OPENING WITH 3- ⁵ / ₈ " STEEL STUDS & CEMENT BOARD SHEATHING ON GYMNASIUM SIDE FOR SUPPORT OF BRICK VENEER	
$12 \text{ INSTALL 1 LAYER } \frac{1}{2} \text{ CEMENT BOARD TO} $ EXISTING WALL	
FILL EXISTING HOLE FROM FLUE REMOVAL WITH CONCRETE TO MATCH DEPTH OF FLOOR SLAB	
14 NEW ELECTRIC PANEL-SEE MEP DRAWINGS	

12

SCHEDULE MODEL* REMARKS BOBRICK B-2908 2436 TORK 59TR BOBRICK B-6861 BOBRICK B-6806 x 18 BOBRICK B-6806 x 36 BOBRICK B-6806 x 42 KIMBERLY CLARK 34364 GOJO-LTX-12 GRAY BOBRICK B-270 BOBRICK B-5193 SCRANTON 42" X 20" WITH PEDESTAL BASES AMERICAN STANDARD 1202-008.266 CORNER SHELF BOBRICK B-6107 BOBRICK B-204-2 BOBRICK B-549 BOBRICK B-7128

ON TYPE NOTES

- 3 %" STEEL STUDS @ 16" O.C. W/ % GYP. BD. ON FINISHED SIDE. TOP OF WALL AT 12" ABOVE NEW CEILING HEIGHT
- 3 ⁵/₈" STEEL STUDS @ 16" O.C. WITH 1/2 " CEMENT BOARD ON FINISHED SIDE WITH SPRAY FOAM INSULATION
- 6" OR 3 5/8" STEEL STUDS @ 16" O.C. WITH ½" CEMENT BOARD SHOWER SIIDE AND 5/8" GYP. BD. ON RAMP SIDE.
- 3 5⁄8" STEEL STUDS @ 16" O.C. WITH $\frac{1}{2}$ " CEMENT BOARD ON FINISHED SIDES
- 2X4 WOOD STUDS @ 16" O.C. WITH 1x4 T & G SIDING EACH SIDE WITH SPRAY FOAM INSULATION
- 2X4 WOOD STUDS @ 16" O.C. WITH 1X4 T & G SIDING ON FINISHED SIDE W/ SPRAY FOAM INSULATION

13

14

15

GENERAL FLOOR PLAN NOTES

- FIELD VERIFY ALL DIMENSIONS & CONDITIONS PRIOR TO EXECUTING ANY WORK. NOTIFY ARCHITECT OF ANY DIMENSIONS OR WORK DIFFERING FROM THAT SHOWN, FOR CLARIFICATION BY THE ARCHITECT PRIOR TO PROCEEDING WITH WORK.
- VERIFY ALL ROUGH OPENINGS FOR DOORS, 2. WINDOWS, EQUIPMENT, & OTHER "BUILT-IN" ITEMS PRIOR TO EXECUTION OF ANY WORK AFFECTED BY SAME.
- LOCATE DOOR OPENINGS WHICH ARE NOT DIMENSIONED OTHERWISE, CENTERED IN WALL AND 6" FROM FINISH WALL TO FINISH JAMB.
- COORDINATE ALL FLOOR DRAINS AND OTHER REFERENCED MECHANICAL, ELECTRICAL, OR PLUMBING ITEMS W/ M.E.P.
- COORDINATE ALL REQUIRED UTILITIES WITH 5. EQUIPMENT MANUFACTURER.
- 6. ALL DIMENSIONS ARE TO FACE OF STUD OR MASONRY - UNLESS OTHERWISE NOTED.
- 7. DO NOT SCALE DRAWINGS WHERE DIMENSIONAL DISCREPANCIES ARE ENCOUNTERED NOTIFY ARCHITECT PRIOR TO PROCEEDING WITH THE WORK.
- COORDINATE HEIGHTS OF OUTLETS & SWITCHING WITH ALL ARCHITECTURAL ITEMS. SEE M/E DRAWINGS FOR LOCATIONS.

STATE OF MISSOURI MICHAEL L. PARSON, GOVERNOR





Peckham & Wright Architects, Inc., d.b.a. PWArchitects, Inc. 2120 Forum Blvd., Ste. 101 Columbia, Missouri 65203 PWArchitects.com | 573.449.2683

. ckham & Wright Architects an Architectural Missouri State Certificate of Authority No. 000244

OFFICE OF ADMINISTRATION **DIVISION OF** FACILITIES MANAGEMENT, **DESIGN AND** CONSTRUCTION

RENOVATE WOMENS LOCKER ROOM, ACADEMY PHYSICAL TRAINING BUILDING

MSHP GENERAL HEAD-QUARTERS COMPLEX 1510 E ELM ST JEFFERSON CITY, MO

PROJECT # R2402-01 SITE # 6001 8136001003 ASSET #

REVISION: DATE:

DATE.
REVISION:
DATE:
REVISION:
DATE:
ISSUE DATE: 09/17/2024


CAD DWG FILE:R2402-CD DRAWN BY: AB/EM CHECKED BY: EM DESIGNED BY: AB/EM

SHEET TITLE:

FLOOR PLAN NOTES FLOOR PLAN DIMENSIONS

SHEET NUMBER:

A-1024 OF 17 SHEETS 09/17/2024

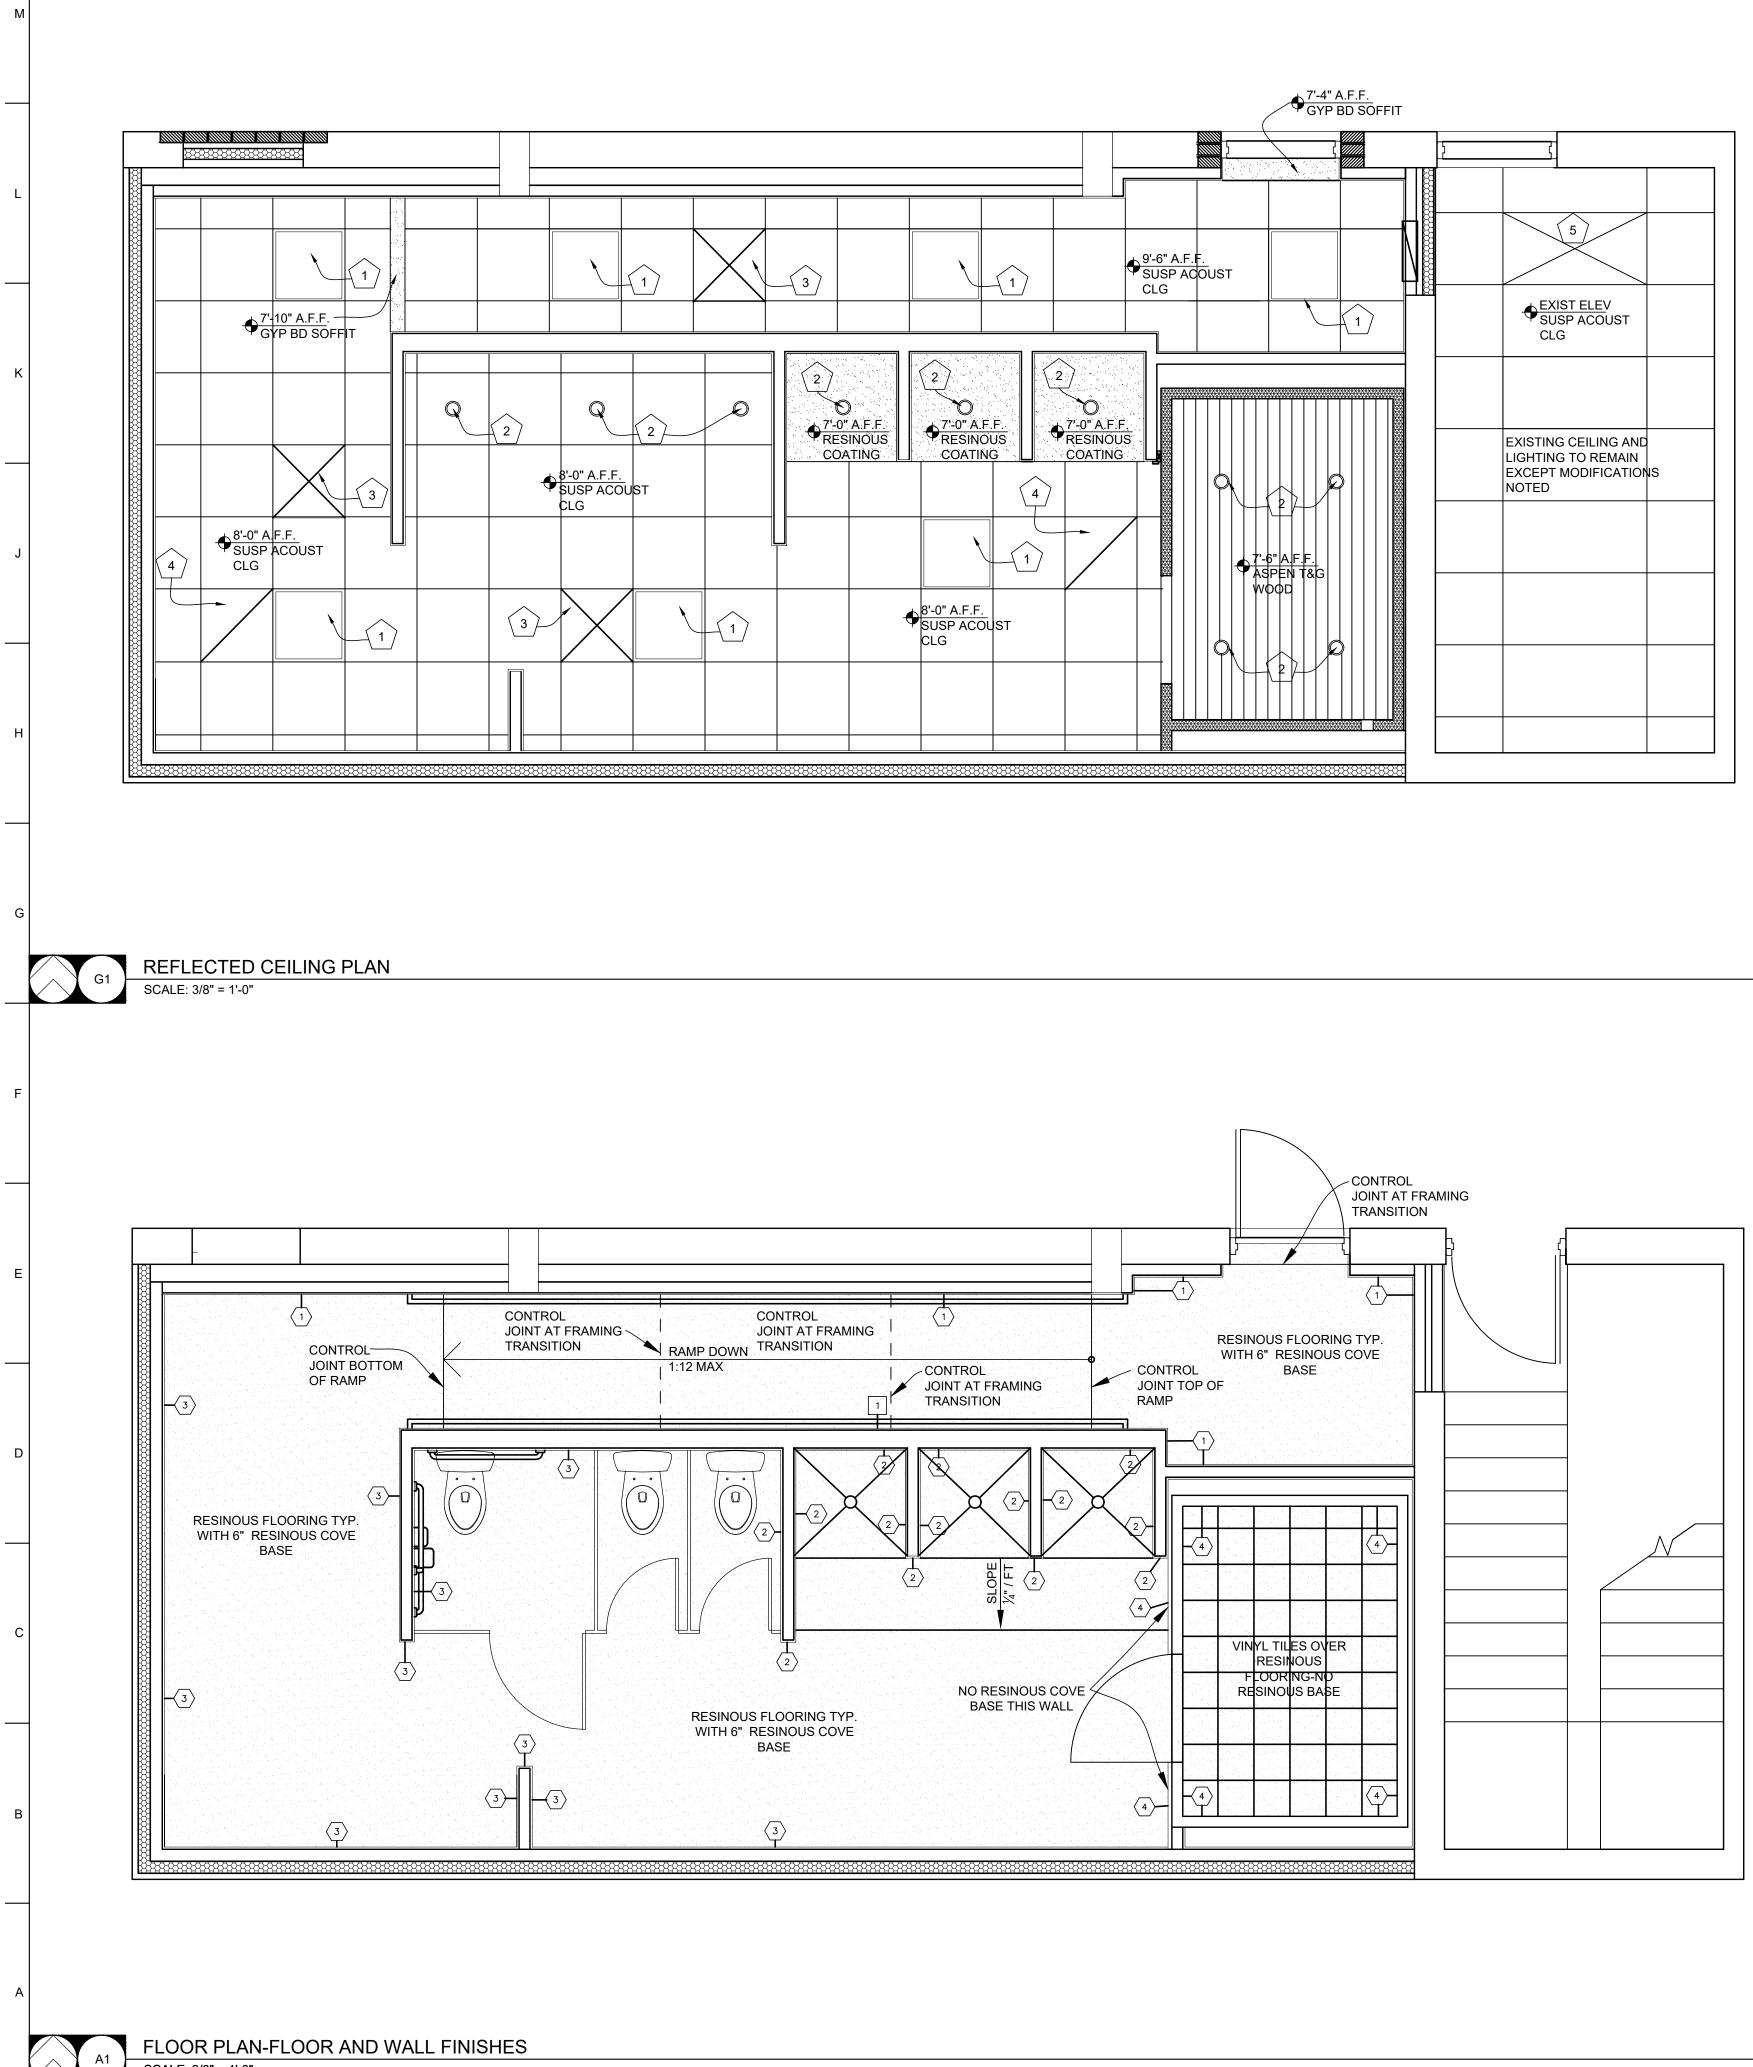

SCALE: 3/8" = 1'-0"

2 3 4 5

CEILING PLAN SCOPE NOTES

- 2 X 2 LIGHT FIXTURE SEE MEP DRAWINGS
- 2 CAN LIGHT FIXTURE SEE MEP DRAWINGS
- 3 SUPPLY AIR DIFFUSER SEE MEP DRAWINGS
- 4 RETURN AIR GRILL SEE MEP DRAWINGS
- 5 MODIFY EXISTING CEILING AND RELOCATE SALVAGED LIGHT FIXTURE TO LOCATION INDICATED. TIE FIXTURE TO STAIR LIGHTING-SEE MEP

WALL FINISH NOTES

10

8

6

7

9

- PAINT OVER GYPSUM BOARD OVER STUDS-PROVIDE 6" OF CEMENT BOARD AT BASE FOR RESINOUS COVE BASE
- (2) RESINOUS WALL COATING OVER CEMENT BOARD OVER STUDS
- $\overline{(3)}$ CERAMIC TILE OVER CEMENT BOARD OVER STUDS

11

12

13

14

15

(4) 1 X 4 WOOD SIDING OVER WOOD STUD FRAMING-SEE SAUNA SPECIFICATIONS

GENERAL CEILING PLAN NOTES

- 1. REFER TO ELECTRICAL DRAWINGS FOR LIGHT FIXTURE SPECIFICATIONS.
- REFER TO MECHANICAL DRAWINGS FOR SUPPLY AND RETURN AIR DIFFUSER LOCATIONS AND HVAC SYSTEM LAYOUT.
- 3. COORDINATE CEILING / SOFFIT FRAMING AND SUPPORTS WITH EXISTING STRUCTURE AND REQUIRED MECHANICAL, ELECTRICAL, AND PLUMBING DESIGN.
- 4. REFER TO ROOM FINISH SCHEDULE AND LEGEND FOR ALL CEILING HEIGHTS AND FINISH REQUIREMENTS.


ONS D	ERIK ERIK
)	CHRISTOPHER MILLER PRIMILLER MUMBER A-7070
ISH	09/17/2024
	Peckham & Wright Architects, Inc., d.b.a. PKACChitects, Inc. Alto Forum Blvd., Ste. 101 Columbia, Missouri 65203 PWArchitects.com 573.449.2683 Peckham & Wright Architects an Architectural Corporation Missouri State Certificate of Authority No. 000244
	OFFICE OF ADMINISTRATION DIVISION OF FACILITIES MANAGEMENT, DESIGN AND CONSTRUCTION
	RENOVATE WOMENS LOCKER ROOM, ACADEMY PHYSICAL TRAINING BUILDING
	MSHP GENERAL HEAD- QUARTERS COMPLEX 1510 E ELM ST JEFFERSON CITY, MO
	PROJECT # R2402-01 SITE # 6001 ASSET # 8136001003
	REVISION: DATE: REVISION: DATE: REVISION: DATE: DATE: ISSUE DATE: 09/17/2024
	CAD DWG FILE:R2402-CD DRAWN BY: <u>AB/EM</u> CHECKED BY: <u>EM</u> DESIGNED BY: <u>AB/EM</u>
	SHEET TITLE: REFLECTED CEILING & FLOOR FINISH PLANS

STATE OF MISSOURI

MICHAEL L. PARSON, GOVERNOR

SHEET NUMBER:

A-102 5 OF 17 SHEETS 09/17/2024

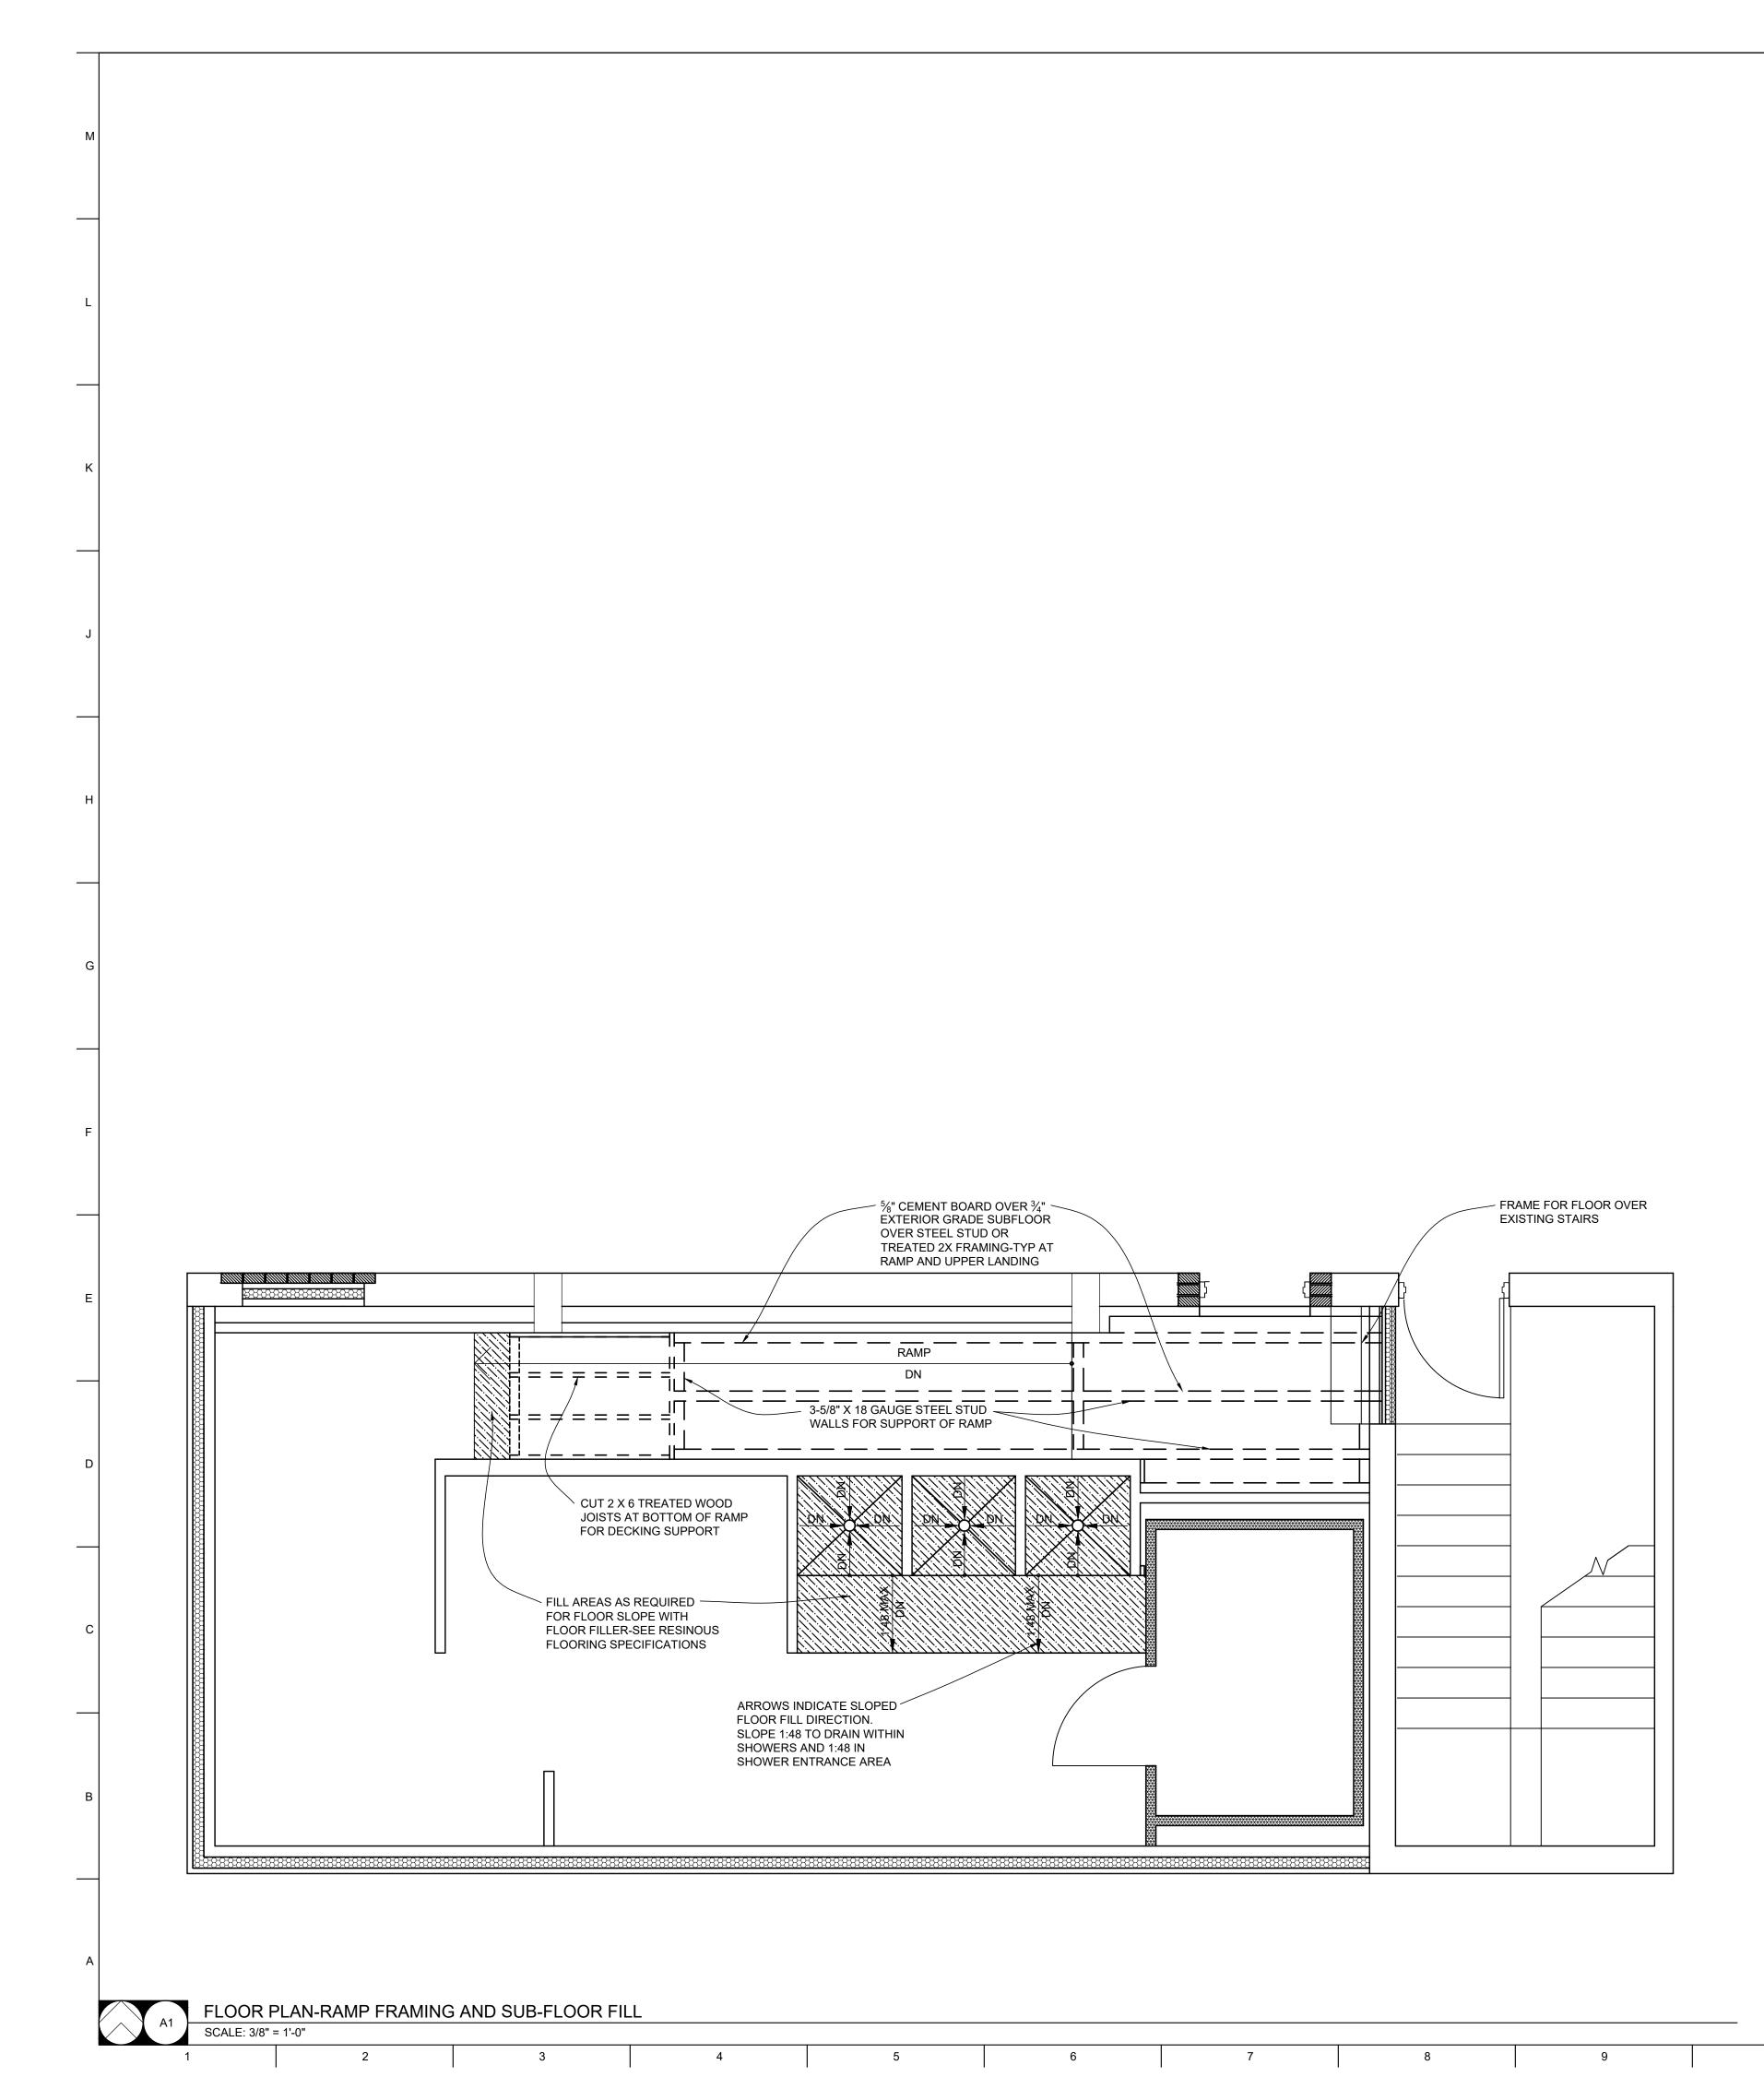

11

12

13

14

15

GENERAL CEILING PLAN NOTES

- 1. REFER TO ELECTRICAL DRAWINGS FOR LIGHT FIXTURE SPECIFICATIONS.
- 2. REFER TO MECHANICAL DRAWINGS FOR SUPPLY AND RETURN AIR DIFFUSER LOCATIONS AND HVAC SYSTEM LAYOUT.
- 3. COORDINATE CEILING / SOFFIT FRAMING AND SUPPORTS WITH EXISTING STRUCTURE AND REQUIRED MECHANICAL, ELECTRICAL, AND PLUMBING DESIGN.
- REFER TO ROOM FINISH SCHEDULE AND LEGEND FOR ALL CEILING HEIGHTS AND FINISH REQUIREMENTS.


IONS	DE MISP
ID)	CHRISTOPHER MILLER MILLER MILLER MILME R A-7070
ISH	09/17/2024
	Peckham & Wright Architects, Inc., d.b.a. PWArchitects, Inc. 2120 Forum Blvd., Ste. 101
	Columbia, Missouri 65203 PWArchitects.com 573.449.2683 Peckham & Wright Architects an Architectural Corporation Missouri State Certificate of Authority No. 000244
	OFFICE OF ADMINISTRATION DIVISION OF FACILITIES MANAGEMENT, DESIGN AND CONSTRUCTION
	RENOVATE WOMENS LOCKER ROOM, ACADEMY PHYSICAL TRAINING BUILDING
	MSHP GENERAL HEAD- QUARTERS COMPLEX 1510 E ELM ST JEFFERSON CITY, MO
	PROJECT #R2402-01SITE #6001ASSET #8136001003
	REVISION: DATE: REVISION: DATE: REVISION:
	DATE: ISSUE DATE: 09/17/2024
	CAD DWG FILE:R2402-CD DRAWN BY: <u>AB/EM</u> CHECKED BY: <u>EM</u> DESIGNED BY: <u>AB/EM</u>
	SHEET TITLE: FLOOR PLAN
	FRAMING AND SUB-FLOOR FILL


STATE OF MISSOURI

MICHAEL L. PARSON, GOVERNOR

SHEET NUMBER:


A-103 6 OF 17 SHEETS 09/17/2024

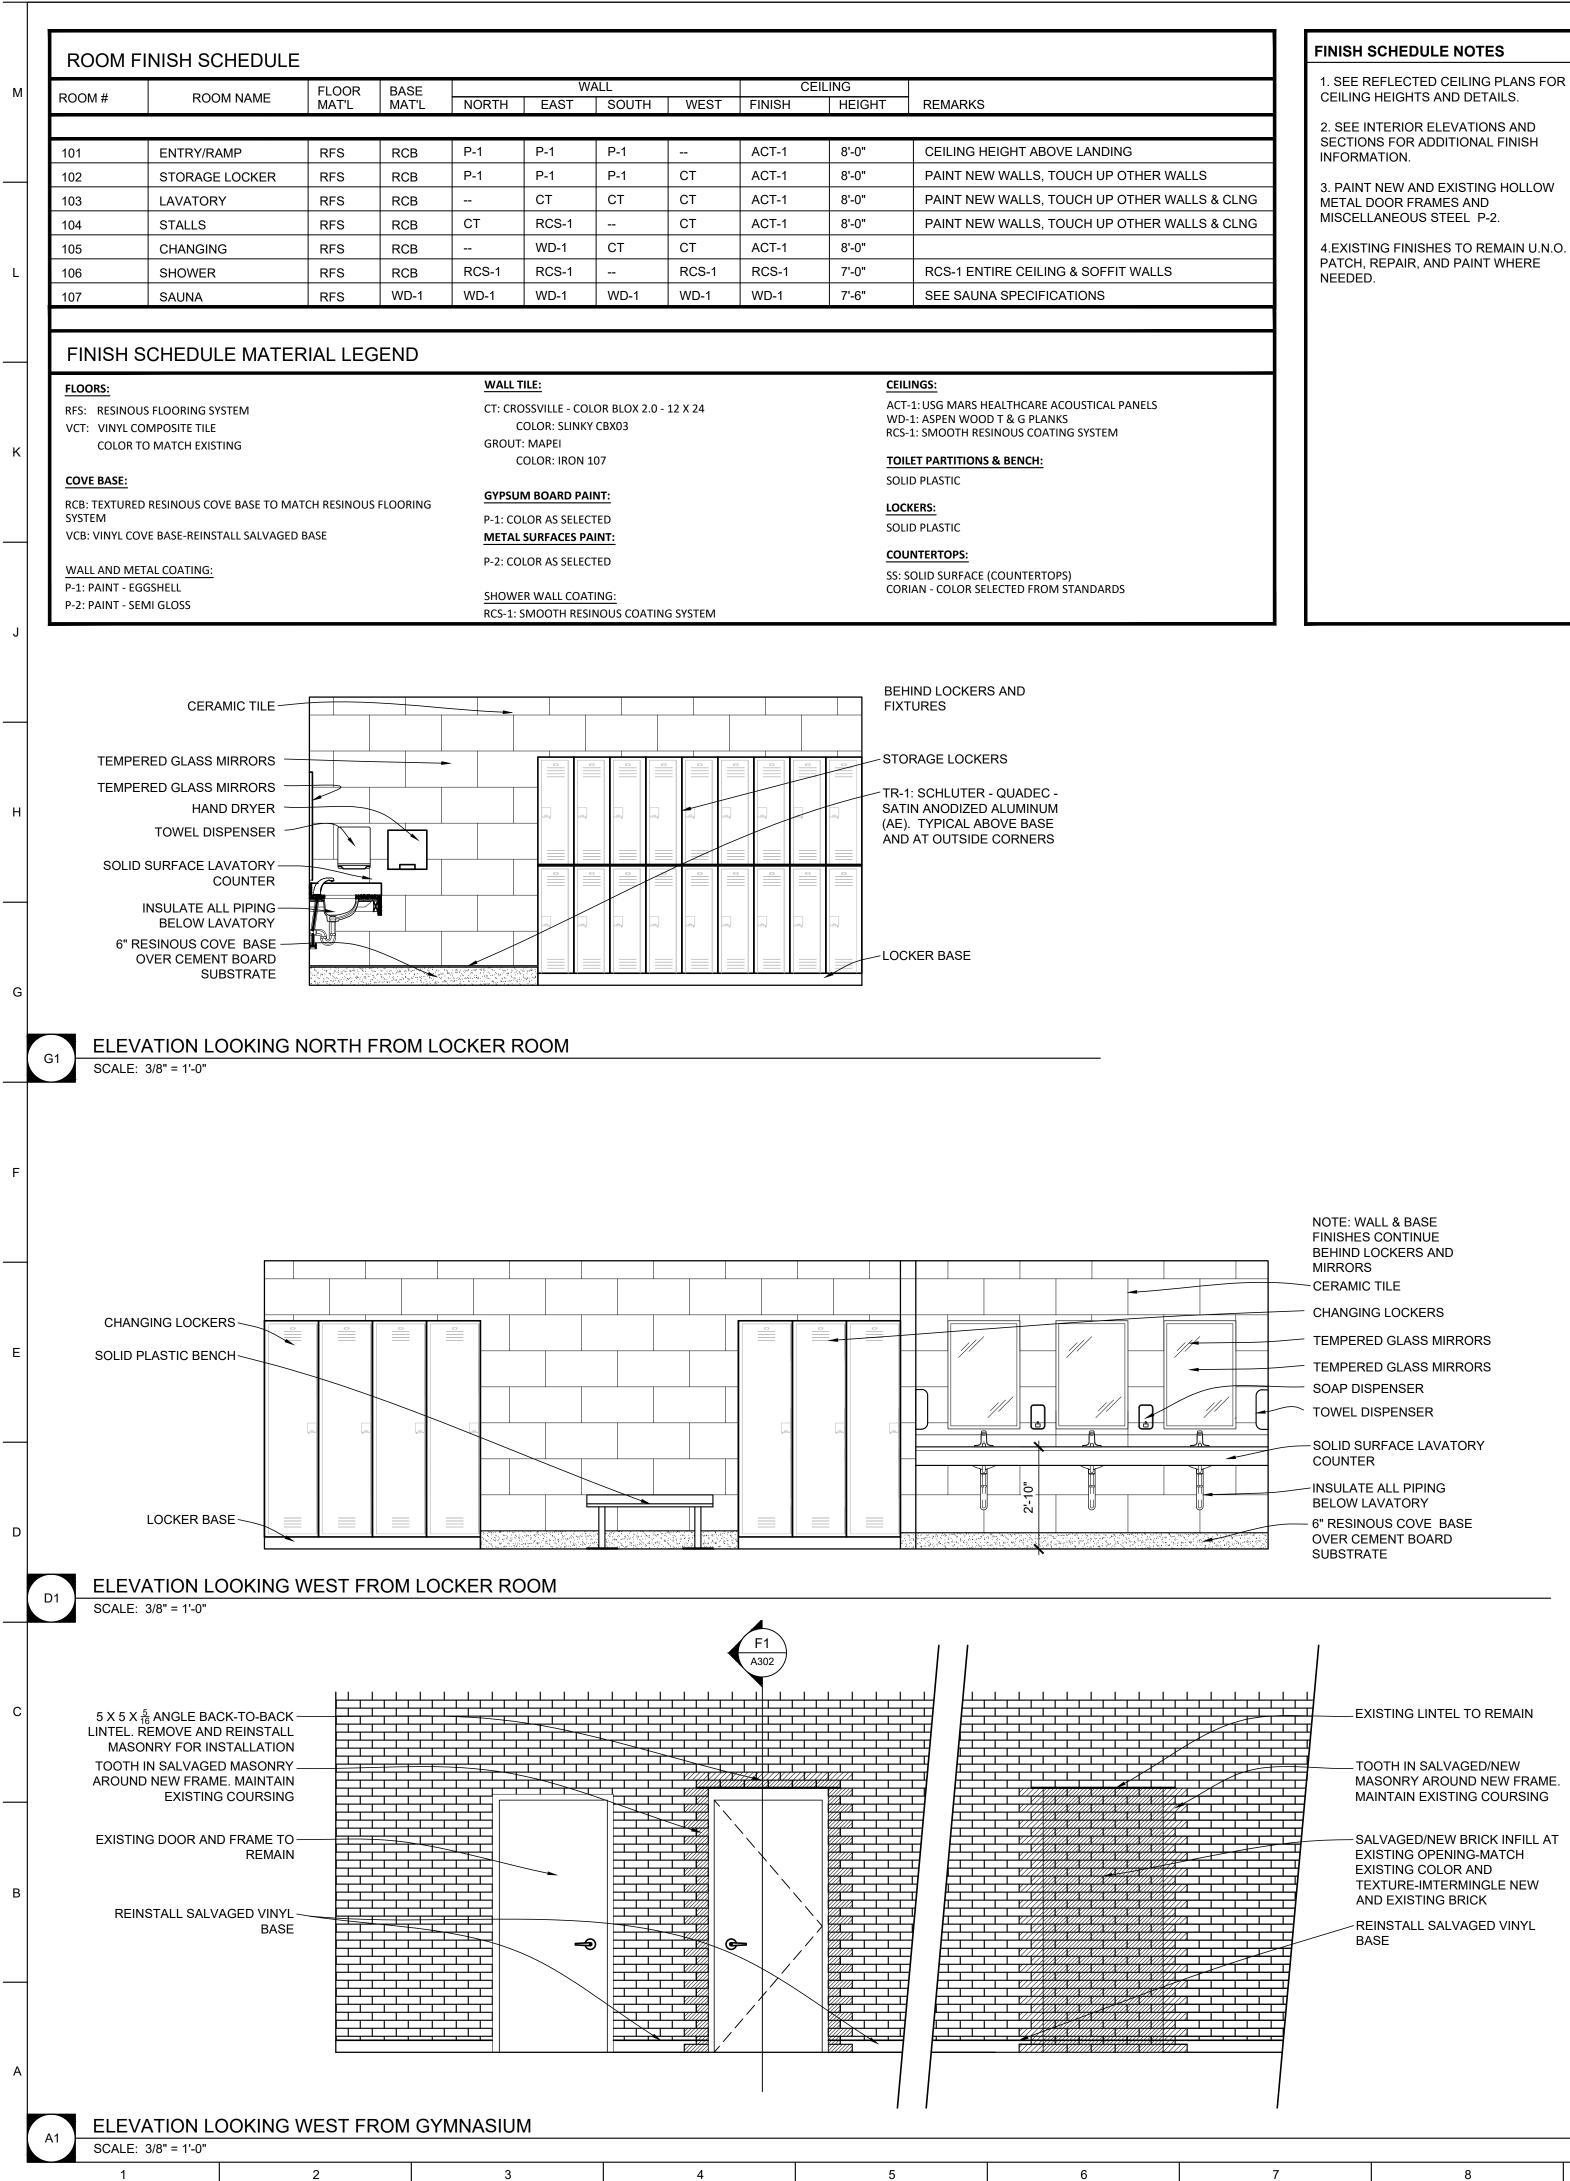

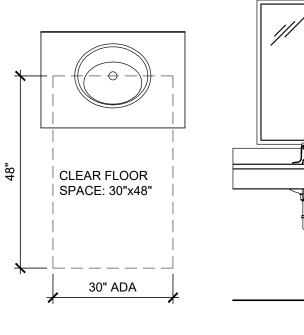





K11 TYPICAL A.D.A. MOUNTING HEIGHTS AT LAVATORIES SCALE: 1/2" = 1'-0"

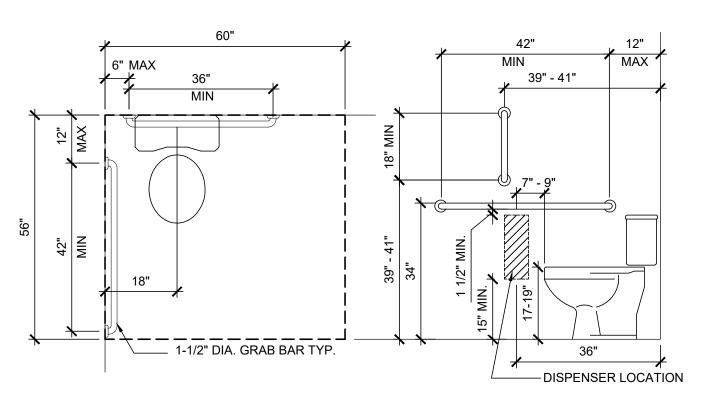

G11 SCALE: 1/2" = 1'-0"

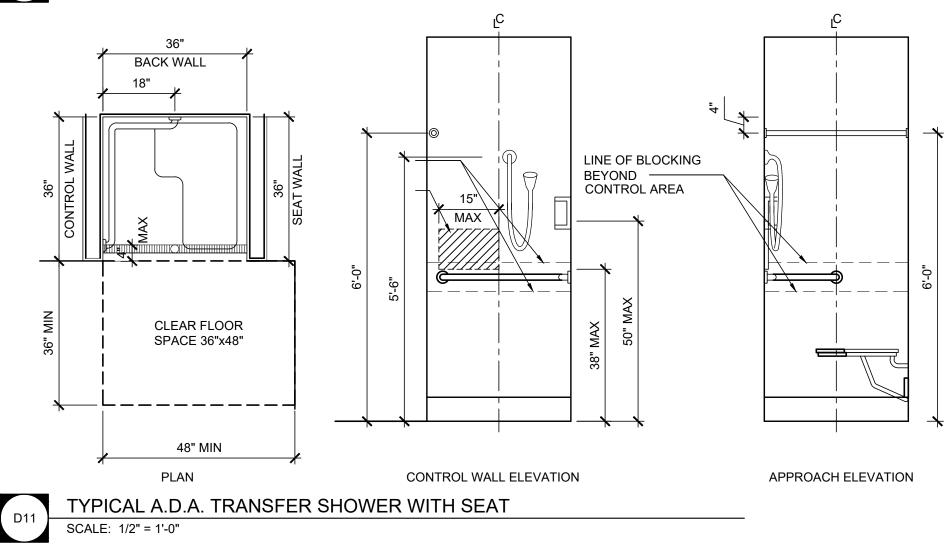


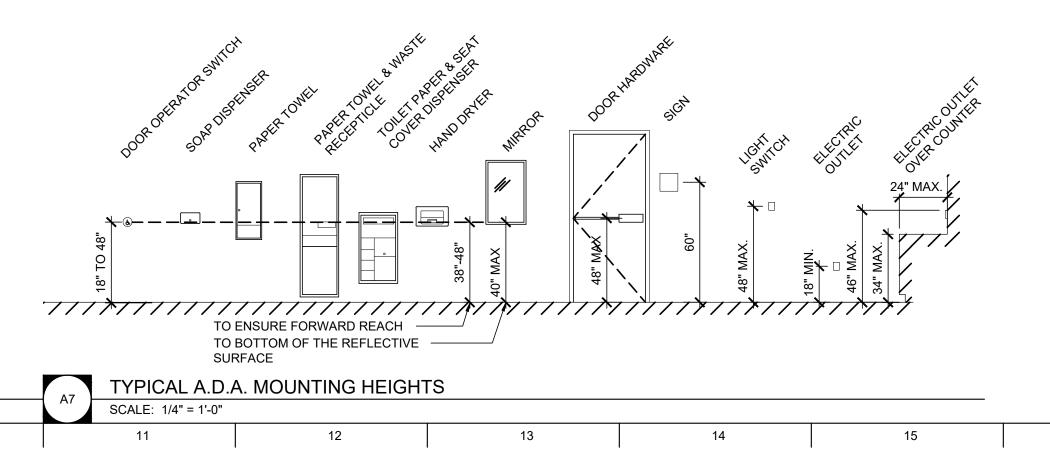


MASONRY AROUND NEW FRAME. MAINTAIN EXISTING COURSING

- -SALVAGED/NEW BRICK INFILL AT

9

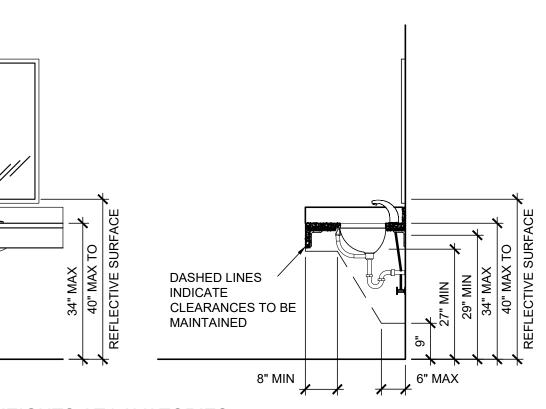


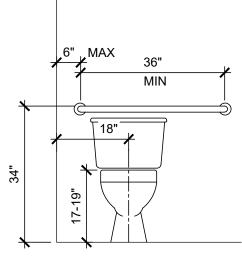


TYPICAL ACCESSIBLE TOILET ACCESSORY MOUNTING LOCATIONS & HEIGHTS

GOVERNOR
ERIK CHRISTOPHER MILLER A-7070 09/17/2024
Peckham & Wright Architects, Inc., d.b.a. PWArchitects, Inc., d.b.a. 2120 Forum Blvd., Ste. 101
Columbia, Missouri 65203 PWArchitects.com 573.449.2683 Peckham & Wright Architects an Architectural Corporation Missouri State Certificate of Authority No. 000244
DIVISION OF
FACILITIES MANAGEMENT, DESIGN AND CONSTRUCTION
FACILITIES MANAGEMENT, DESIGN AND CONSTRUCTION RENOVATE WOMENS OCKER ROOM, ACADEMY PHYSICAL RAINING BUILDING
FACILITIES MANAGEMENT, DESIGN AND CONSTRUCTION RENOVATE WOMENS LOCKER ROOM, ACADEMY PHYSICAL
FACILITIES MANAGEMENT, DESIGN AND CONSTRUCTION RENOVATE WOMENS OCKER ROOM, ACADEMY PHYSICAL FRAINING BUILDING MSHP GENERAL HEAD- QUARTERS COMPLEX 510 E ELM ST
FACILITIES MANAGEMENT, DESIGN AND CONSTRUCTION RENOVATE WOMENS OCKER ROOM, ACADEMY PHYSICAL RAINING BUILDING ASHP GENERAL HEAD- QUARTERS COMPLEX 510 E ELM ST EFFERSON CITY, MO ROJECT # R2402-01 ITE # 6001
FACILITIES MANAGEMENT, DESIGN AND ONSTRUCTION RENOVATE WOMENS OCKER ROOM, CADEMY PHYSICAL RAINING BUILDING ASHP GENERAL HEAD- QUARTERS COMPLEX 510 E ELM ST EFFERSON CITY, MO PROJECT # R2402-01 ITE # 6001 ASSET # 8136001003
FACILITIES MANAGEMENT, DESIGN AND CONSTRUCTION RENOVATE WOMENS OCKER ROOM, ACADEMY PHYSICAL TRAINING BUILDING MSHP GENERAL HEAD- QUARTERS COMPLEX 510 E ELM ST EFFERSON CITY, MO PROJECT # R2402-01 ITE # 6001 ASSET # 8136001003 EVISION: DATE: SUE DATE: 09/17/2024
FACILITIES MANAGEMENT, DESIGN AND CONSTRUCTION RENOVATE WOMENS OCKER ROOM, CADEMY PHYSICAL TRAINING BUILDING ASHP GENERAL HEAD- QUARTERS COMPLEX 510 E ELM ST EFFERSON CITY, MO PROJECT # R2402-01 ATE # 6001 ASSET # 8136001003 EVISION: DATE: EVISION: DATE: SUE DATE: 09/17/2024 CAD DWG FILE:R2402-CD ORAWN BY: AB/EM CHECKED BY: EM DESIGNED BY: AB/EM HEET TITLE: NTERIOR ELEVATION


7 OF 17 SHEETS 09/17/2024

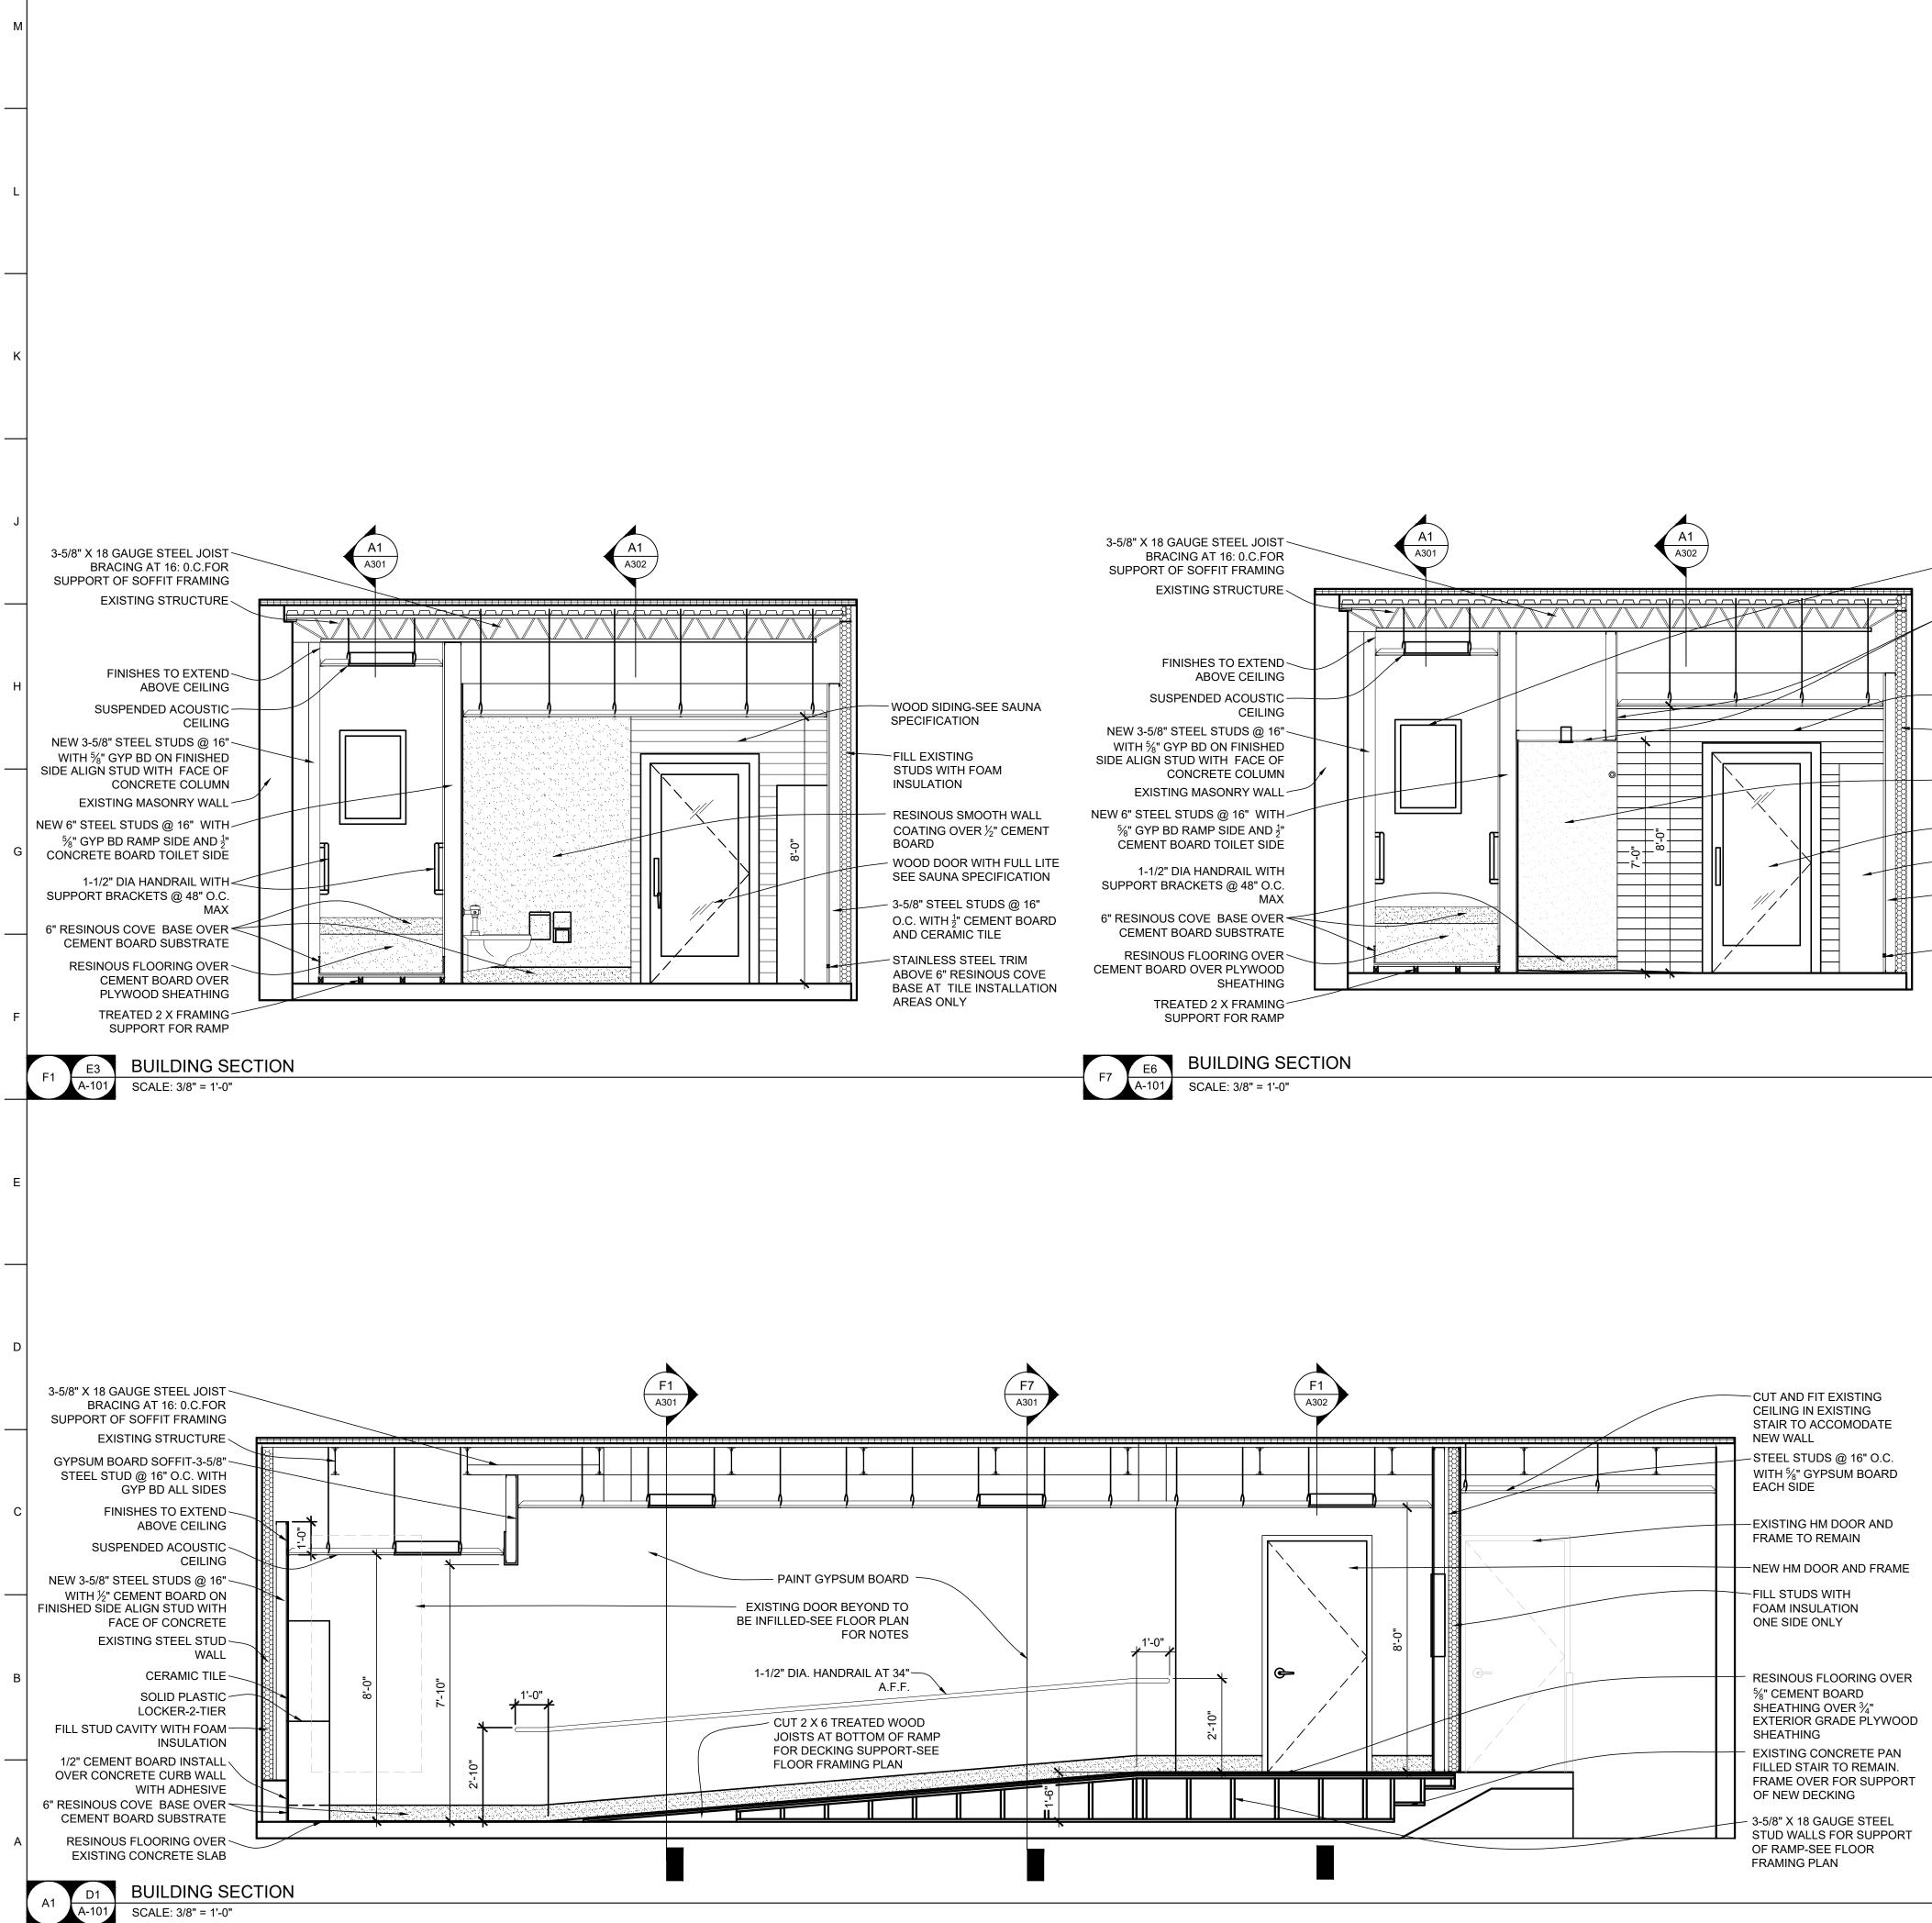


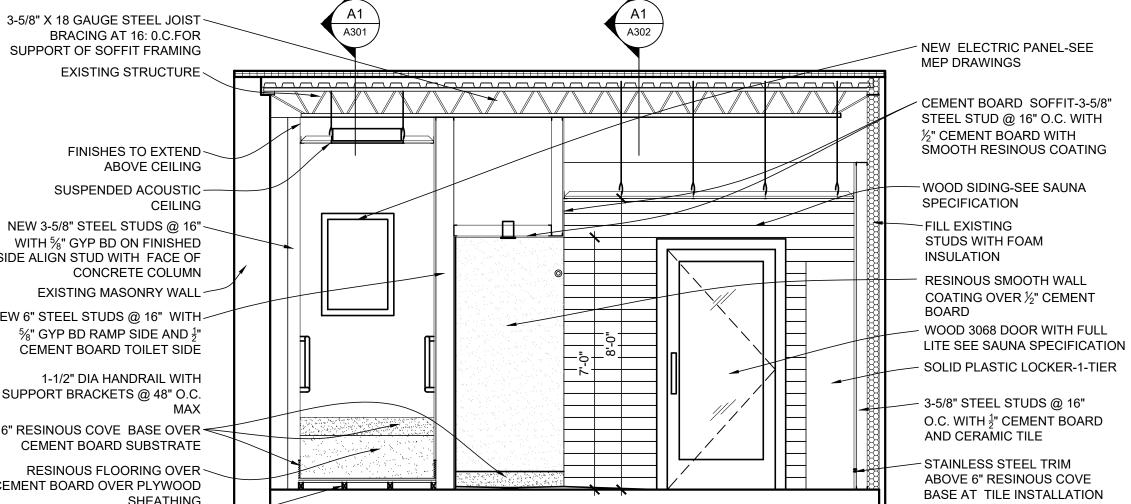

AREAS ONLY

STATE OF MISSOURI MICHAEL L. PARSON, GOVERNOR
ERIK CHRISTOPHER MILLER A-7070 RED AR 09/17/2024
Peckham & Wright Architects, Inc., d.b.a. Peckham & Wright Architects, Inc., d.b.a. DYACCHITECTS, Inc. AL20 Forum Blvd., Ste. 101 Columbia, Missouri 65203 PWArchitects.com 573.449.2683 Peckham & Wright Architects an Architectural Corporation Missouri State Certificate of Authority No. 000244
OFFICE OF ADMINISTRATION DIVISION OF FACILITIES MANAGEMENT, DESIGN AND CONSTRUCTION
RENOVATE WOMENS LOCKER ROOM, ACADEMY PHYSICAL TRAINING BUILDING MSHP GENERAL HEAD- QUARTERS COMPLEX 1510 E ELM ST JEFFERSON CITY, MO
JEFFERSON CITT, MO PROJECT # R2402-01 SITE # 6001 ASSET # 8136001003
REVISION: DATE: REVISION: DATE: REVISION: DATE: DATE: ISSUE DATE: 09/17/2024
CAD DWG FILE: <u>R2402-CD</u> DRAWN BY: <u>AB/EM</u> CHECKED BY: <u>EM</u> DESIGNED BY: <u>AB/EM</u> SHEET TITLE: SECTION DETAILS
sheet number: $A-301$
8 OF 17 SHEETS 09/17/2024

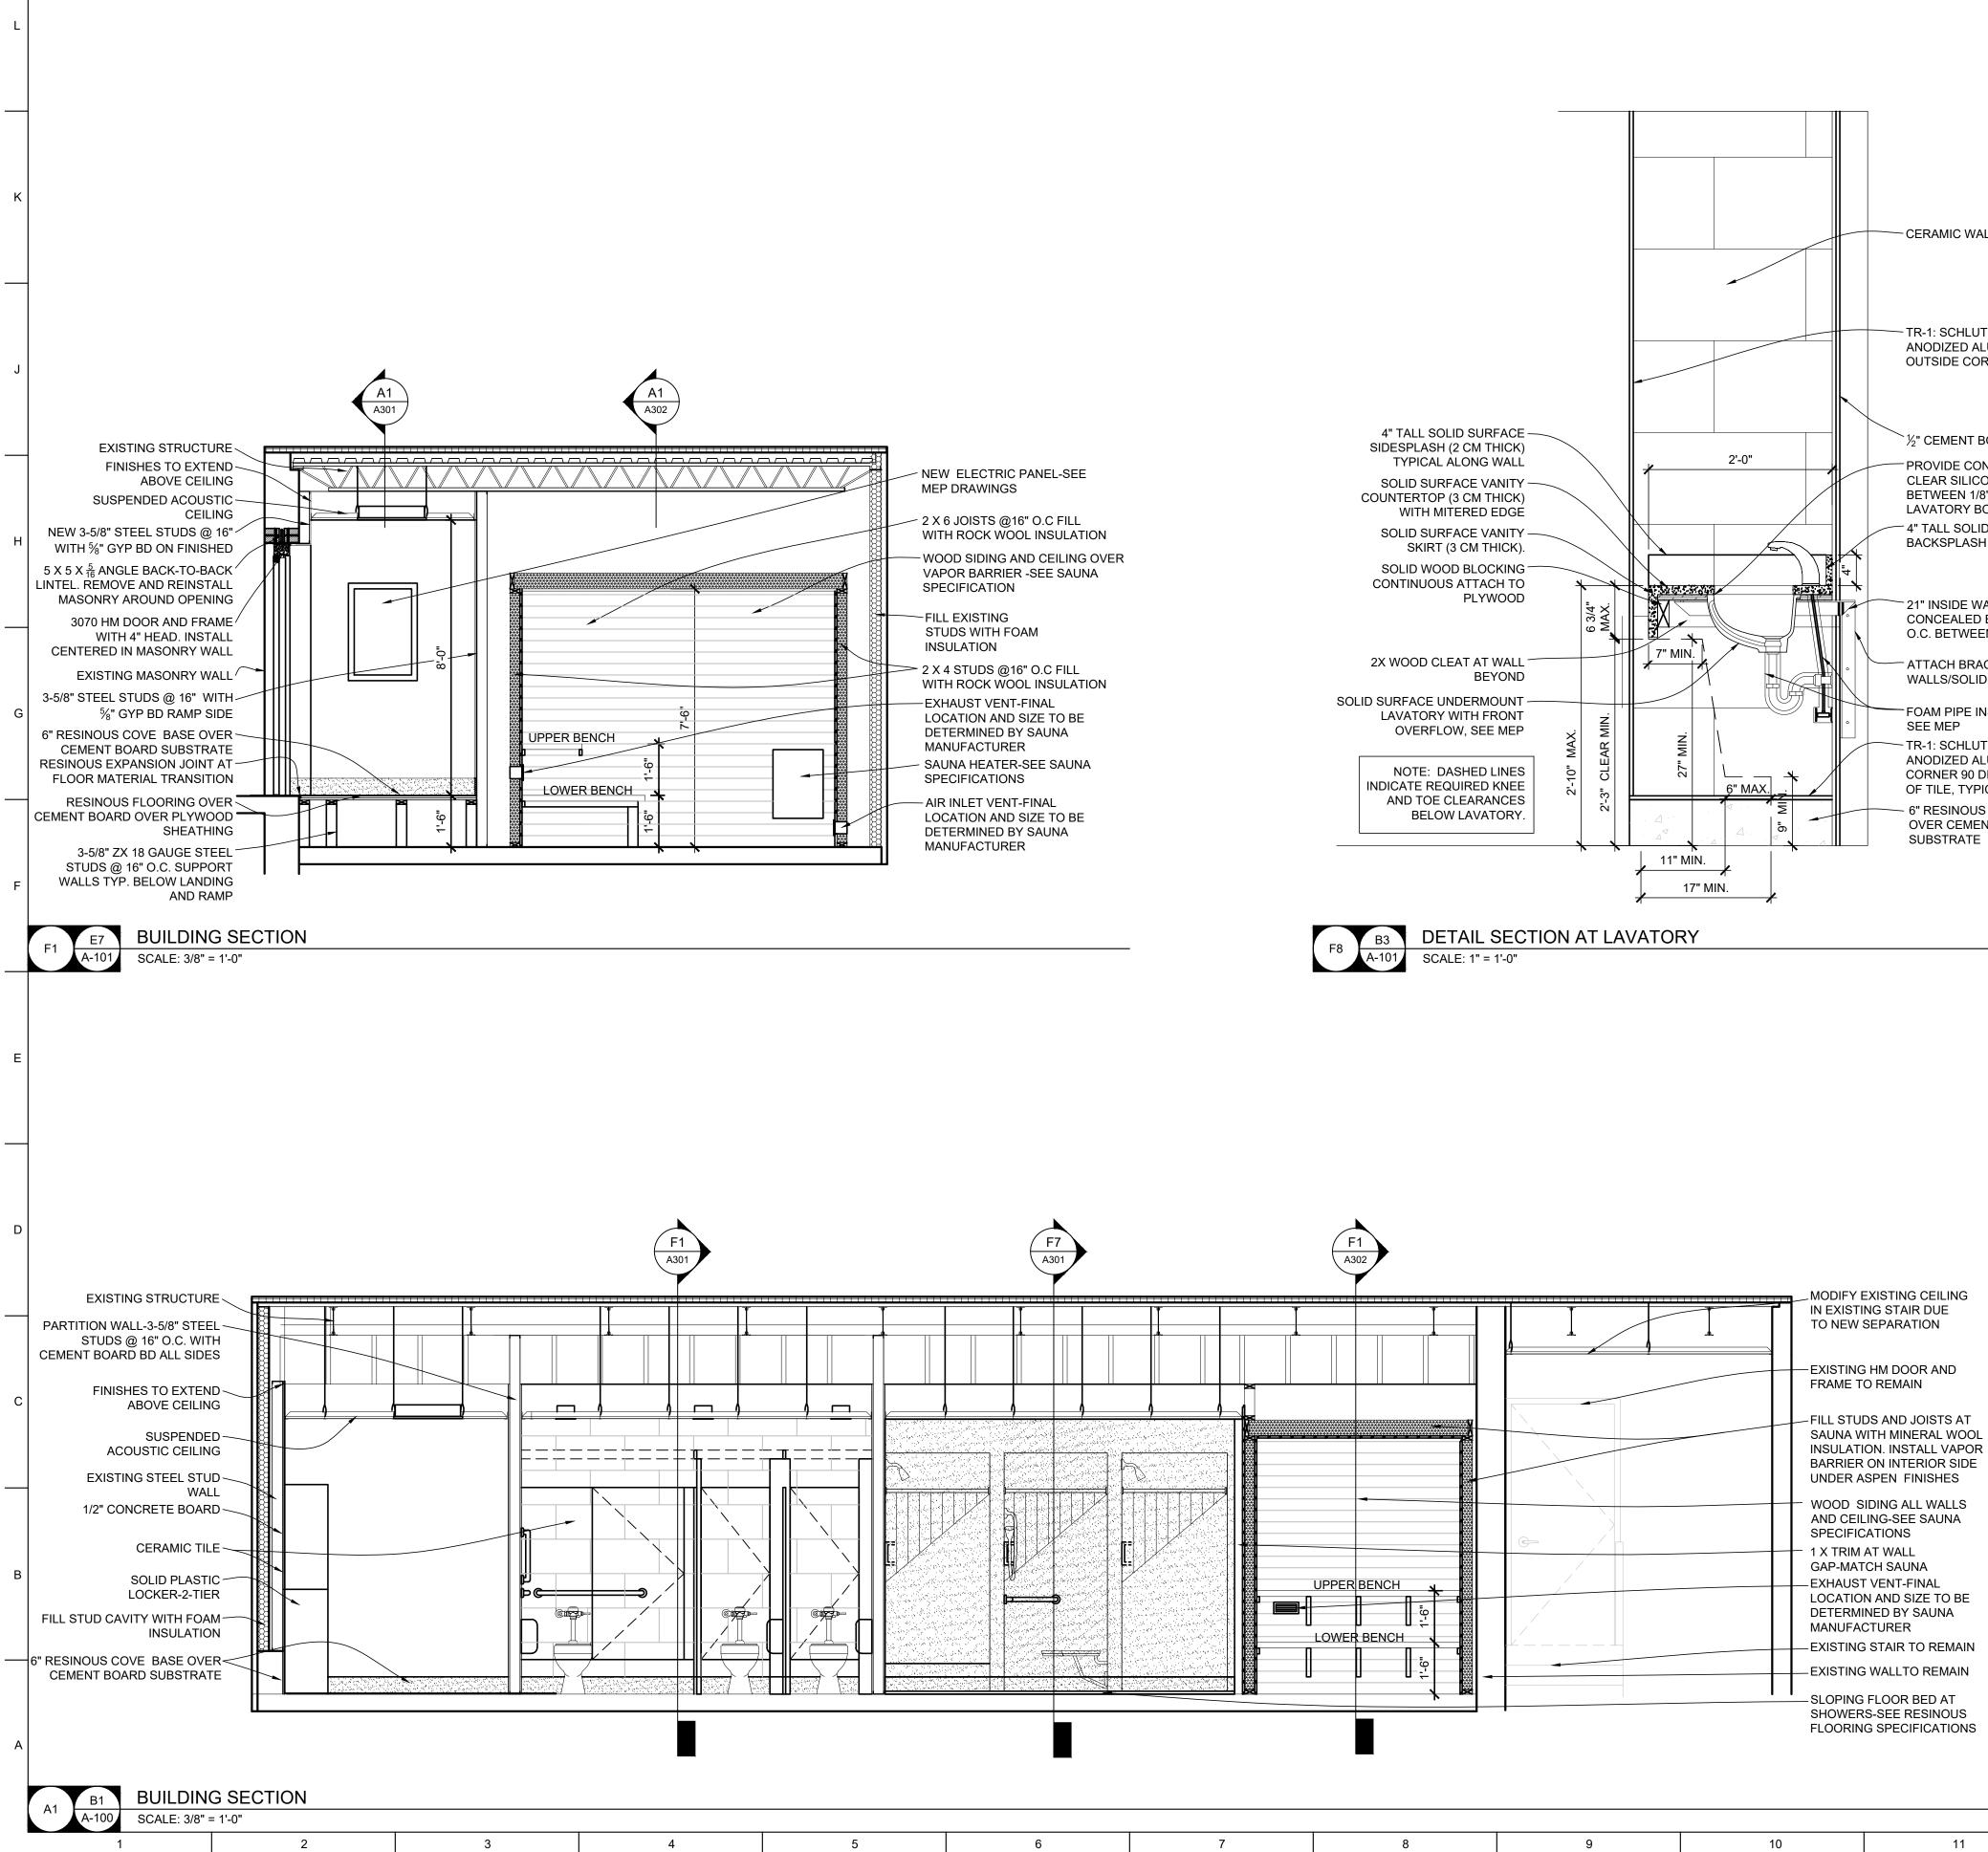

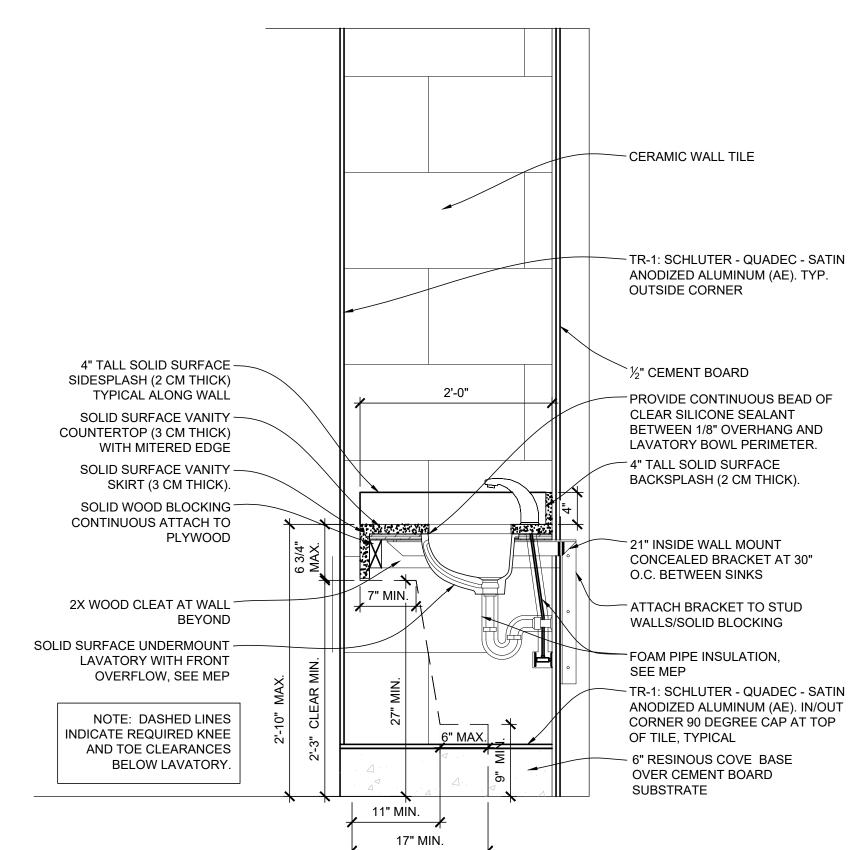






ERIK CHRISTOPHER MILLER MILLER	
HRISTUPHER MILLER MILLER	7
HUY WAINTED TO	
A-7070 RED ABCIT	-
09/1	7/2024
Peckham & Wright Architects, Inc., d.	b.a.
PWArchitects, In 2120 Forum Blvd., Ste. 101	C.
Columbia, Missouri 65203 PWArchitects.com 573.449.2683 Peckham & Wright Architects an Architectural Cor	
Missouri State Certificate of Authority No.	000244
OFFICE OF	
ADMINISTRATION DIVISION OF	
FACILITIES	
MANAGEMENT, DESIGN AND	
CONSTRUCTION	
RENOVATE WOMEN	S
LOCKER ROOM, ACADEMY PHYSICA	т
TRAINING BUILDING	
MSHP GENERAL HEA	AD-
QUARTERS COMPLE	
1510 E ELM ST	\mathbf{c}
JEFFERSON CITY, M	J
PROJECT # R2402-01	l
SITE # 6001	
ASSET # 81360010)03
REVISION:	
DATE: REVISION: DATE:	
DATE: REVISION: DATE:	
ISSUE DATE: 09/17/2024	
CAD DWG FILE <u>:R2402-CD</u> DRAWN BY: <u>AB/EM</u>	
CAD DWG FILE:R2402-CD	
CAD DWG FILE: <u>R2402-CD</u> DRAWN BY: <u>AB/EM</u> CHECKED BY: EM	
CAD DWG FILE:R2402-CD DRAWN BY: <u>AB/EM</u> CHECKED BY: <u>EM</u> DESIGNED BY: <u>AB/EM</u> SHEET TITLE:	\TT \$
CAD DWG FILE:R2402-CD DRAWN BY: <u>AB/EM</u> CHECKED BY: <u>EM</u> DESIGNED BY: <u>AB/EM</u>	AILS
CAD DWG FILE:R2402-CD DRAWN BY: <u>AB/EM</u> CHECKED BY: <u>EM</u> DESIGNED BY: <u>AB/EM</u> SHEET TITLE:	AILS
CAD DWG FILE:R2402-CD DRAWN BY: <u>AB/EM</u> CHECKED BY: <u>EM</u> DESIGNED BY: <u>AB/EM</u> SHEET TITLE:	AILS
CAD DWG FILE:R2402-CD DRAWN BY: <u>AB/EM</u> CHECKED BY: <u>EM</u> DESIGNED BY: <u>AB/EM</u> SHEET TITLE:	AILS
CAD DWG FILE:R2402-CD DRAWN BY: <u>AB/EM</u> CHECKED BY: <u>EM</u> DESIGNED BY: <u>AB/EM</u> SHEET TITLE: SECTION DETA	


09/17/2024


DOOR SCHEDULE								ME	E S	CHE	ΞC	DULE	HDWR	FIRE RATING	F		
DOOR NO.	DOOR NO. DOOR LEAF SIZE W X H MATERIAL						M	ATEI	RIAL				DETAILS		HARDWARE GROUP		
		DOOR ELEVATION	MOOD	HOLLOW METAL		FRAME ELEVATION	MOOD	HOLLOW METAL				HEAD	JAMB	SILL			
101	3'-0" X 7'-0"	D1		\mathbf{X}		F1		\mathbf{X}				A12 / A-601	A12 / A-601		1		SE
101	3'-0" X 6'-8"	D2	\boxtimes			 F2	\bowtie										SE

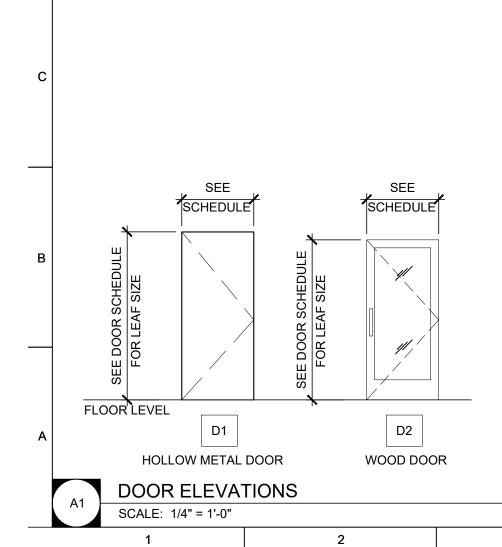

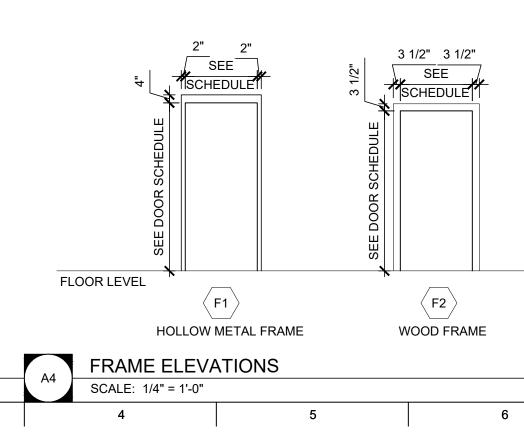

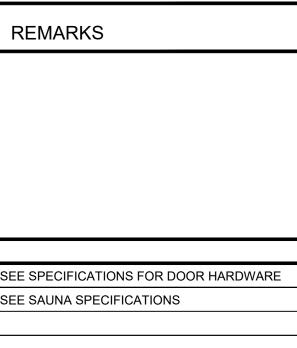


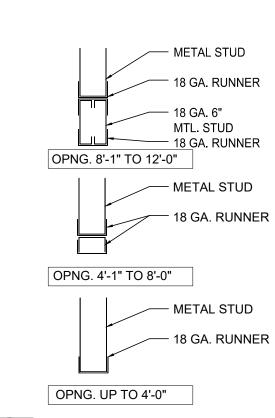

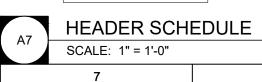

8

A7

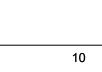

9




11

12

GENERAL DOOR DETAIL NOTES

- 1. FIELD VERIFY ALL DIMENSIONS AND CONDITIONS PRIOR TO EXECUTING ANY WORK. NOTIFY ARCHITECT OF ANY DIMENSIONS OR WORK DIFFERING FROM THAT SHOWN, FOR CLARIFICATION BY THE ARCHITECT PRIOR TO PROCEEDING WITH WORK.
- 2. VERIFY ALL ROUGH OPENINGS FOR DOORS, WINDOWS, EQUIPMENT, & OTHER "BUILT-IN" ITEMS PRIOR TO EXECUTION OF ANY WORK AFFECTED BY SAME.
- 3. SEE DOOR SCHEDULE AND DETAILS FOR DOOR DIMENSIONS AND DETAILS.

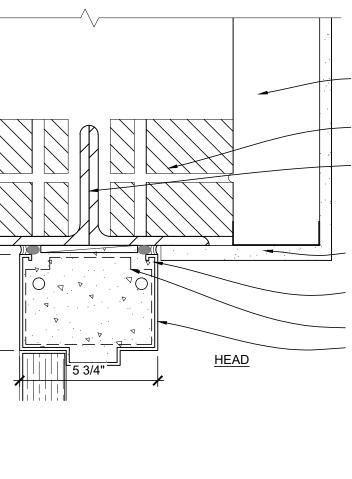


- EXISTING MASONRY WALL

MASONRY AROUND OPENING

5%" GYP BD. - PAINT

1/4" TOOLED SEALANT EA. SIDE - FRAME ANCHOR - H.M. FRAME -GROUT SOLID

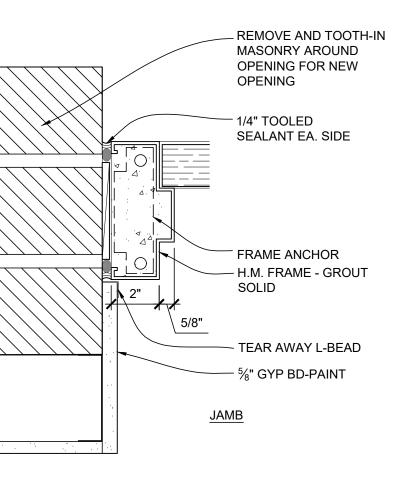

14

15

13

THE MISS
ERIK DE

STATE OF MISSOURI

MICHAEL L. PARSON,

GOVERNOR

09/17/2024



Peckham & Wright Architects, Inc., d.b.a. PWArchitects, Inc. 2120 Forum Blvd., Ste. 101 Columbia, Missouri 65203 PWArchitects.com | 573.449.2683

Peckham & Wright Architects an Architectural Corporation Missouri State Certificate of Authority No. 000244

OFFICE OF ADMINISTRATION **DIVISION OF** FACILITIES MANAGEMENT, **DESIGN AND** CONSTRUCTION

RENOVATE WOMENS LOCKER ROOM, ACADEMY PHYSICAL TRAINING BUILDING

MSHP GENERAL HEAD-QUARTERS COMPLEX 1510 E ELM ST JEFFERSON CITY, MO

PROJECT # R2402-01 SITE # 6001 ASSET # 8136001003

REVISION: DATE: **REVISION:** DATE: **REVISION:** DATE: ISSUE DATE: 09/17/2024

CAD DWG FILE:R2402-CD DRAWN BY: <u>AB/EM</u> CHECKED BY: <u>EM</u> DESIGNED BY: AB/EM

SHEET TITLE: DOOR SCHEDULE DOOR DETAILS

SHEET NUMBER:

A-60 10 OF 17 SHEETS 09/17/2024

GENERAL MEP SPECIFICATIONS

1.	GENERAL
1.1.	ALL WORK SHALL BE PERFORMED IN COMPLIANCE WITH LOCALLY ADOPTED CODES AND
	ORDINANCES.
1.2	. IT IS THE RESPONSIBILITY OF CONTRACTOR TO REVIEW AND UNDERSTAND ALL DRAWINGS
	AND SPECIFICATIONS IN CONTRACT DOCUMENTS. EACH CONTRACTOR IS RESPONSIBLE FOR
	ALL WORK ASSOCIATED WITH THEIR TRADE, REGARDLESS OF WHERE WORK IS DEPICTED IN
	PROJECT DRAWINGS OR SPECIFICATIONS.
1 2	I AVOUT OF SVSTEMS SHOWN ON DI ANS ADE ADDOVIMATE AND SCHEMATIC IN NATIDE

- LAYOUT OF SYSTEMS SHOWN ON PLANS ARE APPROXIMATE AND SCHEMATIC IN NATURE. 1.3. ALL SYSTEMS WILL NEED TO BE FIELD-COORDINATED. CONTRACTOR SHALL INCLUDE THIS COORDINATION IN THEIR SCOPE AND INCLUDE ALL COSTS OF MODIFYING LAYOUT AS REQUIRED IN THEIR BID. PLANS ARE NOT INTENDED TO BE SHOP DRAWINGS FROM WHICH MATERIALS CAN BE ORDERED, FABRICATED, OR INSTALLED WITHOUT ADDITIONAL FIELD MEASUREMENTS AND COORDINATION.
- 1.4. NOT ALL SPECIFIC PIECES AND COMPONENTS OF EACH SYSTEM ARE DETAILED OR OUTLINED ON PLANS. CONTRACTOR IS RESPONSIBLE FOR PROVIDING ALL NECESSARY PARTS AND LABOR TO PRODUCE A COMPLETE AND FULLY OPERATIONAL SYSTEM UNLESS STATED OTHERWISE ON PLANS. CONTRACTOR IS TO PROVIDE AND INCLUDE ALL EQUIPMENT AND MATERIAL NEEDED TO COMPLETE WORK ASSOCIATED WITH THEIR BID UNLESS ANY ITEMS ARE SPECIFICALLY NOTED ON PLANS AS PROVIDED BY OTHERS. ALL MATERIALS TO BE NEW, FIRST CLASS, AND INSTALLED PER MANUFACTURER'S PUBLISHED INSTRUCTIONS.
- 1.5. WHERE CONFLICTS EXIST BETWEEN MEP PLANS AND CIVIL, ARCHITECTURAL, OR STRUCTURAL PLANS, NOTIFY MEP ENGINEER OF DISCREPANCIES FOR CLARIFICATION PRIOR TO PERFORMING ANY WORK THAT MAY CONTRADICT INFORMATION ELSEWHERE IN THE PROJECT PLANS.
- THESE PLANS ARE NOT TO BE SCALED. SEE ARCHITECTURAL PLANS FOR DIMENSIONS. 1.6. WHERE THERE IS A CONFLICT BETWEEN ARCHITECTURAL DIMENSIONS AND MEP DIMENSIONS, ARCHITECTURAL SHALL GOVERN.
- CONTRACTOR IS TO INCLUDE IN THEIR SCOPE THE COST OF ALL PERMITS, INSPECTIONS, 1.7. METERING, TAPS, ETC. ASSOCIATED WITH THEIR WORK.
- CONTRACTOR IS RESPONSIBLE FOR ALL EXCAVATION, CUTTING, CORING, PATCHING, AND 1.8. BACKFILL REQUIRED TO COMPLETE THEIR WORK, UNLESS NOTED OTHERWISE ON PLANS.
- SPECIFIC EQUIPMENT MANUFACTURERS AND/OR MODEL NUMBERS LISTED ON PLANS ARE 1.9. TO ESTABLISH A BASIS-OF-DESIGN FOR QUALITY AND PERFORMANCE, VERIFY THAT SUBSTITUTIONS WILL BE ACCEPTABLE PRIOR TO PURCHASE & INSTALLATION.
- 1.10. NOTIFY ENGINEER OF ANY MAJOR PLAN DISCREPANCIES OR CONFLICTS PRIOR TO PROVIDING BIDS OR COMPLETING ANY WORK.
- 1.11. SEE DISCIPLINE SHEETS FOR ADDITIONAL TRADE SPECIFIC SPECIFICATIONS. 1.12. WHERE SHUTDOWN OF ANY EXISTING UTILITY OR SERVICE TO BUILDING IS REQUIRED FOR COMPLETION OF WORK, COORDINATE OUTAGE WITH OWNER AS TO NOT DISRUPT TYPICAL OPERATIONS.

2. WORKMANSHIP

- SYSTEMS SHALL BE INSTALLED IN A FIRST-CLASS MANNER USING BEST ACCEPTABLE 2.1. METHODS AND PRACTICES. ALL SYSTEMS SHALL BE INSTALLED PARALLEL OR PERPENDICULAR TO BUILDING 2.2.
- ORIENTATION. COMPONENTS SHALL BE INSTALLED LEVEL AND PLUMB WITH ATTENTION GIVEN TO OVERALL AESTHETICS.
- CONTRACTOR IS RESPONSIBLE FOR COORDINATING EQUIPMENT LOCATIONS AND SYSTEM 2.3. ROUTING WITH OTHER TRADES PRIOR TO INSTALLATION. CONTRACTOR TO GUARANTEE ALL MATERIALS AND WORKMANSHIP FOR A PERIOD OF ONE 2.4. YEAR FROM THE DATE THE COMPLETED PROJECT IS RELEASED TO THE OWNER, UNLESS
- NOTED OTHERWISE ON PLANS. DURING INSTALLATION OF MATERIALS OR ACTIVITIES IN NEW WORK SCOPE, AVOID 2.5. DAMAGING EXISTING SURFACES AND EQUIPMENT TO REMAIN. ANY DAMAGE TO EXISTING SURFACES OR EQUIPMENT SHALL BE CORRECTED AT NO COST TO OWNER.


MEP DEMOLITION PLAN GENERAL NOTES:

- OTHER WORK SEQUENCES.
- 2. REMOVE ALL ABANDONED ITEMS (VENTS, CONDUITS, PIPES, DUCTS, CURBS, ETC) AS NOTED. 3. CONTRACTOR SHALL PATCH HOLE WHERE PIPES ARE DEMOLISHED.

MEP DEMOLITION PLAN KEY NOTES:

- (1) DEMOLISH EXISTING HAND DRYER, REMOVE CONDUIT & CONDUCTORS BACK TO PANEL.
- (2) DEMOLISH EXISTING LIGHT FIXTURE, REMOVE CONDUCTORS BACK TO NEAREST J-BOX.
- (3) DEMOLISH EXISTING VAV UNIT & ASSOCIATED DUCTWORK. REMOVE CONDUCTORS BACK TO PANEL.
- (4) DEMOLISH EXISTING PLUMBING FIXTURE.
- (5) DEMOLISH EXISTING LIGHT SWITCH & REMOVE CONDUCTORS BACK TO NEAREST J-BOX.
- (6) DEMOLISH EXISTING RECEPTACLE & REMOVE CONDUCTORS BACK TO NEAREST J-BOX.

1. CONTRACTOR SHALL COORDINATE ALL DEMOLITION & REMOVAL OF DEMOLITION MATERIALS WITH

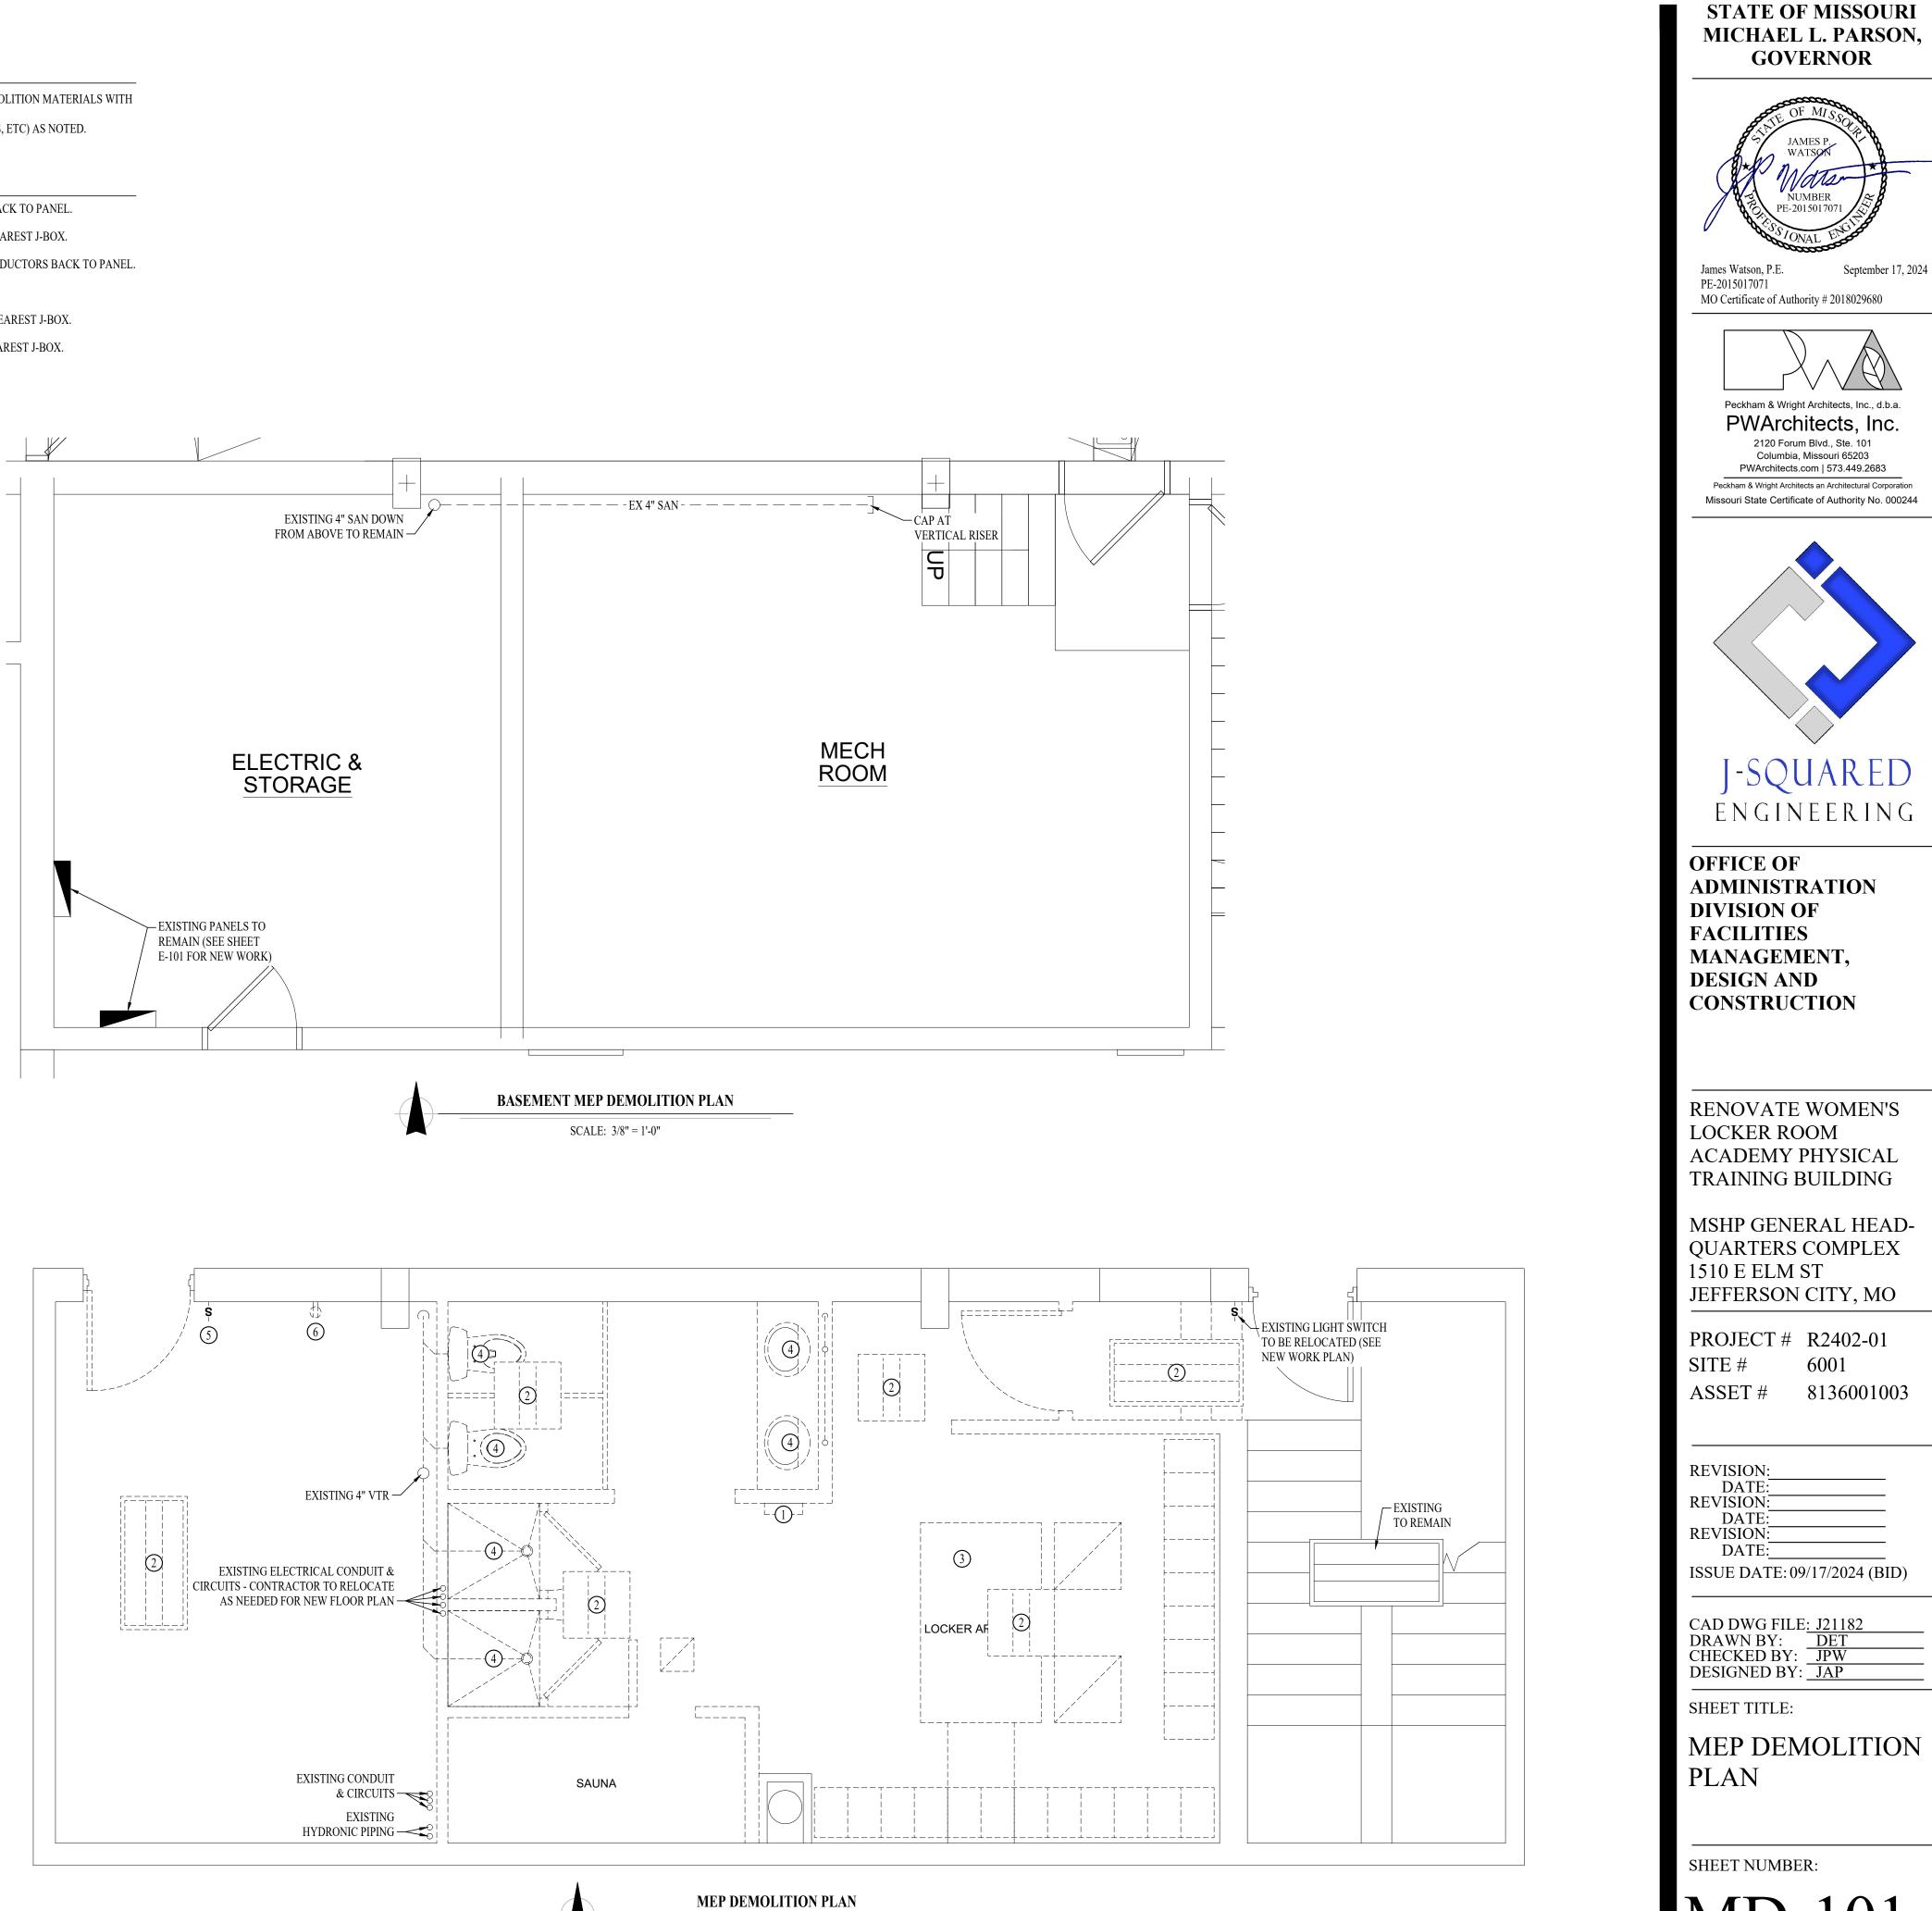

SCALE: 3/8" = 1'-0"

11 OF 17 SHEETS 09/17/2024 (BID)

HVAC PLAN SYMBOL LEGEND

<u> </u>	EQUIPMENT TYPE (REFER TO EQUIPMENT SCHEDULE)
#	EQUIPMENT REFERENCE NUMBER
<u> </u>	DIFFUSER/GRILLE TYPE (REFER TO SCHEDULE)
#	CUBIC FEET PER MINUTE (CFM) / FACE SIZE
	SUPPLY DUCTWORK
	RETURN DUCTWORK
	EXHAUST DUCTWORK
	OUTSIDE AIR DUCTWORK
~~~~~~	FLEX DUCT
	VENT / COMBUSTION AIR
$\left( \star \right)$	TIE INTO EXISTING
	SUPPLY DIFFUSER (HATCH INDICATES "NO FLOW ZONE")
	RETURN DIFFUSER
Γ	BALANCE DAMPER
∑	MOTORIZED DAMPER
ບ <u></u>	CEILING RADIATION DAMPER
ш <u> </u>	FIRE RATED DAMPER
<b>S</b>	SMOKE DAMPER
	THERMOSTAT
CO2	CO2 DETECTOR
09	RETURN DUCT SMOKE DETECTOR WIRED TO FAN STARTER TO SHUT UNIT(S) DOWN AND SEND ALARM SIGNAL TO FIRE ALARM SYSTEM (IF PRESENT) OR TO REMOTE SOUNDER LOCATED IN AN OCCUPIED SPACE (EQUAL TO SYSTEM SENSOR #D4120)
$\langle \! \! \! \! \! \! \! \! \! \! \! \! \! \! \! \! \! \! \!$	DUCT TEMPERATURE SENSOR WIRED TO BAS

#### HVAC PLAN GENERAL NOTES:

1. SEE SHEET M-501 FOR ADDITIONAL HVAC NOTES, DETAIL, AND SCHEDULES.

- FAN TERMINAL UNIT (FTU) SHALL BE WIRED INTO EXISTING BAS. 3. CONTROLS CONTRACTOR (JOHNSON CONTROLS CONTACT BOB WINKLEMAN) SHALL PROVIDE ALL CONTROL VALVES, SENSORS, WIRING, THERMOSTAT, & CONTROL BOARD AS NECESSARY TO
- INTERFACE WITH EXISTING HVAC CONTROLS.
- 4. MECHANICAL CONTRACTOR SHALL INCLUDE CONTROL WORK IN THEIR SCOPE. 5. ALL DUCTWORK IS ABOVE CEILING. CONTRACTOR SHALL MODIFY DUCT AS NECESSARY TO MOUNT DUCT ABOVE CEILING & AVOID EXISTING BUILDING COMPONENTS.

#### HVAC PLAN KEY NOTES:

(1) TIE INTO EXISTING 1" HYDRONIC SUPPLY & RETURN THIS APPROXIMATE LOCATION.


- (2) UNIT MOUNTED ABOVE CEILING. INSTALL PER MANUFACTURER'S INSTALLATION INSTRUCTIONS.
- (3) WIRE MOTORIZED OUTSIDE AIR DAMPER TO BAS. DAMPER SHALL OPEN WHEN EXHAUST FAN (EF-1) IS ON.


(4) BALANCE TO 450 CFM.

(5) BALANCE TO 150 CFM.


(6) PROVIDE 6x6 INLET VENT PER SAUNA MANUFACTURER'S INSTALLATION INSTRUCTIONS.

(7) PROVIDE 6x6 OUTLET VENT PER SAUNA MANUFACTURER'S INSTALLATION INSTRUCTIONS.

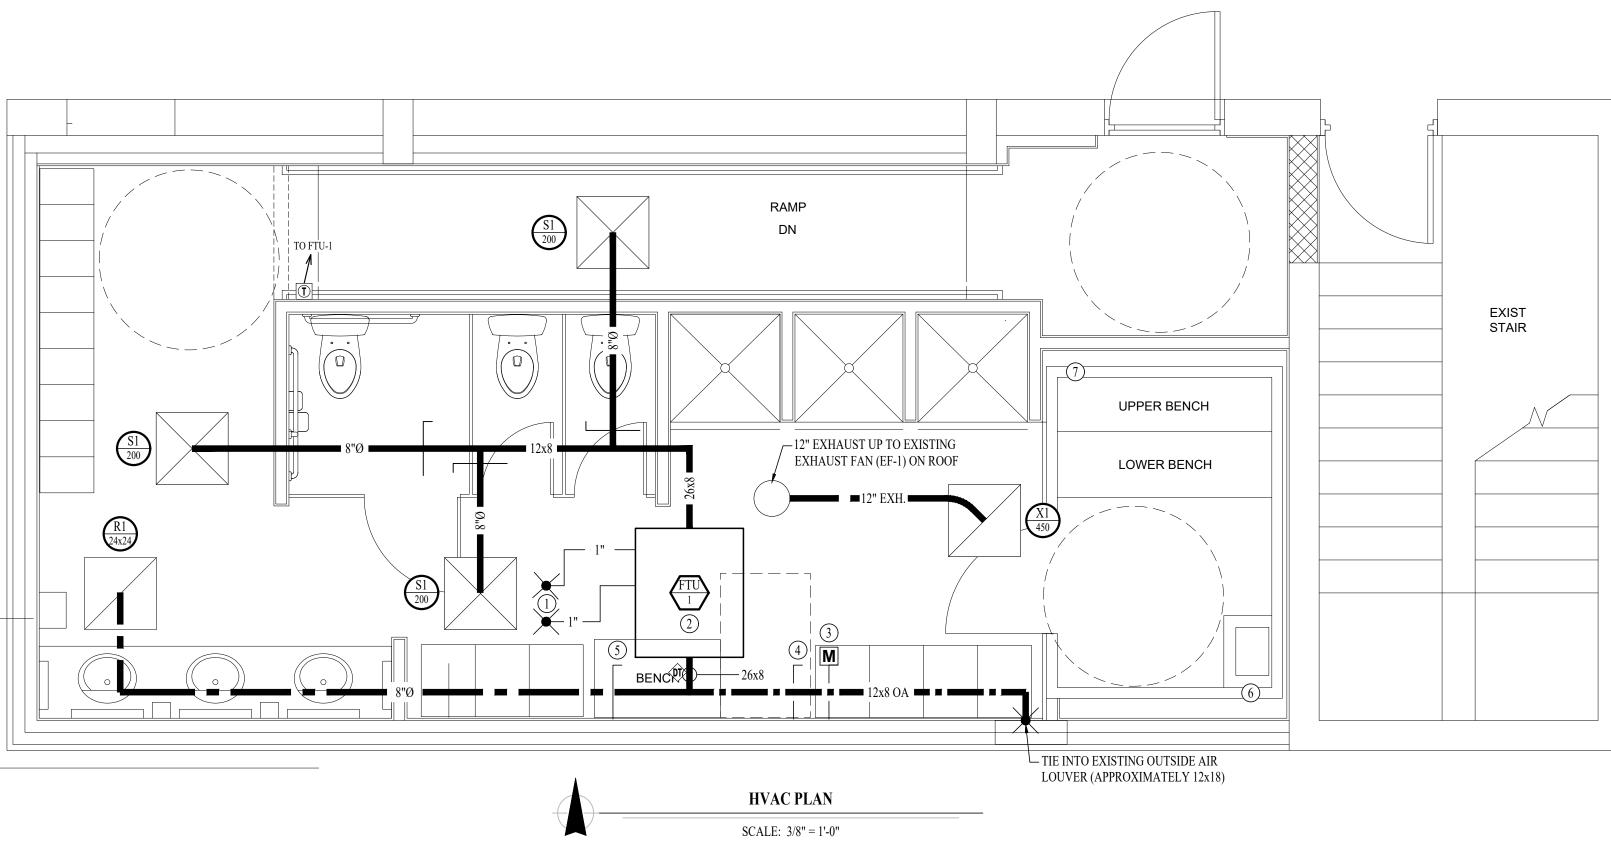

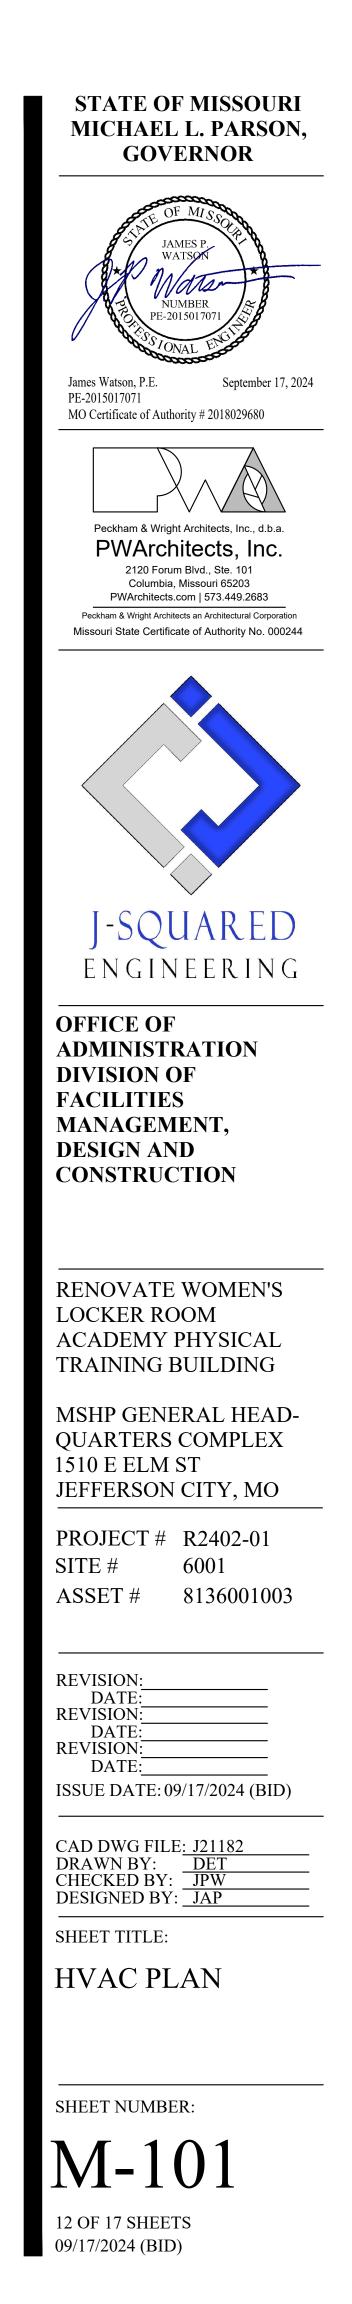

#### HVAC SPECIFICATIONS

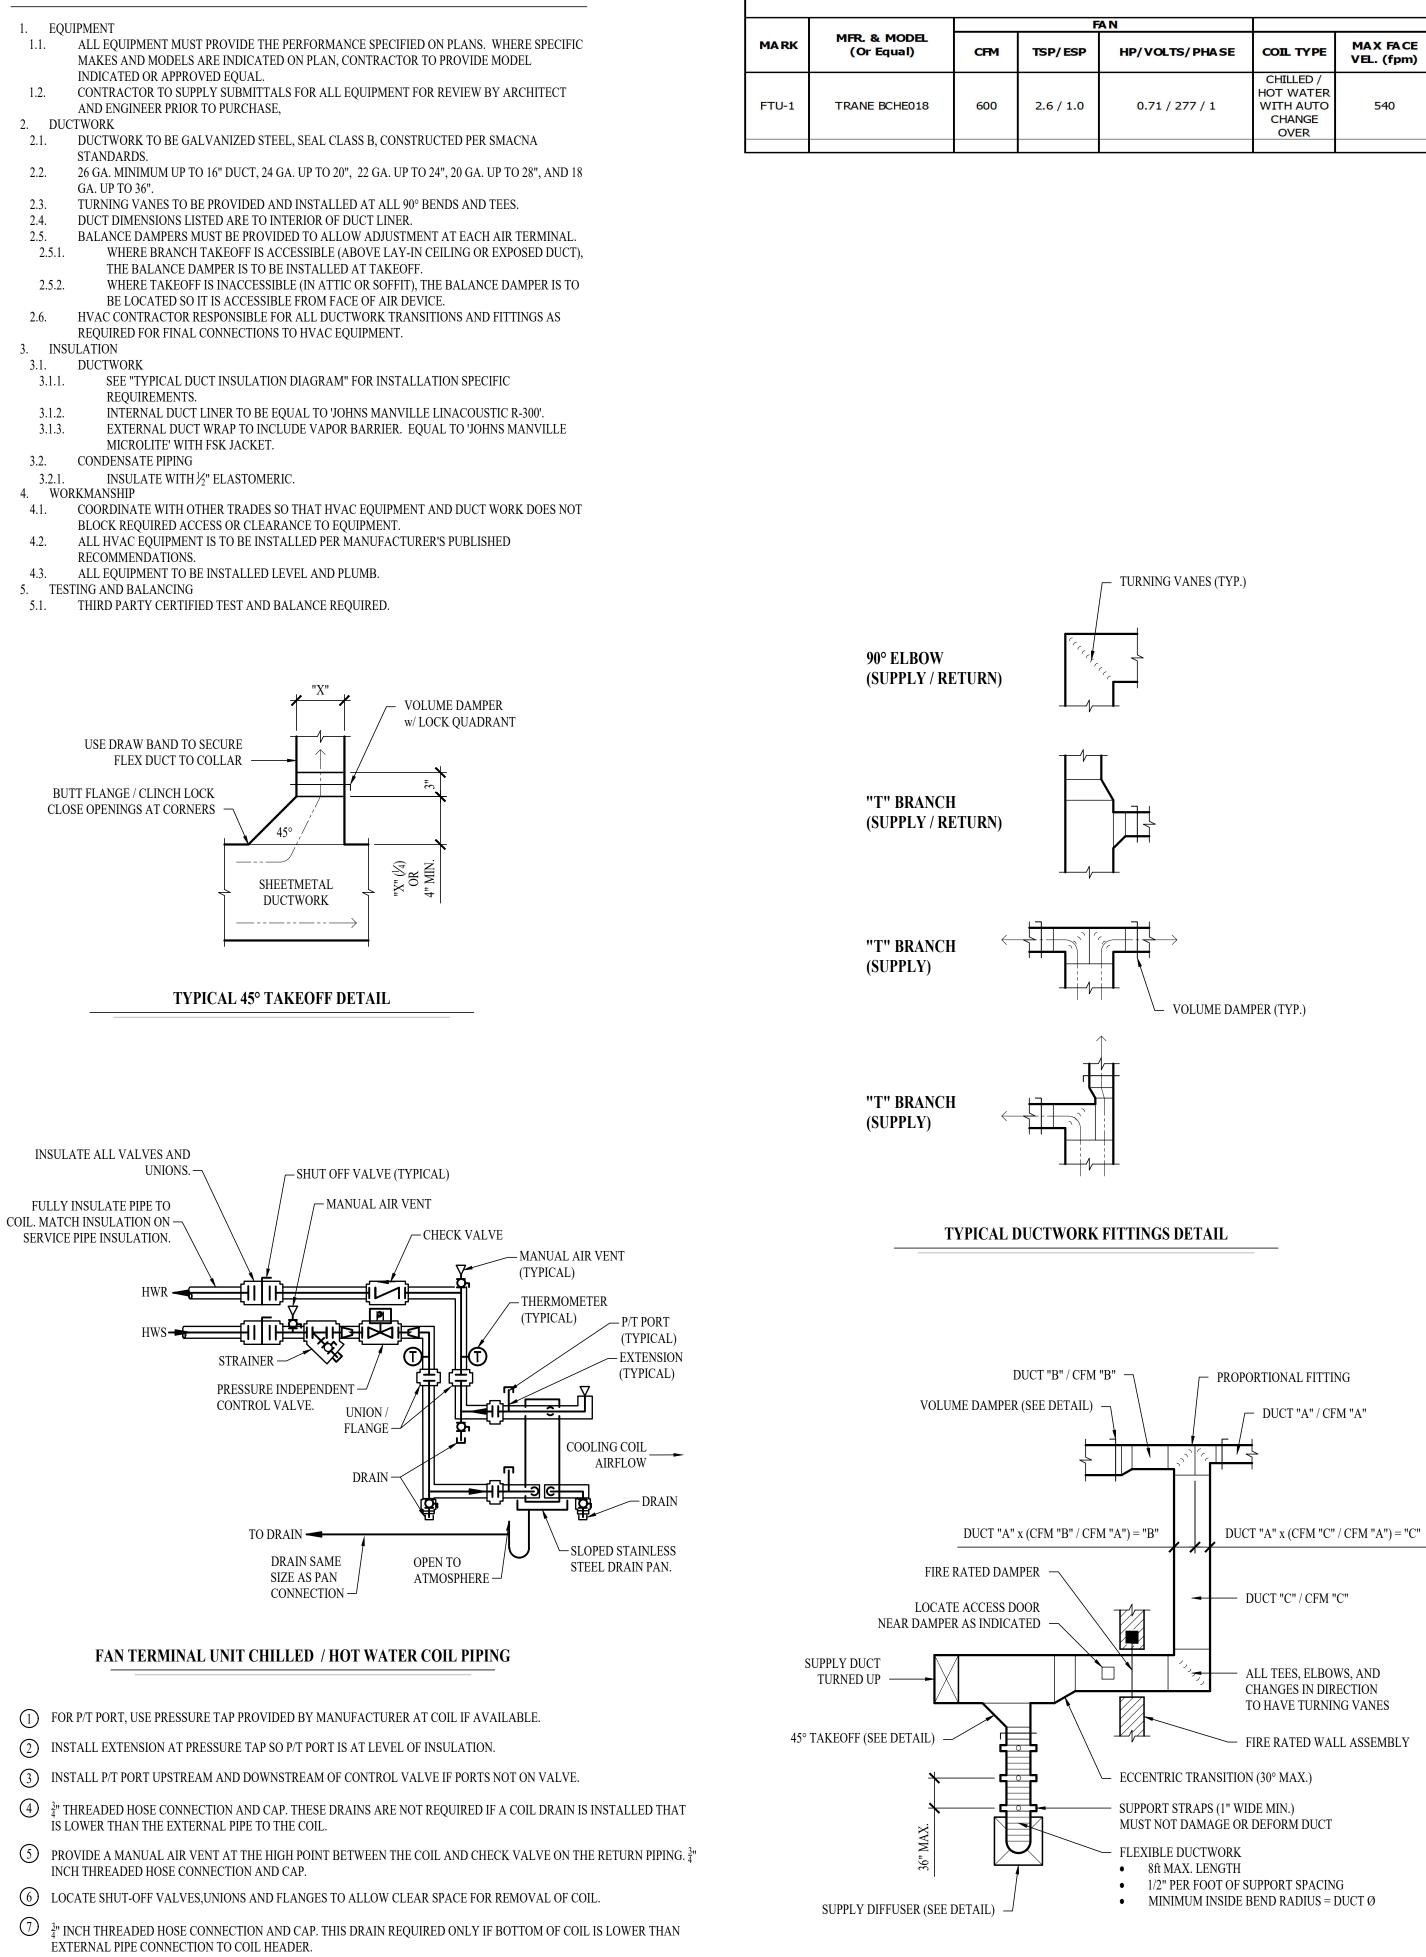

- $\bigcirc$   $\frac{3}{4}$ " INCH THREADED HOSE CONNECTION AND CAP. THIS DRAIN REQUIRED ONLY IF BOTTOM OF COIL IS LOWER THAN
- (8) PROVIDE A MANUAL AIR VENT AT THE HIGH POINT BETWEEN THE SHUT OFF VALVE AND STRAINER ON THE SUPPLY PIPING. 3/4 INCH THREADED HOSE CONNECTION AND CAP.

		FAN TERMINAL UNIT SCHEDULE																			
	Fi	AN		COOLING PERFORMA NCE										HEA TING PERFORMA NCE							
	TSP/ ESP	HP/VOLTS/PHASE	COIL TYPE	MAX FACE VEL. (fpm)	APD (in. wc.)			EAT°F DB/WB			LWT °F DB/WB	WATER ΔP (ft.)	FLOW (gpm)	MAX FACE VEL.	APD (in. wc.)	САРАСІТҮ МВН	EWT °F DB/WB	PERFECTIVE ACTIVE AND ADDRESS AND ADDRESS ADDRES	WATER ΔP (ft.)		REMARKS
	2.6 / 1.0	0.71 / 277 / 1	CHILLED / HOT WATER WITH AUTO CHANGE OVER	540	1.4	50.8	27.2	95 / 78	54	44	60	21.7	6.3	540	1.9	85.43	120	60	1.9	2.8	PROVIDED WITH VARIABLE SPEED ECM FAN AND WITHOUT UNIT CONTROLLER
T																					

DIFFUSER NECK SIZING SCHEDULE									
A IRFLOW (CFM)	NECK SIZE (in)								
0 - 120	6"								
120 - 210	8"								
210 - 325	10"								
325 - 470	12"								
470 - 640	14"								

	AIR DEVICE SCHEDULE										
TAG	SERVICE	MA NUFA CTURER (OR EQUA L)	MODEL (OR EQUAL)	SIZE	Color / Finish	NOTES					
S1	SUPPLY	PRICE	SPD	24x24	WHITE	SEE PLANS FOR AIRFLOW					
R1	RETURN	PRICE	80	AS INDICATED	WHITE						
X1	EXHAUST	PRICE	80	24x24	WHITE						

1. FAN COIL UNIT (TYPICAL OF 1)

**RUN CONDITIONS - SCHEDULED:** THE UNIT SHALL RUN ACCORDING TO A USER DEFINABLE TIME SCHEDULE IN THE

- FOLLOWING MODES:
- OCCUPIED MODE: THE UNIT SHALL MAINTAIN
- A 72°F (ADJ.) COOLING SETPOINT • A 74°F (ADJ.) HEATING SETPOINT.
- UNOCCUPIED MODE (NIGHT SETBACK): THE UNIT SHALL MAINTAIN
- A 75°F (ADJ.) COOLING SETPOINT. • A 70°F (ADJ.) HEATING SETPOINT.

#### ALARMS SHALL BE PROVIDED AS FOLLOWS: • HIGH ZONE TEMP: IF THE ZONE TEMPERATURE IS GREATER THAN THE COOLING SETPOINT BY A USER DEFINABLE AMOUNT (ADJ.). • LOW ZONE TEMP: IF THE ZONE TEMPERATURE IS LESS THAN THE HEATING

SETPOINT BY A USER DEFINABLE AMOUNT (ADJ.).

ZONE SETPOINT ADJUST: THE OCCUPANT SHALL BE ABLE TO ADJUST THE ZONE TEMPERATURE HEATING AND COOLING SETPOINTS AT THE ZONE SENSOR.

ZONE UNOCCUPIED OVERRIDE:

A TIMED LOCAL OVERRIDE CONTROL SHALL ALLOW AN OCCUPANT TO OVERRIDE THE SCHEDULE AND PLACE THE UNIT INTO AN OCCUPIED MODE FOR AN ADJUSTABLE PERIOD OF TIME. AT THE EXPIRATION OF THIS TIME, CONTROL OF THE UNIT SHALL AUTOMATICALLY RETURN TO THE SCHEDULE.

FREEZE PROTECTION: THE UNIT SHALL SHUT DOWN AND GENERATE AN ALARM UPON RECEIVING A

FREEZESTAT STATUS.

FAN: THE FAN SHALL RUN ANYTIME THE UNIT IS COMMANDED TO RUN, UNLESS SHUTDOWN ON SAFETIES.

#### COOLING COIL VALVE:

THE CONTROLLER SHALL MEASURE THE ZONE TEMPERATURE AND MODULATE THE COOLING / HEATING COIL VALVE TO MAINTAIN ITS SETPOINT.

- THE COOLING SHALL BE ENABLED WHENEVER: • OUTSIDE AIR TEMPERATURE IS GREATER THAN 60°F (ADJ.).
- AND THE ZONE TEMPERATURE IS ABOVE COOLING SETPOINT.

• AND THE FAN IS ON.

THE HEATING COIL VALVE SHALL OPEN WHENEVER THE FREEZESTAT IS ON.

## HEATING COIL VALVE:

THE CONTROLLER SHALL MEASURE THE ZONE TEMPERATURE AND MODULATE THE HEATING COIL VALVE TO MAINTAIN ITS HEATING SETPOINT.

#### THE HEATING SHALL BE ENABLED WHENEVER:

- OUTSIDE AIR TEMPERATURE IS LESS THAN 65°F (ADJ.). • AND THE ZONE TEMPERATURE IS BELOW HEATING SETPOINT.
- AND THE FAN IS ON.

THE HEATING COIL VALVE SHALL OPEN WHENEVER THE FREEZESTAT (IF PRESENT) IS ON.

MINIMUM OUTSIDE AIR VENTILATION - FIXED PERCENTAGE: THE OUTSIDE AIR DAMPER SHALL MAINTAIN A MINIMUM POSITION (ADJ.) WHEN EF-1 IS ON..

#### DISCHARGE AIR TEMPERATURE:


- THE CONTROLLER SHALL MONITOR THE DISCHARGE AIR TEMPERATURE.
- ALARMS SHALL BE PROVIDED AS FOLLOWS: • HIGH DISCHARGE AIR TEMP: IF THE DISCHARGE AIR TEMPERATURE IS
- GREATER THAN 120°F (ADJ.). • LOW DISCHARGE AIR TEMP: IF THE DISCHARGE AIR TEMPERATURE IS LESS THAN 40°F (ADJ.).

FAN STATUS:

**TYPICAL DUCTWORK DETAIL** 

- THE CONTROLLER SHALL MONITOR THE FAN STATUS.
- ALARMS SHALL BE PROVIDED AS FOLLOWS:
- FAN FAILURE: COMMANDED ON, BUT THE STATUS IS OFF.
- FAN IN HAND: COMMANDED OFF, BUT THE STATUS IS ON. • FAN RUNTIME EXCEEDED: FAN STATUS RUNTIME EXCEEDS A USER DEFINABLE LIMIT (ADJ.).

POINTS LIST													
	H/	RDWA	<b>RE POIN</b>	ITS	IS SOFTWARE POINTS								
POINT NA ME	AI	AO	BI	BO	AV	BV	LOOP	SCHEDULE	TREND	ALARM	<b>GRAPHIC</b>		
DISCHARGE AIR TEMP	Х								Х		Х		
ZONE SETPOINT ADJUST	Х										X		
ZONE TEMP	Х								Х		Х		
COOLING / HEATING VALVE		Х							Х		Х		
FAN STATUS			Х								Х		
FREEZESTAT			Х						Х	Х	Х		
ZONE OVERRIDE			Х						Х		X		
FAN START / STOP				Х					Х		Х		
COOLING SETPOINT					X				Х		Х		
HEATING SETPOINT					Х				Х		Х		
SCHEDULE								Х					
FAN FAILURE										Х			
FAN IN HAND										Х			
FAN RUNTIME EXCEEDED										Х			
HIGH DISCHARGE AIR TEMP										Х			
HIGH ZONE TEMP										Х			
LOW DISCHARGE AIR TEMP										Х			
LOW ZONE TEMP										Х			
MOTORIZED AIR DAMPER	Х								Х		Х		
MIXED AIR TEMP	Х								Х		Х		
ELECTRIC REHEAT STATUS			Х										
ELECTRIC REHEAT START / STOP				Х									
TOTALS	5	1	4	2	2	0	0	1	10	8	12		
TOTAL HARDWA	RE			12									
		ΤΟΤΑ	L SOFT	VARE						21			

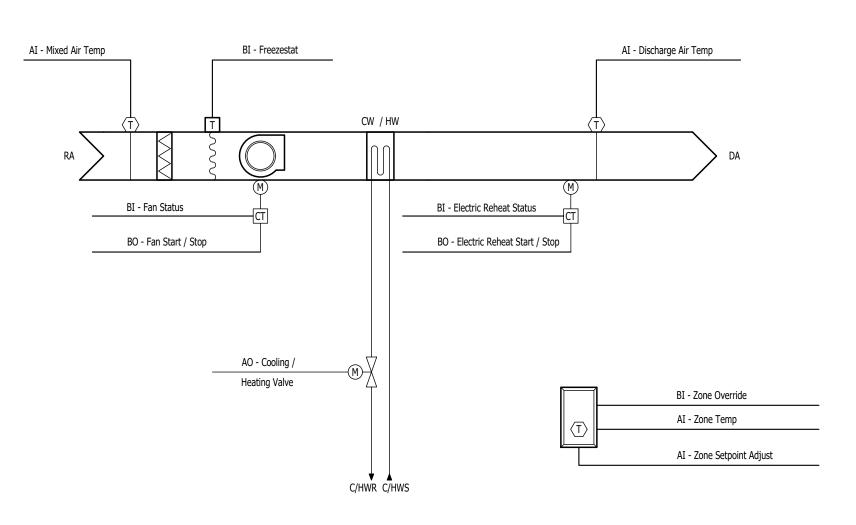

1. VERIFY AIR DEVICE FINISHES WITH OWNER/ARCHITECT PRIOR TO INSTALLATION

FAN TERMINAL UNIT SCHEMATIC

STATE OF MISSOURI MICHAEL L. PARSON, GOVERNOR
NUMBER PE-2015017071
James Watson, P.E. September 17, 2024 PE-2015017071 MO Certificate of Authority # 2018029680
Peckham & Wright Architects, Inc., d.b.a. <b>PWArchitects, Inc.</b> 2120 Forum Blvd., Ste. 101 Columbia, Missouri 65203 PWArchitects.com   573.449.2683 Peckham & Wright Architects an Architectural Corporation Missouri State Certificate of Authority No. 000244
J-SQUARED ENGINEERING OFFICE OF
ADMINISTRATION DIVISION OF FACILITIES MANAGEMENT, DESIGN AND CONSTRUCTION
RENOVATE WOMEN'S LOCKER ROOM ACADEMY PHYSICAL TRAINING BUILDING
MSHP GENERAL HEAD- QUARTERS COMPLEX 1510 E ELM ST JEFFERSON CITY, MO
PROJECT #R2402-01SITE #6001ASSET #8136001003
REVISION: DATE: REVISION: DATE: REVISION: DATE: DATE: ISSUE DATE: 09/17/2024 (BID)
CAD DWG FILE: J21182 DRAWN BY: <u>DET</u> CHECKED BY: JPW DESIGNED BY: JAP SHEET TITLE:
HVAC DETAILS & SCHEDULES
SHEET NUMBER:
M-501 13 OF 17 SHEETS 09/17/2024 (BID)

#### POWER PLAN SYMBOL LEGEND

	CIRCUIT WIRING
──> PX-XX	CIRCUIT TAG
J	JUNCTION BOX
XX +42	RECEPTACLE INDICATES MOUNTING HEIGHT TO BOTTOM OF BOX (STANDARD @ 18" AFF UNLESS NOTED OTHERWISE) "WP" = WEATHERPROOF OUTDOOR RECEPTACLE "AW" = ABOVE WINDOW RECEPTACLE "AC" = ABOVE CEILING RECEPTACLE "EX" = EXISTING RECEPTACLE TO REMAIN
P	GFCI DUPLEX CONVENIENCE RECEPTACLE
•	208V RECEPTACLE
$\blacksquare$	QUADPLEX CONVENIENCE RECEPTACLE
$\mathbf{V}$	DATA / PHONE JACK BOX WITH 1" CONDUIT & PULL STRING) UP TO CEILING SPACE (STANDARD @ 18" AFF UNLESS NOTED OTHERWISE)
D	DISCONNECT
FD	FUSED DISCONNECT
FS	FUSED SWITCH
SD	STARTER / DISCONNECT
$\left  \right\rangle$	TIE INTO EXISTING

#### POWER PLAN KEY NOTES:

1) POWER FOR SAUNA HEATER.

(2) POWER FROM CB BOX (SUPPLIED WITH SAUNA) TO HEATER. ROUTE CABLE BEHIND WALL OF SAUNA.

(3) SAUNA CONTROL WIRING FROM SAUNA CONTROLLER TO CB BOX BELOW LOWER BENCH. ROUTE

WIRING OUTSIDE OF SAUNA ROOM.

(4) CB BOX LOCATED BELOW LOWER BENCH (PROVIDED & INSTALLED BY SAUNA INSTALLER).
 (5) SAUNA TEMPERATURE SENSOR MOUNTED 3" BELOW CEILING ABOVE HEATER. WIRING SHALL RUN FROM SENSOR TO CB BOX. WIRING SHALL BE ROUTED OUTSIDE OF SAUNA ROOM.


(6) J-BOX ABOVE LAY-IN CEILING FOR POWER TO CARD READER.


(7) POWER FOR HAND DRYER.


#### SECURITY PLAN SYMBOL LEGEND

R	READER
ES	ELECTRIC STRIKE


ELECTRIC STRIKE

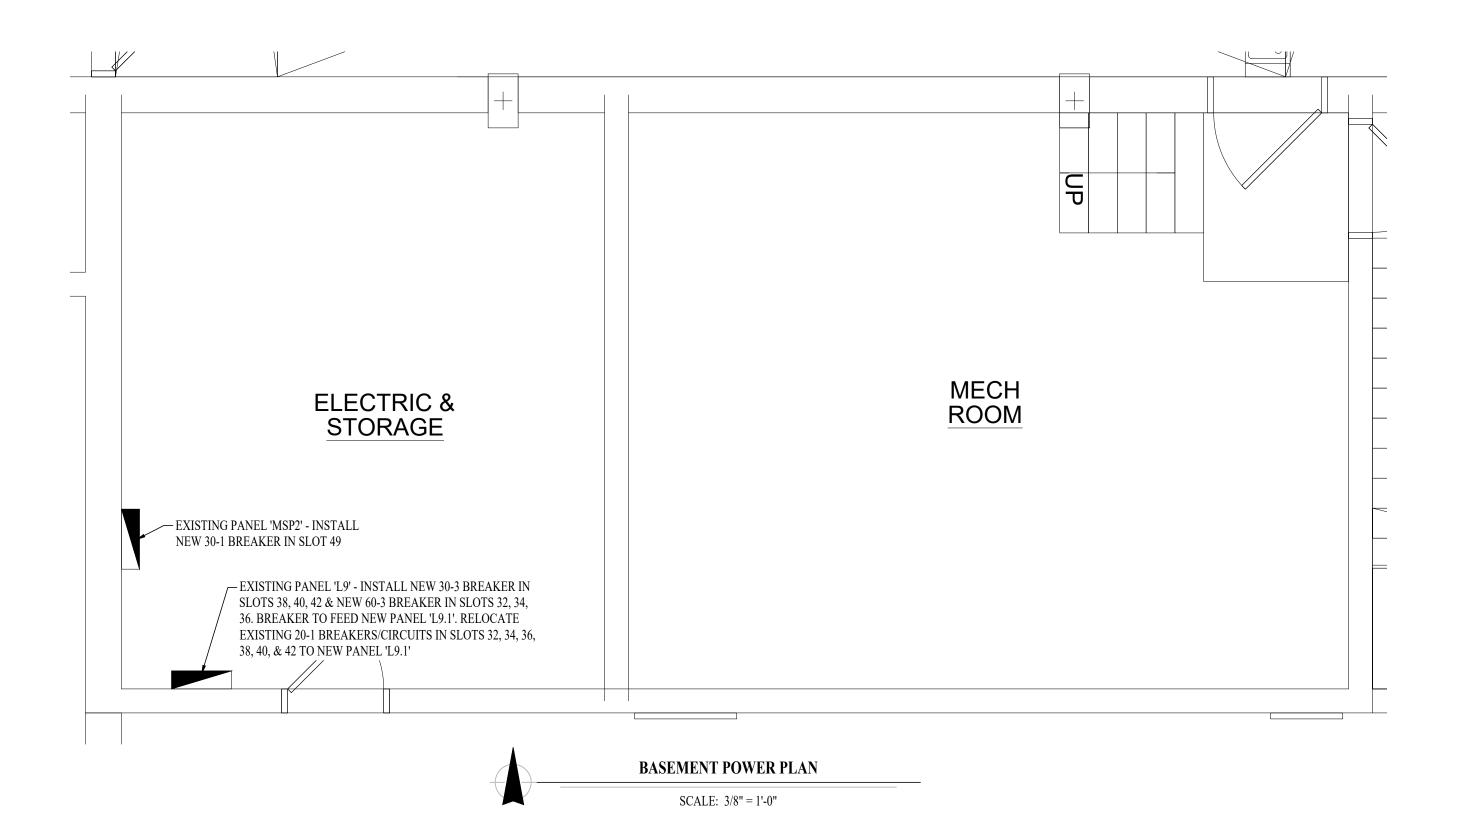

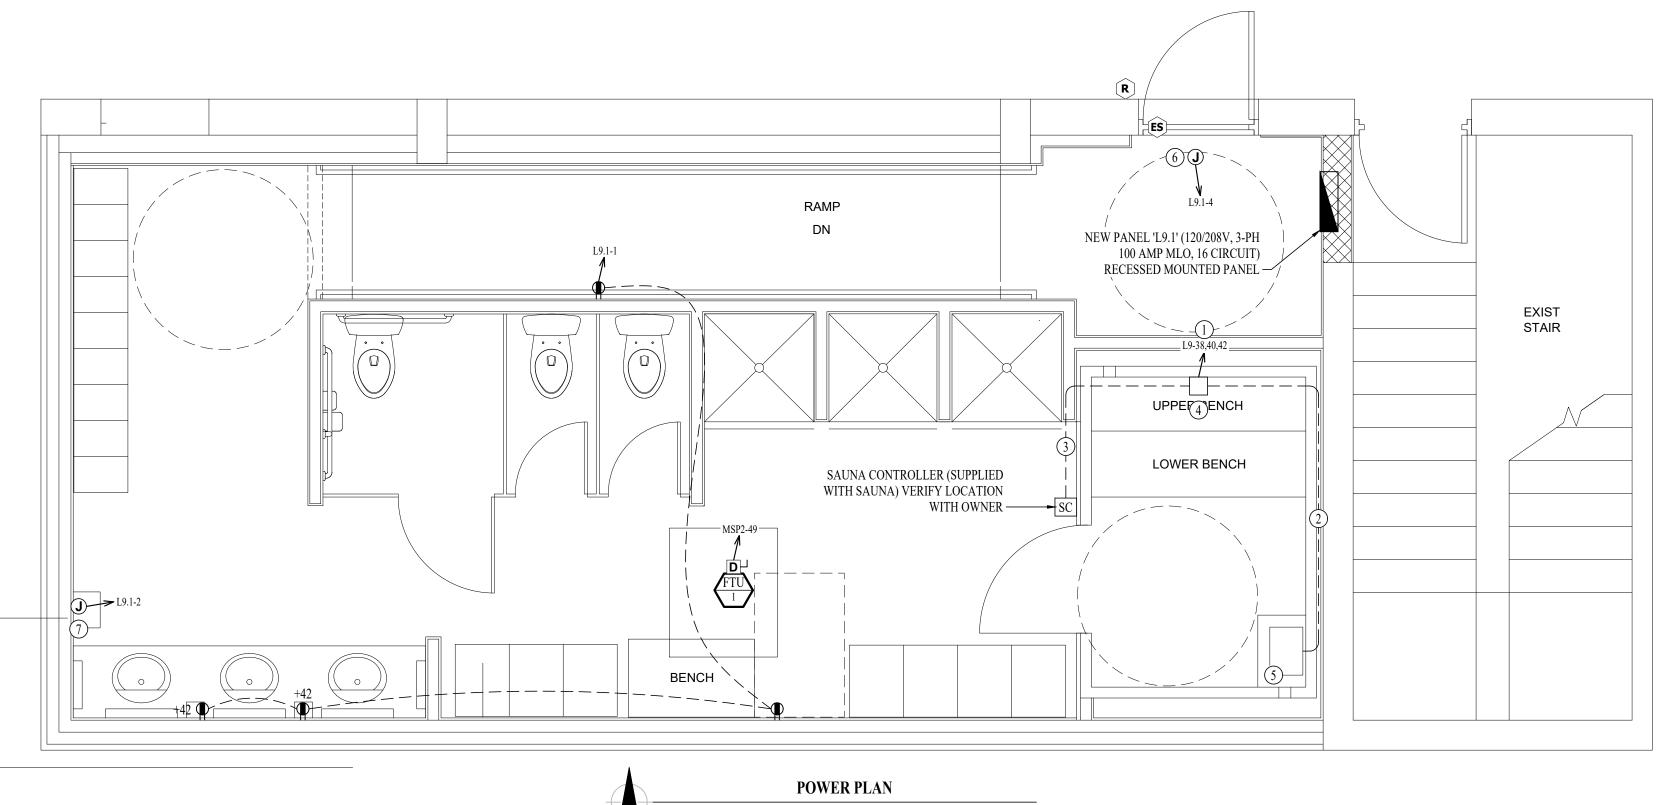

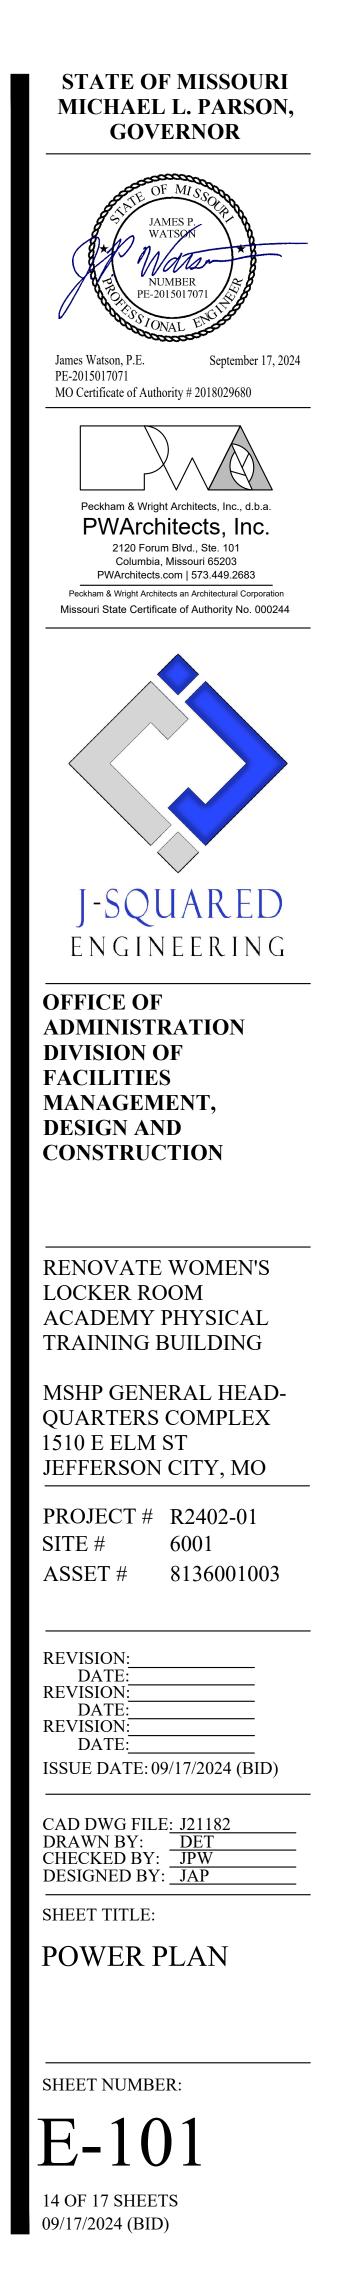

#### LIGHTING PLAN SYMBOL LEGEND

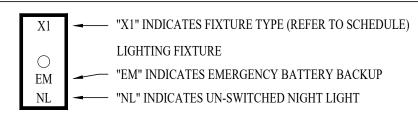

EXIT LIGHT

ĩ X

#### - INDICATES REQUIRED REMOTE HEAD

EMERGENCY EGRESS LIGHT 

#### SWITCH (WALL MOUNTED)

#### — SWITCH TYPE:

- 3 = 3-WAY • 4 = 4-WAY
- OP = PASSIVE INFRARED OCCUPANCY SENSOR
- OU = ULTRASONIC OCCUPANCY SENSOR • OT = DUAL-TECHNOLOGY OCCUPANCY SENSOR
- VP = PASSIVE INFRARED VACANCY SENSOR
- VU = ULTRASONIC VACANCY SENSOR
- VT = DUAL-TECHNOLOGY VACANCY SENSOR • M = MOMENTARY SWITCH
- SS = SCENE SWITCH

Þ_× DIMMER SWITCH (WALL MOUNTED) SWITCH TYPE:

#### • SEE "SWITCH (WALL MOUNTED)" FOR TYPE DESIGNATIONS

#### ∕®x SWITCH (CEILING MOUNTED)

#### SWITCH TYPE:

• SEE "SWITCH (WALL MOUNTED)" FOR TYPE DESIGNATIONS

PP POWER PACK

#### OCCUPANCY SENSOR

- AUTO FULL-ON (OR 50% IF NOTED)
- AUTOMATICALLY TURN OFF LIGHTING AFTER 20 MINUTES WITHOUT
- OCCUPANT DETECTION • WITH MANUAL OVERRIDE CONTROL (IF NOTED)

#### VACANCY SENSOR


- MANUAL FULL-ON
- AUTOMATICALLY TURN OFF LIGHTING AFTER 20 MINUTES WITHOUT
- OCCUPANT DETECTION • WITH MANUAL OVERRIDE CONTROL (IF NOTED)

#### LIGHTING PLAN GENERAL NOTES:

1. OCCUPANCY / VACANCY SENSOR QUANTITIES AND GENERAL LOCATIONS SHOWN FOR REFERENCE ONLY. CONTRACTOR TO PROVIDE AND INSTALL SENSOR WITH SPACING PER MANUFACTURER SPECIFICATIONS AND INCLUDE ADDITIONAL SENSORS IF NECESSARY. CEILING-MOUNTED SENSORS SHALL BE INSTALLED WITHIN MANUFACTURE'S ACCEPTABLE MOUNTING HEIGHT RANGE.

#### LIGHTING PLAN KEY NOTES:

(1) INSTALL LIGHTING KIT PROVIDED WITH SAUNA.

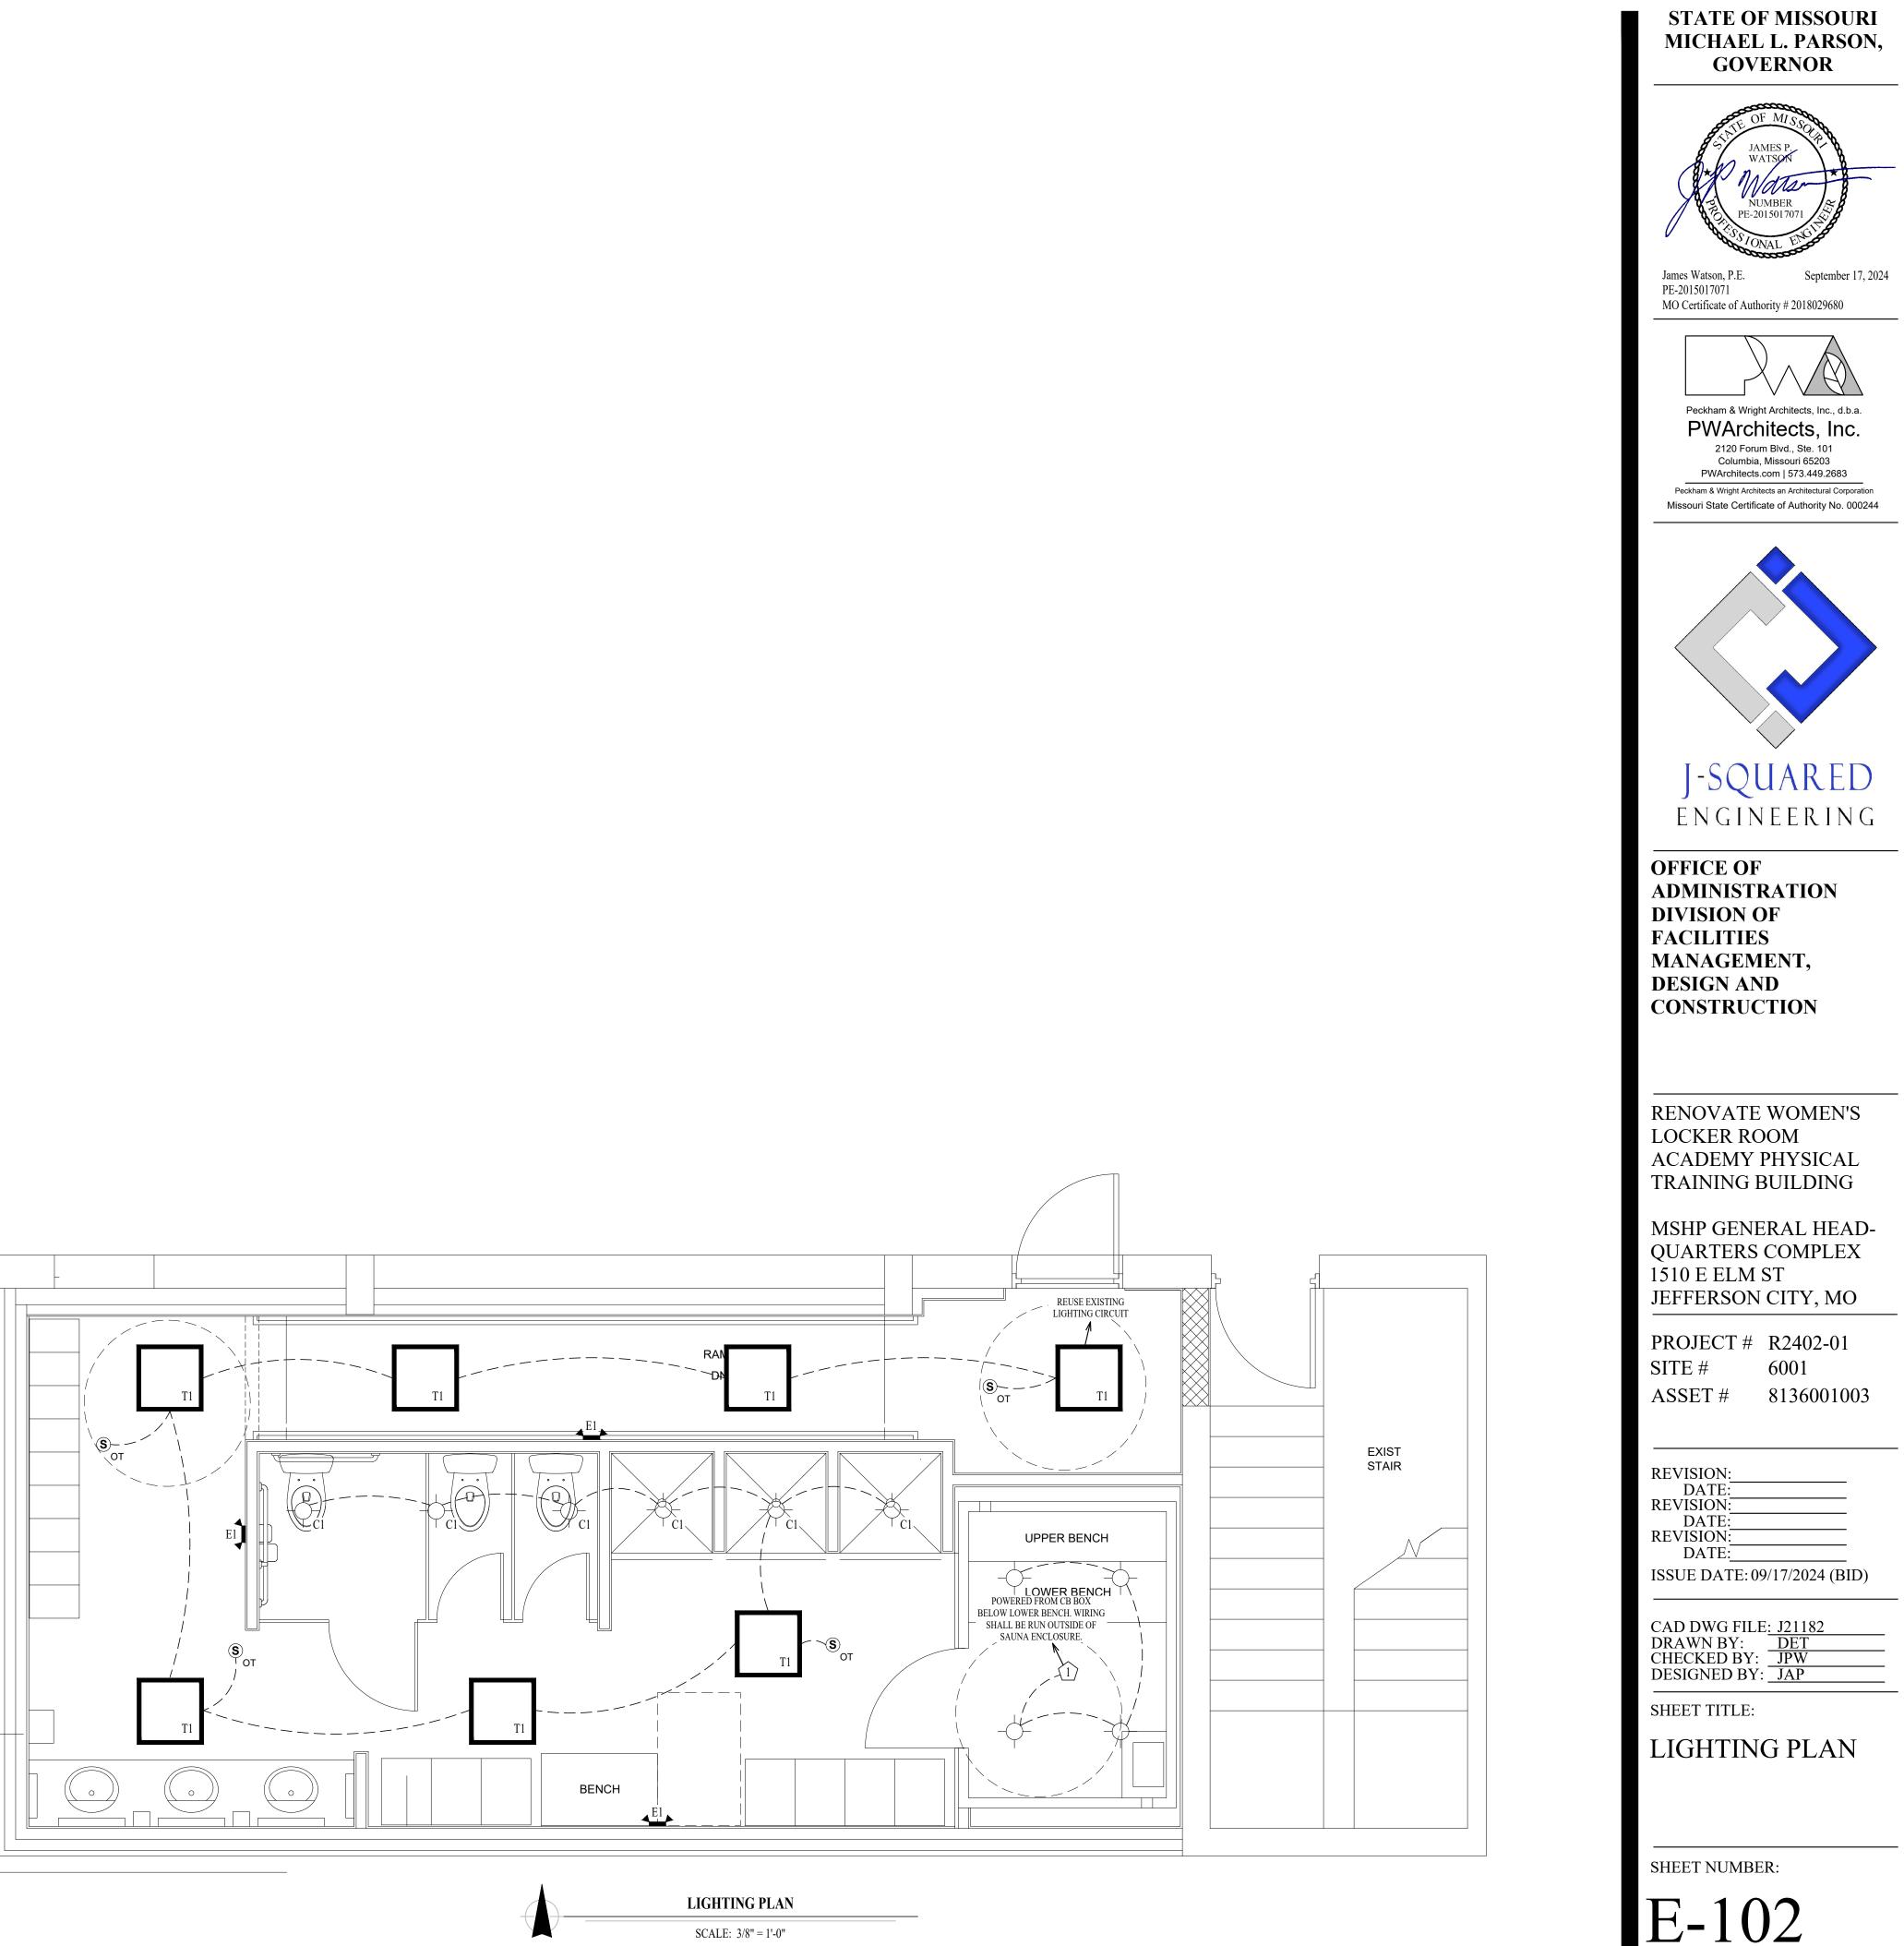














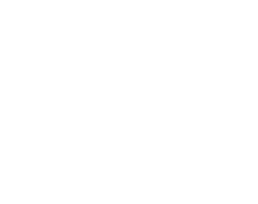



















15 OF 17 SHEETS 09/17/2024 (BID)

SCALE: 3/8" = 1'-0"

#### ELECTRICAL SPECIFICATIONS

#### 1. GENERAL

- 1.1. THE ENTIRE ELECTRICAL SYSTEM SHALL BE CONTINUOUSLY GROUNDED. EVERY BRANCH CONDUIT SHALL INCLUDE A GREEN GROUND CONDUCTOR SIZED PER NEC. 2. MATERIALS
- 2.1. CONDUIT & CONDUCTORS
- 2.1.1. ALL CONDUCTORS SIZES INDICATED ON PLANS ARE COPPER UNLESS NOTED OTHERWISE. 2.1.2. BELOW GRADE CONDUCTORS SHALL BE XHHW-2.
- 2.1.3. MINIMUM CONDUCTOR SIZE SHALL BE #12 UNLESS NOTED OTHERWISE. 120V, 20 AMP CIRCUITS WITH CONDUCTOR LENGTH GREATER THAN 100' SHALL BE MINIMUM #10. ELECTRICAL CONTRACTOR IS RESPONSIBLE FOR MEASURING ACTUAL CONDUCTOR LENGTH AND INCREASING CONDUCTOR SIZE TO COMPENSATE FOR VOLTAGE DROP AS REQUIRED BY NEC. SCHEDULE 40 PVC CONDUIT SHALL BE USED FOR BELOW GRADE
- 2.1.4. INSTALLATIONS

TAG	
C1	
T1	
NOTES:	
1. VERIF	Y
2. REFE	2

PER AWG       SIZE       12       10       10       8       6       8	<b>120V</b> 55' 90' 60' 95' 80'	Ø 277V 130' 205' 135' 220'	<b>208V</b> 115' 180'	Ø 480V 260' 415'	- MINIMUM CONDUIT SIZI 1/2"
12 10 10 10 10 10 10 10 10 10 10 10 10 10	55' 90' 60' 95' 80'	130' 205' 135'	115' 180'	260'	1/2"
10       10       8       8       6	90' 60' 95' 80'	205' 135'	180'		
10 8 8 6	60' 95' 80'	135'		415'	0/41
8 8 6	95' 80'		1201		3/4"
8 6	80'	220'	120'	275'	3/4"
6			190'	445'	1"
		190'	165'	380'	1"
8	130'	300'	260'	605'	1"
	70'	165'	145'	330'	1"
6	110'	260'	225'	525'	1"
6	100'	235'	200'	470'	1'
4	160'	370'	325'	750'	1-1/4"
6	90'	210'	180'	420'	1-1/4"
4	145'	335'	290'	675'	1-1/4"
6	75'	175'	150'	350'	1-1/4"
4	120'	280'	240'	560'	1-1/4"
4	105'	240'	205'	480'	1-1/4"
3	130'	300'	260'	605'	1-1/4"
4	55'	210'	180'	420'	1-1/4"
3	90'	260'	230'	530'	1-1/4"
3	100'	235'	200'	470'	1-1/4"
2	125'	295'	255'	595'	1-1/4"
3	90'	210'	180'	420'	1-1/4"
2	115'	265'	230'	535'	1-1/4"
	6 4 6 4 4 3 4 3 4 3 2 3 2 UIT CONDUC ATING OF 75°	6         90'           4         145'           6         75'           4         120'           4         105'           3         130'           4         55'           3         90'           3         100'           2         125'           3         90'           2         115'	6         90'         210'           4         145'         335'           6         75'         175'           4         120'         280'           4         105'         240'           3         130'         300'           4         55'         210'           3         90'         260'           3         100'         235'           2         125'         295'           3         90'         265'	6         90'         210'         180'           4         145'         335'         290'           6         75'         175'         150'           4         120'         280'         240'           4         105'         240'         205'           3         130'         300'         260'           4         55'         210'         180'           3         90'         260'         230'           3         100'         235'         200'           2         125'         295'         255'           3         90'         210'         180'           2         115'         265'         230'	690'210'180'420'4145'335'290'675'675'175'150'350'4120'280'240'560'4105'240'205'480'3130'300'260'605'455'210'180'420'390'260'230'530'3100'235'200'470'2125'295'255'595'390'210'180'420'

LIGHT FIXTURE SCHEDULE										
MA NUFA CTURER (OR EQUAL)	MODEL NUMBER (OR EQUAL)	DESCRIPTION	MOUNTING	lumen Output	CCT (°K)	CRI	VOLTAGE	WATTS	DIMMING	NOTES
HALO	SLD612-8-35-WH-UNV	6" ROUND LED CAN	SURFACE	1200	3500	80	120	15	120V	
METALUX	22FP4235C	2x2 LED FLAT PANEL	ACT GRID / SURFACE	4641	3500	80	120	39	0-10V	

Y LIGHT FIXTURE FINISHES WITH OWNER / ARCHITECT PRIOR TO INSTALLATION.

R TO ARCHITECTURAL REFLECTED CEILING PLAN FOR CEILING TYPES THROUGHOUT. COORDINATE EXACT MOUNTING DETAILS WITH GENERAL CONTRACTOR.


POWER FACTOR, BALANCED LOAD, NEGLIGIBLE REACTANCE, & SIX OR LESS CURRENT-CARRYING CONDUCTORS IN RACEWAY.

			PAN	IEL 'L	9.1' S	CHE	DULE		
	PANEL SPECIFICA TIONS							TOTAL CONNECTED LO	AD
V	OLTAGE: 120/208V 3-PH	NEMA RATING	1					<b>PHA SE "A" LOAD:</b> 16	AMPS
AM	IPACITY: 100A MLO	PA NEL MOUNTING	SURFACE					PHASE "B" LOAD: 1	AMPS
AIC-	RATING: 22kA							<b>PHASE "C" LOAD:</b> 0	AMPS
CIRCUIT NUMBER	DESCR	IPTION	BREAKER SIZE	AMPS	PHASE	AMPS	BREAKER SIZE	DESCRIPTION	
1	BATHROOM	RECEPTS.	20-1	6	A	10	20-1	HAND DRYER	2
3	RELOCATED C	IRCUIT L9-32	20-1		В	1	20-1	CARD READER	4
5	RELOCATED C	IRCUIT L9-34	20-1		С		20-1	SPARE	6
7	RELOCATED C	CIRCUIT L9-36	20-1		А		20-1	SPARE	8
9	RELOCATED C	IRCUIT L9-38	20-1		В		20-1	SPARE	10
11	RELOCATED C	IRCUIT L9-40	20-1		С				12
13	RELOCATED C	IRCUIT L9-42	20-1		Α				14
15					В				16


NOTES:

A: PANEL SHALL BE EQUAL TO SQUARE D MODEL "QO"

B: ELECTRICIAN SHALL VERIFY EXACT EQUIPMENT OVERCURRENT PROTECTION REQUIREMENTS PRIOR TO PURCHASE & INSTALLATION OF EQUIPMENT. C: AFTER COMPLETION OF WORK, ELECTRICAN SHALL PROVIDE A TYPE WRITTEN PANEL DIRECTORY IN NEW PANEL.

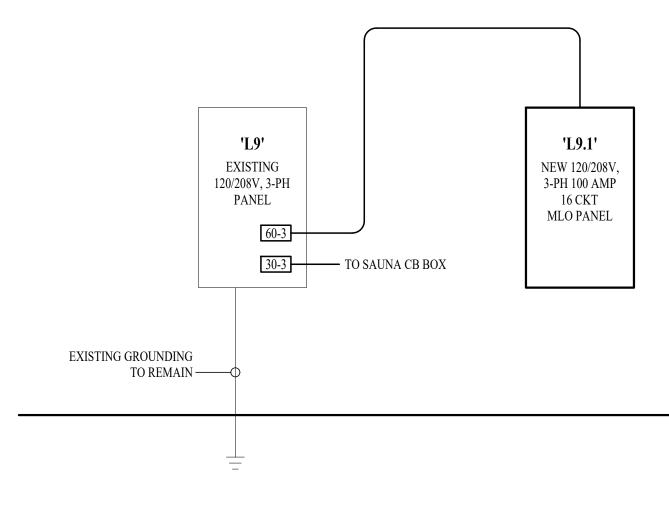



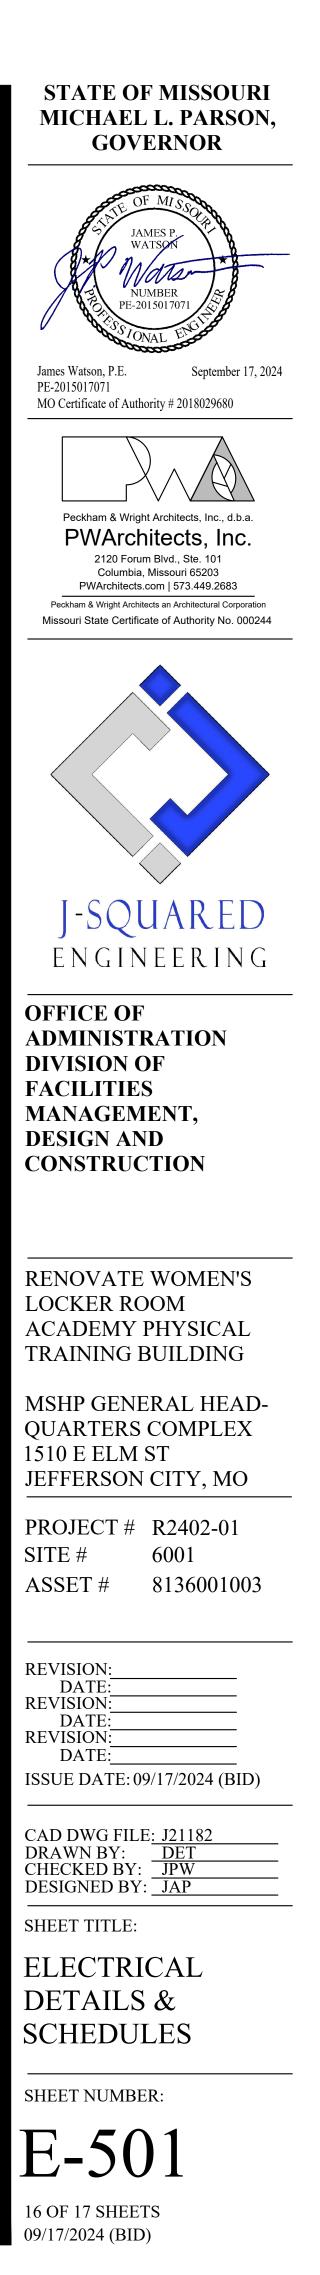

#### SANITARY SEWER PLAN SYMBOL LEGEND


	SANITARY SEWER PIPING
	VENT PIPING
o	PIPING TURNED DOWN / TURNED UP
$\left( \star \right)$	TIE INTO EXISTING

		PLUMBING FIXTURE SCHEDULE						
TAG	DESCRIPTION	MA NUFA CTURER (OR EQUAL)	MODEL (OR EQUAL)	NOTES				
FD	FLOOR DRAIN	ZURN	Z415-BZ	WITH Z1072 TRAP SEAL				
LAV	LAVATORY (DROP-IN W/ MANUAL FAUCET)	AMERICAN STANDARD	0475.028	WITH ZURN Z81104-XL F				
SD	SHOWER DRAIN	JAY R SMITH	2005YA03PB					
SH1	SHOWER SYSTEM - ADA	MOEN	T9342EP15	WITH #8317HD CARTRID				
SH2	SHOWER SYSTEM -STANDARD	MOEN	T9375EP15	WITH #8371HD CARTRID				
WC1	WATER CLOSET - STANDARD HEIGHT - MANUAL FLUSH VALVE	AMERICAN STANDARD	2234.001	WITH ZURN Z6000AV-WS SUSTAINING SEAT				
WC2	WATER CLOSET - ADA HEIGHT - MANUAL FLUSH VALVE	AMERICAN STANDARD	3043.001	WITH ZURN Z6000AV-WS SUSTAINING SEAT				
WCO	WALL CLEAN OUT	-	-					

2. VERIFY FIXTURE FINISHES WITH OWNER / ARCHITECT.

#### WATER PLAN SYMBOL LEGEND

	COLD WATER LINE
	HOT WATER LINE
	HOT WATER RECIRCULATION LINE
M	WATER METER
M	VALVE
0	PUMP
o	PIPING TURNED DOWN / TURNED UP
$\boldsymbol{\lambda}$	TIE INTO EXISTING

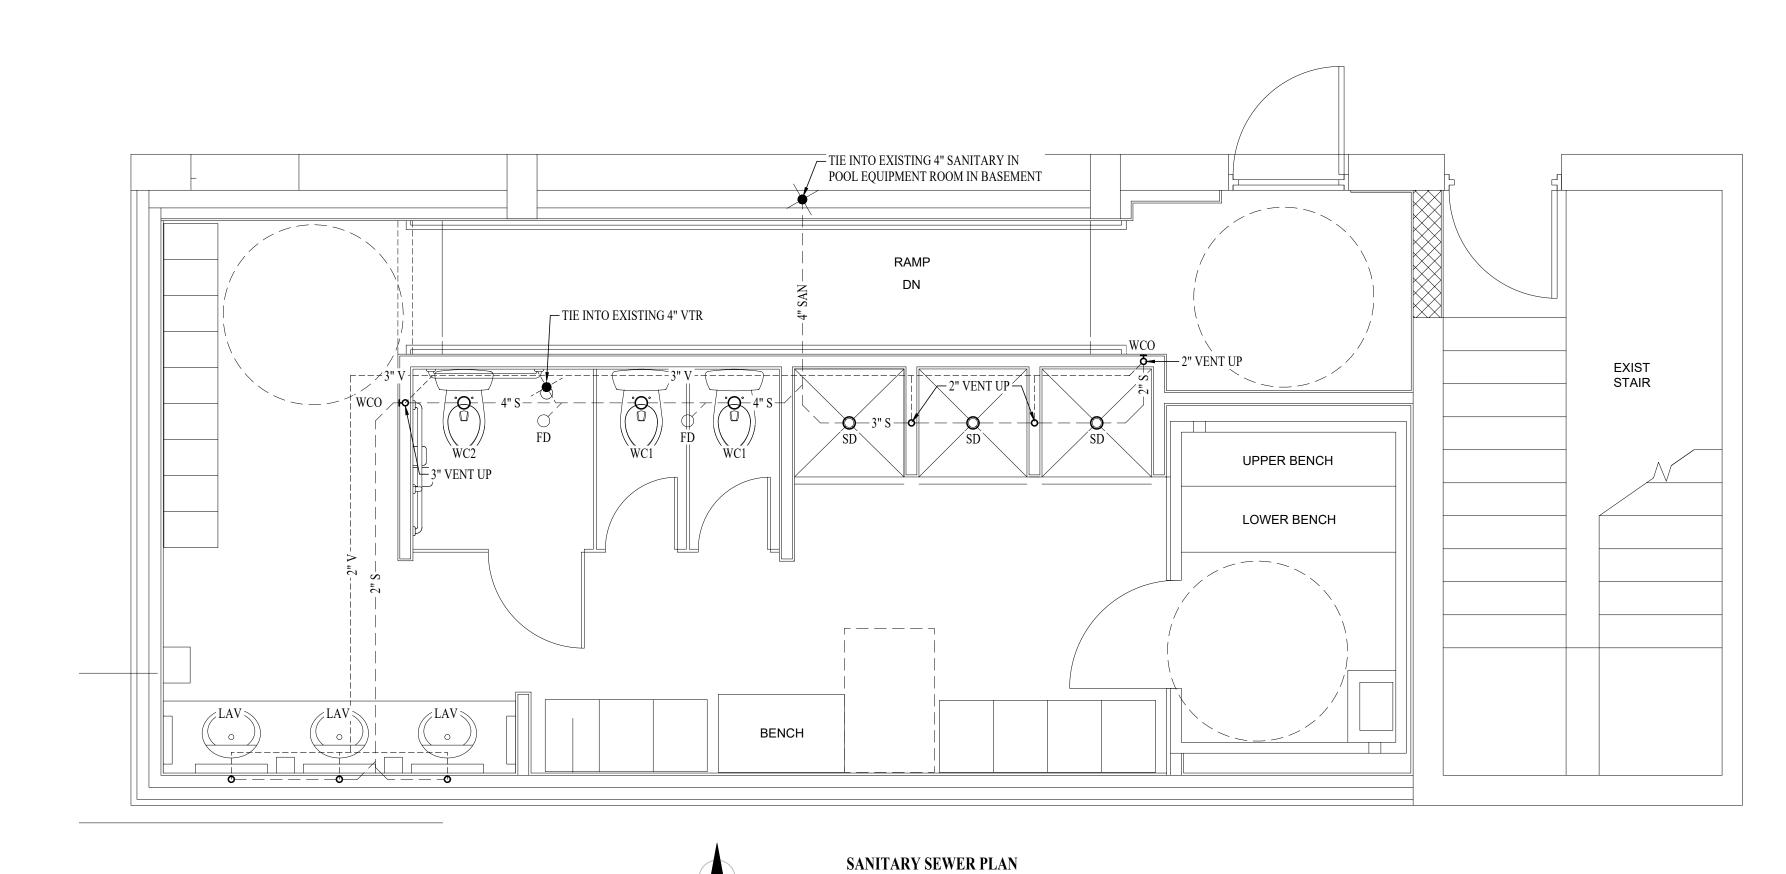

SCALE: 3/8" = 1'-0"

