

RENOVATE COMBINED SUPPORT MAINTENANCE SHOP (CSMS) ANNEX IKE SKELTON TRAINING SITE JEFFERSON CITY, MISSOURI

OWNER: STATE OF MISSOURI
MIKE PARSON,
GOVERNOR

DEPARTMENT OF PUBLIC SAFETY
OFFICE OF THE ADJUTANT GENERAL
MISSOURI NATIONAL GUARD
FACILITIES DIVISION

PROJECT MANAGEMENT: OFFICE OF ADMINISTRATION
DIVISION OF FACILITIES MANAGEMENT
DESIGN AND CONSTRUCTION

APPLICABLE CODES: 2021 INTERNATIONAL BUILDING CODE
2021 INTERNATIONAL EXISTING BUILDING CODE
2020 NATIONAL ELECTRICAL CODE
2021 INTERNATIONAL MECHANICAL CODE
2021 INTERNATIONAL PLUMBING CODE
2018 INTERNATIONAL FUEL GAS CODE
2010 ADA STANDARDS FOR ACCESSIBLE DESIGN

DESIGNER: CASCO DIVERSIFIED CORPORATION

PROJECT NUMBER: T2122-01
SITE NUMBER: 6300
ASSET NUMBER: 8136300017

CASCO
12 SUNNEN DR. SUITE 100
ST. LOUIS, MO 63143
ARCHITECTS / ENGINEERS
314-821-1100

CASCO DIVERSIFIED CORPORATION
MISSOURI STATE CERTIFICATE OF AUTHORITY #000613 (ENG)
MISSOURI STATE CERTIFICATE OF AUTHORITY #000329 (ARCH)

SHEET INDEX


G-001	COVER SHEET
C-001	TOPOGRAPHIC SURVEY AND DEMOLITION PLAN
C-101	SITE PLAN
C-102	GRADING AND EROSION CONTROL PLAN
C-501	EROSION CONTROL DETAILS
C-502	SITE PLAN DETAILS
S-001	STRUCTURAL GENERAL NOTES
S-101	STRUCTURAL PARTIAL PLAN & DETAILS
A-001	ARCHITECTURAL SITE PLAN
A-002	CODE DATA, EGRESS FLOOR PLAN, NOTES AND SYMBOLS
A-101	DEMO FLOOR AND REFLECTED CEILING PLANS
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E-101	ELECTRICAL DEMO FLOOR PLAN
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E-103	ELECTRICAL POWER FLOOR PLAN
E-601	ELECTRICAL LEGEND AND SCHEDULES



ADDRESS:
2302 MILITIA DRIVE
JEFFERSON CITY, MO
65101



VICINITY MAP

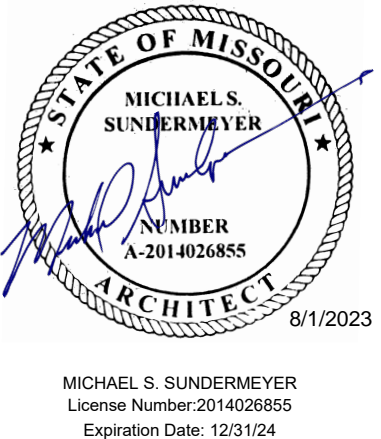


SHEET NUMBER:
G-001
08/01/2023
SHEET 1 OF 29



08-01-2023
Brian K. McMillan
Professional Engineer
No. PE-2003015009

Central Missouri Professional Services, Inc.
ENGINEERING SURVEYING MATERIALS TESTING
2500 E. McCARTY (573) 634-3455
JEFFERSON CITY, MISSOURI 65101
CMPS-INC.COM

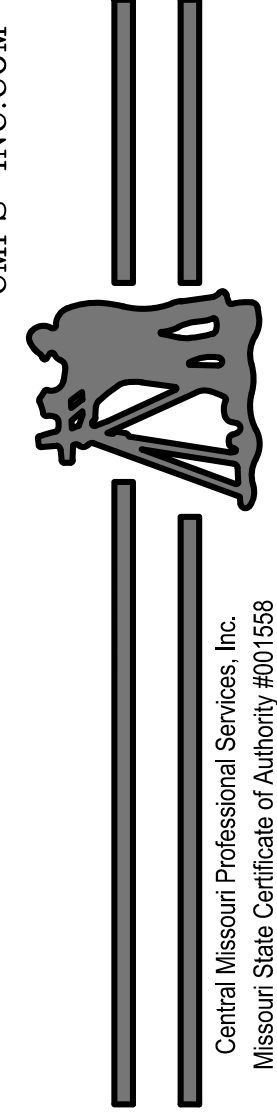

OFFICE OF
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DIVISION OF FACILITIES
MANAGEMENT,
DESIGN AND
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RENOVATE COMBINED
SUPPORT MAINTENANCE
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COMBINED SUPPORT
MAINTENANCE SHOP (CSMS)
2302 MILITIA DRIVE
JEFFERSON CITY, MISSOURI
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PROJECT # T2122-01
SITE # 6300
ASSET# 8136300017

REVISION: _____
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ISSUE DATE: 08/01/2023




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DRAWN BY: PLS
CHECKED BY: PLS/BKM
DESIGNED BY: _____

SHEET TITLE:
TOPOGRAPHIC
SURVEY AND
DEMOLITION PLAN

SHEET NUMBER:


C-001

08/01/2023
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- NOTES:**
- Basis of Bearing: Missouri State Plane Coordinate System
 - Elevation Basis: NAVD 88 as determined by GPS Ties to MoDOT GNSS Network, Modot Station, MOEL, 861.119 feet.

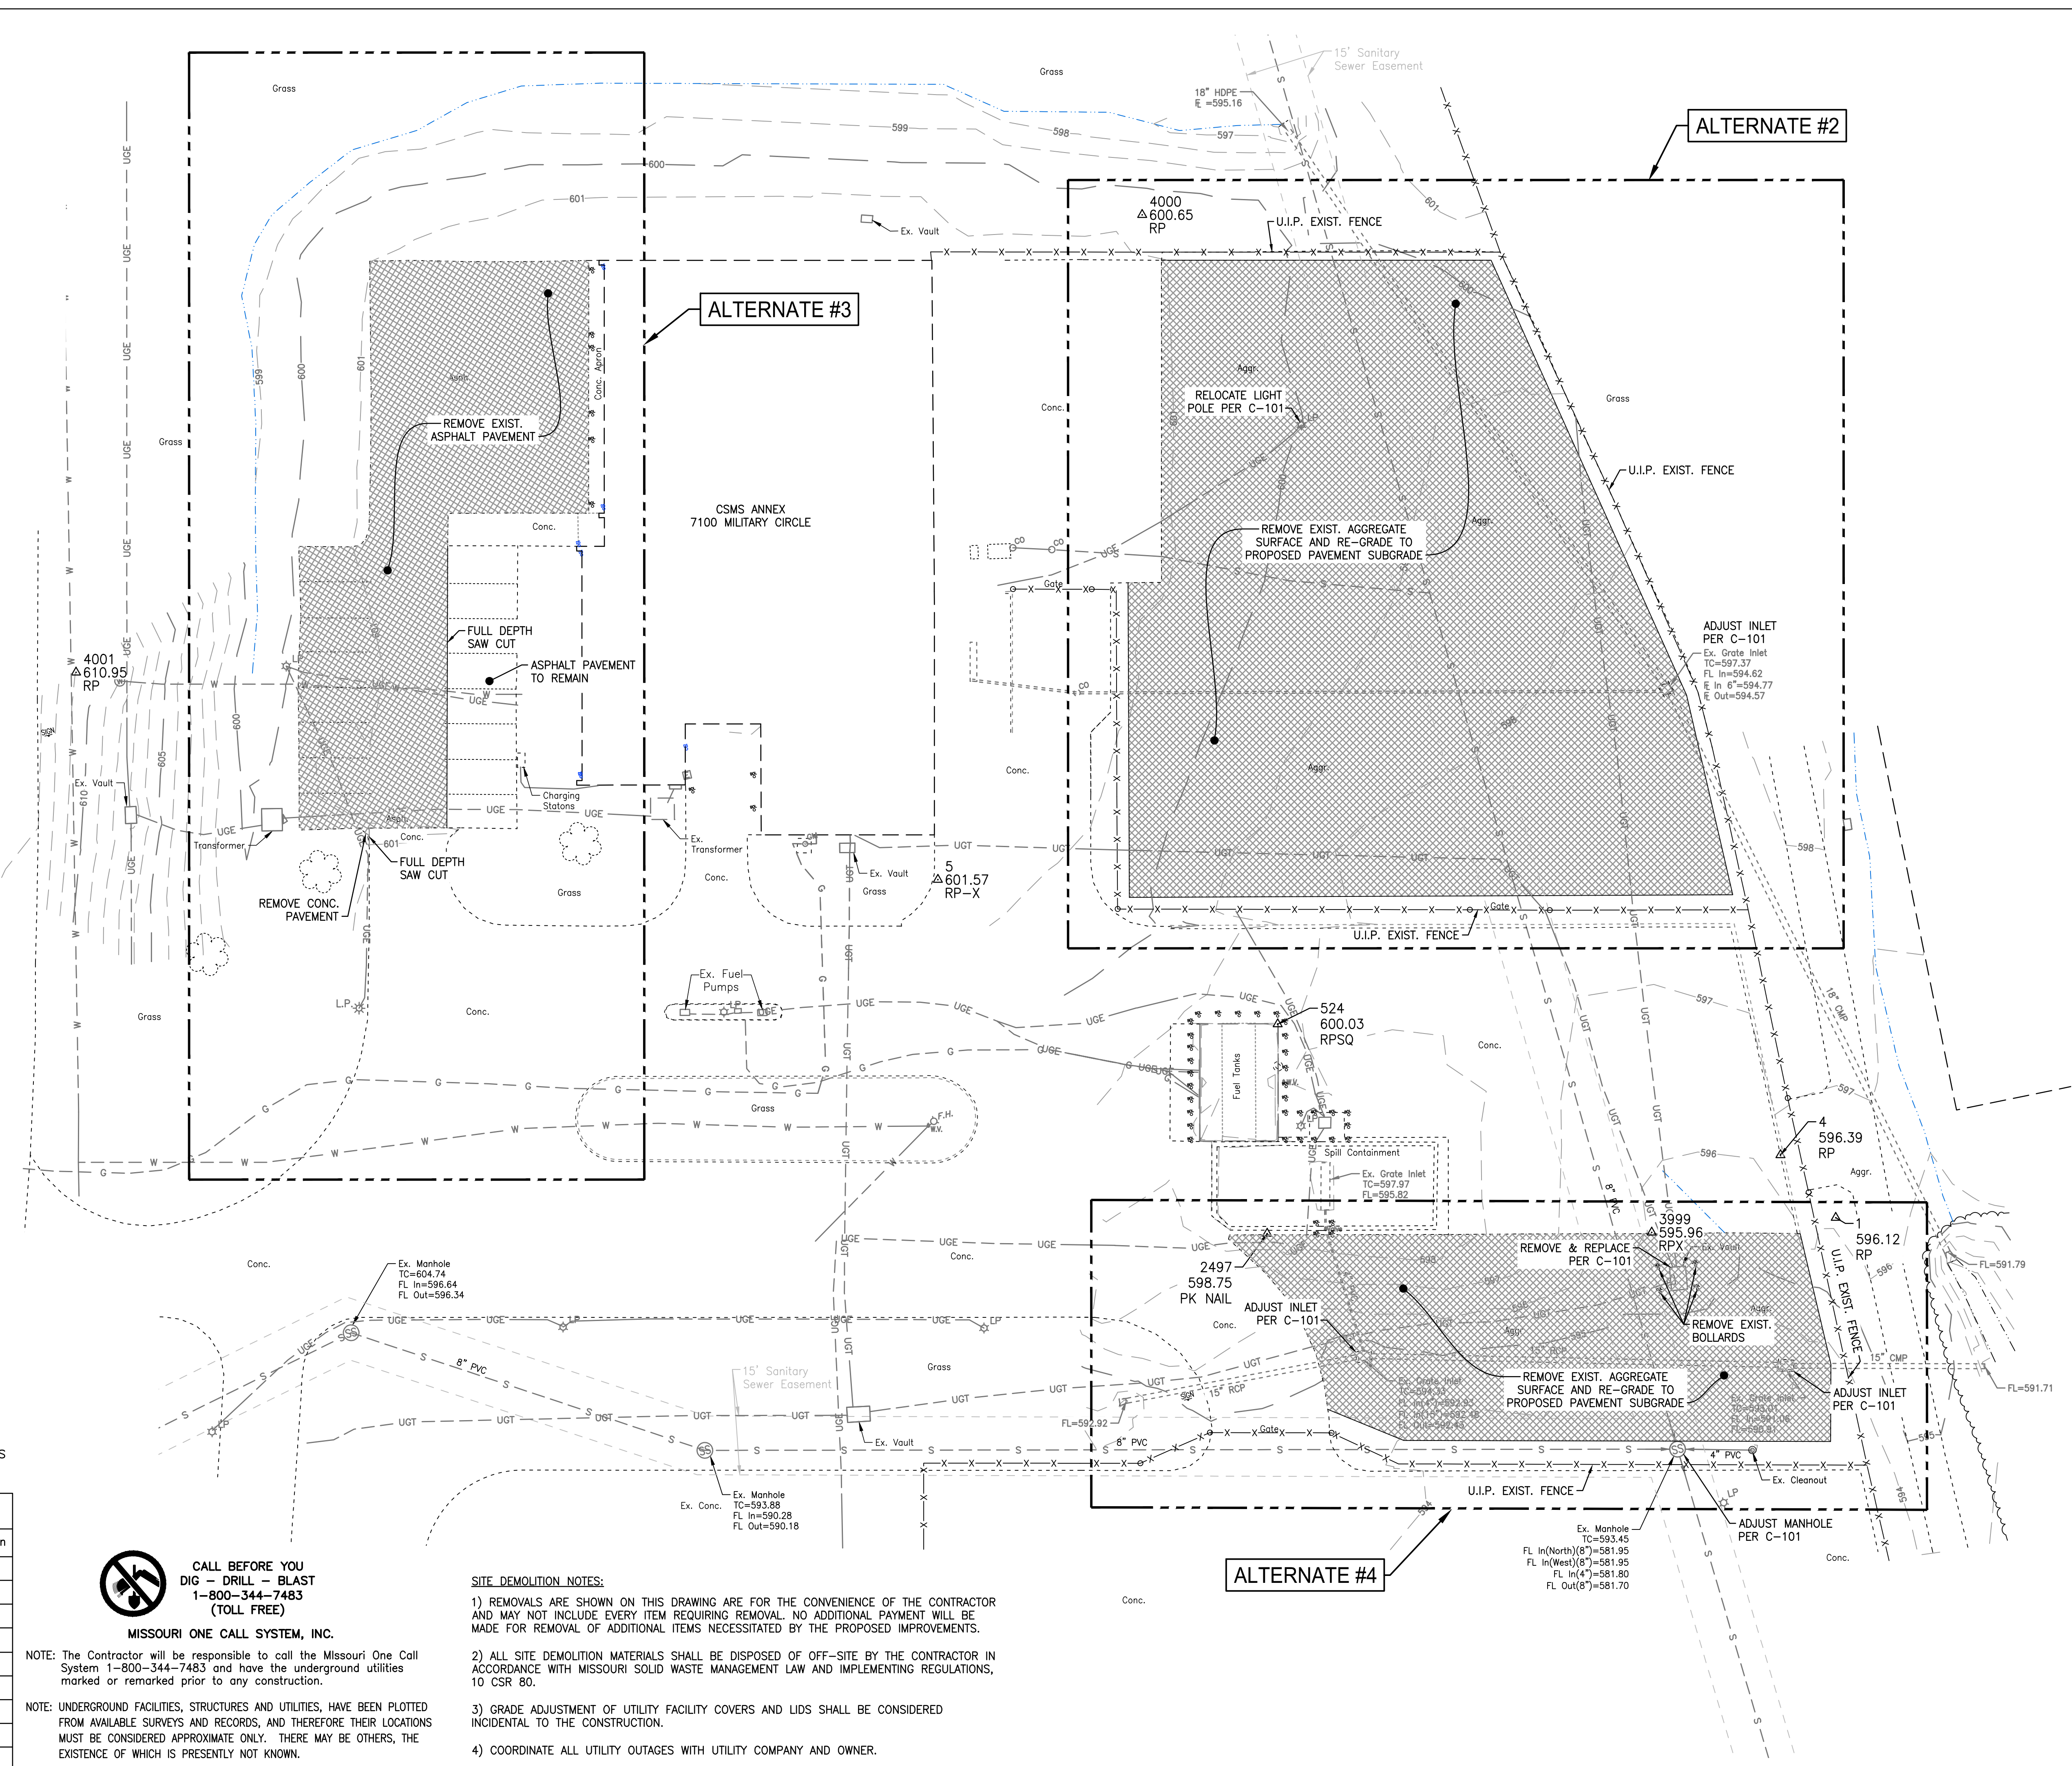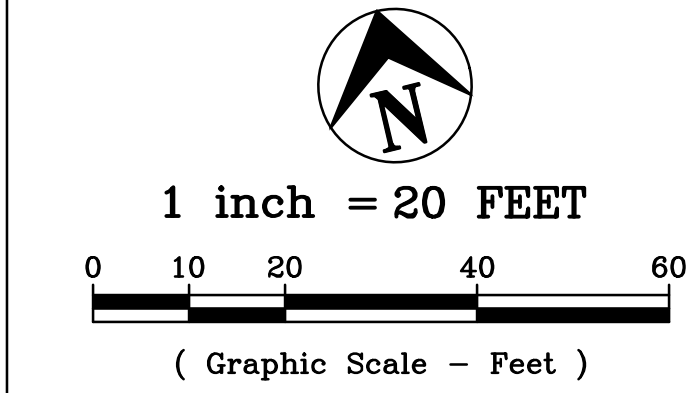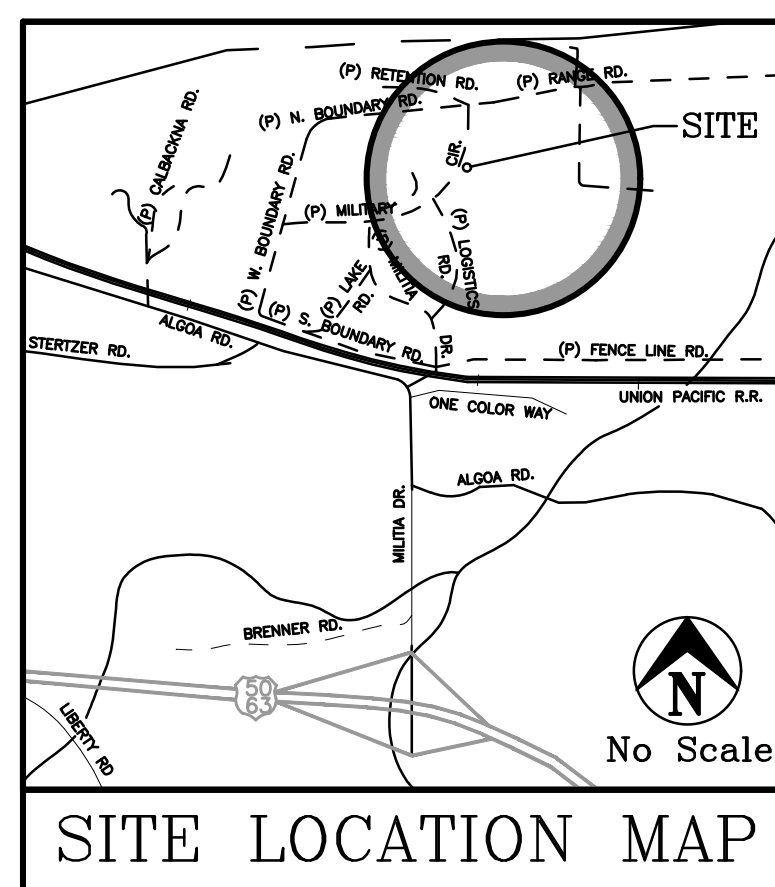Point #	Northing	Easting	Elevation	Description
1	990016.43	1763101.79	596.12	RP
4	990035.27	1763091.73	596.39	RP
5	990153.30	1762898.53	601.57	RP-X
524	990097.40	1762974.48	600.03	RPSQ
1007	990249.33	1762648.25	0.00	RP
2497	990045.95	1762959.53	598.75	PK NAIL
3999	990023.63	1763055.18	595.96	RPX
4000	990306.47	1762988.45	600.65	RP
4001	990255.55	1762696.53	610.95	RP



NOTE: The Contractor will be responsible to call the Missouri One Call System 1-800-344-7483 and have the underground utilities marked or remarked prior to any construction.

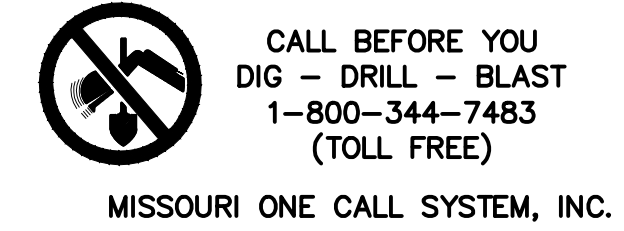
NOTE: UNDERGROUND FACILITIES, STRUCTURES AND UTILITIES, HAVE BEEN PLOTTED FROM AVAILABLE SURVEYS AND RECORDS, AND THEREFORE THEIR LOCATIONS MUST BE CONSIDERED APPROXIMATE ONLY. THERE MAY BE OTHERS, THE EXISTENCE OF WHICH IS PRESENTLY NOT KNOWN.

- SITE DEMOLITION NOTES:**
- REMOVALS ARE SHOWN ON THIS DRAWING ARE FOR THE CONVENIENCE OF THE CONTRACTOR AND MAY NOT INCLUDE EVERY ITEM REQUIRING REMOVAL. NO ADDITIONAL PAYMENT WILL BE MADE FOR REMOVAL OF ADDITIONAL ITEMS NECESSITATED BY THE PROPOSED IMPROVEMENTS.
 - ALL SITE DEMOLITION MATERIALS SHALL BE DISPOSED OF OFF-SITE BY THE CONTRACTOR IN ACCORDANCE WITH MISSOURI SOLID WASTE MANAGEMENT LAW AND IMPLEMENTING REGULATIONS, 10 CSR 80.
 - GRADE ADJUSTMENT OF UTILITY FACILITY COVERS AND LIDS SHALL BE CONSIDERED INCIDENTAL TO THE CONSTRUCTION.
 - COORDINATE ALL UTILITY OUTAGES WITH UTILITY COMPANY AND OWNER.



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ASSET# 8136300017

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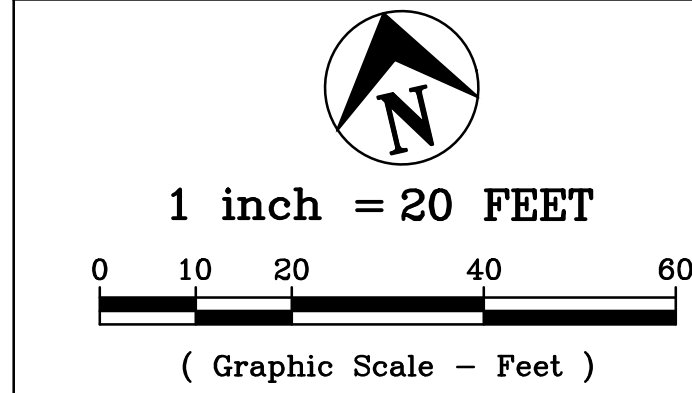
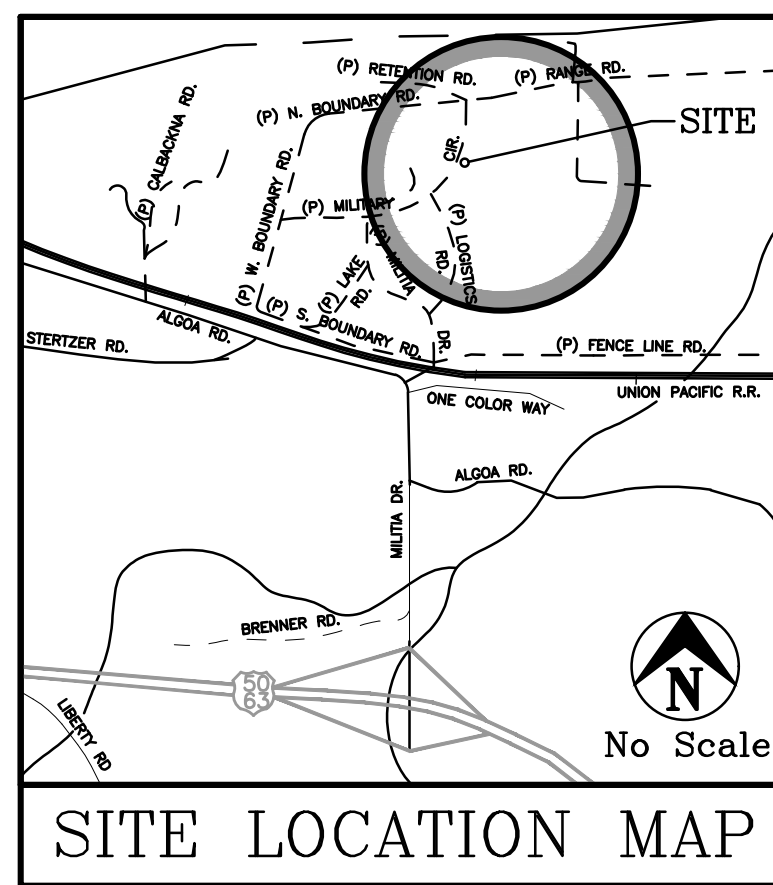
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DRAWN BY: PLS
CHECKED BY: PLS/BKM
DESIGNED BY: _____

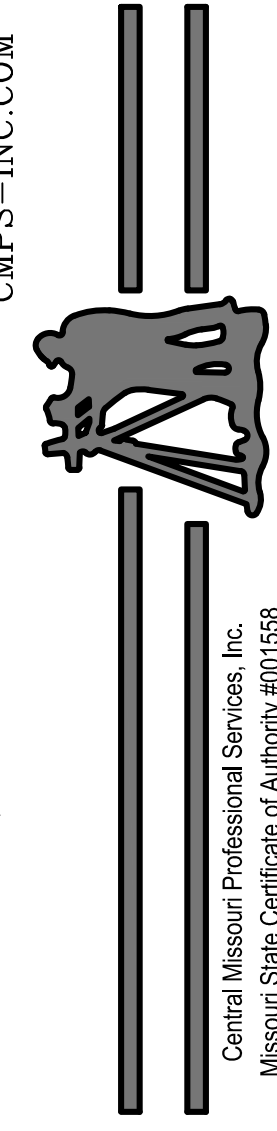SHEET TITLE:
SITE PLAN


SHEET NUMBER:

C-101

08/01/2023
SHEET 3 OF 29



MILITARY CIRCLE

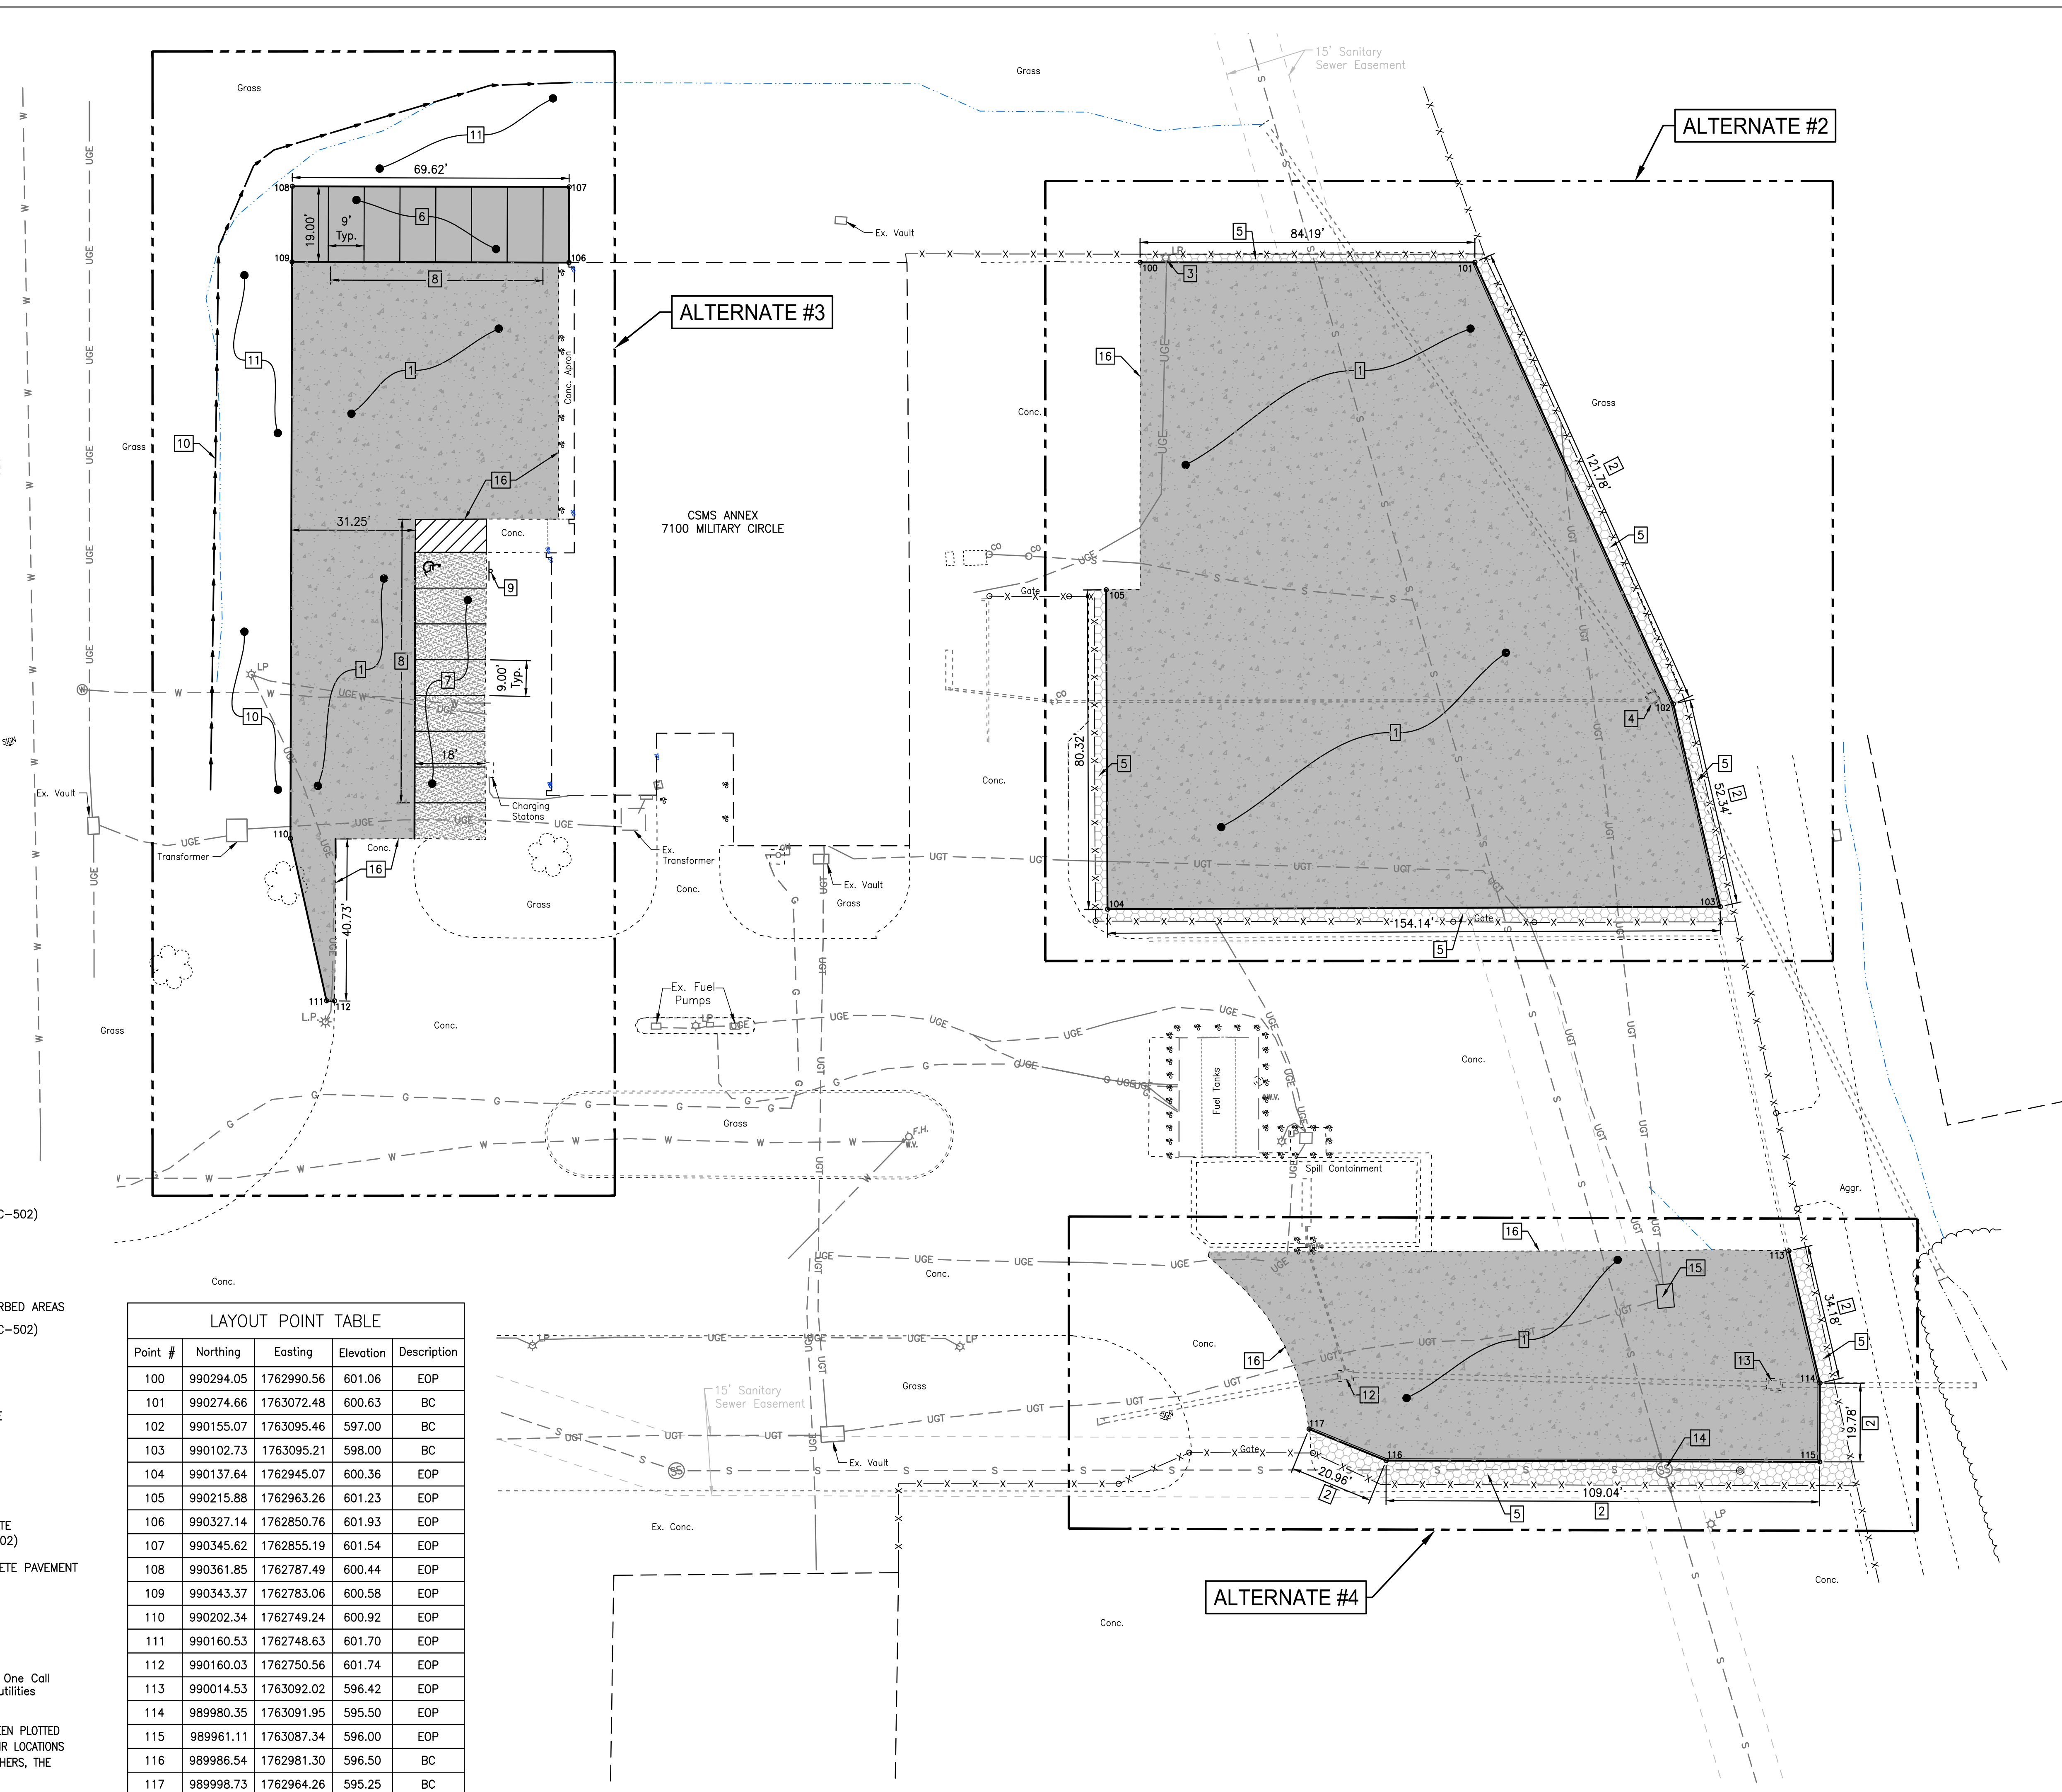

SITE PLAN KEY NOTES

- 1 8" NON-REINFORCED CONCRETE PAVEMENT (DETAIL 1/C-502)
- 2 INTEGRAL CONCRETE CURB (DETAIL 4/C-502)
- 3 RELOCATED LIGHT POLE. SEE ELEC. PLANS
- 4 LOWER INLET GRATE ELEVATION 1.0' TO 596.37
- 5 MIN. 4" THICK AGGREGATE SURFACING OVER ALL DISTURBED AREAS
- 6 5" NON-REINFORCED CONCRETE PAVEMENT (DETAIL 2/C-502)
- 7 SEAL COAT EXISTING ASPHALT PAVEMENT
- 8 4" PAVEMENT MARKING; ADA-BLUE, OTHER-WHITE
- 9 ADA SIGN (DETAIL 5/C-502)
- 10 RE-GRADE EXIST. SWALE TO INSURE POSITIVE DRAINAGE
- 11 SEED AND MULCH ALL DISTURBED AREAS
- 12 RAISE INLET GRATE ELEVATION 2.0' TO 596.30
- 13 RAISE INLET GRATE ELEVATION 1.75' TO 594.75
- 14 RAISE MANHOLE COVER ELEVATION 1.5' TO 594.95.
- 15 REPLACE EXIST. PULL BOX W/ 4'X6" PRECAST CONCRETE PULL BOX WITH TRAFFIC RATED COVER (DETAIL 6/C-502)
- 16 MATCH EXIST. ELEVATION AND DOWEL TO EXIST. CONCRETE PAVEMENT



MISSOURI ONE CALL SYSTEM, INC.
CALL BEFORE YOU
DIG - DRILL - BLAST
1-800-344-7483
(TOLL FREE)



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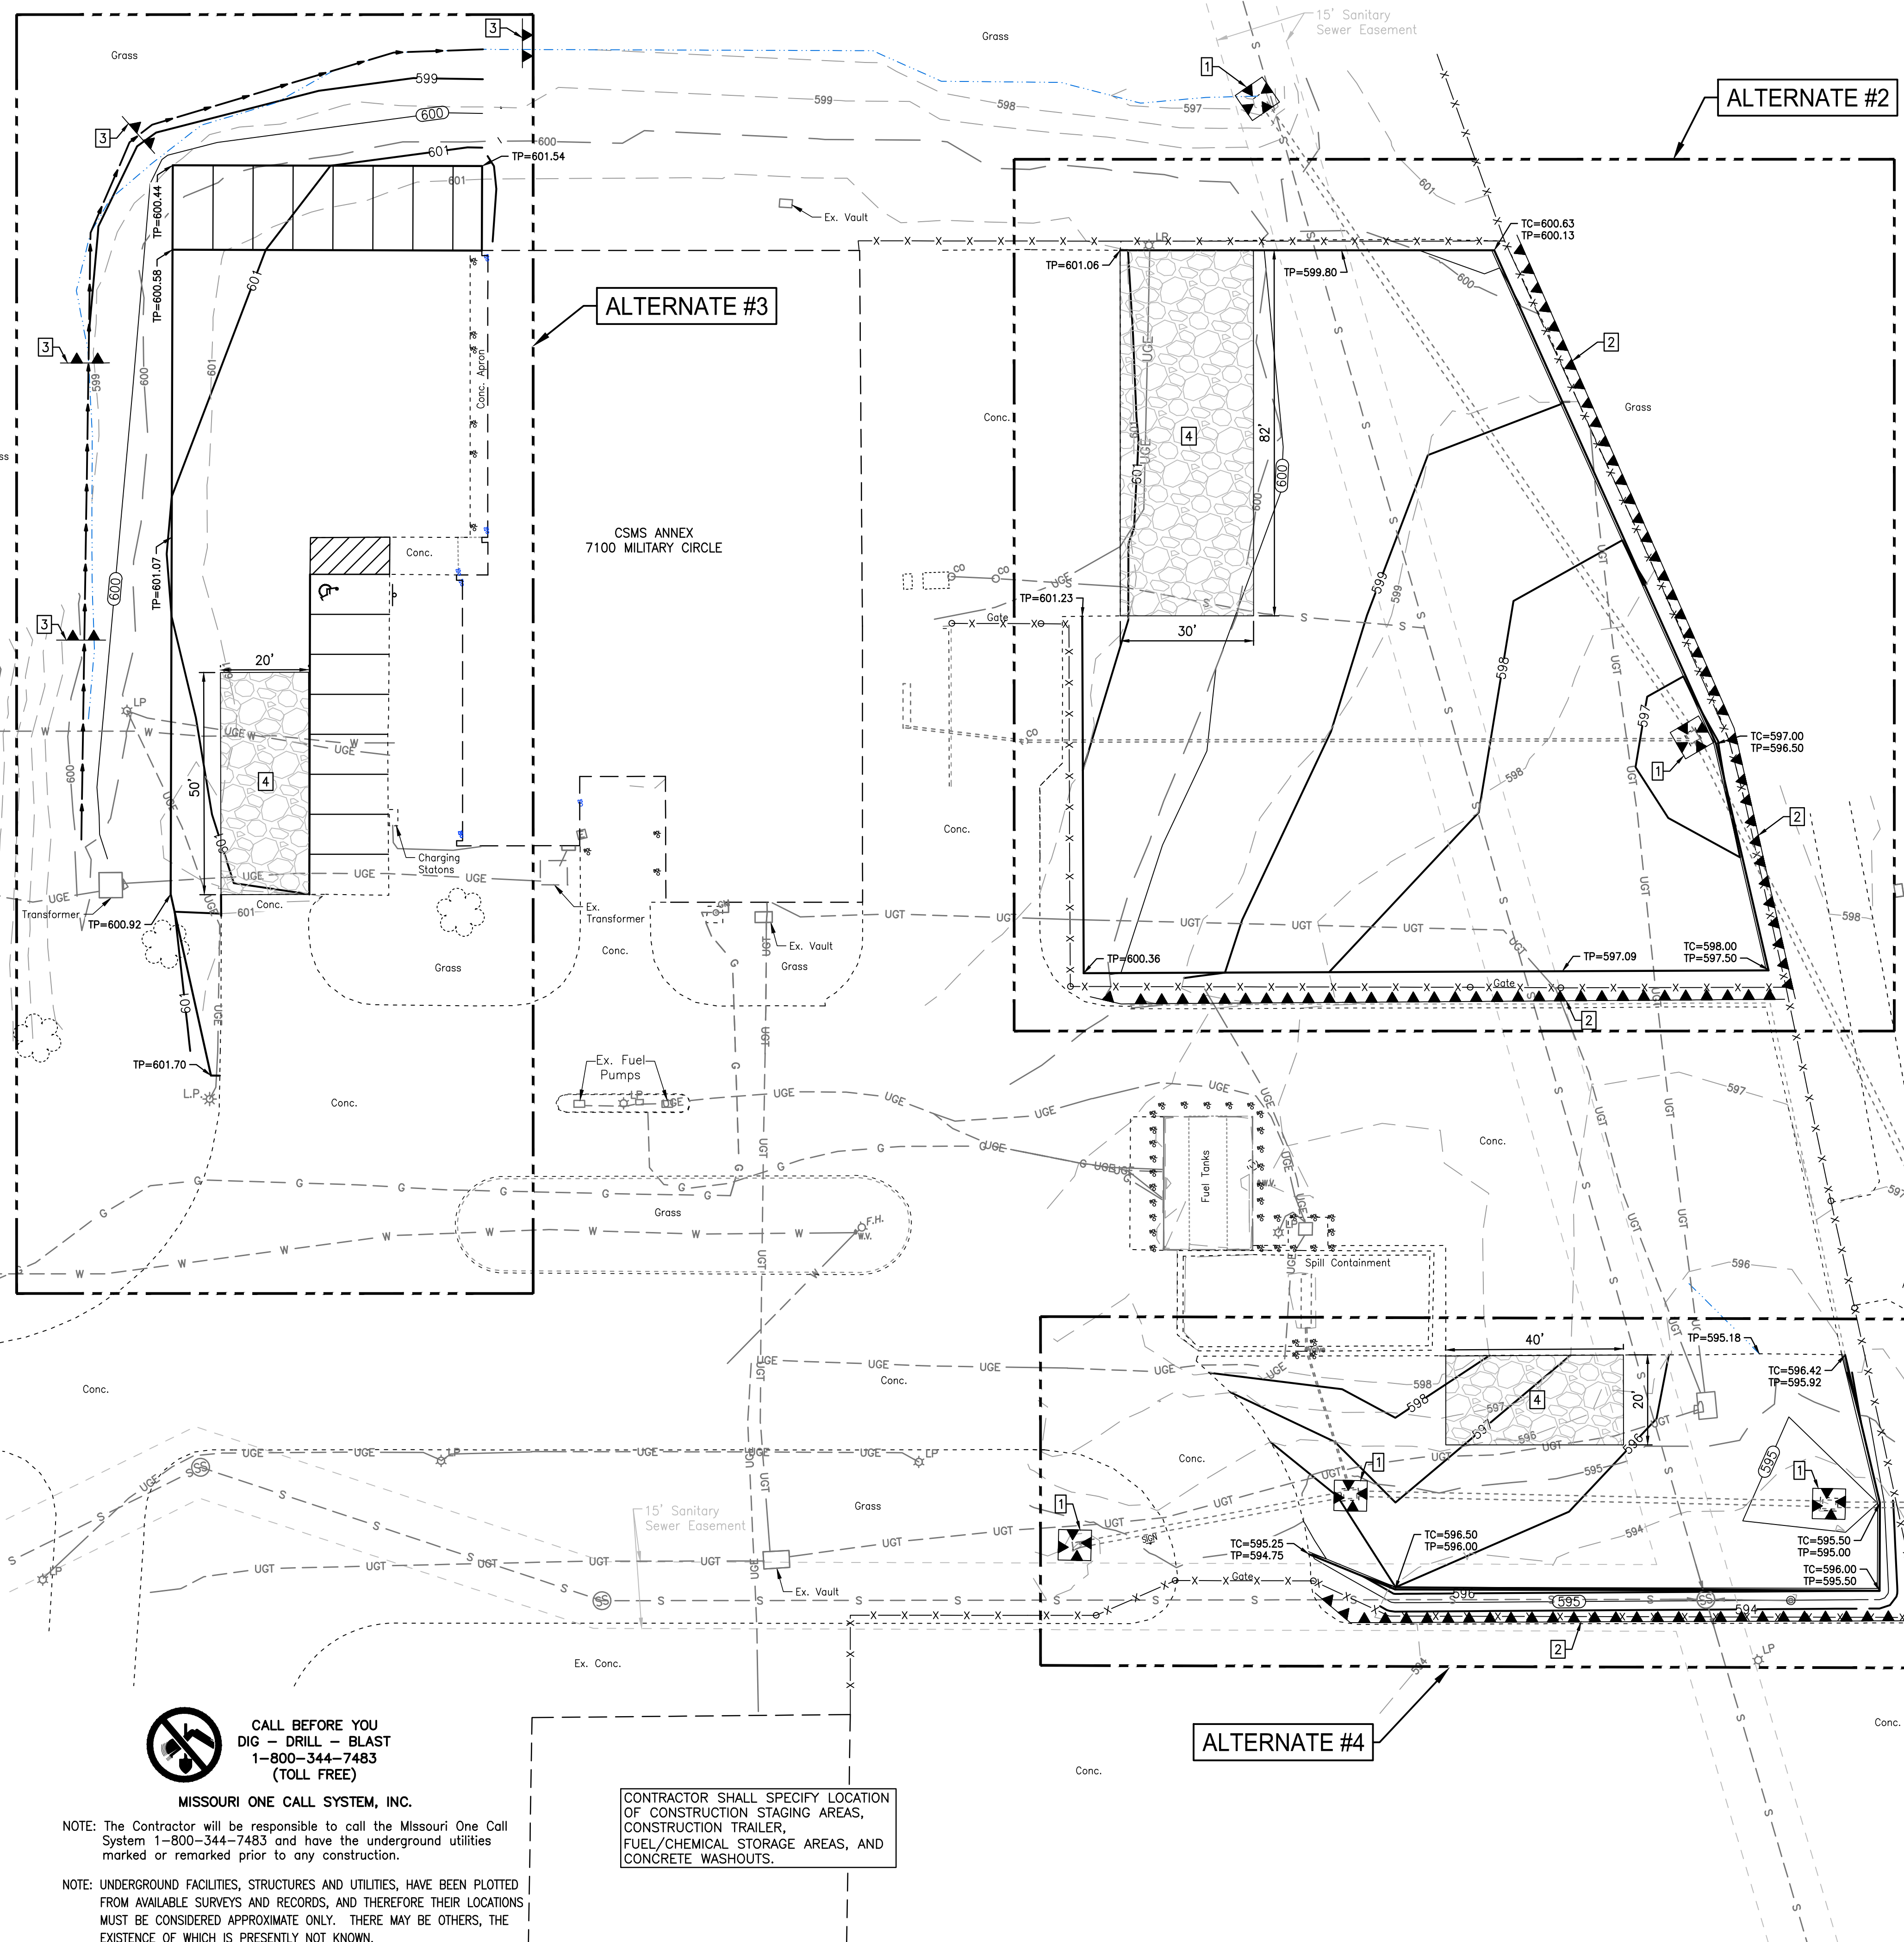
LAYOUT POINT TABLE

Point #	Northing	Eastng	Elevation	Description
100	990294.05	1762990.56	601.06	EOP
101	990274.66	1763072.48	600.63	BC
102	990155.07	1763095.46	597.00	BC
103	990102.73	1763095.21	598.00	BC
104	990137.84	1762945.07	600.36	EOP
105	990215.88	1762963.26	601.23	EOP
106	990327.14	1762850.76	601.93	EOP
107	990345.62	1762855.19	601.54	EOP
108	990361.85	1762787.49	600.44	EOP
109	990343.37	1762783.06	600.58	EOP
110	990202.34	1762749.24	600.92	EOP
111	990160.53	1762748.63	601.70	EOP
112	990160.03	1762750.56	601.74	EOP
113	990014.53	1763092.02	596.42	EOP
114	989980.35	1763091.95	595.50	EOP
115	989961.11	1763087.34	596.00	EOP
116	989986.54	1762981.30	596.50	BC
117	989998.73	1762964.26	595.25	BC

P:\1998\98-232-CASCO-CSMS Addition: 202308-232-CASCO-CSMS Addition.dwg, 7/31/2023 3:17:26 PM, DWG To PDF.pc3



MILITARY CIRCLE

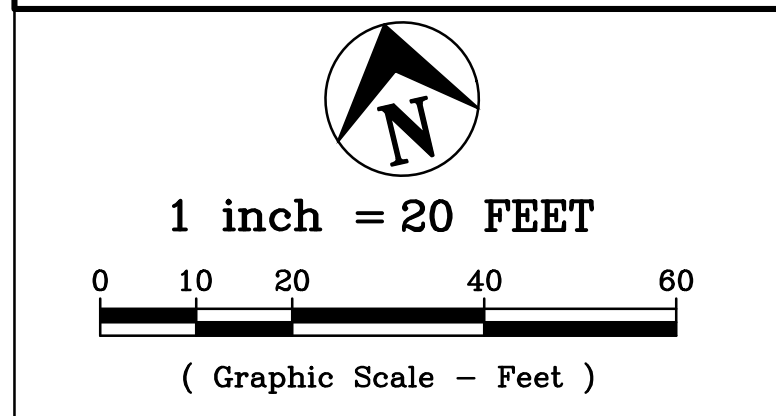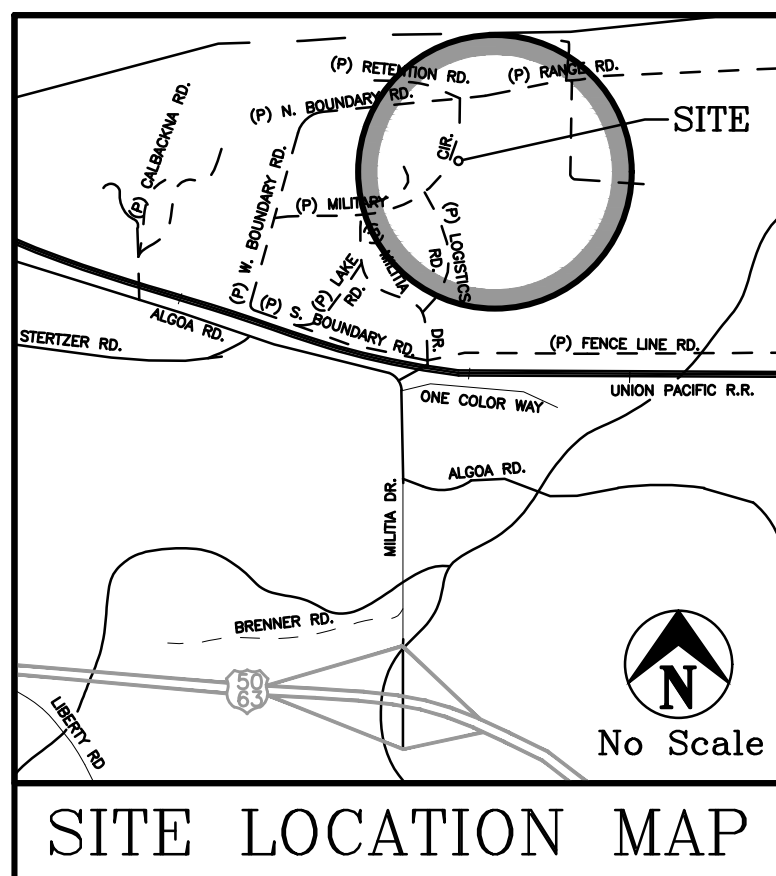

GRADING PLAN KEY NOTES

- 1 INLET BARRIER (DETAIL 1/C-501)
- 2 PERIMETER BARRIER (DETAIL 2/C-501)
- 3 DITCH CHECK (DETAIL 3/C-501)
- 4 AGGREGATE CONSTRUCTION ENTRANCE (DETAIL 4/C-501)

EROSION & SEDIMENT CONTROL NOTES

THE AREA DISTURBED FOR THIS PROJECT IS LESS THAN 1.0 ACRES THEREFORE A DNR LAND DISTURBANCE PERMIT IS NOT REQUIRED. HOWEVER, THE CONTRACTOR SHALL IMPLEMENT BEST MANAGEMENT PRACTICES (BMPs) NECESSARY TO MINIMIZE EROSION AND SEDIMENT FROM ENTERING STORM SEWER SYSTEMS.

THE CONTRACTOR SHALL INSTALL BMPs PER DETAILS AT LOCATIONS SPECIFIED ON THE PLANS OR AS REQUIRED BY CONTRACTORS CONSTRUCTION OPERATION. BMPs SHALL BE INSTALLED PRIOR TO BEGINNING CONSTRUCTION.

THE CONTRACTOR SHALL INSPECT AND MAINTAIN SEDIMENT CONTROL STRUCTURES WEEKLY OR FOLLOWING PRECIPITATION OF GREATER THAN 0.10 INCHES.

THE CONTRACTOR SHALL REMOVE ACCUMULATED SEDIMENT AND MAINTAIN SEDIMENT CONTROL STRUCTURES AS NEEDED TO PREVENT SEDIMENTATION BYPASS OF THE BARRIER.

FUEL, OIL, CHEMICALS, OR OTHER MATERIALS SHALL NOT BE STORED IN AREAS SUBJECT TO SURFACE RUNOFF. THE CONTRACTOR SHALL NOTE ON THE PLANS THE LOCATION OF ANY OUTDOOR MATERIALS STORAGE, LAYDOWN, OR STAGING AREAS. BMPs SHALL BE INSTALLED AND NOTED ON THE PLANS TO MINIMIZE SEDIMENT LEAVING STORAGE, LAYDOWN OR STAGING AREAS. CONTAINMENT MEASURES SHALL BE INSTALLED AND NOTED AROUND ANY FUEL, OIL, OR CHEMICAL STORAGE AREAS.

MINIMIZE TRACKING OF DEBRIS ONTO PAVED SURFACES

THE CONTRACTOR SHALL SWEEP PAVEMENT TO REMOVE ANY DIRT, SILT, OR CONSTRUCTION DEBRIS A MINIMUM OF ONCE PER WEEK OR AS NEEDED.

ALL DISTURBED AREAS SHALL BE STABILIZED PER THE SITE PLAN.



NOTE: The Contractor will be responsible to call the Missouri One Call System 1-800-344-7483 and have the underground utilities marked or remarked prior to any construction.

NOTE: UNDERGROUND FACILITIES, STRUCTURES AND UTILITIES, HAVE BEEN PLOTTED FROM AVAILABLE SURVEYS AND RECORDS, AND THEREFORE THEIR LOCATIONS MUST BE CONSIDERED APPROXIMATE ONLY. THERE MAY BE OTHERS, THE EXISTENCE OF WHICH IS PRESENTLY NOT KNOWN.

CONTRACTOR SHALL SPECIFY LOCATION OF CONSTRUCTION STAGING AREAS, CONSTRUCTION TRAILER, FUEL/CHEMICAL STORAGE AREAS, AND CONCRETE WASHOUTS.



08-01-2023
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No. PE-2003015009

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PROJECT # T2122-01
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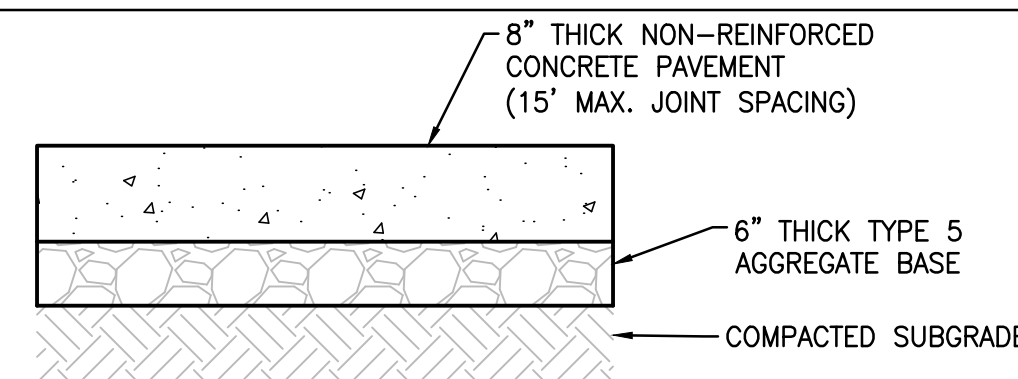
CAD DWG FILE: C102.DWG
DRAWN BY: PLS
CHECKED BY: PLS/BKM
DESIGNED BY: _____

SHEET TITLE:
**GRADING AND
EROSION CONTROL
PLAN**


SHEET NUMBER:
C-102
08/01/2023
SHEET 4 OF 29

GENERAL NOTES:


- All work shall comply with State of Missouri Codes, Standards, Technical Specifications, and all other applicable requirements.
- It is the contractor's responsibility to obtain all necessary permits associated with the installation, notify municipal and state agencies and utility companies having jurisdiction, and to coordinate all inspection required.
- Location of existing utilities are from best information available. Exact location and completeness are not guaranteed. Prior to construction the Contractor shall contact all utility companies concerned. (1-800-DIG-RITE Missouri One Call) If this data is not complete, make test pits and other field locations necessary in order to determine the exact locations of the concerned utilities. Any existing utilities, structures, trees, or other objects which could interfere with the correct completion of the project are also to be located by the Contractor. Any conflicts are to be addressed to the Engineer prior to construction. Additional work resulting from a failure to initially address these items will be at the expense of the Contractor.
- Contractor to be responsible for the protection of new and existing structures, vegetation, walkways, or improvements. No trees outside cuts and fills are to be removed without the approval of the Engineer. No fill is to be placed around existing trees. Damages resulting from construction activities are to be repaired by Contractor at no additional cost to Owner. Any damages shall be brought to the immediate attention of the Engineer.
- All written dimensions, coordinates, bearings, and other written data govern. Prior to starting work all data is to be verified by the contractor.
- Consult Engineer regarding proposed changes, relocation, or modifications prior to the start of work.
- Locations of all existing topographical features are based upon a survey by Central Missouri Professional Services. Horizontal and vertical control points used for this project are noted hereon. The contractor shall use these bench marks for all work performed.
- All fill under pavement is to have 95% compaction. All cut areas under pavement are to be treated as the final lift of fill and compacted to 95%. Non-compressible fill materials such as crushed rock with minimal fines may be used instead of compacted fill to backfill trench excavations.




1 8" NON-REINFORCED CONCRETE PAVEMENT
C-502 NOT TO SCALE

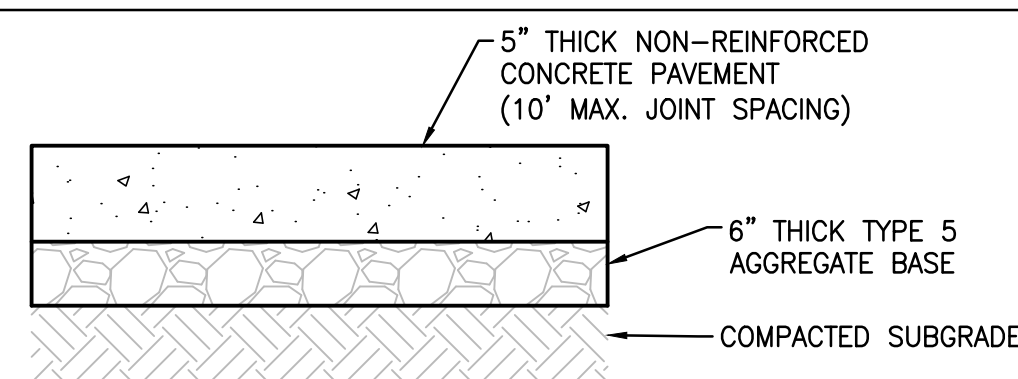


2 5" NON-REINFORCED CONCRETE PAVEMENT
C-502 NOT TO SCALE

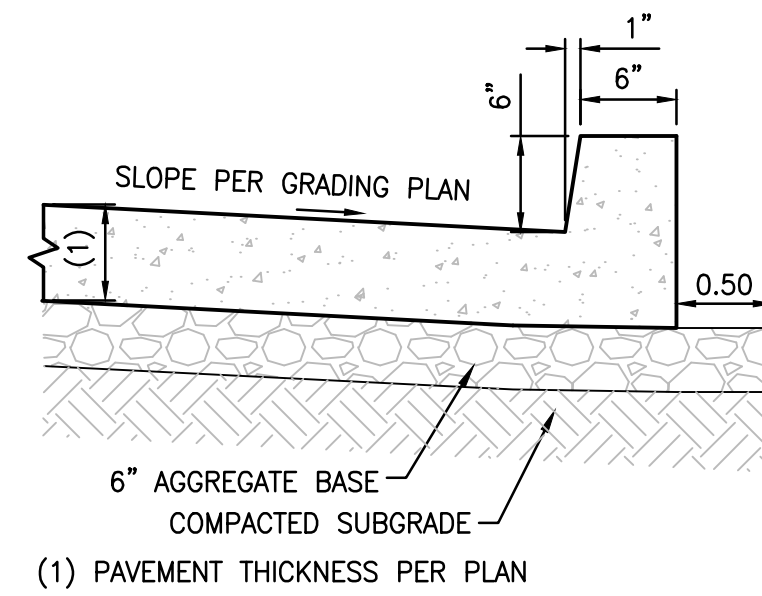


4 INTEGRAL CONCRETE CURB DETAIL
C-502 NOT TO SCALE

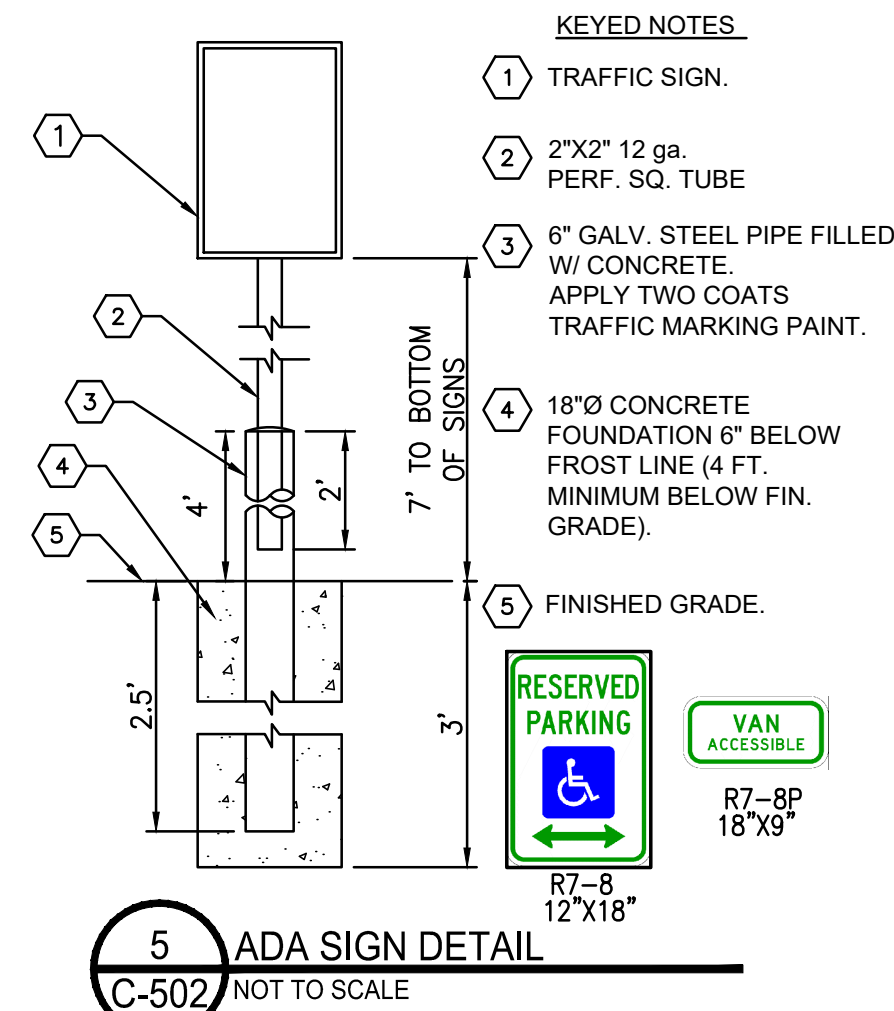


5 ADA SIGN DETAIL
C-502 NOT TO SCALE

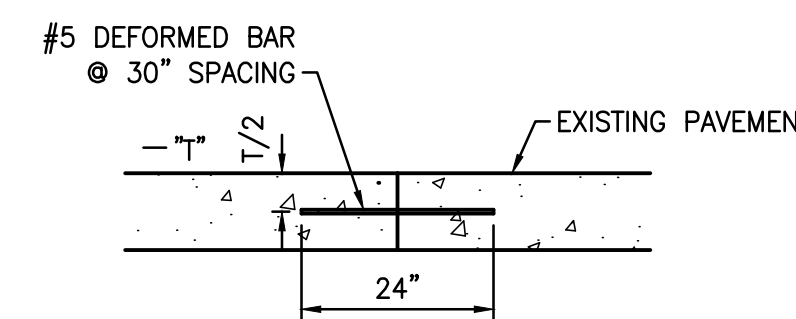

Construction Joint

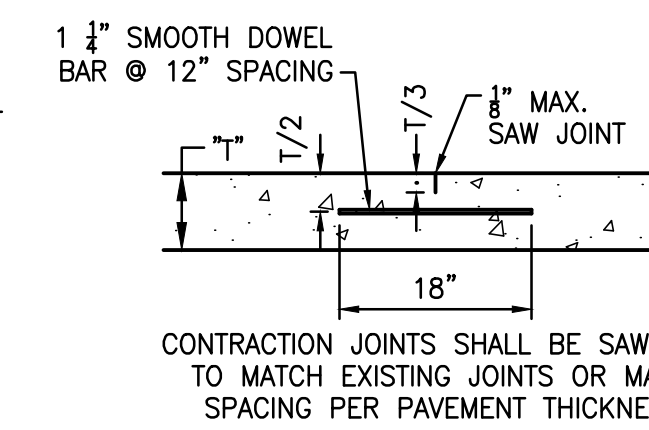


Contraction Joint

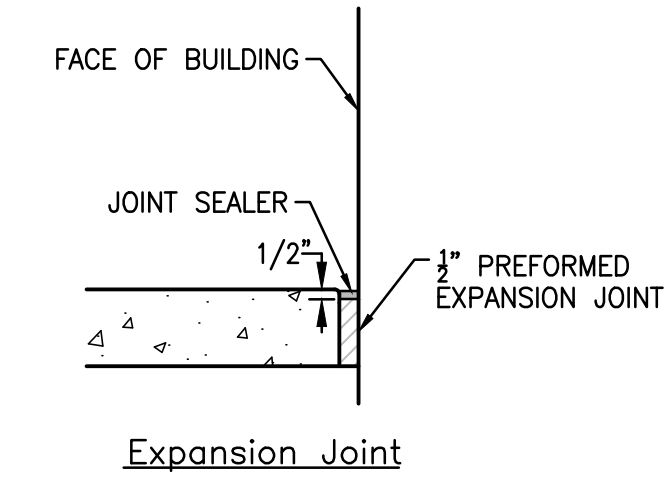


Expansion Joint

3 CONCRETE PAVEMENT JOINT DETAILS
C-502 NOT TO SCALE

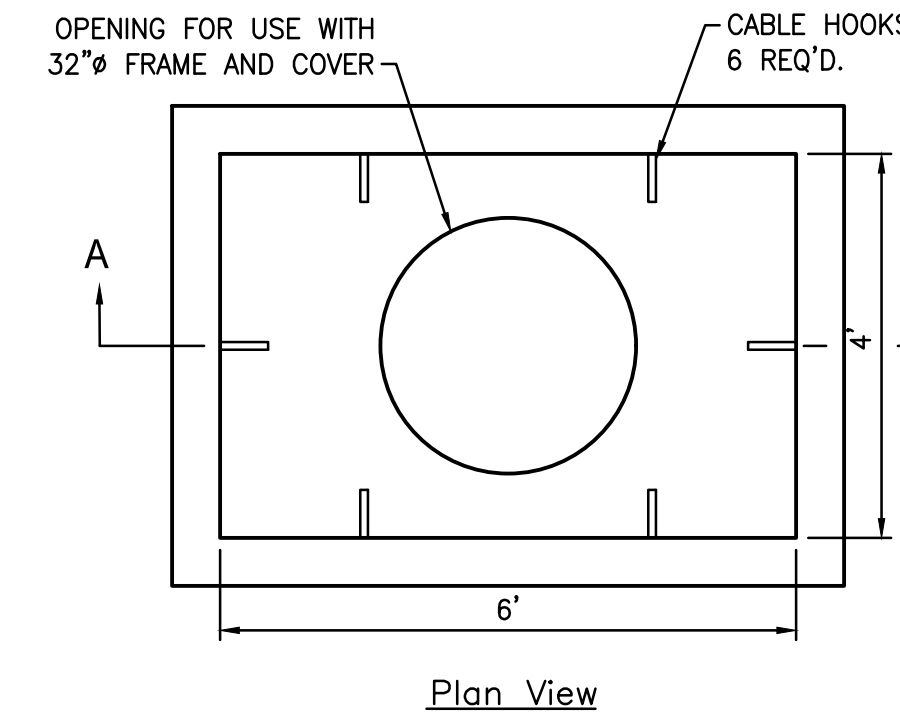

Plan View

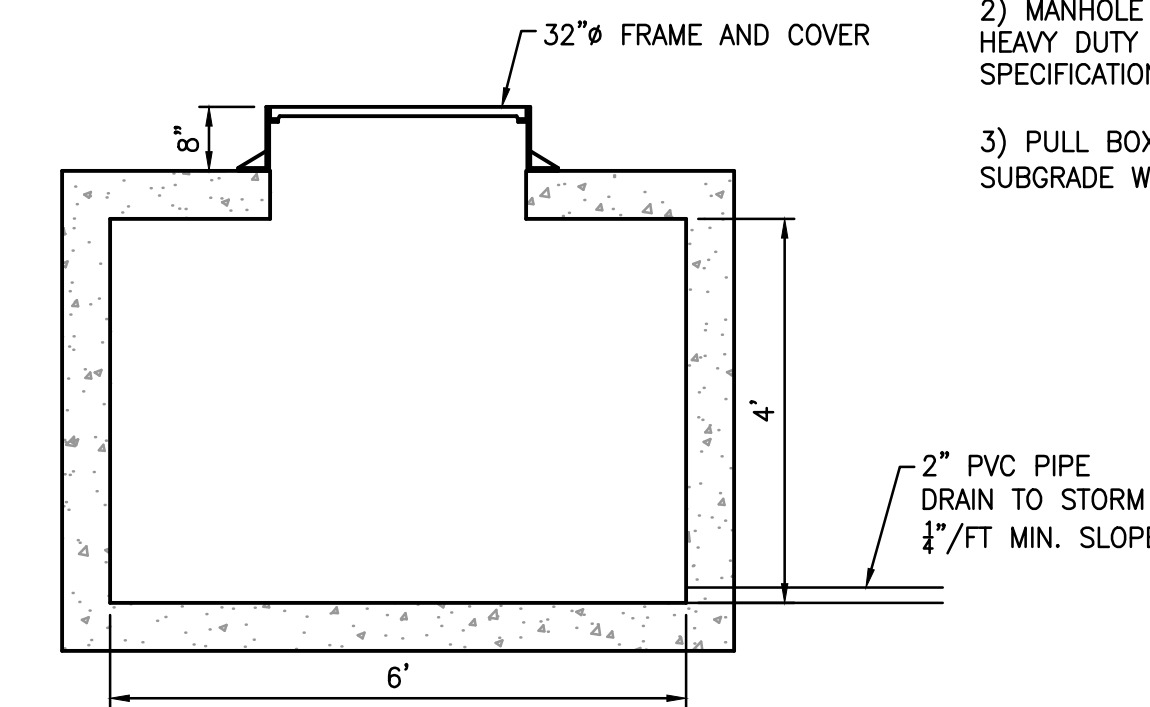

Section A-A

6 TRAFFIC RATED PULL BOX DETAIL
C-502 NOT TO SCALE

- NOTES:
- PULL BOX SHALL BE PRE-CAST CONCRETE MEETING THE FOLLOWING REQUIREMENTS:
4,000 PSI CONCRETE @ 28 DAYS
4%-6% AIR ENTRAINMENT
GRADE 60 REINFORCEMENT
DESIGNED FOR H-20 TRAFFIC LOAD
 - MANHOLE FRAME AND COVER SHALL BE HEAVY DUTY CASTING MEETING ASTM A-48 SPECIFICATIONS.
 - PULL BOX SHALL BE SET ON COMPACTED SUBGRADE WITH MIN 4" CRUSHED STONE BASE.


STATE OF MISSOURI
MICHAEL L. PARSON,
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CAD DWG FILE: C502.DWG
DRAWN BY: PLS
CHECKED BY: PLS/BKM
DESIGNED BY: _____

SHEET TITLE:
SITE PLAN
DETAILS

SHEET NUMBER:

C-502

08/01/2023
SHEET 6 OF 29

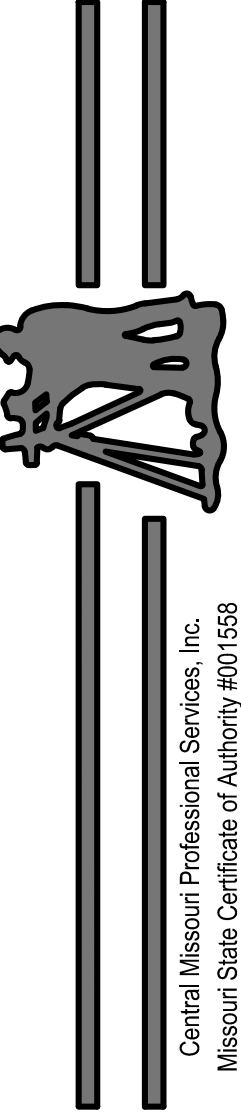BUILDING DESIGN DATA:

GOVERNING BUILDING CODE: 2018 INTERNATIONAL BUILDING CODE (IBC)

- ROOF DEAD LOAD, D (ESTIMATED EXISTING) =25.0 PSF
- MINIMUM ROOF LIVE LOADS, Lr
 - METAL DECK = 20 PSF
 - JOISTS, JOIST GIRDERS, BEAMS, COLUMNS, & FOOTINGS
 - TRIBUTARY LOADED AREA (At): 0 TO 200 SF. = 20 PSF
 - TRIBUTARY LOADED AREA (At): 201 TO 599 SF. = 20*(1.2-0.001*At) PSF
 - TRIBUTARY LOADED AREA (At): 600 SF. AND GREATER = 12 PSF
- ROOF SNOW LOADS, S
 - GROUND SNOW LOAD, Pg = 20 PSF
 - SNOW EXPOSURE FACTOR, Ce = 1.0
 - SNOW LOAD IMPORTANCE FACTOR, Is = 1.0
 - THERMAL FACTOR, Ct = 1.0
 - FLAT-ROOF SNOW LOAD*, Pf = 20 PSF *INCLUDES 5.0 PSF RAIN-ON-SNOW SURCHARGE
 - ALL APPLICABLE EFFECTS DUE TO UNBALANCED SNOW LOADING AND SNOW DRIFTING
- WIND LOADS, W
 - BASIC WIND SPEED (3 SECOND GUST), V = 115 MPH
 - WIND LOAD IMPORTANCE FACTOR, Iw = 1.0
 - BUILDING CATEGORY: ENCLOSED, SIMPLE DIAPHRAGM
 - OVERALL EXPOSURE CATEGORY, C
 - HEIGHT AND EXPOSURE ADJUSTMENT COEFFICIENT = 1.26 (Kzt=1.0)
 - MAIN-WIND-FORCE-RESISTING-SYSTEM WIND DESIGN (ULTIMATE) PRESSURES, W:

MWFRS WIND DESIGN PRESSURES		
LOCATION	DESIGN PRESSURE (PSF)	
INTERIOR ZONE	17.5	
-END ZONE **	26.4	
* THE TOTAL HORIZONTAL LOAD EFFECT ON THE BUILDING SHALL NOT BE LESS THAN THAT BY ASSUMING THAT THE WIND PRESSURES IN ALL ZONES IS EQUAL TO 16.0 PSF		
** END ZONE PRESSURES SHALL APPLY WITHIN 15 FEET OF EACH BUILDING CORNER		
HORIZONTAL		
MAXIMUM WINDWARD ROOF PRESSURE		
-INTERIOR ZONE	-22.0	
-END ZONE **	-31.7	
VERTICAL		
MAXIMUM LEEWARD ROOF PRESSURE		
-INTERIOR ZONE	-14.0	
-END ZONE **	-18.0	

- COMPONENTS AND CLADDING WIND DESIGN (SERVICE LOAD) PRESSURES: PER TABLE BELOW.

COMPONENTS AND CLADDING WIND DESIGN PRESSURES (PSF)				
	ZONE*	EFFECTIVE WIND AREA (SF)	WINDWARD PRESSURE	LEEWARD PRESSURE
ROOF	①	10	10.0	-18.0
		20	10.0	-17.5
		50	10.0	-16.9
		100	10.0	-16.5
		10	10.0	-30.1
	②	20	10.0	-26.9
		50	10.0	-22.7
		100	10.0	-19.5
		10	10.0	-45.4
		20	10.0	-37.6
③	50	10.0	-27.2	
	100	10.0	-19.5	
	10	18.0	-19.5	
	20	17.1	-18.6	
	50	16.1	-17.6	
WALLS	④	100	15.2	-16.8
		500	13.4	-14.9
		10	18.0	-24.1
		20	17.1	-22.4
		50	16.1	-20.3
⑤	100	15.2	-18.6	
	500	13.4	-14.9	

- * ZONE 1 INCLUDES THOSE ROOF ELEMENTS LOCATED OUTSIDE OF 8 FEET OF A ROOF EDGE.
 ZONE 2 INCLUDES THOSE ROOF ELEMENTS LOCATED WITHIN 8 FEET A ROOF EDGE.
 ZONE 3 INCLUDES THOSE ROOF ELEMENTS LOCATED WITHIN 8 FEET OF A ROOF EDGE AND WITHIN 12 FEET OF A BUILDING CORNER.
 ZONE 4 INCLUDES THOSE WALL ELEMENTS LOCATED OUTSIDE OF 8 FEET OF A BUILDING CORNER.
 ZONE 5 INCLUDES THOSE WALL ELEMENTS LOCATED WITHIN 8 FEET OF A BUILDING CORNER.

- SEISMIC DESIGN DATA
 - SEISMIC USE GROUP = 1
 - MAPPED SPECTRAL RESPONSE COEFFICIENTS
 - S_s = 0.207
 - S₁ = 0.108
 - SITE CLASS = E
 - SPECTRAL RESPONSE COEFFICIENTS
 - S_{DS} = 0.322
 - S₁ = 0.305
 - SEISMIC DESIGN CATEGORY = D
 - BASIC SEISMIC-FORCE-RESISTING SYSTEM: BEARING WALL INTERMEDIATE REINFORCED MASONRY SHEAR WALLS
 - RESPONSE MODIFICATION COEFFICIENT = 3.5
 - DEFLECTION AMPLIFICATION FACTOR = 4.0
 - SYSTEM OVERSTRENGTH FACTOR = 2.5
 - ANALYSIS PROCEDURE: EQUIVALENT LATERAL FORCE PROCEDURE
 - BASE SHEAR: V = 33.2 kips

SUBGRADE PREPARATION NOTE:

- THE SITE SUBGRADE SHALL BE PREPARED IN STRICT ACCORDANCE WITH THE RECOMMENDATIONS MADE IN THE "SUBSURFACE INVESTIGATION, ANALYSIS AND GEOTECHNICAL ENGINEERING RECOMMENDATIONS FOR T1921-01 CSMS RENOVATION, JEFFERSON CITY, MISSOURI" DATED JANUARY 31, 2020, PREPARED BY GREDELL ENGINEERING RESOURCES, INC.

CONCRETE:

- ALL CONCRETE SHALL BE NORMAL-WEIGHT (DENSITY=145 PCF) AND SHALL HAVE A 28-DAY COMPRESSIVE STRENGTH IN ACCORDANCE WITH THE FOLLOWING:

SPECIFIED COMPRESSIVE STRENGTH (PSI)	NON AIR-ENTRAINED CONCRETE (LBS.)	AIR-ENTRAINED CONCRETE (LBS.)
3000	470	517
4000	564	611
- THE SLUMP OF ALL CONCRETE SHALL NOT EXCEED 4 IN. UNLESS A HIGH RANGE WATER-REDUCING ADMIXTURE IS USED. THE SLUMP OF CONCRETE PRIOR TO ADDITION OF A HIGH-RANGE WATER-REDUCING ADMIXTURE SHALL NOT EXCEED 4 IN. THE SLUMP OF CONCRETE CONTAINING A HIGH RANGE WATER-REDUCING ADMIXTURE SHALL NOT EXCEED 8 IN.
- ALL EXTERIOR CONCRETE SHALL BE AIR-ENTRAINED WITH 5% +/- 1.5% AIR CONTENT.
- THE COARSE AGGREGATE SIZE SHALL MEET AASHTO #57.
- THE MINIMUM PORTLAND CEMENT CONTENT (ASTM C150 TYPE III) OF ALL CONCRETE SHALL CONFORM TO THE FOLLOWING TABLE (FLY ASH NOT PERMITTED):

SPECIFIED COMPRESSIVE STRENGTH (PSI)	NON AIR-ENTRAINED CONCRETE (LBS.)	AIR-ENTRAINED CONCRETE (LBS.)
3000	470	517
4000	564	611

- THE CONTRACTOR SHALL SUBMIT CONCRETE MIX DESIGNS FOR REVIEW A MINIMUM OF ONE WEEK PRIOR TO THE PLACEMENT OF ANY CONCRETE. THE CONCRETE MIX DESIGNS SHALL INCLUDE ALL STRENGTH DATA NECESSARY TO SHOW COMPLIANCE WITH THE PROJECT SPECIFICATIONS FOR EITHER THE TRIAL BATCH OR FIELD EXPERIENCE METHOD.
- CONCRETE REINFORCING STEEL SHALL CONFORM TO ASTM A615, GRADE 60, UNLESS NOTED OTHERWISE.
- CONCRETE REINFORCING STEEL TO BE WELDED SHALL CONFORM TO ASTM A706.
- WELDED WIRE FABRIC SHALL CONFORM TO ASTM A185.
- ALL REINFORCING SHALL BE DETAILED, FABRICATED, AND PLACED IN ACCORDANCE WITH THE LATEST EDITION OF THE AMERICAN CONCRETE INSTITUTE DETAILING MANUAL.
- ALL REINFORCING SHALL BE SUPPORTED IN FORMS, SPACED WITH NECESSARY ACCESSORIES AND SHALL BE SECURELY WIRED TOGETHER, IN ACCORDANCE WITH THE LATEST EDITION OF THE CRSI "MANUAL OF STANDARD PRACTICE".
- THE MINIMUM CONCRETE CLEAR COVER OVER REINFORCING STEEL, UNLESS NOTED OTHERWISE, SHALL BE:

UNFORMED SURFACE IN CONTACT WITH THE GROUND	3 IN.
FORMED SURFACES EXPOSED TO EARTH OR WEATHER:	
#5 BARS AND SMALLER	1 1/2 IN.
SLABS, WALLS, AND JOISTS:	
#11 BARS AND SMALLER	3/4 IN.
- ALL BASE PLATES, ANCHOR BOLTS, SUPPORT ANGLES, ETC., WHICH ARE BELOW GRADE SHALL BE COVERED WITH A MINIMUM OF 3" OF CONCRETE.
- ALL LAP SPLICES SHALL BE IN ACCORDANCE WITH THAT SHOWN ON THE DRAWINGS.

REINFORCED MASONRY:

- THE REINFORCED CONCRETE MASONRY FOR THIS PROJECT HAS BEEN DESIGNED AND DETAILED IN ACCORDANCE WITH THE ALLOWABLE STRESS DESIGN METHOD OF THE BUILDING CODE REQUIREMENTS AND SPECIFICATION FOR MASONRY STRUCTURES.
- REINFORCED MASONRY SHALL HAVE A MINIMUM COMPRESSIVE STRENGTH, f_m, OF 2000 PSI. MASONRY UNITS SHALL BE NORMAL WEIGHT BLOCK CONFORMING TO ASTM C90 AND SHALL HAVE A MINIMUM NET AREA COMPRESSIVE STRENGTH OF 2000 PSI. MORTAR SHALL CONFORM TO ASTM C270, TYPE S. GROUT SHALL CONFORM TO ASTM C476 AND SHALL HAVE A MINIMUM 28-DAY COMPRESSIVE STRENGTH OF 2000 PSI.
- REINFORCING STEEL SHALL CONFORM TO ASTM A615, GRADE 60, UNLESS NOTED OTHERWISE. REINFORCING STEEL TO BE WELDED SHALL CONFORM TO ASTM A706.
- CONTINUOUS WIRE REINFORCING (JOINT REINFORCING) SHALL BE GALVANIZED TRUSS OR LADDER TYPE FORMED FROM 9 GAUGE COLD - DRAWN STEEL WIRE COMPLYING WITH ASTM A82. JOINT REINFORCING SHALL BE SPACED AT 16" O.C. VERTICALLY IN ALL MASONRY WALLS.
- ALL REINFORCED CELLS, ALL CELLS BELOW GRADE AND ALL CELLS BELOW FINISH FLOOR SHALL BE GROUTED SOLID.
- WHEN A FOUNDATION DOWEL DOES NOT LINE UP WITH A VERTICAL BLOCK CORE, IT SHALL NOT BE SLOPED MORE THAN ONE HORIZONTAL IN 6 VERTICAL. DOWELS MAY BE GROUTED INTO A CELL IN VERTICAL ALIGNMENT, EVEN THOUGH IT IS IN AN ADJACENT CELL TO THE VERTICAL WALL REINFORCING. GROUT THE CELL FOR THE FULL HEIGHT OF THE DOWEL.
- REINFORCING STEEL SHALL BE CENTERED IN THE MASONRY UNIT CELL, UNLESS NOTED OTHERWISE.
- VERTICAL REINFORCING BARS SHALL HAVE A MINIMUM GROUT COVER OF 1/2 OF AN INCH TO THE INSIDE FACE OF MASONRY UNIT AND A MINIMUM TOTAL MASONRY COVER NOT LESS THAN TWO INCHES.
- PARALLEL ADJACENT VERTICAL REINFORCING BARS SHALL HAVE A MINIMUM CLEAR DISTANCE NOT LESS THAN 1 1/2 BAR DIAMETERS NOR 1 1/2 INCHES.
- VERTICAL CELLS THAT WILL BE GROUTED SHALL HAVE A VERTICAL ALIGNMENT TO MAINTAIN A CONTINUOUS UNOBSTRUCTED CELL AREA NOT LESS THAN 3"x4".
- GROUTING SHALL BE STOPPED 1-1/2" BELOW THE TOP OF A COURSE SO AS TO FORM A KEY AT THE POUR JOINT.
- GROUTING OF MASONRY BEAMS OVER OPENINGS SHALL BE DONE IN ONE CONTINUOUS OPERATION.
- ALL BOLTS, ANCHORS, ETC., INSERTED IN THE WALLS, SHALL BE GROUTED SOLID INTO POSITION.
- SPLICED REINFORCING BARS SHALL BE LAPPED A MINIMUM OF 72 BAR DIAMETERS.

STRUCTURAL STEEL:

- STEEL SHALL CONFORM TO THE FOLLOWING GRADES:

WIDE FLANGE SHAPES	A992 OR A572 GR. 50 (Fy = 50 KSI)
CHANNELS, ANGLES, PLATES, ETC. (UNO)	A36 (Fy = 36 KSI)
STRUCTURAL TUBE	A500 (Fy = 46 KSI)
STEEL PIPE	A53 (Fy = 35 KSI)
THREADED RODS	F1554, A36 OR A307
BOLTS	A325
WELDING ELECTRODES	E70XX
 - ALL STRUCTURAL STEEL SHALL BE DETAILED, FABRICATED AND ERECTED IN ACCORDANCE WITH THE AISC CODE OF STANDARD PRACTICE (AISC 303-16), EXCEPT AS MODIFIED IN THESE NOTES AND THE PROJECT SPECIFICATIONS.
 - ALL STRUCTURAL STEEL TO HAVE A SHOP GRADE PRIMER UNLESS NOTED OTHERWISE.
- MISCELLANEOUS:**
- NO CHANGE IN SIZE OR DIMENSION OF STRUCTURAL MEMBERS SHALL BE MADE WITHOUT THE WRITTEN APPROVAL OF THE PROFESSIONAL OF RECORD.
 - STRUCTURAL DRAWINGS ARE INTENDED TO BE USED WITH ARCHITECTURAL AND MECHANICAL DRAWINGS. CONTRACTOR IS RESPONSIBLE FOR COORDINATING SUCH REQUIREMENTS INTO THEIR SHOP DRAWINGS AND WORK.
 - NO OPENINGS SHALL BE MADE IN ANY STRUCTURAL MEMBER WITHOUT THE WRITTEN APPROVAL OF THE PROFESSIONAL OF RECORD.
 - DO NOT SCALE THESE DRAWINGS, USE DIMENSIONS.
 - THE CONTRACTOR SHALL INFORM THE PROFESSIONAL OF RECORD IN WRITING OF ANY DEVIATION FROM THE CONTRACT DOCUMENTS. THE CONTRACTOR SHALL NOT BE RELIEVED OF THE RESPONSIBILITY OF SUCH DEVIATION BY THE PROFESSIONAL OF RECORD REVIEW OF SHOP DRAWINGS, PRODUCT DATA, ETC., UNLESS THE CONTRACTOR HAS SPECIFICALLY INFORMED THE PROFESSIONAL OF RECORD OF SUCH DEVIATION AT THE TIME OF SUBMISSION, AND THE PROFESSIONAL OF RECORD HAS GIVEN WRITTEN APPROVAL TO THE SPECIFIC DEVIATION.
 - ANY DETAIL TITLED AS A TYPICAL DETAIL IS APPLICABLE THROUGHOUT THE DESIGN DRAWINGS. THESE DETAILS ARE DEFINED AS GENERAL STANDARDS THAT ARE USUALLY NOT IDENTIFIED BY SPECIFIC REFERENCE WITHIN THE DRAWINGS. THESE DETAILS MAY BE MODIFIED OR SUPERSEDED BY SPECIFIC DETAILS THAT ARE REFERENCED WITHIN THE DRAWINGS.
 - THE CONTRACTOR IS RESPONSIBLE FOR LIMITING THE AMOUNT OF CONSTRUCTION LOAD IMPOSED UPON THE STRUCTURAL FRAMING. CONSTRUCTION LOADS SHALL NOT EXCEED THE DESIGN CAPACITY OF THE FRAMING AT THE TIME THE LOADS ARE IMPOSED.

EXISTING CONSTRUCTION:


- WORK SHOWN IS NEW UNLESS INDICATED AS EXISTING.
- EXISTING CONSTRUCTION SHOWN IS BASED UPON ASSUMED EXISTING CONDITIONS AND CAN BE USED FOR BIDDING PURPOSES. THE CONTRACTOR SHALL FIELD VERIFY ALL EXISTING JOB CONDITIONS, REVIEW ALL DRAWINGS AND VERIFY DIMENSIONS, ELEVATIONS, AND MEMBER SIZES PRIOR TO CONSTRUCTION OR MATERIAL PURCHASE. THE CONTRACTOR SHALL NOTIFY THE PROFESSIONAL OF RECORD IN WRITING OF ALL DISCREPANCIES AND EXCEPTIONS BEFORE PROCEEDING WITH THE WORK.
- THE REMOVAL, CUTTING, DRILLING, ETC. OF EXISTING CONSTRUCTION SHALL BE PERFORMED WITH GREAT CARE IN ORDER NOT TO JEOPARDIZE THE STRUCTURAL INTEGRITY OF THE BUILDING. IF STRUCTURAL MEMBERS OR MECHANICAL, ELECTRICAL, OR ARCHITECTURAL FEATURES NOT INDICATED FOR REMOVAL INTERFERE WITH THE NEW WORK, THE PROFESSIONAL OF RECORD SHALL BE IMMEDIATELY NOTIFIED AND PRIOR WRITTEN APPROVAL SHALL BE OBTAINED BEFORE REMOVAL OR MODIFICATION OF MEMBERS.
- THE CONTRACTOR SHALL RESTORE ALL EXISTING INCIDENTAL CONSTRUCTION REQUIRED TO BE REMOVED TO ACCOMMODATE THE ERECTION OF THE NEW JOIST CONSTRUCTION TO ITS ORIGINAL WORKING CONDITION.
- THE CONTRACTOR IS SOLELY RESPONSIBLE FOR THE MEANS & METHOD OF ALL DEMOLITION WORK & FOR PROVIDING ALL NECESSARY TEMPORARY SHORING, BRACING & PROTECTION AS NECESSARY FOR SAFETY, STABILITY & PROTECTION OF ALL BUILDING ELEMENTS & STRUCTURE DURING CONSTRUCTION & DEMOLITION.

SPECIAL INSPECTIONS:

- THE OWNER WILL EMPLOY THE SERVICES OF ONE OR MORE SPECIAL INSPECTORS (ACCEPTABLE TO THE STATE OF MISSOURI) TO PROVIDE SPECIAL INSPECTIONS DURING CONSTRUCTION FOR THE REQUIRED SPECIAL INSPECTION ITEMS.
- THE SPECIAL INSPECTOR SHALL BE A QUALIFIED PERSON WHO SHALL DEMONSTRATE COMPETENCE, TO THE SATISFACTION OF THE STATE OF MISSOURI AND THE REGISTERED DESIGN PROFESSIONAL RESPONSIBLE FOR THE DESIGN OF THE STRUCTURE, FOR INSPECTION OF THE PARTICULAR TYPE OF CONSTRUCTION OR OPERATION REQUIRING SPECIAL INSPECTION.
- DUTIES AND RESPONSIBILITIES OF THE SPECIAL INSPECTOR:
 - THE SPECIAL INSPECTOR SHALL OBSERVE THE WORK ASSIGNED FOR CONFORMANCE WITH THE APPROVED DESIGN DRAWINGS AND SPECIFICATIONS. THE INSPECTOR MAY NOT ALTER, MODIFY, ENLARGE OR WAVE ANY OF THE REQUIREMENTS OF THE DOCUMENTS.
 - THE SPECIAL INSPECTOR SHALL FURNISH INSPECTION REPORTS TO THE STATE OF MISSOURI, THE PROFESSIONAL-OF-RECORD, AND THE OWNER. ALL DISCREPANCIES SHALL BE BROUGHT TO THE IMMEDIATE ATTENTION OF THE OWNER FOR CORRECTION. THEN, IF UNCORRECTED, SUBMIT A COMPLETE LIST OF ALL OUTSTANDING DISCREPANCIES ON A WEEKLY BASIS TO THE STATE OF MISSOURI AND THE PROFESSIONAL-OF-RECORD, UNTIL ALL CORRECTIONS HAVE BEEN COMPLETED.
 - THE SPECIAL INSPECTOR SHALL SUBMIT A FINAL SIGNED REPORT STATING WHETHER THE WORK REQUIRING SPECIAL INSPECTION WAS, TO THE BEST OF THE INSPECTOR'S KNOWLEDGE, IN CONFORMANCE WITH THE APPROVED PLANS AND SPECIFICATIONS AND THE APPLICABLE WORKMANSHIP PROVISIONS OF THE BUILDING CODE.
- WHERE SPECIAL INSPECTION REQUIREMENTS DUPLICATE THE REQUIREMENTS OF OTHER SPECIFIED TESTING, DUPLICATE INSPECTIONS SHALL NOT BE REQUIRED.
- STRUCTURAL OBSERVATION (AS DEFINED IN CHAPTER 17 OF THE BUILDING CODE) IS NOT REQUIRED, UNLESS SPECIFICALLY REQUIRED BY THE STATE OF MISSOURI.
- SPECIAL INSPECTIONS SHALL BE PROVIDED IN ACCORDANCE WITH THE FOLLOWING TABLE:

SPECIAL INSPECTIONS SCHEDULE		
SPECIAL INSPECTION	FREQ.	REFERENCED STANDARD(S)
STEEL CONSTRUCTION:		
1. INSPECTION OF BEARING-TYPE CONNECTIONS	PERIODIC	AISC LRFD Sec. M2.5
2. MATERIAL VERIFICATION OF STRUCTURAL STEEL:		AISC LRFD Sec. M2.5
A. IDENTIFICATION MARKINGS TO CONFORM TO ASTM STANDARDS SPECIFIED IN THE APPROVED CONSTRUCTION DOCUMENTS.	---	ASTM A-6 OR ASTM A-568
B. MANUFACTURER'S CERTIFIED MILL TEST REPORTS REQUIRED	---	
3. MATERIAL VERIFICATION OF WELD FILLER MATERIALS:		
A. IDENTIFICATION MARKINGS TO CONFORM TO AWS SPECIFICATION IN THE APPROVED CONSTRUCTION DOCUMENTS	---	AISC ASD Sec. A3.6; AISC LRFD Sec. A3.5
B. MANUFACTURER'S CERTIFICATE OF COMPLIANCE REQUIRED	---	
4. INSPECTION OF WELDING: SINGLE-PASS FILLET WELDS ≤ 5/16"	PERIODIC	AWS D1.1
5. INSPECTION OF STEEL FRAME TO VERIFY COMPLIANCE WITH THE DETAILS ON THE APPROVED CONSTRUCTION DOCUMENTS:		
A. DETAILS SUCH AS BRACING AND STIFFENING	PERIODIC	IBC 1704.3.2
B. MEMBER LOCATIONS		
C. APPLICATION OF JOINT DETAILS AT EACH CONNECTION		
MASONRY CONSTRUCTION:		
1. AS MASONRY CONSTRUCTION BEGINS, THE FOLLOWING SHALL BE VERIFIED TO ENSURE COMPLIANCE:		
A. PROPORTIONS OF SITE PREPARED MORTAR.	PERIODIC	ACI 530.1/ASCE 6/TMS 602:Art. 2.6A
B. CONSTRUCTION OF MORTAR JOINTS.		ACI 530.1/ASCE 6/TMS 602:Art. 3.3B
C. LOCATION OF REINFORCEMENT AND CONNECTORS.		ACI 530.1/ASCE 6/TMS 602: Art. 3.4, 3.6A
2. THE INSPECTION PROGRAM SHALL VERIFY:		
A. SIZE AND LOCATION OF STRUCTURAL ELEMENTS.		ACI 530.1/ASCE 6/TMS 602:Art.3.3G
B. TYPE, SIZE, AND LOCATION OF ANCHORS, INCLUDING OTHER DETAILS OF ANCHORAGE OF MASONRY TO STRUCTURAL MEMBERS, FRAMES, OR OTHER CONSTRUCTION.		ACI 530/ASCE 6/TMS 402-SEC. 1.2.2(e), 2.1.4, 3.1.6, 1.12, 2.1.10.6.2, 3.2.3.4(b)
C. SPECIFIED SIZE, GRADE, AND TYPE OF REINFORCEMENT	PERIODIC	ACI 530.1/ASCE 6/TMS 602: Sec. 1.12; ACI 530.1/ASCE 6/TMS 602:Art. 2.4, 3.4
D. WELDING OF REINFORCING BARS.		ACI 530/ASCE 6/TMS 402: Sec. 2.1.10.2, 3.2.3.4(b)
E. PROTECTION OF MASONRY DURING COLD WEATHER (TEMPERATURE BELOW 40° F) OR HOT WEATHER (TEMPERATURE ABOVE 90° F)		ACI 530.1/ASCE 6/TMS 602: Art. 1.8C, 1.8D
3. PRIOR TO GROUTING, THE FOLLOWING SHALL BE VERIFIED TO ENSURE COMPLIANCE:		
A. GROUT SPACE IS CLEAN.	PERIODIC	ACI 530.1/ASCE 6/TMS 602:Art. 3.2D
B. PLACEMENT OF REINFORCEMENT AND CONNECTORS.		ACI 530/ASCE 5/TMS 402:Sec. 1.12; ACI 530.1/ASCE 6/TMS 602:Art. 3.4
C. PROPORTIONS OF SITE PREPARED GROUT.		ACI 530.1/ASCE 6/TMS 602:Art. 2.6B
D. CONSTRUCTION OF MORTAR JOINTS.		ACI 530.1/ASCE 6/TMS 602:Art. 3.3B
4. GROUT PLACEMENT SHALL BE VERIFIED TO ENSURE COMPLIANCE WITH CODE AND CONSTRUCTION DOCUMENT PROVISIONS.	CONTINUOUS	ACI 530/ASCE 6/TMS 602-ART. 3.5
5. PREPARATION OF ANY REQUIRED GROUT SPECIMENS, MORTAR SPECIMENS, AND/OR PRISMS SHALL BE OBSERVED.	CONTINUOUS	ACI 530/ASCE 6/TMS 602-ART. 1.4. AND IBC SEC. 2105.2.2 AND 2105.3
6. COMPLIANCE WITH REQUIRED INSPECTION PROVISIONS OF THE CONSTRUCTION DOCUMENTS AND THE APPROVED SUBMITTALS SHALL BE VERIFIED.	PERIODIC	ACI 530/ASCE 6/TMS 602-ART. 1.5.
ADHESIVE ANCHORS/REINFORCEMENT:		
1. DURING PLACEMENT OF ADHESIVE ANCHORS OR REINFORCEMENT EMBEDDED WITH ADHESIVE (AS SPECIFIED ON THE CONSTRUCTION DOCUMENTS) IN MASONRY AND CONCRETE:		
A. SIZE AND EMBEDMENT OF ANCHORS/REINF.	CONTINUOUS	MANUFACTURERS INSTALLATION INSTRUCTIONS
B. ANCHORS/REINFORCEMENT INSTALLED PER MANUFACTURERS RECOMMENDATIONS.	CONTINUOUS	

**STATE OF MISSOURI
MICHAEL L. PARSON,
GOVERNOR**

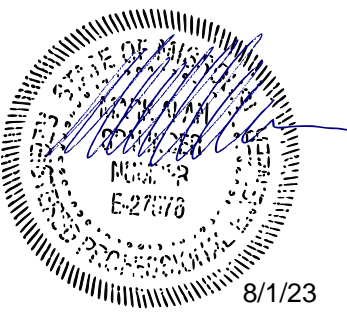

MARK A. SPALINGER
License Number: E-27576
Expiration Date: 12/31/23
PROFESSIONAL SEAL
CASCO Diversified Corporation
MO Certificate of Authority #000329 Arch.
MO Certificate of Authority #000613 Eng.

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12 Sunnen Drive, Suite 100, St. Louis, MO 63143 T: 314.821.1100

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**MISSOURI NATIONAL
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RENOVATE COMBINED
SUPPORT MAINTENANCE
SHOP (CSMS) ANNEX
COMBINED SUPPORT
MAINTENANCE SHOP (CSMS)
2302 MILITIA DRIVE
JEFFERSON CITY, MISSOURI
65101

PROJECT # T2122-01
SITE # 6300
ASSET# 8136300017

REVISION: _____
DATE: _____
REVISION: _____
DATE: _____
REVISION: _____
DATE: _____
ISSUE DATE: 08/01/2023

CAD DWG FILE: _____
DRAWN BY: BWT
CHECKED BY: NDM
DESIGNED BY: NDM


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**STRUCTURAL
GENERAL NOTES**

SHEET NUMBER:


S-001

08/01/2023
SHEET 7 OF 27

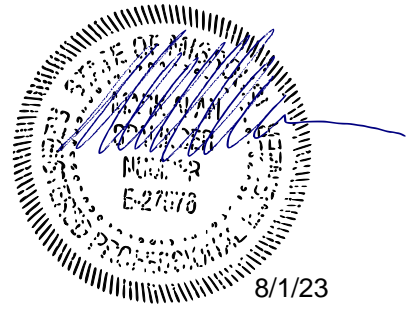


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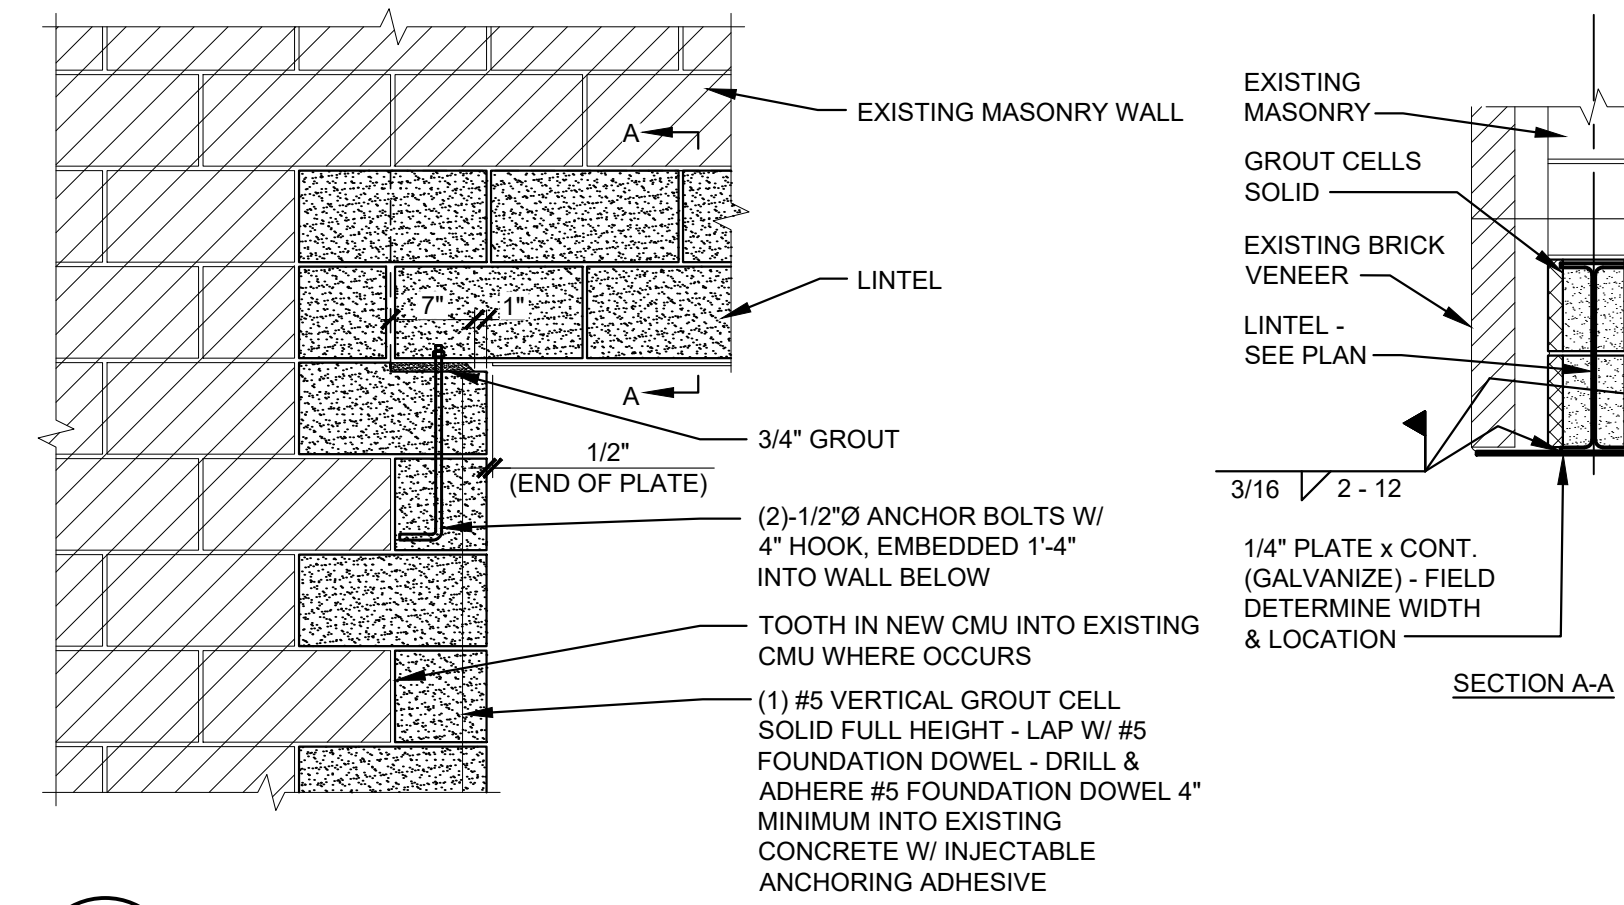
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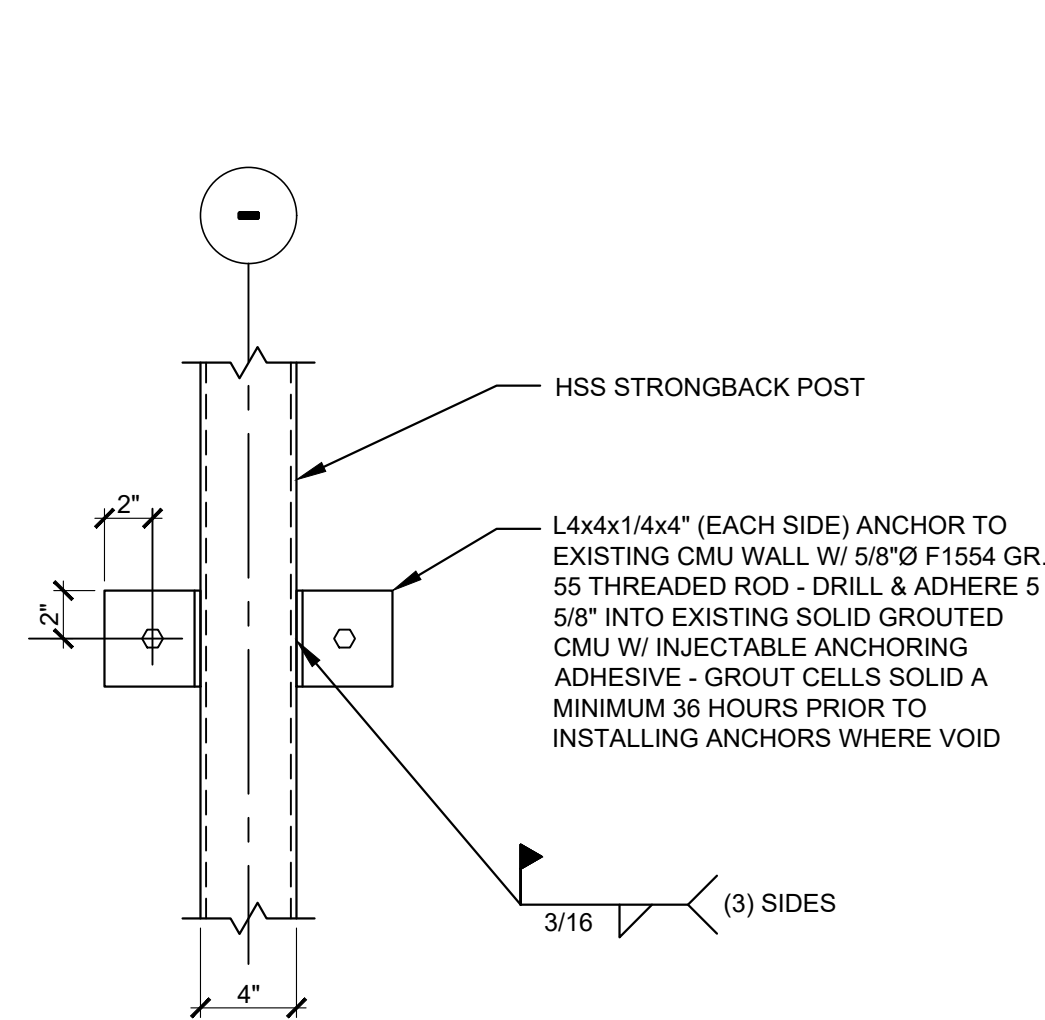
1 PARITAL EXISTING FOUNDATION PLAN
S-101 SCALE: 1/4" = 1'-0"

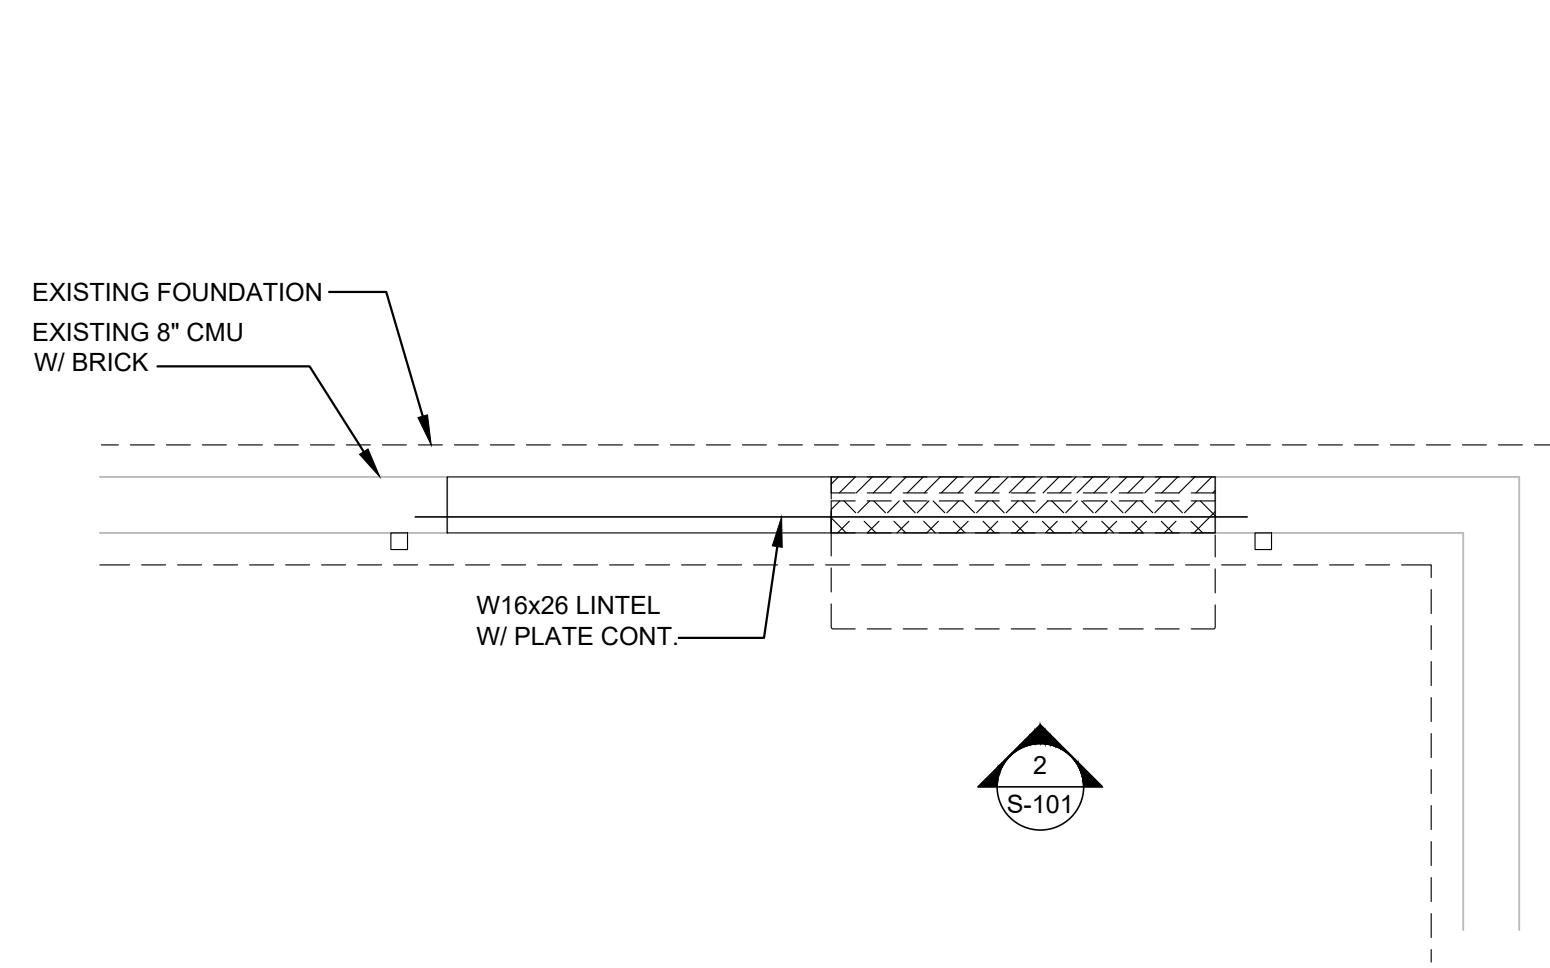


2 ELEVATION
S-101 SCALE: 1/4" = 1'-0"

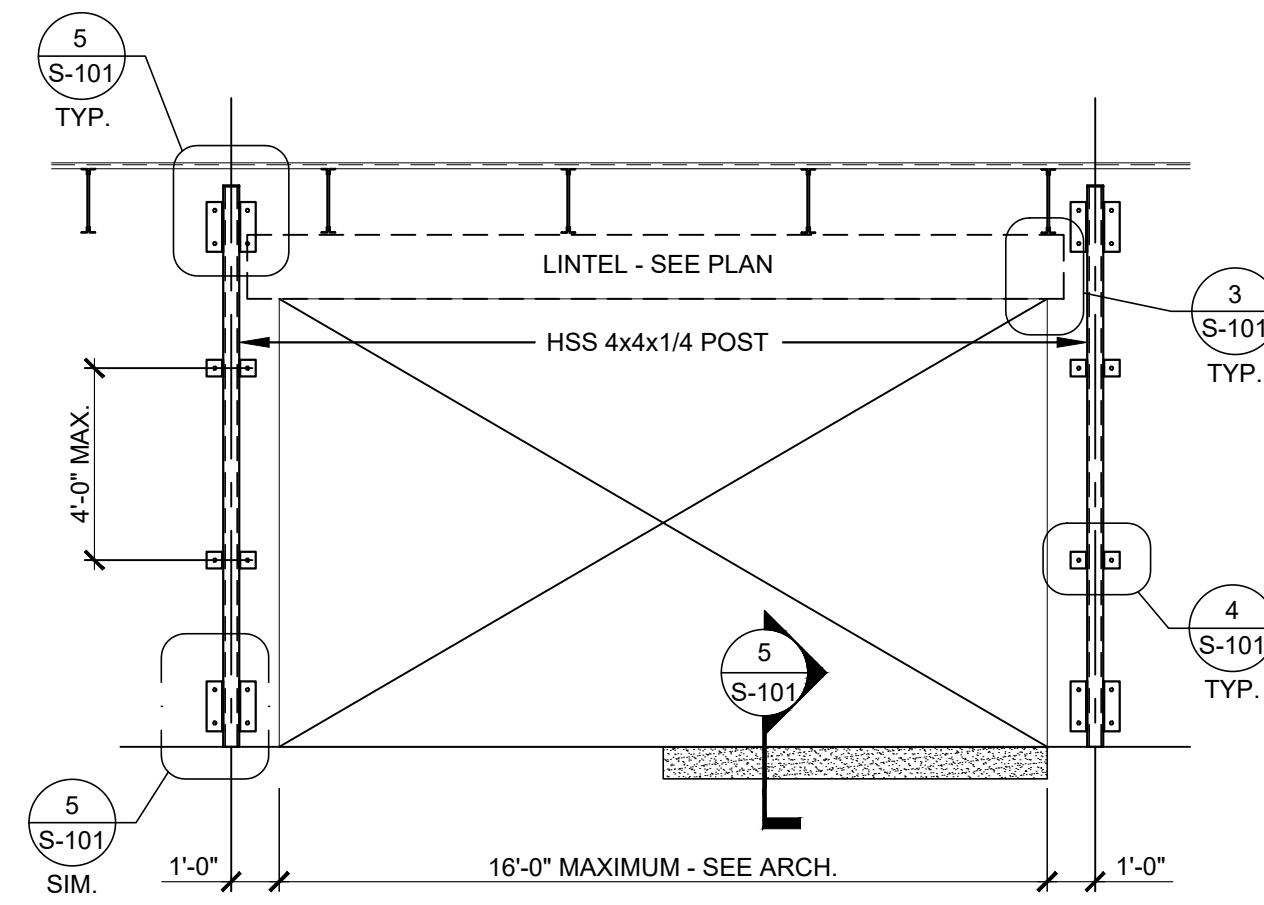


3 DETAIL
S-101 SCALE: 3/4" = 1'-0"



4 DETAIL
S-101 SCALE: 1 1/2" = 1'-0"

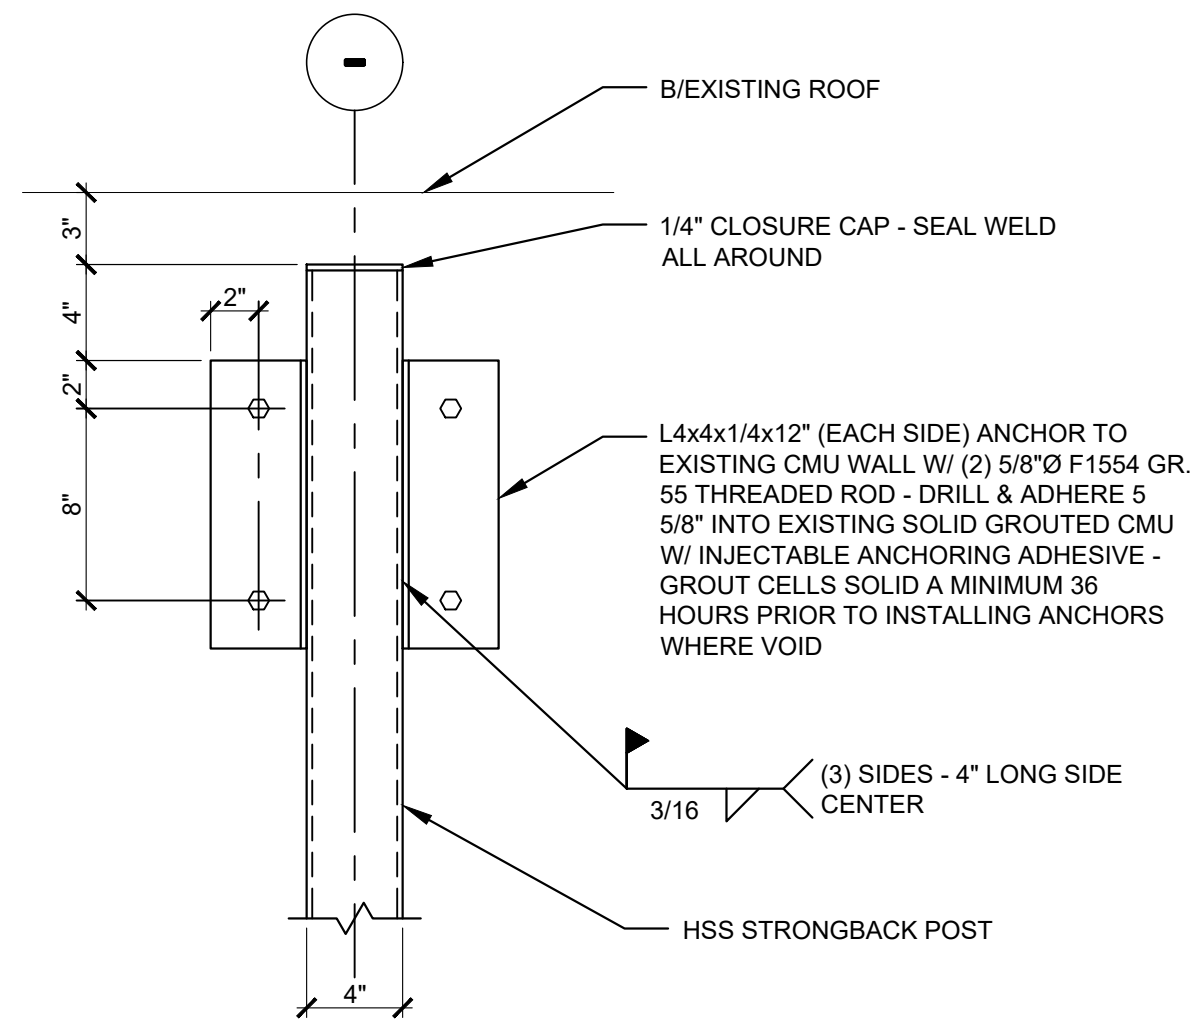

5 DETAIL
S-101 SCALE: 1 1/2" = 1'-0"

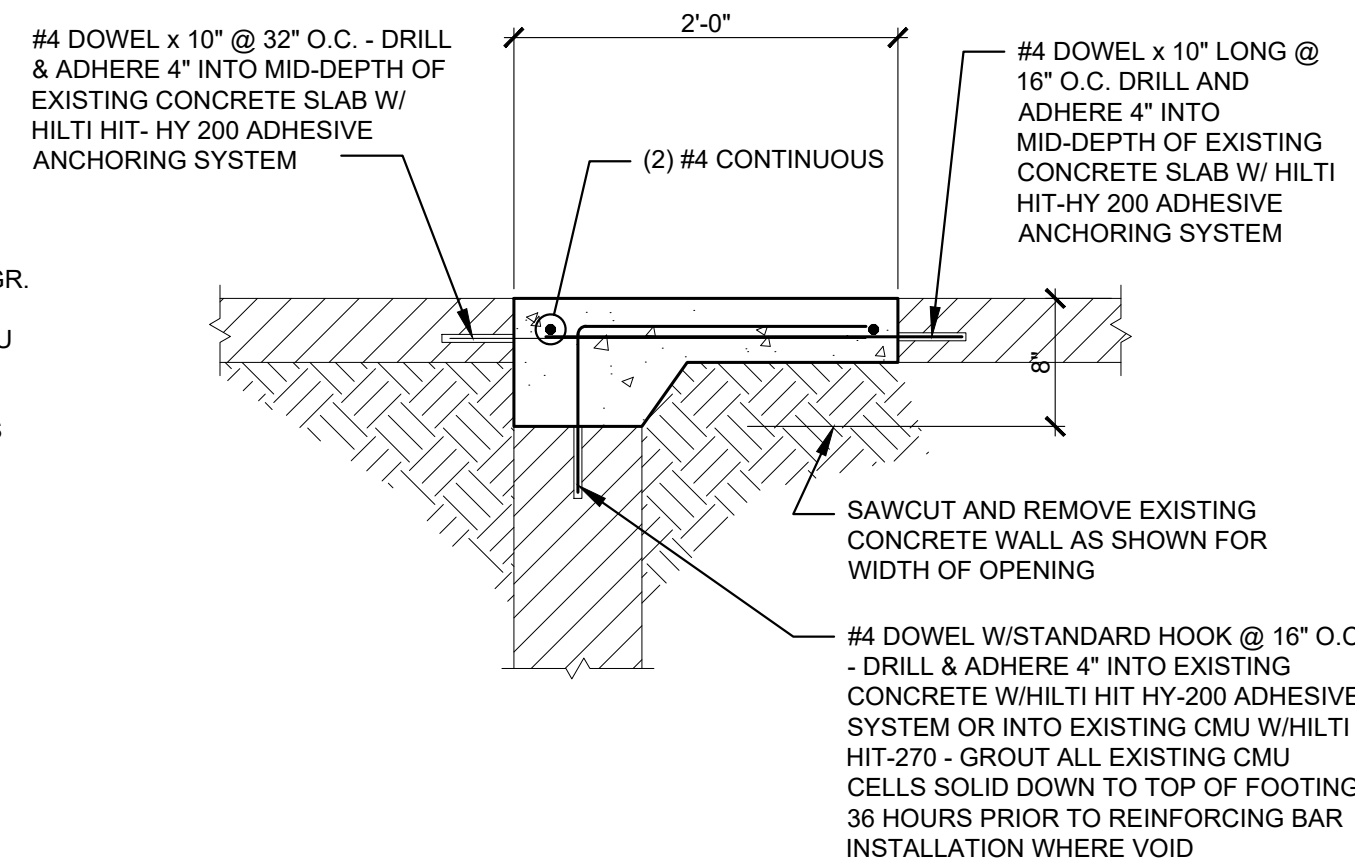

6 DETAIL
S-101 SCALE: 1" = 1'-0"

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65101

PROJECT # T2122-01
SITE # 6300
ASSET# 8136300017

REVISION: _____
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DATE: _____
REVISION: _____
DATE: _____

ISSUE DATE: 08/01/2023

CAD DWG FILE: _____
DRAWN BY: BWT
CHECKED BY: NDM
DESIGNED BY: NDM

SHEET TITLE:

STRUCTURAL
PARTIAL PLAN &
DETAILS

SHEET NUMBER:

S-101

08/01/2023
SHEET 8 OF 27



MICHAEL S. SUNDERMEYER
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65101

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ISSUE DATE: 08/01/2023

CAD DWG FILE: _____
DRAWN BY: _____
CHECKED BY: _____
DESIGNED BY: _____


SHEET TITLE:

ARCHITECTURAL
SITE PLAN


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A-001


08/01/2023
SHEET 9 OF 29

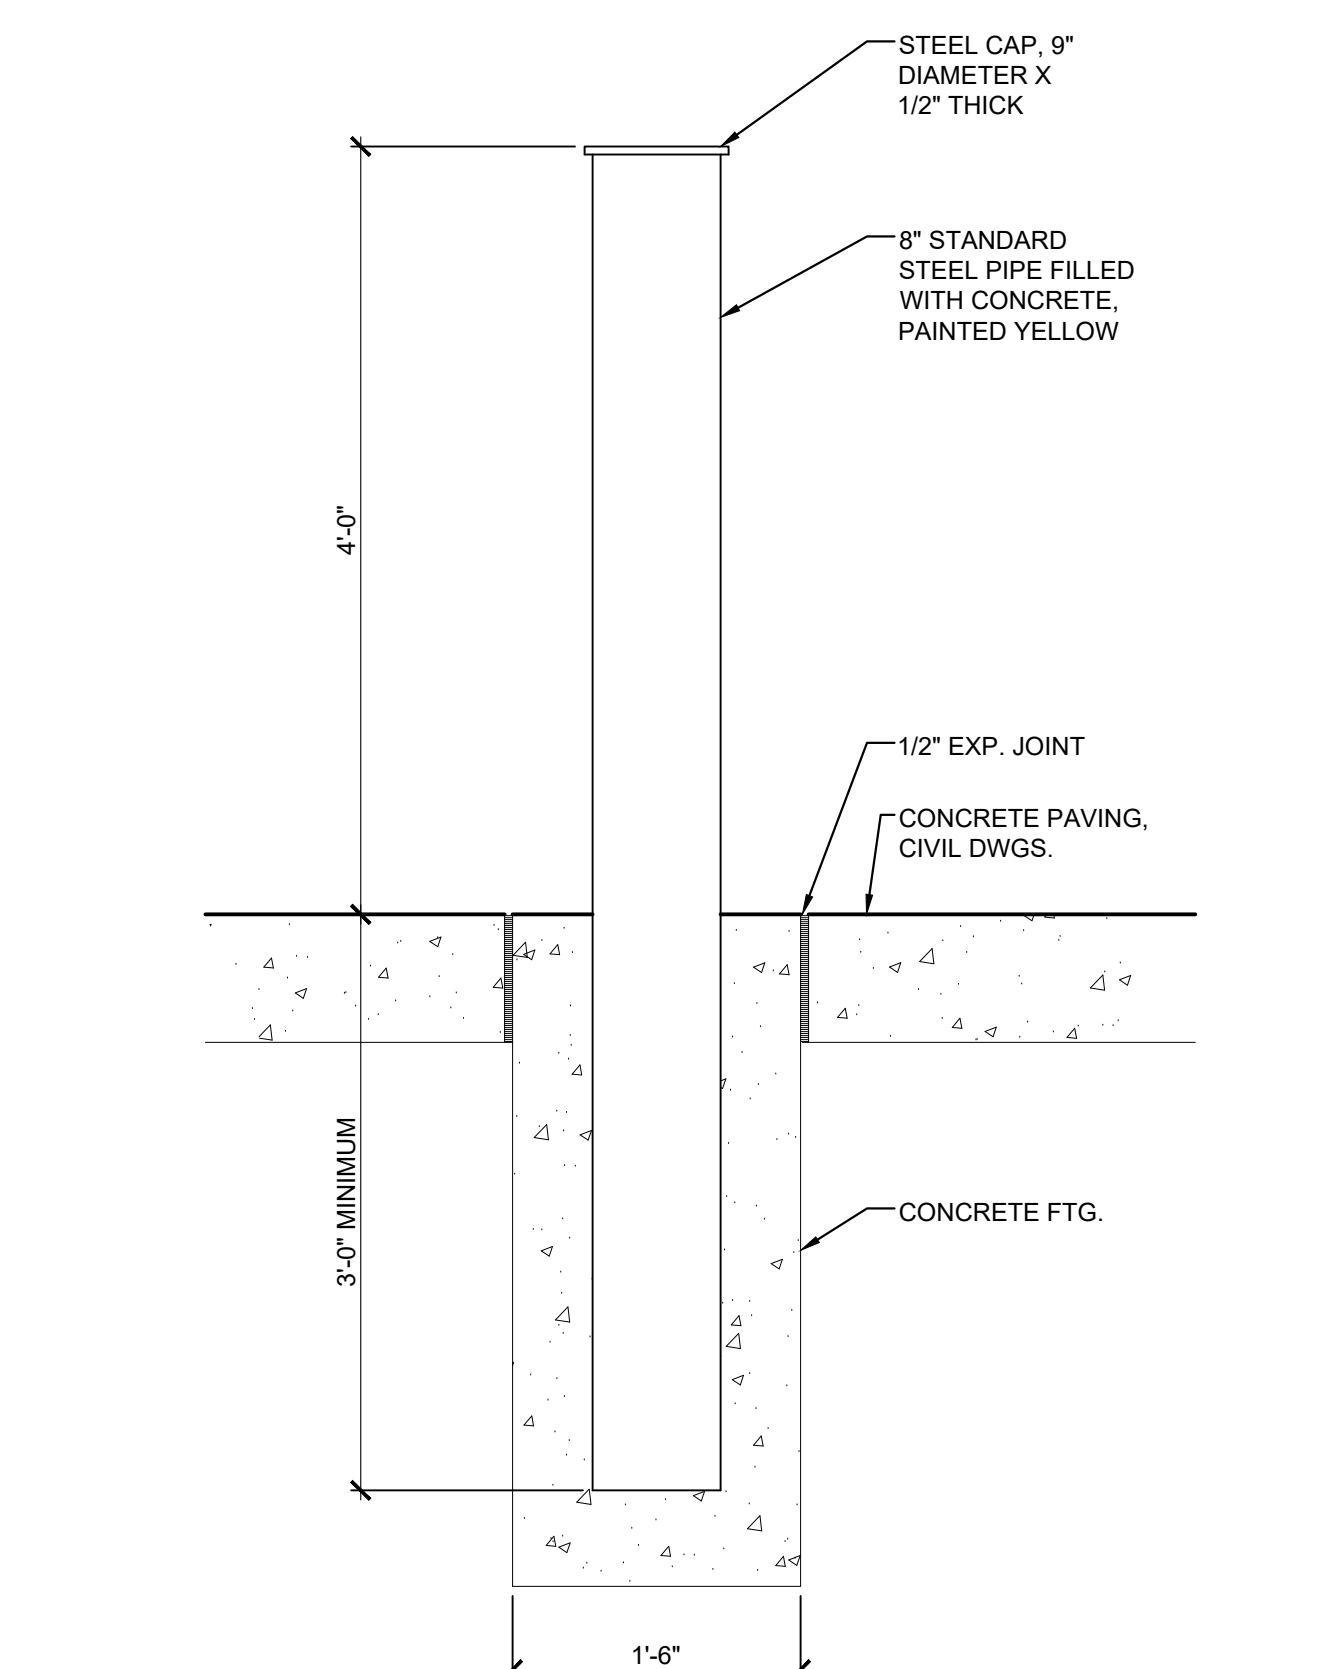


2 BOLLARD DETAIL
SCALE: 1" = 1'-0"

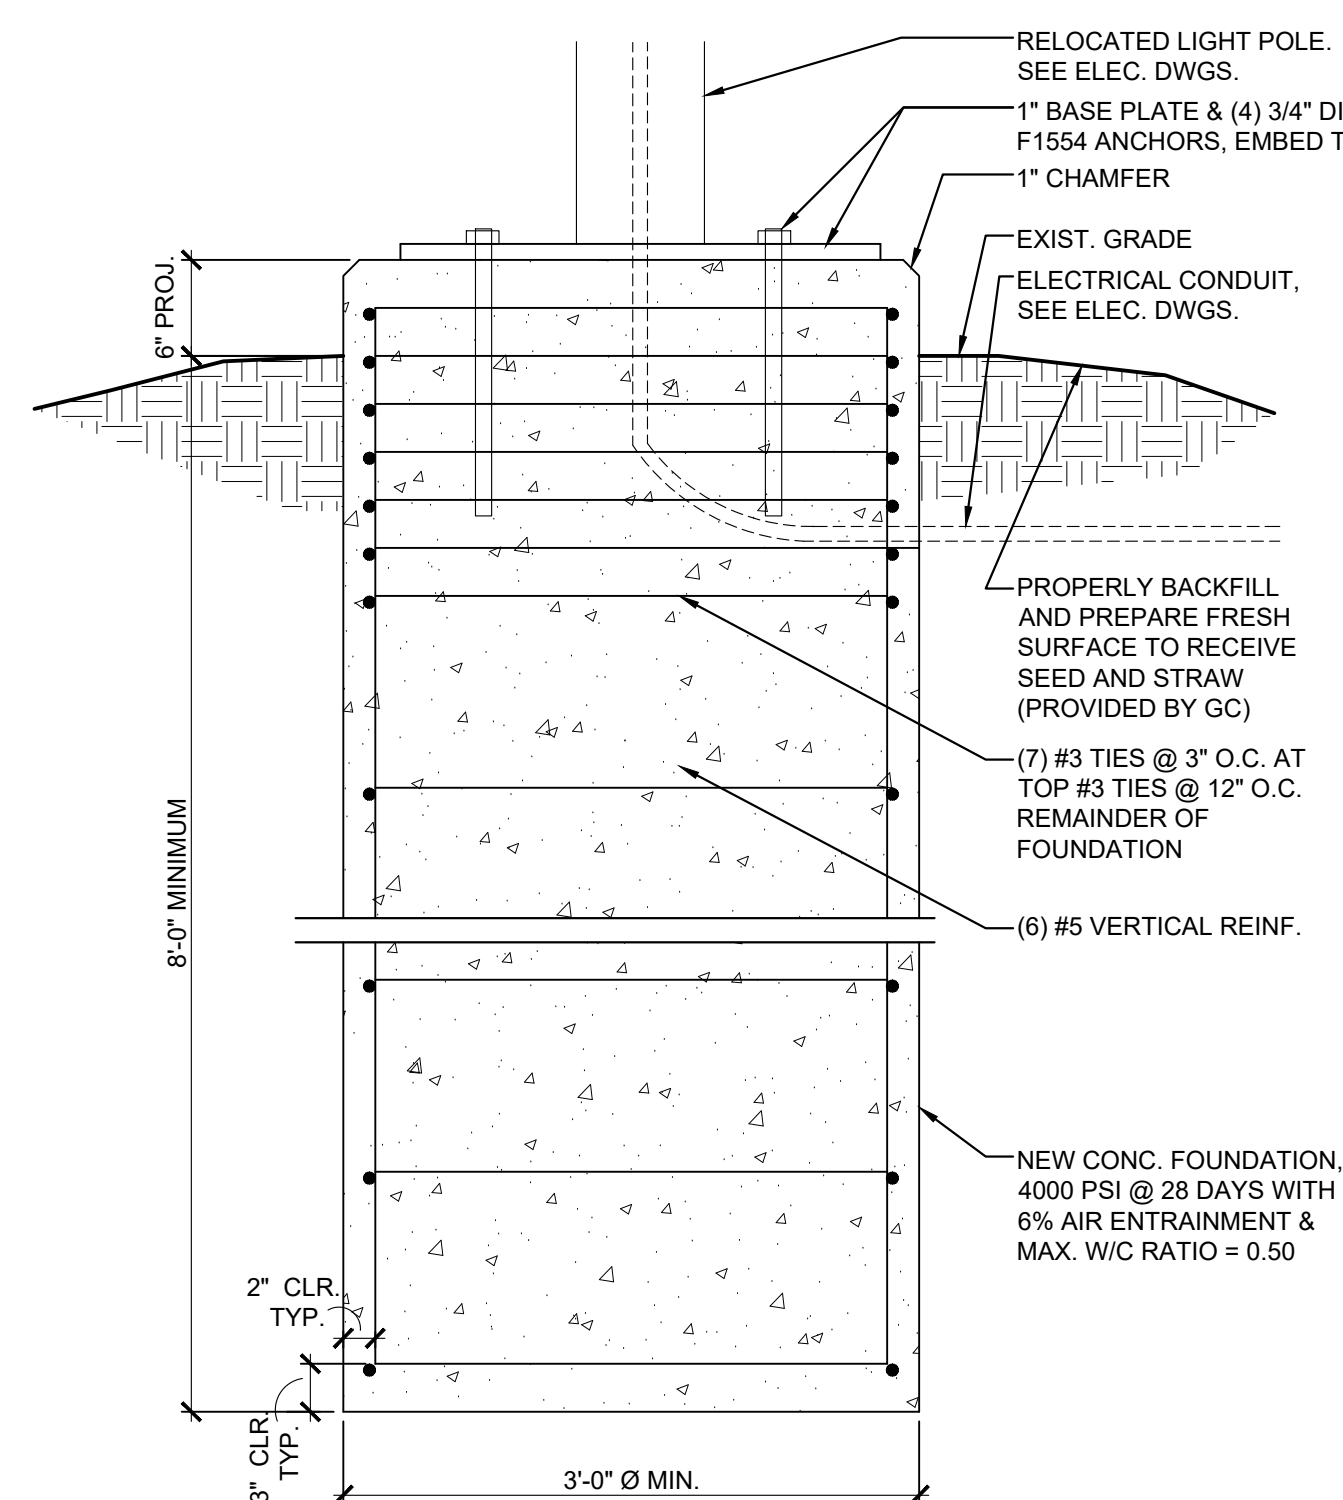

3 LIGHT POLE BASE DETAIL
SCALE: 1" = 1'-0"

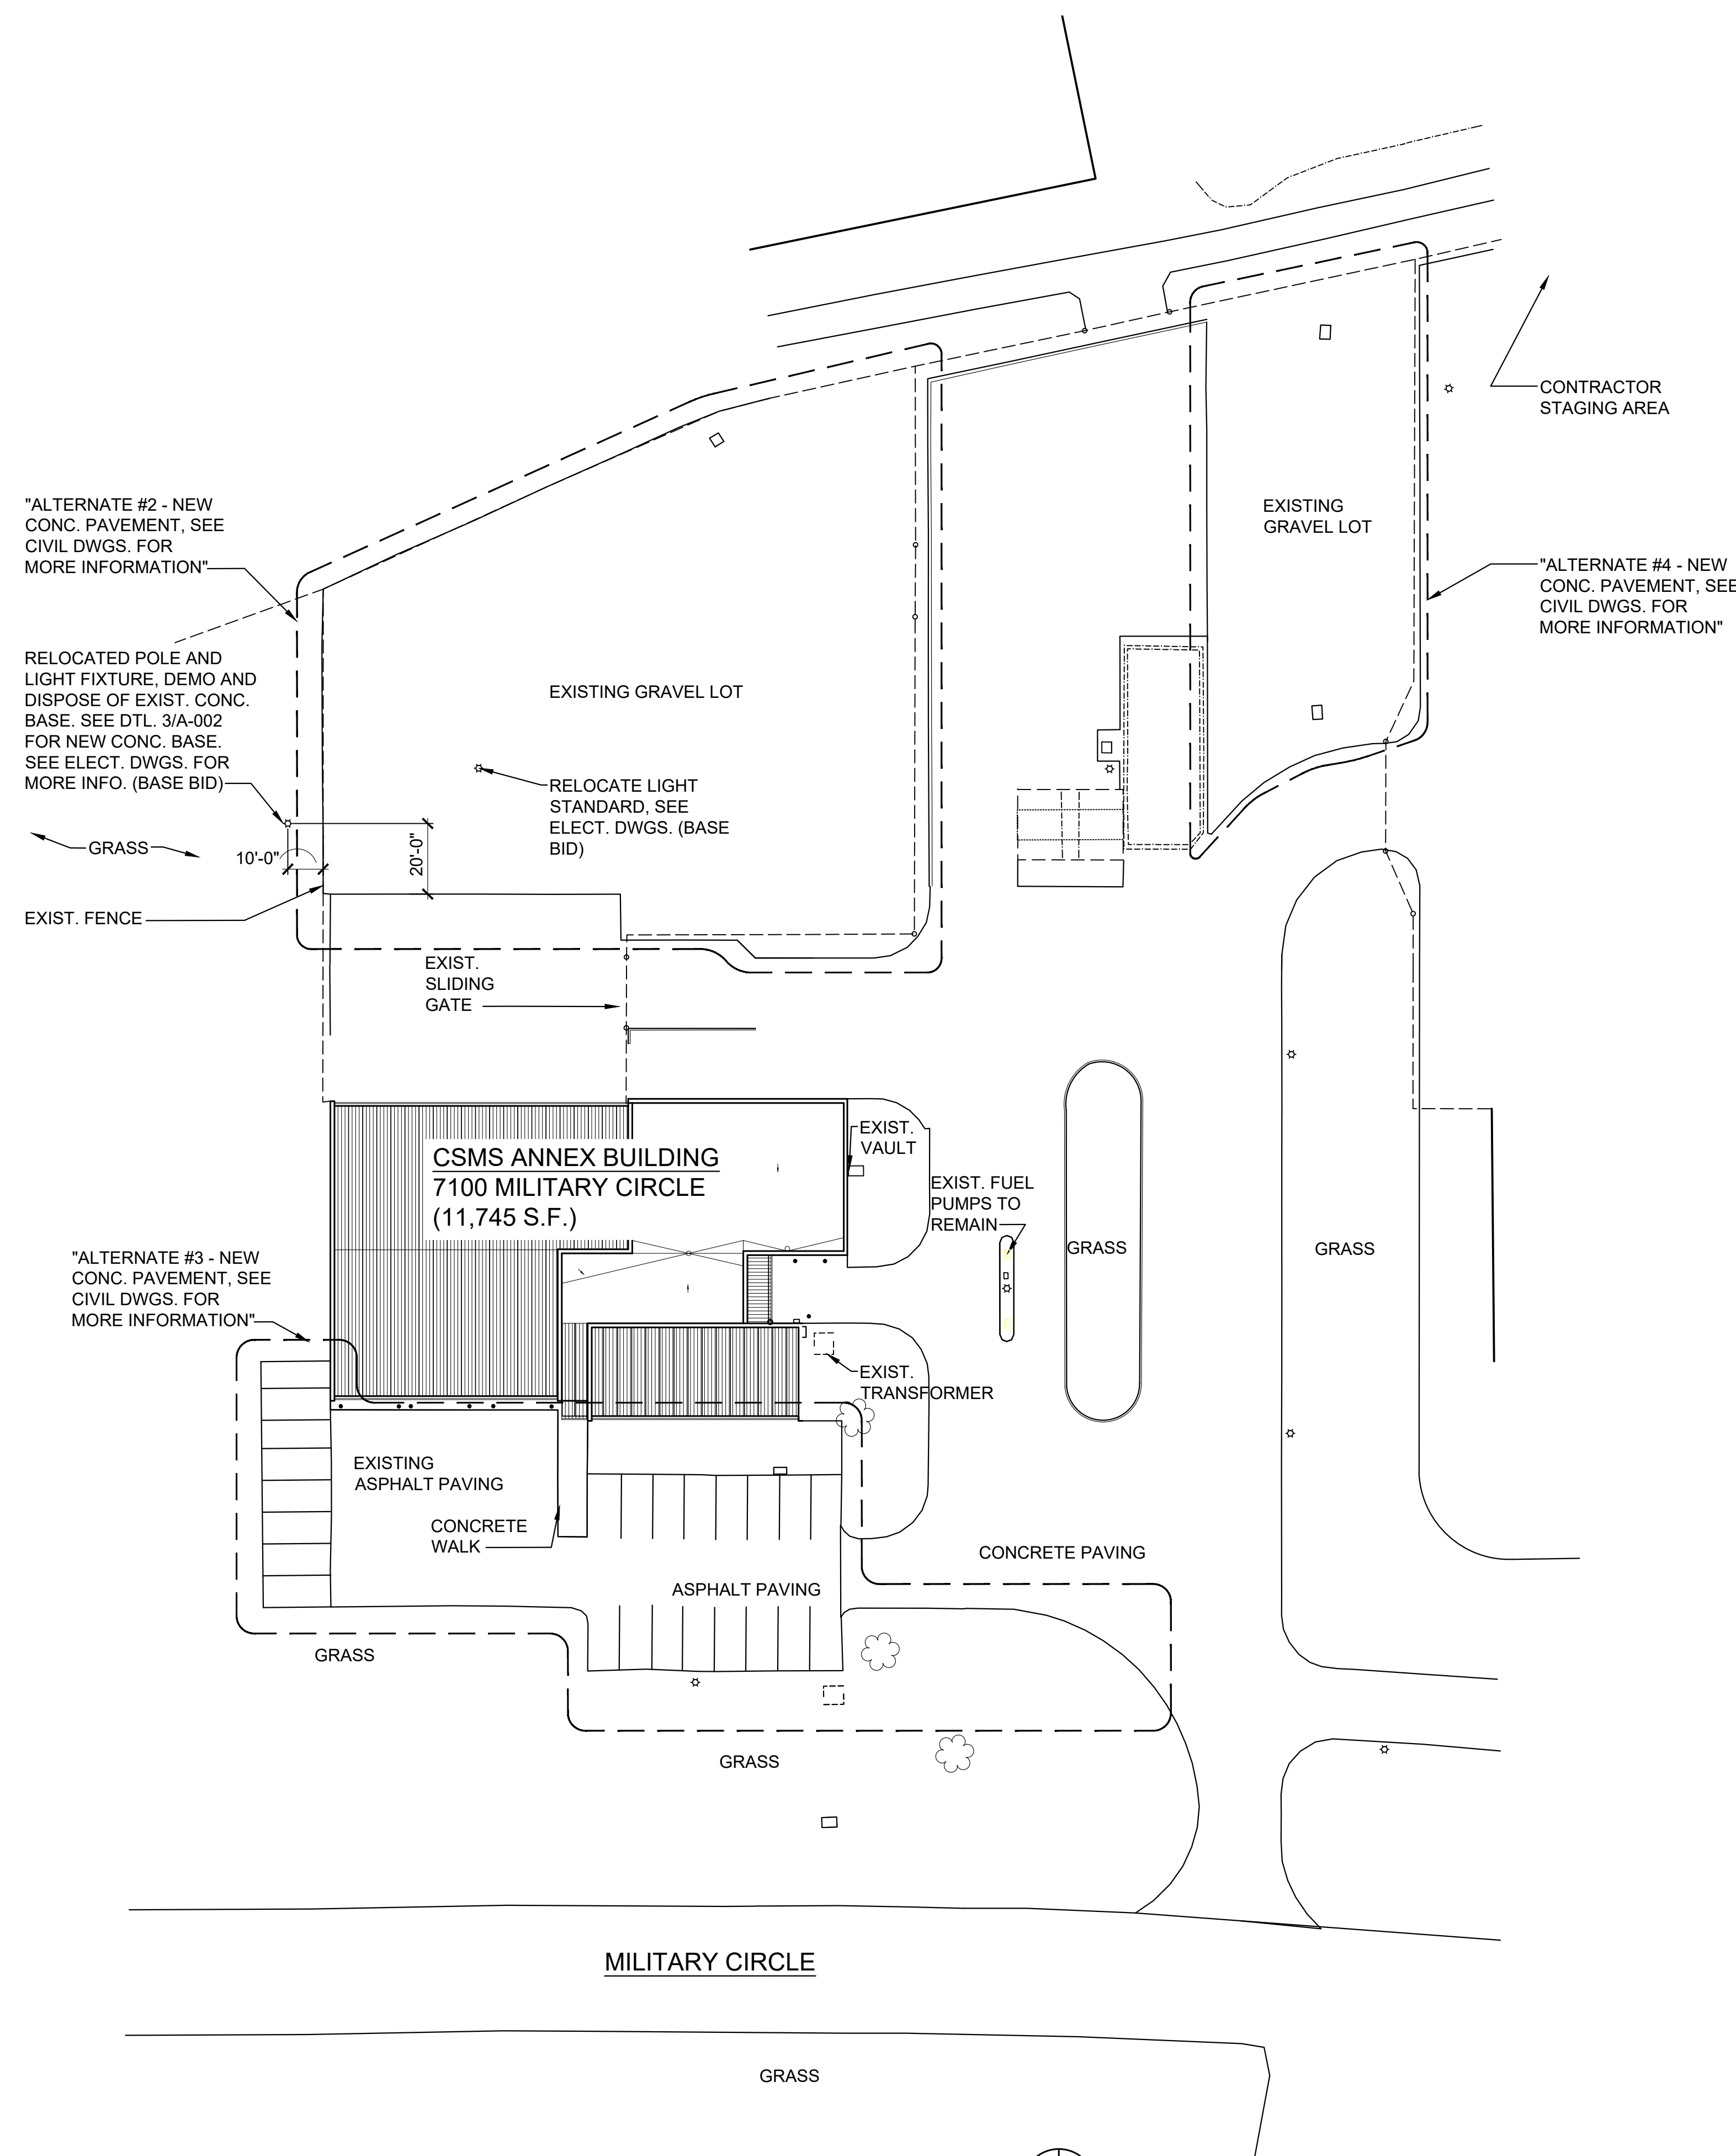

1 ARCHITECTURAL SITE PLAN
SCALE: 1" = 30'-0"

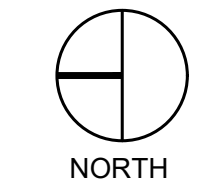



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ADMINISTRATION
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MANAGEMENT,
DESIGN AND
CONSTRUCTION

MISSOURI NATIONAL
GUARD

RENOVATE COMBINED
SUPPORT MAINTENANCE
SHOP (CSMS) ANNEX
COMBINED SUPPORT
MAINTENANCE SHOP (CSMS)
2302 MILITIA DRIVE
JEFFERSON CITY, MISSOURI
65101

PROJECT # T2122-01
SITE # 6300
ASSET# 8136300017


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REVISION: _____
DATE: _____
ISSUE DATE: 08/01/2023

CAD DWG FILE: _____
DRAWN BY: _____
CHECKED BY: _____
DESIGNED BY: _____

SHEET TITLE:
**CODE DATA, EGRESS
FLOOR PLAN, NOTES
& SYMBOLS**

SHEET NUMBER:
A-002
08/01/2023
SHEET 10 OF 29

- GENERAL NOTES:**
- SEE ALTERNATES BELOW FOR ITEMS OUTSIDE OF BASE SCOPE OF WORK.
 - ALL NEW BUILDING MATERIALS TO BE OF NON-COMBUSTIBLE OR WOOD FIRE RETARDANT TREATED MATERIAL.
 - THE CONTRACTOR SHALL COMPLY WITH FEDERAL ENVIRONMENTAL AND OCCUPATIONAL HEALTH AND SAFETY ADMINISTRATION REGULATIONS AND ALL LOCAL AND STATE HEALTH DEPARTMENT REQUIREMENTS AND RECOMMENDATIONS REGARDING MOLD AND MILDEW.
 - IN THE EVENT THE CONTRACTOR DISCOVERS, AT ANY TIME THE PRESENCE OF MOLD AND / OR MILDEW, THE CONTRACTOR SHALL IMMEDIATELY NOTIFY THE OWNER'S REPRESENTATIVE AND THE ARCHITECT / ENGINEER OF RECORD, IN WRITING, OF THE CONCERNS AND/OR SUSPICIONS.
 - THE CONTRACTOR SHALL CONTAIN ALL CONSTRUCTION ACTIVITY (WHICH SHALL INCLUDE STORAGE OF MATERIALS AND EQUIPMENT) WITHIN THE LIMITS OF CONSTRUCTION OR WITHIN THE DESIGNATED STAGING AREA AS DETERMINED BY THE PRE-BID MEETING.
 - THE CONTRACTOR SHALL BE RESPONSIBLE FOR REPAIRING ANY SURFACES DAMAGED BY CONSTRUCTION ACTIVITY THAT IS UNDER THE CONTROL OF THE CONTRACTOR (THIS INCLUDES ALL SUBCONTRACTOR WORK). REPAIRS SHALL MATCH EXISTING MATERIALS AND BE APPROVED BY THE OWNER.
 - THE CONTRACTOR SHALL REMOVE CONSTRUCTION DEBRIS FROM THE JOBSITE ON A REGULAR BASIS, AS IDENTIFIED IN THE SPECIFICATIONS. KEEP DEBRIS CONTAINED TO THE LIMITS OF CONSTRUCTION.
 - THE CONTRACTOR SHALL FIELD VERIFY ALL EXISTING CONDITIONS PRIOR TO FABRICATION.
 - THE CONTRACTOR SHALL ENSURE THAT ALL MOISTURE AND DEBRIS HAVE BEEN ELIMINATED PRIOR TO INSTALLING NEW MATERIALS AND PREPARE SURFACE IN ACCORDANCE WITH MANUFACTURER'S REQUIREMENTS. REFERENCE SPECIFICATIONS FOR FURTHER DIRECTION.
 - SHOULD THE CONTRACTOR OBSERVE ANY DETERIORATED MATERIALS OR DAMAGED STRUCTURAL CONDITIONS, THE ARCHITECT AND OWNER SHALL BE NOTIFIED.
 - CONTRACTOR SHALL INSPECT ALL INTERNAL /EXTERNAL ROOF DRAINS AND INCLUDE ALL COMPONENTS NECESSARY TO CONSTRUCT A COMPLETE DRAINAGE SYSTEM.
 - ANY EQUIPMENT NOT IDENTIFIED TO BE REMOVED IS TO REMAIN UNLESS NOTED OTHERWISE.
 - THE CONTRACT WORK SHALL INCLUDE FURNISHING ALL MATERIALS, EQUIPMENT, TOOLS, LABOR & SERVICES NECESSARY FOR COMPLETION OF THE PROJECT.
 - THE CONTRACTOR SHALL BE RESPONSIBLE FOR THE QUALITY OF WORKMANSHIP & FOR COMPLIANCE WITH THE DESIGN. THE CONTRACTOR SHALL CORRECT ALL ERRORS & DEVIATIONS AS REQUESTED BY THE OWNER.
 - THE CONTRACTOR SHALL BE RESPONSIBLE FOR QUALITY OF ALL REFURBISHED MATERIALS. ALL REFURBISHED MATERIALS TO APPEAR NEW.
 - THE CONTRACTOR SHALL VERIFY ALL RELEVANT DIMENSIONS AND EXISTING CONDITIONS BEFORE PROCEEDING WITH THE AFFECTED WORK AND NOTIFY THE ARCHITECT OF ANY DISCREPANCIES IMMEDIATELY. ALL DISCREPANCIES SHALL BE RESOLVED PRIOR TO PROCEEDING WITH AFFECTED WORK.
 - SHOULD ANY OF THE DETAILED INSTRUCTIONS ON THE DRAWINGS CONFLICT WITH THE NOTES OR SPECIFICATIONS OR WITH EACH OTHER, THE STRICTEST PROVISION SHALL APPLY.
 - JOB SITE CLEANING: DURING DEMOLITION & CONSTRUCTION, THE JOB SITE SHALL BE CLEANED ON A DAILY BASIS, INCLUDING REMOVAL OF TRASH, RUBBLE, DEBRIS & ORGANIZATION OF MATERIALS & EQUIPMENT. UPON COMPLETION OF THE WORK, THE JOB SITE SHALL BE THOROUGHLY CLEANED, INCLUDING AREAS OF THE BUILDING MADE DIRTY BY CONSTRUCTION WORK. THE G.C. SHALL REMOVE TRASH, RUBBLE, TOOLS, EQUIPMENT & EXCESS MATERIALS FROM THE PREMISES. THE BUILDING IS TO BE LEFT IN A CLEAN CONDITION.
 - THE CONTRACTOR IS TO PROVIDE SUPERVISION OF ALL TRADES / SUBS, AS WELL AS ON-SITE SUPERVISION DURING ALL CONSTRUCTION.
 - THE CONTRACTOR IS RESPONSIBLE TO PROVIDE ALL DUMPSTERS REQUIRED FOR EXECUTION OF THE PROJECT SCOPE INCLUDING DISPOSAL OF ALL NON-REUSED FIXTURES.
 - IF ROOF PENETRATIONS ARE REQUIRED ON EXISTING ROOF, THEN THE CONTRACTOR SHALL EMPLOY A ROOFING CONTRACTOR TO MAINTAIN EXISTING WARRANTIES.

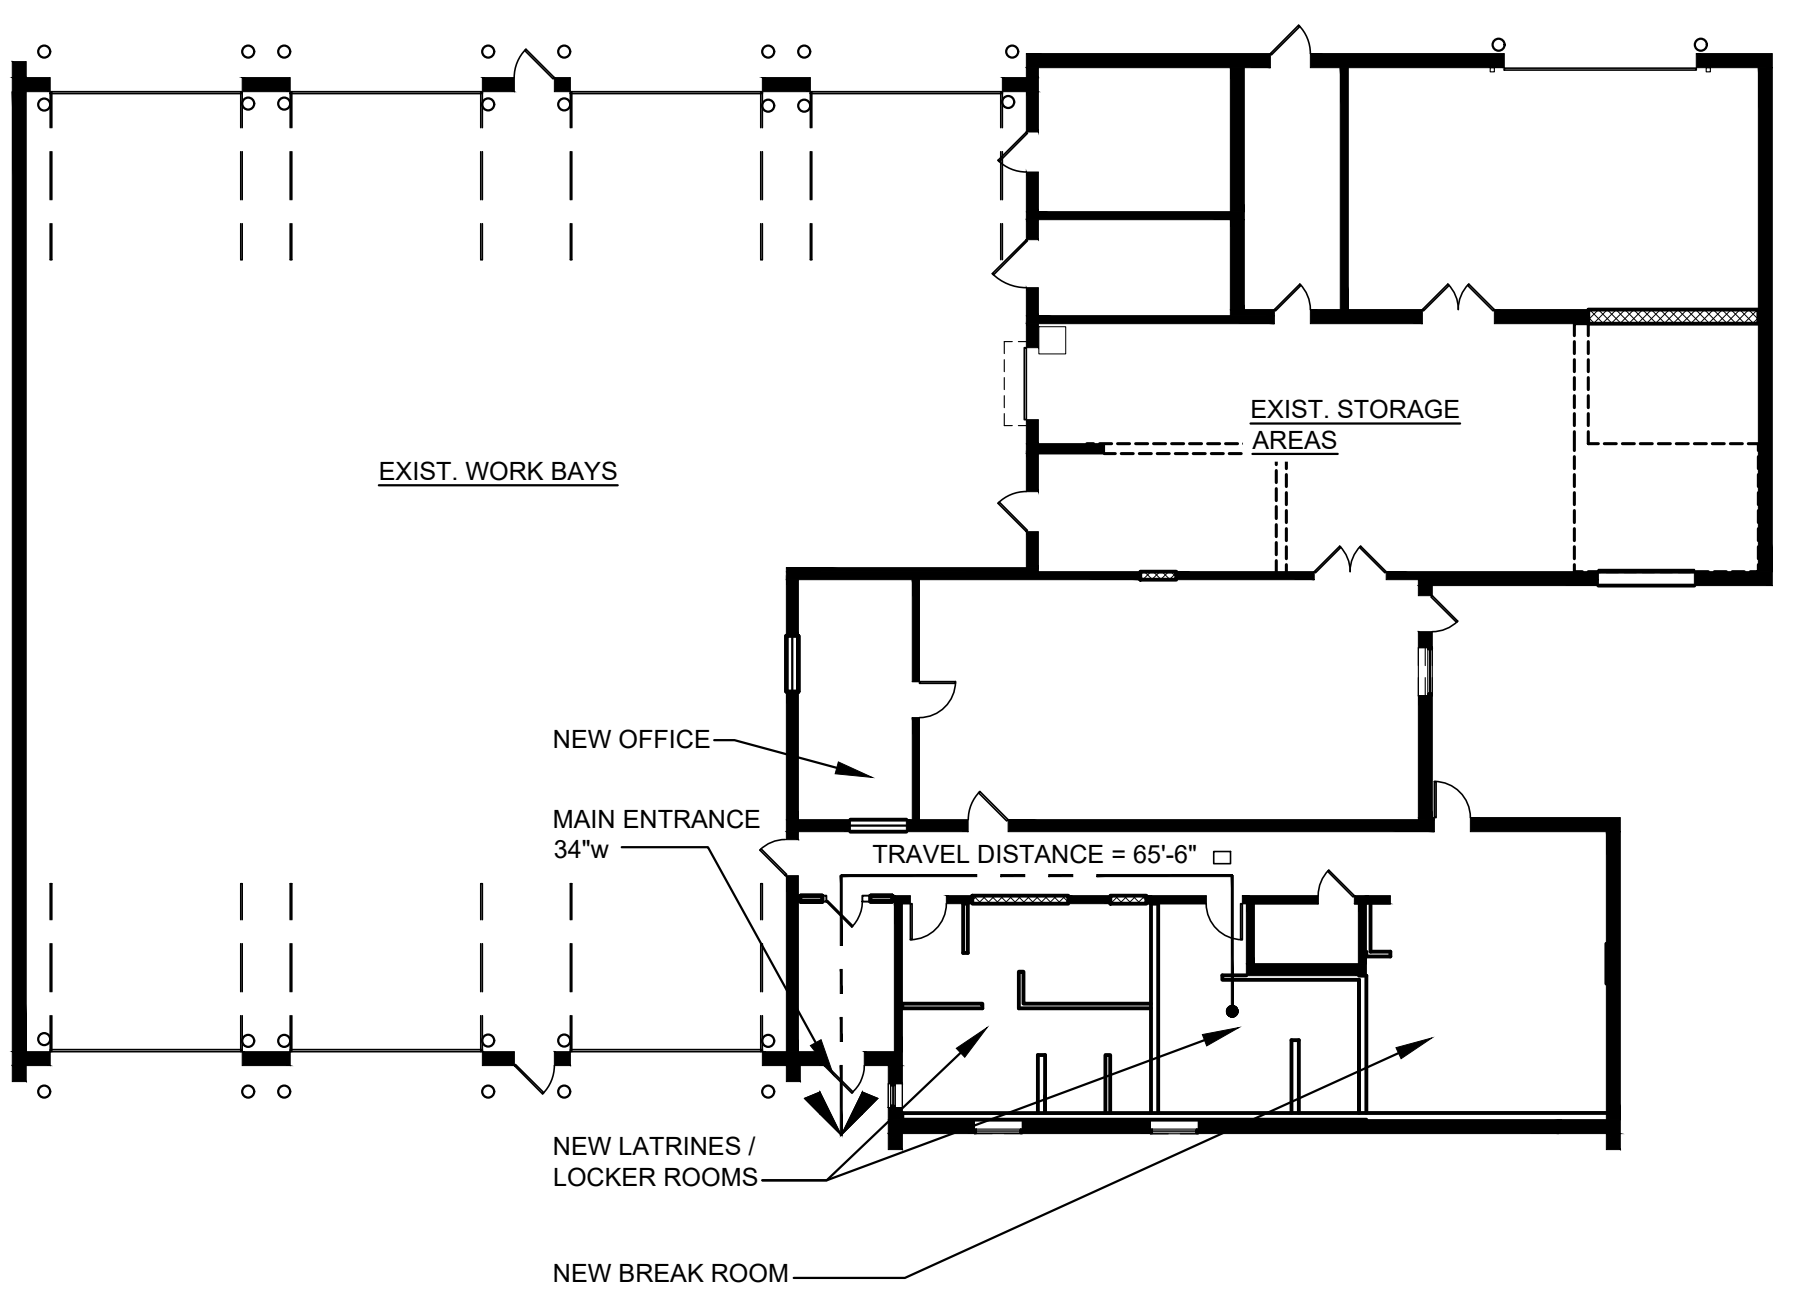

1
A002
EGRESS PLAN
SCALE: NO SCALE

- BID ALTERNATES:**
- VEHICLE EXHAUST REELS - PROVIDE 7 INDIVIDUAL, RETRACTABLE, EXHAUST REELS FOR VEHICLE MAINTENANCE IN THE WORK BAYS (ONE PER DRIVE-IN DOOR). EACH UNIT IS SUPPORTED FROM THE EXISTING STRUCTURE WITH 25" OF 6" DIAMETER FLEXIBLE TUBING, AND WILL BE CONNECTED TO THE EXISTING VEHICLE (DIESEL) EXHAUST STACK WITH COUPLING DEVICES. SEE MECHANICAL DRAWINGS FOR MORE INFORMATION.
 - EAST PARKING LOT - REPLACE EXISTING AGGREGATE PARKING AREA WITH CONCRETE PAVEMENT INCLUDING INTEGRAL 6" CONCRETE CURBS ALONG THE NORTH AND EAST EDGES FOR DRAINAGE TO EXISTING STORM WATER INLETS. SEE SHEET C-101 FOR MORE INFORMATION.
 - EMPLOYEE PARKING - REPAVE EXISTING CAR SPACES, ADD 8 NEW CAR PARKING SPACES ON NORTH END OF LOT. REPLACE CONCRETE AND WIDEN DRIVE ISLE AT ENTRANCE. SEE SHEET C-101 FOR MORE INFORMATION.
 - SOUTHEAST PARKING LOT - REPLACE EXISTING AGGREGATE WITH CONCRETE PAVEMENT, AN INTEGRAL 6" CURB ALONG THE EAST EDGE FOR DRAINAGE TO EXISTING STORM WATER INLETS. SEE SHEET C-101 FOR MORE INFORMATION.

MATERIAL KEY	SYMBOL LEGEND																		
<ul style="list-style-type: none"> NEW CONSTRUCTION NEW BRICK NEW CMU DEMO CONSTRUCTION EXIST. CONSTRUCTION EXISTING DOOR 	<ul style="list-style-type: none"> STEEL CONCRETE FINISH FLOOR FLOOR / STRUCT. ELEVATIONS SECTION CUTS EXTERIOR ELEV. TAG ROOM TAG DOOR TAG EQUIP. TAG KEYED NOTE PARTITION TYPE COLUMN BUBBLE ENLARGED PLAN / DETAIL BUBBLE INTERIOR ELEV. TAG 																		
CODE DATA																			
<p>THESE PLANS WERE PREPARED AND SHALL COMPLY WITH THE FOLLOWING CODES:</p> <ul style="list-style-type: none"> 2018 INTERNATIONAL BUILDING CODE 2012 INTERNATIONAL ENERGY CONSERVATION CODE 2018 INTERNATIONAL PLUMBING CODE 2018 INTERNATIONAL MECHANICAL CODE 2017 NATIONAL ELECTRICAL CODE <p>OCCUPANCY CLASSIFICATION (MIXED OCCUPANCY):</p> <p>USE GROUP TYPES:</p> <ul style="list-style-type: none"> B: BUSINESS (IBC 304) H-2: HIGH HAZARD, GROUP H-2 (IBC 307.4) S-2: STORAGE, LOW-HAZARD (IBC 311.3) <p>BUILDING AREA - PRIMARY COMBINED SUPPORT MAINTENANCE SHOP (CSMS):</p> <p>AREA RESTRICTIONS: PER IBC 506.2 THIS FACILITY IS ALLOWED UNLIMITED AREA</p> <p>BUILDING SQUARE FOOTAGE: 11,845 S.F.</p>	<p>HEIGHT RESTRICTIONS: PER IBC 504.3 THIS FACILITY WILL BE KEPT TO ONE STORY BUILDING CONSTRUCTION TYPE: 2-B (NON-COMBUSTIBLE, UNPROTECTED)</p> <p>MAXIMUM FLOOR AREA ALLOWANCES PER OCCUPANT: (IBC TABLE 1004.5):</p> <table border="1"> <tr> <td>-WORK BAYS</td> <td>200 GROSS</td> </tr> <tr> <td>-OFFICES</td> <td>150 GROSS</td> </tr> <tr> <td>-LOCKER ROOMS</td> <td>50 GROSS</td> </tr> <tr> <td>-ACCESSORY STORAGE AREAS</td> <td>300 GROSS</td> </tr> </table> <p>MINIMUM OCCUPANT LOAD (TABLE 1004.1.2):</p> <table border="1"> <tr> <td>5,860 S.F. AT 200 S.F. / PERSON =</td> <td>30 PERSONS (WORK BAYS)</td> </tr> <tr> <td>1,033 S.F. AT 150 S.F. / PERSON =</td> <td>7 PERSONS (OFFICE)</td> </tr> <tr> <td>607 S.F. AT 50 S.F. / PERSON =</td> <td>12 PERSONS (LOCKER ROOMS)</td> </tr> <tr> <td>3,344 S.F. AT 300 S.F. / PERSON =</td> <td>11 PERSONS (STORAGE/UTILITY AREA)</td> </tr> <tr> <td colspan="2">TOTAL = 60 PERSONS</td> </tr> </table> <p>MEANS OF EGRESS (SECTION 1005):</p> <p>EXIT DOORS - 2" PER PERSON x 60 = 12" x 36"</p>	-WORK BAYS	200 GROSS	-OFFICES	150 GROSS	-LOCKER ROOMS	50 GROSS	-ACCESSORY STORAGE AREAS	300 GROSS	5,860 S.F. AT 200 S.F. / PERSON =	30 PERSONS (WORK BAYS)	1,033 S.F. AT 150 S.F. / PERSON =	7 PERSONS (OFFICE)	607 S.F. AT 50 S.F. / PERSON =	12 PERSONS (LOCKER ROOMS)	3,344 S.F. AT 300 S.F. / PERSON =	11 PERSONS (STORAGE/UTILITY AREA)	TOTAL = 60 PERSONS	
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ABBREVIATIONS			
AFF	ABOVE FINISHED FLOOR	FIN	FINISHED
AC	ACOUSTICAL	FFE	FINISHED FLOOR ELEV.
AVC	AIR CONDITIONING	FFL	FINISHED FLOOR LINE
ALT	ALTERNATE	FE	FIRE EXTINGUISHER
ALUM	ALUMINUM	FEC	FIRE EXTINGUISHER CABINET
AB	ANCHOR BOLT	FT	FIRE TREATED
ARCH	ARCHITECTURAL	FLG	FLASHING
BRG	BEARING	FLR	FLOOR
BM	BENCH MARK	FD	FLOOR DRAIN
BLK	BLOCK	FTG	FOOTING
BLKG	BLOCKING	FDN	FOUNDATION
BD	BOARD	FUR	FURRED(ING)
B.O.	BOTTOM OF	GA	GAGE, GAUGE
BRK	BRICK	GALV	GALVANIZED
BLDG	BUILDING	GC	GENERAL CONTRACT(OR)
CAB	CABINET	GL	GLASS, GLAZING
CLG	CEILING	GYP	GYPSON
CL	CENTER LINE	GWB	GYPSON WALL BOARD
C/O	CENTER OF	HTG	HEATING
CC	CENTER TO CENTER	HTV	HEATING/VENTILATION
CLR	CLEAR	HVAC	/AIR CONDITIONING
COL	COLUMN	HT	HEIGHT
CONC	CONCRETE	HC	HOLLOW CORE
CMU	CONCRETE MASONRY UNIT	HMI	HOLLOW METAL
CONSTR	CONSTRUCTION	HK	HOOK(S)
CONTR	CONTRACTOR	HOR	HORIZONTAL
CONT	CONTINUOUS	HB	HOSE BIBB
CNTR	COUNTER	INSUL	INSULATE(D), (ION)
CFL	COUNTER FLASHING	INT	INTERIOR
CISK	COUNTERSUNK	JST	JOIST
CRS	COURSE(S)	JT	JOINT
CF	CUBIC FOOT	LH	LEFT HAND
CY	CUBIC YARD	LF	LINEAL FOOT
DL	DEAD LOAD	L	LINTEL
DEMO	DEMOLISH, DEMOLITION	LL	LIVE LOAD
DTL	DETAIL	MACH	MACHINE
DIAG	DIAGONAL	MH	MANHOLE
DIAM	DIAMETER	MFR	MANUFACTURER
DIM	DIMENSION	MAS	MASONRY
DR	DOOR	MO	MASONRY OPENING
DS	DOWN SPOUT	MAX	MAXIMUM
D	DRAIN	MECH	MECHANICAL
DWG	DRAWING	MED	MEDIUM
DF	DRINKING FOUNTAIN	MTL	METAL
E	EAST	M	METER(S)
EIFS	EXTERIOR INSULATION AND FINISH SYSTEM	MWK	MILLWORK
ELEC	ELECTRIC(AL)	MIN	MINIMUM
EWC	ELECTRIC WATER COOLER	MISC	MISCELLANEOUS
ELEV	ELEVATION	MT	MOUNT(ED), (ING)
EMER	EMERGENCY	NOM	NOMINAL
EQ	EQUAL	N	NORTH
EXIST	EXISTING	NIC	NOT IN CONTRACT
EXP	EXPOSED	NTS	NOT TO SCALE
EXT	EXTERIOR	OC	ON CENTER(S)
FOF	FACE OF FINISH		
FO	FACE OF		
FOM	FACE OF MASONRY		
FOS	FACE OF STUDS		
FRP	FIBERGLASS REINFORCED PLASTIC		
		OPNG	OPENING
		OPH	OPPOSITE HAND
		OD	OUTSIDE DIAMETER
		OO	OUT TO OUT
		OA	OVERALL
		OH	OVERHEAD
		PTD	PAINT(ED)
		PKG	PARKING
		PLAM	PLASTIC LAMINATE
		PL	PLATE
		PWD	PLYWOOD
		PVC	POLYVINYL CHLORIDE
		PSF	POUNDS PER SQUARE FT.
		PSI	POUNDS PER SQUARE IN.
		PT	PRESSURE TREATED
		PL	PROPERTY LINE
		REM	REMOVE
		RET	RETURN
		RH	RIGHT HAND
		RD	ROOF DRAIN
		RFG	ROOFING
		RM	ROOM
		RO	ROUGH OPENING
		SLNT	SEALANT
		SECT	SECTION
		SHTG	SHEATHING
		SHT	SHEET
		SIM	SIMILAR
		SC	SOLID CORE
		S	SOUTH
		SF	SQUARE FOOT
		SY	SQUARE INCH
		SYD	SQUARE YARD
		STD	STANDARD
		STO	STORAGE
		SUSP	SUSPENDED
		SYM	SYMMETRY, (ICAL)
		TEL	TELEPHONE
		TV	TELEVISION
		THK	THICKNESS
		T&G	TONGUE & GROOVE
		TOM	TOP OF MASONRY
		TPO	THERMOPLASTIC POLYOLEFIN
		TS	TOP OF STEEL
		TOS	TOP OF STEEL
		TW	TOP OF WALL
		TOW	TOP OF WALL
		TYP	TYPICAL
		UNO	UNLESS NOTED OTHERWISE
		VERT	VERTICAL
		VT	VINYL TILE
		WSCT	WAINSCOT
		WC	WATER CLOSET
		WWF	WELDED WIRE FABRIC
		W	WEST
		W	WIDTH, WIDE
		WIN	WINDOW
		W/O	WITHOUT
		WD	WOOD



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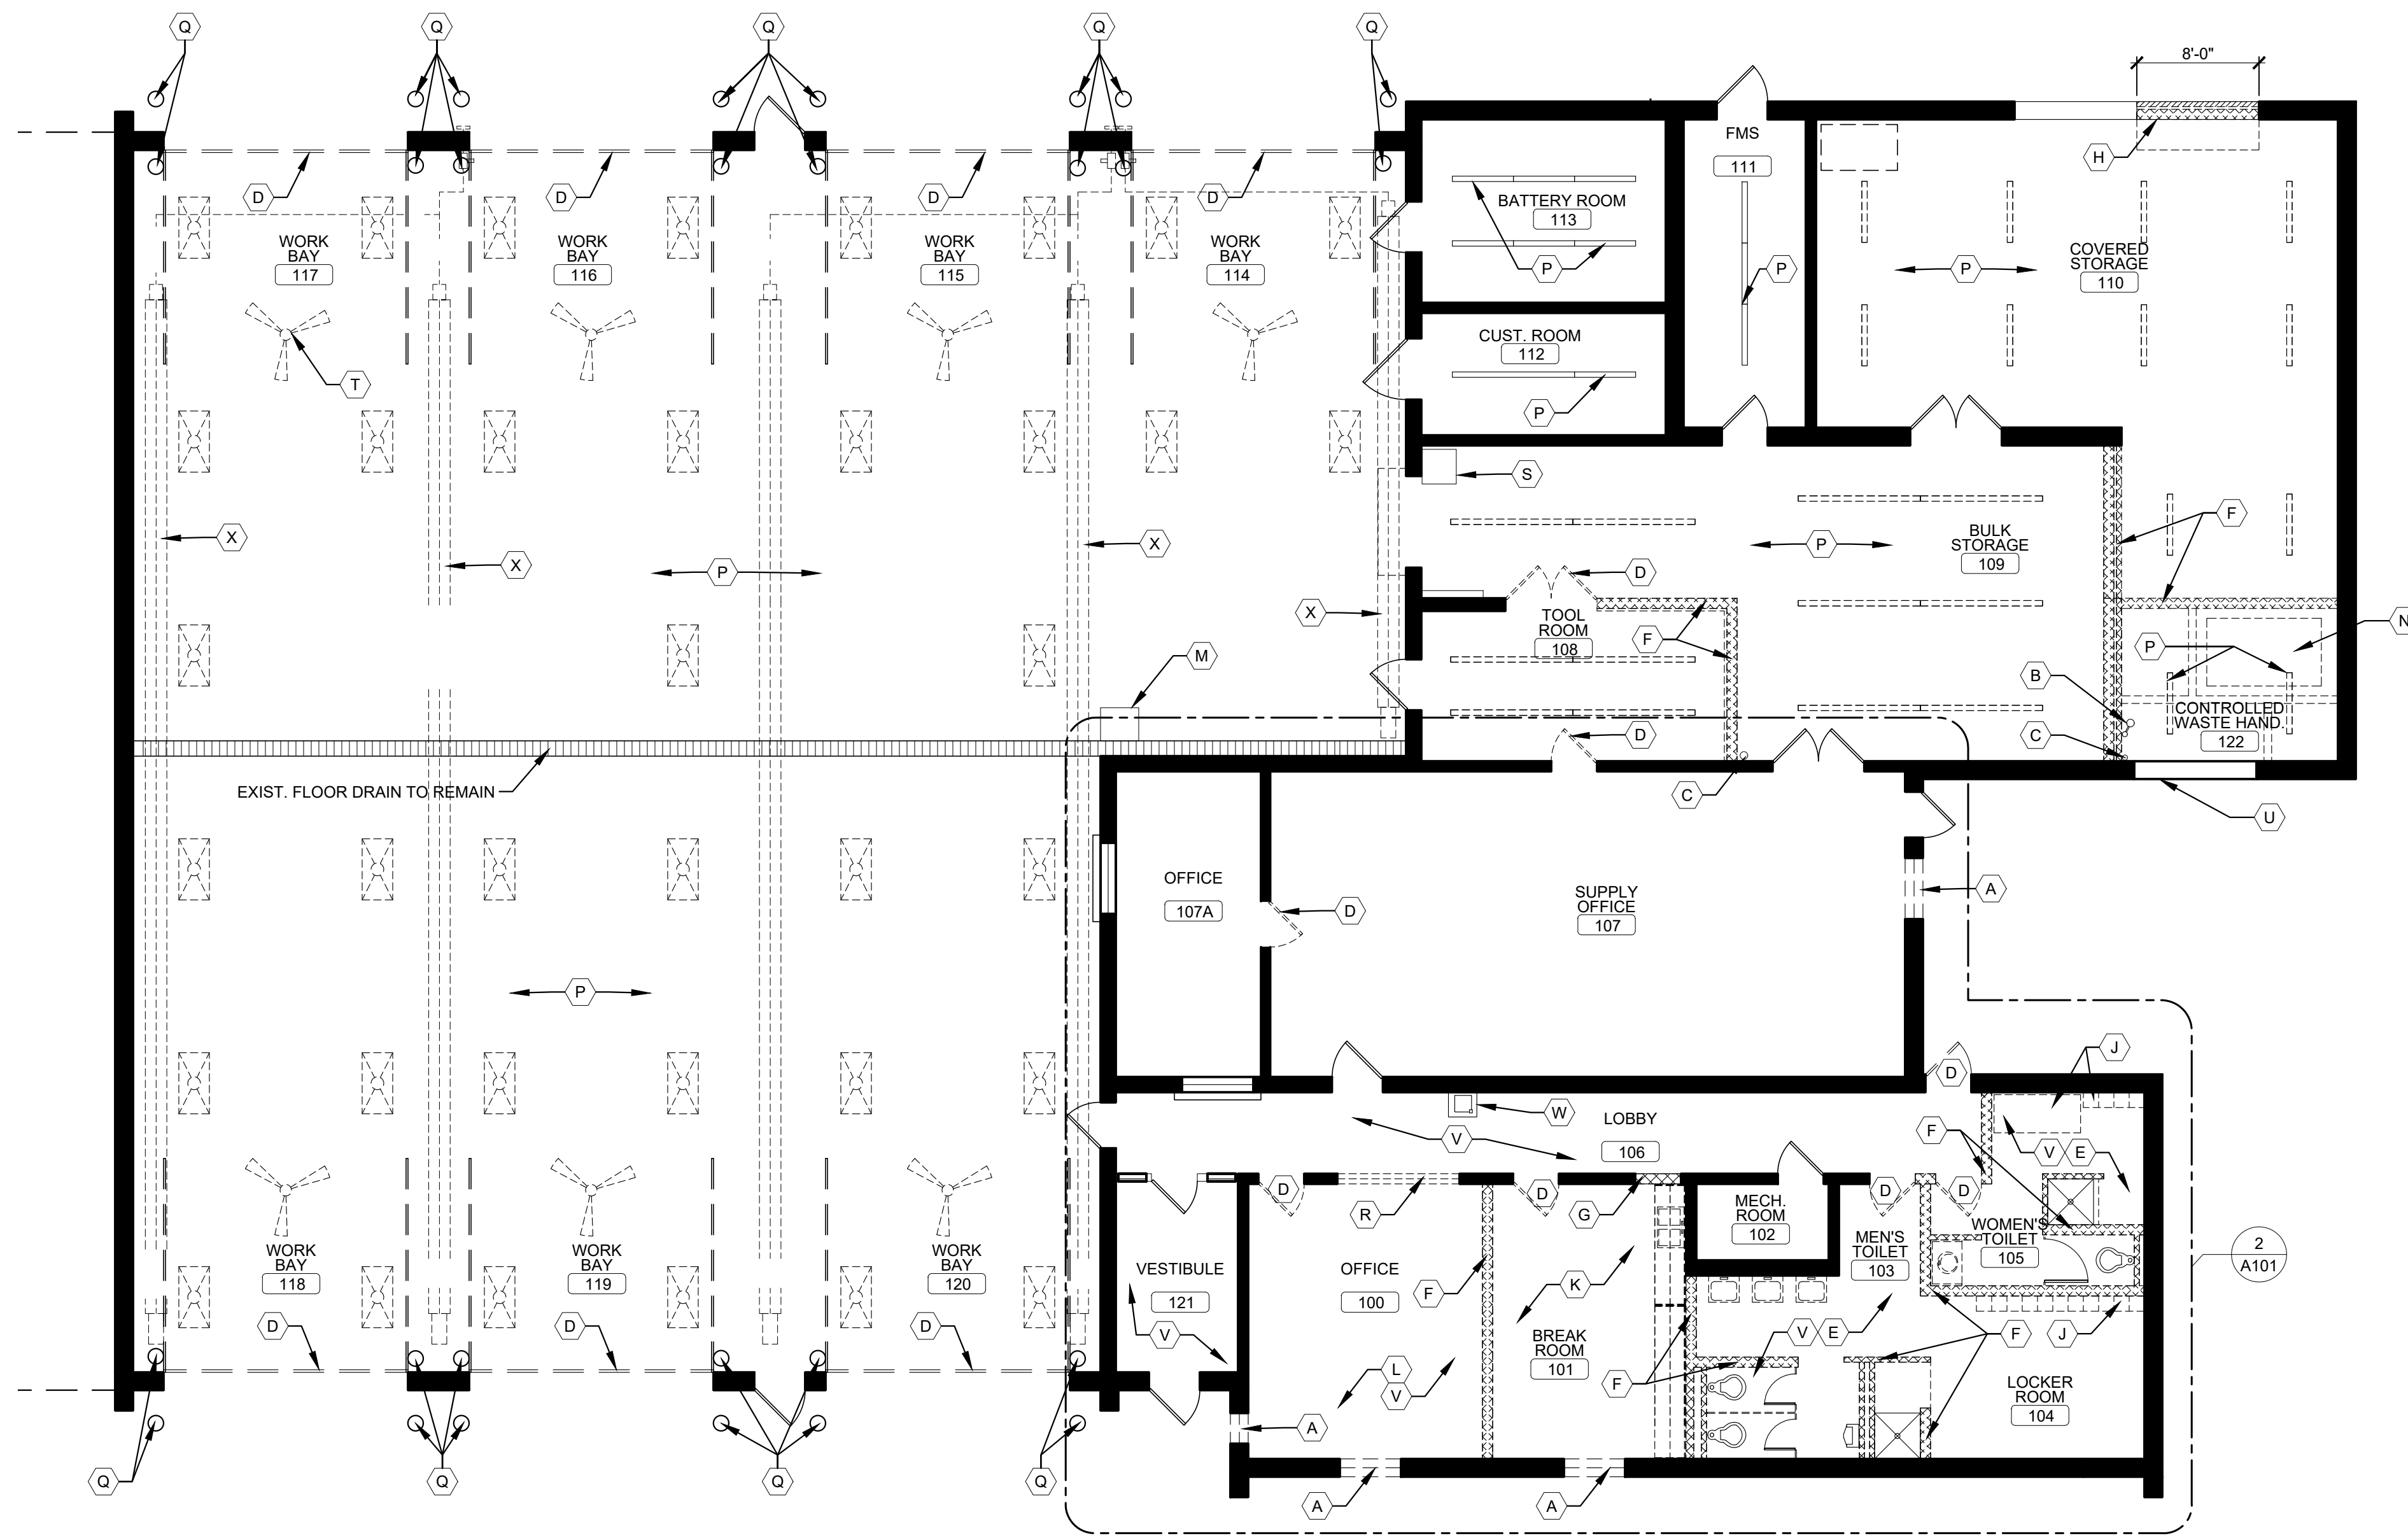
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SHEET TITLE:
**DEMOLITION
FLOOR AND
REFLECTED
CEILING PLANS**


SHEET NUMBER:
A-101
08/01/2023
SHEET 11 OF 29

- GENERAL DEMOLITION NOTES:**
- REFER TO DEMOLITION SPECIFICATIONS FOR ADDITIONAL INFORMATION.
 - REFER TO FLOOR PLAN FOR PROPOSED NEW CONSTRUCTION, SHEET A-102.
 - REFER TO STRUCTURAL, MEP DRAWINGS FOR ADDITIONAL DEMOLITION SCOPE AND REQUIREMENTS.
 - REMOVE ALL EXISTING SITE CONSTRUCTION AND DELETERIOUS MATERIALS UNLESS NOTED OTHERWISE.

- DEMO KEYED NOTES:**
- (A) REMOVE AND DISPOSE OF EXISTING EXTERIOR WINDOWS, REPLACE WITH NEW OF SAME SIZE.
 - (B) EXISTING EYEWASH TO REMAIN. PROTECT DURING DEMO AND CONSTRUCTION
 - (C) EXISTING ROOF DRAIN TO REMAIN. PROTECT DURING DEMO AND CONSTRUCTION.
 - (D) REMOVE AND DISPOSE OF EXISTING DOOR, FRAME, AND ASSOC. HARDWARE.
 - (E) REMOVE EXISTING PLUMBING FIXTURES, COORDINATE UTILITIES BELOW SLAB WITH NEW PLUMBING FIXTURE LOCATIONS, SEE PLUMBING DRAWINGS.
 - (F) DEMOLISH EXISTING CMU BLOCK PARTITIONS COMPLETE. (SHOWN DASHED, TYP.)
 - (G) REMOVE PORTION OF INTERIOR CMU BLOCK WALL FOR RELOCATION OF INTERIOR DOOR. MATCH EXISTING CONSTRUCTION.
 - (H) REMOVE PORTION OF EXISTING EXTERIOR MASONRY WALL, LINTEL, AND CONCRETE SLAB FOR INSTALLATION OF NEW OVERHEAD DOOR. SEE STRUCTURAL FOR MORE INFORMATION.
 - (J) REMOVE AND DISPOSE OF EXISTING LOCKERS.
 - (K) REMOVE AND DISPOSE OF EXISTING BREAK ROOM CASEWORK, EQUIPMENT, FLOORING, AND FINISHES.
 - (L) REMOVE AND SALVAGE EXISTING OFFICE FURNITURE FOR RELOCATION.
 - (M) REMOVE AND SALVAGE EXISTING ICE MACHINE FOR RELOCATION. CAP WATER LINE.
 - (N) EXISTING CURBS AND SLAB TO BE REMOVED COMPLETELY.
 - (O) DEMOLISH CEILING GRID, TILE, LIGHTS (BACK TO SOURCE), AND ALL OTHER RELATED CEILING ITEMS COMPLETE (I.E. DIFFUSERS, SPEAKERS, EMERG. LIGHTS, DUCTWORK, ETC.) SEE MECH. AND ELEC. DWGS. FOR MORE INFO.
 - (P) REMOVE EXISTING LIGHT FIXTURES, SEE ELEC. DWGS.
 - (Q) EXISTING BOLLARD TO REMAIN.
 - (R) REMOVE AND DISPOSE OF EXISTING INTERIOR WINDOW, INFILL TO MATCH WITH ADJACENT CONSTRUCTION.
 - (S) EXISTING STACKED WASHER / DRYER TO REMAIN.
 - (T) REMOVE EXISTING CEILING FANS, TYP.
 - (U) EXISTING OVERHEAD DOOR TO REMAIN, PROTECT DURING DEMO AND PREP TO REFINISH.
 - (V) REMOVE AND DISPOSE OF EXISTING FLOORING. DEMO CONCRTE FLOORS FOR NEW PLUMBING. SEE PLUMBING DRAWINGS.
 - (W) REMOVE EXISTING DRINKING FOUNTAIN, CAP PLUMBING, PATCH / REPAIR WALL FOR REFINISH. SEE ELECTRICAL FOR MORE INFORMATION
 - (X) DEMO EXISTING INFRARED HEATERS, SEE MECHANICAL DRAWINGS FOR MORE INFORMATION.




1 DEMO FLOOR / DEMO REFLECTED CEILING PLAN
SCALE: 1/8" = 1'-0"

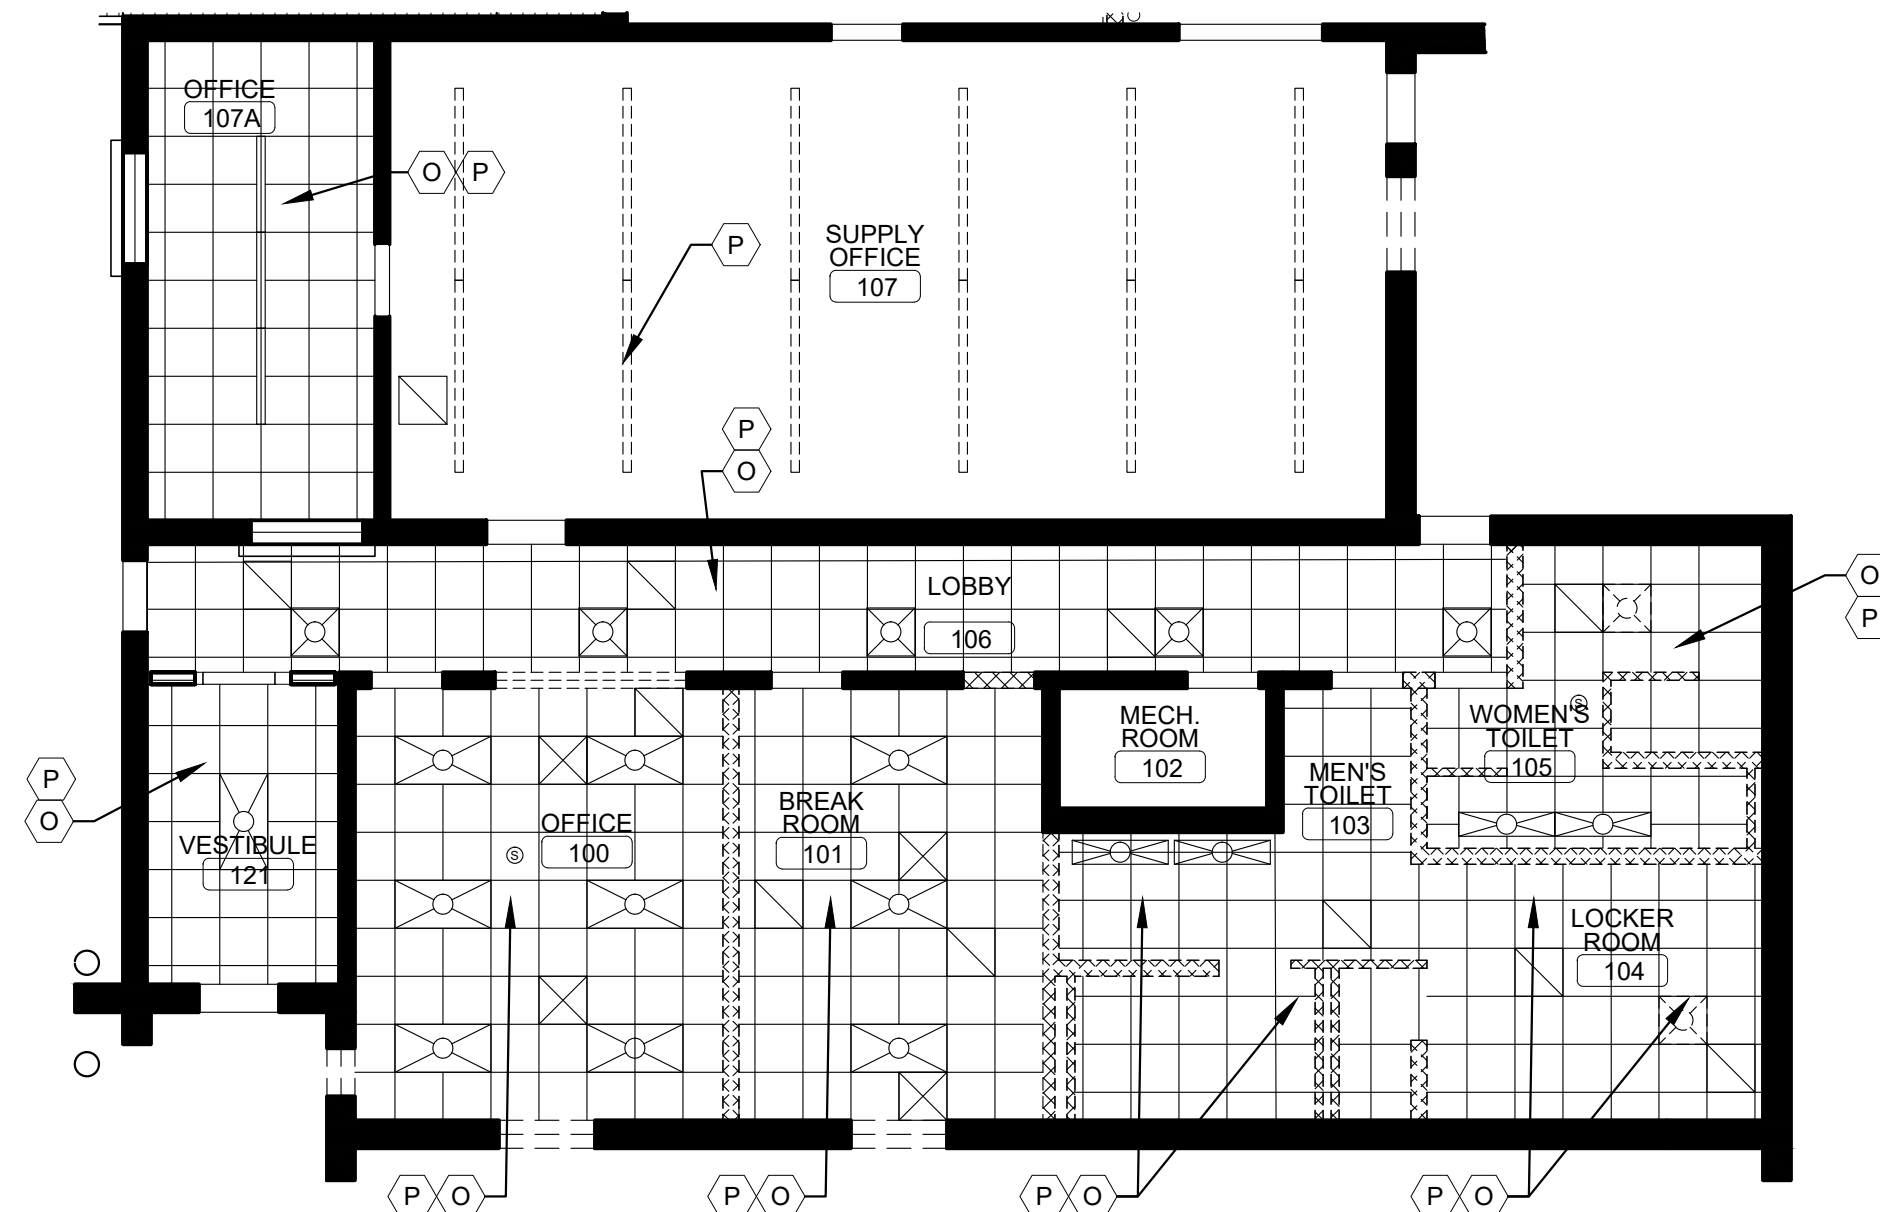


2 DEMO CEILING PLAN @ OFFICES, TOILET RMS, & BREAKROOM
SCALE: 1/8" = 1'-0"



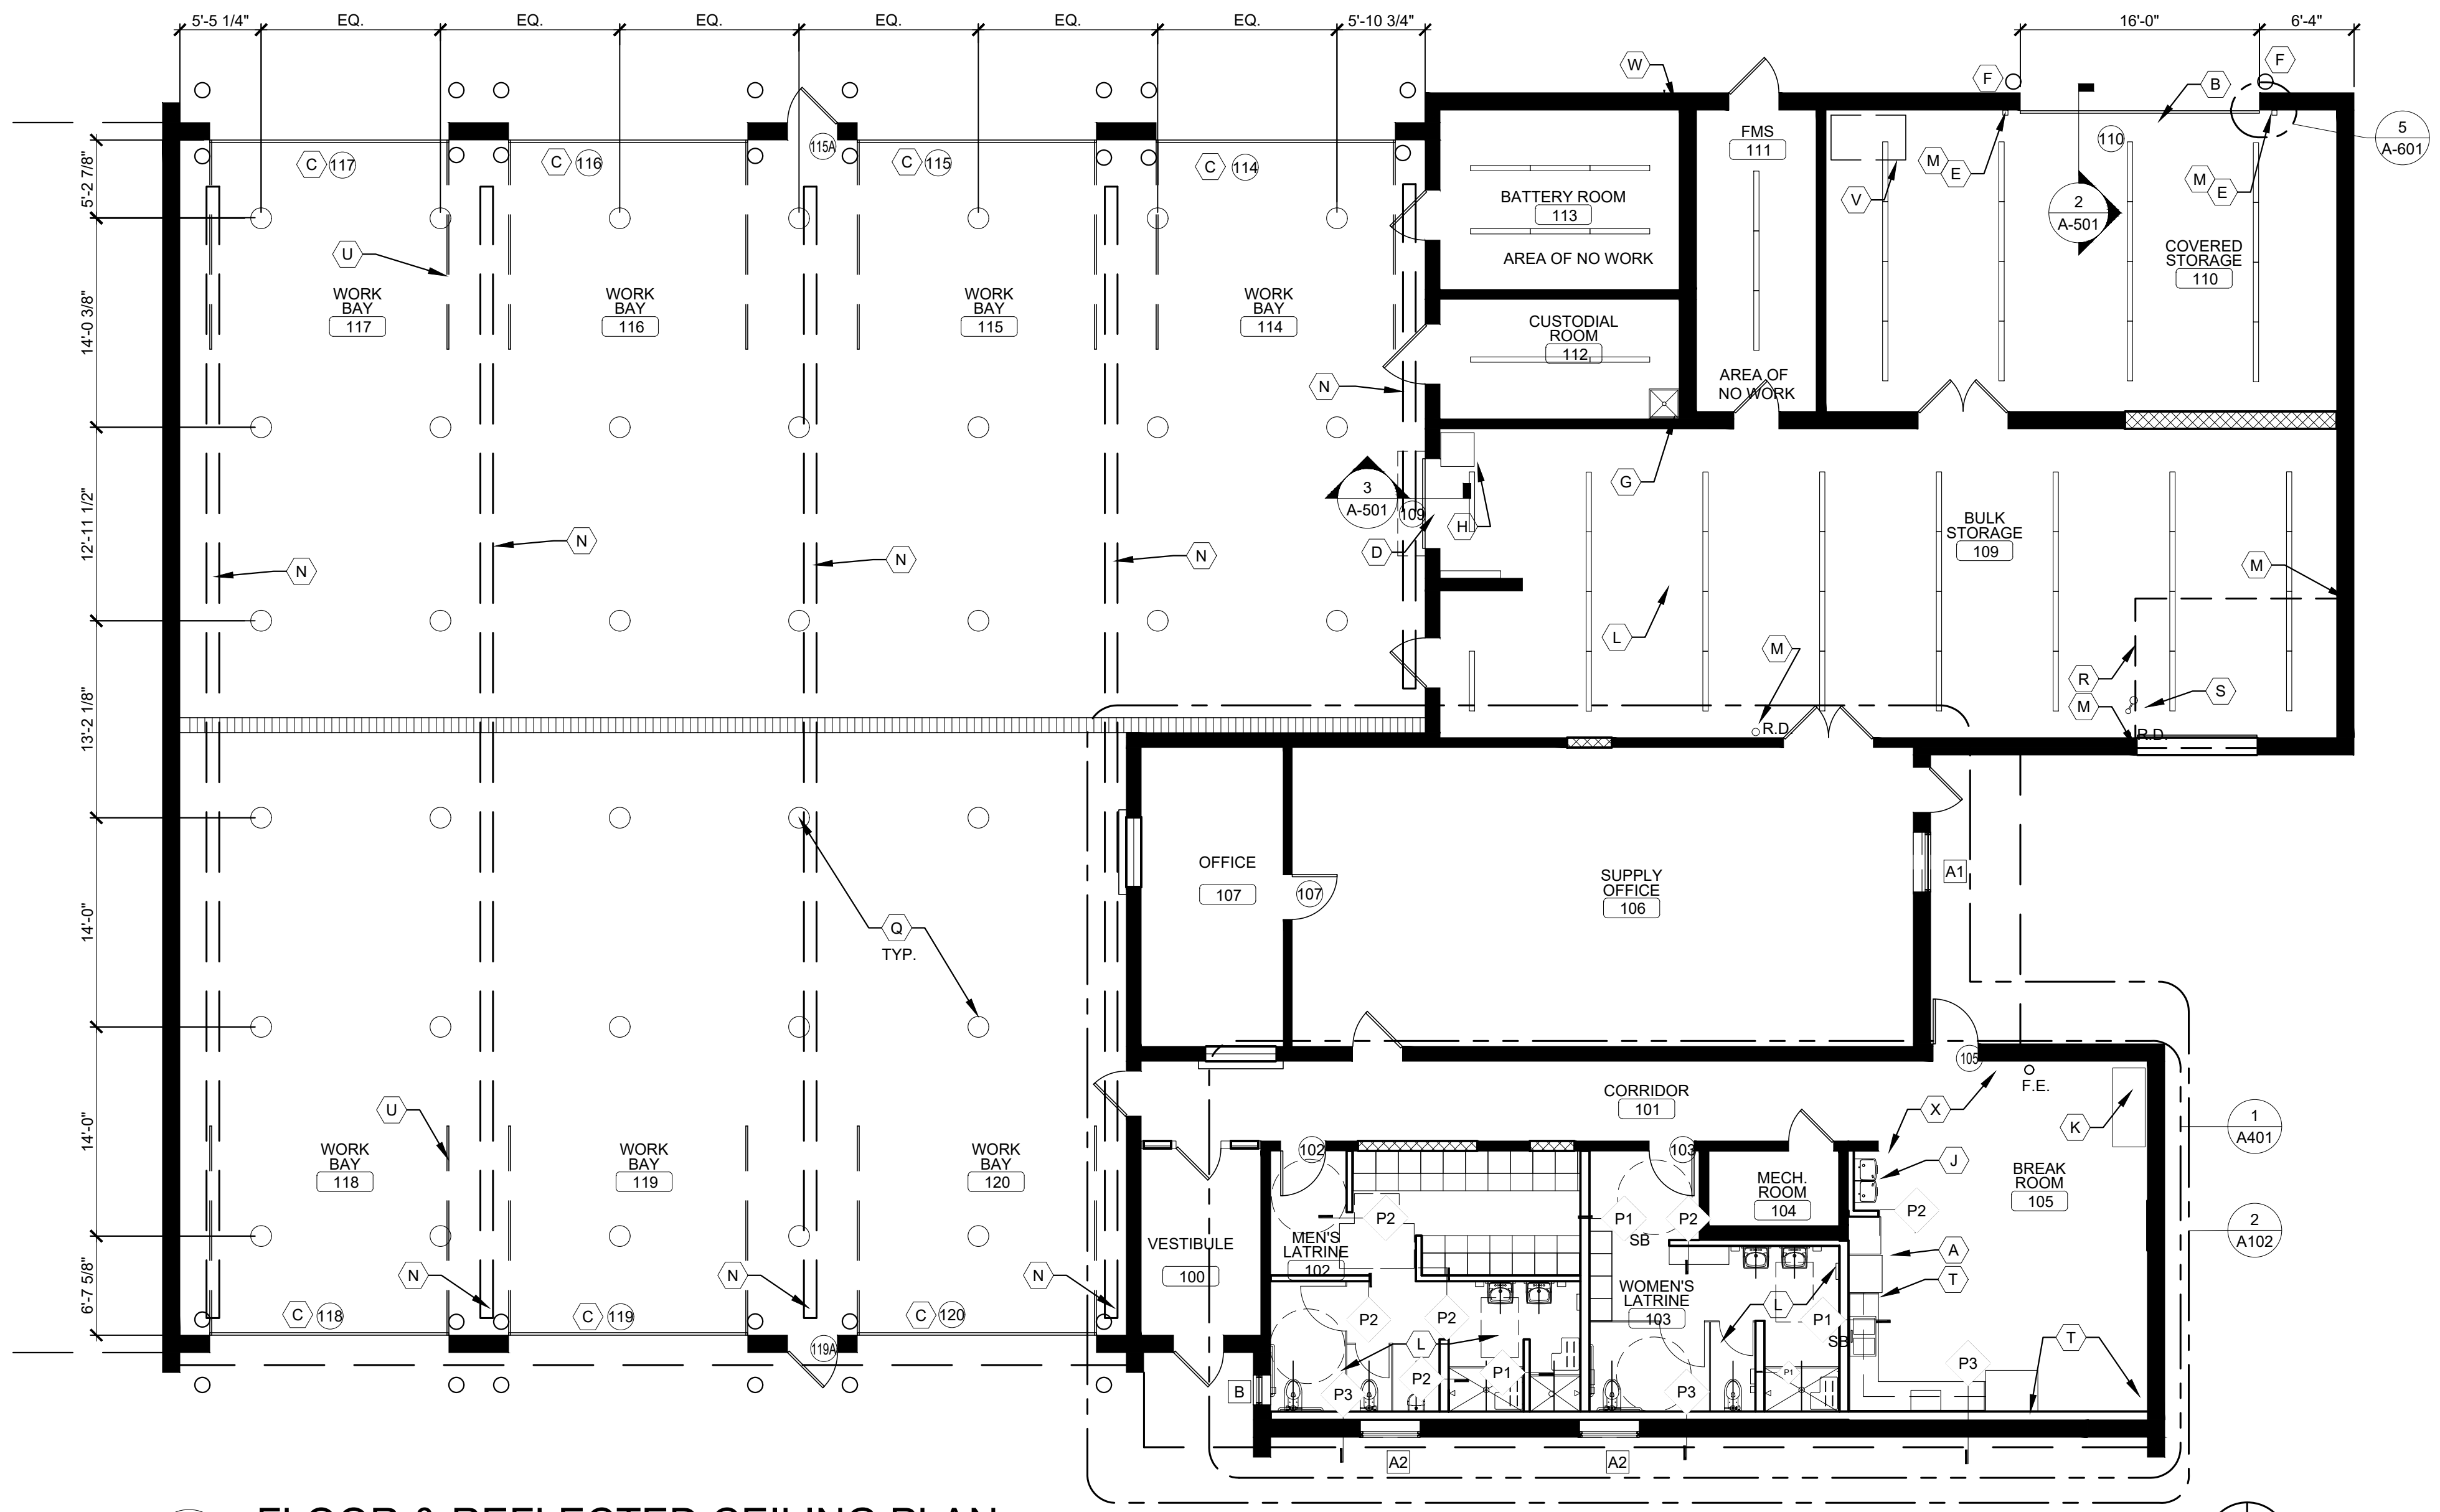

1 FLOOR & REFLECTED CEILING PLAN
 SCALE: 1/8" = 1'-0"

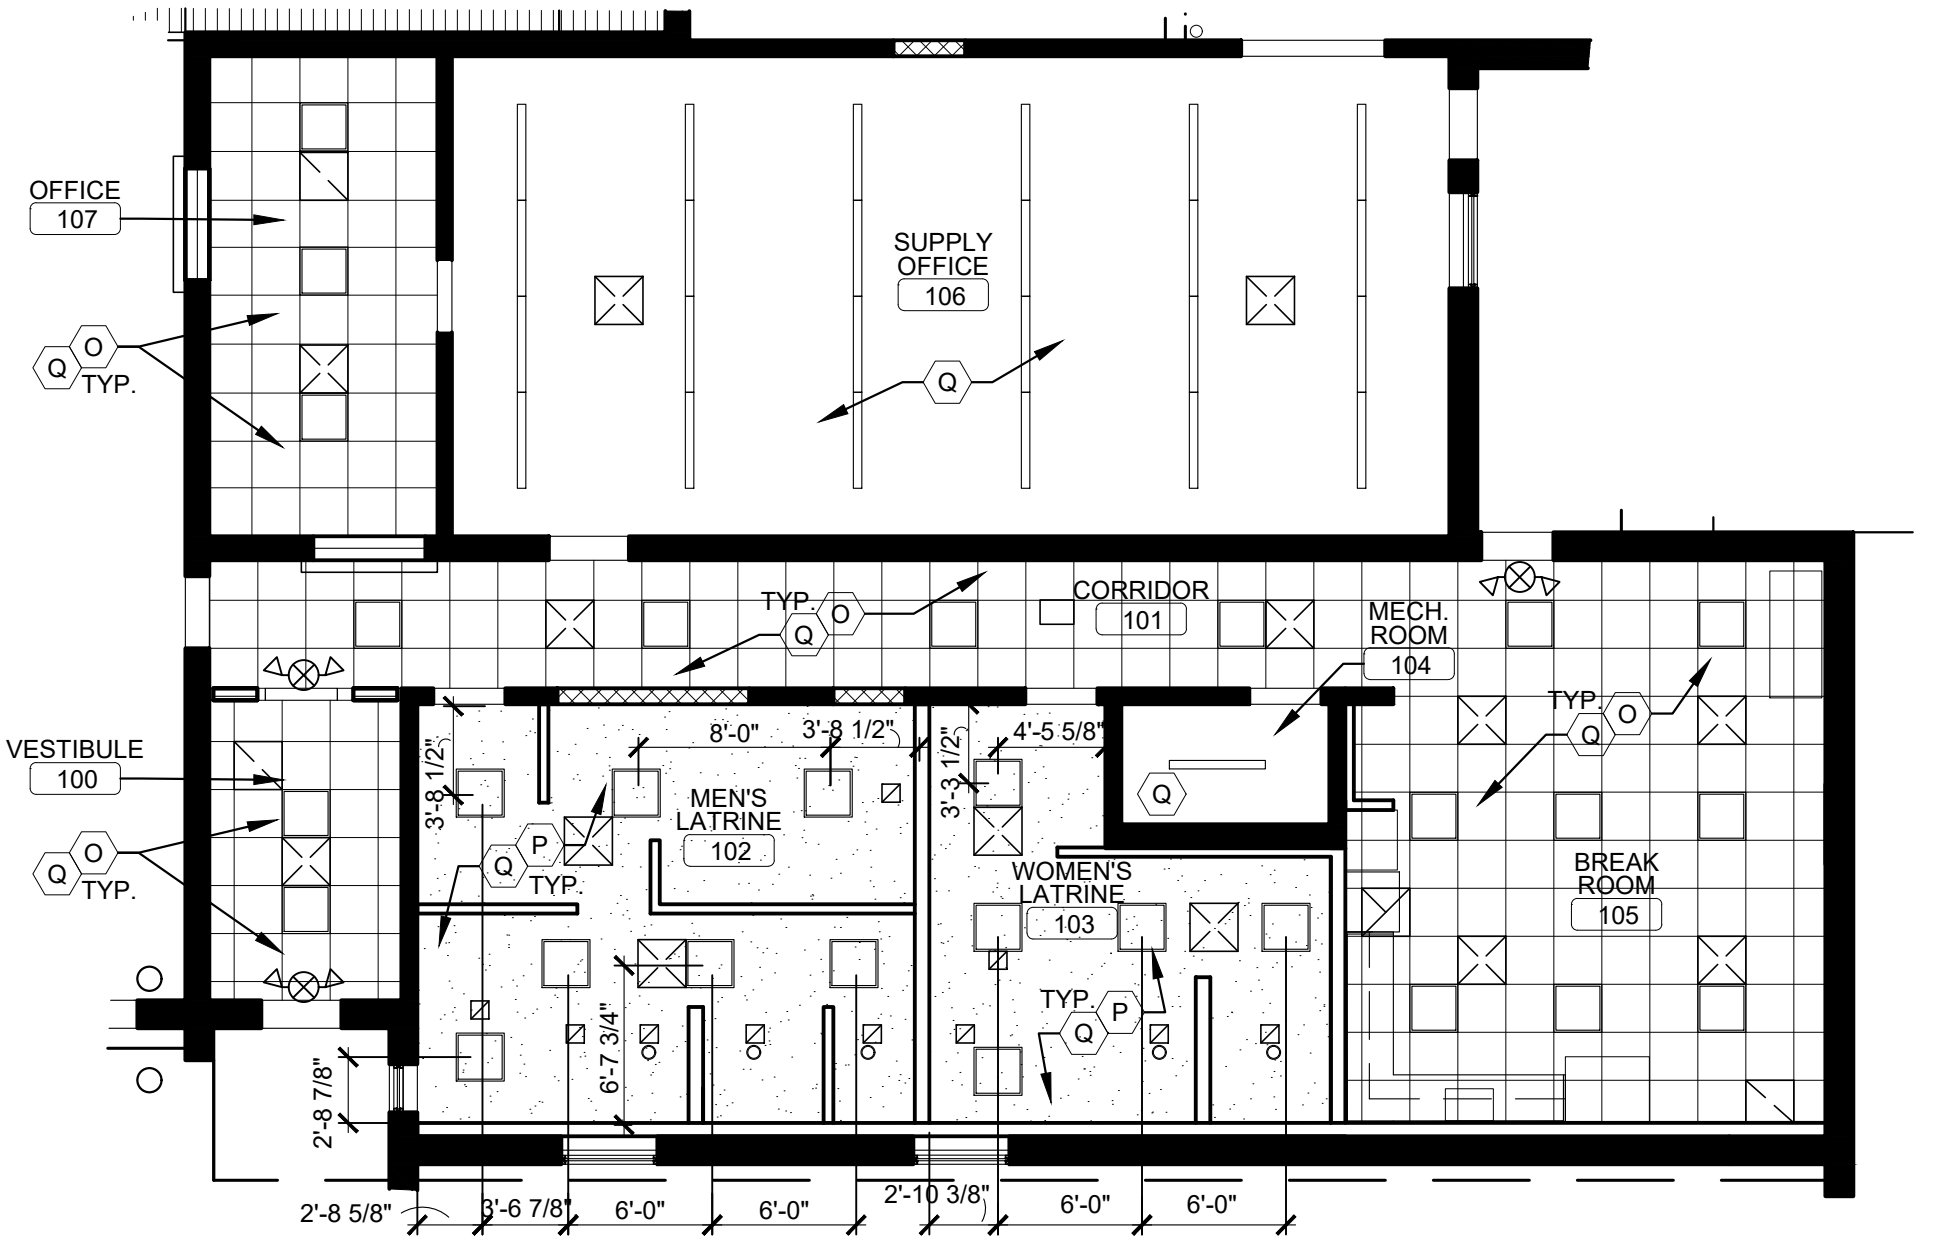

2 REFLECTED CEILING PLAN
 SCALE: 1/8" = 1'-0"

FLOOR PLAN GENERAL NOTES:

- REFER TO GENERAL SPECIFICATIONS FOR ADDITIONAL REQUIREMENTS.
- ALL NEW BUILDING MATERIALS TO BE OF NON-COMBUSTIBLE OR WOOD FIRE RETARDANT TREATED MATERIAL.
- REFER TO DEMOLITION PLANS FOR LOCATIONS OF ALL ITEMS TO BE REMOVED UNLESS NOTED OTHERWISE.
- REFER TO INTERIOR FINISH SCHEDULE FOR NEW WALL FINISHES, FLOOR FINISH AND CEILING HEIGHTS. (A-601)
- ALL INTERIOR WALL DIMENSIONS ARE FROM FACE OF EXISTING OR NEW CMU AND GYPSUM WALLBOARD UNLESS NOTED OTHERWISE.
- ALL EXISTING CONSTRUCTION TO REMAIN SHALL BE CLEANED, PATCH AND REPAIR TO LIKE NEW CONDITION. COORDINATE WITH PROJECT ADMINISTRATOR FOR REPAINTING IF REQUIRED.
- PORTABLE FIRE EXTINGUISHERS (F.E.): PROVIDE PORTABLE FIRE EXTINGUISHERS (MIN.10-LB. QUANTITY OF 1) AS REQUIRED PER LOCAL FIRE MARSHAL.
- SEE PARTITION TYPES ON A-501.

REFLECTED CEILING PLAN GENERAL NOTES:

- MECHANICAL EQUIPMENT SHOWN ON THE REFLECTED CEILING PLAN ARE FOR ARCHITECTURAL LOCATIONS ONLY. REFER TO MECHANICAL DRAWINGS FOR TYPES, SIZES, DISTRIBUTION, CONNECTIONS, AND ALL OTHER REQUIREMENTS.
- LIGHTING FIXTURES SHOWN ON THE REFLECTED CEILING PLAN ARE FOR ARCHITECTURAL LOCATIONS, QUANTITIES, AND GENERAL FIXTURE TYPE ONLY. REFER TO ELECTRICAL DRAWINGS FOR EXACT FIXTURE TYPE AND CIRCUITING.
- CONTRACTOR SHALL COORDINATE THE INSTALLATION OF THE VARIOUS TRADE ITEMS WITHIN THE SPACE ABOVE ALL CEILINGS (INCLUDING, BUT NOT LIMITED TO: STRUCTURAL MEMBERS, MECHANICAL DUCTS AND INSULATION, CONDUITS, RACEWAYS, SPRINKLER SYSTEM, LIGHT FIXTURES, CEILING SYSTEMS, AND ANY SPECIAL STRUCTURAL SUPPORTS REQUIRED) AND SHALL BE RESPONSIBLE FOR MAINTAINING THE FINISH CEILING HEIGHT ABOVE THE FINISH FLOOR INDICATED ON THE DRAWING.


EQUIPMENT SUPPORT NOTES:

- DO NOT PUNCH OR USE DECK ABOVE TO SUPPORT ANY ITEMS SUCH AS: MECHANICAL EQUIPMENT, ELECTRICAL EQUIPMENT, LIGHT FIXTURES, ETC. SHALL BE SUPPORTED FROM STRUCTURAL SUPPORT MEMBERS. GENERAL CONTRACTOR IS RESPONSIBLE TO NOTIFY ALL SUB-CONTRACTORS PRIOR TO WORK TO BE PERFORMED.
- ALL LIGHTS MUST BE PROPERLY INSTALLED AND SUPPORTED TO STRUCTURAL SUPPORT MEMBERS ABOVE CEILING SYSTEM AND ATTACHED DIAGONALLY ON LIGHT FIXTURE OR WHERE SURFACE MOUNT LIGHT FIXTURES OCCURS AT SUSPENDED CEILING SYSTEM. DO NOT SUPPORT FROM FINISH CEILING MATERIAL.

KEYED NOTES:

- (A) REUSE EXISTING ICE MACHINE SALVAGED, SEE PLUMBING DRAWINGS. COORDINATE WITH OWNER EQUIPMENT LOCATIONS.
- (B) NEW 16'-0" x 10'-0" MOTORIZED OVERHEAD DOOR, SEE DOOR SCHEDULE ON SHEET A-601
- (C) NEW 16'-0" x 14'-0" MOTORIZED OVERHEAD DOOR, SEE DOOR SCHEDULE ON SHEET A-601
- (D) NEW 6'-0" x 6'-8" MOTORIZED COILING OVERHEAD DOOR, SEE DOOR SCHEDULE ON SHEET A-601
- (E) NEW STEEL STRONG-BACK SUPPORT AT NEW OVERHEAD DOOR OPENING. SEE STRUCT. DWGS.
- (F) NEW BOLLARD, SEE DETAIL 2/A-001
- (G) NEW MOP SINK AT CUSTODIAL ROOM. SEE PLUMBING DWGS.
- (H) EXISTING WASHER & DYER TO REMAIN.
- (J) NEW HI-LO WATER COOLER. SEE PLUMBING AND ELECT. DWGS.
- (K) EXISTING COPIER RELOCATED.
- (L) REPAIR, PATCH AND FINISH FLOOR AND WALLS TO LIKE NEW CONDITION, WHERE EXISTING FLOOR AND WALL WAS REMOVED. SEE MEP DWGS FOR RELOCATED OR DISCONNECTED CONDUIT AND PIPING. SEE ROOM FINISH SCHEDULE FOR WALL PAINT.
- (M) CLEAN, PATCH, AND REPAIR EXISTING CMU TO LIKE NEW CONDITION WHERE EXISTING BRICK, BLOCK, INSULATION AND MASONRY TIES HAVE BEEN REMOVED. SEE ROOM FINISH SCHEDULE FOR PAINT FINISH ON SHEET A-601.
- (N) NEW GAS FIRED INFRARED HEATERS, SEE MECH. DWGS.
- (O) NEW 2'-0" x 2'-0" ACT.
- (P) NEW WATER RESISTANT GYP BOARD CEILING
- (Q) NEW LED LIGHTING, SEE ELECT. DWGS. ONE FOR ON REPLACEMENT U.N.O.
- (R) AREA OF SLAB INFILL
- (S) EXIST. EYE WASH TO REMAIN
- (T) NEW EQUIPMENT BY OWNER
- (U) OVERHEAD DOOR TRACKS, TYP.
- (V) POWER WASHER, SEE MECH. DWGS.
- (W) PLUMBING FOR RETRACTABLE HOSE, SEE PLUMBING DWGS.

CEILING DEVICE LEGEND

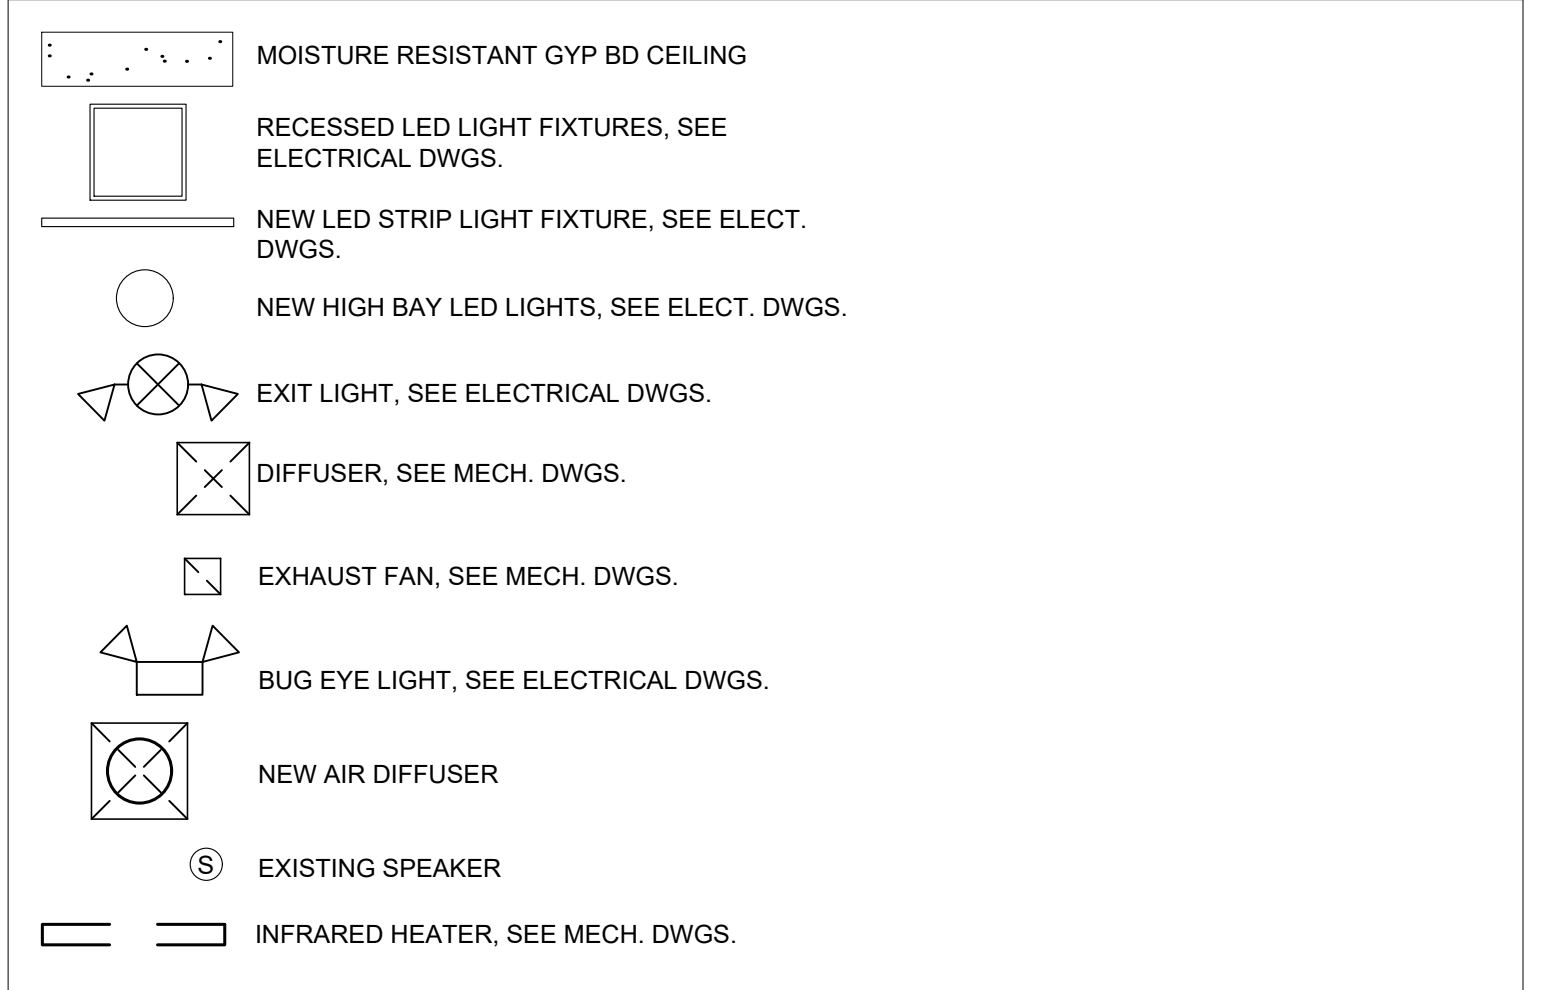

STATE OF MISSOURI
 MICHAEL L. PARSON,
 GOVERNOR



MICHAEL S. SUNDERMEYER
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 MAINTENANCE SHOP (CSMS)
 2302 MILITIA DRIVE
 JEFFERSON CITY, MISSOURI
 65101


PROJECT # T2122-01
 SITE # 6300
 ASSET# 8136300017

REVISION: _____
 DATE: _____
 REVISION: _____
 DATE: _____
 REVISION: _____
 DATE: _____
 ISSUE DATE: 08/01/2023

CAD DWG FILE: _____
 DRAWN BY: _____
 CHECKED BY: _____
 DESIGNED BY: _____

SHEET TITLE:
**FLOOR PLAN
 AND REFLECTED
 CEILING PLANS**

SHEET NUMBER:
A-102
 08/01/2023
 SHEET 12 OF 29

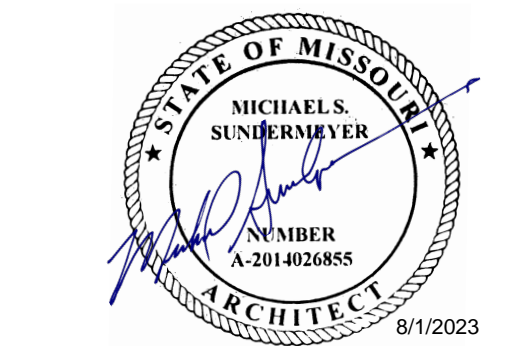

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2302 MILITIA DRIVE
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65101

PROJECT # T2122-01
SITE # 6300
ASSET# 8136300017


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DATE:
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REVISION:
DATE:
ISSUE DATE: 08/01/2023

CAD DWG FILE:
DRAWN BY:
CHECKED BY:
DESIGNED BY:

SHEET TITLE:


ROOF PLAN
AND DETAILS

SHEET NUMBER:
A-103
08/01/2023
SHEET 13 OF 29

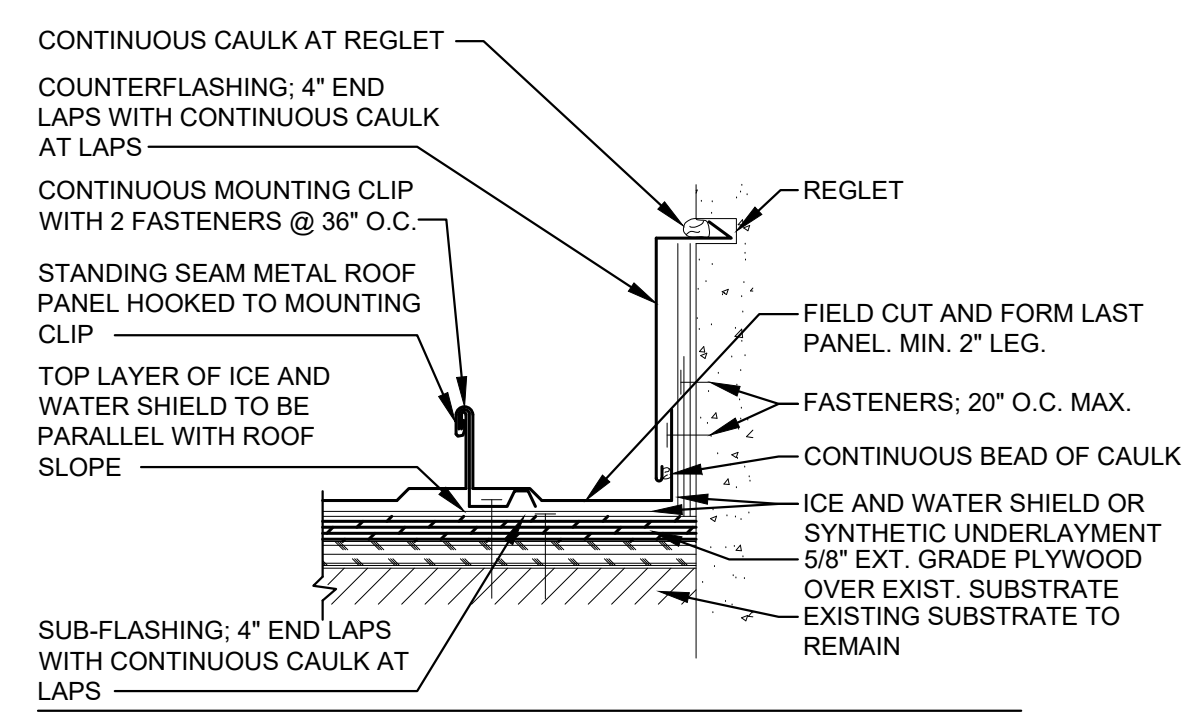

- FIELD CUT LAST PANEL AND FORM NEW LEG. PANEL TO BE CONTINUOUS FROM RIDGE TO EAVE
- SOLID SHEATHING TO BE MINIMUM 1/2" PLYWOOD OR EQUIVALENT IN STRENGTH FOR HOLDING POWER OF FASTENERS.


1 RAKE WALL DETAIL
SCALE: 3" = 1'-0"

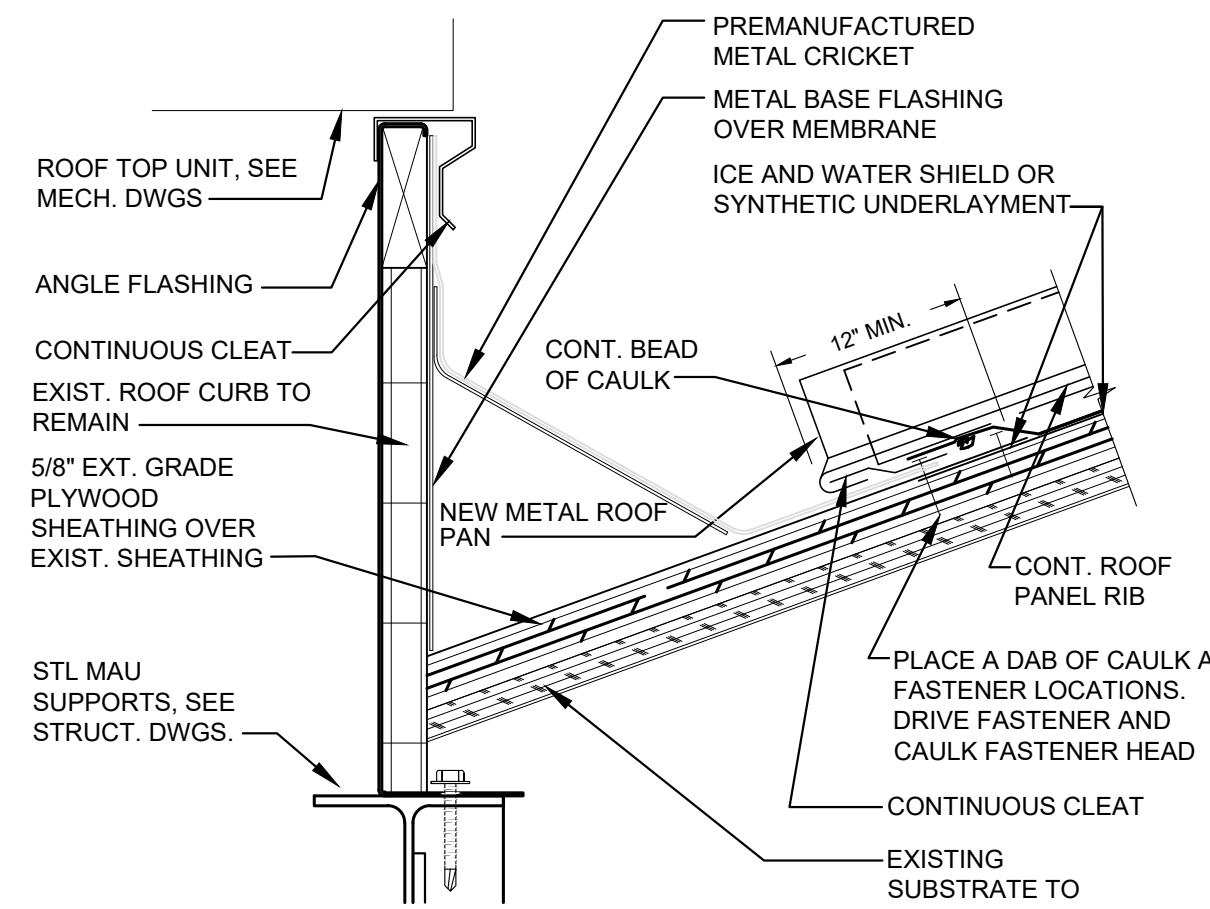

3 CURB DETAIL
SCALE: 3" = 1'-0"


2 NOT USED
SCALE: 3" = 1'-0"

4 NOT USED
SCALE: 3" = 1'-0"

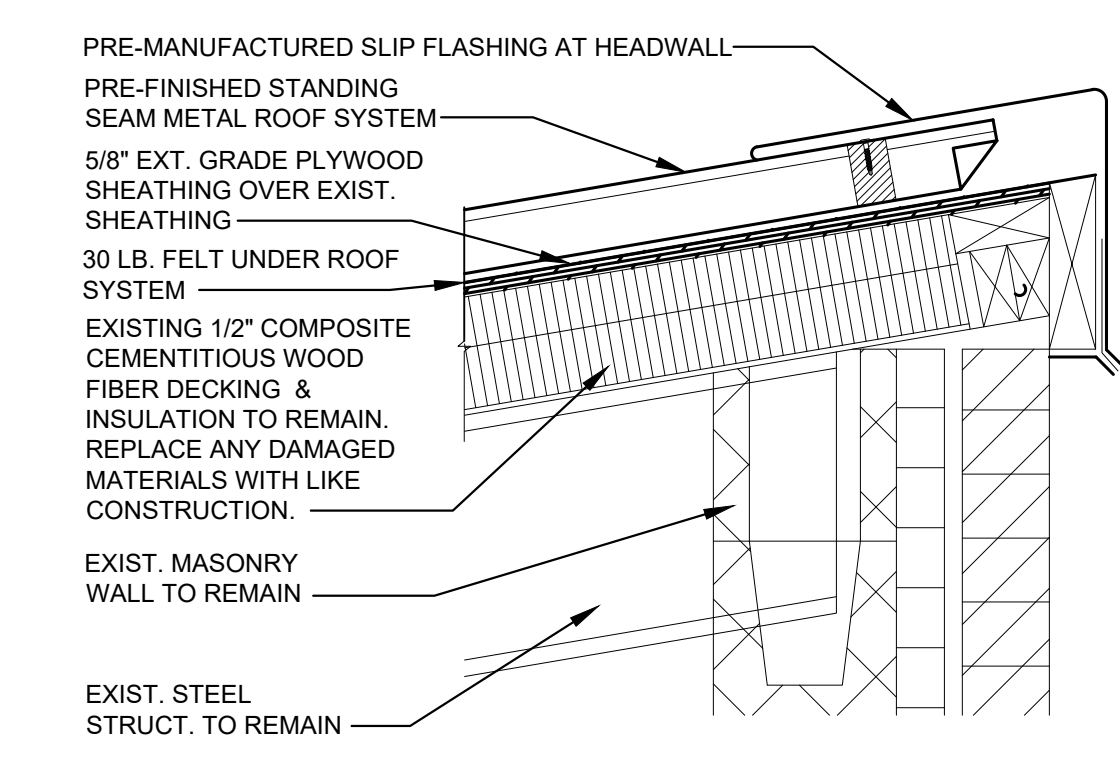


5 ROOF EDGE DETAIL
SCALE: 1 1/2" = 1'-0"


6 NOT USED
SCALE: 1 1/2" = 1'-0"

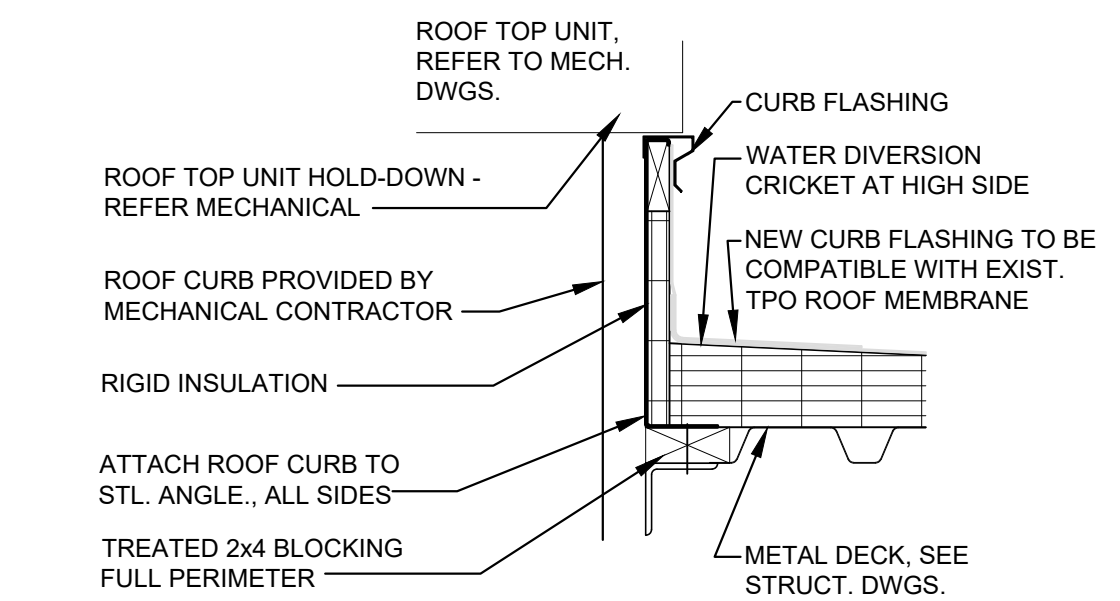


8 CURB DTL. AT TPO ROOF
SCALE: 1 1/2" = 1'-0"

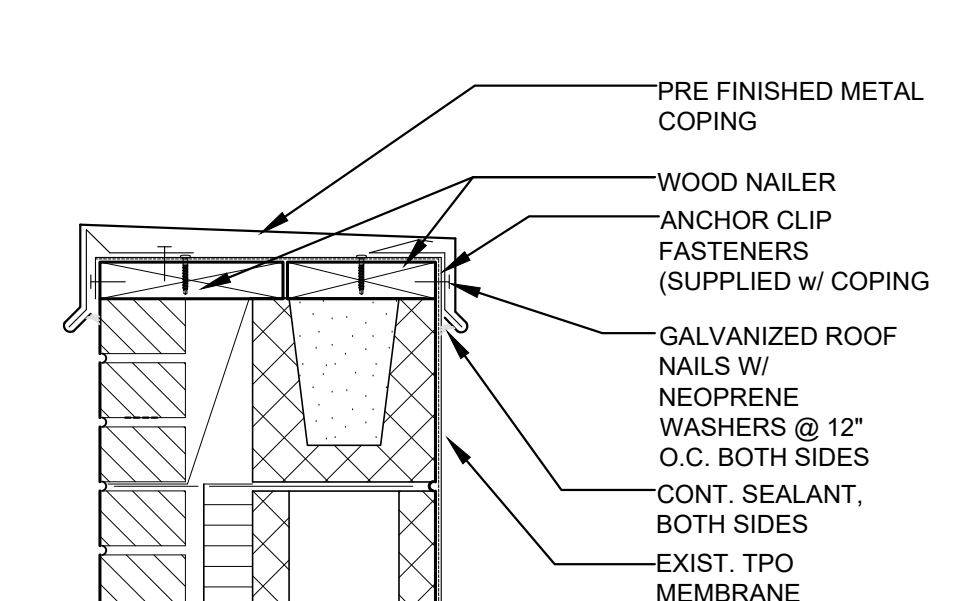


9 METAL COPING DETAIL
SCALE: 1 1/2" = 1'-0"

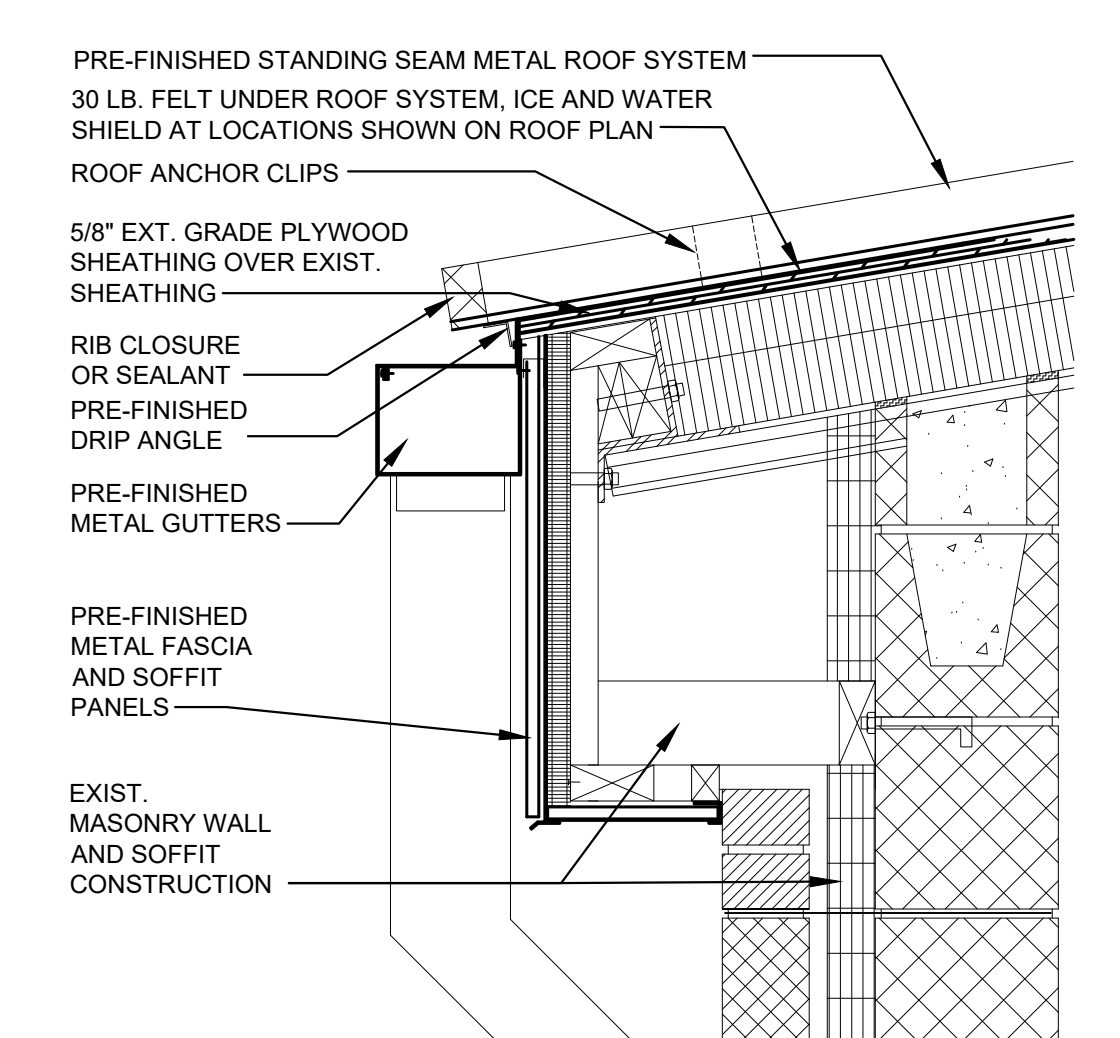

10 GUTTER / FASCIA DTL.
SCALE: 1 1/2" = 1'-0"

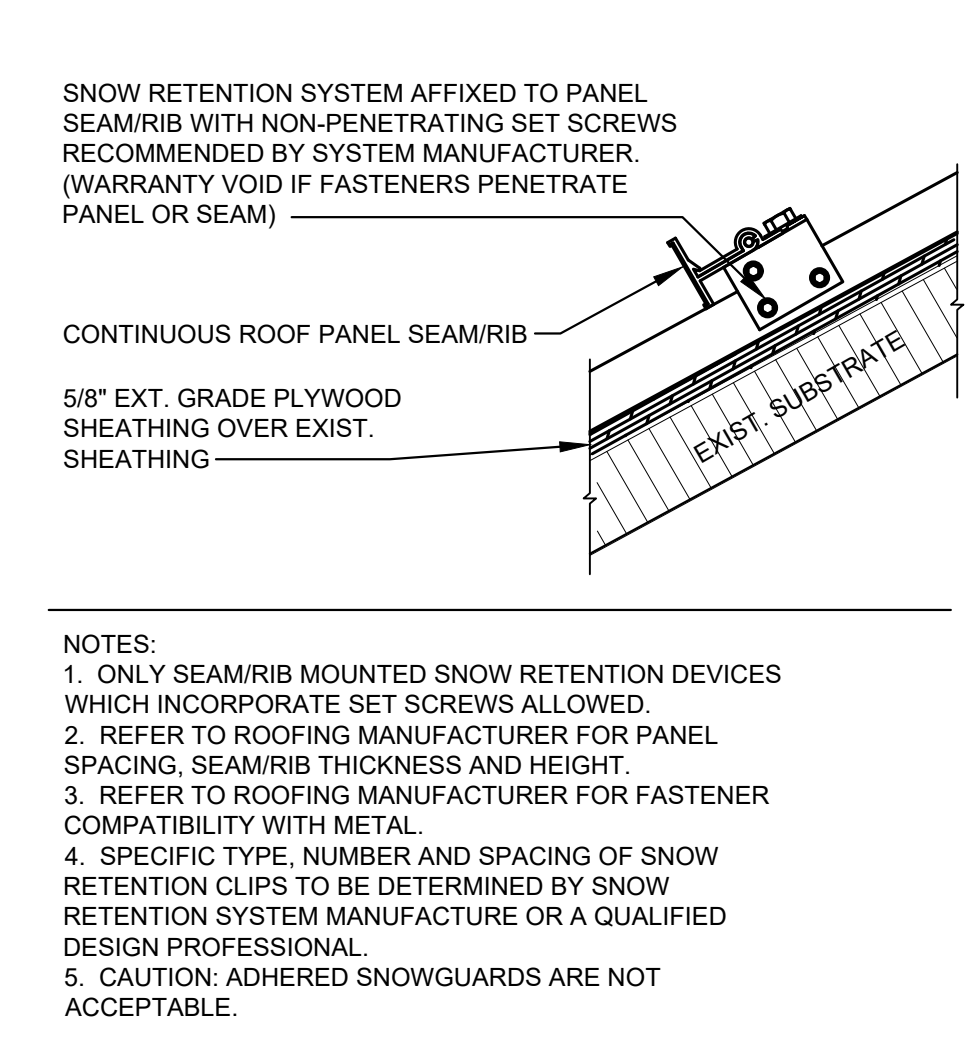

11 SNOW GUARD DETAL
SCALE: 1 1/2" = 1'-0"

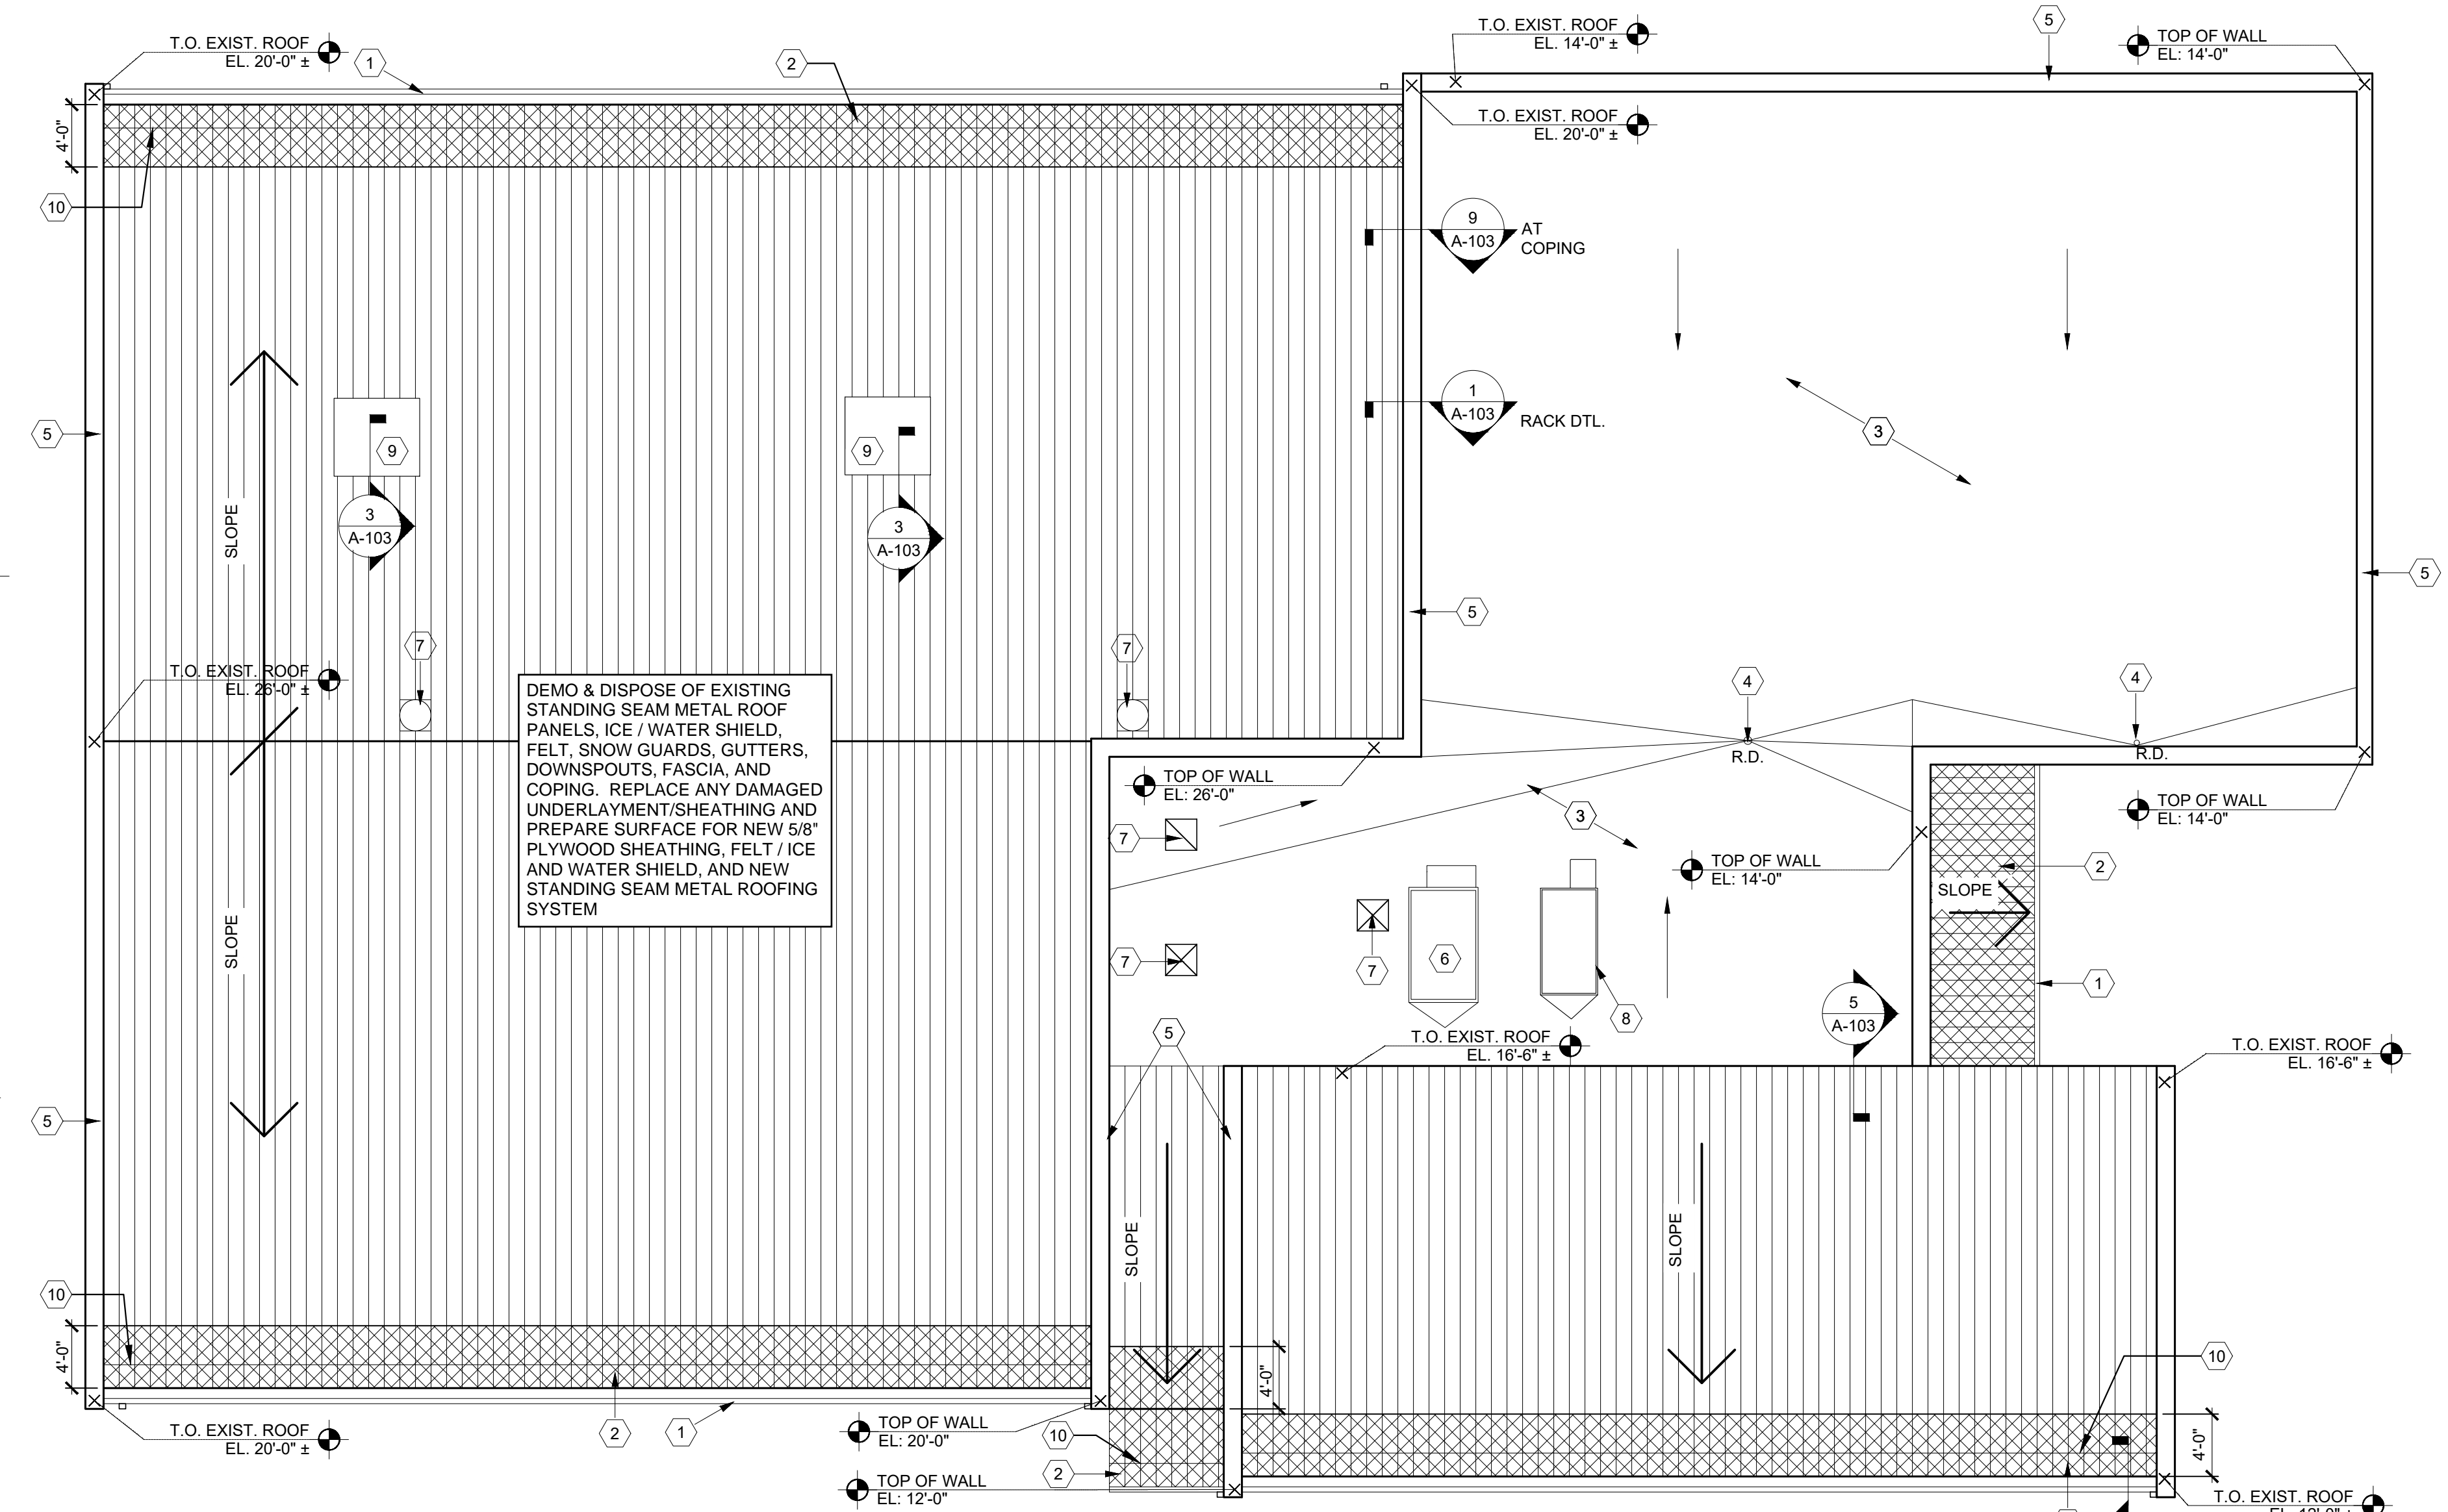

7 ROOF PLAN
SCALE: 1/8" = 1'-0"

- GENERAL DEMOLITION NOTES:
- ROOF WORK AT EXISTING TPO AREAS REQUIRES THE USE OF A ROOFER THAT IS APPROVED BY THE MANUFACTURER IN ORDER NOT TO VOID WARRANTIES IN PLACE. REFERENCE SPECIFICATIONS FOR ROOF WARRANTY INFORMATION.
 - PROVIDE TEMPORARY WEATHER PROTECTION AND SECURITY DEVICES DURING INTERVAL BETWEEN DEMOLITION AND REMOVAL OF EXISTING CONSTRUCTION ON EXTERIOR SURFACES AND INSTALLATION ON NEW CONSTRUCTION TO ENSURE THAT NO WATER LEAKAGE OR DAMAGE OCCURS TO STRUCTURE OR TO INTERIOR AREAS OF EXISTING BUILDING.
 - EXISTING ROOF HAS SHEATHING BUT IS NOT OF ADEQUATE DEPTH TO MEET FASTENING REQUIREMENTS OF THE STANDING SEAM MANUFACTURER. CONTRACTOR SHALL INSTALL NEW 5/8" PLYWOOD SHEATHING OVER EXISTING SHEATHING IN ORDER TO PROPERLY SECURE NEW ROOFING. REFERENCE DETAILS THIS SHEET FOR NEW PLYWOOD SHEATHING.

- KEYED NOTES: NEW STANDING SEAM METAL ROOF BASIS OF DESIGN IS BERRIDGE, COLOR: ROYAL BLUE**
- DEMOM AND DISPOSE OF EXISTING GUTTER AND D.S. SYSTEM. REPLACE WITH NEW GUTTER AND DOWNSPOUT OF THE SAME DIMENSIONS AND LOCATIONS.
 - NEW ICE AND WATER SHIELD, TYP. EXTEND 2'-0" PAST EXTERIOR WALL AND AT PERIMETER OF ROOF TOP PENETRATIONS.
 - EXISTING TPO ROOF TO REMAIN.
 - EXISTING ROOF DRAIN TO REMAIN.
 - REMOVE & DISPOSE OF EXISTING METAL COPING AND ANY DAMAGED BLOCKING. REPLACE WITH NEW FRT BLOCKING AS REQUIRED, AND NEW METAL COPING. SEE DETAIL 10/A-103.
 - EXIST. RTU TO REMAIN, SEE MECH. DWGS.
 - EXISTING EXHAUST FAN TO REMAIN
 - NEW RTU, SEE MECH. AND STRUCT. DWGS. FOR MORE INFORMATION. SEE DTL. 3/A-103 FOR CURB DETAILS.
 - EXISTING AIR INTAKE TO REMAIN
 - SNOW AND ICE GUARDS, SEE DETAIL 11/A-103 AND SPECIFICATIONS FOR MORE INFORMATION



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GENERAL NOTES:


- REFER TO SPECIFICATIONS FOR ADDITIONAL REQUIREMENTS.
- ALL NEW BUILDING MATERIALS TO BE OF NON-COMBUSTIBLE OR WOOD FIRE RETARDANT TREATED MATERIAL.
- REFER TO DEMOLITION PLANS FOR LOCATIONS OF ALL ITEMS TO BE REMOVED UNLESS NOTED OTHERWISE.
- REFER TO INTERIOR FINISH SCHEDULE FOR NEW WALL FINISHES, AND FLOOR FINISH. (A-601)
- ALL INTERIOR WALL DIMENSIONS ARE FROM FACE OF EXISTING OR NEW CMU UNLESS NOTED OTHERWISE.
- ALL EXISTING CONSTRUCTION TO REMAIN SHALL BE CLEANED, PATCHED AND REPAIRED TO LIKE NEW CONDITION.

LEGEND:


	EXISTING BLOCK		A1 - NEW OPERABLE ALUM. WINDOW, MATCH EXIST.		B - NEW FIXED ALUM. WINDOW, MATCH EXIST. W/ SPANDREL GLASS
	EXISTING BRICK		A2 - NEW FIXED ALUM. WINDOW, MATCH EXIST. W/ SPANDREL GLASS		

ROOF MATERIALS (BERRIDGE, CEE-LOCK PANEL - B.O.D.):


STANDING SEAM METAL ROOF, PREFABRICATED GUTTERS, DOWNSPOUTS, FASCIA, AND SOFFITS. COLOR TO BE DETERMINED BY ARCHITECT AND OWNER. SEE ROOF PLAN AND DETAILS ON SHEET A-102 AND SPECIFICATIONS FOR MORE INFORMATION.

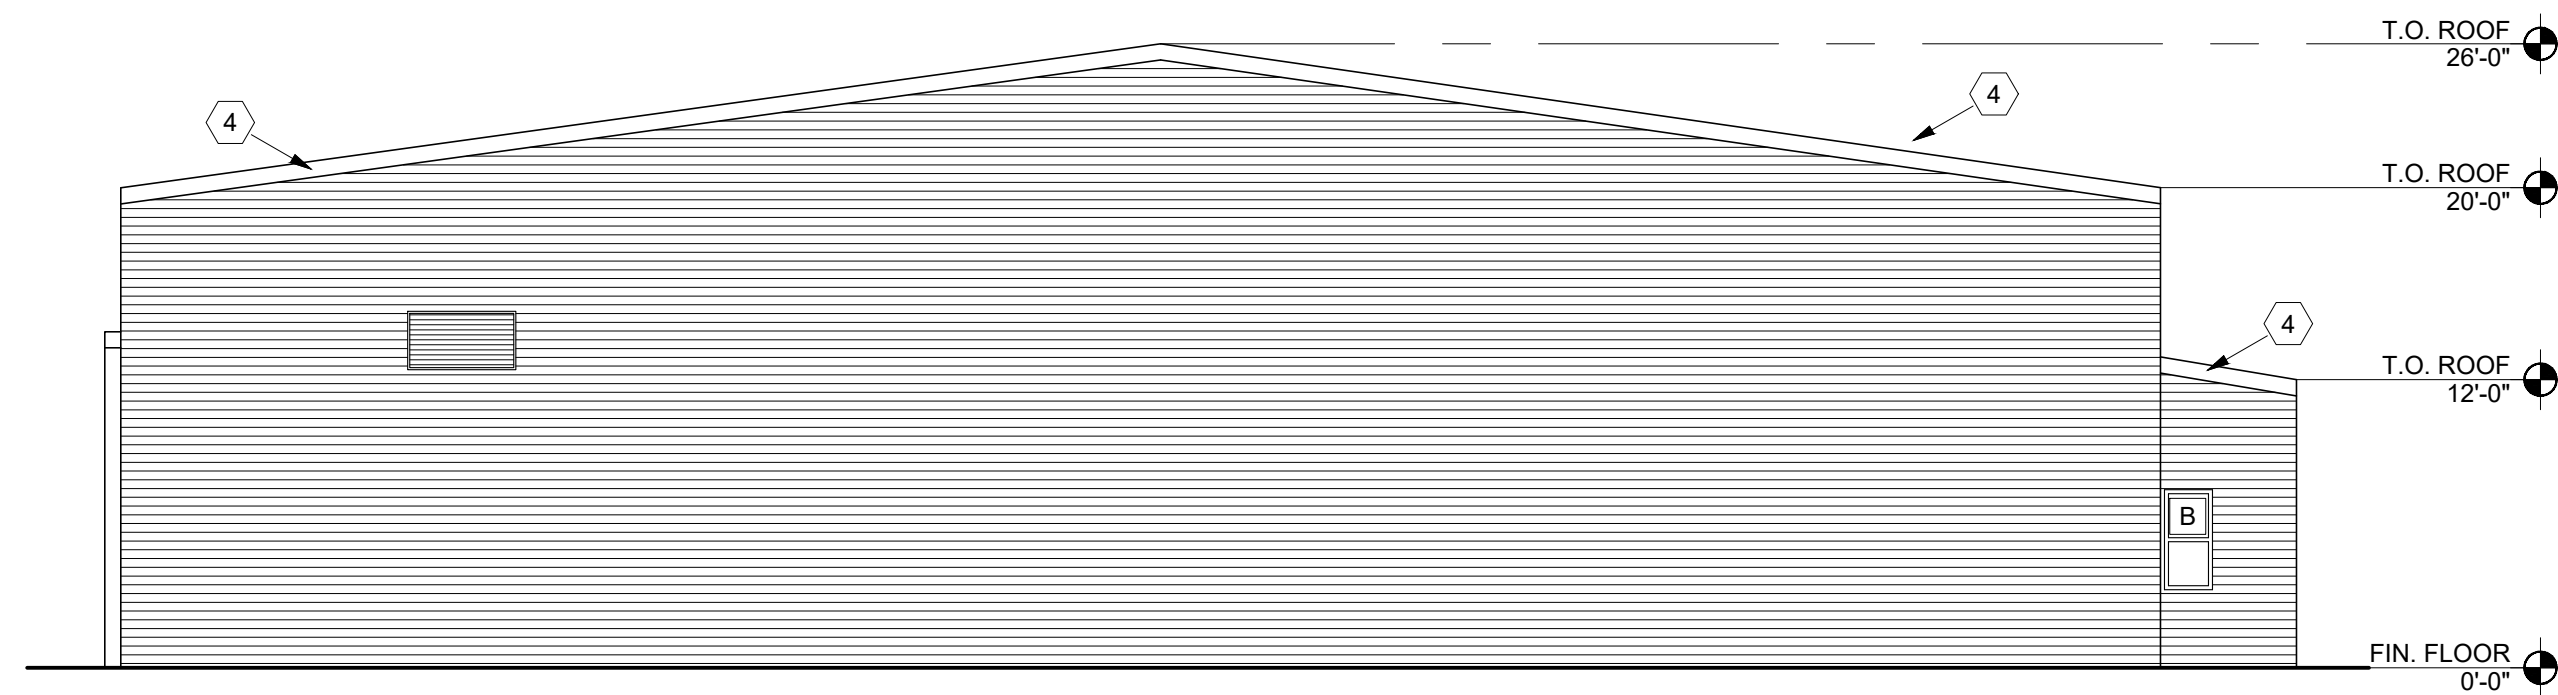


1 NORTH ELEVATION
A-201 SCALE: 1/8" = 1'-0"

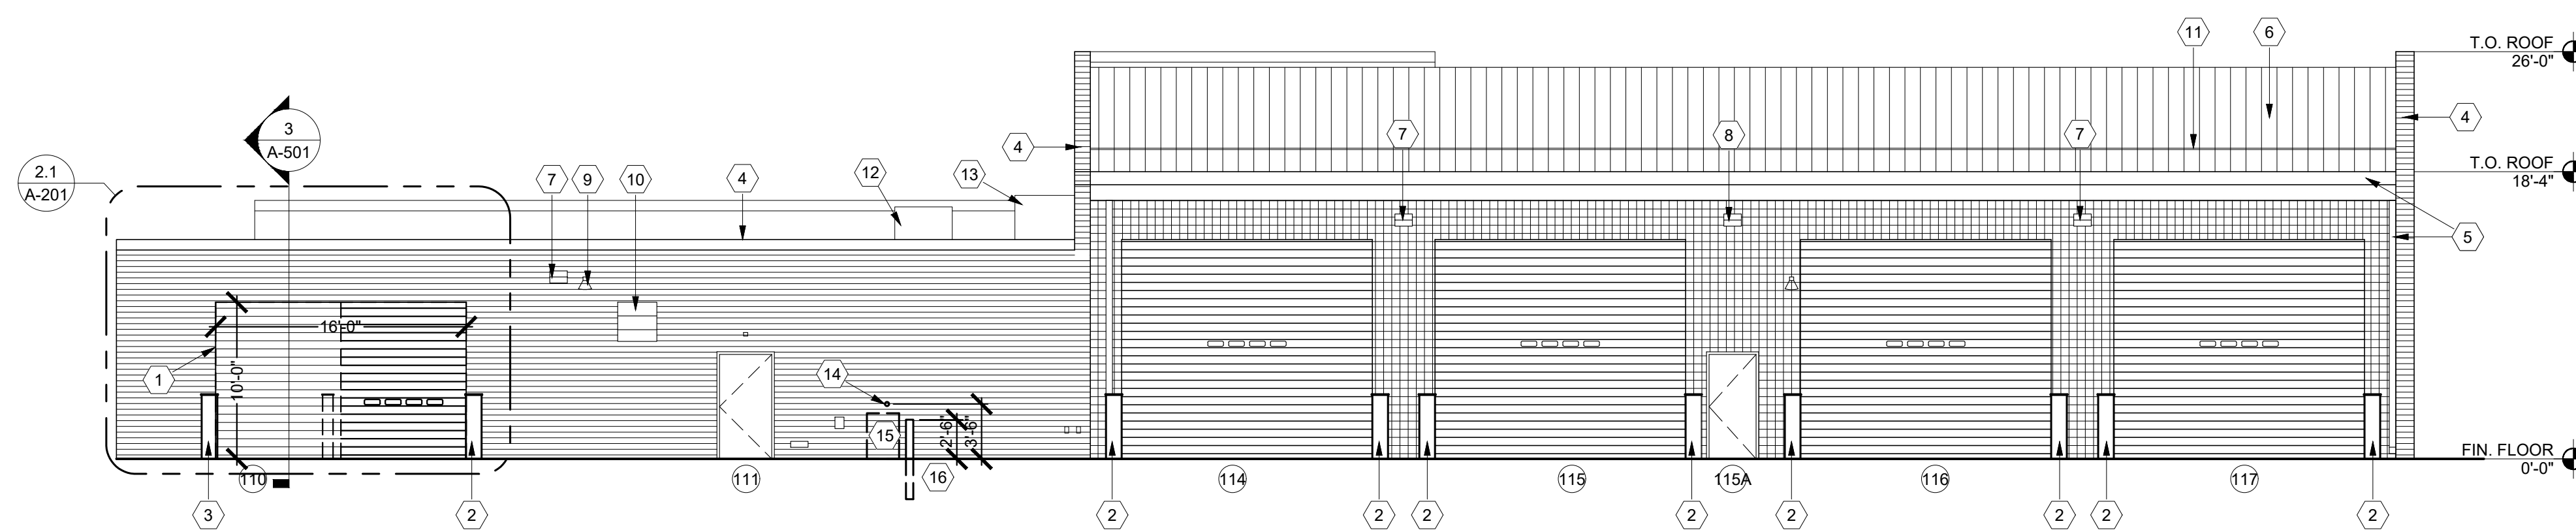


2 EAST ELEVATION
A-201 SCALE: 1/8" = 1'-0"

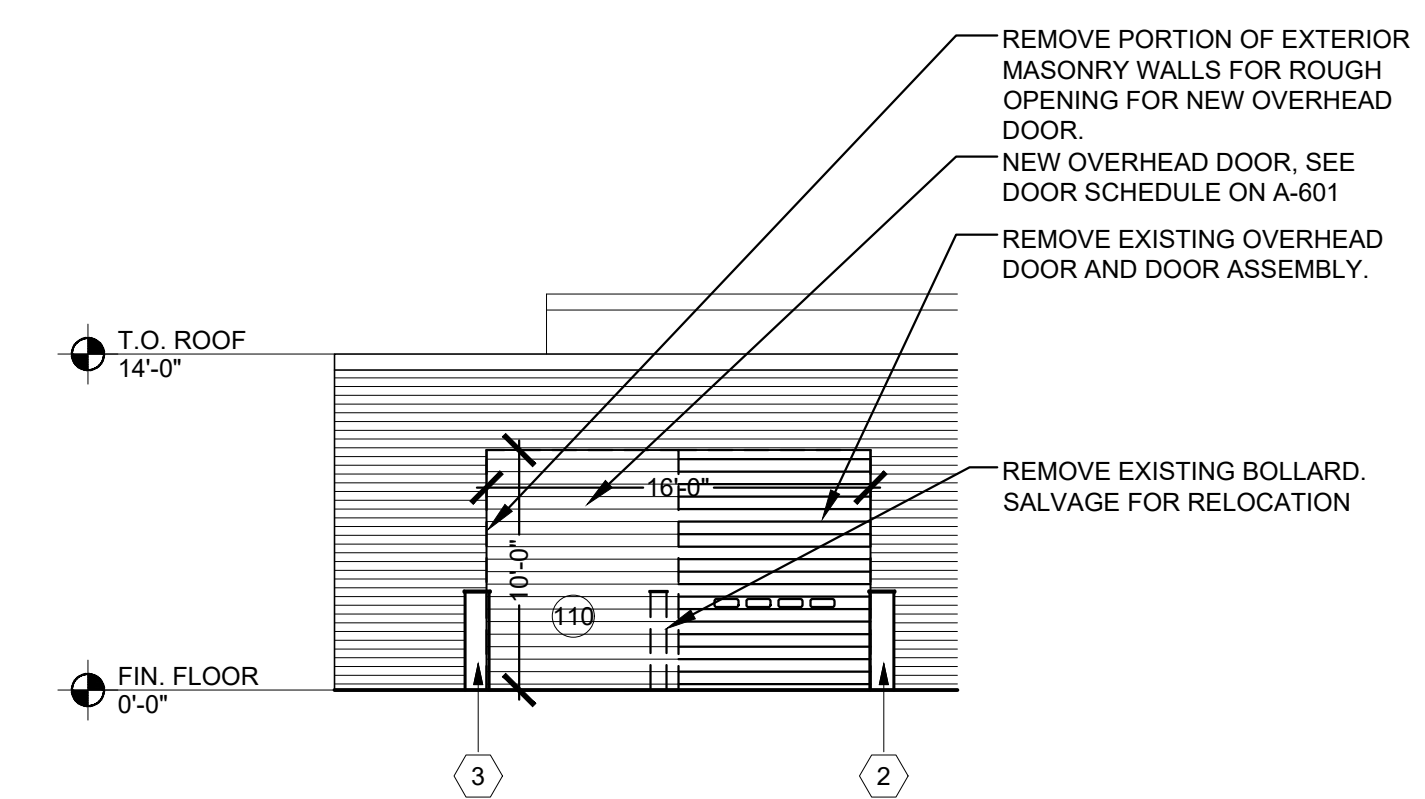

2.1 EAST ELEVATION DEMO
A-201 SCALE: 1/8" = 1'-0"

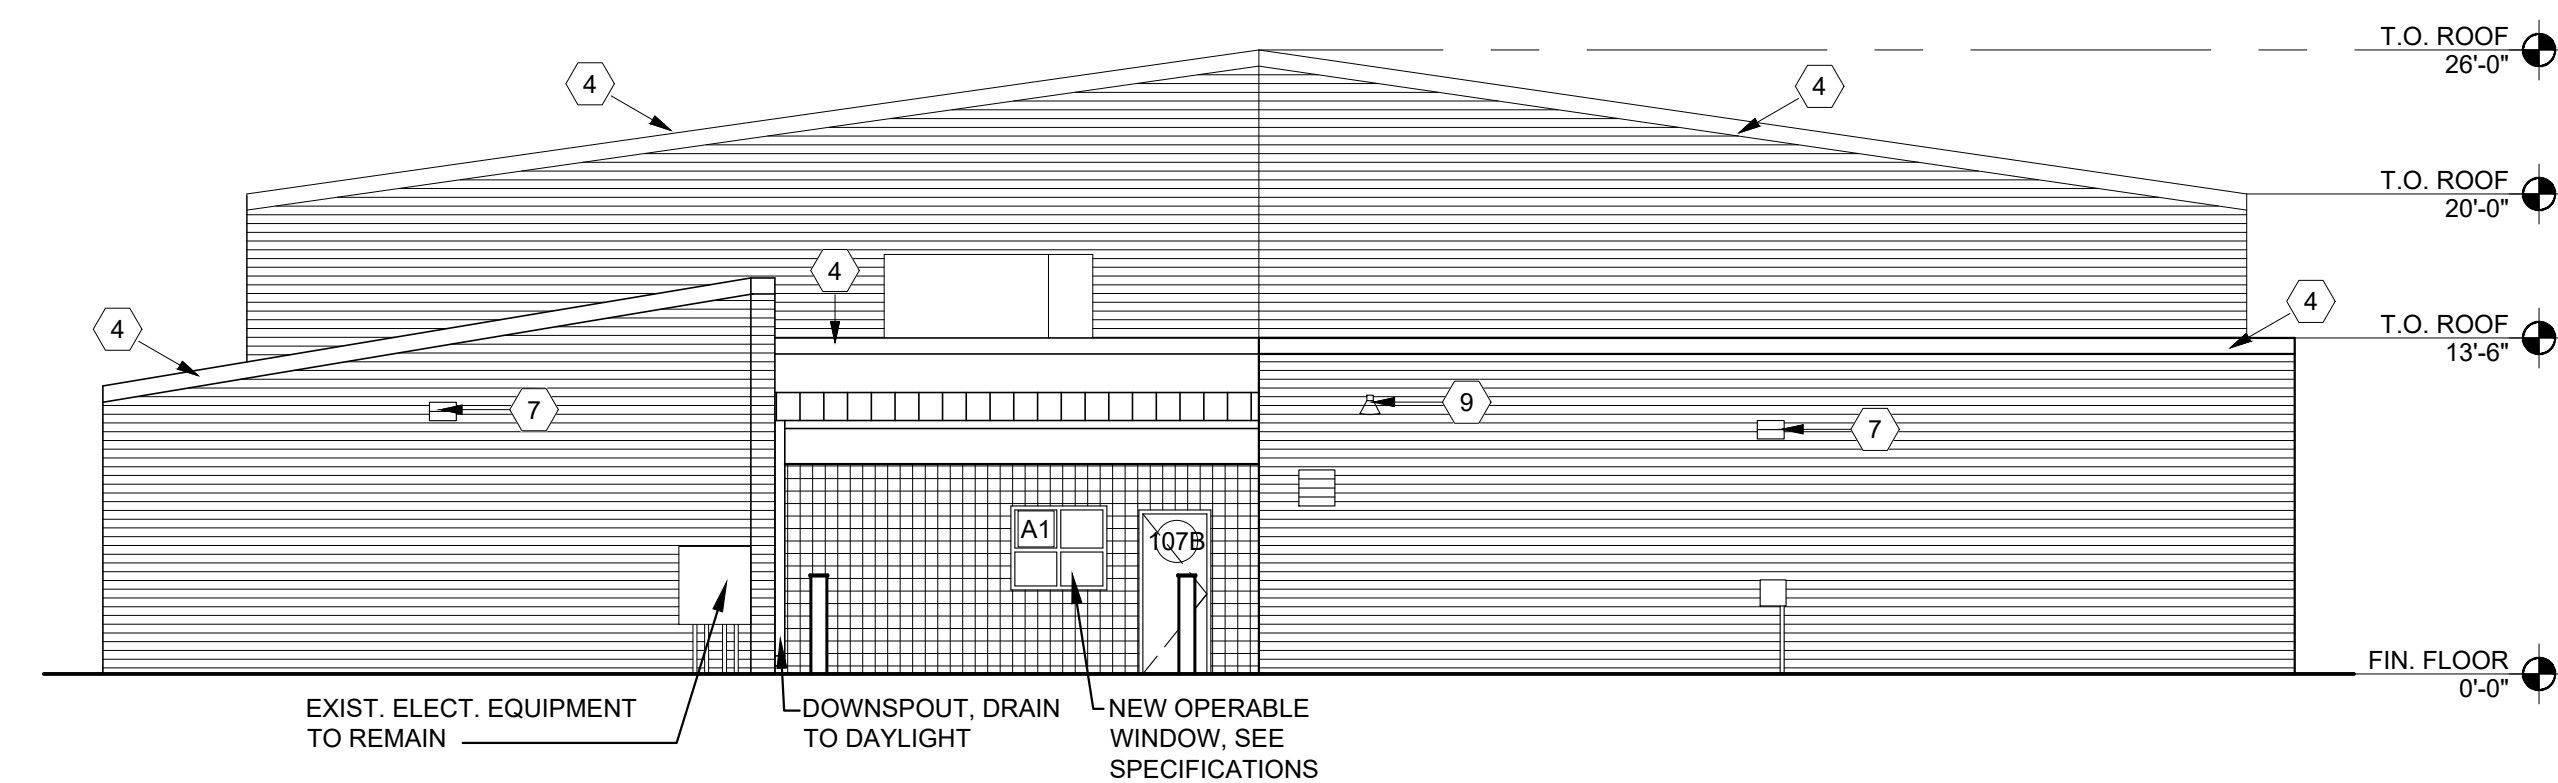

3 SOUTH ELEVATION
A-201 SCALE: 1/8" = 1'-0"

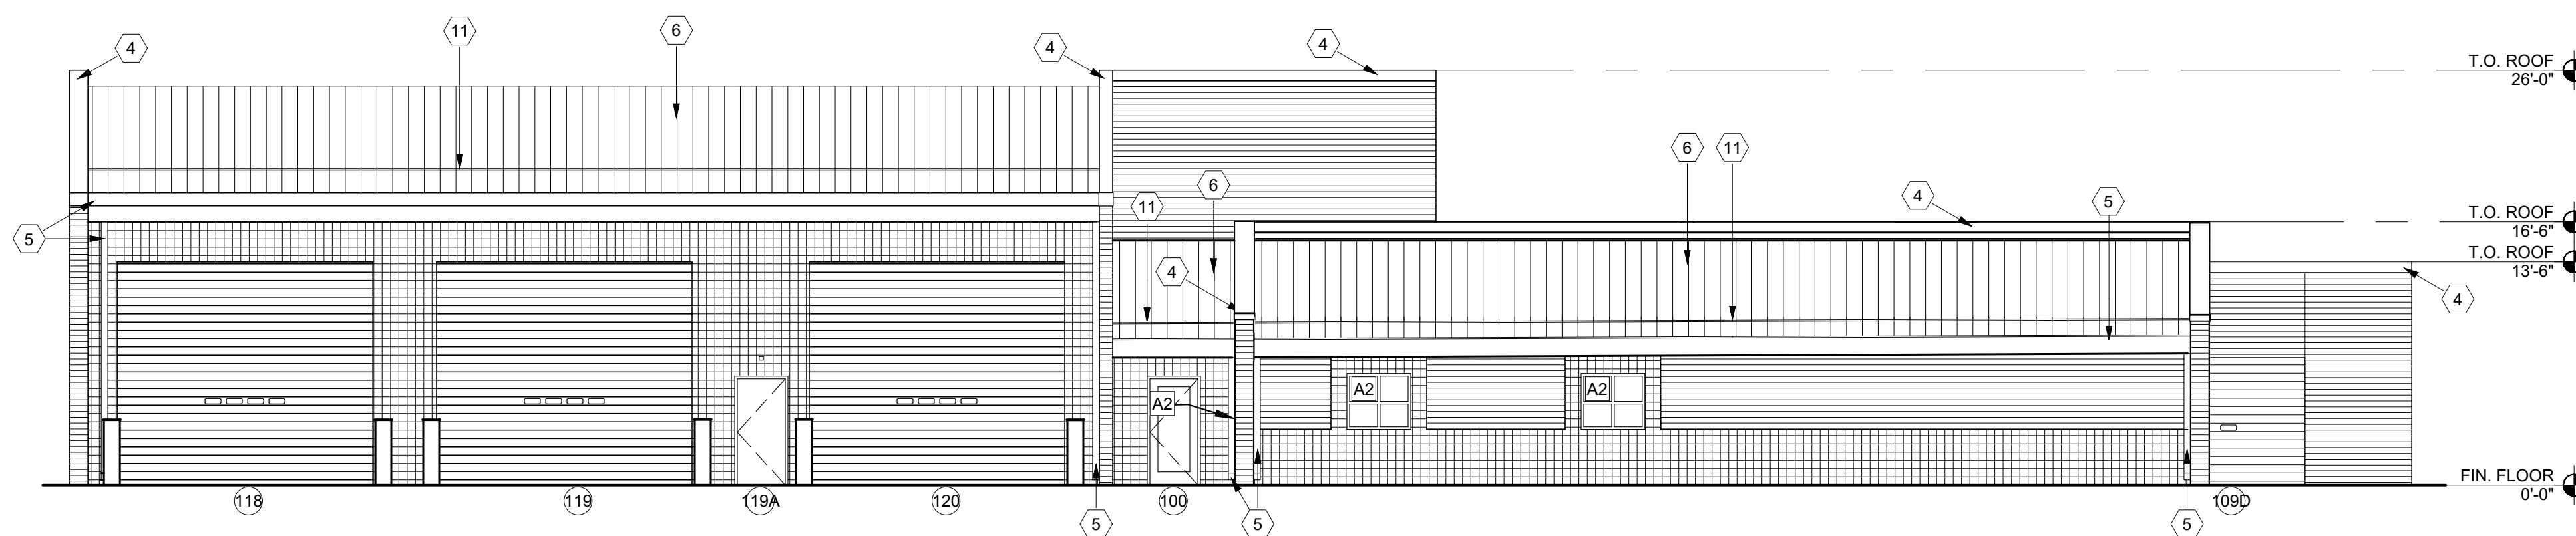

4 WEST ELEVATION
A-201 SCALE: 1/8" = 1'-0"

KEYED NOTES:

- NOT USE
- EXISTING BOLLARDS TO REMAIN.
- RELOCATED CONC. BOLLARDS. SEE DETAIL ON SHT. A-001. REPAINT TO MATCH EXISTING.
- NEW METAL COPING, SEE DETAILS ON SHEET A-102
- PRE-FINISHED GUTTER AND DOWNSPOUT, SEE SPECS.
- NEW STANDING SEAM METAL ROOF, SEE SHEET A-103 (TYP).
- EXIST LIGHT TO REMAIN.
- NEW LIGHT WALL PACK, SEE ELECT. DWGS.
- EXIST. LOUD SPEAKER TO REMAIN.
- EXIST. VENT TO REMAIN.
- NEW SNOW AND ICE GUARDS, SEE DETAIL 11/A-102 AND SPECIFICATIONS FOR MORE INFORMATION.
- NEW MAU, SEE MECHANICAL DRAWING.
- EXISTING RTU TO REMAIN.
- NEW PRESSURE WASH CONNECTION
- PRESSURE WASHER HOSE REEL
- 4" DIAMETER STEEL PIPE PRESSURE WASHER WAND HOLDER

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JEFFERSON CITY, MISSOURI
65101

PROJECT # T2122-01
SITE # 6300
ASSET# 8136300017

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ISSUE DATE: 08/01/2023

CAD DWG FILE: _____
DRAWN BY: _____
CHECKED BY: _____
DESIGNED BY: _____

SHEET TITLE:

EXTERIOR
ELEVATIONS

SHEET NUMBER:

A-201

08/01/2023
SHEET 14 OF 29




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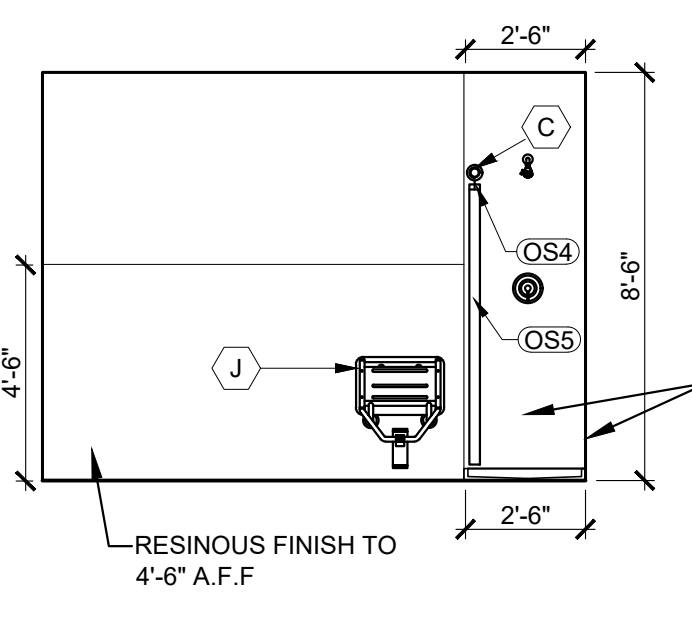
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TOILET ACCESSORIES LEGEND			
MFGR. - USED FOR BASIS OF DESIGN	ITEM DESCRIPTION	QUANTITY	
A SCHOOLLOCKERS.COM	18"x18"x72" METAL LOCKERS	21	
B LOCKERS.COM	15"x48" WOOD BENCH	1	
C BOBRICK	HEAVY DUTY SHOWER CURTAIN ROD	3	
D BOBRICK	18"x36" MIRROR WITH FRAME - B290 1836	4	
E BOBRICK	42" GRAB BAR 6806x42	2	
F BOBRICK	36" GRAB BAR 6806x36	2	
G BOBRICK	NAPKIN DISPOSAL	2	
H BOBRICK	TOILET PAPER DISPENSER	4	
I HINY HIDERS	TOILET PARTITIONS, COLOR: BEIGE	4	
J AP	FOLDING SHOWER BENCH	3	
SP-1	MERIDIAN, #MSB61536SACC	SHOWER PAN	2
SP-2	MERIDIAN, #MSB4230S	SHOWER PAN	1
	OWNER SUPPLIED*		
OS1		SOAP	4
OS2		PAPER TOWELS	2
OS3		TRASH RECEPTICAL	2
OS4		S.S. SHOWER CURTAIN HOOK	3
OSS		VINYL SHOWER CURTAIN	3


- OWNER SUPPLIED ITEMS SHOWN FOR COORDINATION ONLY.
- MANUFACTURERS SHOWN ARE FOR BASIS OF DESIGN ONLY. SEE THE SPECIFICATIONS FOR ACCEPTABLE EQUIVALENT MANUFACTURERS, UNLESS NOTED OTHERWISE.
- PROVIDE FIRE-TREATED WOOD BLOCKING FOR ALL GRAB BARS.
- SHOWER PAN APPROVED EQUIVALENTS: BESTCARE (WHITEHALL MANUFACTURING), FREEDOM SHOWERS, OR AS APPROVED BY ARCHITECT.




1 ENLARGED LATRINES AND BREAK ROOM PLAN
SCALE: 1/4" = 1'-0"

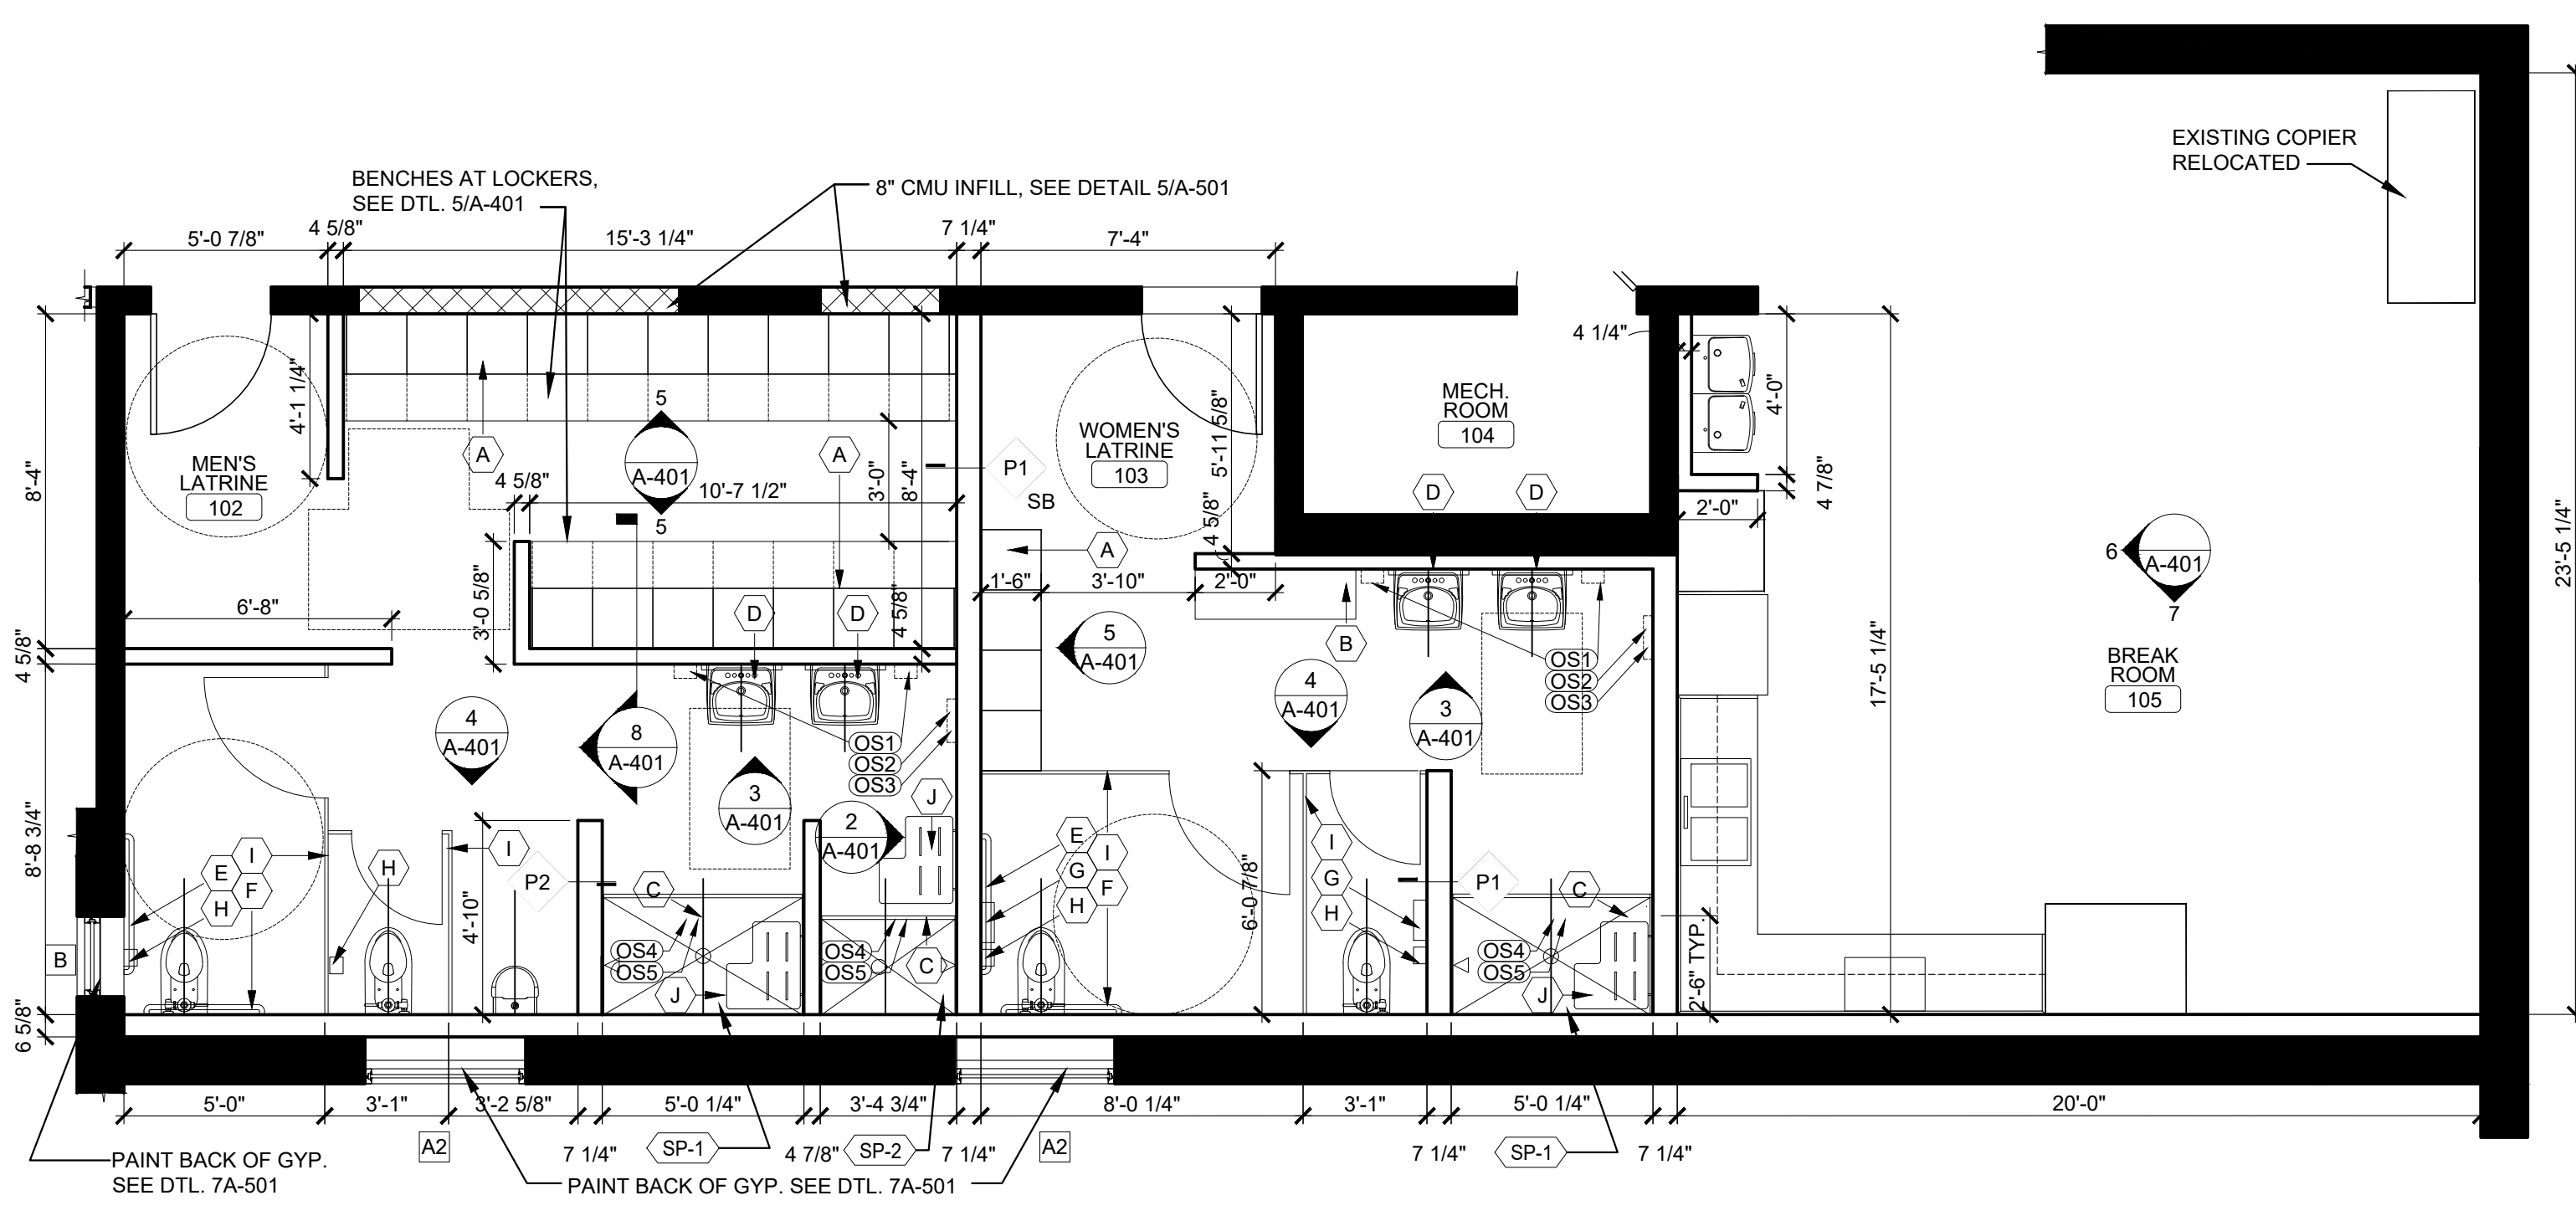


2 TYP. SHOWER STALL ELEV.
SCALE: 1/4" = 1'-0"

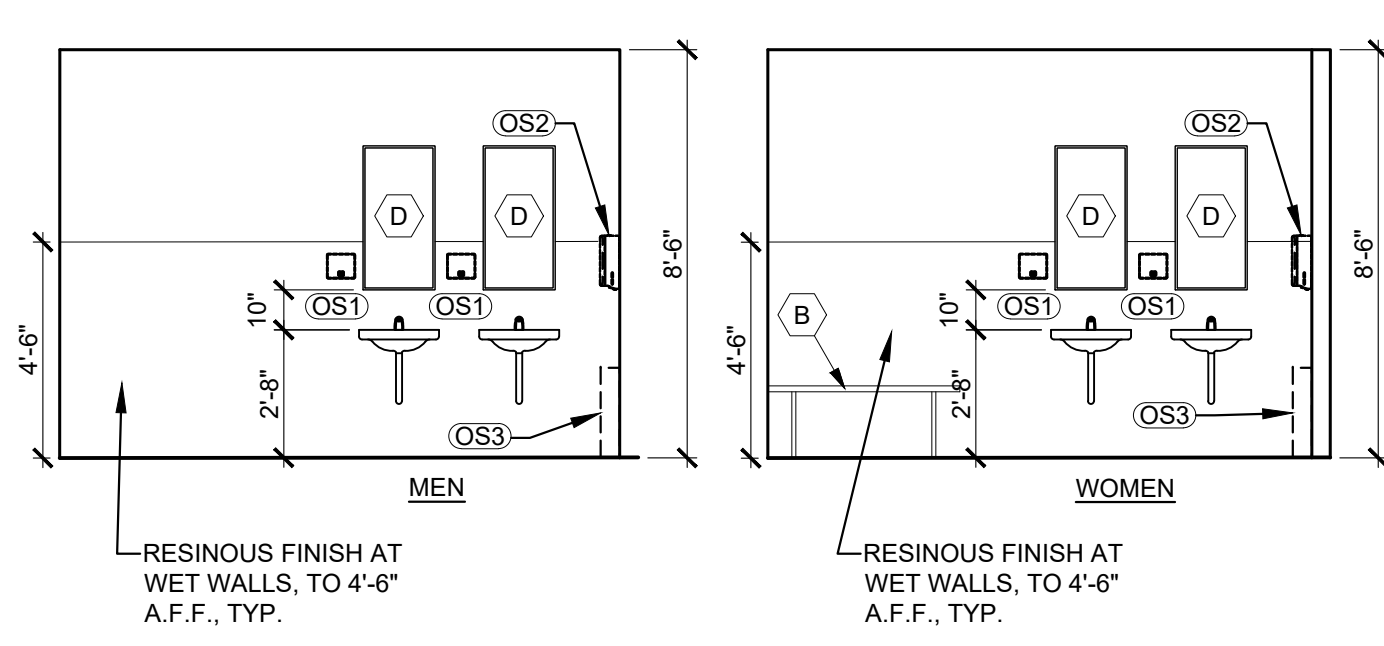


3 LAVATORY ELEVATIONS
SCALE: 1/4" = 1'-0"

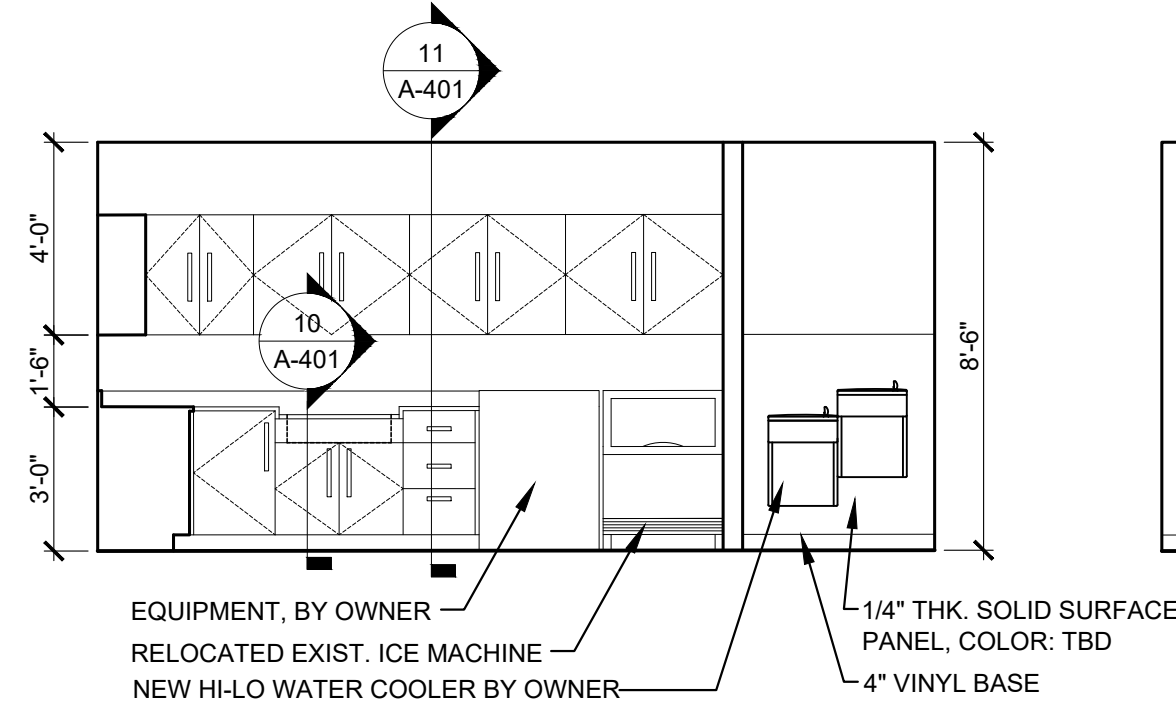


6 BREAKROOM ELEVATION
SCALE: 1/4" = 1'-0"

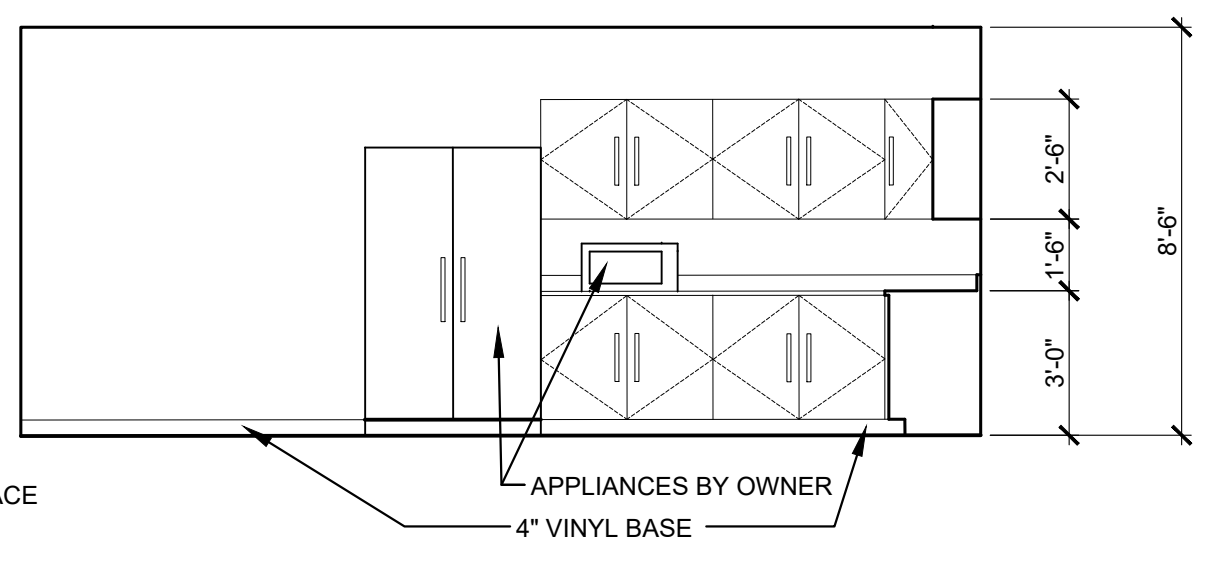


7 BREAKROOM ELEVATION
SCALE: 1/4" = 1'-0"

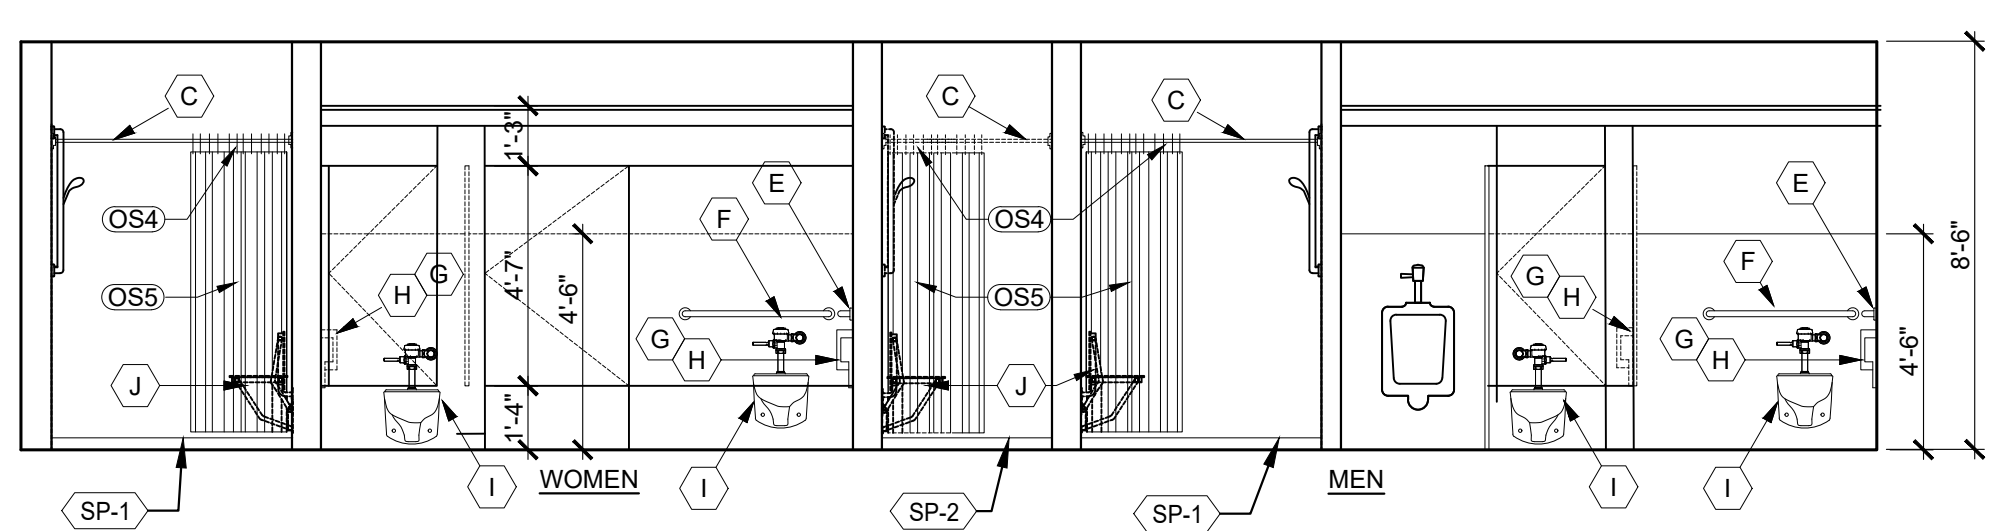


4 LATRINES ELEVATIONS
SCALE: 1/4" = 1'-0"

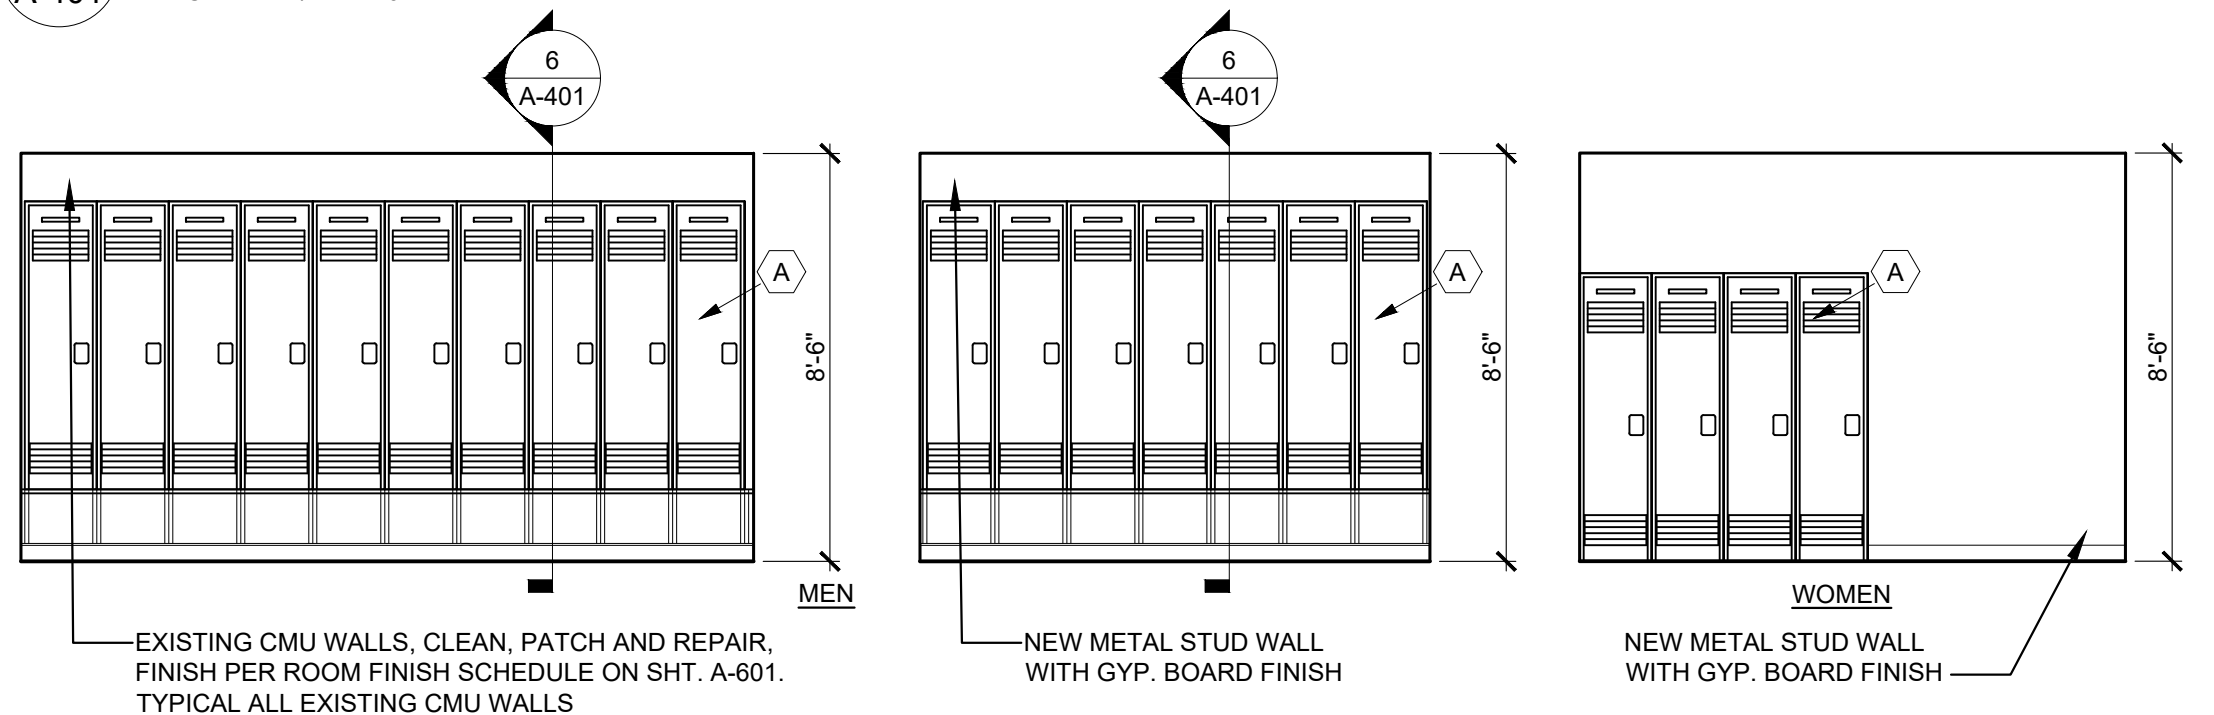


5 LOCKER ELEVATIONS
SCALE: 1/4" = 1'-0"

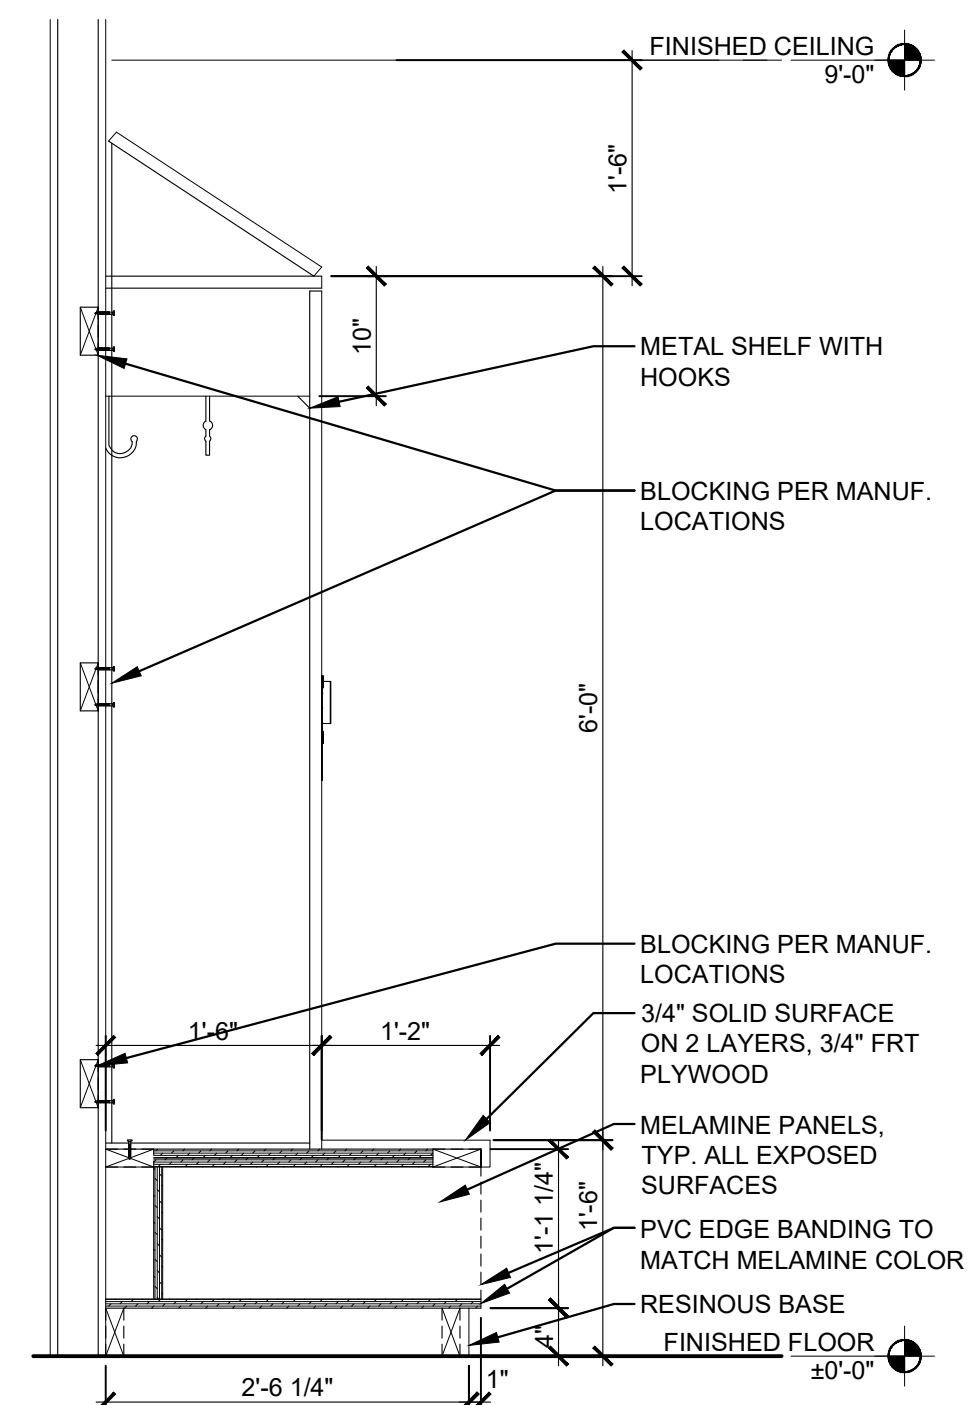

8 SECTION THRU LOCKER
SCALE: 3/4" = 1'-0"

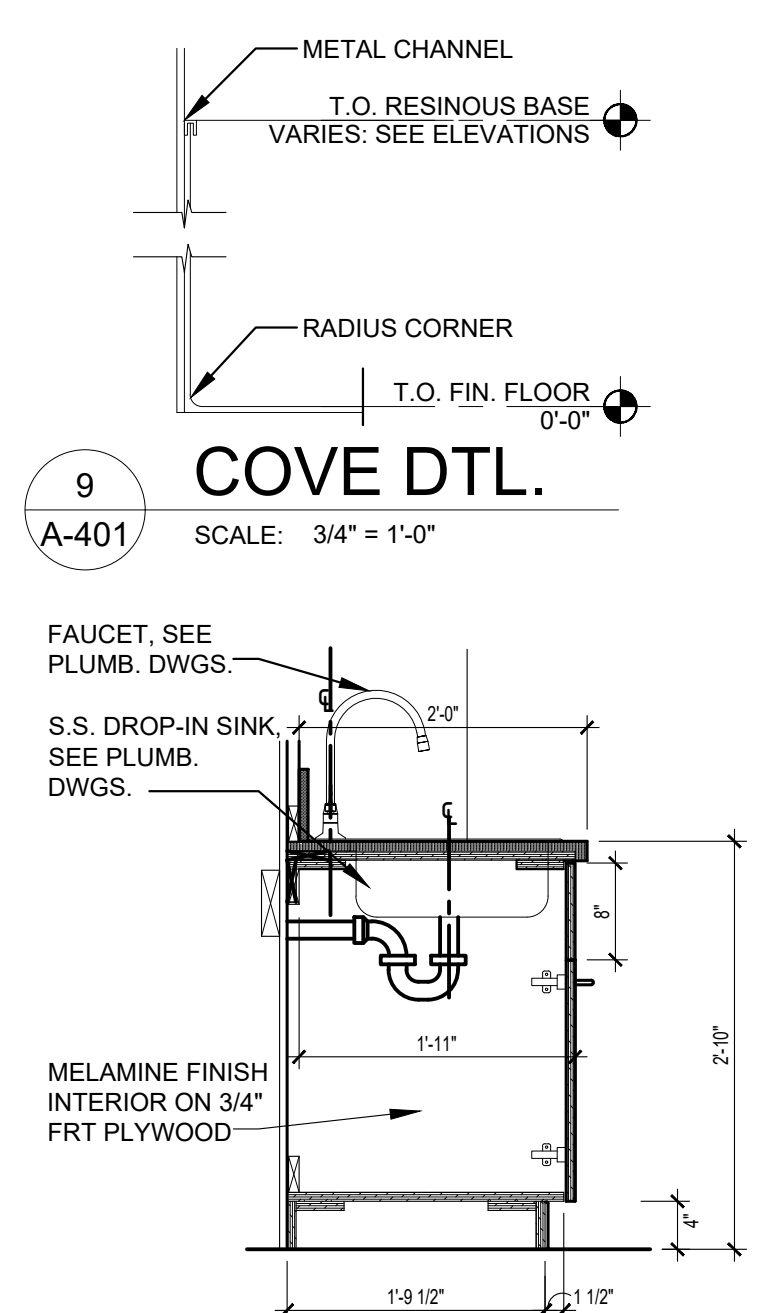

10 SECTION AT SINK BASE
SCALE: 3/4" = 1'-0"

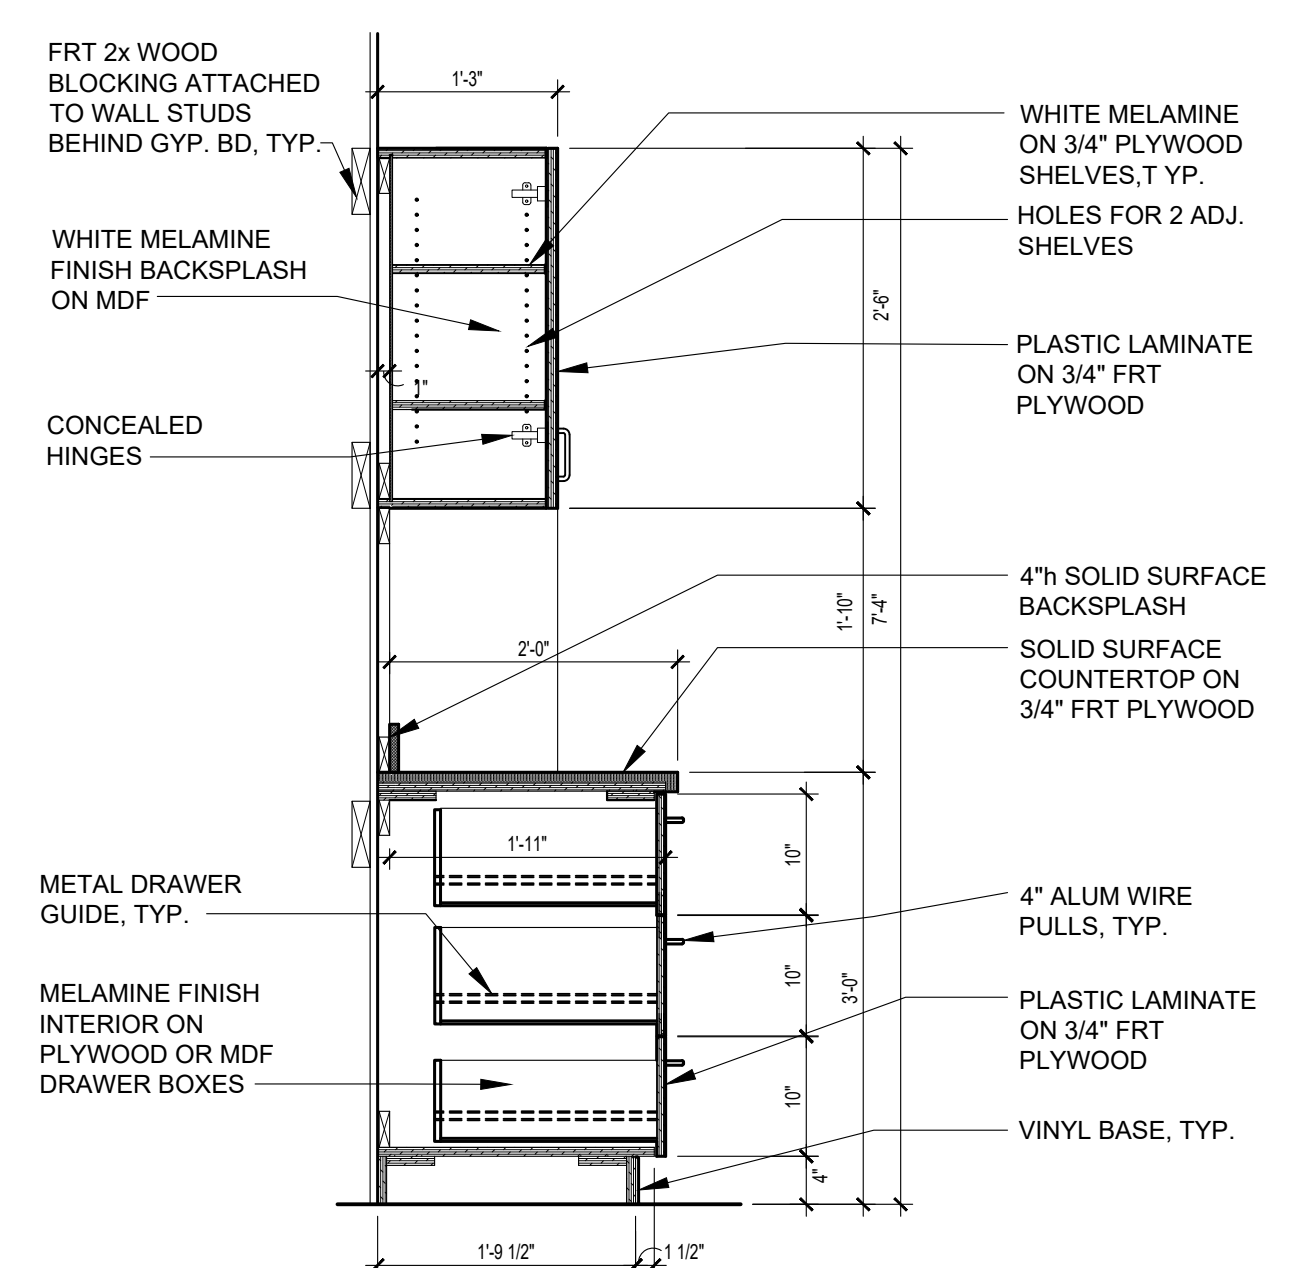

11 SECTION THRU CASEWORK
SCALE: 3/4" = 1'-0"

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CAD DWG FILE: _____
DRAWN BY: _____
CHECKED BY: _____
DESIGNED BY: _____

SHEET TITLE:
**ENLARGED PLANS
AND INTERIOR
ELEVATIONS**

SHEET NUMBER:
A-401
08/01/2023
SHEET 15 OF 29



MICHAEL S. SUNDERMEYER
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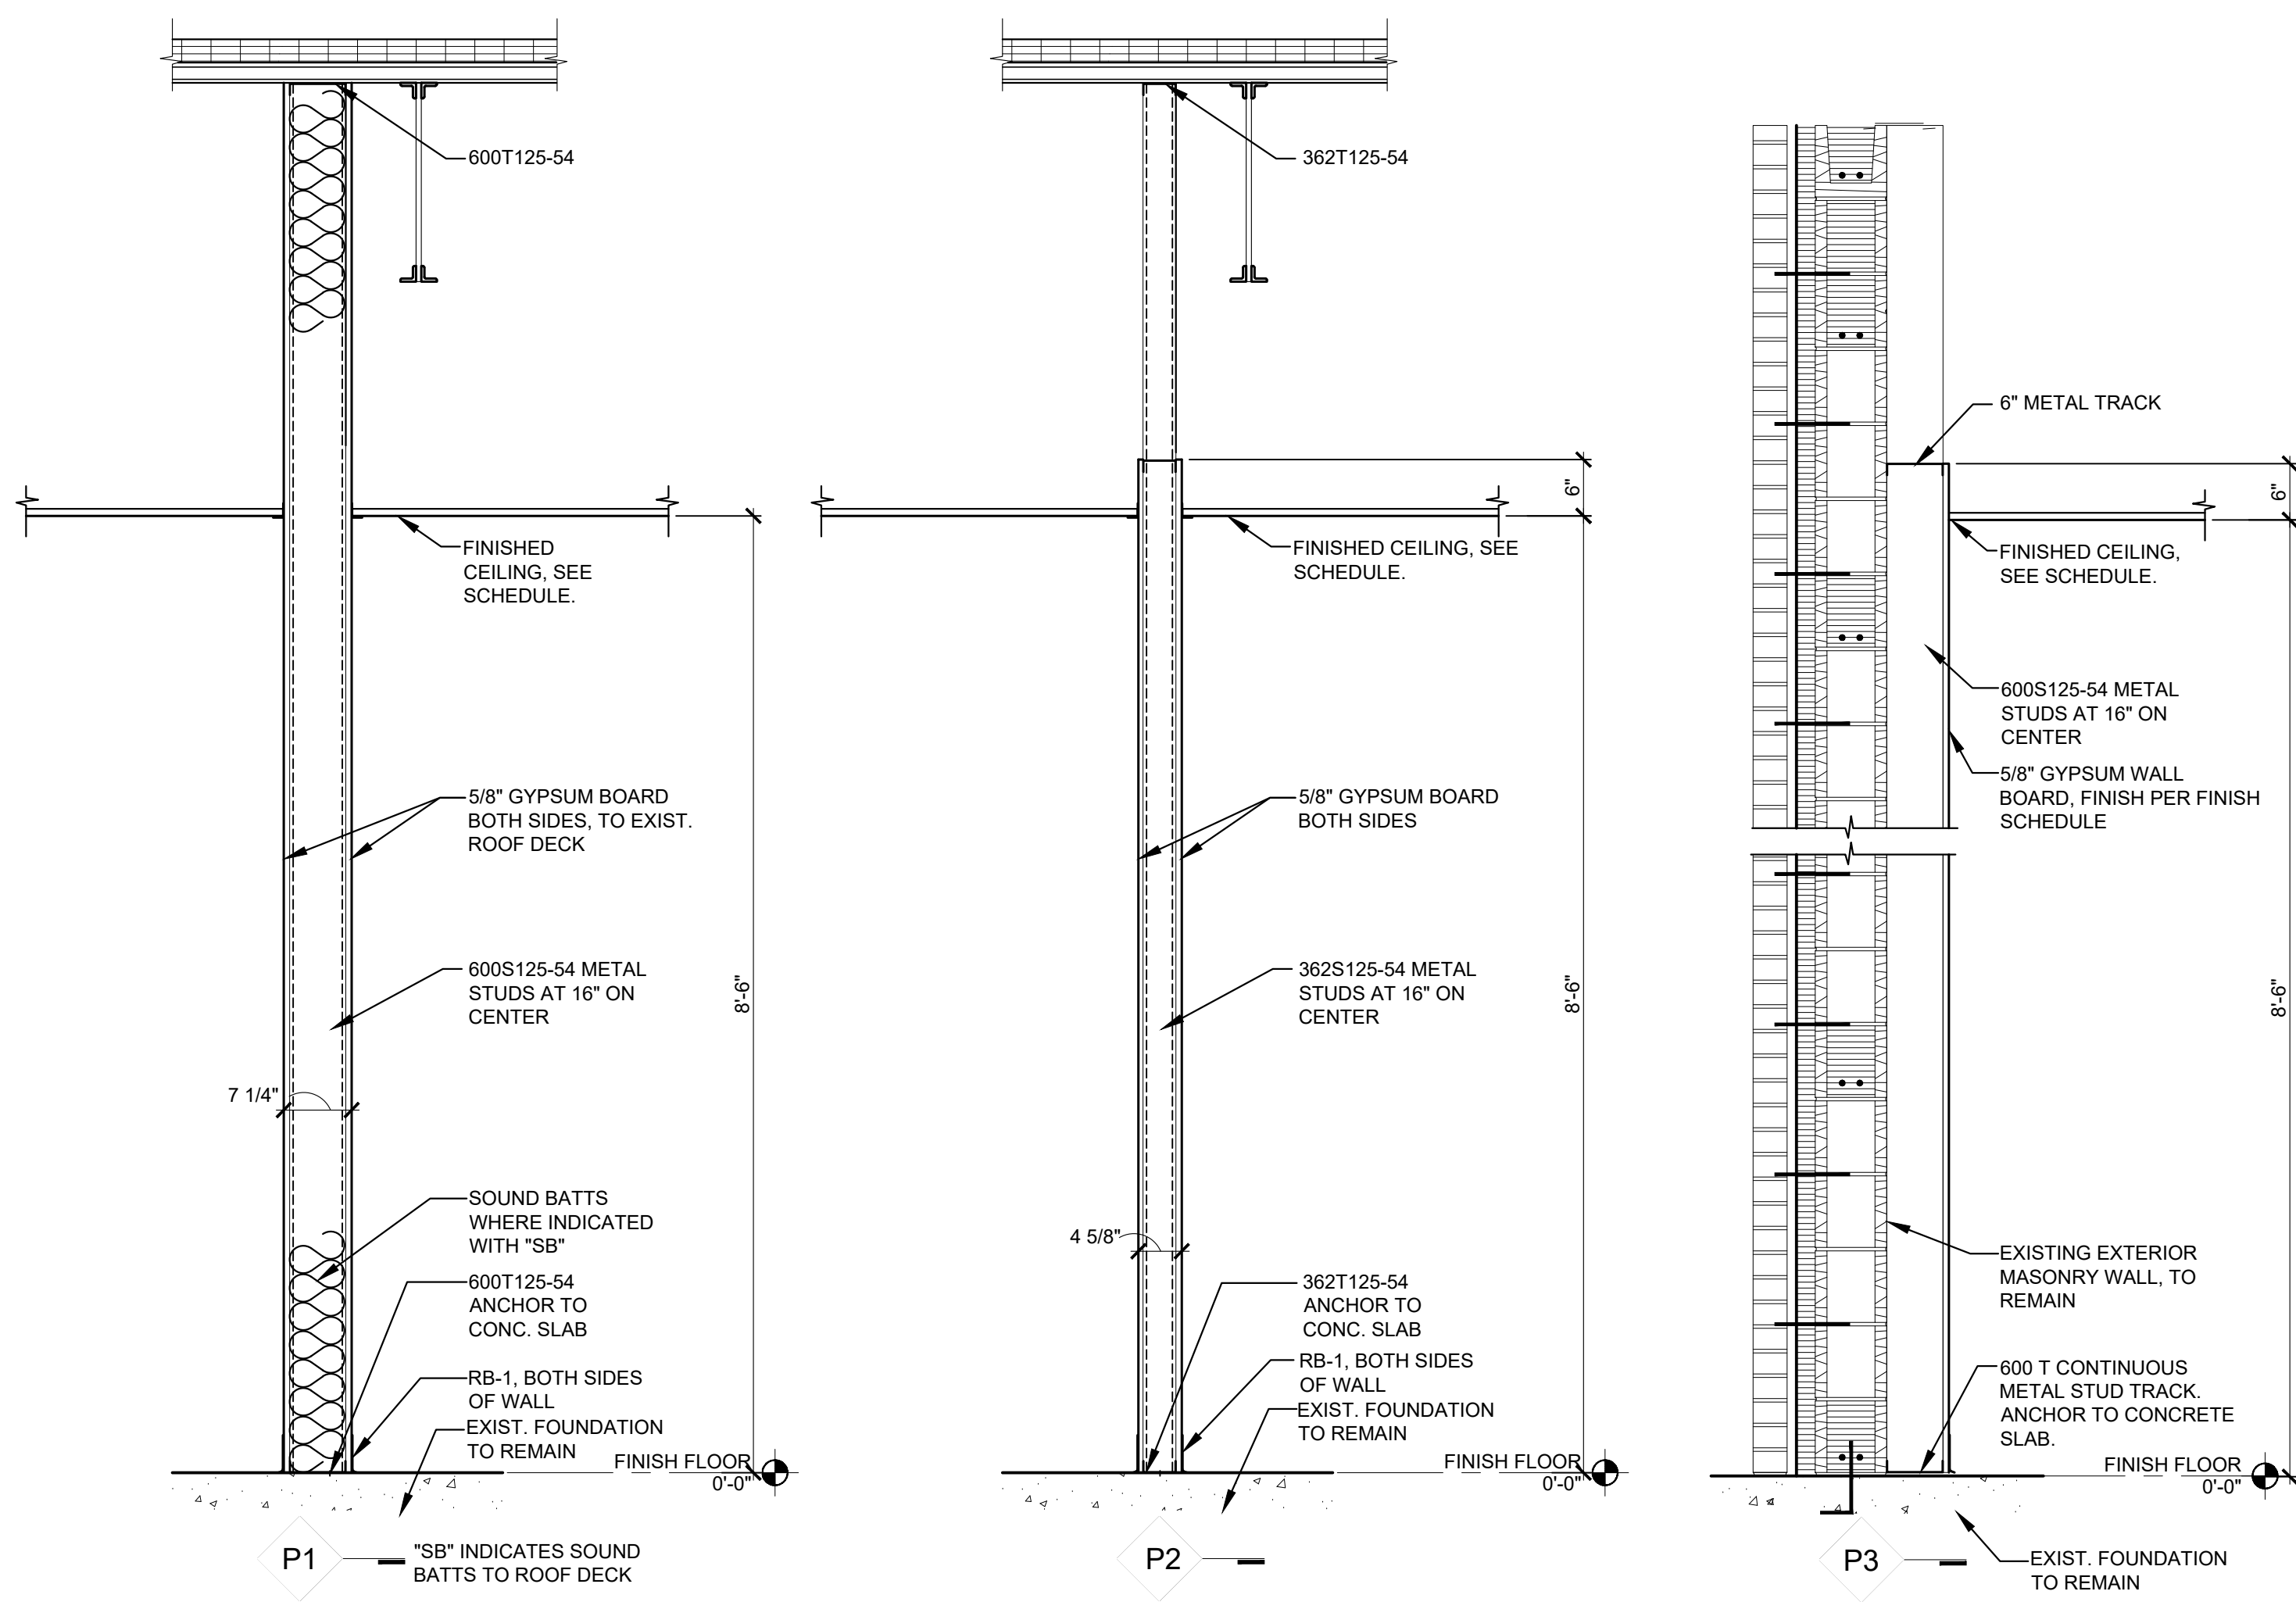
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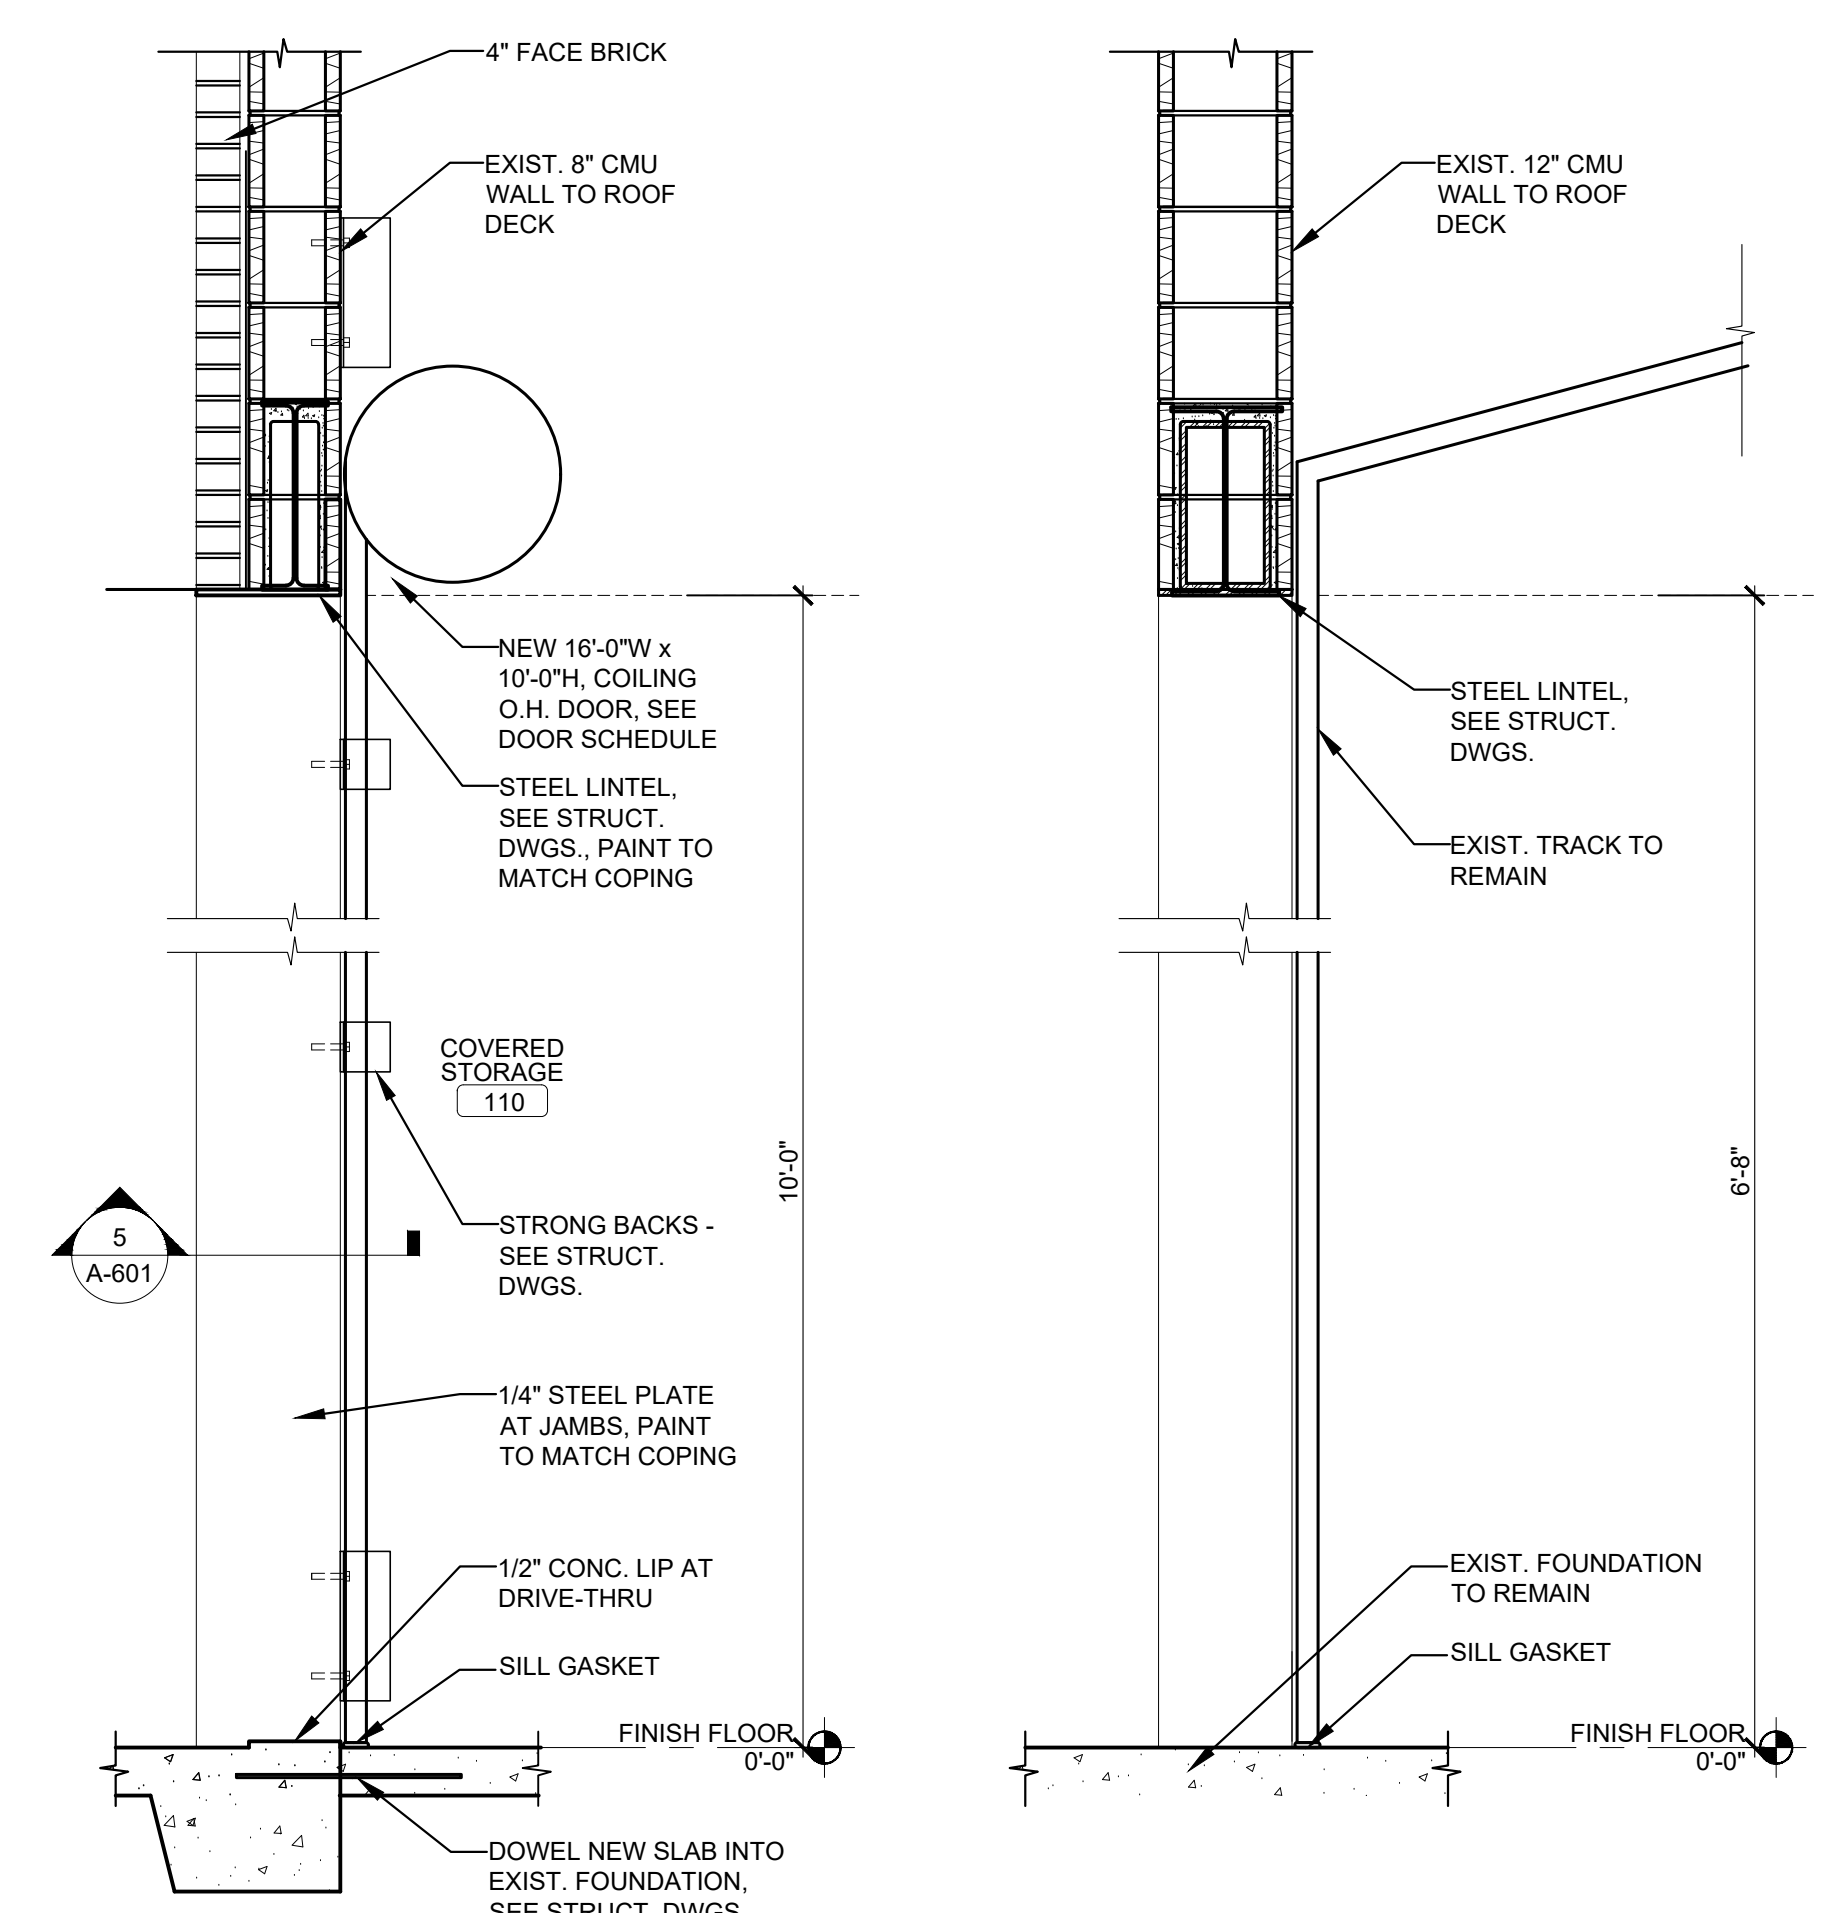
SHEET TITLE:

PARTITION
TYPES AND
DETAILS

SHEET NUMBER:
A-501
08/01/2023
SHEET 15 OF 29




1 PARTITION TYPES
A-501 SCALE: 3/4" = 1'-0"




2 SECTION THROUGH NEW DRIVE IN DOOR
A-501 SCALE: 3/4" = 1'-0"


3 SECTION THROUGH OVERHEAD DOOR EXIST. OPNG.
A-501 SCALE: 3/4" = 1'-0"

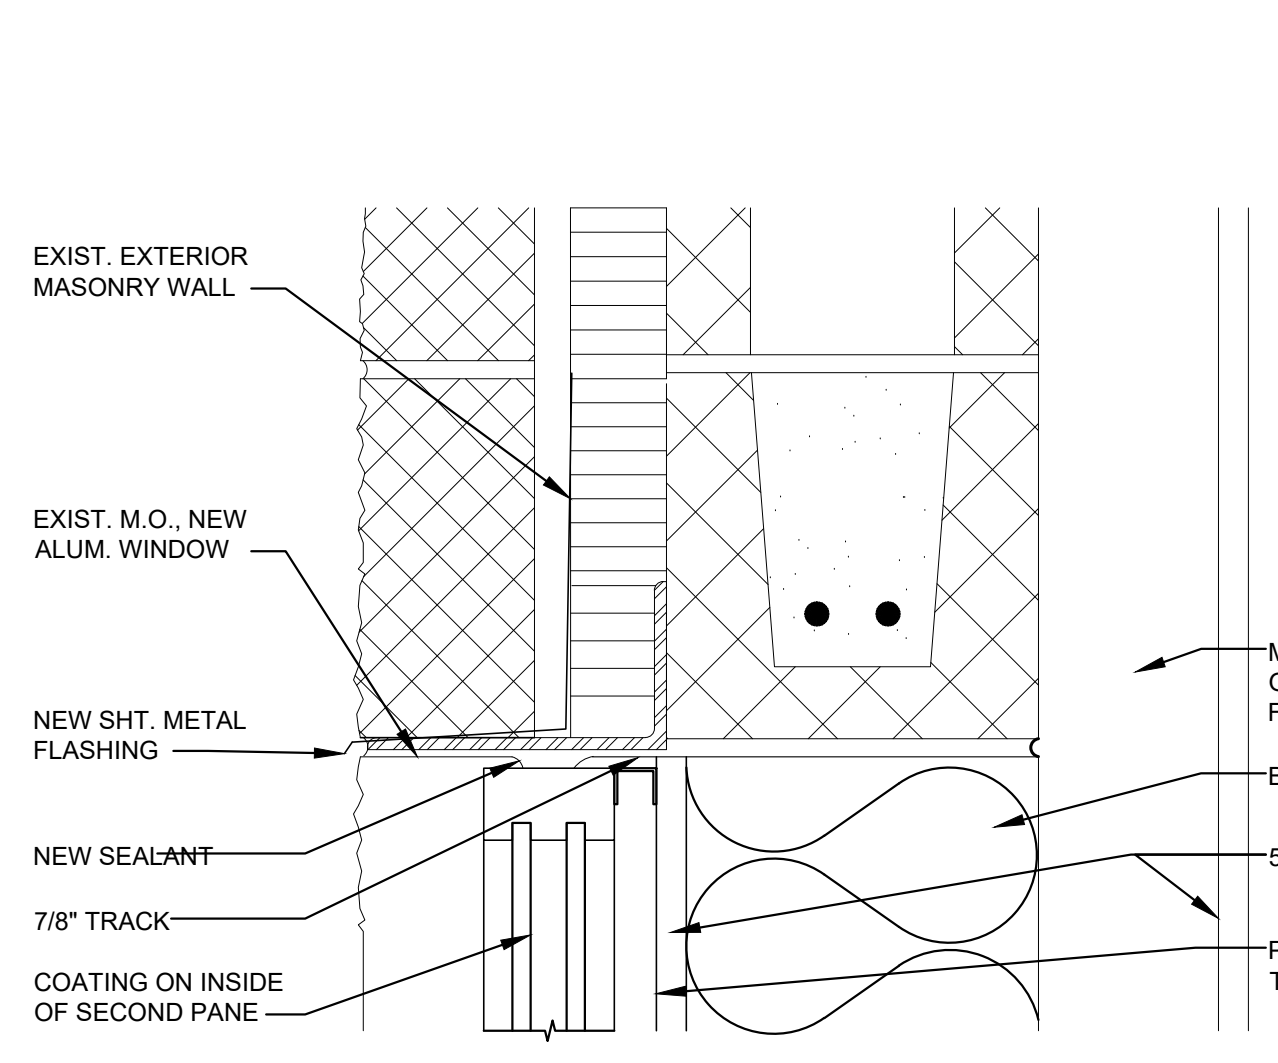


7 WINDOW A2 HEAD DETAIL
A-501 SCALE: 3" = 1'-0"

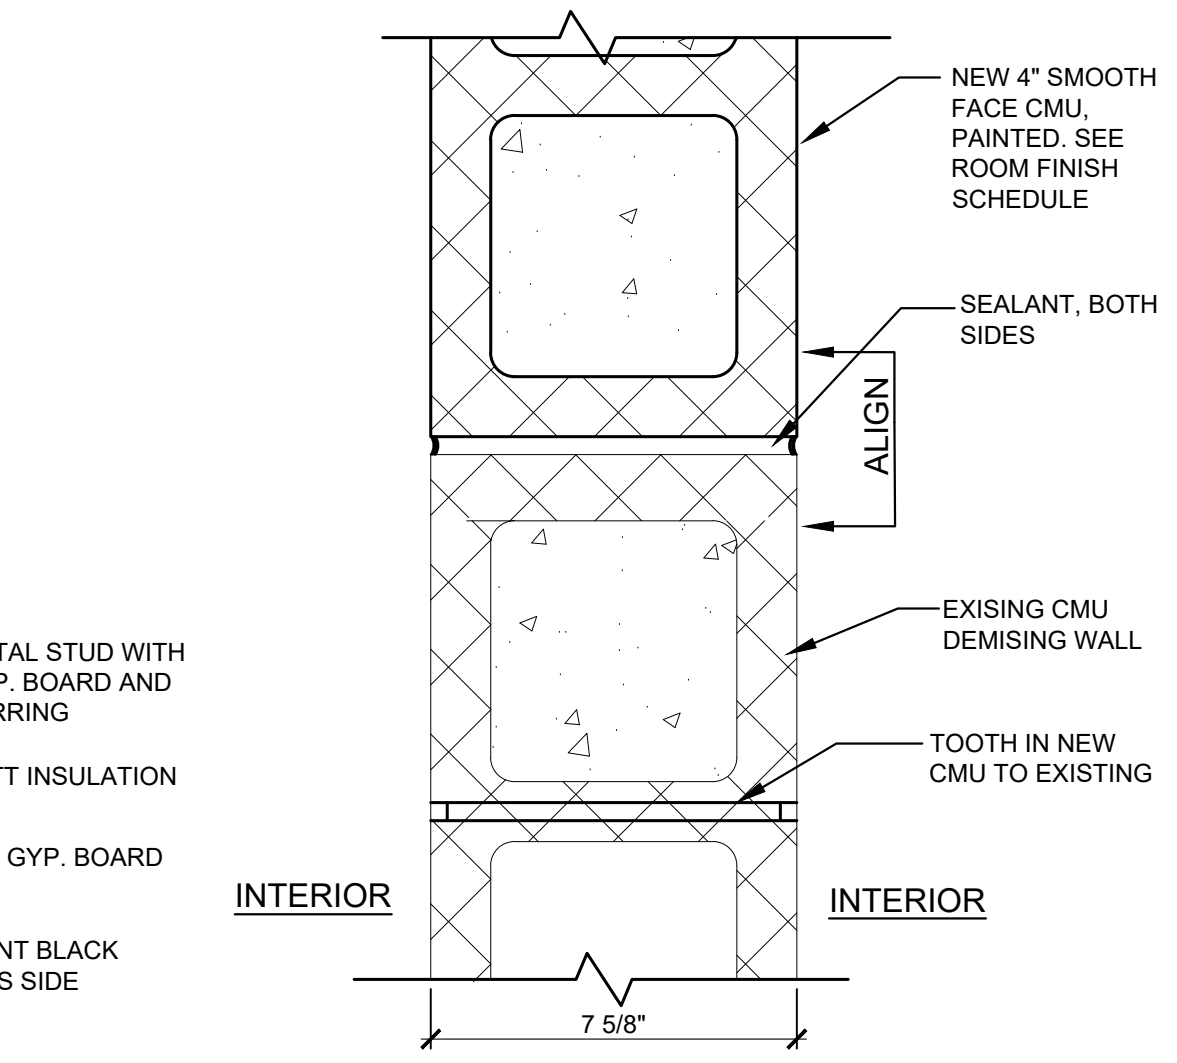


5 INFILL AT EXIST. CMU OPNG
A-501 SCALE: 3" = 1'-0"

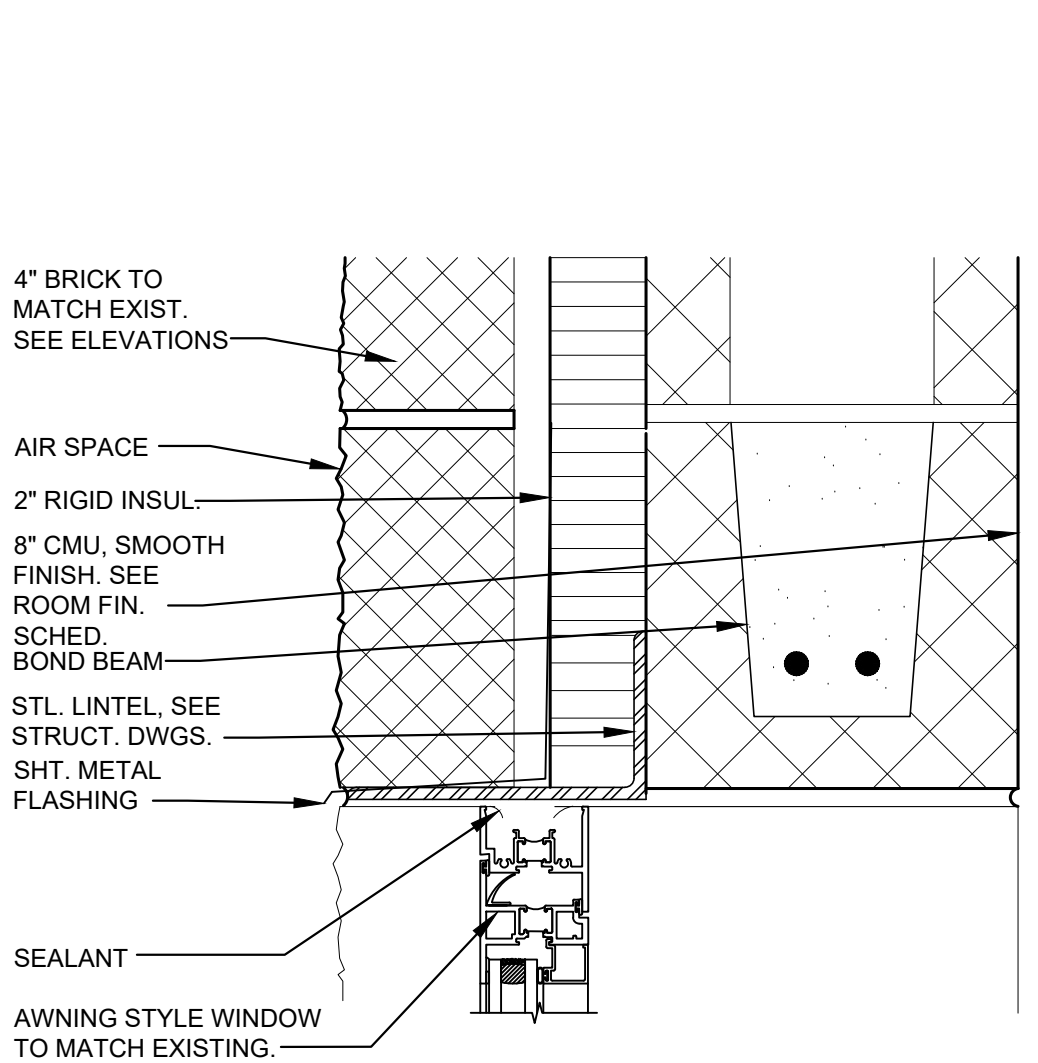


6 WINDOW HEAD DETAIL
A-501 SCALE: 3" = 1'-0"

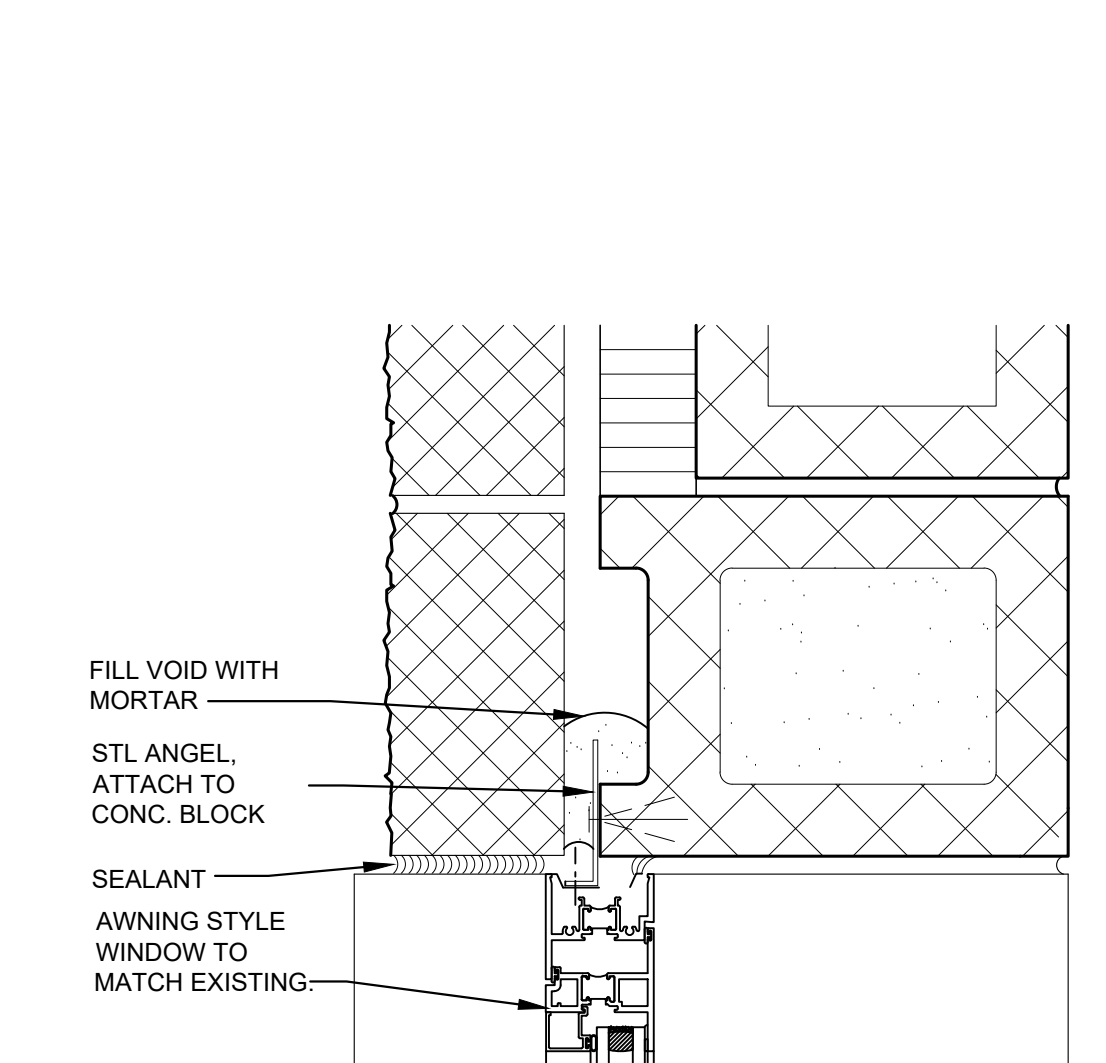

7 WINDOW JAMB DETAIL
A-501 SCALE: 3" = 1'-0"

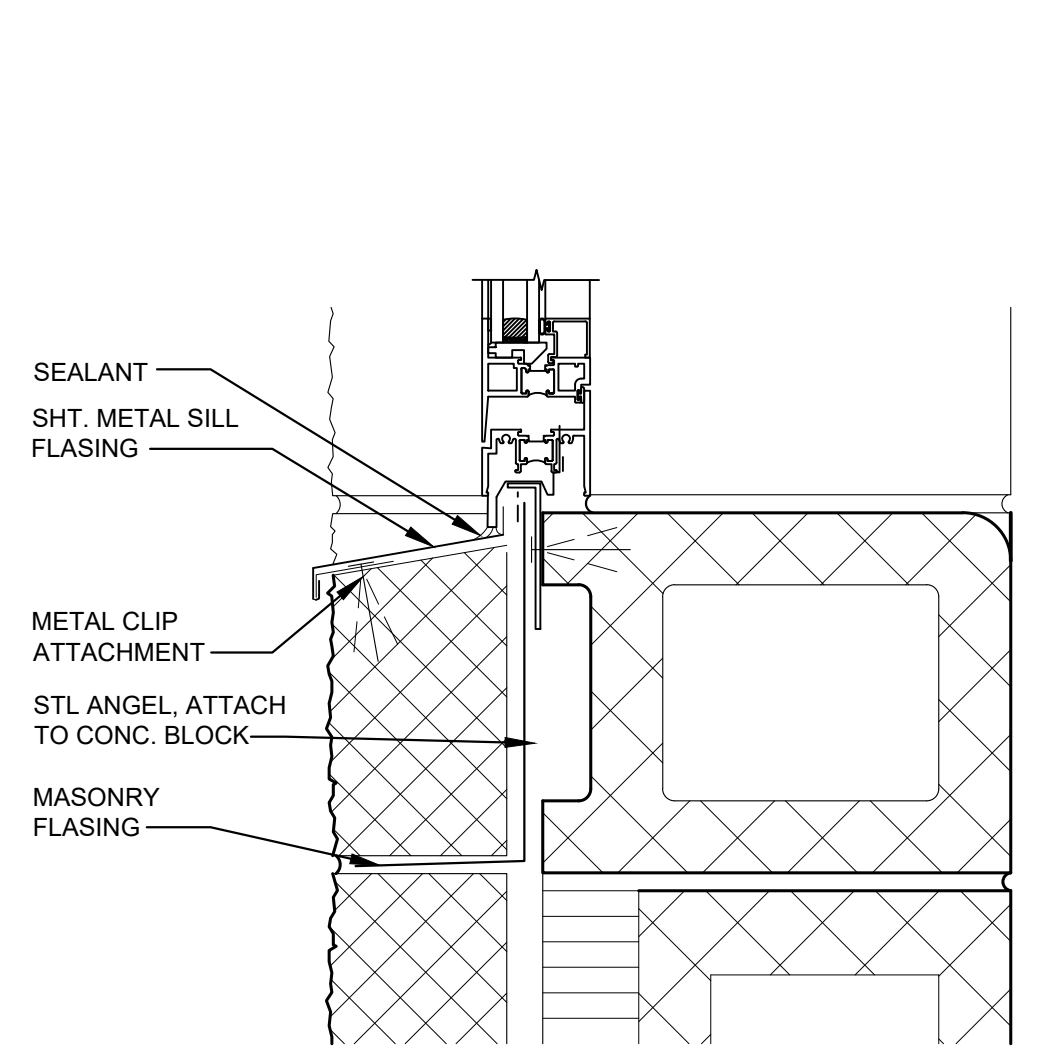

8 WINDOW SILL DETAIL
A-501 SCALE: 3" = 1'-0"

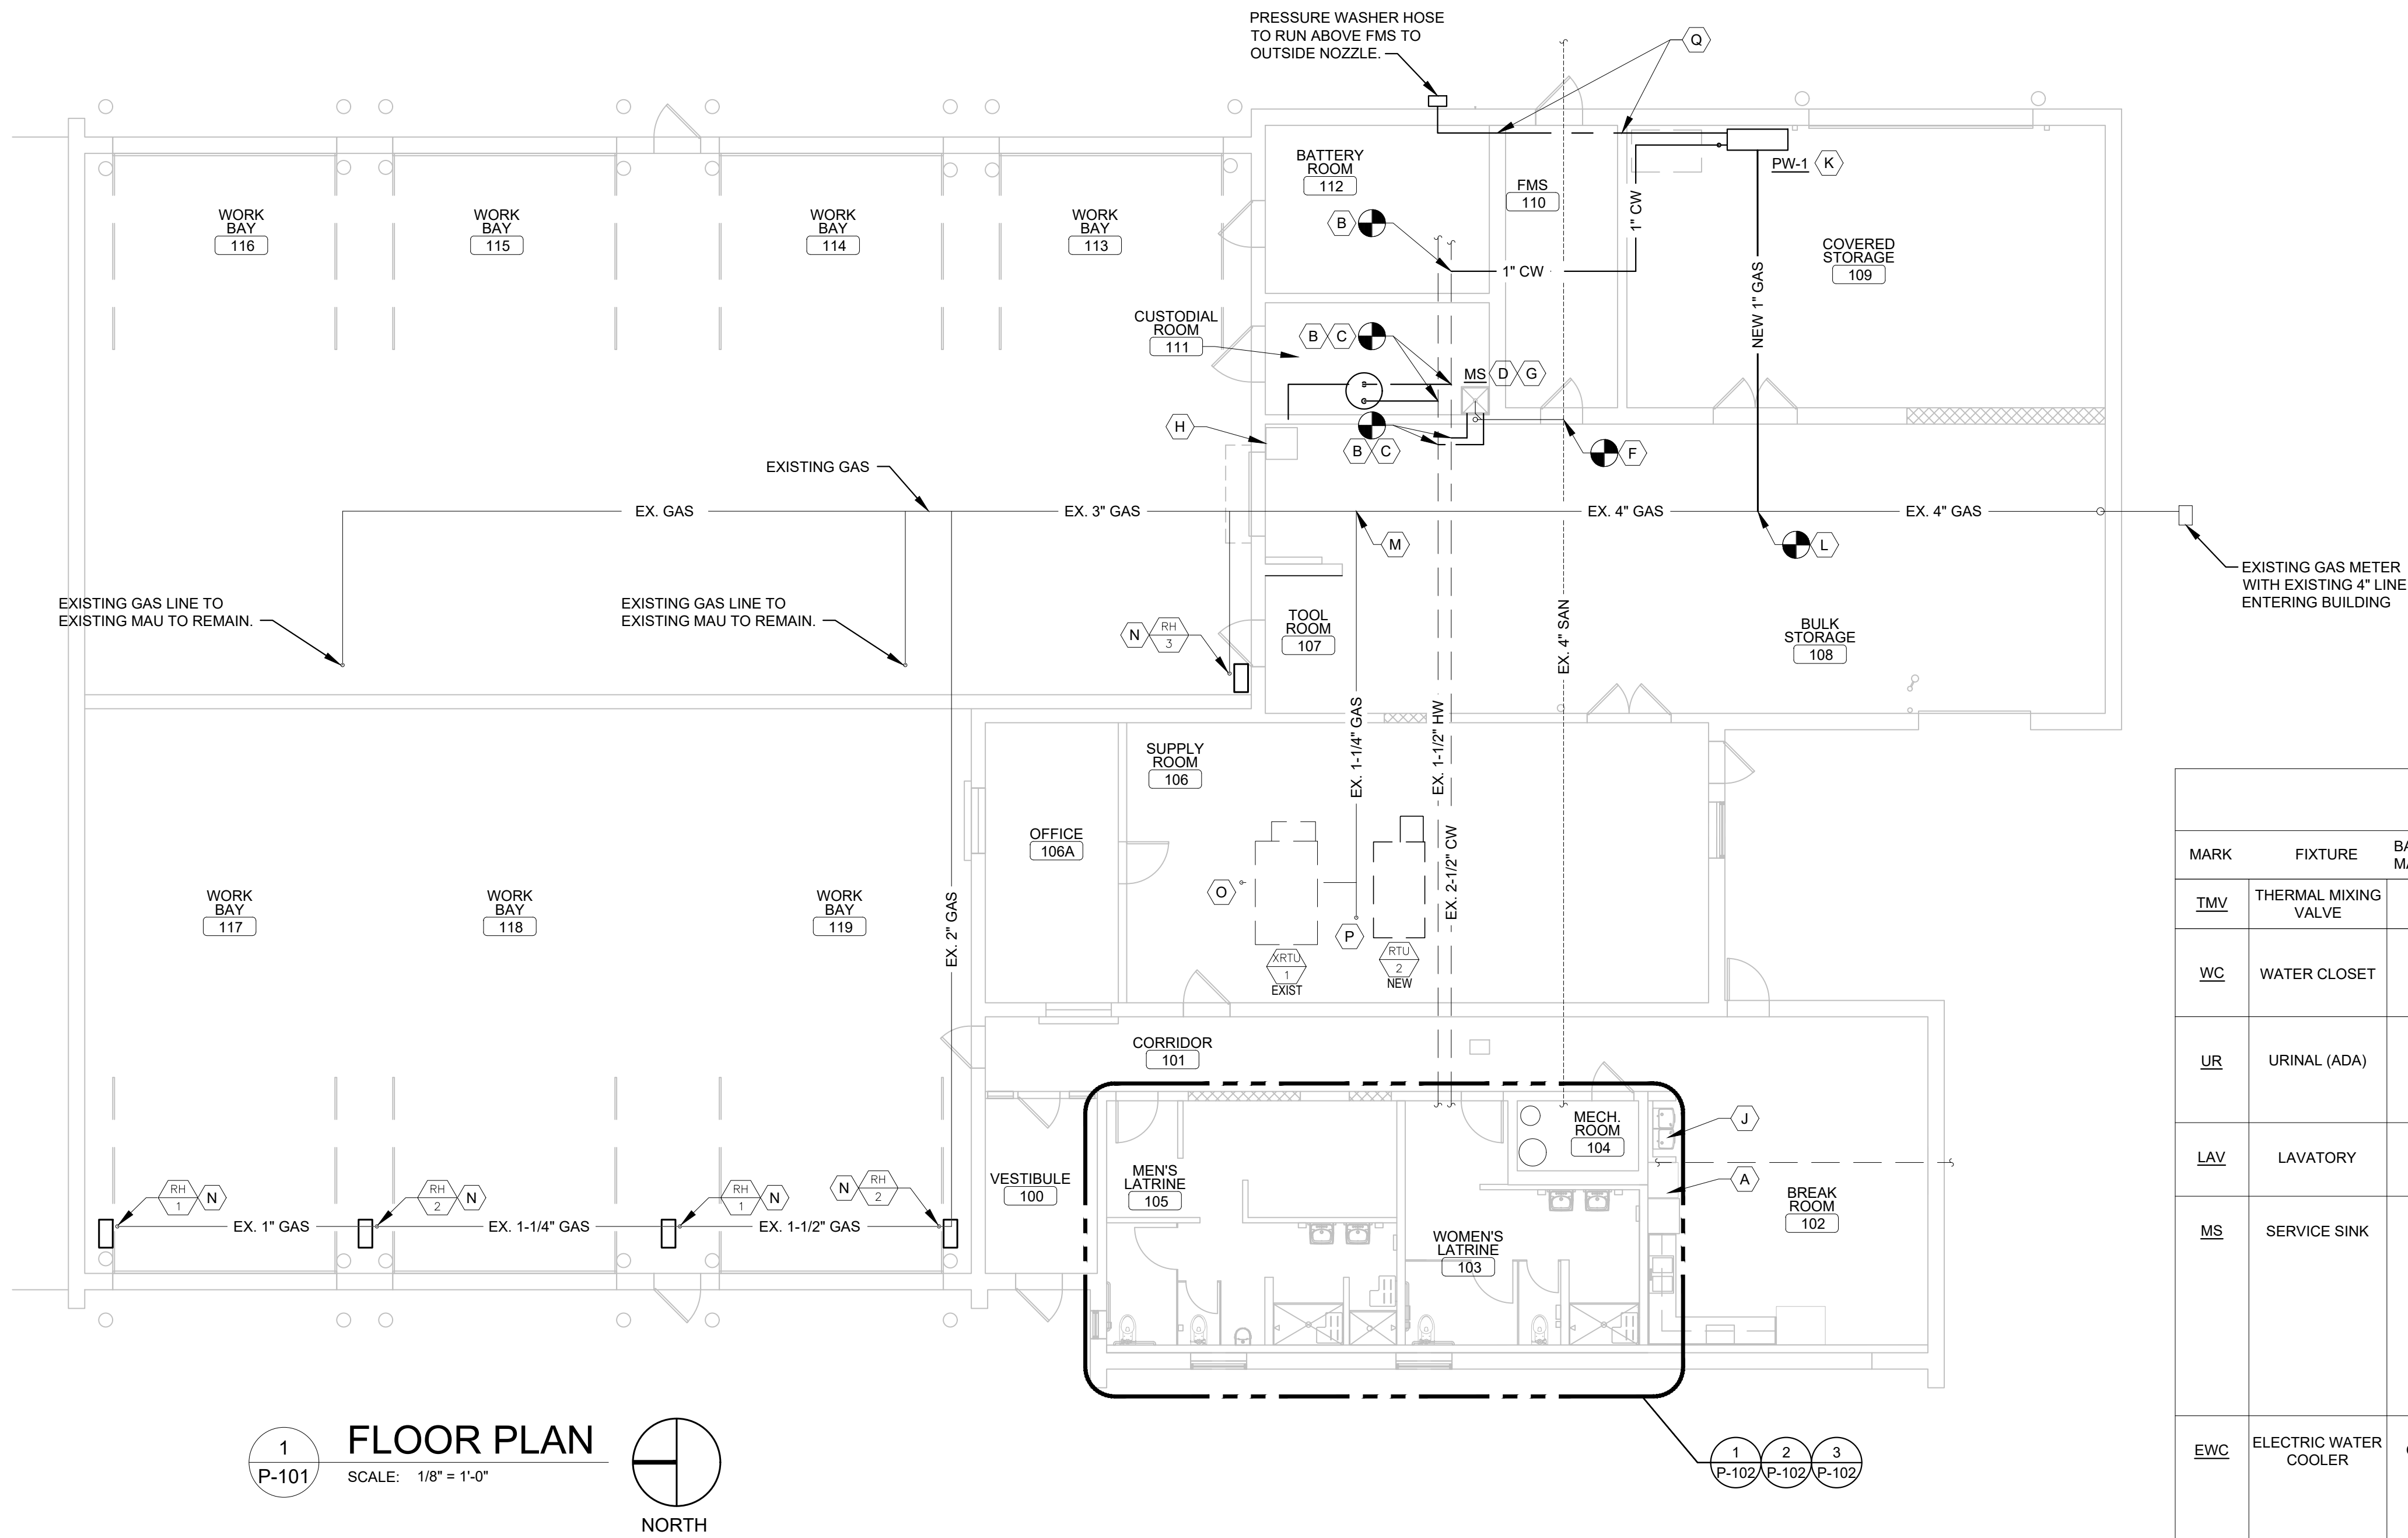

- KEYED NOTES:**
- (A) REUSE EXISTING ICE MACHINE SALVAGED FROM DEMO. COORDINATE WITH OWNER EQUIPMENT LOCATIONS. CONNECT TO NEW 1/2" CW AND DRAIN INTO FLOOR SINK BELOW.
 - (B) CONNECT NEW COLD WATER LINE TO EXISTING COLD WATER LINE. CONTRACTOR SHALL INSTALL SHUTOFF VALVE IN AN EASILY ACCESSIBLE LOCATION ON LINE.
 - (C) CONNECT NEW HOT WATER LINE TO EXISTING HOT WATER LINE. CONTRACTOR SHALL INSTALL SHUTOFF VALVE IN AN EASILY ACCESSIBLE LOCATION ON LINE.
 - (D) CONNECT NEW FIXTURE TO NEW WATER SUPPLY, WASTE, AND VENT PIPING. CONTRACTOR SHALL INSTALL NEW SHUTOFF VALVES ON BOTH CW AND HW LINES.
 - (E) NOT USED.
 - (F) CONNECT NEW SANITARY PIPING TO EXISTING SANITARY PIPING. CONTRACTOR SHALL INSTALL WALL CLEAN OUT.
 - (G) INSTALL CHECK VALVES ON BOTH HOT AND COLD WATER LINES TO MOP SINK.
 - (H) EXISTING WASHER / DRYER.
 - (J) NEW HI-LO WATER COOLER.
 - (K) CONNECT NEW GAS AND WATER SUPPLY TO NEW PRESSURE WASHER IN STORAGE.
 - (L) CONNECT NEW 1" GAS LINE TO PRESSURE WASHER FROM NEW 5" GAS LINE.
 - (M) EXISTING 1-1/4" GAS LINE TO RTU'S, TO REMAIN.
 - (N) RECONNECT NEW BURNER HEADS TO EXISTING GAS PIPING.
 - (O) EXISTING GAS LINE THRU ROOF TO RTU-1 TO REMAIN.
 - (P) EXISTING GAS LINE THRU ROOF TO REMAIN. NEW GAS TRAIN CONNECTION TO RTU-2.
 - (Q) PROVIDE MINIMUM PENETRATION EQUAL TO PIPE DIAMETER. CLEAN AND REPAIR BLOCK. FINISH SMOOTH.

PLUMBING FIXTURE SCHEDULE

MARK	FIXTURE	BASIS OF DESIGN MANUFACTURER & MODEL #	FIXTURE CONNECTIONS				REMARKS	
			CW	HW	W	V		
TMV	THERMAL MIXING VALVE	WATTS LFMV: 1/2 INCH	1/2"	1/2"	--	--	SHALL CONFORM TO STDs: ASSE 1017, ASSE 1069, ASSE 1070. SET AT 110° F MAX.	
WC	WATER CLOSET	AMERICAN STANDARD (ADA), #2257.103	3/4"	--	4"	2"	WALL HUNG 18" HIGH, VITREOUS CHINA, ELONGATED SIPHON JET, FLUSH VALVE: SLOAN # 111 (LOW CONSUMPTION 1.6 GALLON PER FLUSH) SEAT: CHURCH #255SSC WITH OPEN FRONT. CARRIER: J.R. SMITH #0542F (FLOOR MOUNTED) CARRIER MUST BE COMPACT TYPE.	
UR	URINAL (ADA)	AMERICAN STANDARD WASHBROOK #6590.001	1"	--	2"	1-1/2"	WALL-MOUNT ELONGATED 14" RIM URINAL WITH STRAINER, WHITE VITREOUS CHINA, WASHOUT FLUSH ACTION, 1" TOP SPUD. PROVIDE WITH SLOAN LEVER OPERATED DIAPHRAM FLUSH VALVE. PROVIDE WITH J.R. SMITH 0636 URINAL SUPORT. MOUNT AS REQUIRED PER ADA.	
LAV	LAVATORY	AMERICAN STANDARD "LUCERNE" #0355.012	1/2"	1/2"	1-1/2"	1-1/2"	WALL HUNG LAVATORY #0355.012 WHITE; FAUCET: AMERICAN STANDARD #2275.500 POLISHED CHROME, COLONY SOFT 2-HANDLE, 4 INCH.	
MS	SERVICE SINK	FIAT, MODEL: MCB2424	1/2"	1/2"	3"	2"	24" x 24", 10" DEEP, MOLDED STONE MOP SERVICE BASIN WITH STAINLESS STEEL DRAIN. PROVIDE WITH FIAT 830-AA SERVICE FAUCET - CHROME PLATED, 8" CENTERS, WITH VACUUM BREAKER, INTEGRAL STOPS, ADJUSTABLE WALL BRACE, PAIL HOOK AND 3/4" HOSE THREAD ON STOUT. PROVIDE WITH FIAT 632-AA HOSE AND HOSE BRACKET - 5/8" HEAVY DUTY RUBBER HOSE WITH BRASS COUPLING AT ONE END. 5" X 3" STAINLESS STEEL HOSE BRACKET WITH RUBBER GRIP. PROVIDE WITH FIAT 889-CC MOP HANGER - 24" X 3" STAINLESS STEEL BRACKET WITH THREE (3) RUBBER TOOL GRIPS. PROVIDE WITH FIAT 1239-BB 24" ALUMINUM BUMPER GUARD ON EXPOSED EDGES.	
EWC	ELECTRIC WATER COOLER	OASIS, MODEL: PG8ACSL	1/2"	--	1-1/2"	1-1/2"	BARRIER-FREE UNIVERSAL SPLIT LEVEL, ELECTRIC WATER COOLER - SANDSTONE ON GALVANIZED STEEL, WITH STAINLESS STEEL TOP. COOLER SHALL BE RATED FOR 115VAC/1PH. COOLER SHALL DELIVER 8.0 GPH OF 50F WATER, AT 90F AMBIENT TEMPERATURE AND 80F INLET WATER TEMP. BUBBLERS SHALL BE ACTIVATED BY FRONT PADS. COOLER SHALL BE UL LISTED, AND ARI, ANSI A117.1, ADA COMPLIANT. MOUNT AS REQUIRED PER ADA. SEE ALSO ARCHITECTURAL DRAWINGS FOR MOUNTING CONFIGURATION. PROVIDE WITH CANE APRON FOR UPPER UNIT. PROVIDE WITH P-TRAP AND SHUT OFF VALVE.	
WHA	WATER HAMMER ARRESTOR	ZURN Z1700 SERIES 300	1"	--	--	--	REFER TO DETAIL 5/P-501 FOR WATER HAMMER SCHEDULE.	
FD	FLOOR DRAIN	ZURN Z415B	--	--	3"	2"	1/2" TRAP PRIMER CONNECTION, COMBINATION WASTE VENT	
TP	TRAP PRIMER	MIFAB M2-500-NPB	1/2"	--	--	--	WATER SAVER TRAP PRIMER W/ CLEANOUT	
SF	SHOWER FAUCET	TEMPROL SHOWER M# C-96-1-X TMV M# 46-2X-BODY	1/2"	1/2"	--	--	FLOW RATE 2.5 GPM, ADJUSTABLE SPRAY, THERMAL MIXING VALVE SET FOR 110°F MAX. SEE DETAIL 7/P-501	
SD	SHOWER DRAIN	ZURN Z415B FLOOR AND SHOWER DRAIN	--	--	3"	2"	CONTRACTOR IS TO INSTALL WITH P-TRAP AND VENT PER CODE. 5" STRAINER DIAMETER.	
DF	BARRIER-FREE DRINKING FOUNTAIN	ELKAY MANUFACTURING CO. MODEL NO. (EZTLRDDC)	1/2"	--	2"	1-1/2"	TWO-STATION, WALL MOUNTED, ELECTRIC DRINKING FOUNTAIN, BARRIER-FREE ACCESS (ADA). FRONT ONLY EASY TOUCH CONTROL, HIGH UNIT ON RIGHT, ELKAY #EZTLRDDC OR EQUAL. PROVIDE SUPPLY LINE, STOP VALVE & P-TRAP. PROVIDE CANE APRON AS REQUIRED.	
FS	FLOOR SINK	ZURN Z1930	--	--	3"	1-1/2"	SANI-FLOOR RECEPTOR 8" X 4" X 4" WITH 4" DEEP SUMP DEPTH	
WCO	WALL CLEANOUT	JOSAM SERIES 58910 (OR APPROVED EQUIVALENT) TEE CLEANOUT FOR USE IN WALLS. PROVIDE WITH JOSAM SERIES 58600 WALL ACCESS COVER. SEE PLUMBING PLAN AND ISOMETRICS FOR SIZE.						
FCO	FLOOR CLEANOUT	JOSAM SERIES 55000 CLEANOUT FOR USE IN FLOOR. PROVIDE WITH JOSAM STAINLESS STEEL COVER. SEE PLUMBING PLAN AND ISOMETRICS FOR SIZE.						

- NOTES:**
- FIXTURES MAY BE SUBSTITUTED BY AN EQUIVALENT FIXTURE. SEE PLUMBING SPECIFICATIONS FOR EQUIVALENT FIXTURE LIST.
 - ALL FIXTURES SHALL HAVE AN INDIVIDUAL SHUTOFF VALVE.
 - NEW WATER CLOSET TO HAVE TRIP LEVER ON SIDE OF FIXTURE AWAY FROM WALL PER ADA REQUIREMENTS.

1 FLOOR PLAN
SCALE: 1/8" = 1'-0"
NORTH


PRESSURE WASHER SYSTEM SCHEDULE

ID	MANUFACTURER (BASIS OF DESIGN)	MODEL #	TYPE	WATER				STEAM				ELECTRIC				NATURAL GAS - INPUT		WEIGHT (LBS)	EQUIVALENT MANUF MODEL #	EQUIVALENT MANUF MODEL #
				HOT	COLD	GPM	PSI	TEMP	LBS/HR	PSI	HP	VOLTS	PHASE	HZ	CFH	IN.W.C.				
PW-1	DAIMER INDUSTRIES	SM-15900-236DH	FIXED MOUNTED FREE STANDING PRESSURE WASHER SYSTEM	180 - 210 F	AMBIENT	5	3000	330 F	AMBIENT	3000	10	208	3	60	446	7-14	1025	DELCO MODEL: 65044	EASY-KLEEN MODEL: EZN3004-3	

ACCESSORIES:

- DIRECT DRIVE, CAPACITOR START CONTINUOUS DUTY MOTOR -- NEMA DESIGN B.
- NEMA 1 DISCONNECT
- CHEMICAL INFUSION PORT -- HIGH DISCHARGE PRESSURE
- 3 FOOT TRIGGER WAND WITH 0, 15, 25, 40 DEGREE STEAM NOZZLES
- 100 FEET OF HIGH PRESSURE STEAM HOSE -- DISCHARGE
- DIMENSIONS (W x D x H): 52" x 23" x 50"
- AUTOMATIC SHUTOFF TECHNOLOGY: TRIGGER CONTROL TO MOTOR TO REDUCE EQUIPMENT WEAR
- ELECTRONIC SPARK IGNITION NATURAL GAS HEAT EXCHANGER

STATE OF MISSOURI
MICHAEL L. PARSON,
GOVERNOR

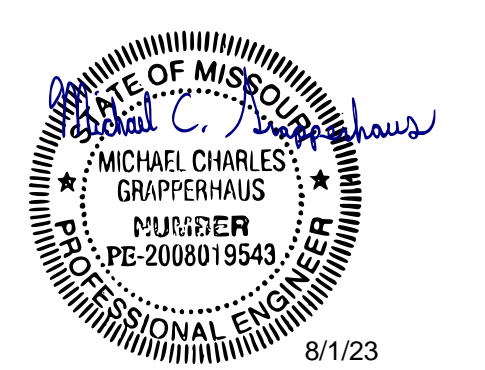

MICHAEL C. GRAPPERHAUS
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Expiration Date: 12/31/24
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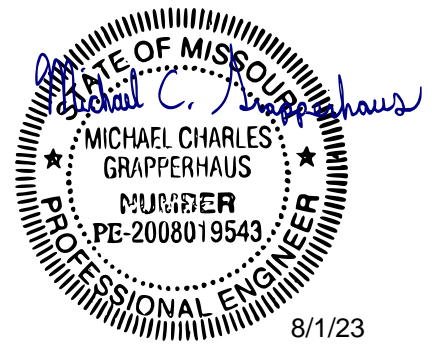
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SITE # 6300
ASSET# 8136300017

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DATE: _____
ISSUE DATE: 08/01/2023

CAD DWG FILE: _____
DRAWN BY: MEA
CHECKED BY: JST
DESIGNED BY: JST

SHEET TITLE:
PLUMBING FLOOR PLAN AND SCHEDULES

SHEET NUMBER:
P-101
08/01/2023
SHEET 18 OF 29



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Expiration Date: 8/1/23


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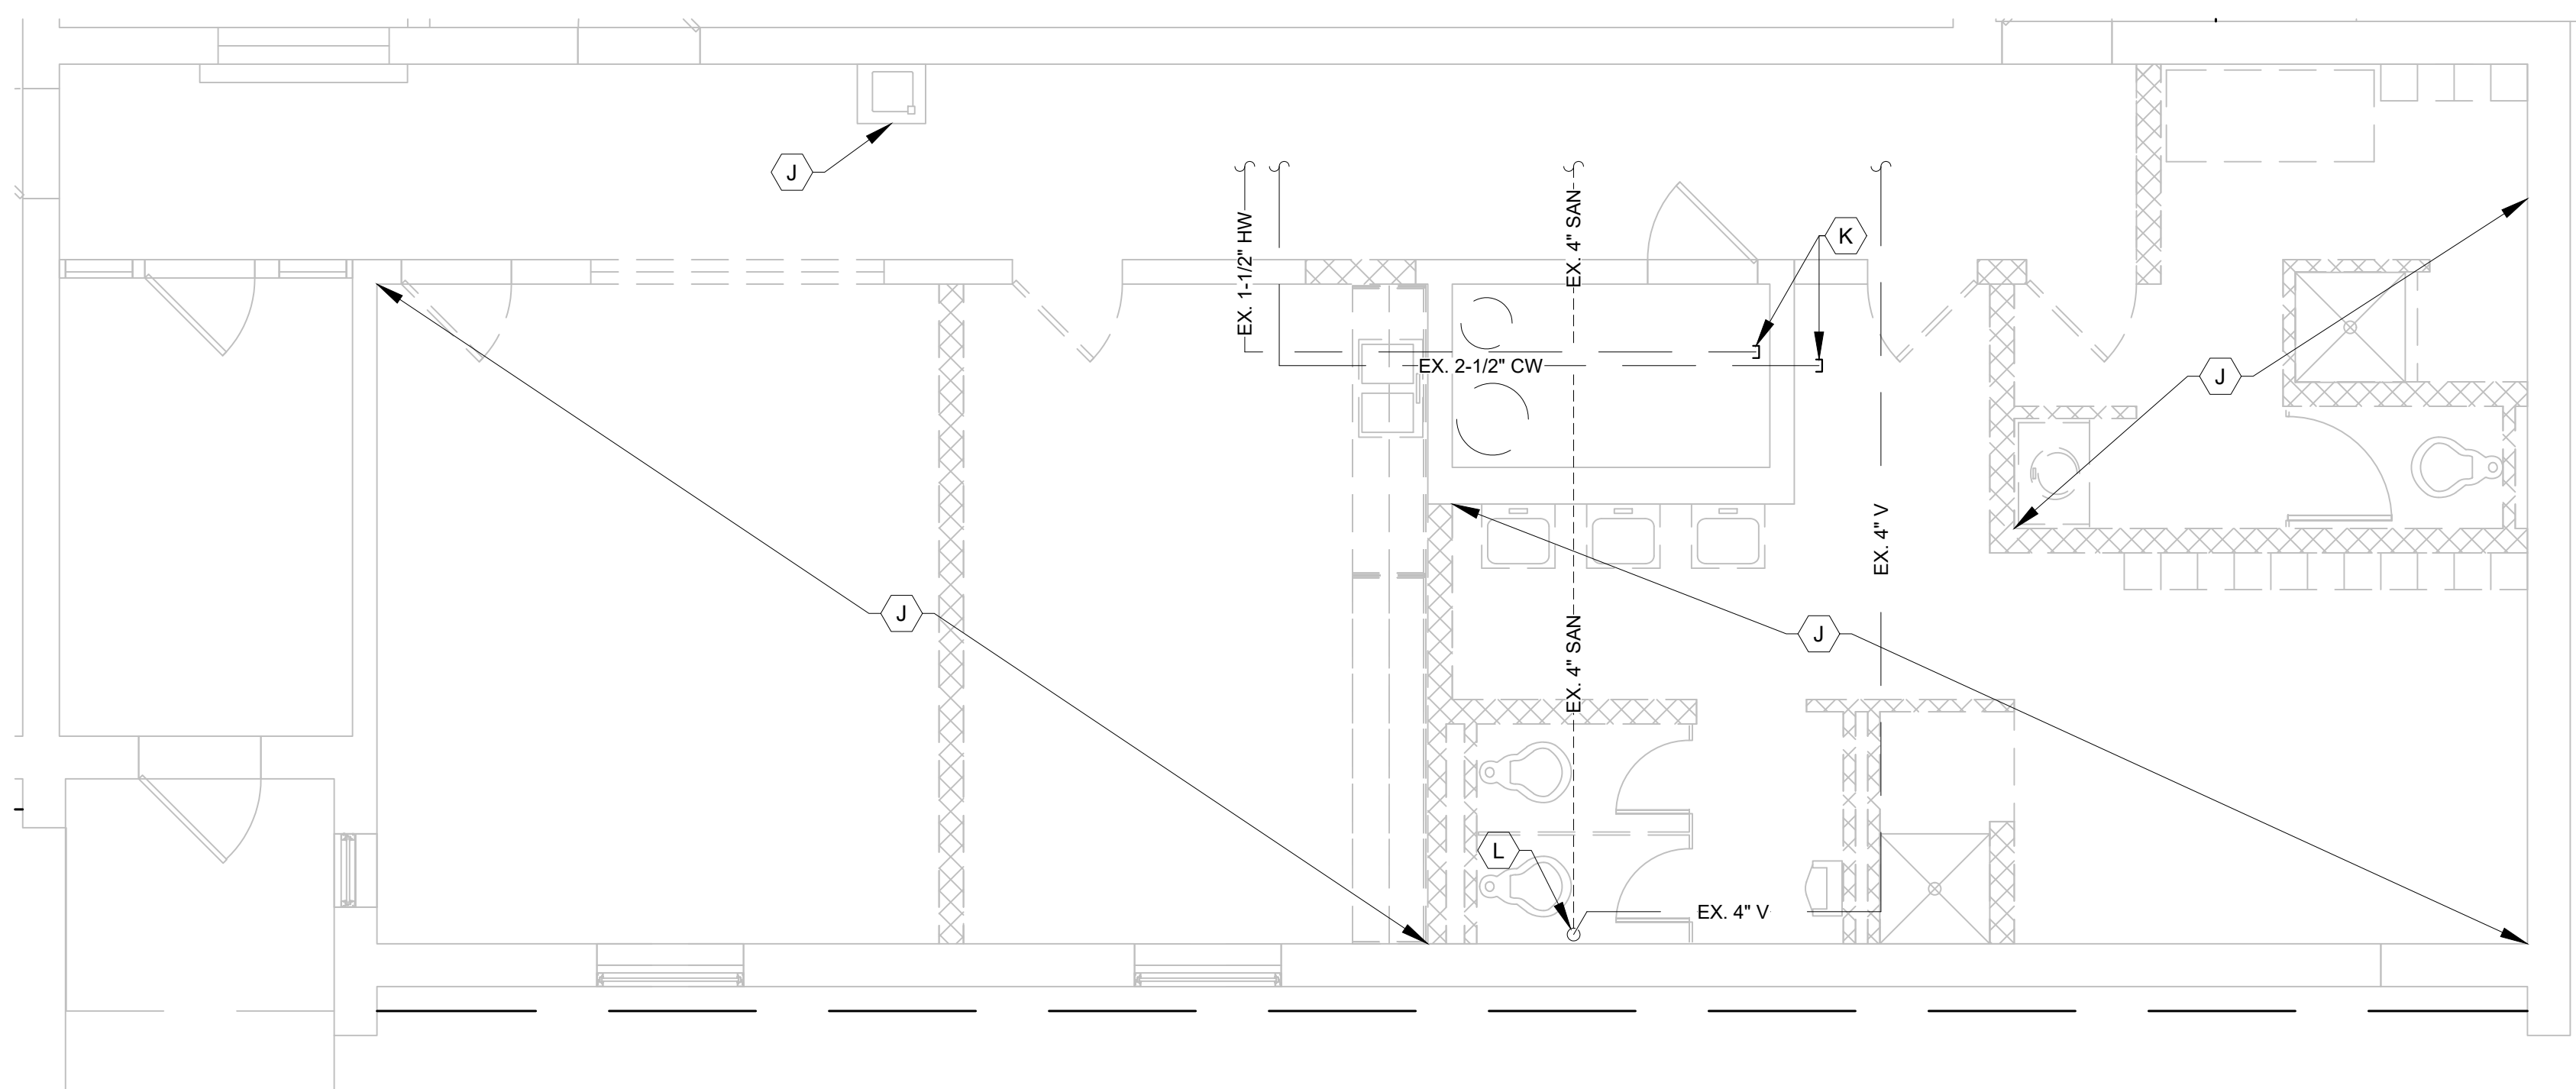
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PLUMBING SYMBOLS LEGEND	
— SAN —	NEW SANITARY SEWER (BELOW SLAB)
— EX SAN —	EXISTING SANITARY PIPING
— V —	NEW SANITARY VENT
— EX V —	EXISTING SANITARY VENT
— EX HW —	EXISTING HOT WATER PIPING
— HW —	NEW HOT WATER PIPING
— CW —	NEW DOMESTIC COLD WATER
— CW —	NEW WATER (WITH SHUT OFF VALVE)
— EX CW —	EXISTING DOMESTIC COLD WATER
XXX	EQUIPMENT/FIXTURE DESIGNATION
⬡	KEYED NOTE
⬢	REVISION NUMBER
⊙	POINT OF CONNECTION (NEW TO EXISTING)
TYP.	TYPICAL
V.I.F.	VERIFY IN FIELD
▷	FLOW DIRECTION


- # KEYED NOTES:
- A) REUSE EXISTING ICE MACHINE SALVAGED FROM DEMO. COORDINATE WITH OWNER EQUIPMENT LOCATIONS. CONNECT TO NEW 1/2" CW LINE AND DRAIN TO FS.
 - B) CONNECT NEW COLD WATER LINE TO EXISTING COLD WATER LINE. CONTRACTOR SHALL INSTALL SHUTOFF VALVE IN AN EASILY ACCESSIBLE LOCATION ON LINE.
 - C) CONNECT NEW HOT WATER LINE TO EXISTING HOT WATER LINE. CONTRACTOR SHALL INSTALL SHUTOFF VALVE IN AN EASILY ACCESSIBLE LOCATION ON LINE.
 - D) CONNECT NEW FIXTURE TO NEW WATER SUPPLY, WASTE, AND VENT PIPING. CONTRACTOR SHALL INSTALL NEW SHUTOFF VALVES ON BOTH CW AND HW LINES.
 - E) CONNECT NEW 4" VENT PIPING TO EXISTING 4" VENT PIPING.
 - F) CONNECT NEW SANITARY PIPING TO EXISTING SANITARY PIPING. CONTRACTOR SHALL INSTALL WALL CLEAN OUT. CONNECT NEW 4" VENT TO EXISTING 4" VENT.
 - G) CONNECT NEW SANITARY PIPING TO EXISTING SANITARY PIPING.
 - H) NEW HI-LO WATER COOLER.
 - J) REMOVE AND PROPERLY DISPOSE OF EXISTING PLUMBING FIXTURES AND ASSOCIATED PIPING, UNLESS OTHERWISE INDICATED. REMOVE AND PROPERLY DISPOSE OF ALL SANITARY PIPING ABOVE SLAB. CAP SANITARY LINES FLUSH WITH SLAB ELEVATION.
 - K) REMOVE AND PROPERLY DISPOSE OF ALL HOT AND COLD WATER PIPING BACK TO LOCATION SHOWN ON PLAN. PROVIDE SHUTOFF VALVE AND CAP FOR RECONNECTION WHERE INDICATED ON PLAN.
 - L) REMOVE AND PROPERLY DISPOSE OF ALL VENT PIPING TO LOCATION SHOWN ON PLAN.



2 ENLARGED WATER PLAN
SCALE: 1/4" = 1'-0"
NORTH

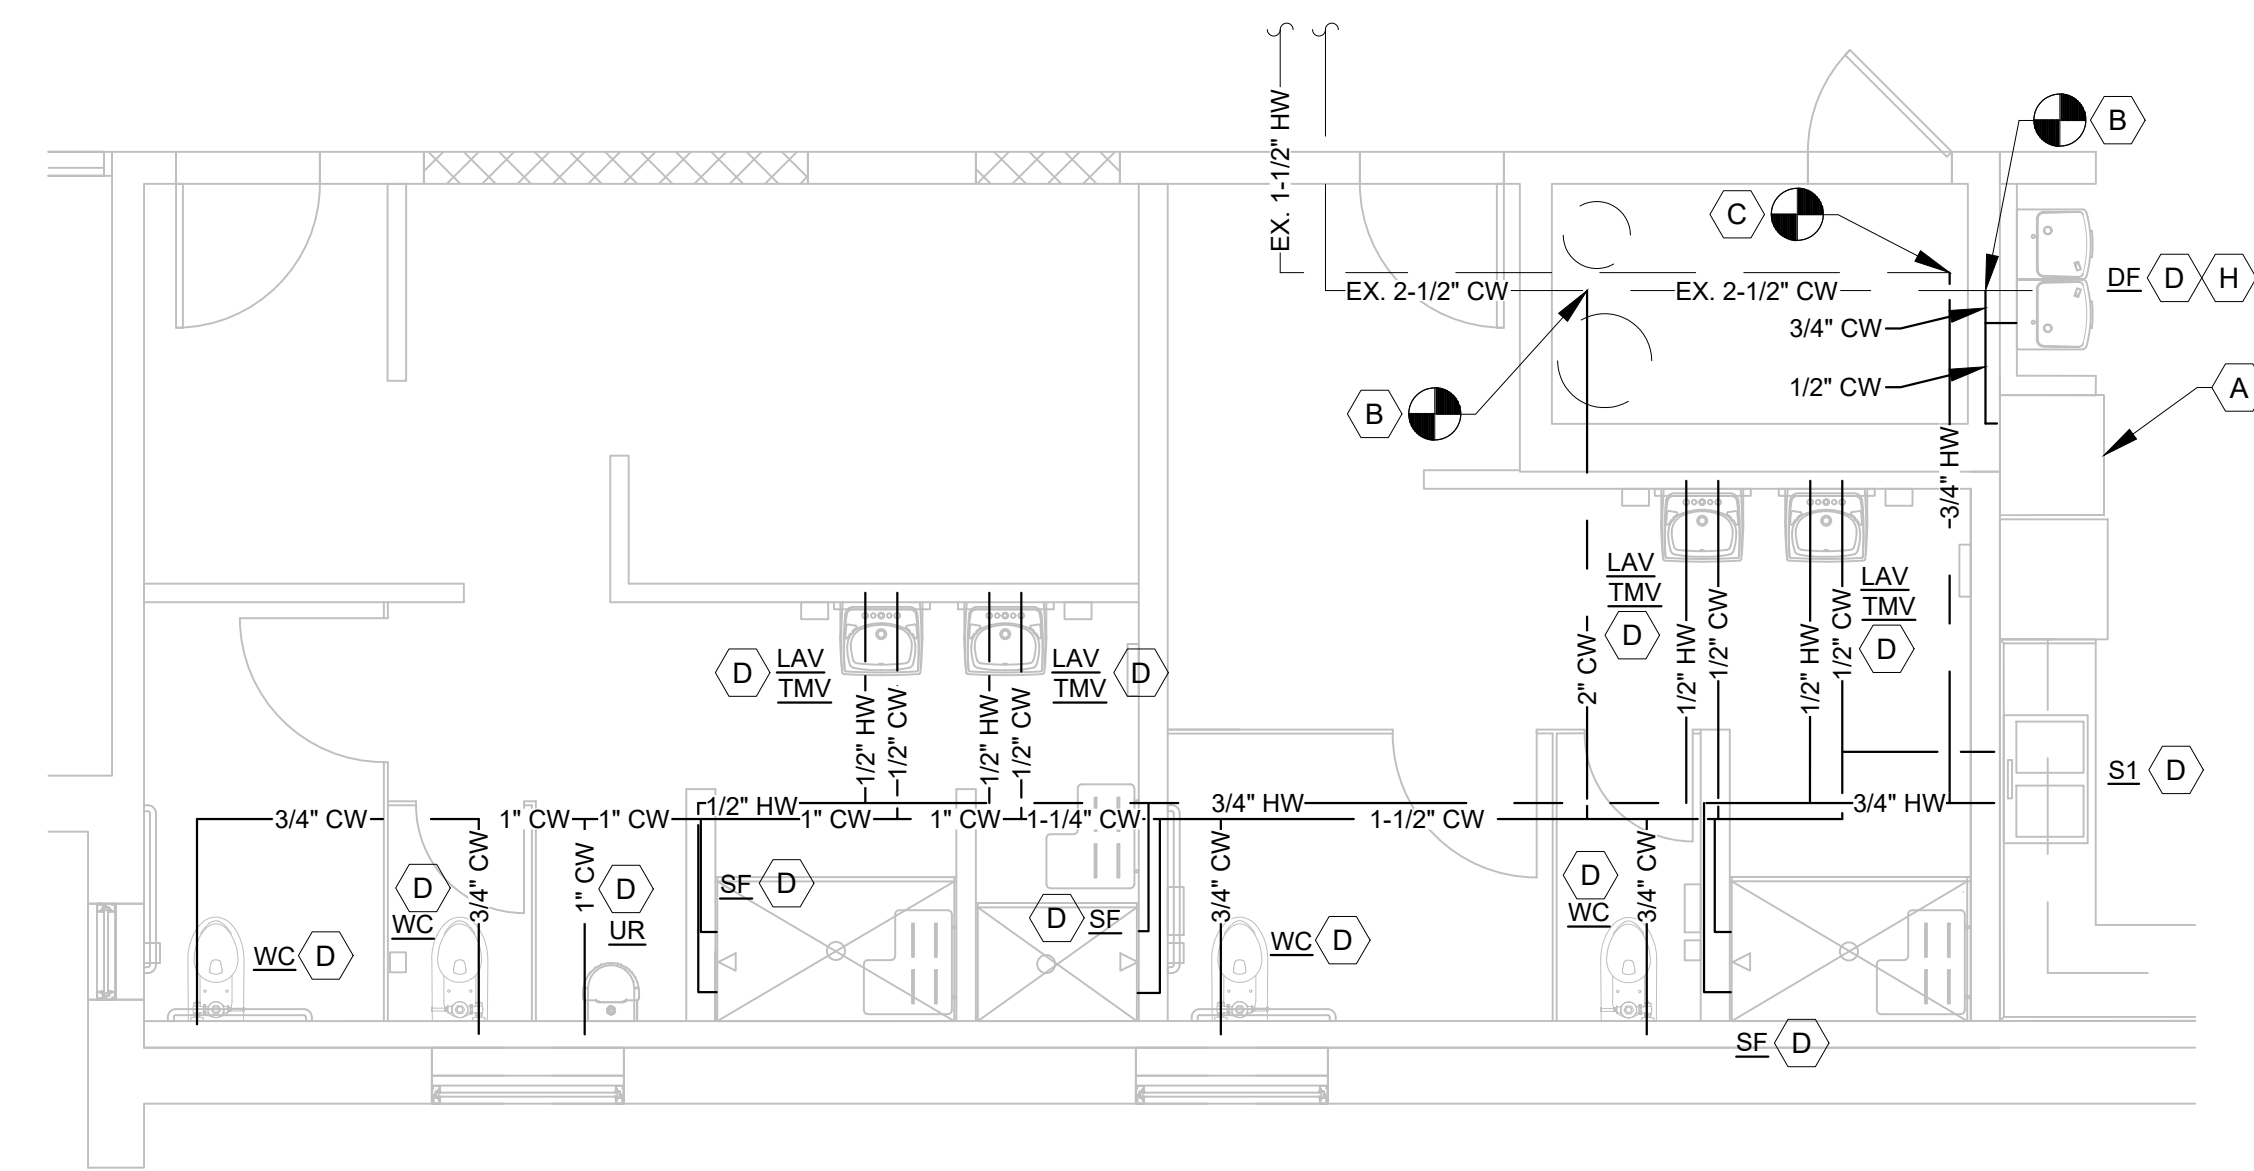

1 ENLARGED DEMO PLUMBING PLAN
SCALE: 1/4" = 1'-0"
NORTH

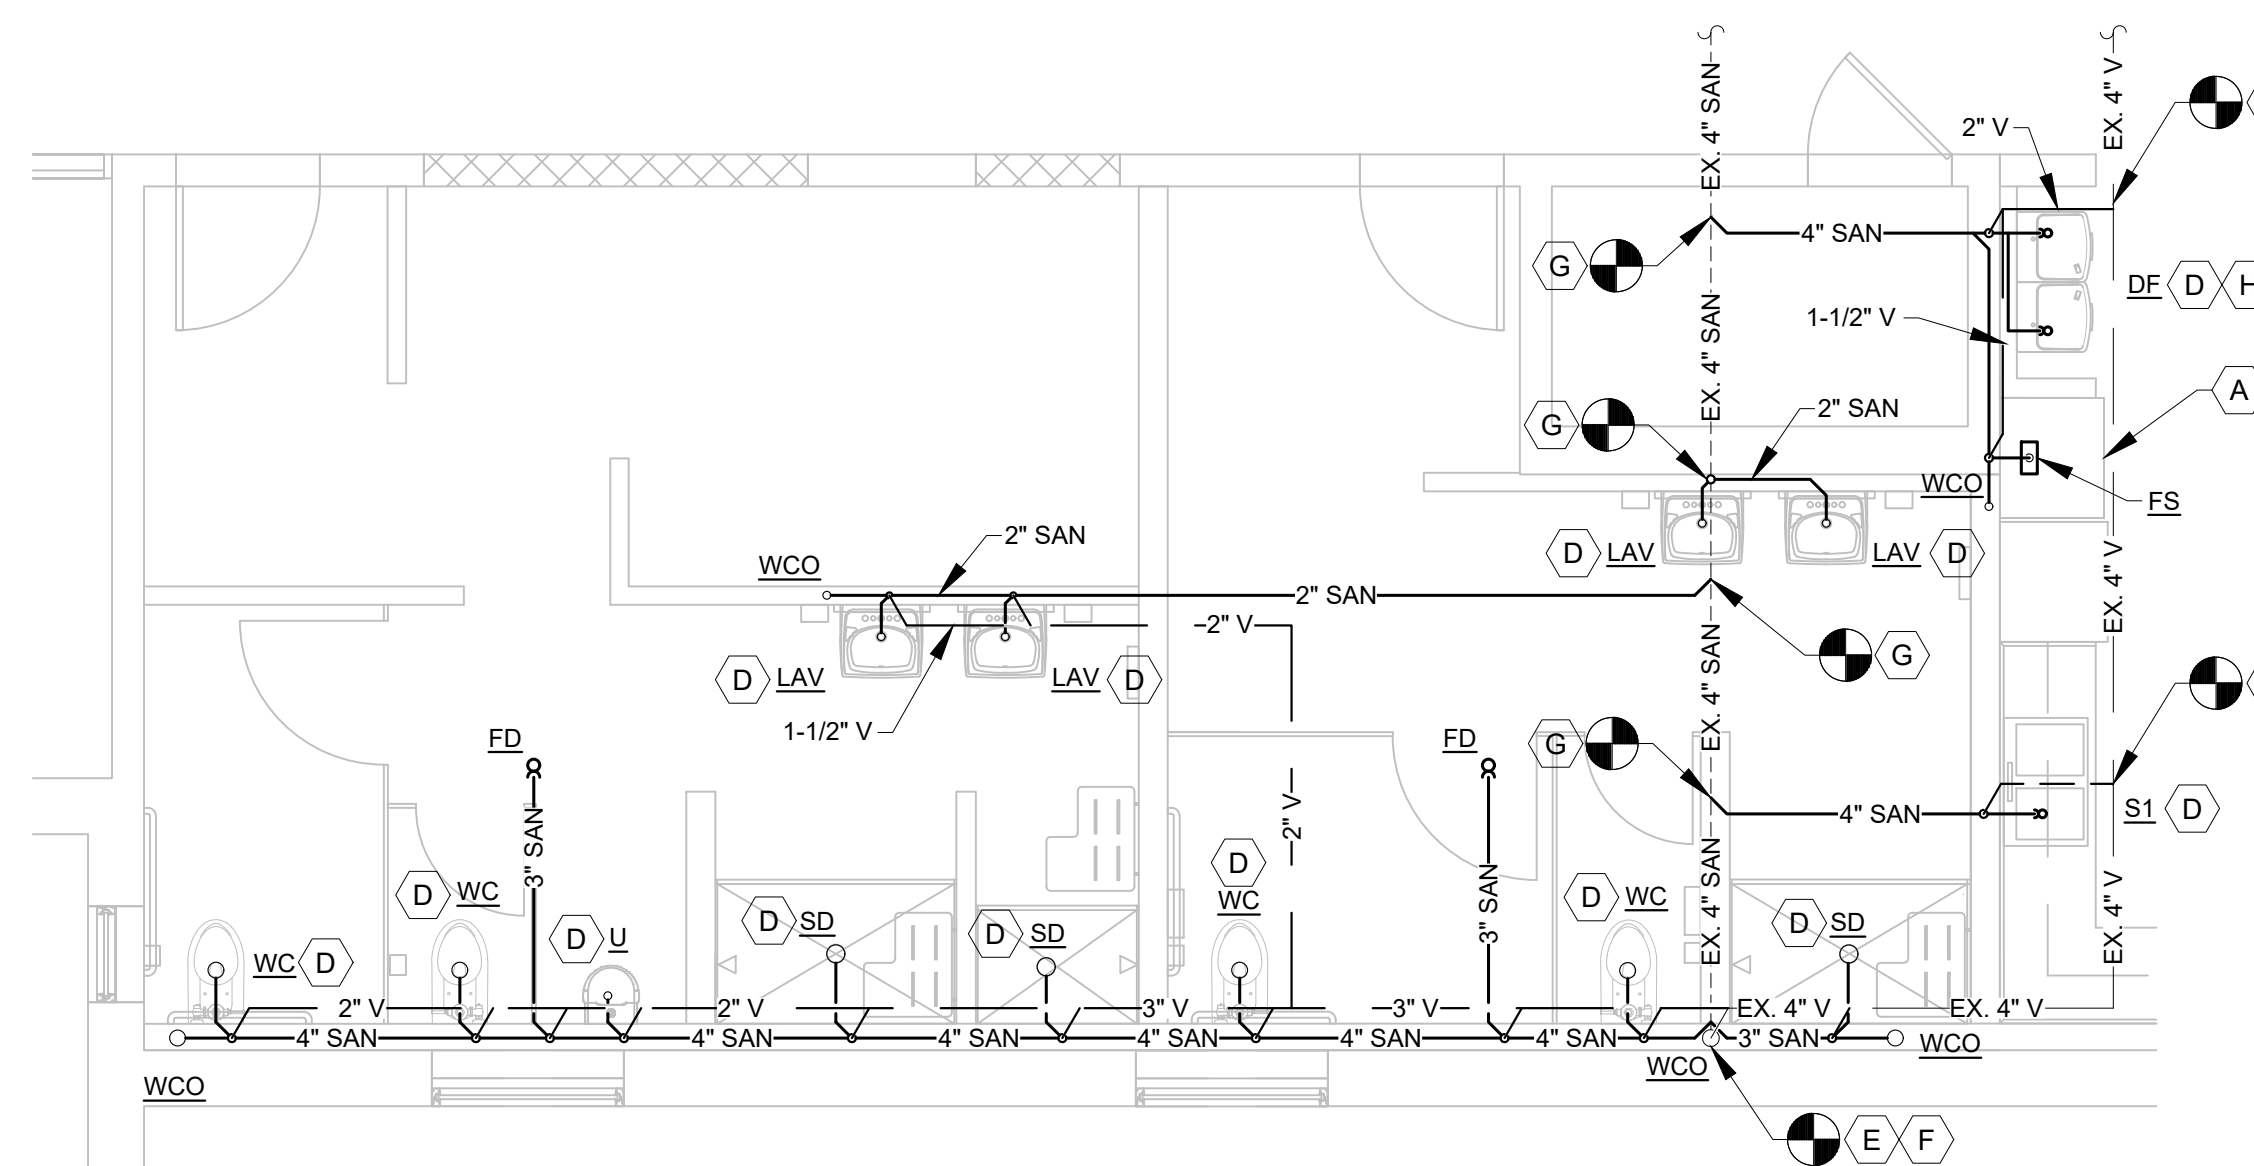

3 ENLARGED SANITARY & VENT PLAN
SCALE: 1/4" = 1'-0"
NORTH

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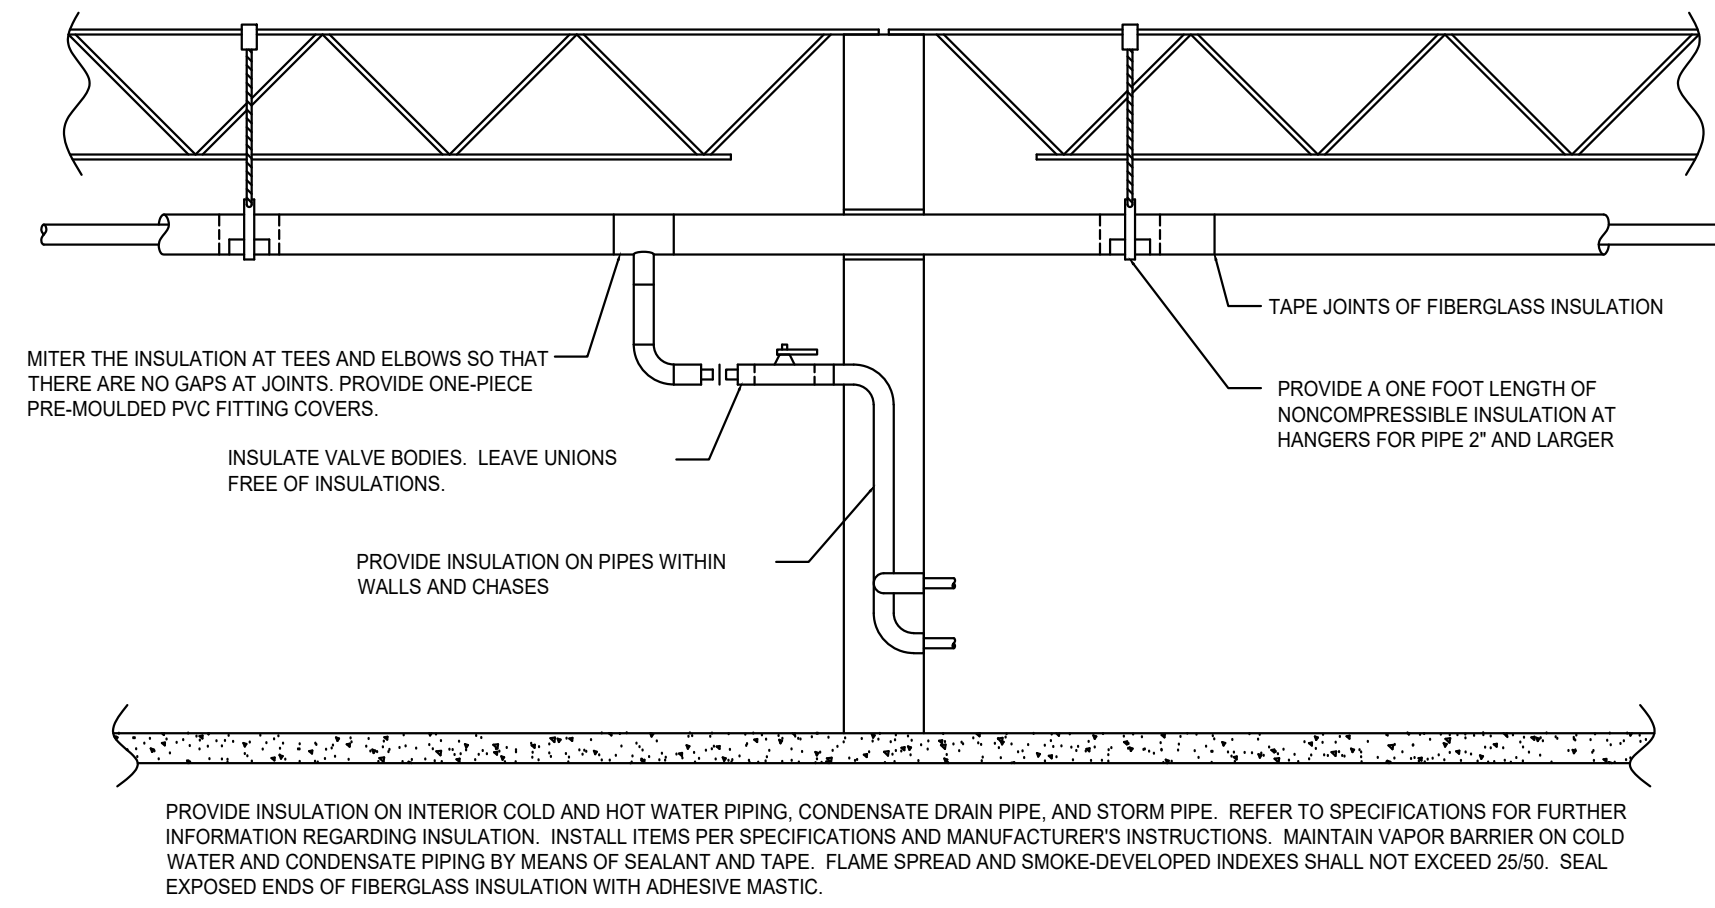
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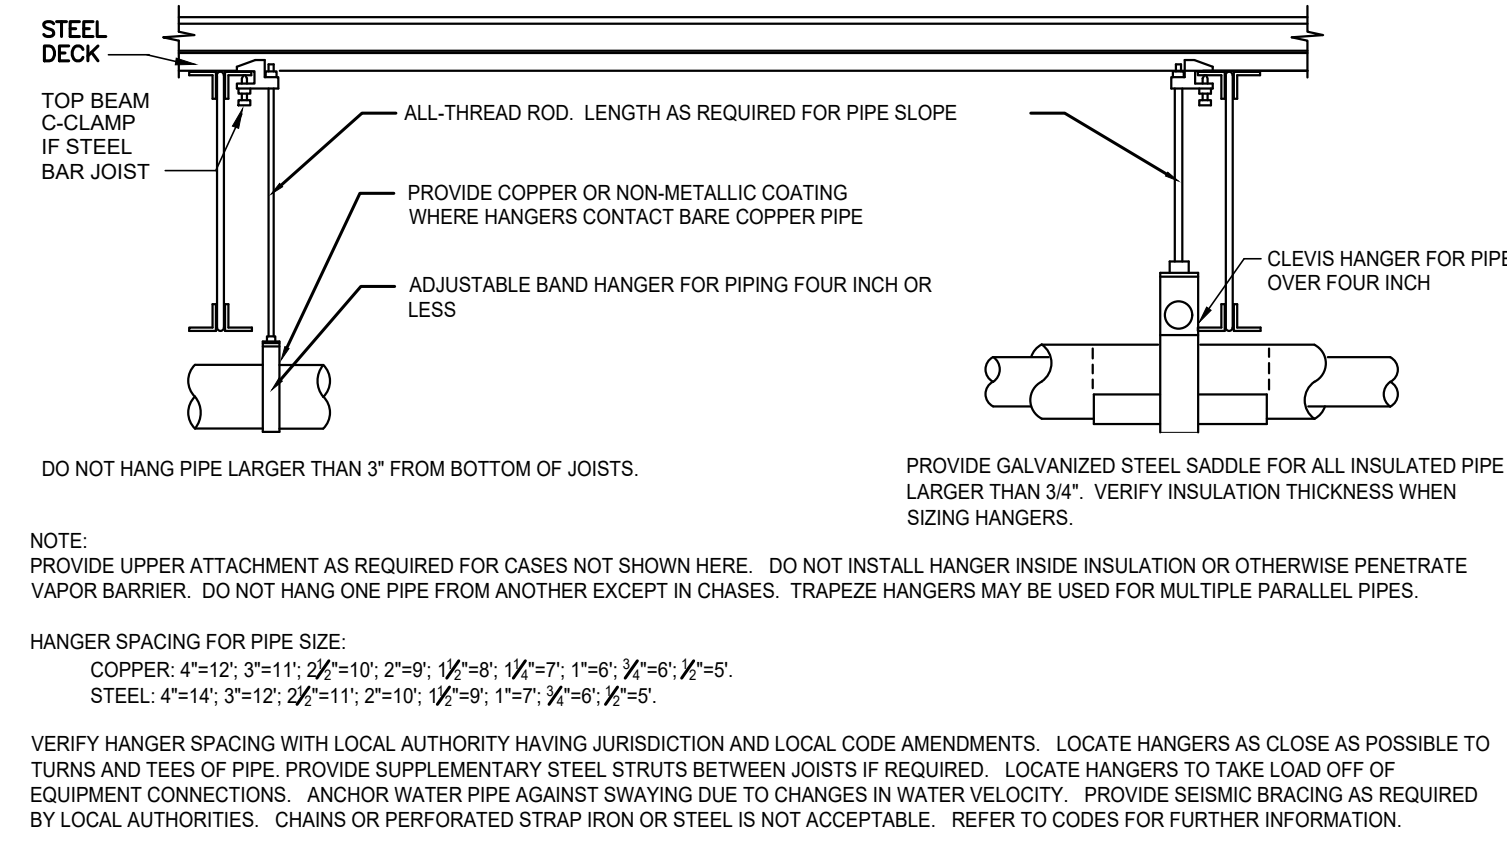
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CHECKED BY: JST
DESIGNED BY: JST

SHEET TITLE:
**ENLARGED
PLUMBING
FLOOR PLANS**


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P-102
08/01/2023
SHEET 19 OF 29




1 PIPE INSULATION DETAIL
SCALE: N.T.S.



2 PIPE HANGER DETAIL
SCALE: N.T.S.

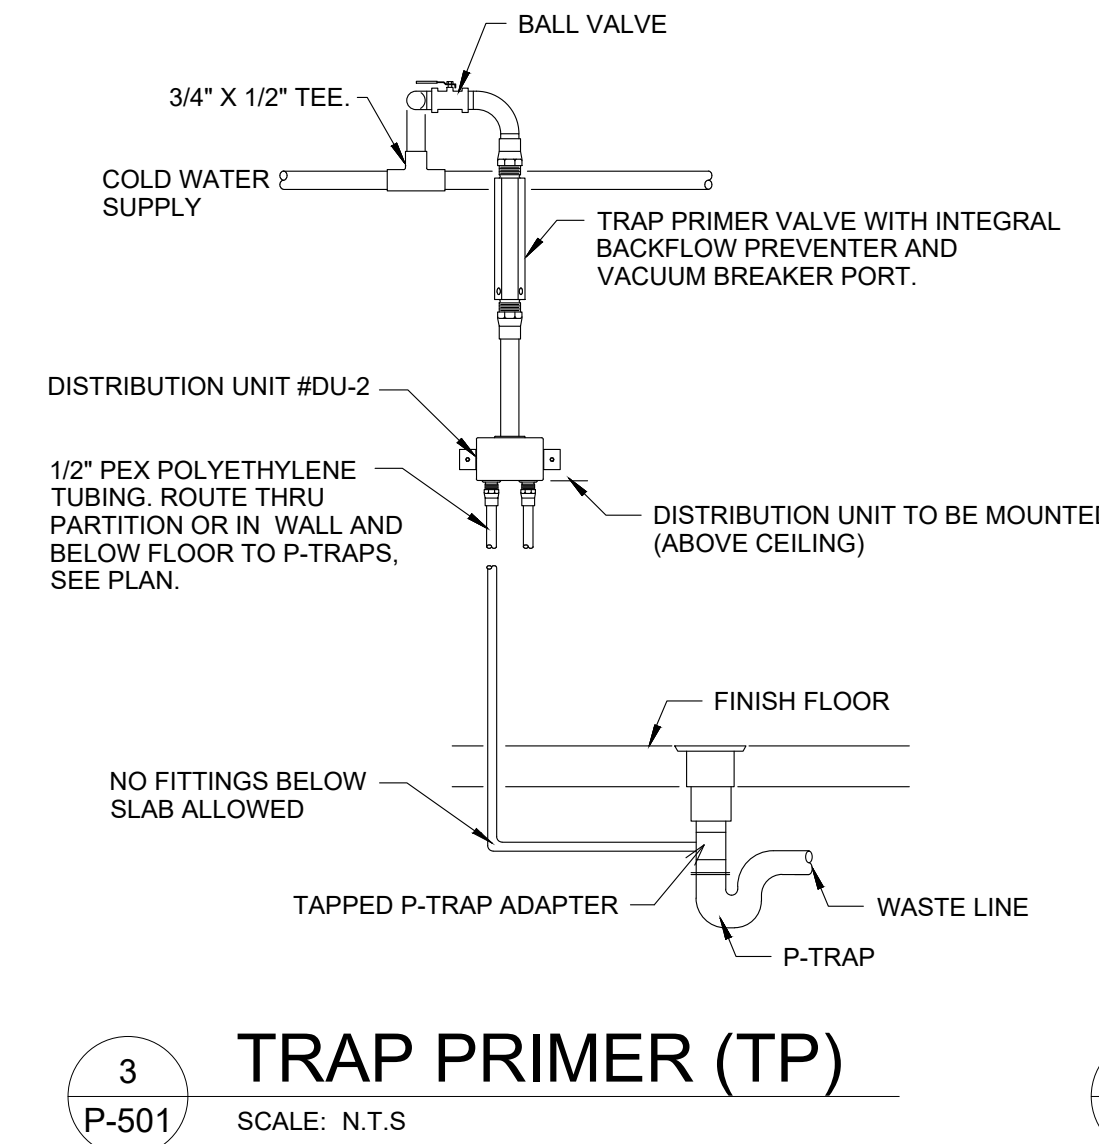

3 TRAP PRIMER (TP)
SCALE: N.T.S.

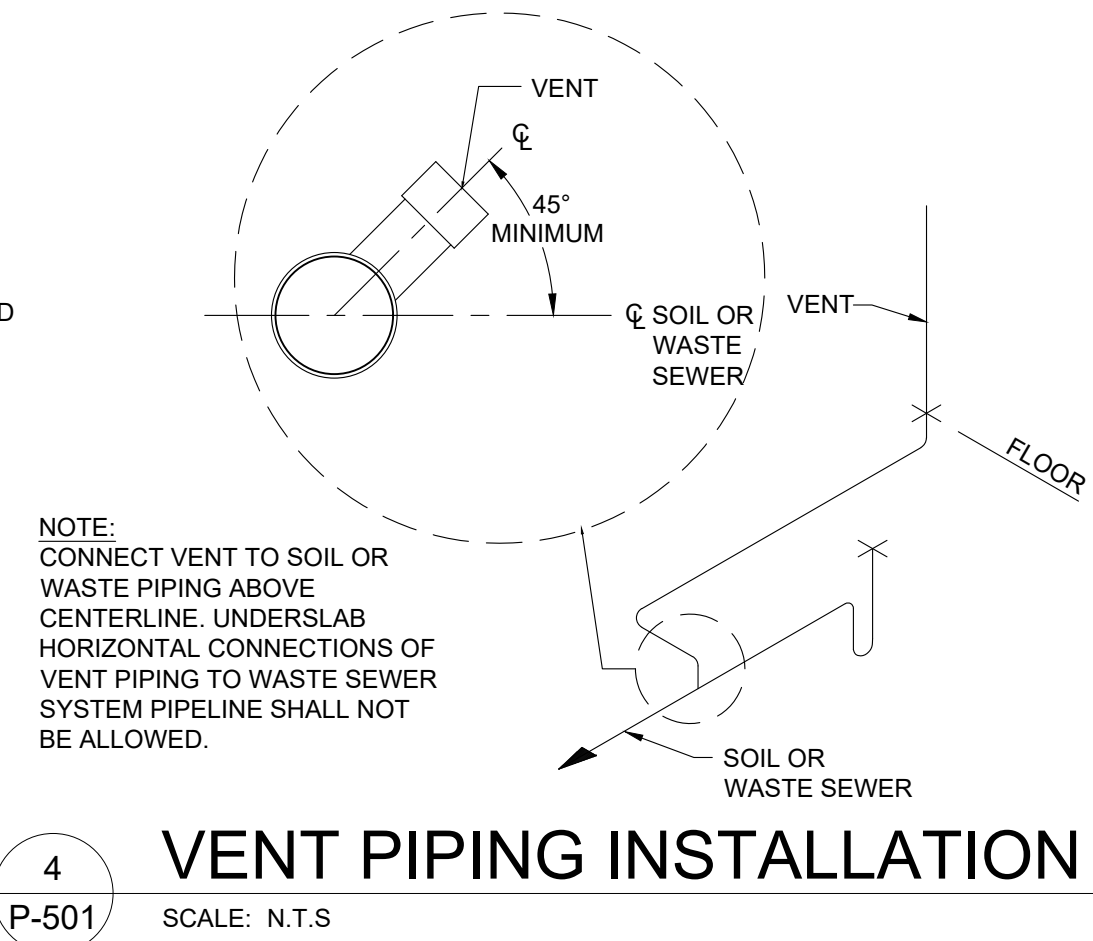

4 VENT PIPING INSTALLATION
SCALE: N.T.S.

INSTALL PER PDI STANDARDS AND MANUFACTURER'S INSTRUCTIONS


HOT OR COLD WATER SUPPLY

IF HORIZONTAL BRANCH IS LESS THAN 20' LONG, PROVIDE ONE WHA AT END OF LINE. IF BRANCH IS GREATER THAN 20' LONG, PROVIDE ANOTHER WHA IN MIDDLE. EACH SIZED FOR HALF THE FIXTURE UNITS.


SINGLE FIXTURE			MULTIPLE FIXTURES		
PDI SIZE	PIPE SIZE	FIXTURE UNIT LOAD	FIXTURE	COLD	HOT
A	1/2"	1-11	VALVE WATER CLOSET	5	---
B	3/4"	12-32	TANK WATER CLOSET	2.5	---
C	1"	33-60	URINAL	4	---
D	1 1/4"	61-113	LAVATORY	.75	.75
E	1 1/2"	114-154	SINK	1.5	1.5
F	2"	154-330	JANITOR'S SINK	2.5	2.5
			SHOWER/BATHTUB	1.5	1.5

5 WATER HAMER ARRESTERS
SCALE: N.T.S.


PC TO PROVIDE WATER HAMMER ARRESTERS BY SIOUX CHIEF, PRECISION PLUMBING PRODUCTS, WATTS OR APPROVED EQUIVALENT WITH PISTON AND O-RING CONSTRUCTION, HAVING PDI #WH-201, ASSE #1010 AND ANSI #A112.26.1M CERTIFICATION. INSTALL IN HORIZONTAL OR VERTICAL POSITION, BUT NEVER UPSIDE DOWN. INSTALL IN LINE WITH WATER FLOW DIRECTION IF POSSIBLE. SIZE THE UNITS AS SHOWN ON THE DRAWINGS AND/OR PER THE TABLES SHOWN ABOVE.

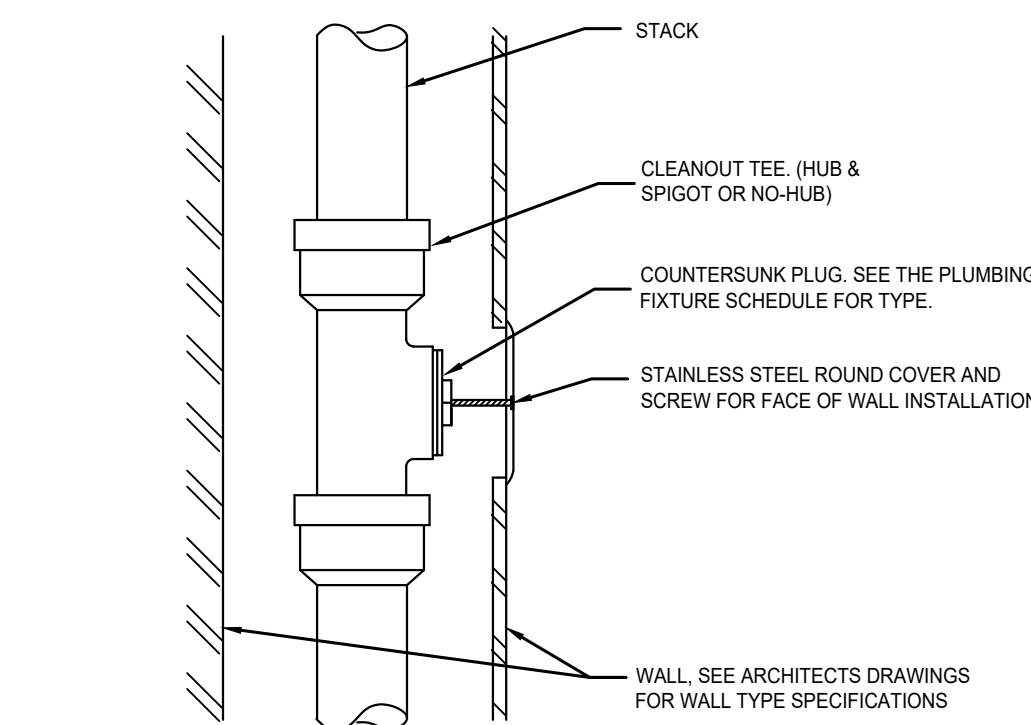


6 WALL CLEANOUT DETAIL
SCALE: N.T.S.

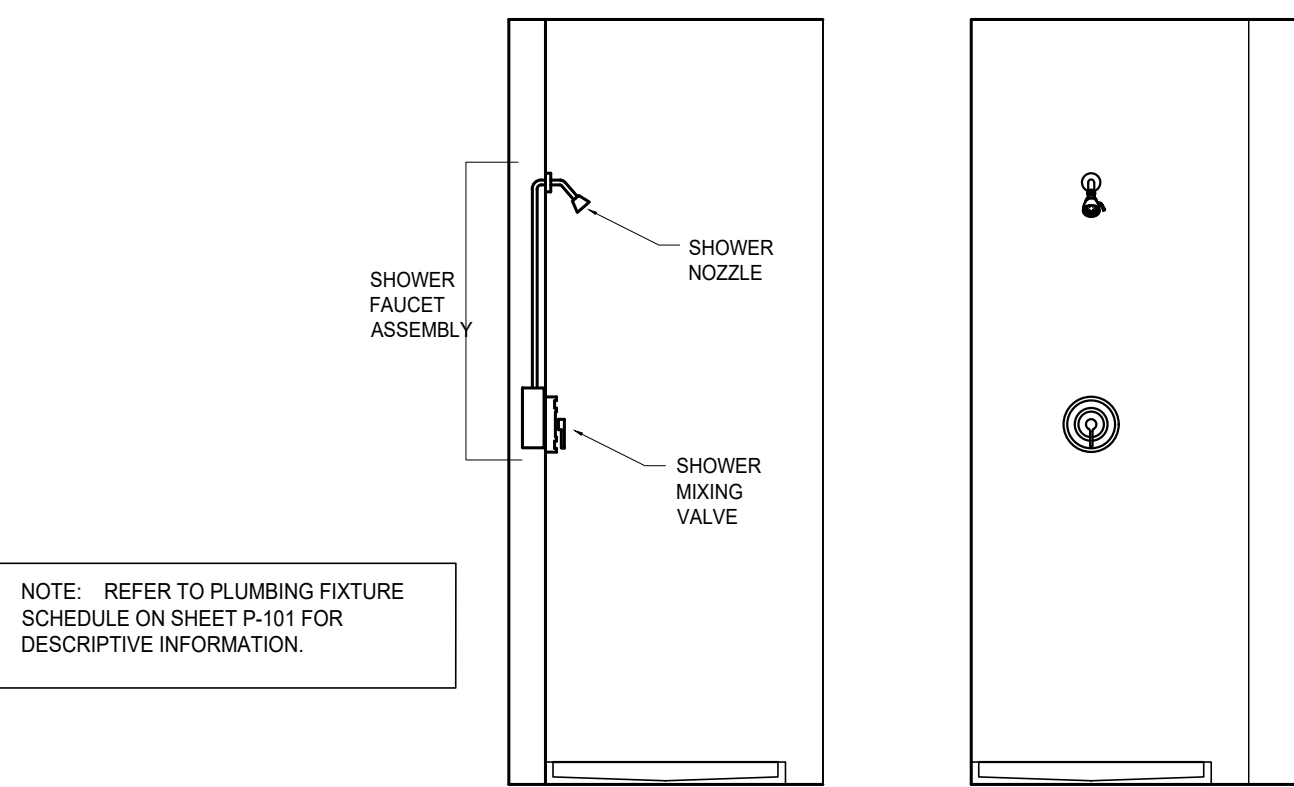

7 SHOWER FAUCET ASSEMBLY DETAIL
SCALE: N.T.S.

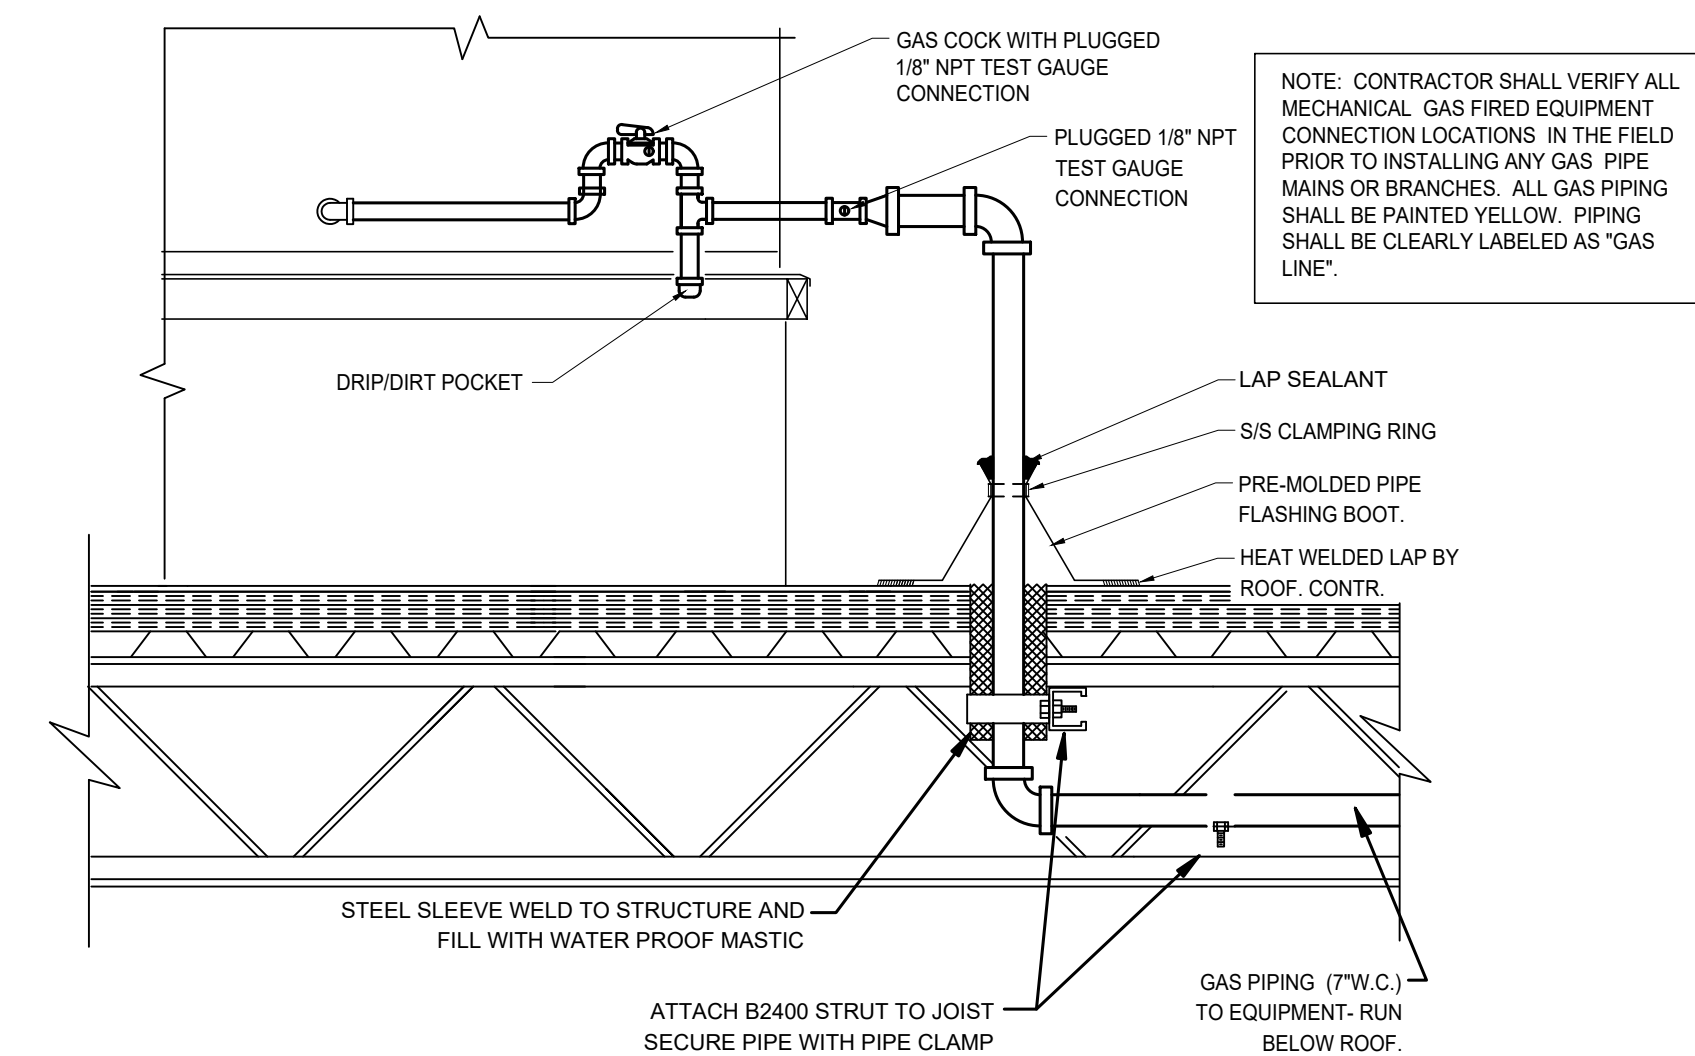

8 ROOFTOP UNIT GAS PIPING DETAIL
SCALE: N.T.S.

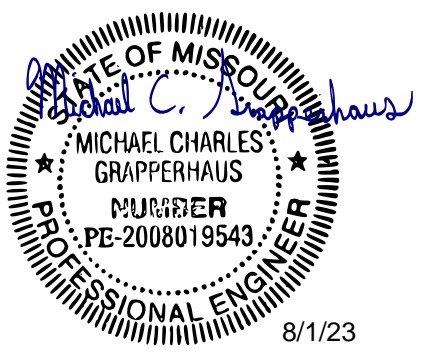

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DESIGNED BY: JST


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PLUMBING
DETAILS

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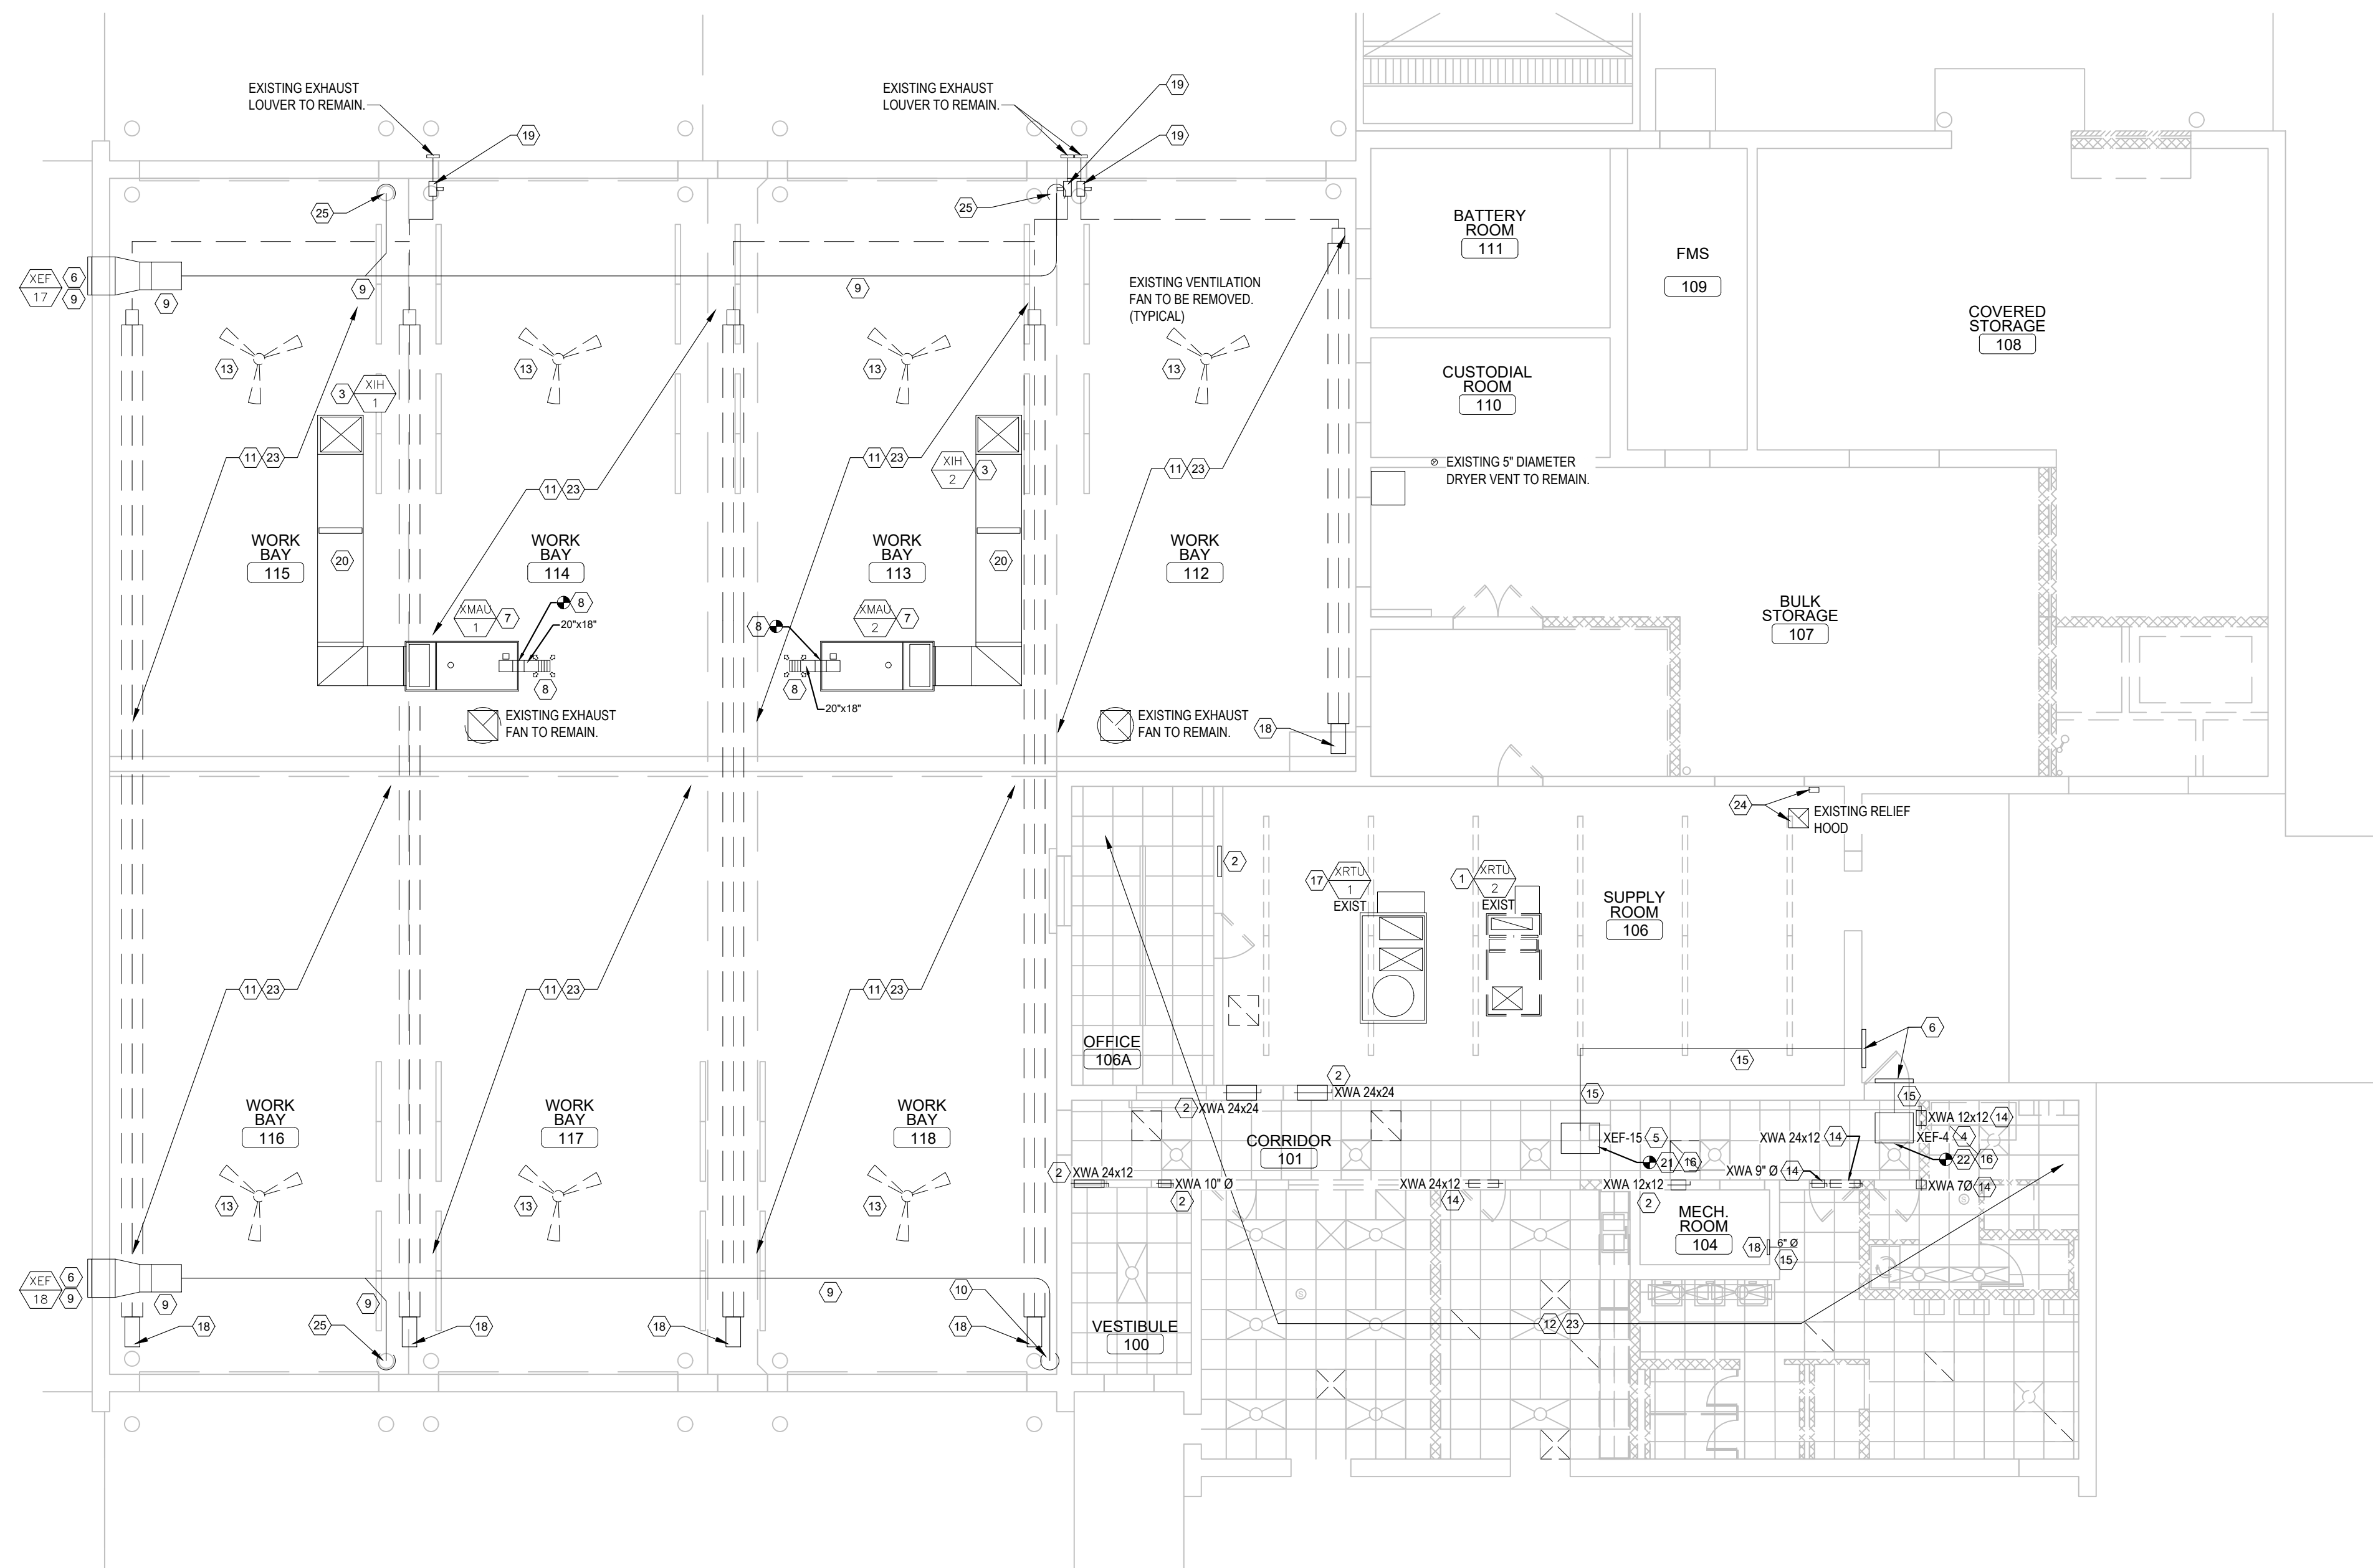
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1
M-101
MECHANICAL FLOOR PLAN
SCALE: 1/8" = 1'-0"
NORTH

- DEMOLITION GENERAL NOTES:**
- DEMOLITION PLAN SHOWS APPROXIMATE LAYOUT OF EXISTING MECHANICAL & PIPING SYSTEMS AND IS NOT INTENDED TO PRESENT "AS-BUILT" CONDITIONS. GC TO VISIT SITE AND OTHERWISE BECOME FAMILIAR WITH ACTUAL CONDITIONS WHEN BIDDING THE WORK.
 - PROVIDE ALL NECESSARY SHORING, BRACING, AND SUPPORT TO PREVENT MOVEMENT, SETTLEMENT, OR COLLAPSE OF STRUCTURE OF ELEMENT TO BE DEMOLISHED, AND ADJACENT STRUCTURE OR ELEMENT SHOWN TO REMAIN. SHORING AND BRACING SHALL BE DESIGNED BY CONTRACTOR'S PROFESSIONAL ENGINEER LICENSED IN THE APPLICABLE JURISDICTION.
 - G.C. TO PROVIDE DUMPSTER & CONTINUOUS CLEAN-UP DURING DEMOLITION TO PROVIDE SAFE AND CLEAN WORK SITE.
 - ALL DIMENSIONS TO BE FIELD VERIFIED AFTER DEMOLITION HAS BEEN COMPLETED. NOTIFY ARCHITECT OF RECORD IMMEDIATELY IF ANY DISCREPANCIES ARE FOUND.
 - EXISTING PARTITIONS, FINISHES, EQUIPMENT AND FIXTURES THAT ARE TO REMAIN ARE TO BE PROTECTED BY THE G.C. THROUGHOUT THE DEMOLITION PROCESS UNLESS NOTED OTHERWISE (I.N.O.)
 - REMOVE ALL EXISTING ELECTRICAL EQUIPMENT ASSOCIATED TO REMOVED HVAC UNITS & PIPING, INCLUDING ELECTRICAL CONDUIT, JUNCTION BOXES, WIRING, ETC. AND ALL RELATED EQUIPMENT THAT WILL NOT BE RE-USED. TYPICAL THROUGHOUT AREA OF WORK. COORDINATE ALL ELECTRICAL WORK WITH ENGINEERING DRAWINGS AND NEW PLANS.
 - VERIFY WITH THE OWNER, PRIOR TO DEMOLITION, ALL REMOVED ITEMS TO BE SALVAGED, STORED, OR THROWN AWAY. REMOVE DEBRIS, RUBBISH AND OTHER MATERIALS RESULTING FROM DEMOLITION OPERATIONS FROM BUILDING SITE. COORDINATE WITH THE OWNER ANY AND ALL NECESSARY SHUTOFF, CAPPING AND CONTINUATION OF UTILITY SERVICES PRIOR TO COMMENCEMENT. THE OWNER ASSUMES NO RESPONSIBILITY FOR ACTUAL CONDITION OF ITEMS OR STRUCTURES TO BE DEMOLISHED.
 - PROMPTLY REPAIR DAMAGES CAUSED BY DEMOLITION TO ANY ADJACENT FACILITIES AT NO COST TO OWNER.
 - DO NOT INTERRUPT EXISTING UTILITIES SERVING ADJACENT FACILITIES. COORDINATE ANY SHUT OFF OR TEMPORARY DISRUPTION WITH CSMS PROJECT MANAGER.
 - DO NOT CLOSE, BLOCK OR OTHERWISE OBSTRUCT STREETS, WALKS OR OTHER FACILITIES OCCUPIED OR USED BY THE GENERAL PUBLIC.
 - COMPLY WITH LOCAL, STATE AND FEDERAL APPLICABLE REGULATIONS.
 - REFER TO ARCHITECTURAL INSTRUCTION FOR ROOF PATCH & REPAIR RELATED TO REMOVAL OF MECHANICAL & PIPING SYSTEMS.

- # KEYED NOTES:**
- REMOVE MAU AND ALL ASSOCIATED COMPONENTS & CONNECTING DUCTWORK. DISCONNECT ELECTRIC SERVICE AND PRESERVE CONDUCTORS FOR RECONNECTION TO NEW EQUIPMENT. DISCONNECT AND REMOVE CONNECTING GAS PIPING. REMOVE CONDENSATE DRAINAGE. ROOF CURB IS TO REMAIN FOR CONTINUED USE.
 - RETURN WALL ASSEMBLY TO REMAIN.
 - EXISTING INTAKE AIR HOODS TO REMAIN IN PLACE FOR CONTINUED USE.
 - EXISTING LOCKER ROOM IN-LINE EXHAUST FAN TO REMAIN FOR REUSE.
 - EXISTING BREAK ROOM IN-LINE EXHAUST FAN TO REMAIN FOR REUSE.
 - EXISTING EXHAUST WALL LOUVERS TO REMAIN FOR CONTINUED USE.
 - EXISTING MAKE-UP AIR UNITS SERVING THE SERVICE BAYS TO REMAIN IN PLACE FOR CONTINUED USE.
 - REMOVE MAU SUPPLY DUCTWORK. STORE EXISTING DUCT-MOUNTED SUPPLY AIR DIFFUSER FOR REUSE, PROTECT FROM DAMAGE.
 - EXISTING VEHICLE EXHAUST SYSTEM (IN-LINE FAN, WALL LOUVER, DUCTWORK), TO REMAIN IN PLACE FOR CONTINUED USE.
 - REMOVE 8" VEHICLE EXHAUST DUCT DROPS & ASSOCIATED COMPONENTS.
 - REMOVE GAS FIRED INFRARED HEATING SYSTEMS AND ALL ASSOCIATED COMPONENTS, TUBING, BURNER HEADS, HANGERS, SUPPORTS. DISCONNECT ELECTRIC SERVICE AND PRESERVE CONDUCTORS FOR RECONNECTION TO NEW EQUIPMENT. DISCONNECT GAS PIPING & PRESERVE FOR RECONNECTION TO NEW EQUIPMENT.
 - REMOVE ALL DUCTWORK, DIFFUSERS, GRILLS, ACCESSORIES.
 - REMOVE AND DISPOSE OF EXISTING CEILING FAN. SEE ELECTRICAL DRAWINGS FOR FURTHER INFORMATION.
 - REMOVE RETURN WALL ASSEMBLY.
 - EXISTING EXHAUST DUCTWORK TO REMAIN FOR CONTINUED USE.
 - REMOVE DUCTWORK FROM FAN INLET. PRESERVE FLANGES AND CONNECTION POINTS FOR RECONNECTION.
 - EXISTING RTU-1 SHALL REMAIN FOR CONTINUED USE. PROTECT FROM DAMAGE.
 - GAS PIPING CONNECTION TO INFRARED HEATING UNIT TO REMAIN FOR RECONNECTION TO NEW EQUIPMENT. SEE PIPING DRAWINGS.
 - REMOVE RADIANT HEATING SYSTEM VACUUM BLOWERS. DISCONNECT ELECTRIC SERVICE AND PRESERVE CONDUCTORS FOR RECONNECTION.
 - DUCTWORK TO REMAIN FOR CONTINUED USE.
 - REMOVE KITCHEN EXHAUST DUCTWORK INCLUDING EXHAUST GRILLS TO EXHAUST FAN INLET. KITCHEN EXHAUST FAN TO AND DISCHARGE DUCTWORK TO REMAIN IN PLACE FOR CONTINUED USE.
 - REMOVE LOCKER ROOM EXHAUST DUCTWORK INCLUDING EXHAUST GRILLS TO EXHAUST FAN INLET. LOCKER ROOM EXHAUST FAN AND DISCHARGE DUCTWORK TO REMAIN IN PLACE FOR CONTINUED USE.
 - REMOVE THERMOSTATS AND ASSOCIATED CONTROLS.
 - REMOVE RELIEF HOOD (RH-20) AND WALL-MOUNTED STATIC PRESSURE CONTROLLER.
 - REMOVE 12" VEHICLE EXHAUST DUCT DROPS & ASSOCIATED COMPONENTS.

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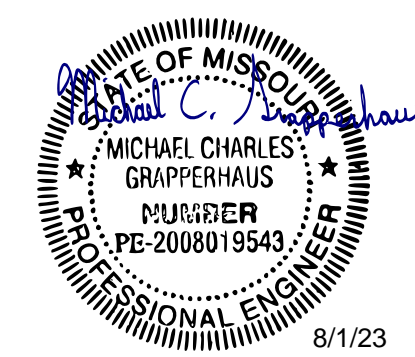
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ISSUE DATE: 08/01/2023

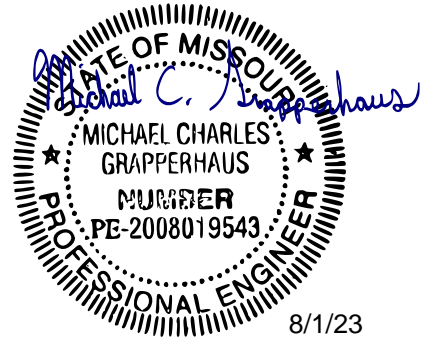CAD DWG FILE: _____
DRAWN BY: MEA
CHECKED BY: JST
DESIGNED BY: JST

SHEET TITLE:

**MECHANICAL
DEMOLITION
PLAN**

SHEET NUMBER:
M-101
08/01/2023
SHEET 21 OF 29



MICHAEL C. GRAPPERHAUS
License Number: PE-2008019543
Expiration Date: 12/31/24
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GAS FIRED RADIANT HEATER SCHEDULE (NEGATIVE PR)

MARK	MANUFACTURER & MODEL	MBH INPUT	THERM EFF	GAS CONN	TUBE SIZE	BURNER TUBE LENGTH	COMBUST CHAMBER LENGTH	RADIANT EMITTER LENGTH	POWER REQUIREMENTS	VACUUM BLOWER DATA	UNIT DIMENSIONS	MOUNTING HEIGHT
RH-1	DETROIT RADIANT PRODUCTS, MODEL: HLV-180	180 / 144	92%	7/8"	4" RND.	66 FT.	10 FT.	66 FT.	120 / 1PH / 2 AMP	REFER TO VACUUM BLOWER SCHEDULE	WIDTH = 18" HEIGHT = 18"	14'-0"
RH-2	DETROIT RADIANT PRODUCTS, MODEL: HLV-120	120 / 96	92%	7/8"	4" RND.	66 FT.	10 FT.	66 FT.	120 / 1PH / 2 AMP	REFER TO VACUUM BLOWER SCHEDULE	WIDTH = 18" HEIGHT = 18"	14'-0"
RH-2	DETROIT RADIANT PRODUCTS, MODEL: HLV-60	60 / 50	92%	7/8"	4" RND.	33 FT.	10 FT.	66 FT.	120 / 1PH / 2 AMP	REFER TO VACUUM BLOWER SCHEDULE	WIDTH = 18" HEIGHT = 18"	14'-0"

ACCEPTABLE MANUFACTURERS FOR EQUIVALENT OF SCHEDULE PRODUCT:
* REFLECT O-RAY (COMBUSTION RESEARCH CORP), SPACE-RAY (GAS-FIRED PRODUCTS, INC), ROBERTS / GORDON, INC.

NOTES:

- HEATERS SHALL BE INSTALLED PER MANUFACTURER'S INSTALLATION INSTRUCTIONS.
- HEATERS SHALL BE CONTROLLED BY A SINGLE OR TWO-STAGE 24-7 PROGRAMMABLE DIGITAL THERMOSTAT, MOUNTED 4'-0" ABOVE THE FINISHED FLOOR. SEE MECHANICAL PLAN FOR LOCATIONS.
- VACUUM BLOWERS SHALL MAINTAIN A CONTINUOUS NEGATIVE PRESSURE DURING OPERATION, THROUGH CONNECTED BURNERS, BURNER TUBES, EMITTERS, BALANCING DAMPERS, AND TAIL PIPE.
- COMBUSTION TUBES: 4" DIA 16 GAUGE TITANIUM ALLOY STEEL TUBES
- EMITTER TUBES: 4" DIA 18 GAUGE ALUMINIZED STEEL TUBES WITH EMISSIVE BLACK COATING (EMISSIVITY = 0.95)
- LINEAR PARABOLIC REFLECTORS ALONG ENTIRE LENGTH OF COMBUSTION CHAMBER & EMITTERS: HIGHLY POLISHED REFLECTIVE SURFACE TO DIVERT RADIANT ENERGY TO THE SPACE & FLOOR
- HOT ROLLED TUBING NOT ALLOWED.
- SINGLE OR TWO-STAGE GAS VALVE, HOT SURFACE IGNITION, DIGITAL BURNER CONTROLS
- FLUE PIPE MATERIAL SHALL BE WELDED SEAM ALUMINIZED STEEL TUBING WITH LONG RADIUS SINGLE PIECE WELDED FITTINGS (ELBOWS & TEES)
- TUBING JOINTS SHALL BE SECURED & SEALED WITH SCREWS AND HIGH TEMPERATURE MASTIC SEALANT.
- WARRANTY: 3-YEAR BURNER CONTROL BOX, 1 YEAR VACUUM PUMP, 5 YEARS COMBUSTION & RADIANT TUBES, 10 YEARS BURNER.

VACUUM BLOWER SCHEDULE (FOR RADIANT HEATERS)

MARK	MANUFACTURER & MODEL	SYSTEM MBH	INLET/OUTLET CONNECTION SIZE	RPM	VOLTS	HP	RLA	UNIT DIMENSIONS	MOUNTING HEIGHT
VF-1	DETROIT RADIANT PRODUCTS, MODEL: PB9B-1PH	280 - 545	4" RND.	3450	208 / 1	3/4	5.0	LENGTH = 19.8" WIDTH = 14.5" HEIGHT = 16.5"	14'-0"
VF-2	DETROIT RADIANT PRODUCTS, MODEL: PB8B-1PH	50 - 275	4" RND.	3450	208 / 1	1/2	3.9	LENGTH = 19.8" WIDTH = 11.0" HEIGHT = 16.5"	14'-0"

ACCEPTABLE MANUFACTURERS FOR EQUIVALENT OF SCHEDULE PRODUCT:
* REFLECT O-RAY (COMBUSTION RESEARCH CORP), SPACE-RAY (GAS-FIRED PRODUCTS, INC), ROBERTS / GORDON, INC.

NOTES:

- VACUUM BLOWERS SHALL BE INSTALLED PER MANUFACTURER'S INSTALLATION INSTRUCTIONS.
- ELECTRICAL CONTRACTOR TO PROVIDE LINE VOLTAGE WIRING TO THE CONTROL RELAY OF THE VACUUM BLOWERS.
- SEE PLAN VIEW FOR VACUUM BLOWER LOCATIONS.
- VACUUM BLOWERS SHALL MAINTAIN A CONTINUOUS NEGATIVE PRESSURE DURING OPERATION, THROUGH CONNECTED BURNERS, BURNER TUBES, EMITTERS, BALANCING DAMPERS, AND TAIL PIPE.
- FLUE PIPE MATERIAL SHALL BE WELDED SEAM ALUMINIZED STEEL TUBING WITH LONG RADIUS SINGLE PIECE WELDED FITTINGS (ELBOWS & TEES)
- TUBING JOINTS SHALL BE SECURED & SEALED WITH SCREWS AND HIGH TEMPERATURE MASTIC SEALANT.
- TEFC MOTOR WITH HEAT SLINGER.
- PRIMARY AIR DAMPER AT INLET TO VACUUM BLOWER
- WARRANTY: 1 YEAR VACUUM BLOWER.

GENERAL NOTES:


- REFER TO SPECIFICATIONS FOR ADDITIONAL REQUIREMENTS.
- THE CONTRACTOR SHALL BE RESPONSIBLE FOR FIELD VERIFICATION OF THE CONTRACT DOCUMENTS. THE ENGINEER AND OWNER SHALL BE NOTIFIED OF ANY UNFORESEEN CONDITIONS WHICH MAY AFFECT PROGRESS OR COST OF WORK PERFORMED.
- THE CONTRACTOR SHALL INCLUDE FURNISHING ALL MATERIAL, EQUIPMENT, TOOLS, LABOR, AND SERVICES NECESSARY FOR COMPLETION OF THE PROJECT.
- THE CONTRACTOR SHALL BE RESPONSIBLE FOR THE QUALITY OF WORKMANSHIP AND FOR COMPLIANCE WITH THE DESIGN.
- THE CONTRACTOR SHALL CORRECT ALL ERRORS AND DEVIATIONS AS REQUESTED BY THE OWNER.
- THE CONTRACTOR SHALL CONTACT THE OWNER/ENGINEER IMMEDIATELY IF ANY WORKER ENCOUNTERS HAZARDOUS MATERIALS.
- THE CONTRACTOR SHALL COORDINATE MECHANICAL DRAWINGS WITH THE ELECTRICAL DRAWINGS AND SPECIFICATIONS BEFORE PROCEEDING WITH THE WORK AND SHALL NOTIFY THE ARCHITECT OF ANY DISCREPANCIES OR CONFLICTS IMMEDIATELY. ALL DISCREPANCIES SHALL BE RESOLVED PRIOR TO THE CONTRACTOR PROCEEDING WITH WORK.
- ALL PRECAUTIONS SHALL BE TAKEN NOT TO DISTURB EXISTING SERVICES AND UTILITIES.
- THERMOSTATS, & REMOTE TEMPERATURE SENSORS SHALL BE MOUNTED AT 6'0" A.F.F.
- ALL COMPONENTS OF HVAC SYSTEM INCLUDING ROOFTOP UNIT, DUCTWORK, DUCTWORK INSULATION, DIFFUSERS, AND GRILLS SHALL BE INSTALLED BY CONTRACTOR.
- INTERNAL DUCT LINER SHALL NOT BE ALLOWED. EXTERIOR WRAP FOR SUPPLY & RETURN DUCT SHALL BE R-4 TWO (2) INCH +/- THICK, 34 LB. DENSITY. ALL DUCTWORK SHALL BE INSULATED IN ACCORDANCE WITH THE LATEST ISSUE OF SMACNA'S AND NESCA'S MINIMUM INSTALLATION STANDARDS.
- ALL COMPONENTS OF THE NEW GAS FIRED INFRARED HEATING SYSTEMS (SEVEN) SHALL BE INSTALLED BY A FACTORY-TRAINED CONTRACTOR IN ACCORDANCE WITH MANUFACTURERS INSTALLATION INSTRUCTIONS.
- BID ALTERNATE #1: ALL COMPONENTS OF THE NEW VEHICLE EXHAUST HOSE REELS & ACCESSORIES (SEVEN) SHALL BE INSTALLED BY A FACTORY-TRAINED CONTRACTOR IN ACCORDANCE WITH MANUFACTURERS INSTALLATION INSTRUCTIONS.
- DATUM SYMBOL INDICATES POINT OF NEW TO EXISTING CONNECTION. PROVIDE TRANSITION AS REQUIRED FOR NEW DUCT CONNECTION.

KEYED NOTES:

- INSTALL NEW ROOFTOP UNIT (RTU-2) AT OR NEAR LOCATION WHERE HEATING & VENTILATING UNIT HAD BEEN REMOVED. RE USE EXISTING CURB, INSTALL NEW CURB ADAPTER. INSTALL FULL SIZE SUPPLY AND RETURN DUCT DROPS. MAKE CONNECTIONS OF GAS PIPING AS SHOWN ON PLUMBING DRAWINGS. PROVIDE A MINIMUM SERVICE CLEARANCE OF 4 FEET BETWEEN RTU-1 (EXISTING) AND RTU-2 (NEW).
 - RETURN WALL ASSEMBLY TO REMAIN.
 - EXISTING INTAKE AIR HOODS TO REMAIN IN PLACE FOR CONTINUED USE.
 - EXISTING IN-LINE EXHAUST FAN. SERVICE FAN FOR CONTINUED USE. BALANCE AIR FLOW TO VALUE INDICATED IN EQUIPMENT SCHEDULE. FAN SHALL BE ELECTRICALLY INTERLOCKED WITH DOAS-2. SEE SEQUENCE OF OPERATION.
 - EXISTING IN-LINE EXHAUST FAN. SERVICE FAN FOR CONTINUED USE. REDUCE AIR FLOW TO VALUE INDICATED IN EQUIPMENT SCHEDULE.
 - EXISTING EXHAUST FAN LOUVERS TO REMAIN FOR CONTINUED USE.
 - EXISTING MAKE-UP AIR UNITS SERVING THE SERVICE BAYS TO REMAIN IN PLACE FOR CONTINUED USE.
 - REMOVE EXISTING SUPPLY DUCTWORK, REPLACE WITH NEW DUCTWORK FOR STRUCTURAL CLEARANCE. REUSE EXISTING SUPPLY LOUVER.
 - EXISTING VEHICLE EXHAUST SYSTEM (IN-LINE FAN, WALL LOUVER, DUCTWORK). SERVICE FOR CONTINUED USE.
 - BID ALTERNATE #1: REMOVE VERTICAL DUCT DROP. INSTALL NEW HOSE REEL ASSEMBLY CONSISTING OF THREE COMPONENTS (VE-1, VE-2, VE-3). REFER TO VEHICLE EXHAUST EQUIPMENT SCHEDULE ON SHEET M-601.
 - INSTALL NEW GAS FIRED INFRARED HEATING SYSTEM TO REPLACE EXISTING, CONSISTING OF: BURNER HEAD, INFRARED TUBULAR ASSEMBLY, VACUUM PRODUCER, WALL EXHAUST TERMINATION. SEE SCHEDULE ON THIS SHEET.
 - NOT USED
 - NOT USED
 - REMOVE RETURN WALL ASSEMBLY.
 - EXISTING EXHAUST DUCTWORK TO REMAIN FOR CONTINUED USE.
 - INSTALL NEW DUCTWORK FROM EXISTING FAN INLET.
 - EXISTING RTU-1 SHALL BE SERVICED AS NECESSARY TO RESTORE PERFORMANCE & CONDITION TO LIKE-NEW STATUS.
 - BALANCE EXISTING EXHAUST THROUGH GRILLE TO 100 CFM
 - REPLACE RADIANT HEATING SYSTEM VACUUM FANS WITH NEW VACUUM FANS AT ELEVATION OF THE EXISTING FANS.
 - INSTALL PRESSURE WASHER FLUE EXHAUST, 6" DIAMETER, AGACSA TYPE B GAS FLUE PIPE WITH ACCESSORIES AND WALL CAP. WALL CAP ELEVATION TO BE 8 FEET ABOVE PAVEMENT.
 - INSTALL THERMOSTATS AT 4 FT. AFF. ATTACH TO WALL.
 - INSTALL SHEETMETAL SHIELDS TO BOTTOM OF INFRARED REFLECTOR TO PROTECT PROCESS EQUIPMENT, 4 LOCATIONS. SHIELDS SHALL BE OF PROPER LENGTH THE PREVENT HEAT DAMAGE TO DISPENSING SYSTEMS.
- IF REQUIRED, RELOCATION OF EXISTING SERVICE BAY EQUIPMENT TO BE ACCOMPLISHED BY NATIONAL GUARD STAFF, FINAL SERVICE CONNECTIONS SHALL BE DONE BY G.C. SEE ELECTRICAL DWGS.

KEYED NOTES:

- PROVIDE DUCT RISERS AND DROPS AS REQUIRED FOR FIELD INSTALLATION AND TRADE COORDINATION. NOTIFY OWNER'S REPRESENTATIVE OF DISCREPANCIES BEFORE STARTING WORK.
- DRAWINGS FOR HVAC WORK ARE DIAGRAMMATIC, SHOWING THE GENERAL LOCATION, TYPE, LAYOUT, AND EQUIPMENT REQUIRED. THE DRAWINGS SHALL NOT BE SCALED FOR EXACT MEASUREMENT. REFER TO MANUFACTURER'S STANDARD INSTALLATION DRAWINGS FOR EQUIPMENT CONNECTIONS AND INSTALLATION REQUIREMENTS. PROVIDE DUCTWORK, CONNECTIONS, ACCESSORIES, OFFSETS, AND MATERIALS NECESSARY FOR A COMPLETE SYSTEM.
- ALL WORK SHALL COMPLY WITH STATE CODE REQUIREMENTS.
- USE OF COMBUSTIBLE MATERIALS IS NOT ALLOWED IN THE CEILING SPACE. MATERIALS USED IN THE CEILING SPACE SHALL HAVE FLAME SPREAD RATING NOT TO EXCEED 25, AND SMOKE DEVELOPED RATING NOT TO EXCEED 50 WHEN TESTED IN ACCORDANCE WITH ASTM E 84. ALL EXPOSED WIRING IN THE CEILING SPACE PLENUM SHALL BE CEILING PLENUM RATED.
- INSULATE NEW SUPPLY DUCTWORK WITH MINIMUM 1-1/2" THICK FOIL-BACKED DUCT WRAP.
- WITHIN THE OFFICE AND LOCKER ROOM (LATRINE) AREAS, EQUIVALENTLY SIZED RECTANGLE DUCTWORK IS ALLOWED IN LIEU OF ROUND DUCTWORK. DUCTWORK SHALL BE SIZED FOR MAXIMUM PRESSURE DROP OF 0.08"W/100 FT OF DUCT, AND MAXIMUM VELOCITY NOT TO EXCEED 1500 FPM.
- ALL NEW DUCTWORK AND DUCTWORK FITTINGS & TRANSITIONS SHALL BE IN ACCORDANCE TO THE REQUIREMENTS OF SMACNA DUCT CONSTRUCTION STANDARDS.
- CONTRACTOR SHALL FIELD VERIFY ALL BUILDING CONDITIONS AND HVAC EQUIPMENT, IN ENTIRETY, PRIOR TO COMMENCING WITH WORK. NOTIFY OWNER'S REPRESENTATIVE OF ALL POSSIBLE CONFLICTS UPON VERIFICATION OF FIELD CONDITIONS.
- CONTRACTOR SHALL PROVIDE A TEST AND BALANCE REPORT OF THE ASSOCIATED HVAC SYSTEMS UPON COMPLETION OF THE PROJECT. ANY DIFFUSER AIR FLOW DISCREPANCIES FROM THE REPORT SHALL BE FIXED BY THE CONTRACTOR.
- FLEXIBLE INSULATED DUCT PERMITTED ONLY ABOVE LAY-IN CEILINGS, AND SHALL NOT BE A SUBSTITUTE FOR HARD-DUCT 90 DEG ELBOWS. MAXIMUM LENGTH OF INSULATED FLEX DUCT SHALL NOT EXCEED 5 FEET.

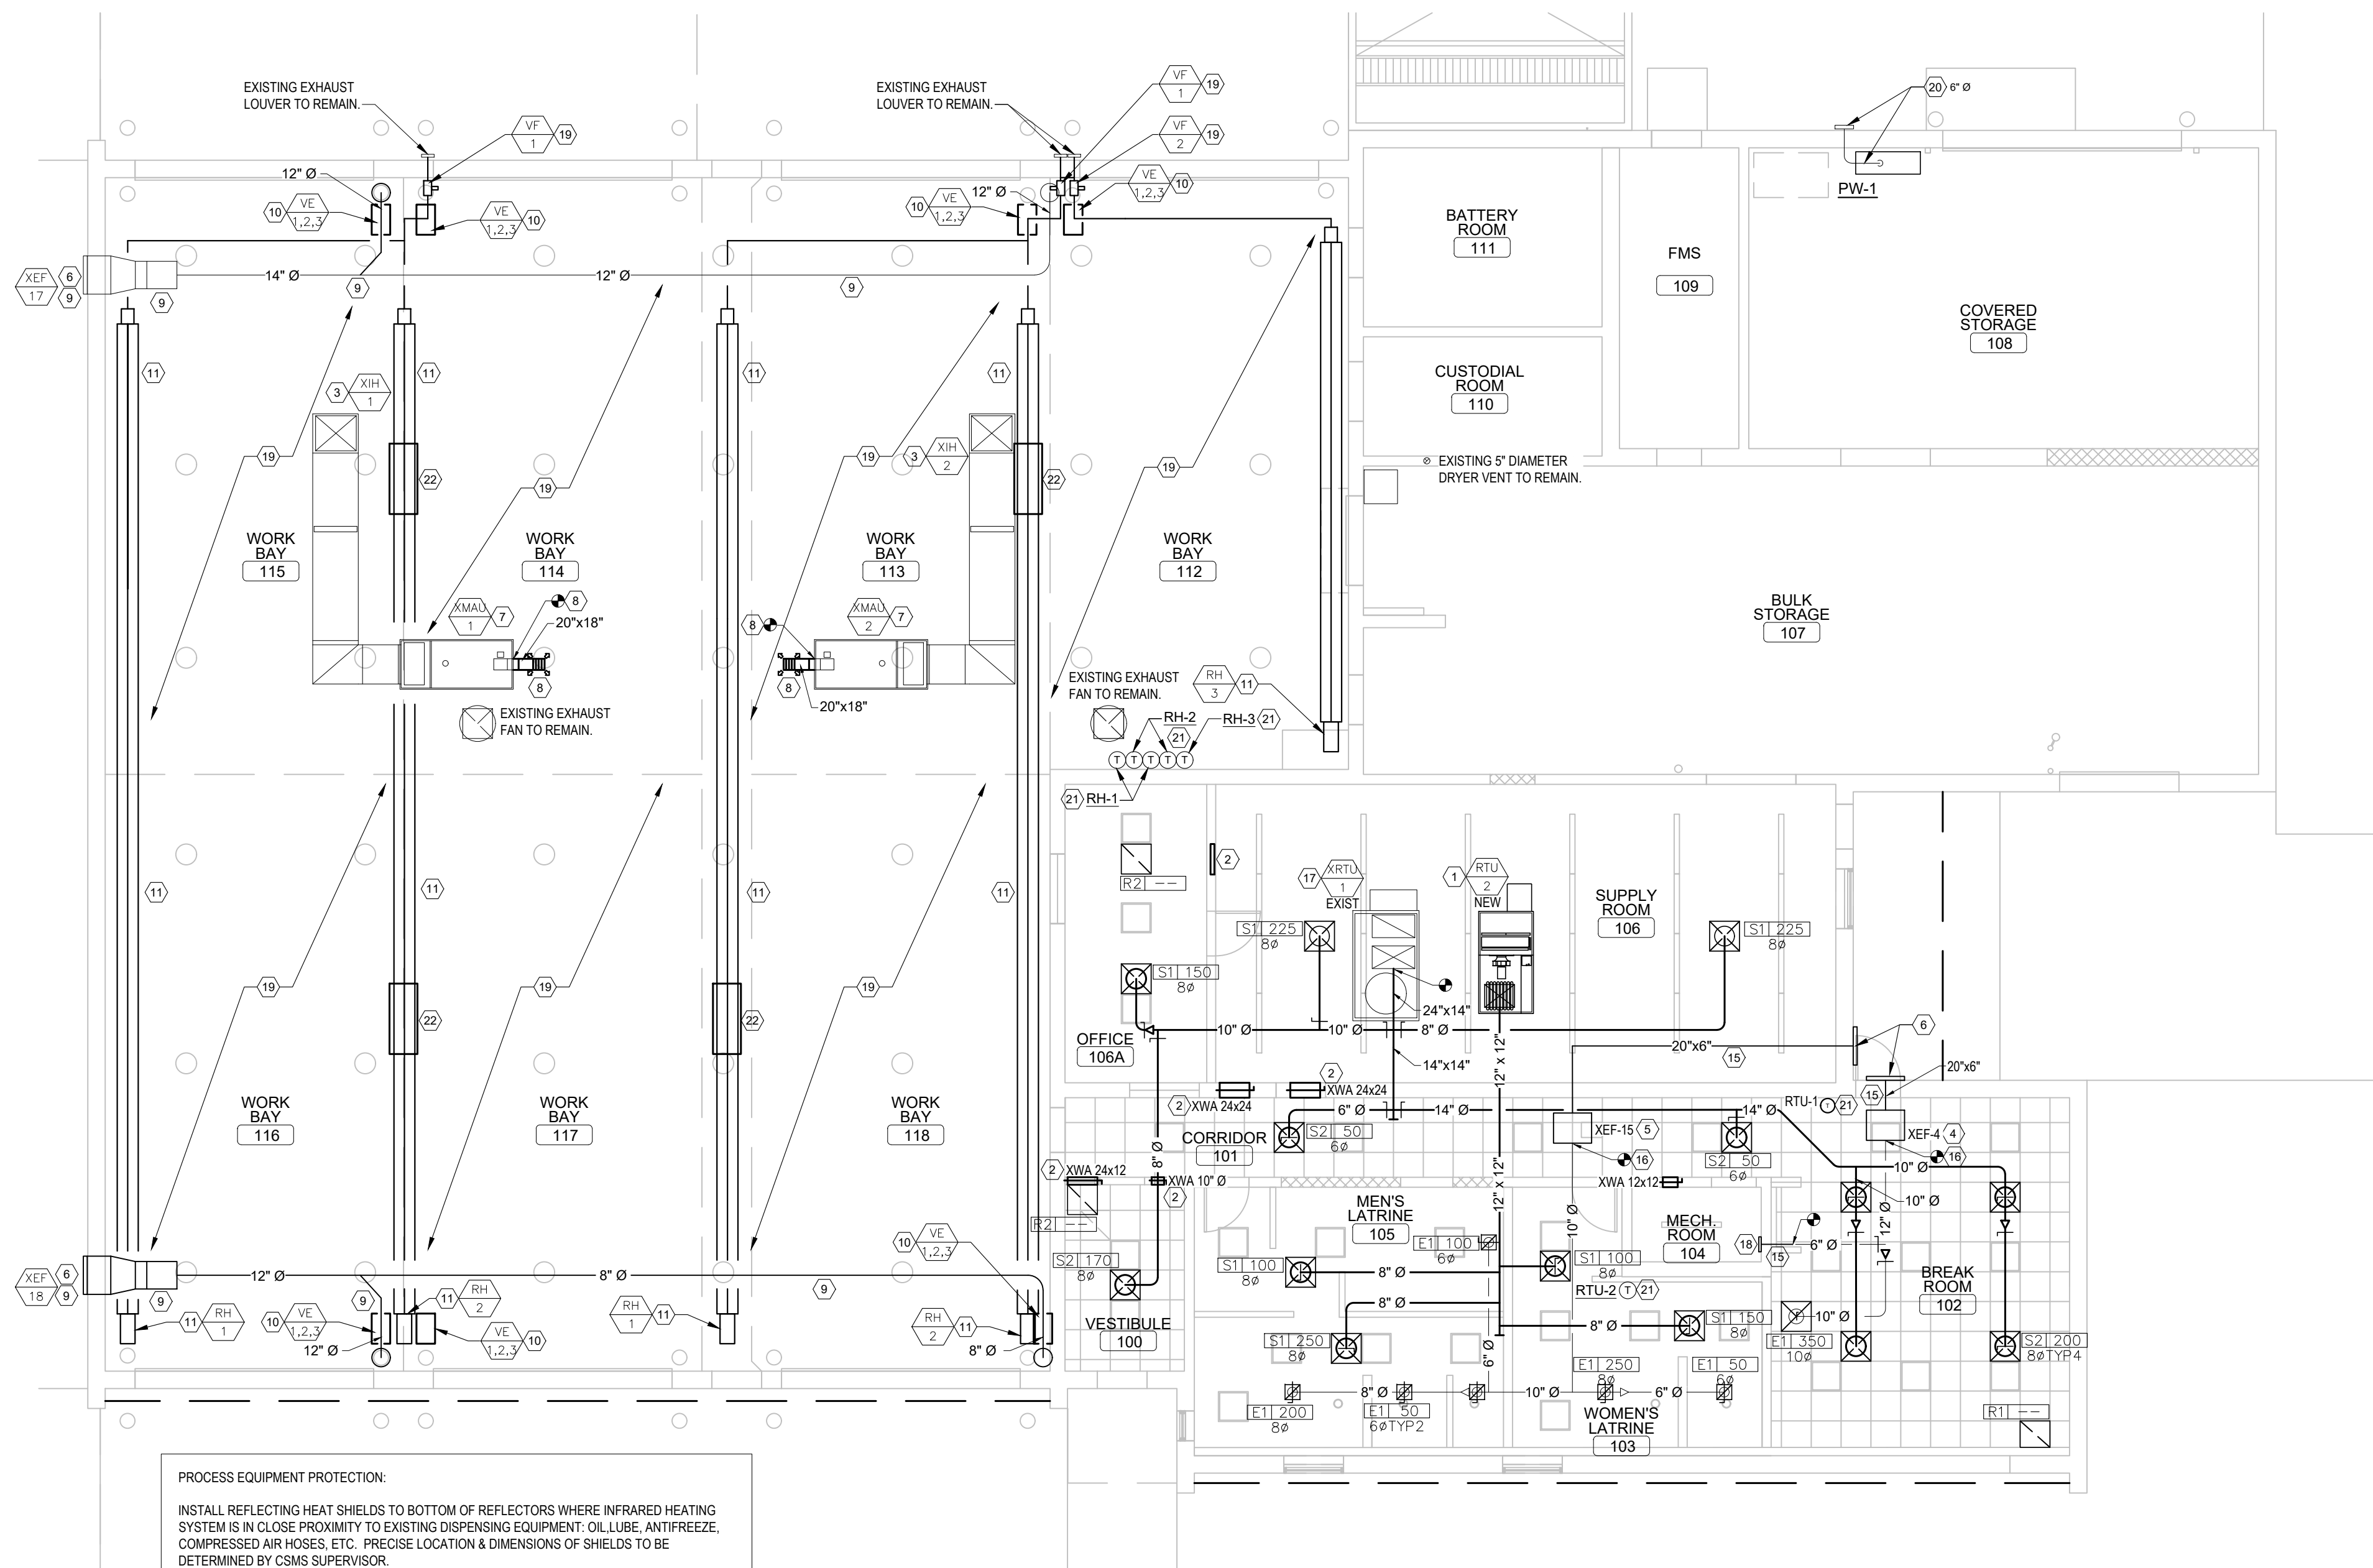

MECHANICAL FLOOR PLAN
SCALE: 1/8" = 1'-0"
NORTH

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CONSTRUCTION**

**MISSOURI NATIONAL
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RENOVATE COMBINED
SUPPORT MAINTENANCE
SHOP (CSMS) ANNEX
COMBINED SUPPORT
MAINTENANCE SHOP (CSMS)
2302 MILITIA DRIVE
JEFFERSON CITY, MISSOURI
65101

PROJECT # T2122-01
SITE # 6300
ASSET# 8136300017


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DATE: _____
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DATE: _____
ISSUE DATE: 08/01/2023

CAD DWG FILE:
DRAWN BY: MEA
CHECKED BY: JST
DESIGNED BY: JST

SHEET TITLE:

**MECHANICAL
FLOOR PLAN**

SHEET NUMBER:
M-102
08/01/2023
SHEET 22 OF 29

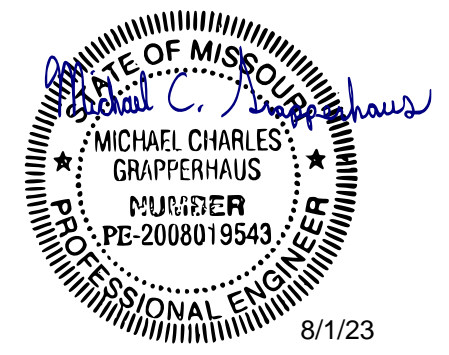

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MECHANICAL
ROOF PLAN

SHEET NUMBER:

M-103


08/01/2023
SHEET 23 OF 29

KEYED NOTES:


- 1 NEW RTUS ARE TO BE MOUNTED ON CURB ADAPTER. SUPPLY AND RETURN DUCTWORK UP TO RTU SHALL BE FULL SIZE OF RTU CURB DUCT OPENING. TRANSITIONS SHALL BE MADE IN VERTICAL DROP TO MATCH DIMENSIONS OF DUCTWORK SHOWN ON MECHANICAL DRAWINGS IN ACCORDANCE WITH SMACNA STANDARDS. BOTTOM AND SIDES OF ROOF CURBS TO BE INSULATED WITH R-19 BATT INSULATION. SEE DETAILS ON SHEET M-501 FOR ADDITIONAL INFORMATION.
- 2 SMOKE DETECTORS FOR ROOFTOP UNITS SHALL BE LOCATED WITHIN SUPPLY AIR PLENUM AND SHALL DE-ACTIVATE RTU UPON SENSING SMOKE AND SHALL BE TIED INTO BUILDING'S FIRE ALARM CONTROL PANEL WITH SUPERVISORY SIGNAL. WIRING BY CONTRACTOR. REFER TO ELECTRICAL DRAWINGS FOR ADDITIONAL INFORMATION.
- 3 EXISTING ROOFTOP UNIT (XRTU-1) AND ROOFTOP UNIT (RTU-2) ARE ENABLED/DISABLED VIA EXISTING TIMECLOCK. CONTRACTOR SHALL MAKE FINAL CONTROLS CONNECTIONS AND PROVIDE UNIT OPERATIONAL CHECK-OUT.
- 4 CONTRACTOR TO PROVIDE 12" HIGH REFLECTIVE UNIT NUMBERS WITH THE SPECIFIC RTU # TO BE POSTED ON EACH UNIT ON THE CONTROL PANEL DOOR AND SIDE WITH THE DISCONNECT SWITCH IN A LOCATION VISIBLE FROM THE ROOF HATCH.
- 5 EXISTING 5"Ø DRYER VENT THROUGH THE ROOF TO REMAIN.
- 6 FOR EXISTING ROOFTOP UNIT (XRTU-1), APPLY NEW EQUIPMENT LABEL FROM EQUIPMENT MANUFACTURER, PER INSTRUCTIONS FROM THE EQUIPMENT SCHEDULE ON SHEET M801.
- 7 EXISTING OUTSIDE AIR INTAKE TO REMAIN.
- 8 CONTRACTOR IS RESPONSIBLE FOR PROCUREMENT AND INSTALLATION OF THIS UNIT, ASSOCIATED COMPONENTS, ALL DUCTWORK & ROOF FRAMING, AND ALL ROOF STRUCTURAL MODIFICATIONS AS NEEDED TO SUPPORT NEW UNIT. REFER TO ALL EQUIPMENT SCHEDULES & DETAILS PERTAINING TO THIS PIECE OF EQUIPMENT.
- 9 EXISTING ROOF DRAIN TO REMAIN.

GENERAL NOTES:

1. REFER TO SPECIFICATIONS FOR ADDITIONAL REQUIREMENTS.
2. THE CONTRACTOR SHALL BE RESPONSIBLE FOR FIELD VERIFICATION OF THE CONTRACT DOCUMENTS. THE ENGINEER AND OWNER SHALL BE NOTIFIED OF ANY UNFORESEEN CONDITIONS WHICH MAY AFFECT PROGRESS OR COST OF WORK PERFORMED.
3. THE CONTRACT WORK SHALL INCLUDE FURNISHING ALL MATERIAL, EQUIPMENT, TOOLS, LABOR, AND SERVICES NECESSARY FOR COMPLETION OF THE PROJECT.
4. THE CONTRACTOR SHALL BE RESPONSIBLE FOR THE QUALITY OF WORKMANSHIP AND FOR COMPLIANCE WITH THE DESIGN.
5. THE CONTRACTOR SHALL CORRECT ALL ERRORS AND DEVIATIONS AS REQUESTED BY THE OWNER.
6. THE CONTRACTOR SHALL CONTACT THE OWNER/ENGINEER IMMEDIATELY IF ANY WORKER ENCOUNTERS HAZARDOUS MATERIALS.
7. THE CONTRACTOR SHALL COORDINATE MECHANICAL DRAWINGS WITH THE ELECTRICAL DRAWINGS AND SPECIFICATIONS BEFORE PROCEEDING WITH THE WORK AND SHALL NOTIFY THE ARCHITECT OF ANY DISCREPANCIES OR CONFLICTS IMMEDIATELY. ALL DISCREPANCIES SHALL BE RESOLVED PRIOR TO THE CONTRACTOR PROCEEDING WITH WORK.
8. ALL PRECAUTIONS SHALL BE TAKEN NOT TO DISTURB EXISTING SERVICES AND UTILITIES.

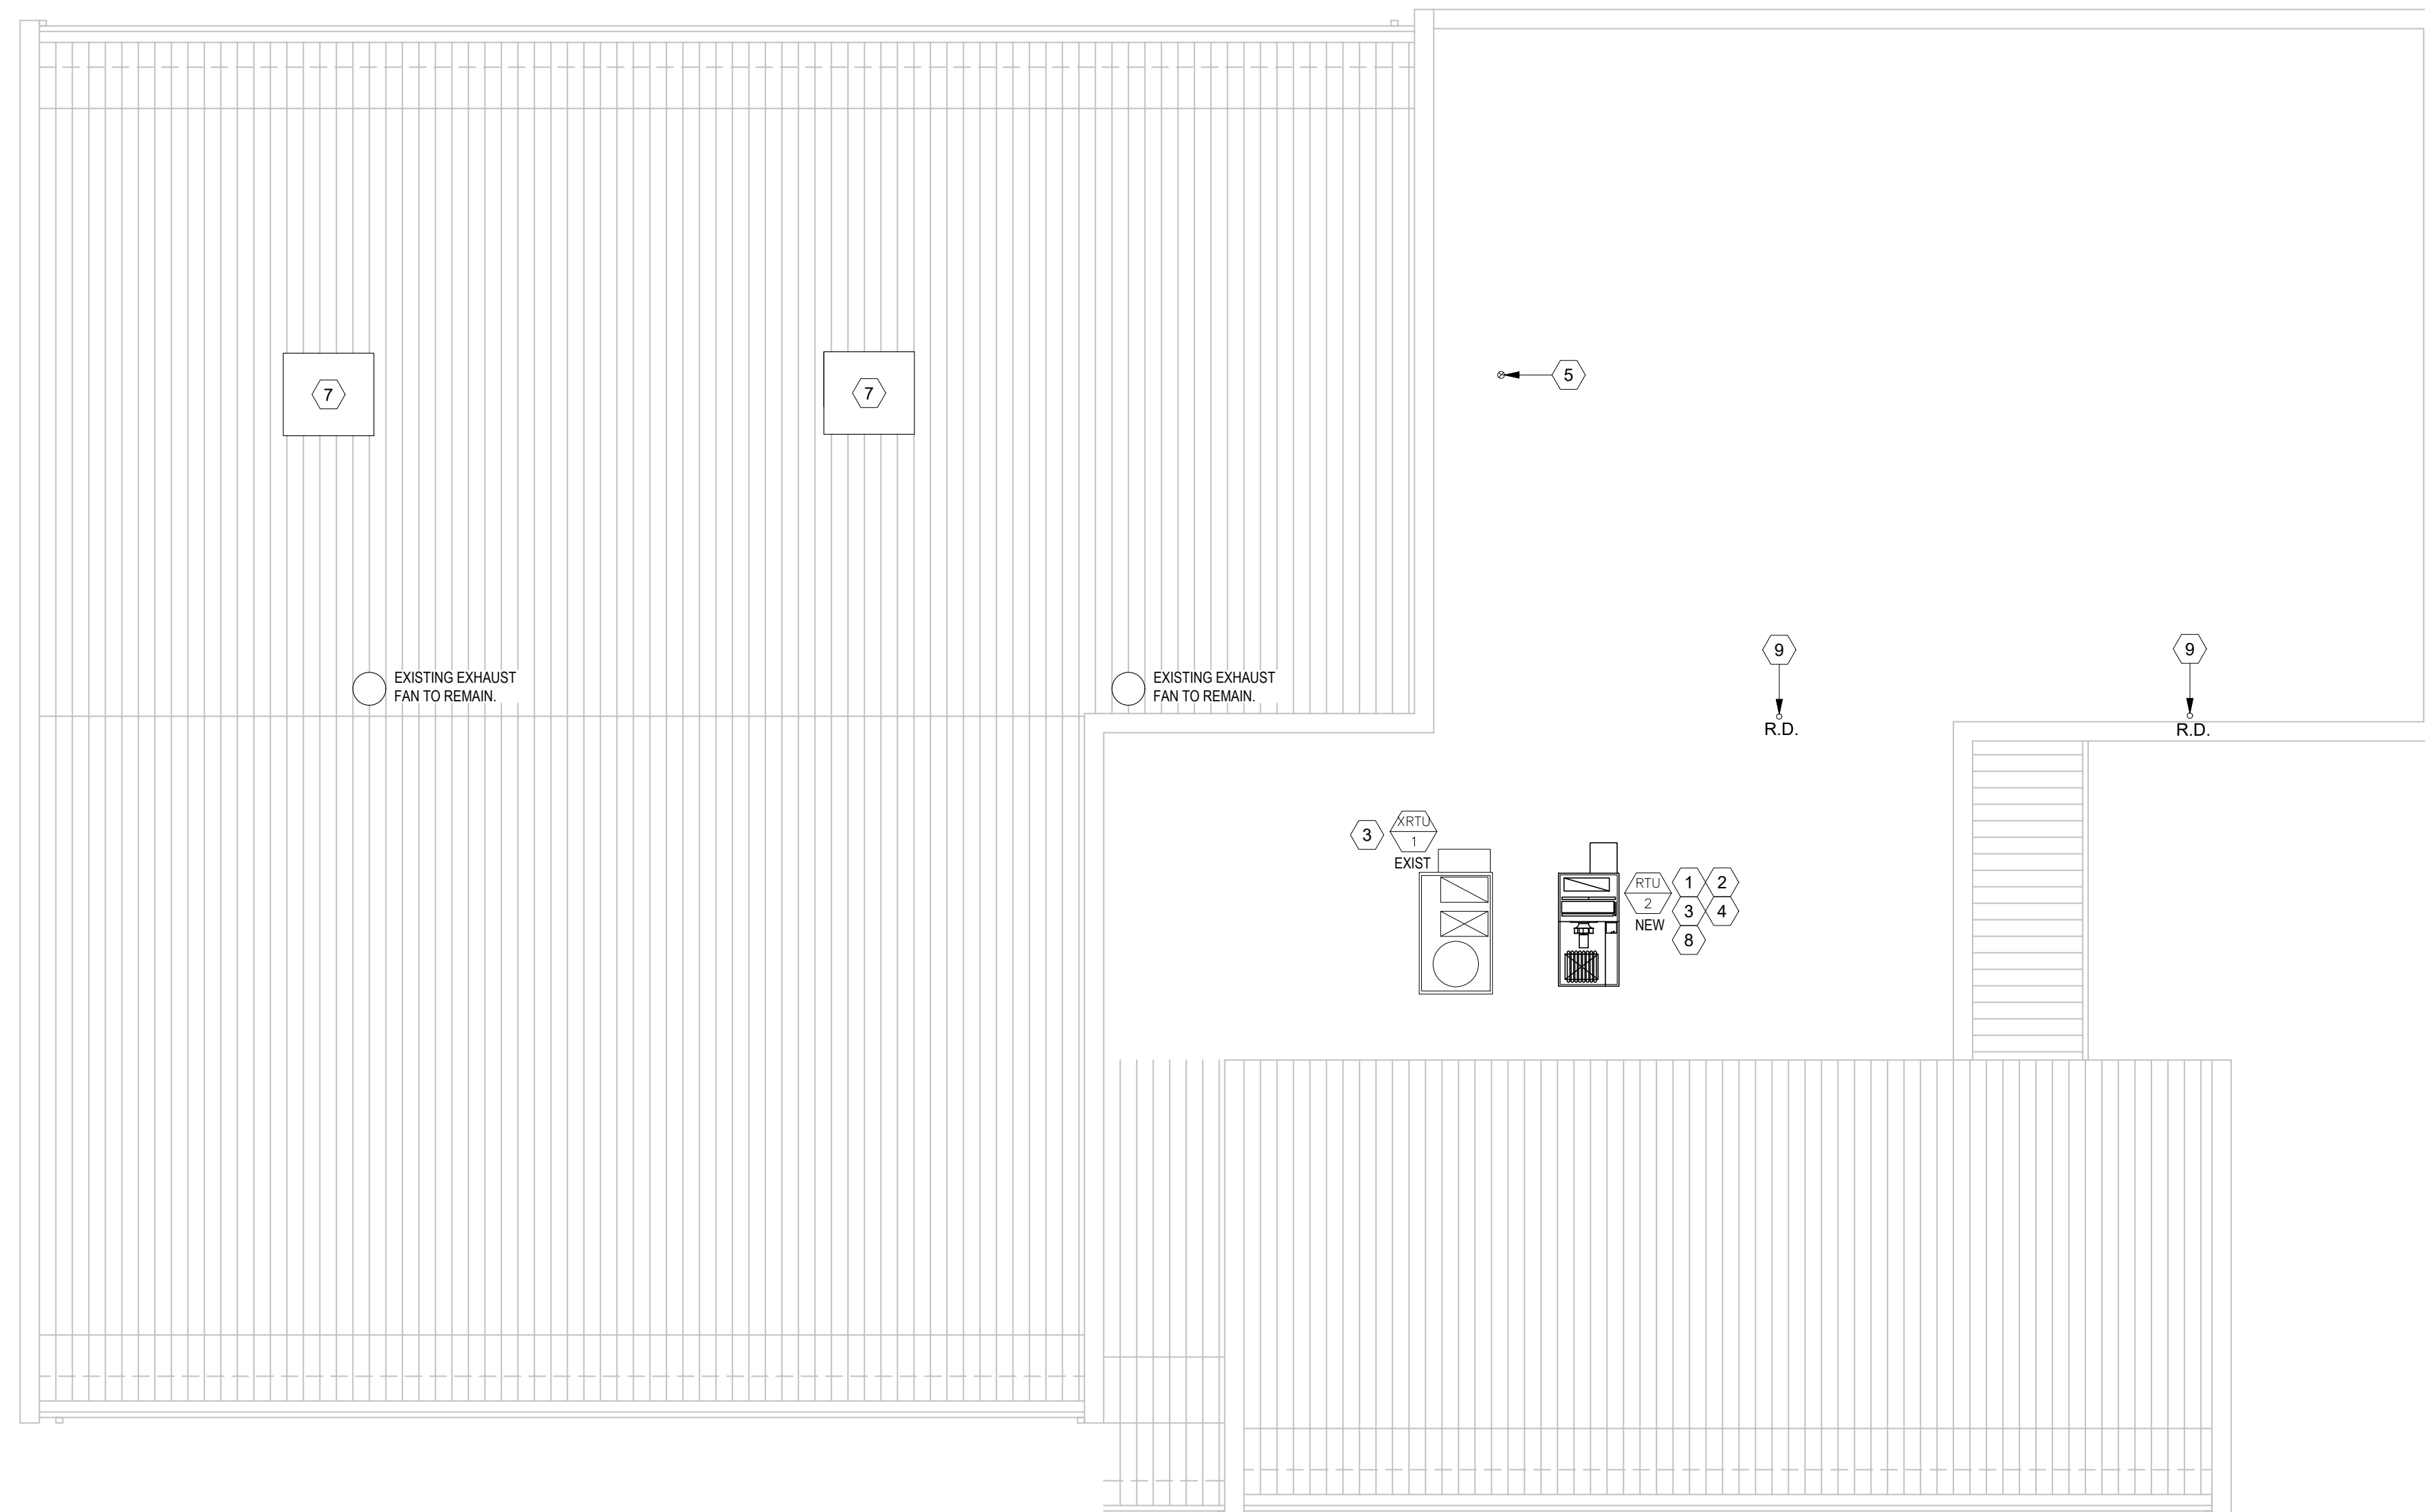

1
M-102
SCALE: 1/8" = 1'-0"
NORTH

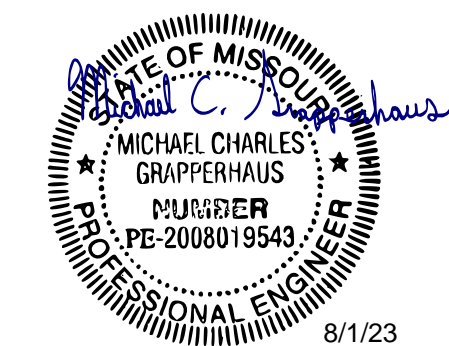


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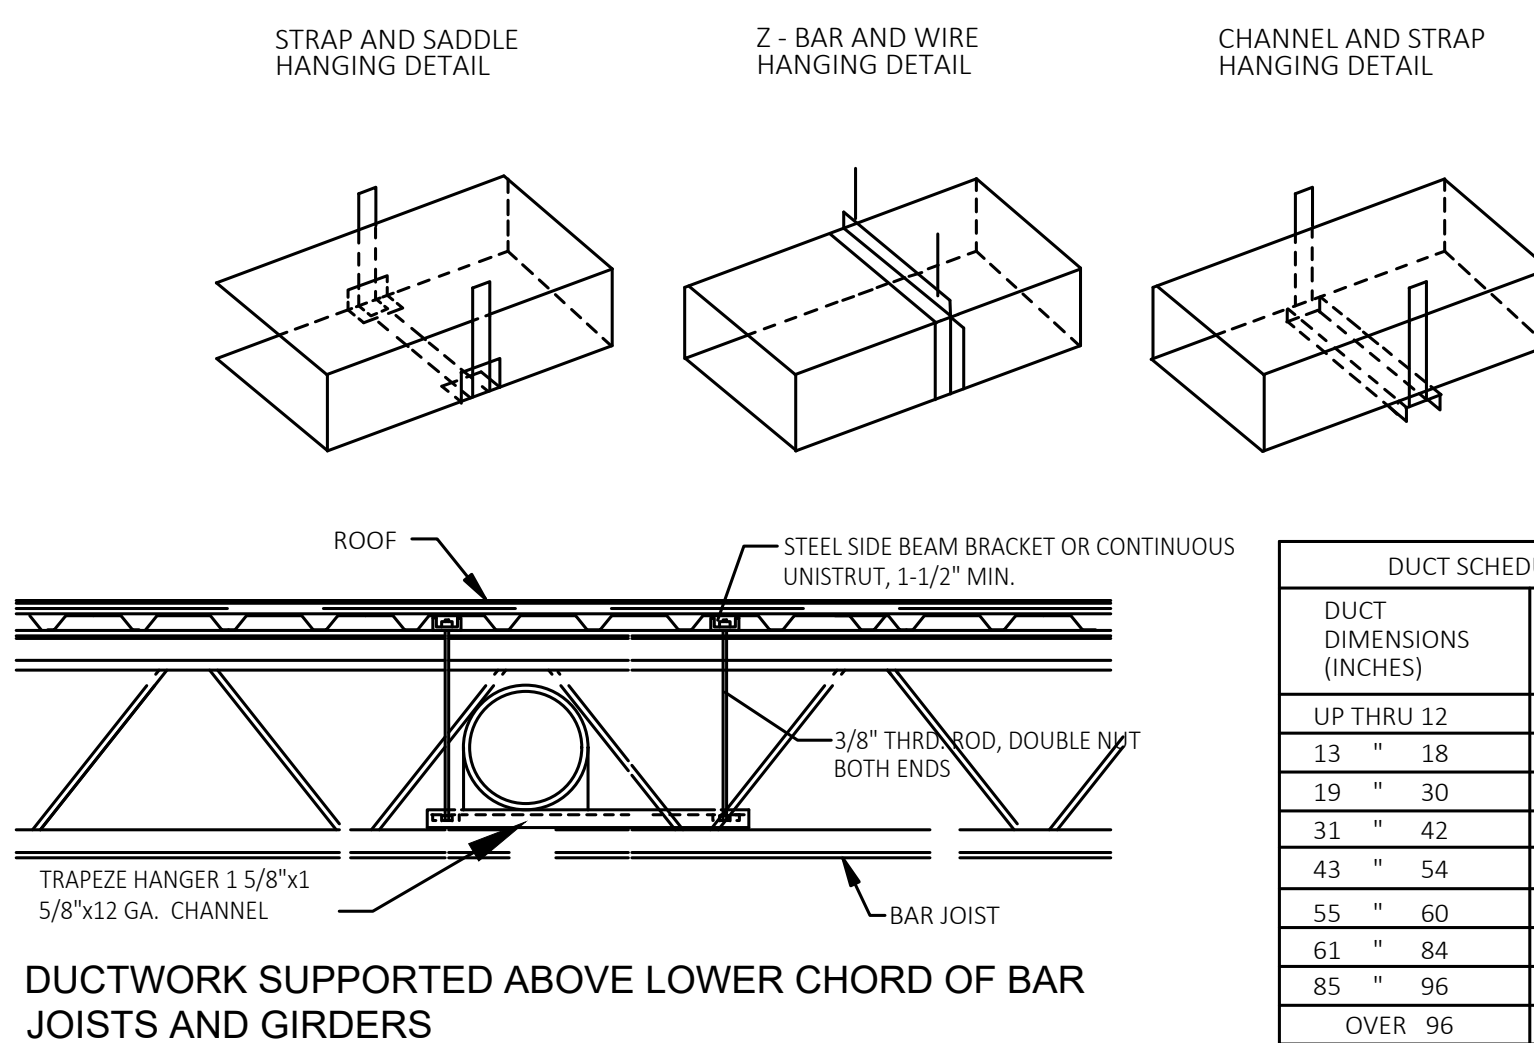
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NOTES FOR THIS DRAWING

- FLEXIBLE DUCTS SHALL BE INSTALLED TO PROVIDE SWEEPING CONFIGURATION WITH NOT LESS THAN MANUFACTURER'S RECOMMENDED BEND RADIUS WITHOUT UNDUE RESTRICTIONS, BUT NOT CREATING UNNECESSARY SAGS OR CURVES. FLAT BANDING MATERIAL NOT LESS THAN 1-1/2" WIDE SHALL BE USED TO SUSPEND FLEXIBLE DUCTS. DUCTING FURNISHED WITH FACTORY INSTALLED GROMMETS SHALL BE SUSPENDED BY WIRES ATTACHED TO GROMMETS. REFER TO PROJECT MANUAL.
- CONTRACTOR SHALL SUBMIT A CERTIFIED TESTING AND AIR BALANCE REPORT BASED ON THE EQUIPMENT DESIGNATIONS. SEE PROJECT MANUAL SECTION 15500.
- CONTRACTOR SHALL VERIFY FIELD CONDITIONS PRIOR TO ORDERING ANY MATERIALS OR FABRICATING ANY DUCTWORK. CONTRACTOR SHALL NOTIFY ENGINEER PRIOR TO BEGINNING WORK IF FIELD CONDITIONS PROHIBIT INSTALLATION OF EQUIPMENT AND DUCTWORK PER THE DRAWINGS AND SPECIFICATIONS.
- FAILURE TO INSTALL THE EQUIPMENT AND DUCTWORK PER THE DRAWINGS AND SPECIFICATIONS MAY RESULT IN EXCESSIVE DUCT PRESSURE LOSS AND INSUFFICIENT AIR FLOW.
- THE CONTRACTOR SHALL ASSUME FULL RESPONSIBILITY FOR DEVIATIONS FROM THE DRAWINGS AND SPECIFICATIONS NOT APPROVED BY THE ENGINEER. THIS SHALL INCLUDE ALL COSTS ASSOCIATED WITH BRINGING THE EQUIPMENT AND DUCTWORK INTO COMPLIANCE WITH THE DESIGN STANDARDS.




5 DUCT CONSTRUCTION DETAILS
SCALE: 1/4" = 1'-0"

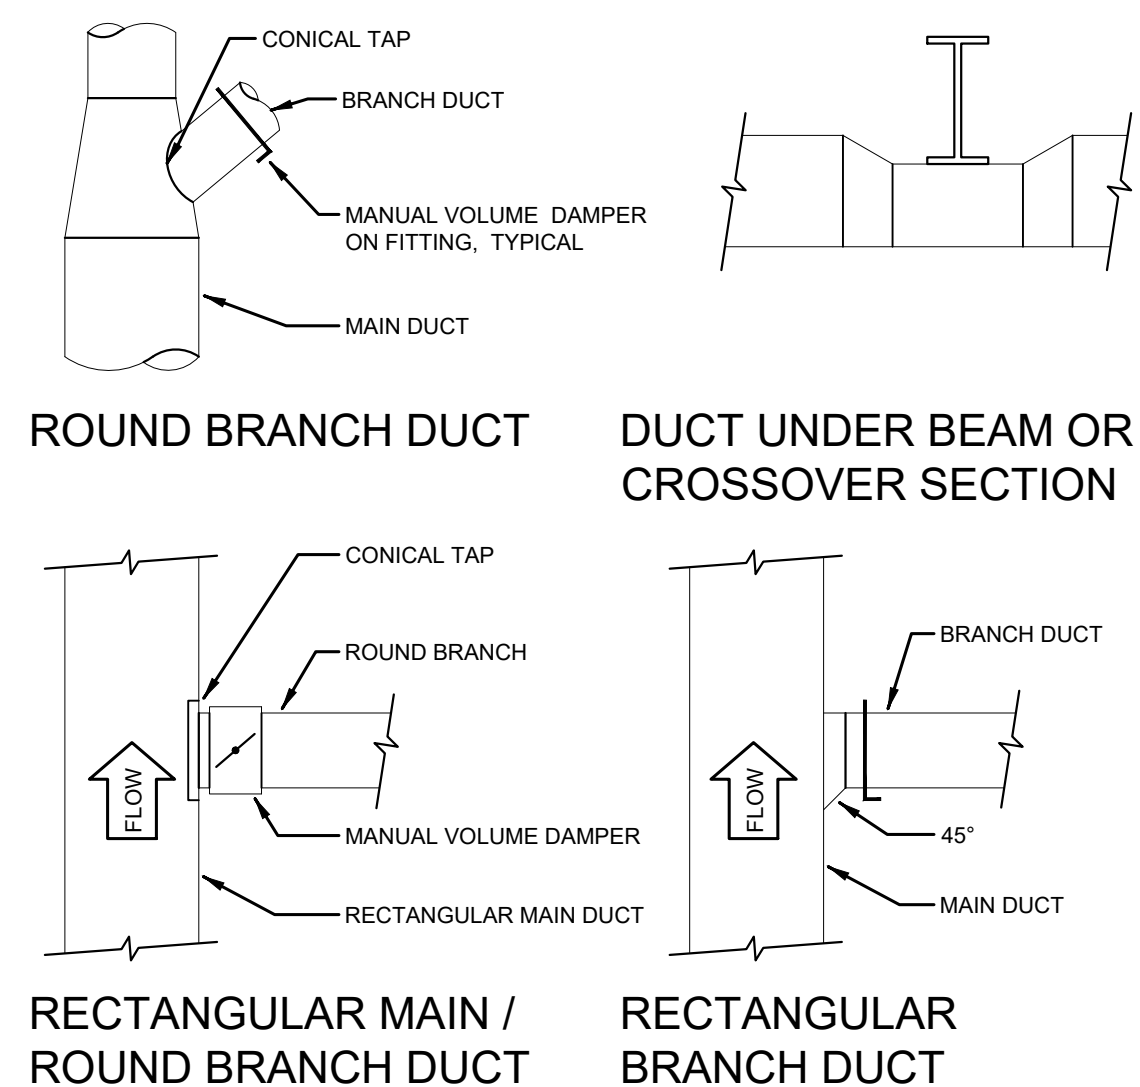


DUCT DIMENSIONS (INCHES)	TYPE HANGER
UP THRU 12	A
13 " 18	A
19 " 30	A/B
31 " 42	B
43 " 54	B
55 " 60	B
61 " 84	C
85 " 96	C
OVER 96	D


4 DUCTWORK SUPPORT DETAILS
SCALE: 1/4" = 1'-0"

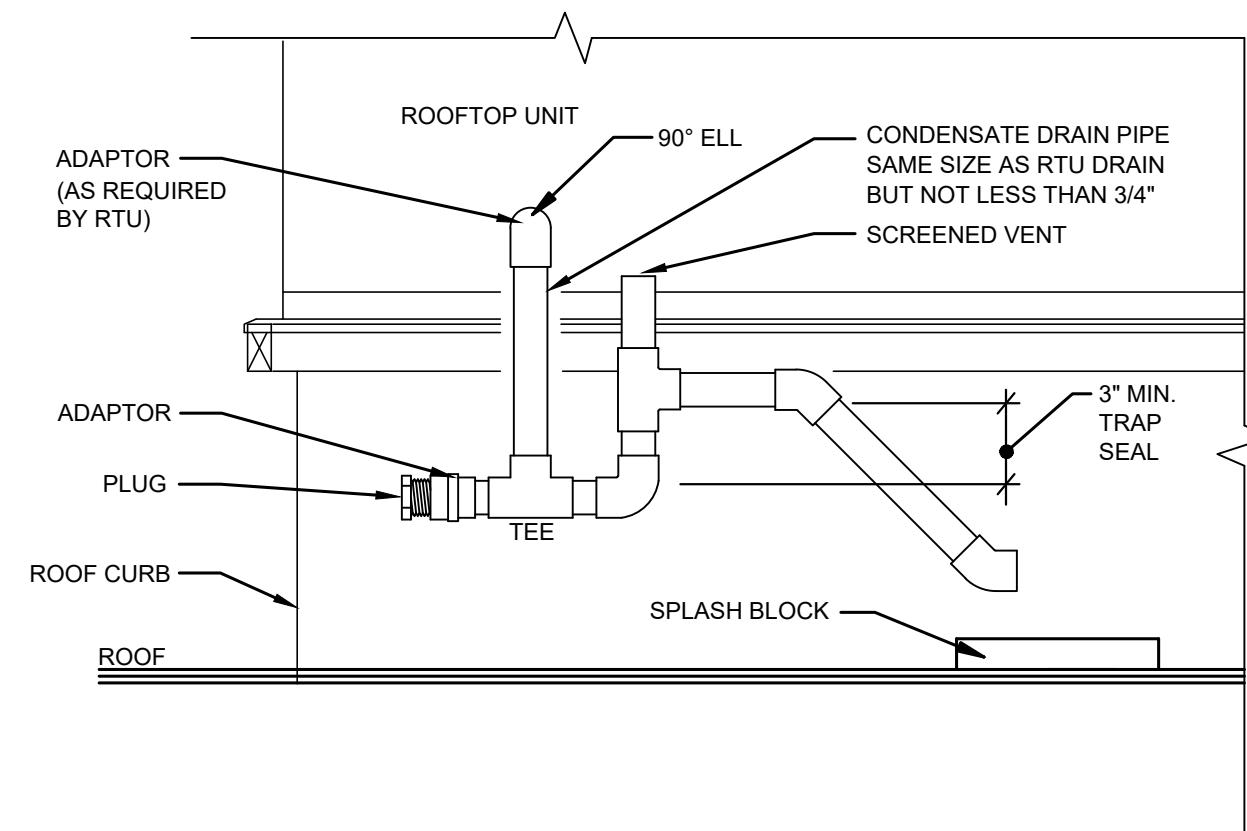

3 ROOFTOP CONDENSATE PIPING DETAIL
SCALE: 1/4" = 1'-0"

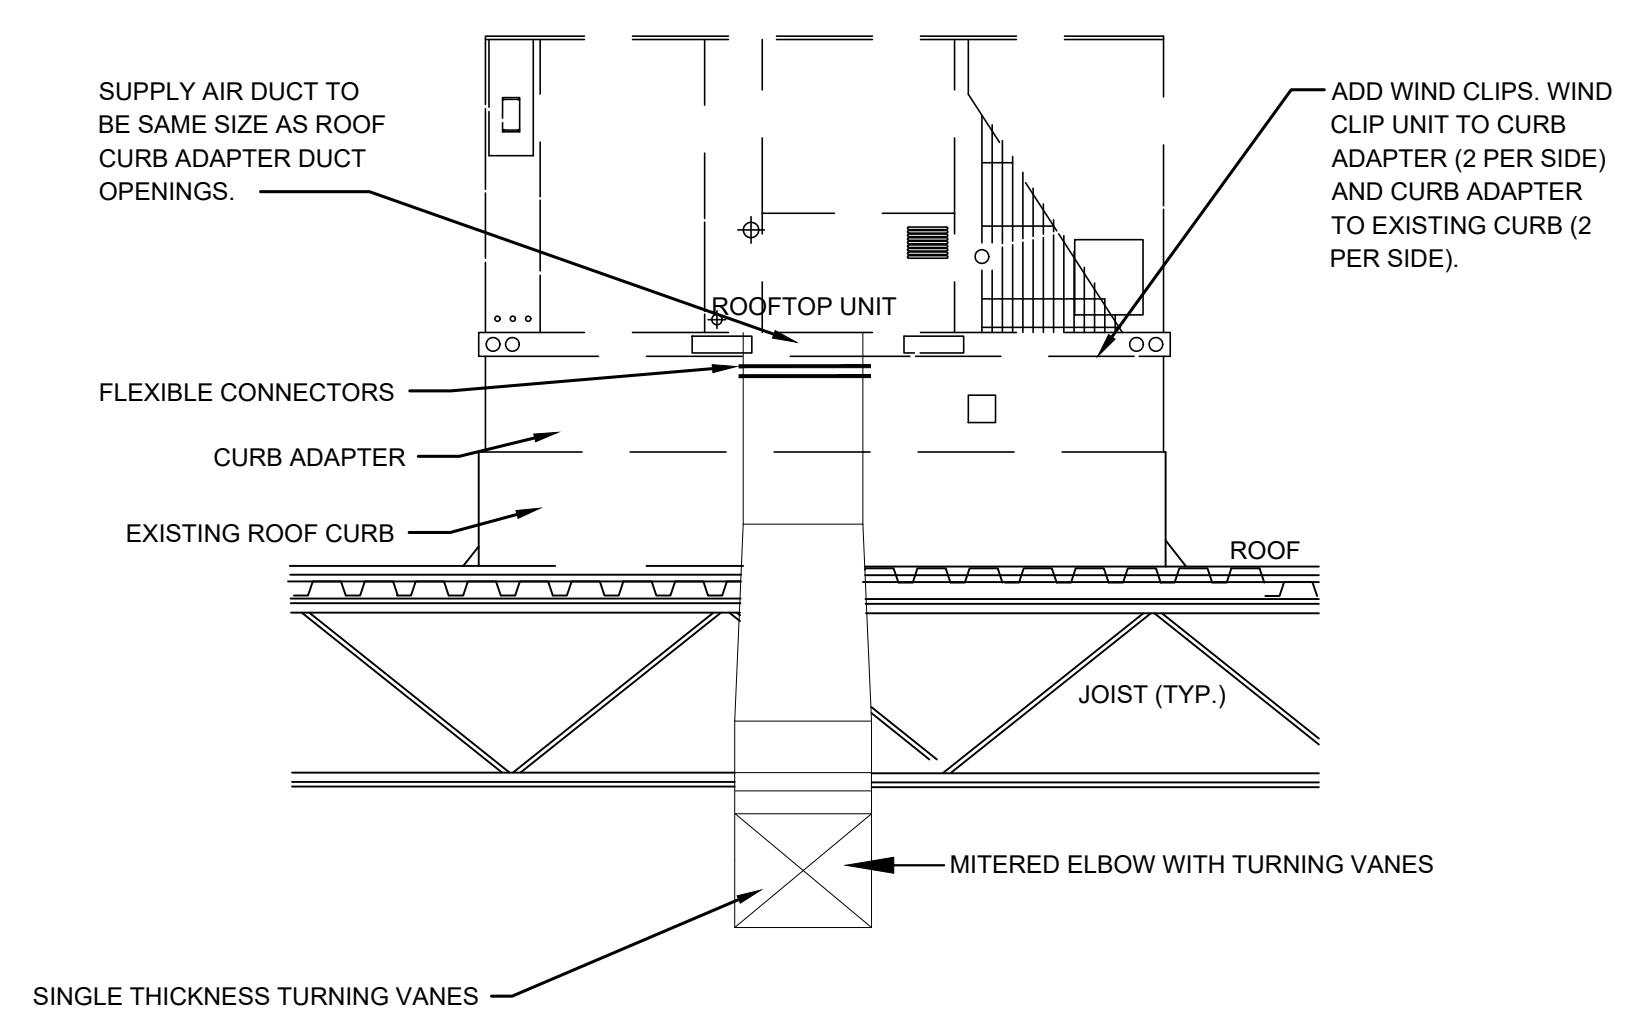

2 ROOFTOP SECTION DETAIL
SCALE: 1/4" = 1'-0"

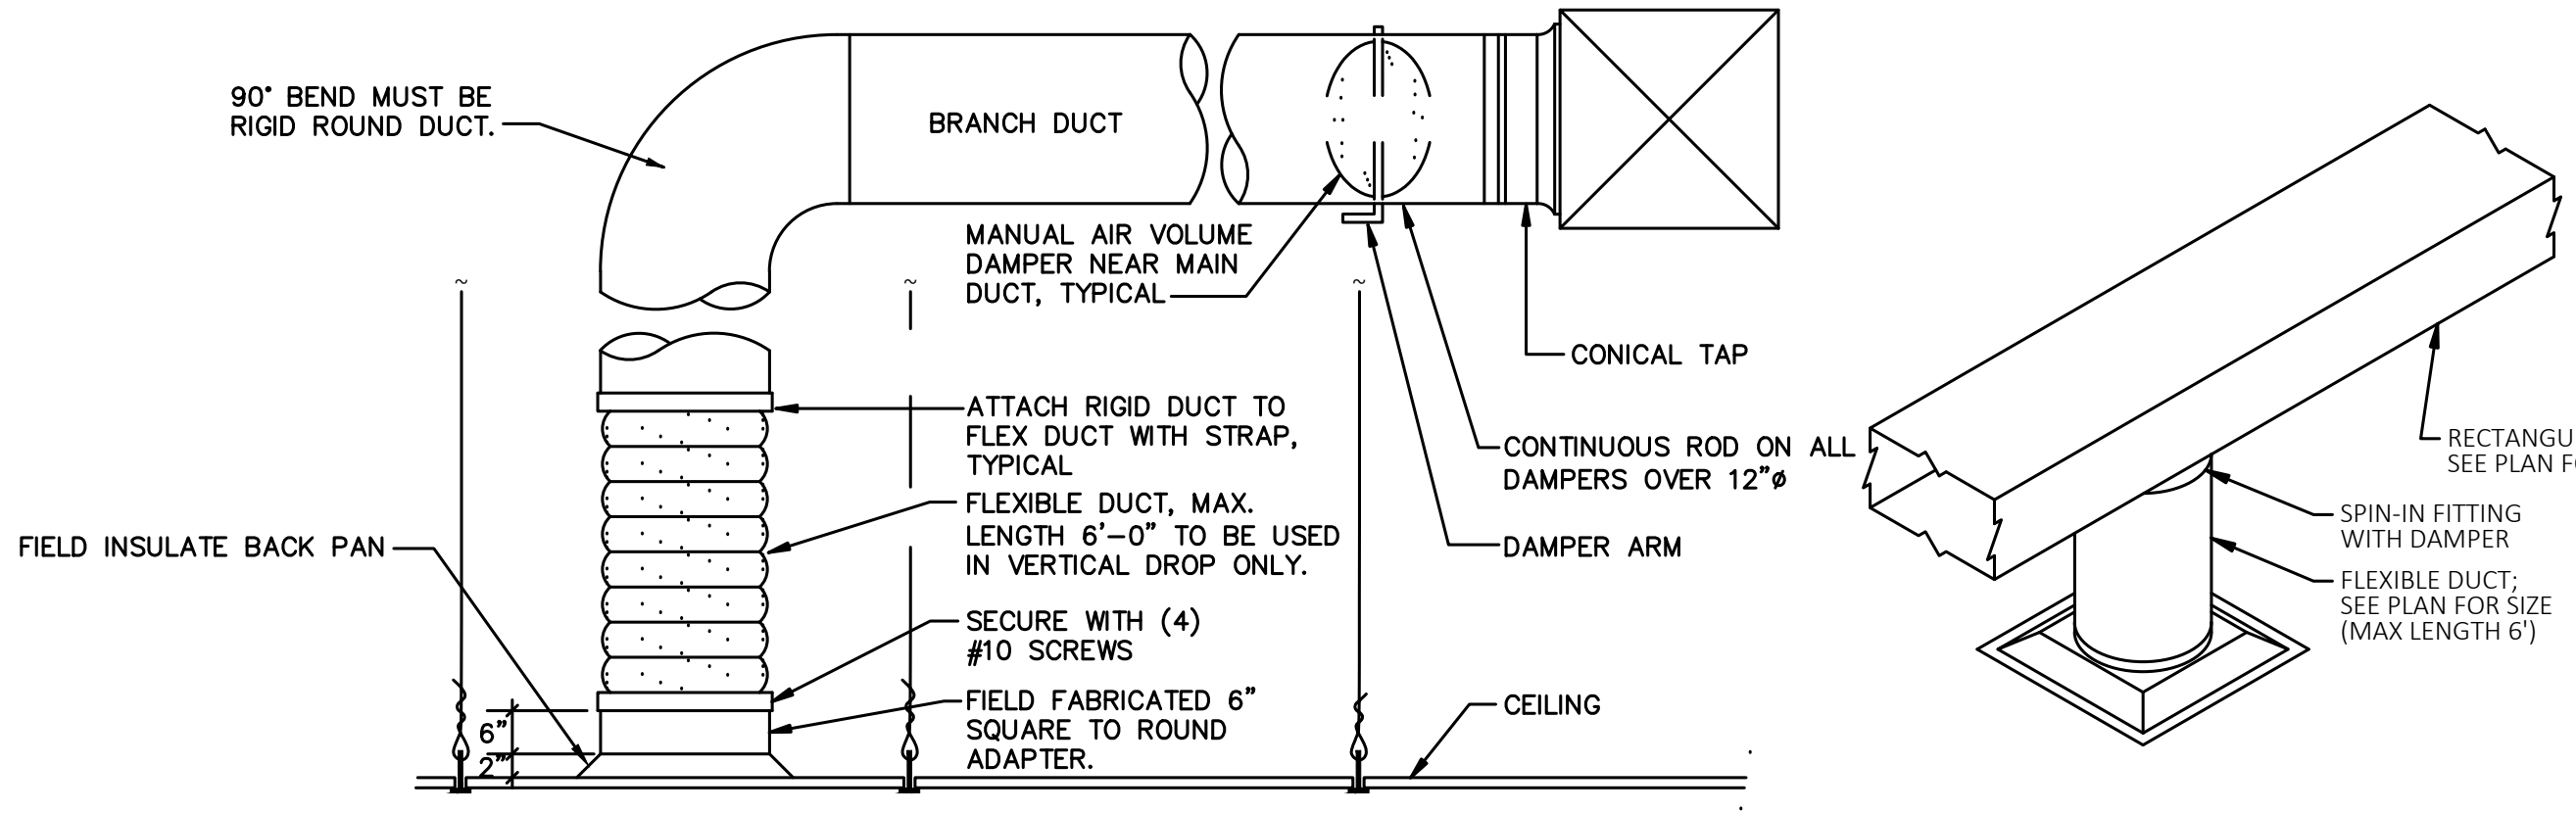

1 DIFFUSER CONNECTION DETAIL
SCALE: 1/4" = 1'-0"

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PROJECT # T2122-01
SITE # 6300
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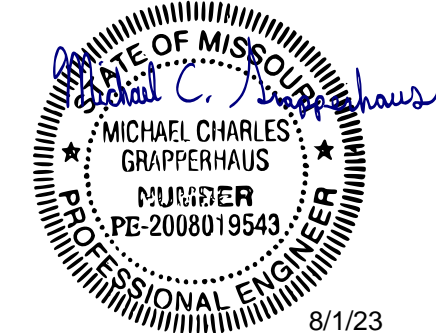
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CAD DWG FILE: _____
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CHECKED BY: JST
DESIGNED BY: JST

SHEET TITLE:

MECHANICAL
DETAILS

SHEET NUMBER:
M-501
08/01/2023
SHEET 24 OF 29



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NEW DOAS ROOFTOP UNIT SCHEDULE (RTU): GAS FIRED HEATING (BASIS OF DESIGN)

ID	MANUFACTURER (BASIS OF DESIGN)	MODEL NO.	AREA SERVED	VENTILATION		SUPPLY FAN				GAS HEAT				COOLING COIL						HOT GAS REHEAT		COMPRESSORS		ELECTRICAL					EER/IEER /SEER @ ASHRAE 90.1 MIN	WEIGHT / LBS	ACCESSORIES	NOTES
				MAX OA	TOTAL	ESP	MOTOR	INPUT	OUTPUT	EAT	LAV	NOMINAL	TOTAL	SENS	LAT	EAT	LAT	SENS	MAX LAT	NO	RLA (EA)	VOLTS	PHASE	HERTZ	MOCP	MCA						
RTU-2	GREENHECK	RV-10-4I-B-E1	LOCKER ROOMS	600	600	0.75	0.5	75.0	60.0	4.1	96.7	5	54.2	26.3	27.9	95.6 / 79.4	54.9 / 54.7	26.0	94.2 / 59.8	1	NA	208	3	60	30.0	20.2	-- / -- / 14.0	1363	1 THRU 21	1 THRU 12		
NOTES:				ACCESSORIES:																							EQUIVALENT MANUFACTURER MODEL #		EQUIVALENT MANUFACTURER MODEL #			
<ol style="list-style-type: none"> CONSTANT VOLUME DOAS ROOFTOP UNIT WITH MODULATING COMPRESSOR, MODULATING CONDENSER REHEAT, MODULATING GAS HEATING. STATIC PRESSURE IS THE EXTERNAL STATIC PRESSURE WHICH EXCLUDES ANY PRESSURE DROPS WITHIN THE UNIT. PERFORM TESTING AND BALANCING AND SUBMIT CERTIFIED REPORTS TO THE ENGINEER. CONTRACTOR TO ENSURE THAT OUTDOOR AIR INTAKES ARE A MINIMUM OF 10'-0" AWAY FROM ANY EXHAUST FAN DISCHARGE, PLUMBING VENT OR OTHER CONTAMINANT SOURCE. INSTALL NEW PACKAGED ROOFTOP UNIT AND CURB ADAPTER ON EXISTING ROOF CURB. ELECTRICAL CONNECTION TO BE SINGLE POINT AND TO BE THROUGH THE BOTTOM OF THE UNIT. GAS CONNECTION REQUIREMENT: 1 PSI (11 TO 14") WC GAS PRESSURE. REFER TO ROOF FRAMING PLAN FOR EXACT LOCATION OF ROOFTOP UNITS. ADDRESSABLE SMOKE DETECTOR SHALL BE PROVIDED & WIRED BY FIRE ALARM CONTRACTOR AND INSTALLED IN THE UNIT CABINET WITH PROBE EXTENDING INTO THE SUPPLY AIR DISCHARGE PLENUM BY THE MECHANICAL CONTRACTOR. MAXIMUM AIR VELOCITY THROUGH COOLING COIL SHALL NOT EXCEED 500 FEET PER MIN. UNIT WEIGHT INCLUDES 300 LBS FOR CURB ADAPTER CONTRACTOR TO PROVIDE ROOF CURB ADAPTER. DOAS RTU TO BE ELECTRICALLY INTERLOCKED TO EXISTING FAN XEF-15. EXISTING TIME CLOCK TO ENABLE/DISABLE OPERATION OF DOAS RTU & XEF-15. 				<ol style="list-style-type: none"> INDIRECT FIRED HEAT EXCHANGER DOUBLE WALL CONSTRUCTION, 2" R13 FOAM INSULATION HINGED ACCESS DOORS 2" INCH PANEL FILTERS, MERV 8 DIRECT DRIVE PLENUM BLOWER & MOTOR ASSEMBLY WITH VFD & VFD BYPASS (ADJ SETPOINT) BOTTOM POWER ENTRY KIT DISCONNECT SWITCH (NON FUSED), FACTORY INSTALLED SERVICE OUTLETS (GFCI TYPE, NEMA 4, FACTORY MOUNTED & WIRED) WEATHER HOOD TEMP/ENTHALPY 100% ECONOMIZER, MOTORIZED OUTDOOR AIR DAMPER PAINTED EXTERIOR - PERMATECTOR GRAY DDC UNIT MOUNTED MICROPROCESSOR CONTROLLER - SINGLE ZONE VAV FUNCTION WITH DIGITAL INPUT TO SET FAN SPEED. 7-DAY PROGRAMMABLE FUNCTION, LEAVING AIR TEMP SENSOR. OUTDOOR AIR WEATHER HOOD DIRTY FILTER SENSOR CONDENSER HAIL GUARDS EQUIPMENT OPERATIONAL CHECK (EOC) 3-ROW EVAPORATOR COIL WITH TXV (W/ EXT EQUALIZER) REFRIGERANT: R410A STAINLESS STEEL HEAT EXCHANGERS 12:1 MODULATING GAS INPUT, DIRECT SPARK IGNITION VARIABLE CAPACITY COMPRESSOR MODULATING HOT GAS REHEAT, 2 ROW COIL WITH TXV 																							RTU-2		CAPTIVEAIRE CASRTU-1		RUPPAIR PARTU-1	

EXISTING ROOFTOP UNIT SCHEDULE (RTU): GAS FIRED HEATING

ID	MANUFACTURER	MODEL NO.	AREA SERVED	VENTILATION		SUPPLY FAN				GAS HEAT				COOLING COIL						HOT GAS REHEAT		COMPRESSORS		ELECTRICAL					EER/IEER /SEER @ ARI 340	WEIGHT / LBS	ACCESSORIES	NOTES
				MIN OA	MAX OA	TOTAL	ESP	MOTOR	INPUT	OUTPUT	EAT	LAV	NOMINAL	TOTAL	SENS	LAT	EAT	LAT	SENS	MAX LAT	NO	RLA (EA)	VOLTS	PHASE	HERTZ	MOCP	MCA					
XRTU-1	TRANE	YHC060E3RYA18H0C0A1B	OFFICE, PARTS STORAGE, BREAK RM	82	350	2000	0.75	1.0	80	64	4.1	100.7	5	63.5	47.3	16.2	80/67	58	25.3	69.5	1	NA	208	3	60	45	32.1	12.85/--/15.0	1013	1 THRU 21	1 THRU 4	
NOTES:				EXISTING ACCESSORIES:																												
<ol style="list-style-type: none"> EXISTING TIME CLOCK TO ENABLE/DISABLE OPERATION OF EXISTING RTU-1. ADDRESSABLE SMOKE DETECTOR SHALL BE PROVIDED & WIRED BY FIRE ALARM CONTRACTOR AND INSTALLED IN THE UNIT CABINET WITH PROBE EXTENDING INTO THE SUPPLY AIR DISCHARGE PLENUM BY THE MECHANICAL CONTRACTOR, IF FUNCTIONING SMOKE DETECTOR IS DAMAGED OR MISSING. YEAR OF MANUFACTURER: 2012 HIGH EFFICIENCY UNIT WITH STAINLESS STEEL HEAT EXCHANGER CONTRACTOR SHALL ATTACH NEW NAMEPLATE DECALS FROM TRANE COMPANY TO REPLACE THE EXISTING THAT ARE WEATHERED. CONTRACTOR SHALL OBTAIN FROM EQUIPMENT MANUFACTURER A REPLACEMENT EQUIPMENT LABEL BASED ON THE LEGIBLE/EXISTING SERIAL NUMBER. THIS NEW LABEL SHALL REPLACE THE WEATHERED LABEL AND SHALL BE APPLIED AT THE SAME LOCATION AS THE EXISTING LABEL. EXISTING LABEL SHALL BE SCRAPED OFF TO PROVIDE A PROPER ADHESIVE METAL SURFACE FOR THIS NEW LABEL. 				<ol style="list-style-type: none"> INDIRECT FIRED HEAT EXCHANGER 2 INCH PANEL FILTERS, MERV 7 ROOF CURB - 14" HIGH BOTTOM POWER ENTRY KIT DISCONNECT SWITCH (NON FUSED), FACTORY INSTALLED SERVICE OUTLETS (GFCI TYPE, NEMA 3R, FACTORY MOUNTED/POWERED) WEATHER HOOD COMPARATIVE ENTHALPY 100% ECONOMIZER, MOTORIZED OUTDOOR AIR & MOTORIZED RE-CIRCULATION DAMPERS, BAROMETRIC RELIEF. STAINLESS STEEL HEAT EXCHANGER, MEDIUM HEAT CAPACITY, SINGLE STAGE DIRTY FILTER SENSOR CONDENSER HAIL GUARDS 4-ROW EVAPORATOR COIL WITH TXV REFRIGERANT: R410A SINGLE ZONE VAV FUNCTION, MULTI-SPEED DIRECT DRIVE EVAP MOTOR. DEHUMIDIFICATION HOT GAS REHEAT, 2-ROW COIL, ZONE HUMIDISTAT 																												

DIFFUSER, REGISTER AND GRILLE SCHEDULE

ID	TYPE	ROUND NECK SIZE	FACE SIZE	FILTER SIZE	MOUNTING	CFM RANGE	MANUFACTURERS MODEL # (BASIS OF DESIGN)	REMARKS/OPTIONS	EQUIVALENT MANUF / MODEL #	EQUIVALENT MANUF / MODEL #
S-1	SUPPLY DIFFUSER	PLAN	24" x 24"	N/A	SURFACE MOUNT	100-250	TITUS OMNI, TYPE 1	1 THRU 3	PRICE SPD	KRUEGER PLQ
S-2	SUPPLY DIFFUSER	PLAN	24" x 24"	N/A	LAY-IN MOUNT	100-250	TITUS OMNI, TYPE 2	1 THRU 3	PRICE SPD	KRUEGER PLQ
R-1	RETURN GRILLE	PLAN	20" x 24"	N/A	LAY-IN/SURFACE	200-350	TITUS 50F	1, 3	NAILOR 51EC-OA	KRUEGER EGC15
R-2	RETURN GRILLE	PLAN	24" x 24"	N/A	LAY-IN/SURFACE	200-350	TITUS 50F	1, 3	NAILOR 51EC-OA	KRUEGER EGC15
E-1	EXHAUST GRILLE	PLAN	12" x 12"	N/A	SURFACE	50-350	TITUS 50F	1, 35	NAILOR 51EC-OA	KRUEGER EGC15
NOTES:										
<ol style="list-style-type: none"> INSTALLED OPPOSED BLADE DAMPER. BAKED ENAMEL FINISH, COLOR TO BE WHITE. INSULATED BACKPAN 										

VEHICLE EXHAUST SYSTEM SCHEDULE (ALTERNATE #1)

ID	NEW / EXISTING	MANUFACTURER (BASIS OF DESIGN)	MODEL #	SERIAL #	TYPE	DRIVE	CFM	FAN RPM	S.P. (IN. W.G.)	HP	MOTOR VOLTS	PHASE	HZ	SERVICE	WEIGHT (LBS)	ACCESSORIES	INSTALLATION NOTES	EQUIVALENT MANUF MODEL #	EQUIVALENT MANUF MODEL #
XEF-17	EXISTING	ACME INDUSTRIAL	215 A/9H	92030403	CLASS I, INLINE TUBULAR CENTRIFUGAL	BELT	2600	3200	5.0	5	208	3	60	EAST WALL SERVICE BAY	180	1 - 3, 5, 12	1	GREENHECK G-099 HP - VG/4/A	SOLER & PALAU SDBDe-12-3/4-1750
XEF-18	EXISTING	ACME INDUSTRIAL	215 A/9H	92030403	CLASS I, INLINE TUBULAR CENTRIFUGAL	BELT	1950	3689	5.0	3	208	3	60	WEST WALL SERVICE BAY	180	1 - 3, 5, 12	1	GREENHECK G-098 HP - VG/4/A	SOLER & PALAU SDBDe-10-1/3-1450
VE-1	NEW	CAR-MON	TSR-S32, 6 INCH TUBING		TUBING STORAGE REEL, RETRACTABLE		650							EAST & WEST WALL SERVICE BAY	--	6, 7, 8, 10, 11	--	PLYMOVENT CORP SER, FEB, HRR	FUME-A-VENT CO HRS, BA, BAA
VE-2	NEW	CAR-MON	RDS-6, 6 INCH EXH CONN		DIESEL STACK ADAPTER, HEAT RESIST EPDM WITH LIFTING RING		650							EAST & WEST WALL SERVICE BAY	--	4, 9, 11	--	PLYMOVENT CORP SER, FEB, HRR	FUME-A-VENT CO HRS, BA, BAA
VE-3	NEW	CAR-MON	TYPE NTC 6 INCH HOSE		25 FT: 600 DEG F TEMP LIMIT, OIL RESISTANT		650							EAST & WEST WALL SERVICE BAY	--	11	--	PLYMOVENT CORP SER, FEB, HRR	FUME-A-VENT CO HRS, BA, BAA
ACCESSORIES:																			
<ol style="list-style-type: none"> BACKWARD INCLINED STEEL WHEEL, BELT DRIVE, CAPACITOR START CONTINUOUS DUTY MOTOR. NEMA 1 DISCONNECT DISCHARGE WALL LOUVER WITH ACCESS. MOLDED EPDM WITH CURVED CONTOUR SHAPE, STEEL COLLAR WITH DEBRIS SCREEN BACKDRAFT DAMPER STRUCTURAL MOUNTING DIMENSIONS, BOLT PATTERN (L x W): 9.75" x 34.75". RIGIDLY ATTACH TO STRUCTURE. TOP FRAME DIMENSIONS (L X W): 12" X 44.75". DRUM DIAMETER: 32" RETRACTABLE SPRING MECHANISM FOR HOSE RETRACTION ONTO HOSE REEL FOR STORAGE. VARIOUS TAIL PIPE ADAPTERS AVAILABLE FOR CONNECTION TO THE HOSE. TUBULAR STEEL WELDED CONSTRUCTION. TOTAL OF SEVEN ASSEMBLIES. 																			
INSTALLATION NOTES:																			
<ol style="list-style-type: none"> CONTRACTOR TO INSTALL VEHICLE EXHAUST COMPONENTS (VE-1, VE-2, VE-3) AS DETAILED IN MANUFACTURERS INSTALLATION INSTRUCTIONS, AT LOCATIONS SHOWN ON SHEET M-102. CONTRACTOR SHALL RESTORE THE FAN STRUCTURE, ROTATIONAL COMPONENTS, AND FUNCTIONS TO "AS NEW" CONDITION AND PERFORMANCE 																			

EXISTING EXHAUST FAN SCHEDULE

ID	NEW / EXISTING	MANUFACTURER	MODEL #	TYPE	DRIVE	CFM	FAN RPM	S.P. (IN. W.G.)	HP	MOTOR VOLTS	PHASE	HZ	WEIGHT (LBS)	INSTALLATION NOTES
XEF-4	EXISTING	---	---	IN-LINE	--	450	1075	0.5	1/2	208	3	60	67	1, 3, 5, 6
XEF-15	EXISTING	---	---	IN-LINE	--	700	1075	0.5	1/3	115	1	60	56	1, 2, 3, 4, 6
INSTALLATION NOTES:														
<ol style="list-style-type: none"> RESTORE THE FAN STRUCTURE, ROTATIONAL COMPONENTS, MOTORS, CONTROLLERS, AND FUNCTIONS TO "AS NEW" CONDITION AND PERFORMANCE EXISTING WALL-MOUNT SPEED CONTROL & ON/OFF SWITCH SHALL BE RELOCATED TO LOCATION SHOWN ON PLAN M-102. ADJUST FAN PERFORMANCE TO MATCH CFM OF SCHEDULE. XEF-15 SHALL BE INTERLOCKED TO RTU-2, AND ENABLED/DISABLED THROUGH THE EXISTING TIME CLOCK. XEF-4 IS TO BE ENABLED/DISABLED THROUGH THE EXISTING TIME CLOCK, AND OPERATED BY WALL TOGGLE SWITCH IN BREAKROOM. IF SPEED CONTROL DEVICE IS MISSING OR NON-FUNCTIONAL, THEN CONTRACTOR SHALL ADD/REPLACE ELECTRIC SPEED CONTROL DEVICE. SPEED CONTROL DEVICE SHALL BE ACCESSIBLE FOR ADJUSTMENT. 														

SEQUENCE OF OPERATION: (NEW RTU-2)

- A. GENERAL: THE FOLLOWING DESCRIBES THE SEQUENCE OF OPERATION FOR INDIRECT-FIRED CONSTANT VOLUME DOAS ROOFTOP UNIT WITH FAN VFD SETPOINT, MODULATED HOT GAS REHEAT, SERVING THE LOCKER ROOMS.
- THIS DOAS UNIT SHALL BE ENABLED/DISABLED AND INTERLOCKED TO LOCKER ROOM EXHAUST FAN XEF-15 VIA CONNECTION TO THE EXISTING TIME CLOCK.
- B. OCCUPIED HOURS:
- UNIT OUTDOOR AIR DAMPER SHALL OPEN TO THE MAXIMUM POSITION AND UNIT SUPPLY FAN SHALL OPERATE CONTINUOUSLY BY UNIT CONTROLLER.
 - INTERLOCKED RESTROOM EXHAUST FAN SHALL OPERATE.
 - UNIT CONTROLLER SHALL MAINTAIN THE EVAPORATOR LEAVING AIR TEMP OF 55 DEG F DB BY MODULATING MECHANICAL REFRIGERATION BASED ON THE COMPARATIVE OA & RETURN AIR ENTHALPY DIFFERENCE VIA SENSOR INPUT.
 - HOT GAS REHEAT SHALL BE ENABLED AND MODULATE BY THE UNIT CONTROLLER TO MAINTAIN THE SETPOINT DISCHARGE AIR TEMPERATURE.
 - UNIT CONTROLLER SHALL DETERMINE BY INPUT FROM SPACE TEMPERATURE SENSOR WHEN TO ENABLE THE MODULATING GAS BURNER TO MAINTAIN THE DISCHARGE TEMPERATURE SETPOINT.
- C. UNOCCUPIED HOURS:
- UNOCCUPIED HOURS DETERMINED FROM SETTINGS OF THE TIME CLOCK.
 - LOCKER ROOM EXHAUST FAN (XEF-15) SHALL NOT OPERATE.
 - UNIT OUTDOOR AIR DAMPER SHALL REMAIN CLOSED AND UNIT SUPPLY FAN SHALL CYCLE OFF BY UNIT CONTROLLER.
 - HEATING AND COOLING FUNCTIONS ARE NOT OPERATING.
 - ROOM TEMPERATURE SENSOR SHALL INITIATE COOLING OR HEATING AT THE SELECTED UNOCCUPIED ROOM TEMPERATURES, IF ENABLED BY THE TIME CLOCK.
 - UNIT REFRIGERATION SYSTEM SHALL CYCLE WITH MODULATED HOT GAS REHEAT FOR SPACE TEMP AND HUMIDITY CONTROL, OR THE STAGES OF GAS HEATING SHALL CYCLE IN RESPONSE TO THE ROOM TEMPERATURE SENSOR TO PROVIDE COOLING OR HEATING OF THE UNOCCUPIED INTERIOR SPACES, IF ENABLED BY THE TIME CLOCK.
- D. SMOKE ALARM FUNCTION.
- UNIT OUTDOOR AIR DAMPER SHALL CLOSE AND UNIT SUPPLY FAN SHALL STOP ON A SIGNAL FROM DUCT SMOKE DETECTOR. DUCT SMOKE DETECTOR SHALL SEND A SIGNAL TO REMOTE FIRE PROTECTION ALARM DEVICE.

SEQUENCE OF OPERATION: (EXISTING RTU-1)

- A. GENERAL: THE FOLLOWING DESCRIBES THE SEQUENCE OF OPERATION FOR EXISTING CONSTANT VOLUME ROOFTOP UNIT WITH SINGLE ZONE VAV FUNCTION, SERVING OFFICE, PART STORAGE, AND BREAKROOM.
- THIS ROOFTOP UNIT SHALL BE ENABLED/DISABLED BY CONNECTION TO THE EXISTING TIME CLOCK. TIME CLOCK TO INITIATE OPERATIONS.
- B. OCCUPIED HOURS:
- UNIT OUTDOOR AIR DAMPER SHALL OPEN TO ITS MINIMUM POSITION AND UNIT SUPPLY FAN SHALL OPERATE CONTINUOUSLY.
 - COOLING: UNIT CONTROLLER SHALL CYCLE STAGES OF COOLING BY SELECTING COMPRESSOR STAGE AND CORRESPONDING LOW OR HIGH SPEED SUPPLY FAN OPERATION TO MAINTAIN ROOM TEMPERATURE SETPOINT VIA UNIT CONTROLLER AND SENSORS. HEATING: UNIT CONTROLLER SHALL CYCLE STAGES OF GAS HEATING AND CORRESPONDING LOW OR HIGH SPEED SUPPLY FAN OPERATION TO MAINTAIN ROOM TEMPERATURE SETPOINT VIA UNIT CONTROLLER AND SENSORS.
 - UNIT ECONOMIZER CYCLE SHALL BE INITIATED UPON A SIGNAL FROM OUTDOOR AND RETURN AIR TEMPERATURE AND ENTHALPY SENSORS. OUTDOOR AIR DAMPER, RETURN AIR DAMPER, AND UNIT COMPRESSOR(S) SHALL CYCLE TO MAINTAIN SPACE SETPOINT.
- C. UNOCCUPIED HOURS:
- UNIT OUTDOOR AIR DAMPER SHALL REMAIN CLOSED AND UNIT SUPPLY FAN SHALL REMAIN OFF.
 - HEATING AND COOLING FUNCTIONS ARE NOT OPERATING.
 - IF ENABLED BY TIME CLOCK
 - UNIT CONTROLLER SHALL INITIATE LOW SPEED FAN OPERATION, OPEN OUTDOOR AIR DAMPER TO MINIMUM POSITION, INITIATE COOLING OR HEATING.
 - COOLING: UNIT CONTROLLER SHALL CYCLE STAGES OF COOLING BY SELECTING COMPRESSOR STAGE AND CORRESPONDING LOW OR HIGH SPEED SUPPLY FAN OPERATION TO MAINTAIN ROOM TEMPERATURE SETPOINT VIA UNIT CONTROLLER AND SENSORS.
 - HEATING: UNIT CONTROLLER SHALL CYCLE STAGES OF GAS HEATING AND CORRESPONDING LOW OR HIGH SPEED SUPPLY FAN OPERATION TO MAINTAIN ROOM TEMPERATURE SETPOINT VIA UNIT CONTROLLER AND SENSORS.
 - ECONOMIZER FUNCTION SHALL BE INITIATED UPON A SIGNAL FROM OUTDOOR AND RETURN AIR TEMPERATURE AND ENTHALPY SENSORS. OUTDOOR AIR DAMPER, RETURN AIR DAMPER, AND UNIT COMPRESSOR(S) SHALL CYCLE TO MAINTAIN SPACE SETPOINT.
- D. WARM-UP MODE:
- IF ENABLED BY TIME CLOCK.
 - UNIT CONTROLLER SHALL MAINTAIN OUTDOOR AIR DAMPER CLOSED AND UNIT SUPPLY FAN SHALL CYCLE ON A SIGNAL FROM SPACE SENSOR.
 - UNIT CONTROLLER SHALL INITIATE COOLING OR HEATING.
 - COOLING: UNIT CONTROLLER SHALL CYCLE STAGES OF COOLING BY SELECTING COMPRESSOR STAGE AND CORRESPONDING LOW OR HIGH SPEED SUPPLY FAN OPERATION TO MAINTAIN ROOM TEMPERATURE SETPOINT VIA UNIT CONTROLLER AND SENSORS.
 - HEATING: UNIT CONTROLLER SHALL CYCLE STAGES OF GAS HEATING AND CORRESPONDING LOW OR HIGH SPEED SUPPLY FAN OPERATION TO MAINTAIN ROOM TEMPERATURE SETPOINT VIA UNIT CONTROLLER AND SENSORS.
- E. SMOKE ALARM FUNCTION.
- UNIT OUTDOOR AIR DAMPER SHALL CLOSE AND UNIT SUPPLY FAN SHALL STOP ON A SIGNAL FROM DUCT SMOKE DETECTOR. DUCT SMOKE DETECTOR SHALL SEND A SIGNAL TO REMOTE FIRE PROTECTION ALARM DEVICE.

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PROJECT # T2122-01
SITE # 6300
ASSET# 8136300017

REVISION: _____
DATE: _____
REVISION: _____
DATE: _____
REVISION: _____
DATE: _____
ISSUE DATE: 08/01/2023

CAD DWG FILE: _____
DRAWN BY: MEA
CHECKED BY: JST
DESIGNED BY: JST

SHEET TITLE:

MECHANICAL
SCHEDULES

SHEET NUMBER:

M-601

08/01/2023
SHEET 25 OF 29



DAVID A. TRETTER
License Number: 021293
Expiration Date: 12/31/23
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CHECKED BY: DAT
DESIGNED BY: _____

SHEET TITLE:

**ELECTRICAL
DEMO FLOOR
PLAN**

SHEET NUMBER:

E-101


08/01/2023
SHEET 26 OF 29

DEMOLITION GENERAL NOTES:


- A. COORDINATE DEMOLITION AND NEW WORK WITH ALL DISCIPLINES AND EXISTING CONDITIONS PRIOR TO CONSTRUCTION.
- B. PERFORM ALL WORK IN ACCORDANCE WITH THE ELECTRICAL CODE, O.S.H.A., PERTINENT NFPA CODES, THE RULES AND REGULATIONS OF ALL LOCAL, STATE AND FEDERAL AUTHORITIES HAVING JURISDICTIONS, AND ALL STANDARDS APPLIED BY THE BUILDING MANAGEMENT. PROVIDE OWNER WITH CERTIFICATES OF INSPECTION.
- C. REFER TO ARCHITECTURAL DRAWINGS FOR AREAS OF DEMOLITION. EXISTING LIGHTING FIXTURES, EXIT SIGNS AND OTHER CEILING MOUNTED DEVICES TO BE REMOVED IN THESE AREAS SHALL BE DISCONNECTED FROM THEIR EXISTING SOURCES TO ALLOW FOR REMOVAL UNLESS OTHERWISE NOTED ON ARCHITECTURAL DRAWINGS. WIRING AND CONDUIT SHALL BE REMOVED BACK TO SOURCE/PANEL.
- D. MISCELLANEOUS WIRING DEVICES, TELE/COMMUNICATION DEVICES, LIGHTING FIXTURES, EXIT LIGHTS, ETC. MOUNTED ON PARTITIONS TO BE REMOVED OR CONCEALED BY NEW CONSTRUCTION SHALL BE DISCONNECTED FROM THEIR SERVICE SOURCE TO ALLOW FOR REMOVAL.
- E. MAINTAIN CONTINUITY OF ALL ACTIVE LIGHTING & POWER CIRCUITS. INTERRUPT WIRING AND REROUTE WHERE REQUIRED TO POWER EXISTING DEVICES TO REMAIN. PROVIDE AS-BUILT DRAWINGS INDICATING ALL RELOCATIONS AND CIRCUIT ADJUSTMENTS IN PANELBOARDS. UPDATE PANELBOARD CIRCUIT DIRECTORIES FOR ALL PANELBOARDS AFFECTED BY THE WORK.
- F. OWNER RETAINS RIGHTS OF SALVAGE FOR ELECTRICAL EQUIPMENT AND LIGHT FIXTURES TO BE REMOVED. COORDINATE WITH OWNER THE EQUIPMENT AND FIXTURES TO BE SALVAGED AND THE LOCATION FOR STORAGE. AVOID DAMAGE TO SALVAGED EQUIPMENT. FIXTURES AND DEVICES DURING DEMOLITION WORK AND DURING TRANSPORT TO OWNER'S DESIGNATED STORAGE LOCATION.
- G. ALL PREVIOUSLY ABANDONED OR OBSOLETE CONDUIT AND WIRING SHALL BE REMOVED IN ITS ENTIRETY.
- H. REVIEW EXISTING CONDITIONS PRIOR TO START OF DEMOLITION AND COORDINATE ANY POWER INTERRUPTIONS WITH OWNERS REPRESENTATIVE.
- I. SEAL ALL PENETRATIONS THROUGH FLOORS, WALLS, CEILINGS, AND ROOF WHERE ELECTRICAL COMPONENTS ARE REMOVED AND WHERE THE EXISTING PENETRATION IS NOT USED FOR THE NEW INSTALLATION. REPAIR DAMAGED SURFACES TO MATCH ADJACENT AREAS.
- J. REMOVE ALL EXISTING ELECTRICAL EQUIPMENT, FIXTURES, SYSTEMS, CONDUIT AND WIRING NO LONGER REQUIRED AFTER PROJECT COMPLETION.

DEMOLITION KEYED NOTES:

1. EXISTING WALL OUTLETS: DISCONNECT WALL OUTLETS/DEVICES AND WIRING REMOVED BACK TO PANEL. PATCHING OF WALLS BY OTHERS. FOR ADDITIONAL DEMO WORK, SEE ARCHITECTURAL DRAWINGS
2. EXISTING LIGHT FIXTURES: DISCONNECT LIGHT FIXTURES, WALL FIXTURES, AND WIRING BACK TO SOURCE. CEILING AND WALL FIXTURES TO BE DISCARDED.
3. DEMOLISHED WALLS: PRIOR TO WALL DEMOLITION, DISCONNECT WALL OUTLETS/DEVICES AND WIRING REMOVED BACK TO SOURCE. OUTLETS TO BE REMOVED WITH DEMOLISHED WALLS, UNO. FOR ADDITIONAL DEMO WORK, SEE ARCHITECTURAL DRAWINGS.
4. EXISTING SECURITY/FIRE ALARM SYSTEMS: FIRE ALARM CONTRACTOR TO DETERMINE IF EXISTING FIRE ALARM SYSTEM MAY BE REUSED IN WHOLE OR PART. DEMO ANY EXISTING SECURITY/FIRE ALARM DEVICES NOT TO BE REUSED. FIRE ALARM CONTRACTOR IS RESPONSIBLE FOR OPERABLE AND FULLY CODE COMPLIANT SYSTEMS. UNUSED WIRING TO BE REMOVED AND DISCARDED.
5. PRIOR TO REMOVAL OF PADDLE FAN, DISCONNECT POWER AND REMOVE FEEDER BACK TO SOURCE.
6. PRIOR TO REMOVAL OF OH DOOR AND MOTOR, DISCONNECT FEEDER, TIE-UP AND MAKE SAFE FOR REUSE. SALVAGE DISCONNECT AND REUSE IF COMPATIBLE WITH NEW DOOR MOTOR. SEE SHEET E103 FOR NEW WORK.
7. EXISTING ROOF TOP UNIT TO REMAIN IN-PLACE AND CONNECTED.
8. DISCONNECT FEEDERS AND REMOVE BACK TO SOURCE PRIOR TO REMOVAL OF ROOF TOP UNIT. SEE SHEET E103 FOR NEW WORK.
9. OVEN CIRCUITRY: PRIOR TO REMOVAL OF WALL, DISCONNECT WIRING FOR OVEN, TIE-UP AND MAKE SAFE FOR REUSE. SEE SHEET E103 FOR NEW WORK.
10. EXISTING WATER COOLER: AFTER WATER COOLER HAS BEEN REMOVED, DISCONNECT AND REMOVE CIRCUITRY BACK TO SOURCE. WALL PATCH WORK BY OTHERS.

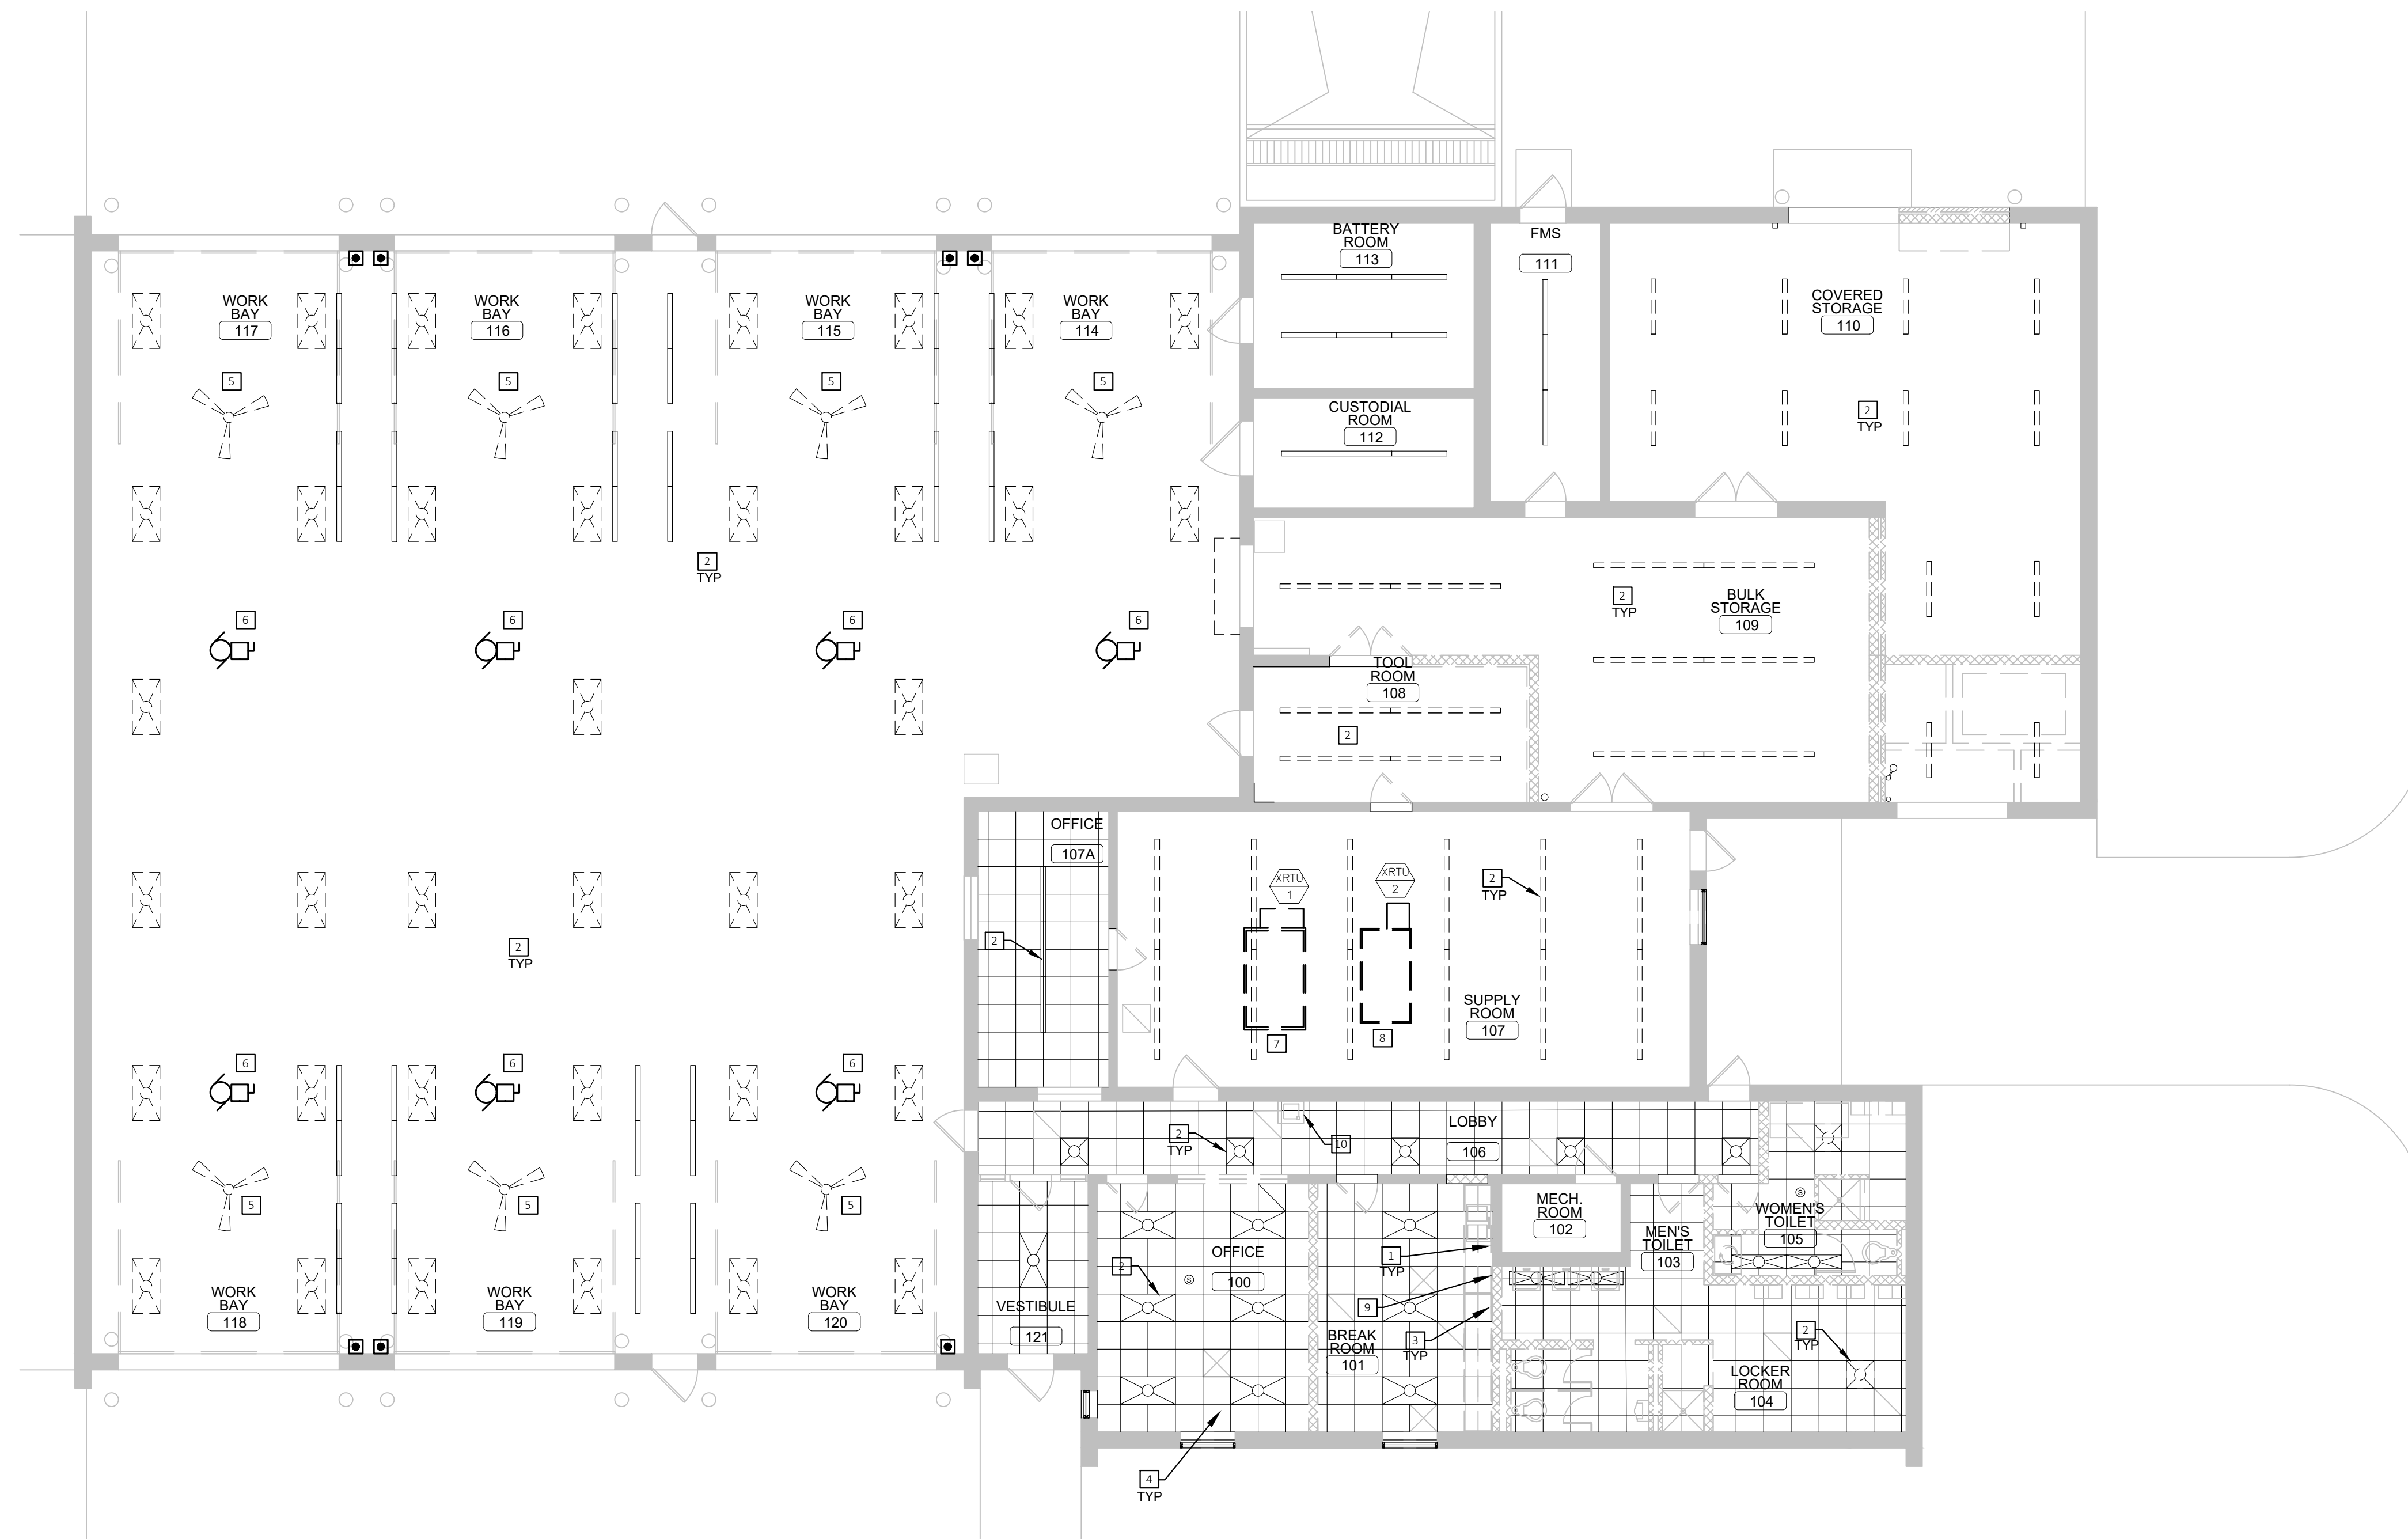

1 ELECTRICAL DEMO FLOOR PLAN
SCALE: 1/8" = 1'-0"

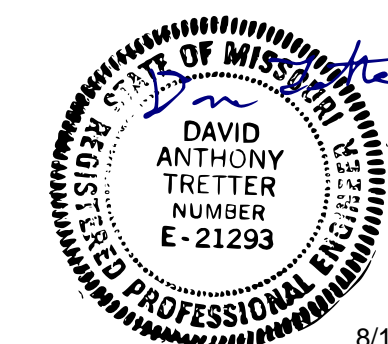

8/1/23

DAVID A. TRETTER
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SHEET TITLE:


ELECTRICAL
LIGHTING
FLOOR PLAN

SHEET NUMBER:

E-102

08/01/2023
SHEET 27 OF 29

EXISTING YARD SITE POLE
LIGHT. SEE SHEET A-001
FOR NEW LOCATION.

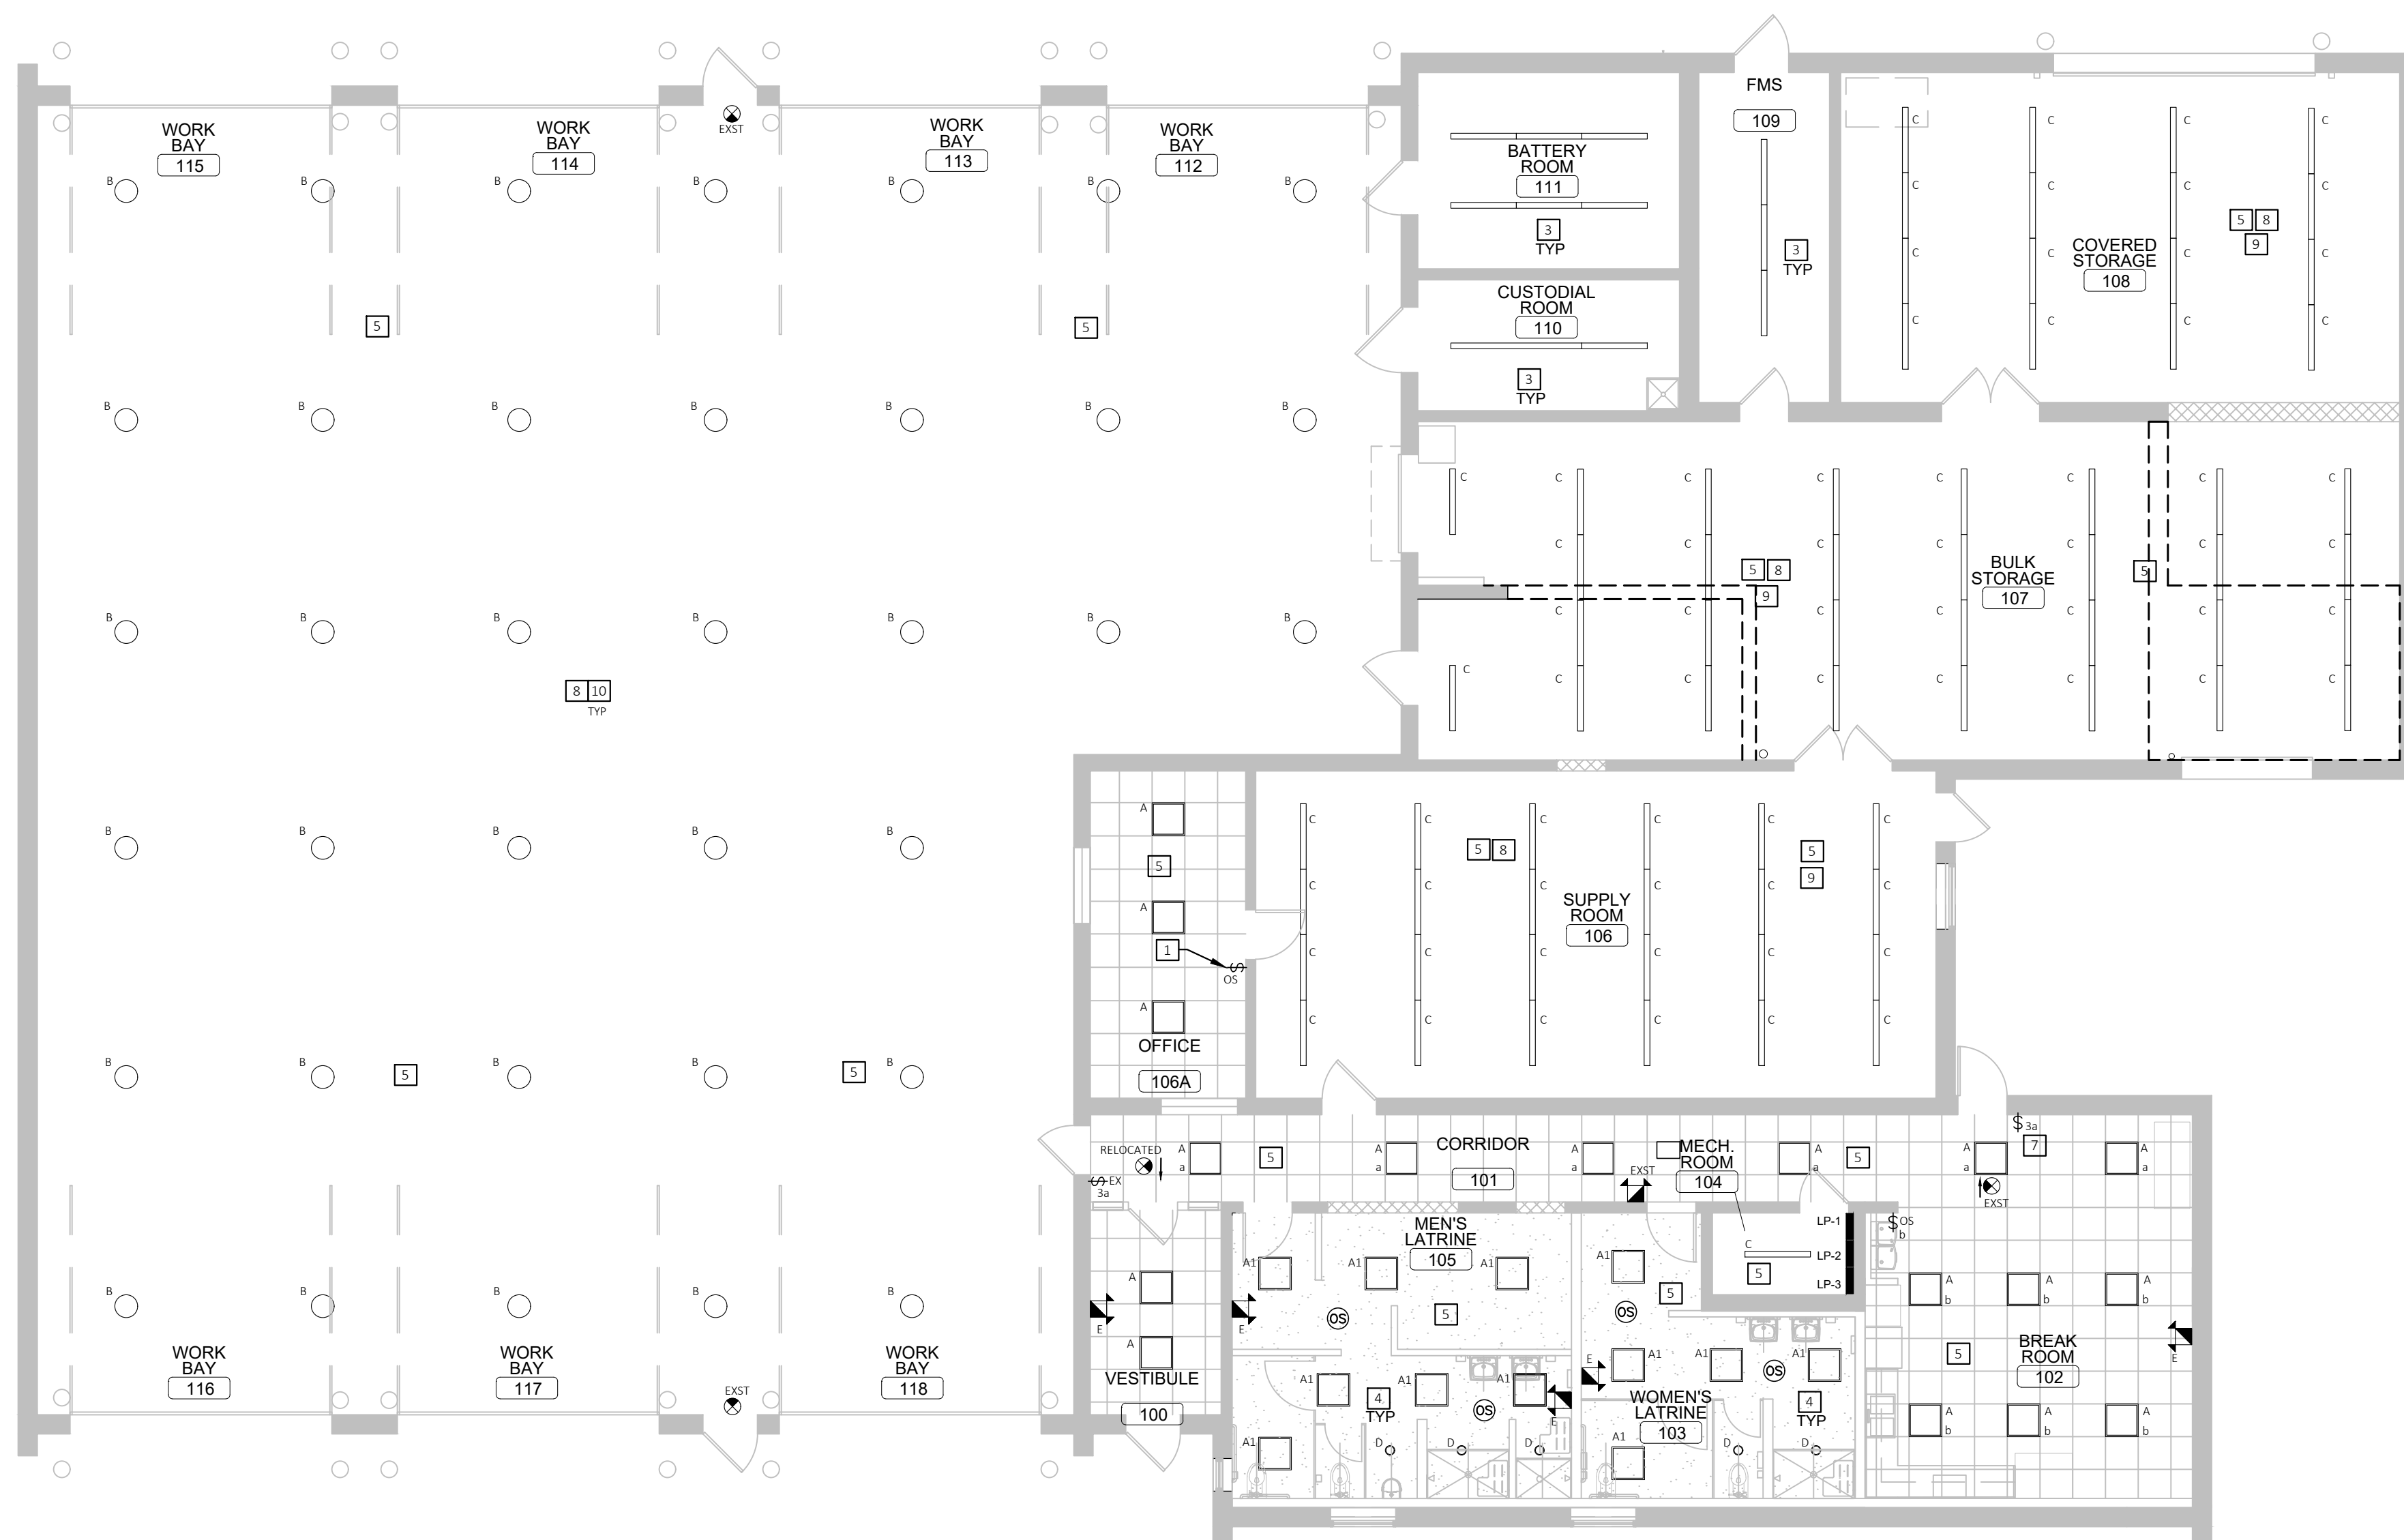

- LIGHTING GENERAL NOTES**
- FOR LIGHT FIXTURE SCHEDULE, SEE SHEET E601.
 - LOCATIONS SHOWN ARE APPROXIMATE. CONTRACTOR SHALL COORDINATE ACTUAL LOCATIONS WITH OTHER TRADES AND THE OWNER OR THE OWNERS AUTHORIZED REPRESENTATIVE.
 - CONDUIT RUNS SHALL BE INSTALLED PER STATE AND LOCAL CODES.
 - ALL MATERIALS SHALL BE NEW, WITH "UL" APPROVED LABELS.
 - DEVICE LOCATIONS SHOWN ON THE PLAN SHALL BE PLACED EXACTLY AS SHOWN. REFER ANY QUESTIONS TO THE ARCHITECT.
 - ALL FIXTURES, WIRE, AND ELECTRIC DEVICES SHALL BE U.L. APPROVED TYPE.
 - ALL BRANCH LIGHTING AND RECEPTACLE CIRCUITS IN EXCESS OF 100 FT FROM PANEL SHALL BE #10 AWG.
 - NEW LIGHTING SHALL BE RECONNECTED TO CURRENT LIGHTING CIRCUITS AND CONTROLS, UNO.
 - ALL LED LIGHTS SHALL HAVE DEDICATED NEUTRAL.
 - CONTRACTOR SHALL FURNISH ALL LABOR MATERIALS AND EQUIPMENT FOR THE COMPLETE INSTALLATION.
 - ALL LUMINAIRES ARE FED FROM PANEL LP2, U.N.O.


- # LIGHTING KEYED NOTES:**
- WALL OCCUPANCY SENSOR: PROVIDE DUAL TECHNOLOGY (PIR & ULTRA-SONIC) OCCUPANCY SENSOR WITH MANUAL ON-OFF, LEGRAND "WATTSTOPPER" #DW-100 OR APPROVED EQUAL.
 - PROVIDE JUNCTION BOX ABOVE ACCESSIBLE CEILING SPACE FOR LIGHTING CIRCUIT(S).
 - EXISTING LIGHTING AND SWITCHING IN THIS AREA TO REMAIN IN-PLACE AND CONNECTED.
 - CEILING FIXTURE SHALL BE SURFACE MOUNTED TO SUB-CEILING WITH SURFACE CEILING KIT. SEE LIGHT FIXTURE SCHEDULE.
 - NEW LIGHT FIXTURES IN THIS ROOM/AREA TO BE RECONNECTED TO EXISTING LIGHTING CIRCUIT(S) AND CONTROLS IN THIS ROOM/AREA, UNO.
 - DISCONNECT, REMOVE EXISTING SITE LIGHT POLE AND SALVAGE FOR REUSE. SEE SHEET A-001 FOR NEW LOCATION. AFTER LIGHT POLE IS IN-PLACE, EXTEND FEEDER AS REQUIRED AND RECONNECT TO EXISTING LIGHTING CIRCUIT(S) AND CONTROLS.
 - PROVIDE NEW 3-WAY WALL SWITCH AND CONNECT TO LIGHTING FIXTURES IN CORRIDOR.
 - EXISTING ROOM EMERGENCY BATTERY FIXTURES TO REMAIN.
 - INSTALL NEW LIGHT FIXTURES AT SAME MOUNTING HEIGHT AS PREVIOUS FIXTURES.
 - PENDANT MOUNT LIGHT FIXTURES AT 15'-0" AFF TO BOTTOM OF FIXTURE.

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E-102 **ELECTRICAL LIGHTING FLOOR PLAN**
SCALE: 1/8" = 1'-0"



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1
E-103 **ELECTRICAL POWER FLOOR PLAN**
SCALE: 1/8" = 1'-0"

- POWER GENERAL NOTES:**
- ALL WORK SHALL CONFORM TO THE REQUIREMENTS OF THE APPLICABLE BUILDING CODE, AND ANY OTHER LOCAL CODES AND ORDINANCES.
 - WORKMANSHIP SHALL BE FIRST QUALITY AND IN ACCORDANCE WITH BEST PRACTICES FOR THE TRADE BY SKILLED WORKERS.
 - ALL MATERIALS SHALL BE NEW, WITH "UL" APPROVED LABELS.
 - ALL ELECTRICAL EQUIPMENT AND SYSTEMS SHALL BE TESTED AND ADJUSTED FOR PROPER OPERATION. COMPLETE WIRING SYSTEM SHALL BE FREE OF SHORT AND OPEN CIRCUITS.
 - CONTRACTOR SHALL OBTAIN AND PAY ALL FEES AND PERMITS REQUIRED FOR THE CONSTRUCTION OF THE PROJECT.
 - ALL ELECTRICAL EQUIPMENT SHOWN SHALL BE ELECTRICALLY PROTECTED AND PROPERLY WIRED IN ACCORDANCE WITH LOCAL BUILDING CODES. COORDINATE LOCATIONS AND ELECTRICAL DATA WITH THE OWNER.
 - SUPPLY AND INSTALL NEW ELECTRICAL DEVICES AS SHOWN.
 - DEVICE LOCATIONS SHOWN ON THE PLAN SHALL BE PLACED EXACTLY AS SHOWN. COORDINATE WITH INTERIOR ELEVATIONS.
 - ALL WALL OUTLETS SHALL BE INSTALLED 18" AFF TO CENTER OF OUTLET, UNLESS NOTED OTHERWISE.
 - ALL FIXTURES, WIRE, AND ELECTRIC DEVICES SHALL BE UL APPROVED.
 - ALL WIRING SHALL BE AS SPECIFIED UNDER ELECTRICAL SPEC. SECTION.
 - ALL REINSTALLED EMERGENCY ALARMS SHALL BE IN COMPLIANCE - NFPA 72 - CURRENT EDITION
 - ALL BRANCH LIGHTING AND RECEPTACLE CIRCUITS IN EXCESS OF 100 FT. TO LOAD CENTER FROM PANEL SHALL BE #10 AWG.

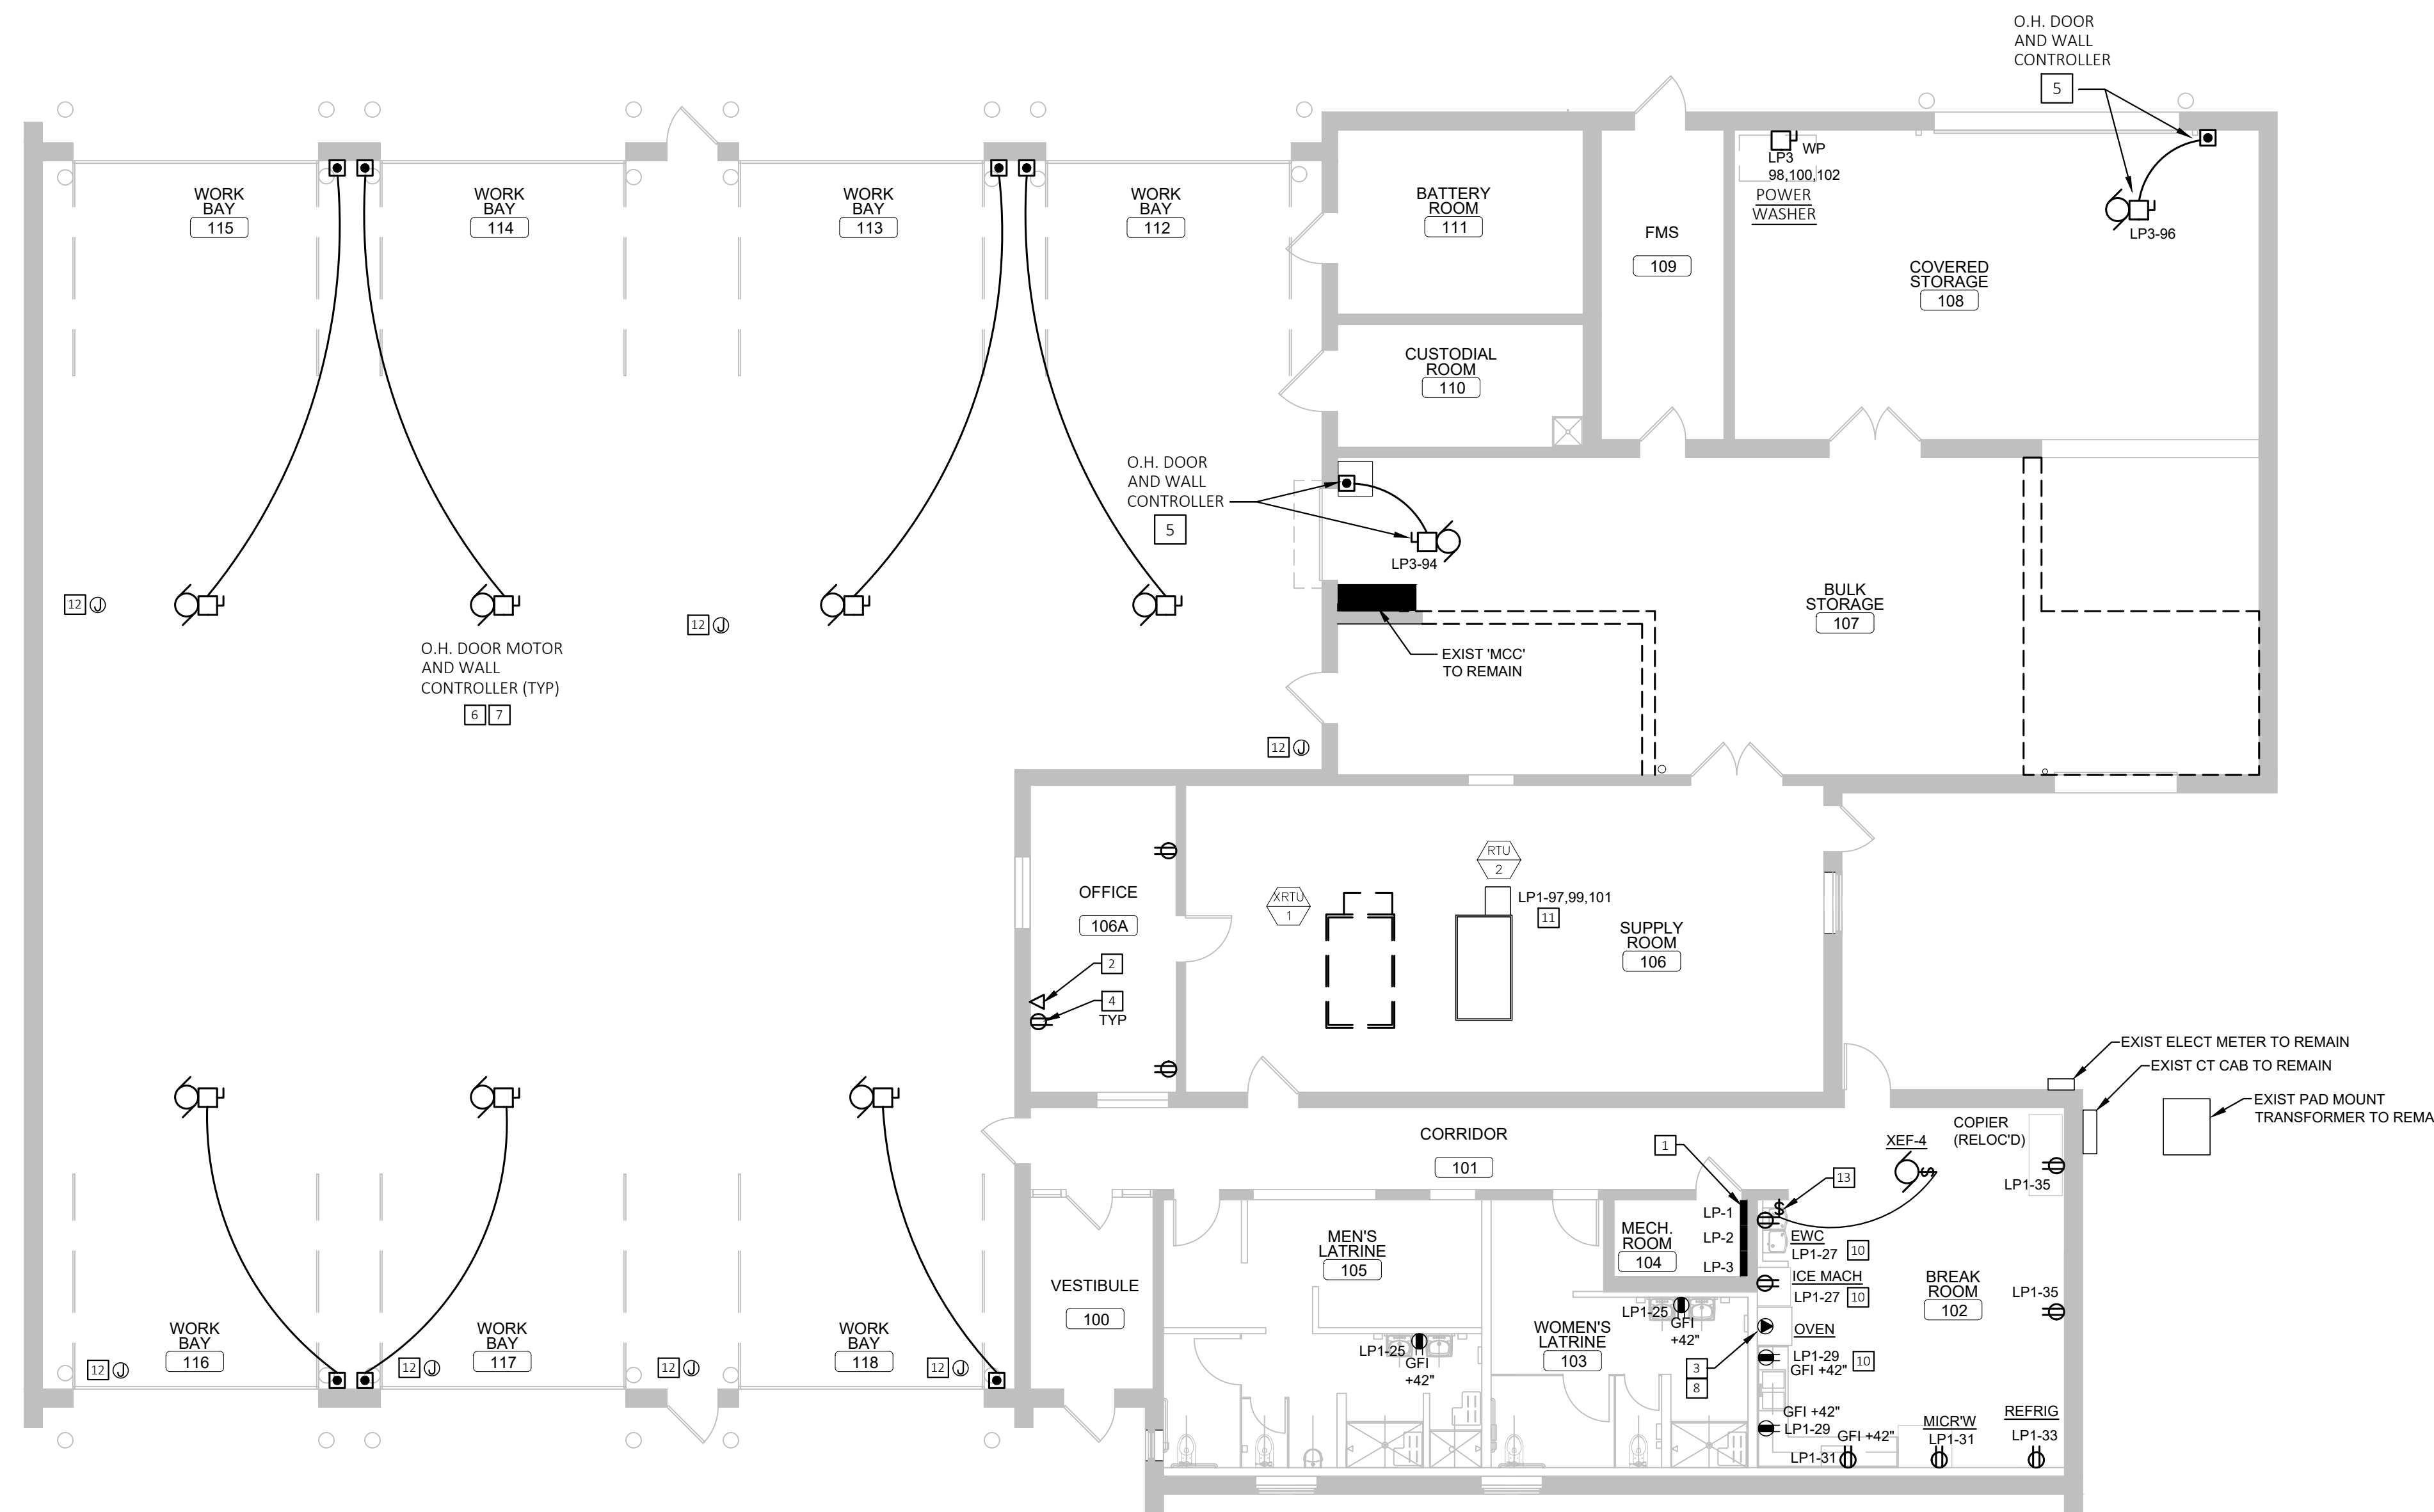- # POWER KEY NOTES:**
- MECHANICAL ROOM: ALL EXISTING ELECTRICAL PANELS, LIGHTING CONTRACTOR IN THIS ROOM TO REMAIN - NO CHANGE.
 - TELE/DATA: EC SHALL PROVIDE BACKBOX AT 18" AFF WITH 3/4" C AND PULLCORD TO ACCESSIBLE CEILING SPACE FOR COMMUNICATION CABLING BY OWNER'S VENDOR.
 - OVEN: PROVIDE NEMA 5-30 OUTLET FOR OVEN. VERIFY CORD/PLUG CONFIGURATION WITH OUTLET.
 - PROVIDE NEW WALL OUTLETS AND CONNECT TO EXISTING RECEPTACLE CIRCUIT IN AREA/ROOM. FIELD VERIFY.
 - PROVIDE 30A-1P NF DISC SWITCH FOR MOTORIZED OVERHEAD DOOR. CONNECT PER MANUFACTURER'S INSTRUCTIONS.
 - AFTER NEW O.H. DOOR IS IN-PLACE, COORDINATE THE INSTALLATION OF THE DOOR MOTOR AND WALL OPERATOR. EXTEND FEEDER, TIED-UP DURING DEMOLITION WORK AND CONNECT DOOR MOTOR AND WALL OPERATOR AS REQUIRED. COORDINATE ALL ELECTRICAL WORK WITH O.H. DOOR REPRESENTATIVE.
 - VERIFY THAT THE LOAD OF THE NEW O.H. DOOR MOTOR IS EQUAL OR LESS THE REMOVED O.H. DOOR MOTOR AND NOT REQUIRING LARGER DISCONNECT AND CIRCUIT BREAKER SIZE. IF LARGER THAN CURRENT BREAKER SIZE, REPLACE CIRCUIT BREAKER IN PANEL AND INCREASE FEEDER SIZE.
 - REROUTE WIRING PREVIOUSLY TIED-UP DURING DEMO WORK TO NEW OVEN OUTLET AND RECONNECT AS REQUIRED. VERIFY CIRCUIT BREAKER & WIRE SIZE IS COMPATIBLE WITH NEW OUTLET.
 - PROVIDE JUNCTION BOX HIGH IN CEILING SPACE FOR DATA/COMMUNICATION CABLES BY OTHERS. ROUTE 1" C WITH PULLCORD BETWEEN JUNCTION BOX AND MAIN COMMUNICATION EQUIPMENT.
 - REPLACE PANEL CIRCUIT BREAKER WITH GFCI TYPE.
 - DISCONNECT FURNISHED WITH UNIT, FED WITH 3#8, #10G, 3/4" C. EXTEND NEAREST RTU RECEPTACLE CIRCUIT TO THIS UNIT'S RECEPTACLE.
 - PRIOR TO REMOVAL OF GAS FIRED HEATER, DISCONNECT CIRCUIT AND TIE-UP FOR REUSE. AFTER NEW GAS FIRED HEATER IS IN-PLACE, RECONNECT TO EXISTING CIRCUIT.
 - PROVIDE 20A-1P HP RATED WALL TOGGLE SWITCH AND CONNECT TO EXISTING EXHAUST FAN. COORDINATE WORK WITH MC.

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JEFFERSON CITY, MISSOURI
65101

PROJECT # T2122-01
SITE # 6300
ASSET# 8136300017

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DESIGNED BY: _____

SHEET TITLE:
**ELECTRICAL
POWER FLOOR
PLAN**

SHEET NUMBER:
E-103
08/01/2023
SHEET 28 OF 29



DAVID A. TRETTER
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SHEET TITLE:

ELECTRICAL
LEGEND AND
SCHEDULES

SHEET NUMBER:

E-601

08/01/2023
SHEET 29 OF 29

ABBREVIATIONS (NOTE: NOT ALL ABBREVIATIONS ARE USED)			
AFF	ABOVE FINISHED FLOOR	EM	EMERGENCY
AL	ALUMINUM	EWC	ELECTRIC WATER COOLER
AMP	AMPERE	EXISTG	EXISTING
ATS	AUTO-TRANSFER-SWITCH	GFCI	GROUND FAULT CURRENT INTERUPTER
BFG	BELOW FINISHED GRADE	FL	FLOOR
BLDG	BUILDING	FLUOR	FLUORESCENT
CB	CIRCUIT BREAKER	GND OR (G)	GROUND
CKT	CIRCUIT	IG	ISOLATED GROUND
CLG	CEILING	JB	JUNCTION BOX
COND OR "C"	CONDUIT	MCB	MAIN CIRCUIT BREAKER
CONN	CONNECT	MDP	MAIN DISTRIBUTION PANEL
CONT	CONTRACTOR	MLO	MAIN LUG ONLY
CU	COPPER	MTD HT	MOUNTING HEIGHT
C/T	CURRENT TRANSFORMER	NF	NON FUSED
DIM	DIMMER	NIC	NOT IN CONTRACT
DMC	DESTINATION MATERNITY	OFOI	OWNER FURNISH, OWNER INSTALL
DISC SW	DISCONNECT SWITCH	RT	RAIN TIGHT, NEMA 3R
DP	DOUBLE POLE	RTU	ROOF TOP UNIT
DT	DOUBLE THROW	SW	SWITCH
DPP	DISTRIBUTION POWER PANEL	UG	UNDER GROUND
EC	EMPTY CONDUIT	UNO	UNLESS NOTED OTHERWISE
EF	EXHAUST FAN	WP	WEATHER-PROOF
V.I.F.	VERIFY IN FIELD	XFMR	TRANSFORMER

LIGHTING FIXTURE SCHEDULE							
TYPE	MANF	CATALOG NO.	LAMP DATA			REMARKS	WATTS
			**	NO.	LAMPS		
A	METALUX	22CZ2-44-UNV-L840-CD1-U	L	1	4400 LUMENS 4000K LED	2' X 2' LED TROFFER, RECESSED MTD, 0-10V DIMMABLE FIXTURE	33W
A1	METALUX	22CZ2-44-UNV-L840-CD1-U WITH DF-22W-U KIT	L	1	4400 LUMENS 4000K LED	2' X 2' LED TROFFER, RECESSED MTD WITH DRYWALL FRAME KIT, 0-10V DIMMABLE FIXTURE	33W
B	LEOTEK	ES2-88H-MV-NW-FT-DB-450	L	1	14254 LUMENS 4000K LED	23"WD X 12"DP LED WALL MOUNT FIXTURE, DIFFUSED LENSE, 0-10V DIMMABLE FIXTURE, DARK BRONZE FINISH	126W
C	METALUX	4SNLED-LD541SL-LW-UNV-L840-CD1-U	L	1	4214 LUMENS 3500K LED	4-FT LED STRIP LIGHT FIXTURE, 0-10V DIMMABLE FIXTURE	35W
D	PORTFOLIO	LDR16B-15-D010 (HOUSING) EU6B-1020-80-35 (POWER MODULE) 6LB-M-1-H (TRIM)	L	1	1500 LUMENS 4000K LED	6" DIAMETER, RECESSED DOWNLIGHT, 0-10V DIMMABLE FIXTURE, WHITE FINISH	16W
E	SURE-LITE	APEL	L	2		WALL MOUNT 2-HEAD EMERGENCY BATTERY FIXTURE, WHITE FINISH	2W

** LAMPS L - LED; F - FLUORESCENT; CF - COMPACT FLUORESCENT; MH - METAL HALIDE;

NOTES:
A. CONTRACTOR SHALL BE RESPONSIBLE FOR COORDINATION AND QUANTITY OF FIXTURES.
B. PROVIDE ALL NECESSARY ACCESSORIES, CONNECTORS, HANGERS, END CAPS, ETC FOR A COMPLETE OPERABLE INSTALLATION.
C. ALL LUMINAIRES ARE 120V, UNLESS NOTED OTHERWISE.

NOTES	MOUNT: SURFACE 120/208 3-PHASE, 4W						EX PANEL LP3			CAPACITY: 225A			INT CAP: EXISTING			NOTES		
	LOCATION: ELECTRICAL ROOM						LUGS: MLO			DEMAND LOAD: 37A			AV. FAULT: EXISTING					
CKT	LTG	REC	HVAC	MSC	NP	DESCRIPTION	AMP	POLE	⊕	AMP	POLE	DESCRIPTION	LTG	REC	HVAC	MSC	NP	CKT
85						PROVISIONS	20	1	A	40	2							86
87						EXISTING	20	2	C	40	2							88
89												EXISTING						90
91																		92
93						EXISTING	70	3	B	20	1	O.H DOOR				1.9		94
95												O.H DOOR				1.9		96
97			2.4													1.3		98
99			2.4			RTU-2	30	3	A	20	3	POWER WASHER				1.3		100
101			2.4													1.3		102
103						PROVISIONS												104
105						PROVISIONS				20	3	EXISTING						106
107						PROVISIONS												108
109						EXISTING	20	1	A									110
111						EXISTING	20	1	B	20	3	EXISTING						112
113						EXISTING	20	1	C									114
115						EXISTING	20	1	A	20	1	EXISTING						116
117						EXISTING	20	1	B	20	1	EXISTING						118
119						EXISTING	20	1	C	20	1	EXISTING						120
121												EXISTING						122
123						EXISTING	20	3	B	20	1							124
125																		126
127						EXISTING	20	1	A			EXISTING						128
129						EXISTING	20	1	B	50	2	EXISTING						130
131						EXISTING	50	2	A	20	1							132
133												SPARE						134
135						EXISTING	20	2	B	20	1	SPARE						136
137												PROVISIONS						138
139						EXISTING	30	2	A	20	1	EXISTING						140
141												EXISTING						142
143						PROVISIONS												144

PHASE BALANCE			LOAD TYPE	CONNECTED	DEMAND	DEMAND FORMULA	TOTAL LOAD	
⊕	LOAD	%	RECEPTACLE	0.0 KVA	0.0 KVA	LOAD X 125% NEC 210.19 CONTINUOUS	CONNECTED	DEMAND
				0.0 KVA	0.0 KVA	10KVA + 50% REMAINDER NEC 220.44	14.9 KVA	13.5KVA
A	3.2 KVA	24%	HVAC	7.2 KVA	5.8 KVA	LOAD X 80% (USED MCA IN CALCULATION)	41.4A	37.4A
B	5.1 KVA	38%	MSC	7.7 KVA	7.7 KVA	LOAD X 100% NEC 210.19 NON-CONT.		
C	5.1 KVA	38%	NP	0.0 KVA	0.0 KVA	NONCOINCIDENTAL LOADS NEC 220.80		

FILENAME: Copy of 2202009 LOAD.xlsm

NOTES:
A. EXISTING 3-SECTION PANEL. (SECTION #3)
B. "LO" PROVIDE LOCKABLE CIRCUIT BREAKER WITH ABILITY TO BE "LOCKED ON". "GFI" PROVIDE GFI CIRCUIT BREAKER.
C. NEW WORK IN **BOLD**.
D. PROVIDE NEW C/B WITH SAME INTERRUPTING RATING, SAME MANUFACTURER.