# COMPANY HEADQUARTERS & ADMINISTRATION SUPPLY BUILDING MACON TRAINING SITE MACON, MISSOURI

OWNER: STATE OF MISSOURI

MIKE L. PARSON, GOVERNOR

DEPARTMENT OF PUBLIC SAFETY MISSOURI NATIONAL GUARD OFFICE OF ADJUTANT GENERAL

PROJECT OFFICE OF ADMINISTRATION,

MANAGEMENT: DIVISION OF FACILITIES MANAGEMENT,

**DESIGN & CONSTRUCTION** 

DESIGNER: PWArchitects, Inc.

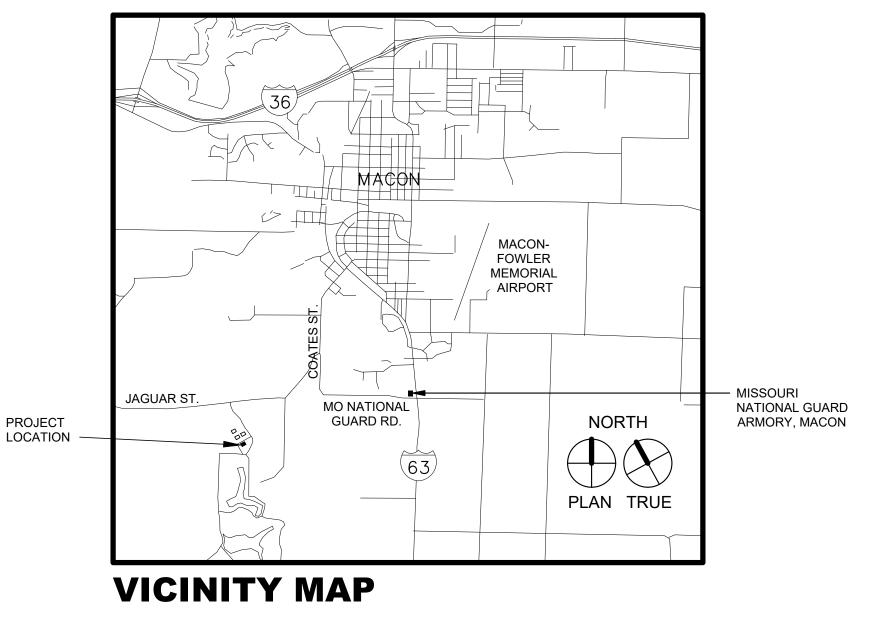
PROJECT NUMBER: T2214-01

SITE NUMBER: 6319

ASSET NUMBER: 8136319018







# INDEX OF DRAWINGS

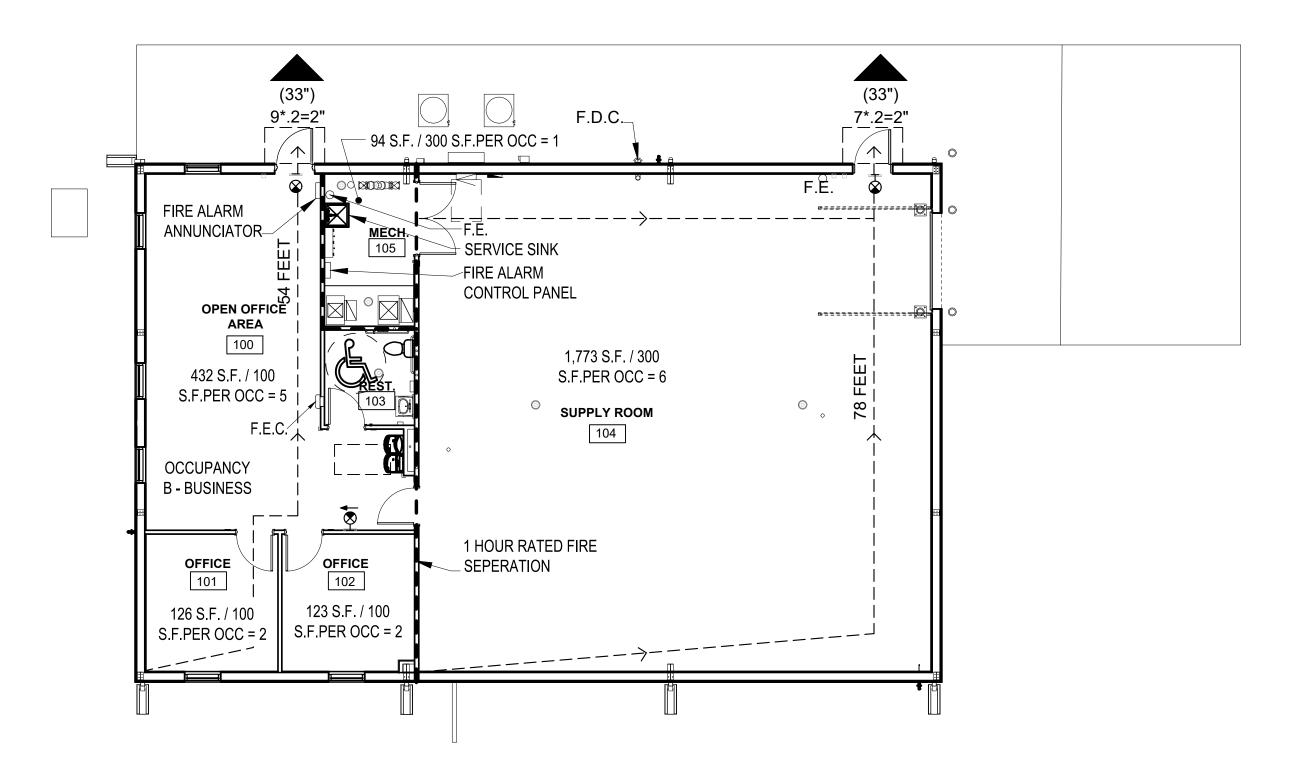
### NO. SHEET SHEET TITLE

G-001 COVER SHEET, INDEX OF DRAWINGS & LOCATION MAP 2 G-002 LIFE SAFETY PLAN & CODE ANALYSIS C-001 CIVIL NOTES C-002 EROSION CONTROL & GRADING PLAN C-003 UTILITY PLAN - BASE BID C-004 SITE PLAN - BASE BID C-005UTILITY & SITE PLAN - ALTERNATE 1 STRUCTURAL 8 S-100 COVER / GENERAL STRUCTURAL DATA 9 S-200 FOUNDATION PLAN 10 S-210 FOUNDATION DETAILS ARCHITECTURAL 11 A-001 SYMBOLS, ABBREVIATIONS & NOTES 12 A-101 FLOOR, REFLECTED CEILING & ROOF PLANS 13 A-201 BUILDING SECTIONS, ELEVATIONS & DETAILS 14 A-202 INTERIOR ELEVATIONS, FINISH SCHEDULE & DETAILS 15 A-301 WALL SECTIONS & DETAILS 16 A-501 PARTITION TYPES & DETAILS 17 A-601DOOR & WINDOW SCHEDULES & DETAILS 18 MEP-101 MECHANICAL - ELECTRICAL - PLUMBING COVER SHEET 19 M-101 HVAC PLAN 20 M-101A HVAC PLAN ALTERNATE 21 M-501 HVAC DETAILS & SCHEDULES 22 E-101 POWER PLAN 23 E-102 LIGHTING PLAN 24 E-501 ELECTRICAL DETAILS & SCHEDULES 25 F-101 FIRE ALARM PLAN 26 P-101 SANITARY SEWER PLAN 27 P-102 WATER PLAN 28 P-501 PLUMBING DETAILS & SCHEDULES

COVER SHEET, INDEX OF DRAWINGS & LOCATION MAP

G-001

01 OF 28 SHEETS



H1

CODE, EGRESS & LIFE SAFETY PLAN

SCALE: 1/8" = 1'-0"

LEGEND: LIFE SAFETY PLAN

1 HR FIRE BARRIER

FEC FIRE EXTINGUISHER CABINET (EXISTING &/OR RELOCATED EXISTING)

FE FIRE EXTINGUISHER ON WALL-HUNG BRACKET (EXISTING)

EXIT SIGNAGE


FIRE DEPARTMENT CONNECTION
F.D.C.

00 EGRESS CAPACITY REQUIRED
(xx") EGRESS WIDTH PROVIDED (IN INCHES)
EGRESS DIRECTION

TRAVEL DISTANCE

### CODE ANALYSIS SUMMARY DESIGN FACILITIES TO BE CONSTRUCTED BASED ON 2018 MASTER PLAN MACON TRAINING SITE 1616 SOUTH MISSOURI STREET US HIGHWAY 63 SOUTH MACON, MISSOURI 63552 MACON COUNTY MONG PROJECT NUMBER: T2214-01 **GLMV PROJECT NUMBER: 0** COMPANY HEADQUARTERS AND ADMINISTRATION BUILDING (NEW CONSTRUCTION PROJECT) JURISDICTION: MISSOURI OFFICE OF ADMINISTRATION - FACILITIES MANAGEMENT, DESIGN & CONSTRUCTION MISSOURI NATIONAL GUARD FIRE DEPARTMENT: MACON FIRE DEPARTMENT **INTERNATIONAL BUILDING CODE (IBC) BUILDING INFORMATION** MAIN OCCUPANCY TYPE (304.1): B (BUSINESS) ADDITIONAL (MIXED) OCCUPANCIES (CHAPTER 3): S-2 (STORAGE) CONSTRUCTION TYPE (TABLE 601): (NON-COMBUSTIBLE / NO FIRE-RESISTIVE REQUIREMENTS) BASIC ALLOWABLE AREA (TABLE 506.2): 23,000 S.F. W/ AUTOMATIC SPRINKLER SYSTEM (1-STORY): 92,000 S.F. BASIC ALLOWABLE HEIGHT (TABLE 504.3 & 504.4): 3-STORIES / 75'-0" FRONTAGE INCREASE (EQ. 5-5) If = [(228/228)-0.25] 30/30 If = 0.75TOTAL AREA INCREASE (EQ. 5-1) $Aa = [92,000 \text{ S.F.} + (23,000 \text{ S.F.} \times 0.75)]$ Aa = 109,250 S.F. MAXIMUM ALLOWABLE AREA: 109,250 S.F. ACTUAL (GROSS) BUILDING AREA: 2,909 S.F. ACTUAL HEIGHT: 1-STORY / 18' - 3" REQUIRED EXITS PER STORY (TABLE 1006.3.1): EXITS PROVIDED IN DESIGN: MAXIMUM EXIT ACCESS TRAVEL DISTANCE (TABLE 1017.2) DEAD END CORRIDOR LENGTH (SECTION 1020.4): NOT TO EXCEED 50 FEET **BUILDING ELEMENTS FIRE-RESISTANCE RATING REQUIREMENTS (TABLE 601)** 0-HOURS PRIMARY STRUCTURAL FRAME: INTERIOR BEARING WALLS: 0-HOURS EXTERIOR BEARING WALLS: 0-HOURS FLOOR CONSTRUCTION: 0-HOURS **ROOF CONSTRUCTION:** 0-HOURS NON-BEARING WALLS & PARTITIONS 0-HOURS EXTERIOR: INTERIOR: 0-HOURS **BUILDING OCCUPANCY LOAD (TABLE 1004.1.2)** OCC. PER S.F. AREA 1/100 S.F. 432 S 5 OCCUPANTS **OPEN OFFICE AREA** OFFICE #1 1/100 S.F. 126 S.F. 2 OCCUPANTS 2 OCCUPANTS OFFICE # 2 1/100 S.F. 123 S.F. 1/300 S.F. 1 OCCUPANT MECH. RM. 60 S.F. SUPPLY ROOM 1/300 S.F. 1,773 S.F. 6 OCCUPANTS 16 OCCUPANTS TOTAL: **BUILDING SEPARATIONS:** (SEE NFPA CODE SUMMARY) 1 HOUR SEPARATION REQUIRED BETWEEN B OCCUPANCY AND S2 OCCUPANCY (508.4) PLUMBING FIXTURES OCCUPANCY B OCCUPANCY S-2 TOTAL REQ. TOTAL PROVIDED (9 OCC.) (7 OCC) 1/25 OCC = .36 1/100 OCC = .07 LAVATORIES: OTHER - SERVICE SINK: - (exception e) DRINKING FOUNTAINS: 1/100 OCC = .09 1/1000 OCC = .007EDITION: 2018 EDITION: 2018 IMC EDITION: 2018 NEC EDITION: 2017 IFGC NFPA 101 EDITION: 2018 EDITION: 2015 IECC EDITION: 2018 ADA ABA EDITION: 2010 EDITION: 2015 PROJECT IS LOCATED ON LAND OWNED BY THE NATIONAL GUARD AND IS OUTSIDE THE JURISDICTION OF THE CITY OF MACON AND MACON COUNTY. ALL SPACES ARE ACCESSIBLE. ADJACENT PARKING LOTS HAVE AN ACCESSIBLE ROUTE TO THE FIRE PROTECTION SYSTEMS ARMY NATIONAL GUARD, DG 415-5 (GENERAL FACILITIES INFORMATION DESIGN GUIDE): (SECTION 1-3.15) - INCORPORATE EFFICEINT AND COST-EFFECTIVE FIRE PROTECTION AND DETECTION SYSTEMS IN ALL ARNG FACILITY DESIGNS. (FIRE PROTECTION SYSTEMS - UFGS 21 13 00) - REGARDLESS OF THE CONSTRUCTION TYPE, ANY FACILITIES MEETING THE FOLLOWING CRITERIA SHOULD BE PROVIDED WITH AN APPROPRIATE FIRE PROTECTION SYSTEM: OPERATIONAL IMPAIRMENT WOULD REDUCE THE OPERATIONAL READINESS AND RESPONSIVENESS OF THE STRATEGIC OR TACTICAL DEFENSIVE AND OFFENSIVE CAPABILITY. NFPA 101 : LIFE SAFETY CODE OCCUPANCY (SECTION 6.1.8.1.4): **BUSINESS/STORAGE** OCCUPANT LOAD FACTORS (TABLE 7.3.1.2): ROOM\_ OPEN OFFICE AREA OCC. PER S.F. 1/100 S.F. OCC. PER RM. 5 OCCUPANTS AREA 432 S.F. OFFICE #1 125 S.F. 2 OCCUPANTS 1/100 S.F. OFFICE # 2 1/100 S.F. 124 S.F. 2 OCCUPANTS MECH. RM. 0 OCCUPANT SUPPLY ROOM 0 OCCUPANTS 9 OCCUPANTS TOTAL: EGGRESS WIDTH REQ'D (TABLE 7.3.3.1): 9 OCCUPANTS x 0.2"/OCC. = **1.8**" AVAILABLE EGRESS WIDTH: MIN. CORRIDOR WIDTH: MAX. COMMON PATH OF TRAVEL (SECT. 38.2.5.3.1): 100 FEET MAX. DEAD-END CORRIDORS (SECTION 38.2.5.2.1): 50 FEET MAX. TRAVEL DISTANCE (SECTION 38.2.6.1): 200 FEET **SEPARATION OF OCCUPANCIES (TABLE 6.1.14.4.1)**: 2-HOURS BUSINESS & STORAGE (LOW AND ORDINARY HAZARD) REDUCED BY 1-HOUR DUE TO THE PRESENCE OF SPRINKLERS 1-HOUR (SECT. 6.1.14.4.3) MECHANICAL ROOM 1-HOUR PER NFPA 70, 72 & UFC 3-600-01 FIRE ALARM SYSTEM: FIRE PROTECTION SYSTEMS: **AUTOMATIC SPRINKLER SYSTEM PER NFPA 13** (TABLE 28.3.2.2.2, HAZARDOUS AREA PROTECTION FOR BOILER & FUEL-FIRED HEATER ROOMS SERVING MORE THAN A SINGLE GUEST ROOM OR GUEST SUITE) PORTABLE EXTINGUISHING EQUIP. PER NFPA

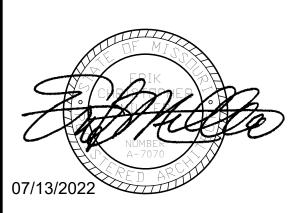STATE OF MISSOURI MICHAEL L. PARSON, GOVERNOR





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Missouri Army National Guard

Macon Training Site 29614 Jaguar Street Macon, MO 63552

COMPANY HEADQUARTERS & ADMINISTRATION SUPPLY BUILDING

PROJECT # T2214-01 SITE # 6319 ASSET # 8136319018

REVISION:
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DATE:
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REVISION:
DATE:
DATE
ISSUE DATE: 07/13/2022
1000E DATE: 07/13/2022

CAD DWG FILE:
DRAWN BY: LC
CHECKED BY: EM
DESIGNED BY: EM

SHEET TITLE:
LIFE SAFETY
PLAN & CODE
ANALYSIS

SHEET NUMBER:

07/13/2022

G-002

2 OF 28 SHEETS

# GENERAL NOTES:

THE STORM SEWER NETWORK DESIGN FOR THIS PROJECT IS BASED ON OPEN CHANNEL FLOW; THEREFORE THE HYDRAULIC GRADE LINE IS AT OR LESS THAN THE CROWN OF THE PIPE.

EXISTING UTILITIES SHOWN FOR REFERENCE ONLY. CONTRACTOR SHALL COORDINATE LOCATES (HORIZONTAL AND VERTICAL) PRIOR TO ANY EXCAVATION.

ALL EXCAVATION TO BE IN ACCORDANCE WITH SECTIONS 319.010-319.050, REVISED STATUTES OF THE STATE OF MISSOURI. SUCH COMPLIANCE SHALL NOT, HOWEVER, EXCUSE ANY PERSON MAKING ANY EXCAVATION FROM DOING SO IN A CAREFUL AND PRUDENT MANNER, NOR SHALL IT EXCUSE SUCH PERSON FROM LIABILITY FOR ANY DAMAGE OR INJURY TO UNDERGROUND UTILITIES RESULTING FROM THE EXCAVATION.

A GEOTECHNICAL EVALUATION HAS BEEN PERFORMED BY CROCKETT GEOTECHNICAL TESTING LAB (GTL). REFER TO REPORT NUMBER G22783 DATED JUNE 8, 2022 BY CROCKETT GTL.

ALL SLOPES ARE 3:1 OR FLATTER UNLESS OTHERWISE NOTED.

IT IS THE INTENT OF THESE PLANS TO COMPLY WITH THE REQUIREMENTS OF THE MoDNR CLEAN WATER COMMISSION.

ALL DISTURBED AREAS WITHIN THE "LIMITS OF DISTURBANCE" SHALL BE FINE GRADED, SEEDED, AND MULCHED.

THE CONTRACTOR IS RESPONSIBLE FOR MAINTAINING ALL EROSION CONTROL DEVICES AND REMOVING THEM ONCE THE SITE IS STABILIZED.

SANITARY SEWER PIPE TO BE 4" PVC SDR 35 UNLESS OTHERWISE NOTED.

ALL SEWERLINES SHALL BE CONSTRUCTED AT LEAST 10 FEET HORIZONTALLY, EDGE TO EDGE, FROM ANY WATERLINE AND AT LEAST 24 INCHES VERTICALLY BETWEEN THE OUTSIDE LIMITS OF THE SANITARY SEWER AND WATERLINE. FOR CONDITIONS OTHER THAN THOSE IDENTIFIED ABOVE, CONTACT THE ENGINEER FOR SPECIFIC INSTRUCTIONS.

ALL HDPE PIPE SHALL BE INSTALLED PER MANUFACTURER'S RECOMMENDATIONS. REFER TO DETAIL FOR PIPE BEDDING REQUIREMENTS.

TOTAL DISTURBED AREA ON SITE = 15,000 SQ. FT.

MISSOURI DNR LAND DISTURBANCE PERMIT IS NOT REQUIRED.

# LEGEND OF SYMBOLS:

	EXISTING CURB	FF=XXX.X	FINISH FLOOR OF STRUCTURE
	PROPOSED CURB	(XXX.XXX TC)	PROPOSED TOP OF CURB ELEVATION
	RIP RAP	(XXX.XX TP)	PROPOSED TOP OF PAVEMENT ELEVATION
	EXISTING STRUCTURE	(XXX.XX FG)	PROPOSED FINISH GRADE ELEVATION
	EXISTING TREELINE	(XXX.XX TW)	PROPOSED TOP OF WALL
~~~	PROPOSED TREELINE	XX	LOT NUMBER
-000	EDGE OF WATERWAY		
— W — —	EXISTING WATERLINE	$\langle X \rangle$	STORM SEWER STRUCTURE LABEL
w	PROPOSED WATERLINE	V	CANITARY COMER CERUCTURE LARGE
— G — —	EXISTING GAS LINE	(X)	SANITARY SEWER STRUCTURE LABEL
— G ———	PROPOSED GAS LINE	H.P.	HIGH POINT
UT	EXISTING UNDERGROUND TELEPHONE	L.P.	LOW POINT
UTV	EXISTING UNDERGROUND CABLE TELEVISION		
- HVE	EXISTING HIGH VOLTAGE ELECTRIC	<del>-0</del>	EXISTING SIGNS
- OE ——	EXISTING OVERHEAD ELECTRIC	Ø	EXISTING POWER POLE
-UE	EXISTING UNDERGROUND ELECTRIC	ĞV	EXISTING GAS VALVE
OETV ——	EXISTING OVERHEAD ELEC. & TV		EXISTING WATER VALVE
0ETVT ——	EXISTING OVERHEAD ELEC., TV & TELE.	©	EXISTING GAS METER
s ——	EXISTING SANITARY SEWER	₩ ~	EXISTING WATER METER
- s ——	PROPOSED SANITARY SEWER	Ÿ	EXISTING FIRE HYDRANT
····XXX·····	EXISTING MINOR CONTOUR	©	MANHOLE
XXX- — —	EXISTING MAJOR CONTOUR	— <b>-•</b>	EXISTING SANITARY SEWER LATERAL
—XXX———	PROPOSED MINOR CONTOUR	<b>—•</b>	PROPOSED SANITARY SEWER LATERAL
—XXX———	PROPOSED MAJOR CONTOUR	®	PROPOSED TRACER WIRE TEST STATION B
	100 YEAR FLOOD PLAIN	AC	EXISTING AIR CONDITIONER
	FLOODWAY	T	EXISTING TELEPHONE PEDESTAL
- · ·	ORDINARY HIGH WATER MARK	ET	EXISTING ELECTRICAL TRANSFORMER
	STREAM SIDE BUFFER	E	EXISTING ELECTRIC METER
	OUTER STREAM BUFFER	¤	EXISTING LIGHT POLE
		$\rightarrow$	EXISTING GUY WIRE

### STATE OF MISSOURI MICHAEL L. PARSON, GOVERNOR



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COMPANY HEADQUARTERS & ADMINISTRATION BLDG.

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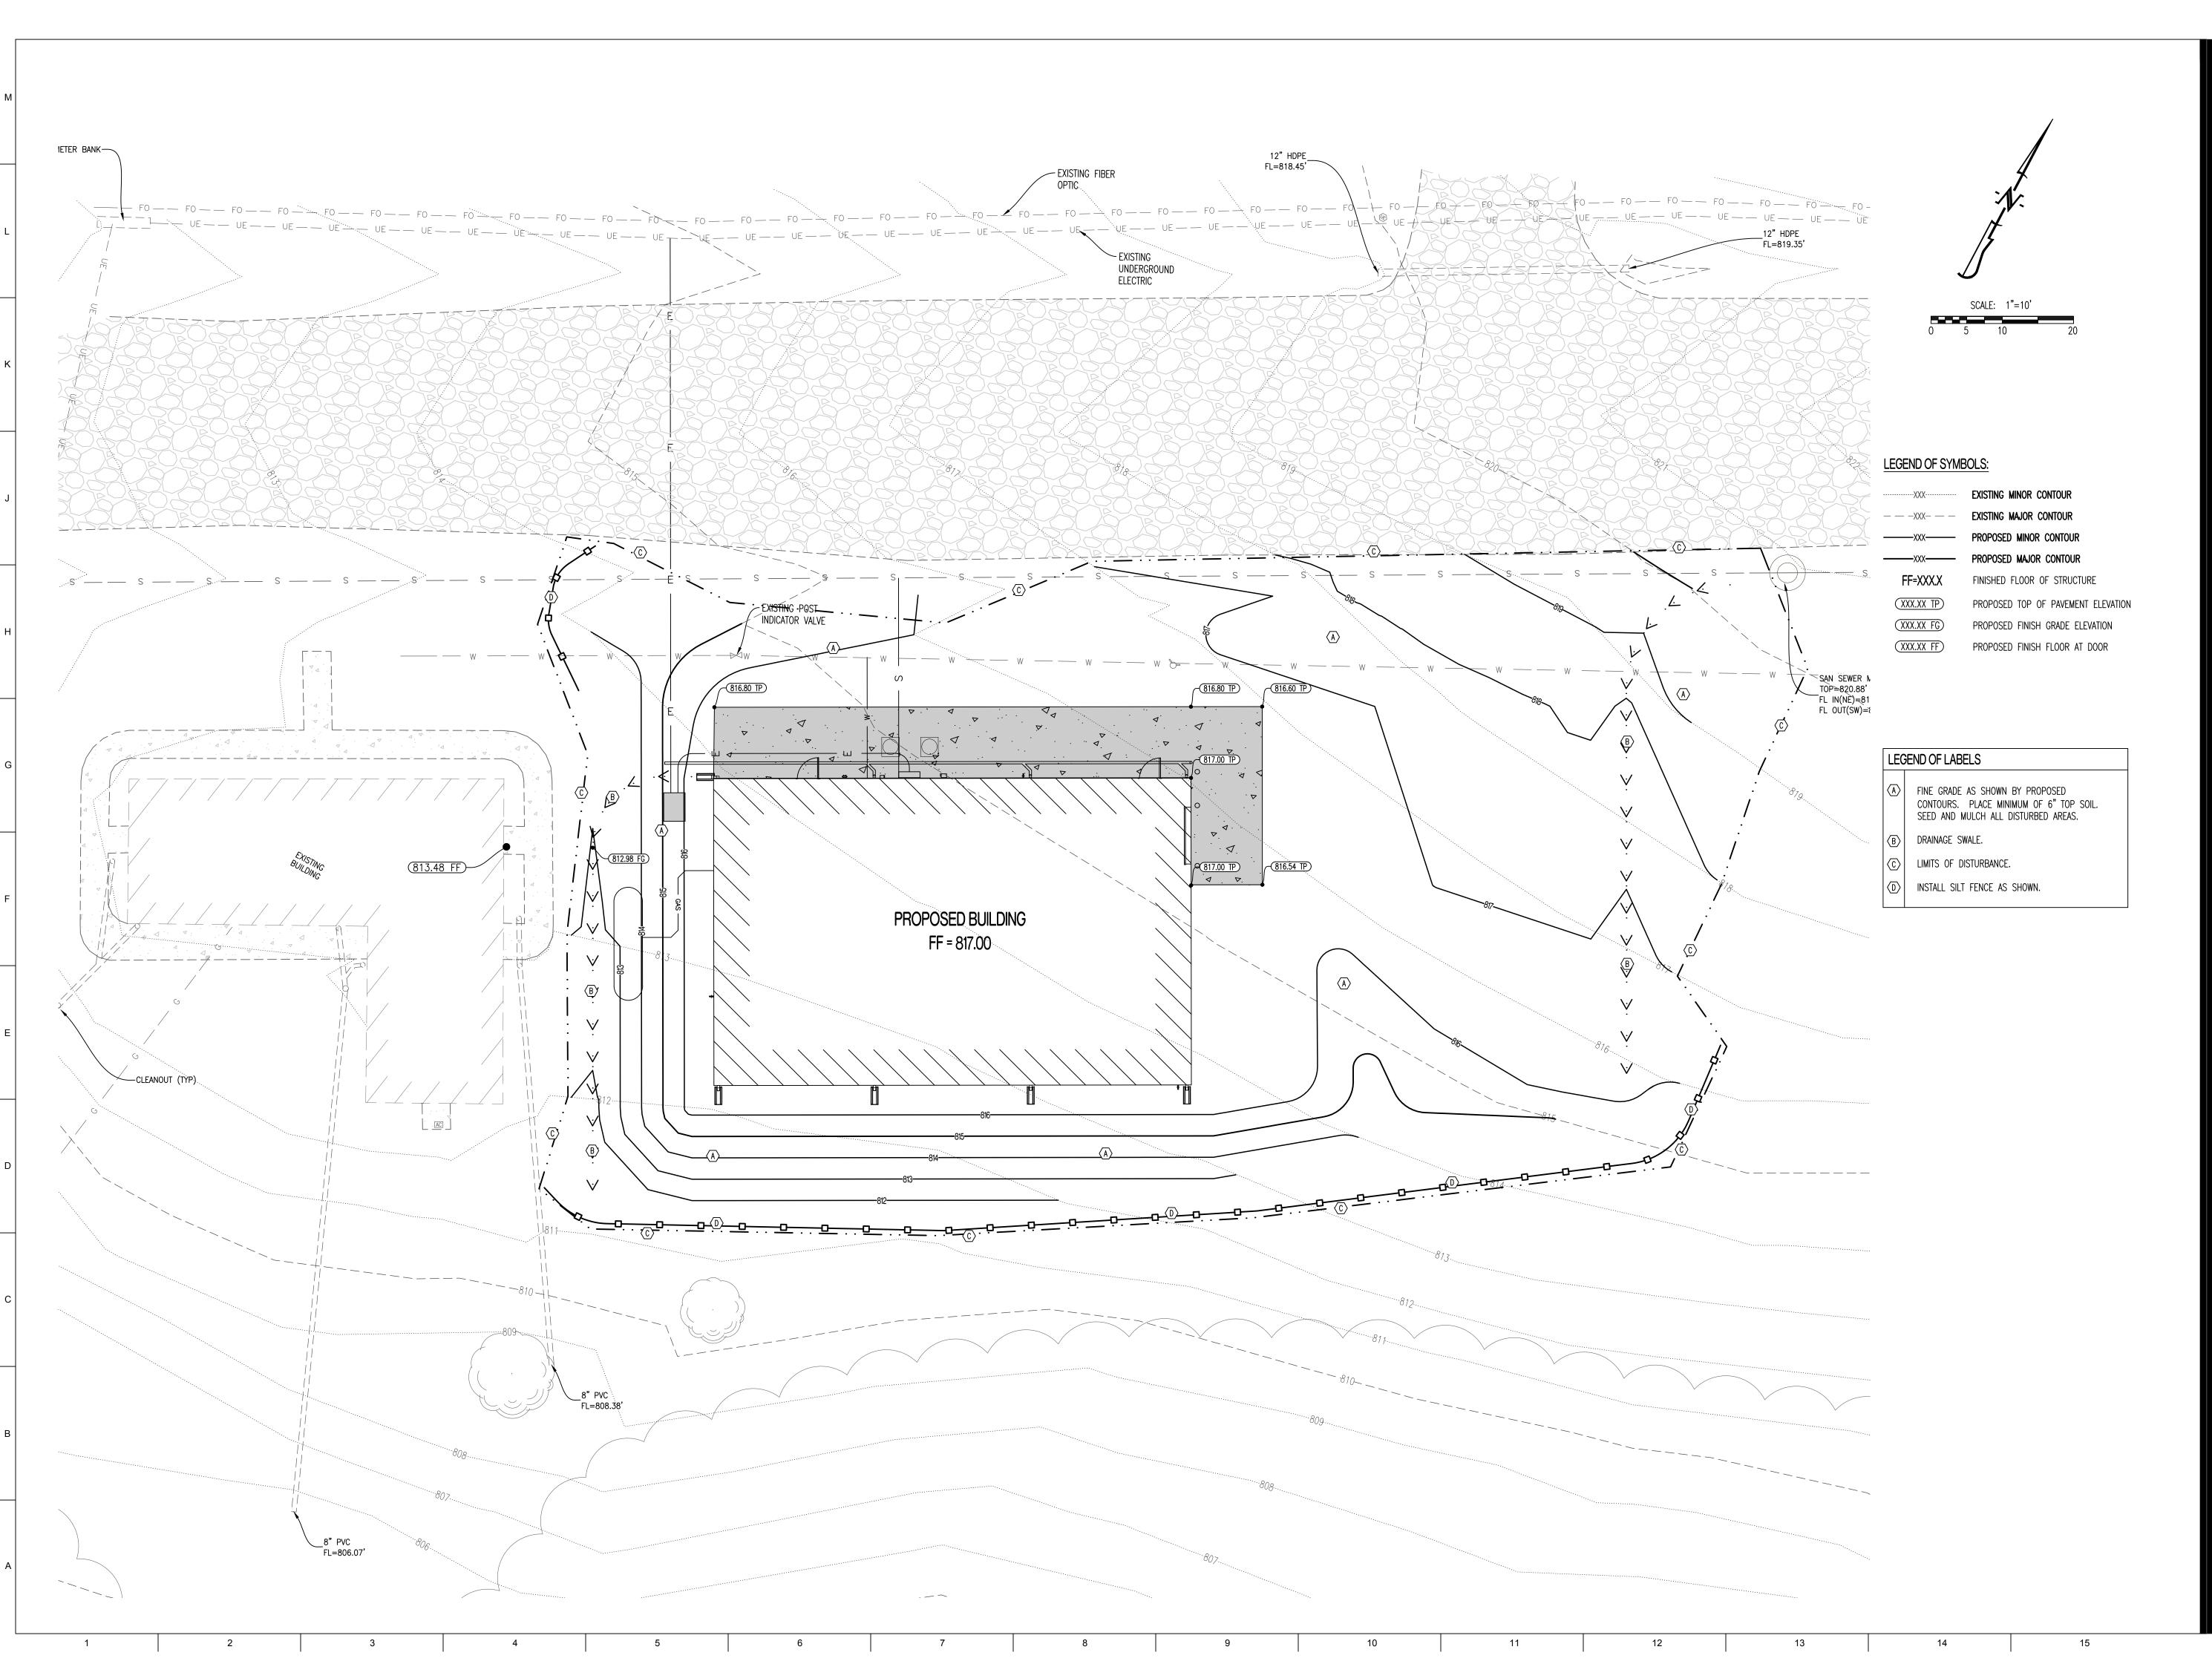
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CHECKED BY: TD


DESIGNED BY: <u>TWC</u>
SHEET TITLE:

CIVIL NOTES

SHEET NUMBER:

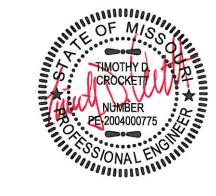C-00





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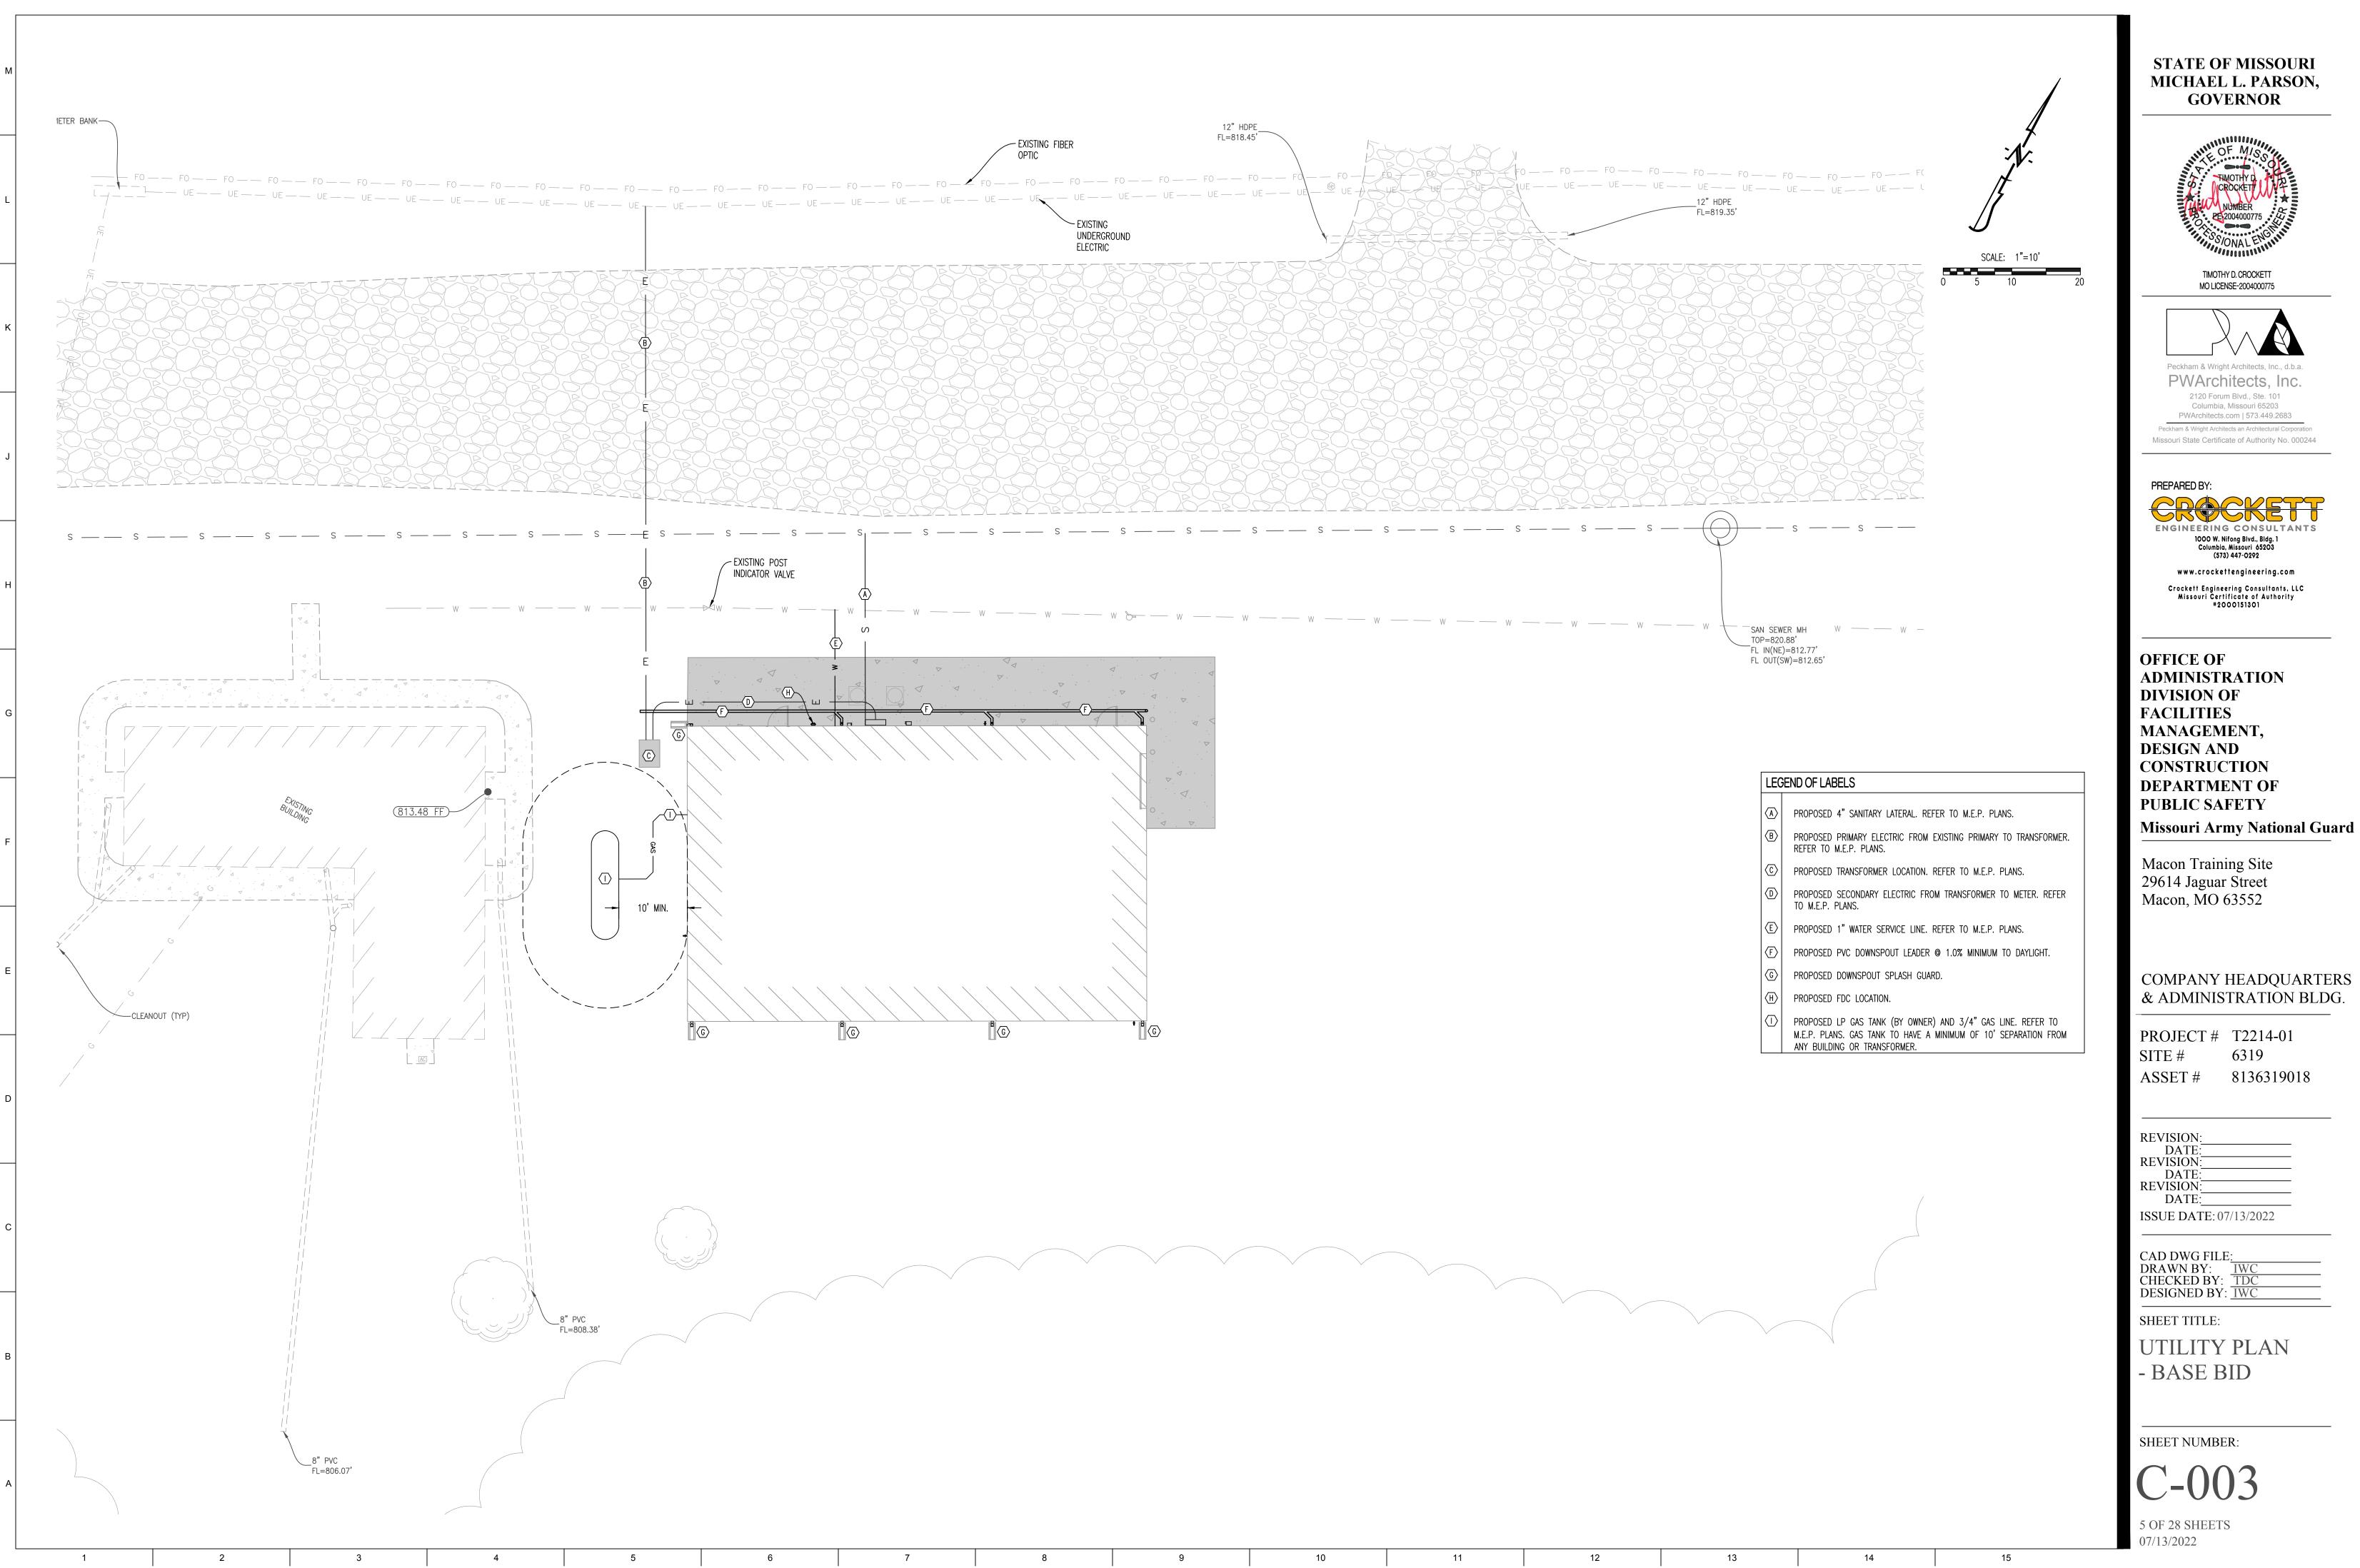
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CHECKED BY: TDC
DESIGNED BY: IWC

SHEET TITLE:

EROSION
CONTROL &
GRADING PLAN

SHEET NUMBER:

C-002



MICHAEL L. PARSON,





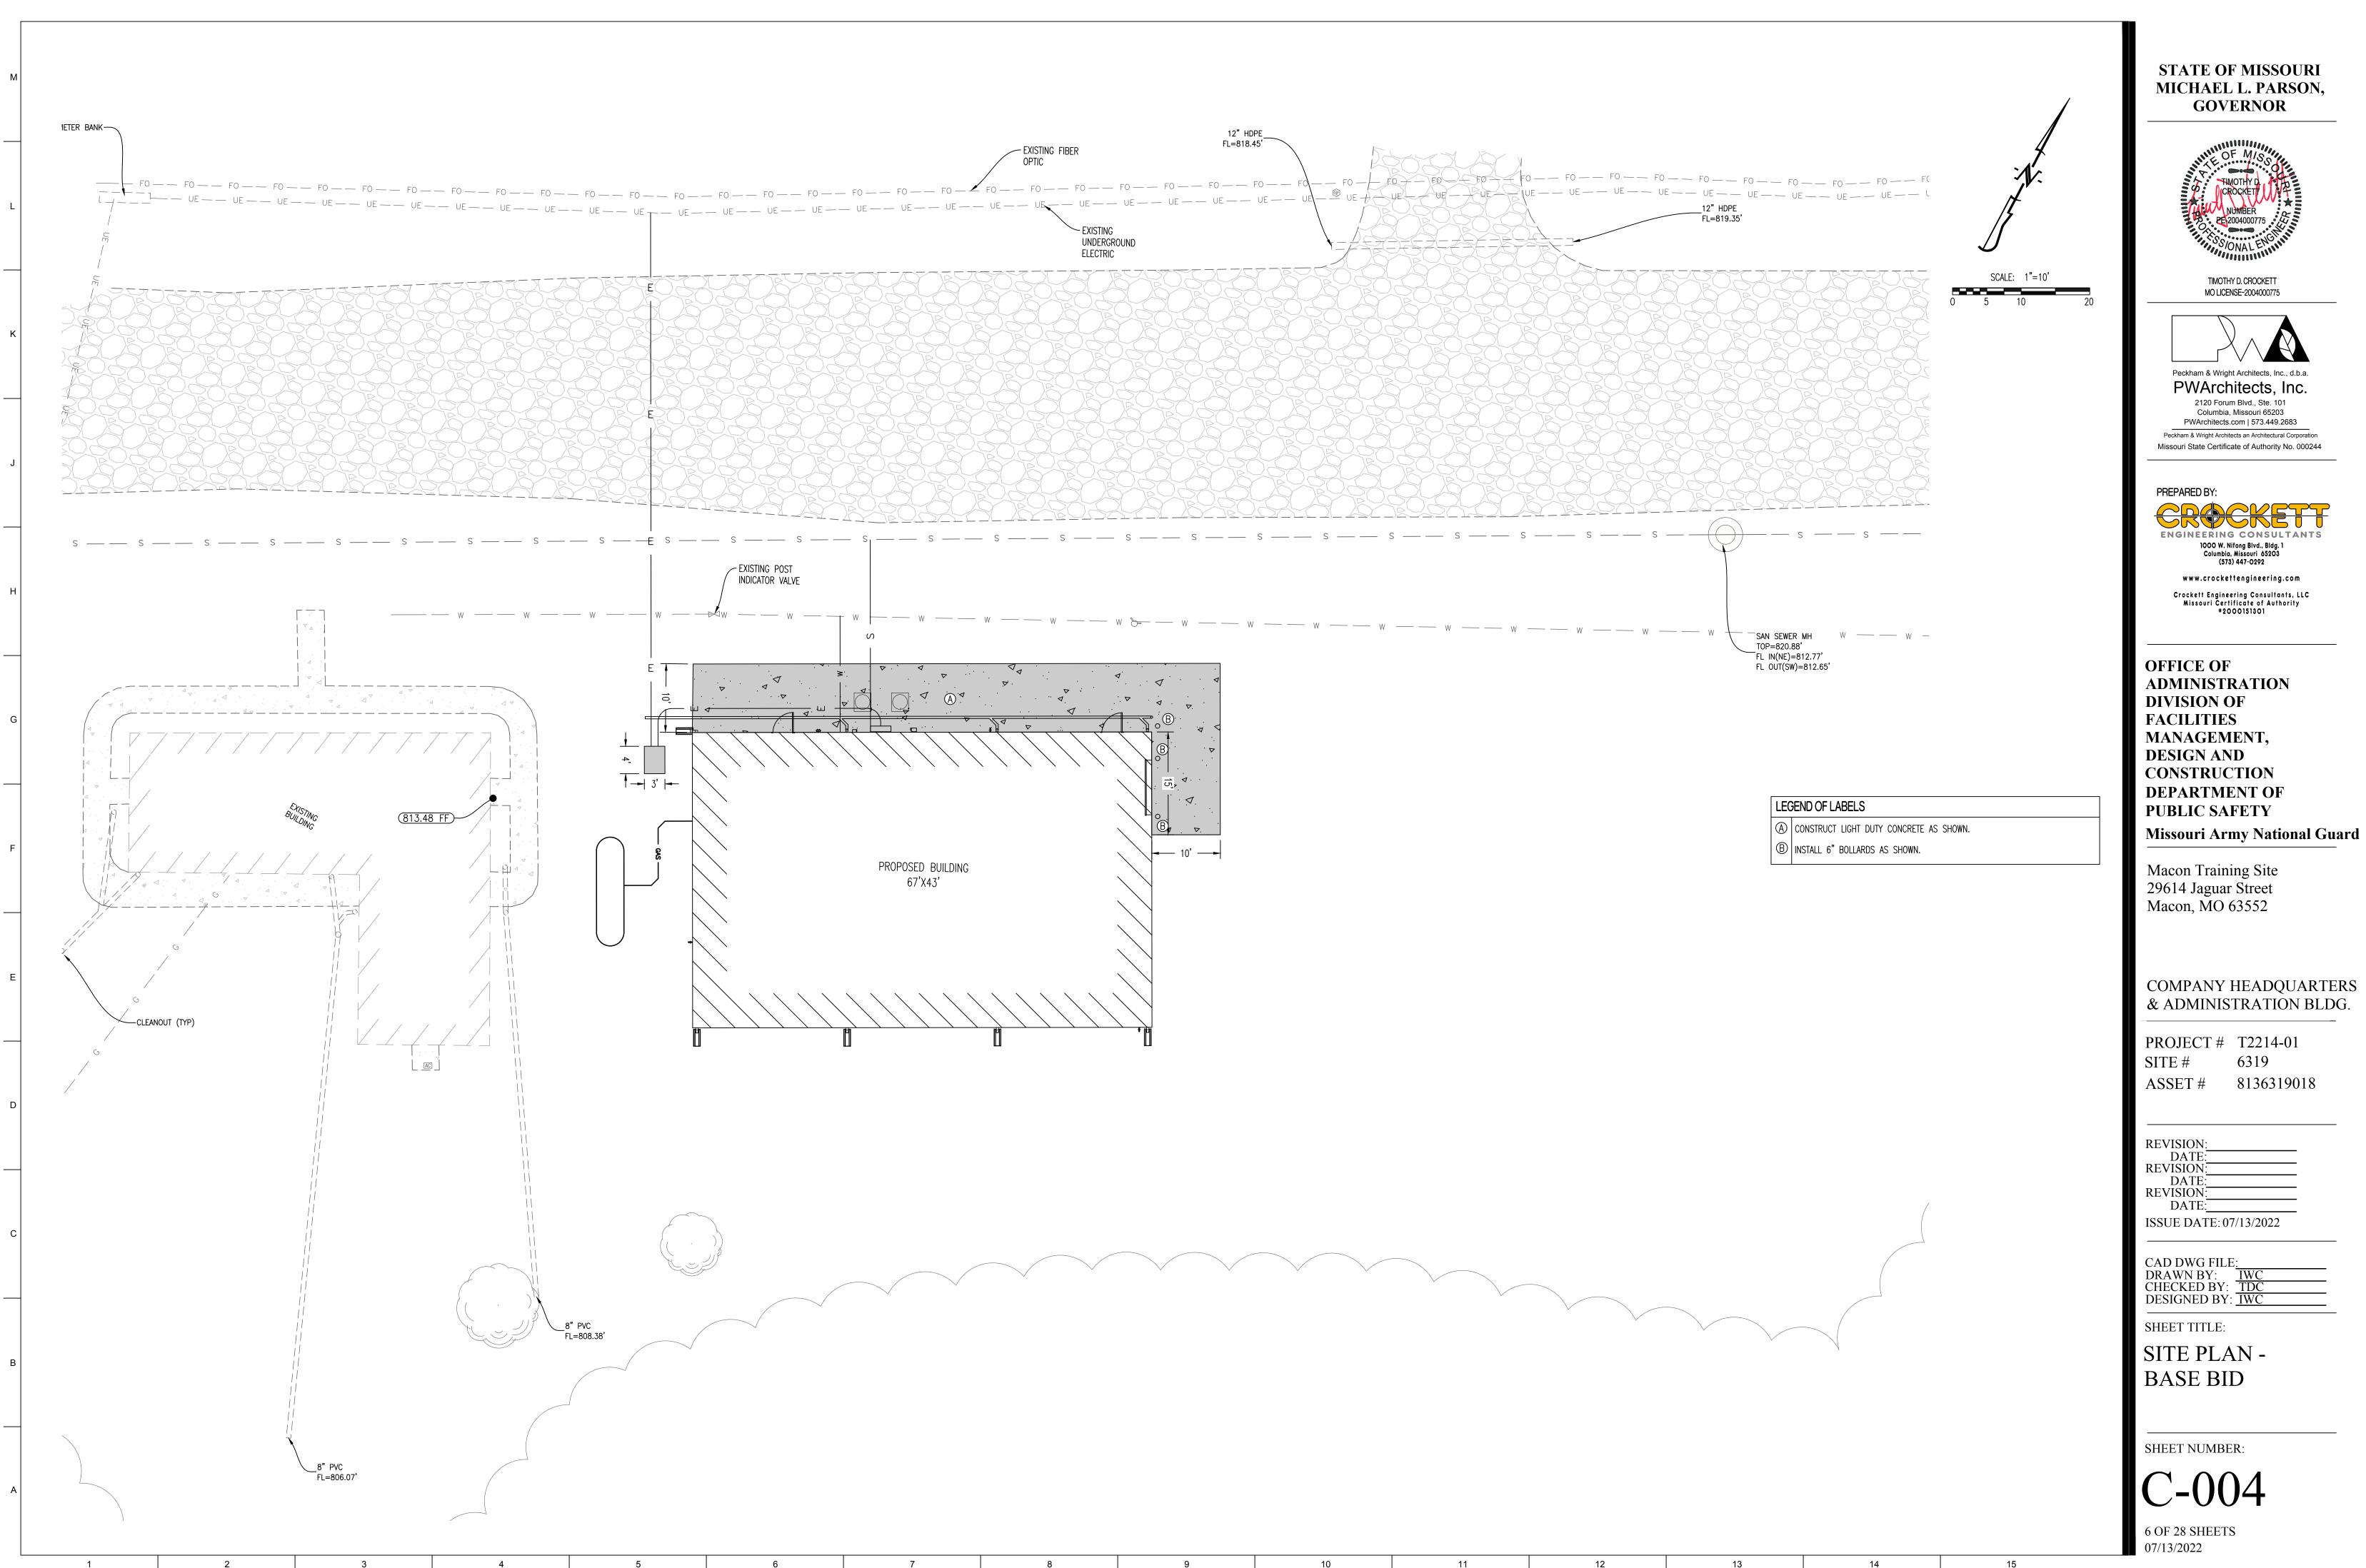
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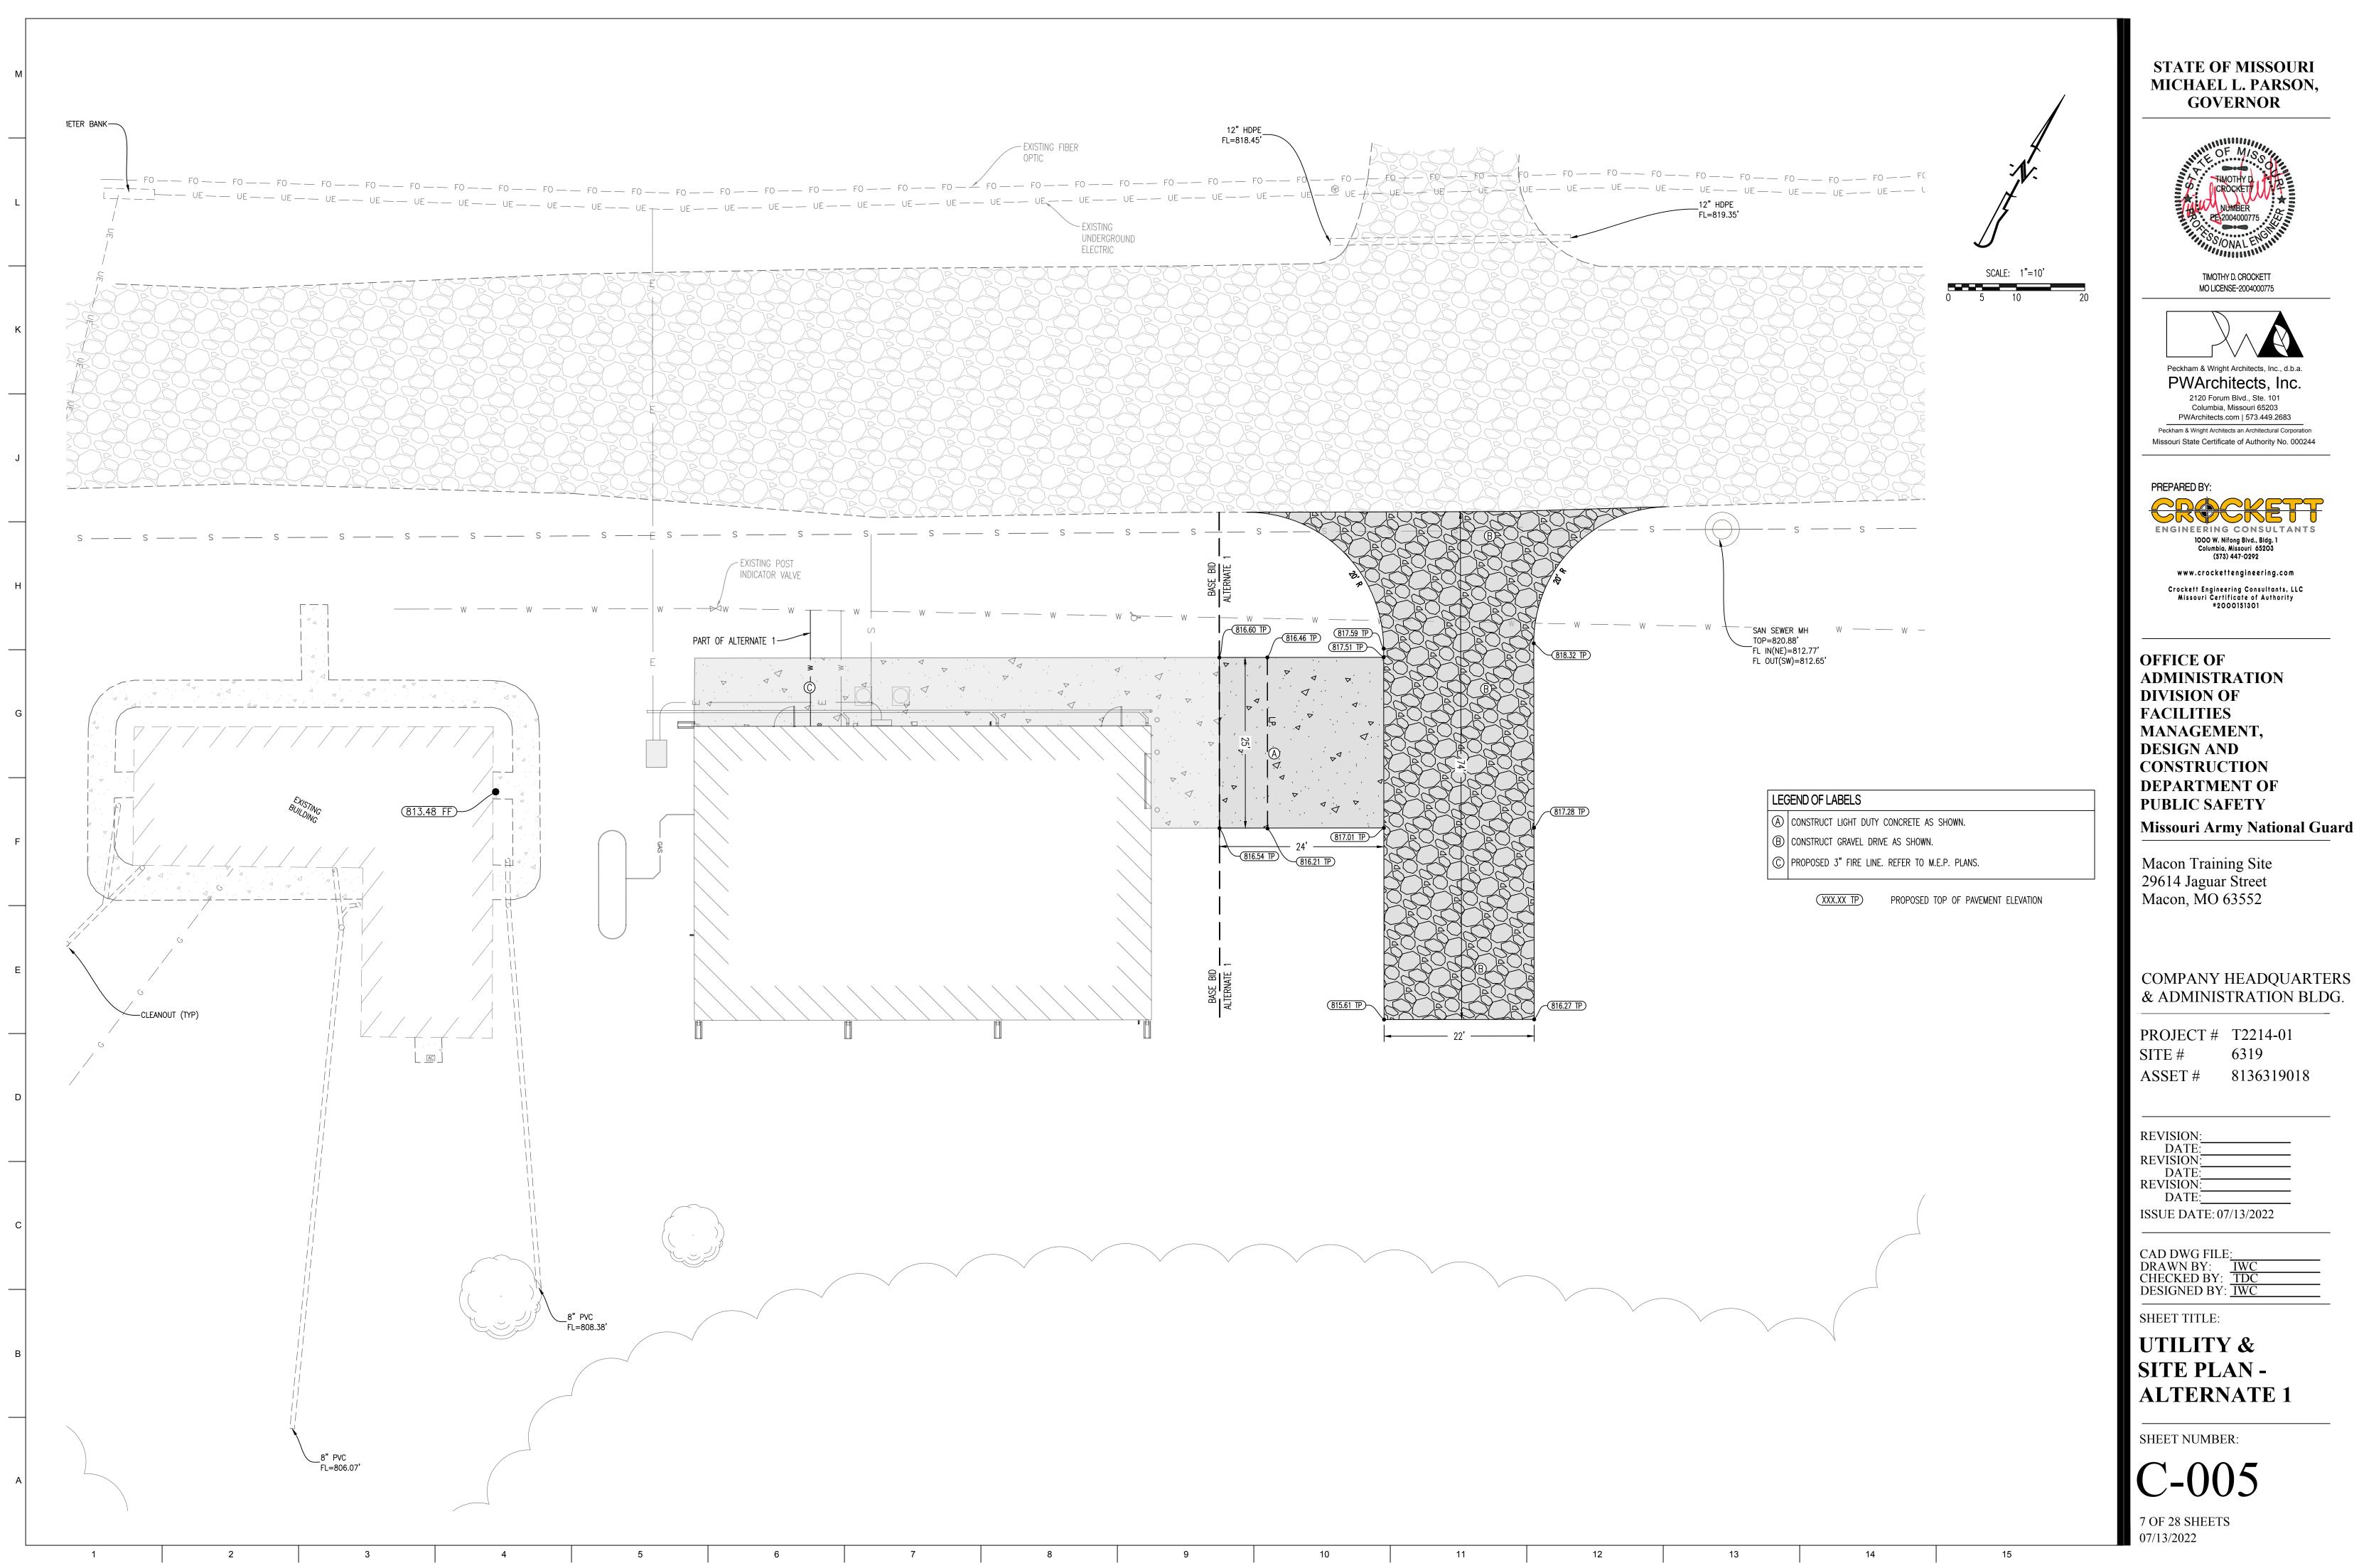
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COMPANY HEADQUARTERS



& ADMINISTRATION BLDG.

### GENERAL NOTES

ELEVATION DATUM

SEE ARCHITECTURAL DRAWINGS OR SITE PLAN FOR FINISH FLOOR ELEVATIONS

DESIGN SPECIFICATIONS

2018 INTERNATIONAL BUILDING CODE

### EARTHWORK

EARTHWORK OPERATIONS SHALL BE PERFORMED UNDER THE DIRECTION OF A PROFESSIONAL TESTING AGENCY TO ASSURE COMPLIANCE WITH THE RECOMMENDATIONS OF THE SOILS REPORT BY CROCKETT GTL DATED JUNE 8, 2022.

CONCRETE WORK SHALL CONFORM TO ALL REQUIREMENTS OF THE CURRENT ACI 301, SPECIFICATIONS FOR STRUCTURAL CONCRETE FOR BUILDINGS, ACI 318 BUILDING CODE REQUIREMENTS FOR STRUCTURAL CONCRETE, ACI 305 SPECIFICATIONS FOR HOT WATER CONCRETE, AND ACI 306 SPECIFICATIONS FOR COLD WEATHER CONCRETE, WITH THE FOLLOWING ADDITIONAL REQUIREMENTS:

1. CONCRETE SHALL DEVELOP THE FOLLOWING 28-DAY MINIMUM COMPRESSIVE STRENGTH: FOUNDATIONS 3,000 PSI

- 3,500 PSI CAST-IN-PLACE WALLS FLOOR SLAB 4,000 PSI EXTERIOR SLABS, WALLS AND CURBS - 4,000 PSI

2. ALL FOOTINGS SHALL BEAR ON UNDISTURBED SOIL OR ENGINEERED FILL. 3. CHLORIDE— BASED ADMIXTURES ARE PROHIBITED IN ALL REINFORCED CONCRETE.

4. REINFORCING STEEL SHALL CONFORM TO ASTM A615, A616, OR A617, GRADE 60. 5. ALL CONTINUOUS REINFORCING STEEL THAT MEETS AT A CORNER SHALL BE TIED TOGETHER WITH A

CORNER BAR THAT HAS SUFFICIENT LAP DISTANCE IN EACH DIRECTION 6. CONTINUOUS REINFORCING BARS LAP LENGTH SHALL BE A MINIMUM OF 48 BAR DIAMETERS UNLESS NOTED OTHERWISE

7. CONCRETE SLUMP SHALL BE A MAXIMUM OF 4" +/- 1" (ASTM C- 143) AS DELIVERED IN THE FIELD. CONTRACTOR MAY USE CHEMICAL ADMIXTURES TO ATTAIN A MAXIMUM SLUMP OF 8" FOR WORKABILITY. NO WATER MAY BE ADDED TO THE CONCRETE MIX ON SITE UNLESS WATER IS WITHHELD AT THE BATCHING FACILITY. IF WATER IS WITHHELD AT THE BATCHING FACILITY IT SHOULD BE REFLECTED ON THE LOAD TICKET. THE TOTAL AMOUNT OF WATER IN THE MIX SHALL NOT EXCEED WHAT IS NOTED ON THE APPROVED MIXED. THIS SHALL BE NOTED IN THE SPECIAL INSPECTOR'S RECORDS.

8. CONCRETE EXPOSED TO WEATHER, VEHICLES, AND/OR DEICING CHEMICALS SHALL BE AIR-ENTRAINED WITH 6% (+/-) 1.5% ENTRAINED AIR BY VOLUME AT POINT OF DISCHARGE. DO NOT ALLOW AIR CONTENT OF TROWELED FINISHED FLOORS TO EXCEED 3%.

9. SUBMIT CONCRETE MIX PROPORTIONS PRIOR TO START OF WORK. DO NOT BEGIN CONCRETE PRODUCTION UNTIL MIXES HAVE BEEN REVIEWED AND ARE ACCEPTABLE TO THE ENGINEER. 10.READY MIX CONCRETE SHALL COMPLY WITH REQUIREMENTS OF ASTM C94.

11.CONCRETE WORK EXECUTION A. CONSTRUCT FORMS TO CORRECT SIZE, SHAPE, ALIGNMENT, ELEVATION AND POSITION; AND TO

SUPPORT VERTICAL AND LATERAL LOADS. B. POSITION, SUPPORT, AND SECURE REINFORCEMENT AGAINST DISPLACEMENT. MINIMUM CONCRETE COVER FOR REINFORCEMENT SHALL BE, UNLESS NOTED OTHERWISE ON THE DRAWINGS: CAST AGAINST AND EXPOSED TO EARTH.......3 INCHES

> EXPOSED TO EARTH OR WEATHER......2 INCHES NOT EXPOSED TO WEATHER OR

IN CONTACT WITH EARTH.......1 1/2 INCHES

C. PROVIDE CONTROL JOINTS IN SLABS-ON-GRADE AT NOT GREATER THAN 15 FEET ON CENTER IN EACH DIRECTION. SAW CUT CONTROL JOINTS MINIMUM 1/4 OF SLAB DEPTH, AS SOON AFTER SLAB FINISHING WITHOUT DISLODGING AGGREGATE.

D. STEEL TROWEL FINISH ALL INTERIOR CONCRETE SLABS, BROOM FINISH ALL EXTERIOR CONCRETE

E. CURE ALL CONCRETE IN COMPLIANCE WITH ACI 301, USING A LIQUID TYPE MEMBRANE, NON-RESIDUAL, CURING COMPOUND COMPLYING WITH ASTM C309. ASSURE COMPATIBILITY WITH FINISH FLOOR COVERING.

### **POST-INSTALLED ANCHORS**

- 1. ALL POST-INSTALLED ANCHORS SHALL MEET THE REQUIREMENTS OF THE CODE-CITED EDITION OF ACI 318, APPENDIX "D", AND SHALL BE ACCEPTABLE FOR BOTH CRACKED AND UNCRACKED CONCRETE.
- 2. EXPANSION ANCHORS HAVE BEEN DESIGNED AS HILTI KWIK BOLT TZ ANCHORS, UNLESS NOTED
- 3. ADHESIVE ANCHORS HAVE BEEN DESIGNED TO USE HILTI HIT HY 200 ADHESIVE IN CONCRETE OR SOLID
- MASONRY, UNLESS NOTED OTHERWISE. 4. EQUIVALENT ANCHORS MAY BE SUBMITTED FOR THE ENGINEER'S APPROVAL. SUBMITTALS ARE THE CONTRACTOR'S RESPONSIBILITY AND MUST INCLUDE EVALUATION REPORTS FROM THE INTERNATIONAL
- CONFERENCE OF BUILDING OFFICIALS (ICBO). 5. EMBEDMENT DEPTH IS DEFINED AS THE DISTANCE FROM THE SURFACE OF THE LOAD-BEARING BASE MATERIAL TO THE DEEPEST PART OF THE ANCHOR AFTER THE ANCHOR HAS BEEN DRIVEN INTO THE
- HOLE BUT NOT YET EXPANDED. 6. ADHESIVE ANCHORS SHALL BE ACCEPTABLE FOR LONG-TERM LOADING. WHEN BASE MATERIAL TEMPERATURES ARE BELOW 40 DEG F, ONLY NON-EPOXY-BASED ADHESIVES SHALL BE USED.
- 7. POST-INSTALLED ANCHORS SHALL ONLY BE USED WHERE SPECIFIED ON THE DRAWINGS. THE CONTRACTOR SHALL OBTAIN APPROVAL FROM THE ENGINEER PRIOR TO USING POST-INSTALLED ANCHORS FOR MISSING OR MISPLACED CAST-IN-PLANE ANCHORS. CARE SHALL BE TAKEN TO AVOID CONFLICTS WITH EXISTING REINFORCING BARS. HOLES SHALL BE DRILLED AND CLEANED PER ANCHOR MANUFACTURER'S SPECIFICATIONS.
- 8. STAINLESS STEEL ANCHORS ARE REQUIRED AT ALL PERMANENTLY EXPOSED WEATHER CONDITIONS.

### PRE-ENGINEERED STEEL BUILDING STRUCTURE

- 1. DESIGN, FABRICATION, AND ERECTION OF STRUCTURAL STEEL SHALL BE IN ACCORDANCE WITH THE CURRENT EDITION OF THE AISC SPECIFICATIONS FOR STRUCTURAL STEEL BUILDINGS, THE AISC SPECIFICATIONS FOR THE DESIGN OF COLD FORMED STEEL STRUCTURAL MEMBERS, THE AISC CODE OF STANDARD PRACTICE FOR STEEL BUILDINGS AND BRIDGES, AND CURRENT OSHA STANDARDS.
- 2. ALL STRUCTURAL AND MISCELLANEOUS STEEL ITEMS SHALL RECEIVE ONE COAT OF RUST INHIBITIVE
- 3. ALL WELDING SHALL BE DONE BY QUALIFIED WELDERS IN ACCORDANCE WITH THE CURRENT EDITION OF THE AWS STRUCTURAL WELDING CODE.
- 4. THIS STEEL STRUCTURE SHALL BE DESIGNED IN ACCORDANCE WITH THE SPECIFIED CODE.
- 5. PER IBC TABLE 1604.3 ROOF MEMBERS SHALL BE DESIGNED AND CONSTRUCTED FOR A MAXIMUM TOTAL LOAD DEFLECTION OF L/120 AND L/180 LIVE LOAD, WALL GIRTS SHALL BE DESIGNED FOR A MAXIMUM TOTAL LOAD DEFLECTION OF L/120 WITHOUT BRICK AND TOTAL FRAME DEFLECTION SHALL BE LIMITED TO H/60. (ALL DEFLECTIONS BASED ON SERVICE WIND LOAD)
- 6. LOADING DESIGN DATA SHALL BE AS FOLLOWS:

6.1. ROOF LOADINGS: 6.1.1. LIVE LOAD

20 PSF 6.1.2. COLLATERAL LOAD 5 PSF (MECHANICAL, SPRINKLER & LIMITED CEILINGS) 6.1.3. DEAD LOAD STRUCTURE WEIGHT

6.2. SNOW LOAD (DRIFTING AND SLIDING SNOW IN ADDITION TO UNIFORM LOAD):

20 PSF 6.2.1. Pg= 6.2.2. ls= 1.0 6.3. SEISMIC DESIGN DATA:

6.3.1. OCCUPANCY CATEGORY 6.3.2. SITE CLASSIFICATION 6.3.3. le = 1.0 0.116 6.3.4. Ss =

6.3.5. S1 = 0.076 6.4. WIND LOADINGS: 6.4.1. V = 108 MPH (3-SECOND GUST) 6.4.2. lw =

1.0 6.4.3. EXPOSURE = 7. SUBMITTALS SHALL INCLUDE THE FOLLOWING:

a. SHOP DRAWINGS PREPARED UNDER THE SUPERVISION OF, AND SIGNED AND SEALED BY A PROFESSIONAL ENGINEER REGISTERED IN THE STATE OF MISSOURI INCLUDING ANCHOR PLAN AND

10

11

12

13

- b. DESIGN LOADS FOR FOUNDATION AND ANCHOR DESIGN INCLUDING VERTICAL, HORIZONTAL, AND LATERAL LOADS AT EACH COLUMN BASE.
- 8. NET ALLOWABLE BEARING CAPACITY 2,500 PSF

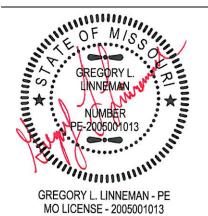
### SPECIAL INSPECTIONS

THE FOLLOWING ITEMS REQUIRE SPECIAL INSPECTION IN ACCORDANCE WITH CHAPTER 17 OF THE INTERNATIONAL BUILDING CODE.

- a. CONCRETE GROUT DESIGN MIX (PERIODIC)
- b. PLACING OF CONCRETE AND REINFORCING STEEL (CONTINUOUS OF CONCRETE SAMPLING /
- PERIODIC OF REINFORCING)
- c. BOLTS & ANCHORS EMBEDDED IN CONCRETE (PERIODIC)
- d. STRUCTURAL STEEL FABRICATIONS (UNLESS AISC APPROVED)
- e. STRUCTURAL STEEL BOLTING & WELDING (PERIODIC)
- f. POST INSTALLED ANCHORS IN CONCRETE (CONTINUOUS)
- g. IN-SITU SOILS, EXCAVATIONS, FILLING & COMPACTION (PERIODIC)

THE CONTRACTOR SHALL REQUEST SPECIAL INSPECTION OF THE ITEMS LISTED ABOVE PRIOR TO THOSE ITEMS BECOMING INACCESSIBLE AND UNOBSERVABLE DUE TO PROGRESSION OF THE WORK.

### STATE OF MISSOURI MICHAEL L. PARSON, **GOVERNOR**



7/13/22

Peckham & Wright Architects, Inc., d.b.a PWArchitects, Inc. 2120 Forum Blvd., Ste. 101

Columbia, Missouri 65203 PWArchitects.com | 573.449.2683 Missouri State Certificate of Authority No. 000244

ENGINEERING CONSULTANTS 1000 W. Nifong Blvd., Bldg. 1 Columbia, Missouri 65203 (573) 447-0292

www.crockettengineering.com Crockett Engineering Consultants, LLC Missouri Certificate of Authority #2000151301

**OFFICE OF ADMINISTRATION DIVISION OF FACILITIES** MANAGEMENT, **DESIGN AND** CONSTRUCTION **DEPARTMENT OF** PUBLIC SAFETY

Missouri Army National Guard

Macon Training Site 29614 Jaguar Street Macon, MO 63552

COMPANY HEADQUARTERS & ADMINISTRATION SUPPLY BUILDING

6319 ASSET# 8136319018

PROJECT # T2214-01

**REVISION:** DATE: REVISION DATE: REVISION: DATE: ISSUE DATE: 07/13/2022

CAD DWG FILE DRAWN BY: CHECKED BY: GL DESIGNED BY: GLI

SHEET TITLE: GENERAL STRUCTURAL

SHEET NUMBER:

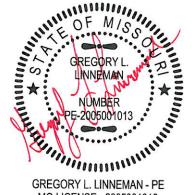
DATA

8 OF 28 SHEETS

07/13/2022

HAIRPIN KEY ALL DIMENSIONS ARE FROM FACE OF FOUNDATION WALL OR FRAMING; EDGE OF SLAB OR TRUSS/RAFTER; OR CENTERLINE OF COLUMN, BEAM, OR JOIST UNLESS NOTED OTHERWISE. #4 HAIRPIN #5 HAIRPIN EDGE OF SLAB — & STEEL LINE — EDGE OF SLAB & STEEL LINE 67'-0" 22'-6" 22'-0" 22'-6" F2 S210 EDGE OF SLAB — & STEEL LINE - EDGE OF SLAB & STEEL LINE "WA" (TYP. @ PERIMETER) (r----<del>-</del>----´\_\_\_\_\_\_` CONTRACTION 5" CONCRETE FLOOR SLAB F10 S210 JOINTS (TYP.) w/ 6x6 - W2.9xW2.9 WWF OVER 10 mil VAPOR BARRIER &
6" CLEAN GRANULAR FILL &
18" LVC (24" TOTAL LVC)
FIN. FLR. REFERENCE ELEV. = 100'-0" B — PROJECT # T2214-01 (A)---- EDGE OF SLAB & STEEL LINE EDGE OF SLAB — & STEEL LINE **FOUNDATION PLAN** PLAN NORTH S200 SCALE:  $\frac{1}{4}$ " = 1'-0"

STATE OF MISSOURI MICHAEL L. PARSON, **GOVERNOR** 



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FOUNDATION PLAN

SHEET NUMBER:

07/13/2022

**FOOTING SCHEDULE** 

3'-0"

3'-0"

4 - #5 x 2'-6" EACH WAY, TOP & BOTTOM

5 - #5 x 3'-0" EACH WAY, TOP & BOTTOM

15

MARK | WIDTH (W) | LENGTH (L) | DEPTH (D) | REINFORCING

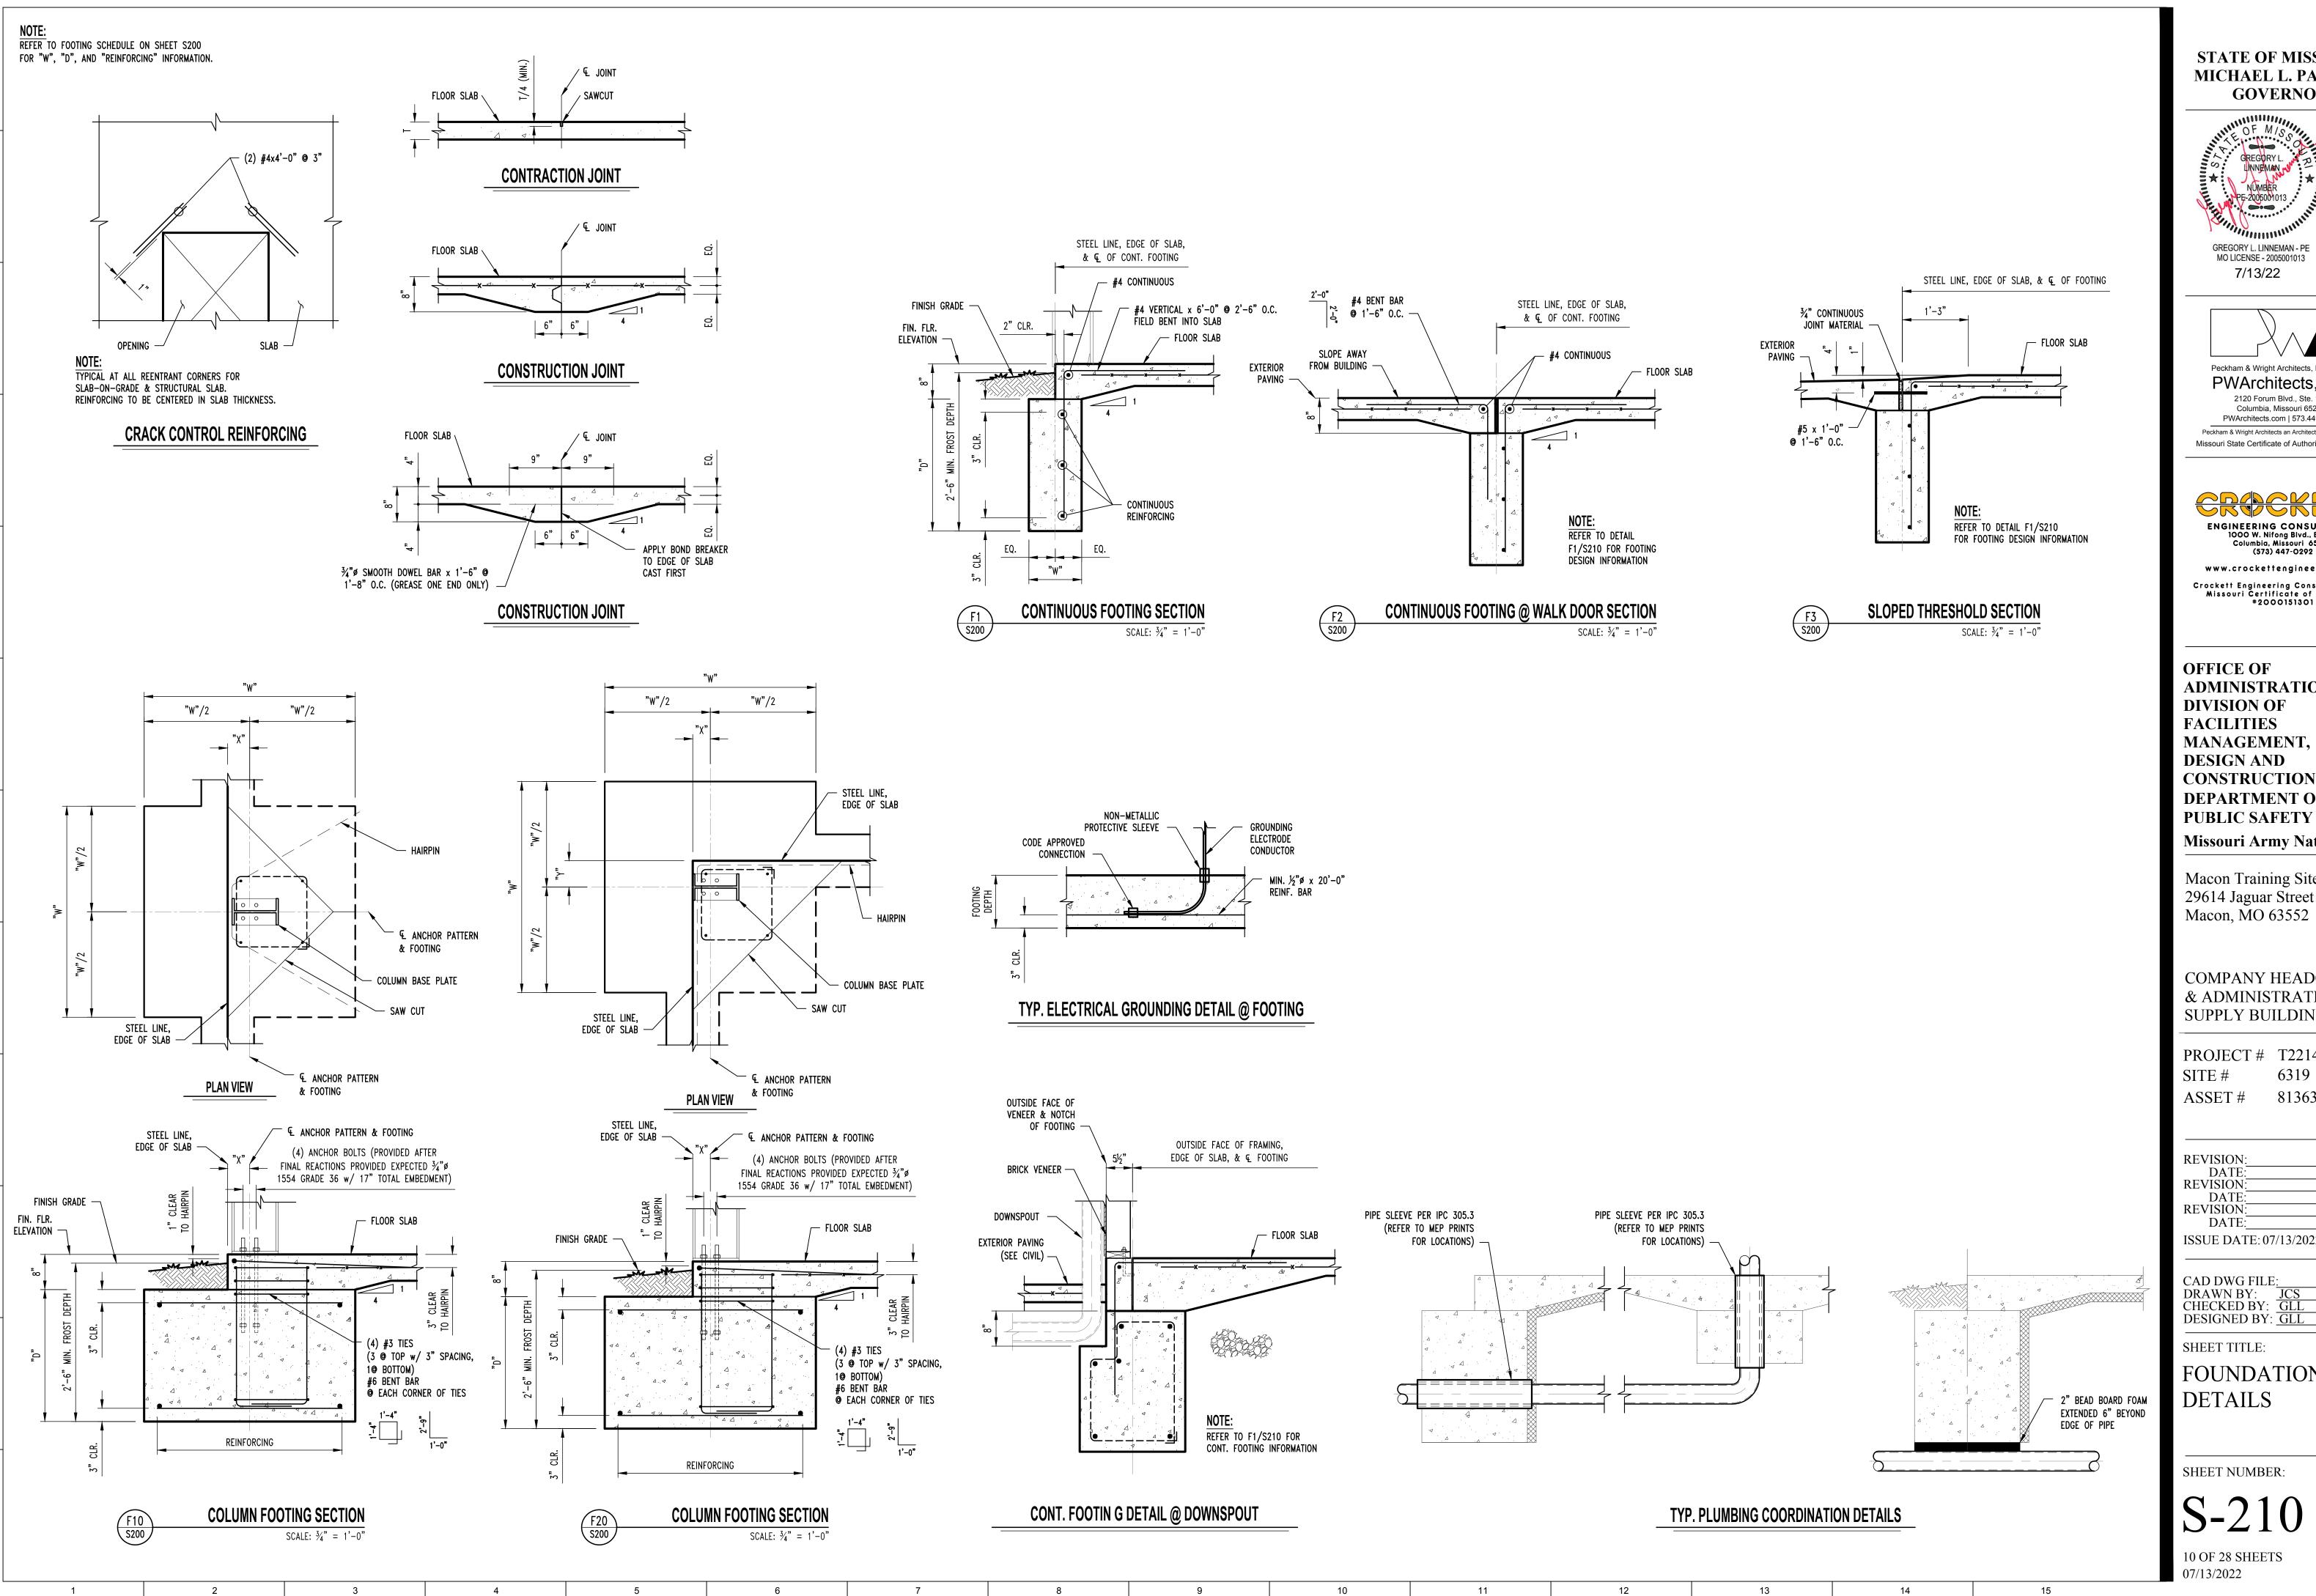
"BB" 3'-6" SQ.

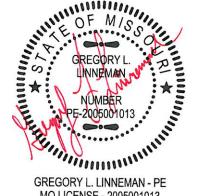
11

9 OF 28 SHEETS

"CC" 4'-6" SQ. 3'-0" 6 - #5 x 4'-0" EACH WAY, TOP & BOTTOM FOOTING SIZE TO BE DETERMINED ONCE FINAL PRE-ENGINEERED BUILDING REACTIONS ARE PROVIDED TO THE STRUCTURAL ENGINEER. "WA" 1'-0" CONT. 2'-6" 3 - #4 CONTINUOUS

EXACT ANCHOR BOLT SIZE & VERIFICATION OF EXACT





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Missouri Army National Guard

Macon Training Site 29614 Jaguar Street Macon, MO 63552

COMPANY HEADQUARTERS & ADMINISTRATION SUPPLY BUILDING

PROJECT # T2214-01 6319 8136319018

REVISION DATE: **REVISION** DATE: REVISION: DATE: ISSUE DATE: 07/13/2022

CAD DWG FILE DRAWN BY: JCS CHECKED BY: GL DESIGNED BY: GLI

SHEET TITLE:

FOUNDATION **DETAILS** 

SHEET NUMBER:

ABBREVIATIONS

			_			N			_		
Α	AD\/	ABOVE	F	FAB.	FABRICATE / FABRICATION	N	NRC	NOISE REDUCTION COEFFICIENT	Т	TEL.	TELEPHONE
	ABV. A.F.F.	ABOVE ABOVE FINISHED FLOOR		F.O.W.	FAC OF WALL		NOM.	NOMINAL		TV	TELEVISION
	ACOUST.	ACOUSTICAL		F.M.	FACTORY MUTUAL		N.	NORTH		TEMP.	TEMPORARY / TEMPERATURE
	ACT	ACOUSTICAL CEILING TILE		FT.	FEET / FOOT		N/A	NOT APPLICABLE		THK.	THICK
	ADD.	ADDITION / ADDENDUM		F.V.	FIELD VERIFY		N.I.C.	NOT IN CONTRACT		THRU	THROUGH
	ADJ.	ADJUSTABLE / ADJACENT		FIN.	FINISHED / FINISH		N.T.S. NO.	NOT TO SCALE NUMBER		TOIL.	TOILET
	A/C	AIR CONDITIONING		F.A. FACP	FIRE ALARM FIRE ALARM CONTROL PANEL		NO.	NUMBER		T.&G. T.&B.	TONGUE AND GROOVE TOP AND BOTTOM
	ALT. AL. / ALUM.	ALTERNATE ALUMINUM		F.E.B.	FIRE EXTINGUISHER BRACKET	0				T.O.	TOP OF
	AL. / ALOW.	AMERICAN WIRE GAUGE		F.E.C.	FIRE EXTINGUISHER CABINET	_	OCC.	OCCUPANT / OCCUPANCY		T.O.C.	TOP OF CURB
	ADA	AMERICAN WITH DISABILITIES ACT		F.H.	FIRE HYDRANT		O.C.	ON-CENTER		T.O.W.	TOP OF WALL
	A.B.	ANCHOR BOLT		F.P.	FIRE PROTECTION / FIRE PROOF /		OPNG.	OPENING		TS.	TRANSITION STRIP / TUBE STEE
	A.B.	ANCHOR BOLT			FIRE PROOFING		OPP.	OPPOSITE		T.	TREAD(S)
	APPROX.	APPROXIMATE		F.R.	FIRE-RATED		O.D.	OVERALL / OUTSIDE DIMENSION	•	TYP.	TYPICAL
	ARCH.	ARCHITECT / ARCHITECURAL		FLR. F.D.	FLOOR FLOOR DRAIN		O.H.	OVERHEAD / OVERHANG			
	ASPH.	ASPHALT		F.D. FLG.	FLOOR DRAIN FLOORING	Р			U		LINII EOO NOTED OTHEDWIOE
	AUTO. AVG.	AUTOMATIC AVERAGE		FLUOR.	FLUORESCENT	'	PT.	PAINT		U.N.O.	UNLESS NOTED OTHERWISE
	AVG.	AVERAGE		FTG.	FOOTING		PTD.	PAINTED	V		
В				FDN.	FOUNDATION		PR.	PAIR	•		
	BSMT.	BASEMENT		FURN.	FURNITURE / FURNISH		PTN. / PART.	. PARTITION		V.B.	VAPOR BARRIER
	BM.	BEAM		FUT.	FUTURE		PVMT.	PAVEMENT		VTR	VENT THROUGH ROOF
	BRG.	BEARING					PERF.	PERFORATED		VERT. /	VERTICAL
	B.M.	BENCH MARK	G	CALV	CALVANIZED / CALVALLIME		PERIM.	PERIMETER		VER.	VECTION
	BTWN.	BETWEEN		GALV. GA.	GALVANIZED / GALVALUME GAUGE		PERM. PERP.	PERMANENT PERPENDICULAR		VEST. VCT	VESTIBULE VINYL COMPOSITION TILE
	BLK.	BLOCK		G.C.	GENERAL CONTRACTOR		PH.	PHASE / PHASED		VCI	VIIVIE COMPOSITION TIEE
	BLKG. BD.	BLOCKING BOARD		GL.	GLASS		PLAS.	PLASTIC	W		
	B.O.	BOTTOM OF		GLAZ.	GLAZING		PLAM	PLASTIC LAMINATE		W.C.	WATER CLOSET
	BRZ	BRONZE		GOVT.	GOVERNMENT		PLMG. /	PLUMBING		WP	WEATHERPROOF
	BLDG.	BUILDING		G.B.	GRAB BAR		PLUMB.			WT.	WEIGHT
	B.U.	BUILT-UP		GYP.	GYPSUM		PLYWD.	PLYWOOD		W.W.F.	WELDED WIRE FABRIC
							PVC PORC	POLYVINYL CHLORIDE		W.W.M.	WELDED WIRE MESH
С			Н	HDW	HARDWARE		PORC. P.C.F.	PORCELAIN POUNDS PER CUBIC FOOT		W.	WEST / WIDE / WIDTH
	CAB.	CABINET		HDWD.	HARDWOOD		P.C.F. P.L.F.	POUNDS PER CUBIC FOOT  POUNDS PER LINEAR FOOT		WIN.	WINDOW
	CPT	CARPET		HTG.	HEATING		P.S.F.	POUNDS PER SQUARE FOOT		W/	WITH
	C.I.P.	CAST IN PLACE		HVAC	HEATING, VENTILATING & AIR		P.S.I.	POUNDS PER SQUARE INCH		W/O	WITHOUT
	CLG. C	CEILING CENTER LINE			CONDITIONING		PWR.	POWER		WD. WB	WOOD WOOD BASE
	CT	CERAMIC TILE		HVY.	HEAVY		P.C.	PRE CAST		VVD	WOOD BASE
	C.O.	CLEAN OUT		HT.	HEIGHT		PRE-ENG.	PRE-ENGINEERED	Х		
	CLR.	CLEAR / CLEARANCE		H.	HIGH		PRE-FIN.	PRE-FINISHED		XFER	TRANSFORMER
	CLO.	CLOSET		H.C.	HOLLOW CORE		PROJ.	PROJECT / PROJECTION		Χ	TYPE X
	COL.	COLUMN		HM HORZ. /	HOLLOW METAL HORIZONTAL		PL	PROPERTY LINE			
	COMB.	COMBINATION		HOR.	HORIZONTAL	Q			Υ		
	CONC.	CONCRETE		H.W.	HOT WATER HEATER	Q	QTY.	QUANTITY		YD.	YARD
	CMU	CONCRETE MASONRY UNIT		HR.	HOUR		QT	QUARRY TILE	_		
	COND. CONF.	CONDITION / CONDENSER CONFERENCE					~.	23	Z		
	CONF.	CONSTRUCTION	I			R					
	CD	CONSTRUCTION DOCUMENT(S)		ID	IDENTIFICATION		R.	RADIUS / RISER(S)			
	CONT.	CONTINUAL / CONTINUOUS		IN.	INCH / INCHES		RECEPT.	RECEPTION			
	CONTR.	CONTRACTOR		INCL. I.D.	INCLUDE / INCLUDED INSIDE DIAMETER		RE:	REFERENCE			
	C.J.	CONTROL / CONSTRUCTION JOINT		INST.	INSTRUCTIONS / INSTALL /		RCP	REFLECTED CEILING PLAN			
	CU	COPPER		11101.	INSTALLATION		REF.	REFRIGERATOR			
	CORR.	CORRIDOR		INSUL.	INSULATION / INSULATED		REG. REINF.	REGULATION / REGISTERED REINFORCED / REINFORCEMENT			
	CU. FT.	CUBIC FEET		INT.	INTERIOR		RMV.	REMOVE			
	CFM	CUBIC YARD					REQD.	REQUIRED			
	CU. YD.	CUBIC YARD	J				RET.	RETURN			
D				JAN.	JANITOR JOINT		RA	RETURN AIR			
_	DK.	DARK		JT. JST.	JOINT		REV.	REVERSE / REVERSED / REVISED /			
	D.	DEEP / DEPTH		JCT.	JUNCTION		R.H.	REVISION RIGHT HAND			
	DEMO	DEMOLITION					R.O.W.	RIGHT OF WAY			
	DTL.	DETAIL	K				RTU	ROOF TOP UNIT			
	DIAG.	DIAGONAL / DIAGONALLY		KIT.	KITCHEN		RM.	ROOM			
	DIA. DIM.	DIAMETER DIMENSION					R.O.	ROUGH OPENING			
	D.W.	DISH WASHER	L				R.S.	ROUGH SAWN			
	DISP.	DISPENSER / DISPLAY		LAM.	LAMINATE		RB	RUBBER / RESILIENT BASE			
	DIV.	DIVIDE		LVL LAT.	LAMINATED VENEER LUMBER LATERAL	-					
	DOC.	DOCUMENT(S) / DOCUMENTED		LAT. LAV.	LAVATORY	S	0.4.1.	CANUTADY			
	DR.	DOOR		LAV. L.H.	LEFT HAND		SAN. S.S.	SANITARY SANITARY SEWER / SERIVCE SINK /			
	DBL.	DOUBLE		LT.	LIGHT		J.J.	STAINLESS STEEL			
	DN.	DOWN		LED	LIGHT EMITTING DIODE		SCHED.	SCHEDULE			
	DS. DWG.	DOWNSPOUT DRAWING		LTG.	LIGHTING		SCRN.	SCREEN / SCREENED			
	DWG. D.F.	DRINKING FOUNTAIN		LIN.	LINE / LINEAR		SECT.	SECTION			
	D.F.	PENNY		L.F.	LINEAR FEET		SHTG.	SHEATHING			
	-			LINO	LINOLEUM		SHT.	SHEET			
Е				LOC. LG.	LOCATION / LOCATE LONG/LENGTH		SIM. SC.	SIMILAR SOLID CORE			
	EA. E.W.	EACH EACH WAY		LB.	POUND / POUNDS		SCWD.	SOLID CORE WOOD DOOR			
	□.VV. □	EAST					SSM	SOLID SURFACE MATERIAL			
	E. ELECT. /	ELECTRICAL	М				STC	SOUND TRANSMISSION CLASS			
	ELEC.			M.H.	MANHOLE		S.	SOUTH			
	EL.	ELEVATION		MFR.	MANUFACTURED / MANUFACTURER		SPKR.	SPEAKER			
	ELEV.	ELEVATOR		MFG.	MANUFACTURING		SPEC.	SPECIFICATION(S)			
	ENCL.	ENCLOSE / ENCLOSED / ENCLOSURE		MAS.	MASONRY MASONRY ODENING		SQ.	SQUARE			
	EQ.	EQUAL FOLUDMENT		M.O. MATL.	MASONRY OPENING MATERIAL		S.F. / SF	SQUARE FEET			
	EQUIP. EST.	EQUIPMENT ESTIMATE		MAX.	MAXIMUM		SQ. IN. SQ. YD.	SQUARE INCH SQUARE YARD			
	EXIST.	EXISTING		MECH.	MECHANICAL		S.&V.	STAIN AND VARNISH			
	EXP.	EXPANSION / EXPOSED		MED.	MEDIUM		STD.	STANDARD			
	E.J.	EXPANSION JOINT		MEMB.	MEMBRANE		STL.	STEEL			
	EXT.	EXTERIOR		MTL.	METAL		SL	STEEL LINE			
	E.I.F.S.	EXTERIOR INSULATED FINISH		M.	METER(S)		STOR.	STORAGE			
		SYSTEM		MM.	MILLIMETER(S)		SD	STORM DRAIN / SMOKE DETECTOR /			
				MIN.	MINIMUM		ст.	SUPPLY DUCT / SOAP DISPENSER			
				MIR.	MIRROR MISCELLANEOUS		ST. STRUCT.	STREET STRUCTURAL / STRUCTURE			
				MISC. MONG	MISCELLANEOUS MISSOURI NATIONAL GUARD		SUSP.	SUSPENDED			
				MOD.	MODULAR / MODIFY		SYM.	SYMMETIRCAL			
				MTD.	MOUNTED		SYS.	SYSTEM			
				MULT.	MULTIPLE						


SYMBOLS LEGEND

DRAWING BULLET WITH NORTH ARROW	
	GRID REFERENCE
DRAWING TITLE  SCALE: X/X" = 1'-0"	ARCH. SCALE
DRAWING BULLET WITHOUT NORTH ARROW	
	GRID REFERENCE
A1 A2 DRAWING TITLE A100 SCALE: X/X" = 1'-0"	ARCH. SCALE  PAGE FIRST REFERENCED (IF APPLICABLE)
ELEVATION BULLETS	PLAN / ELEVATION DETAIL BULLET
GRID REFERENCE SHEET NUMBER ONE ELEVATION SCOPE OF WORK BULLET	GRID REFERENCE  A1  A100  SHEET NUMBER
DOOR MARK BULLET	SECTION BULLET
000A	GRID REFERENCE ALWAYS ON TOP
WINDOW MARK BULLET	SHEET NUMBER
	NORTH ARROW
REVISION NOTE BULLET	
GENERAL NOTE BULLET	COLUMN LINE BULLETS
DENOLIMA DIZ DILILI ET	1
BENCHMARK BULLET  000.OO'  ***** FLOOR	SPOT ELEV. BULLETS
WALL PARTITION (TYPE) FLAG	
A —	TC - TOP OF CURB TG - TOP OF GRADE TW - TOP OF WALL TP - TOP OF PAVING

# MATERIAL LEGEND

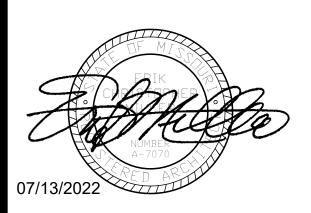LARGE S	SCALE	SMALL S	SCALE
BRICK MASONRY UNIT			PLAN, SECTION ELEVATION
CONCRETE MASONRY UNIT			PLAN, SECTION ELEVATION
CONCRETE	4 4 4 4 4 4 4 4 4 4 4 4 4 4 4 4 4 4 4 4		PLAN, SECTION
GYPSUM BOARD			PLAN, SECTION
			ELEVATION
GROUTED AREA OF: CMU/CAVITY/DOOR FRAME			PLAN, SECTION
MISCELLANEOUS ITEMS: AS NOTED ON EACH SHEET			PLAN, SECTION, ELEVATION
INSULATION			PLAN, SECTION
ROOF SHINGLES			PLAN, ELEVATION
CONTINUOUS WOOD FRAMING			PLAN, SECTION
WOOD BLOCKING			PLAN, SECTION
PLYWOOD	, , , , , , , , , , , , , , , , , , ,		PLAN, SECTION
EXISTING BUILDING			PLAN, SECTION

STATE OF MISSOURI MICHAEL L. PARSON, **GOVERNOR** 





**OFFICE OF ADMINISTRATION DIVISION OF FACILITIES** MANAGEMENT, **DESIGN AND** CONSTRUCTION **DEPARTMENT OF PUBLIC SAFETY** Missouri Army National Guard

Macon Training Site 29614 Jaguar Street Macon, MO 63552

COMPANY HEADQUARTERS & ADMINISTRATION SUPPLY BUILDING

PROJECT # T2214-01 6319 ASSET # 8136319018

REVISION:	
DATE:	
REVISION:	
DATE:	
REVISION:	
DATE:	
ISSUE DATE: 07/13/2022	

CAD DWG FILE:
DRAWN BY: LC
CHECKED BY: EM
DESIGNED BY: EM


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SYMBOLS, ABBREVIATIONS AND NOTES

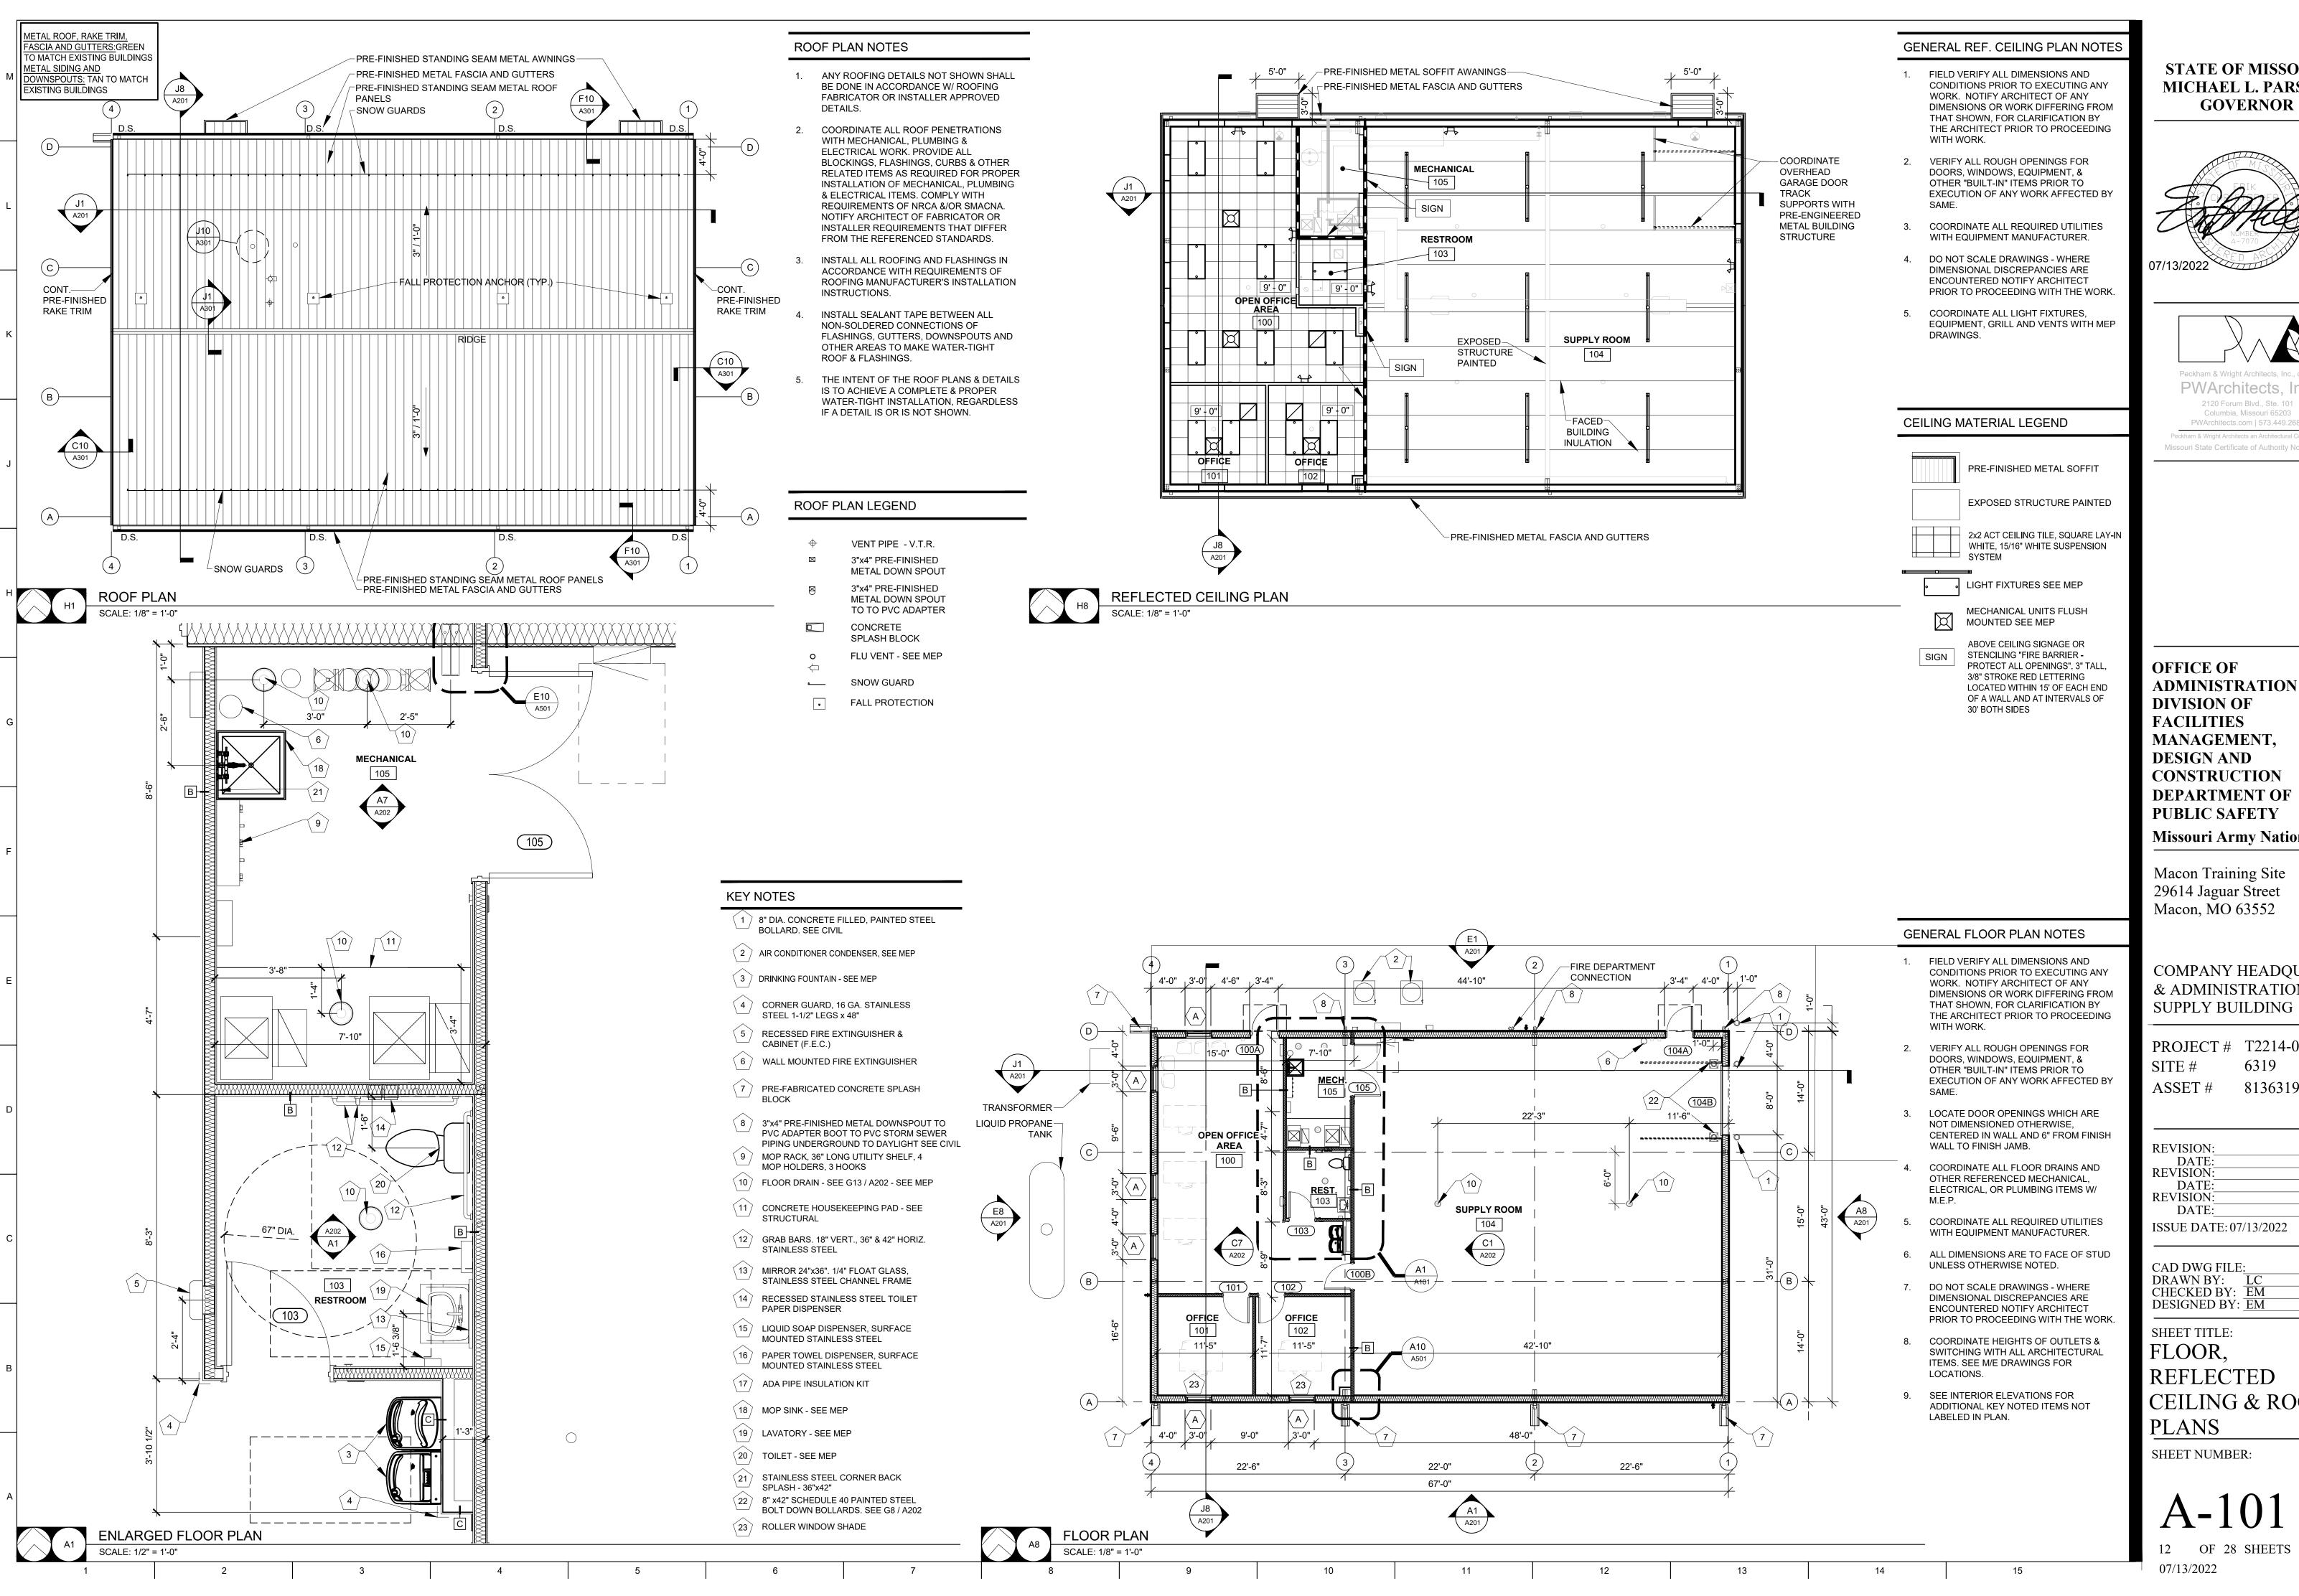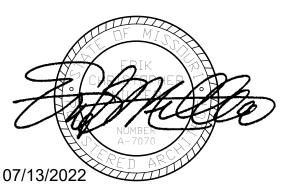
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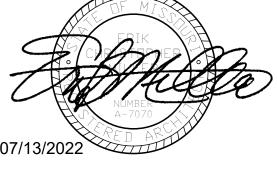
07/13/2022

OF 28 SHEETS



STATE OF MISSOURI MICHAEL L. PARSON,







PWArchitects.com | 573.449.2683 Missouri State Certificate of Authority No. 000244

**OFFICE OF ADMINISTRATION DIVISION OF FACILITIES** MANAGEMENT, **DESIGN AND** CONSTRUCTION **DEPARTMENT OF PUBLIC SAFETY** 

Missouri Army National Guard

Macon Training Site 29614 Jaguar Street Macon, MO 63552

COMPANY HEADQUARTERS & ADMINISTRATION

PROJECT # T2214-01 6319

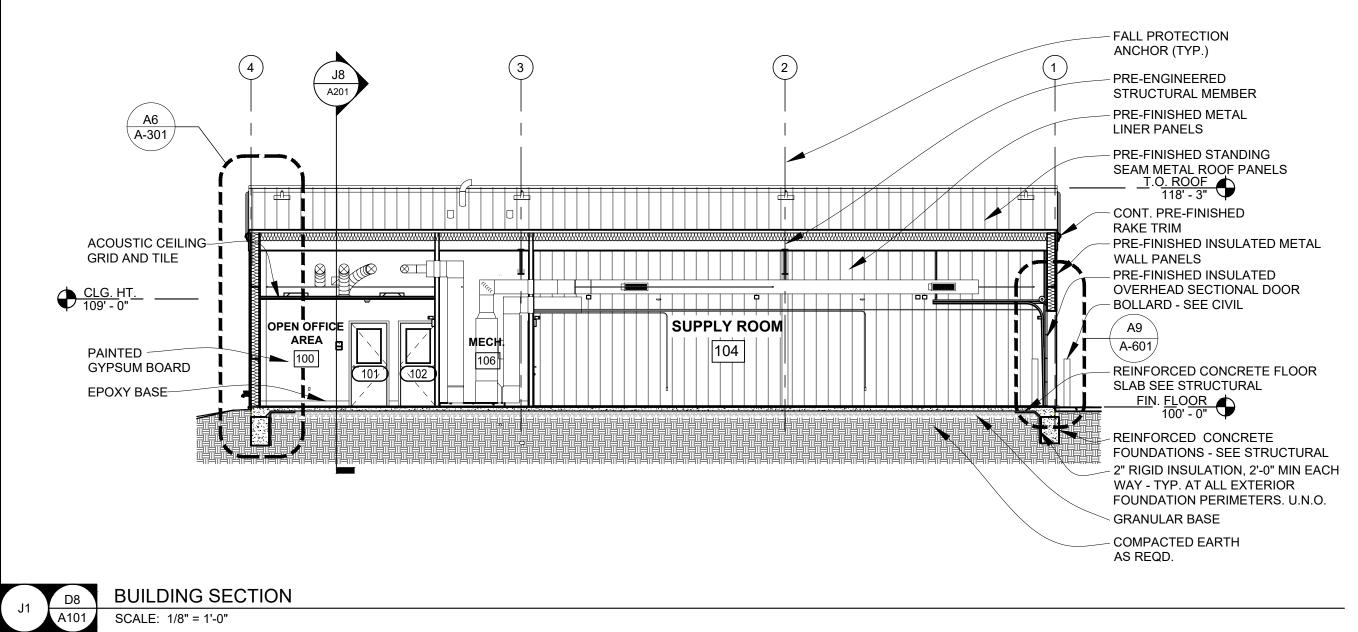
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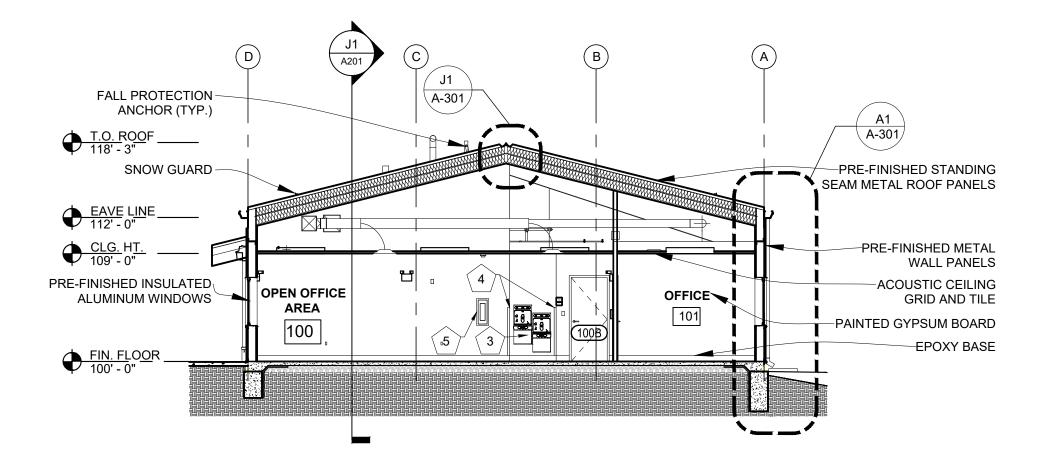
ISSUE DATE: 07/13/2022

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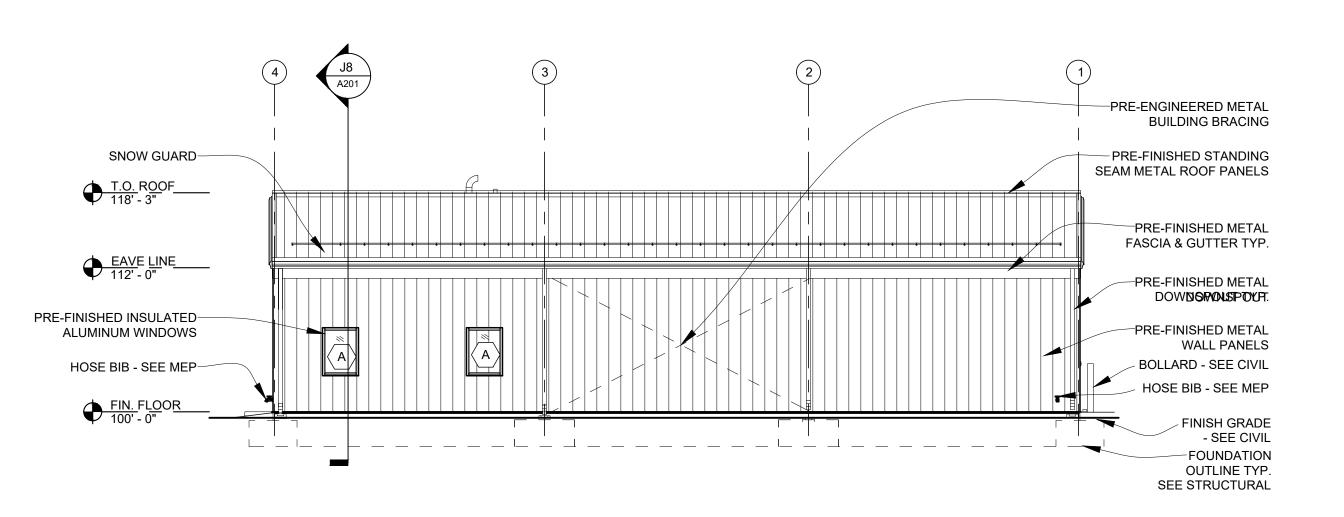
SHEET TITLE: REFLECTED **CEILING & ROOF** 

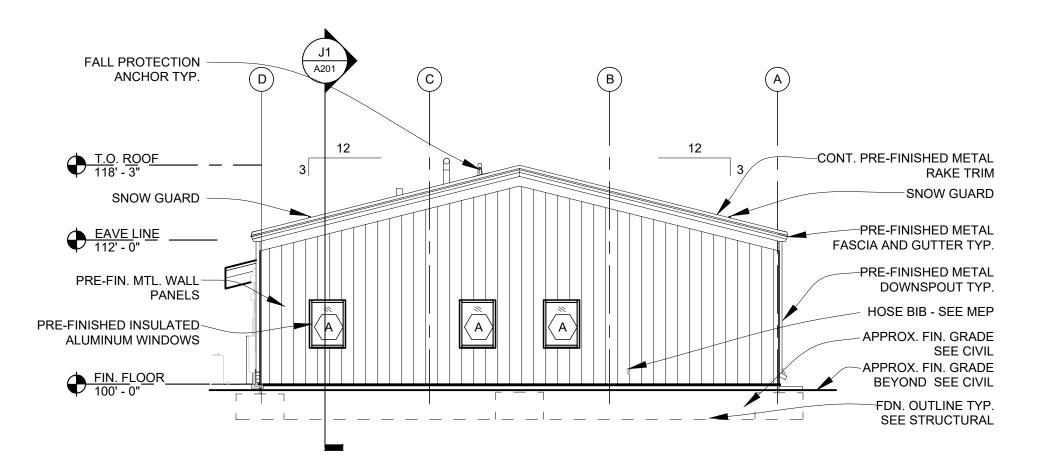
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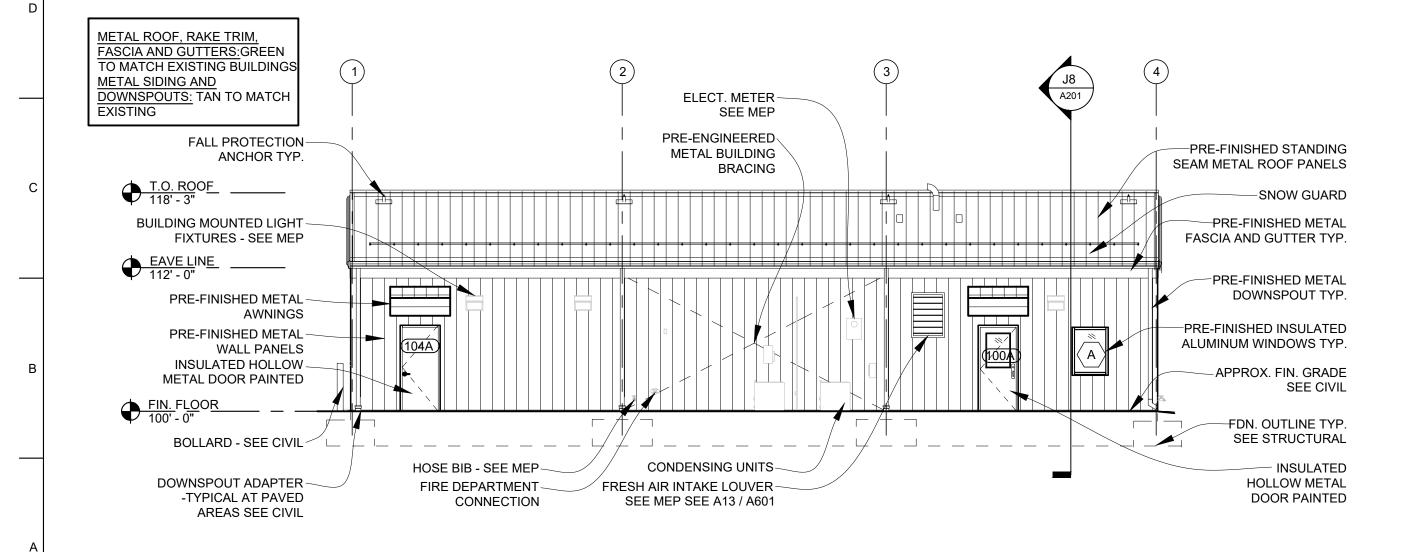







NORTH ELEVATION

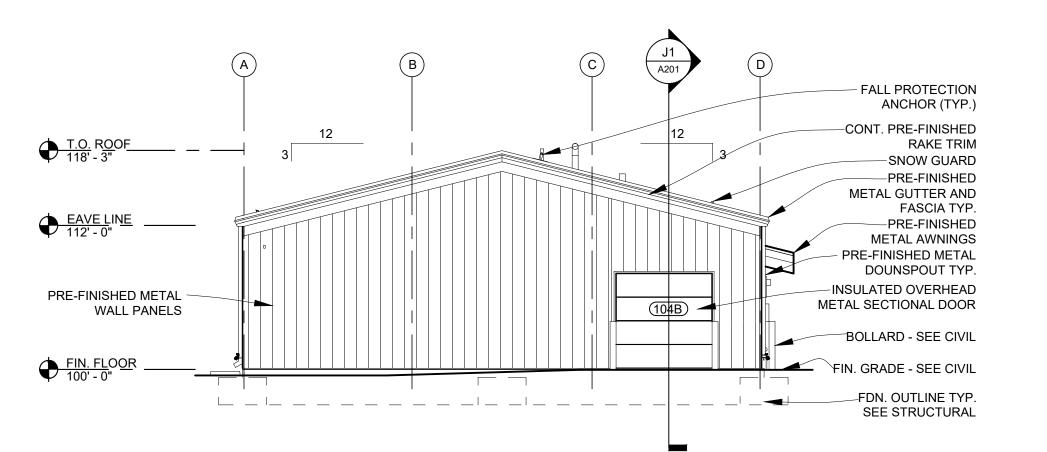SCALE: 1/8" = 1'-0"





A8 C14 EAST ELEVATION
A101 SCALE: 1/8" = 1'-0"

**GENERAL ELEVATION NOTES** 

- SEE WALL SECTIONS FOR ADDITIONAL DETAILS, MATERIALS, NOTES, AND DIMENSIONS.
- 2. SEE SITE PLAN FOR EXACT FINISH GRADE ELEVATIONS.
- 3. SEE SITE PLAN FOR SIDEWALKS & SLABS, DETAILS, LOCATIONS AND DIMENSIONS.

### GENERAL BUILDING SECTION NOTES

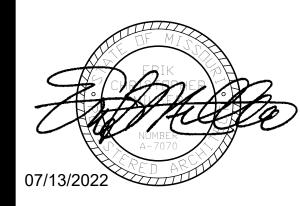
SEE FINISH SCHEDULE FOR ALL FINISHES AND CEILING HEIGHTS.

- 2. FIELD VERIFY ALL DIMENSIONS AND CONDITIONS PRIOR TO EXECUTING ANY WORK. NOTIFY ARCHITECT OF ANY DIMENSIONS OR WORK DIFFERING FROM THAT SHOWN, FOR CLARIFICATION BY THE ARCHITECT PRIOR TO PROCEEDING WITH
- VERIFY ALL ROUGH OPENINGS FOR DOORS, WINDOWS, EQUIPMENT & OTHER "BUILT-IN" ITEMS PRIOR TO EXECUTION OF ANY WORK AFFECTED BY SAME.
- 4. SEE DOOR AND WINDOW SCHEDULES FOR ALL DOOR AND WINDOW DIMENSIONS AND DETAILS.
- 5. REFER TO M.E.P. DRAWINGS FOR DETAILED INFORMATION REGARDING M.E.P.

### **KEY NOTES**

- 1 8" DIA. CONCRETE FILLED, PAINTED STEEL BOLLARD. SEE CIVIL
- 2 AIR CONDITIONER CONDENSER, SEE MEP
- (3) DRINKING FOUNTAIN SEE MEP
- CORNER GUARD, 16 GA. STAINLESS STEEL 1-1/2" LEGS x 48"
- RECESSED FIRE EXTINGUISHER & CABINET (F.E.C.)
- 6 WALL MOUNTED FIRE EXTINGUISHER
- (7) PRE-FABRICATED CONCRETE SPLASH
- BLOCK (8) 3"x4" PRE-FINISHED METAL DOWNSPOUT TO PVC ADAPTER BOOT TO PVC STORM SEWER PIPING UNDERGROUND TO
- DAYLIGHT SEE CIVIL 9 MOP RACK, 36" LONG UTILITY SHELF, 4
- MOP HOLDERS, 3 HOOKS (10) FLOOR DRAIN - SEE G13 / A202 - SEE MEP
- (11) CONCRETE HOUSEKEEPING PAD SEE
- (12) GRAB BARS. 18" VERT., 36" & 42" HORIZ.
- STAINLESS STEEL
- MIRROR 24"x36". 1/4" FLOAT GLASS, STAINLESS STEEL CHANNEL FRAME
- RECESSED STAINLESS STEEL TOILET PAPER DISPENSER
- LIQUID SOAP DISPENSER, SURFACE MOUNTED STAINLESS STEEL
- PAPER TOWEL DISPENSER, SURFACE MOUNTED STAINLESS STEEL
- (17) ADA PIPE INSULATION KIT
- (18) MOP SINK SEE MEP
- (19) LAVATORY SEE MEP
- (20) TOILET SEE MEP
- (21) STAINLESS STEEL CORNER BACK SPLASH - 36"x42"
- 8" x42" SCHEDULE 40 PAINTED STEEL BOLT DOWN BOLLARDS. SEE G8 / A202
- (23) ROLLER WINDOW SHADE

STATE OF MISSOURI MICHAEL L. PARSON, **GOVERNOR** 





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Missouri Army National Guard

Macon Training Site 29614 Jaguar Street Macon, MO 63552

COMPANY HEADQUARTERS & ADMINISTRATION SUPPLY BUILDING

8136319018

PROJECT # T2214-01 6319

**REVISION: REVISION:** REVISION: DATE: ISSUE DATE: 07/13/2022

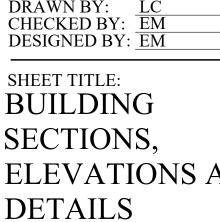
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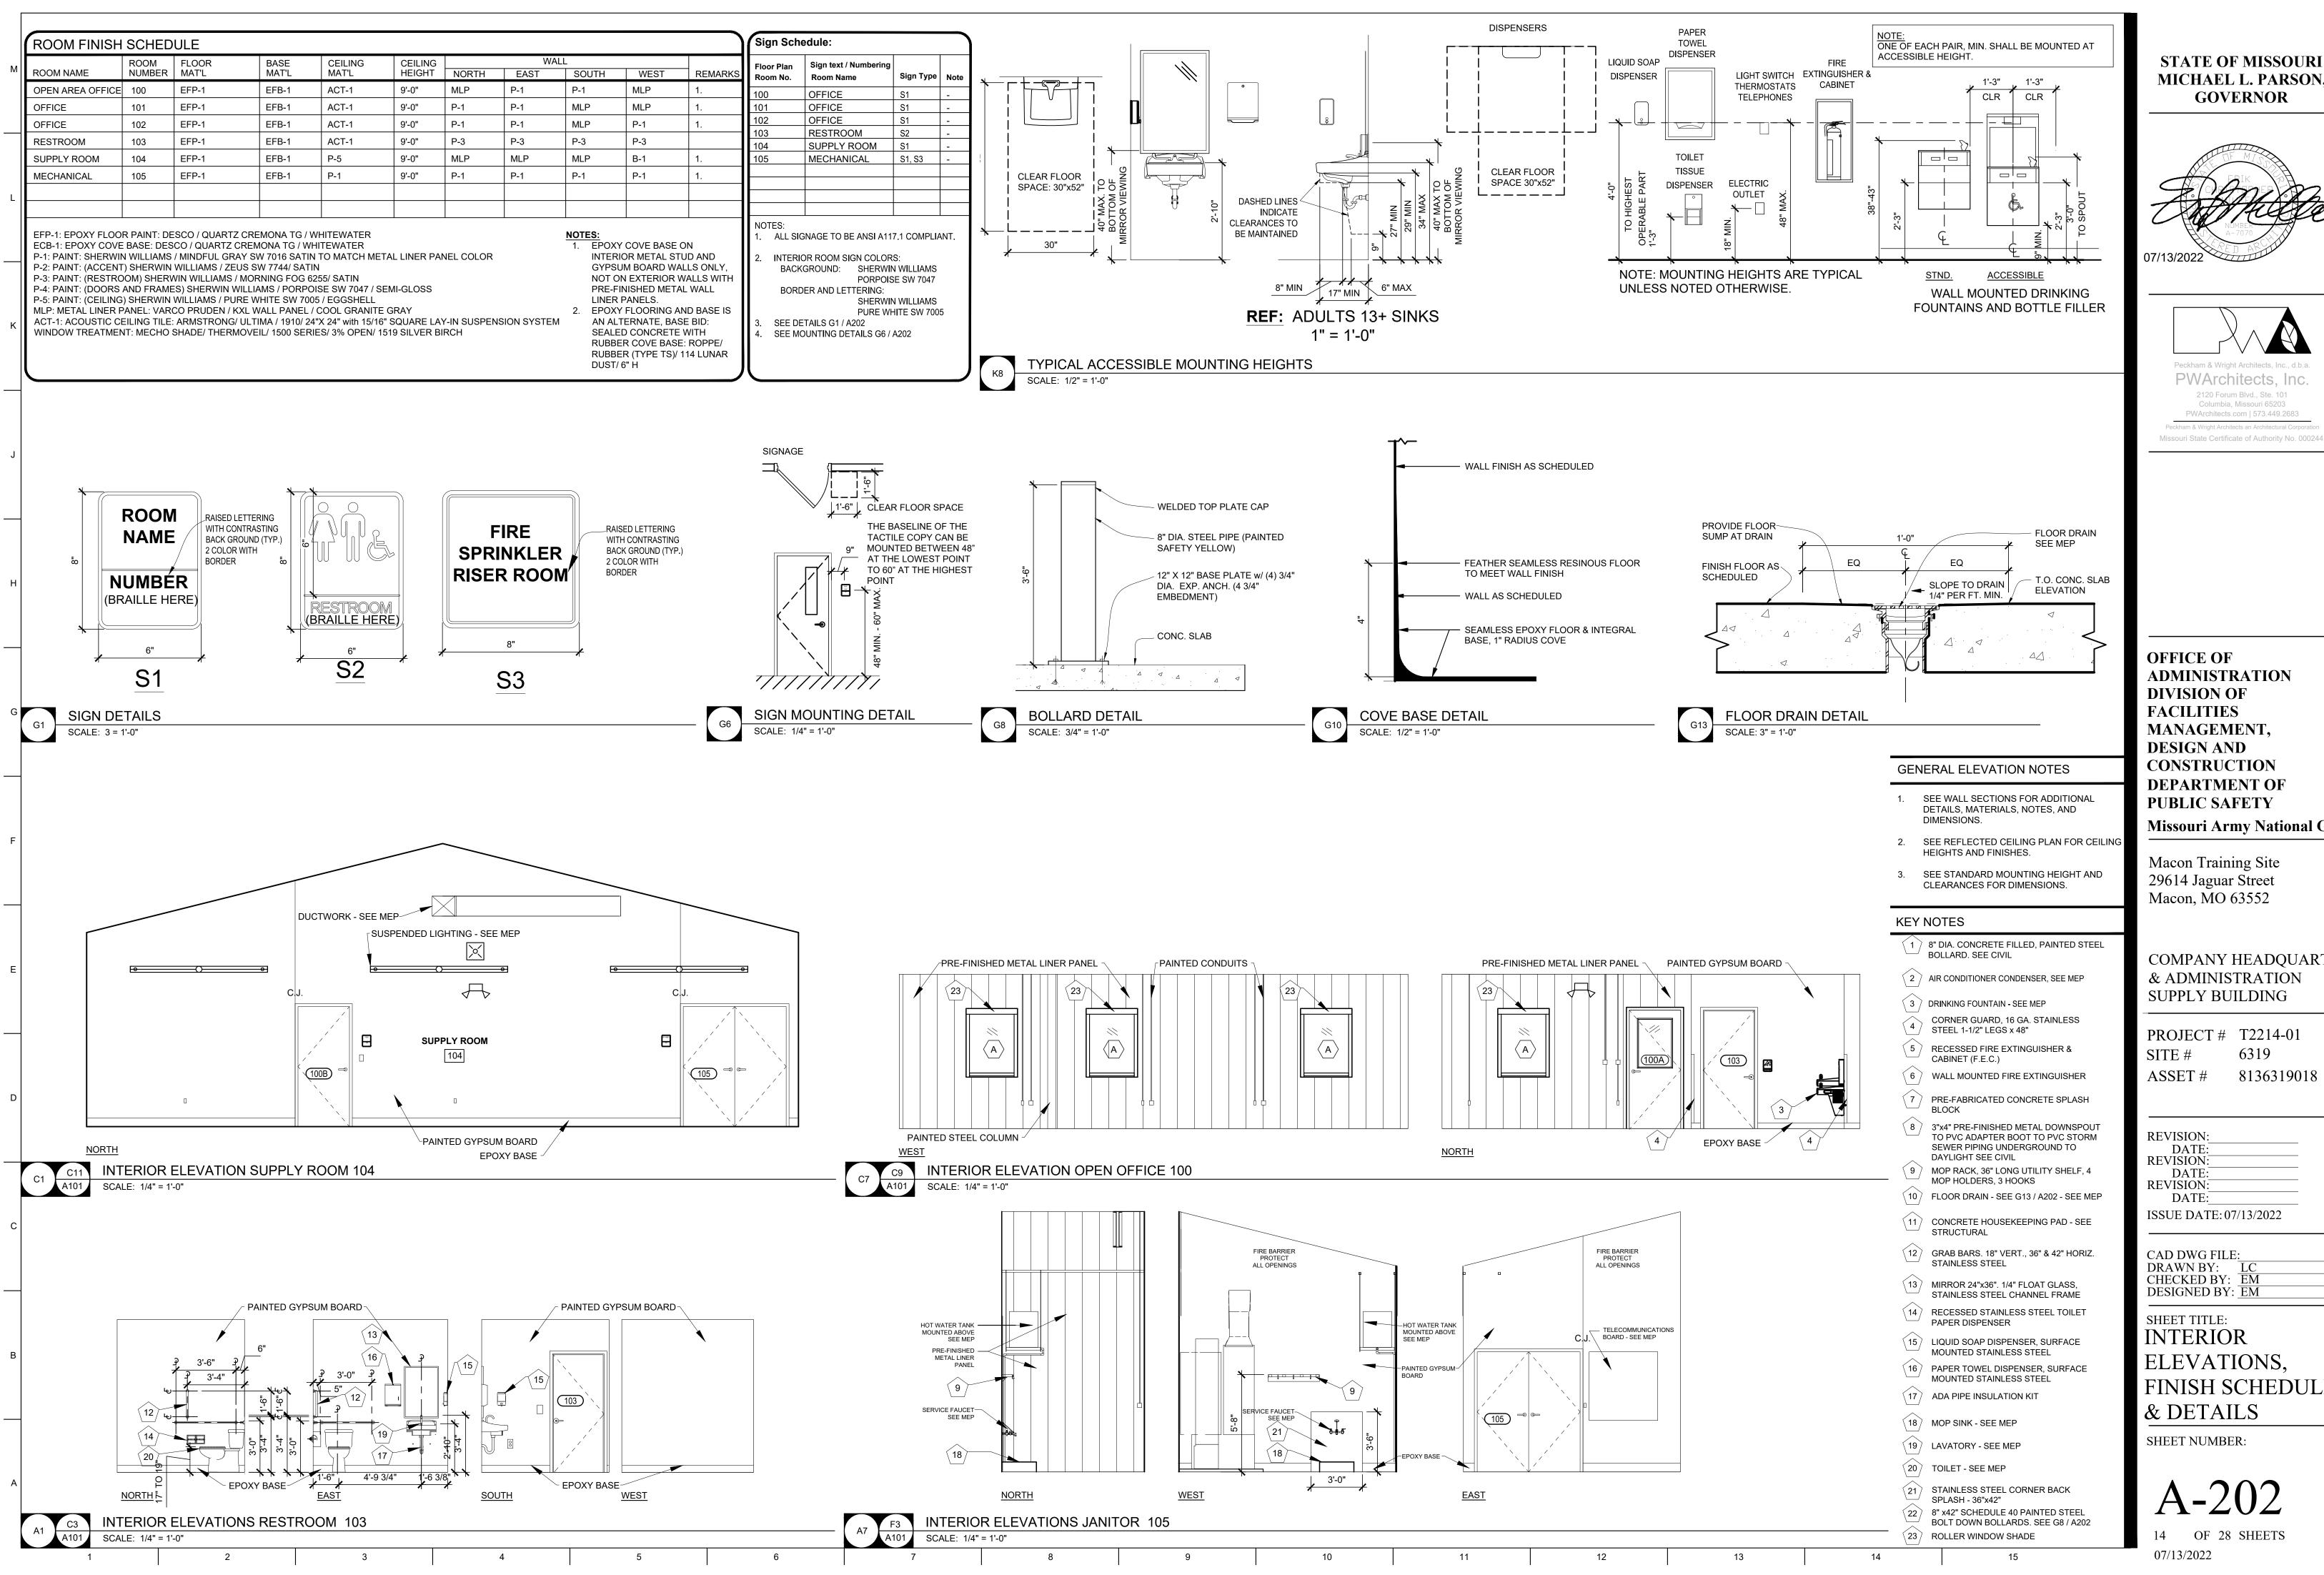
BUILDING SECTIONS, **ELEVATIONS AND** 


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07/13/2022

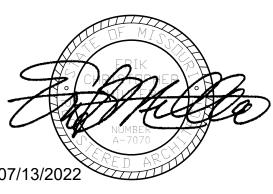OF 28 SHEETS









**ADMINISTRATION** 

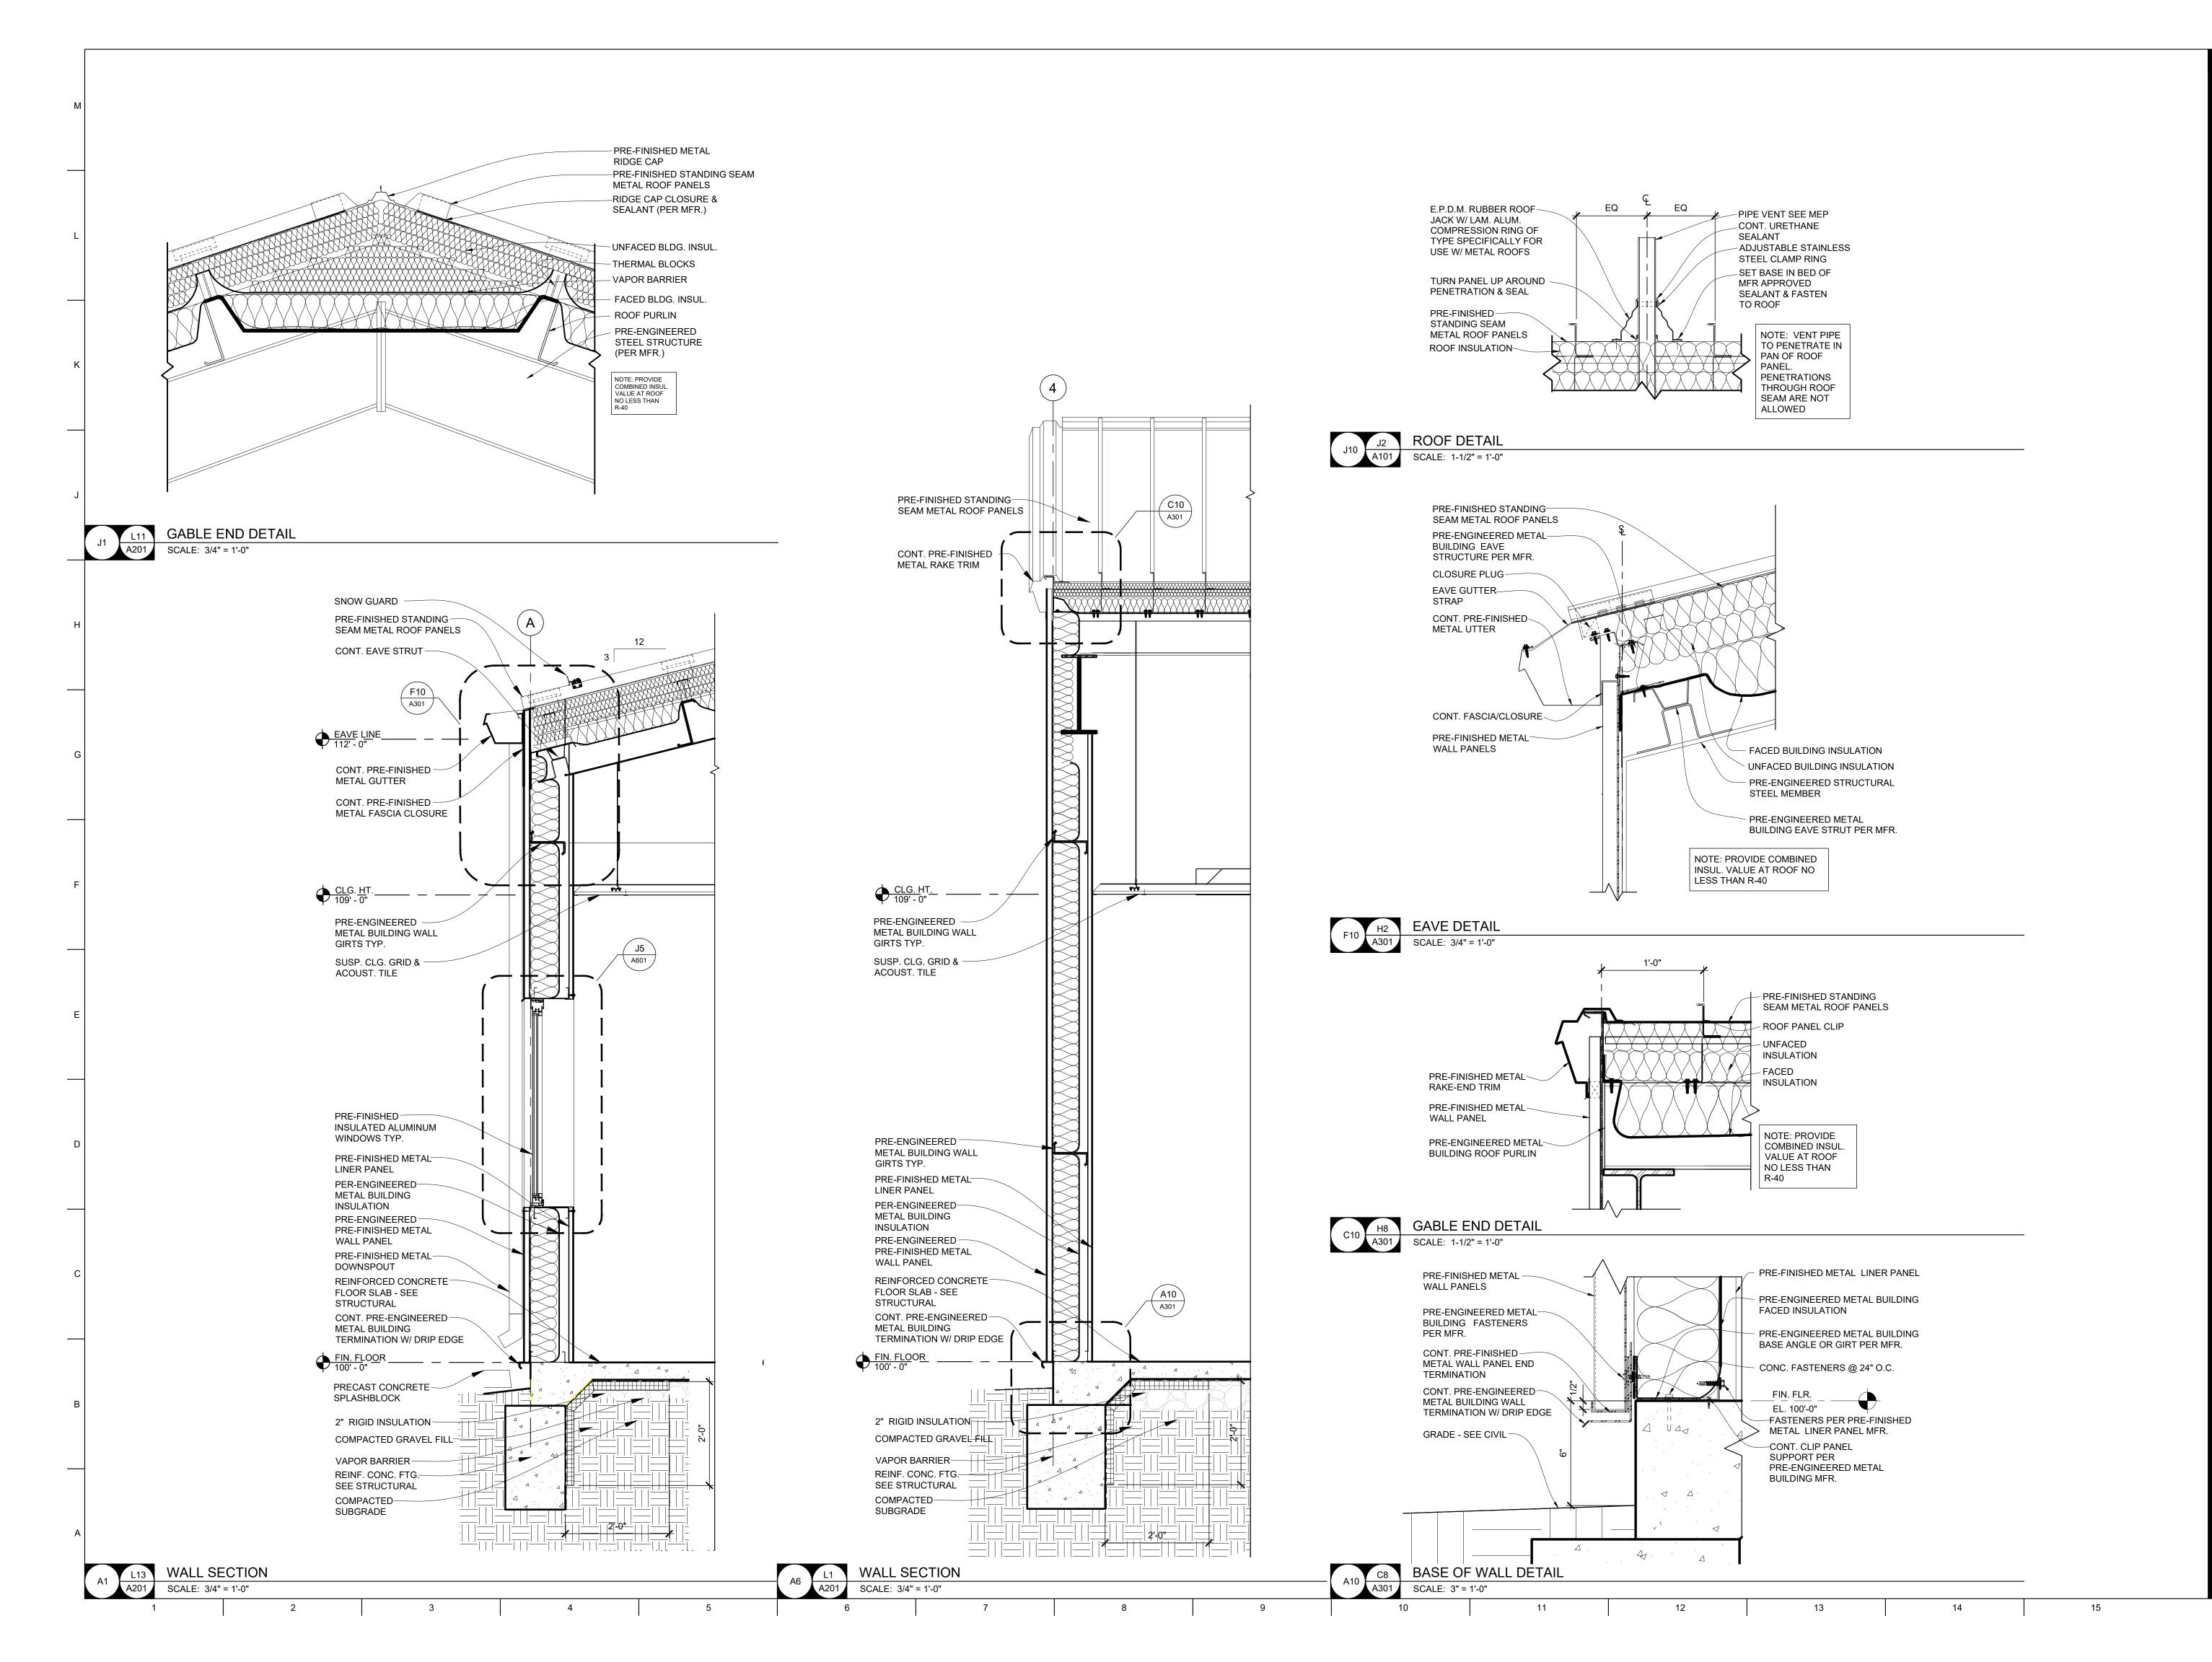
Missouri Army National Guard

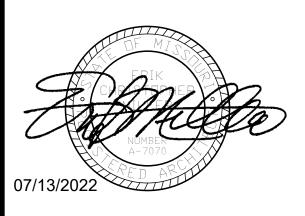
COMPANY HEADQUARTERS & ADMINISTRATION

PROJECT # T2214-01

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FINISH SCHEDULE







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COMPANY HEADQUARTERS & ADMINISTRATION SUPPLY BUILDING

PROJECT # T2214-01 SITE # 6319 ASSET # 8136319018

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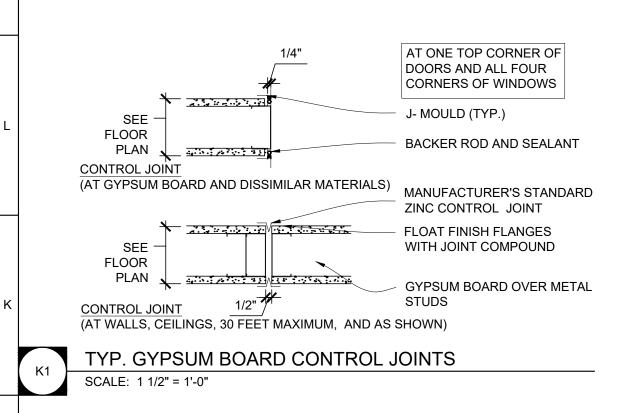
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WALL SECTIONS &
DETAILS

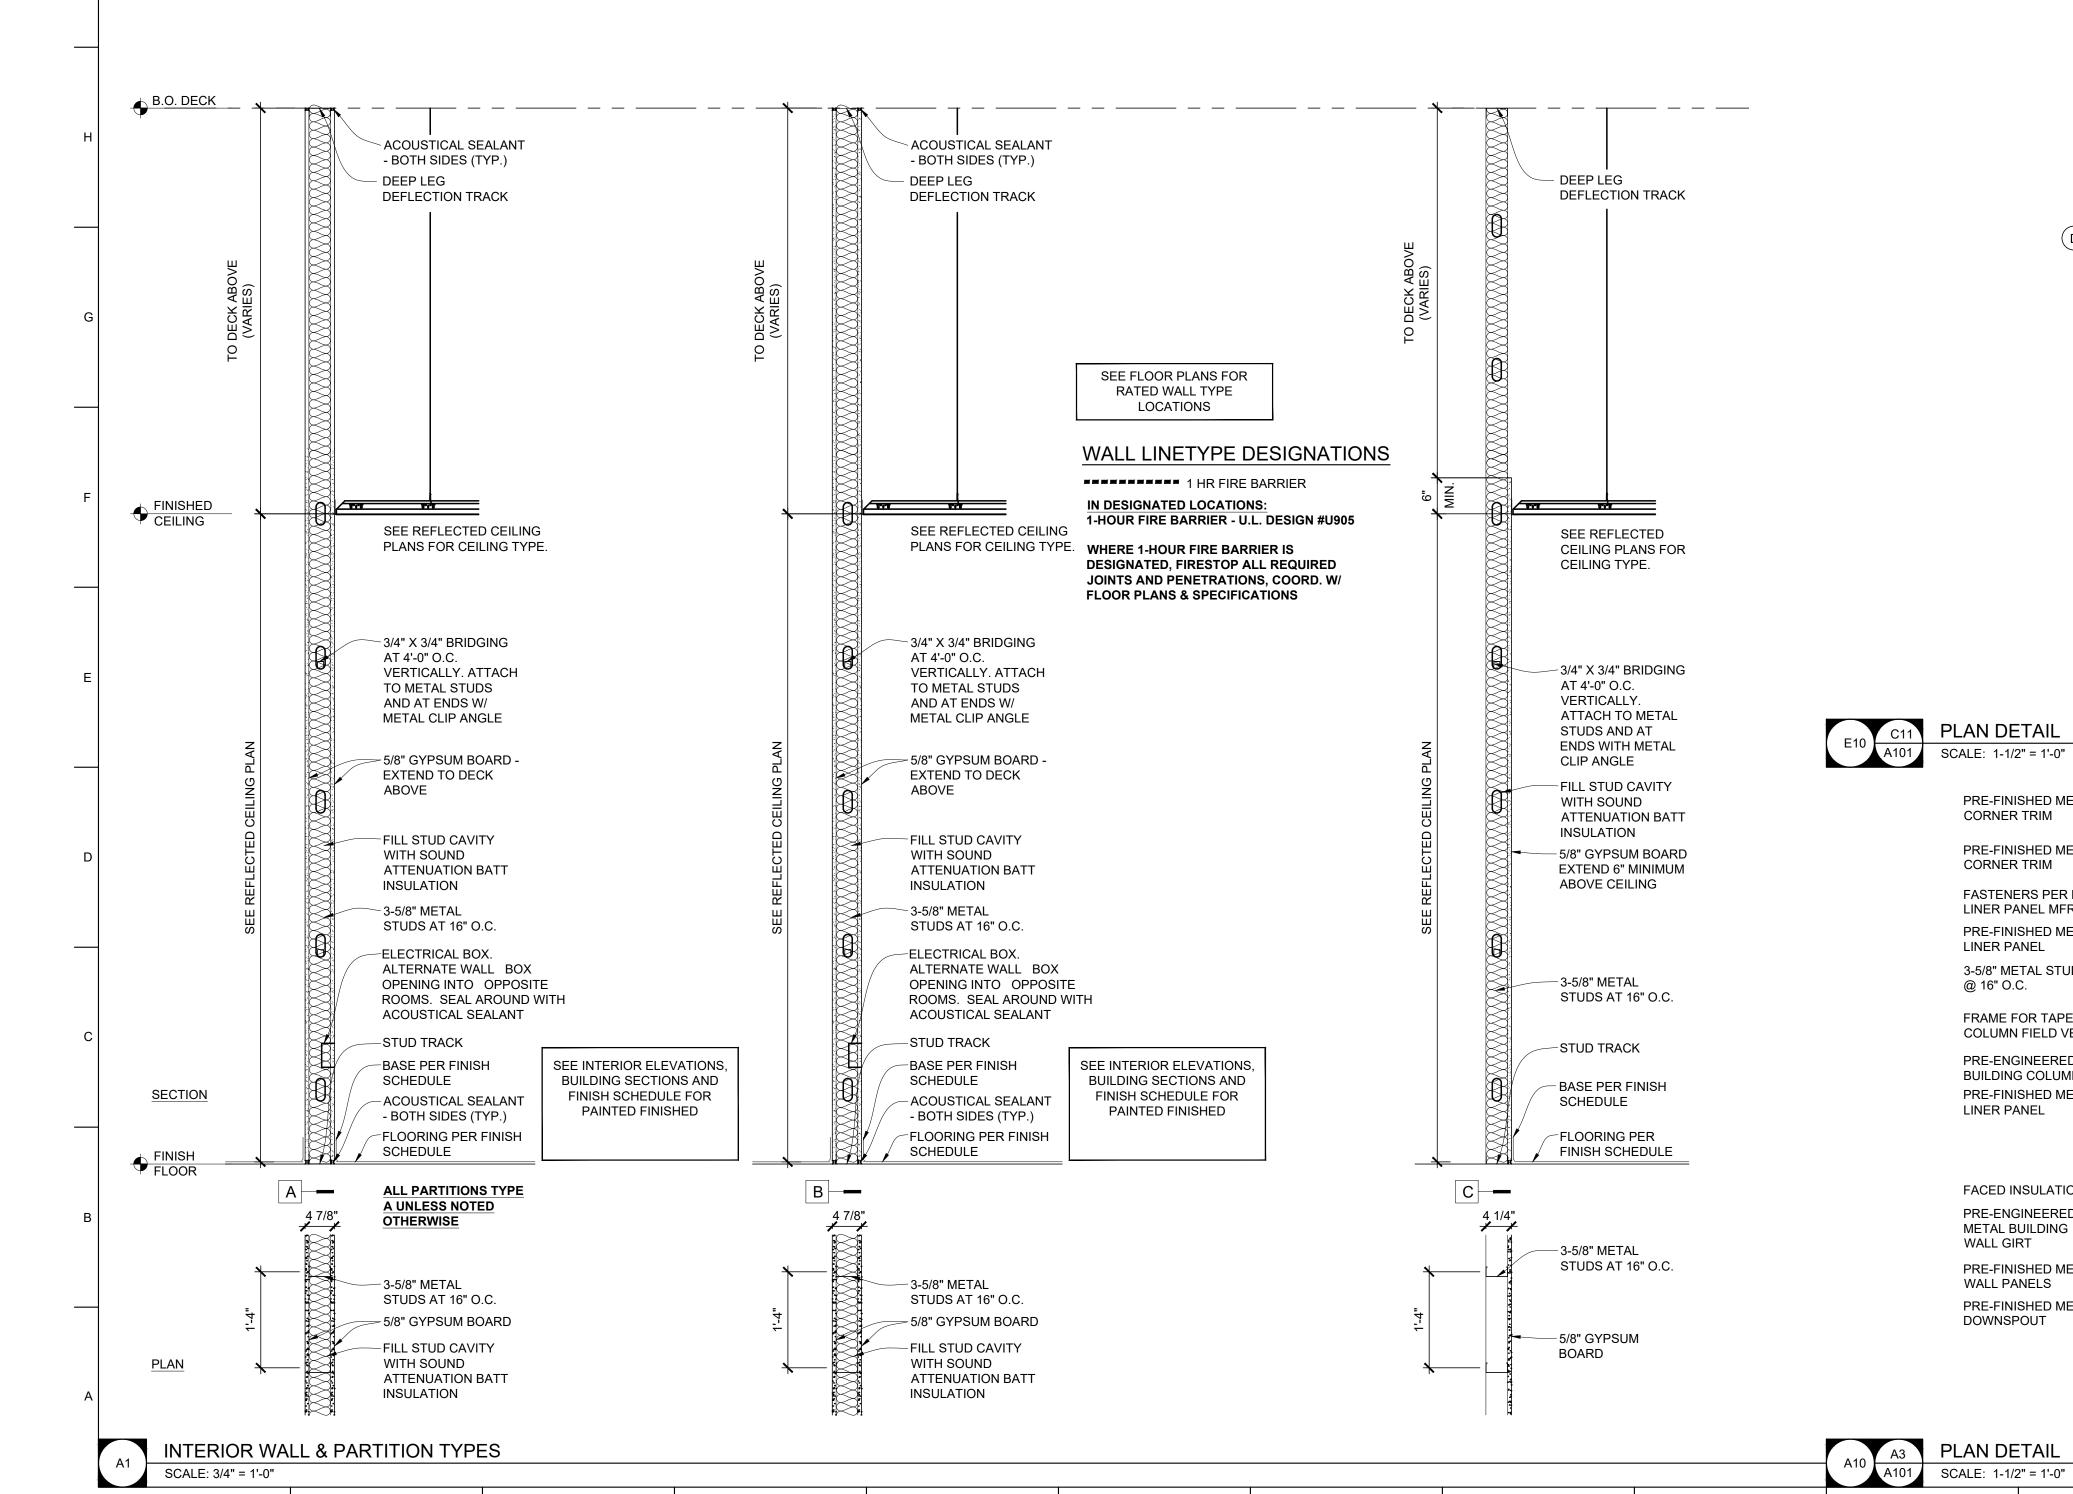
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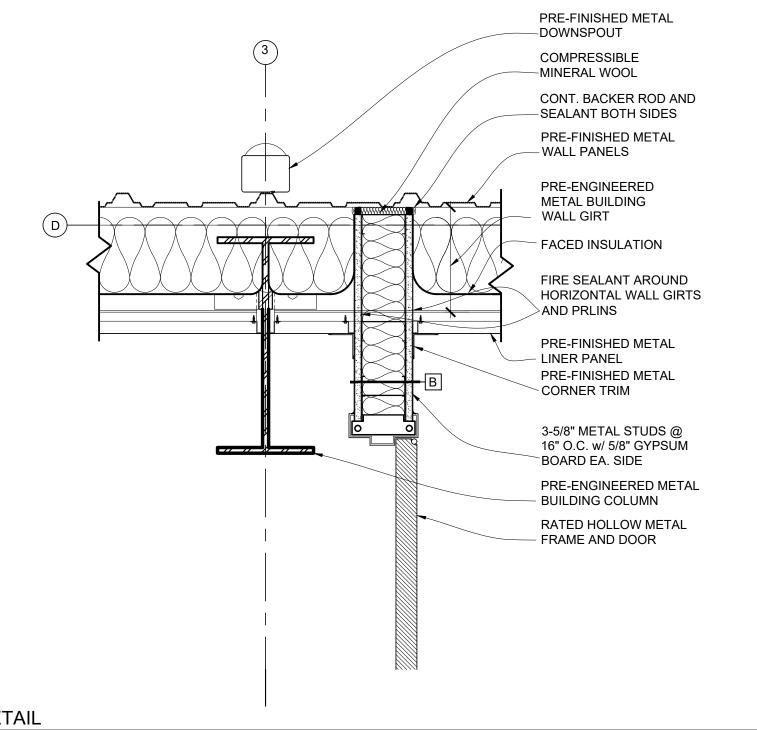
A-301


15 OF 28 SHEET

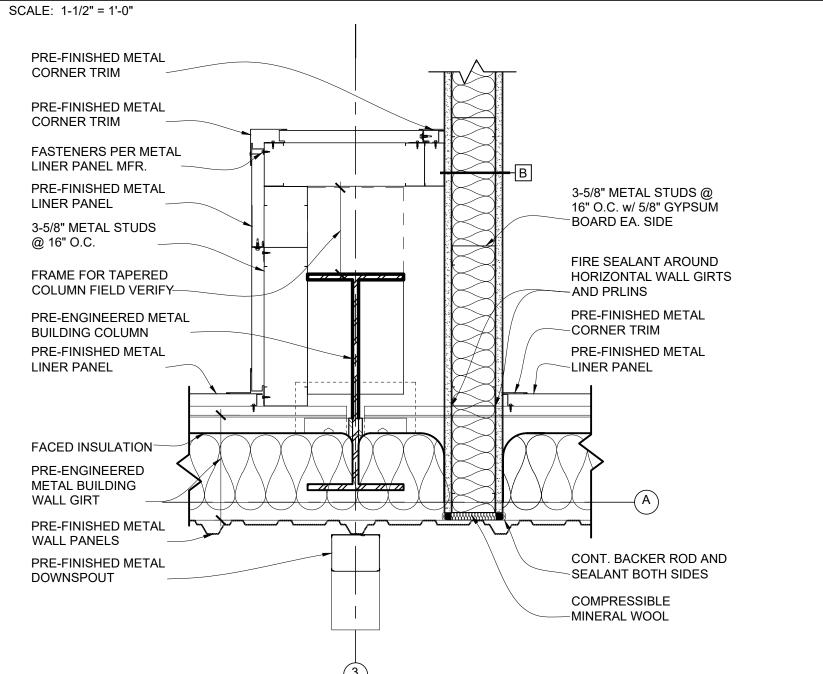07/13/2022










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STATE OF MISSOURI MICHAEL L. PARSON, **GOVERNOR** 



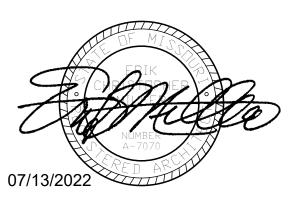

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COMPANY HEADQUARTERS & ADMINISTRATION SUPPLY BUILDING

PROJECT # T2214-01 6319 8136319018 ASSET#

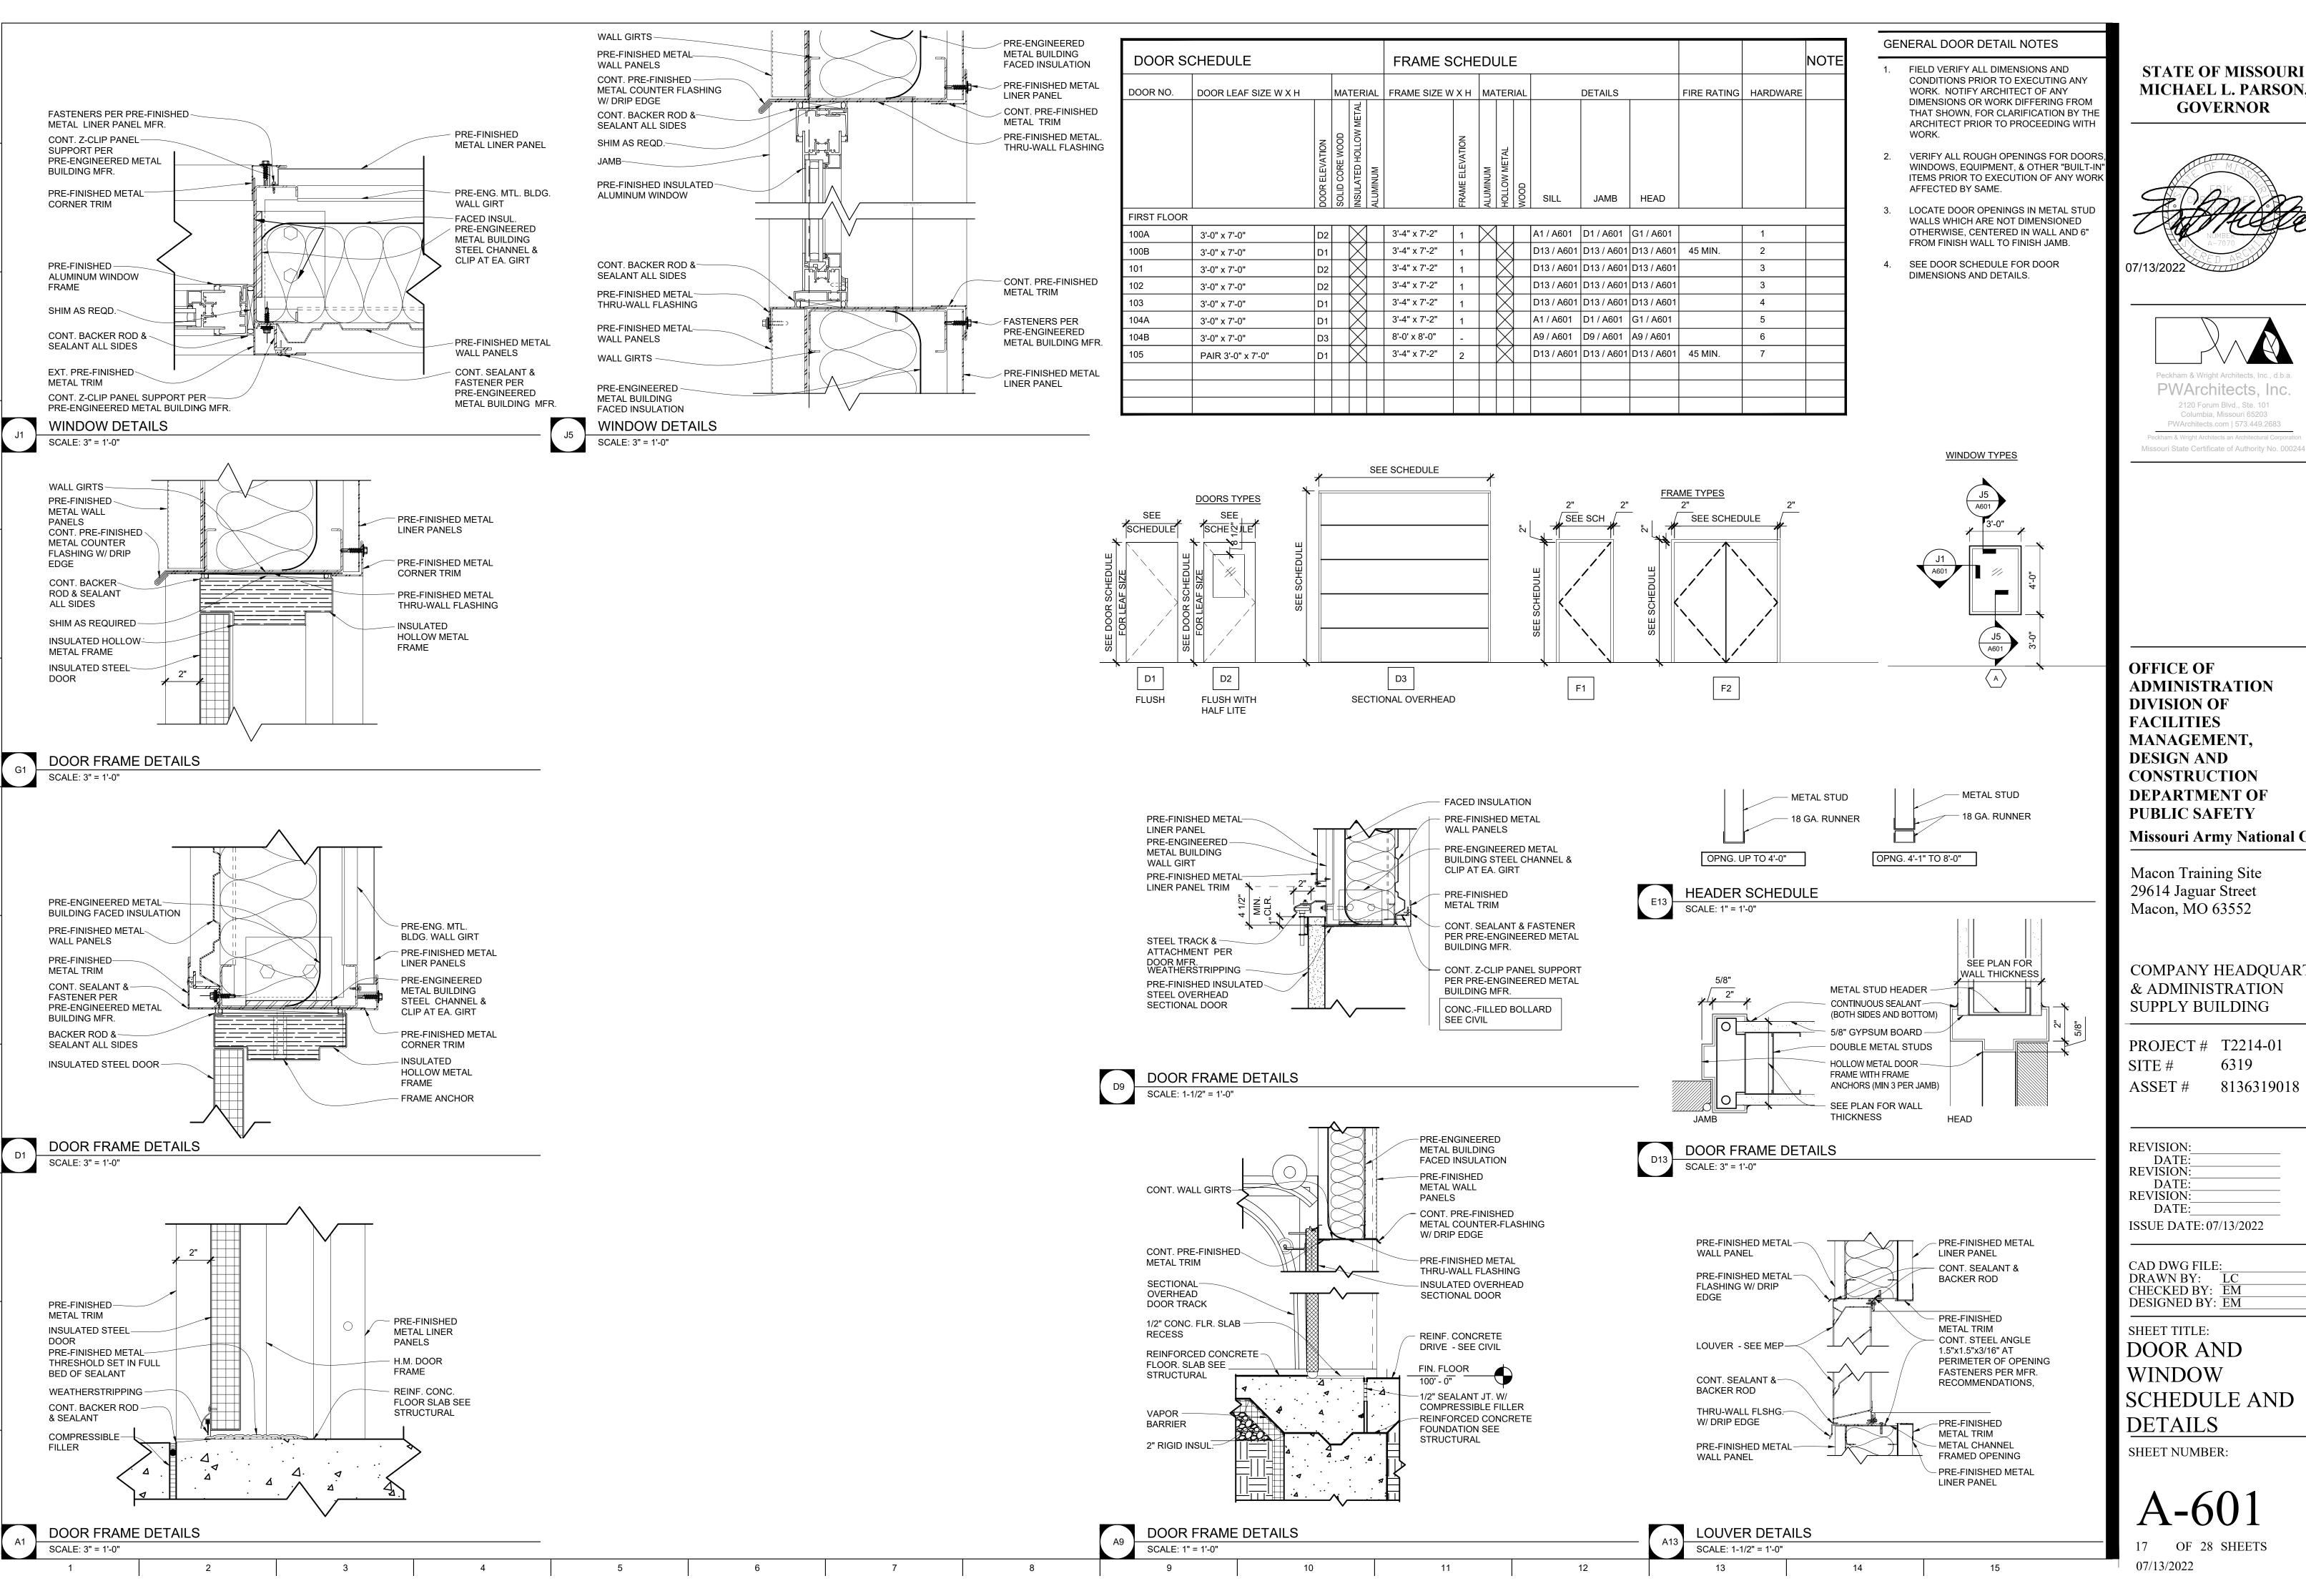
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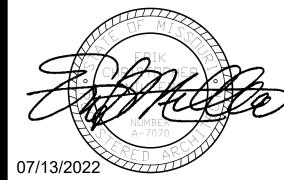
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DESIGNED BY: EM SHEET TITLE: PARTITION TYPES

SHEET NUMBER:

& DETAILS







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COMPANY HEADQUARTERS & ADMINISTRATION SUPPLY BUILDING

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DATE:	
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DATE:	
ISSUE DATE: 07/13/2022	

CAD DWG FILE: DRAWN BY: CHECKED BY: DESIGNED BY: EM

SHEET TITLE: DOOR AND WINDOW SCHEDULE AND **DETAILS** 

SHEET NUMBER:

07/13/2022

Mechanical - Electrical - Plumbing Design Drawings for

# COMPANY HEADQUARTERS & ADMINISTRATIVE SUPPLY BUILDING

Macon Training Site 29614 Jaguar Street Macon, MO 63552

### **GENERAL MEP SPECIFICATIONS**

- DRAWINGS OR SPECIFICATIONS.
- THE LAYOUT OF SYSTEMS SHOWN ON PLANS ARE APPROXIMATE AND WILL NEED TO BE COORDINATED IN FIELD. THE CONTRACTOR SHALL INCLUDE THIS COORDINATION IN HIS SCOPE
- AND INCLUDE ALL COSTS OF MODIFYING THE LAYOUT AS REQUIRED IN HIS BID. 3. THE CONTRACTOR IS RESPONSIBLE FOR PROVIDING ALL NECESSARY PARTS AND LABOR TO PRODUCE A COMPLETE AND FULLY OPERATIONAL SYSTEM UNLESS STATED OTHERWISE ON
- 4. ALL MATERIALS TO BE NEW, FIRST CLASS, AND INSTALLED PER MANUFACTURE'S PUBLISHED
- 5. ALL WORK SHALL BE PERFORMED IN COMPLIANCE WITH LOCALLY ADOPTED CODES AND
- 6. CONTRACTOR IS RESPONSIBLE FOR TO COORDINATE EQUIPMENT LOCATIONS AND SYSTEM
- ROUTING WITH OTHER TRADES PRIOR TO INSTALLATION.
- 7. CONTRACTOR TO GUARANTEE ALL MATERIALS AND WORKMANSHIP FOR A PERIOD OF ONE YEAR FROM THE DATE THE PROJECT IS TURN OVER TO THE OWNER, UNLESS NOTED OTHERWISE.
- 8. CONTRACTOR IS TO INCLUDE IN HIS SCOPE THE COST OF ALL PERMITS, INSPECTIONS, METERING,
- AND TAPS ASSOCIATED WITH HIS WORK. 9. CONTRACTOR IS RESPONSIBLE FOR ALL EXCAVATION, CUTTING, CORING, PATCHING, AND
- BACKFILL REQUIRED TO COMPLETE HIS WORK, UNLESS NOTED OTHERWISE. 10. THESE PLANS ARE NOT TO BE SCALED. SEE ARCHITECTURAL PLANS FOR DIMENSIONS. WHERE
- THERE IS A CONFLICT BETWEEN ARCHITECTURAL DIMENSIONS AND MEP DIMENSION, ARCHITECTURAL SHALL GOVERN.
- 11. SEE DISCIPLINE SHEETS FOR ADDITIONAL DISCIPLINE SPECIFIC SPECIFICATIONS.

### FIRE RATED PENETRATION NOTES

- A UL LISTED FIRESTOP SYSTEM SHALL BE INSTALLED AT EACH PENETRATION OF A HORIZONTAI
- OR VERTICAL RATED ASSEMBLY IN ACCORDANCE WITH ASTM E814 OR UL 1479. EACH CONTRACTOR IS RESPONSIBLE FOR PROVIDING PROTECTION FOR HIS PENETRATIONS THRU
- RATED ASSEMBLIES.
- THE GENERAL CONTRACTOR IS RESPONSIBLE FOR PROVIDING AND MAINTAINING A CATALOG OF ALL UL LISTED FIRESTOP ASSEMBLIES

### REFERENCED CODES IN EFFECT

2018 INTERNATIONAL MECHANICAL CODE

**2018 INTERNATIONAL PLUMBING CODE** 

2018 INTERNATIONAL FUEL GAS CODE

2018 INTERNATIONAL FIRE CODE

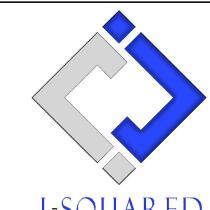
2017 NATIONAL ELECTRIC CODE

2018 INTERNATIONAL ENERGY CONSERVATION CODE

STATE OF MISSOURI MICHAEL L. PARSON **GOVERNOR** 



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COMPANY HEADQUARTERS & ADMINISTRATION BLDG.

PROJECT # T2214-01 6319 8136319018 ASSET#

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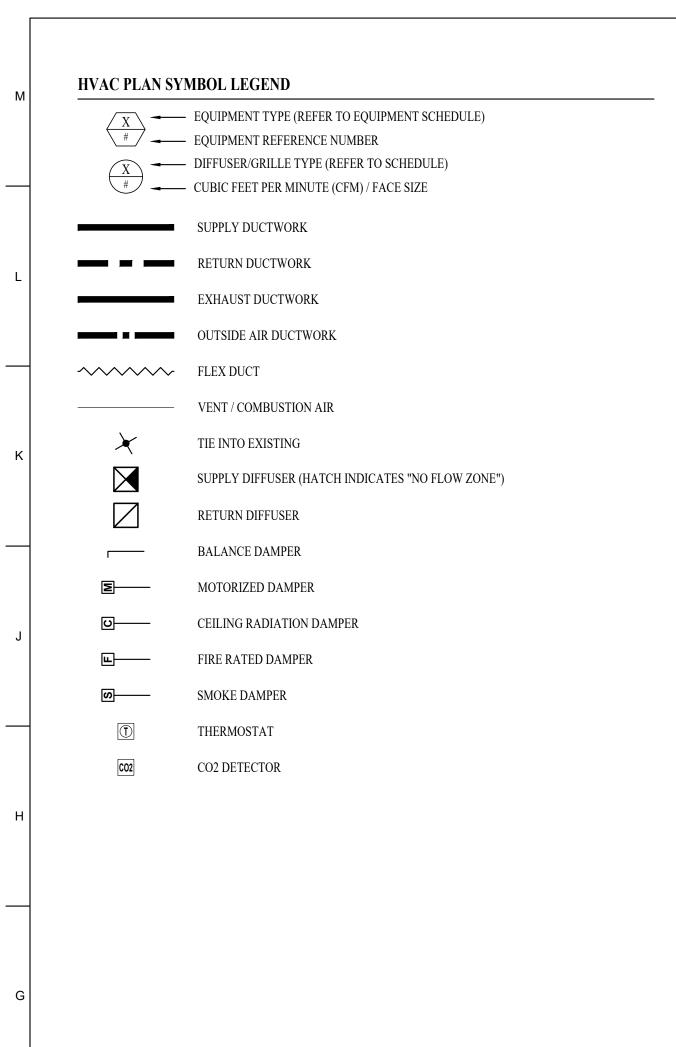
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SHEET TITLE:

MECHANICAL -ELECTRICAL -PLUMBING COVER SHEET

SHEET NUMBER:

MEP-101




### **HVAC PLAN GENERAL NOTES:**

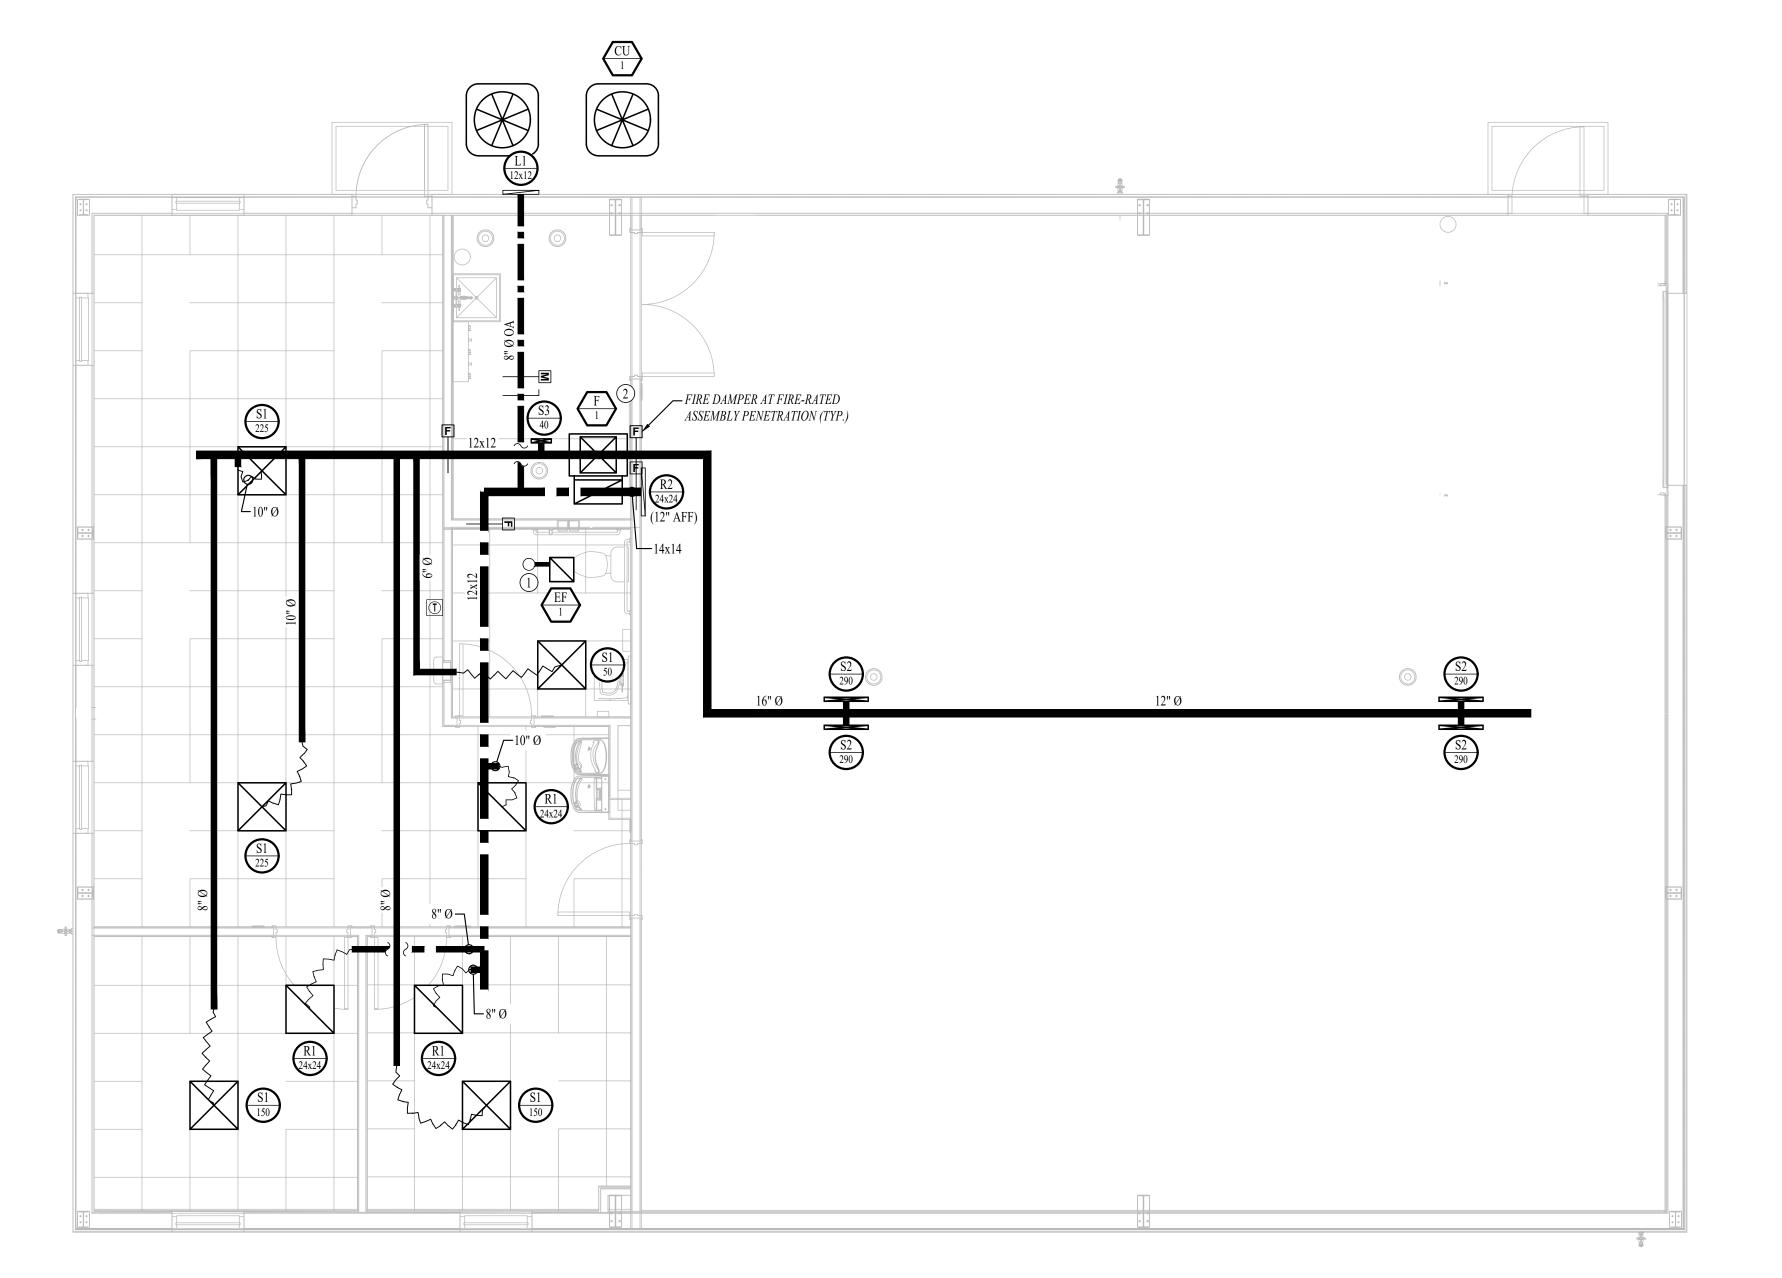SEE SHEET M-501 FOR ADDITIONAL HVAC NOTES, DETAIL, AND SCHEDULES.
 SEE SHEET M101A FOR ALTERNATE HVAC BID.

**HVAC PLAN KEY NOTES:** 

1) 6" EXHAUST UP TO EXHAUST GOOSENECK ON ROOF WITH ¾" HARDWARE CLOTH OVER OPEN END.

2 FURNACE EXHAUST AND COMBUSTION AIR UP TO CONCENTRIC VENT ON ROOF.





### STATE OF MISSOURI MICHAEL L. PARSON, GOVERNOR

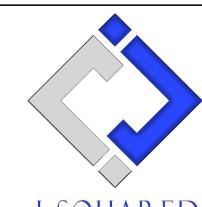


July 13, 2022



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PROJECT # T2214-01 SITE # 6319 ASSET # 8136319018

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ISSUE DATE: 07/13/2022

CAD DWG FILE:
DRAWN BY: PDH
CHECKED BY: ACW
DESIGNED BY: ACW

SHEET TITLE:

HVAC PLAN

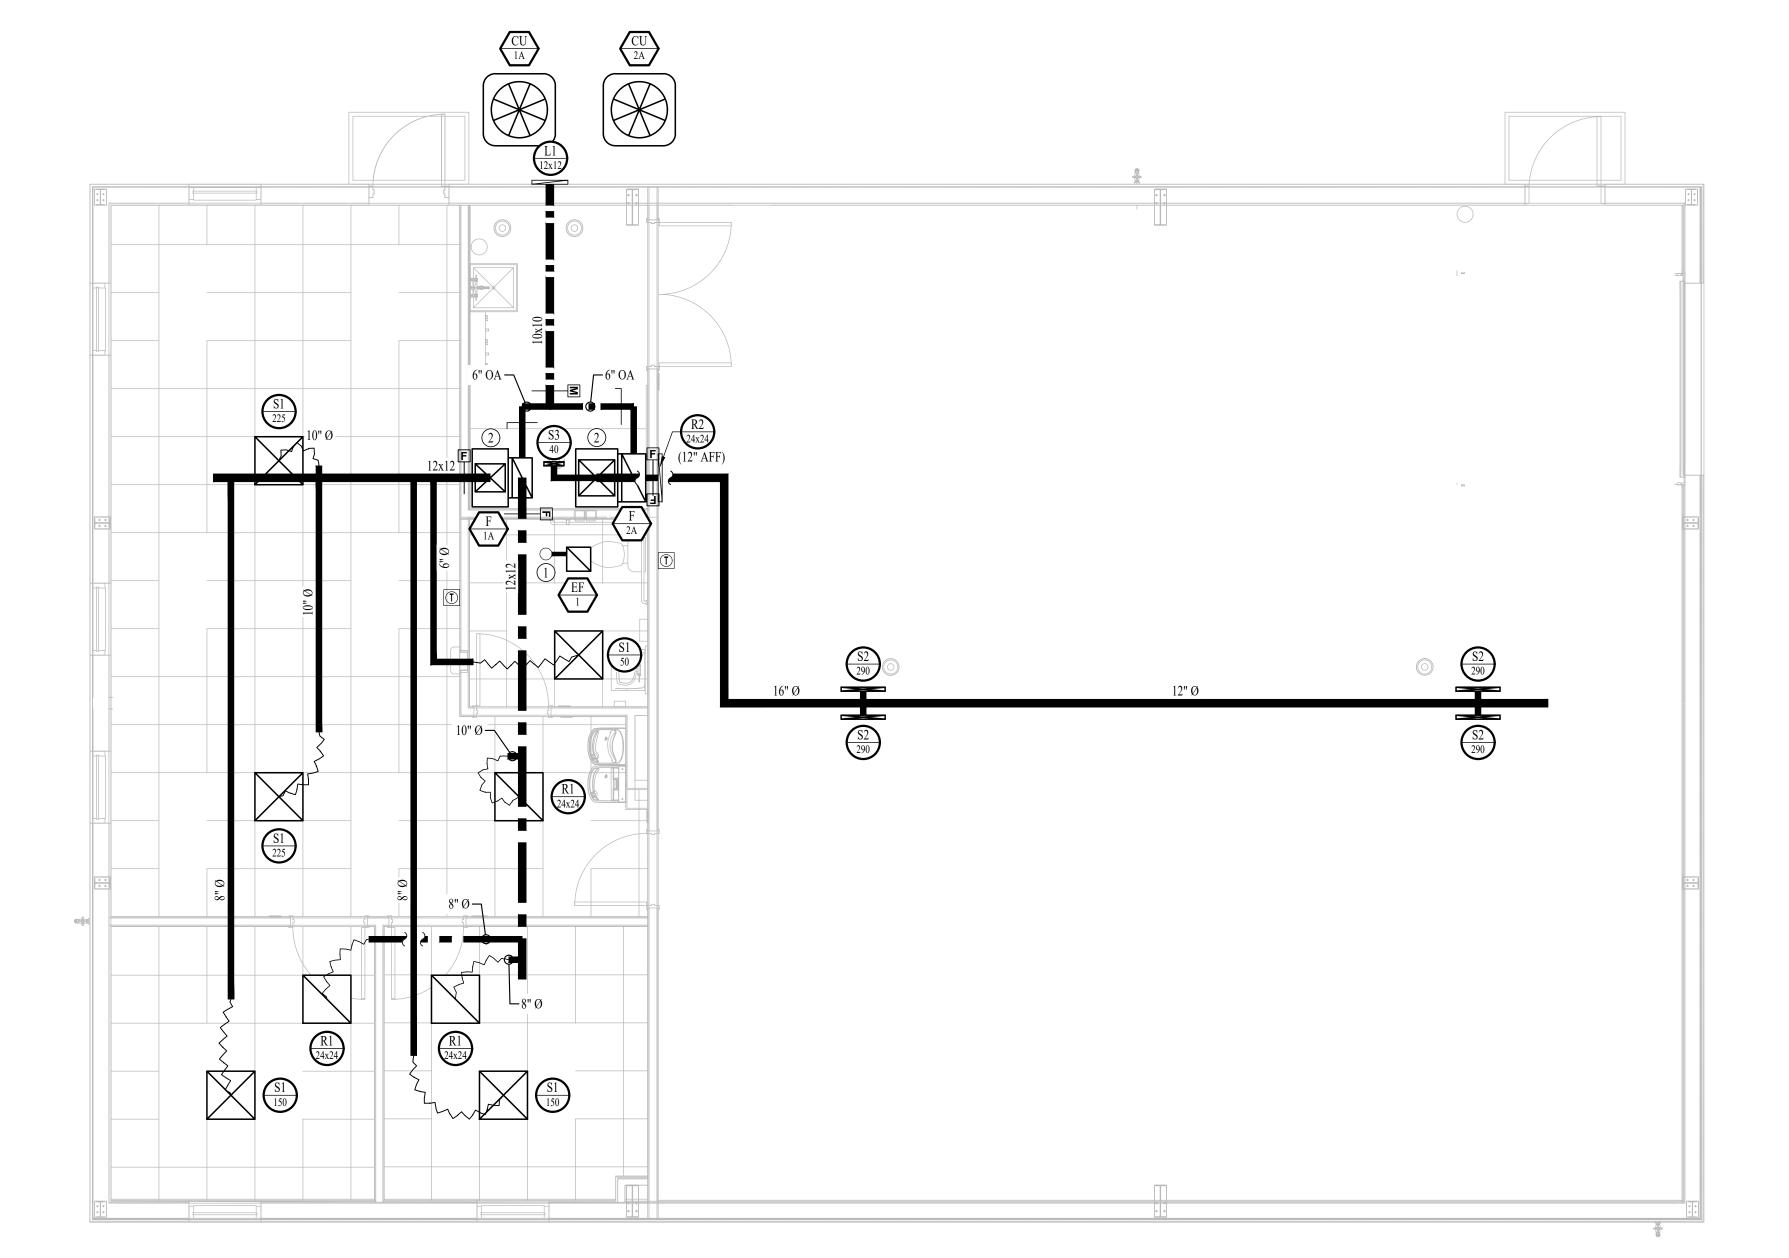
SHEET NUMBER:

M-101



(1) 6" EXHAUST UP TO EXHAUST GOOSENECK ON ROOF WITH \%" HARDWARE CLOTH OVER OPEN END.

(2) FURNACE EXHAUST AND COMBUSTION AIR UP TO CONCENTRIC VENT ON ROOF.





STATE OF MISSOURI MICHAEL L. PARSON, **GOVERNOR** 





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Missouri Army National Guard

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PROJECT # T2214-01 6319 8136319018 ASSET#

REVISION: **REVISION: REVISION:** DATE:

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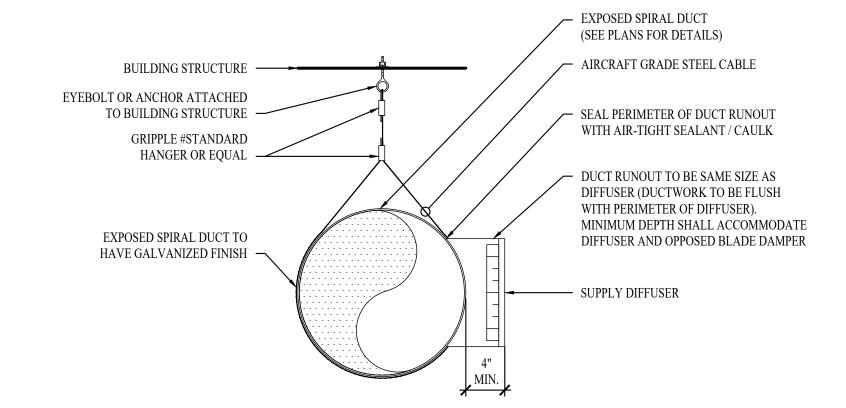
SHEET TITLE:

HVAC PLAN -ALTERNATE #2


SHEET NUMBER:

### **HVAC SPECIFICATIONS**

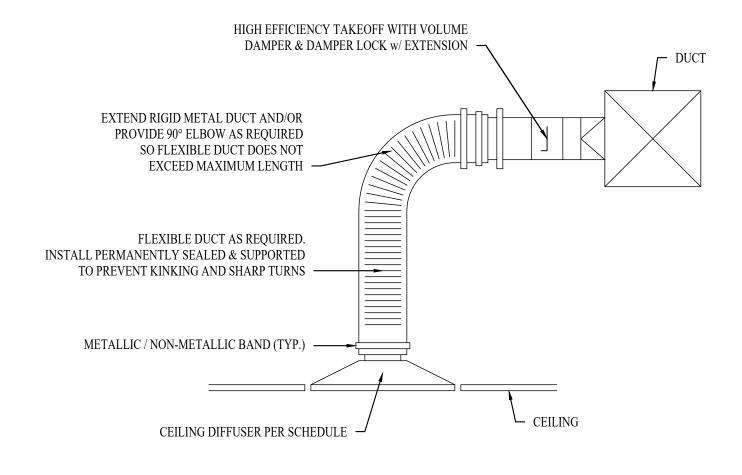- WORKMANSHIP
- 1.1. COORDINATE WITH OTHER TRADES SO THAT HVAC EQUIPMENT AND DUCT WORK DOES NOT
- BLOCK REQUIRED ACCESS OR CLEARANCE TO EQUIPMENT.
- ALL HVAC EQUIPMENT IS TO BE INSTALLED PER MANUFACTURER'S PUBLISHED
- RECOMMENDATIONS. 1.3. ALL EQUIPMENT TO BE INSTALLED LEVEL AND PLUMB.



### **EXPOSED SPIRAL DUCT SECTION DETAIL**



	HVAC EQUIPMENT SCHEDULE (BASE BID)																	
TAC	EQUIPMENT	SIZE	ODJENITA TION	TOTAL	OA AIRFLOW	HEA	TING	(IA: 80 D	COOLING B/67 WB, OA	A: 95 DB)	]	ELECTRICAL	4	NOTES				
TAG	DESCRIPTION	(TONS)	ORIENTATION	(CFM) (AMX/MIN (CFM)		(CFM)   MAX/MIN		(CFM)   MAX/MIN   1		LP GAS INPUT MIN. AFUE EFF. (KBTU) (%)		SENSIBLE (KBTU)	TOTAL (KBTU)	MIN EFF. (SEER)	VOLTS/PH MCA OCP			NOTES
F-1	FURNACE	5	UPFLOW	2000	175 / 0	100	90	-	-	-	120	14	20	1, 2, 3, 4				
CU-1	CONDENSING UNIT	5	-	-	-	-	-	41.0	57.0	13	208/1	33	50	5, 6				
EF-1	EXHAUST FAN	-	IN-CEILING	70	-	-	-	-	-	-	120/1	1	20-1	7				


- 1. PROVIDE AND INSTALL 7 DAY PROGRAMABLE HONEYWELL THERMOSTAT. COORDINATE EXACT MOUNTING LOCATION WITH OWNER.
- 2. INCLUDE CORROSION RESISTANT DRAIN PAN WITH OVERFLOW SWITCH WIRED TO SHUT DOWN UNIT.
- 3. PROVIDE WITH MANUFACTURER'S PROPANE CONVERSION KIT & CONDENSATE NEUTRALIZATION KIT.
- 4. WITH LOW LEAKAGE MOTORIZED OUTSIDE AIR DAMPER. DAMPER TO CONTROL OPEN DURING OCCUPIED HOURS AND CLOSED DURING UNOCCUPIED HOURS THRU THERMOSTAT SCHEDULE.
- 5. WITH FACTORY HAIL GUARD.
- 6. LOW AMBIENT PACKAGE FOR OPERATION TO 0° F.
- 7. EXHAUST FAN EQUAL TO BROAN #671 WITH BACKDRAFT DAMPER

	HVAC EQUIPMENT SCHEDULE (ALTERNATE BID)														
TAG	EQUIPMENT	SIZE	ORIENTATION	TOTAL AIRFLOW	OA AIRFLOW	HEA	TING	(IA: 80 D	COOLING B/67 WB, OA	A: 95 DB)	I	ELECTRICAL			
IAG	DESCRIPTION	(TONS)	ORIENTATION	(CFM)	MAX/MIN (CFM)		MIN. AFUE EFF. (%)	SENSIBLE (KBTU)	TOTAL (KBTU)	MIN EFF. (SEER)	VOLTS/PH	MCA	ОСР	NOTES	
F-1A	FURNACE	2	UPFLOW	800	70 / 0	40	90	-	-	-	120/1	10	20-1	1, 2, 3, 4, 7	
F-2A	FURNACE	3	UPFLOW	1200	105 / 0	60	90	-	-	-	120/1	10	20-1	1, 2, 3, 4, 7	
CU-1A	CONDENSING UNIT	2	-	-	-	-	-	17.2	23.0	13	240/1	18	30-2	5, 6, 7	
CU-2A	CONDENSING UNIT	3	-	_	-	_	_	24.5	33.6	13	240/1	19	30-2	5, 6, 7	
EF-1	EXHAUST FAN	1-	IN-CEILING	70	-	-	-	-	-	-	120/1	1	20-1	8	

- 1. PROVIDE AND INSTALL 7 DAY PROGRAMABLE HONEYWELL THERMOSTAT. COORDINATE EXACT MOUNTING LOCATION WITH OWNER.
- 2. INCLUDE CORROSION RESISTANT DRAIN PAN WITH OVERFLOW SWITCH WIRED TO SHUT DOWN UNIT. 3. PROVIDE WITH MANUFACTURER'S PROPANE CONVERSION KIT & CONDENSATE NEUTRALIZATION KIT.
- 4. WITH LOW LEAKAGE MOTORIZED OUTSIDE AIR DAMPER. DAMPER TO CONTROL OPEN DURING OCCUPIED HOURS AND CLOSED DURING UNOCCUPIED HOURS THRU THERMOST AT SCHEDULE.
- WITH FACTORY HAIL GUARD.
- 6. LOW AMBIENT PACKAGE FOR OPERATION TO 0° F.
- 7. PROVIDE AS ALTERNATE BID PACKAGE #2 SEE PLAN SHEETS FOR DETAILS
- 8. EXHAUST FAN EQUAL TO BROAN #671 WITH BACKDRAFT DAMPER


TAG	SERVICE	MANUFACTURER (OR EQUAL)	MODEL (OR EQUAL)	SIZE	COLOR / FINISH	NOTES
L1	OA	POTTOFF	EFD	AS INDICATED	PRIMED	PAINT TO MATCH EXTERIO
R1	RETURN	PRICE	80	AS INDICATED	WHITE	
R2	RETURN	PRICE	530	AS INDICATED	WHITE	
S1	SUPPLY	PRICE	SPD	24x24	WHITE	
S2	SUPPLY	PRICE	520	12x6	WHITE	


### TYPICAL LAY-IN DIFFUSER DETAIL

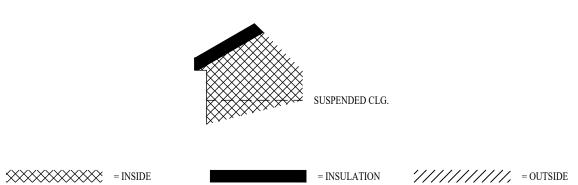


### DUCT INSIDE THERMAL ENVELOPE INSULATION REQUIREMENTS

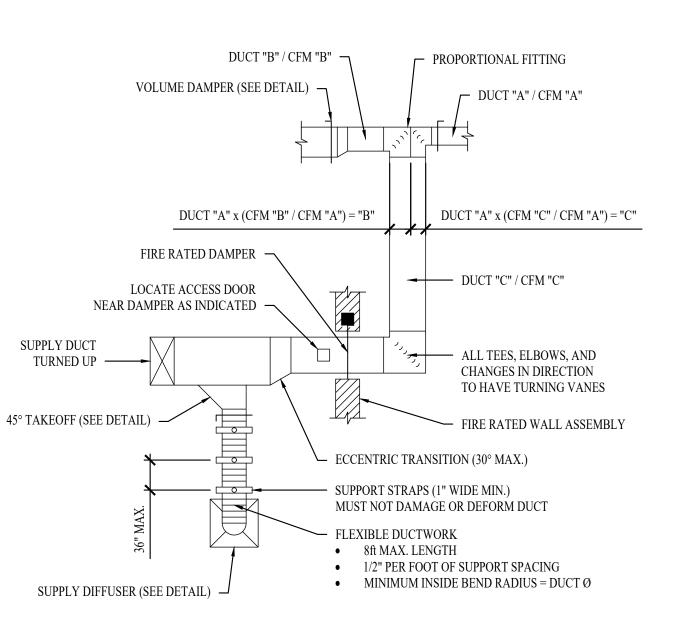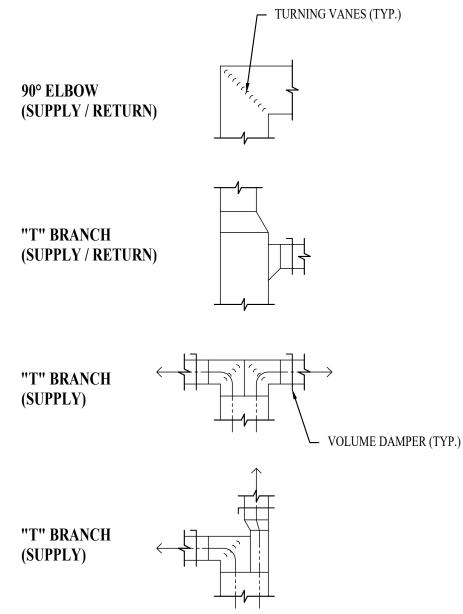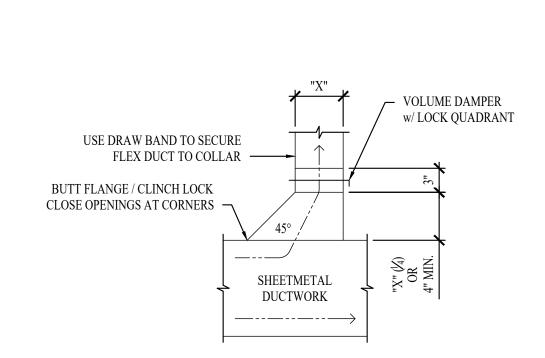	SOLMITON REQU	
RE	CTANGULAR	
•	SUPPLY =	1" WRAP
•	RETURN =	NONE
•	EXHAUST =	NONE
•	OUTSIDE AIR =	2" WRAP
RO	UND	
•	SUPPLY =	1½" WRAP
•	RETURN =	NONE
•	EXHAUST =	NONE
•	OUTSIDE AIR =	2" WRAP
SPI	RAL	
•	SUPPLY =	NONE
•	RETURN =	NONE
•	EXHAUST =	NONE
•	OUTSIDE AIR =	2" WRAP







TYPICAL BUILDING INTERIOR DUCT INSULATION DIAGRAM

TYPICAL DUCTWORK DETAIL

TYPICAL DUCTWORK FITTINGS DETAIL


TYPICAL 45° TAKEOFF DETAIL

### STATE OF MISSOURI MICHAEL L. PARSON, **GOVERNOR**




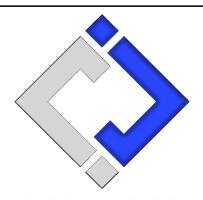
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COMPANY HEADQUARTERS & ADMINISTRATION BLDG.

PROJECT # T2214-01 6319 8136319018 ASSET#

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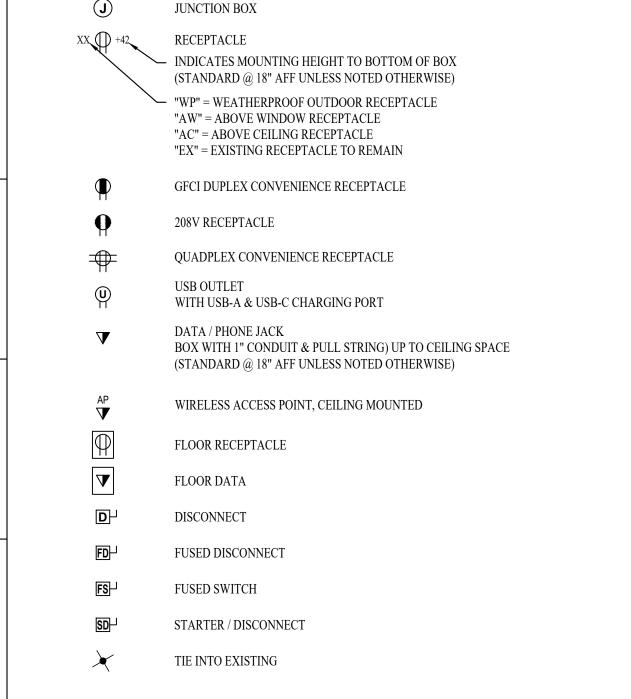
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SHEET TITLE:

HVAC DETAILS & SCHEDULES

SHEET NUMBER:



— UNDERGROUND PRIMARY CONDUIT/CONDUCTORS

- UNDERGROUND SECONDARY CONDUIT/CONDUCTORS

FROM TRANSFORMER TO METER BASE; SEE POWER RISER FOR DETAILS

FROM ACROSS DRIVE AISLE;

SEE POWER RISER FOR DETAILS

### POWER PLANS GENERAL NOTES:

POWER PLAN SYMBOL LEGEND

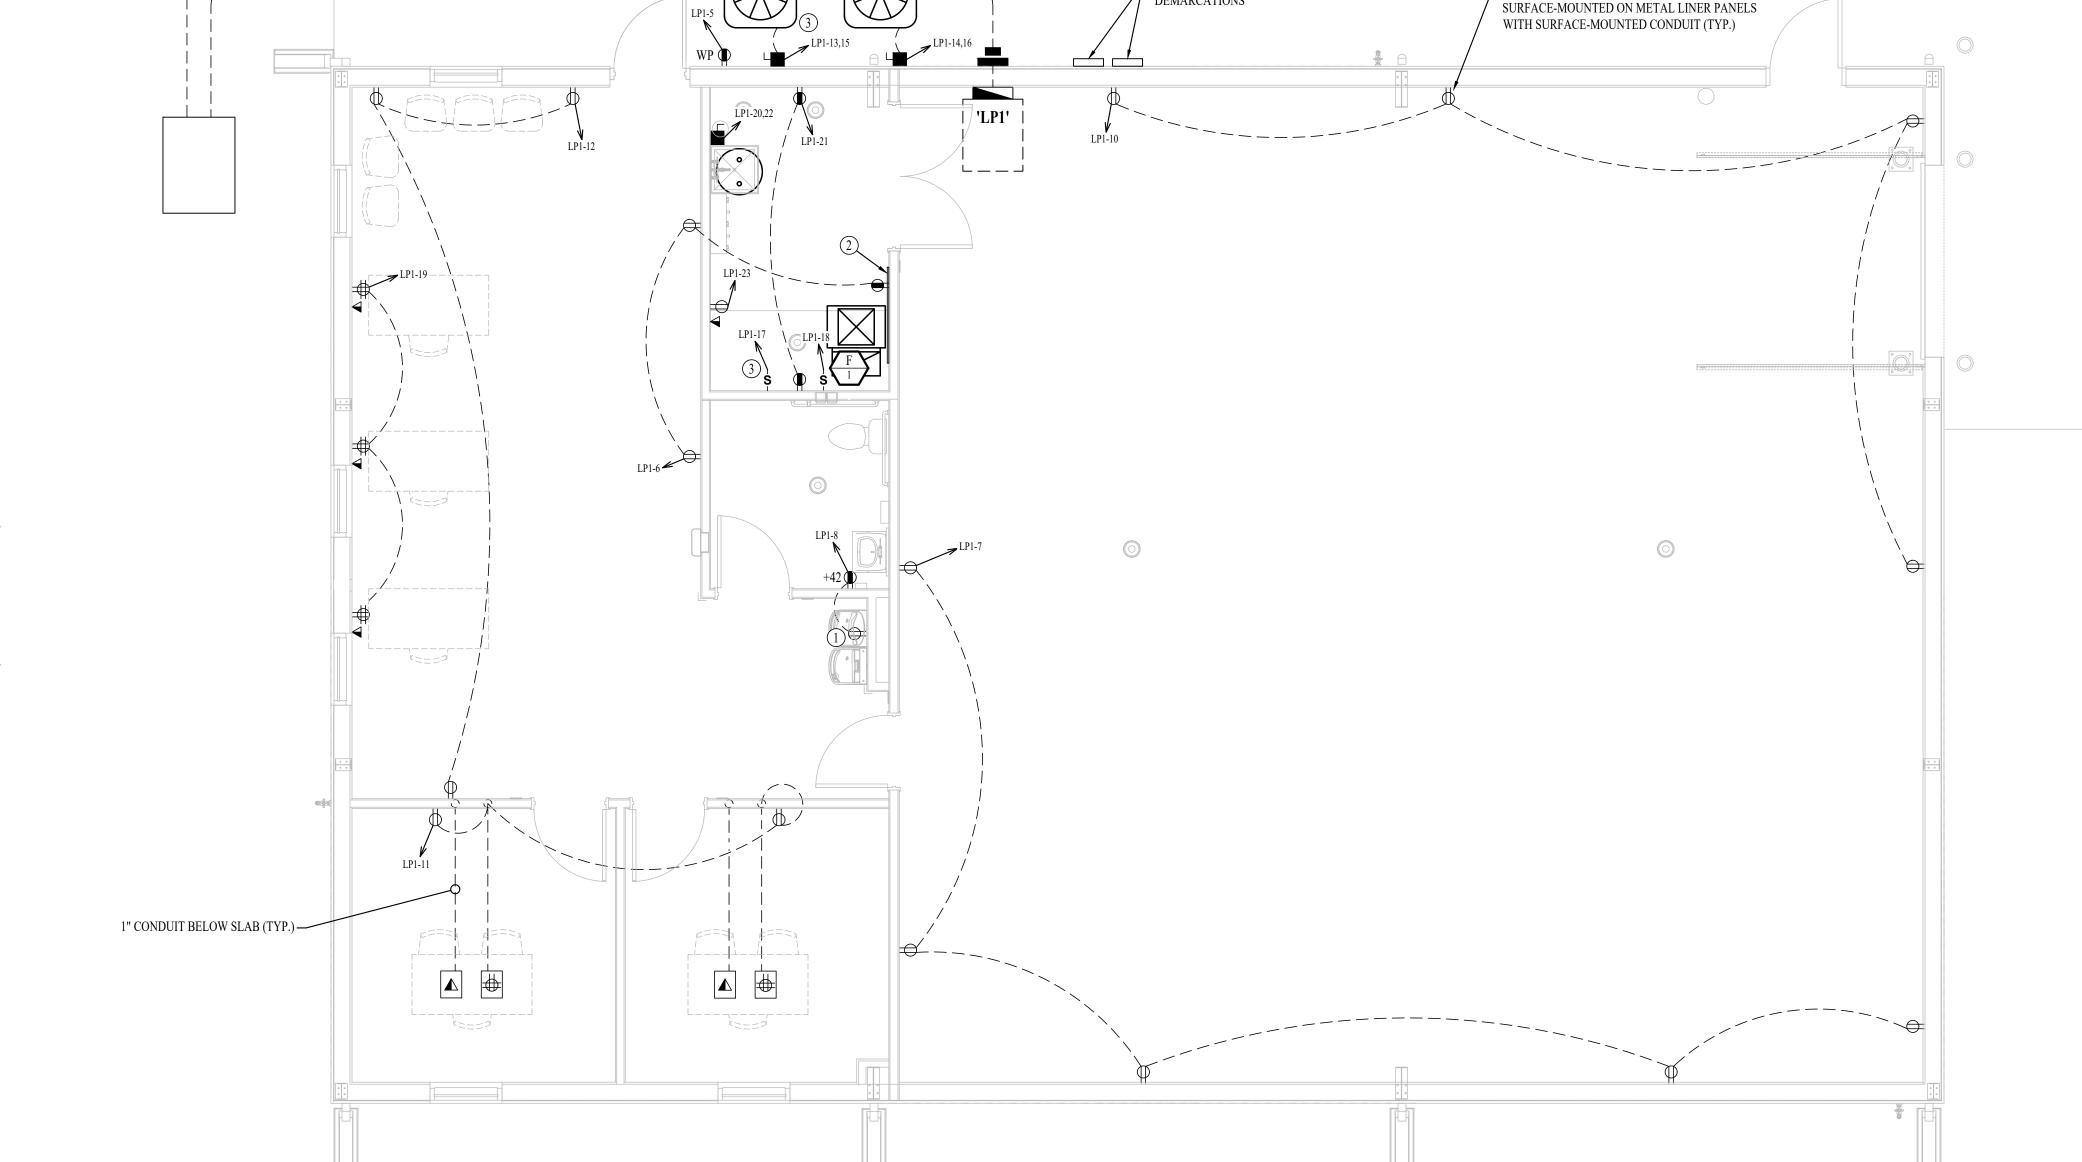
\_ \_ \_ CIRCUIT WIRING

→ PX-XX CIRCUIT TAG

- 1. SEE SHEET E-501 FOR ADDITIONAL ELECTRICAL NOTES, DETAILS, & SCHEDULES. 2. PROVIDE ALTERNATE BID FOR TWO ADDITIONAL CIRCUITS (LP1-14,16 & LP1-18) FOR HVAC
- EQUIPMENT. SEE SHEET M-101A & M-501 FOR HVAC EQUIPMENT DETAILS'

### POWER PLANS KEY NOTES:

- (1) WIRE DRINKING FOUNTAIN DOWNSTREAM OF GFCI RECEPTACLE SO THAT DRINKING FOUNTAIN RECEPTACLE IS GFCI PROTECTED.
- (2) 48"x48"x3/4" FIRE TREATED PLYWOOD TELECOMMUNICATIONS BOARD. PROVIDE GROUNDING BUS AND CONNECT TO SYSTEM GROUND.
- (3) AS ALTERNATE BID PACKAGE #2, PROVIDE BID TO PROVIDE & INSTALL (2) HVAC SYSTEM CIRCUITS. SEE PANEL SCHEDULE FOR CIRCUIT DETAILS.



- TELECOMMUNICATION

DEMARCATIONS

\_ ALL POWER/DATA ON EXTERIOR WALLS TO BE



### STATE OF MISSOURI MICHAEL L. PARSON, **GOVERNOR**





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SHEET TITLE:

POWER PLAN

SHEET NUMBER:

### LIGHTING PLAN SYMBOL LEGEND X1 "X1" INDICATES FIXTURE TYPE (REFER TO SCHEDULE) LIGHTING FIXTURE "EM" INDICATES EMERGENCY BATTERY BACKUP "NL" INDICATES UN-SWITCHED NIGHT LIGHT EXIT LIGHT ─ INDICATES REQUIRED REMOTE HEAD EMERGENCY EGRESS LIGHT SWITCH (WALL MOUNTED) · SWITCH TYPE: $\bullet \qquad 3 = 3\text{-WAY}$ $\bullet \qquad 4 = 4\text{-WAY}$ • OP = PASSIVE INFRARED OCCUPANCY SENSOR • OU = ULTRASONIC OCCUPANCY SENSOR • OT = DUAL-TECHNOLOGY OCCUPANCY SENSOR • VP = PASSIVE INFRARED VACANCY SENSOR • VU = ULTRASONIC VACANCY SENSOR • VT = DUAL-TECHNOLOGY VACANCY SENSOR • M = MOMENTARY SWITCH • SS = SCENE SWITCH DIMMER SWITCH (WALL MOUNTED) • SEE "SWITCH (WALL MOUNTED)" FOR TYPE DESIGNATIONS SWITCH (CEILING MOUNTED) • SEE "SWITCH (WALL MOUNTED)" FOR TYPE DESIGNATIONS POWER PACK OCCUPANCY SENSOR • AUTO FULL-ON (OR 50% IF NOTED) AUTOMATICALLY TURN OFF LIGHTING AFTER 20 MINUTES WITHOUT OCCUPANT DETECTION • WITH MANUAL OVERRIDE CONTROL (IF NOTED) VACANCY SENSOR

### **ELECTRICAL PLANS GENERAL NOTES:**

OCCUPANT DETECTION

• WITH MANUAL OVERRIDE CONTROL (IF NOTED)

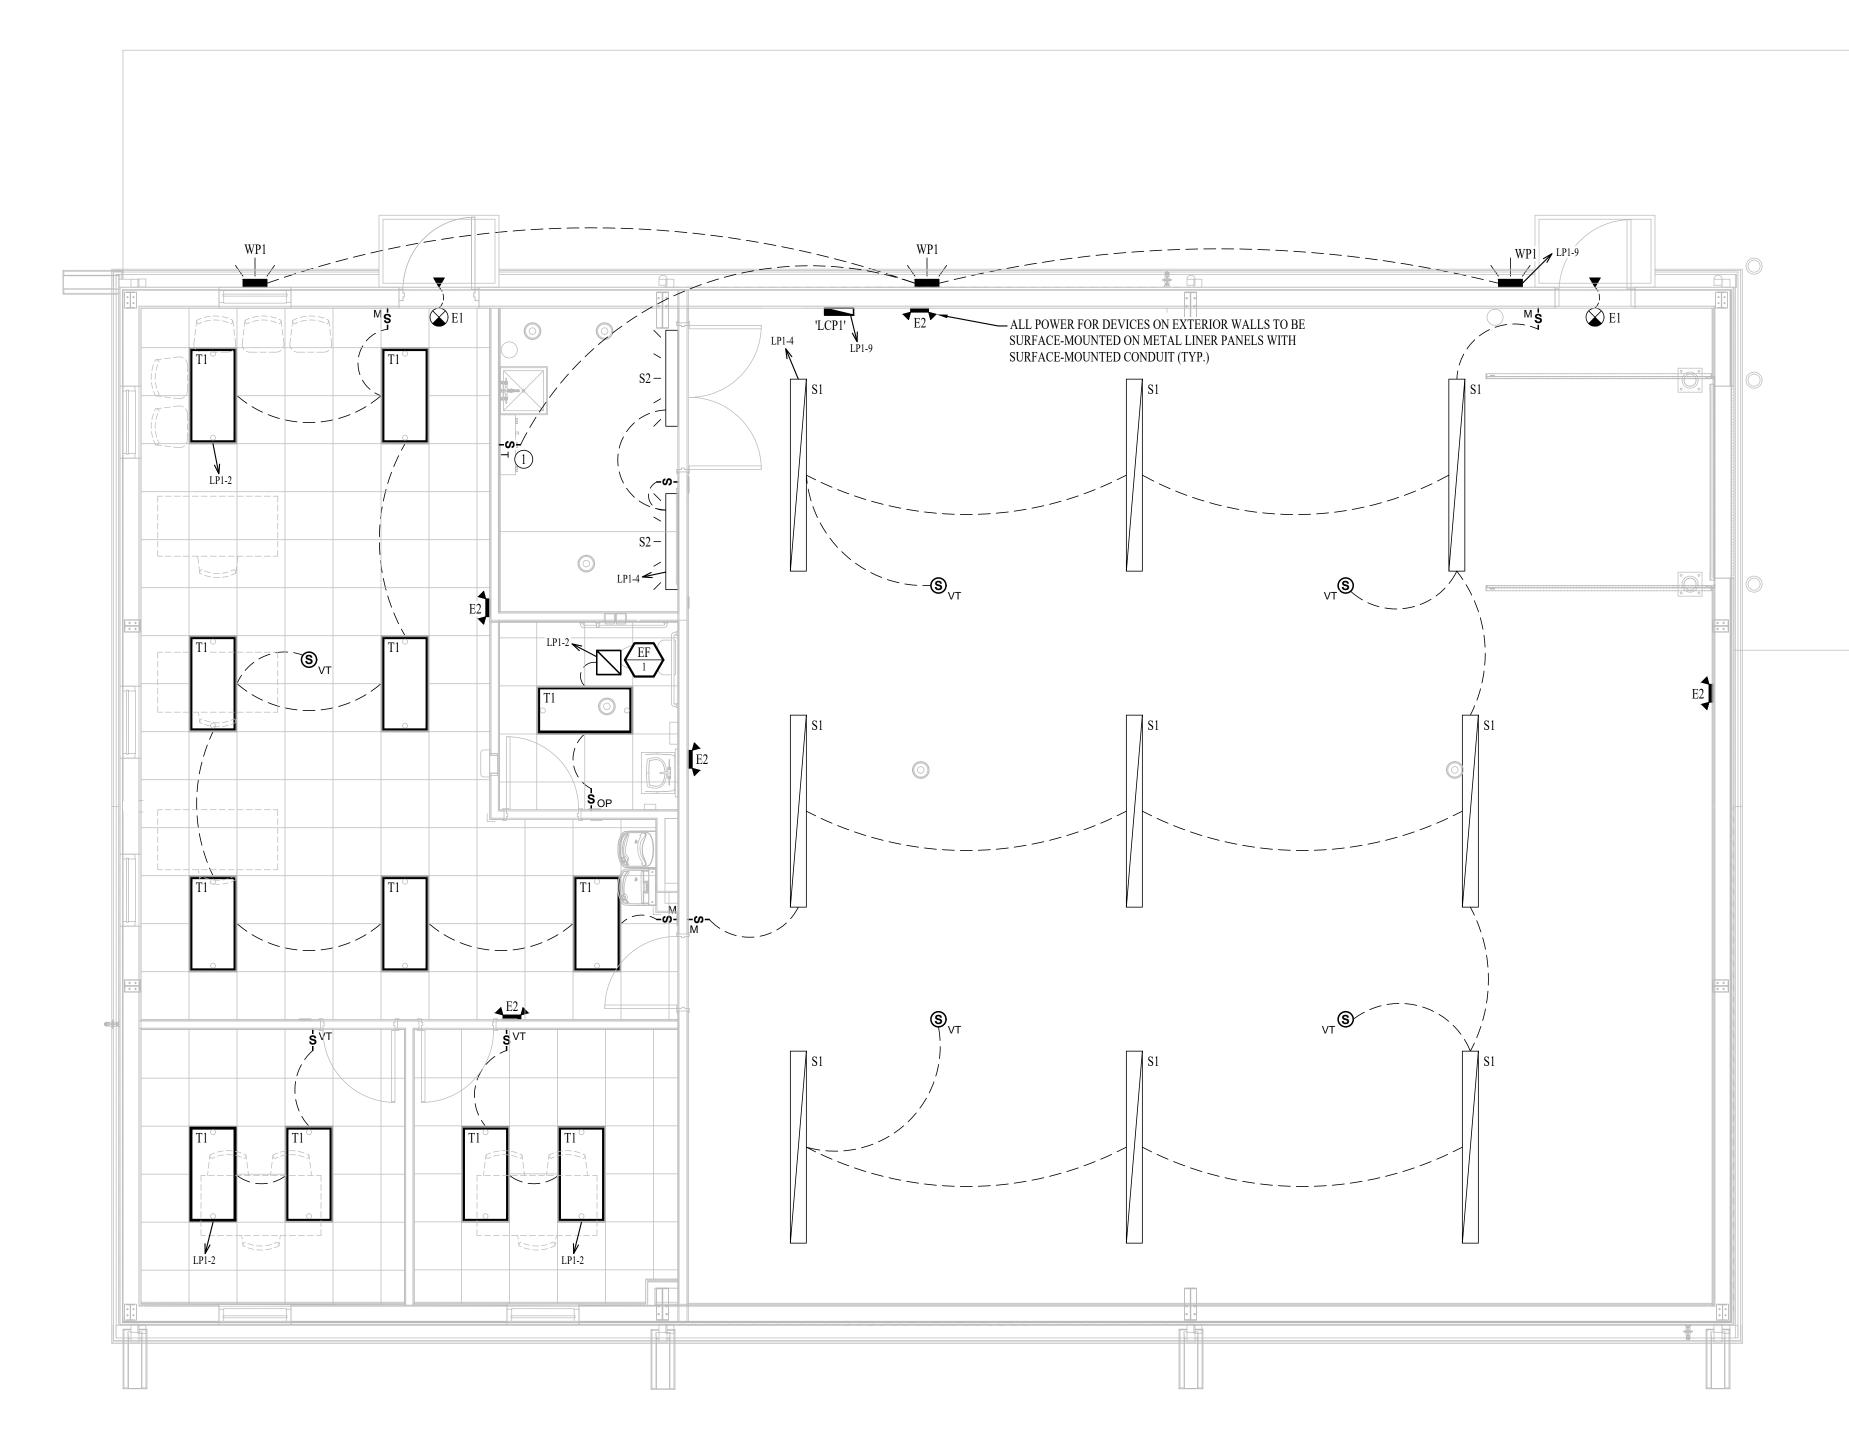
 SEE SHEET E-501 FOR ADDITIONAL ELECTRICAL NOTES, DETAILS, & SCHEDULES.
 OCCUPANCY / VACANCY SENSOR QUANTITIES AND GENERAL LOCATIONS SHOWN FOR REFERENCE ONLY. CONTRACTOR TO PROVIDE AND INSTALL SENSOR WITH SPACING PER MANUFACTURER SPECIFICATIONS AND INCLUDE ADDITIONAL SENSORS IF NECESSARY. CEILING-MOUNTED SENSORS

SHALL BE INSTALLED WITHIN MANUFACTURE'S ACCEPTABLE MOUNTING HEIGHT RANGE.

AUTOMATICALLY TURN OFF LIGHTING AFTER 20 MINUTES WITHOUT


### ELECTRICAL PLANS KEY NOTES:

 $\textcircled{1} \ \ WIRE \ THRU \ ASTRONOMICAL \ TIMESWITCH \ EQUAL \ TO \ WATTSTOPPER \ \#RT-200.$ 





### STATE OF MISSOURI MICHAEL L. PARSON, GOVERNOR

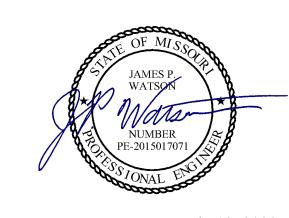

July 13, 2022



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Missouri Army National Guard

Macon Training Site 29614 Jaguar Street Macon, MO 63552

COMPANY HEADQUARTERS & ADMINISTRATION BLDG.

PROJECT # T2214-01 SITE # 6319 ASSET # 8136319018

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ISSUE DATE: 07/13/2022

CAD DWG FILE:
DRAWN BY: PDH
CHECKED BY: ACW
DESIGNED BY: ACW

SHEET TITLE:

LIGHTING PLAN

SHEET NUMBER:

E-102

23 OF 28 SHEETS 07/13/2022

2 3 4 5 6 7 8 9 10 11 12 13 14 15

### **ELECTRICAL SPECIFICATIONS**

1. GENERAL

1.1. THE ENTIRE ELECTRICAL SYSTEM SHALL BE CONTINUOUSLY GROUNDED. EVERY BRANCH

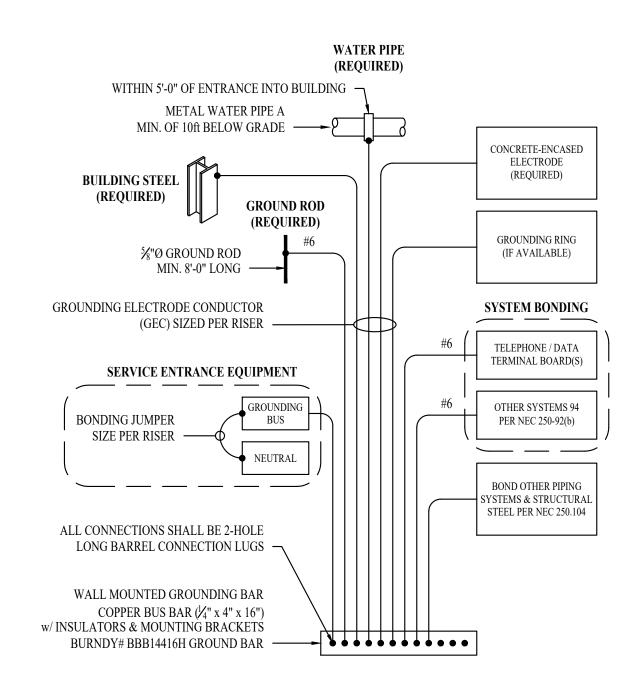
CONDUIT SHALL INCLUDE A GREEN GROUND CONDUCTOR SIZED PER NEC. PROVIDE PERMANENT ARC-FLASH LABEL AFFIXED TO EVERY DISCONNECT AND PANEL.

1.3. PROVIDE TYPE WRITTEN PANEL SCHEDULE FOR EACH PANEL.


2. MATERIALS 2.1. CONDUIT & CONDUCTORS

2.1.1. SEE PROJECT SPECIFICATIONS FOR DETAILS/REQUIREMENTS.

2.2.1. CONTRACTOR TO PROVIDE J-BOXES, COVER PLATES, AND ANY ACCESSORIES REQUIRED TO PROVIDE A COMPLETE SYSTEM. SEE ARCHITECTURAL PLANS FOR DEVICE COLORS.



TYPICAL GROUNDING & BONDING DETAIL

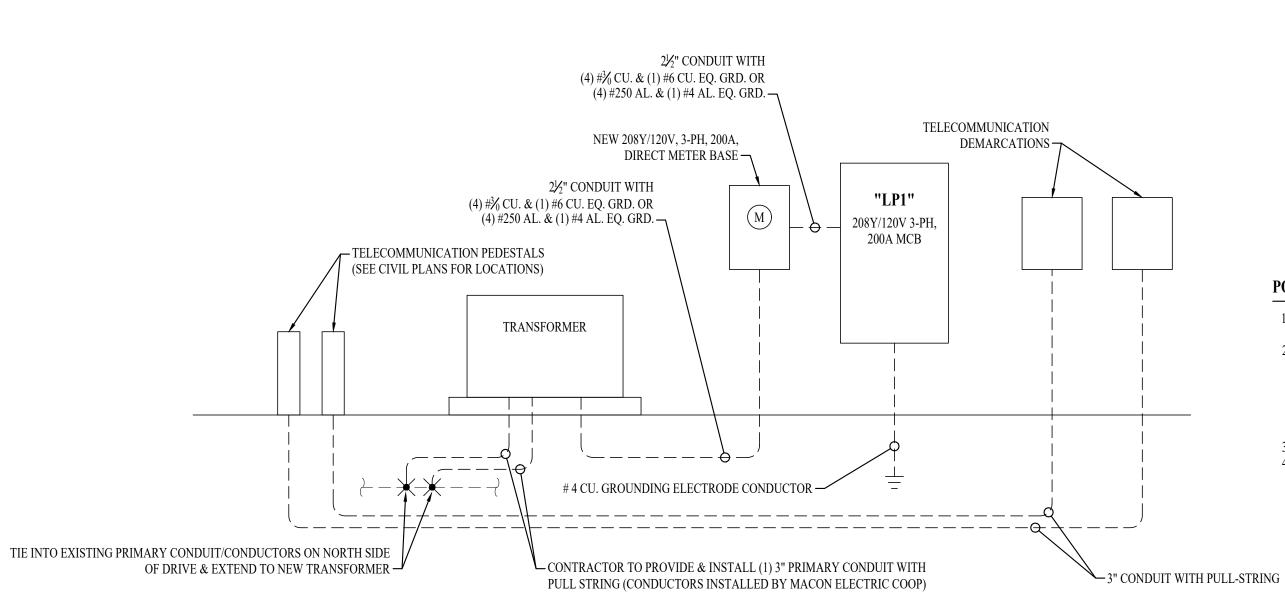

**POWER RISER** 

	LIGHT FIXTURE SCHEDULE									
TAG	MANUFACTURER (OR EQUAL)	MODEL NUMBER (OR EQUAL)	DESCRIPTION	MOUNTING	LUMEN OUTPUT	CCT (°K)	CRI	VOLTS	WATTS	NOTES
E1	SURE-LITES	APCH7R WITH APWR2	INTERIOR EXIT LIGHT WITH EXTERIOR REMOTE HEAD	CEILING	-	-	-	120	1	WITH RED LETTERS
E2	SURE LITES	APEL	EMERGENCY EGRESS LIGHT	WALL	-	-	-	120	1	MOUNT A 8' A.F.F.
S1	METALUX	8STLED-LD5-95SL-LW-UNV-L840-CD1-U	8' LED STRIP	SUSPENDED	9785	4000	80	1 <b>2</b> 0	82	SUSPEND TO 10' A.F.F.
S2	METALUX	4BCLED-LD4-40SLF-UNV-L840-CD1-U	4' WALL MOUNT LED	SURFACE/WALL	4000	4000	80	120	42	MOUNT AT 9' A.F.F.
T1	METALUX	24FP4740C	2x4 LED FLAT PANEL	ACT GRID	4990	4000	80	120	40	
WP1	LUMARK	WPMLED10B	LED WALLPACK	EXTERIOR WALL	4869	4000	80	1 <b>2</b> 0	38	MOUNT AT 8' A.F.F.
NOTES:										

		P	ANEL'	LP1' SC	HEDUI	Æ		
	VOLTAGE	PANEI	L SIZE	MOU	NTING	AIC RATING		
120/240V 1-PH							PHASE "A" LOAD	111
		200A	200A MCB		SURFACE		PHA SE "B" LOAD	111.5
	NEMA RATING: 1							
CIRCUIT NUMBER	DESCRIPTION	BREAKER SIZE	AMPS	PHASE	AMPS	BREAKER SIZE	DESCRIPTION	CIRCUI NUMBE
1	TVSS	20-2	2	A	5	20-1	LIGHTING	2
3	-	-	2	В	5	20-1	LIGHTING	4
5	EXTERIOR RECEPT.	20-1	1.5	A	4.5	20-1	OFFICE / PHONE BOARD RECEPTS.	6
7	STORAGE RECEPTS.	20-1	7.5	В	8	20-1	RESTROOM RECEPT. / DRINKING FOUNTAIN	8
9	EXTERIOR LIGHTING / LCP1	20-1	4	A	6	20-1	STORAGE RECEPTS.	10
11	OFFICE RECEPTS.	20-1	9	В	4.5	20-1	OFFICE RECEPTS.	12
13	CU-2	30-2	19	A	<b>18</b> / 33	<b>50-2</b> / 30-2	CU-1	14
15	-	-	19	В	<b>18</b> / 33	-	-	16
17	F-2	20-1	10	A	10	20-1	F-1	18
19	OPEN OFFICE QUADS	20-1	9	В	13	20-2	WATER HEATER	20
21	MECH. ROOM RECEPS	20-1	3	A	13	-	-	22
23	RECEPT FOR FACP	20-1	1.5	В			OPEN	24
25	SPARE	20-1		A			OPEN	26
27	SPARE	20-1		В			OPEN	28
29	SPARE	20-1		А			OPEN	30
31	SPARE	20-1		В			OPEN	32
33	SPARE	20-1		А			OPEN	34
35	SPARE	20-1		В			OPEN	36
37	SPARE	20-1		А			OPEN	38
39	SPARE	20-1		В			OPEN	40
41	SPARE	20-1		А			OPEN	42

A: PANEL SHALL BE EQUAL TO SQUARE D MODEL "QO"

1. VERIFY LIGHT FIXTURE FINISHES WITH OWNER / A RCHITECT PRIOR TO INSTALLATION

- B: ELECTRICIAN SHALL VERIFY BREAKER WITH EQUIPMENT PRIOR TO PURCHASE & INSTALL.
- AFTER COMPLETION OF WORK, ELECTRICAN SHALL PROVIDE A TYPE WRITTEN PANEL DIRECTORY IN NEW PANEL.
- D: FOR CIRCUIT'S ABOVE SHOWN IN BOLD ITALICS PROVIDE ALTERNATE BID FOR CIRCUIT AS PART OF ALTERNATE BID PACKAGE #2 SEE PLANS FOR DETAILS

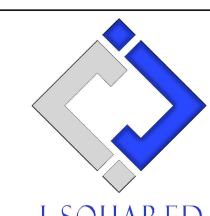
### **POWER RISER GENERAL NOTES:**

- COORDINATE DETAILS & REQUIREMENTS FOR ELECTRIC SERVICE WITH MACON ELECTRIC COOPERATIVE 1.1. POINT OF CONTACT: MICHAEL LUCAS (660) 591-5390
- 2. ELECTRICAL EQUIPMENT AIC RATINGS CALCULATED BASED ON THE FOLLOWING;
- 2.1. TRANSFORMER: 75kVA 3-PH; 3.50% Z; 100% PF; APPROXIMATELY WHERE SHOWN ON PLANS.
- ELECTRICAL PANEL LOCATIONS INSTALLED APPROXIMATELY WHERE SHOWN ON PLANS. ELECTRICAL CONTRACTOR TO FIELD VERIFY FINAL EQUIPMENT LOCATIONS AND PERFORM ADDITIONAL AIC RATING CALCULATIONS
- 2.4. CONTRACTOR TO PERMANENTLY LABEL ALL SWITCHGEAR WITH CALCULATED AIC-RATINGS.
- VERIFY MAIN DISCONNECT REQUIREMENTS WITH UTILITY PROVIDER PRIOR TO PURCHASE & INSTALLATION OF ELECTRICAL SWITCHGEAR. 4. ELECTRICAL CONTRACTOR TO PROVIDE & INSTALL TRANSFORMER PAD PER UTILITY PROVIDER SPECIFICATIONS.

STATE OF MISSOURI MICHAEL L. PARSON, **GOVERNOR** 



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Missouri Army National Guard

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COMPANY HEADQUARTERS & ADMINISTRATION BLDG.

PROJECT # T2214-01 6319 8136319018 ASSET#

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ISSUE DATE: 07/13/2022

CAD DWG FILE	):
DRAWN BY:	PDH
CHECKED BY:	ACW
<b>DESIGNED BY:</b>	ACW

SHEET TITLE:

ELECTRICAL DETAILS & SCHEDULES

SHEET NUMBER:

24 OF 28 SHEETS

07/13/2022

### FIRE ALARM PLAN SYMBOL LEGEND

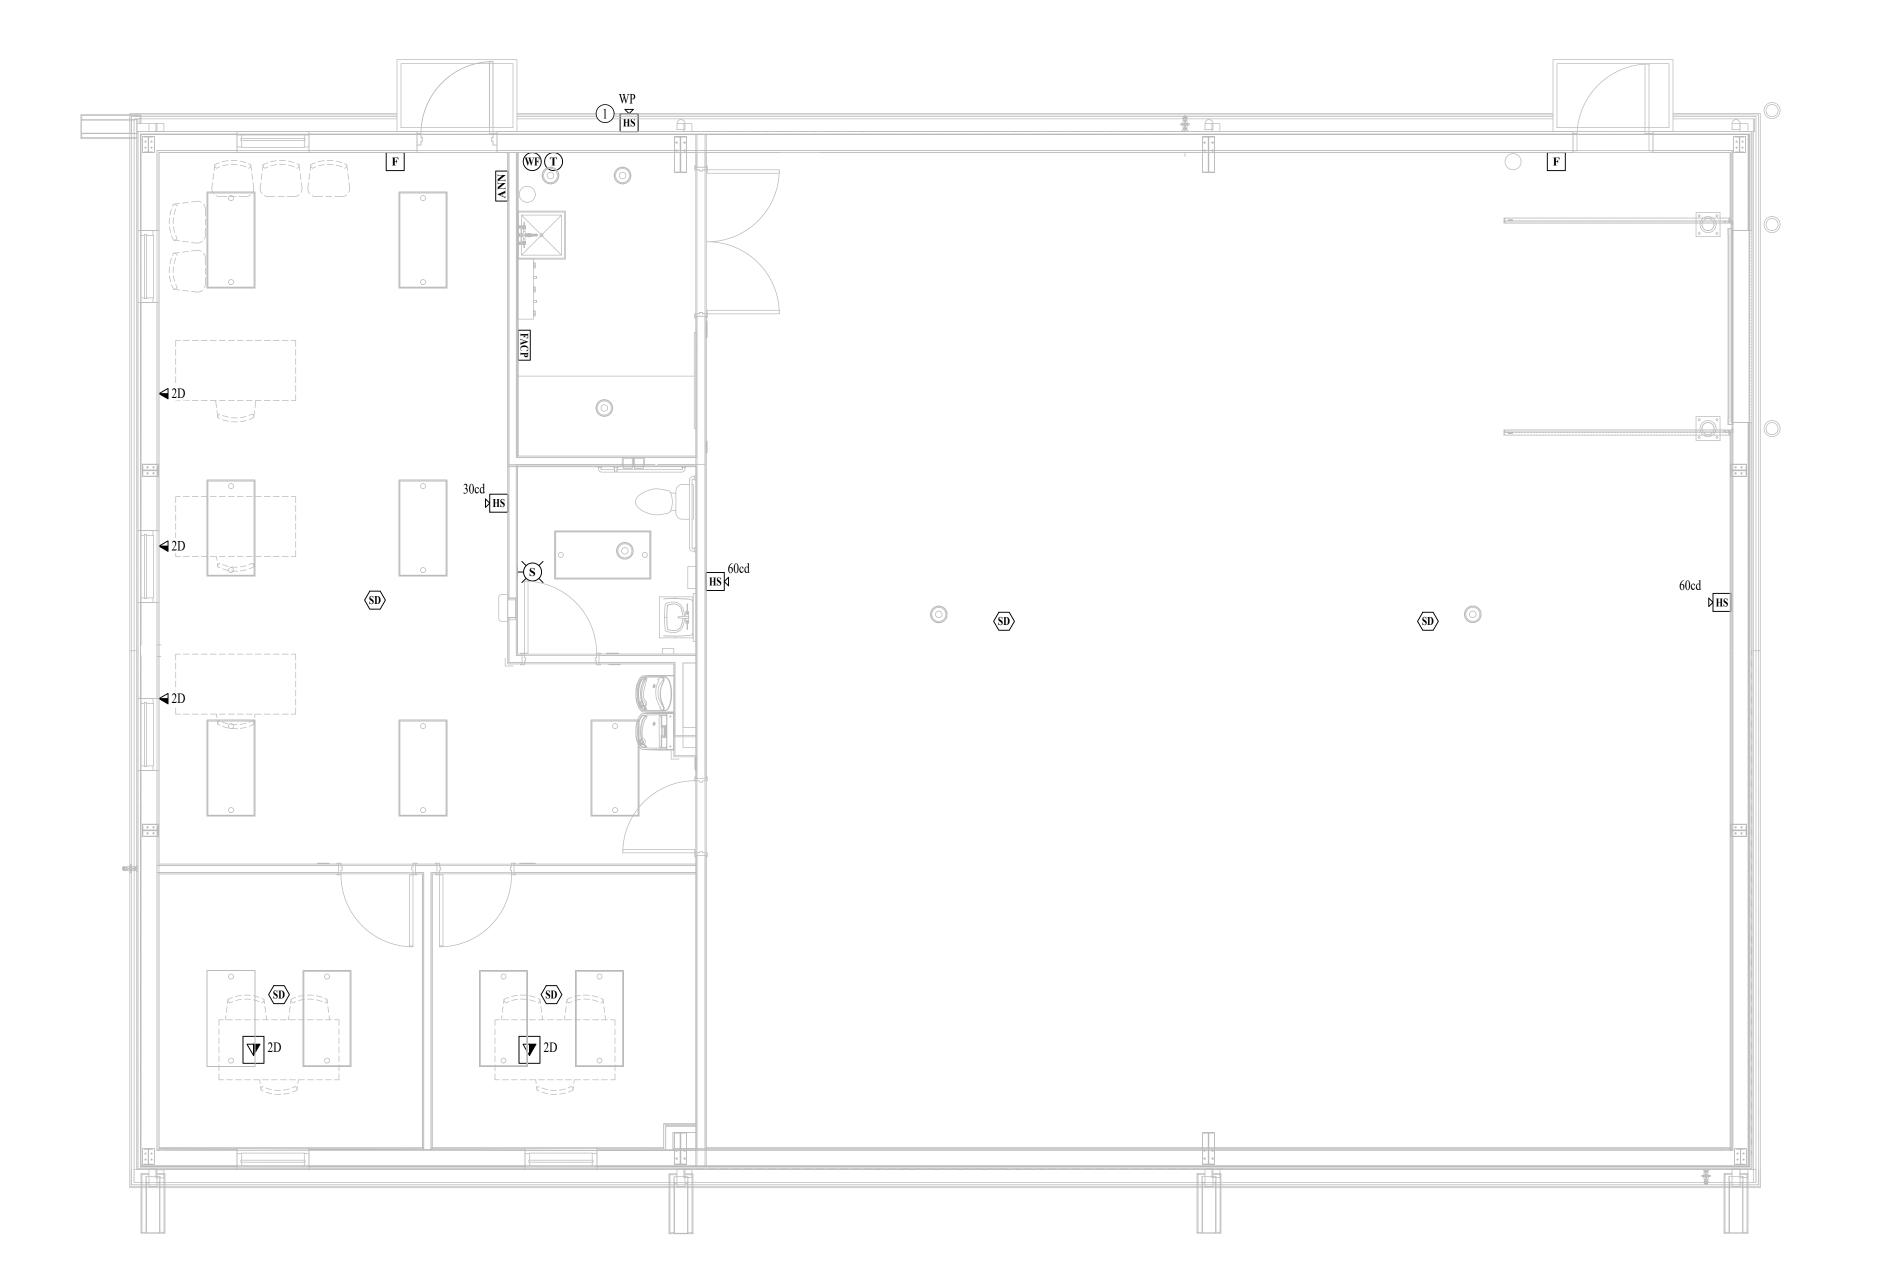
- F MANUAL PULL STATION
- M MODULE
- OUTPUT MODULE
- SMOKE DETECTOR
- STROBE CEILING MOUNT
- STROBE WALL MOUNT
- HORN STROBE WALL MOUNT
- HS) HORN STROBE CEILING MOUNT
- TAMPER SWITCH
- WF) WATER FLOW SWITCH
- FACP FIRE ALARM CONTROL PANEL
- ANN FIRE ALARM ANNUNCIATOR

### FIRE ALARM PLAN GENERAL NOTES:

1. PROVIDE DUCT SMOKE DETECTORS IN RETURN AND SUPPLY AIR PATHS FOR AIR HANDLING EQUIPMENT 5 NOMINAL TONS AND LARGER AND WHERE SHOWN ON PLANS. INTERLOCK WITH AIR HANDLING EQUIPMENT TO SHUT DOWN UNIT UPON SMOKE DETECTION.

### FIRE ALARM PLAN KEY NOTES:

1 PROVIDE EXTERIOR, BUILDING MOUNTED, WEATHER PROOF COMBINATION AUDIBLE/VISUAL ALARM FOR FIRE DEPARTMENT NOTIFICATION NEAR FIRE DEPARTMENT CONNECTION. COORDINATE EXACT LOCATION WITH FIRE DEPARTMENT.





### STATE OF MISSOURI MICHAEL L. PARSON, GOVERNOR



July 13, 2022



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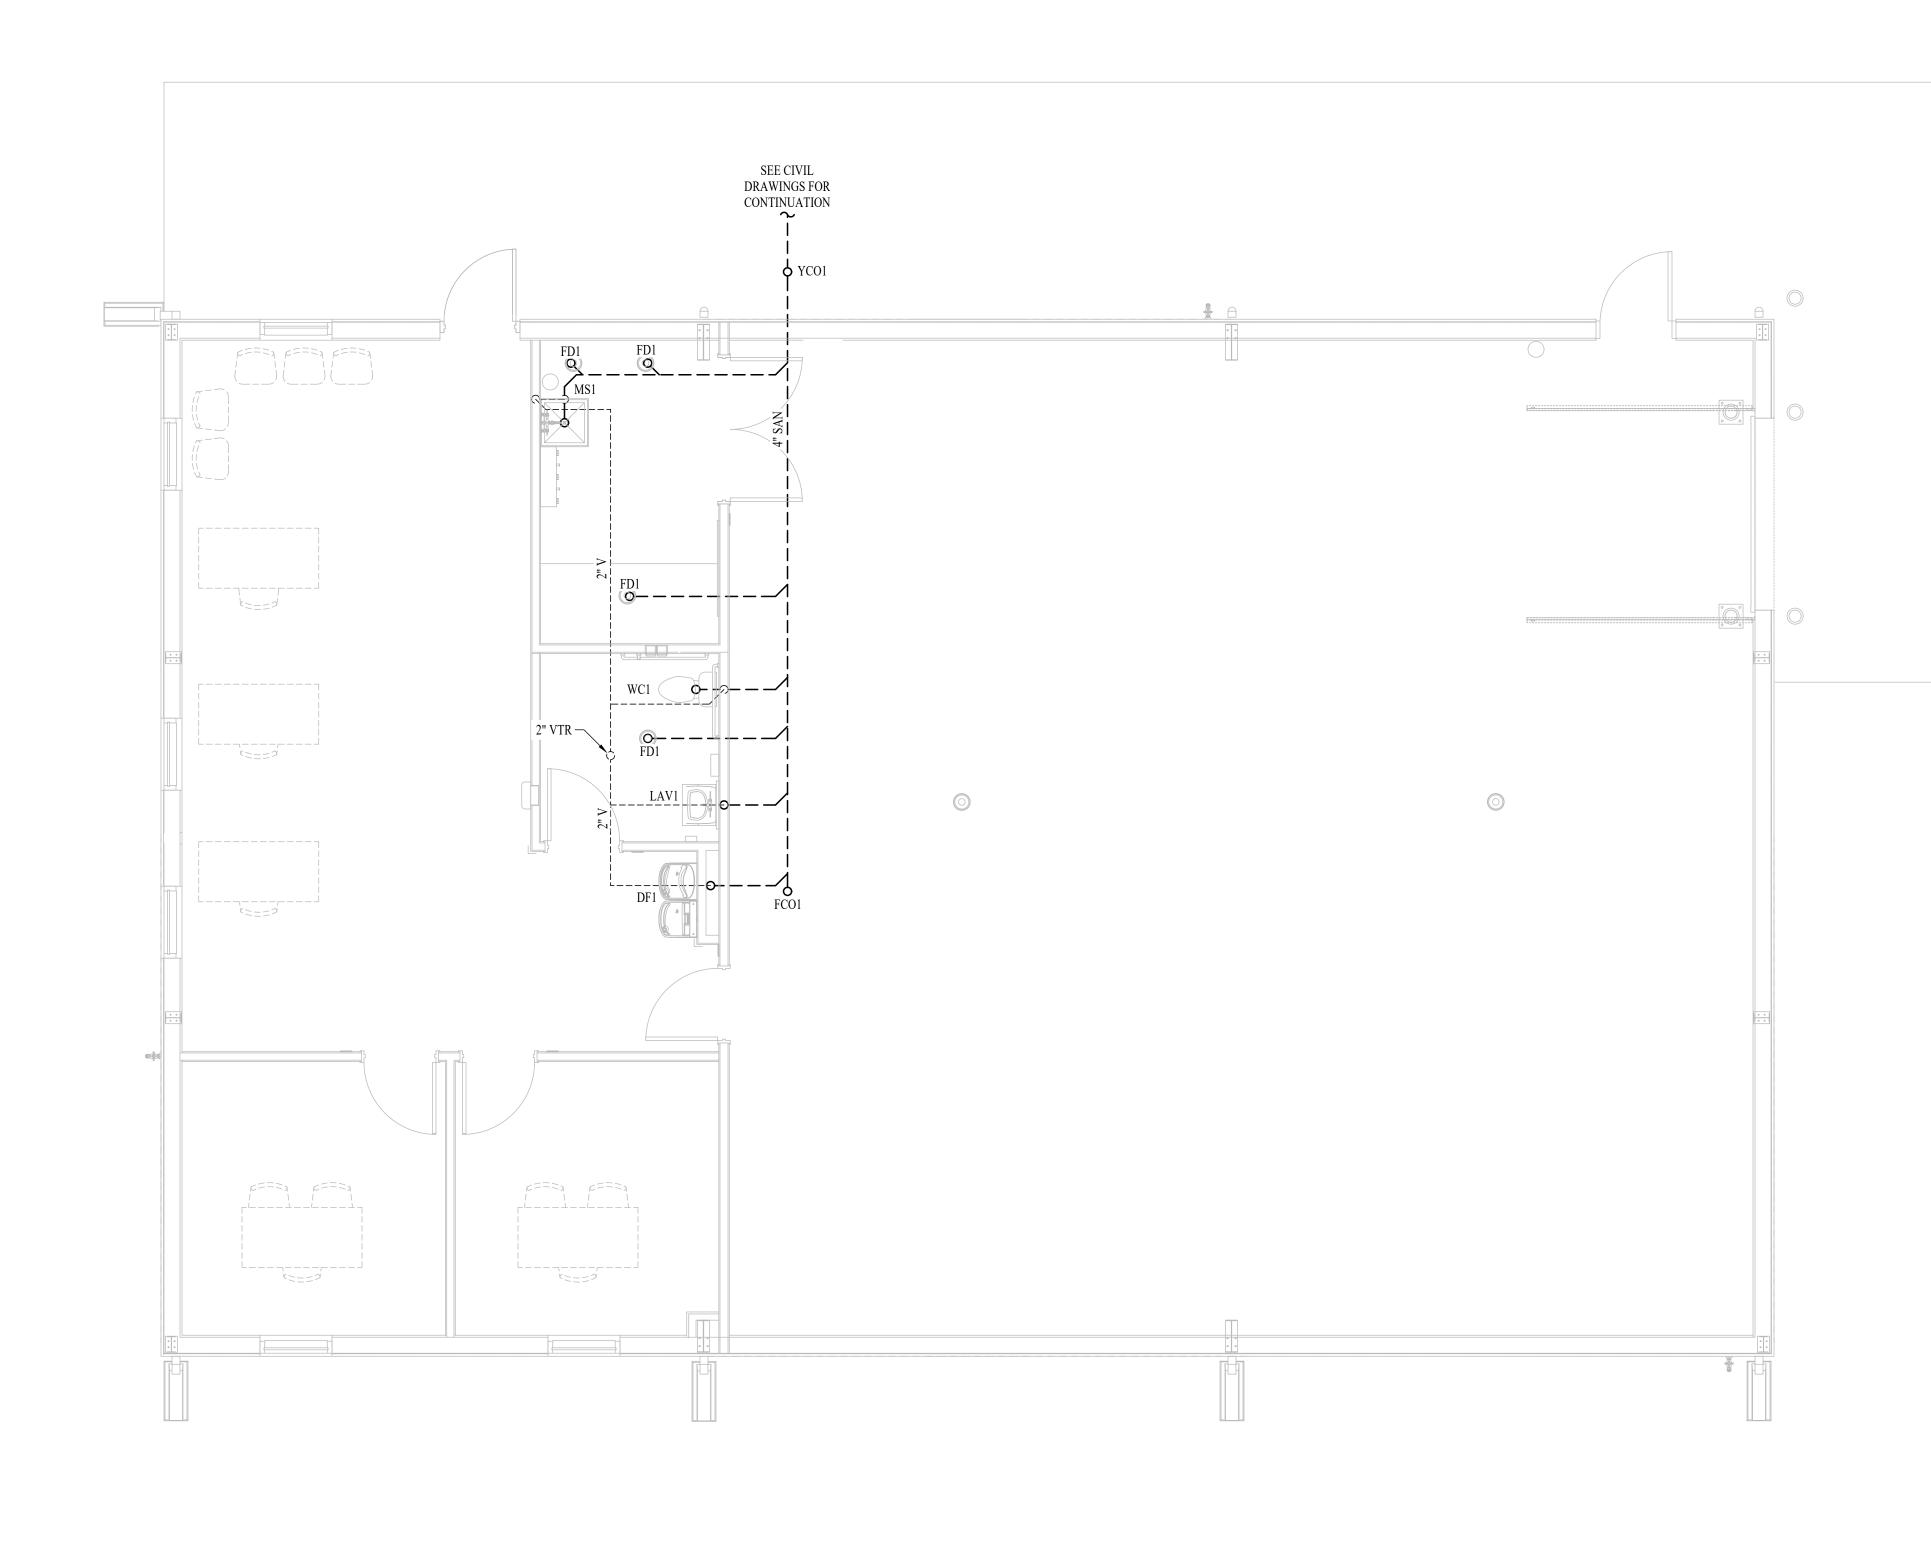
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FIRE ALARM PLAN

SHEET NUMBER:

F-10



SANITARY SEWER PLAN

SCALE: 1/4" = 1'-0"

SANITARY SEWER PLAN SYMBOL LEGEND

PIPING TURNED DOWN / TURNED UP

SANITARY SEWER PLAN GENERAL NOTES:

TIE INTO EXISTING

1. SEE SHEET P-501 FOR ADDITIONAL PLUMBING NOTES, DETAIL, AND SCHEDULES.

**————** SANITARY SEWER PIPING

---- VENT PIPING

STATE OF MISSOURI MICHAEL L. PARSON, GOVERNOR



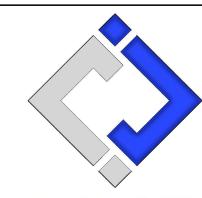
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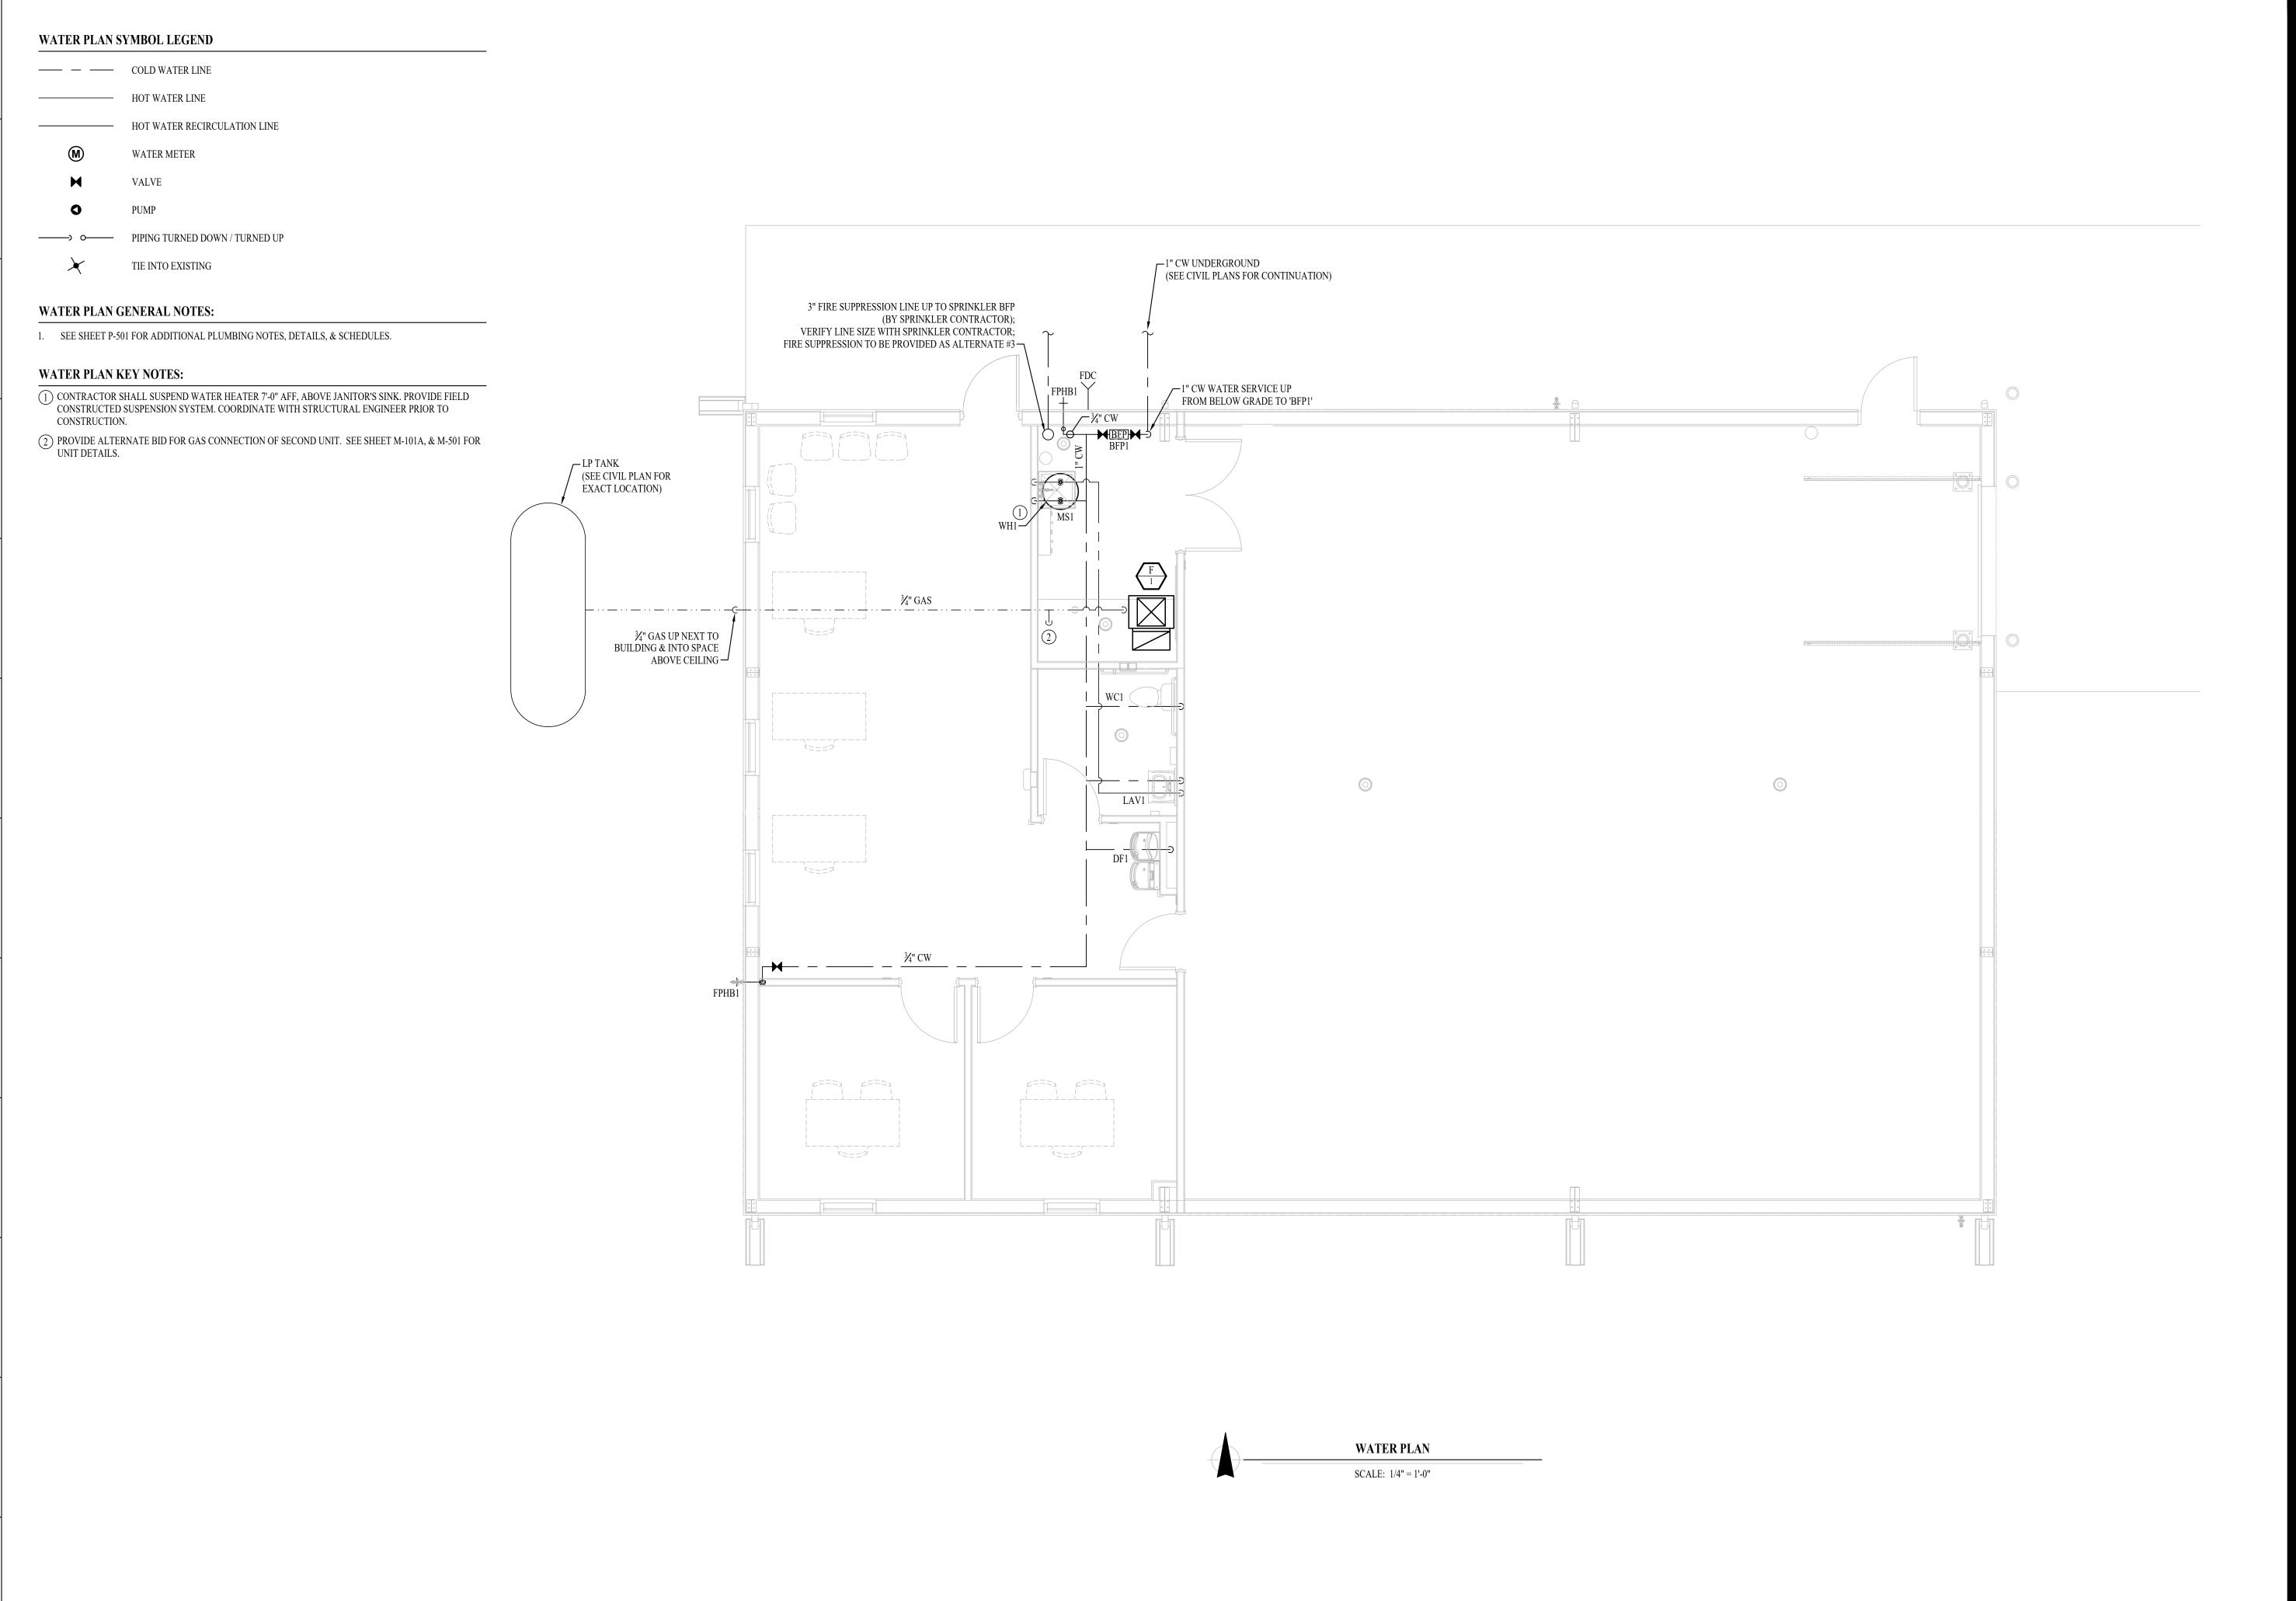
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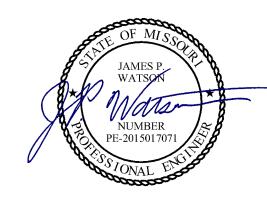
SHEET TITLE:

SANITARY SEWER PLAN

SHEET NUMBER:

P-10





July 13, 2



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ISSUE DATE: 07/13/2022

CAD DWG FILE:
DRAWN BY:
CHECKED BY:
DESIGNED BY:
ACW

SHEET TITLE:

WATER PLAN

SHEET NUMBER:

P-102

### PLUMBING SPECIFICATIONS

1. GENERAL

1.1. CONTRACTOR IS RESPONSIBLE TO PROVIDE ALL ESCUTCHEONS, ¼ TURN STOPS, P-TRAPS, AND SUPPLY LINES TO PROVIDE A COMPLETE SYSTEM AT EACH FIXTURE INDICATED ON PLANS UNLESS NOTED OTHERWISE.

2. SANITARY 2.1. NO PIPE SMALLER THAN 2" BELOW GRADE.

ALL VENT PIPE TERMINATIONS ARE TO BE LOCATED EITHER 10' HORIZONTALLY OR 3' ABOVE MECHANICAL AIR INTAKE LOCATIONS.

3. DOMESTIC WATER

3.1. PROVIDE WATER HAMMER ARRESTORS AT ALL QUICK-CLOSE VALVES. FIXTURES REQUIRING WATER HAMMER ARRESTORS INCLUDE BUT ARE NOT LIMITED TO FLUSH VALVES, SENSOR FAUCETS, AND WASHING MACHINE BOXES. AIR CHAMBERS ARE NOT ACCEPTABLE.

4. GAS PIPING

4.1. WHERE PIPING IS EXPOSED ON EXTERIOR FACE OF BUILDING, PAINT TO MATCH BUILDING.

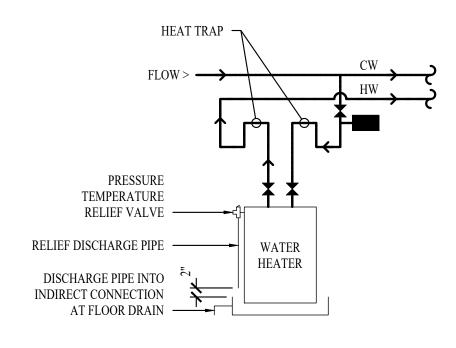
PAINT YELLOW IN ALL OTHER LOCATIONS.

TAG	DESCRIPTION	MANUFACTURER (OR EQUAL)	MODEL (OR EQUAL)	NOTES
BFP1	BACKFLOW PREVENTER	WILKINS	975XL2	RPZ - 3/4"
DF1	HIGH / LOW DRINKING FOUNTAIN	ELKAY	EZSTL8WSLK	WITH BOTTLE FILLIING STATION
EXP1	EXPANSION TANK	WATTS	PLT-5	
FCO1	FLOOR CLEANOUT	ZURN	1400	
FD1	FLOOR DRAIN	ZURN	Z415-BZ	WITH Z1072 TRAP SEAL
FPHB1	FROST PROOF HOSE BIB	WOODFORD	MODEL 67	
LA V1	LA VA TORY (WALL HUNG W/MANUAL FA UCET)	AMERICAN STANDARD	0355.012	WITH ZURN Z81104-XL FAUCET, 1/4 TURN STOPS, BRAIDED STAINLESS STEEL SUPPLIES, TRUBRO LAV GUARD 2, & 'TMV1'
MS1	MOP SINK	FIAT	MSB2424	WITH ZURN Z843M1 FAUCET WITH WALL HOOK
TMVl	THERMOSTATIC MIXING VALVE - POINT OF USE	WATTS	LFUSG	
WC1	WATER CLOSET - ADA HEIGHT - TANK	AMERICAN STANDARD	215AA.004	WITH CHURCH 9500SSCT SELF SUSTAINING SEAT, STAINLESS BRAIDED SUPPLY, AND 1/4 TURN SHUT-OFF.
WH1	WATER HEATER	RUUD	EGSP20	20 GALLON, 240V, 3000W, WITH EXP1


nons.				
1	1 VERIEV NECESSARV FIXTURES MEET ADA	REQUIREMENTS WITH	A RCHITECT PRIOR TO I	NSTALLATION

FIXTURE	FIXTURE			SUPPLY PIPING		
ТҰРЕ	TYPICAL ABBREVIATION	WASTE CONNECTION	VENT CONNECTION	COLD WATER CONNECTION	HOT WATER CONNECTION	
DRINKINGFOUNTAIN	DF	1-1/2"	1-1/4"	1/2"	-	
FLOOR DRAIN	FD	3"	2"	-	-	
HAND / HAIR SINK	HS / SK	2"	1-1/4"	1/2"	1/2"	
HOSE BIBB	HB	-	-	3/4"	-	
LAVATORY	LAV	1-1/2"	1-1/4"	1/2"	1/2"	
MOP SINK	MS	3"	1-1/2"	1/2"	1/2"	
ICE MAKER OUTLET BOX	REF	-	-	1/2"	-	
SHOWER	SH	3"	1-1/2"	1/2"	1/2"	
URINAL	UR	2"	1-1/4"	3/4"	-	
WATER CLOSET (FLUSH TANK)	WC	3"	2"	1/2"	-	
WATER CLOSET (FLUSH VALVE)	WC	3"	2"	1"	_	


1. SIZES SHOWN ABOVE ARE TYPICAL UNLESS NOTED OTHERWISE ON PLANS



WATER HEATER DETAIL

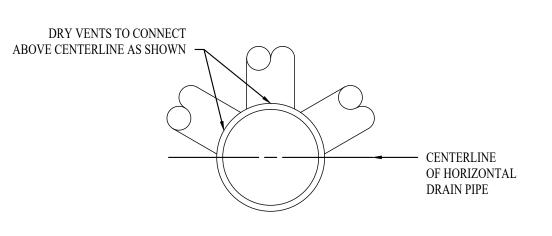


DRY VENT DETAIL

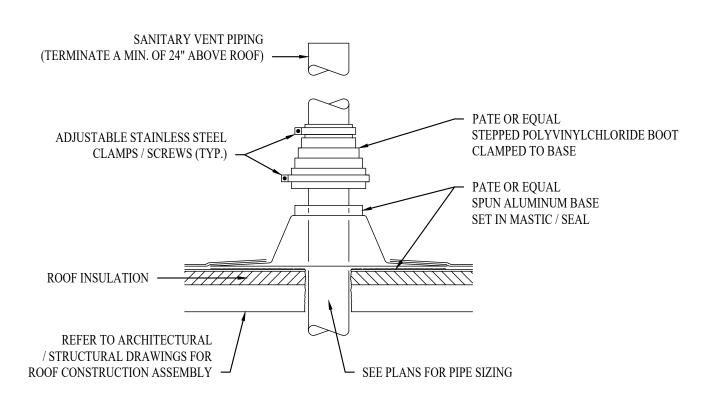

SANITARY VENT THRU ROOF DETAIL
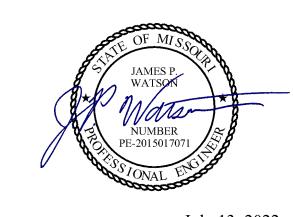
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