# CONSTRUCT SOLAR ARRAY FMS BUILDING 5175 FORT LEONARD WOOD, MO

# INDEX OF DRAWINGS

G-001 COVER SHEET E-001 ELECTRICAL LEGEND AND NOTES E-101 ELECTRICAL PLAN SOLAR ARRAY E-501 ELECTRICAL DETAILS E-601 ELECTRICAL ONE LINE DIAGRAM


# **OWNER:**

# STATE OF MISSOURI MICHAEL L. PARSON, GOVERNOR

# MISSOURI NATIONAL GUARD OFFICE OF THE ADJUTANT GENERAL FACILITIES MANAGEMENT OFFICE

# PROJECT MANAGEMENT:

# OFFICE OF ADMINISTRATION **DIVISION OF FACILITIES MANAGEMENT** DESIGN AND CONSTRUCTION

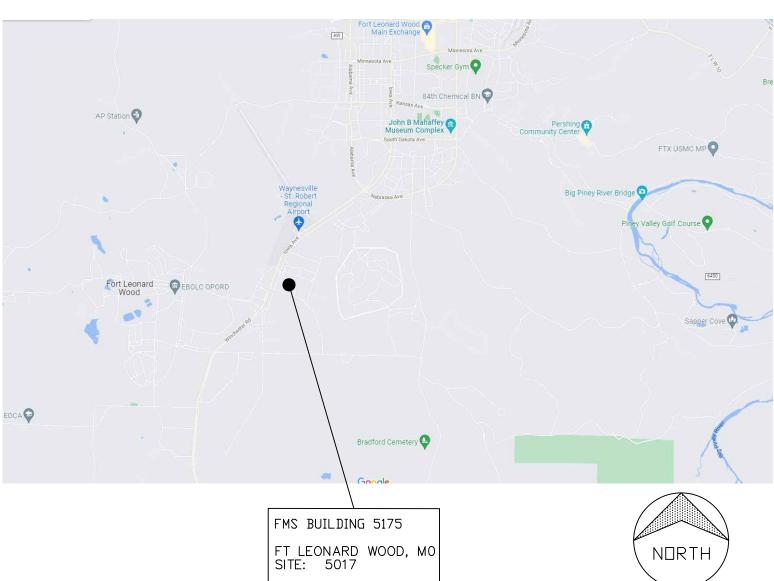


### SITE LOCATION MAP



T2224-01 **PROJECT NUMBER:** 



CROSSED SWORDS ENGINEERING **1619 NE OAK TREE DRIVE** LEE'S SUMMIT MO 64086 (816) 309-0099 ROBERT7721@AOL.COM MO CERTIFICATE OF AUTHORITY #2016003099

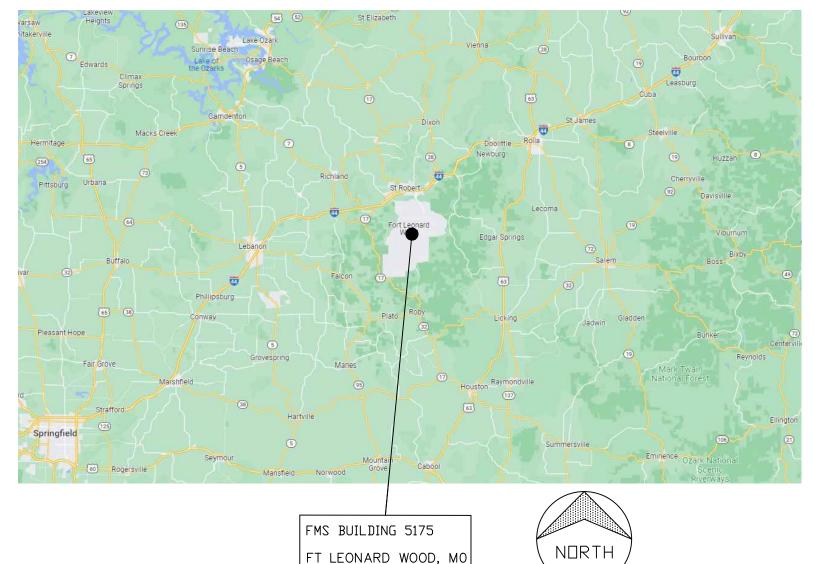

FT LEONARD WOOD, MC SITE: 5017

# **APPLICABLE CODES/DESIGN CONSIDERATIONS**

**INTERNATIONAL BUILDING CODE (IBC) 2021** THE AMERICAN WITH DISABILITIES ACT (ADAAG) 2010 **INTERNATIONAL MECHANICAL CODE (IMC) 2021** INTERNATIONAL PLUMBING CODE (IPC) 2021 ASHRAE 90.1 - 2016 ENERGY STANDARD FOR BUILDINGS NATIONAL ELECTRIC CODE (NEC) 2020

# DESIGNER: CROSSED SWORDS ENGINEERING

6306 SITE NUMBER: 8136306004 ASSET NUMBER:

# **REGIONAL LOCATION MAP**

ISSUED FOR CONSTRUCTION 2/14/2023

SHEET NUMBER:



# GENERAL ELECTRICAL NOTES

- PHOTOVOLTAIC (PV) SYSTEMS SHALL COMPLY WITH THE NATIONAL ELECTRIC CODE (NEC) ARTICLE 690. 2. ALL WORK SHALL BE COMPLETED IN ACCORDANCE WITH MANUFACTURERS'S LISTING AND INSTALLATION INSTRUCTIONS, AND THE
- RELEVANT CODES AS SPECIFIED BY THE AUTHORITY HAVING JURISDICTION'S (AHJ) APPLICABLE CODES 3. THE UTILITY INTERCONNECTION APPLICATION MUST BE APPROVED AND PV SYSTEM INSPECTED PRIOR TO PARALLEL OPERATION
- 4. LOAD-SIDE INTERCONNECTION SHALL BE IN ACCORDANCE WITH [NEC 690.64 (B)]
- 5. ALL PV SYSTEM COMPONENTS; MODULES, UTILITY-INTERACTIVE INVERTERS, AND SOURCE CIRCUIT COMBINER BOXES ARE IDENTIFIED AND LISTED FOR USE IN PHOTOVOLTAIC SYSTEMS AS REQUIRED BY [NEC 690.4] & [NEC 690.60]
- 6. PV MODULES:UL 1703 CERTIFIED, NFPA 70 CLASS C FIRE INVERTER(S):UL 1741 CERTIFIED, IEEE 1547, 929, 519 COMBINER BOX(S):UL 1703 OR UL 1741 ACCESSORY
- 7. PV STRING HOME RUNS MUST BE LABELED AT ALL TERMINATIONS. UNLESS NOTED OTHERWISE, THE WORK SHALL INCLUDE FURNISHING MATERIALS, EQUIPMENT, ACCESSORIES, AND LABOR NECESSARY TO COMPLETE ALL INSTALLATION AS INDICATED ON THE DRAWINGS
- 8. SUPPORT CONDUCTORS IN VERTICAL CONDUIT IN ACCORDANCE WITH THE REQUIREMENTS OF NEC 300.19.

#### **GROUNDING NOTES**

1. ONLY ONE CONNECTION TO AC CIRCUITS WILL BE USED FOR SYSTEM GROUNDING (NEC 690.42).

- 2. RACKING AND STRUCTURAL COMPONENTS MUST BE ELECTRICALLY BONDED TOGETHER BY AN ACCEPTABLE MEANS. RACKING SYSTEM SHALL BE LISTED UL2703.
- 3. MODULES SHALL BE GROUNDED WITH EQUIPMENT GROUNDING CONDUCTORS BONDED TO A LOCATION MEETING MANUFACTURER REQUIREMENTS WITH A MEANS OF BONDING LISTED FOR THIS PURPOSE
- 4. A GROUNDING ELECTRODE SYSTEM IN ACCORDANCE WITH NEC 690.47 AND NEC 250.50 THROUGH NEC 250.166 SHALL BE PROVIDED. 5. PV SYSTEM SHALL BE GROUNDED IN ACCORDANCE WITH NEC 250.21 AND ALL METAL PARTS OR MODULE FRAMES ACCORDING TO NEC 690.43.
- 6. ALL CONDUIT BETWEEN THE UTILITY AC DISCONNECT AND THE POINT OF CONNECTION IN THE MDP SHALL HAVE GROUNDED BUSHINGS AT BOTH ENDS.

# ABBREVIATIONS

А	AMPERE
AC	ALTERNATING CURRENT
AFCI	ARC-FAULT CIRCUIT INTERRUPTER
AHJ	AUTHORITY HAVING JURISDICTION
AIC	AMERAGE INTERRUPTION CAPACITY
ATS	AUTOMATIC TRANSFER SWITCH
AWG	AMERICAN WIRE GAUGE
CB-#	CIRCUIT BREAKER
BLDG	BUILDING
DC	DIRECT CURRENT
DWG	DRAWING
EMT	ELECTRICAL METALLIC TUBE
GFCI	GROUND FAULT CIRCUIT INTERRUPTER
GFP	GROUND FAULT PROTECTION
GND	GROUND
GEC	GROUNDING ELECTRODE CONDUCTOR
IBC	INTERNATIONAL BUILDING CODE
IFC	INTERNATIONAL FIRE CODE
KW	KILOWATT
MCB	MAIN CIRCUIT BREAKER
MDP	MAIN DISTRIBUTION PANEL
MLO	MAIN LUG ONLY
MTS	MANUAL TRANSFER SWITCH
Ν	NEUTRAL
NEC	NATIONAL ELECTRICAL CODE
NTS	NOT TO SCALE
OC	ON CENTER
OCPD	OVERCURRENT PROTECTION DEVICE
Р	POLE
PH	PHASE
POC	POINT OF CONNECTION
PV	PHOTOVOLTAIC
RMC	RIGID METALLIC CONDUIT
SC	SOURCE CIRCUIT
TYP	TYPICAL
UL	UNDERWRITERS LABORATORY
V	VOLT OR VOLTAGE
W	WATT
XFMR	TRANSFORMER

SYMBOLS LEGEND			
~~~~~~~~~~~~~~~~~~~~~~~~~~~~~~~~~~~~~~	ELECTRICAL BREAKER	1. SOLA CO	
-0 ~0-	ELECTRICAL DISCONNECT SWITCH	2. ARR/	
	ELECTRICAL FUSE	ELI ST	
	ELECTRICAL FUSED DISCONNECT SWITCH	3. INVE	
M	METER		
<u> </u>	SYSTEM OR EQUIPMENT GROUND		
— —	CONDUIT DOWN		
— —́	CONTINUATION OF CONDUIT		
	PHOTOVOLTAIC (PV) MODULE		
	DC/AC INVERTER		
	POWER TRANSFORMER	SITE	
	CONNECTED CONDUCTOR	UTILITY	
APPLICABLE CODES			
NATIONAL ELECTRIC CODE (NEC), 2020 INTERNATIONAL BUILDING CODE (IBC), 2021			

INTERNATIONAL FIRE CODE (IFC), 2021

LACLEDE ELECTRIC COOP UTILITY REQUIREMENTS

# SYSTEM NOTES

AR ARRAY CONSISTS OF PV MODULES, ONNECTED IN SERIES.

RAYS HAVE BEEN PLACED TO MINIMIZE OR IMINATE SHADING IMPACT FROM ADJACENT TRUCTURES AND/OR OBSTRUCTIONS. ERTERS SHALL BE TRANSFORMERLESS TRING INVERTERS, LOCATED PER PLAN.

# E INFORMATION

COMPANY: LACLEDE ELECTRIC COOP

OF CONTACT: Y ROSENTHAL DE ELECTRIC COOP ENTHAL@LACLEDEELECTIC.COM -532-3164

# CONSTRUCTION GENERAL NOTES

- 1. ALL ELECTRICAL WORK SHALL BE PERFORMED BY A QUALIFIED LICENSED ELECTRICIAN AND/OR APPRENTICES WORKING UNDER THE DIRECT SUPERVISION OF THE LICENSED CONTRACTOR.
- 2. ALL WORK CARRIED OUT SHALL COMPLY WITH THE SPECIFICATIONS, APPLICABLE MUNICIPAL AND UTILITY COMPANY SPECIFICATIONS AND LOCAL JURISDICTIONAL CODES, ORDINANCES, AND APPLICABLE REGULATIONS.
- 3. PRIOR TO COMMENCEMENT OF ANY WORK, THE CONTRACTOR SHALL NOTIFY THE ENGINEER OF ANY DISCREPANCIES NOTED AMONG SITE CONDITIONS, MANUFACTURER RECOMMENDATIONS, OR AUTHORITY HAVING JURISDICTION. IF THE SPECIFIED EQUIPMENT CANNOT BE INSTALLED AS SHOWN ON THESE DRAWINGS, THE CONTRACTOR SHALL SUBMIT TO THE ENGINEER OF RECORD A WRITTEN "RFI" (REQUEST FOR INFORMATION) PROPOSING AN ALTERNATIVE OR SEEKING CLARIFICATION.
- 4. THE CONTRACTOR SHALL MAINTAIN IN GOOD CONDITION ONE COMPLETE SET OF PLANS WITH ALL REVISIONS, ADDENDA, AND CHANGE ORDERS ON THE PREMISES AT ALL TIMES.
- 5. UNLESS NOTED OTHERWISE, THE WORK SHALL INCLUDE FURNISHING MATERIALS, EQUIPMENT, ACCESSORIES, AND LABOR NECESSARY TO COMPLETE ALL INSTALLATIONS AS INDICATED ON THE DRAWINGS.
- 6. ALL MATERIALS FURNISHED AND INSTALLED SHALL BE IN STRICT ACCORDANCE WITH ALL APPLICABLE CODES. REGULATIONS. AND ORDINANCES. CONTRACTOR SHALL ISSUE ALL APPROPRIATE NOTICES AND COMPLY WITH ALL LAWS, ORDINANCES, RULES, REGULATIONS, AND LAWFUL ORDERS OF ANY PUBLIC AUTHORITY REGARDING THE PERFORMANCE OF WORK.
- 7. THE CONTRACTOR SHALL INSTALL ALL EQUIPMENT AND MATERIALS IN ACCORDANCE WITH MANUFACTURER'S RECOMMENDATIONS UNLESS SPECIFICALLY STATED OTHERWISE.
- 8. CONTRACTOR SHALL BE RESPONSIBLE FOR THE SAFETY OF WORK AREA, ADJACENT AREAS AND BUILDING OCCUPANTS THAT ARE LIKELY TO BE AFFECTED BY THE WORK UNDER THIS CONTRACT. WORK SHALL CONFORM TO ALL OSHA REQUIREMENTS AND THE LOCAL JURISDICTION.
- 9. CONTRACTOR SHALL LEAVE PREMISES IN A CLEAN CONDITION. ALL DEBRIS AND OTHER REFUSE SHALL BE REMOVED FROM THE SITE AND DISPOSED OF IN A LAWFUL MANNER PER SPECIFICATIONS.
- 10. THE CONTRACTOR SHALL PROTECT EXISTING IMPROVEMENTS, PAVEMENTS, CURBS, LANDSCAPING AND STRUCTURES NOT PART OF THE SCOPE OF WORK AS IDENTIFIED IN THESE PLANS.
- 11. DUE TO THE FACT THAT PV MODULES ARE ENERGIZED WHENEVER THEY ARE EXPOSED TO LIGHT, CONTRACTOR SHALL DISABLE THE ARRAY DURING INSTALLATION AND SERVICE BY SHORT CIRCUITING, OPEN CIRCUITING, OR COVERING ARRAY WITH AN OPAQUE COVER ACCORDING TO MANUFACTURER'S INSTRUCTION.

# MONITORING AND CONTROLS

CONTRACTOR SHALL PROVIDE A WIRELESS MONITORING AND CONTROLS NETWORK. THE SOLAR INVERTERS SHALL BE PROVIDED WITH MANUFACTURER STANDARD WIRELESS ACCESS CAPABILITY. CONTRACTOR SHALL PROVIDE CELLULAR HOTSPOT THAT WILL UPLOAD AND ALLOW CONTROL FROM A PASSWORD PROTECTED WEB ACCESS SYSTEM. THE CONTRACTOR SHALL INSTALL THE WEB MONITORING SOFTWARE ON AN EXISTING COMPUTER AS DESIGNATED BY THE STATE PROJECT MANAGER. SEE SPECIFICATION 263100 FOR ADDITIONAL INFORMATION.

#### **STATE OF MISSOURI** MICHAEL L. PARSON, GOVERNOR





CROSSED SWORDS ENGINEERING 1619 NE OAK TREE DR. LEE'S SUMMIT MO 64086 (816) 309-0099 Robert7721@aol.com MO STATE CERTIFICATE OF AUTHORITY#2016003099

**OFFICE OF ADMINISTRATION DIVISION OF FACILITIES** MANAGEMENT, DESIGN **AND CONSTRUCTION** 

MISSOURI NATIONAL GUARD **OFFICE OF THE ADJUTANT GENERAL FACILITIES MANAGEMENT OFFICE** 

CONSTRUCT SOLAR ARRAY

#### FMS BUILDING 5175 FT. LEONARD WOOD, MO 65473

PROJECT # T2224-01 SITE # 6306 ASSET # 8136306004

**REVISION:** DATE: REVISION DATE: **REVISION:** DATE:

ISSUE DATE: 2/14/2023

CAD DWG FILE:E-001.DWG DRAWN BY: **RFS** CHECKED BY: DESIGNED BY: RFS

SHEET TITLE: ELECTRICAL LEGEND AND NOTES

SHEET NUMBER:


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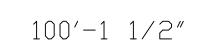
2 OF 5 SHEETS **FEBRUARY 14, 2023**  GENERAL NOTES

- 1. SEE GENERAL NOTES SHEET E-001 FOR ADDITIONAL INFORMATION
- 2. ALL CONDUIT RUNS ABOVE GRADE.
- 3. SYSTEM INFORMATION. (FOR REFERENCE ONLY) SOLAR MODULE WEIGHT: 49.6 LBS. SOLAR MODULE DIMENSIONS: 79.06"X39.45"X1.57"
- 4. ALL WORK SHALL BE IN ACCORDANCE WITH THE NATIONAL ELECTRIC CODE (NEC) 2020 AND UTILITY STANDARDS.

PLAN NOTES

- 1 INSTALL ROOF MOUNTED SOLAR ARRAY. SEE SHEET E-601 FOR DETAILED SOLAR MODULE AND EQUIPMENT INFORMATION. ROOF MOUNTS SHALL BE PER DETAILS ON SHEET E-501.
- 2 INSTALL NEW DC TO AC SOLAR INVERTER.
- $\overline{3}$  INSTALL NEW AC FUSED DISCONNECT PER UTILITY COMPANY REQUIREMENTS.
- $\langle 4 \rangle$  CONNECT SOLAR ARRAY AC VIA ROOF MOUNTED WIRE AND CONDUIT TO EXISTING ELECTRICAL PANEL P-1.



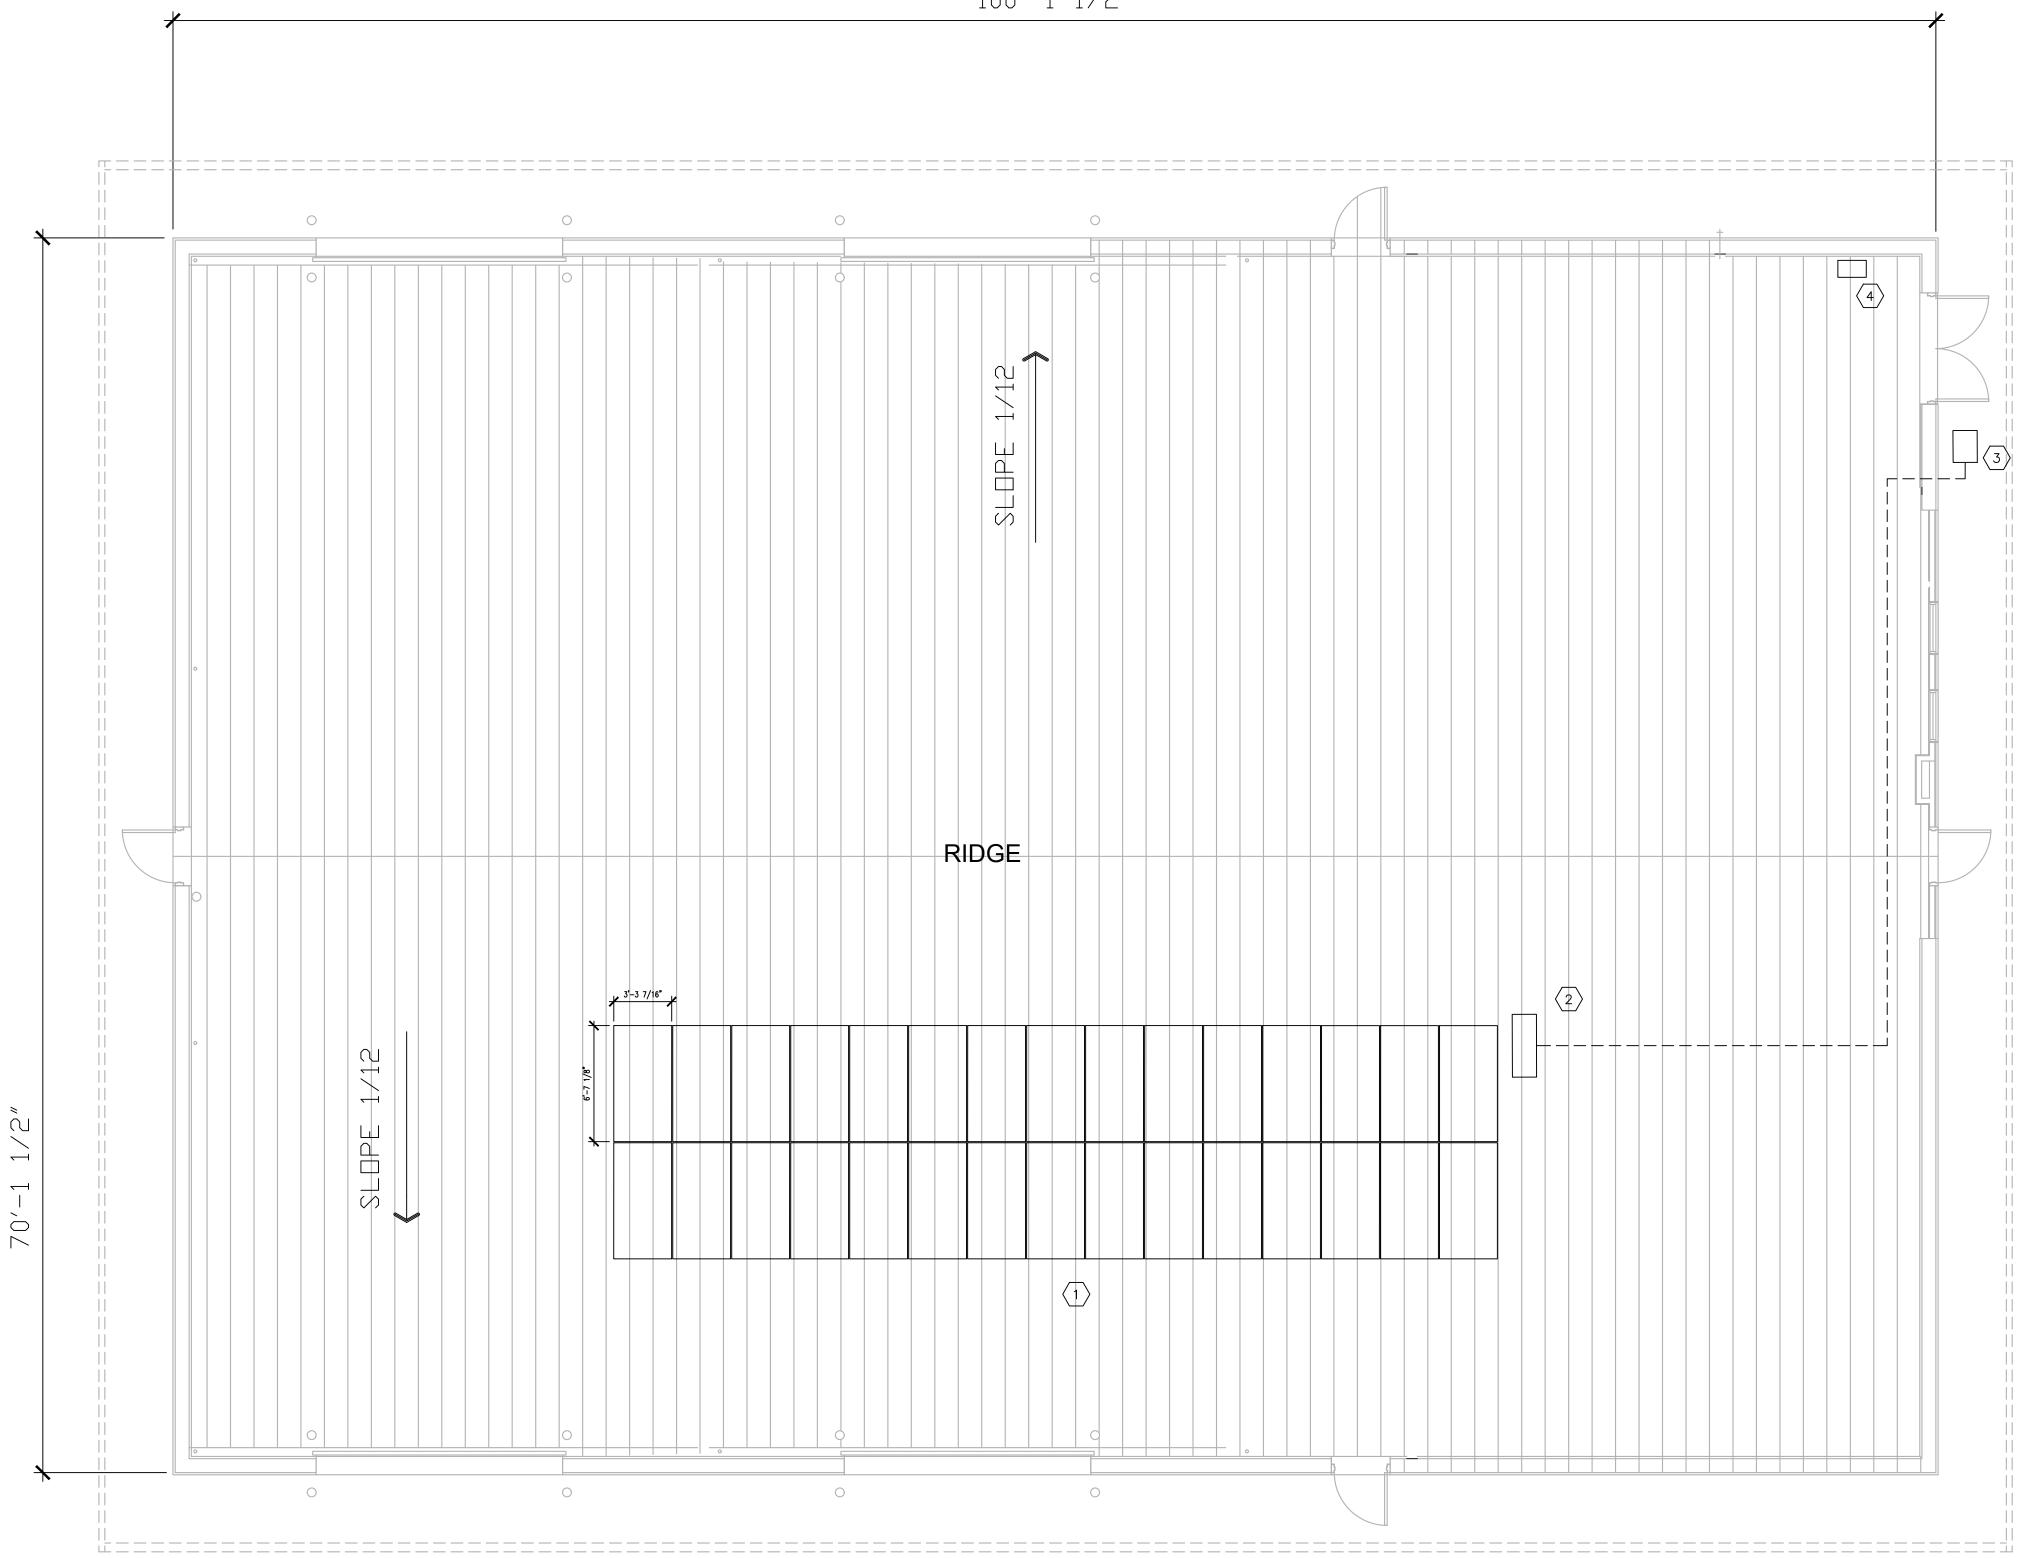



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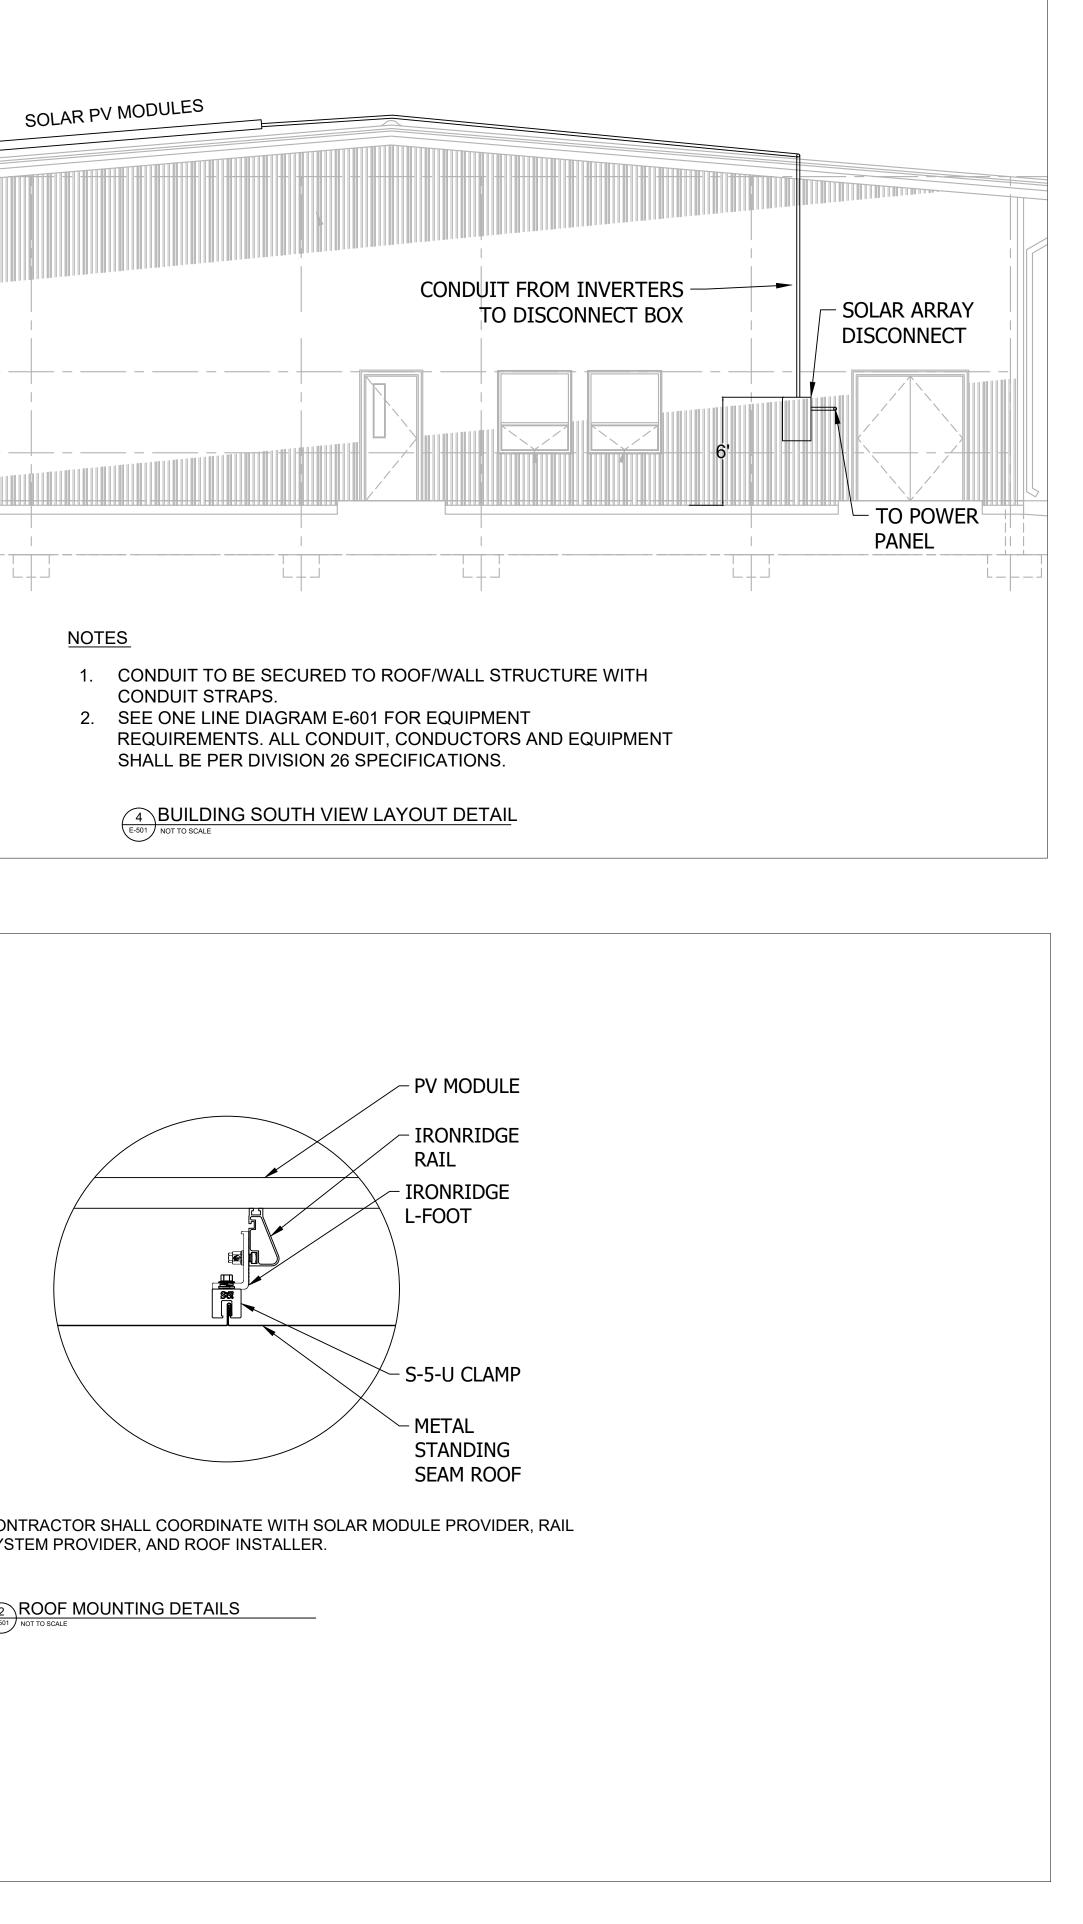
**3** OF 5 SHEETS FEBRUARY 14, 2023

1	ROOF PLAN	
3/16"=1'-0"	_	

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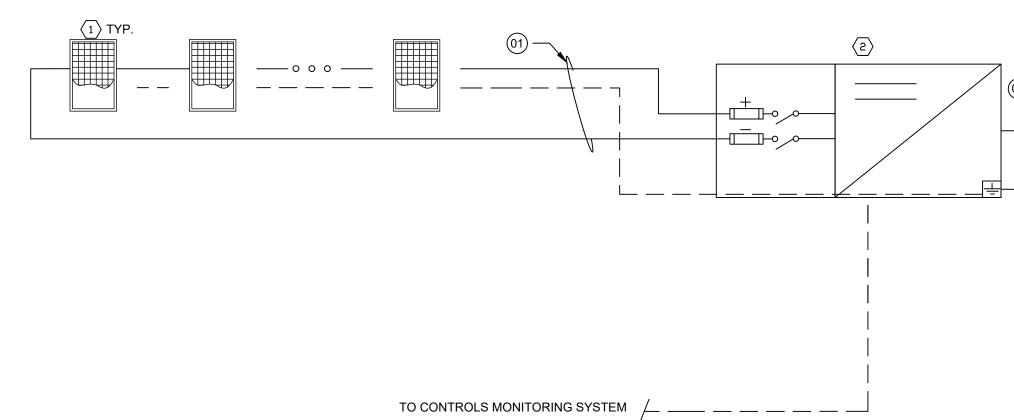


STATE OF MISSOURI MICHAEL L. PARSON, GOVERNOR
ROBERT FISCHWILL PROFESSION 2/14/2023
ROSSED SWORDS ENGINEERING 1619 NE OAK TREE DR. LEE'S SUMMIT MO 64086 816) 309-0099 Robert7721@aol.com
MO STATE CERTIFICATE OF AUTHORITY#2016003099 DFFICE OF ADMINISTRATION
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MISSOURI NATIONAL GUARD OFFICE OF THE ADJUTANT GENERAL FACILITIES MANAGEMENT OFFICE
CONSTRUCT SOLAR ARRAY
FMS BUILDING 5175 FT. LEONARD WOOD, MO 65473
PROJECT # T2224-01 SITE # 6306 ASSET # 8136306004
REVISION: DATE: REVISION: DATE: REVISION: DATE: DATE: SSUE DATE: 2/14/2023
CAD DWG FILE: E-501.DWG DRAWN BY: RFS CHECKED BY: RFS DESIGNED BY: RFS SHEET TITLE: ELECTRICAL
DETAILS
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4 OF 5 SHEETS FEBRUARY 14, 2023

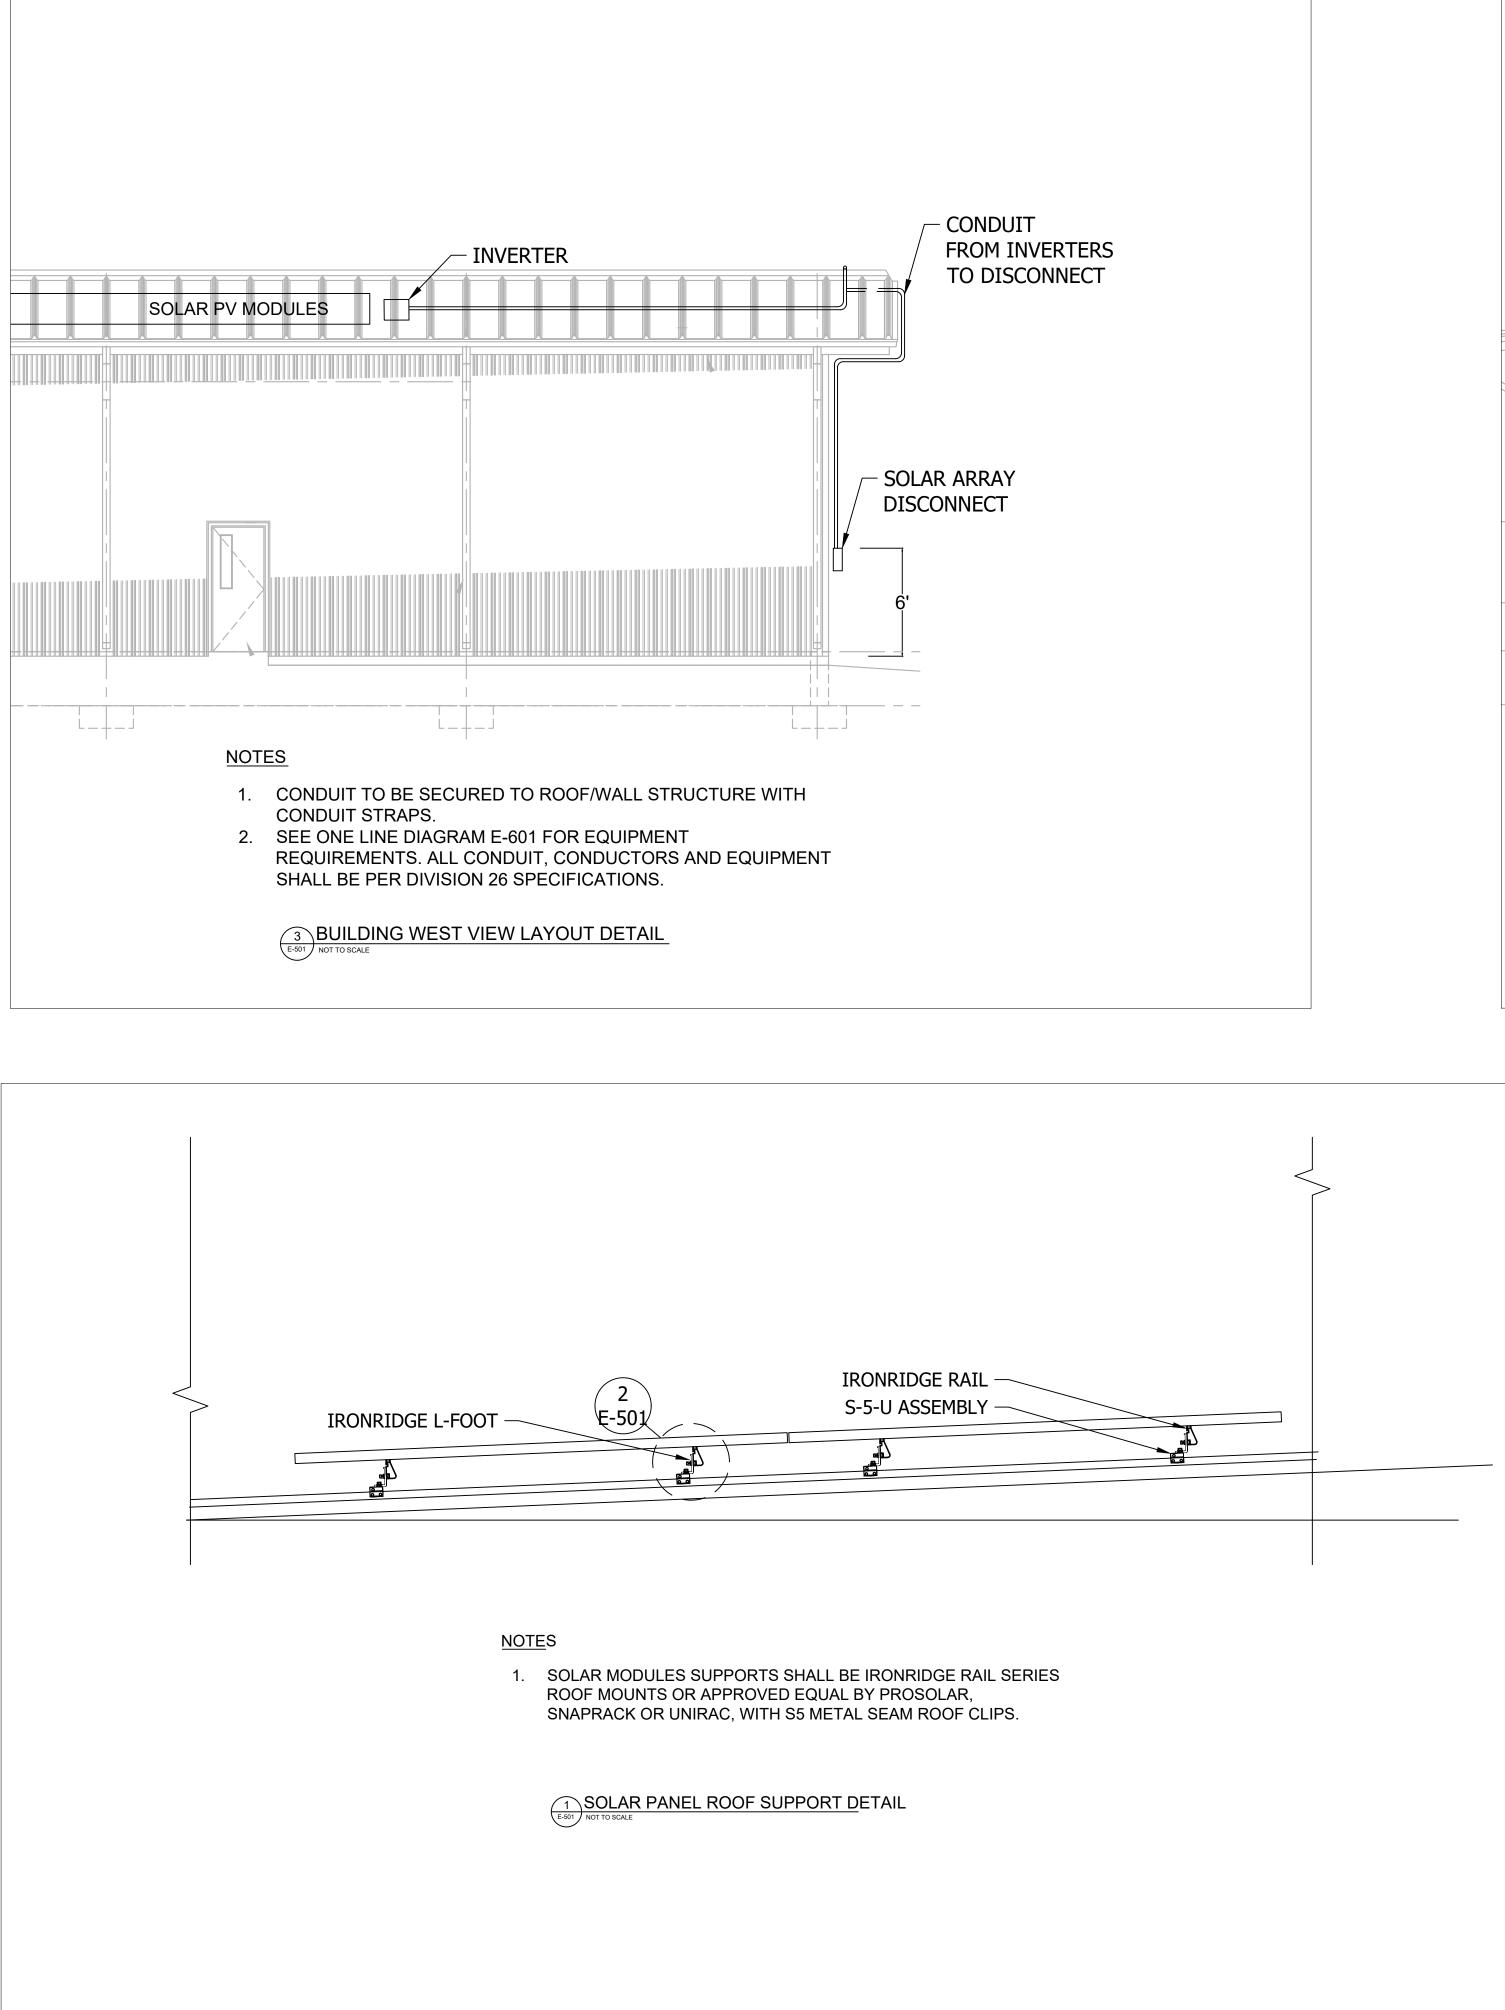SHEET NOTES

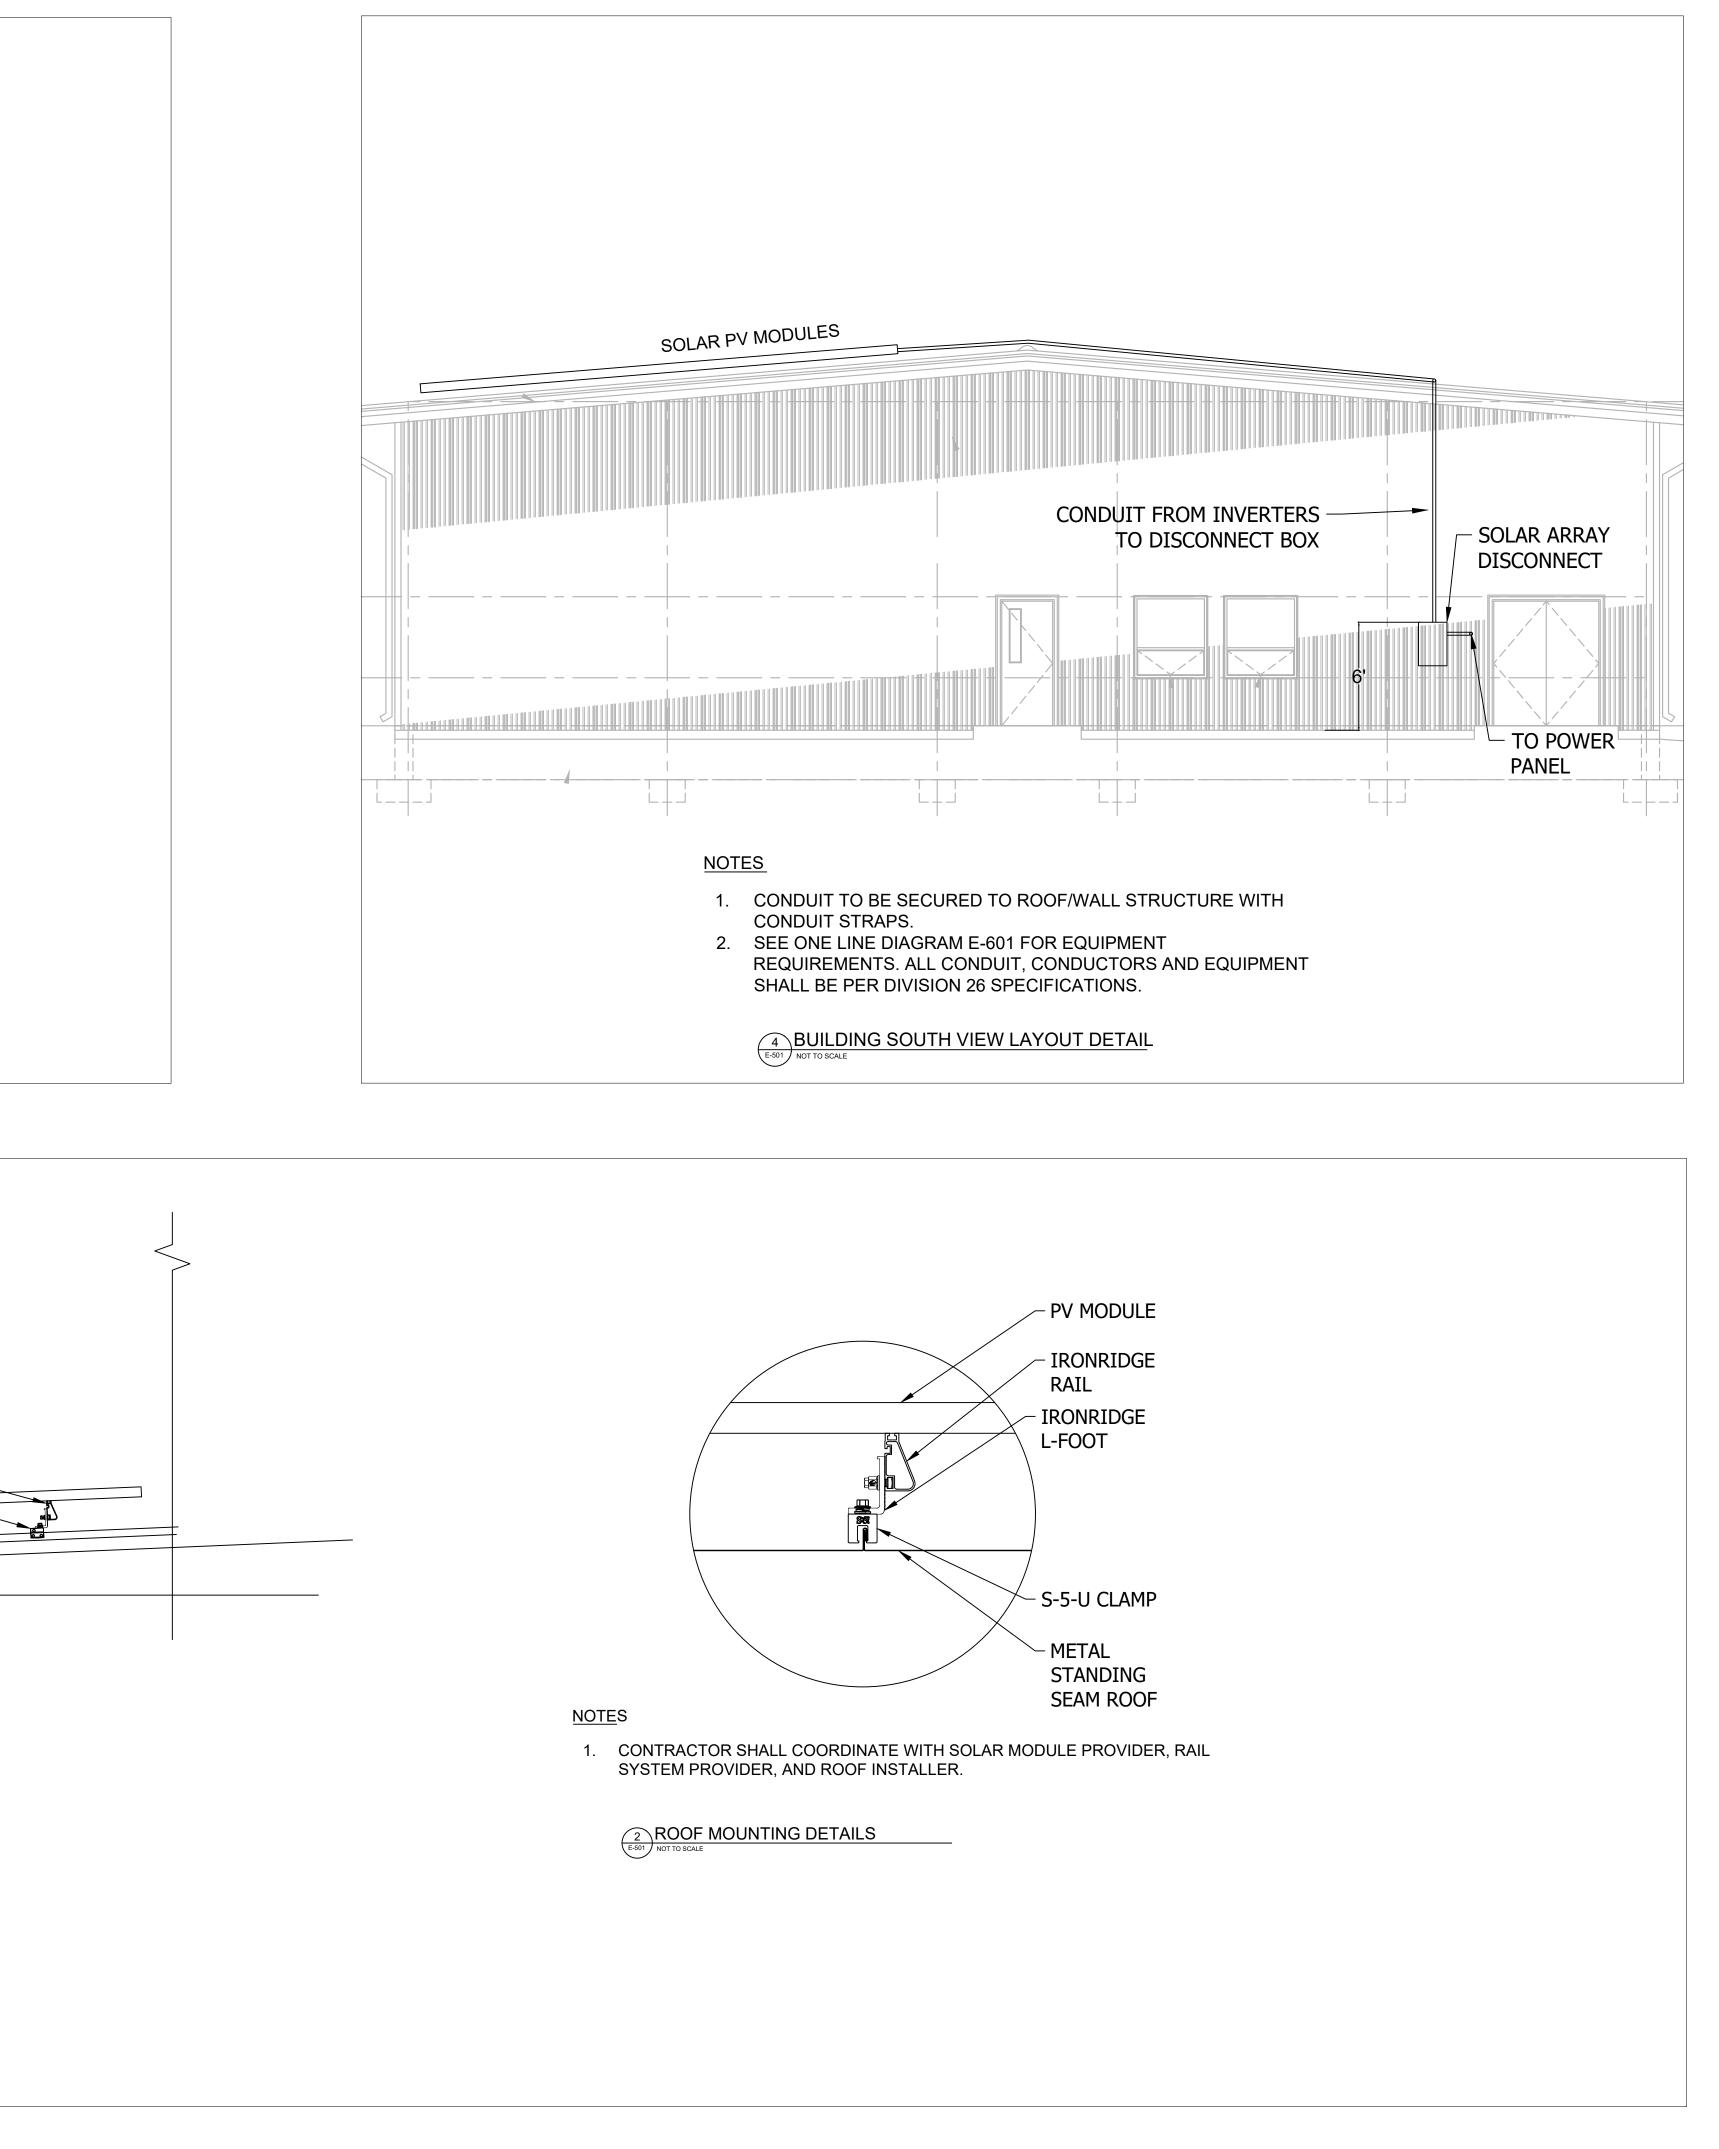- 1. SOLAR MODULES INCLUDE OUTDOOR RATED QUICK CONNECTS WITH MULTI CONTACT CONNECTORS FOR MODULE INTERCONNECTION. DO NOT REMOVE THE QUICK CONNECTS, OTHERWISE THE
- MODULE WARRANTY AND THE UL LISTING MAY BE INVALIDATED. 2. PV MODULES STRUNG IN SERIES. MODULE AND RACKING GROUNDING ACCOMPLISHED VIA
- CONTINUOUS CU CONDUCTOR. 3. MODIFY EXISTING ELECTRICAL PANEL AS REQUIRED FOR THE CONNECTION OF INVERTER OUTPUT POWER TO THE PANEL.


#### INVERTER #1 MPPT1: 1 STRINGS OF 15 MODULES IN SERIES MPPT2: 1 STRINGS OF 15 MODULES IN SERIES



(#)		PV EQUIPMENT LIST
ID	QTY	DESCRIPTION
1	30	JINKO JMK400M-72HL-V, SOLAR MODULE
2	1	10.0 kW STRING INVERTER. 2 MPPT WITH 6 INPUT PAIRS PER MPPT. 208V, 3 PHASE OUTPUT, 60 HZ. FRONIUS SYMO MODEL 10.0-3 208
3	0	NOT USED
4	1	SOLAR SYSTEM AC DISCONNECT, FUSED 60A, 3 PHASE, NEMA 3R
5	1	EXISTING MAIN PANEL P-1. 208V, 3PH.
6	1	EXISTING METER LOCATED AT BUILDING 5175 TRANSFORMER

ID	
01	
02	
03	
04	

#### BUILDING 5175 - 10 KW AC OUTPUT SOLAR ARRAY DC TO AC RATIO 1.2

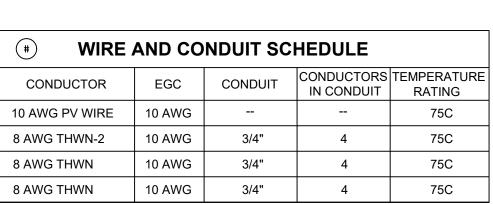


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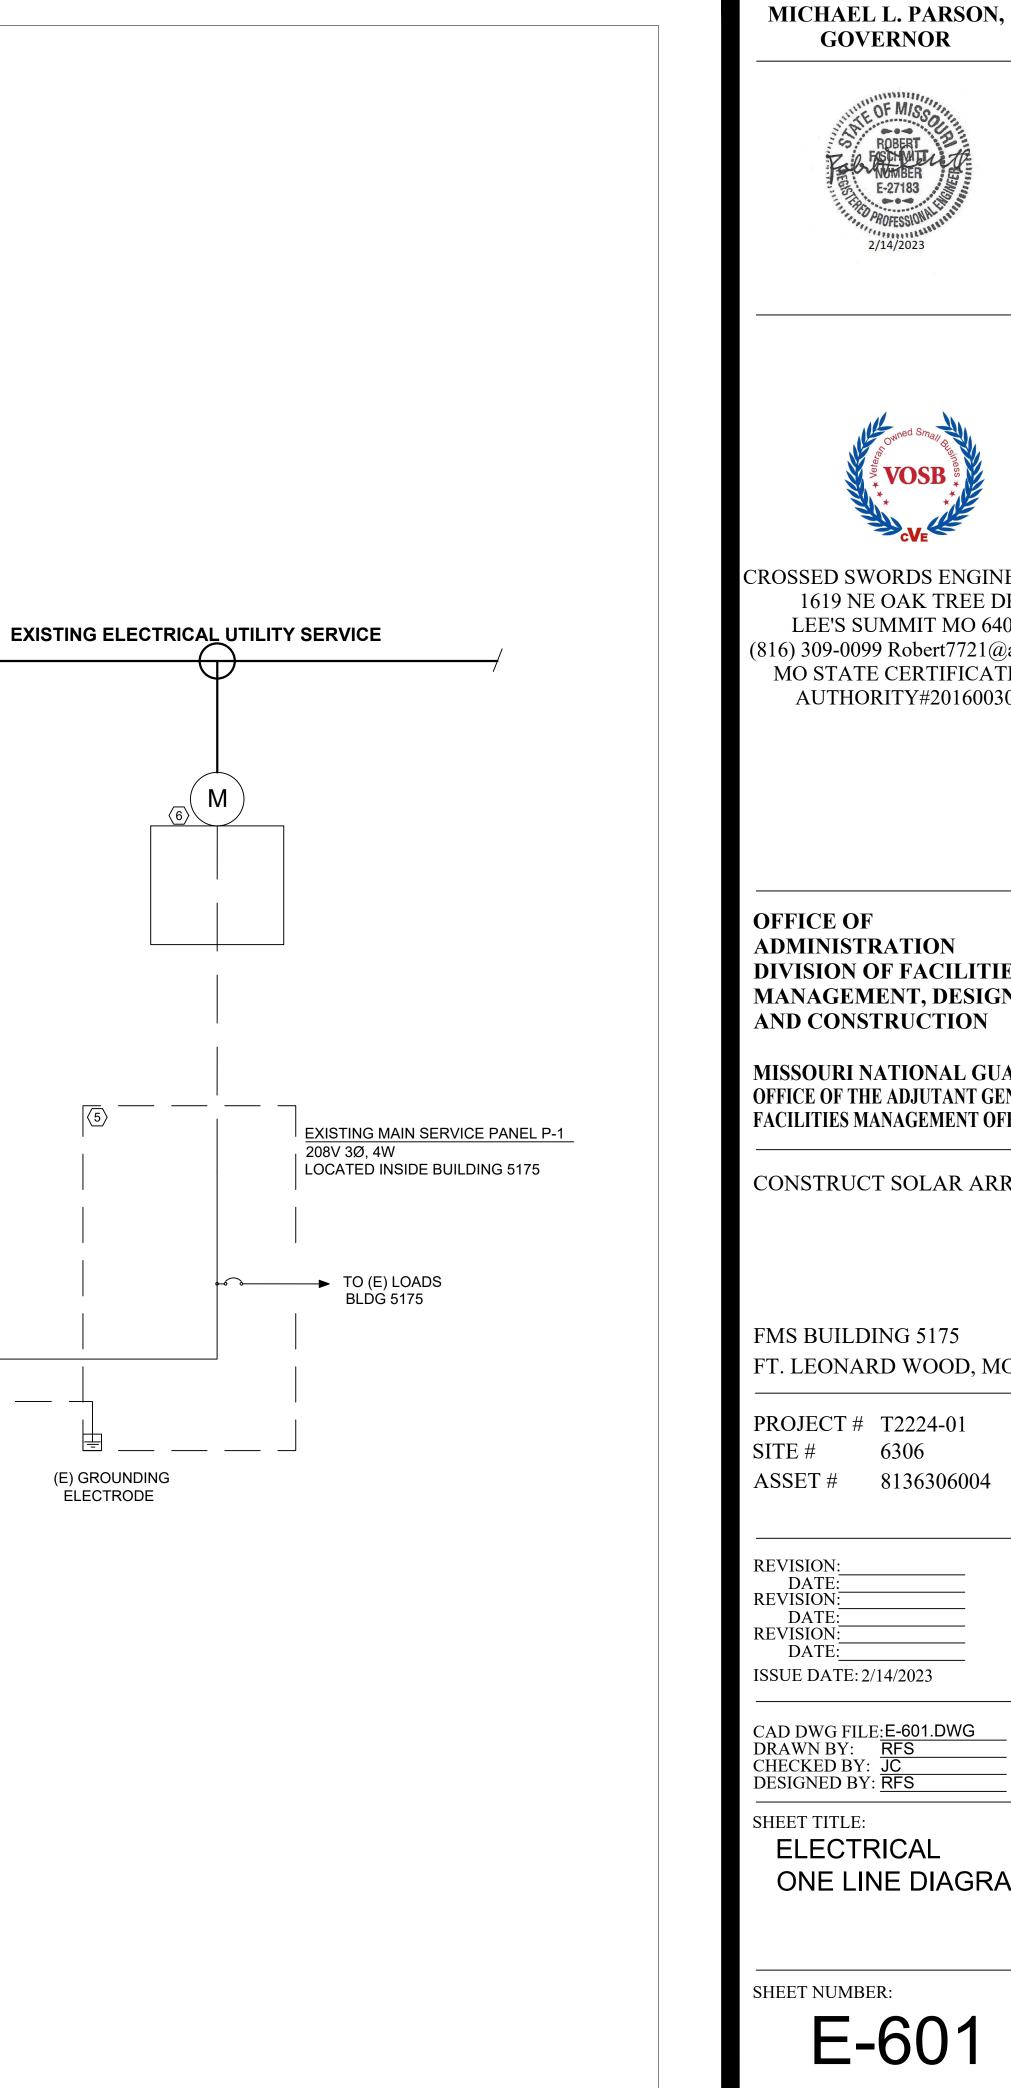
1. ALL EXPOSED SOURCE CIRCUIT CONDUCTORS SHALL BE 600V RATED PV-WIRE SUITABLE FOR USE WITH TRANSFORMLESS INVERTERS.

2. ALL CONDUIT TO BE PER SPECIFICATIONS UNLESS OTHERWISE REQUIRED BY LOCAL AHJ. 3. ALL CONDUIT SIZES ARE BASED ON MINIMUM PER NEC CODE REQUIREMENTS.

4. WIRE AMPACITY IS BASED ON NUMBER OF WIRES PER CONDUIT. IF CONDUITS ARE INSTALLED DIFFERENTLY THAN SHOWN, WIRE SIZES MAY BE AFFECTED.

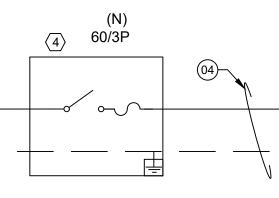

SITE CONDITIONS:			
ASHRAE MAX AVG. TEMP:		98.3°F	
ASHRAE EXTREME MIN TEMP		-0.4°F	
PV MODULE OUTPUT			
VOC:		49.1 Vdc	
TEMP. COEFFICIENT OF Voc		-0.29 %/°C	2
ISC		10.61 Ad	C
VMP		40.16 Vd	с
IMP		9.96 Adc	
INVERTER DETAILS			
RATED POWER OUTPUT (kW) 10.0			10.0
OUTPUT VOLTAGE (V)			208
OUTPUT CURRENT (A)			27.7
SOURCE CIRCUIT DETAILS			
MODULES PER STRING 15			
TEMPERATURE ADJUSTED VOC		824.9	
SHORT CIRCUIT CURRENT		49	9.1



# VOSE CROSSED SWORDS ENGINEERING 1619 NE OAK TREE DR. LEE'S SUMMIT MO 64086 (816) 309-0099 Robert7721@aol.com MO STATE CERTIFICATE OF AUTHORITY#2016003099 **OFFICE OF** ADMINISTRATION **DIVISION OF FACILITIES** MANAGEMENT, DESIGN AND CONSTRUCTION MISSOURI NATIONAL GUARD **OFFICE OF THE ADJUTANT GENERAL** FACILITIES MANAGEMENT OFFICE CONSTRUCT SOLAR ARRAY FMS BUILDING 5175 FT. LEONARD WOOD, MO 65473 PROJECT # T2224-01 6306

**STATE OF MISSOURI** 

<b>REVISION:</b>	
DATE:	
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ISSUE DATE: 2/14/2023

CAD DWG FILE:E-601.DWG DRAWN BY: RFS CHECKED BY:  $\overline{JC}$ DESIGNED BY: RFS

SHEET TITLE: ELECTRICAL ONE LINE DIAGRAM

SHEET NUMBER:

FEBRUARY 14, 2023

E-601 5 OF 5 SHEETS