
RENOVATE USPFO VAULT USPFO DEPLOYMENT STORAGE FACILITY IKE SKELTON TRAINING SITE JEFFERSON CITY, MISSOURI

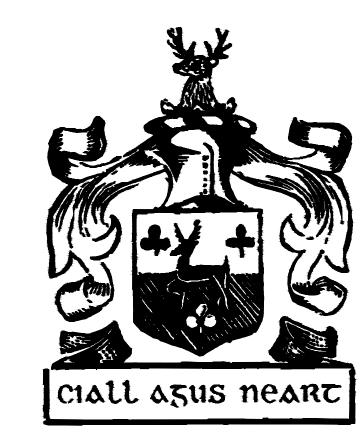

OWNER:

STATE OF MISSOURI MICHAEL L. PARSON,

GOVERNOR

DEPARTMENT OF THE NATIONAL GUARD

PROJECT MANAGEMENT:

OFFICE OF ADMINISTRATION DIVISION OF FACILITIES MANAGEMENT, DESIGN

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CONNELL ARCHITECTURE, P.C.

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573-875-2455

brianconnell@connellarchitecture.com

DESIGNER: CONNELL ARCHITECTURE, P.C.

2311 EAST WALNUT STREET SUITE B


COLUMBIA, MISSOURI 65201

PROJECT NUMBER: T2226-01

SITE NUMBER: ASSET NUMBER: 6300

8136300015



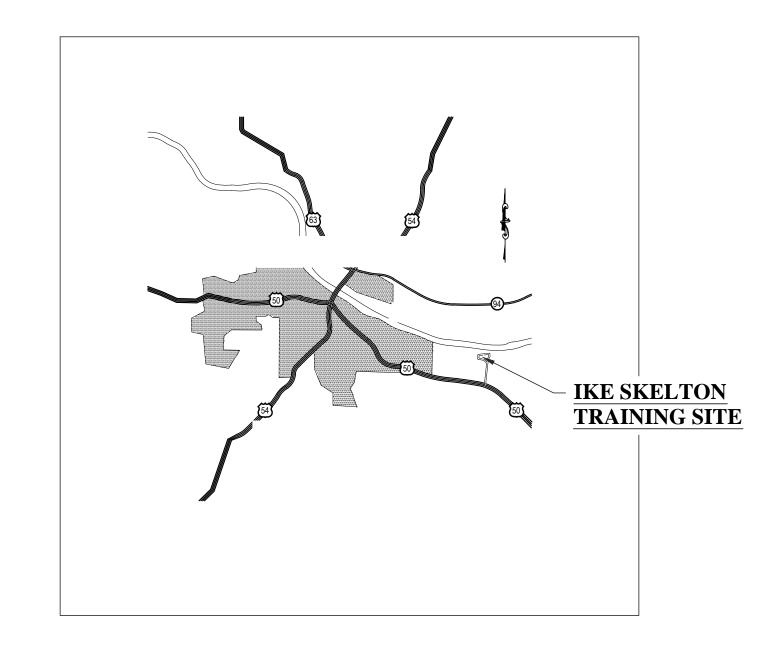








VICINITY MAP - IKE SKELTON TRAINING SITE

- USPFO DEPLOYMENT STORAGE WAREHOUSE

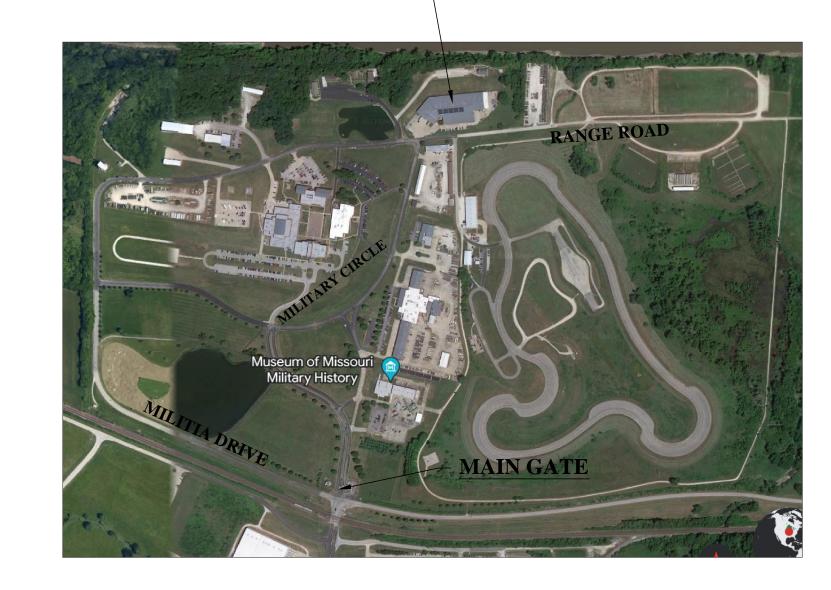





SITE MAP - IKE SKELTON TRAINING SITE

NOT TO SCALE

GENERAL NOTES:

IT IS THE RESPONSIBILITY OF THE GENERAL CONTRACTOR AND EACH SUBCONTRACTOR TO REVIEW THE DRAWINGS TO ASSURE COORDINATION OF ALL WORK AFFECTING EACH TRADE.

FAILURE TO REVIEW ALL CONTRACT DOCUMENTS FOR APPLICABLE ITEMS OF WORK SHALL NOT RELIEVE THE RESPONSIBLE PARTY FROM PERFORMING ALL WORK REQUIRED BY THE CONTRACT DOCUMENTS.

- 1. DRAWINGS THESE DRAWINGS SHALL NOT BE SCALED. REFER TO DIMENSIONS INDICATED, ACTUAL SIZES OF CONSTRUCTION ITEMS, OR OTHER RELIABLE METHODS OF LOCATING CONSTRUCTION. WHERE NO DIMENSION OR METHOD OF DETERMINING A LOCATION IS GIVEN, VERIFY CORRECT LOCATION WITH CONNELL ARCHITECTURE P.C. PRIOR TO INSTALLATION.
- 2. DIMENSIONS DIMENSIONS ON PLANS ARE FROM FACE OF CONCRETE, MASONRY, OR FRAMING UNLESS OTHERWISE NOTED. DIMENSIONS INDICATED AS "CLEAR" ARE CRITICAL FOR MINIMUM REQUIRED CLEARANCES AND SHALL BE A MINIMUM DIMENSION MEASURED FROM FACE OF FINISH MATERIALS.
- 3. COORDINATION GENERAL CONTRACTOR SHALL COORDINATE REQUIREMENTS OF ALL TRADES TO ALLOW FOR TIMELY INCLUSION IN THE WORK SO AS NOT TO DELAY THE WORK OR THE WORK OF ANY SUBCONTRACTOR.
- 4. EXISTING CONDITIONS THE EXISTING CONDITIONS SHOWN ON THESE DRAWINGS ARE DERIVED FROM OBSERVATIONS AND MEASUREMENTS TAKEN DURING SITE VISITS AND FROM ARCHIVE INFORMATION PROVIDED BY THE OWNER. THE CONTRACTOR SHALL VERIFY ALL EXISTING CONDITIONS ON THE JOB SITE AND NOTIFY THE CONSTRUCTION ADMINISTRATOR OF DEVIATIONS FROM THESE DRAWINGS PRIOR TO FABRICATION AND INSTALLATION OF THE WORK.
- 5. PRECAUTIONS CONTRACTOR SHALL IMMEDIATELY REPORT ANY UNFORESEEN CONDITIONS DISCOVERED IN THE WORK WHICH COULD RESULT IN DAMAGE TO THE STRUCTURE OR INJURY TO THE OCCUPANTS TO THE OWNER'S REPRESENTATIVE AND THE CONSTRUCTION ADMINISTRATOR. IMPLEMENT NECESSARY PRECAUTIONS TO PROPERLY SUPPORT THE STRUCTURE AND PROTECT THE OCCUPANTS.
- 6. HAZARDOUS MATERIALS CONTRACTOR SHALL IMMEDIATELY REPORT THE DISCOVERY OF ANY HAZARDOUS MATERIALS TO THE OWNER'S REPRESENTATIVE AND CONSTRUCTION ADMINISTRATOR.
- 7. SITE UTILIZATION USE OF THE SITE FOR ANY CONSTRUCTION STAGING OR OTHER OPERATIONS SHALL BE COORDINATED WITH THE OWNER'S REPRESENTATIVE AND CONSTRUCTION ADMINISTRATOR. THE CONTRACTOR'S OPERATIONS SHALL NOT OBSTRUCT OR ADVERSELY AFFECT ANY PUBLIC RIGHT-OF-WAY OR ADJACENT PROPERTIES.
- 8. EXIT ACCESS MAINTAIN FREE, SAFE, AND APPROVED MEANS OF EGRESS IN AND OUT OF PROJECT LOCATION AND EXISTING OCCUPIED BUILDINGS IN ACCORDANCE WITH REQUIREMENTS OF APPLICABLE REGULATORY AGENCIES.
- 9. CONTRACTOR SHALL FURNISH & INSTALL ALL SYSTEMS, MATERIALS, COMPONENTS AND ACCESSORIES REQUIRED FOR A COMPLETE INSTALLATION, WHETHER OR NOT ALL SUCH MATERIALS & DETAILS OF INSTALLATION HAVE BEEN SPECIFICALLY MENTIONED OR SHOWN ON THE CONSTRUCTION DRAWINGS. ALL INSTALLATION AND DETAILS TO CONFORM TO MANUFACTURER'S WRITTEN SPECIFICATIONS AND RECOMMENDATIONS.
- 10. ANY AND ALL MATERIALS NOTED "TO REMAIN" ARE EXISTING MATERIALS TO REMAIN A PART OF THE WORK UNLESS OTHERWISE NOTED. ANY MATERIAL NOT DESIGNATED "TO REMAIN" SHALL BE REMOVED AND DISPOSED OF IN A LEGAL MANNER, AND REPLACED WITH NEW MATERIALS UNLESS OTHERWISE NOTED.

CODES & REGULATIONS

- 1. ALTERATIONS AND ADDITION SHALL COMPLY WITH 2021 IBC, 2021 IFC, 2021 IMC, 2020 NEC.
- 2. ALTERATIONS AND ADDITION SHALL COMPLY WITH ICC ANSI A117.1.
- 2. VAULT DOOR SHALL CONFORM TO FEDERAL SPECIFICATION AA-D-600 GSA CLASS 5.

DRAWING SHEET INDEX:

ARCHITECTURAL DRAWINGS

G-001 COVER PAGE

-002 LOCATION MAPS & DRAWING INDEX

AD-100 SELECTIVE DEMOLITION PLAN - EXISTING VAULT

A-100 VAULT PLAN & ELEVATIONS - EXISTING + ADDITION

A-300 VAULT WALL SECTIONS - EXISTING + ADDITION

STRUCTURAL DRAWINGS

S-100 GENERAL STRUCTURAL DATA

200 FOUNDATION PLANS & DETAILS

S-300 ROOF PLAN & DETAILS

MECHANICAL-ELECTRICAL-PLUMBING DRAWINGS

E-101 MECHANICAL & ELECTRICAL PLANS

IE-501 MECHANICAL & ELECTRICAL DETAILS & SCHEDULES

STATE OF MISSOURI MICHAEL L. PARSON, GOVERNOR



7/20/2023
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OFFICE OF ADMINISTRATION DIVISION OF FACILITIES MANAGEMENT, DESIGN AND CONSTRUCTION

MISSOURI NATIONAL GUARD

RENOVATE USPFO VAULT

USPFO DEPLOYMENT STORAGE WAREHOUSE 7001 RANGE ROAD

IKE SKELTON TRAINING SITE 2302 MILITIA DRIVE JEFFERSON CITY, MO 65101

PROJECT No. T2226-01
SITE No. 6300
ASSET No. 8136300015

REVISION:
DATE:
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DATE:

REVISION:
DATE:
ISSUE DATE: 7/20/2023

1550E DATE: 7/20/202

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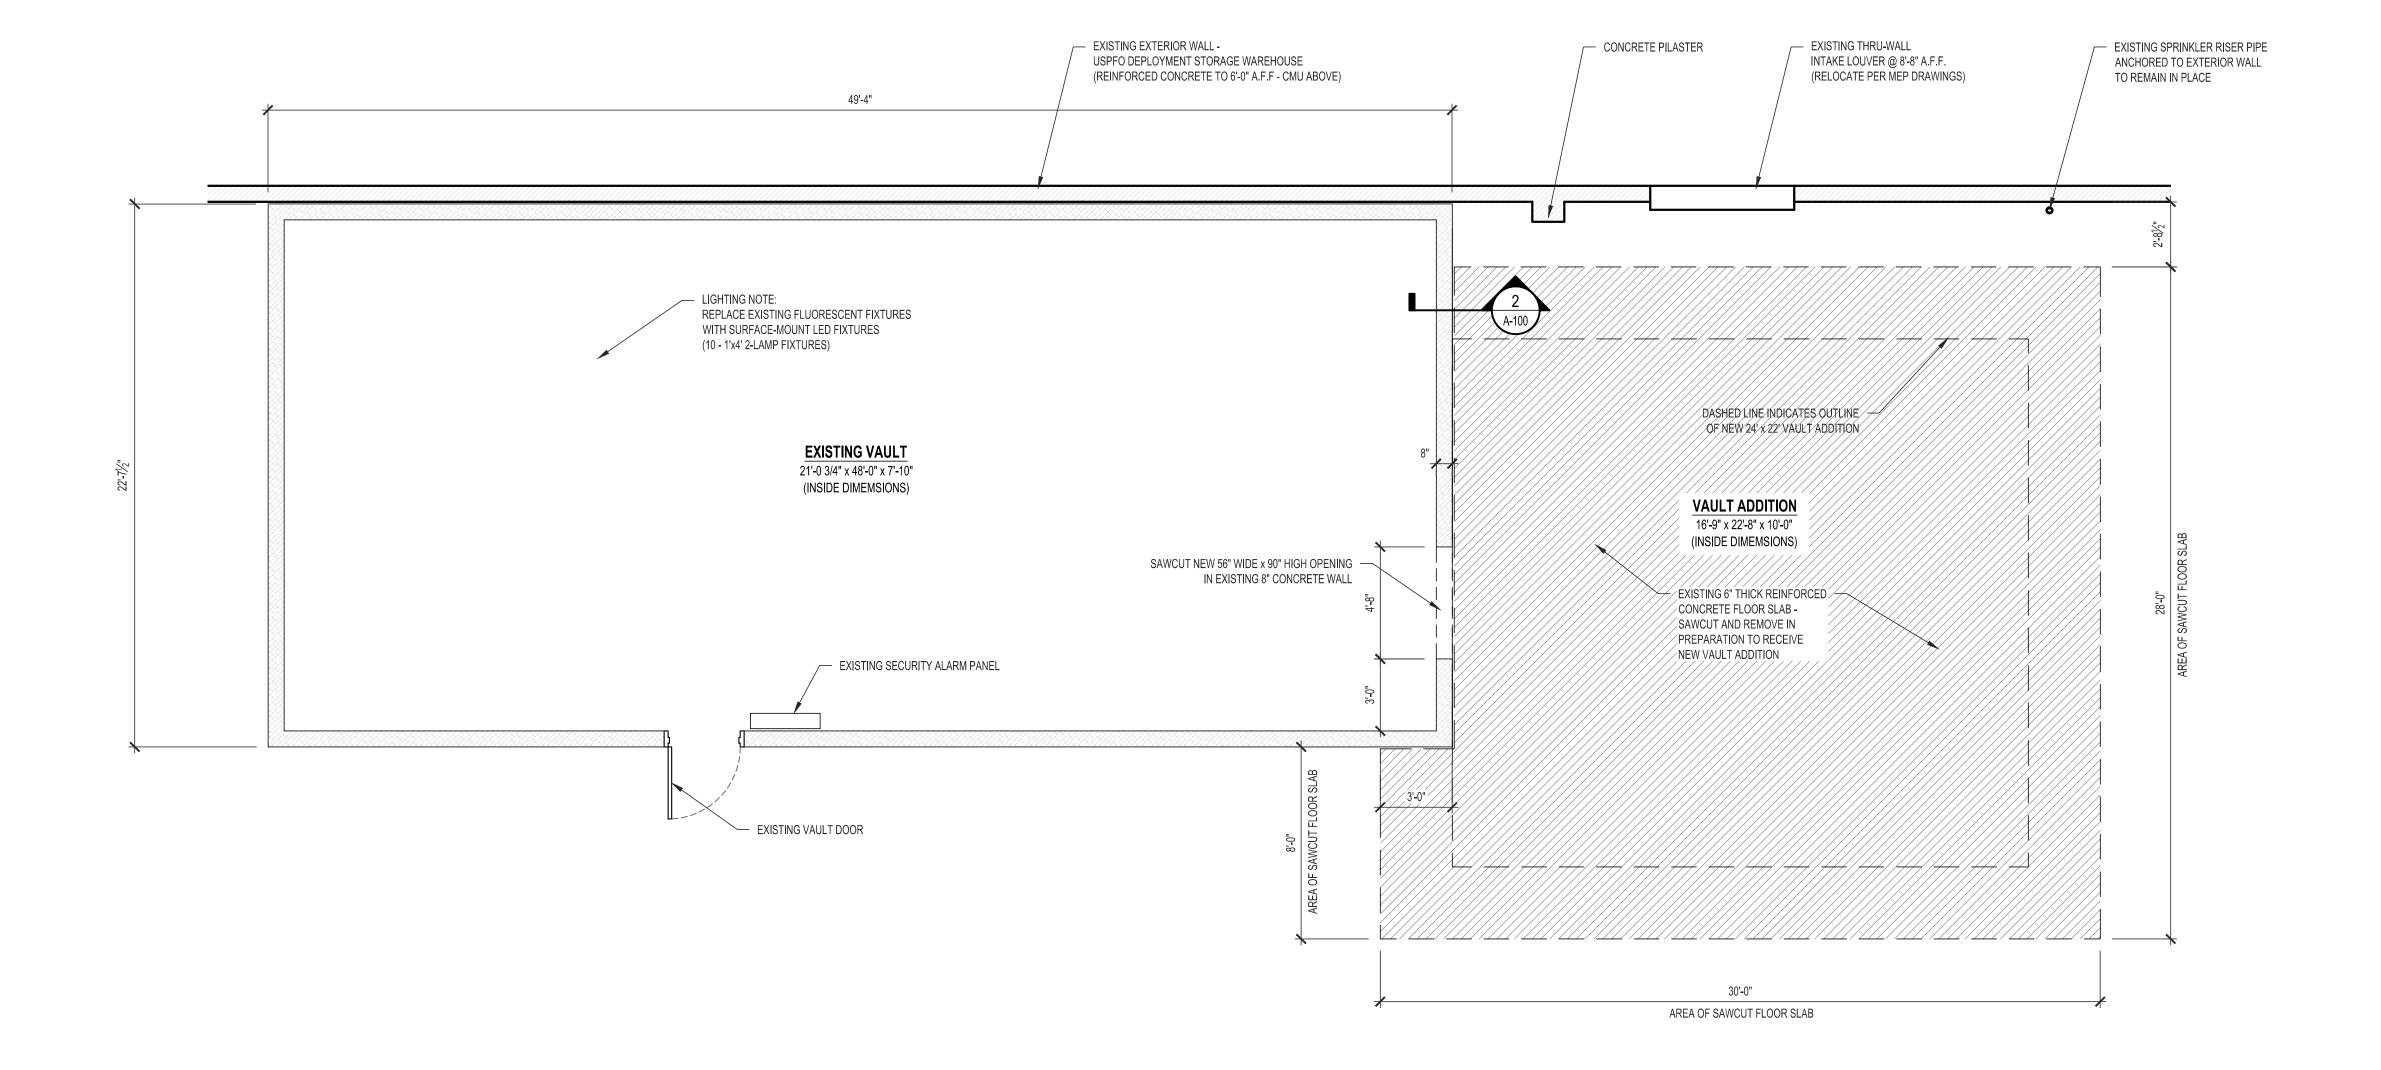
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DESIGNED BY:
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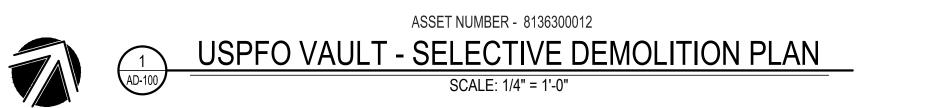
SHEET TITLE:

LOCATION MAPS & DRAWING INDEX

SHEET NUMBER:

SHEET 2 OF 10 ISSUE DATE: 7/20/2023









7/20/2025
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ISSUE DATE: 7/20/2023

CAD DWG FILE:

T2226-01-6300-8136300012-AD-100

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DESIGNED BY:
BDC
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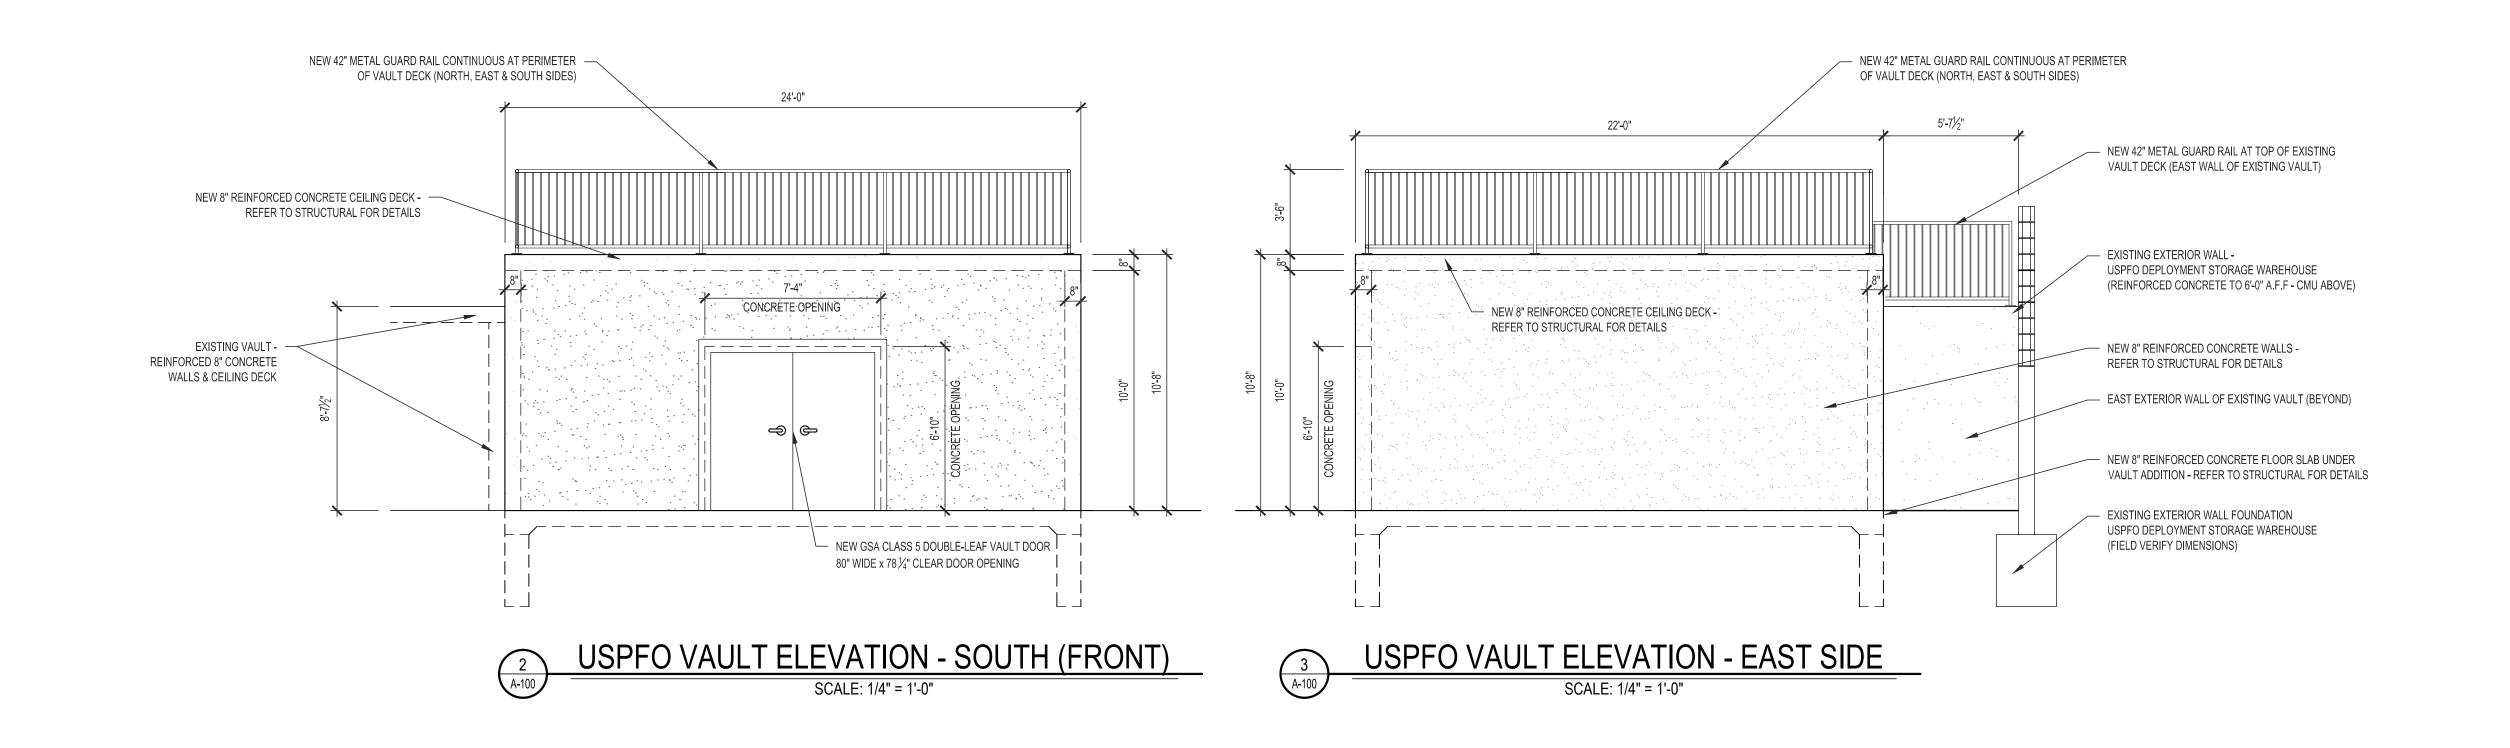
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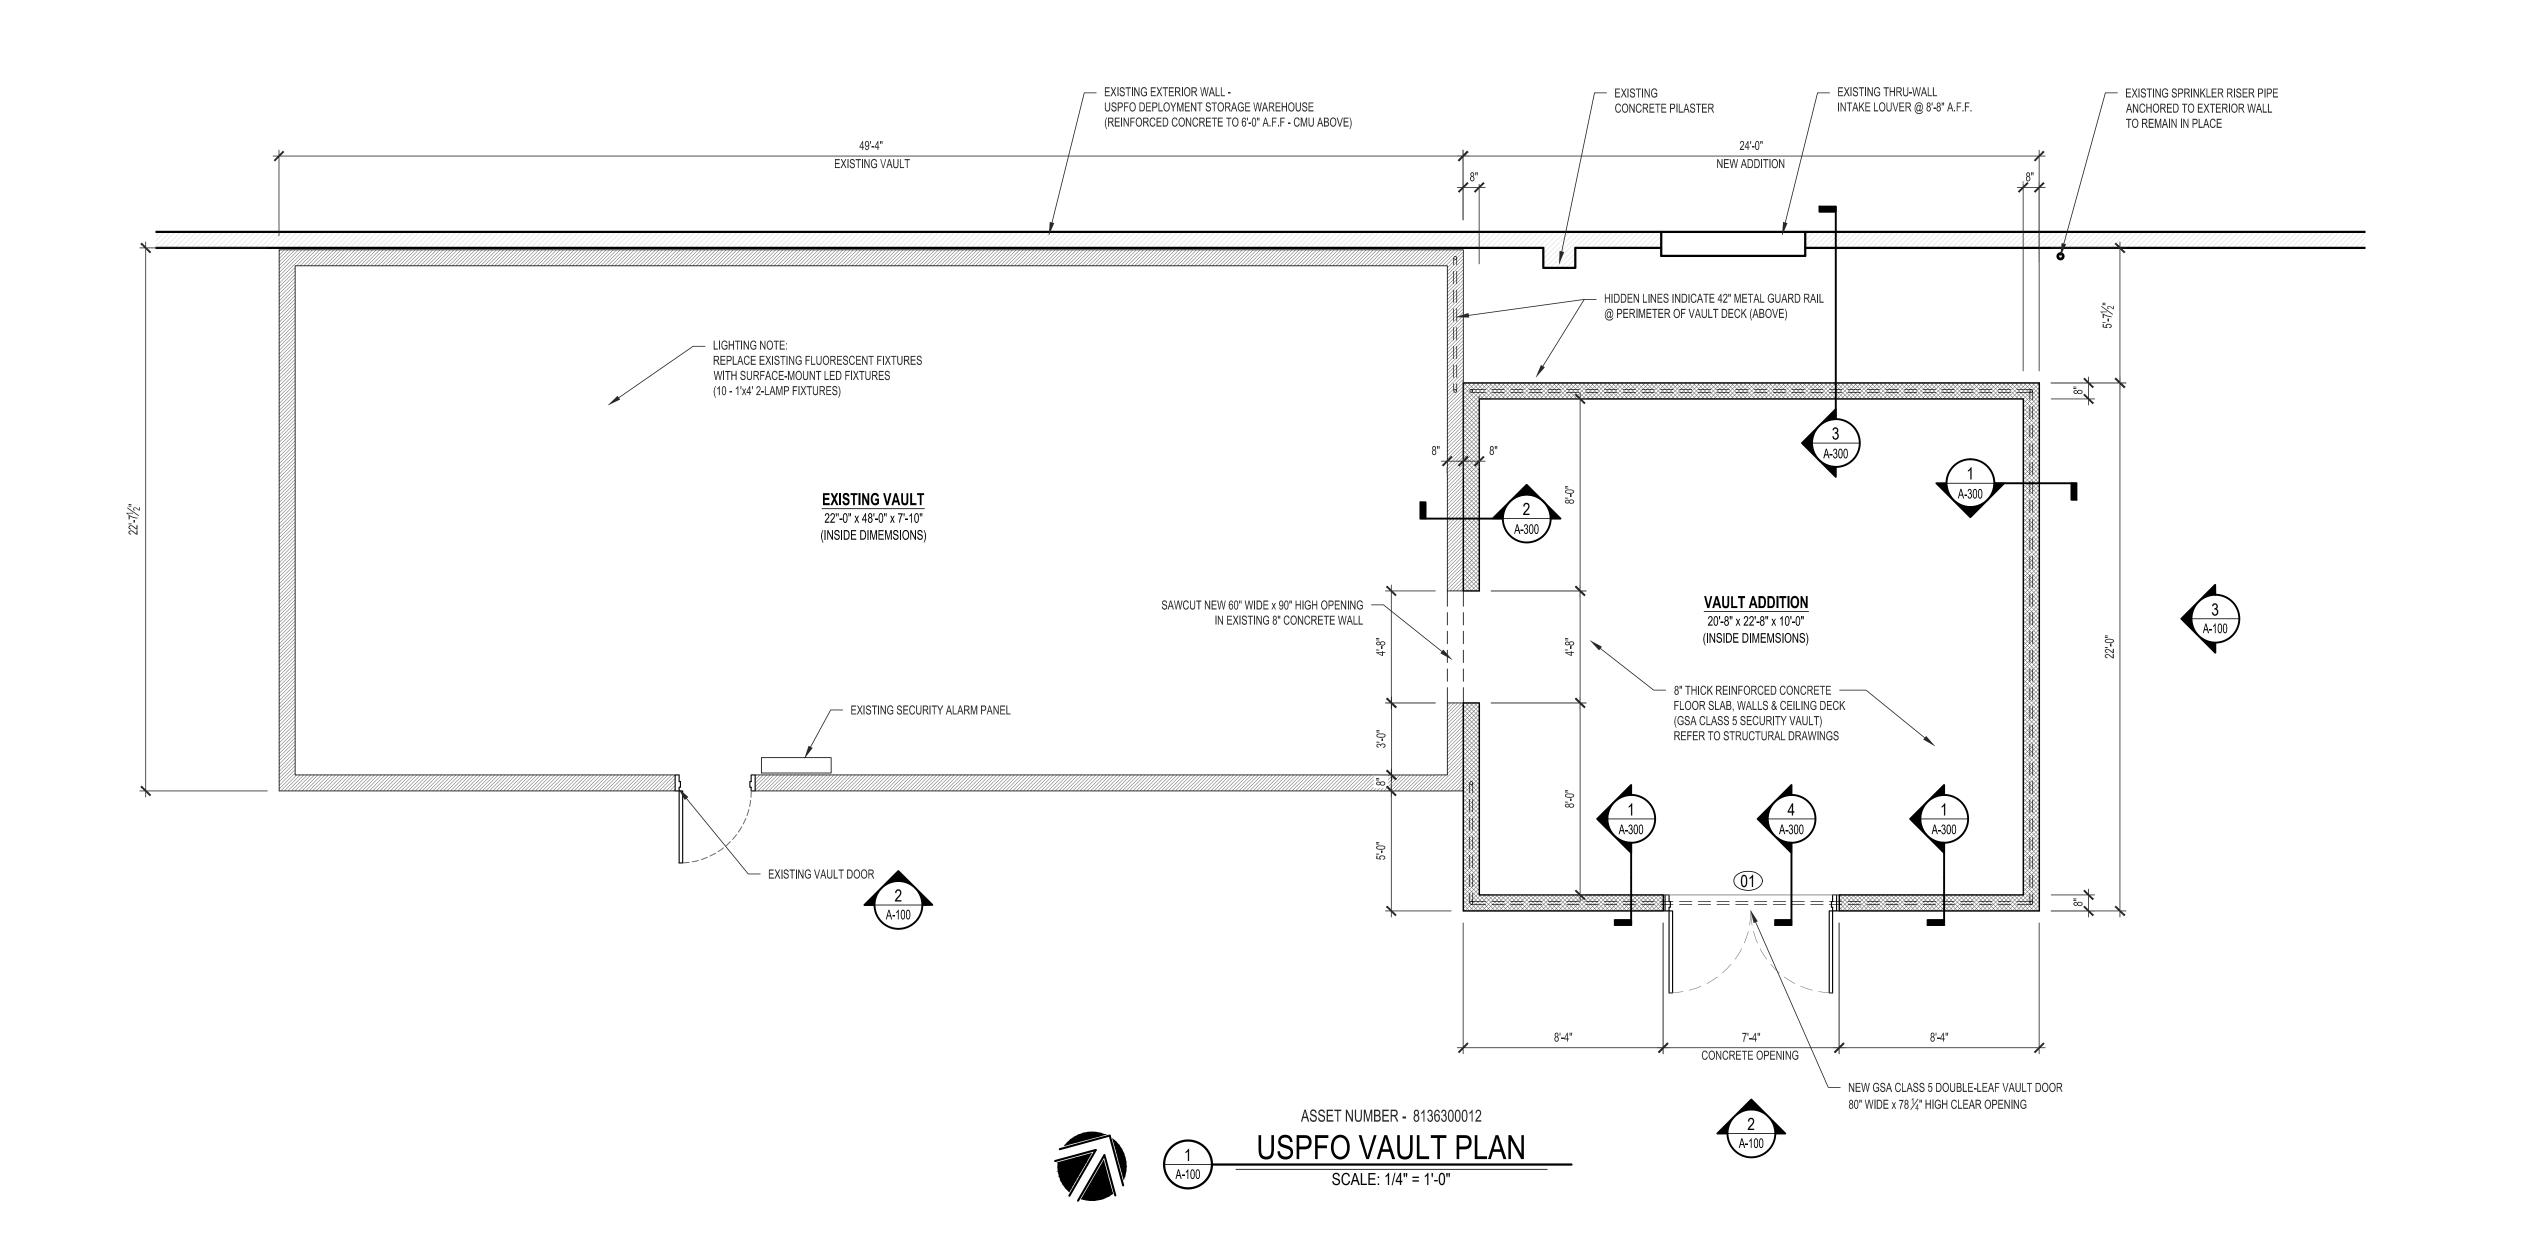
SELECTIVE DEMOLITION PLAN

SHEET NUMBER:

AD-100

SHEET 3 OF 10 ISSUE DATE: 7/20/2023





STATE OF MISSOURI MICHAEL L. PARSON, **GOVERNOR**



BRIAN DOUGLAS CONNELL ARCHITECT MO A-5036

OFFICE OF ADMINISTRATION DIVISION OF FACILITIES MANAGEMENT, DESIGN AND CONSTRUCTION

MISSOURI NATIONAL GUARD

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USPFO DEPLOYMENT STORAGE WAREHOUSE 7001 RANGE ROAD

IKE SKELTON TRAINING SITE 2302 MILITIA DRIVE **JEFFERSON CITY, MO 65101**

PROJECT No. T2226-01 SITE No. 6300 8136300015 ASSET No.

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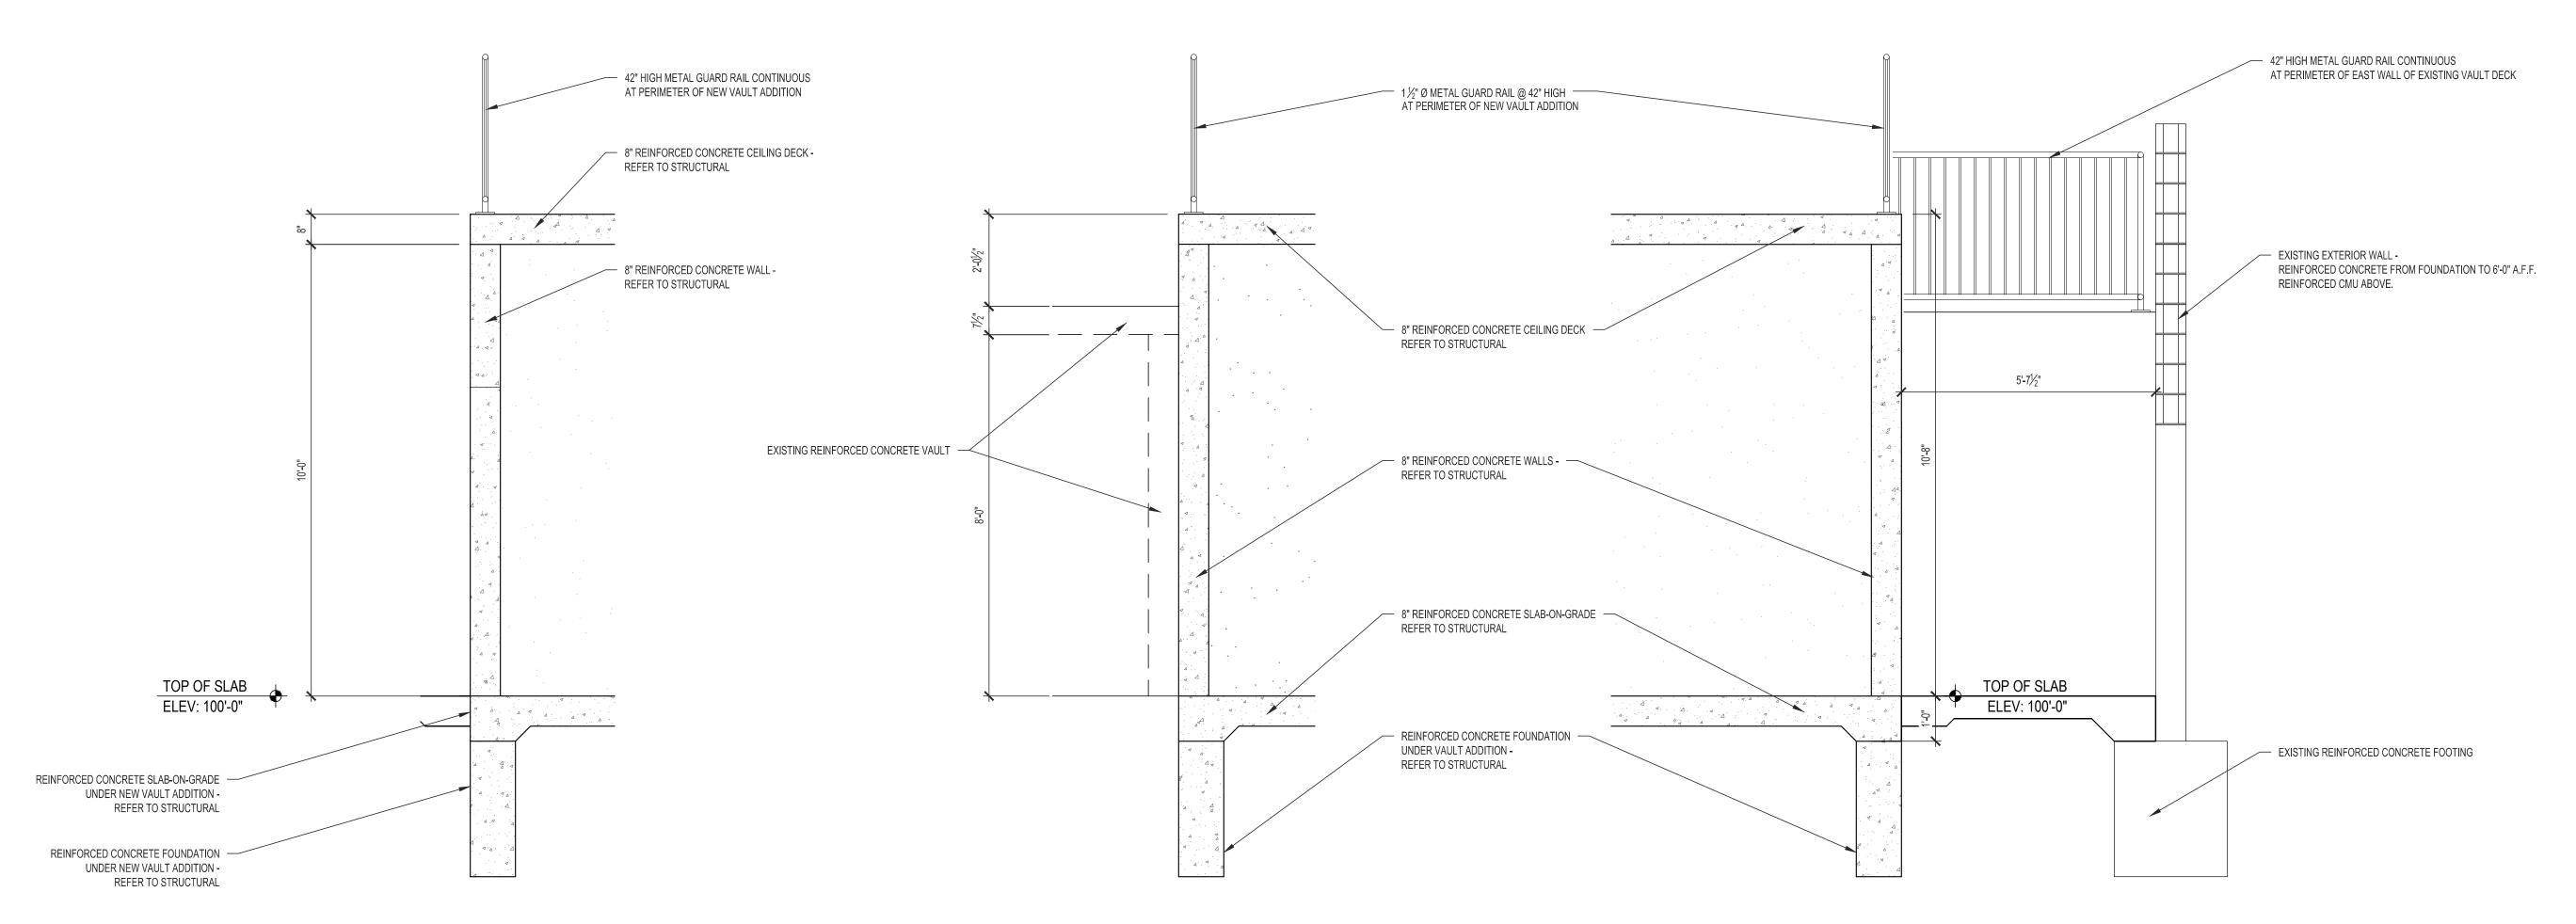
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VAULT FLOOR PLAN -EXISTING + ADDITION

SHEET NUMBER:


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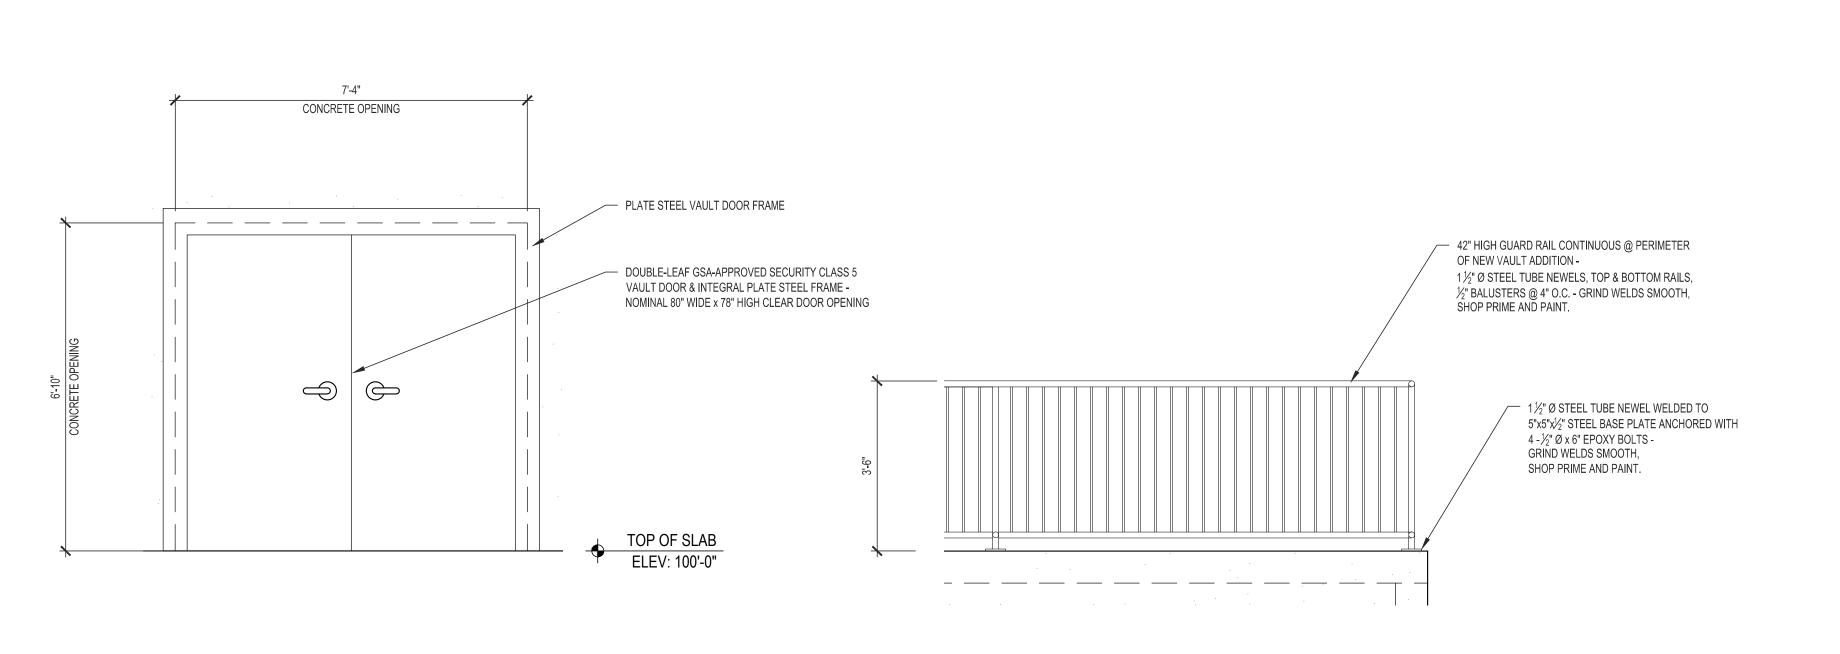










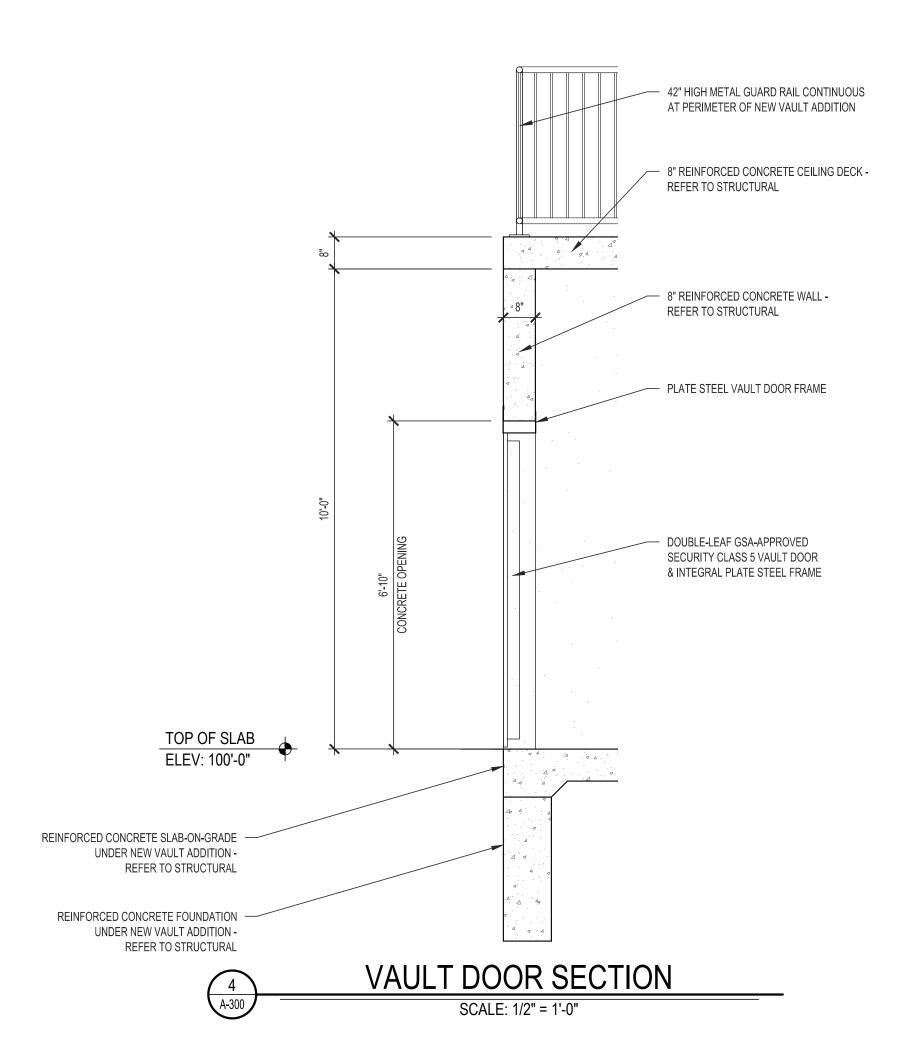

VAULT DOOR ELEVATION

SCALE: 1/2" = 1'-0"



STATE OF MISSOURI MICHAEL L. PARSON, GOVERNOR



7/20/2023

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USPFO DEPLOYMENT STORAGE WAREHOUSE 7001 RANGE ROAD

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CAD DWG FILE:

T2226-01-6300-8136300012-A-300

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CHECKED BY:
DESIGNED BY:
BDC
BDC

SHEET TITLE:

VAULT WALL SECTIONS EXISTING + ADDITION

SHEET NUMBER:

A-300
SHEET 5 OF 10
ISSUE DATE: 7/20/2023

Renovate USPFO Vault

GENERAL NOTES

SEE ARCHITECTURAL DRAWINGS OR SITE PLAN FOR FINISH FLOOR ELEVATIONS

2018 INTERNATIONAL BUILDING CODE

EARTHWORK OPERATIONS SHALL BE PERFORMED UNDER THE DIRECTION OF A PROFESSIONAL TESTING AGENCY TO ASSURE COMPLIANCE WITH THE RECOMMENDATIONS OF THE SOILS REPORT.

CONCRETE WORK SHALL CONFORM TO ALL REQUIREMENTS OF THE CURRENT ACI 301, SPECIFICATIONS FOR STRUCTURAL CONCRETE FOR BUILDINGS, ACI 318 BUILDING CODE REQUIREMENTS FOR STRUCTURAL CONCRETE, ACI 305 SPECIFICATIONS FOR HOT WATER CONCRETE, AND ACI 306 SPECIFICATIONS FOR COLD WEATHER CONCRETE, WITH THE FOLLOWING ADDITIONAL REQUIREMENTS:

1. CONCRETE SHALL DEVELOP THE FOLLOWING 28-DAY MINIMUM COMPRESSIVE STRENGTH:

CAST-IN-PLACE WALLS - 3,500 PSI

2. ALL FOOTINGS SHALL BEAR ON UNDISTURBED SOIL OR ENGINEERED FILL

NOT EXPOSED TO WEATHER OR

3. CHLORIDE- BASED ADMIXTURES ARE PROHIBITED IN ALL REINFORCED CONCRETE. 4. REINFORCING STEEL SHALL CONFORM TO ASTM A615, A616, OR A617, GRADE 60. 5. ALL CONTINUOUS REINFORCING STEEL THAT MEETS AT A CORNER SHALL BE TIED TOGETHER WITH A

CORNER BAR THAT HAS SUFFICIENT LAP DISTANCE IN EACH DIRECTION 6. CONTINUOUS REINFORCING BARS LAP LENGTH SHALL BE A MINIMUM OF 48 BAR DIAMETERS UNLESS

7. CONCRETE SLUMP SHALL BE A MAXIMUM OF 4" +/- 1" (ASTM C- 143) AS DELIVERED IN THE FIELD. CONTRACTOR MAY USE CHEMICAL ADMIXTURES TO ATTAIN A MAXIMUM SLUMP OF 8" FOR WORKABILITY. NO WATER MAY BE ADDED TO THE CONCRETE MIX ON SITE UNLESS WATER IS WITHHELD AT THE BATCHING FACILITY. IF WATER IS WITHHELD AT THE BATCHING FACILITY IT SHOULD BE REFLECTED ON THE LOAD TICKET. THE TOTAL AMOUNT OF WATER IN THE MIX SHALL NOT EXCEED WHAT IS NOTED ON

THE APPROVED MIXED. THIS SHALL BE NOTED IN THE SPECIAL INSPECTOR'S RECORDS. 8. CONCRETE EXPOSED TO WEATHER, VEHICLES, AND/OR DEICING CHEMICALS SHALL BE AIR-ENTRAINED WITH 6% (+/-) 1.5% ENTRAINED AIR BY VOLUME AT POINT OF DISCHARGE. DO NOT ALLOW AIR

CONTENT OF TROWELED FINISHED FLOORS TO EXCEED 3%. 9. SUBMIT CONCRETE MIX PROPORTIONS PRIOR TO START OF WORK. DO NOT BEGIN CONCRETE PRODUCTION UNTIL MIXES HAVE BEEN REVIEWED AND ARE ACCEPTABLE TO THE ENGINEER.

10.READY MIX CONCRETE SHALL COMPLY WITH REQUIREMENTS OF ASTM C94. 11.CONCRETE WORK EXECUTION A. CONSTRUCT FORMS TO CORRECT SIZE, SHAPE, ALIGNMENT, ELEVATION AND POSITION; AND TO

SUPPORT VERTICAL AND LATERAL LOADS.

B. POSITION, SUPPORT, AND SECURE REINFORCEMENT AGAINST DISPLACEMENT, MINIMUM CONCRETE COVER FOR REINFORCEMENT SHALL BE. UNLESS NOTED OTHERWISE ON THE DRAWINGS: CAST AGAINST AND EXPOSED TO EARTH.......3 INCHES EXPOSED TO EARTH OR WEATHER......2 INCHES

IN CONTACT WITH EARTH.....1 ½ INCHES C. PROVIDE CONTROL JOINTS IN SLABS-ON-GRADE AT NOT GREATER THAN 15 FEET ON CENTER IN EACH DIRECTION. SAW CUT CONTROL JOINTS MINIMUM 1/4 OF SLAB DEPTH, AS SOON AFTER SLAB FINISHING WITHOUT DISLODGING AGGREGATE.

D. STEEL TROWEL FINISH ALL INTERIOR CONCRETE SLABS, BROOM FINISH ALL EXTERIOR CONCRETE

E. CURE ALL CONCRETE IN COMPLIANCE WITH ACI 301, USING A LIQUID TYPE MEMBRANE. NON-RESIDUAL, CURING COMPOUND COMPLYING WITH ASTM C309. ASSURE COMPATIBILITY WITH FINISH FLOOR COVERING.

POST-INSTALLED ANCHORS

- 1. ALL POST-INSTALLED ANCHORS SHALL MEET THE REQUIREMENTS OF THE CODE-CITED EDITION OF ACI 318, APPENDIX "D", AND SHALL BE ACCEPTABLE FOR BOTH CRACKED AND UNCRACKED CONCRETE.
- 2. EXPANSION ANCHORS HAVE BEEN DESIGNED AS HILTI KWIK BOLT TZ ANCHORS, UNLESS NOTED
- 4. EQUIVALENT ANCHORS MAY BE SUBMITTED FOR THE ENGINEER'S APPROVAL. SUBMITTALS ARE THE CONTRACTOR'S RESPONSIBILITY AND MUST INCLUDE EVALUATION REPORTS FROM THE INTERNATIONAL
- CONFERENCE OF BUILDING OFFICIALS (ICBO) 5. EMBEDMENT DEPTH IS DEFINED AS THE DISTANCE FROM THE SURFACE OF THE LOAD-BEARING BASE MATERIAL TO THE DEEPEST PART OF THE ANCHOR AFTER THE ANCHOR HAS BEEN DRIVEN INTO THE
- 6. ADHESIVE ANCHORS SHALL BE ACCEPTABLE FOR LONG-TERM LOADING. WHEN BASE MATERIAL TEMPERATURES ARE BELOW 40 DEG F, ONLY NON-EPOXY-BASED ADHESIVES SHALL BE USED.
- 7. POST—INSTALLED ANCHORS SHALL ONLY BE USED WHERE SPECIFIED ON THE DRAWINGS. THE CONTRACTOR SHALL OBTAIN APPROVAL FROM THE ENGINEER PRIOR TO USING POST-INSTALLED ANCHORS FOR MISSING OR MISPLACED CAST-IN-PLANE ANCHORS. CARE SHALL BE TAKEN TO AVOID CONFLICTS WITH EXISTING REINFORCING BARS. HOLES SHALL BE DRILLED AND CLEANED PER ANCHOR
- 8. STAINLESS STEEL ANCHORS ARE REQUIRED AT ALL PERMANENTLY EXPOSED WEATHER CONDITIONS.

SPECIAL INSPECTIONS

THE FOLLOWING ITEMS REQUIRE SPECIAL INSPECTION IN ACCORDANCE WITH CHAPTER 17 OF THE INTERNATIONAL BUILDING CODE.

- a. CONCRETE GROUT DESIGN MIX (PERIODIC)
- b. PLACING OF CONCRETE AND REINFORCING STEEL (CONTINUOUS OF CONCRETE SAMPLING / PERIODIC OF REINFORCING)
- c. BOLTS & ANCHORS EMBEDDED IN CONCRETE (PERIODIC)
- d. STRUCTURAL STEEL FABRICATIONS (UNLESS AISC APPROVED)
- e. STRUCTURAL STEEL BOLTING & WELDING (PERIODIC)
- f. POST INSTALLED ANCHORS IN CONCRETE (CONTINUOUS)
- q. IN-SITU SOILS, EXCAVATIONS, FILLING & COMPACTION (PERIODIC)

THE CONTRACTOR SHALL REQUEST SPECIAL INSPECTION OF THE ITEMS LISTED ABOVE PRIOR TO THOSE ITEMS BECOMING INACCESSIBLE AND UNOBSERVABLE DUE TO PROGRESSION OF THE WORK.

DESIGN DATA 2018 INTERNATIONAL BUILDING CODE / ASCE 7-16 **BUILDING OCCUPANCY CATEGORY** EARTHQUAKE DESIGN DATA $S_S = 0.320$ $S_1 = 0.130$ $S_{DS} = 0.260$ $S_{D1} = 0.180$ SITE CLASS D (UNKNOWN) SEISMIC DESIGN CATEGORY D BASIC SEISMIC-FORCE-RESISTING SYSTEM = ORDINARY REINFORCED CONCRETE WALL R = 5.00 $W_0 = 2.5$ $C_d = 4.50$ $I_{E} = 1.50$ **EQUIVALENT LATERAL FORCE PROCEDURE** V = .078W

1,500 lbs/sq.ft

NET ALLOWABLE SOIL BEARING

STATE OF MISSOURI MICHAEL L. PARSON, **GOVERNOR**





MANAGEMENT, DESIGN AND CONSTRUCTION **MISSOURI ARMY**

DIVISION OF FACILITIES

NATIONAL GUARD

RENOVATE USPFO VAULT

USPFO DEPLOYMENT STORAGE WAREHOUSE 7001 RANGE ROAD

IKE SKELTON TRAINING SITE 2302 MILITARY DRIVE **JEFFERSON CITY, MO 65101**

PROJECT No. T2226-01 SITE No. 6300 ASSET No. 8136300015

REVISION: REVISION: DATE: **REVISION:** DATE:

ISSUE DATE: 07/20/2023

CAD DWG FILE:

DRAWN BY: CHECKED BY: DESIGNED BY:

SHEET TITLE:

GENERAL STRUCTURAL


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6 OF 10 SHEETS


ISSUE DATE: 07/20/2023

NOTE:
ALL DIMENSIONS ARE FROM FACE OF FOUNDATION WALL OR FRAMING;
EDGE OF SLAB OR TRUSS/RAFTER; OR CENTERLINE
OF COLUMN, BEAM, OR JOIST UNLESS NOTED OTHERWISE.



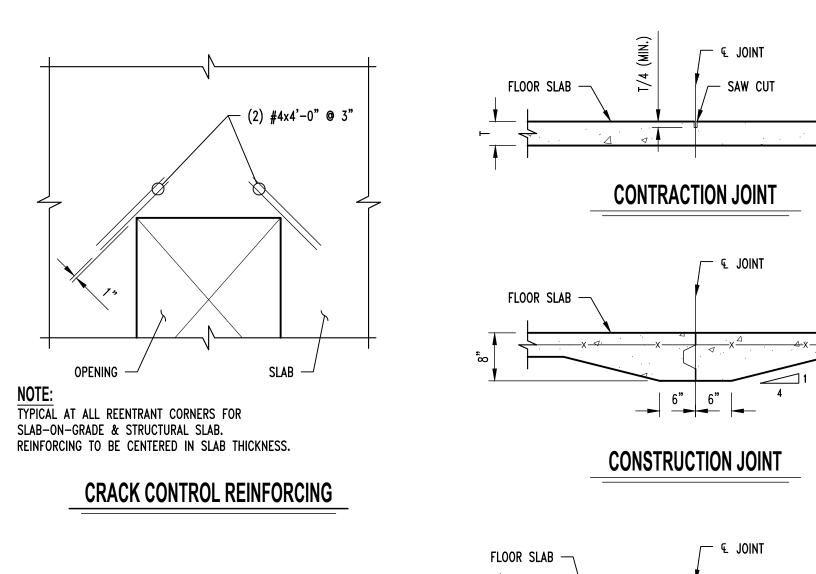


¾"ø SMOOTH DOWEL BAR x 1'-6" ⊚ 1'-8" O.C. (GREASE ONE END ONLY) —

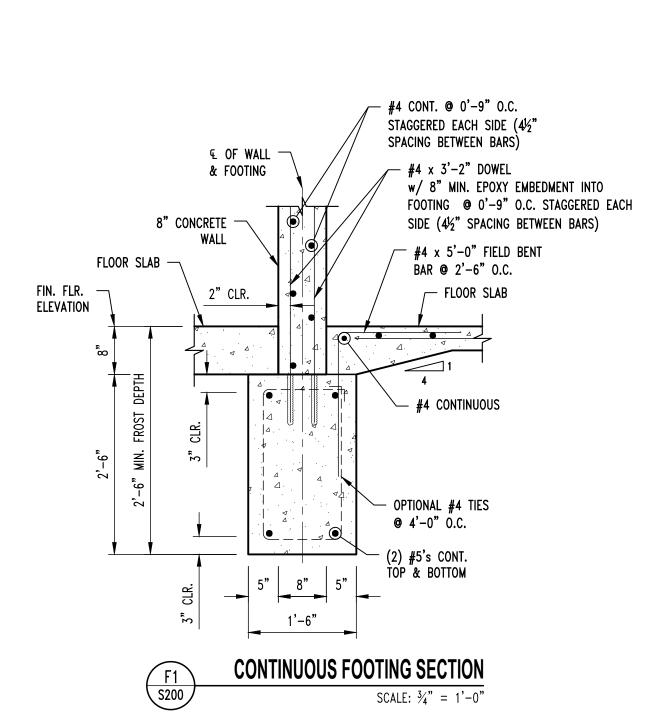



APPLY BOND BREAKER TO EDGE OF SLAB

CAST FIRST

CONSTRUCTION JOINT

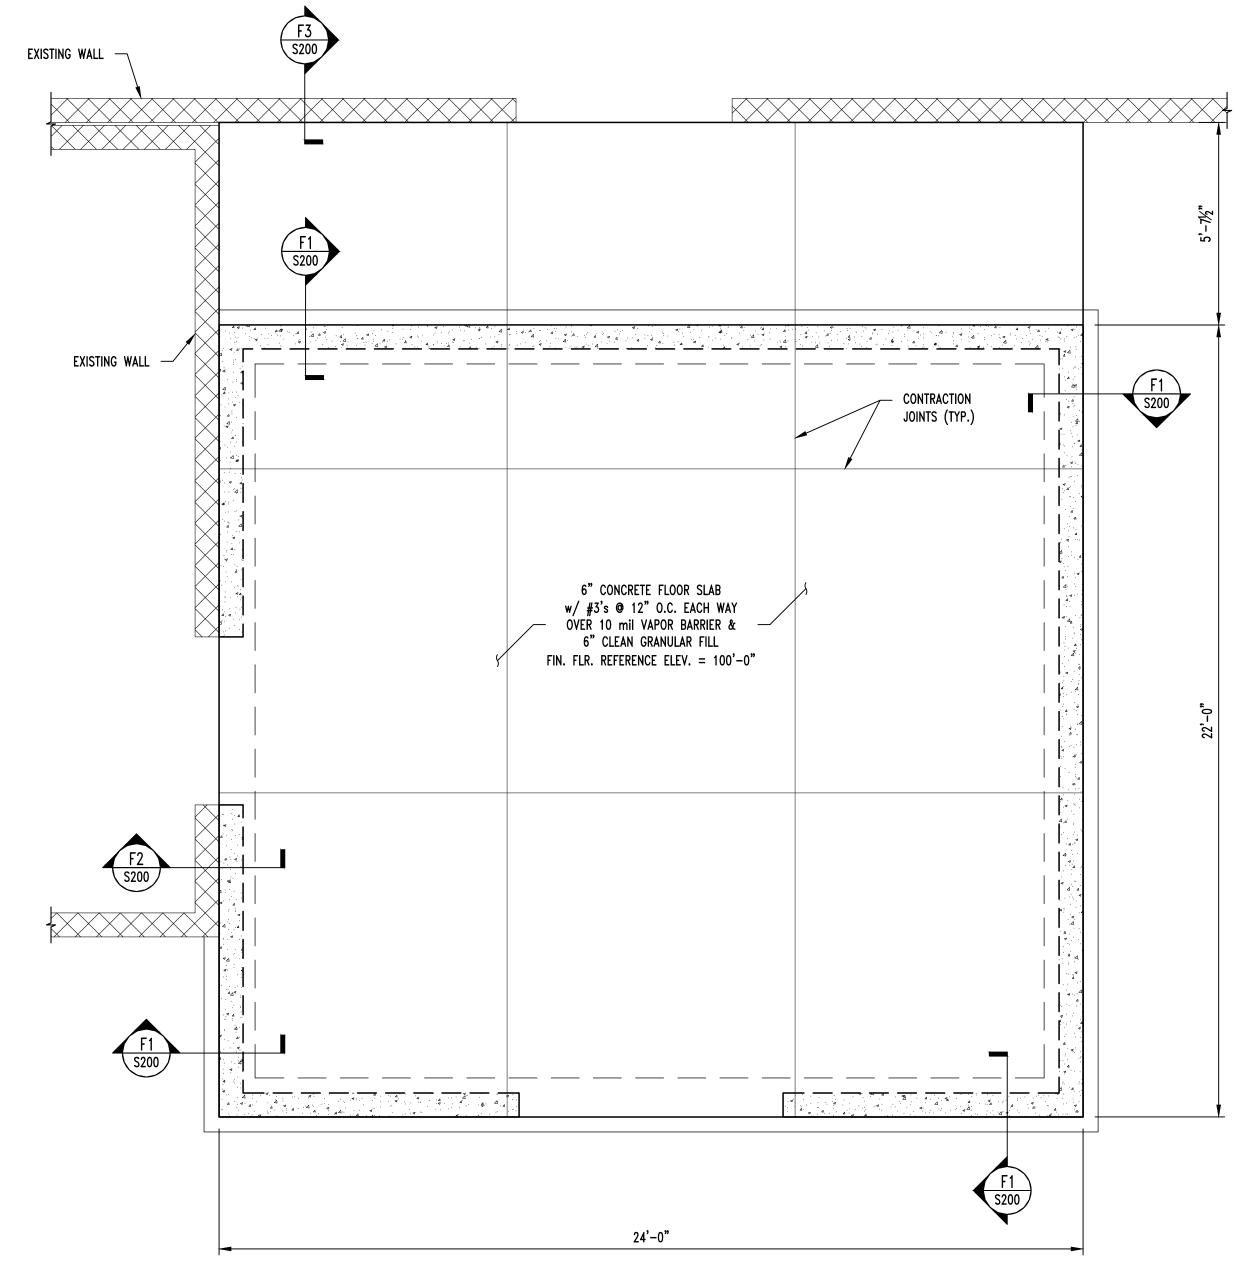

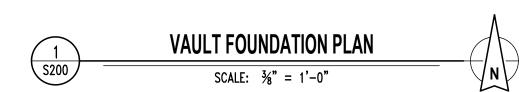

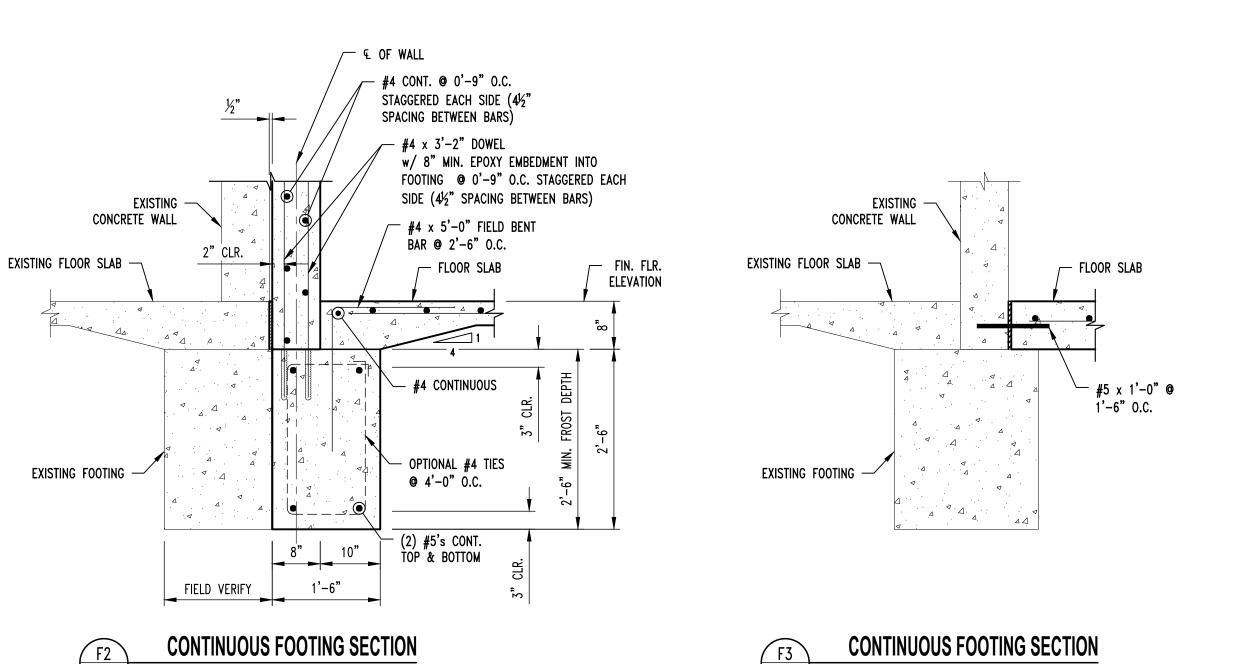

SCALE: $\frac{3}{4}$ " = 1'-0"

STATE OF MISSOURI MICHAEL L. PARSON, GOVERNOR



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OFFICE OF ADMINISTRATION DIVISION OF FACILITIES MANAGEMENT, DESIGN AND CONSTRUCTION

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CAD DWG FILE:

DRAWN BY: JCS
CHECKED BY: JWV
DESIGNED BY: JWV


SHEET TITLE:

FOUNDATION PLANS & DETAILS

SHEET NUMBER:

S-200
7 OF 10 SHEETS
ISSUE DATE: 07/20/2023

SCALE: $\frac{3}{4}$ " = 1'-0"

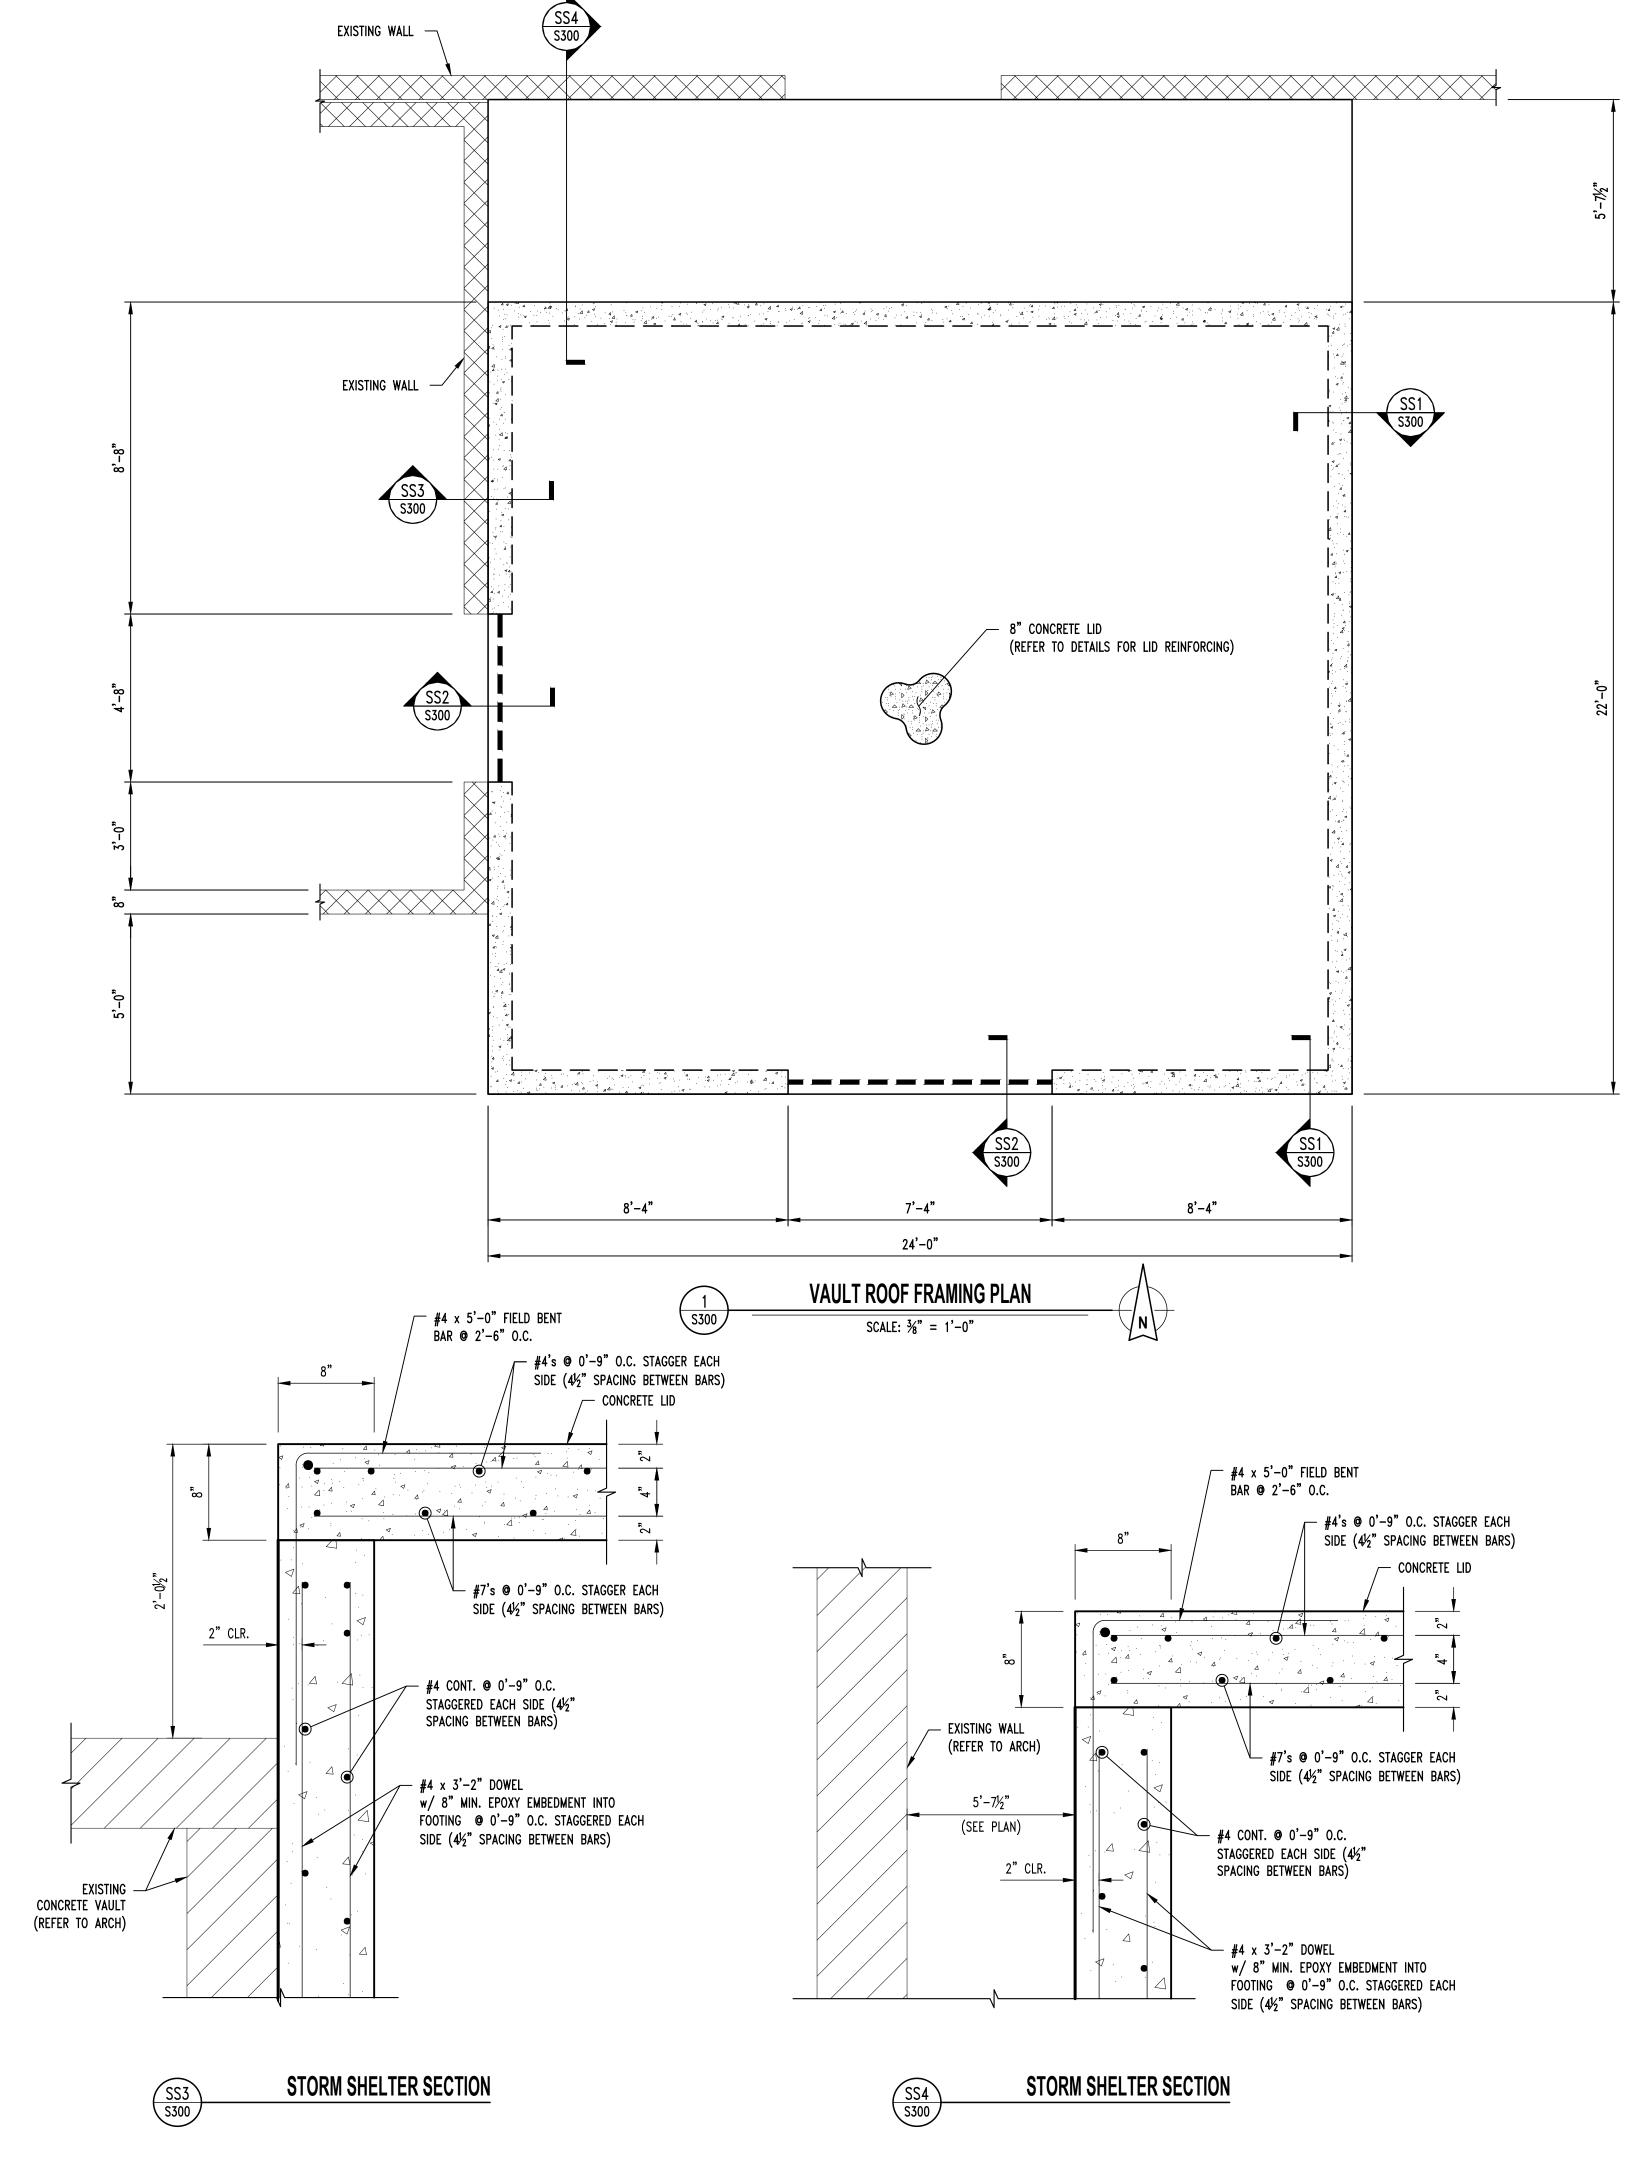

STATE OF MISSOURI MICHAEL L. PARSON, GOVERNOR



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OFFICE OF
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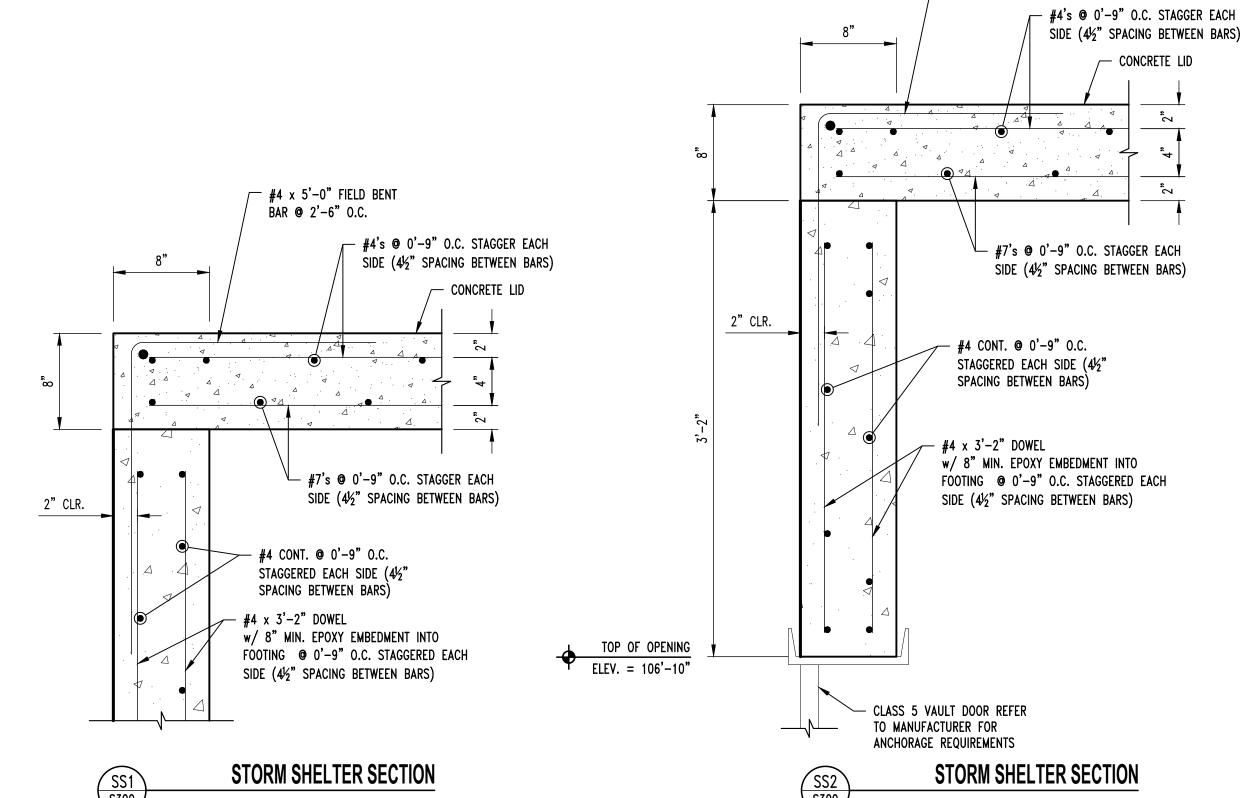
DRAWN BY: JCS
CHECKED BY: JWV
DESIGNED BY: JWV

SHEET TITLE:

ROOF PLAN & DETAILS

SHEET NUMBER:

S-300 8 OF 10 SHEETS ISSUE DATE: 07/20/2023



#4 x 5'-0" FIELD BENT BAR @ 2'-6" O.C.

ELECTRICAL PLAN SYMBOL LEGEND

EXIT LIGHT

INDICATES REQUIRED REMOTE HEAD

SWITCH (WALL MOUNTED)

SWITCH (WALL MOUNTED

SWITCH TYPE:

3 = 3-WAY

4 = 4-WAY
 OP = PASSIVE INFRARED OCCUPANCY SENSOR
 OU = ULTRASONIC OCCUPANCY SENSOR
 OT = DUAL-TECHNOLOGY OCCUPANCY SENSOR

OT = DUAL-TECHNOLOGY OCCUPANCY SENSOR
 VP = PASSIVE INFRARED VACANCY SENSOR
 VU = ULTRASONIC VACANCY SENSOR

VT = DUAL-TECHNOLOGY VACANCY SENSOR
 M = MOMENTARY SWITCH
 SS = SCENE SWITCH

DIMMER SWITCH (WALL MOUNTED)

SWITCH TYPE:
 SEE "SWITCH (WALL MOUNTED)" FOR TYPE DESIGNATIONS

SWITCH (CEILING MOUNTED)

SWITCH TYPE:

SEE "SWITCH (WALL MOUNTED)" FOR TYPE DESIGNATIONS

• SEE "SWITCH (WALL MOUNTED)" FOR TYPE DESIGNATION

OCCUPANCY SENSOR

• AUTO FULL-ON (OR 50% IF NOTED)

AUTOMATICALLY TURN OFF LIGHTING AFTER 20 MINUTES WITHOUT

OCCUPANT DETECTION

• WITH MANUAL OVERRIDE CONTROL (IF NOTED)

VACANCY SENSOR

MANUAL FULL-ON

AUTOMATICALLY TURN OFF LIGHTING AFTER 20 MINUTES WITHOUT
OCCUPANT DETECTION

OCCUPANT DETECTIONWITH MANUAL OVERRIDE CONTROL (IF NOTED)


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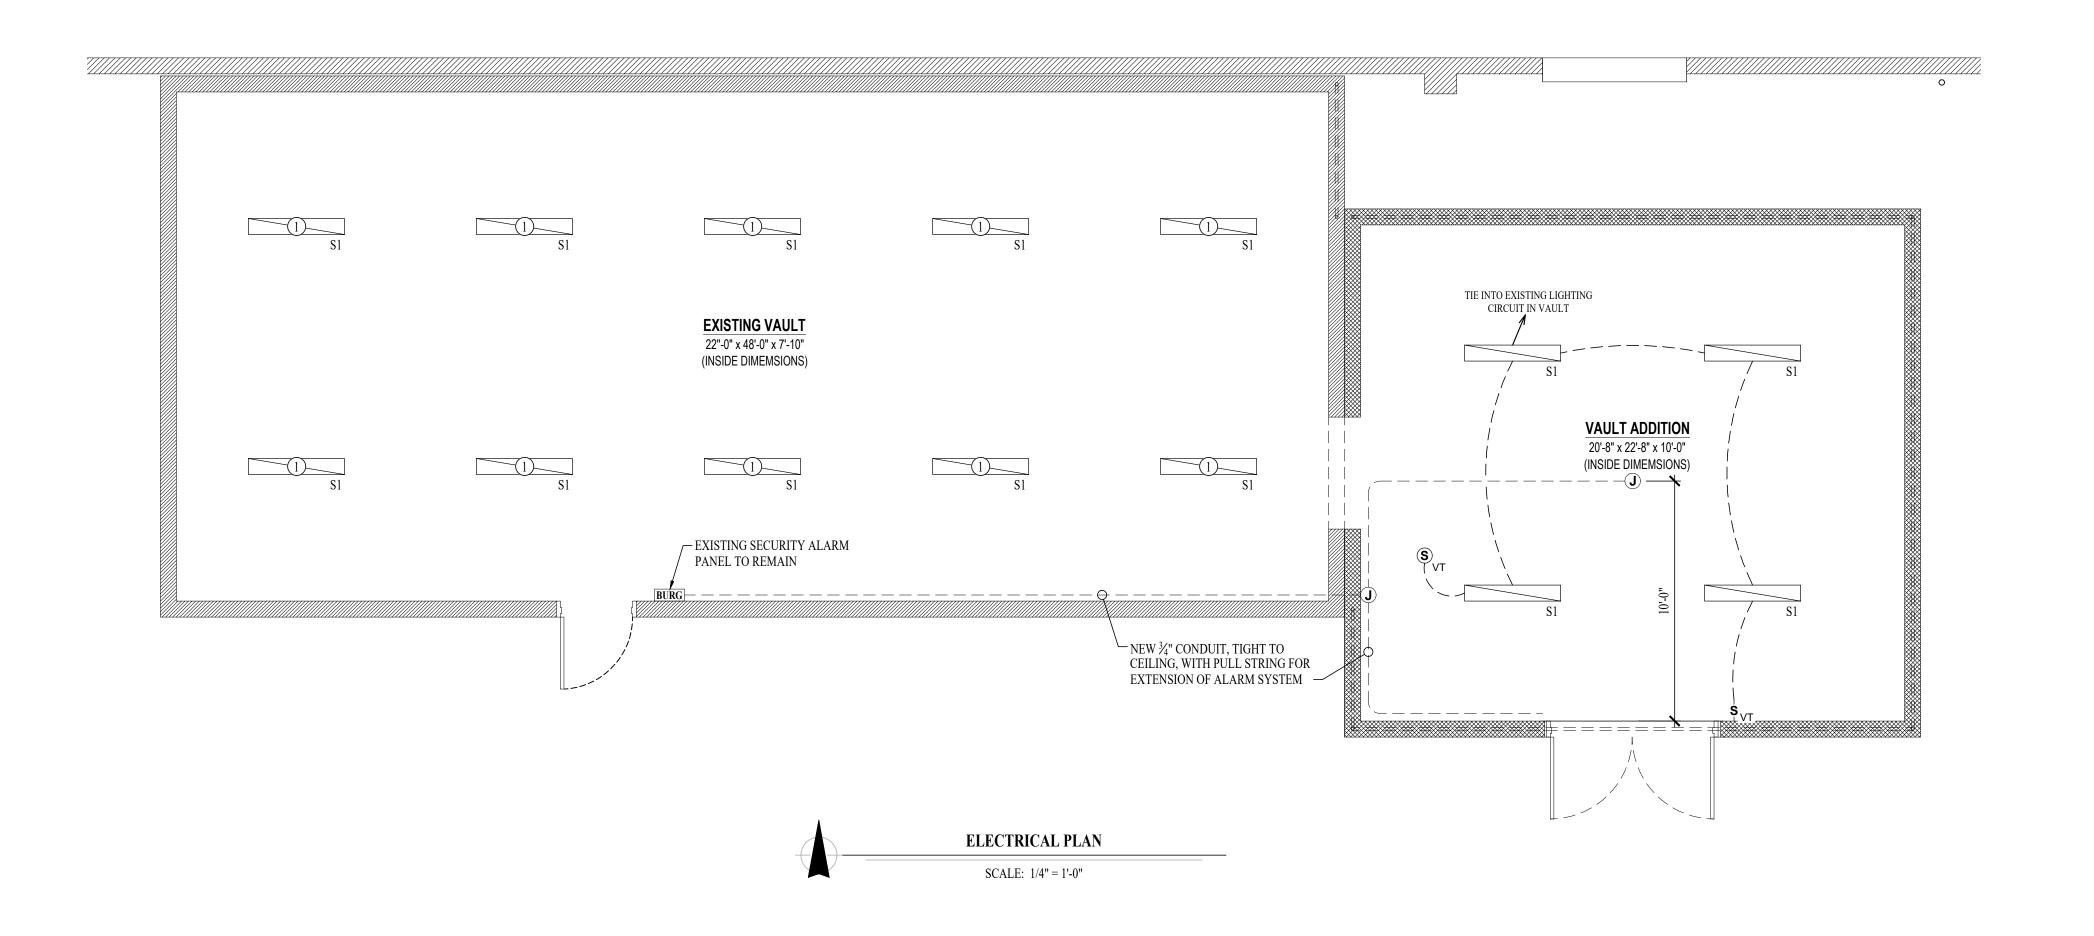
SEE SHEET ME-501 FOR ADDITIONAL ELECTRICAL NOTES, DETAILS, & SCHEDULES.
OCCUPANCY / VACANCY SENSOR QUANTITIES AND GENERAL LOCATIONS SHOWN FOR REFERENCE ONLY. CONTRACTOR TO PROVIDE AND INSTALL SENSOR WITH SPACING PER MANUFACTURER SPECIFICATIONS AND INCLUDE ADDITIONAL SENSORS IF NECESSARY. CEILING-MOUNTED SENSORS SHALL BE INSTALLED WITHIN MANUFACTURE'S ACCEPTABLE MOUNTING HEIGHT RANGE.

ELECTRICAL PLAN KEY NOTES:

1) REPLACE EXISTING FLUORESCENT FIXTURE WITH NEW LED FIXTURE AS INDICATED. EXISTING


SWITCHING & CIRCUIT TO REMAIN.



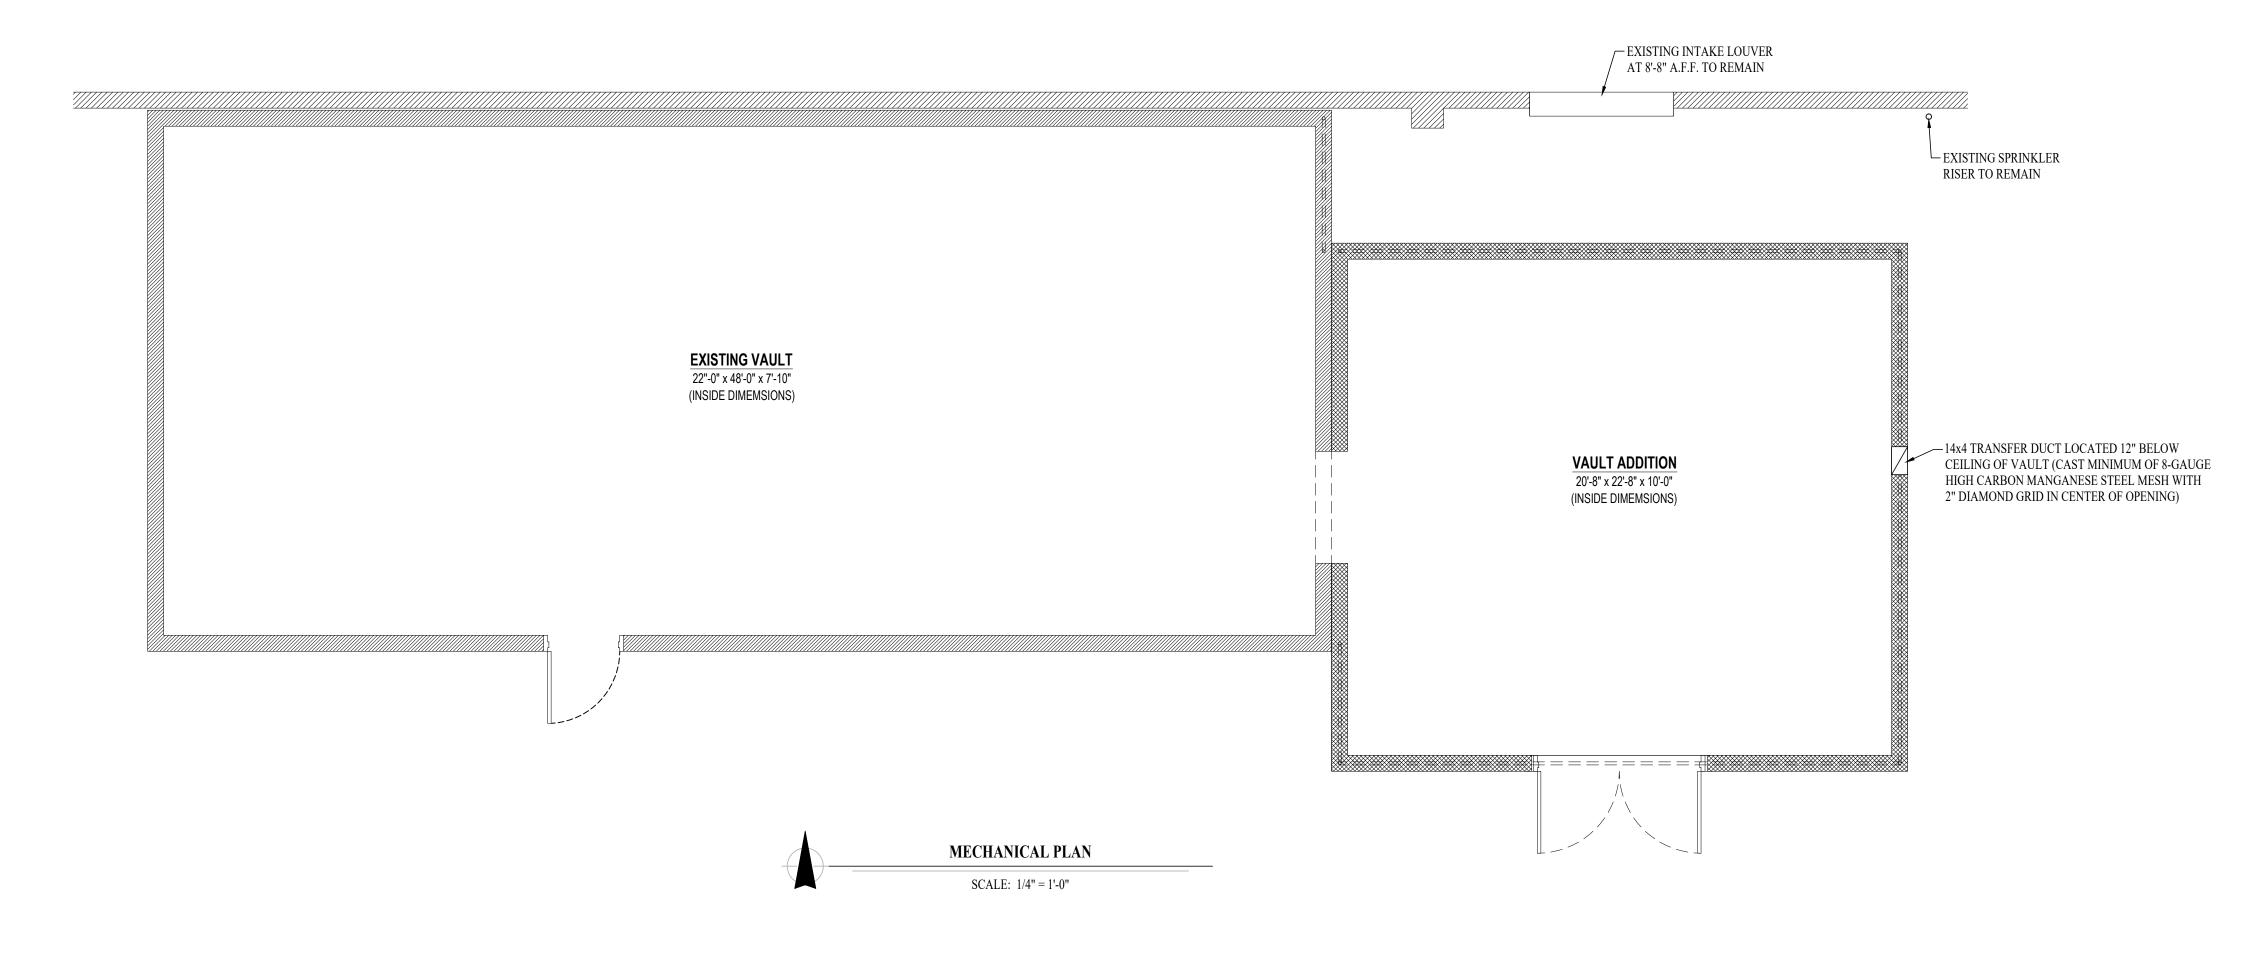

STATE OF MISSOURI MICHAEL L. PARSON, GOVERNOR



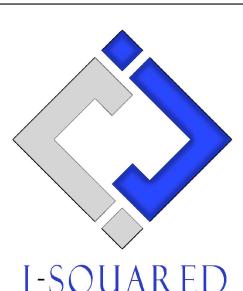

J-SQUAREL Engineering

2400 Bluff Creek Drive, Suite 101 Columbia, Missouri 65201 573 - 234 - 4492 phone www.j-squaredeng.com

OFFICE OF ADMINISTRATION DIVISION OF FACILITIES MANAGEMENT, DESIGN AND CONSTRUCTION

MISSOURI ARMY NATIONAL GUARD

RENOVATE USPFO VAULT

USPFO DEPLOYMENT STORAGE WAREHOUSE 7001 RANGE ROAD

IKE SKELTON TRAINING SITE 2302 MILITIA DRIVE JEFFERSON CITY, MO 65101

PROJECT # T2226-01 SITE # 6300 ASSET # 8136300015

REVISION:
DATE:
REVISION:
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REVISION:
DATE:
USSUE DATE: 07/20/2023

CAD DWG FILE: J20830
DRAWN BY: DET
CHECKED BY: JPW
DESIGNED BY: JAP

SHEET TITLE:

MECHANICAL & ELECTRICAL PLANS

SHEET NUMBER:

ME-10

9 OF 10 SHEETS ISSUE DATE: 07/20/2023

ELECTRICAL SPECIFICATIONS

- 1. GENERAL
- 1.1. THE ENTIRE ELECTRICAL SYSTEM SHALL BE CONTINUOUSLY GROUNDED. EVERY BRANCH CONDUIT SHALL INCLUDE A GREEN GROUND CONDUCTOR SIZED PER NEC.
- 2. MATERIALS
- 2.1. CONDUIT & CONDUCTORS
- 2.1.1. ALL CONDUCTORS SIZES INDICATED ON PLANS ARE COPPER UNLESS NOTED OTHERWISE.
- BELOW GRADE CONDUCTORS SHALL BE XHHW-2.
 - MINIMUM CONDUCTOR SIZE SHALL BE #12 UNLESS NOTED OTHERWISE. 120V, 20 AMP CIRCUITS WITH CONDUCTOR LENGTH GREATER THAN 100' SHALL BE MINIMUM #10. ELECTRICAL CONTRACTOR IS RESPONSIBLE FOR MEASURING ACTUAL CONDUCTOR LENGTH AND INCREASING CONDUCTOR SIZE TO COMPENSATE FOR VOLTAGE DROP AS REQUIRED BY NEC.
- 2.1.4. SCHEDULE 40 PVC CONDUIT SHALL BE USED FOR BELOW GRADE INSTALLATIONS

LIGHT FIXTURE SCHEDULE										
TAG	MANUFACTURER (OR EQUAL)	MODEL NUMBER (OR EQUAL)	DESCRIPTION	MOUNTING	LUMEN OUTPUT	CCT (°K)	CRI	VOLTS	WATTS	NOTES
S1	METALUX	4SNLED-LD5-85HL-UNV-L835-CD1-U	4' LINEAR	WALL BRACKET	8471	3500	80	UNV	62	
NOTES:										
1. VERIFY LIGHT FIXTURE FINISHES WITH OWNER / ARCHITECT PRIOR TO INSTALLATION										

MO Certificate of Authority # 2018029680

PE-2015017071

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SCHEDULES

10 OF 10 SHEETS ISSUE DATE: 07/20/2023