MISSOURI NATIONAL GUARD ROOF REPLACEMENT, TUCKPOINTING, AND INTERIOR REPAIRS SIKESTON, MISSOURI READINESS CENTER BID DOCUMENTS 2024.05.03

OWNER:

STATE OF MISSOURI MICHAEL L. PARSON, GOVERNOR

DEPARTMENT OF MISSOURI NATIONAL GUARD

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SITE #:

OFFICE OF ADMINISTRATION DIVISION OF FACILITIES MANAGEMENT, **DESIGN AND CONSTRUCTION**


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DRAWING ABBREVIATIONS

А	
	EL CLASS A DOOR
	AIR CONDITION
	ARCHITECT/ENGINEER
AB	ANCHOR BOLT
ACC	ANCHOR BOLT ACCESSIBLE AUTOMATIC CONTROL SYSTEM
ACS	AUTOMATIC CONTROL SYSTEM
	R ACCESS DOOR NL ACCESS PANEL
	ACOUSTICAL CEILING TILE
ADA	AMERICANS WITH DISABILITIES ACT
ADMIN	ADMINISTRATION
	ABOVE FINISHED COUNTER
	ABOVE FINISHED FLOOR
AFG	
AF5	ABOVE FINISHED SLAB
AHU	AGGREGATE AIR HANDLING UNIT
AIB	AIR INFILTRATION BARRIER
	ALTERNATE
ALUM	ALUMINUM
ANOD	ANODIZE ACOUSTICAL PANEL CEILING
-	0X APPROXIMATE AS REQUIRED
	ARCHITECT
ASC	ABOVE SUSPENDED CEILING
ASSY	ABOVE SUSPENDED CEILING ASSEMBLY ACOUSTICAL TILE CEILING
ATC	ACOUSTICAL TILE CEILING
	AVERAGE
AVVI	ACOUSTICAL WALL TREATMENT
В	
_	L CLASS B DOOR
BALC	BALCONY
BB	BASEBOARD
BC	BOOKCASE BOARD
BDDA RD	BOARD BOUNDARY
	BOUNDARY BELOW FINISH FLOOR
	BUILDER'S HARDWARE
	ACTURER'S ASSOCIATION
BLDG	BUILDING
	BLOCKING
	BUILT-IN
BN	BULLNOSE
BOS BOT	BOTTOM OF STEEL BOTTOM BUILDING PAPER
BP	BUILDING PAPER
BRKT	BRACKET
	BASEMENT
BTWN	BETWEEN
BUR	BUILT-UP ROOFING
С	
	C CAST CONCRETE
C LABE	EL CLASS C DOOR
CATW	CABINET CATWALK CAVITY
CAV	CAVITY
CDD	
	CEMENTITIOUS (BACKER) BOARD
CD	CONSTRUCTION DOCUMENTS
CD CDW	CONSTRUCTION DOCUMENTS CHILLED DRINKING WATER
CD CDW CEM PI	CONSTRUCTION DOCUMENTS
CD CDW CEM PI CER CF	CONSTRUCTION DOCUMENTS CHILLED DRINKING WATER LAS CEMENT PLASTER CERAMIC CONTRACTOR FURNISHED
CD CDW CEM PI CER CF CF/CI	CONSTRUCTION DOCUMENTS CHILLED DRINKING WATER LAS CEMENT PLASTER CERAMIC CONTRACTOR FURNISHED CONTRACTOR
CD CDW CEM PI CER CF CF/CI FURNIS	CONSTRUCTION DOCUMENTS CHILLED DRINKING WATER LAS CEMENT PLASTER CERAMIC CONTRACTOR FURNISHED CONTRACTOR SHED/CONTRACTOR INSTALLED
CD CDW CEM PI CER CF CF/CI FURNIS	CONSTRUCTION DOCUMENTS CHILLED DRINKING WATER LAS CEMENT PLASTER CERAMIC CONTRACTOR FURNISHED CONTRACTOR SHED/CONTRACTOR INSTALLED
CD CDW CEM PI CER CF CF/CI FURNIS CFE CFI G	CONSTRUCTION DOCUMENTS CHILLED DRINKING WATER LAS CEMENT PLASTER CERAMIC CONTRACTOR FURNISHED CONTRACTOR SHED/CONTRACTOR INSTALLED CONTRACTOR FURNISHED EQUIPMENT COUNTERELASHING
CD CDW CEM PI CER CF CF/CI FURNIS CFE CFLG CFM	CONSTRUCTION DOCUMENTS CHILLED DRINKING WATER LAS CEMENT PLASTER CERAMIC CONTRACTOR FURNISHED CONTRACTOR SHED/CONTRACTOR INSTALLED CONTRACTOR FURNISHED EQUIPMENT COUNTERFLASHING CUBIC FEET PER MINUTE
CD CDW CEM PI CER CF CF/CI FURNIS CFE CFLG CFM CFMF CFS	CONSTRUCTION DOCUMENTS CHILLED DRINKING WATER LAS CEMENT PLASTER CERAMIC CONTRACTOR FURNISHED CONTRACTOR SHED/CONTRACTOR INSTALLED CONTRACTOR FURNISHED EQUIPMENT COUNTERFLASHING CUBIC FEET PER MINUTE COLD-FORMED METAL FRAMING CUBIC FEET PER SECOND
CD CDW CEM PI CER CF CF/CI FURNIS CFE CFLG CFM CFMF CFS	CONSTRUCTION DOCUMENTS CHILLED DRINKING WATER LAS CEMENT PLASTER CERAMIC CONTRACTOR FURNISHED CONTRACTOR SHED/CONTRACTOR INSTALLED CONTRACTOR FURNISHED EQUIPMENT COUNTERFLASHING CUBIC FEET PER MINUTE COLD-FORMED METAL FRAMING CUBIC FEET PER SECOND
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CD CDW CEM PI CER CF CF/CI FURNIS CFE CFLG CFM CFMF CFS CG CI CIP	CONSTRUCTION DOCUMENTS CHILLED DRINKING WATER LAS CEMENT PLASTER CERAMIC CONTRACTOR FURNISHED CONTRACTOR SHED/CONTRACTOR INSTALLED CONTRACTOR FURNISHED EQUIPMENT COUNTERFLASHING CUBIC FEET PER MINUTE COLD-FORMED METAL FRAMING CUBIC FEET PER SECOND CORNER GUARD CAST IRON CAST-IN-PLACE
CD CDW CEM PI CER CF CF/CI FURNIS CFE CFLG CFM CFMF CFS CG CI CIP CJ	CONSTRUCTION DOCUMENTS CHILLED DRINKING WATER LAS CEMENT PLASTER CERAMIC CONTRACTOR FURNISHED CONTRACTOR SHED/CONTRACTOR INSTALLED CONTRACTOR FURNISHED EQUIPMENT COUNTERFLASHING CUBIC FEET PER MINUTE COLD-FORMED METAL FRAMING CUBIC FEET PER SECOND CORNER GUARD CAST IRON CAST-IN-PLACE CONTROL JOINT
CD CDW CEM PI CER CF CF/CI FURNIS CFE CFLG CFMF CFS CG CI CIP CJ CL	CONSTRUCTION DOCUMENTS CHILLED DRINKING WATER LAS CEMENT PLASTER CERAMIC CONTRACTOR FURNISHED CONTRACTOR SHED/CONTRACTOR INSTALLED CONTRACTOR FURNISHED EQUIPMENT COUNTERFLASHING CUBIC FEET PER MINUTE COLD-FORMED METAL FRAMING CUBIC FEET PER SECOND CORNER GUARD CAST IRON CAST-IN-PLACE CONTROL JOINT CENTER LINE
CD CDW CEM PI CER CF CF/CI FURNIS CFE CFLG CFMF CFS CG CI CIP CJ CL CLG	CONSTRUCTION DOCUMENTS CHILLED DRINKING WATER LAS CEMENT PLASTER CERAMIC CONTRACTOR FURNISHED CONTRACTOR SHED/CONTRACTOR INSTALLED CONTRACTOR FURNISHED EQUIPMENT COUNTERFLASHING CUBIC FEET PER MINUTE COLD-FORMED METAL FRAMING CUBIC FEET PER SECOND CORNER GUARD CAST IRON CAST-IN-PLACE CONTROL JOINT CENTER LINE CEILING
CD CDW CEM PI CER CF/CI FURNIS CFE CFLG CFM CFMF CFS CG CI CIP CJ CL CLG CLG DI	CONSTRUCTION DOCUMENTS CHILLED DRINKING WATER LAS CEMENT PLASTER CERAMIC CONTRACTOR FURNISHED CONTRACTOR SHED/CONTRACTOR INSTALLED CONTRACTOR FURNISHED EQUIPMENT COUNTERFLASHING CUBIC FEET PER MINUTE COLD-FORMED METAL FRAMING CUBIC FEET PER SECOND CORNER GUARD CAST IRON CAST-IN-PLACE CONTROL JOINT CENTER LINE
CD CDW CEM PI CER CF CF/CI FURNIS CFE CFLG CFM CFMF CFS CG CI CIP CJ CLG CLG DI CLG HT CLL	CONSTRUCTION DOCUMENTS CHILLED DRINKING WATER LAS CEMENT PLASTER CERAMIC CONTRACTOR FURNISHED CONTRACTOR SHED/CONTRACTOR INSTALLED CONTRACTOR FURNISHED EQUIPMENT COUNTERFLASHING CUBIC FEET PER MINUTE COLD-FORMED METAL FRAMING CUBIC FEET PER SECOND CORNER GUARD CAST IRON CAST-IN-PLACE CONTROL JOINT CENTER LINE CEILING FF CEILING DIFFUSER FF CEILING DIFFUSER CEILING HEIGHT COLUMN LINE
CD CDW CEM PI CER CF CF/CI FURNIS CFE CFLG CFM CFS CG CI CIP CJ CLG CLG DI CLG HT CLL CLO	CONSTRUCTION DOCUMENTS CHILLED DRINKING WATER LAS CEMENT PLASTER CERAMIC CONTRACTOR FURNISHED CONTRACTOR SHED/CONTRACTOR INSTALLED CONTRACTOR FURNISHED EQUIPMENT COUNTERFLASHING CUBIC FEET PER MINUTE COLD-FORMED METAL FRAMING CUBIC FEET PER SECOND CORNER GUARD CAST IRON CAST-IN-PLACE CONTROL JOINT CENTER LINE CEILING FF CEILING DIFFUSER FF CEILING DIFFUSER CEILING HEIGHT COLUMN LINE CLOSET
CD CDW CEM PI CER CF/CI FURNIS CFE CFLG CFM CFMF CFS CG CI CIP CJ CLG CLG DI CLG DI CLG HT CLL CLO CLR	CONSTRUCTION DOCUMENTS CHILLED DRINKING WATER LAS CEMENT PLASTER CERAMIC CONTRACTOR FURNISHED CONTRACTOR SHED/CONTRACTOR INSTALLED CONTRACTOR FURNISHED EQUIPMENT COUNTERFLASHING CUBIC FEET PER MINUTE COLD-FORMED METAL FRAMING CUBIC FEET PER SECOND CORNER GUARD CAST IRON CAST-IN-PLACE CONTROL JOINT CENTER LINE CEILING FF CEILING DIFFUSER FF CEILING DIFFUSER CEILING HEIGHT COLUMN LINE CLOSET COLOR
CD CDW CEM PI CER CF/CI FURNIS CFE CFLG CFM CFS CG CI CIP CJ CLG CLG DI CLG DI CLG HT CLL CLO CLR CLRM CMU	CONSTRUCTION DOCUMENTS CHILLED DRINKING WATER LAS CEMENT PLASTER CERAMIC CONTRACTOR FURNISHED CONTRACTOR SHED/CONTRACTOR INSTALLED CONTRACTOR FURNISHED EQUIPMENT COUNTERFLASHING CUBIC FEET PER MINUTE COLD-FORMED METAL FRAMING CUBIC FEET PER SECOND CORNER GUARD CAST IRON CAST-IN-PLACE CONTROL JOINT CENTER LINE CEILING FF CEILING DIFFUSER FF CEILING DIFFUSER CEILING HEIGHT COLUMN LINE CLOSET COLOR CLASSROOM CONCRETE MASONRY UNIT
CD CDW CEM PI CER CF CF/CI FURNIS CFE CFLG CFM CFS CG CI CIP CJ CLG CLG DI CLG DI CLG HI CLU CLG CLR CLR CLR CLR CLR CLR CLR CLR CLR CLR	CONSTRUCTION DOCUMENTS CHILLED DRINKING WATER LAS CEMENT PLASTER CERAMIC CONTRACTOR FURNISHED CONTRACTOR FURNISHED CONTRACTOR FURNISHED EQUIPMENT COUNTERFLASHING CUBIC FEET PER MINUTE COLD-FORMED METAL FRAMING CUBIC FEET PER SECOND CORNER GUARD CAST IRON CAST-IN-PLACE CONTROL JOINT CENTER LINE CEILING FF CEILING DIFFUSER FF CEILING DIFFUSER CEILING HEIGHT COLUMN LINE CLOSET COLOR CLASSROOM CONCRETE MASONRY UNIT CONDENSATE
CD CDW CEM PI CER CF CF/CI FURNIS CFE CFLG CFM CFS CG CI CLG CLG CLG CLG DI CLG HT CLL CLO CLR CLRM CMU CNDS CDR	CONSTRUCTION DOCUMENTS CHILLED DRINKING WATER LAS CEMENT PLASTER CERAMIC CONTRACTOR FURNISHED CONTRACTOR FURNISHED CONTRACTOR FURNISHED EQUIPMENT COUNTERFLASHING CUBIC FEET PER MINUTE COLD-FORMED METAL FRAMING CUBIC FEET PER SECOND CORNER GUARD CAST IRON CAST-IN-PLACE CONTROL JOINT CENTER LINE CEILING FF CEILING DIFFUSER CEILING HEIGHT COLOM LINE CLOSET COLOR CLASSROOM CONCRETE MASONRY UNIT CONDENSATE CARD READER
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CD CDW CEM PI CER CF CF/CI FURNIS CFE CFLG CFM CFS CG CI CLG CLG CLG CLG CLG CLG CLG CLG CLG CLG	CONSTRUCTION DOCUMENTS CHILLED DRINKING WATER LAS CEMENT PLASTER CERAMIC CONTRACTOR FURNISHED CONTRACTOR FURNISHED CONTRACTOR FURNISHED EQUIPMENT COUNTERFLASHING CUBIC FEET PER MINUTE COLD-FORMED METAL FRAMING CUBIC FEET PER SECOND CORNER GUARD CAST IRON CAST-IN-PLACE CONTROL JOINT CENTER LINE CEILING FF CEILING DIFFUSER FF CEILING DIFFUSER CEILING HEIGHT COLOM LINE CLOSET COLOR CLASSROOM CONCRETE MASONRY UNIT CONDENSATE CARD READER CLEANOUT COLUMN COMMUNICATION
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CD CDW CEM PI CER CF CF/CI FURNIS CFE CFLG CFM CFMF CFS CG CI CLG CLG CLG CLG CLG DI CLG DI CLG TT CLG CLG DI CLG TT CLG CLG CLG CLG CLG CLG CLG CLG CLG CLG CLG CLG CLG CLC CLG CLG CLG CLC CLC CLG CLC CLC CLG CLC CLC CLC CLC CLC CLC CLC CLC CLC CLC	CONSTRUCTION DOCUMENTS CHILLED DRINKING WATER LAS CEMENT PLASTER CERAMIC CONTRACTOR FURNISHED CONTRACTOR FURNISHED CONTRACTOR FURNISHED EQUIPMENT COUNTERFLASHING CUBIC FEET PER MINUTE COLD-FORMED METAL FRAMING CUBIC FEET PER SECOND CORNER GUARD CAST IRON CAST-IN-PLACE CONTROL JOINT CENTER LINE CEILING FF CEILING DIFFUSER CEILING HEIGHT COLOR CLASSROOM CONCRETE MASONRY UNIT CONDENSATE CARD READER CLEANOUT COLUMN COMMUNICATION CONCRETE
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CD CDW CEM PI CER CF CF/CI FURNIS CFE CFLG CFM CFMF CFS CG CI CLG CLG CLG CLG CLG CLG CLG CLG CLG CLG	CONSTRUCTION DOCUMENTS CHILLED DRINKING WATER LAS CEMENT PLASTER CERAMIC CONTRACTOR FURNISHED CONTRACTOR FURNISHED CONTRACTOR FURNISHED EQUIPMENT COUNTERFLASHING CUBIC FEET PER MINUTE COLD-FORMED METAL FRAMING CUBIC FEET PER SECOND CORNER GUARD CAST IRON CAST-IN-PLACE CONTROL JOINT CENTER LINE CEILING FF CEILING DIFFUSER CEILING HEIGHT COLOMN LINE CLOSET COLOR CLASSROOM CONCRETE MASONRY UNIT CONDENSATE CARD READER CLEANOUT COLUMN COMMUNICATION CONCRETE FLR CONCRETE FLOOR CONFERENCE CONTINUE DCOORDINATE
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CD CDW CEM PI CER CF CF/CI FURNIS CFE CFLG CFM CFMF CFS CG CI CLG CLG CLG CLG CLG CLG CLG CLG CLG CLG	CONSTRUCTION DOCUMENTS CHILLED DRINKING WATER LAS CEMENT PLASTER CERAMIC CONTRACTOR FURNISHED CONTRACTOR FURNISHED CONTRACTOR FURNISHED EQUIPMENT COUNTERFLASHING CUBIC FEET PER MINUTE COLD-FORMED METAL FRAMING CUBIC FEET PER SECOND CORNER GUARD CAST IRON CAST-IN-PLACE CONTROL JOINT CENTER LINE CEILING FF CEILING DIFFUSER ICEILING HEIGHT COLUMN LINE CLOSET COLOR CLASSROOM CONCRETE MASONRY UNIT CONDENSATE CARD READER CLEANOUT COLUMN COMMUNICATION CONCRETE FLR CONCRETE FLOOR CONFERENCE CONTINUE DCOORDINATE CORRIDOR CONCRETE PIPE
CD CDW CEM PI CER CF CF/CI FURNIS CFE CFLG CFM CFMF CFS CG CI CLG CLG CLG CLG CLG CLG CLG CLG CLG CLG	CONSTRUCTION DOCUMENTS CHILLED DRINKING WATER LAS CEMENT PLASTER CERAMIC CONTRACTOR FURNISHED CONTRACTOR FURNISHED CONTRACTOR FURNISHED EQUIPMENT COUNTERFLASHING CUBIC FEET PER MINUTE COLD-FORMED METAL FRAMING CUBIC FEET PER SECOND CORNER GUARD CAST IRON CAST-IN-PLACE CONTROL JOINT CENTER LINE CEILING FF CEILING DIFFUSER FF CEILING DIFFUSER FF CEILING DIFFUSER COLOR CLASSROOM CONCRETE MASONRY UNIT CONDENSATE CARD READER CLEANOUT COLUMN COMMUNICATION CONCRETE FLR CONCRETE FLOOR CONFERENCE CONTINUE DCOORDINATE CORRIDOR CONCRETE PIPE CARPET
CD CDW CEM PI CER CF CF/CI FURNIS CFE CFLG CFM CFMF CFS CG CI CLG CLG CLG CLG CLG CLG CLG CLG CLG CLG	CONSTRUCTION DOCUMENTS CHILLED DRINKING WATER LAS CEMENT PLASTER CERAMIC CONTRACTOR FURNISHED CONTRACTOR FURNISHED CONTRACTOR FURNISHED EQUIPMENT COUNTERFLASHING CUBIC FEET PER MINUTE COLD-FORMED METAL FRAMING CUBIC FEET PER SECOND CORNER GUARD CAST IRON CAST-IN-PLACE CONTROL JOINT CENTER LINE CEILING FF CEILING DIFFUSER ICEILING HEIGHT COLUMN LINE CLOSET COLOR CLASSROOM CONCRETE MASONRY UNIT CONDENSATE CARD READER CLEANOUT COLUMN COMMUNICATION CONCRETE FLR CONCRETE FLOOR CONFERENCE CONTINUE DCOORDINATE CORRIDOR CONCRETE PIPE CARPET CONTROL ROOM CAST STONE
CD CDW CEM PI CER CF/CI FURNIS CFE CFLG CFM CFMF CFS CG CI CLG CLG CLG CLG CLG CLG CLG CLG CLG CLG	CONSTRUCTION DOCUMENTS CHILLED DRINKING WATER LAS CEMENT PLASTER CERAMIC CONTRACTOR FURNISHED CONTRACTOR FURNISHED CONTRACTOR FURNISHED EQUIPMENT COUNTERFLASHING CUBIC FEET PER MINUTE COLD-FORMED METAL FRAMING CUBIC FEET PER SECOND CORNER GUARD CAST IRON CAST-IN-PLACE CONTROL JOINT CENTER LINE CEILING FF CEILING DIFFUSER ICEILING HEIGHT COLOWN LINE CLOSET COLOR CLASSROOM CONCRETE MASONRY UNIT CONDENSATE CARD READER CLEANOUT COLUMN COMMUNICATION CONCRETE FLR CONCRETE FLOOR CONFERENCE CONTROL ROOM CONCRETE PIPE CARPET CONTROL ROOM CAST STONE CASEWORK
CD CDW CEM PI CER CF/CI FURNIS CFE CFLG CFM CFS CG CI CLG CLG CLG CLG CLG CLG CLG CLG CLG CLG	CONSTRUCTION DOCUMENTS CHILLED DRINKING WATER LAS CEMENT PLASTER CERAMIC CONTRACTOR FURNISHED CONTRACTOR FURNISHED CONTRACTOR FURNISHED EQUIPMENT COUNTERFLASHING CUBIC FEET PER MINUTE COLD-FORMED METAL FRAMING CUBIC FEET PER SECOND CORNER GUARD CAST IRON CAST-IN-PLACE CONTROL JOINT CENTER LINE CEILING FF CEILING DIFFUSER ICEILING HEIGHT COLOMN LINE CLOSET COLOR CLASSROOM CONCRETE MASONRY UNIT CONDENSATE CARD READER CLEANOUT COLUMN COMMUNICATION CONCRETE FLR CONCRETE FLOOR CONFERENCE CONTINUE DCOORDINATE CORRIDOR CONCRETE PIPE CARPET CONTROL ROOM CAST STONE CASEWORK CERAMIC TILE
CD CDW CEM PI CER CF/CI FURNIS CFE CFLG CFM CFM CFS CG CI CLG CLG CLG CLG CLG CLG CLG CLG CLG CLG	CONSTRUCTION DOCUMENTS CHILLED DRINKING WATER LAS CEMENT PLASTER CERAMIC CONTRACTOR FURNISHED CONTRACTOR FURNISHED CONTRACTOR FURNISHED EQUIPMENT COUNTERFLASHING CUBIC FEET PER MINUTE COLD-FORMED METAL FRAMING CUBIC FEET PER SECOND CORNER GUARD CAST IRON CAST-IN-PLACE CONTROL JOINT CENTER LINE CEILING FF CEILING DIFFUSER ICEILING HEIGHT COLOMN LINE CLOSET COLOR CLASSROOM CONCRETE MASONRY UNIT CONDENSATE CARD READER CLEANOUT COLUMN COMMUNICATION CONCRETE FLR CONCRETE FLOOR CONFERENCE CONTINUE DCOORDINATE CORRIDOR CONCRETE PIPE CARPET CONTROL ROOM CAST STONE CASEWORK CERAMIC TILE CERAMIC TILE BASE
CD CDW CEM PI CER CF/CI FURNIS CFE CFLG CFMF CFS CG CI CLG CLG CLG CLG CLG CLG CLG CLG CLG CLG	CONSTRUCTION DOCUMENTS CHILLED DRINKING WATER LAS CEMENT PLASTER CERAMIC CONTRACTOR FURNISHED CONTRACTOR FURNISHED CONTRACTOR FURNISHED EQUIPMENT COUNTERFLASHING CUBIC FEET PER MINUTE COLD-FORMED METAL FRAMING CUBIC FEET PER SECOND CORNER GUARD CAST IRON CAST-IN-PLACE CONTROL JOINT CENTER LINE CEILING FF CEILING DIFFUSER ICEILING HEIGHT COLOR CLASSROOM CONCRETE MASONRY UNIT CONDENSATE CAED READER CLEANOUT COLUMN COMMUNICATION CONCRETE FLR CONCRETE FLOOR CONFERENCE CONTINUE DCOORDINATE CONCRETE PIPE CARPET CONTROL ROOM CAST STONE CASEWORK CERAMIC TILE BASE CERAMIC TILE BASE CERAMIC TILE FLOOR
CD CDW CEM PI CER CF/CI FURNIS CFE CFLG CFMF CFS CG CI CLG CLG CLG CLG CLG CLG CLG CLG CLG CLG	CONSTRUCTION DOCUMENTS CHILLED DRINKING WATER LAS CEMENT PLASTER CERAMIC CONTRACTOR FURNISHED CONTRACTOR FURNISHED CONTRACTOR FURNISHED EQUIPMENT COUNTERFLASHING CUBIC FEET PER MINUTE COLD-FORMED METAL FRAMING CUBIC FEET PER SECOND CORNER GUARD CAST IRON CAST-IN-PLACE CONTROL JOINT CENTER LINE CEILING FF CEILING DIFFUSER ICEILING HEIGHT COLOR CLASSROOM CONCRETE MASONRY UNIT CONDENSATE CAED READER CLEANOUT COLUMN COMMUNICATION CONCRETE FLR CONCRETE FLOOR CONFERENCE CONTINUE DCOORDINATE CONCRETE PIPE CARPET CONTROL ROOM CAST STONE CASEWORK CERAMIC TILE BASE CERAMIC TILE BASE CERAMIC TILE FLOOR
CD CDW CEM PI CER CF/CI FURNIS CFE CFLG CFMF CFS CG CI CLG CLG CLG CLG CLG CLG CLG CLG CLG CLG	CONSTRUCTION DOCUMENTS CHILLED DRINKING WATER LAS CEMENT PLASTER CERAMIC CONTRACTOR FURNISHED CONTRACTOR FURNISHED CONTRACTOR FURNISHED EQUIPMENT COUNTERFLASHING CUBIC FEET PER MINUTE COLD-FORMED METAL FRAMING CUBIC FEET PER SECOND CORNER GUARD CAST IRON CAST-IN-PLACE CONTROL JOINT CENTER LINE CEILING FF CEILING DIFFUSER ICEILING HEIGHT COLOMN LINE CLOSET COLOR CLASSROOM CONCRETE MASONRY UNIT CONDENSATE CARD READER CLEANOUT COLUMN COMMUNICATION CONCRETE FLR CONCRETE FLOOR CONFERENCE CONTINUE DCOORDINATE CORRIDOR CONCRETE PIPE CARPET CONTROL ROOM CAST STONE CASEWORK CERAMIC TILE CERAMIC TILE BASE
CD CDW CEM PI CER CF/CI FURNIS CFE CFLG CFM CFS CG CI CLG CLG CLG CLG CLG CLG CLG CLG CLG CLG	CONSTRUCTION DOCUMENTS CHILLED DRINKING WATER LAS CEMENT PLASTER CERAMIC CONTRACTOR FURNISHED CONTRACTOR FURNISHED CONTRACTOR FURNISHED EQUIPMENT COUNTERFLASHING CUBIC FEET PER MINUTE COLD-FORMED METAL FRAMING CUBIC FEET PER SECOND CORNER GUARD CAST IRON CAST-IN-PLACE CONTROL JOINT CENTER LINE CEILING FF CEILING DIFFUSER ICEILING HEIGHT COLOR CLASSROOM CONCRETE MASONRY UNIT CONDENSATE CAED READER CLEANOUT COLUMN COMMUNICATION CONCRETE FLR CONCRETE FLOOR CONFERENCE CONTINUE DCOORDINATE CONCRETE PIPE CARPET CONTROL ROOM CAST STONE CASEWORK CERAMIC TILE BASE CERAMIC TILE BASE CERAMIC TILE FLOOR
CD CDW CEM PI CER CF CF/CI FURNIS CFE CFLG CFM CFS CG CI CLG CLG CLG CLG CLG CLG CLG CLG CLG CLG	CONSTRUCTION DOCUMENTS CHILLED DRINKING WATER LAS CEMENT PLASTER CERAMIC CONTRACTOR FURNISHED CONTRACTOR FURNISHED EQUIPMENT CONTRACTOR FURNISHED EQUIPMENT COUNTERFLASHING CUBIC FEET PER MINUTE COLD-FORMED METAL FRAMING CUBIC FEET PER SECOND CORNER GUARD CAST IRON CAST IRON CAST-IN-PLACE CONTROL JOINT CENTER LINE CEILING FF CEILING DIFFUSER FCEILING HEIGHT COLOR CLASSROOM CONCRETE MASONRY UNIT CONDENSATE CAD READER CLEANOUT COLUMN COMMUNICATION CONCRETE FLR CONCRETE FLOOR CONFERENCE CONTROL ROOM CONCRETE PIPE CARPET CONTROL ROOM CAST STONE CASEWORK CERAMIC TILE BASE CERAMIC TILE FLOOR CONTER CASEMORK CERAMIC TILE FLOOR CONTER CONTROL ROOM CAST STONE CASEMORK CERAMIC TILE FLOOR CONTER CONTROL ROOM CAST STONE CASEMORK CERAMIC TILE FLOOR CONTER CUBIC FEET CASEMENT WINDOW
CD CDW CEM PI CER CF CF/CI FURNIS CFE CFLG CFM CFS CG CI CLG CLG CLG CLG CLG CLG CLG CLG CLG CLG	CONSTRUCTION DOCUMENTS CHILLED DRINKING WATER LAS CEMENT PLASTER CERAMIC CONTRACTOR FURNISHED CONTRACTOR FURNISHED CONTRACTOR FURNISHED EQUIPMENT COUNTERFLASHING CUBIC FEET PER MINUTE COLD-FORMED METAL FRAMING CUBIC FEET PER SECOND CORNER GUARD CAST IRON CAST-IN-PLACE CONTROL JOINT CENTER LINE CEILING FF CEILING DIFFUSER I CEILING HEIGHT COLUMN LINE CLOSET COLOR CLASSROOM CONCRETE MASONRY UNIT CONDENSATE CARD READER CLEANOUT COLUMN COMMUNICATION CONCRETE FLR CONCRETE FLOOR CONFERENCE CONTROL ROOM CONCRETE PIPE CARPET CONTROL ROOM CAST STONE CASEWORK CERAMIC TILE BASE CERAMIC TILE FLOOR CUBIC FEET CASEMENT WINDOW
CD CDW CEM PI CER CF CF/CI FURNIS CFE CFLG CFM CFS CG CI CLG CLG CLG CLG CLG CLG CLG CLG CLG CLG	CONSTRUCTION DOCUMENTS CHILLED DRINKING WATER LAS CEMENT PLASTER CERAMIC CONTRACTOR FURNISHED CONTRACTOR FURNISHED EQUIPMENT CONTRACTOR FURNISHED EQUIPMENT COUNTERFLASHING CUBIC FEET PER MINUTE COLD-FORMED METAL FRAMING CUBIC FEET PER SECOND CORNER GUARD CAST IRON CAST-IN-PLACE CONTROL JOINT CENTER LINE CEILING FF CEILING DIFFUSER FCEILING HEIGHT COLOR CLASSROOM CONCRETE MASONRY UNIT CONDENSATE CARD READER CLEANOUT CONCRETE FLOOR CONCRETE FLR CONCRETE FLOOR CONFERENCE CONTROL FOR CONCRETE PIPE CARPET CONTROL ROOM CONCRETE PIPE CARPET CONTROL ROOM CONCRETE PIPE CARPET CONTROL ROOM CAST STONE CASEWORK CERAMIC TILE CERAMIC TILE FLOOR CONTROL ROOM CAST STONE CASEWORK CERAMIC TILE FLOOR CENTER CUBIC FEET CASEMENT WINDOW
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CD CDW CEM PI CER CF CF/CI FURNIS CFE CFLG CFM CFS CG CI CLG CLG CLG CLG CLG CLG CLG CLG CLG CLG	CONSTRUCTION DOCUMENTS CHILLED DRINKING WATER LAS CEMENT PLASTER CERAMIC CONTRACTOR FURNISHED CONTRACTOR FURNISHED EQUIPMENT COUNTERFLASHING CUBIC FEET PER MINUTE COLD-FORMED METAL FRAMING CUBIC FEET PER SECOND CORNER GUARD CAST IRON CAST IRON CAST-IN-PLACE CONTROL JOINT CENTER LINE CEILING DIFFUSER FF CEILING DIFFUSER CEILING HEIGHT COLOR CLASSROOM CONCRETE MASONRY UNIT CONDENSATE CARD READER CLEANOUT COLUMN COMMUNICATION CONCRETE FIR CONCRETE FLOOR CONFRENCE CONTROL ROOM CONCRETE PIPE CARPET CONTROL ROOM CAST STONE CASEWORK CERAMIC TILE CERAMIC TILE BASE CERAMIC TILE BASE CERAMIC TILE FLOOR CONTERENCE CONTROL ROOM CAST STONE CASEWORK CERAMIC TILE BASE CERAMIC TILE BASE CERAMIC TILE BASE CERAMIC TILE BASE CERAMIC TILE FLOOR CUBLE DEMOLITION DEPTH SL CLASS D DOOR DOUBLE DEMOLITION DEPARTMENT
CD CDW CEM PI CER CF/CI FURNIS CFE CFLG CFM CFS CG CI CLG CLG CLG CLG CLG CLG CLG CLG CLG CLG	CONSTRUCTION DOCUMENTS CHILLED DRINKING WATER LAS CEMENT PLASTER CERAMIC CONTRACTOR FURNISHED CONTRACTOR FURNISHED CONTRACTOR FURNISHED EQUIPMENT COUNTERFLASHING CUBIC FEET PER MINUTE COLD-FORMED METAL FRAMING CUBIC FEET PER SECOND CORNER GUARD CAST IRON CAST IRON CAST IRON CAST IRON CAST IRON CAST IRON CAST IRON CAST IRON CAST IRON CAST IRON CONTROL JOINT CEILING FF CEILING DIFFUSER I CEILING HEIGHT COLOR CLASSROOM CONCRETE MASONRY UNIT CONDENSATE CARD READER CLEANOUT COLUMN COMMUNICATION CONCRETE FLR CONCRETE FLOOR CONFERENCE CONTROL ROOM CAST STONE CASEWORK CERAMIC TILE CERAMIC TILE BASE CERAMIC TILE FLOOR CONTROL ROOM CAST STONE CASEWORK CERAMIC TILE FLOOR CONTROL ROOM CAST STONE CASEWORK CERAMIC TILE FLOOR CUBIC FEET CASEMENT WINDOW
CD CDW CEM PI CER CF/CI FURNIS CFE CFLG CFM CFS CG CI CLG CLG CLG CLG CLG CLG CLG CLG CLG CLG	CONSTRUCTION DOCUMENTS CHILLED DRINKING WATER LAS CEMENT PLASTER CERAMIC CONTRACTOR FURNISHED CONTRACTOR FURNISHED CONTRACTOR FURNISHED EQUIPMENT COUNTERFLASHING CUBIC FEET PER MINUTE COLD-FORMED METAL FRAMING CUBIC FEET PER SECOND CORNER GUARD CAST IRON CAST IRON CAST IRON CAST IRON CAST IRON CAST IRON CAST IRON CAST IRON CAST IRON CAST IRON CONTROL JOINT CEILING FF CEILING DIFFUSER I CEILING HEIGHT COLOR CLASSROOM CONCRETE MASONRY UNIT CONDENSATE CARD READER CLEANOUT COLUMN COMMUNICATION CONCRETE FLR CONCRETE FLOOR CONFERENCE CONTROL ROOM CAST STONE CASEWORK CERAMIC TILE CERAMIC TILE BASE CERAMIC TILE FLOOR CONTROL ROOM CAST STONE CASEWORK CERAMIC TILE FLOOR CONTROL ROOM CAST STONE CASEWORK CERAMIC TILE FLOOR CUBIC FEET CASEMENT WINDOW
CD CDW CEM PI CER CF/CI FURNIS CFE CF/CI FURNIS CFE CF/CI CFE CF/CI CFE CFM CFS CG CI CLG CLG CLG CLG CLG CLG CLG CLG CLG CLG	CONSTRUCTION DOCUMENTS CHILLED DRINKING WATER LAS CEMENT PLASTER CERAMIC CONTRACTOR FURNISHED CONTRACTOR FURNISHED CONTRACTOR FURNISHED EQUIPMENT COUNTERFLASHING CUBIC FEET PER MINUTE COLD-FORMED METAL FRAMING CUBIC FEET PER SECOND CORNER GUARD CAST IRON CAST IRON CONTROL JOINT CENTER LINE CEILING FF CEILING DIFFUSER FC CEILING DIFFUSER CEILING HEIGHT COLOR CLASSROOM CONCRETE MASONRY UNIT CONDENSATE CARD READER CLEANOUT COLUMN COMMUNICATION CONCRETE FLR CONCRETE FLOOR CONCRETE PIPE CARPET CONCRETE PIPE CARPET CONTROL ROOM CAST STONE CASEWORK CERAMIC TILE BASE CERAMIC TILE BASE
CD CDW CEM PI CER CF/CI FURNIS CFE CFLG CFMF CFS CG CIP CJ CLG DI CLG DI CLG CLG CLG DI CLG	CONSTRUCTION DOCUMENTS CHILLED DRINKING WATER LAS CEMENT PLASTER CERAMIC CONTRACTOR FURNISHED CONTRACTOR FURNISHED CONTRACTOR FURNISHED EQUIPMENT COUNTERFLASHING CUBIC FEET PER MINUTE COLD-FORMED METAL FRAMING CUBIC FEET PER SECOND CORNER GUARD CAST IRON CAST IN-PLACE CONTROL JOINT CENTER LINE CEILING FF CEILING DIFFUSER FC CILING HEIGHT COLOR CLASSROOM CONCRETE MASONRY UNIT CONDENSATE CARD READER CLEANOUT COLUMN COMMUNICATION CONFERENCE CONTROL PIPE CARPET CONTROL FIPE CONCRETE PIPE CARPET CONCRETE PIPE CARPET CONTROL ROOM CAST STONE CASEWORK CERAMIC TILE CERAMIC TILE FLOOR CONTERE CASEMORY CERAMIC TILE FLOOR CONTERE CASEMORY CERAMIC TILE FLOOR CONTROL ROOM CAST STONE CASEWORK CERAMIC TILE FLOOR CONTROL ROOM CAST STONE CASEMORY CERAMIC TILE FLOOR CONTROL ROOM CAST STONE CASEMORY CERAMIC TILE FLOOR CONTROL ROOM CAST STONE CASEMORY CERAMIC TILE FLOOR CONTROL ROOM CAST STONE CASEMORY CERAMIC TILE FLOOR CONTROL ROOM CAST STONE CASEMENT WINDOW
CD CDW CEM PI CER CF/CI FURNIS CFE CF/CI FURNIS CFE CF/CI FURNIS CFE CF/CI CF CF CF CF CF CF CF CF CF CF CF CF CF	CONSTRUCTION DOCUMENTS CHILLED DRINKING WATER LAS CEMENT PLASTER CERAMIC CONTRACTOR FURNISHED CONTRACTOR FURNISHED CONTRACTOR FURNISHED EQUIPMENT COUNTERFLASHING CUBIC FEET PER MINUTE COLD-FORMED METAL FRAMING CUBIC FEET PER SECOND CORNER GUARD CAST IRON CAST IRON CONTROL JOINT CENTER LINE CEILING FF CEILING DIFFUSER FC CEILING DIFFUSER CEILING HEIGHT COLOR CLASSROOM CONCRETE MASONRY UNIT CONDENSATE CARD READER CLEANOUT COLUMN COMMUNICATION CONCRETE FLR CONCRETE FLOOR CONCRETE PIPE CARPET CONCRETE PIPE CARPET CONTROL ROOM CAST STONE CASEWORK CERAMIC TILE BASE CERAMIC TILE BASE

EIFS SYSTEI EJ ES EL ENTR EPS (INSUL) EQ EWC EXP EXT EXT EXT EXT GF	EACH EACH FACE EXTERIOR INSULATION AND FINISH W EXPANSION JOINT EACH SIDE ELEVATION ELEVATOR ENTRANCE EXPANDED POLYSTYRENE BOARD
FAAP FAS BD FC BRK FCO FD FDTN FE FEC FED FF EL FF EL FF EL FF EL FF EL FF FIN BS FIN FLF FIN FIN FIN FIN FLF FLC FLC FLC FLC FLC FLC FLC FLC FLC	FIRE ALARM FIRE ALARM ANNUNCIATOR PANEL FASCIA BOARD FACE BRICK FLOOR CLEANOUT FLOOR DRAIN FOUNDATION FIRE EXTINGUISHER FIRE EXTINGUISHER FIRE EXTINGUISHER CABINET FEDERAL FINISH FACE FINISH FLOOR ELEVATION JL FOIL BACKED INSULATION FIBERGLASS FIRE HOSE FULL HEIGHT PARTITION FINISH FINISH BOTH SIDES FINISH FLOOR FINISH GRADE FIXTURE FOLDING FLEXIBLE FLOORING FLUSH MOUNT FLOOR FACTORY MUTUAL FACE OF CONCRETE FACE OF MASONRY FIRE RESISTANT FIBER REINFORCED GYPSUM FRAMING FIBERGLASS REINFORCED PLASTIC FIRE RETARDANT TREATED WOOD FEDERAL SPECIFICATION FASTENER FEET FOOTING FABRIC WALLCOVERING
GALV GB GFCI CONTR GFGI GOVER GFRG GLZ GR FL GUT GYP BI	NATURAL GAS GALVANIZED GRAB BAR GOVERNMENT FURNISHED ACTOR INSTALLED GOVERNMENT INSTALLED MMENT INSTALLED GLASS-FIBER-REINFORCED GYPSUN GLAZING GROUND FLOOR GUTTER O GYPSUM BOARD AS GYPSUM PLASTER
HDW HDWD (FILTEF HM HMD HORIZ HT	HOSE BIBB HIGH DENSITY POLYETHYLENE HARDWARE HARDWOOD HIGH EFFICIENCY PARTICULATE AIR () HOLLOW METAL HOLLOW METAL DOOR HORIZONTAL HEIGHT HYDRAULIC
INSUL INT	INTERNATIONAL BUILDING CODE INSULATION INTERIOR IN LIEU OF
	JANITOR
KIT	KEYPAD KITCHEN KICKPLATE
LAV LBR LDG LF LIB LIN LKR LOC LT LVDR	LAMINATE LAVATORY LUMBER POUND LANDING LINEAR FEET (FOOT) LIBRARY LINEAR LOCKER LOCATION LIGHT LOUVER DOOR LOUVER

MACH RM MACHINE ROOM MATL MATERIAL MAX MAXIMUM MC MOISTURE CONTENT MD METAL DECK MECH MECHANICAL MECH RM MECHANICAL ROOM MEMB MEMBRANE MF MILL FINISH MFR MANUFACTURER MID MIDDLE MIL STD MILITARY STANDARD MIN MINIMUM MINUTE MIRR MIRROR MISC MISCELLANEOUS MLDG MOLDING (MOULDING) MO MASONRY OPENING MOD MODIFY MB MOISTURE BARRIER MTG MOUNTING MTL METAL MVBL MOVABLE MWP MEMBRANE WATERPROOFING NORTH Ν NA NOT APPLICABLE NFPA NATIONAL FIRE PROTECTION ASSOCIATION NIC NOT IN CONTRACT NO NUMBER NOM NOMINAL NP NO PAINT NRC NOISE REDUCTI 0 OA OVERALL OC ON CENTER OD OUTSIDE DIAMETER OFD OVERFLOW DRAIN OFF OFFICE OGL OBSCURE GLASS OPH OPPOSITE HAND OPNG OPENING OPP OPPOSITE OPQ OPAQUE OWSJ OPEN WEB STEEL JOIST OPR OPERABLE ORD OVERFLOW ROOF DRAIN ORIG ORIGINAL PUBLIC ADDRESS PA PAR PARAPET PAT PATTERN PB PULL BOX PBD PARTICLEBOARD PCC PRECAST CONCRETE PCF POUNDS PER CUBIC FOOT PCT PERCENT PERF PERFORATED PERIM PERIMETER PH PHASE PIL PILASTER PROPERTY LINE PL PL GL PLATE GLASS PLAM PLASTIC LAMINATE PLAS PLASTER PLBG PLUMBING PLG PILING PLYWD PLYWOOD PNL PANEL PP PL PUSH/PULL PLATE PR PAIR PRCST PRECAST PRKG PARKING PS CONC PRESTRESSED CONCRETE PSF POUNDS PER SQUARE FOOT PSI POUNDS PER SQUARE INCH PT PRESSURE TREATED PTD PAPER TOWEL DISPENSER PTDR PAPER TOWEL DISPENSER AND RECEPTACLE PTN PARTITION PWR POWER QUARRY TILE QT QTY QUANTITY R ------RB RESILIENT BASE RBM REINFORCED BRICK MASONRY RBR RUBBER RC REINFORCED CONCRETE RCP REFLECTED CEILING PLAN RD ROOF DRAIN RDG INS RIGID INSULATION, SOLID REC RECESSED REC ROOM RECREATION ROOM REF REFERENCE REM REMOVABLE REP REPAIR REPL REPLACE REQ REQUIRE REQD REQUIRED RESIL RESILIENT REST RESTROOM RF RESILIENT FLOORING RFG ROOFING RH ROOF HATCH RHR RIGHT HAND REVERSE ROOF LEADER RL RLG RAILING RM ROOM RO ROUGH OPENING RSD ROLLING STEEL DOOR RV ROOF VENT RVL REVEAL

SB

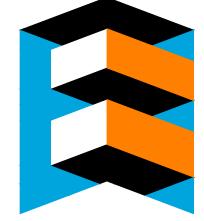SF

SJ

ST

STL

SW

T/S

TC

TD

TEL

TFF


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BUILDING SUMMARY



GENERAL NOTES

- THE CONTRACTOR SHALL VISIT THE SITE AND BE KNOWLEDGEABLE OF CONDITIONS THEREON, AND SHALL INVESTIGATE, VERIFY AND BE RESPONSIBLE FOR ALL CONDITIONS OF THE PROJECT, AND SHALL NOTIFY THE OWNER OF ANY CONDITIONS REQUIRING MODIFICATION BEFORE PROCEEDING WITH THE WORK.
- THE CONTRACTOR SHALL THOROUGHLY REVIEW THE CONTRACT DOCUMENTS PRIOR TO CONSTRUCTION AND AS AMENDMENTS MAY BE MADE AS CONSTRUCTION PROCEEDS, AND SHALL NOTIFY THE OWNER OF ANY DISCREPANCIES, CONFLICTS, INCONSISTENCIES, ERRORS OR OMISSIONS THAT MAY BE DISCOVERED. IN SUCH CASES THE CONTRACTOR IS TO OBTAIN CLARIFICATION OR VERIFICATION OF INTENT PRIOR TO PROCEEDING WITH THE WORK.
- THE WORK IS TO BE PERFORMED IN CONFORMANCE WITH APPLICABLE WRITTEN CODES, ORDINANCES, LAWS, RULES, REGULATIONS AND REQUIREMENTS OF AUTHORITIES HAVING JURISDICTION. IF THE CONTRACTOR PERFORMS OR PROCEEDS IN A MANNER CONTRARY TO ANY SUCH REQUIREMENTS THE CONTRACTOR ASSUMES FULL RESPONSIBILITY THEREFORE AND SHALL BEAR COSTS RESULTING FROM NONCOMPLIANCE OR VIOLATION, INCLUDING COSTS ASSOCIATED WITH REPAIRING, REPLACING OR OTHERWISE BRINGING THE WORK INTO CONFORMANCE. THE CONTRACTOR IS TO BRING TO THE OWNER'S ATTENTION ANY CONDITIONS REPRESENTED IN THE CONTRACT DOCUMENTS THAT ARE NOT IN CONFORMANCE WITH APPLICABLE REQUIREMENTS.
- THE CONTRACTOR IS TO MAINTAIN ON SITE A COPY OF THE APPLICABLE EDITION OF THE UL FIRE RESISTANCE DIRECTORY AND OTHER FIRE RESISTIVE STANDARDS REFERENCED IN THE CONTRACT DOCUMENTS FOR USE BY INSPECTORS AT TIMES OF INSPECTION.
- CONTRACT DOCUMENTS SHALL NOT BE REPRODUCED AS THE BASIS FOR REQUIRED SUBMITTALS UNLESS PRIOR WRITTEN PERMISSION HAS BEEN OBTAINED FROM THE ARCHITECT. SUBMITTALS CONTAINING CONTRACT DOCUMENTS OR PORTIONS OF CONTRACT DOCUMENTS WILL BE REJECTED AND RETURNED TO THE CONTRACTOR WITHOUT ACTION OR COMMENT, AND ARE NOT TO BE USED FOR PROCUREMENT, FABRICATION OR INSTALLATION OF ANY WORK IN THE PROJECT
- WHERE WORK OR EQUIPMENT IS INDICATED AS 'NOT IN CONTRACT (NIC)' IN THE DOCUMENTS, SUCH WORK OR EQUIPMENT SHALL BE PROVIDED OUTSIDE THE CONTRACT SCOPE REPRESENTED IN THESE DOCUMENTS. THE CONTRACTOR SHALL COORDINATE HIS WORK WITH NIC ITEMS AND COOPERATE TO AFFECT THE IMPLEMENTATION OF SUCH WORK OR INSTALLATION.
- DETAILS NOT SHOWN ARE TO BE SIMILAR IN CHARACTER TO THOSE DRAWN. WHERE SPECIFIC DIMENSIONS, DETAILS OR DESIGN INTENT CANNOT BE DETERMINED THE CONTRACTOR IS TO OBTAIN CLARIFICATION FROM THE OWNER BEFORE PROCEEDING WITH HE WORK.
- "ALIGN" AS USED IN THESE DOCUMENTS SHALL SUPERSEDE ANY DIMENSIONAL INFORMATION INDICATED IF DISCREPANCIES OCCUR, NOTIFY OWNER IMMEDIATELY.
- "CLEAR" AS USED IN THESE DOCUMENTS SHALL MEAN THAT THE CONDITION IS NOT ADJUSTABLE WITHOUT THE APPROVAL OF THE ARCHITECT. CLEAR DIMENSIONS ARE TYPICALLY TO FINISH FACE.
- "MAXIMUM" OR "MAX" AS USED IN THESE DOCUMENTS SHALL MEAN THE CONDITION IS SLIGHTLY ADJUSTABLE BUT MAY NOT VARY TO A DIMENSION OR QUANTITY GREATER THAN THAT SHOWN WITHOUT APPROVAL OF THE ARCHITECT.
- "MINIMUM" OR "MIN" AS USED IN THESE DOCUMENTS SHALL MEAN THE CONDITION IS SLIGHTL ADJUSTABLE BUT MAY NOT VARY TO A DIMENSION OR QUANTITY LESS THAN THAT SHOWN WITHOUT APPROVAL OF THE ARCHITECT
- "TYPICAL" OR "TYP" AS USED IN THESE DOCUMENTS SHALL MEAN THE CONDITION OR DIMENSION IS THE SAME OR REPRESENTATIVE FOR SIMILAR CONDITIONS THROUGHOUT.
- "+/-" AS USED IN THESE DOCUMENTS SHALL MEAN THE DIMENSION OR QUANTITY IS SLIGHTL ADJUSTABLE TO ACCOMMODATE ACTUAL CONDITIONS.
- 4. CONTRACTOR SHALL VERIFY ALL DIMENSIONS AND CONDITIONS SHOWN ON THE DRAWINGS AT THE JOB SITE AND SHALL NOTIFY THE OWNER OF ANY OMISSIONS, DISCREPANCIES, AND/OR CONFLICTS BEFORE PROCEEDING WITH THE JOB.
- DO NOT SCALE DRAWINGS, DIMENSIONS GOVERN, LARGE SCALE DETAILS GOVERN OVER SMALL SCALE.

STATE OF MISSOURI MICHAEL L. PARSON, GOVERNOR

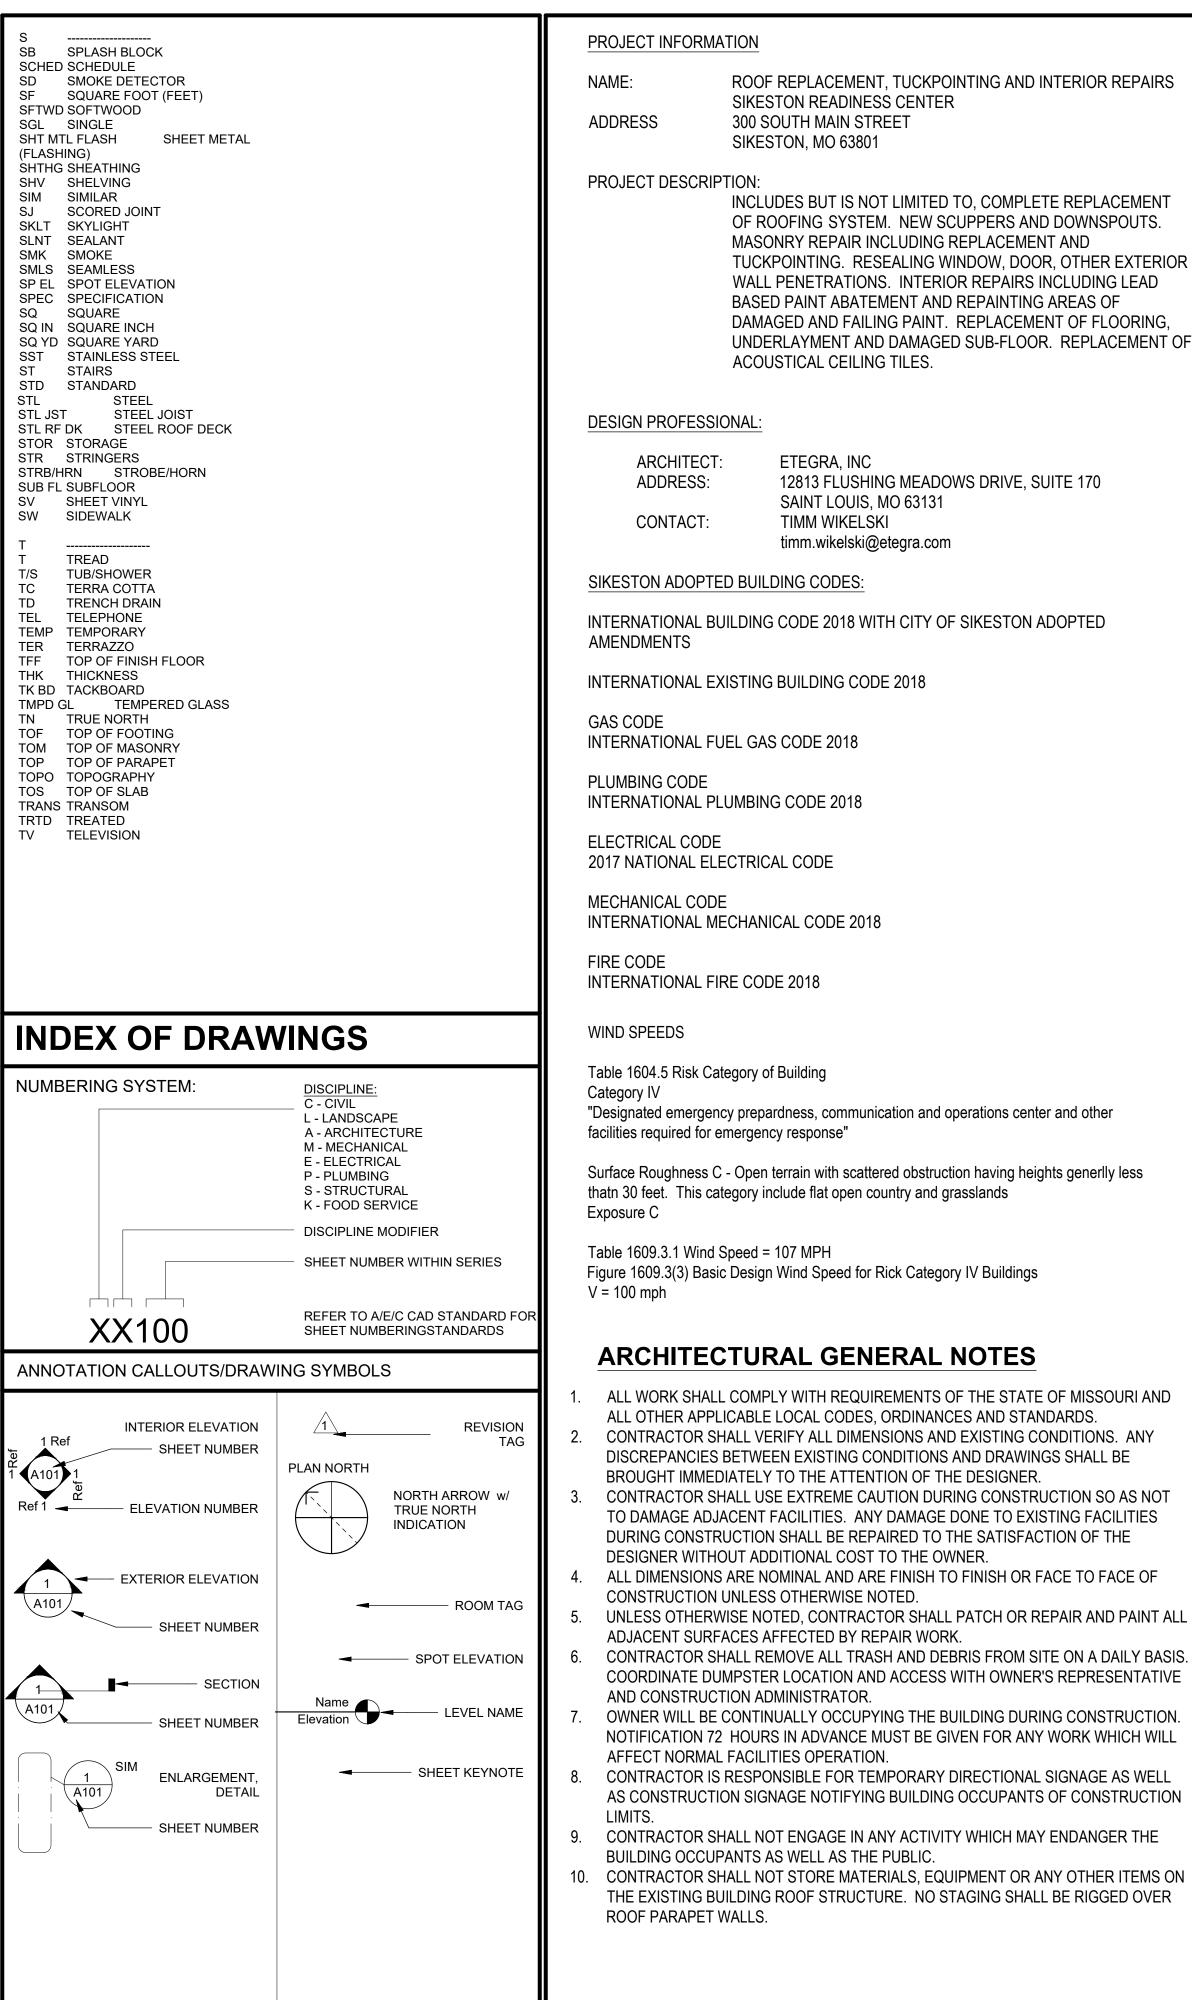





OFFICE OF ADMINISTRATION DIVISION OF FACILITIES MANAGEMENT. **DESIGN AND CONSTRUCTION**

DEPARTMENT OF NATIONAL GUARD

ROOF REPLACEMENT, TUCKPOINTING, AND INTERIOR REPAIRS

MISSOURI NATIONAL GUARD SIKESTON MISSOURI **READINESS CENTER** 300 S. MAIN STREET SIKESTON, MISSOURI 63801

PROJECT: T2235-01 ASSET: 8136317001 SITE#: 6317


REVISION: DATE: **REVISION**: DATE: **REVISION:** DATE: ISSUE DATE: 05/03/2024

CAD DWG FILE:G-002.DWG DRAWN BY: B. KEITEL CHECKED BY: B. HESTERBERG DESIGNED BY: T. WIKELSKI

SHEET TITLE:

GENERAL NOTES AND ABBREVIATIONS

SHEET NUMBER:

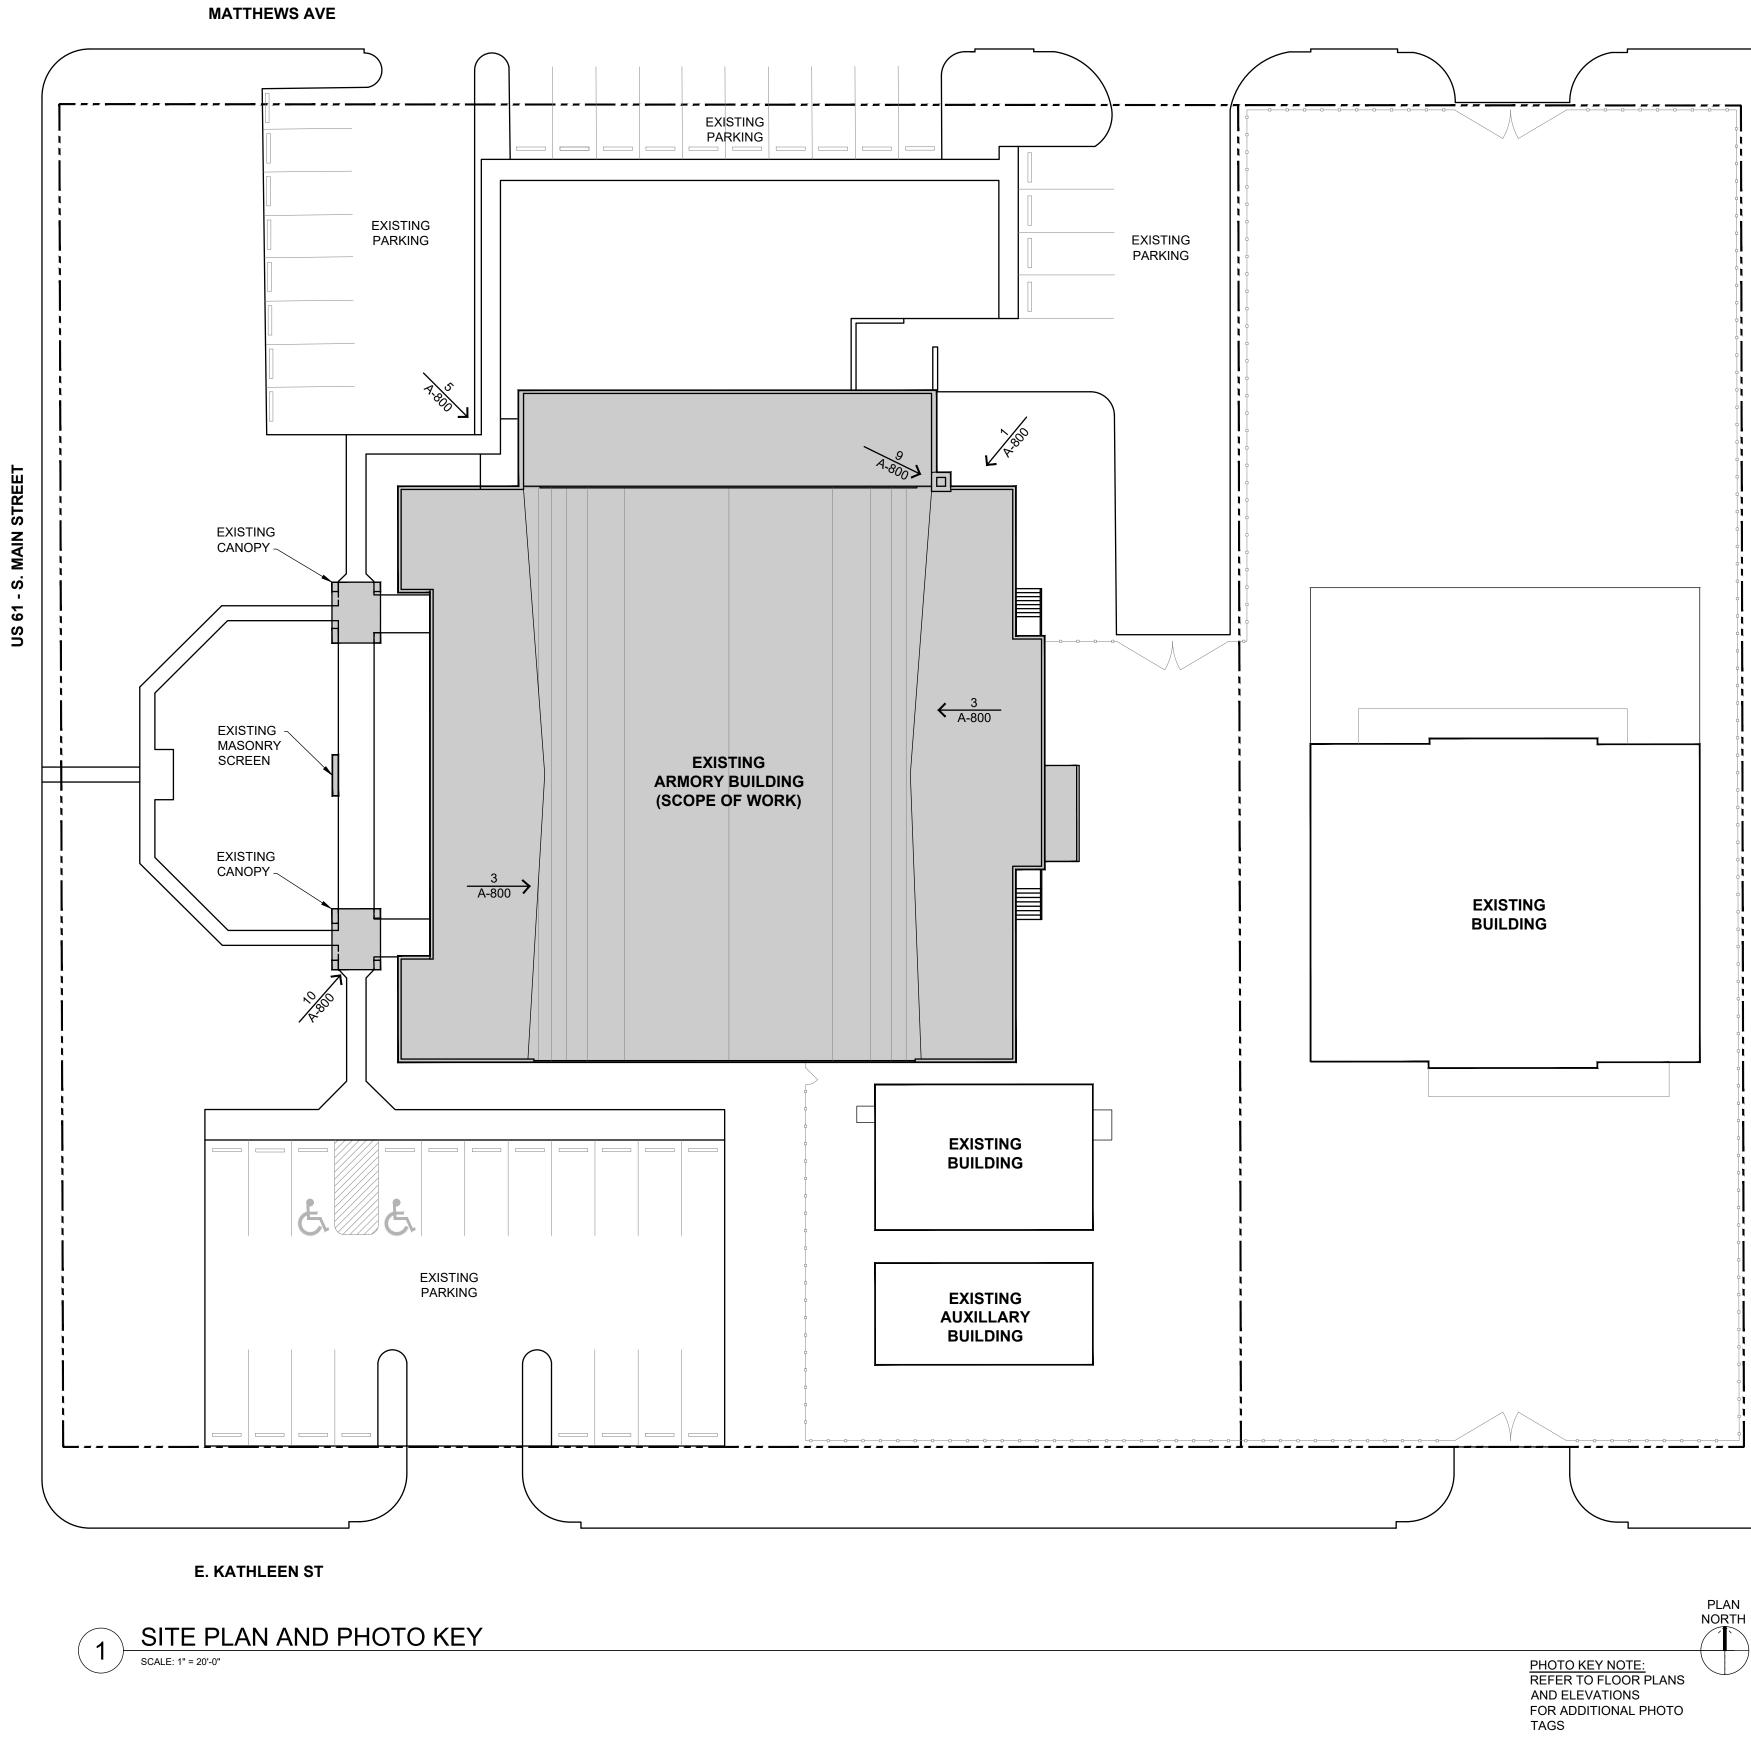

PROJECT MATRIX OVERVIEW

BASE BID	ALTERNATE 1
ACM ENCAPSULATION	ROOF ACM ABATEMENT
DEMO ROOFING DETAIL:	
DEMO EXISTING EPDM ROOFING MEMBRANE	DEMO EXISTING EPDM ROC
DEMO EXISTING RIGID INSULATION	DEMO EXISTING RIGID INSU
EXISTING 5/8" GYP BD TO REMAIN	DEMO EXISTING 5/8" GYP B
EXISTING WOOD DECKING TO REMAIN	EXISTING WOOD DECKING
NEW ROOFING DETAIL:	
NEW 60 MIL TPO ROOFING MEMBRANE	NEW 60 MIL TPO ROOFING I
NEW 1/2" COVER BOARD	NEW 1/2" COVER BOARD
NEW 2 1/2" RIGID INSULATION	NEW 2 1/2" RIGID INSULATIO
NEW 2 1/2" RIGID INSULATION	NEW 2 1/2" RIGID INSULATIO
NEW 5/8" SUBSTRATE BOARD	NEW 5/8" SUBSTRATE BOAF
NEW VAPOR BARRIER	NEW VAPOR BARRIER
EXISTING 5/8" GYP BD TO REMAIN	
EXISTING WOOD DECKING TO REMAIN	EXISTING WOOD DECKING
TUCKPOINTING	
TUCKPOINTING CHIMNEY- NORTH SIDE	
TUCKPOINTING CHIMNEY - EAST SIDE	
OPENINGS	
NEW SEALANT AT EXISTING WINDOWS	
GARAGE DOOR LINTEL REPAIR	
WINDOW LINTEL REPAIR	
FINISHES	
REMOVAL OF EXISTING LEAD PAINT	
INTERIOR PAINTING	
NEW FLOORING	
NEW CEILING/CEILING REPAIR	
·	

NOTE:

- 1. PROJECT MATRIX OVERVIEW IS ONLY INTENDED TO HELP CLARIFY THE SCOPE OF WORK THAT IS IMPACTED BY THE ALTERNATE, ADD ALTERNATE AND UNIT PRICING. IT IS NOT A COMPLETE ENCOMPASSING ENUMERATION OF THE TOTAL SCOPE OF WORK.
- 2. CONTRACTOR IS RESPONSIBLE FOR ALL WORK IDENTIFIED AND DESCRIBED IN THE CONSTRUCTION DOCUMENTS, DRAWINGS AND SPECIFICATION.


	ADD ALTERNATE 2	UNIT PRICING
OFING MEMBRANE		
SULATION		
BD		
G TO REMAIN		
G MEMBRANE		
ION		
ION		
ARD		
G TO REMAIN		
	TUCKPOINTING CHIMNEY - WEST SIDE	ADDITIONAL TUCKPOINTING
		ADDITIONAL INTERIOR PAINTING
		ADDITIONAL CLG TILE REPLACEMENT

STATE OF MISSOURI MICHAEL L. PARSON, GOVERNOR
BRUCE LYNN BRUCE LYNN HESTERBERG NUMBER A-6107 A R C HI VIE 5/3/2024
ETEGRA 12813 FLUSHING MEADOWS DRIVE, SUITE 170 TOWN & COUNTRY, MO 63131 WWW.ETEGRA.COM
OFFICE OF ADMINISTRATION DIVISION OF FACILITIES
MANAGEMENT, DESIGN AND CONSTRUCTION DEPARTMENT OF NATIONAL GUARD
ROOF REPLACEMENT, TUCKPOINTING, AND INTERIOR REPAIRS MISSOURI NATIONAL GUARD SIKESTON MISSOURI READINESS CENTER 300 S. MAIN STREET SIKESTON, MISSOURI 63801 PROJECT: T2235-01 ASSET: 8136317001 SITE#: 6317
REVISION: DATE: DATE: REVISION: DATE: DATE: REVISION: DATE: DATE: ISSUE DATE: 05/03/2024 CAD DWG FILE:G-003.DWG DRAWN BY: B. KEITEL CHECKED BY: B. HESTERBER DESIGNED BY: T. WIKELSKI

SHEET TITLE: Project Site Plan

SHEET NUMBER:

G-003 3 OF 21 SHEETS 05/03/2024

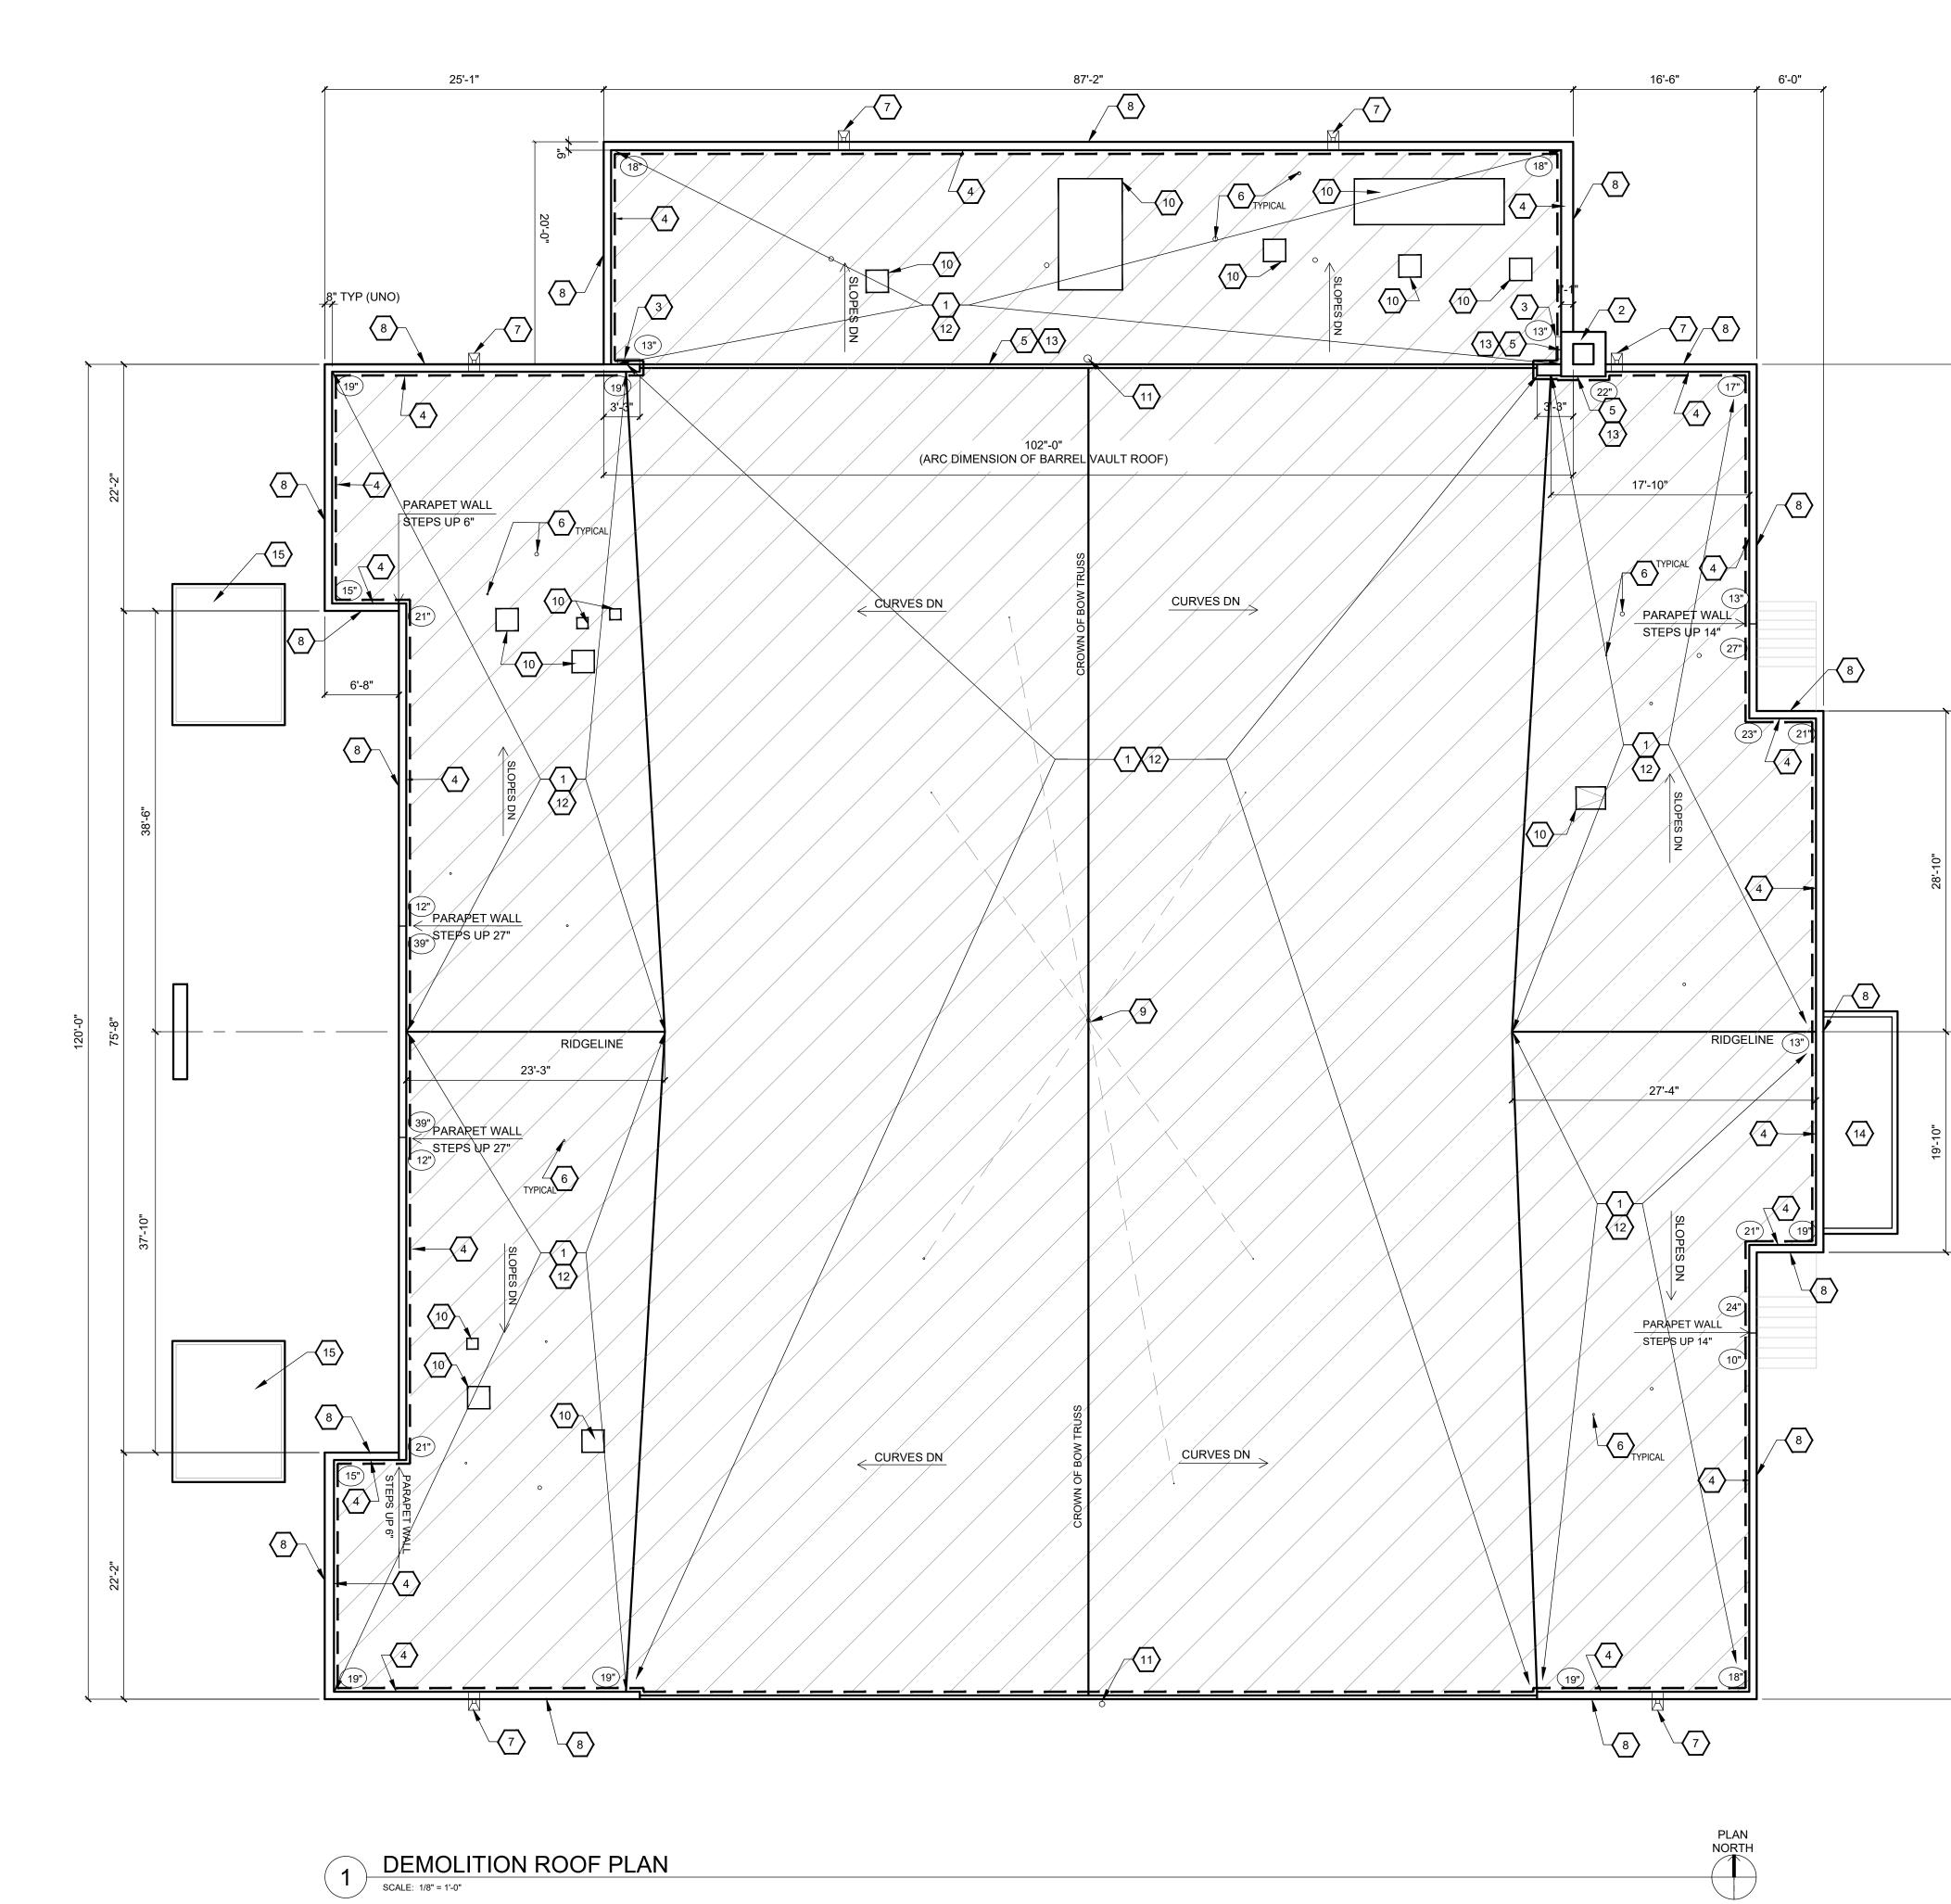



	GENERAL NOTES
1.	PROVIDE DUST CONTROL IN ALL AREAS IMPACTED BY
2.	CONSTRUCTION. PROTECT ALL EXISTING FINISHES TO REMAIN.
3.	ASSUMED ELEVATION OF 100'-0" AT FINISH FLOOR OF FIRST FLOOR (SEE DEMOLITION PLAN FOR EXISTING "TOP OF ROOF DECK" ELEVATIONS & PARAPET
4.	HEIGHTS). VERIFY ABANDONED VENTS AND EXHAUST FAN HOUSINGS/CURBS AND REMOVE. REPAIR DECK &
5.	PREPARE FOR SURFACE FOR NEW ROOF. ROOFING CONTRACTOR SHALL INSPECT ALL EXISTING
0.	SUBSTRATE MATERIALS AFTER REMOVAL OF
	EXISTING ROOFING. NOTIFY DESIGNER IMMEDIATELY OF ANY DEFECTS WHICH WOULD AFFECT THE
	PERFORMANCE OF THE NEW ROOFING INSTALLATION AND/OR NEW ROOFING WARRANTY.
6.	ROOFING CONTRACTOR SHALL INSPECT ALL VENTS AND VENTILATORS FOR THE PRESENCE OF FOREIGN
	DEBRIS BLOCKING THE FREE FLOW OF AIR. ANY DEBRIS FOUND SHALL BE REMOVED AND DISPOSED.
7.	NOTED SIZES OF VENTS AND EQUIPMENT BASES ARE APPROXIMATE, CONTRACTOR SHALL VERIFY ALL
8.	SIZES. CONTRACTOR SHALL INCLUDE IN THE BASE BID, THE REMOVAL AND REPLACEMENT OF 400 SQUARE FEET OF WOOD ROOF DECKING.
	KEYED NOTES
1.	BASE BID
	REMOVE AND DISPOSE OF EXISTING SINGLE-PLY ROOFING MEMBRANE, RIGID INSULATION BOARD, AND ANY RELATED FASTENERS AND TERMINATION BARS. RE: DETAIL 3/A-500 FOR ADDITIONAL INFORMATION
	ALTERNATE NO. 1 REMOVE AND DISPOSE OF EXISTING SINGLE-PLY ROOFING MEMBRANE, RIGID INSULATION BOARD, GYP BOARD AND ANY RELATED FASTENERS AND TERMINATION BARS.
	RE: DETAIL 3A/A-500 FOR ADDITIONAL INFORMATION
2.	EXISTING MASONRY CHIMNEY STRUCTURE TO REMAIN.
3.	EXISTING METAL ACCESS LADDER TO BE REMOVED, MODIFIED, REPAIRED AND PAINTED, THEN REINSTALLED.
4.	REMOVE AND DISPOSE OF EXISTING SINGLE-PLY MEMBRANE FROM INTERIOR FACE OF EXISTING PARAPET OR FACE OF MASONRY WALL.
5.	REMOVE TERM BAR AND EPDM FLASHING.
6.	REMOVE AND DISPOSE OF EXISTING FLASHING BOOT. CLEAN EXISTING VENT PIPE AS REQUIRED FOR INSTALLATION OF NEW FLASHING BOOT.
7.	REMOVE EXISTING METAL DOWNSPOUTS, RAIN CONDUCTORS AND WALL BRACKETS FOR RECYCLING.
8.	REMOVE EXISTING ALUMINUM PARAPET COPING SYSTEM AND RELATED FASTENERS FOR RECYCLING.
9.	EXISTING CENTER ANTENNA AND SUPPORT CABLES TO REMAIN. TEMPORARILY REMOVE GUY LINES DURING ROOF REPLACEMENT.
10.	MAINTAIN EXISTING EQUIPMENT AND EQUIPMENT CURBS. MAINTAIN EXISTING HATCH CURB. REMOVE EXISTING EPDM FLASHING & ASSOCIATED COMPONENTS FOR DISPOSAL.
11.	REMOVE EXISTING GABLE ANTENNA AND EXTERIOR WALL BRACKETS PERMANENTLY FOR RECYCLING. (COORDINATE REMOVAL WITH PROJECT MANAGER)
12.	<u>ALTERNATE NO. 1</u> REMOVE ALL ACM PER THE HAZARDOUS MATERIALS REPORT INCLUDING THE FELT AND ANY RESIDUE ON THE WOOD DECKING.
13.	REMOVE EXISTING ASBESTOS IMPREGNATED SEALANT AS INDICATED IN HAZMAT INVESTIGATION.
14.	LOWER ROOF (NO WORK)
15.	UNDERSIDE OF DETACHED CANOPY: REMOVE DETERIORATED PAINT AT EXPOSED STEEL
	SYMBOL LEGEND
<	XXX KEYED NOTE
	APROXIMATE PARAPET HEIGHT
	FOR KEY NOTES: 1 12

STATE OF MISSOURI MICHAEL L. PARSON, GOVERNOR







OFFICE OF ADMINISTRATION DIVISION OF FACILITIES MANAGEMENT, **DESIGN AND CONSTRUCTION**

DEPARTMENT OF NATIONAL GUARD

ROOF REPLACEMENT, TUCKPOINTING, AND INTERIOR REPAIRS

MISSOURI NATIONAL GUARD SIKESTON MISSOURI **READINESS CENTER** 300 S. MAIN STREET SIKESTON, MISSOURI 63801

PROJECT: T2235-01 ASSET: 8136317001 SITE#: 6317

REVISION: DATE: **REVISION:** DATE: REVISION: DATE:


ISSUE DATE: 05/03/2024

CAD DWG FILE:AD-110.DWG DRAWN BY: <u>B. KEITEL</u> CHECKED BY: <u>B. HESTERBER</u>G DESIGNED BY: <u>T. WIKELSKI</u>

SHEET TITLE: DEMOLITION ROOF PLAN


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AD-110




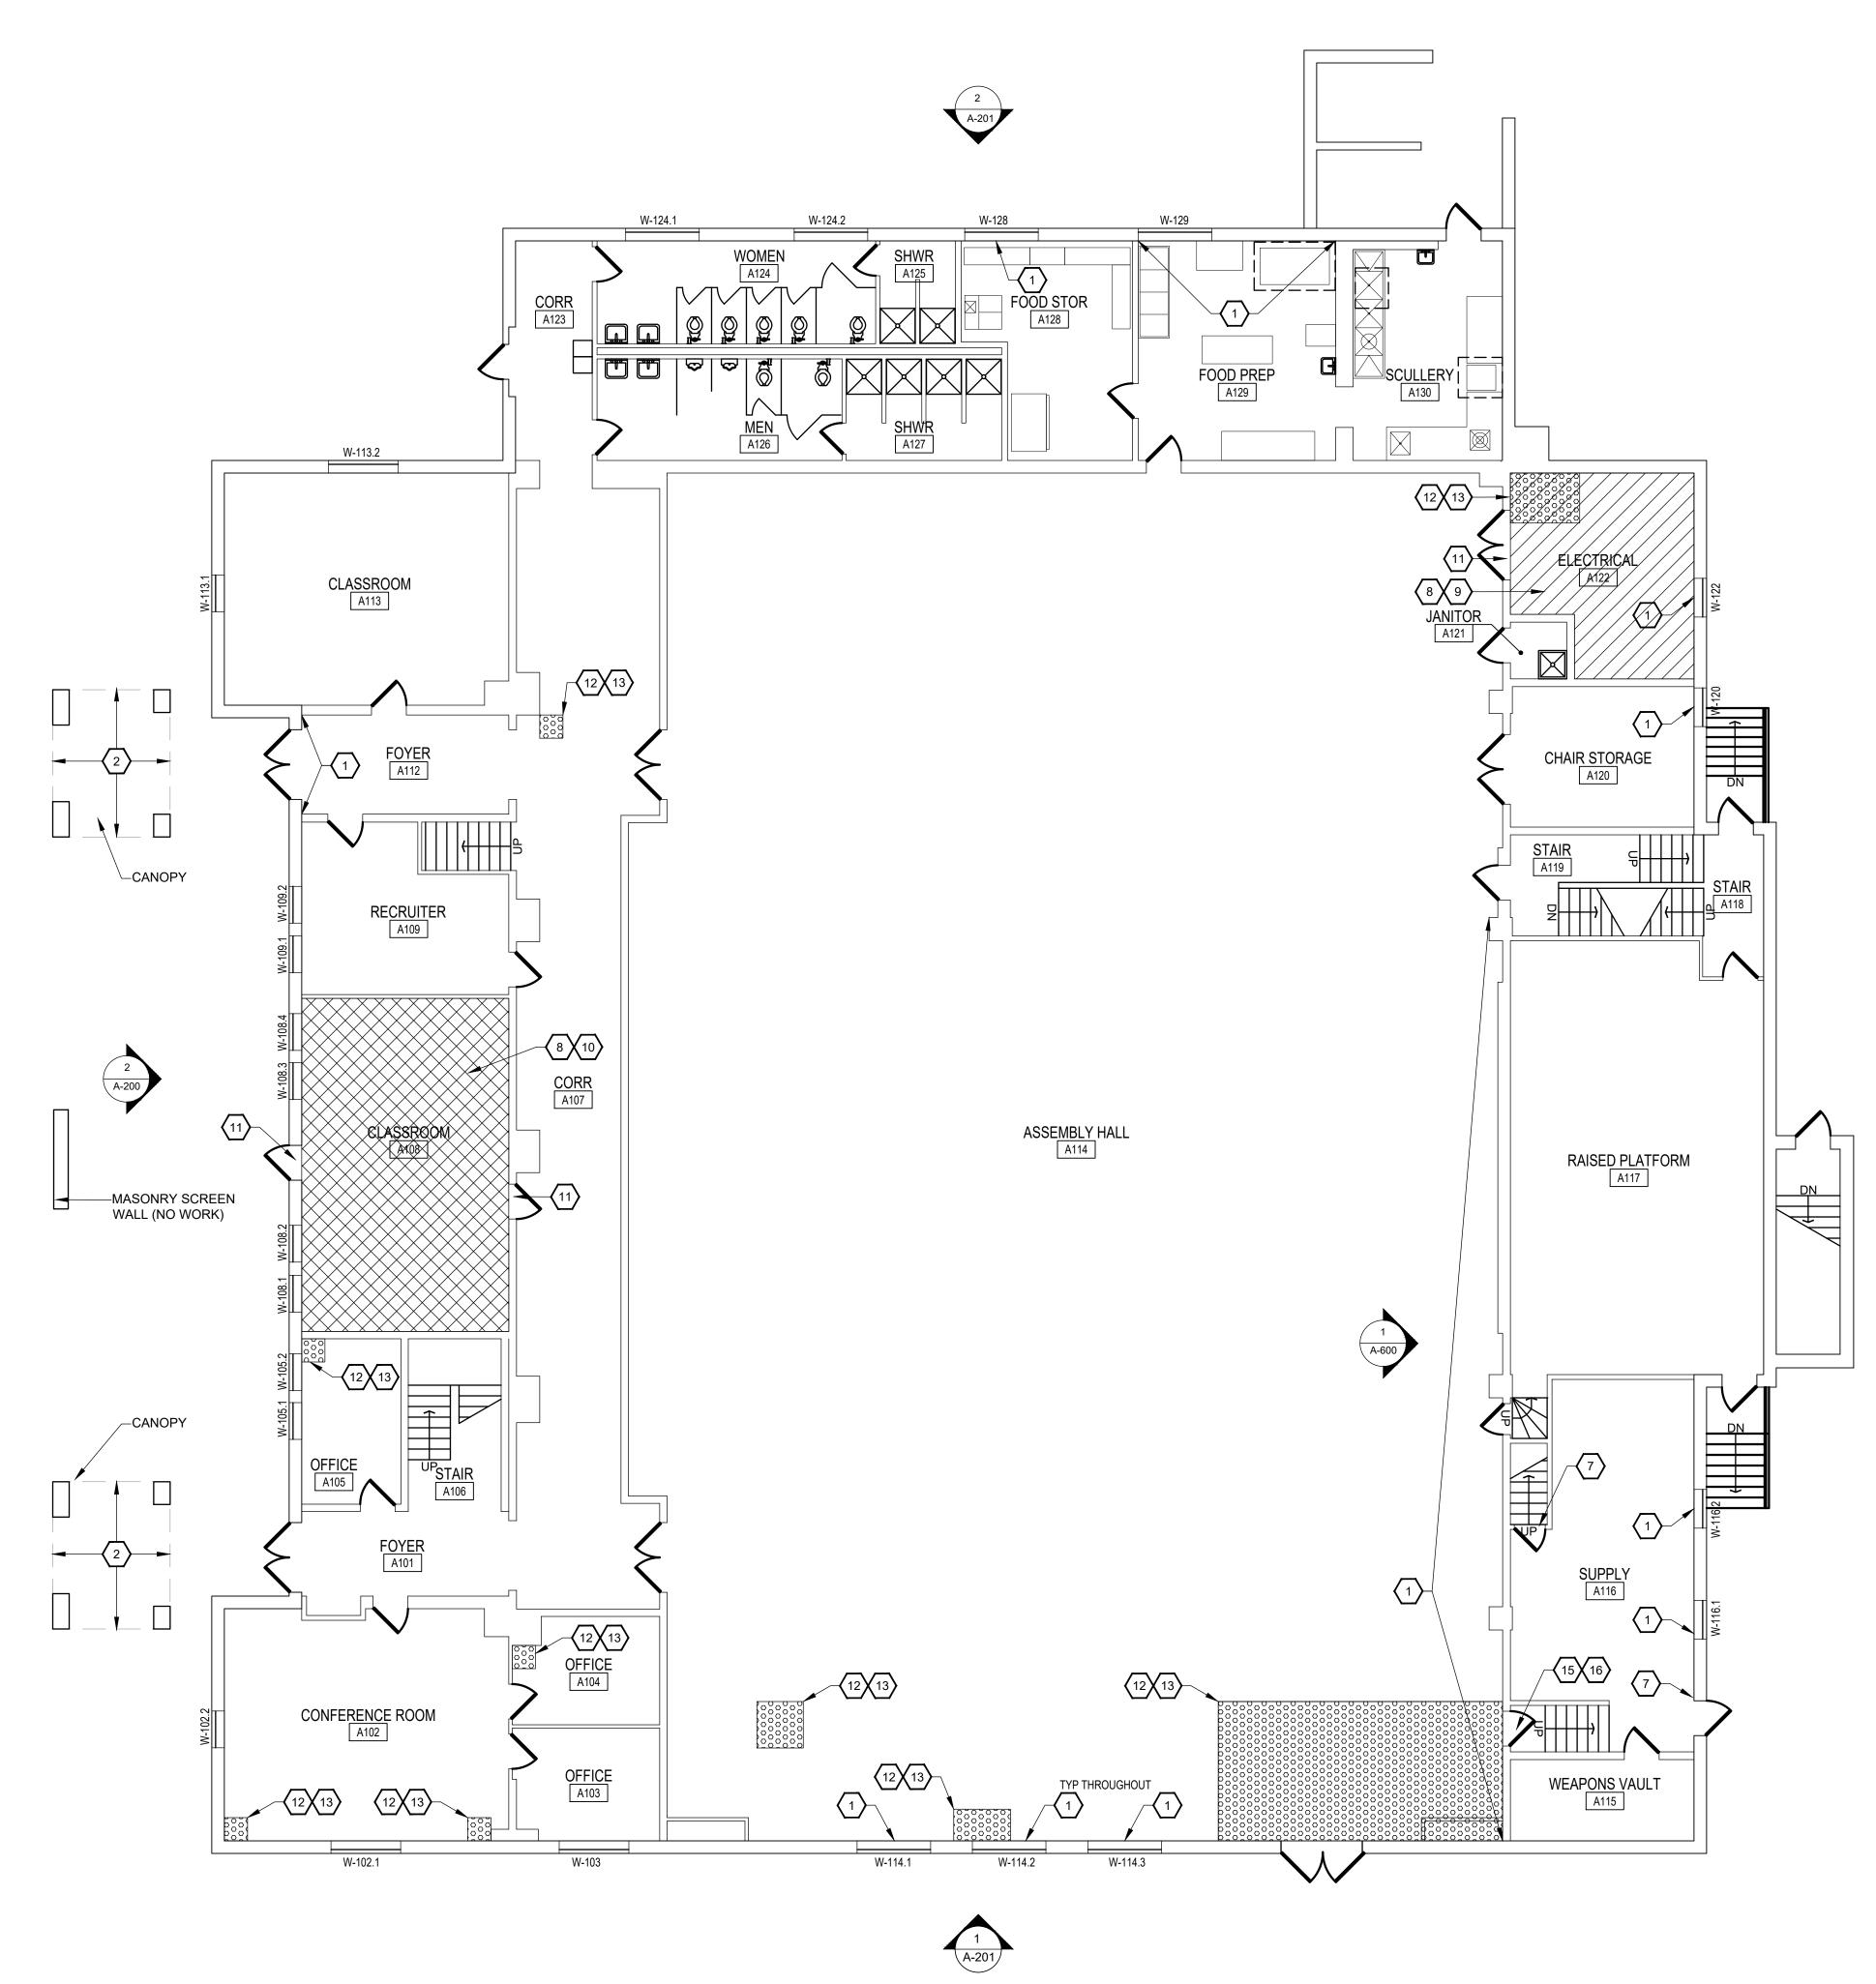





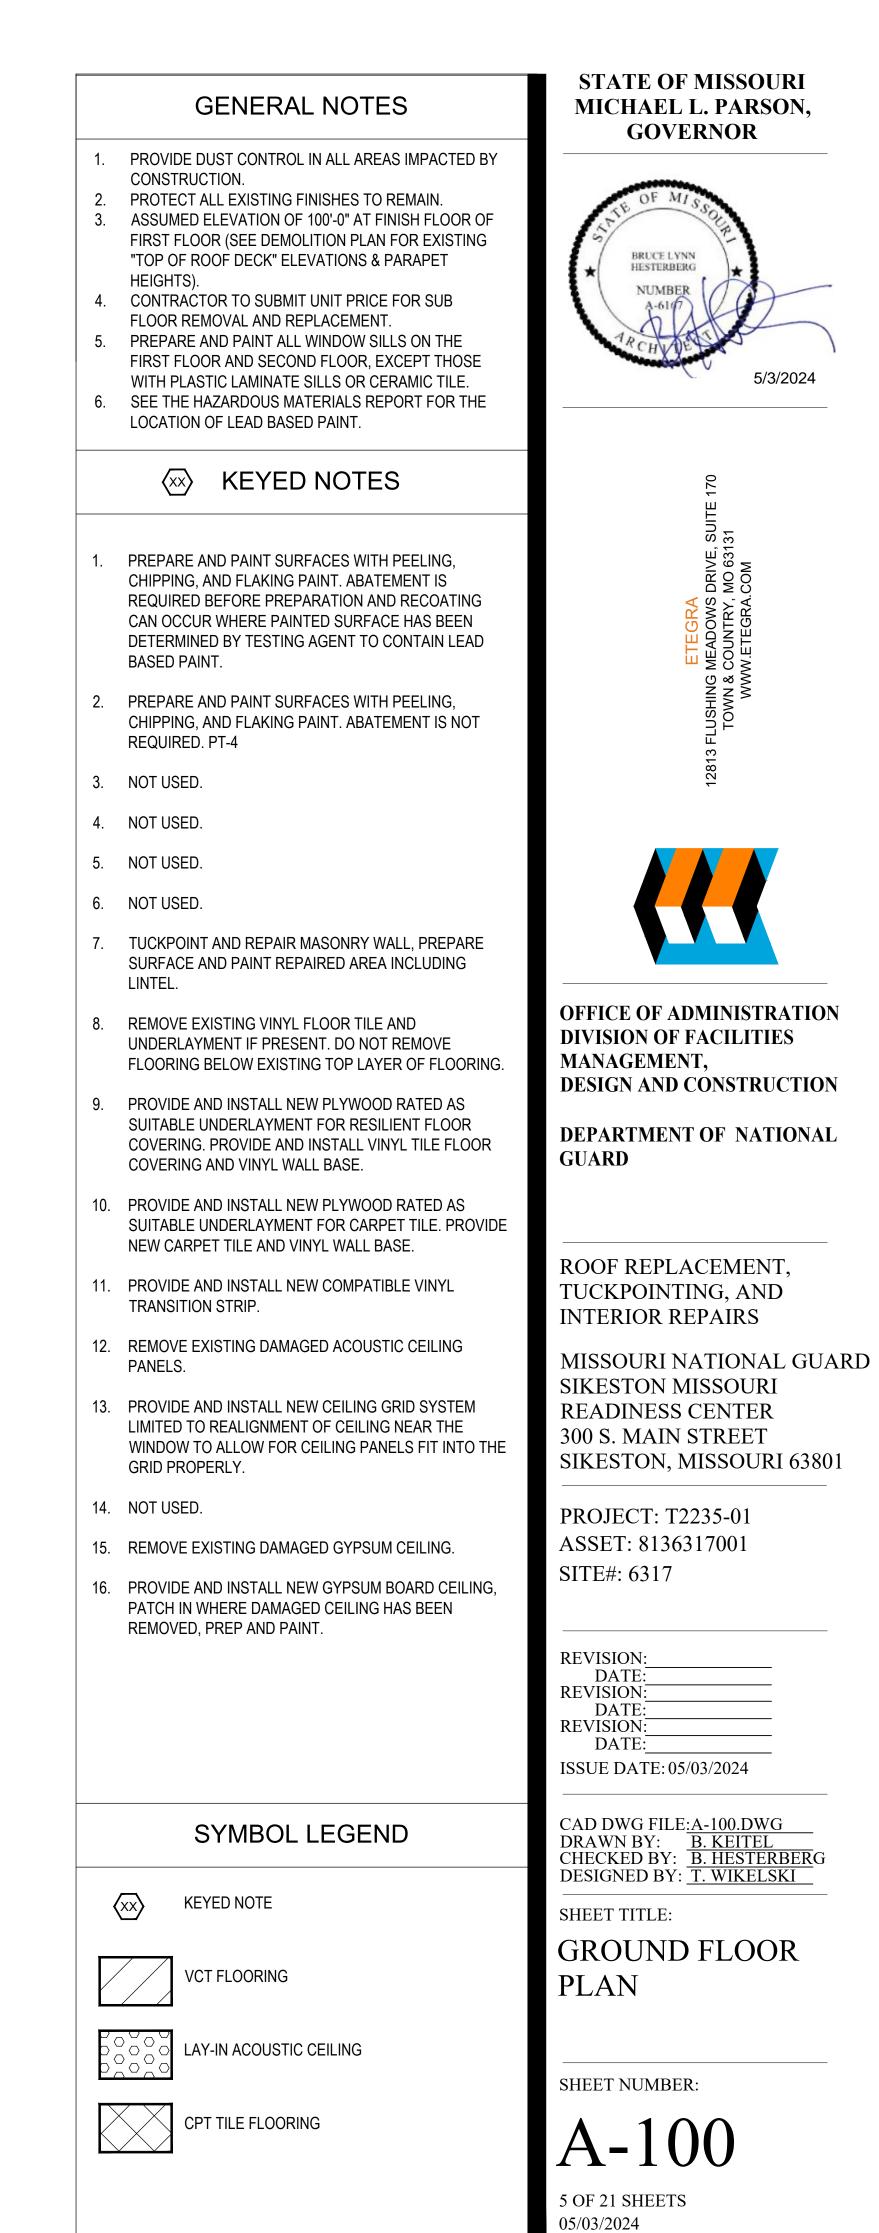

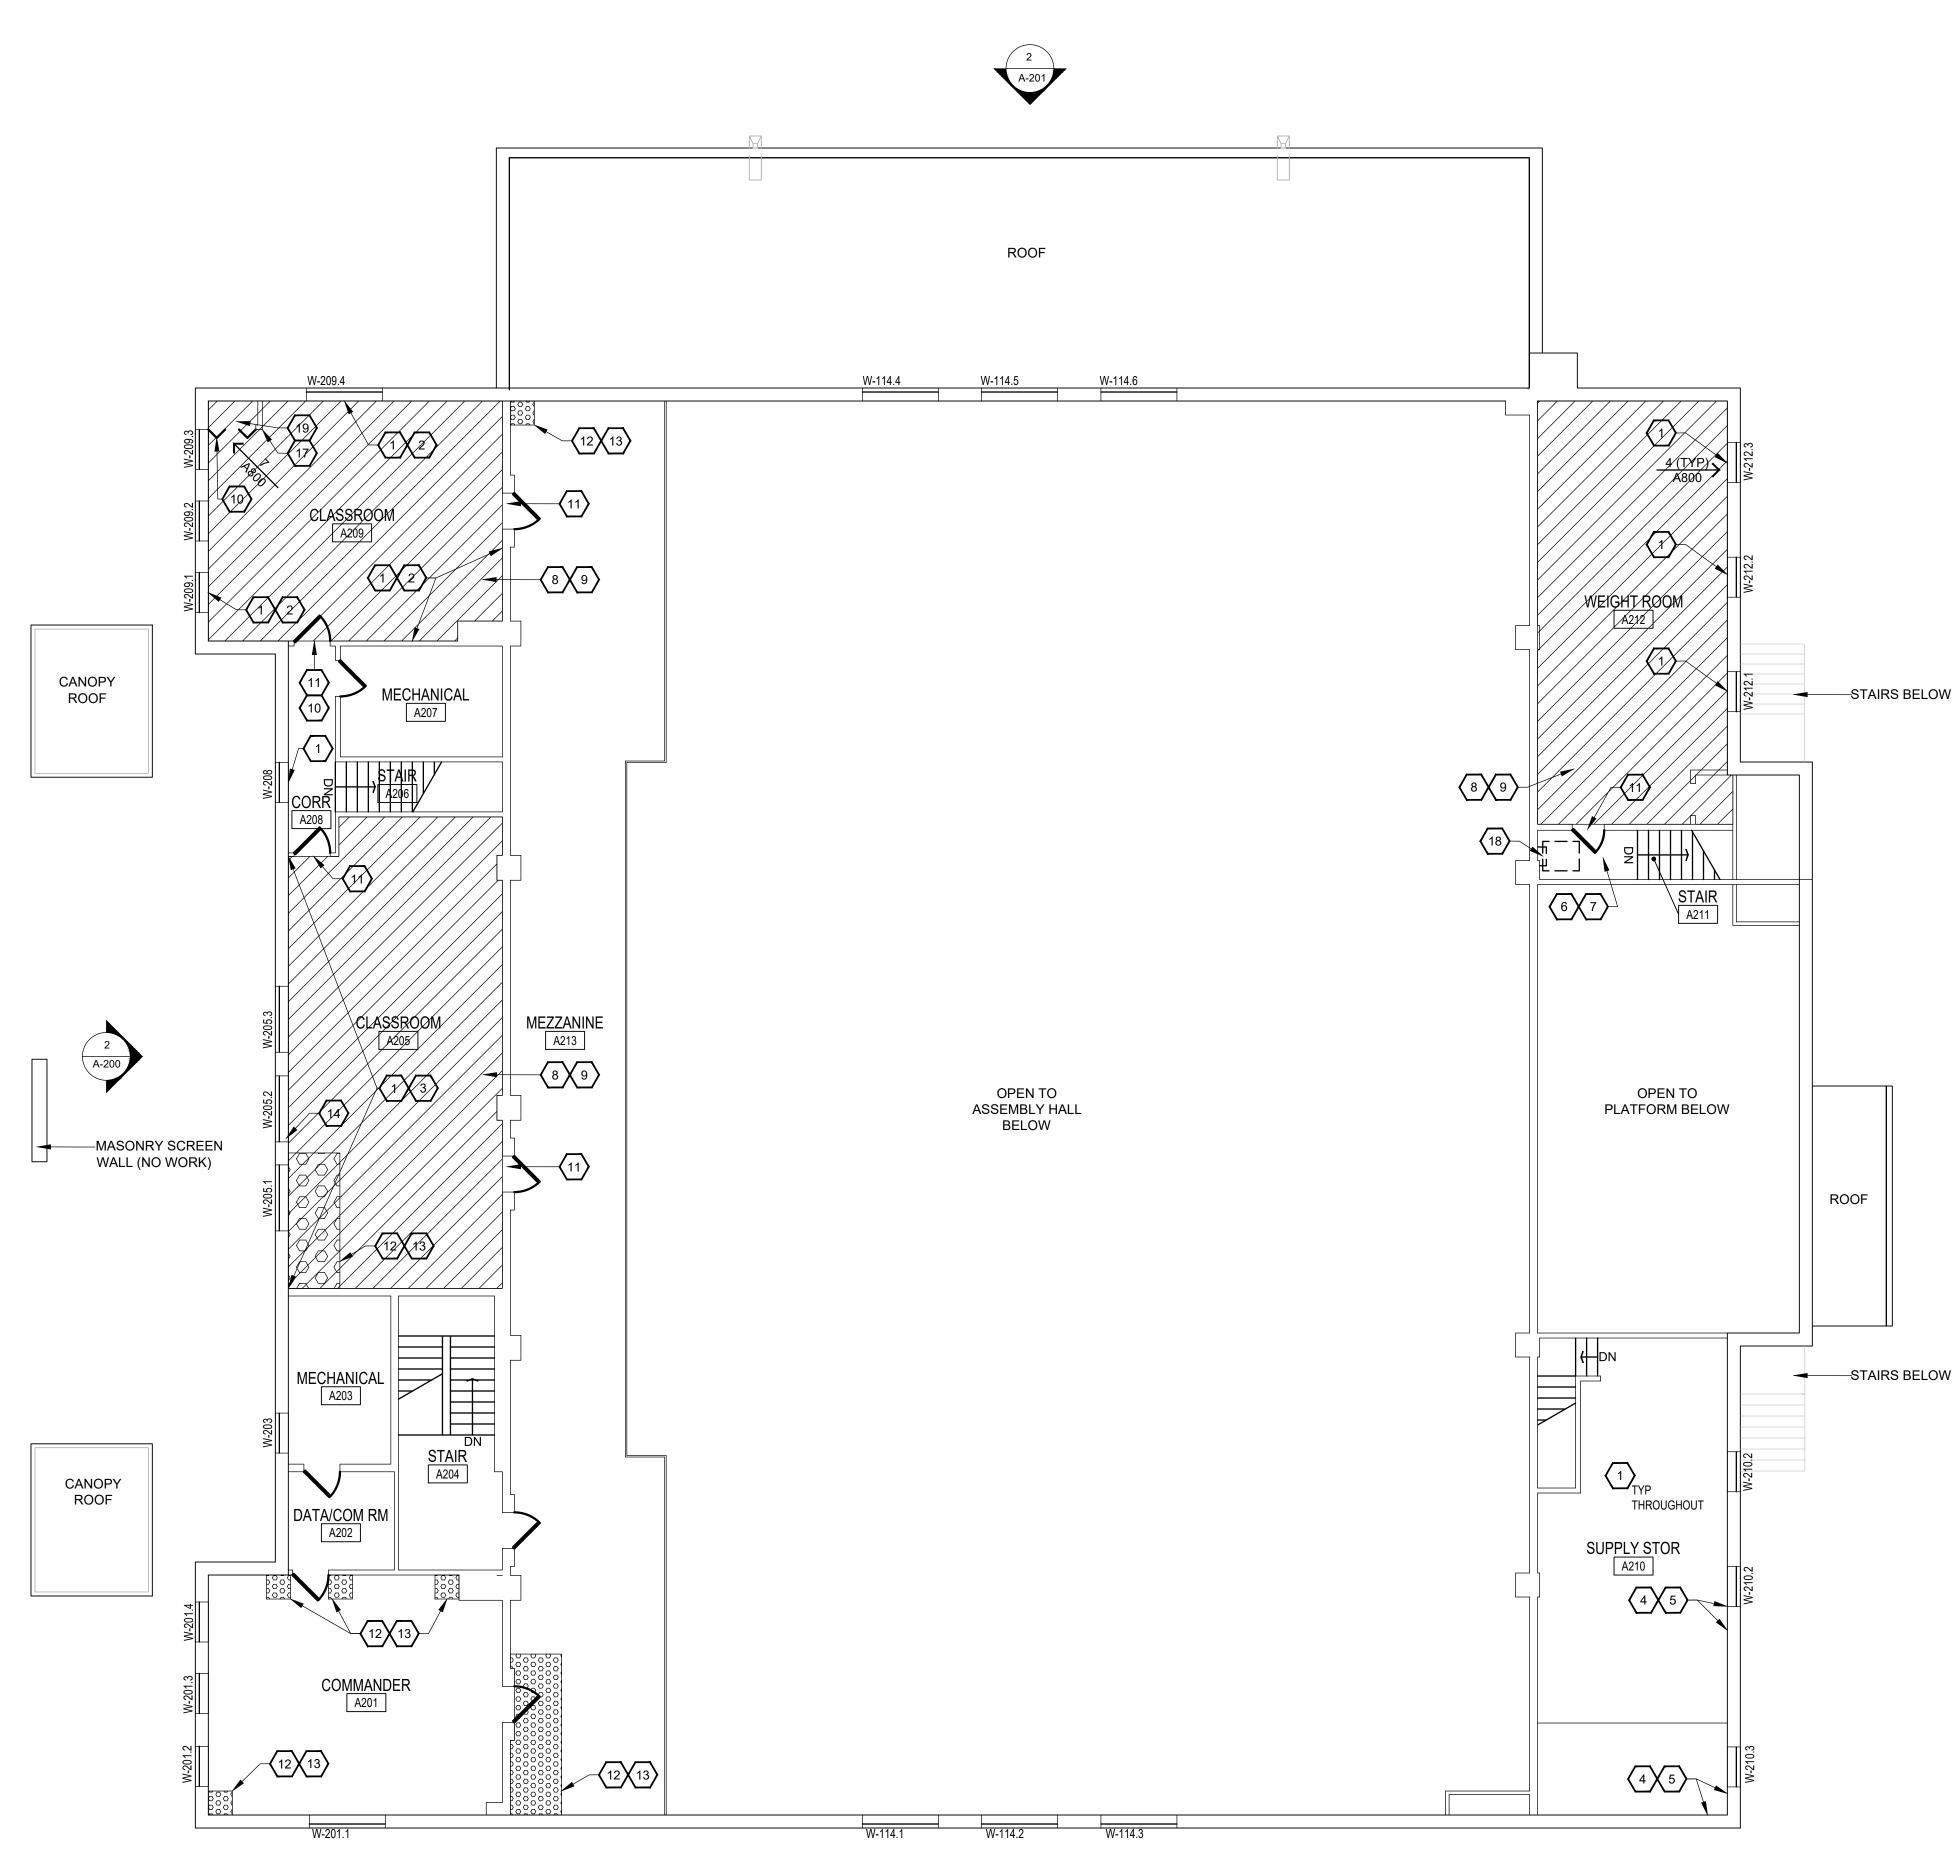










	GENERAL NOTES	STATE OF MISSOURI MICHAEL L. PARSON, GOVERNOR
	 PROVIDE DUST CONTROL IN ALL AREAS IMPACTED BY CONSTRUCTION. PROTECT ALL EXISTING FINISHES TO REMAIN. ASSUMED ELEVATION OF 100'-0" AT FINISH FLOOR OF FIRST FLOOR (SEE DEMOLITION PLAN FOR EXISTING "TOP OF ROOF DECK" ELEVATIONS & PARAPET HEIGHTS). CONTRACTOR TO SUBMIT UNIT PRICE FOR SUB FLOOR REMOVAL AND REPLACEMENT. PREPARE AND PAINT ALL WINDOW SILLS ON THE FIRST FLOOR AND SECOND FLOOR, EXCEPT THOSE WITH PLASTIC LAMINATE SILLS OR CERAMIC TILE. SEE THE HAZARDOUS MATERIALS REPORT FOR THE LOCATION OF LEAD BASED PAINT. 	BRUCE LYNN BRUCE LYNN BRUCE LYNN HESTERBERG NUMBER A-6107 A-6107 A-6107 J/2024
	KEYED NOTES	170
	1. PREPARE AND PAINT SURFACES WITH PEELING, CHIPPING, AND FLAKING PAINT. ABATEMENT IS REQUIRED BEFORE PREPARATION AND RECOATING CAN OCCUR WHERE PAINTED SURFACE HAS BEEN DETERMINED BY TESTING AGENT TO CONTAIN LEAD BASED PAINT.	ETEGRA 2813 FLUSHING MEADOWS DRIVE, SUITE 170 TOWN & COUNTRY, MO 63131 WWW.ETEGRA.COM
	2. PREPARE SURFACES AND PAINT ALL WALLS.	N N N N N N N N N N N N N N N N N N N
	3. PREPARE SURFACES AND PAINT ENTIRE WEST WALL.	TOWI
	4. TUCKPOINT AND REPAIR MASONRY WALL, PREPARE SURFACE AND PAINT REPAIRED AREA INCLUDING LINTELS.	12813 F
	5. PATCH AND REPAIR MASONRY STAIR STEP CRACK.	
	6. REMOVE EXISTING DAMAGED FLOORING AT STAIR LANDING BELOW ROOF HATCH.	
	7. PROVIDE AND INSTALL NEW FLOORING WHERE DAMAGED FLOORING HAS BEEN REMOVED AT STAIR LANDING BELOW ROOF HATCH.	
	8. REMOVE EXISTING VINYL FLOOR TILE AND UNDERLAYMENT IF PRESENT. DO NOT REMOVE FLOORING BELOW EXISTING TOP LAYER OF FLOORING.	OFFICE OF ADMINISTRATION DIVISION OF FACILITIES MANAGEMENT,
1 A-200	9. PROVIDE AND INSTALL NEW PLYWOOD RATED AS SUITABLE UNDERLAYMENT FOR RESILIENT FLOOR COVERING. PROVIDE AND INSTALL VINYL TILE FLOOR COVERING AND VINYL WALL BASE.	DESIGN AND CONSTRUCTION DEPARTMENT OF NATIONAL GUARD
\mathbf{Y}	10. UNDERCUT EXISTING DOOR AS REQUIRED TO ALLOW FOR NEW FLOORING INSTALLATION.	
	11. PROVIDE AND INSTALL NEW COMPATIBLE VINYL TRANSITION STRIP.	ROOF REPLACEMENT, TUCKPOINTING, AND
	12. REMOVE EXISTING DAMAGED ACOUSTIC CEILING PANELS.	INTERIOR REPAIRS
	13. PROVIDE AND INSTALL NEW ACOUSTIC CEILING PANELS TO MATCH THE EXISTING ADJACENT.	MISSOURI NATIONAL GUARD SIKESTON MISSOURI READINESS CENTER
	14. PROVIDE AND INSTALL NEW CEILING GRID SYSTEM LIMITED TO REALIGNMENT OF CEILING NEAR THE WINDOW TO ALLOW FOR CEILING PANELS FIT INTO THE GRID PROPERLY.	300 S. MAIN STREET SIKESTON, MISSOURI 63801
	15. NOT USED.	PROJECT: T2235-01 ASSET: 8136317001
	16. NOT USED.	SITE#: 6317
	17. DEMOLISH I/T CLOSET AND PUNCH DOWN BLOCKS, PATCH/REPAIR WALLS. PATCH IN NEW CEILING TO MATCH EXISTING ADJACENT.	REVISION:
	18. REMOVE AND REPLACE ROOF HATCH. SEE DETAIL 4/A-501	DATE: REVISION: DATE: REVISION:
	19. REMOVE EXISTING SPRINKLER HEAD AND CAP SPRINKLER LINE ABOVE CEILING.	DATE: ISSUE DATE: 05/03/2024
		CAD DWG FILE: <u>A-101.DWG</u> DRAWN BY: <u>B. KEITEL</u> CHECKED BY: <u>B. HESTERBER</u> G DESIGNED BY: <u>T. WIKELSKI</u>
	SYMBOL LEGEND	SHEET TITLE:
	KEYED NOTE	SECOND FLOOR PLAN
	VCT FLOORING	SHEET NUMBER:
		A-101

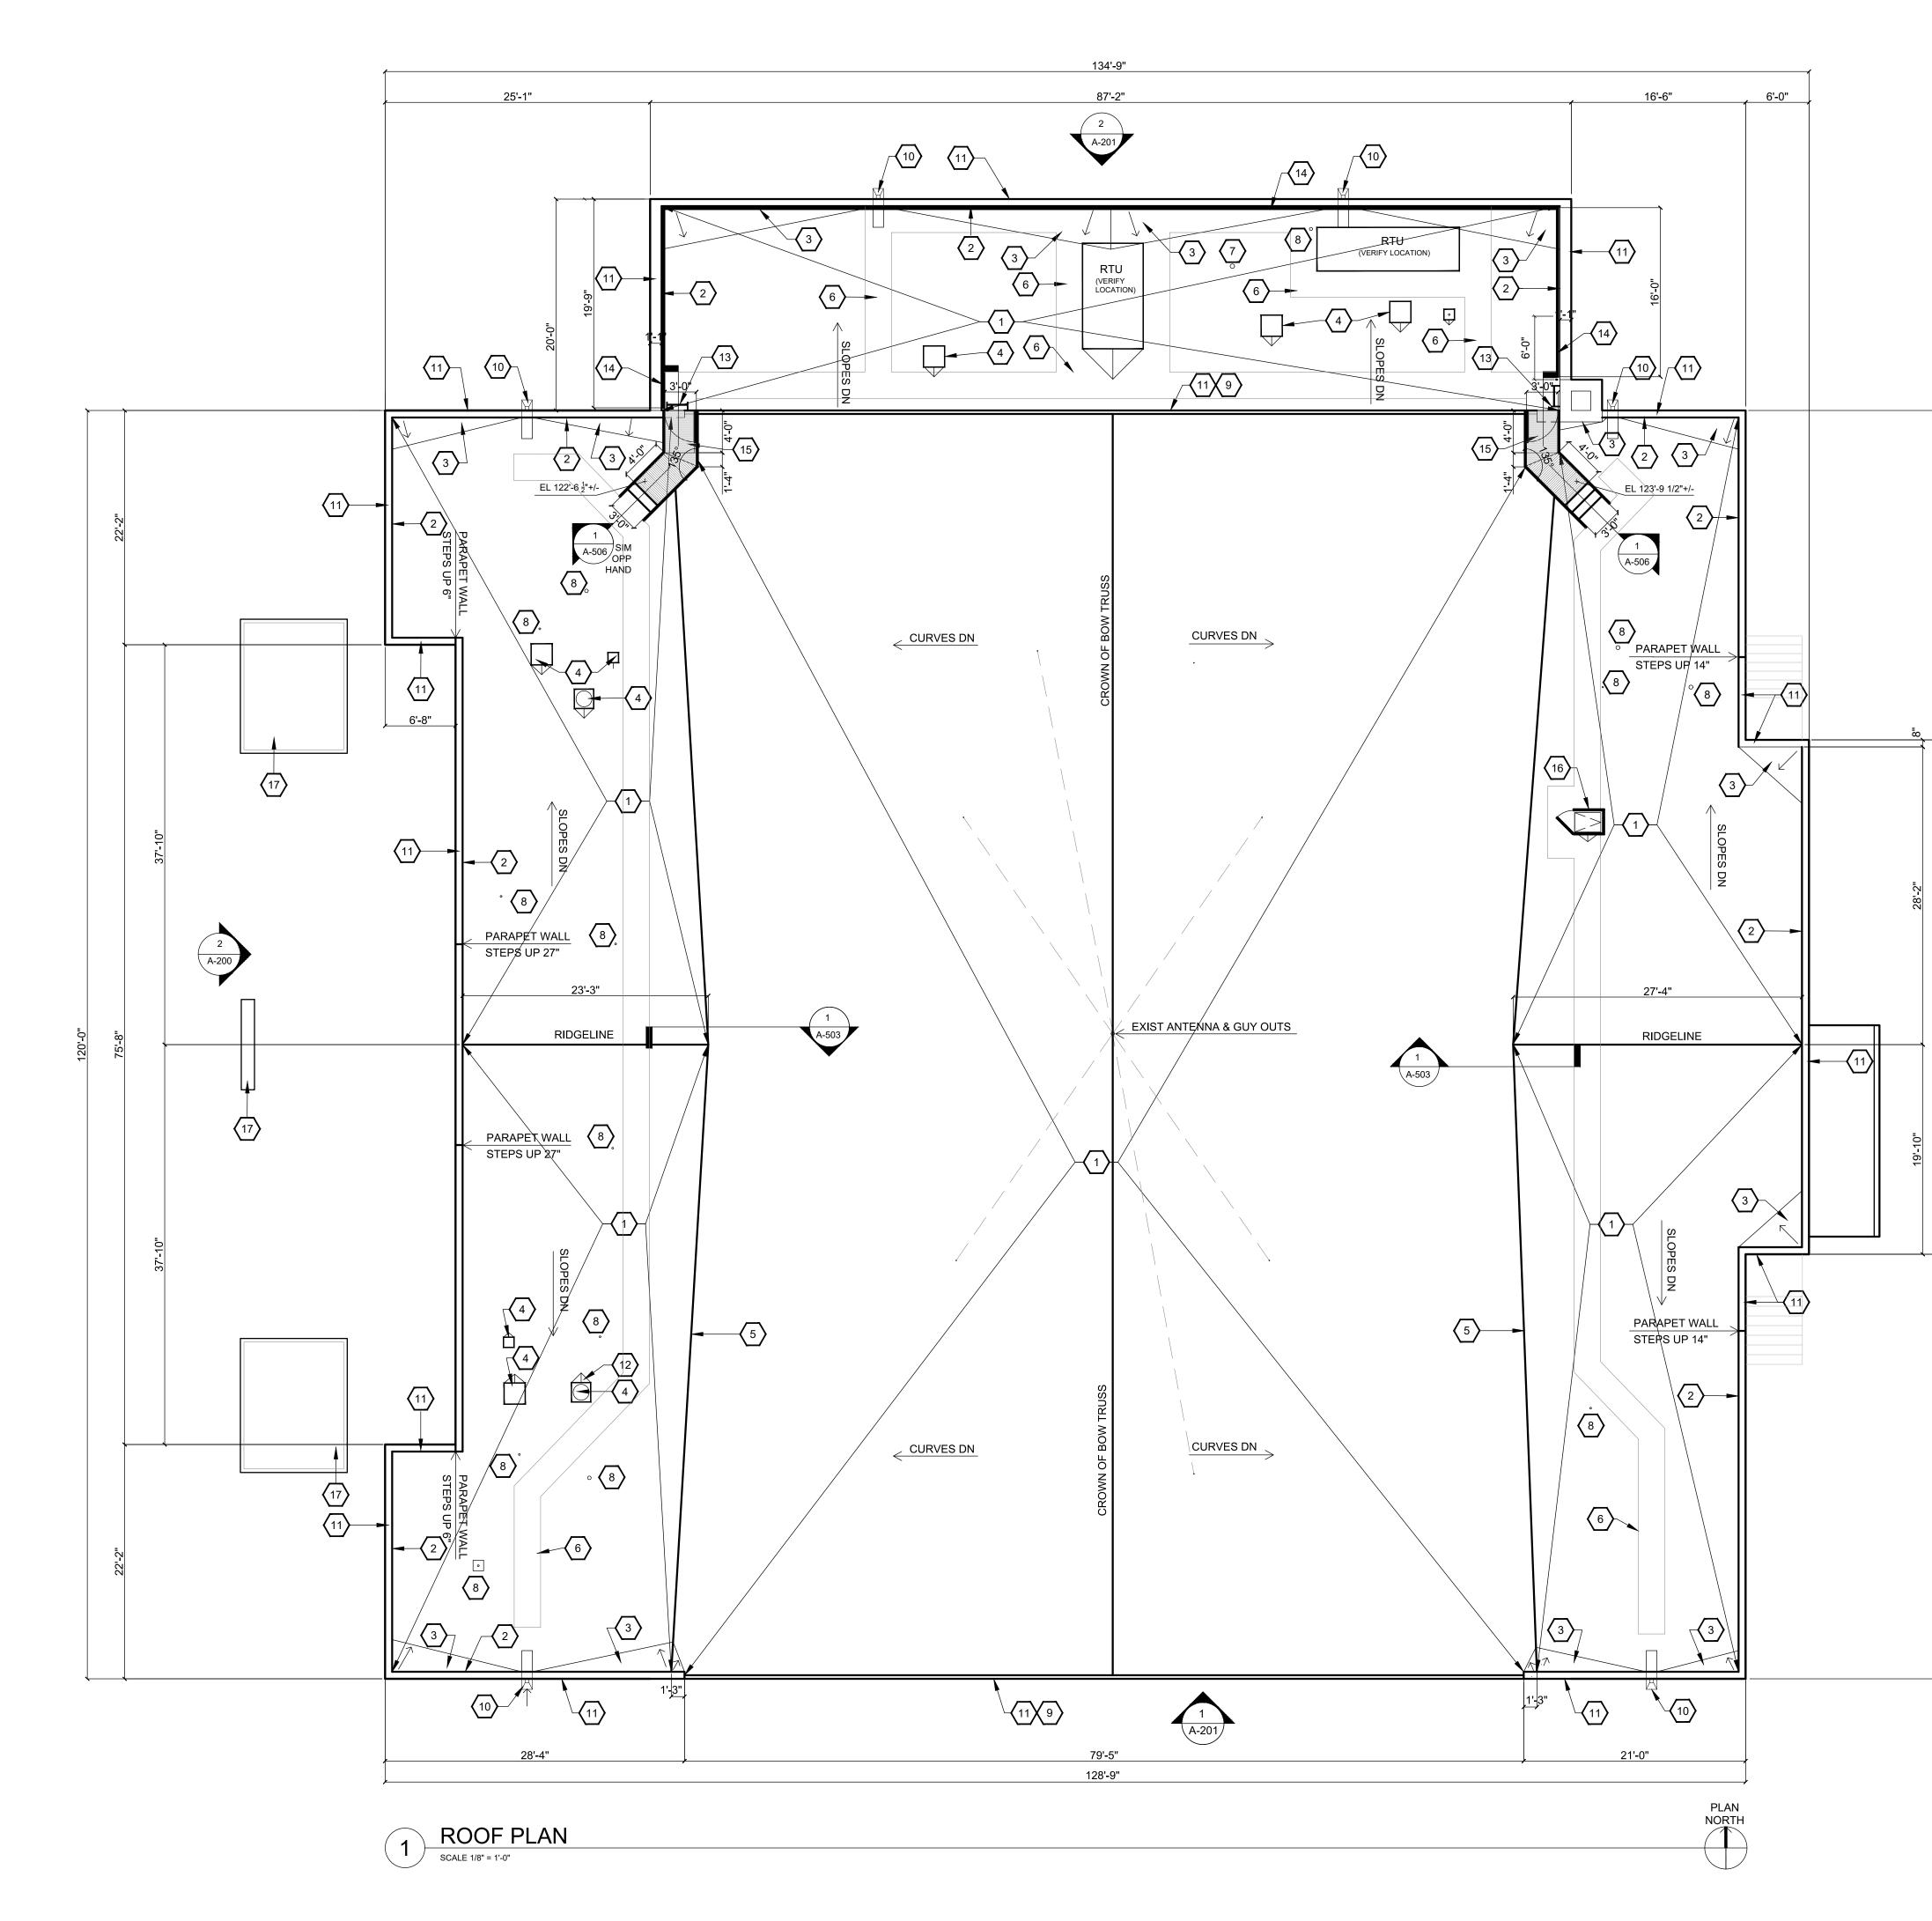

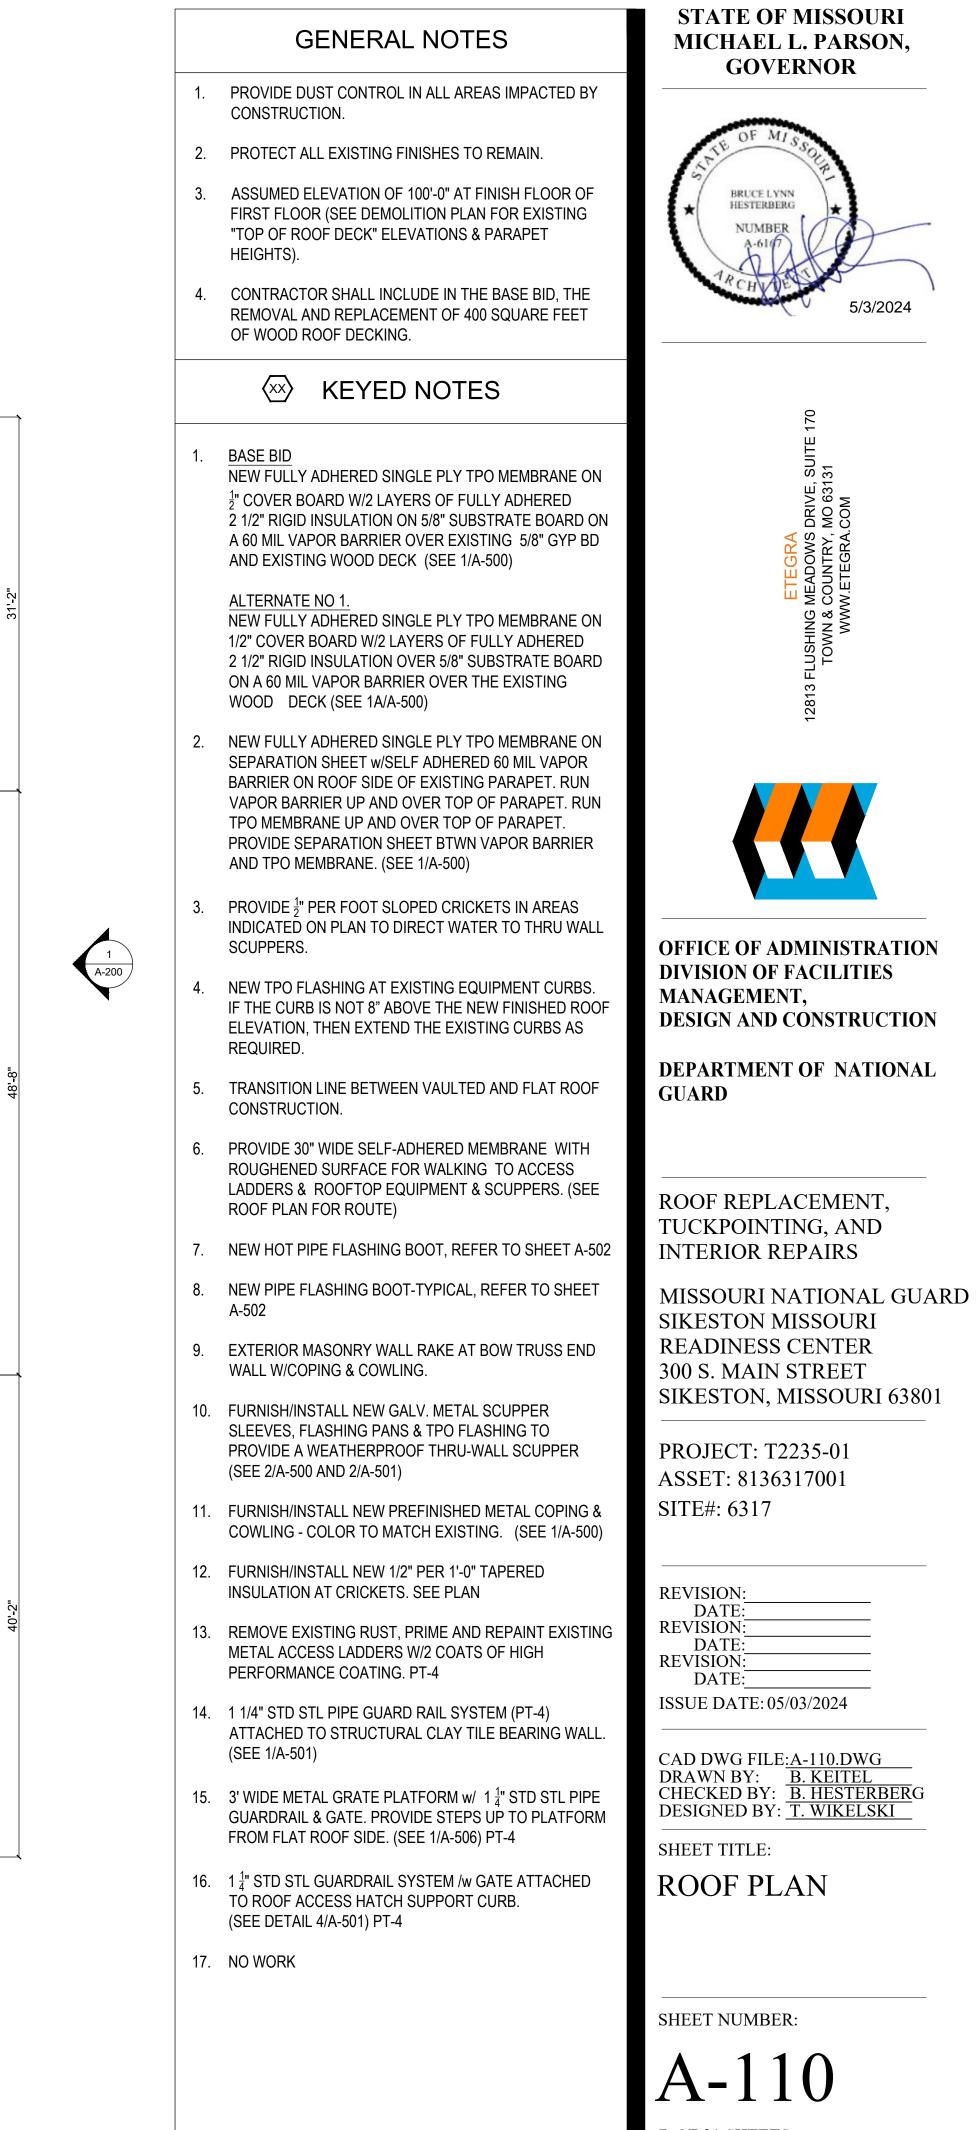




EAST ELEVATION SCALE 1/8" = 1'-0"

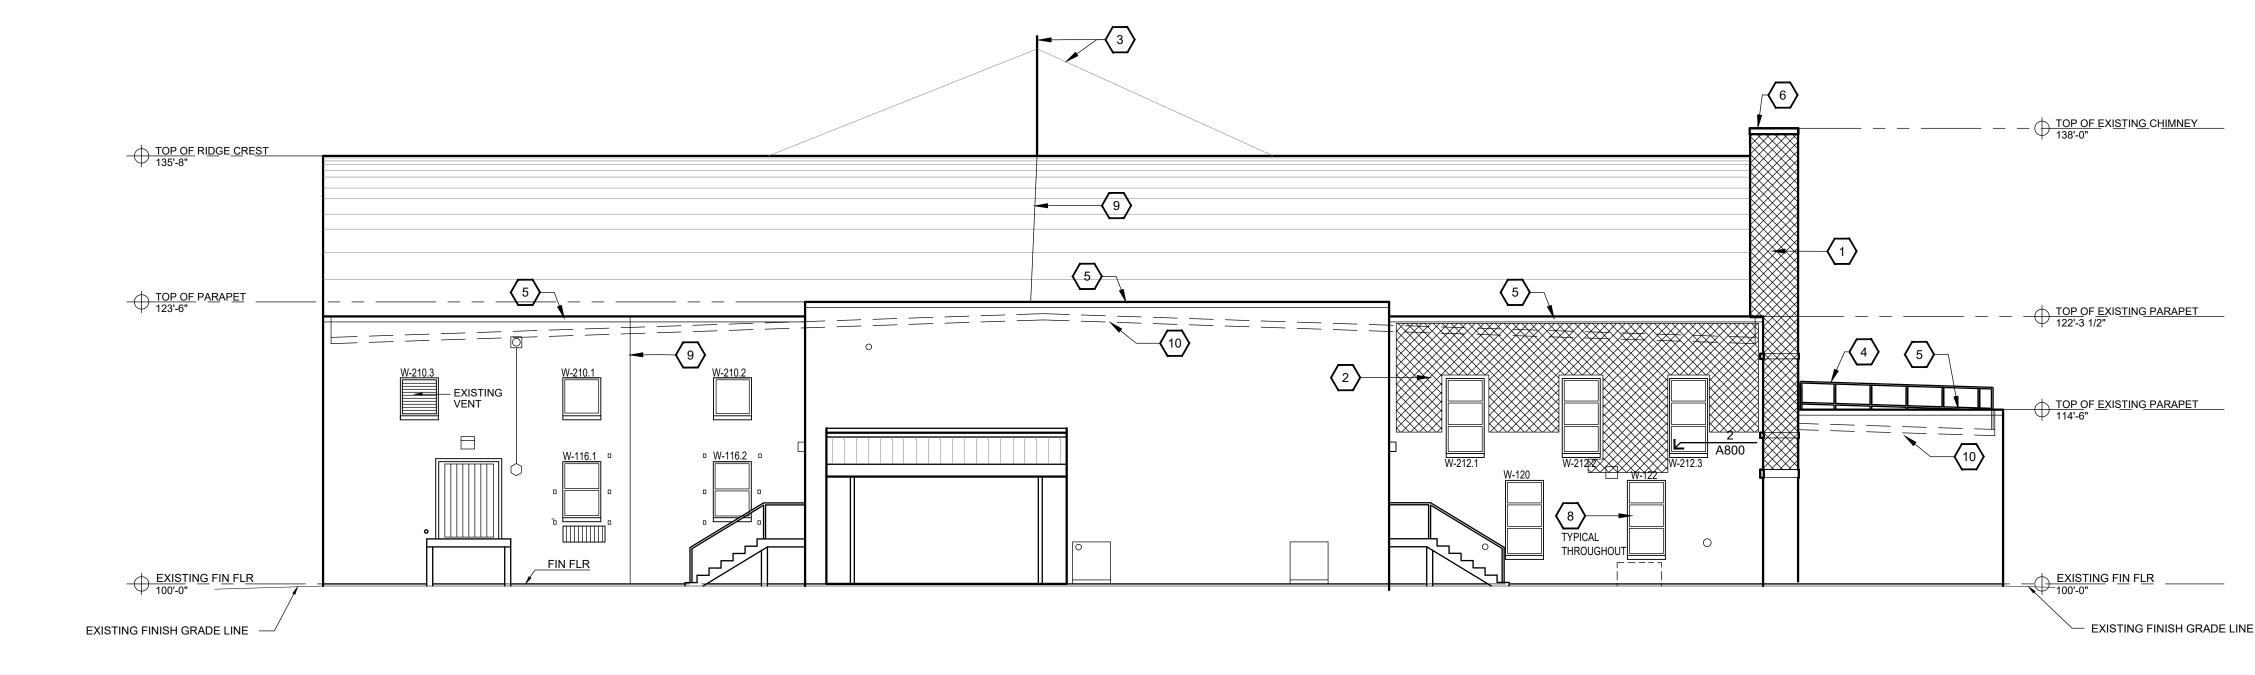



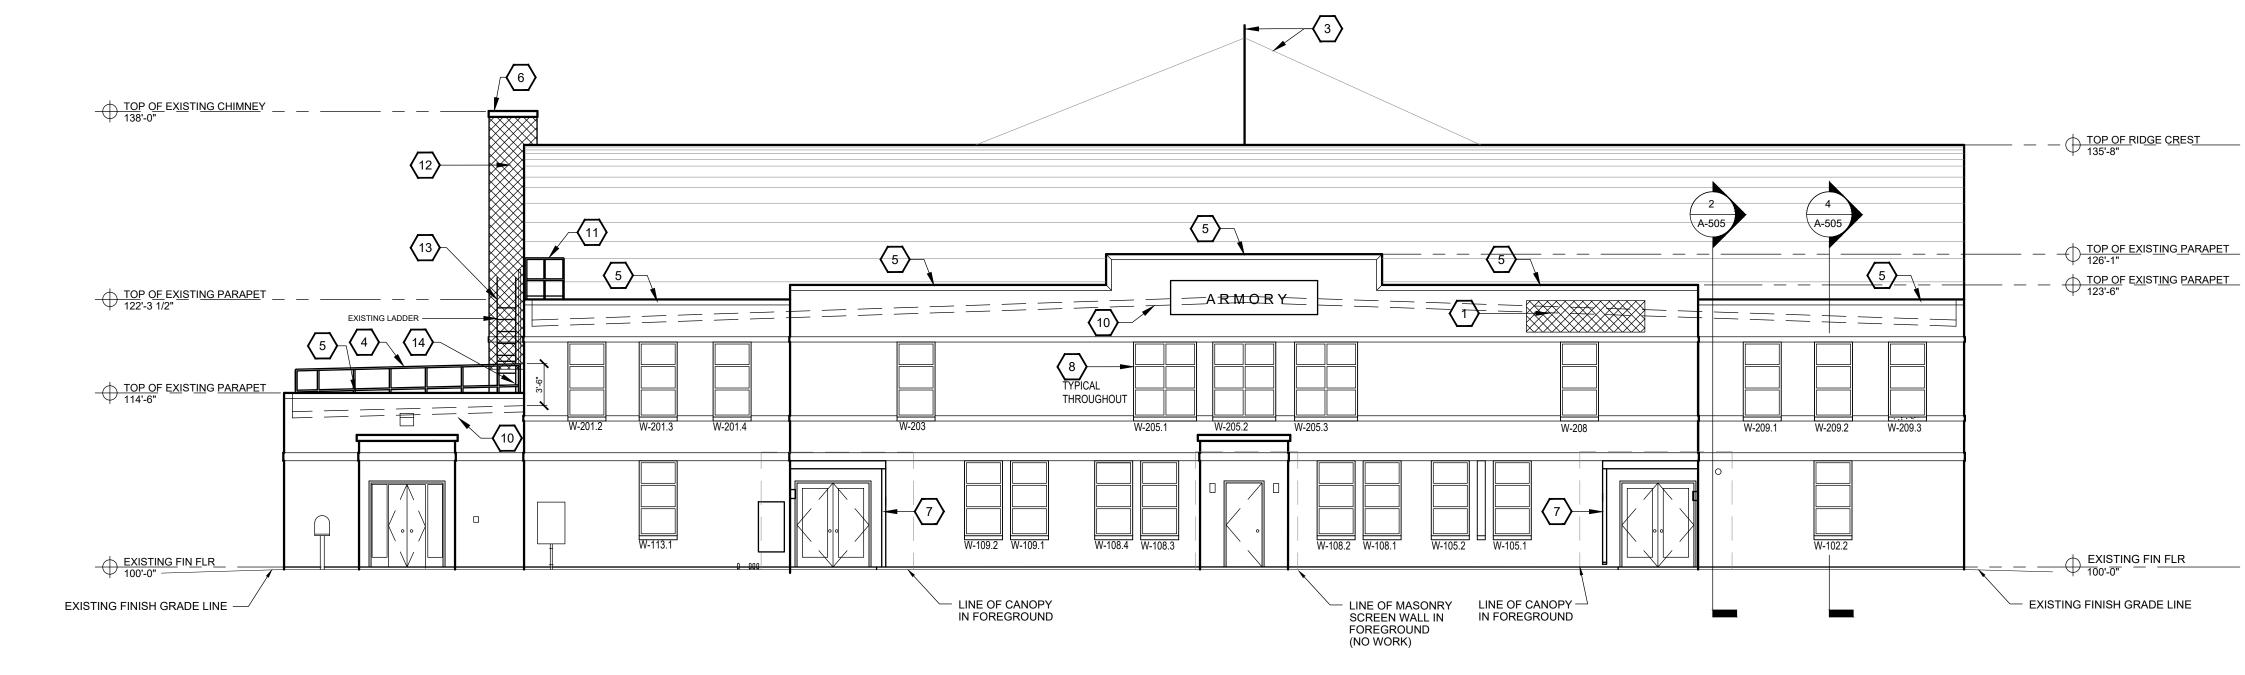

✓ KEYED NOTES

- 1. TUCKPOINT HATCHED AREA. (SEE SPECIFICATIONS)
- 2. TUCKPOINT VARIOUS AND RANDOM SMALL LOCATIONS OF LOOSE/WEAK MORTAR THIS AREA. EACH AREA WILL REQUIRE APPROXIMATELY 50% TUCKPOINTING. (SEE SPECIFICATIONS)
- 3. EXISTING CENTER ANTENNA TO REMAIN INCLUDING GUY OUT CABLES AND SUPPORT PIPES. (REMOVE GUY OUT CABLES AND LIGHTNING PROTECTION DURING NEW ROOF INSTALLATION AND REINSTALL AFTER THE WORK IS COMPLETE)(COORDINATE REMOVAL AND RE-INSTALLATION WITH PROJECT MANAGER)
- 4. NEW GALV. STL GUARDRAIL (PT-4) AT LOW ROOF ADJACENT TO PARAPET (SEE SECTION DETAIL 1/A-501)
- NEW 0.80 THICK PREFINISHED METAL COPING -COLOR TO MATCH EXISTING. (SEE SECTION DETAIL 1A-500)
- 6. REMOVE AND REPLACE PREFIN. GALVANIZED CHIMNEY CAP - COLOR TO MATCH PREFIN. MT COPING.
- 7. EXISTING METAL PANEL CANOPY NOT IN PROJECT SCOPE.
- 8. REMOVE EXISTING WINDOW SEALANT AND REINSTALL NEW SEALANT TYPICAL ALL WINDOWS
- 9. TEMPORARY REMOVAL OF LIGHTNING PROTECTION CABLE DURING NEW ROOF INSTALLATION. REINSTALL AFTER NEW ROOF IS COMPLETE.
- 10. BOTTOM LINE INDICATES LOCATION OF EXISTING ROOF DECK - TOP LINE INDICATES ELEVATION OF NEW ROOF SYSTEM.
- 11. LADDER ACCESS PLATFORM w/1" BAR GRATE FLOOR, 6"x4"x $_8^3$ " STL ANGLE FRAME ON 6"x6"x $_8^3$ " STL PLATE ON 4"x4"STL TUBE POSTS. SECURE 1 $\frac{1}{4}$ " STD STL PIPE GUARDRAIL TO 6" STL ANGLE FRAME. (ALL STL IS GALVANIZED AND HIGH PERFORMANCE COATING FINISH (PT-4) (SEE 1/A-506)
- 12. ADD ALTERNATE NO. 2 TUCKPOINT HATCHED AREA: WEST SIDE OF CHIMNEY (SEE SPECIFICATION)
- 13. REMOVE EXISTING LADDER FOR REPAIRS, MODIFICATIONS AND PAINTING. REINSTALL IN ORIGINAL LOCATION
- 14. REMOVE EXISTING ASBESTOS IMPREGNATED SEALANT AS INDICATED IN HAZMAT INVESTIGATION NOTED AS **ACM FLACK FLASHING CAULK AT CHIMNEY/BRICK**. RESEAL.


SYMBOL LEGEND





TUCKPOINTING

KEYED NOTE

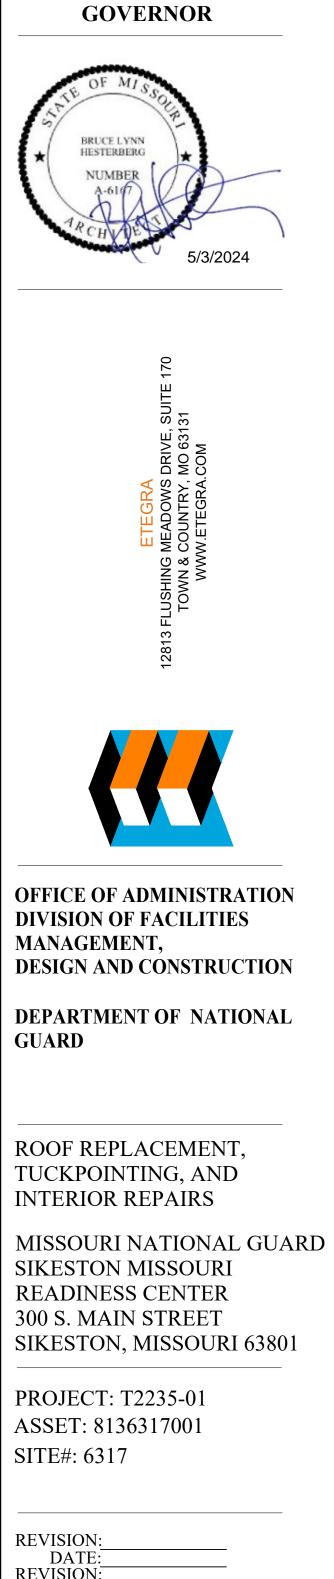

STATE OF MISSOURI

MICHAEL L. PARSON,

DATE:
REVISION:
DATE:
REVISION:
DATE:
ISSUE DATE: 05/03/2024

CAD DWG FILE:<u>A-200.DWG</u> DRAWN BY: <u>B. KEITEL</u> CHECKED BY: <u>B. HESTERBER</u>G DESIGNED BY: <u>T. WIKELSKI</u>


SHEET TITLE: WEST AND EAST ELEVATIONS

SHEET NUMBER:


A-200 8 OF 21 SHEETS 05/03/2024



SOUTH ELEVATION SCALE: 1/8" = 1'-0"

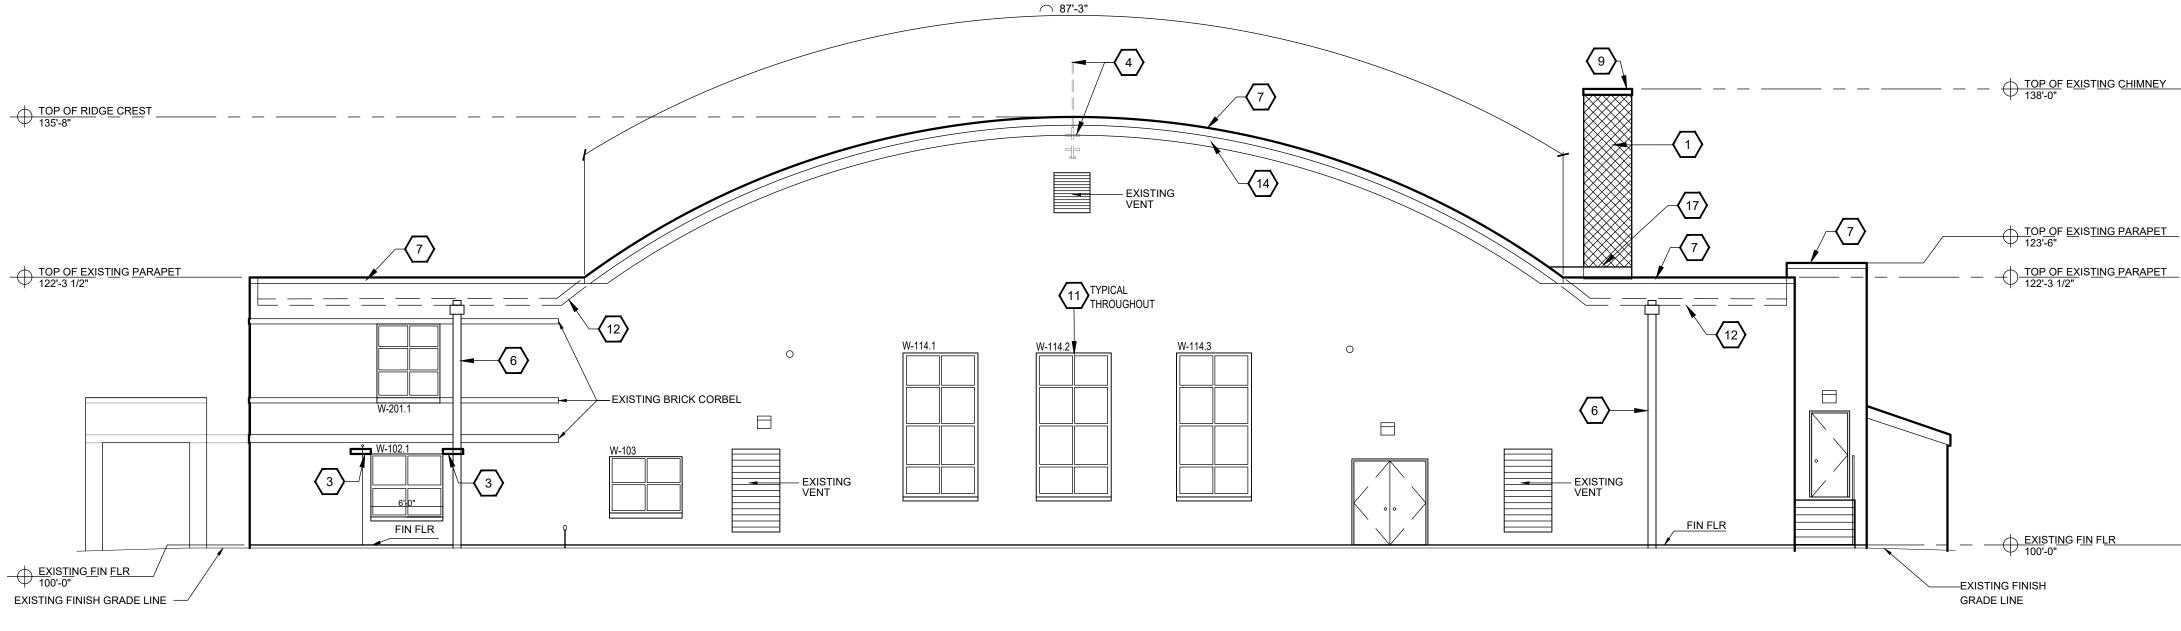



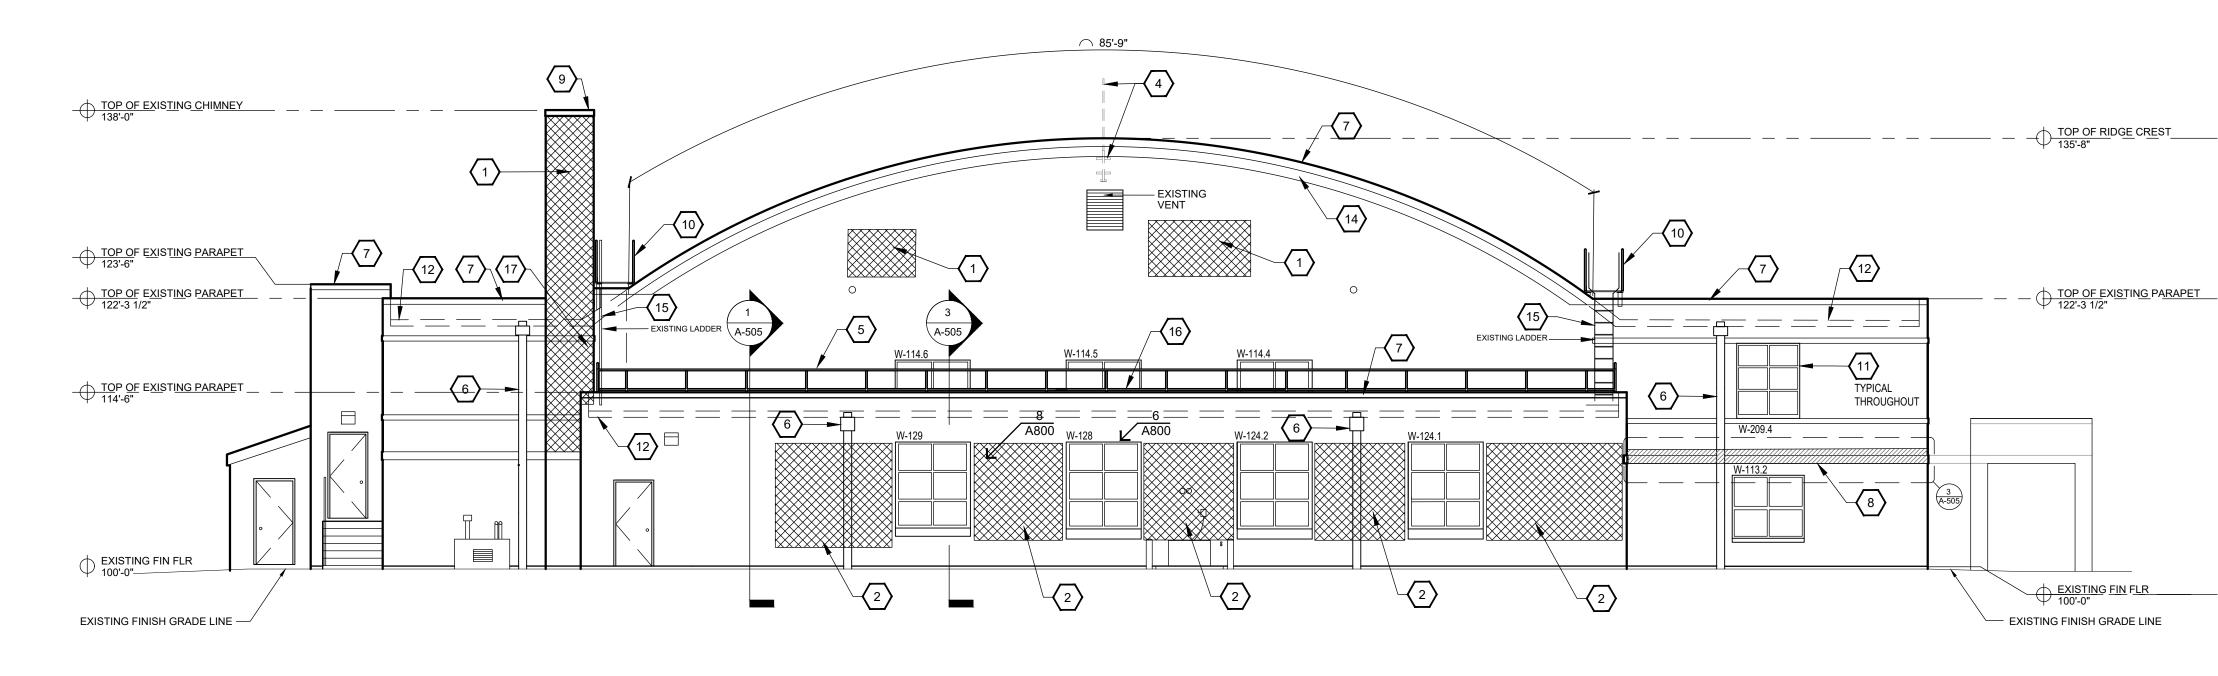

KEYED NOTES

- 1. TUCKPOINT HATCHED AREA. (SEE SPECIFICATIONS)
- 2. TUCKPOINT VARIOUS AND RANDOM SMALL LOCATIONS OF LOOSE/WEAK MORTAR THIS AREA. EACH AREA WILL REQUIRE APPROXIMATELY 50% TUCKPOINTING. (SEE SPECIFICATIONS)
- **REMOVE & REPLACE DAMAGED BRICK ON FLANKING** SIDES OF WINDOW AT LINTEL. SHOP FABRICATE LIP BRICK REPLACEMENT.
- EXISTING GABLE ANTENNA & WALL BRACKETS TO BE REMOVED IN TOTAL. REPAIR DAMAGED MASONRY AT WALL BRACKETS. (COORDINATE REMOVAL WITH PROJECT MANAGER)
- 5. NEW GALV. STL GUARDRAIL (PT-4) AT LOW ROOF ADJACENT TO PARAPET (SEE SECTION DETAIL 1/A-501)
- REPLACE EXISTING DOWNSPOUTS, RAIN 6 CONDUCTORS AND SCUPPER SLEEVES WITH IDENTICAL SIZE AND COLOR. (SEE SECTION DETAILS 2/A-501 & 1/A-500 FOR SCUPPER AND RAIN CONDUCTOR)
- NEW 0.80 THICK PREFINISHED METAL COPING -COLOR TO MATCH EXISTING. (SEE SECTION DETAIL 1/A-500)
- REPAIR OF EXISTING GARAGE DOOR LINTEL (PT-3) (SEE ELEVATION & DETAILS A-508)
- REMOVE AND REPLACE PREFIN GALVANIZED CHIMNEY CAP - COLOR TO MATCH PREFIN MTL COPING.
- 10. LADDER ACCESS PLATFORM w/1" BAR GRATE FLOOR, 6"x4" STL ANGLE FRAME ON 6"x6"STL PLATE ON 4"x4" STL TUBE POSTS. SECURE 1¹/₄" STD STL PIPE GUARDRAIL TO 6" STL ANGLE FRAME. (ALL STEEL IS GALVANIZED AND HIGH PERFORMANCE COATING FINISH PT-4) (SEE 1/A-506)
- 11. REMOVE EXISTING WINDOW SEALANT AND REINSTALL NEW SEALANT TYPICAL ALL WINDOWS
- 12. BOTTOM LINE INDICATES LOCATION OF EXISTING **ROOF DECK - TOP LINE INDICATES ELEVATION OF** NEW ROOF SYSTEM.
- 13. NOT USED.
- 14. PROVIDE PREFINISHED METAL COWLING AT TOP OF END WALLS ADJACENT TO BOW TRUSS ROOF - LAP EXTERIOR FACE OF COPING OVER COWLING.
- 15. REMOVE EXISTING LADDER FOR REPAIRS, MODIFICATIONS AND PAINTING. REINSTALL IN ORIGINAL LOCATION.
- 16. REMOVE EXISTING ASBESTOS IMPREGNATED SEALANT AS INDICATED IN HAZMAT INVESTIGATION NOTED AS ACM BLACK FLASHING CAULK AT NORTH **CENTRAL WINDOW**. RESEAL WINDOW.
- 17. REMOVE EXISTING ASBESTOS IMPREGNATED SEALANT AS INDICATED IN HAZMAT INVESTIGATION NOTED AS ACM FLACK FLASHING CAULK AT CHIMNEY/BRICK. RESEAL.


SYMBOL LEGEND



KEYED NOTE



TUCKPOINTING

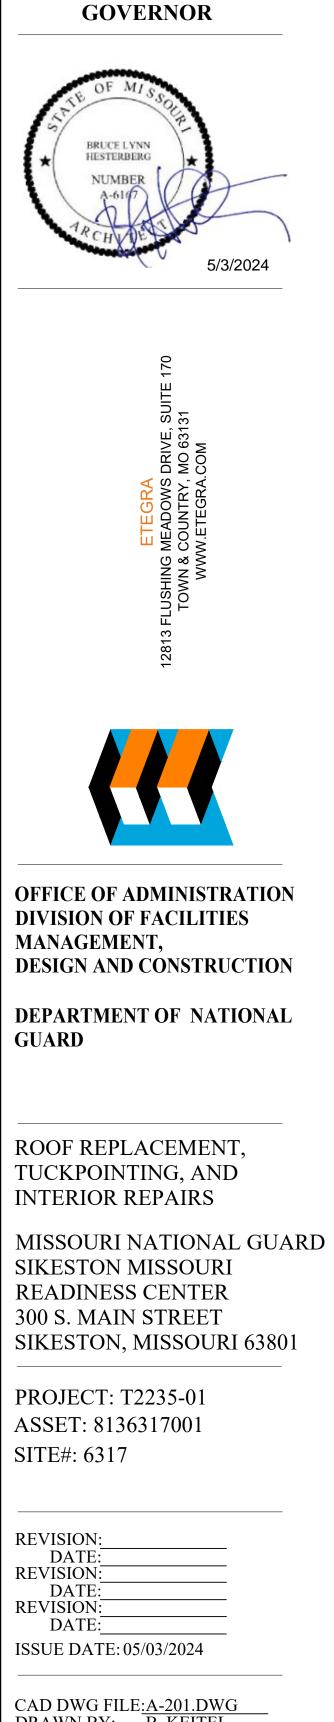

STATE OF MISSOURI


MICHAEL L. PARSON,


CAD DWG FILE:<u>A-201.DWG</u> DRAWN BY: <u>B. KEITEL</u> CHECKED BY: <u>B. HESTERBER</u>G DESIGNED BY: T. WIKELSKI

SHEET TITLE: NORTH AND SOUTH ELEVATIONS

SHEET NUMBER:


A-201 9 OF 21 SHEETS 05/03/2024

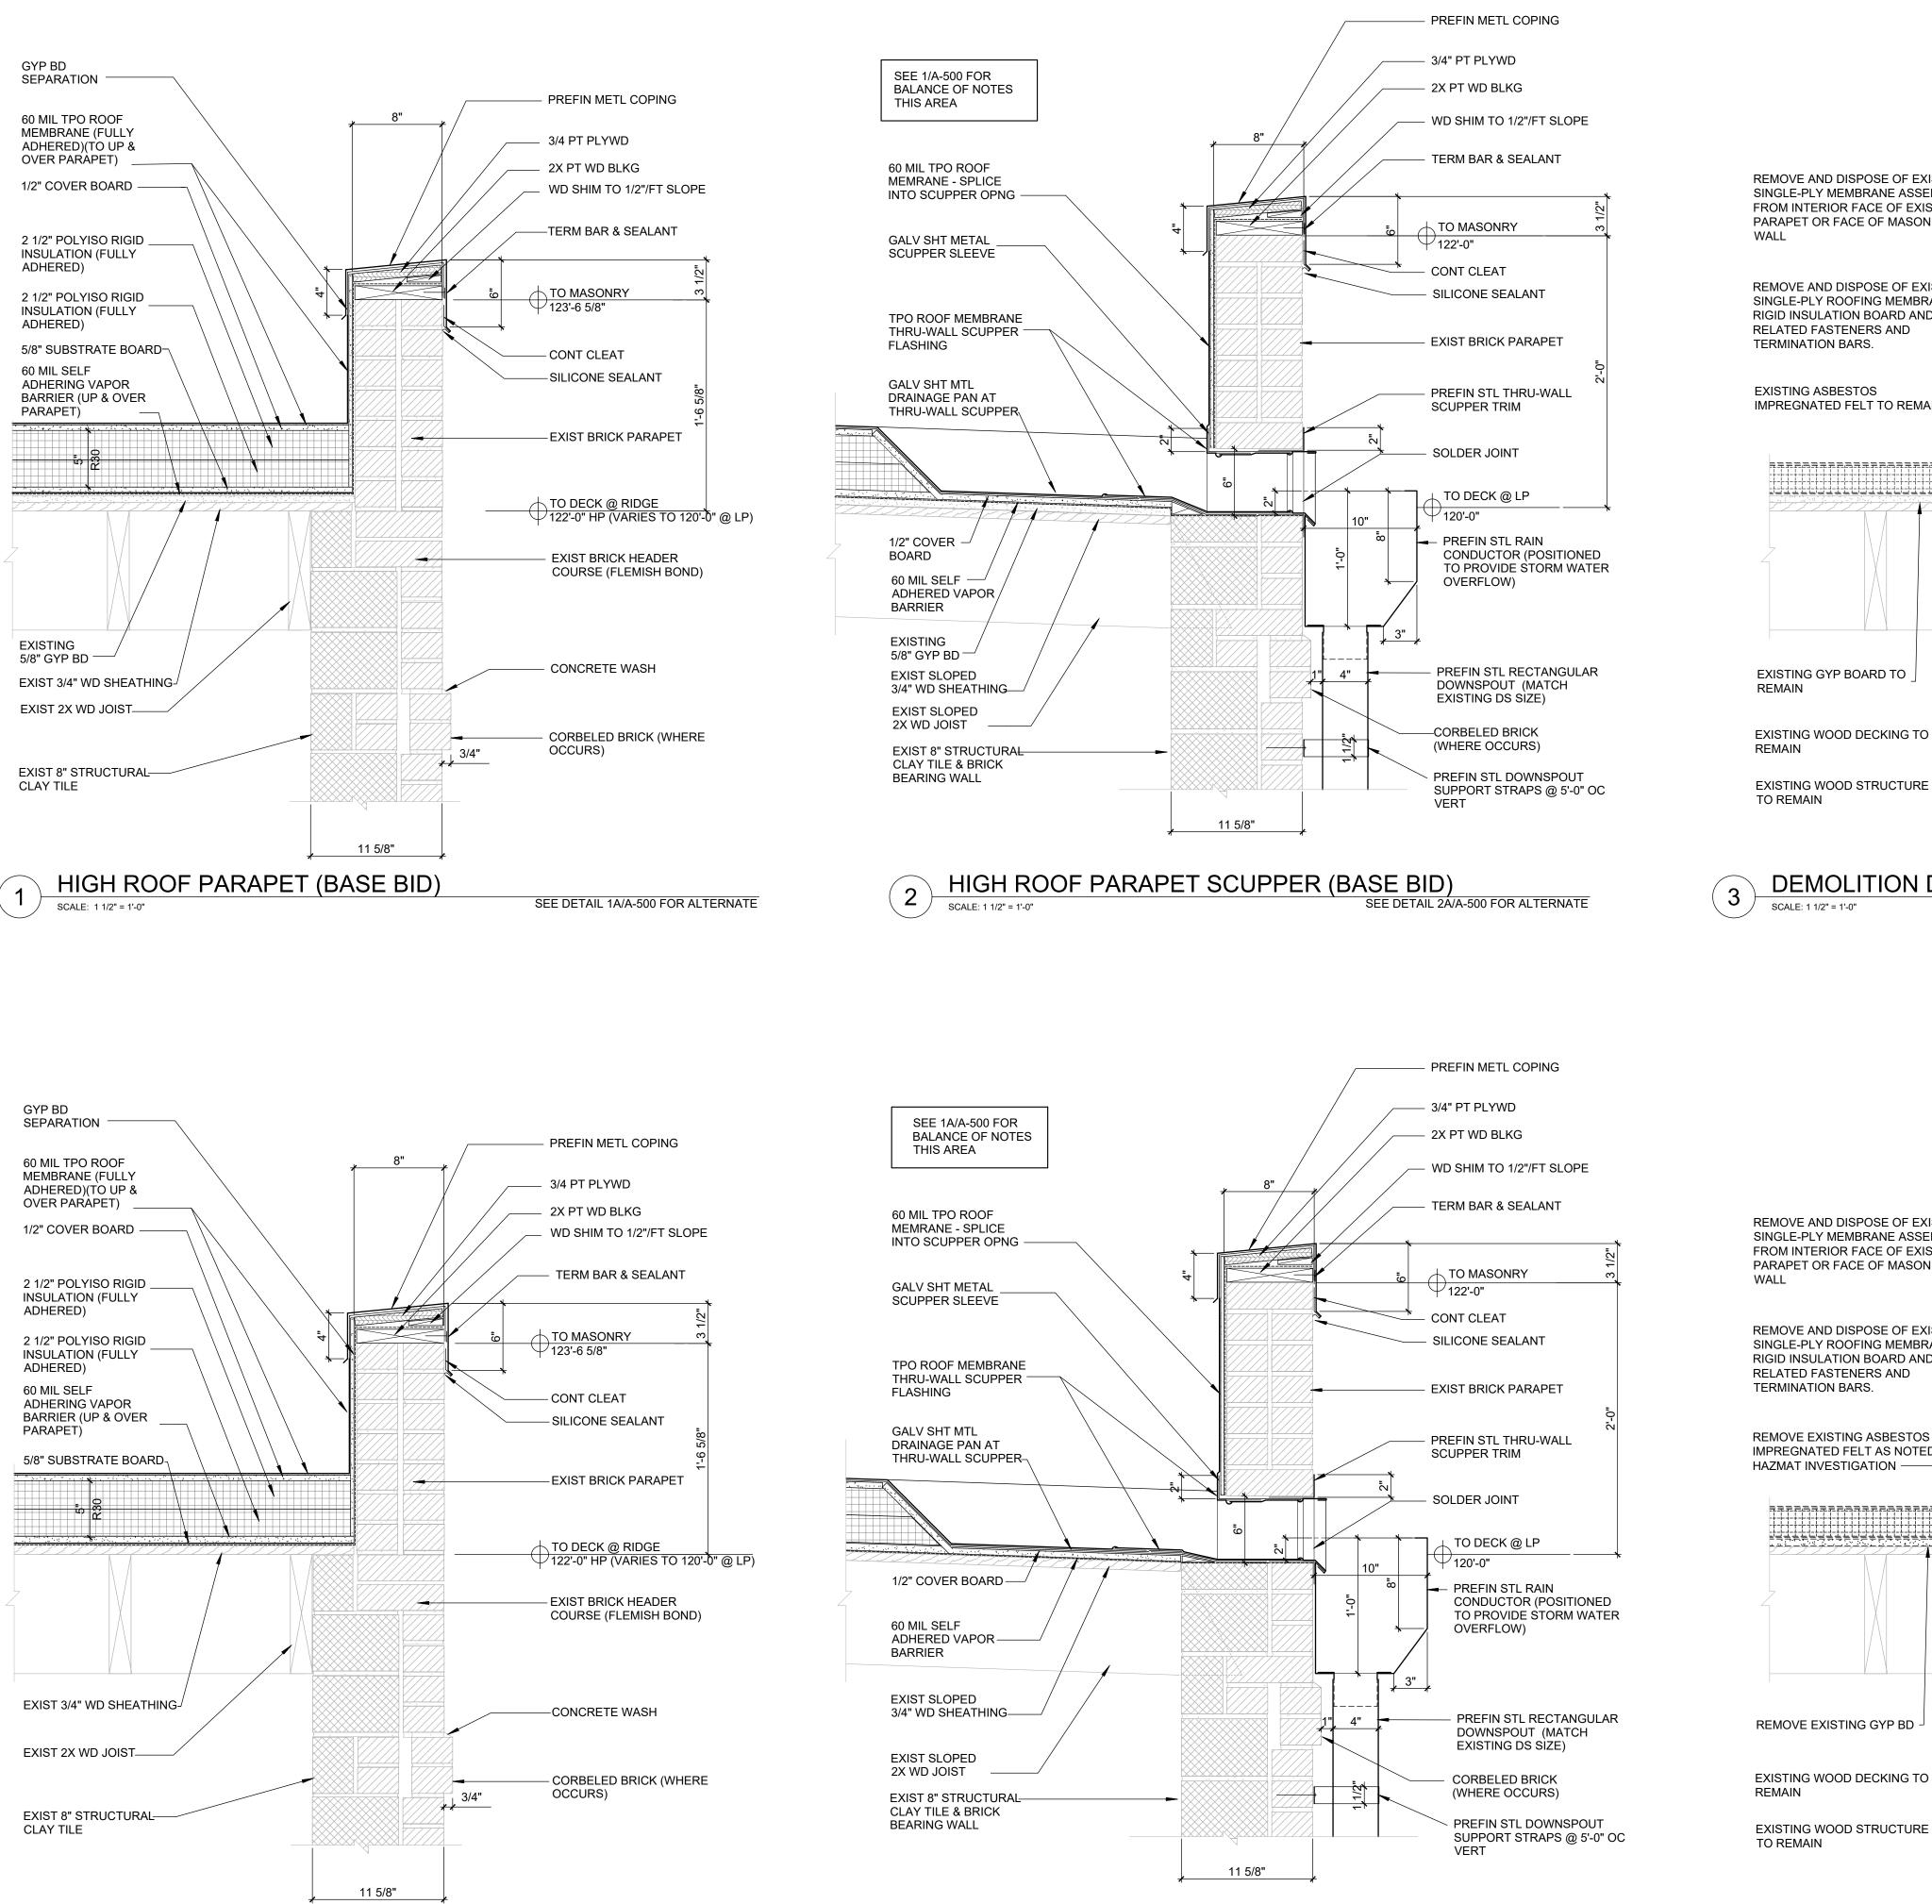


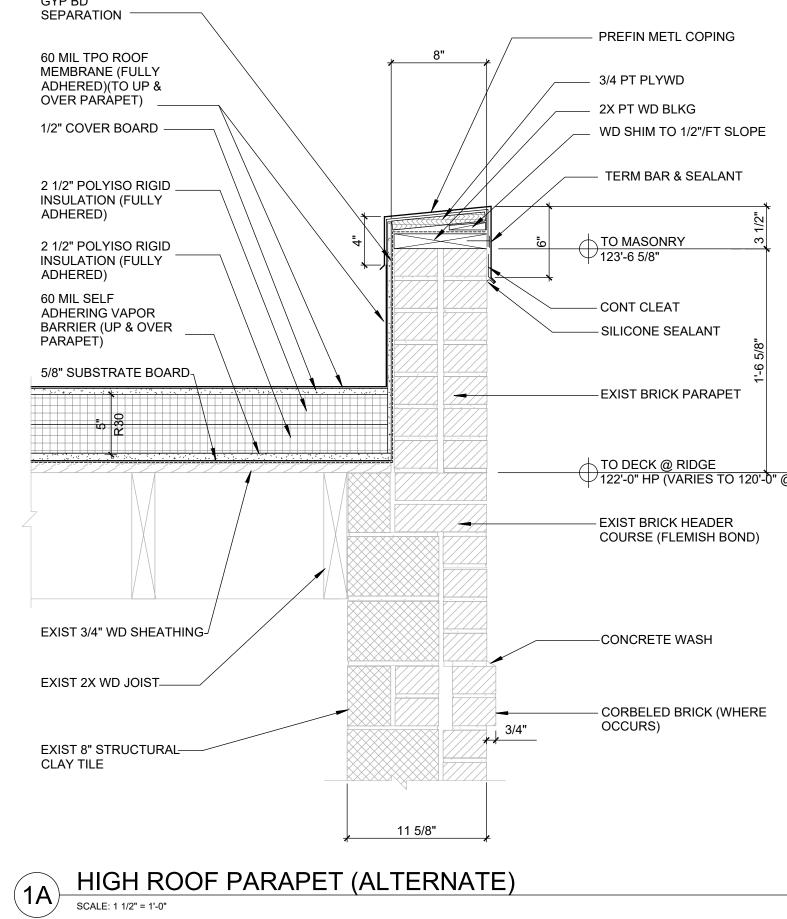

HIGH ROOF PARAPET SCUPPER (ALTERNATE) (**2**A) SCALE: 1 1/2" = 1'-0"



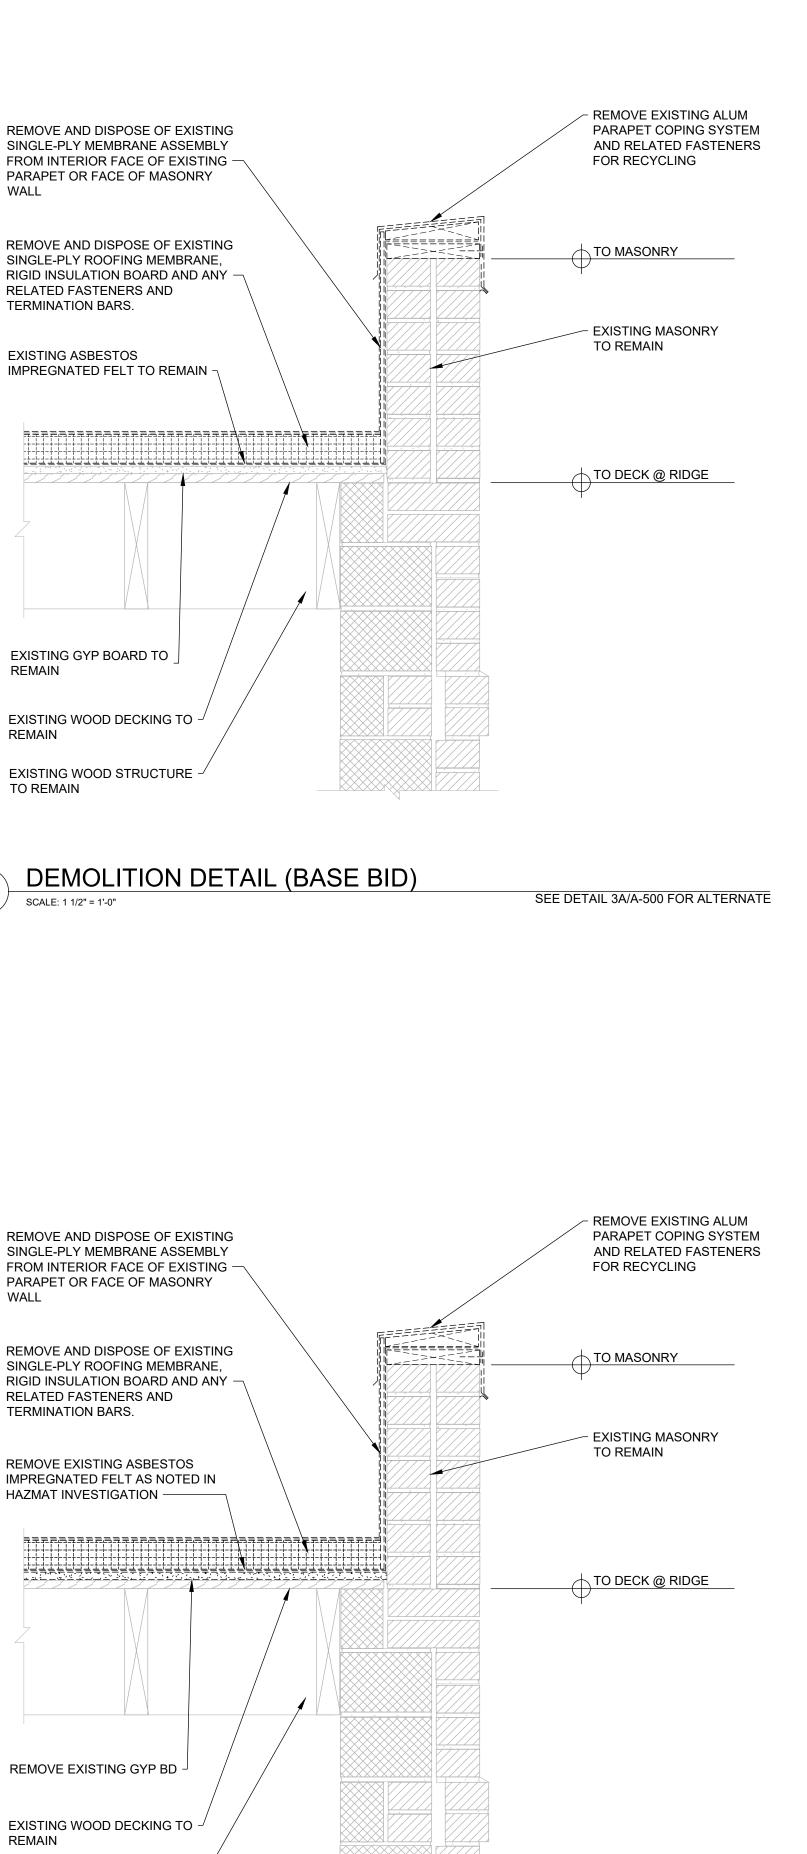

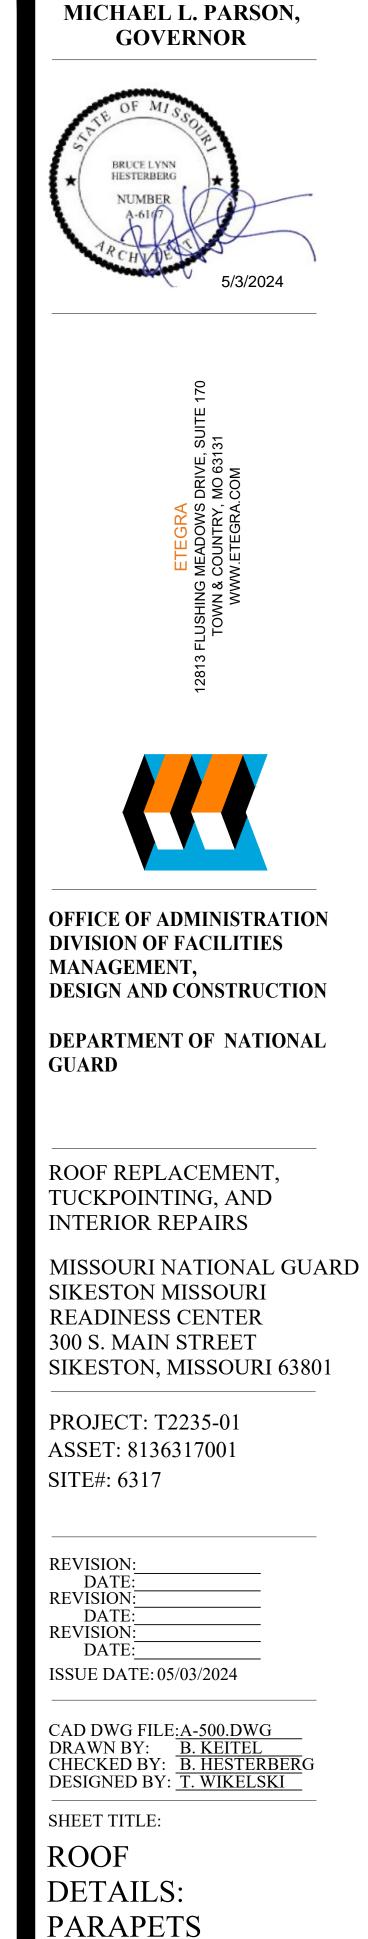



STATE OF MISSOURI

DEMO DETAIL (ALTERNATE)


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 $^{1}A-500$ 10 OF 21 SHEETS 05/03/2024



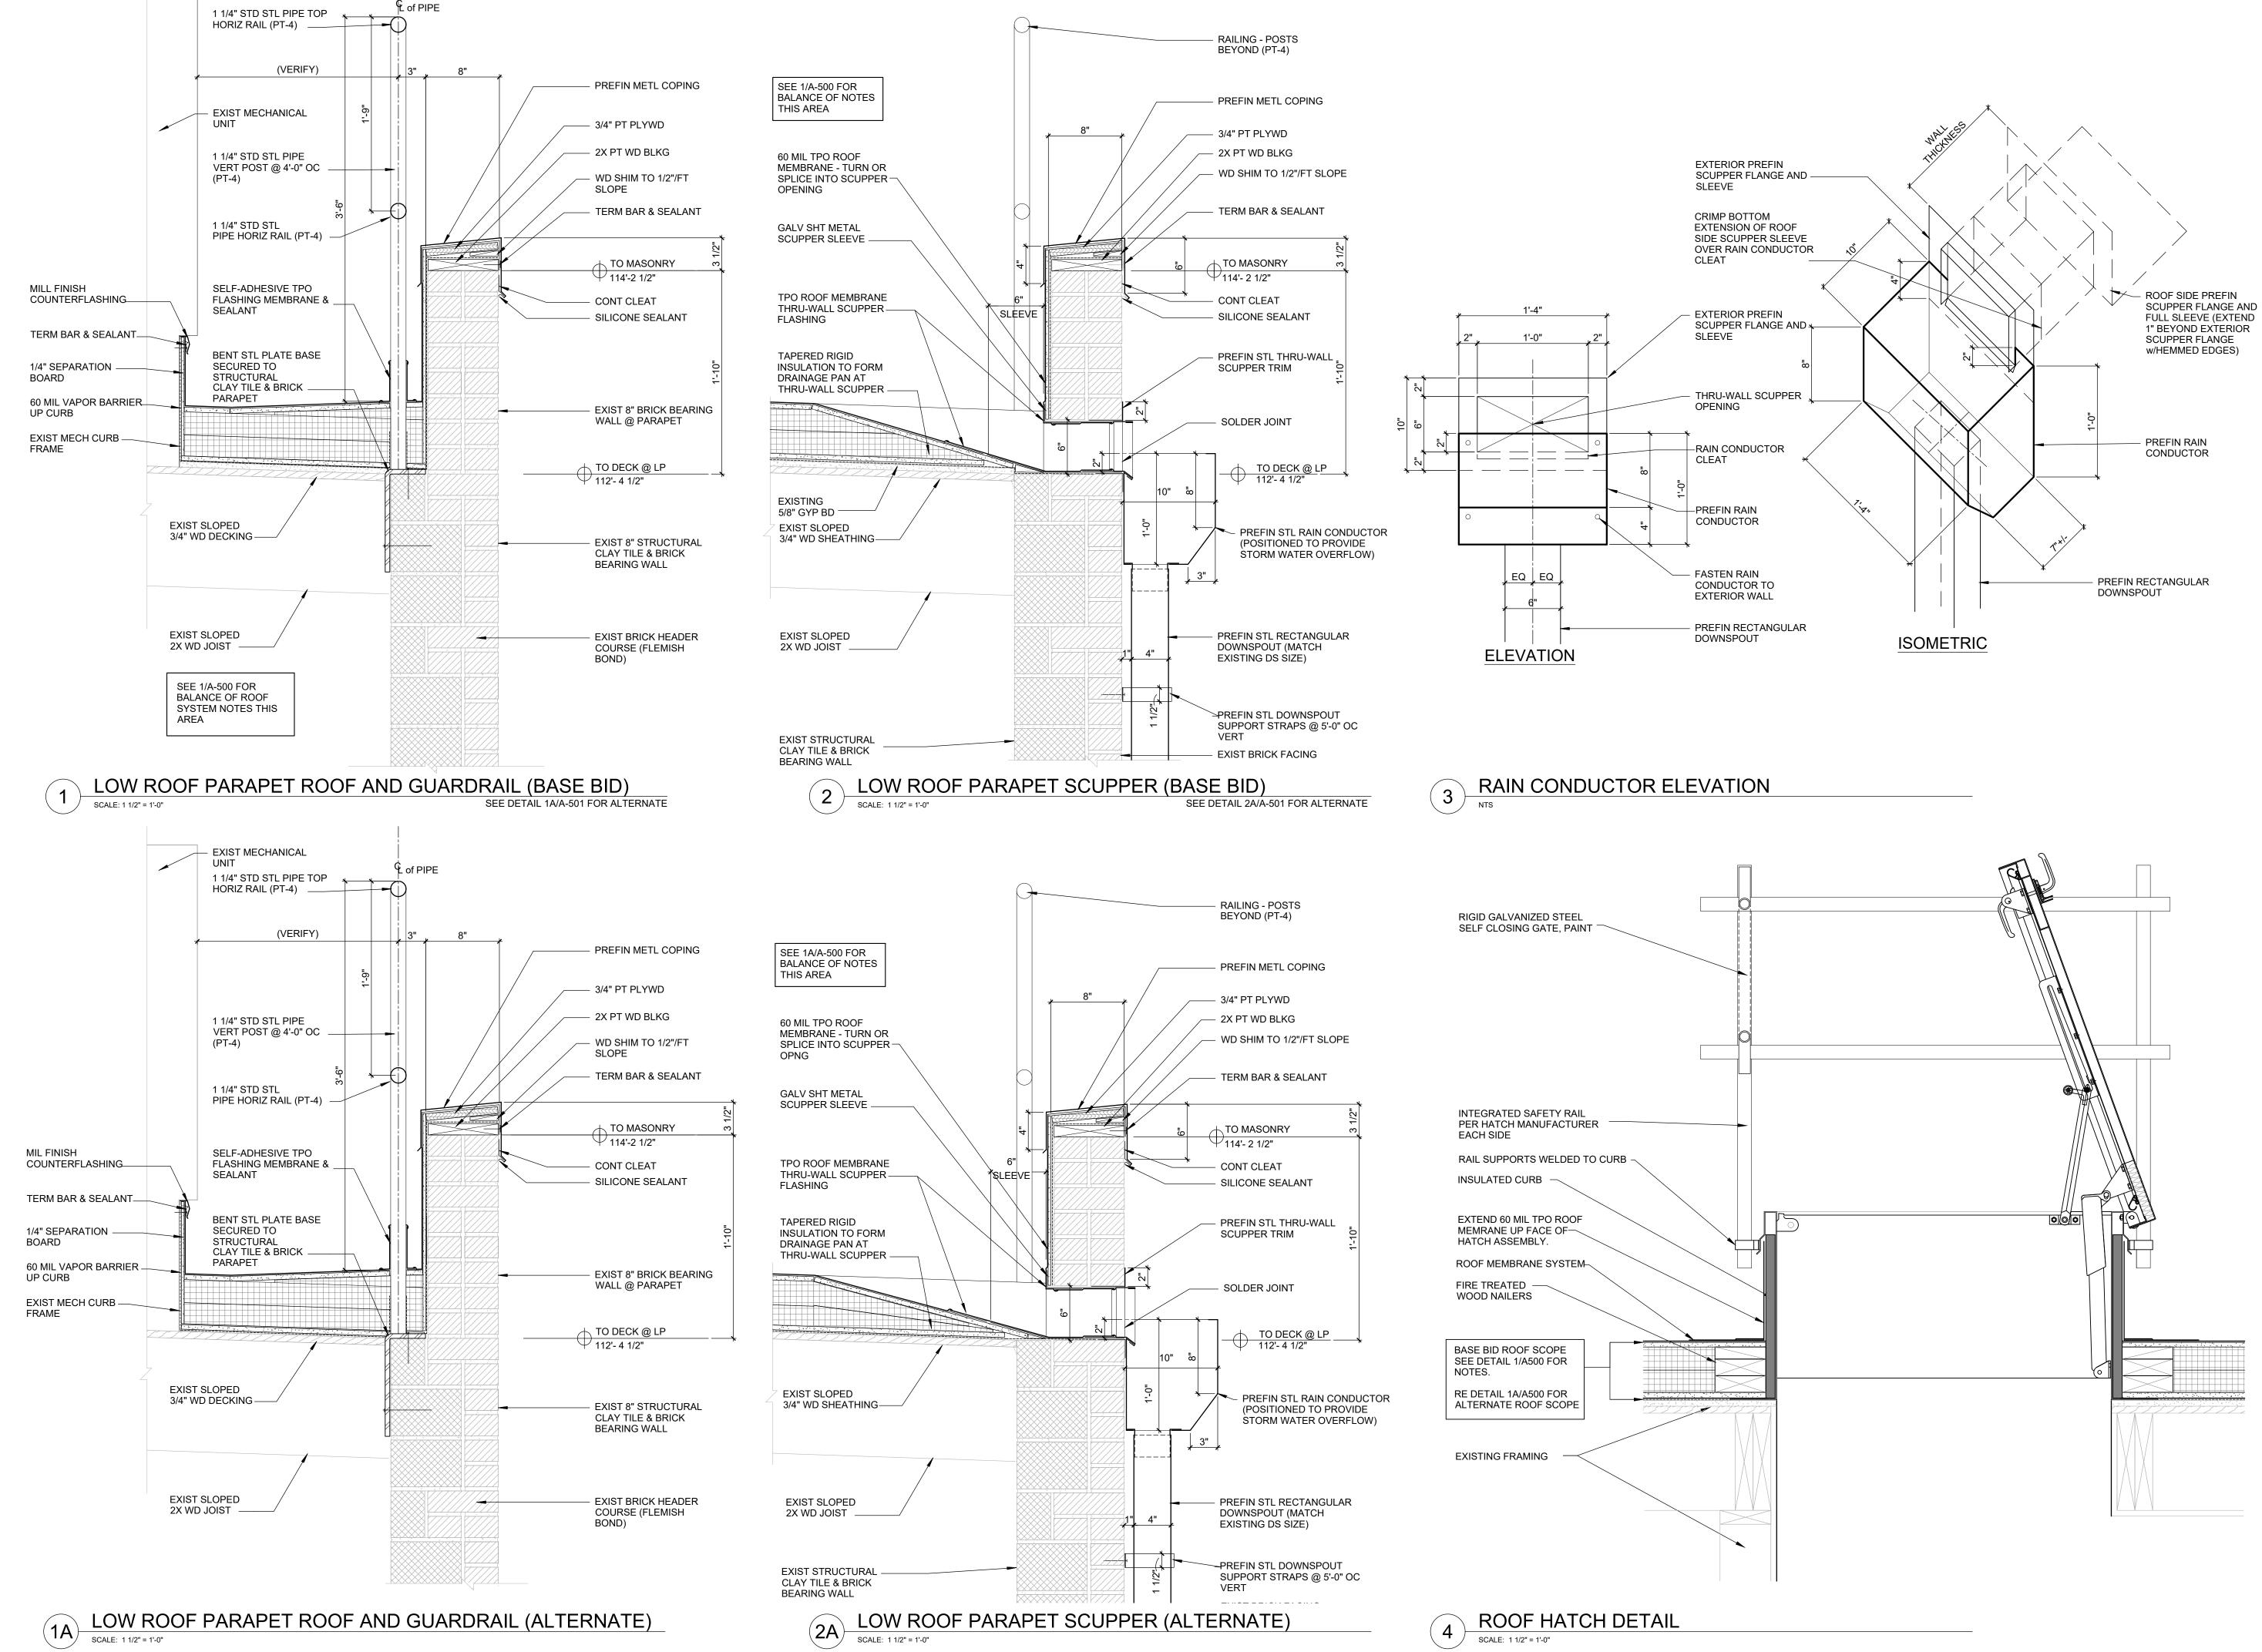

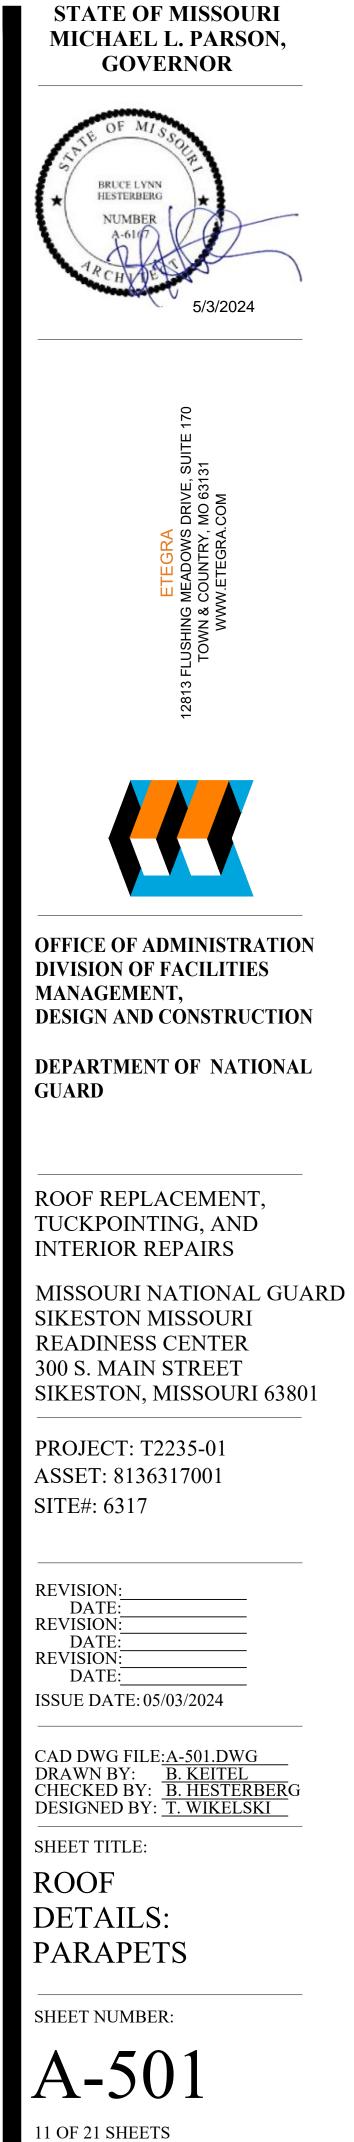
05/03/2024

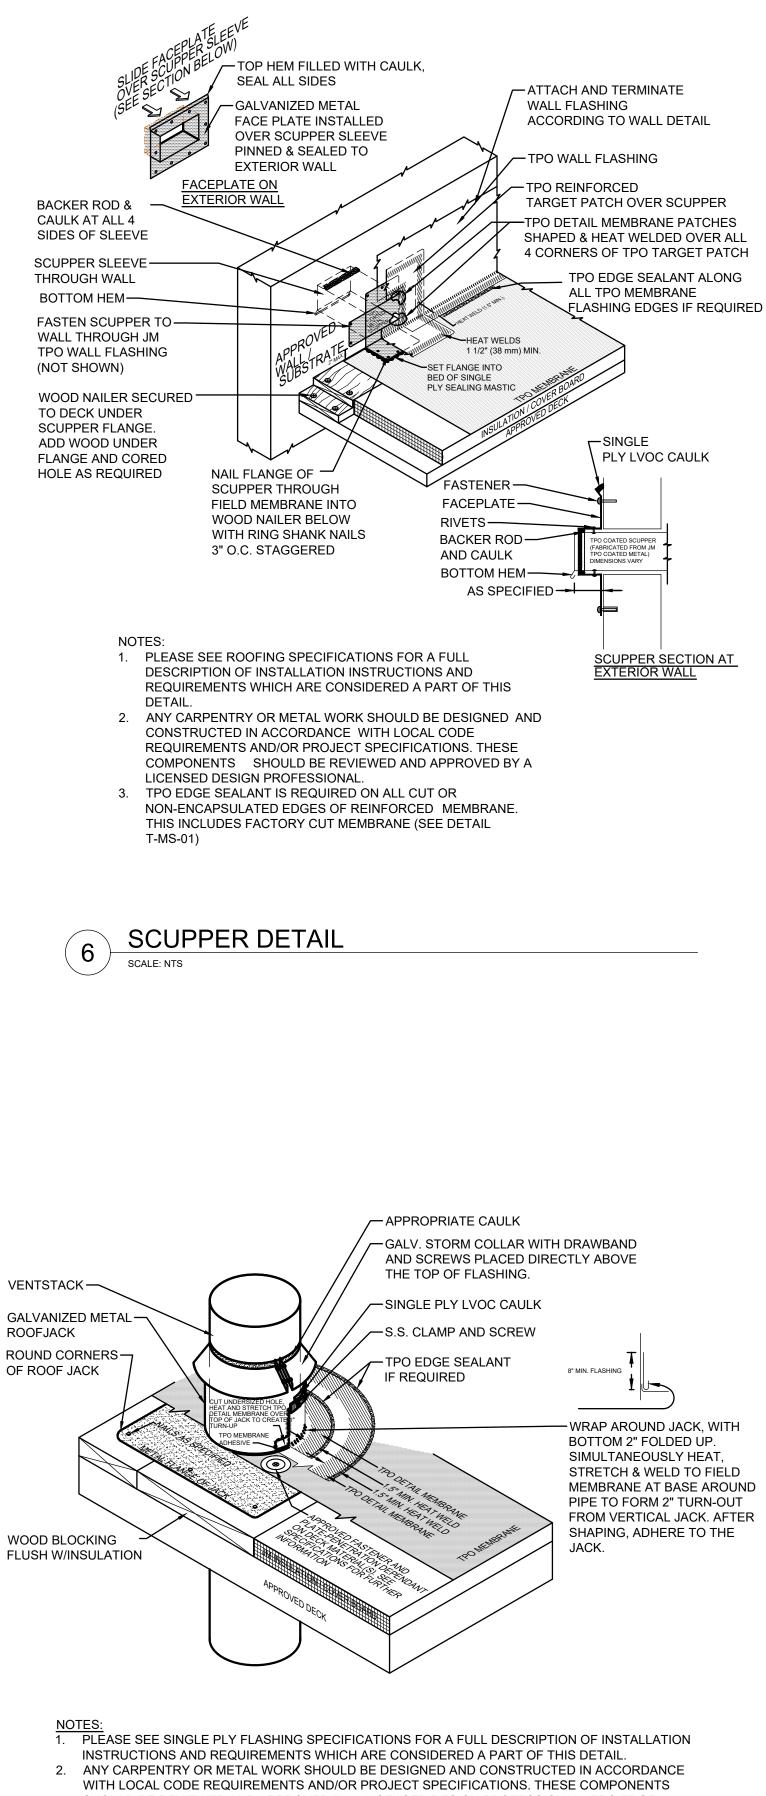

SHOULD BE REVIEWED AND APPROVED BY A LICENSED DESIGN PROFESSIONAL. TPO EDGE SEALANT IS REQUIRED ON ALL CUT OR NON-ENCAPSULATED EDGES OF REINFORCED


3. MEMBRANE. THIS INCLUDES FACTORY CUT MEMBRANE (SEE DETAIL T-MS-01)

VENT PIPE DETAIL SCALE: NTS

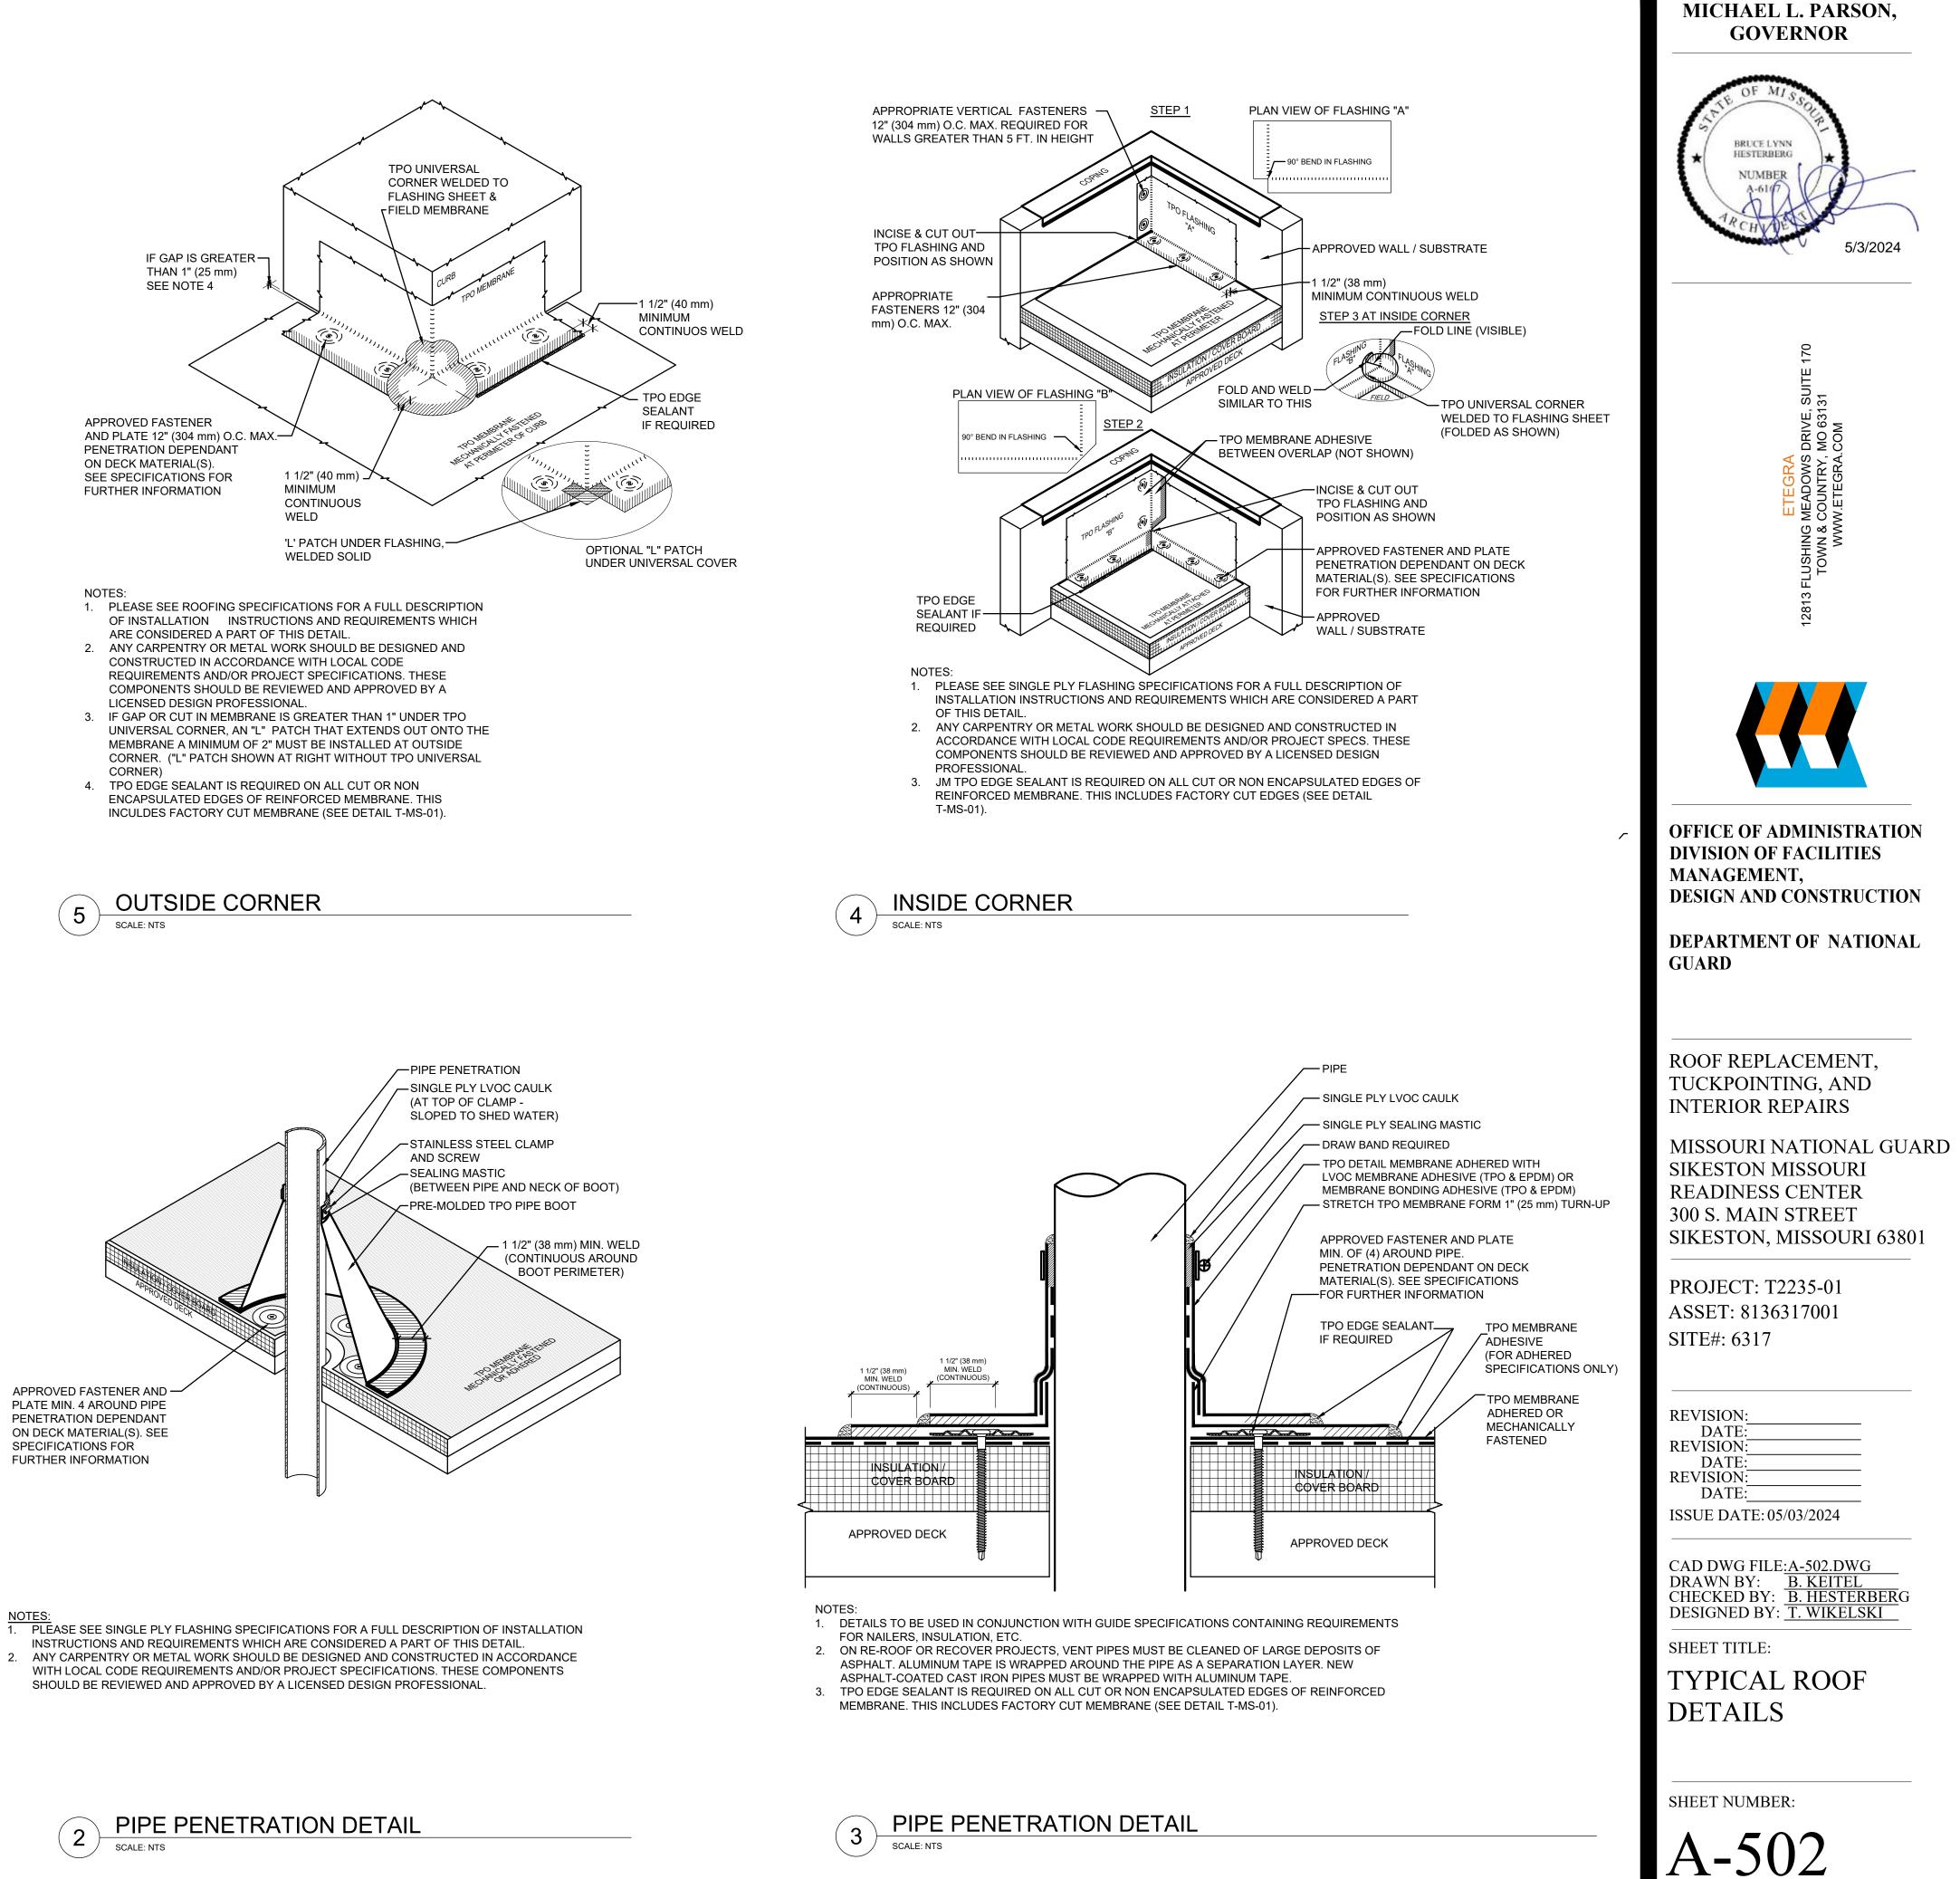






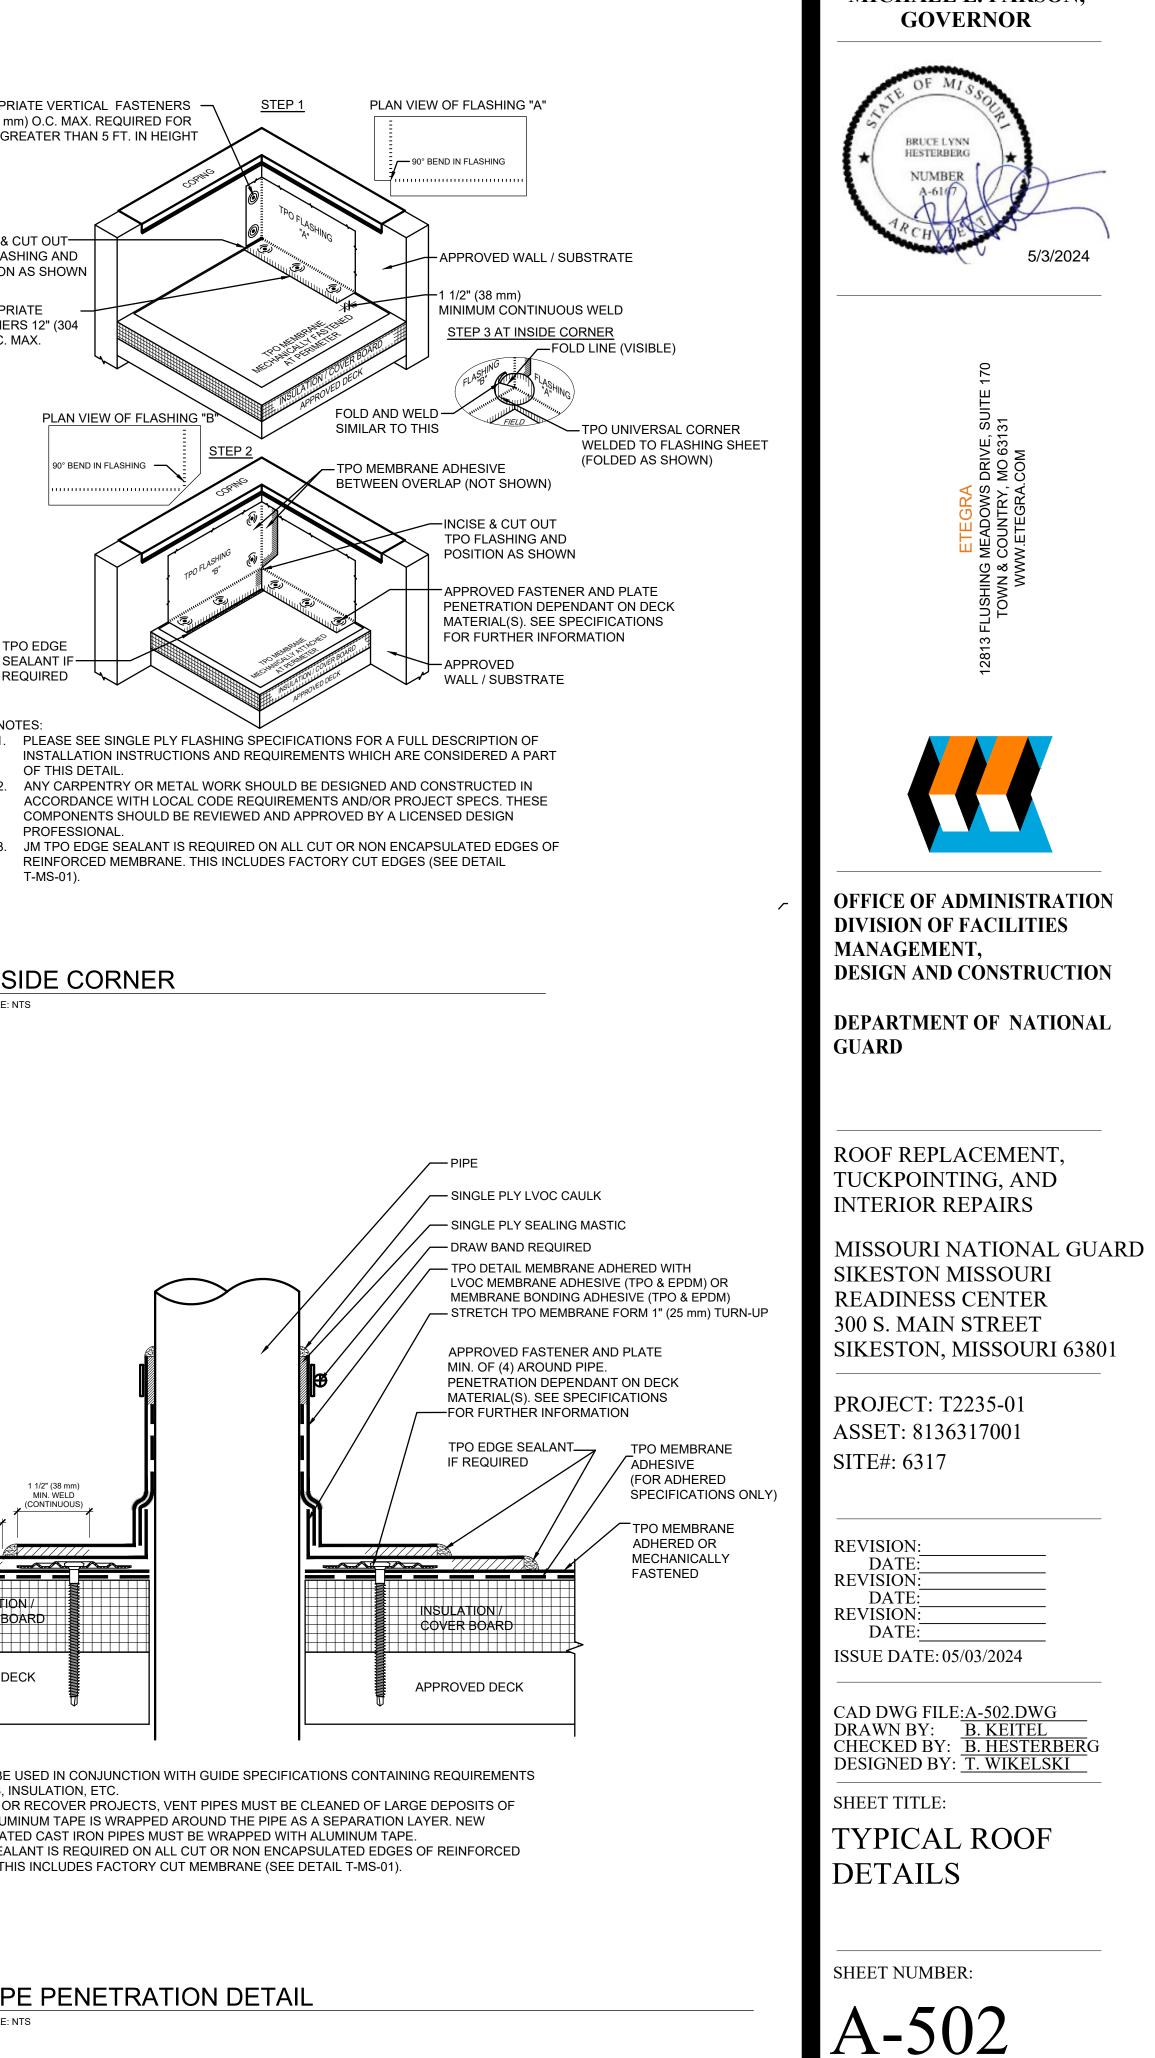

STATE OF MISSOURI

12 OF 21 SHEETS


05/03/2024

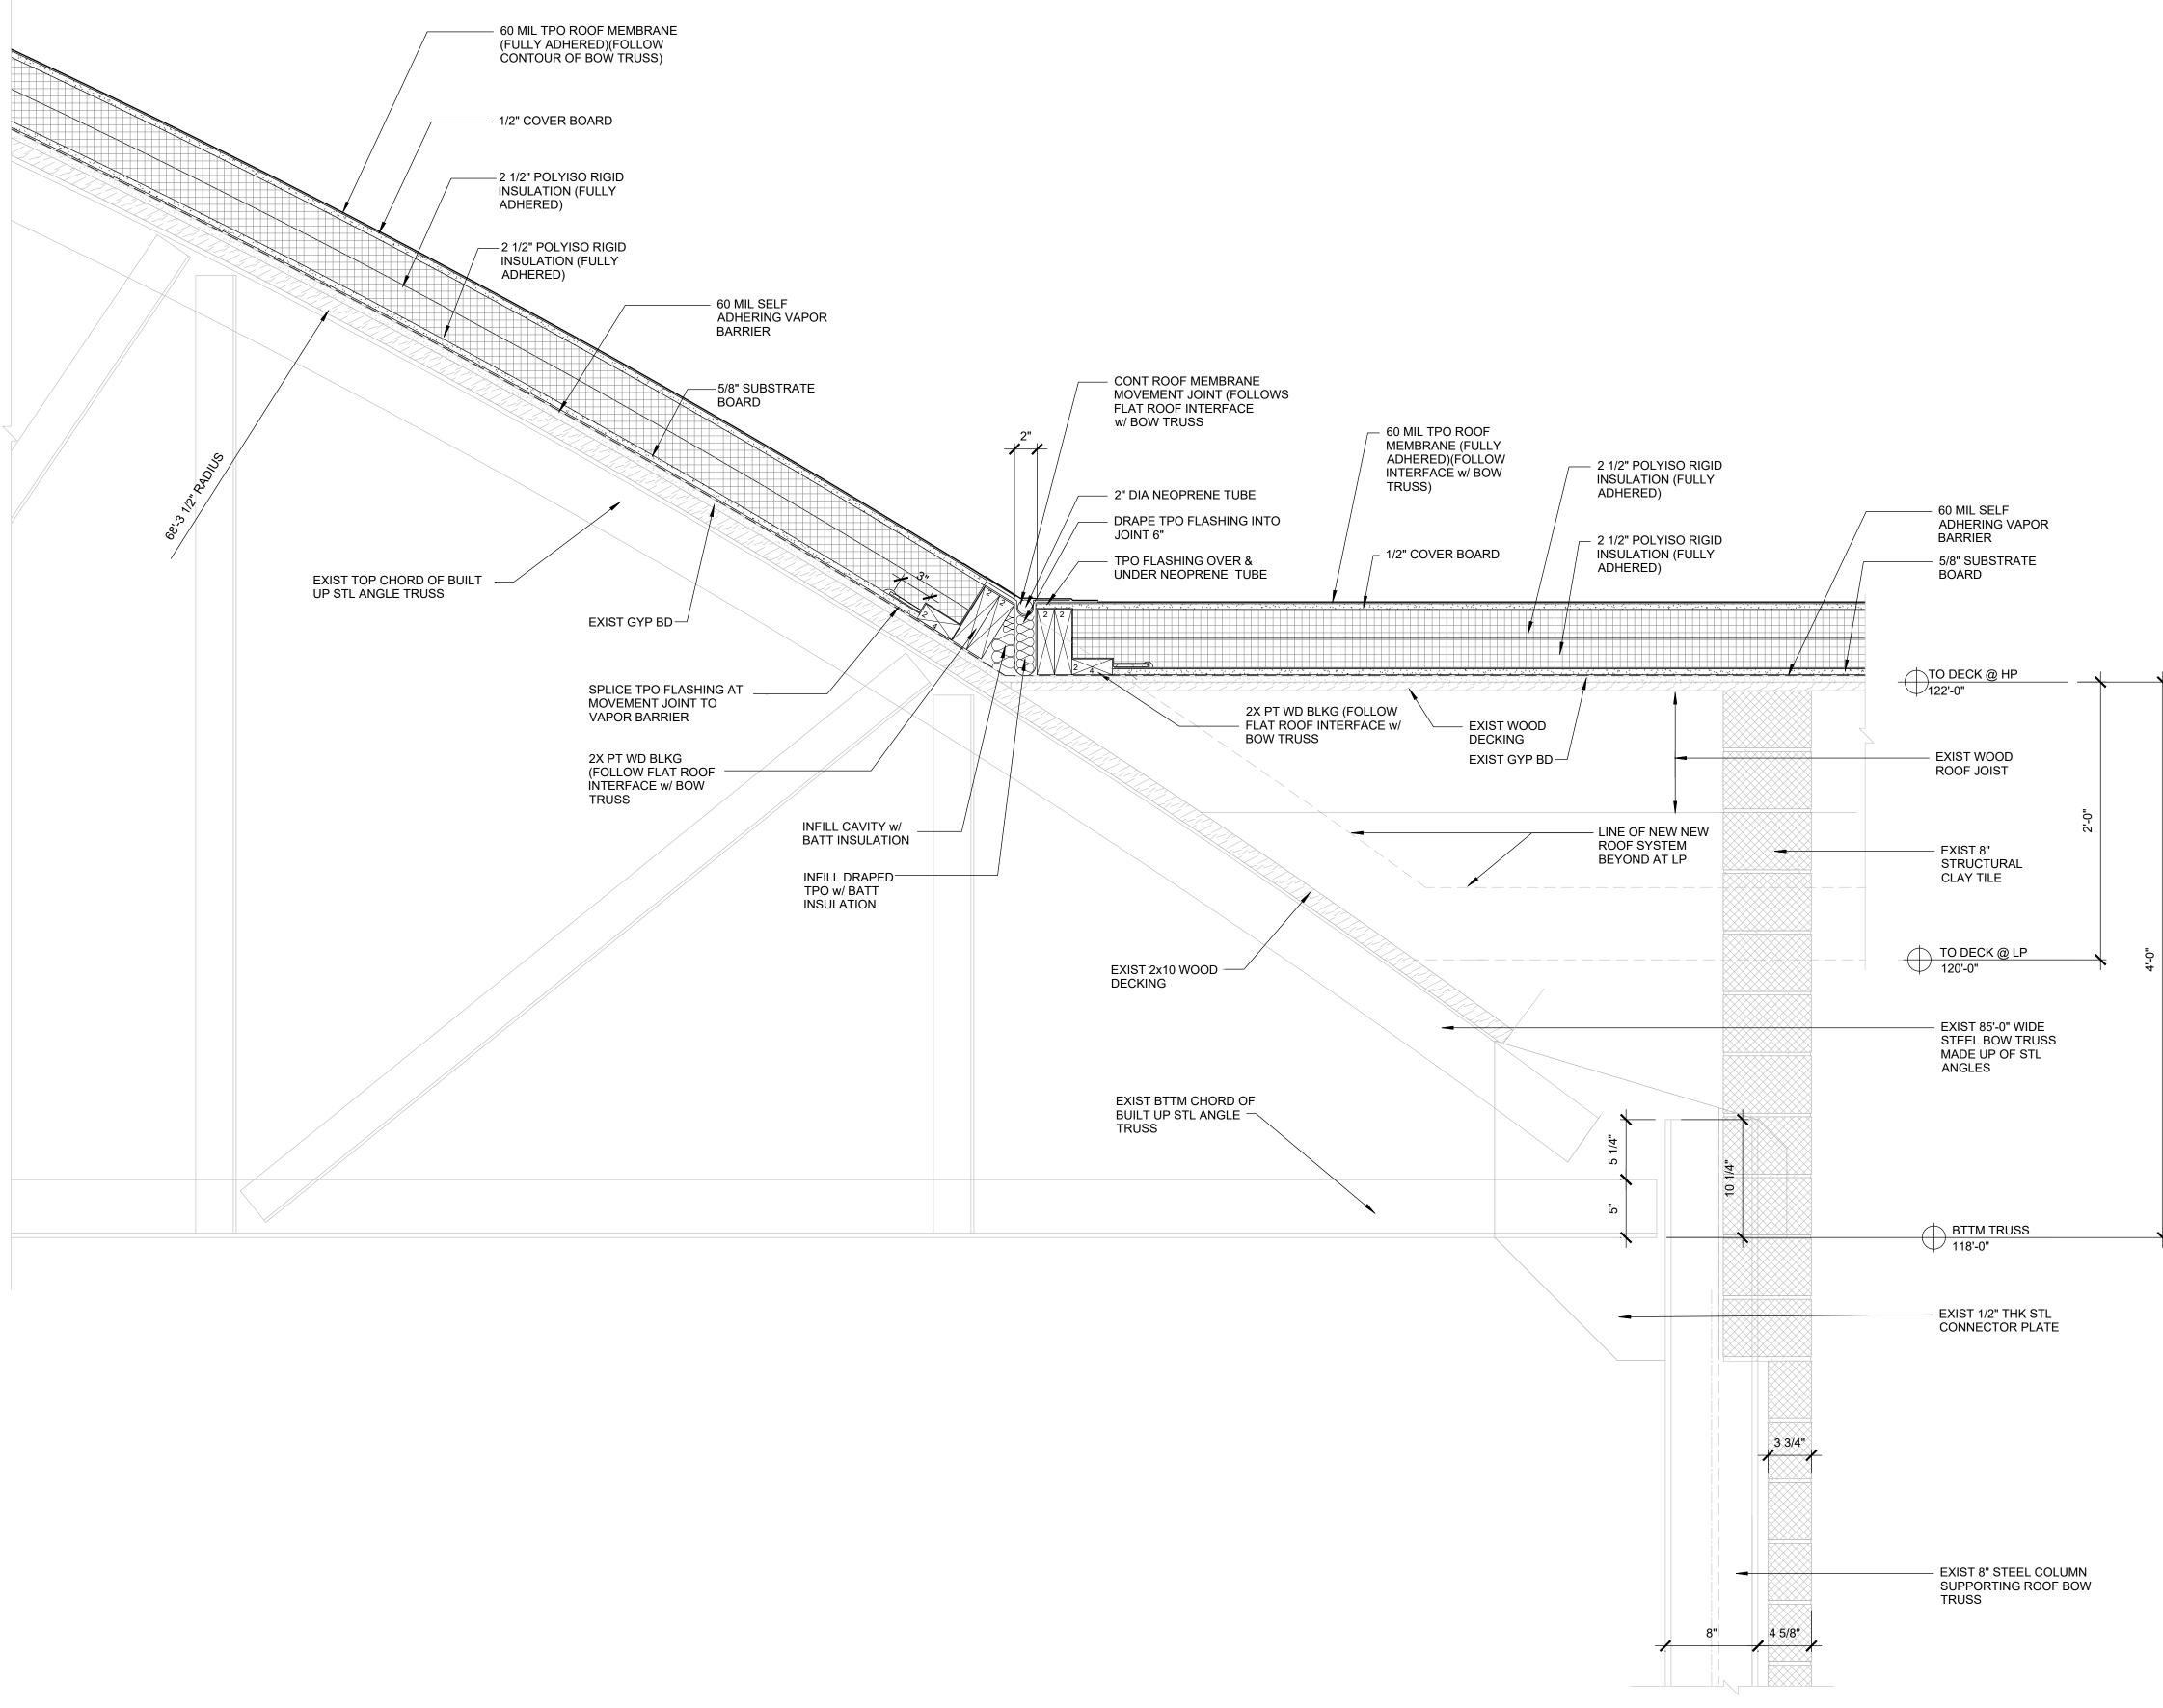


BOW TRUSS AT FLAT ROOF (1) SCALE: 1 1/2" = 1'-0"

SEE DETAIL 1/A-504 FOR ALTERNATE


STATE OF MISSOURI MICHAEL L. PARSON, GOVERNOR
BRUCE LYNN HESTERBERG NUMBER A-6107 ARCHIVE
ETEGRA 12813 FLUSHING MEADOWS DRIVE, SUITE 170 TOWN & COUNTRY, MO 63131 WWW.ETEGRA.COM
OFFICE OF ADMINISTRATION DIVISION OF FACILITIES MANAGEMENT, DESIGN AND CONSTRUCTION
DEPARTMENT OF NATIONAL GUARD
ROOF REPLACEMENT, TUCKPOINTING, AND INTERIOR REPAIRS MISSOURI NATIONAL GUARD
SIKESTON MISSOURI READINESS CENTER 300 S. MAIN STREET SIKESTON, MISSOURI 63801
PROJECT: T2235-01 ASSET: 8136317001 SITE#: 6317
REVISION: DATE: REVISION: DATE: REVISION: DATE: DATE: ISSUE DATE: 05/03/2024
CAD DWG FILE:A-503.DWG DRAWN BY: <u>B. KEITEL</u> CHECKED BY: <u>B. HESTERBER</u> G DESIGNED BY: <u>T. WIKELSKI</u> SHEET TITLE: ROOF DETAILS
SHEET NUMBER: A-503 13 OF 21 SHEETS 05/03/2024

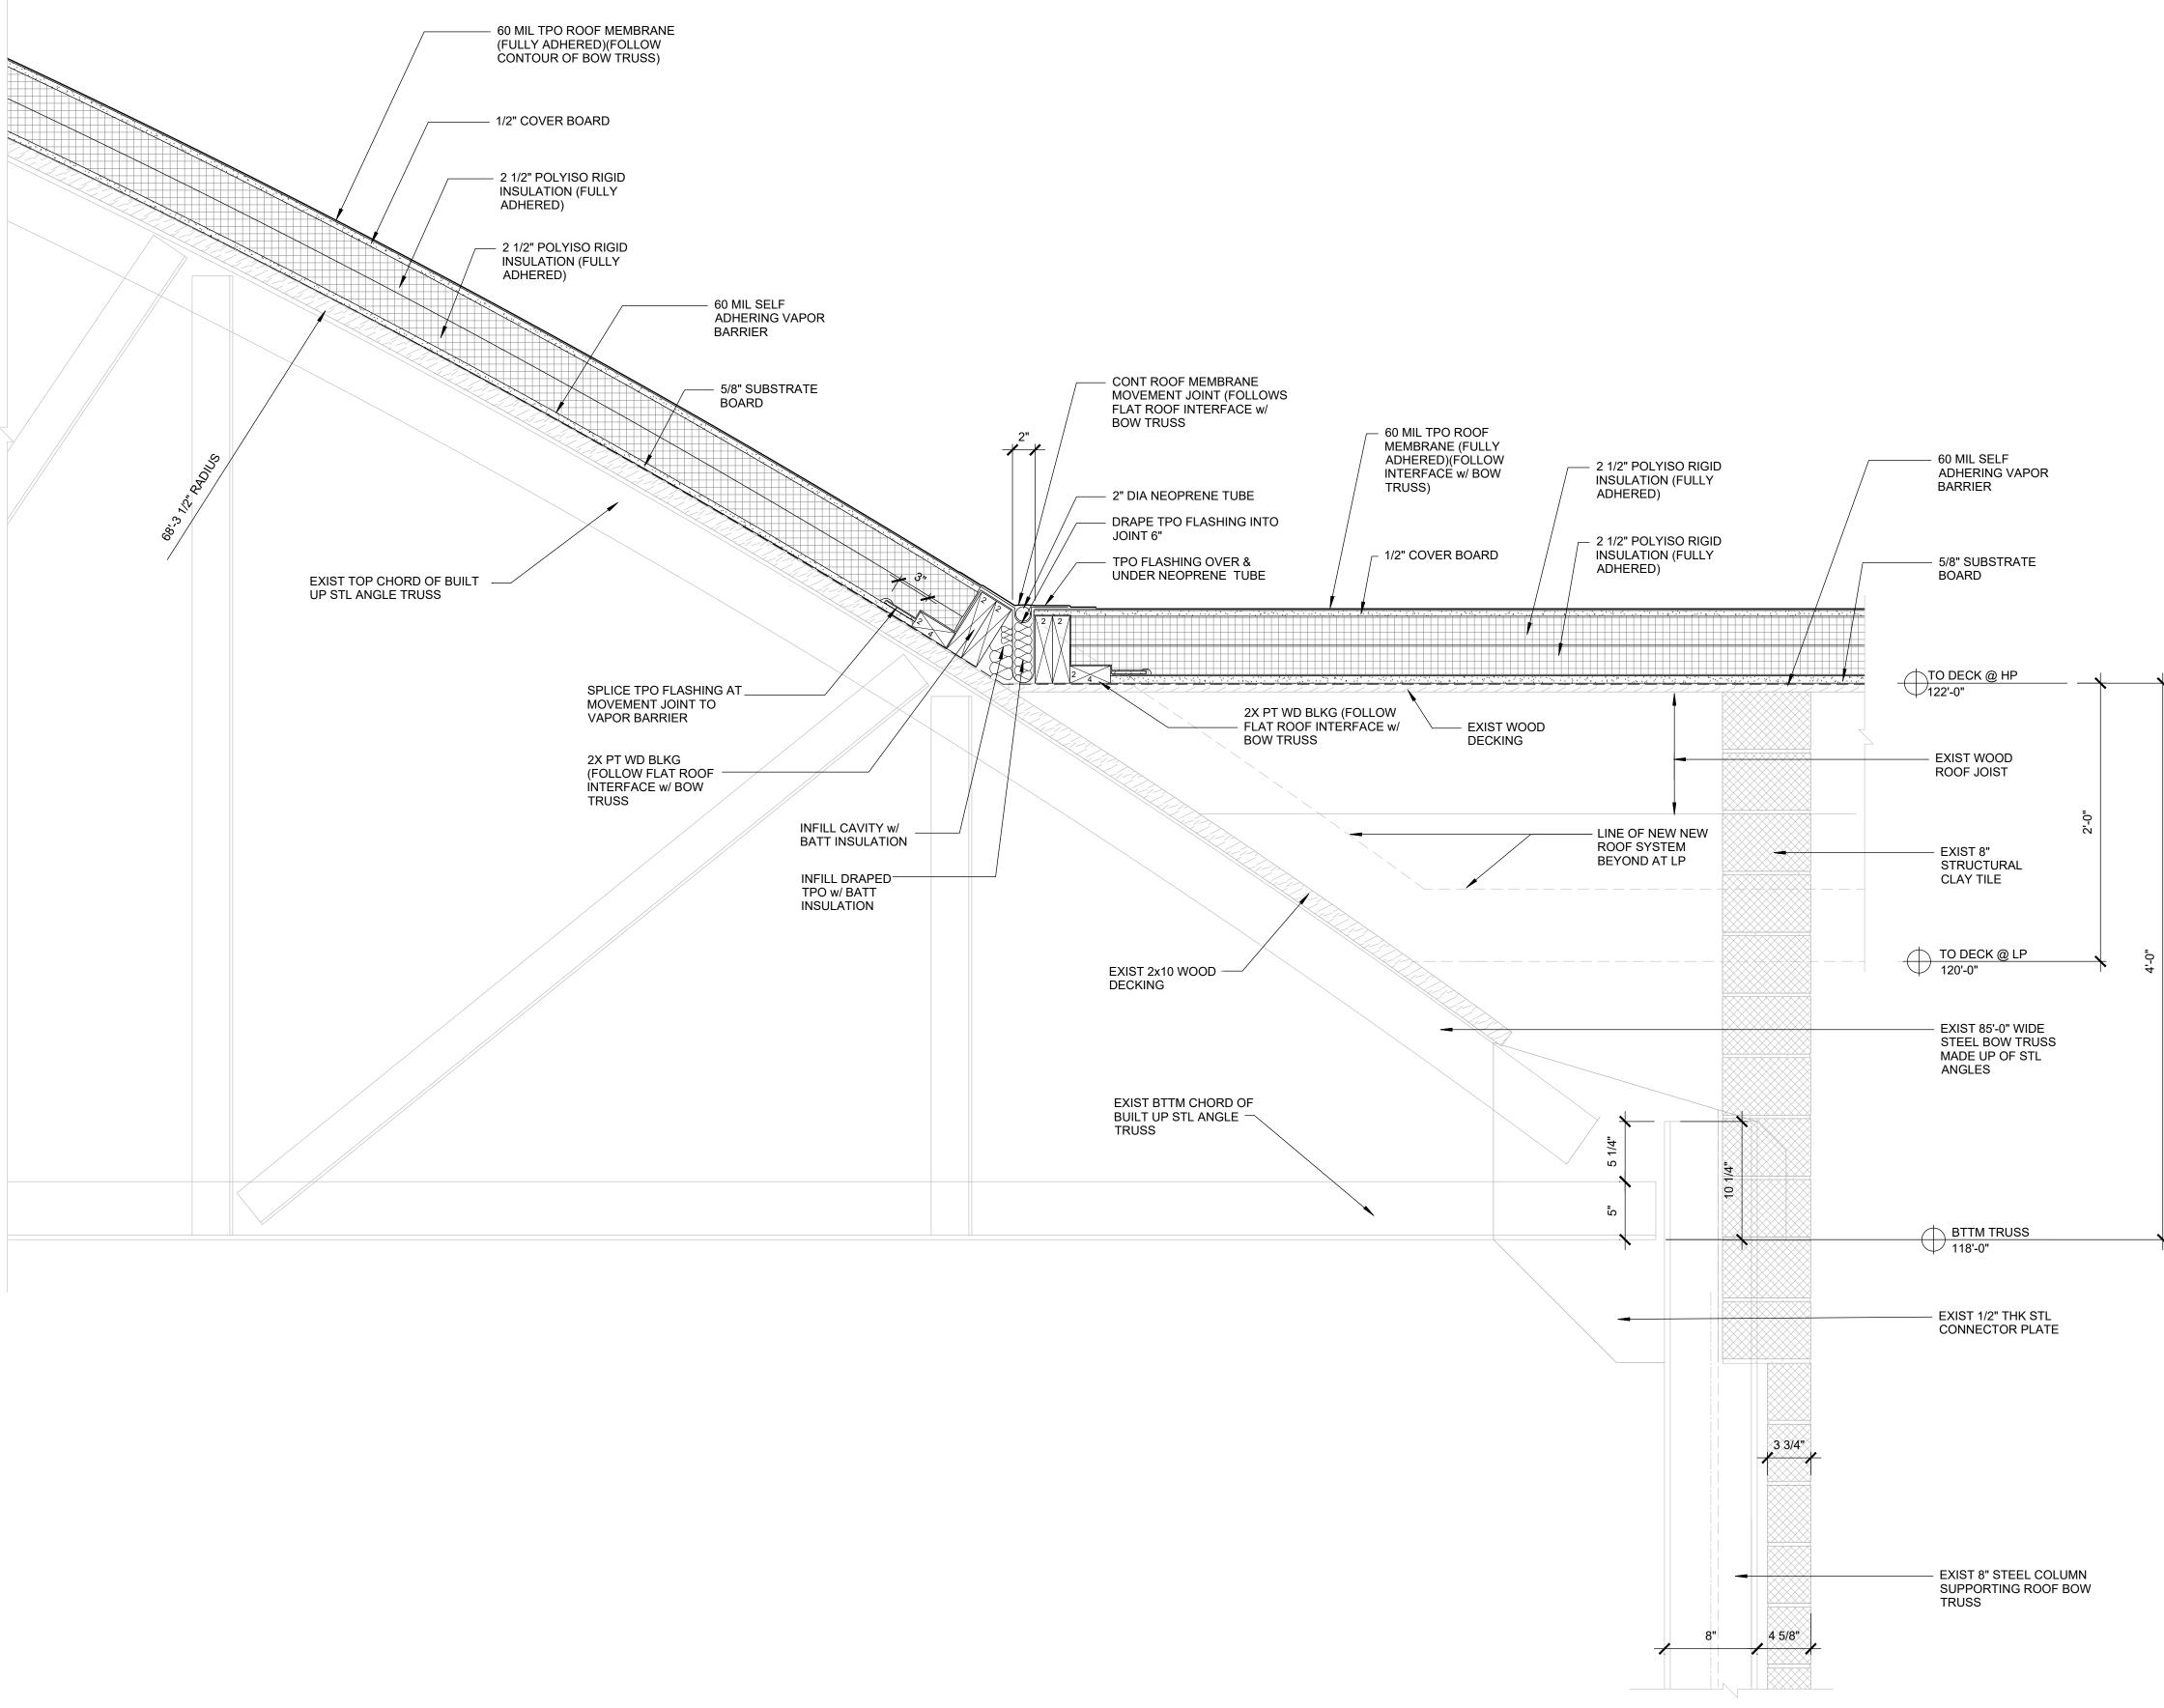


STATE OF MISSOURI MICHAEL L. PARSON, GOVERNOR
BRUCE LYNN HESTERBERG NUMBER A-6107 AR CHIVE S/3/2024
ETEGRA 12813 FLUSHING MEADOWS DRIVE, SUITE 170 TOWN & COUNTRY, MO 63131 WWW.ETEGRA.COM
OFFICE OF ADMINISTRATION DIVISION OF FACILITIES MANAGEMENT, DESIGN AND CONSTRUCTION DEPARTMENT OF NATIONAL
GUARD
ROOF REPLACEMENT, TUCKPOINTING, AND INTERIOR REPAIRS
MISSOURI NATIONAL GUARD SIKESTON MISSOURI READINESS CENTER 300 S. MAIN STREET SIKESTON, MISSOURI 63801
PROJECT: T2235-01 ASSET: 8136317001 SITE#: 6317
REVISION: DATE: REVISION: DATE: REVISION: DATE: DATE: ISSUE DATE: 05/03/2024
CAD DWG FILE <u>:A-504.DWG</u> DRAWN BY: <u>B. KEITEL</u> CHECKED BY: <u>B. HESTERBER</u> G DESIGNED BY: <u>T. WIKELSKI</u>
SHEET TITLE: ROOF DETAIL ALTERNATE
sheet number: $A-504$

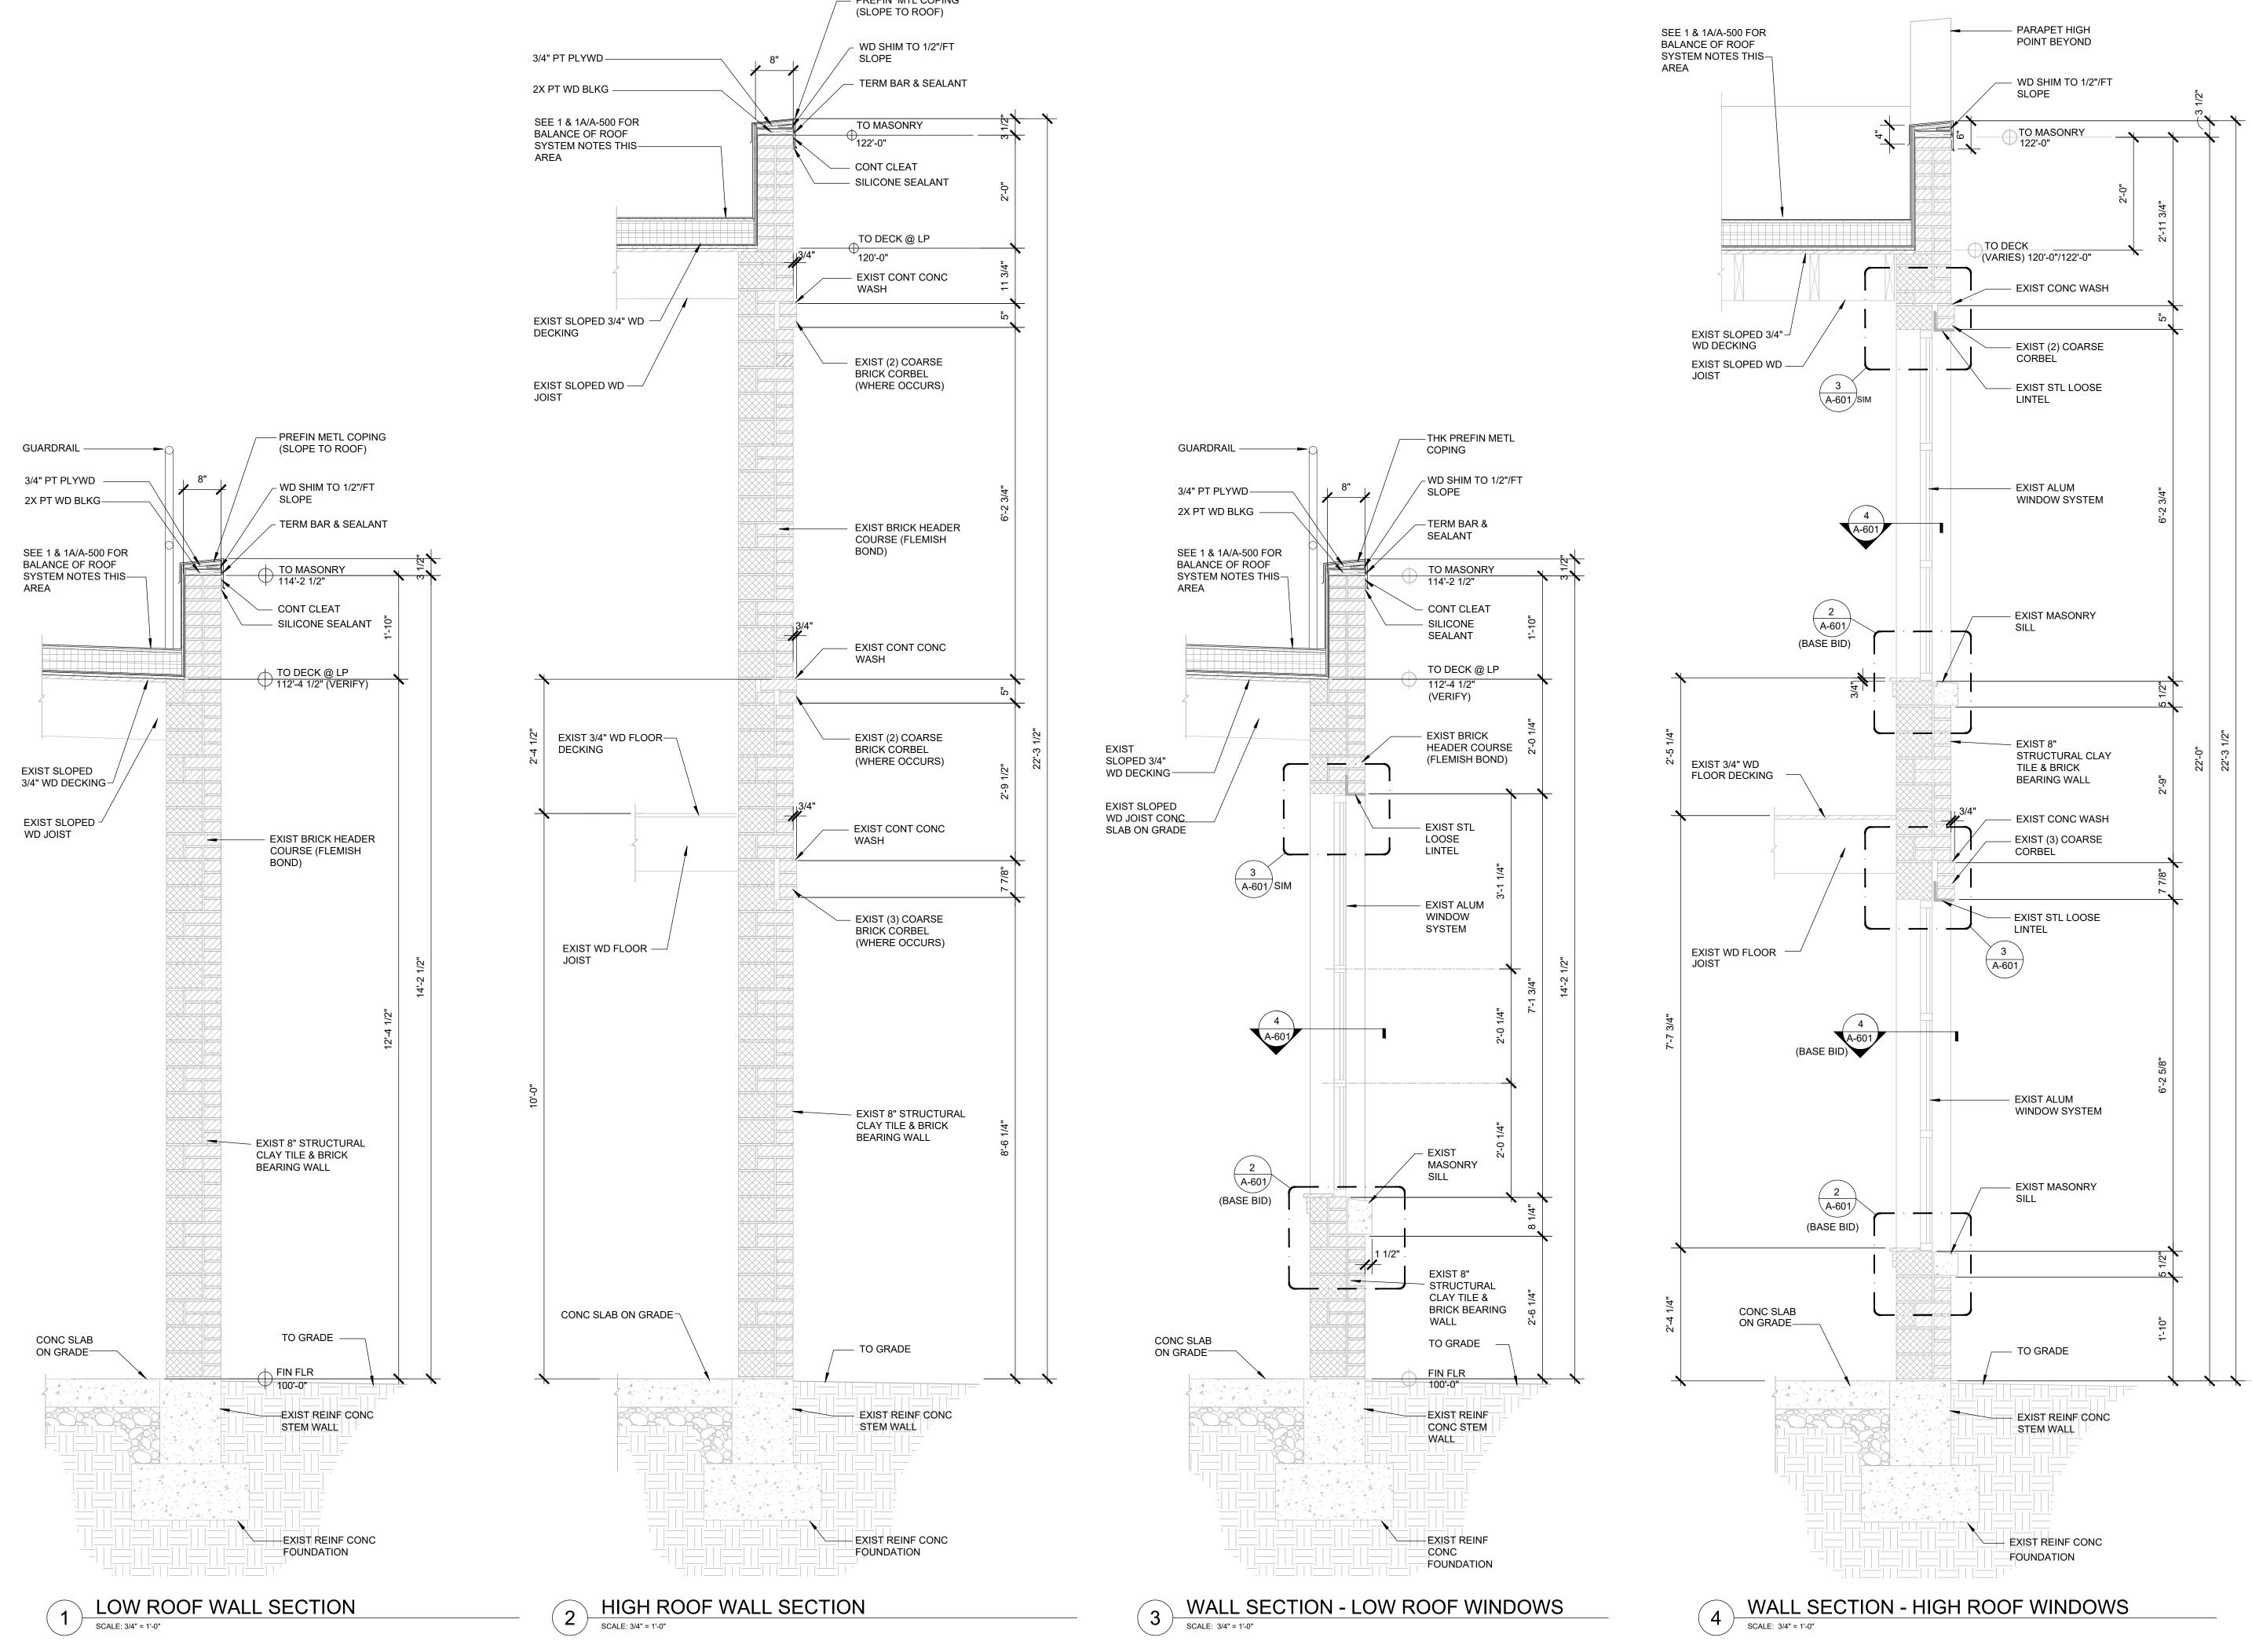


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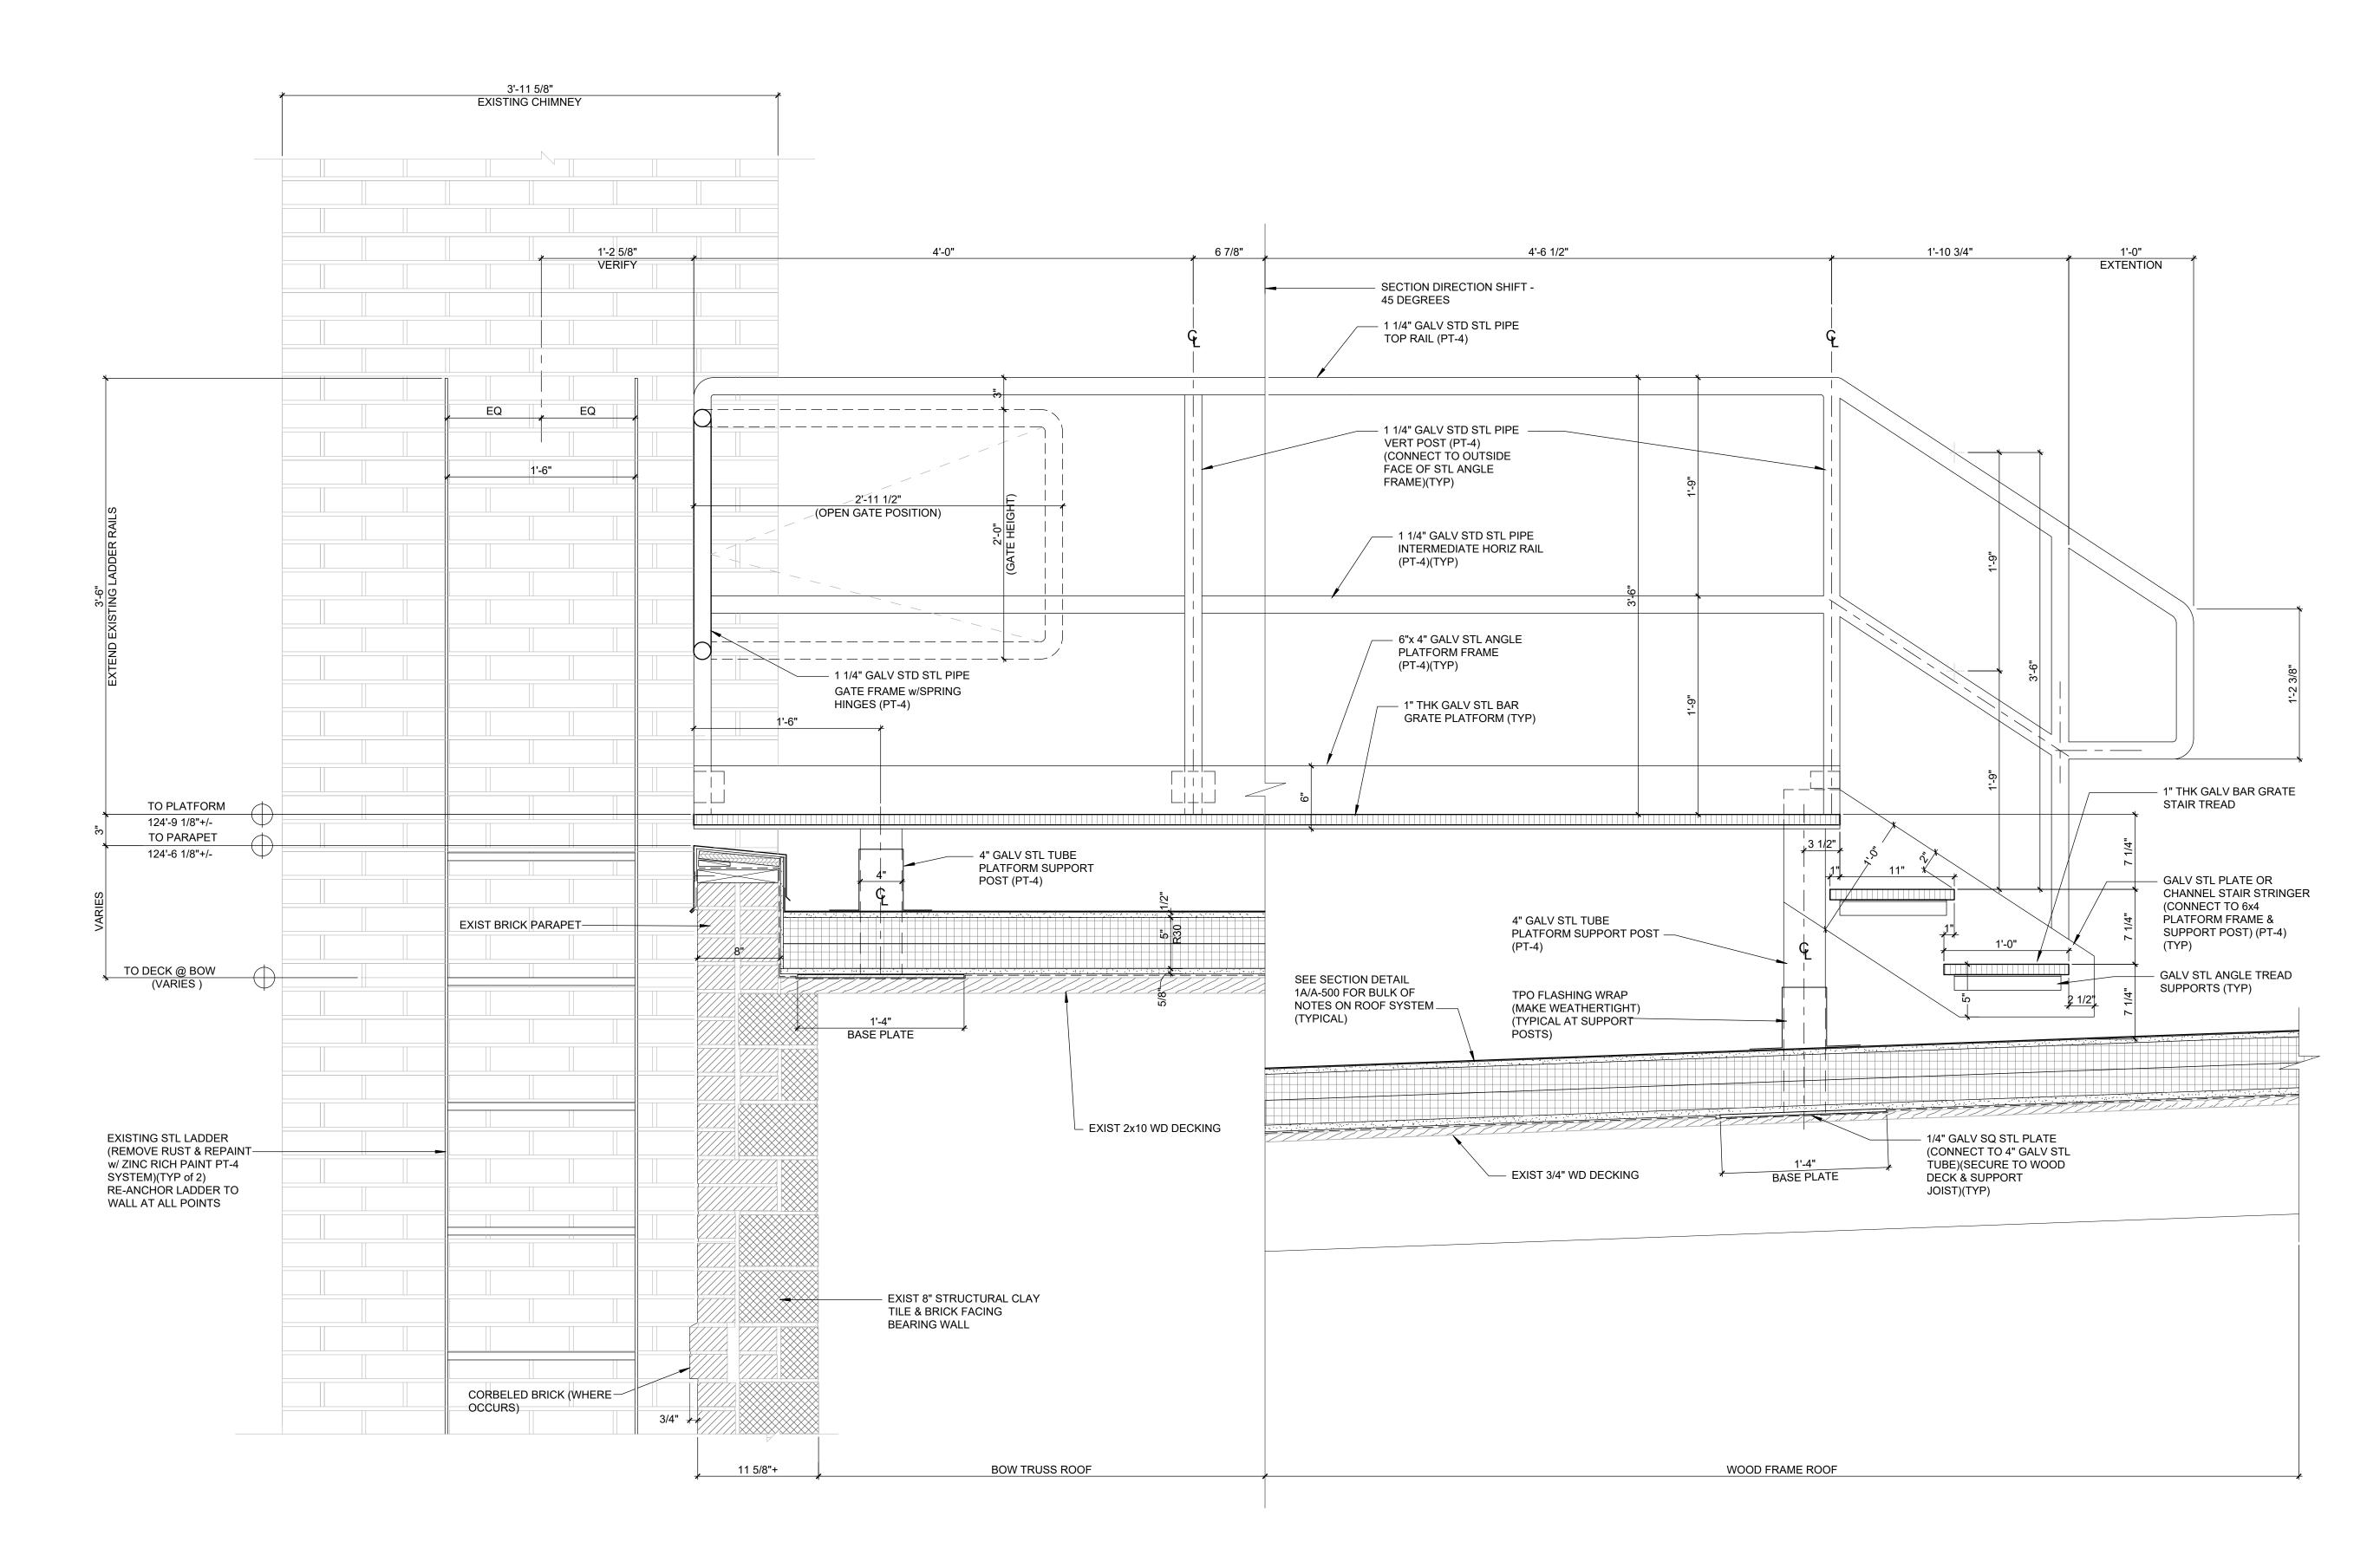


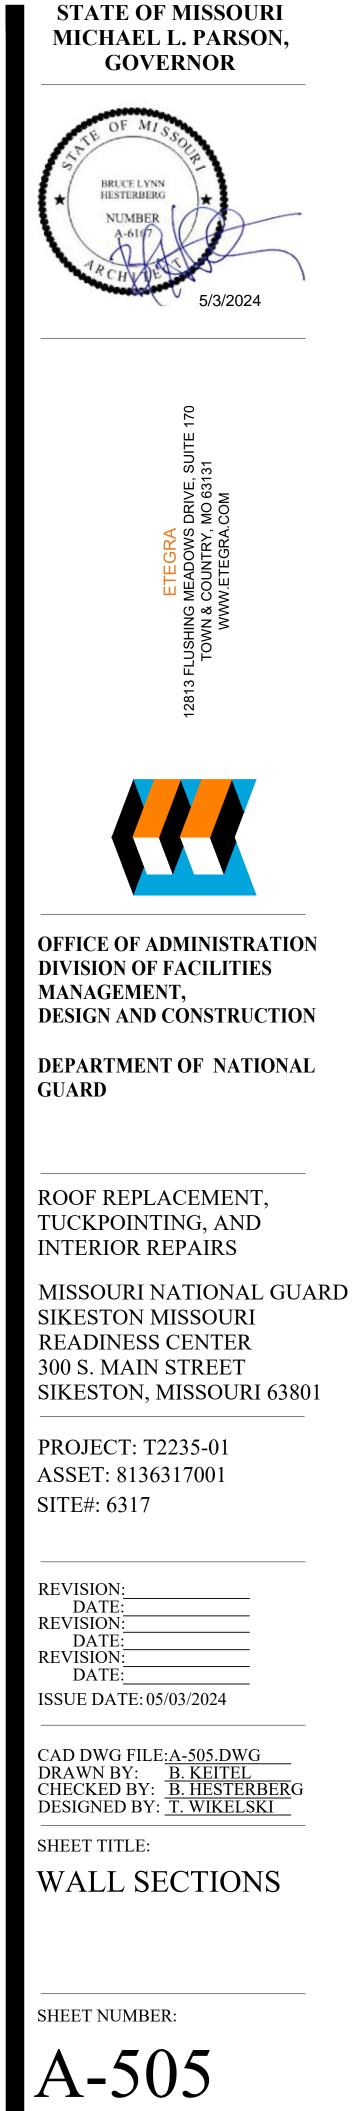

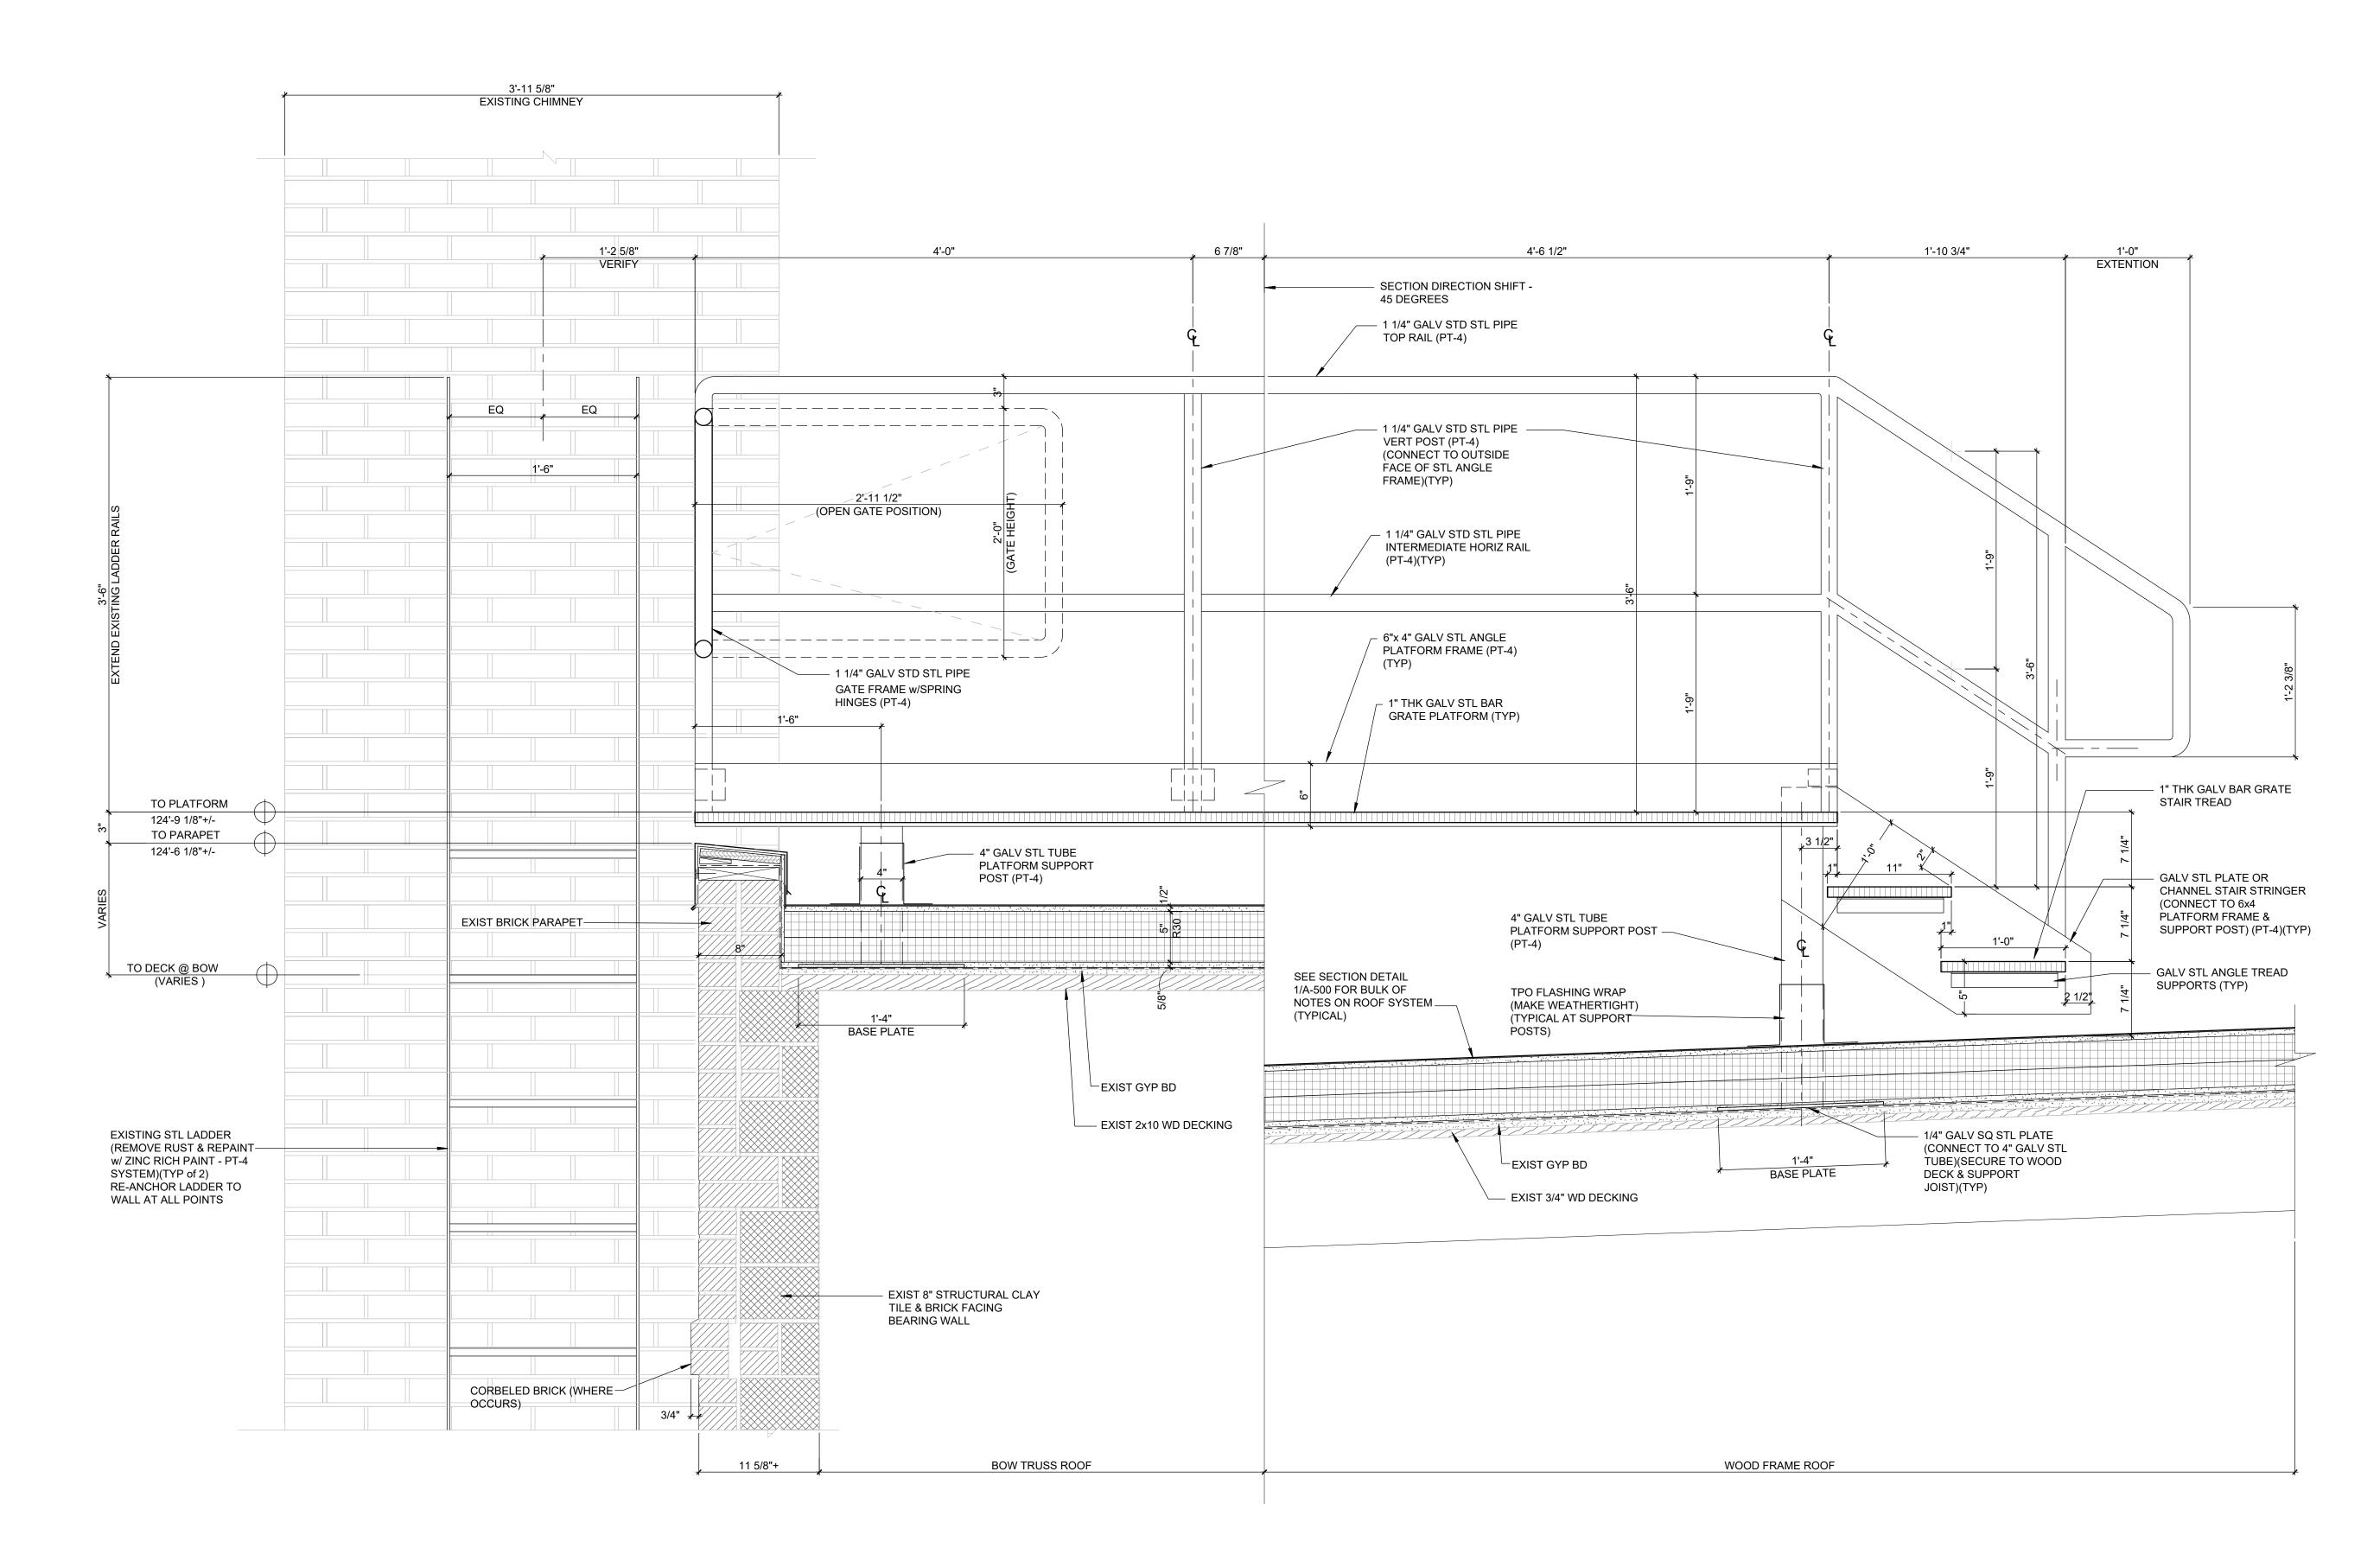
1 SECTION DETAIL - LADDER ACCESS PLATFORM (BASE BID) SCALE: 1 1/2" = 1"-0"

SEE DETAIL 1/A-507 FOR ALTERNATE




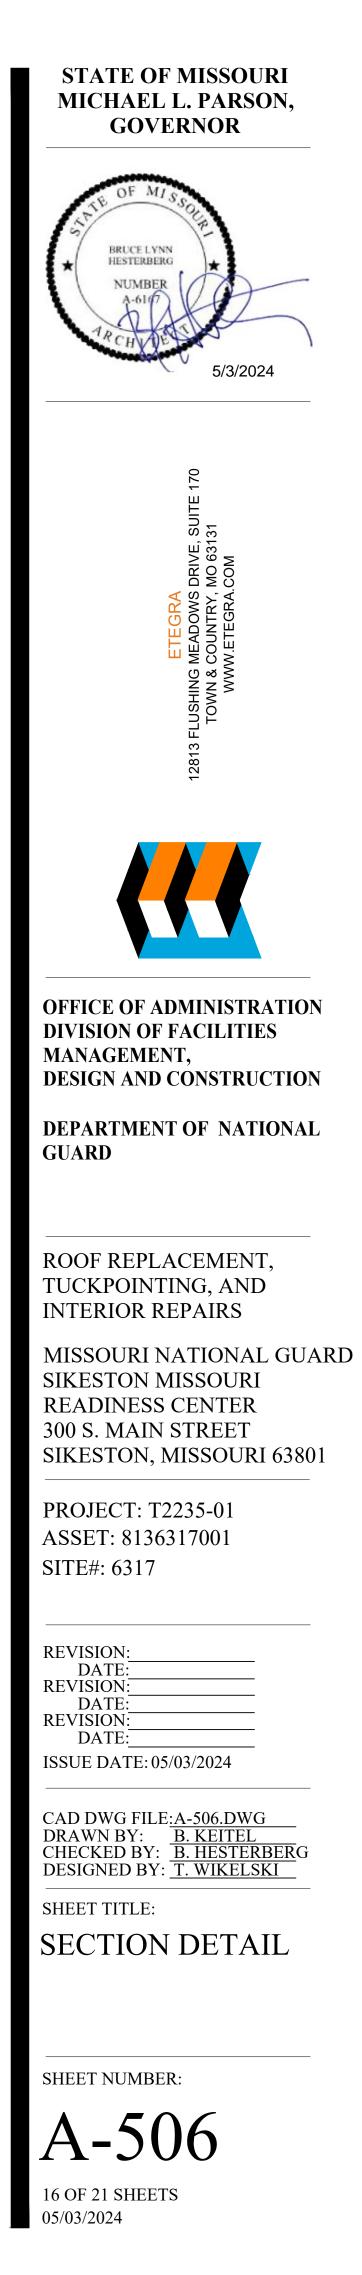


SECTION DETAIL - LADDER ACCESS PLATFORM (ALTERNATE) **1** SCALE: 1 1/2" = 1'-0"

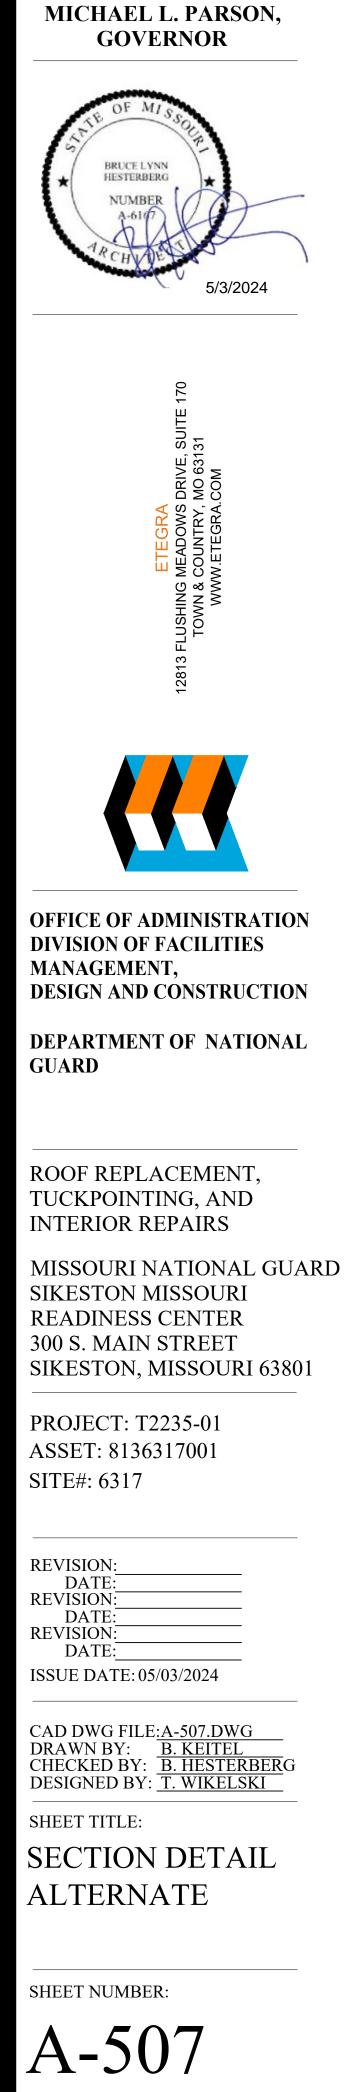


STATE OF MISSOURI

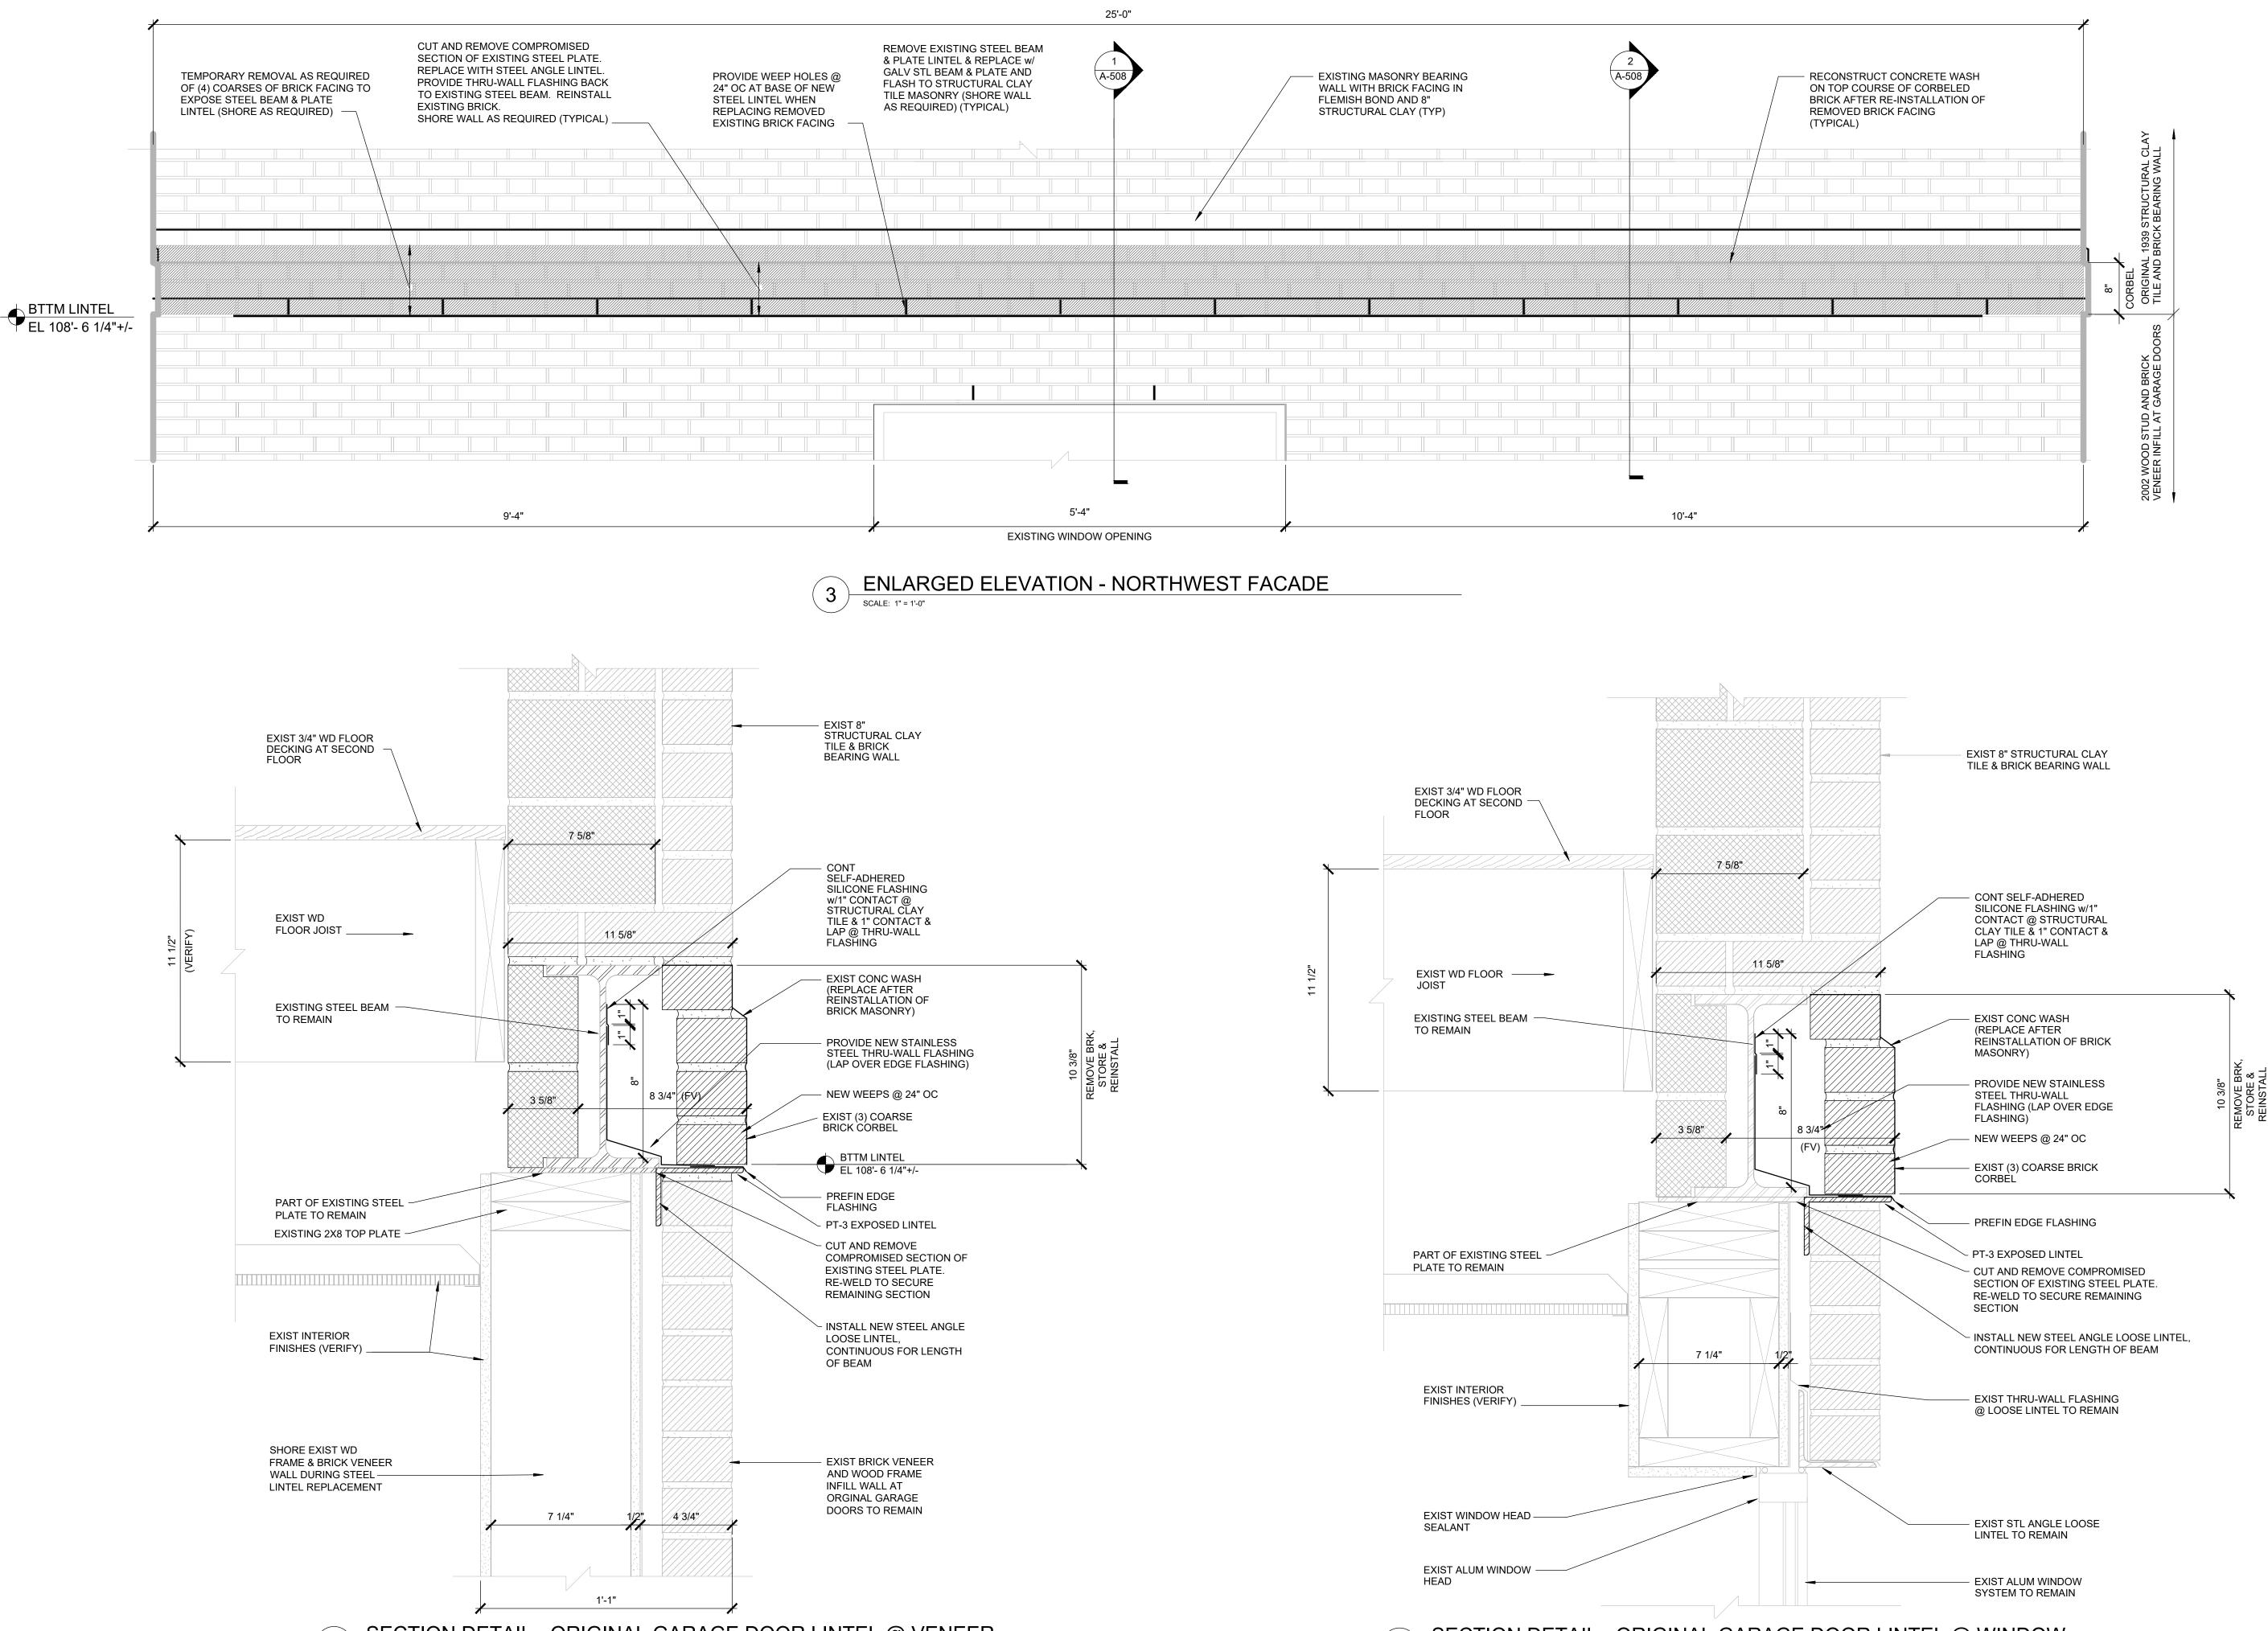

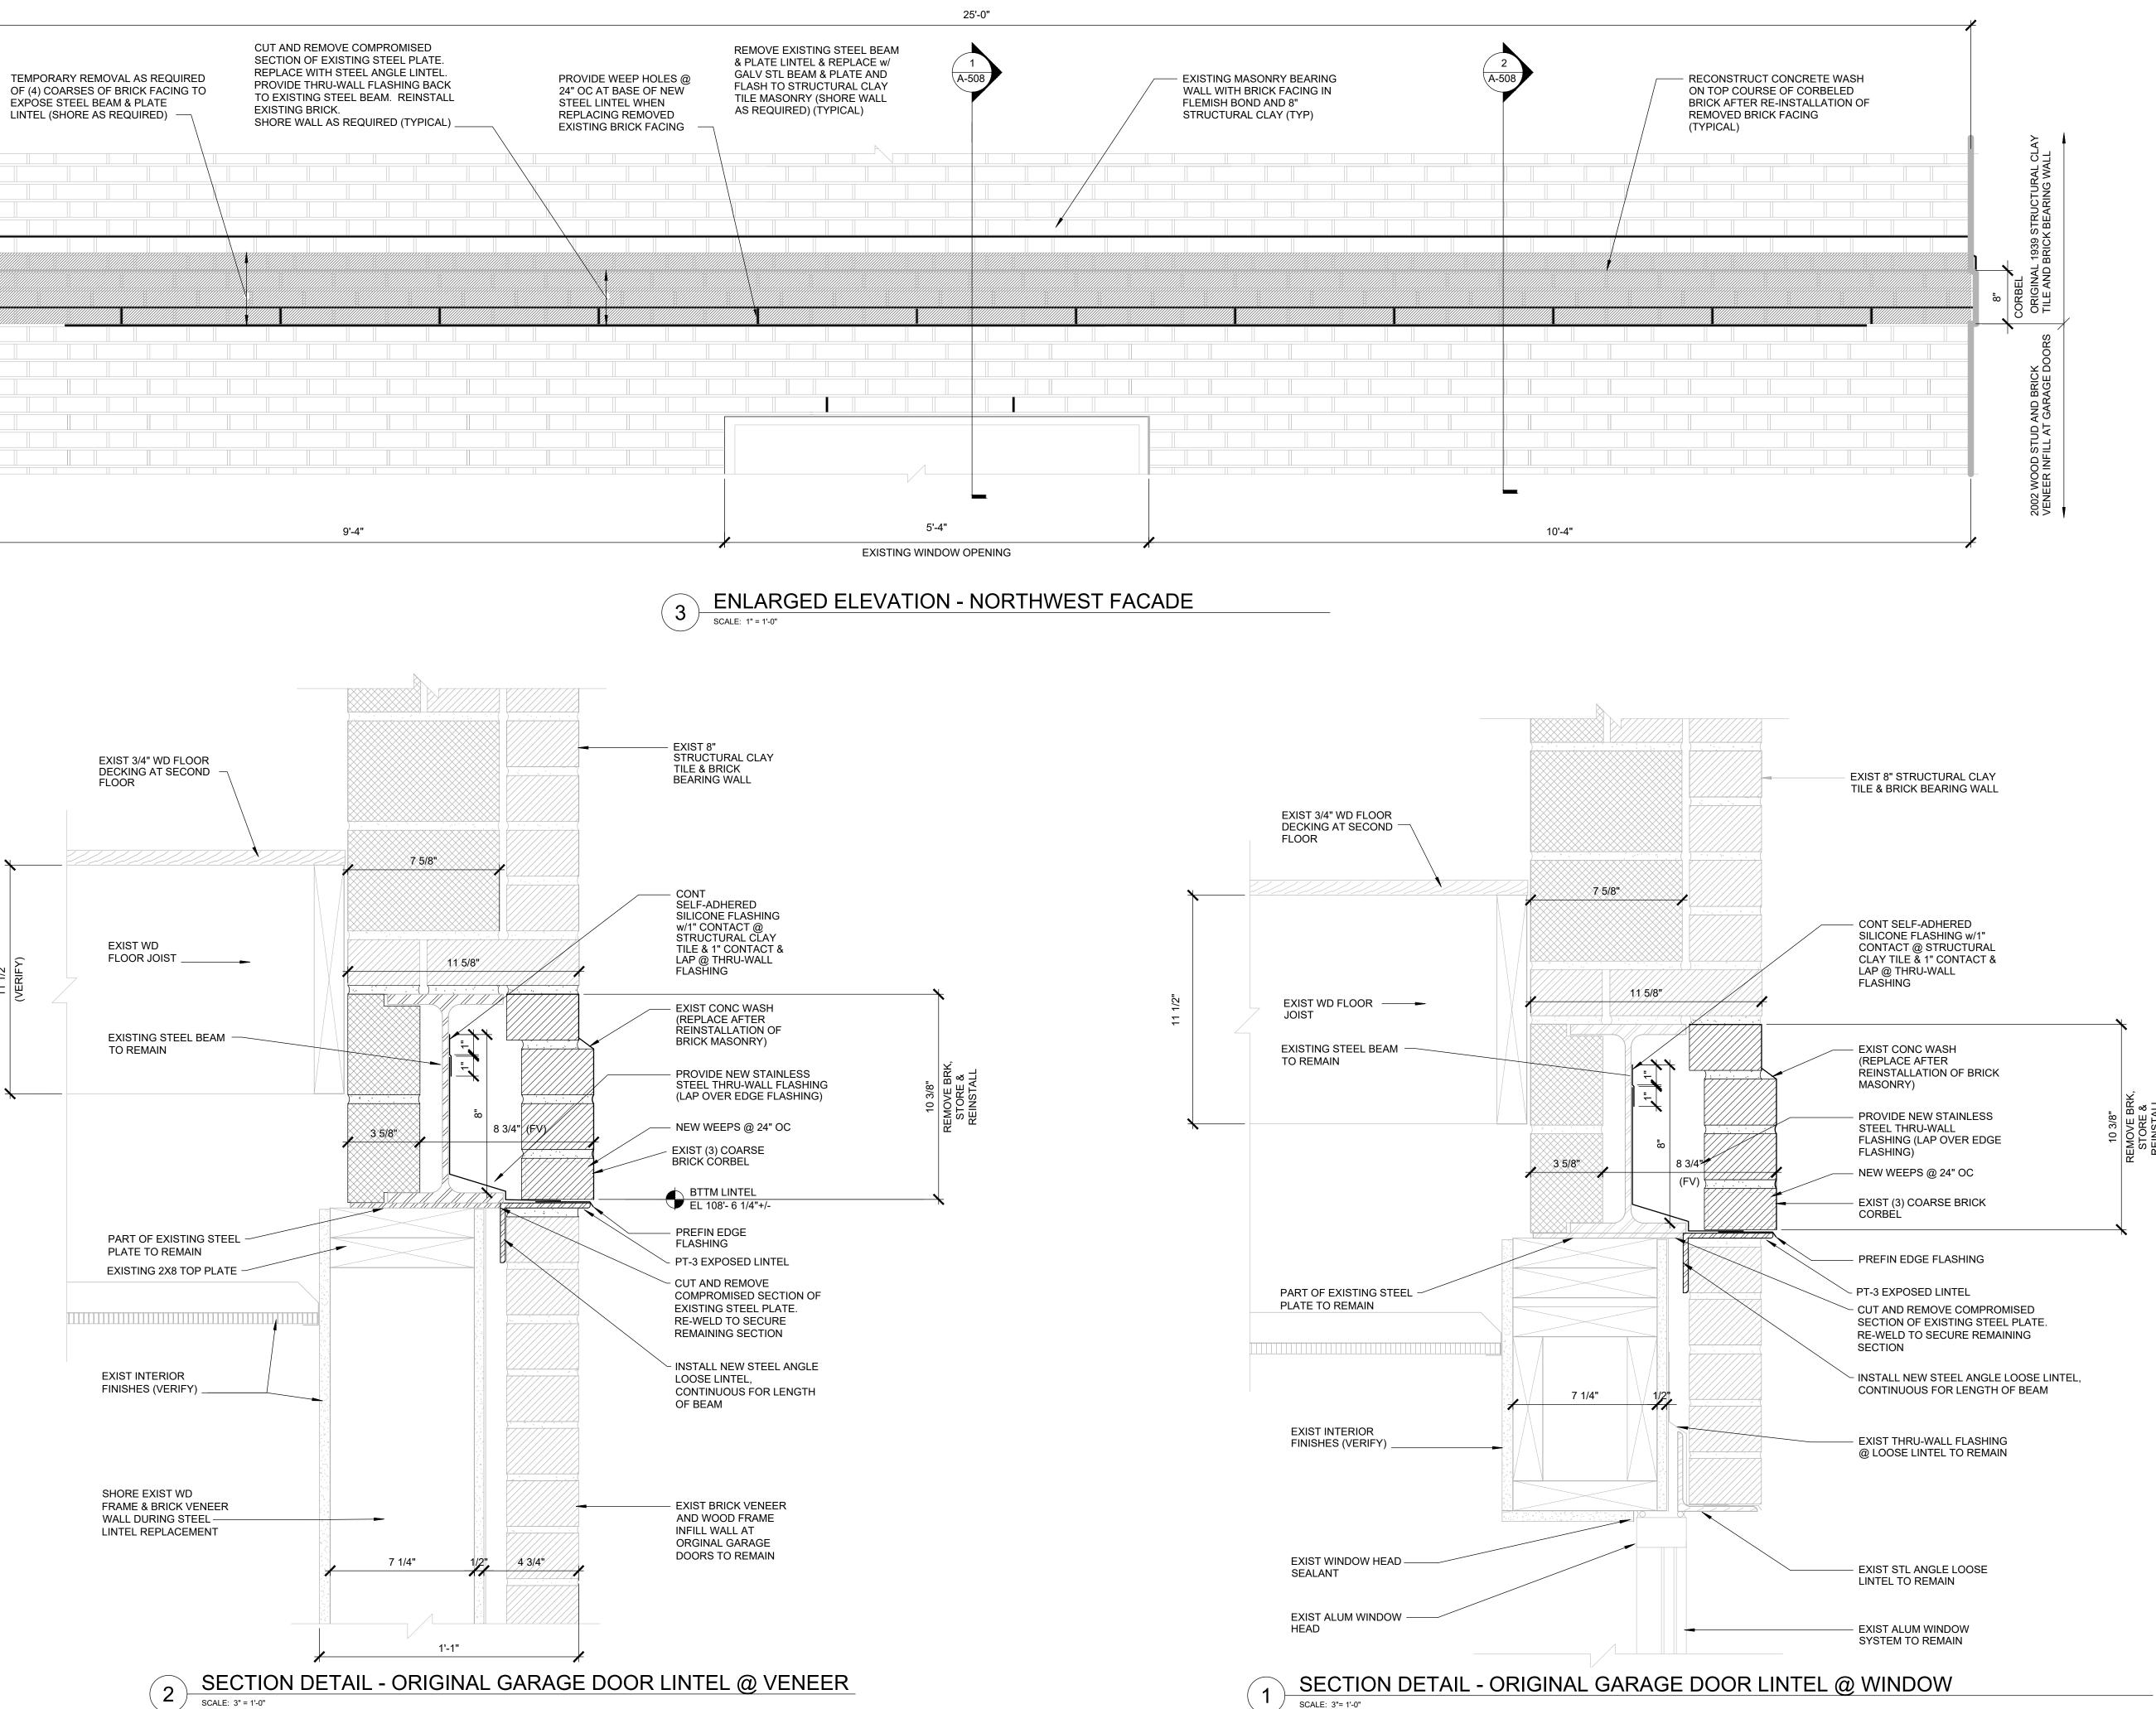

SCALE: 3"= 1'-0"

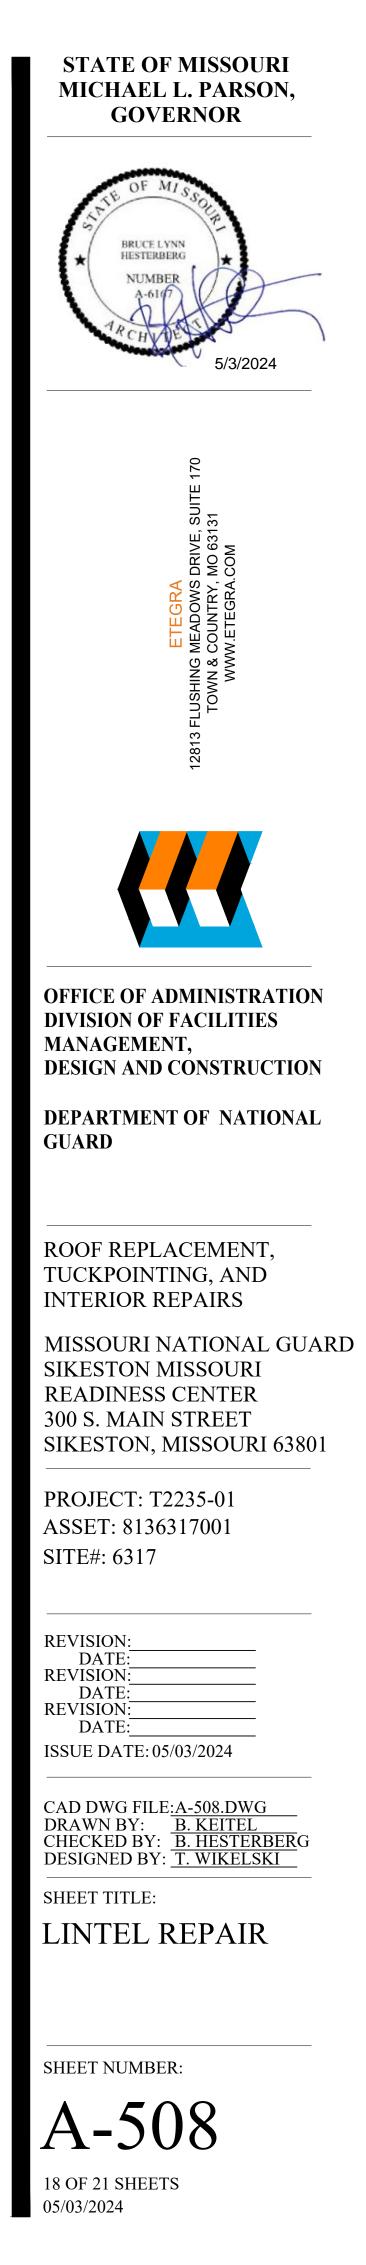






RM #	NAME	FLO	OR	BA	BASE WALL					CEILING		NOTES
		COMPLETE ROOM	FINISH	COMPLETE ROOM	FINISH	WALLS (N S E W)	SPECIFIC PATCH AREAS - RE PLAN	FINISH	*PAINT WINDOW SILLS	SPECIFIC PATCH AREAS - RE PLAN	FINISH	
GROUN	D FLOOR						, I			1		,
A101	FOYER											
A102	CONFERENCE ROOM								х	Х	ACT-1	
A103	OFFICE								х			
A104	OFFICE									Х	ACT-1	
A105	OFFICE								X	X	ACT-1	
A106	STAIR											
A107	CORRIDOR									X	ACT-1	
A108	CLASSROOM	X	CPT-1	X	VB-1				x			
A109	RECRUITER								X			
A110	NOT USED											
A111	NOT USED											
A112	FOYER					W		PT-1				
A112 A113	CLASSROOM					vv		1 1-1	x			
A113 A114	ASSEMBLY HALL						X	PT-1	X	x	ACT-1	
A114 A115							^	F I - I	^	^	AUT-1	
							V		v	v		
A116							X	PT-1	X	X	GYP/PT-2	
A117	RAISED PLATFORM											
A118	STAIR											
A119	STAIR											
A120	CHAIR STORAGE						X	PT-1				
A121	JANITOR											
A122	ELECTRICAL	Х	VCT-1	X	VB-1		X	PT-1	X	X	ACT-1	
A123	CORRIDOR								X			
A124	WOMEN											
A125	SHOWER											
A126	MEN											
A127	SHOWER											
A128	FOOD STORAGE						Х	PT-1	Х			
A129	FOOD PREP					Ν		PT-1	Х			
A130	SCULLERY											
SECON	D FLOOR											
A201	COMMANDER								x	x	ACT-1	
A201	DATA/COM ROOM											
A202	MECHANICAL								X			
A203	STAIR											
	CLASSROOM	X	VCT-1	x	VB-1	W		PT-1	X	x	ACT-1	
A205		^	v01-1	^	V D- I	VV		۳۱-۱	X	^	AUT-T	
A206	STAIR											
A207	MECHANICAL							57 <i>i</i>				
A208	CORRIDOR						X	PT-1	X			
A209	CLASSROOM	Х	VCT-1	X	VB-1	NSEW		PT-1	X	X	ACT-1	
A210	SUPPLY STORAGE						X	PT-1	X			
A211	STAIR	Х	VCT-1	X	VB-1							
A212	WEIGHT ROOM	Х	VCT-1	X	VB-1		X	PT-1	X			
A213	MEZZANINE									X	ACT-1	
									1			

*NOTE: DO NOT PAINT OVER WINDOW SILLS THAT HAVE PLASTIC LAMINATE OR CERAMIC TILES

TAG	TYPE	MANUFACTURER	PRODUCT #	COLOR	NOTES
INTERIO	DR				
CPT-1	CARPET TILE FLOORING				
VCT-1	VINYL COMPOSITION TILE				
VB-1	VINYL BASE				
PT-1	WALL PAINT			MATCH EXISTING	
PT-2	CEILING PAINT			MATCH EXISTING	
ACT-1	LAY IN ACOUSTICAL TILE			MATCH EXISTING	
EXTERI	OR				
PT-3	LINTELS			MATCH BRICK COLOR	
PT-4	HIGH PERF COATING			BLACK	

WALL SECTION TO REPAINT MATCH COLORS AND WAINSCOT PATTERN. INCLUDE DOORS, DOOR FRAMES, JAMBS, RETURNS, EXPOSED CONDUITS, ETC FOR A COMPLETE, THOROUGH PAINTING EFFORT

STATE OF MISSOURI MICHAEL L. PARSON, GOVERNOR
BRUCE LYNN HESTERBERG NUMBER A-6107 ARCHIVE
ETEGRA 12813 FLUSHING MEADOWS DRIVE, SUITE 170 TOWN & COUNTRY, MO 63131 WWW.ETEGRA.COM
OFFICE OF ADMINISTRATION DIVISION OF FACILITIES MANAGEMENT, DESIGN AND CONSTRUCTION
DEPARTMENT OF NATIONAL GUARD
ROOF REPLACEMENT, TUCKPOINTING, AND INTERIOR REPAIRS MISSOURI NATIONAL GUARD SIKESTON MISSOURI READINESS CENTER 300 S. MAIN STREET SIKESTON, MISSOURI 63801
PROJECT: T2235-01 ASSET: 8136317001 SITE#: 6317
REVISION: DATE: REVISION: DATE: REVISION: DATE: DATE: ISSUE DATE: 05/03/2024
CAD DWG FILE:A-600.DWG DRAWN BY: <u>B. KEITEL</u> CHECKED BY: <u>B. HESTERBER</u> G DESIGNED BY: <u>T. WIKELSKI</u> SHEET TITLE: ROOM FINISH SCHEDULE
SHEET NUMBER: A-600 19 OF 21 SHEETS 05/03/2024

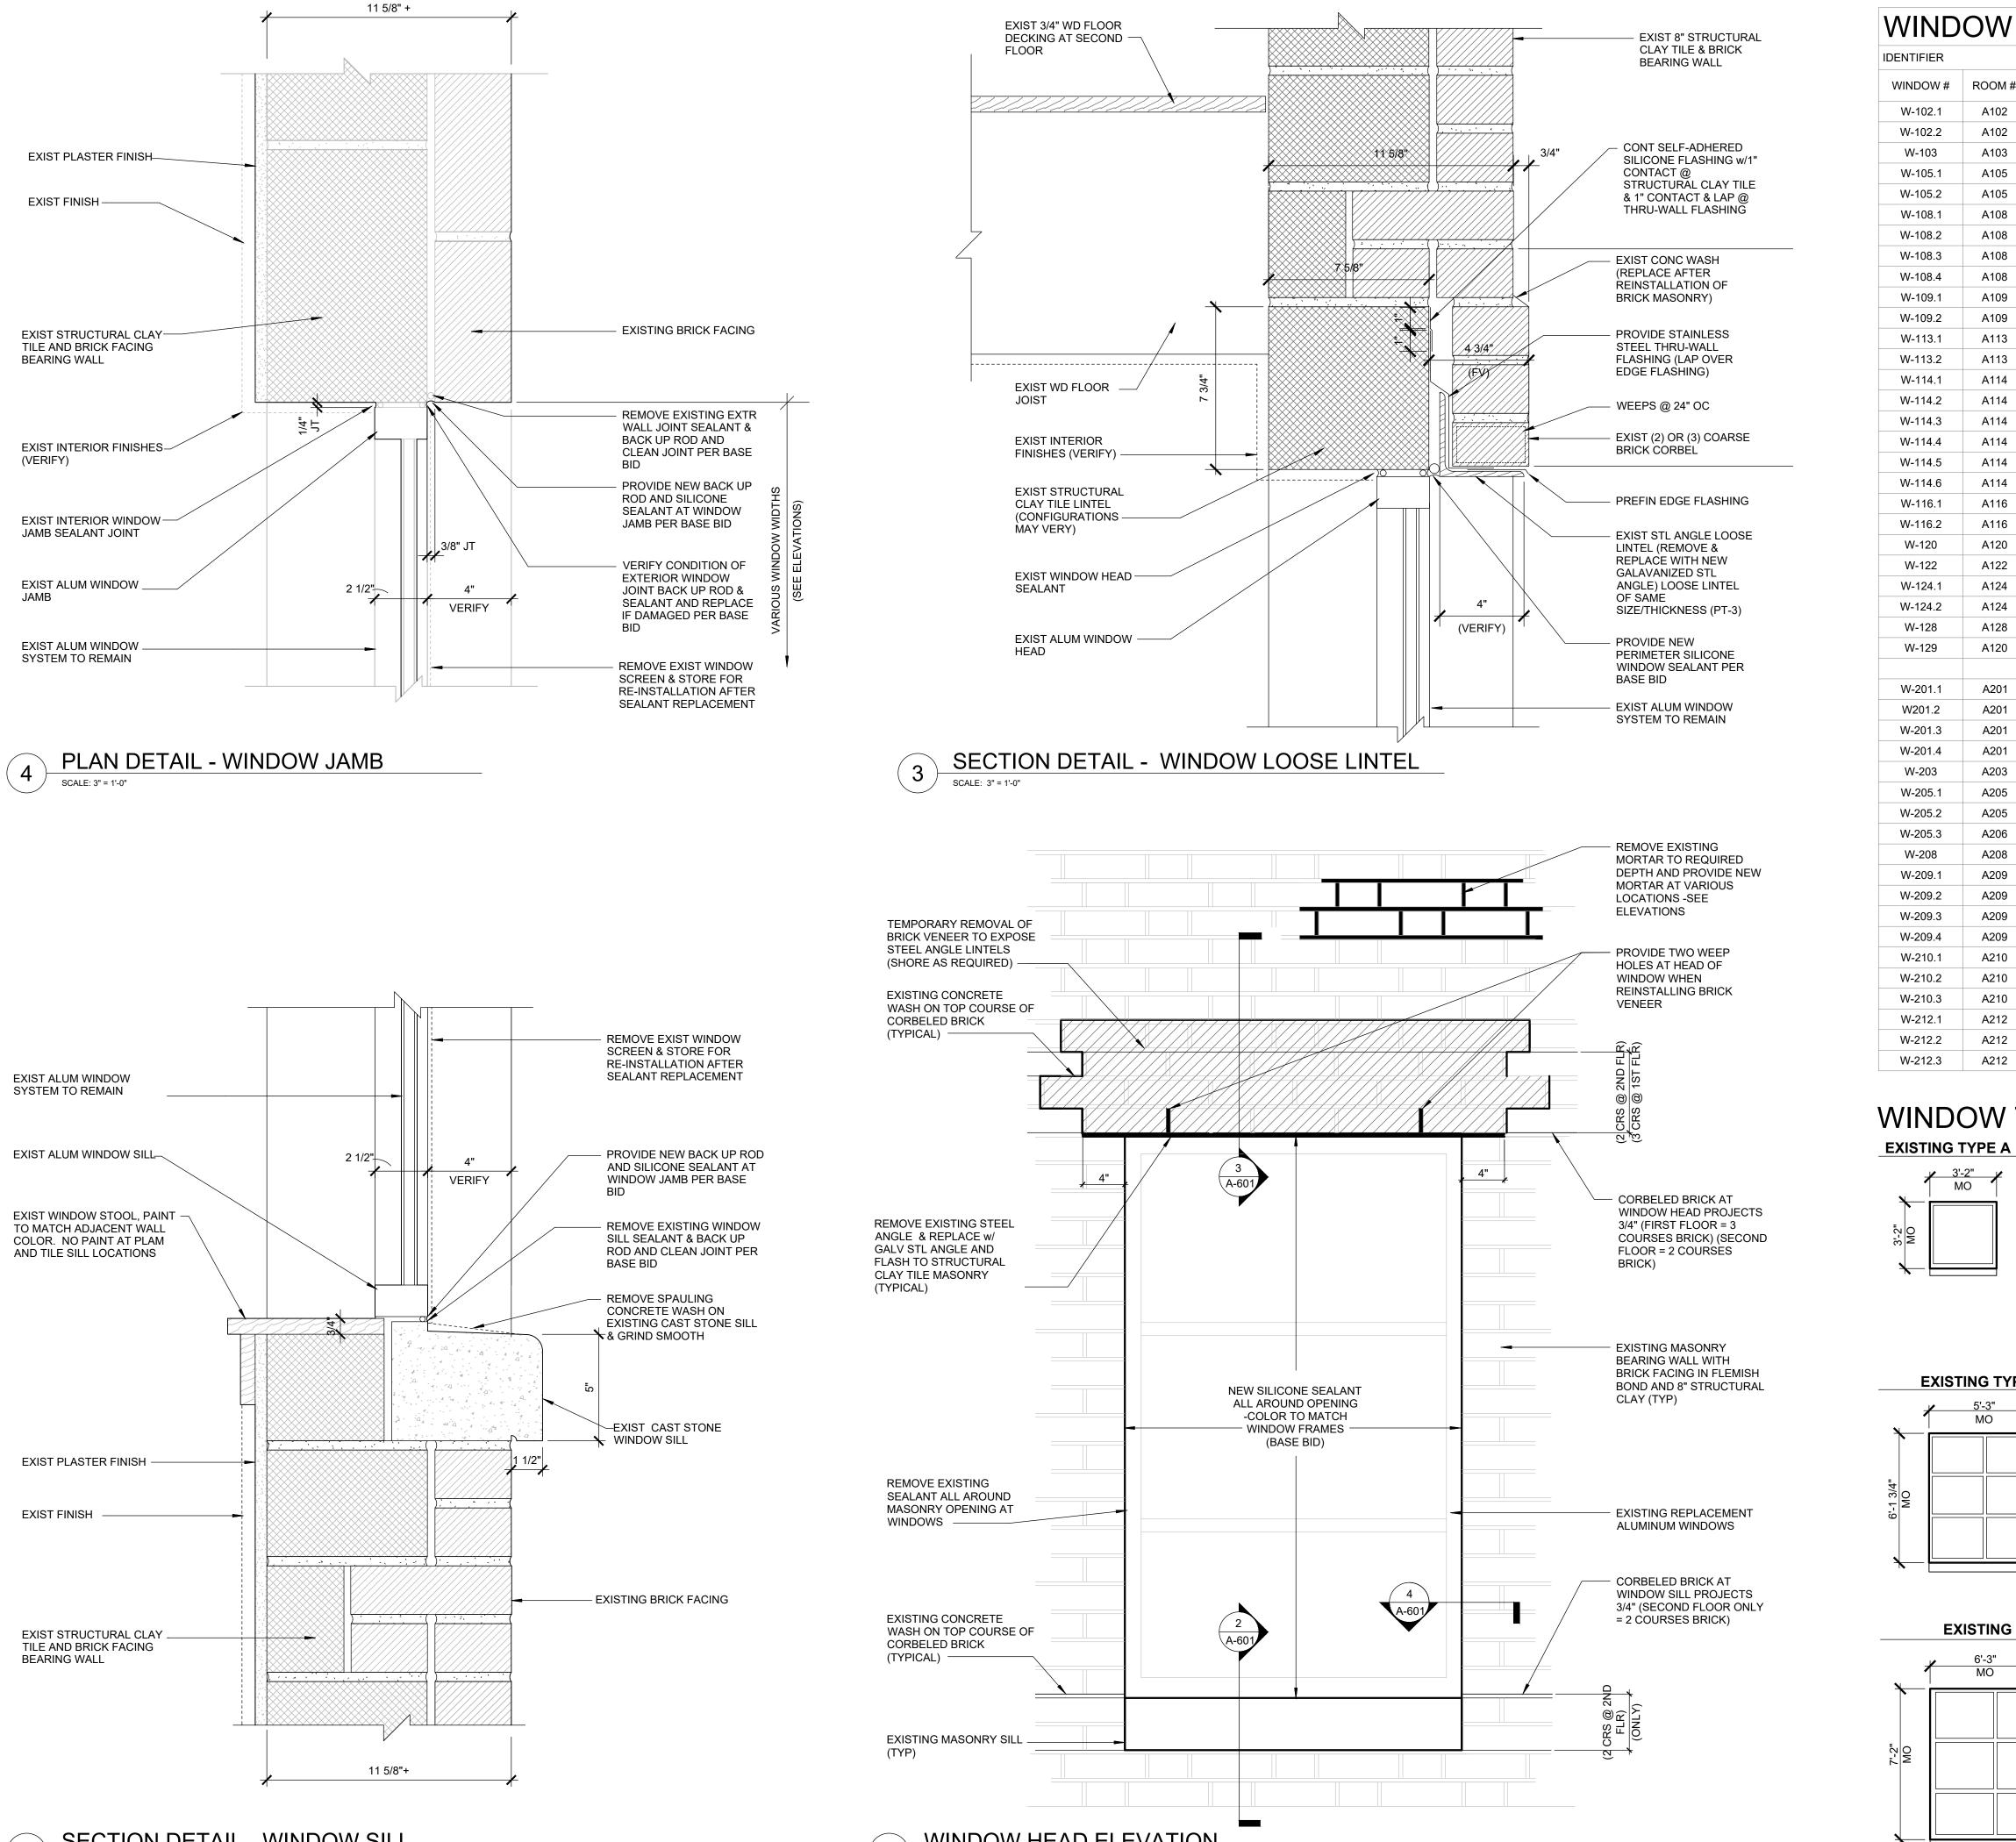




SECTION DETAIL - WINDOW SILL SCALE: 3" = 1'-0"


WINDOW HEAD ELEVATION


SCALE: 1 1/2" = 1'-0"

SW 3	SCHEDUI	E		
			SCOPE OF	REPAIR
ROOM #	NAME	TYPE	SEALANT	LINTEL
A102	CONFERENCE RM	E	YES	YES
A102	CONFERENCE RM	С	YES	YES
A103	OFFICE	E	YES	YES
A105	OFFICE	С	YES	YES
A105	OFFICE	С	YES	YES
A108	CLASSROOM	С	YES	YES
A108	CLASSROOM	С	YES	YES
A108	CLASSROOM	С	YES	YES
A108	CLASSROOM	С	YES	YES
A109	RECRUITER	С	YES	YES
A109	RECRUITER	С	YES	YES
A113	CLASSROOM	С	YES	YES
A113	CLASSROOM	E	YES	YES
A114	ASSEMBLY HALL	F	YES	YES
A114	ASSEMBLY HALL	F	YES	YES
A114	ASSEMBLY HALL	F	YES	YES
A114	ASSEMBLY HALL	Н	YES	YES
A114	ASSEMBLY HALL	Н	YES	YES
A114	ASSEMBLY HALL	Н	YES	YES
A116	SUPPLY	В	YES	YES
A116	SUPPLY	В	YES	YES
A120	CHAIR STORAGE	С	YES	YES
A122	ELECTRICAL	С	YES	YES
A124	WOMEN	G	YES	YES
A124	WOMEN	G	YES	YES
A128	FOOD STORAGE	G	YES	YES
A120	FOOD PREP	G	YES	YES
A201	COMMANDER	D	YES	YES
A201	COMMANDER	С	YES	YES
A201	COMMANDER	С	YES	YES
A201	COMMANDER	С	YES	YES
A203	MECHANICAL	С	YES	YES
A205	CLASSROOM	С	YES	YES
A205	CLASSROOM	С	YES	YES
A206	CLASSROOM	С	YES	YES
A208	CORRIDOR	С	YES	YES
A209	CLASSROOM	С	YES	YES
A209	CLASSROOM	С	YES	YES
A209	CLASSROOM	С	YES	YES
A209	CLASSROOM	D	YES	YES
A210	SUPPLY STOR	A	YES	YES
A210	SUPPLY STOR	A	YES	YES
A210	SUPPLY STOR	VENT	YES	YES
A212	WEIGHT ROOM	С	YES	YES
A212	WEIGHT ROOM	С	YES	YES
A212	WEIGHT ROOM	С	YES	YES
	1	1	1	

WINDOW TYPES

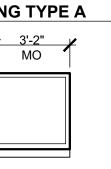

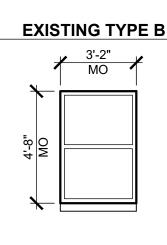

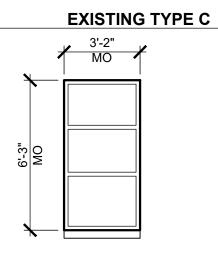












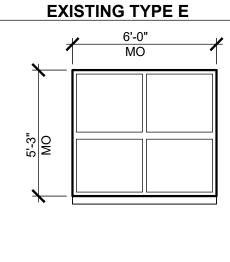

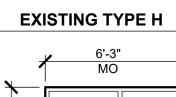



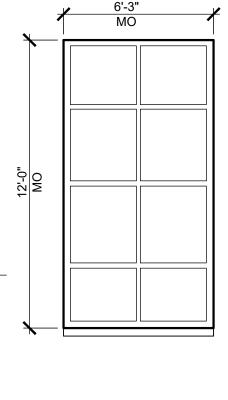

EXISTING TYPE F

<u>NOTE:</u> ALL DIMENSIONS TO **BE FIELD VERIFIED**

STATE OF MISSOURI MICHAEL L. PARSON, GOVERNOR
BRUCE LYNN HESTERBERG NUMBER A-6107 A.C.H.V.HE.U.S. 5/3/2024
ETEGRA 12813 FLUSHING MEADOWS DRIVE, SUITE 170 TOWN & COUNTRY, MO 63131 WWW.ETEGRA.COM
OFFICE OF ADMINISTRATION DIVISION OF FACILITIES MANAGEMENT, DESIGN AND CONSTRUCTION
DEPARTMENT OF NATIONAL GUARD
ROOF REPLACEMENT, TUCKPOINTING, AND INTERIOR REPAIRS
MISSOURI NATIONAL GUARD SIKESTON MISSOURI READINESS CENTER 300 S. MAIN STREET SIKESTON, MISSOURI 63801
PROJECT: T2235-01 ASSET: 8136317001 SITE#: 6317
REVISION: DATE: REVISION: DATE: REVISION: DATE: ISSUE DATE: 05/03/2024
CAD DWG FILE: <u>A-601.DWG</u> DRAWN BY: <u>B. KEITEL</u> CHECKED BY: <u>B. HESTERBER</u> G DESIGNED BY: <u>T. WIKELSKI</u>
SHEET TITLE: WINDOW SCHEDULE AND DETAIL
sheet number: $A-601$

STATE OF MISSOURI









1 EXTERIOR MORTAR DAMAGE

2 EXTERIOR SEALANT DETERIORATION

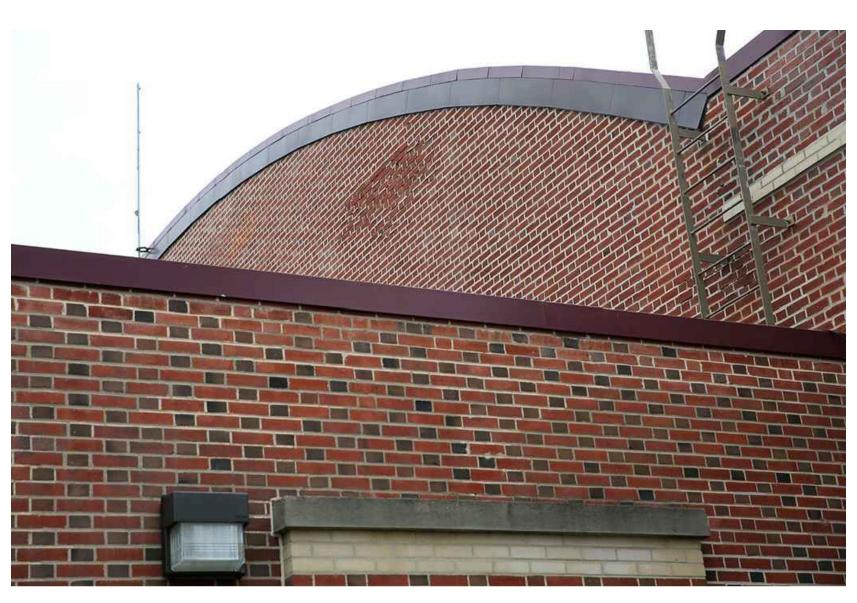



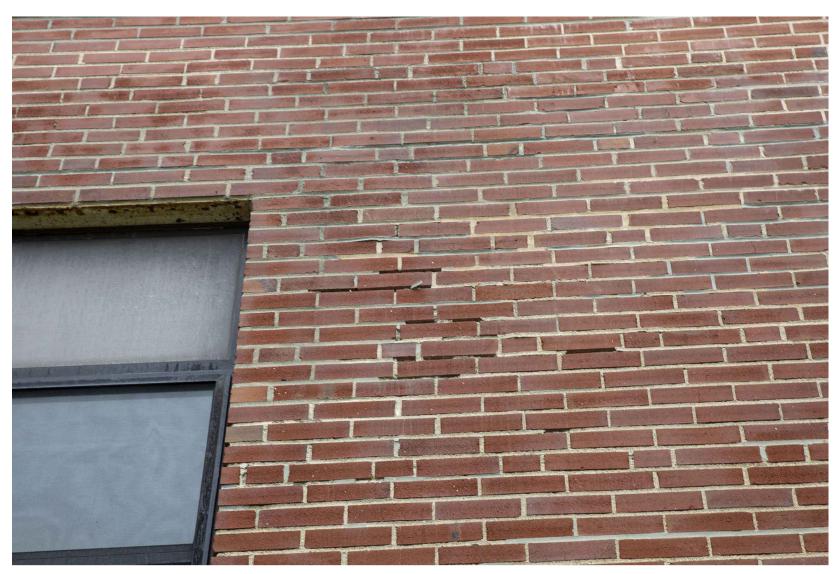









3 ROOF DAMAGE












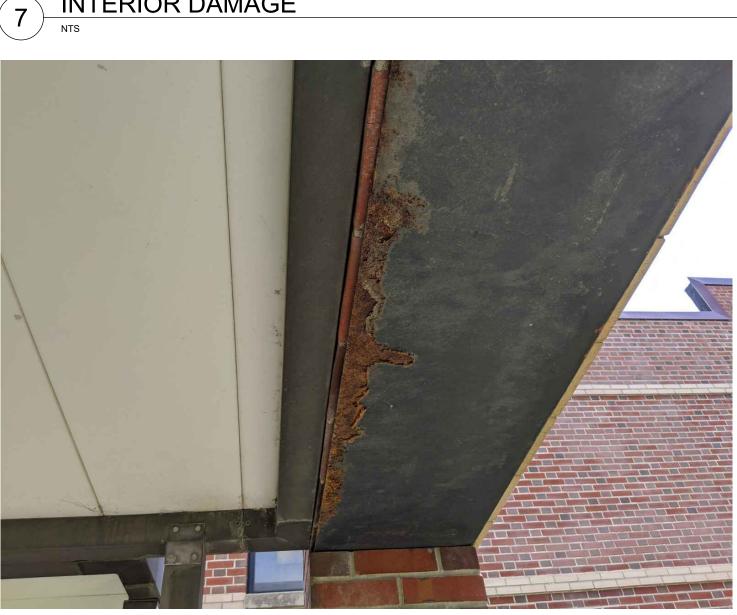





GENERAL NOTES

PHOTO-DOCUMENTATION PROVIDED IS ONLY A REFERENCE TO THE NATURE OF WEAR AND DAMAGE PRESENT ON THE SITE. ALL EXISTING CONDITIONS OF THE PROJECT SHALL BE FIELD VERIFIED FOR THEIR EXACT AND TIMELY CONDITION.





STATE OF MISSOURI MICHAEL L. PARSON, GOVERNOR
BRUCE LYNN HESTERBERG NUMBER A-61/07 ARCHIVAE 5/3/2024
ETEGRA 12813 FLUSHING MEADOWS DRIVE, SUITE 170 TOWN & COUNTRY, MO 63131 WWW.ETEGRA.COM
OFFICE OF ADMINISTRATION DIVISION OF FACILITIES MANAGEMENT,
DESIGN AND CONSTRUCTION DEPARTMENT OF NATIONAL GUARD
ROOF REPLACEMENT, TUCKPOINTING, AND INTERIOR REPAIRS
MISSOURI NATIONAL GUARD SIKESTON MISSOURI READINESS CENTER 300 S. MAIN STREET SIKESTON, MISSOURI 63801
PROJECT: T2235-01 ASSET: 8136317001 SITE#: 6317
REVISION: DATE: REVISION: DATE: REVISION:

DATE: ISSUE DATE: 05/03/2024

CAD DWG FILE:A-800.DWG DRAWN BY: <u>B. KEITEL</u> CHECKED BY: <u>B. HESTERBER</u>G DESIGNED BY: <u>T. WIKELSKI</u>

SHEET TITLE: PHOTOS

SHEET NUMBER:

A-800 21 OF 21 SHEETS 05/03/2024