

ADDENDUM NO. 02

TO: PLANS AND SPECIFICATIONS FOR STATE OF MISSOURI

Renovate Interior & Exterior
Anderson Readiness Center
Anderson, Missouri
PROJECT NO.: T2421-01

Bid Opening Date: 1:30 PM, Thursday, April 30, 2026 (Unchanged)

Bidders are hereby informed that the construction Plans and/or Specifications are modified as follows:

SPECIFICATION CHANGES:

1. NONE

DRAWINGS CHANGES:

1. Sheet A-010 – See Attached revised sheet A-010
 - a. Added keynote D4 to offices 119, 120, and 121.

2. Sheet A-300 – See Attached revised sheet A-300
 - a. Updated door hardware to clarify that doors 123, 124, 126, and 127 are wood doors, not HM Doors.



GENERAL COMMENTS:

1. NONE

ATTACHMENTS:

- A. Sheet A-010 (1 Page)
- B. Sheet A-300 (1 Page)

END ADDENDUM 02

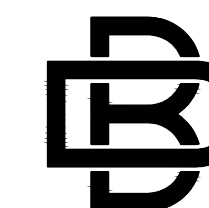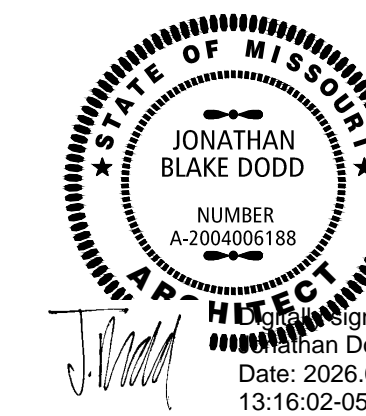

BUXTON KUBIK DODD
DESIGN COLLECTIVE
3100 S. NATIONAL AVENUE, SUITE 300
SPRINGFIELD, MO 65807
PHONE: 417.890.5543 FAX: 417.890.5563
MISSOURI CERTIFICATE OF AUTHORITY NO. A-2006007284

OFFICE OF ADMINISTRATION
DIVISION OF FACILITIES
MANAGEMENT,
DESIGN AND CONSTRUCTION

DEPARTMENT OF PUBLIC
SAFETY
THE MISSOURI
NATIONAL GUARD

RENOVATE INTERIOR &
EXTERIOR
ANDERSON READINESS
CENTER

712 ANDERSON STREET
ANDERSON, MISSOURI 64831

PROJECT # T2421-01
SITE # 6272
FACILITY # 8136272002

REVISION: Δ
DATE: 04/23/2026
REVISION: _____
DATE: _____
REVISION: _____
DATE: _____

ISSUE DATE: 02/20/2026

CAD DWG FILE: A-010
DRAWN BY: JD
CHECKED BY: JD
DESIGNED BY: JD

SHEET TITLE:
**DEMOLITION
PLAN**

SHEET NUMBER:

A-010


11 OF 35 SHEETS
02/20/2026

GENERAL DEMOLITION NOTES



- COORDINATE WITH OWNER ON TO VERIFY ANY / ALL ITEMS TO BE SALVAGE PRIOR TO COMMENCING WITH DEMOLITION. PROTECT ALL ITEMS THAT ARE SALVAGED AND REINSTALL WHERE NOTED. COORDINATE LOCATION OF ALL OTHER ITEMS SALVAGED BUT NOT REINSTALLED.
- CONTRACTOR SHALL COORDINATE WORK WITH OTHER CONTRACTS/TRADES AS REQUIRED FOR ALL CONSTRUCTION ACCESS, CONSTRUCTION AREAS, AND DEMOLITION WORK REQUIRE
- PATCH AND REPAIR ANY ASPHALT AND/OR CONCRETE PAVING AREAS AS REQ'D. THAT WERE DAMAGED DURING CONSTRUCTION; SEE CIVIL PLANS.
- REMOVE AND DISPOSE OF ANY AND ALL TRASH, DEBRIS, ETC. THROUGHOUT RENOVATION AREA. SEE SPECIFICATIONS FOR ADDITIONAL DISPOSAL NOTES.
- SEE SPECIFICATIONS FOR DISPOSAL OF ALL DEMOLISHED MATERIALS AND DEBRIS.
- SEE FLOOR PLANS, ROOF PLAN, SECTIONS, ELEVATIONS & DETAILS FOR ADDITIONAL DETAILED DEMOLITION INFORMATION REQUIRED FOR NEW CONSTRUCTION AND ITS AFFECT ON DEMOLITION ITEMS DESCRIBED HERE IN. NOT ALL DEMOLITION REQUIRED MAY BE SHOWN ON THE DEMOLITION PLANS. THESE PLANS ARE FOR GENERAL INFORMATION & DESIGN INTENT. IT IS THE RESPONSIBILITY OF THE CONTRACTOR TO FULLY REVIEW AND UNDERSTAND THE CONTRACT DOCUMENTS AND THE EXTENT OF DEMOLITION REQUIRED FOR NEW CONSTRUCTION INDICATED.
- NOT ALL WALLS/PARTITIONS MAY BE SHOWN ACCURATELY ON PLAN; G.C. & DEMO SUB-CONTRACTOR RESPONSIBLE TO FIELD VERIFY EXISTING CONDITIONS.
- GENERAL CONTRACTOR TO SHORE EXISTING WALLS / STRUCTURE TO REMAIN UNTIL NEW WORK IS IN PLACE; SEE STRUCTURAL AND SPECIFICATIONS ALSO.
- SEE MEP DEMOLITION PLANS/NOTES FOR ANY ADDITIONAL DEMOLITION INFORMATION INCLUDING REMOVAL OF EXISTING PIPING, CONDUIT, ELECTRICAL/MECH DEVICES, ETC. PATCH AND REPAIR ANY WALL/FLOOR/ROOF PENETRATIONS WHERE THESE ITEMS PENETRATED ANY FLOOR SLAB/WALLS, TO MATCH EXISTING.
- PROTECT ANY EXISTING VOICE, DATA, ELECTRICAL OUTLETS, THERMOSTATS, FIRE ALARM EQUIPMENT, LIGHTING, EMERGENCY ETC. NOT SHOWN TO BE REMOVED ON MEP PLANS. NOT ALL ITEMS MAY BE INDICATED. VERIFY WITH ARCHITECT & OWNER FOR CLARIFICATION IF ANY DISCREPANCIES ARE DISCOVERED.
- CONTRACTOR IS RESPONSIBLE FOR PROVIDING A DEBRIS AND DUST FREE ENVIRONMENT FOR ANYALL PROJECTION RACKING AND EQUIPMENT. IF EQUIPMENT IS IN NEED OF MOVING/RELOCATING FOR MEANS OF CONSTRUCTION, THE CONTRACTOR MUST CONSULT THE ARCHITECT AND OWNER BEFORE PROCEEDING.
- SEE SITE PLAN & SITE DETAILS FOR ANY SITE DEMOLITION REQUIRED.

DEMOLITION PLAN KEYNOTES

- REMOVE EXISTING INTERIOR NON-LOAD BEARING STUD WALL PARTITIONS, CMU PARTITIONS, ATTACHED DOORS, WINDOWS, TRIM, SHOWER COMPARTMENTS, EMBEDDED PLUMBING COMPONENTS, ETC. AS REQUIRED FOR EXTENTS OF NEW CONSTRUCTION. CLEAN, PATCH & REPAIR ANY ADJACENT SURFACES TO MATCH EXISTING OR TO RECEIVE NEW FINISHES SPECIFIED. SEE WALL SECTIONS FOR FURTHER INFORMATION.
- REMOVE EXISTING WALL LOUVER, DOOR, DOOR FRAME, TRIM & OTHER COMPONENTS, ETC. AS REQUIRED FOR NEW CONSTRUCTION. CONFIRM WITH OWNER ON ANY ITEMS TO BE SALVAGED PRIOR TO REMOVAL; DISCARD ANY ITEMS NOT SALVAGED. CLEAN, PATCH, REPAIR ALL ADJACENT SURFACES TO RECEIVE NEW WALL OR DOOR CONSTRUCTION. SEE FLOOR PLANS, ELEVATIONS AND WALL SECTIONS FOR ADDITIONAL INFORMATION.
- REMOVE EXISTING LIGHT POLE & ASSOCIATED EQUIPMENT. SEE MEP DRAWINGS & SPECIFICATIONS FOR ADDITIONAL INFORMATION.
- REMOVE ALL EXISTING FLOOR COVERING PRODUCTS, ADHESIVES AND WALL BASE THIS AREA. PREP FLOORS FOR INSTALLATION OF NEW FLOORING AS SPECIFIED.
- SAWCUT & REMOVE EXISTING CONCRETE FLOOR SLAB, FLOORING AND WALL BASE IN THIS AREA AS REQUIRED FOR ANYALL NEW WASTE PIPING REQUIRED BELOW FINISH FLOOR FOR NEW PLUMBING FIXTURES, ELEC CONDUIT & FLOOR BOXES; COORD. SIZE OF SAWCUT REQUIRED WITH PLUMBING/FOUNDATION CONTRACTOR. SEE MEP AND STRUCTURAL DRAWINGS ALSO. SEE FLOOR PLAN NOTES FOR NEW CONCRETE SLAB PATCHING. REPAIR/RECONSTRUCT ANY EXISTING WALL FRAMING/DRYWALL TO MATCH EXISTING AS REQUIRED. PROVIDE 4000 PSI, 4" THICK CONCRETE SLAB PATCHING W/ W/M 6X6-W/ 4XW/1.4 OVER 10 MIL POLYETHYLENE VAPOR BARRIER AT ALL FLOOR SLAB AREAS REQUIRED TO BE SAWCUT FOR NEW WASTE PIPING / PLUMBING FIXTURES; SEE DEMOLITION PLANS & MEP DEMOLITION DRAWINGS FOR LOCATIONS. DOWEL NEW SLAB INTO EXISTING SLAB W/ #5'S AT 24" O.C. TYPICAL. SEE FLOOR PLANS & DETAILS FOR RECESSED SLAB AREAS AT ALL NEW SHOWER COMPARTMENTS.
- REMOVE EXISTING SPLIT-SYSTEM AIR CONDITIONING UNITS & ASSOCIATED EXTERIOR CONDENSING UNITS PER MECHANICAL DRAWINGS. PATCH WALLS TO MATCH EXISTING AT REMOVED DISCONNECT & REFRIGERANT PIPING EXTERIOR WALL PENETRATIONS, TYP.
- REMOVE EXISTING DOOR LEAF & ASSOCIATED HARDWARE AS PART OF BID ALTERNATE #01.
- REMOVE EXISTING SUSPENDED OR STUD FRAMED GYPSUM BOARD CEILING SYSTEM, INTEGRATED LIGHTING, DIFFUSERS, GRILLES, ETC.; SEE MEP DRAWINGS FOR ADDITIONAL INFORMATION.
- OWNER (MONG) SHALL BE RESPONSIBLE FOR REMOVAL OF EXISTING GEAR LOCKER SYSTEMS, BENCHES, ACCESSORIES & COMPONENTS IN THE EXISTING LOCKER AREA PRIOR TO NEW CONSTRUCTION. COORDINATE W/ OWNER FOR SAID WORK.
- REMOVE EXISTING PLUMBING FIXTURES, SHOWER FIXTURES, GRAB BARS & TOILET ACCESSORIES; SEE PLUMBING DRAWINGS & SPECS FOR ADDITIONAL INFORMATION. RETAIN TOILET ACCESSORIES FOR RE-USE/RE-INSTALLATION.
- REMOVE EXISTING TOILET PARTITIONS & URINAL SCREENS.
- REMOVE EXISTING DOOR & SIDE LITE GLAZING; SEE DOOR SCHEDULE FOR INSTALLATION OF INSUL MTL PANELS.
- REMOVE EXISTING BACKFLOW PREVENTER; SEE MEP DRAWINGS FOR ADDITIONAL INFORMATION.
- REMOVE EXISTING PAINT ON EXISTING NORTH FACING CMU WALLS THAT IS BUBBLING/PEELING AROUND EXISTING WINDOWS; PREP AND RE-PAINT WALLS PER PAINT SPECIFICATIONS TO MATCH EXISTING/ADJACENT CMU WALL CONSTRUCTION - FIELD VERIFY.

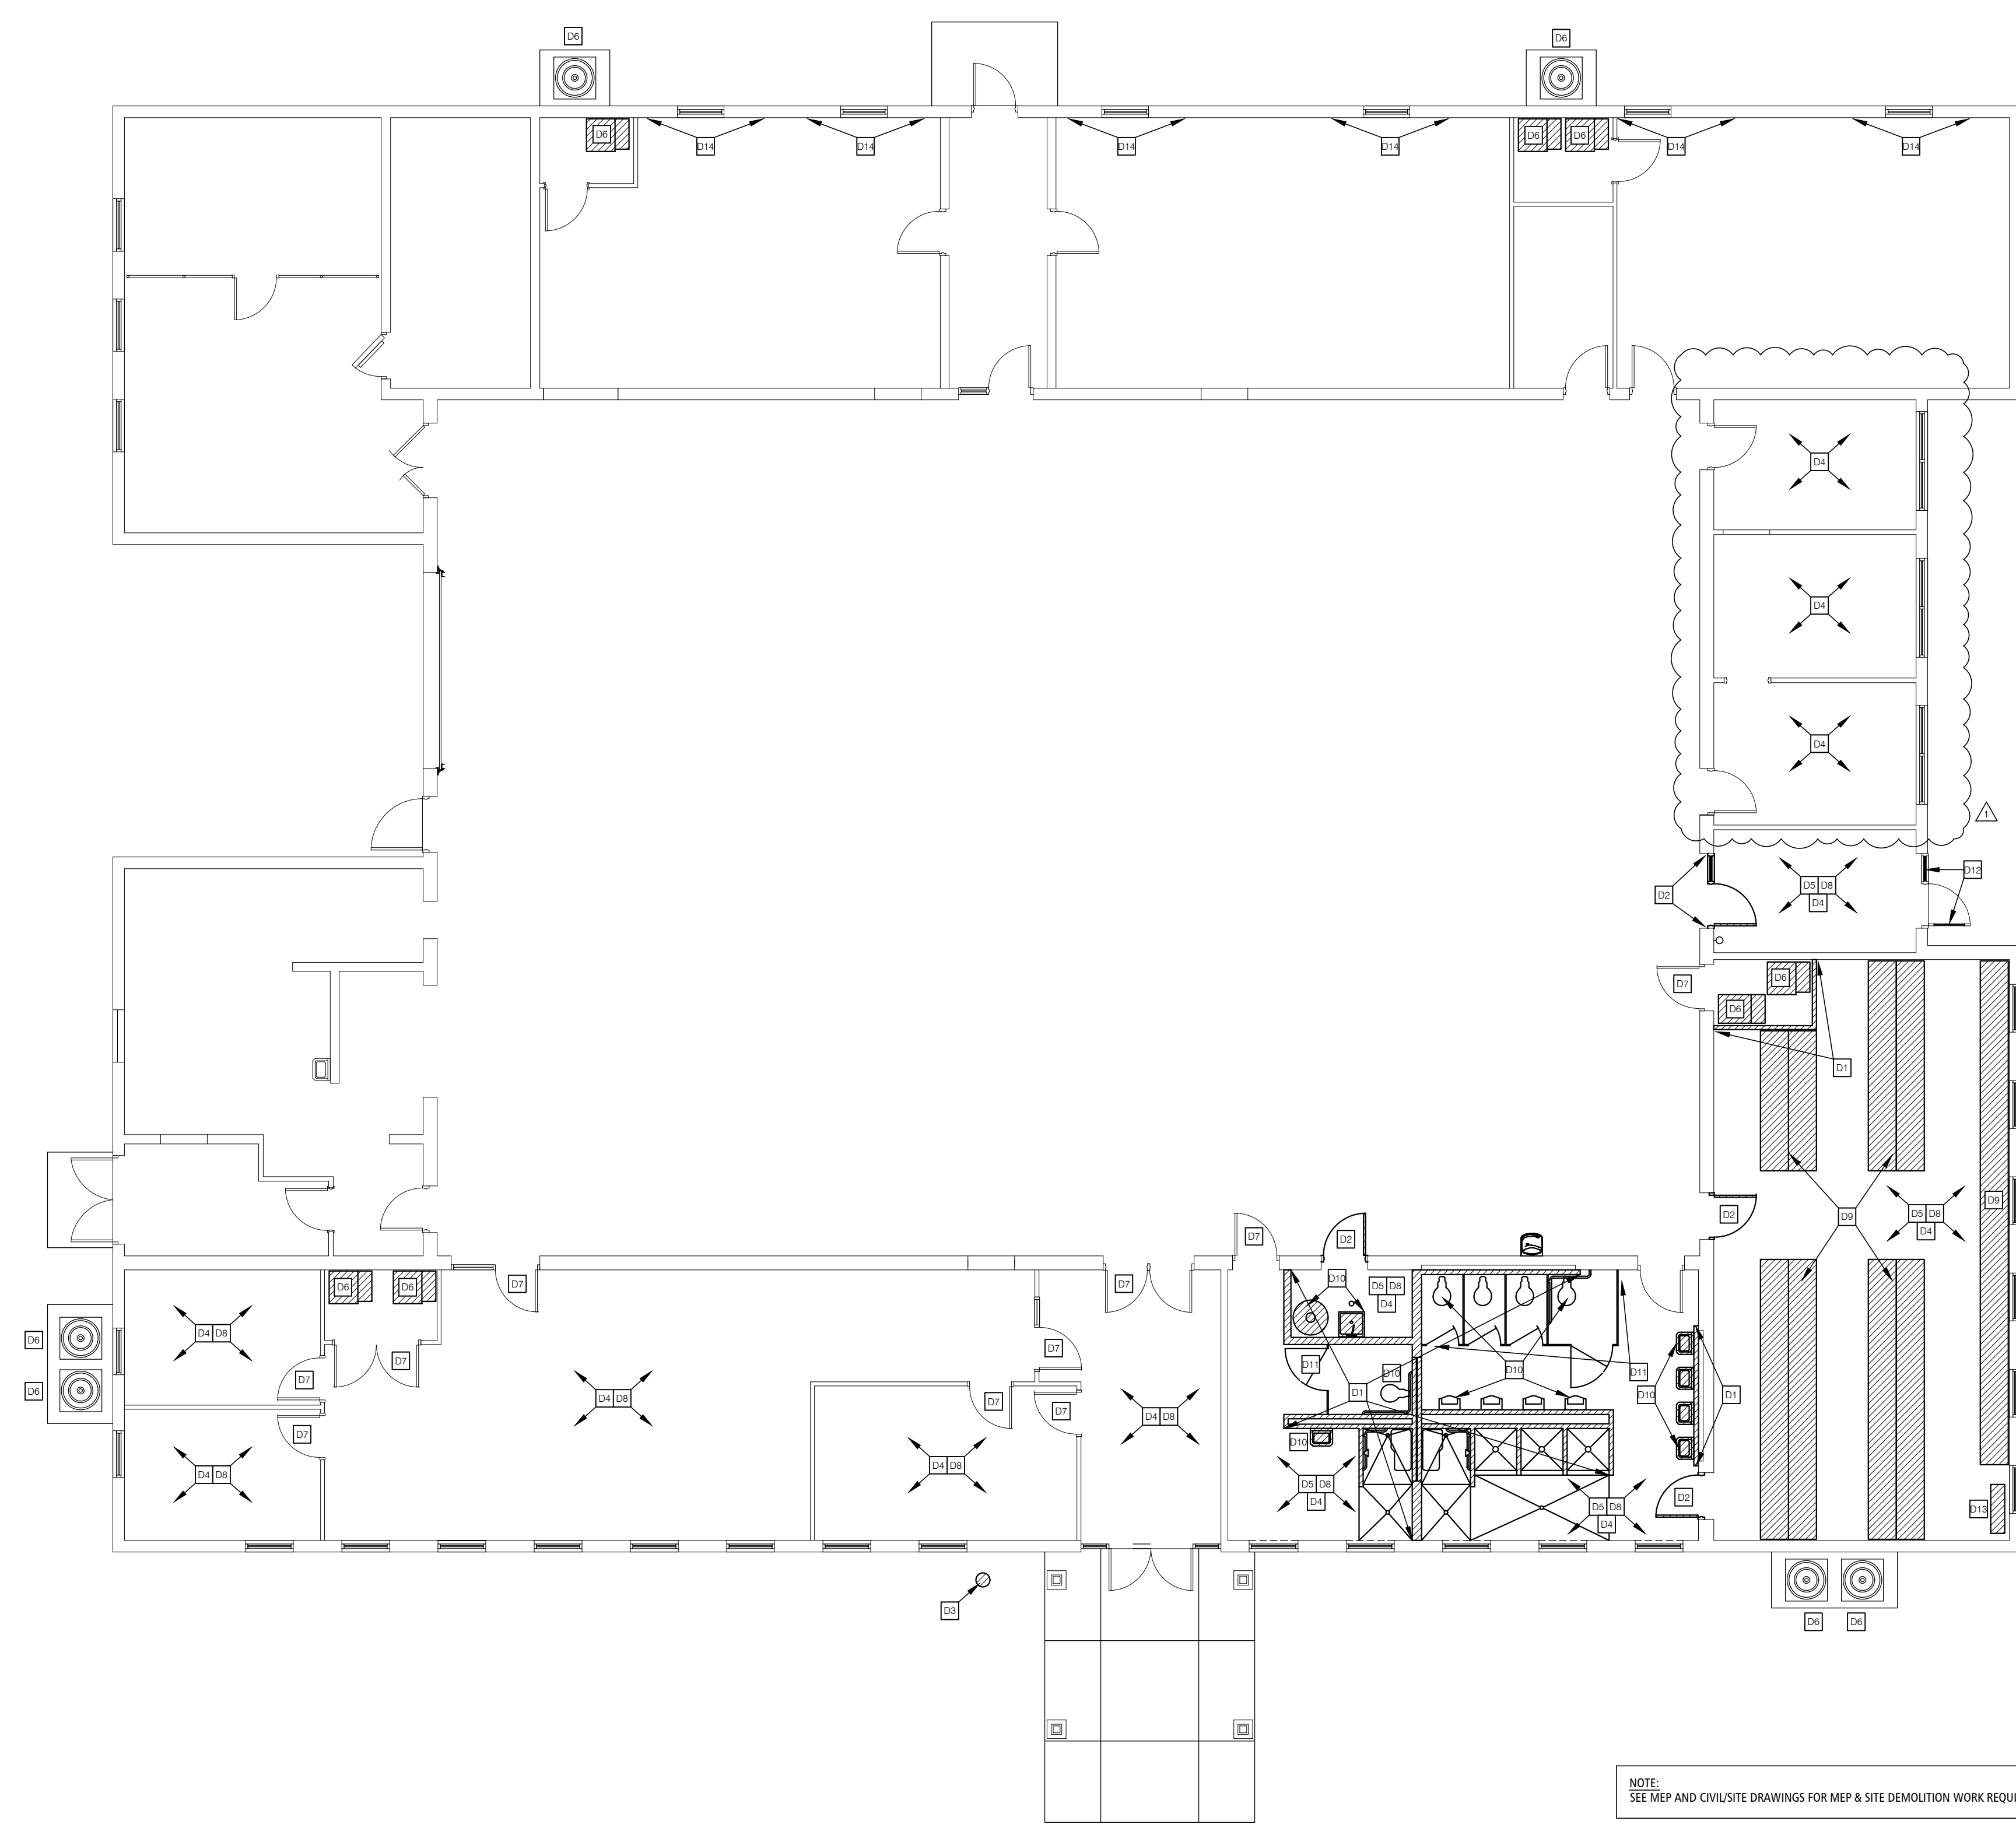

NOTE:
SEE MEP AND CIVIL/SITE DRAWINGS FOR MEP & SITE DEMOLITION WORK REQUIRED.

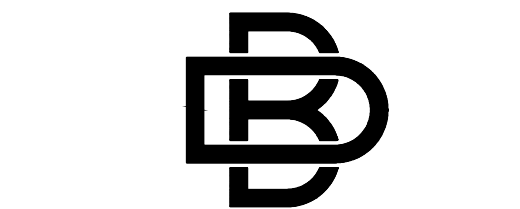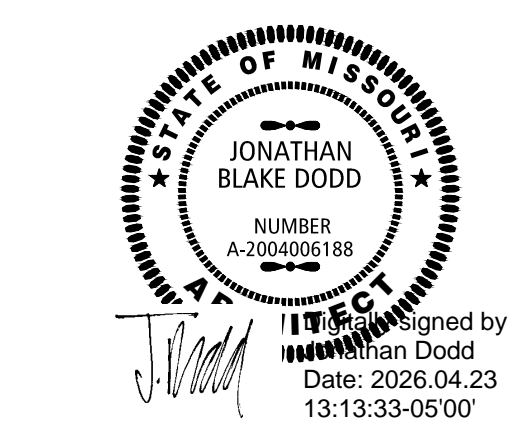

BUXTON KUBIK DODD
DESIGN COLLECTIVE
3100 S. NATIONAL AVENUE, SUITE 300
SPRINGFIELD, MO 65807
PHONE: 417.890.5543 FAX: 417.890.5563
MISSOURI CERTIFICATE OF AUTHORITY NO. A-2006007284

OFFICE OF ADMINISTRATION
DIVISION OF FACILITIES
MANAGEMENT,
DESIGN AND CONSTRUCTION

DEPARTMENT OF PUBLIC
SAFETY
THE MISSOURI
NATIONAL GUARD

RENOVATE INTERIOR &
EXTERIOR
ANDERSON READINESS
CENTER

712 ANDERSON STREET
ANDERSON, MISSOURI 64831

PROJECT # T2421-01
SITE # 6272
FACILITY # 8136272002

REVISION:
DATE: 04/23/2026
REVISION:
DATE:
REVISION:
DATE:
ISSUE DATE: 02/20/2026

CAD DWG FILE: A-300
DRAWN BY: JD
CHECKED BY: JD
DESIGNED BY: JD


SHEET TITLE:
DOORS

SHEET NUMBER:

A-300

15 OF 35 SHEETS
02/20/2026

DOOR ELEVATIONS

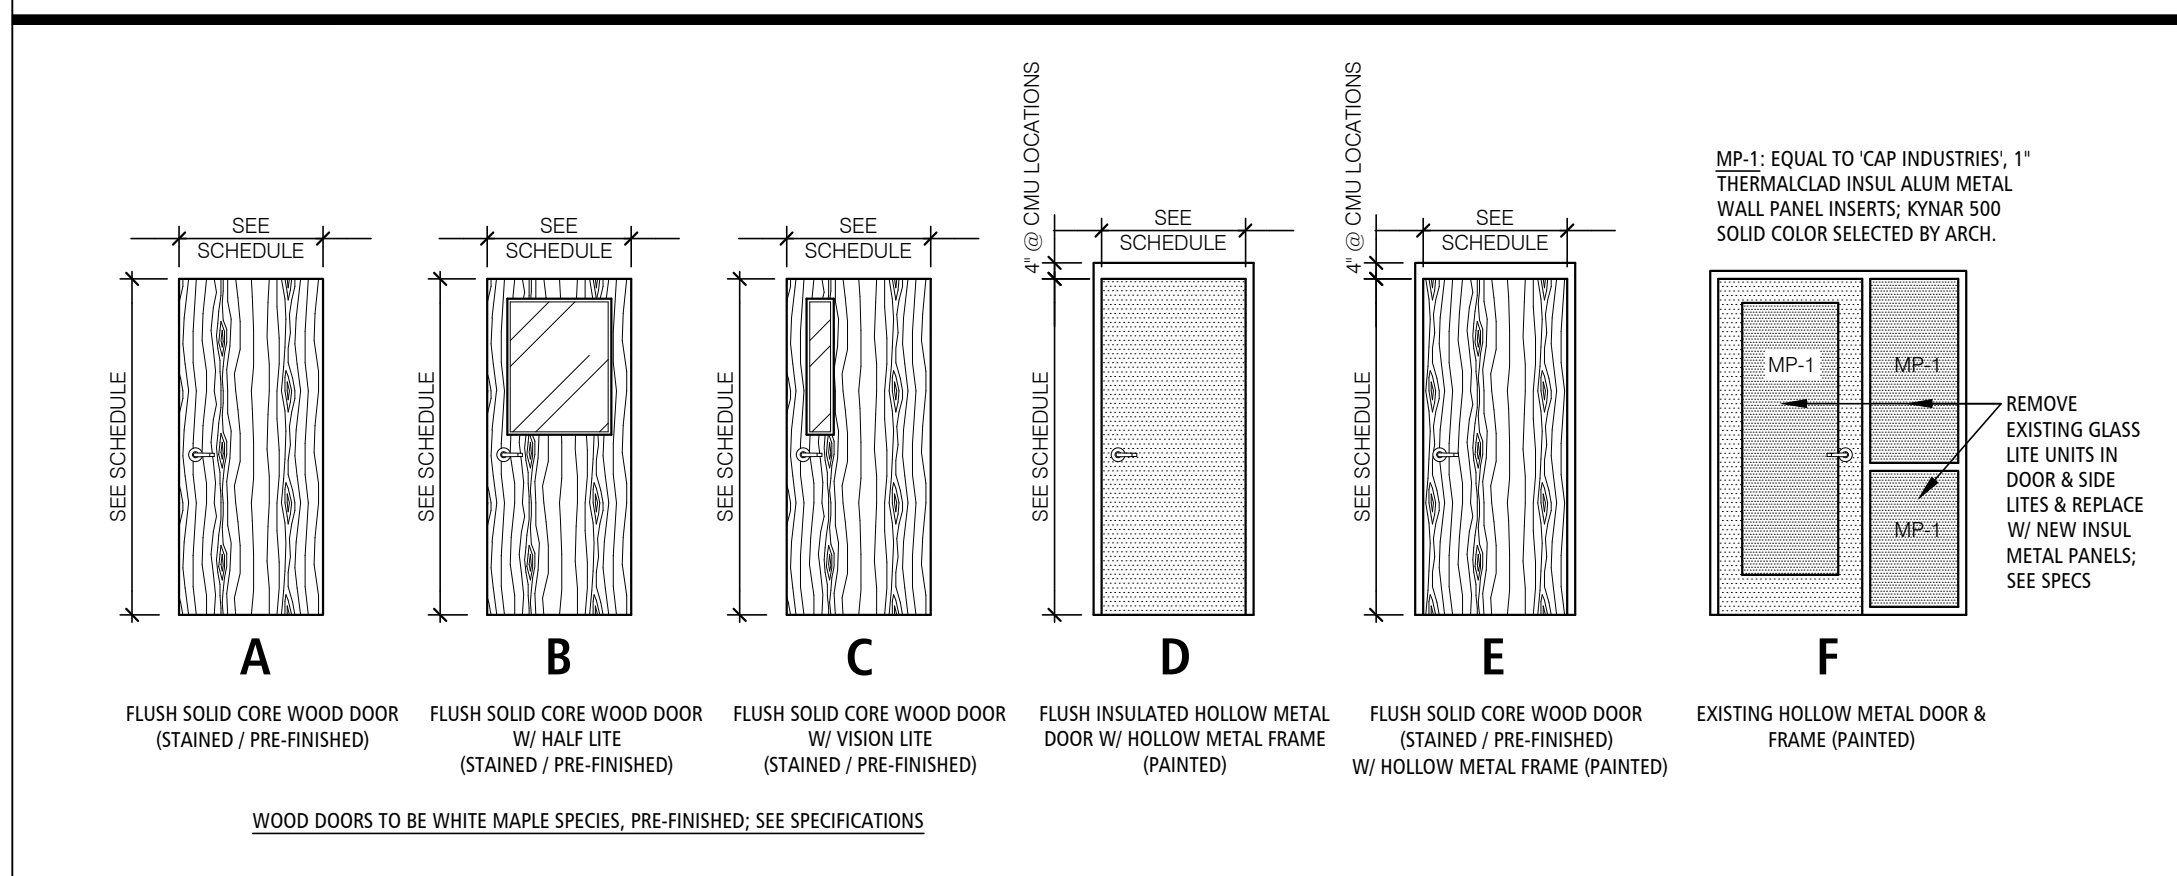


DOOR HARDWARE SCHEDULE

<p>GROUP 1 REPLACE EXISTING DOOR LEAF(S) - BID ALTERNATE #01 REMOVE & REINSTALL EXISTING DOOR HARDWARE: HINGES, CLOSER, LOCKSET/PANIC DEVICES, ETC.</p> <p>GROUP 2A 3070 HM DOOR / HM FRAME DOOR # 122 3 EA HINGES 1 EA STOREROOM LOCK 1 EA MORITSE CYLINDER 1 EA WALL STOP</p> <p>GROUP 2B 3070 WD DOOR / HM FRAME DOOR # 124 3 EA HINGES 1 EA STOREROOM LOCK 1 EA MORITSE CYLINDER 1 EA WALL STOP</p> <p>GROUP 3 EXISTING HM DOOR / HM FRAME DOOR # 122A EXISTING HARDWARE TO REMAIN - DOOR TO BE RE-PAINTED, GLAZING REMOVED & REPLACED WITH INSUL METAL PANEL INSERTS.</p> <p>GROUP 4 3070 WD DOOR / HM FRAME DOOR # 123, 126, 127 3 EA HINGES 1 EA PUSH/PULL SET 1 EA CLOSER 1 EA WALL/FLOOR STOP</p> <p>*** NOTE*** KEYWAY TO MATCH OWNERS EXISTING KEYWAY SYSTEM (7-PIN BEST CORES - NO SUBSTITUTION)</p> <p>MANUFACTURERS USED: (SEE SPECIFICATIONS FOR SUBSTITUTIONS / ALTERNATE MANUFACTURERS LISTING)</p>	<p>MANUFACTURERS USED: (SEE SPECIFICATIONS FOR SUBSTITUTIONS / ALTERNATE MANUFACTURERS LISTING)</p> <p>MCKINNEY OR EQUIVALENT YALE OR EQUIVALENT ROCKWOOD OR EQUIVALENT PEMCO OR EQUIVALENT</p>
--	---

DOOR & FRAME FINISHES

WD = SOLID CORE FLUSH WOOD DOOR	F1 = PAINTED
AL = PRE-FINISHED ALUM. DOOR OR FRAME	F2 = PREFINISHED
HM = HOLLOW METAL DOOR OR FRAME	
IHM = INSULATED HOLLOW METAL DOOR OR FRAME	
ST = STEEL DOOR OR FRAME; SEE SPECIFICATIONS	

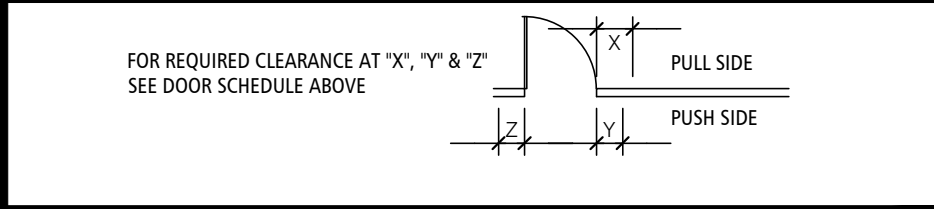

GENERAL DOOR/HARDWARE NOTES

- ALL DOORS ARE TO HAVE REQUIRED WALL/FLOOR DOOR STOPS.
- SEALANT & BACKER ROD (IF REQ'D.) SHALL BE USED AT INSIDES AND OUTSIDES OF ALL DOOR FRAMES. COLOR TO BE APPROVED BY ARCHITECT.
- ALL FRAMES ARE TO HAVE A MIN. OF THREE ANCHORS AT EACH DOOR JAMB.
- ALL DOOR HARDWARE TO BE LEVER TYPE. ALL EGRESS DOORS SHALL BE OF TYPE THAT DOOR CAN BE OPENED FROM EGRESS SIDE WITHOUT USE OF KEYS. SPECIAL KNOWLEDGE OR EFFORT. THRESHOLD DOORS SHALL NOT EXCEED 1/2" IN HEIGHT FROM WALK TO FLOOR SLAB. SEE HARDWARE SCHEDULE IN SPECS.
- ALL NEW DOOR HARDWARE TO BE ADA COMPLIANT - SEE SPECS ALSO.
- FINISH OF NEW DOOR HARDWARE IS PER FINISH SCHEDULE OR HARDWARE SCHEDULE.
- COORDINATE LEFT/RIGHT HAND HARDWARE REQUIREMENTS WITH DOOR SWINGS ON PLAN.
- ALL EXISTING HM DOORS AND HM DOOR FRAMES SHALL BE PREPARED & RE-PAINTED. SEE SPECS & FINISH PLANS AND SCHEDULES. REMOVE & REINSTALL EXISTING DOORS AND HARDWARE AS REQUIRED FOR PAINTING WORK.
- CONTRACTOR SHALL REMOVE & RETAIN ALL EXISTING BEST 7-PIN CORES FROM ALL AFFECTED DOORS ON THE PROJECT AND RE-INSTALL THE CORES INTO ALL NEW AFFECTED DOOR LOCKSETS.

WINDOW SCHEDULE

EXISTING WINDOW TO REMAIN (PROTECT) (SIZE/TYP MAY VARY BY LOCATION)	EW
--	----


DOOR SCHEDULE

NO	DOOR SIZE	DOOR ELEV	DOOR	RATING	FRAME	HEAD DETAIL	JAMB DETAIL	SILL DETAIL	HARDWARE SET	CARD READER	CLEARANCE			REMARKS
											X	Y	Z	
101	EXISTING ALUM STOREFRONT DOOR SYSTEM TO REMAIN	-	-	-	-	-	-	-	-	-	-	-	-	-
101A	PAIR 3'-0" X 7'-0" X 1 3/4" W/ REMOVABLE ASTRAGAL (F.V.)	B	WD/F2	-	EXIST/F1	-	-	-	GROUP 1	-	-	-	-	BID ALTERNATE #01; EXISTING DOOR TO REMAIN AS-IS IN BASE BID
102	3'-0" X 7'-0" X 1 3/4" (FIELD VERIFY)	A	WD/F2	-	EXIST/F1	-	-	-	GROUP 1	-	-	-	-	BID ALTERNATE #01; EXISTING DOOR TO REMAIN AS-IS IN BASE BID
102A	3'-0" X 7'-0" X 1 3/4" (FIELD VERIFY)	A	WD/F2	-	EXIST/F1	-	-	-	GROUP 1	-	-	-	-	BID ALTERNATE #01; EXISTING DOOR TO REMAIN AS-IS IN BASE BID
103	3'-0" X 7'-0" X 1 3/4" (FIELD VERIFY)	B	WD/F2	-	EXIST/F1	-	-	-	GROUP 1	-	-	-	-	BID ALTERNATE #01; EXISTING DOOR TO REMAIN AS-IS IN BASE BID
103A	3'-0" X 7'-0" X 1 3/4" (FIELD VERIFY)	A	WD/F2	-	EXIST/F1	-	-	-	GROUP 1	-	-	-	-	BID ALTERNATE #01; EXISTING DOOR TO REMAIN AS-IS IN BASE BID
104	3'-0" X 7'-0" X 1 3/4" (FIELD VERIFY)	A	WD/F2	-	EXIST/F1	-	-	-	GROUP 1	-	-	-	-	BID ALTERNATE #01; EXISTING DOOR TO REMAIN AS-IS IN BASE BID
105	3'-0" X 7'-0" X 1 3/4" (FIELD VERIFY)	A	WD/F2	-	EXIST/F1	-	-	-	GROUP 1	-	-	-	-	BID ALTERNATE #01; EXISTING DOOR TO REMAIN AS-IS IN BASE BID
106	PAIR 3'-0" X 7'-0" X 1 3/4" (FIELD VERIFY)	A	WD/F2	-	EXIST/F1	-	-	-	GROUP 1	-	-	-	-	BID ALTERNATE #01; EXISTING DOOR TO REMAIN AS-IS IN BASE BID
107	EXISTING DOOR & FRAME TO REMAIN	-	-	-	-	-	-	-	-	-	-	-	-	PAINT EXISTING HM DOOR & FRAME PER FINISH SCHEDULE
107A	EXISTING DOOR & FRAME TO REMAIN	-	-	-	-	-	-	-	-	-	-	-	-	PAINT EXISTING HM DOOR & FRAME PER FINISH SCHEDULE
108	EXISTING DOOR & FRAME TO REMAIN	-	-	-	-	-	-	-	-	-	-	-	-	PAINT EXISTING HM DOOR & FRAME PER FINISH SCHEDULE
109	EXISTING DOOR & FRAME TO REMAIN	-	-	-	-	-	-	-	-	-	-	-	-	PAINT EXISTING HM DOOR & FRAME PER FINISH SCHEDULE
110	EXISTING CHAIN LINK GATE DOOR TO REMAIN	-	-	-	-	-	-	-	-	-	-	-	-	EXISTING DOOR/FRAME TO REMAIN - NO NEW WORK
111	EXISTING STEEL VAULT DOOR TO REMAIN	-	-	-	-	-	-	-	-	-	-	-	-	EXISTING DOOR/FRAME TO REMAIN - NO NEW WORK
112	EXISTING DOOR & FRAME TO REMAIN	-	-	-	-	-	-	-	-	-	-	-	-	PAINT EXISTING HM DOOR & FRAME PER FINISH SCHEDULE
113	3'-0" X 7'-0" X 1 3/4" (FIELD VERIFY)	C	WD/F2	-	EXIST/F1	-	-	-	GROUP 1	-	-	-	-	BID ALTERNATE #01; EXISTING DOOR TO REMAIN AS-IS IN BASE BID
114	3'-0" X 7'-0" X 1 3/4" (FIELD VERIFY)	A	WD/F2	-	EXIST/F1	-	-	-	GROUP 1	-	-	-	-	BID ALTERNATE #01; EXISTING DOOR TO REMAIN AS-IS IN BASE BID
114A	EXISTING DOOR & FRAME TO REMAIN	-	-	-	-	-	-	-	-	-	-	-	-	PAINT EXISTING HM DOOR & FRAME PER FINISH SCHEDULE
115	3'-0" X 7'-0" X 1 3/4" (FIELD VERIFY)	C	WD/F2	-	EXIST/F1	-	-	-	GROUP 1	-	-	-	-	BID ALTERNATE #01; EXISTING DOOR TO REMAIN AS-IS IN BASE BID
116	EXISTING DOOR & FRAME TO REMAIN	-	-	-	-	-	-	-	-	-	-	-	-	PAINT EXISTING HM DOOR & FRAME PER FINISH SCHEDULE
117	EXISTING DOOR & FRAME TO REMAIN	-	-	-	-	-	-	-	-	-	-	-	-	PAINT EXISTING HM DOOR FRAME PER FINISH SCHEDULE
118	EXISTING DOOR & FRAME TO REMAIN	-	-	-	-	-	-	-	-	-	-	-	-	PAINT EXISTING HM DOOR FRAME PER FINISH SCHEDULE
119	EXISTING DOOR & FRAME TO REMAIN	-	-	-	-	-	-	-	-	-	-	-	-	PAINT EXISTING HM DOOR FRAME PER FINISH SCHEDULE
121	EXISTING DOOR & FRAME TO REMAIN	-	-	-	-	-	-	-	-	-	-	-	-	PAINT EXISTING HM DOOR FRAME PER FINISH SCHEDULE
122	3'-0" X 7'-0" X 1 3/4"	D	IHM/F1	-	IHM/F1	6/A-600	3/A-600	-	GROUP 2	-	-	-	-	PAINT EXISTING HM DOOR & FRAME PER FINISH SCHEDULE, REPLACE GLASS LITES
122A	EXISTING DOOR & FRAME TO REMAIN	F	-	-	-	-	-	-	GROUP 3	-	-	-	-	PAINT EXISTING HM DOOR & FRAME PER FINISH SCHEDULE, REPLACE GLASS LITES
123	3'-0" X 7'-0" X 1 3/4" (FIELD VERIFY)	E	WD/F2	-	HMF/F1	5/A-600	2/A-600	-	GROUP 4	-	18"	12"	-	BID ALTERNATE #01; EXISTING DOOR TO REMAIN AS-IS IN BASE BID
124	3'-0" X 7'-0" X 1 3/4"	E	WD/F2	-	HMF/F1	4/A-600	4/A-600	-	GROUP 2	-	-	-	-	PAINT EXISTING HM DOOR FRAME PER FINISH SCHEDULE
126	3'-0" X 7'-0" X 1 3/4" (FIELD VERIFY)	A	WD/F2	-	EXIST/F1	5/A-600	2/A-600	-	GROUP 4	-	18"	12"	-	BID ALTERNATE #01; EXISTING DOOR TO REMAIN AS-IS IN BASE BID
127	3'-0" X 7'-0" X 1 3/4" (FIELD VERIFY)	A	WD/F2	-	EXIST/F1	5/A-600	2/A-600	-	GROUP 4	-	18"	12"	-	BID ALTERNATE #01; EXISTING DOOR TO REMAIN AS-IS IN BASE BID
128	EXISTING DOOR & FRAME TO REMAIN	-	-	-	-	-	-	-	-	-	-	-	-	PAINT EXISTING HM DOOR FRAME PER FINISH SCHEDULE
128A	EXISTING SECTIONAL OVERHEAD DOOR TO REMAIN	-	-	-	-	-	-	-	-	-	-	-	-	EXISTING DOOR/FRAME TO REMAIN - NO NEW WORK

METAL STUD BOX BEAM HEADER SCHEDULE


APPROXIMATE SPAN	METAL STUD BOX BEAM HEADER	COMMENTS
UP TO 8'-0"	2- 600S162-54 (DOUBLE JACK & KING AT EACH END) WITH TRACK TOP & BOTTOM	
8'-1" TO 12'-0"	2- 600S162-54 (DOUBLE JACK & KING AT EACH END) WITH TRACK TOP & BOTTOM	
12'-1" TO 15'-0"	2- 800S162-54 (DOUBLE JACK & KING AT EACH END) WITH TRACK TOP & BOTTOM	
15'-1" TO 18'-0"	2- 800S250-54 (DOUBLE JACK & KING AT EACH END) WITH TRACK TOP & BOTTOM	

- NOTES:
1. PROVIDE MIN. DOUBLE JACK STUDS AND KING ON BOTH SIDES OF ALL METAL STUD WALL OPENINGS FOR HEADERS
2. PROVIDE 18 GAUGE RUNNER TRACK AT TOP AND BOTTOM OF HEADER. SEE WALL TYPES THIS SHEET FOR WALL WIDTHS.

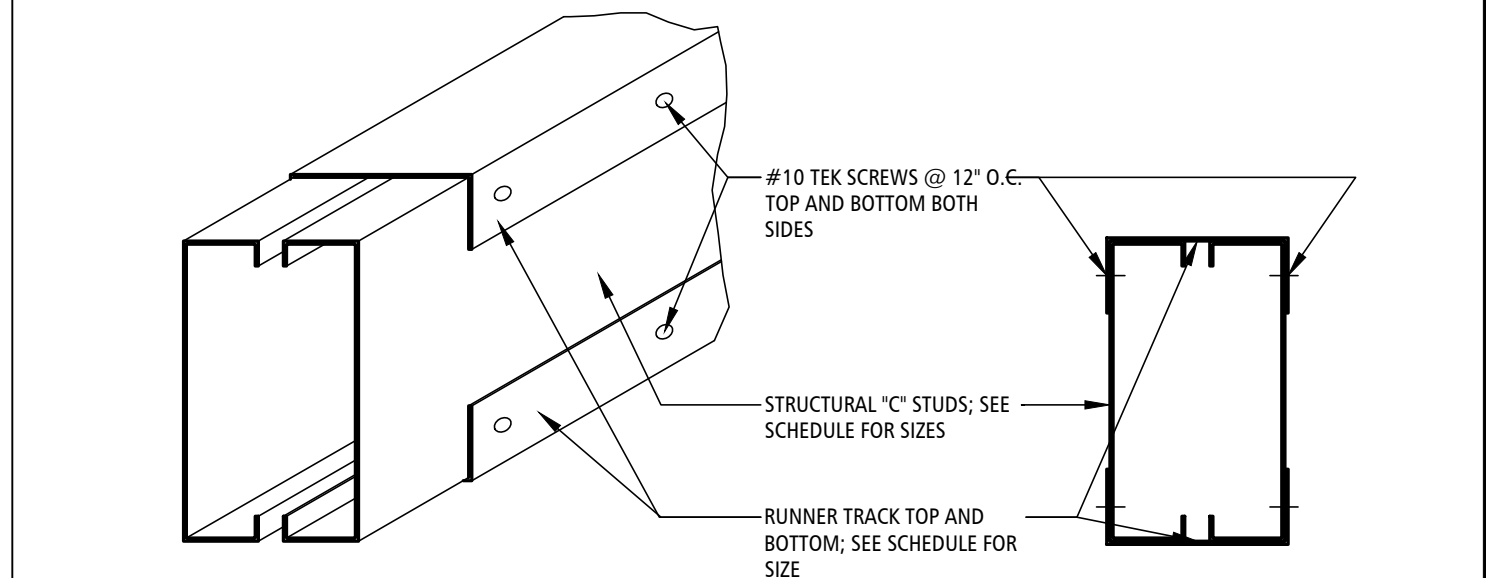


BOX BEAM HEADER DETAIL 8
SCALE: NOT TO SCALE A-300


NOT USED 7
SCALE: 1-1/2"=1'-0" A-300

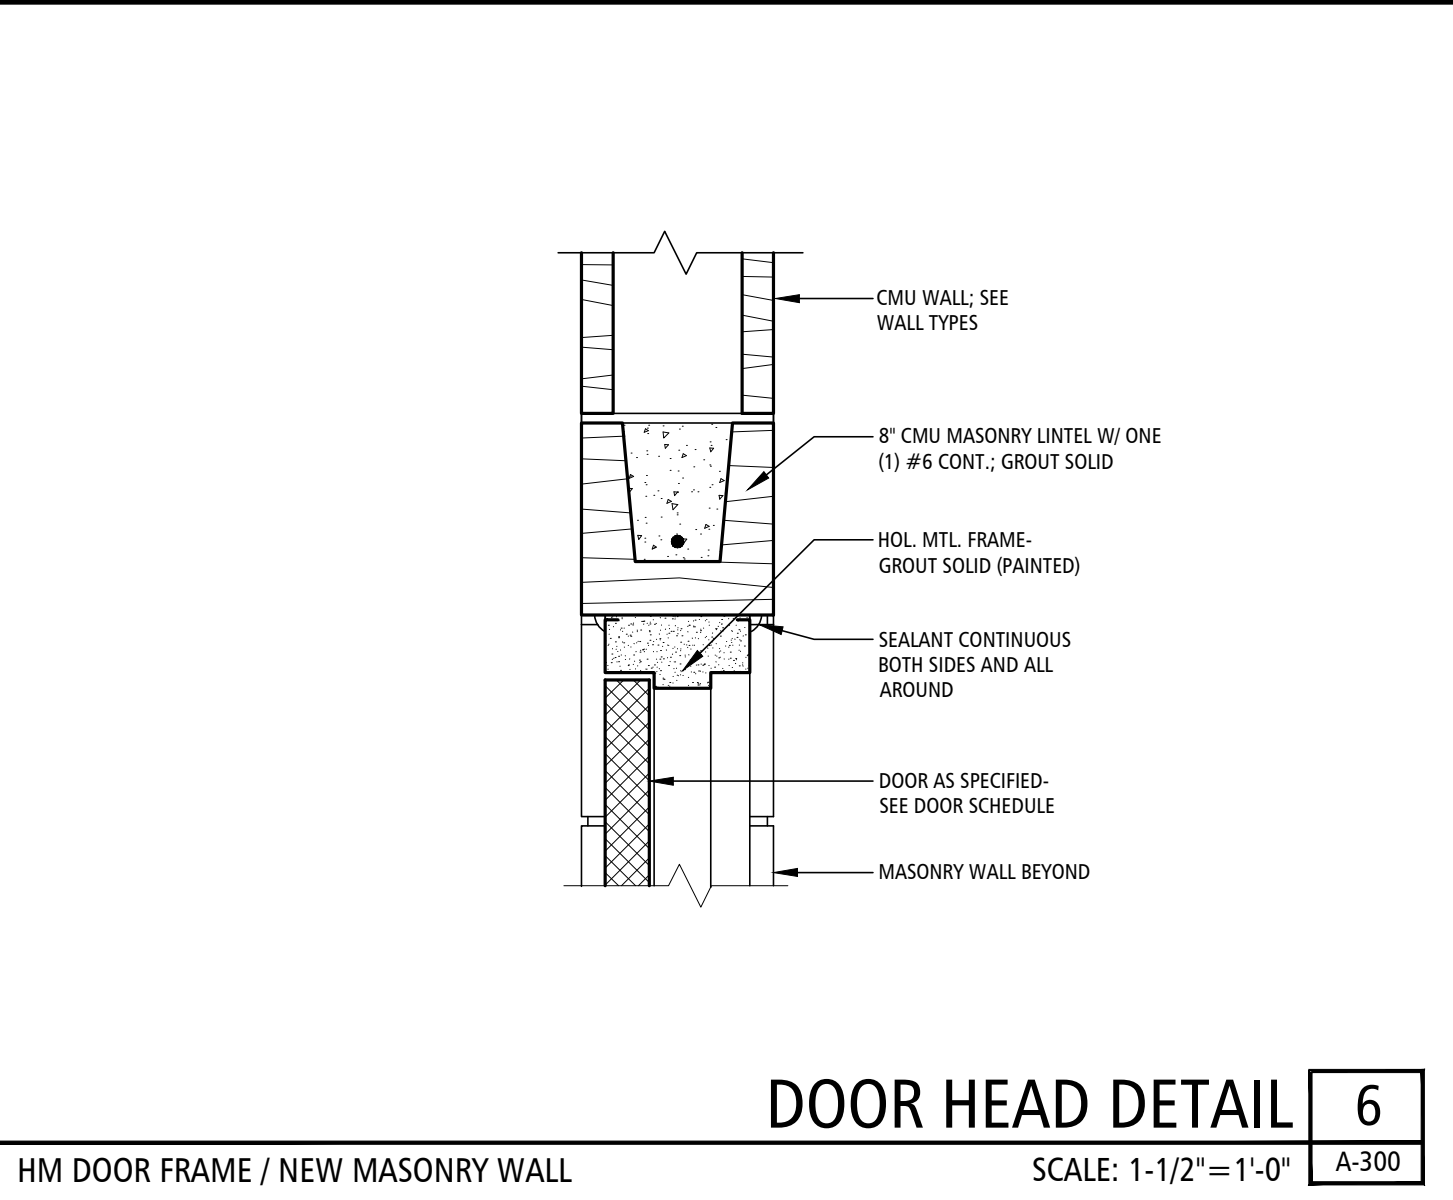


DOOR HEAD DETAIL 6
SCALE: 1-1/2"=1'-0" A-300

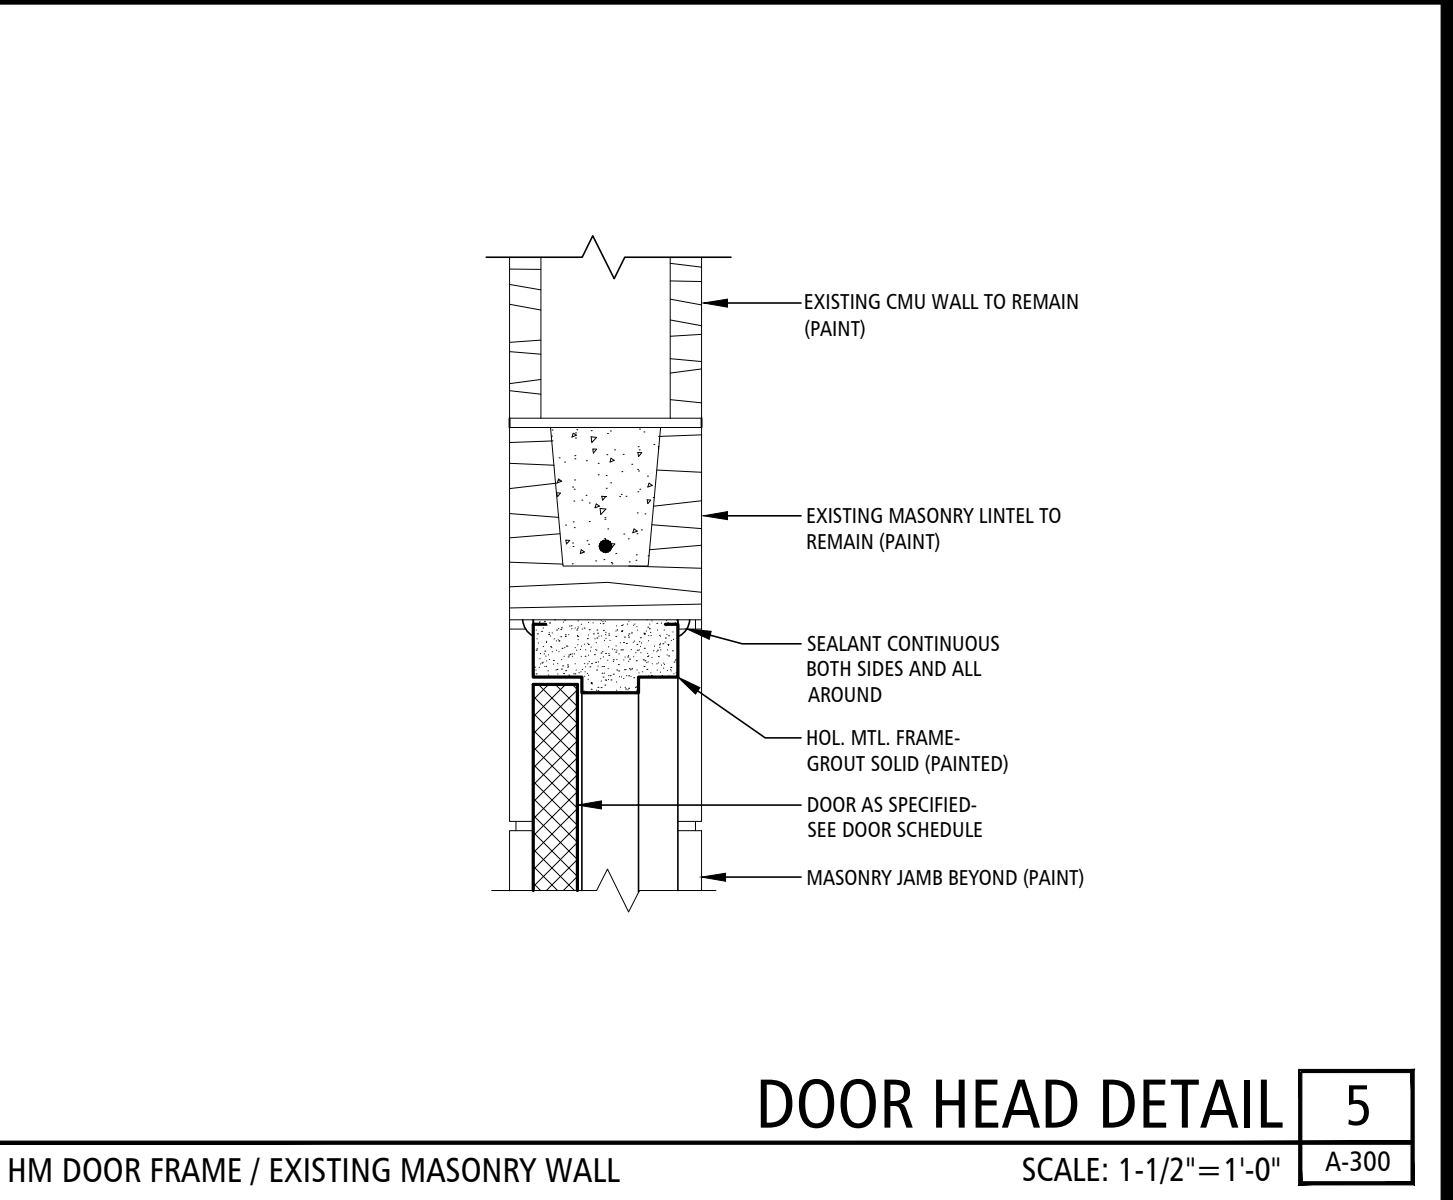


DOOR HEAD DETAIL 5
SCALE: 1-1/2"=1'-0" A-300

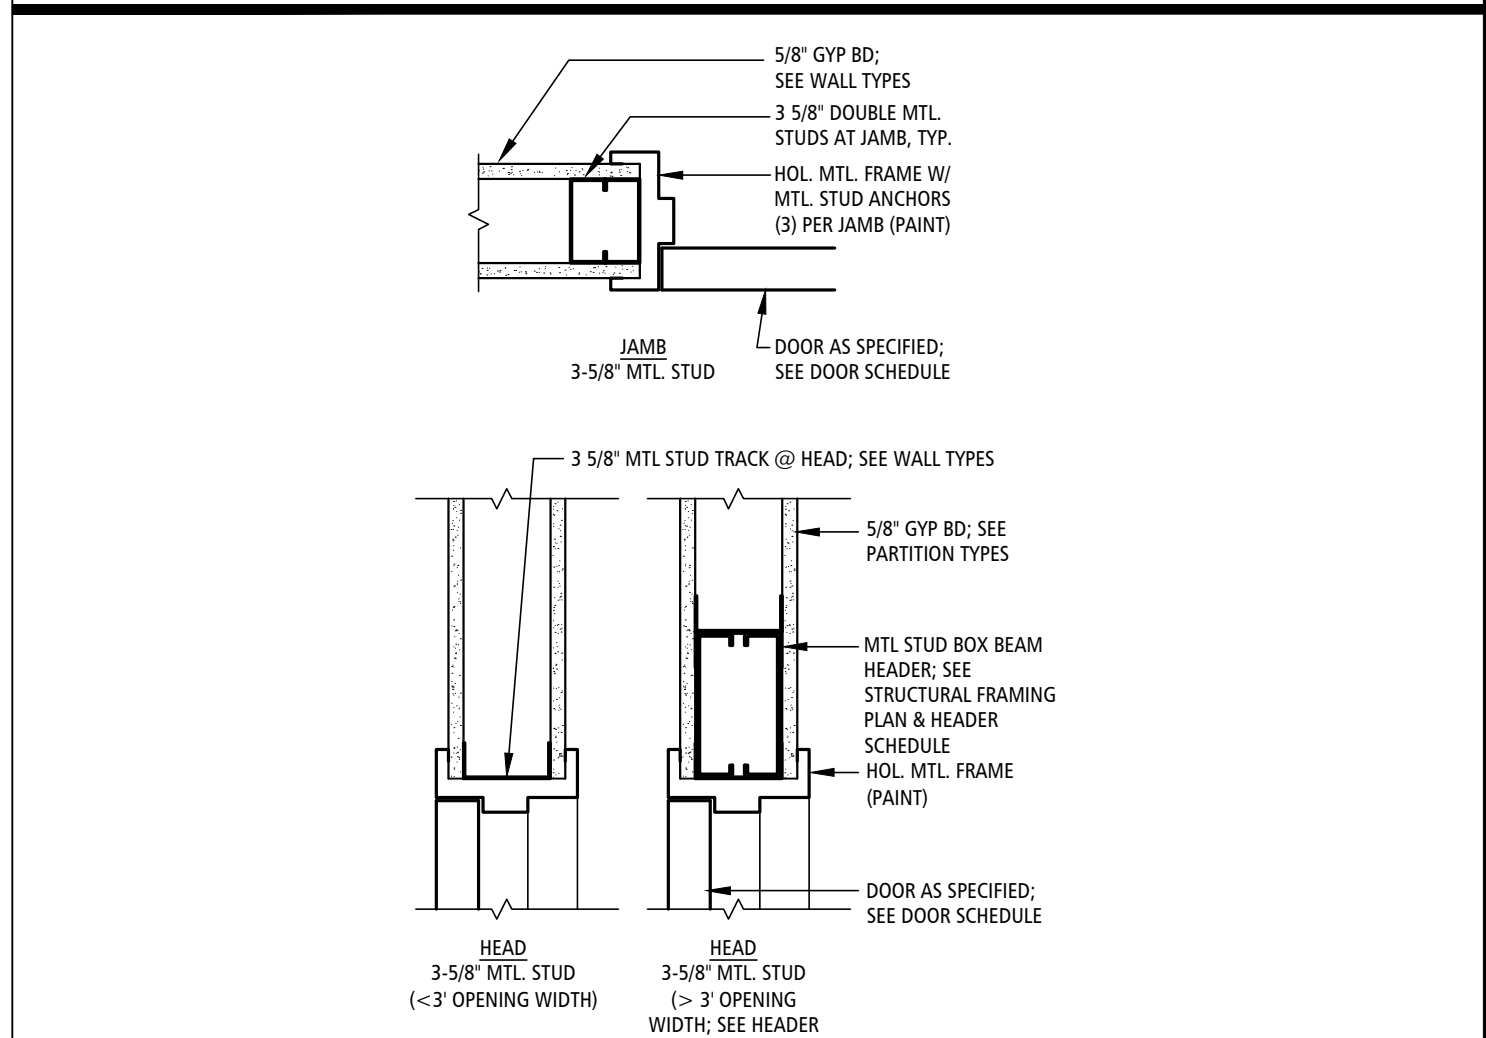


DOOR DETAIL 4
SCALE: 1-1/2"=1'-0" A-300

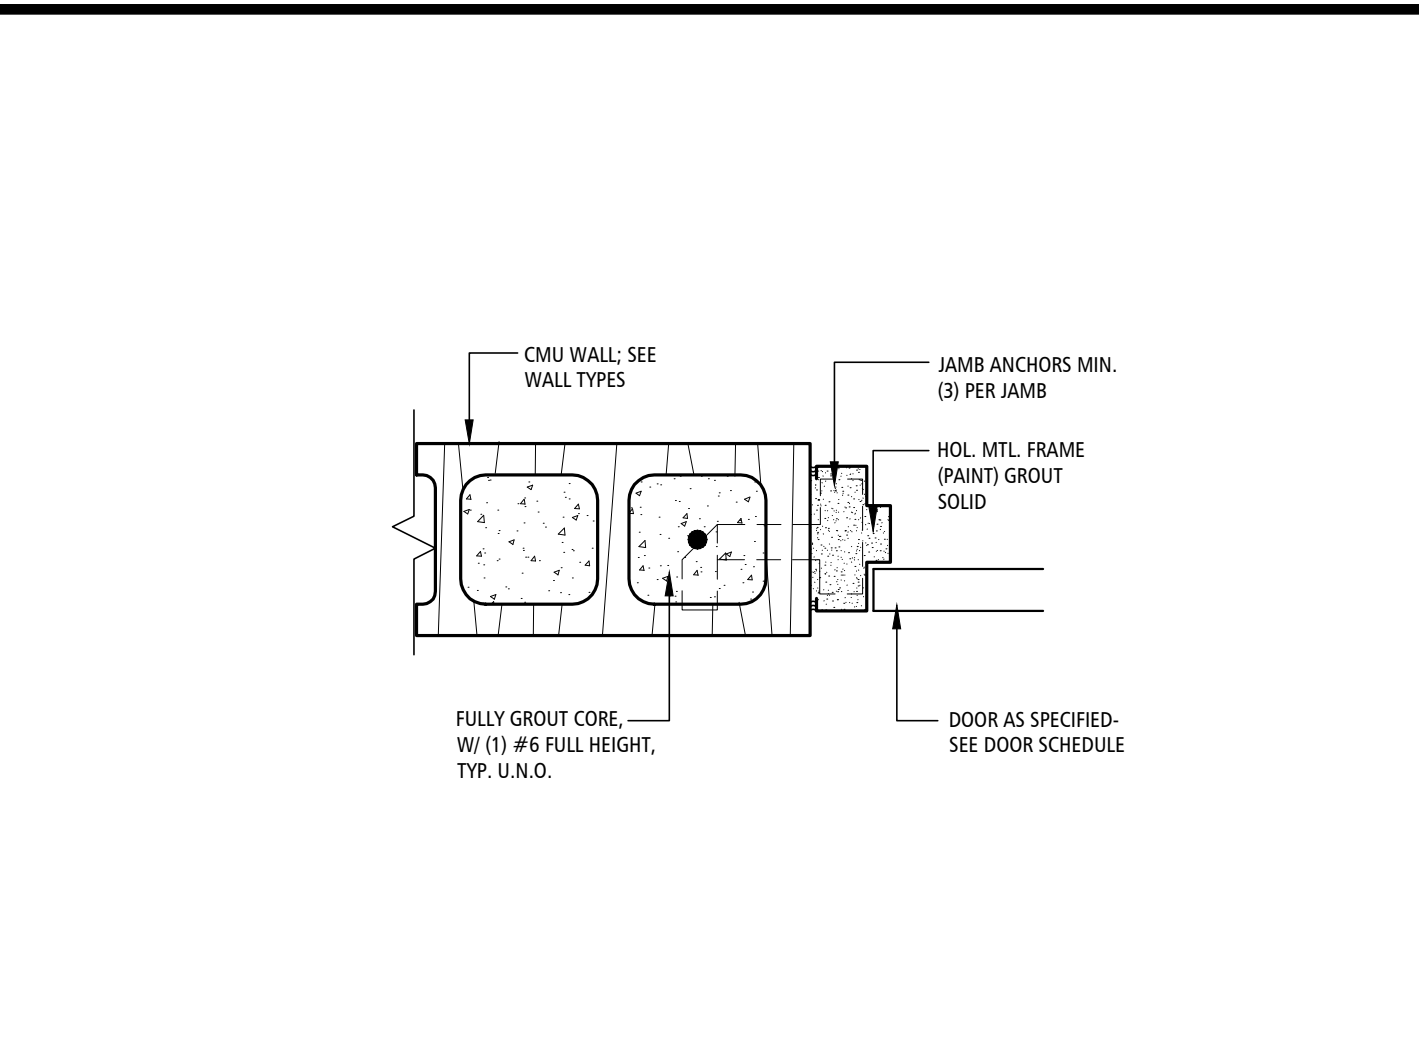

DOOR JAMB DETAIL 3
SCALE: 1-1/2"=1'-0" A-300

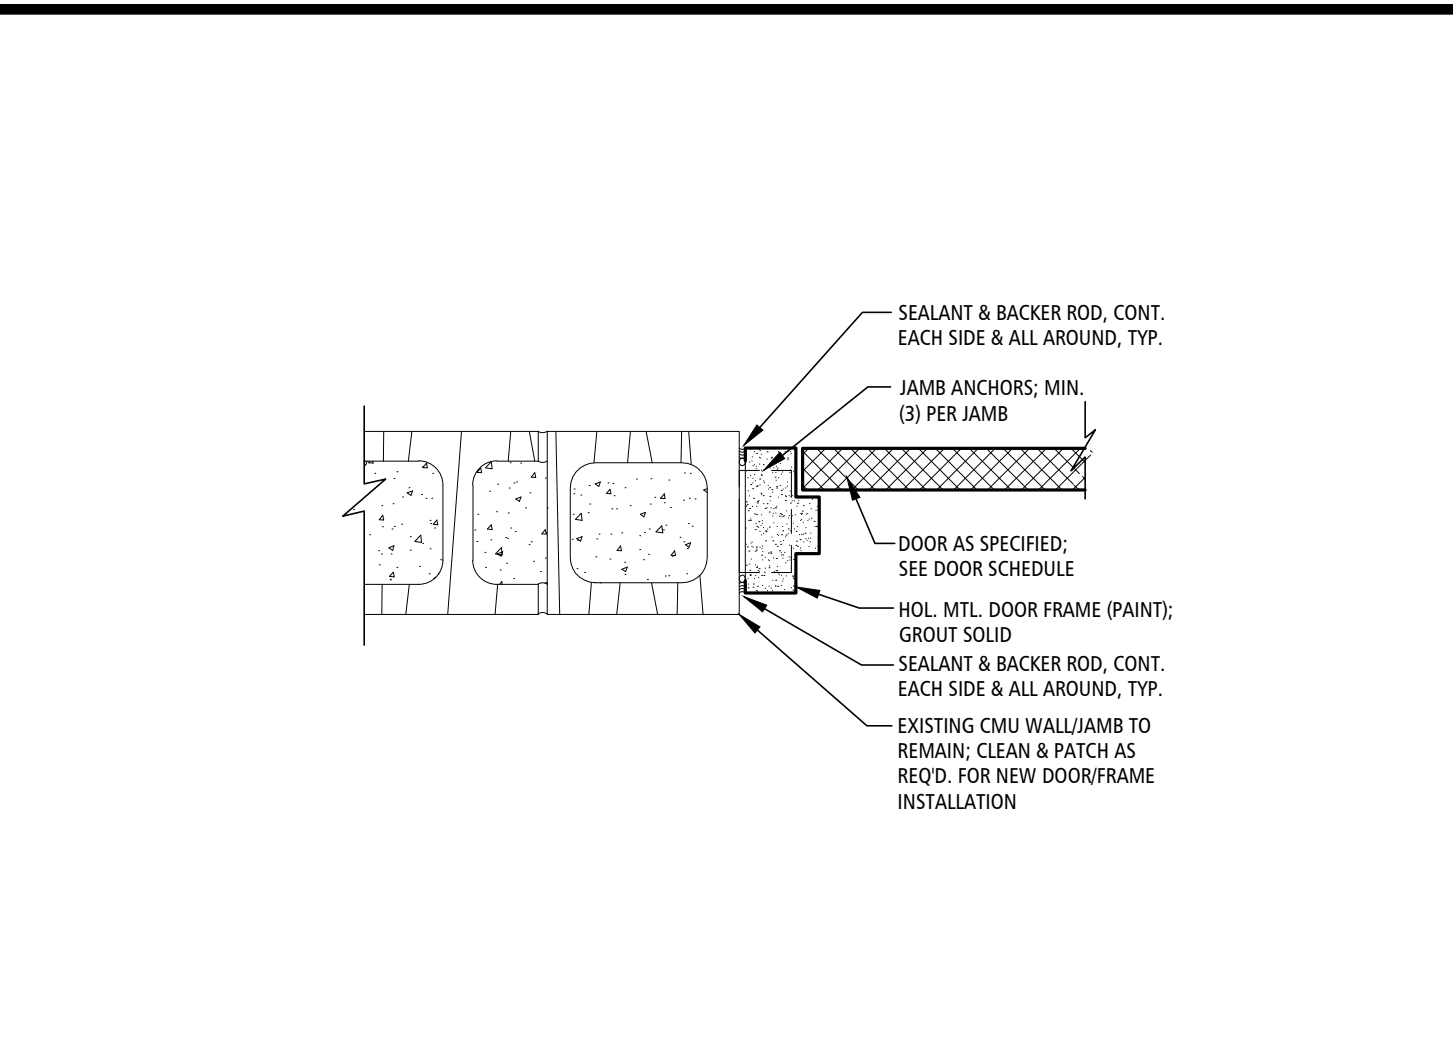

DOOR JAMB DETAIL 2
SCALE: 1-1/2"=1'-0" A-300

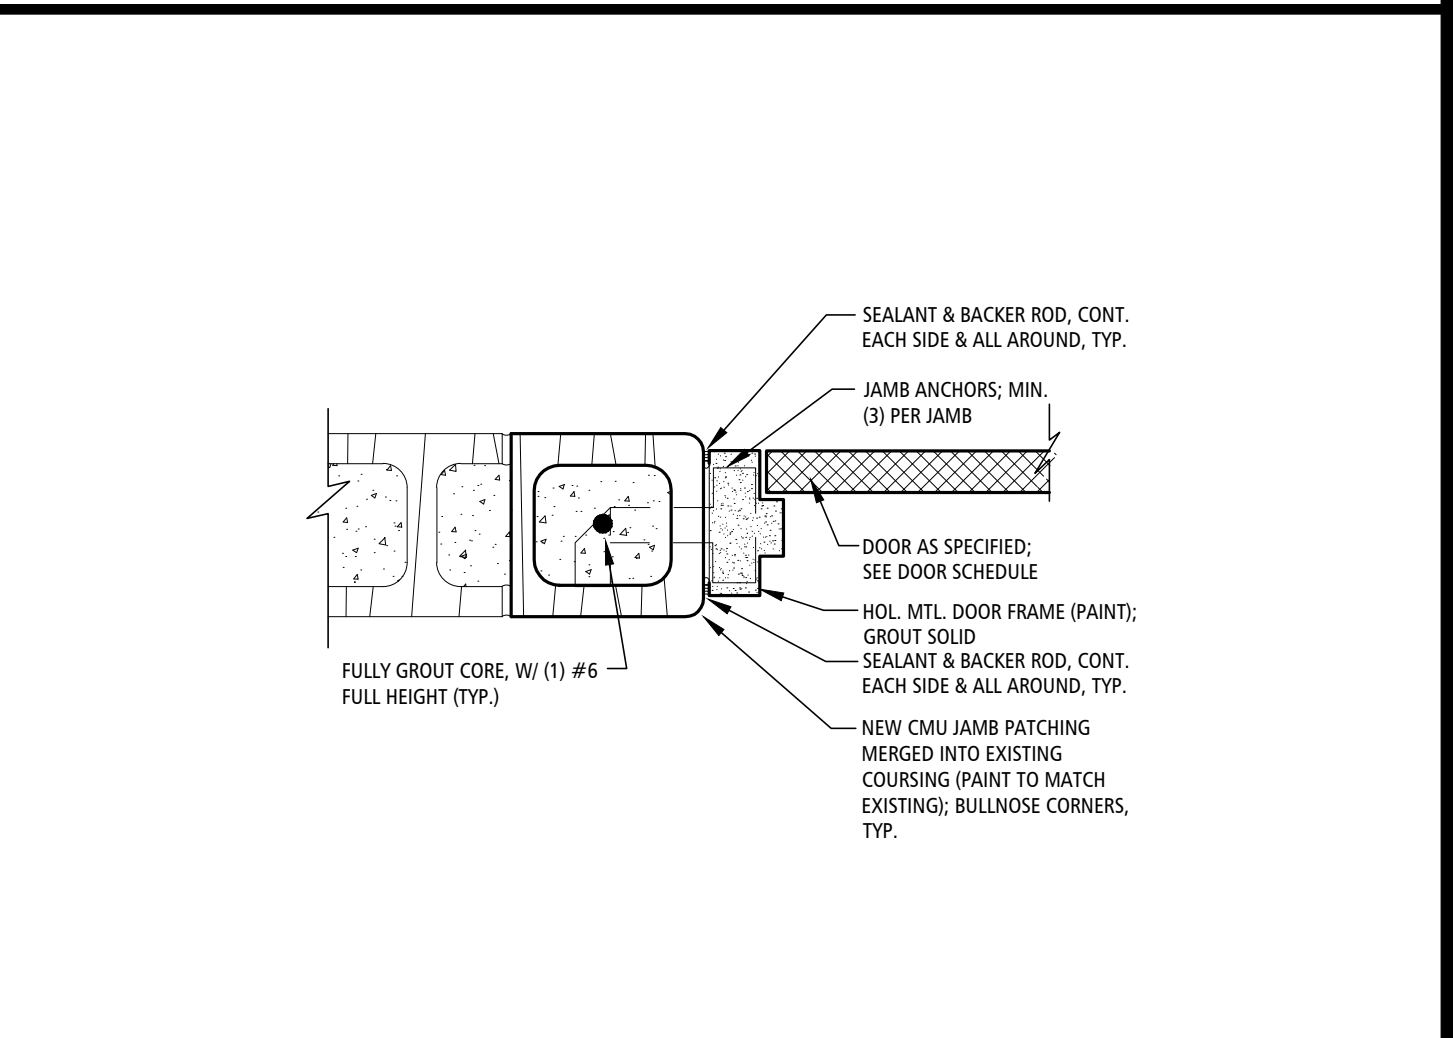

DOOR JAMB DETAIL 1
SCALE: 1-1/2"=1'-0" A-300

HM DOOR FRAME / NEW MASONRY WALL

HM DOOR FRAME / EXISTING MASONRY WALL

HM DOOR FRAME / NEW MASONRY JAMB