#### **ADDENDUM NO. 1**

#### TO: PLANS AND SPECIFICATIONS FOR STATE OF MISSOURI

Lambert Field Building 231 Renovations St. Louis Readiness Center St. Ann, Missouri PROJECT NO.: T2424-01

Bid Opening Date: 1:30 PM, Tuesday, September 9, 2025

Bidders are hereby informed that the construction Plans and/or Specifications are modified as follows:

#### **SPECIFICATION CHANGES:**

- 1. Project Manual Cover
  - a. Change St. Ann to Bridgeton
- 2. Section 072119 Foamed-In-Place Insulation
  - a. CHANGE Part 2.1, B to read

"Intumescent fireproof & thermal barrier coating – DC 315 paint FireShell F10E Or comparable product"

#### **DRAWING CHANGES:**

1. Replace drawing sheets M101, M102, E101 and E102 with drawing sheets M101, M102, E101 and E102 attached to this addendum

#### **GENERAL COMMENTS:**

- 1. The Pre-Bid Meeting was held on August 28, 2025 followed by a walk-through of the facility. The Pre-Bid Meeting sign-in sheet is attached.
- 2. Bidders needing additional site inspection should contact Gary Rice at 636-698-4292 to schedule a time.
- 3. Please contact Paul Girouard, Contract Specialist, at 573-751-4797 or <a href="mailto:pail.girouard@oa.mo.gov">pail.girouard@oa.mo.gov</a> for questions about bidding procedures and MBE\WBE\SDVE goals and submittal requirements.
- 4. The deadline for technical questions was September 2, 2025 at noon.
- 5. Changes to, or clarification of, the bid documents are only made as issued in the addenda.
- 6. All correspondence with respect to this project must include the State of Missouri project number as indicated above.
- 7. Current Plan holders list available online at: <a href="https://www.oafmdcplanroom.com/projects/2985/plan-holders/t2424-01-lambert-field-building-231-renovations-st-louis-readiness-center">https://www.oafmdcplanroom.com/projects/2985/plan-holders/t2424-01-lambert-field-building-231-renovations-st-louis-readiness-center</a>

- 8. Prospective Bidders contact American Document Solutions, 1400 Forum Blvd Suite 1C, Columbia MO 65201, 573-446-7768 to order official plans and specifications.
- 9. All bids shall be submitted on the bid form without additional terms and conditions, modifications, or stipulations. Each space on the bid form shall be properly filled including a bid amount for the alternates. Failure to do so will result in rejection of the bid.
- 10. MBE/WBE/SDVE participation requirements can be found in DIVISION 00. The MBE/WBE/SDVE participation goals are 10%/10%/3%, respectively. Only certified firms as of the bid opening date can be used to satisfy the MBE/WBE/SDVE participation goals for this project. If a bidder is unable to meet a participation goal, a Good Faith Effort Determination Form must be completed. Failure to complete this process will result in rejection of the bid.
- 11. All stored items in the building will be removed prior to start of construction. The contractor will NOT have to protect any of the owner's stored property. However, any building elements that may be damaged during construction, i.e., electrical, etc. should be protected from the weather

#### **ATTACHMENTS:**

- 1. Specifications:
  - a. Specification Section 072119 Foamed-In-Place insulation (2 pages)
- 2. Revised Drawings:
  - a. M101
  - b. M102
  - c. E101
  - d. E102
- 3. Pre-Bid Sign-In Sheet

#### **END ADDENDUM NO. 1**

#### SECTION 072119 - FOAMED-IN-PLACE INSULATION

#### PART 1 - GENERAL

#### 1.1 SUMMARY

- A. Section Includes:
  - 1. Closed-cell spray polyurethane foam.

#### 1.2 ACTION SUBMITTALS

A. Product Data: For each type of product.

#### 1.3 INFORMATIONAL SUBMITTALS

- A. Product test reports.
- B. Research reports.

#### PART 2 - PRODUCTS

#### 2.1 CLOSED-CELL SPRAY POLYURETHANE FOAM


- A. Closed-Cell Spray Polyurethane Foam: ASTM C1029, Type II, minimum density of 2 lb/cu. ft. and minimum aged R-value at 1-inch thickness of 6.2 deg F x h x sq. ft./Btu at 75 deg F.
  - 1. Surface-Burning Characteristics: Comply with ASTM E84; testing by a qualified testing agency. Identify products with appropriate markings of applicable testing agency.
    - a. Flame-Spread Index: 25 or less.
    - b. Smoke-Developed Index: 450 or less.
  - 2. Fire Propagation Characteristics: Passes NFPA 285 testing as part of an approved assembly.
- B. Intumescent fireproof & thermal barrier coating
  - 1. DC 315 paint
  - 2. FireShell F10E
  - 3. Or comparable product

#### PART 3 - EXECUTION

#### 3.1 INSTALLATION


- A. Comply with insulation manufacturer's written instructions applicable to products and applications.
- B. Spray insulation to envelop entire area to be insulated and fill voids.
- C. Apply in multiple passes to not exceed maximum thicknesses recommended by manufacturer. Do not spray into rising foam.
- D. Apply the DC 315 paint upon completion of the spray foam insulation coating per manufacturer's recommendations/specifications.

END OF SECTION 072119

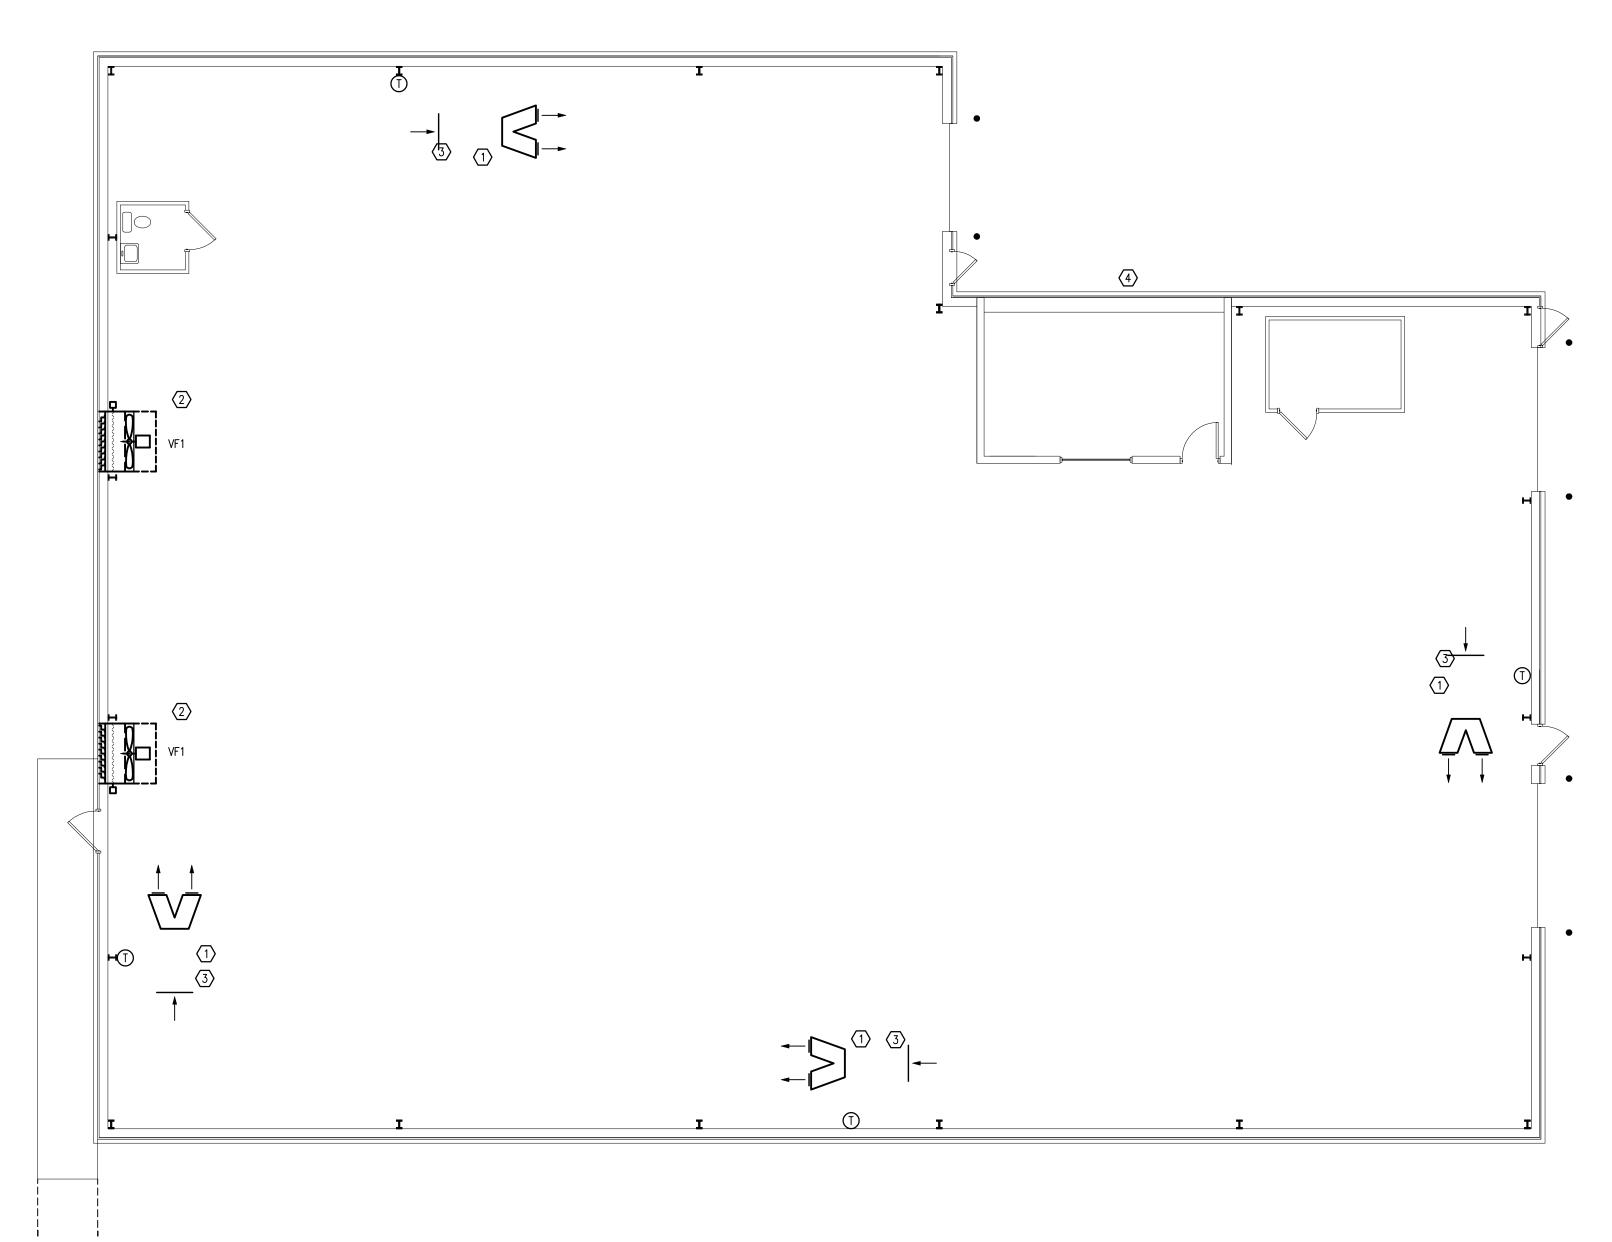



MARK	QTY	HTG BTU IN	HTG BTU OUT	TOTAL CLG	SENS CLG	CFM @ 0.5"	O.A. CFM	V / ø	FLA	МОСР	MODEL	REMARKS
F1		60,000	E 4000	24000	18000	800	160	120 / 1	7.8	20	GMVC960603BNA	1,2,3
C1	<u> </u>	60,000	54000	24000	16000	800	160	208/1	8.4	20	GSX140241L	1,2
VENTILA	1	1									I	
MARK	QTY	CFM	ESP	DRIVE	RPM	SONES	HP	V / ø	WATTS	MOCP	MODEL	REMARKS
VF1	-	15,000	0.250"	BELT	649	21.7	2	208 / 3	_	20	-	1,4
CEILING	FANS										<u> </u>	
MARK	QTY	CFM	ESP	DRIVE	RPM	SONES	HP	V / ø	WATTS	МОСР	MODEL	REMARKS
CF1	_	94,965		DIRECT	102	-	-	208 / 1	-	20	-	1,2

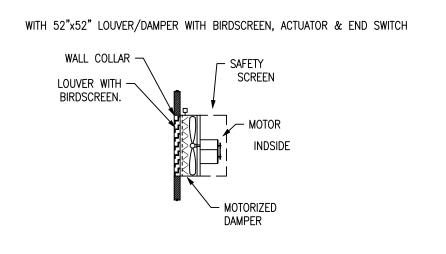

NOTE: #4 REBAR TO BE WELDED TO THE STRUCTURE ON 6x6 CENTER EACH WAY.



## **GENERAL NOTES:**

- . VERIFY PLUMBING, HVAC, POWER, AND LIGHTING REQUIREMENTS FOR OWNER'S SPECIFIC EQUIPMENT PRIOR TO ROUGH-IN.
- 2. COORDINATE INSTALLATION OF EQUIPMENT WITH MANUFACTURERS' INSTALLATION INSTRUCTIONS PRIOR TO ROUGH-IN.
- 3. CONTRACTOR SHALL MAINTAIN FIRE RATING OF ANY PENETRATION AND SHALL SEAL ANY PENETRATION IN A FLOOR, CEILING, OR EXTERIOR WALL.
- 4. INSTALL A FIRE DAMPER AT EVERY FIRE RATED ASSEMBLY PENETRATION TO MAINTAIN FIRE RATING OF ASSEMBLY.
- 5. VERIFY RECEPTACLE MOUNTING HEIGHTS AND LOCATIONS WITH OWNER AND ARCHITECTURAL ELEVATIONS PRIOR TO ROUGH-IN.
- 6. THERMOSTATS SHALL BE MOUNTED AT 60" (42" ADA) TO CENTER ABOVE FINISHED
- 7. DEMO EXISTING UNIT HEATERS, CAP UNUSED GAS PIPING, AND REMOVE 5 FLUE

## **KEYED NOTES:**

- 1 HUNG FROM CEILING. VENT TO CONCENTRIC VENT KIT THRU WALL/ROOF(USE EXISTING FLUE OPENING), MAINTAIN 10' MINIMUM CLEARANCE FROM FRESH AIR OPENINGS. INSTALL STAINLESS STEEL DRIP GUARD WHEN THRU BRICK WALL. CONNECT TO EXISTING GAS PIPING. MOUNT THERMOSTAT ON COLUMN.
- 2 SEE DETAIL 2/6.
- (3) CONNECT TO EXISTING GAS PIPE.
- 4 EXISTING TO REMAIN.

# **DESIGN AND CONSTRUCTION OFFICE OF THE** ADJUTANT GENERAL

MISSOURI NATIONAL GUARD

OFFICE OF ADMINISTRATION

DIVISION OF FACILITIES

MANAGEMENT,

STATE OF MISSOURI MIKE KEHOE,

**GOVERNOR** 

FREDDIE L. MALICOAT - ENGINEER MO# E-16897

DATE: 07/11/2025 FREDDIE L. MALICOAT

ENGINEER - MO# E-16897

**OFFICE OF THE** 

ADJUTANT GENERAL

FACILITIES DIVISION

MISSOURI NATIONAL GUARD

## **ST. LOUIS READINESS CENTER LAMBERT FIELD BUILDING RENOVATIONS**

**FACILITIES DIVISION** 

**BUILDING 231** 10800 INTERNATIONAL BLVD. BRIDGETON, ST. LOUIS COUNTY, MISSOURI

PROJECT # T242401 ASSET # 8136280001 SITE # 6280

REVISION:
DATE:
REVISION:
DATE:
REVISION:
DATE:
ISSUE DATE: 09/03/2025

CAD DWG FILE: 23160.dwg DRAWN BY: FM CHECKED BY: FM DESIGNED BY: FM

SHEET TITLE:

HVAC PLAN


SHEET NUMBER:

M101

SHEET 6 OF 9 DATE 09/03/2025

MECHANICAL SYMBOL SCHEDULE WASTE PIPING ----- V ----- VENT PIPING COLD WATER PIPING GAS PIPING <del>- 1⊃1 1≳1 1⊙1 -</del> PIPE FITTINGS (ELL DOWN - TEE DOWN - TEE UP) - CHECK VALVE - STRAINER ——I|I———— | UNION —────────────────────── GAS COCK BALANCING COCK AIR TERMINAL TAG. "A" INDICATES MARK ON GRILLE AND REGISTER SCHEDULE. "200" INDICATES AIR VOLUME IN CFM. "12x12" INDICATES FACE SIZE. - 🖺 -AIR TERMINALS (REGISTER — GRILLE) FIRE DAMPER SMOKE DAMPER ---MANUAL DAMPER MOTORIZED DAMPER \_\_\_\_ THERMOSTAT - HUMIDISTAT (ZONE SUBSCRIPT) VENT - VENT THROUGH ROOF VTR CLEAN OUT SUPPLY AIR RETURN AIR - EXHAUST AIR FRESH AIR EΑ E/R NEW CONNECTS TO EXISTING - EXISTING TO REMAIN  $\oplus$ PENDANT MOUNTED SPRINKLER HEAD  $\odot$ UPRIGHT MOUNTED SPRINKLER HEAD PENDANT HEAD BELOW / UPRIGHT HEAD ABOVE SIDEWALL SPRINKLER HEAD EXTENDED COVERAGE SIDEWALL SPRINKLER HEAD

## STATE OF MISSOURI MIKE KEHOE, GOVERNOR

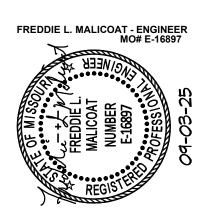

DATE: 07/11/2025 FREDDIE L. MALICOAT ENGINEER - MO# E-16897

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MISSOURI NATIONAL GUARD FACILITIES DIVISION

OFFICE OF ADMINISTRATION DIVISION OF FACILITIES MANAGEMENT, DESIGN AND CONSTRUCTION

OFFICE OF THE ADJUTANT GENERAL

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## ST. LOUIS READINESS CENTER LAMBERT FIELD BUILDING RENOVATIONS

BUILDING 231 10800 INTERNATIONAL BLVD. BRIDGETON, ST. LOUIS COUNTY, MISSOURI

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CAD DWG FILE: 23160.dwg
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DESIGNED BY: FM

SHEET TITLE:

HVAC PLAN

SHEET NUMBER:

M102

SHEET 7 OF 9 DATE 09/03/2025



ELECTRICAL PLAN (ALT. #1)

SCALE: 1/8" = 1'-0"

NEW 120/208V, 3ø, -4W, S/N, 400A, MLO, 42 CIRCUIT PANEL

W/ GROUND BAR KIT

SEE NOTE #6 IN GENERAL NOTES. TYPICAL.

SEE NOTE #6 IN — GENERAL NOTES AND KEY NOTE #4. TYPICAL OF 4.

SEE NOTE #6 IN — GENERAL NOTES.

**GENERAL NOTES:** 

ARCHITECTURAL ELEVATIONS PRIOR TO ROUGH-IN.

- . VERIFY PLUMBING, HVAC, POWER, AND LIGHTING REQUIREMENTS FOR OWNER'S SPECIFIC EQUIPMENT PRIOR TO ROUGH-IN.
- 2. COORDINATE INSTALLATION OF EQUIPMENT WITH MANUFACTURERS' INSTALLATION INSTRUCTIONS PRIOR TO ROUGH-IN.
- 3. CONTRACTOR SHALL MAINTAIN FIRE RATING OF ANY PENETRATION AND SHALL SEAL ANY PENETRATION IN A FLOOR, CEILING, OR EXTERIOR WALL.
- 4. VERIFY RECEPTACLE MOUNTING HEIGHTS AND LOCATIONS WITH OWNER AND
- 5. LIGHT SWITCHES SHALL BE MOUNTED AT 42" TO CENTER ABOVE FINISHED FLOOR.
- 6. REPLACE EXISTING LIGHT WITH NEW LIGHT FIXTURE. CONNECT TO EXISTING LIGHTING

## **KEYED NOTES:**

- REPLACE IN PLACE WITH NEW EXIT/EMERGENCY LIGHT. CONNECT TO EXISTING CONTINUOUSLY POWERED CIRCUIT.
- (2) CONNECT TO NEW 20A-1P BREAKER IN EXISTING ELECTRICAL PANEL. VERIFY LOCATION, SPACE, AND CAPACITY.
- (3) CONNECT TO EXISTING CIRCUIT FROM OLD EQUIPMENT IN THE SAME AREA.
- 4 PROVIDE EXTRA CONDUCTOR AND CONNECT TO EXISTING CONTINUOUSLY POWERED CIRCUIT FOR EMERGENCY LIGHTS.

	P2-22,24	HOME RUN CIRCUIT TO PANEL P2, CIRCUITS 22,24
,xk	·,- ·	EACH ARROW INDICATES ONE CIRCUIT
		SHORT HATCH MARKS INDICATE # OF PHASE CONDUCTORS
		LONG HATCH MARKS INDICATE # OF NEUTRAL CONDUCTORS
1		NO HATCH MARK INDICATES TWO CONDUCTORS
——— Е -		ELECTRICAL SERVICE OR FEEDER WIRING
		WIRING IN WALL OR CEILING - WIRING IN FLOOR
φ #	•	RECEPTACLE OUTLET (DUPLEX - QUADRUPLEX - SPECIAL POWER)
▼ 1	lacktriangledown	COMMUNICATIONS OUTLET (TELEPHONE - CATV - DATA/PHONE)
→3D4P	S K T OS	WALL SWITCH (3-WAY - DIMMER - 4-WAY - PILOT - SPEED - KEYED - TIMER - OCCUPANCY)
<del>-</del> ф-		LED STYLE LIGHT FIXTURE (CEILING MOUNTED - WALL MOUNTED)
PS .	S	LED STYLE LIGHT FIXTURE (ENCLOSED - STRIP) (S INDICATES SPLIT WIRED)
<b>→</b> ~□	4 4 A	EXIT LIGHT - EMERGENCY LIGHT - EMERGENCY/EXIT LIGHT
фс ⊚	ф	OTHER RECEPTACLE OUTLET (CLOCK - FLOOR - SPLIT WIRED)
		ELECTRIC PANEL
S		SPEAKER - PUSH TO TALK
J	P	JUNCTION BOX - PULL BOX
F	D	DISCONNECT (FUSED - NONFUSED)
S	C	STARTER - CONTACTOR
5-208	<u>-3</u> Q	ELECTRIC MOTOR (5 HP - 208V - 3 PHASE)
①1	⊕ <sub>1</sub>	THERMOSTAT - HUMIDISTAT (ZONE SUBSCRIPT)
ф 42 G	W U	OUTLET MODIFIERS (MOUNT HEIGHT INCHES — GFI PROTECTED — WEATHER PROOF GFI — USB)
	<u> </u>	CHOKE DETECTOR HEAT DETECTOR DUST DETECTOR HANDLE CT.T.C.
	D (F)	SMOKE DETECTOR — HEAT DETECTOR — DUCT DETECTOR — MANUAL PULL STATION
(AV)	<u> </u>	AUDIO VISUAL - VISUAL
<u>M</u>	R	MAGNETIC DOOR HOLDER - INTERLOCK RELAY
FACE	_	END OF LINE RESISTOR
I FACE	Ί	FIRE ALARM CONTROL PANEL

# LIGHTING FIXTURE SCHEDULE MARK MANUFACTURER AND MODEL NUMBER TYPE LAMPS MOUNTING REMARKS

			#	SIZE		
Α	METALUX 4MB-5SL-RNDU-UNV-L840-CD-U	LED	1	48.1	PENDANT	1,7
В	METALUX 24GR-LD5-64-F1-UNV-L840-CD1-U	LED	1	35	-	1,2,8
С	LUMARK WPSLED15S	LED	1	57.2	WALL	1,4,5
E1	SURE-LITES LPXC25R3	LED	2	1.1	SURFACE	1,3
E2	SURE-LITES SRP13WH	LED	1	1.25	SURFACE	1,5
E3	METALUX 4MB-5SL-RNDU-UNV-L840-CD-EL14WSD-U	LED	1	48.1	PENDANT	1,6,7

VERIFY COLOR AND MOUNTING HEIGHT WITH ARCHITECTURAL PLANS.

1. OR APPROVED EQUAL.

2. DRYWALL FRAME-IN KIT DF-24W-U FOR FIXTURES IN OFFICE.

- 2. DRYWALL FRAME—IN KIT DF—24W—U FOR FIXTURES IN OFFICE.

  3. REMOTE HEADS AS SHOWN.

  4. CONTROLLED VIA EXISTING LIGHTING CONTACTOR


  5. WET LOCATION APPROVED.

  6. WITH EMERGENCY BATTERY BACKUP.

  7. MOUNT AT SAME HEIGHT AS EXISTING. FURNISH AND INSTALL NEW CABLE HANGERS SUPPORTED FROM

8. SURFACE MOUNT KIT SK-24-WS FOR FIXTURES IN VAULT.

STATE OF MISSOURI MIKE KEHOE, **GOVERNOR** 

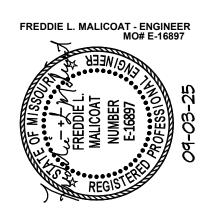

DATE: 07/11/2025 FREDDIE L. MALICOAT ENGINEER - MO# E-16897

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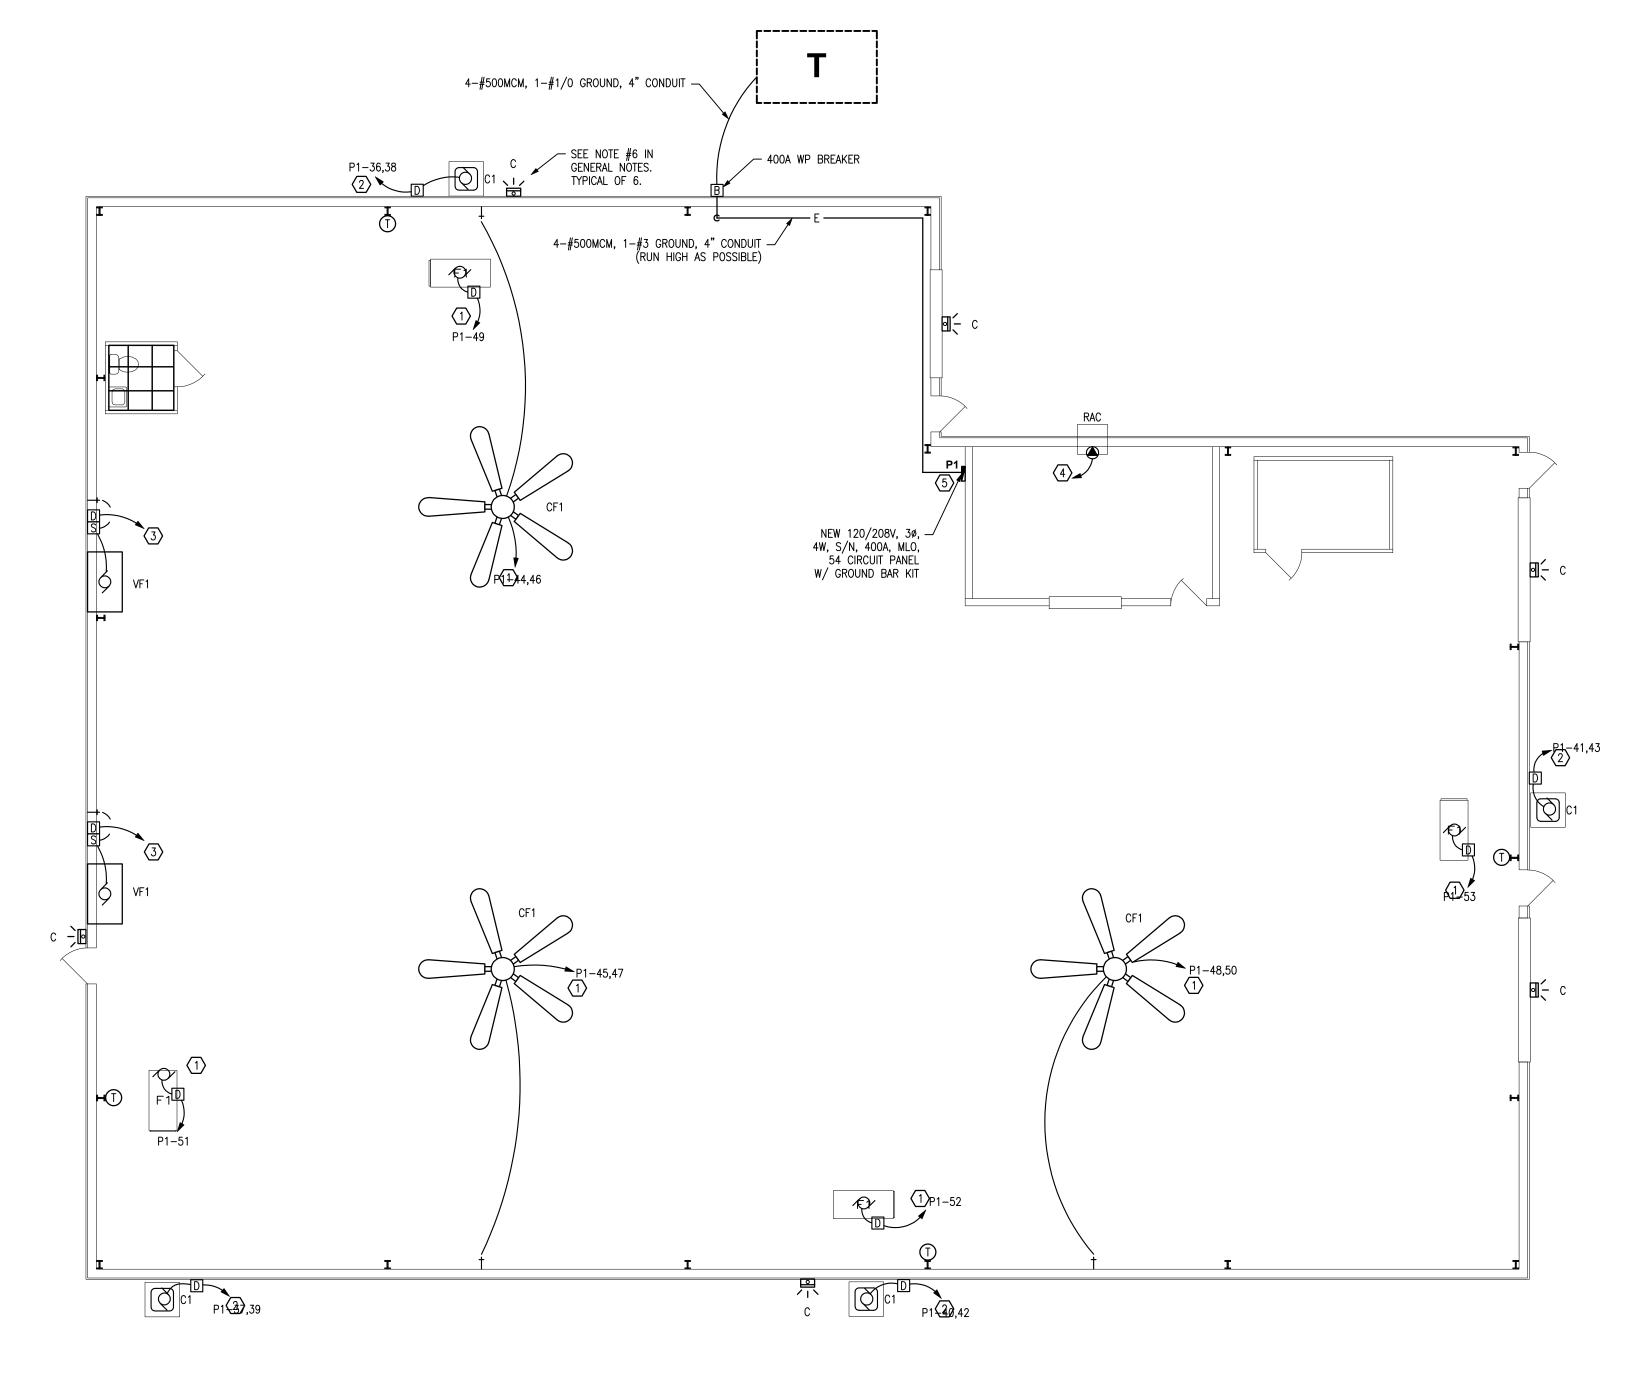
SHEET TITLE:

**ELECTRICAL** PLAN

SHEET NUMBER:

E101

SHEET 8 OF 9 DATE 09/03/2025



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**GENERAL NOTES:** 

ARCHITECTURAL ELEVATIONS PRIOR TO ROUGH-IN.

INSTRUCTIONS PRIOR TO ROUGH-IN.

- . VERIFY PLUMBING, HVAC, POWER, AND LIGHTING REQUIREMENTS FOR OWNER'S SPECIFIC EQUIPMENT PRIOR TO ROUGH-IN.
- 2. COORDINATE INSTALLATION OF EQUIPMENT WITH MANUFACTURERS' INSTALLATION
- 3. CONTRACTOR SHALL MAINTAIN FIRE RATING OF ANY PENETRATION AND SHALL SEAL ANY PENETRATION IN A FLOOR, CEILING, OR EXTERIOR WALL.
- 4. VERIFY RECEPTACLE MOUNTING HEIGHTS AND LOCATIONS WITH OWNER AND
- 5. LIGHT SWITCHES SHALL BE MOUNTED AT 42" TO CENTER ABOVE FINISHED FLOOR.
- 6. REPLACE EXISTING LIGHT WITH NEW LIGHT FIXTURE. CONNECT TO EXISTING LIGHTING

## **KEYED NOTES:**

- 1 CONNECT TO NEW 20A-1P BREAKER IN NEW ELECTRICAL PANEL P1.
- (2) CONNECT TO NEW 20A-2P BREAKER IN NEW ELECTRICAL PANEL P1.
- CONNECT TO NEW 30A-2P BREAKER IN NEW ELECTRICAL PANEL P1. WIRE SIZE: 2-#10, 1-#10 GROUND.
- 4 EXISTING TO REMAIN.
- 5 REMOVE AND RELOCATE FROM EXISTING PANEL: 1-30A/3P, 3-20A/3P, 1-30/1P, 21-20A/1P BREAKERS.

VOLTS 120/208 MAIN CAPACITY 400 A MLO PHASE 3 WIRE 4 BUSS MATERIAL B WATTS **P1** MOUNTING C WATTS 4558 TOTAL WATTS 13736 CIRC LOCATION / DESCRIPTION LOCATION / DESCRIPTION CIRC BRKR WATTS Ø WATTS BRKR В В C 874 20-2 CONDENSER C1 36 20-2 874 A 874 7 CONDENSER C1 - 874 B 874 20-2 CONDENSER C1 40 20-2 874 41 CONDENSER C1 - 874 A 500 20-2 CF1 44 20-2 500 B 500 CF1 48 - 500 C 500 20-2 20-1 936 A 500 49 FURNACE F1 20-1 936 B 936 20-1 51 FURNACE F1 FURNACE F1 52 20-1 936 C 53 FURNACE F1

## STATE OF MISSOURI MIKE KEHOE, **GOVERNOR**

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## **ST. LOUIS READINESS CENTER LAMBERT FIELD BUILDING RENOVATIONS**

**BUILDING 231** 10800 INTERNATIONAL BLVD. BRIDGETON, ST. LOUIS COUNTY, **MISSOURI** 

PROJECT # T242401 ASSET # 8136280001 SITE # 6280

**REVISION: REVISION:** REVISION: ISSUE DATE: 09/03/2025

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SHEET TITLE:

# **ELECTRICAL** PLAN

SHEET NUMBER:

E102

SHEET 9 OF 9 DATE 09/03/2025

### Pre-Bid Meeting Attendance Sheet Lambert Field Building Renovations, Building 231 Lambert Building 231 Lambert

Project No. T-242401	
Ahmed Kalabani 314-581-4629 ahmed K	•
Name & Til March BOSHONS 314 522 1011 CINTERCACE SHILL	Address
MANLE FINTERFACESTI, COM	Address
DAVE DAVIS (189800940 DDavISQ HABERBERGETINC. Em	
DUSTIN HACIONS (209) 620-0825 DUSTING SESCONSTRUCTION.COM	
John Kesselhein 636 388.9608 Jesselheim Ouspire-	
Tim Sithel 314-581-7714 Timedextranedestrialst.	
Nolan Milden 8/5-644-1292 nahlden @/cozeny wagner com	
FRED BENSCOTER 573-760-2713 FBENSCOTER @ KOZENY WAGNER-COM	
SAKE VERBLE SMYTH 6369463000 BIDSWICCSTLMO. COM	
Apply Thomas 514265-4015 athomas @ Kaiserclec.com	
Chris Helu GIV-251-2733 Sutter firld e loctrico	
Justin Rogers 573-301-4995 Jahov. com	
Justin. Roopers @ Brown and root com	
Mike Right 314-667-5913 mright promeri construction	_
AARON Fretuell 314.858.018 agronfeway NE contracting.com	_
Spey Rice 636698422 2004 drice 18 wife @	
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