ADDENDUM NO. 1

TO: PLANS AND SPECIFICATIONS FOR STATE OF MISSOURI

Upgrade Electric Network Camp Rising Sun Lake of the Ozarks State Park Kaiser, Missouri PROJECT NO.: X2202-01

Bid Opening Date: 1:30 PM, Thursday, May 18, 2023 (Not Changed)

Bidders are hereby informed that the construction Plans and/or Specifications are modified as follows:

SPECIFICATION CHANGES:

None

DRAWINGS CHANGES:

- 1. Sheet E-001 Electrical Symbols, Abbreviations & General Notes
 - a. REVISE per attached Revision A, dated 05/11/2023.
- 2. Sheet ES-101 Electrical Site Demolition Plan North
 - a. REVISE per attached Revision A, dated 05/11/2023.
- 3. Sheet ES-102 Electrical Site Demolition Plan South
 - a. REVISE per attached Revision A, dated 05/11/2023.
- 4. Sheet ES-103 Electrical Site Plan North
 - a. REVISE per attached Revision A, dated 05/11/2023.
- 5. Sheet ES-104 Electrical Site Plan South
 - a. REVISE per attached Revision A, dated 05/11/2023.
- 6. <u>Sheet ED-601 One-Line Diagram Demolition</u>
 - a. REVISE per attached Revision A, dated 05/11/2023.
- 7. Sheet E-401 Electrical Plans
 - a. REVISE per attached Revision A, dated 05/11/2023.
- 8. Sheet E-502 Lighting Fixture Installation Details Alt Bid No. 1
 - a. REVISE per attached Revision A, dated 05/11/2023.

- 9. Sheet E-601 One-Line Diagram
 - a. REVISE per attached Revision A, dated 05/11/2023.
- 10. Sheet E-603 Panelboard & Lighting Fixture Schedules & Alt Bid No. 1
 - a. REVISE per attached Revision A, dated 05/11/2023.

GENERAL COMMENTS:

- 1. The Pre-Bid Meeting was held May 3, 2023 followed by a walk-through of the project site. The Pre-bid Meeting sign-in sheet is attached.
- 2. Bidders who wish to perform a site inspection should contact DNR State Park's staff Larry Webb or Morgan Carson at (573) 348-2696, Larry.Webb@dnr.mo.gov or Morgan.Carson@dnr.mo.gov to schedule a time to enter the Park.
- 3. Please contact Paul Girouard, Contract Specialist, at (573) 751-4797, Paul.Girouard@oa.mo.gov for questions about bidding procedures, MBE\WBE\SDVE Goals, and other submittal requirements.
- 4. The deadline for technical questions was May 10, 2023 at noon (12:00 PM).
- 5. Changes to, or clarification of, the bid documents are only made as issued in the addenda.
- 6. All correspondence with respect to this project must include the State of Missouri project number as indicated above.
- 7. Current Planholders list is available online at: X2202-01 Upgrade Electric Network Camp Rising Sun Lake of the Ozarks State Park :: Plan Holders :: State of Missouri Office of Administration (oafmdcplanroom.com)
- 8. Prospective Bidders contact American Document Solutions, 1400 Forum Blvd Suite 7A, Columbia MO 65203, (573) 446-7768 to get plans and specifications.
- All bids shall be submitted on the bid form without additional terms and conditions, modifications, or stipulations. Each space on the bid form shall be properly filled including a bid amount for each alternate. Failure to do so will result in rejection of the bid.
- 10. MBE/WBE/SDVE participation requirements can be found in DIVISION 00. The MBE/WBE/SDVE participation goals are 10%/10%/3%, respectively. Only certified firms as of the bid opening date can be used to satisfy the MBE/WBE/SDVE participation goals for this project. If a bidder is unable to meet a participation goal, a Good Faith Effort Determination Form must be completed. Failure to complete this process will result in rejection of the bid.

ATTACHMENTS:

- 1. Pre-Bid Meeting Sign-In Sheet
- Revised Sheets E-001, ES-101, ES-102, ES-103, ES-104, ED-601, E-401, E-502, E-601, E-603

May 11, 2023

END ADDENDUM NO. 1

Pre-Bid Meeting Attendance Sheet Project-Upgrade Electric Network-Camp Rising Sun Lake Ozark State Park Kaiser, Missouri

Project No. X2202-01 10:00 AM, May 3, 2023

Name & Title	Company Name Type of Contracting	MBE/WBE/ SDVE Status	Phone	E-Mail Address
Scott Zeller Project Manager	OA-FMDC	-	573-751-2668	Scott.Zeller@oa.mo.gov
Nathan Graesse, Design Engineer	DNR State Parks	-	573-751-5360	Nathan.Graessle@dnr.mo.gov
Larry Webb, Superintendent	DNR State Parks	-	573-348-2694 ext. 236	<u>Larry.Webb@dnr.mo.gov</u>
Morgan Carson, Assistant Superintendent	DNR State Parks	-	573-348-2694 ext. 227	Morgan.Carson@dnr.mo.gov
Barry Freiner, A/E Rep	Rogers-Schmidt	-	636-600-1551	bfreiner@rogers-schmidt.com
Ken Stevens, Construction Administrator	OA-FMDC	-	573-526-5768	Ken.Stevens@oa.mo.gov

Pre-Bid Meeting Attendance Sheet Project-Upgrade Electric Network-Camp Rising Sun Lake Ozark State Park Kaiser, Missouri

Project No. X2202-01 10:00 AM, May 3, 2023

Name & Title	Company Name Type of Contracting	MBE/WBE/ SDVE Status	Phone	E-Mail Address
Adam Enboden, Deputy Regional Director	DNR State Parks	_	417-532-7161	Adam.Enboden@dnr.mo.gov
Justin Adams, Regional Director	DNR State Parks		417-276-4259	Justin.Adams@dnr.mo.gov
Paul Girouard, Contract Specialist	OA-FMDC	-	573-751-4797	Paul.Girouard@oa.mo.gov
Laura Hendrickson, Deputy Director of Operations	DNR State Parks	-	573-751-2123	Laura.Hendrickson@dnr.mo.gov
Tim OHO Project Manager	Kaiser Glectric	mathematical Print	573-556-6188	totto@kaisercentralmo.com

ELECTRICAL SYMBOLS

KEYNOTE; SPECIFICALLY REFERENCED TO AN ITEM ON THE FIELD OF THE DRAWING. DIGITS IDENTIFY NOTE NUMBER. LTG FIXTURE TYPE PER LTG FIXTURE SCHEDULE FDR NUMBER PER FDR SCHEDULE CONDUIT EXPOSED CONDUIT OR CABLE TURNED DOWN CONDUIT OR CABLE TURNED UP CONDUIT BELOW GRADE FLEXIBLE CONDUIT OR CABLE DISCONNECT SWITCH F = FUSIBLEC = CIRCUIT BREAKERJUNCTION BOX JUNCTION BOX W/ SPLICE(S) NEW PANELBOARD EXISTING PANELBOARD SINGLE POLE SWITCH 120V DUPLEX RECEPTACLE 120V GROUND FAULT CIRCUIT INTERRUPTER DUPLEX RECEPTACLE 120V DUPLEX RECEPTACLE W/ WEATHERPROOF COVER SPD SURGE PROTECTIVE DEVICE SURGE ARRESTER **→** બા GROUNDING ROD EARTH GROUNDING CONNECTION WIRING CROSSING, CONNECTION WIRING CROSSING, NO CONNECTION EQUIPMENT CONNECTION - OLLI-- FUSED SWITCH CIRCUIT BREAKER UUU TRANSFORMER \bigcap ELECTRIC METER СТ CT CABINET

FIECTRICAL ABBREVIATIONS

	ELECTRICAL	ABBRE	VIATIONS
Α	AMPERE(S)	LC	LOAD CENTER
ABAND	ABANDONED	LFMC	LIQUIDTIGHT FLEXIBLE METAL
AC	ALTERNATING CURRENT	LP	CONDUIT LIGHTING PANELBOARD
A/C	AIR-CONDITIONER	M	METER
AF	AMP FUSE OR AMP FRAME	MAX	MAXIMUM
AFF	ABOVE FINISHED FLOOR	MCB	MAIN CIRCUIT BREAKER
AFG	ABOVE FINISHED GRADE	MCCB	MOLDED CASE CIRCUIT BREAK
AIC	AMPERE INTERRUPTING CAPACITY (RMS SYMMETRICAL)	MIN	MINIMUM
ALT	ALTERNATE	MLO	MAIN LUG ONLY
	APPROXIMATELY	MTD	MOUNTED
	ASSOCIATED	N OR	NEUTRAL
ASSY	ASSEMBLY	NEUT N/A	NOT APPLICABLE
AVAIL	AVAILABLE	NEC	NATIONAL ELECTRICAL CODE
AWG	AMERICAN WIRE GAUGE		NATIONAL FIRE PROTECTION
BFG	BELOW FINISHED GRADE	NFPA	AGENCY
BKR	BREAKER	NIC	NOT IN CONTRACT
BLDG	BUILDING	NTS	NOT TO SCALE
С	CONDUIT OR CONDUCTOR	ОН	OVERHEAD
СВ	CIRCUIT BREAKER	OHE -	OVERHEAD ELECTRIC
CKT	CIRCUIT	P	POLE(S)
CNTRL	CONTROL	P/0	PART OF
CONC	CONCRETE	PNL	PANEL
CT	CURRENT TRANSFORMER	PNLBD	PANELBOARD
CTR	CENTER	PSI	POUNDS PER SQUARE INCH SCHEDULE 40
CU	COPPER	PVC	POLYVINYLCHLORIDE CONDUIT
D OR DP	DEEP	PWR	POWER
DG	DOWN GUY	REC OR RECPT	RECEPTACLE
DIA	DIAMETER		REQUIRED
DISC	DISCONNECT		REQUIREMENTS
DN	DOWN		
DS	DISCONNECT SWITCH	RM	ROOM
DWG	DRAWING	RMC	RIGID METAL CONDUIT
ELEV	ELEVATION	RMS	ROOT MEAN SQUARE
ELEC	ELECTRIC OR ELECTRICAL	RV SA	RECREATIONAL VEHICLE SURGE ARRESTOR
ENCL	ENCLOSURE	S.C.	SHORT CIRCUIT
EQUIP	EQUIPMENT	SCH	SCHEDULE
EWH	ELECTRIC WATER HEATER		SERVICE ENTRANCE OR SERVI
EXIST	EXISTING	SE	EQUIP
EXT	EXTERIOR	SP	SINGLE POLE
F FDR	FUSE OR FUSIBLE FEEDER	SPD	SURGE PROTECTIVE DEVICE
FL	FLOOR	SS	STAINLESS STEEL
FRT	FRONT	STL	STEEL
GA	GAUGE	STRD	STRANDED
GALV	GALVANIZED	SYM TEMP	SYMMETRICAL TEMPORARY
GF	GROUND FAULT	TERM	TERMINATION
GFCI	GROUND FAULT CIRCUIT		THERMAL MAGNETIC CIRCUIT
01 01	INTERRUPTER GALVANIZED RIGID STEEL	TMCB	BREAKER
GRC	CONDUIT	TYP	TYPICAL
G OR	GROUND	UE	UNDERGROUND ELECTRIC
GRD	FREQUENCY IN CYCLES PER	UG	UNDERGROUND
HZ	SECOND	UP	UTILITY POLE
INCL	INCLUDING	V \/A	VOLT(S) VOLT-AMPERE(S)
INFO	INFORMATION	VA W	WATT(S), WIRE(S) OR WIDE
INS	INSULATED	w/ W/	WITH
J, JB, J-BOX	JUNCTION BOX	w/ W/G	WITH GROUND
kA	KILOAMPERE(S)	•	WITHOUT
kAIC	KILOAMPERE INTERRUPTING	WP	WEATHERPROOF
	CAPACITY (RMS SYMMETRICAL)	XFMR	TRANSFORMER
KCM	THOUSAND CIRCULAR MIL(S)	Z	IMPEDANCE
kV	KILOVOLT AMPERE(S)	&	AND
kVA	KILOVOLT-AMPERE(S)	Δ	DELTA
kW Wh	KILOWATT_HOUR(S)	#	NUMBER
kWh I	KILOWATT-HOUR(S)	%	PERCENT
L	LINE OR LONG	a.	DUACE OR DIAMETER

Ø PHASE OR DIAMETER

LA LIGHTING ARRESTER

STATE OF MISSOURI MICHAEL L. PARSON, **GOVERNOR**



BARRY D. FREINER Registered Professional Engineer MO # E-24220 Expires 12-31-2024

ROGERS-SCHMIDT ENGINEERING CO., P.C. CONSULTING ENGINEERS 1736 WEST PARK CENTER DR. SUITE 204 ST. LOUIS, MO 63026 PHONE: 636-600-1551 EMAIL: bfreiner@rogers-schmidt.com MISSOURI STATE CERTIFICATE

OF AUTHORITY #000408

OFFICE OF ADMINISTRATION DIVISION OF FACILITIES MANAGEMENT, **DESIGN AND CONSTRUCTION**

DEPARTMENT OF NATURAL RESOURCES DIVISION OF STATE PARKS

UPGRADE ELECTRIC **NETWORK** CAMP RISING SUN

LAKE OF THE OZARKS STATE PARK 403 HIGHWAY 134 KAISER, MISSOURI 65047

PROJECT # X2202-01 SITE# 5306 ASSET # 7815306134

REVISION: DATE: **REVISION:** DATE:

REVISION: A ADDENDUM 1
DATE: 05/11/2023

ISSUE DATE: 03/28/2023

CAD DWG FILE: X2202-01-5306-7815306134- E-001.DWG DRAWN BY: MNS
CHECKED BY: BDF DESIGNED BY: BDF

SHEET TITLE: ELECTRICAL SYMBOLS, ABBREVIATIONS & GENERAL NOTES


SHEET NUMBER:

5 OF 20 SHEETS

MARCH 28, 2023


GENERAL ELECTRICAL NOTES:

- A. THE CONTRACTOR SHALL PROVIDE ALL HOLES IN FLOORS AND WALLS AS REQUIRED FOR CONDUIT ROUTING. SEAL PENETRATIONS IN ACCORDANCE WITH THE SPECIFICATIONS.
- B. COORDINATE EXACT LOCATIONS OF CONDUIT RUNS WITH EXISTING CONDITIONS AND WITH THE OWNER'S REPRESENTATIVE. INDICATE FINAL ROUTING OF ALL CONDUITS ON "AS BUILT" DRAWINGS.
- C. ALL INFORMATION CONTAINED ON THIS DRAWING APPLIES TO ES, ED AND E SERIES DRAWINGS.
- D. THERE MAY BE SYMBOLS AND/OR ABBREVIATIONS SHOWN ON THIS SHEET THAT ARE NOT APPLICABLE TO THIS PROJECT.

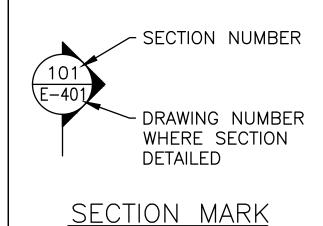

SECTION NUMBER E-401/SCALE: 1/4" = 1'-0"DRAWING NUMBER WHERE SECTION DETAILED

SECTION IDENTIFICATION SYMBOL

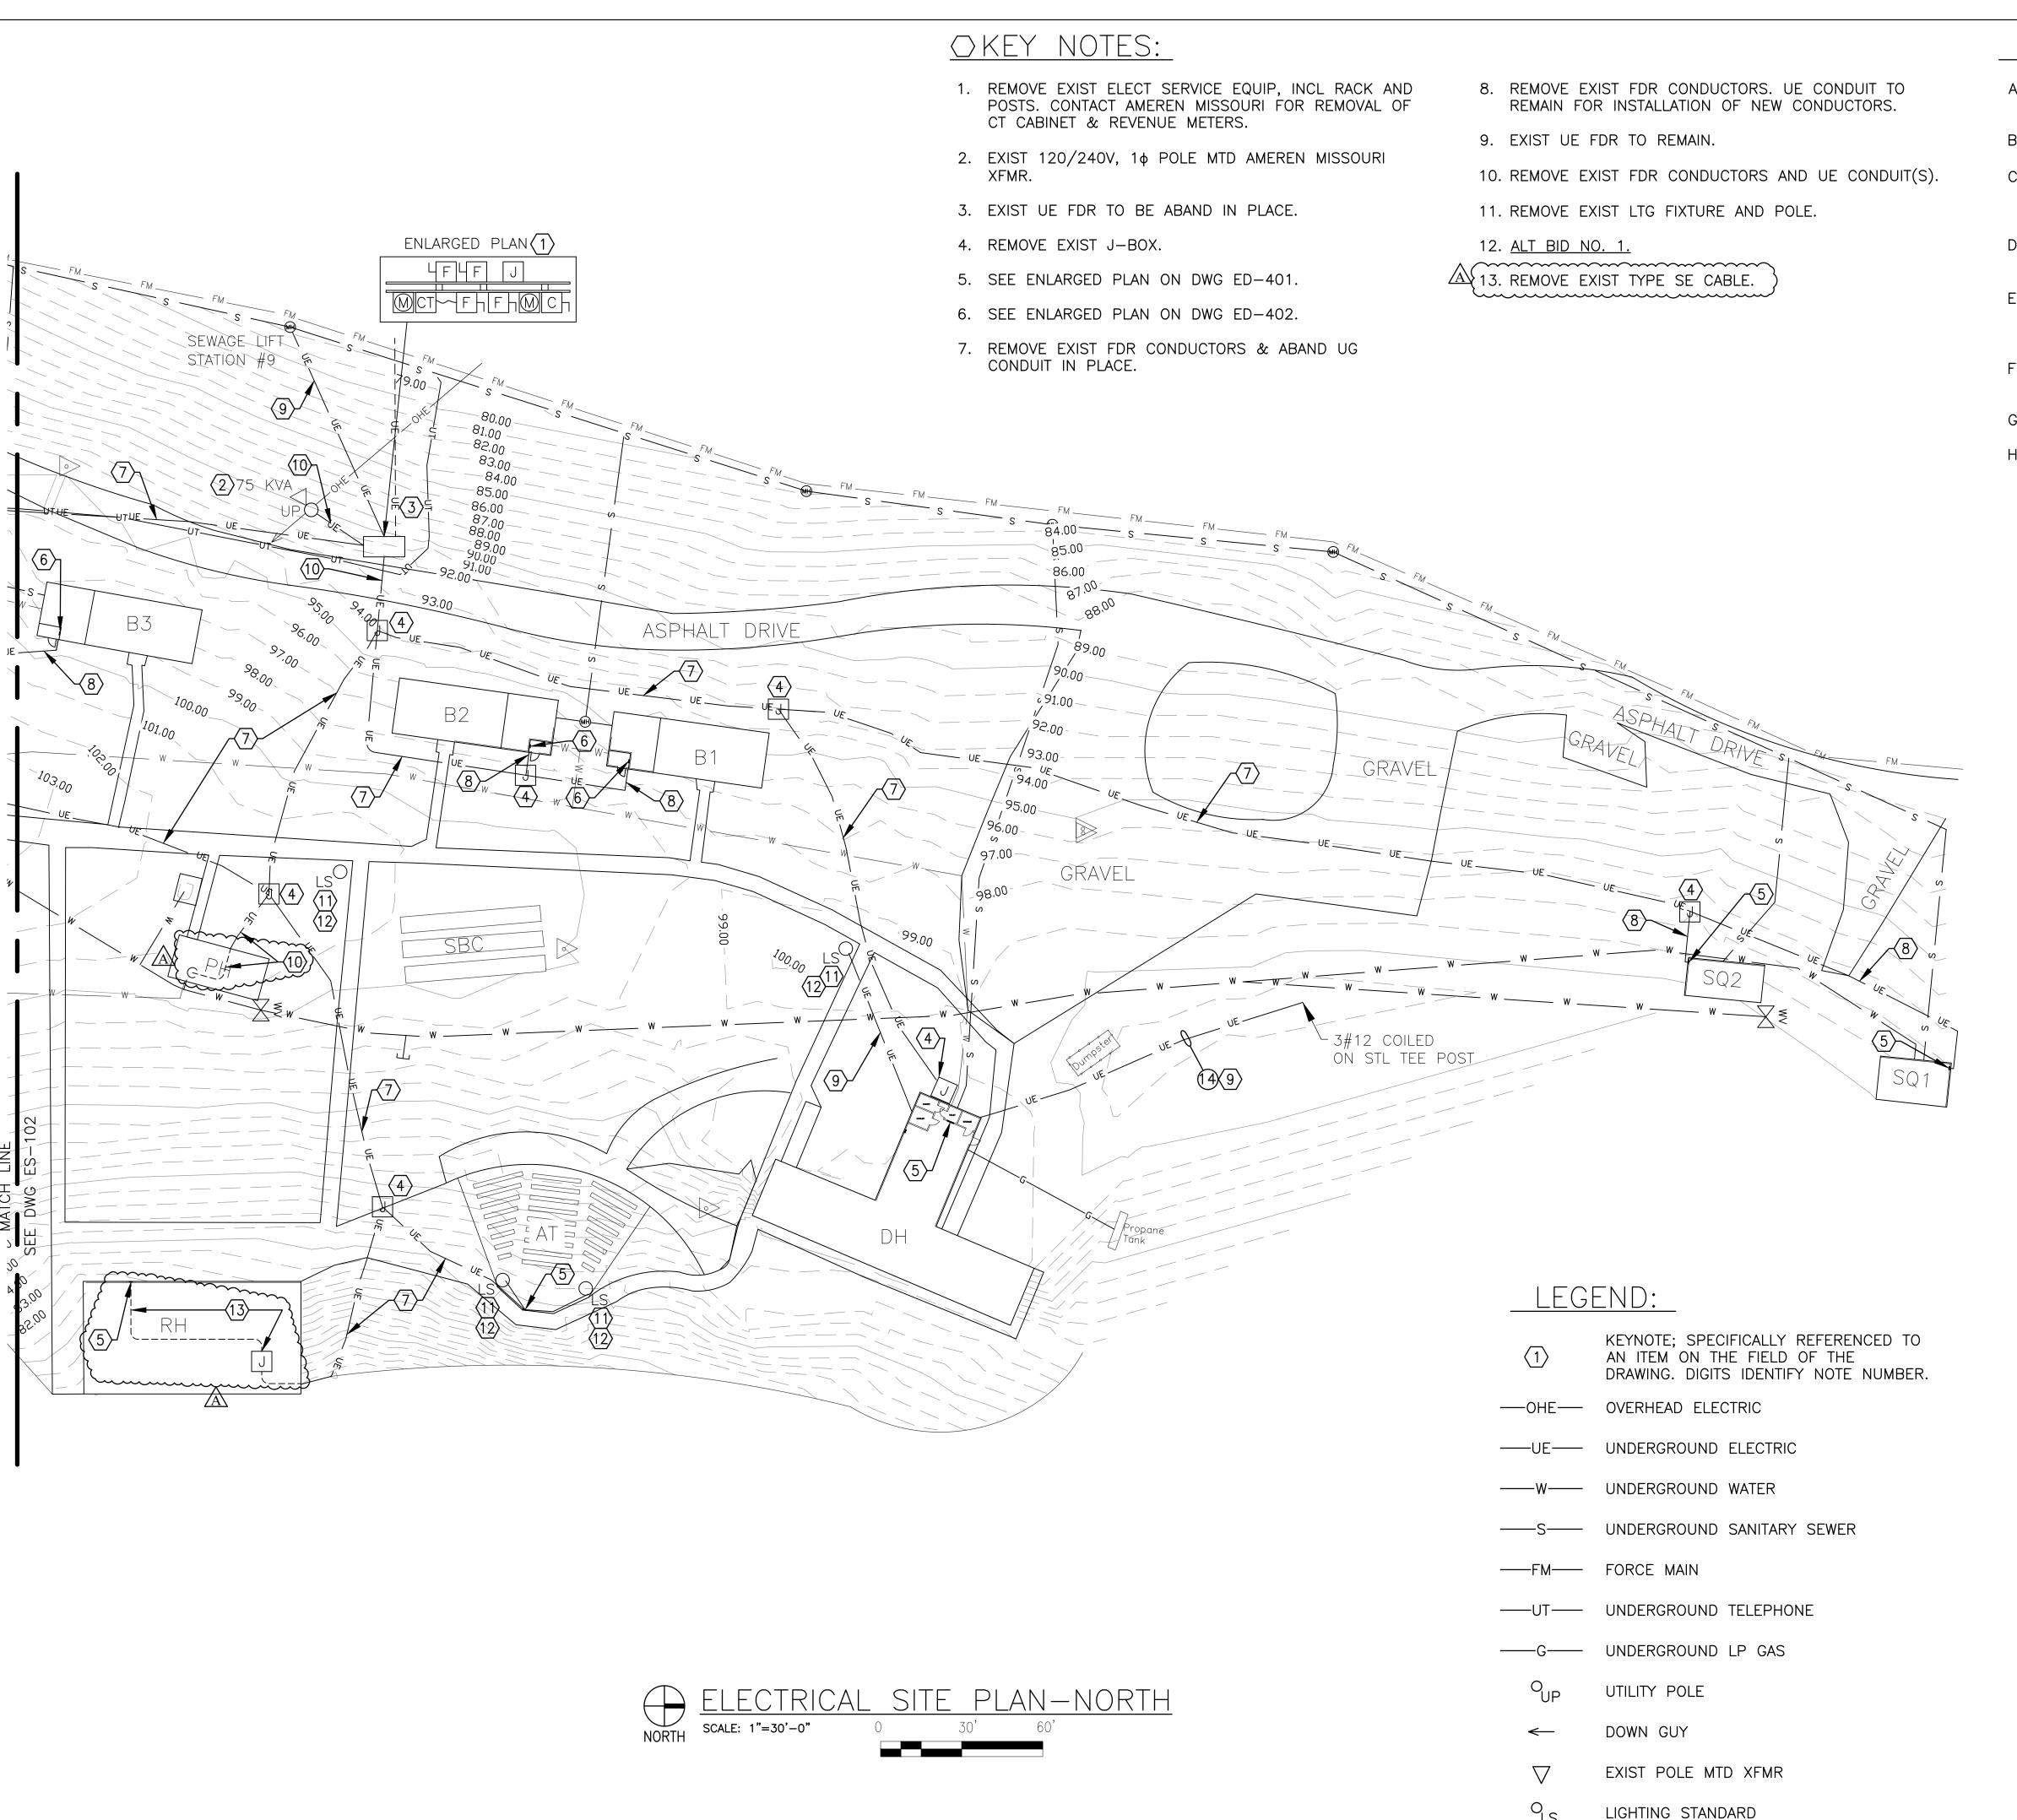

- A. FIELD VERIFY EXISTING CONDITIONS PRIOR TO PROCEEDING.
- B. FIELD VERIFY ALL DIMENSIONS.
- C. ALL UG UTILITIES ARE PRIVATELY (STATE) OWNED. FIELD LOCATE ALL UTILITIES PRIOR TO ANY EXCAVATING.
- D. COORDINATE ELECTRICAL SERVICE DISCONNECTIONS WITH AMEREN MISSOURI (866-992-6619).
- E. REMOVE ABOVE GRADE PORTION OF CONDUIT DOWN TO 2'-0" MIN BFG FOR UE FDRS THAT ARE SHOWN TO BE ABAND.
- F. SEE DWGS ED-401 & ED-402 FOR BLDG ELECTRICAL DEMOLITION PLANS.

STRUCTURE LEGEND:

AMPHITHEATER

BARRACKS

DINING HALL

PUMP HOUSE

RECREATION HALL

STAFF QUARTERS

SHUFFLE BOARD COURTS

- G. SEE DWG ED-601 FOR DEMO FDR SCHEDULE.
- H. REFERENCE SPECIFICATION SECTION 012300 FOR DESCRIPTION OF ALTERNATE BID ITEMS.

5-11-23 ROFESSION BARRY D. FREINER

BARRY D. FREINER
Registered Professional Engineer
MO # E-24220
Expires 12-31-2024

STATE OF MISSOURI

GOVERNOR

MICHAEL L. PARSON,

ROGERS-SCHMIDT ENGINEERING CO., P.C. CONSULTING ENGINEERS 1736 WEST PARK CENTER DR. SUITE 204 ST. LOUIS, MO 63026 PHONE: 636-600-1551

ST. LOUIS, MO 63026 PHONE: 636-600-1551 EMAIL: bfreiner@rogers-schmidt.com MISSOURI STATE CERTIFICATE OF AUTHORITY #000408

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PROJECT # X2202-01 SITE # 5306

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REVISION: _____

REVISION:
DATE:
REVISION: ADDENDUM 1
DATE: 05/11/2023

DATE: 05/11/2023
ISSUE DATE: 03/28/2023

CAD DWG FILE: X2202-01-5306-7815306134- ES-101.DWG

DRAWN BY: M N S/K E T
CHECKED BY: B D F

DESIGNED BY:

BDF

SHEET TITLE:

ELECTRICAL SIT

ELECTRICAL SITE DEMOLITION PLAN - NORTH

SHEET NUMBER:

ES-101

○ KEY NOTES: 1. EXIST LOAD CENTER TO REMAIN. 6. REMOVE EXIST FDR CONDUCTORS. UE CONDUIT TO REMAIN FOR INSTALLATION OF NEW CONDUCTORS. 2. REMOVE EXIST UG J-BOX. 7. EXIST UE FDR TO REMAIN. 3. SEE ENLARGED PLAN ON DWG ED-401. 8. REMOVE EXIST LTG FIXTURE AND POLE. 4. SEE ENLARGED PLAN ON DWG ED-402. 9. EXIST LTG FIXTURES & POLE TO BE REMOVED. RETURN LTG FIXTURES TO CONSTRUCTION REPRESENTATIVE. 5. REMOVE EXIST FDR CONDUCTORS & ABAND UG CONDUIT IN PLACE. 10. EXIST POLE TO REMAIN. REMOVE EXIST CB DISC SW, GRAVEL DRIVE BULL HORN & LTG FIXTURES FROM POLE. RETURN LTG FIXTURES TO CONSTRUCTION REPRESENTATIVE. 11. <u>ALT BID NO. 1.</u> Fuel GRAVEL SQ4 -103,091X8 LSO/ BBC (11X9) LSQ 97.00-95.00-STRUCTURE LEGEND: BASKETBALL COURT BARRACKS OFFICE PLAY COURT

ELECTRICAL SITE PLAN-SOUTH

NORTH ELECTRI
SCALE: 1"=30'-0"

GENERAL NOTES:

- A. FIELD VERIFY EXISTING CONDITIONS PRIOR TO PROCEEDING.
- B. FIELD VERIFY ALL DIMENSIONS.
- C. ALL UG UTILITIES ARE PRIVATELY (STATE) OWNED. FIELD LOCATE ALL UTILTITIES PRIOR TO ANY EXCAVATING.
- D. REMOVE ABOVE GRADE PORTION OF CONDUIT DOWN TO 2'-0" MIN BFG FOR UE FDRS THAT ARE SHOWN TO BE ABAND.
- E. SEE DWGS ED-401 & ED-402 FOR BLDG ELECTRICAL DEMOLITION PLANS.
- F. SEE DWG ED-601 FOR DEMO FDR SCHEDULE.
- G. REFERENCE SPECIFICATION SECTION 012300 FOR DESCRIPTION OF ALTERNATE BID ITEMS.

STATE OF MISSOURI MICHAEL L. PARSON, **GOVERNOR**



BARRY D. FREINER Registered Professional Engineer MO # E-24220 Expires 12-31-2024

ROGERS-SCHMIDT ENGINEERING CO., P.C. **CONSULTING ENGINEERS** 1736 WEST PARK CENTER DR. SUITE 204 ST. LOUIS, MO 63026 PHONE: 636-600-1551 EMAIL: bfreiner@rogers-schmidt.com

MISSOURI STATE CERTIFICATE

OF AUTHORITY #000408

OFFICE OF ADMINISTRATION **DIVISION OF FACILITIES** MANAGEMENT, **DESIGN AND CONSTRUCTION**

DEPARTMENT OF NATURAL RESOURCES DIVISION OF STATE PARKS

UPGRADE ELECTRIC **NETWORK** CAMP RISING SUN

LAKE OF THE OZARKS STATE PARK 403 HIGHWAY 134 KAISER, MISSOURI 65047

PROJECT # X2202-01 5306 SITE#

ASSET # 7815306134

REVISION: REVISION: DATE:

REVISION: ADDENDUM 1 DATE: 05/11/2023

ISSUE DATE: <u>03/28/2023</u>

CAD DWG FILE: X2202-01-5306-7815306134- ES-102.DWG

DRAWN BY: CHECKED BY: DESIGNED BY: BDF

SHEET TITLE: ELECTRICAL SITE **DEMOLITION PLAN** - SOUTH

SHEET NUMBER:

ES-102

7 OF 20 SHEETS MARCH 28, 2023

LEGEND:

KEYNOTE; SPECIFICALLY REFERENCED TO AN ITEM ON THE FIELD OF THE DRAWING. DIGITS IDENTIFY NOTE NUMBER.

---OHE--- OVERHEAD ELECTRIC

——UE—— UNDERGROUND ELECTRIC

-----W---- UNDERGROUND WATER

-----S---- UNDERGROUND SANITARY SEWER


——FM—— FORCE MAIN

REST ROOMS

STAFF QUARTERS

----UT---- UNDERGROUND TELEPHONE

LIGHTING STANDARD

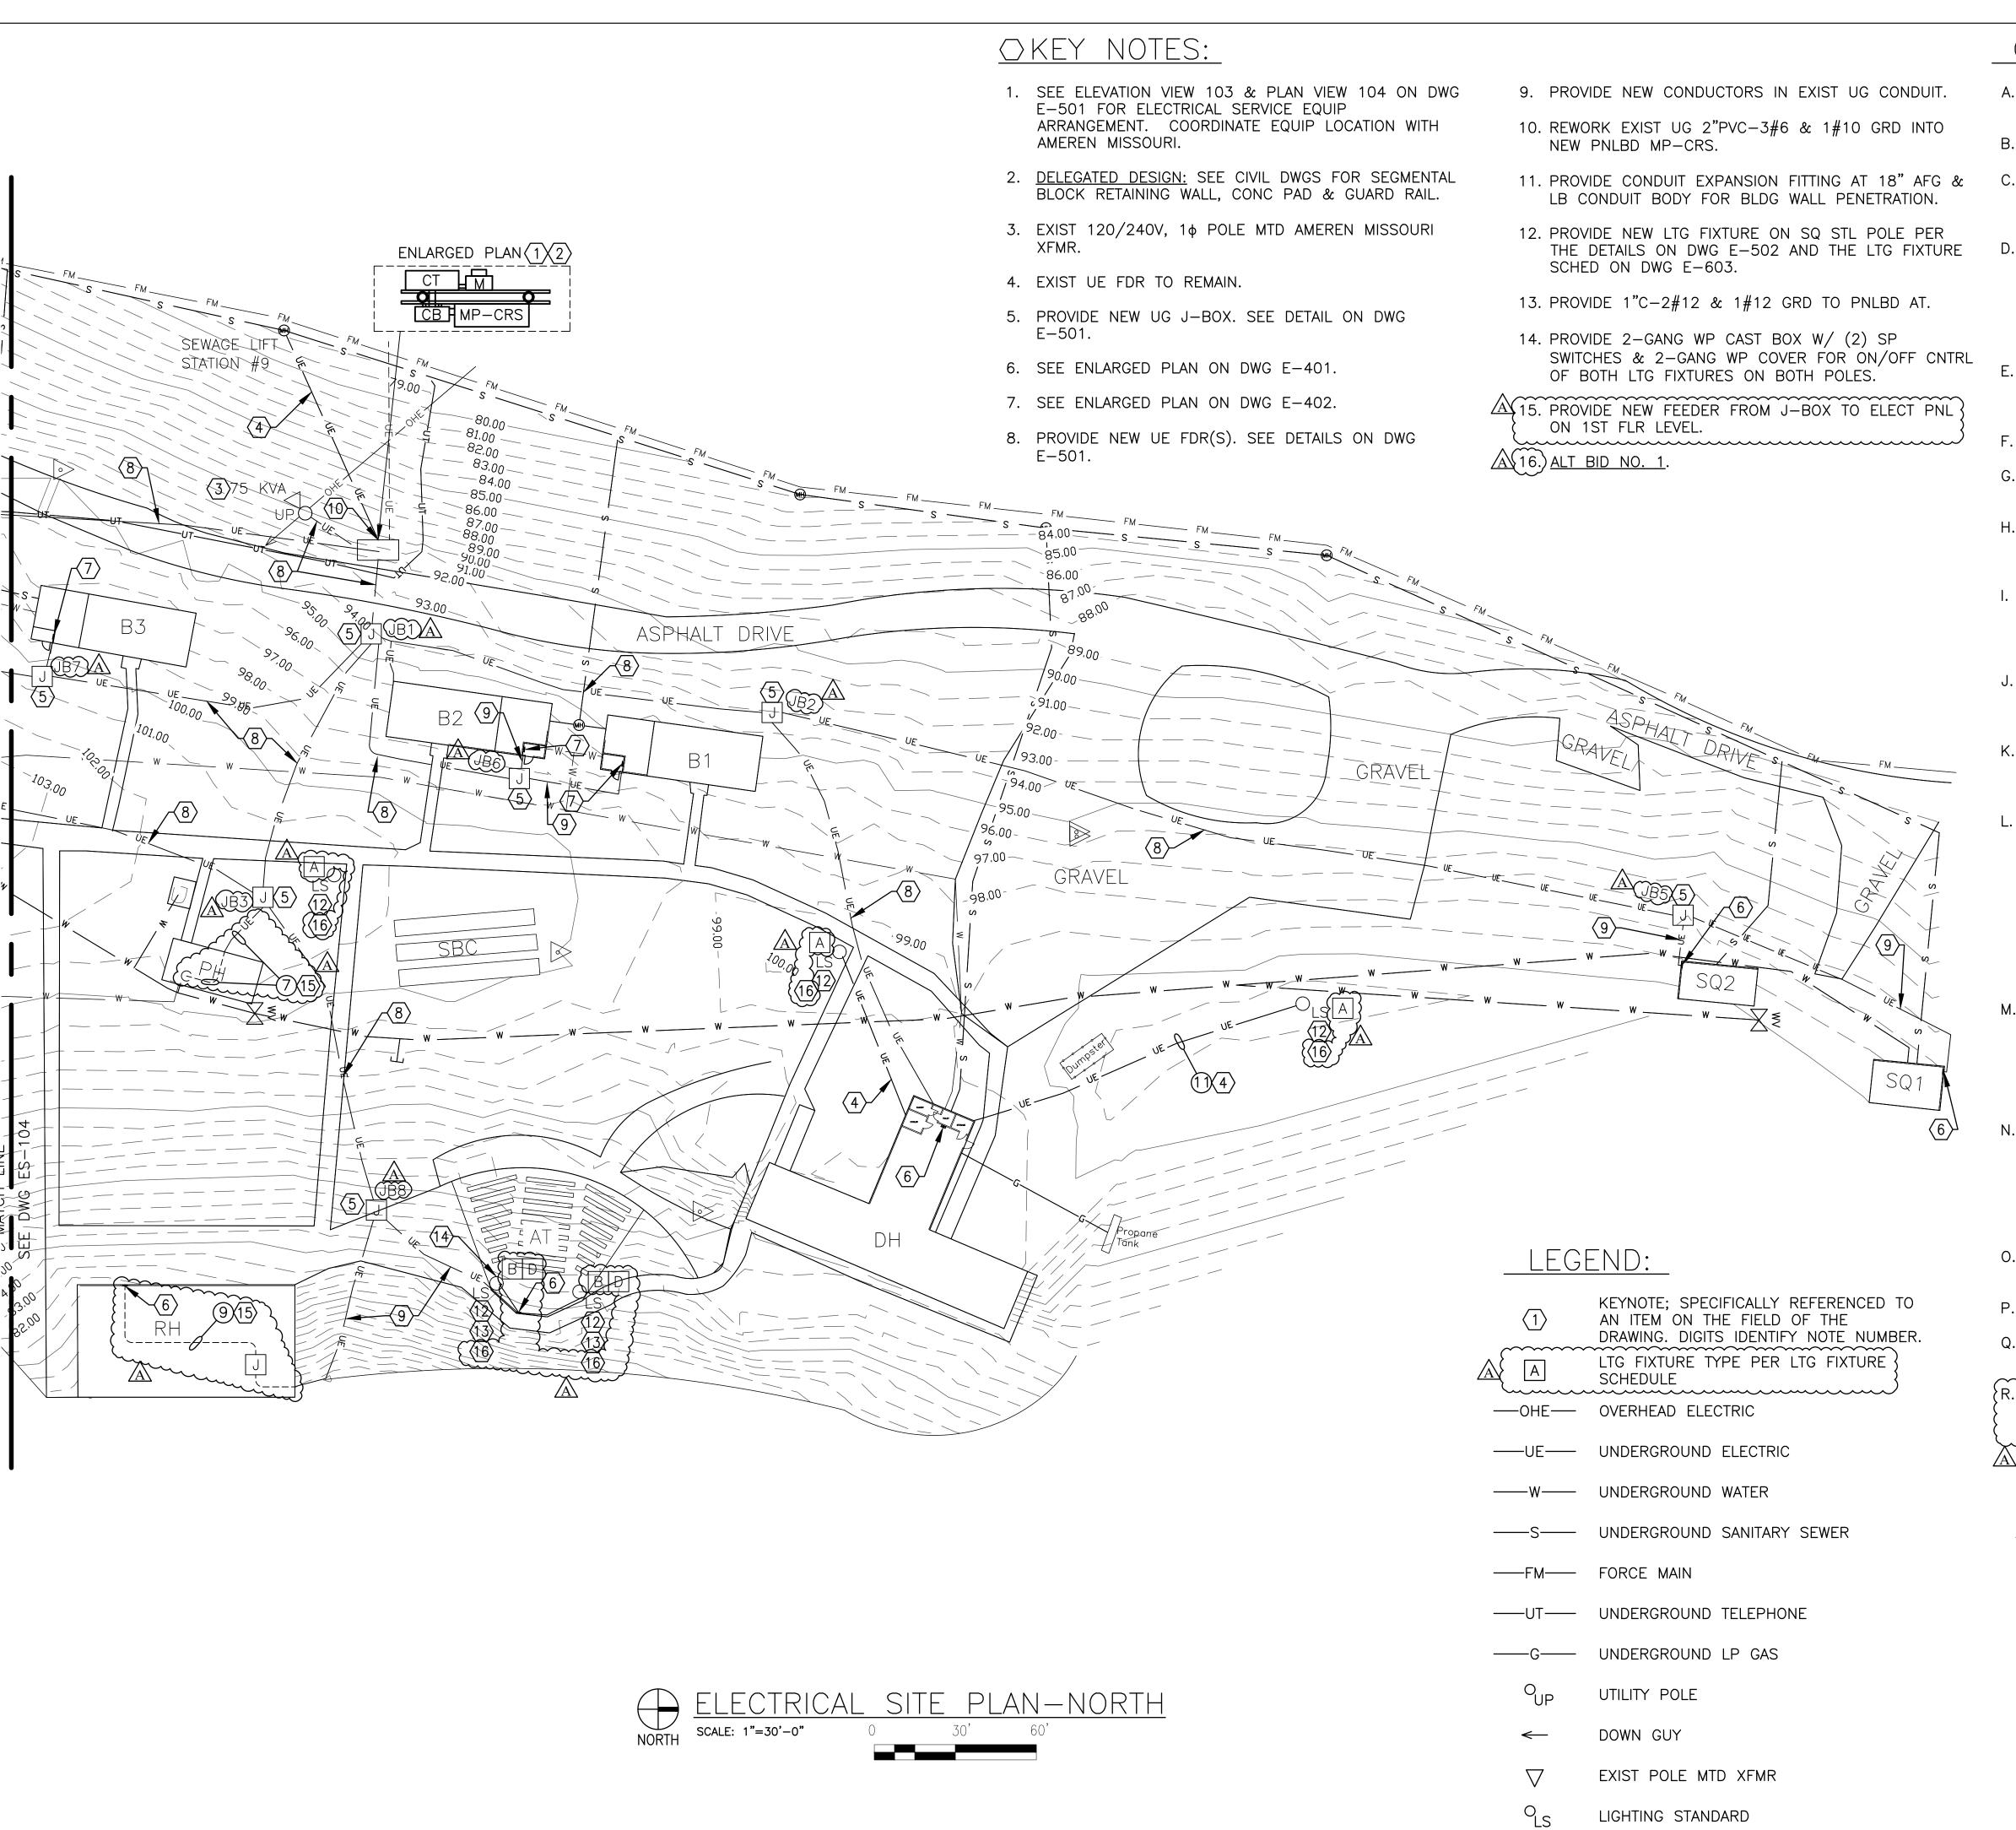

- A. FIELD VERIFY EXISTING CONDITIONS PRIOR TO PROCEEDING.
- B. FIELD VERIFY ALL DIMENSIONS.
- C. ALL UG UTILITIES ARE PRIVATELY (STATE) OWNED. FIELD LOCATE ALL UTILITIES PRIOR TO ANY EXCAVATING.
- D. CONTACT THE OSAGE BEACH FIRE DEPARTMENT (573-348-1221) FOR AN ELECTRICAL SERVICE INSPECTION. ONCE OBFD INSPECTION TAG HAS BEEN APPLIED TO THE ELEC SERVICE EQUIP, COORDINATE ELECTRICAL SERVICE CONNECTIONS WITH AMEREN MISSOURI (1-866-992-6619).
- E. THE ENTIRE INSTALLATION MUST BE INSTALLED IN ACCORDANCE WITH NFPA 70 (NEC) AND ANY AND ALL OTHER GOVERNING CODES AND ORDINANCES.
- F. ALL ELECTRICAL CONDUCTORS SHALL BE COPPER.
- G. ALL DIRECT BURIED CABLE SHALL BE XLPE-USE INSULATED POWER CABLES.
- H. DIRECT BURIED CABLES ENTERING OR LEAVING A TRENCH SHALL BE PROTECTED BY SCH 40 PVC CONDUIT.
- I. SCH 40 PVC CONDUIT SHALL BE USED FOR SE CONDUCTORS TO SE PNLBD. CABLES ARE ONLY PERMITTED TO BE DIRECT BURIED BETWEEN THE SE PANELBOARD AND THE MAIN PNLBD AT EACH BLDG.
- J. ALL EXTERIOR SWITCHES, CIRCUIT BREAKERS, RECEPTACLES, CONTROL EQUIPMENT, AND METERING DEVICES SHALL HAVE WEATHERPROOF ENCL.
- K. PROVIDE A 5/8—INCH x 8—FOOT GROUND ROD WITH #2 AWG STRANDED CU GRD AT THE MAIN PNLBD AT EACH BLDG.
- CARE SHALL BE TAKEN TO AVOID DAMAGING TREES.
 ROUTE NEW UG CONDUITS/CONDUCTORS AS REQD TO MINIMIZE ROOT DAMAGE. TRENCHES SHALL BE OUTSIDE THE CROWN WIDTH OF TREES OR A MIN OF 10FT FROM BASE OF TRUNK, WHICHEVER IS SHORTER. IF THE TREE SPACING DOES NOT PERMIT THIS, THEN BISECT THE DISTANCE BETWEEN THE TREES. UG FDRS MAY BE DIRECTIONAL BORED WITH SCH 40 HDPE CONDUIT IF NECESSARY TO AVOID DAMAGING LARGE ROOTS THAT MIGHT KILL TREES.
- M. SUBMIT A COPY OF THIS DWG AS A SHOP DWG SUBMITTAL SHOWING THE PROPOSED ROUTING & LENGTH OF THE UG FDR CONDUCTORS FROM THE SE PNLBD TO THE MAIN PNLBD FOR EACH BLDG TO ALLOW FOR VERIFICATION OF THE VOLTAGE DROP CALCULATIONS.
- N. MAINTAIN 6" MIN SEPARATION BETWEEN UG FDR CONDUITS/CABLES SHARING A COMMON TRENCH, 12" MIN SEPARATION BETWEEN UG FDR CONDUITS/CABLES AND UG SE CONDUITS AND 12" MIN SEPARATION BETWEEN UG FEEDER CONDUITS/CABLES AN ALL OTHER UG UTILITIES.
- O. SEE DWGS E-401 & E-402 FOR BLDG ELECTRICAL PLANS.
- P. SEE DWG E-601 FOR FDR SCHEDULE.
- Q. REFERENCE SPECIFICATION SECTION 012300 FOR DESCRIPTION OF ALTERNATE BID ITEMS.
- R. PATCH ALL CONCRETE WALKS AT UE FDR CROSSINGS WITH CONC THICKNESS AND EXPOSED AGGREGATE FINISH TO MATCH EXISTING.

STRUCTURE LEGEND:

AT AMPHITHEATER

B_ BARRACKS

H DINING HALL


H PUMP HOUSE

RH RECREATION HALL

SQ_ STAFF QUARTERS

SHUFFLE BOARD COURTS

STATE OF MISSOURI MICHAEL L. PARSON, GOVERNOR

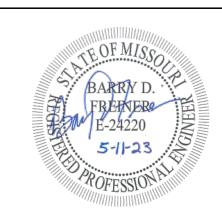

BARRY D. FREINER
Registered Professional Engineer
MO # E-24220
Expires 12-31-2024

ROGERS-SCHMIDT ENGINEERING CO., P.C. CONSULTING ENGINEERS 1736 WEST PARK CENTER DR. SUITE 204

ST. LOUIS, MO 63026 PHONE: 636-600-1551 EMAIL: bfreiner@rogers-schmidt.com MISSOURI STATE CERTIFICATE OF AUTHORITY #000408

OFFICE OF ADMINISTRATION DIVISION OF FACILITIES MANAGEMENT, DESIGN AND CONSTRUCTION

DEPARTMENT OF NATURAL RESOURCES DIVISION OF STATE PARKS

UPGRADE ELECTRIC
NETWORK
CAMP RISING SUN

LAKE OF THE OZARKS STATE PARK 403 HIGHWAY 134 KAISER, MISSOURI 65047

PROJECT # X2202-01 SITE # 5306

ASSET # 7815306134

REVISION:
DATE:
REVISION:
DATE:

DATE:
REVISION: A ADDENDUM 1
DATE: 05/11/2023

ISSUE DATE: 03/28/2023

CAD DWG FILE: X2202-01-5306-7815306134- ES-103.DWG

DRAWN BY: MN S/K E T
CHECKED BY: B D F

DESIGNED BY: BDF


SHEET TITLE:

ELECTRICAL C

ELECTRICAL SITE PLAN - NORTH

SHEET NUMBER:

ES-103

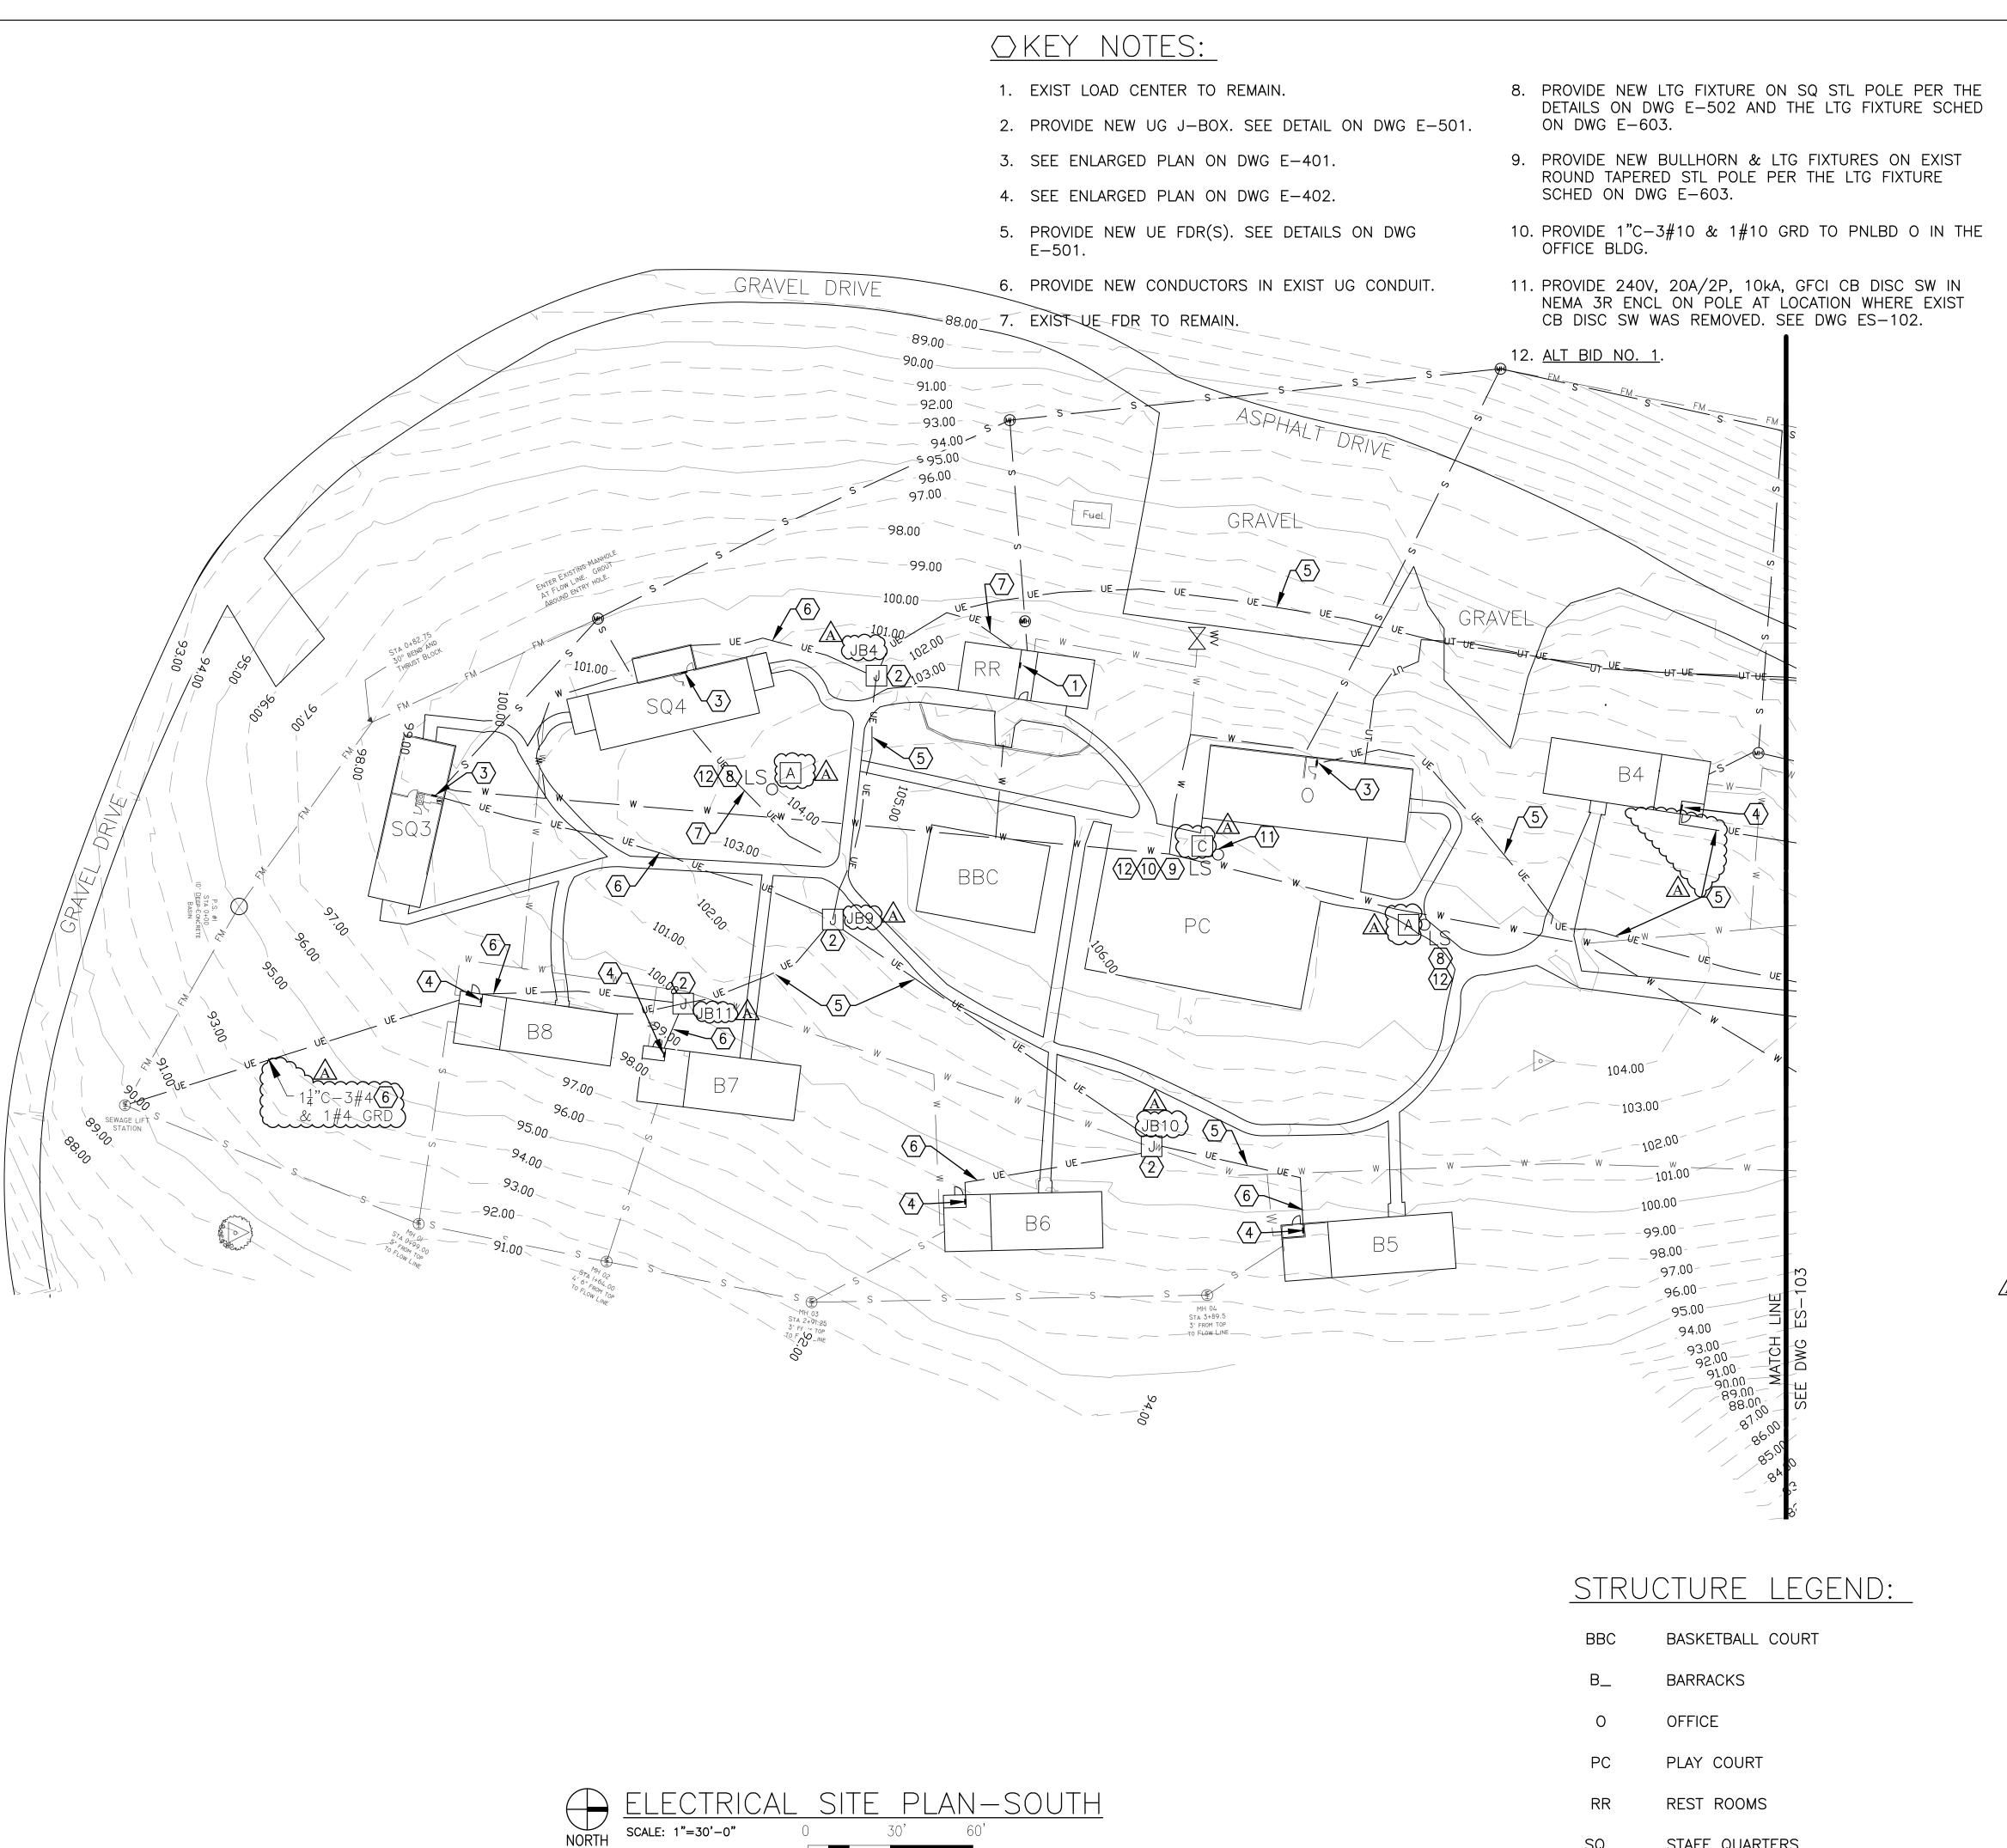

- A. FIELD VERIFY EXISTING CONDITIONS PRIOR TO PROCEEDING.
- B. FIELD VERIFY ALL DIMENSIONS.
- C. ALL UG UTILITIES ARE PRIVATELY (STATE) OWNED. FIELD LOCATE ALL UTILTITIES PRIOR TO ANY **EXCAVATING**
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- E. ALL ELECTRICAL CONDUCTORS SHALL BE COPPER.
- F. ALL DIRECT BURIED CABLE SHALL BE XLPE-USE INSULATED POWER CABLES.
- G. DIRECT BURIED CABLES ENTERING OR LEAVING A TRENCH SHALL BE PROTECTED BY SCH 40 PVC CONDUIT.
- H. SCH 40 PVC CONDUIT SHALL BE USED FOR SE CONDUCTORS TO SE PNLBD. CABLES ARE ONLY PERMITTED TO BE DIRECT BURIED BETWEEN THE SE PANELBOARD AND THE MAIN PNLBD AT EACH BLDG.
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- J. PROVIDE A 5/8-INCH x 8-FOOT GROUND ROD WITH #2 AWG STRANDED CU GRD AT THE MAIN PNLBD AT ËACH BLDG.
- K. CARE SHALL BE TAKEN TO AVOID DAMAGING TREES. ROUTE NEW UG CONDUITS/CONDUCTORS AS REQD TO MINIMIZE ROOT DAMAGE. TRENCHS SHALL BE OUTSIDE THE CROWN WIDTH OF TREES OR A MIN OF 10FT FROM BASE OF TRUNK, WHICHEVER IS SHORTER. IF THE TREE SPACING DOES NOT PERMIT THIS, THEN BISECT THE DISTANCE BETWEEN THE TREES. UG FDRS MAY BE DIRECTIONAL BORED WITH SCH 40 HDPE CONDUIT IF NECESSARY TO AVOID DAMAGING LARGE ROOTS THAT MIGHT KILL TREES.
- L. SUBMIT A COPY OF THIS DWG AS A SHOP DWG SUBMITTAL SHOWING THE PROPOSED ROUTING & LENGTH OF THE UG FDR CONDUCTORS FROM THE SE PNLBD TO THE MAIN PNLBD FOR EACH BLDG TO ALLOW FOR VERIFICATION OF THE VOLTAGE DROP CALCULATIONS.
- M. MAINTAIN 6" MIN SEPARATION BETWEEN UG FDR CONDUITS/CABLES SHARING A COMMON TRENCH, 12" MIN SEPARATION BETWEEN UG FDR CONDUITS/CABLES AND UG SE CONDUITS AND 12" MIN SEPARATION BETWEEN UG FEEDER CONDUITS/CABLES AN ALL OTHER UG UTILITIES.
- N. SEE E-400 SERIES DWGS FOR BLDG ELECTRICAL PLANS.
- O. SEE DWG E-601 FOR FDR SCHEDULE.
- P. REFERENCE SPECIFICATION SECTION 012300 FOR DESCRIPTION OF ALTERNATE BID ITEMS.
- WITH CONC THICKNESS AND EXPOSED AGGREGATE FINISH TO MATCH EXISTING.

LEGEND:

KEYNOTE; SPECIFICALLY REFERENCED TO AN ITEM ON THE FIELD OF THE DRAWING. DIGITS IDENTIFY NOTE NUMBER LTG FIXTURE TYPE PER LTG FIXTURE SCHEDULE

---OHE--- OVERHEAD ELECTRIC

——UE—— UNDERGROUND ELECTRIC

-----W---- UNDERGROUND WATER

-----S---- UNDERGROUND SANITARY SEWER


——FM—— FORCE MAIN

STAFF QUARTERS

----UT---- UNDERGROUND TELEPHONE

LIGHTING STANDARD

STATE OF MISSOURI MICHAEL L. PARSON, **GOVERNOR**

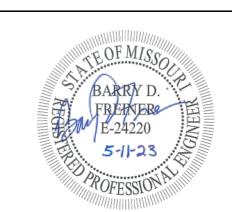

BARRY D. FREINER Registered Professional Engineer MO # E-24220 Expires 12-31-2024

ROGERS-SCHMIDT ENGINEERING CO., P.C. CONSULTING ENGINEERS 1736 WEST PARK CENTER DR. SUITE 204 ST. LOUIS, MO 63026 PHONE: 636-600-1551 EMAIL: bfreiner@rogers-schmidt.com

MISSOURI STATE CERTIFICATE OF AUTHORITY #000408

OFFICE OF ADMINISTRATION **DIVISION OF FACILITIES** MANAGEMENT, **DESIGN AND CONSTRUCTION**

DEPARTMENT OF NATURAL RESOURCES DIVISION OF STATE PARKS

UPGRADE ELECTRIC **NETWORK** CAMP RISING SUN

LAKE OF THE OZARKS STATE PARK 403 HIGHWAY 134 KAISER, MISSOURI 65047

PROJECT # X2202-01 5306

ASSET # 7815306134 **REVISION:**

REVISION: DATE: REVISION: A ADDENDUM 1

DATE: $\frac{1}{05}/11/2023$ ISSUE DATE: <u>03/28/2023</u>

CAD DWG FILE: X2202-01-5306-7815306134- ES-104.DWG DRAWN BY: MNS/KET
CHECKED BY: BDF

DESIGNED BY: BDF SHEET TITLE:

ELECTRICAL SITE PLAN - SOUTH

SHEET NUMBER:

ES-104

	[DEMC	DLITIO	N FEE	DER :	SCHE	DULE	=	
		PH/	ASE CONDUC	CTORS		JTRAL DUCTOR		JNDING UCTOR	RACEWAY
FEEDER NUMBER	CIRCUIT VOLTAGE	PHASE	QTY PER PHASE	SIZE	QTY	SIZE	QTY	SIZE	TRADE SIZE
1	120/240	2	1	300 KCM	1	300 KCM	-	_	2 1/2"
2	120/240	2	1	4/0	1	3/0	-	-	2"
3	120/240	2	1	4/0	1	2/0	-	-	3"
4	120/240	2	1	4/0 AL	1	3/0 AL	-	-	3"
5	120/240	2	1	3/0 AL	1	3/0 AL	-	-	3"
6	120/240	2	1	3/0 AL	1	2/0 AL	-	-	2"
7	120/240	2	1	3/0	1	2/0	1	6	2"
8	120/240	2	1	2/0	1	2/0	-	-	2"
9	120/240	2	1	2	1	2	-	-	2"
10	120/240	2	1	2	1	2	-	-	1 1/4"
11)	120	1	1	3	1	3	1	8	1 1/4"
12	120/240	2	1	6	1	6	1	8	2"
13	120/240	2	1	6	1	6	1	10	1"
(14)	120	1	1	12	1	12	1	12	3/4"

 $+2\sqrt{2}$

LC SQ4 100A MLO

10kA

8 CKT

 $\langle 7 \rangle$

LC SQ3

20 CKT

 $\langle 7 \rangle \langle 8 \rangle$

10kA

100A/2P MCB

LC RR

10kA

24 CKT

100A/2P MCB

NO SCALE

LC SQ1

125A MLO

10kA 7 8 CKT

LC DH1A 100A MLO 10kA 7 8 CKT

LC B6

10kA

100A/2P

24 CKT

(7)(8)(9)

7\9\
PC LTS
DISC SW

(EAST)

+9(2)

PC LTS

(WEST)

 $\langle 7 \rangle \langle 9 \rangle$

LC DH2

10kA 7 30 CKT

LC DH1

10kA 7 30 CKT

200A/2P MCB 150A/2P MCB

 $\sqrt{}$

LC B7

10kA

24 CKT

(7)(8)(9)

100A/2P MCB

LC B8 100A/2P MCB

10kA

24 CKT

 $7 \times 8 \times 9$

LC SQ2

125A MLO


10kA 7 8 CKT

GENERAL NOTES:

- A. ALL CONDUCTORS ARE COPPER UNLESS NOTED OTHERWISE.
- B. REFERENCE SPECIFICATION SECTION 012300 FOR DESCRIPTION OF ALTERNATE BID ITEMS.

○ KEY NOTES:

- 1. REMOVE CONDUIT AND CONDUCTORS.
- 2. REMOVE CONDUCTORS AND ABAND BELOW GRADE CONDUIT IN PLACE.
- 3. ABAND BELOW GRADE PORTION OF EXIST FDR IN PLACE.
- 4. REMOVE CONDUCTORS AND LEAVE CONDUIT IN PLACE FOR REUSE FOR NEW FDR.
- 5. EXIST FDR TO BE EXTENDED INTO NEW PNLBD MP-CRS. SEE DWG E-601.
- 6. EXIST FDR TO REMAIN.

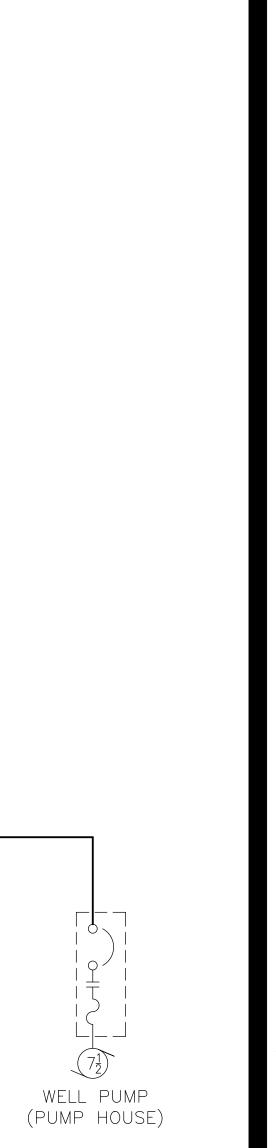

OFFICE OF ADMINISTRATION DIVISION OF FACILITIES MANAGEMENT, **DESIGN AND CONSTRUCTION**

STATE OF MISSOURI

GOVERNOR

MICHAEL L. PARSON,

BARRY D. FREINER

Registered Professional Engineer

MO # E-24220 Expires 12-31-2024

ROGERS-SCHMIDT

ENGINEERING CO., P.C.

CONSULTING ENGINEERS

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MISSOURI STATE CERTIFICATE OF AUTHORITY #000408

DEPARTMENT OF NATURAL RESOURCES DIVISION OF STATE PARKS

UPGRADE ELECTRIC NETWORK CAMP RISING SUN

LAKE OF THE OZARKS STATE PARK 403 HIGHWAY 134 KAISER, MISSOURI 65047

PROJECT # X2202-01 5306

7815306134 ASSET# **REVISION:**

DATE:

REVISION: DATE: REVISION: \triangle ADDENDUM 1 DATE: 05/11/2023

ISSUE DATE: <u>03/28/2023</u>

CAD DWG FILE: X2202-01-5306-7815306134- ED-601.DWG DRAWN BY: _CHECKED BY: _ DESIGNED BY: BDF


SHEET TITLE: ONE-LINE DIAGRAM -


DEMOLITION


SHEET NUMBER:


MARCH 28, 2023

12 OF 20 SHEETS

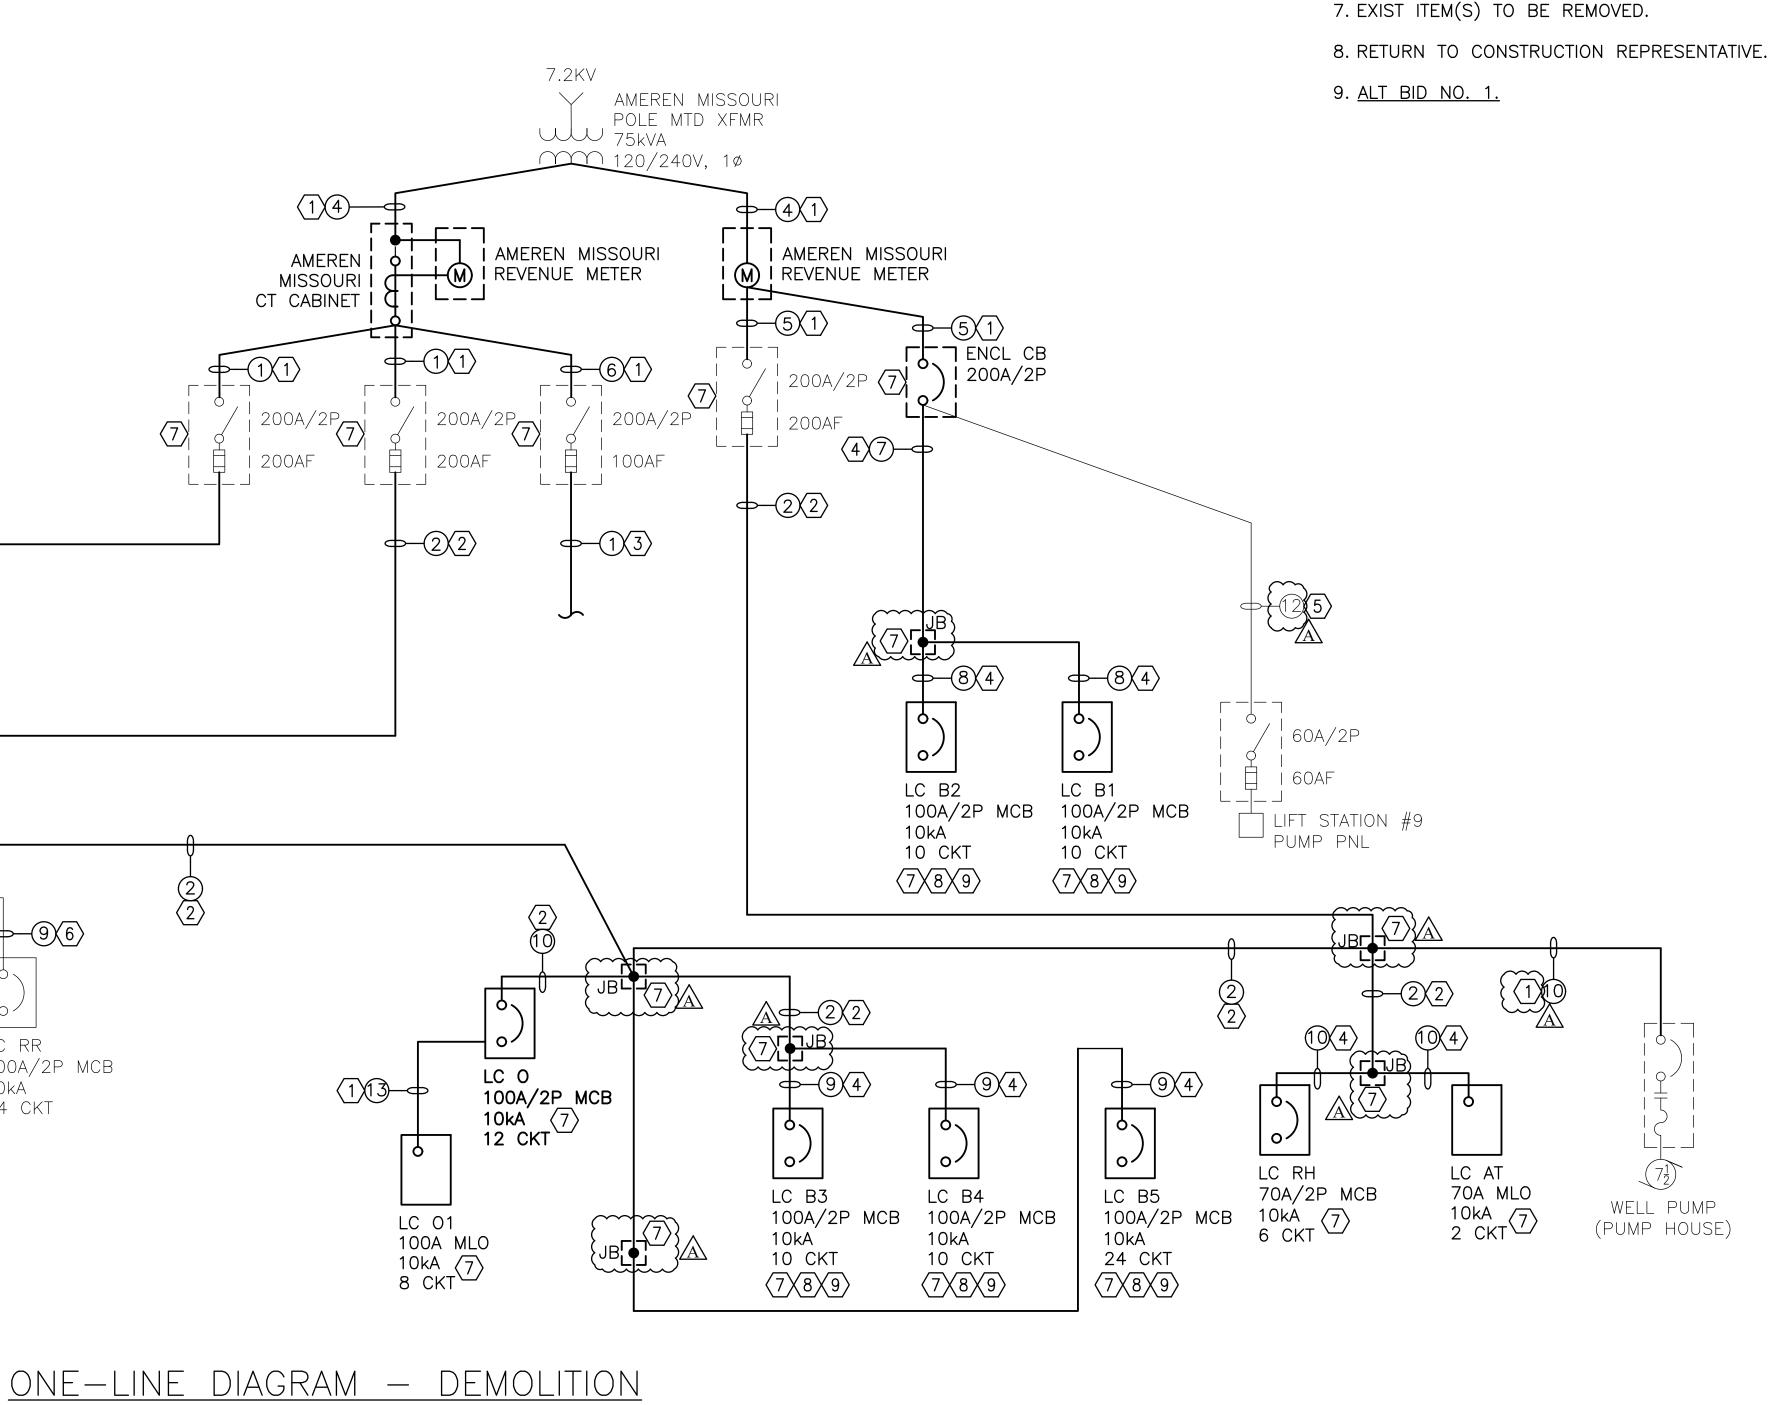

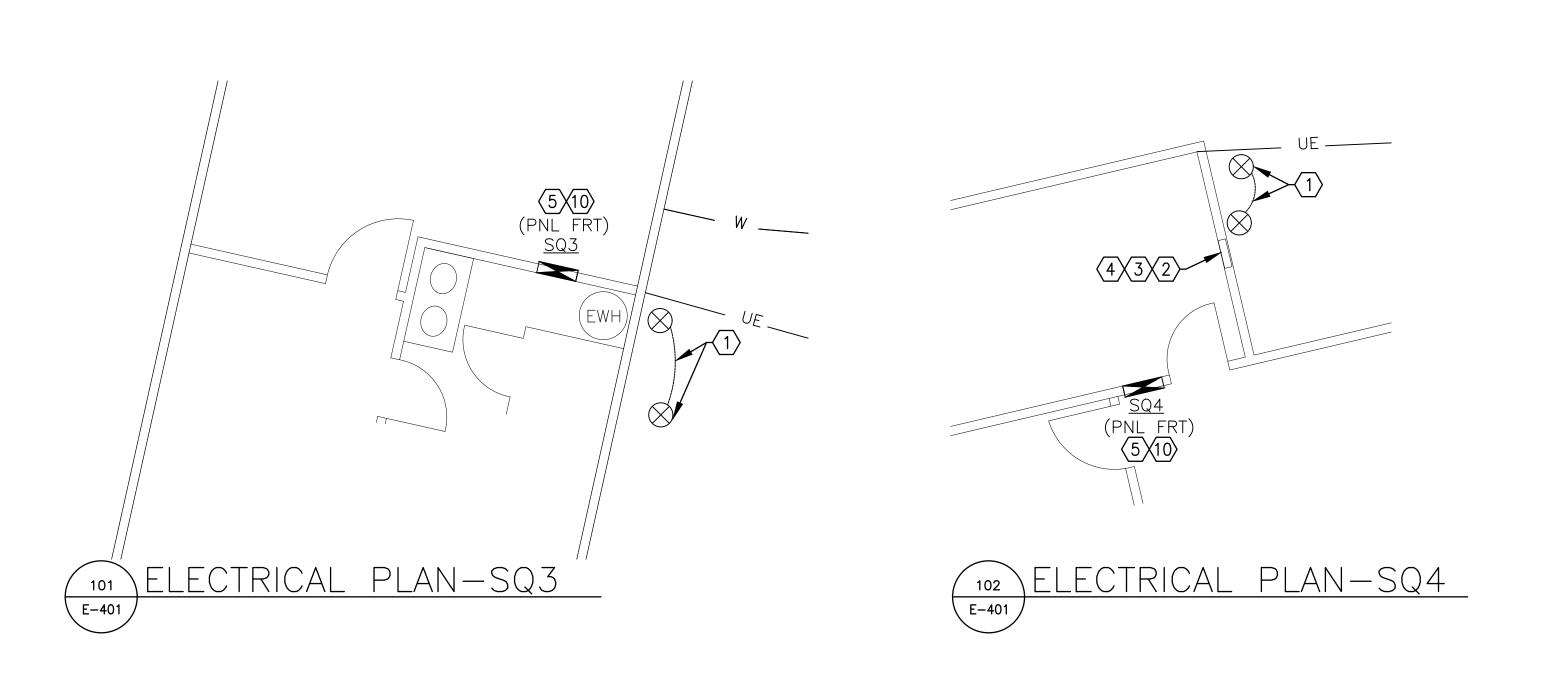

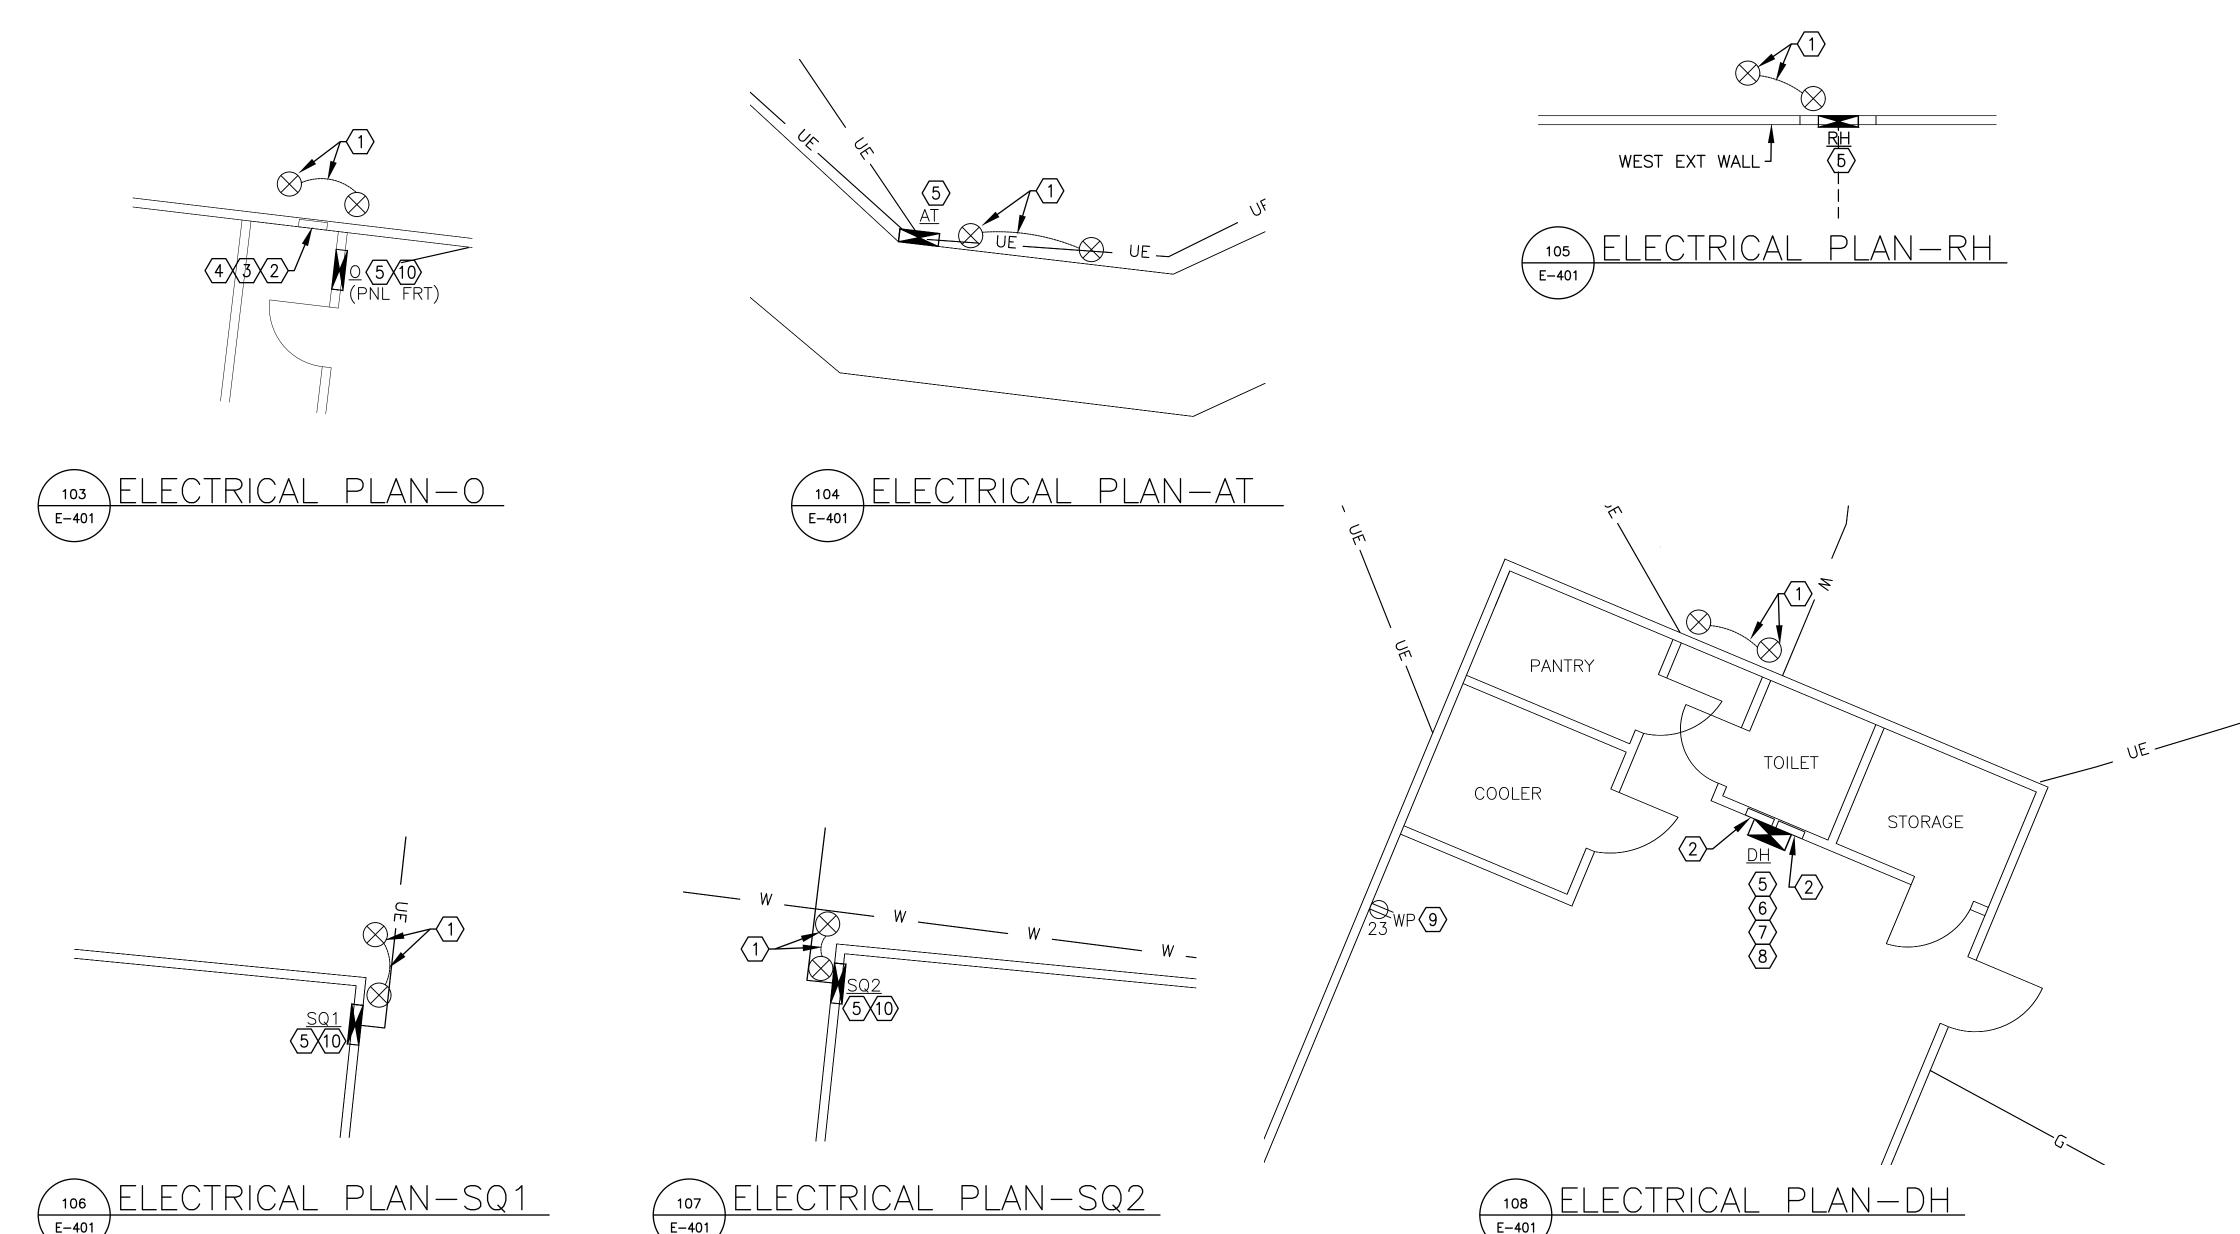

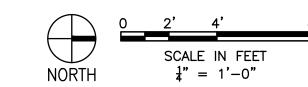

- A. FIELD VERIFY EXISTING CONDITIONS PRIOR TO PROCEEDING.
- B. FIELD VERIFY ALL DIMENSIONS.
- C. PROVIDE SCH 80 PVC CONDUIT OVER EXIST #6 GRD ELECTRODE CONDUCTOR ON EXTERIOR OF BLDG TO 12" BFG.
- D. PATCH ALL WALLS DISTURBED BY CONSTRUCTION

 ACTIVITIES TO MATCH EXIST AND TOUCH UP FINISH

 WITH PAINT/STAIN/SEALER TO MATCH EXIST SUBJECT

 TO APPROVAL OF CONSTRUCTION REPRESENTATIVE.

○ KEY NOTES:

- 1. PROVIDE 5/8"ØX8'L COPPERCLAD STL GRD ROD 3'-0" FROM EXIST GRD ROD. BOND THE NEW GRD ROD TO EXIST W/ BFG #6 SOLID COPPER CONDUCTOR.
- 2. PROVIDE 12 GAUGE STL COVER WITH EDGES GROUND SMOOTH FOR EXPOSED PORTION OF EXIST FLUSH MTD LOAD CENTER ENCLOSURE THAT IS BEING USED AS A JUNCTION BOX. PAINT TO MATCH WALL.
- 3. PROVIDE 1½"C THROUGH ATTIC BETWEEN EXIST FLUSH MTD LOAD CENTER ENCL AND NEW SEMI-FLUSH MTD PNLBD FOR 3#2 & 1#6 GRD MAIN FDR CONDUCTORS.
- 4. PROVIDE \(\frac{3}{4}\) C-2\(\psi\) 10, 4\(\psi\) 12 \(& 1\(\psi\) 10 \(\text{GRD}\) & 1\(\psi\) 10 \(\text{CPT}\) 10 \(& 1\(\psi\) 10 \(\text{GRD}\) FROM EXIST FLUSH MTD LOAD CENTER ENCL THROUGH ATTIC TO NEW SURFACE MTD PNLB.
- 5. PROVIDE NEW PNLBD PER SPECIFICATION SECTION 262416. RECONNECT EXISTING BRANCH CKT WIRING. DO NOT BOND EQUIP GRD BUS TO NEUT BUS.
- 6. PROVIDE #2 GRD ELECTRODE CONDUCTOR TO NEW §"DIAx8'L COPPERCLAD STL GRD ROD AND METAL COLD WATER PIPE THAT IS IN CONTACT WITH THE EARTH FOR 6' OR MORE (IF AVAILABLE).
- 7. PROVIDE (3) 2" CHASE NIPPLES BETWEEN BACK OF NEW PNLBD AND EACH OF THE TWO EXIST FLUSH MTD LOAD CENTER ENCLOSURE AND EXTEND EXIST BRANCH CKT WIRING INTO NEW PNLBD.
- 8. BOLT NEW PNLBD TO FLR ON 13" U—CHANNEL SUPPORTS INSTALLED BETWEEN FLR & BOTTOM OF ENCLOSURE.
- 9. PROVIDE RECPT IN TYPE FD CAST BOX UNDER SS COUNTERTOP WITH 2#12 & 1#12 GRD IN EXIST DH FOR EXIST WATER SOFTENER.
- 10. TRIM WOOD WALL PANELING AND HEADER OFF 2X4

 WALL STUDS ABOVE AND BELOW NEW RECESSED

 PNLBD ENCLOSURE AS REQD. PATCH WALL TO

 MATCH EXIST MATERIALS AND FINISH. PROVIDE

 (WOODEN QUARTER ROUND MOLDING TO TRIM

 AROUND EXPOSED PORTION OF NEW PNLBD ENCL

 (PROTRUDING THROUGH WALL. PAINT/STAIN/SEAL TO

 (MATCH EXIST FINISH.

STATE OF MISSOURI MICHAEL L. PARSON, GOVERNOR



BARRY D. FREINER
Registered Professional Engineer
MO # E-24220
Expires 12-31-2024

ROGERS-SCHMIDT
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MISSOURI STATE CERTIFICATE OF AUTHORITY #000408

OFFICE OF ADMINISTRATION DIVISION OF FACILITIES MANAGEMENT, DESIGN AND CONSTRUCTION

DEPARTMENT OF NATURAL RESOURCES DIVISION OF STATE PARKS

UPGRADE ELECTRIC NETWORK CAMP RISING SUN

LAKE OF THE OZARKS STATE PARK 403 HIGHWAY 134 KAISER, MISSOURI 65047

PROJECT # X2202-01 SITE # 5306

ASSET # 7815306134

DATE:
REVISION:
DATE:
REVISION:
ADDENDUM 1
DATE:
05/11/2023

REVISION:

ISSUE DATE: 03/28/2023

CAD DWG FILE: X2202-01-5306-7815306134- E-401.DWG

DRAWN BY: MNS

CHECKED BY: BDF


SHEET TITLE:
ELECTRICAL

DESIGNED BY: BDF

SHEET NUMBER:

PLANS

E-40

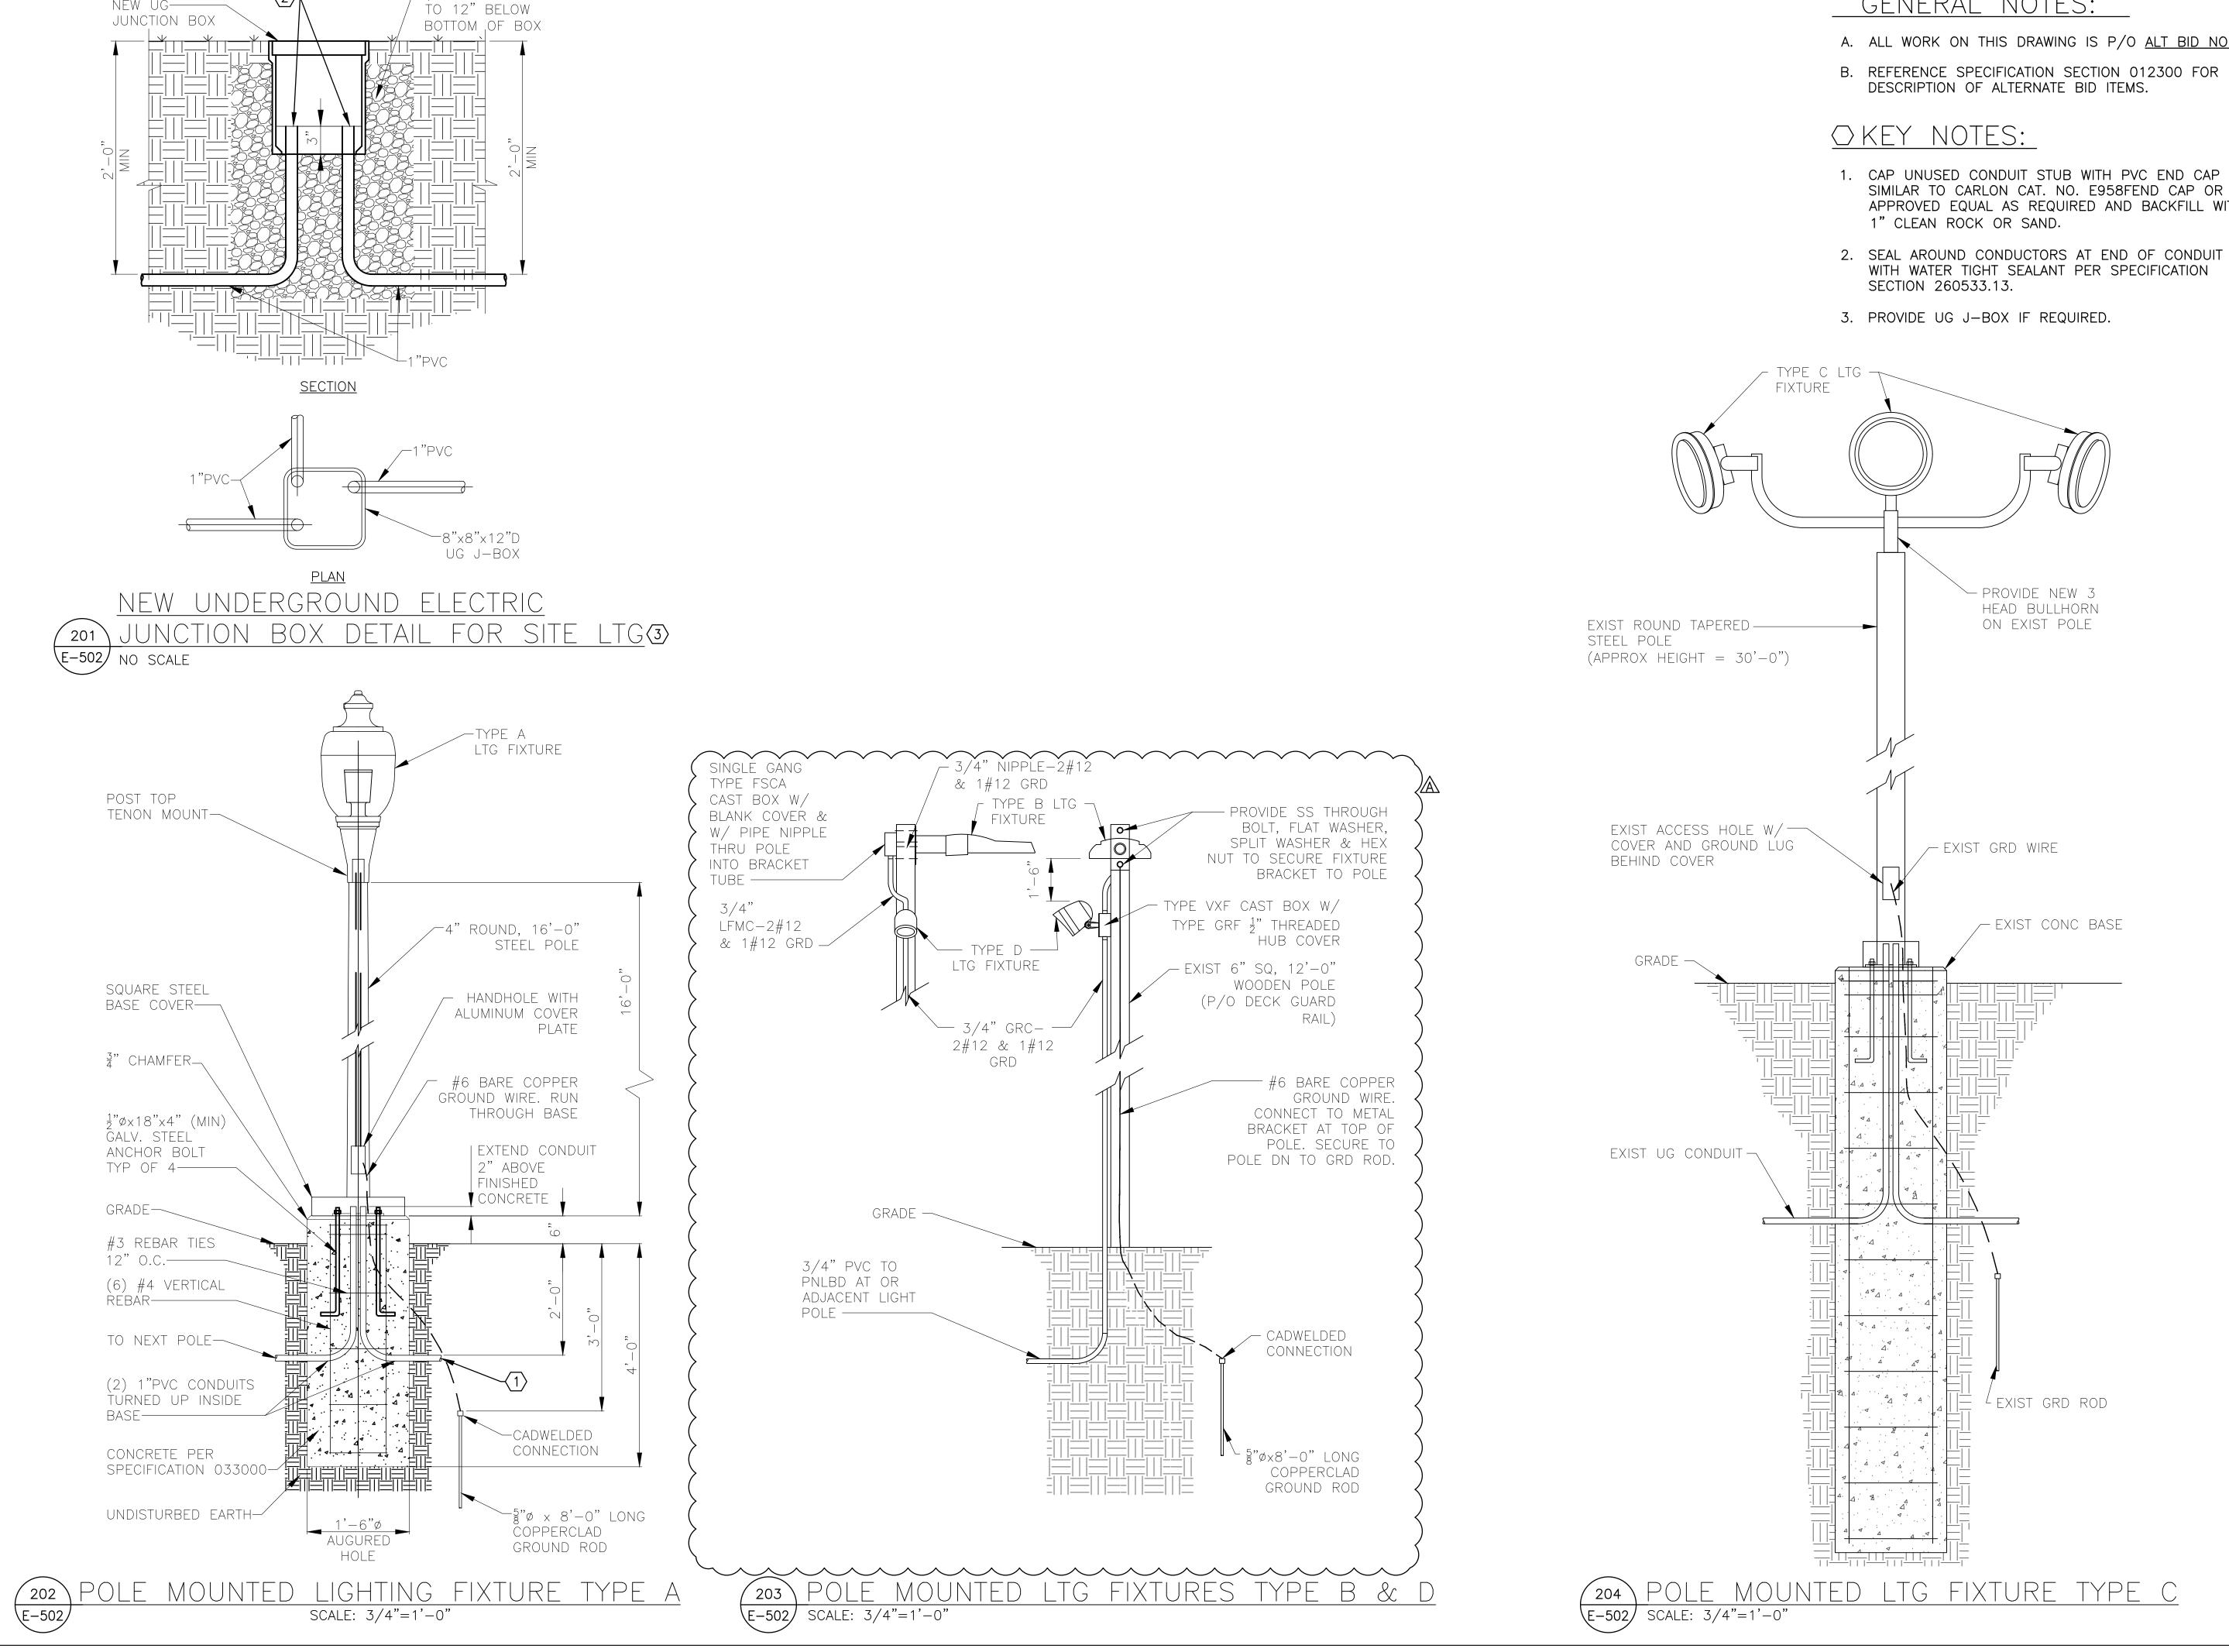


 $-\frac{3}{4}$ " CRUSHED STONE

NEW UG-

GENERAL NOTES:

- A. ALL WORK ON THIS DRAWING IS P/O ALT BID NO. 1
- SIMILAR TO CARLON CAT. NO. E958FEND CAP OR APPROVED EQUAL AS REQUIRED AND BACKFILL WITH

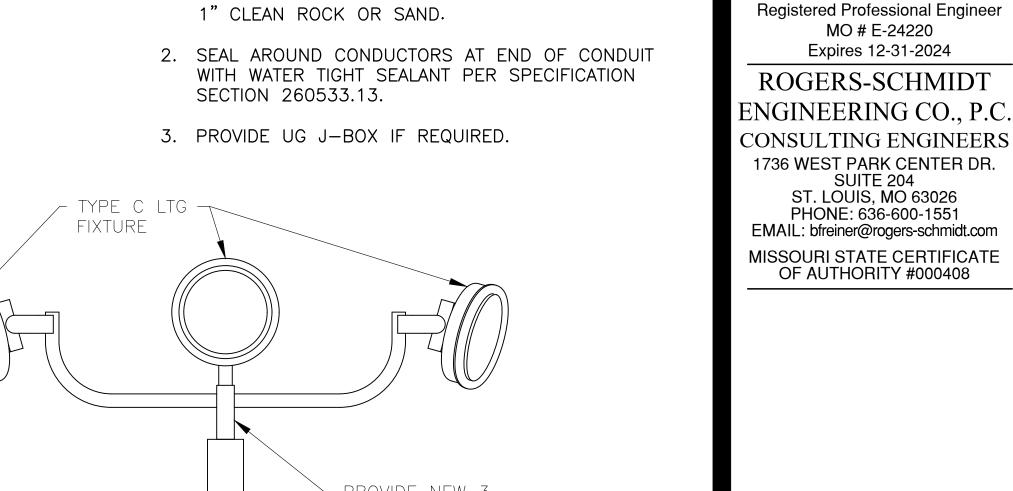

OFFICE OF ADMINISTRATION **DIVISION OF FACILITIES** MANAGEMENT, **DESIGN AND CONSTRUCTION**

STATE OF MISSOURI

GOVERNOR

MICHAEL L. PARSON,

BARRY D. FREINER

DEPARTMENT OF NATURAL RESOURCES DIVISION OF STATE PARKS

UPGRADE ELECTRIC **NETWORK** CAMP RISING SUN

LAKE OF THE OZARKS STATE PARK 403 HIGHWAY 134 KAISER, MISSOURI 65047

PROJECT # X2202-01 5306

7815306134

REVISION: REVISION: DATE:

ASSET #

REVISION: ADDENDUM 1 DATE: $\frac{273}{05/11/2023}$ ISSUE DATE: <u>03/28/2023</u>

CAD DWG FILE: X2202-01-5306-7815306134- E-502.DWG

DRAWN BY: KE T/M N S CHECKED BY: B D F DESIGNED BY: BDF

SHEET TITLE:

LIGHTING FIXTURE **INSTALLATION** DETAILS -ALT BID NO. 1

SHEET NUMBER:


E-502

			FEED	ER SC	HED	DULE (3		
		PHA	SE CONDU	CTORS	_	JTRAL DUCTOR		JNDING OUCTOR	RACEWAY
FEEDER NUMBER	CIRCUIT VOLTAGE	PHASE	QTY PER PHASE	SIZE	QTY	SIZE	QTY	SIZE	TRADE SIZE
1	120/240	2	2	500 KCM	2	500 KCM	-	-	(2) 3"
2	120/240	2	2	500 KCM	2	500 KCM	1	3/0	3 1/2" NIPPLE
3	120/240	2	1	600 KCM	1	600 KCM	1	1/0	3 1/2"
4	120/240	2	1	500 KCM	1	500 KCM	1	1/0	3"
5	120/240	2	1	250 KCM	1	250 KCM	1	{ 2 }	2 1/2"
6	120/240	2	1	4/0	1	4/0	1	2 }	2" A
7	120/240	2	1	{ 1/0	1	1/0	1	4	2" }
8	120/240	2	1	2	1	2	1	4 {	2"
9	120/240	2	1	2	1	2	1	{ 4 }	1 1/4"
10	120/240	2	1	6	1	6	1	10	2" OR 1 1/4"
11	120/240	2	1	10	1	10	1	10	3/4" OR 1"
(12)	7 120	1	1	12	7	12		12	3/4"

- A. PROVIDE ARC FLASH HAZARD WARNING LABEL PER SPECIFICATION SECTIONS 260553 AND 260573 ON ENCLOSED MCB, EACH PNLBD, WELL PUMP MS & EACH DISC SW.
- B. ALL CONDUCTORS SHALL BE COPPER.
- C. REFERENCE SPECIFICATION SECTION 012300 FOR DESCRIPTION OF ALTERNATE BID ITEMS.

○KEY NOTES:

- 1. MCB TO BE IN SEPARATE NEMA 3R ENCL W/ AN ISOLATED NEUT BUS & AN EQUIP GRD BUS BONDED TOGETHER W/ 1#3/0 MAIN BONDING JUMPER.
- 2. PROVIDE LABEL INDICATING MAXIMUM AVAILABLE FAULT CURRENT AND DATE THE FAULT CURRENT CALCULATION WAS PERFORMED PER NEC 110.24(A). LABEL MUST BE WEATHER AND UV RESISTANT FOR OUTDOOR EQUIP.
- 3. FDR SIZES SHOWN ARE MIN REQD SIZES.
- 4. CONDUCTORS FROM CT CAB TO MCB AND FROM MCB TO PNLB TO BE RUN IN ONE $3\frac{1}{2}$ GRC NIPPLE WITH THREADED CONDUIT HUBS.
- 5. REWORK EXIST UG FDR INTO NEW PNLBD.
- 6. <u>ALT BID NO. 1</u>.
- 7. ALT BID NO. 3: PROVIDE FACTORY MTD SPD PER SPECIFICATION SECTION 262416.

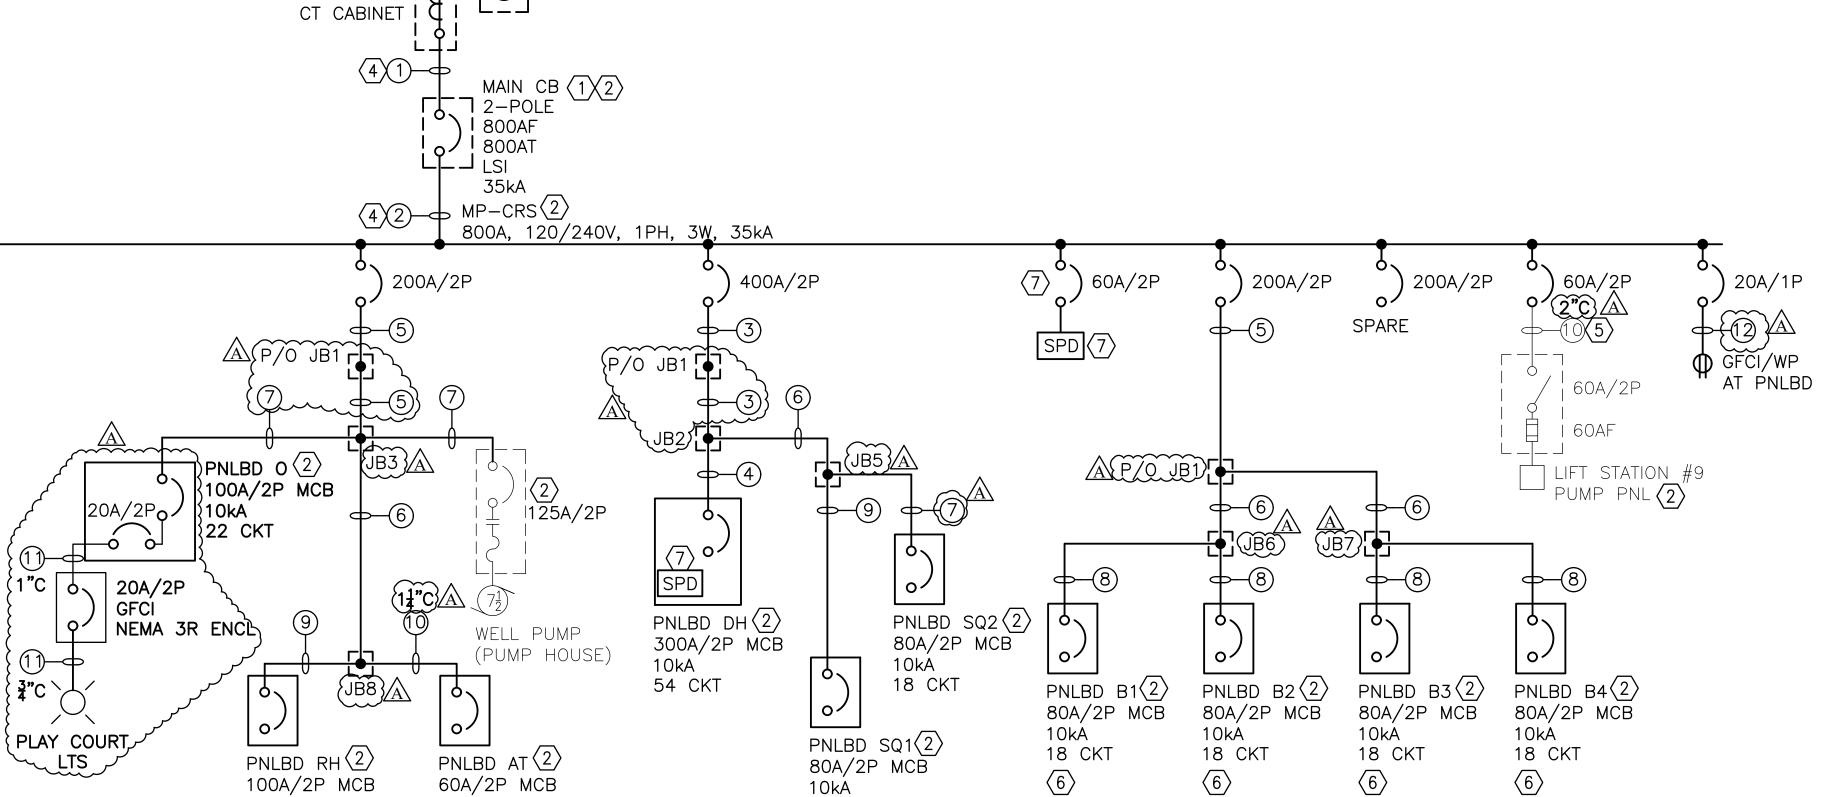

10kÅ

18 CKT

ONE-LINE DIAGRAM NO SCALE

60A/2P MCB

10kA 8 CKT

7.2KV

MISSOURI İ

200A/2P

0/

10kA

PNLBD SQ4(2) 100A/2P MCB

10kA 18 CKT

24 CKT

LC RR**(2)** 100A/2P MCB

GFCÍ

10kA

18 CKT

{ **¾**"C \

PLAY COURT} لر LTS

PNLBD B5(2) 80A/2P MCB

10kÅ

6

18 CKT

PNLBD SQ3 (2) 100A/2P MCB

10kA

18 CKT

200A/2P

PNLBD B7(2) 80A/2P MCB

18 CKT

PNLBD B6 $\langle 2 \rangle$ 80A/2P MCB

10kA

18 CKT

(7)SPD

PNLBD B8(2) 80A/2P MCB

10kÁ

18 CKT

 ~ 75 kVA

AMEREN MISSOURI

i AMEREN MISSOURI

REVENUE METER

120/240V, 1ø

UUU POLE MTD XFMR

STATE OF MISSOURI MICHAEL L. PARSON, **GOVERNOR**



BARRY D. FREINER Registered Professional Engineer MO # E-24220 Expires 12-31-2024

ROGERS-SCHMIDT ENGINEERING CO., P.C. **CONSULTING ENGINEERS** 1736 WEST PARK CENTER DR. SUITE 204 ST. LOUIS, MO 63026 PHONE: 636-600-1551 EMAIL: bfreiner@rogers-schmidt.com MISSOURI STATE CERTIFICATE OF AUTHORITY #000408

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DEPARTMENT OF NATURAL RESOURCES DIVISION OF STATE PARKS

UPGRADE ELECTRIC NETWORK CAMP RISING SUN

LAKE OF THE OZARKS STATE PARK 403 HIGHWAY 134 KAISER, MISSOURI 65047

PROJECT # X2202-01 5306 7815306134

REVISION: DATE: **REVISION:** DATE:

ASSET#

REVISION: A ADDENDUM 1
DATE: 05/11/2023

ISSUE DATE: <u>03/28/2023</u>

CAD DWG FILE: X2202-01-5306-7815306134- E-601.DWG DRAWN BY: CHECKED BY: DESIGNED BY: _

SHEET TITLE: ONE-LINE DIAGRAM

SHEET NUMBER:

			NEW F	PANEL	.BOAR	D SQ3	SCHE	EDULE (1)(2)			
СКТ		POLES		VOLT-AI	MPERES	VOLT-AI	MPERES		POLES		СКТ
NO	AMPS	P0	LOAD	ØA	ØB	ØA	ØB	LOAD	8	AMPS	NO
1	20	1	BATHROOM GFCI RECPT	180		2250					2
3	20	1	EAST & CENTER ROOM & EAST EXTERIOR LIGHTS		-		2250	WATER HEATER	2	30	4
5	20	1	WEST & CENTER ROOM RECPTS	-		-		WEST ROOM & WEST EXTERIOR LIGHTS	1	20	6
7	20	1	EAST ROOM RECPTS		-		-	BATHROOM LTS & EXH FAN & SHOWER LIGHTS	1	20	8
9	20	1	SPARE	-		75		SMOKE DETECTORS	1	15	10
11	20	1	SPARE		-		-	SPARE	1	20	12
13	20	1	SPARE	-		-		SPARE	1	20	14
15	100	2	MAIN		-		-	SPARE	1	20	16
17	100	2	MAIN	-		-		SPARE	1	15	18
100 AM	IP MCB, 1	20/240	DV-1Ø-3W, 18 CKT, 10kA	180	0	2325	2250	TOTAL LOAD:		VA	

			NEW F	PANEL	BOAR	D SQ4	SCHE	EDULE(1)(2)			
CVT		POLES		VOLT-A	MPERES	VOLT-AN	MPERES		ES		CVT
CKT NO	AMPS	10d	LOAD	ØA	ØB	ØA	ØB	LOAD	POLI	AMPS	CKT NO
1	- 30	2	WATER LIEATER	-		-		SOUTH BUNK & SOUTH PORCH LIGHTS	1	20	2
3	30	2	WATER HEATER		-		75	SMOKE DETECTORS	1	20	4
5	20	1	BATHROOM LIGHTS & DUSK TO DAWN LIGHT	-		-		NORTH BUNK & NORTH PORCH LIGHTS	1	20	6
7	20	1	MIDDLE ROOM RECPTS & BATHROOM GFCI RECPTS		-		-	SOUTH BUNK RECPTS	1	15	8
9	20	1	SPARE	-		-		NORTH BUNK RECPTS	1	20	10
11	20	1	SPARE		1		ı	SPARE	1	20	12
13	20	1	SPARE	-		-		SPARE	1	20	14
15	100	2	MAIN		-		-	SPARE	1	20	16
17	100		IVIAIIV	-		-		SPARE	1	15	18
100 AN	1P MCB, 1	120/240)V-1Ø-3W, 18 CKT, 10kA	0	0	0	75	TOTAL LOAD:		VA	

NEMA TYPE 1 SEMI-FLUSH MTD ENCLOSURE W/ SURFACE COVER

NEMA TYPE 1 SEMI-FLUSH MTD ENCLOSURE W/ SURFACE COVER

NEMA TYPE 1 SEMI-FLUSH MTD ENCLOSURE W/ SURFACE COVER

LAMP TYPE: LED = LIGHT EMITTING DIODE

			NE	W PANE	LBOA	RD O	SCHE	DULE(1)(2)			
OLIT		ES		VOLT-A	MPERES	VOLT-A	MPERES		ES		OLIT
CKT NO	AMPS	POLES	LOAD	ØA	ØB	ØA	ØB	LOAD	POLES	AMPS	CKT NO
1	- 30	2	WATER HEATER	-		-		?? LIGHTS	1	20	2
3	30	2	WATER HEATER		-		-	?? RECPTS	1	20	4
5	20	1	?? RECPTS	-		-		BATHROOM & ?? LIGHTS	1	20	6
7	20	1	?? RECPTS		-		-	?? OUTLETS	1	15	8
9	20	1	?? RECPTS	-		180		BATHROOM GFCI RECPT	1	20	10
11	20	1	NORTH ROOM & HALL RECPTS		-		-	?? OUTSIDE LEFT RECPT	1	20	12
13	20	1	INTERIOR & PORCH LIGHTS	-		-		SPARE	1	20	14
15	20	1	NORTH ROOM & HALL RECPTS		-		-	?? OUTSIDE LEFT RECPT	1	20	16
17	20	1	INTERIOR & PORCH LIGHTS	-		-		SPARE	1	20	18
19	20	1	SPARE		-		-	?? RECPTS UNDER PANELS	1	20	20
21	15	1	SPARE	-		75		SMOKE DETECTORS	1	15	22
23	100	2	MAIN		-		950	PLAY COURT LIGHTS	2	20	24
25	100		MAIN	-		950		TEAT COURT LIGHTS		20	26
100 AN	1P MCB.	120/24	0V-1Ø-3W, 18 CKT, 10kA	0	0	1205	950	TOTAL LOAD		VA	

CKT		POLES		VOLT-AI	VOLT-AMPERES		MPERES				C
NO	AMPS	POI	LOAD	ØA	ØB	ØA	ØB	LOAD	POLI	AMPS	
1	20	1	?? OUTSIDE LIGHTS / BACK LIGHTS	-		-		?? 4 BACK WALL LIGHTS / MAIL ROOM	1	20	
3	20	1	CEILING FANS		-		-	?? 2 RIGHT SIDE LIGHTS	1	20	
5	20	1	?? BSMT LIGHTS & RECPTS	-		-		?? RECEPTACLES	1	20	
7	20	1	SPARE		-		-	?? 2 MIDDLE LIGHTS & RIGHT SIDE RECPT	1	20	
9	20	1	SPARE	-		-		SPARE	1	20	
11	20	1	SPARE		-		-	SPARE	1	20	
13	20	1	SPARE	-		-		SPARE	1	20	
15	100	2	MAIN		-		-	SPARE	1	20	
17	100	2	MAIN	-		-		SPARE	1	15	
			0V-1Ø-3W, 18 CKT, 10kA LUSH MTD ENCLOSURE W/ SURFACE COVE	0 R	0	0	0	TOTAL LOAD:		VA	

			NEW	PANE	LBOAF	RD AT	SCHE	DULE 1			
CKT		POLES		VOLT-A	MPERES	VOLT-AI	MPERES		ES		CVT
NO NO	AMPS	P01	LOAD	ØA	ØB	ØA	ØB	LOAD	POL	AMPS	CKT NO
1	20	2	CDADE	-		180		GFCI RECPT AT PANEL	1	20	2
3	20	2	SPARE		-		140	AMPHITHEATER LIGHTING	1	20	4
5	20	1	SPARE	-		-		SPARE	1	20	6
7	15	1	SPARE		-		-	SPARE	1	15	8
9	-	1	SPACE	-		-		SPACE	1	-	10
11	-	1	SPACE		-		-	SPACE	1	-	12
13	-	1	SPACE	-		-		SPACE	1	-	14
15	60	2	MAIN		-		-	SPACE	1	-	16
17	60	2	MAIN	-		-		SPACE	1	-	18

TYPE	DECODIDATION	MANUFACTURER	LAMP DATA			VOLTAGE	FIXTURE	MOUNTING	FINISH	REMARKS
TYPE	DESCRIPTION	CATALOG NUMBER	TYPE	WATTS	SPECIFICATIONS	VOLTAGE	WATTAGE	MOUNTING	FINISH	REMARKS
А	ACORN POST LIGHT	GLP BH1/AB40AC-CL/G3LED40-T5-40K/PCLL/SP1/BT W/ LUMECON H-RSS16B4-4-T304-BA ROUND STEEL POLE OR APPROVED EQUAL BY ACCUITY OR COOPER	LED	41	4000K, ≥ 70 CRI, ≥ 141 LPW, 5,793 LUMENS TYPE V OPTICS	120	41	POLE ON CONCRETE BASE ON GRADE	TEXTURED BLACK	4" ROUND, 16' TALL STEEL POLE FURNISHED W/ GALV STL ANCHORAGE KIT, SQ STL BASE COVER PAINTED TO MATCH POLE, AND WITH PHOTOCONTROL AND 10kA/10kV SURGE PROTECTION ON FIXTURE
В	ARM MTD AREA LIGHT	LUMECON LDS-SAL-45-BK-T3-1-40-TM W/ MORRIS CAT #79904 8" LONG BRACKET OR APPROVED EQUAL BY ACCUITY OR COOPER	LED	45	4000K, ≥ 80 CRI, ≥ 146 LPW, 6,567 LUMENS TYPE III OPTICS	120	45	EXIST WOODEN POLE	BLACK	20kA/40kV SURGE PROTECTION ON FIXTURE. THROUGH BOLT MORRIS BRACKET TO SIDE OF POLE AT TOP AND MOUNT FIXTURE TENON TO MORRIS BRACKET.
С	SPORTS LIGHT	EIKO SIG/600W/740/UD W/ SIG/SF W/ MORRIS 79954 3 HEAD BULLHORN OR APPROVED EQUAL BY ACCUITY OR COOPER	LED	600	4000K, > 70 CRI, ≥ 165 LPW 98,750 LUMENS	240	600	3 HEAD BULLHORN ON EXIST 30' STEEL POLE	BLACK	20kA/20kV SURGE PROTECTION ON FIXTURE PROVIDE WITH SLIPFITTER FOR 2-3/8" PIPE AND 4 HEAD VERTICAL BLACK STEEL OR ALUMINUM BULLHORD FOR EXISTING ROUND STEEL POLE
D	BULLET SPOT LIGHT	CREE C-FL-B-RDN-2L-40K-BLK OR APPROVED EQUAL BY ACCUITY OR COOPER	LED	22	4000K, ≥70 CRI, ≥127 LPW, 2,800 LUMENS 20° NARROW DISTRIBUTION SPOT	120	22 (CAŠT BŎX ON POLE FOR TYPE B LTG FIXTURE	BI ACK	MOUNT TO 1/2" THREADED CAST COVER ON CAST BOX ON TYPE B FIXTURE POLE AT 18" DOWN FROM TOP OF POLE.

60 AMP MCB, 120/240V-1Ø-3W, 18 CKT, 10kA

NEMA TYPE 3R SURFACE MTD OUTDOOR ENCLOSURE

GENERAL NOTES:

- A. PROVIDE ARC FLASH HAZARD WARNING LABEL PER SPECIFICATION SECTIONS 260553 AND 260573 ON EACH PNLBD.
- B. REFERENCE SPECIFICATION SECTION 012300 FOR DESCRIPTION OF ALTERNATE BID ITEMS.

OKEY NOTES:

- 1. PROVIDE NEW PNLBD PER SPECIFICATION SECTION 262416.
- 2. TRACE EXIST CIRCUITS & IDENTIFY LOADS SERVED FOR COMPLIANCE WITH NEC 408.4. UPDATE PNLBD CKT DIRECTORIES ON AS-BUILT DWGS.
- 3. <u>ALT BID NO. 1</u>

TOTAL LOAD:

STATE OF MISSOURI MICHAEL L. PARSON, GOVERNOR



BARRY D. FREINER
Registered Professional Engineer
MO # E-24220
Expires 12-31-2024

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OF AUTHORITY #000408

OFFICE OF ADMINISTRATION DIVISION OF FACILITIES MANAGEMENT, DESIGN AND CONSTRUCTION

DEPARTMENT OF NATURAL RESOURCES DIVISION OF STATE PARKS

UPGRADE ELECTRIC NETWORK CAMP RISING SUN

LAKE OF THE OZARKS STATE PARK 403 HIGHWAY 134 KAISER, MISSOURI 65047

PROJECT # X2202-01 SITE # 5306

ASSET # 7815306134

REVISION:

DATE:

REVISION:
DATE:
REVISION:
ADDENDUM 1
DATE:
05/11/2023

ISSUE DATE: <u>03/28/2023</u>

CAD DWG FILE: X2202-01-5306-7815306134- E-603.DWG

7815306134- E-603.DWG

DRAWN BY: MNS

CHECKED BY: BDF

DESIGNED BY: B D F

PANELBOARD &
LIGHTING FIXTURE
SCHEDULES &
ALT BID NO. 1

SHEET NUMBER:

E-603