Addendum No. 02

TO: PLANS AND SPECIFICATIONS FOR STATE OF MISSOURI

Construct Six New Cabins Echo Bluff State Park Eminence, MO

Project No: X2208-01

Bid Opening Date: 1:30 PM, Thursday, May 18, 2023 (Changed in Addendum 01)

Bidders are hereby informed that the construction Plans and/or Specifications are modified as follows:

SPECIFICATION CHANGES:

- 1. Section 07 2119 Foamed-in-place Insulation
 - a. ADD 2.1.A.9.d as follows:
 - d. Holcim (Gaco) www.holcimbe.com/en
- 2. <u>Section 07 2500 Weather Barriers</u>
 - a. ADD 2.2.A.12.b.5 as follows:5) W.R. Meadows, Air-Shield LMP www.wrmeadows.com/
- 3. Section 07 4646 Fiber-Cement Siding
 - a. ADD 2.1.C.4 as follows:
 - 4. LP Building Solutions www.lpbuildingsolutions.com
- 4. Section 32 9300 Plant Materials and Accessories
 - b. REMOVE this section in entirety from the bid set. Owner to provide all planting installation. All aggregate mulch material, edging materials and filler fabric shall be furnished and installed per plans/details.
- 4. Section 32 9200 Turf and Grasses:
 - a. ADD paragraph 1.1.A.2 as follows: Turfgrass Sodding
 - b. ADD paragraph 2.2.A as follows:

Tall Fescue Blend: Grown within 200 miles of the project site. Submit complete grower information including location, seed harvest information, and seed mixture breakdown.

c. ADD paragraph 3.3.A-M as follows:

- A. Install sod within 24 hours from time of harvesting
- B. Do not lay sod on frozen or uneven ground.
- C. Lightly moisten topsoil immediately prior to laying sod.
- D. Lay first roll in straight line with subsequent rows parallel and tight with no open joints visible.
- E. Lay sod smooth and do not stretch or overlap.
- F. Stagger lateral joints 12 inches minimum.
- G. Align with adjoining turf areas.
- H. When new sod is placed adjacent to existing sod, cut common edge of existing sod vertically with a sod cutter.
- I. Do not rip or tear sod.
- J. On slopes, begin sod at bottom and progress upwards, laying rows perpendicular to the flow of water.
- K. Stake sod placed on slopes greater than 3:1. Drive stakes at an angle against flow of runoff to $\frac{1}{2}$ inch above sod, and not more than 30 inches apart.
- L. Water sod immediately after laying; as sections are completed, roll entire area.
- M. Thoroughly water to depth sufficient that underside of new sod pad and soil immediately below are thoroughly moist.

5. <u>Section 33 3616 – Septic Tank Effluent Pumping</u>

- a. REMOVE and REPLACE Paragraph 2.2.F. as follows:
 - F. High-Head Effluent Pumps:

Pump shall be as indicated on the table on Sheet C-503. Pump shall be rated for 13.19 gpm at 96.1 ft of TDH. They should include a 20 foot long extra heavy duty (SO) electrical cord with ground. Pump shall be UL and CSA listed as an effluent pump. Pump shall be provided with a non-prorated five-year warranty.

DRAWING CHANGES:

- 1. Sheet E-103 See Attached revised sheet E-103
 - a. REVISE keynote 10 and associated equipment location as follows:

PROVIDE A TELEPHONE/DATA 8 PORT PATCH PANEL AND TELEPHONE FIBER DEMARC.

- 2. Sheet E-104 See Attached revised sheet E-104
 - a. REVISE keynote 9 and associated equipment location as follows:

PROVIDE A TELEPHONE/DATA 8 PORT PATCH PANEL AND TELEPHONE FIBER DEMARC.

- 3. Sheet E-401 See Attached revised sheet E-401
 - a. REVISE general note A as follows:

UTILITY COMPANY: HOWELL OREGON COOPERATIVE 417-256-2131

TELEPHONE COMPANY: CENTURYLINK 417-255-8221

b. ADD general note B as follows:

B. PROVIDE PULL BOXES FLUSH WITH EVERY 300' ALONG TELEPHONE FIBER CONDUIT. PROVIDE A PEDESTAL EVERY 900' ALONG TELEPHONE FIBER. THE PEDESTAL SHALL AS A PULL BOX. PROVIDE ADDITIONAL PEDESTALS AS NECESSARY TO ACCOMMODATE CABLE LENGTHS. SPLICING OF FIBER OPTIC CABLES WILL NOT BE ACCEPTABLE.

c. ADD general note C as follows:

C. ALL PEDESTAL & DEMARCATION LOCATIONS MUST ACCOMODATE FIBER TERMINATIONS TO BE MOUNTED. LOCKED AND MAINTAINED BY STATE OF MISSOURI (SOM) STAFF.

d. REVISE keynote 3 as follows:

PROVIDE (6) 2-STRAND MULTI-MODE FIBER OPTIC CABLES, RATED FOR OUTDOOR WET LOCATIONS IN 4"C FROM EXISTING MAIN FIBER CONNECTION IN LODGE. FIBER OPTIC CABLE TO TERMINATE ON FIBER DEMARC IN MECHANICAL ROOM FOR EACH CABIN.

- e. REVISE Electrical Site Plan to add handhole sizes.
- 4. Sheet E-402 See Attached revised sheet E-402
 - a. ADD general note A as follows:

A. PROVIDE PULL BOXES FLUSH WITH EVERY 300' ALONG TELEPHONE FIBER CONDUIT. PROVIDE A PEDESTAL EVERY 900' ALONG TELEPHONE FIBER. THE PEDESTAL SHALL AS A PULL BOX. PROVIDE ADDITIONAL PEDESTALS AS NECESSARY TO ACCOMMODATE CABLE LENGTHS. SPLICING OF FIBER OPTIC CABLES WILL NOT BE ACCEPTABLE.

b. ADD general note B as follows:

B. ALL PEDESTAL & DEMARCATION LOCATIONS MUST ACCOMODATE FIBER TERMINATIONS TO BE MOUNTED. LOCKED AND MAINTAINED BY STATE OF MISSOURI (SOM) STAFF.

- 5. Sheet E-603 See Attached revised sheet E-603
 - a. REVISE panelboard DPB.

GENERAL:

1. The following questions were received:


- a. "I notice that in detail 5 on page L-501 it calls for Alabamia Sunset Decorative Gravel to a depth of 3" but in the specifications on page 32 9300-0 it calls for cobble landscape mulch that has a size range of 30% 12-18", 50% 6-10", 20% 3-4". Can you confirm that this is the correct size and type of material for the rock mulch areas around each cabin?"
 - i. Spec section 32 9300 removed from bid set. All aggregate mulch materials, edging materials and filter fabric shall be furnished and installed per plans/details.
- b. "Is there a spot on the property that we could dump clean fill? Also is there a spot that we can store the onsite topsoil for reuse?"
 - Yes, there is a location on site to locate clean fill, however, it will need to be piled/mounded up. Yes, there is a location onsite to store topsoil for reuse. To be identified at the pre-construction meeting.
- c. "Do we need to rock the existing bioswale? I see that there is bioswale rock in the specifications, but it is not called out in the plans."
 - i. Rock is only to be provided where called out on the plans. See C104.
- d. "In the plans the only stormwater drainage pipe I see is the 18" pipe on note 11 page C-103. Is that the only stormwater utility we need to install? It looks like there is already pipe installed for the two walkways on the west side of the site in the existing bioswale. The specifications give details about manholes, catch basins and stormwater inlets in section 334100 but the only manholes I see called out in the plans in the sanitary sewer."
 - i. Yes, the only proposed pipe on the plans to be installed for storm sewer.
- e. "Is the water main hooked to the city of Eminence local water system?"
 - i. No, Echo Bluff State Park is fed by a series of wells on-site.
- f. "Would steel jacketed or another type of MC cable be considered for concealed branch circuits due to these structures being wood framed for a more efficient installation vs the specified 3/4" minimum conduit?"
 - i. No, MC cable does not ensure future modifications are able to be made to the facility.
- g. "Would fire alarm MC cable be acceptable for the fire alarm circuits vs the specified 3/4" minimum conduit?"
 - i. No, MC cable does not ensure future modifications are able to be made to the facility.
- h. "Please provide specifications and responsibility matrix for the communication, fiber and telephone (Div 27) equipment, WAP and horizontal wiring?"
 - Communication equipment/devices are shown for infrastructure only, as noted on symbols sheet. Fiber/telephone is to be coordinated with CenturyLink, per addendum.
- i. "MDP schedule calls for a Nema 1 enclosure rating. Should this be revised to Nema 3R for outdoor use?"


 i. Per specification section 262416 – PANELBOARDS, section 2.2.I.1: The outdoor panelboards, including DPB (the MDP on this project) should have a NEMA 250 Type 3R enclosure.

ATTACHMENTS:

- 1. E-103 Addendum 02 Revision (1 Page)
- 2. E-104 Addendum 02 Revision (1 Page)
- 3. E-401 Addendum 02 Revision (1 Page)
- 4. E-402 Addendum 02 Revision (1 Page)
- 5. E-603 Addendum 02 Revision (1 Page)

END OF ADDENDUM 02

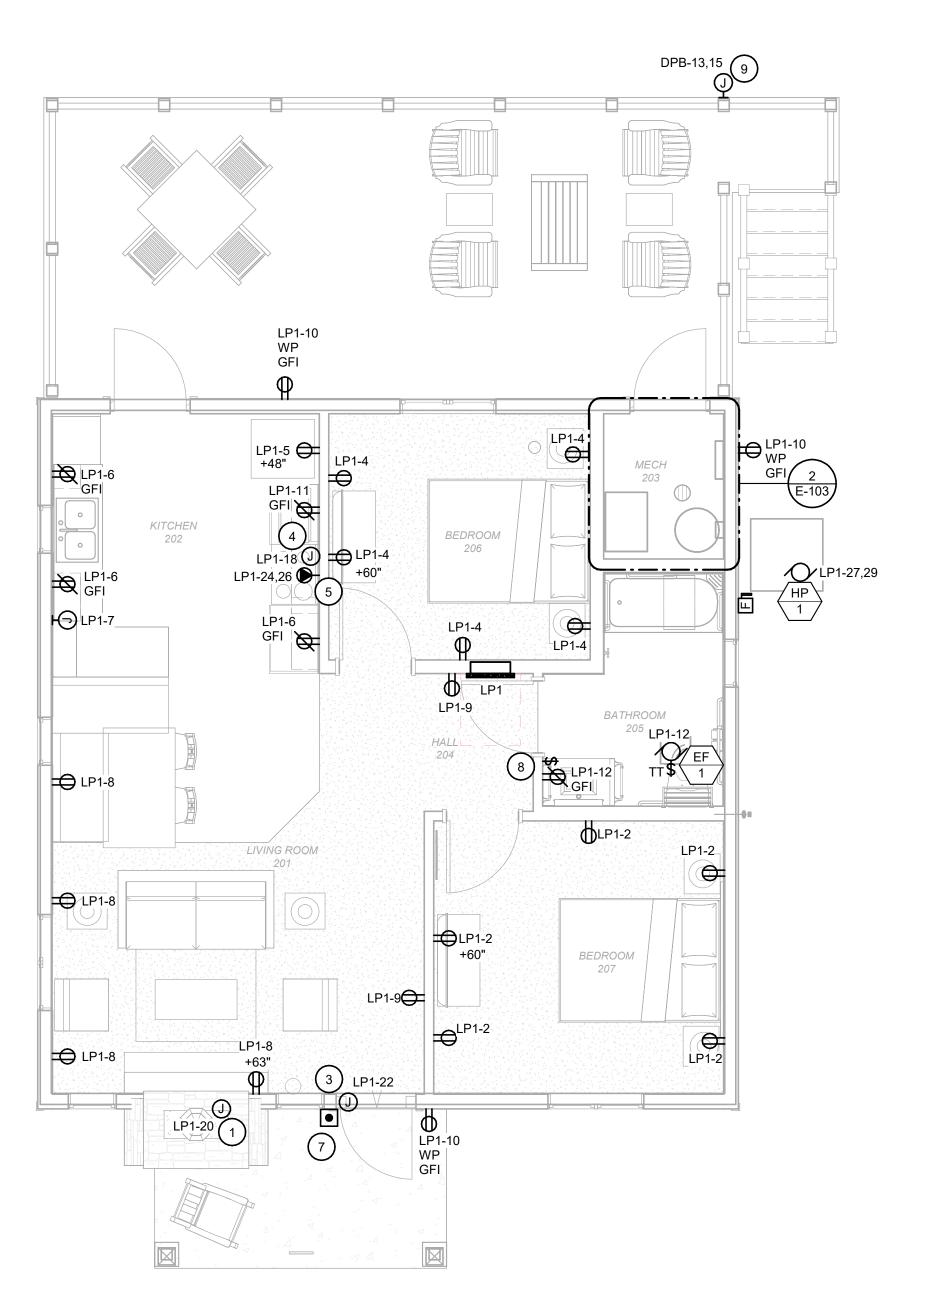

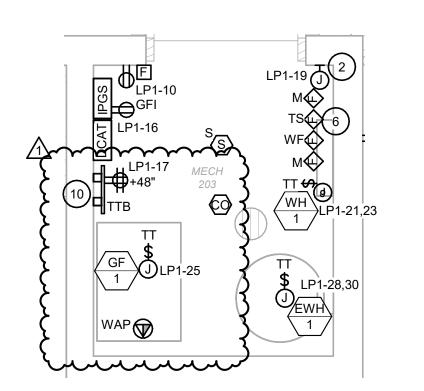

ENLARGED PLAN SCALE: 1/2" = 1'-0"

GENERAL NOTES

A. NOT USED

KEYNOTES

- PROVIDE CONNECTION TO GAS FIRED FIREPLACE INSERT. COORDINATE EXACT LOCATION AND CONNECTION TYPE WITH ARCHITECTURAL TRADE AND VENDOR.
- 2 PROVIDE A DEDICATED CIRCUIT FOR WATER SUPPLY HEAT TRACE LOCATED IN CRAWL SPACE. COORDINATE EXACT LOCATION WITH PLUMBING TRADE.
- 3 PROVIDE CONNECTION TO ACCESS CONTROL SYSTEM CARD READER. COORDINATE EXACT REQUIREMENTS WITH OWNER'S VENDOR.
- 4 PROVIDE CONNECTION TO OVERHEAD RANGE HOOD. COORDINATE EXACT LOCATION AND CONNECTION TYPE WITH ARCHITECTURAL TRADE AND VENDOR.
- 5 PROVIDE A NEMA 14-50 RECEPTACLE FOR ELECTRIC RANGE.
- 6 PROVIDE A MONITOR MODULES FOR SPRINKLER RISER.
- PROVIDE A WIRELESS DOORBELL NOTIFICATION SYSTEM. CENTRALALERT MODEL CA-360 SHALL BE CONSIDERED AS BASIS OF DESIGN. THE SYSTEM SHALL INCLUDE: 1 ALARM CLOCK MASTER UNITS WITH INTEGRATED FLASHER AND AUDIBLE ALARM, RECHARGABLE BATTERIES FOR ALL MASTER UNITS, 1 WIRELESS DOORBELL, AND 1 BED SHAKER UNIT. PROVIDE CENTRAL ALERT MODEL CA-RX AS SUB-MASTER TO BE PLACED ON LIVING ROOM END TABLE. LOCATE MASTER UNIT ON ACCESSIBLE BEDROOM NIGHT STAND. KROWN KA1000 AND CLARITY AL10 SHALL BE CONSIDERED APPROVED MODELS WHEN PROVIDED WITH PERIPHERAL DEVICES AS REQUIRED FOR BASIS OF DESIGN. CONTRACTOR SHALL SUBMIT PRODUCT DATA SHEETS.
- 8 PROVIDE SWITCH FOR EXHAUST FAN CONTROL.
- 9 PROVIDE CONNECTION TO LIFT STATION CONTROL PANEL, LSCP1. COORDINATE EXACT LOCATION WITH CIVIL TRADE. PROVIDE CONDUIT AND WIRE FROM LIFT STATION CONTROL PANEL TO PUMPS AS REQUIRED BY VENDOR. SEE SHEET ES1.1 FOR MORE INFORMATION.
- \cdots PROVIDE A TELEPHONE/DATA 8 PORT PATCH PANEL AND TELEPHONE FIBER

STATE OF MISSOURI MICHAEL L. PARSON, GOVERNOR





20 ALLEN AVENUE, SUITE 200 ST LOUIS, MISSOURI 63119 (314) 962-7900 / info@f-w.com

Farnsworth Group, Inc. Missouri State Certificate of Authority #000744 Engineers | Architects | Surveyors | Scientists

CONSTRUCTION **DOCUMENTS**

ADMINISTRATION DIVISION OF FACILITIES MANAGEMENT, DESIGN AND CONSTRUCTION

OFFICE OF

DEPARTMENT OF NATURAL RESOURCES DIVISION OF STATE PARKS

ECHO BLUFF STATE PARK CONSTRUCT **SIX NEW CABINS**

Eminence, Missouri

PROJECT #.: X2208-01 SITE #.: FACILITY #.: 7815230517

DESCRIPTION: # DATE:

1 05/11/2023 ADD 02

DRAWN BY: KES CHECKED BY: DFM DESIGNED BY: TLA


SHEET TITLE:


FLOOR PLAN -**POWER - TWO BEDROOM CABIN**

SHEET NUMBER:

E-103

SHEET 66 of 75 ISSUE DATE: 03/02/2023

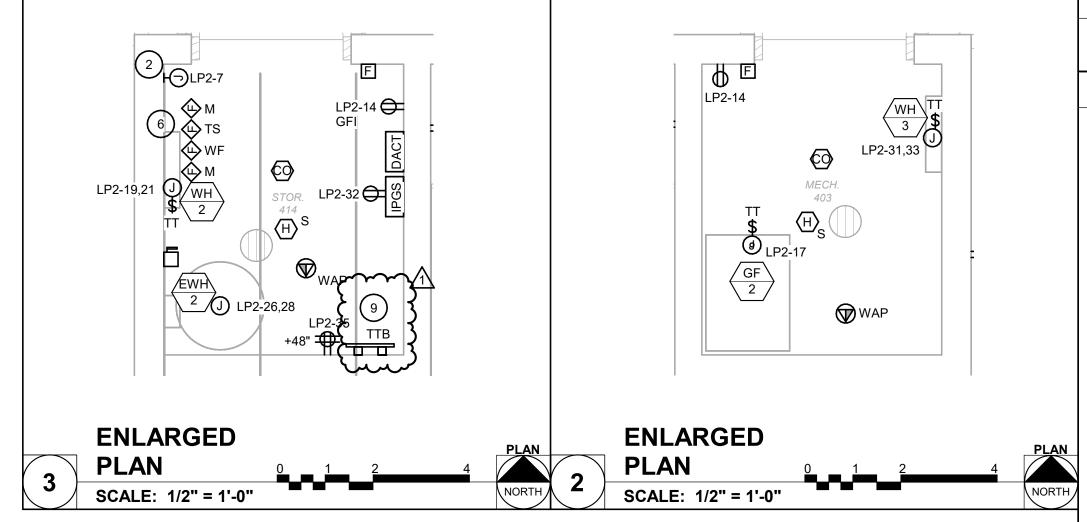

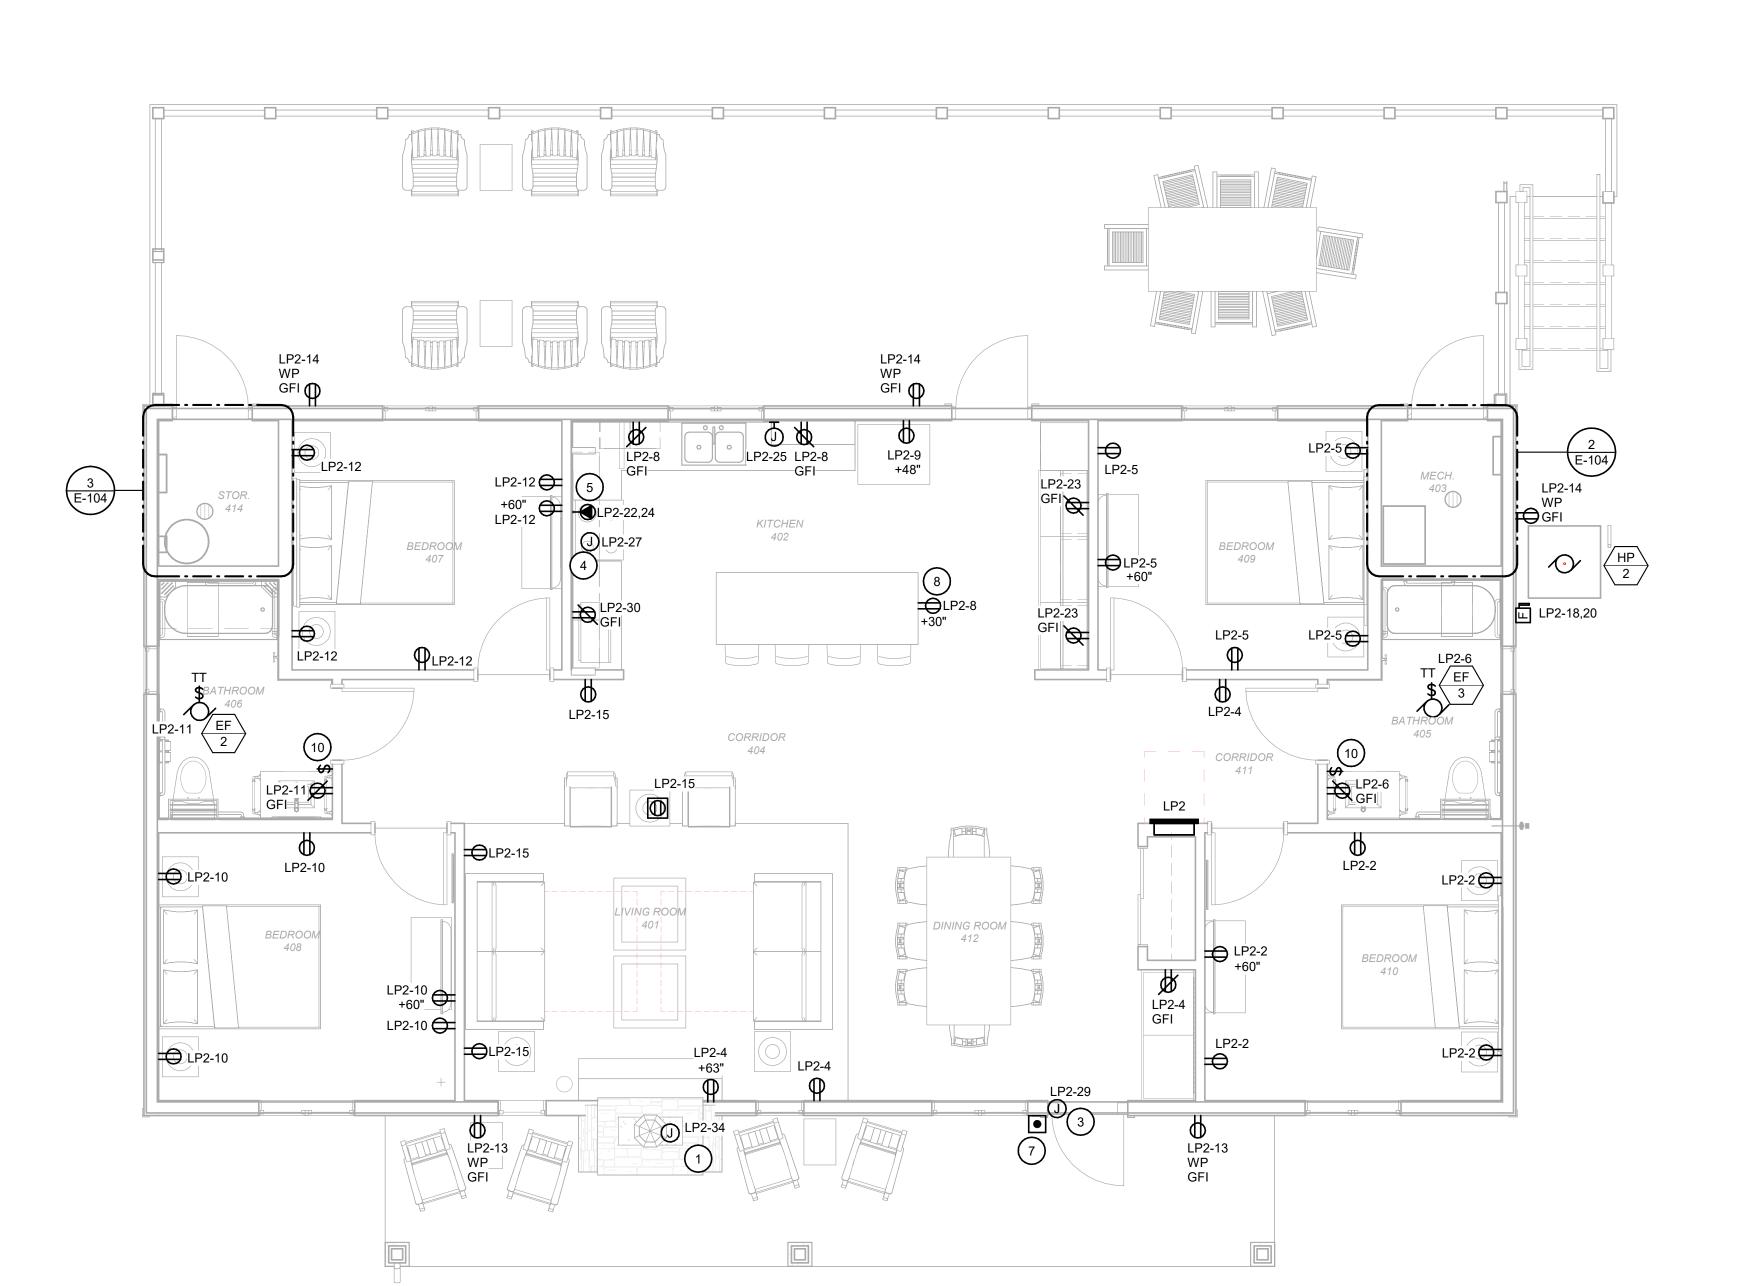

GENERAL NOTES

A. NOT USED

KEYNOTES

1 PROVIDE CONNECTION TO GAS FIRED FIREPLACE INSERT. COORDINATE EXACT LOCATION AND CONNECTION TYPE WITH ARCHITECTURAL TRADE AND VENDOR.

- 2 PROVIDE A DEDICATED CIRCUIT FOR WATER SUPPLY HEAT TRACE LOCATED IN CRAWL SPACE. COORDINATE EXACT LOCATION WITH PLUMBING TRADE.
- 3 PROVIDE CONNECTION TO ACCESS CONTROL SYSTEM CARD READER. COORDINATE EXACT REQUIREMENTS WITH OWNER'S VENDOR.
- 4 PROVIDE A JUNCTION BOX FOR OVERHEAD RANGE HOOD.
- 5 PROVIDE A NEMA 14-50 RECEPTACLE FOR ELECTRICAL RANGE.
- 6 PROVIDE MONITOR MODULES FOR SPRINKLER RISER.
- 7 PROVIDE A WIRELESS DOORBELL NOTIFICATION SYSTEM. CENTRALALERT MODEL CA-360 SHALL BE CONSIDERED AS BASIS OF DESIGN. THE SYSTEM SHALL INCLUDE: 1 ALARM CLOCK MASTER UNITS WITH INTEGRATED FLASHER AND AUDIBLE ALARM, BED SHAKER UNIT. PROVIDE CENTRAL ALERT MODEL CA-RX AS SUB-MASTER TO BE PLACED ON LIVING ROOM END TABLE. LOCATE MASTER UNIT ON ACCESSIBLE BEDROOM NIGHT STAND. KROWN KA1000 AND CLARITY AL10 SHALL BE CONSIDERED APPROVED MODELS WHEN PROVIDED WITH PERIPHERAL DEVICES AS REQUIRED FOR BASIS OF DESIGN. CONTRACTOR SHALL SUBMIT PRODUCT DATA
- 8 PROVIDE DUPLEX RECEPTACLE MOUNTED HORIZONTALLY. \leftarrow
- 9 PROVIDE A TELEPHONE/DATA 8 PORT PATCH PANEL AND TELEPHONE FIBER
- 10 PROVIDE SWITCH FOR EXHAUST FAN CONTROL.

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Eminence, Missouri

PROJECT #.: X2208-01 SITE #.: FACILITY #.: 7815230517 # DATE: DESCRIPTION:

1 05/11/2023 ADD 02


DRAWN BY: KES CHECKED BY: DFM DESIGNED BY: TLA

SHEET TITLE:

FLOOR PLAN -**POWER - FOUR BEDROOM CABIN**

SHEET NUMBER:

E-104

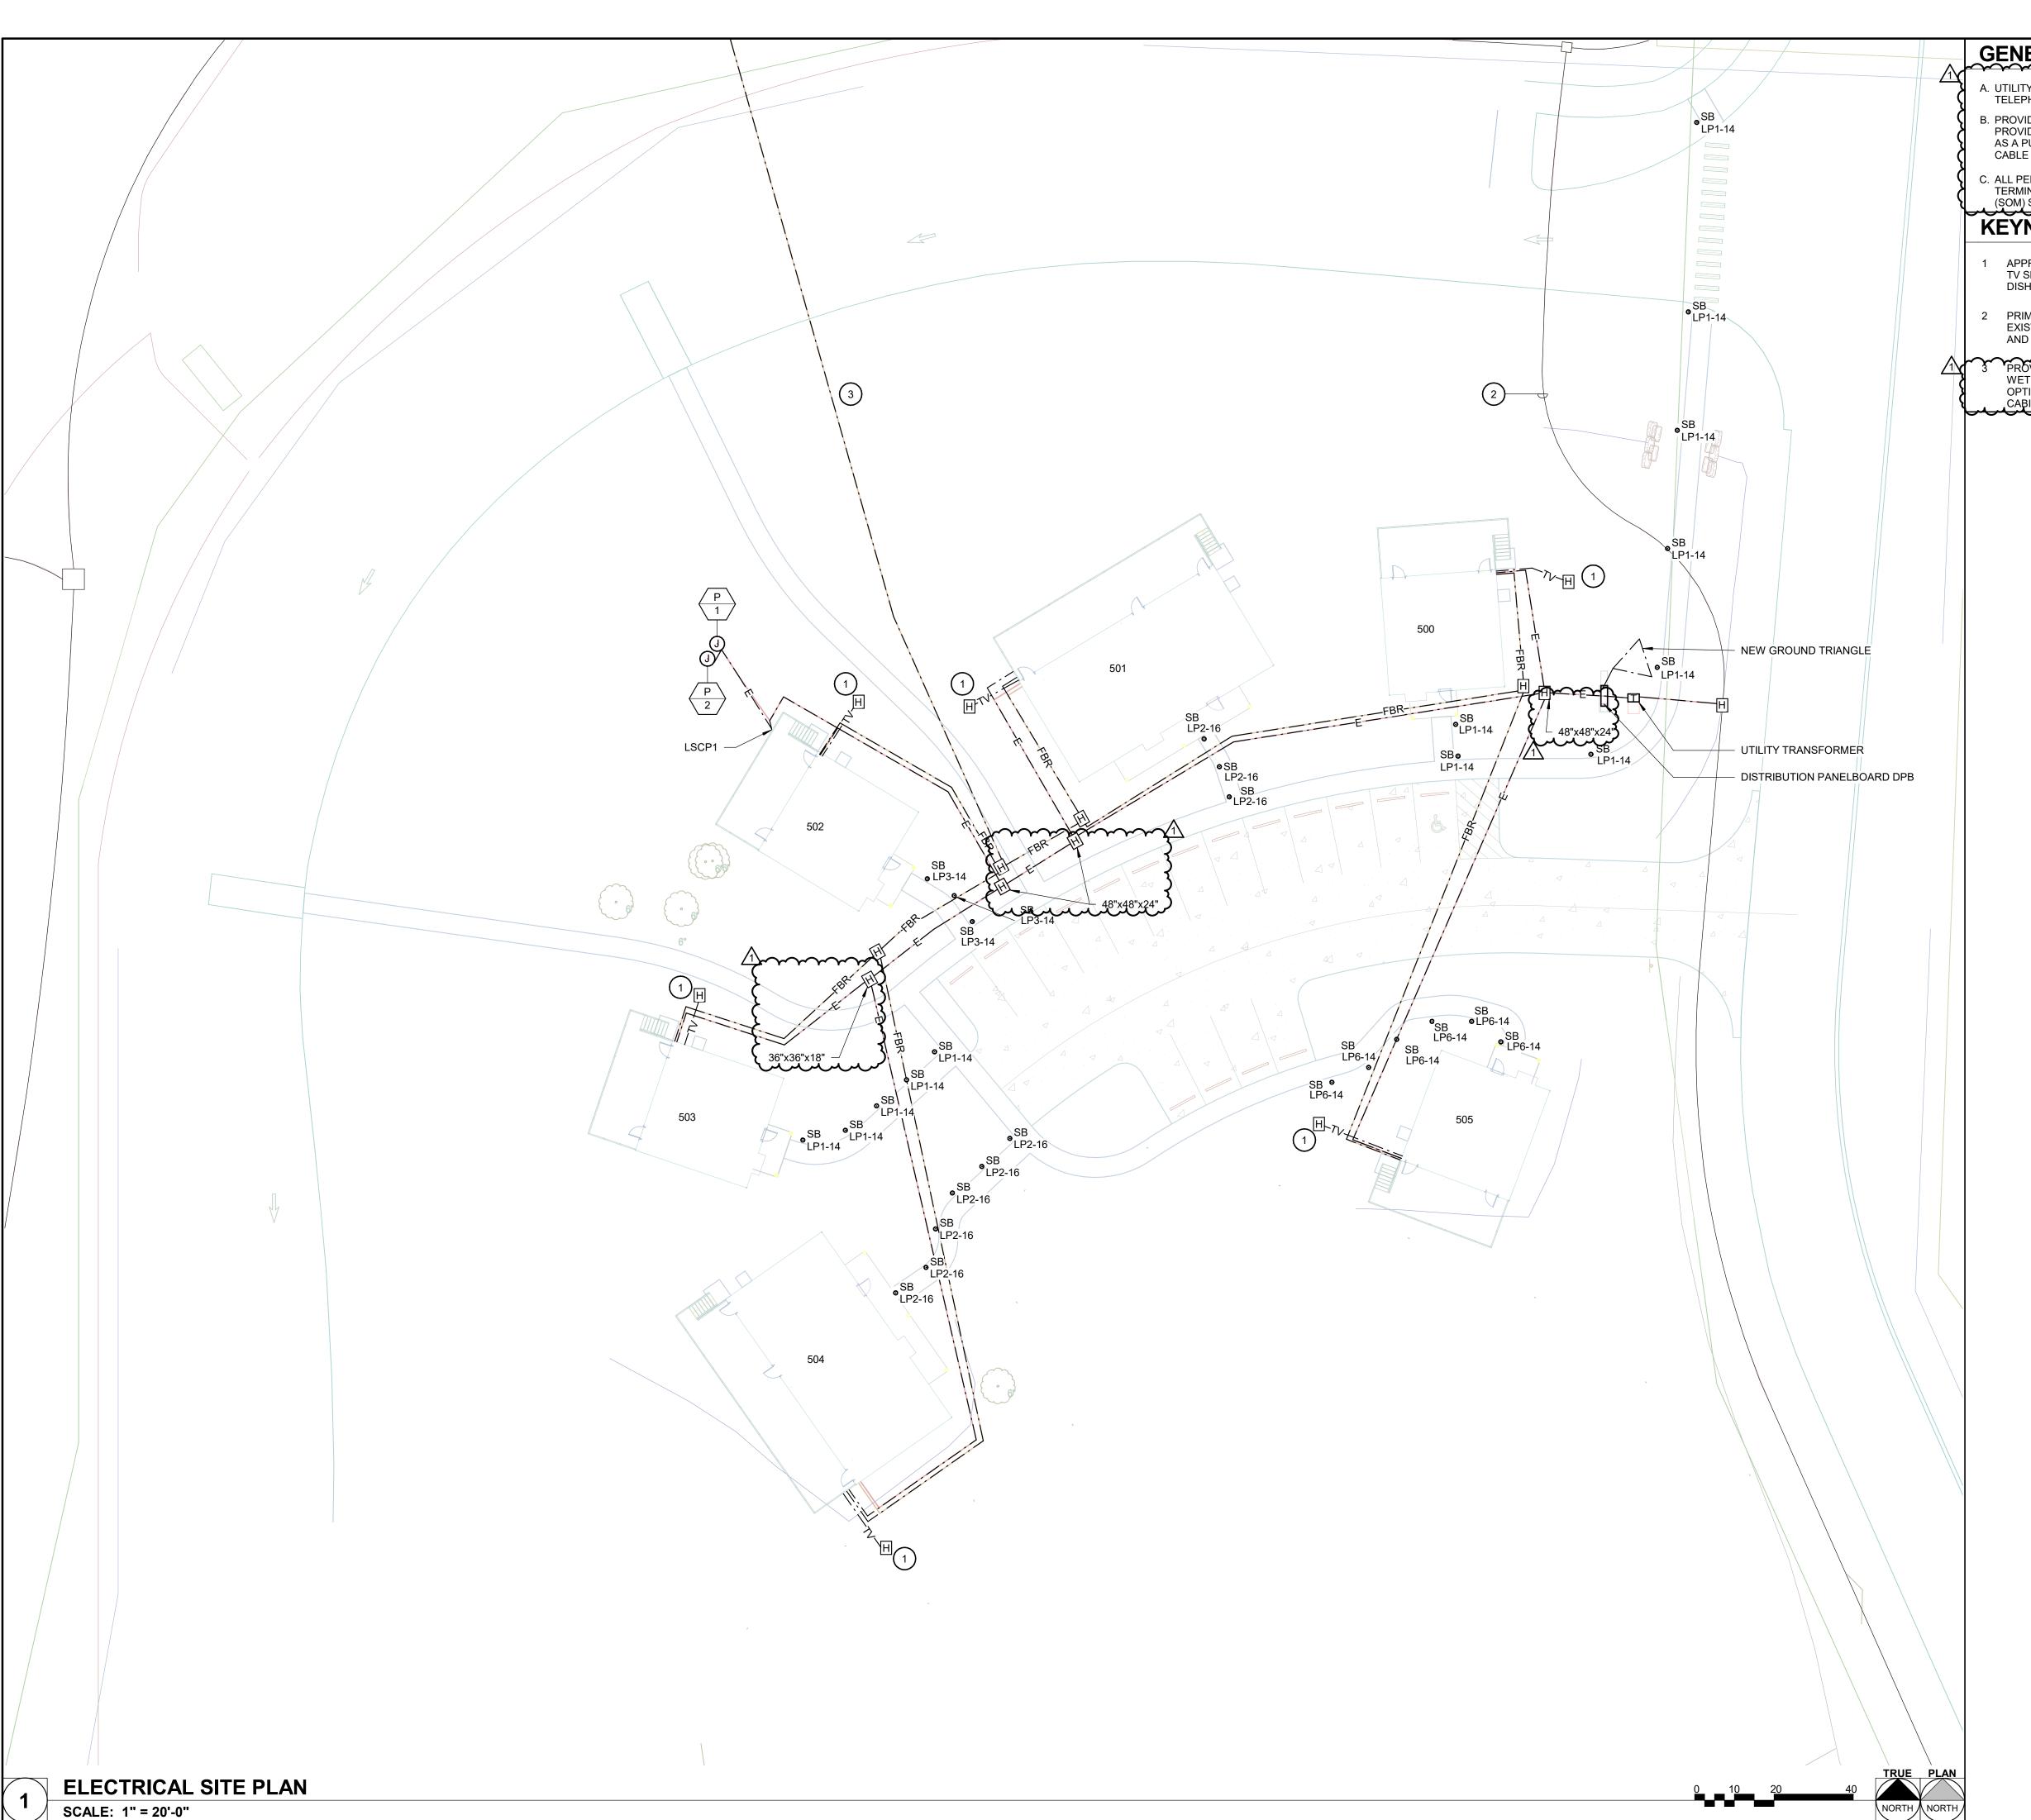

GENERAL NOTES

- A. UTILITY COMPANY: HOWELL OREGON COOPERATIVE 417-256-2131
- TELEPHONE COMPANY: CENTURYLINK 417-255-8221
- B. PROVIDE PULL BOXES FLUSH WITH EVERY 300' ALONG TELEPHONE FIBER CONDUIT. PROVIDE A PEDESTAL EVERY 900' ALONG TELEPHONE FIBER. THE PEDESTAL SHALL AS A PULL BOX. PROVIDE ADDITIONAL PEDESTALS AS NECESSARY TO ACCOMMODATE CABLE LENGTHS. SPLICING OF FIBER OPTIC CABLES WILL NOT BE ACCEPTABLE.
- C. ALL PEDESTAL & DEMARCATION LOCATIONS MUST ACCOMODATE FIBER

(SOM) STAFF. KEYNOTES

- APPROXIMATE LOCATION OF SATELLITE DISH. COORDINATE EXACT LOCATION WITH TV SERVICE PROVIDER AND CIVIL. PROVIDE A 2" RGS CONDUIT FROM SATELLITE DISH (MOUNTED ON A POLE) GOING TO EXTERIOR 4"x4" JUNCTION BOX ON CABIN.
- PRIMARY ELECTRICAL CONDUCTORS AND CONDUIT BY UTILITY. CONNECT TO EXISTING PRIMARY CONDUCTORS IN THIS AREA. COORDINATE EXACT LOCATIONS AND CONNECTIONS WITH UTILITY COMPANY.
- WET LOCATIONS IN 4"C FROM EXISTING MAIN FIBER CONNECTION IN LODGE. FIBER OPTIC CABLE TO TERMINATE ON FIBER DEMARC IN MECHANICAL ROOM FOR EACH

STATE OF MISSOURI MICHAEL L. PARSON, GOVERNOR





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DEPARTMENT OF NATURAL RESOURCES DIVISION OF STATE PARKS

ECHO BLUFF STATE PARK CONSTRUCT **SIX NEW CABINS**

Eminence, Missouri

PROJECT #.: X2208-01 SITE #.: FACILITY #.: 7815230517

DATE: DESCRIPTION: 1 05/11/2023 ADD 02

DRAWN BY: KES CHECKED BY: DFM DESIGNED BY: TLA

SHEET TITLE:

ELECTRICAL SITE PLAN

SHEET NUMBER:

E-401

SHEET 70 of 75 ISSUE DATE: 03/02/2023



GENERAL NOTES

A. PROVIDE PULL BOXES FLUSH WITH EVERY 300' ALONG TELEPHONE FIBER CONDUIT.
PROVIDE A PEDESTAL EVERY 900' ALONG TELEPHONE FIBER. THE PEDESTAL SHALL
AS A PULL BOX. PROVIDE ADDITIONAL PEDESTALS AS NECESSARY TO ACCOMMODATE
CABLE LENGTHS. SPLICING OF FIBER OPTIC CABLES WILL NOT BE ACCEPTABLE.


B. ALL PEDESTAL & DEMARCATION LOCATIONS MUST ACCOMODATE FIBER
TERMINATIONS TO BE MOUNTED. LOCKED AND MAINTAINED BY STATE OF MISSOURI
(SOM) STAFF.

KEYNOTES (#)

1 PROVIDE(6) 2-STRAND MULTI-MODE FIBER OPTIC CABLES, RATED FOR OUTDOOR WET LOCATIONS IN 4"C FROM EXISTING MAIN FIBER CONNECTION IN LODGE WITH ONE CABLE DEDICATED TO EACH NEW CABIN SITE SHOWN ON SHEET E-401.

2 ALL FIXTURES IN THIS AREA ARE FIXTURE TYPE SB, CIRCUITED TO LP1-14. SPACING FOR THESE FIXTURES IS 30'0".

STATE OF MISSOURI MICHAEL L. PARSON, GOVERNOR

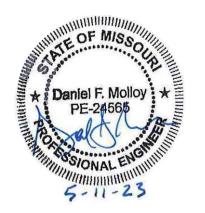



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DEPARTMENT OF NATURAL RESOURCES DIVISION OF STATE PARKS

ECHO BLUFF STATE PARK CONSTRUCT SIX NEW CABINS

Eminence, Missouri

PROJECT #.: X2208-01 SITE #.: 5235 FACILITY #.: 7815230517

DATE: DESCRIPTION:
1 05/11/2023 ADD 02

DRAWN BY: KES
CHECKED BY: DFM
DESIGNED BY: TLA

SHEET TITLE:

ELECTRICAL SITE PLAN

SHEET NUMBER:

E-402

SHEET 71 of 75 ISSUE DATE: 03/02/2023

					PAN	ELBC	ARD	DPB								
	VOLTAGE:	CONNECTED LOAD PER				ISOLATED GROUND BUS (Y/N):						N				
	PHASE/WIRE:			PHASE				BUSSING:						SEE SPEC		
RATED AMPERAGE: 1200 A						A E		3			MOUNTING:				SURFACE	
MAIN: 1200 A MCB 1									MCB GROUND FAULT PROTECTION (Y/N):						N	
SCC RATING (SYM): 42,000					126194 VA		128160 VA		MCB SHUNT TRIP (Y/N):							
					1052 A		1068 A		MCB 100% RATED (Y/N):					N		
СКТ	IDENTIFICATION	TYPE (*)	BKR SIZE	POLES		A	В		POLES	BKR SIZE	TYPE (*)	IDENTIFICATION			СКТ	
1	PANEL LP1 (2 BR)		225 A	2	18668	28575	21820	23885	2	300 A		PANEL LP2 (4 BR)			2	
5 7	PANEL LP3 (2 BR)		225 A	2	16292	16292	19420	19420	2	225 A		PANEL LP4 (2 BR)		-	6 8	
9	PANEL LP5 (4 BR)		300 A	2	28575	16292	22695	19420	2	225 A		PANEL LP6 (2 BR)	2 BR)		10 12	
13 15	PANEL LSCP1		20 A	2	1500		1500								14 16	
17															18	
19 Load C	lassification			Connected	Load	Demand	Factor	Demar	l Load			PANEL TOTALS			20	
Motor 1560 V/									00 VA							
Lighting - Continuous 3478 V/									8 VA TO		TOTA	L CONNECTED LOAD:	25435	4 VA		
Receptacle 14580 V						'A 84.29°		1229		90 VA		TOTAL DEMAND: 2488		9 VA		
Appliance - Dwelling Unit 29300 V					/A 75.00°		%	2197	75 VA TOTAL CO		ONNECTED CURRENT: 1060		4			
Other Continuous Load 12480 V					/A 125.00		% 1560		00 VA T		TOTA	OTAL DEMAND CURRENT:		4		
Other Non-Continuous Load 31550 \					'A 100.00%)%	3158	50 VA							
NOTES																

2. (*) NUMBER INDICATES BREAKER TYPE: 1 = AFCI, 2 = CLASS A 5mA GFCI, 3 = 30mA GFPE, 4 = SHUNT TRIP ACTIVATED, 5 = PANELBOARD FEEDER SERVING UNIT SHALL BE LOCKABLE USING A PADLOCK, IN ACCORDANCE WITH OSHA LOCK-OUT-TAG RULES, 6 = LSI, 7 = LSIG.

1. ALL BREAKERS ARE STANDARD UNLESS OTHERWISE NOTED

CKT

1. ALL BREAKERS ARE STANDARD UNLESS OTHERWISE NOTED

VOLTAGE: 240/120V

MAIN: 225 A MCB

TYPE BKR
(*) SIZE

20 A

20 A

20 A

20 A

40 A

20 A

20 A

25 A

20 A 1

20 A 1

20 A 1

20 A 1 500

1 l

Connected Load

520 VA

1298 VA

4820 VA

14500 VA

6480 VA

12870 VA

1 500

3335

PHASE/WIRE: 1Ø / 3W

RATED AMPERAGE: 225 A

SCC RATING (SYM): 22,000

IDENTIFICATION

1 LTG 202,203,205,206,EXTERIOR

9 RCPT - RM 201,204 EXHAUST FAN

ELECTRIC WALL HEATER (WH1)

27 HEAT PUMP CONDENSING UNIT

3 LTG 201,204,207

5 REFRIGERATOR

7 DISHWASHER

11 MICROWAVE

17 PATCH PANEL

19 HEAT TRACE

25 GAS FURNACE (GF1)

13 SPARE15 SPARE

29 (HP1)

31 SPARE

33 SPARE

35 SPARE

37 SPACE

39 SPACE

41 SPACE

Receptacle

Load Classification

Lighting - Continuous

Appliance - Dwelling Unit

Other Non-Continuous Load

Other Continuous Load

2. (*) NUMBER INDICATES BREAKER TYPE: 1 = AFCI, 2 = CLASS A 5mA GFCI, 3 = 30mA GFPE, 4 = SHUNT TRIP ACTIVATED, 5 = PANELBOARD FEEDER SERVING UNIT SHALL BE LOCKABLE USING A PADLOCK, IN ACCORDANCE WITH OSHA LOCK-OUT-TAG RULES, 6 = LSI, 7 = LSIG.

Demand Factor

125.00%

125.00%

100.00%

75.00%

125.00%

100.00%

PANELBOARD LP1

CONNECTED LOAD PER

PHASE

21820 VA

182 A

725 900

2200 720

1500 700

0 1200

500 200

2400 | 4800

3335 2640

0 | 0

Demand Load

650 VA

1623 VA

4820 VA

10875 VA

8100 VA

12870 VA

Α

18668 VA

156 A

200

4800

(TYPICAL FOR CABINS 1, 3, 4 & 6)

BKR TYPE SIZE (*)

20 A

20 A

20 A

20 A

20 A

20 A

50 A

30 A

20 A

20 A

20 A

1 20 A

20 A

20 A

POLES

ISOLATED GROUND BUS (Y/N): N

MCB SHUNT TRIP (Y/N):

MCB 100% RATED (Y/N):

RCPT - RM 203, EXTERIOR

TG EXTERIOR PATH

FIRE ALARM PANEL

ACCESS CONTROL

RANGE HOOD

FIREPLACE

RANGE

SPARE

SPARE

SPARE

SPACE

SPACE

SPACE

RCPT - RM 206, EXHAUST FAN

ELECTRIC WATER HEATER (EWH1)

PANEL TOTALS

TOTAL CONNECTED LOAD: 40488 VA

TOTAL CONNECTED CURRENT: 169 A

TOTAL DEMAND CURRENT: 162 A

TOTAL DEMAND: 38938 VA

IDENTIFICATION

MCB GROUND FAULT PROTECTION (Y/N):

RCPT - RM 207

RCPT - RM 206

RCPT- RM 202

RCPT - RM 201

BUSSING: SEE SPEC

Ν

Ν

42

MOUNTING: RECESSED

					PAN	IELBO)ARD	LP2	(TYPIC	AL FOR C	CABINS 2	2 & 5)		
	VOLTAGE: 240/120		CONNECTED LOAD PER				ISOLATED GROUND BUS (Y/N):							
PHASE/WIRE: 1Ø / 3W						PHASE				BUSSING:				
RATED AMPERAGE: 400 A						A B			MOUNTING:					SPEC SSED
	MAIN: 300 A N	1CB								MCB GI	ROUND	FAULT PROTECTION (Y/N):		
SCC RATING (SYM): 22,000						28575 VA 2388		885 VA						
2001011110 (01111). [22,000						38 A		9 A		MCB SHUNT TRIP (Y/N): MCB 100% RATED (Y/N):				
СКТ	IDENTIFICATION	TYPE (*)	BKR SIZE	POLES		А В		POLES	BKR SIZE	TYPE (*)	IDENTIFICATION		СКТ	
1	LTG-401,403,405,409,410,412,EXT		20 A	1	1375	900			1	20 A	1	RCPT - RM 410		2
3	LTG-402,404,406,407,408,411,412		20 A	1			793	720	1	20 A		RCPT - RM 401,411,412		4
5	RCPT - RM 409		20 A	1	900	700			1	20 A		RCPT - RM 405, EXHAUST FAN		6
7	HEAT TRACE	3	20 A	1			500	540	1	20 A		RCPT - RM 402		8
9	REFRIGERATOR	2	20 A	1	1000	900			1	20 A		RCPT - RM 408		10
11	RCPT - RM 406, EXHAUST FAN		20 A	1			700	900	1	20 A		RCPT - RM 407		12
13	RCPT - EXTERIOR		20 A	1	360	900			1	20 A		RCPT - RM 403, EXTERIOR		14
15	RCPT - RM 401,404		20 A	1			720	12	1	20 A		LTG EXTERIOR PATH		16
17	GAS FURNACE (GF1)		20 A	1	1000	3840	3840		2	45 A	2	HEAT PUMP CONDENSING UNIT		18
19	-ELECTRIC WALL HEATER (WH2)	RIC WALL HEATER (WH2) 2 25		2			2400	3840		-10 / 1		(HP2)		20
21	, ,	2 25		2	2400	4800			2 50 A	50 Δ	2	RANGE		22
23	RCPT - RM 402		20 A 1				360	4800				10.1102		24
25	DISHWASHER		20 A 1		2200	3000			2	30 A	2	ELECTRIC WATER HEATE	R (FWH2)	26
27	RANGE HOOD		20 A	1			500	3000		30 A		LLLOTRIO WATERTILATE	I (L V V I I Z)	28
29	ACCESS CONTROL		20 A	1	200	1500			1	20 A		MICROWAVE		30
31	ELECTRIC WALL HEATER (WH3)	25 A		2			2400	1200	1	20 A		FIRE ALARM PANEL		32
33	, ,				2400	200			1	20 A		FIREPLACE		34
35	PATCH PANEL		20 A	1			500	0	1	20 A		SPARE		36
37	SPARE		20 A	1	0	0			1	20 A	ļ	SPARE		38
39	SPARE		20 A	1			0	0	1	20 A		SPARE		40
41			20 A	1	0	0		_	1	20 A		SPARE		42
	Classification	Load Demand I				nd Load			PANEL TOTALS					
Motor 1040 V										0 VA			2014	
Lighting - Continuous 2180 V												L CONNECTED LOAD: 524		
Receptacle 9760 V										TOTAL CO		TOTAL DEMAND: 5099 DNNECTED CURRENT: 219		
Appliance - Dwelling Unit 14800 \								11100 VA		10				
Other Continuous Load 6000 V.								7500 VA 18680 VA		-	IOIA	L DEMAND CURRENT: 212	А	
Other Non-Continuous Load 18680 \						100.00)%	1868	80 VA	+				
										+				
										+				
					+									

NOTES

- 1. ALL BREAKERS ARE STANDARD UNLESS OTHERWISE NOTED
- 2. (*) NUMBER INDICATES BREAKER TYPE: 1 = AFCI, 2 = CLASS A 5mA GFCI, 3 = 30mA GFPE, 4 = SHUNT TRIP ACTIVATED, 5 = PANELBOARD FEEDER SERVING UNIT SHALL BE LOCKABLE USING A PADLOCK, IN ACCORDANCE WITH OSHA LOCK-OUT-TAG RULES, 6 = LSI, 7 = LSIG.

STATE OF MISSOURI MICHAEL L. PARSON, GOVERNOR





20 ALLEN AVENUE, SUITE 200 ST LOUIS, MISSOURI 63119 (314) 962-7900 / info@f-w.com

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CONSTRUCTION DOCUMENTS

ADMINISTRATION
DIVISION OF FACILITIES
MANAGEMENT, DESIGN
AND CONSTRUCTION

OFFICE OF

DEPARTMENT OF NATURAL RESOURCES DIVISION OF STATE PARKS

ECHO BLUFF STATE PARK CONSTRUCT SIX NEW CABINS

Eminence, Missouri

PROJECT #.: X2208-01
SITE #.: 5235
FACILITY #.: 7815230517
DATE: DESCRIPTION:

1 05/11/2023 ADD 02

DRAWN BY: KES
CHECKED BY: DFM
DESIGNED BY: TLA

SHEET TITLE:

SCHEDULES

SHEET NUMBER:

E-603

SHEET 75 of 75 ISSUE DATE: 03/02/2023