
REPLACE HIGHWAY PP BRIDGE KATY TRAIL STATE PARK MOKANE, MISSOURI

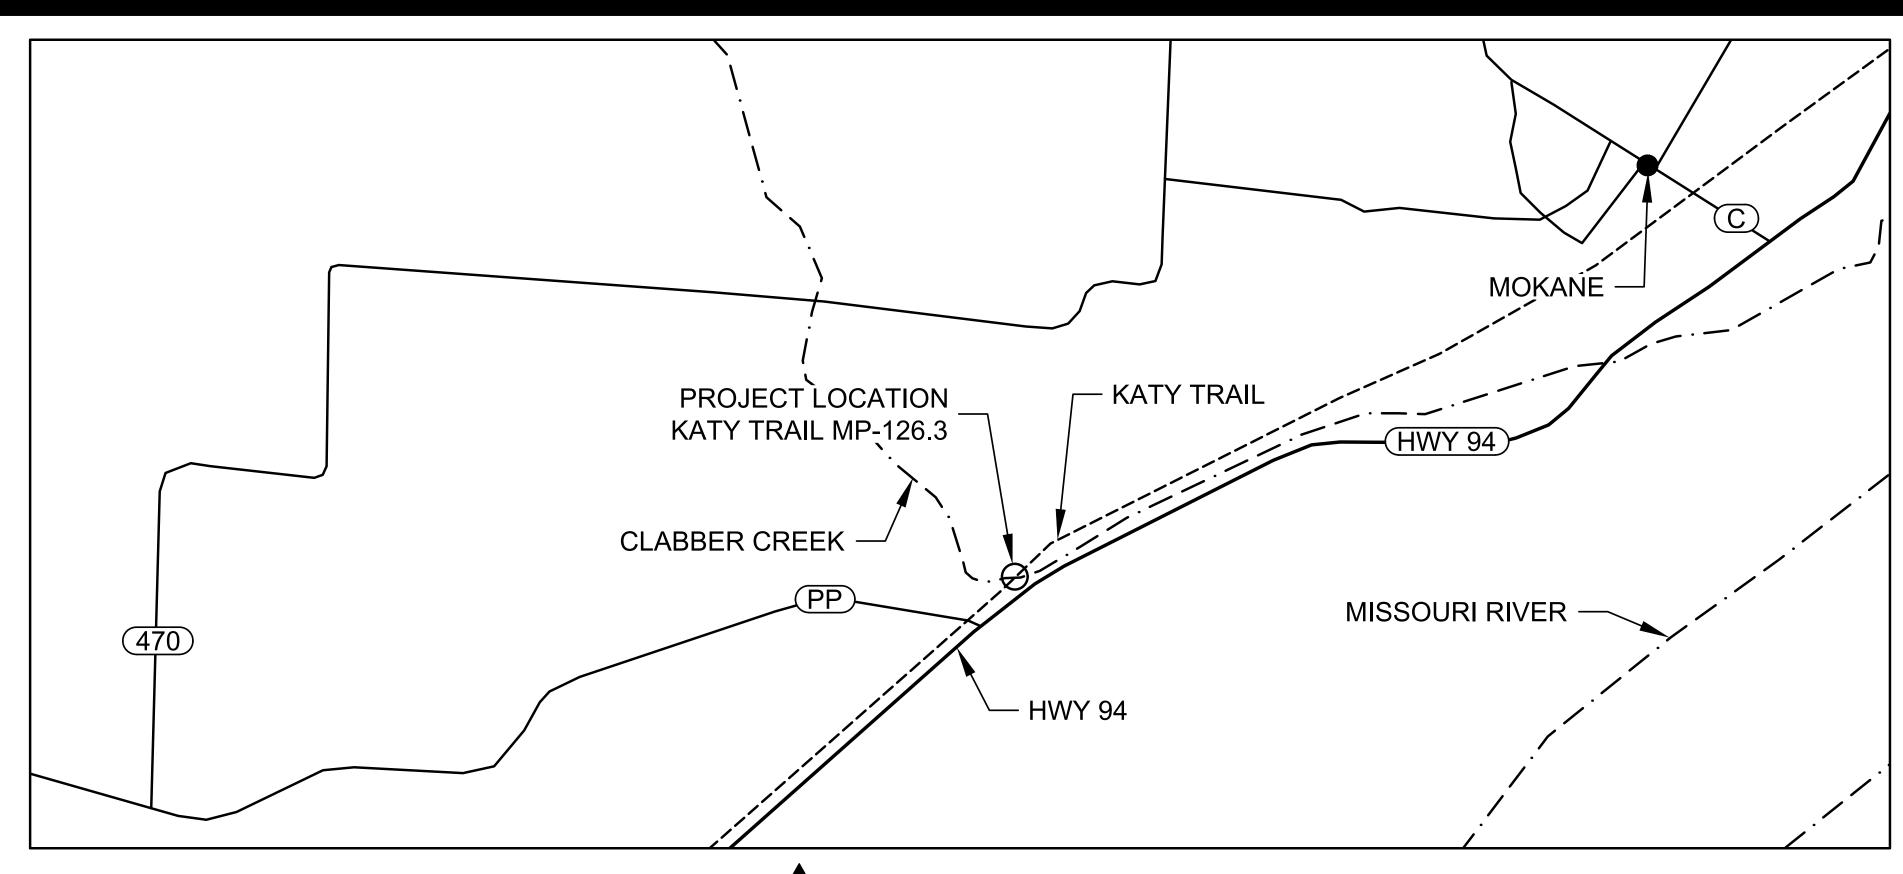



OWNER: STATE OF MISSOURI

MICHAEL L. PARSON,

GOVERNOR

DEPARTMENT OF NATURAL RESOURCES
DIVISION OF MISSOURI STATE PARKS

PROJECT OFFICE OF ADMINISTRATION

MANAGEMENT: DIVISION OF FACILITIES MANAGEMENT,

DESIGN AND CONSTRUCTION





1901 Pennsylvania Dr. Columbia, MO 65202 573.814.1568 | www.mecresults.com

MO CERTIFICATES OF AUTHORITY E-2006023253 S-2012009395 EXPIRES DEC. 31, 2024 DESIGNER: McCLURE ENGINEERING COMPANY

MICHAEL M. HALL, P.E.


MHALL@MCCLUREVISION.COM

PROJECT NUMBER: X2227-01

SITE NUMBER: 5501


ASSET NUMBER: 7815501002

SHEET NUMBER:

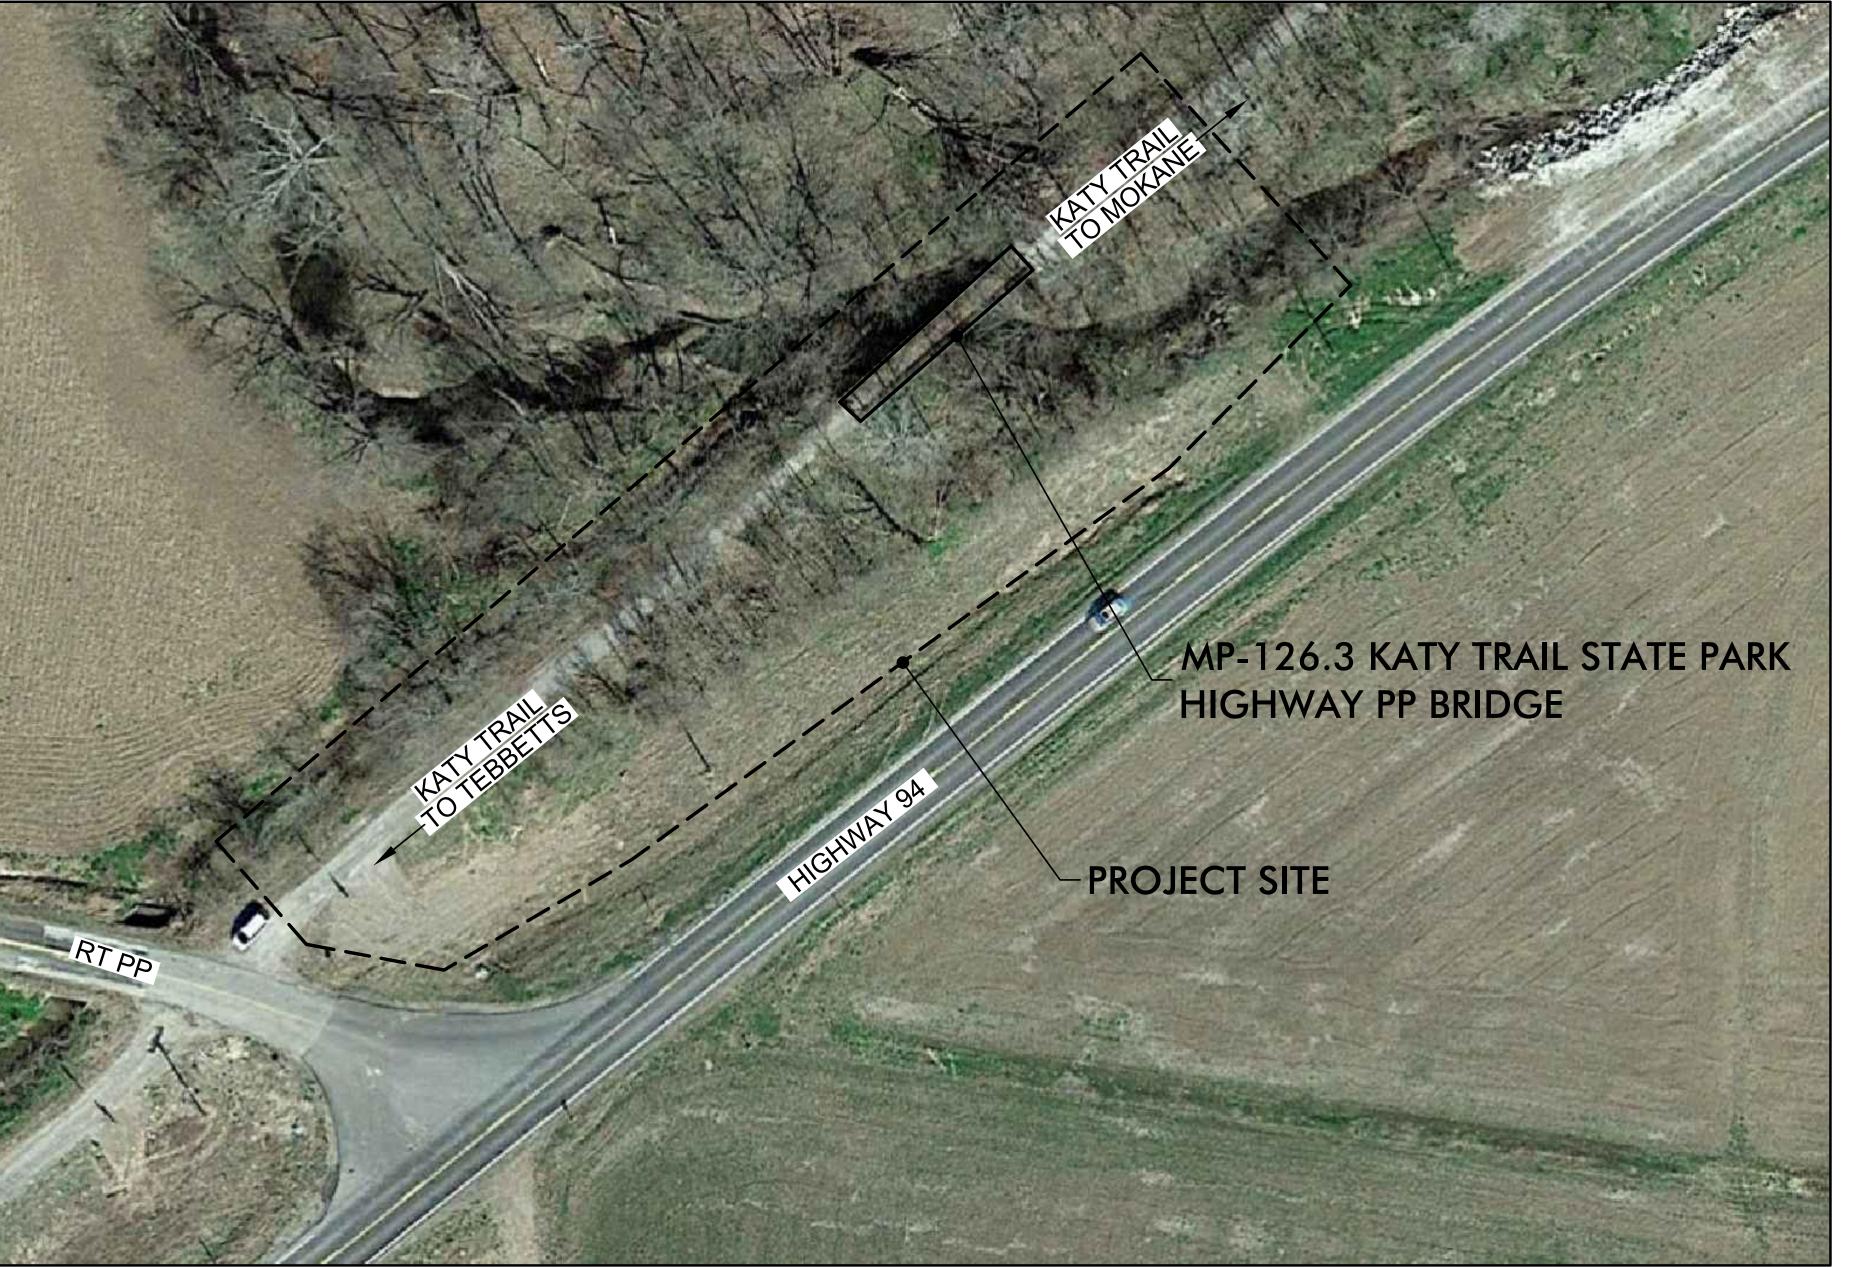




ll ll	VDE:	X OF SHEETS
NUMBER	TITLE	DESCRIPTION
1	G-001	COVER SHEET
2	G-002	LOCATION MAP & LEGENDS
3	G-003	GENERAL NOTES & QUANTITIES
4	CD-001	SITE DEMOLITION PLAN
5	C-101	SITE PLAN & PROFILE
6	C-102	EROSION CONTROL PLAN
7	C-103	TRAIL CROSS SECTIONS
8	C-104	TRAIL CROSS SECTIONS
9	S-201	BENT 1 & 2 PLAN
10	S-202	BENT 1 ELEVATION & SECTIONS
11	S-203	BENT 2 ELEVATIONS & SECTIONS
12	S-204	BILL OF REINFORCING
13	D-001	TYPICAL DETAILS

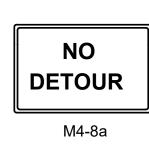



TRAFFIC CONTROL SIGNAGE

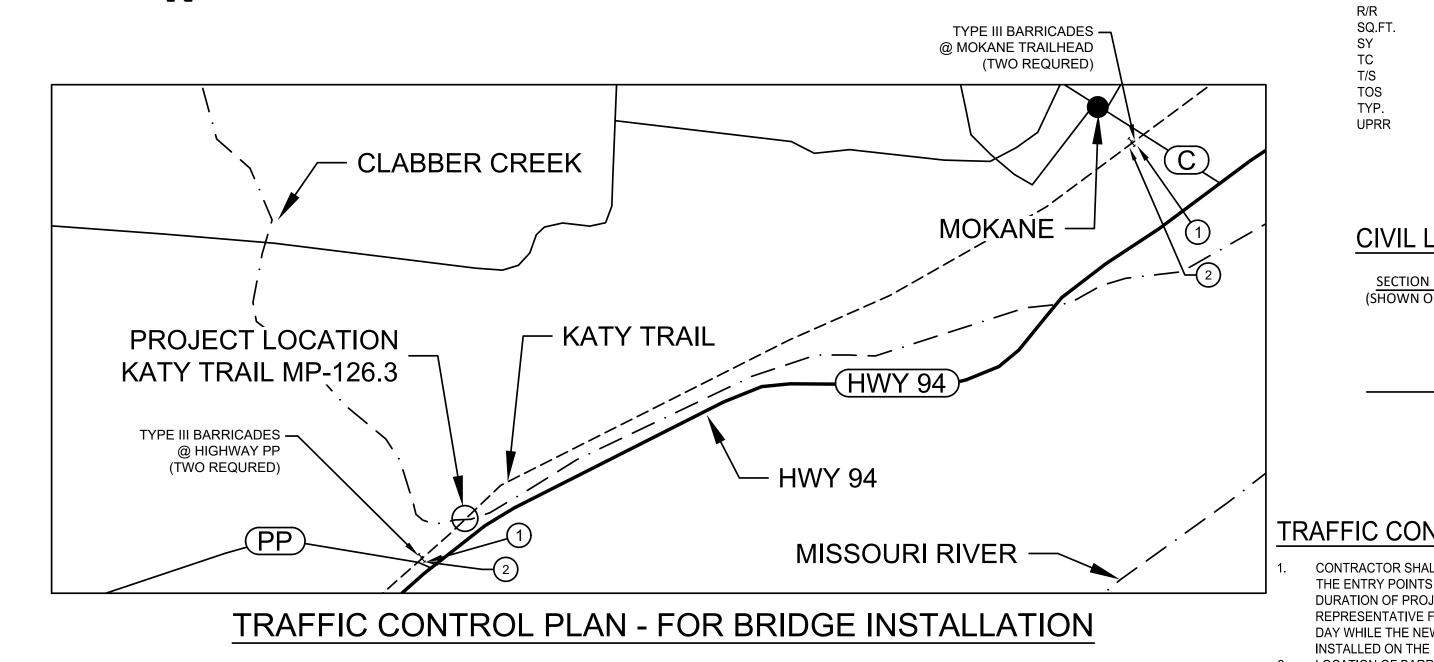

HATCH LEGEND

THE ENTRY POINTS OF THE KATY TRAIL THROUGH

DAY WHILE THE NEW BRIDGE STRUCTURE IS BEING

b. AT THE MOKANE TRAILHEAD.
BARRICADES SHALL INCLUDE R11-2 'TRAIL CLOSED' AND
M4-8a "NO DETOUR" SIGNS.


DURATION OF PROJECT AND PROVIDE ONE

INSTALLED ON THE BRIDGE ABUTMENTS.

LOCATION OF BARRICADES SHALL BE:

a. AT HIGHWAY PP/KATY TRAIL.

LINETYPE LEGEND

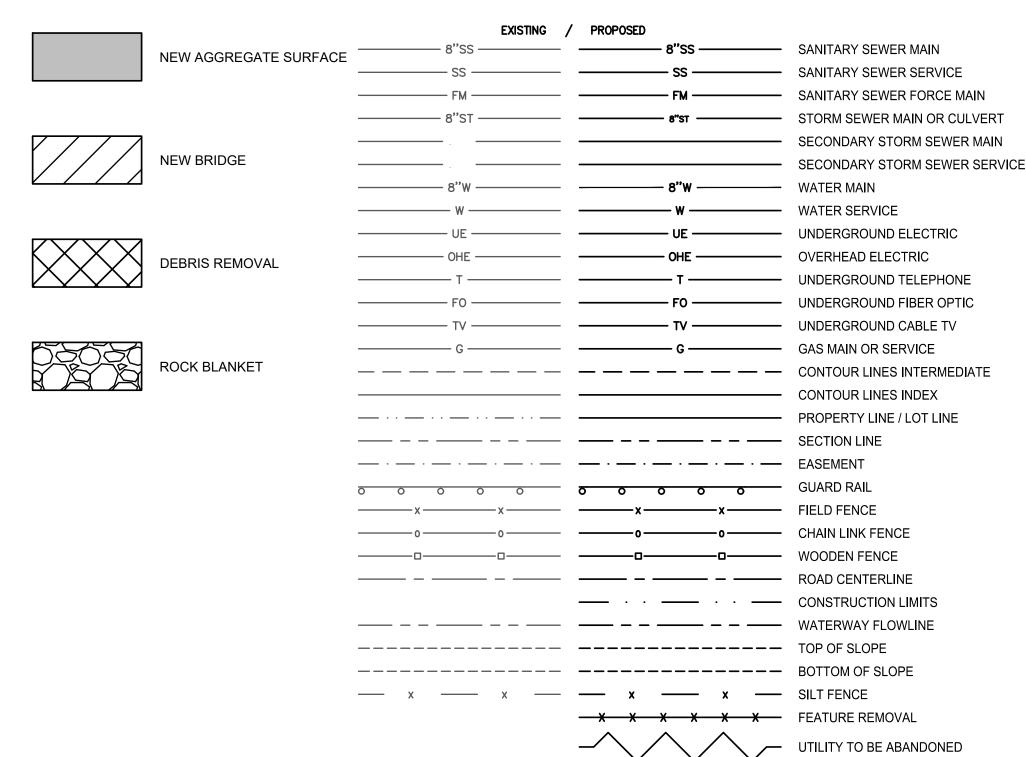

SYMBOL LEGEND

		<u>2 1 MB</u>	OL LEGI	<u>END</u>
A.C.C. ANSI ASTM ASSY. AWWA BC BM BOT C CP CL DIP	ASPHALT CEMENT CONCRETE AMERICAN NATIONAL STANDARDS INSTITUTE AMERICAN SOCIETY FOR TESTING & MATERIALS ASSEMBLY AMERICAN WATER WORKS ASSOCIATION BACK OF CURB BENCH MARK BOTTOM OF SLOPE CUT CONTROL POINT CENTERLINE DUCTILE IRON PIPE	EXISTING /	PROPOSED S S S S S S S S S S S S S S S S S S	SANITARY SEWER MANHOLE SANITARY SEWER CLEANOUT AIR RELEASE MANHOLE/DRAIN MANHO STORM SEWER MANHOLE STORM SEWER CLEANOUT STORM SEWER INTAKE STORM SEWER BEEHIVE INTAKE FLARED END SECTION FIRE HYDRANT WATER VALVE WATER VALVE MANHOLE
EP F FES	EDGE OF PAVEMENT FILL FLARED END SECTION	₩M ○+YH	₩M ○+YH	WATER METER MANHOLE YARD HYDRANT
FL HMA MAX. MIN. S P.C.C. PSI. R.O.W. RCP R/R SQ.FT. SY TC T/S TOS TYP. UPRR	FLARED END SECTION FLOWLINE HOT MIX ASPHALT MAXIMUM MINIMUM OFFSET PORTLAND CEMENT CONCRETE PRESSURE PER SQUARE INCH RIGHT OF WAY REINFORCED CONCRETE PIPE RAILROAD SQUARE FEET SQUARE YARD TOP OF CURB TOP OF SLAB TOP OF SLOPE TYPICAL UNION PACIFIC RAILROAD			ELECTRIC MANHOLE / VAULT ELECTRIC PEDESTAL / TRANSFORMER OUTDOOR ELECTRIC POWER OUTLET POWER POLE POWER POLE w/ STREET LIGHT STREET LIGHT POLE GUY WIRE TRAFFIC SIGNAL TRAFFIC SIGNAL BOX TRAFFIC SIGNAL MANHOLE / VAULT RAILROAD CROSSING SIGNAL TELEPHONE MANHOLE / VAULT TELEPHONE PEDESTAL CABLE TV MANHOLE / VAULT CABLE TV PEDESTAL GAS VALVE IRON PIN FOUND/PROPERTY PIN
SECTI	ON DESIGNATION N ON SAME SHEET)	® 	® MB	BOLLARD (BUMPER POST) MISCELLANEOUS SIGN MAILBOX
	VIEWING DIRECTION OF SECTION	© \{\}	® ∰ ₩	WELL DECIDUOUS TREE EVERGREEN TREE
	A SECTION IDENTIFICATION			SHRUB OR BUSH
		M Fl	·····	TREE OR SHRUB LINE STUMP
FIC CO	ONTROL NOTES:	•	•	SANITARY SERVICE
TRACTOR S	SHALL PROVIDE TYPE III BARRICADES AT	© FP □		SOIL BORINGS
FINITE Y POIN	NIS DE THE KATY TRAIL THRUIGH	/ 1		LLAC DOLE

FLAG POLE

SLOPE INDICATORS

CONTROL POINT

BENCH MARK

IRON PIN SET

PROPERTY PIN

STATE OF MISSOURI MICHAEL L. PARSON, **GOVERNOR**





OFFICE OF ADMINISTRATION DIVISION OF FACILITIES MANAGEMENT, **DESIGN & CONSTRUCTION**

DEPARTMENT OF NATURAL RESOURCES **DIVISION OF MISSOURI** STATE PARKS

REPLACE HIGHWAY PP BRIDGE KATY TRAIL STATE PARK

KATY TRAIL - MP126.3 MOKANE, MO

PROJECT NO. X2227-01 SITE NO. 5501 ASSET NO. 7815501002

REVISION:
DATE:
REVISION:
DATE:
REVISION:
DATE:
ISSUE DATE: 03/03/2023

CAD DWG FILE:X2227-01-C-GNL-01
DRAWN BY: JJB
CHECKED BY: MMH
DESIGNED BY: ADM

SHEET TITLE:

LOCATION MAP & LEGENDS

SHEET NUMBER:

|G-002|

FOUND	ATION D	ATA	
LOCATION		END BENT 1	END BENT 2
PILE TYPE AND SIZE		HP10x42	HP10x42
NUMBER		3	3
APPROXIMATE LENGTH	(FT)	33	33
DESIGN BEARING	(TONS)	40	50
ESTIMATED PILE TIP ELEV.	(FT)	502.00	502.00
MINIMUM PILE TIP ELEV.	(FT)	523.50	517.50
	LOCATION PILE TYPE AND SIZE NUMBER APPROXIMATE LENGTH DESIGN BEARING ESTIMATED PILE TIP ELEV.	LOCATION PILE TYPE AND SIZE NUMBER APPROXIMATE LENGTH (FT) DESIGN BEARING (TONS) ESTIMATED PILE TIP ELEV. (FT)	PILE TYPE AND SIZE HP10x42 NUMBER 3 APPROXIMATE LENGTH (FT) 33 DESIGN BEARING (TONS) 40 ESTIMATED PILE TIP ELEV. (FT) 502.00

NOTE:

- MINIMUM ENERGY REQUIREMENT OF HAMMER IS BASED ON PLAN LENGTH AND DESIGN BEARING VALUE OF PILES.
- PILES SHALL BE DRIVEN TO PRACTICAL REFUSAL PER FHWA-MODIFIED GATES DYNAMIC FORMULA.
- NO ADDITIONAL PAYMENT WILL BE FOR PILE SPLICES.
- EXCAVATION FOR STRUCTURES SHALL INCLUDE ALL CLASSES OF EXCAVATION. NO EXTRA PAYMENT WILL BE MADE FOR ROCK EXCAVATION IF ROCK IS ENCOUNTERED. REFER TO GEOTECHNICAL REPORT IN SPECIFICATION INDEX.

DESIGN SPECIFICATIONS:

AASHTO LRFD GUIDE SPECIFICATIONS FOR DESIGN OF PEDESTRIAN BRIDGES, 2ND EDITION.
AASHTO LRFD SPECIFICATIONS 7TH EDITION AND APPLICABLE INTERIMS.
STATE OFFICE OF ADMINISTRATION DESIGN GUIDELINES.

DESIGN LOADING:

DEAD LOAD
UNIFORM LIVE LOAD OF 90 PSF
H20 DESIGN VEHICLE
LATERAL WIND LOAD OF 25 PSF ON PROJECTED AREA
20 PSF UPWARD WIND

DESIGN UNIT STRESSES:

CLASS B-2 CONCRETE f'c = 4,000 PSI
REINFORCING STEEL (NON-EPOXY) (GRADE 60) Fy = 60,000 PSI
STEEL PILING = A709 GRADE 50, Fb = 12,500 PSI
STRUCTURAL STEEL = A709 GRADE 50

NEOPRENE BEARINGS:

BEARINGS SHALL BE 60 DUROMETER PLAIN NEOPRENE PADS.

NEOPRENE PAD SHALL BE BONDED TO BEARING SEAR WITH AN EPOXY ADHESIVE AS APPROVED BY BEARING MANUFACTURER FOR BONDING NEOPRENE TO CONCRETE.

REINFORCING STEEL

MINIMUM CLEARANCE TO REINFORCING STEEL SHALL 2", UNLESS OTHERWISE SHOWN.

PAYMENT FOR REINFORCING STEEL SHALL BE INCLUDED IN CONCRETE ITEMS.

STRUCTURAL STEEL:

CONTRACTOR SHALL UTILIZE A FABRICATOR THAT MEETS THE APPROPRIATE INSTITUTE OF STEEL CONSTRUCTION (AISC) CERTIFICATION.

DIAPHRAGM STRUCTURAL STEEL: A706 GRADE 50.

ALL WELDING OPERATIONS RELATED TO STRUCTURAL STEEL, INCLUDING MATERIAL AND PERSONNEL SHALL MEET THE AMERICAN WELDING SOCIETY (AWS) SPECIFICATIONS.

WELDED STUD SHEAR CONNECTORS SHALL CONFORM TO REQUIREMENTS OF ASTM A108.

GEOTECHNICAL INVESTIGATION:

REFER TO GEOTECHNICAL REPORT IN APPENDIX A OF THE PROJECT SPECIFICATIONS FOR ADDITIONAL INFORMATION. PROVIDE PILE DRIVING POINTS AT ALL PILE LOCATIONS.

ALL PILES SHALL DRIVEN TO ROCK. BASIS OF ROCK DEPTH FOR BENTS 1 & 2 FROM ADJACENT MODOT BRIDGE K0936 AS ROCK IS DEEPER THAN THE SOIL INVESTIGATION FOR THE PROJECT. (SEE APPX A)

ROCK BLANKET

ROCK BLANKET SHALL BE PROVIDED AND PLACED AT EACH ABUTMENT TO LIMITS SHOWN ON PLANS AND SHALL MATCH EXISTING GROUNDLINE AS CLOSE AS POSSIBLE. EXCAVATION REQUIRED TO PLACE ROCK BLANKET SHALL BE CONSIDERED INCIDENTAL.

MATERIAL FOR ROCK BLANKET SHALL BE DURABLE STONE CONTAINING A COMBINED TOTAL OF NO MORE THAN 10 PERCENT OF SOIL, SAND, SHALE OR NON-DURABLE ROCK.

MATERIAL SHALL CONTAIN A LARGE PERCENTAGE OF PIECES AS LARGE AS THE THICKNESS OF BLANKET WILL PERMIT, WITH ENOUGH SMALLER PIECES OF VARIOUS SIZES TO FILL THE LARGER VOIDS. FOR TYPE 2 ROCK BLANKET AT LEAST 60 PERCENT OF THE MASS SHALL BE PIECES HAVING A VOLUME OF 1 CUBIC FOOT OR MORE. ACCEPTANCE OF QUALITY AND SIZE OF MATERIAL WILL BE MADE BY VISUAL INSPECTION AT THE JOB SITE BY THE ENGINEER.

A TRENCH AT TOE OF ROCK SLOPE SHALL BE EXCAVATED TO A DEPTH OF 4 FEET. ROCK SHALL BE PLACED ON SLOPE TO SPECIFIED THICKNESS AND MANIPULATED SUCH THAT MOST FLAT SIDES ARE IN CONTACT WITH SUB-GRADE. THEREBY ELIMINATING LARGE VOIDS. FINISHED SURFACE OF BLANKET SHALL BE SET TO AN APPEARANCE FREE FROM SEGREGATION AND WITH A PROPORTIONATE QUANTITY OF LARGER PIECES SHOWING.

GEOTEXTILE/FILTER FABRIC:

GEOTEXTILE FOR FILTER FABRIC SHALL BE IN ACCRODANCE WITH PHYSICAL AND CHEMICAL REQURIEMENTS OF AASHTO M 288.

PERMANENT EROSION CONTROL GEOTEXTILE SHALL BE USED UNDER THE ROCK BLANKET. THE MINIMUM

PERMITTIVITY SHALL BE 1.0 SEC-1. THE MATERIAL SHALL BE EITHER AASHTO CLASS 1 OR CLASS 2.

SUBSURFACE DRAINAGE GEOTEXTILE SHALL BE USED AS IN SUBSURFACE DRAINAGE AS A FILTER TO PROTECT DRAINAGE MEDIA FROM CLOGGING WITH FINES FROM ADJACENT SOIL SUCH AS WRAPPING OF DRAIN PIPES. MINIMUM PERMATIVITTY SHALL BE 1.0 SEC-1. THE MATERIAL SHALL AASHTO CLASS 2.

SEPARATION GEOTEXTILE SHALL BE USED AS A SEPARATION MATERIAL TO PREVENT MIXING OF DISSIMILAR MATERIAL AND TO CONTROL MIGRATION OF BACKFILL MATERIAL. THE MINIMUM PERMITTIVITY SHALL BE 1.0 SEC-1. THE MATERIAL SHALL AASHTO CLASS01.

AGGREGATE BASE:

AGGREGATE BASE FOR CONSTRUCTION OF NEW TRAIL SHALL BE MISSOURI DEPARTMENT OF TRANSPORTATION TYPE 5 OR APPROVED EQUAL. THE AGGREGATE SHALL CONSIST OF CRUSHED STONE OR GRAVEL. THE AGGREGATE SHALL NOT CONTAIN MORE THAN 15 PERCENT DELETERIOUS ROCK AND SHALE. IF CRUSHED STONE IS USED, SAND MAY BE ADDED ONLY FOR THE PURPOSED OF REDUCING THE PLASTICITY INDEX OF THE FRACTION PASSING THE NO. 40 SIEVE IN THE FINISHED PRODUCT. THE FRACTION PASSING THE NO. 40 SIEVE SHALL HAVE A PLASTICITY INDEX NOT TO EXCEED SIX. AND SAND, SILT AND CLAY, AND DELETERIOUS ROCK AND SHALE SHALL BE UNIFORMLY DISTRIBUTED THROUGHOUT THE MATERIAL. WHEN SAND AND GRAVEL AGGREGATE ARE USED, THE FRACTION PASSING THE NO. 200 SIEVE SHALL BE LESS THAN ONE HALF OF THAT FRACTION PASSING THE NO. 30 SIEVE. AGGREGATE BASE SHALL BE IN ACCORDANCE WITH THE FOLLOWING GRADATION REQUIREMENTS:

SIEVE	PERCENT BY WEIGHT
1-INCH	100
1/2-INCH	60-90
NO. 4	35-60
NO. 30	10-35
NO. 200	0-15

GENERAL NOTES:

STATE OFFICE OF ADMINISTRATION DESIGN SPECIFICATIONS AND THE PROJECT SPECIFICATIONS SHALL GOVERN.

THE CONTRACTOR SHALL LOCATE ALL UTILITIES AROUND THE BRIDGE PROJECT LOCATION PRIOR TO EXCAVATION OR CONSTRUCTION.

REFER TO PROJECT SPECIFICATIONS FOR BRIDGE SUPPLIER AND BRIDGE STYLE ALTERNATIVES. RAILS AND PICKETS SHALL BE INCLUDED WITH THE PREFABRICATED BRIDGE. (SEE SPECIFICATION SECTION 2021412)

CONTRACTORS SCOPE OF WORK:

SHALL INCLUDE THE FOLLOWING TASKS AND THOSE ACTIVITIES INCIDENTAL TO THE FOLLOWING TASKS:

FIELD VERIFY ALL DIMENSIONS PRIOR TO ORDERING MATERIALS.

SELECTION AND PURCHASE OF PREFABRICATED BRIDGE IN ACCORDANCE WITH PROJECT.

PROVIDE "H" STYLE BRIDGE CROSS SECTION.

CONSTRUCT BRIDGE ABUTMENTS INCLUDING ALL REQUIRED INCIDENTAL CONCRETE WORK.

ASSEMBLY OF PREFABRICATED BRIDGE AND ITS ERECTION ON THE COMPLETED ABUTMENT FOUNDATIONS IN ACCORDANCE WITH BRIDGE MANUFACTURERS RECOMMENDATION

CONSTRUCTION OF CAST IN PLACE CONCRETE DECK ON BRIDGE ACCORDING TO MANUFACTURERS RECOMMENDED DETAILS AND SPECIFICATIONS INCLUDING PROVIDING REBAR, RELATED MATERIALS AND CONCRETE CURING.

PURCHASE AND INSTALLATION OF ALL NECESSARY MATERIALS FOR INSTALLATION OF JOINT SEALS BETWEEN THE ABUTMENT BACKWALL AND THE ENDS OF DECK AT EACH END BENT LOCATION.

PEDESTRIAN BRIDGE MANUFACTURER SHALL SPECIFY JOINT SEAL SYSTEM TO BE USED AND SHALL PROVIDE INSTALLATION INSTRUCTIONS.

FABRICATE AND INSTALL APPROACH HANDRAIL ON WINGWALLS AT END BENTS WHICH MATCHES RAILING ON BRIDGES.

CONTRACTOR SHALL SUBMIT SEALED PLANS AND CALCULATIONS BY A MISSOURI REGISTERED PROFESSIONAL ENGINEER FOR PREFABRICATED BRIDGE TO ENGINEER FOR REVIEW AND APPROVAL. PLANS SHALL CLEARLY IDENTIFY THE MANUFACTURER, STYLE, SECTION, REACTIONS, ABUTMENT SEAT REQUIREMENTS, BEARING ASSEMBLY GEOMETRY AND JOINT SEAL DETAILS.

CONTRACTOR SHALL NOT BEGIN CONSTRUCTION OF BRIDGE ABUTMENTS UNTIL THEY HAVE RECEIVED APPROVED SHOP DRAWINGS FOR PREFABRICATED BRIDGE.

PREFABRICATED BRIDGE MANUFACTURER IS RESPONSIBLE FOR DESIGN OF CONCRETE DECK AND DECK REINFORCING. CONTRACTOR SHALL SUPPLY DECK REINFORCING TO CONSTRUCT CONCRETE BRIDGE DECK IN ACCORDANCE WITH MANUFACTURERS SUPPLIED DETAILS AND SPECIFICATIONS.

NON-SHRINK GROUT FOR ANCHOR BOLT INSTALLATION SHALL BE NON-METALLIC, PRE-PACKED GROUT CONFORMING TO ASTM C-1107 WITH A MINIMUM COMPRESSIVE STRENGTH OF 7,000 PSI AT 28 DAYS WHEN TESTED ACCORDING TO ASTM C 109

CONCRETE BRIDGE DECK SHALL HAVE A BROOM FINISH

SITE NOTES:

- 1. THESE PLANS WERE GENERATED FROM AVAILABLE RECORDS OF EXISTING DESIGN DOCUMENTS AND FIELD SURVEYS CONDUCTED FOR THIS PROJECT. FIELD VERIFICATION OF ALL ELEVATIONS AND EXISTING CONDITIONS SHOWN ON THE PLANS SHOULD BE MADE PRIOR TO COMMENCEMENT OF CONSTRUCTION ACTIVITIES. McCLURE ENGINEERING COMPANY DOES NOT IMPLY OR GUARANTEE ACCURACY OF THE EXISTING INFORMATION REPRESENTED ON THE PLANS.
- 2. NOTIFY ALL UTILITY COMPANIES KNOWN TO BE WITHIN THE CONSTRUCTION LIMITS OF THE SCHEDULE PRIOR TO EACH STAGE OF CONSTRUCTION.
- SCHEDULE PRIOR TO EACH STAGE OF CONSTRUCTION.
 3. PRIOR TO CONSTRUCTION, THE CONTRACTOR SHALL UNCOVER EXISTING UTILITIES AT CRITICAL
- LOCATIONS TO VERIFY EXACT HORIZONTAL AND VERTICAL LOCATION.

 4. MISSOURI UNDERGROUND FACILITY SAFETY AND DAMAGE PREVENTION STATUTE (RSMo CHAPTER 319) REQUIRES NOTICE TO MISSOURI ONE CALL 1-800-DIG-RITE (OR 811) NOT LESS THAN 72 HOURS OR MORE THAN 10 WORKING DAYS PRIOR TO BEGINNING EXCAVATION, EXCLUDING WEEKENDS
- AND HOLIDAYS. SEE WWW.MO1CALL.COM FOR ADDITIONAL DETAILS.

 5. THE MEANS AND METHODS OF SAFETY OF THE CONTRACTOR'S EMPLOYEES ARE SOLELY THE
- RESPONSIBILITY OF THE CONTRACTOR

 6. NO WORK SHALL BE PERFORMED BEYOND THE PROJECT LIMITS WITHOUT PRIOR AUTHORIZATION
- OF THE OWNER'S REPRESENTATIVE.

ROADWAYS, ETC. SHALL BE KEPT CLEAN AT ALL TIMES.

- 7. PROTECT EXISTING UTILITIES DURING CONSTRUCTION.8. MAINTAIN POSITIVE DRAINAGE ON THE SITE THROUGHOUT THE PROJECT DURATION.
- MAINTAIN POSITIVE DRAINAGE ON THE SITE THROUGHOUT THE PROJECT DURATION.
 SITE CLEAN-UP SHALL BE PERFORMED ON AN DAILY BASIS. SIDEWALKS, PARKING LOTS,
- ALL OPEN EXCAVATIONS SHALL BE PROTECTED. ORANGE CONSTRUCTION FENCE AS A MINIMUM.
 REPLACE ANY PROPERTY MONUMENTS REMOVED, DISTURBED OR DESTROYED DURING CONSTRUCTION. MONUMENTS SHALL BE SET BY A LAND SURVEYOR REGISTERED TO PRACTICE IN
- THE STATE OF MISSOURI.

 12. CONTROL DUST SPREADING FROM ALL WORK AND STAGING AREAS PER SPECIFICATION 024116.
- 13. ANY WORK REQUIRED TO COMPLETE THE SCOPE OF THIS PROJECT BUT NOT SPECIFICALLY CALLED OUT SHALL BE CONSIDERED INCIDENTAL TO THE PROJECT. NO ADDITIONAL COMPENSATION SHALL BE ALLOWED FOR THE COMPLETION OF THIS WORK.
- 14. REPAIR OR REPLACE EXISTING FACILITIES (CURBS, PAVEMENT, UTILITIES, ETC.) TO REMAIN, AT NO ADDITIONAL EXPENSE TO THE OWNER.
- 15. WORK THAT DOES NOT CONFORM TO THE REQUIREMENTS OF THE CONTRACT WILL BE CONSIDERED UNACCEPTABLE. UNACCEPTABLE WORK, WHETHER THE RESULT OF POOR WORKMANSHIP, USE OF DEFECTIVE MATERIALS, DAMAGE THROUGH CARELESSNESS OR ANY OTHER CAUSE, FOUND TO EXIST PRIOR TO THE FINAL ACCEPTANCE OF THE WORK SHALL BE REMOVED AND REPLACED IN AN ACCEPTABLE MANNER, AS REQUIRED BY McCLURE ENGINEERING COMPANY AT THE CONTRACTOR'S EXPENSE. WORK DONE CONTRARY TO THE DIRECTION OF McCLURE ENGINEERING COMPANY, WORK DONE BEYOND THE PROJECT LIMITS OR ANY EXTRA WORK DONE WITHOUT AUTHORIZATION WILL NOT BE PAID FOR.

MISSOURI DEPARTMENT OF NATURAL RESOURCES LAND DISTURBANCE NOTE:

- THIS PROJECT DISTURBS LESS THAN ONE ACRE IN TOTAL, THEREFORE IS EXEMPT FROM NEEDING A LAND DISTURBANCE PERMIT FROM THE STATE OF MISSOURI OR LOCAL REGULATORS.
- 2. IT SHALL BE THE RESPONSIBILITY OF THE CONTRACTOR TO SUBMIT FORM 106, TO MISSOURI DEPARTMENT OF NATURAL RESOURCES, HISTORIC PRESERVATION PROGRAM FOR ANY BORROW AREAS TO BE USED ON THIS PROJECT.

STATE OF MISSOURI MICHAEL L. PARSON, GOVERNOR



olumbia, MO 65202 573.814.1568 | ww.mecresults.com IO CERTIFICATES OF AUTHORITY E-2006023253 S-2012009395



OFFICE OF ADMINISTRATION DIVISION OF FACILITIES MANAGEMENT, DESIGN & CONSTRUCTION

DEPARTMENT OF NATURAL RESOURCES DIVISION OF MISSOURI STATE PARKS

REPLACE HIGHWAY PP BRIDGE KATY TRAIL STATE PARK

KATY TRAIL - MP126.3 MOKANE, MO 65059

PROJECT NO. X2227-01 SITE NO. 5501 ASSET NO. 7815501002

REVISION:
DATE:
REVISION:
DATE:
REVISION:
DATE:
ISSUE DATE: 03/03/2023


CAD DWG FILE:X2227-01-C-GNL-01
DRAWN BY: JJB
CHECKED BY: MMH
DESIGNED BY: ADM

SHEET TITLE:

GENERAL NOTES & QUANTITIES

SHEET NUMBER

G-003

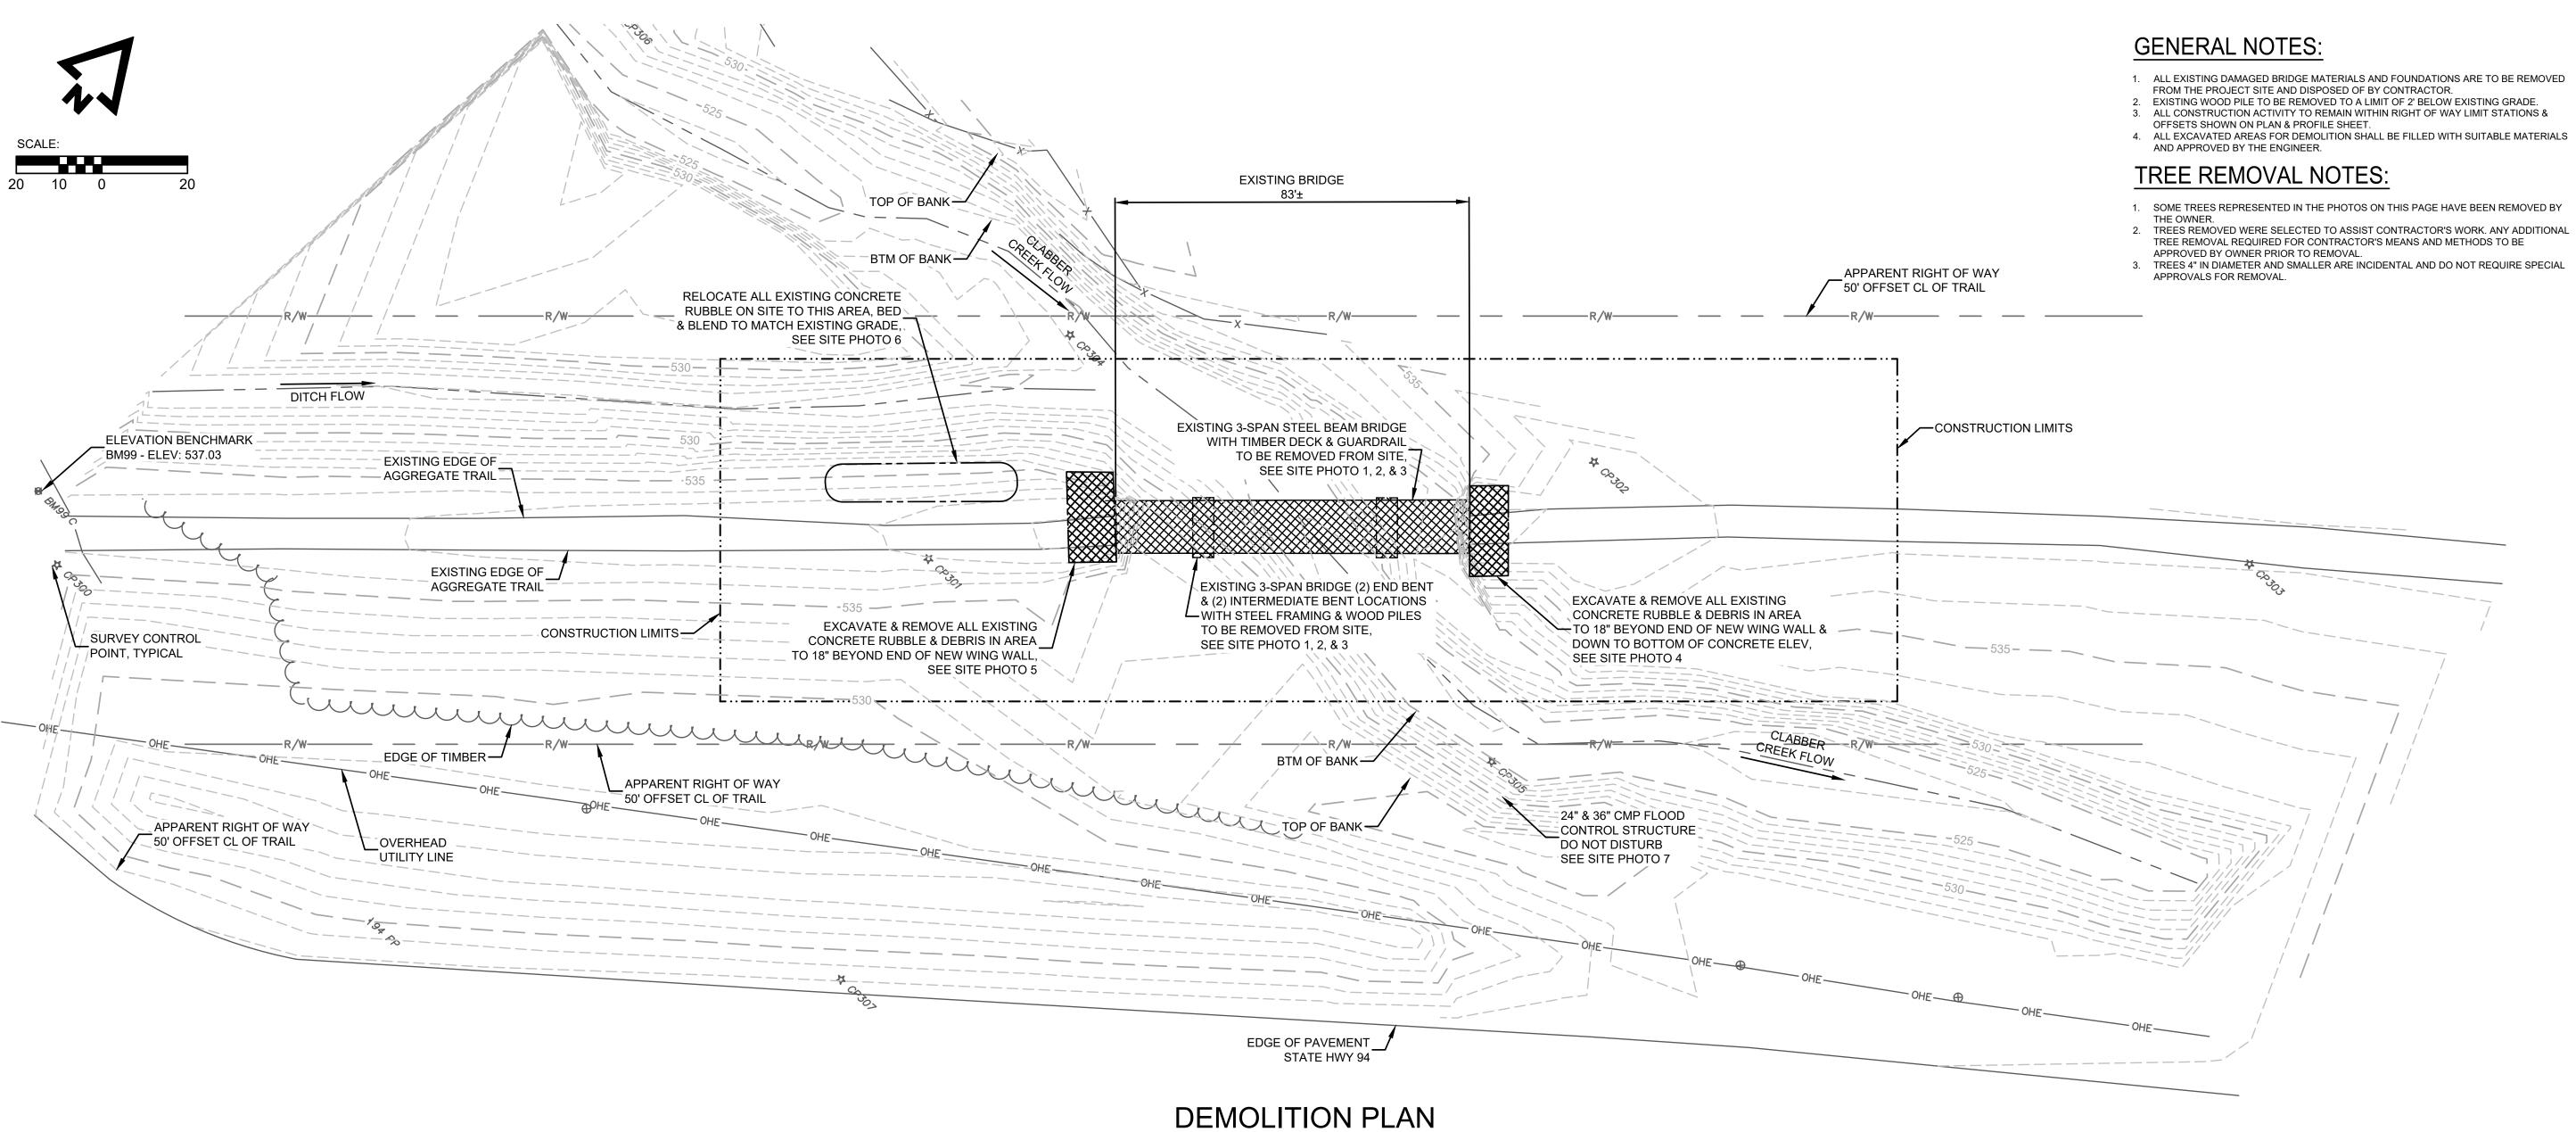



NOT TO SCALE



SITE PHOTO 5 NOT TO SCALE



RELOCATE EXISTING CONCRETE
RUBBLE SHOWN TO BE ON LEFT SIDE OF SITE PHOTO 2 EMBANKMENT FROM STATION 11+50 TO 12+00 NOT TO SCALE



SITE PHOTO 6 NOT TO SCALE



REMOVE ENTIRE EXISTING 3-SPAN BRIDGE WITH STEEL & TIMBER FRAMING FROM SITE SITE PHOTO 3 NOT TO SCALE



SITE PHOTO 7 NOT TO SCALE

 DO NOT DISTURB EXISTING CMP PIPE FLOOD CONTROL STUCTURES

- 1. ALL EXISTING DAMAGED BRIDGE MATERIALS AND FOUNDATIONS ARE TO BE REMOVED

Exp. 12/31/2023

STATE OF MISSOURI

MICHAEL L. PARSON,

GOVERNOR



OFFICE OF ADMINISTRATION DIVISION OF FACILITIES MANAGEMENT, **DESIGN & CONSTRUCTION**

DEPARTMENT OF NATURAL RESOURCES **DIVISION OF MISSOURI** STATE PARKS

REPLACE HIGHWAY PP BRIDGE KATY TRAIL STATE PARK

KATY TRAIL - MP126.3 MOKANE, MO

PROJECT NO. X2227-01 SITE NO. 5501 ASSET NO. 7815501002

REVISION:
DATE:
REVISION:
DATE:
REVISION:
DATE:

ISSUE DATE: 03/03/2023

CAD DWG FILE:X2227-01-C-DEM-01
DRAWN BY: JJB
CHECKED BY: MMH
DESIGNED BY: ADM

SHEET TITLE:

RELOCATE EXISTING CONCRETE
 RUBBLE SHOWN TO BE ON LEFT SIDE OF
 EMBANKMENT FROM STATION 11+50 TO 12+00


SITE PHOTO 4


NOT TO SCALE

SITE DEMOLITION PLAN

SHEET NUMBER:

CD-001

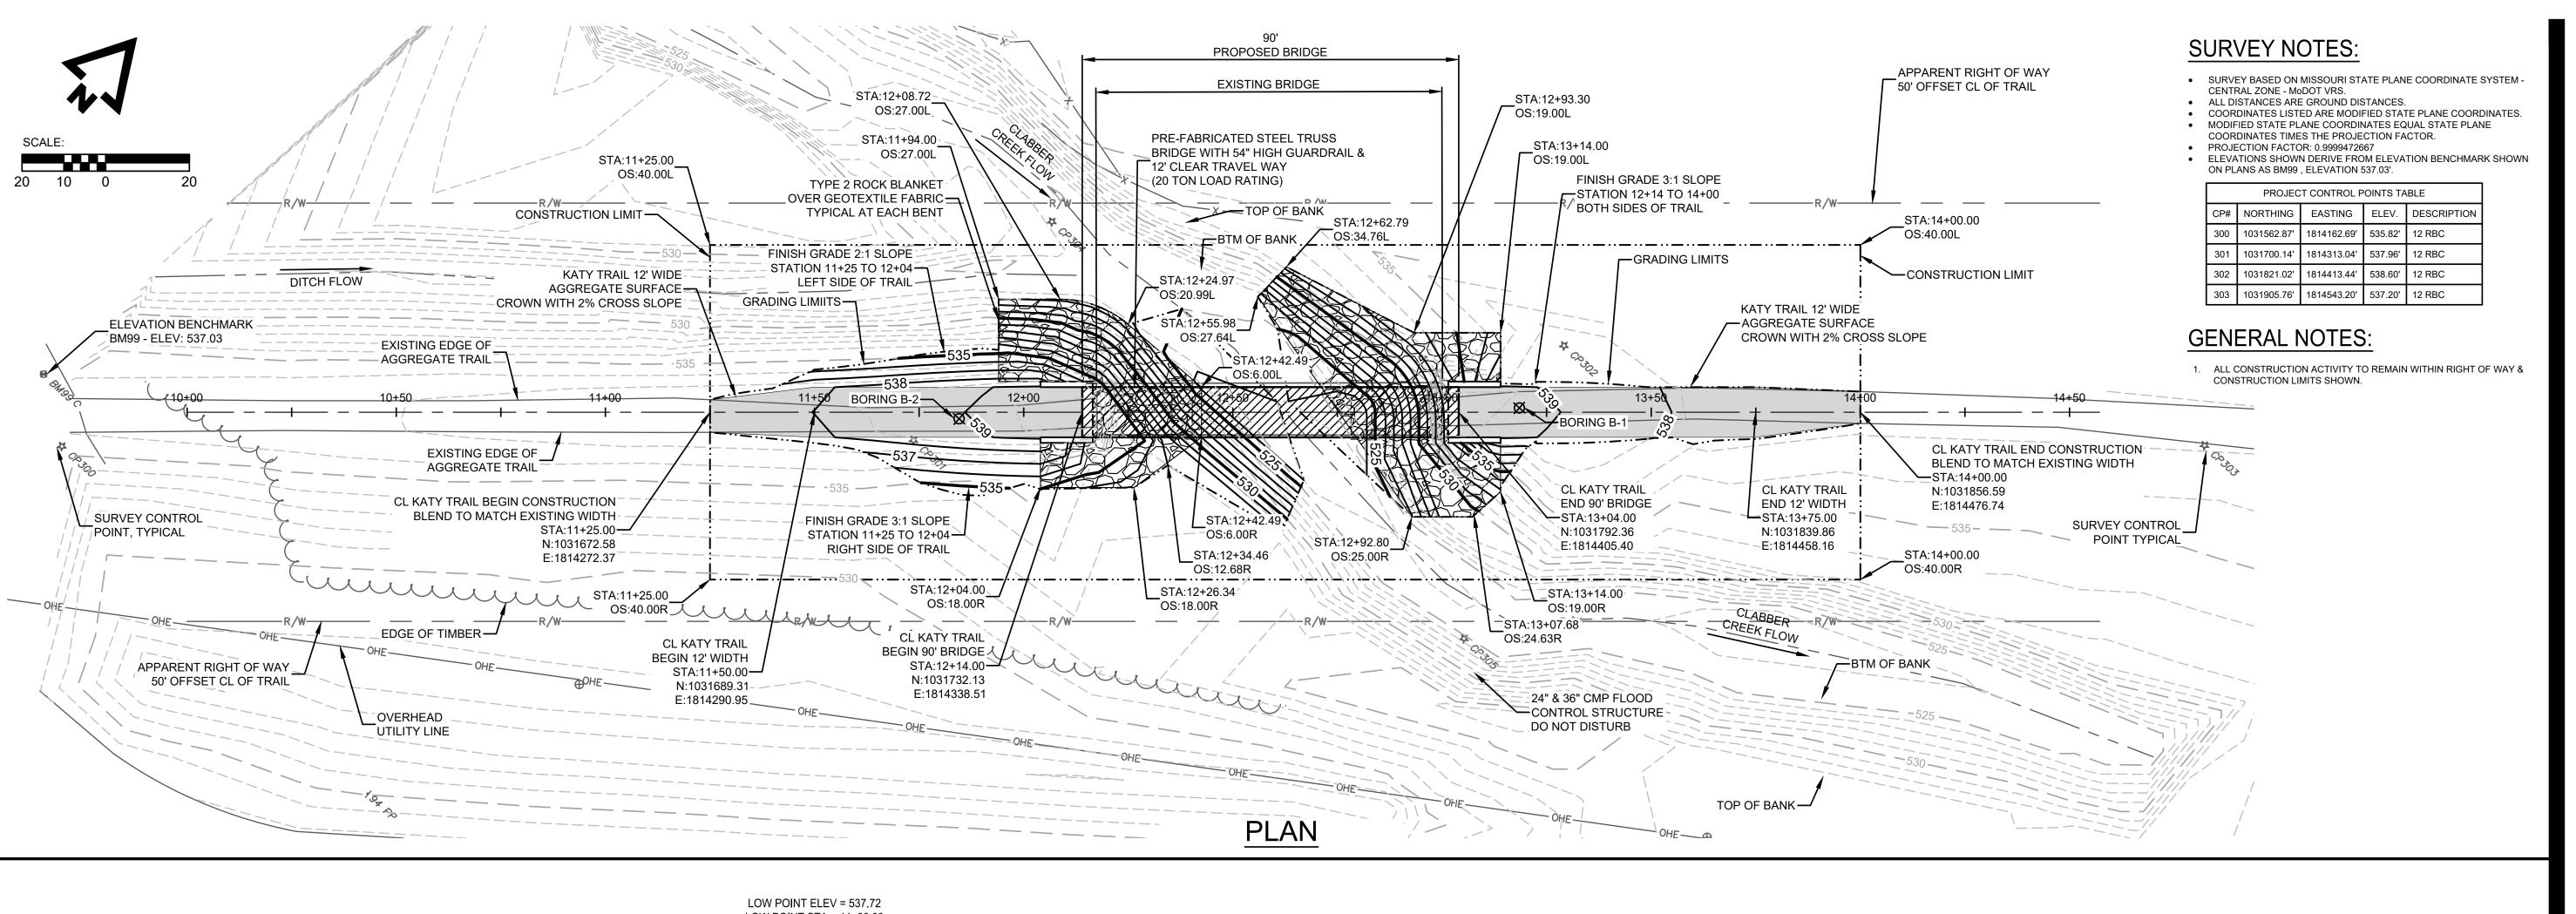

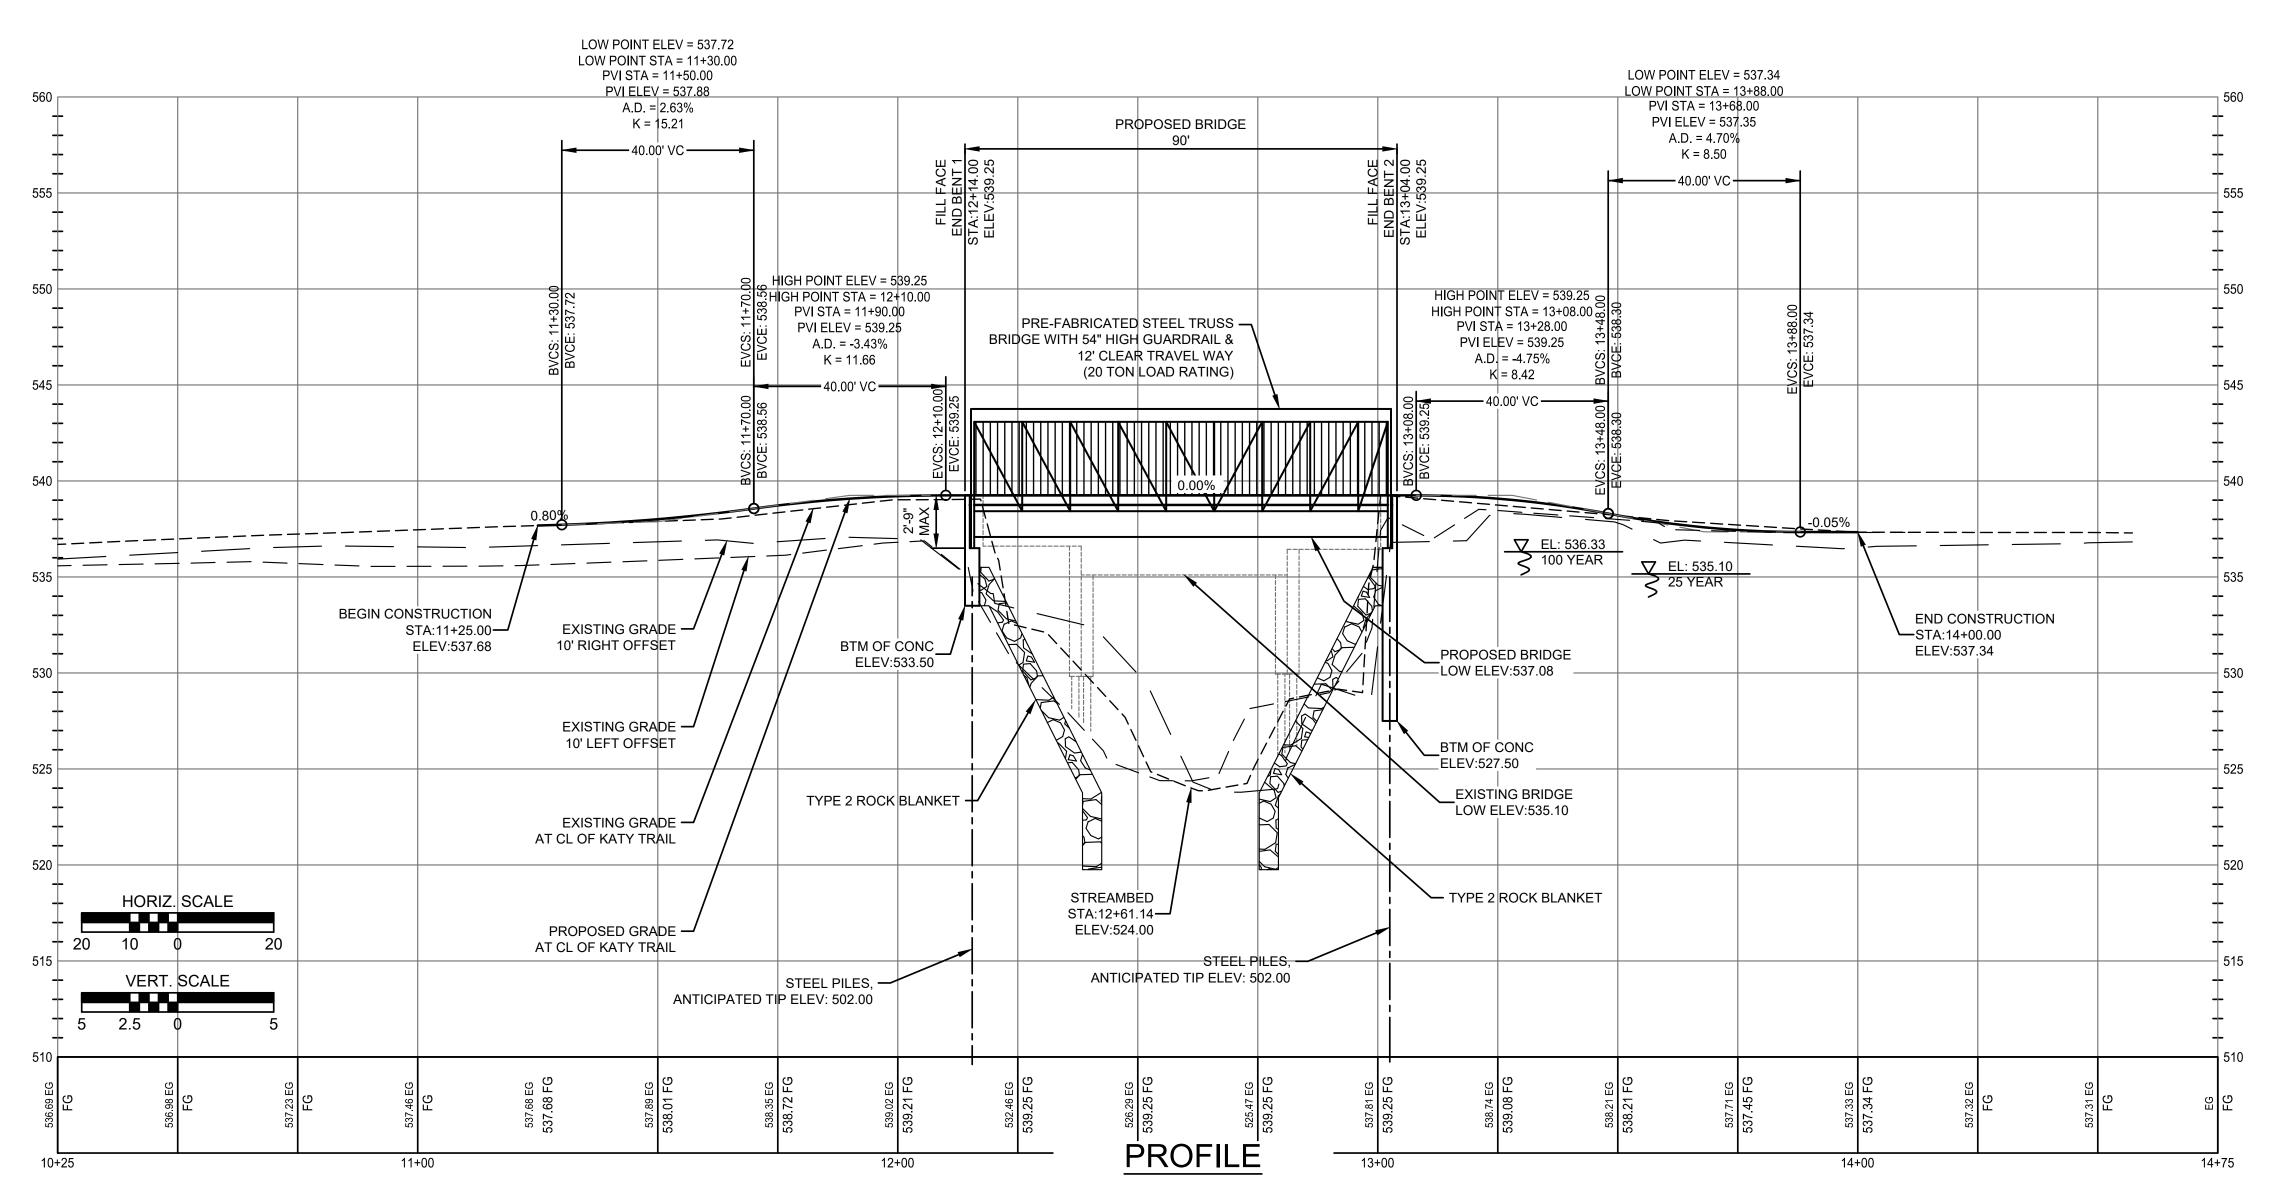

STATE OF MISSOURI MICHAEL L. PARSON, GOVERNOR



Columbia, MO 65202
573.814.1568 |
www.mecresults.com
MO CERTIFICATES OF
AUTHORITY
E-2006023253
S-2012009395
EXPIRES DEC. 31, 2024



OFFICE OF ADMINISTRATION DIVISION OF FACILITIES MANAGEMENT, DESIGN & CONSTRUCTION

DEPARTMENT OF NATURAL RESOURCES DIVISION OF MISSOURI STATE PARKS

REPLACE HIGHWAY PP BRIDGE KATY TRAIL STATE PARK

KATY TRAIL - MP126.3 MOKANE, MO 65059

PROJECT NO. X2227-01 SITE NO. 5501 ASSET NO. 7815501002

REVISION:
DATE:
REVISION:
DATE:
REVISION:
DATE:
ISSUE DATE: 03/03/2023


CAD DWG FILE:X2227-01-C-PLN-01
DRAWN BY: JJB
CHECKED BY: MMH
DESIGNED BY: ADM

SHEET TITLE:

SITE PLAN & PROFILE


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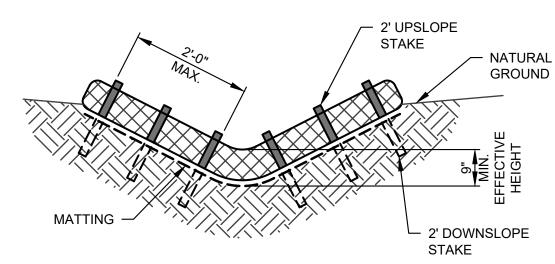
C-10

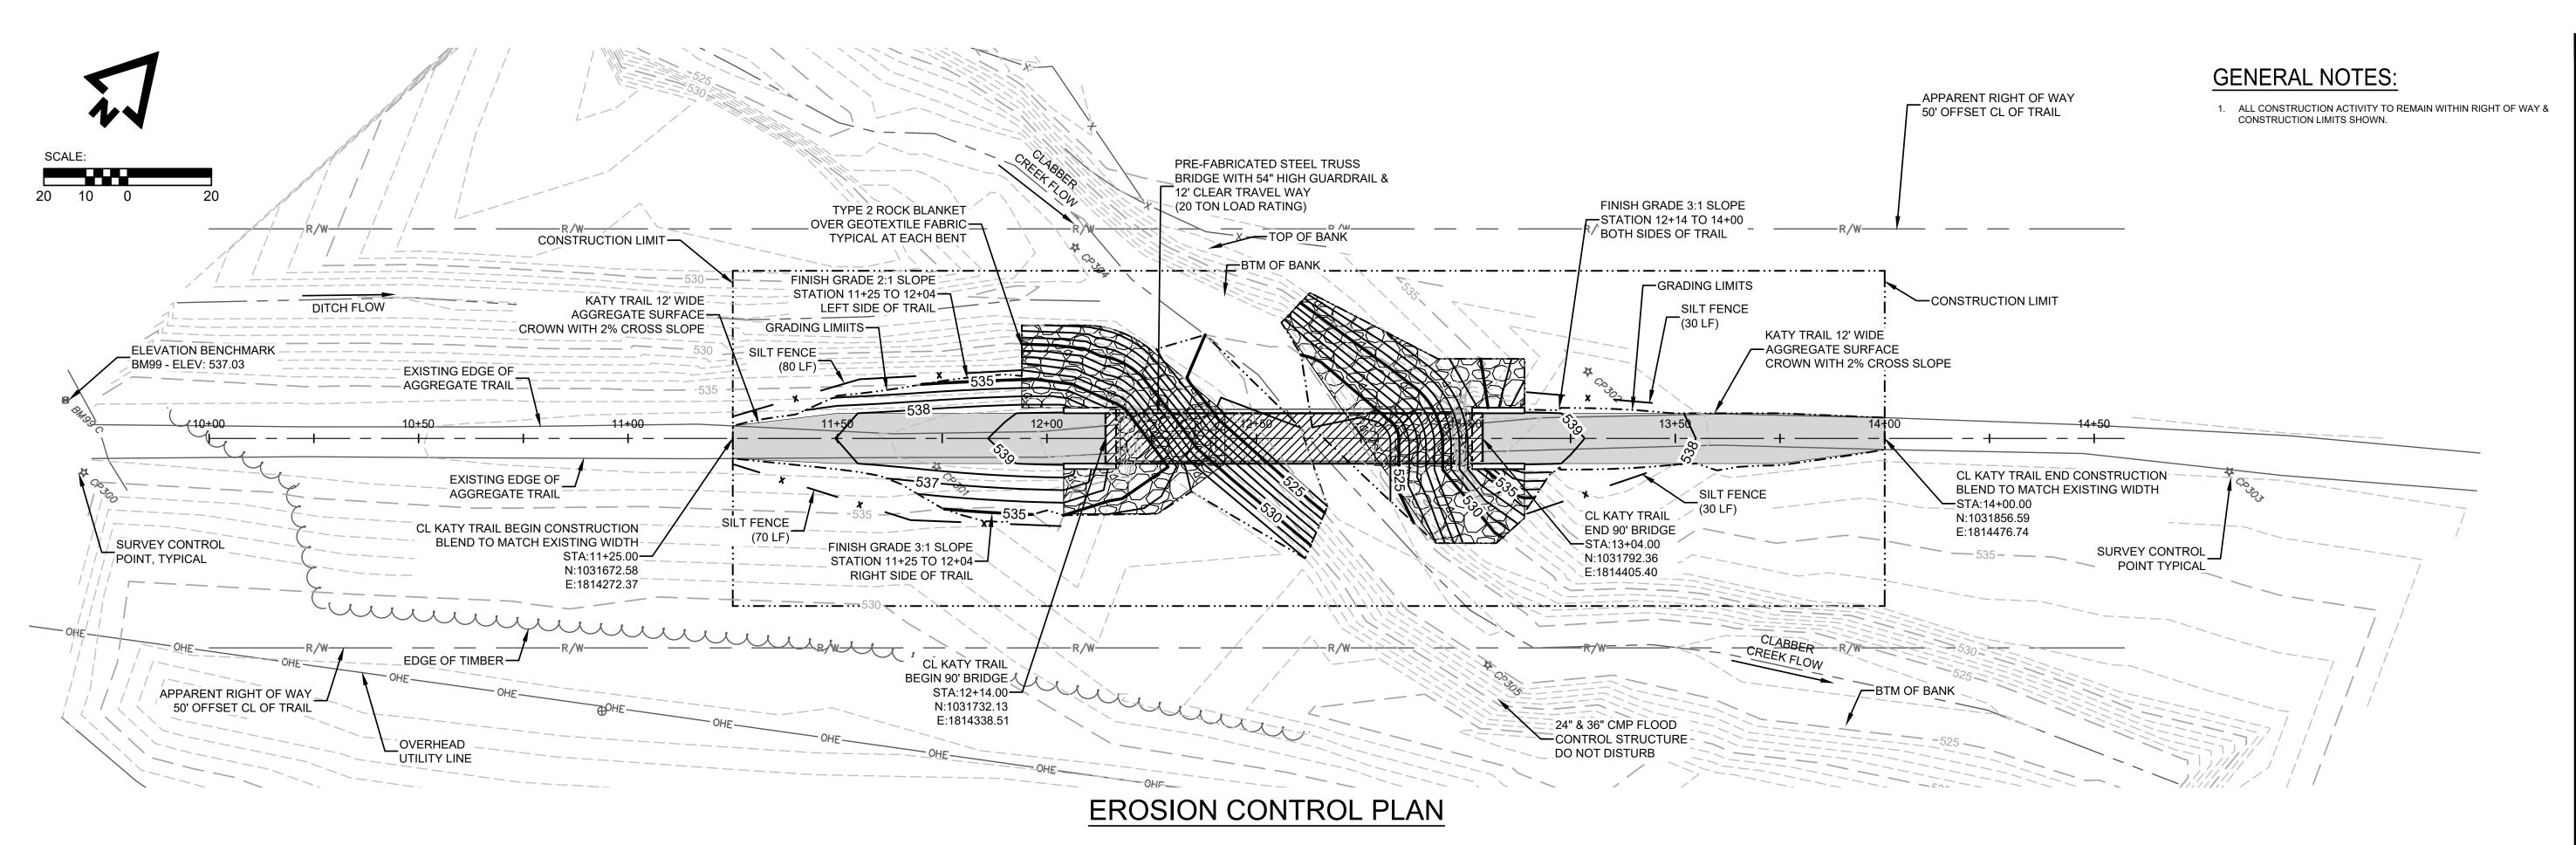

PLAN NOTE:


1. EROSION CONTROL SHOWN PROVIDES FINISH GRADE EROSION CONTROL UNTIL VEGETATION IS ESTABLISHED INSIDE GRADING LIMITS. PAYMENT FOR ADDITIONAL EROSION CONTROL REQUIRED DURING CONSTRUCTION OPERATIONS IS INCIDENTAL TO OTHER BID ITEMS.



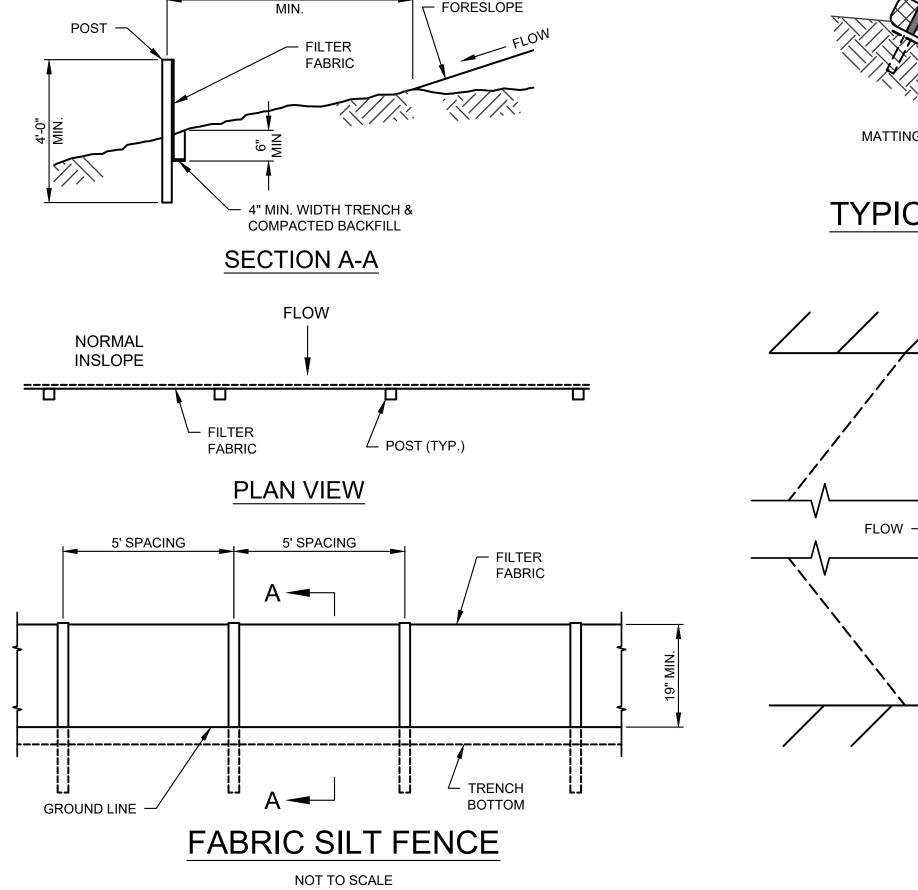


TYPICAL SECTION VEE DITCH

NOT TO SCALE

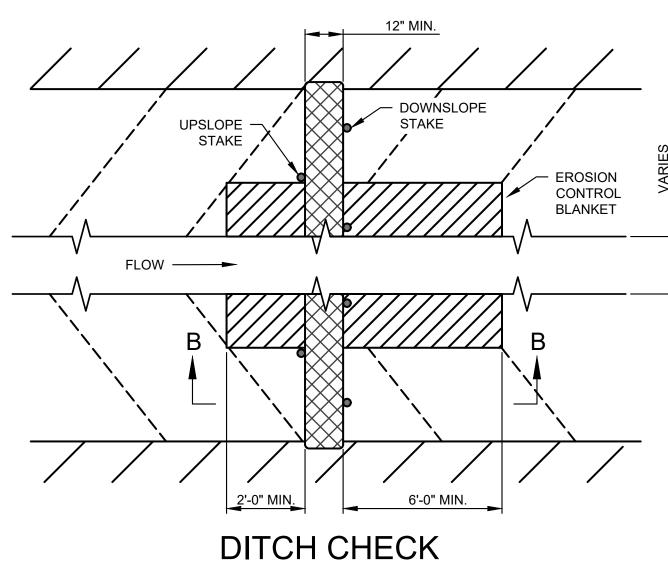

PLAN VIEW

NOT TO SCALE

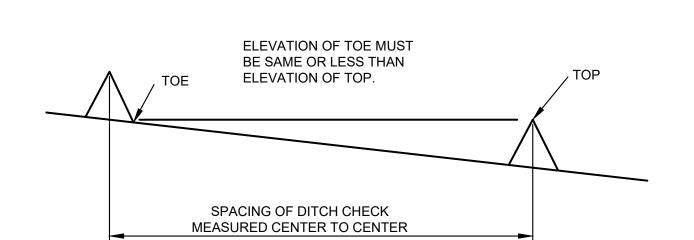

MINIMUM DITCH CHECK SPACING

NOT TO SCALE

GENERAL NOTES:

- USE MINIMUM 12 IN. DIAMETER LOG/SOCK.
 USE 2 FT. WOODEN STAKES WITH A 2 IN. BY 2 IN. NOMINAL CROSS
- SECTION.

 3. INSTALL LOG/SOCK TO A HEIGHT IN DITCH SO FLOW WILL NOT WASH AROUND LOG/SOCK AND SCOUR DITCH SLOPES OR AS
- DIRECTED BY ENGINEER.

 4. INSTALL A MINIMUM OF 2 UPSLOPE STAKES AND 4 DOWNSLOPE STAKES AT AN ANGLE TO WEDGE LOG/SOCK TO BOTTOM OF
- . EROSION CONTROL BLANKET SHALL BE ANCHORED ACCORDING TO THE MANUFACTURER'S RECOMMENDATIONS.
- 6. OTHER PROPRIETARY DITCH CHECKS MAY BE SUBSTITUTED AS DIRECTED BY THE ENGINEER.
- 7. INSTALLATION OF PROPRIETARY DITCH CHECKS SHALL BE

	ACCORDING TO THE MANUFACTURER'S RECOMMENDATIONS.
STAKES	

SECTION B-B

NOT TO SCALE

EXAMPLE DITCH CHECK SPACING FOR STANDARD HEIGHTS

SPACING

FOR 9"

EFFECTIVE

HEIGHT

50

19

12

11

DITCH CL

SLOPE %

0.5

1.0

1.5

2.0

2.5

3.0

3.5

4.0

4.5

5.0

5.5

6.0

6.5

7.0

7.5

8.0

8.5

9.0

9.5

10.0

SPACING
FOR 18"
EFFECTIVE
HEIGHT

SPACING
FOR 18"
EFFECTIVE
HEIGHT

SITE NO. 5501

KATY TRAIL - MP126.3
MOKANE, MO
65059

ROJECT NO. X2227-01
SITE NO. 5501

75

60

43

38

33

25

23

20

18

17

REVISION:	
DATE:	
REVISION:	
DATE:	
REVISION:	
DATE:	
ISSUE DATE: 03/03/2023	

ASSET NO. 7815501002

CAD DWG FILE:X2227-01-C-PLN-01

DRAWN BY: JJB
CHECKED BY: MMH
DESIGNED BY: ADM


SHEET TITLE:

EROSION CONTROL PLAN

SHEET NUMBER:

C-102

6 OF 13 SHEETS MARCH 3, 2023

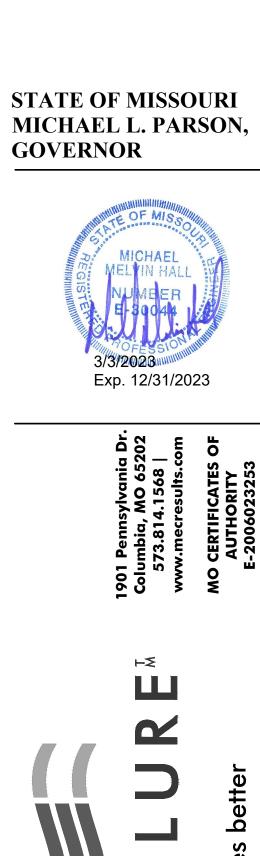

OFFICE OF ADMINISTRATION

DIVISION OF FACILITIES

DESIGN & CONSTRUCTION

NATURAL RESOURCES DIVISION OF MISSOURI

HIGHWAY PP BRIDGE


KATY TRAIL STATE PARK

MANAGEMENT,

STATE PARKS

REPLACE

DEPARTMENT OF

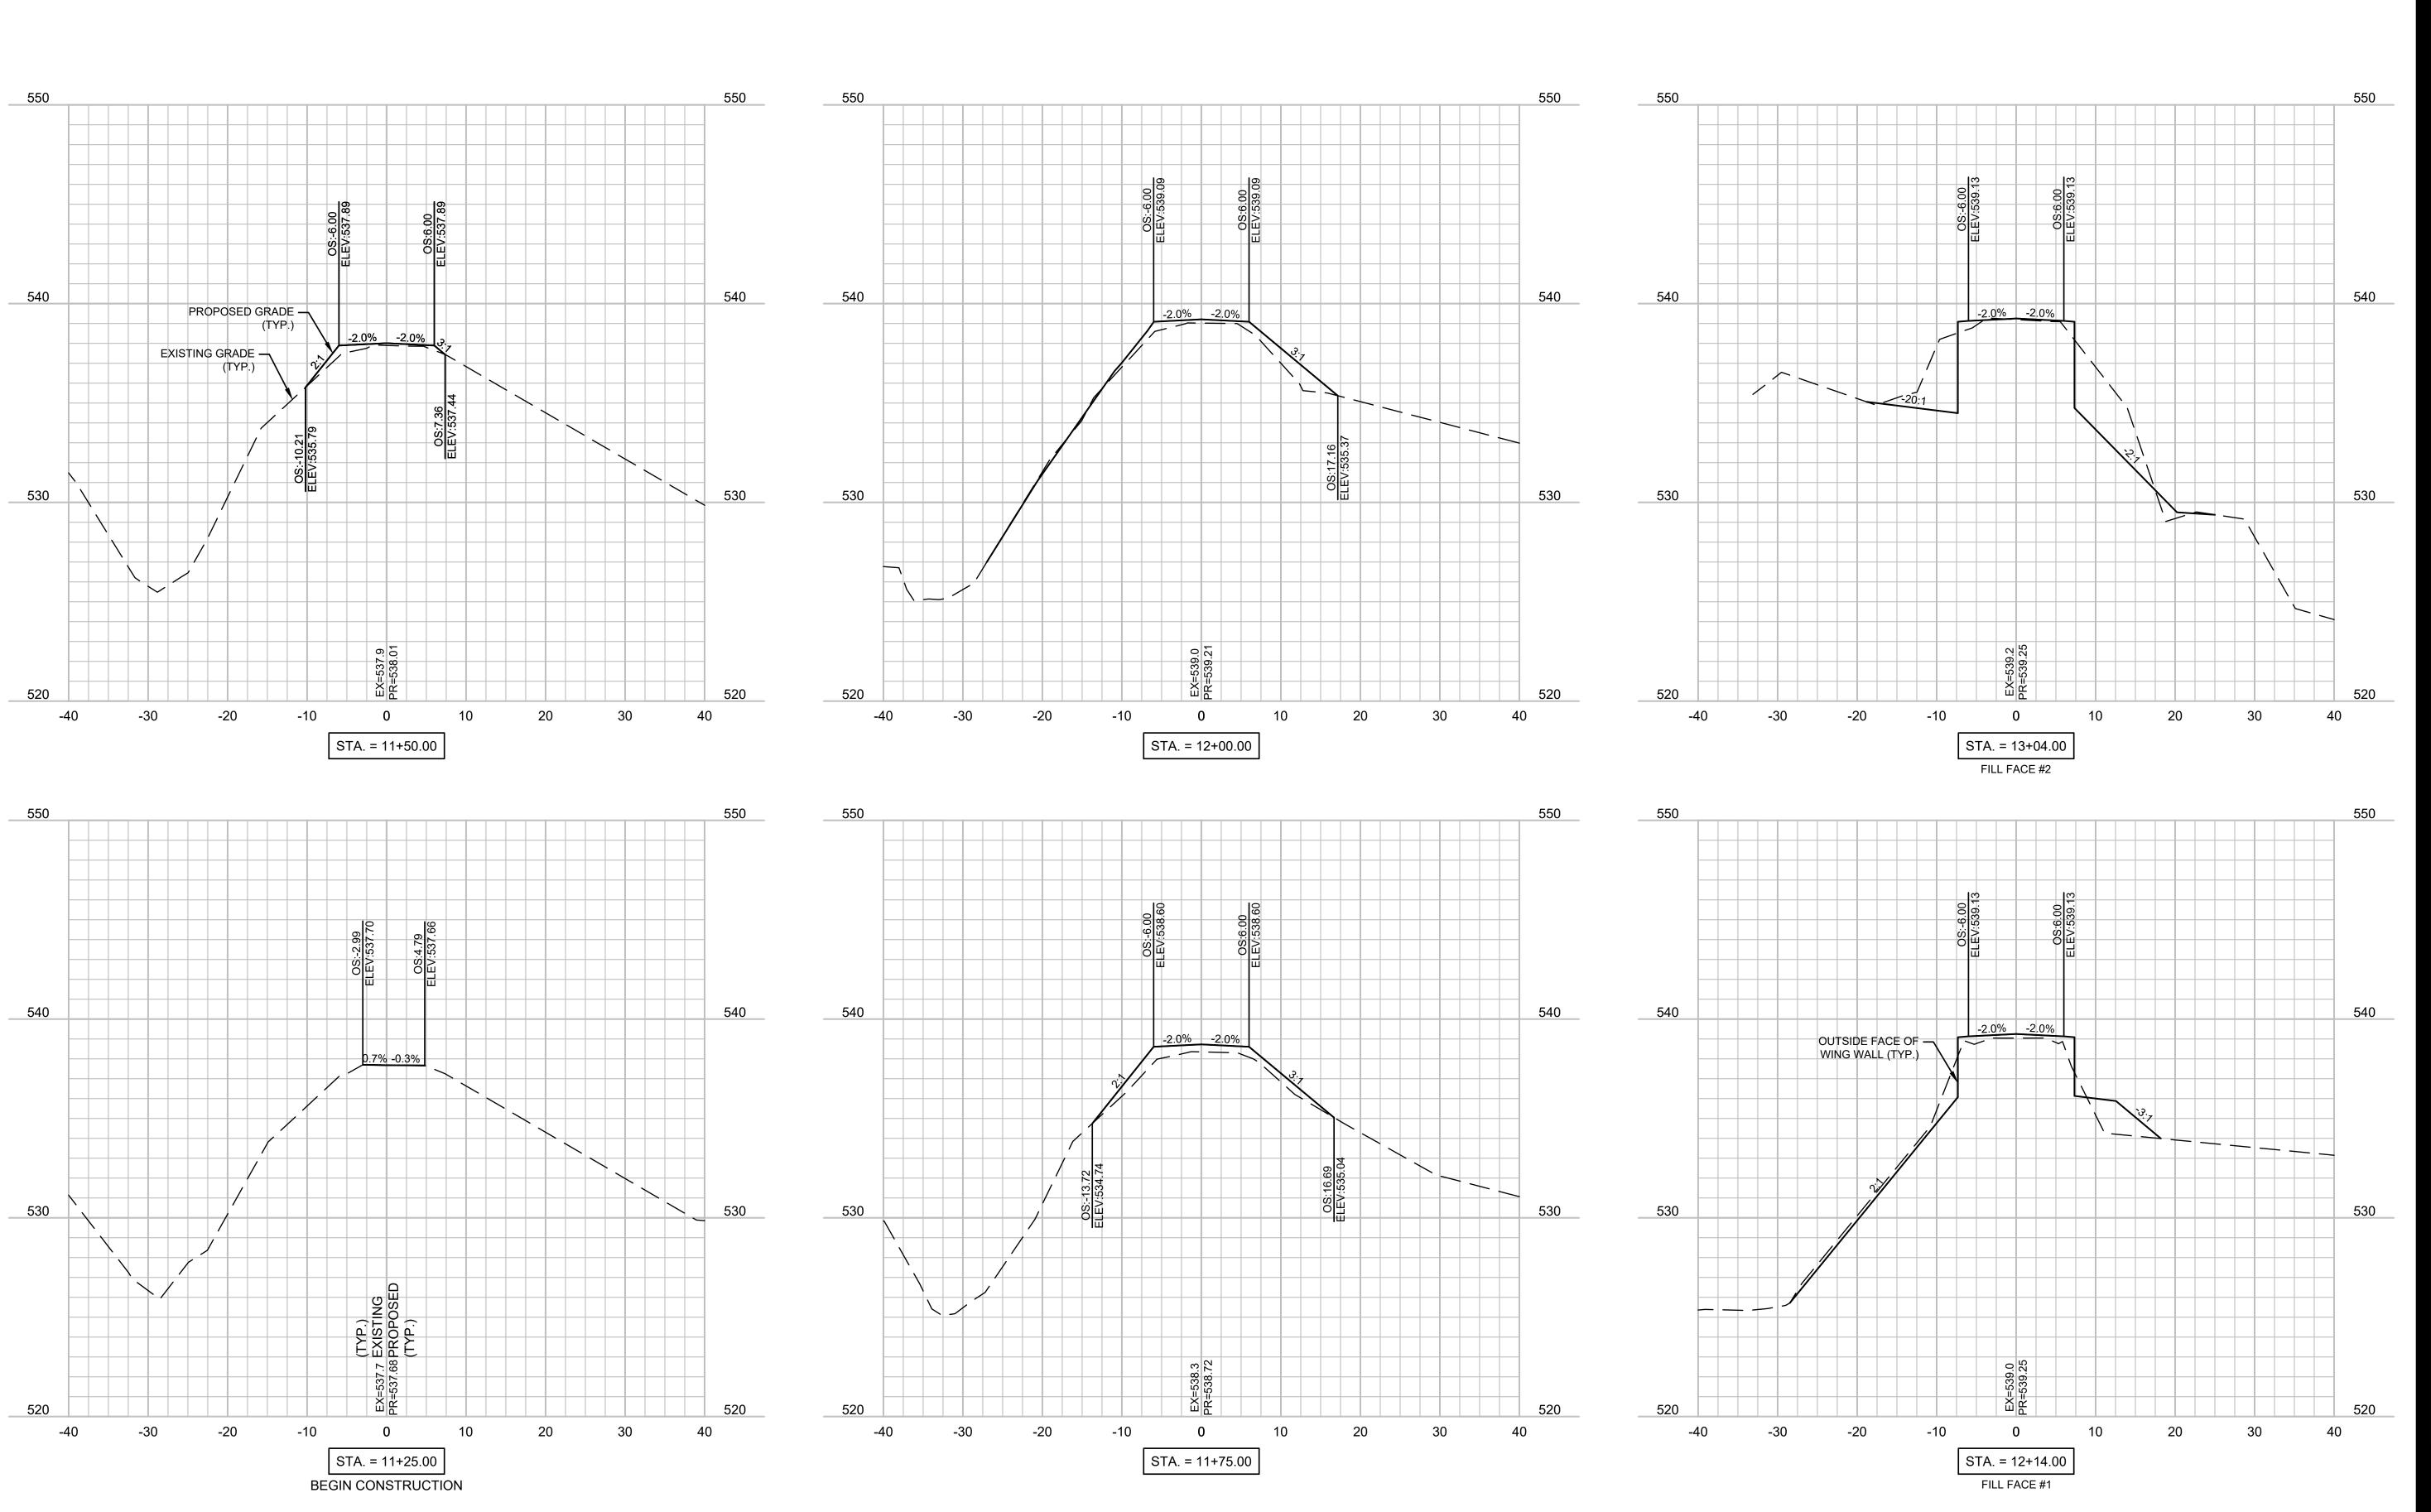

STATE OF MISSOURI MICHAEL L. PARSON, GOVERNOR



Columbia, MO 65202 573.814.1568 | www.mecresults.com MO CERTIFICATES OF AUTHORITY E-2006023253 S-2012009395



OFFICE OF ADMINISTRATION DIVISION OF FACILITIES MANAGEMENT, DESIGN & CONSTRUCTION

DEPARTMENT OF NATURAL RESOURCES DIVISION OF MISSOURI STATE PARKS

REPLACE HIGHWAY PP BRIDGE KATY TRAIL STATE PARK

KATY TRAIL - MP126.3 MOKANE, MO 65059

PROJECT NO. X2227-01 SITE NO. 5501 ASSET NO. 7815501002

REVISION:	
DATE:	•
REVISION:	•
DATE:	•
REVISION:	•
DATE:	•
ISSUE DATE: 03/03/2023	-


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DRAWN BY: JJB
CHECKED BY: MMH
DESIGNED BY: ADM

SHEET TITLE:

TRAIL CROSS SECTIONS

SHEET NUMBER:

C-103

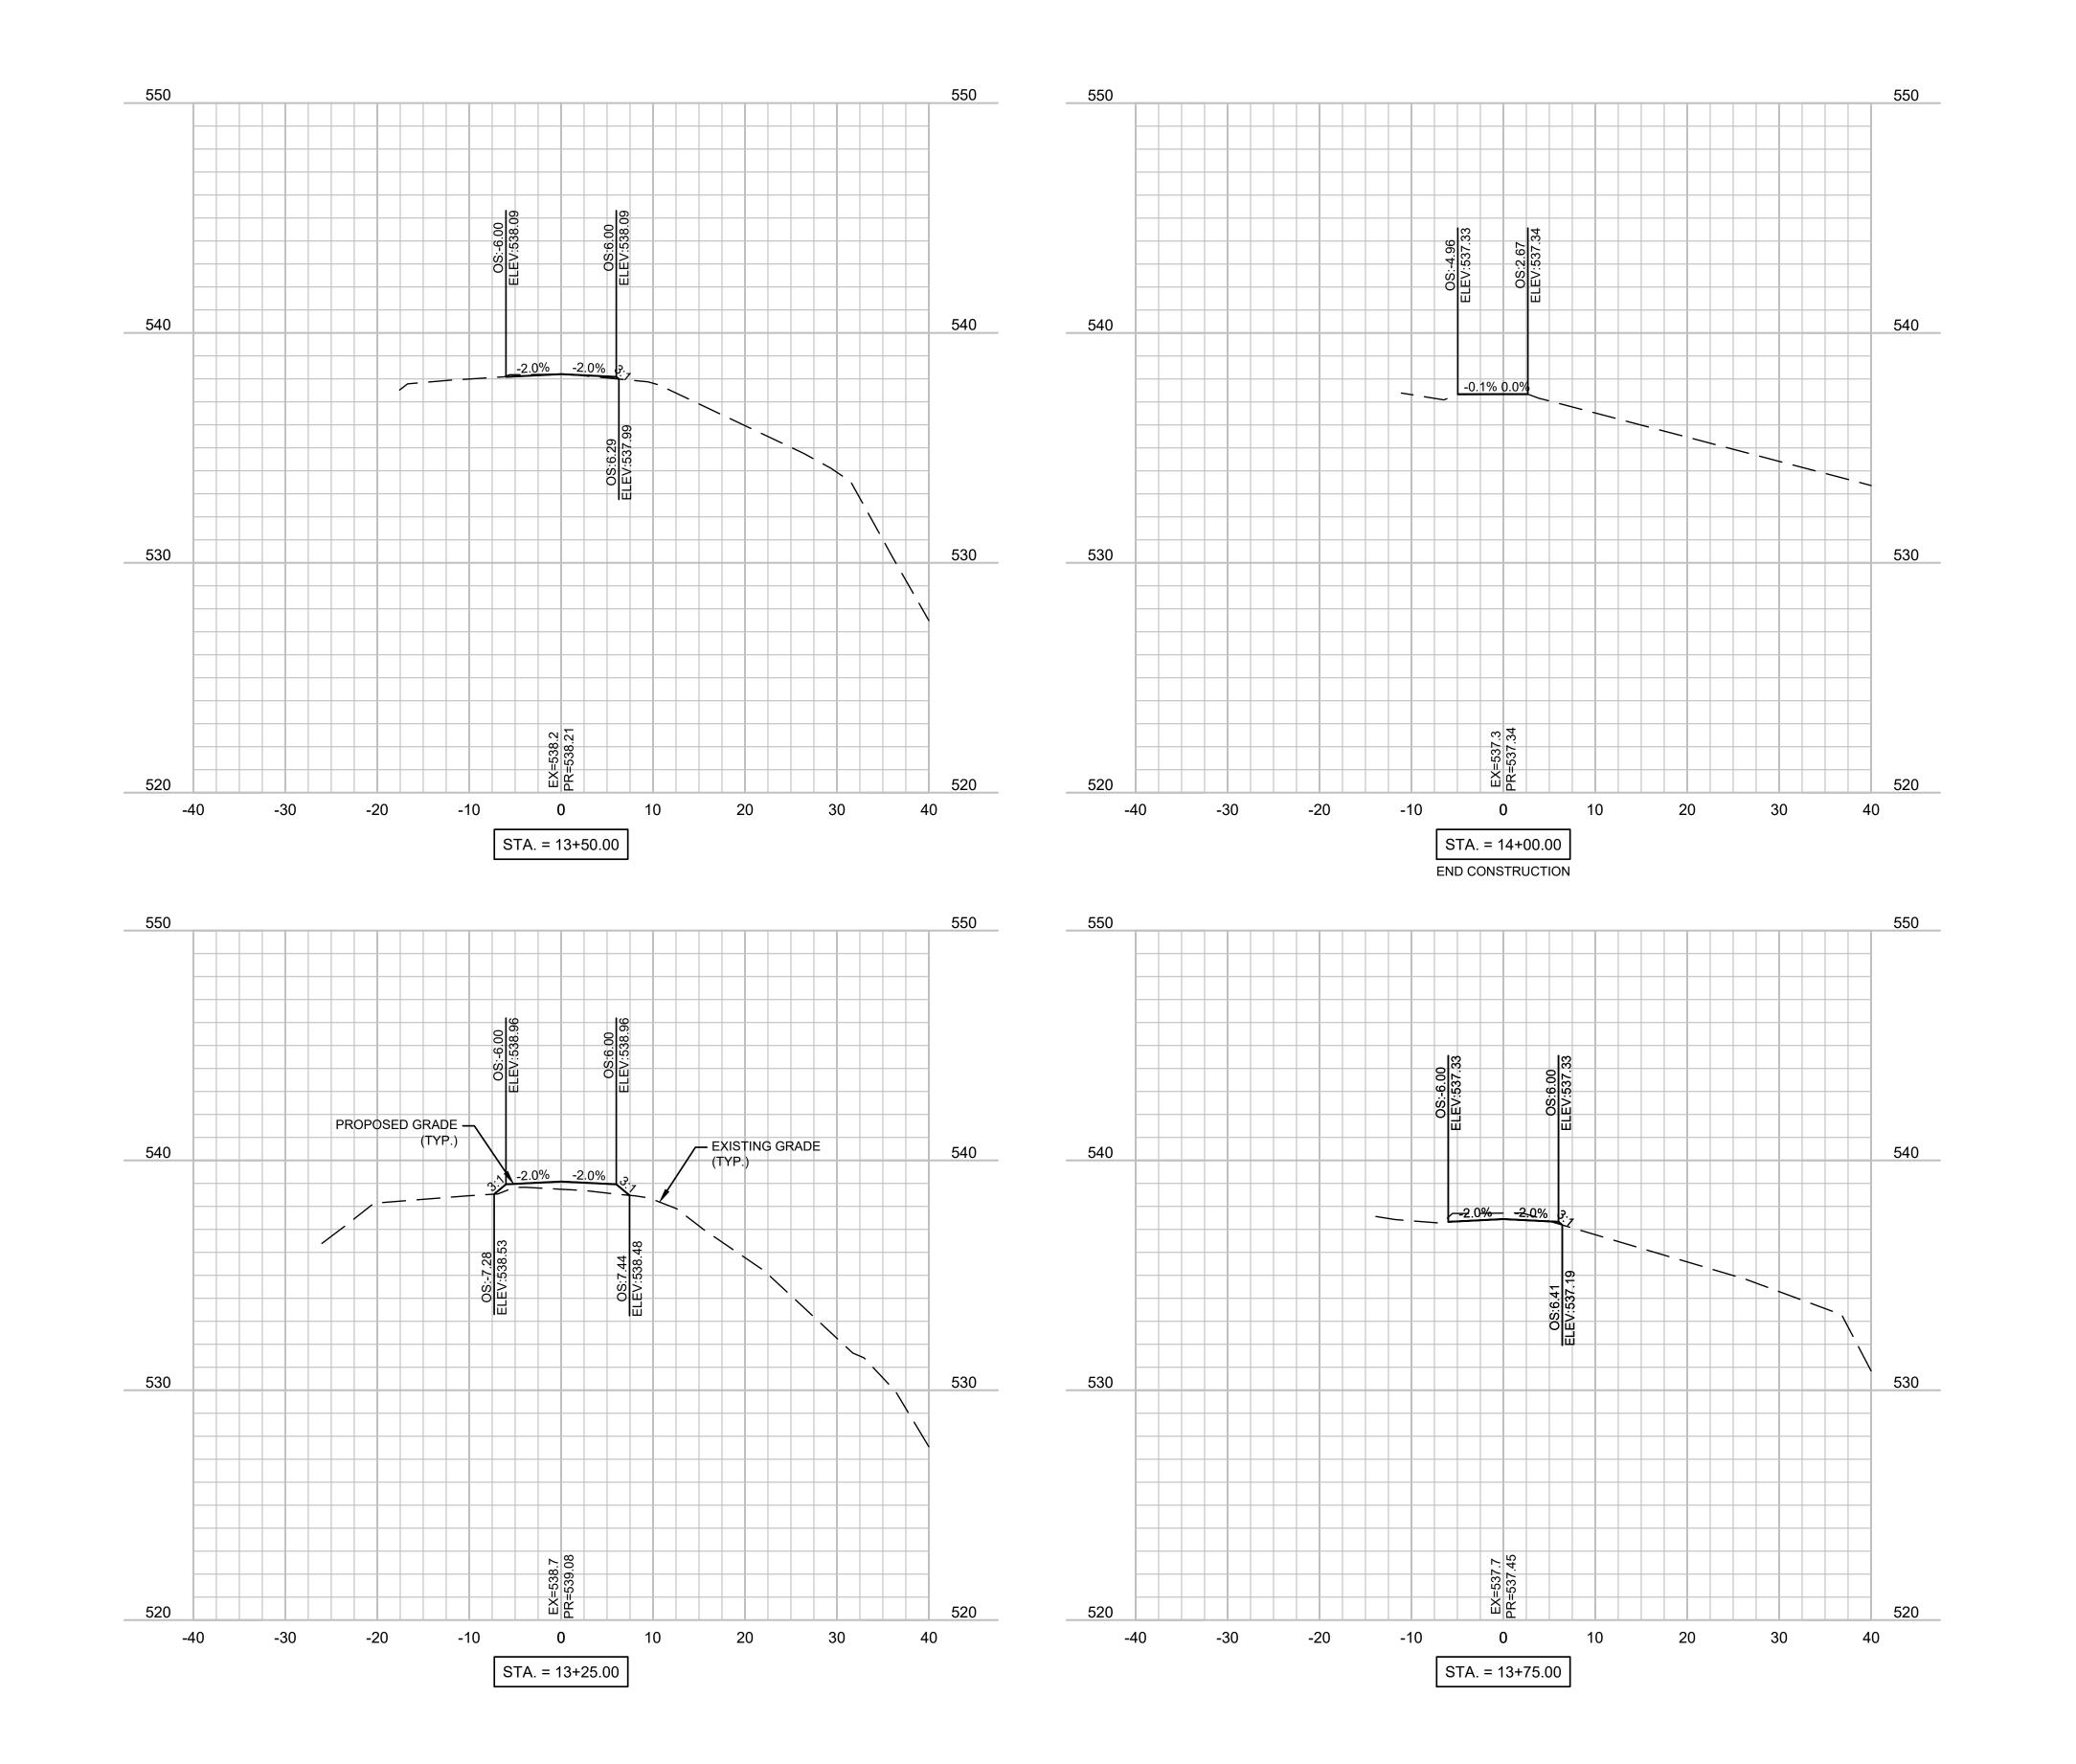

EARTHWORK QUANTITIES: TOTAL CUT: 3.10 CU. YD. TOTAL FILL: 28.10 CU. YD.

STATE OF MISSOURI MICHAEL L. PARSON, **GOVERNOR**





OFFICE OF ADMINISTRATION DIVISION OF FACILITIES MANAGEMENT, **DESIGN & CONSTRUCTION**

DEPARTMENT OF NATURAL RESOURCES DIVISION OF MISSOURI STATE PARKS

REPLACE HIGHWAY PP BRIDGE KATY TRAIL STATE PARK

KATY TRAIL - MP126.3 MOKANE, MO

PROJECT NO. X2227-01 SITE NO. 5501 ASSET NO. 7815501002


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DATE:
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DATE:
ISSUE DATE: 03/03/2023

CAD DWG FILE:X2227-01-C-FGR-01
DRAWN BY: JJB
CHECKED BY: MMH
DESIGNED BY: ADM

SHEET TITLE:

TRAIL CROSS SECTIONS


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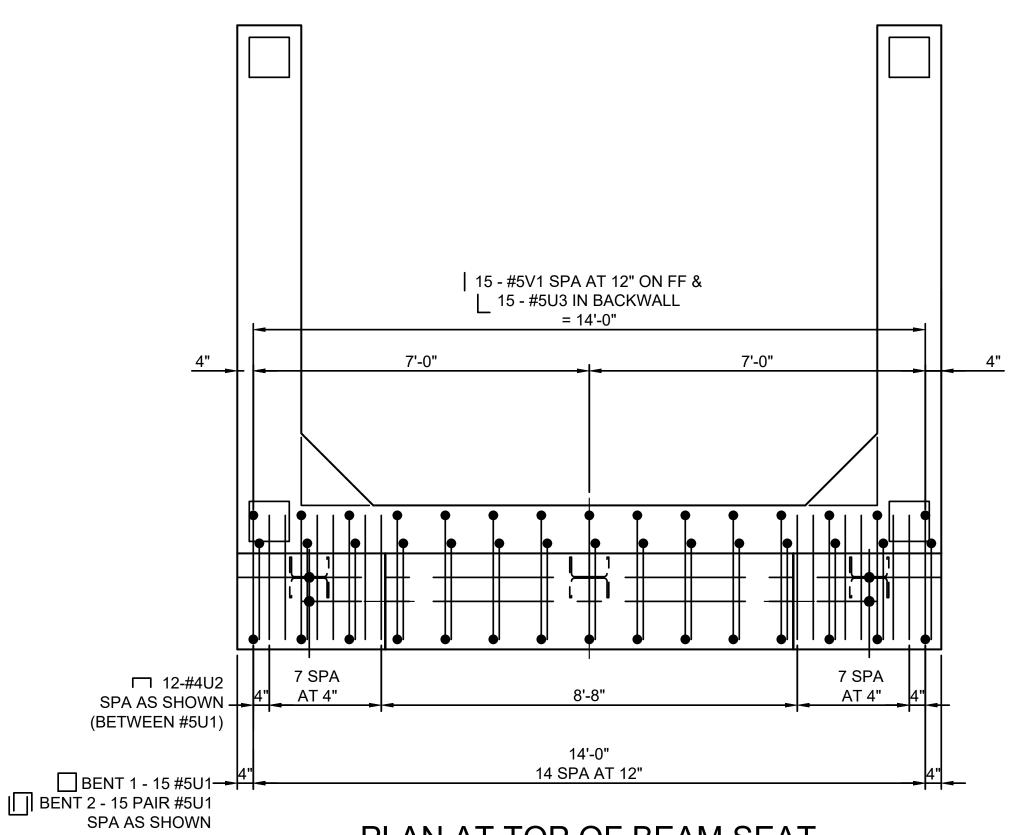


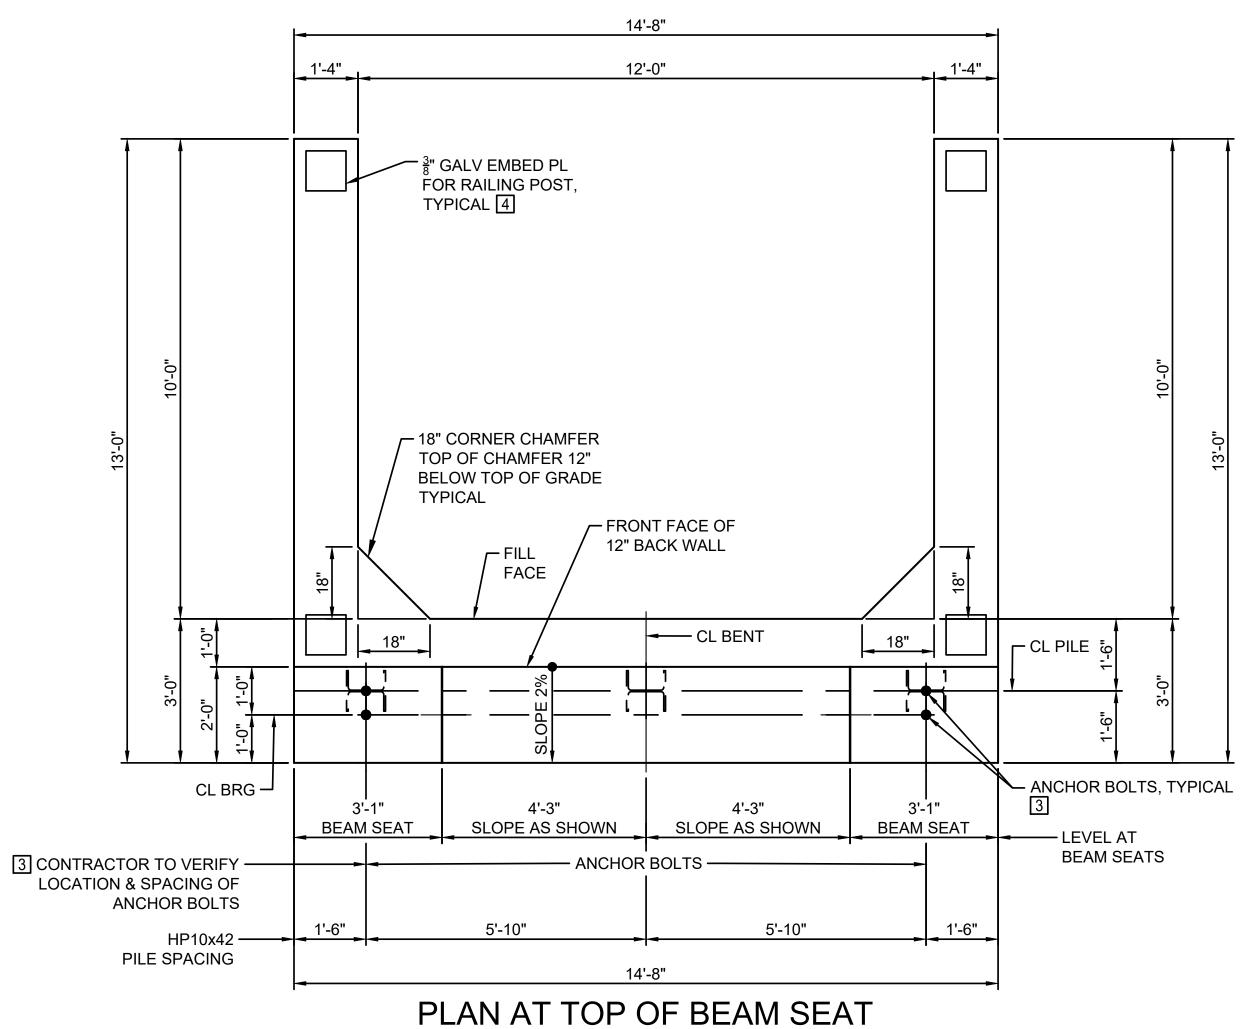SHOWING DIMENSIONS

SCALE: 1/2" = 1'-0"

BENT 1 BENT 3



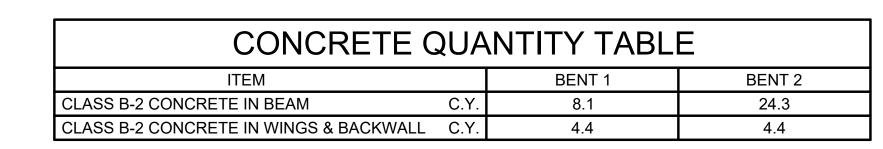

PLAN AT TOP OF BEAM SEAT
SHOWING STIRRUPS & DOWELS

SCALE: ½" = 1'-0"

14-8" 11-4" 11-4" 11-6" 11-4" 11-6" 11-6" 11-6" 11-6" 11-6" 11-6" 11-6" 11-6" 11-6" 11-6" 11-6" 11-6" 11-6" 11-6"

PLAN AT TOP OF BEAM SEAT SHOWING PILES & REINFORCING

SCALE: ½" = 1'-0"

14'-8"


PILE SPACING

GENERAL NOTES:

- SEE SHEET NO. 10. FOR BENT 1 ELEVATIONS, SECTIONS AND KEY NOTES.
- 2. SEE SHEET NO. 11 FOR BENT 2 ELEVATIONS, SECTIONS AND KEY NOTES
- 3. CONTRACTOR SHALL VERIFY BEAM SEAT ELEVATION AT EACH BENT WITH REQUIREMENTS OF OF SELECTED PREFABRICATED BRIDGE SUPPLIER AND SHALL ADJUST THE BRIDGE SEAT ELEVATIONS AS REQUIRED TO ACCOMMODATE THE BRIDGE MANUFACTURER. IT MAY BE NECESSARY TO ADJUST LENGTHS OF STEEL REINFORCING STIRRUPS TO ACCOMMODATE AN ADJUSTED SEAT ELEVATION. ALL NECESSARY ADJUSTMENTS SHALL BE MADE PRIOR TO ORDERING OF REINFORCEMENT AND SHALL BE MADE AT NO ADDITIONAL COST.
- CONTRACTOR SHALL COORDINATE LOCATION OF ANCHOR BOLTS WITH REQUIREMENTS OF SELECTED PREFABRICATED BRIDGE AND COORDINATE LOCATION OF ANCHOR BOLTS WITH REINFORCEMENT IN ABUTMENTS AND SHIFT REINFORCEMENT AS REQUIRED TO INSTALL ANCHOR BOLTS.
- 5. SEE BILL OF REINFORCING SHEET FOR ESTIMATED STEEL REINFORCEMENT PIECE SIZES & DIMENSIONS. (NO.12)
- CONTRACTOR SHALL LOCATE NEW PILING AS NECESSARY TO MISS ANY EXISTING TIMBER PILING THAT MAY REMAIN BELOW GRADE. NOTIFY ENGINEER IF PILE IS MOVED 6" OR MORE FROM LOCATION SHOWN ON THE PLANS.


KEY NOTES:

3 FIELD DRILL AND INSTALL ANCHOR BOLTS AFTER BRIDGE IS IN FINAL POSITION. ANCHOR BOLTS SHALL BE INSTALLED ACCORDING TO BRIDGE MANUFACTURER'S SPECIFICATIONS INCLUDING LOCATION, EMBEDMENT AND PROJECTION.

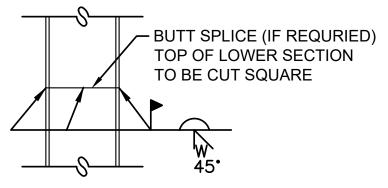

STEEL PILE SPLICE DETAIL

GALVANIZING MATERIAL SHALL BE OMITTED OR REMOVED ONE INCH CLEAR OF WELD LOCATIONS IN ACCORDANCE WITH SPECIFICATION SECTION 316216 IF APPLICABLE.

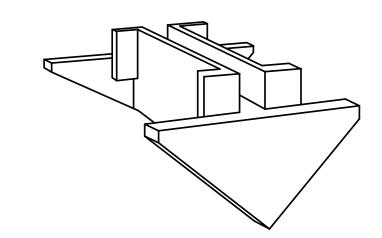

THE PILE POINT SHALL BE A ONE-PIECE UNIT OF CAST STEEL. THE CUTTING EDGES SHALL BE HARDENED. THE PILE POINT SHALL BE DESIGNED TO PENETRATE BOULDERS WITHOUT INJURY TO THE PILE. THE PILE POINTS SHALL BE WELDED, IN ACCORDANCE WITH MANUFACTURER'S RECOMMENDATIONS, TO EACH STEEL PILE AT THE ABUTMENTS BEFORE DRIVING. TOTAL OF 3 REQUIRED EACH BENT, TOTAL OF 6 FOR PROJECT.


CAST STEEL PILE POINT

NOT TO SCALE

STATE OF MISSOURI MICHAEL L. PARSON, GOVERNOR



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OFFICE OF ADMINISTRATION DIVISION OF FACILITIES MANAGEMENT, DESIGN & CONSTRUCTION

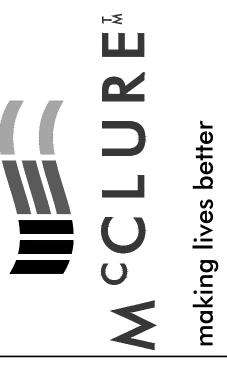DEPARTMENT OF NATURAL RESOURCES DIVISION OF MISSOURI STATE PARKS

REPLACE HIGHWAY PP BRIDGE KATY TRAIL STATE PARK

KATY TRAIL - MP126.3 MOKANE, MO

PROJECT NO. X2227-01 SITE NO. 5501 ASSET NO. 7815501002

REVISION:
DATE:
REVISION:
DATE:
REVISION:
DATE:
ISSUE DATE: 03/03/2023


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DRAWN BY: JJB
CHECKED BY: MMH
DESIGNED BY: ADM


SHEET TITLE:

BENT 1 & 2 PLAN


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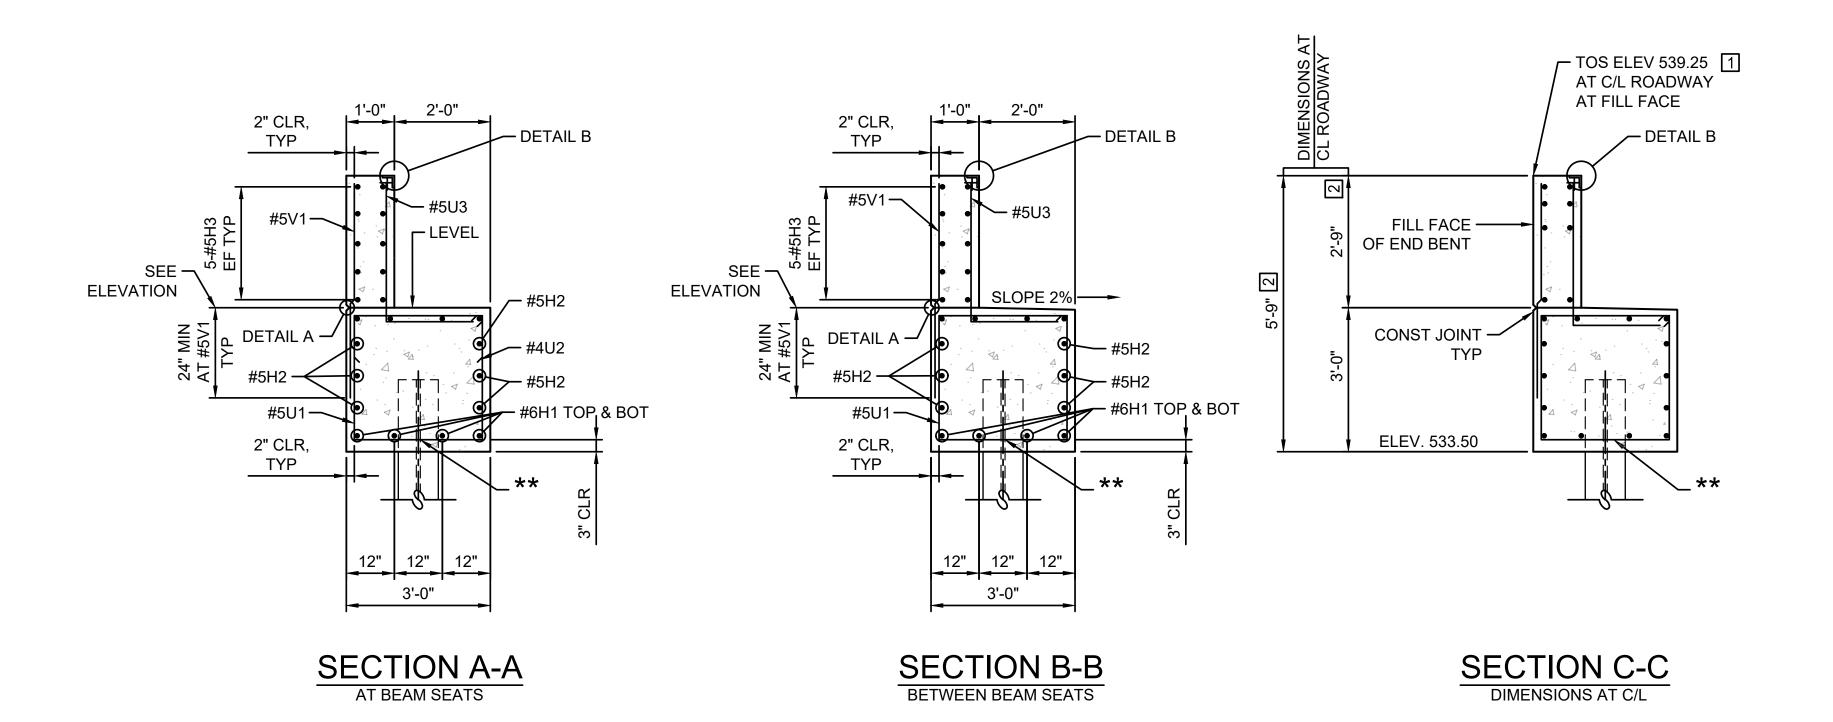
|S-201|




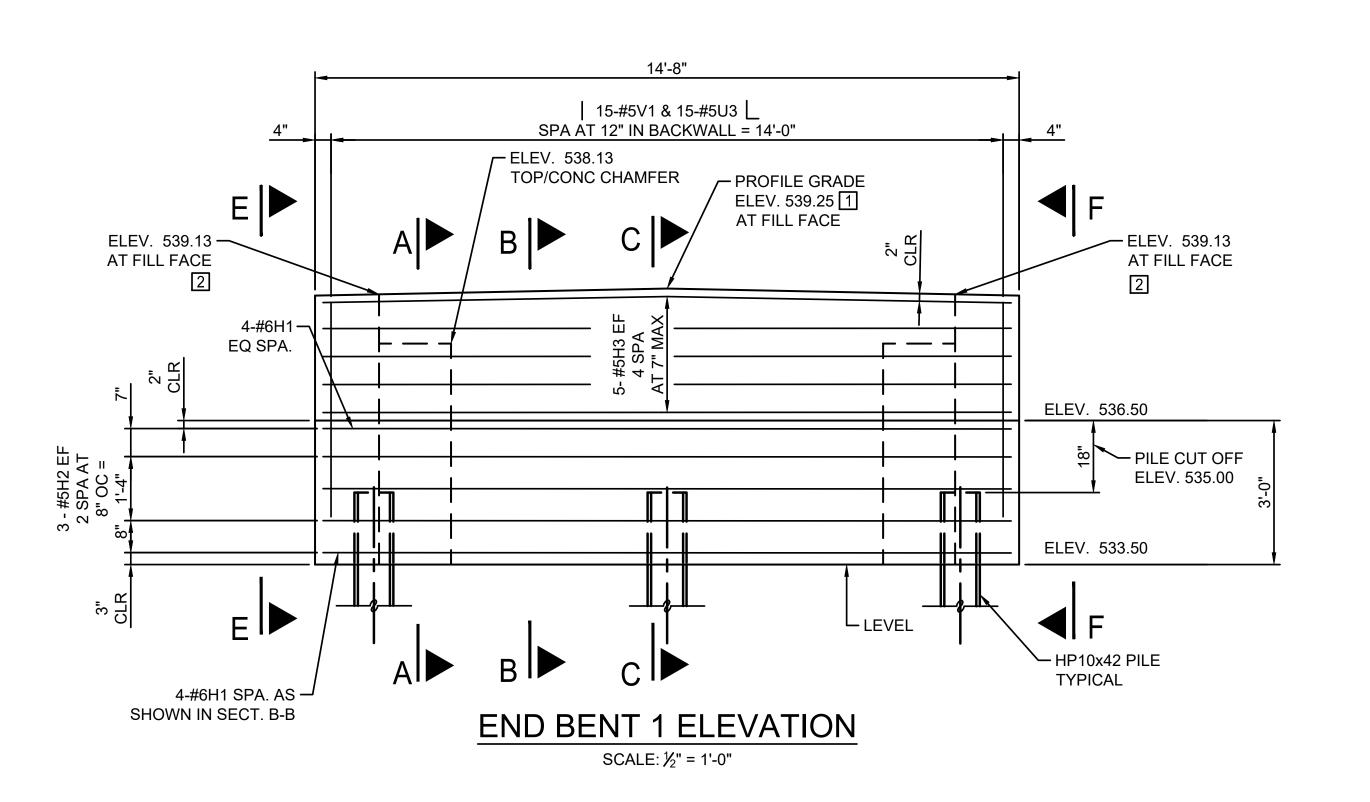


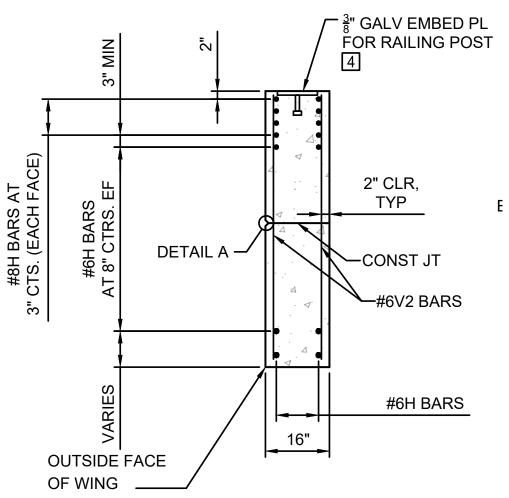TYPICAL SECTION
THRU WING
NOT TO SCALE



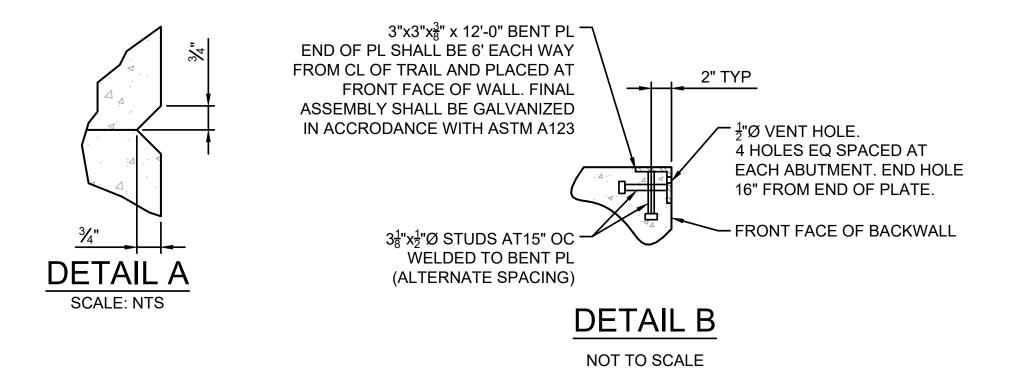

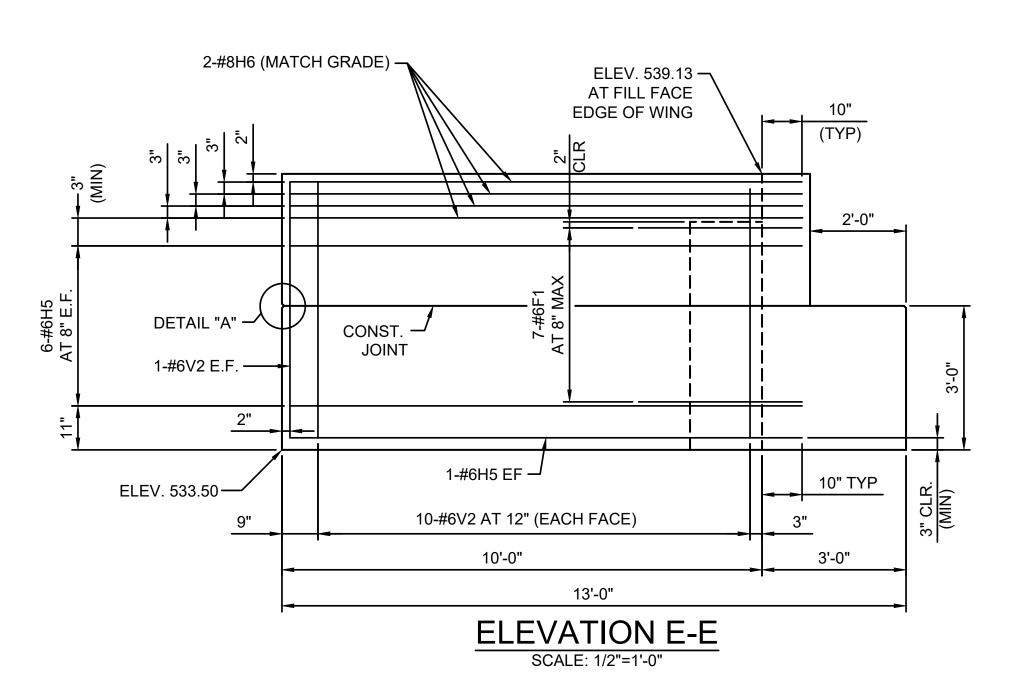

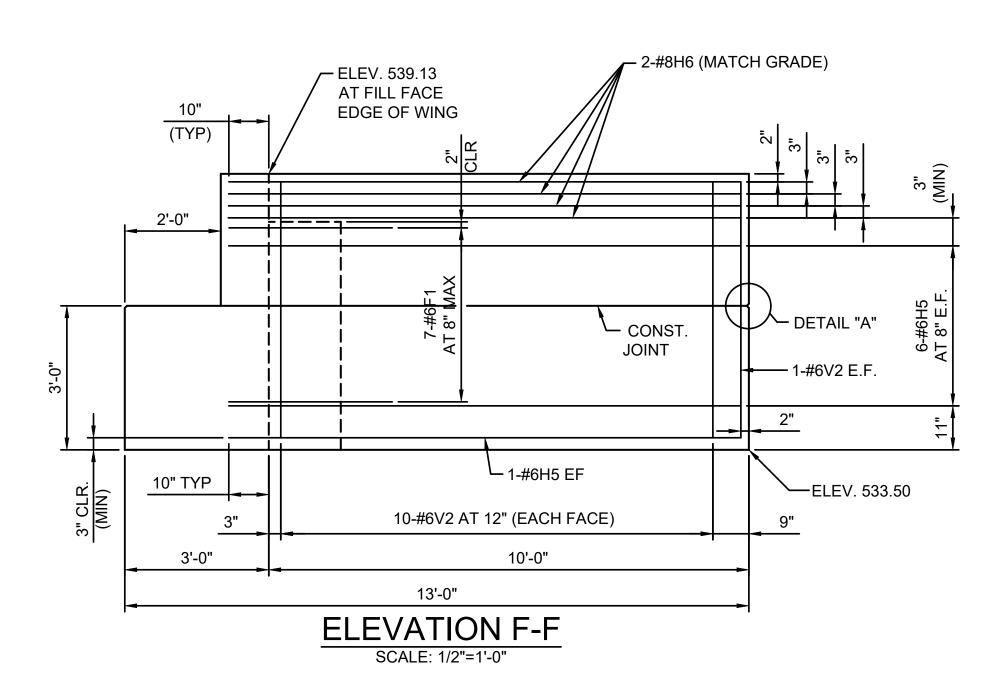

KEY NOTES:

- 1 TOP OF ABUTMENT BACKWALL AND SLOPE OF BACKWALL MUST MATCH TOP OF CONCRETE BRIDGE DECK. SEE "CROWN DETAIL" ON D-001
- 2 HEIGHT OF BACKWALL AND TOP OF CONCRETE AT BRIDGE SEAT ARE BASED ON PRELIMINARY BRIDGE INFORMATION. THE CONTRACTOR SHALL BASE THEIR BID ON THE DIMENSIONS SHOWN AND ALLOW FOR POSSIBLE VARIATION IN THE BACKWALL HEIGHT AND BEAM SEAT ELEVATION TO ACCOMMODATE THE REQUIREMENTS OF THE ACTUAL PREFABRICATED BRIDGE TO BE SUPPLIED. THE BRIDGE MANUFACTURER AND CONTRACTOR SHALL PROVIDE EXACT HEIGHT REQUIREMENTS WITH FINAL BRIDGE DETAILS AND DESIGN TO ENGINEER FOR REVIEW AND APPROVAL PRIOR TO CONSTRUCTION.


3 NOT USED.

SIZE AND PLACEMENT OF THE EMBEDDED PLATES SHALL ACCOMMODATE THE SEPARATE 10'-0" LONG HANDRAIL SECTION PROVIDED BY THE PEDESTRIAN BRIDGE MANUFACTURER THAT IS MOUNTED TO THE TOP OF THE ABUTMENT WING WALL. THE ATTACHMENT METHOD OF THE HANDRAIL SHALL BE DETERMINED AND PROVIDED BY THE BRIDGE MANUFACTURER. THE CONTRACTOR MAY PROPOSE AN ALTERNATIVE ATTACHMENT METHOD TO THE CONCRETE WINGWALL TO BE APPROVED BY THE ENGINEER AT NO ADDITIONAL COST TO THE PROJECT BID.

NOTE. ★★:CUT BOTTOM LEG OF STIRRUP (2" MAX CLEARANCE) AT PILE LOCATIONS. STATE OF MISSOURI MICHAEL L. PARSON, GOVERNOR



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DEPARTMENT OF NATURAL RESOURCES DIVISION OF MISSOURI STATE PARKS

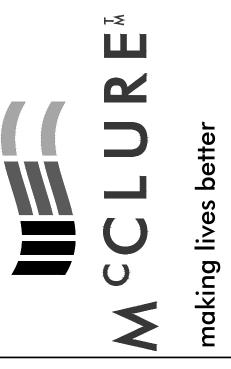REPLACE HIGHWAY PP BRIDGE KATY TRAIL STATE PARK

KATY TRAIL - MP126.3 MOKANE, MO 65059

PROJECT NO. X2227-01 SITE NO. 5501 ASSET NO. 7815501002

REVISION:	
DATE:	
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ISSUE DATE: 03/03/2023	
155UE DATE: 05/05/2025	


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DRAWN BY: JJB
CHECKED BY: MMH
DESIGNED BY: ADM


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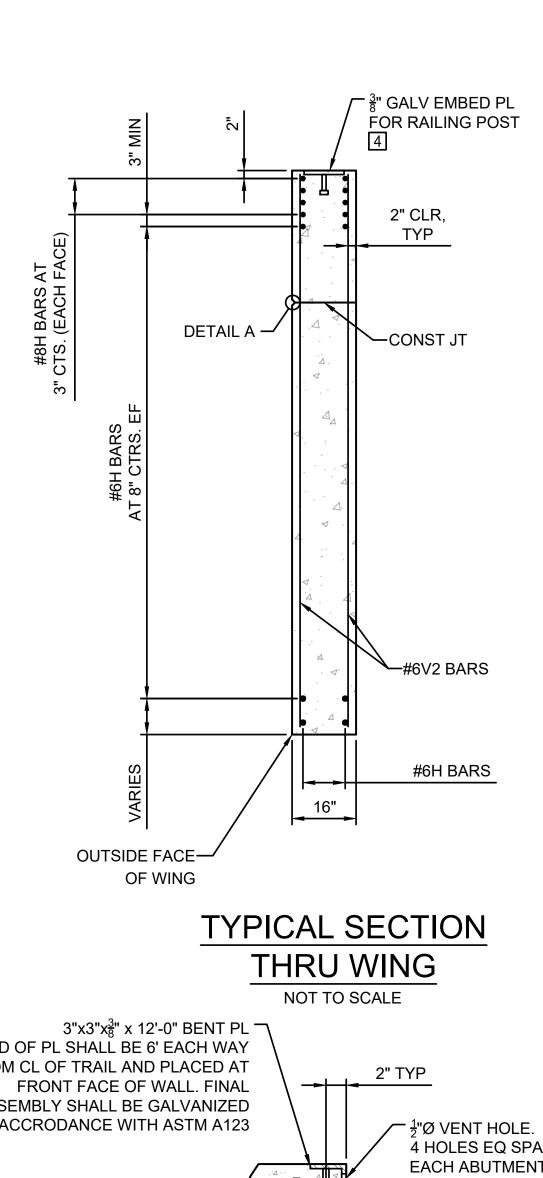
BENT 1 ELEVATION & SECTIONS


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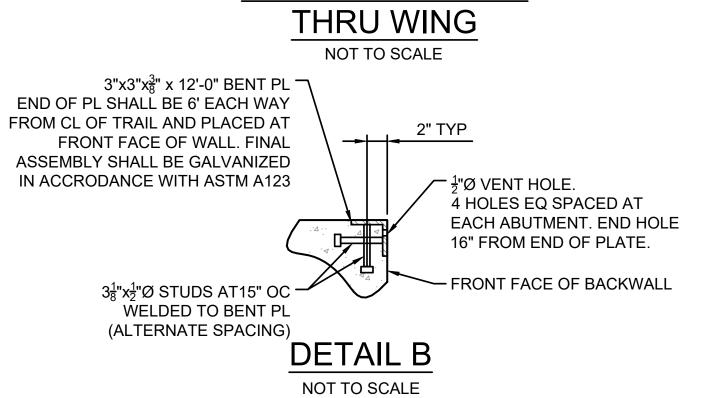
S-202







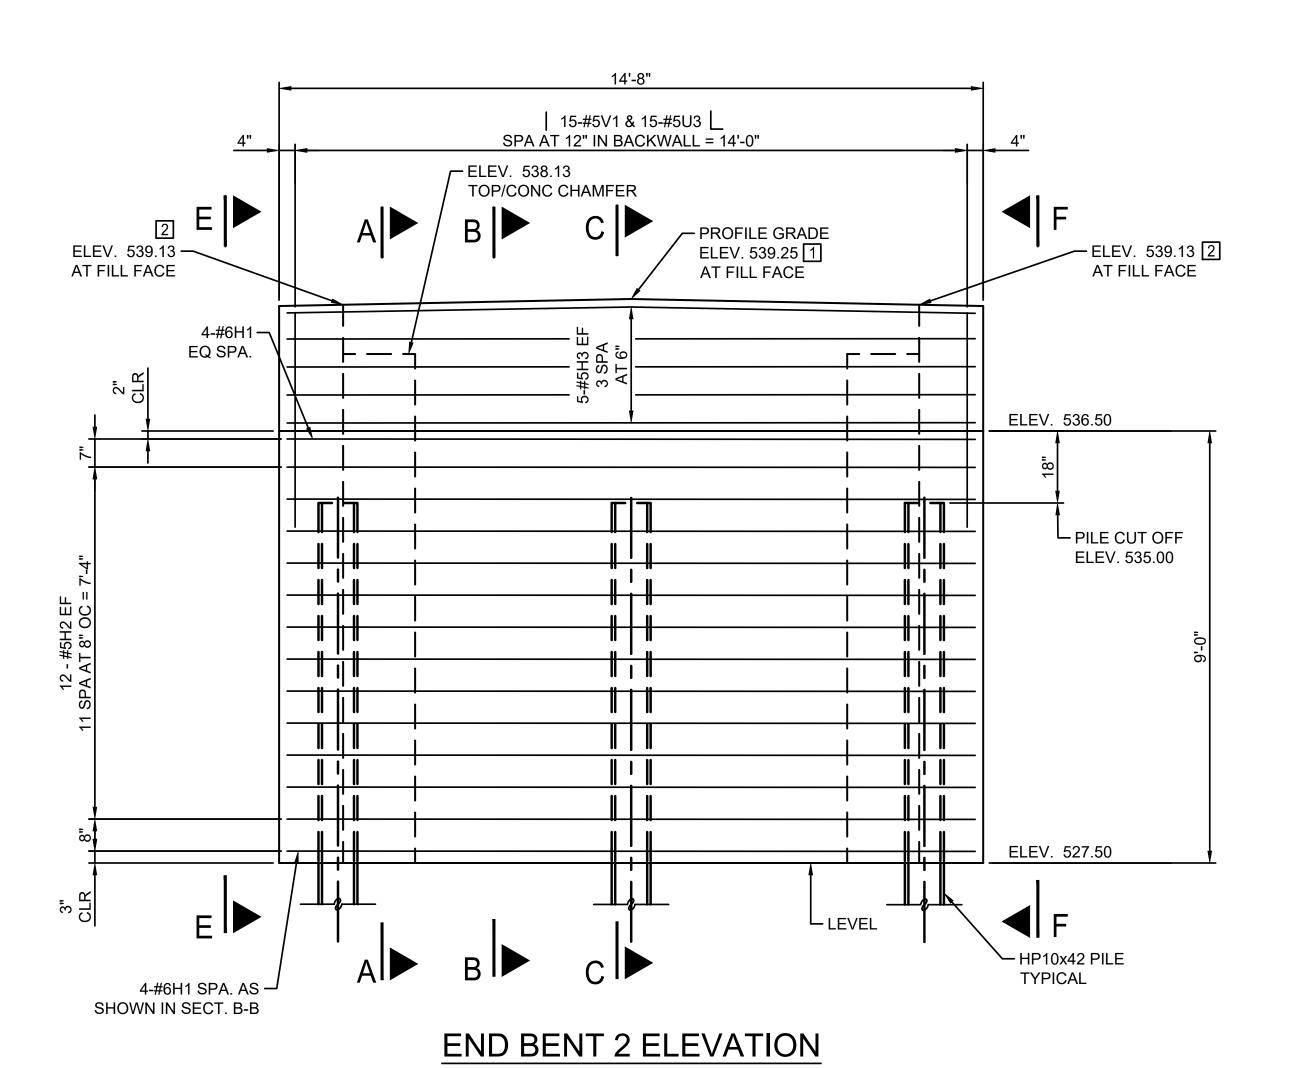

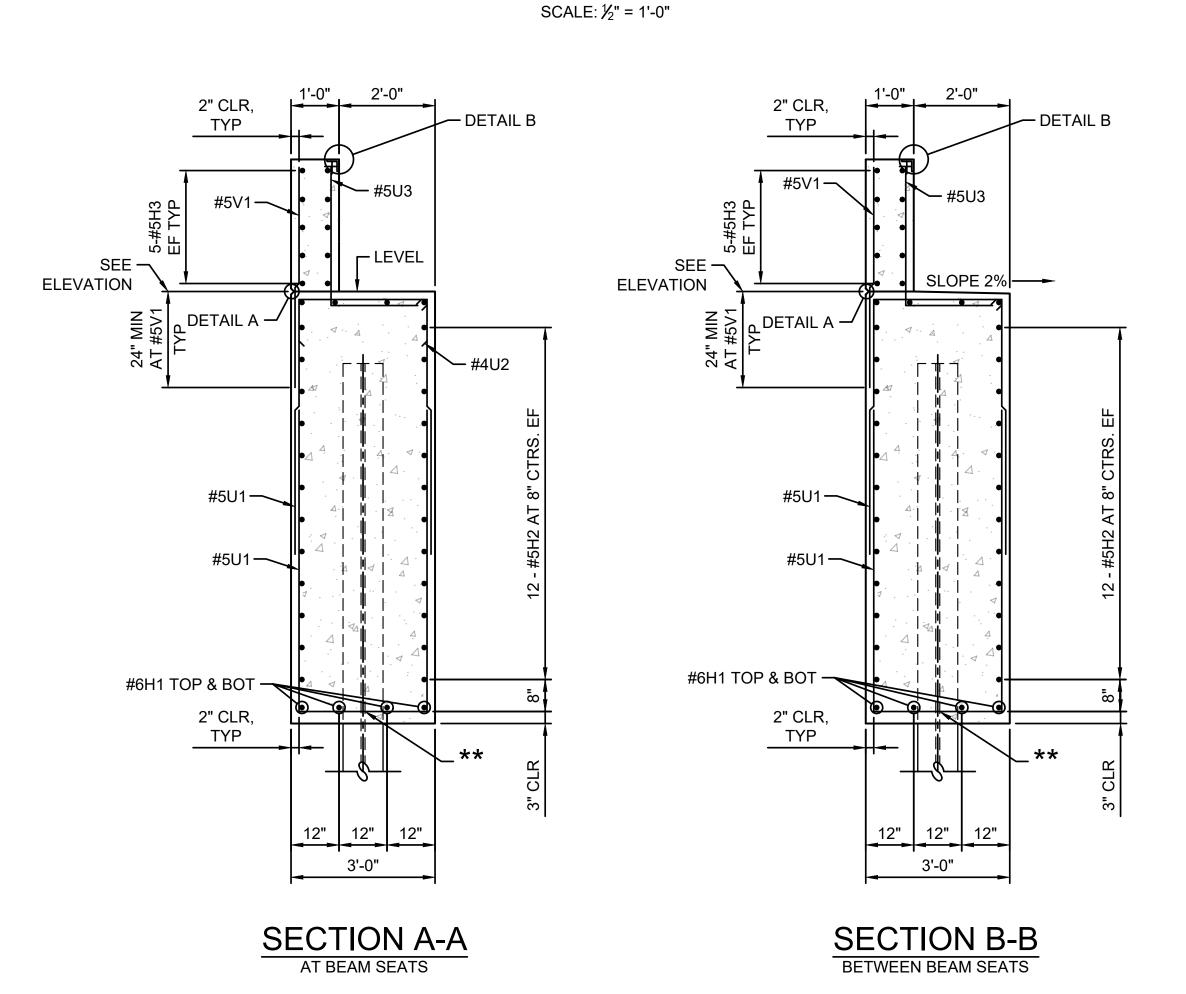

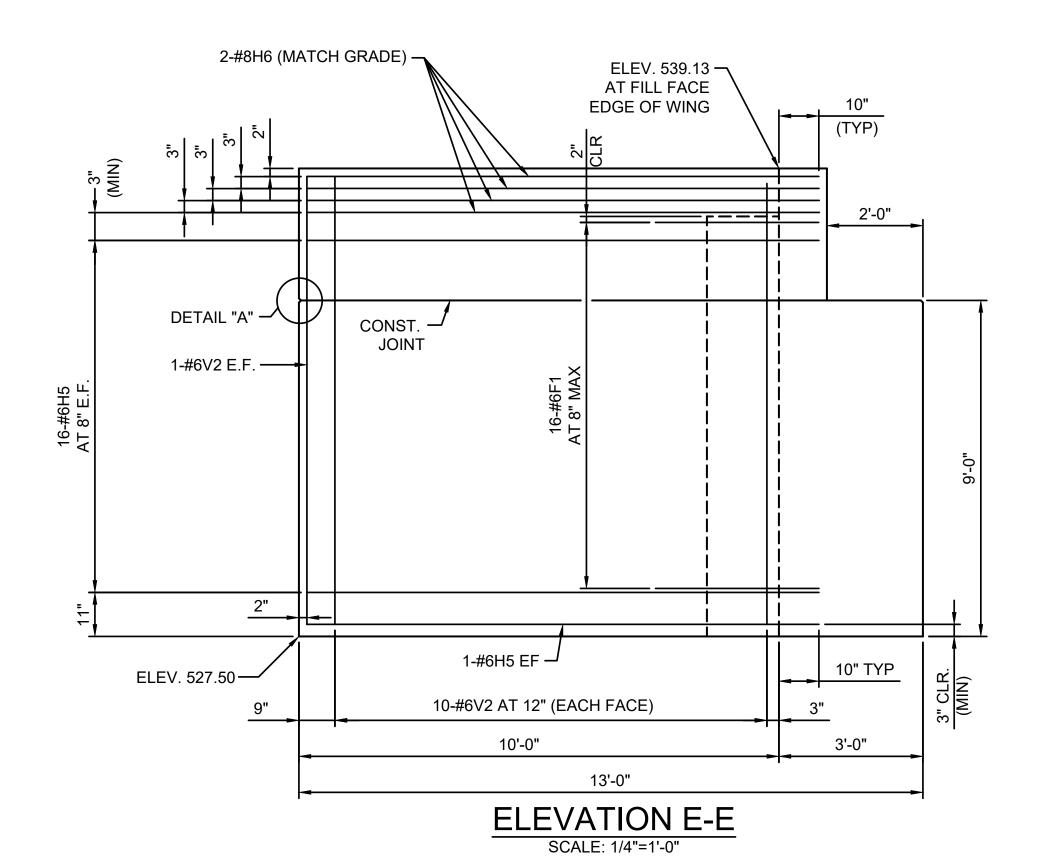

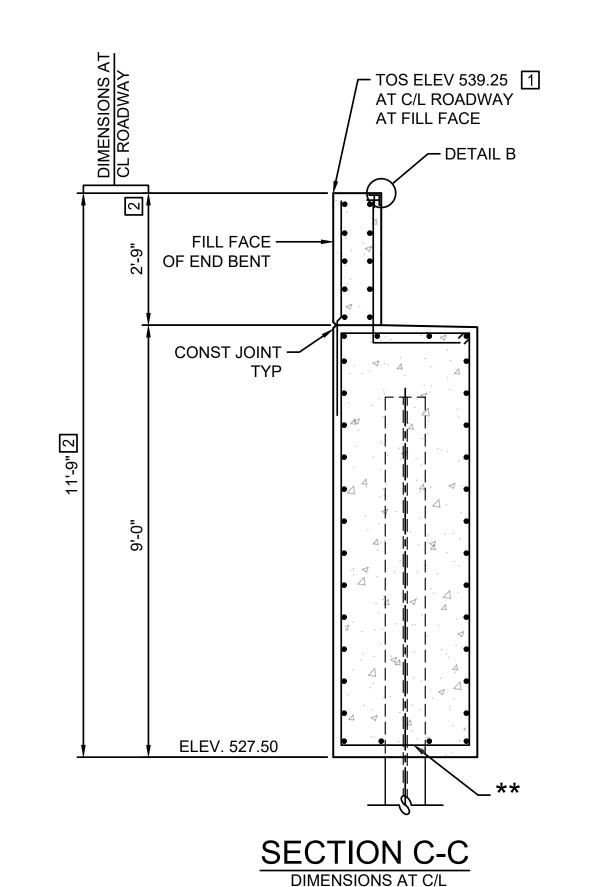

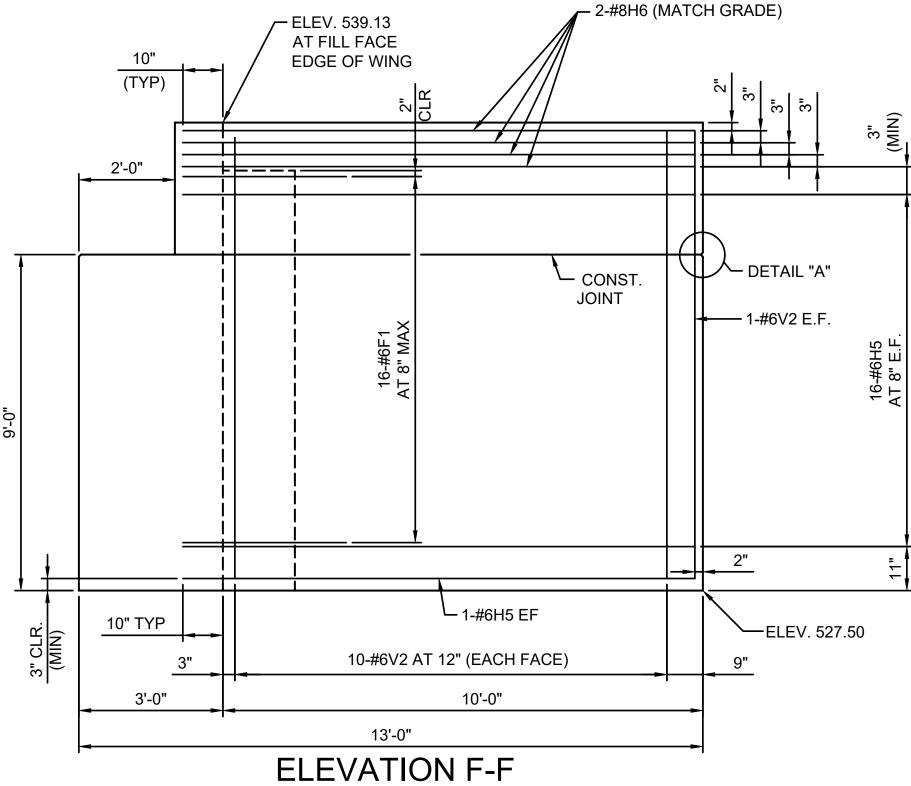

KEY NOTES:

SCALE: 1/4"=1'-0"

1 TOP OF ABUTMENT BACKWALL AND SLOPE OF BACKWALL MUST MATCH TOP OF CONCRETE BRIDGE DECK. SEE "CROWN DETAIL" ON D-001

HEIGHT OF BACKWALL AND TOP OF CONCRETE AT BRIDGE SEAT ARE BASED ON PRELIMINARY BRIDGE INFORMATION. THE CONTRACTOR SHALL BASE THEIR BID ON THE DIMENSIONS SHOWN AND ALLOW FOR POSSIBLE VARIATION IN THE BACKWALL HEIGHT AND BEAM SEAT ELEVATION TO ACCOMMODATE THE REQUIREMENTS OF THE ACTUAL PREFABRICATED BRIDGE TO BE SUPPLIED. THE BRIDGE MANUFACTURER AND CONTRACTOR SHALL PROVIDE EXACT HEIGHT REQUIREMENTS WITH FINAL BRIDGE DETAILS AND DESIGN TO ENGINEER FOR REVIEW AND APPROVAL PRIOR TO CONSTRUCTION.

3 NOT USED.

DETAIL A

SCALE: NTS

SIZE AND PLACEMENT OF THE EMBEDDED PLATES SHALL ACCOMMODATE THE SEPARATE 10'-0" LONG HANDRAIL SECTION PROVIDED BY THE PEDESTRIAN BRIDGE MANUFACTURER THAT IS MOUNTED TO THE TOP OF THE ABUTMENT WING WALL. THE ATTACHMENT METHOD OF THE HANDRAIL SHALL BE DETERMINED AND PROVIDED BY THE BRIDGE MANUFACTURER. THE CONTRACTOR MAY PROPOSE AN ALTERNATIVE ATTACHMENT METHOD TO THE CONCRETE WINGWALL TO BE APPROVED BY THE ENGINEER AT NO ADDITIONAL COST TO THE PROJECT BID.

STATE OF MISSOURI MICHAEL L. PARSON, GOVERNOR



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OFFICE OF ADMINISTRATION DIVISION OF FACILITIES MANAGEMENT, DESIGN & CONSTRUCTION

DEPARTMENT OF NATURAL RESOURCES DIVISION OF MISSOURI STATE PARKS

REPLACE HIGHWAY PP BRIDGE KATY TRAIL STATE PARK

KATY TRAIL - MP126.3 MOKANE, MO 65059

PROJECT NO. X2227-01 SITE NO. 5501 ASSET NO. 7815501002

REVISION:	
DATE:	
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ISSUE DATE: 03/03/2023	

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CHECKED BY: MMH
DESIGNED BY: ADM


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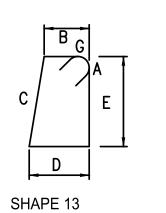
BENT 2 ELEVATION & SECTIONS


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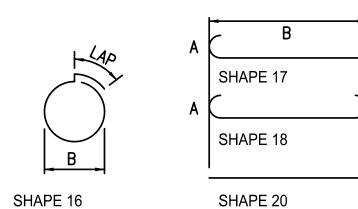
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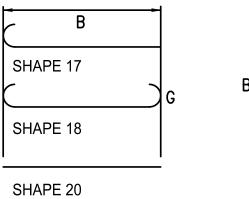
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	MA No																DIME	NSIONS							₫ ±		
REQ'D.				EPOXY (E)	SHAPE NO.	STIRRUP (S)	SUBSTR. (X)	VARIES (V)	ЕАСН	(inches)		В		С		D		E		F		Н		K	NOMINAL	ACTUAL LENGTH	WEIGHT
NO.	SIZE	MARK	LOCATION END BENT NO. 1	EPO)	SHAF	STIR	SUB	VARI	NO.	Incr.	FT.	IN	FT.	IN	FT.	IN	FT.	IN	FT.	IN	FT.	IN	FT.	IN	FT. IN.	FT. IN.	LBS.
8	6	H1	BEAM		20						14	4.000													14' 4"	14' 4"	173
6 10	5 5	H2 H3	BEAM BACKWALL		20						14 14	4.000 4.000													14' 4" 14' 4"	14' 4" 14' 4"	90 150
28	6	H5	WINGS		20						10	8.000													10' 8"	10' 8"	449
16	8	H6	WINGS		20						10	8.000													10' 8"	10' 8"	456
14	6	F1	BM/BKWL/WNGS		25						2	3.000	4	7.875	1	2.000					3	3.500	3	3.500	8' 1"	8' 0"	169
15	5	U1	BEAM		13	S					2	8.000	2	6.500	2	8.000	2	6.500							11' 4"	11' 0"	173
12	4	U2	BEAM		10	S							0	10.000	2	8.000									4' 4"	4' 2"	34
15	5	U3	BEAMBKWL		19						3	0.000	2	0.000											5' 0"	4' 11"	77
15	5	V1	BEAMBKWL		20						4	8.000													4' 8"	4' 8"	74
44	6	V2	WINGS		20						5	7.000													5' 7"	5' 7"	369
			END BENT NO. 2																							SUBTOTAL	2214
8	6	H1	BEAM		20						14	4.000													14' 4"	14' 4"	173
24	5	H2	BEAM BACKWALL		20						14	4.000													14' 4" 14' 4"	14' 4" 14' 4"	359 150
10	5 6	H3 H5	WINGS		20						14 10	4.000 8.000													10' 8"	10' 8"	1026
16	8	H6	WINGS		20						10	8.000													10' 8"	10' 8"	456
32	6	F1	BWBKWL/WNGS		25						2	3.000	4	7.875	1	2.000					3	3.500	3	3.500	8' 1"	8' 0"	385
32		1 1	DIVIDITIVE/VVINGS		25							3.000	-	7.073	'	2.000						3.300		3.300	0 1		363
		U1	BEAM		10									10.000		8.000									14' 4"	14' 1"	441
12 15	<u>4</u> 5	U2 U3	BEAM BEAMBKWL		10 19	S					3	0.000	0	10.000	2	8.000									4' 4" 5' 0"	4' 2" 4' 11"	34 77
			DE (WE)		"							0.000		0.000													, ,
15	5	V1	BEAMBKWL		20						4	8.000													4' 8"	4' 8"	74
44	6	V2	WINGS		20						11	5.500													11' 6"	11' 6" SUBTOTAL	761 3936
																										TOTAL	6150
																			<u> </u>		 						
												<u> </u>						<u> </u>		<u> </u>							
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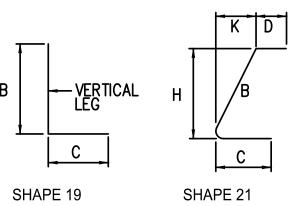










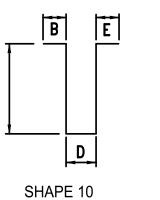

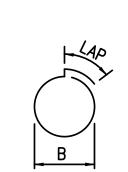



BENDING DIAGRAMS

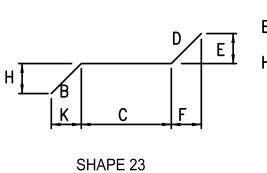

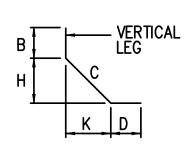

SHAPE 25

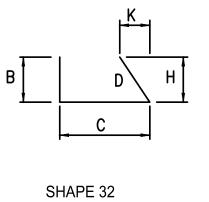

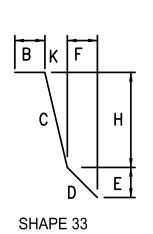

1. ALL STANDARD HOOKS AND BENDS OTHER THAN 180 DEG. TO BE BENT WITH THE SAME PROCEDURE AS FOR 90 DEG. STD. HOOKS

- 2. NOMINAL LENGTHS ARE BASED ON OUT TO OUT DIMENSIONS SHOWN IN BENDING DIAGRAMS AND ARE LISTED FOR FABRICATORS USE. (NEAREST INCH)
- 3. ACTUAL LENGTHS ARE MEASURED ALONG CENTERLINE BAR TO THE NEAREST
- 4. LENGTH OF SERIES BARS REPRESENTS THE AVERAGE LENGTH OF BARS IN THE SERIES TO THE NEAREST INCH.
- 5. REINFORCING STEEL (GRADE 60) Fy = 60,000 PSI.
- 6. REINFORCING WEIGHT SHOWN ON THIS SHEET IS ACTUAL WEIGHT. WEIGHT SHOWN IN THE TABLE OF ESTIMATED QUANTITIES IS ROUNDED TO THE NEAREST 10 LBS.
- 7. STEEL BILL OF MATERIAL IS AN ESTIMATED QUANTITY LIST TO ASSIST CONTRACTOR. CONTRACTOR IS RESPONSIBLE FOR ACTUAL QUANTITIES. IF ANY STEEL QUANTITY DIFFERS, CONTACT ENGINEER PRIOR TO PLACEMENT.

ABBREVIATIONS:

E = EPOXY COATED REINFORCEMENT.

S = STIRRUP.

V = BAR DIMENSIONS VARY IN EQUAL INCREMENTS.

NO. EA. = NUMBER OF BARS OF EACH LENGTH.

STATE OF MISSOURI MICHAEL L. PARSON, GOVERNOR





OFFICE OF ADMINISTRATION DIVISION OF FACILITIES MANAGEMENT, **DESIGN & CONSTRUCTION**

DEPARTMENT OF NATURAL RESOURCES **DIVISION OF MISSOURI** STATE PARKS

REPLACE HIGHWAY PP BRIDGE KATY TRAIL STATE PARK

KATY TRAIL - MP126.3 MOKANE, MO


PROJECT NO. X2227-01 SITE NO. 5501 ASSET NO. 7815501002

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DATE:
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ISSUE DATE: 03/03/2023

CAD DWG FILE:X2227-01-S-BRS-01 DRAWN BY: JJB CHECKED BY: MMH DESIGNED BY: ADM


SHEET TITLE: BILL OF REINFORCING

SHEET NUMBER:

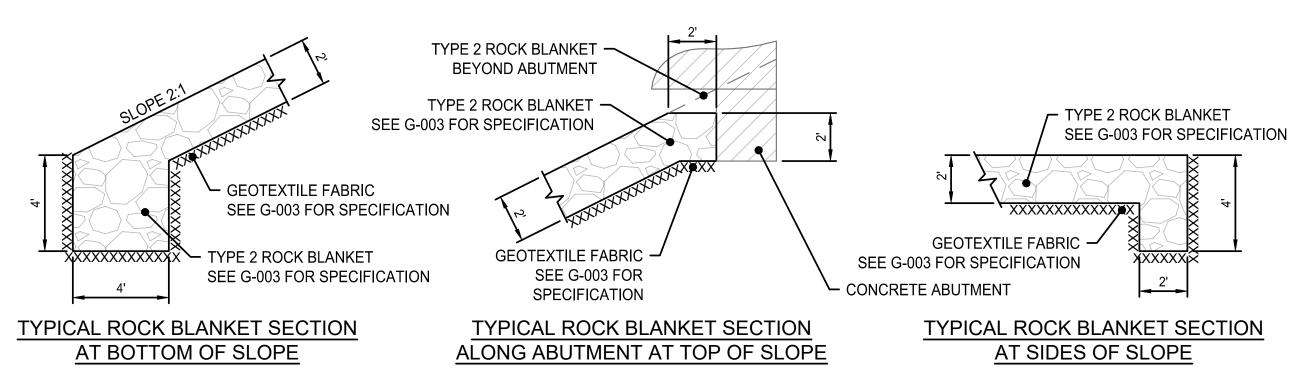


TYPICAL ROCK BLANKET SECTIONS


NOT TO SCALE

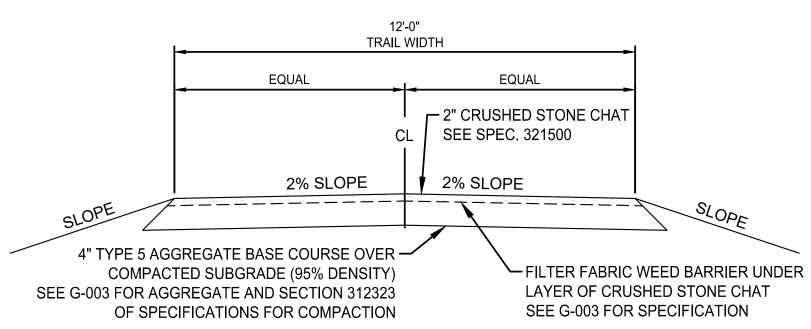

TYPICAL TRAIL SECTION

NOT TO SCALE

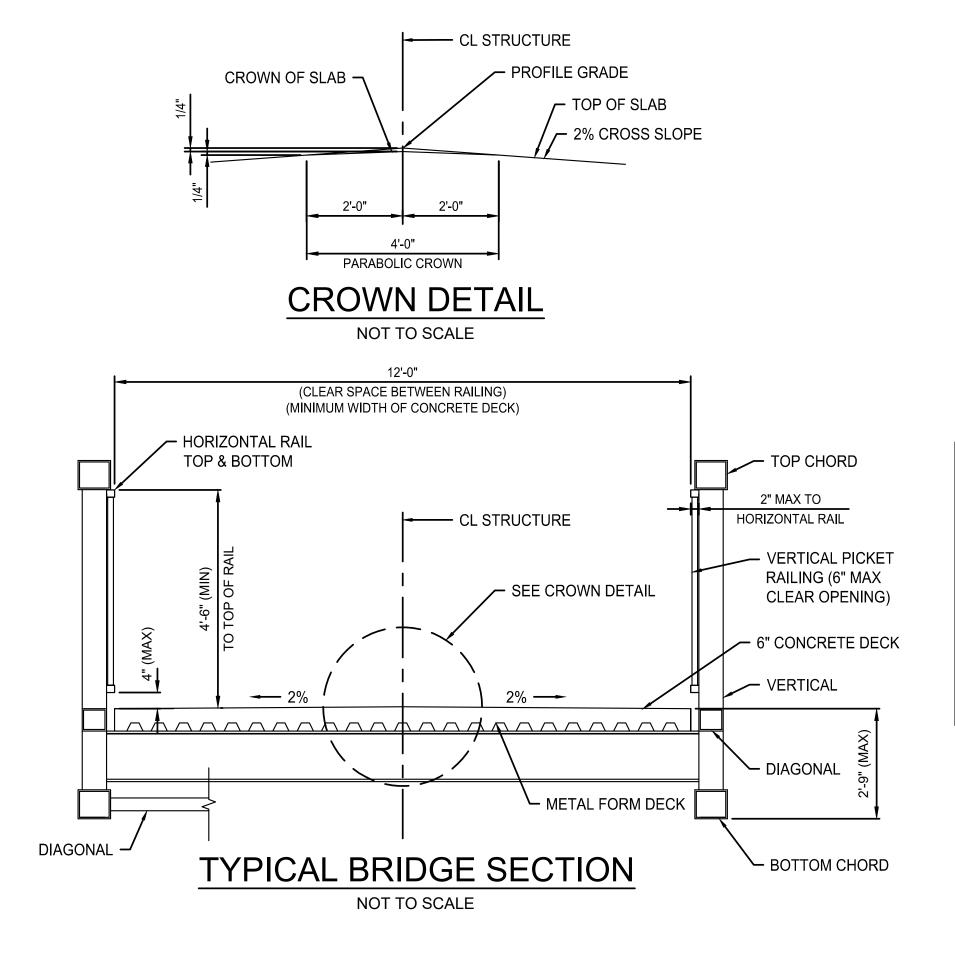


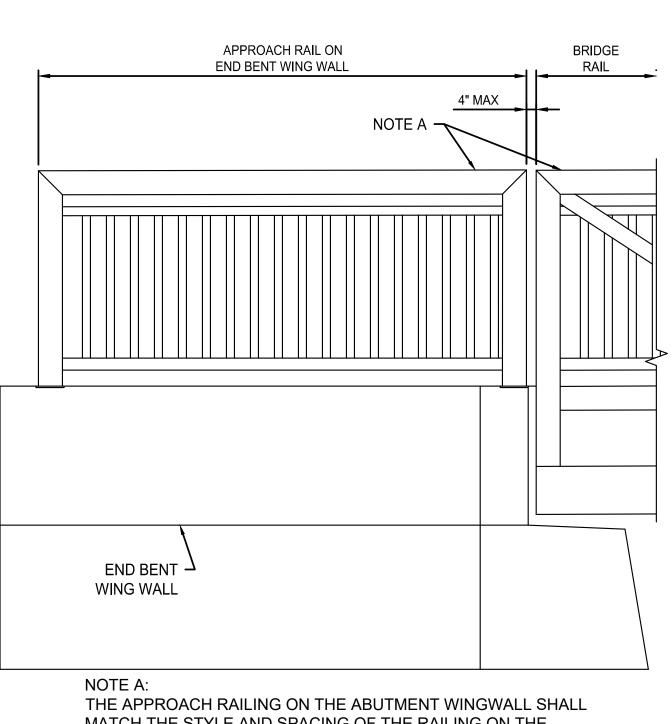

MATCH THE STYLE AND SPACING OF THE RAILING ON THE BRIDGE. THE END POSTS AND TOP RAIL SHALL MATCH THE SIZE OF THE BRIDGE END POST AND TOP CHORD.

END BENT APPROACH RAIL **ELEVATION VIEW**

NOT TO SCALE

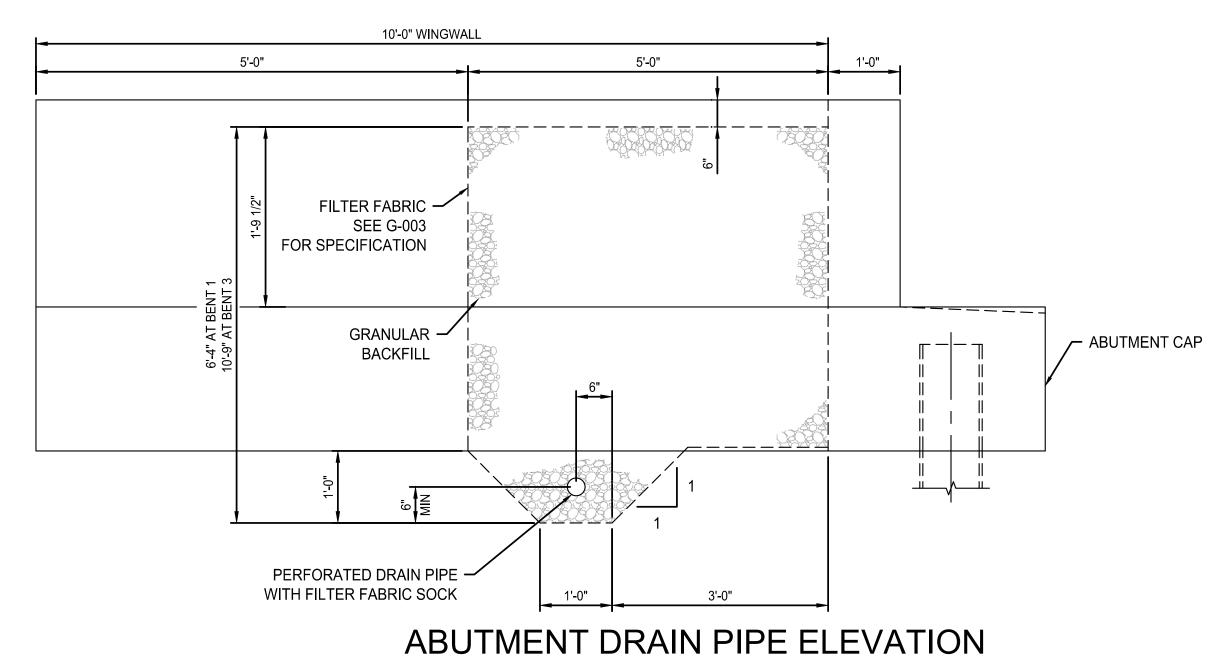

NOTE A:

FABRIC SOCK.

AND ROCK BLANKET.

DRAIN PIPE MAY BE EITHER 4" DIAMETER CORRUGATED

POLYVINYL CHLORIDE (PVC) DRAIN PIPE, OR 4" DIAMETER

PLACE DRAIN PIPE BEHIND CAP AS SHOWN AND SLOPE TO

LIMITS OF ABUTMENT TO EXIT AT GROUND LINE.

LOWEST GRADE OF GROUND LINE BEYOND LIMITS OF ABUTMENT

PERFORATED DRAIN PIPE SHALL BE USED BEHIND CAP WITHIN LIMITS OF ABUTMENT. PLAIN PIPE SHALL BE USED OUTSIDE


CORRUGATED POLYETHYLENE (PE) DRAIN PIPE WITH FILTER

NOT TO SCALE

GRANULAR BACKFILL

THE GRANULAR BACKFILL SHALL BE GRAVEL, CRUSHED STONE, OR OTHER APPROVED MATERIAL, IN ACCORDANCE WITH THE **FOLLOWING GRADATION REQUIREMENTS:**

GRANULAR BACKFILL REQUIREMENTS							
SIEVE SIZE	PERCENT BY WEIGHT (MASS)						
1-INCH	100						
3/4-INCH	90-100						
3/8-INCH	20-55						
NO. 4	0-10						
NO. 8	0-5						

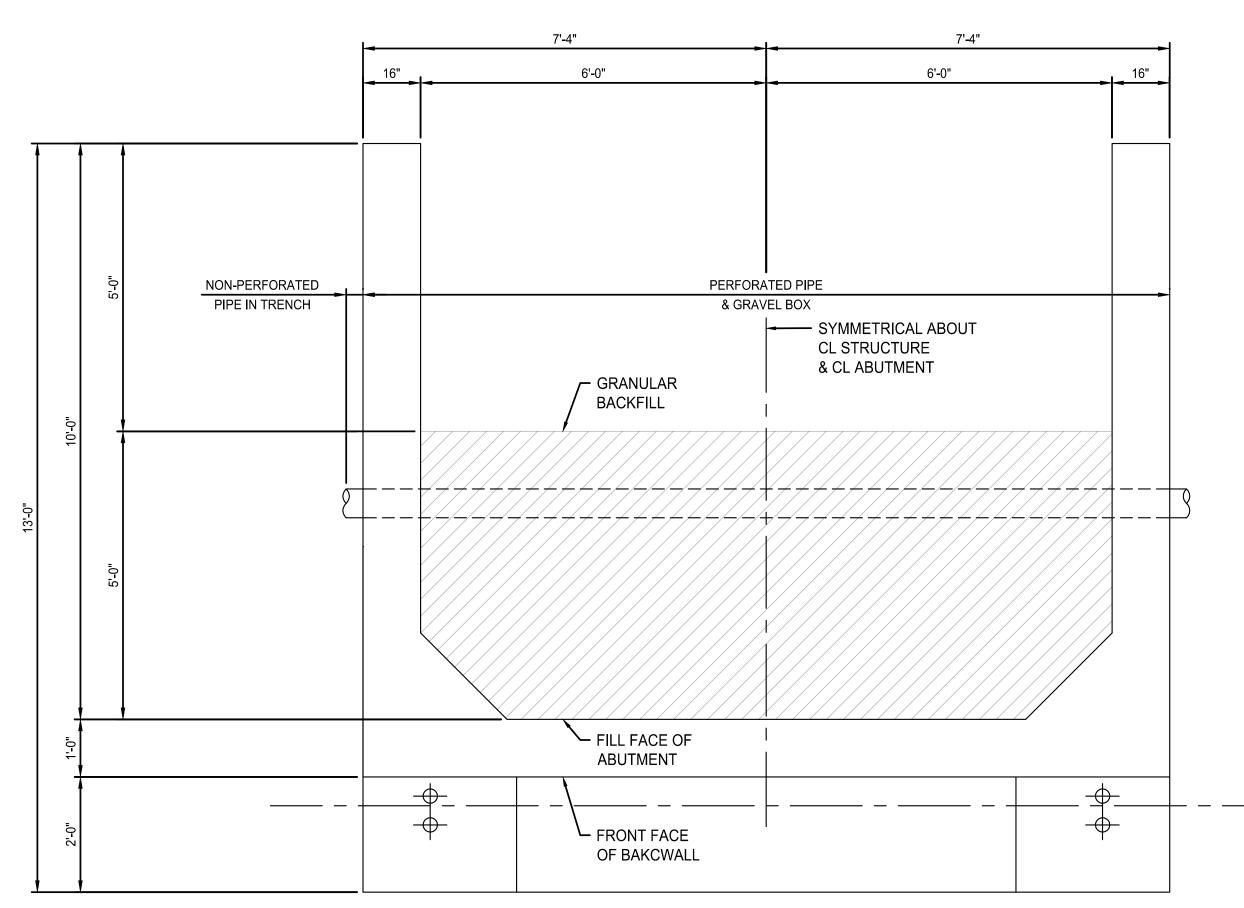

ABUTMENT DRAIN PIPE PLAN

NOT TO SCALE

STATE OF MISSOURI MICHAEL L. PARSON, **GOVERNOR**





OFFICE OF ADMINISTRATION **DIVISION OF FACILITIES** MANAGEMENT, **DESIGN & CONSTRUCTION**

DEPARTMENT OF NATURAL RESOURCES **DIVISION OF MISSOURI** STATE PARKS

REPLACE HIGHWAY PP BRIDGE KATY TRAIL STATE PARK

KATY TRAIL - MP126.3 MOKANE, MO

PROJECT NO. X2227-01 SITE NO. 5501 ASSET NO. 7815501002

REVISION: DATE **REVISION**: DATE: ISSUE DATE: 03/03/2023

CAD DWG FILE:X2227-01-C-DTL-01
DRAWN BY: JJB
CHECKED BY: MMH DESIGNED BY: ADM

SHEET TITLE:

TYPICAL DETAILS

SHEET NUMBER: