Water and Sewer Improvements Dr. Edmund A. Babler Memorial State Park Wildwood, Missouri

STATE OF MISSOURI OWNER:

MICHAEL L. PARSON,

GOVERNOR

DEPARTMENT OF

NATURAL RESOURCES DIVISION OF STATE PARKS

PROJECT OFFICE OF ADMINISTRATION

C-119

C-120

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DIVISION OF FACILITIES MANAGEMENT,

DESIGN AND CONSTRUCTION

SITE PLAN

SITE PLAN

CIVIL DESIGN, INC. WBE DBE

STANDARD DETAILS

STANDARD DETAILS

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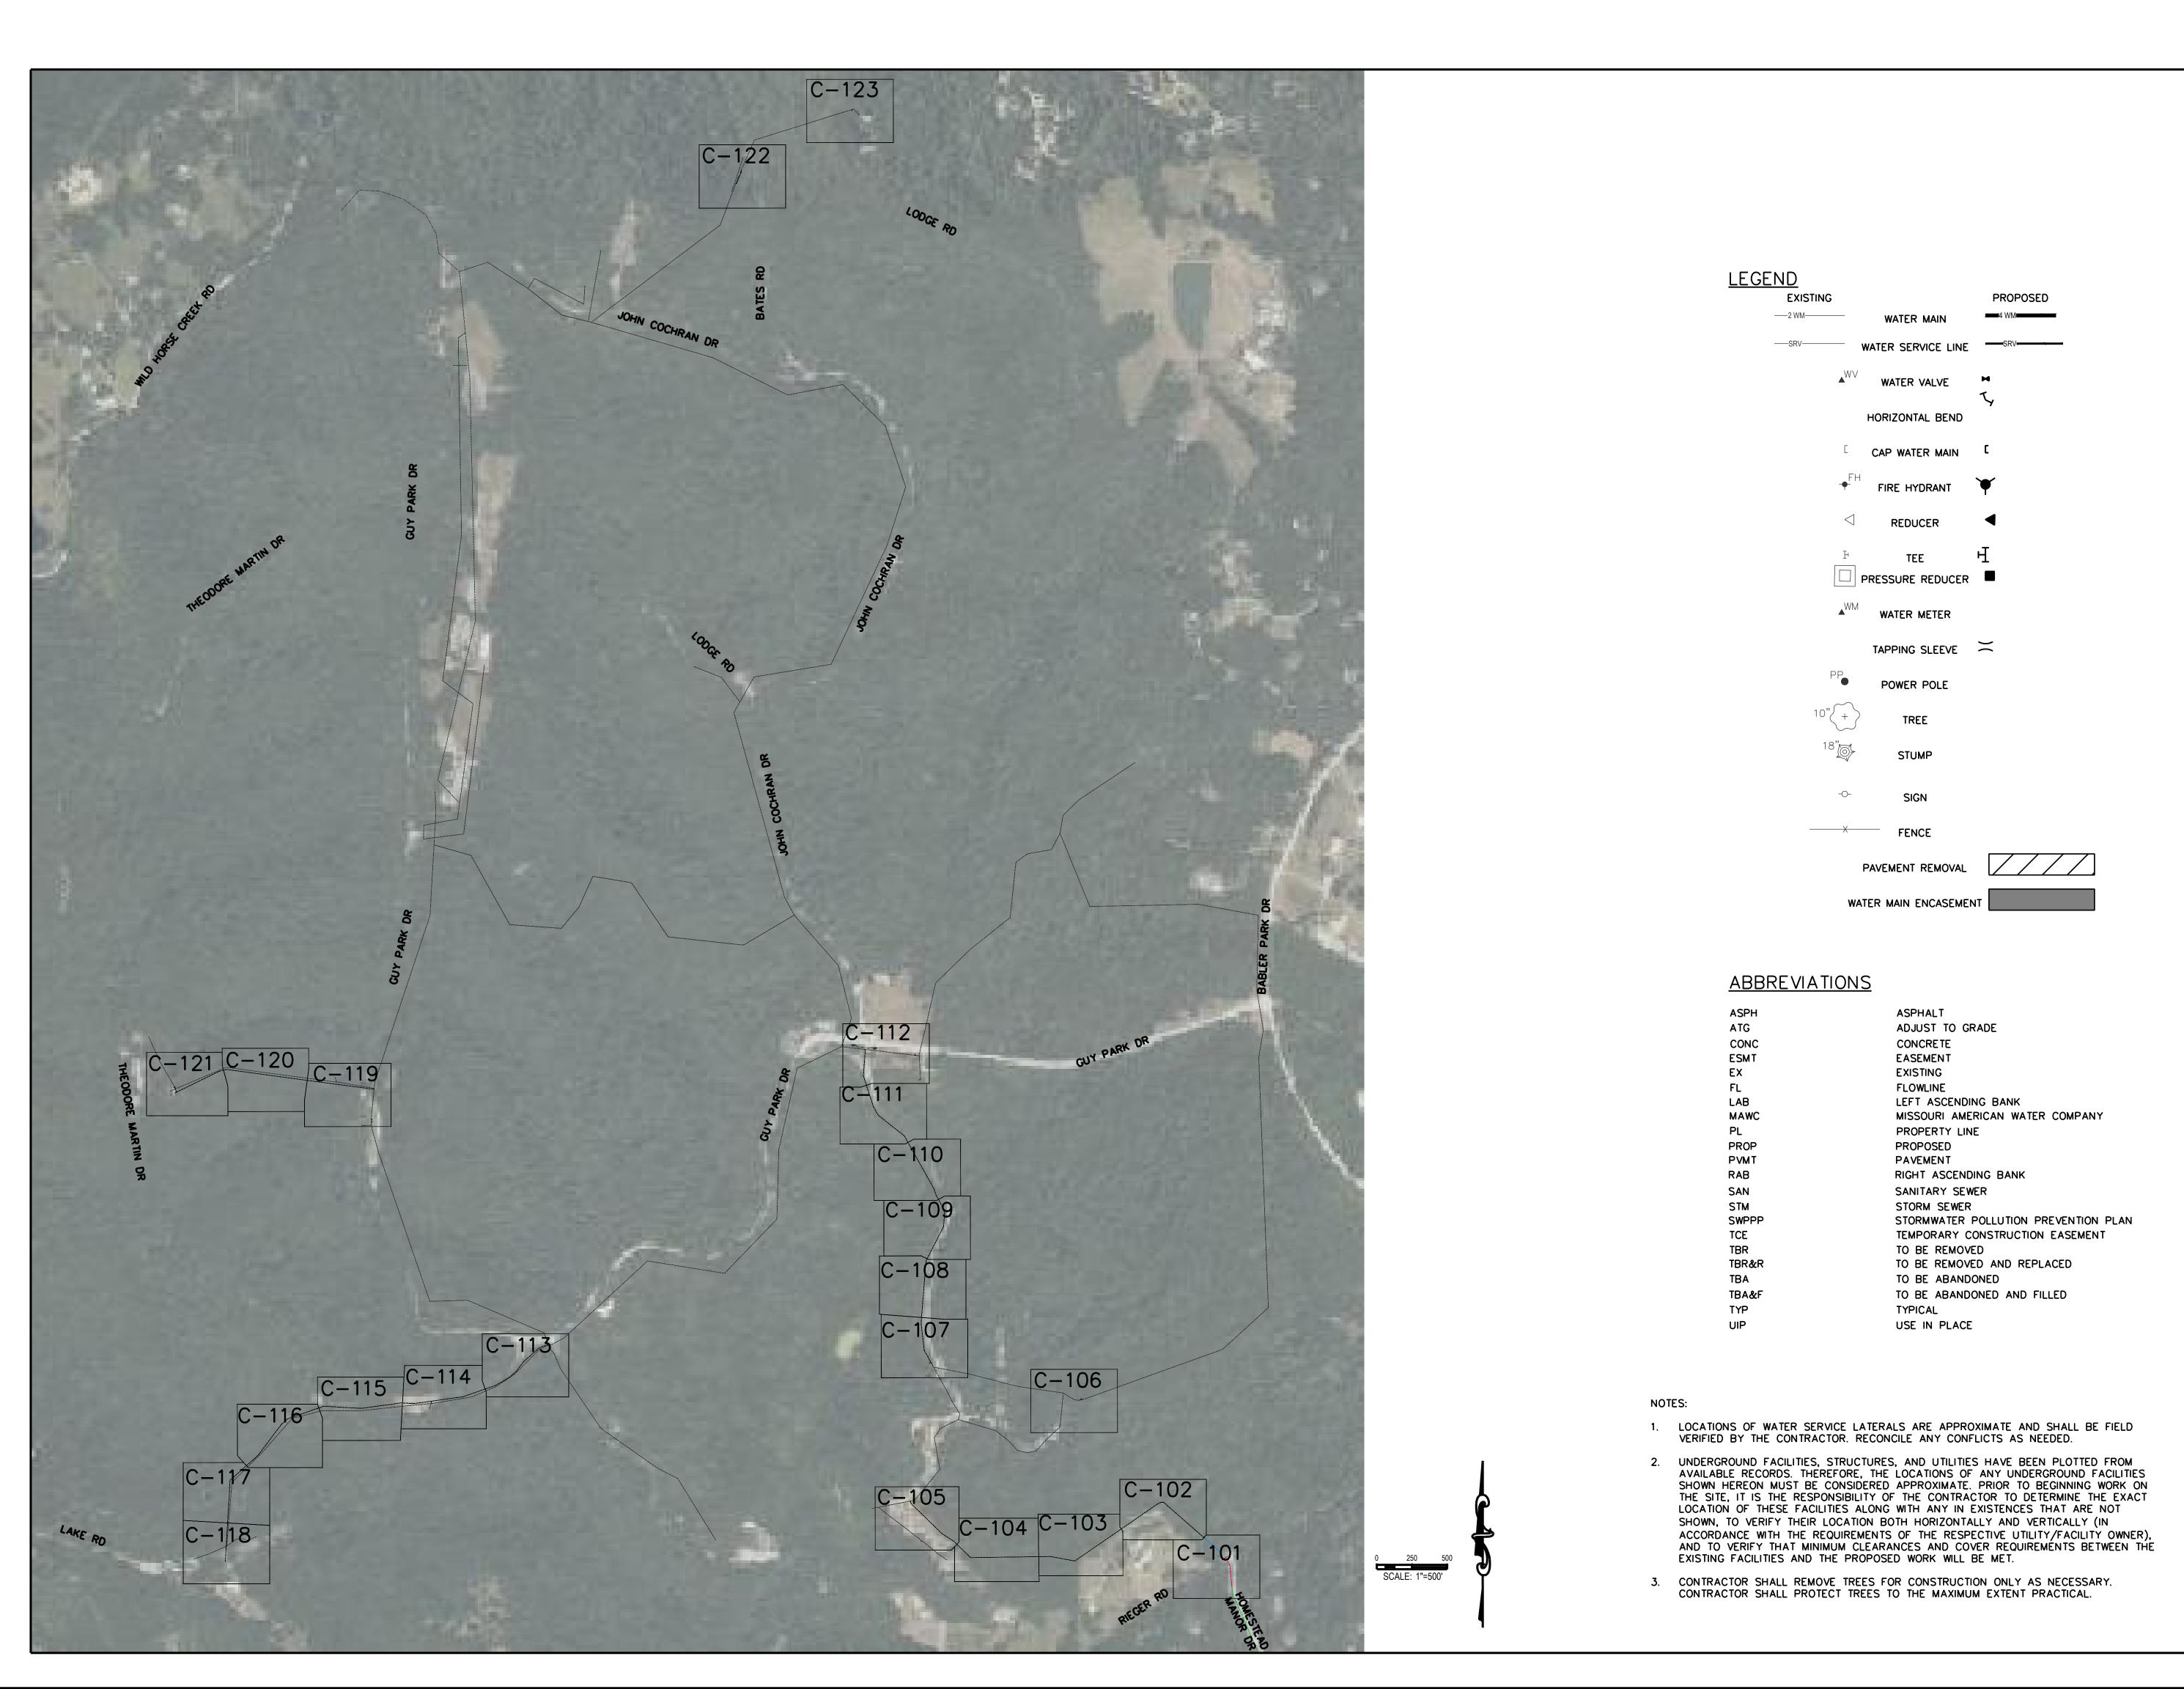
C-406

DESIGNER: CIVIL DESIGN, INC.

PROJECT NUMBER: X2301-01

SITE NUMBER: 5201 ASSET NUMBER: 7815201059

MO AMERICAN WATER COMPANY STANDARD DETAILS





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I Engineering #2002006804

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OFFICE OF ADMINISTRATION DIVISION OF FACILITIES MANAGEMENT, DESIGN AND CONSTRUCTION

DEPARTMENT OF NATURAL RESOURCES DIVISION OF STATE PARKS

WATER AND SEWER IMPROVEMENTS

DR. EDMUND A. BABLER MEMORIAL STATE PARK 800 GUY PARK DRIVE WILDWOOD, MISSOURI 63005

PROJECT # **X2301-01** CDI PROJECT # **5917**

SITE # **5201** ASSET # **7815201059**

REVISION:	
DATE:	-
REVISION:	-
DATE:	_
REVISION:	_
DATE:	_
ISSUE DATE:	_

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DRAWN BY: KDF
CHECKED BY: WMK
DESIGNED BY: KDF


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OVERALL PLAN SHEET


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C-100


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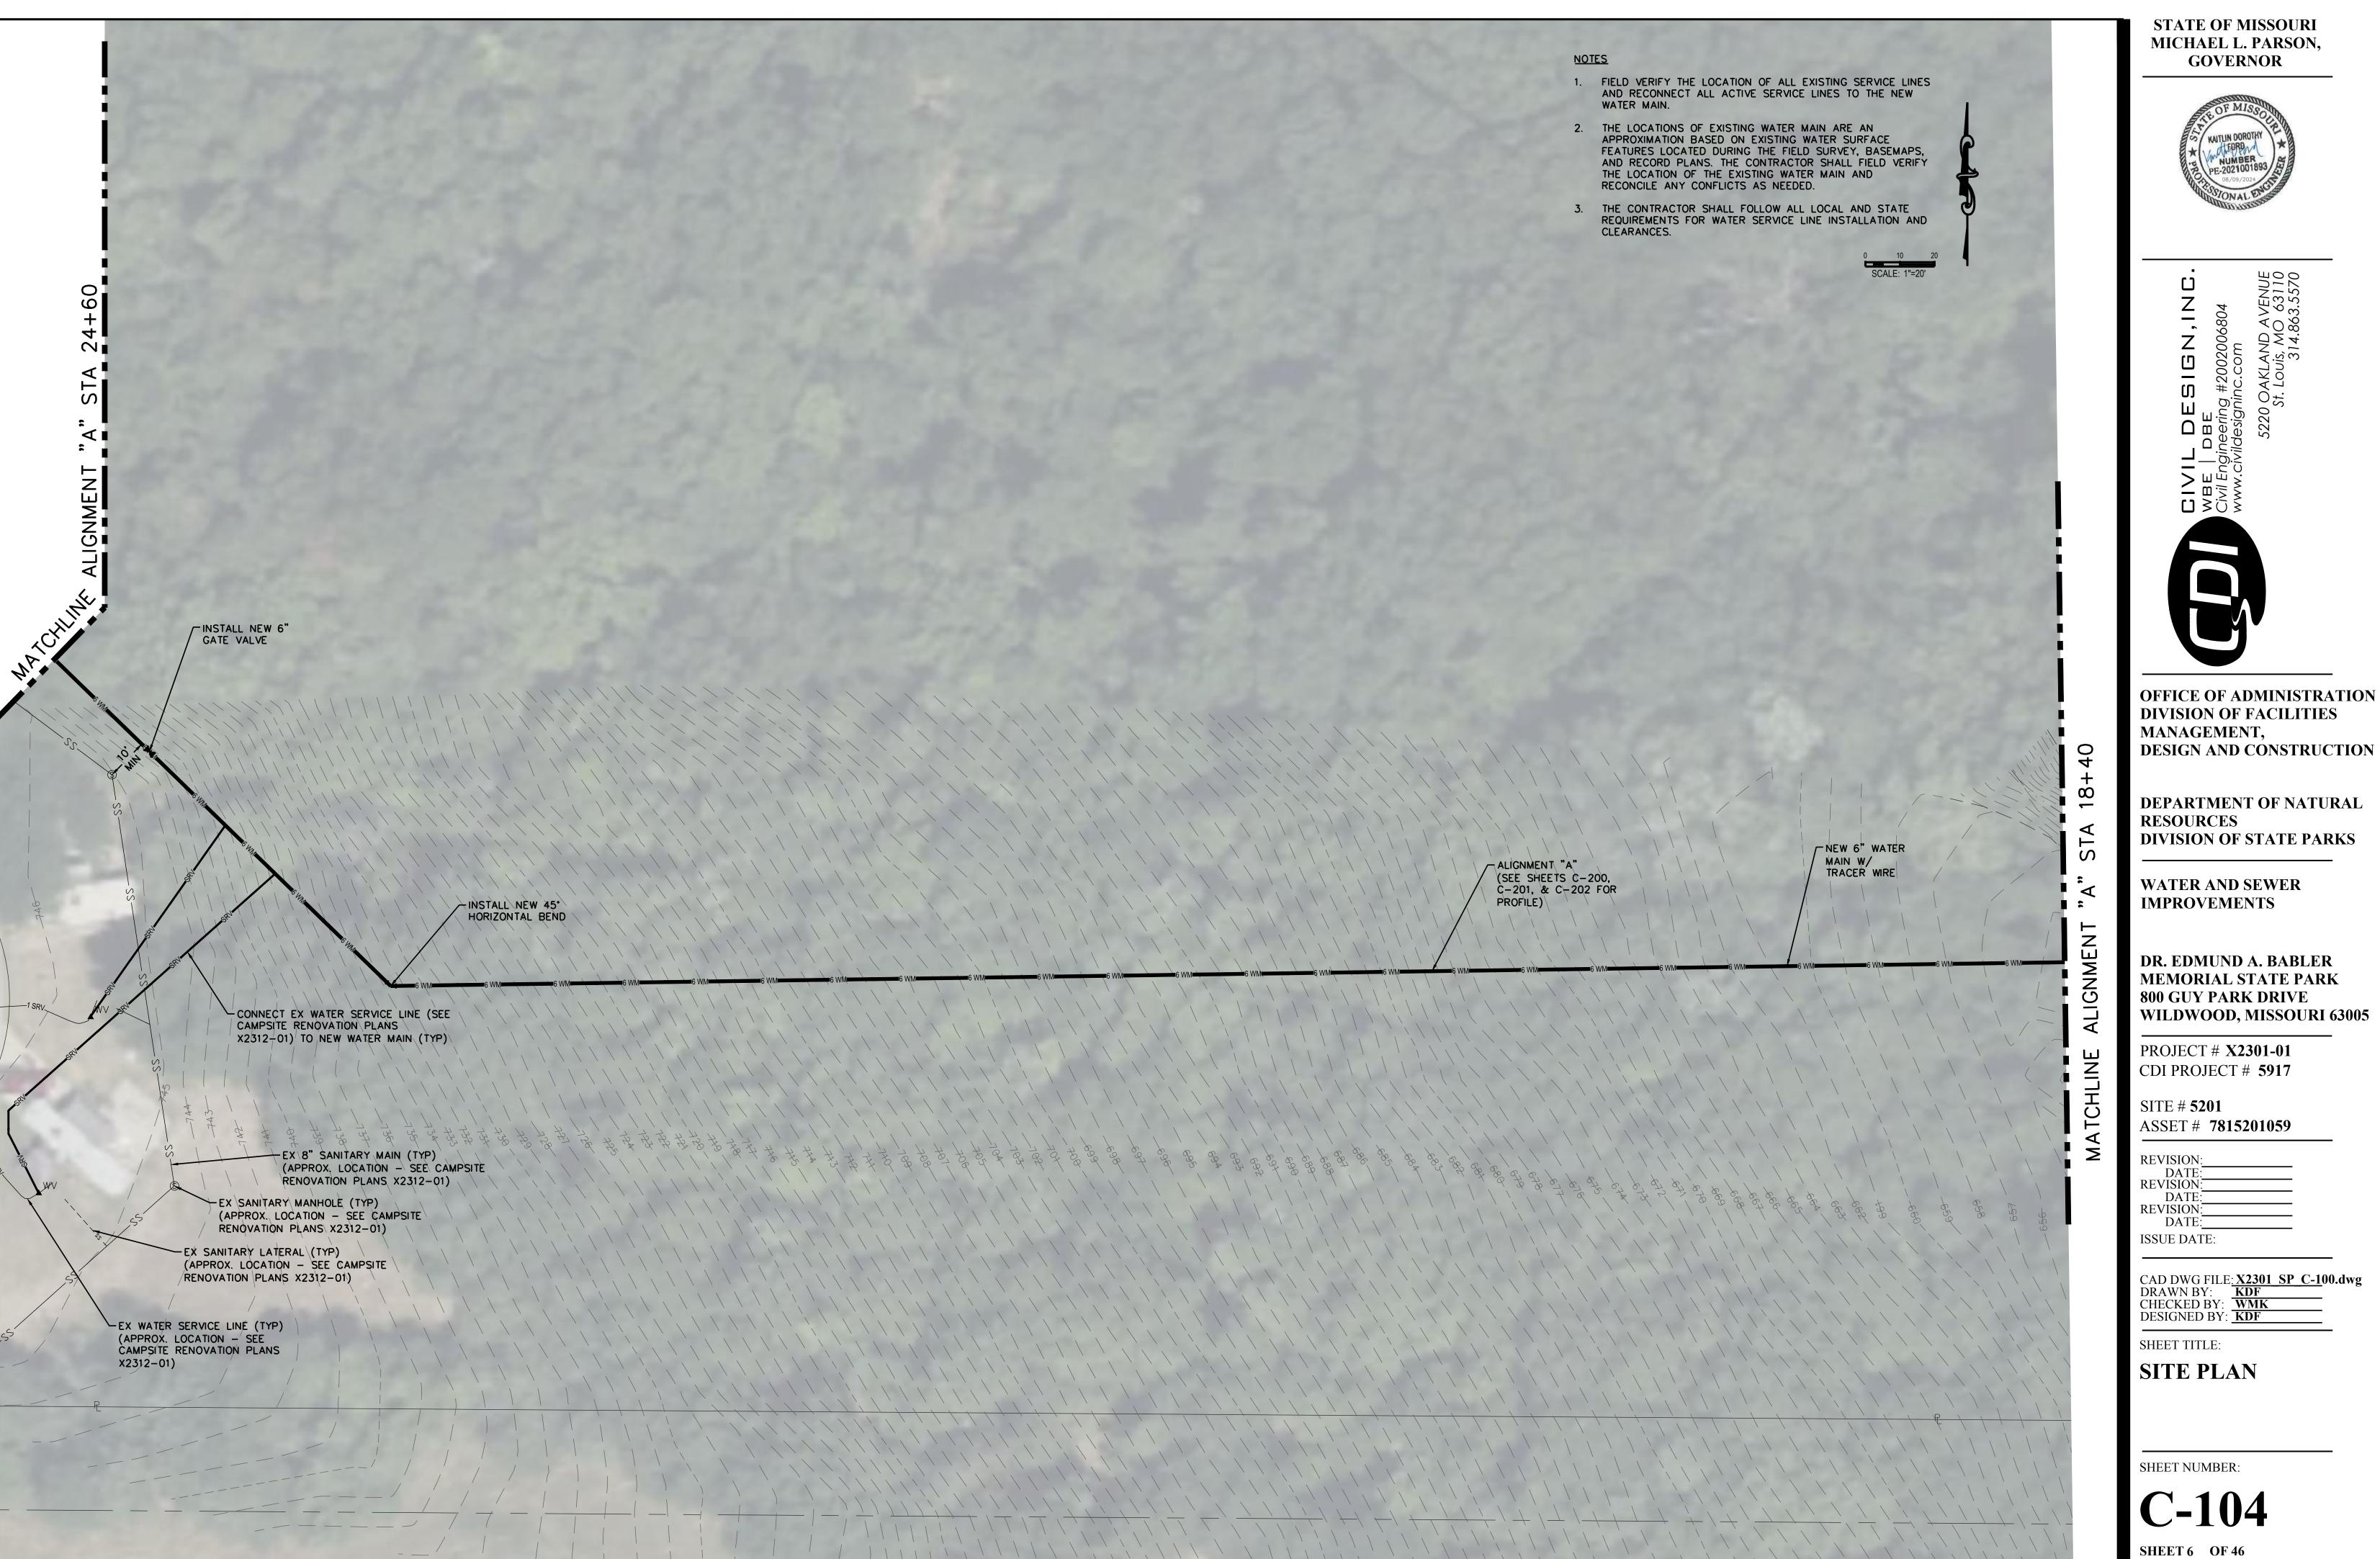


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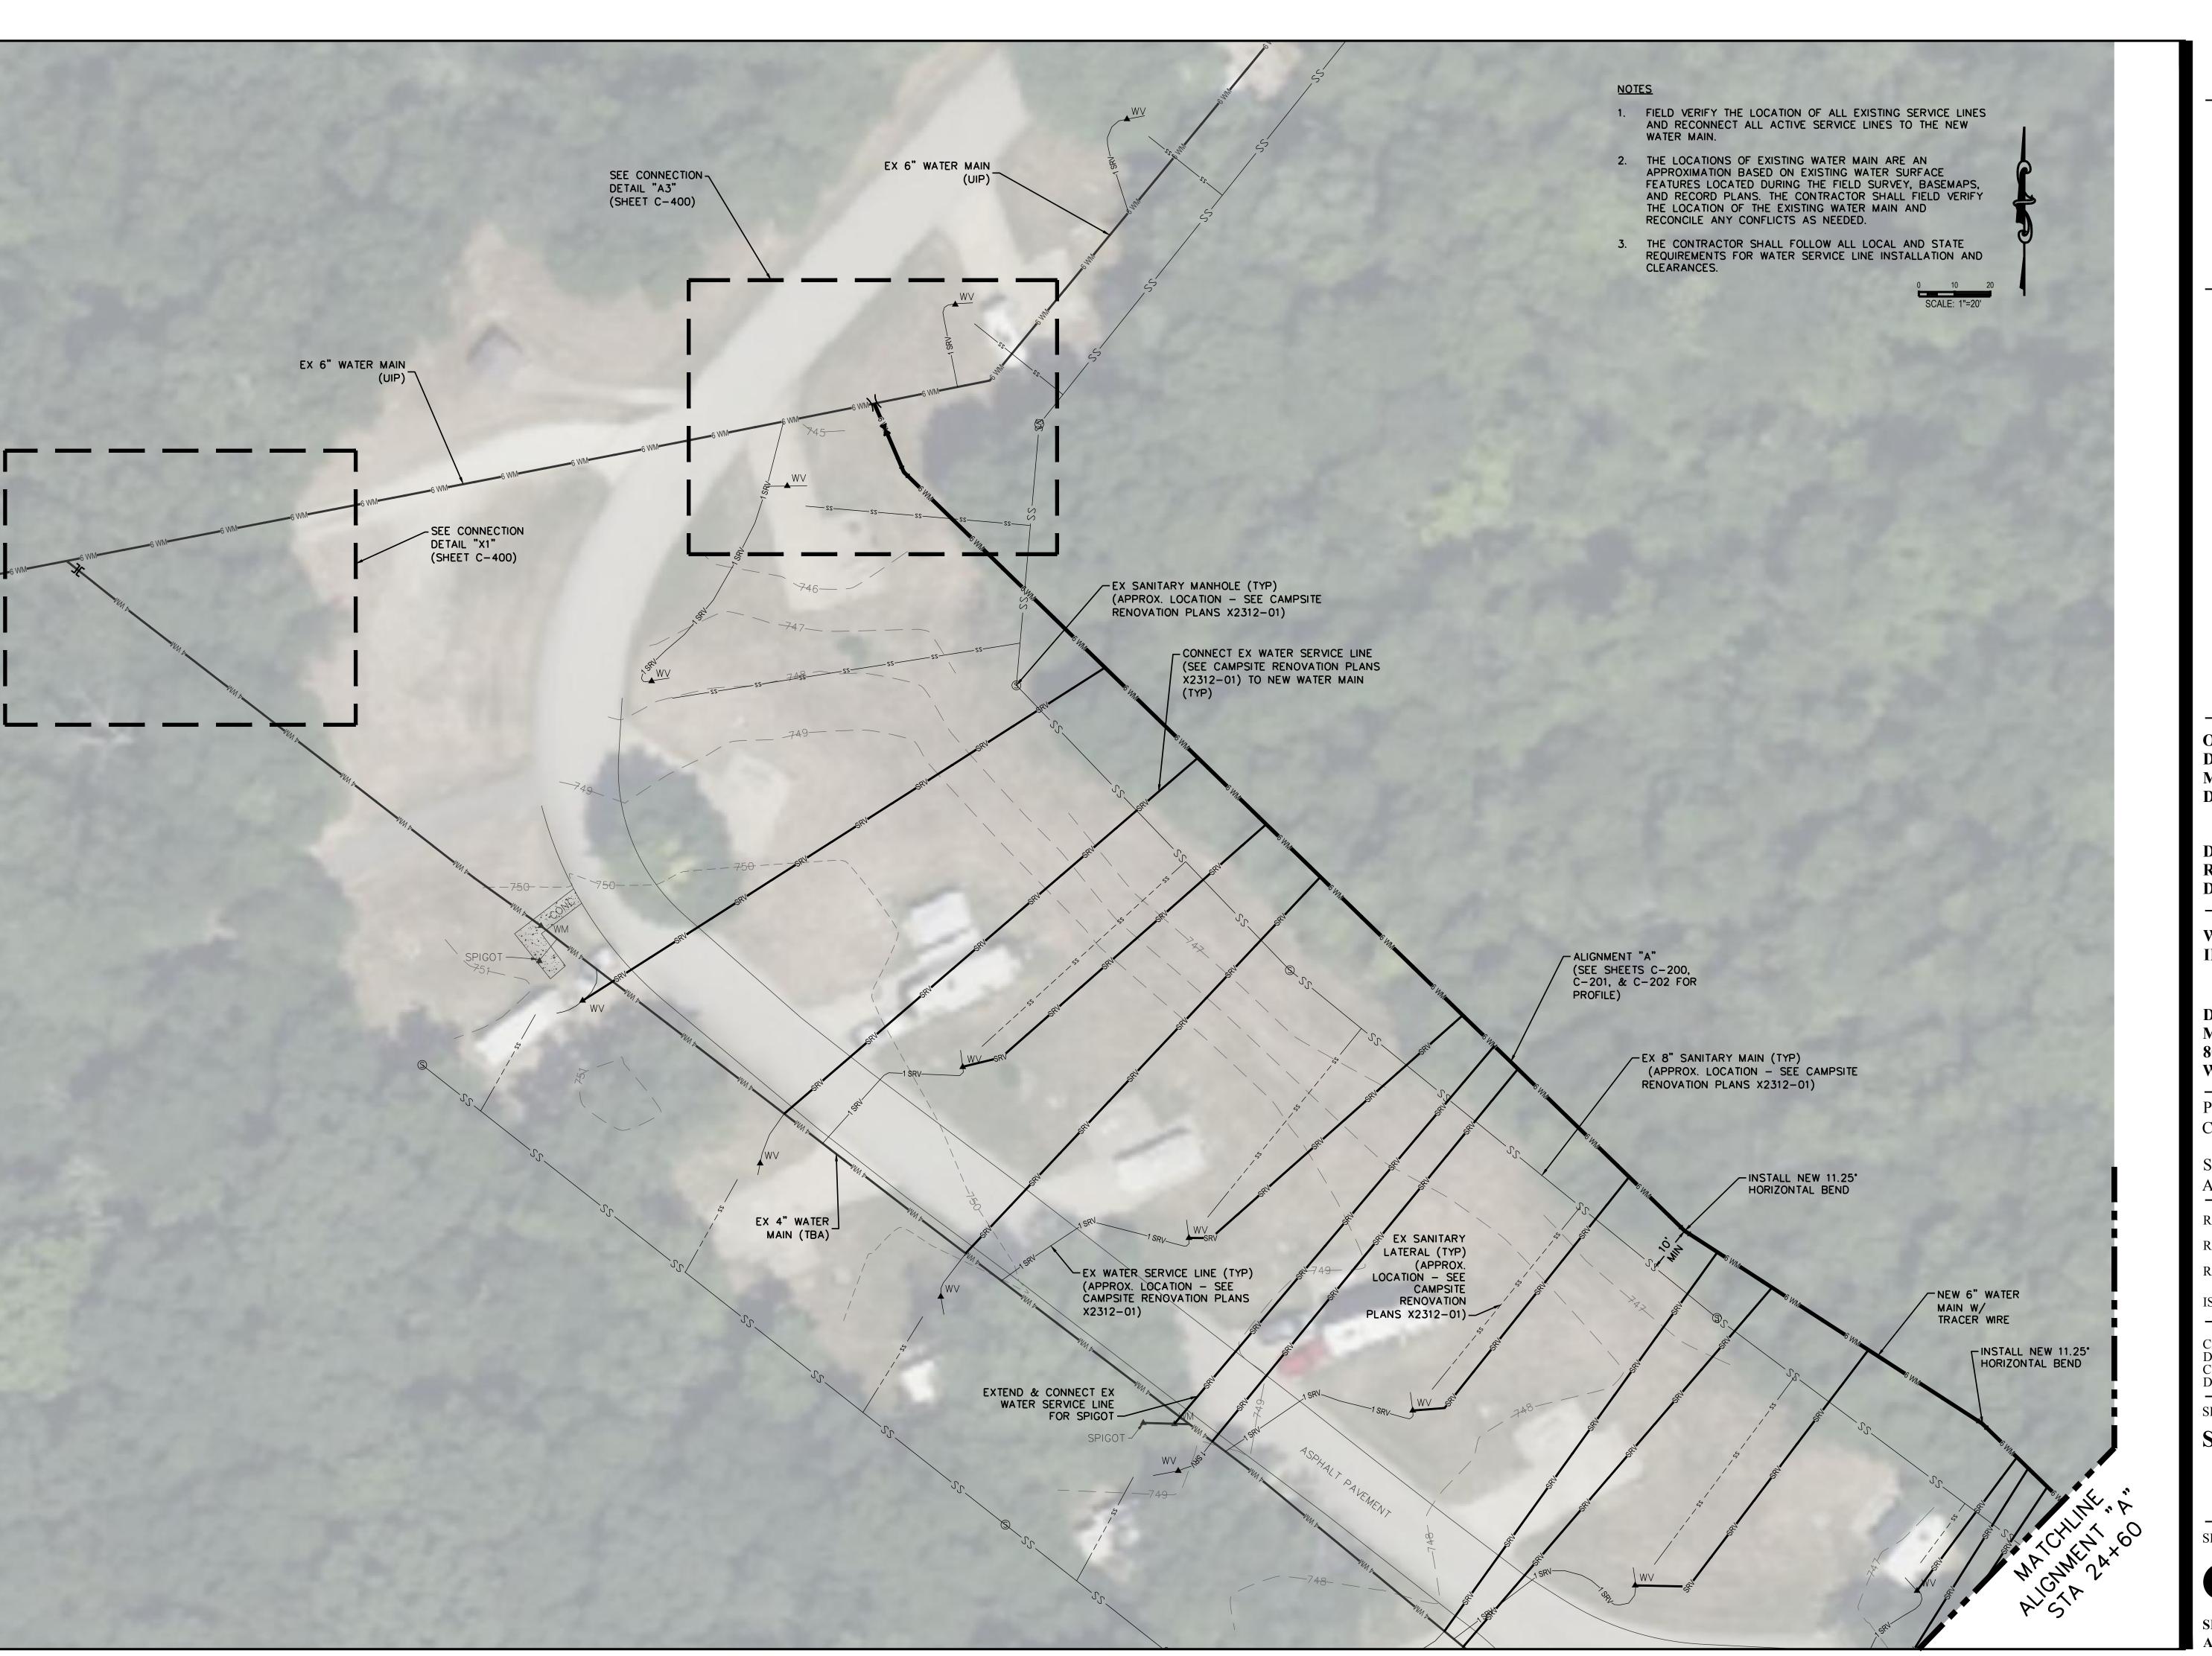


AUGUST 9, 2024

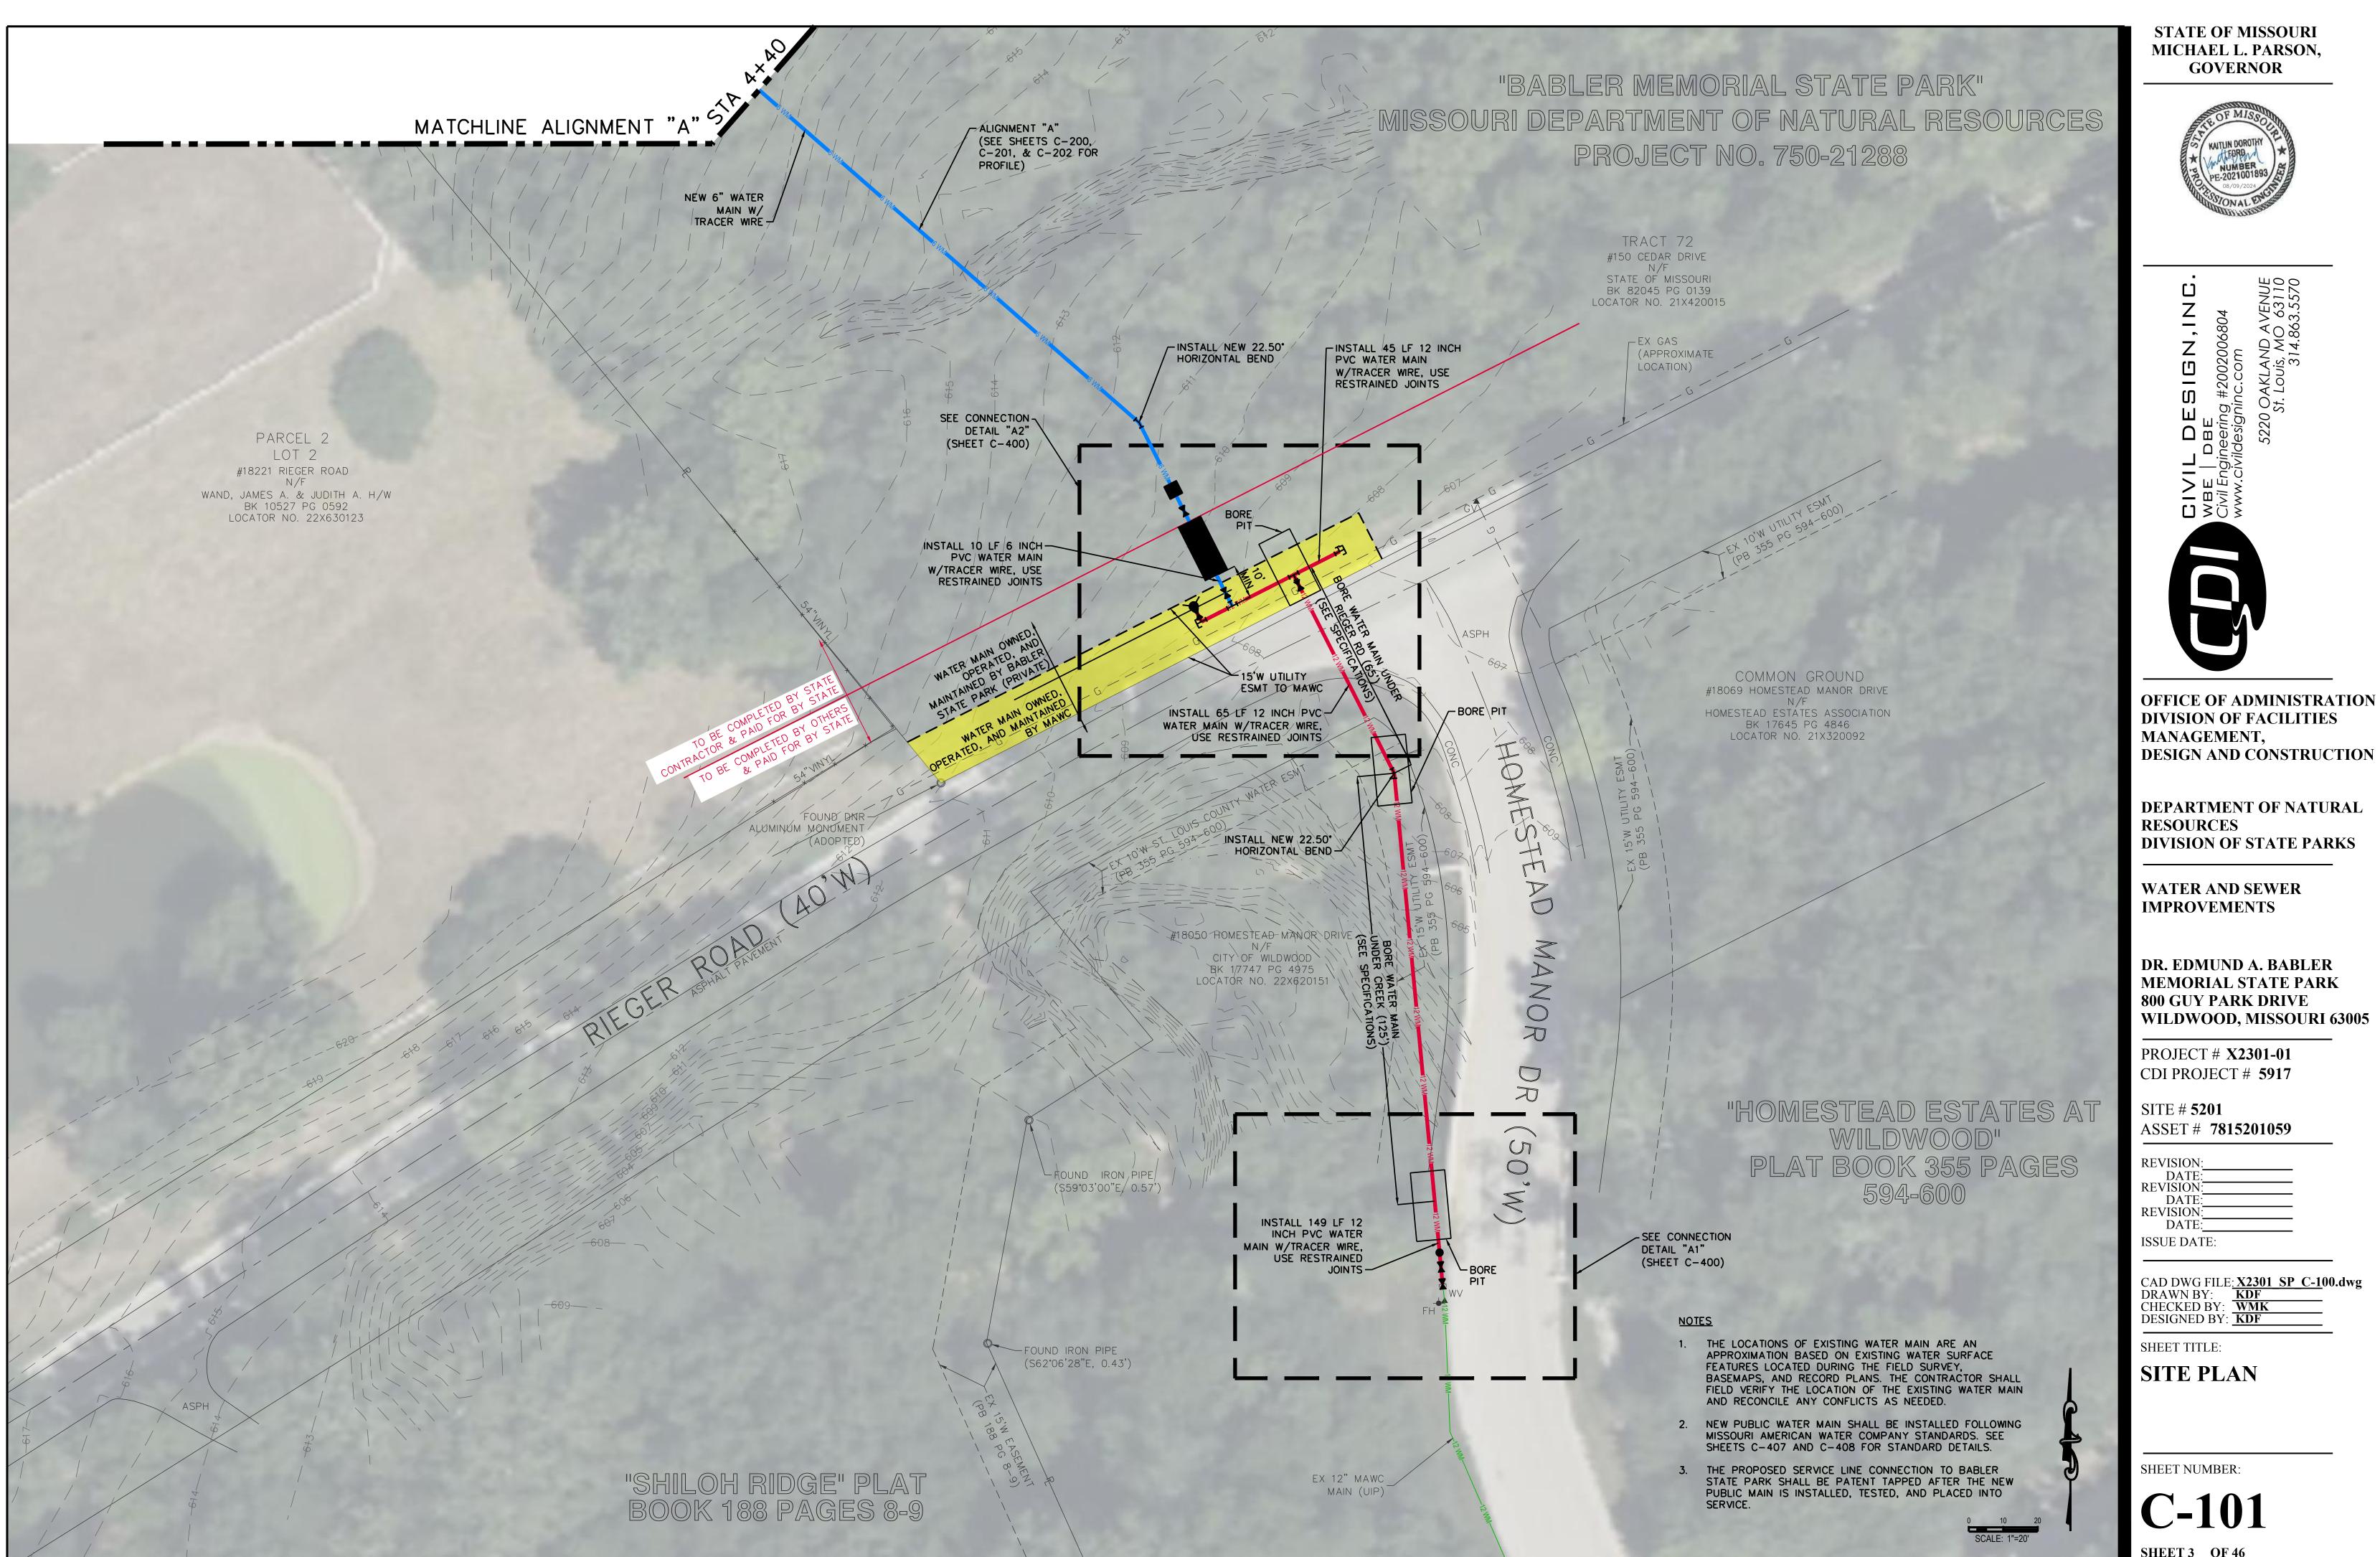

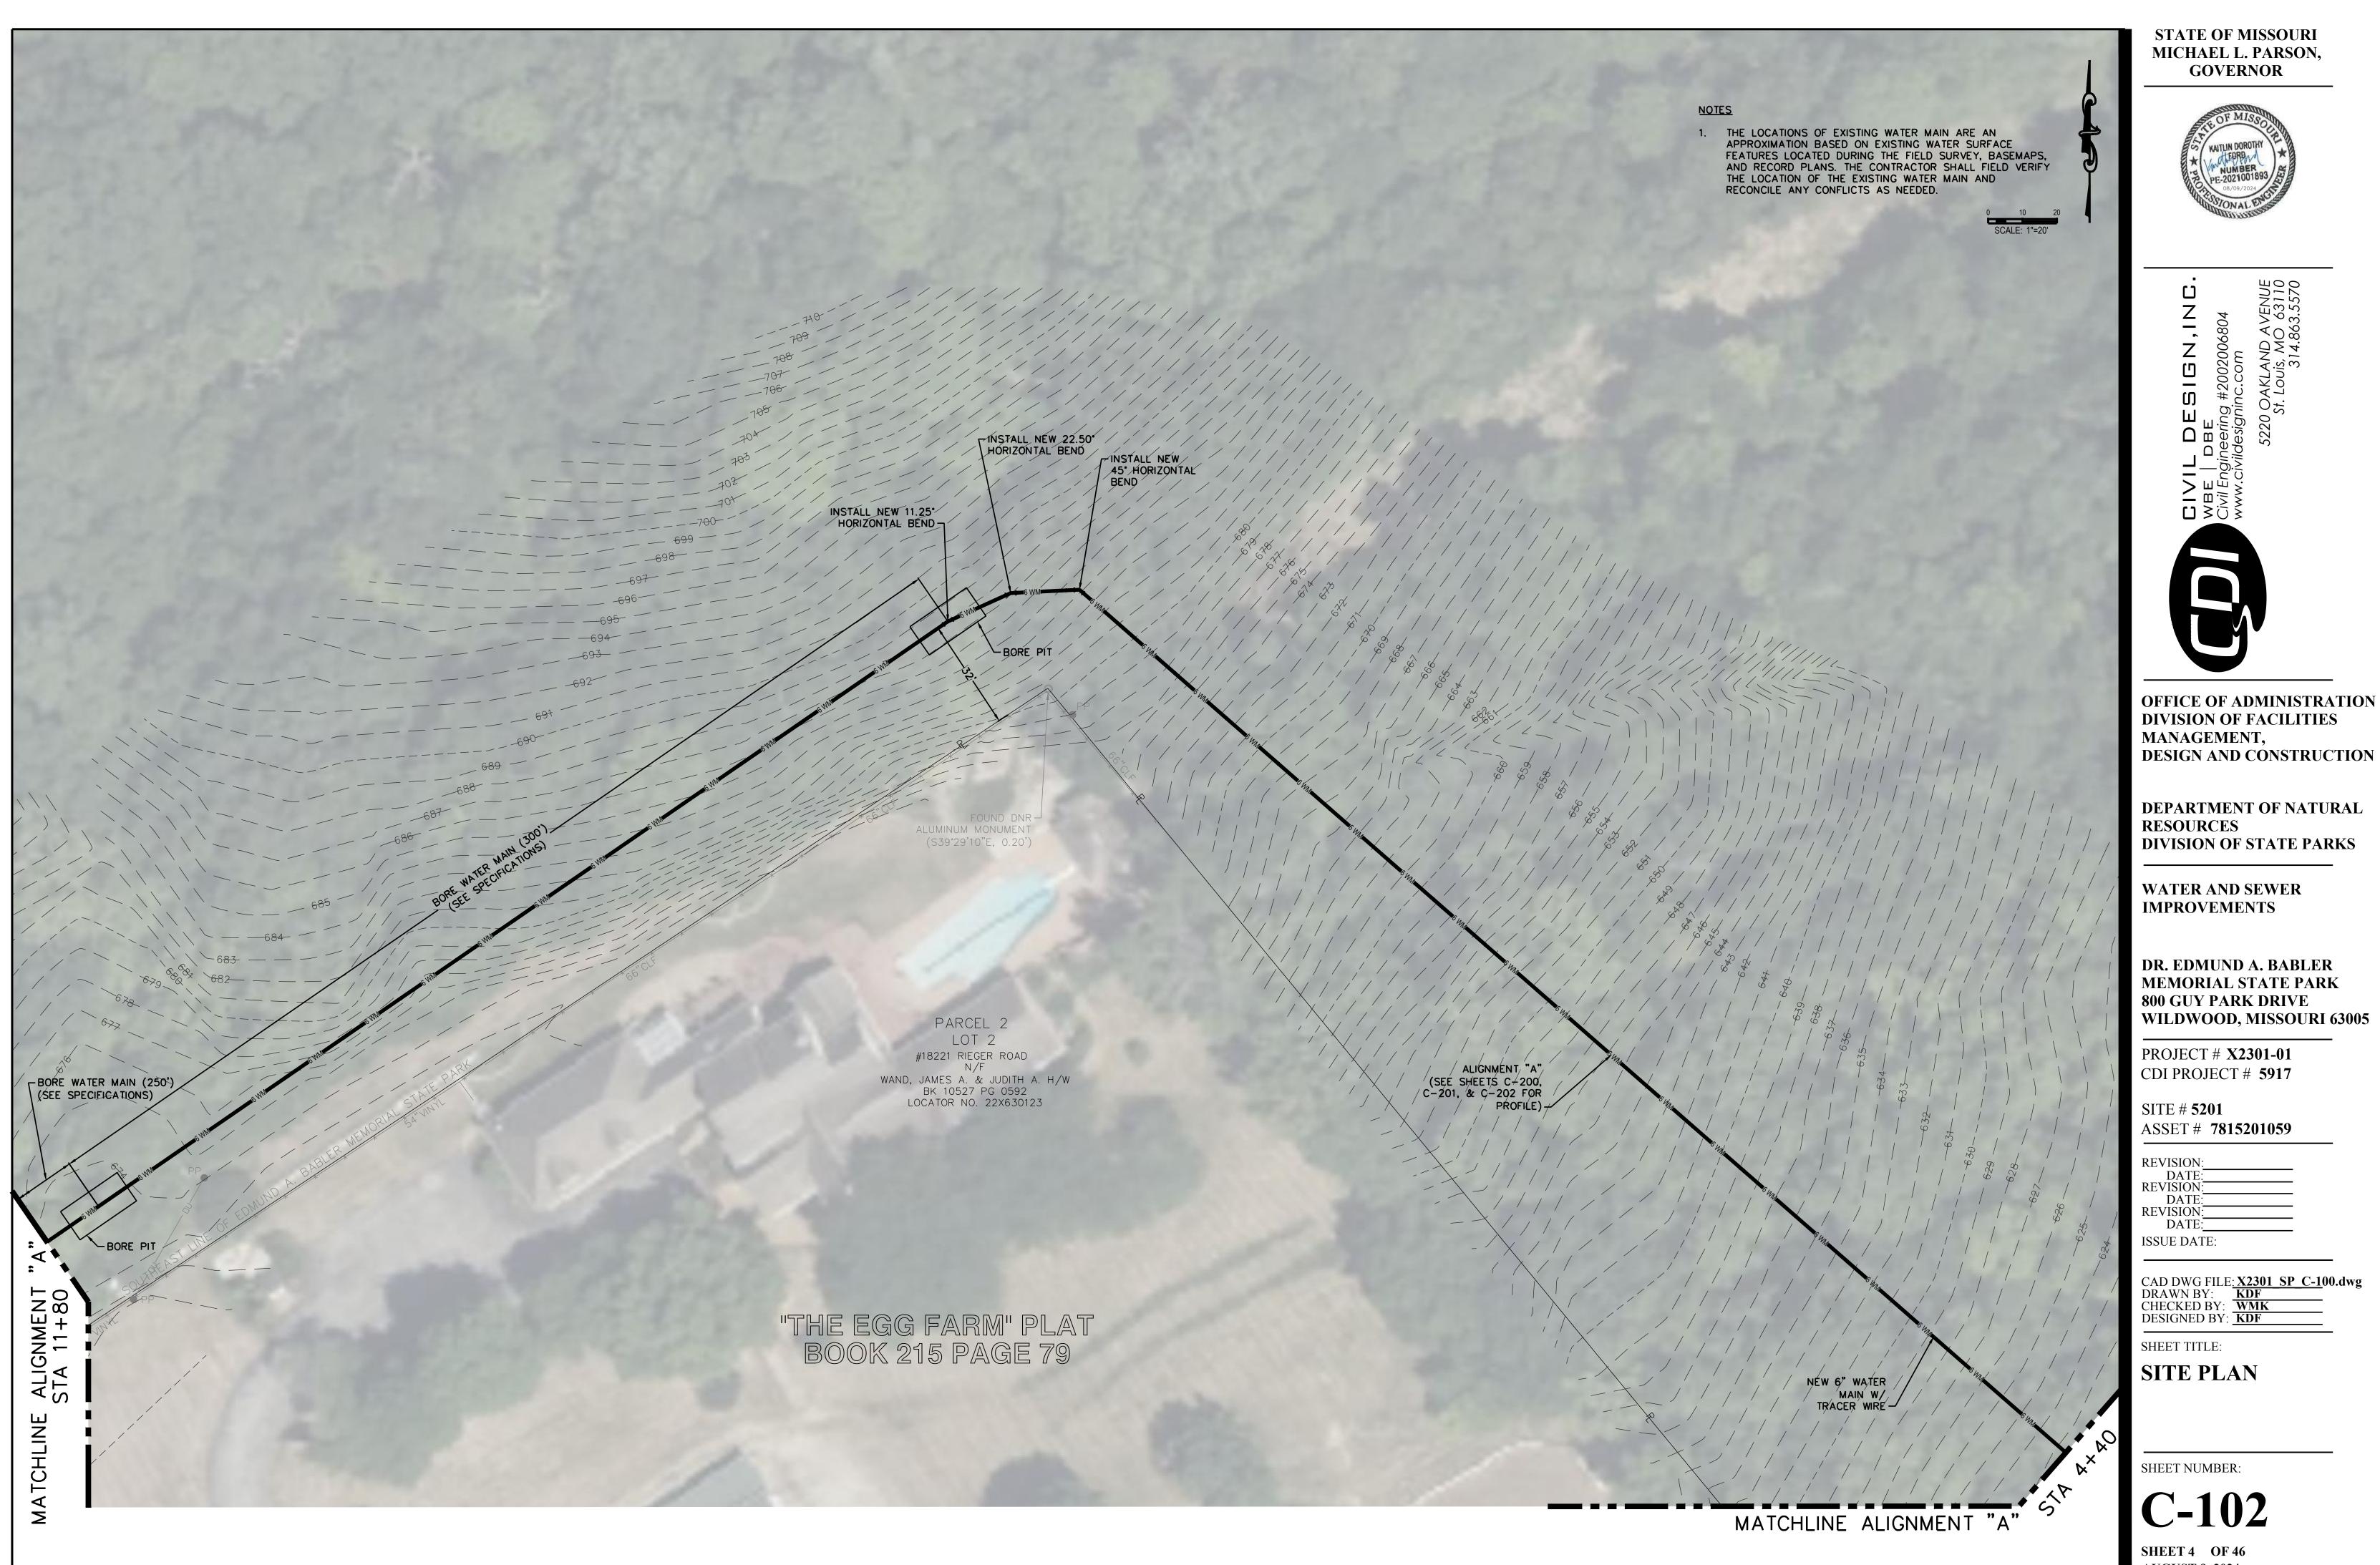

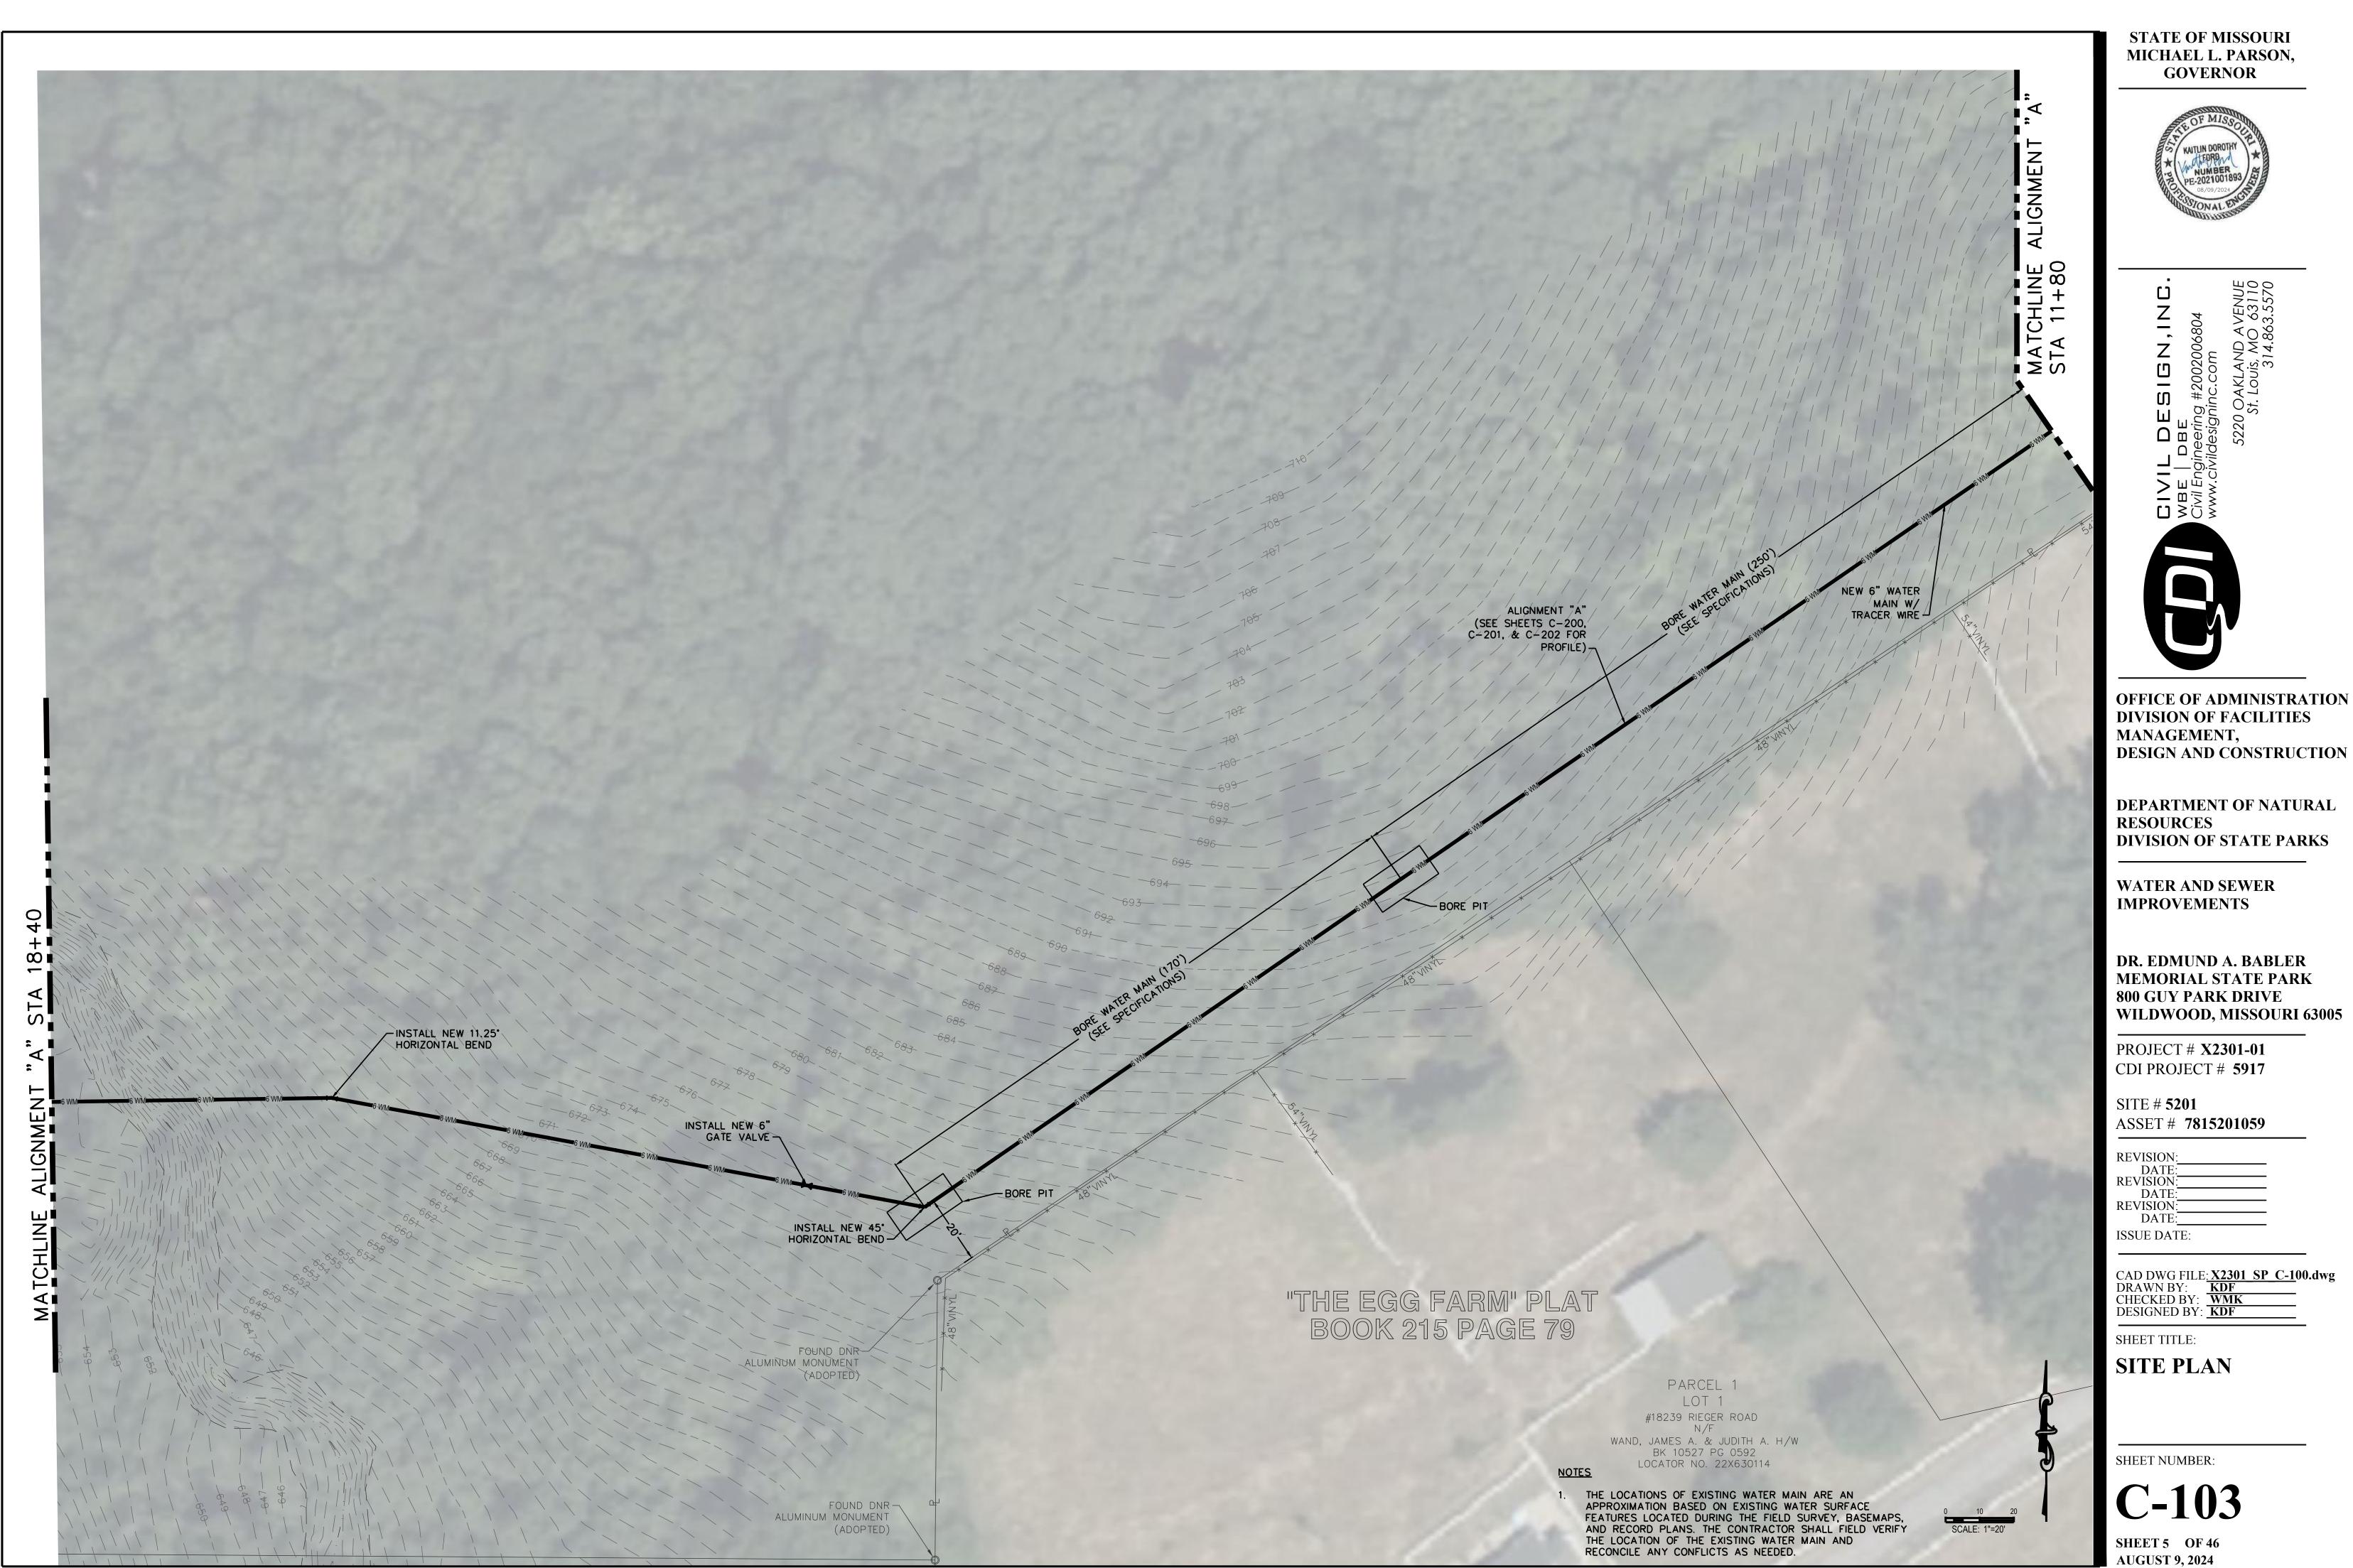AUGUST 9, 2024






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WATER AND SEWER IMPROVEMENTS

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PROJECT # **X2301-01** CDI PROJECT # **5917**

SITE # **5201** ASSET # **7815201059**

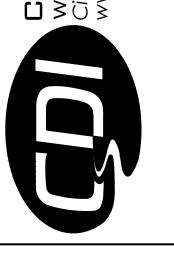DEVICION.
REVISION:
DATE:
REVISION:
DATE:
REVISION:
DATE:
ISSUE DATE:

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DRAWN BY: KDF
CHECKED BY: WMK
DESIGNED BY: KDF


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SITE PLAN


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C-105


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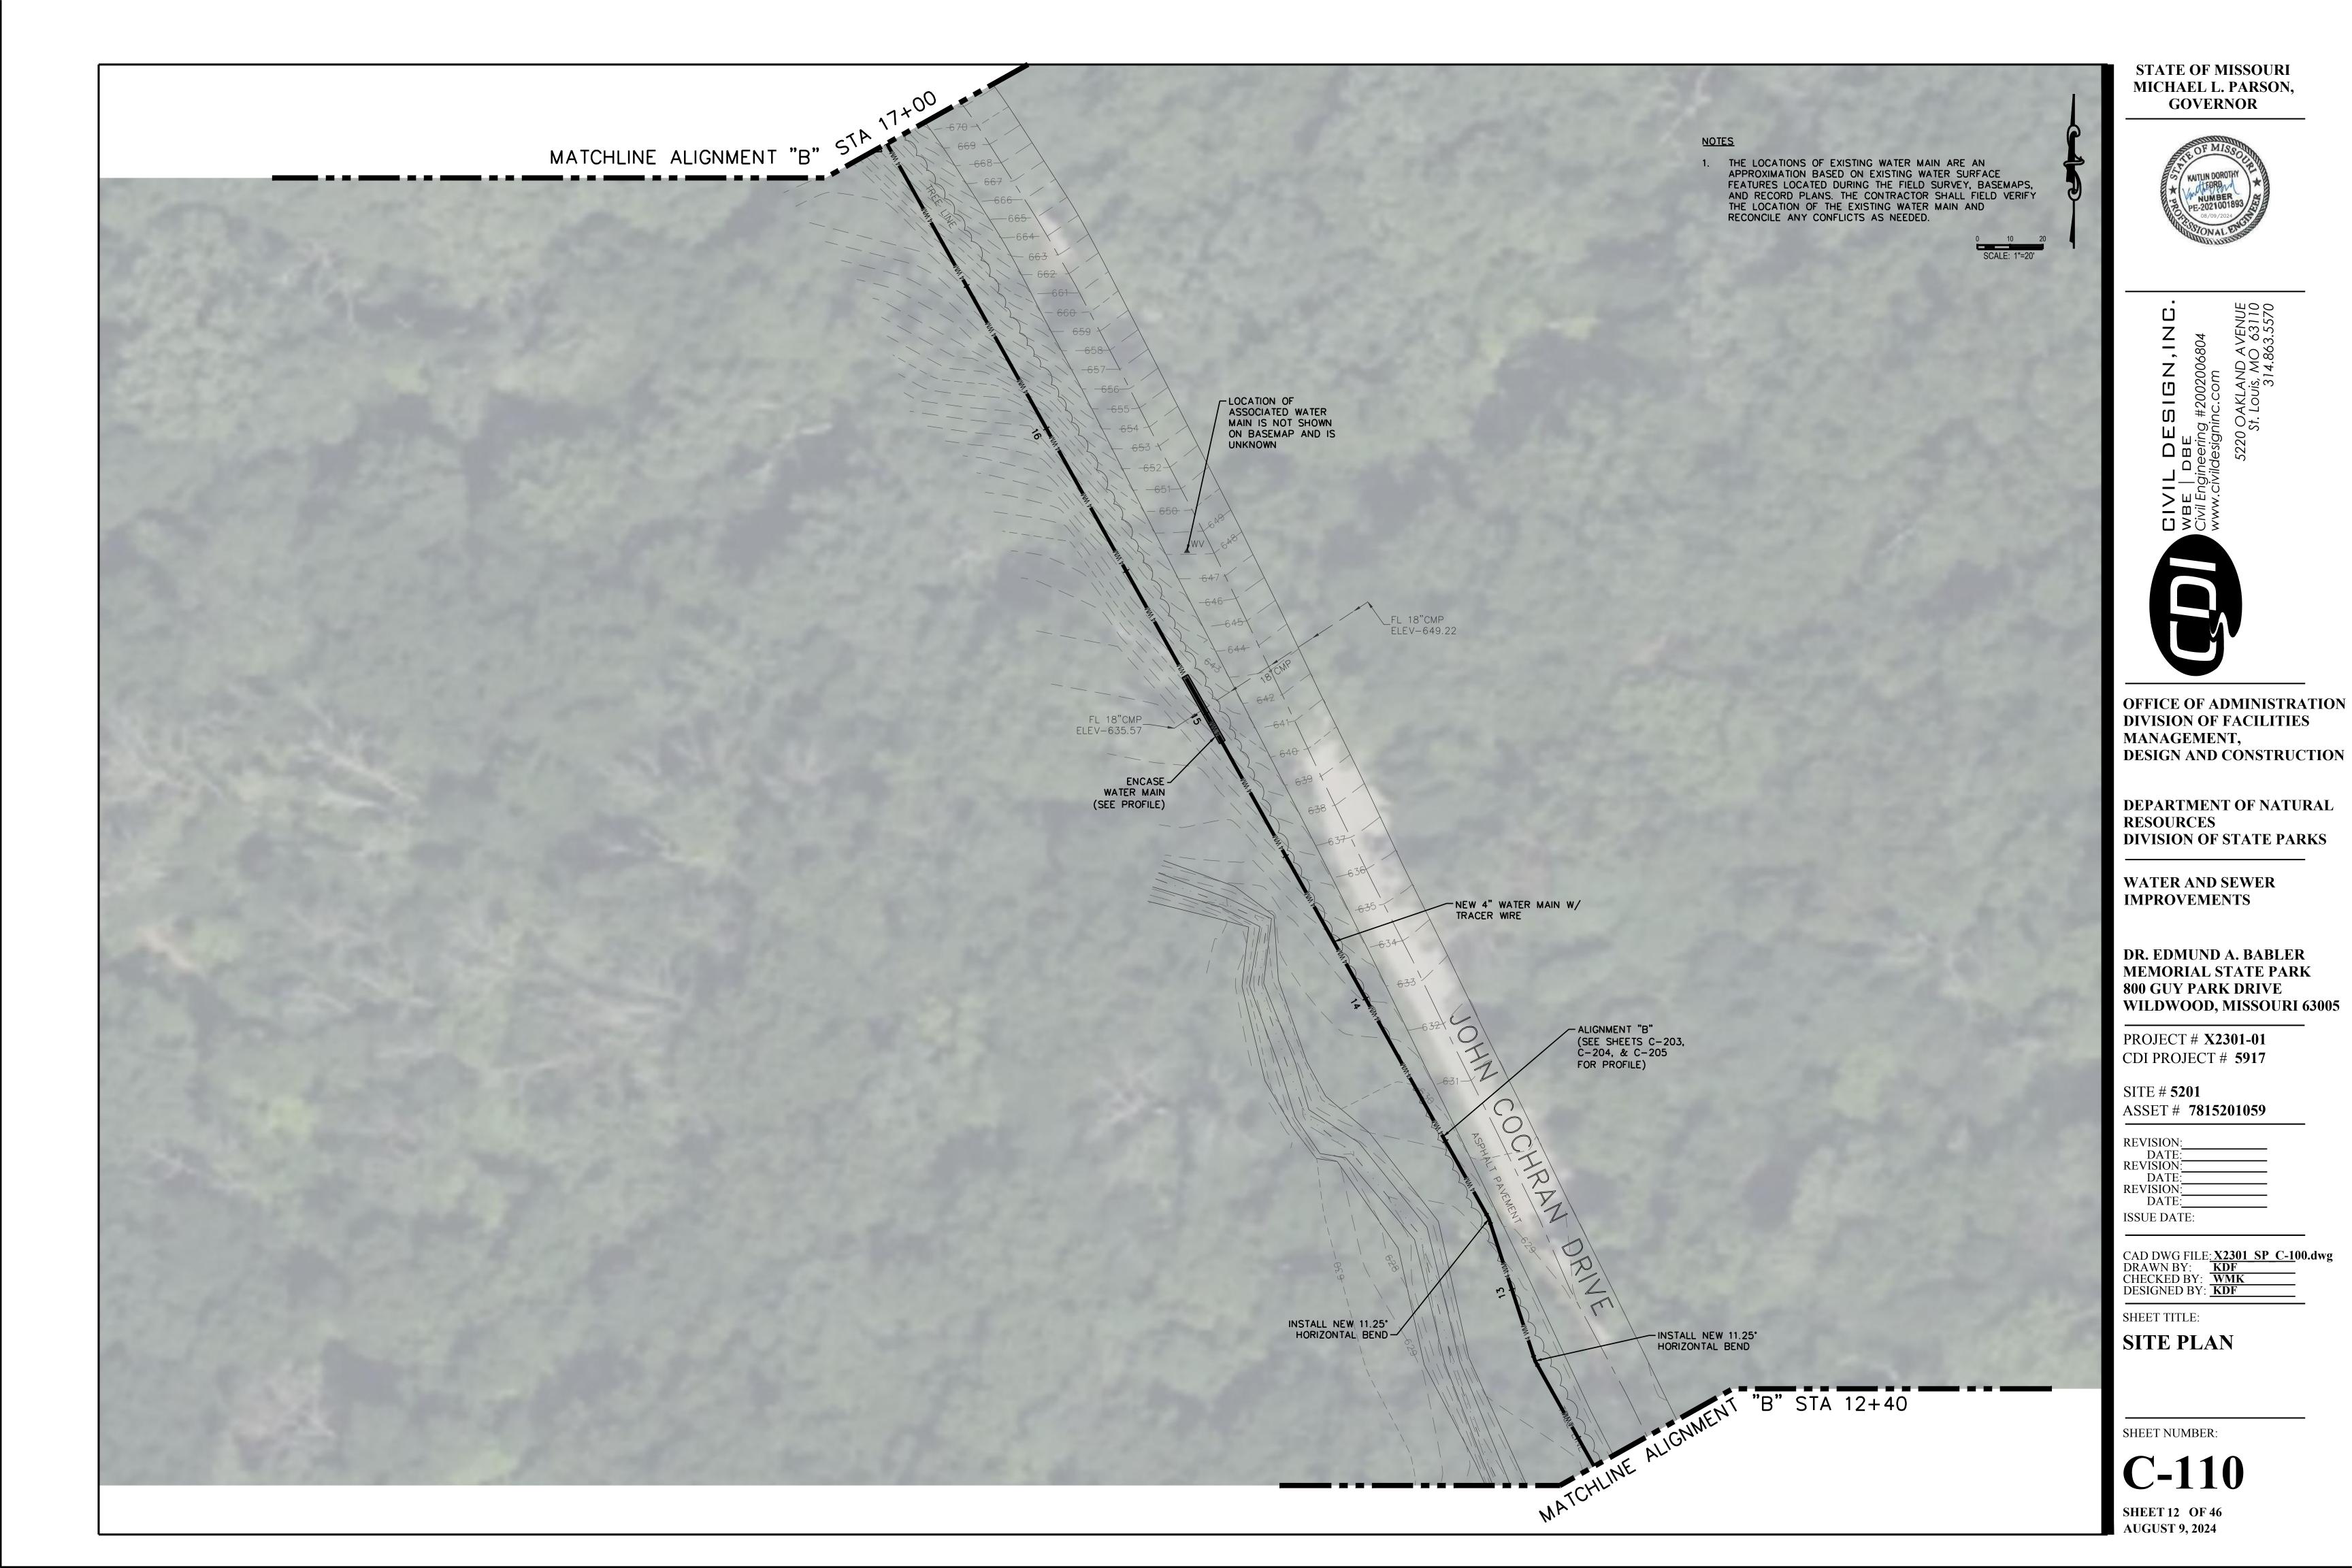



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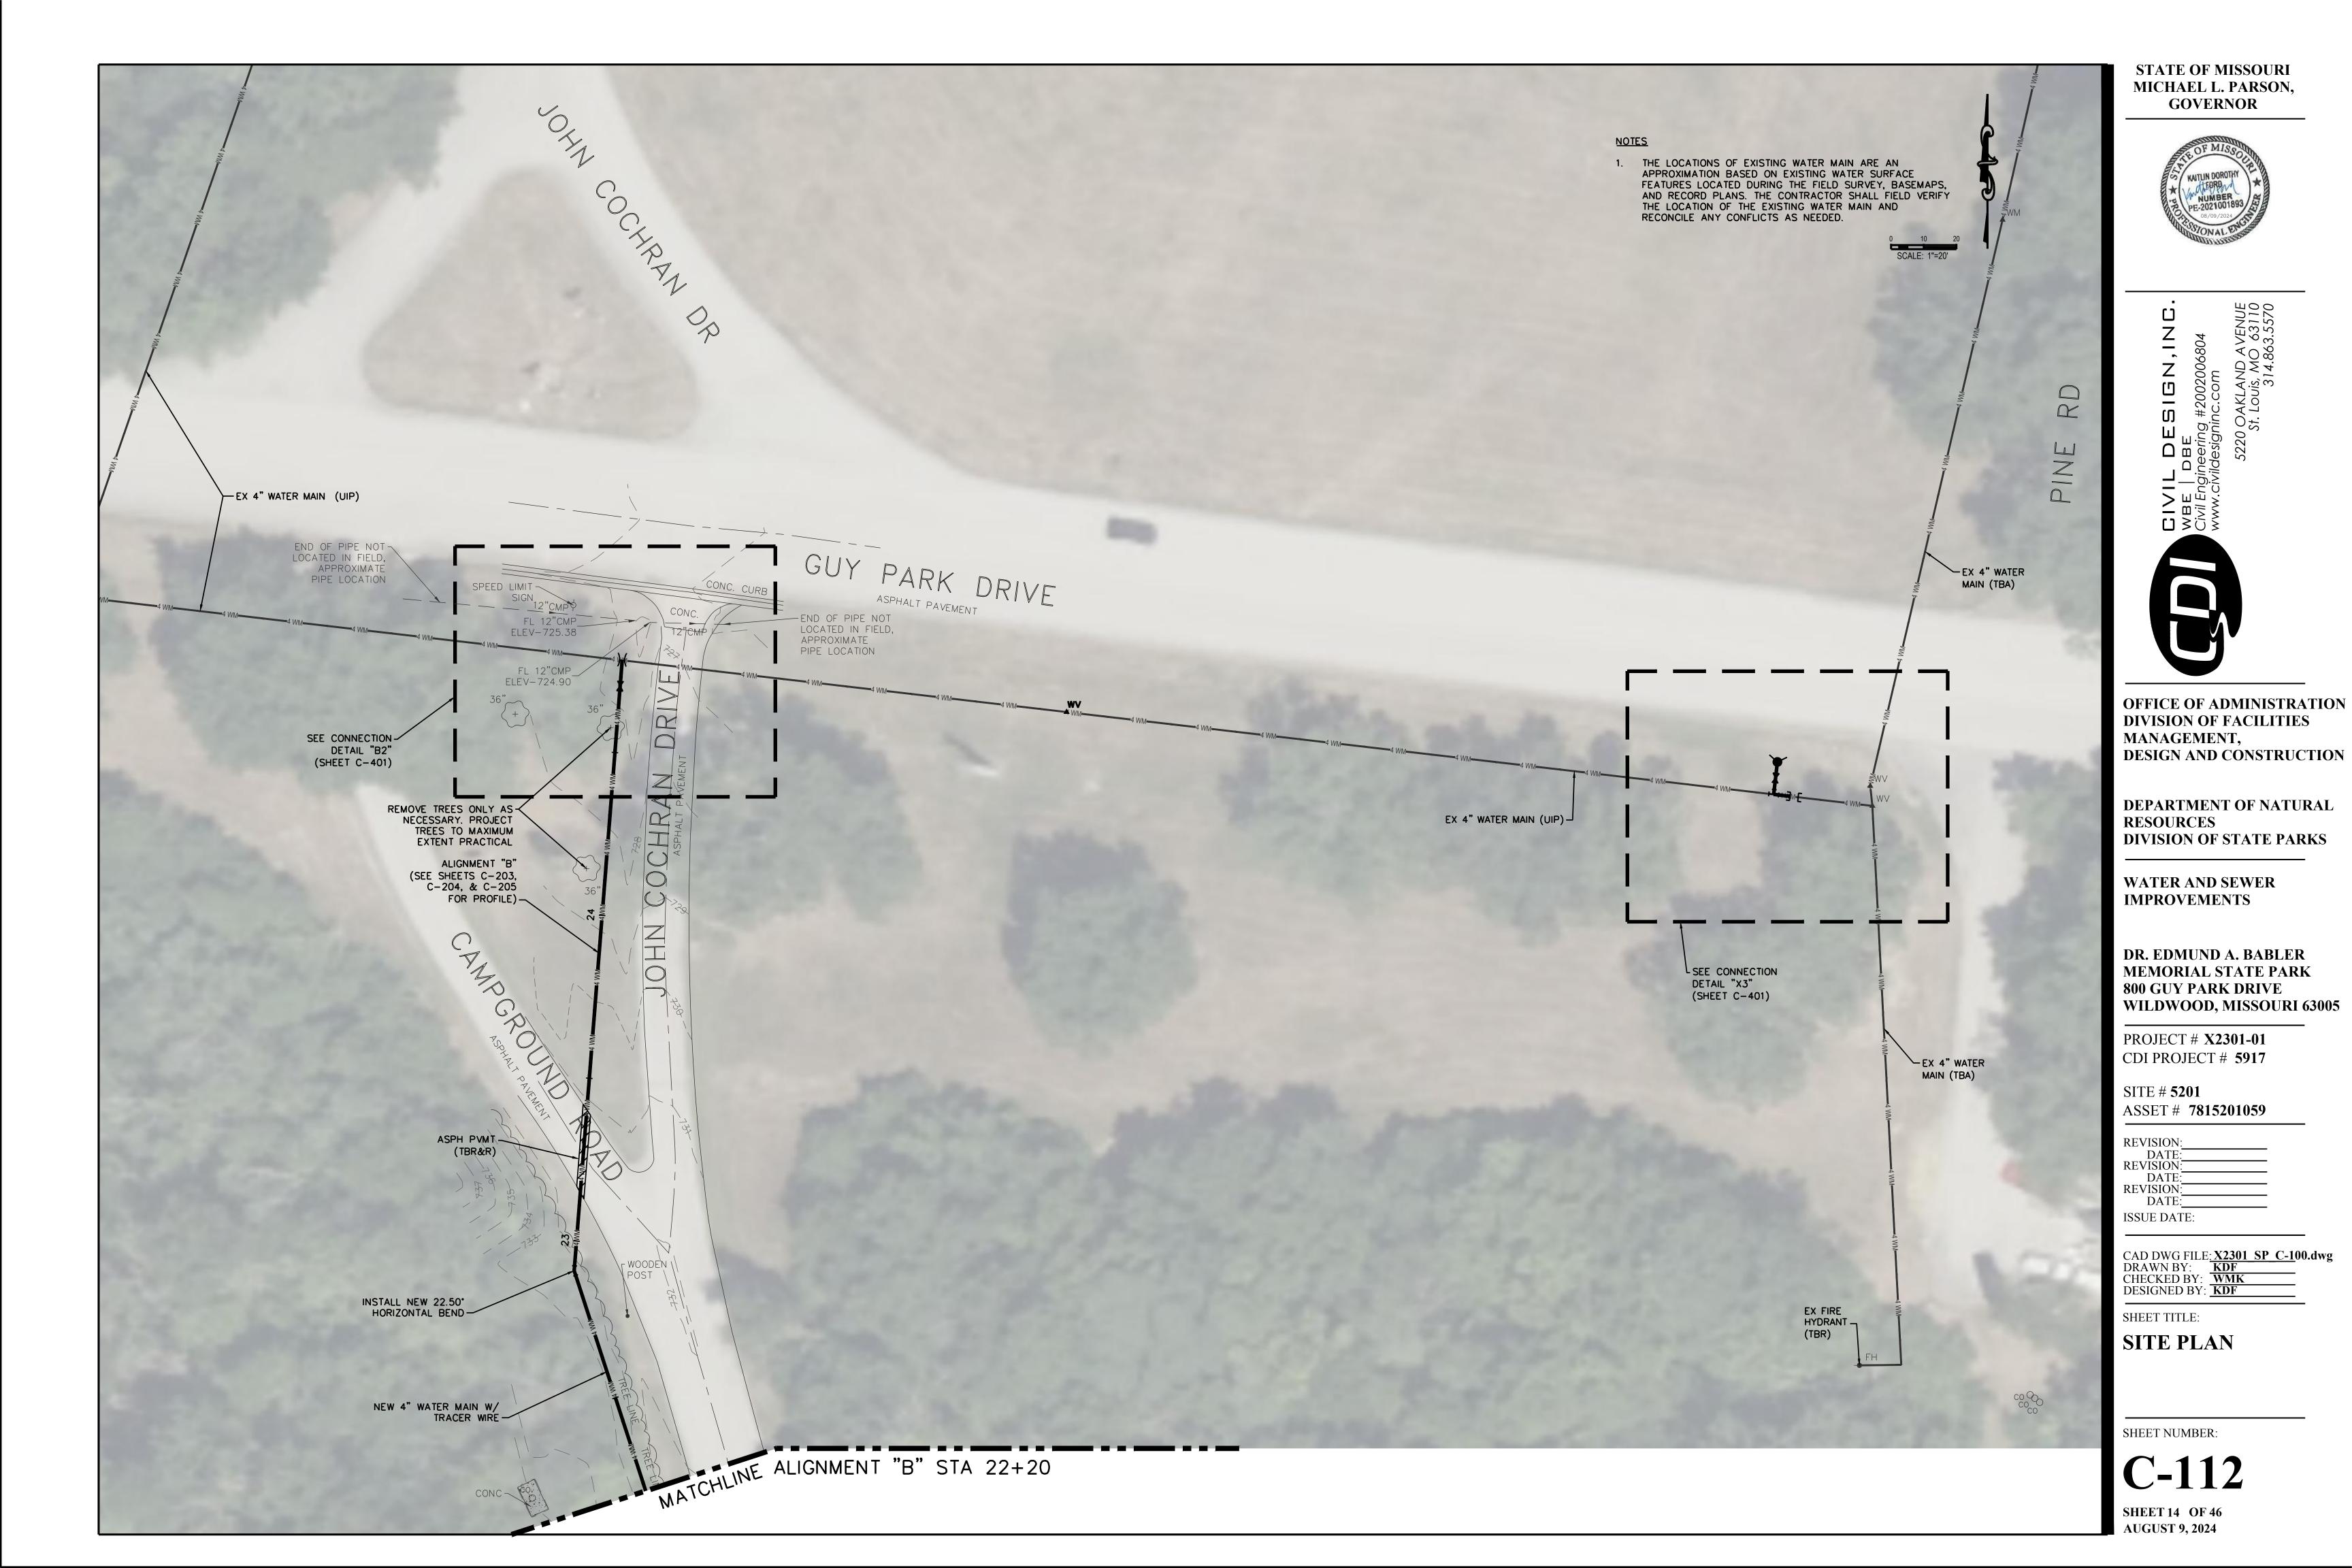





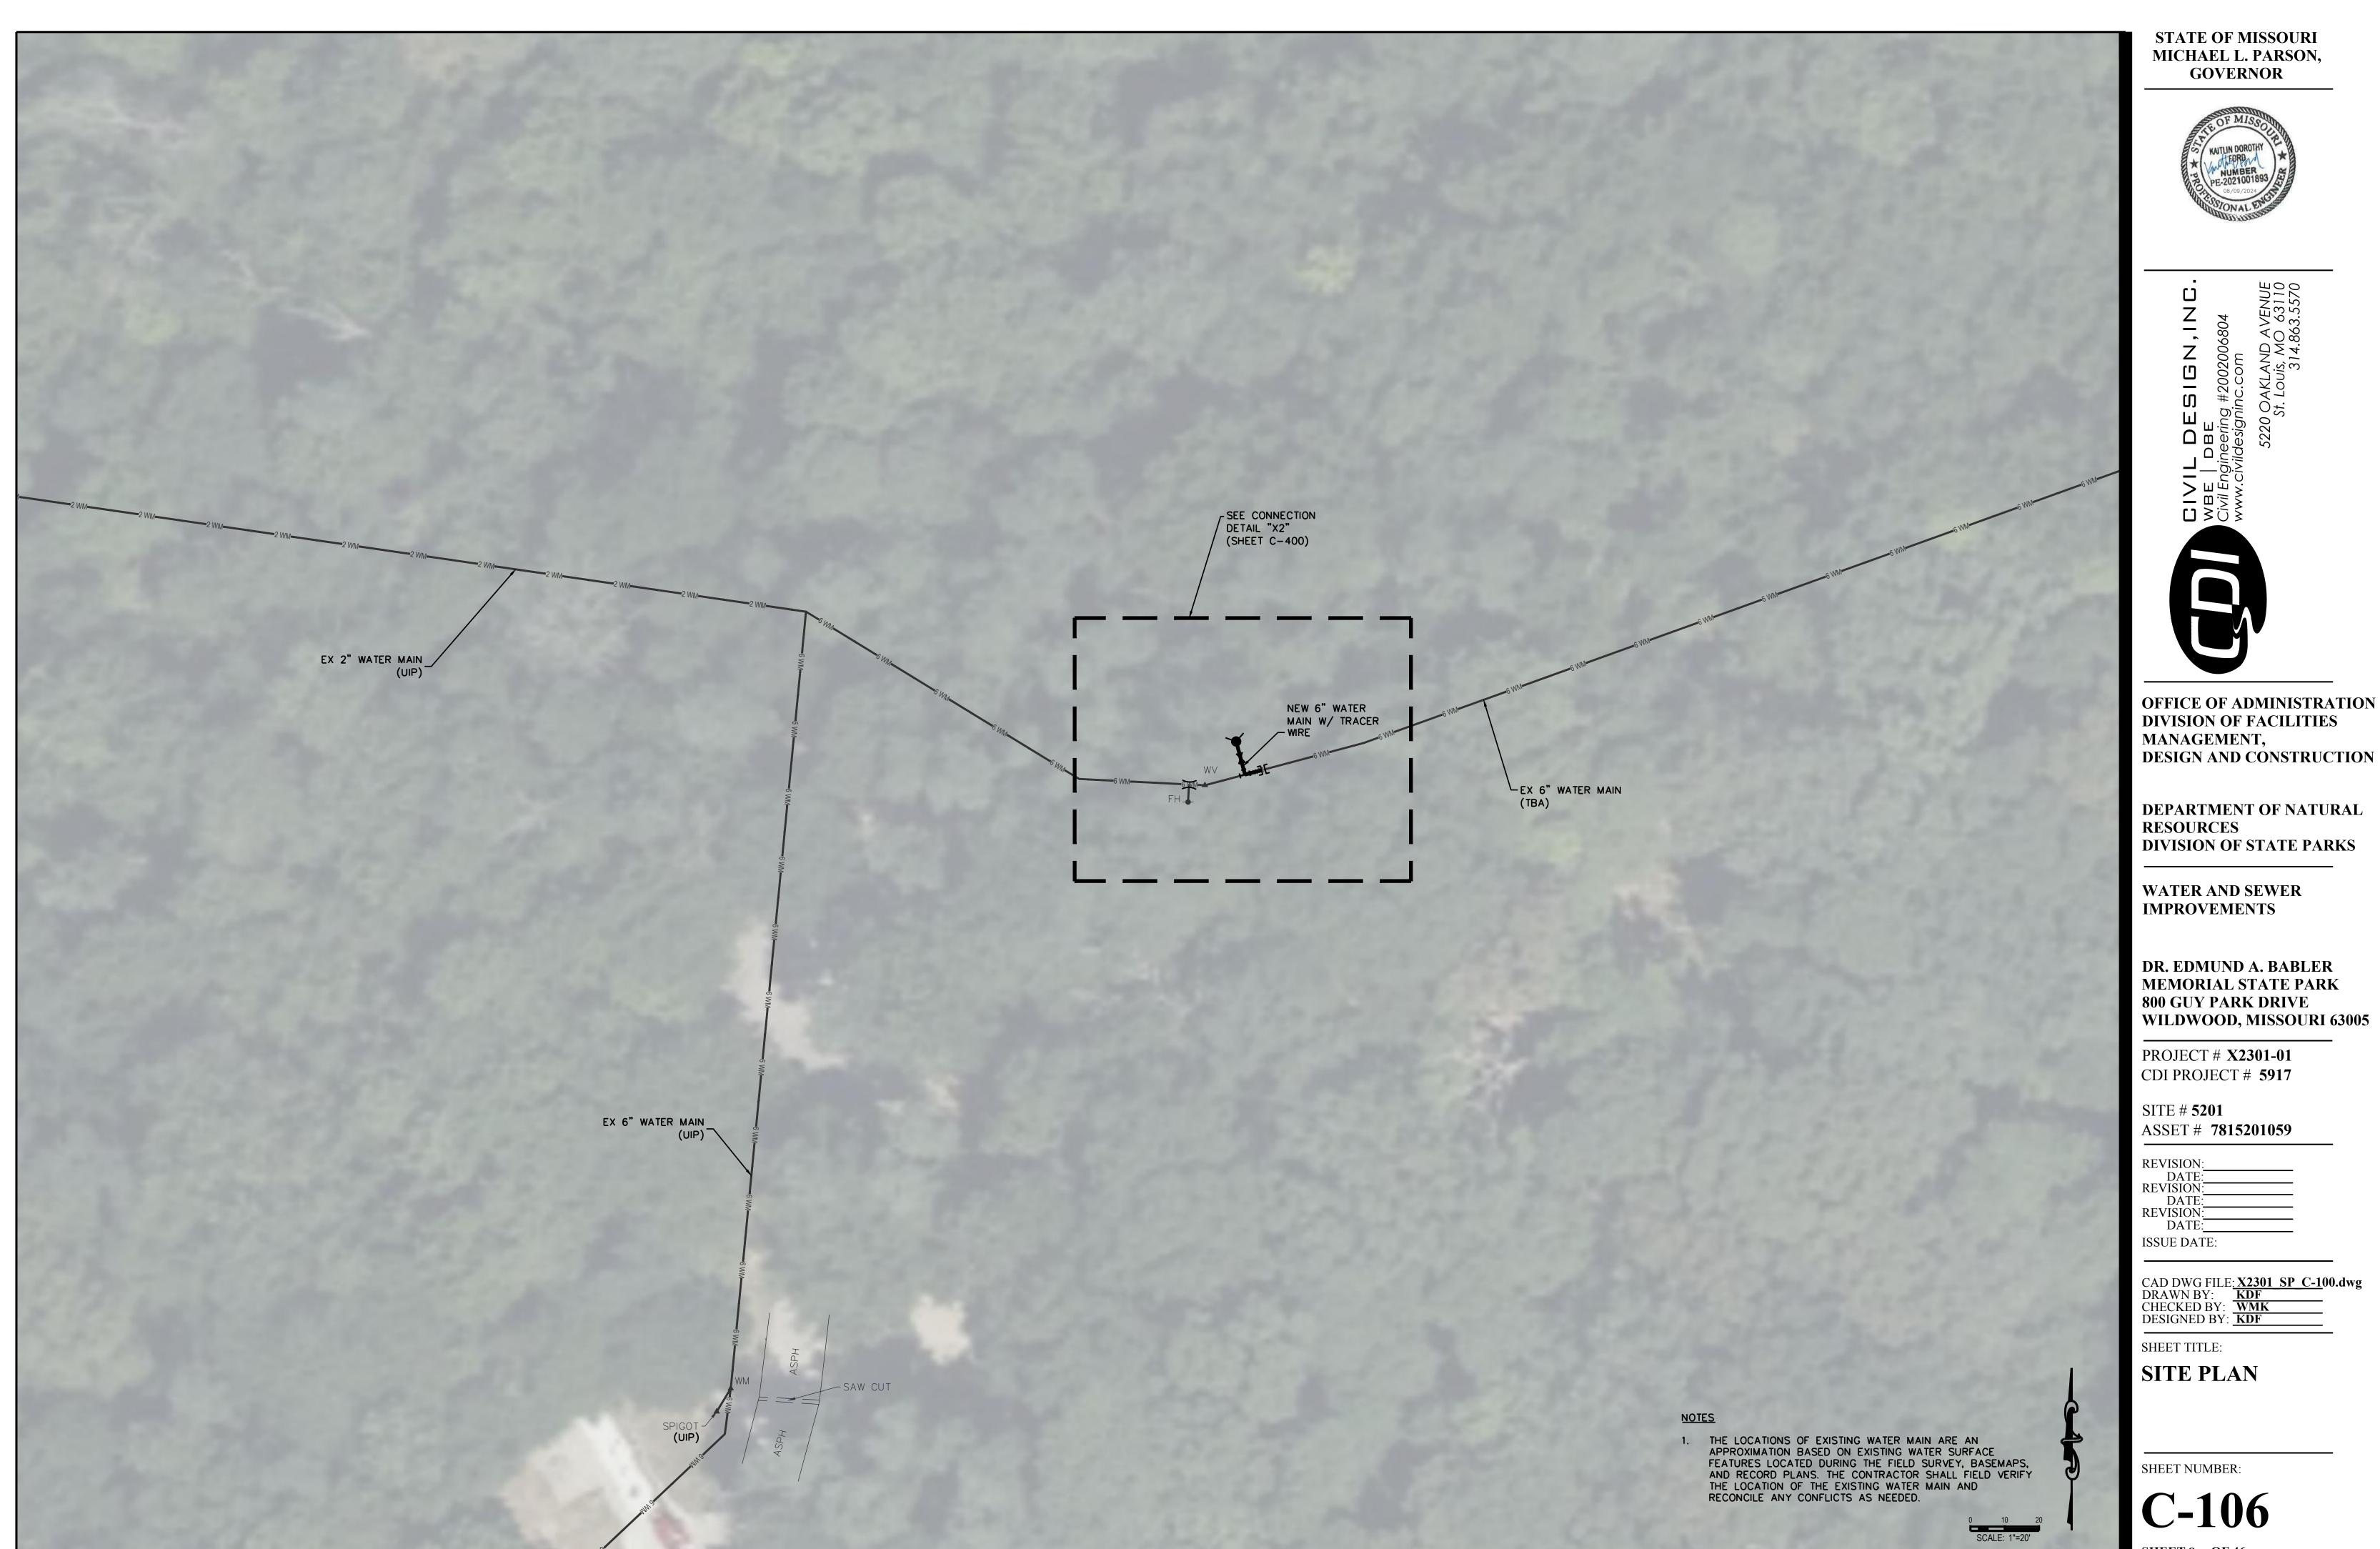

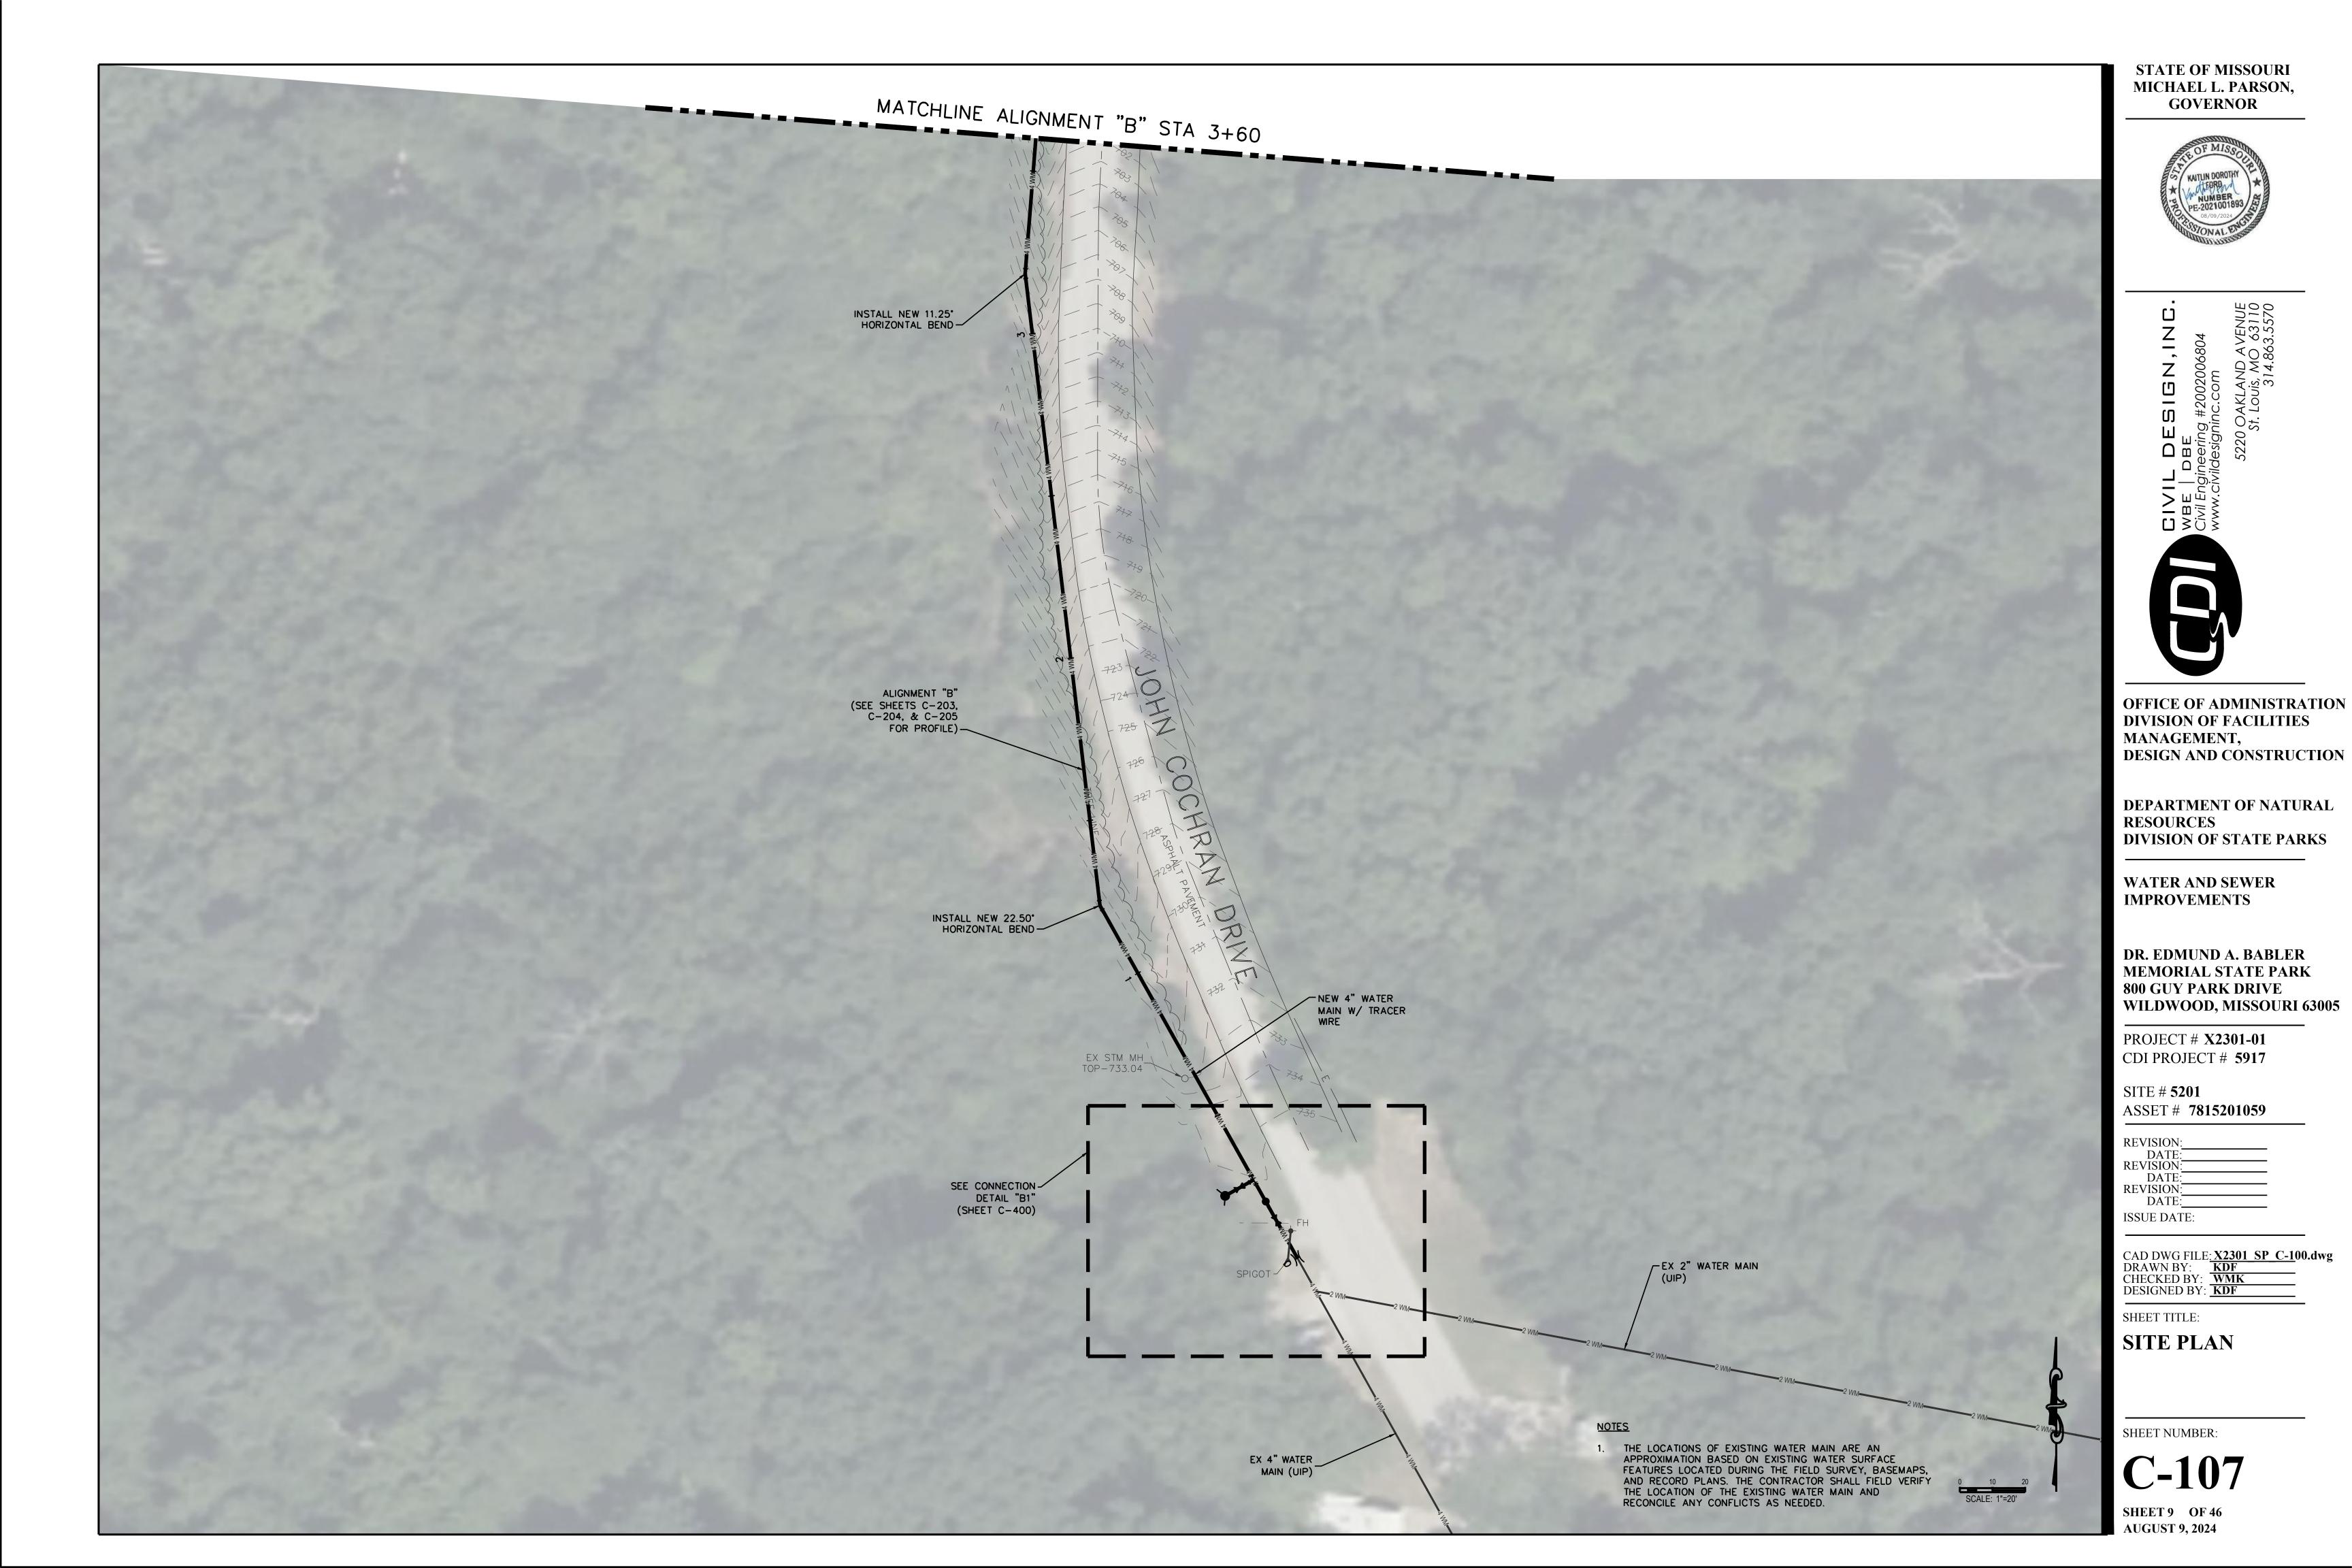
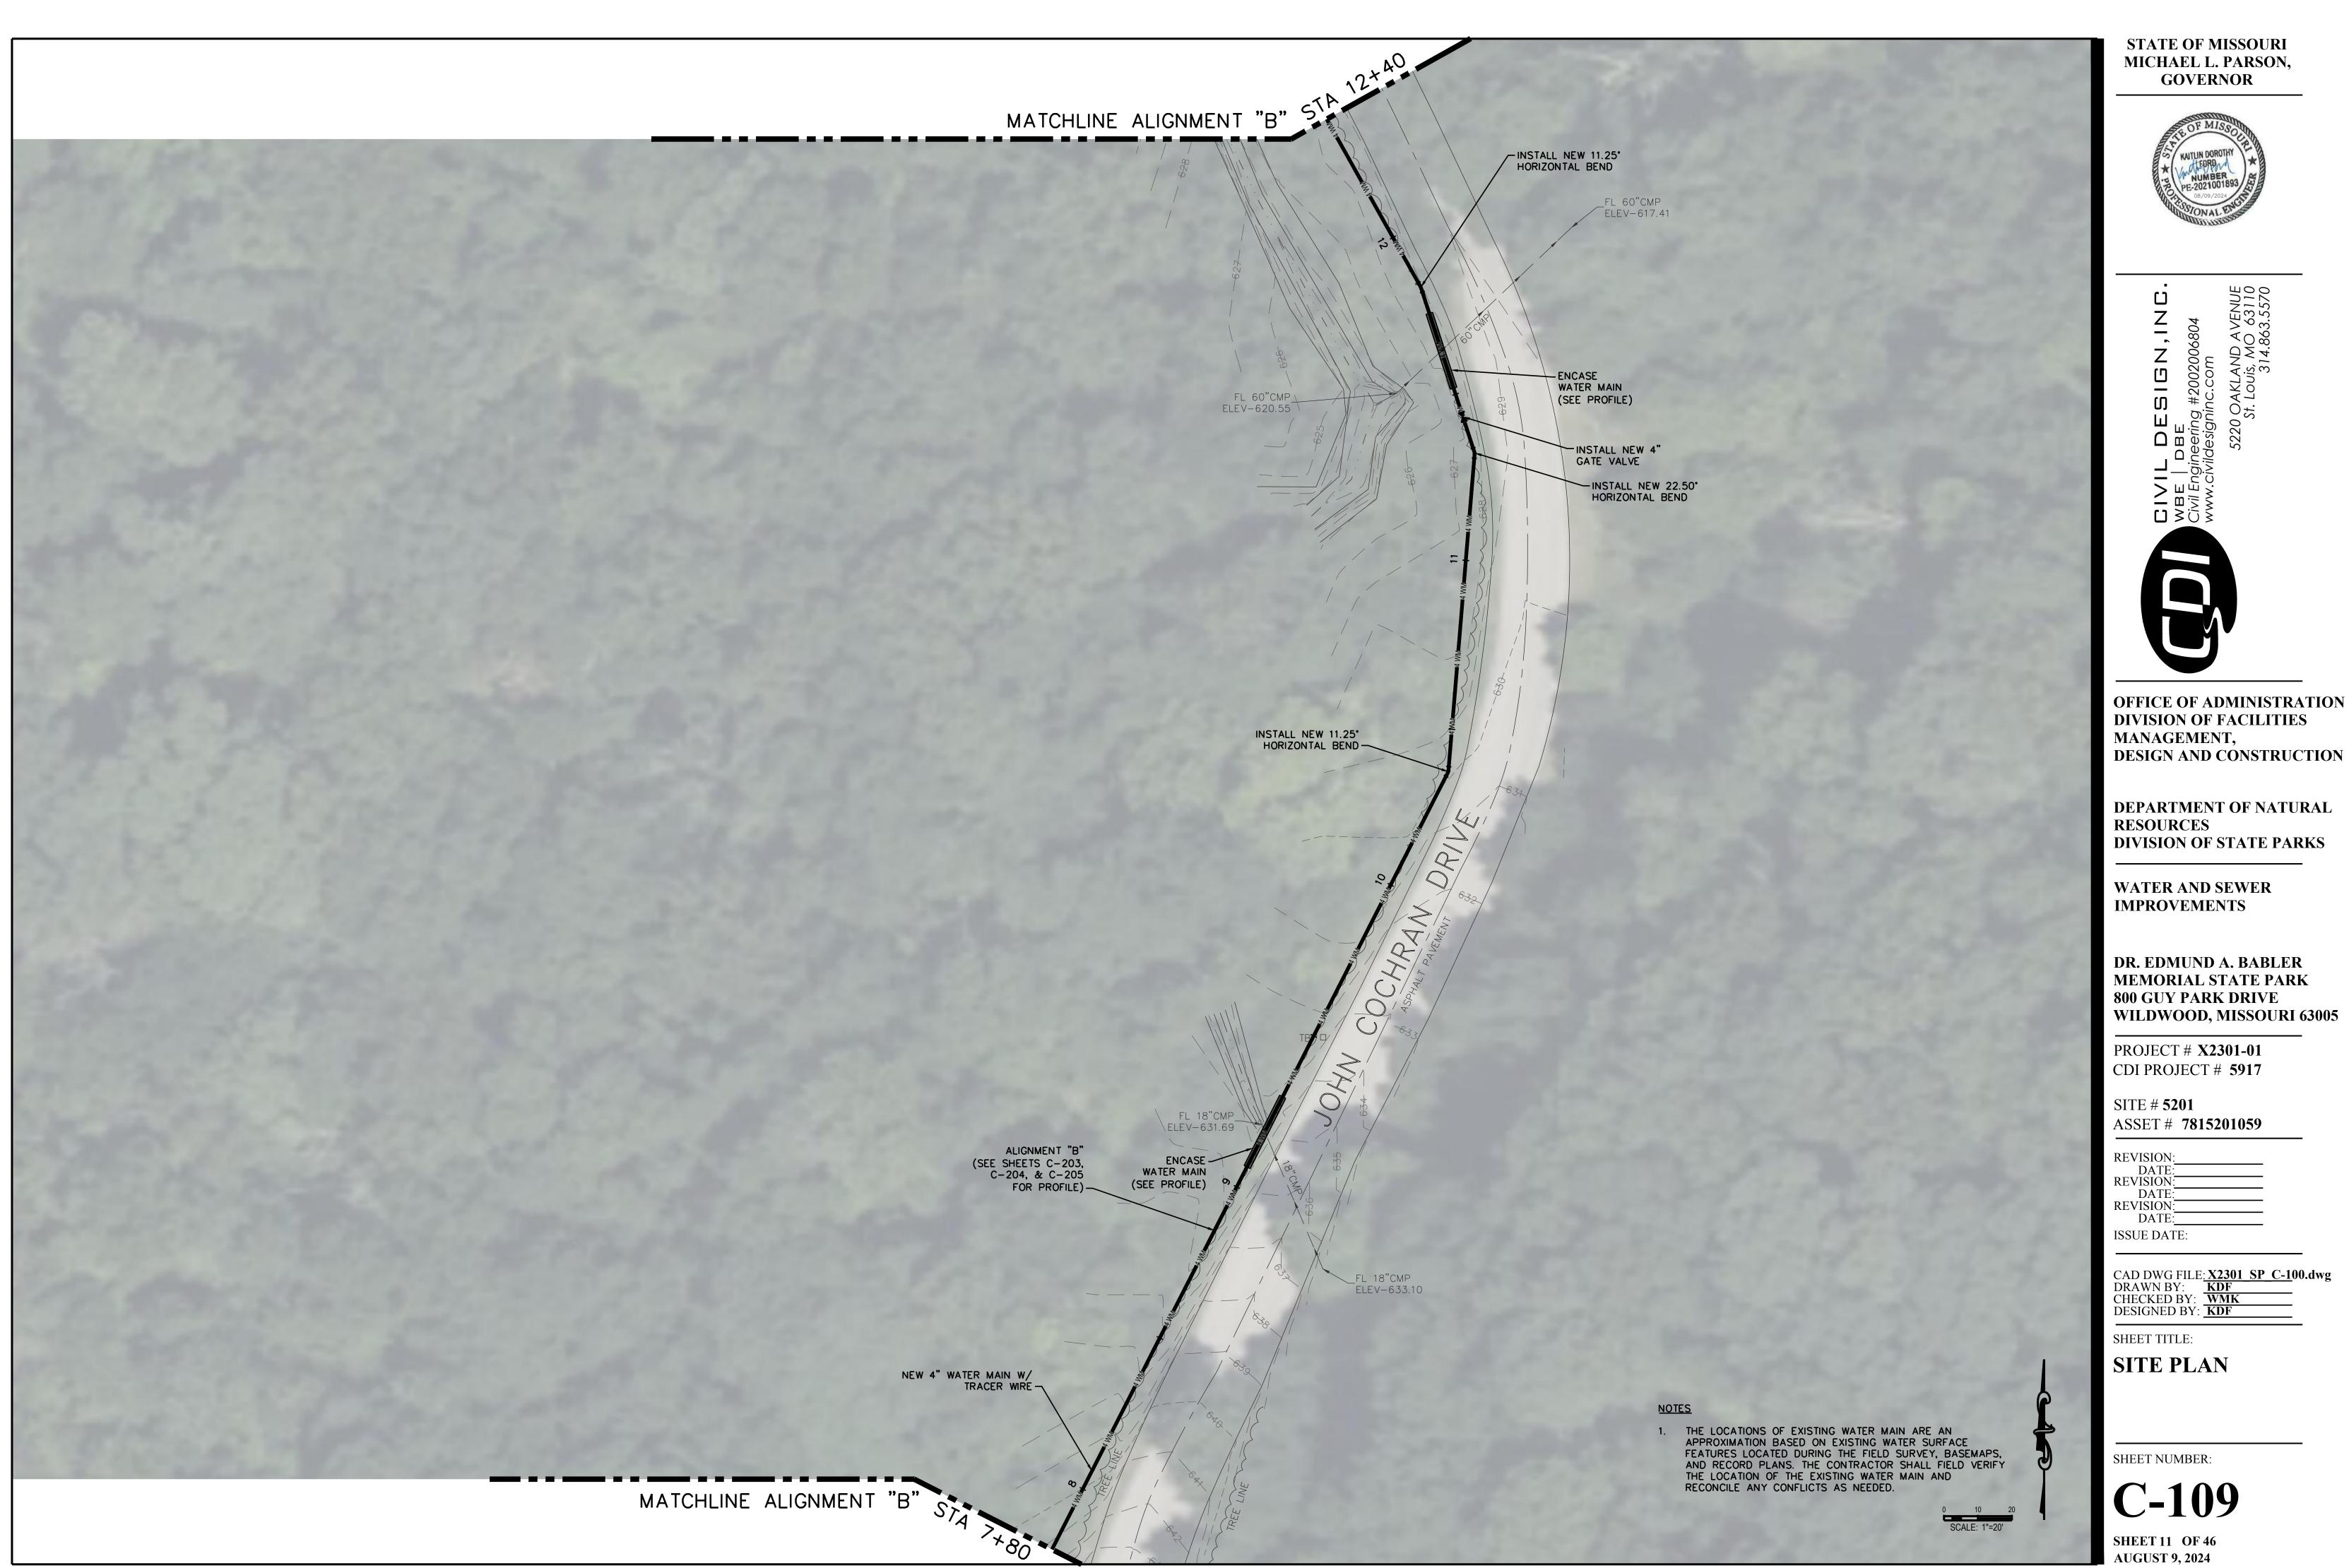
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OFFICE OF ADMINISTRATION **DIVISION OF FACILITIES DESIGN AND CONSTRUCTION**

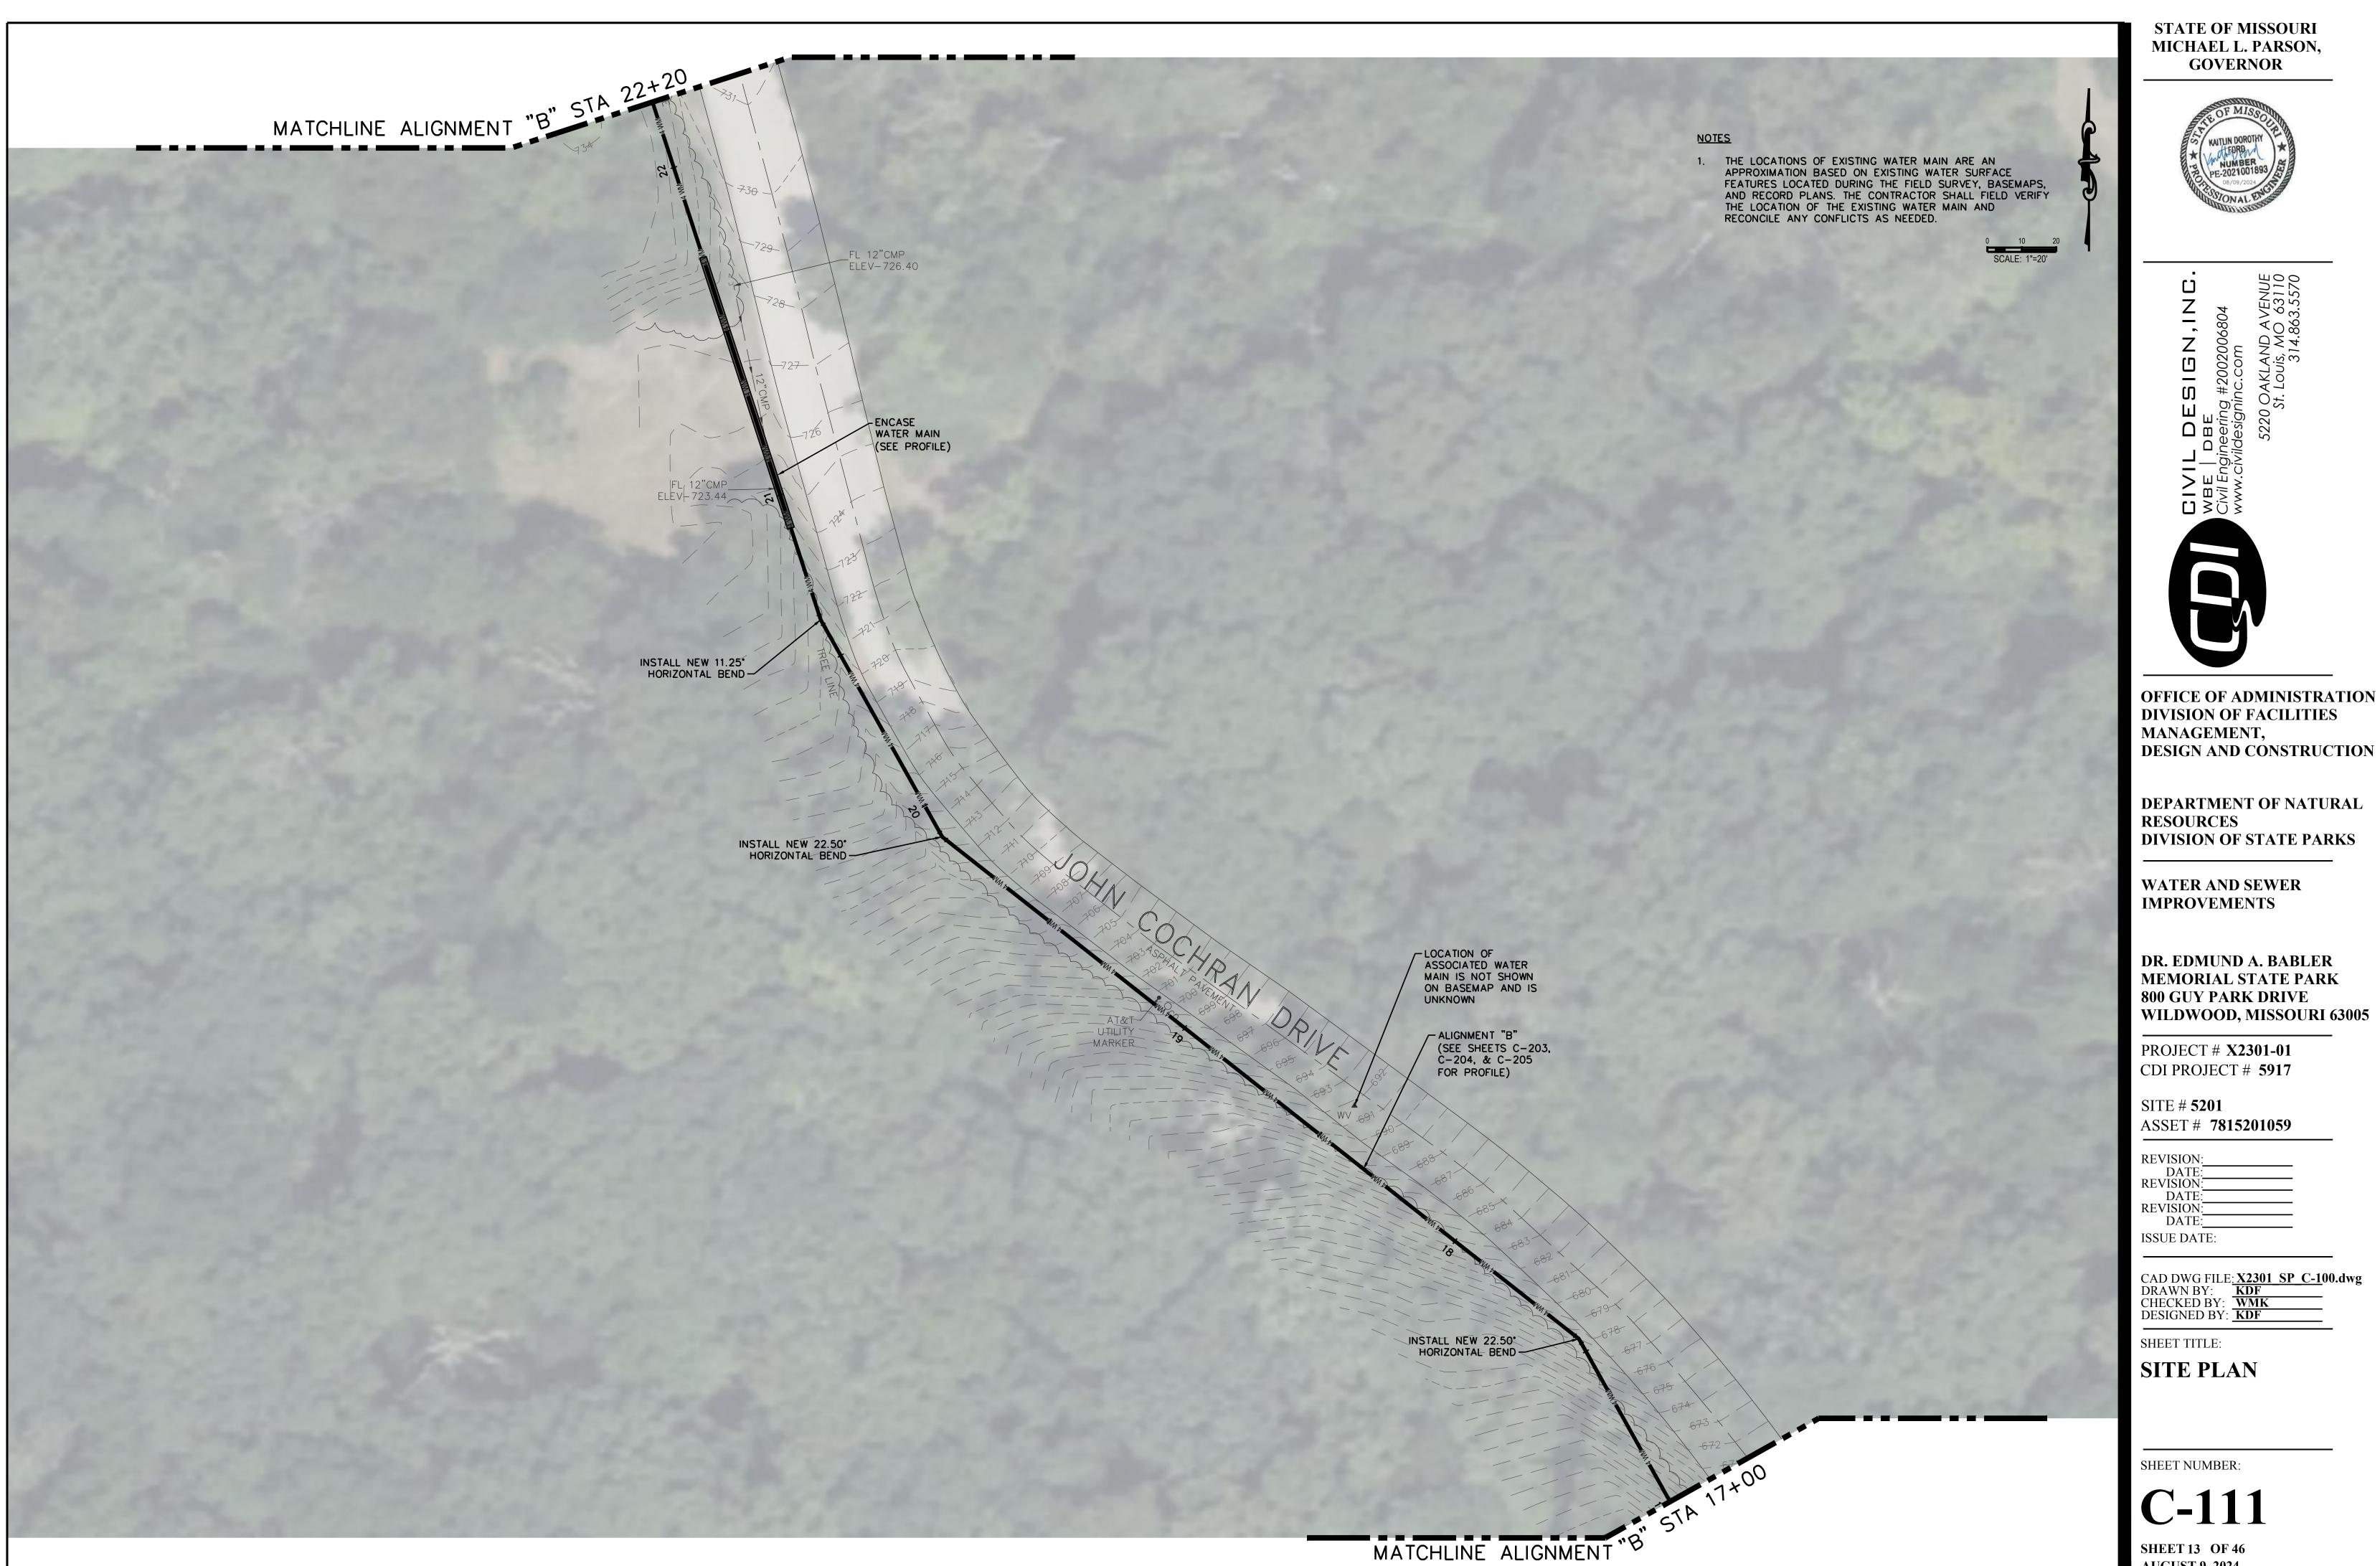DEPARTMENT OF NATURAL **DIVISION OF STATE PARKS**

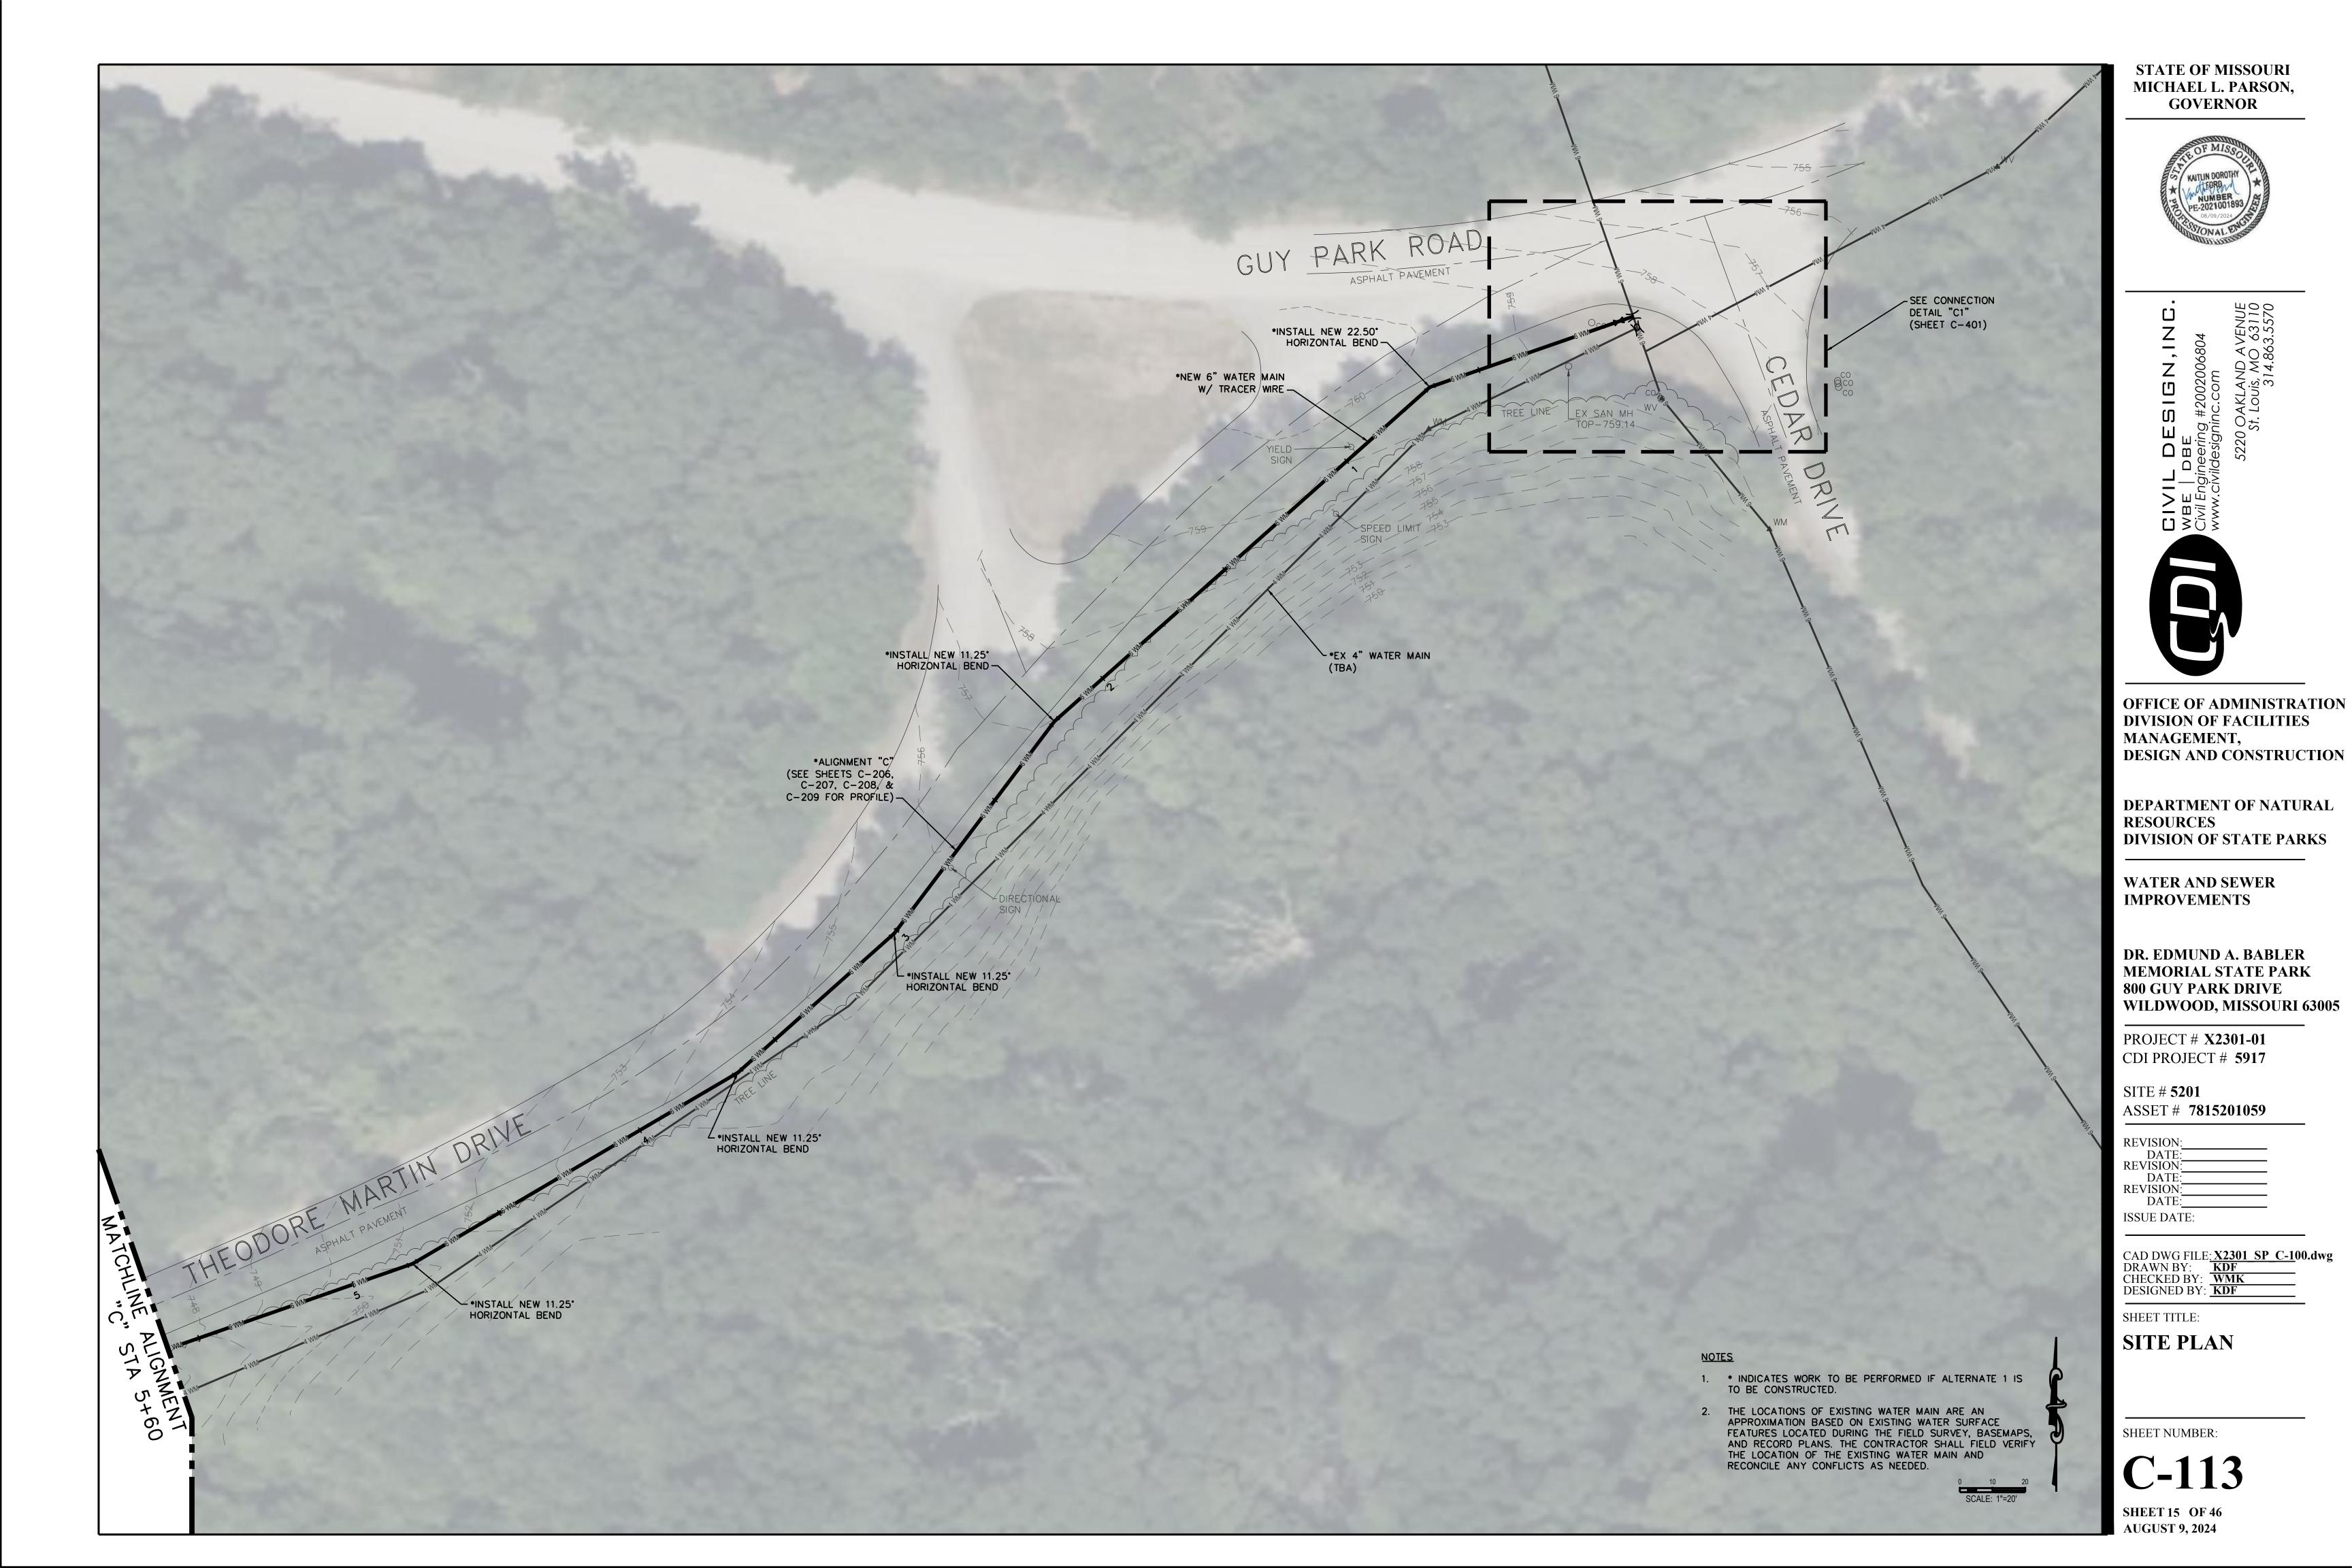DR. EDMUND A. BABLER MEMORIAL STATE PARK

CAD DWG FILE: X2301 SP C-100.dwg
DRAWN BY: KDF
CHECKED BY: WMK
DESIGNED BY: KDF

AUGUST 9, 2024




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AUGUST 9, 2024




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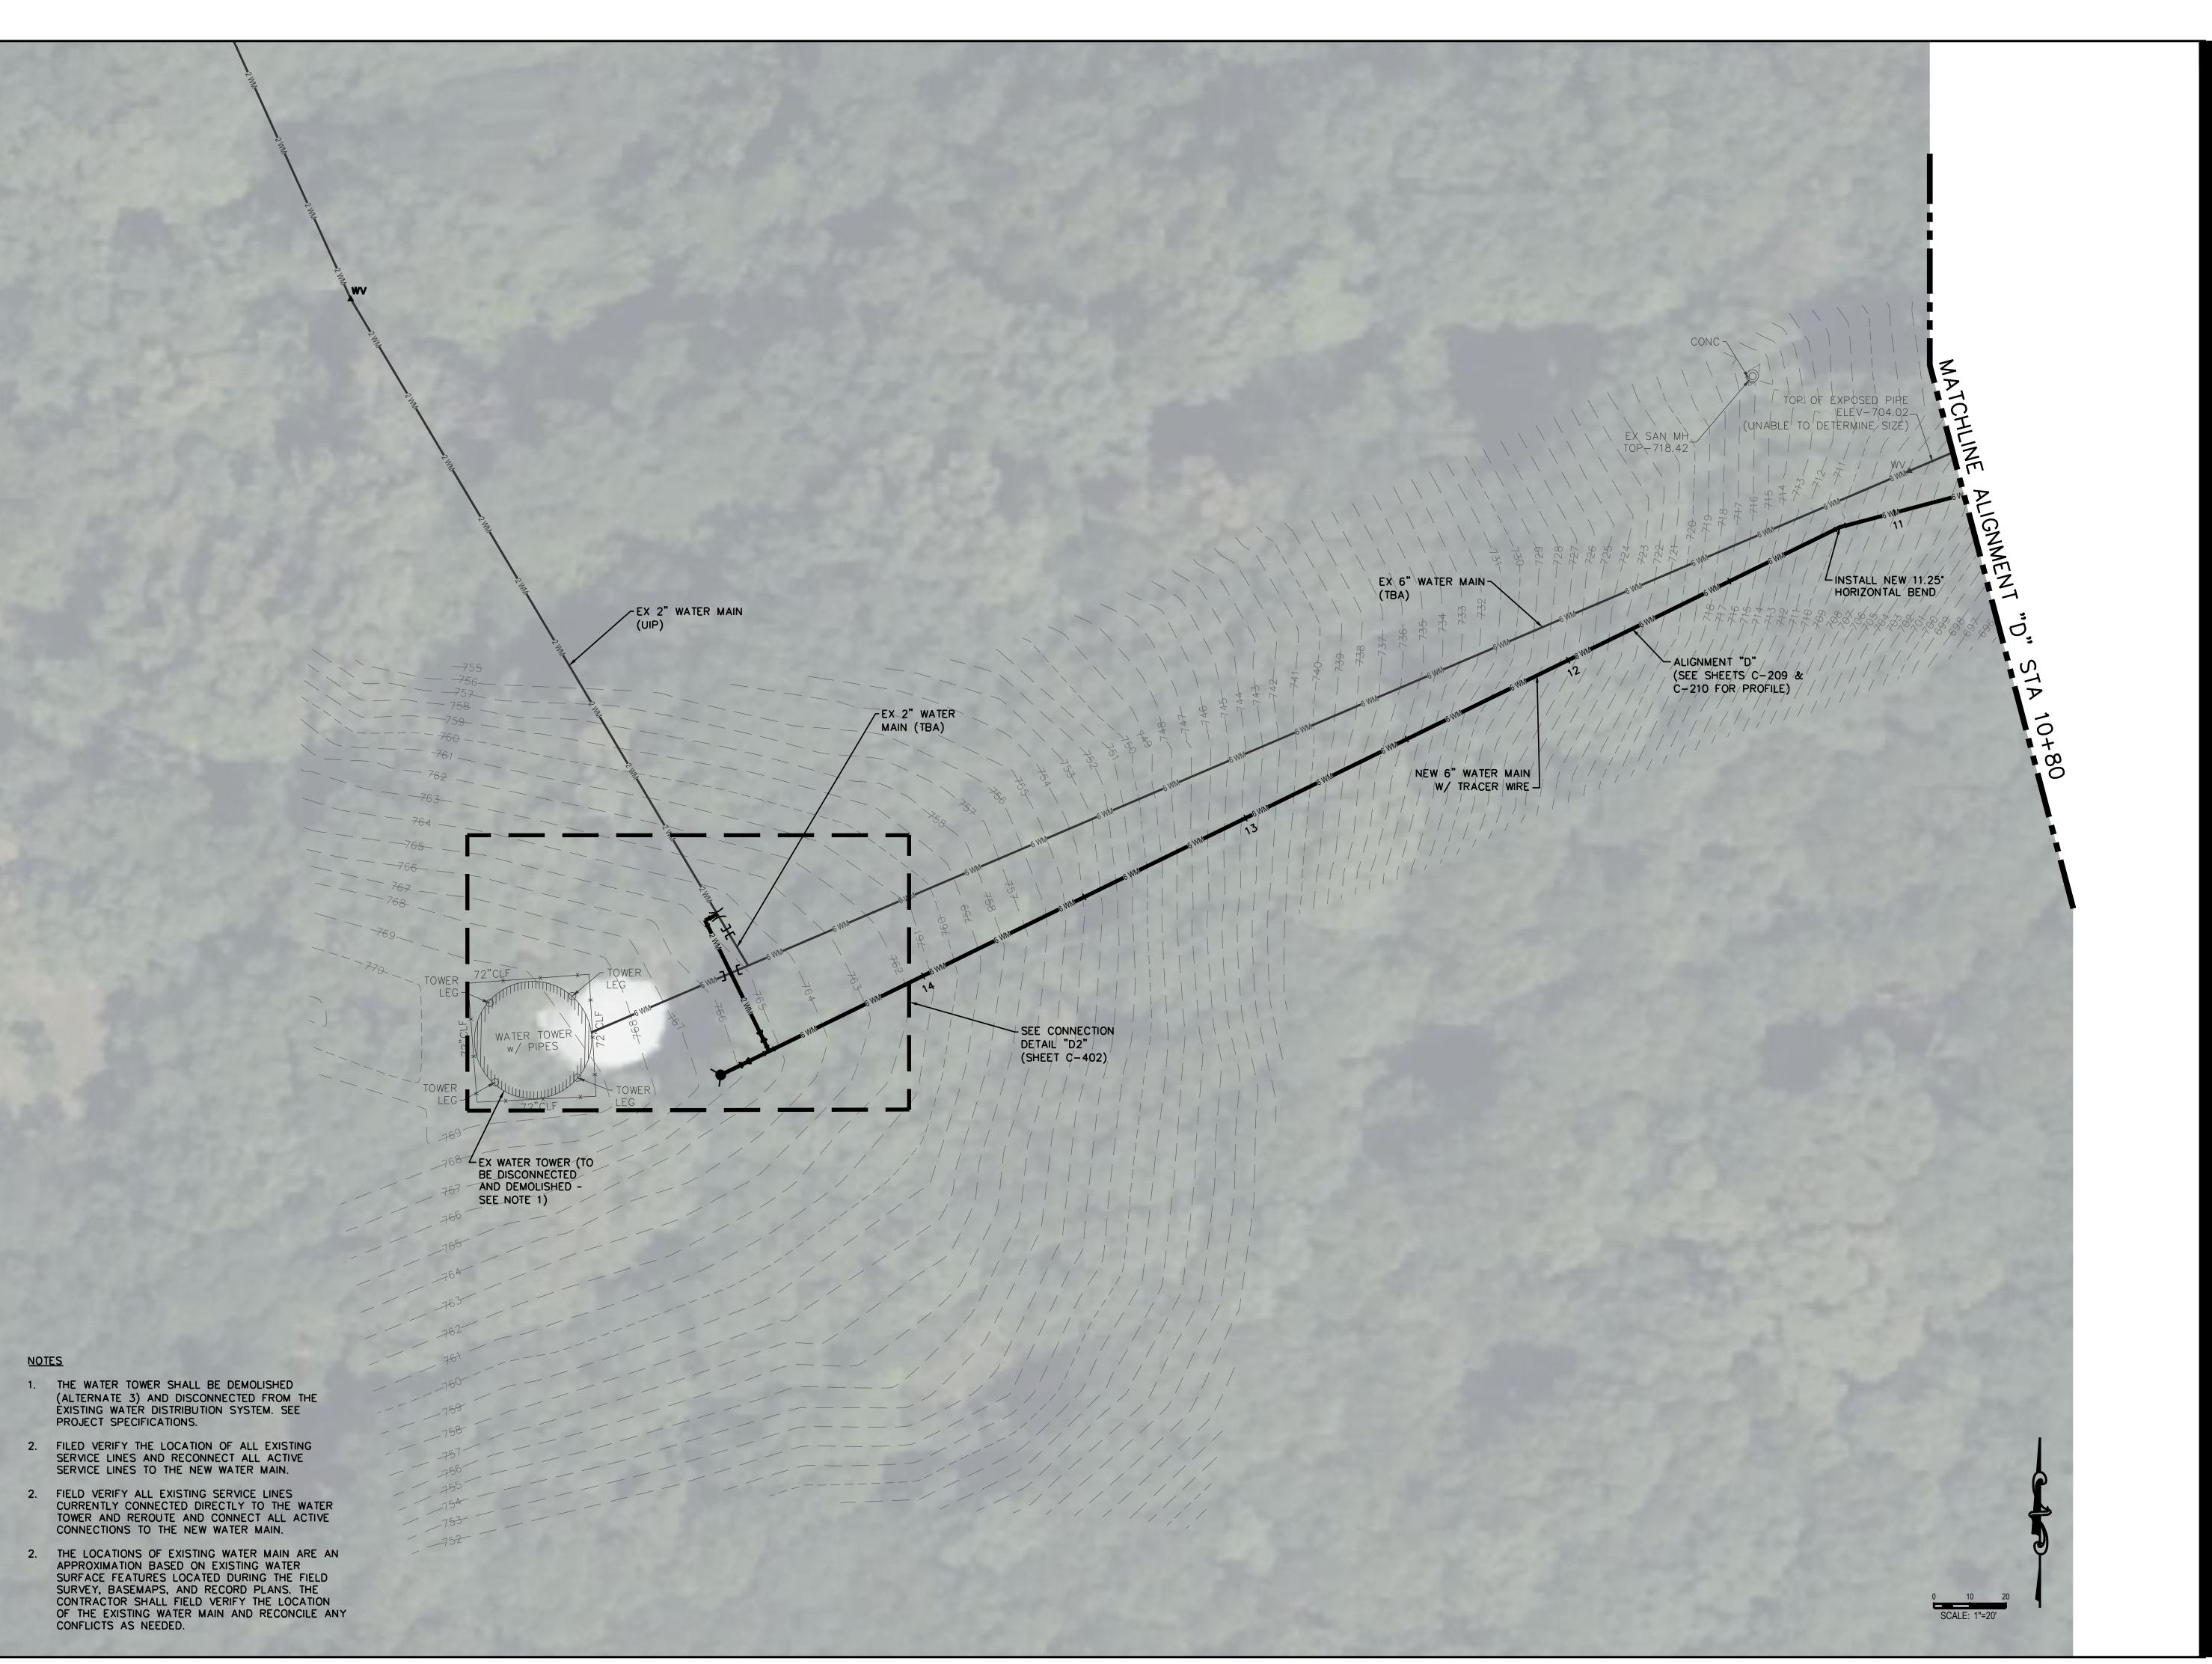
AUGUST 9, 2024

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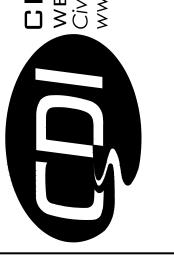


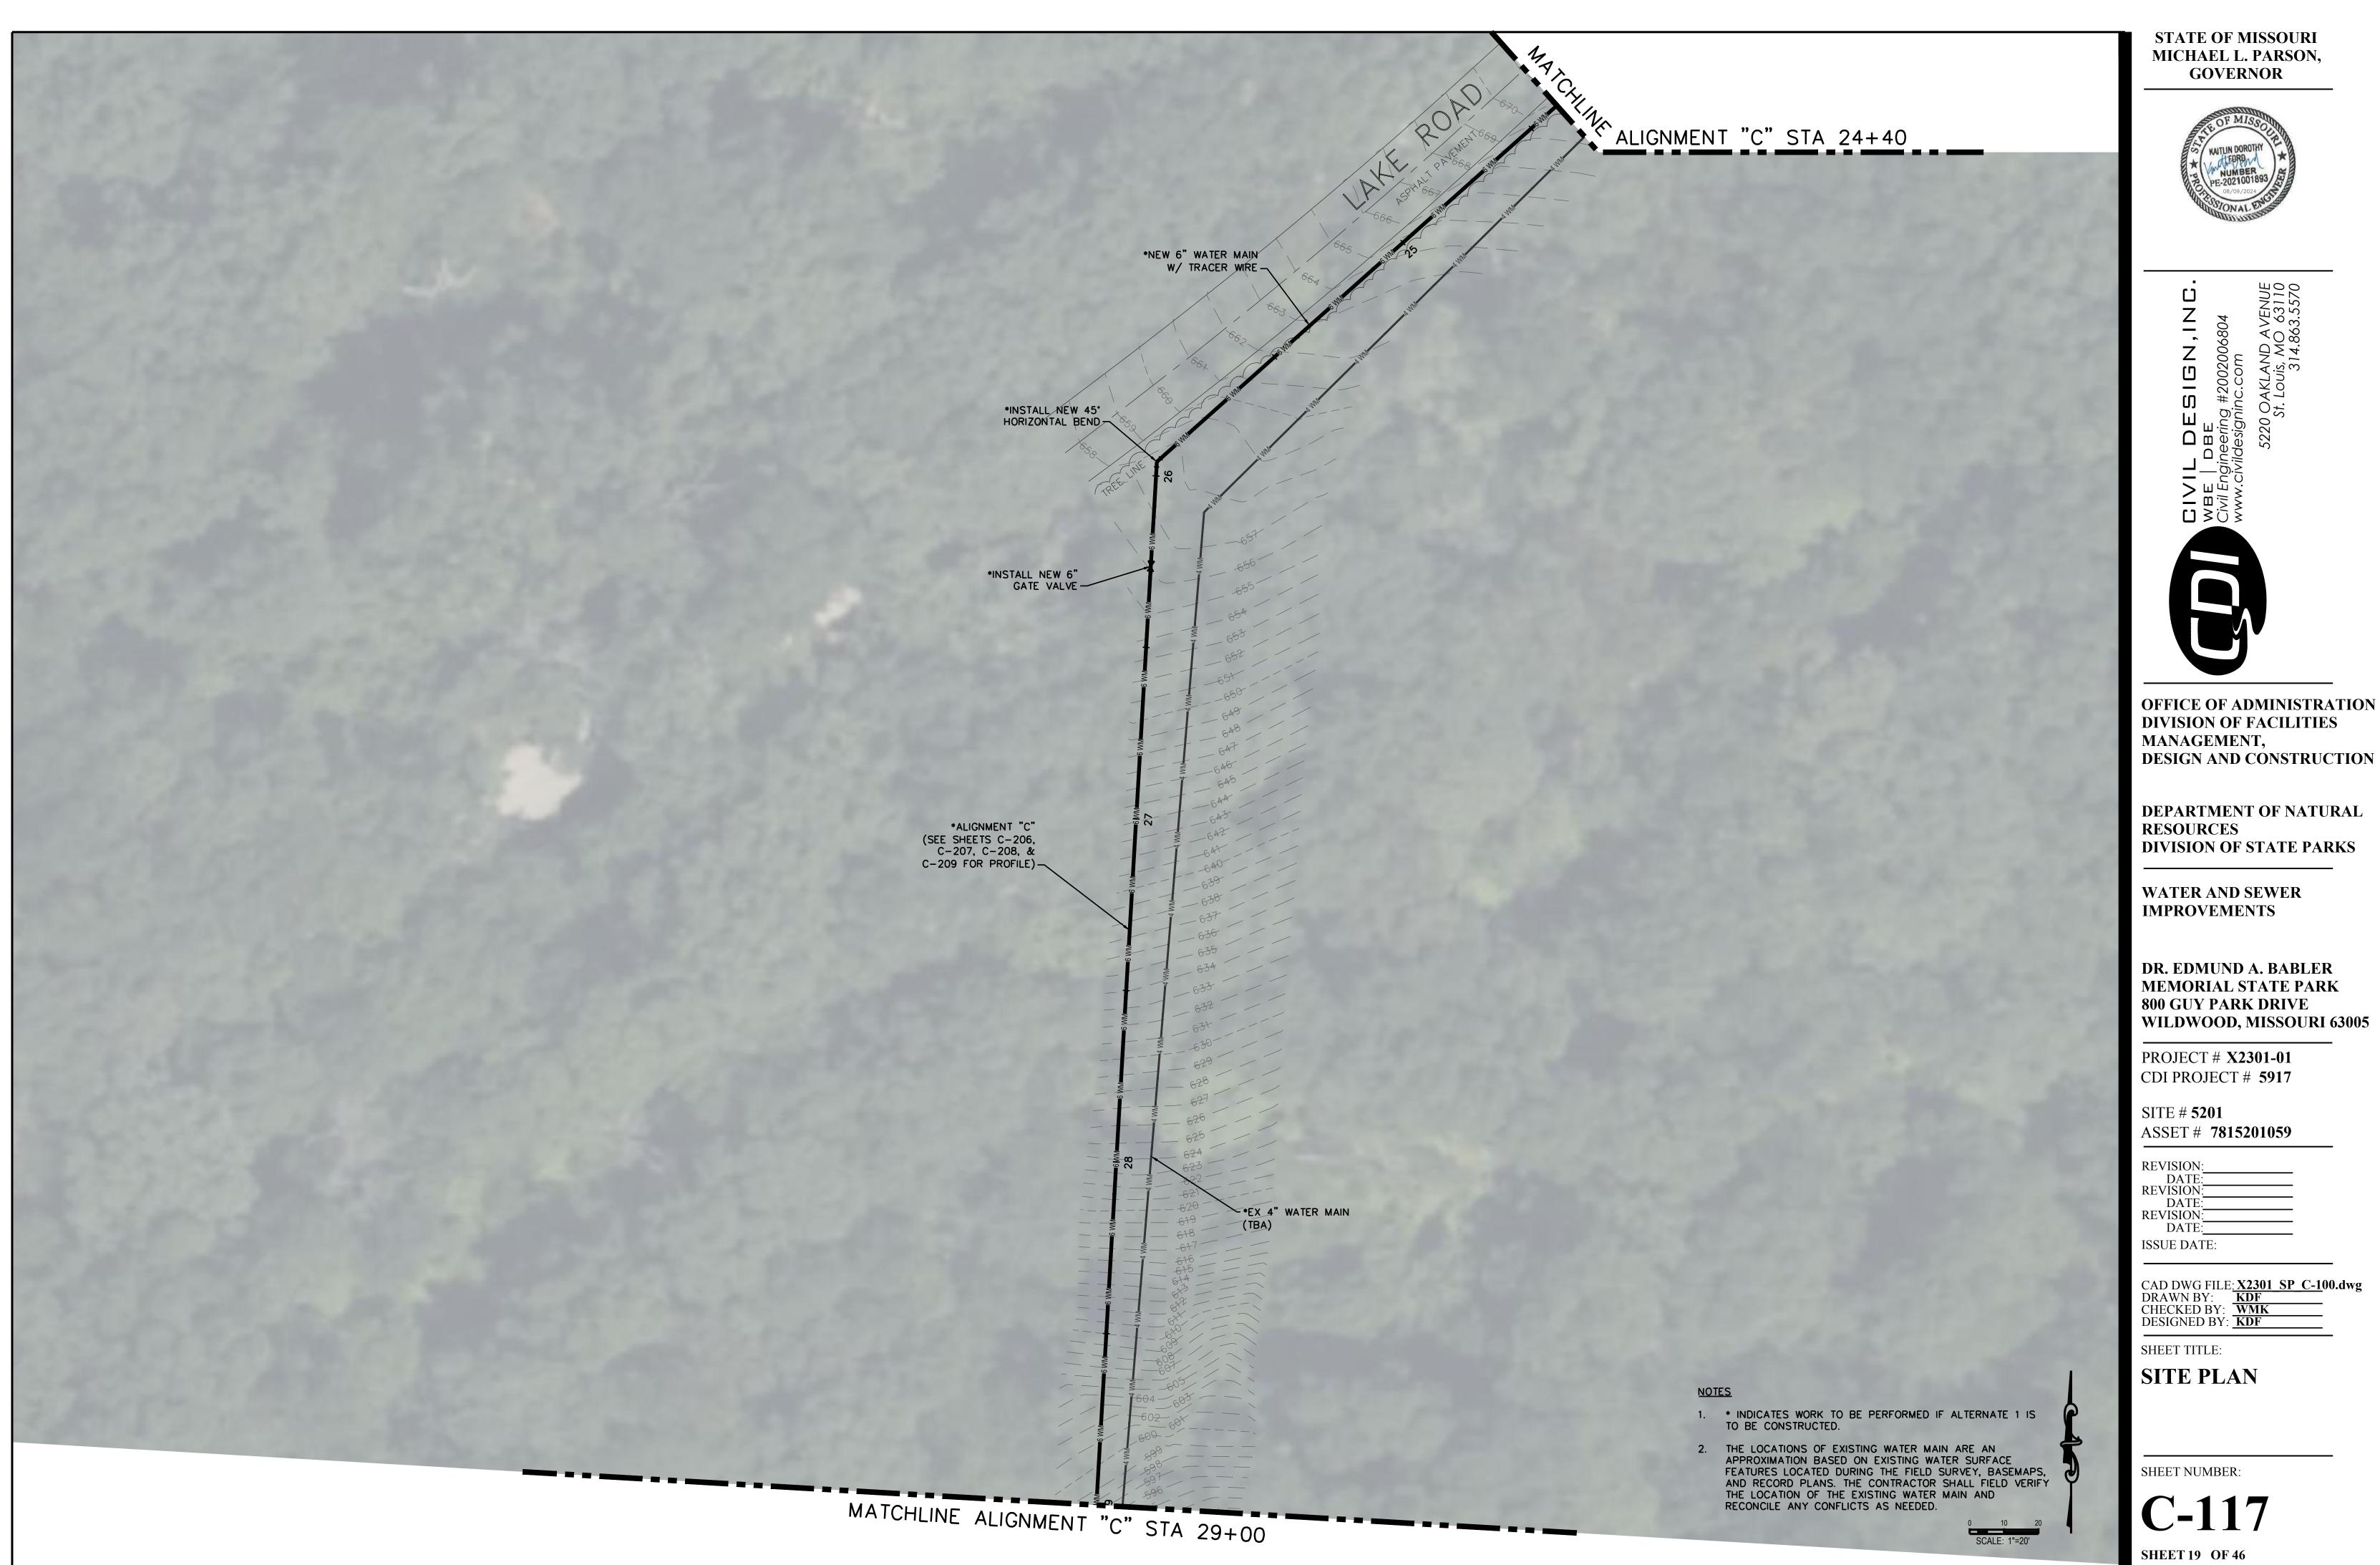SHEET 22 OF 46 AUGUST 9, 2024



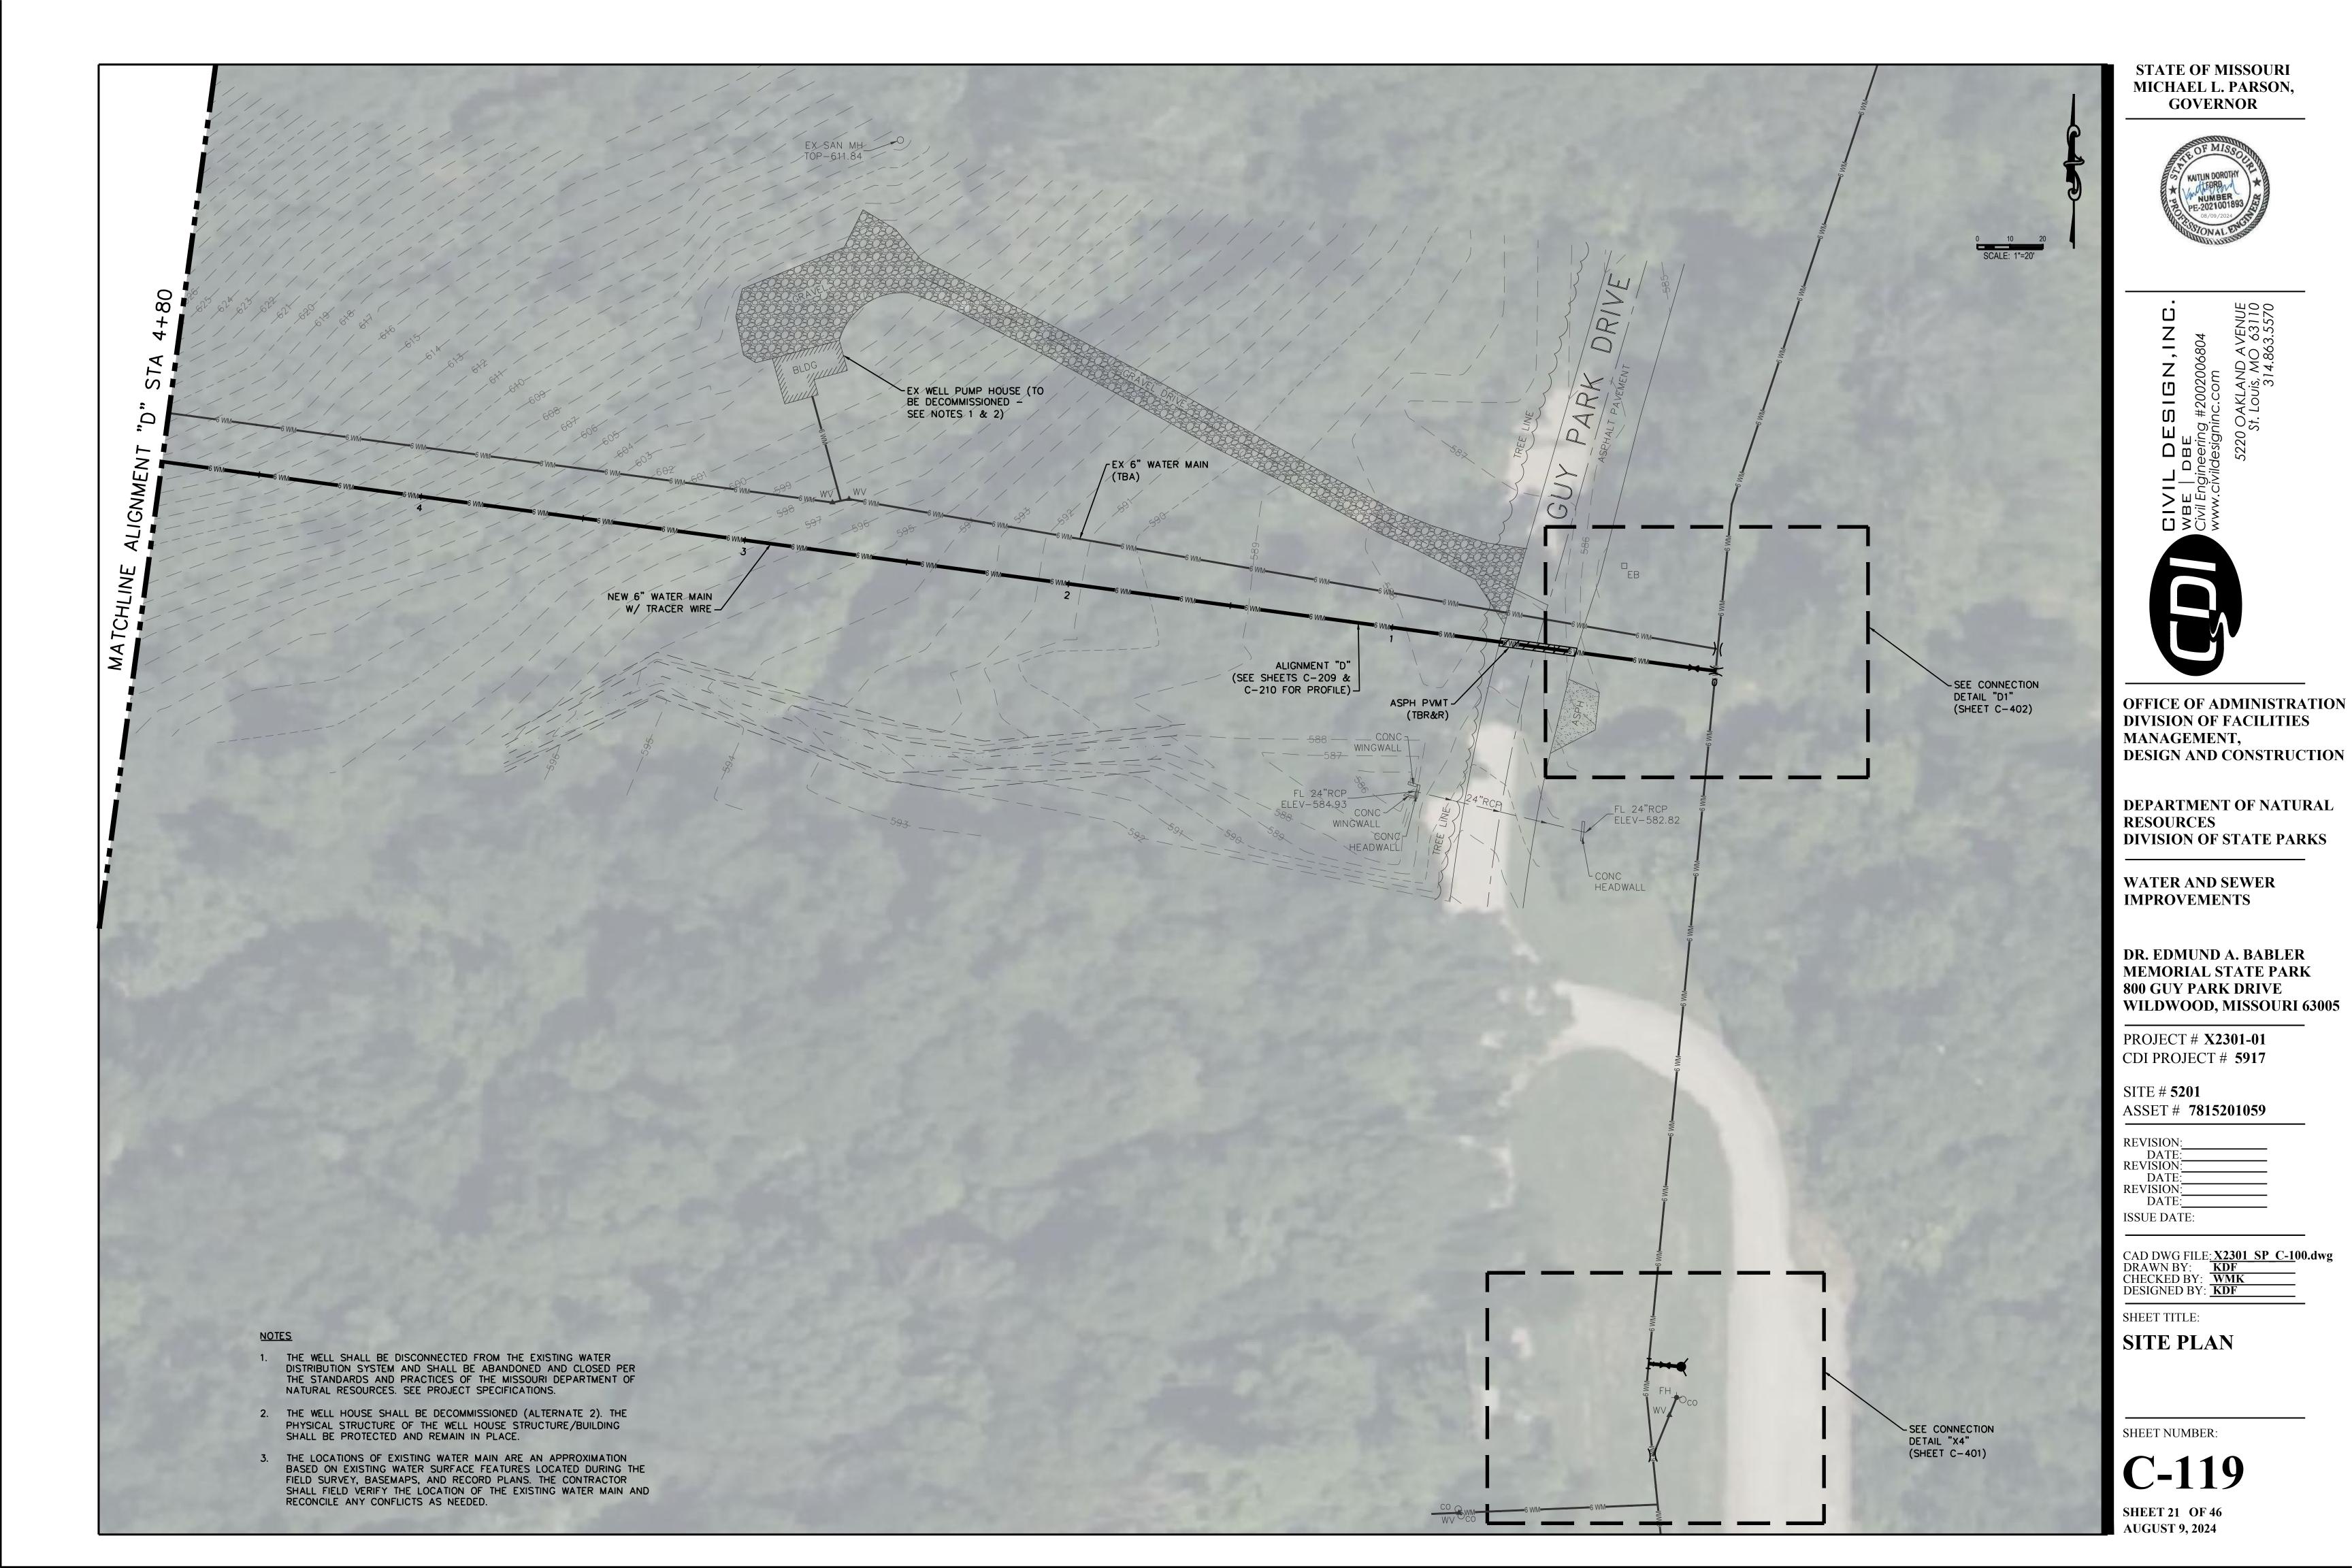

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OFFICE OF ADMINISTRATION DIVISION OF FACILITIES MANAGEMENT, DESIGN AND CONSTRUCTION

DEPARTMENT OF NATURAL RESOURCES
DIVISION OF STATE PARKS

WATER AND SEWER IMPROVEMENTS

DR. EDMUND A. BABLER MEMORIAL STATE PARK 800 GUY PARK DRIVE WILDWOOD, MISSOURI 63005

PROJECT # **X2301-01**CDI PROJECT # **5917**

SITE # **5201** ASSET # **7815201059**

REVISION:
DATE:
REVISION:
DATE:
REVISION:
DATE:
ISSUE DATE:

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CHECKED BY: WMK
DESIGNED BY: KDF

SHEET TITLE:

SITE PLAN

SHEET NUMBER:

C-12


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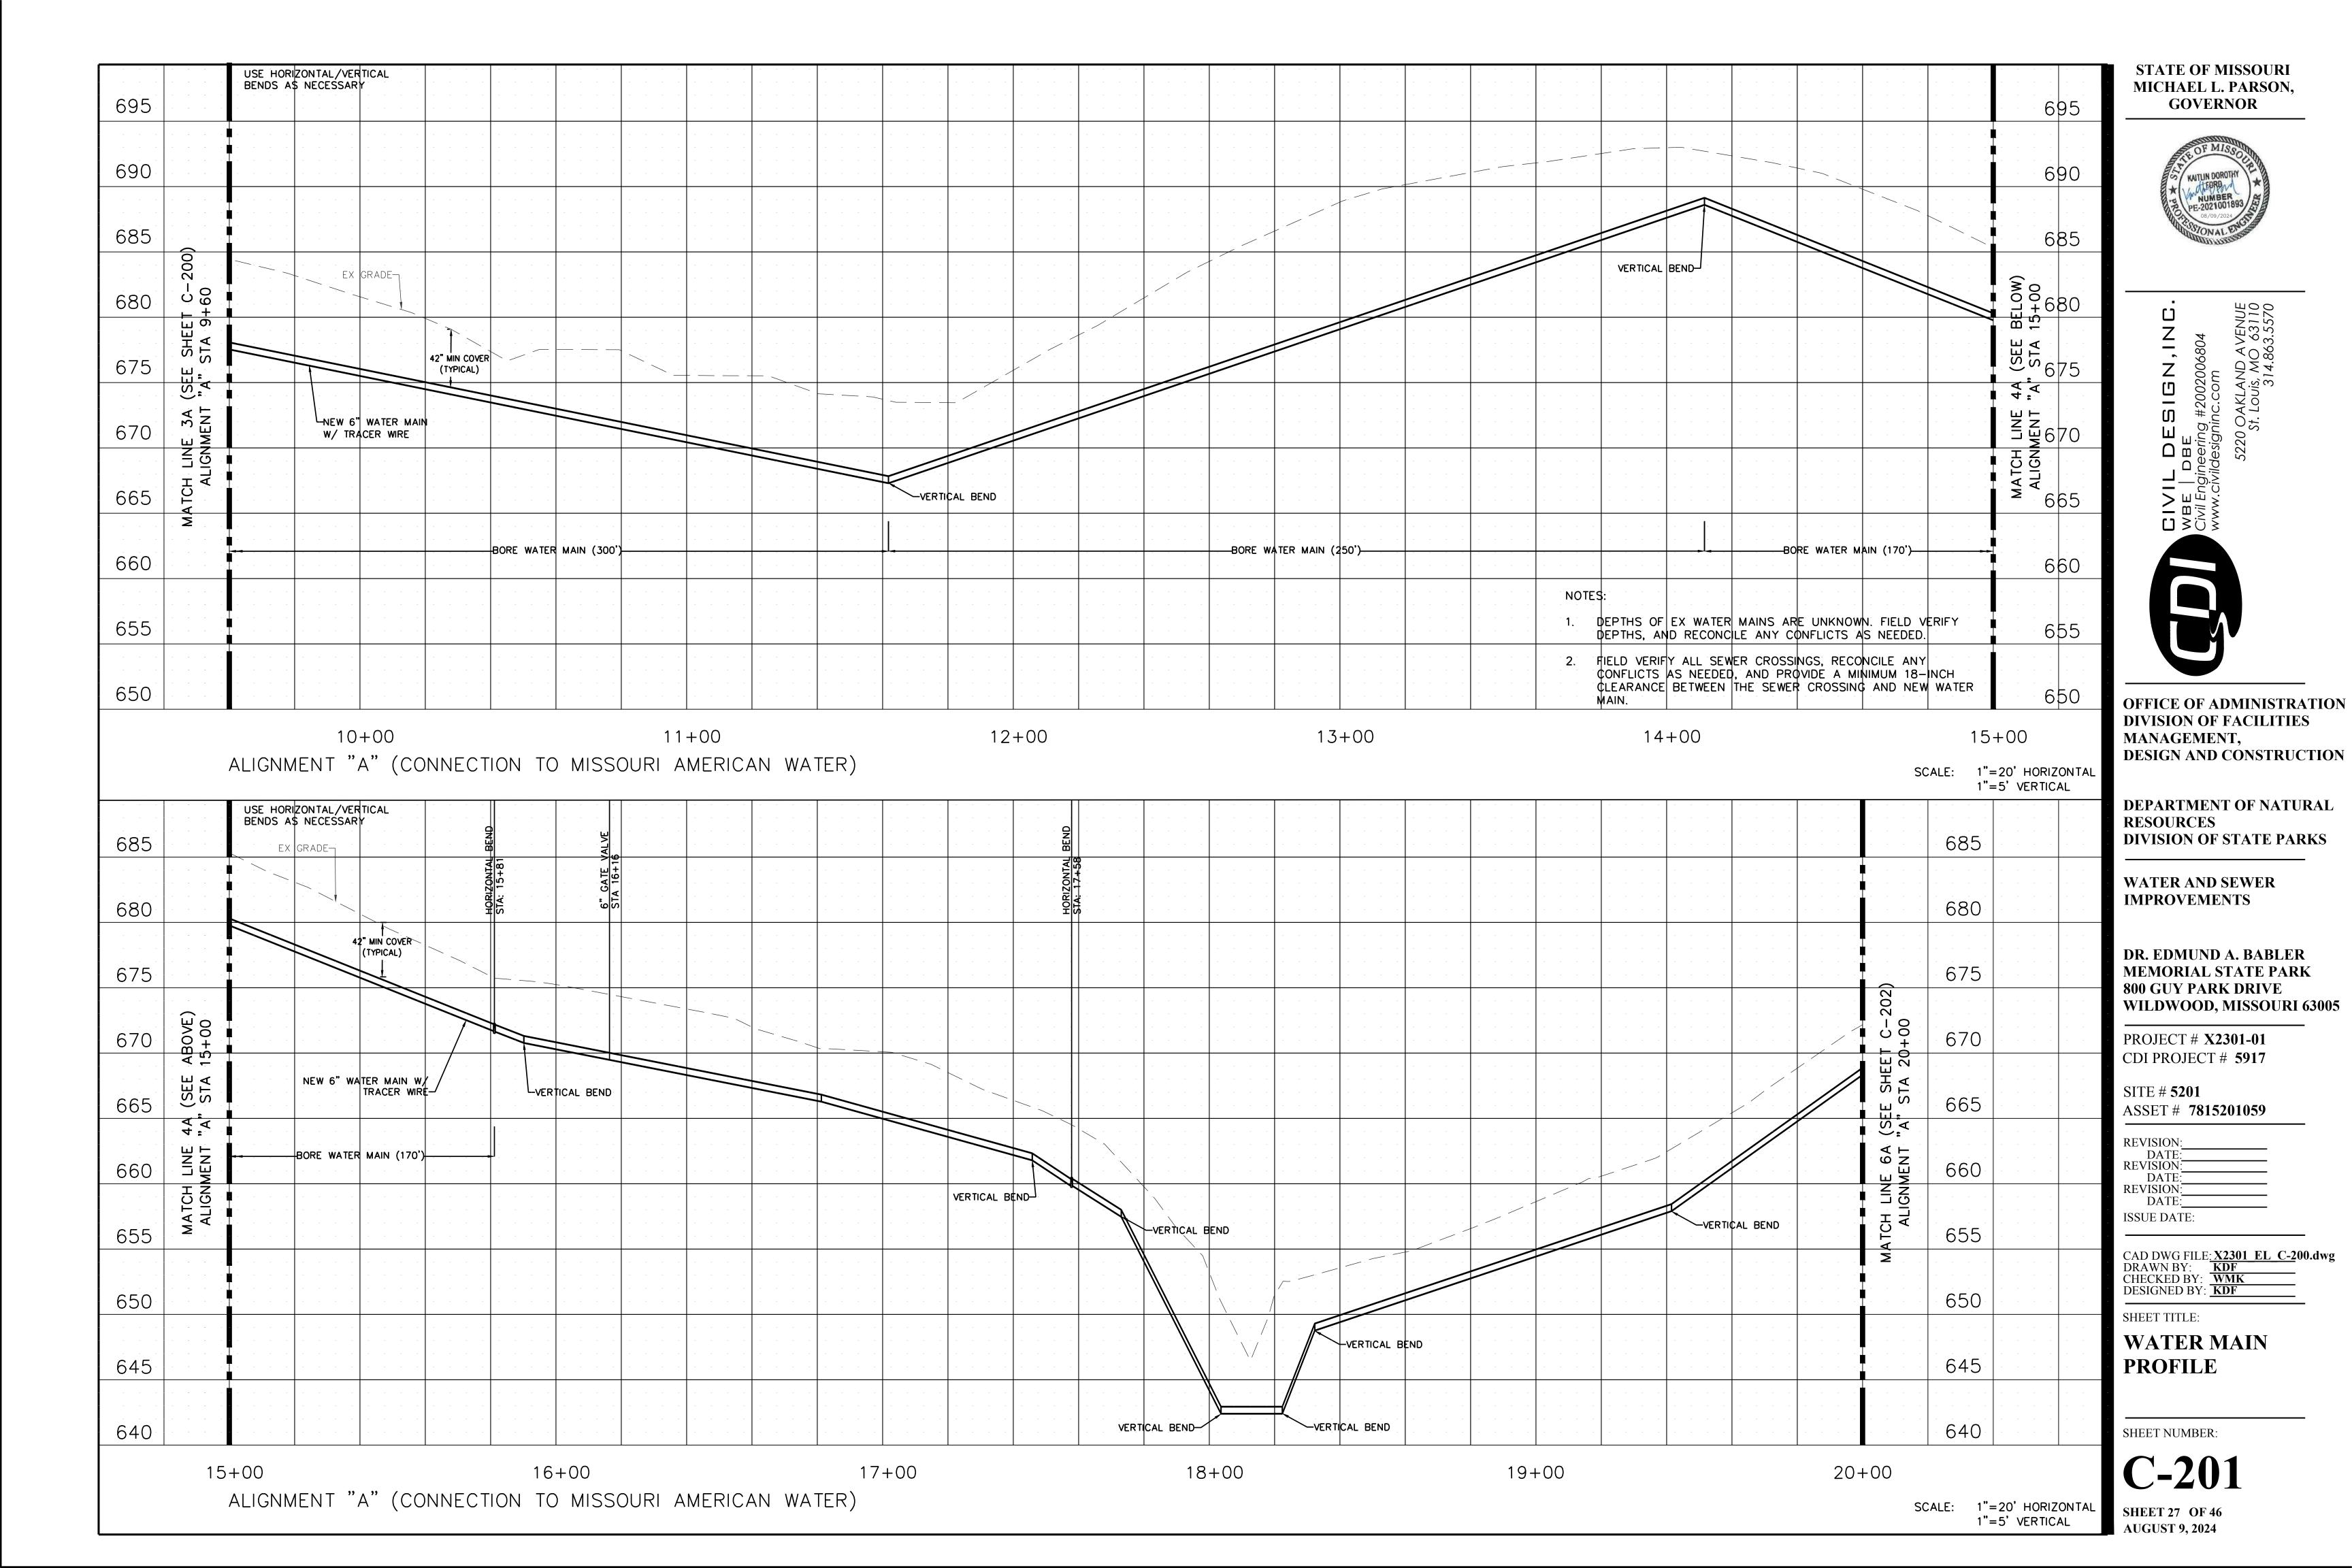



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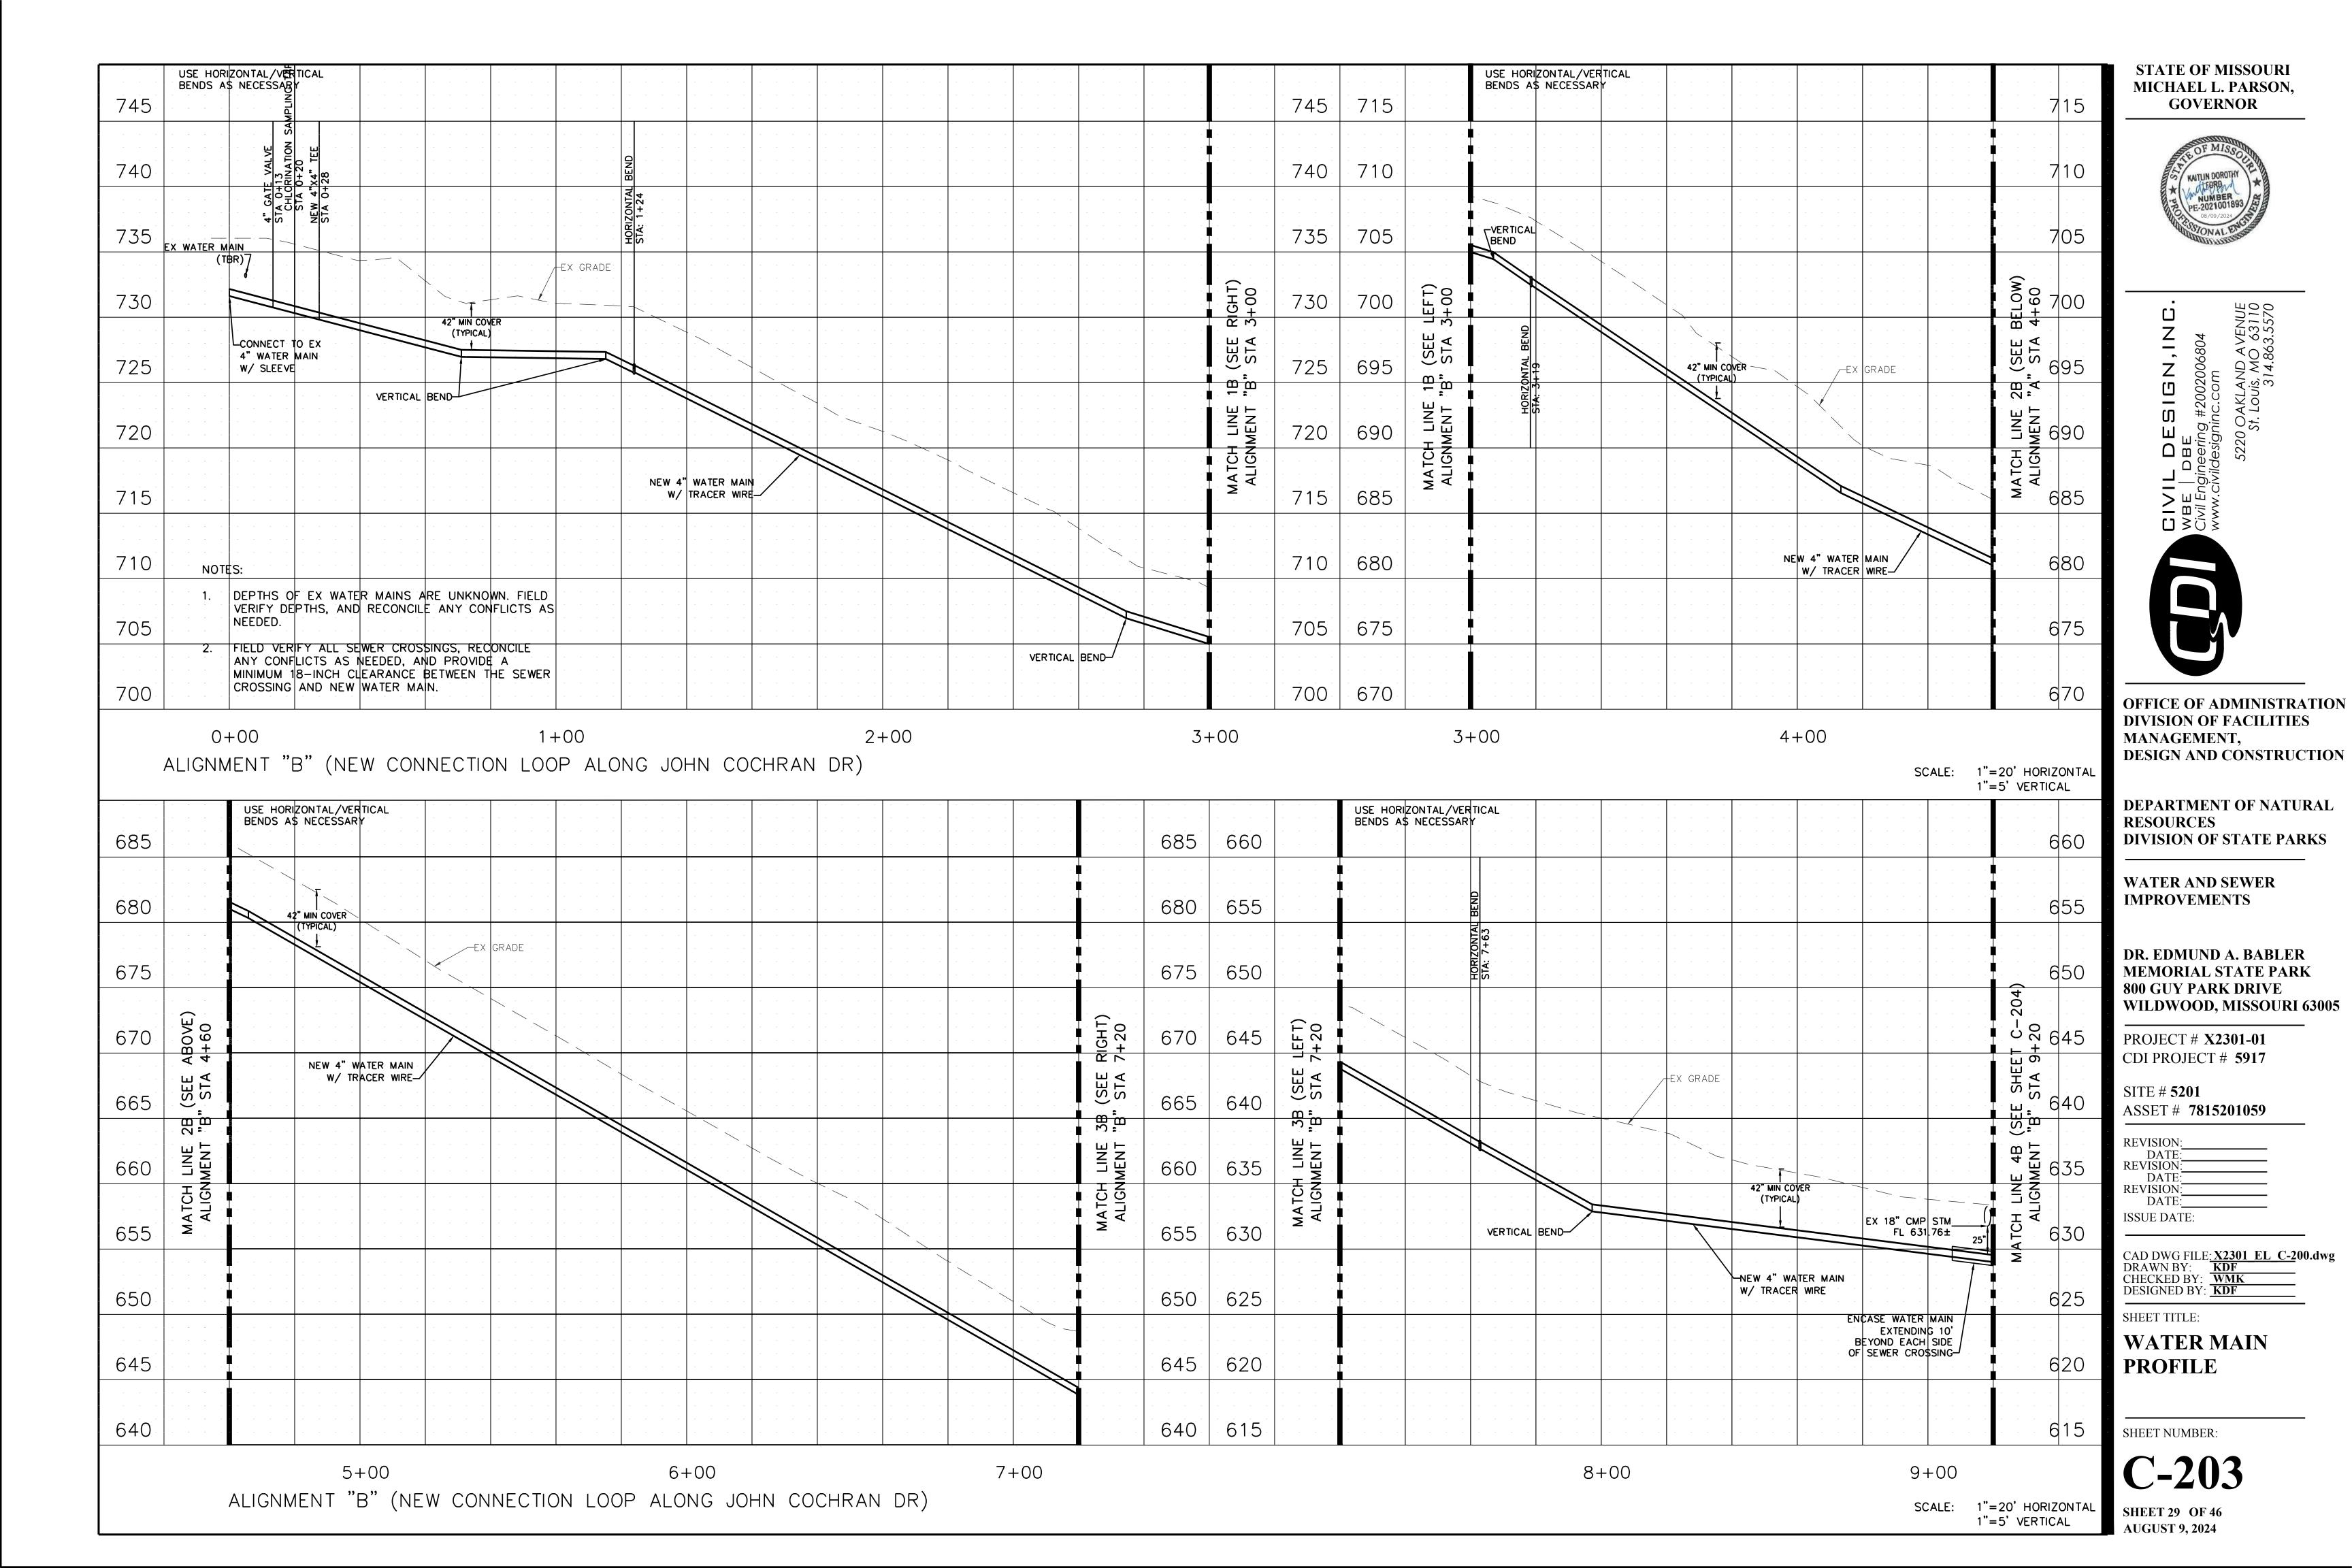



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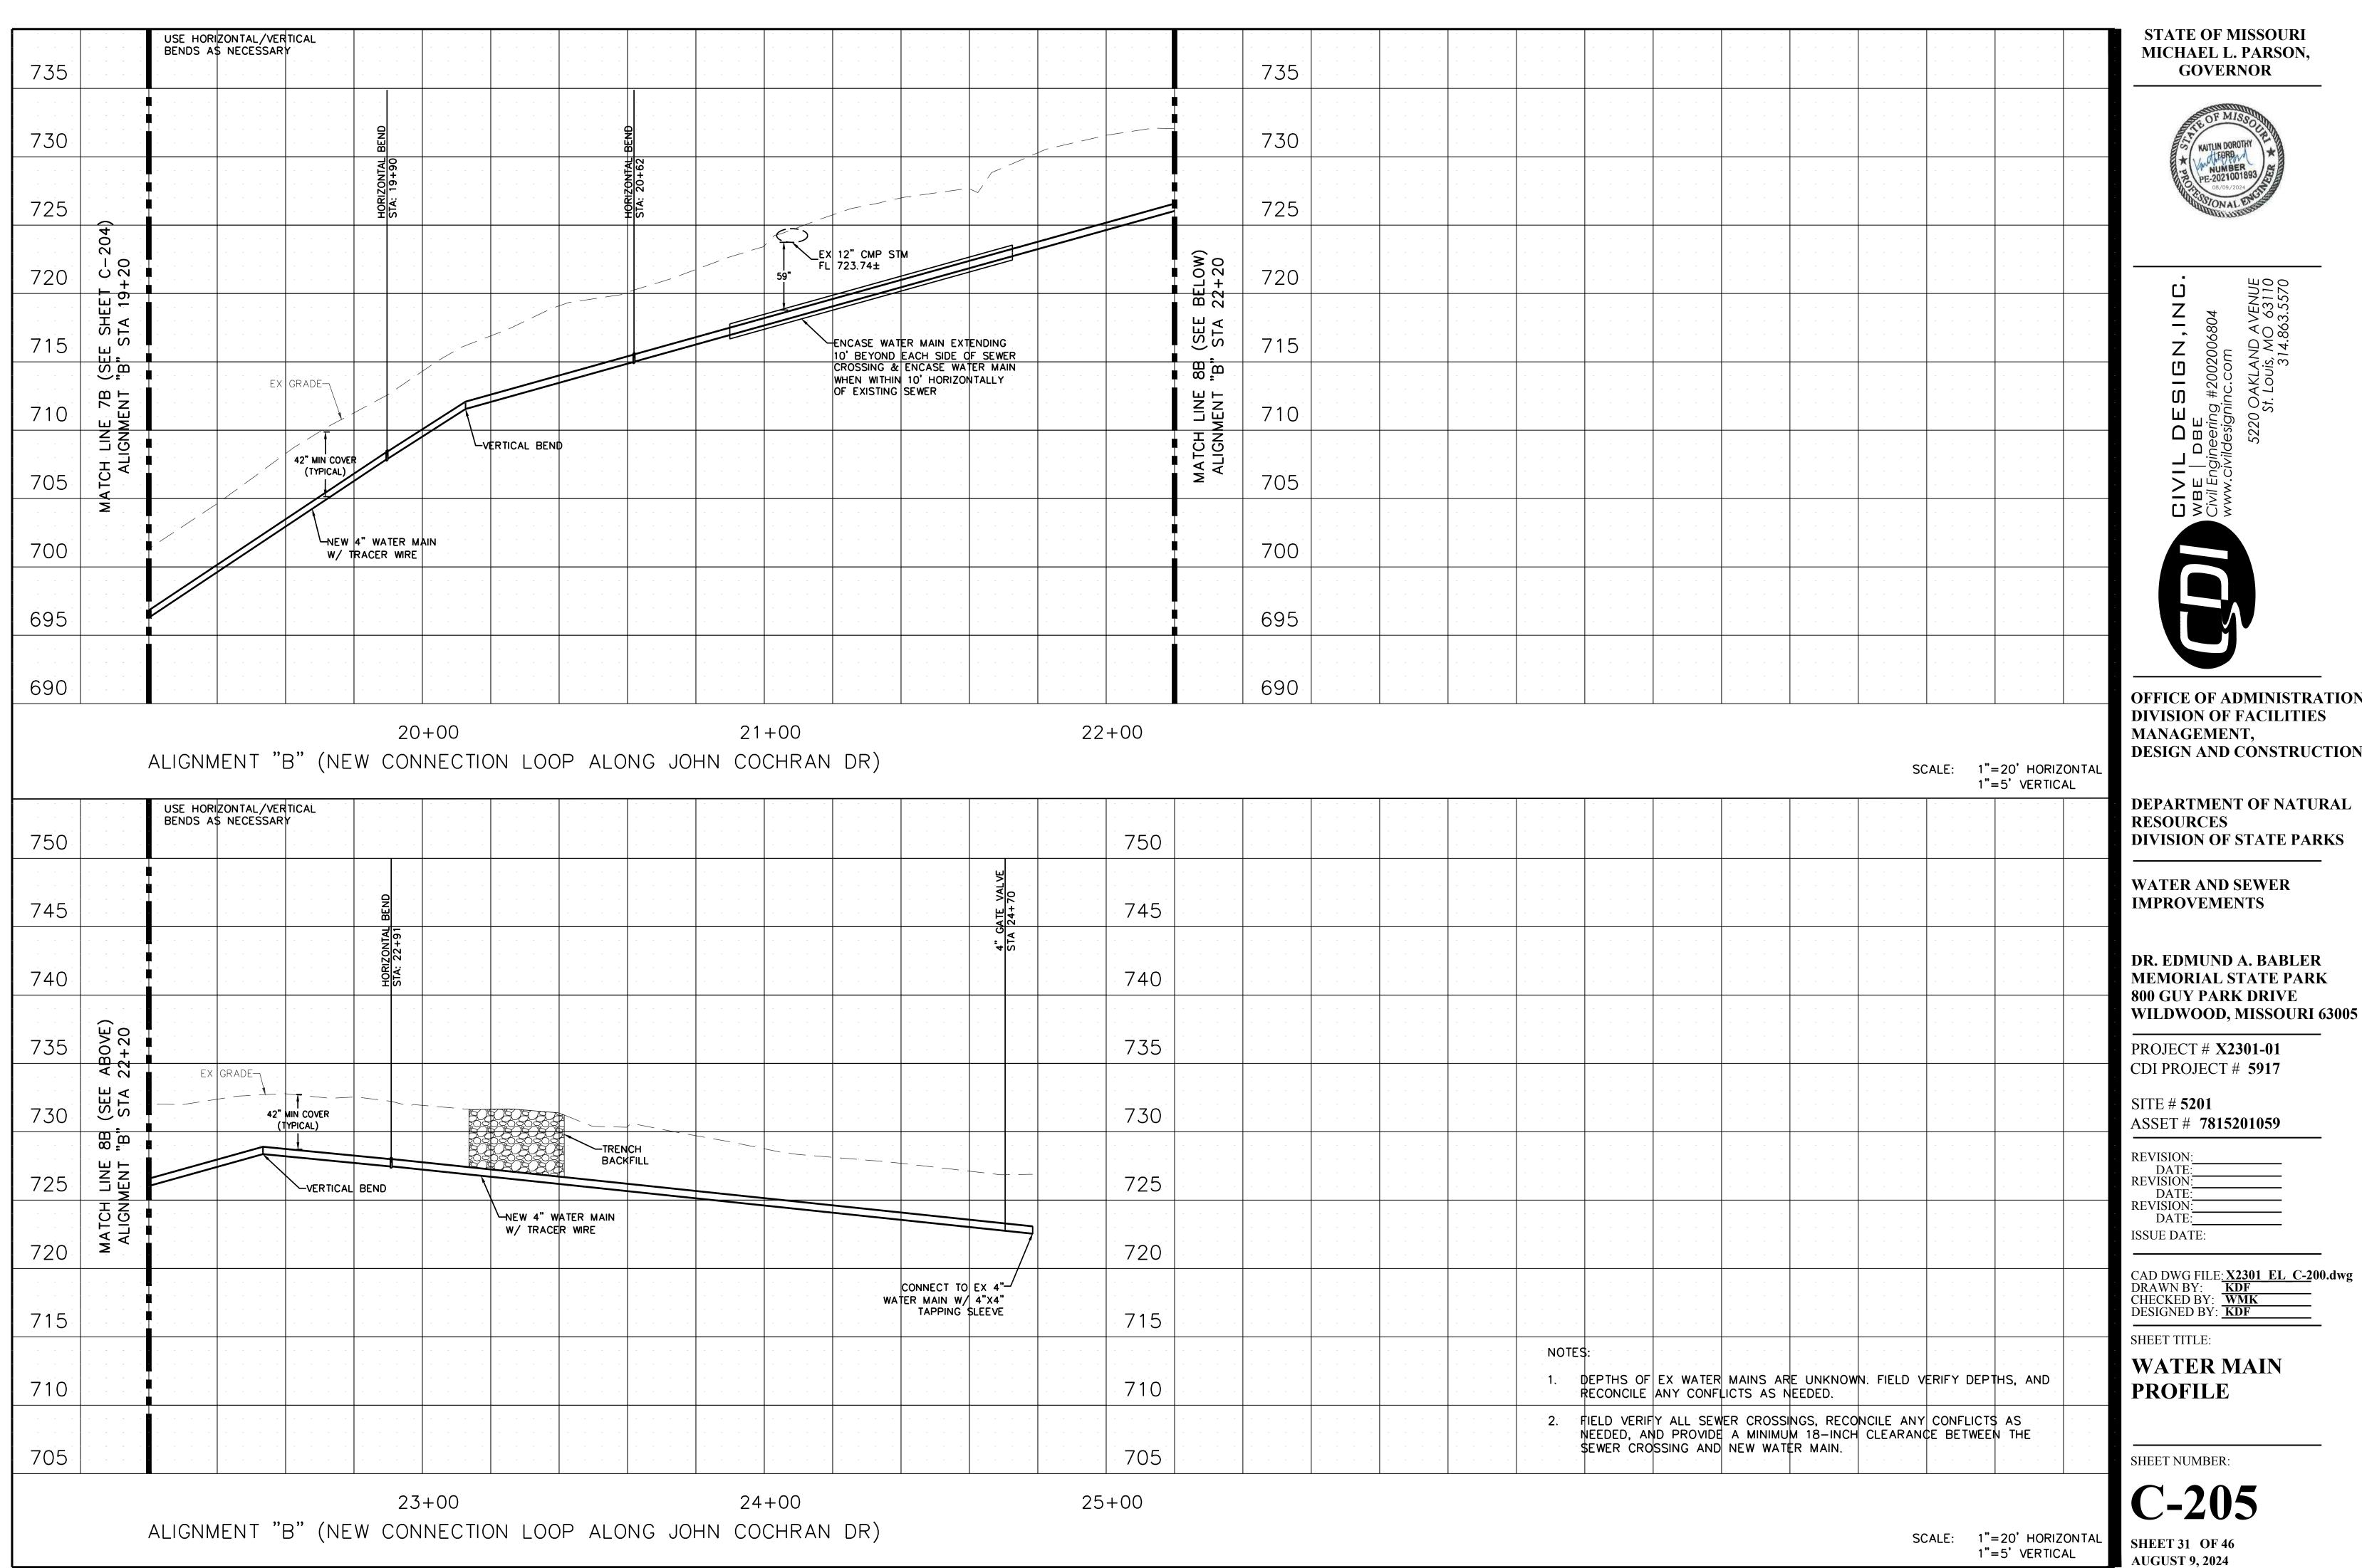







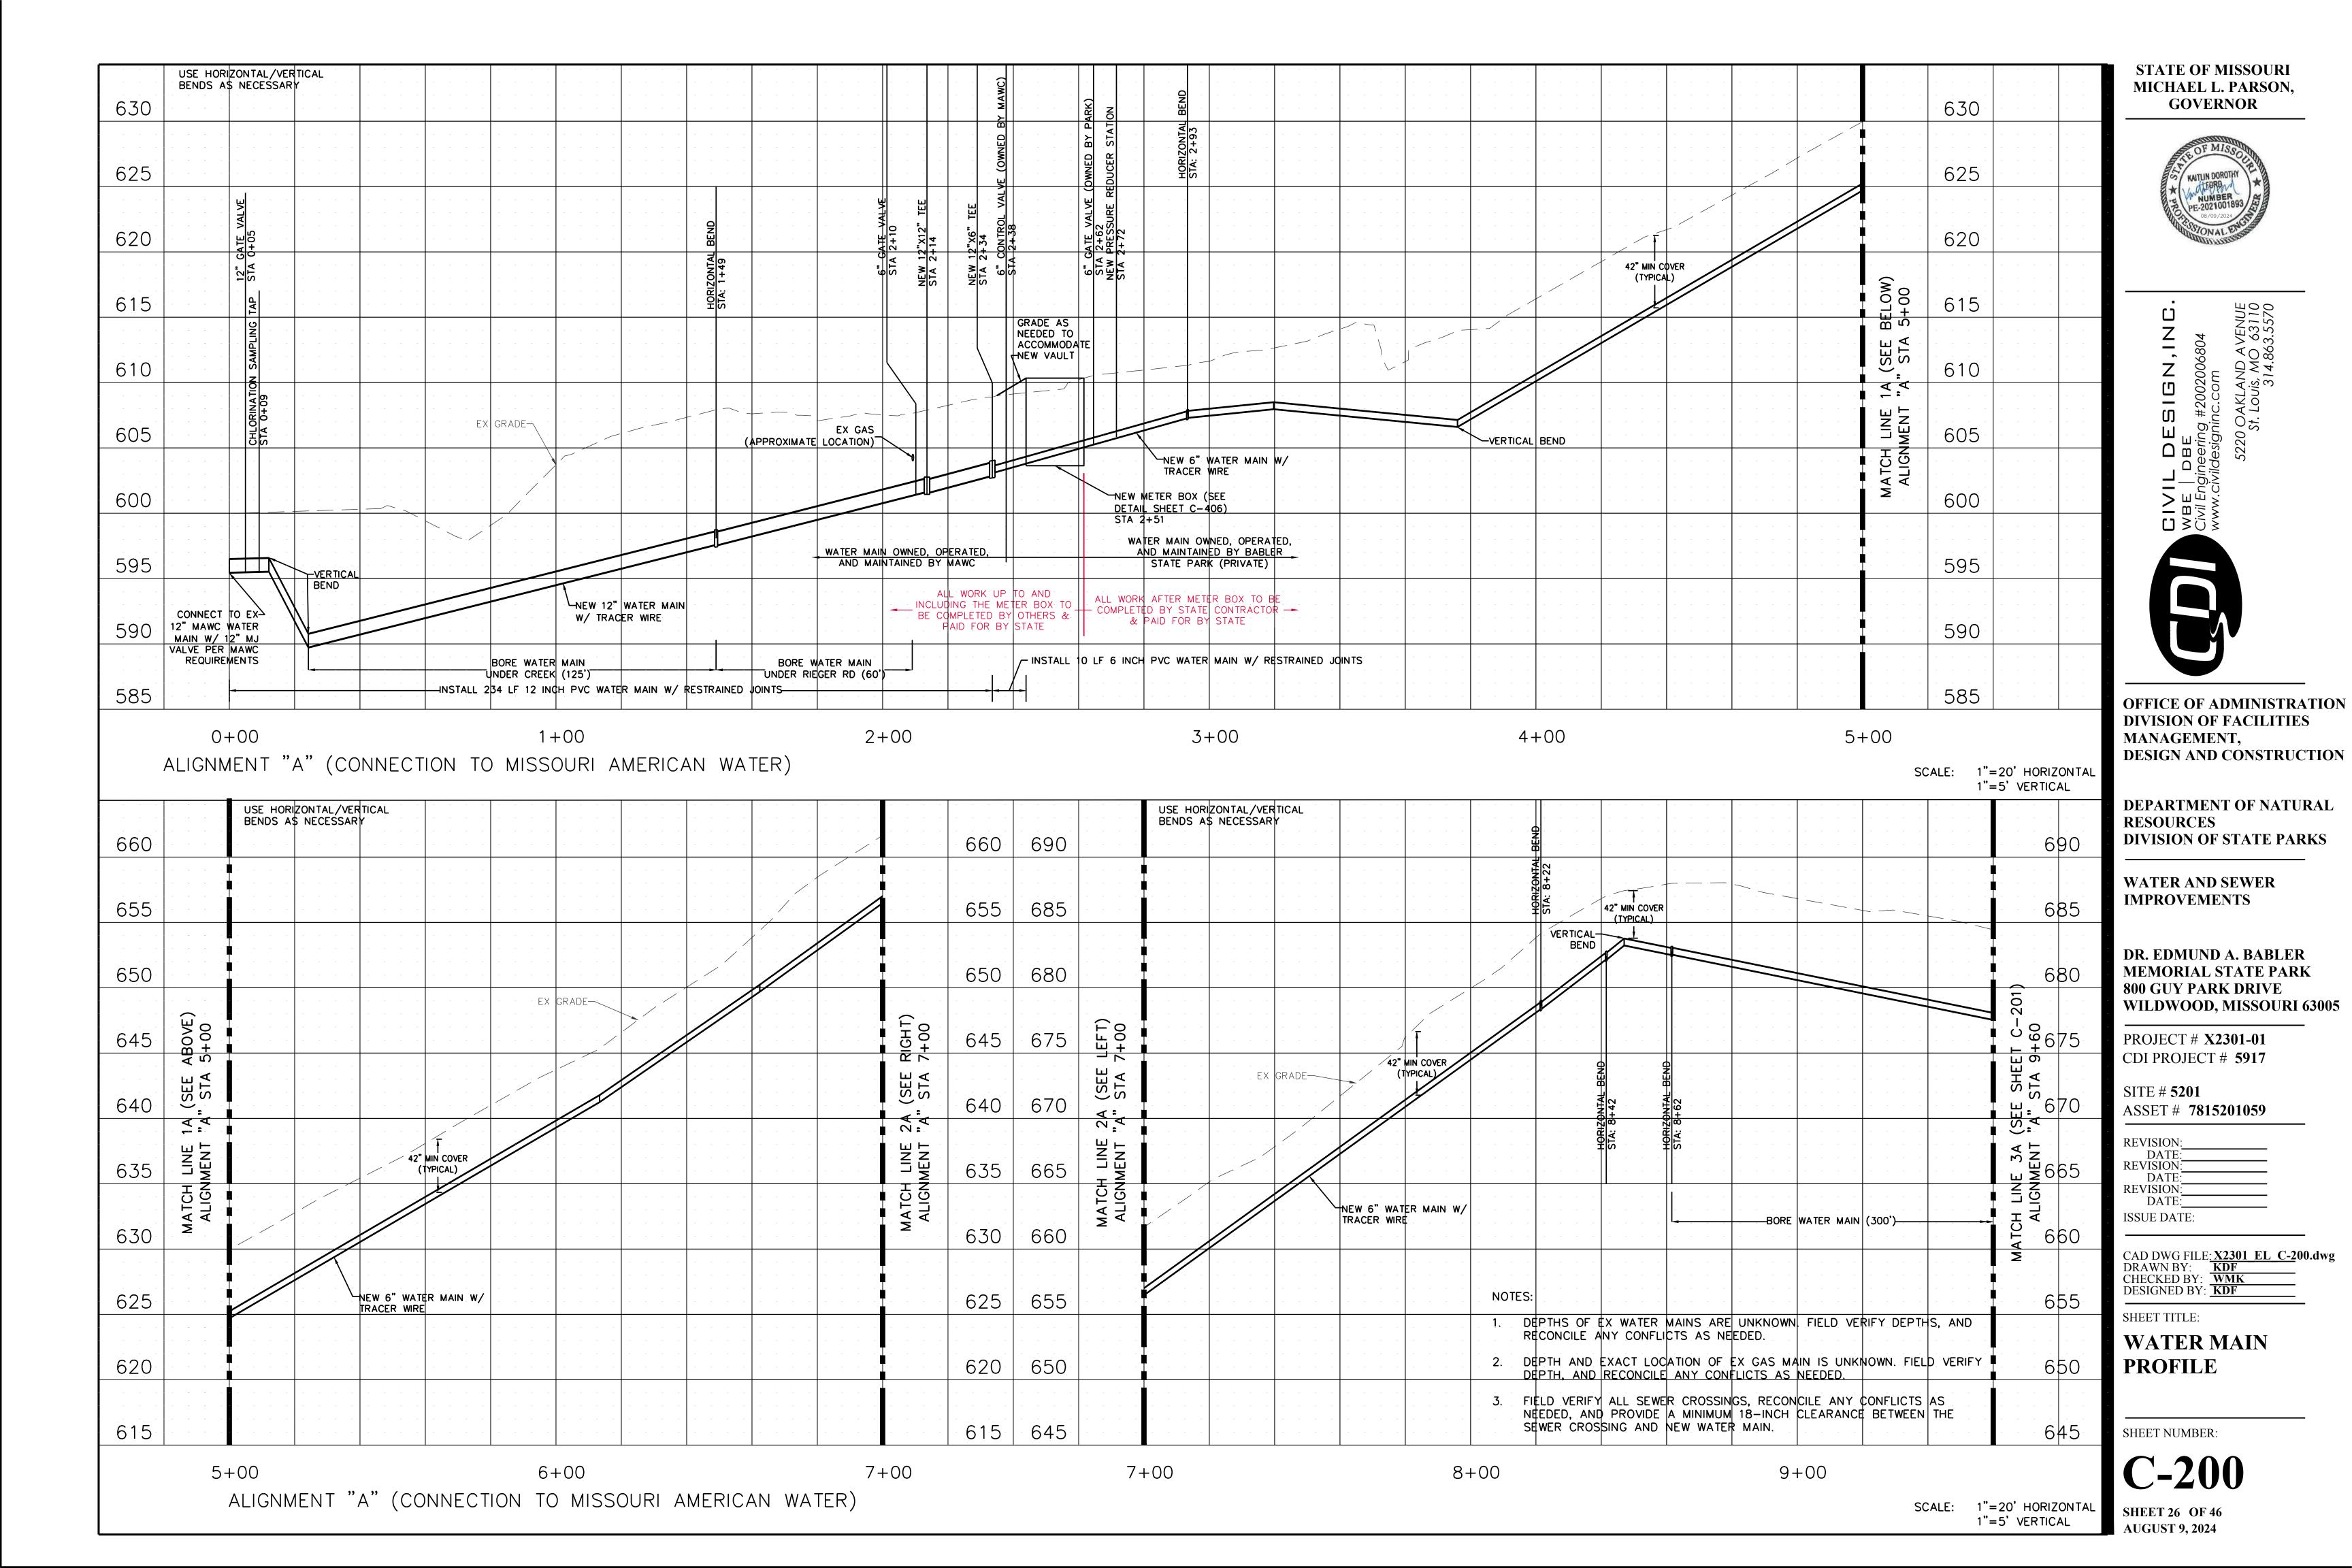

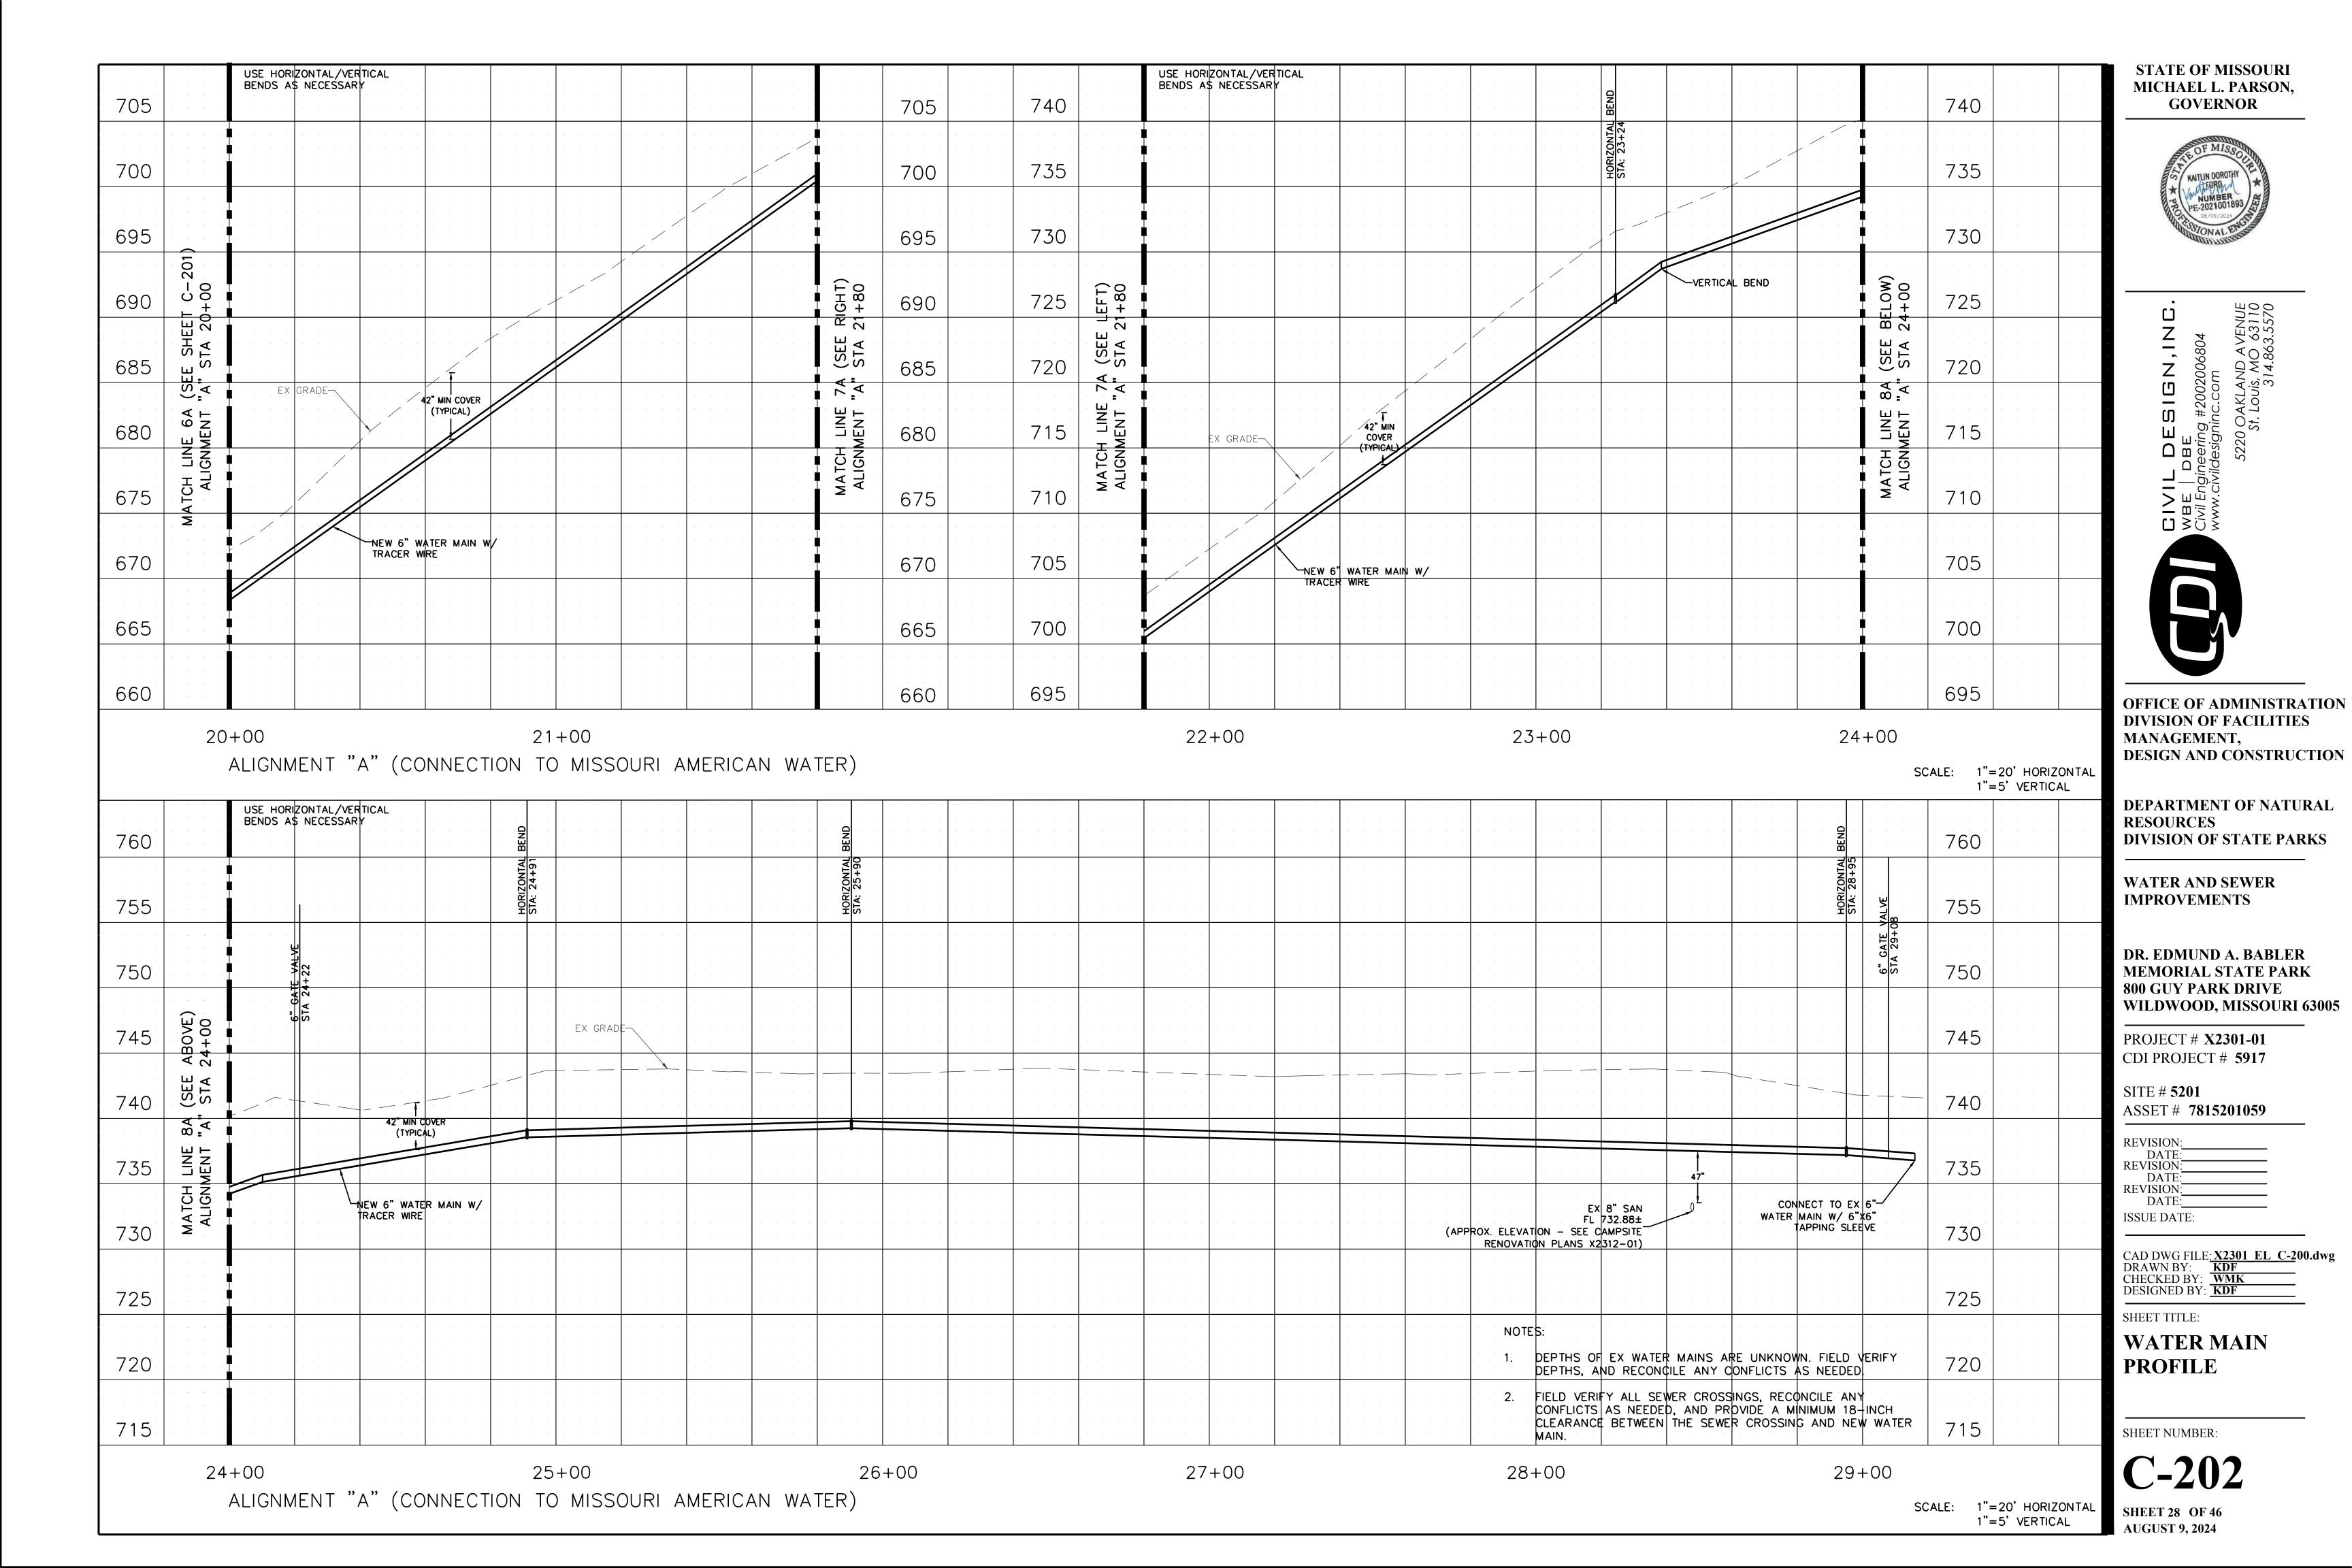
OFFICE OF ADMINISTRATION

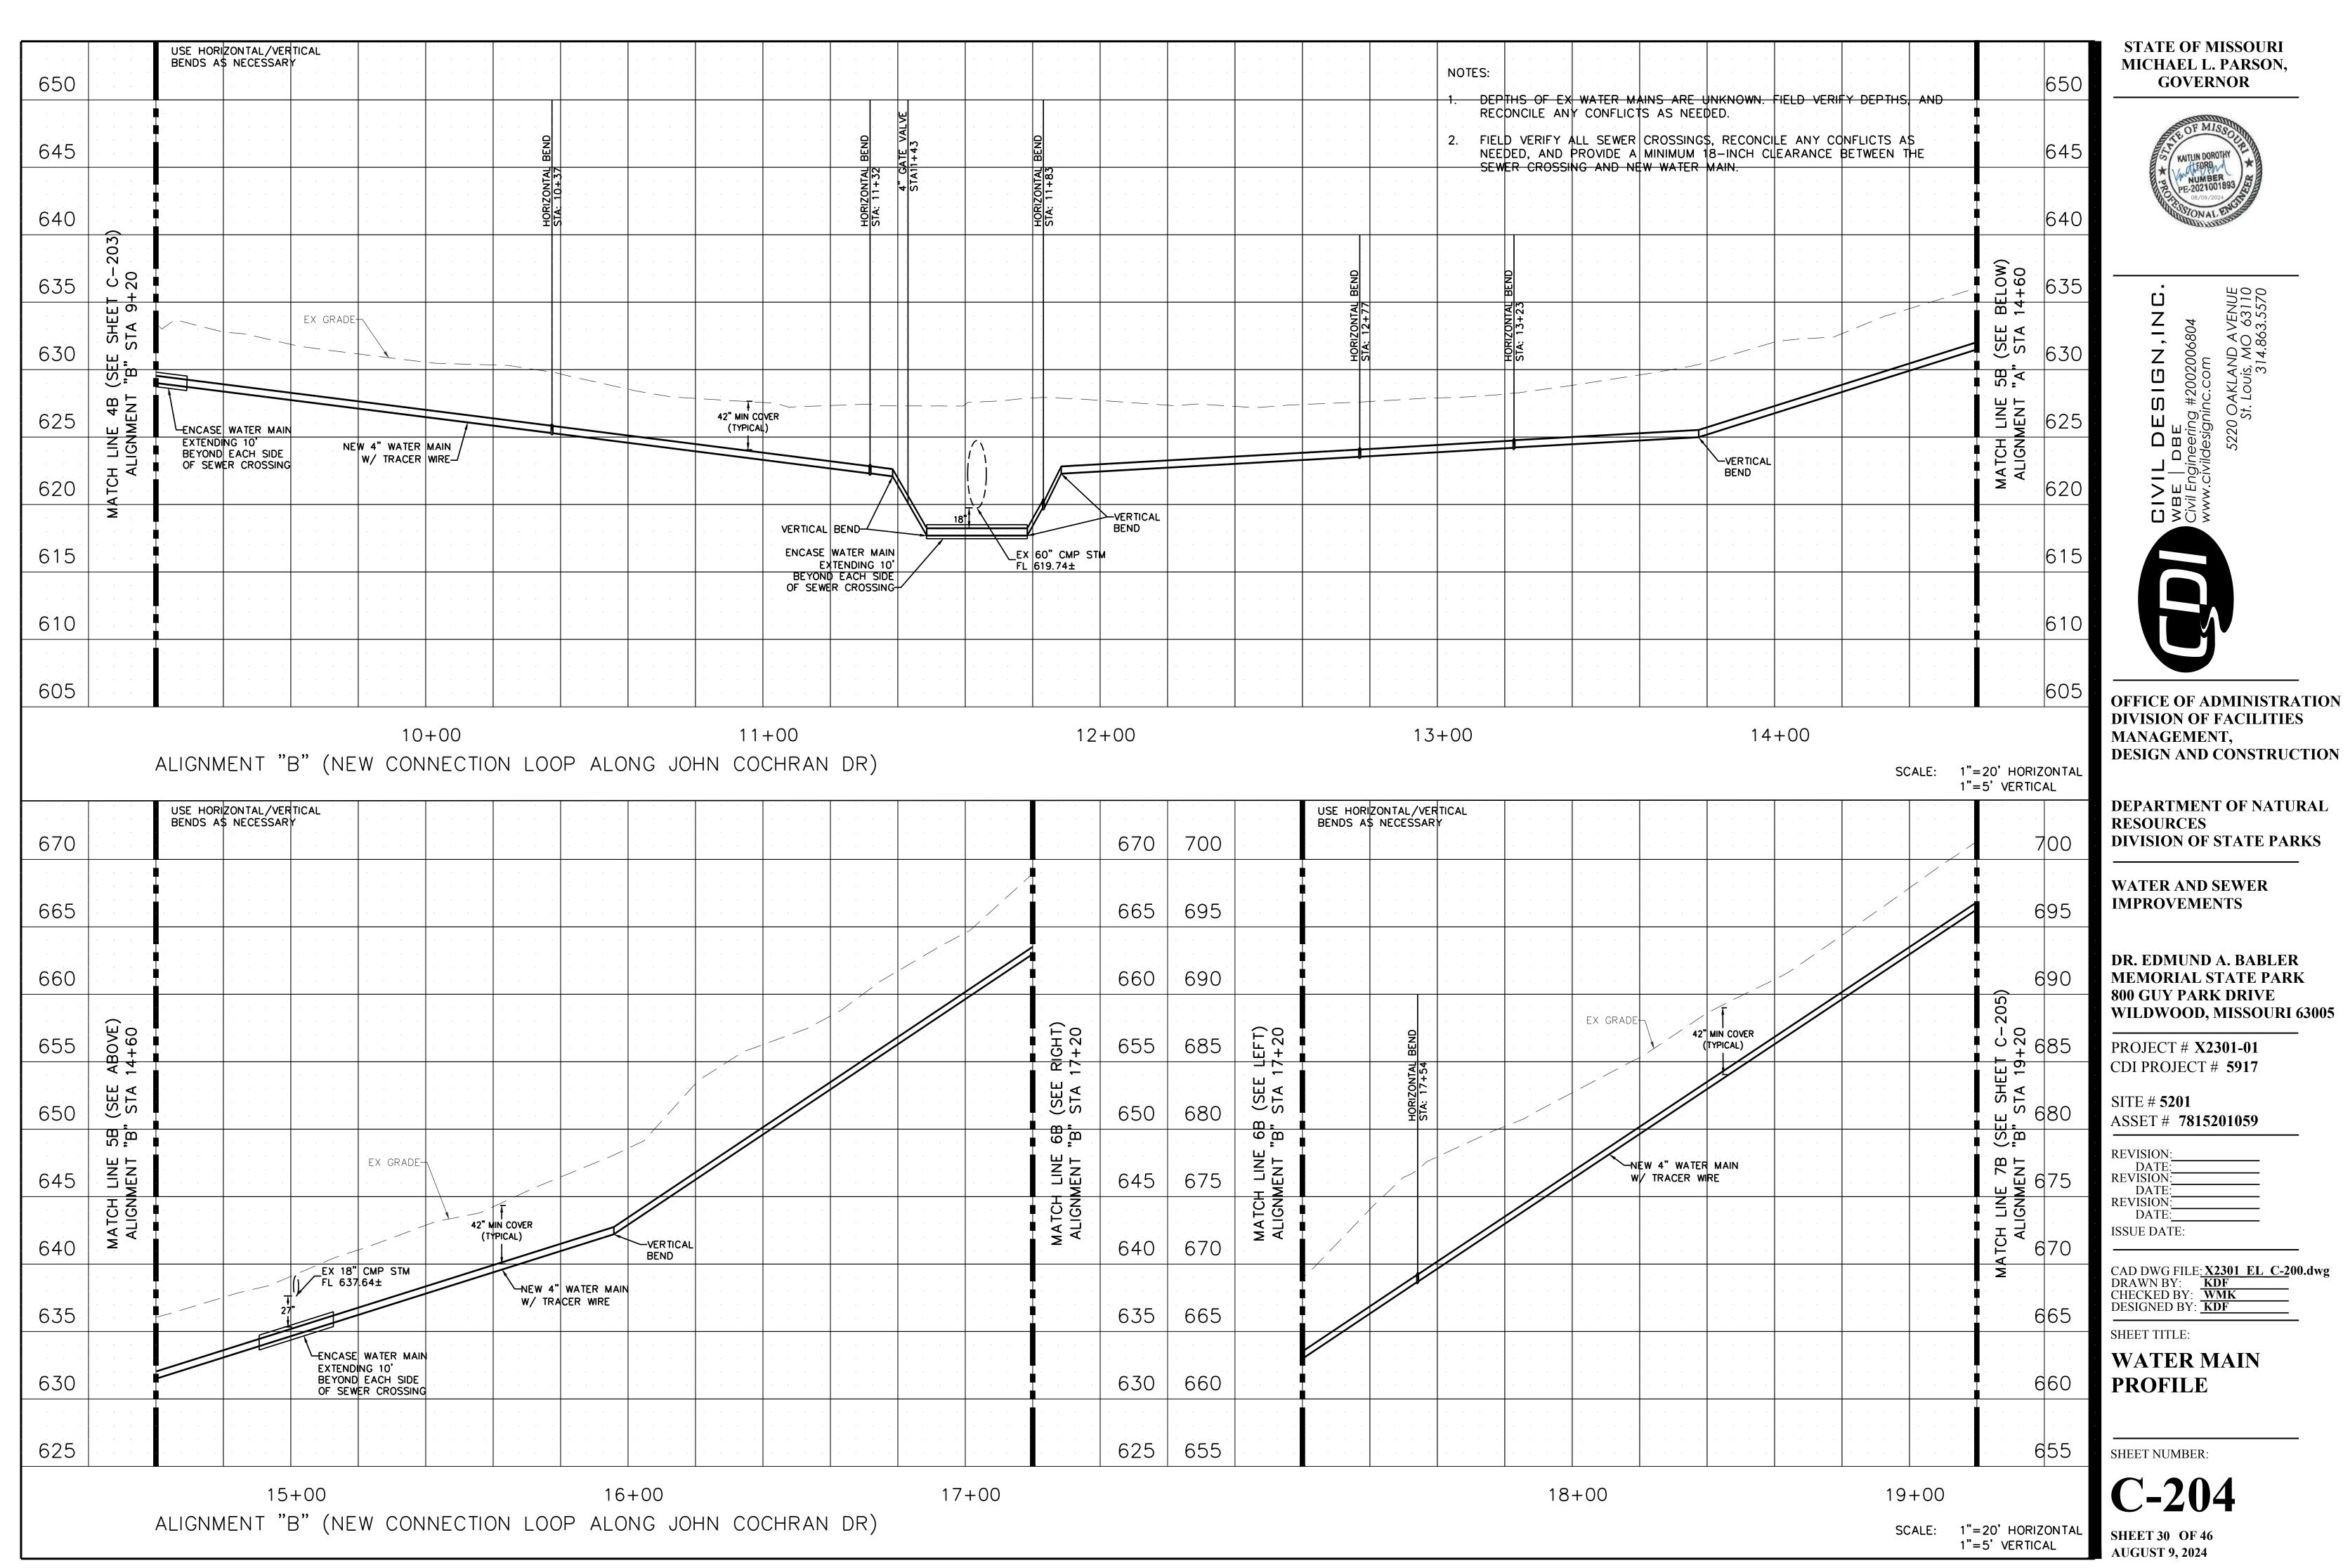



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CHECKED BY: WMK
DESIGNED BY: KDF

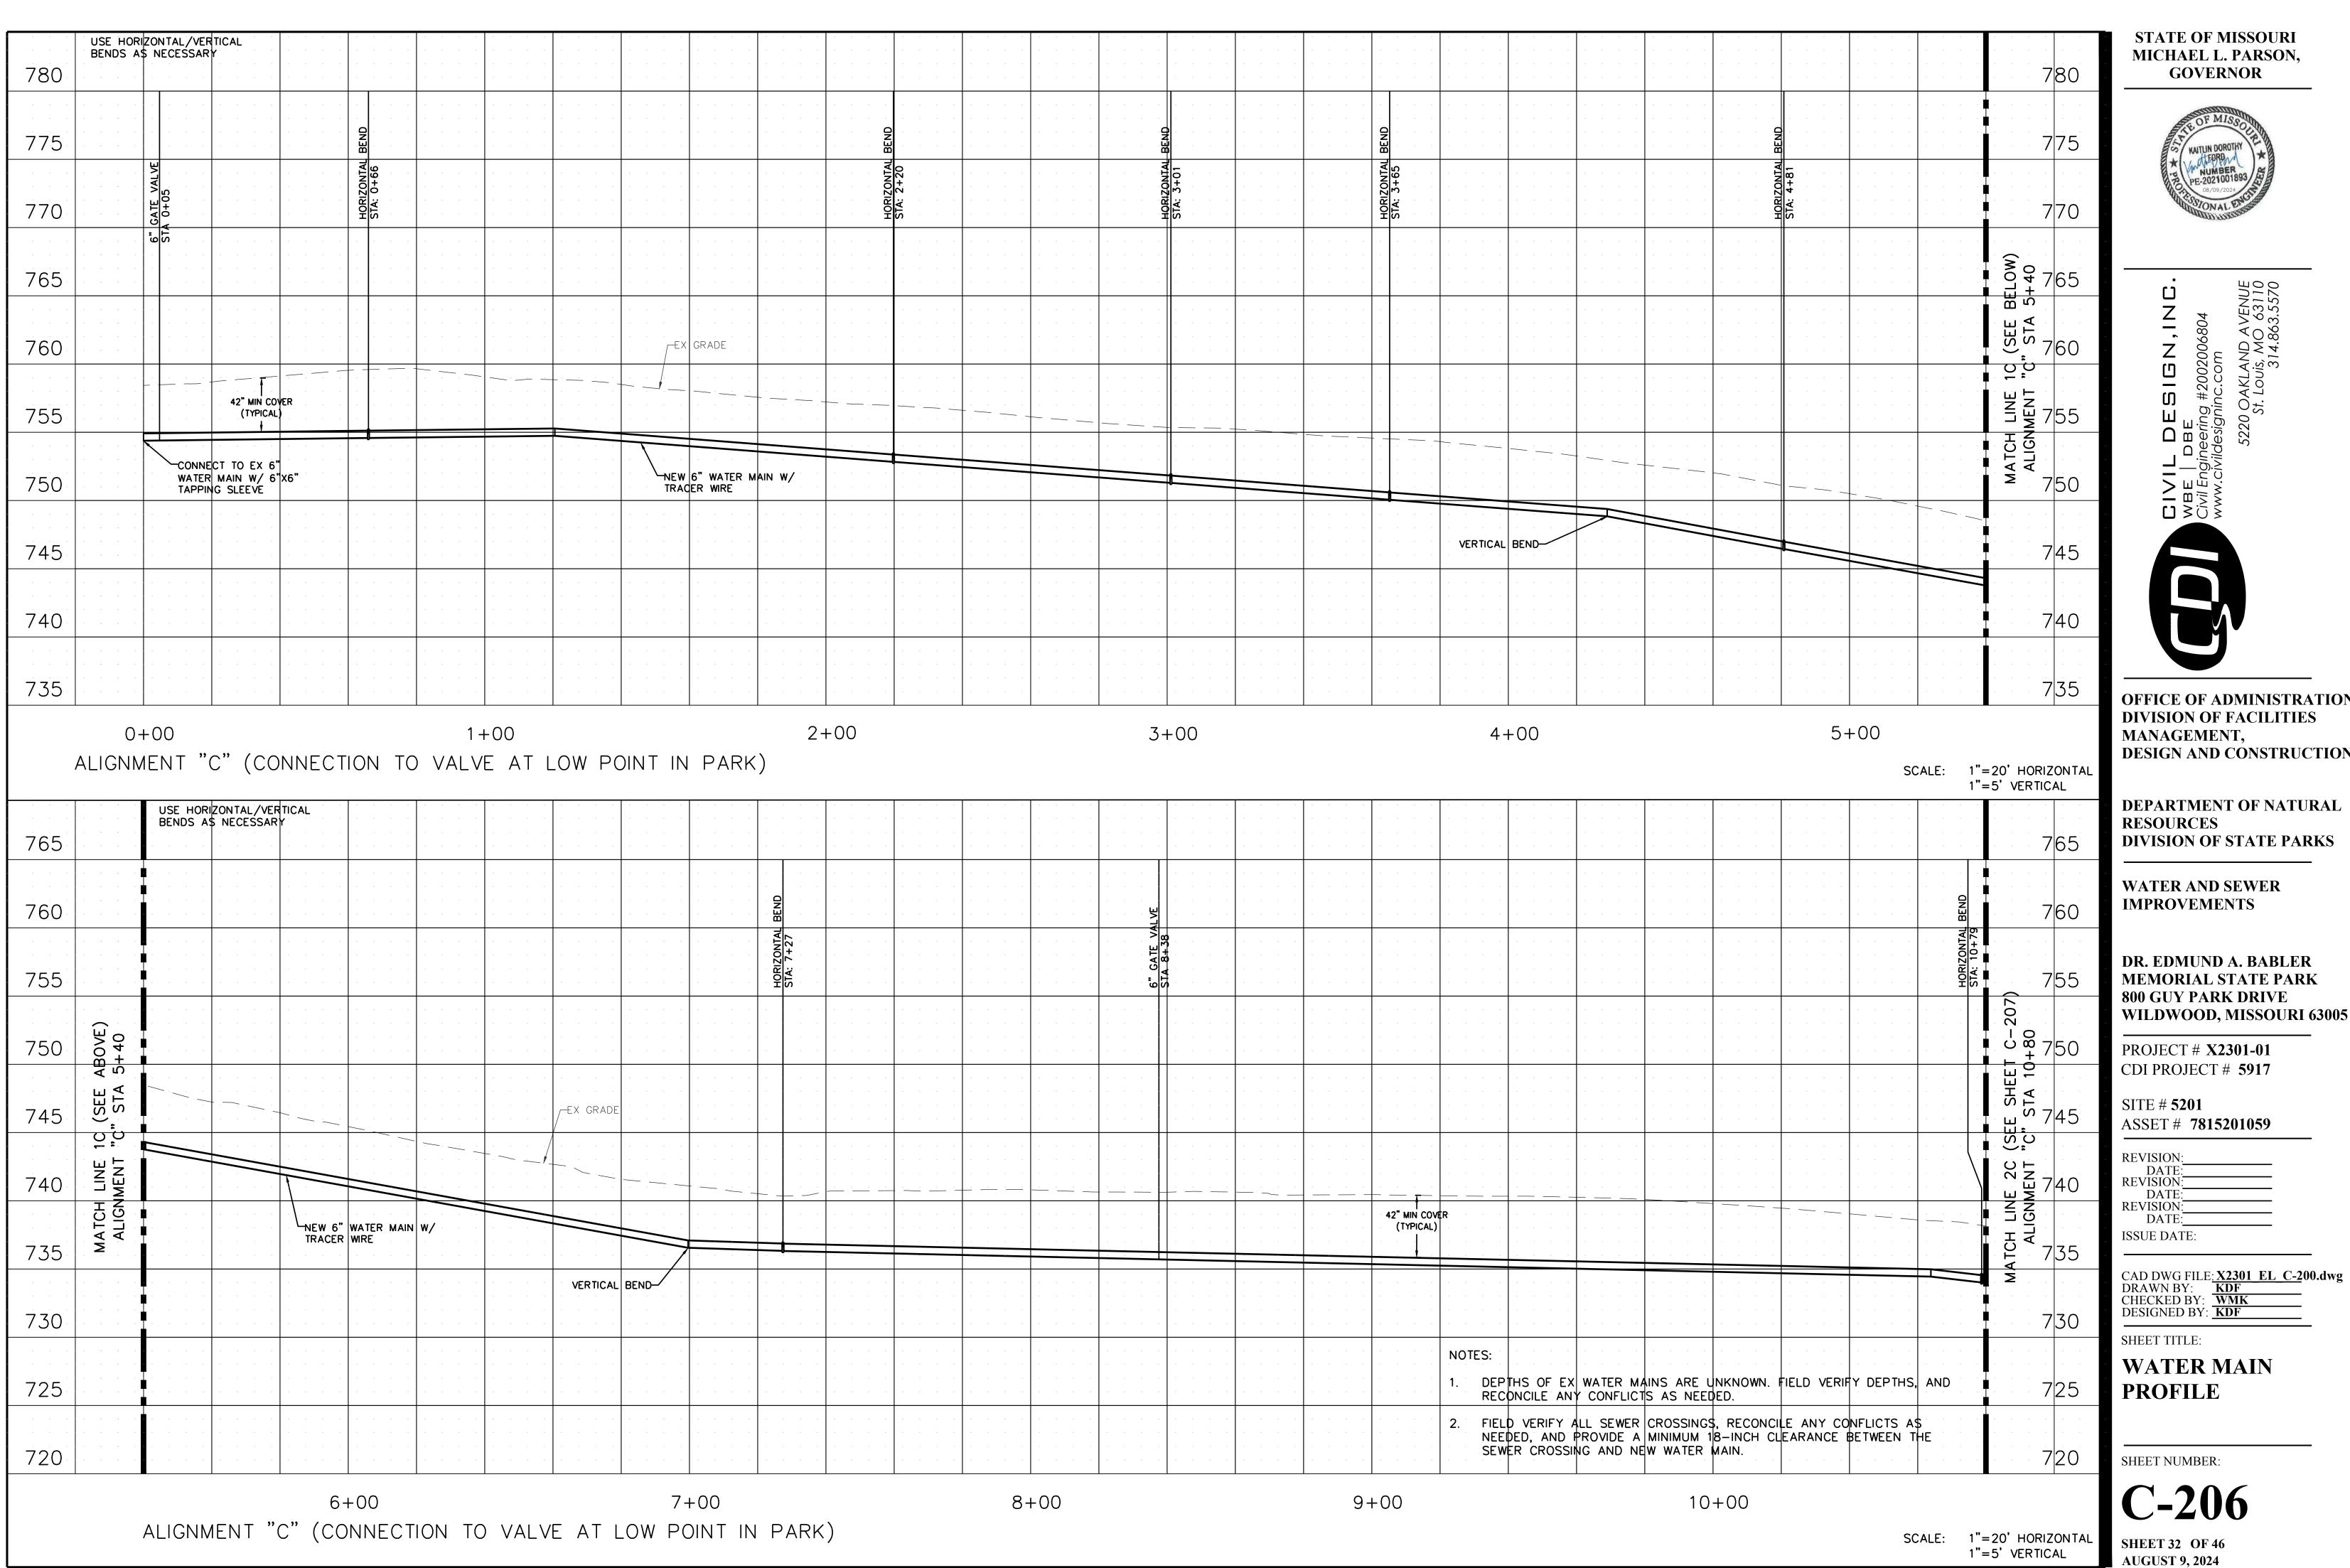



WILDWOOD, MISSOURI 63005

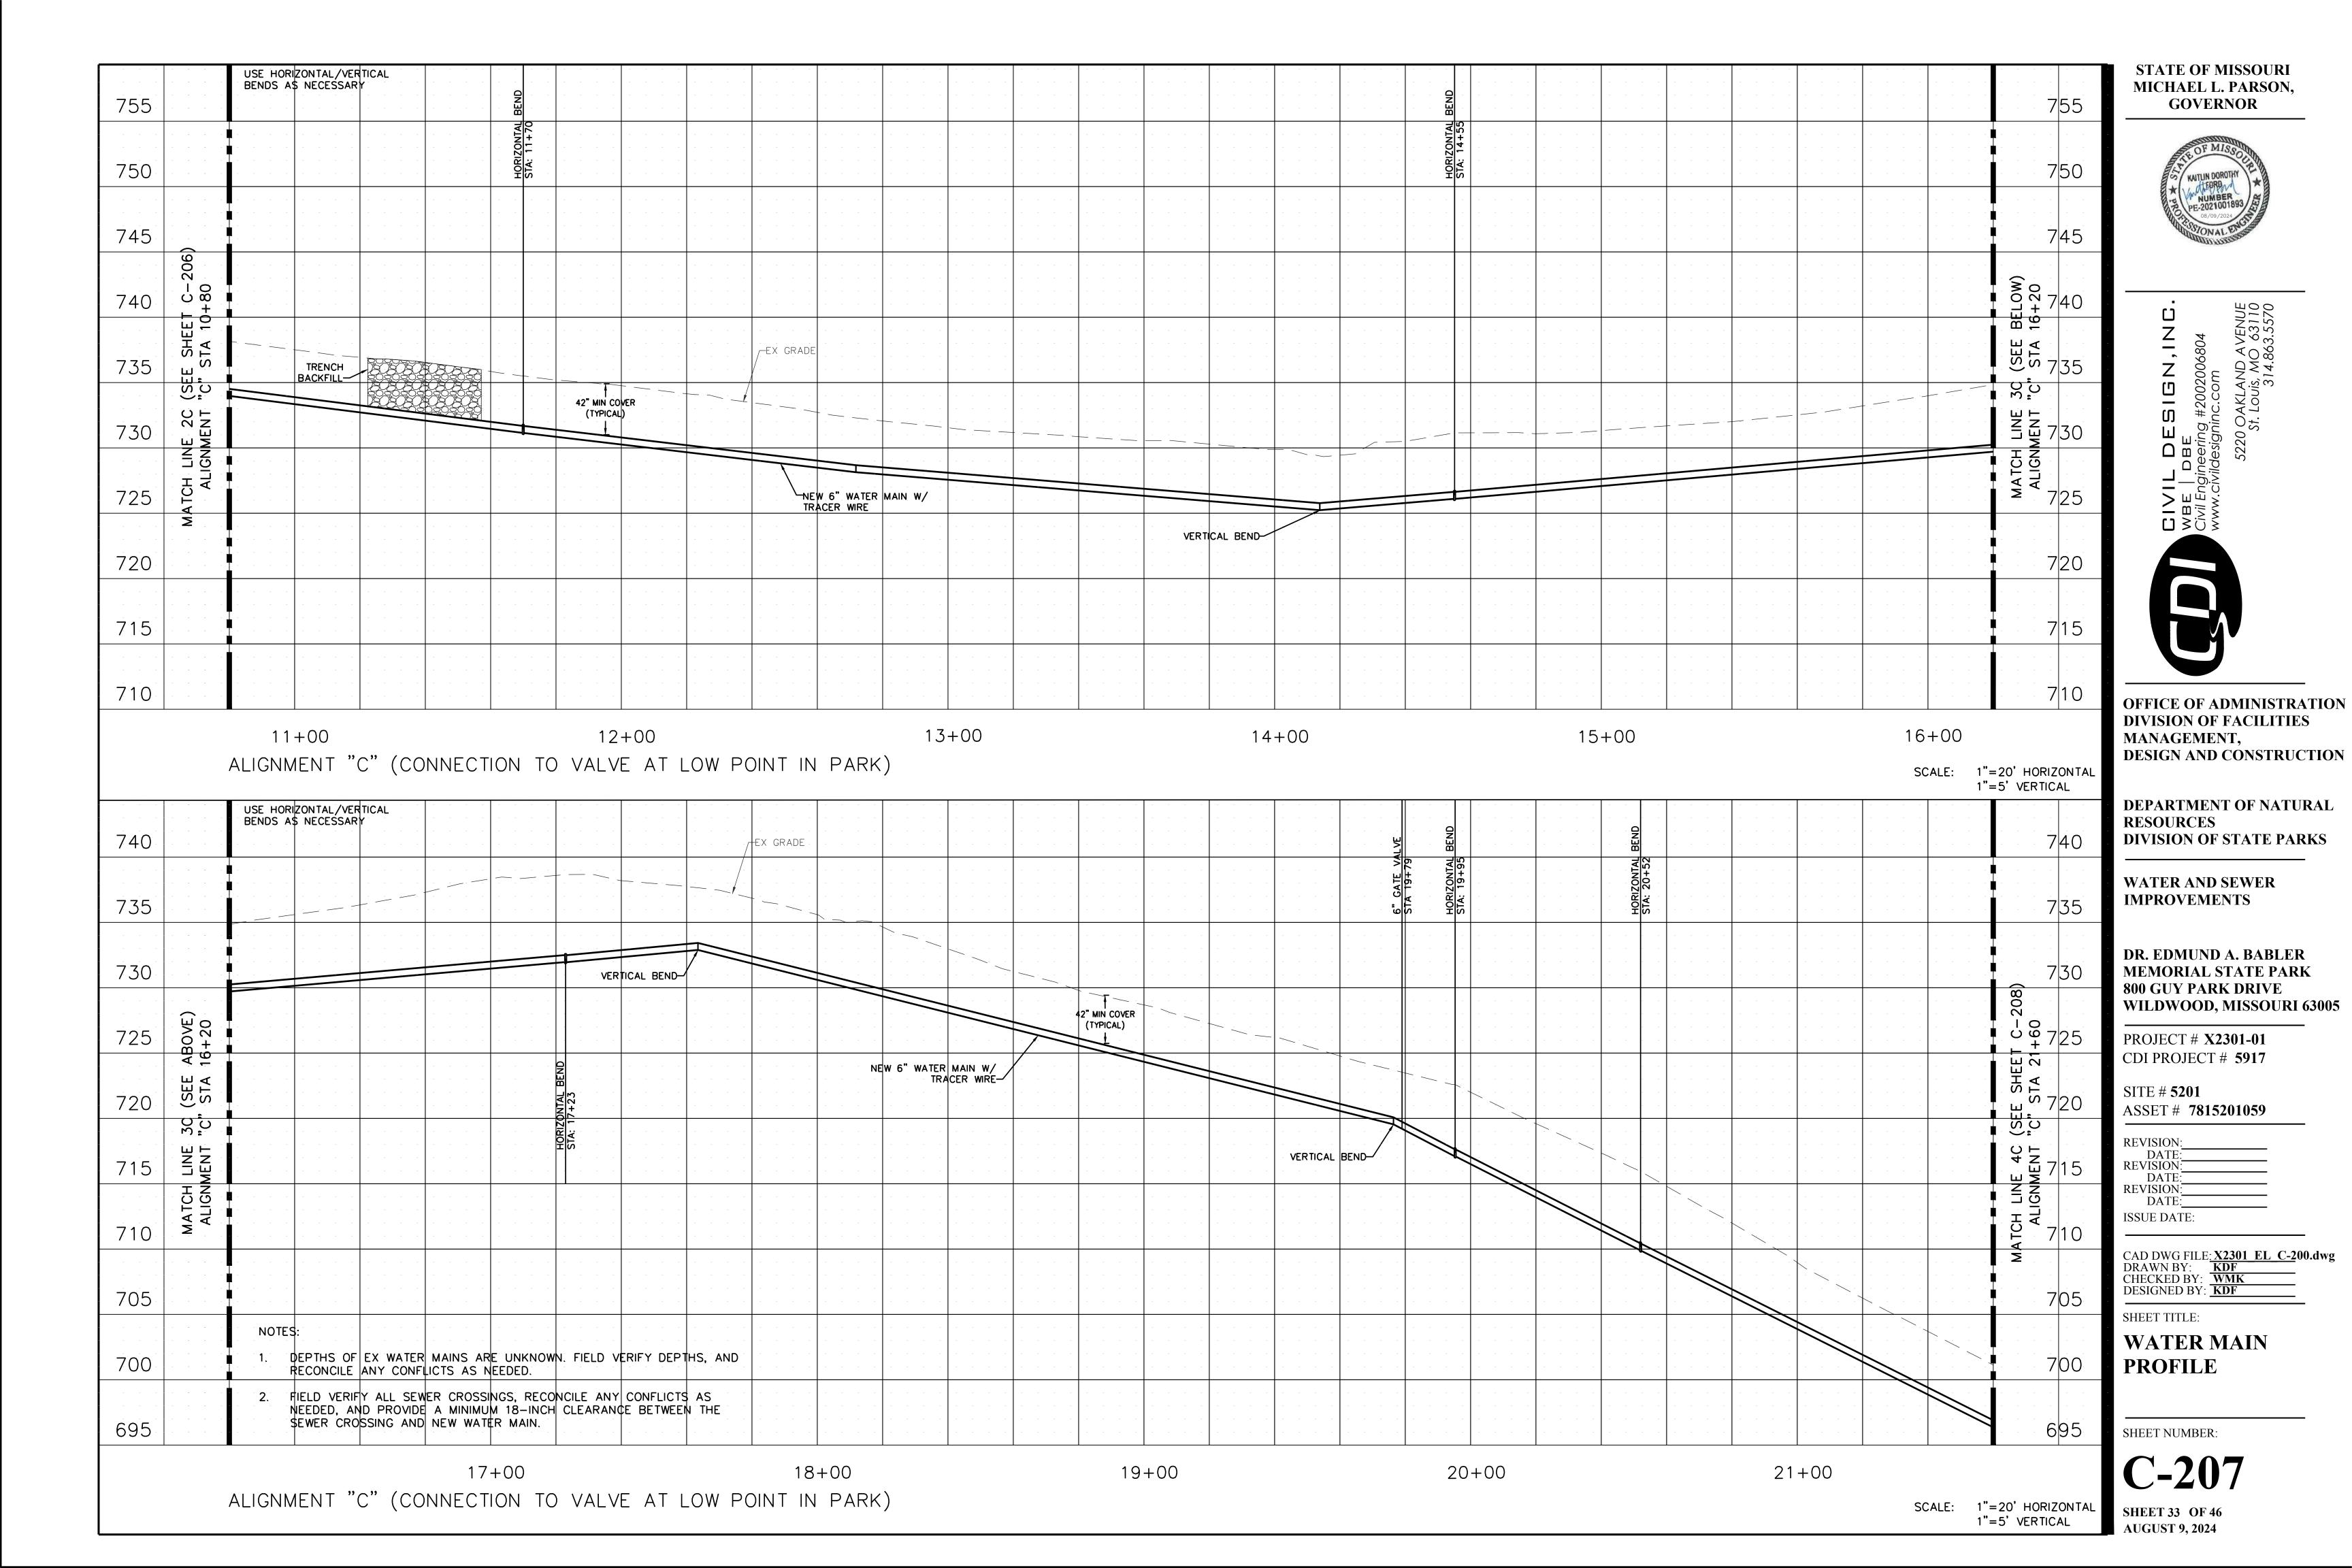

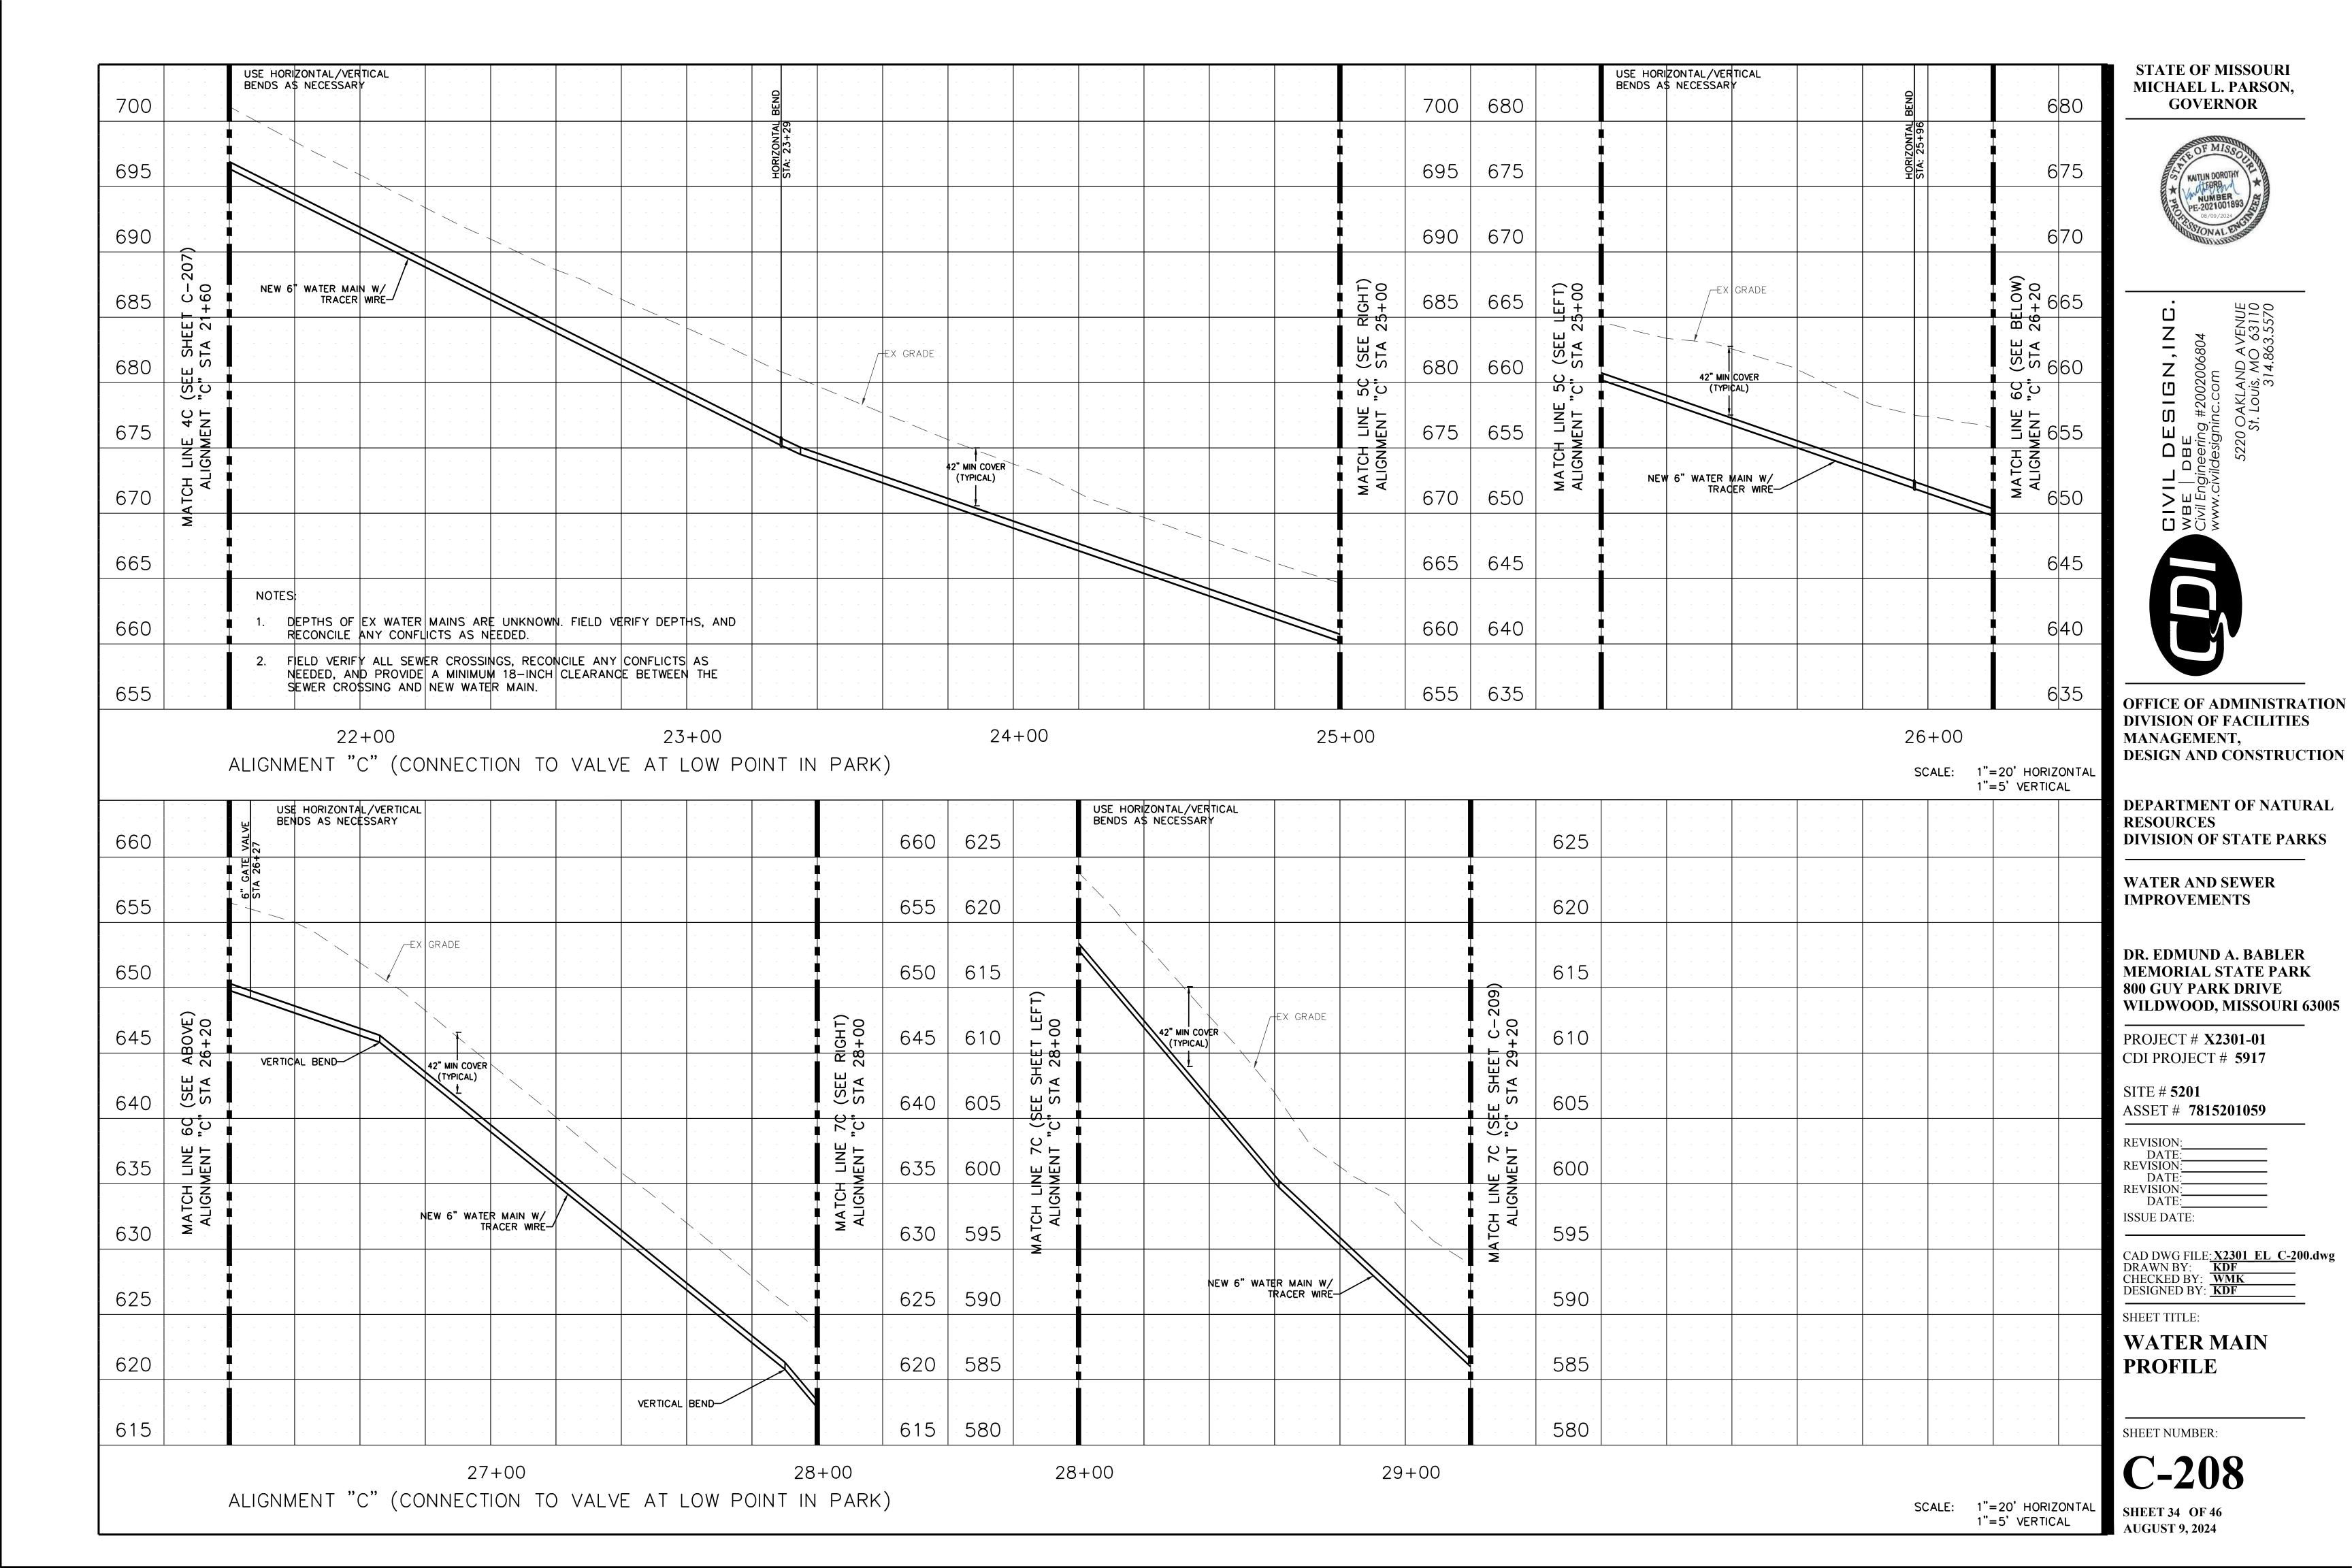

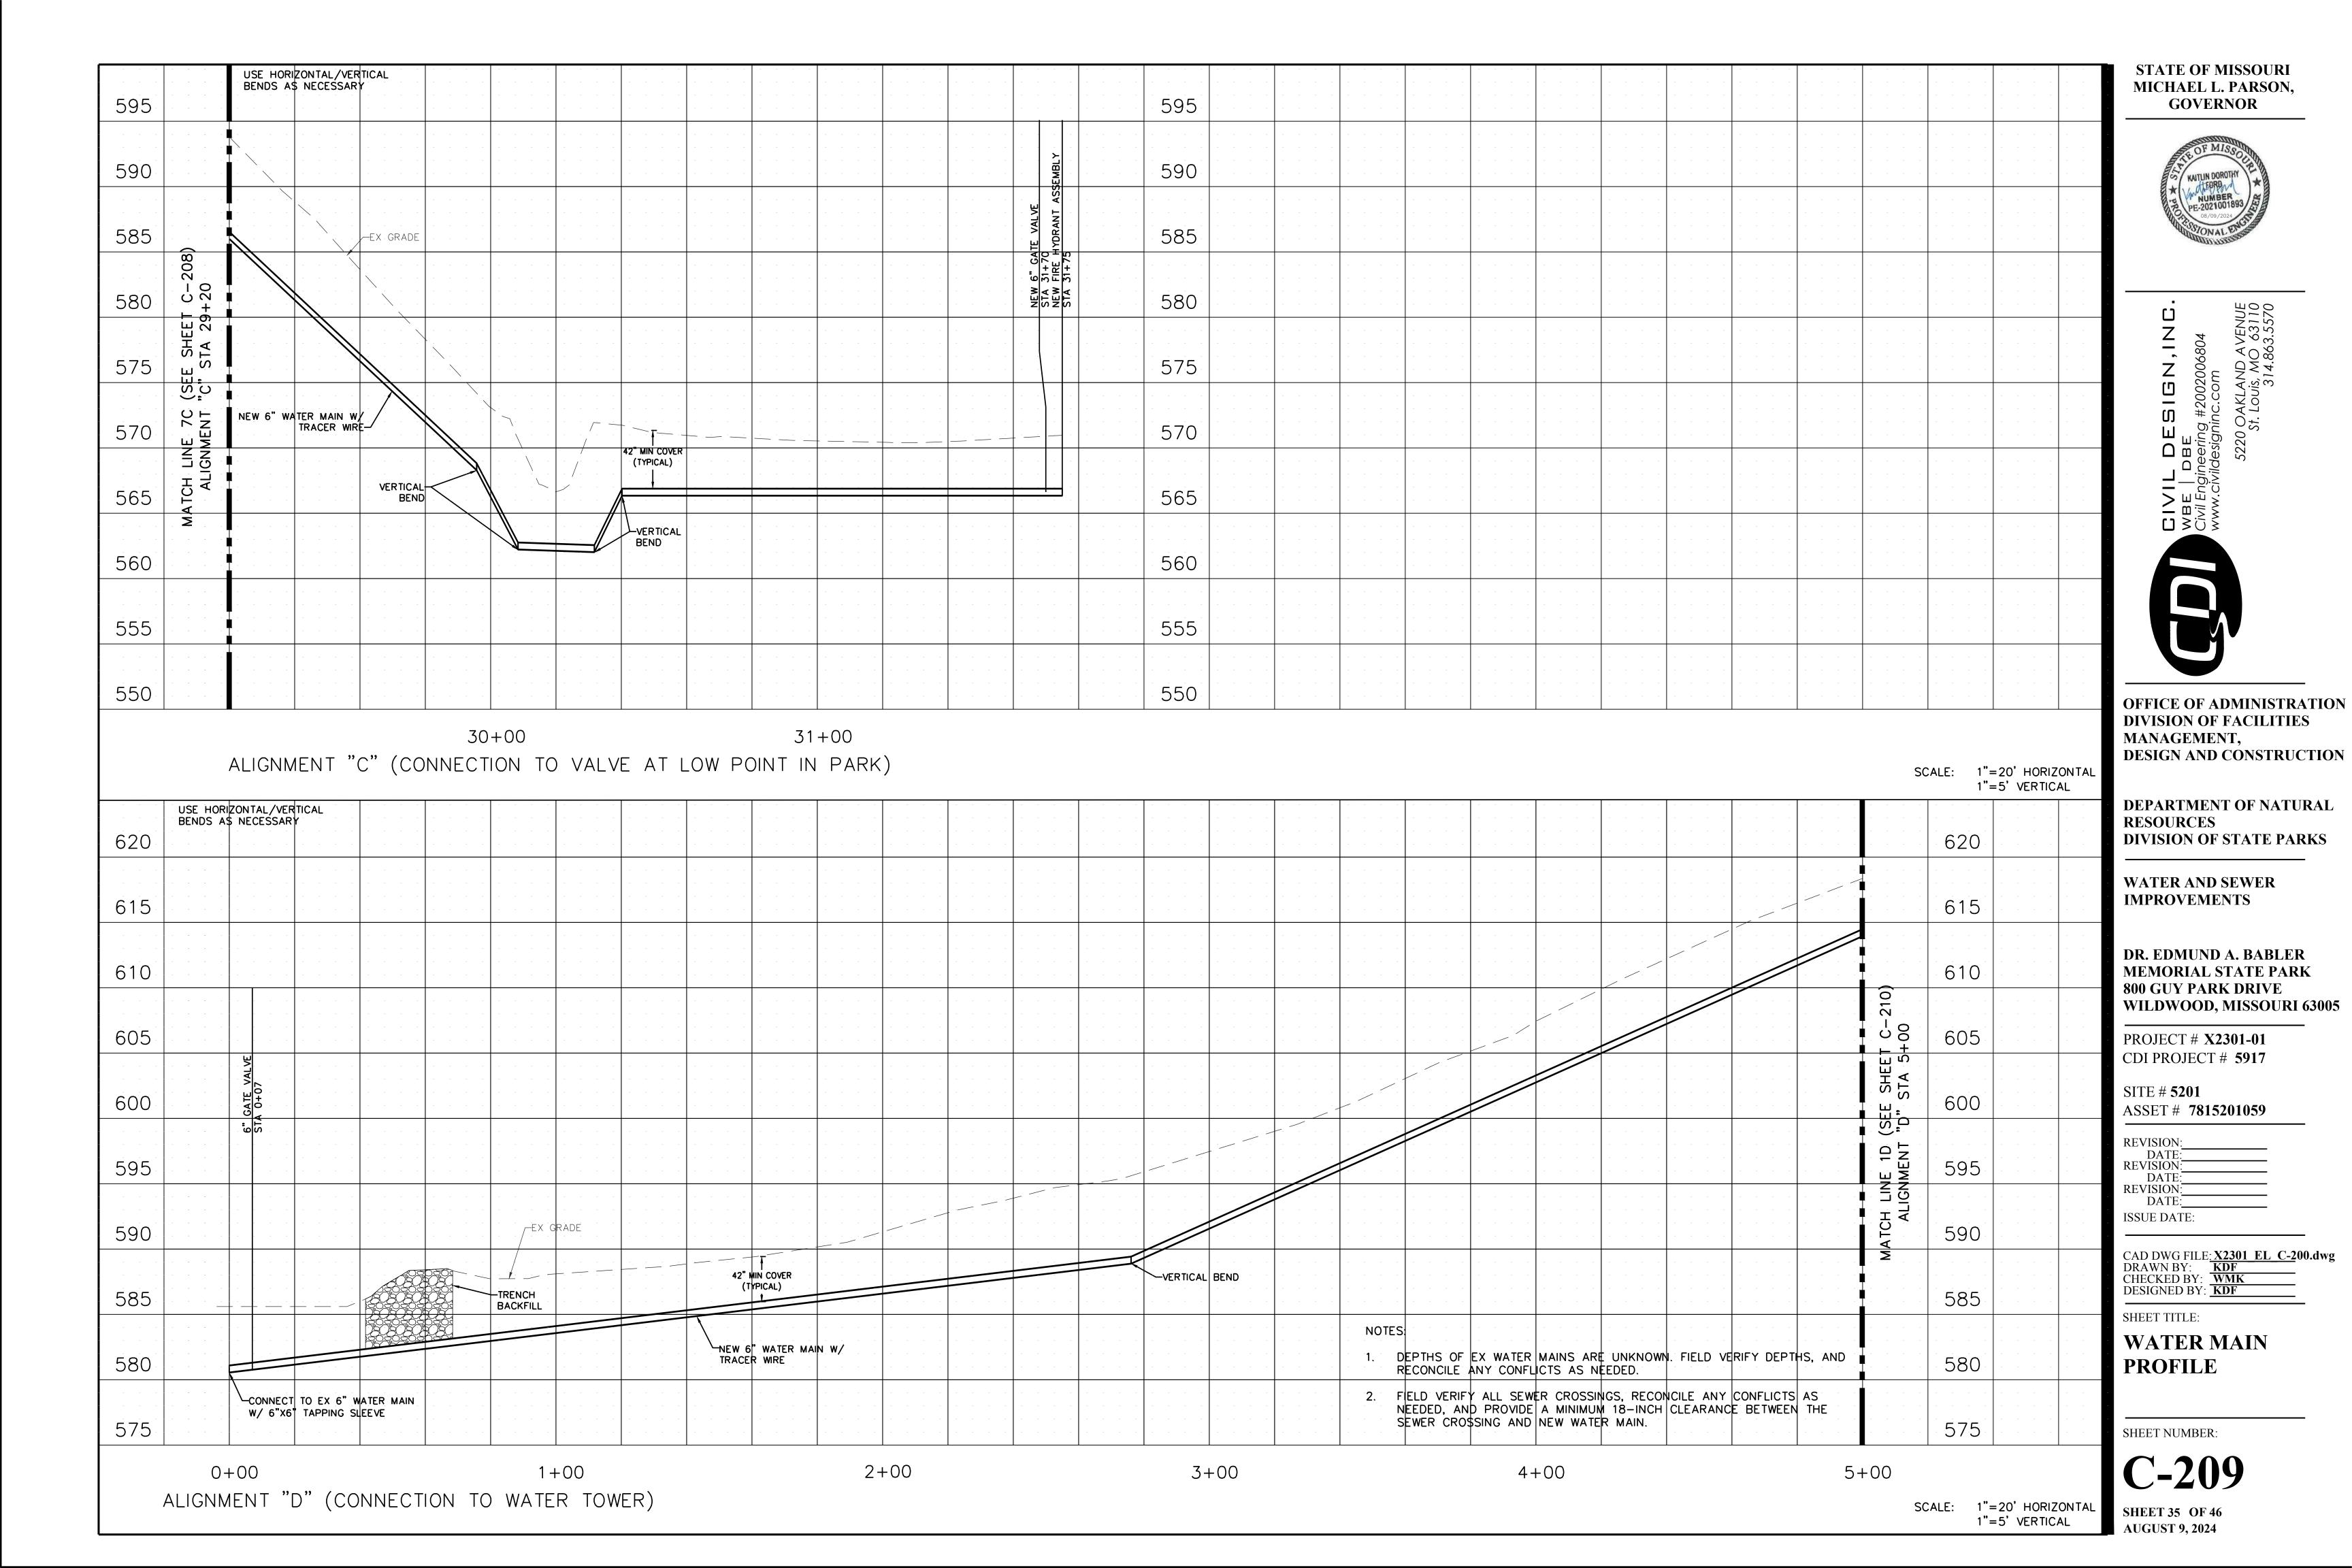


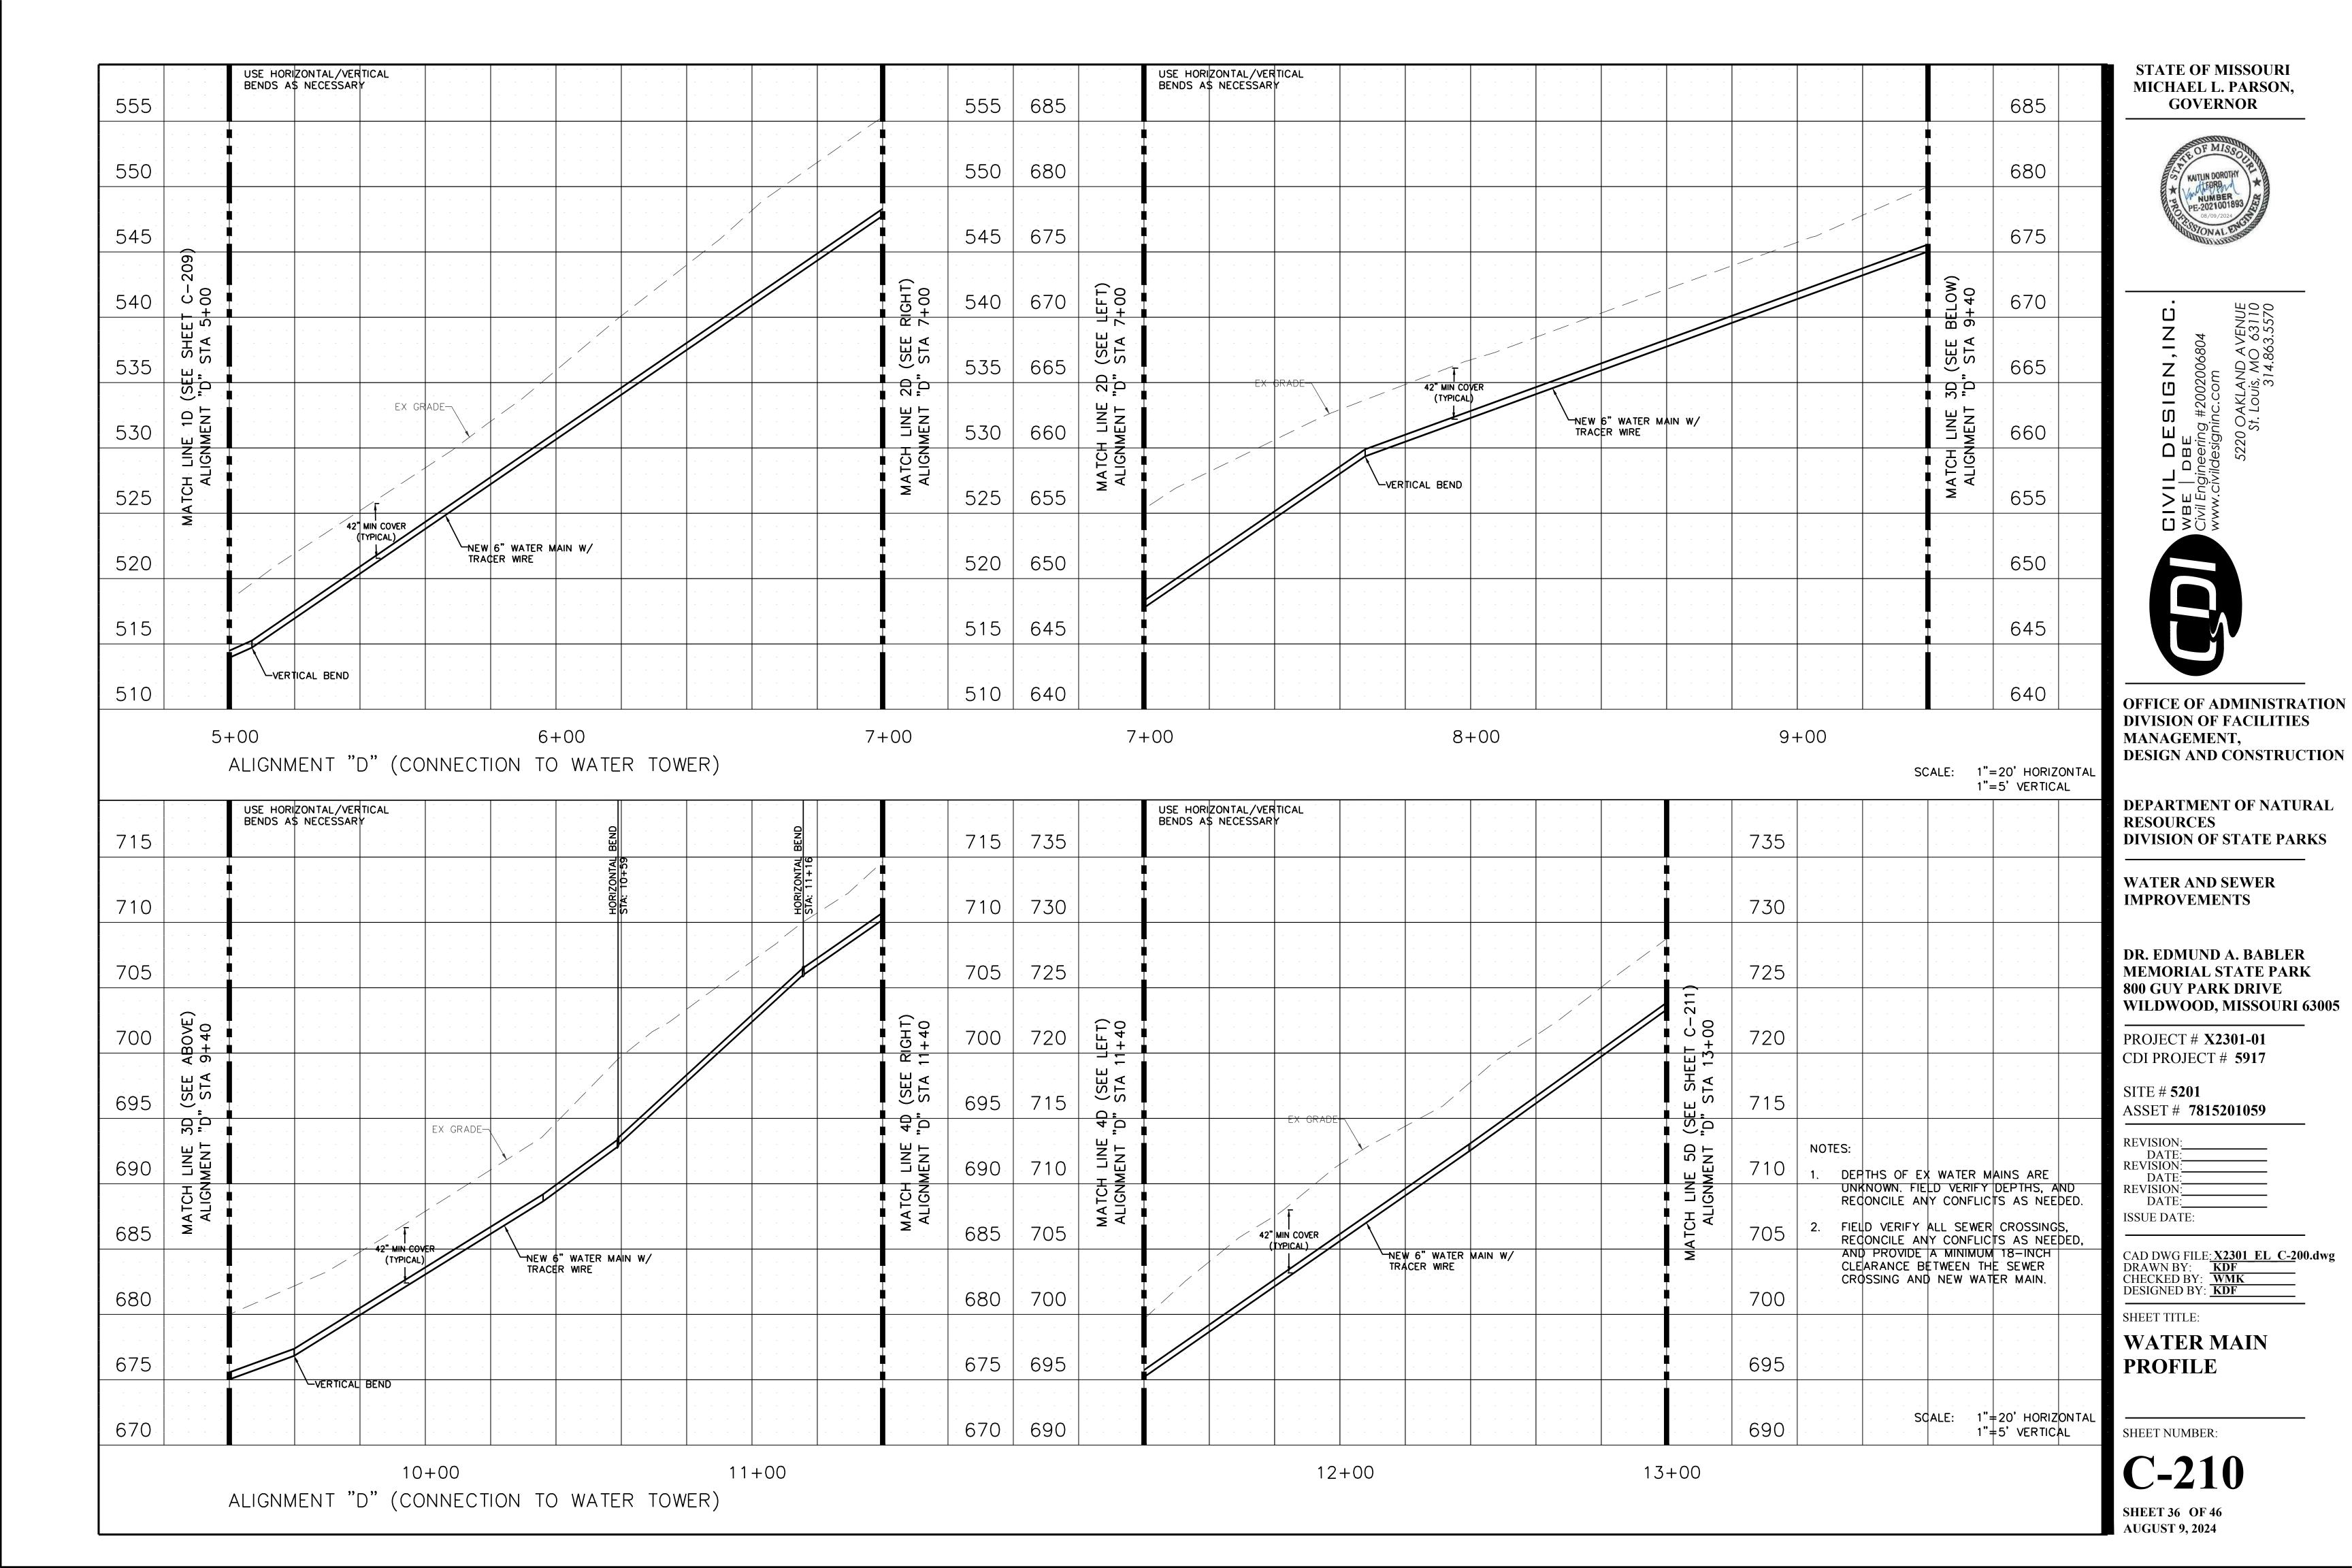


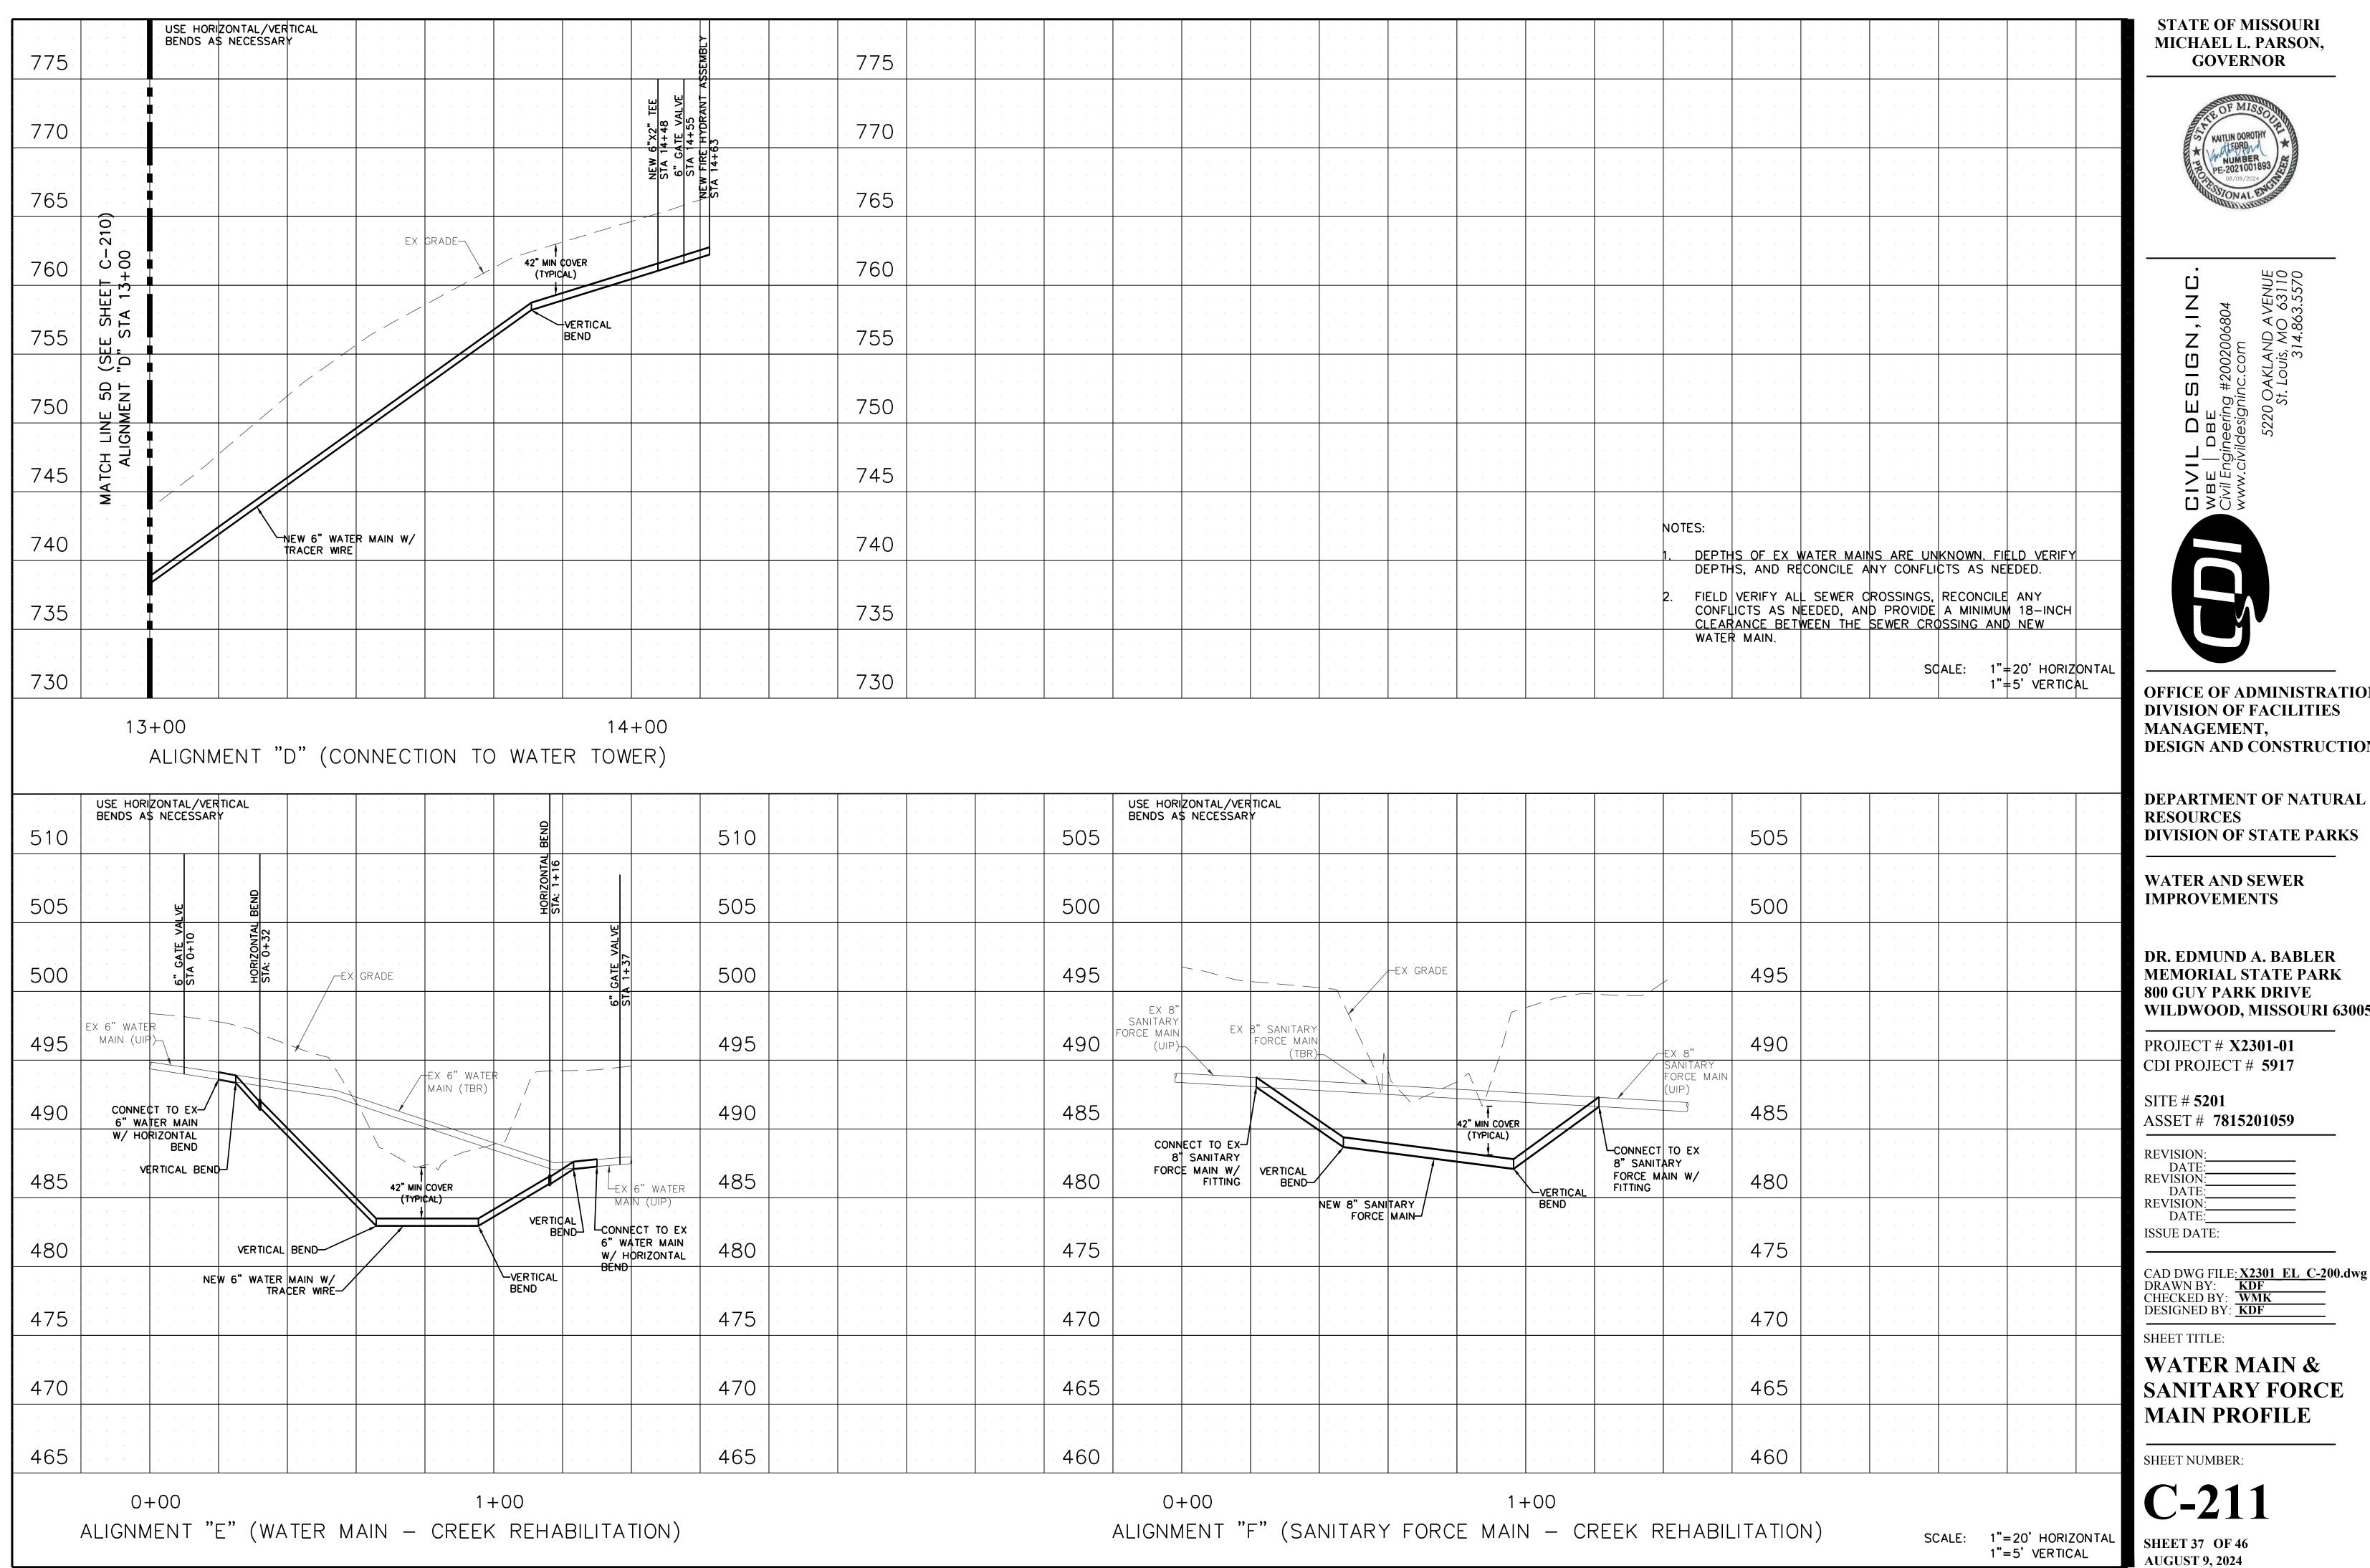



WILDWOOD, MISSOURI 63005

CAD DWG FILE: X2301 EL C-200.dwg
DRAWN BY: KDF
CHECKED BY: WMK
DESIGNED BY: KDF

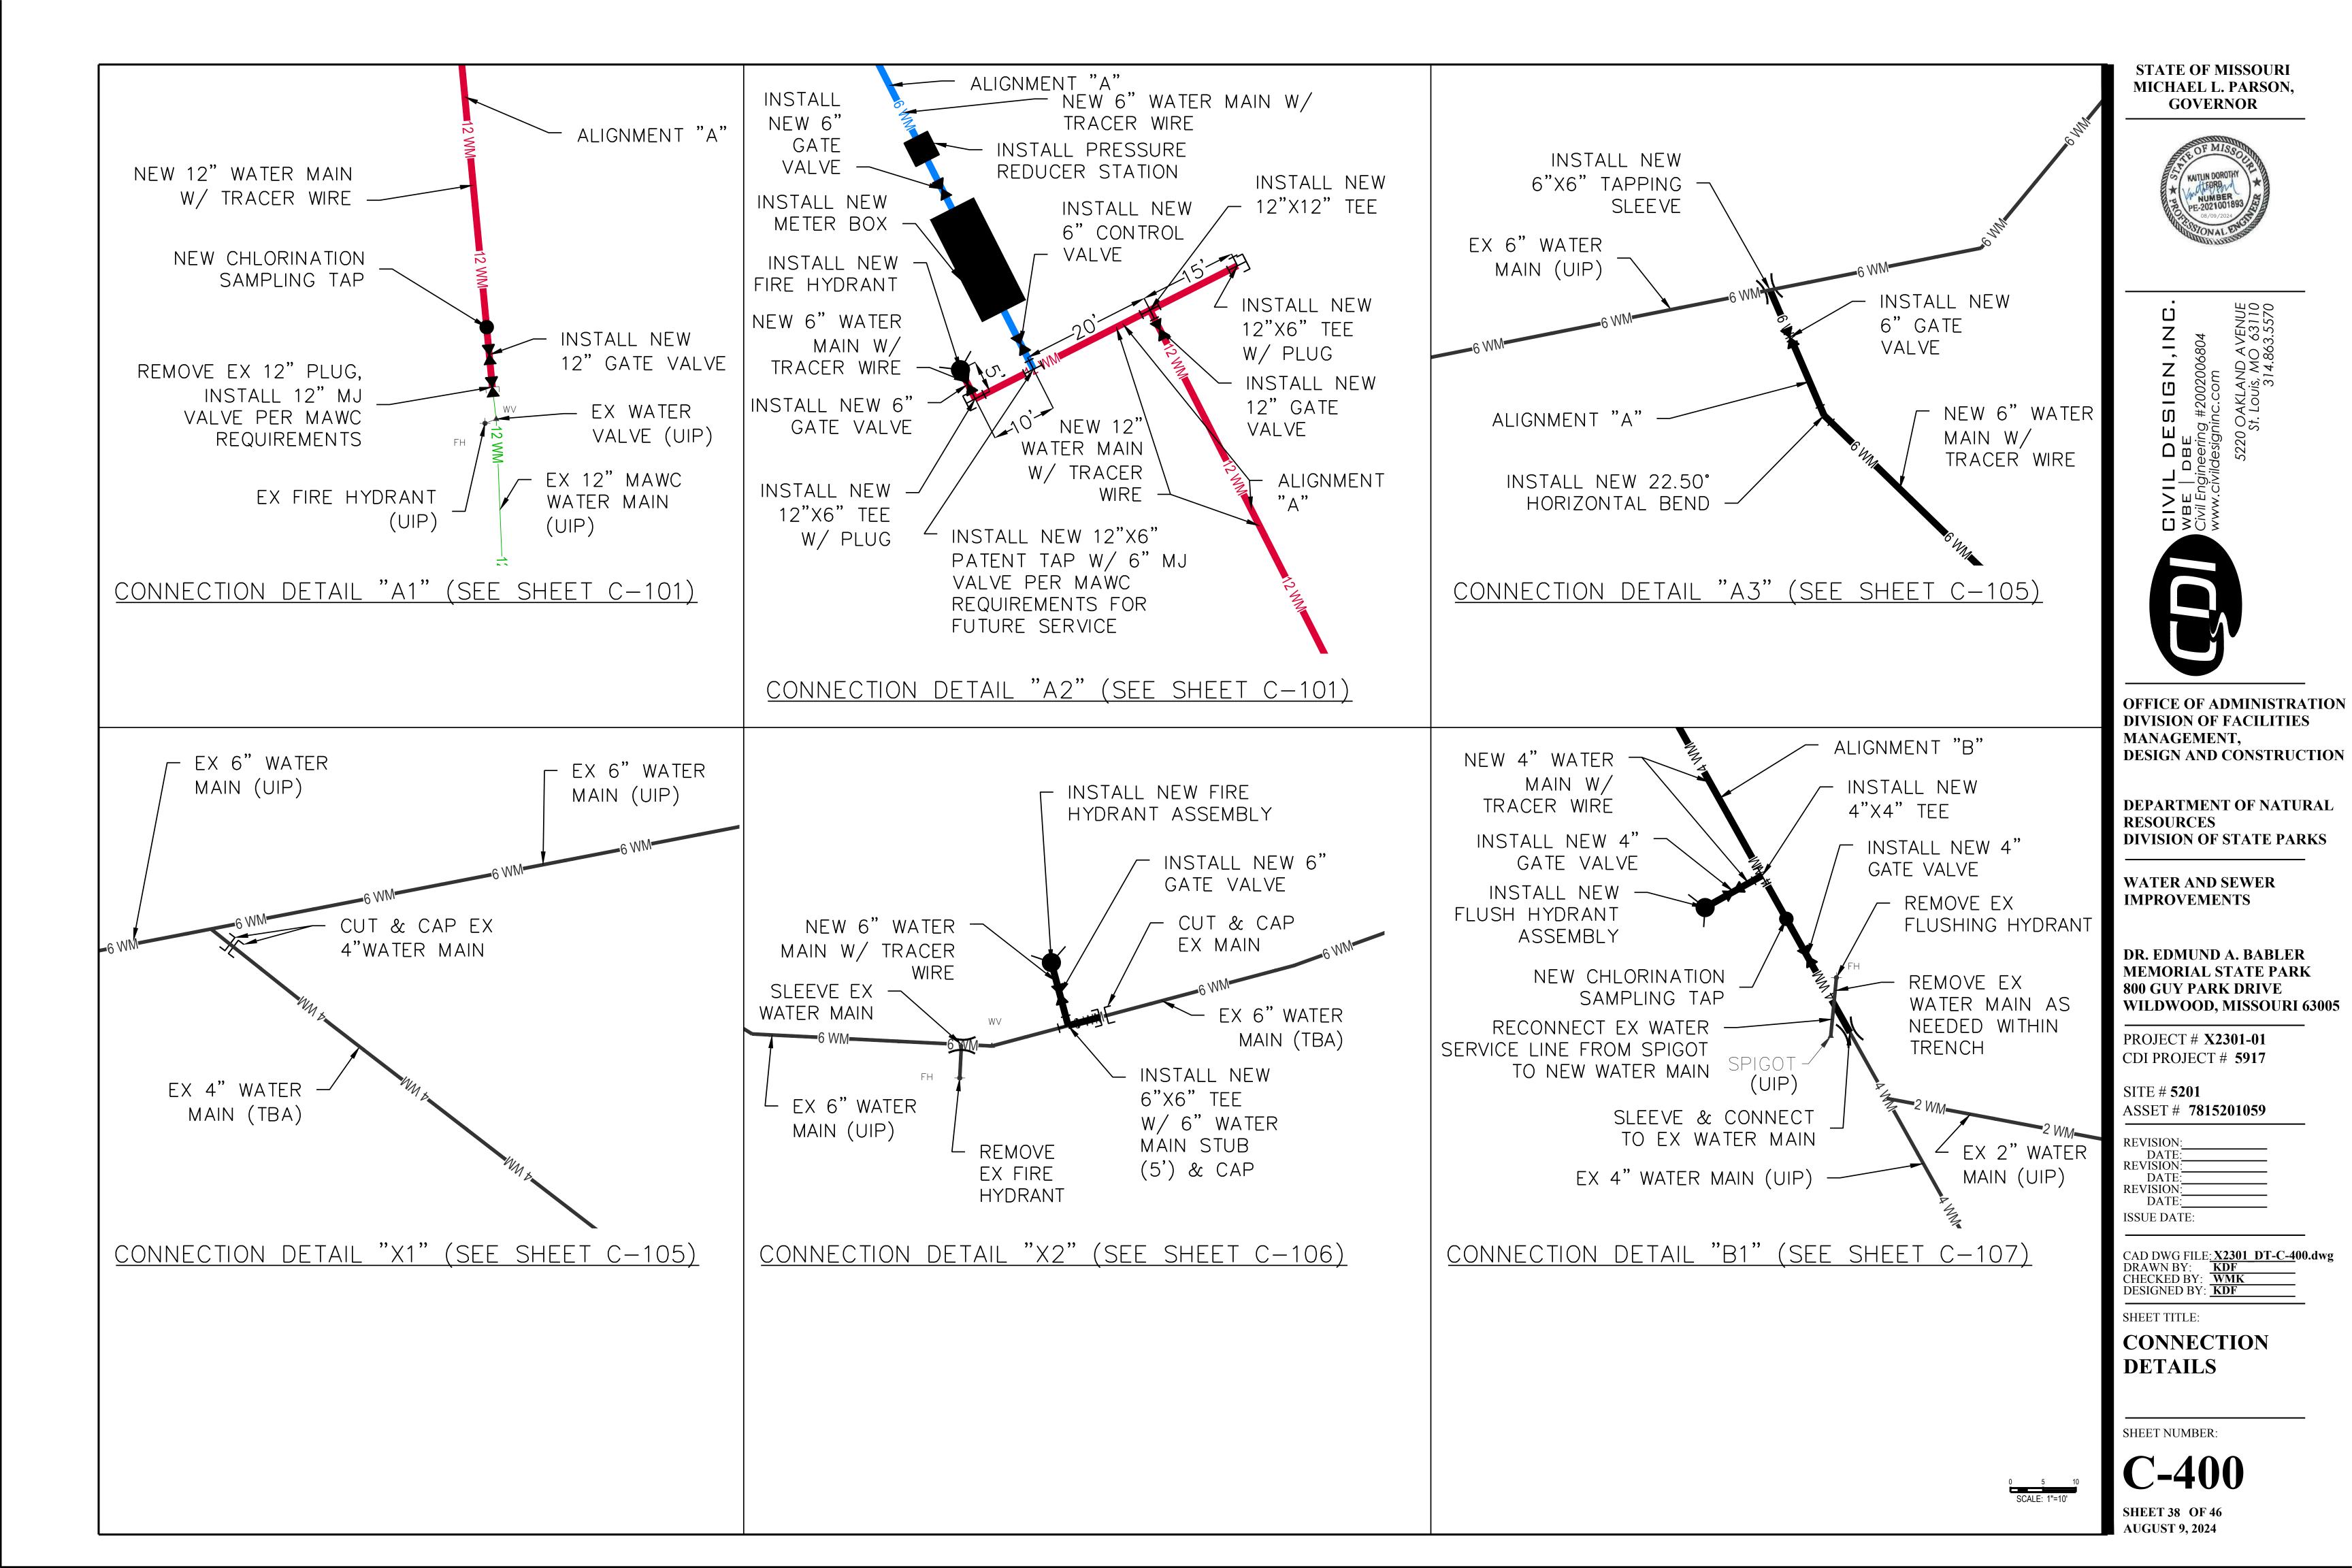

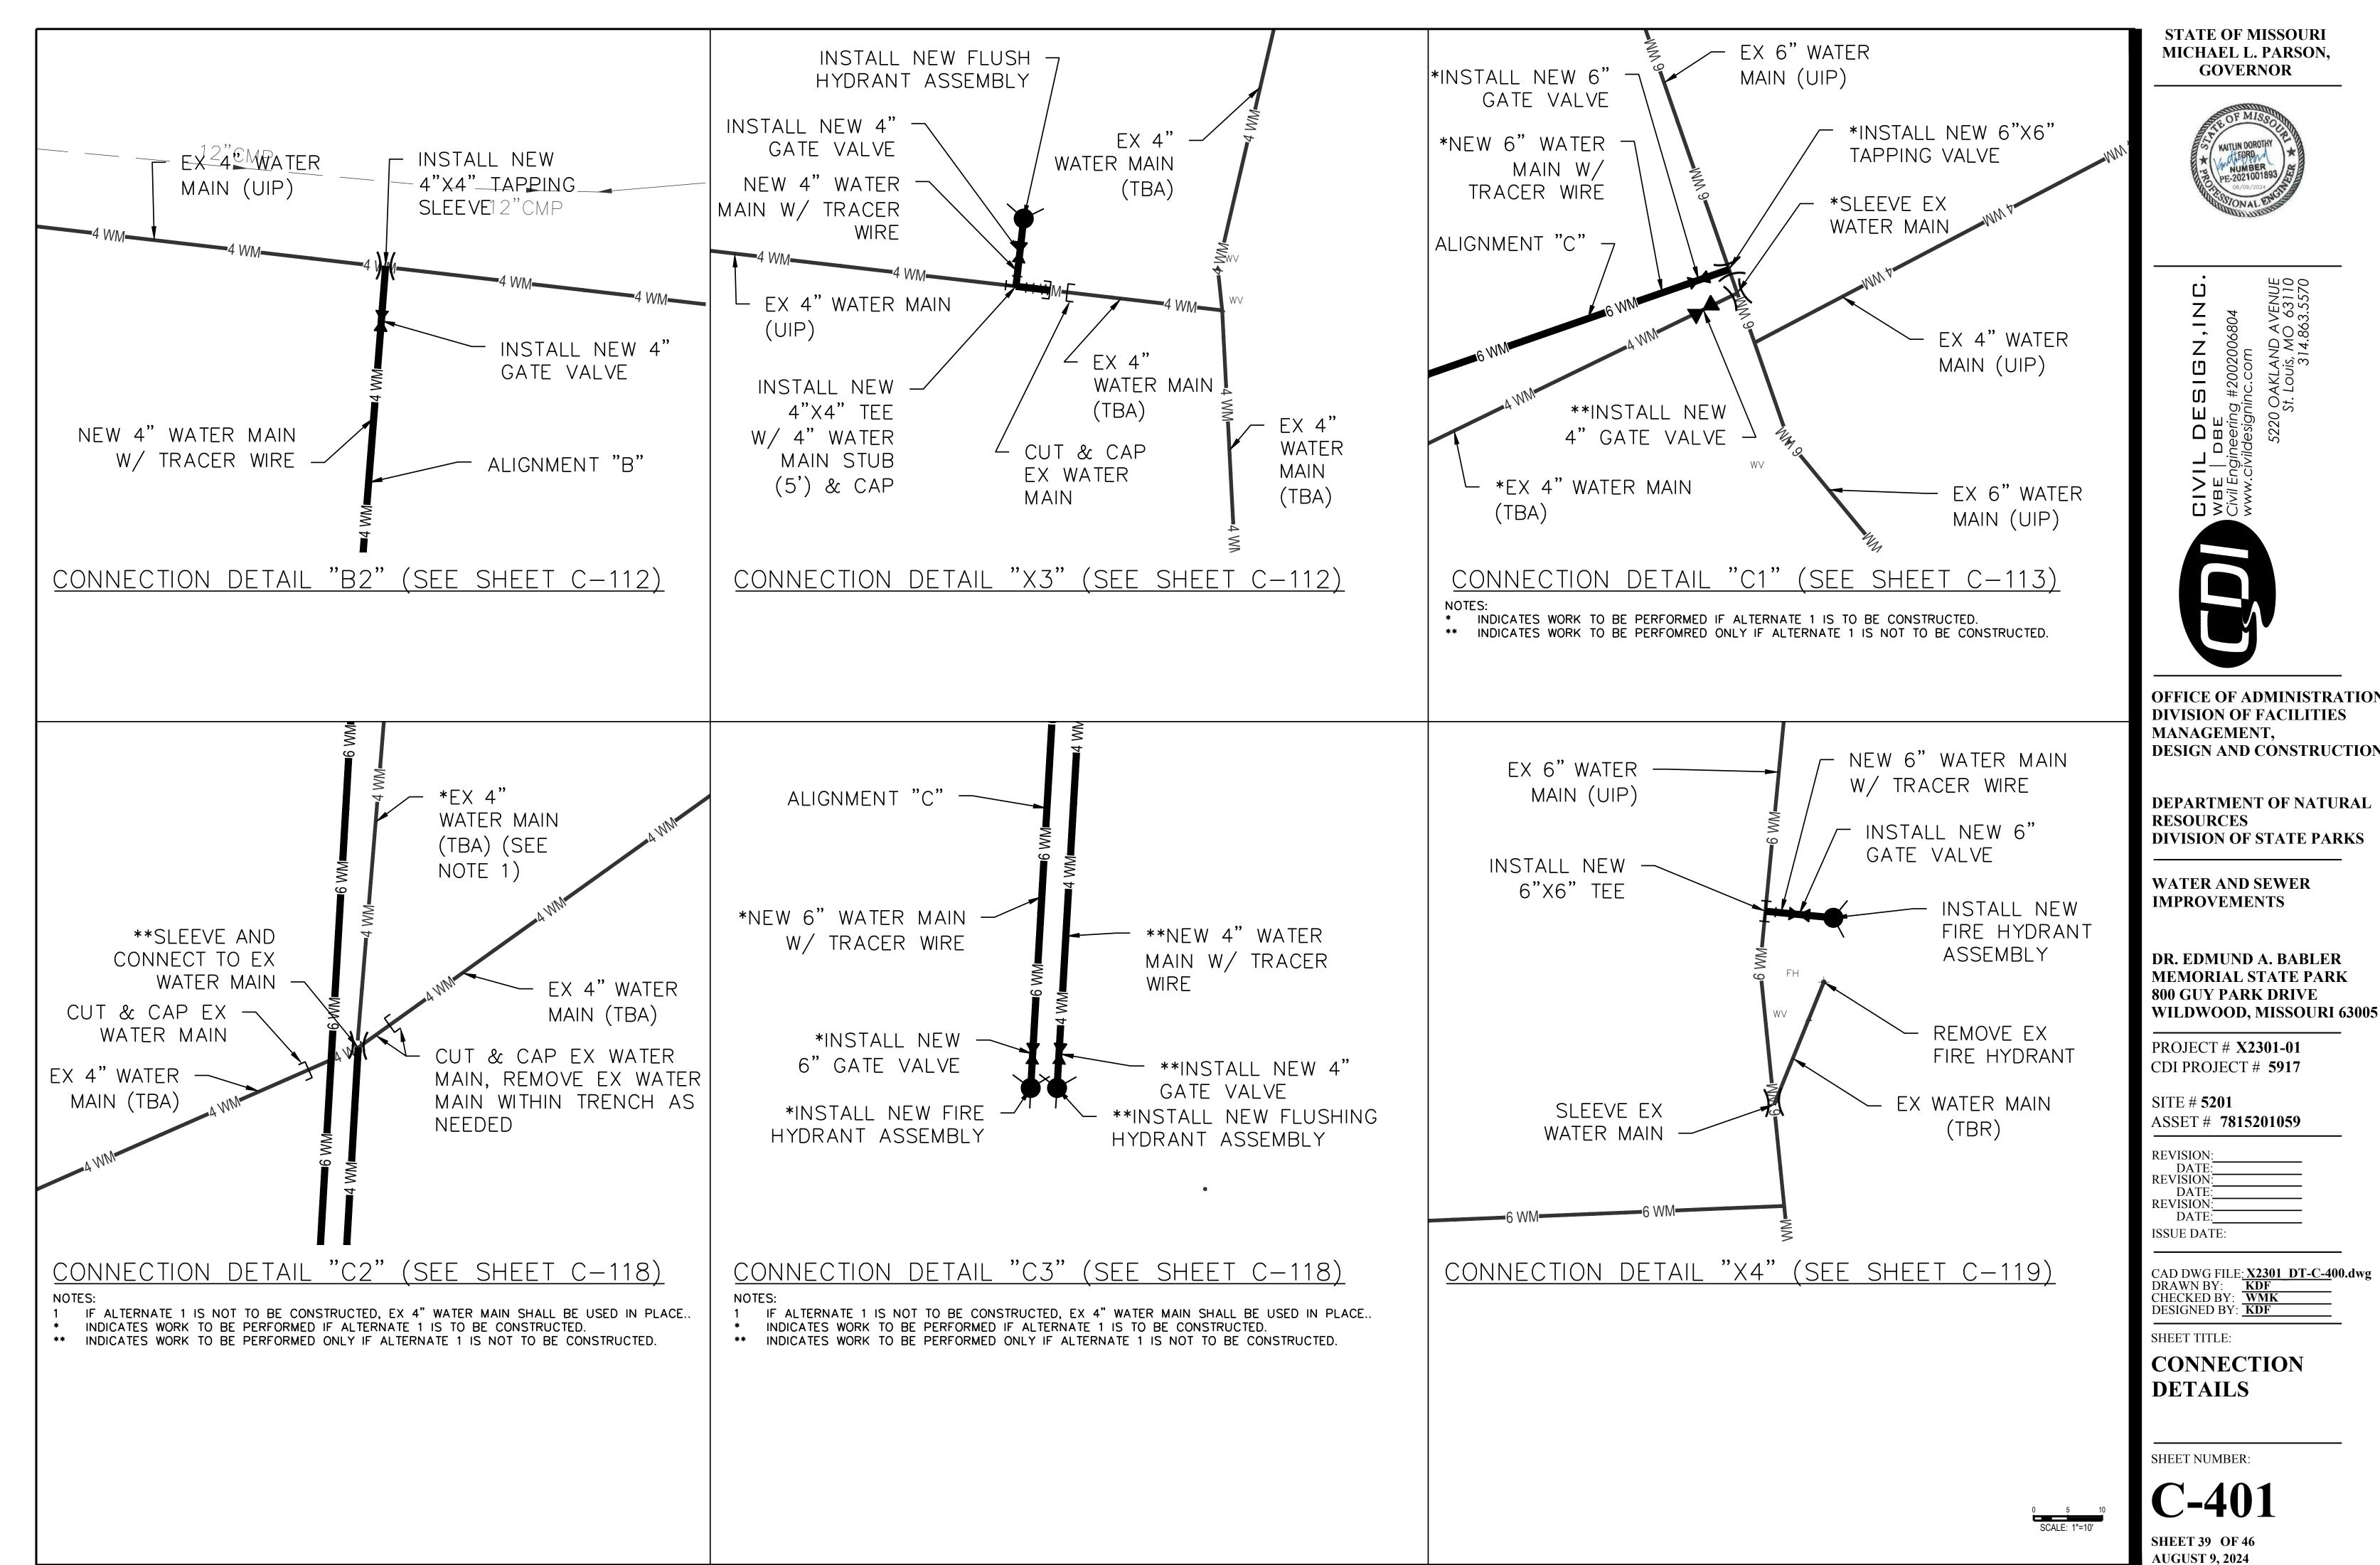


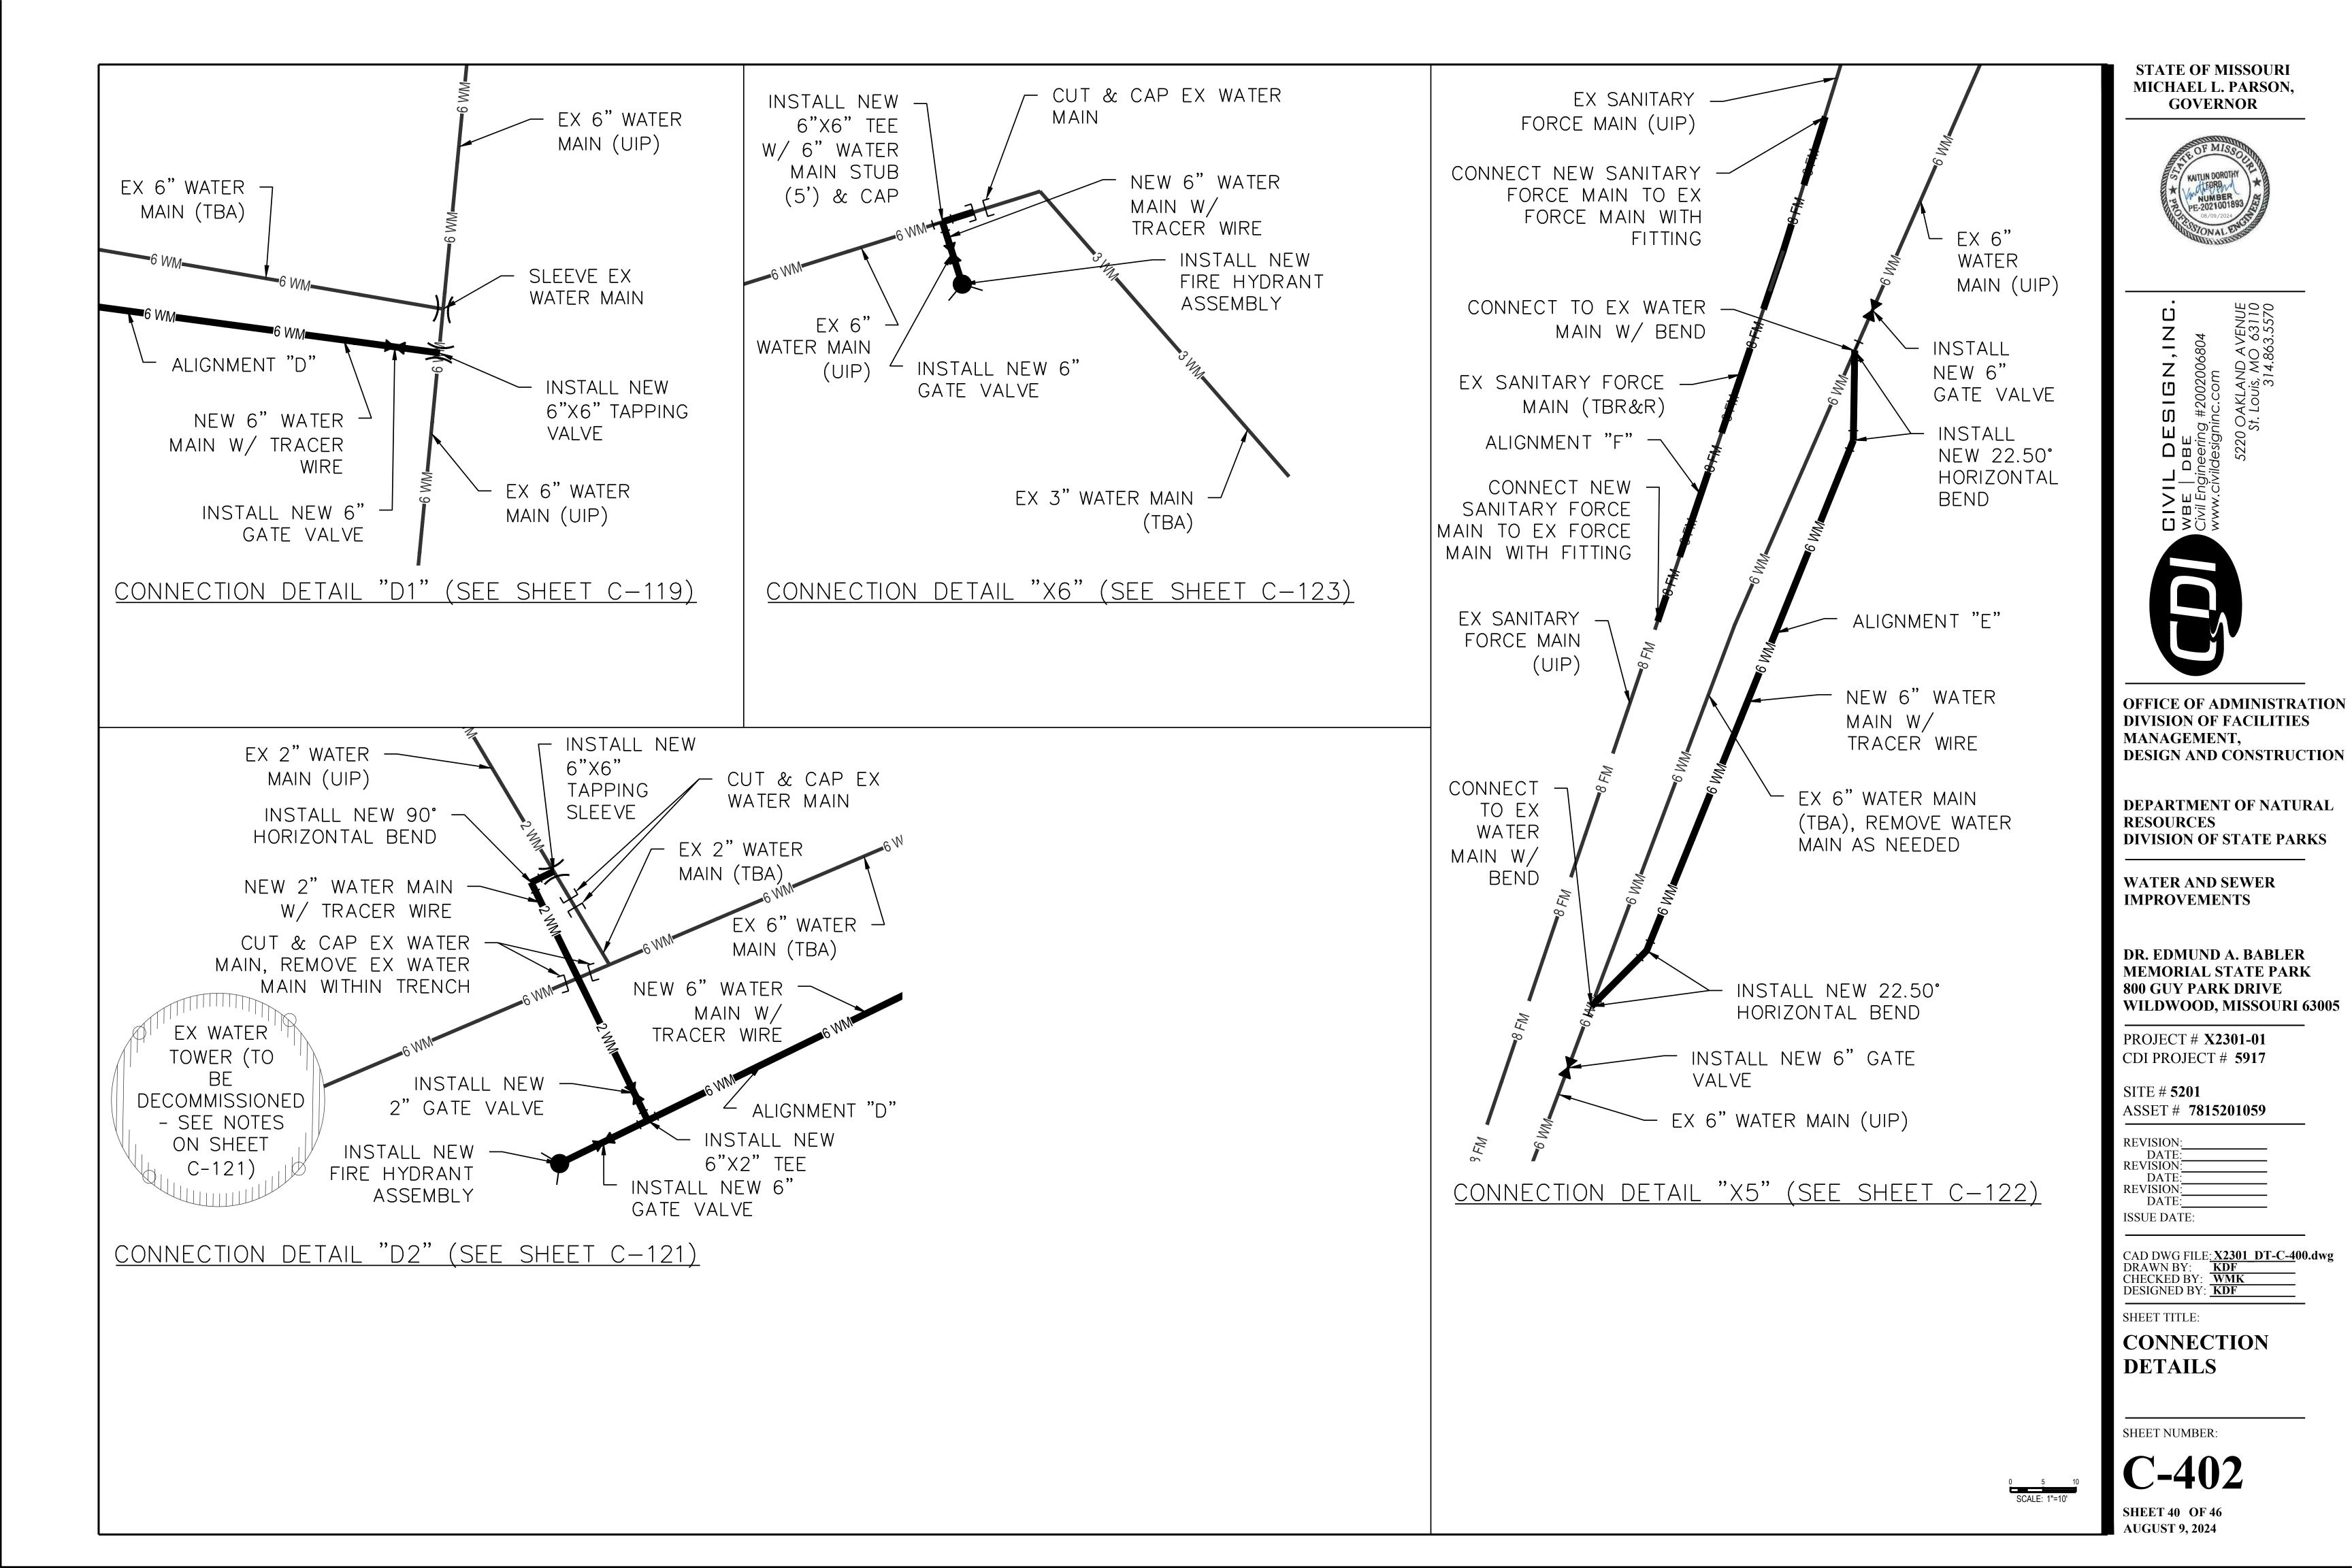

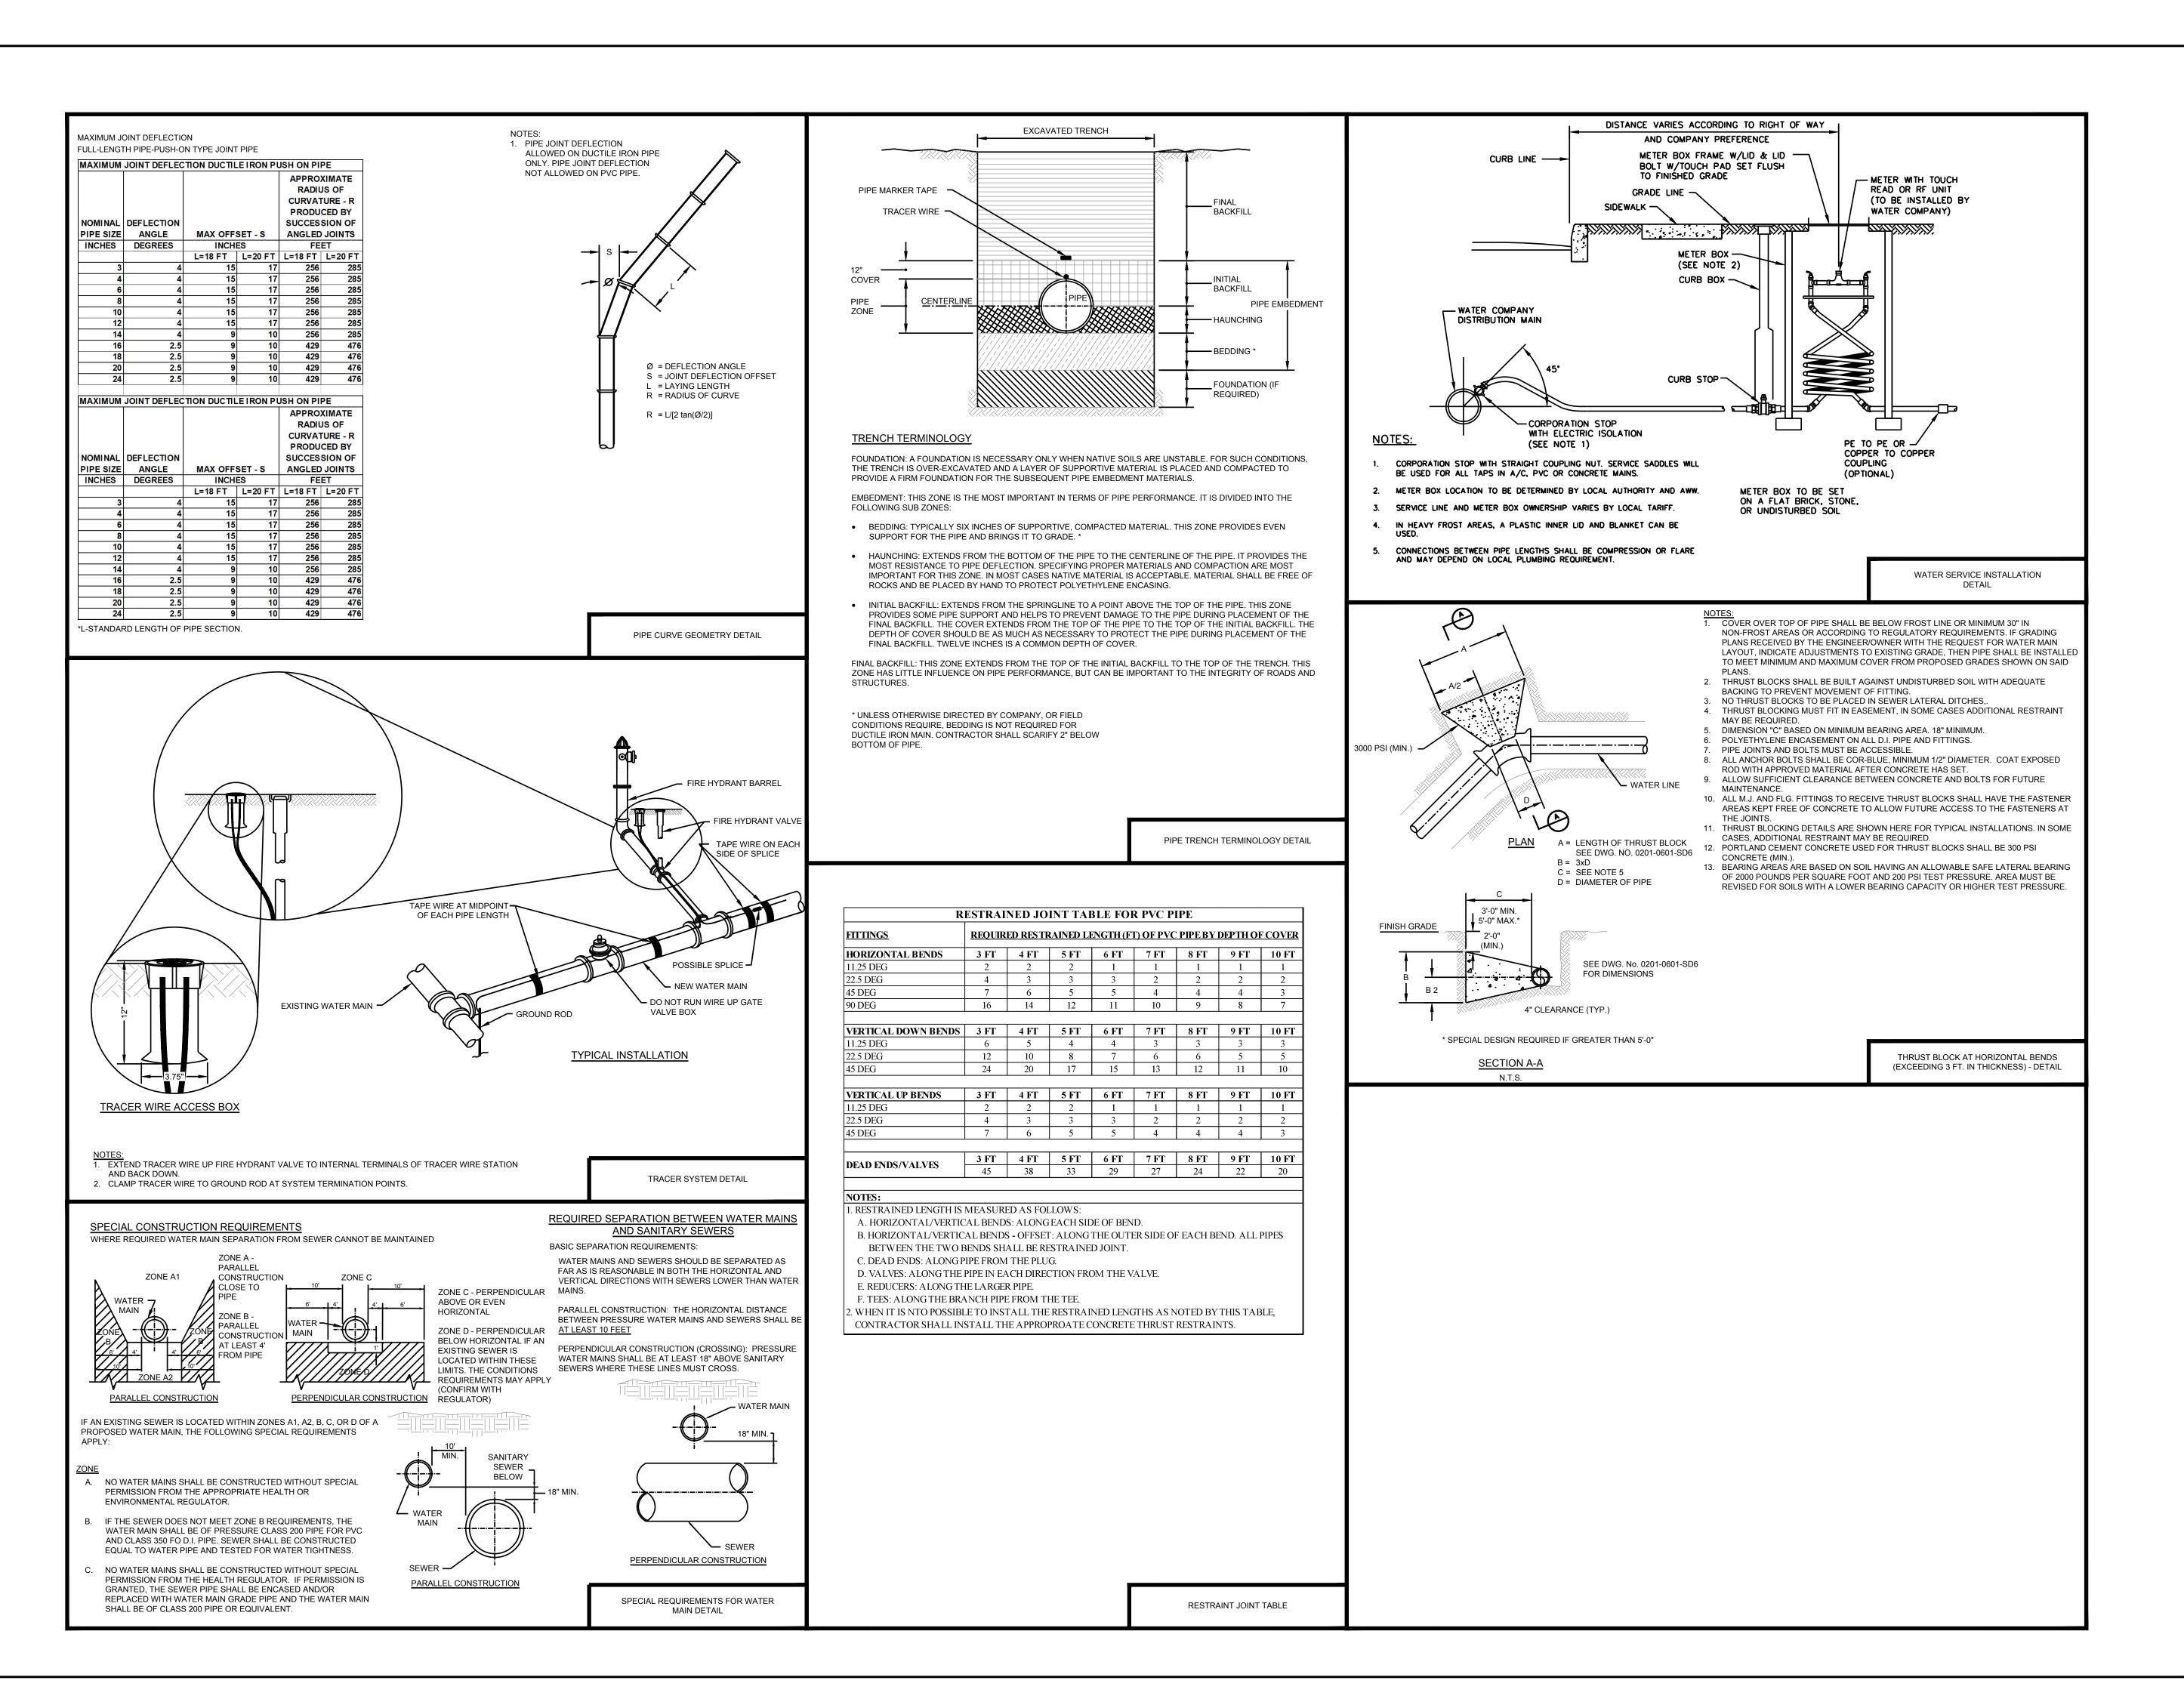



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OFFICE OF ADMINISTRATION DIVISION OF FACILITIES MANAGEMENT, DESIGN AND CONSTRUCTION

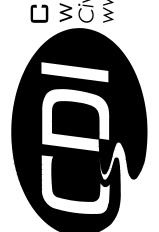DEPARTMENT OF NATURAL RESOURCES DIVISION OF STATE PARKS

WATER AND SEWER IMPROVEMENTS

DR. EDMUND A. BABLER MEMORIAL STATE PARK 800 GUY PARK DRIVE WILDWOOD, MISSOURI 63005

PROJECT # **X2301-01**CDI PROJECT # **5917**

SITE # **5201** ASSET # **7815201059**

REVISION:
DATE:
REVISION:
DATE:
REVISION:
DATE:
ISSUE DATE:

CAD DWG FILE: X2301 DT-C-400.dwg
DRAWN BY: KDF
CHECKED BY: WMK
DESIGNED BY: KDF


SHEET TITLE:

STANDARD DETAILS

SHEET NUMBER:

C-40

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OFFICE OF ADMINISTRATION DIVISION OF FACILITIES MANAGEMENT, DESIGN AND CONSTRUCTION

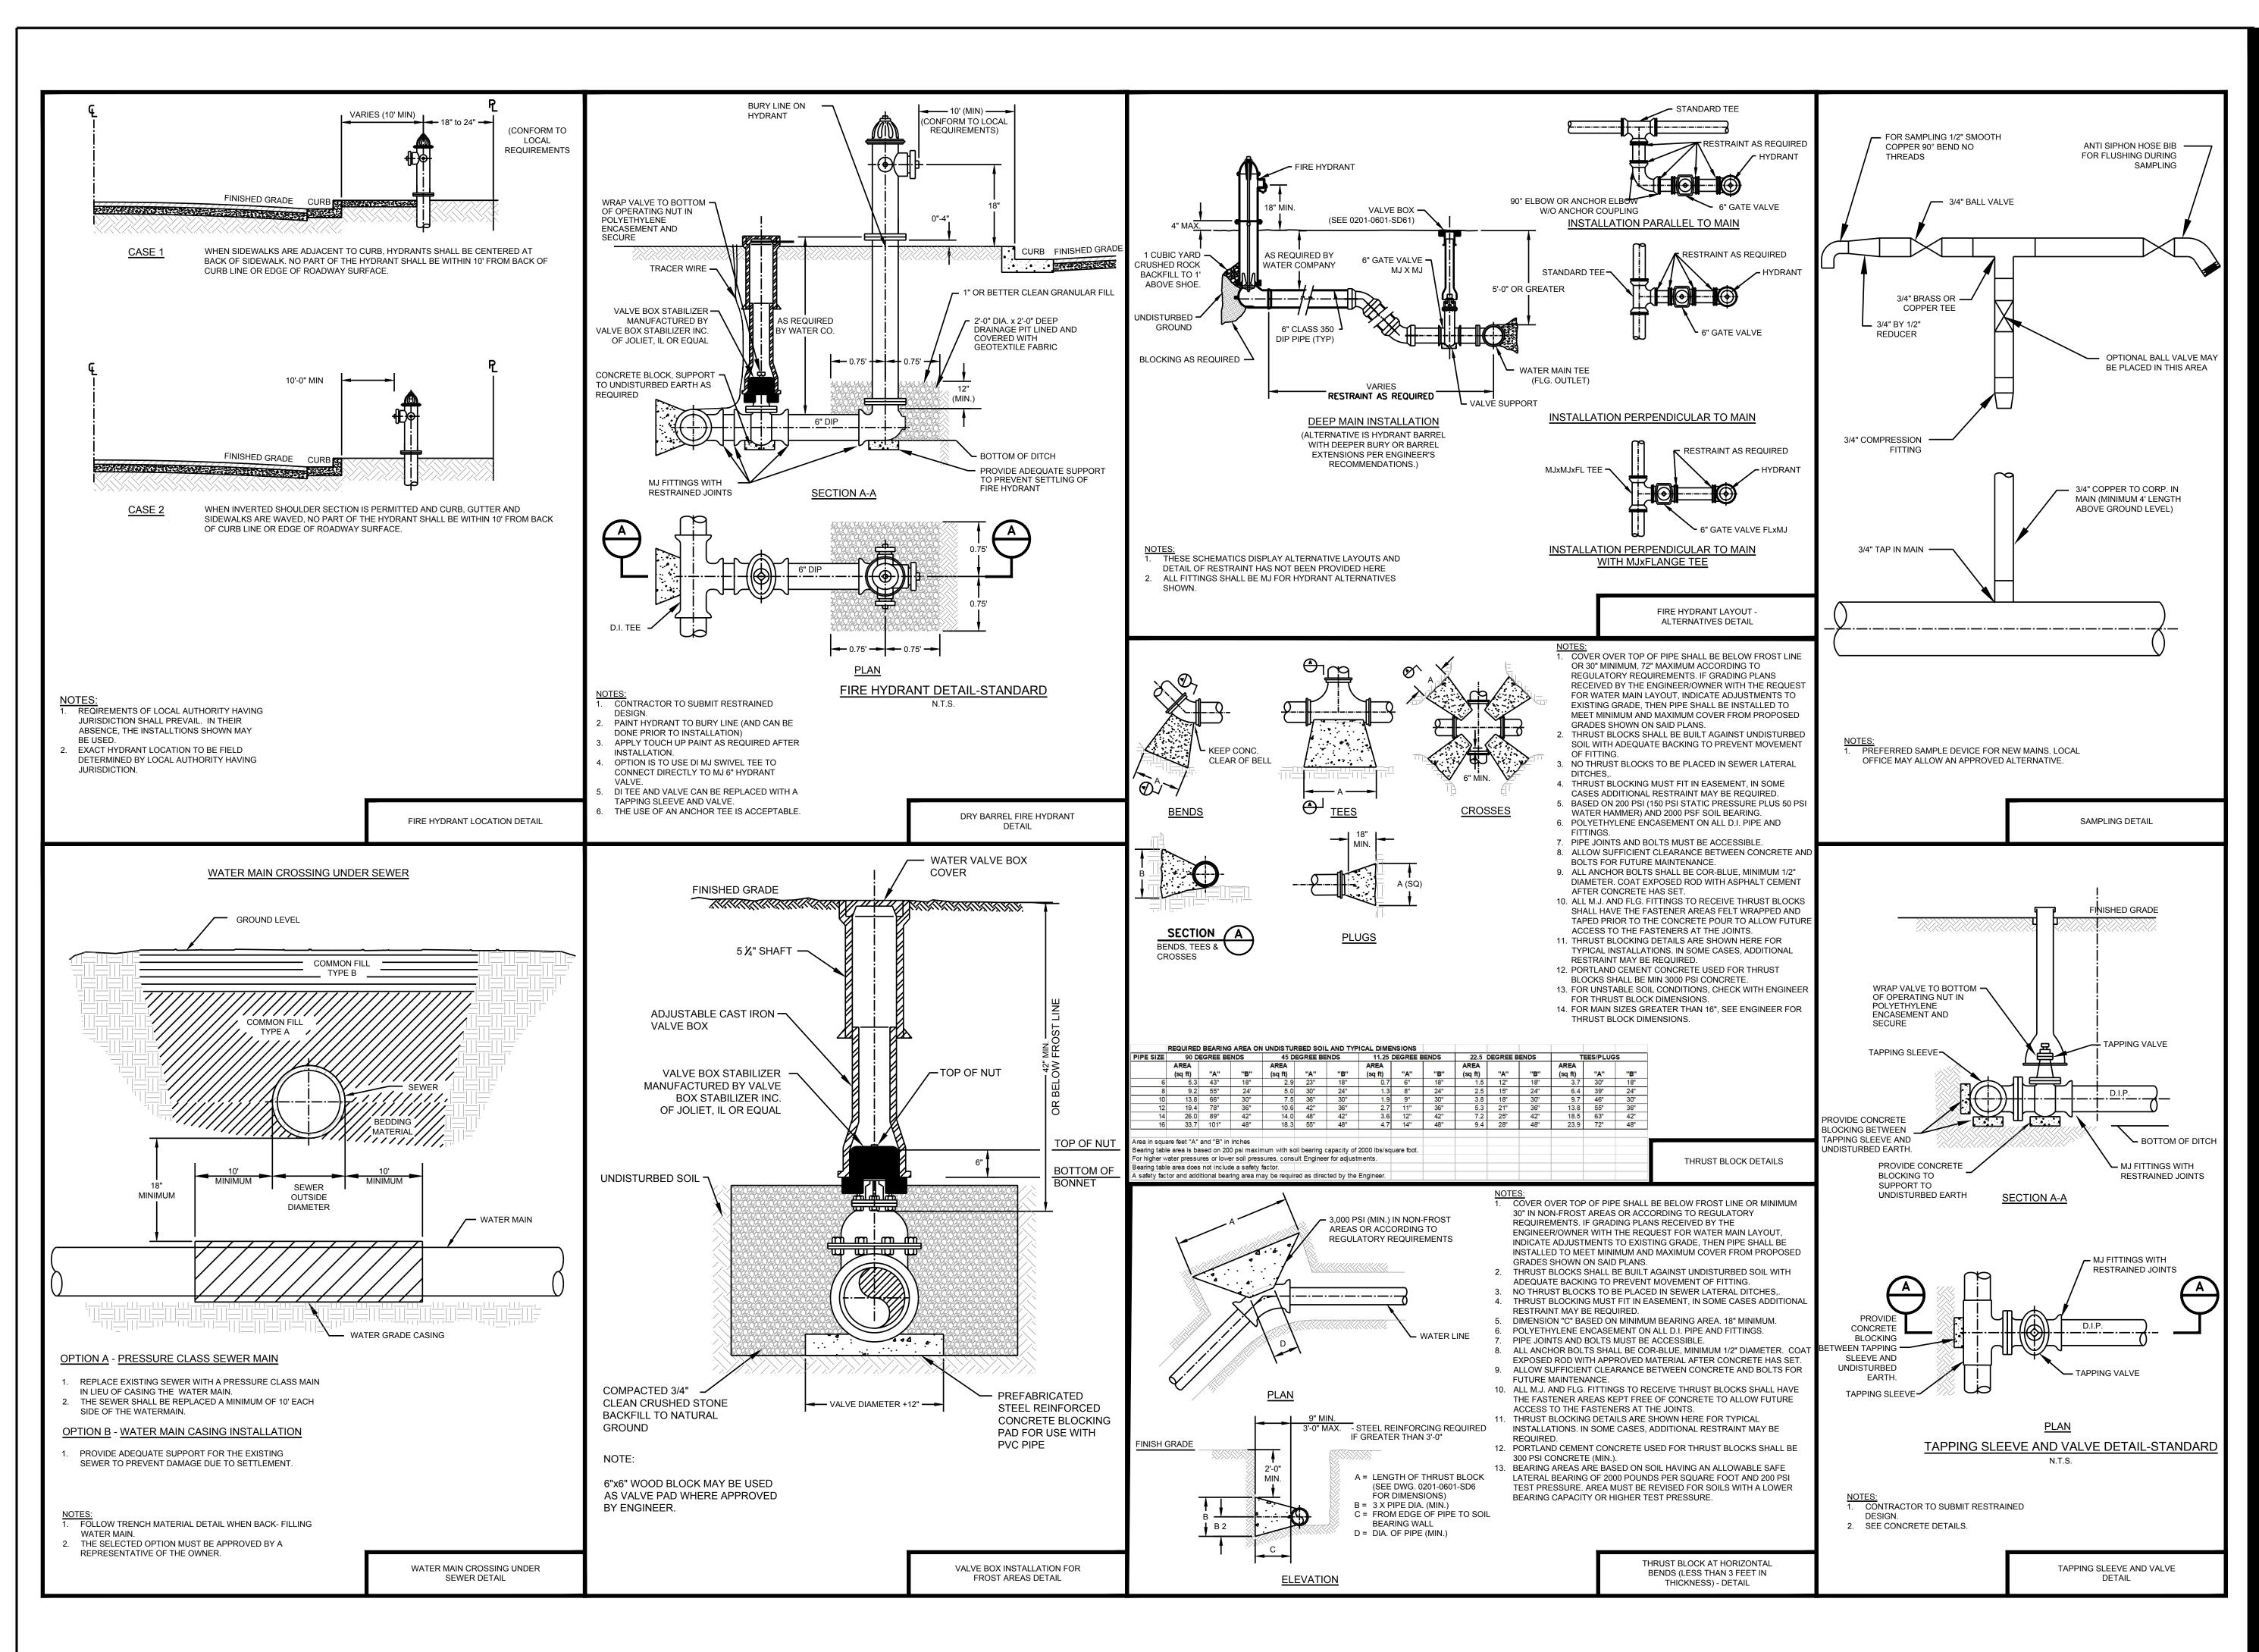DEPARTMENT OF NATURAL RESOURCES DIVISION OF STATE PARKS

WATER AND SEWER IMPROVEMENTS

DR. EDMUND A. BABLER MEMORIAL STATE PARK 800 GUY PARK DRIVE WILDWOOD, MISSOURI 63005

PROJECT # **X2301-01**CDI PROJECT # **5917**

SITE # **5201** ASSET # **7815201059**

REVISION:	
DATE:	
REVISION:	
DATE:	
REVISION:	
DATE:	
ISSUE DATE:	

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DRAWN BY: KDF
CHECKED BY: WMK
DESIGNED BY: KDF


SHEET TITLE:

STANDARD DETAILS

SHEET NUMBER:

C-404

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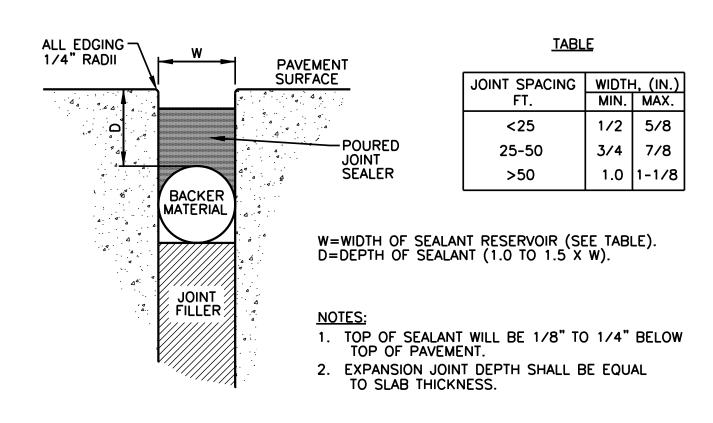

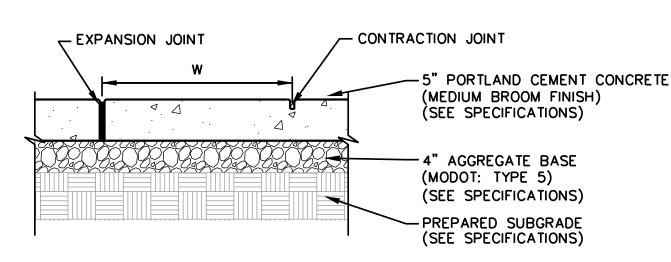
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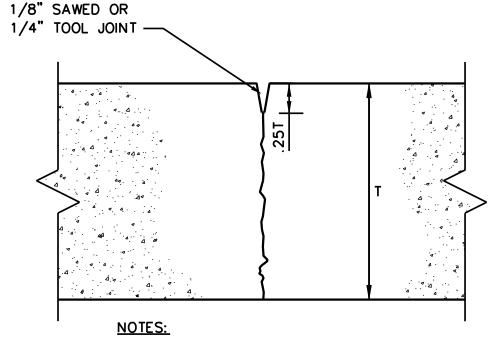
- 1. W=WIDTH OF SIDEWALK; VARIES-SEE PLANS
- 2. SPACE CONTRACTION JOINTS AT W WHERE APPLICABLE—SEE PLAN. PLACE EXPANSION JOINTS AT 3xW.
- 3. EXPANSION JOINT SHALL BE PLACED THROUGH THE FULL DEPTH

OF THE SIDEWALK.

CONCRETE PAVEMENT-PEDESTRIAN




B EXPANSION JOINT NOT TO SCALE




- 1. "T" DENOTES CONCRETE THICKNESS
 (SEE PAVEMENT SECTIONS)
- 2. SAWCUT JOINTS WITHIN 16 HOURS OF
- PLACEMENT.

 3. USE ONLY IN CONCRETE WALKS.



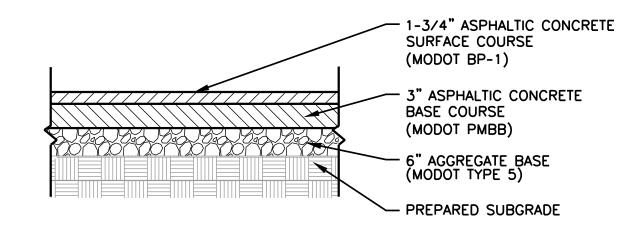



ASPHALT PAVEMENT
NOT TO SCALE

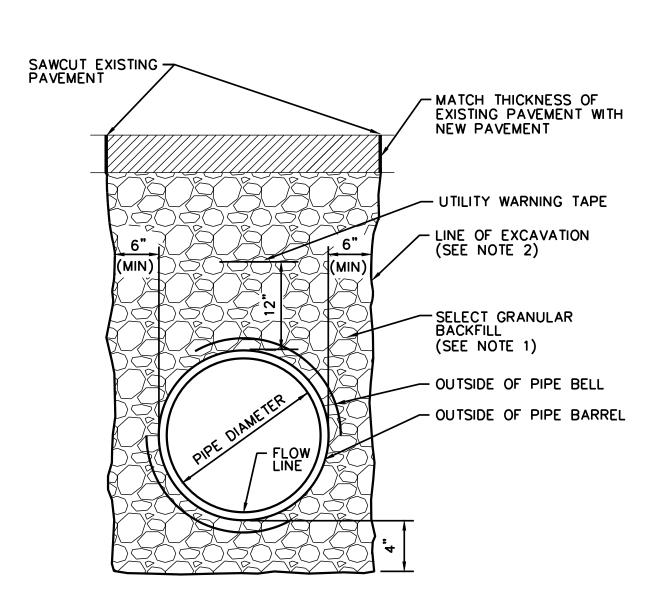

NOTES:


- SELECT GRANULAR BACKFILL SHALL CONSIST OF CRUSHED LIMESTONE AND SCREENINGS. COMPACT BACKFILL TO 95% MAXIMUM DENSITY AS DETERMINED BY THE MODIFIED PROCTOR COMPACTION TEST. (ASTM D 1557)
- 2. CONTRACTOR SHALL BE RESPONSIBLE FOR SHORING AND BENCHING TRENCH EXCAVATIONS IN ACCORDANCE WITH ALL LOCAL, STATE, FEDERAL AND OSHA REQUIREMENTS.

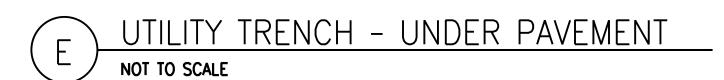


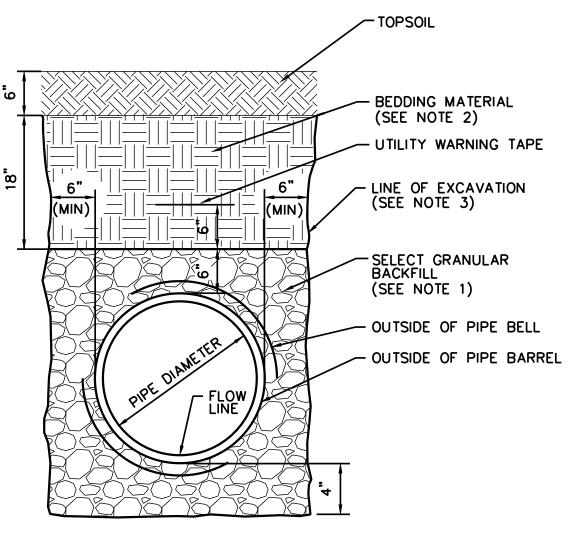


NOTES:

- SELECT GRANULAR BACKFILL SHALL CONSIST OF CRUSHED LIMESTONE AND SCREENINGS. COMPACT BACKFILL TO 95% MAXIMUM DENSITY AS DETERMINED BY THE MODIFIED PROCTOR COMPACTION TEST. (ASTM D 1557)
- 2. COMPACT BEDDING MATERIAL UNDER LAWNS TO 85% MAXIMUM DENSITY AS DETERMINED BY THE MODIFIED PROCTOR COMPACTION TEST. (ASTM D 1557)
- 3. CONTRACTOR SHALL BE RESPONSIBLE FOR SHORING AND BENCHING TRENCH EXCAVATIONS IN ACCORDANCE WITH ALL LOCAL, STATE, FEDERAL AND OSHA REQUIREMENTS.

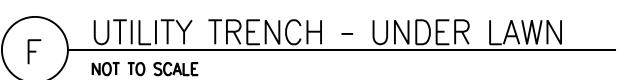

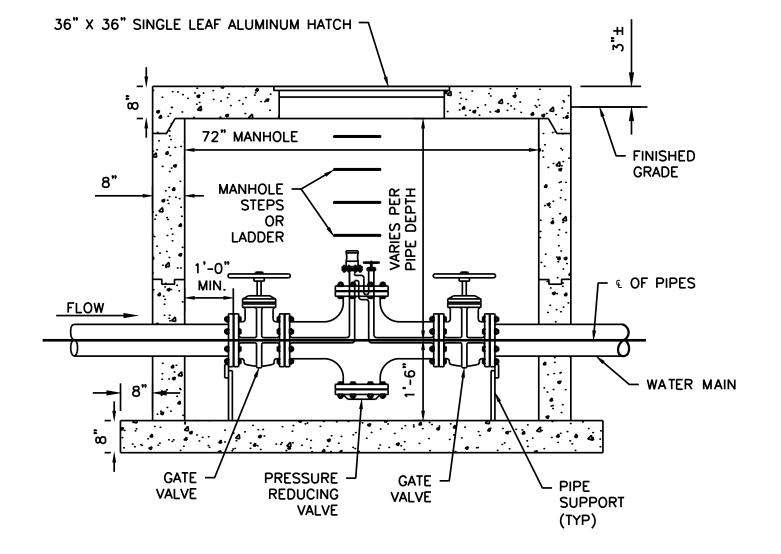

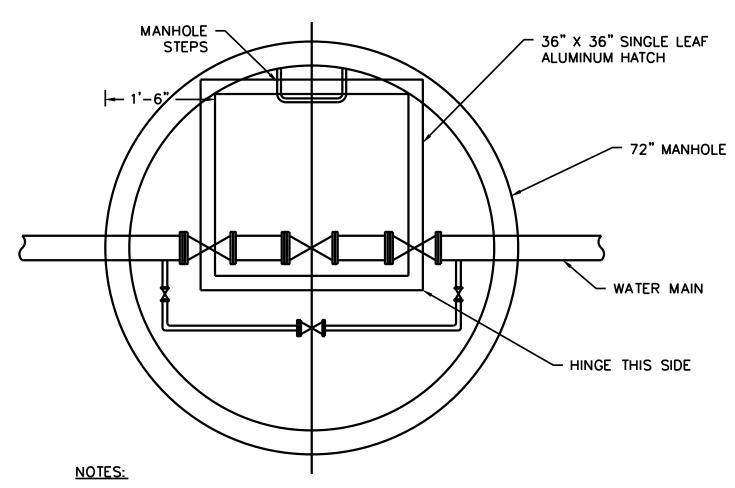

 CONTRACTOR SHALL FOLLOW MANUFACTURER SPECIFICATIONS FOR THE INSTALLATION OF PRESSURE REDUCER VALVE AND OTHER APPURTENANCES, THIS INCLUDES BUT NOT LIMITED TO ANY ADDITIONAL COUPLINGS, SEALANTS, BALL VALVES, BLOWDOWN VALVES, AIR VALVES, AND SUMP DRAINS.

PRESSURE	REDUCER	STATION	& VAULT	
NOT TO SCALE			_	

STATE OF MISSOURI MICHAEL L. PARSON, GOVERNOR



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WATER AND SEWER IMPROVEMENTS

DR. EDMUND A. BABLER MEMORIAL STATE PARK 800 GUY PARK DRIVE WILDWOOD, MISSOURI 63005

PROJECT # **X2301-01**CDI PROJECT # **5917**

SITE # **5201** ASSET # **7815201059**

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REVISION:	
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CAD DWG FILE: X2301 DT-C-400.dwg
DRAWN BY: KDF
CHECKED BY: WMK
DESIGNED BY: KDF

SHEET TITLE:

STANDARD DETAILS

SHEET NUMBER:

C-405

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MISSOURI AMERICAN WATER	FILE NO. INDEX NO. ISSUED DATE 07-2022 AMENDED DATE 10-25-2023
OPENING MUST BEGIN 3'X 3' ALUMINUM SPRING FLUSH WITH VALVE FLANGE, LOADED HATCH OUTLET SIDE. TEE WITH 2" LOCKING VALVE WITH VALVE BOX THREADED RODS TO RESTRAIN PIPE 16'7" OR AS NECESSARY TO HOUSE VALVES, METER & CHECK VALVES.	METER A SIZE A 4" 69" 6" 81" 10" 96" 8" 96" 10" 96" THREADED RODS TO RESTRAIN PIPE GATE VALVE (CUSTOMER OWNED) INSULATED FLANGE CONNECTION SEE DETAIL MB-001
<u>PLAN</u> SE AN	EE NOTE 10 ND 13 THREADED RODS
500Ib LOAD CAPACITY POWDER COATED FIXED VAULT LADDER OR APPROVED EQUAL WITH BILCO LU—1 LADDER SAFETY POST—STEEL, YELLOW POWDER COAT OR APPROVED EQUAL	TO RESTRAIN PIPE
METER BOX A A A A A A A A A A A A A	SEE NOTE 10 AND 13
 VAULT WALLS AND ROOF TO BE OF CONCRETE. LIDS AND FRAMES OF OPENING TO BE SET IN PLACE, NOT IN CONCRETE. LIDS SHALL BE LOADED. OPENING WILL REQ. DOUBLE DOORS FOR ALL METER SIZES WITH AN OPENING OF UNRESTRICTED ACCESS OF OPENING TO BE FLUSH WITH OUTLET VALVE FLANGE. VALVING MUST HAVE FLANGED ENDS, BE IN ALIGNMENT, AND BE ADEQUATELY SECURED TO 	12" SPACING FROM BOTTOM OF FLOOR TO BOTTOM OF LADDER MADE OF ALUMINUM & SPRING 96"x 48" TO ALLOW
THRUST WITH METER REMOVED. 4. CLASS 52 D.I. PIPING THROUGH BOX AND EXTENDED MIN. 6' OUTSIDE BOX. (ZINC COATED V—BIO POLYWRAP OPTIONAL IN HIGHLY CORROSIVE SOIL AREAS)	DI PIPE WITH
 OWNER SUBJECT TO SUBSIDY COST FOR METER. METER BOX CONTROL VALVES TO BE LOCATED AS NEAR TO METER BOX AS PRACTICAL. CONNECTION TO PUBLIC WATER MAIN WILL NOT BE MADE BEFORE METER PIT AND PIPING A PROPERTY LINE VALVE INSTALLED, UNLESS APPROVED BY AUTHORIZED COMPANY REPRESEN ANY DEVIATION FROM PIPE DEPTH SHOWN MUST BE APPROVED BY AUTHORIZED COMPANY TO CONSTRUCTION. 	ITATIVE.
9. BOX TO BE SET WITH TOP OF BOX AT FINISHED GRADE WITH NO EXTENSION ALLOWED. 10. DRAINAGE FACILITIES MUST BE PROVIDED, OR BOX OTHERWISE KEPT FREE OF WATER. NO UNLESS APPROVED BY AUTHORIZED COMPANY REPRESENTATIVE. 11. BY-PASS SIZE SAME AS METER SIZE. 12. CHECK VALVES REQUIRED FOR EACH METER BOX INSTALLATION AND SHALL BE RATED AT 2	
SHALL HAVE A RESILIENT SEAT. 13. DRAIN NEEDS TO BE GRADED TO ALLOW WATER DRAINAGE AWAY AND OUT FROM VAULT 14. ALL STEEL BOLTS INCLUDING THE NUTS, WASHERS, LUGS, CLAMPS, AND BRACKETS USED F SHALL COMFORM TO AWWA C111 STANDARDS AND SHALL BE FACTORY COATED WITH AN AP COATING. THREADED RODS INCLUDING THE NUTS AND STANDARD WASHERS USED FOR THR MEET ASTM F1554 GRADE 55 OR GRADE 105 WITH HEAVY HEX DH NUTS AND SHALL BE CO FLUOROPOLYMER COATING. APPROVED PTFE FLUOROPOLYMER COATING PRODUCTS INCLUDE SERIES 1420, 1421, 1424, OR APPROVED EQUAL. PTFE FLUOROPOLYMER COATINGS SHALL IS	OR BOLT ACCESSORIES PPROVED PTFE FLUOROPOLYMER EADED ROD ACCESSORIES SHALL DATED WITH PTFE FLUOROKOTE #1™, OR XYLAN™,
A TEMPORARY FLANGED DUCTILE IRON SPOOL PIECE MUST BE INSTALLED IN THE PLACE OF 3" AND LARGER, TO ENSURE PIPE ALIGNMENT. MAWC PERSONNEL WILL REMOVE SPOOL PIE INSTALLATION AND WILL LEAVE IN METER VAULT FOR CONTRACTOR TO ACQUIRE FOR FUTUR	CE AT TIME OF METER
PRINT AND READ DISCLAIMER METER BOX FOR FIRE FLOW METER SERVICE	N WITHOUT NOTICE 10-25-2023 CE ERBOX/METERBOX_20200821.DWG



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Civil Engineering #2002006804

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OFFICE OF ADMINISTRATION DIVISION OF FACILITIES MANAGEMENT, DESIGN AND CONSTRUCTION

DEPARTMENT OF NATURAL RESOURCES
DIVISION OF STATE PARKS

WATER AND SEWER IMPROVEMENTS

DR. EDMUND A. BABLER MEMORIAL STATE PARK 800 GUY PARK DRIVE WILDWOOD, MISSOURI 63005

PROJECT # **X2301-01**CDI PROJECT # **5917**

SITE # **5201** ASSET # **7815201059**

REVISION:
DATE:
REVISION:
DATE:
REVISION:
DATE:
ISSUE DATE:

CAD DWG FILE: X2301 DT-C-400.dwg
DRAWN BY: KDF
CHECKED BY: WMK
DESIGNED BY: KDF


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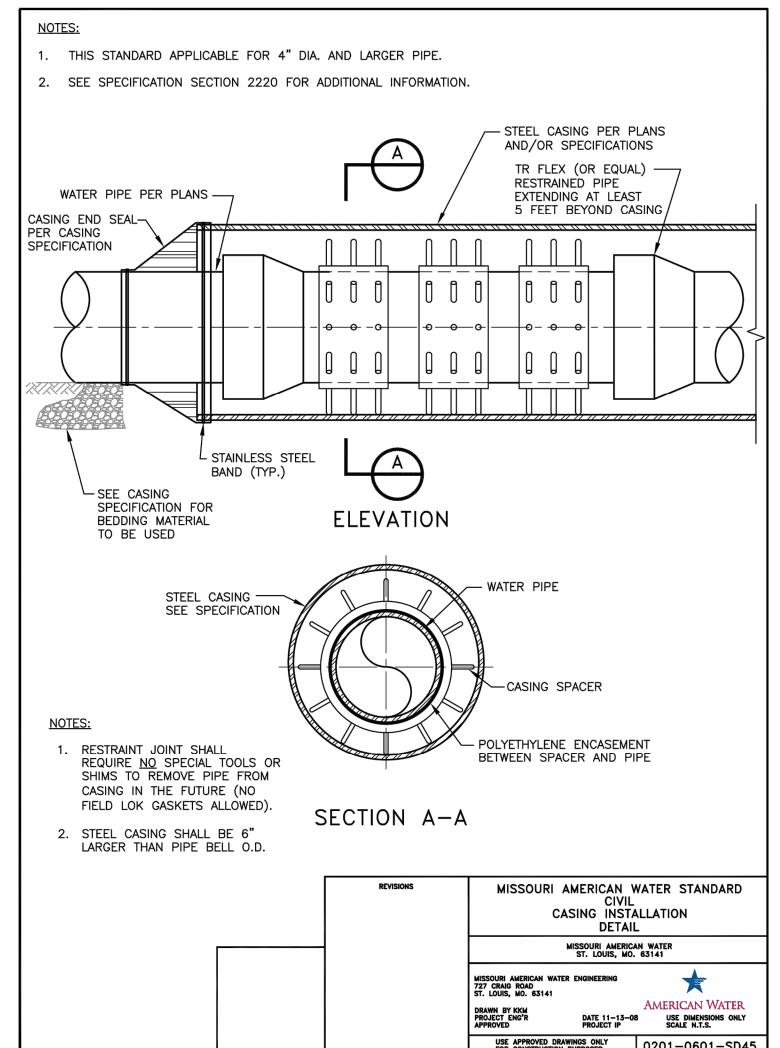
STANDARD DETAILS


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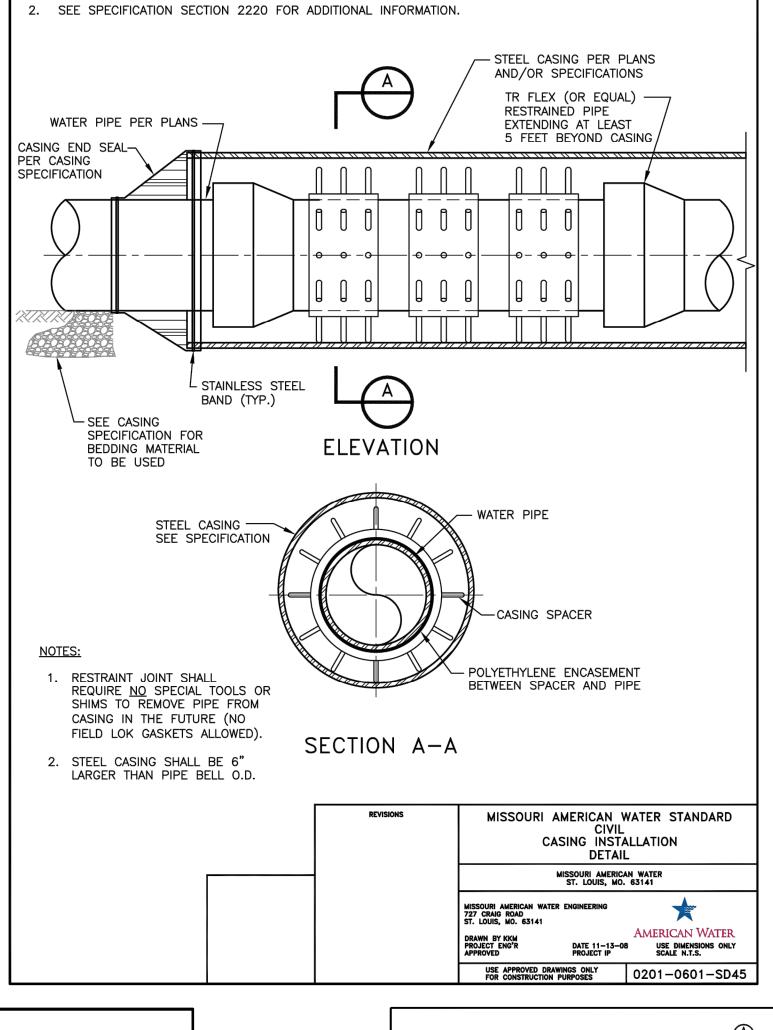
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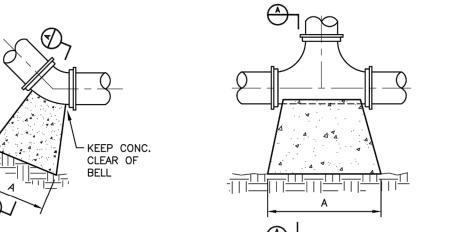
SHEET 44 OF 46 AUGUST 9, 2024







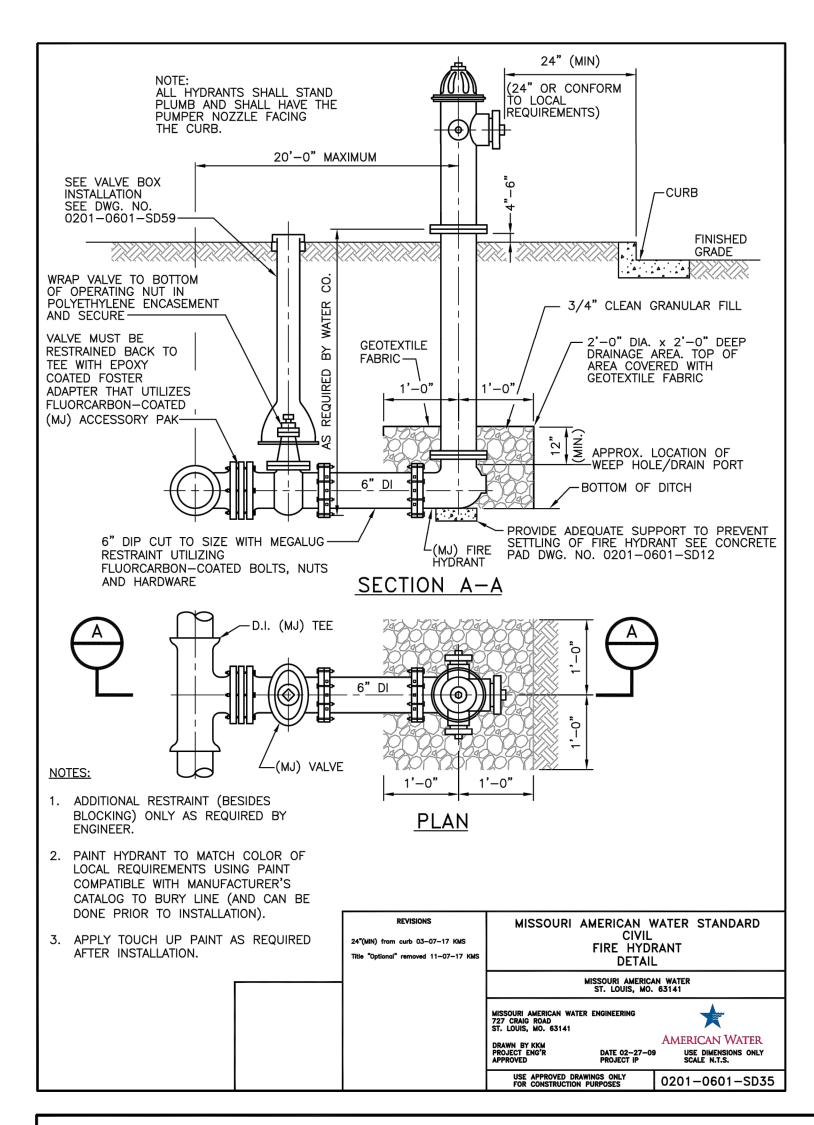

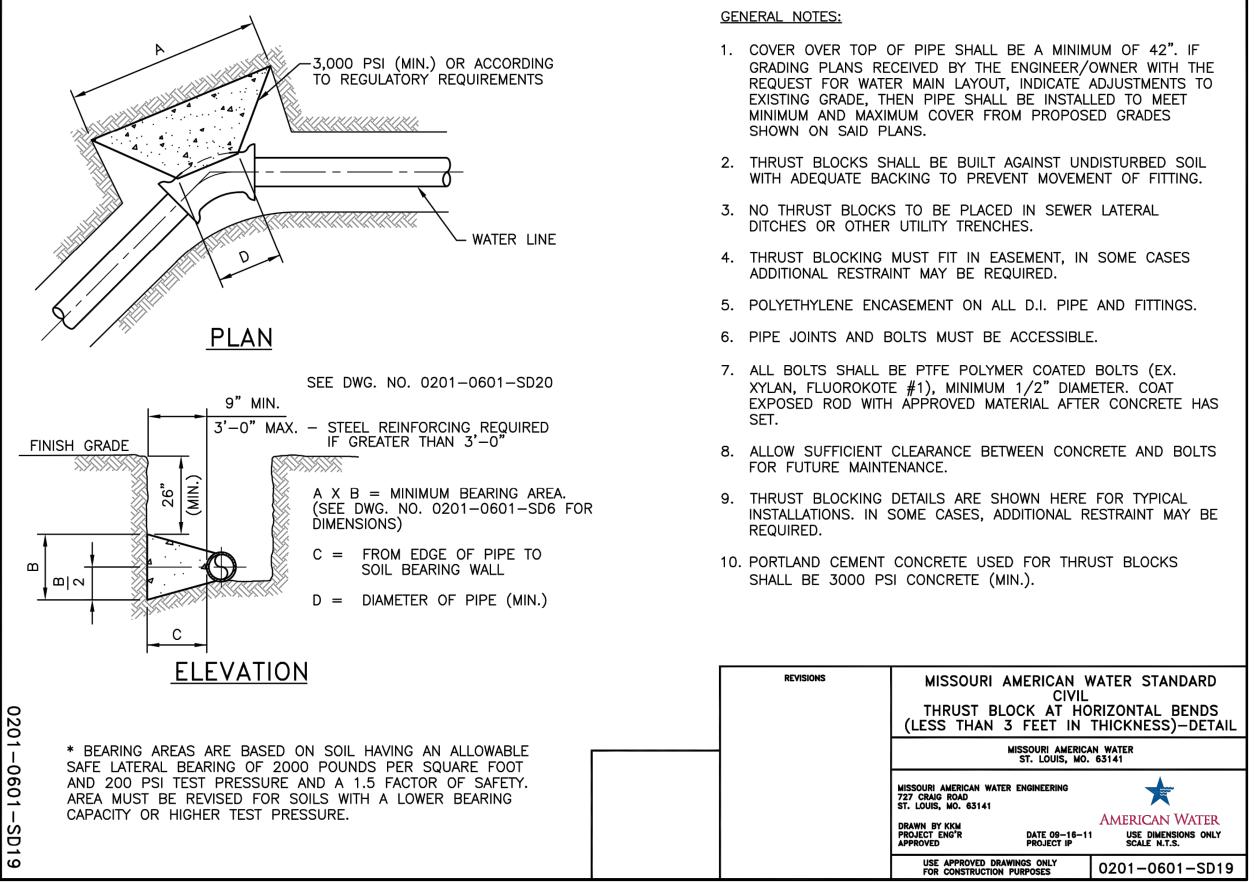



SECTION

BENDS AND

REQUIRED MINIMUM BEARING AREA ON UNDISTURBED SOIL						
	90 DEGREE BENDS	45 DEGREE BENDS	22.5 DEGREE BENDS	11.25 DEGREE BENDS	TEES/PLUGS	
PIPE SIZE	AREA (SQ. FT.)	AREA (SQ. FT.)	AREA (SQ. FT.)	AREA (SQ. FT.)	AREA (SQ. FT.)	
6	8.0	4.5	2.0	1.0	6.0	
8	14.0	7.5	4.0	2.0	10.0	
10	20.5	11.0	6.0	3.0	14.5	
12	29.0	16.0	8.0	4.0	20.5	

<u>BENDS</u>

- 1. BEARING TABLE AREA IS BASED ON 200 PSI MAXIMUM WITH SOIL BEARING CAPACITY OF 2000 LBS/SQUARE FOOT WITH A 1.5 SAFETY FACTOR.
- 2. FOR HIGHER WATER PRESSURES OR LOWER SOIL PRESSURES, CONSULT ENGINEER FOR ADJUSTMENTS.
- 3. A SAFETY FACTOR AND ADDITIONAL BEARING AREA MAY BE REQUIRED AS DIRECTED BY THE ENGINEER.
- 4. FOR DEVELOPER LAY PROJECTS, THE DEVELOPER SHALL VERIFY SOIL BEARING CAPACITIES.
- 5. SEE DWG. NO. 0201-0601-SD19 AND DWG. NO. 0201-0601-SD20 FOR ADDITIONAL BLOCKING INFORMATION.

5'-0" MIN. - PAT TAP SLEEVE OR SADDLE PAT TAP VALVE AND VALVE BOX FINAL CLOSURE BY DEVELOPER DISTANCE VARIABLE 6' MIN. TO 10' MAX. (PIPE FURNISHED BY DEVELOPER/CONTRACTOR - M.J. SOLID SLEEVE FURNISHED
AND INSTALLED BY DEVELOPER/CONTRACTOR (WHEN REQUIRED) PIPE INSTALLED BY DEVELOPER — PRIOR TO CONNECTION - EXCAVATION BY DEVELOPER/CONTRACTOR NOTE: BOTTOM OF EXCAVATION TO BE 12" BELOW BOTTOM OF PIPE AND REASONABLY LEVEL 1. TAP CONNECTIONS TO AC (TRANSITE PIPE) 4" AND LARGER REQUIRE AN EXCAVATION 5 FT. IN WIDTH. (MAIN SIZE IS VARIABLE). 2. ALL EXCAVATIONS SHALL COMPLY WITH ALL FEDERAL, STATE, AND LOCAL REGULATIONS FOR PROTECTION OF WORKERS. 3. IF PIPE BELL IS EXPOSED IN TAP HOLE OR OTHER OBSTACLES ENCOUNTERED, CONTACT LOCAL WATER COMPANY DISTRICT PERSONNEL FOR FIELD REVIEW BEFORE COMPLETING EXCAVATION. 4. TAP HOLE SHOULD BE FREE OF WATER AND MUD TO ALLOW SAFE HANDLING OF HEAVY SLEEVES AND TAPPING MACHINE. 5. BLOCKING BEHIND TAP TO BE PER REQUIREMENTS ON DWG. NO. 0201-0601-SD6. MISSOURI AMERICAN WATER STANDARD CIVIL PATENT TAP EXCAVATION REQUIREMENTS DETAIL AMERICAN WATER DATE 11-13-08 USE DIMENSIONS ONLY PROJECT IP SCALE N.T.S. USE APPROVED DRAWINGS ONLY FOR CONSTRUCTION PURPOSES 0201-0601-SD52

- 1. COVER OVER TOP OF PIPE SHALL BE 42". IF GRADING PLANS RECEIVED BY THE ENGINEER/OWNER WITH THE REQUEST FOR WATER MAIN LAYOUT, INDICATE ADJUSTMENTS TO EXISTING GRADE, THEN PIPE SHALL BE INSTALLED TO MEET MINIMUM AND MAXIMUM COVER FROM PROPOSED GRADES SHOWN ON SAID PLANS. TOP OF FINISH CONCRETE TO BE A
- THRUST BLOCKS SHALL BE BUILT AGAINST UNDISTURBED SOIL TO PREVENT MOVEMENT OF FITTING.
- 3. NO THRUST BLOCKS TO BE PLACED IN SEWER LATERAL DITCHES,.
- THRUST BLOCKING MUST FIT IN EASEMENT, IN SOME CASES ADDITIONAL RESTRAINT MAY BE REQUIRED.
- 5. POLYETHYLENE ENCASEMENT ON ALL D.I. PIPE AND FITTINGS.

MINIMUM OF 26" FROM FINISH GRADE.

- 6. PIPE JOINTS AND BOLTS MUST BE ACCESSIBLE.
- 7. ALLOW SUFFICIENT CLEARANCE BETWEEN CONCRETE AND BOLTS FOR FUTURE MAINTENANCE.
- 8. ALL BOLTS SHALL BE PTFE POLYMER COATED BOLTS (EX. XYLAN,
- FLUOROKOTE #1), MINIMUM 1/2" DIAMETER. COAT EXPOSED ROD WITH APPROVED COATING AFTER CONCRETE HAS SET.
- 9. THRUST BLOCKING DETAILS ARE SHOWN HERE FOR TYPICAL INSTALLATIONS. IN SOME CASES, ADDITIONAL RESTRAINT MAY BE REQUIRED.
- 10. PORTLAND CEMENT CONCRETE USED FOR THRUST BLOCKS SHALL BE MIN 3000 PSI CONCRETE.
- 11. FOR UNSTABLE SOIL CONDITIONS, CHECK WITH ENGINEER FOR THRUST
- 12. FOR MAIN SIZES GREATER THAN 12", SEE ENGINEER FOR THRUST BLOCK DIMENSIONS.

MISSOURI AMERICAN WATER STANDARD THRUST BLOCK MISSOURI AMERICAN WATER ST. LOUIS, MO. 63141 DATE 09-16-11 USE DIMENSIONS ONLY PROJECT IP SCALE N.T.S.

USE APPROVED DRAWINGS ONLY FOR CONSTRUCTION PURPOSES 0201-0601-SD6

STATE OF MISSOURI MICHAEL L. PARSON, **GOVERNOR**



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OFFICE OF ADMINISTRATION DIVISION OF FACILITIES MANAGEMENT, DESIGN AND CONSTRUCTION

DEPARTMENT OF NATURAL RESOURCES **DIVISION OF STATE PARKS**

WATER AND SEWER **IMPROVEMENTS**

DR. EDMUND A. BABLER MEMORIAL STATE PARK **800 GUY PARK DRIVE** WILDWOOD, MISSOURI 63005

PROJECT # X2301-01 CDI PROJECT # 5917

SITE # **5201**

ASSET # **7815201059** REVISION: REVISION DATE

> REVISION: ISSUE DATE:


CAD DWG FILE: **X2301 DT-C-400.dwg** DRAWN BY: CHECKED BY: WMK DESIGNED BY: KDF

SHEET TITLE:

MO AMERICAN WATER COMPANY STANDARD DETAILS

SHEET NUMBER:

SHEET 45 OF 46 **AUGUST 9, 2024**

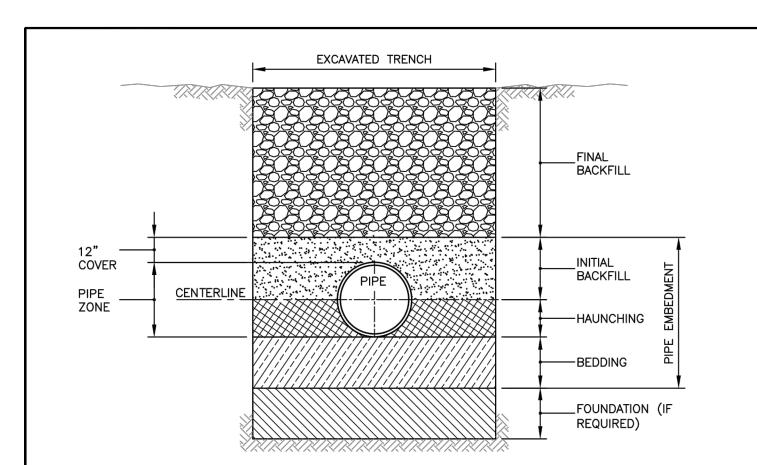

TRENCH TERMINOLOGY

FOUNDATION: A FOUNDATION IS NECESSARY ONLY WHEN NATIVE SOILS ARE UNSTABLE. FOR SUCH CONDITIONS, THE TRENCH IS OVER-EXCAVATED AND A LAYER OF SUPPORTIVE MATERIAL IS PLACED AND COMPACTED TO PROVIDE A FIRM FOUNDATION FOR THE SUBSEQUENT PIPE EMBEDMENT MATERIALS. MUST BE APPROVED BY THE ENGINEER PRIOR TO OVER-DIG.


EMBEDMENT: THIS ZONE IS THE MOST IMPORTANT IN TERMS OF PIPE PERFORMANCE. IT IS DIVIDED INTO THE FOLLOWING SUB ZONES:


- BEDDING: TYPICALLY SIX INCHES OF SUPPORTIVE, COMPACTED MATERIAL. THIS ZONE PROVIDES EVEN SUPPORT FOR THE PIPE AND BRINGS IT TO GRADE.
- HAUNCHING: EXTENDS FROM THE BOTTOM OF THE PIPE TO THE CENTERLINE OF THE PIPE. IT PROVIDES THE MOST RESISTANCE TO PIPE DEFLECTION. SPECIFYING PROPER MATERIALS AND COMPACTION ARE MOST IMPORTANT FOR THIS ZONE.
- INITIAL BACKFILL: EXTENDS FROM THE SPRINGLINE TO A POINT ABOVE THE TOP OF THE PIPE. THIS ZONE PROVIDES SOME PIPE SUPPORT AND HELPS TO PREVENT DAMAGE TO THE PIPE DURING PLACEMENT OF THE FINAL BACKFILL. THE COVER EXTENDS FROM THE TOP OF THE PIPE TO THE TOP OF THE INITIAL BACKFILL. THE DEPTH OF COVER SHOULD BE AS MUCH AS NECESSARY TO PROTECT THE PIPE DURING PLACEMENT OF THE FINAL BACKFILL. TWELVE INCHES IS A COMMON DEPTH OF COVER.

FINAL BACKFILL: THIS ZONE EXTENDS FROM THE TOP OF THE INITIAL BACKFILL TO THE TOP OF THE TRENCH. THIS ZONE HAS LITTLE INFLUENCE ON PIPE PERFORMANCE, BUT CAN BE IMPORTANT TO THE INTEGRITY OF ROADS AND STRUCTURES.

SEE SPECIFICATION SECTION 2210 FOR DESCRIPTION OF BACKFILL AND BEDDING MATERIAL.

REVISIONS	MISSOURI AMERICAN V CIVIL PIPE TRENCH TE DETAIL	RMINOLOGY
	MISSOURI AMERICA ST. LOUIS, MO.	
	MISSOURI AMERICAN WATER ENGINEERING 727 CRAIG ROAD ST. LOUIS, MO. 63141	*
	DRAWN BY KKM PROJECT ENG'R APPROVED DATE 11-13-08 PROJECT IP	AMERICAN WATER USE DIMENSIONS ONLY SCALE N.T.S.
	USE APPROVED DRAWINGS ONLY FOR CONSTRUCTION PURPOSES	0201-0601-SD53

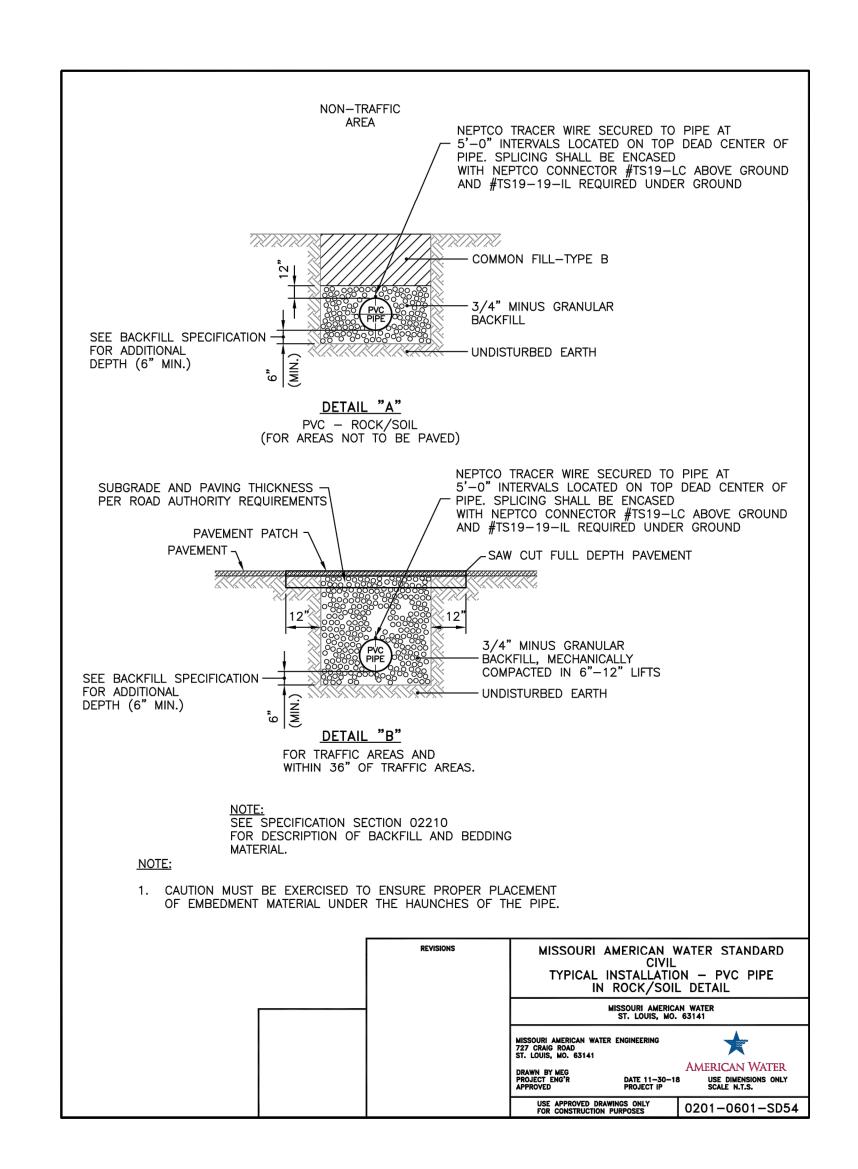

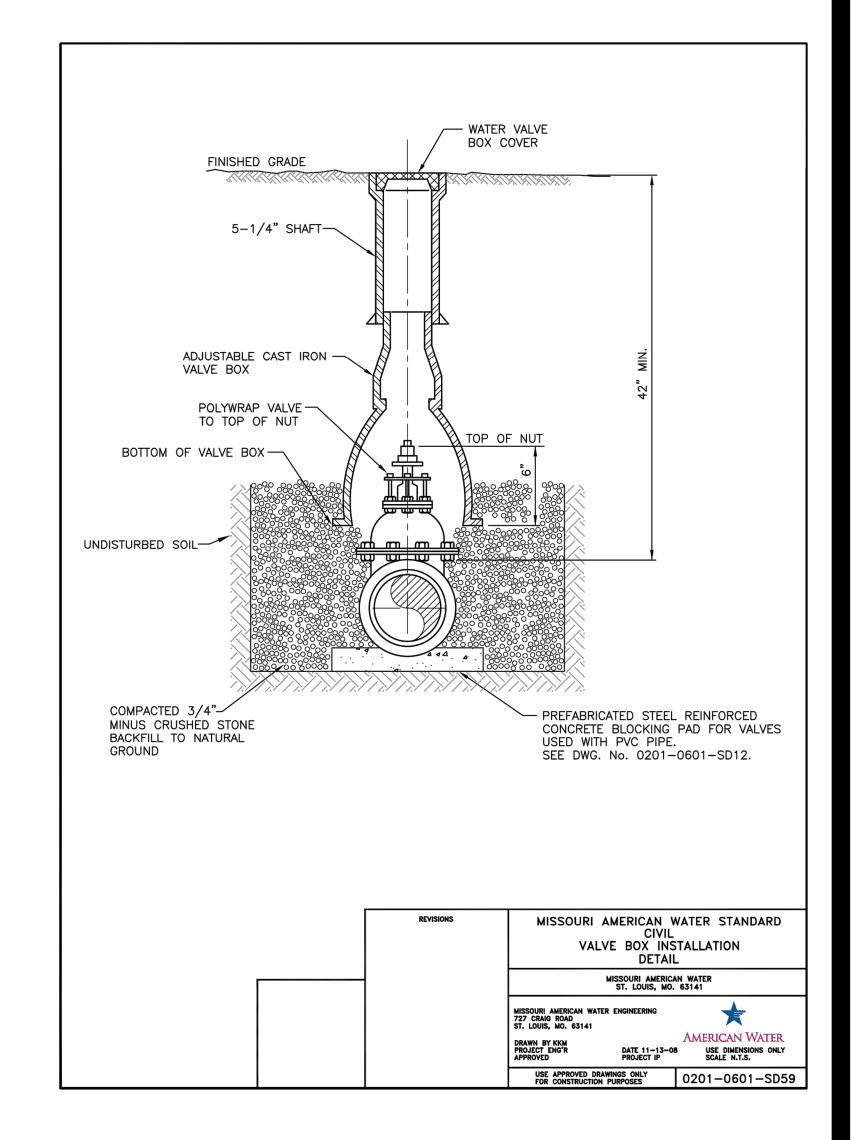

STATE OF MISSOURI MICHAEL L. PARSON, GOVERNOR



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OFFICE OF ADMINISTRATION DIVISION OF FACILITIES MANAGEMENT, DESIGN AND CONSTRUCTION

DEPARTMENT OF NATURAL RESOURCES
DIVISION OF STATE PARKS

WATER AND SEWER IMPROVEMENTS

DR. EDMUND A. BABLER MEMORIAL STATE PARK 800 GUY PARK DRIVE WILDWOOD, MISSOURI 63005

PROJECT # **X2301-01**CDI PROJECT # **5917**

SITE # **5201** ASSET # **7815201059**

REVISION:
DATE:
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REVISION:
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CAD DWG FILE: X2301 DT-C-400.dwg
DRAWN BY: KDF
CHECKED BY: WMK
DESIGNED BY: KDF

SHEET TITLE:

MO AMERICAN
WATER COMPANY
STANDARD DETAILS

SHEET NUMBER:

C-408

SHEET 46 OF 46 AUGUST 9, 2024