REPLACE 29 BASIC SITES WITH 25 NEW PREMIUM SITES LAKE OF THE OZARKS STATE PARK, KAISER, MISSOURI

SURVEY CONTROL POINTS

		TATE PLANE COORL		
NAD 83	, MISSOURI CENTH	RAL ZONE, NAVD 8	8, U.S. SURVE	Y FEET
POINT #	<u>NORTH</u>	<u>EAST</u>	<u>ELEVATION</u>	<u>DESCRIPTION</u>
CP2	814536.03	1618396.65	665.76	IRON
CP4	814254.39	1618403.98	671.27	IRON
CP5	814677.50	1618704.54	684.39	IRON
CP6	814861.03	1618303.86	664.57	IRON
CP7	813993.55	1618512.81	<i>674.22</i>	IRON
CP8	814035.43	1618743.52	693.49	IRON
CP9	814252.47	1618627.77	687.47	IRON
CP10	814374.05	1618741.71	695.19	IRON
CP12	814835.21	1618699.05	692.84	IRON

BENCH MARK

BM - MISSOURI DEPARTMENT OF TRANSPORTATION VRS NETWORK.

FLOODPLAIN NOTE

PORTIONS OF THIS PROPERTY ARE LOCATED IN ZONE "X" AREAS DETERMINED TO BE OUTSIDE THE 0.2% ANNUAL CHANCE FLOODPLAIN, AND SPECIAL FLOOD HAZARD AREAS, AS SHOWN BY FLOOD INSURANCE RATE MAP NUMBER 29029C0255D, DATED APRIL 18, 2018.



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DECODIDATION CLIEFT NO	
<u>DESCRIPTION SHEET NO.</u>	
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SITE PLAN	
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OWNER:

STATE OF MISSOURI

MICHAEL L. PARSON,

GOVERNOR

DEPARTMENT OF

NATURAL RESOURCES, DIVISION OF STATE PARKS

PROJECT

OFFICE OF ADMINISTRATION

MANAGEMENT:

DIVISION OF FACILITIES MANAGEMENT,


DESIGN AND CONSTRUCTION

DESIGNER: PROJECT NUMBER: SITE NUMBER: ENGINEERING SURVEYS & SERVICES

X2316-01 5306

ASSET NUMBER: 7815306134



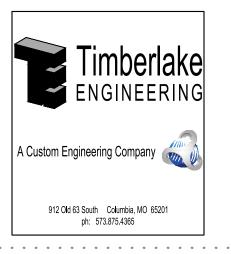

SHEET NUMBER:

G-001

1 OF 17 SHEETS

SEQUENCE OF EVENTS

- 1. PRIOR TO CONSTRUCTION, COORDINATE AND HAVE A PRE—CONSTRUCTION MEETING REGARDING SWPPP TRAINING WITH CONSTRUCTION PERSONNEL.
- 2. DETERMINE ALL UTILITY FIELD LOCATES AS NECESSARY WITH MISSOURI DEPARTMENT OF NATURAL RESOURCES, DIVISION OF STATE PARKS STAFF.
- 3. INSTALL ALL PERIMETER EROSION AND SEDIMENT CONTROL PER PLAN. DISTURB ONLY THE AREAS NECESSARY FOR INSTALLATION.
- 4. COMMENCE ALL CLEARING AND GRUBBING PER PLAN. THE CONTRACTOR SHALL REMOVE ALL STUMPS BY EXCAVATING TO INCLUDE REMOVAL OF ASSOCIATED ROOT SYSTEM. THE CONTRACTOR SHALL OBTAIN ALL
- 5. THE CONTRACTOR SHALL PERFORM A SITE SURVEY AFTER CLEARING AND GRUBBING IN ORDER TO CONFIRM TOPOGRAPHY ON THE PLANS IS ACCURATE PRIOR TO MASS GRADING.
- 6. STRIP TOPSOIL IN GRADING AREAS AND STOCKPILE AS SHOWN ON THE PLANS.
- 7. COMMENCE SITE GRADING.

REQUIRED PERMITS.

- 8. INSTALL STORM SEWERS PER PLAN. INSTALL INLET PROTECTION IMMEDIATELY UPON THE COMPLETION OF EACH STORM STRUCTURE.
- 9. INSTALL SITE UTILITIES AS GRADING ALLOWS.
- 10. FINALIZE CAMPER SITE PAD SUBGRADE PREPARATION AND COMMENCE CAMPER SITE CONSTRUCTION.
- 11. FINALIZE PAVEMENT SUBGRADE PREPARATION. INSTALL BASE MATERIAL AS REQUIRED FOR PAVED AREAS.
- 12. COMMENCE PAVEMENT AND SIDEWALK CONSTRUCTION.
- 13. COMPLETE FINISH GRADING, TOPSOIL PLACEMENT, SEED/SOD, AND MULCH ALL DISTURBED AREAS. EXCESS TOPSOIL SHALL BE DISPOSED OF ONSITE PER OWNERS DISCRETION.
- 14. REMOVE ALL TEMPORARY EROSION AND SEDIMENT CONTROLS ONCE ALL DISTURBED AREAS HAVE BEEN STABILIZED.

HAZARDOUS SUBSTANCE NOTE

- 1. SUBSTANCES REGULATED BY FEDERAL LAW UNDER THE RESOURCE CONSERVATION AND RECOVERY ACT (RCRA) OR THE COMPREHENSIVE ENVIRONMENTAL RESPONSE COMPENSATION AND LIABILITY ACT (CERCLA) WHICH ARE TRANSPORTED, STORED OR USED FOR MAINTENANCE, CLEANING OR REPAIRS SHALL BE MANAGED ACCORDING TO THE PROVISIONS OF RCRA AND CERCLA.
- 2. ALL PAINTS, SOLVENTS, PETROLEUM PRODUCTS AND PETROLEUM WASTE PRODUCTS (EXCEPT FUELS) AND STORAGE CONTAINERS (SUCH AS DRUMS, CANS OR CARTONS) SHALL BE STORED SUCH THAT THESE MATERIALS ARE NOT EXPOSED TO STORM WATER. SUFFICIENT PRACTICES OF SPILL PREVENTION, CONTROL AND/OR MANAGEMENT SHALL BE PROVIDED TO PREVENT ANY SPILLS OF THESE POLLUTANTS FROM ENTERING A WATER OF THE STATE. ANY CONTAINMENT SYSTEM USED TO IMPLEMENT THIS REQUIREMENT SHALL BE CONSTRUCTED OF MATERIALS COMPATIBLE WITH THE SUBSTANCES CONTAINED AND SHALL ALSO PREVENT THE CONTAMINATION OF GROUNDWATER.
- 3. THE APPLICANT SHALL NOTIFY BY TELEPHONE AND IN WRITING THE DEPARTMENT OF NATURAL RESOURCES, WATER POLLUTION CONTROL PROGRAM, POST OFFICE BOX 176, JEFFERSON CITY, MO 65102, 1-800-361-4827, OF ANY OIL SPILLS OR IF HAZARDOUS SUBSTANCES ARE FOUND DURING THE PROSECUTION OF WORK UNDER THIS PERMIT.

LEGEND ELECTRIC LINE TELECOMMUNICATIONS LINE UNDERGROUND ELECTRIC LINE SANITARY SEWER LINE STORM SEWER LINE WATER LINE **FENCE** _____X____ TREE & BRUSH LINE DRAINAGE SWALE ----EXISTING CONTOUR **ANCHOR** IRON R/W MARKER *∕ CP#* CONTROL POINT CORRUGATED METAL PIPE CO CLEANOUT ELECTRIC PEDESTAL FLARED END SECTION FLOW LINE FIRE PIT (SIZES VARY) UTILITY POLE TRASH POST WATER HYDRANT WATER METER *WATER VALVE* R ROCK DITCH CHECK SEDIMENT TRAP \odot SILT FENCE TEMPORARY DIVERSION DIKE TREE PRESERVATION BARRIER FINISH CONTOUR FINISH GRADE ELEVATION PROPOSED SANITARY SEWER LINE PROPOSED WATER LINE PROPOSED UNDERGROUND ELECTRIC PROPOSED STORM SEWER PROPOSED WATER VALVE THRUST BLOCK Ш THRUST COLLAR ASPHALT PAVEMENT HEAVY DUTY CONCRETE PAVEMENT REMOVAL TO BE REMOVED

GRADING AND STORM SEWER CONSTRUCTION NOTES

- ALL STORM SEWER PIPES AND INLETS SHALL MEET HEAVY DUTY TRAFFIC (HS20) LOADING AND BE INSTALLED ACCORDINGLY.
- 2. REINFORCED CONCRETE PIPE (RCP) SHALL BE INSTALLED PER THE "EMBEDMENT OF RCP STORM SEWER PIPE"
 DETAIL. PIPE CLASS SHALL BE APPROPRIATE TO DEPTH AND BEDDING MATERIAL AS SHOWN IN SCHEDULE.
- 3. ALL RCP PIPE JOINTS SHALL BE SOIL TIGHT PER CURRENT MODOT SPECIFICATIONS SECTION 726.3.1.
- 4. CONTRACTOR SHALL ADJUST ALL GRATES, MANHOLES, VALVE BOXES, ETC. TO MATCH FINISH GRADES, AS REQUIRED.
- 5. ALL STORM SEWER MANHOLES IN PAVED AREAS SHALL BE FLUSH WITH PAVEMENT, AND SHALL HAVE TRAFFIC BEARING RING & COVERS. MANHOLES IN UNPAVED AREAS SHALL BE FLUSH WITH FINISH GRADE. LIDS SHALL BE LABELED "STORM SEWER". TOP OF BOXES SHALL BE SLOPED TO MATCH PAVEMENT GRADE.
- 6. PIPE LENGTHS ARE GIVEN FROM CENTER OF STRUCTURE OR DOWNSTREAM END OF FLARED END SECTIONS.
- 7. ALL FLARED END SECTIONS FOR CONCRETE PIPE SHALL BE REINFORCED PRECAST CONCRETE.
- 8. ALL SITES USED FOR IMPORTING OR EXPORTING OF FILL MATERIAL SHALL HAVE AN ACTIVE MISSOURI DEPARTMENT OF NATURAL RESOURCES LAND DISTURBANCE PERMIT, AS REQUIRED.
- 9. CONTRACTOR SHALL REMOVE ALL TRASH AND DEBRIS, TREES AND BRUSH, AND OTHER MATERIAL CREATED AS A RESULT OF CONSTRUCTION. MATERIAL SHALL BE DISPOSED OF IN COMPLIANCE WITH ALL APPLICABLE LAWS AND REGULATIONS. NO BURNING ON SITE WILL BE ALLOWED.
- 10. CONTRACTOR SHALL REMOVE ALL STUMPS BY EXCAVATING TO INCLUDE REMOVAL OF ASSOCIATED ROOT SYSTEM.
- 11. CONTRACTOR SHALL NOT ADVANCE TRENCH EXCAVATION BEYOND AMOUNT THAT CAN ACCOMMODATE PIPE INSTALLATION AND BACKFILLING AT THE END OF EACH DAY.
- 12. ENGINEERED FILL SHOULD BE FREE OF FROZEN SOIL, ORGANICS, RUBBISH, LARGE ROCKS, WOOD, OR OTHER DELETERIOUS MATERIAL. COHESIVE FILLS SHOULD BE UNIFORMLY COMPACTED TO AT LEAST 95 PERCENT OF THE "STANDARD" MAXIMUM DRY DENSITY AND BE WITHIN -2 TO +4 PERCENT OF OPTIMUM MOISTURE CONTENT AS DESCRIBED BY ASTM D698. GRANULAR FILLS SHOULD BE UNIFORMLY COMPACTED TO AT LEAST 95 PERCENT OF THE "STANDARD" MAXIMUM DRY DENSITY. THE MOISTURE CONTENT SHOULD BE HIGH ENOUGH TO PROVIDE FOR PROPER COMPACTION BUT LOW ENOUGH TO PREVENT UNDUE PUMPING. PLACE FILL MATERIAL IN LOOSE LIFTS NOT TO EXCEED 8 INCHES IN THICKNESS.
- 13. ROCKS AND STONES THAT EXCEED THE THICKNESS OF THE LOOSE LIFT FILL LAYER SHOULD BE REMOVED AND DISPOSED OF OFF THE IMMEDIATE CONSTRUCTION AREA.
- 14. IMPORTED SOILS PROPOSED FOR USE AS FILL OR BACKFILL SHOULD BE REVIEWED AND ANALYZED BY THE GEOTECHNICAL ENGINEER PRIOR TO USE ON SITE. SOIL CLASSIFIED AS MH, OH, OL, OR PT (HIGH PLASTICITY SOILS AND ORGANIC SOILS) BY THE UNIFIED SOIL CLASSIFICATION SYSTEM (ASTM D2487) SHOULD NOT BE IMPORTED FOR USE AS ENGINEERED FILL. SUITABLE IMPORTED MATERIALS FOR GENERAL SITE FILL ARE THOSE THAT CLASSIFY AS GW, GM, GC, SC, AND CL IN ACCORDANCE WITH ASTM D 2487. MATERIALS CLASSIFIED AS CH SHOULD BE APPROVED BY THE GEOTECHNICAL ENGINEER PRIOR TO THEIR IMPORTATION AND ONLY USED OUTSIDE THE BUILDING PAD AT DEPTHS BELOW THE UPPER 2 FEET OF SUBGRADE. SUBJECT TO FINAL DESIGN REQUIREMENTS FOR WALL BACKFILL, SUITABLE IMPORTED MATERIALS FOR WALL AND TRENCH BACKFILL ARE THOSE THAT CLASSIFY AS GW, GP, GM, GC, SM, SW, SP, SC, AND CL IN ACCORDANCE WITH ASTM D2487.
- 15. FILLS PLACED IN AREAS WHERE THE NATURAL SLOPE IS GREATER THAN 5H:1V (HORIZONTAL TO VERTICAL) SHOULD BE BENCHED INTO THE EXISTING GRADE TO REDUCE THE POTENTIAL FOR SLIPPAGE BETWEEN EXISTING SLOPES AND ENGINEER FOLIPPAGE. BENCHES SHOULD BE LEVEL AND WIDE ENOUGH TO ACCOMMODATE COMPACTION AND EARTH
- 16. FILL AND SUBGRADE CONSTRUCTION SHOULD NOT BE STARTED ON FOUNDATION SOIL, PARTIALLY COMPLETED FILL, OR SUBGRADES THAT CONTAIN FROST OR ICE. FILL SHOULD NOT BE CONSTRUCTED USING FROZEN SOIL. FROZEN SOIL SHOULD BE REMOVED PRIOR TO PLACING FILL MATERIAL.
- 17. AFTER STRIPPING AND GRUBBING OPERATIONS ARE COMPLETED AND PRIOR TO FILL PLACEMENT, AREAS TO BE FILLED SHALL BE PROOF ROLLED USING A LOADED TANDEM AXLE DUMP TRUCK TO IDENTIFY SOFT AND UNSUITABLE AREAS. SOFT MATERIAL MAY BE MOISTURE CONDITIONED AND REUSED AS ENGINEERED FILL, UNSUITABLE AND DELETERIOUS MATERIAL SHALL BE REMOVED FROM SITE.
- 18. ALL NEW UTILITY TRENCHES SHOULD BE BACKFILLED IN ACCORDANCE WITH APPROPRIATE CONTROLLED ENGINEERED FILL SPECIFICATIONS.
- 19. FIELD DENSITY TESTS SHOULD BE CONDUCTED IN ACCORDANCE WITH ASTM D6938 (NUCLEAR METHODS) OR ASTM D
 1556 (SAND CONE METHOD). FIELD DENSITY TESTS SHOULD BE PERFORMED AT THE RATE OF ONE TEST PER 2,500
 SQUARE FEET PER LIFT WITHIN THE BUILDING AND 10,000 SQUARE FEET PER LIFT BENEATH PAVEMENTS,
 SIDEWALKS, AND OTHER POTENTIAL STRUCTURAL AREAS WITH A MINIMUM OF 3 TESTS PER LIFT AND ONE TEST
 PER 150 LINEAL FEET PER LIFT FOR FOUNDATION, TRENCH AND WALL BACKFILL.
- 20. BUILDING PAD AND PARKING AREAS SHALL BE PROOF—ROLLED WITH A FULLY LOADED TANDEM AXLE DUMP TRUCK TO IDENTIFY ANY SOFT OR UNSUITABLE AREAS, PRIOR TO BASE ROCK PLACEMENT. THE PROOF—ROLL SHALL BE OBSERVED BY THE PROJECT GEOTECHNICAL ENGINEER. AREAS IDENTIFIED AS UNSUITABLE SHALL BE OVER EXCAVATED AND RECONSTRUCTED WITH ENGINEERED FILL.
- 21. CONTRACTOR SHALL ASSURE POSITIVE DRAINAGE AWAY FROM ALL BUILDINGS FOR ALL LANDSCAPED AND PAVED AREAS.
- 22. CONTRACTOR SHALL PLACE STOCKPILED TOPSOIL FROM SITE IN ALL LANDSCAPE AREAS TO A MINIMUM DEPTH OF OF 6", UNLESS NOTED OTHERWISE IN PROJECT SPECIFICATIONS. ANY EXCESS TOPSOIL SHALL BE DISPOSED OF ONSITE PER OWNER.

CONSTRUCTION NOTES

- 1. All TREES AND BRUSH GENERATED FROM CLEARING AND GRUBBING OPERATIONS SHALL BE HAULED OFF SITE BY THE CONTRACTOR. OPEN BURRING WILL NOT BE ALLOWED WITHIN THE PROJECT LIMITS.
- 2. THE CONTRACTOR IS SPECIFICALLY CAUTIONED THAT THE LOCATION AND/OR ELEVATION OF EXISTING UTILITIES AS SHOWN ON THESE PLANS IS BASED ON RECORDS OF THE VARIOUS UTILITY COMPANIES, AND WHERE POSSIBLE, MEASUREMENTS TAKEN IN THE FIELD. THE INFORMATION IS NOT TO BE RELIED ON AS BEING EXACT OR COMPLETE. THE CONTRACTOR MUST CALL THE APPROPRIATE UTILITY COMPANIES AT LEAST 72 HOURS BEFORE ANY EXCAVATION TO REQUEST EXACT FIELD LOCATION OF UTILITIES. IT SHALL BE THE RESPONSIBILITY OF THE CONTRACTOR TO RELOCATE ALL EXISTING UTILITIES WHICH CONFLICT WITH THE PROPOSED IMPROVEMENTS SHOWN ON THE PLANS.
- 3. CONSTRUCTION SHALL COMPLY WITH ALL APPLICABLE GOVERNING CODES AND BE CONSTRUCTED TO SAME.
- 4. IT SHALL BE THE RESPONSIBILITY OF THE CONTRACTOR TO PROTECT ALL IDENTIFIED PROPERTY CORNERS, LAND SURVEY CORNERS, AND ACCESSORIES. THE CONTRACTOR SHALL CAUSE THE CORNERS AND ACCESSORIES TO BE REFERENCED BY A LICENSED LAND SURVEYOR, AND ANY SUCH CORNER OR ACCESSORIES DISTURBED OR DESTROYED DURING CONSTRUCTION SHALL BE RESET BY THE SURVEYOR AT THE ORIGINAL LOCATION, AND FILE THE RESTORATIONS AND MONUMENT DOCUMENTS AS THE LAW REQUIRES.
- 5. CONTRACTOR SHALL SUBMIT SHOP DRAWINGS TO ENGINEERING SURVEYS AND SERVICES FOR REVIEW AND APPROVAL FOR ALL MATERIALS BEFORE ORDERING.
- 6. ALL DIMENSIONS ARE TO BACK OF CURB, FACE OF SIDEWALK, OR EDGE OF PAVEMENT, UNLESS OTHERWISE NOTED.
- 7. ALL STRIPING SHALL BE 4" WIDE WHITE LINES, ACCESSIBLE SPACES SHALL BE 4" WIDE BLUE LINES AND ALL STRIPING SHALL BE A MINIMUM OF 2 COATS.
- 8. CONTRACTOR SHALL ADJUST AND/OR CUT EXISTING PAVEMENT AS NECESSARY TO ASSURE A SMOOTH FIT AND
- 9. STANDARD DUTY AND HEAVY DUTY PAVEMENT MAY BE CONCRETE OR ASPHALT UNLESS OTHERWISE NOTED.
- 10. CONTRACTOR SHALL NOTIFY ADJACENT PROPERTY OWNERS IN WRITING 30 DAYS PRIOR TO CONSTRUCTION.
- 11. IF A CONFLICT EXISTS BETWEEN THE CIVIL PLANS AND CIVIL SPECIFICATIONS, THE CIVIL PLANS SHALL GOVERN.
- 12. ALL INCIDENTAL ITEMS INCLUDING BUT NOT LIMITED TO SIGNS, PAVEMENT MARKING, PAVEMENT, CURBS, TRUNCATED DOMES, FENCING, LANDSCAPING, IRRIGATION, ETC. EITHER DAMAGED OR REMOVED DURING CONSTRUCTION SHALL BE RETURNED TO ORIGINAL CONDITIONS BY THE CONTRACTOR.

STORM WATER POLLUTION PREVENTION PLAN NOTES

- CONTRACTOR SHALL FOLLOW THE STORM WATER POLLUTION PREVENTION PLAN (SWPPP) AND ADHERE TO ALL
 TERMS & CONDITIONS AS OUTLINED IN THE GENERAL N.P.D.E.S. PERMIT FOR STORM WATER DISCHARGE ASSOCIATED
 WITH CONSTRUCTION ACTIVITIES. A COPY OF THIS PLAN, SWPPP, AND ALL PERMITS SHALL REMAIN ON SITE
 THROUGHOUT CONSTRUCTION.
- 2. NO LAND CLEARING OR GRADING SHALL BEGIN UNTIL ALL EROSION CONTROL MEASURES HAVE BEEN INSTALLED AND APPROVAL HAS BEEN RECEIVED FROM AUTHORITIES.
- 3. IMMEDIATELY UPON COMPLETION OF FINISH GRADING IN EACH AREA, ALL LANDSCAPING AREAS SHALL BE STABILIZED PER PLANS AND/OR SPECIFICATIONS.
- 4. SHOULD CONSTRUCTION STOP FOR LONGER THAN 14 DAYS, THE SITE SHALL BE SEEDED AS SPECIFIED IN THE
- 5. THIS PLAN SHALL NOT BE CONSIDERED ALL INCLUSIVE AS THE CONTRACTOR SHALL TAKE ALL NECESSARY PRECAUTIONS TO PREVENT SOIL SEDIMENT FROM LEAVING THE SITE.
- 6. CONTRACTOR SHALL COMPLY WITH ALL STATE AND LOCAL ORDINANCES THAT APPLY.
- 7. ADDITIONAL EROSION AND SEDIMENT CONTROL MEASURES SHALL BE INSTALLED IF DEEMED NECESSARY BY ON SITE
- 8. CONTRACTOR SHALL BE RESPONSIBLE TO TAKE WHATEVER MEANS NECESSARY TO ESTABLISH PERMANENT SOIL STABILIZATION.
- 9. CONTRACTOR SHALL REMOVE ALL TRASH, DEBRIS, TREES & BRUSH AND OTHER MATERIAL CREATED AS A RESULT OF THE CONSTRUCTION WORK AND THE SITE SHALL BE RETURNED TO ITS ORIGINAL CONDITION.
- 10. ALL PERIMETER LANDSCAPED AREAS SHALL BE GRASS COVERED.
- 11. THE SITE CONTRACTOR SHALL INCLUDE MAINTENANCE OF ALL BMP'S AS PART OF THEIR CONTRACT AND SHALL BE RESPONSIBLE FOR THE PROJECT UNTIL THE SITE HAS OBTAINED FINAL STABILIZATION IN ACCORDANCE WITH THE NPDES PERMIT AND SWPPP.

UTILITY CONSTRUCTION NOTES

- 1. SITE CONTRACTOR SHALL COORDINATE WITH MISSOURI DEPARTMENT OF NATURAL RESOURCES, DIVISION OF STATE PARKS STAFF WHEN LOCATING UTILITIES WITHIN THE PARK.
- 2. LOCATION OF SITE UTILITIES SHALL BE VERIFIED BY CONTRACTOR WITH MISSOURI DEPARTMENT OF NATURAL RESOURCES, DIVISION OF STATE PARKS STAFF AND THE PROPER UTILITY COMPANY PROVIDING SERVICE PRIOR TO THE START OF CONSTRUCTION.
- 3. EXISTING UTILITIES SHALL BE VERIFIED IN FIELD PRIOR TO INSTALLATION OF ANY NEW LINES.
- 4. UTILITY TIE-INS ARE SHOWN IN APPROXIMATE LOCATIONS. REFER TO MEP PLANS FOR EXACT TIE-IN OF ALL UTILITIES.
- 5. SITE CONTRACTOR SHALL COORDINATE WITH ALL UTILITY COMPANIES AND MISSOURI DEPARTMENT OF NATURAL RESOURCES, DIVISION OF STATE PARKS STAFF FOR INSTALLATION REQUIREMENTS AND SPECIFICATIONS. CONTRACTOR IS RESPONSIBLE FOR COMPLYING WITH THE SPECIFICATIONS OF CITY OF OSAGE BEACH WITH REGARDS TO MATERIALS AND INSTALLATION OF THE SEWER LINES AND MISSOURI DEPARTMENT OF NATURAL RESOURCES FOR WATER LINES.
- 6. SITE CONTRACTOR WILL BE RESPONSIBLE FOR ALL TAP AND TIE ON FEES REQUIRED, AS WELL AS COST OF UNDERGROUND SERVICE CONNECTIONS TO THE BUILDING.
- 7. ALL TRENCHING, PIPE LAYING, AND BACKFILLING SHALL BE IN ACCORDANCE WITH FEDERAL OSHA REGULATIONS, BACKFILL OF TRENCHES THROUGH ANY IMPROVED AREAS, SUCH AS STREET, DRIVES OR PARKING LOTS SHALL BE COMPACTED TO MINIMUM 95% STANDARD PROCTOR DENSITY (ASTM D-698).
- 8. PROPOSED ELECTRIC LINES ARE SHOWN FOR COORDINATION PURPOSES ONLY. SYSTEM DESIGN PREPARED BY EACH RESPECTIVE AGENCY. REFER TO MEP PLANS FOR CONDUIT REQUIREMENTS.
- 9. ALL UNDERGROUND UTILITY CONDUITS SHALL BE PLACED 48" BELOW FINISH GRADE UNLESS NOTED OTHERWISE.
- 10. WATER MAINS SHALL BE LAID AT LEAST 10 FEET HORIZONTALLY, MEASURED EDGE TO EDGE, FROM ANY EXISTING OR PROPOSED SANITARY SEWER. WATER MAINS CROSSING SANITARY SEWERS SHALL BE LAID TO PROVIDE A MINIMUM VERTICAL CLEAR DISTANCE OF 18 INCHES BETWEEN THE OUTSIDE OF THE WATER MAIN AND THE OUTSIDE OF THE SANITARY SEWER. CENTER A FULL LENGTH OF WATER MAIN OVER OR UNDER THE SEWER SO BOTH WATER MAIN JOINTS ARE AS FAR FROM THE SEWER AS POSSIBLE. AT SANITARY SEWER CROSSINGS, PLACE COMPACTED CLAY SOIL BACKFILL 18 INCHES ABOVE OR BELOW THE WATER MAIN FOR A DISTANCE OF AT LEAST 10 FEET ON EITHER SIDE OF THE SANITARY SEWER. CONTRACTOR SHALL NOTIFY ENGINEER IF HORIZONTAL AND VERTICAL SEPARATION CANNOT BE PROVIDED.
- 11. ALL UNDERGROUND LINES SHALL BE INSTALLED, INSPECTED AND APPROVED BEFORE BACKFILLING.
- 12. TOPS OF EXISTING ELECTRIC, SANITARY, STORM, WATER, TELECOMMUNICATION, GAS, IRRIGATION, CHILLED WATER, AND STEAM STRUCTURES SHALL BE RAISED AS NECESSARY TO BE FLUSH WITH PROPOSED FINISHED ELEVATIONS.
- 13. ALL CONCRETE FOR ENCASEMENTS SHALL HAVE A MINIMUM 28 DAY COMPRESSION STRENGTH OF 3000 P.S.I.
- 14. ALL NECESSARY INSPECTIONS AND/OR CERTIFICATIONS REQUIRED BY CODE AND/OR UTILITY SERVICE COMPANIES SHALL BE PERFORMED PRIOR TO ANNOUNCED BUILDING POSSESSION AND THE FINAL CONNECTION OF SERVICE.
- 15. PVC CONDUIT SHALL BE SCHEDULE 40 PVC WITH LONG SWEEPS ONLY (36" MINIMUM RADIUS) AND CONTAIN PULLTAPE, UNLESS OTHERWISE NOTED.
- 16. A MINIMUM 18" OF VERTICAL SEPARATION SHALL BE MAINTAINED BETWEEN THE OUTSIDE OF THE ELECTRIC CONDUIT AND THE OUTSIDE OF THE WATER, STORM SEWER, SANITARY SEWER, OR GAS PIPE AT ALL CROSSINGS.
- 17. STUBS FOR FUTURE UTILITIES SHOULD BE CLEARLY MARKED AND ES&S CONTACTED FOR DATA COLLECTION.

UTILITY NOTES

THE LOCATIONS, SIZES, AND MATERIAL TYPES OF UNDERGROUND UTILITIES INDICATED ON THE PLAT, NOT VISIBLE OR APPARENT FROM THE SURFACE, ARE SHOWN IN THEIR APPROXIMATE LOCATIONS FROM A MISSOURI ONE CALL SYSTEM LOCATE, OR UTILITY COMPANY RECORDS AND WERE NOT VERIFIED IN THE FIELD. UNDERGROUND UTILITY SERVICES TO BUILDINGS WERE NOT LOCATED.

WA TE

ELECTRIC

AMEREN MISSOURI

WILMORE LANE

LAKE OZARK, MISSOURI 65049

CONTACT: 800-552-7583

TELECOMMUNICATIONS AT&T ADDRESS

SANITARY SEWER

STORM SEWER


CONTACT:

SITE CONTRACTOR SHALL CONTACT AMEREN—MISSOURI TO COORDINATE INSTALLATION OF ELECTRIC SERVICES. RESPONSIBILITY OF INSTALLATION SHALL BE AS FOLLOWS.

ELECTRIC NOTES

SUPPLIED BY:	INSTALLED BY:
	CONTRACTOR
CONTRACTOR	CONTRACTOR UTILITY
	UTILITY
UTILITY	UTILITY
CONTRACTOR	CONTRACTOR
CONTRACTOR	CONTRACTOR
U IILI I Y	UTILITY UTILITY
	UTILITY CONTRACTOR

STATE OF MISSOURI MICHAEL L. PARSON, GOVERNOR

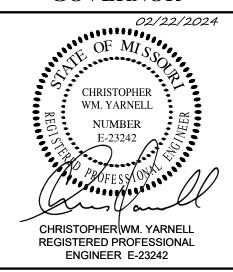



OFFICE OF ADMINISTRATION DIVISION OF FACILITIES MANAGEMENT, DESIGN AND CONSTRUCTION

DEPARTMENT OF NATURAL RESOURCES, DIVISION OF STATE PARKS

LAKE OF THE OZARKS
STATE PARK
REPLACE 29 BASIC SITES WITH 25
NEW PREMIUM SITES

LAKE OF THE OZARKS STATE PARK CAMPGROUND #4 MO ROUTE 134 KAISER, MISSOURI 65047 CAMDEN COUNTY

PROJECT # X2316-01 SITE # 5306 ASSET # 7815306134

REVISION:
DATE:
REVISION:
DATE:
REVISION:
DATE:
ISSUE DATE: 02/22/2024

CAD DWG FILE:XXX
DRAWN BY: CLR
CHECKED BY: CWY
DESIGNED BY: CWY

SHEET TITLE:


GENERAL NOTES


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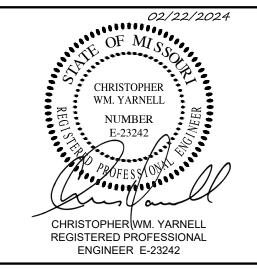
G-002

2 OF 17 SHEETS

02/22/2024



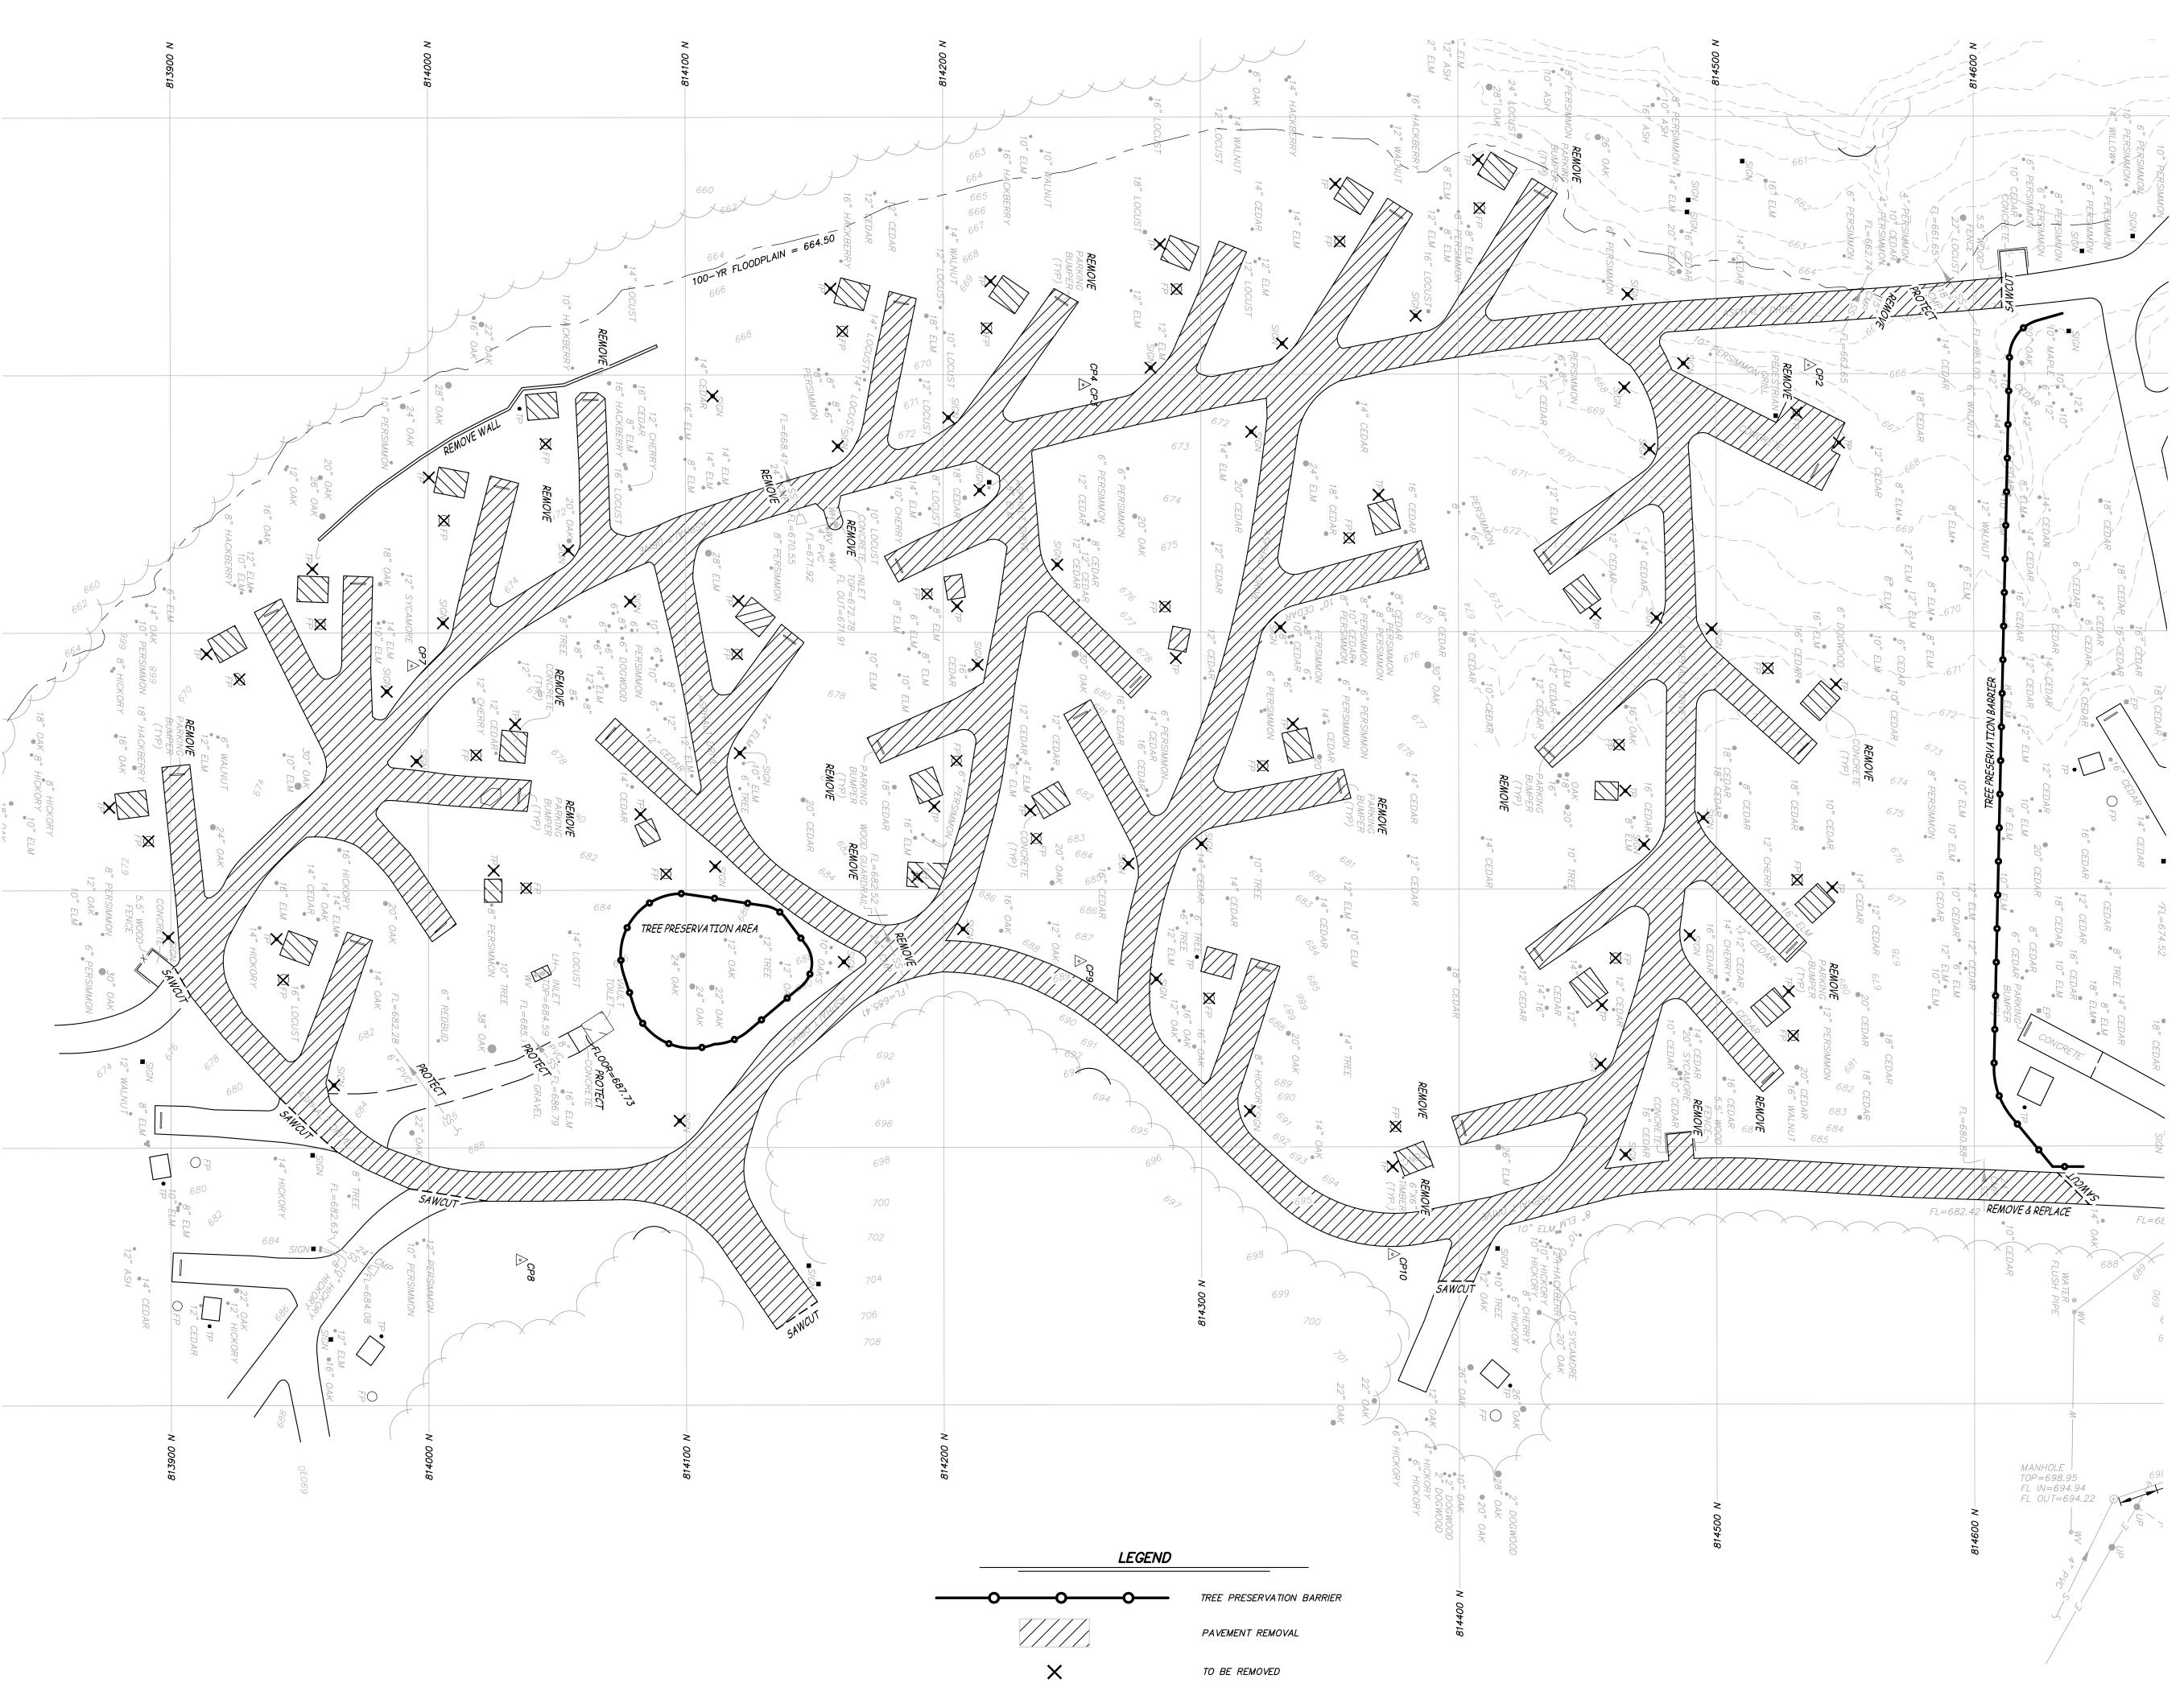

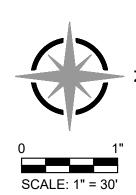



OFFICE OF ADMINISTRATION DIVISION OF FACILITIES MANAGEMENT, DESIGN AND CONSTRUCTION

DEPARTMENT OF NATURAL RESOURCES, DIVISION OF STATE PARKS

LAKE OF THE OZARKS
STATE PARK
REPLACE 29 BASIC SITES WITH 25
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LAKE OF THE OZARKS STATE PARK CAMPGROUND #4 MO ROUTE 134 KAISER, MISSOURI 65047 CAMDEN COUNTY

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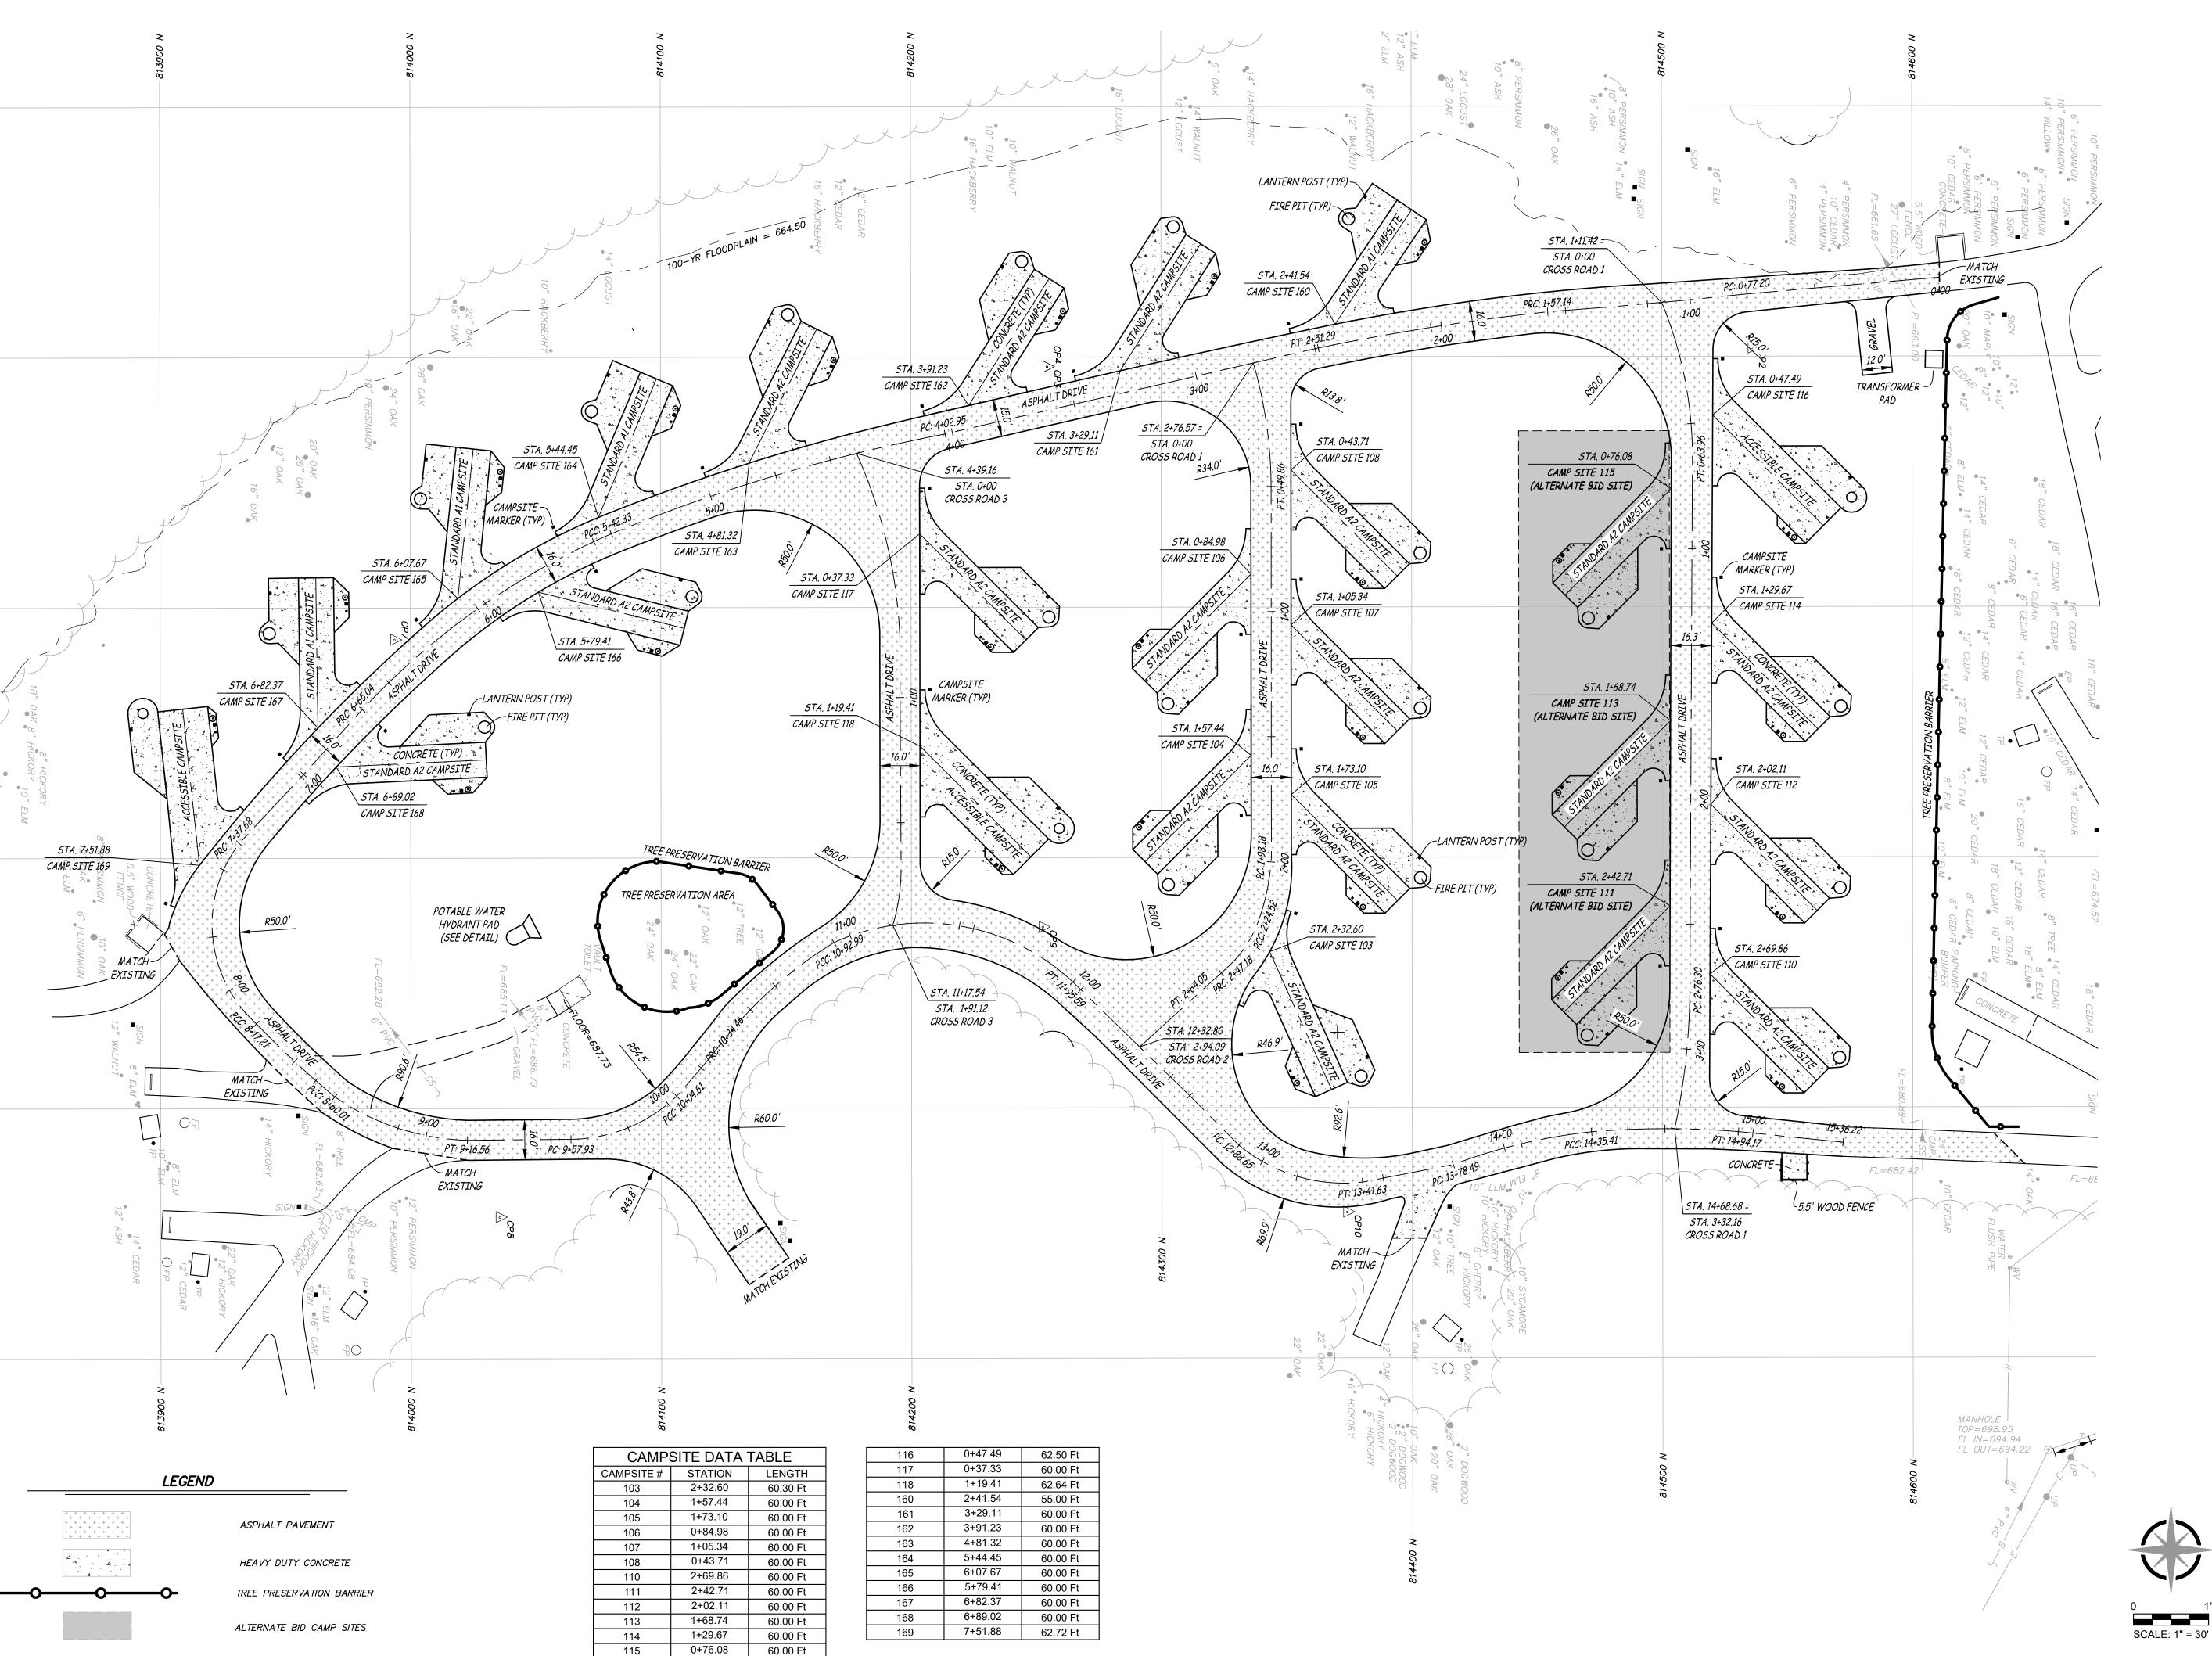
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DRAWN BY: CLR
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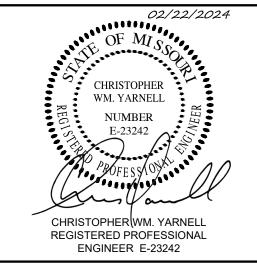
DEMOLITION PLAN

SHEET NUMBER:

C-10









OFFICE OF ADMINISTRATION DIVISION OF FACILITIES MANAGEMENT, **DESIGN AND CONSTRUCTION**

DEPARTMENT OF NATURAL RESOURCES, **DIVISION OF STATE PARKS**

LAKE OF THE OZARKS STATE PARK REPLACE 29 BASIC SITES WITH 25 NEW PREMIUM SITES

LAKE OF THE OZARKS STATE PARK CAMPGROUND #4 MO ROUTE 134 KAISER, MISSOURI 65047 CAMDEN COUNTY

PROJECT # X2316-X01 5306 7815306134 ASSET#

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CHECKED BY: CWY
DESIGNED BY: CWY


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SITE PLAN


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C-102







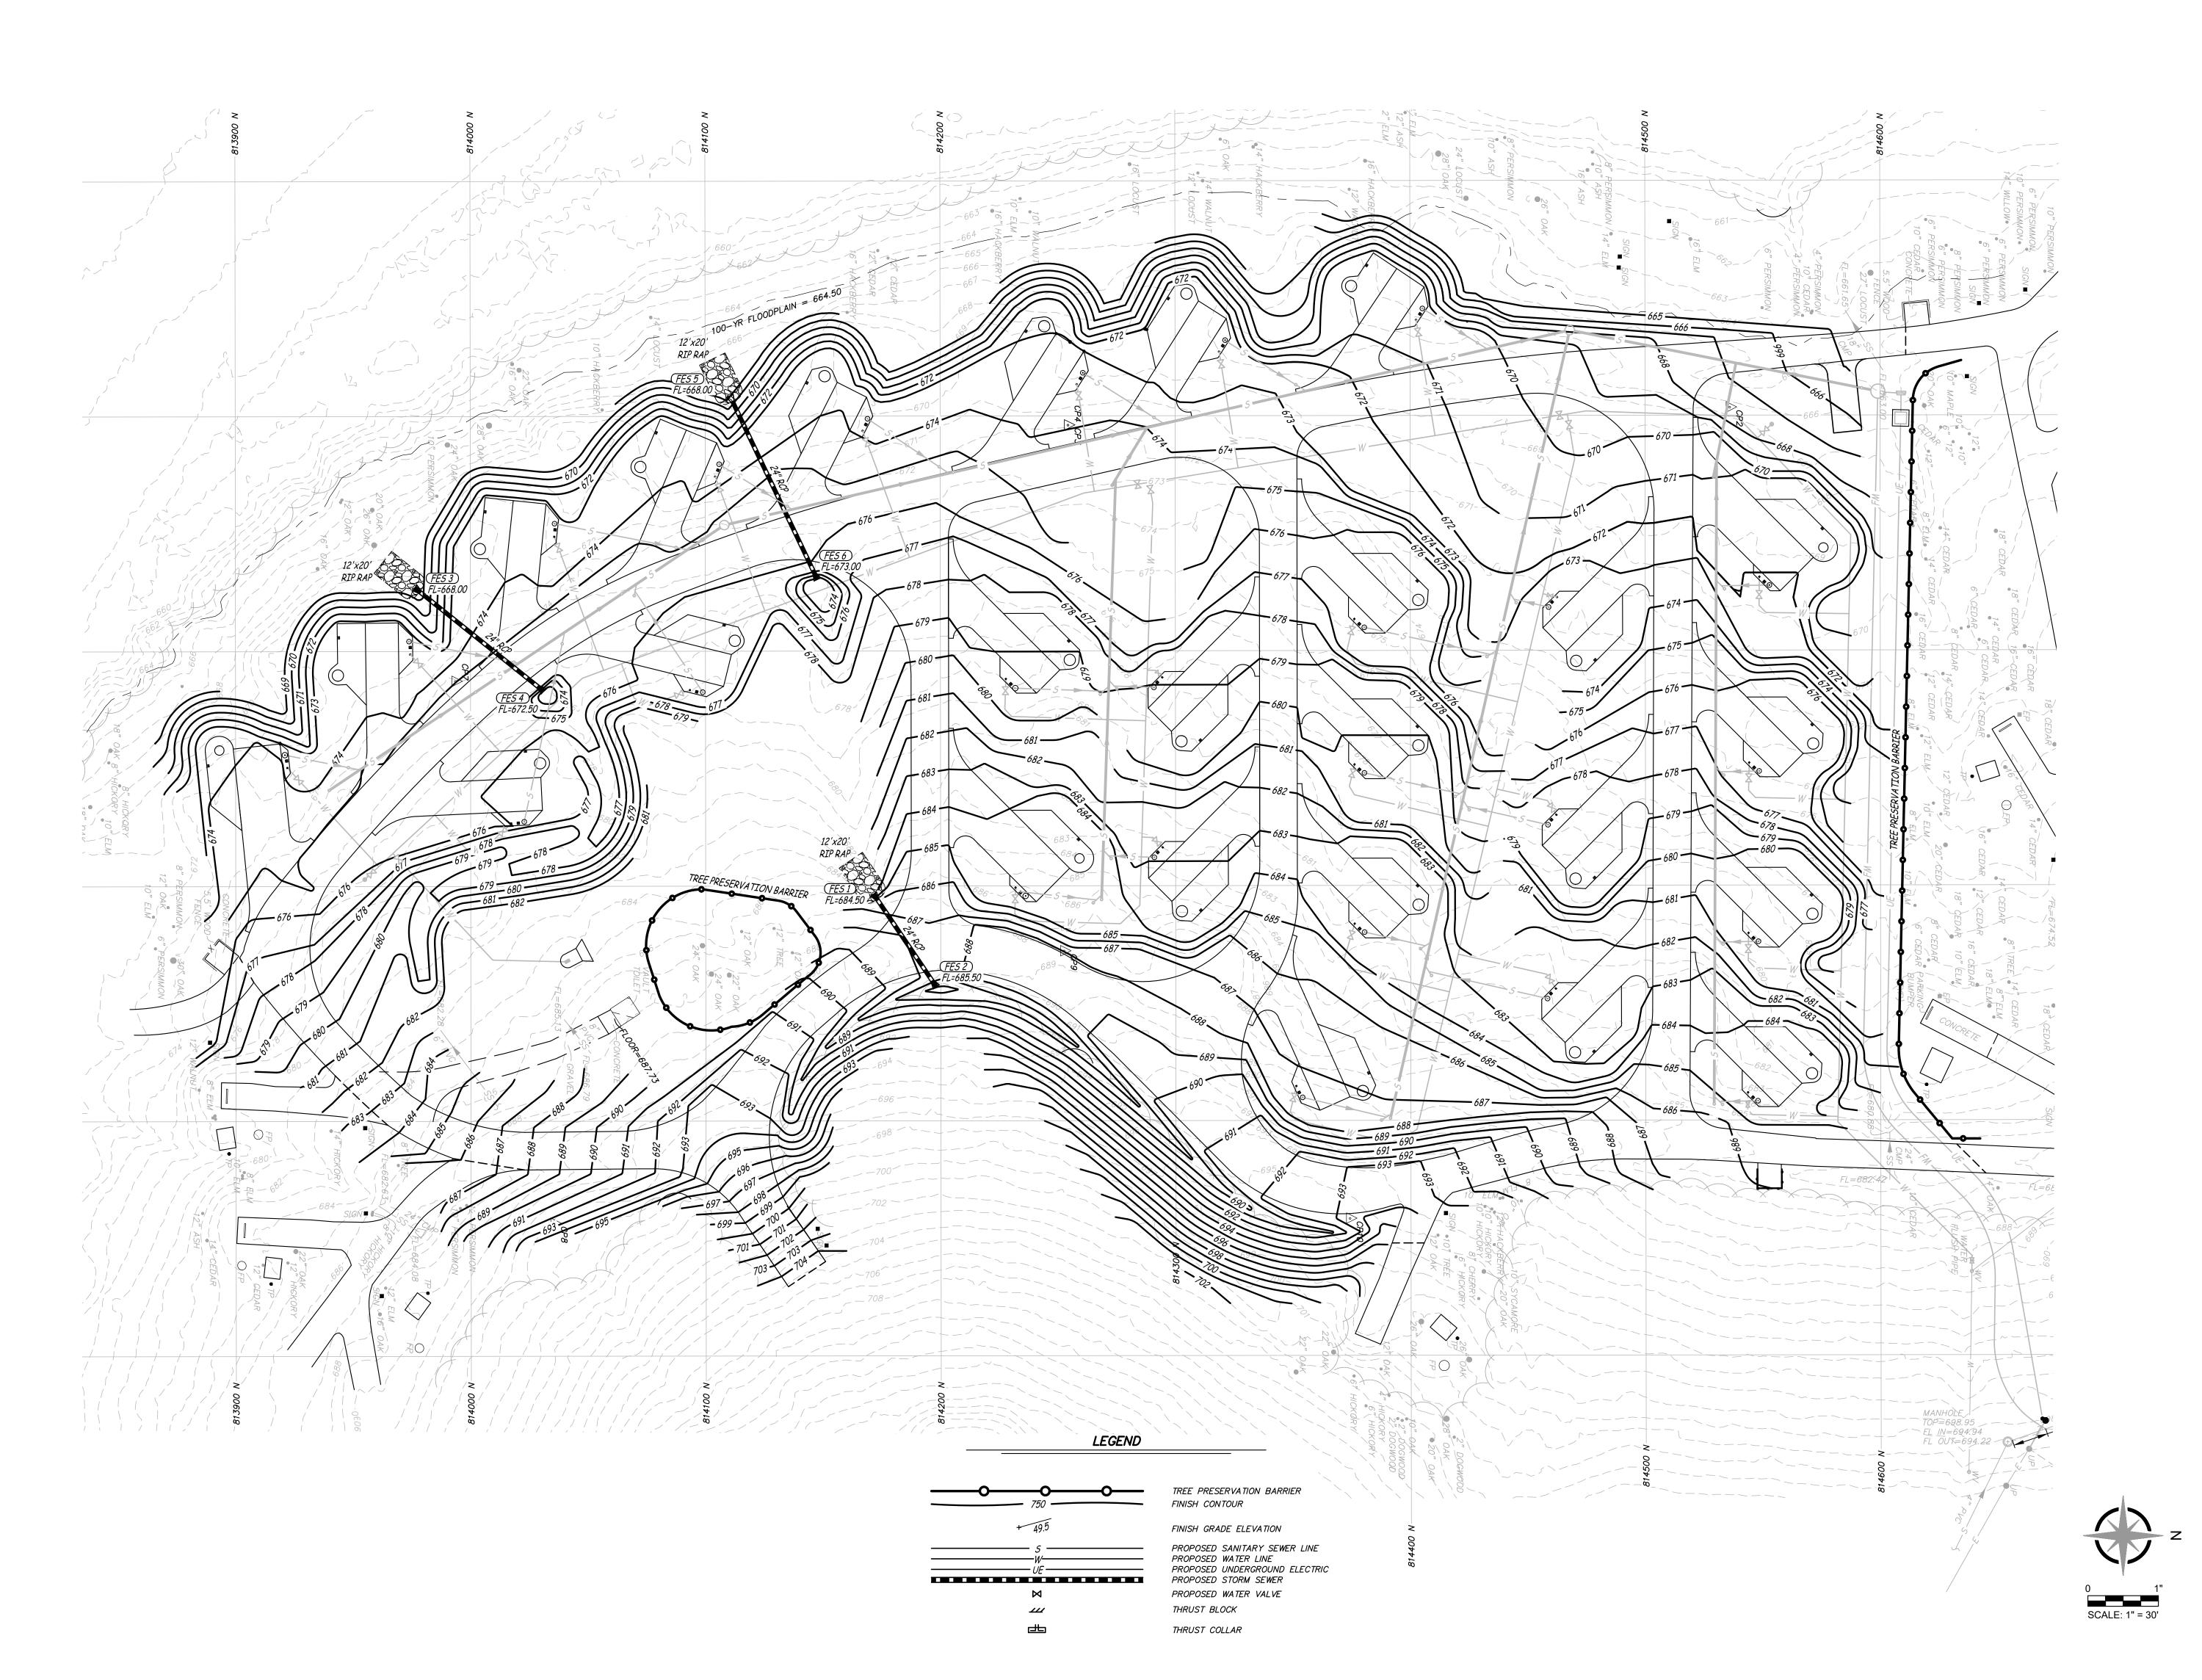

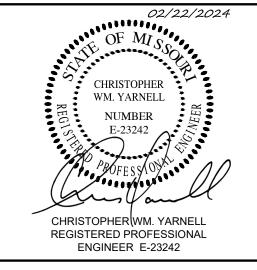

OFFICE OF ADMINISTRATION DIVISION OF FACILITIES MANAGEMENT, DESIGN AND CONSTRUCTION

DEPARTMENT OF NATURAL RESOURCES DIVISION OF STATE PARKS

LAKE OF THE OZARKS
STATE PARK
REPLACE 29 BASIC SITES WITH 25
NEW PREMIUM SITES

LAKE OF THE OZARKS STATE PARK CAMPGROUND #4 MO ROUTE 134 KAISER, MISSOURI 65047 CAMDEN COUNTY

PROJECT # X2316-01 SITE # 5306 ASSET # 7815306134

REVISION:
DATE:
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REVISION:
DATE:
ISSUE DATE: 02/22/2024


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CHECKED BY: CWY
DESIGNED BY: CWY

SHEET TITLE:

GRADING PLAN

SHEET NUMBER:

C-103

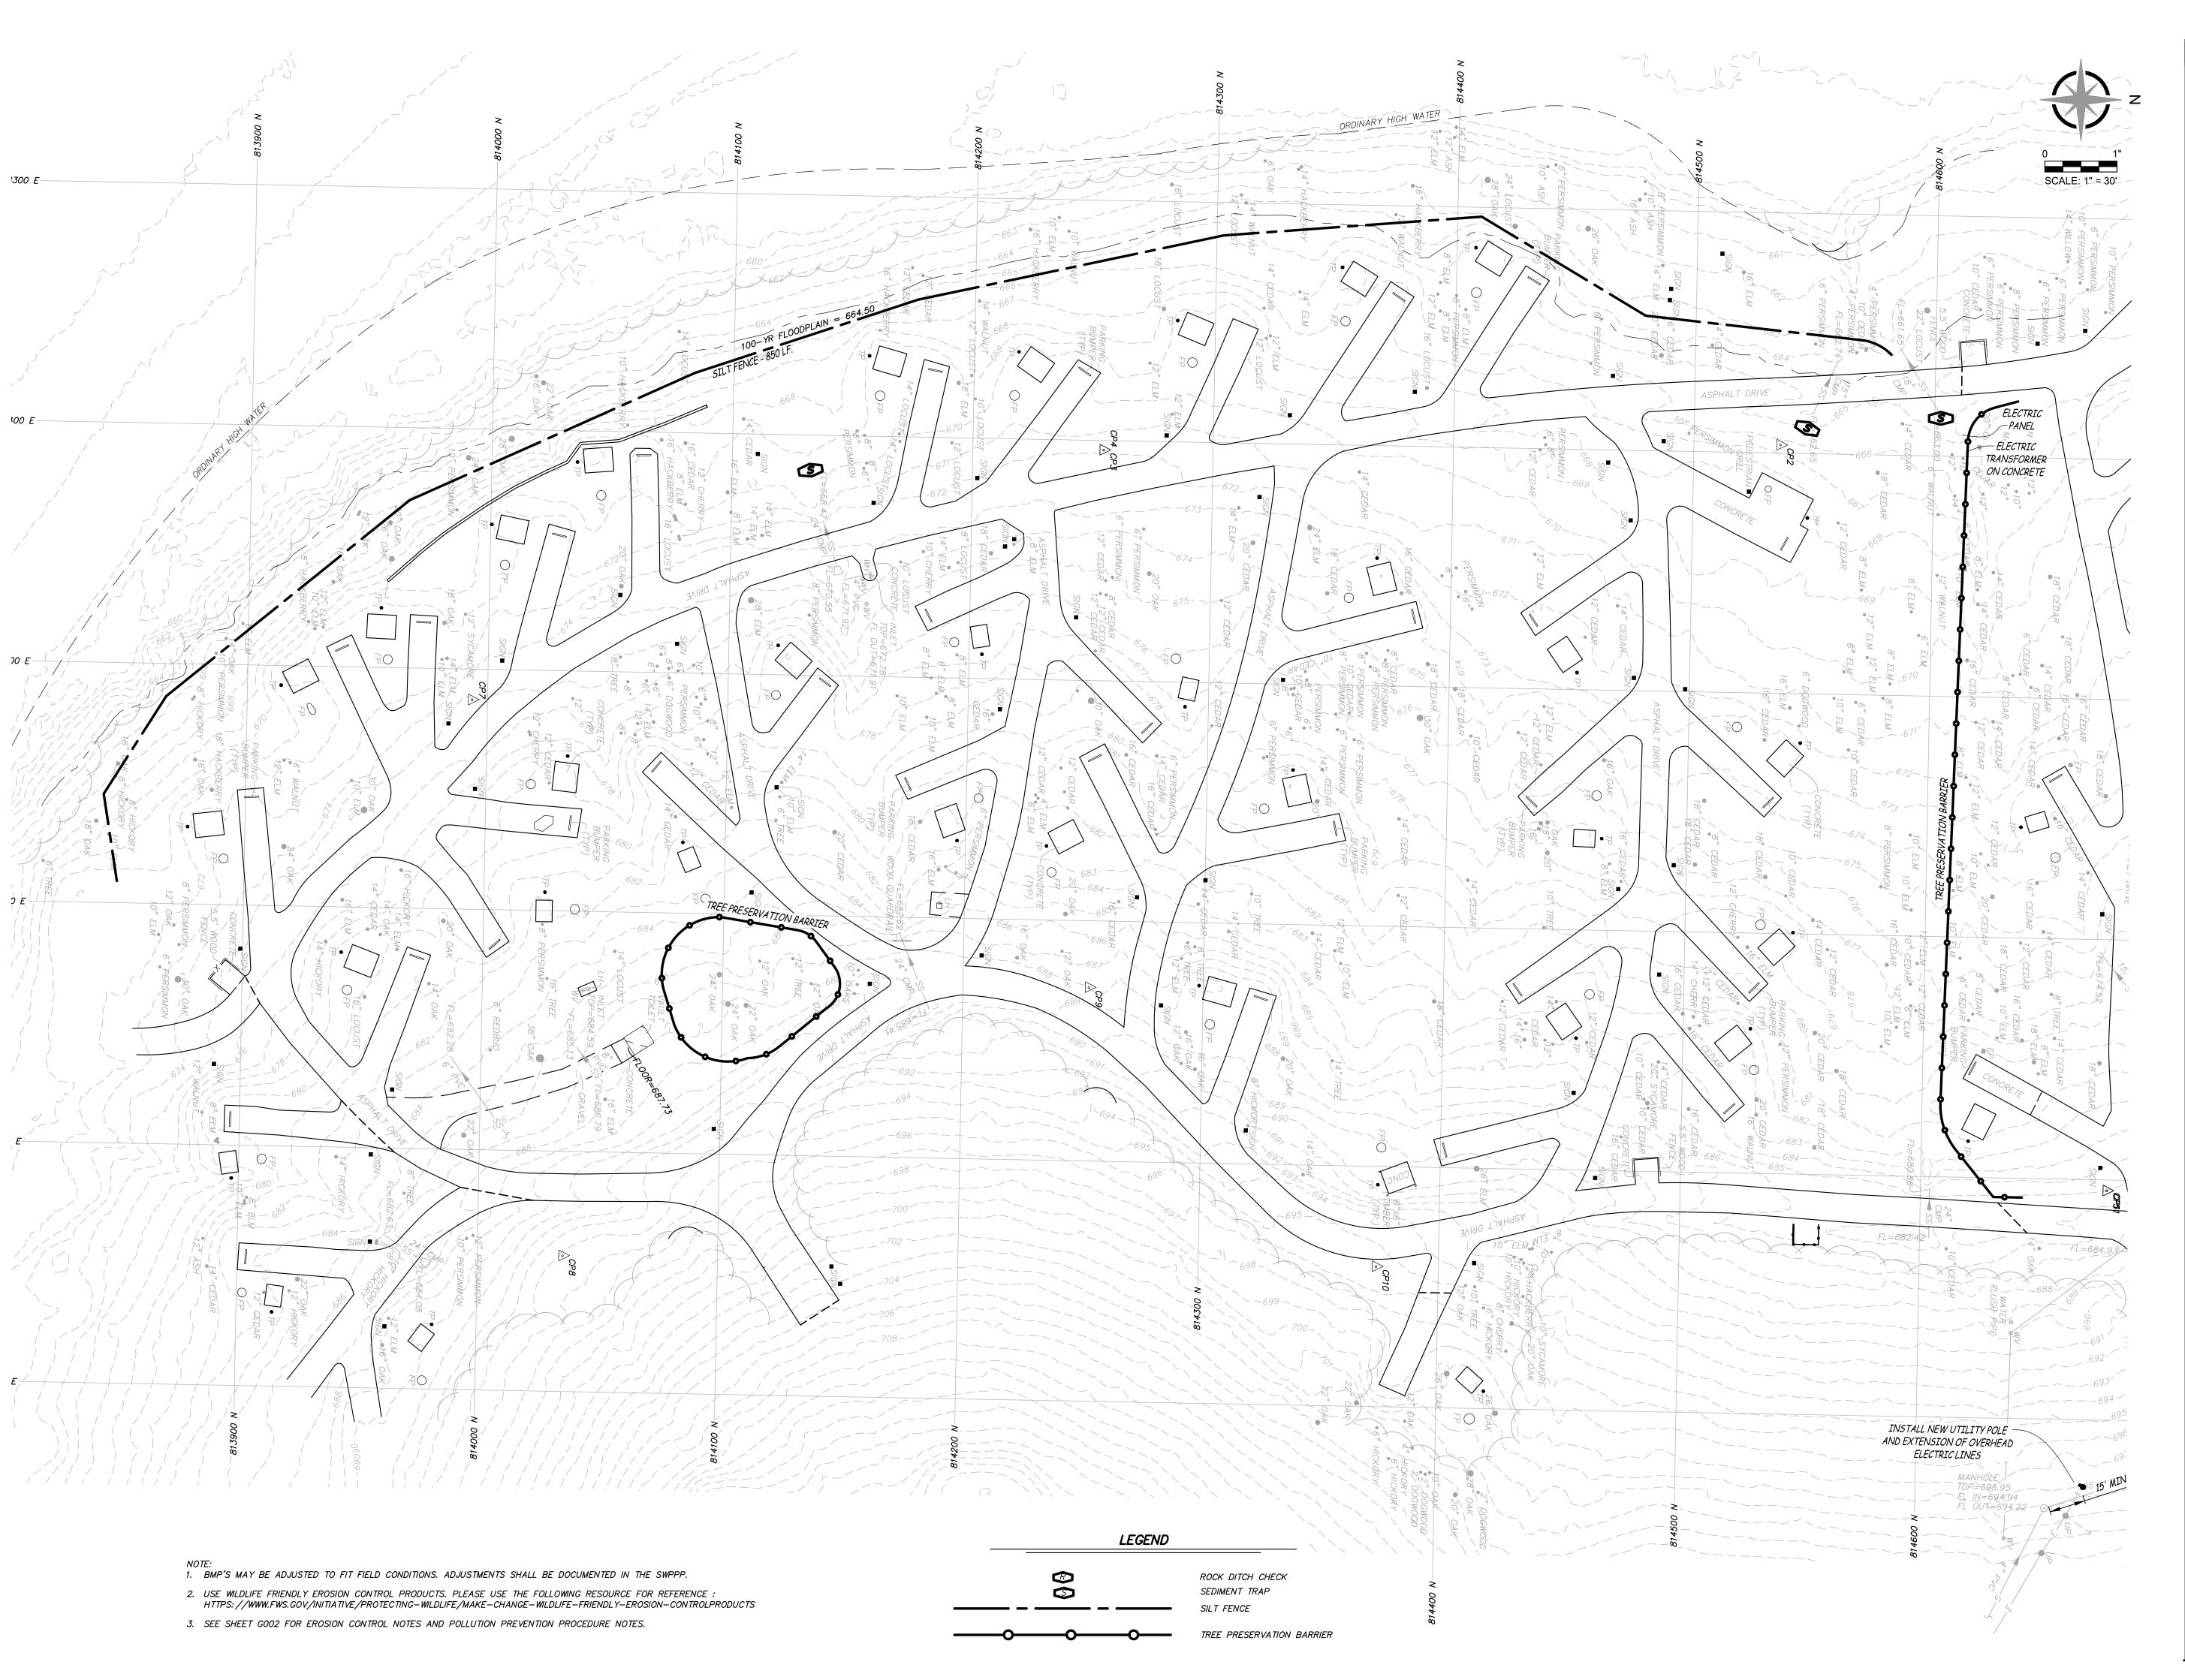

OZ/22/2024

OF MISSO

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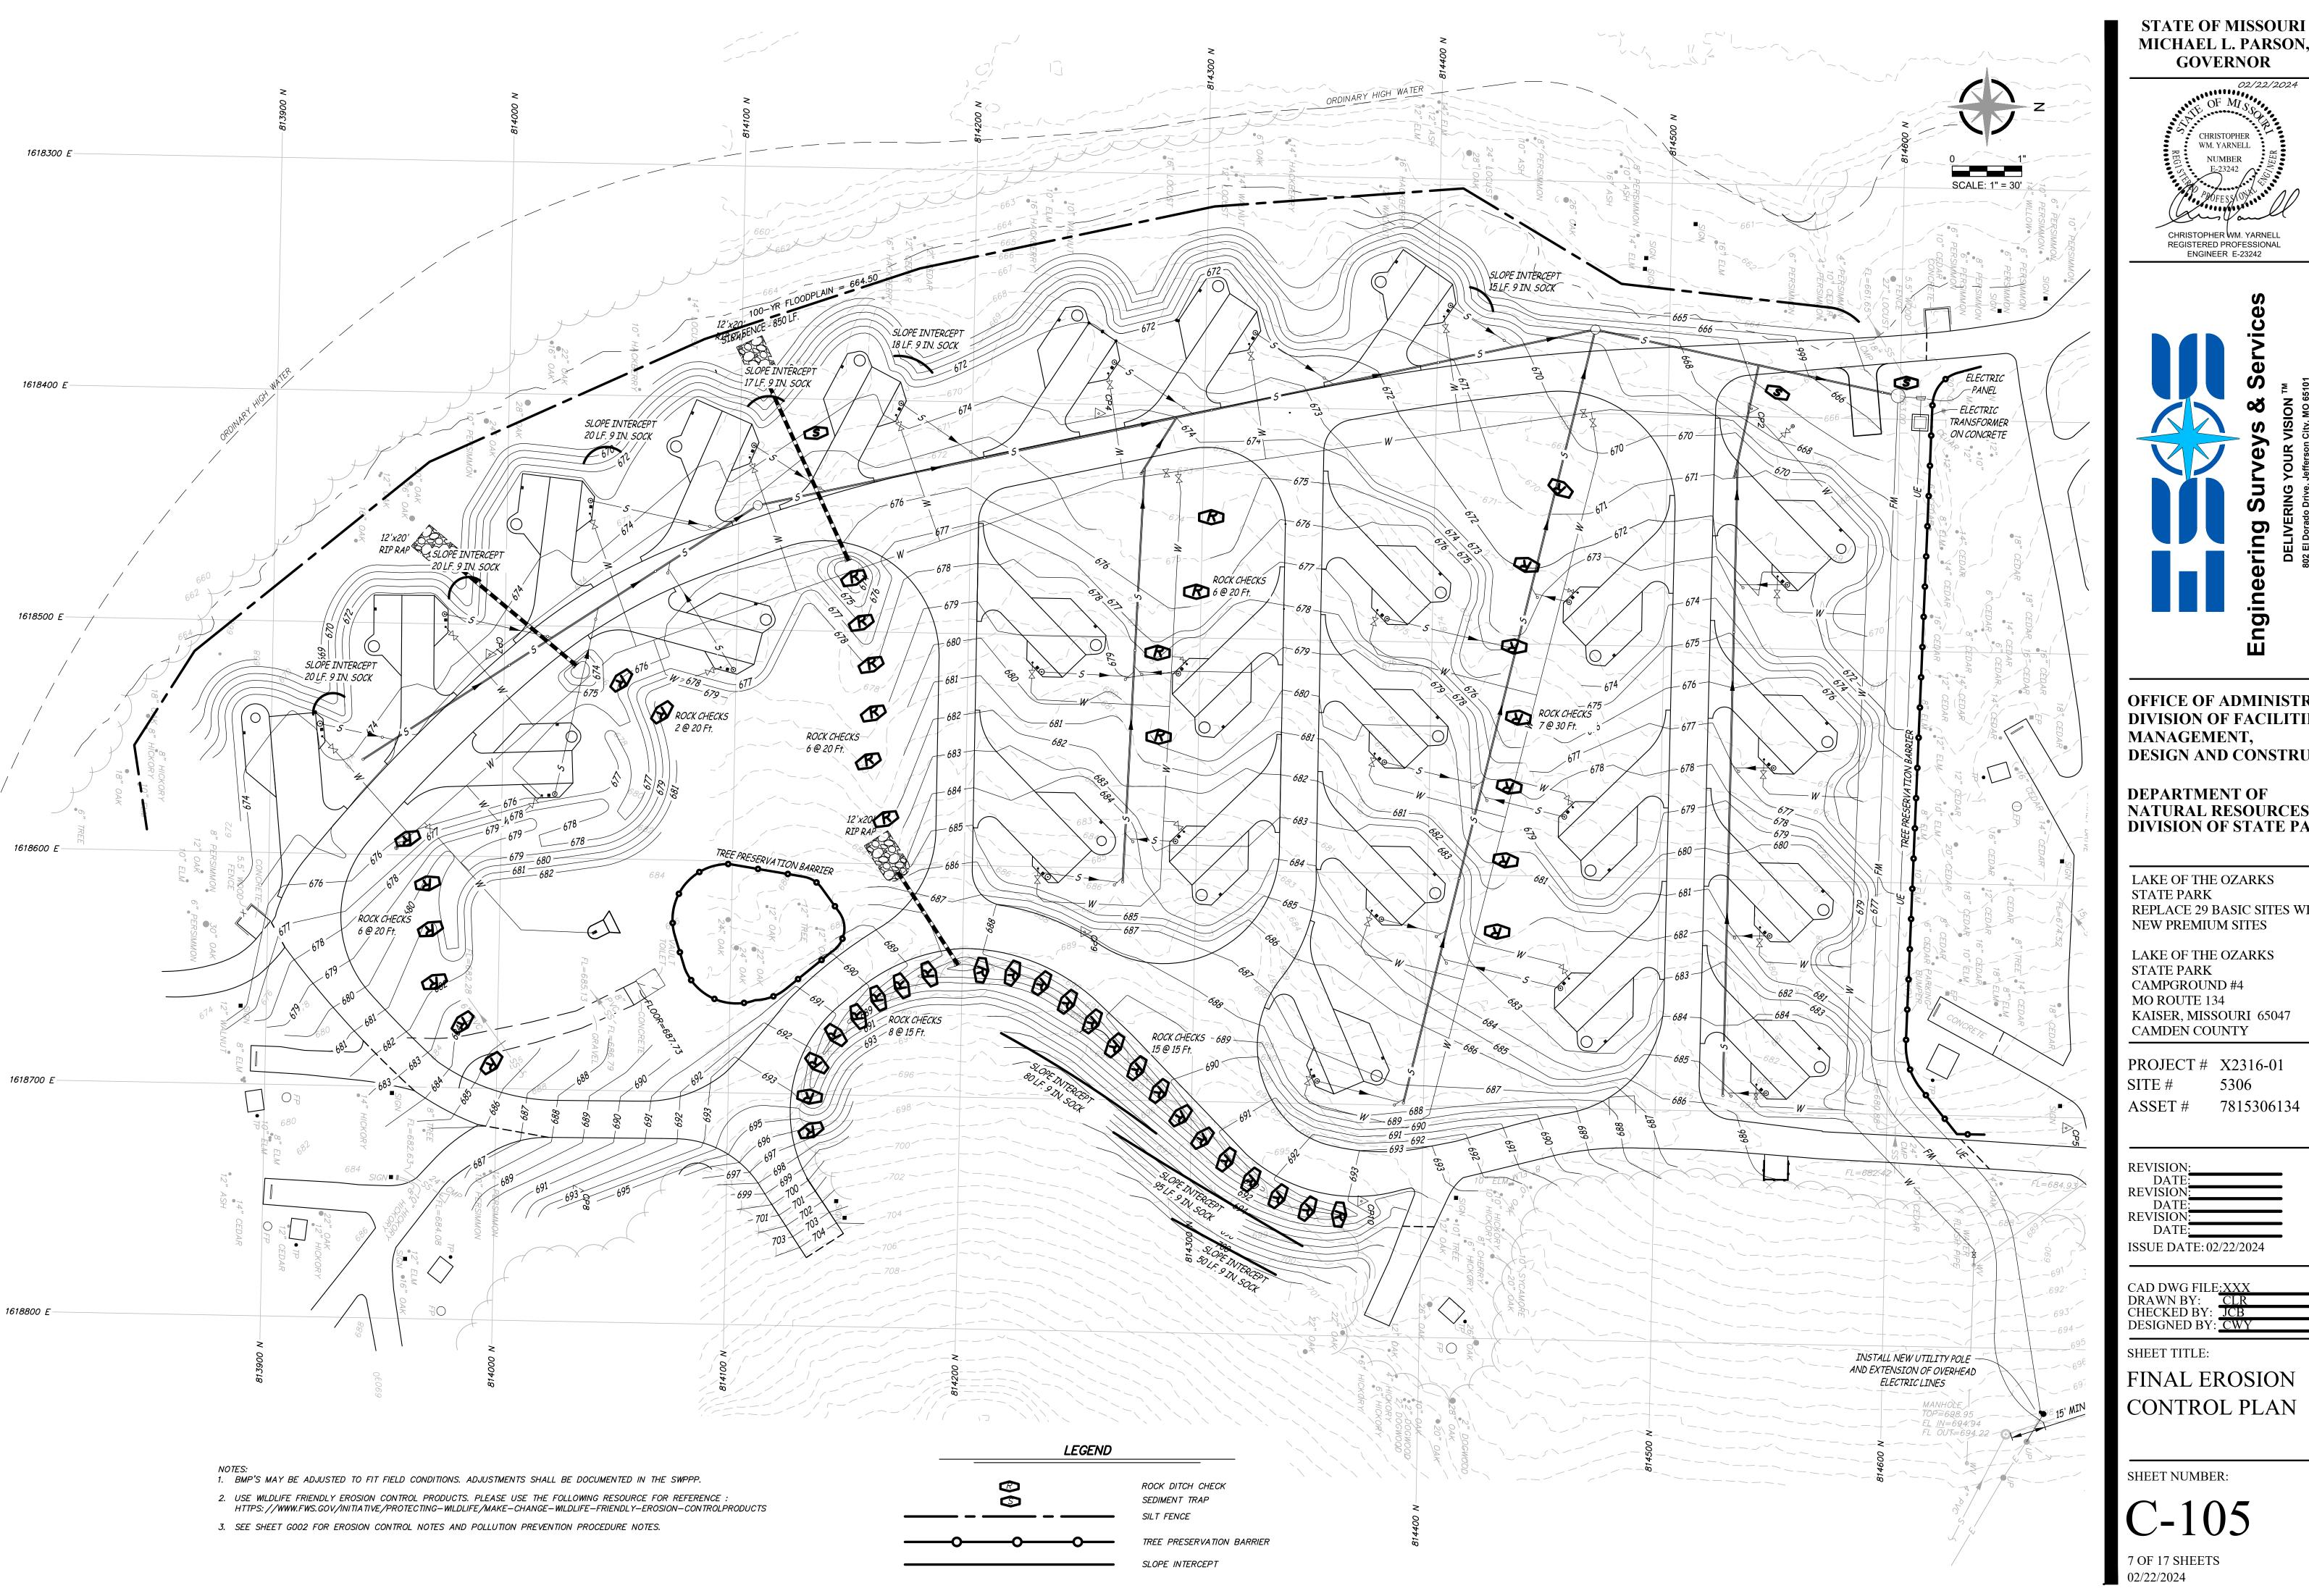
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INITIAL EROSION CONTROL PLAN


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C-104

6 OF 17 SHEETS



MICHAEL L. PARSON,

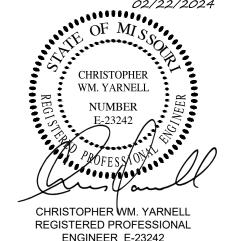


OFFICE OF ADMINISTRATION DIVISION OF FACILITIES **DESIGN AND CONSTRUCTION**

DEPARTMENT OF NATURAL RESOURCES, **DIVISION OF STATE PARKS**

REPLACE 29 BASIC SITES WITH 25

KAISER, MISSOURI 65047

FINAL EROSION CONTROL PLAN

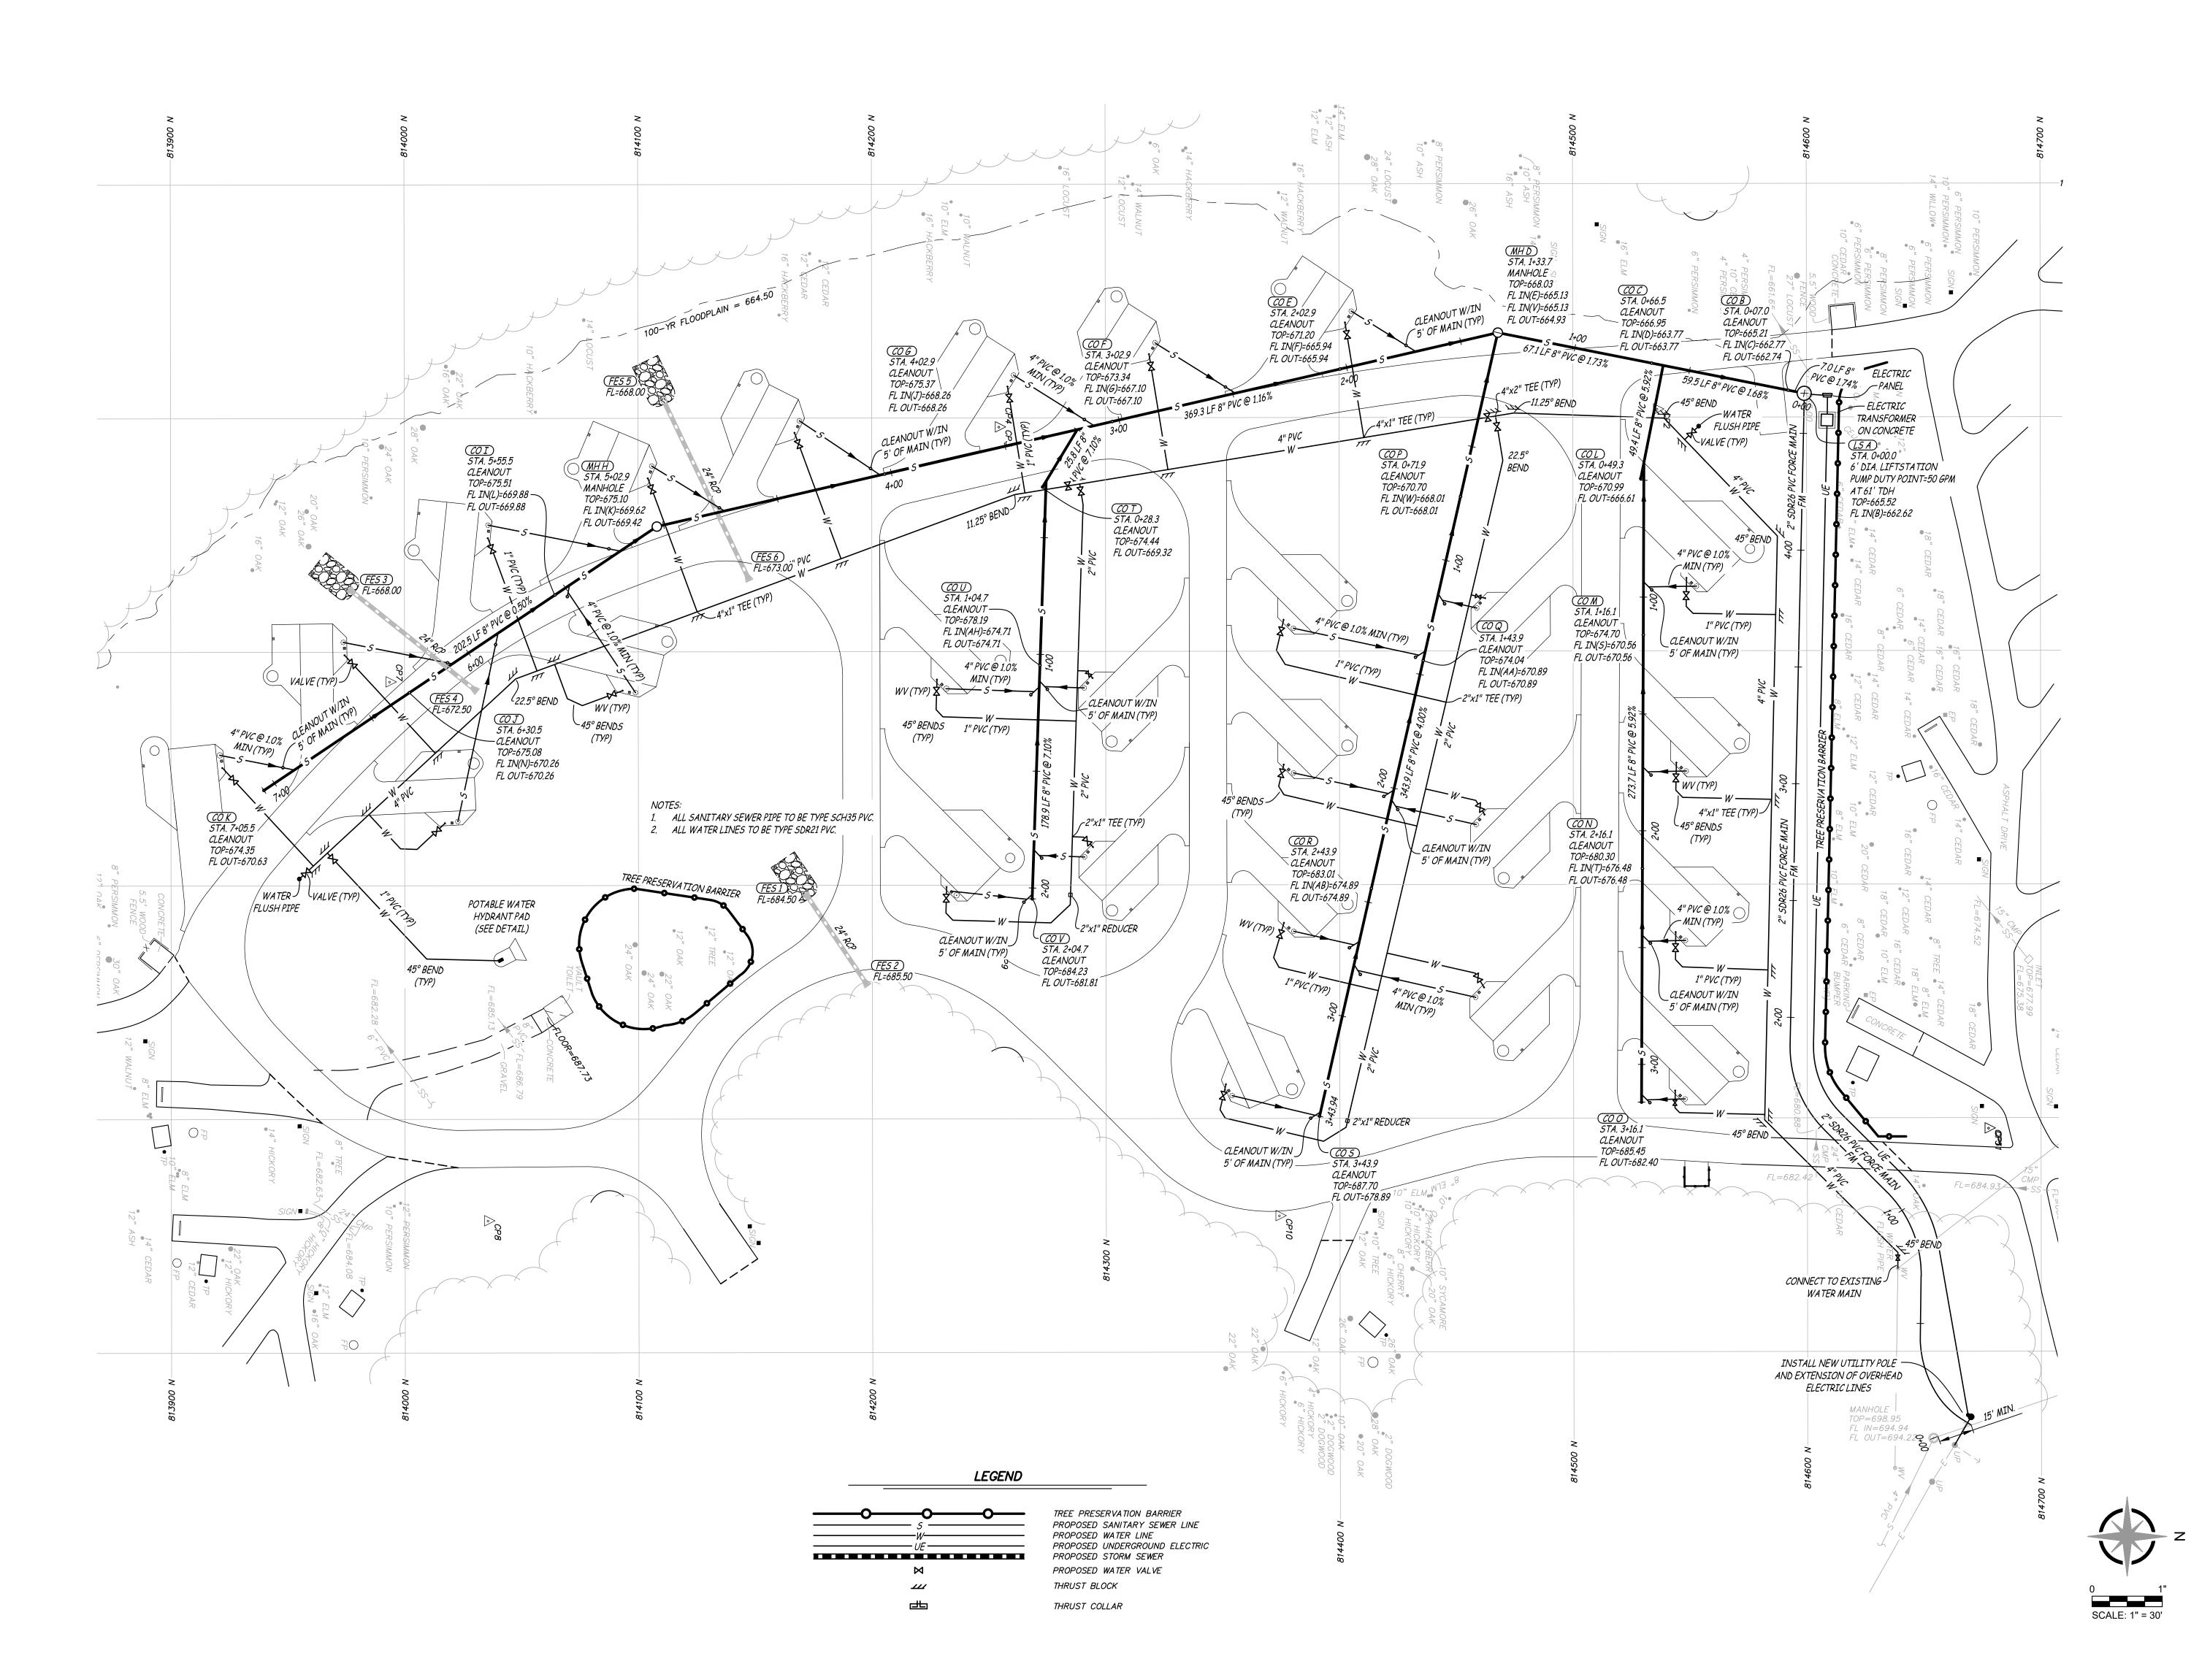







OFFICE OF ADMINISTRATION DIVISION OF FACILITIES MANAGEMENT, DESIGN AND CONSTRUCTION

DEPARTMENT OF NATURAL RESOURCES, DIVISION OF STATE PARKS

LAKE OF THE OZARKS
STATE PARK
REPLACE 29 BASIC SITES WITH 25
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LAKE OF THE OZARKS
STATE PARK
CAMPGROUND #4
MO ROUTE 134
KAISER, MISSOURI 65047
CAMDEN COUNTY

PROJECT # X2316-01 SITE # 5306 ASSET # 7815306134

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ISSUE DATE: 02/22/2024


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UTILITY PLAN

SHEET NUMBER:

C-106



1+00

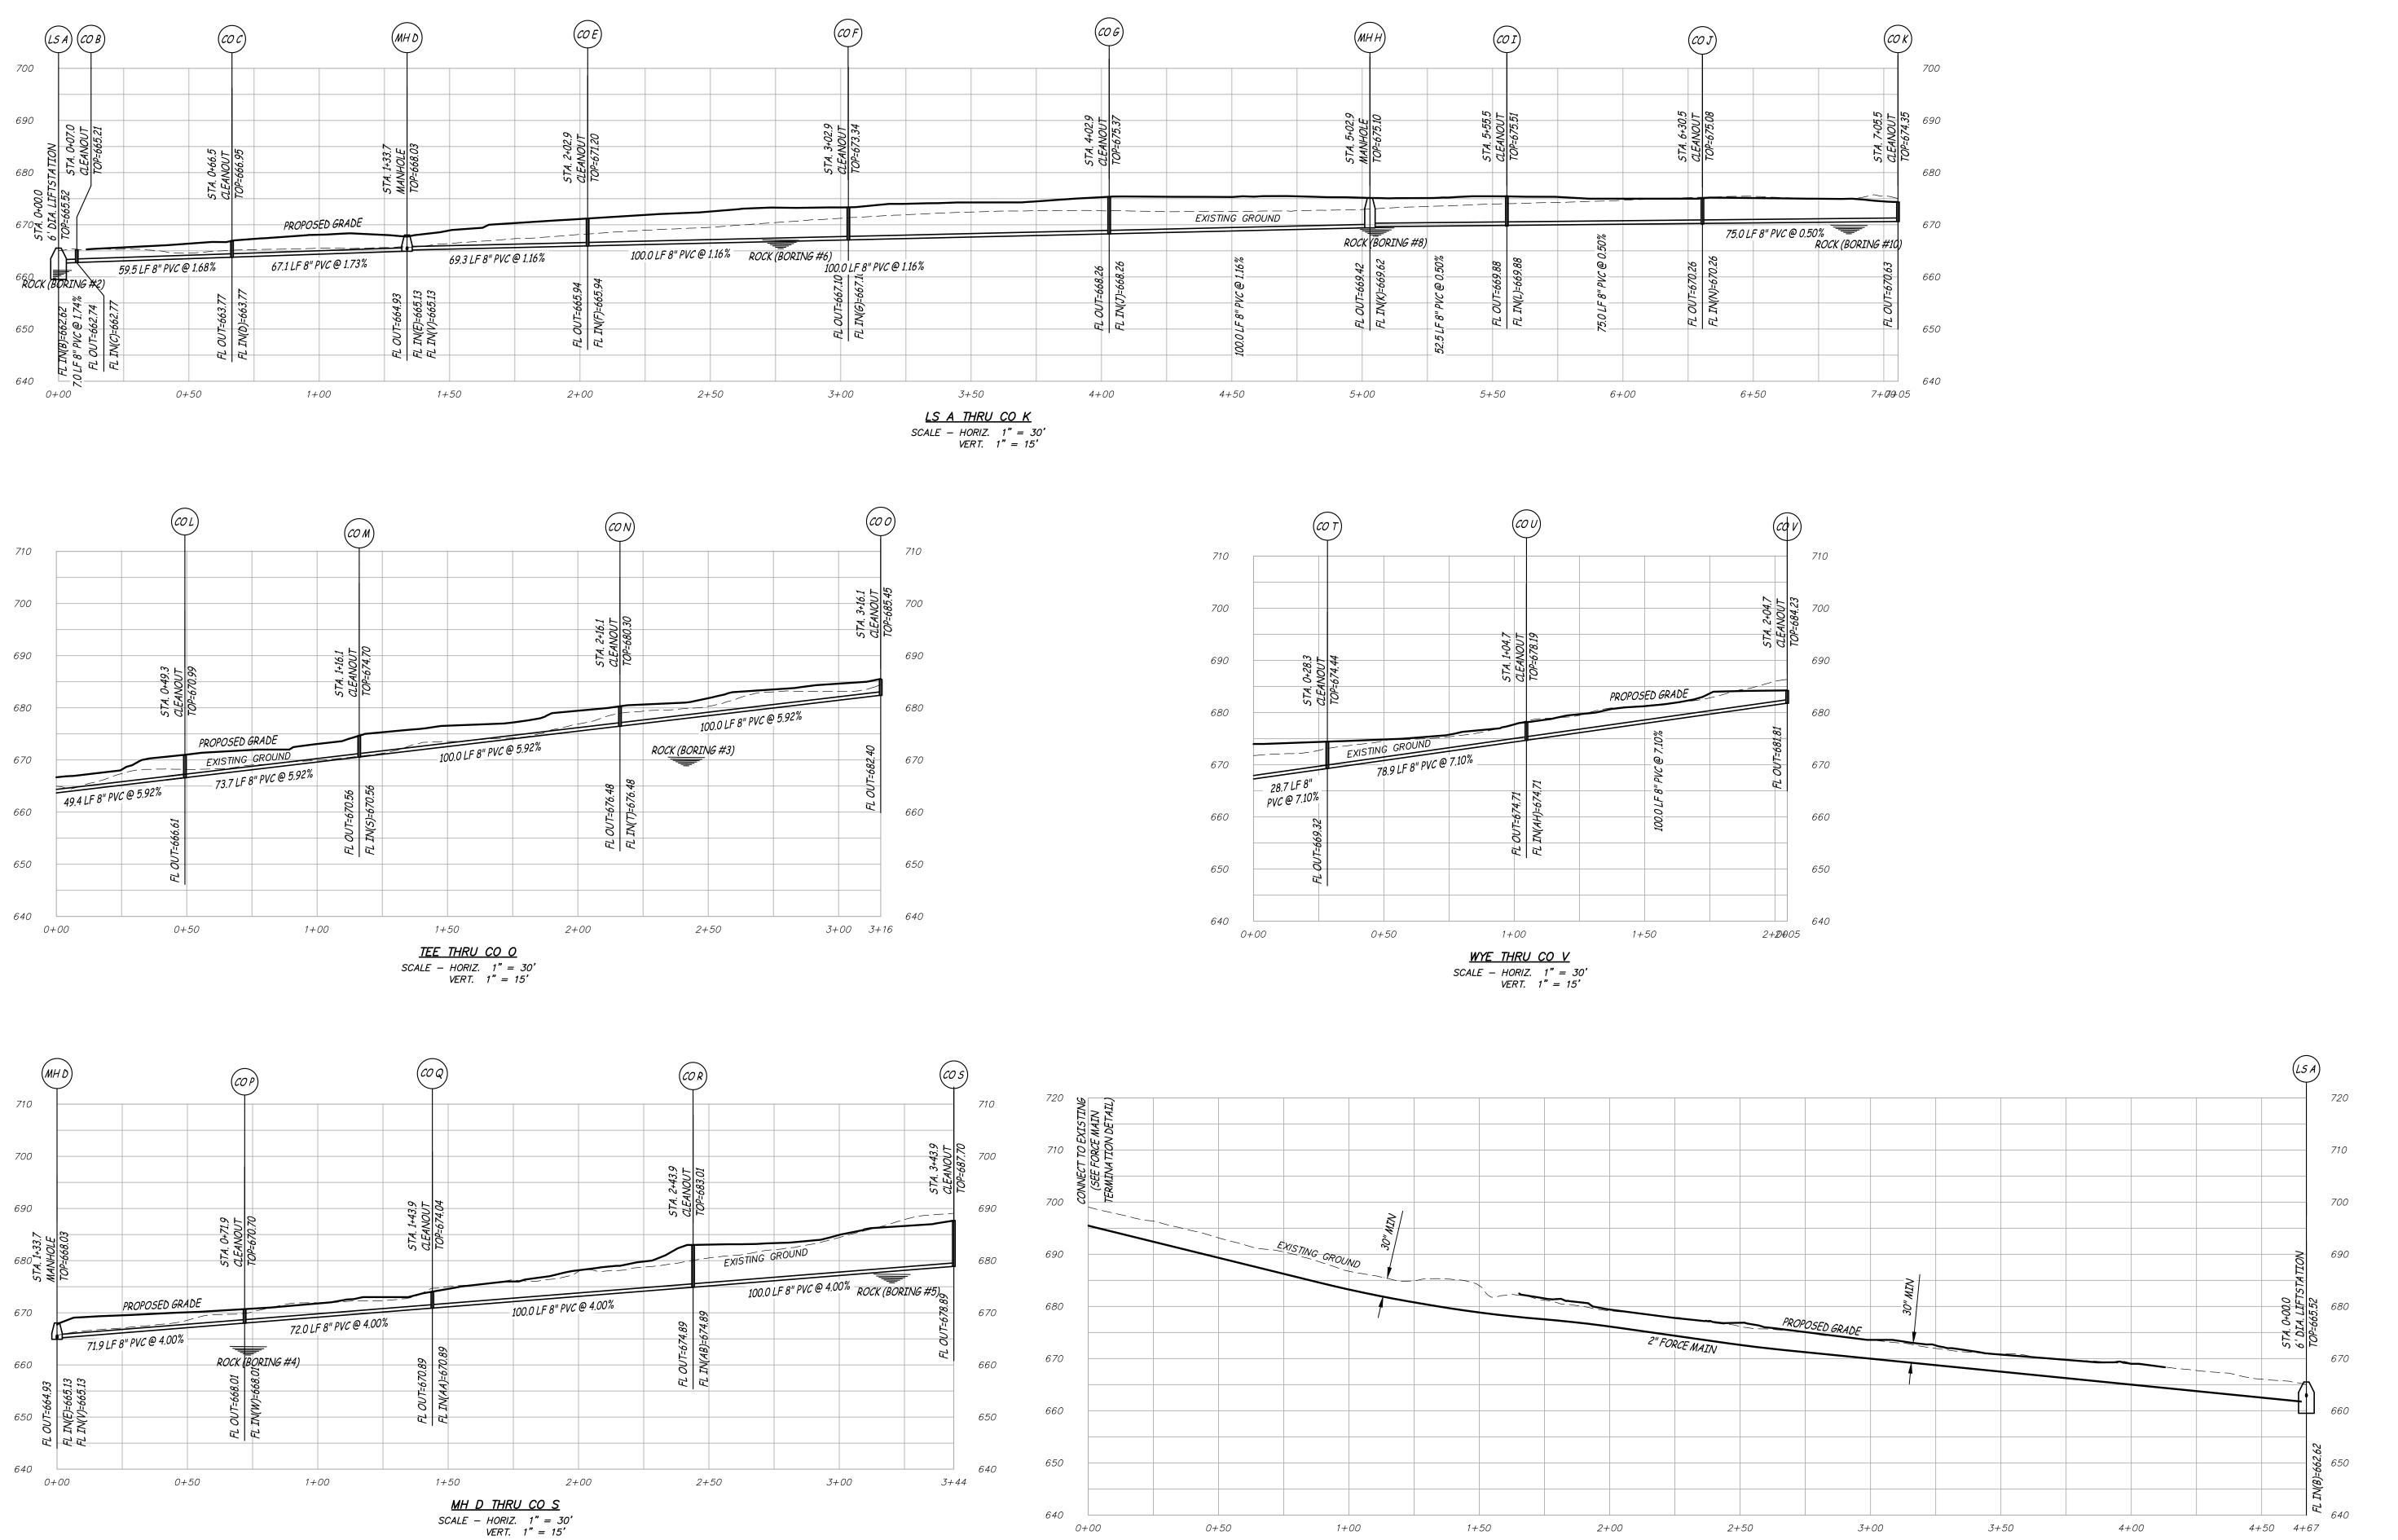0+50

0+00

1+50


2+00

2+50

SANITARY FORCE MAIN SCALE - HORIZ. 1" = 30' VERT. 1" = 10' 3+00


3+50

4+00

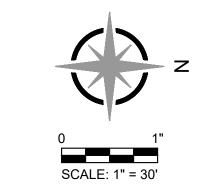

4+50 4+67

STATE OF MISSOURI MICHAEL L. PARSON, **GOVERNOR**

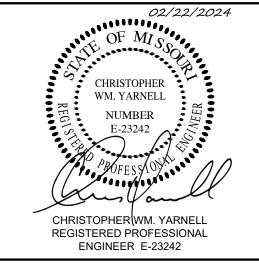



OFFICE OF ADMINISTRATION DIVISION OF FACILITIES MANAGEMENT, **DESIGN AND CONSTRUCTION**

DEPARTMENT OF NATURAL RESOURCES, **DIVISION OF STATE PARKS**

LAKE OF THE OZARKS STATE PARK REPLACE 29 BASIC SITES WITH 25 NEW PREMIUM SITES

LAKE OF THE OZARKS STATE PARK CAMPGROUND #4 MO ROUTE 134 KAISER, MISSOURI 65047 CAMDEN COUNTY

PROJECT # X2316-01 5306 7815306134 ASSET#


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CHECKED BY: CWY
DESIGNED BY: CWY

SHEET TITLE:

SANITARY SEWER PROFILES

SHEET NUMBER:



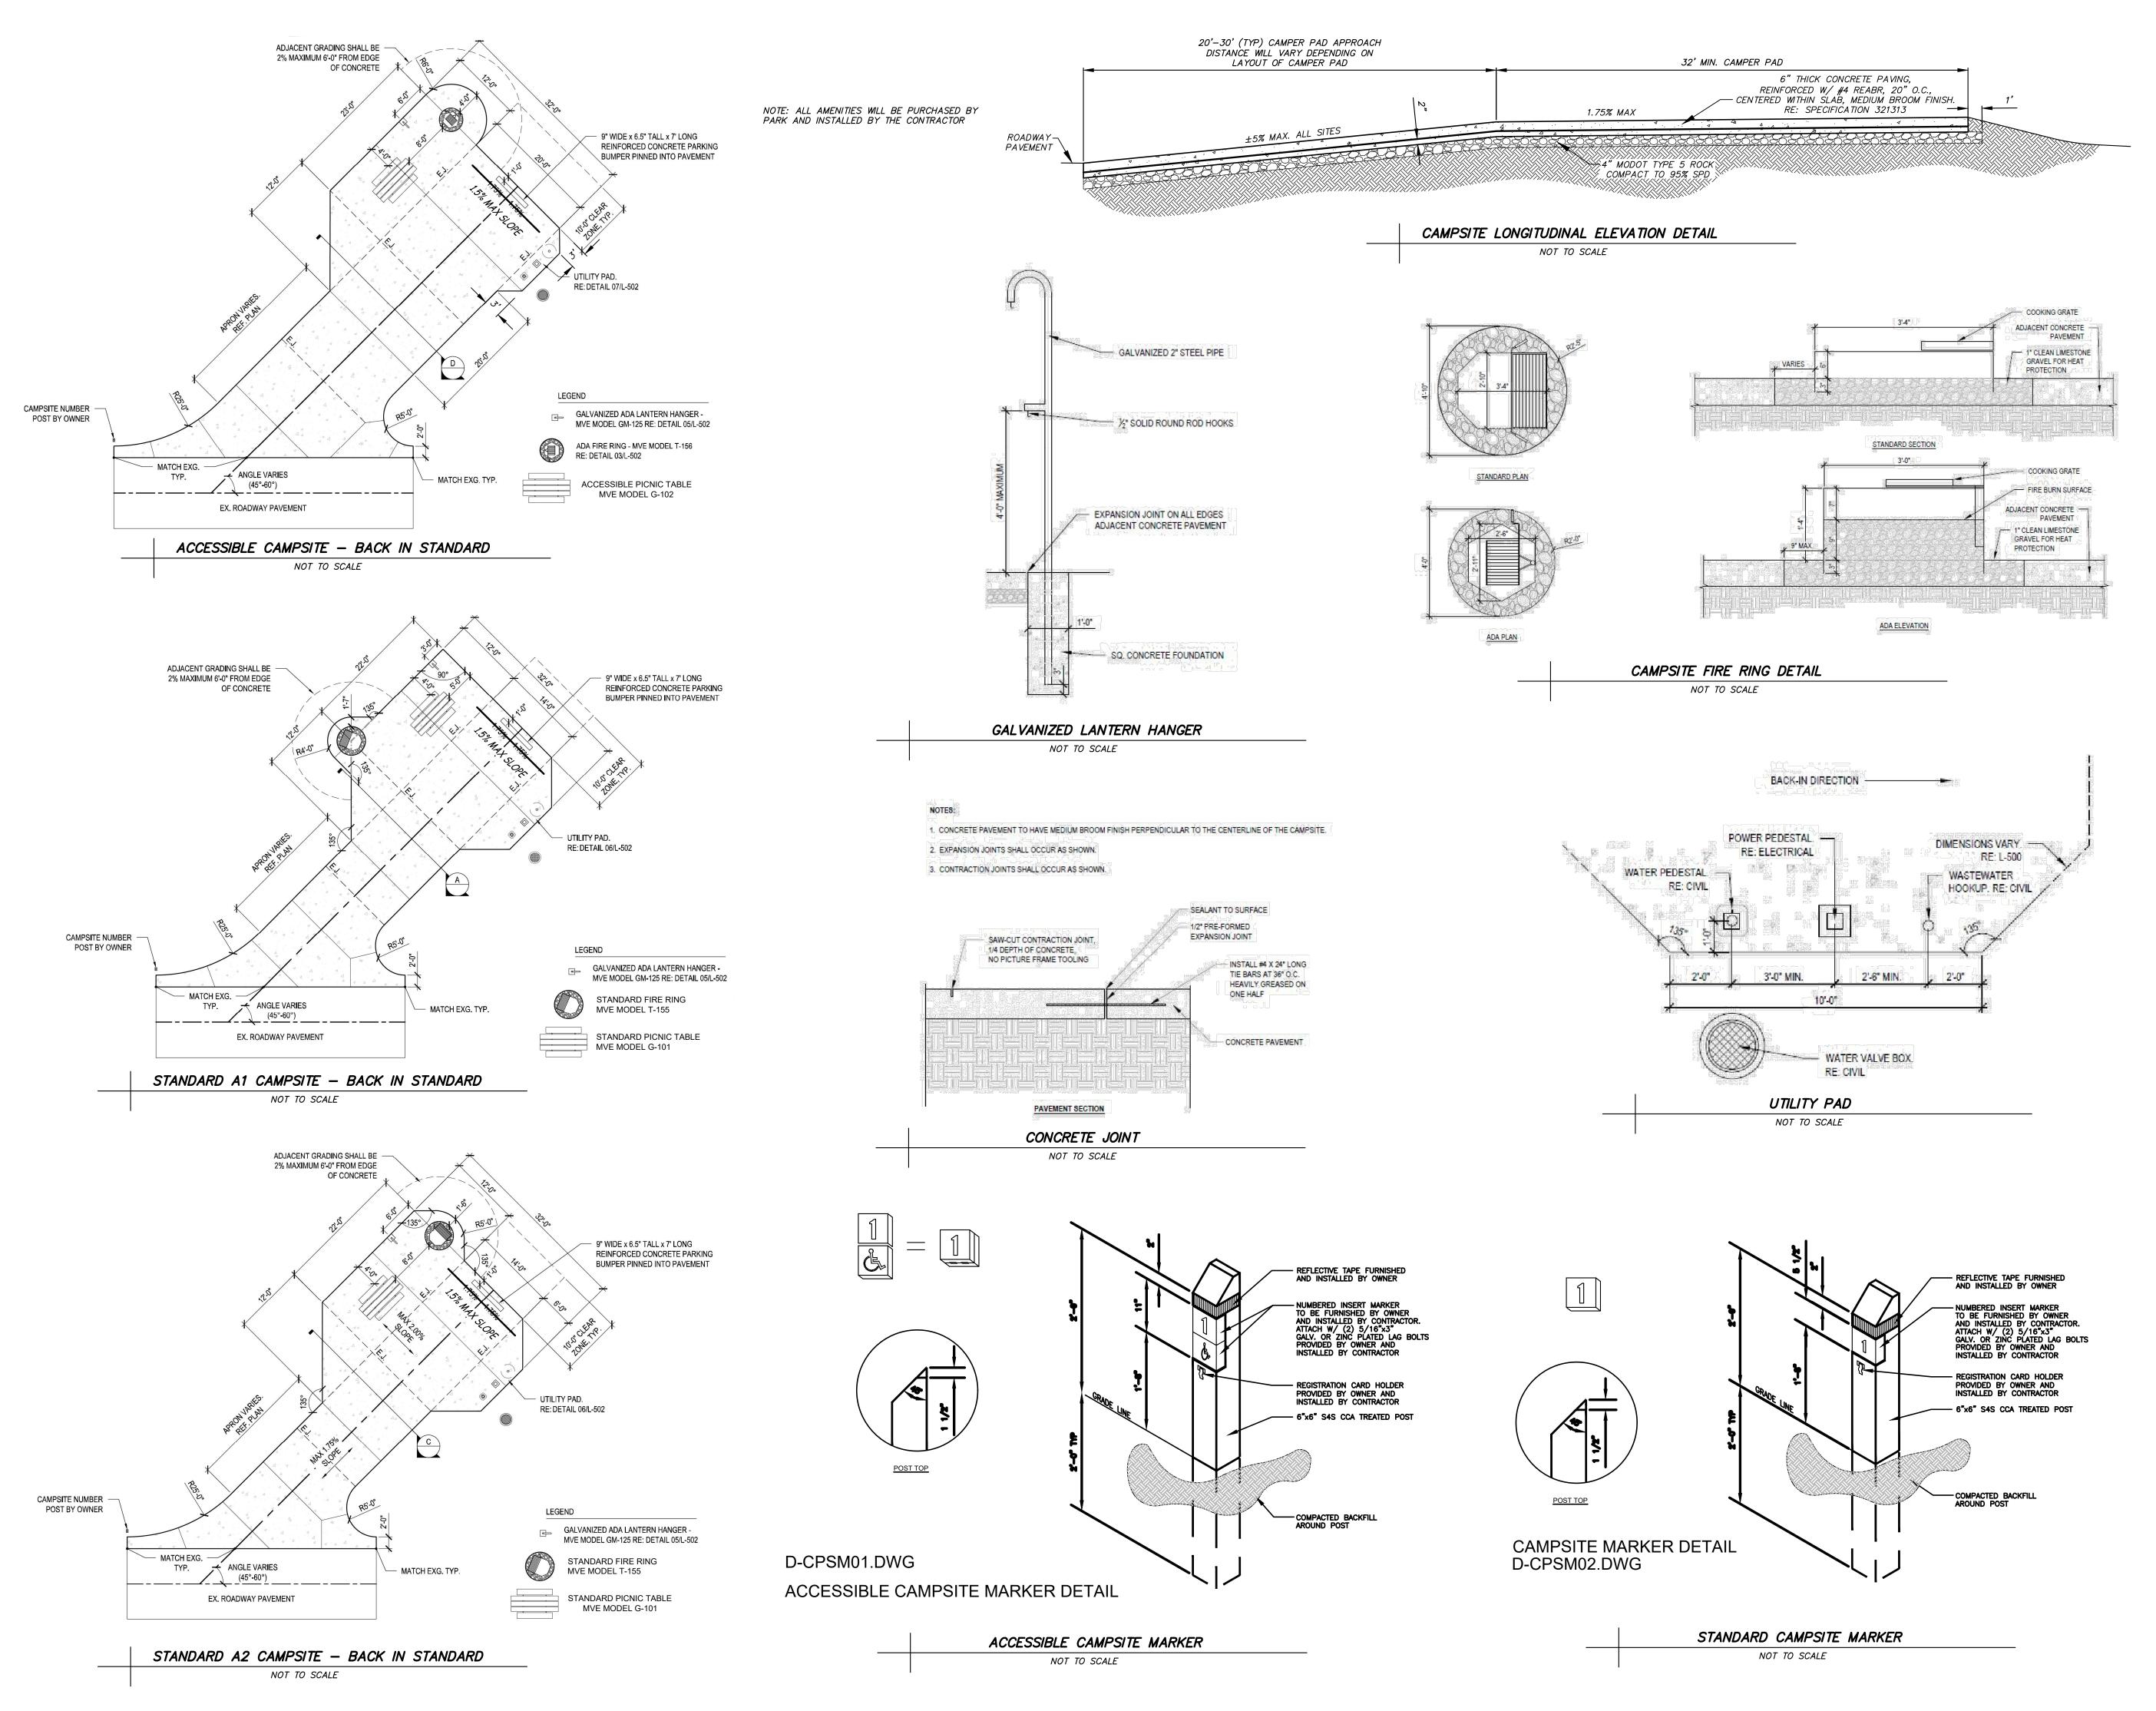



OFFICE OF ADMINISTRATION DIVISION OF FACILITIES MANAGEMENT, DESIGN AND CONSTRUCTION

DEPARTMENT OF

NATURAL RESOURCES, DIVISION OF STATE PARKS

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STATE PARK
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PROJECT # X2316-01 SITE # 5306 ASSET # 7815306134

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ISSUE DATE: 02/22/2024


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SITE DETAILS

SHEET NUMBER:


[C-50]




OPTIONAL PAVEMENT

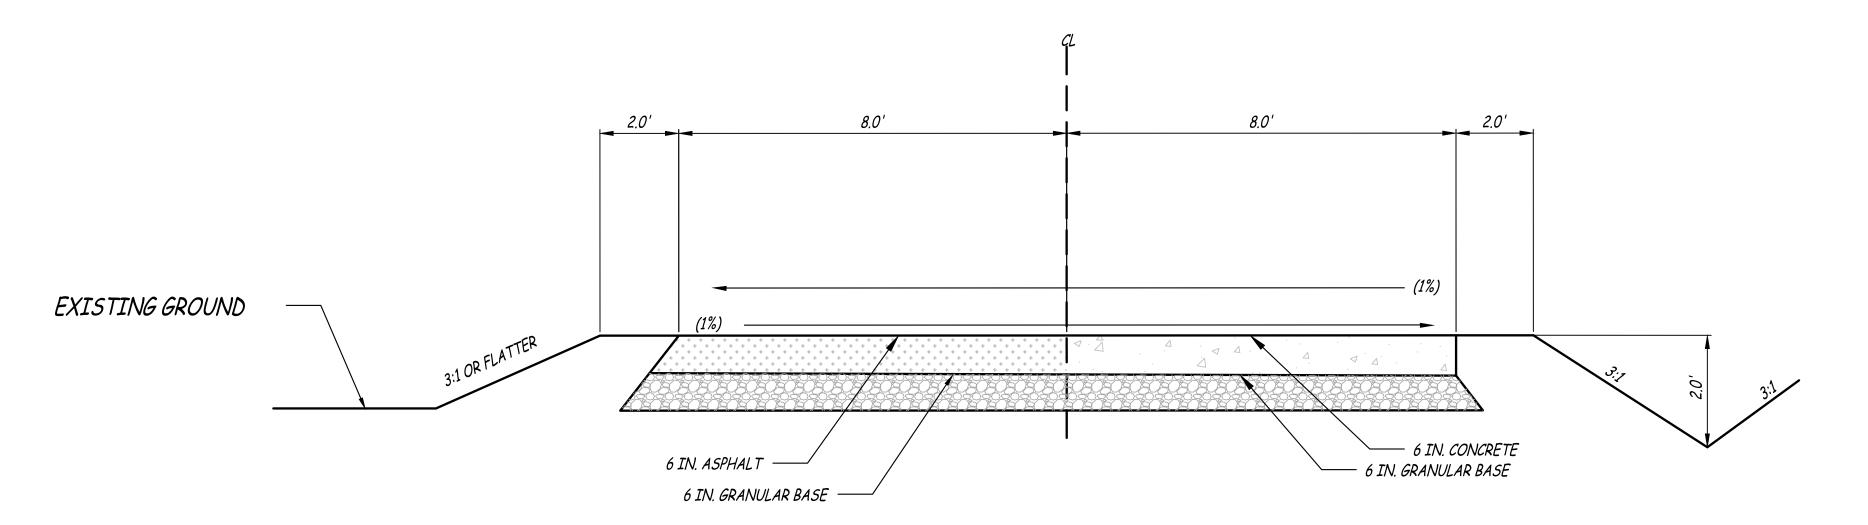PROPOSED HALF TYPICAL SECTION ON TANGENT

MAIN LINE - STATION 0+00 TO STATION 10+00 MAIN LINE - STATION 13+51.87 TO STATION 15+36.22 CROSS ROAD 1 - STATION 0+00 TO STATION 3+32.16 CROSS ROAD 2 - STATION 0+00 TO STATION 2+94.09 CROSS ROAD 3 - STATION 0+00 TO STATION 1+91.12 OPTIONAL PAVEMENT
2 INCHES OF BITUMINOUS PAVEMENT OVER 4 INCHES
OF BITUMINOUS BASE
OR
6 INCHES OF CONCRETE PAVEMENT WITH 15' JOINTS

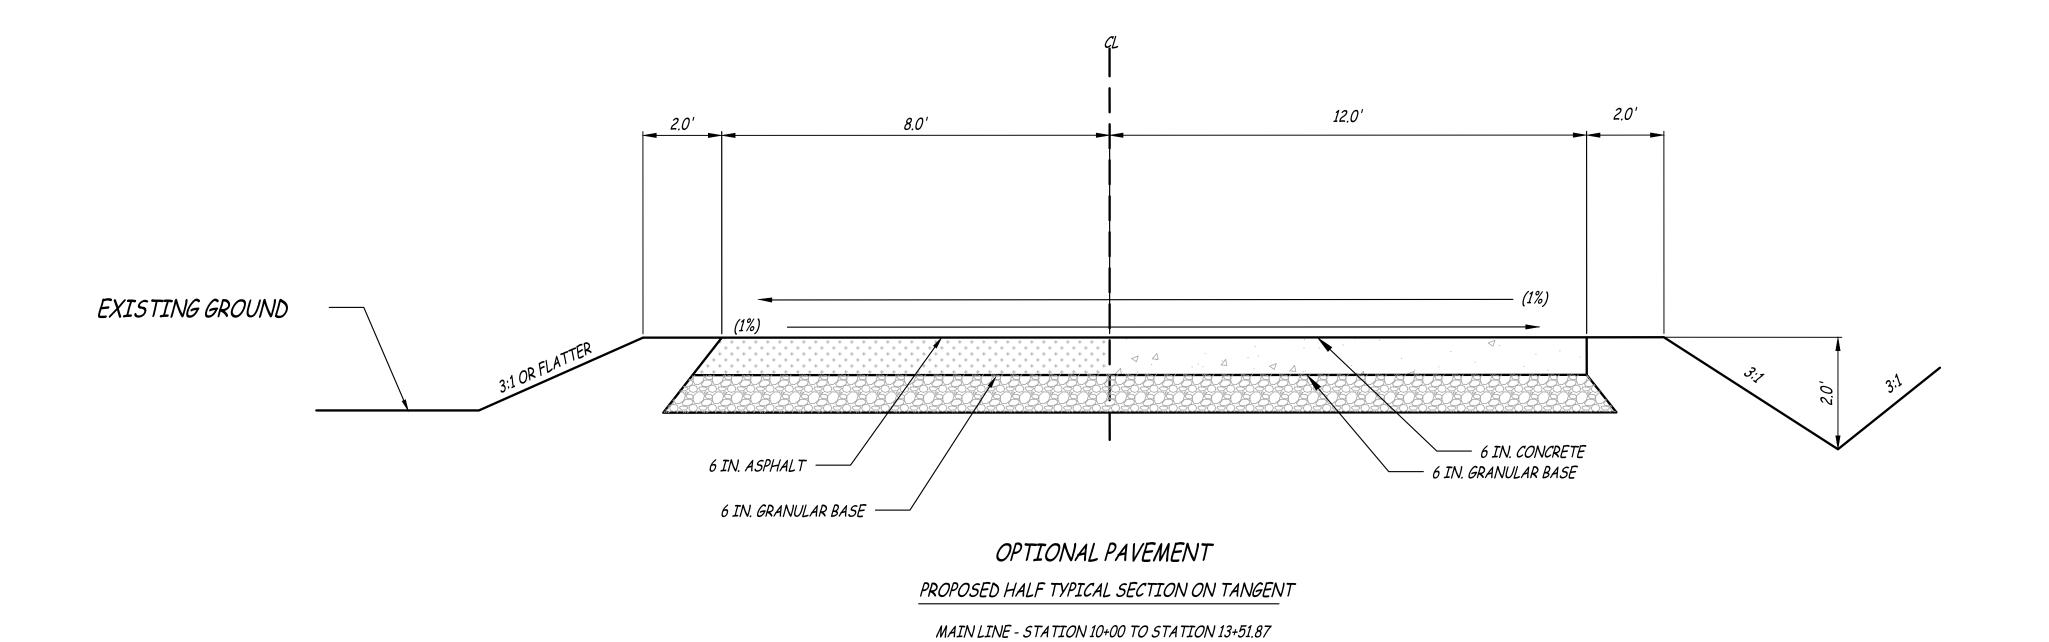

STATE OF MISSOURI MICHAEL L. PARSON, GOVERNOR

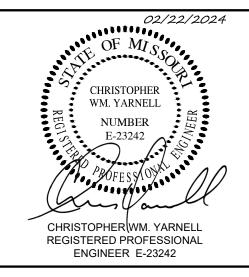



OFFICE OF ADMINISTRATION DIVISION OF FACILITIES MANAGEMENT, DESIGN AND CONSTRUCTION

DEPARTMENT OF

NATURAL RESOURCES, DIVISION OF STATE PARKS

LAKE OF THE OZARKS
STATE PARK
REPLACE 29 BASIC SITES WITH 25
NEW PREMIUM SITES

LAKE OF THE OZARKS
STATE PARK
CAMPGROUND #4
MO ROUTE 134
KAISER, MISSOURI 65047
CAMDEN COUNTY

PROJECT # X2316-01 SITE # 5306 ASSET # 7815306134

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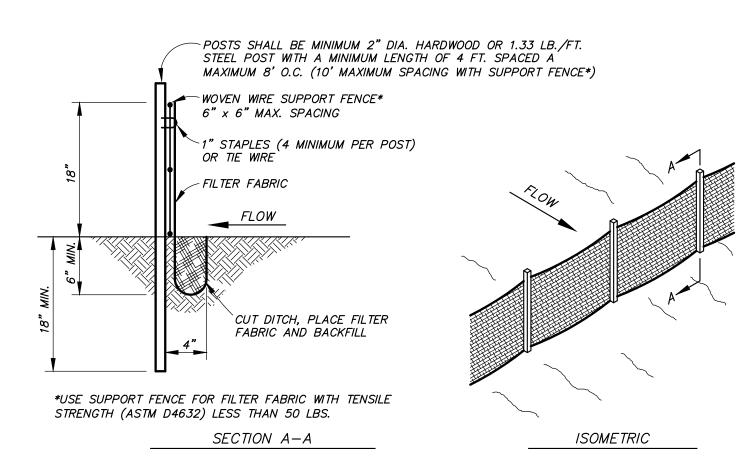
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CHECKED BY: CWY
DESIGNED BY: CWY

SHEET TITLE:

SITE DETAILS

SHEET NUMBER:

C-502




NOTES:

1. CONTRACTOR SHALL INSTALL SILT FENCE AT TOE OF SLOPES OF ALL AREAS AFFECTED BY CONSTRUCTION

- PRIOR TO ANY DISTURBANCE ON THE SITE. SILT FENCE SHALL REMAIN UNTIL VEGETATION HAS BEEN ESTABLISHED ON DISTURBED AREAS.
- BUILT UP SEDIMENT SHALL BE REMOVED FROM SILT FENCE WHEN IT HAS REACHED ONE-THIRD THE HEIGHT OF THE FENCE. 4. SILT FENCES SHALL BE INSPECTED FOR DEPTH OF SEDIMENT, TEARS, ETC., TO VERIFY THE FABRIC IS
- SECURELY ATTACHED TO THE POSTS, THE POSTS ARE SECURELY IN THE GROUND, AND THE FABRIC IS SECURELY IMBEDDED IN THE GROUND TO PREVENT RUNOFF FROM GOING UNDER ANY PART OF THE FENCE. 5. CONTRACTOR SHALL REMOVE ALL SILT FENCES WHEN ALL DISTURBED AREAS ARE COVERED WITH A MINIMUM 80% VEGETATION. SEED AND MULCH ALL AREAS DISTURBED DURING REMOVAL.

SILT FENCE DETAIL

NOT TO SCALE

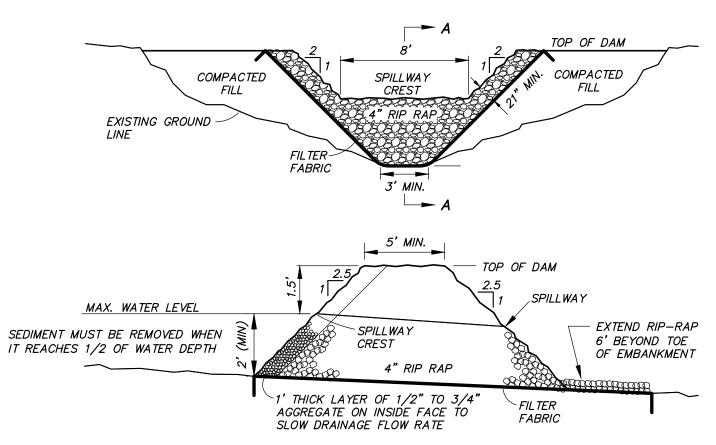


SECTION A-A

NOTES:
1. CONSTRUCTION OF TEMPORARY SEDIMENT TRAP SHALL BE PER THE CURRENT "PROTECTING WATER QUALITY" FIELD GUIDE AVAILABLE ON THE MISSOURI DEPARTMENT OF NATURAL RESOURCES WEBSITE.

2. SEDIMENT REMOVED FROM STRUCTURE SHALL BE DISPOSED OF ONSITE AS DIRECTED BY OWNER.

TEMPORARY SEDIMENT TRAP NOT TO SCALE

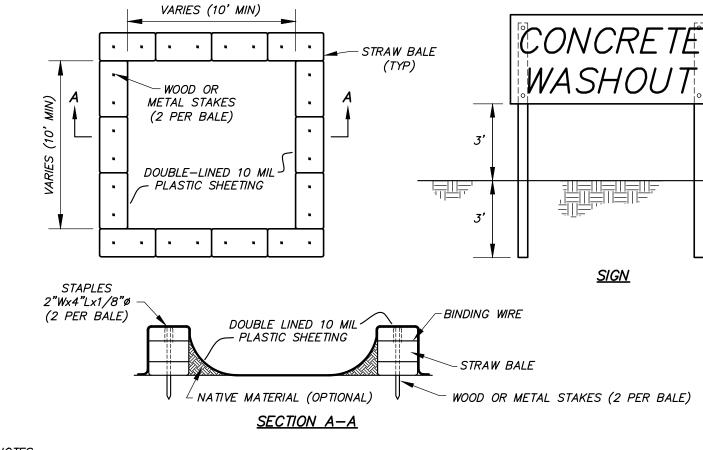


1. ALL CONCRETE WASTE MATERIAL, INCLUDING WASHOUT WATER, SHALL BE TOTALLY CONTAINED. 2. SEE SWPPP FOR MORE DETAILS.


- 3. UPON PROJECT COMPLETION CONTRACTOR SHALL REMOVE AND DISPOSE OF ALL CONCRETE WASTE FROM THE OWNER'S PROPERTY PER ALL APPLICABLE SOLID WASTE REGULATIONS.
- 4. CONSTRUCT SIGN OF WEATHER PROOF MATERIALS OF A SIZE EASILY READABLE BY CONCRETE TRUCK DRIVERS. PLACE
- SIGN WITHIN 10' OF WASHOUT. 5. CONTRACTOR SHALL CONTAIN WASHOUT WATERS AT ALL TIMES.

CONCRETE WASHOUT AREA

NOT TO SCALE

WRAP ROCK AROUND

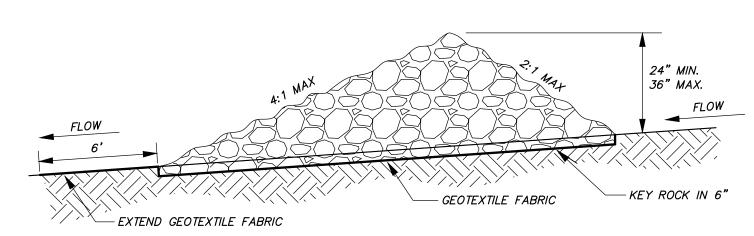

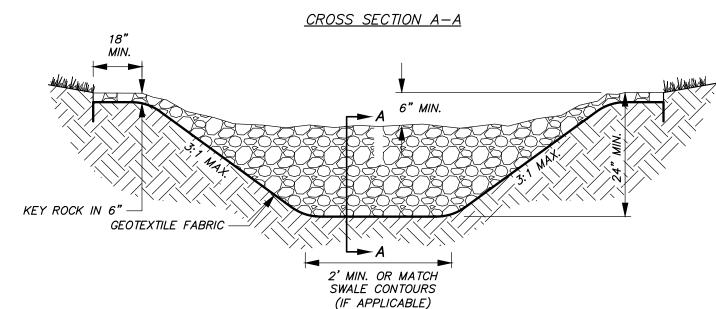


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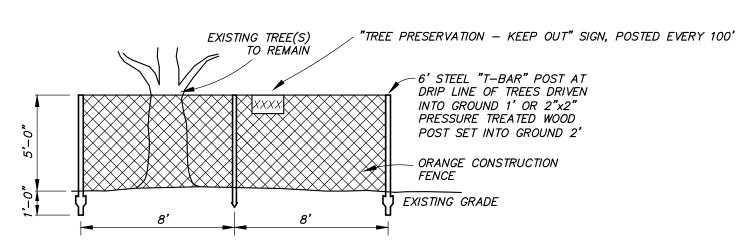
1. CHECK DAMS SHALL BE PLACED SUCH THAT THE RESULTANT PONDING WILL NOT CAUSE INCONVENIENCE OR DAMAGE TO ADJACENT AREAS. 2. ROCK SHALL BE WELL-GRADED ANGULAR STONE, A D50 OF 3 INCH OR GREATER.

- CHECK DAMS SHALL BE UTILIZED DURING ROUGH GRADING AND SHALL BE REMOVED ONCE THE FINAL GRADING AND CHANNEL STABILIZATION IS APPLIED, UNLESS NOTED OTHERWISE. 4. CHECK DAMS SHALL BE UNDERLAIN BY A NON-WOVEN POLYPROPYLENE GEOTEXTILE FABRIC TO EASE
- INSTALLATION AND REMOVAL. IT SHALL EXTEND 6 FEET BEYOND THE TOE OF THE CHECK DAM AS SHOWN. 5. SEDIMENT SHALL BE REMOVED WHEN IT REACHES HALF THE HEIGHT OF THE CHECK DAM. 6. KEY STONE INTO CHANNEL BANKS AND EXTEND IT BEYOND THE ABUTMENTS A MINIMUM OF 18" TO PREVENT FLOW AROUND DAM.
- 7. THE MIDDLE OF THE CHECK DAM SHALL BE THE LOWEST POINT SO THE STORM WATER FLOW IS DIRECTED OVER THE MIDDLE OF THE DAM. 8. THE DOWN GRADIENT SIDE SHALL BE AT A LOWER ANGLE TO ALLOW FOR ENERGY DISSIPATION OF THE STORM WATER FLOW OVER THE CHECK DAM.


TEMPORARY ROCK CHECK DAM

NOT TO SCALE




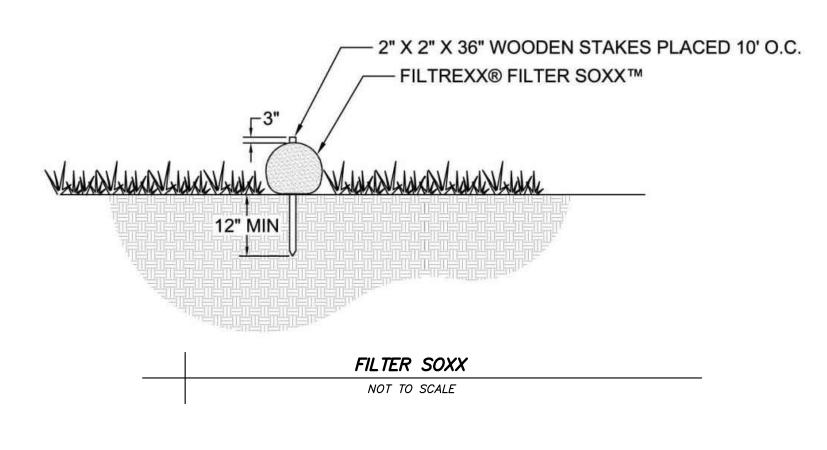

TREE PRESERVATION BARRIER W/ CONSTRUCTION FENCE NOT TO SCALE

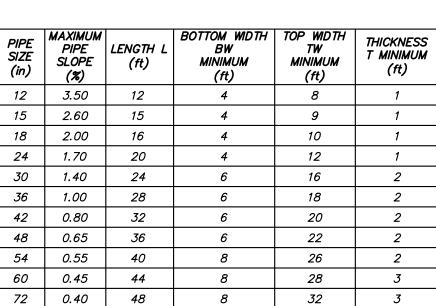

STATE OF MISSOURI MICHAEL L. PARSON, **GOVERNOR**

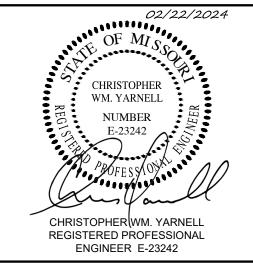



DIVISION OF FACILITIES MANAGEMENT, **DESIGN AND CONSTRUCTION**


OFFICE OF ADMINISTRATION

DEPARTMENT OF NATURAL RESOURCES, **DIVISION OF STATE PARKS**

LAKE OF THE OZARKS STATE PARK REPLACE 29 BASIC SITES WITH 25 NEW PREMIUM SITES

LAKE OF THE OZARKS STATE PARK CAMPGROUND #4 MO ROUTE 134 KAISER, MISSOURI 65047 CAMDEN COUNTY

PROJECT # X2316-01 5306 7815306134 ASSET#

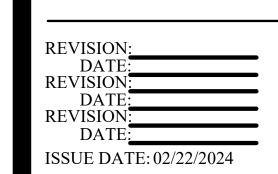



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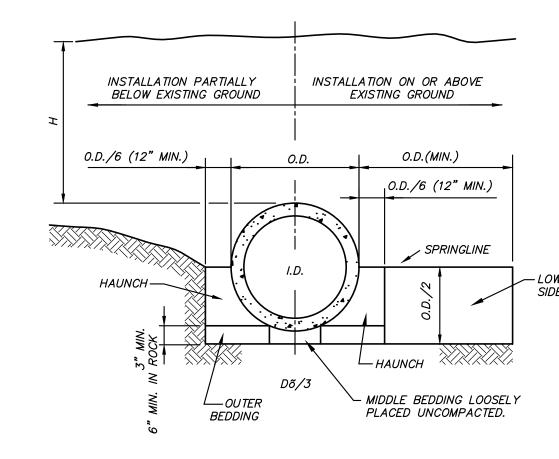
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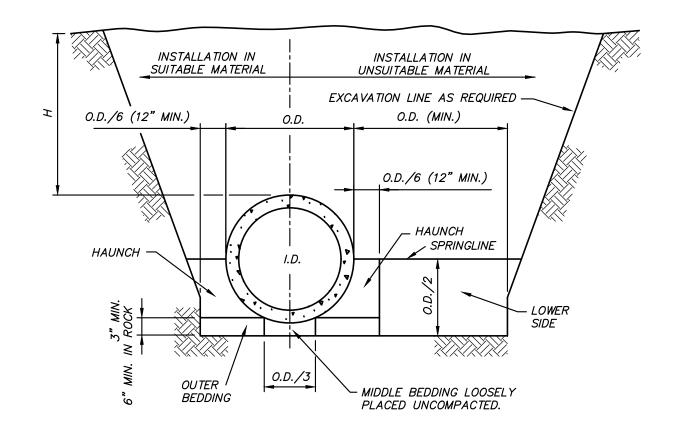
EROSION CONTROL DETAILS

SHEET NUMBER:





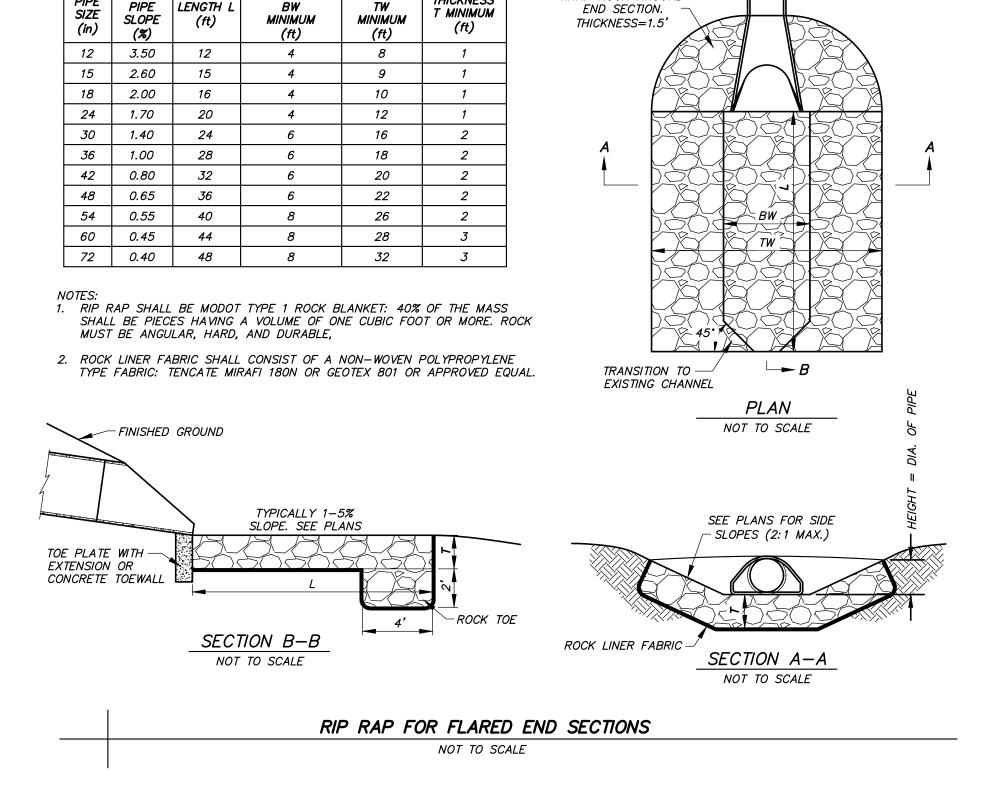

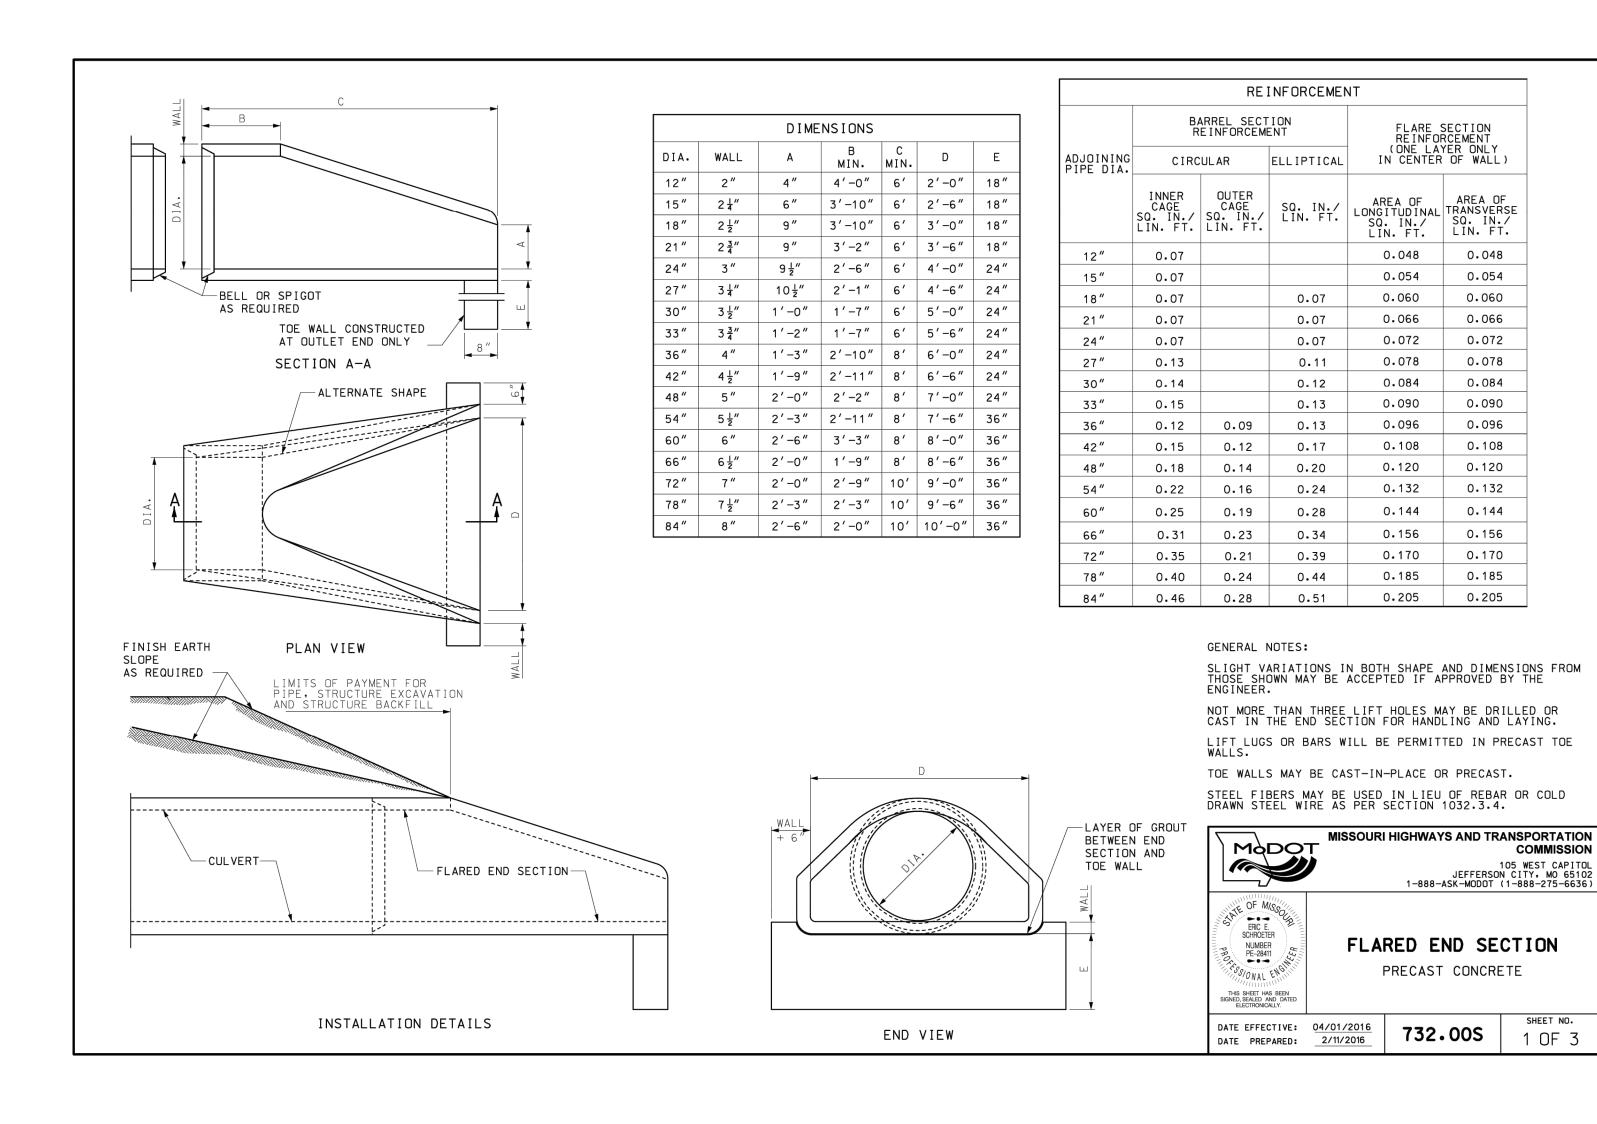

EMBANKMENT INSTALLATIONS

TRENCH INSTALLATION

MAXIMUM HEIGHT OF FILL OVER RCP CULVERTS ISTALLATION TYPE CLASS CLA	
TYPE CLASS I CLASS II CLASS III CLASS IV CLASS V	MAXIM
CEASS I CEASS II CEASS III CEASS IV CEASS V	ISTALLATION
TYPE 1 14 18 21 33 50	TYPE
	TYPE 1
TYPE 2 9 12 16 25 38	TYPE 2
TYPE 3 7 10 12 19 30	TYPE 3
TYPE 4 5 7 8 13 19	TYPE 4

NOTE: IF FILL HEIGHT EXCEEDS 50 FEET, A SPECIAL DESIGN CONCRETE PIPE WILL BE REQUIRED USING TYPE 1 INSTALLATION.

0.048

0.054

0.060

0.066

0.072

0.078

0.084

0.096

0.132

COMMISSION

1 OF 3

O	NSTRUCTION SEQUEN	CE:				
,	PLACE BEDDING MATERIAL	<i>TO</i>	GRADE.	DO	NOT	COMPA
•	MICTALL DIDE TO COLOR					

I.D.= NORMAL INSIDE DIAMETER OF PIPE. O.D. = OUTSIDE DIAMETER OF PIPE. H = FILL COVER HEIGHT OVER PIPE (FEET) INSTALL PIPE TO GRADE. 3. COMPACT BEDDING OUTSIDE THE MIDDLE THIRD OF THE PIPE. MIN. = MINIMUM4. PLACE AND COMPACT THE HAUNCH AREA UP TO THE SPRINGLINE. >>>>>> = UNDISTURBED SOIL 5. COMPLETE BACKFILL ACCORDING TO SPECIFICATIONS.

GENERAL NOTES:

1. MULTIPLE PIPE CULVERTS SHALL BE INSTALLED WITH A MINIMUM CLEARANCE BETWEEN PIPES OF 1/2 O.D. OR 12",

LEGEND

WHICHEVER IS GREATER, BUT NOT TO EXCEED 36". 2. USE MINIMUM CLASS III PIPE UNLESS NOTED OTHERWISE. CLASS IV & V SHALL BE USED AS REQUIRED BY BACKFILL DEPTH. CLASS I AND CLASS II REINFORCED CONCRETE PIPE SHALL ONLY BE USED FOR SEWERS IN TRENCHES OUTSIDE ROADBEDS, STREET LIMITS, PARKING LOTS AND INFLUENCE OF ANY STRUCTURE.


	BEDDING AND COMP. (% MAX. DRY DENS						
		HAUNCH	AND OUTER BE	DDING	LOWER SIDE BEDDING		
INSTALLATION TYPE	BEDDING THICKNESS	CATEGORY 1 SOIL (A)	CATEGORY 2 SOIL (B)	CATEGORY 3 SOIL (C)	CATEGORY 1 SOIL (A)	CATEGORY 2 SOIL (B)	CATEGORY 3 SOIL (C)
1	O.D./24 MINIMUM, NOT LESS THAN 3". IF ROCK FOUNDATION, USE O.D./12 MINIMUM, NOT LESS THAN 6".	95	N/A	N/A	90	95	100
2	O.D/24 MINIMUM, NOT LESS THAN 3". IF ROCK FOUNDATION, USE O.D./12 MINIMUM, NOT LESS THAN 6".	90	95	N/A	85	90	95
3	O.D./24 MINIMUM, NOT LESS THAN 3". IF ROCK FOUNDATION, USE O.D./12 MINIMUM, NOT LESS THAN 6".	85	90	95	85	90	95
4	O.D./24 MINIMUM, NOT LESS THAN 3". IF ROCK FOUNDATION, USE O.D./12 MINIMUM, NOT LESS THAN 6".	NO COMPACTION REQUIRED	NO COMPACTION REQUIRED	85	NO COMPACTION REQUIRED	NO COMPACTION REQUIRED	85

(A) WELL GRADED MIXTURE OF STONE FRAGMENTS, GRAVEL AND SAND IN ACCORANCE W/ AASHTO M 145 GROUP A-1 OR A-3 (B) LOW PLASTIC GRANULAR MATERIAL IN ACCORDANCE W/ AASHTO M145 GROUP A-2 OR A-4 (C) SILTY CLAYS IN ACCORDANCE W/ AASHTO M145 GROUP A-5, A-6, OR A-7

EMBEDMENT OF RCP STORM SEWER PIPE

NOT TO SCALE

STATE OF MISSOURI MICHAEL L. PARSON, **GOVERNOR**

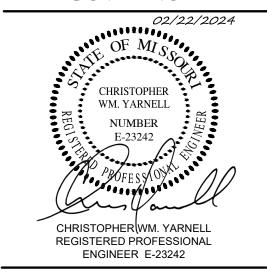



OFFICE OF ADMINISTRATION DIVISION OF FACILITIES MANAGEMENT, **DESIGN AND CONSTRUCTION**

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PROJECT # X2316-01 5306 7815306134 ASSET#


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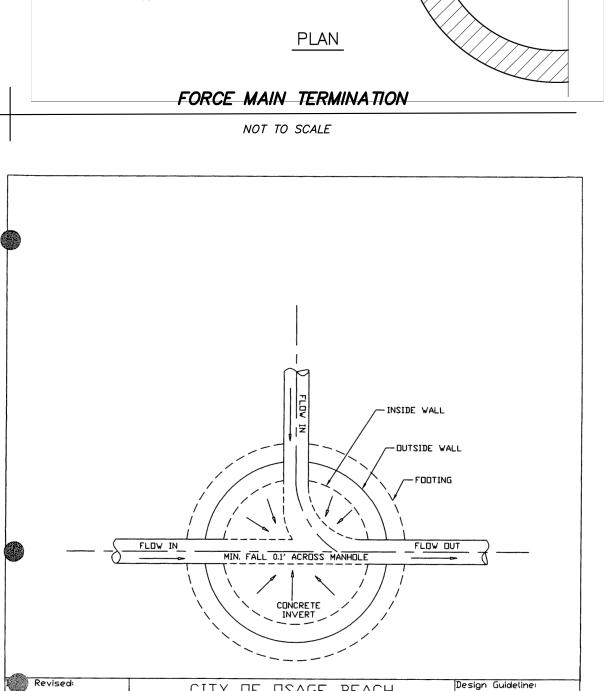
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STORM SEWER DETAILS

SHEET NUMBER:





CITY OF OSAGE BEACH

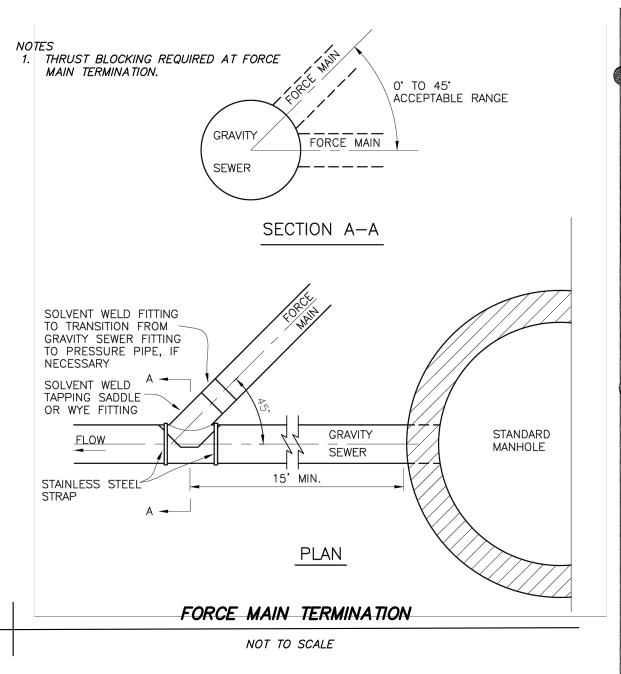TYPICAL DETAIL

MANHOLE INVERT DETAIL

NOT TO SCALE


SECTION 3


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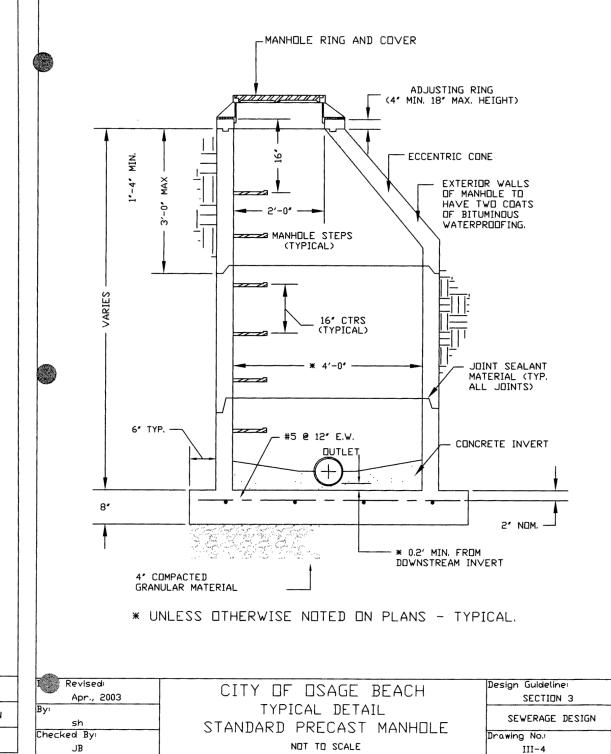
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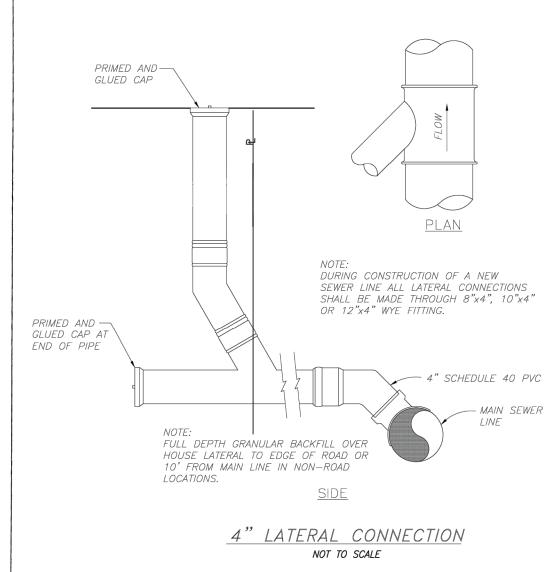
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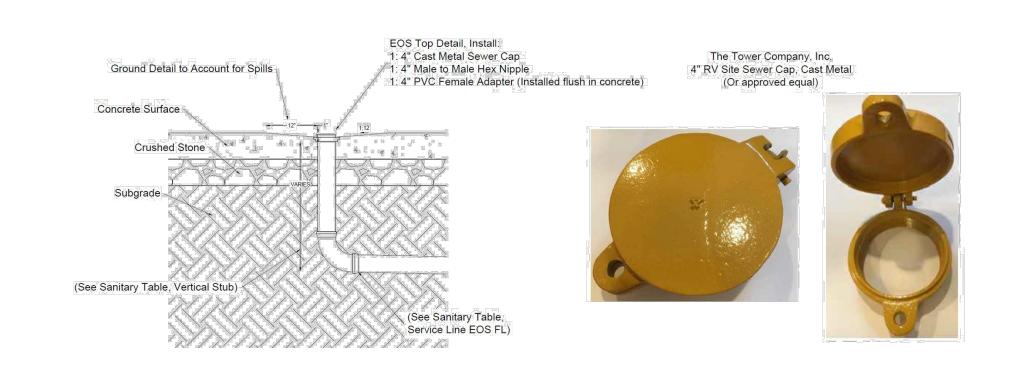
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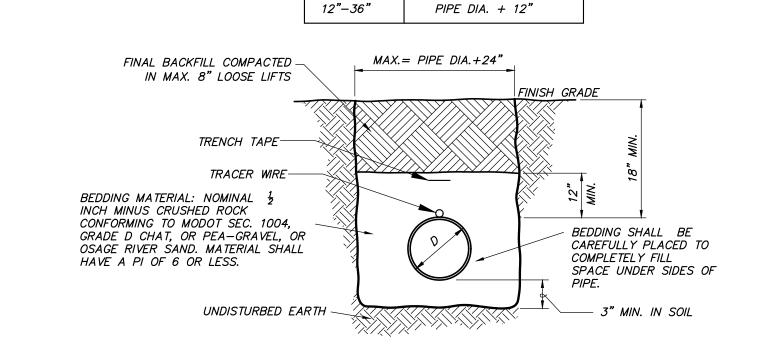








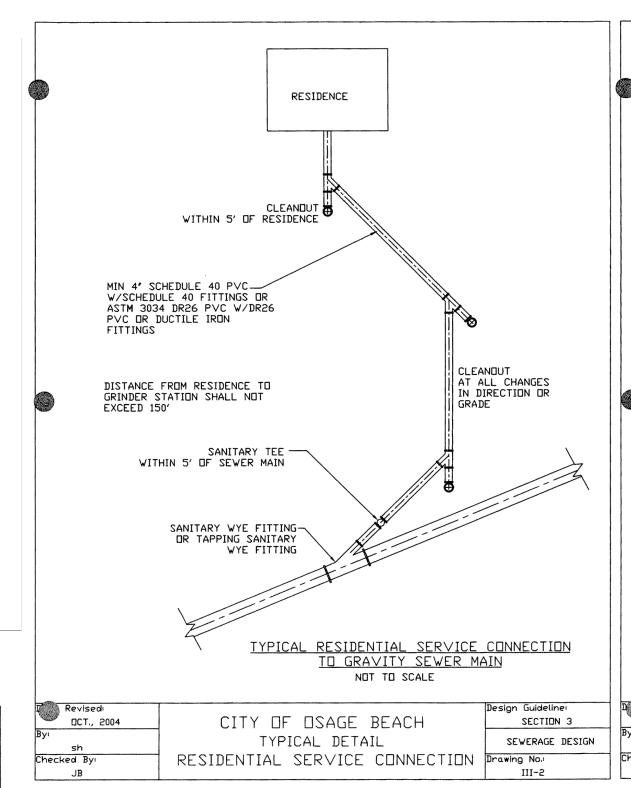

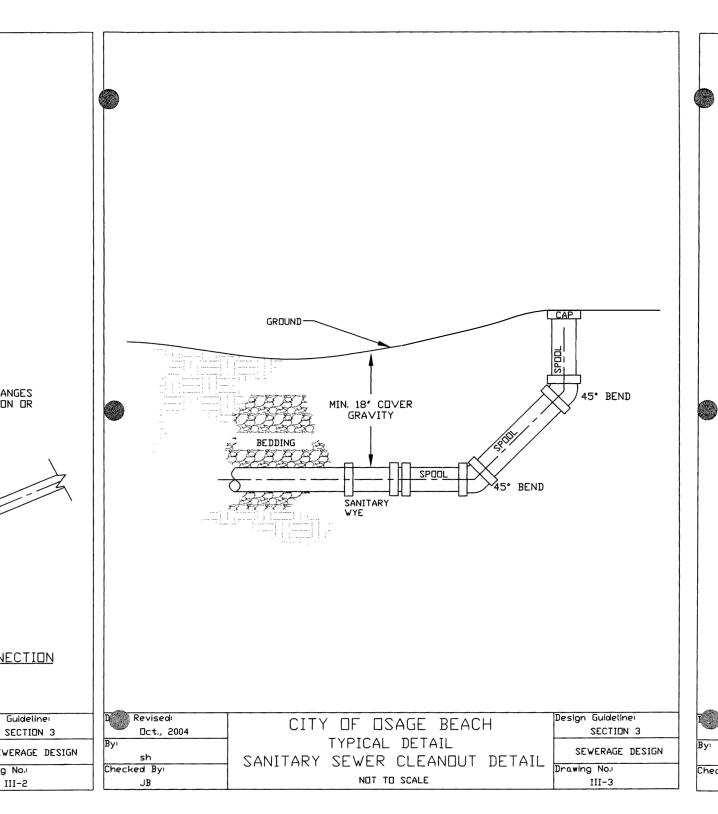

PIPE DIA.


≤6"


8"–10"


MIN. TRENCH WIDTH


PIPE DIA. + 18" PIPE DIA. + 10"



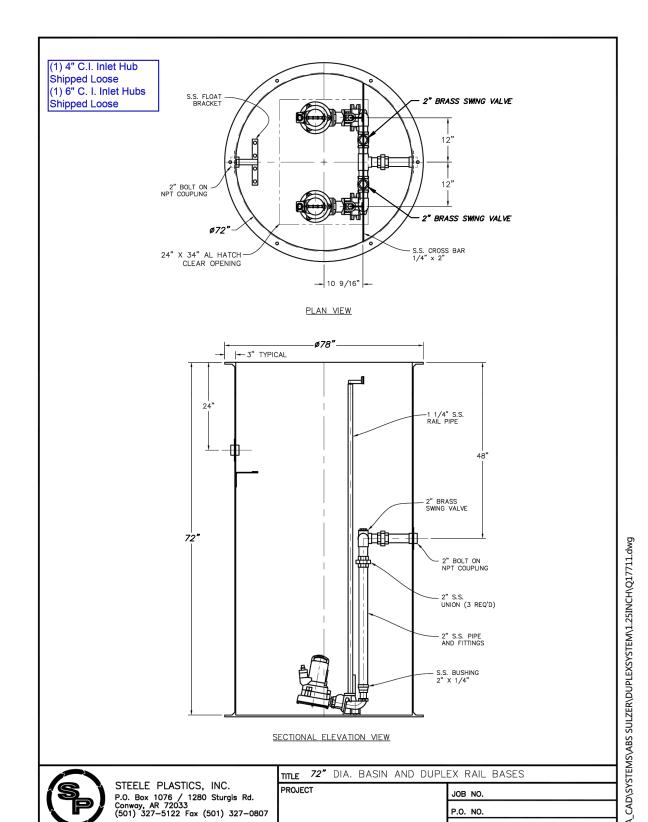

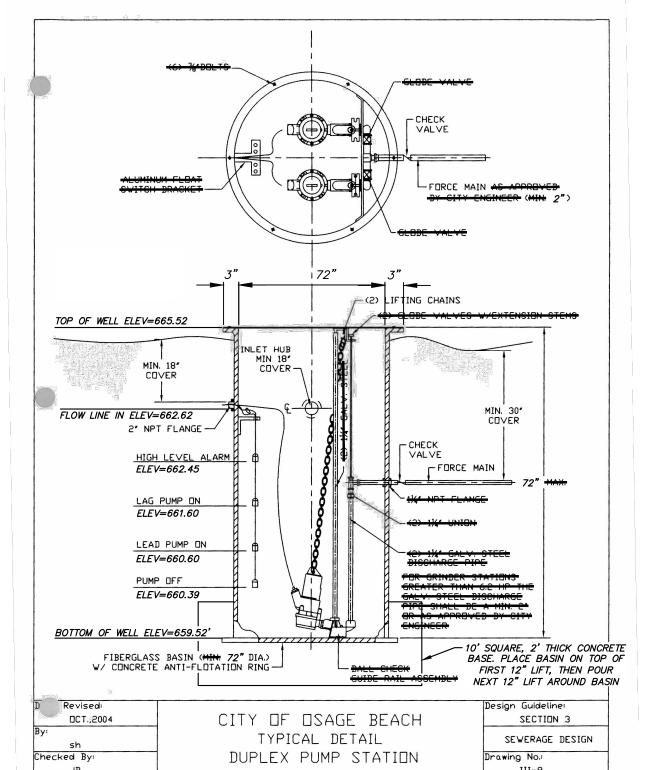

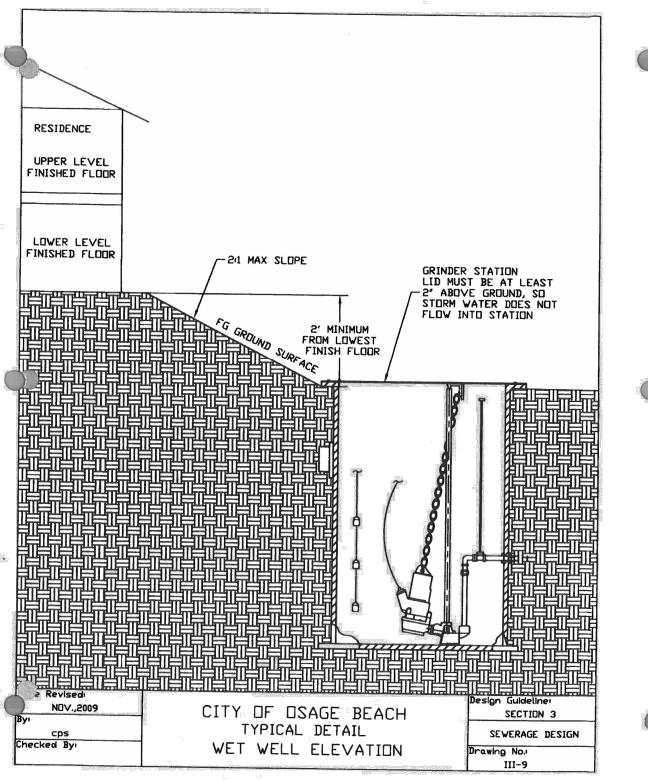

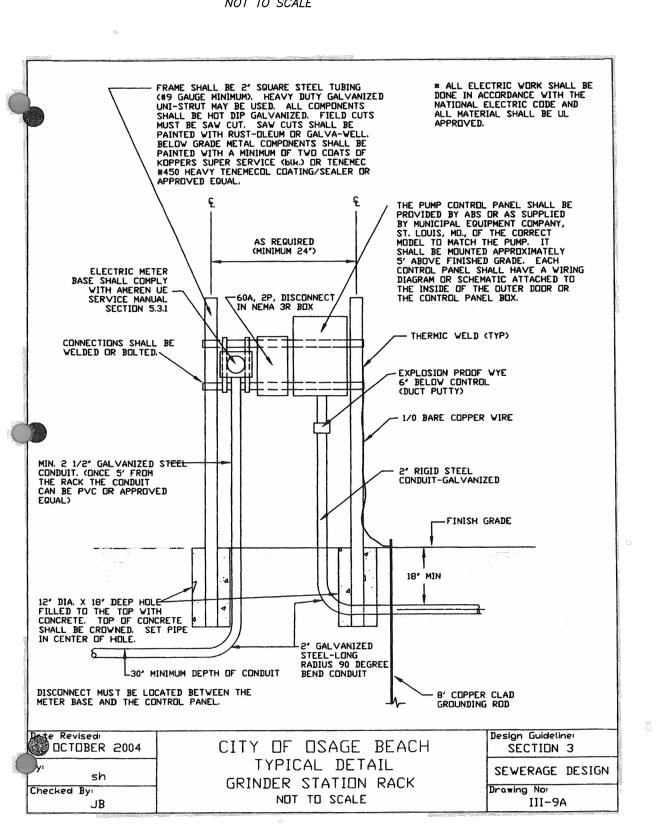

STATE OF MISSOURI MICHAEL L. PARSON, **GOVERNOR**





OFFICE OF ADMINISTRATION DIVISION OF FACILITIES MANAGEMENT, **DESIGN AND CONSTRUCTION**

DEPARTMENT OF NATURAL RESOURCES, **DIVIISON OF STATE PARKS**

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PROJECT # X2316-01 5306 7815306134 ASSET #


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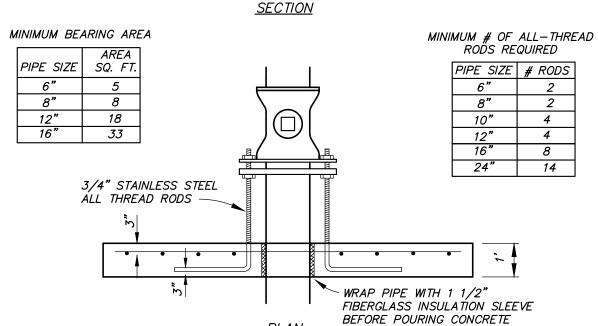
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SANITARY SEWER **DETAILS**

SHEET NUMBER:







NOTES:

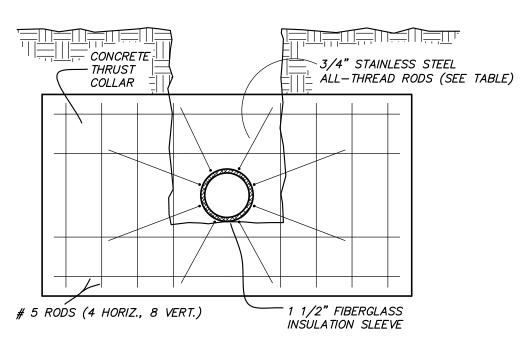1. THE #5 REBAR ARE NOT REQUIRED FOR 6" PIPE.




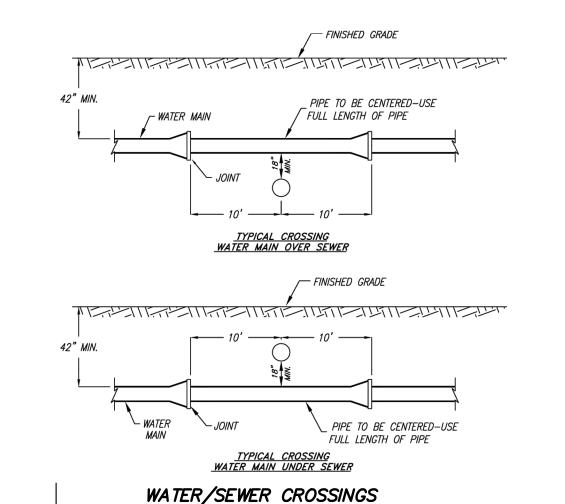


NOT TO SCALE

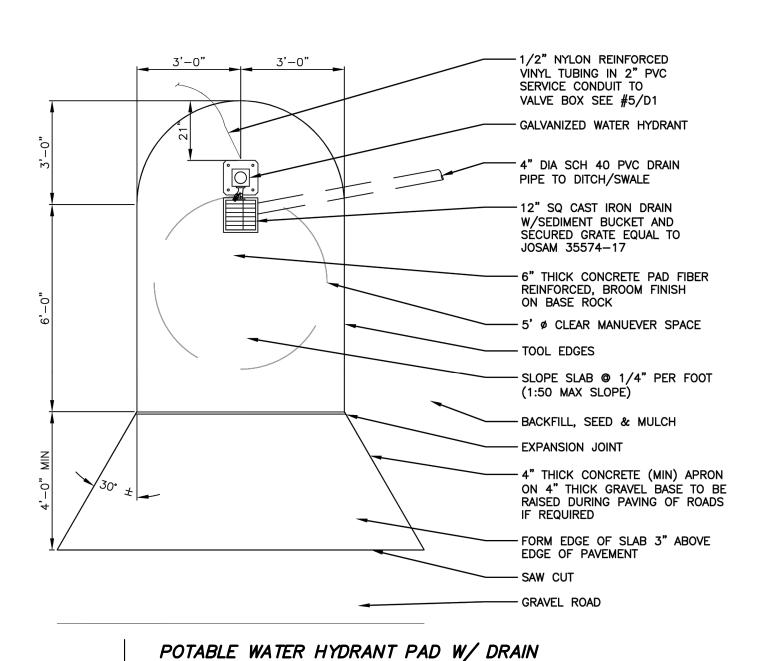


NOT TO SCALE

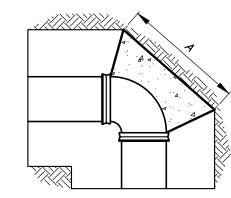


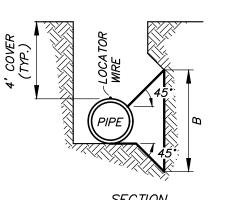

<u>PLAN</u>					SECTION				
11 1/4	* BEND	22 1/2	* BEND	45° E	BEND	90° E	BEND	TE	Έ
Α	В	Α	В	Α	В	Α	В	Α	В
1'-0"	0'-6"	1'-3"	0'-9"	1'-6"	1'-0"	2'-0"	1'-6"	2'-6"	1'-9"
1'-0"	0'-9"	1'-6"	1'-0"	2'-0"	1'-6"	2'-9"	2'-0"	3'-3"	2'-3"
1'-6"	1'-0"	2'-3"	1'-6"	3'-0"	2'-0"	4'-0"	2'-9"	5 ' -0"	3'-3"
2'-0"	1'-6"	3'-0"	2'-0"	4'-0"	2'-9"	5'-6"	3'-9"	6'-0"	4'-0"
	A 1'-0" 1'-0" 1'-6"	11 1/4' BEND A B 1'-0" 0'-6" 1'-0" 0'-9" 1'-6" 1'-0"	11 1/4' BEND 22 1/2 A B A 1'-0" 0'-6" 1'-3" 1'-0" 0'-9" 1'-6" 1'-6" 1'-0" 2'-3"	A B A B 1'-0" 0'-6" 1'-3" 0'-9" 1'-0" 0'-9" 1'-6" 1'-0" 1'-6" 1'-0" 2'-3" 1'-6"	A B A B A 1'-0" 0'-6" 1'-3" 0'-9" 1'-6" 1'-0" 0'-9" 1'-6" 1'-0" 2'-0" 1'-6" 1'-0" 2'-3" 1'-6" 3'-0"	A B A B A B 1'-0" 0'-6" 1'-3" 0'-9" 1'-6" 1'-0" 1'-0" 0'-9" 1'-6" 1'-0" 2'-0" 1'-6" 1'-6" 1'-0" 2'-3" 1'-6" 3'-0" 2'-0"	11 1/4° BEND 22 1/2° BEND 45° BEND 90° E A B A B A B A 1'-0" 0'-6" 1'-3" 0'-9" 1'-6" 1'-0" 2'-0" 1'-0" 0'-9" 1'-6" 1'-0" 2'-0" 1'-6" 2'-9" 1'-6" 1'-0" 2'-3" 1'-6" 3'-0" 2'-0" 4'-0"	11 1/4* BEND 22 1/2* BEND 45* BEND 90* BEND A B A B A B 1'-0" 0'-6" 1'-3" 0'-9" 1'-6" 1'-0" 2'-0" 1'-6" 1'-0" 0'-9" 1'-6" 1'-0" 2'-0" 1'-6" 2'-9" 2'-0" 1'-6" 1'-0" 2'-3" 1'-6" 3'-0" 2'-0" 4'-0" 2'-9"	A B A B


THRUST BLOCK DETAIL NOT TO SCALE

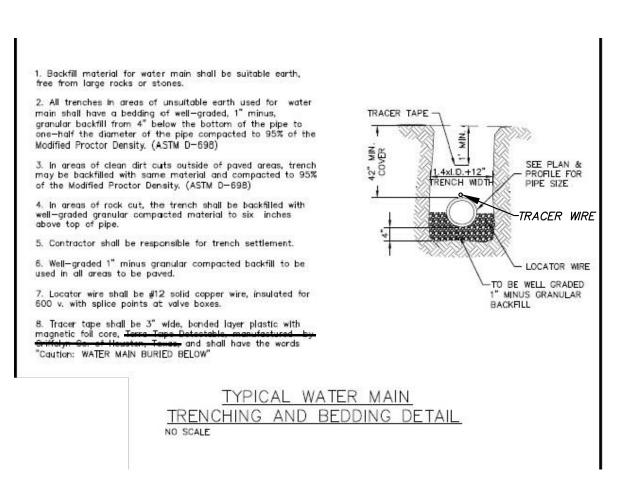

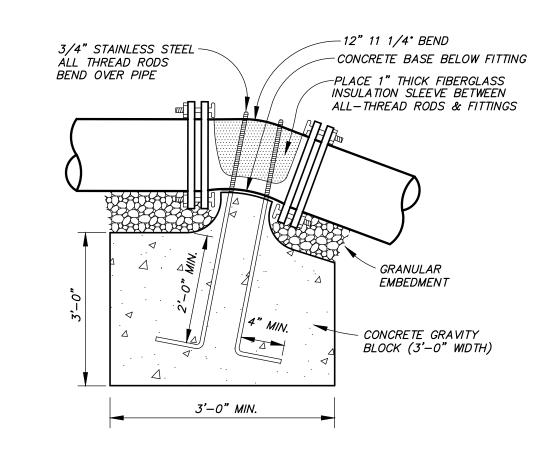



VERTICAL THRUST BLOCK DETAIL


NOT TO SCALE

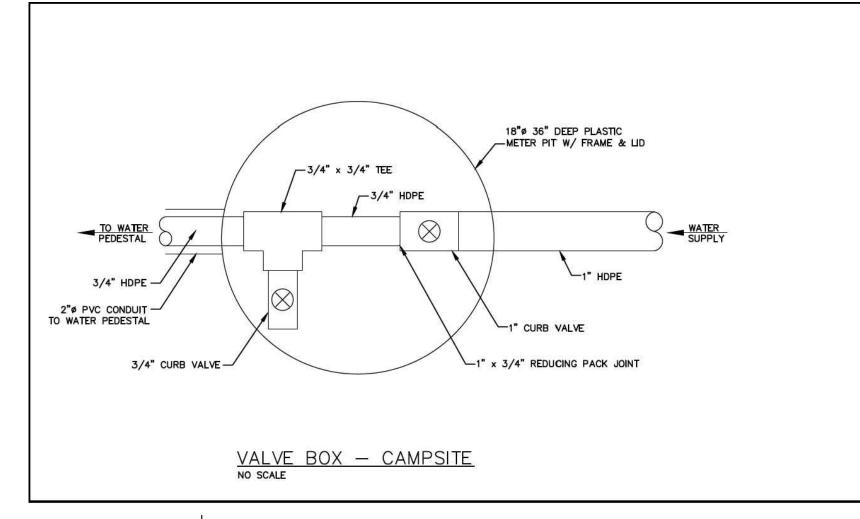

CAMPSITE WATER VALVE BOX

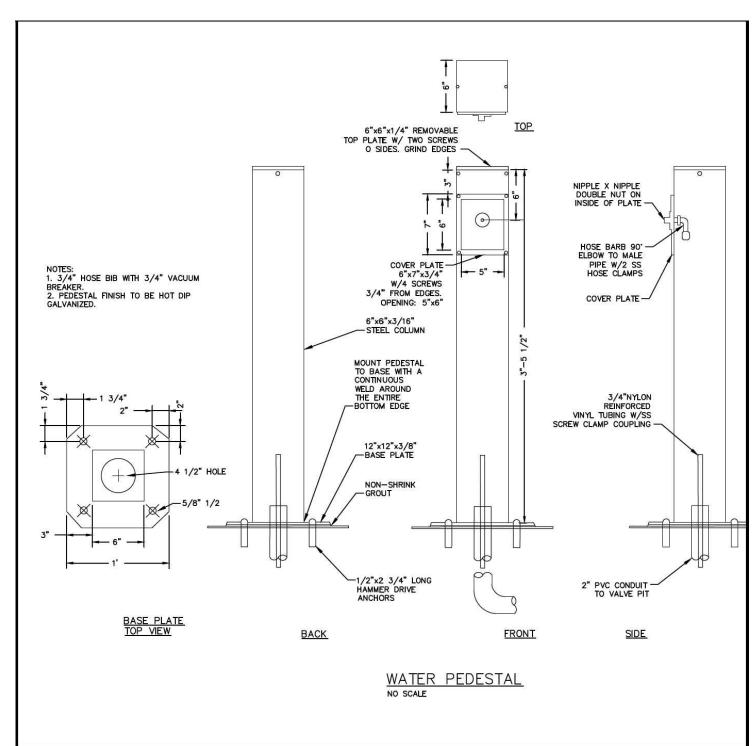


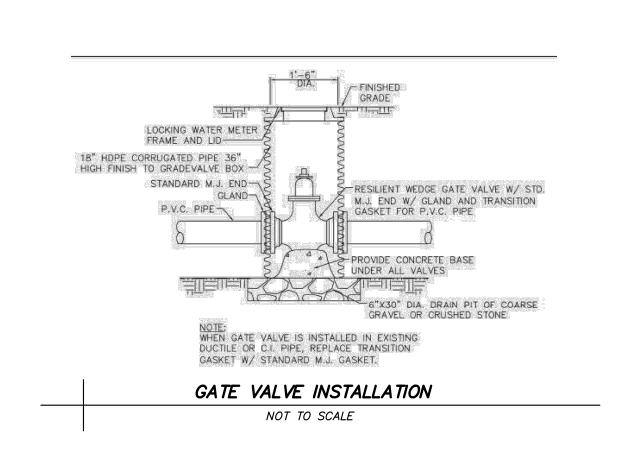

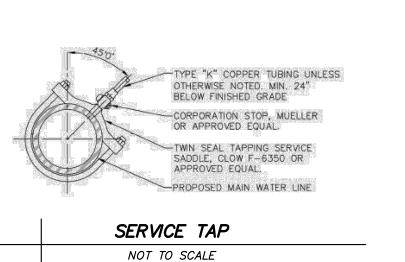





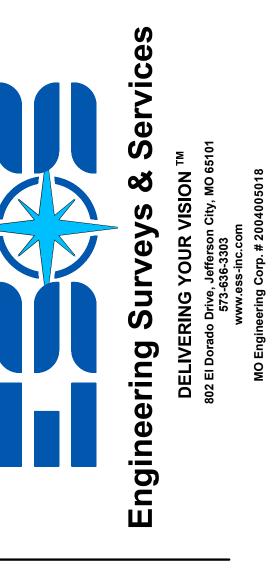

OFFICE OF ADMINISTRATION **DIVISION OF FACILITIES** MANAGEMENT, **DESIGN AND CONSTRUCTION**

DEPARTMENT OF NATURAL RESOURCES, **DIVISION OF STATE PARKS**

LAKE OF THE OZARKS STATE PARK REPLACE 29 BASIC SITES WITH 25 NEW PREMIUM SITES

LAKE OF THE OZARKS STATE PARK CAMPGROUND #4 MO ROUTE 134 KAISER, MISSOURI 65047 CAMDEN COUNTY

PROJECT # X2316-01 5306 7815306134 ASSET#


REVISION: DATE **REVISION REVISION** ISSUE DATE: 02/22/2024


CAD DWG FILE:XXX
DRAWN BY: CLR
CHECKED BY: CWY
DESIGNED BY: CWY


SHEET TITLE:

WATERLINE DETAILS

SHEET NUMBER:

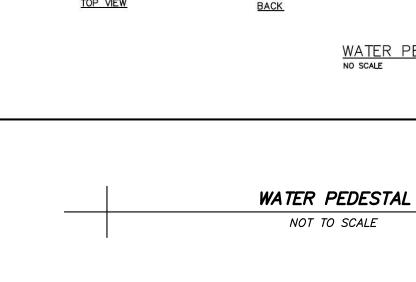

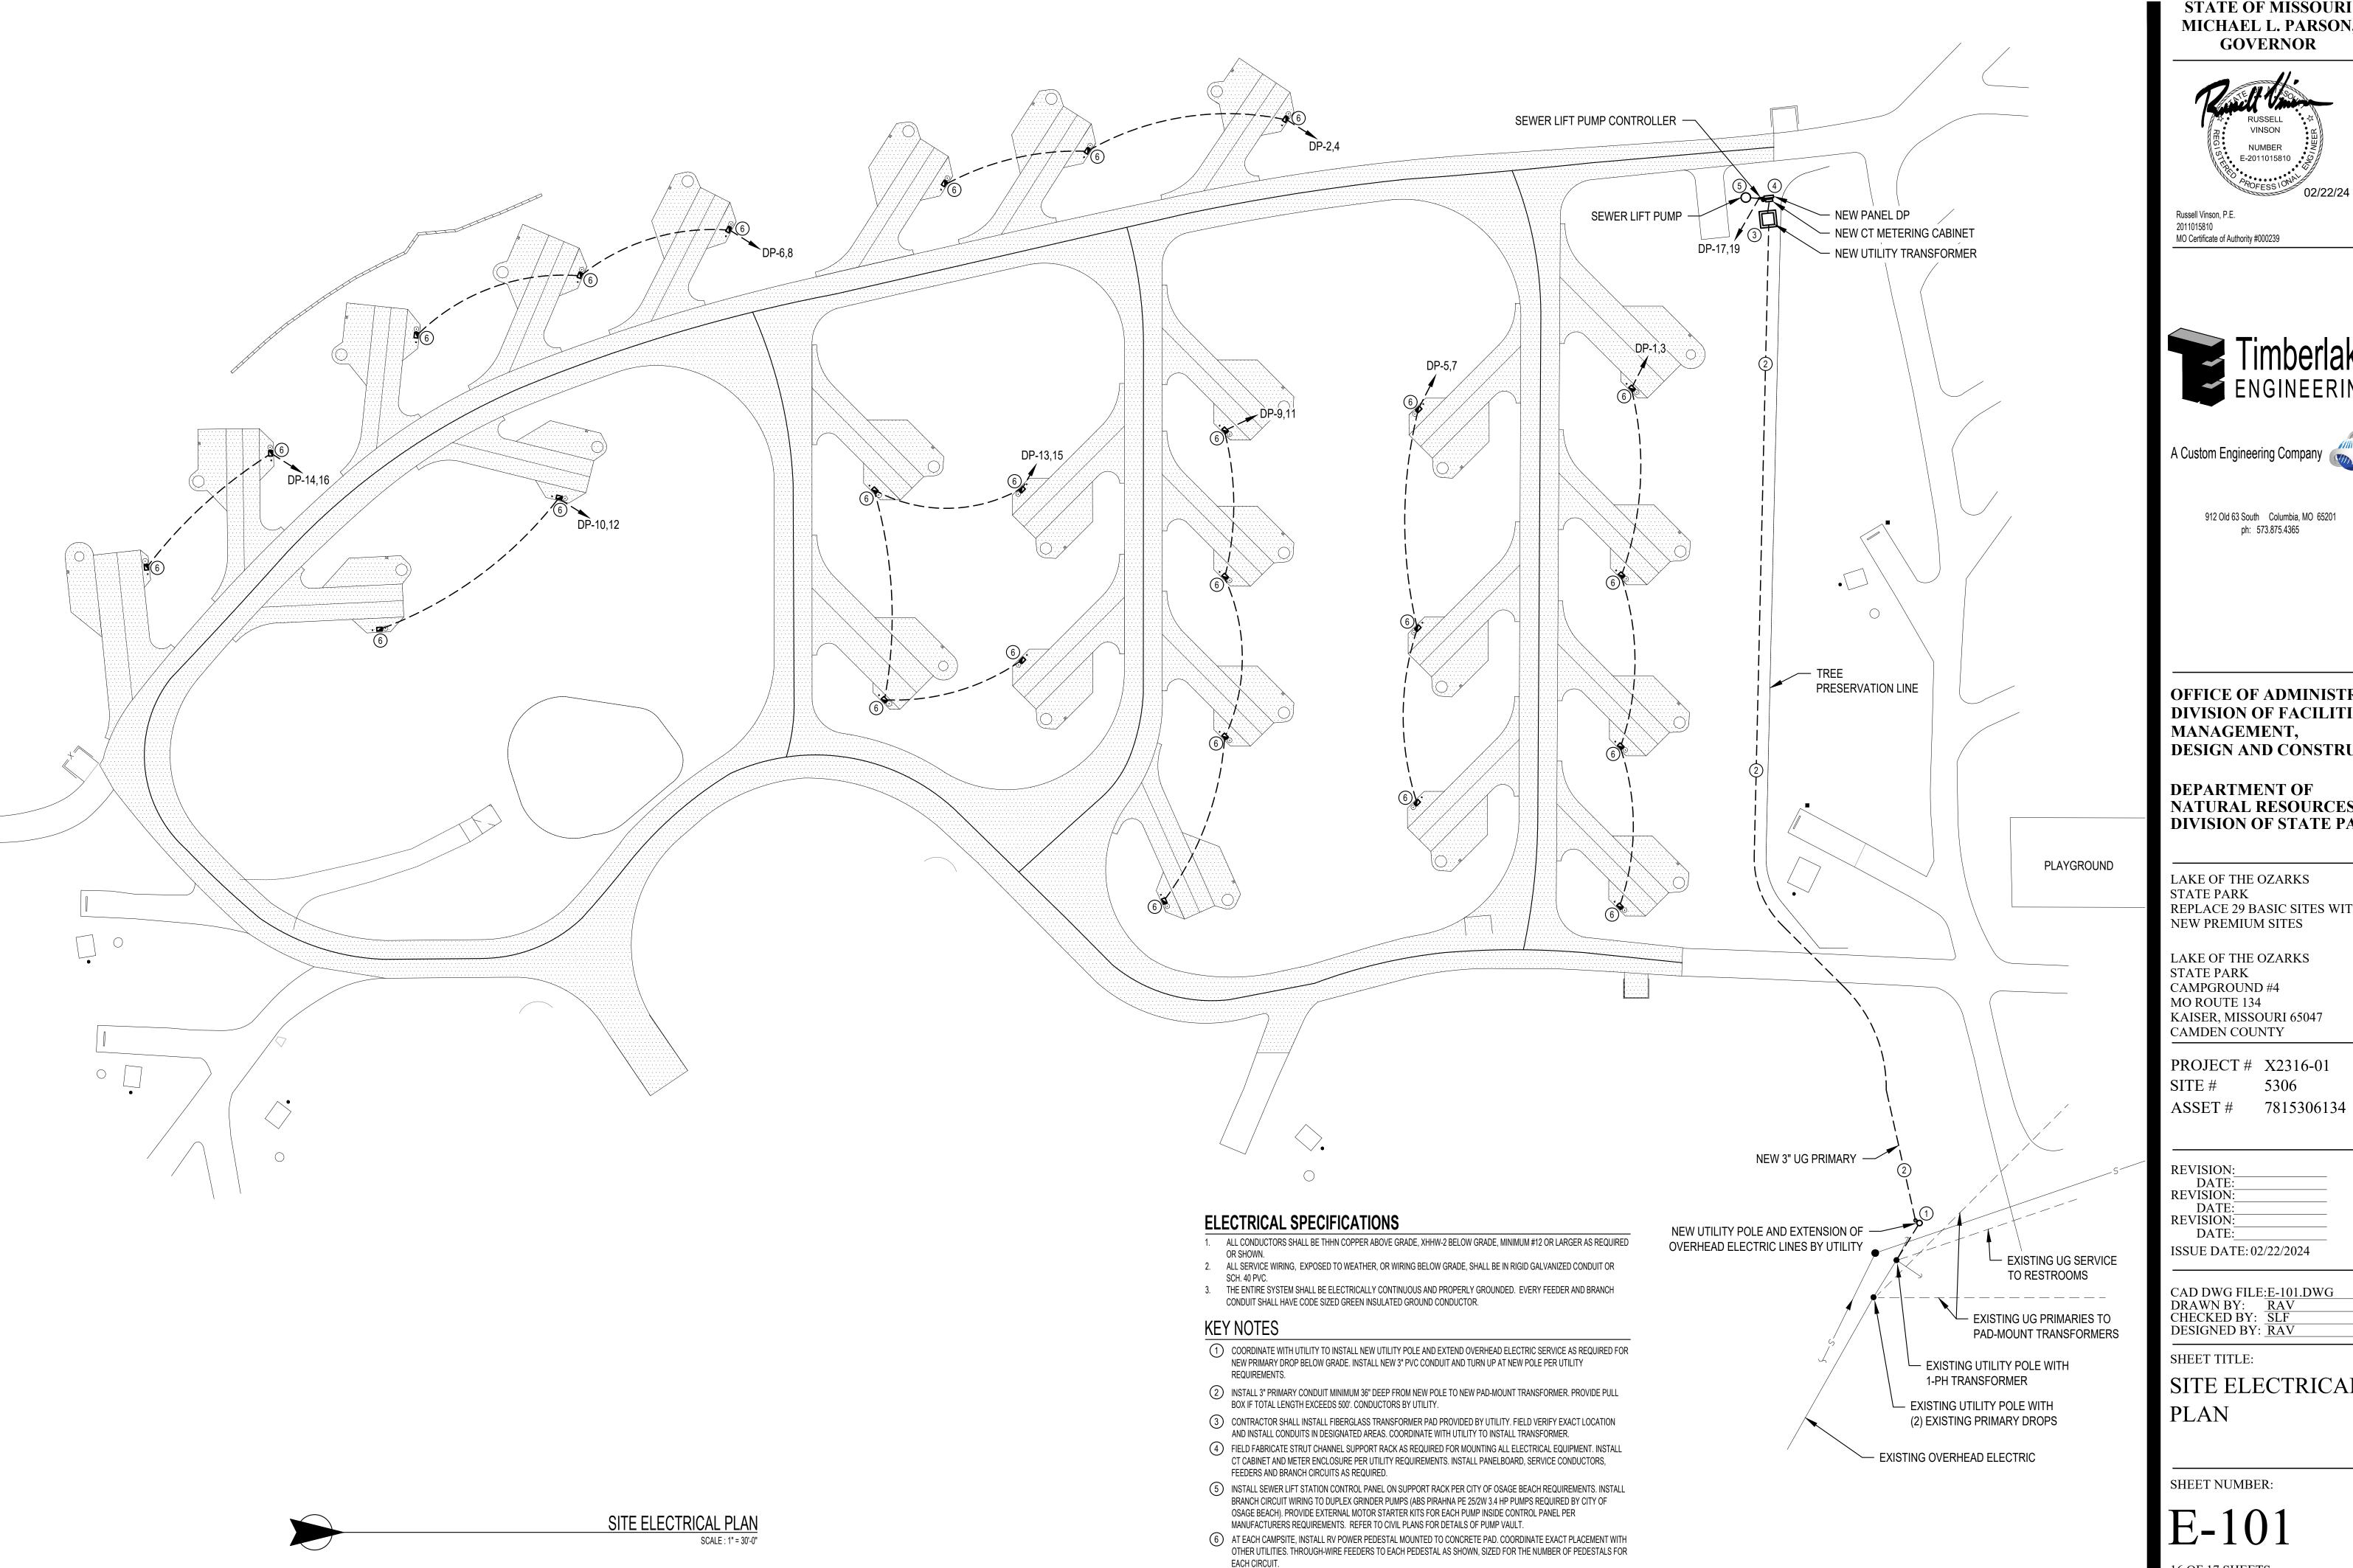

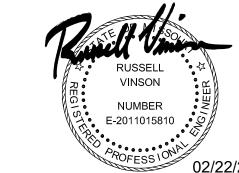



A Custom Engineering Company

912 Old 63 South Columbia, MO 65201 ph: 573.875.4365

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DEPARTMENT OF NATURAL RESOURCES, DIVISION OF STATE PARKS

LAKE OF THE OZARKS REPLACE 29 BASIC SITES WITH 25


LAKE OF THE OZARKS CAMPGROUND #4 MO ROUTE 134 KAISER, MISSOURI 65047

PROJECT # X2316-01 5306

CAD DWG FILE:E-101.DWG DRAWN BY: RAV CHECKED BY: SLF DESIGNED BY: RAV

SITE ELECTRICAL

SHEET NUMBER:

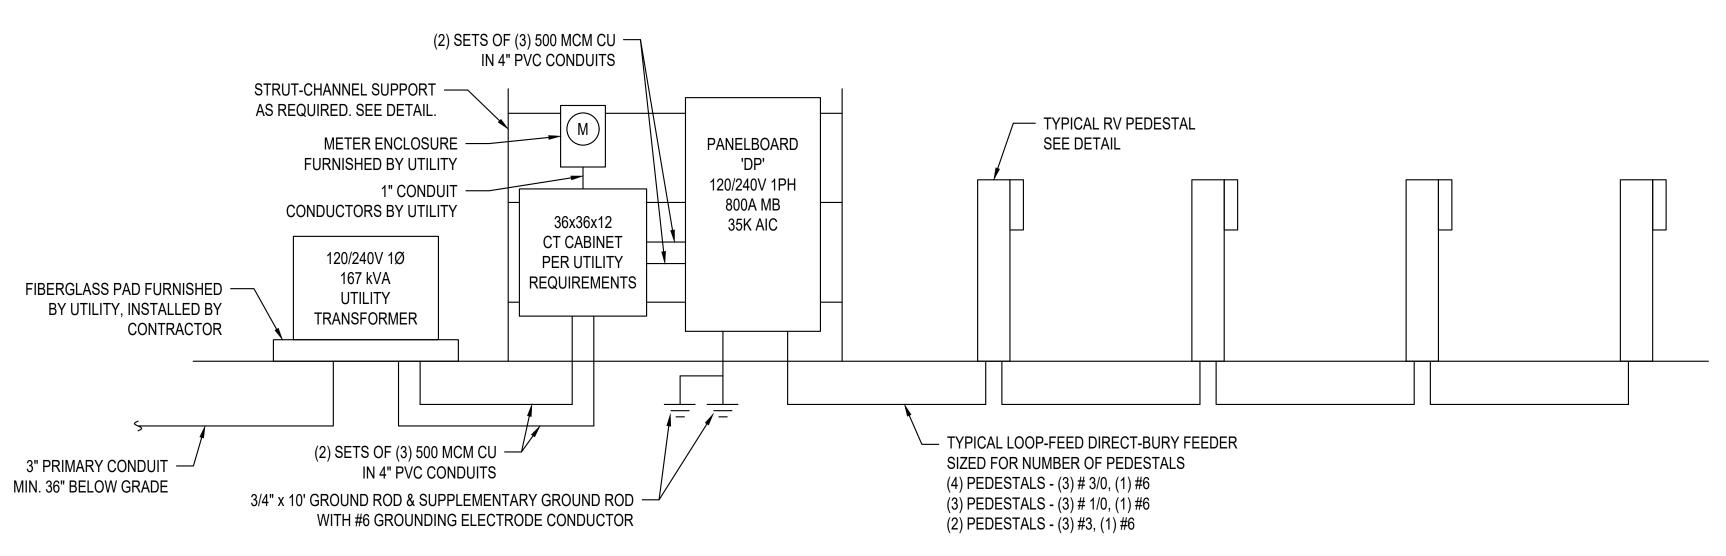


ELECTRICAL RISER DIAGRAM

ELECT	RICAL PANEL SCHEDULE						PANEL NO.	DP
VOLTS:	120/240	MAIN	CAPACITY:	800/	A MB		"A" AMPS =	1263.3
PHASE:	1	I	MOUNTING:	SUR	FACE		"B" AMPS =	1263.3
WIRE:	(2 SETS) 500 MCM CU	BUSS	MATERIAL:	COF	PPER			
AIR:	35K AIC	SQUARI	E D MODEL:	I-L	INE	1		
CKT.	LOCATION/DESC.	BREAKER	AMPS	PH.	AMPS	BREAKER	LOCATION/DESC.	CKT.
1	4 RV SITES	200-2	200	А	150	150-2	3 RV SITES	2
3	\	1	200	В	150	1	1	4
5	3 RV SITES	150-2	150	А	150	150-2	3 RV SITES	6
7	1	1	150	В	150	1	1	8
9	4 RV SITES	200-2	200	А	100	100-2	2 RV SITES	10
11	\	1	200	В	100	1	1	12
13	4 RV SITES	200-2	200	А	100	100-2	2 RV SITES	14
15	\	1	200	В	100	1	١	16
17	SEWER LIFT STATION (3.4 HP DUPLEX)	35-2	13.3	А			SPACE	18
19	\	1	13.3	В			SPACE	20
21	SPACE			А			SPACE	22
23	SPACE			В			SPACE	24
25	SPACE			А			SPACE	26
27	SPACE			В			SPACE	28
29	SPACE			А			SPACE	30
31	SPACE			В			SPACE	32
33	SPACE			А			SPACE	34
35	SPACE			В			SPACE	36
37	SPACE			А			SPACE	38
39	SPACE			В			SPACE	40
41	SPACE			А			SPACE	42

NOTE: ELECTRICIAN TO VERIFY ALL EQUIPMENT POWER REQUIREMENTS PRIOR TO ANY EQUIPMENT & BREAKER PURCHASE OR INSTALLATION.


PROVIDE WITH LOCKABLE NEMA 3R CABINET

PER NEC TABLE 551.73(A) THE CALCULATED DEMAND FACTOR APPLIED FOR 25 RV SITES IS 42%. THE TOTAL CALCULATED SERVICE DEMAND IS 538.3 AMPS.

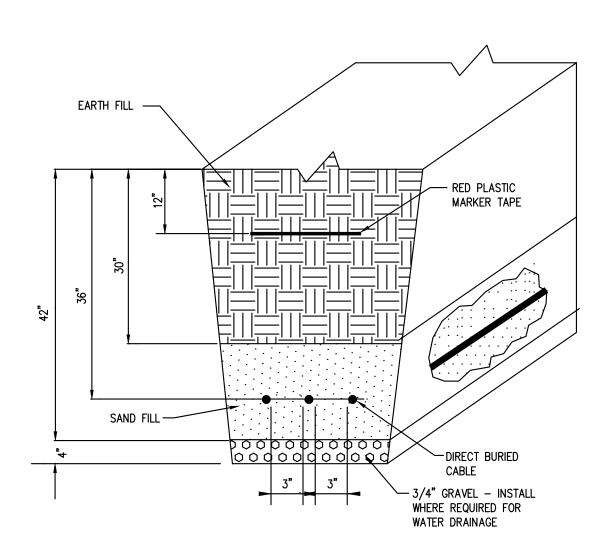


INSTALLATION OF DIRECT BURIED


UNDERGROUND CABLES NOT TO SCALE

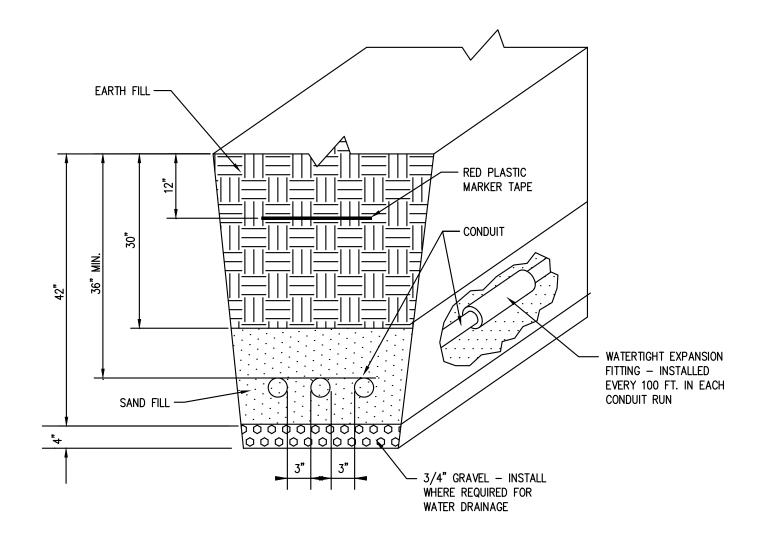


INSTALLATION OF UNDERGROUND PRIMARY CONDUITS NOT TO SCALE

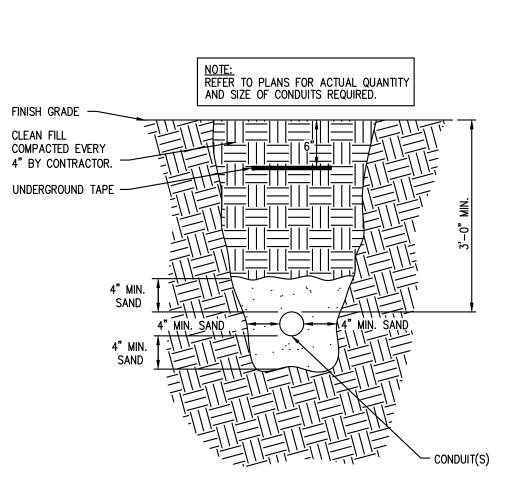


UNDERGROUND PRIMARY CONDUIT TRENCH DETAIL

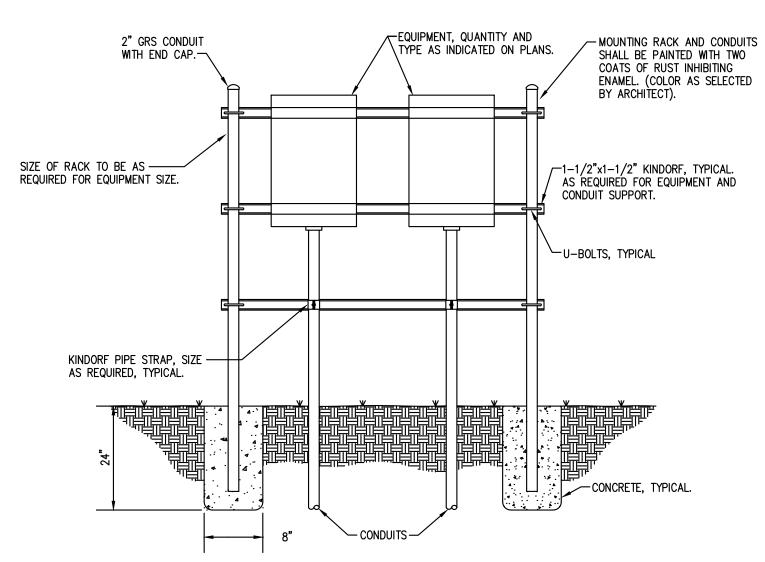


EQUIPMENT RACK MOUNTED AT GRADE DETAIL NOT TO SCALE

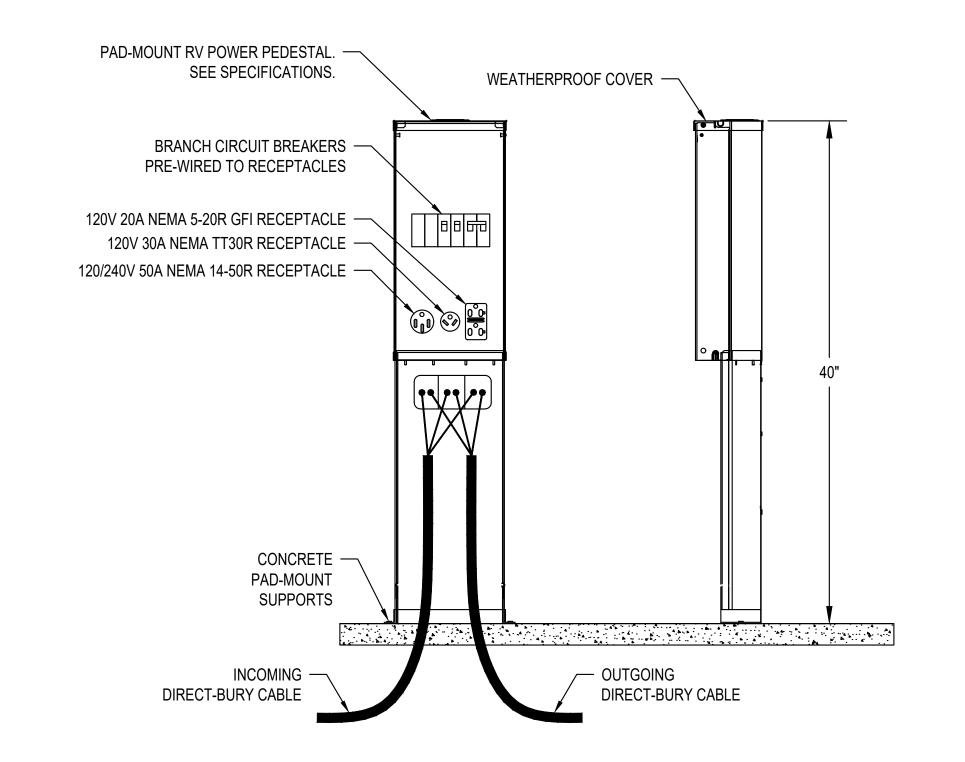

RV CAMPSITE POWER PEDESTAL

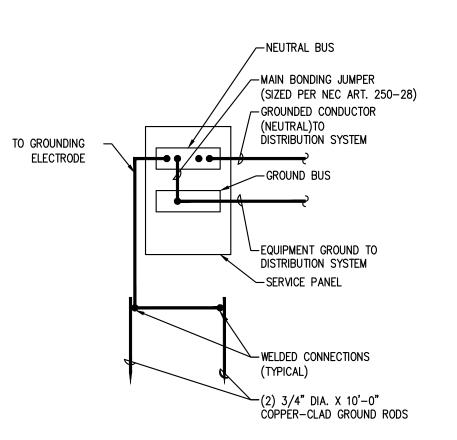

SERVICE GROUNDING ELECTRODE CONNECTION DETAIL

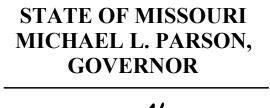



Russell Vinson, P.E. 2011015810 MO Certificate of Authority #000239





912 Old 63 South Columbia, MO 65201 ph: 573.875.4365

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REVISION: DATE: **REVISION:** DATE: **REVISION:** DATE: ISSUE DATE: 02/22/2024

CAD DWG FILE:E-101.DWG DRAWN BY: \overline{RAV} CHECKED BY: SLF

SHEET TITLE:

ELECTRIC **SCHEDULES** AND DETAILS

DESIGNED BY: RAV

SHEET NUMBER: