


NEW PREMIUM 63 SITE LOOP CAMPGROUND

ST. FRANCOIS STATE PARK

BONNE TERRE, MISSOURI

ASSET NUMBER: 7815216025

SITE NUMBER: 5216

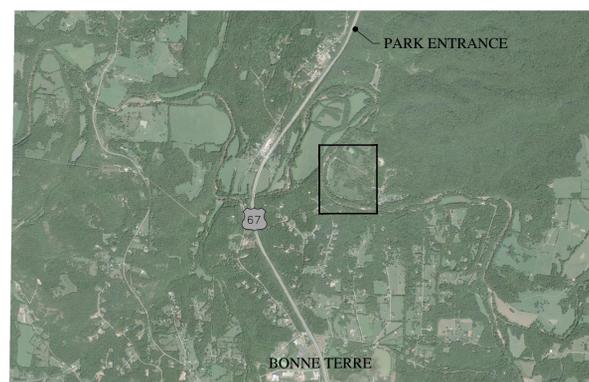

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OWNER: STATE OF MISSOURI
 MICHAEL L. PARSON,
 GOVERNOR
 DEPARTMENT OF
 NATURAL RESOURCES
 MISSOURI STATE PARKS

PROJECT MANAGEMENT: OFFICE OF ADMINISTRATION
 DIVISION OF FACILITIES MANAGEMENT,
 DESIGN AND CONSTRUCTION

PROJECT NUMBER: X2317-01


CIVIL ENGINEER & ARCHITECT
 COCHRAN
 530A E. INDEPENDENCE DR.
 UNION, MO 63084
 PHONE: (636)-584-0540

MECHANICAL, ELECTRICAL,
 & STRUCTURAL ENGINEER
 CASE ENGINEERING INC.
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SHEET NUMBER:

G-001

1 OF 56 SHEETS
 03/28/2025

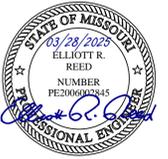

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of Authority Numbers:
Survey : 000350
Engineering : 001655
Architecture : 2002014240

OFFICE OF ADMINISTRATION
DIVISION OF FACILITIES
MANAGEMENT,
DESIGN AND CONSTRUCTION

DEPARTMENT OF
NATURAL RESOURCES
MISSOURI STATE PARKS

NEW PREMIUM 63 SITE
LOOP CAMPGROUND

ST. FRANCOIS STATE PARK
8920 US-67N
BONNE TERRE, MO 63628

PROJECT # X2317-01
SITE # 5216
ASSET # 7815216025

REVISION: _____
DATE: _____
REVISION: _____
DATE: _____
REVISION: _____
DATE: _____

ISSUE DATE: 03/28/2025

CAD DWG FILE: X2317-GN-101
DRAWN BY: LJR
CHECKED BY: ERR
DESIGNED BY: ERR

SHEET TITLE:

GENERAL
NOTES

SHEET NUMBER:

C-101

2 OF 56 SHEETS
03/28/2025

EROSION CONTROL NOTES

1. Land disturbing activities shall not commence until approval to do so has been received by governing agencies and until all erosion control measures have been taken.
2. Contractor shall assure positive drainage from buildings for all natural & paved areas.
3. No land clearing or grading shall begin until all erosion control measures have been installed.
4. Site grading shall not proceed until erosion control measures have been taken.
5. Should construction stop for longer than 14 days, the site shall be seeded as specified by temporary seeding mix.
6. Maintain erosion control measures after each rain and at least once a week.
7. This plan shall not be considered all inclusive as the contractor shall take all necessary precautions to prevent soil sediment from leaving the site.
8. Contractor shall comply with all state and local ordinances that apply.
9. Additional erosion and sediment control measures will be installed if deemed necessary by on site inspection.
10. If installation of storm drainage system should be interrupted by weather or nightfall, the pipe ends shall be covered with filter fabric.
11. Contractor shall be responsible to take whatever means necessary to establish permanent soil stabilization.
12. The contractor is responsible for keeping stormwater run-off and siltation under control during construction.
13. Contractor shall maintain the site in a well-drained manner in order to assume the shortest possible drying time after each rainfall. This will mean that pumping of standing water in low areas on the site will most likely be required during construction.
14. It shall be the contractor's responsibility to keep mud and silt on site off of streets.
15. In areas where french drain & storm sewer share the same trench, backfill shall be clean to allow for proper drainage.

GENERAL PLAN NOTES

1. The sitework on this project shall meet or exceed the State of Missouri Office of Administration standards and specifications.
2. Bearings referenced to grid north of the Missouri Coordinate System OF 1983, East Zone per GPS Observations utilizing THE MODOT VRS RTK Network and Monuments for Station LEAD.
3. Project Benchmark is GRS LEAD. ELEV. = 827.82 (NAVD 88).
3. Flood Zones: Portions of this property lie within "ZONE X"(UNSHADED), areas determined to be outside the 0.2% annual chance floodplain and "ZONE A" determined to be inside the 1% chance flood area (100 PER YEAR) per Flood Insurance Rate Map for St. Francois County, Missouri & Incorporated Areas, per Panel 135 OF 450, Community Panel Number 29187C01350, effective date June 16, 2011
4. The contractor is encouraged to visit the site prior to submitting their bid for this project.
5. This property is in accordance with generally accepted construction practices, the Contractor will be solely and completely responsible for conditions of the job site, including safety of all persons and property during performance of the work. This requirement will apply continuously and not be limited to normal working hours, Contractor will be responsible for providing and maintaining all barricades, warning signs, flashing lights and traffic control devices during construction. Contractor to comply with all OSHA regulation requirements and safety meeting requirement.
6. All survey monuments disturbed during construction shall be replaced by a licensed land surveyor licensed in the state in which this project is located at the Contractor's expense.
7. Underground structures, facilities and utilities have been plotted from available surveys and records. Therefore, their locations must be considered approximate only. There may be others, the existence of which is presently not known.
8. No investigation has been performed by Cochran regarding hazardous waste, underground conditions or utilities affecting the tract shown hereon.
9. Contractor to contact telephone, electric, gas, water and cable companies to have underground utilities located on this site and adjacent to this site prior to doing any excavating.
10. The Contractor is specifically cautioned that the location and/or elevation of existing utilities as shown on these plans is based on records of the various utility companies and, where possible, measurements taken in the field. The information is not to be relied on as being exact or complete. The Contractor must call the appropriate utility company to request exact field location of utilities. It shall be the responsibility of the Contractor to relocate all existing utilities, which conflict with the new improvements shown on plans.
11. All trenching, pipe laying, and backfilling shall be in accordance with Federal OSHA Regulations.
12. Contractor shall coordinate adjustments to existing utilities with appropriate utility company as work progresses.
13. Contractor shall coordinate the scheduling and location of the demolition and installation of all utilities, including stakeout, conduit required, trenching required, etc. Contractor shall contact each utility provider with at least 30 days advance notice of any work to be done.
14. If any existing structures to remain are damaged during construction it shall be the Contractor's responsibility to repair and/or replace the existing structure as necessary to return it to existing conditions or better.
15. All trenches under paved areas shall be backfilled with granular material and compacted to meet compaction requirements for the road/parking lot.
16. Contractor shall provide a minimum of 18" of clearance between sanitary sewer and waterlines and a minimum of 18" of clearance between storm sewers and waterlines. This may mean that lowering of waterlines may be necessary. City must approve any lowering of waterlines prior to work. Contractor shall provide a minimum of 10' of horizontal separation between waterlines and sanitary sewer lines.
17. Precast structures may be used at Contractor's option.
18. Storm and sanitary sewer plan information depicts pipe lengths and grades calculated from the center of all structures.
19. All storm pipe entering structures shall be grouted to assure connection at structure is watertight.
20. Utility Contractor shall provide 2' x 2' x 8" thick concrete apron at all sanitary and storm cleanouts outside of building, see details.
21. All un surfaced areas are to receive 4 inches of topsoil. Contractor to seed, mulch, fertilize, and maintain all areas outside of paved areas that were disturbed during construction until an acceptable stand of grass is established. The Contractor shall be responsible to take whatever means necessary to establish permanent soil stabilization.
22. Existing grade contours shown at 1 foot intervals. New grade contours shown at 1 foot intervals.
23. All cut or fill slopes shall be 3:1 or flatter unless otherwise noted.
24. TP = Top of pavement
TC = Top of curb
TG = Top of grade
TW = Top of wall
EX = Existing
25. Contractor shall saw cut all curb and gutter sections, concrete medians and along pavement where new construction ties into existing areas. Contractor shall adjust and/or cut existing pavement as necessary to assure a smooth fit and continuous grade. Contractor shall maintain traffic flow and provide traffic control throughout construction.
26. Contractor shall be responsible to remove any basements, wells, utility lines, foundations, cisterns, cellars, etc. on site which exist and are within the projects construction area.
27. All existing structures unless otherwise noted to remain, (i.e. fencing, trees, concrete, asphalt pavement, utilities, etc.) within the construction area shall be removed and disposed off-site in a manner meeting local and state regulations. Any burning on site shall be subject to local and state ordinances and the Owner's Specifications.
28. All demolition, disposal, etc. fees are to be paid by the Contractor.
29. Parking is to be striped with 4" wide painted yellow lines as indicated.
30. Storm sewer and sanitary sewer shall be constructed from the lowest point to the highest point. (Downstream to Upstream)

PIPE MATERIAL NOTES

1. Storm sewer pipe shall be reinforced concrete pipe, Class III per ASTM C-76, with flexible plastic bitumen gaskets at joints. Pipe shall be installed in accordance with pipe manufacturer's installation guidelines.
2. Sanitary sewer pipe shall be SDR 21 PVC.
3. Storm sewer downspout collector pipe shall be SDR 35 PVC pipe. Storm sewer downspout laterals shall be Schedule 40 PVC pipe.
4. Storm sewer flared ends shall be reinforced concrete.
5. Water lines shall be SDR 21, class 200 PVC pipe. Water lines 2" and smaller shall be SDR 9 PE tubing. All water lines constructed shall have a minimum of 42 inches of cover below finish grade, unless otherwise indicated on the plans.



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Missouri State Certificate
of Authority Numbers:
Survey : 000380
Engineering : 001655
Architecture : 2002014240

**OFFICE OF ADMINISTRATION
DIVISION OF FACILITIES
MANAGEMENT,
DESIGN AND CONSTRUCTION**

**DEPARTMENT OF
NATURAL RESOURCES
MISSOURI STATE PARKS**

NEW PREMIUM 63 SITE
LOOP CAMPGROUND

ST. FRANCOIS STATE PARK
8920 US-67N
BONNE TERRE, MO 63628

PROJECT # X2317-01
SITE # 5216
ASSET # 7815216025


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DATE:	_____
REVISION:	_____
DATE:	_____
ISSUE DATE:	03/28/2025

CAD DWG FILE: X2317-TS-102
DRAWN BY: JRG
CHECKED BY: ERR
DESIGNED BY: ERR

SHEET TITLE:
**EXISTING
CONDITIONS**

SHEET NUMBER:

C-102

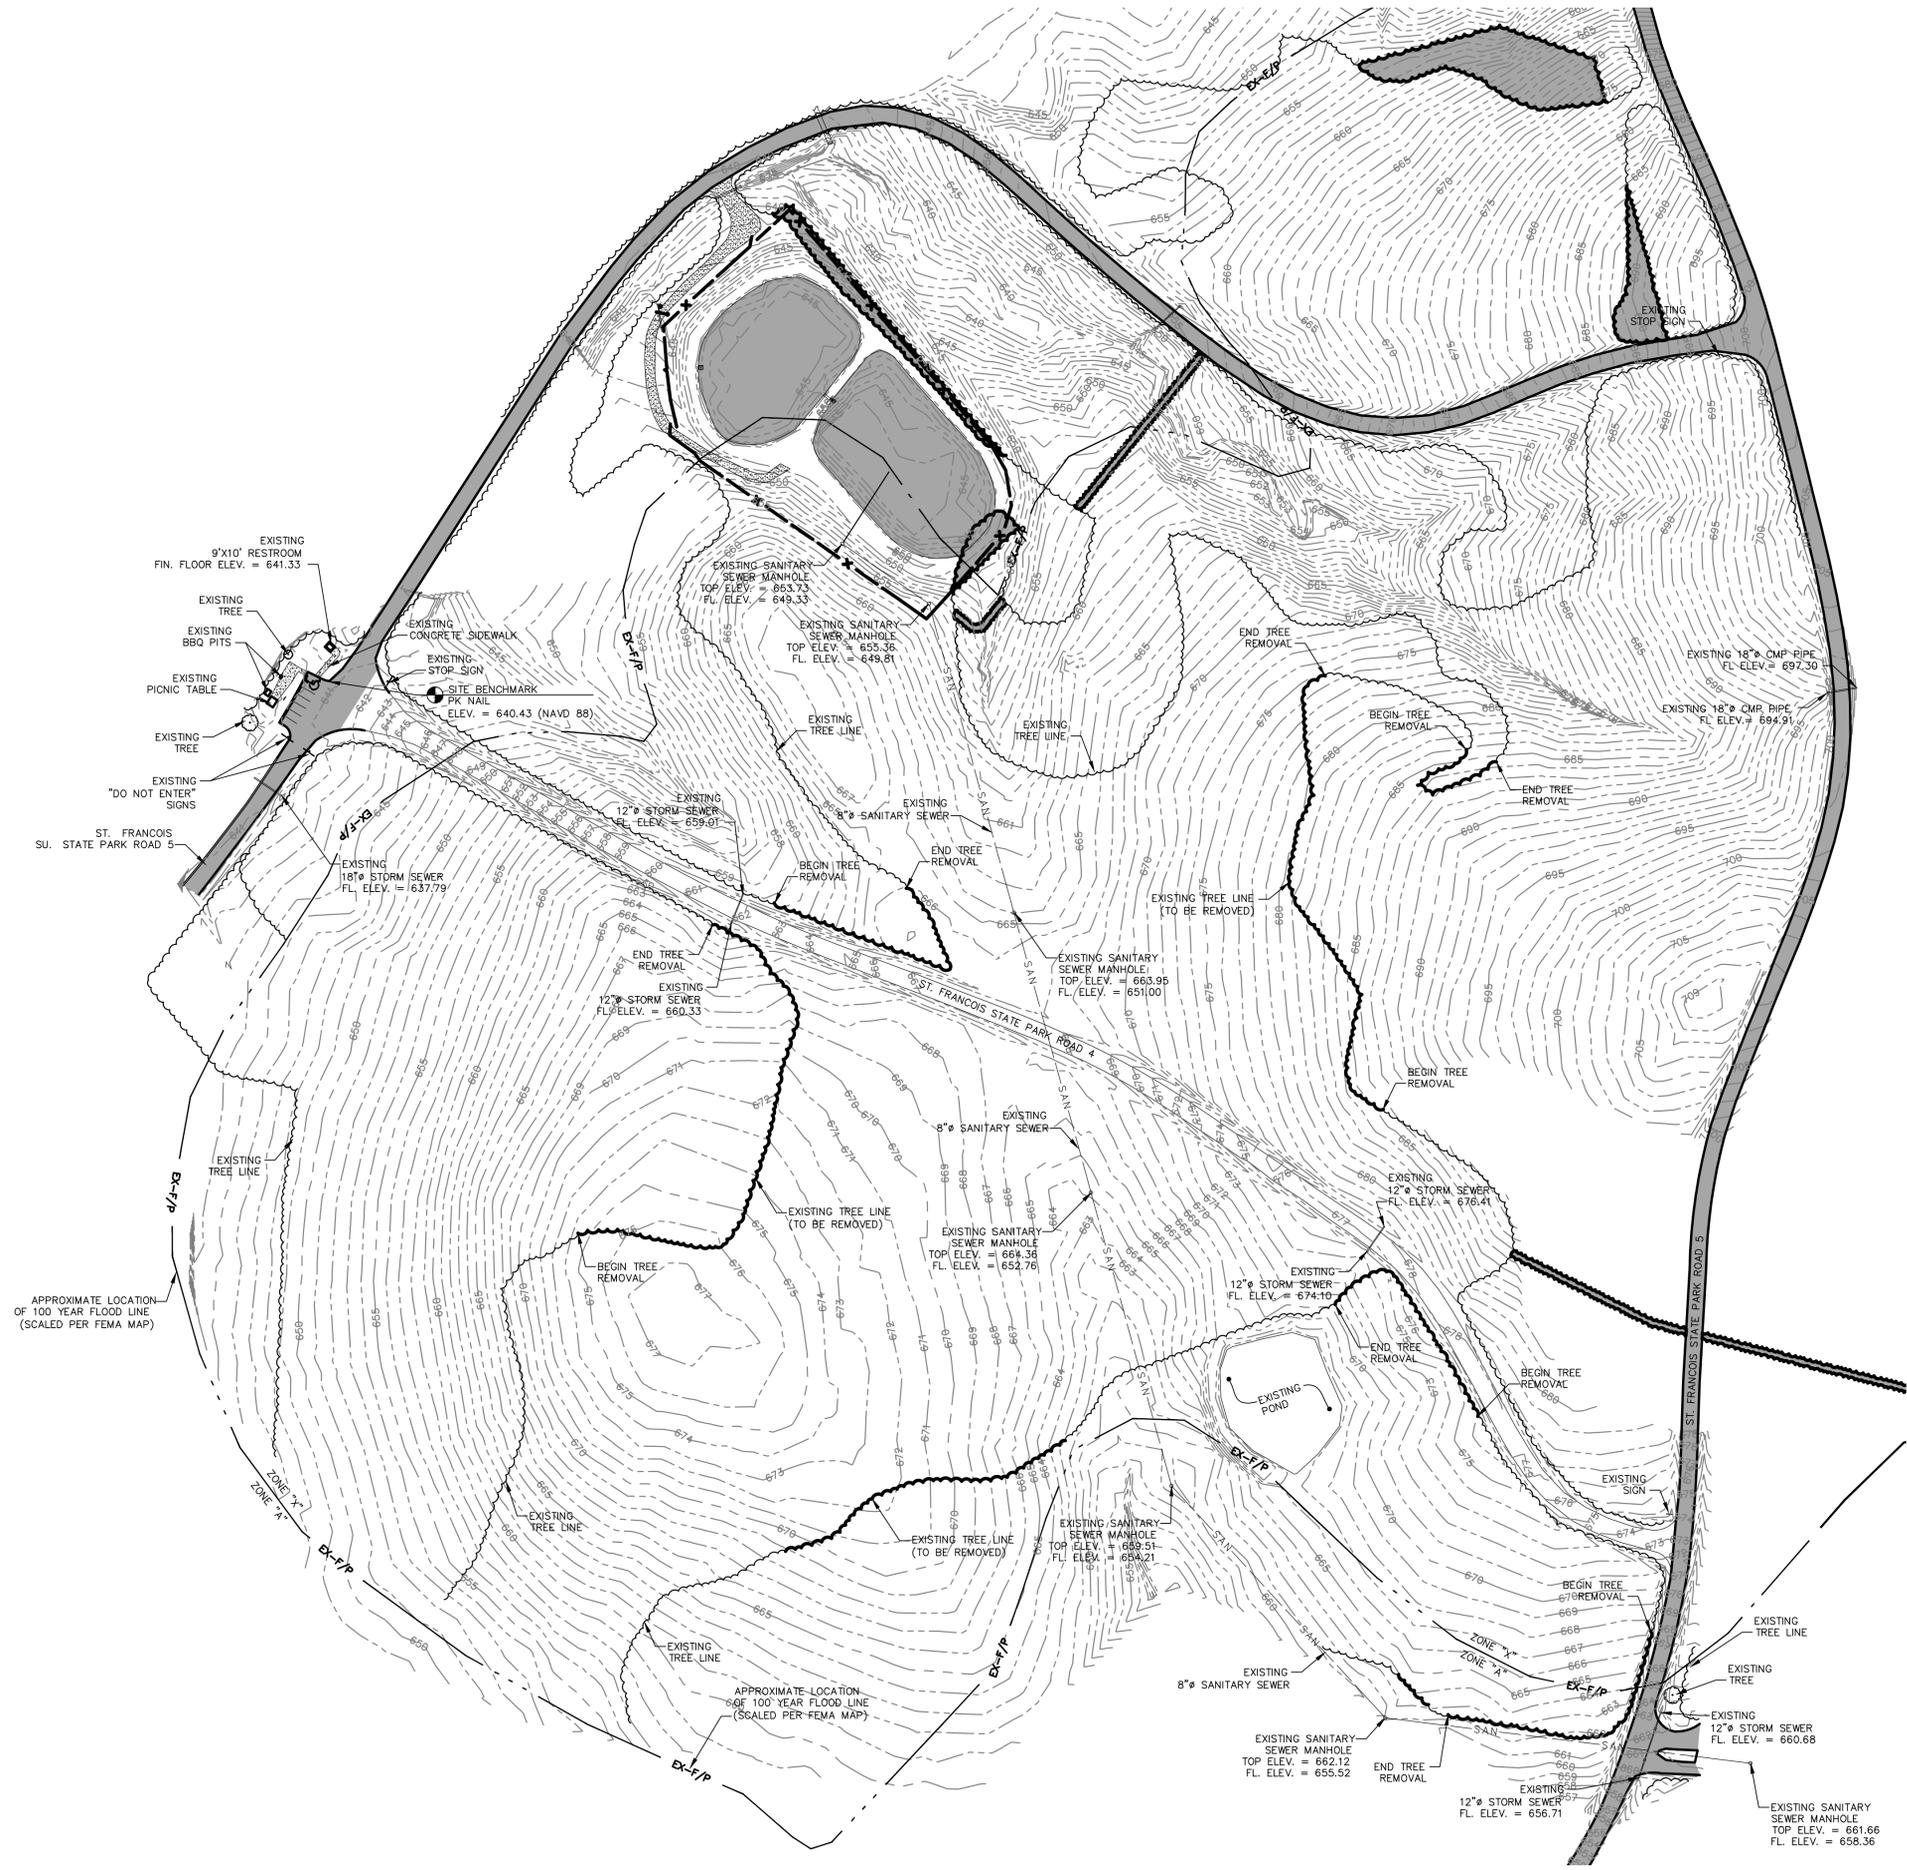

MARCH, 2025

LEGEND


INDEX CONTOUR	---	500
INTERMEDIATE CONTOUR	---	
SANITARY SEWER	SAN	
SANITARY MANHOLE	○	
STORM SEWER	SS	
TREE	○	
ASPHALT PAVEMENT	▬	
TREE LINE	~	

NOTES:

1. BEARINGS REFERENCED TO GRID NORTH OF THE MISSOURI COORDINATE SYSTEM OF 1983, EAST ZONE AND ELEVATIONS REFERENCED TO NAVD 1988 PER GPS OBSERVATIONS UTILIZING THE MODOT VRS RTK NETWORK AND GRS MONUMENT "LEAD"
2. UNDERGROUND STRUCTURES, FACILITIES AND UTILITIES HAVE BEEN PLOTTED FROM AVAILABLE SURVEYS AND RECORDS. THEREFORE, THEIR LOCATIONS MUST BE CONSIDERED APPROXIMATE ONLY. THERE MAY BE OTHERS, THE EXISTENCE OF WHICH IS PRESENTLY NOT KNOWN.
3. PORTIONS OF THIS PROPERTY LIE WITHIN "ZONE X" (UNSHADED), AREAS DETERMINED TO BE OUTSIDE THE 0.2% ANNUAL CHANCE FLOODPLAIN AND "ZONE A" DETERMINED TO BE INSIDE THE 1% CHANCE FLOOD AREA (100 PER YEAR) PER FLOOD INSURANCE RATE MAP FOR ST. FRANCOIS COUNTY, MISSOURI & INCORPORATED AREAS, PER PANEL 135 OF 450, COMMUNITY PANEL NUMBER 29187C01350, EFFECTIVE DATE JUNE 16, 2011
4. PROJECT BENCHMARK IS GRS LEAD ELEV. = 827.82
5. SITE BENCHMARK: IS A P.K. NAIL LOCATED AT THE SOUTHEAST OF THE EXISTING ACCESSIBLE PARKING SPACE ELEV. = 640.43 (NAVD 88)
6. FIELDWORK WAS PERFORMED BY J.L.W. MAY 2, 2023

APPROXIMATE LOCATION OF 100 YEAR FLOOD LINE (SCALED PER FEMA MAP)

APPROXIMATE LOCATION OF 100 YEAR FLOOD LINE (SCALED PER FEMA MAP)

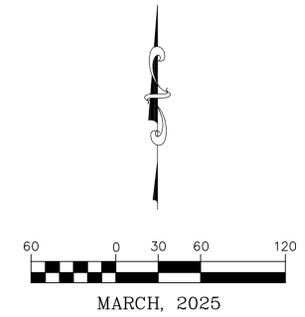

LEGEND	
EXISTING	PROPOSED
---	INDEX CONTOUR
---	INTERMEDIATE CONTOUR
---	SANITARY SEWER
○	SANITARY MANHOLE
○	TREE
○	TREELINE
▨	ASPHALT PAVEMENT
▨	CONCRETE PAVEMENT

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ST. FRANCOIS STATE PARK
8920 US-67N
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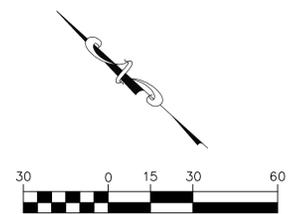
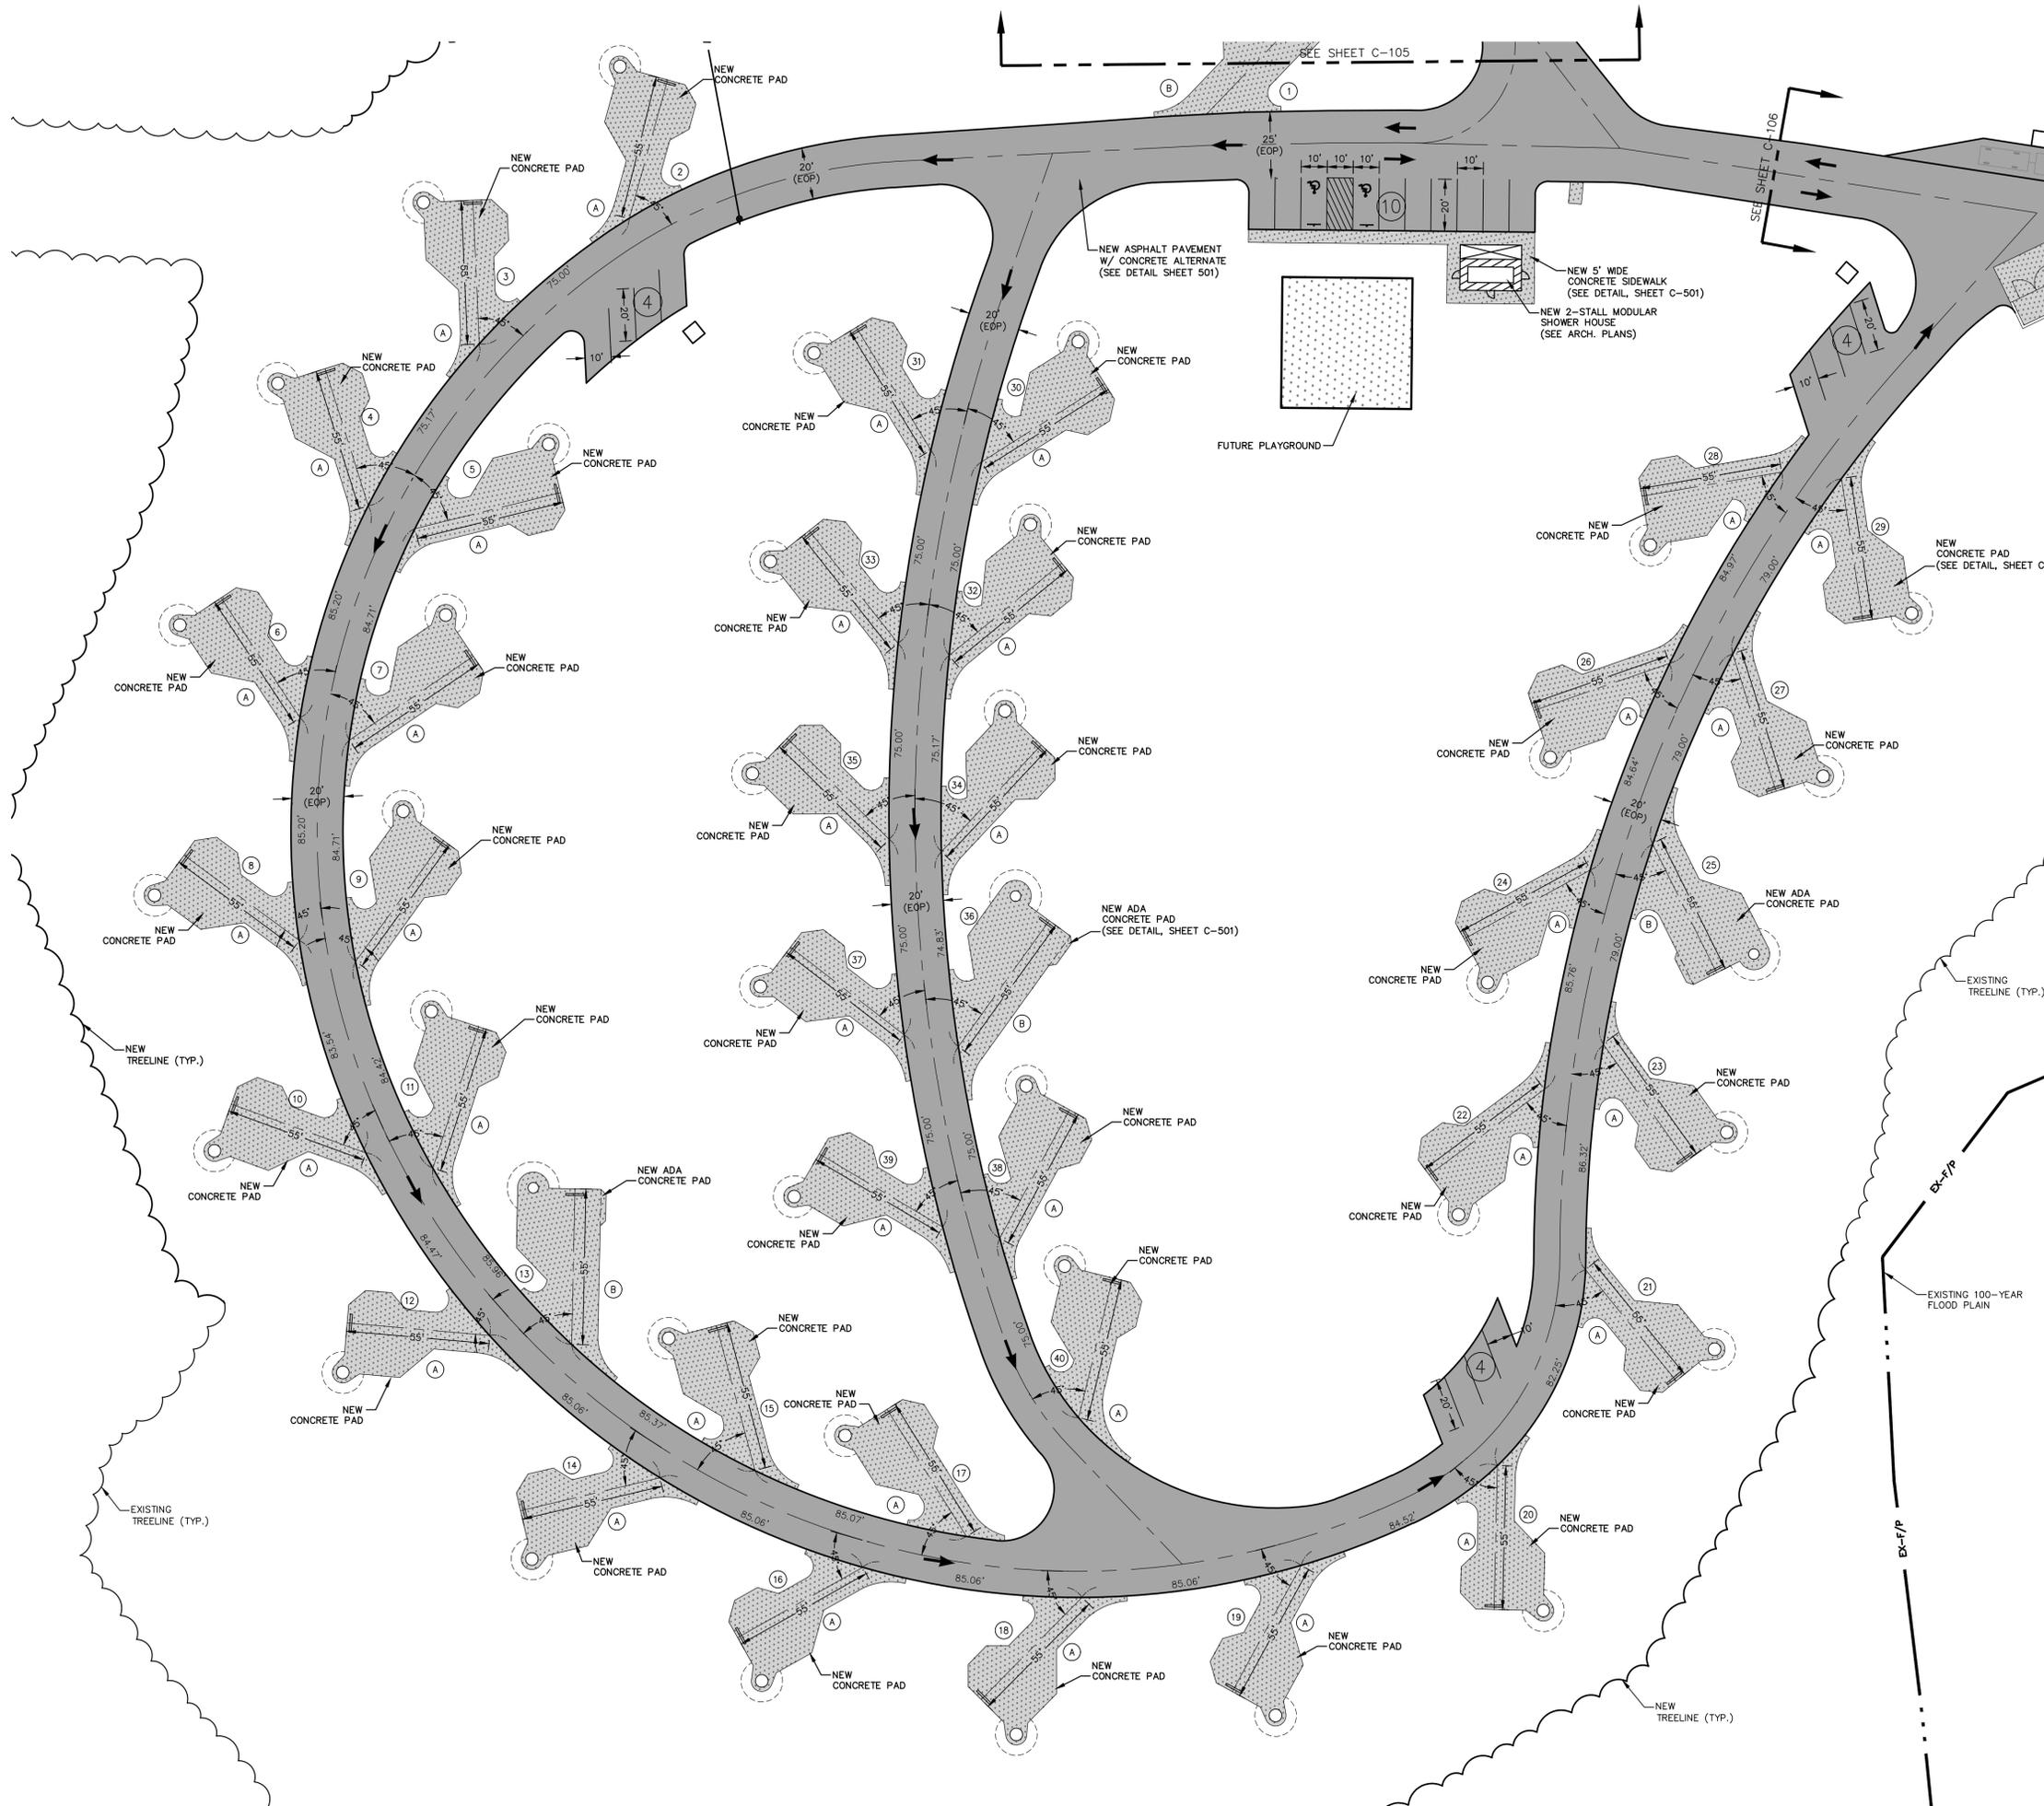
PROJECT # X2317-01
SITE # 5216
ASSET # 7815216025

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DATE: _____
REVISION: _____
DATE: _____
REVISION: _____
DATE: _____
ISSUE DATE: 03/28/2025

CAD DWG FILE: X2317-SPO-103
DRAWN BY: JRG
CHECKED BY: ERR
DESIGNED BY: ERR

SHEET TITLE:
**OVERALL
SITE PLAN**

SHEET NUMBER:
C-103
4 OF 56 SHEETS
03/28/2025



MARCH, 2025

LEGEND

EXISTING	PROPOSED

SITE LEGEND

	STALL STYLE A - BACK-IN STANDARD
	STALL STYLE B - ADA BACK-IN STANDARD

NOTE: ALL TREE CLEARING SHALL OCCUR BETWEEN NOVEMBER 1ST AND MARCH 31ST.

STATE OF MISSOURI
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Engineering : 001655
Architecture : 2002014240

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DEPARTMENT OF
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NEW PREMIUM 63 SITE
LOOP CAMPGROUND

ST. FRANCOIS STATE PARK
8920 US-67N
BONNE TERRE, MO 63628

PROJECT # X2317-01
SITE # 5216
ASSET # 7815216025

REVISION: _____
DATE: _____
REVISION: _____
DATE: _____
REVISION: _____
DATE: _____
ISSUE DATE: 03/28/2025

CAD DWG FILE: X2317-SP-104
DRAWN BY: LJR
CHECKED BY: ERR
DESIGNED BY: ERR

SHEET TITLE:
**SITE
PLAN**

SHEET NUMBER:

C-104

5 OF 56 SHEETS
03/28/2025



MARCH, 2025

LEGEND

EXISTING	PROPOSED

SITE LEGEND

- (A) STALL STYLE A - BACK-IN STANDARD
- (B) STALL STYLE B - ADA BACK-IN STANDARD

NOTE: ALL TREE CLEARING SHALL OCCUR BETWEEN NOVEMBER 1ST AND MARCH 31ST.

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Architecture : 2002014240

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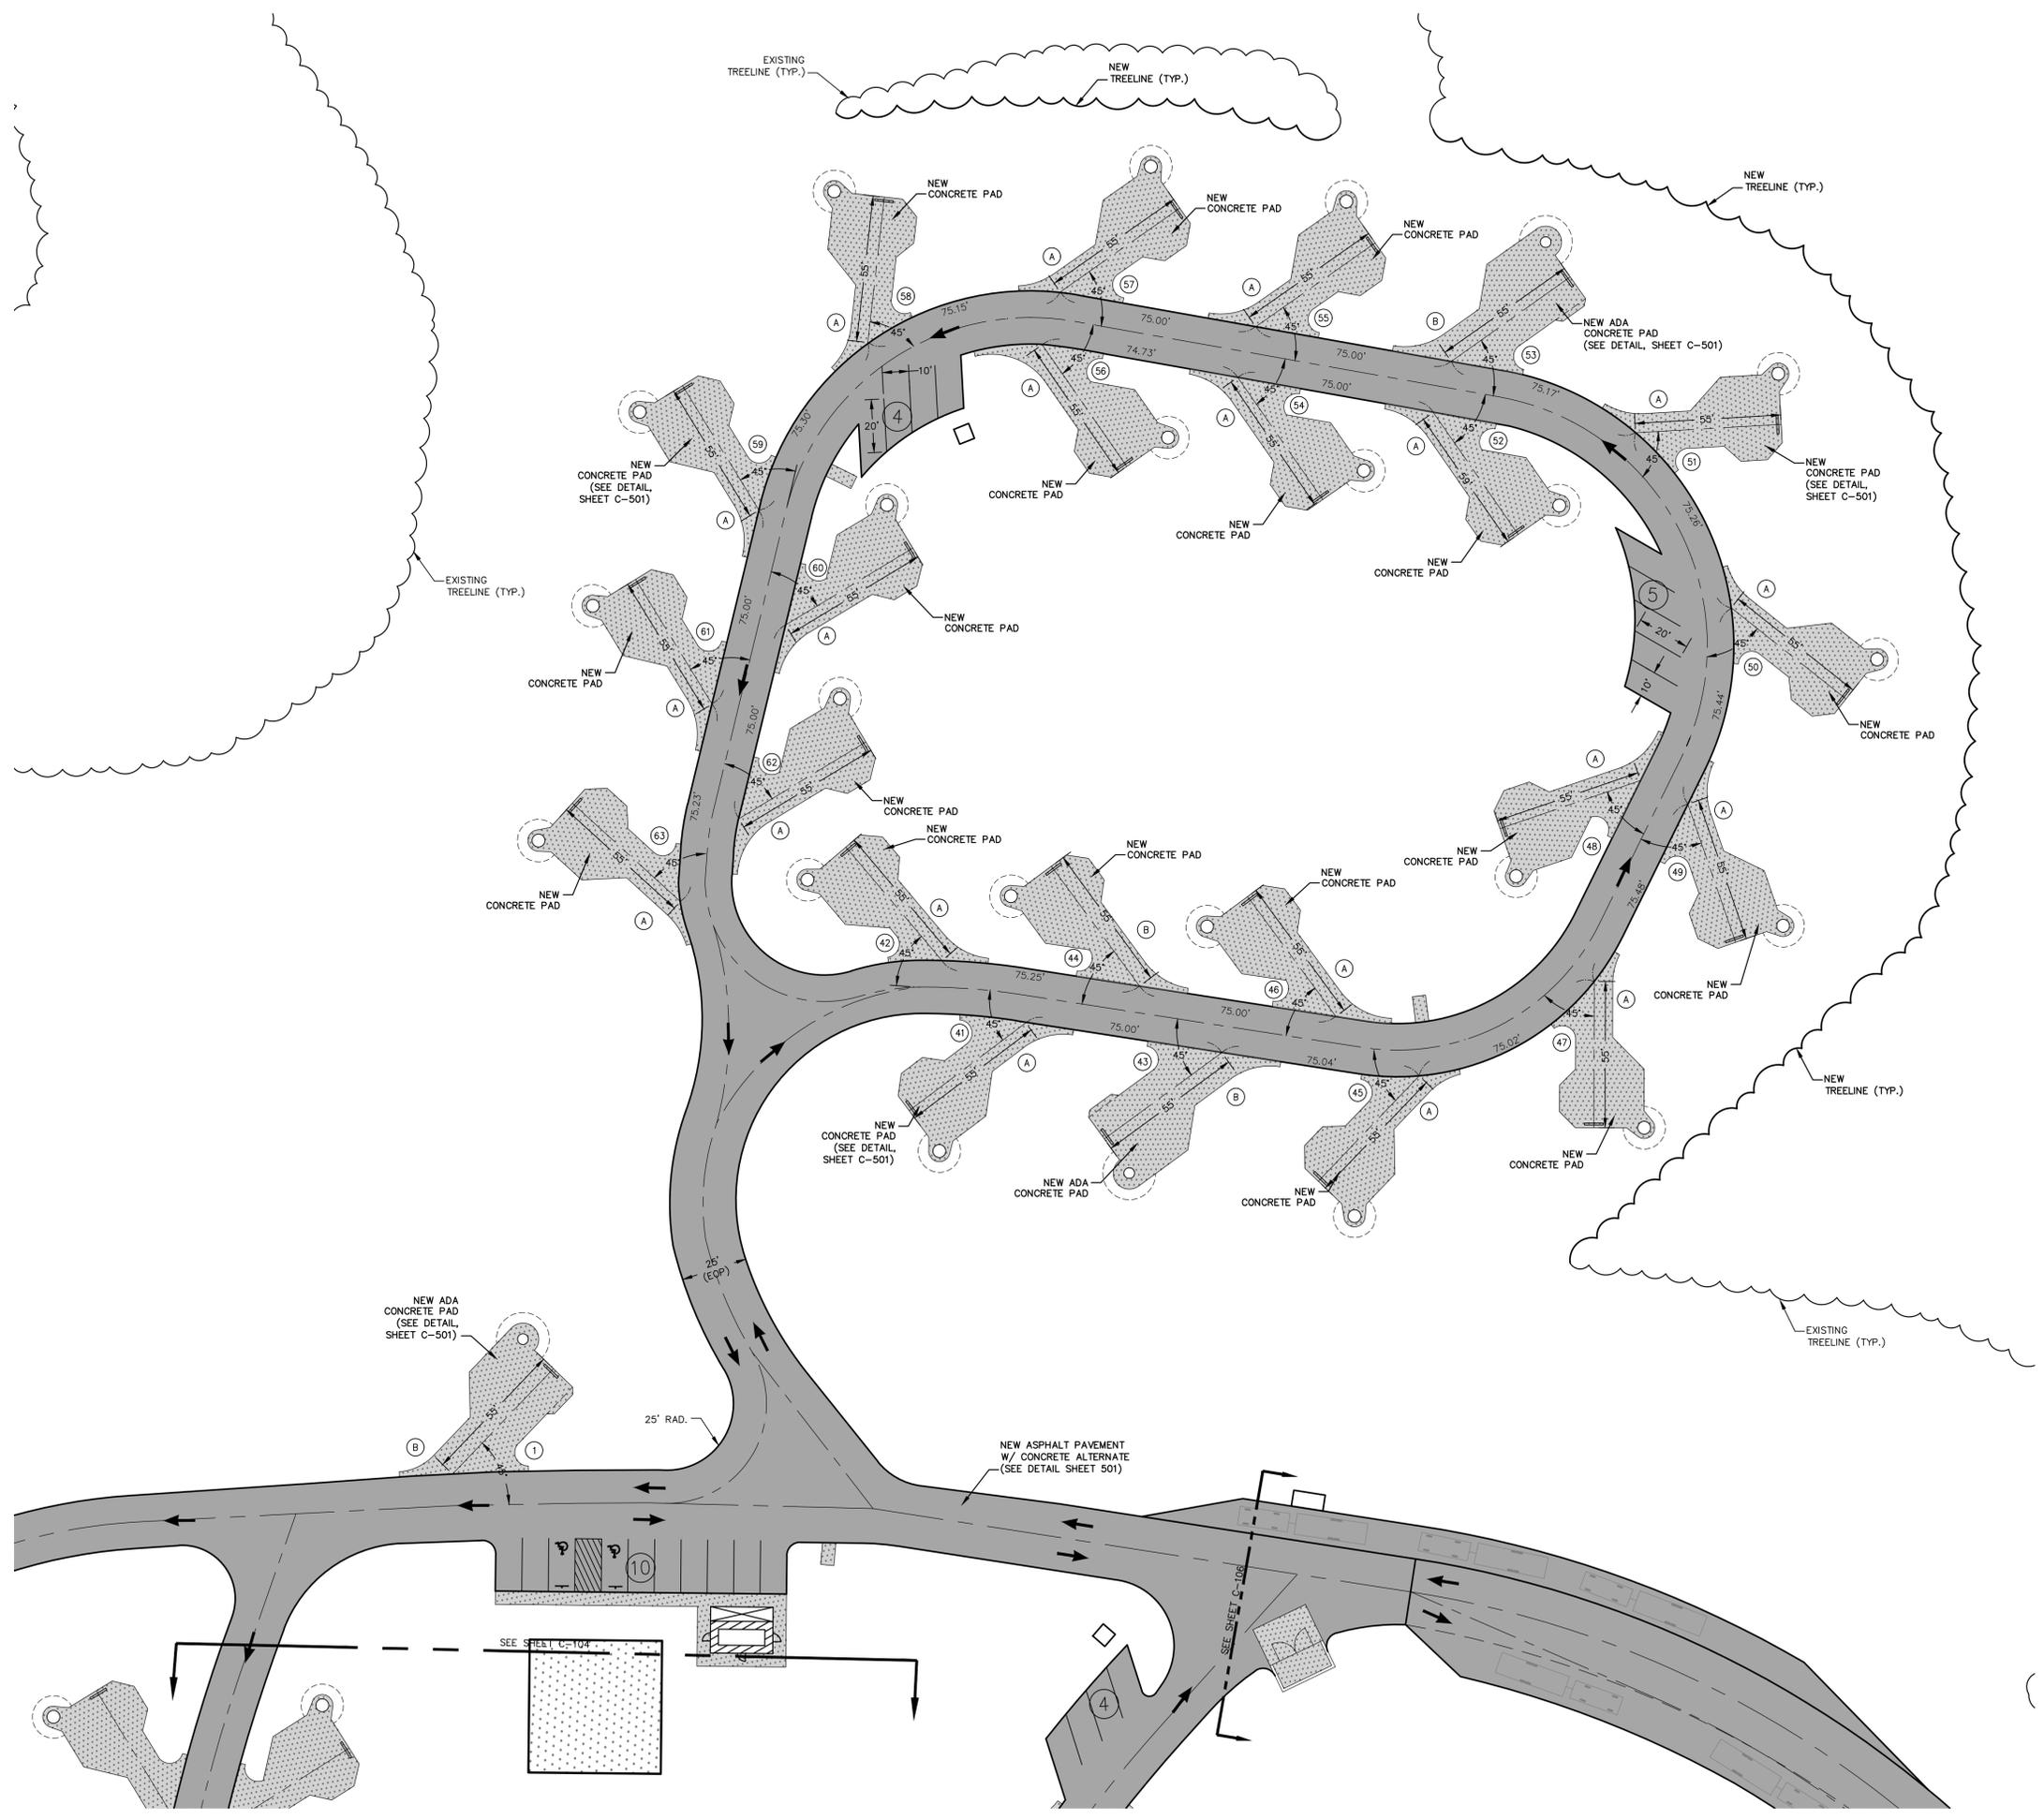
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SITE # 5216
ASSET # 7815216025



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CAD DWG FILE: X2317-SP-105
DRAWN BY: LJR
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DESIGNED BY: ERR

SHEET TITLE:
**SITE
PLAN**

SHEET NUMBER:
C-105
6 OF 56 SHEETS
03/28/2025



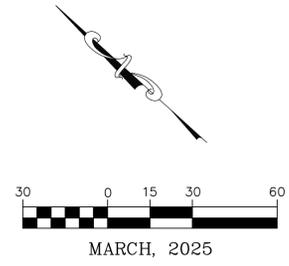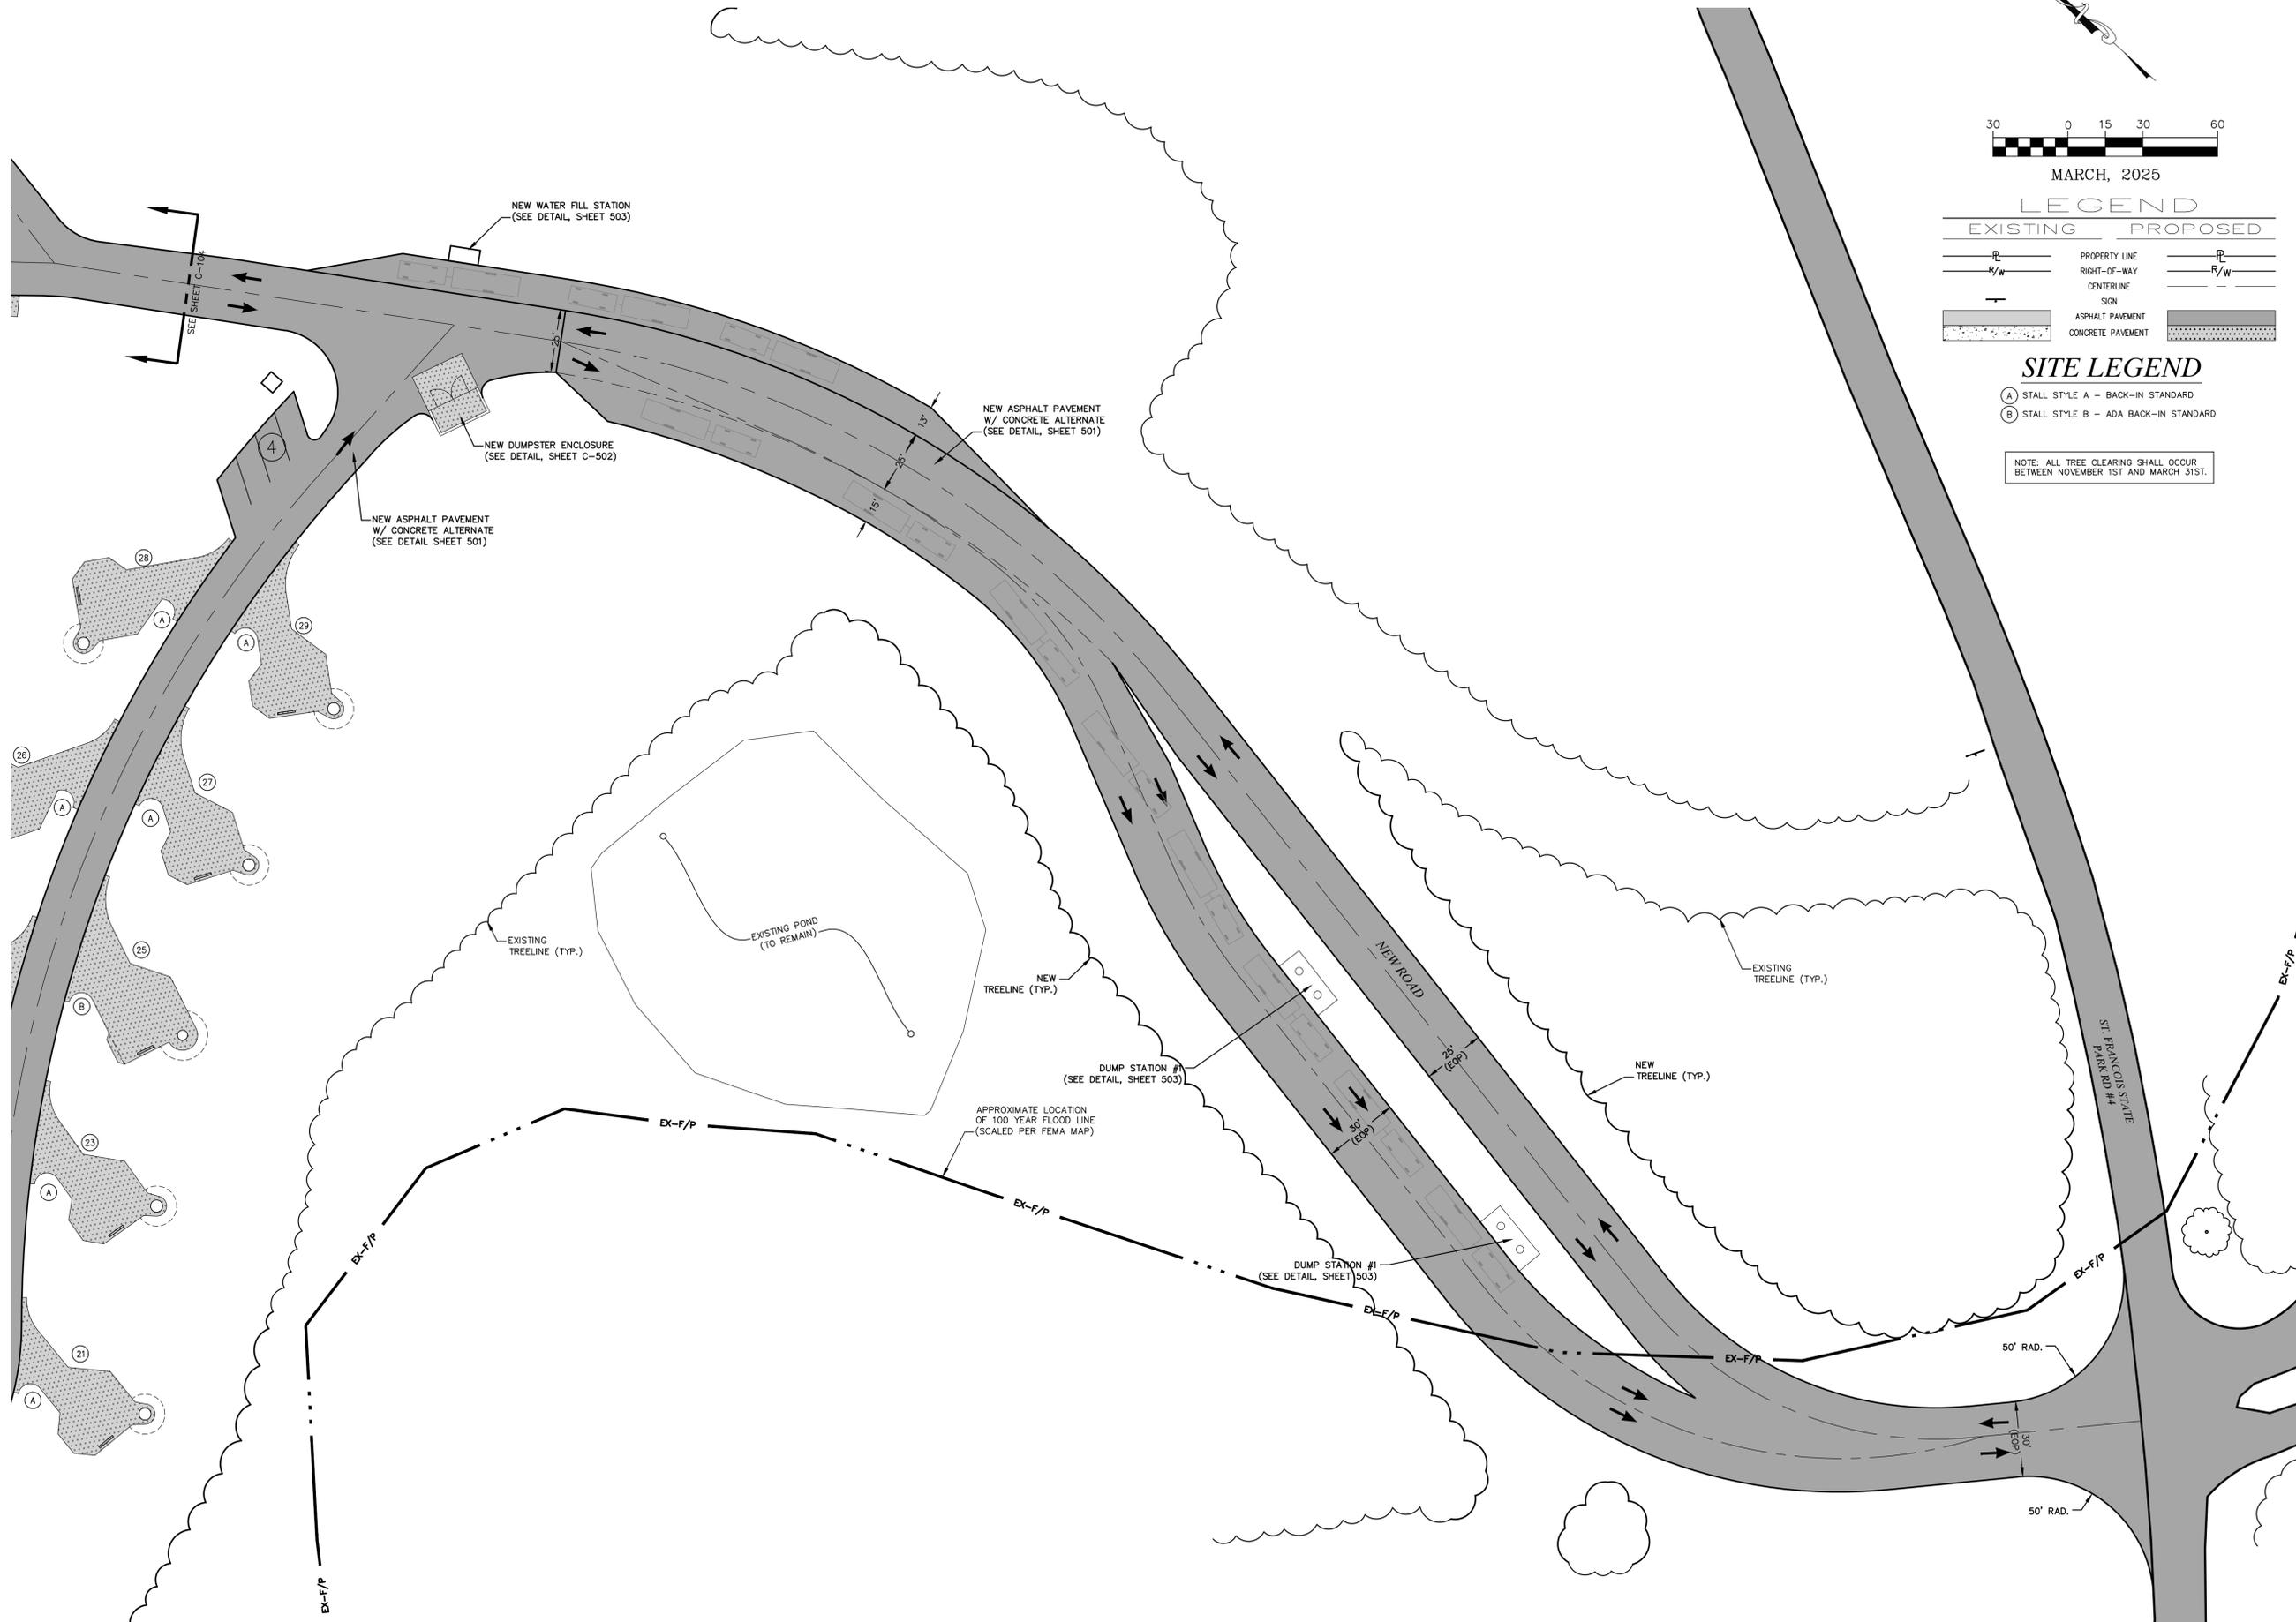

MARCH, 2025

LEGEND

EXISTING	PROPOSED

- SITE LEGEND**
- (A) STALL STYLE A - BACK-IN STANDARD
 - (B) STALL STYLE B - ADA BACK-IN STANDARD
- NOTE: ALL TREE CLEARING SHALL OCCUR BETWEEN NOVEMBER 1ST AND MARCH 31ST.

STATE OF MISSOURI
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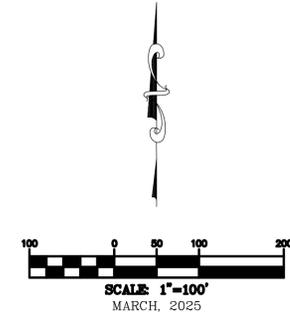
ISSUE DATE: 03/28/2025

CAD DWG FILE: X2317-SP-106
DRAWN BY: LJR
CHECKED BY: ERR
DESIGNED BY: ERR

SHEET TITLE:
**SITE
PLAN**

SHEET NUMBER:
C-106
7 OF 56 SHEETS
03/28/2025

OVERALL UTILITY PLAN





① NEW TRANSFORMER PAD
(AMEREN WILL PROVIDE PAD
CONTRACTOR WILL INSTALL PAD)



UG PRIMARY EQUIPMENT
Primary Pedestal Single Phase
2-3-4 Way 200A Loadbreak

51 11 06 **
5kV, 15kV
1 of 2

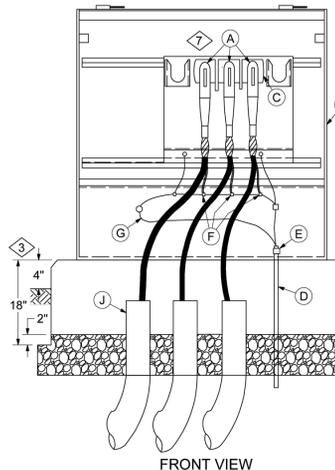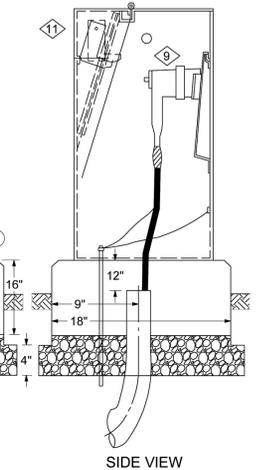FRONT VIEW SIDE VIEW

CONSTRUCTION NOTE(S):

1. An initial depth of 18" shall be excavated and all loose soil shall be removed or tamped. The length and width of the hole should be sized to allow a minimum of 6" of clearance on all sides.
2. To install the 36" radius bends, an increase in the initial excavation depth will be required. After the bends have been installed, crushed stone screening shall be placed and tamped to the level shown.
3. The final depth should be adjusted to provide 4" of exposed ground sleeve pad at final grade.
4. Stabilize the ground sleeve pad over the conduits before backfilling so that there will be no shifting. Provide 12" of space between the load bearing surface of the ground sleeve pad and the end of each conduits.
5. To further stabilize the ground sleeve pad and the bends, place additional screening inside the ground sleeve pad and hand tamp in place.
6. Backfill with loose material, **DO NOT** backfill next to the ground sleeve pad with chunks of material or rocks. Pack loose backfill by foot tamping and do not tamp excessively close to the ground sleeve pad sides.

DISTRIBUTION CONSTRUCTION STANDARDS	REV	DATE	ENG	DESCRIPTION
	16	01/01/23	JMW	Converted to new format
	15	08/14/17	JMW	

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Engineering : 001655
Architecture : 2002014240

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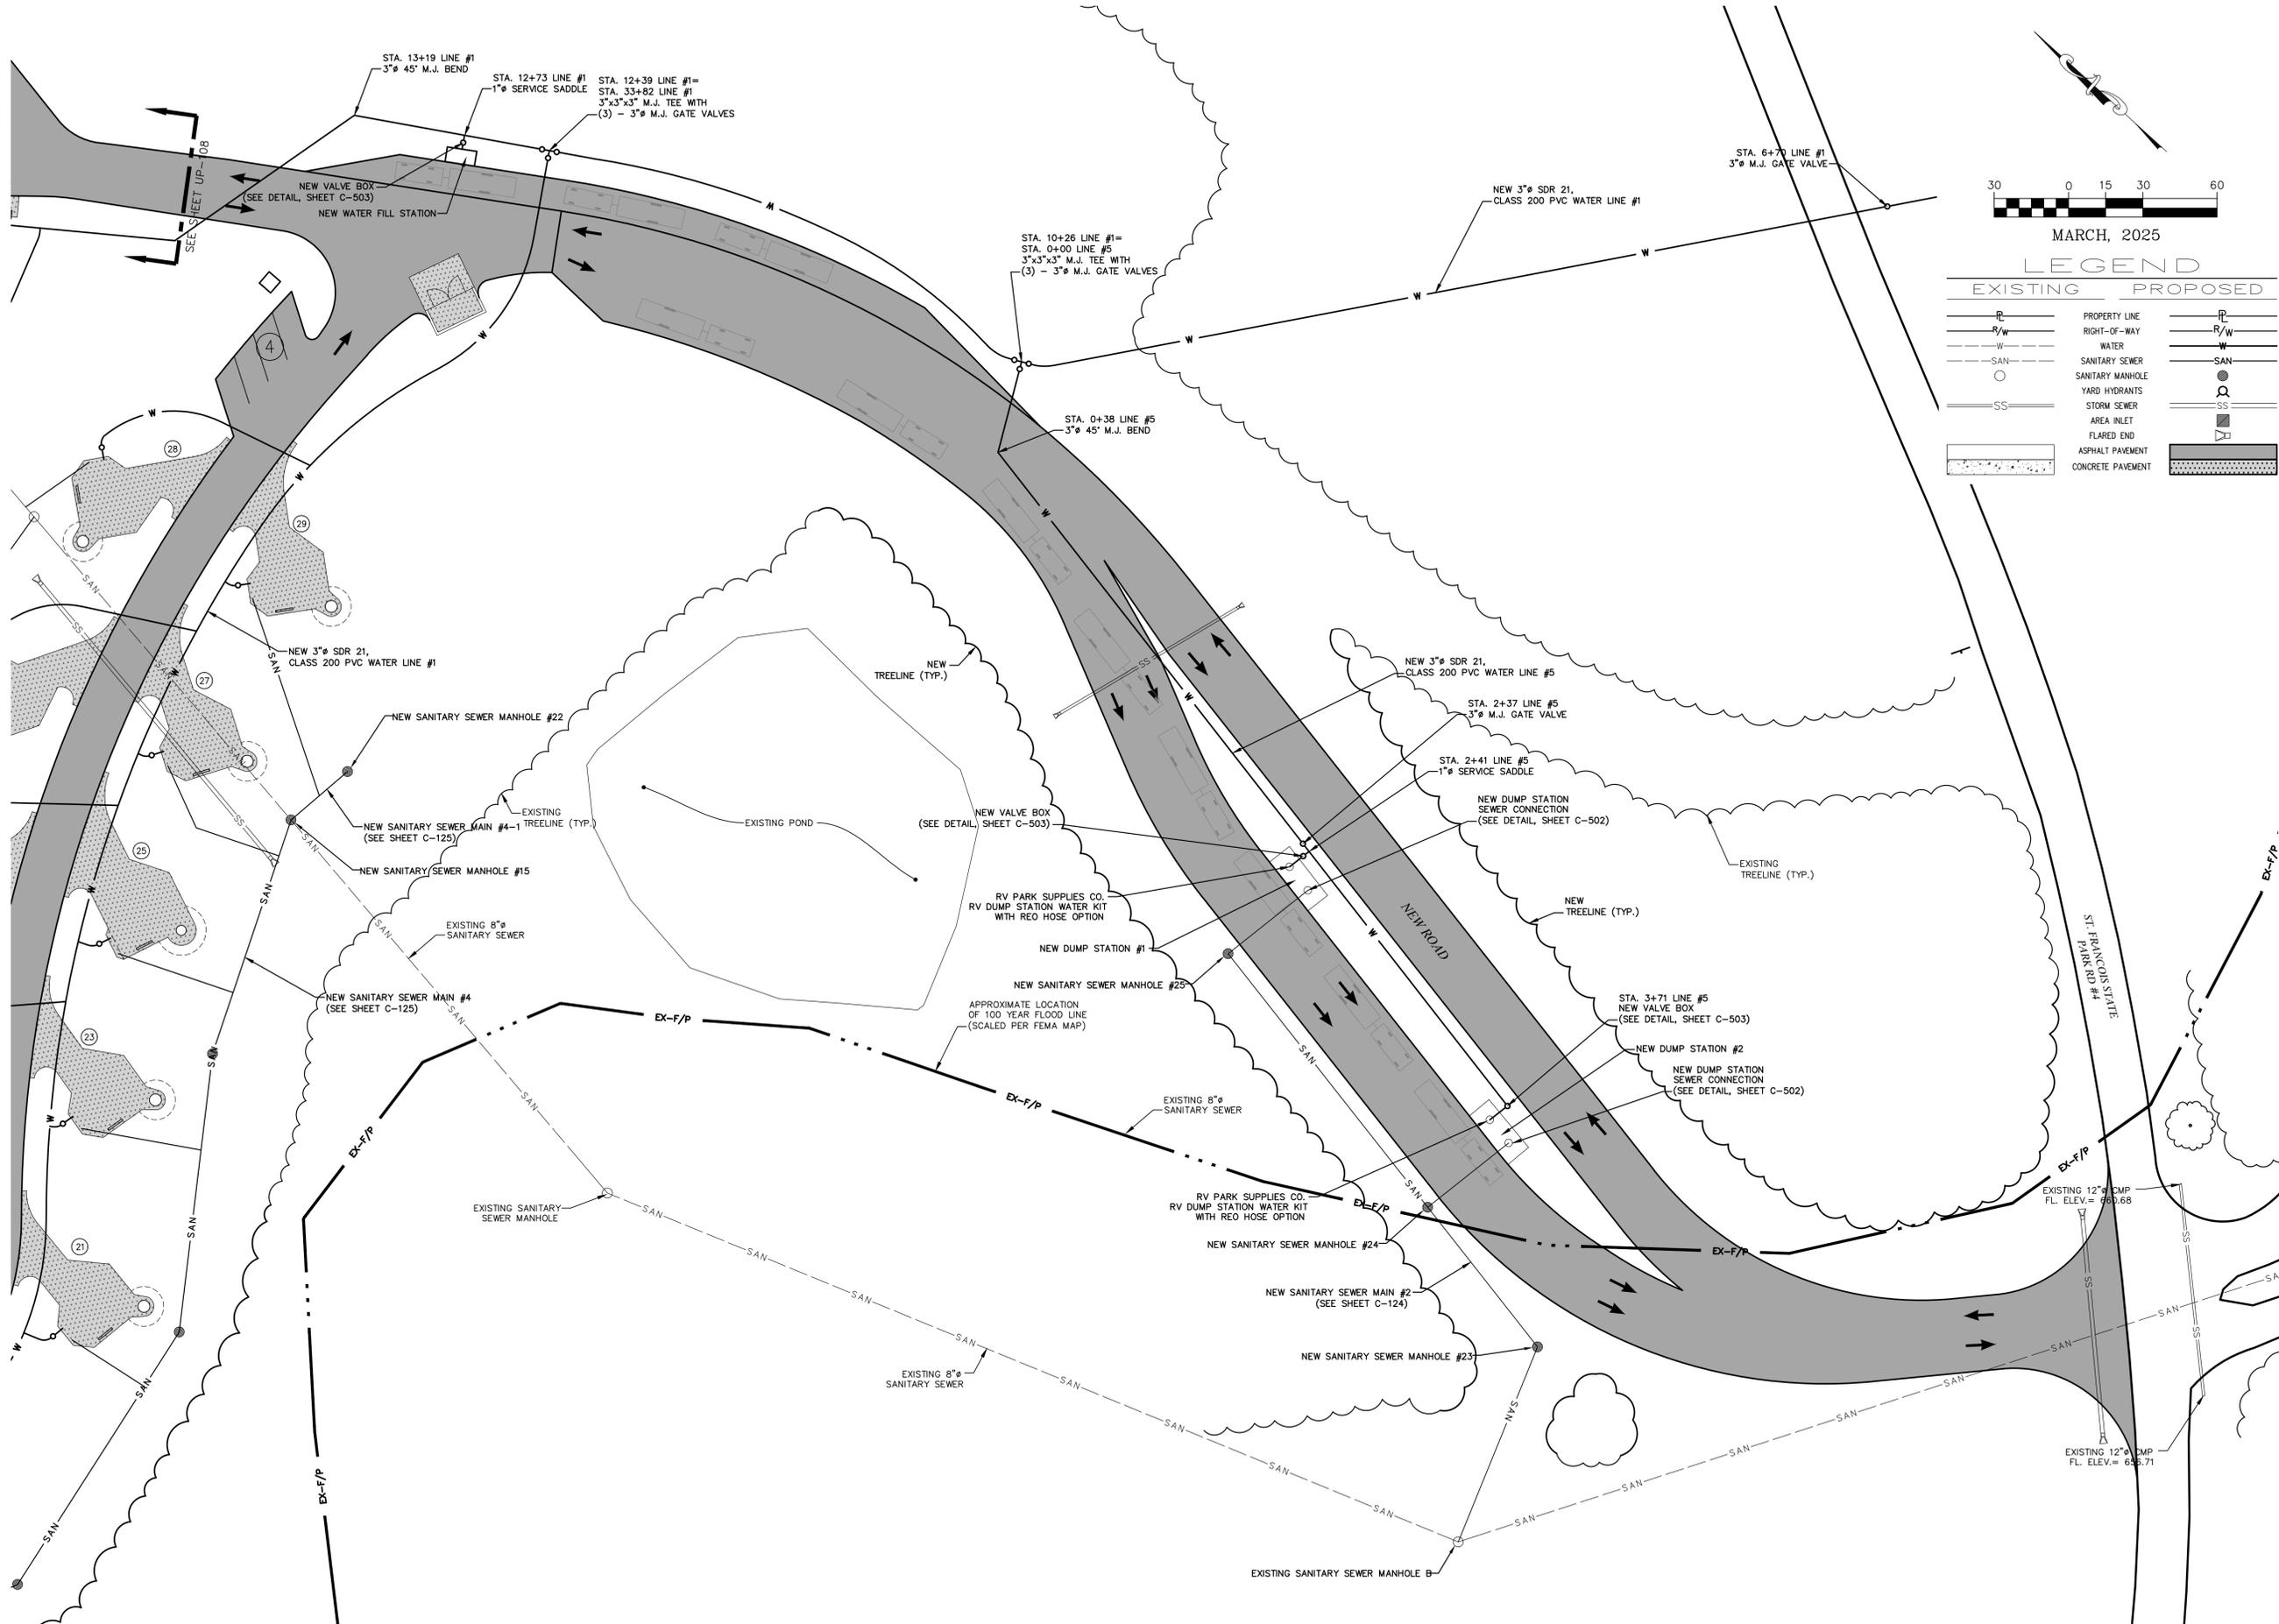
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CHECKED BY: ERR
DESIGNED BY: ERR

SHEET TITLE:
**OVERALL
UTILITY PLAN**

SHEET NUMBER:

C-107


8 OF 56 SHEETS
03/28/2025



MARCH, 2025

LEGEND

EXISTING	PROPOSED

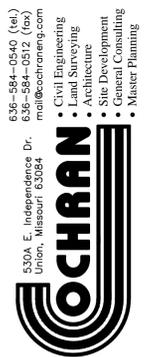

Missouri State Certificate
of Authority Number:
Survey : 0003560
Engineering : 001655
Architecture : 2002014240

OFFICE OF ADMINISTRATION
DIVISION OF FACILITIES
MANAGEMENT,
DESIGN AND CONSTRUCTION

DEPARTMENT OF
NATURAL RESOURCES
MISSOURI STATE PARKS

NEW PREMIUM 63 SITE
LOOP CAMPGROUND

ST. FRANCOIS STATE PARK
8920 US-67N
BONNE TERRE, MO 63628

PROJECT # X2317-01
SITE # 5216
ASSET # 7815216025

REVISION: _____
DATE: _____
REVISION: _____
DATE: _____
REVISION: _____
DATE: _____
ISSUE DATE: 03/28/2025


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DRAWN BY: LJR
CHECKED BY: ERR
DESIGNED BY: ERR

SHEET TITLE:
**UTILITY
PLAN**

SHEET NUMBER:

C-110

11 OF 56 SHEETS
03/28/2025

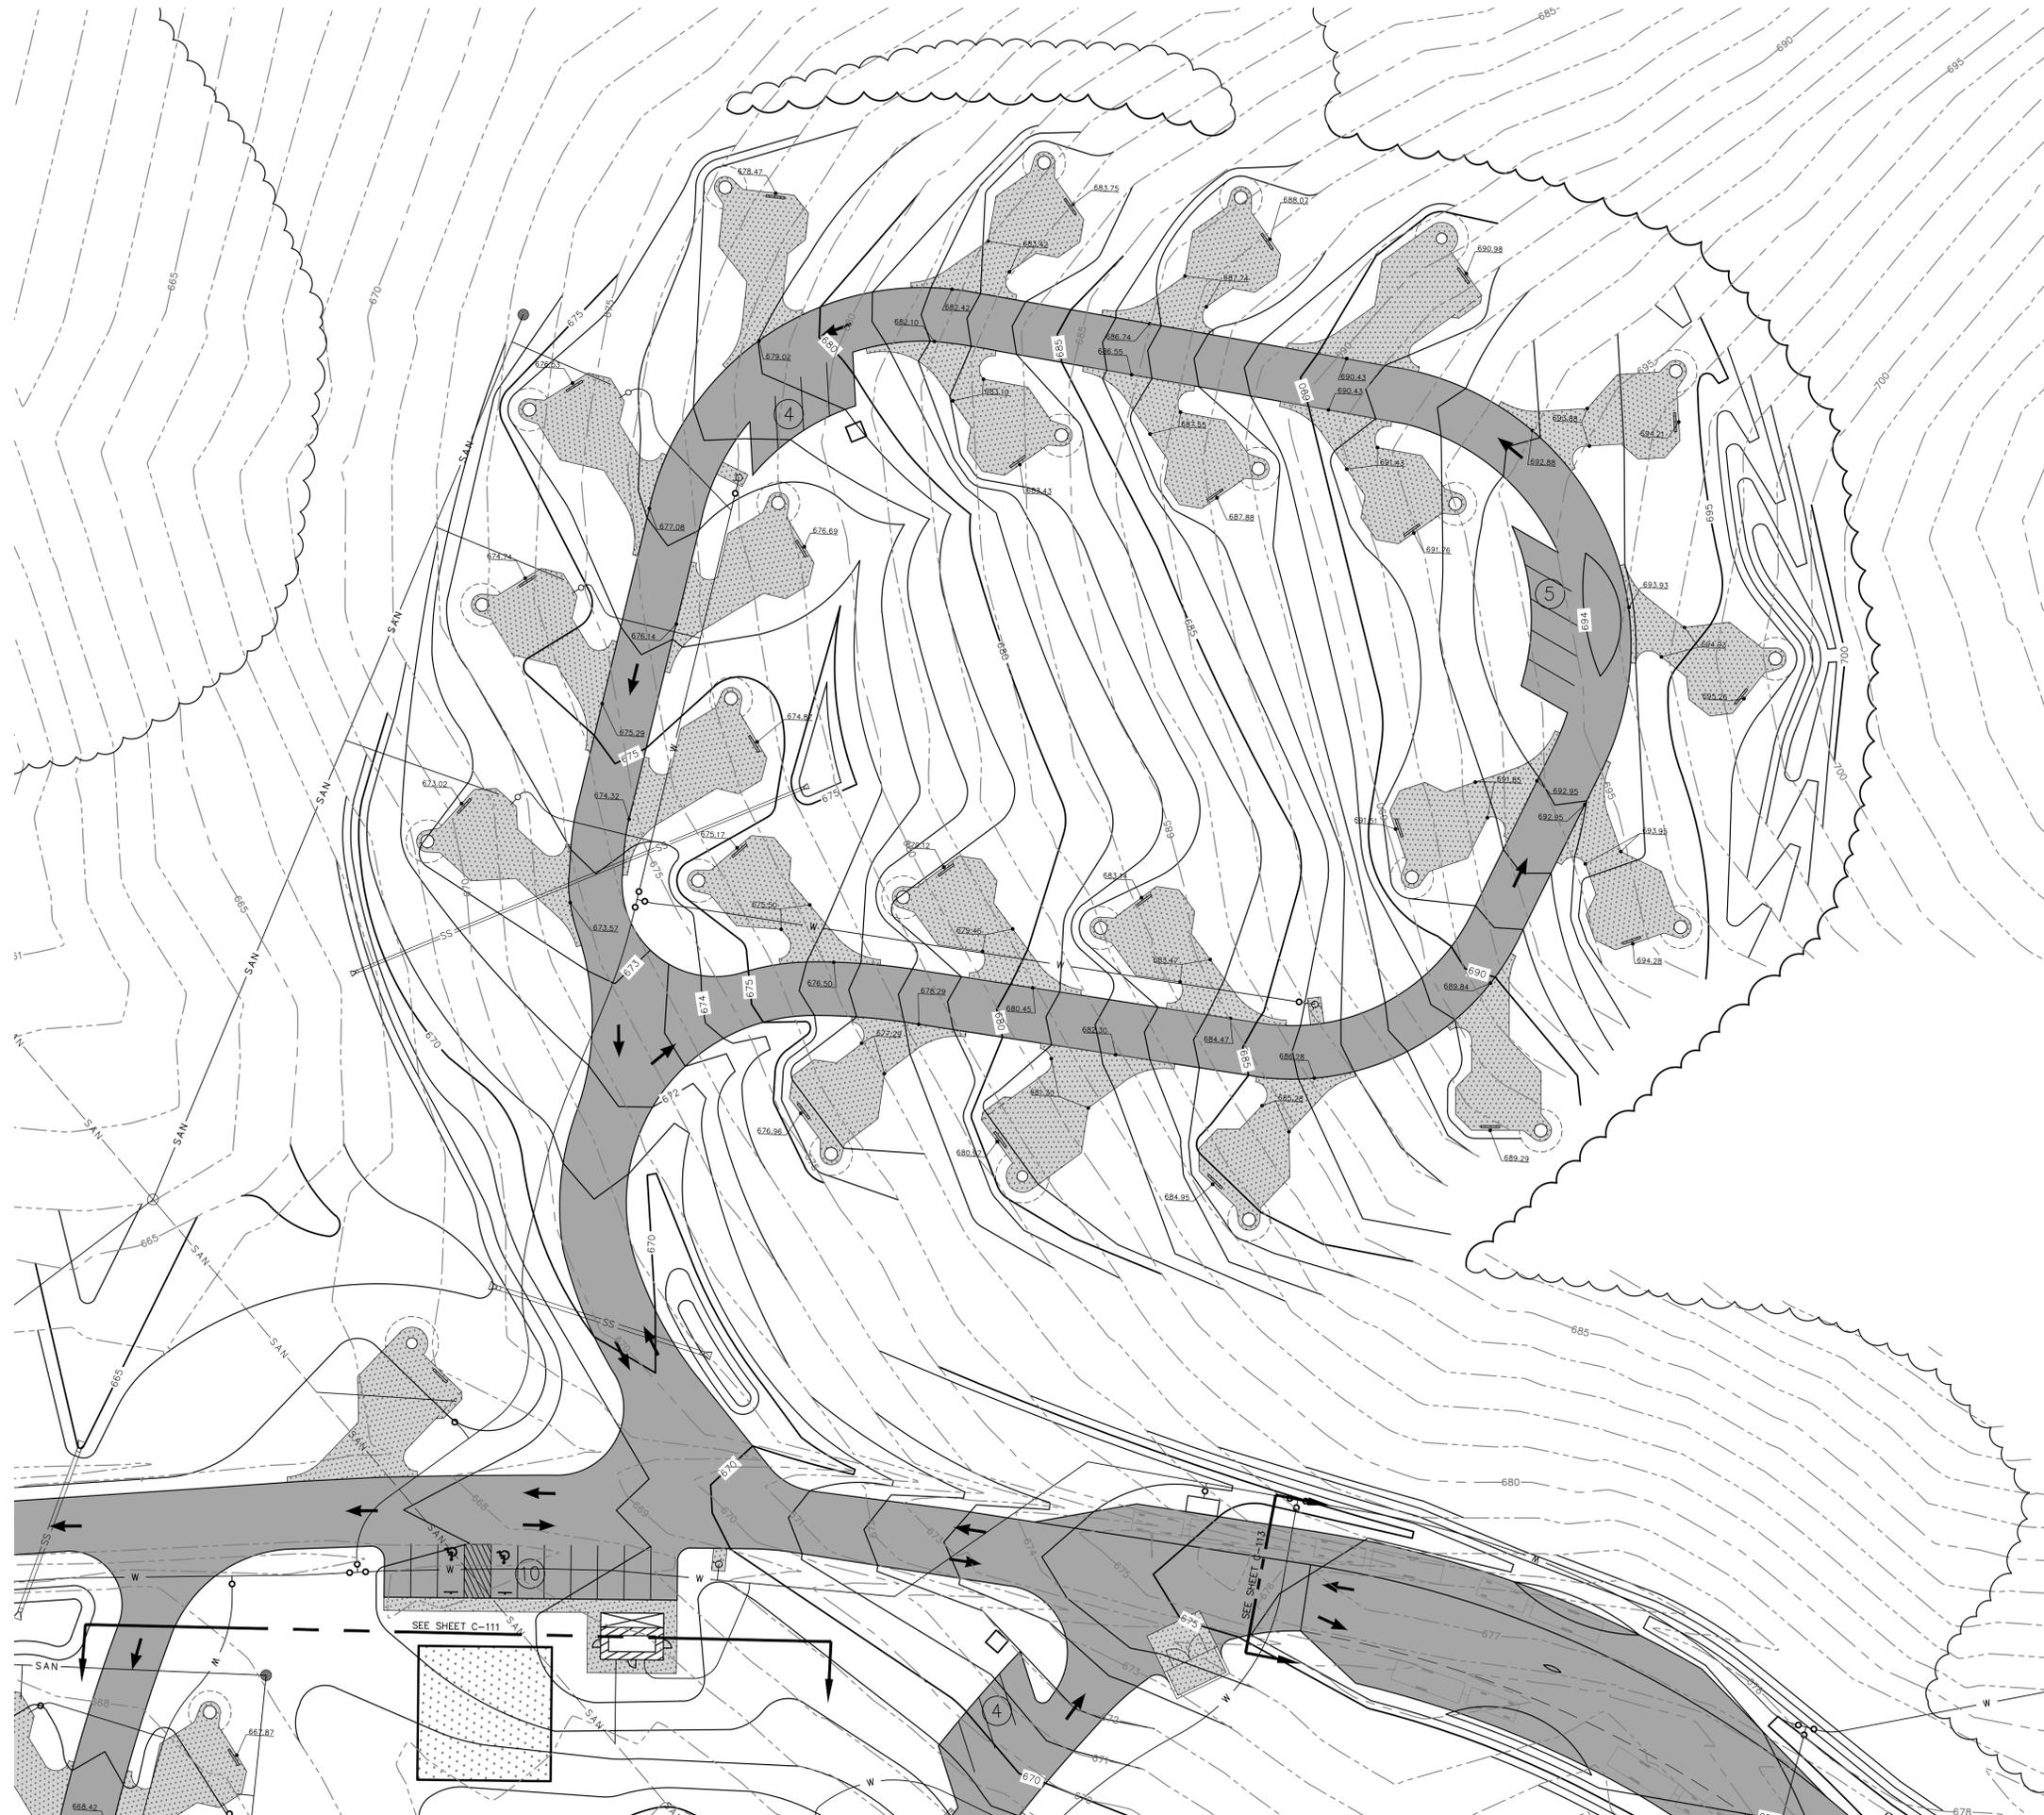

MARCH, 2025

EXISTING	PROPOSED

STATE OF MISSOURI
MICHAEL L. PARSON,
GOVERNOR



636-564-0540 (tel.)
636-564-0512 (fax)
mailto:info@ochran.com
Civil Engineering
Land Surveying
Architecture
Site Development
General Consulting
Master Planning



Missouri State Certificate
of Authority Numbers:
Survey : 000356
Engineering : 001655
Architecture : 2002014240

OFFICE OF ADMINISTRATION
DIVISION OF FACILITIES
MANAGEMENT,
DESIGN AND CONSTRUCTION

DEPARTMENT OF
NATURAL RESOURCES
MISSOURI STATE PARKS

NEW PREMIUM 63 SITE
LOOP CAMPGROUND

ST. FRANCOIS STATE PARK
8920 US-67N
BONNE TERRE, MO 63628

PROJECT # X2317-01
SITE # 5216
ASSET # 7815216025



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DATE:	_____
REVISION:	_____
DATE:	_____
REVISION:	_____
DATE:	_____
ISSUE DATE:	03/28/2025

CAD DWG FILE: X2317-GP-112
DRAWN BY: LJR
CHECKED BY: ERR
DESIGNED BY: ERR

SHEET TITLE:
**GRADING
PLAN**

SHEET NUMBER:
C-112


13 OF 56 SHEETS
03/28/2025

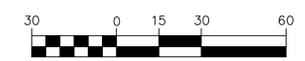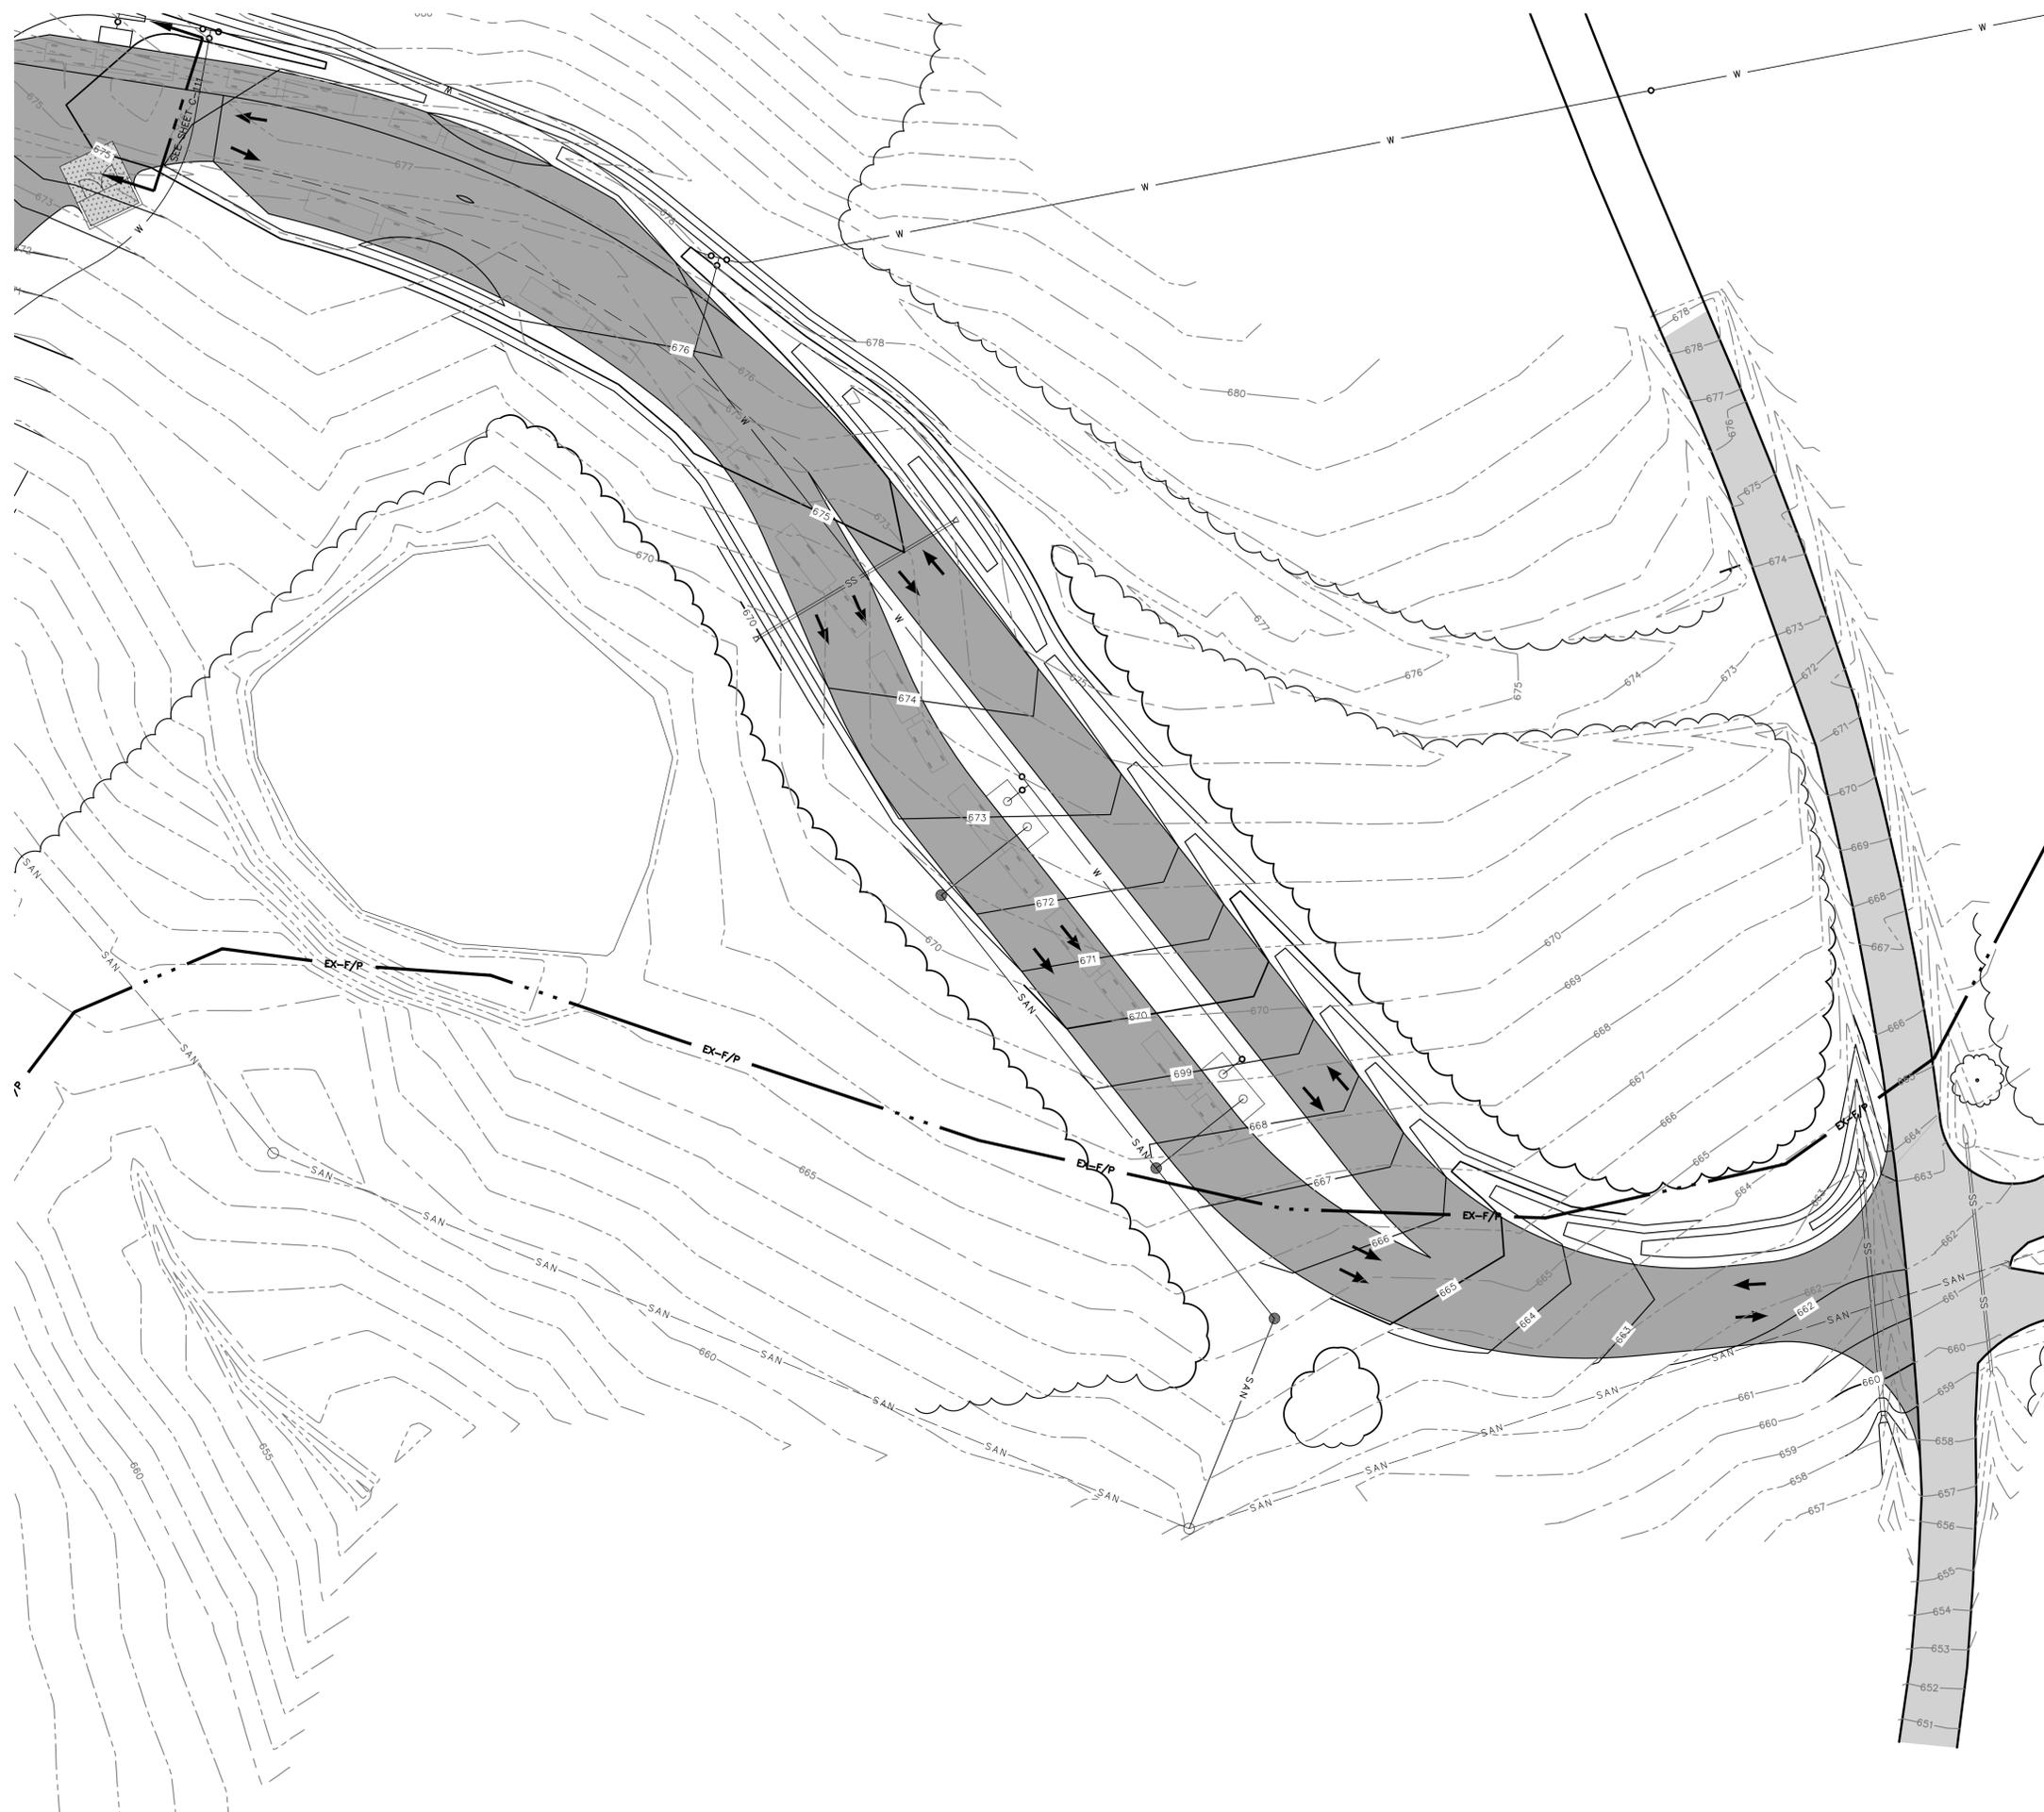

LEGEND

EXISTING		PROPOSED	
	PROPERTY LINE		PROPERTY LINE
	RIGHT-OF-WAY		RIGHT-OF-WAY
	SANITARY SEWER		SANITARY SEWER
	SANITARY MANHOLE		SANITARY MANHOLE
	STORM SEWER		STORM SEWER
	FLARED END SECTIONS		FLARED END SECTIONS
	WATER LINE		WATER LINE
	FIRE HYDRANTS		FIRE HYDRANTS
	TREELINE		TREELINE
	CONCRETE PAVEMENT		CONCRETE PAVEMENT
	ASPHALT PAVEMENT		ASPHALT PAVEMENT

STATE OF MISSOURI
MICHAEL L. PARSON,
GOVERNOR

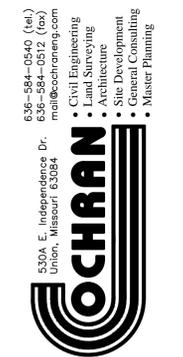

Missouri State Certificate
of Authority Numbers:
Survey : 000356
Engineering : 001655
Architecture : 2002014240

OFFICE OF ADMINISTRATION
DIVISION OF FACILITIES
MANAGEMENT,
DESIGN AND CONSTRUCTION

DEPARTMENT OF
NATURAL RESOURCES
MISSOURI STATE PARKS

NEW PREMIUM 63 SITE
LOOP CAMPGROUND

ST. FRANCOIS STATE PARK
8920 US-67N
BONNE TERRE, MO 63628

PROJECT # X2317-01
SITE # 5216
ASSET # 7815216025

REVISION: _____
DATE: _____
REVISION: _____
DATE: _____
REVISION: _____
DATE: _____
ISSUE DATE: 03/28/2025


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DRAWN BY: LJR
CHECKED BY: ERR
DESIGNED BY: ERR

SHEET TITLE:
**GRADING
PLAN**

SHEET NUMBER:

C-113


14 OF 56 SHEETS
03/28/2025

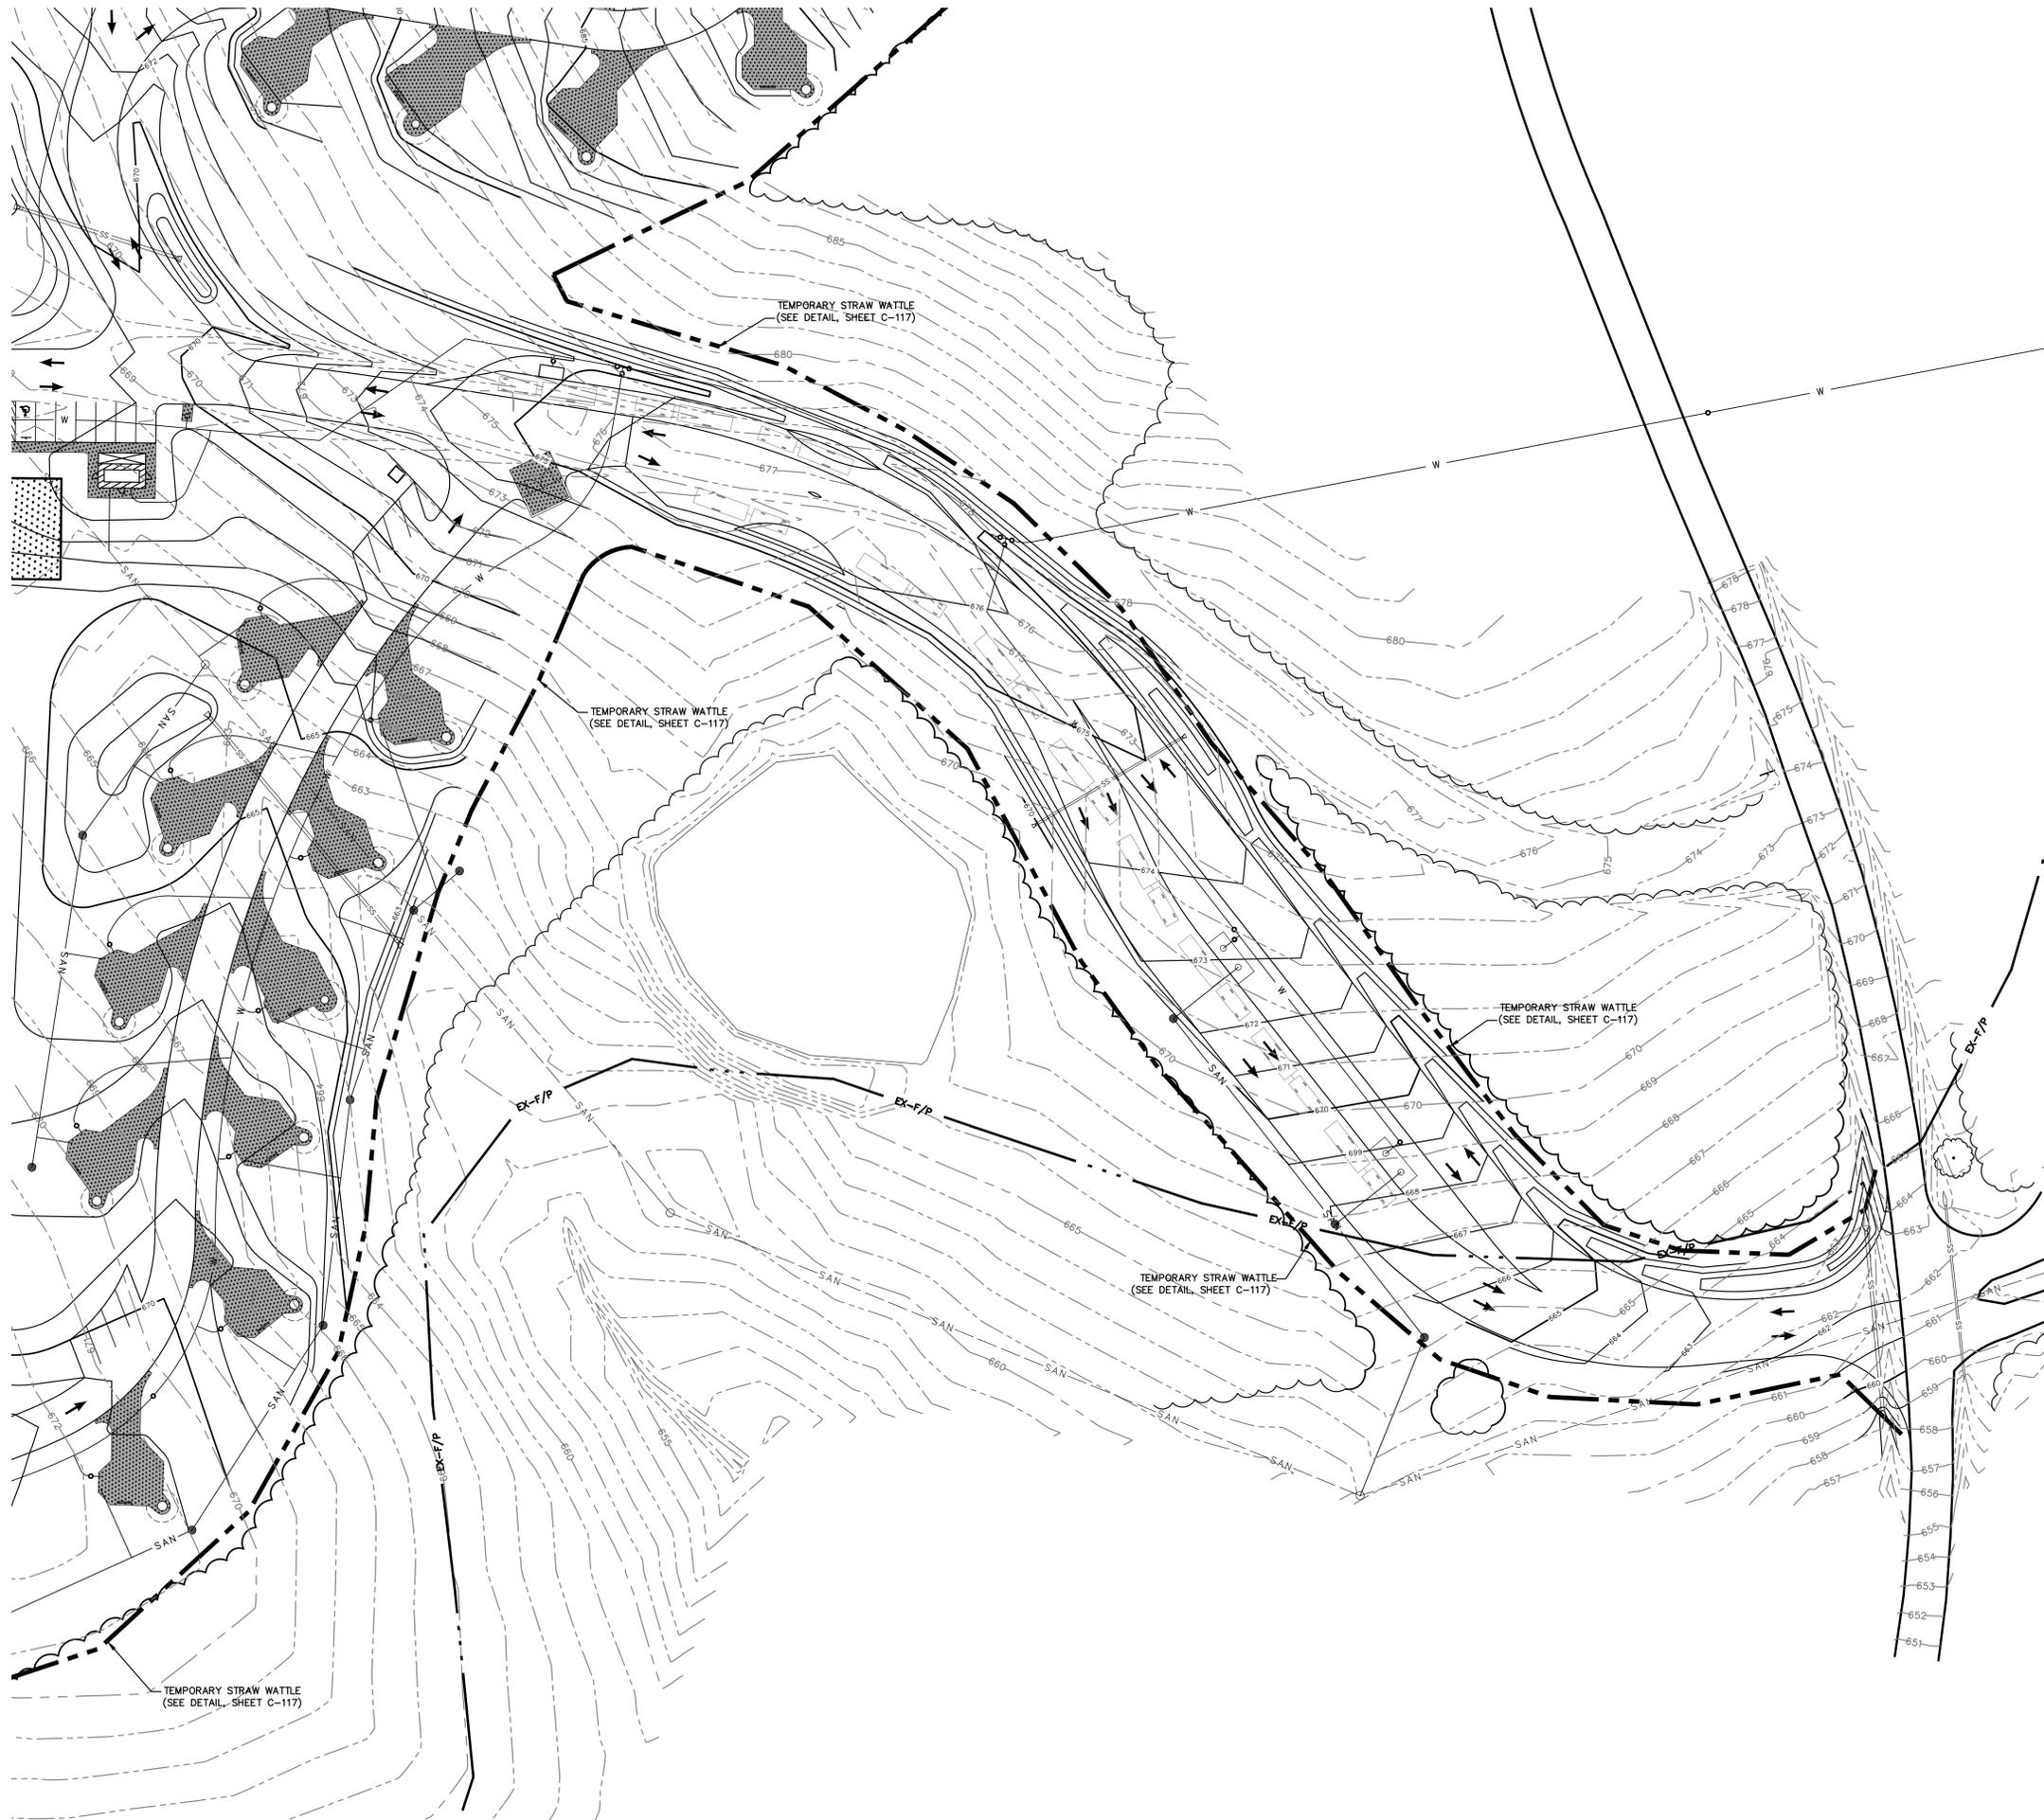

0 15 30 60
MARCH, 2025

EXISTING		PROPOSED	
---	INDEX CONTOUR	---	500
- - - -	INTERMEDIATE CONTOUR	---	SAN
- - - -	SANITARY SEWER	○	SANITARY MANHOLE
○	SANITARY MANHOLE	○	SS
---	STORM SEWER	○	FLARED END
---	FLARED END	---	W
---	WATER LINE	---	W
---	STRAW WATTLE	---	W
---	TREELINE	---	W
---	ASPHALT PAVEMENT	---	W
---	CONCRETE PAVEMENT	---	W

STATE OF MISSOURI
MICHAEL L. PARSON,
GOVERNOR

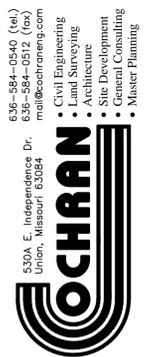

Missouri State Certificate
of Authority Number:
Survey : 000350
Engineering : 001655
Architecture : 2002014240

OFFICE OF ADMINISTRATION
DIVISION OF FACILITIES
MANAGEMENT,
DESIGN AND CONSTRUCTION

DEPARTMENT OF
NATURAL RESOURCES
MISSOURI STATE PARKS

NEW PREMIUM 63 SITE
LOOP CAMPGROUND

ST. FRANCOIS STATE PARK
8920 US-67N
BONNE TERRE, MO 63628

PROJECT # X2317-01
SITE # 5216
ASSET # 7815216025

REVISION: _____
DATE: _____
REVISION: _____
DATE: _____
REVISION: _____
DATE: _____
ISSUE DATE: 03/28/2025

CAD DWG FILE: X2317-ES-116
DRAWN BY: LJR
CHECKED BY: ERR
DESIGNED BY: ERR

SHEET TITLE:
EROSION & SEDIMENT
CONTROL PLAN

SHEET NUMBER:


C-116

17 OF 56 SHEETS
03/28/2025



A **terisac** Company

Straw Wattle Installation Guide

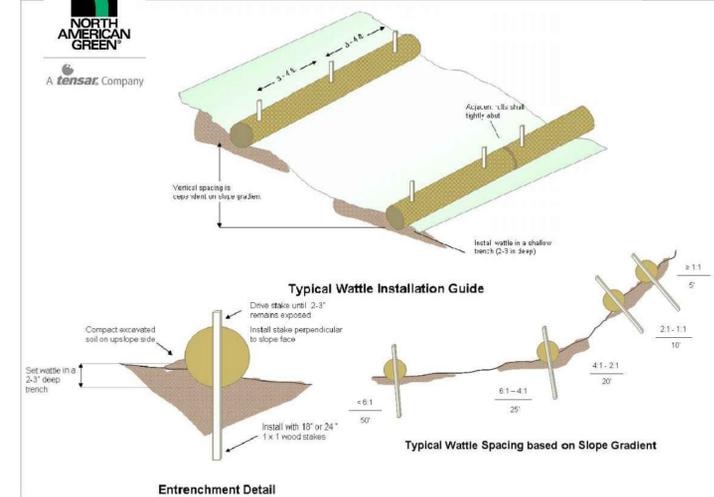

- BEGIN AT THE LOCATION WHERE THE WATTLE IS TO BE INSTALLED BY EXCAVATING A 2-3" (5-7.5 CM) DEEP X 9" (22.9 CM) WIDE TRENCH ALONG THE CONTOUR OF THE SLOPE. EXCAVATED SOIL SHOULD BE PLACED UP-SLOPE FROM THE ANCHOR TRENCH.
- PLACE THE WATTLE IN THE TRENCH SO THAT IT CONTOURS TO THE SOIL SURFACE. COMPACT SOIL FROM THE EXCAVATED TRENCH AGAINST THE WATTLE ON THE UPHILL SIDE. ADJACENT WATTLES SHOULD TIGHTLY ABUT.
- SECURE THE WATTLE WITH 18-24" (45.7-61 CM) STAKES EVERY 3-4' (0.9 - 1.2 M) AND WITH A STAKE ON EACH END. STAKES SHOULD BE DRIVEN THROUGH THE MIDDLE OF THE WATTLE LEAVING AT LEAST 2-3" (5-7.5 CM) OF STAKE EXTENDING ABOVE THE WATTLE. STAKES SHOULD BE DRIVEN PERPENDICULAR TO SLOPE FACE.


North American Green Straw Wattles are a Best Management Practice (BMP) that offers an effective and economical alternative to silt fence and straw bales for sediment control and storm water runoff.

Guidelines are provided to assist in design, installation, and structure spacing. The guidelines may require modification due to variation in soil type, rainfall intensity or duration, and amount of runoff affecting the application site.

To maximize sediment containment with the Straw Wattle, place the initial structure at the top/crest of the slope if significant runoff is expected from above. If no runoff from above is expected, the initial Straw Wattle can be installed at the appropriate distance downhill from the top/crest of the slope. The final structure should be installed at or just beyond the bottom/toe of the slope. Wattles should be installed perpendicular to the primary direction of overland flow.

Straw Wattles are a temporary sediment control device and are not intended to replace rolled erosion control products (RECPs) or hydraulic erosion control products (HECPs). If vegetation is desired for permanent erosion control, North American Green recommends that RECPs or HECPs be used to provide effective immediate erosion control until vegetation is established. Straw Wattles may be used in conjunction with blankets, mats, and mulches as supplemental sediment and runoff control for these applications. Like all sediment control devices, the effectiveness of the Straw Wattle is dependent on storage capacity.

For additional installation assistance, please contact North American Green's Technical Services Department at 1-800-772-2040
 5401 St. Wendel – Cynthiana Road, Poseyville, IN 47633
 1-800-772-2040 www.nagreen.com Rev. 1/2011

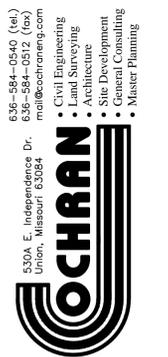

Missouri State Certificate of Authority Numbers:
 Survey : 000350
 Engineering : 001655
 Architecture : 2002014240

OFFICE OF ADMINISTRATION
 DIVISION OF FACILITIES
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 DESIGN AND CONSTRUCTION

DEPARTMENT OF
 NATURAL RESOURCES
 MISSOURI STATE PARKS

NEW PREMIUM 63 SITE
 LOOP CAMPGROUND

ST. FRANCOIS STATE PARK
 8920 US-67N
 BONNE TERRE, MO 63628

PROJECT # X2317-01
 SITE # 5216
 ASSET # 7815216025

REVISION: _____
 DATE: _____
 REVISION: _____
 DATE: _____
 REVISION: _____
 DATE: _____

ISSUE DATE: 03/28/2025

CAD DWG FILE: X2317-ES-117
 DRAWN BY: LJR
 CHECKED BY: ERR
 DESIGNED BY: ERR

SHEET TITLE:
 EROSION & SEDIMENT
 DETAIL SHEET

SHEET NUMBER:

C-117
 18 OF 56 SHEETS
 03/28/2025



636-564-0540 (tel.)
636-564-0512 (fax)
mail@ochran.com
630A E. Independence Dr.
Union, Missouri 63084



Missouri State Certificate
of Authority Numbers:
Survey : 000380
Engineering : 001655
Architecture : 2002014240

OFFICE OF ADMINISTRATION
DIVISION OF FACILITIES
MANAGEMENT,
DESIGN AND CONSTRUCTION

DEPARTMENT OF
NATURAL RESOURCES
MISSOURI STATE PARKS

NEW PREMIUM 63 SITE
LOOP CAMPGROUND

ST. FRANCOIS STATE PARK
8920 US-67N
BONNE TERRE, MO 63628

PROJECT # X2317-01
SITE # 5216
ASSET # 7815216025

REVISION: _____
DATE: _____
REVISION: _____
DATE: _____
REVISION: _____
DATE: _____
ISSUE DATE: 03/28/2025

CAD DWG FILE: X2317-STM-118
DRAWN BY: LJR
CHECKED BY: ERR
DESIGNED BY: ERR

SHEET TITLE:
**STORM SEWER
PLAN & PROFILE
LINE A, B, & C**

SHEET NUMBER:



C-118

19 OF 56 SHEETS
03/28/2025




MARCH, 2025


EXISTING		PROPOSED	
	PROPERTY LINE		R/W
	RIGHT-OF-WAY		R/W
	SANITARY SEWER		SAN
	SANITARY MANHOLE		SAN
	WATER LINE (SIZE)		W
	HYDRANTS		W
	CONCRETE PAVEMENT		CONCRETE PAVEMENT
	ASPHALT PAVEMENT		ASPHALT PAVEMENT

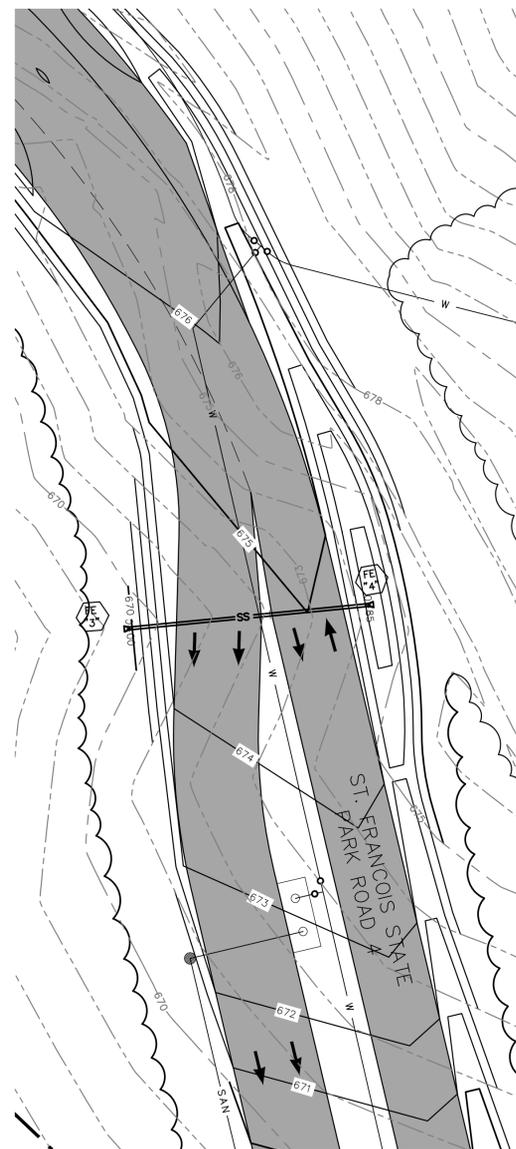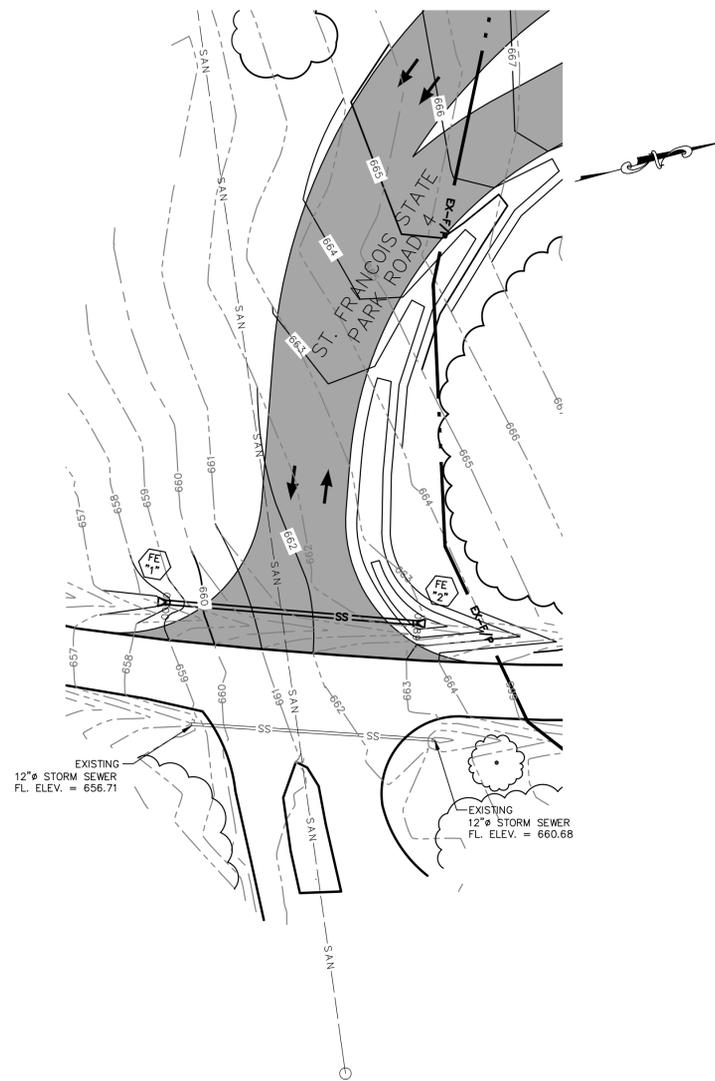


LINE A


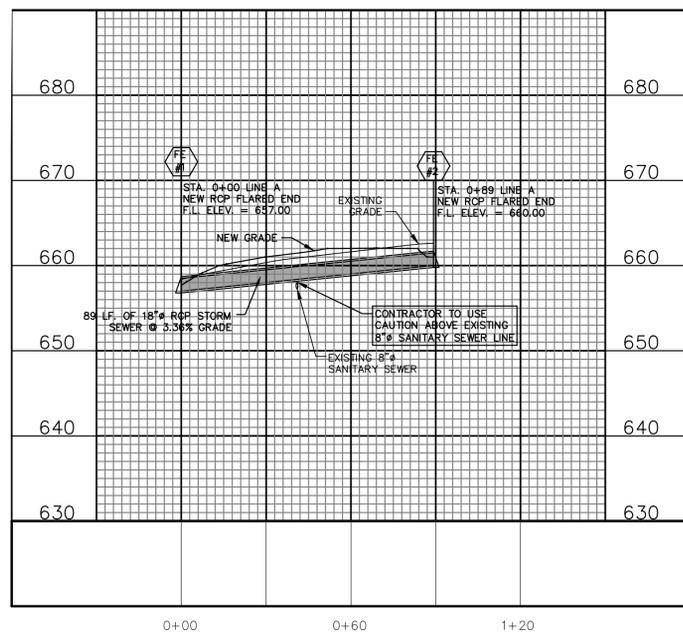


LINE B

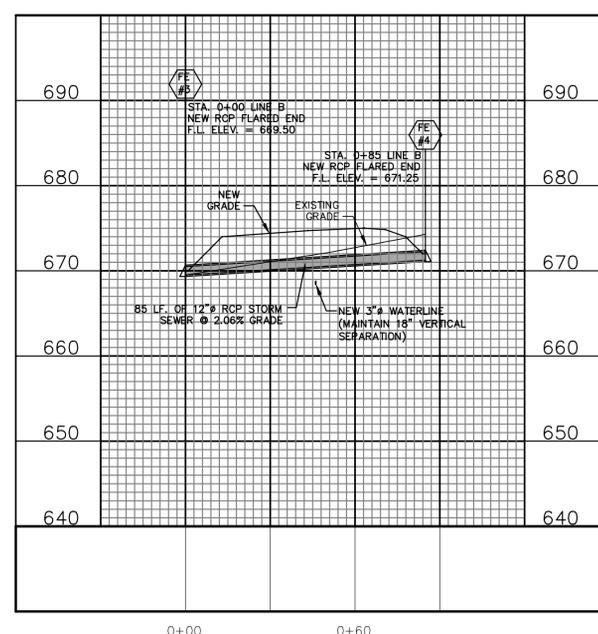

LINE C

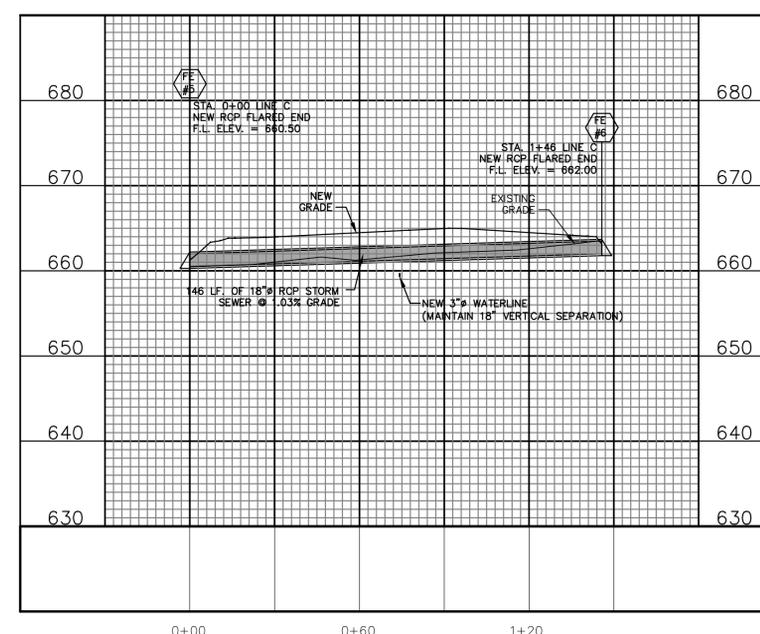

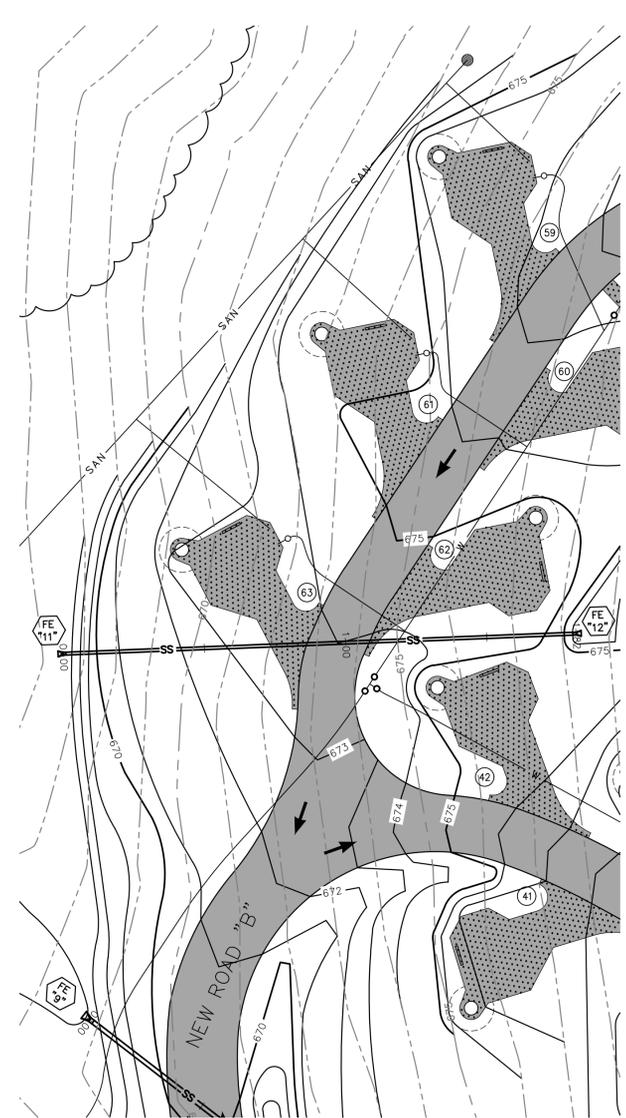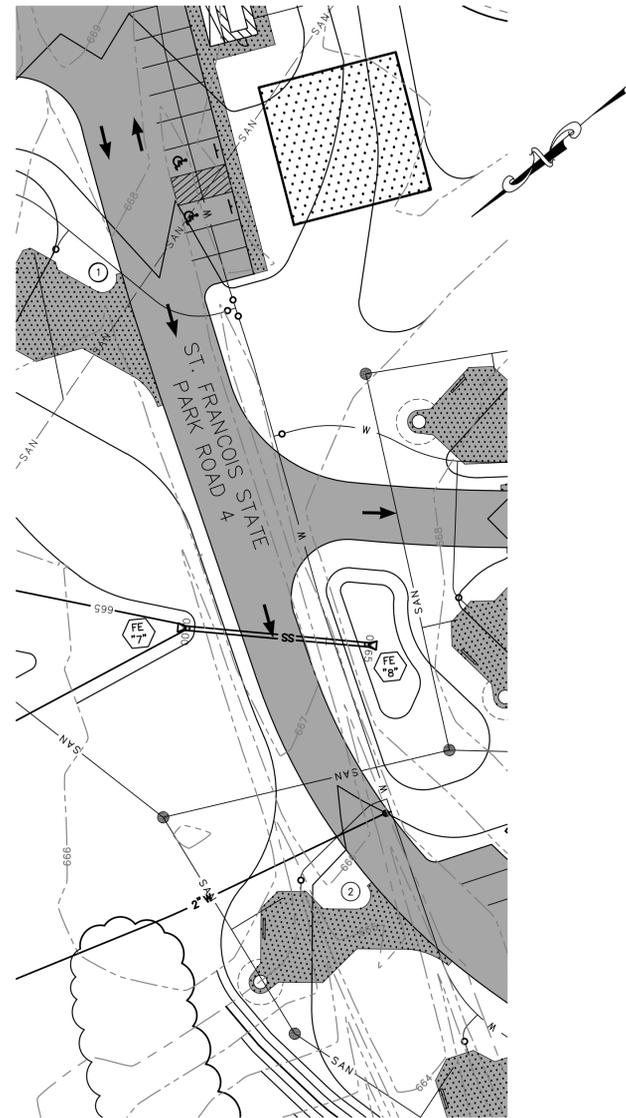


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MARCH, 2025


LEGEND

EXISTING	PROPOSED



LINE D

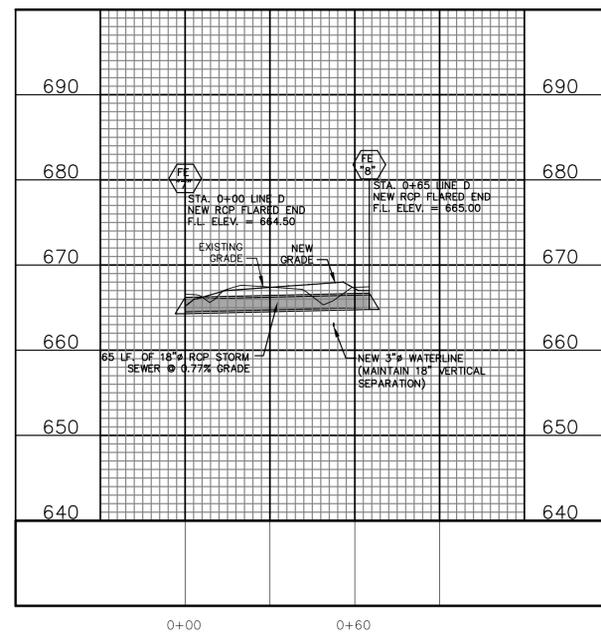

LINE E

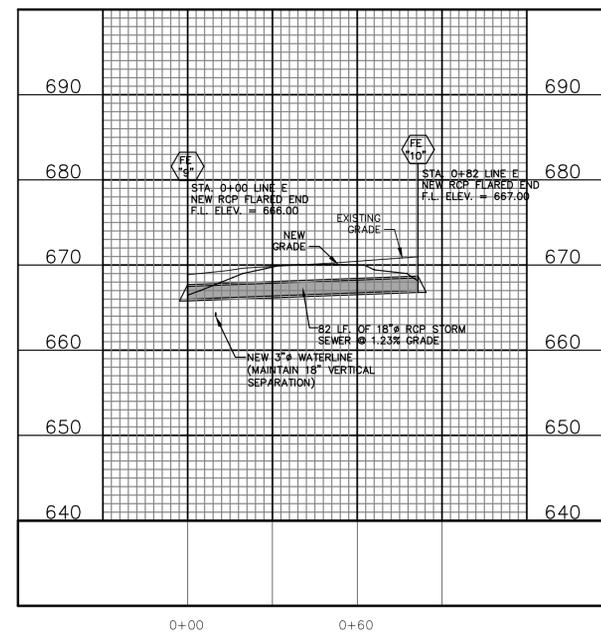

LINE F

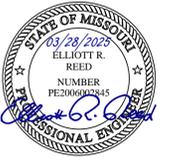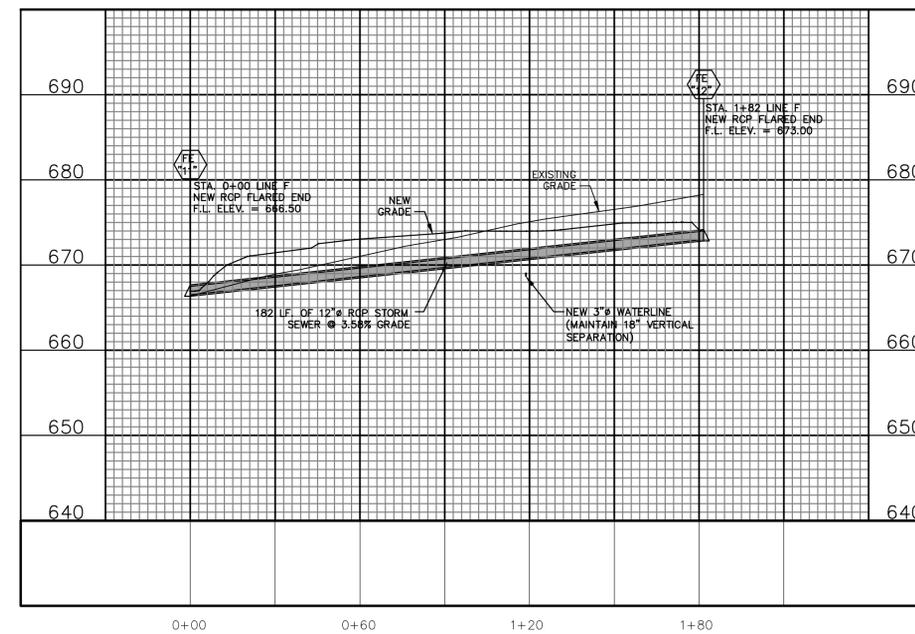

Missouri State Certificate
of Authority Numbers:
Survey : 0003560
Engineering : 001655
Architecture : 2002014240

OFFICE OF ADMINISTRATION
DIVISION OF FACILITIES
MANAGEMENT,
DESIGN AND CONSTRUCTION

DEPARTMENT OF
NATURAL RESOURCES
MISSOURI STATE PARKS

NEW PREMIUM 63 SITE
LOOP CAMPGROUND

ST. FRANCOIS STATE PARK
8920 US-67N
BONNE TERRE, MO 63628

PROJECT # X2317-01
SITE # 5216
ASSET # 7815216025



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DATE: _____
REVISION: _____
DATE: _____
REVISION: _____
DATE: _____
ISSUE DATE: 03/28/2025

CAD DWG FILE: X2317-STM-119
DRAWN BY: LJR
CHECKED BY: ERR
DESIGNED BY: ERR


SHEET TITLE:
**STORM SEWER
PLAN & PROFILE
LINE D, E, & F**

SHEET NUMBER:

C-119

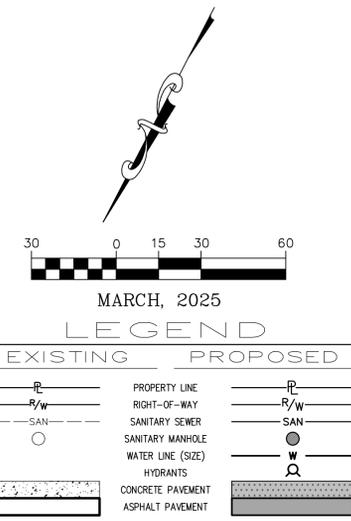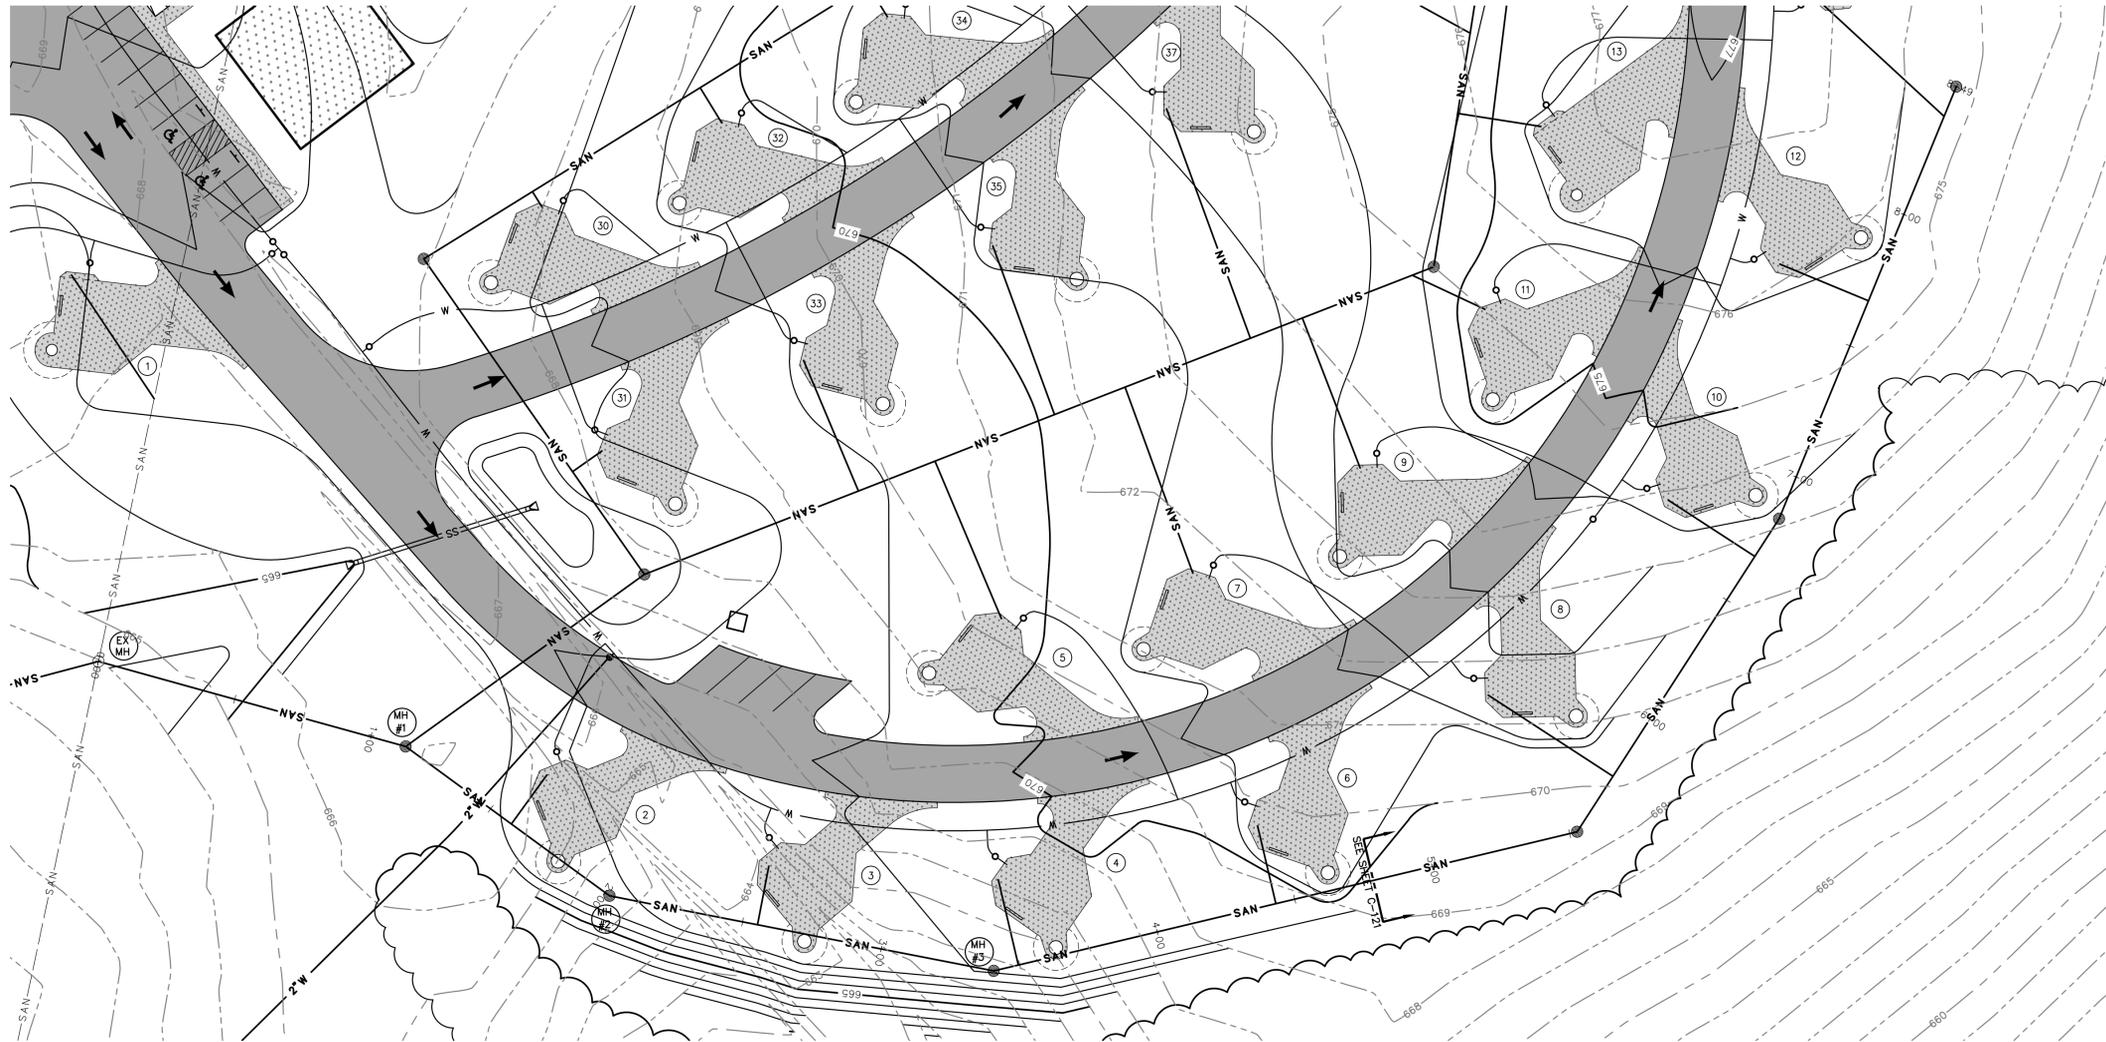

STATE OF MISSOURI
MICHAEL L. PARSON,
GOVERNOR

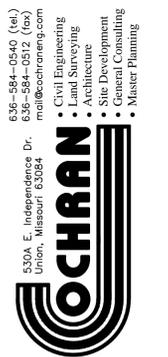

Missouri State Certificate
of Authority Numbers:
Survey : 003350
Engineering : 001655
Architecture : 2002014240

OFFICE OF ADMINISTRATION
DIVISION OF FACILITIES
MANAGEMENT,
DESIGN AND CONSTRUCTION

DEPARTMENT OF
NATURAL RESOURCES
MISSOURI STATE PARKS

NEW PREMIUM 63 SITE
LOOP CAMPGROUND

ST. FRANCOIS STATE PARK
8920 US-67N
BONNE TERRE, MO 63628

PROJECT # X2317-01
SITE # 5216
ASSET # 7815216025

REVISION: _____
DATE: _____
REVISION: _____
DATE: _____
REVISION: _____
DATE: _____
ISSUE DATE: 03/28/2025


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DESIGNED BY: ERR


SHEET TITLE:
**SANITARY SEWER
PROFILE LINE #1
STA. 0+00 TO 5+40**

SHEET NUMBER:

C-120

21 OF 56 SHEETS
03/28/2025

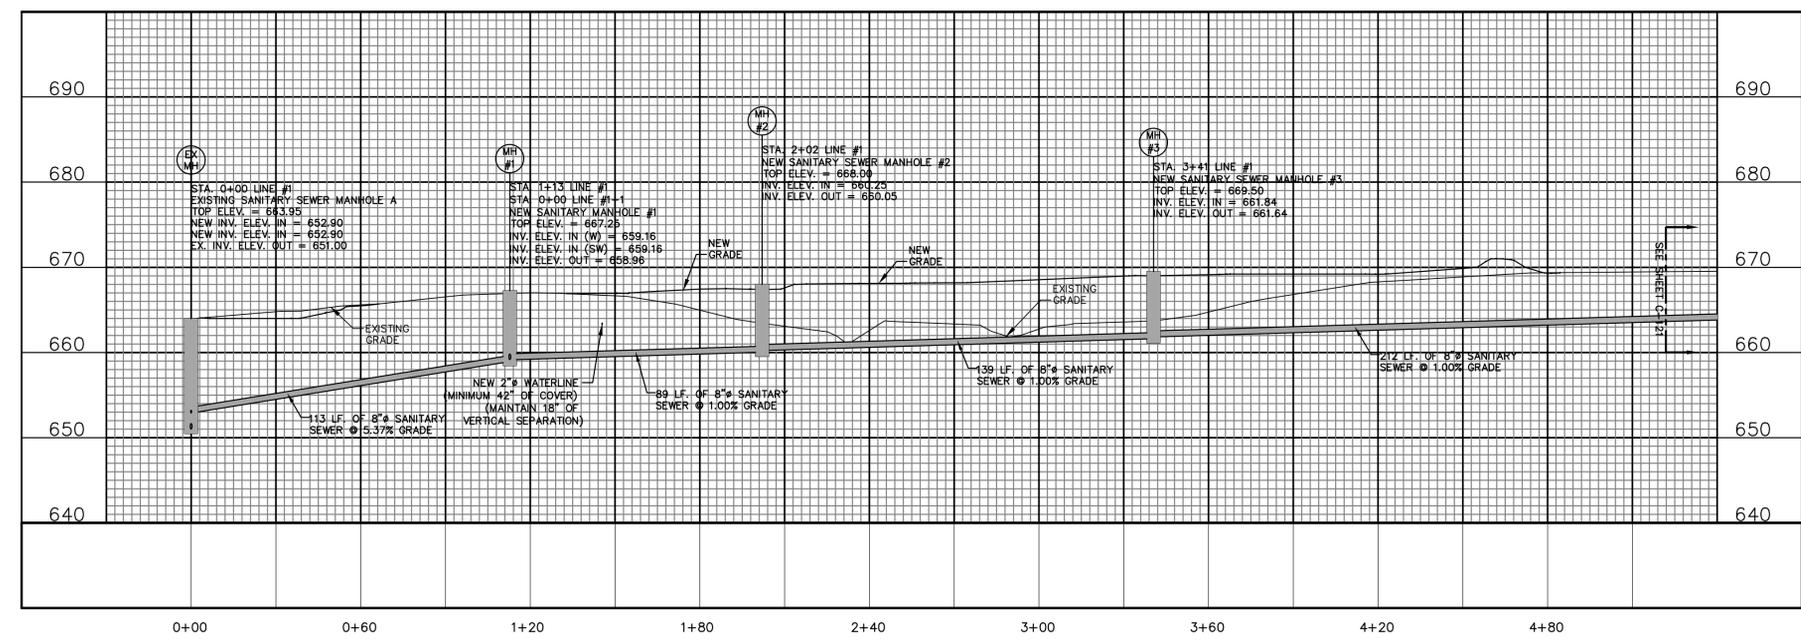


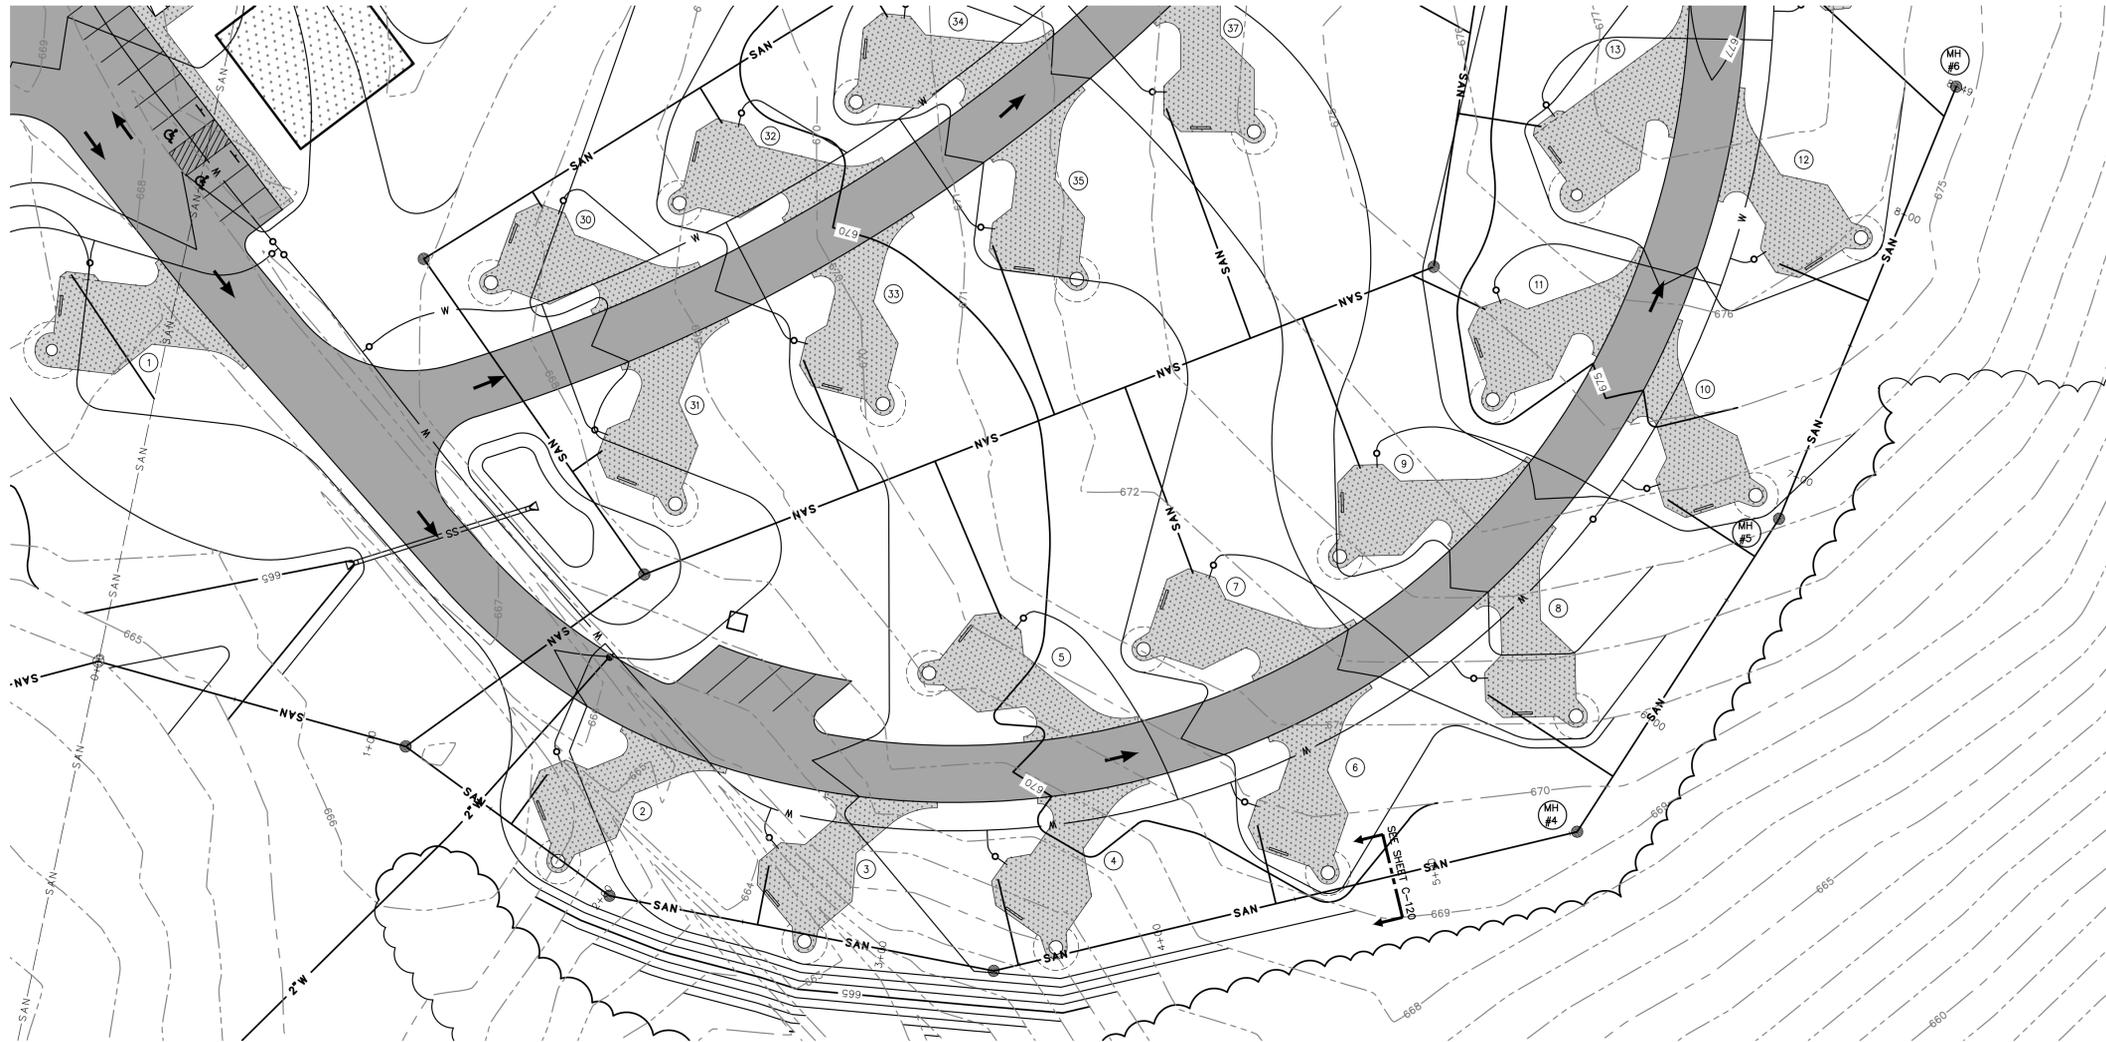

MARCH, 2025

LEGEND

EXISTING	PROPOSED

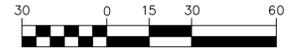

STATE OF MISSOURI
MICHAEL L. PARSON,
GOVERNOR



630A E. Independence Dr.
Union, Missouri 63084

COCHRAN

Civil Engineering
Land Surveying
Architecture
Site Development
General Consulting
Master Planning

Missouri State Certificate
of Authority Numbers:
Survey : 003366
Engineering : 001655
Architecture : 2002014240

OFFICE OF ADMINISTRATION
DIVISION OF FACILITIES
MANAGEMENT,
DESIGN AND CONSTRUCTION

DEPARTMENT OF
NATURAL RESOURCES
MISSOURI STATE PARKS

NEW PREMIUM 63 SITE
LOOP CAMPGROUND

ST. FRANCOIS STATE PARK
8920 US-67N
BONNE TERRE, MO 63628

PROJECT # X2317-01
SITE # 5216
ASSET # 7815216025

REVISION: _____
DATE: _____
REVISION: _____
DATE: _____
REVISION: _____
DATE: _____

ISSUE DATE: 03/28/2025


CAD DWG FILE: X2317-SANS-121
DRAWN BY: LJR
CHECKED BY: ERR
DESIGNED BY: ERR

SHEET TITLE:
**SANITARY SEWER
PROFILE LINE #1
STA. 5+40 TO 9+20**

SHEET NUMBER:

C-121


22 OF 56 SHEETS
03/28/2025

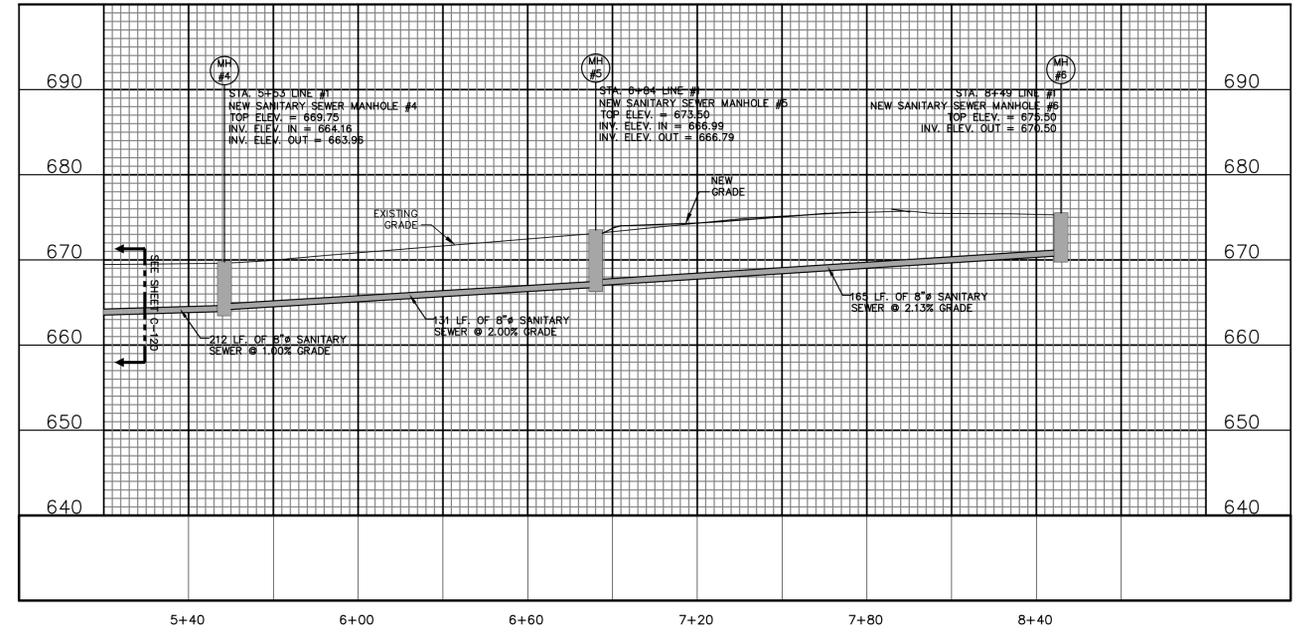



MARCH, 2025

EXISTING		PROPOSED	
	PROPERTY LINE		R/W
	RIGHT-OF-WAY		SAN
	SANITARY SEWER		W
	SANITARY MANHOLE		W
	WATER LINE (SIZE)		Q
	HYDRANTS		CONCRETE PAVEMENT
	CONCRETE PAVEMENT		ASPHALT PAVEMENT
	ASPHALT PAVEMENT		

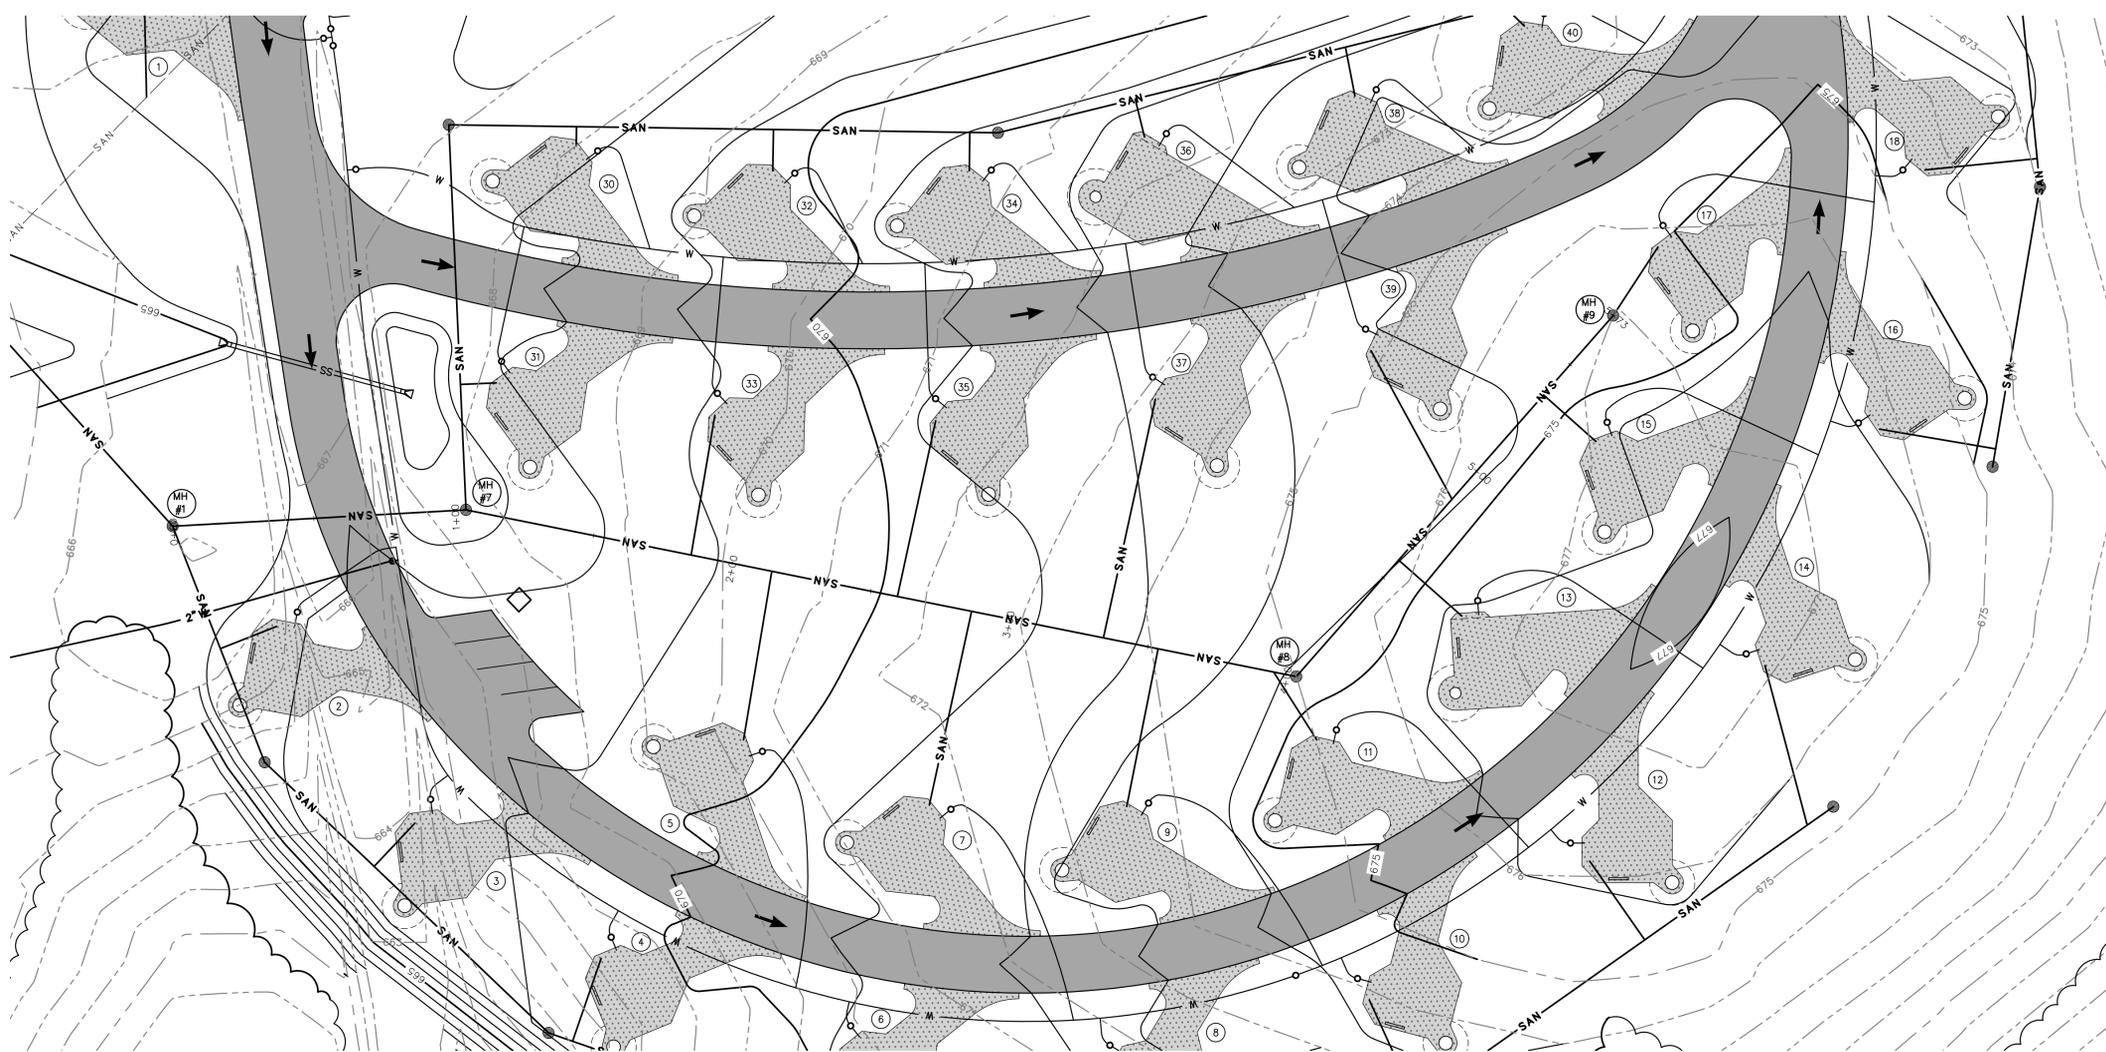

Missouri State Certificate
of Authority Numbers:
Survey : 000350
Engineering : 001655
Architecture : 2002014240

OFFICE OF ADMINISTRATION
DIVISION OF FACILITIES
MANAGEMENT,
DESIGN AND CONSTRUCTION

DEPARTMENT OF
NATURAL RESOURCES
MISSOURI STATE PARKS

NEW PREMIUM 63 SITE
LOOP CAMPGROUND

ST. FRANCOIS STATE PARK
8920 US-67N
BONNE TERRE, MO 63628

PROJECT # X2317-01
SITE # 5216
ASSET # 7815216025

REVISION: _____
DATE: _____
REVISION: _____
DATE: _____
REVISION: _____
DATE: _____
ISSUE DATE: 03/28/2025


CAD DWG FILE: X2317-SANS-122
DRAWN BY: LJR
CHECKED BY: ERR
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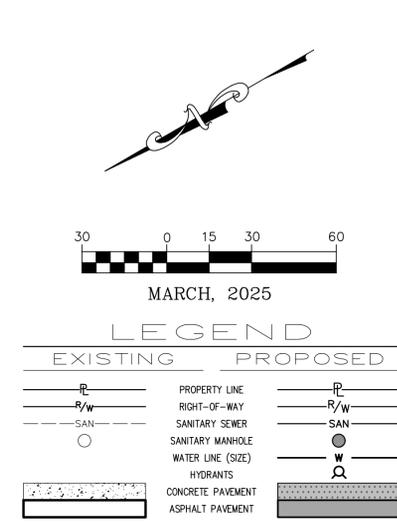
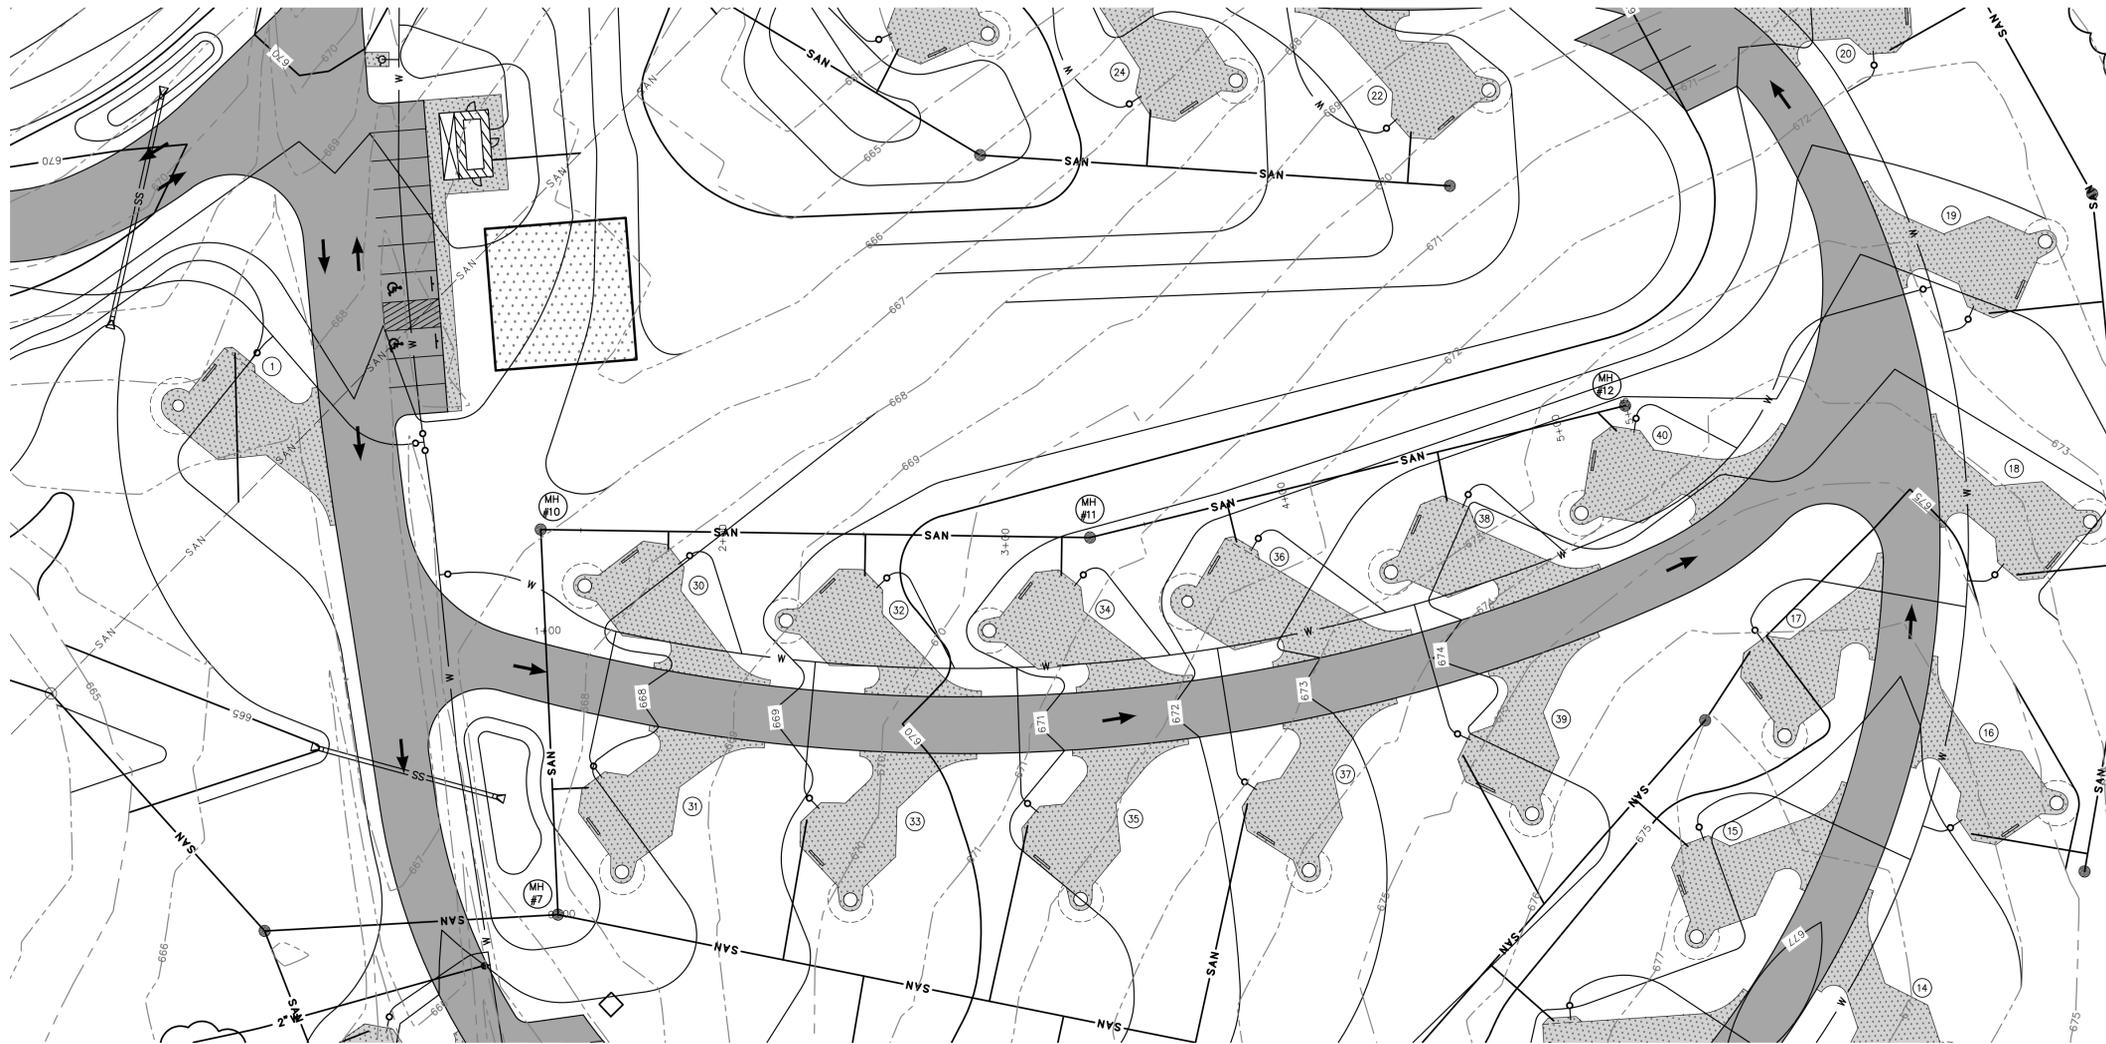
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**SANITARY SEWER
PROFILE LINE #1-1**

SHEET NUMBER:


C-122

23 OF 56 SHEETS
03/28/2025



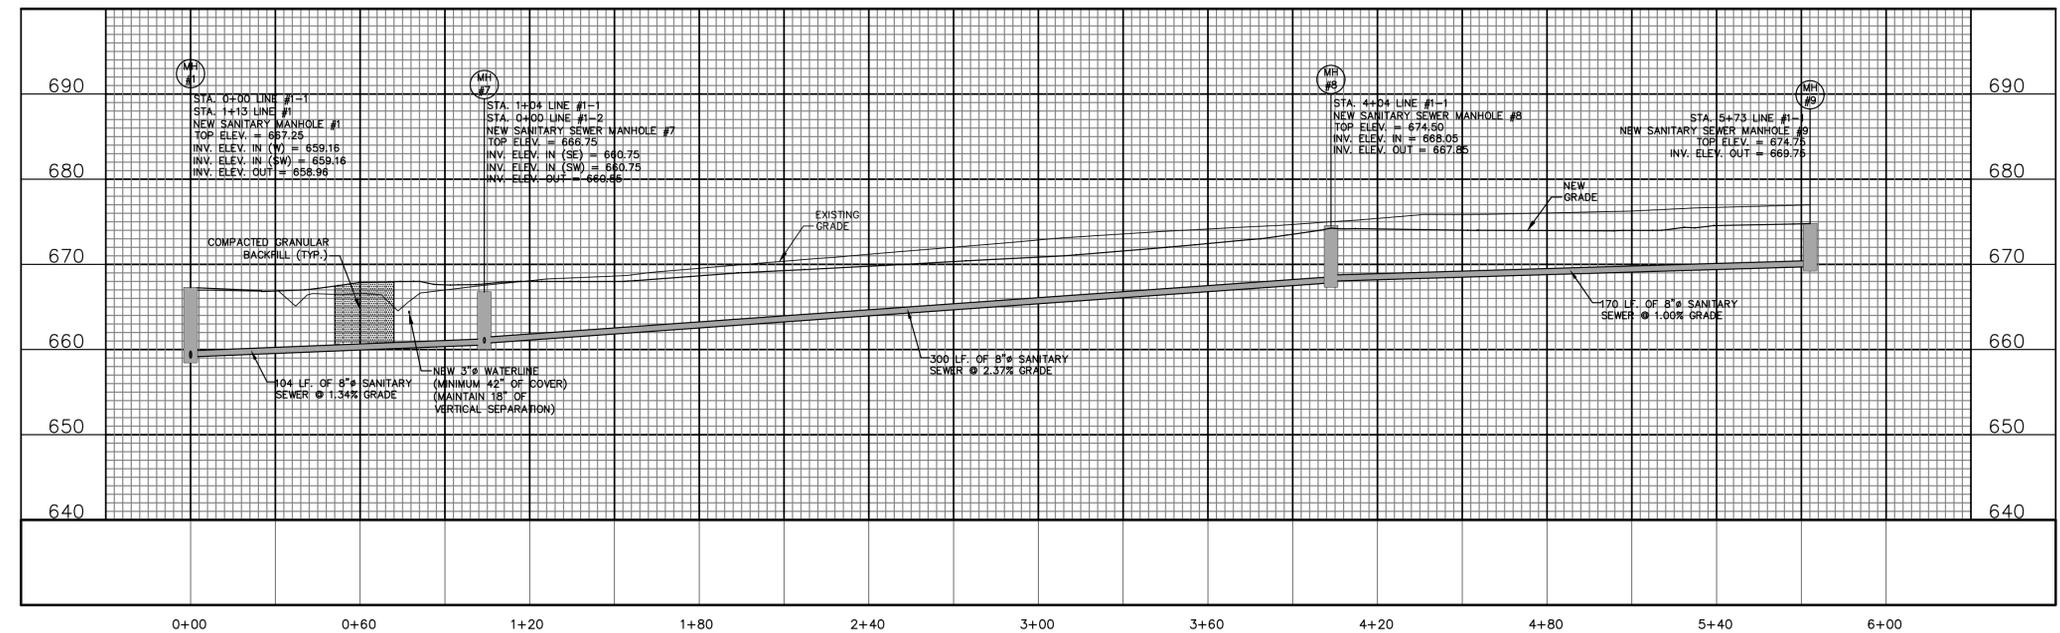

STATE OF MISSOURI
MICHAEL L. PARSON,
GOVERNOR

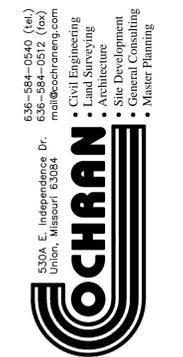

Missouri State Certificate
of Authority Numbers:
Survey : 0003560
Engineering : 001655
Architecture : 2002014240

OFFICE OF ADMINISTRATION
DIVISION OF FACILITIES
MANAGEMENT,
DESIGN AND CONSTRUCTION

DEPARTMENT OF
NATURAL RESOURCES
MISSOURI STATE PARKS

NEW PREMIUM 63 SITE
LOOP CAMPGROUND

ST. FRANCOIS STATE PARK
8920 US-67N
BONNE TERRE, MO 63628

PROJECT # X2317-01
SITE # 5216
ASSET # 7815216025

REVISION: _____
DATE: _____
REVISION: _____
DATE: _____
REVISION: _____
DATE: _____
ISSUE DATE: 03/28/2025


CAD DWG FILE: X2317-SANS-123
DRAWN BY: LJR
CHECKED BY: ERR
DESIGNED BY: ERR

SHEET TITLE:
**SANITARY SEWER
PROFILE LINE #1-2**


SHEET NUMBER:

C-123



24 OF 56 SHEETS
03/28/2025

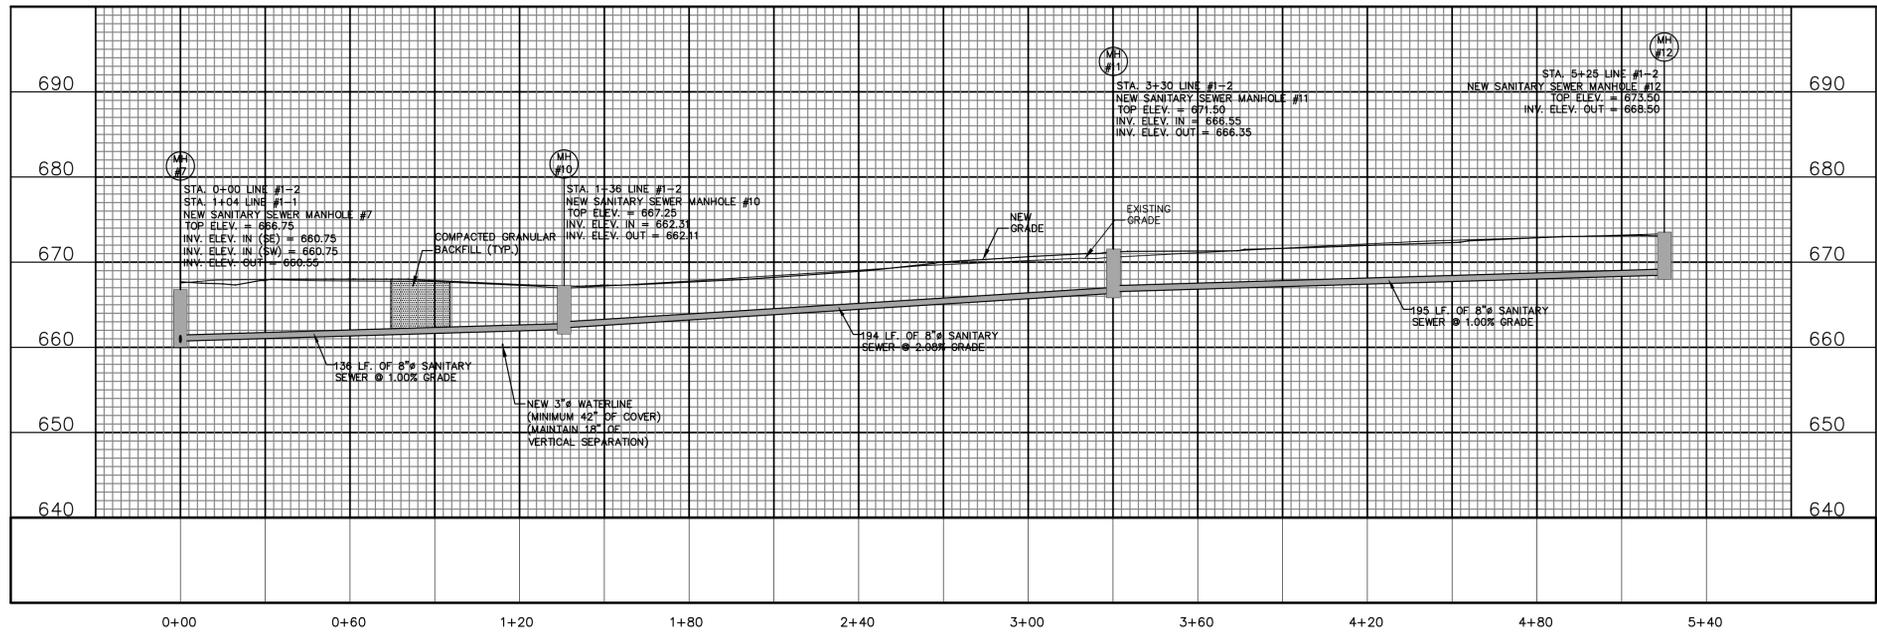

SANITARY SEWER LINE #2

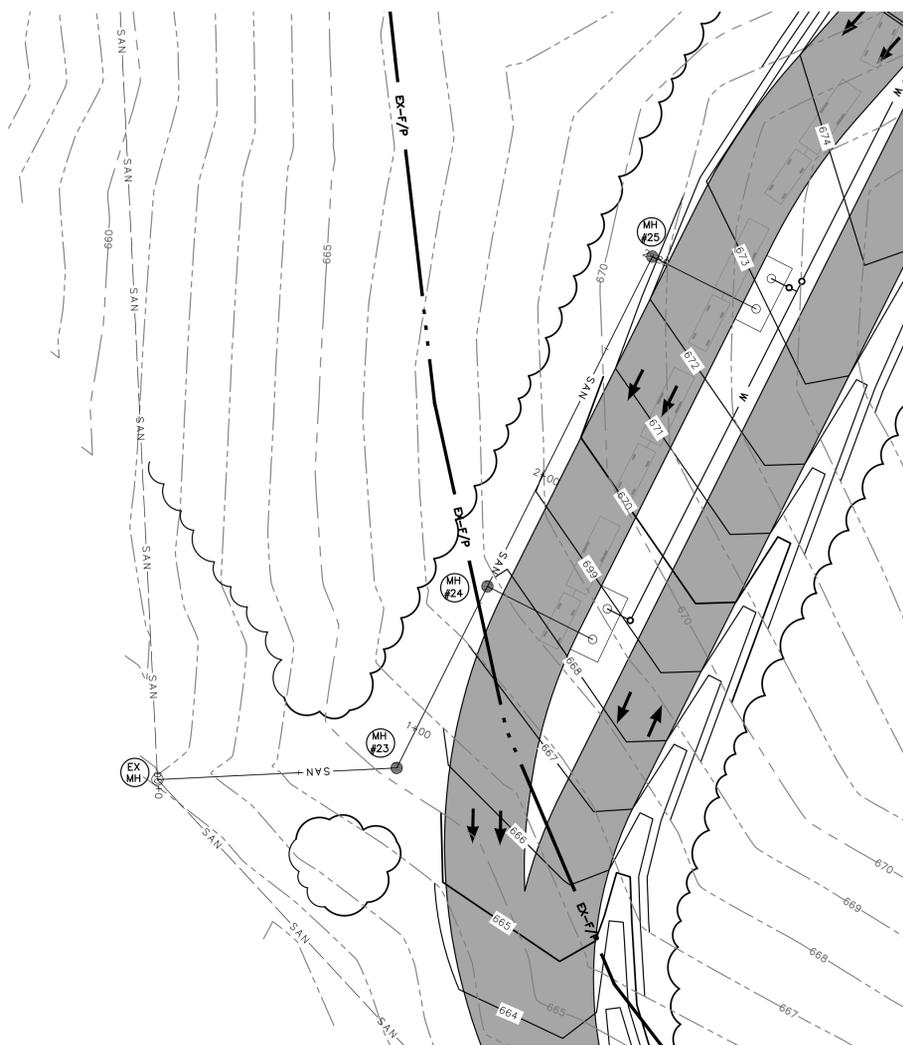

SANITARY SEWER LINE #3

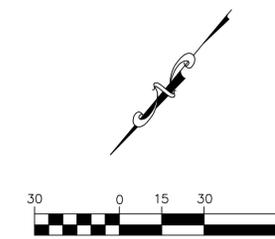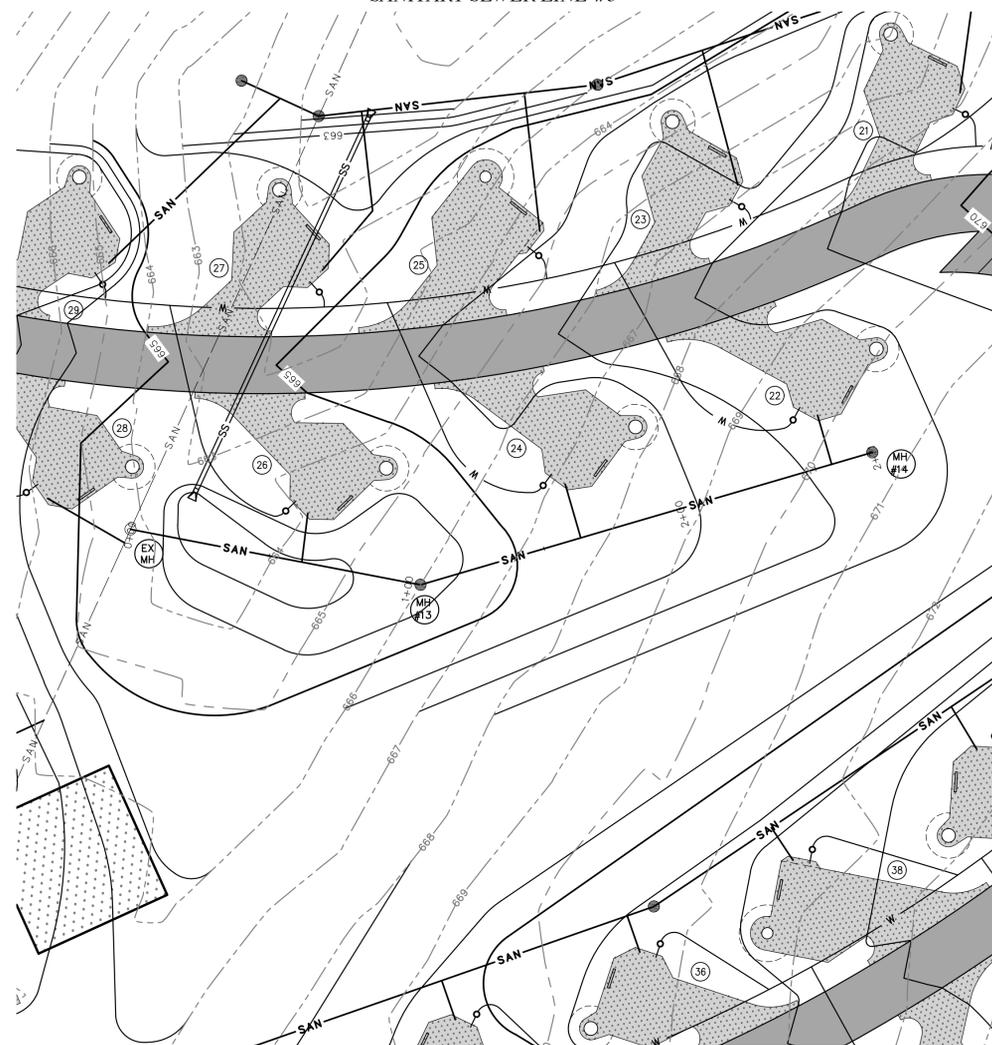


MARCH, 2025


LEGEND

EXISTING	PROPOSED

SANITARY SEWER LINE #2

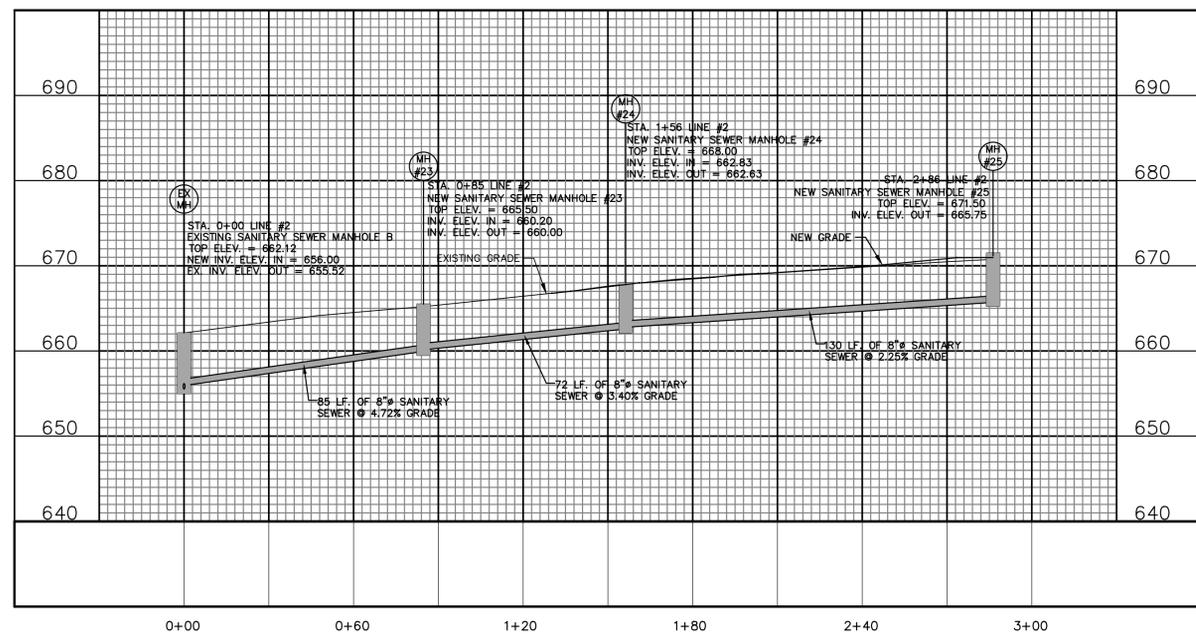

SANITARY SEWER LINE #3

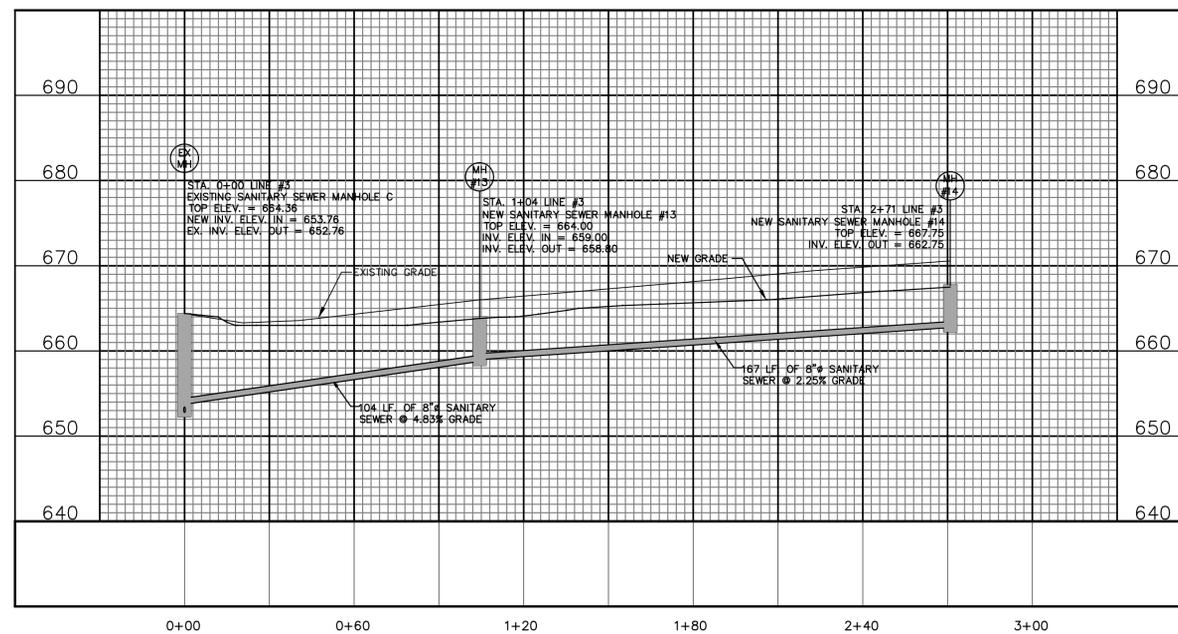

636-564-0540 (tel.)
636-564-0512 (fax)
mail@cochran.com
Cochran Engineering
Civil Engineering
Land Surveying
Architecture
Site Development
General Consulting
Master Planning



Missouri State Certificate
of Authority Numbers:
Survey : 003380
Engineering : 001655
Architecture : 2002014240

OFFICE OF ADMINISTRATION
DIVISION OF FACILITIES
MANAGEMENT,
DESIGN AND CONSTRUCTION

DEPARTMENT OF
NATURAL RESOURCES
MISSOURI STATE PARKS

NEW PREMIUM 63 SITE
LOOP CAMPGROUND

ST. FRANCOIS STATE PARK
8920 US-67N
BONNE TERRE, MO 63628

PROJECT # X2317-01
SITE # 5216
ASSET # 7815216025

REVISION: _____
DATE: _____
REVISION: _____
DATE: _____
REVISION: _____
DATE: _____
ISSUE DATE: 03/28/2025

CAD DWG FILE: X2317-SANS-124
DRAWN BY: LJR
CHECKED BY: ERR
DESIGNED BY: ERR

SHEET TITLE:
SANITARY SEWER
PROFILE LINE #2 & #3

SHEET NUMBER:

C-124

25 OF 56 SHEETS
03/28/2025



636-564-0540 (tel.)
636-564-0512 (fax)
mail@cochraneng.com
Cochran Engineering
Civil Engineering
Land Surveying
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Missouri State Certificate
of Authority Numbers:
Survey : 003356
Engineering : 001655
Architecture : 2002014240

OFFICE OF ADMINISTRATION
DIVISION OF FACILITIES
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DESIGN AND CONSTRUCTION

DEPARTMENT OF
NATURAL RESOURCES
MISSOURI STATE PARKS

NEW PREMIUM 63 SITE
LOOP CAMPGROUND

ST. FRANCOIS STATE PARK
8920 US-67N
BONNE TERRE, MO 63628

PROJECT # X2317-01
SITE # 5216
ASSET # 7815216025

REVISION: _____
DATE: _____
REVISION: _____
DATE: _____
REVISION: _____
DATE: _____
ISSUE DATE: 03/28/2025



CAD DWG FILE: X2317-SANS-125
DRAWN BY: LJR
CHECKED BY: ERR
DESIGNED BY: ERR

SHEET TITLE:
**SANITARY SEWER
PLAN & PROFILE
LINE #4 & #4-1**

SHEET NUMBER:

C-125



26 OF 56 SHEETS
03/28/2025

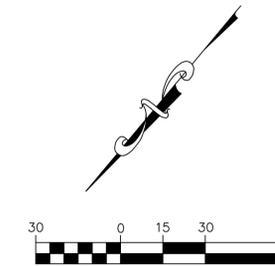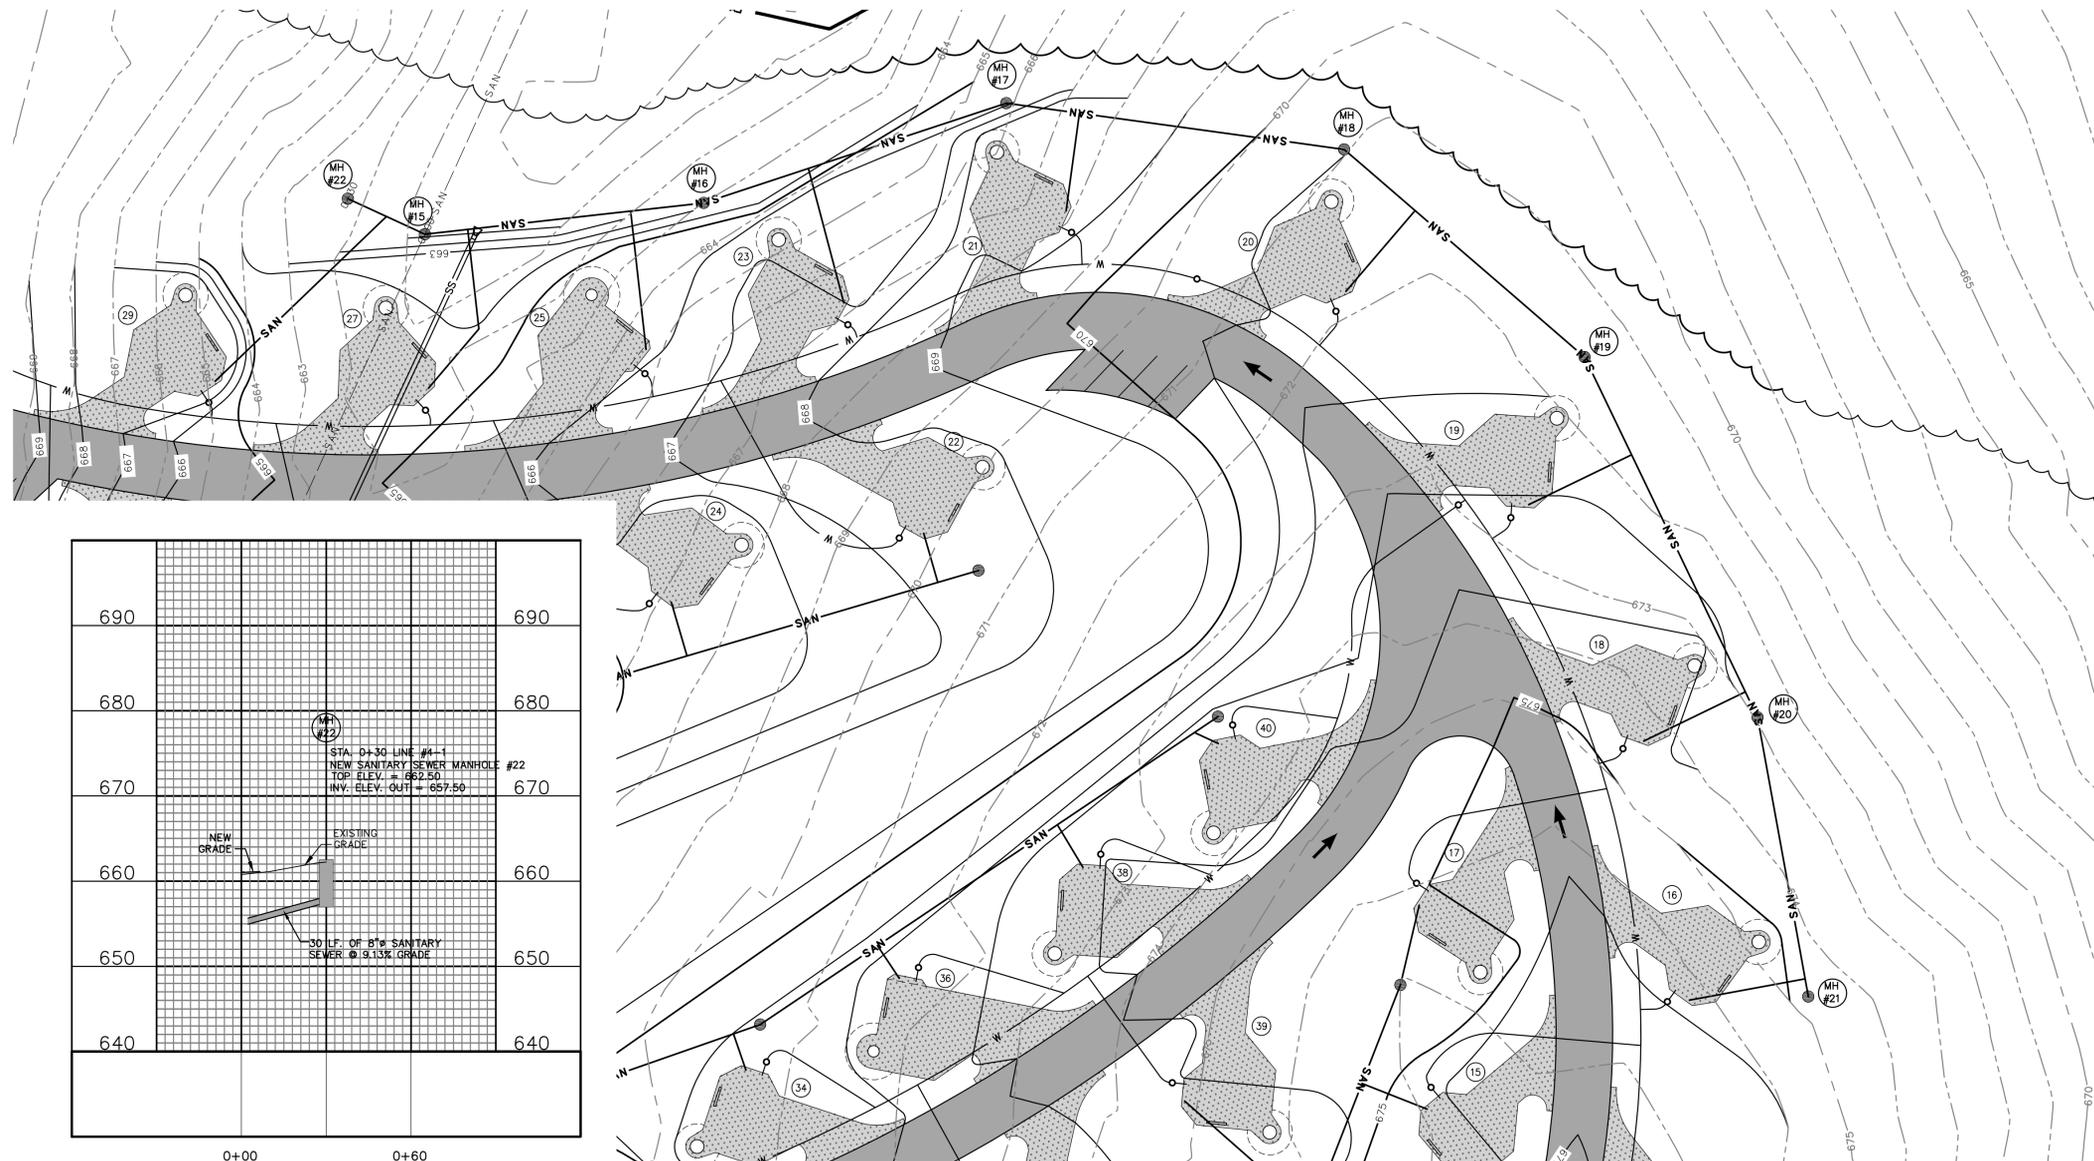


MARCH, 2025

LEGEND

EXISTING	PROPOSED

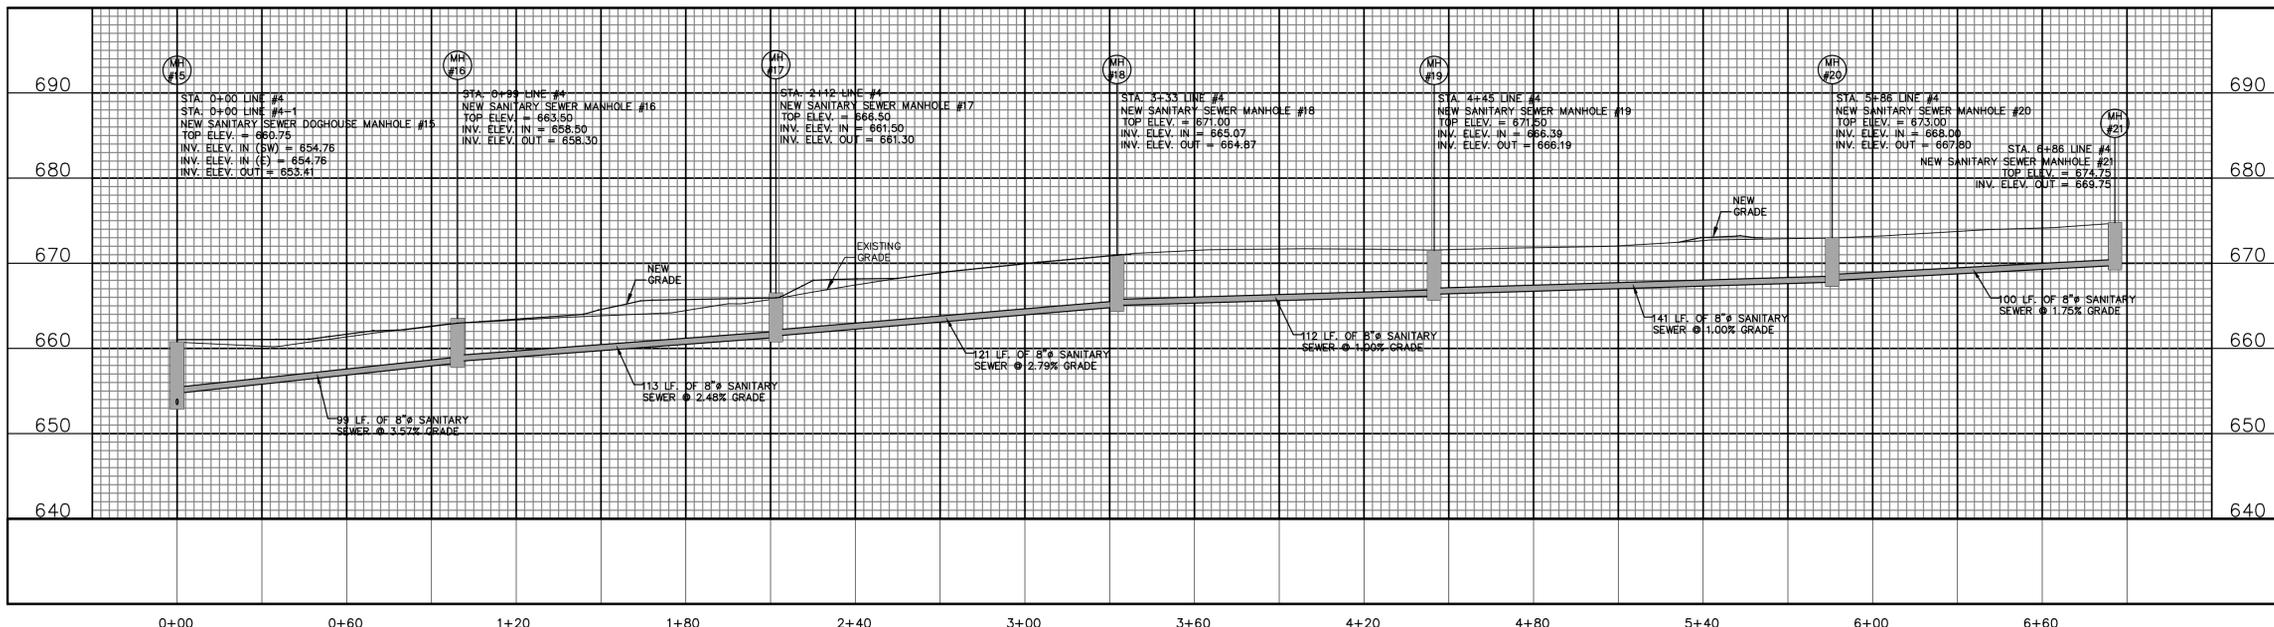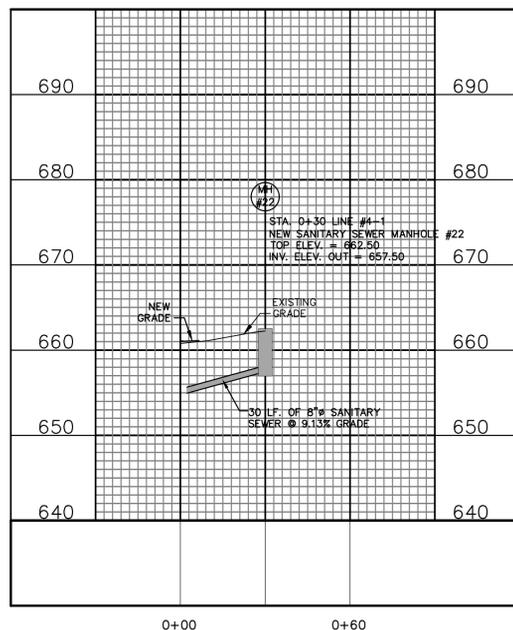

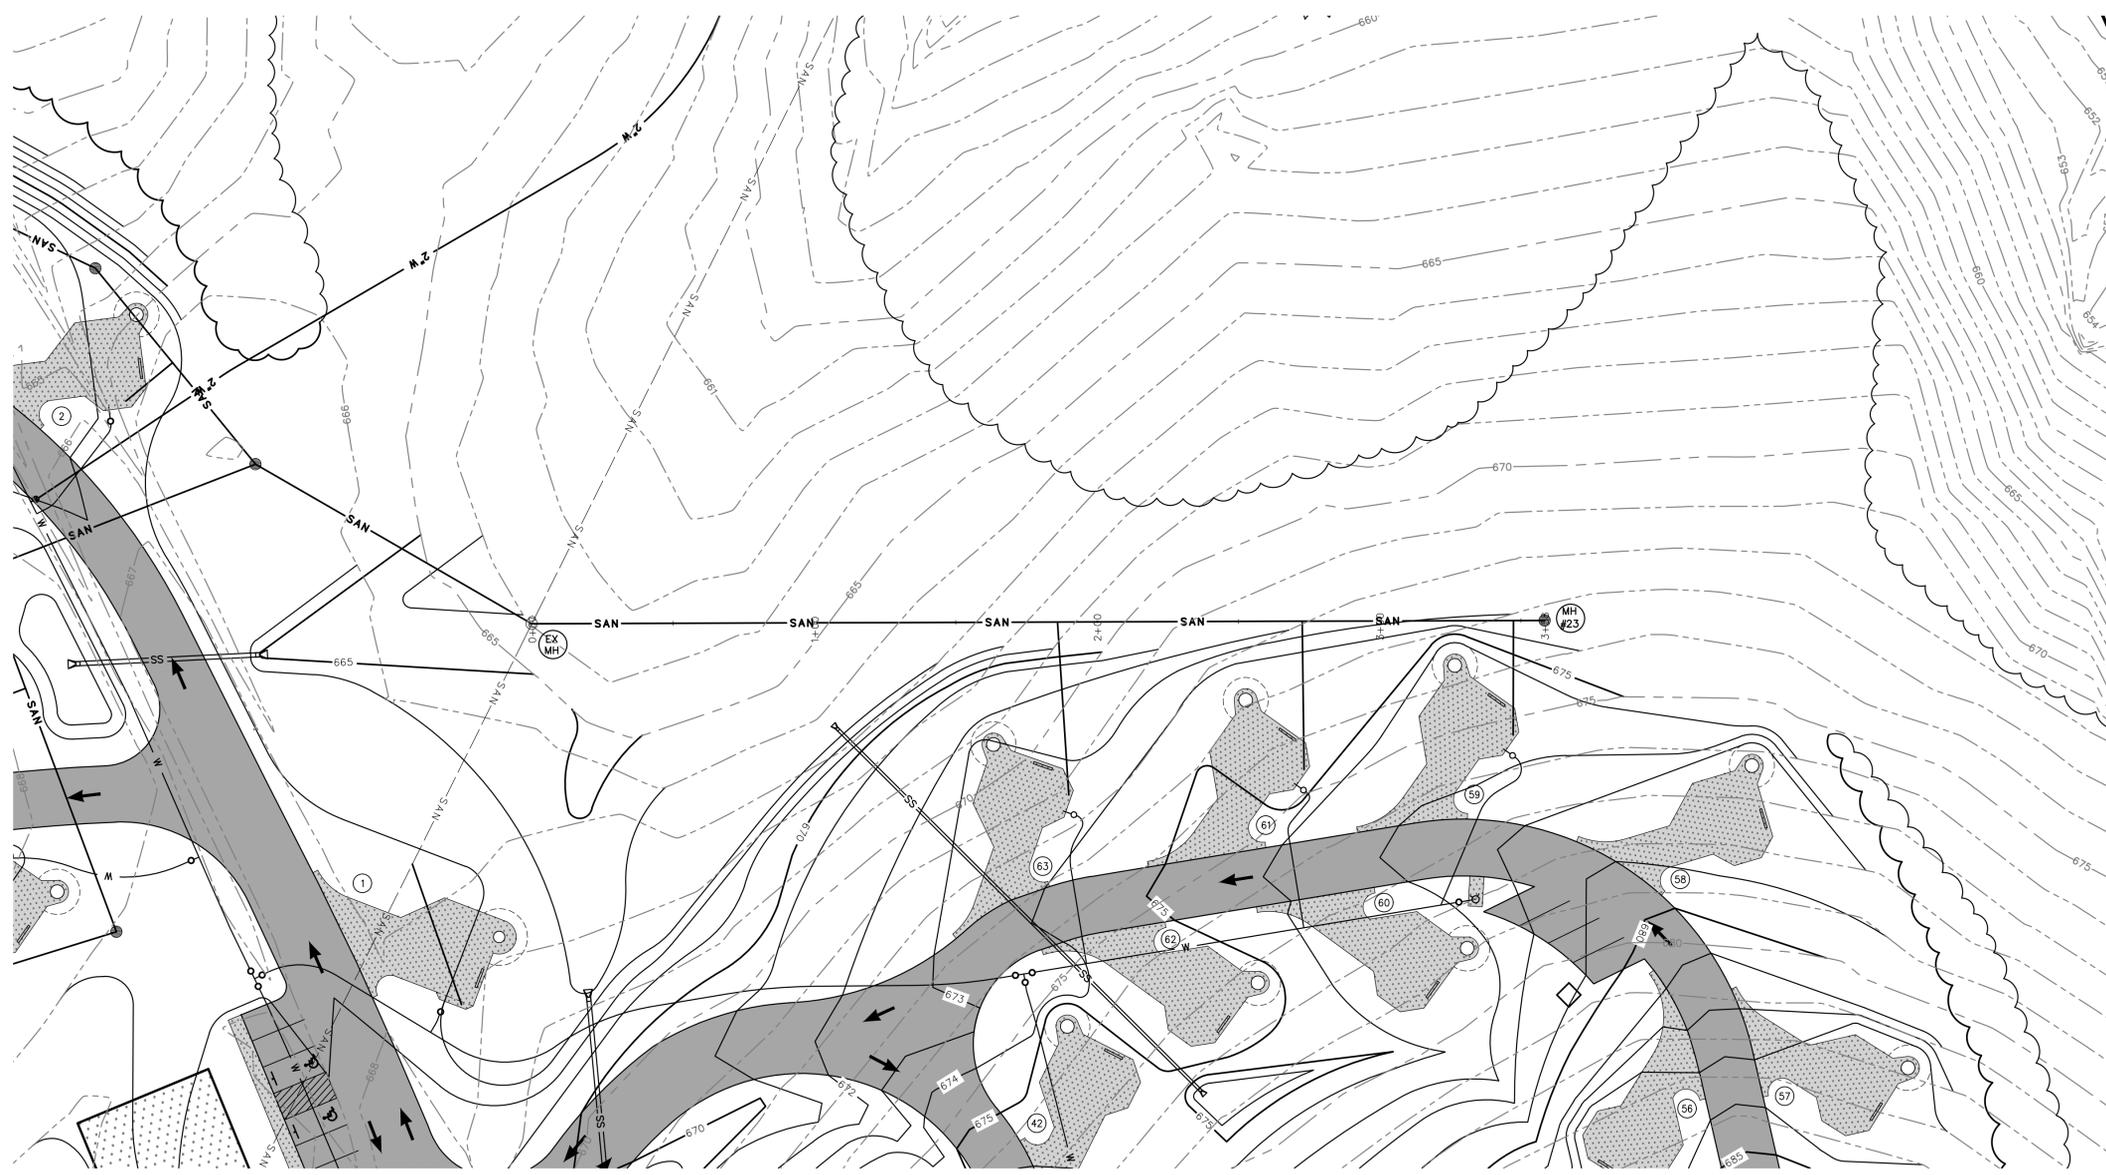

MARCH, 2025

LEGEND

EXISTING	PROPOSED

STATE OF MISSOURI
MICHAEL L. PARSON,
GOVERNOR



636-564-0540 (tel.)
636-564-0512 (fax)
mail@ochran.com

COCHRAN
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Land Surveying
Architecture
Site Development
General Consulting
Master Planning

Missouri State Certificate
of Authority Numbers:
Survey : 003350
Engineering : 001655
Architecture : 2002014240

OFFICE OF ADMINISTRATION
DIVISION OF FACILITIES
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DEPARTMENT OF
NATURAL RESOURCES
MISSOURI STATE PARKS

NEW PREMIUM 63 SITE
LOOP CAMPGROUND

ST. FRANCOIS STATE PARK
8920 US-67N
BONNE TERRE, MO 63628

PROJECT # X2317-01
SITE # 5216
ASSET # 7815216025


REVISION: _____
DATE: _____
REVISION: _____
DATE: _____
REVISION: _____
DATE: _____
ISSUE DATE: 03/28/2025


CAD DWG FILE: X2317-SANS-125A
DRAWN BY: LJR
CHECKED BY: ERR
DESIGNED BY: ERR

SHEET TITLE:
**SANITARY SEWER
PLAN & PROFILE
LINE #5**

SHEET NUMBER:
C-125A



27 OF 56 SHEETS
03/28/2025

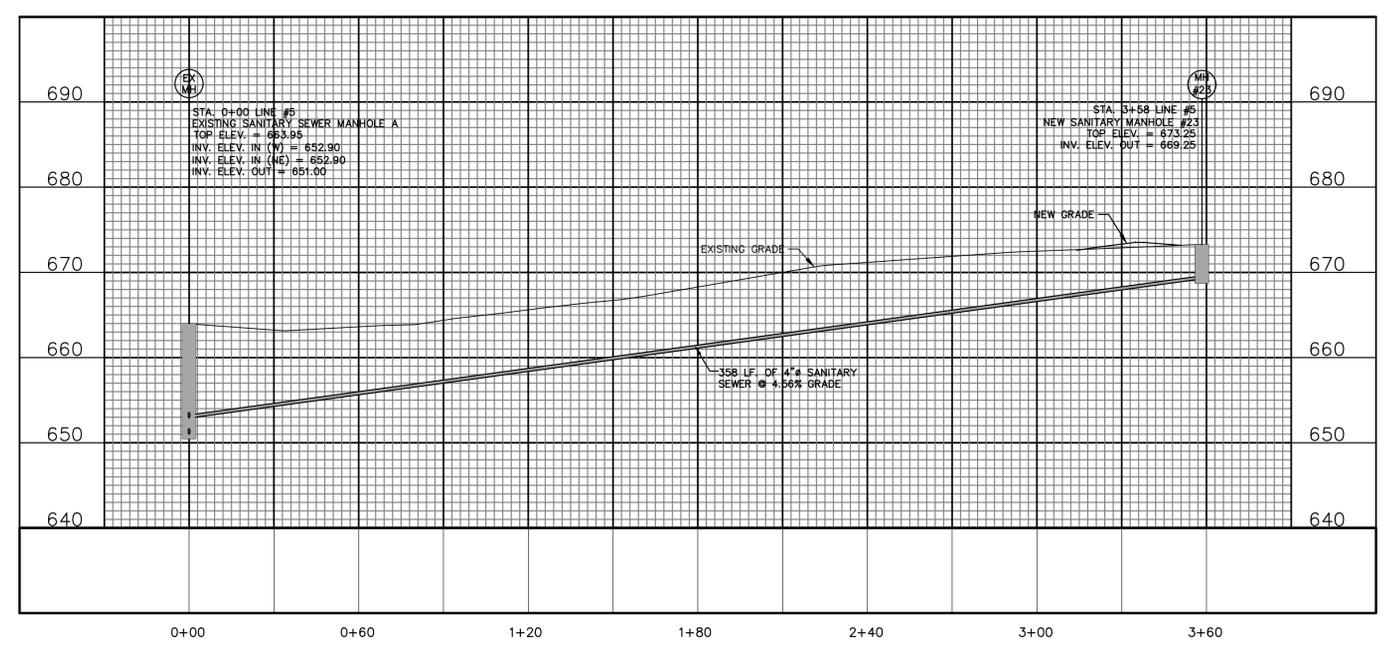

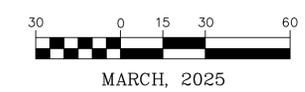

MARCH, 2025

EXISTING		PROPOSED	
	PROPERTY LINE		RIGHT-OF-WAY
	INDEX CONTOUR		500
	INTERMEDIATE CONTOUR		SAN
	SANITARY SEWER		SANITARY MANHOLE
	WATER LINE (SIZE)		HYDRANTS
	CONCRETE PAVEMENT		ASPHALT PAVEMENT

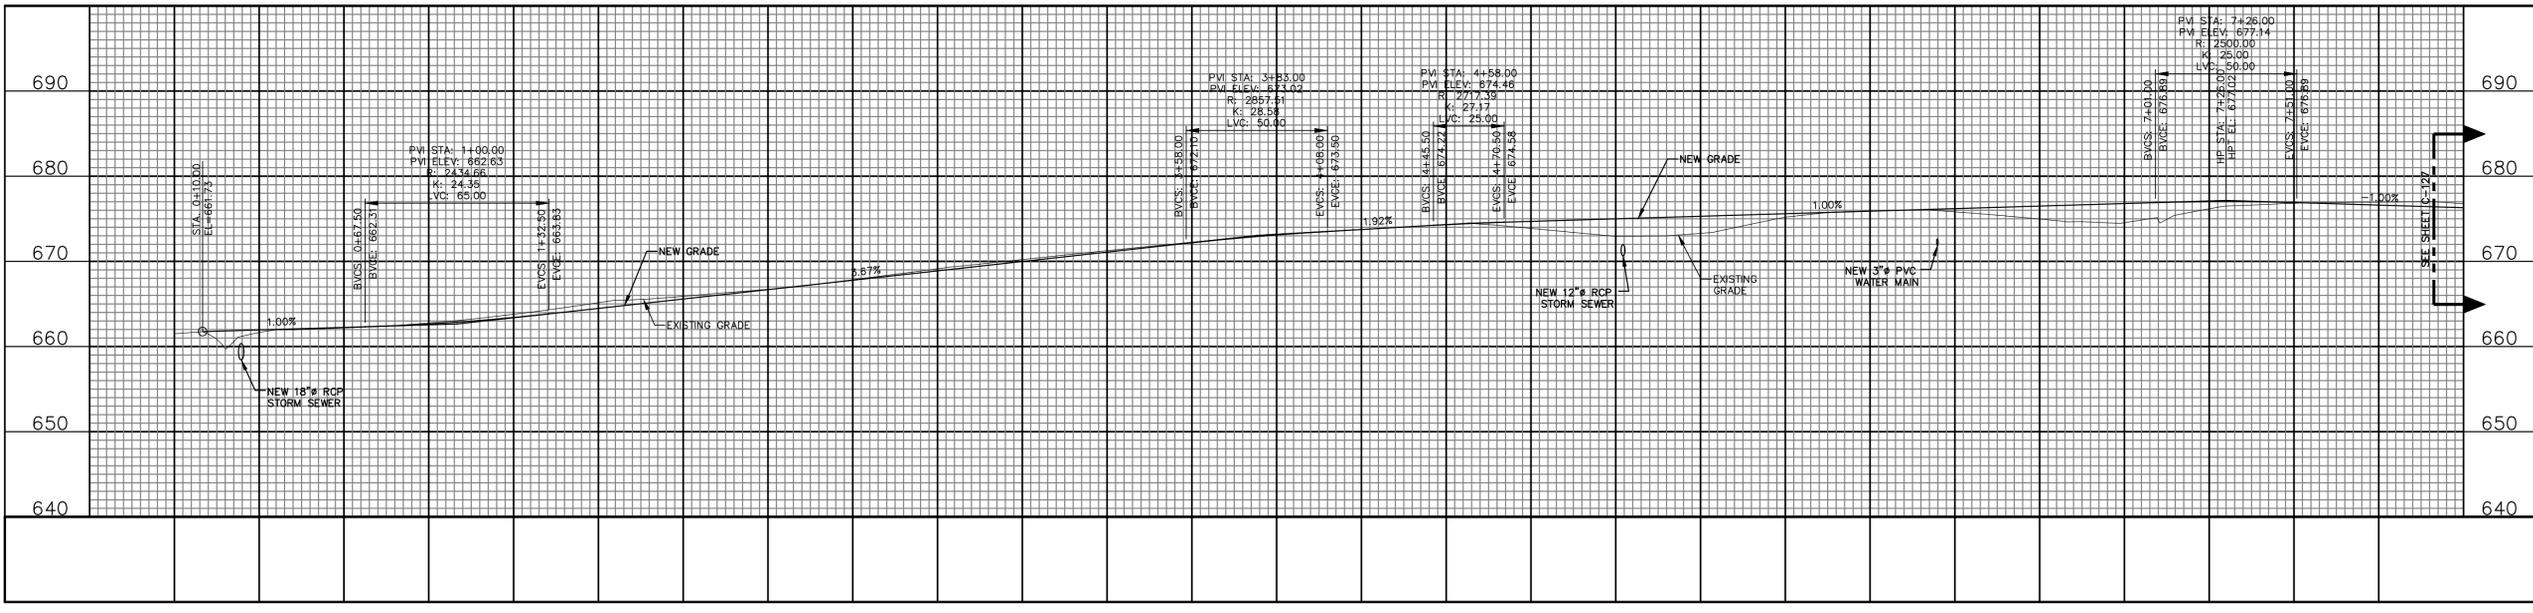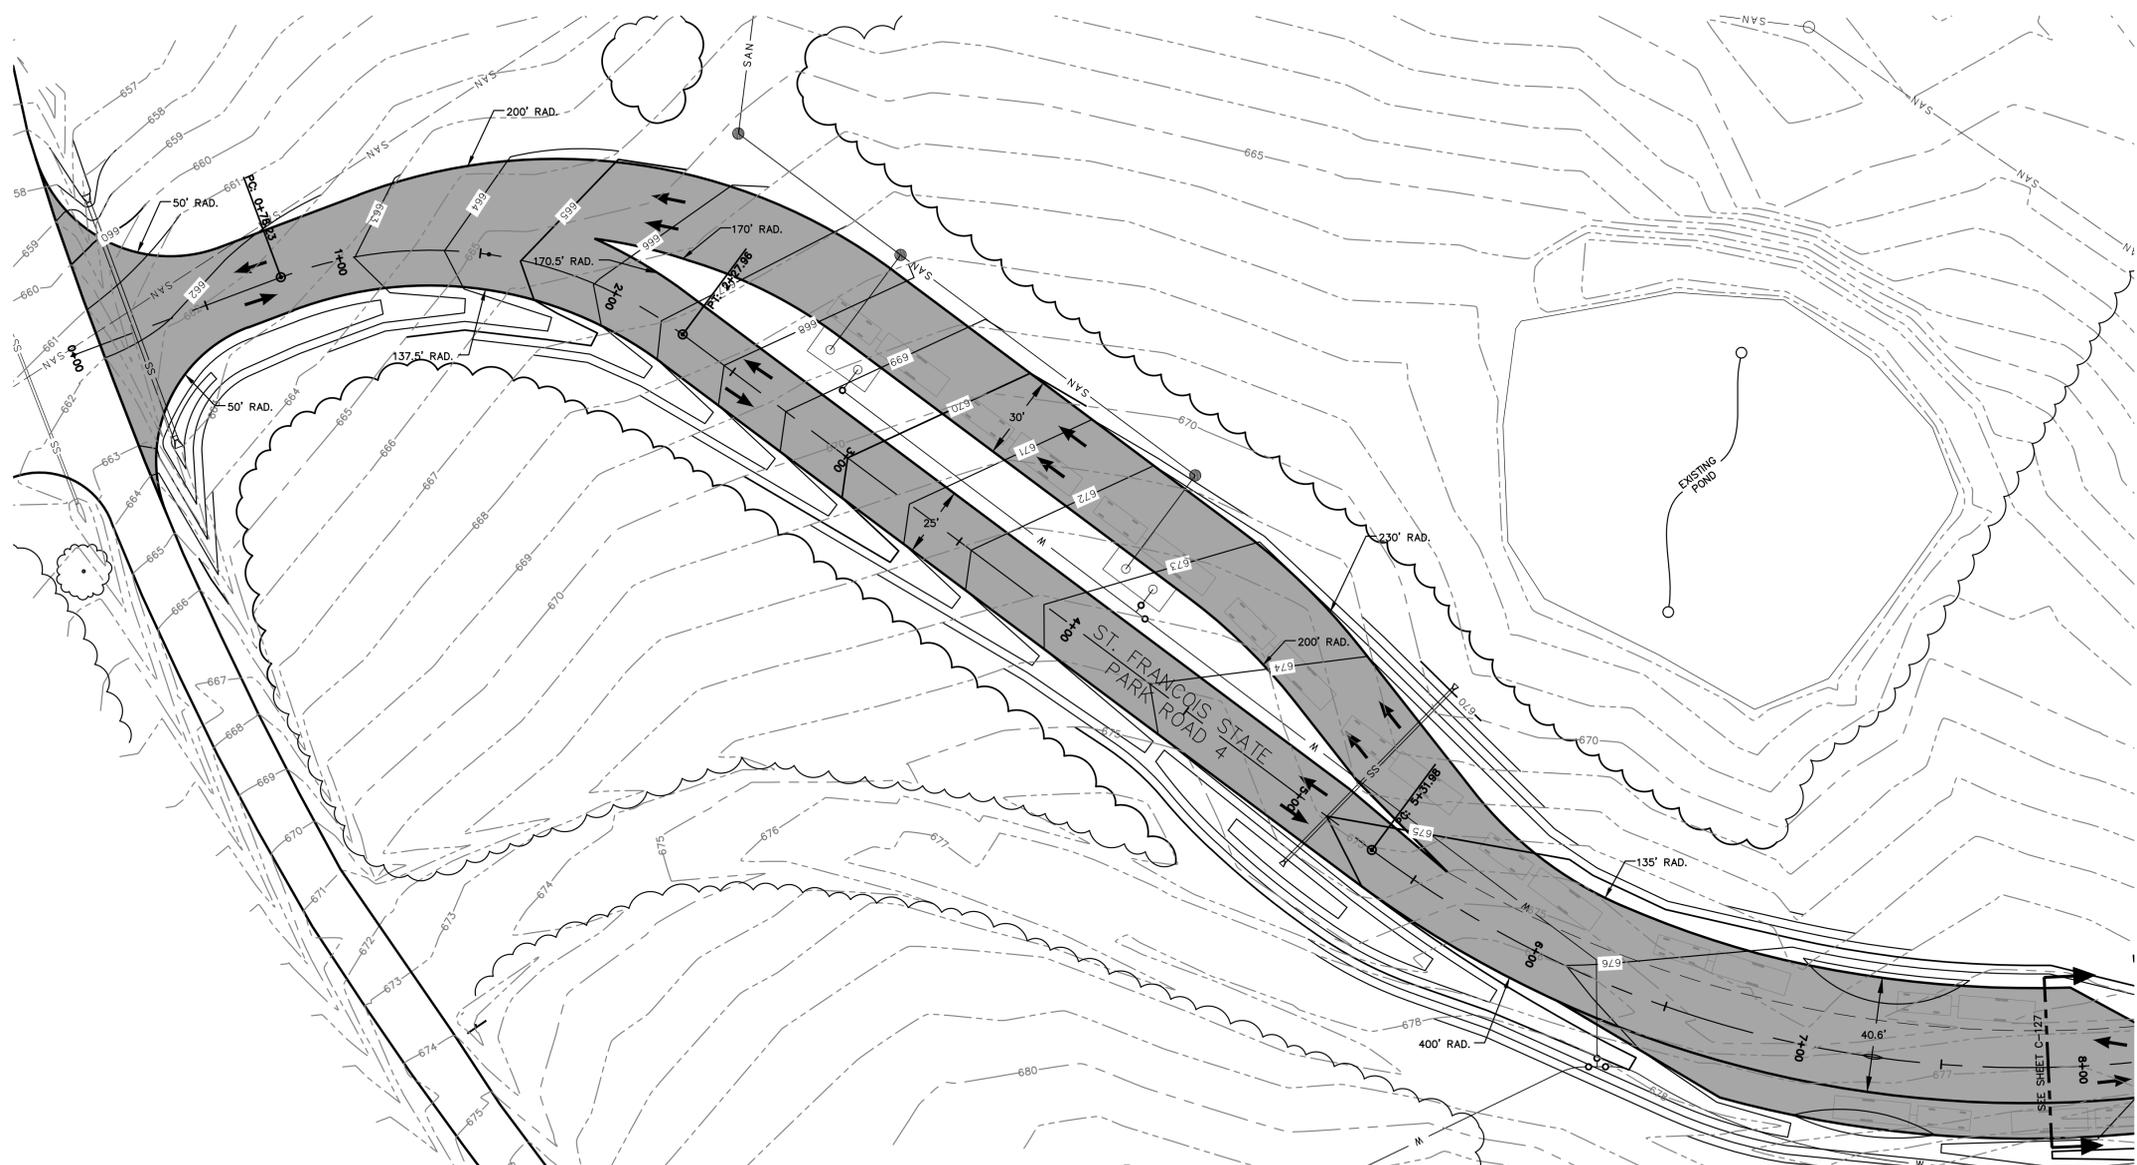

630A E. Independence Dr.
Union, Missouri 63084

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Missouri State Certificate
of Authority Numbers:
Survey : 003566
Engineering : 001655
Architecture : 2002014240

OFFICE OF ADMINISTRATION
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DEPARTMENT OF
NATURAL RESOURCES
MISSOURI STATE PARKS

NEW PREMIUM 63 SITE
LOOP CAMPGROUND

ST. FRANCOIS STATE PARK
8920 US-67N
BONNE TERRE, MO 63628

PROJECT # X2317-01
SITE # 5216
ASSET # 7815216025


REVISION: _____
DATE: _____
REVISION: _____
DATE: _____
REVISION: _____
DATE: _____
ISSUE DATE: 03/28/2025

CAD DWG FILE: X2317-RP-126
DRAWN BY: LJR
CHECKED BY: ERR
DESIGNED BY: ERR

SHEET TITLE:
ROAD PLAN
ENTRANCE ROAD
STA. 0+00 TO 7+80



SHEET NUMBER:

C-126

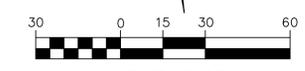

MARCH, 2025

EXISTING		PROPOSED	
	PROPERTY LINE		RIGHT-OF-WAY
	INDEX CONTOUR		RIGHT-OF-WAY
	INTERMEDIATE CONTOUR		SANITARY SEWER
	SANITARY MANHOLE		WATER LINE (SIZE)
	HYDRANTS		CONCRETE PAVEMENT
	ASPHALT PAVEMENT		ASPHALT PAVEMENT

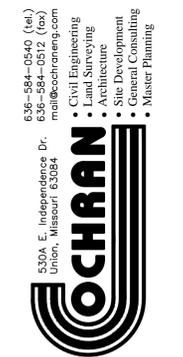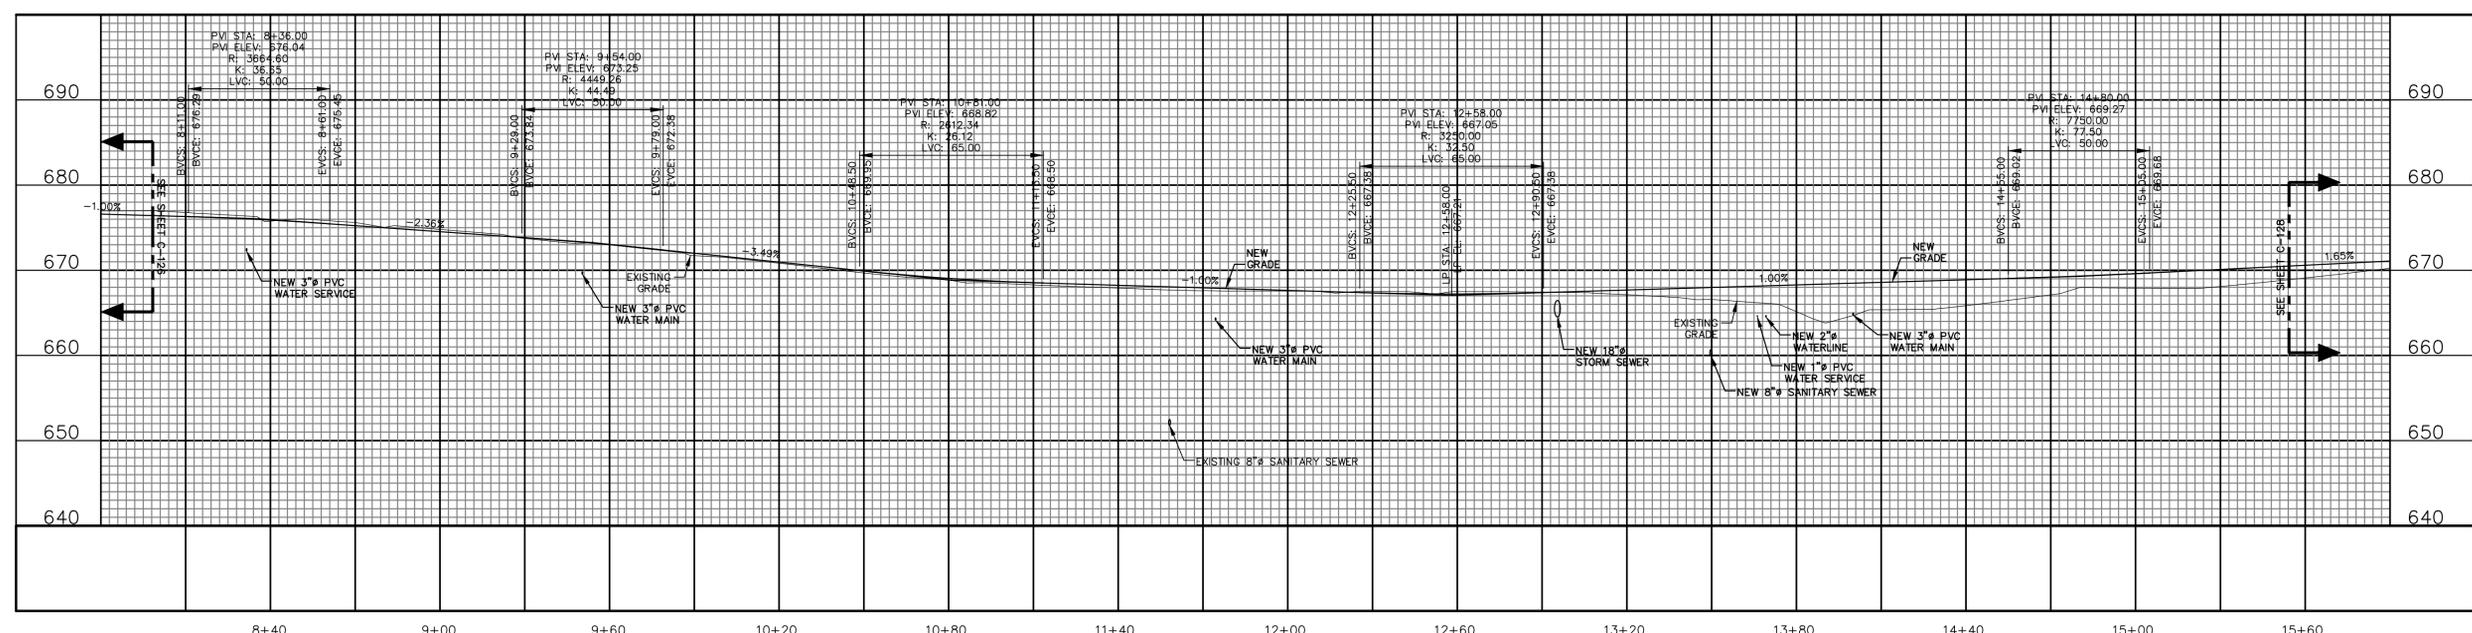

Missouri State Certificate of Authority Numbers:
Survey : 000350
Engineering : 001655
Architecture : 2002014240

OFFICE OF ADMINISTRATION
DIVISION OF FACILITIES
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DEPARTMENT OF
NATURAL RESOURCES
MISSOURI STATE PARKS

NEW PREMIUM 63 SITE
LOOP CAMPGROUND

ST. FRANCOIS STATE PARK
8920 US-67N
BONNE TERRE, MO 63628

PROJECT # X2317-01
SITE # 5216
ASSET # 7815216025


REVISION: _____
DATE: _____
REVISION: _____
DATE: _____
REVISION: _____
DATE: _____
ISSUE DATE: 03/28/2025

CAD DWG FILE: X2317-RP-127
DRAWN BY: LJR
CHECKED BY: ERR
DESIGNED BY: ERR

SHEET TITLE:
ROAD PLAN
ENTRANCE ROAD
STA. 7+80 TO 15+60



SHEET NUMBER:

C-127

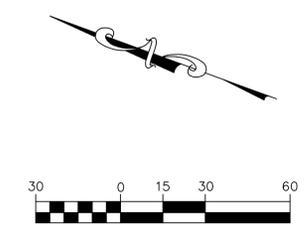

MARCH, 2025

EXISTING		PROPOSED	
	PROPERTY LINE		RIGHT-OF-WAY
	INDEX CONTOUR		RIGHT-OF-WAY
	INTERMEDIATE CONTOUR		SANITARY SEWER
	SANITARY MANHOLE		WATER LINE (SIZE)
	HYDRANTS		CONCRETE PAVEMENT
	ASPHALT PAVEMENT		ASPHALT PAVEMENT

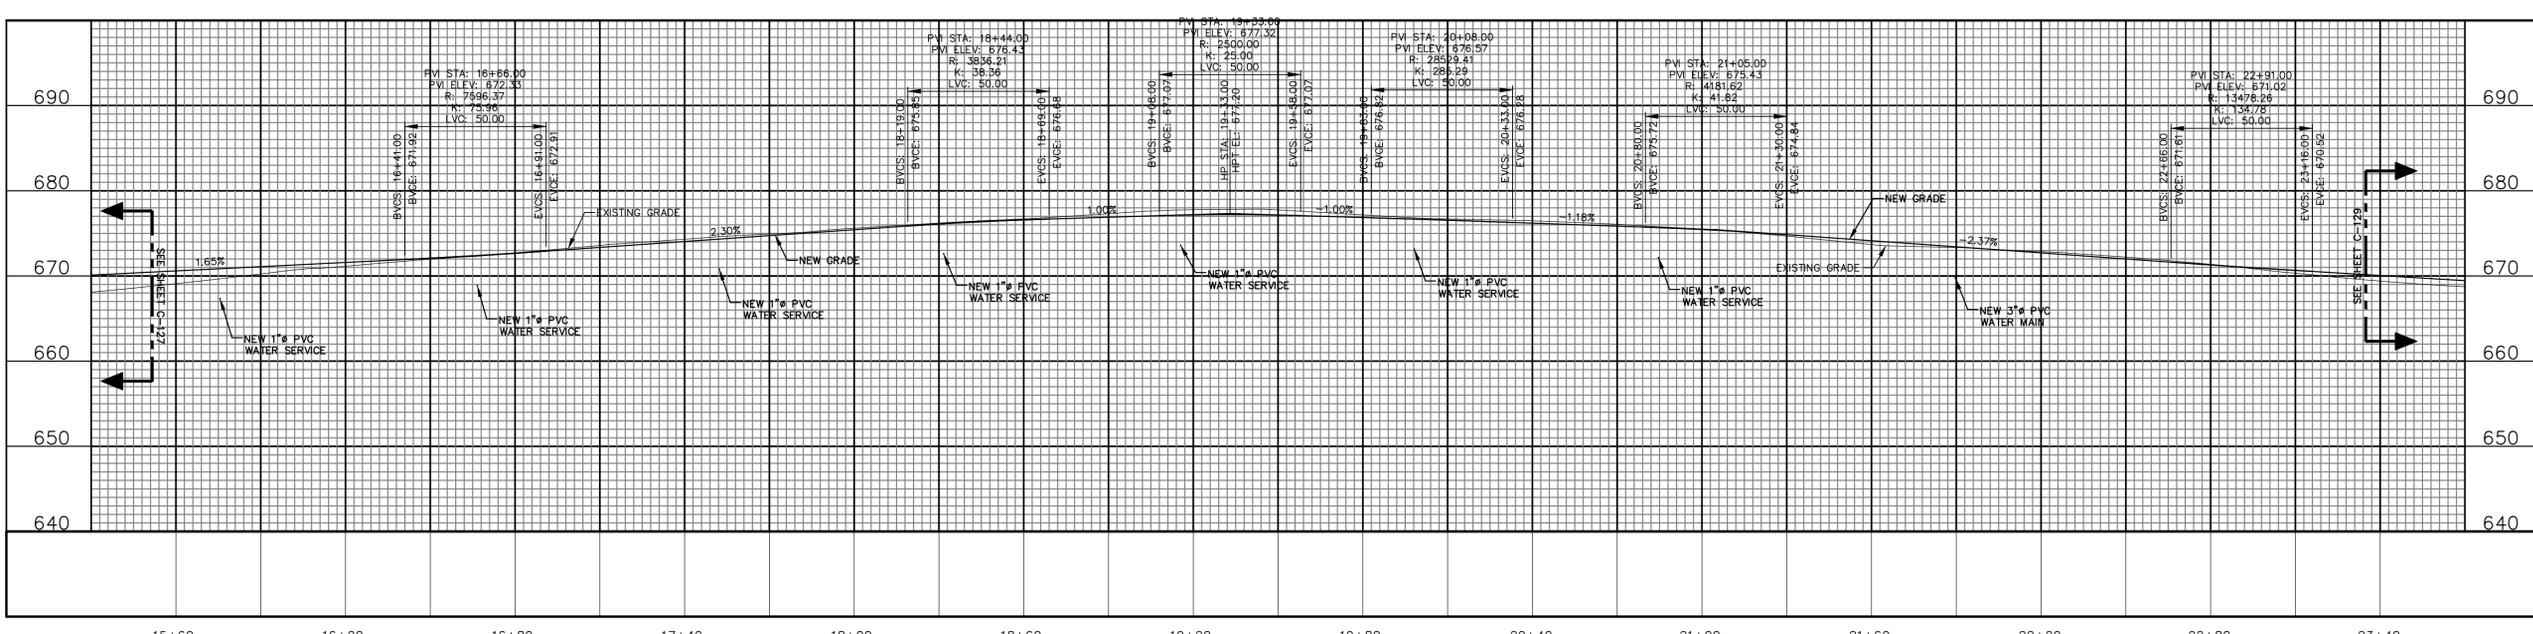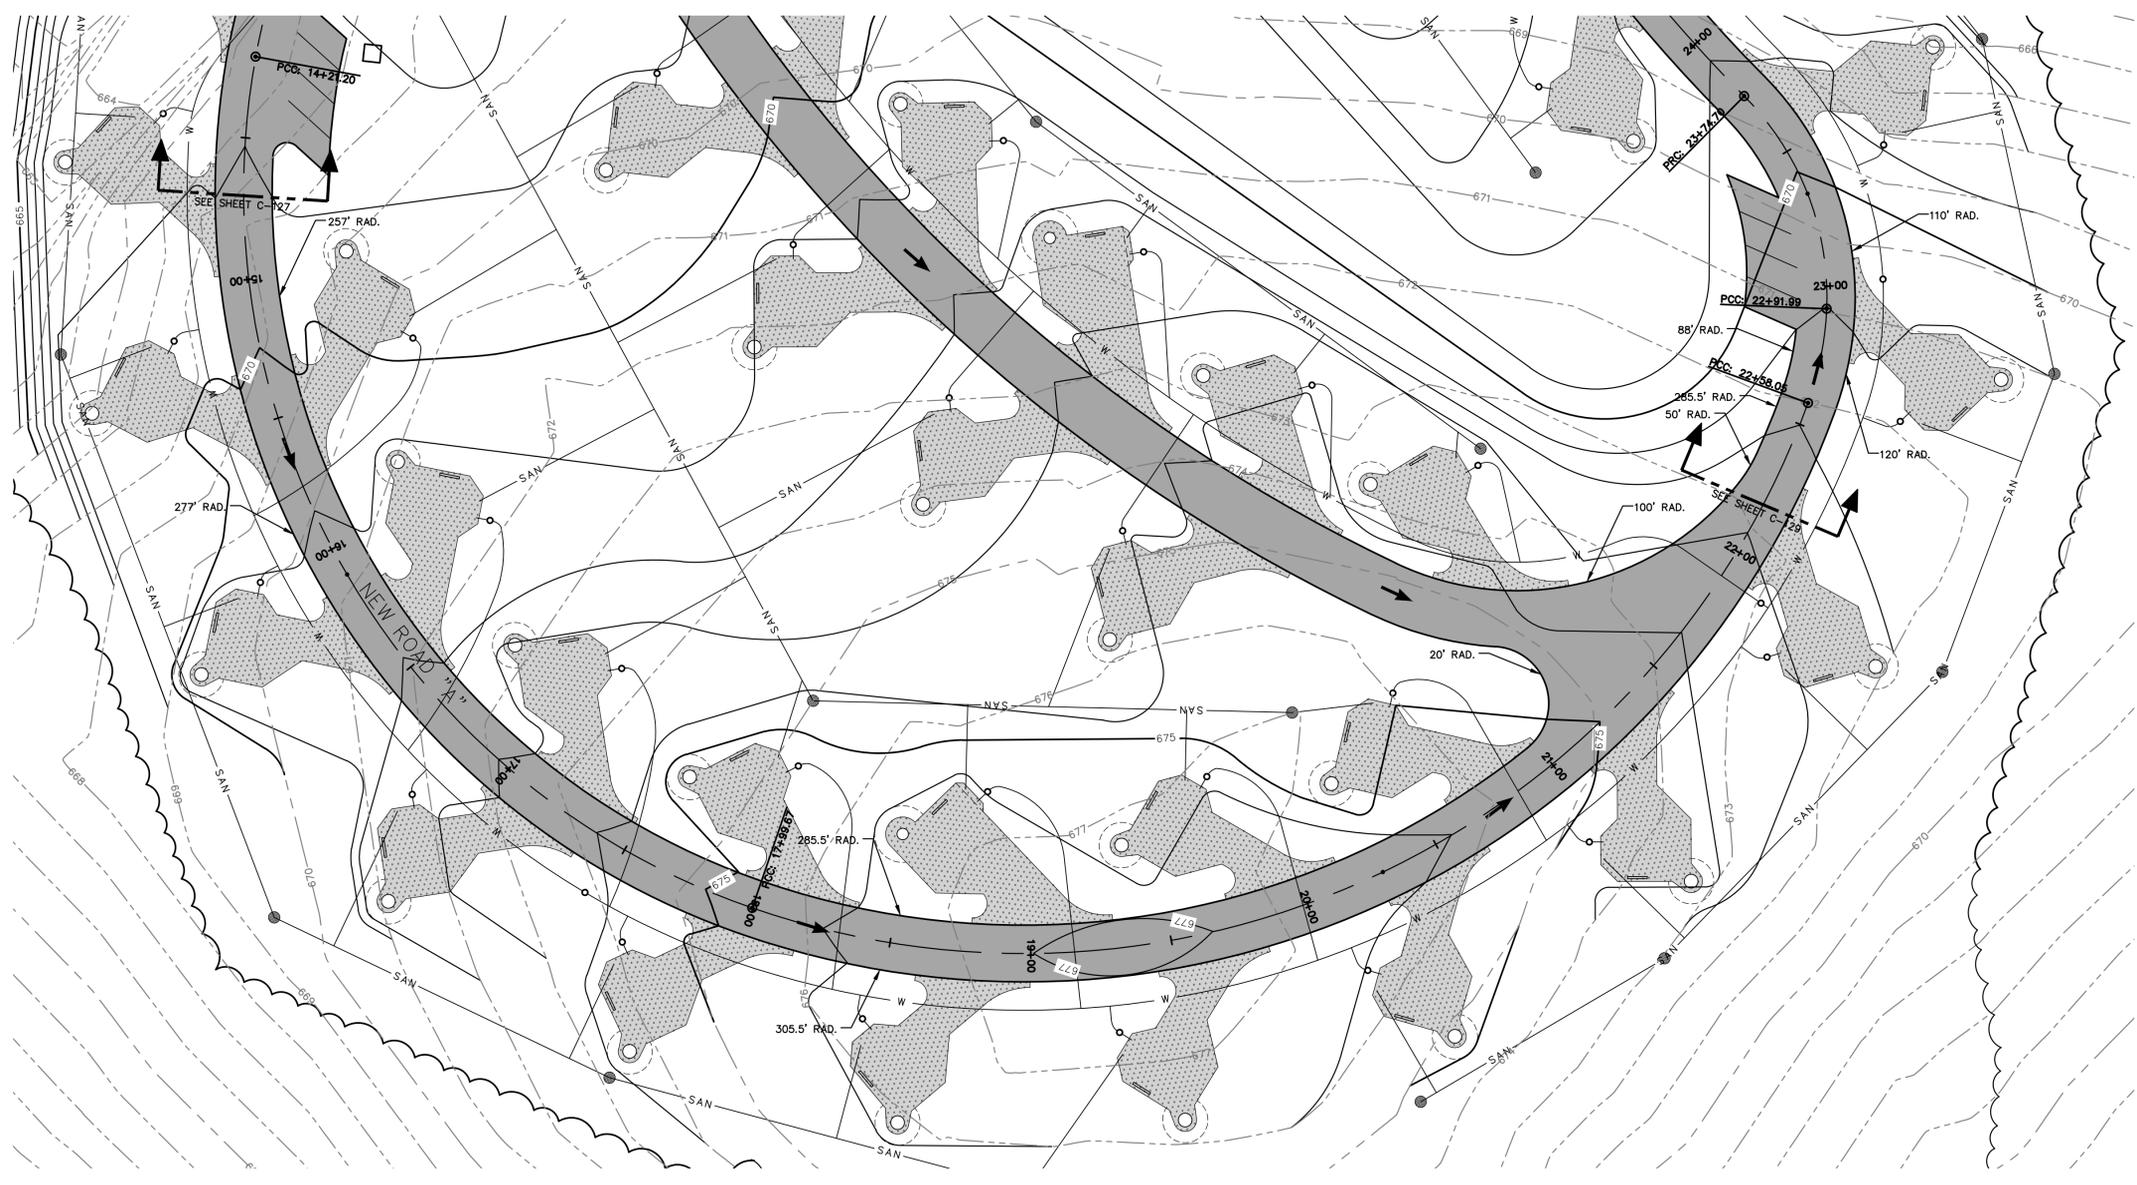

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Engineering : 001655
Architecture : 2002014240

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DEPARTMENT OF
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MISSOURI STATE PARKS

NEW PREMIUM 63 SITE
LOOP CAMPGROUND

ST. FRANCOIS STATE PARK
8920 US-67N
BONNE TERRE, MO 63628

PROJECT # X2317-01
SITE # 5216
ASSET # 7815216025


REVISION: _____
DATE: _____
REVISION: _____
DATE: _____
REVISION: _____
DATE: _____
ISSUE DATE: 03/28/2025

CAD DWG FILE: X2317-RP-128
DRAWN BY: LJR
CHECKED BY: ERR
DESIGNED BY: ERR

SHEET TITLE:
ROAD PLAN
ENTRANCE ROAD
STA. 15+60 TO 23+40

SHEET NUMBER:

C-128

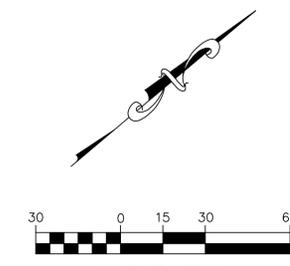


MARCH, 2025

LEGEND

EXISTING	PROPOSED

STATE OF MISSOURI
MICHAEL L. PARSON,
GOVERNOR

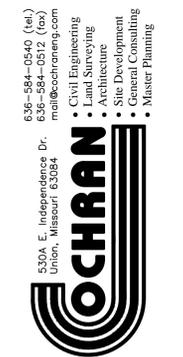

Missouri State Certificate
of Authority Numbers:
Survey : 0003560
Engineering : 001655
Architecture : 2002014240

OFFICE OF ADMINISTRATION
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DESIGN AND CONSTRUCTION

DEPARTMENT OF
NATURAL RESOURCES
MISSOURI STATE PARKS

NEW PREMIUM 63 SITE
LOOP CAMPGROUND

ST. FRANCOIS STATE PARK
8920 US-67N
BONNE TERRE, MO 63628

PROJECT # X2317-01
SITE # 5216
ASSET # 7815216025

REVISION: _____
DATE: _____
REVISION: _____
DATE: _____
REVISION: _____
DATE: _____

ISSUE DATE: 03/28/2025


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CHECKED BY: ERR
DESIGNED BY: ERR



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ROAD PLAN
ENTRANCE ROAD
STA. 23+40 TO 28+27

SHEET NUMBER:

C-129

31 OF 56 SHEETS
03/28/2025

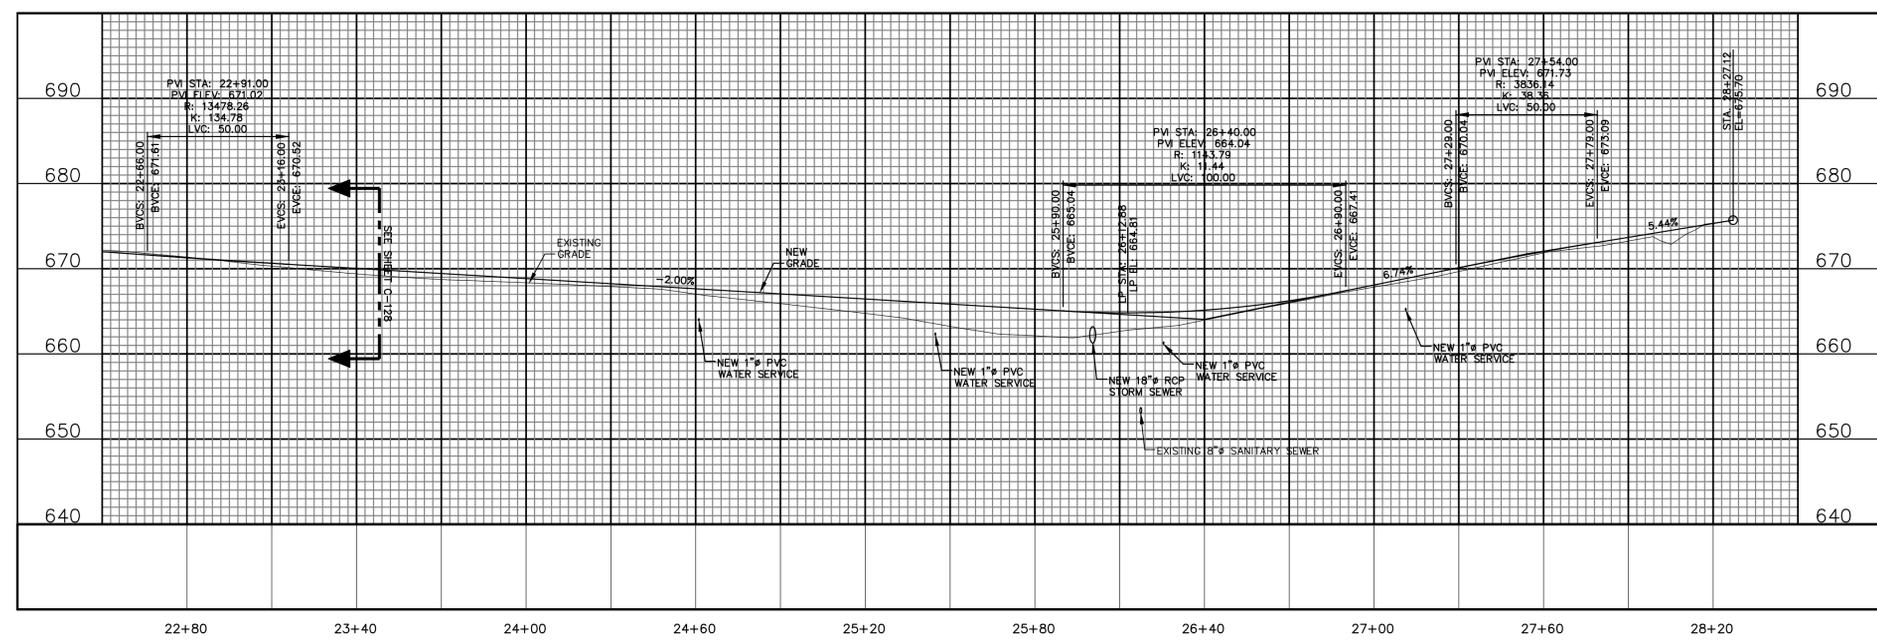


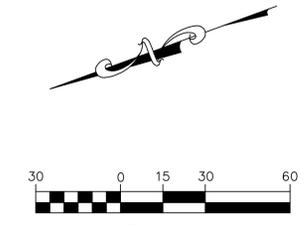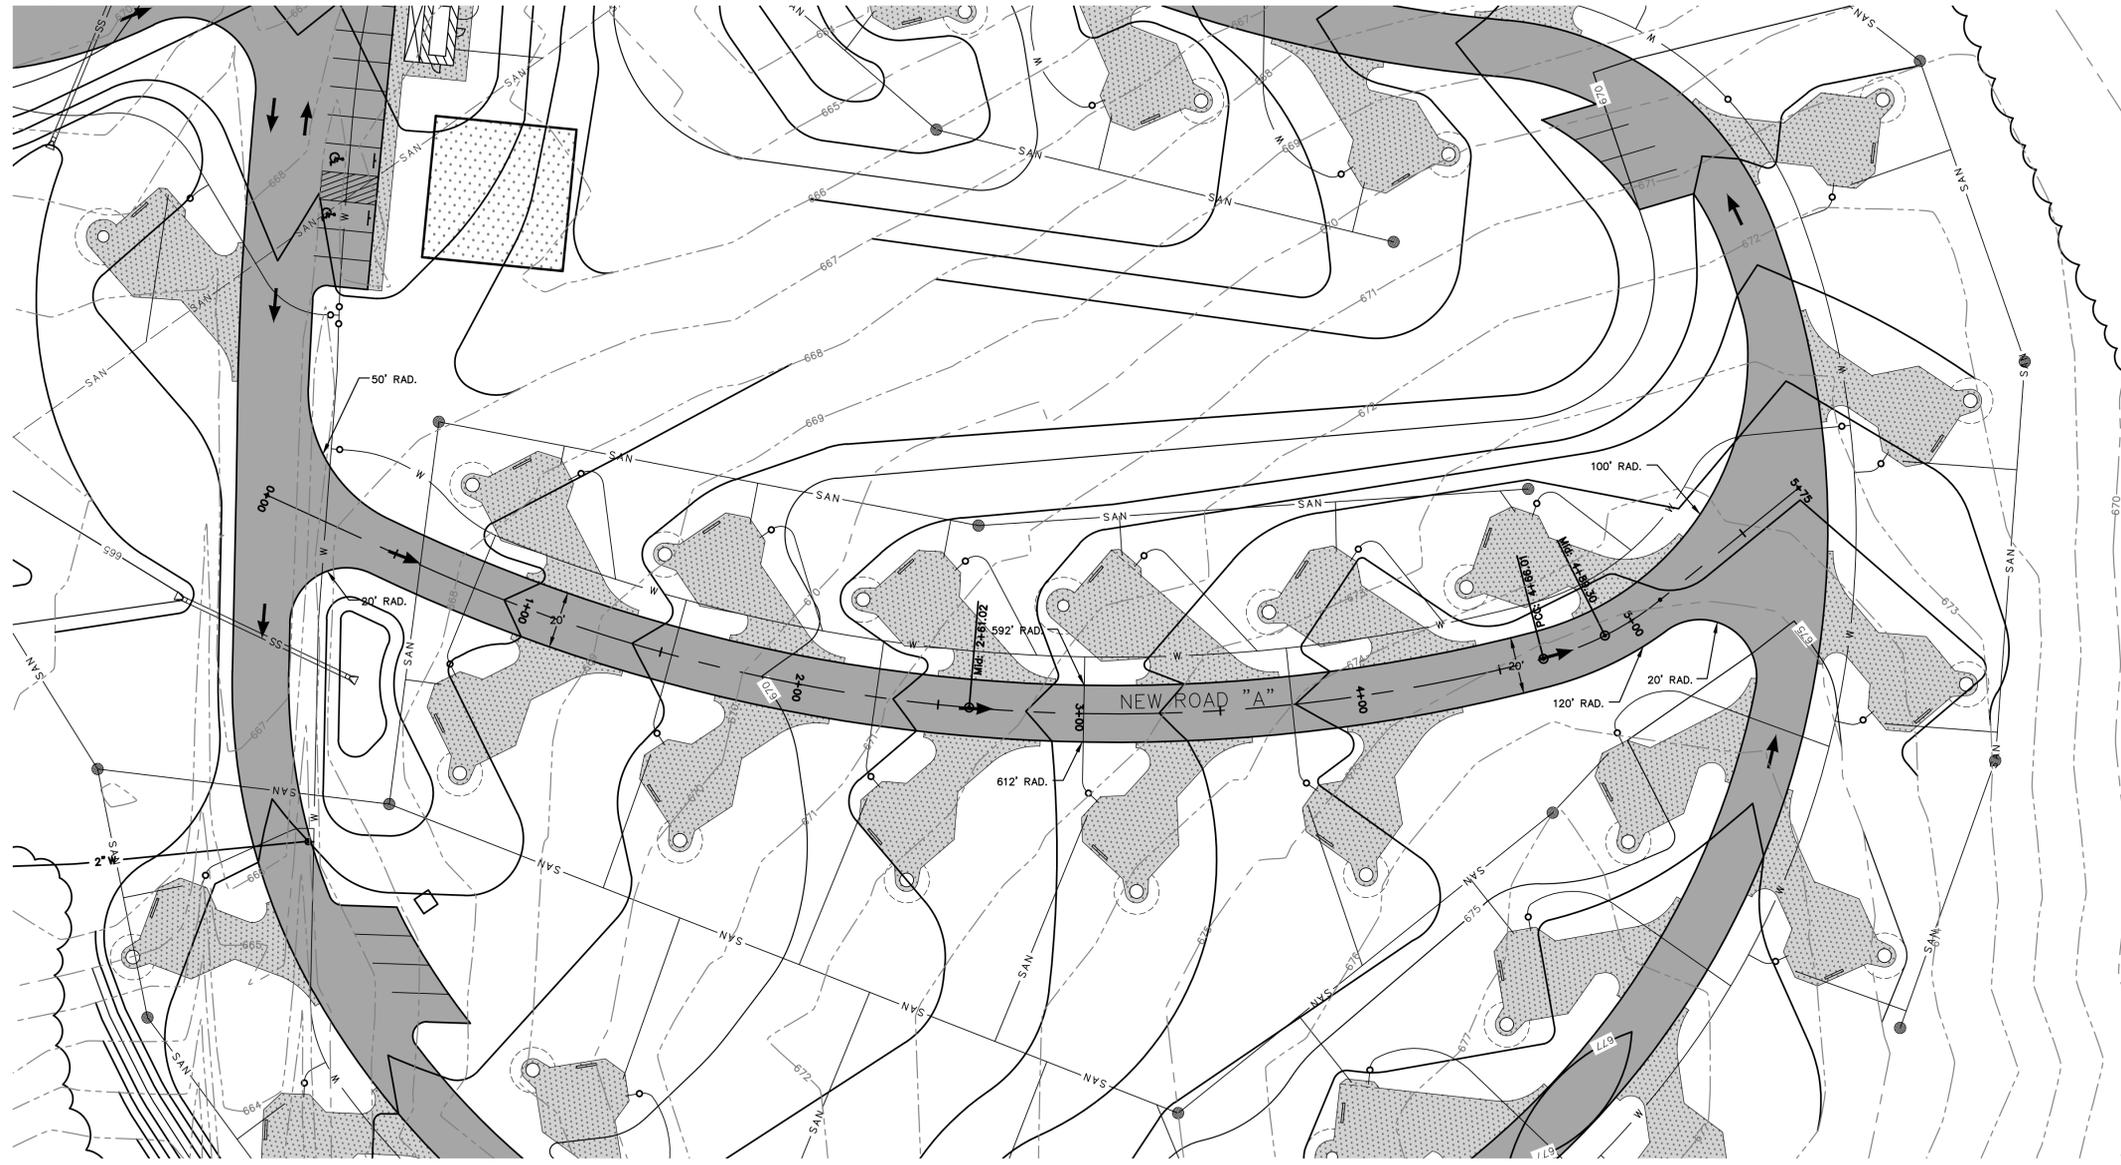

MARCH, 2025

LEGEND

EXISTING	PROPOSED

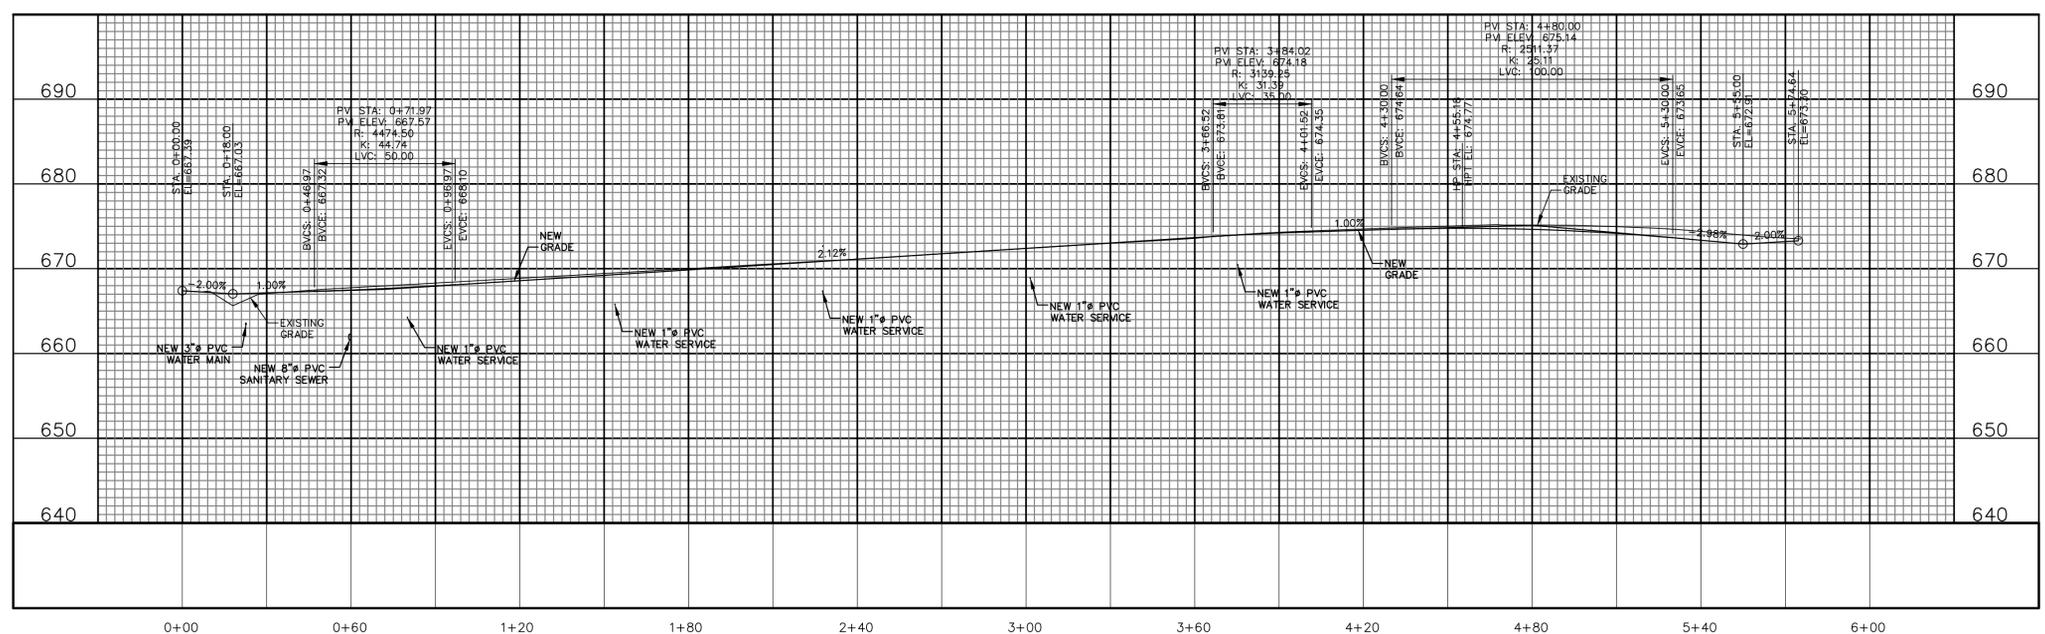

STATE OF MISSOURI
MICHAEL L. PARSON,
GOVERNOR



636-564-0540 (tel.)
636-564-0512 (fax)
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Cochran Engineering
Civil Engineering
Land Surveying
Architecture
Site Development
General Consulting
Master Planning



Missouri State Certificate
of Authority Numbers:
Survey : 0003560
Engineering : 001655
Architecture : 2002014240

OFFICE OF ADMINISTRATION
DIVISION OF FACILITIES
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DESIGN AND CONSTRUCTION

DEPARTMENT OF
NATURAL RESOURCES
MISSOURI STATE PARKS

NEW PREMIUM 63 SITE
LOOP CAMPGROUND

ST. FRANCOIS STATE PARK
8920 US-67N
BONNE TERRE, MO 63628

PROJECT # X2317-01
SITE # 5216
ASSET # 7815216025

REVISION: _____
DATE: _____
REVISION: _____
DATE: _____
REVISION: _____
DATE: _____
ISSUE DATE: 03/28/2025


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DRAWN BY: LJR
CHECKED BY: ERR
DESIGNED BY: ERR

SHEET TITLE:
ROAD PLAN
CENTER ROAD
STA. 0+00 TO 5+75

SHEET NUMBER:

C-130

32 OF 56 SHEETS
03/28/2025

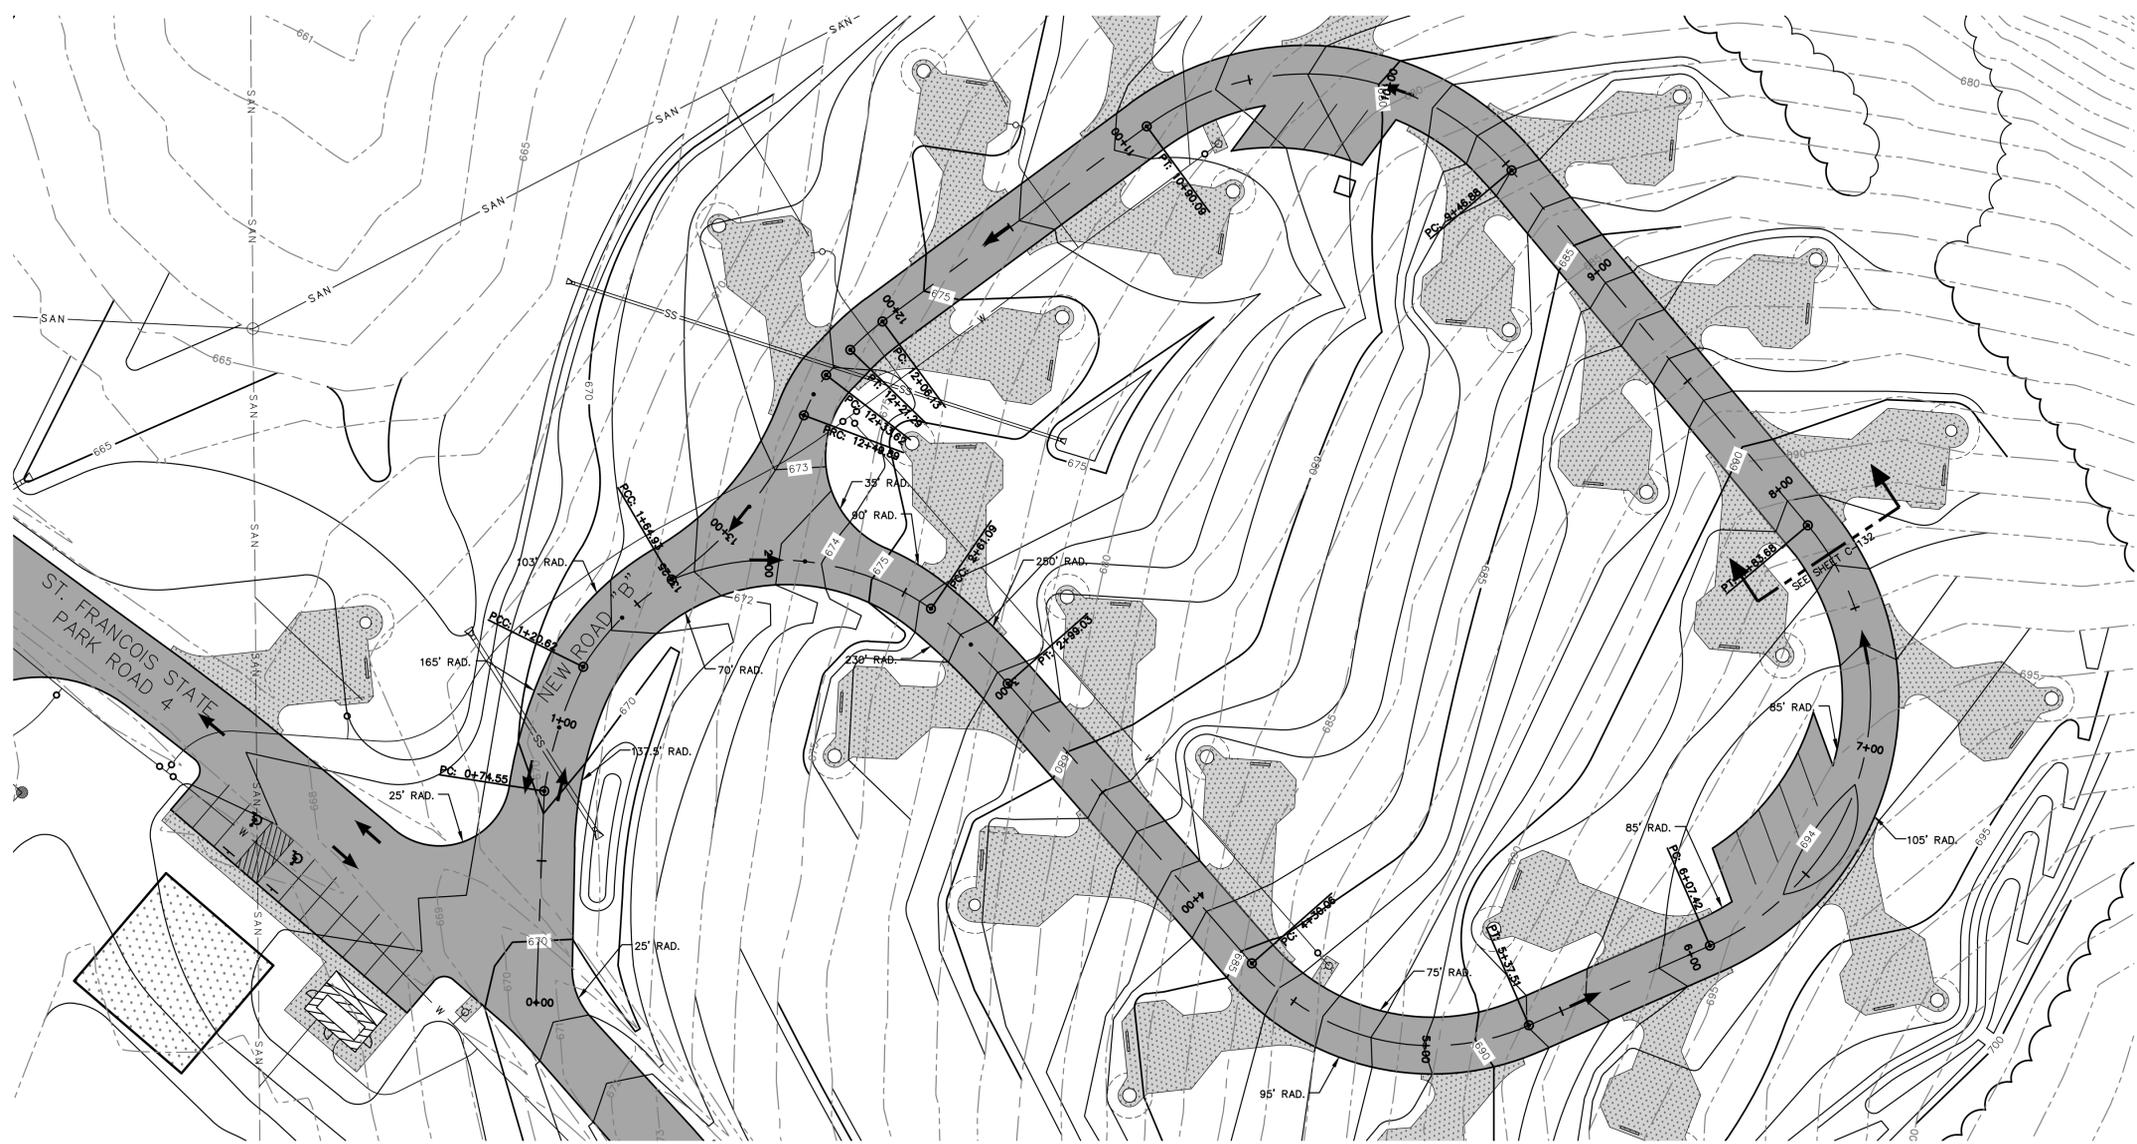

MARCH, 2025

LEGEND

EXISTING	PROPOSED

STATE OF MISSOURI
MICHAEL L. PARSON,
GOVERNOR



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Union, Missouri 63084

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Site Development
General Consulting
Master Planning

Missouri State Certificate
of Authority Numbers:
Survey : 003380
Engineering : 001655
Architecture : 2002014240

OFFICE OF ADMINISTRATION
DIVISION OF FACILITIES
MANAGEMENT,
DESIGN AND CONSTRUCTION

DEPARTMENT OF
NATURAL RESOURCES
MISSOURI STATE PARKS

NEW PREMIUM 63 SITE
LOOP CAMPGROUND

ST. FRANCOIS STATE PARK
8920 US-67N
BONNE TERRE, MO 63628

PROJECT # X2317-01
SITE # 5216
ASSET # 7815216025

REVISION: _____
DATE: _____
REVISION: _____
DATE: _____
REVISION: _____
DATE: _____
ISSUE DATE: 03/28/2025


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DESIGNED BY: ERR



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**ROAD PLAN
NORTH ROAD
STA. 0+00 TO 7+80**

SHEET NUMBER:

C-131

33 OF 56 SHEETS
03/28/2025

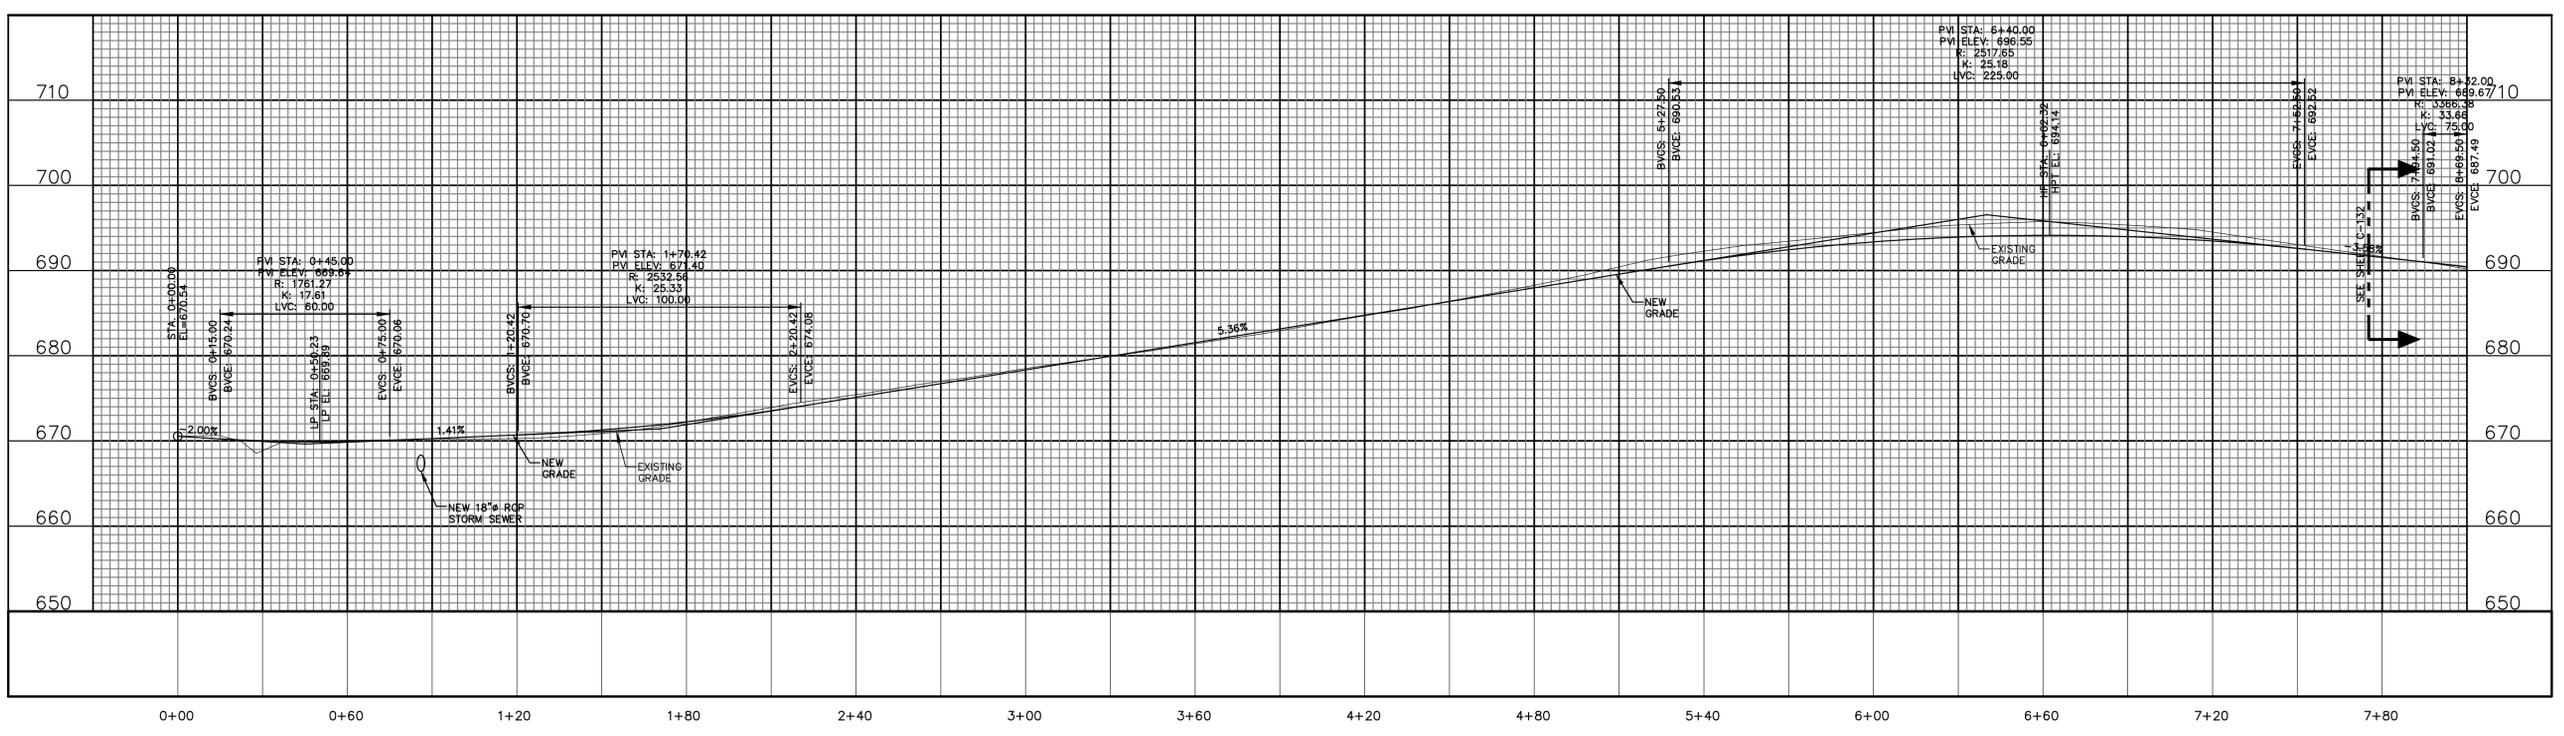


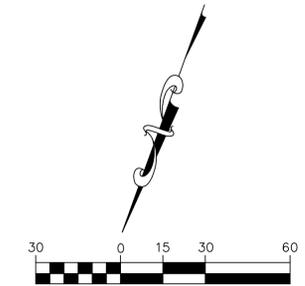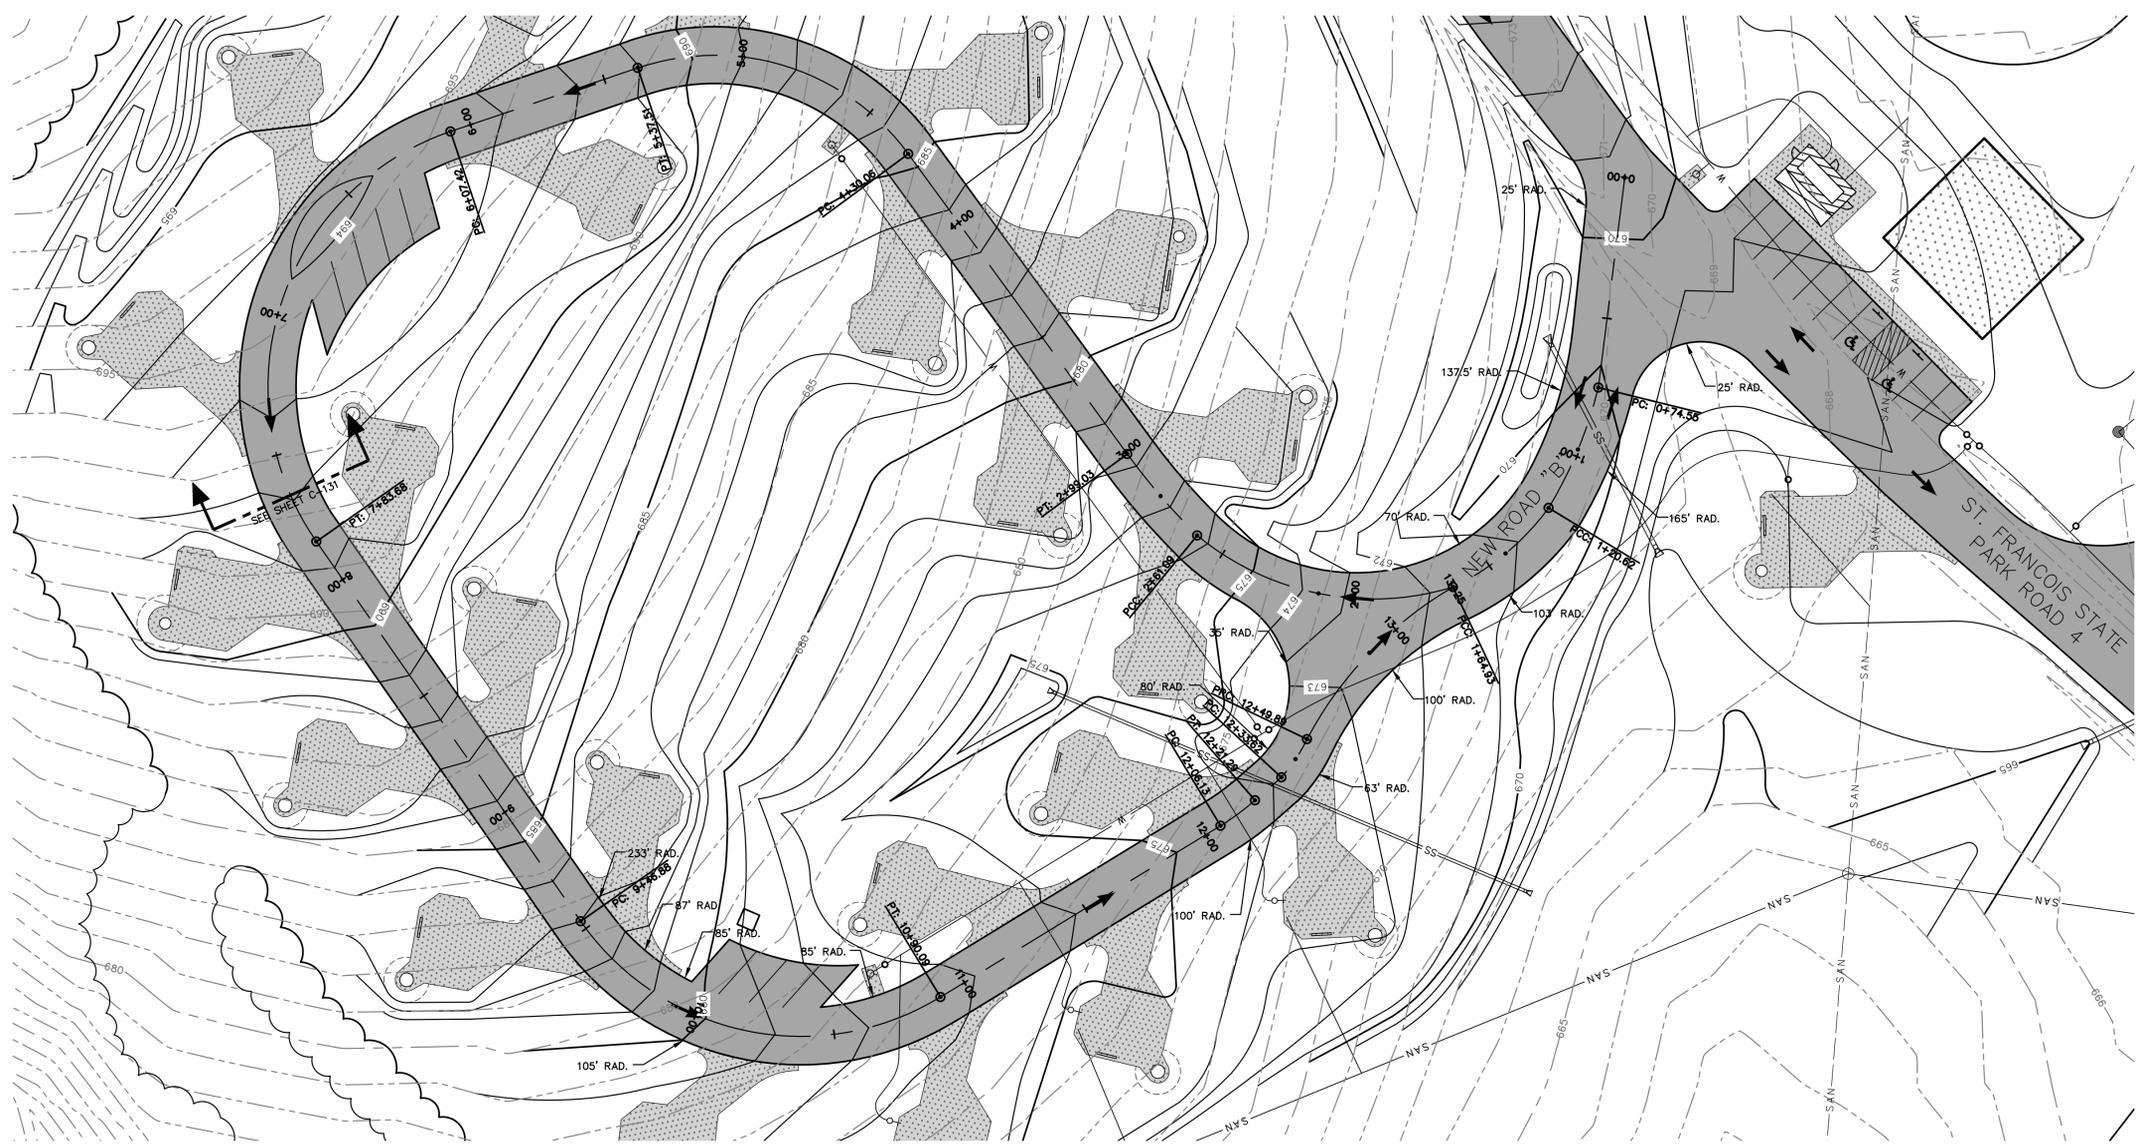


MARCH, 2025

LEGEND

EXISTING	PROPOSED

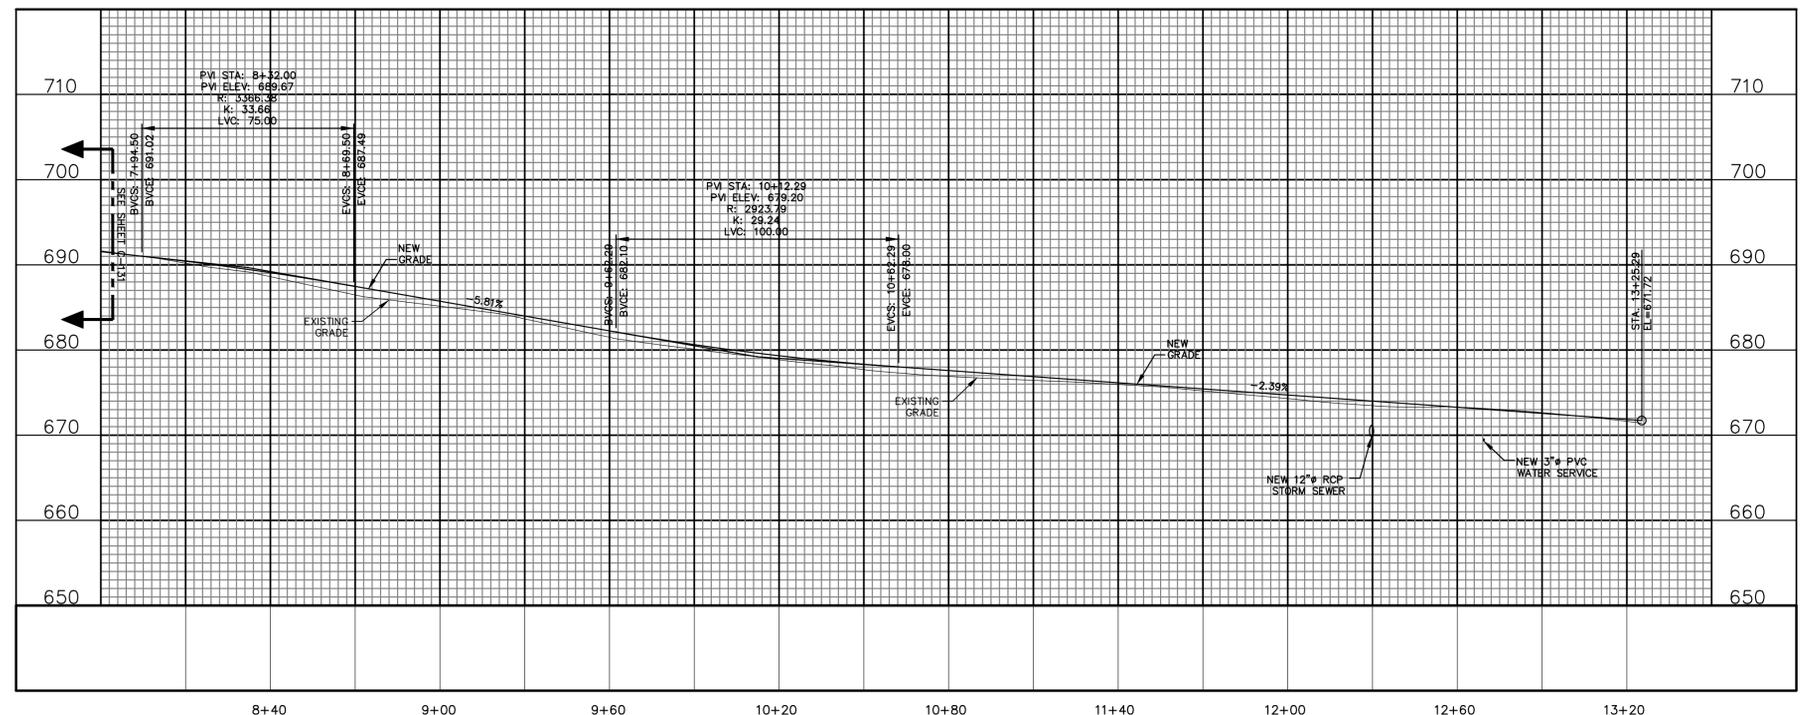

STATE OF MISSOURI
MICHAEL L. PARSON,
GOVERNOR

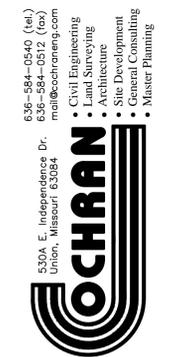

Missouri State Certificate
of Authority Numbers:
Survey : 003350
Engineering : 001655
Architecture : 2002014240

OFFICE OF ADMINISTRATION
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MISSOURI STATE PARKS

NEW PREMIUM 63 SITE
LOOP CAMPGROUND

ST. FRANCOIS STATE PARK
8920 US-67N
BONNE TERRE, MO 63628

PROJECT # X2317-01
SITE # 5216
ASSET # 7815216025

REVISION: _____
DATE: _____
REVISION: _____
DATE: _____
REVISION: _____
DATE: _____
ISSUE DATE: 03/28/2025


CAD DWG FILE: X2317-RP-132
DRAWN BY: LJR
CHECKED BY: ERR
DESIGNED BY: ERR

SHEET TITLE:
ROAD PLAN
NORTH ROAD
STA. 7+80 TO 13+25


SHEET NUMBER:

C-132


34 OF 56 SHEETS
03/28/2025

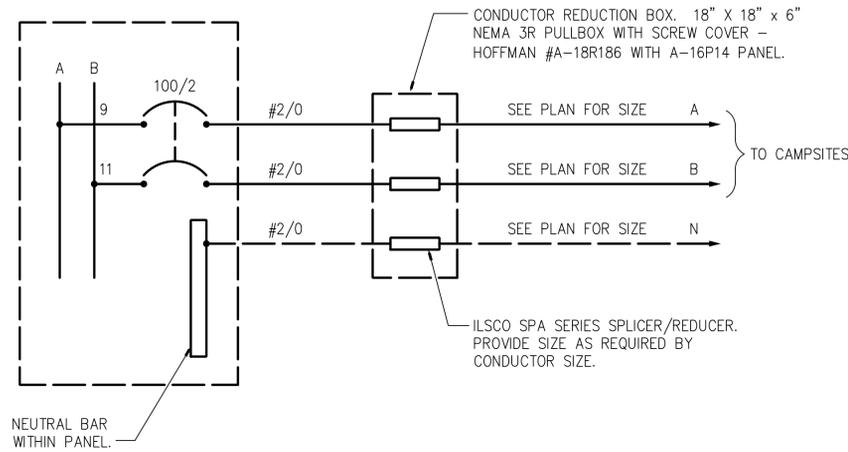


F TYPICAL CONDUCTOR REDUCTIONS AT DPx
NO SCALE

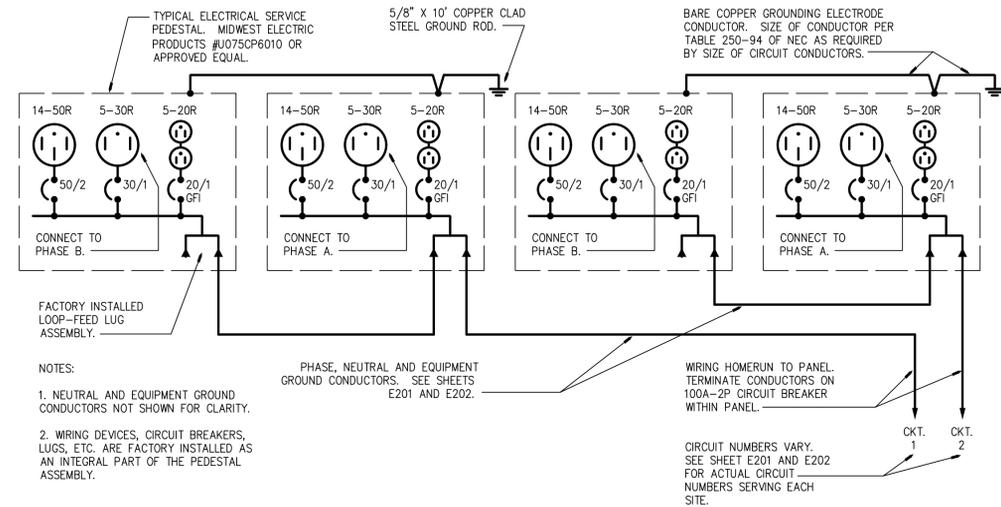


B CAMPSITE SERVICE PEDESTAL POWER SUPPLY
NO SCALE

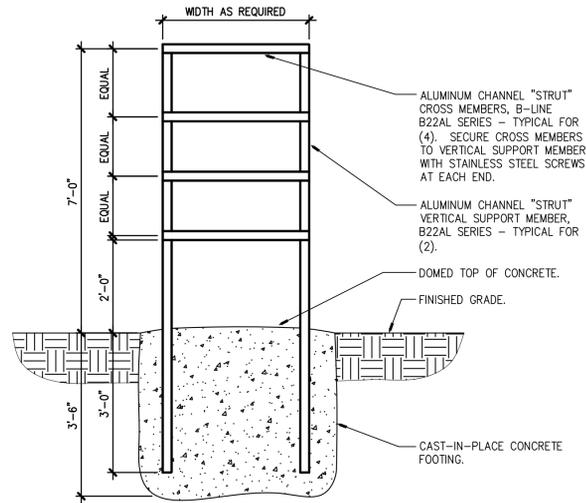


D EXTERIOR PANELBOARD SUPPORT STRUCTURE
NO SCALE

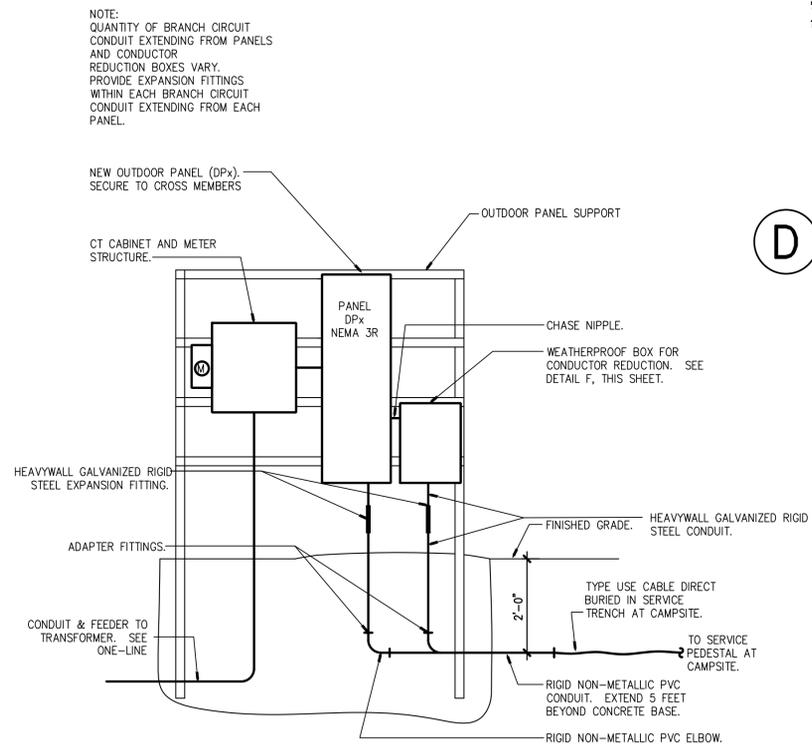

C CONDUIT INSTALLATION AT PANELS
NO SCALE

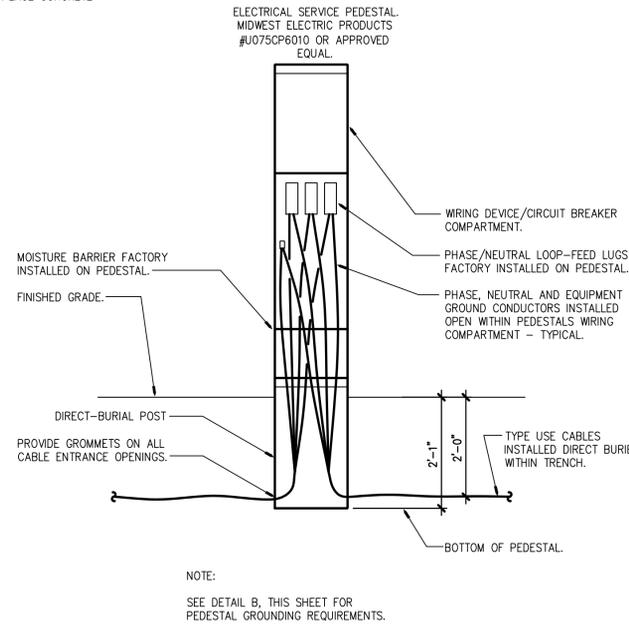

E ELECTRICAL SERVICE PEDESTAL
NO SCALE

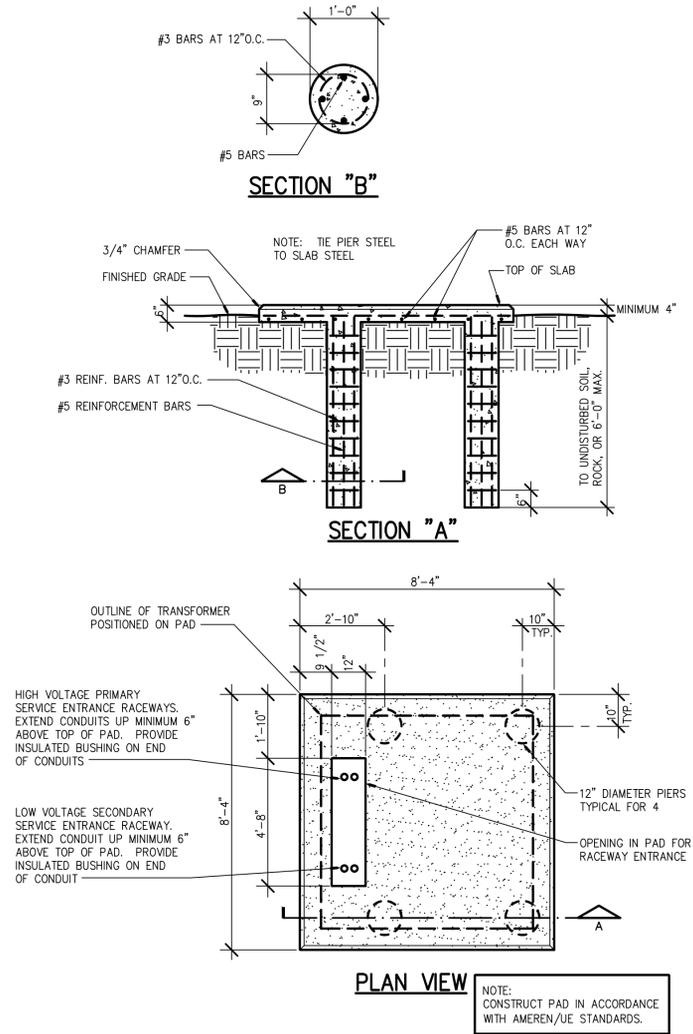

A TRANSFORMER PAD DETAIL
NO SCALE



03/28/25

CASE
Engineering Inc.

T 636.349.1600
F 636.349.1730
796 Merus Court
St. Louis, MO 63026
CERTIFICATE OF AUTHORITY NO. 001498

OFFICE OF ADMINISTRATION
DIVISION OF FACILITIES
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DESIGN AND CONSTRUCTION

DEPARTMENT OF
NATURAL RESOURCES
MISSOURI STATE PARKS

NEW 63 SITE
LOOP CAMPGROUND

ST. FRANCOIS STATE PARK
8920 US-67N
ST. FRANCOIS COUNTY, MISSOURI

PROJECT # X2317-01
SITE # 5216
ASSET # 7815216025

REVISION:
DATE:
REVISION:
DATE:
REVISION:
DATE:
ISSUE DATE: 03/28/2025

CAD DWG FILE: COC-MO-16-23
DRAWN BY: BDW
CHECKED BY: DRC
DESIGNED BY: BDW

SHEET TITLE:
ELECTRICAL
DETAILS &
ONE-LINE

SHEET NUMBER:

E101

35 OF 56 SHEETS
03/28/2025



03/28/25

CASE
Engineering Inc.
796 Merus Court
St. Louis, MO 63026
T 636.349.1600
F 636.349.1730
CERTIFICATE OF AUTHORITY NO. 001498

OFFICE OF ADMINISTRATION
DIVISION OF FACILITIES
MANAGEMENT,
DESIGN AND CONSTRUCTION

DEPARTMENT OF
NATURAL RESOURCES
MISSOURI STATE PARKS

NEW 63 SITE
LOOP CAMPGROUND

ST. FRANCOIS STATE PARK
8920 US-67N
ST. FRANCOIS COUNTY, MISSOURI

PROJECT # X2317-01
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REVISION: _____
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DATE: _____
ISSUE DATE: 03/28/2025



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DRAWN BY: BDW
CHECKED BY: DRC
DESIGNED BY: BDW

SHEET TITLE:
**ELECTRICAL
SITE PLAN**

SHEET NUMBER:

E201

37 OF 56 SHEETS
03/28/2025

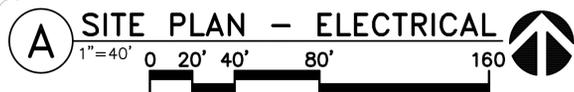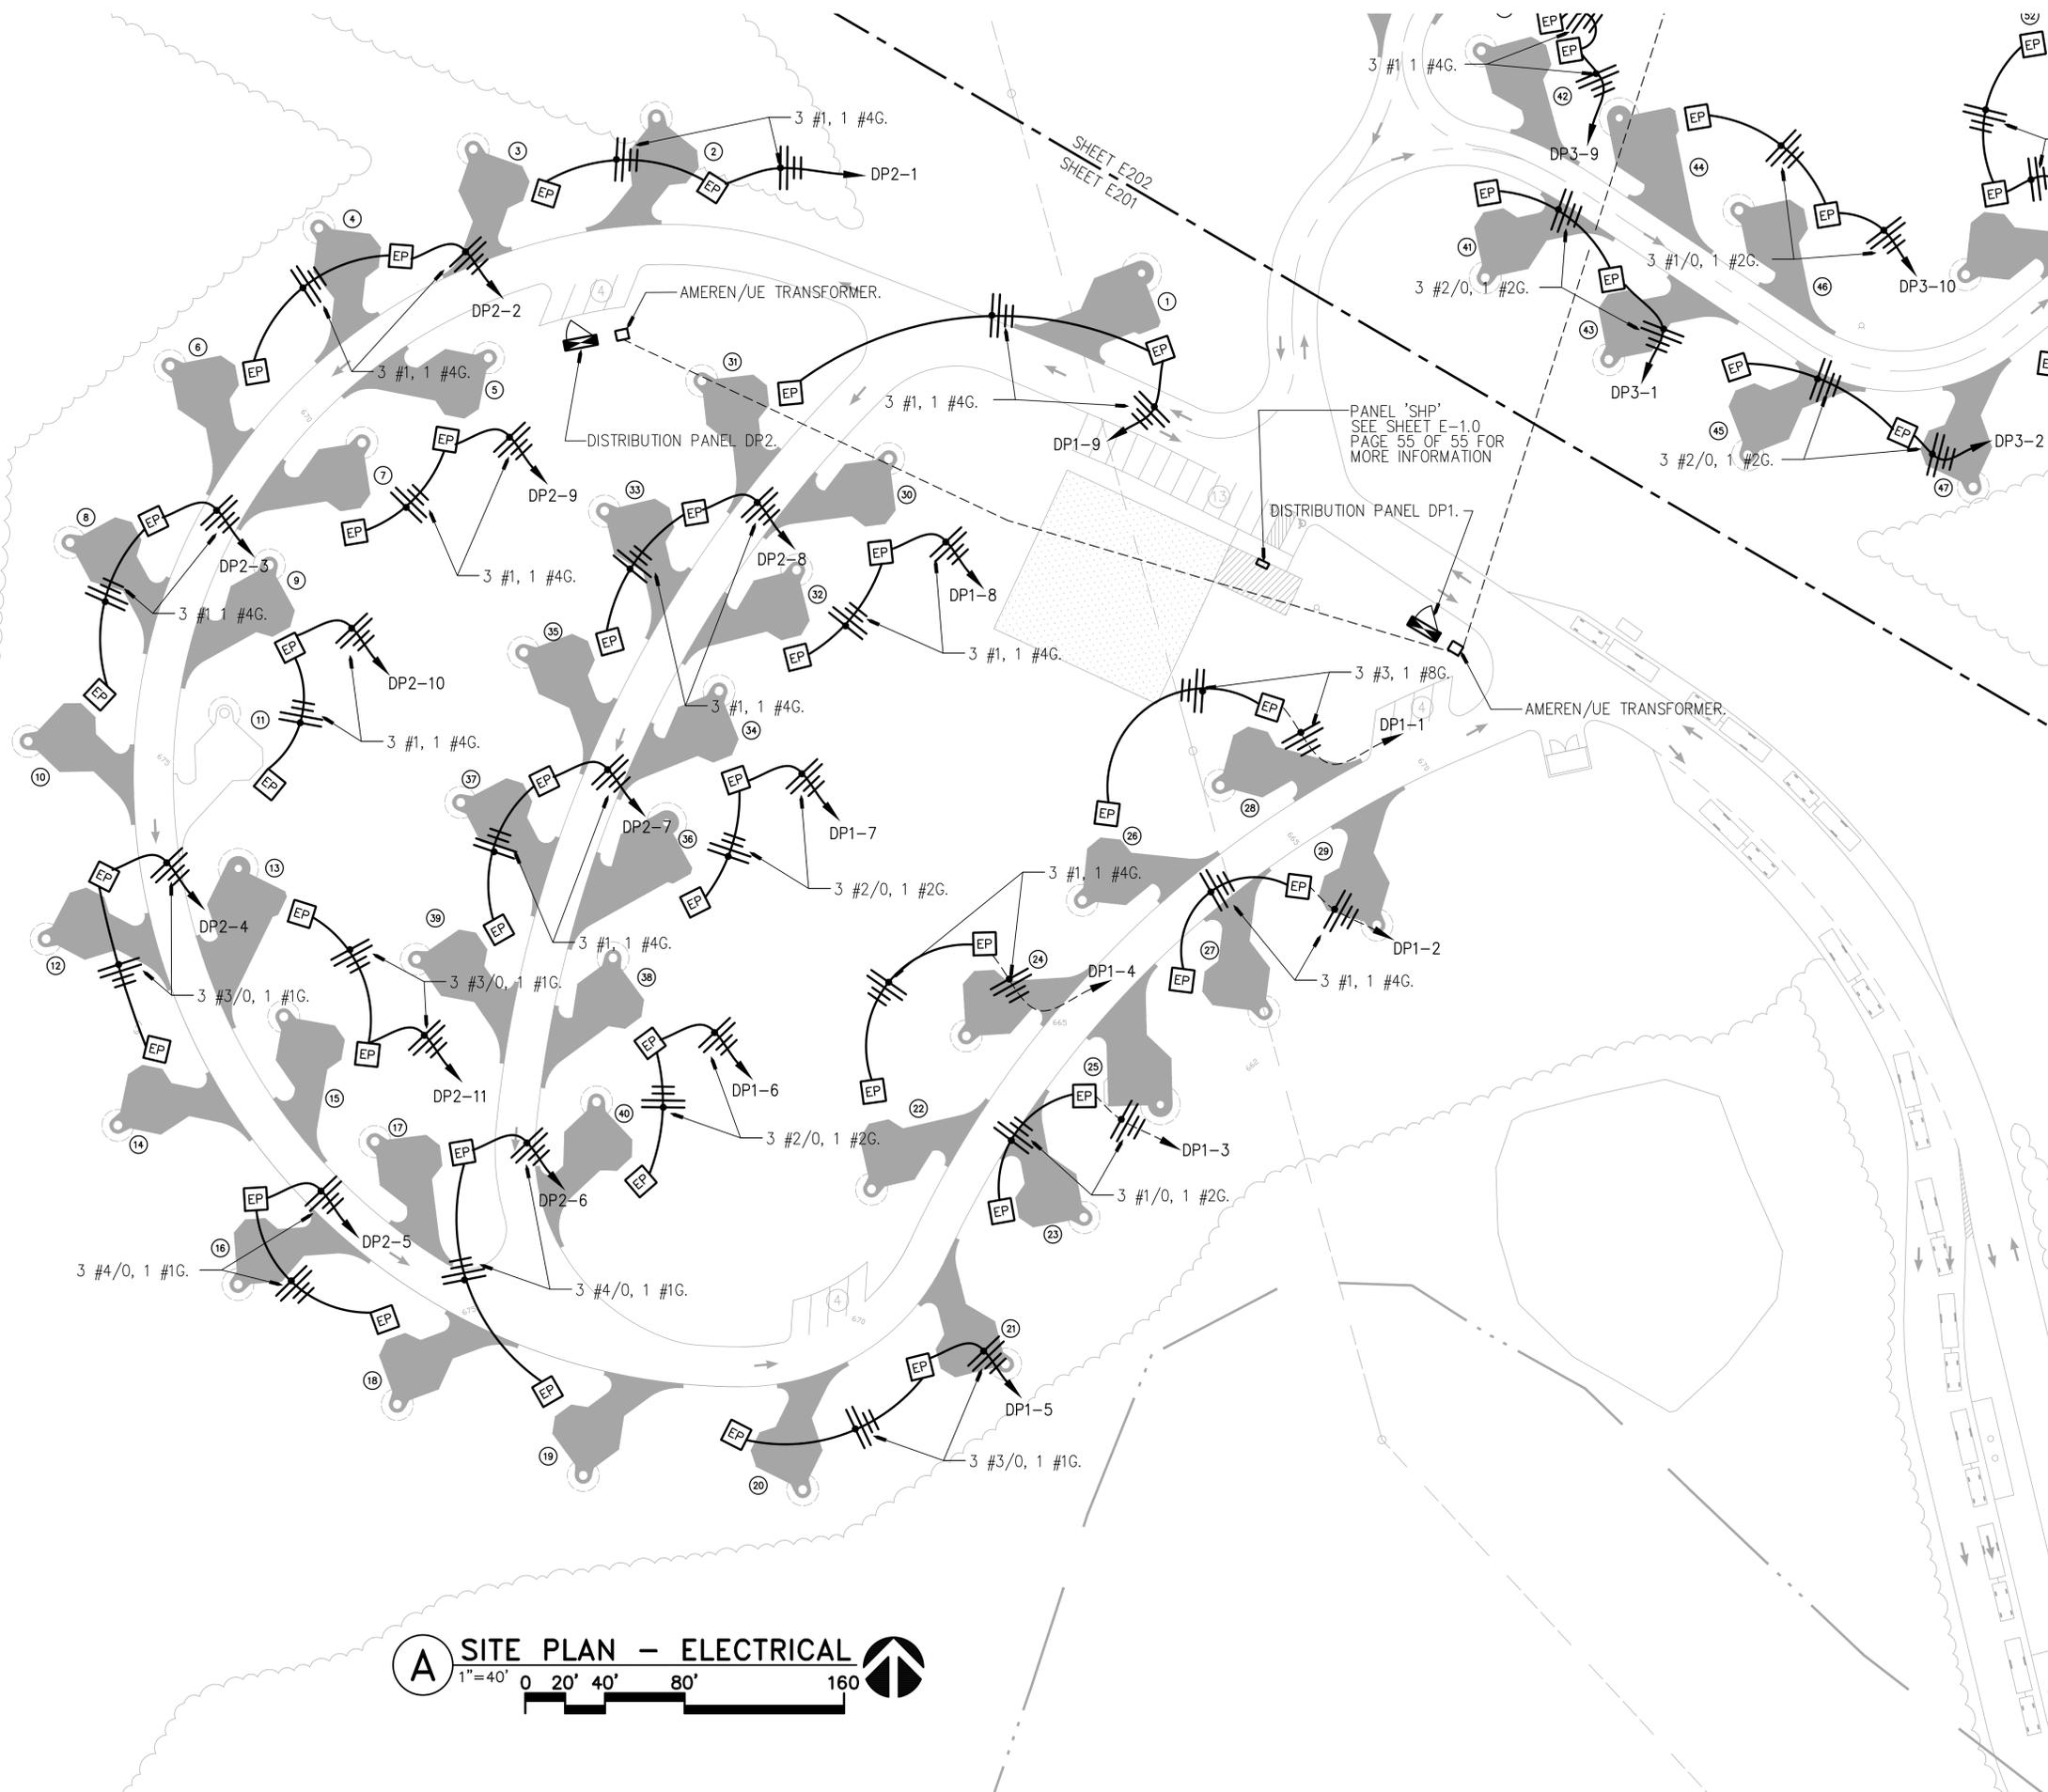



03/28/25

CASE
Engineering Inc.

T 636.349.1600
F 636.349.1730
796 Merus Court
St. Louis, MO 63026
CERTIFICATE OF AUTHORITY NO. 001498

OFFICE OF ADMINISTRATION
DIVISION OF FACILITIES
MANAGEMENT,
DESIGN AND CONSTRUCTION

DEPARTMENT OF
NATURAL RESOURCES
MISSOURI STATE PARKS

NEW 63 SITE
LOOP CAMPGROUND

ST. FRANCOIS STATE PARK
8920 US-67N
ST. FRANCOIS COUNTY, MISSOURI

PROJECT # X2317-01
SITE # 5216
ASSET # 7815216025

REVISION: _____
DATE: _____
REVISION: _____
DATE: _____
REVISION: _____
DATE: _____

ISSUE DATE: 03/28/2025


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SHEET TITLE:
ELECTRICAL
SITE PLAN

SHEET NUMBER:

E202


















38 OF 56 SHEETS
03/28/2025

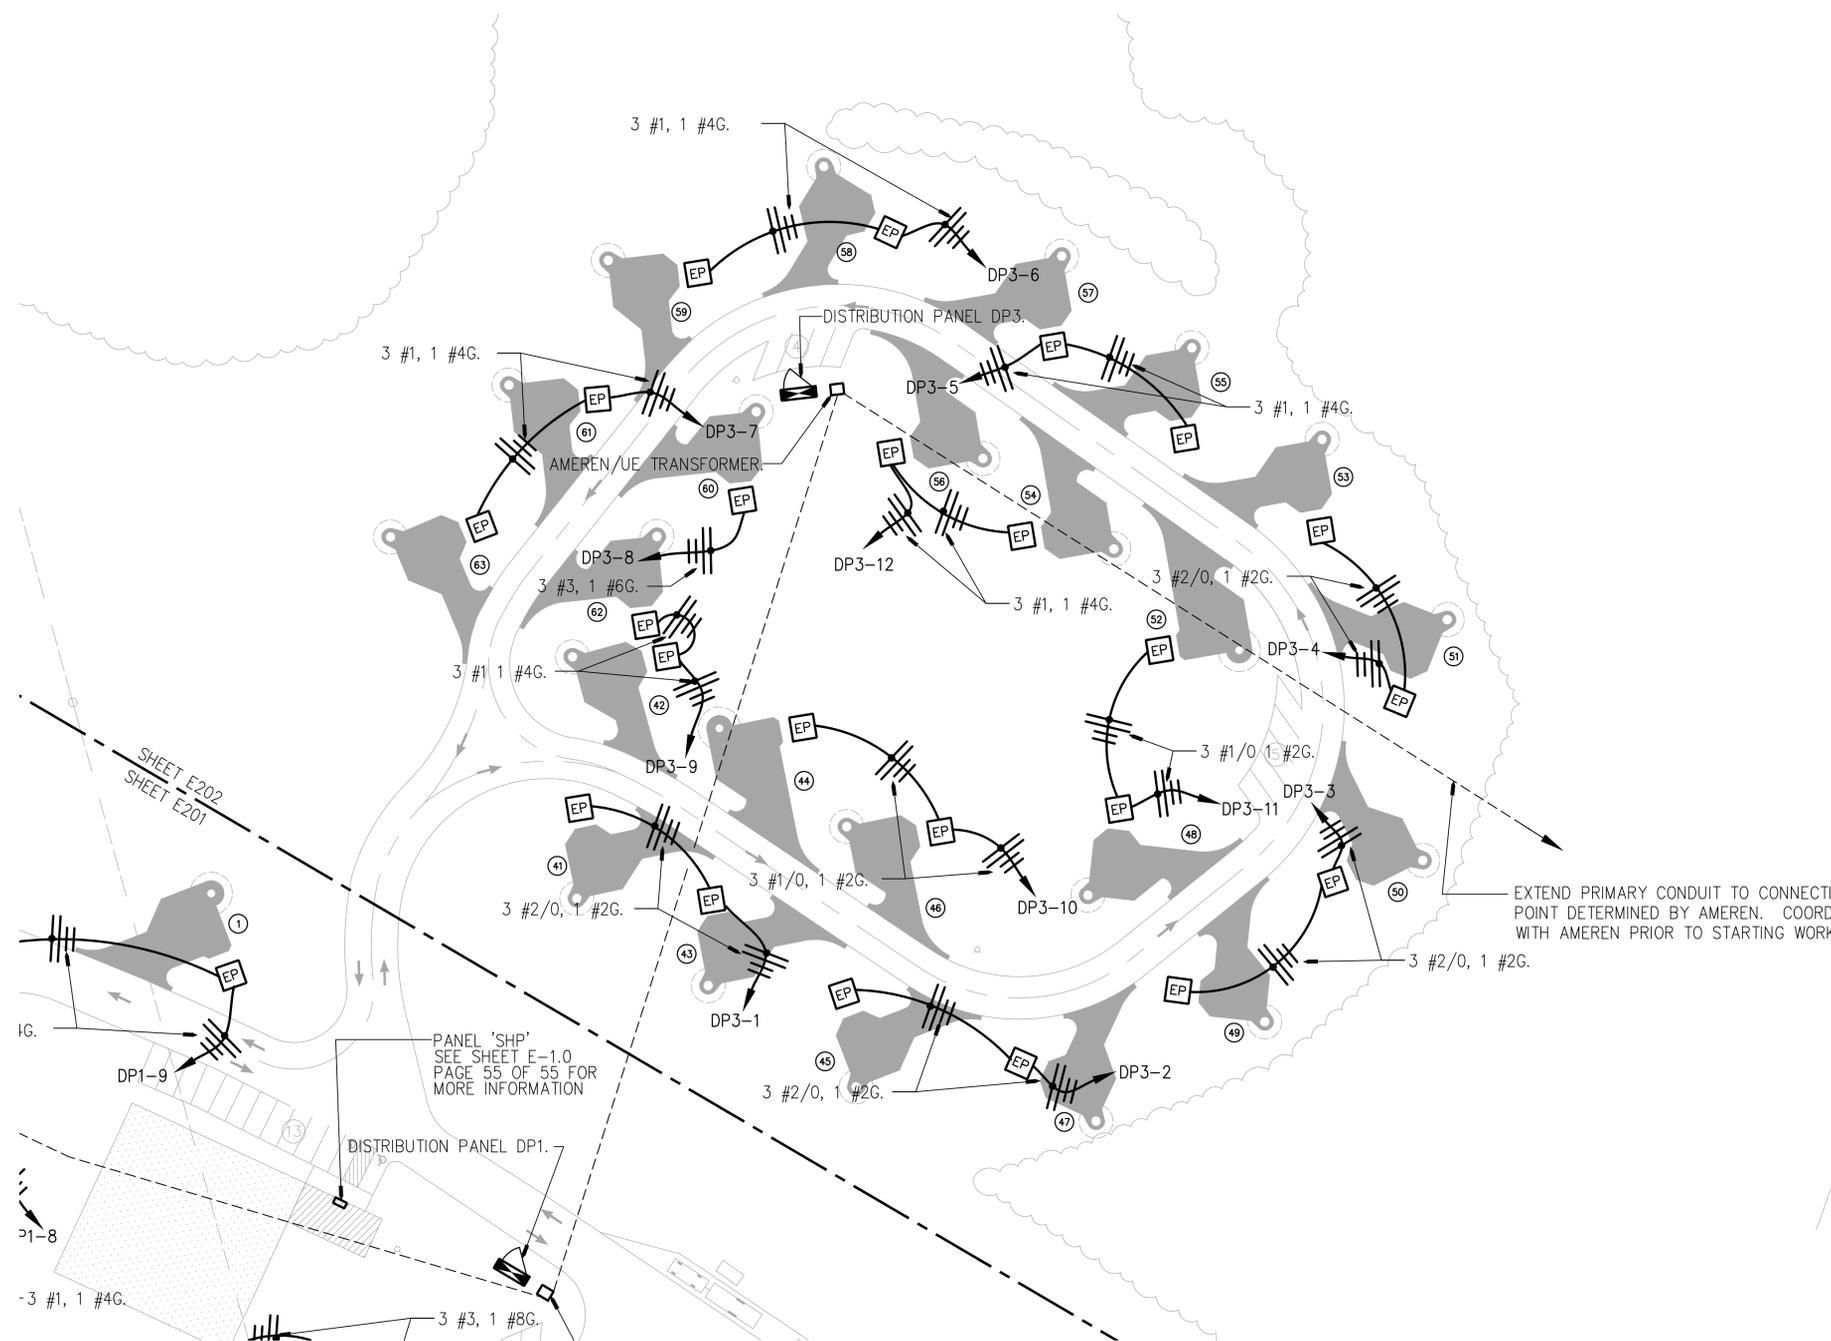

A SITE PLAN - ELECTRICAL
1"=40'
0 20' 40' 80' 160'

PANEL 'SHP'
SEE SHEET E-1.0
PAGE 55 OF 55 FOR
MORE INFORMATION

EXTEND PRIMARY CONDUIT TO CONNECT
POINT DETERMINED BY AMEREN. COORDI
WITH AMEREN PRIOR TO STARTING WORK

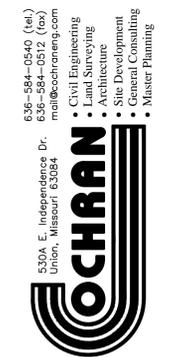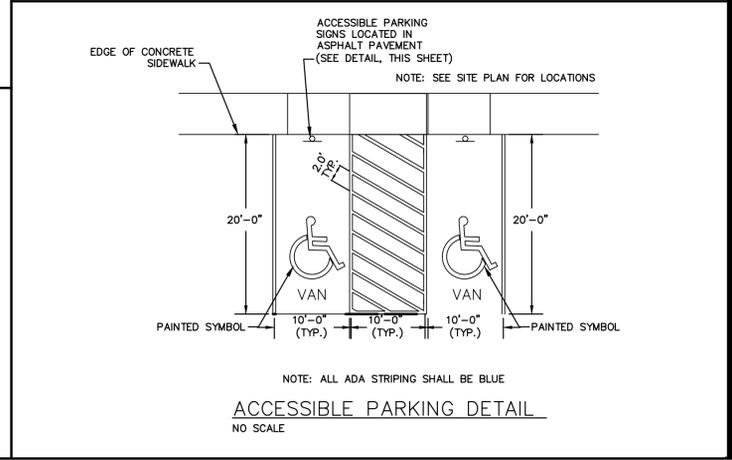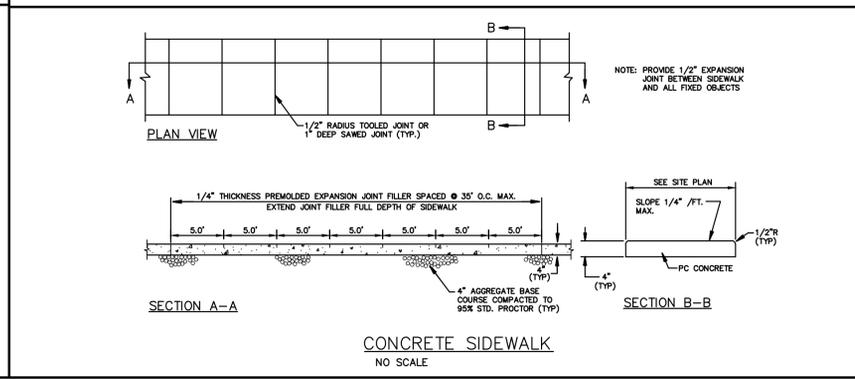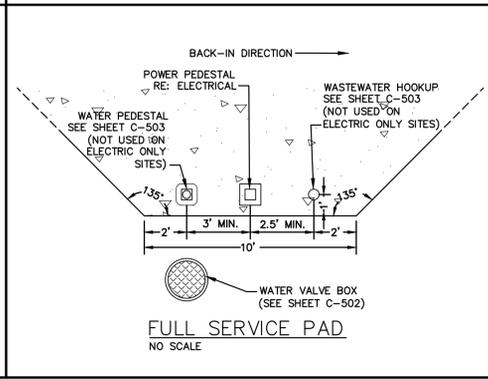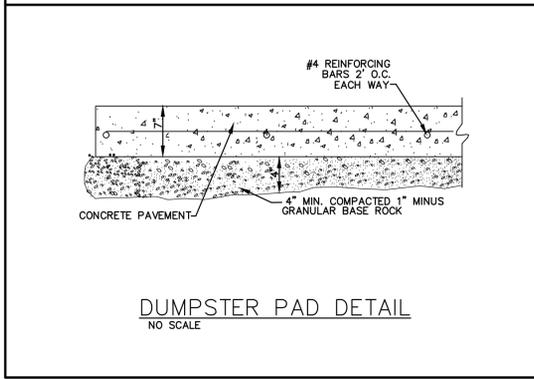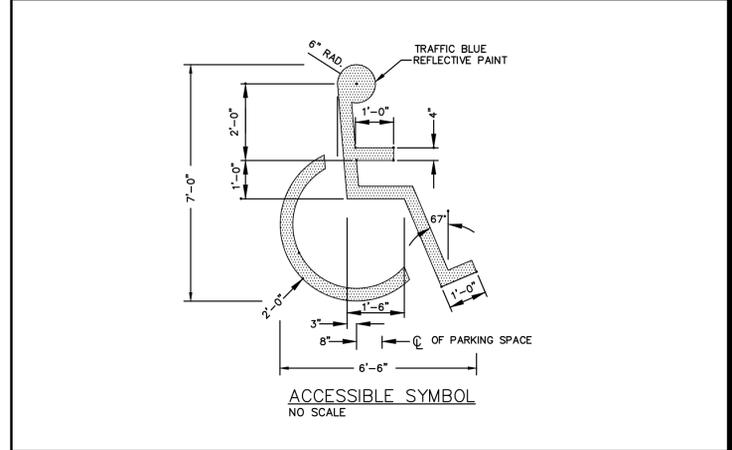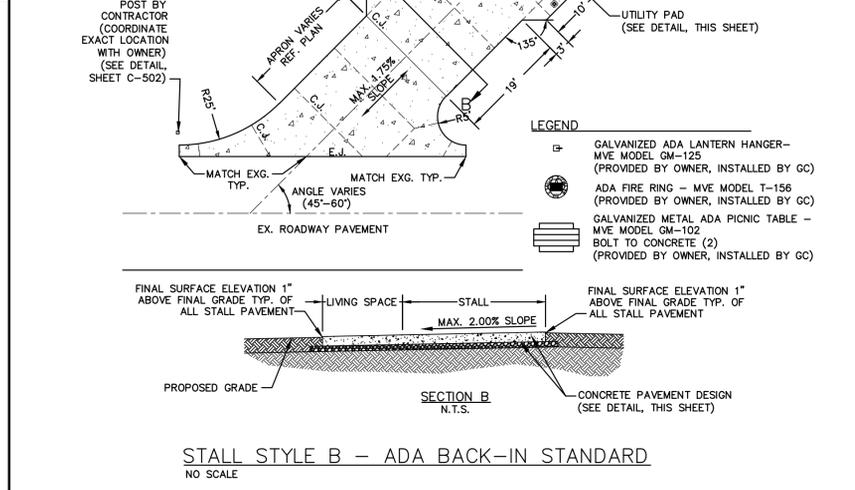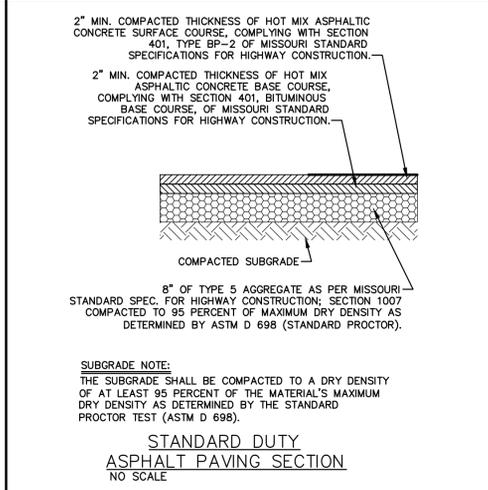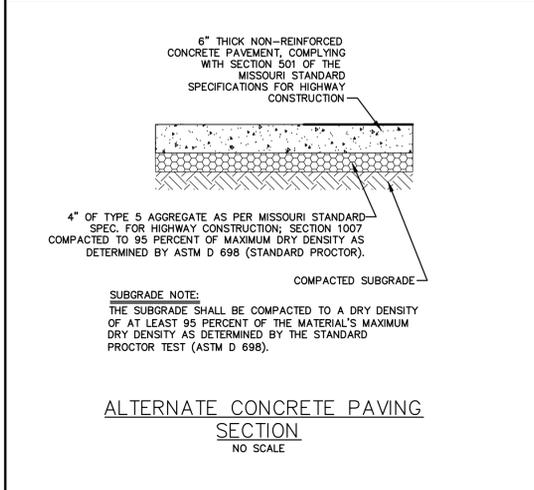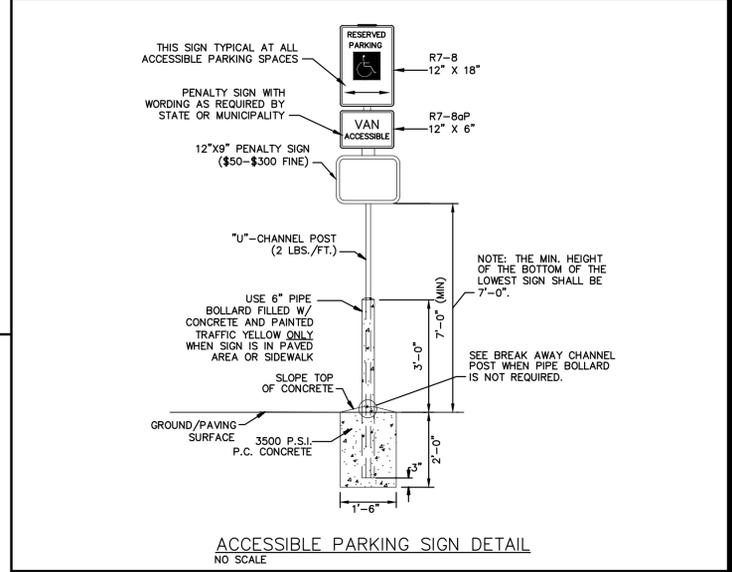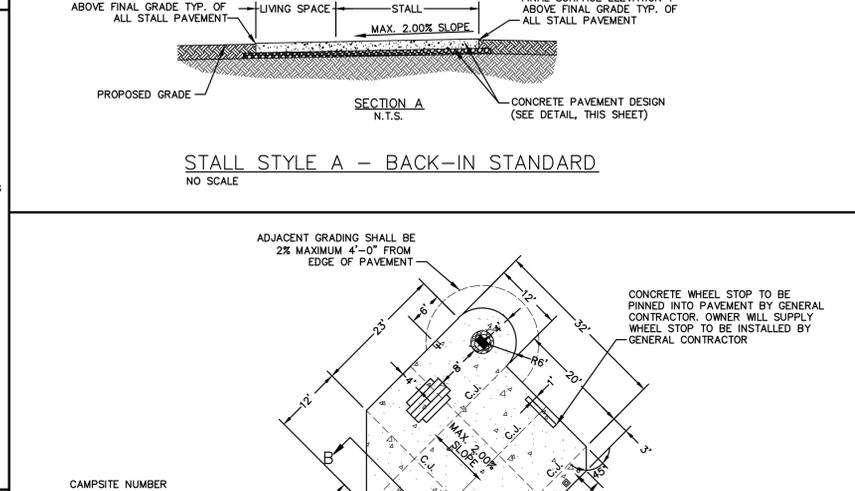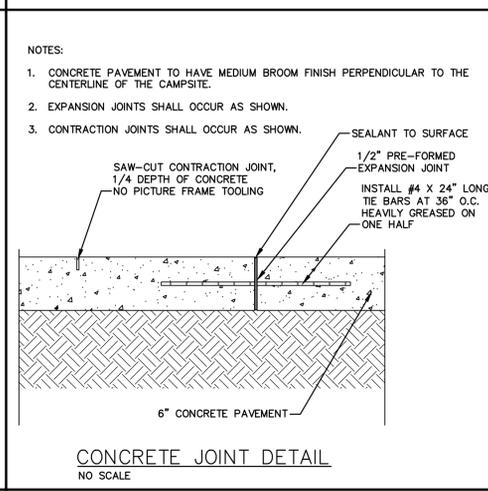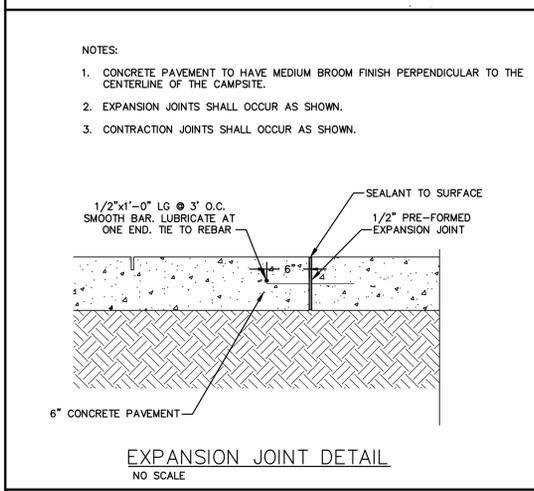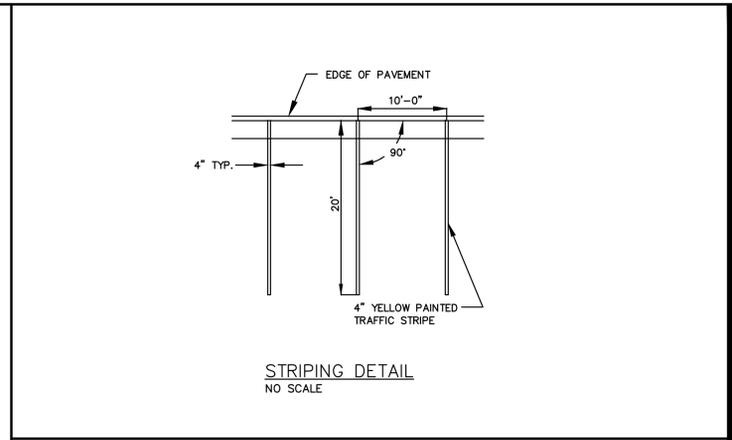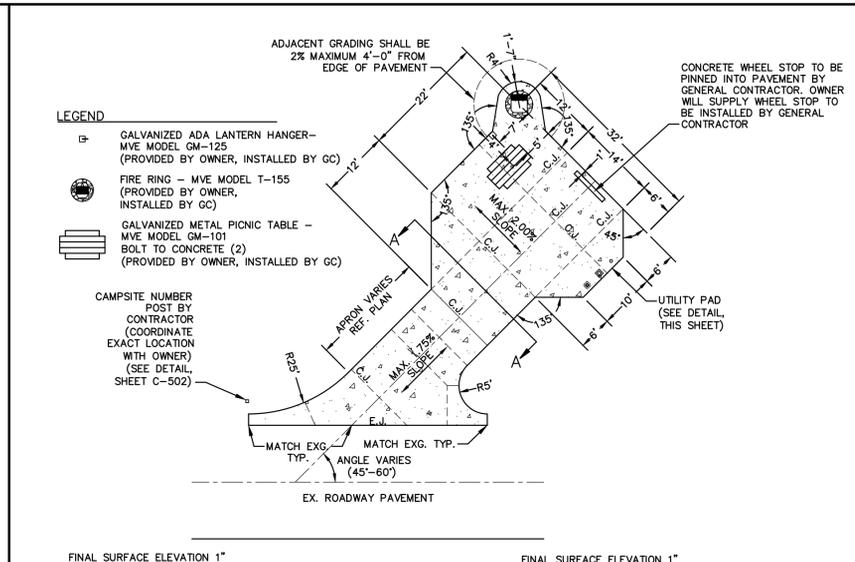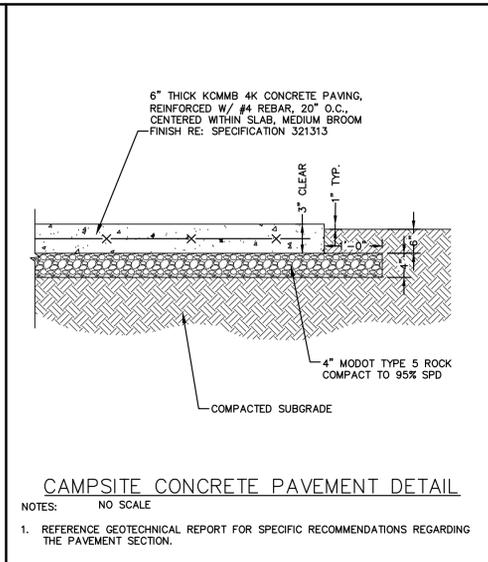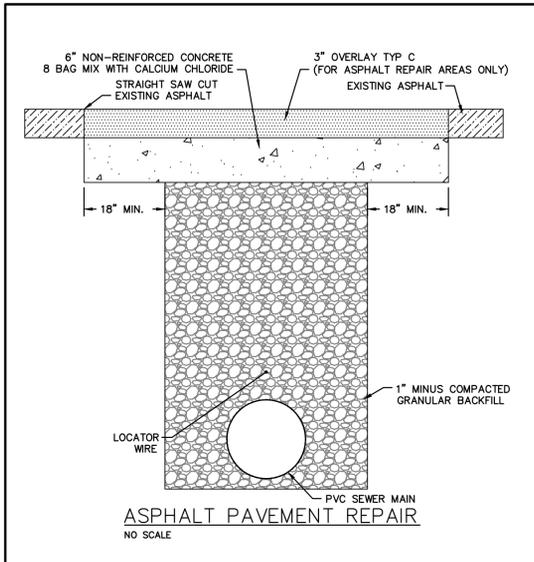

Missouri State Certificate of Authority Numbers:
Survey : 003380
Engineering : 001655
Architecture : 2002014240

OFFICE OF ADMINISTRATION
DIVISION OF FACILITIES
MANAGEMENT,
DESIGN AND CONSTRUCTION

DEPARTMENT OF
NATURAL RESOURCES
MISSOURI STATE PARKS

NEW PREMIUM 63 SITE
LOOP CAMPGROUND

ST. FRANCOIS STATE PARK
8920 US-67N
BONNE TERRE, MO 63628

PROJECT # X2317-01
SITE # 5216
ASSET # 7815216025

REVISION: _____
DATE: _____
REVISION: _____
DATE: _____
REVISION: _____
DATE: _____
ISSUE DATE: 03/28/2025




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CHECKED BY: RKS
DESIGNED BY: RKS

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DETAIL SHEET

SHEET NUMBER:










C-501

39 OF 56 SHEETS
03/28/2025

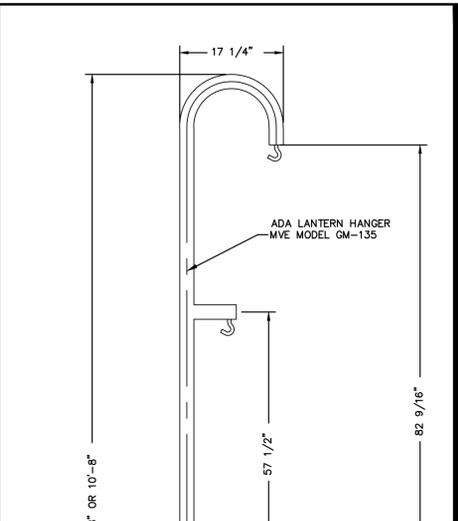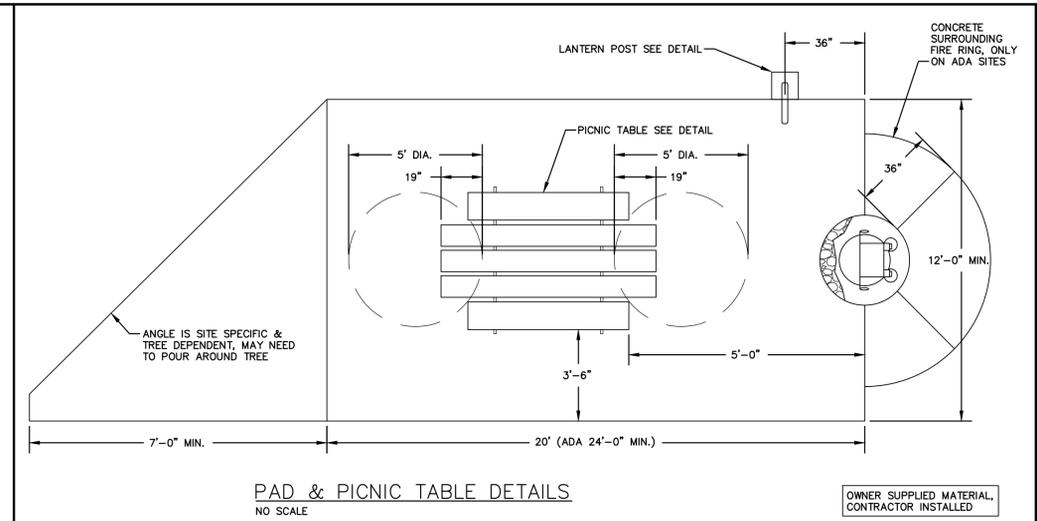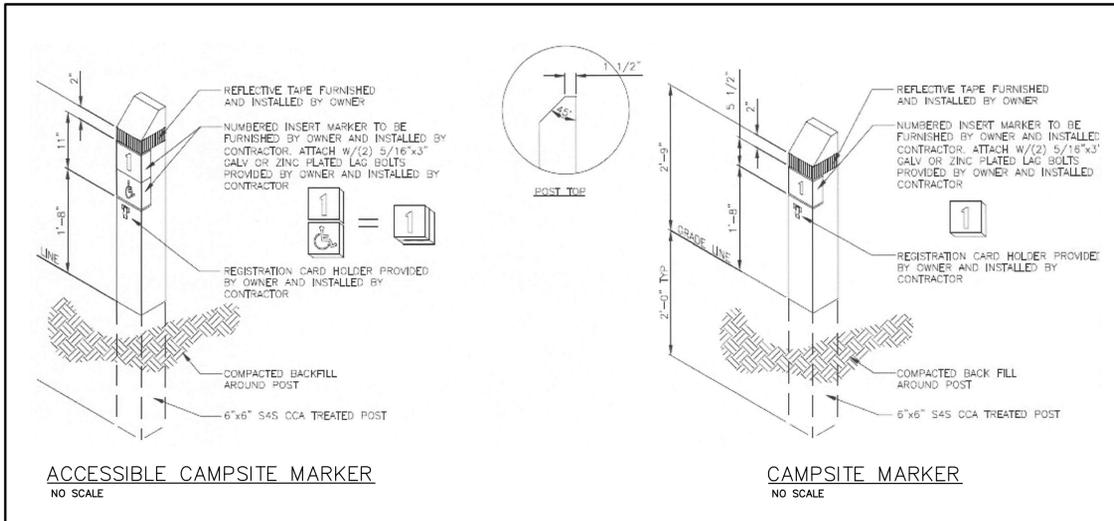

PLAN NOTES

- Concrete Pier: 18" wide x 2'-6" deep concrete pier with bottom of foundation to be 2'-6" minimum below finish grade. Extend foundation 1'-0" past the centerline of the gate post. Embed post in pier 2'-0".
- Floor Construction: 7" concrete slab reinforced with #6 welded wire mesh, place mesh 2" clear of top of slab, over 4" minimum of compacted 1" minus granular base. Light broom finish, seal and cure slab with "VOCOMP - 30" as manufactured by W. R. Meadows, Apply per manufacturer's written instructions. Provide 1 1/2" deep sawcut control joints @ 15'-0" o.c. maximum (equally spaced).
- Wall Construction: Each section shall have (2) 2x6 treated horizontal members with vertical 1x6 vinyl planks attached with galvanized exterior screws. Attach panels to steel tabs with 1/2" galvanized carriage bolts with nuts and washers, paint.
- Gate Construction:
 - Gate Leaf: 1x6 vinyl on 2"x2"x1/8" galvanized steel frame with cross members to prevent racking and sag. White in color. Screw planks to steel frame with corrosion resistant fasteners.
 - Gate Latch: Heavy All Purpose Latch by National Manufacturing Company, Catalog No. V1135. Zinc Finish.
 - Gate Hinges: 14" hinge strap (National Hardware stock# N130-799) and 3/8" pintle (National Hardware stock# N131-409). Minimum gap between post and gate is 2 1/2". One pair per gate leaf.
 - Cane Bolt: 5/8" x 18" adjustable throw cane bolt by National Manufacturing Company, Catalog No. V835.

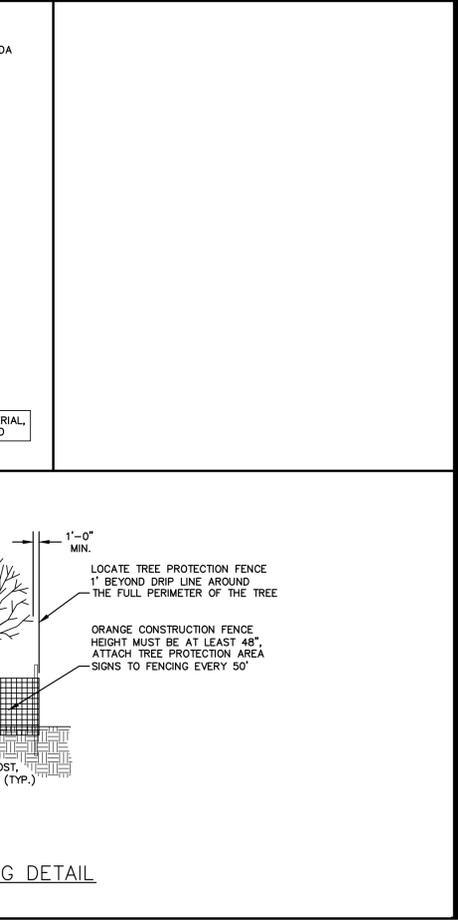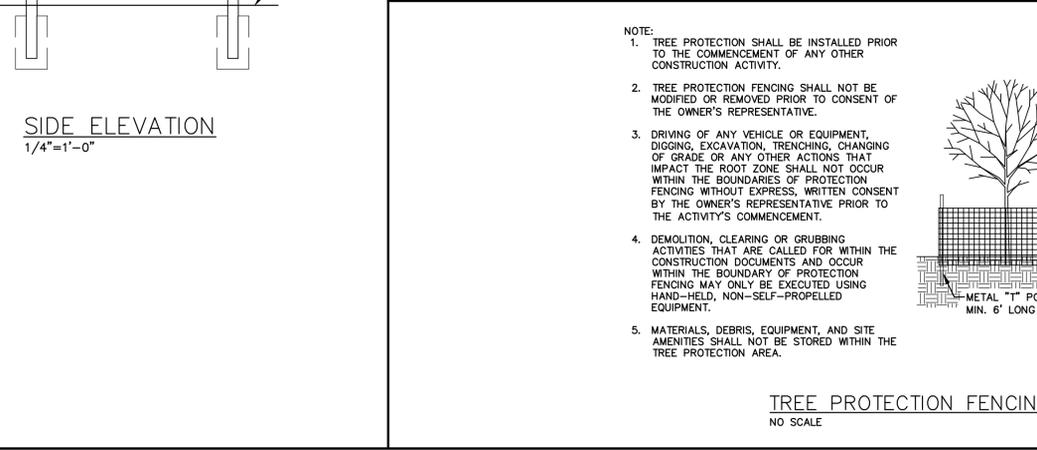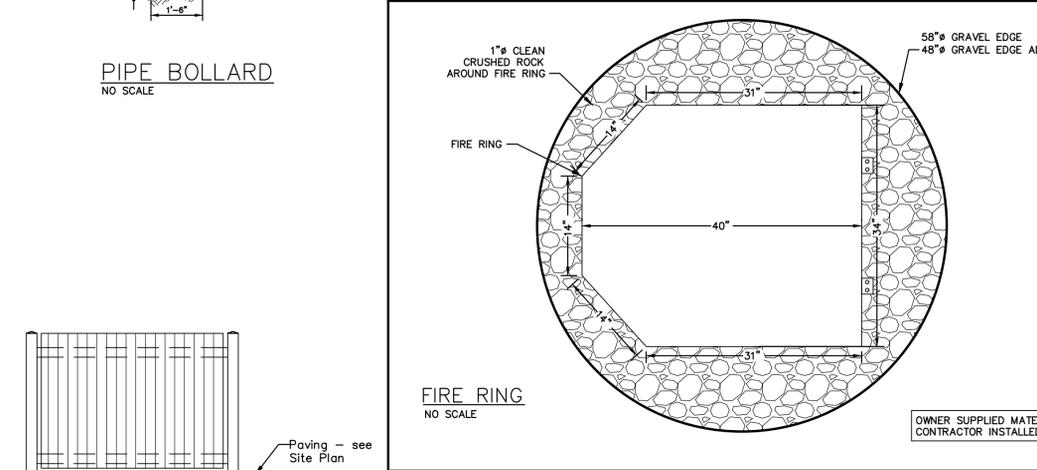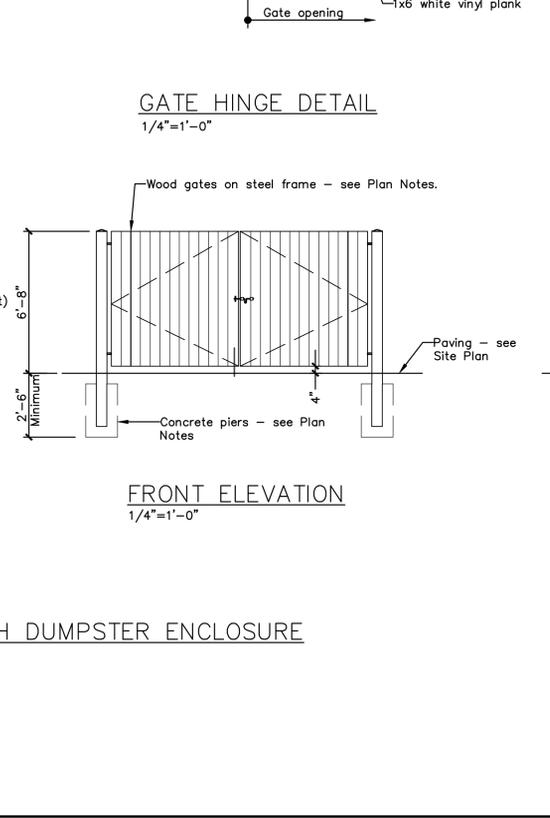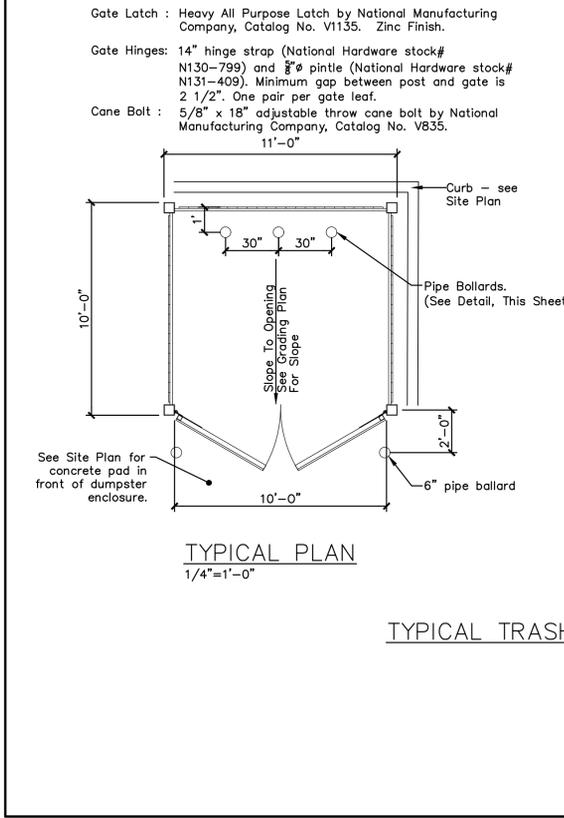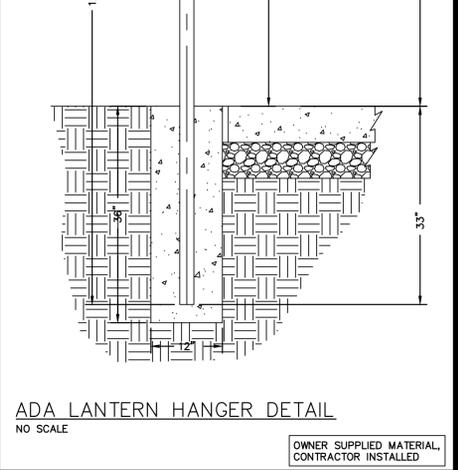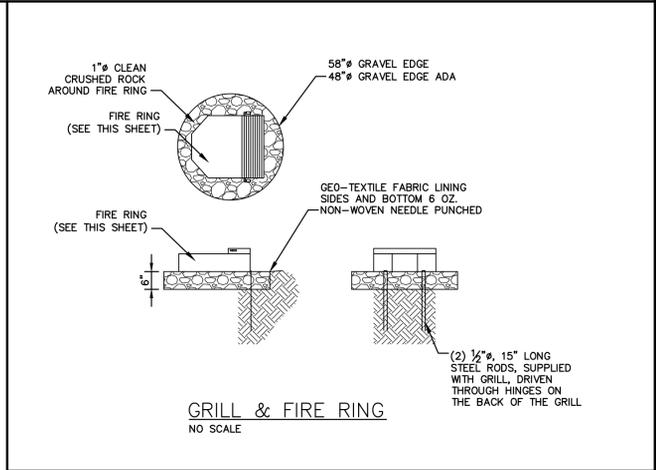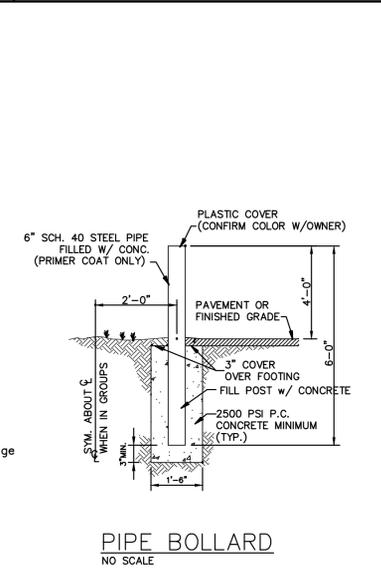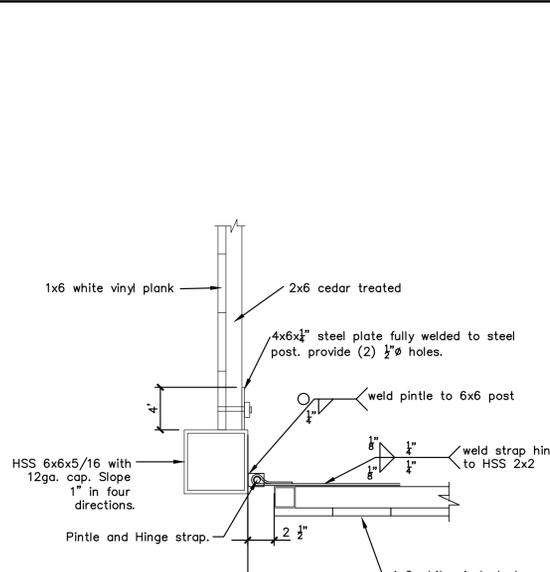

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Civil Engineering
Land Surveying
Architecture
Site Development
General Consulting
Master Planning

630A E. Independence Dr.
Union, Missouri 63084

Missouri State Certificate
of Authority Numbers:
Survey : 003580
Engineering : 001655
Architecture : 2002014240

OFFICE OF ADMINISTRATION
DIVISION OF FACILITIES
MANAGEMENT,
DESIGN AND CONSTRUCTION

DEPARTMENT OF
NATURAL RESOURCES
MISSOURI STATE PARKS

NEW PREMIUM 63 SITE
LOOP CAMPGROUND

ST. FRANCOIS STATE PARK
8920 US-67N
BONNE TERRE, MO 63628












PROJECT # X2317-01
SITE # 5216
ASSET # 7815216025

REVISION: _____
DATE: _____
REVISION: _____
DATE: _____
REVISION: _____
DATE: _____
ISSUE DATE: 03/28/2025

CAD DWG FILE: X2317-DS-502
DRAWN BY: LJR
CHECKED BY: ERR
DESIGNED BY: ERR

SHEET TITLE:
DETAIL SHEET

SHEET NUMBER:
C-502
40 OF 56 SHEETS
03/28/2025

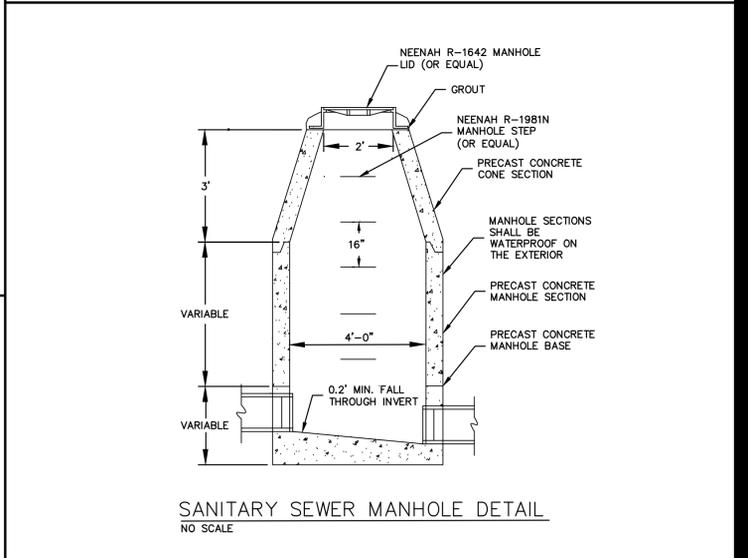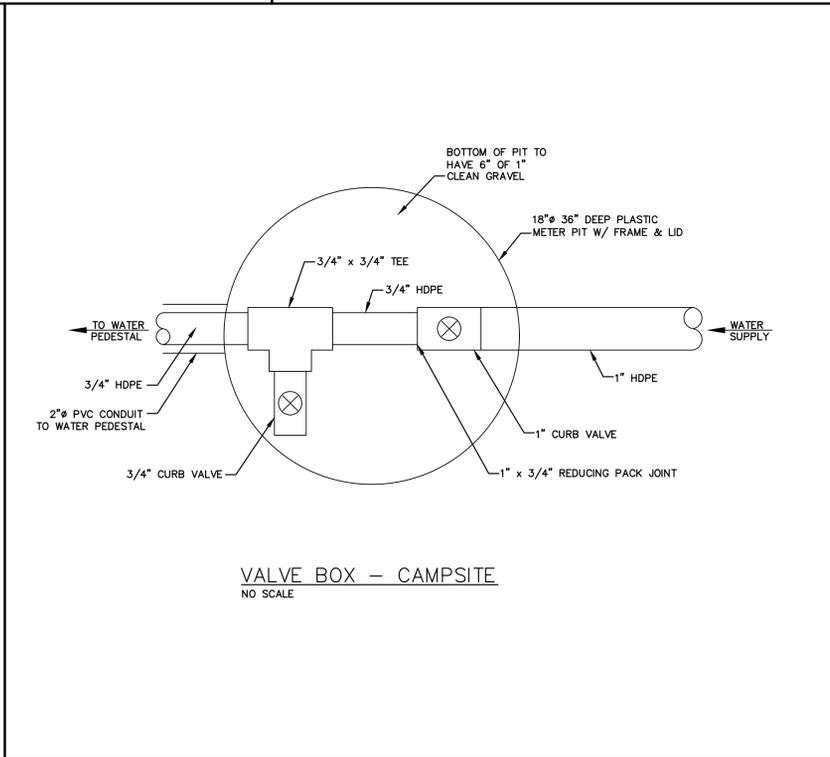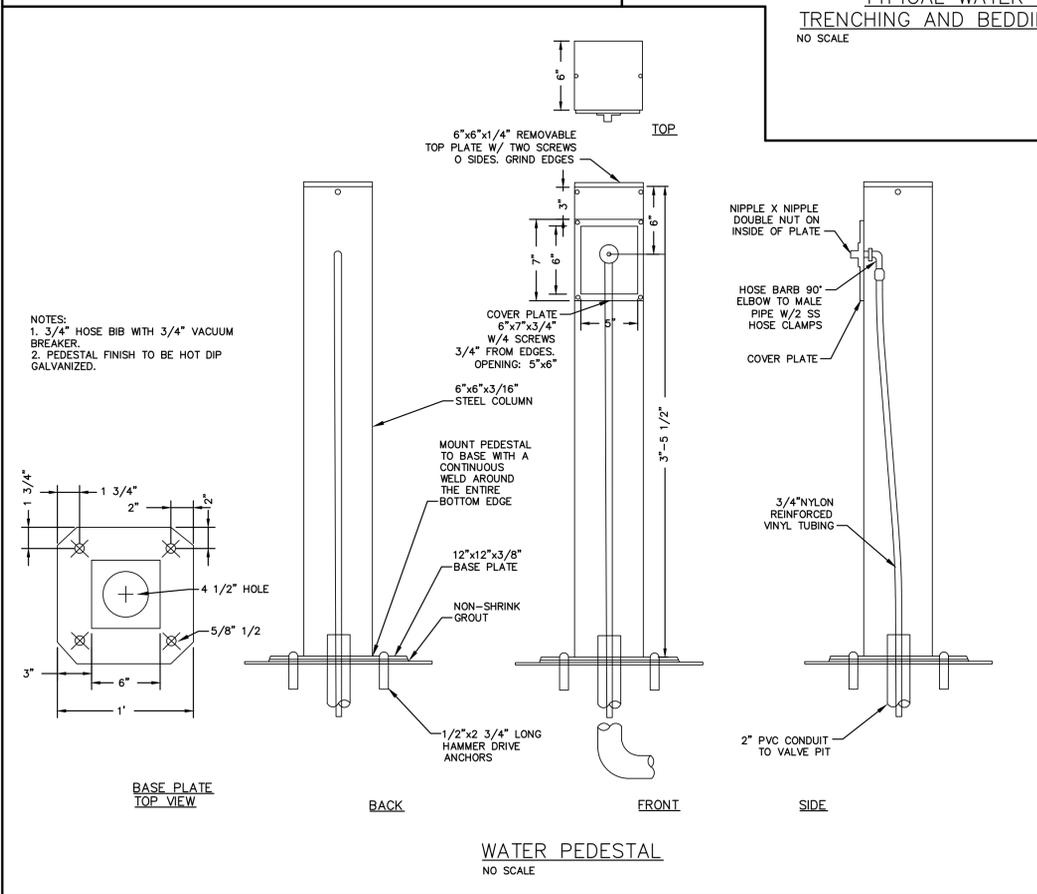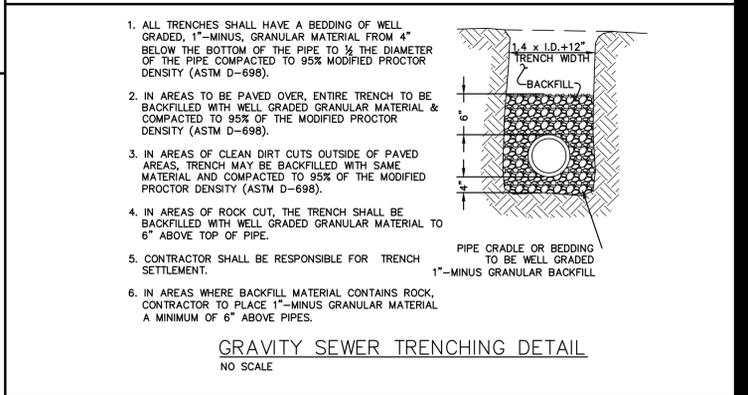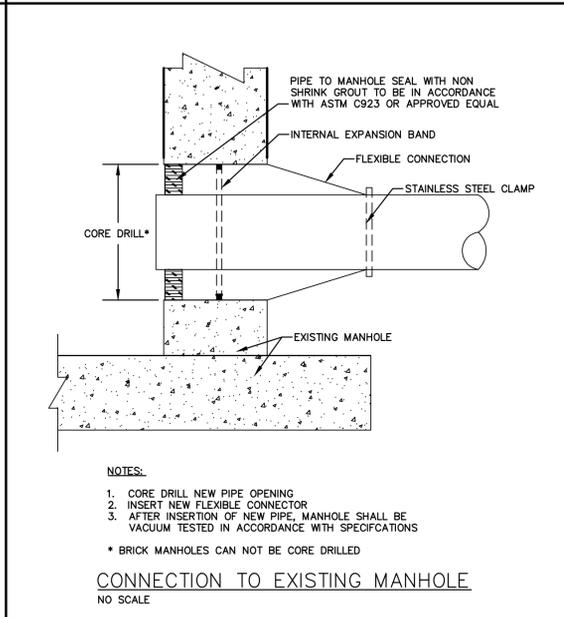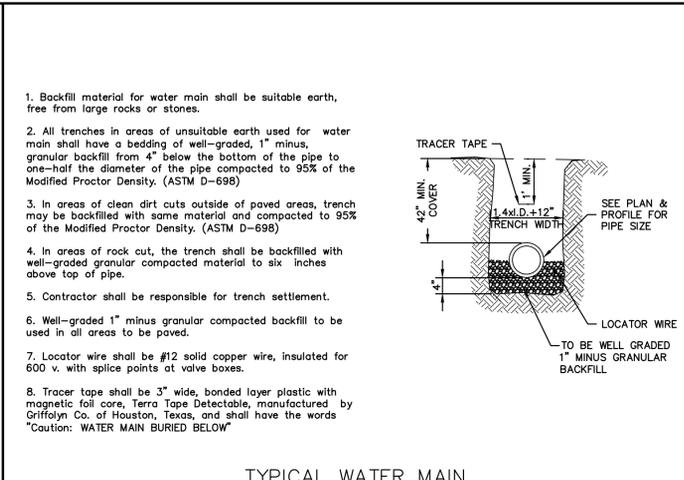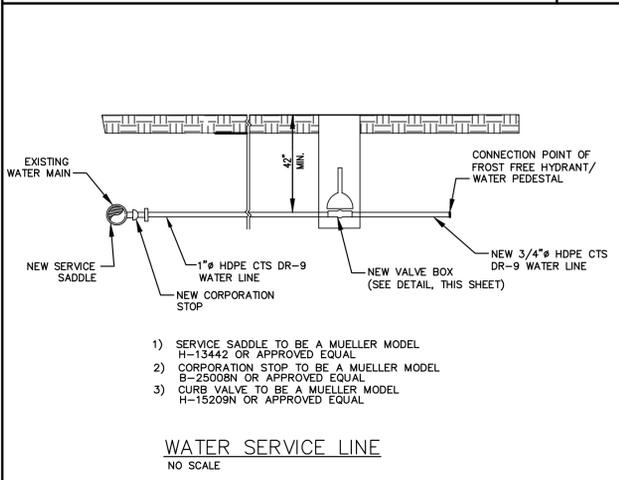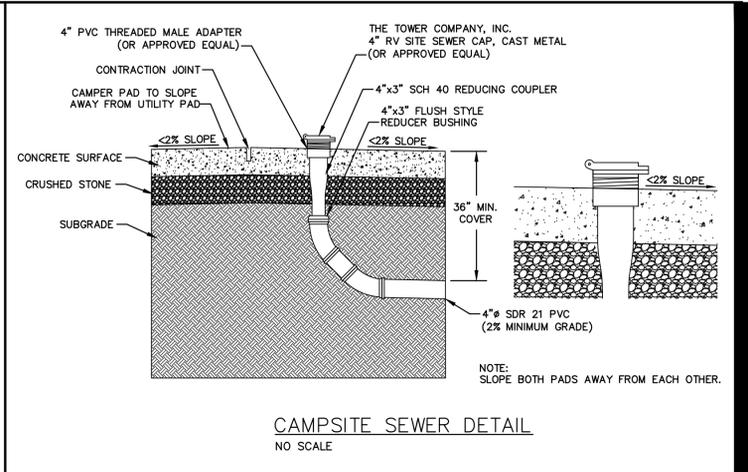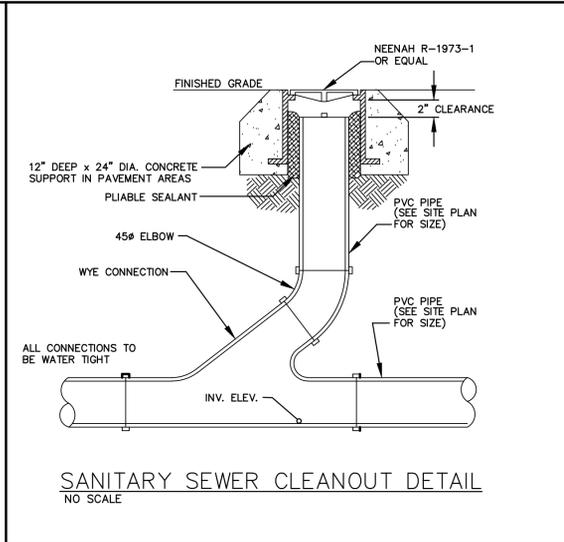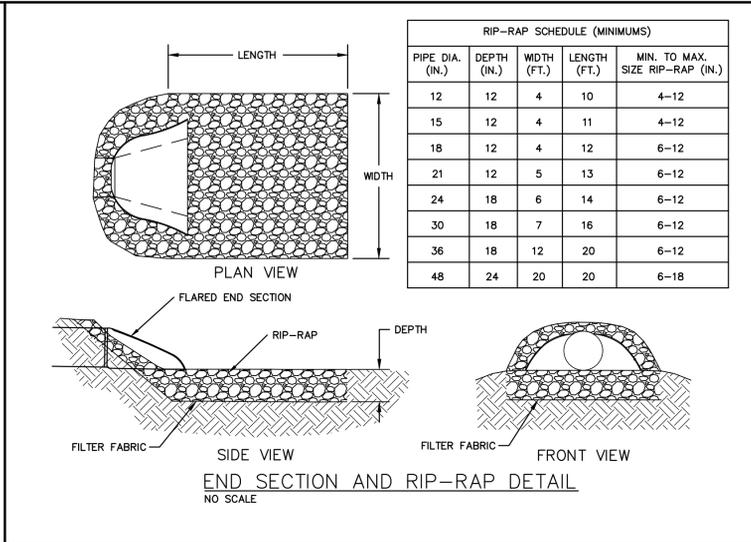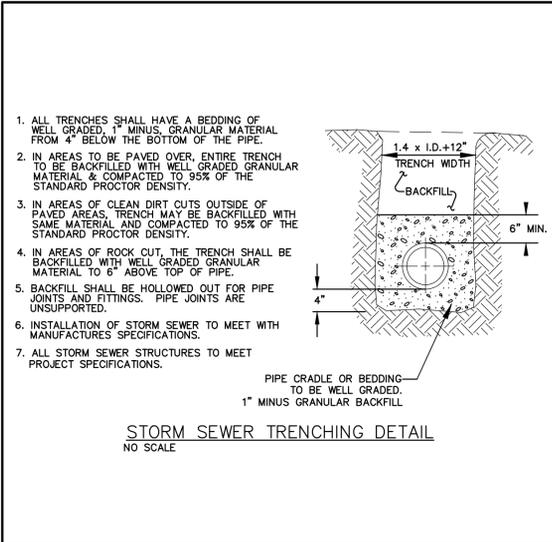

636-564-0540 (tel.)
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m.l.parson@cochran.com



Missouri State Certificate of Authority Numbers:
Survey : 000350
Engineering : 001655
Architecture : 2002014240

OFFICE OF ADMINISTRATION
DIVISION OF FACILITIES
MANAGEMENT,
DESIGN AND CONSTRUCTION

DEPARTMENT OF
NATURAL RESOURCES
MISSOURI STATE PARKS

NEW PREMIUM 63 SITE
LOOP CAMPGROUND

ST. FRANCOIS STATE PARK
8920 US-67N
BONNE TERRE, MO 63628

PROJECT # X2317-01
SITE # 5216
ASSET # 7815216025

REVISION: _____
DATE: _____
REVISION: _____
DATE: _____
REVISION: _____
DATE: _____
ISSUE DATE: 03/28/2025

CAD DWG FILE: X2317-DS-503
DRAWN BY: BAB
CHECKED BY: RKS
DESIGNED BY: RKS

SHEET TITLE:
DETAIL SHEET

SHEET NUMBER:
C-503
41 OF 56 SHEETS
03/28/2025

ABBREVIATIONS


ACT	Acoustical Ceiling	HVAC	Heating, Ventilating, and Air
AF	Above Finish Floor	Horiz.	Horizontal
Alum	Aluminum	HM	Hollow Metal
e	Anodized	Insul	Insulation
By Owner	Furnished & delivered by Owner, installed by Contractor	Jt.	Joint
Cpt	Carpet	M.O.	Masonry Opening
CJ	Control Joint	MBS	Metal Building Supplier
CMU	Concrete Block Unit Masonry	MWP	Metal Wall Panel
Conc	Concrete	NIC	Not in Contract Installed and Furnished by owner (shown dashed)
¢	Centerline	OC	On center
D6	Downspout	OH	Opposite hand
Dugs.	Drawings	opp	Opposite
¢	Diameter	Pa	Paint
EFS	Exterior Insulation Finishing System	Pl	Plate
EJ	Expansion Joint	#	Square Foot
EI	Elevation	StF	Square Foot
FD	Floor Drain	Typ	Typical
Fdn	Foundation	TW	Top of wall
FEC	Fire Extinguisher Cabinet	UNO	Unless noted otherwise
FRP	Fiberglass Panel	w/	With
Ga	Gauge	Wd	Wood
Galv	Galvanized	WWF	Welded Wire Fabric
GB	Gypsum Board		
GC	General Contractor		

GENERAL NOTES

- The General Contractor shall verify the existing conditions and dimensions and shall notify the Architect of any discrepancies that may affect the work prior to commencing construction.
- All dimensions are to the finish face of new walls.
- Install reducer strips between different floor finish levels and finishes as required.
- The General Contractor shall install required wall blocking for all new casework, shelving, or equipment. See the drawings for exact locations.
- Unless otherwise indicated, all materials and equipment shown on the drawings other than the existing is to be furnished and installed by the Contractor.
- Install portable fire extinguishers per the International Fire Code (By Owner NIC).
- Colors and finishes as selected by Owner.

KEY NOTES

- Electrical panel - see Electrical Drawings
- New hot water heater - see Plumbing Drawings
- ADA accessible shower, slope concrete to drain
- 4'-0"x1'-6" fixed vinyl window with obscure glass
- Duplex electrical outlet - see Electrical Drawings
- Key operated hose bibb - see Plumbing Drawings
- Towel hook
- Bench (N.I.C.)
- Not Used
- Hose bibb - see Plumbing Drawings
- Folding shower seat - see Interior Elevations
- Wall mounted exhaust fan - see Mechanical Drawings
- Unisex accessible restroom sign with Braille
- Furnace - see Mechanical Drawings

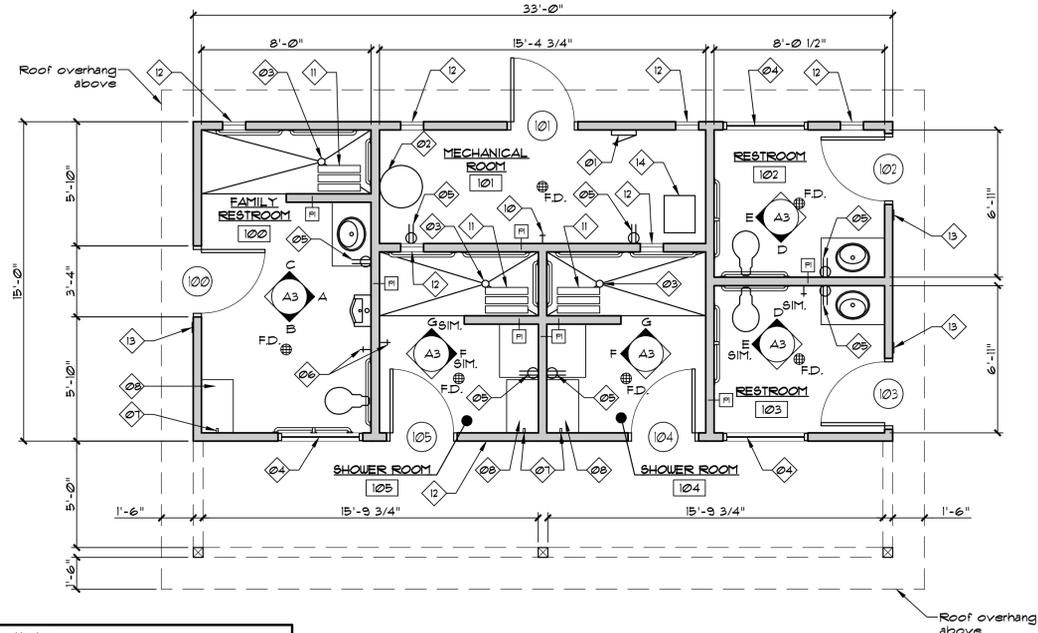

FLOOR PLAN
1/4" = 1'-0"


MATERIAL INDICATIONS / SYMBOLS

MATERIAL INDICATIONS	SYMBOLS
[Symbol]	BATT INSULATION
[Symbol]	DEMO WALL
[Symbol]	EXISTING WALL
[Symbol]	STUD PARTITION
[Symbol]	WOOD BLOCKING OR FRAMING
[Symbol]	RATED PARTITION

EXTERIOR PRODUCT FINISH SCHEDULE

MATERIAL	DESCRIPTION	MANUFACTURER	NOTES
Asphalt Shingle Roof	30-year architectural grade shingles, Color: As selected by Owner	CertainTeed	
Window	200 series 48"x18" picture windows Color: As selected by Owner	Andersen Windows	
Fiber cement lap siding	Select CedarMill 1/2" wide, 6" exposure Color: As selected by Owner	James Hardie	
Trim	All 1x trim indicated to be fiber cement Color: As selected by Owner	James Hardie	


NOTE: Provide products indicated or approved equal

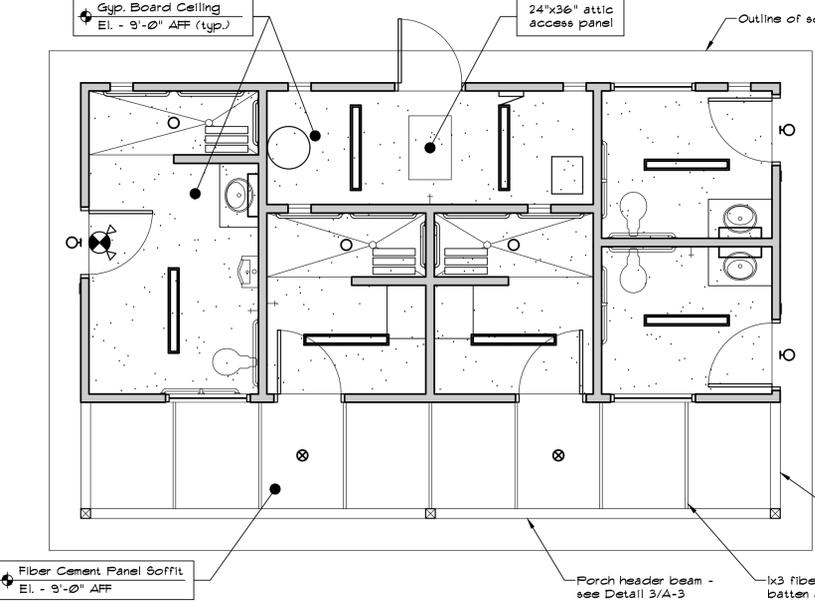


REFLECTED CEILING PLAN
1/4" = 1'-0"

CEILING LEGEND


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EXTERIOR SOFFIT LIGHT	[Symbol]
GYP. BOARD CEILING	[Symbol]
EXTERIOR DOWN LIGHT	[Symbol]
SURFACE MOUNT STRIP FIXTURE	[Symbol]
WALL MOUNTED STRIP FIXTURE	[Symbol]
SURFACE MOUNTED FLUSH LIGHT	[Symbol]

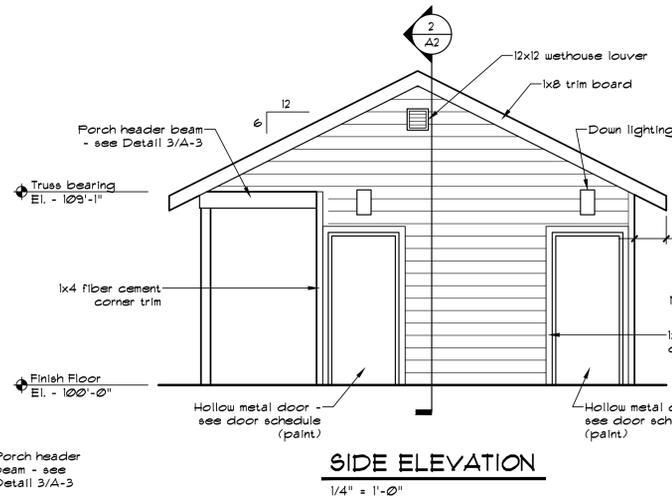


SIDE ELEVATION
1/4" = 1'-0"

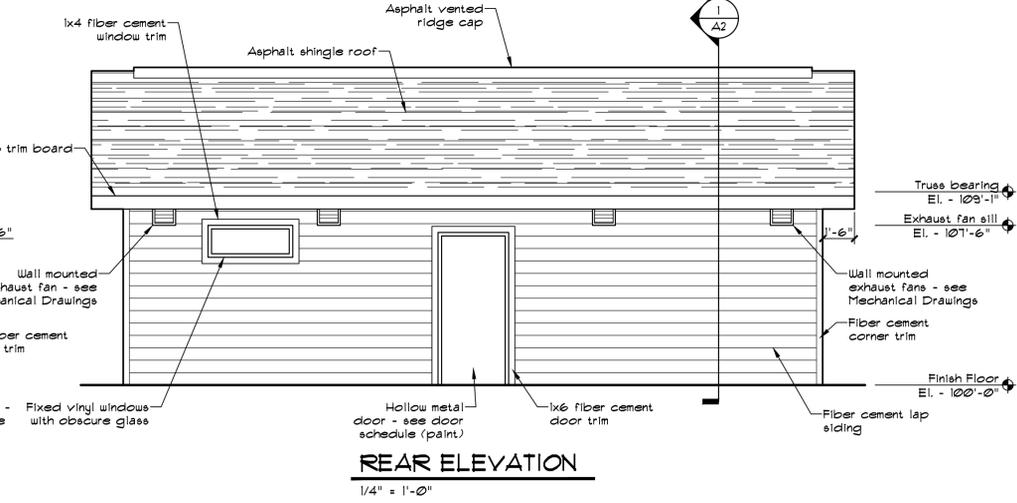

REAR ELEVATION
1/4" = 1'-0"

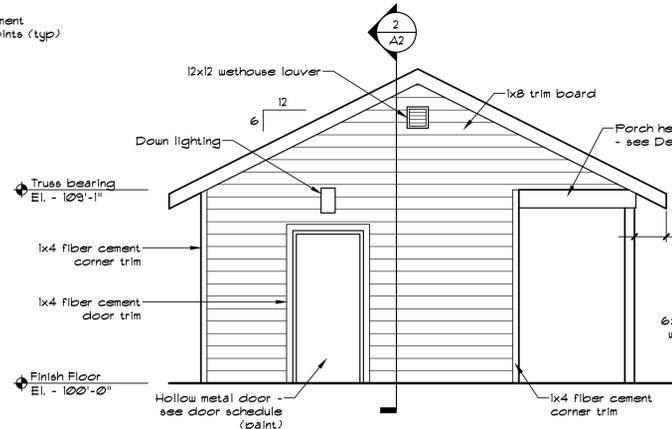

SIDE ELEVATION
1/4" = 1'-0"

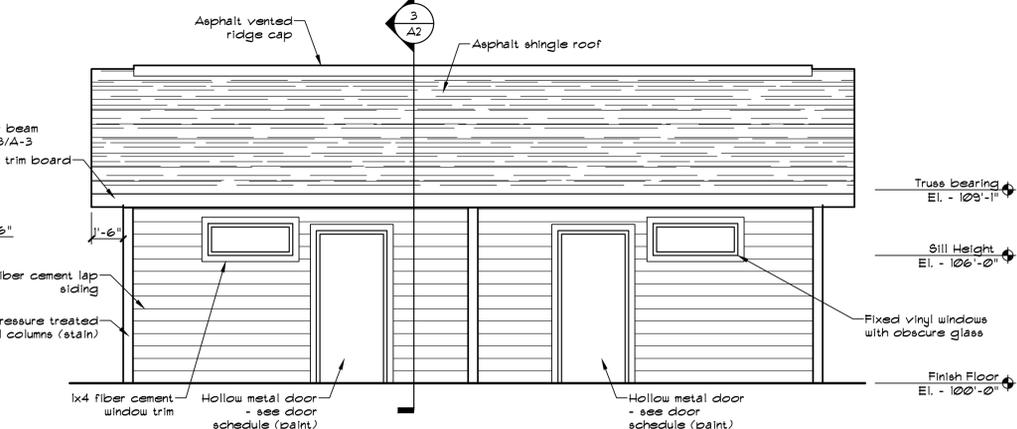

FRONT ELEVATION
1/4" = 1'-0"



Missouri State Certificate of Authority Numbers:
Survey : 000350
Engineering : 001655
Architecture : 2002014240

OFFICE OF ADMINISTRATION
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MANAGEMENT,
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DEPARTMENT OF
NATURAL RESOURCES
MISSOURI STATE PARKS

NEW PREMIUM 63 SITE
LOOP CAMPGROUND

ST. FRANCOIS STATE PARK
8920 US-67N
BONNE TERRE, MO 63628

PROJECT # X2317-01
SITE # 5216
ASSET # 7815216025

REVISION: _____
DATE: _____
REVISION: _____
DATE: _____
REVISION: _____
DATE: _____
ISSUE DATE: 03/28/2025

CAD DWG FILE: X2317-A-A1
DRAWN BY: AMS
CHECKED BY: JAM
DESIGNED BY: JAM

SHEET TITLE:
**FLOOR PLAN
& ELEVATIONS**

SHEET NUMBER:

A-1



Missouri State Certificate
of Authority Number:
Survey : 000566
Engineering : 001655
Architecture : 2002014240

OFFICE OF ADMINISTRATION
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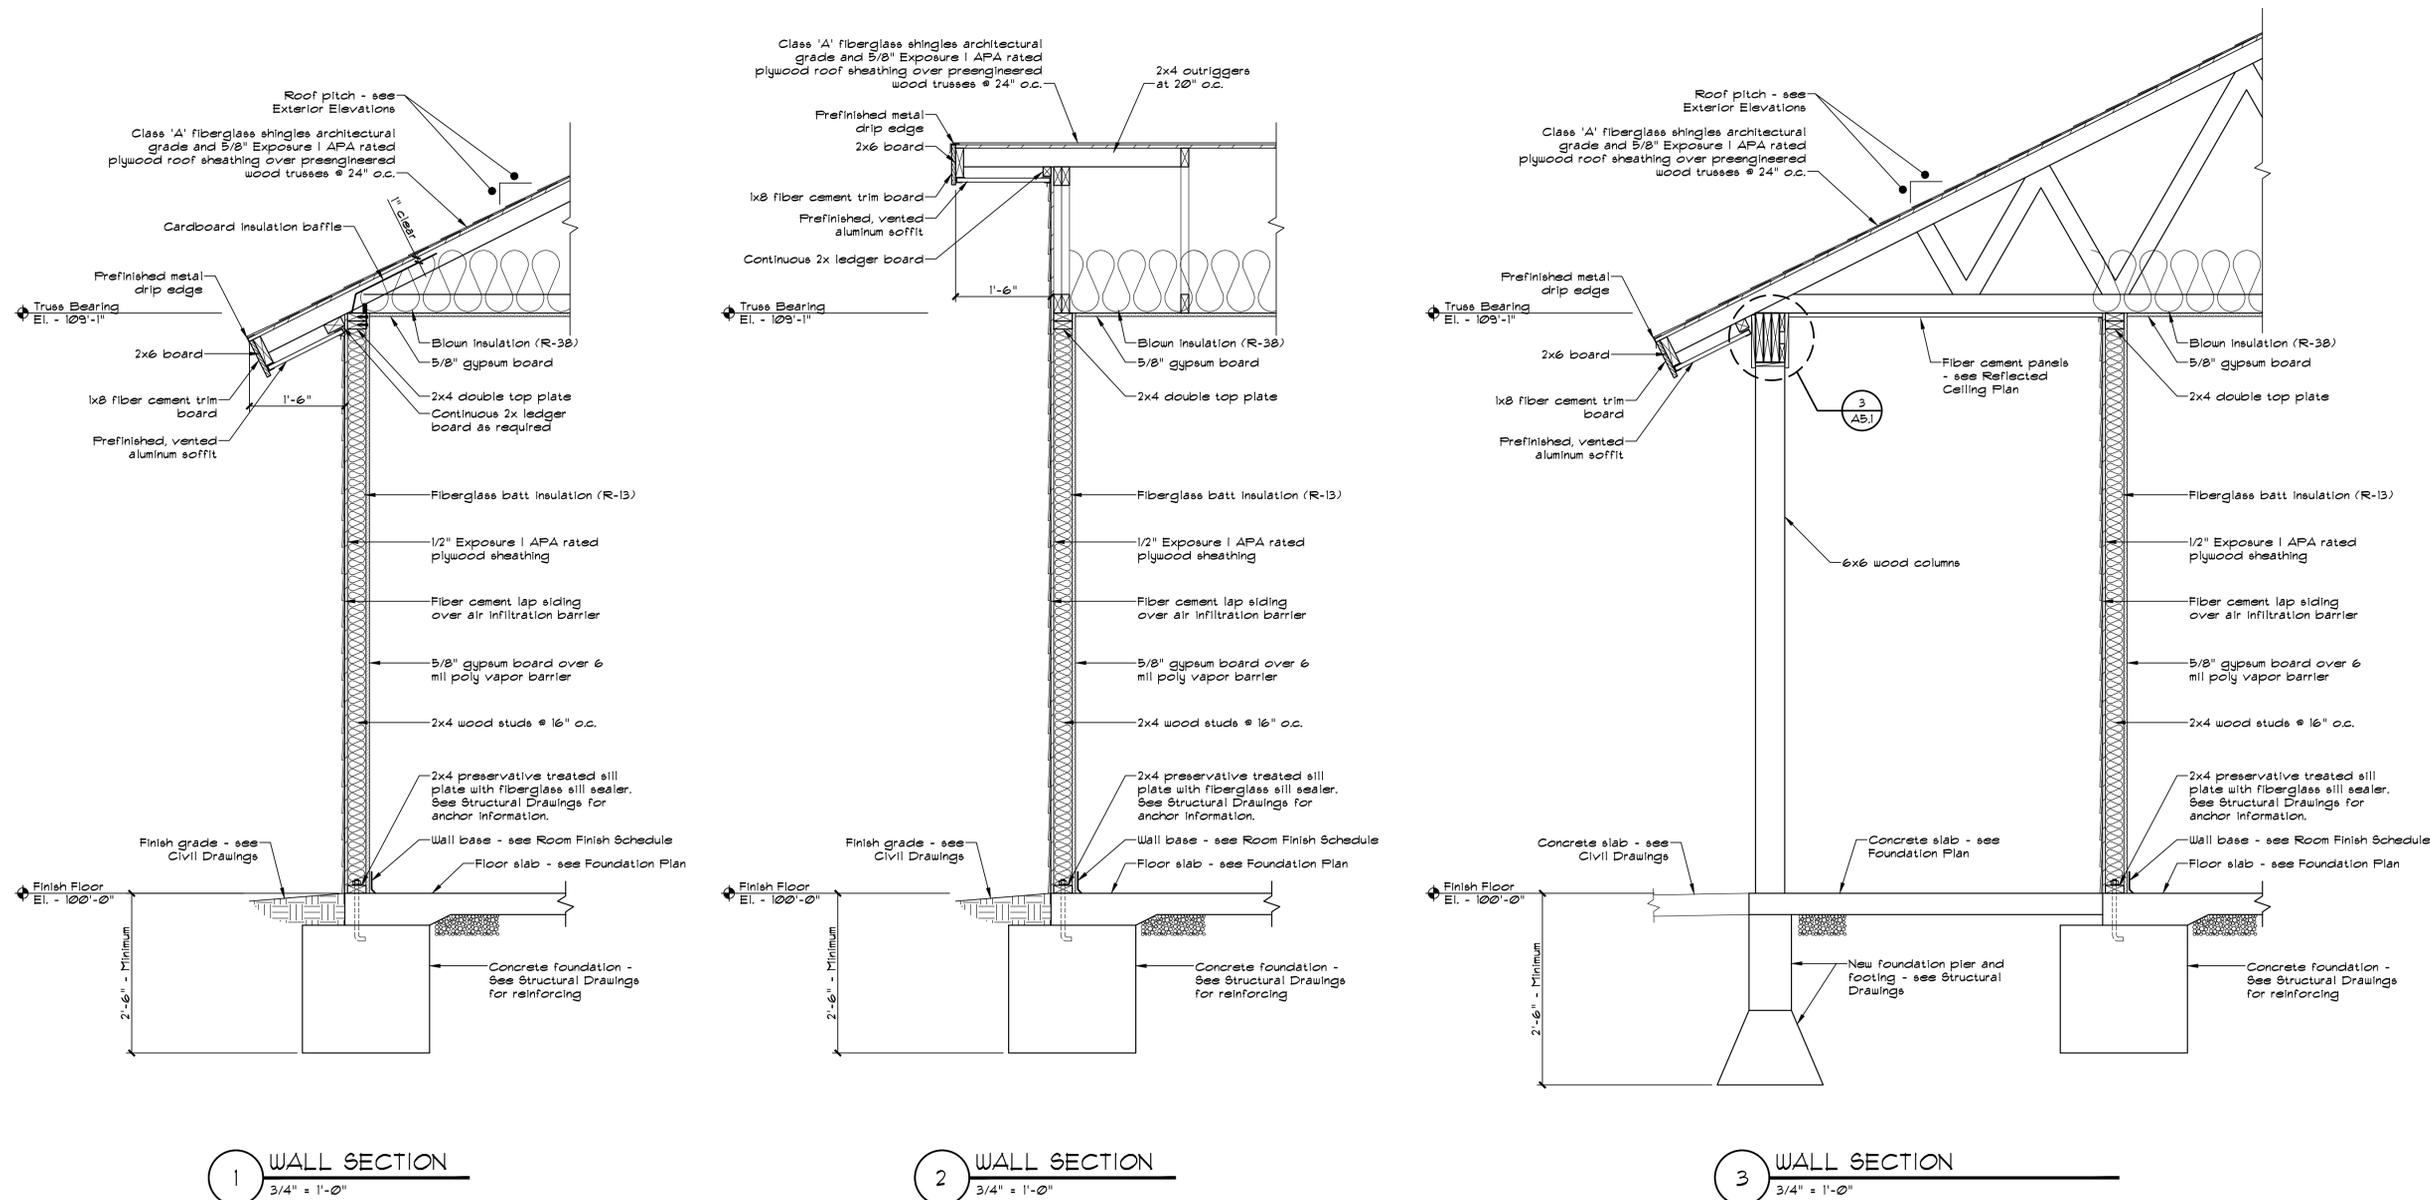
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DRAWN BY: AMS
CHECKED BY: JAM
DESIGNED BY: JAM

SHEET TITLE:
FLOOR PLAN
& ELEVATIONS

SHEET NUMBER:

A-2

43 OF 56 SHEETS
03/28/2025





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Architecture
Site Development
General Consulting
Master Planning



Missouri State Certificate
of Authority Numbers:
Survey : 003580
Engineering : 001655
Architecture : 2002014240

OFFICE OF ADMINISTRATION
DIVISION OF FACILITIES
MANAGEMENT,
DESIGN AND CONSTRUCTION

DEPARTMENT OF
NATURAL RESOURCES
MISSOURI STATE PARKS

NEW PREMIUM 63 SITE
LOOP CAMPGROUND

ST. FRANCOIS STATE PARK
8920 US-67N
BONNE TERRE, MO 63628

PROJECT # X2317-01
SITE # 5216
ASSET # 7815216025

REVISION: _____
DATE: _____
REVISION: _____
DATE: _____
REVISION: _____
DATE: _____

ISSUE DATE: 03/28/2025

CAD DWG FILE: X2317-A-A1
DRAWN BY: AMS
CHECKED BY: JAM
DESIGNED BY: JAM

SHEET TITLE:
INTERIOR
ELEVATIONS

SHEET NUMBER:

A-3


44 OF 56 SHEETS
03/28/2025

HARDWARE SCHEDULE

Group	Manufacturer
Group 1	
3 Butt hinges 5-BB-1-4.5x4.5-6.52	Ives
1 Mortise Lockset LV3456 x ATH x 626	Schlage
1 Seal FK33BL	Femko
1 Closer 1461-3049SCN8 x D81 x US26D x thru-bolt (SPRING HCU5H Arm)	LCN
1 Weatherstripping 332CR	Femko
1 Door sweep 315CN	Femko
1 1/2" tall thermally broken ADA compliant threshold	Femko
1 Lockguard LG13	Ives
1 Drip edge	Femko

Group 2	
3 Butt hinges 5-FB-1-4.5x4.5-6.52	Ives
1 Storeroom Lockset ND80PD x ATH x 626	Schlage
1 Weatherstripping 332CR	Femko
1 Door sweep 315CN	Femko
1 1/2" tall thermally broken ADA compliant threshold	Femko
1 Lockguard LG13	Ives
1 Door holder 4 stop 494R	Rockwood
1 Drip edge	Femko

NOTES
1. All hardware shall be lever type, handicap accessible.
2. Locksets with keys shall be keyed as directed by the Owner. The hardware supplier shall coordinate keying with the Owner.
3. See Specifications for additional requirements and acceptable alternate manufacturers.

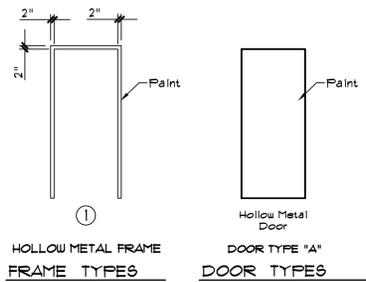

DOOR SCHEDULE

Door Number	Door Type	Door Size	Door Mat'l	HDUE Group	Frame Type	Frame Finish	Door Finish	UL Rating	Notes
100	A	3'-0" x 7'-0" x 1 3/4"	HM	1	1	P	P		Note 1
101	A	3'-0" x 7'-0" x 1 3/4"	HM	2	1	P	P		Note 1
102	A	3'-0" x 7'-0" x 1 3/4"	HM	1	1	P	P		Note 1
103	A	3'-0" x 7'-0" x 1 3/4"	HM	1	1	P	P		Note 1
104	A	3'-0" x 7'-0" x 1 3/4"	HM	1	1	P	P		Note 1
105	A	3'-0" x 7'-0" x 1 3/4"	HM	1	1	P	P		Note 1

NOTES
1. Galvanized and insulated door

ABBREVIATION LEGEND
P Paint (field) EX Existing
HM Hollow Metal

ROOM FINISH SCHEDULE

ROOM NO.	ROOM NAME	FLOOR	BASE	WALLS				CEILING	REMARKS
				NORTH	EAST	WEST	SOUTH	MAT'L	
100	Family Restroom	Conc	-	FRP	FRP	FRP	FRP	GB	
101	Mechanical Room	Conc	VB	FRP	FRP	FRP	FRP	GB	
102	Restroom	Conc	-	FRP	FRP	FRP	FRP	GB	
103	Restroom	Conc	-	FRP	FRP	FRP	FRP	GB	
104	Shower Room	Conc	-	FRP	FRP	FRP	FRP	GB	
105	Shower Room	Conc	-	FRP	FRP	FRP	FRP	GB	


NOTES
1. All colors and finishes as selected by Owner.

ABBREVIATION LEGEND
GB Gypsum Board EX Existing
Conc Concrete PAINT Paint
FRP Fiberglass Reinforced Plastic Panels VB Vinyl Base


TOILET ACCESSORY SCHEDULE

NO.	DESCRIPTION	MATERIAL	FINISH	REMARKS
1	Mirror - with metal frame			
2	Toilet Paper Dispenser	---	---	Surface mount, by Owner (N.I.C.)
3	Grab Bar, 1 1/2" x 36"	stainless steel	satn	36" mounting height
4	Grab Bar, 1 1/2" x 42"	stainless steel	satn	36" mounting height
5	Grab Bar, 1 1/2" x 18"	stainless steel	satn	See elevations
6	Handicapped Accessible Plumbing Fixture - See PLUMBING DRAWINGS			
7	Grab Bar, 1 1/2" x 24"	stainless steel	satn	36" mounting height
8	Folding Shower Seat - 24"x16" - Barrier Free or approved equal	Teakwood	--	18" seat height


NOTES
1. Provide solid blocking where toilet partitions, grab bars, dispensers, lavatories, etc. are mounted to walls. Coordinate locations with owner provided equipment.
2. Soap & paper towel dispensers shall be mounted such that access point is located 44" above the finish floor.
3. Refer to Plumbing Drawings for fixture information.
4. All grab bars in accessible areas to be mounted to resist a 250 lbs force in any direction.
5. Coordinate each toilet accessory mounting with each wall type and finish schedule.

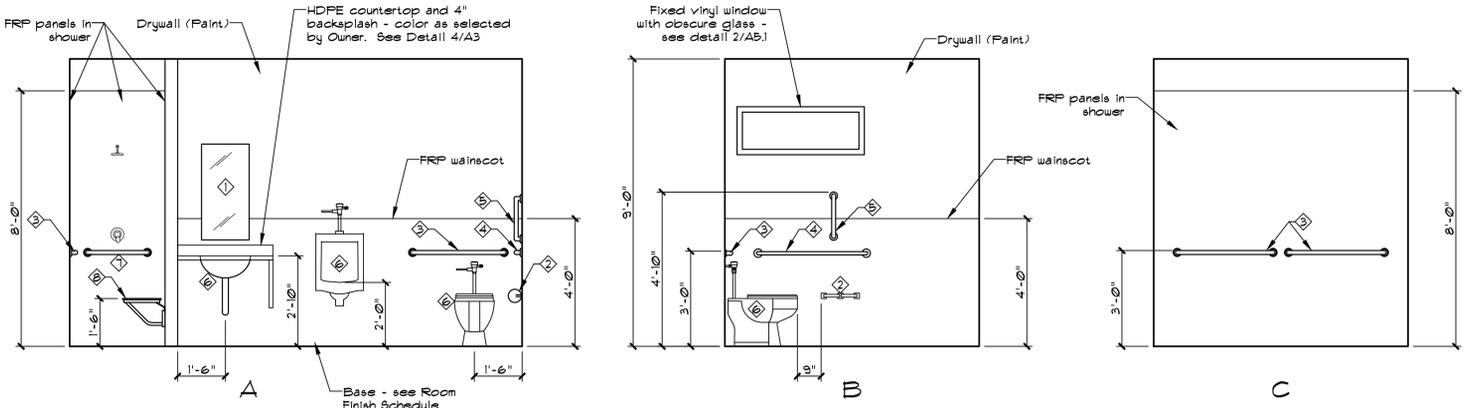

ELEVATIONS - FAMILY RESTROOM (100)



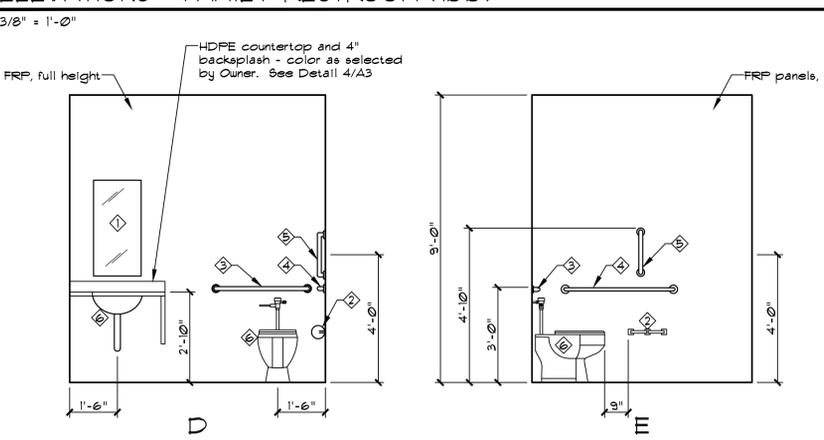


ELEVATIONS - RESTROOM (102)



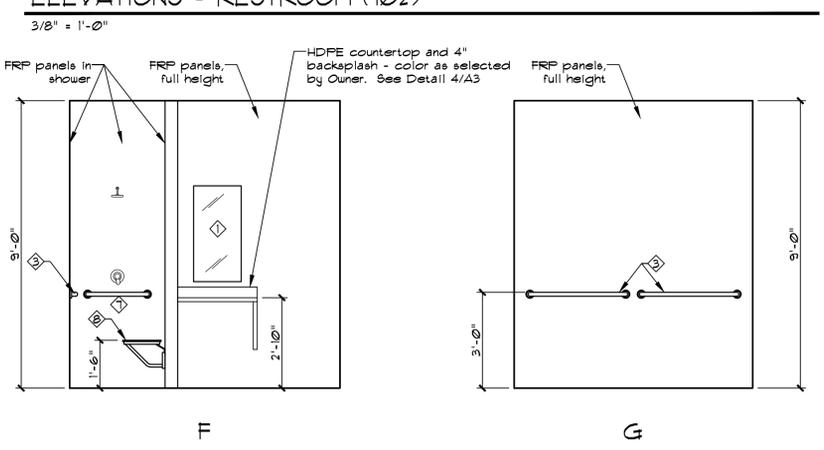


ELEVATIONS - SHOWER ROOM (104)


3/8" = 1'-0"

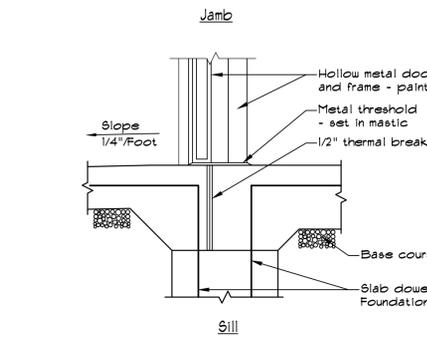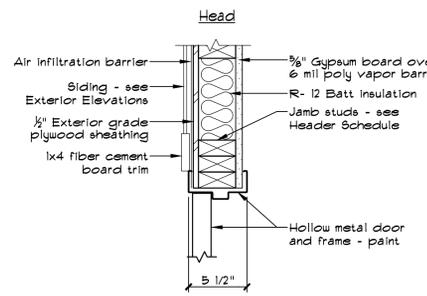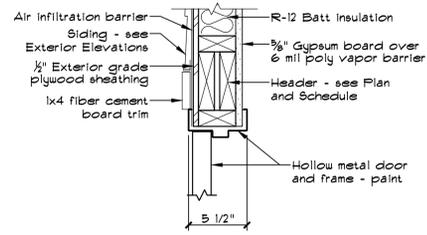


1 EXTERIOR HOLLOW METAL DOOR DETAILS
1 1/2" = 1'-0"

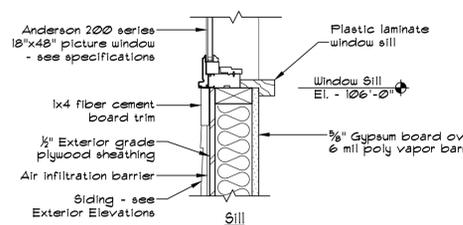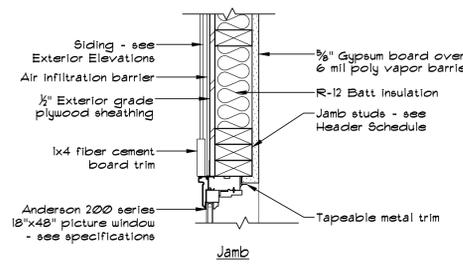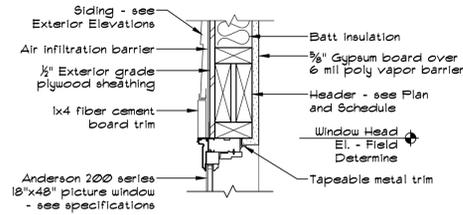


2 WINDOW DETAILS
1 1/2" = 1'-0"

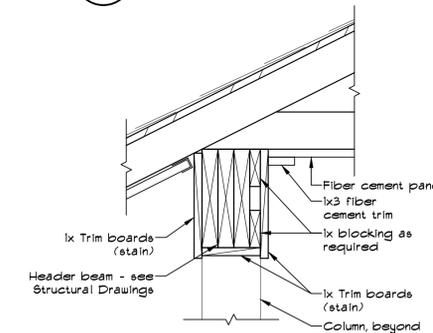


3 PORCH HEADER DETAIL
1 1/2" = 1'-0"

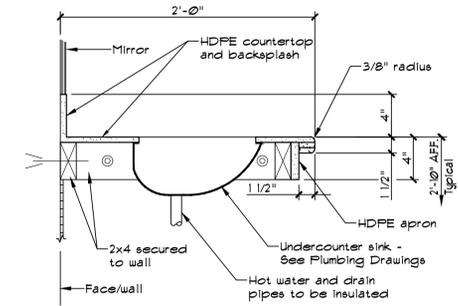

4 LAVATORY SECTION
1 1/2" = 1'-0"

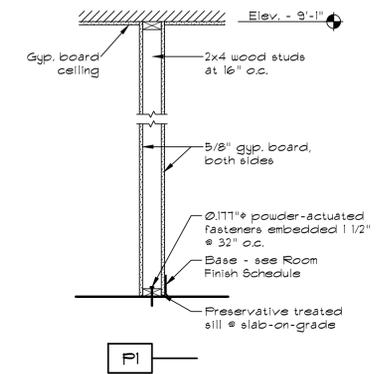

PARTITION TYPES
3/4" = 1'-0"

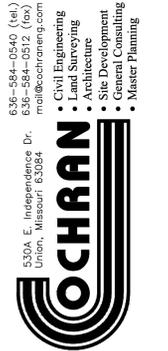

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DETAILS

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A-4

45 OF 56 SHEETS
03/28/2025

STRUCTURAL ABBREVIATIONS

Table with 2 columns: Abbreviation and Full Name. Includes # POUND(S), NUMBER; & AND; (E) EXISTING; @ AT; AB ANCHOR BOLT (S); ADDL ADDITIONAL; ALT ALTERNATE; ARCH ARCHITECT(URAL); B/FTG BOTTOM OF FOOTING; BLDG BUILDING; BLKG BLOCKING; BM BEAM; BMD BOTTOM OF METAL DECK; BN BOUNDARY NAIL; BOT BOTTOM; BP BASE PLATE; BRG BEARING; BS BOUNDARY SCREW; BTWN BETWEEN; CANT CANTILEVER(ED); CFS COLD-FORMED STEEL; CIP CAST-IN-PLACE; CJ CONTROL OR CONST JOINT; CL CENTER LINE; CLR CLEAR; CMU CONCRETE MASONRY UNIT; COL COLUMN; CONC CONCRETE; CONN CONNECTION; CONST CONSTRUCTION; CONT CONTINUOUS; CTR CENTER; DBA DEAD BAR ANCHOR; DBL DOUBLE; DC DEMAND CRITICAL (WELD); deg DEGREE; DET DETAIL(S); DF DOUGLAS FIR; DFL DOUGLAS FIR LARCH; dia DIAMETER; DIM DIMENSION; DWG DRAWING; DWL DOWEL; EA EACH; EE EACH END; EF EACH FACE; EL ELEVATION; ELEV ELEVATOR; EMB EMBEDMENT; EN EDGE NAIL; EOJ END OF JOIST; EOS EDGE OF SLAB; EQ EQUAL; ETC ET CETERA; EW EACH WAY; EXP EXPANSION; EXT EXTERIOR; FDN FOUNDATION; FF FINISH FLOOR; FIN FLR FINISH FLOOR; FLR FLOOR; FRMG FRAMING; FRT FIRE-RETARDANT TREATED; FS FAR SIDE; FTG FOOTING; FV FIELD VERIFY; ga GAUGE; GALV GALVANIZE(D); GLB GLULAM BEAM; HDR HEADER; HGR HANGER; HK HOOK; HORIZ HORIZONTAL; HSS HOLLOW STRUCTURAL SECTION

STRUCTURAL ABBREVIATIONS

Table with 2 columns: Abbreviation and Full Name. Includes INT INTERIOR; ISF INSIDE FACE; J/BRG JOIST BEARING; JG JOIST GIRDER; JG/BRG JOIST GIRDER BEARING; JST JOIST; JT JOINT; kip 1,000 POUNDS; ksi kips PER SQUARE INCH; LB POUND; LLH LONG LEG HORIZONTAL; LLV LONG LEG VERTICAL; MAX MAXIMUM; MECH MECHANICAL; MEZZ MEZZANINE; MFR MANUFACTURER; MIN MINIMUM; MISC MISCELLANEOUS; MTL METAL; NS NEAR SIDE; NTS NOT TO SCALE; oc ON CENTER; OH OPPOSITE HAND; OPNG OPENING; OSF OUTSIDE FACE; PAF POWER-ACTUATED FASTENER; PARA PARAPET; PEMB PRE-ENGINEERED METAL BUILDING (MANUFACTURER); PIL PILASTER; PL PLATE; PLBG PLUMBING; PLYWD PLYWOOD; psf POUNDS PER SQUARE FOOT; psi POUNDS PER SQUARE INCH; PTDF PRESSURE TREATED DOUGLAS FIR; PTDFL PRESSURE TREATED DOUGLAS FIR LARCH; PTSPF PRESSURE TREATED SPRUCE PINE FIR; PTSYP PRESSURE TREATED SOUTHERN YELLOW PINE; QT QUANTITY; REINF REINFORCED, REINFORCING; REQD REQUIRED; RTU ROOF TOP UNIT; SCHED SCHEDULE; SD SNOW DRIFT; SHTG SHEATHING; SIM SIMILAR; SL SNOW LOAD; SPF SPRUCE PINE FIR; STD STANDARD; STL STEEL; STRUC STRUCTURAL; SYP SOUTHERN YELLOW PINE; T&B TOP AND BOTTOM; T&G TONGUE AND GROOVE; T/BRG TRUSS BEARING; T/CONC TOP OF CONCRETE; T/FTG TOP OF FOOTING; T/PAN TOP OF PANEL; T/PARA TOP OF PARAPET; T/PIL TOP OF PILASTER; T/S TOP OF SLAB; T/STL TOP OF STEEL; TYP TYPICAL; UNO UNLESS NOTED OTHERWISE; USGS US GEOLOGICAL SURVEY; VAR VARIES; VERT VERTICAL; w/ WITH; WHS WELDED HEADED STUD(S); WP WORK POINT; WWR WELDED WIRE REINFORCEMENT

BUILDING CODES AND STANDARDS USED FOR DESIGN

- 1. INTERNATIONAL BUILDING CODE 2018 EDITION
ASCE 7-16
OCCUPANCY CATEGORY: II
DESIGN LOADS
1. DESIGN LOADS
ROOF LIVE LOAD: 20 psf
ROOF DEAD LOAD: 20 psf
2. SNOW LOAD DESIGN CRITERIA
SNOW LOAD IMPORTANCE FACTOR, I: 1.0
GROUND SNOW LOAD, Pg: 20 psf
FLAT ROOF SNOW LOAD, Pf: 13.6 psf
THERMAL FACTOR, Ct: 1.0
EXPOSURE FACTOR, Ce: 1.0
MINIMUM FROST DEPTH: 2'-6"
3. WIND LOAD DESIGN CRITERIA
WIND IMPORTANCE FACTOR, I: 1.0
ULTIMATE WIND SPEED: 108 MPH (3 SEC GUST)
WIND EXPOSURE CATEGORY: C
WIND ENCLOSURE CLASSIFICATION: ENC
Gcpi: +/- 0.18
4. SEISMIC LOAD DESIGN CRITERIA
REDUNDANCY FACTOR, rho: 1.3
SEISMIC IMPORTANCE FACTOR, I: 1.0
SITE CLASS: D
SPECTRAL RESPONSE ACCELERATIONS: Ss=0.510g, S1=0.192g, Sds=0.473g, Sd1=0.284g
SEISMIC DESIGN CATEGORY: LFWWWWSP
BASIC SEISMIC-FORCE RESISTING SYSTEM: 6.5
RESPONSE MODIFICATION FACTOR, R: 2.5
SYSTEM OVER-STRENGTH FACTOR, Omega: 4
DEFLECTION AMPLIFICATION FACTOR, Cd: 0.073
SEISMIC RESPONSE COEFFICIENT, Cs: EQUIVALENT LATERAL FORCE
ANALYSIS PROCEDURE USED:

GENERAL STRUCTURAL NOTES

- 1. THIS DRAWING SET IS TO BE VIEWED AS A WHOLE AND COORDINATED WITH ARCHITECTURAL, MECHANICAL, CIVIL, AND OTHER DISCIPLINES. ALL WORK PERTAINING TO A SPECIFIC CONTRACTOR MAY OR MAY NOT BE SHOWN ON SPECIFIC DRAWING SECTIONS. IT IS EACH SUBCONTRACTOR'S RESPONSIBILITY TO PREPARE HIS BID FROM A COMPLETE SET OF PLANS.
2. THE CONTRACTOR SHALL FOLLOW WRITTEN DIMENSIONS ONLY. DO NOT SCALE DRAWINGS. DIMENSIONS NOT SHOWN ON PLAN TO BE COORDINATED WITH ARCHITECTURAL PLANS.
3. ALL DETAILS AND SECTIONS SHOWN ON THE DRAWINGS ARE INTENDED TO BE TYPICAL AND SHALL APPLY AT ANY SIMILAR SITUATION ELSEWHERE ON THE JOB, EXCEPT WHERE A DIFFERENT DETAIL OR SECTION IS SHOWN.
4. THE STRUCTURE SHALL BE ADEQUATELY BRACED AND SHORED DURING ERECTION AGAINST WIND AND ERECTION LOADS. STRUCTURAL MEMBERS ARE DESIGNED FOR "IN-PLACE" LOADS ONLY.
5. THE GENERAL CONTRACTOR SHALL VERIFY ALL OPENING SIZES, PAD SIZES, AND LOCATIONS WITH THE RESPECTIVE CONTRACTORS.
6. THE CONTRACTOR SHALL NOTIFY THE ARCHITECT AND ENGINEER IMMEDIATELY OF ANY DISCREPANCIES BETWEEN CONSTRUCTION DOCUMENTS AND ACTUAL FIELD CONDITIONS.
7. THE VARIOUS SUBCONTRACTORS ARE RESPONSIBLE FOR PLACING SLEEVES, OUTLET BOXES, ANCHORS, VENT OPENINGS, ETC. THAT MAY BE REQUIRED IN FOUNDATION WALLS. CONSTRUCTION MANAGER SHALL COORDINATE ALL PLACEMENT OF ITEMS IN FOUNDATION WALLS.
8. SEE ARCHITECTURAL PLANS FOR ADDITIONAL DETAILS AND INFORMATION.
9. ALL ELEVATIONS GIVEN ARE REFERENCED TO FINISHED FLOOR ELEVATIONS AT 100'-0", UNLESS SHOWN AS USGS ELEVATIONS.
10. WHERE GENERAL NOTES OR TYPICAL DETAILS CONTRADICT INFORMATION PROVIDED IN BUILDING SECTIONS, THE BUILDING SECTIONS TAKE PRECEDENCE.
11. WHERE INFORMATION PROVIDED IN THESE STRUCTURAL DRAWINGS CONTRADICTS INFORMATION PROVIDED IN PROJECT SPECIFICATIONS, THE SPECIFICATIONS SHALL TAKE PRECEDENCE.
12. FOR ARCHITECTURAL, MEP, & STRUCTURAL COORDINATION: MODELED ELEMENTS SHOWN ON STRUCTURAL DRAWINGS SUCH AS TRUSSES, OPEN-WEB JOISTS, AND JOIST GIRDERS, ARE NOT THE FINAL CONFIGURATION. ALL COORDINATION SHALL BE PERFORMED BETWEEN THE VARIOUS TRADES AND THE SUPPLIERS OF THESE ELEMENTS FOR THE STRUCTURE, NOT WITH THE STRUCTURAL MODEL.
13. THIS DRAWING SET IS TO BE VIEWED AS A WHOLE. ALL TYPICAL DETAILS AND GENERAL NOTES SHOWN IN THESE DRAWINGS ARE APPLICABLE TO THE PROJECT EVEN IF THEY ARE NOT SHOWN ON PLANS OR SECTIONS.
14. DESIRED ALTERATIONS TO ANY DETAIL, MEMBER SIZE, MEMBER TYPE, OR ANY OTHER STRUCTURAL COMPONENT SHOWN ON THE DRAWINGS, SHALL BE SUBMITTED AS A REQUEST IN WRITING TO CASE ENGINEERING. CASE ENGINEERING WILL NOT BE RESPONSIBLE FOR CHANGES TO THE DESIGN OR DETAILS MADE DURING SHOP DRAWINGS DEVELOPMENT, DURING CONSTRUCTION, OR AT ANY OTHER TIME WITHOUT WRITTEN CONSENT.

DEFERRED SUBMITTALS

THE FOLLOWING DESIGN ELEMENTS MUST BE SIGNED & SEALED BY A PROFESSIONAL ENGINEER (PE/SE) REGISTERED IN THE STATE WHERE THIS PROJECT IS LOCATED, AND SUBMITTED TO THE ARCHITECT AND ENGINEER OF RECORD. DESIGNED DRAWINGS AND CALCULATIONS SHALL BE SUBMITTED FOR REVIEW AND RECORD.

- 5. PRE-FABRICATED WOOD TRUSS CALCULATIONS AND FABRICATION DRAWINGS INCLUDING:
A. ALL TRUSS-TO-TRUSS CONNECTIONS
B. PLAN AND DETAILS FOR THE LOCATIONS OF ALL ERECTION/TEMPORARY AND PERMANENT LATERAL AND DIAGONAL BRACING AND/OR BLOCKING.
C. FRAMING PLAN LAYOUT (DIMENSIONED AND TO SCALE).
D. EACH TRUSS SHALL BE LEGIBLY BRANDED, MARKED, OR OTHERWISE HAVE PERMANENTLY AFFIXED THERETO THE FOLLOWING INFORMATION LOCATED WITHIN 2 FEET OF THE CENTER OF THE SPAN ON THE FACE OF THE BOTTOM CHORD.
a. IDENTITY OF THE COMPANY MANUFACTURING THE TRUSS
b. DESIGN LOADS
c. TRUSS SPACING

EXCAVATION AND EARTHWORK NOTES

- 1. THE BEARING VALUE AND LATERAL EARTH PRESSURES OF THE SOILS IS PER CONSERVATIVE VALUES FROM IBC. THE FOUNDATION DESIGN IS BASED ON THE FOLLOWING NET ALLOWABLE BEARING AND LATERAL EARTH PRESSURES:
• SPREAD FOOTINGS 1,500 psf
• CONT. WALL FOOTINGS 1,500 psf
• ACTIVE PRESSURE 35 psf/ft
• AT-REST PRESSURE 60 psf/ft
• PASSIVE PRESSURE 250psf/ft
• FRICTION COEFFICIENT 0.25
2. ALL FOOTING EXCAVATIONS SHALL BE INSPECTED, PRIOR TO CONCRETE PLACEMENT, BY A SOILS ENGINEER TO VERIFY SUITABLE BEARING MATERIAL OF CAPACITY AS SPECIFIED.
3. NOTIFY THE OWNER'S REPRESENTATIVE WHEN ADDITIONAL EXCAVATION IS REQUIRED TO REACH SUITABLE BEARING MATERIAL.
4. THE SOILS ENGINEER SHALL CERTIFY IN WRITING THAT ALL FOUNDATIONS WERE PLACED ON SOIL WITH THE BEARING VALUE AS SPECIFIED.
5. WITHIN THE EXCAVATION AREA OF FOUNDATIONS, ALL VEGETATION, TOPSOIL, PREVIOUSLY PLACED FILL AND UNSUITABLE SOILS SHALL BE REMOVED. ALL FOOTINGS TO BEAR ON VIRGIN SOIL OR PROPERLY PLACED AND COMPACTED ENGINEERED FILL. FOUNDATION DESIGN DOES NOT ACCOUNT FOR WINTER CONSTRUCTION. ANY UNENCLOSED / UNHEATED SPACES SHALL BE ADEQUATELY PROTECTED AGAINST FROST DURING WINTER CONSTRUCTION BY THE CONTRACTOR.
6. IF ANY SOFT SPOTS, OR AREAS QUESTIONABLE FOR ANY REASONS ARE ENCOUNTERED BY THE CONTRACTOR, ARCHITECT/ENGINEER SHALL BE NOTIFIED IMMEDIATELY SO THAT ANY REQUIRED ACTION MAY BE TAKEN PRIOR TO CONTINUATION OF CONSTRUCTION IN THAT AREA.

POST-INSTALLED ANCHOR NOTES

- POST-INSTALLED ANCHORS SHALL ONLY BE USED WHERE SPECIFIED ON THE CONSTRUCTION DOCUMENTS. THE CONTRACTOR SHALL OBTAIN APPROVAL FROM THE ENGINEER OF RECORD PRIOR TO INSTALLING POST-INSTALLED ANCHORS IN PLACE OF MISSING OR MISPLACED CAST-IN-PLACE ANCHORS. CARE SHALL BE TAKEN IN PLACING POST-INSTALLED ANCHORS TO AVOID CONFLICTS WITH EXISTING REBAR. HOLES SHALL BE DRILLED AND CLEANED IN ACCORDANCE WITH THE MANUFACTURER'S WRITTEN INSTRUCTIONS. SUBSTITUTION REQUESTS FOR PRODUCTS OTHER THAN THOSE SPECIFIED ON THESE DRAWINGS SHALL BE SUBMITTED BY THE CONTRACTOR TO THE ENGINEER OF RECORD ALONG WITH CALCULATIONS THAT ARE PREPARED & SEALED BY A REGISTERED PROFESSIONAL ENGINEER. THE CALCULATIONS SHALL DEMONSTRATE THAT THE SUBSTITUTED PRODUCT IS CAPABLE OF ACHIEVING, AT A MINIMUM, THE PERTINENT EQUIVALENT PERFORMANCE VALUES OF THE SPECIFIED PRODUCT USING THE BUILDING CODE.
1. TYPICAL POST-INSTALLED ANCHORS IN CONCRETE AND CMU SHALL COMPLY WITH THE LATEST OF THEIR RESPECTIVE ICC EVALUATION REPORTS.
2. WHEN INSTALLING ANCHORS IN CONCRETE AND CMU, CONTRACTOR SHALL LOCATE EXISTING REINFORCING STEEL, CONDUITS, ETC. PRIOR TO DRILLING FOR ANCHORS. CONTRACTOR SHALL USE CARE AND CAUTION TO PREVENT DAMAGE TO EXISTING REINFORCING BARS.
3. CONTRACTOR SHALL PROVIDE 1" MINIMUM CLEARANCE BETWEEN EDGES OF ANY HOLES FOR POST-INSTALLED ANCHORS AND EXISTING REINFORCING STEEL.
4. CONTRACTOR SHALL PROVIDE INSPECTION AND TESTING AS REQUIRED PER THE "SPECIAL INSPECTIONS" SECTION OF THESE GENERAL STRUCTURAL NOTES.
5. CONTRACTOR SHALL USE A HOLLOW DRILL BIT AND VACUUM SYSTEM WHEN DRILLING INTO CEMENTITIOUS MATERIALS.

WOOD FRAMING NOTES

- 1. WOOD FRAMING SHALL CONFORM TO THE "LUMBER TABLE" UNLESS NOTED OTHERWISE.
2. FOR WOOD FASTENING REQUIREMENTS, REFER TO TABLE 2304.9.1 FOR IBC 2012 AND OLDER, OR TABLE 2304.10.1 FOR IBC 2015 AND NEWER.
3. ALL NAILS SHALL BE GALVANIZED COMMON WIRE NAILS UNLESS OTHERWISE NOTED. SEE "WOOD FASTENER TYPES SCHEDULE" FOR MINIMUM FASTENER DIMENSIONS. NAILS IN CONTACT WITH FIRE RETARDANT TREATED OR PRESSURE TREATED WOOD SHALL BE HOT-DIP GALVANIZED (ASTM A153) OR STAINLESS STEEL (TYPE 304 OR 316), WHEN REQUIRED TO PREVENT SPLITTING, PRE-DRILL FOR NAILS WITH 1/8" DIAMETER DRILL BIT.
4. BOLTS AND LAG SCREWS SHALL CONFORM TO ASTM A307 AND ANSI/ASME STANDARD B18.2.1-1981, AND SHALL BE GALVANIZED. BOLTS AND LAG SCREWS IN CONTACT WITH FIRE RETARDANT TREATED OR PRESSURE TREATED WOOD SHALL BE HOT-DIP GALVANIZED (ASTM A153) OR STAINLESS STEEL (TYPE 304 OR 316). STANDARD WASHERS SHALL BE PROVIDED UNDER HEAD AND NUT OF ALL BOLTS IN WOOD FRAMING. BOLT THREADS SHALL NOT BEAR ON WOOD. DRILLED HOLES FOR BOLTS SHALL BE 1/16" LARGER IN DIAMETER THAN BOLT.
5. ALL BOLTS SHALL BE RETIGHTENED IMMEDIATELY PRIOR TO CLOSING IN FRAMING. METAL FRAMING CONNECTORS SHALL BE "SIMPSON" BRAND OR ENGINEERED APPROVED EQUIVALENT AND SHALL BE GALVANIZED. METAL FRAMING CONNECTORS IN CONTACT WITH FIRE RETARDANT TREATED OR PRESSURE TREATED WOOD SHALL BE HOT-DIP GALVANIZED (ASTM A123) OR STAINLESS STEEL (TYPE 316L). METAL FRAMING CONNECTORS SHALL BE INSTALLED IN ACCORDANCE WITH THE MANUFACTURER'S LATEST PUBLISHED INSTALLATION INSTRUCTIONS USING THE LARGER SIZE AND QUANTITY OF FASTENERS INDICATED, UNLESS OTHERWISE NOTED.
6. WASHERS USED IN SHEAR WALLS AND ANCHOR HOLD DOWNS SHALL BE SQUARE WASHERS OF SIZE AND THICKNESS INDICATED IN "SHEAR WALL SHEATHING AND FASTENER SCHEDULE". ROUND WASHERS ARE NOT ACCEPTABLE FOR SHEAR WALL APPLICATIONS.
7. ALL BOLTS, WASHERS, NAILS, METAL FRAMING CONNECTORS AND OTHER FASTENERS IN CONTACT WITH PRESERVATIVE OR FIRE RETARDANT TREATED LUMBER SHALL BE HOT-DIPPED GALVANIZED (ASTM A153) OR STAINLESS STEEL (TYPE 304 OR 316). THE CONTRACTOR SHALL BE RESPONSIBLE FOR ENSURING THAT WOOD USED FOR STRUCTURAL PURPOSES IS KEPT AS DRY AS POSSIBLE BEFORE AND DURING CONSTRUCTION. A MAXIMUM MOISTURE CONTENT SHALL BE MAINTAINED UNTIL THE BUILDING ENVELOPE IS CLOSED IN AND WATER-PROOFED AS FOLLOWS:
A. KILN-DRIED LUMBER: 19%
B. TIMBERS: 19%
C. GLULAM BEAMS: 16%
D. LVL & PSL: 12%
E. PLYWOOD: 8%
F. OSB: 4%
8. ALL WOOD IN CONTACT WITH CONCRETE OR MASONRY SHALL BE PRESSURE-TREATED. ALL WOOD EXPOSED TO WEATHER SHALL BE PRESSURE-TREATED. PRESSURE TREATMENT OF WOOD THAT IS CUT SHALL BE REINSTATED ON CUT EDGES.

PRE-FABRICATED WOOD TRUSS NOTES

- 1. DESIGN AND FABRICATION SHALL BE IN ACCORDANCE WITH THE TRUSS PLATE INSTITUTE PUBLICATION "DESIGN SPECIFICATION FOR METAL PLATE CONNECTED WOOD TRUSSES", LATEST EDITION.
2. PROVIDE ALL PERMANENT TRUSS BRACING INDICATED ON DRAWINGS OR SPECIFIED BY TRUSS MANUFACTURER. IN ADDITION, PROVIDE TEMPORARY BRACING AS INDICATED IN THE TRUSS PLATE INSTITUTE BOOKLET "BRACING WOOD TRUSSES: COMMENTARY AND RECOMMENDATIONS BWT-76".
3. NO FIELD MODIFICATIONS OF TRUSSES ARE PERMITTED UNLESS FABRICATOR PROVIDES CALCULATIONS AND DRAWINGS SHALL BE SIGNED AND SEALED BY A REGISTERED ENGINEER (REGISTERED IN THE STATE WHERE THE PROJECT IS LOCATED).
4. REFER TO "DEFERRED SUBMITTALS" FOR ADDITIONAL REQUIREMENTS.

Table with 2 columns: Member and Specifications. Title: PRE-FABRICATED WOOD ROOF TRUSSES - DESIGN CRITERIA TABLE. Rows include TOP CHORD, BOTTOM CHORD, WIND UPLIFT, LOAD DURATION FACTOR, TRUSS SPACING, DEFLECTION LIMITS, CAMBER.

Table with 3 columns: Member, Species, Grade. Title: LUMBER TABLE. Rows include 2x PLATES, STRIPPING, MISC CONCEALED FRAMING, BLKG, & FIRE STOPPING; SILLS ON CONCRETE OR MASONRY; 2x LUMBER; TIMBER 5x5 AND LARGER; SHEAR WALL SHEATHING; ROOF SHEATHING.

Table with 3 columns: Type, Diameter, Length. Title: WOOD FASTENER TYPES SCHEDULE. Includes notes on manufacturing and installation. Rows include 16d COMMON, 10d COMMON, 8d COMMON, #9 SD SCREW, #10 SD SCREW, SDS SCREW.

SHOP DRAWING AND SUBMITTAL NOTES

- 1. SHOP DRAWINGS AND/OR SUBMITTALS SHALL BE FURNISHED FOR ALL STRUCTURAL COMPONENTS. UNLESS OTHERWISE NOTED, THESE SHALL BE SUBMITTED FOR REVIEW PRIOR TO FABRICATION IN ACCORDANCE WITH THESE CONTRACT DRAWINGS AND PROJECT SPECIFICATIONS (IF APPLICABLE). CONTRACTOR SHALL ALLOW A MINIMUM OF 2 WEEKS FROM RECEIPT OF SHOP DRAWINGS FOR CASE ENGINEERING INC. TO PROVIDE RESPONSE.
2. PRIOR TO SUBMITTAL TO THE ENGINEER, THE CONTRACTOR AND ARCHITECT SHALL HAVE REVIEWED THE SHOP DRAWINGS AND MADE ANY CORRECTIONS REQUIRED. THE CONTRACTOR AND ARCHITECT SHALL STAMP THE DRAWINGS, INDICATING THE SUBMITTAL HAS BEEN REVIEWED.
3. STRUCTURAL DRAWINGS ARE THE SOLE PROPERTY OF CASE ENGINEERING. REPRODUCTION OF STRUCTURAL DRAWINGS FOR USE IN SHOP DRAWING SUBMITTALS IS NOT ACCEPTABLE WITHOUT OUR WRITTEN AGREEMENT.

STATE OF MISSOURI
MICHAEL L. PARSON,
GOVERNOR



PROFESSIONAL SEAL



OFFICE OF ADMINISTRATION
DIVISION OF FACILITIES
MANAGEMENT, DESIGN AND
CONSTRUCTION

DEPARTMENT OF
NATURAL RESOURCES
MISSOURI STATE PARKS

NEW PREMIUM 63 SITE
LOOP CAMPGROUND

ST. FRANCOIS STATE PARK
8920 US-67N
BONNE TERRE, MO 63628

PROJECT # X2317-01
SITE # 5216
ASSET # 7815216025

REVISION:
DATE:
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REVISION:
DATE:
ISSUE DATE: 03/28/2025

CAD DWG FILE: COC-MO-16-23 RV22
DRAWN BY: AEM
CHECKED BY: SJS
DESIGNED BY: AEM

SHEET TITLE:

GENERAL NOTES

SHEET NUMBER:

S1.1

CONCRETE NOTES

- ALL CONCRETE WORK INCLUDING FORMING, REINFORCING, MIXING, PLACING, FINISHING AND CURING SHALL BE DONE IN ACCORDANCE WITH THE ACI MANUAL OF CONCRETE PRACTICE INCLUDING "BUILDING CODE REQUIREMENTS FOR STRUCTURAL CONCRETE", ACI 318, AND "SPECIFICATIONS FOR STRUCTURAL CONCRETE", ACI 301 LATEST EDITIONS. IT SHALL BE THE RESPONSIBILITY OF THE MIX DESIGN SUPPLIER TO PROPORTION MIXES APPROPRIATELY TO REACH THE REQUIRED PROPERTIES NOTED, AND SHALL BE APPROPRIATE FOR THEIR INTENDED USE. ADMIXTURES MEETING ASTM C494 ARE OPTIONAL. HOWEVER, AIR-ENTRAINING ADMIXTURES MEETING ASTM C260 SHALL BE USED FOR CONCRETE EXPOSED TO THE EXTERIOR OR FREEZE-THAW CYCLES.
- CONTRACTOR SHALL SUBMIT CONCRETE MIX DESIGNS FOR EACH INTENDED USE ON THE PROJECT FOR REVIEW AND APPROVAL BY THE ENGINEER OF RECORD. CONTENTS OF THE MIX DESIGN SHALL COMPLY WITH, AND INCLUDE ALL INFORMATION REQUIRED BY, ACI 318, CHAPTER 5 (FOR 2011 AND EARLIER CODE EDITIONS), & CHAPTER 26 (FOR 2014 CODE EDITION). THIS INCLUDES, BUT IS NOT LIMITED TO NUMBER OF TESTS AND AGE OF TESTS INCLUDED IN THE MIX DESIGN REPORT.
- ALL CONCRETE DENSITY SHALL BE NORMAL WEIGHT (145 pcf +/- 5) UNLESS OTHERWISE INDICATED. LIGHT WEIGHT CONCRETE SHALL BE 110 pcf +/- 5, UNO. FLY ASH ALLOWANCES:
 - 20% MAXIMUM BY WEIGHT OF CEMENTITIOUS IN FOOTINGS
 - 15% MAXIMUM BY WEIGHT OF CEMENTITIOUS MATERIAL IN SLABS
- COORDINATE CONCRETE WORK WITH THAT OF OTHER TRADES TO ALLOW FOR SETTING OF SLEEVES, ACCESSORIES, ETC.
- ALL REINFORCING STEEL, ANCHOR RODS, DOWELS, AND INSERTS SHALL BE WELL-SECURED IN POSITION PRIOR TO PLACING CONCRETE. DO NOT "WET SET" OR "FLOAT" INTO CONCRETE.
- TEST CYLINDERS WILL BE REQUIRED, AND RECORDS OF RESULTS SHALL BE SUBMITTED TO ENGINEER OF RECORD. PROVIDE A MINIMUM OF (4) 6"x12" CYLINDERS FOR TESTING (1 AT 7 DAYS, 2 AT 28 DAYS, ONE SPARE). ALTERNATIVELY, PROVIDE A MINIMUM (5) 4"x8" CYLINDERS FOR TESTING (1 AT 7 DAYS, 3 AT 28 DAYS, ONE SPARE). SLUMP TESTS ARE RECOMMENDED.
- CONSTRUCTION JOINTS IN CONCRETE INDICATED WITH A ROUGH, CLEAN SURFACE SHALL HAVE A 1/4" AVERAGE AMPLITUDE.
- ALL COLD JOINTS SHALL BE ROUGHENED AND CLEANED PRIOR TO PLACING CONCRETE. SLUMP: CONCRETE MIXES SHALL BE PROPORTIONED TO ACHIEVE A MAXIMUM SLUMP OF 8" FOR CONCRETE CONTAINING HIGH RANGE WATER REDUCING ADMIXTURE. 6" FOR CONCRETE CONTAINING A MID-RANGE WATER REDUCING ADMIXTURE PRE-ADDITIVE. MIXES SHALL HAVE A WATER SLUMP OF 2'-3" (3" TO 4" FOR CONCRETE RECEIVING A "DRY-SHAKE" HARDENER). MAXIMUM 4" WATER SLUMP FOR ALL OTHER CONCRETE NOT CONTAINING A WATER REDUCER.
- SELF-CONSOLIDATING CONCRETE MAY BE USED FOR ALL ARCHITECTURAL CONCRETE AND HEAVILY REINFORCED MEMBERS AS SHOWN ON THE DRAWINGS. ALL SELF-CONSOLIDATING CONCRETE SHALL CONTAIN THE SPECIFIED HIGH-RANGE WATER-REDUCING ADMIXTURE AND VISCOSITY-MODIFYING ADMIXTURE WHERE REQUIRED. MINIMUM SPREAD OF 22"-30" WHEN MEASURED IN ACCORDANCE WITH ASTM C1611 OR AS REQUIRED BY THE SUCCESSFUL TEST PLACEMENT. THE WORKABILITY, PUMPABILITY, FINISHABILITY, AND SETTING TIME OF THE PROPOSED MIX DESIGN SHALL BE VERIFIED WITH A SUCCESSFUL TEST PLACEMENT ONSITE. COMPRESSIVE STRENGTH: 5000 PSI AT 28 DAYS OR AS NOTED ON THE DRAWINGS.
- AIR CONTENT: ALL CONCRETE EXPOSED TO FREEZING AND THAWING AND/OR REQUIRED TO BE WATER TIGHT SHALL HAVE AN AIR CONTENT OF 4.5% TO 7.5%. ALL INTERIOR SLABS AND ALL SLABS TO RECEIVE DRY-SHAKE SHALL HAVE A MAXIMUM AIR CONTENT OF 3%.
- DEPOSIT AND CONSOLIDATE CONCRETE FOR FLOORS AND SLABS IN A CONTINUOUS OPERATION, WITHIN LIMITS OF CONSTRUCTION JOINTS, UNTIL PLACEMENT OF A PANEL OR SECTION IS COMPLETE.
 - CONSOLIDATE CONCRETE DURING PLACEMENT OPERATIONS, SO CONCRETE IS THOROUGHLY WORKED AROUND REINFORCEMENT AND OTHER EMBEDDED ITEMS AND INTO CORNERS.
 - MAINTAIN REINFORCEMENT IN POSITION ON CHAIRS DURING CONCRETE PLACEMENT.
 - SCREED SLAB SURFACES WITH A STRAIGHT EDGE AND STRIKE OFF TO CORRECT ELEVATIONS.
 - UTILIZE A VIBRATORY SCREED FOR CONCRETE THAT WILL RECEIVE DIAMOND POLISH FINISH. KEEP VIBRATING SCREED MOVING CONTINUOUSLY ACROSS SURFACE. DO NOT STOP SCREED IN ANY ONE PLACE WHILE VIBRATING.
 - SLOPE SURFACES UNIFORMLY TO DRAINS WHERE REQUIRED.
 - BEGIN INITIAL FLOATING USING BULL FLOATS OR DARBIES TO FORM A UNIFORM AND OPEN-TEXTURED SURFACE PLANE BEFORE EXCESS BLEED WATER APPEARS ON THE SURFACE. DO NOT FURTHER DISTURB SLAB SURFACES BEFORE STARTING FINISHING OPERATIONS.
 - THE USE OF HIGHWAY STRAIGHT EDGES OR "BUMP CUTTERS" ON CONCRETE SLABS TO BE POLISHED IS PROHIBITED.
- CONCRETE TO BE POLISHED SHALL RECEIVE A HARD STEEL TROWEL FINISH WITH A MINIMUM OF (3) SEPARATE PASSES WITH POWER TROWEL TO ACHIEVE CLASS 5 FINISH AS DESCRIBED IN ACI 302R. HAND TROWELLING SHALL BE LIMITED TO ONLY THOSE AREAS NECESSARY. REFER TO ARCHITECTURAL DRAWINGS FOR ADDITIONAL INFORMATION.
 - INSPECT TROWELLING MACHINE AND REMOVE ACCUMULATED MORTAR PRIOR TO EACH PASS.
 - FINISH SURFACE SHALL BE FREE OF TROWEL MARKS, BURN MARKS AND MOTTLING. ALL CONCRETE SHALL HAVE A MINIMUM 28-DAY COMPRESSIVE STRENGTH IN ACCORDANCE WITH THE FOLLOWING:
 - AIR ENTRAINMENT IS NOT RECOMMENDED FOR SURFACES TO BE GIVEN A SMOOTH, DENSE, HARD-TROWELED FINISH. COORDINATE FINISH REQUIREMENTS WITH ARCHITECTURAL DRAWINGS AND/OR SPECIFICATIONS.

CONCRETE TABLE				
INTENDED USE	EXPOSURE CLASS	MIN 28 DAY STRENGTH (psi)	MAX WATER-CEMENT RATIO	% TOTAL AIR LIMITS
INTERIOR SLAB ON GRADE	F0	4,000	0.50	3
FOOTING & FOUNDATION WALLS	F0	4,000	0.50	4.5 TO 7.5

REINFORCING STEEL NOTES

- NON-WELDED STEEL BAR REINFORCING SHALL CONFORM TO ASTM A615, GRADE 60. WELDED STEEL BAR REINFORCING SHALL CONFORM TO ASTM A706.
- WELDING OF REINFORCING STEEL SHALL BE PERFORMED BY AWS QUALIFIED WELDERS IN CONFORMANCE WITH AWS D1.1 USING E90 ELECTRODES FOR ASTM A615 REBAR, AND E80 ELECTRODES FOR ASTM A706 REBAR UNLESS OTHERWISE NOTED ON THE DRAWINGS.
- WELDED WIRE REINFORCEMENT (WWR) SHALL BE SMOOTH WIRE PER ASTM A185 WITH MINIMUM YIELD STRENGTH, fy = 65 ksi, OR DEFORMED WIRE PER ASTM A497 WITH MINIMUM YIELD STRENGTH, fy = 70 ksi, UNLESS NOTED OTHERWISE.
- MINIMUM CONCRETE COVER FOR REINFORCING STEEL IN CAST-IN-PLACE (NON-PRESTRESSED) CONCRETE SHALL BE AS FOLLOWS UNLESS OTHERWISE NOTED ON THE DRAWINGS:
 - CONCRETE CAST AGAINST EARTH = 3"
 - CONCRETE EXPOSED TO EARTH OR WEATHER:
 - #6 BAR AND LARGER = 2"
 - #5 BAR AND SMALLER = 1 1/2"
 - CONCRETE NOT EXPOSED TO EARTH OR WEATHER (SLABS, WALLS, & JOISTS):
 - #14 BARS AND LARGER = 1 1/2"
 - #11 BARS AND SMALLER = 3/4"
 - CONCRETE NOT EXPOSED TO EARTH OR WEATHER (BEAMS & COLUMNS):
 - PRIMARY REINFORCEMENT, TIES, STIRRUPS, & SPIRALS = 1 1/2"
- ALL DETAILING, FABRICATION, AND ERECTION OF REINFORCING STEEL SHALL CONFORM TO THE LATEST EDITION OF ACI 315 (SP-66), DETAILS AND DETAILING OF CONCRETE REINFORCEMENT.
- LAP SPLICE LENGTHS FOR BARS INSTALLED IN CONCRETE AND CMU SHALL BE IN ACCORDANCE WITH THE TABLE.

DEVELOPMENT LENGTH OF STANDARD HOOKS IN CONCRETE NOTES

- VALUES IN TABLE ARE BASED ON 60ksi REBAR. FOR OTHER REBAR YIELD STRENGTHS, MULTIPLY VALUES IN THE TABLE BY THE SPECIFIED YIELD STRENGTH DIVIDED BY 60.
- SEE ACI 318 SECTION 12.5 FOR ALLOWABLE REDUCTIONS IN DEVELOPMENT LENGTH. IT SHALL NOT BE LESS THAN 8 BAR DIAMETERS OR 6 INCHES.
- HOOKEED BARS ARE NOT CONSIDERED EFFECTIVE IN DEVELOPING BARS IN COMPRESSION.
- REBAR IN ALL CONCRETE MEMBERS SHALL HAVE STANDARD HOOKS WHERE SHOWN ON SECTIONS IN ACCORDANCE WITH "DEVELOPMENT LENGTH OF STANDARD HOOKS IN TENSION" TABLE, UNLESS SPECIFICALLY NOTED OTHERWISE ON THE DRAWINGS.

DEVELOPMENT LENGTH OF STANDARD HOOKS IN CONCRETE - 60 ksi...			
BAR SIZE	fc = 4,000 psi	fc = 4,500 psi	fc = 5,000 psi
#3	8	7	7
#4	10	9	9
#5	12	12	11
#6	15	14	13
#7	17	16	15
#8	19	18	17
#9	22	21	20
#10	25	23	22
#11	27	26	24

TENSION LAP SPLICE LENGTH IN CONCRETE NOTES

- FOR HORIZONTAL BARS, VALUES IN THE TABLE SHALL BE MULTIPLIED BY 1.3 WHERE MORE THAN 12 INCHES OF FRESH CONCRETE IS CAST BELOW THE BAR.
- WHERE CLEAR SPACING OF BARS BEING SPLICED IS AT LEAST 2 BAR DIAMETERS AND CLEAR COVER AT LEAST 1 BAR DIAMETER, USE CASE 1. FOR ALL OTHER BAR ARRANGEMENTS, USE CASE 2.
- VALUES IN THE TABLE ARE BASED ON 60ksi REBAR. FOR OTHER REBAR YIELD STRENGTHS, MULTIPLY VALUES IN THE TABLE BY THE SPECIFIED YIELD STRENGTH DIVIDED BY 60.
- WHERE BARS OF DIFFERENT SIZES ARE SPLICED, PROVIDE THE LAP LENGTH OF THE LARGER BAR.
- WELDED WIRE REINFORCEMENT (DEFORMED OR PLAIN WIRE) SHALL BE LAPPED ONE FULL MESH SQUARE PLUS 2 INCHES MINIMUM, BUT NOT LESS THAN 12 INCHES.
- REBAR IN ALL CONCRETE MEMBERS SHALL BE SPLICED IN ACCORDANCE WITH "TENSION LAP SPLICE LENGTH" TABLE, UNLESS SPECIFICALLY NOTED OTHERWISE ON THE DRAWINGS.

TENSION LAP SPLICE LENGTH IN CONCRETE - 60 KSI REBAR TABLE (INCHES)								
fc =	3,500psi	3,500psi	4,000psi	4,000psi	4,500psi	4,500psi	5,000psi	5,000psi
BAR SIZE	CASE 1	CASE 2						
#3	20	30	19	28	18	27	17	25
#4	27	40	25	37	24	35	23	34
#5	33	50	31	47	30	44	28	42
#6	40	60	37	56	35	53	34	50
#7	58	87	54	81	51	77	49	73
#8	66	99	62	93	59	88	56	83
#9	75	112	70	105	66	99	63	94
#10	84	126	79	118	74	111	71	106
#11	93	140	87	131	82	123	78	117

SPECIAL INSPECTIONS

- REFER TO THE SPECIAL INSPECTION TABLES FOR THE LIST OF ELEMENTS OF CONSTRUCTION THAT SHALL REQUIRE SPECIAL INSPECTION. THIS SHALL BE CONSIDERED A GUIDE, AND THE CONTRACTOR AND INSPECTOR SHALL REFER TO THE IBC FOR COMPLETE REQUIREMENTS, QUALIFICATIONS, EXCEPTIONS, AND SUBMITTALS. REFER TO IBC CHAPTER 17, THE OWNER SHALL BE RESPONSIBLE FOR EMPLOYING THE SPECIAL INSPECTION AGENCY. ANY "OBSERVATIONS" BY THE EOR WILL NOT BE TO PERFORM SPECIAL INSPECTIONS AND SHALL NOT BE INTERPRETED AS SUCH.
- COPIES OF ALL INSPECTION REPORTS THAT REPORT COMPLIANCE SHALL BE SUBMITTED TO THE ARCHITECT OF RECORD, STRUCTURAL ENGINEER OF RECORD, AND BUILDING INSPECTOR WITHIN 7 CALENDAR DAYS OF COMPLETION OF THAT PORTION OF WORK. A MINIMUM OF ONE (1) PROGRESS REPORT PER MONTH FOR EACH TYPE OF CONSTRUCTION REQUIRING SPECIAL INSPECTION SHALL BE SUBMITTED TO THE STRUCTURAL ENGINEER OF RECORD.
- SPECIAL INSPECTOR SHALL INFORM ENGINEER OF RECORD IMMEDIATELY OF NON-COMPLIANCE WITH CONSTRUCTION DOCUMENTS OR APPROVED SUBMITTALS. CONTACT ENGINEER OF RECORD THE SAME DAY NON-COMPLIANCE IS DISCOVERED AND FOLLOW UP WITH AN OFFICIAL REPORT WITHIN 2 BUSINESS DAYS.
- THE SPECIAL INSPECTIONS IDENTIFIED ON THE PLANS ARE IN ADDITION TO, AND NOT A SUBSTITUTE FOR THOSE INSPECTIONS REQUIRED TO BE PERFORMED BY A BUILDING INSPECTOR.
- SPECIAL INSPECTIONS ARE NOTED AS EITHER "CONTINUOUS" OR "PERIODIC". A "CONTINUOUS" INSPECTION REQUIRES THE PRESENCE OF A QUALIFIED INSPECTOR IN THE VICINITY OF THE WORK BEING PERFORMED FOR 100% OF THAT WORK. A "PERIODIC" INSPECTION REQUIRES PART-TIME OBSERVATION OF THE WORK BEING PERFORMED. THE INSPECTOR SHALL ALSO OBSERVE THE FINAL CONDITION OF THE WORK BEFORE IT IS CLOSED FROM VIEW.
- WHEN WORK IN MORE THAN ONE CATEGORY OF WORK REQUIRING SPECIAL INSPECTION IS TO BE PERFORMED SIMULTANEOUSLY, OR THE GEOGRAPHIC LOCATION OF THE WORK IS SUCH THAT IT CANNOT BE CONTINUOUSLY OBSERVED, IT SHALL BE THE RESPONSIBILITY OF THE AGENT TO EMPLOY A SUFFICIENT NUMBER OF SPECIAL INSPECTORS TO ASSURE THAT ALL WORK IS CONTINUOUSLY INSPECTED IN ACCORDANCE WITH THOSE PROVISIONS.
- SPECIAL INSPECTIONS AND TESTS ARE NOT REQUIRED FOR PORTIONS OF STRUCTURES DESIGNED AND CONSTRUCTED IN ACCORDANCE WITH THE COLD-FORMED STEEL LIGHT-FRAME CONSTRUCTION PROVISIONS OF SECTION 2211 OF THE IBC OR THE CONVENTIONAL LIGHT-FRAME CONSTRUCTION PROVISIONS OF SECTION 2308 OF THE IBC.

SPECIAL INSPECTIONS - CONCRETE TABLE

ITEM	INSPECTION FREQUENCY	SCOPE
REINFORCEMENT	PERIODIC	INSPECT REINFORCEMENT AND PLACEMENT; VERIFY CONFORMANCE WITH CONSTRUCTION DOCUMENTS, AND THAT BARS ARE FREE FROM MATERIALS THAT COULD PREVENT BOND, ARE ADEQUATELY LAPPED, SPLICED, TIED, AND SUPPORTED
ANCHOR INSTALLATION	PERIODIC	INSPECT CAST-IN-PLACE ANCHORS AND BOLTS
ANCHOR INSTALLATION	CONTINUOUS	INSPECT POST-INSTALLED MECHANICAL AND ADHESIVE ANCHORS PER THE REQUIREMENTS IN THEIR RESPECTIVE ICC-ES REPORTS
MIX DESIGN	PERIODIC	VERIFY USE OF APPROVED MIX DESIGN
SAMPLING AND TESTING	CONTINUOUS	PRIOR TO CONCRETE PLACEMENT, FABRICATE SPECIMENS FOR STRENGTH TESTING; PERFORM SLUMP AND AIR CONTENT TESTS, AND DETERMINE TEMPERATURE OF THE CONCRETE
CONCRETE PLACEMENT	PERIODIC	VERIFY MAINTENANCE OF CURING TEMPERATURE AND TECHNIQUES
CONCRETE PLACEMENT	PERIODIC	VERIFY STRENGTH OF CONCRETE PRIOR TO STRESSING TENDONS IN POST-TENSIONED CONCRETE, AND PRIOR TO REMOVAL OF SHORES
CONCRETE PLACEMENT	PERIODIC	INSPECT FORMWORK FOR SHAPE, LOCATION, AND DIMENSIONS OF CONCRETE MEMBER BEING FORMED
CONCRETE PLACEMENT	CONTINUOUS	CONCRETE PLACEMENT

SPECIAL INSPECTIONS - SOILS AND FOUNDATIONS TABLE

ITEM	INSPECTION FREQUENCY	SCOPE
SOILS	PERIODIC	VERIFY MATERIALS BELOW SHALLOW FOUNDATIONS ARE ADEQUATE TO ACHIEVE THE DESIGN BEARING CAPACITY; VERIFY EXCAVATIONS ARE EXTENDED TO PROPER DEPTH AND HAVE REACHED PROPER MATERIAL; PERFORM CLASSIFICATION AND TESTING OF COMPACTED FILL MATERIALS; PRIOR TO PLACEMENT OF COMPACTED FILL, INSPECT SUBGRADE AND VERIFY THAT SITE HAS BEEN PREPARED PROPERLY
SOILS	CONTINUOUS	VERIFY USE OF PROPER MATERIALS, DENSITIES, LIFT THICKNESSES, AND COMPACTION OF FILL; VERIFY MATERIALS AND PROCEDURES COMPLY WITH THE GEOTECHNICAL REPORT

SPECIAL INSPECTIONS - WOOD TABLE		
ITEM	INSPECTION FREQUENCY	SCOPE
DIAPHRAGM AND SHEAR WALL	PERIODIC	WOOD SHEAR WALLS, SHEAR PANELS, AND DIAPHRAGMS, INCLUDING NAILING, BOLTING, ANCHORING, AND OTHER FASTENING TO COMPONENTS OF THE MAIN LATERAL SYSTEM WHEN THE FASTENER SPACING IS LESS THAN OR EQUAL TO 4 INCHES ON CENTER
METAL PLATE CONNECTED WOOD TRUSSES WITH CLEAR SPAN OF 60FT OR GREATER	PERIODIC	VERIFY TEMPORARY, ERECTION, AND PERMANENT BRIDGING AND BRACING IS INSTALLED IN ACCORDANCE WITH THE APPROVED TRUSS SUBMITTAL PACKAGE

STATE OF MISSOURI
MICHAEL L. PARSON,
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DEPARTMENT OF
NATURAL RESOURCES
MISSOURI STATE PARKS

NEW PREMIUM 63 SITE
LOOP CAMPGROUND

ST. FRANCOIS STATE PARK
8920 US-67N
BONNE TERRE, MO 63628

PROJECT # X2317-01
SITE # 5216
ASSET # 7815216025

REVISION: _____
DATE: _____
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ISSUE DATE: 03/28/2025

CAD DWG FILE: COC-MO-16-23 RV22
DRAWN BY: AEM
CHECKED BY: SIS
DESIGNED BY: AEM

SHEET TITLE:

GENERAL NOTES

SHEET NUMBER:

S1.2

47 OF 56 SHEETS
03/28/2025



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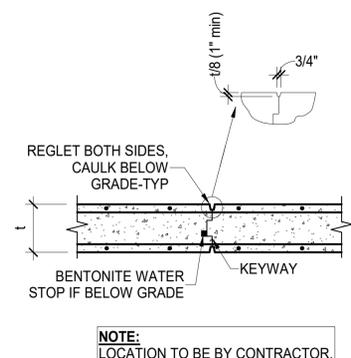
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DRAWN BY: AEM
CHECKED BY: SIS
DESIGNED BY: AEM

SHEET TITLE:


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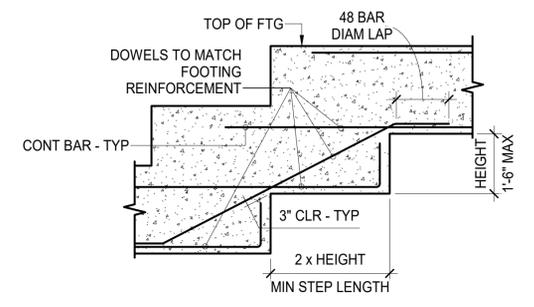
S1.3
48 OF 56 SHEETS
03/28/2025



A TYP CONCRETE WALL CONSTRUCTION JOINT DETAILS
S1.3 N.T.S.




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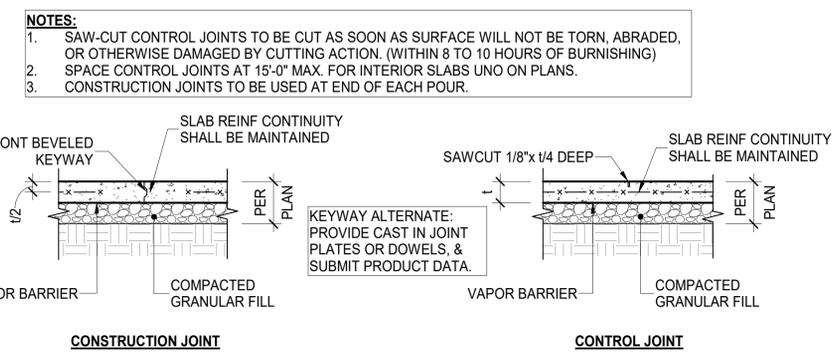


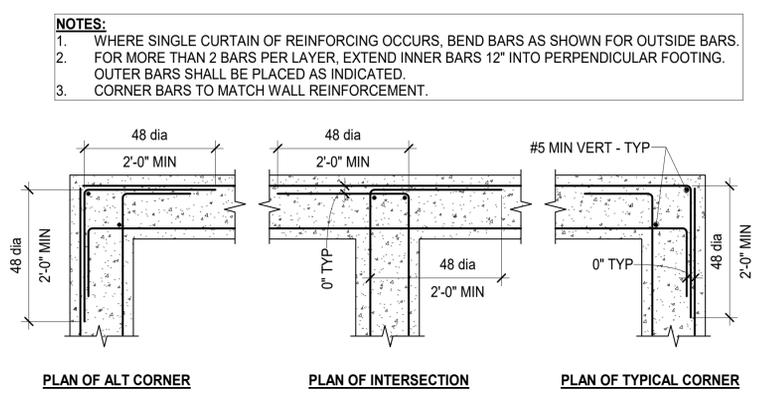C TYP FOOTING STEP
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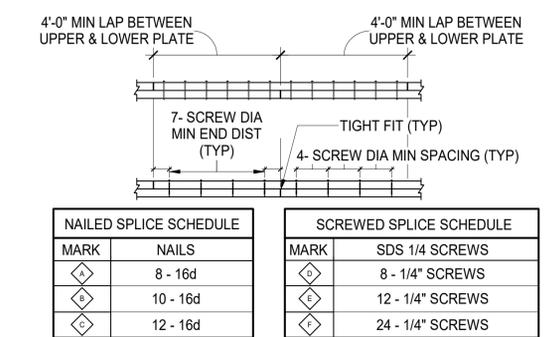
A TYP CONCRETE WALL CONSTRUCTION JOINT DETAILS
S1.3 N.T.S.



D TYP FOUNDATION PIPE PENETRATION DETAILS
S1.3 N.T.S.

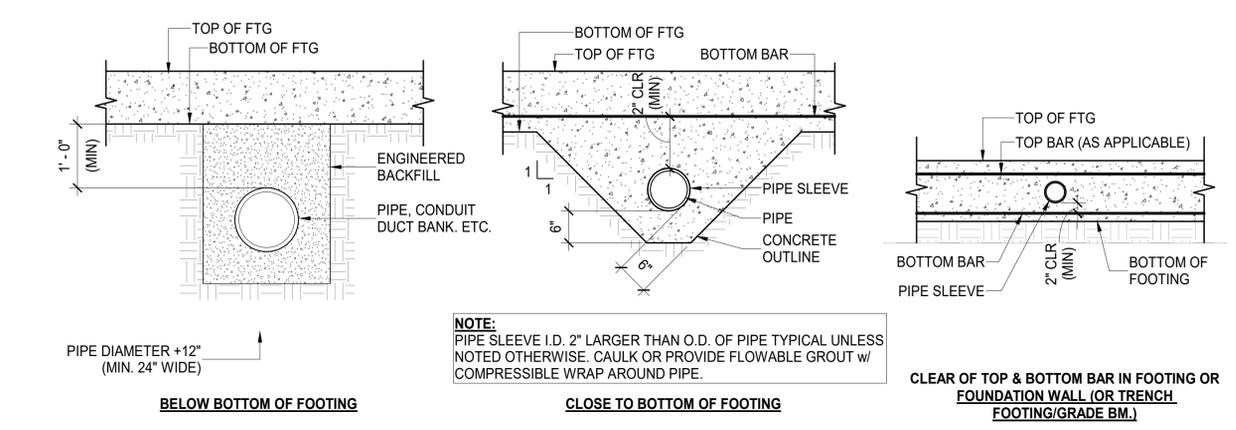


E TYP SLAB-ON-GRADE CONSTRUCTION JOINT DETAILS
S1.3 N.T.S.



NAILED SPLICE SCHEDULE		SCREWED SPLICE SCHEDULE	
MARK	NAILS	MARK	SDS 1/4" SCREWS
A	8 - 16d	D	8 - 1/4" SCREWS
B	10 - 16d	E	12 - 1/4" SCREWS
C	12 - 16d	F	24 - 1/4" SCREWS


- NOTES:**
- SPLICE 2x DOUBLE TOP PLATES PER MARK "A" AND 3x DOUBLE TOP PLATES PER MARK "D" OF THE ABOVE SCHEDULE, UNLESS OTHERWISE INDICATED.
 - SCREWS SHALL BE 3" LONG FOR 2x PLATES AND 5" LONG FOR 3x PLATES.
 - JOINTS IN UPPER AND LOWER PLATE SHALL BE CENTERED OVER STUD OR MULLION.
 - ALL NAILS SHALL BE COMMON WIRE NAILS.
 - SCHEDULE INDICATES NUMBER OF NAILS OR SCREWS ON EACH SIDE OF EACH JOINT.

F TYPICAL TOP PLATE SPLICE DETAIL
S1.3 N.T.S.

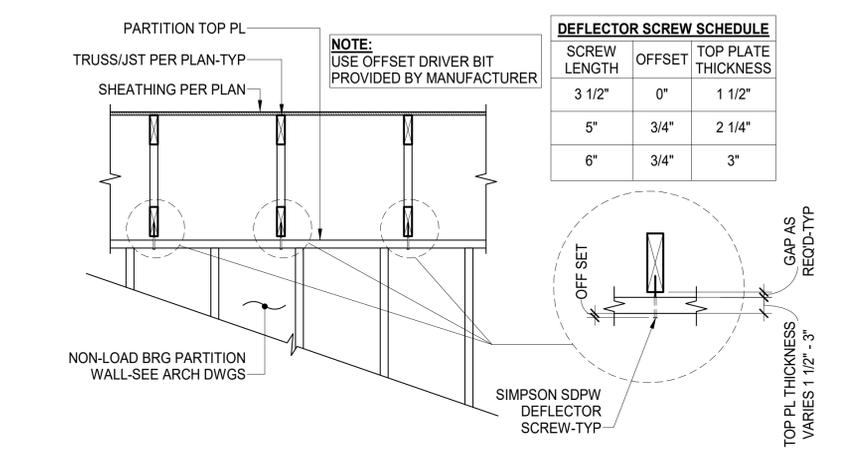

SCREW LENGTH	OFFSET	TOP PLATE THICKNESS
3 1/2"	0"	1 1/2"
5"	3/4"	2 1/4"
6"	3/4"	3"

G TYP SLIP CONNECTION @ NON LOAD-BEARING WOOD PARTITION WALL
S1.3 N.T.S.

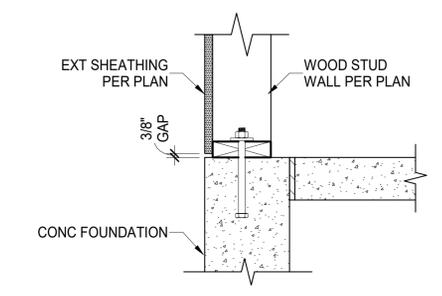

H TYPICAL SHEATHING GAP DETAIL
S1.3 N.T.S.



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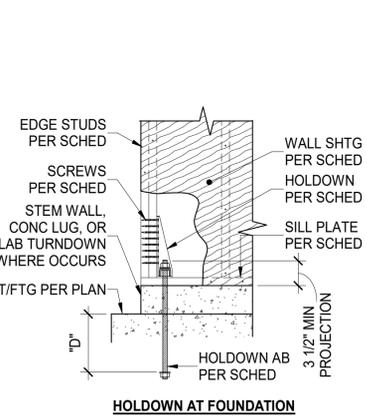
SILL PL BOLTS & SOLE PL SCREWS SCHEDULE			
MARK	WALL SIDES SHEATHED	FASTENER SPACING "B" (NOTES #5-6)	
		BOLT	SCREW
⑥	1	34"	5"
	2	16"	2"
④	1	22"	3"
	2	10"	1.5"
③	1	16"	2"
	2	8"	1"

WALL SHEATHING AND NAILING SCHEDULE			
MARK	SHTG SPEC	NAIL SIZE	EN SPCG "E"
⑥	15/32" *	10d	6"
④	15/32" *	10d	4"
③	15/32" *	10d	3"

* PANELS SHALL BE SHEATHING GRADE, SEE LUMBER SCHEDULE FOR REQUIREMENTS.

- NOTES:**
- FIELD NAILING (FN): 10d @ 12"oc.
 - ALL NAILS SHALL BE COMMON OR BOX WIRE NAILS.
 - MINIMUM DIMENSION OF ANY SHEATHING SHEET EQUALS 16" OR STUD SPACING, WHICHEVER IS GREATER.
 - ALL SHEAR WALL SHEATHING PANEL EDGES SHALL BE FULLY BLOCKED WITH FULL DEPTH 2x STUD BLOCKING-TYP-UNO.
 - SILL PLATES SHALL BE FASTENED WITH 5/8" dia x 7" LG EMBED ANCHOR BOLTS PER FASTENER SPACING "B" IN SCHEDULE ABOVE. ALTERNATIVELY, USE 5/8" x 8" LG SIMPSON TITEN HD SCREW ANCHORS. BOTH OPTIONS REQUIRE 3"x3"x0.229" PLATE WASHERS AT EACH AB.
 - SOLE PLATES SHALL BE FASTENED WITH 1/4" dia (#14) x 4 1/2" LG WOOD SCREWS PER SCREW FASTENERS SPACING "B" IN SCHEDULE ABOVE. PRE-DRILL HOLES FOR #14 WOOD SCREWS PER NDS 12.1.5.3 ALTERNATIVELY, CONTRACTOR MAY USE SIMPSON STRONG-TIE SDS25412 STRONG-DRIVE SCREWS AND DOUBLE THE SCREW SPACING PER THE SCHEDULE ABOVE. NO PRE-DRILLING REQUIRED FOR SDS SCREWS. REFER TO ARCH DRAWINGS/ SPECIFICATIONS FOR FIRE-RETARDANT AND PRESERVATIVE TREATMENT, IF REQUIRED.
 - REFER TO ARCH DRAWINGS/ SPECIFICATIONS FOR FIRE-RETARDANT AND PRESERVATIVE TREATMENT, IF REQUIRED.


A TYP SHEAR WALL SHEATHING AND FASTENER SCHEDULE - WOOD CONSTRUCTION
S1.4 N.T.S.




HOLDOWN SCHEDULE							
MARK	EDGE STUDS	SIMPSON HOLDOWN	SDS 1/4"x2.5" STUD SCWS	SIMPSON AB (CIP)	"D" (CIP)	HILTI AB (POST-INSTALLED)	"D" (POST-INSTALLED)
A	2 - 2x	HDU2-SDS2.5	6	SSTB16	12 5/8"	5/8" GR.36	8"
B	2 - 2x	HDU4-SDS2.5	10	SSTB20	16 5/8"	5/8" GR.36	10"
C	2 - 2x	HDU5-SDS2.5	14	SSTB24	20 5/8"	5/8" GR.36	12"
D	3 - 2x	HDU8-SDS2.5	20	SSTB28	24 7/8"	7/8" GR.36	14"
E	6x	HHDU11-SDS2.5	30	SSTB34	28 7/8"	1" GR.36	16"
F	6x	HHDU14-SDS2.5	36	SSTB36	28 7/8"	1" GR.36	16"

- NOTES:**
- HOLDOWN ANCHOR BOLTS SHALL BE HOT-DIPPED GALVANIZED (ASTM A153). CONTRACTOR MAY CHOOSE CAST-IN-PLACE OR POST-INSTALLED OPTION. ADHERE WITH HILTI HIT-HY 200 SAFE SET SYSTEM ADHESIVE FOR POST-INSTALLED OPTION. IF "N/A" IS SHOWN, POST-INSTALLED OPTION IS NOT ALLOWED.
 - THICKENED FOOTING WHERE REQUIRED TO ACHIEVE MINIMUM ANCHOR BOLT EMBEDMENT.
 - WHERE HOLDOWN OCCURS ADJACENT TO A POST ON THE PLAN, USE THE LARGER OF THE INDICATED POST OR THE SCHEDULE EDGE STUDS.


C TYP HOLDOWN SCHEDULE & DETAILS
S1.4 N.T.S.

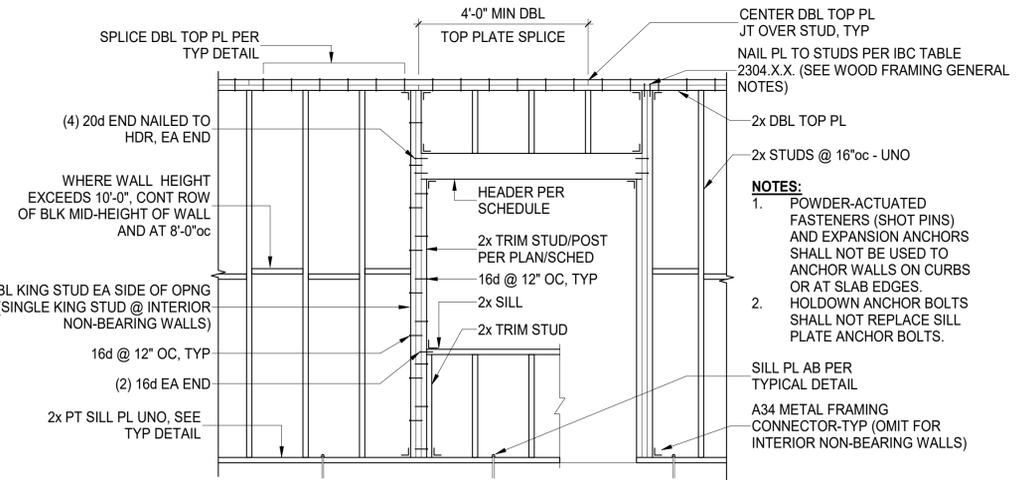

E TYP STRUCTURAL WALL PANEL FRAMING ELEVATION
S1.4 N.T.S.

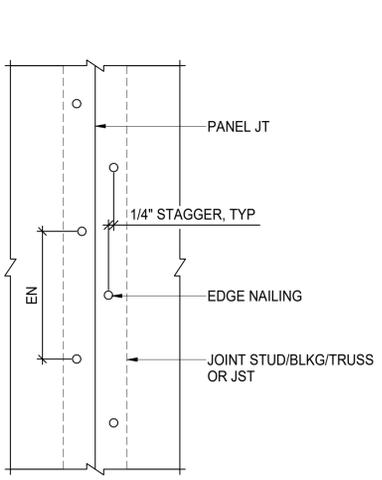


F TYP STAGGERED EDGE NAILING DETAIL
S1.4 N.T.S.

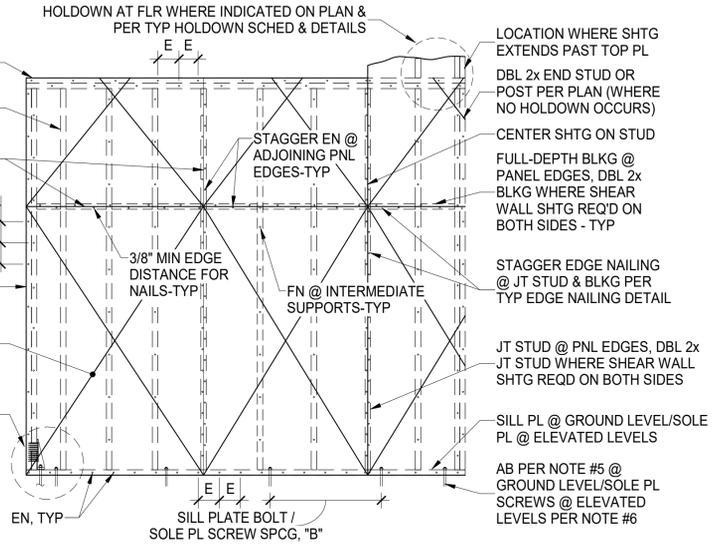

DIAPHRAGM SHEATHING & NAILING SCHEDULE							
MARK	SHTG SPEC	NAILS IZE	BN SPCG	EN SPCG	FN SPCG	TRANSV BLKG	EDGE MEMBER THICK
R1	19/32" *	10d	6"	6"	12"	NO	2"


- NOTE:**
- DIAPHRAGM SHEATHING NAILS SHALL BE DRIVEN SO THAT THEIR HEADS ARE FLUSH WITH THE SURFACE OF THE SHEATHING.
 - 10d COMMON NAILS CAN BE SUBSTITUTED WITH #9 x 2" SCREW WSV2 BY SIMPSON STRONG-TIE.

B TYP ROOF SHEATHING DETAIL - WOOD CONSTRUCTION
S1.4 N.T.S.

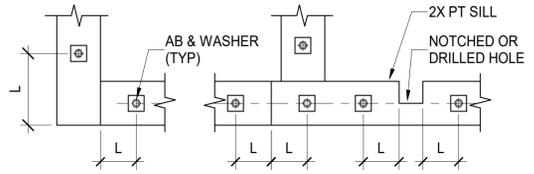

- NOTES:**
- TYPICAL ANCHOR BOLT END DISTANCE L = 4 1/2" MIN, 12" MAX.
 - ANCHOR BOLTS SHALL BE INSTALLED AT 12" MAXIMUM FROM EACH END OF EACH SILL PLATE PIECE, AND SHALL BE SPACED AT 48" ON CENTER MAXIMUM. SEE TYPICAL SHEAR WALL DETAIL FOR ANCHOR BOLT SPACING AT SHEAR WALLS.
 - WHERE SILL PLATE IS NOTCHED, DRILLED OR CUT MORE THAN ONE THIRD OF ITS WIDTH, INSTALL ANCHOR BOLT EACH SIDE AS SHOWN. NOTCHES, CUTS AND HOLES SHALL BE TREATED WITH A PRESERVATIVE SOLUTION CONFORMING TO AWPA STANDARD M4.
 - ANCHOR BOLTS SHALL BE 5/8" DIAMETER FULLY THREADED WITH 3"x3" x 0.229" PLATE WASHERS, UNLESS OTHERWISE NOTED.
 - MINIMUM ANCHOR BOLT EMBEDMENT SHALL BE 7", MEASURED FROM TOP OF THE CONCRETE SLAB. FOR ANCHOR BOLTS EMBEDDED IN CONCRETE CURBS NOT POURED MONOLITHICALLY WITH THE FOUNDATION (NON-INTEGRAL CURBS), THE LENGTH OF ANCHOR BOLT IN CONCRETE CURBS SHALL NOT APPLY TO THIS MINIMUM EMBEDMENT.
 - ANCHOR BOLTS WITH DAMAGED THREADS SHALL NOT BE USED.
 - WHERE SILL PLATE ANCHORS MUST BE POST-INSTALLED, PROVIDE 3/4" dia x 8 1/2" SIMPSON TITEN HD STAINLESS STEEL SCREW ANCHORS (INTEGRAL CURBS ONLY, OR NO CURB), OR 5/8" dia x (8 1/2" + CURB HEIGHT) STAINLESS STEEL THREADED ROD ANCHORS INSTALL w/ HILTI HIT-HY 200 ADHESIVE OR EQUIVALENT. POST-INSTALLED ANCHORS SHALL NOT REPLACE HOLDOWN ANCHOR BOLTS UNLESS ALLOWED IN THE HOLDOWN SCHEDULE.

D TYPICAL SILL PLATE ANCHOR BOLT DETAIL
S1.4 N.T.S.

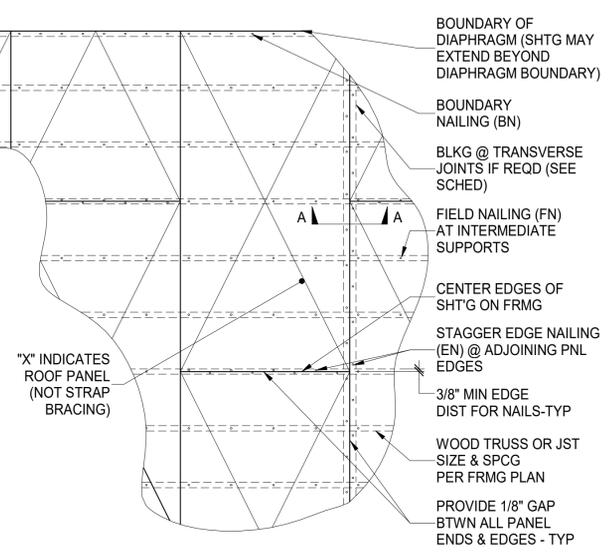

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DEPARTMENT OF
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MISSOURI STATE PARKS

NEW PREMIUM 63 SITE
LOOP CAMPGROUND

ST. FRANCOIS STATE PARK
8920 US-67N
BONNE TERRE, MO 63628

PROJECT # X2317-01
SITE # 5216
ASSET # 7815216025

REVISION: _____
DATE: _____
REVISION: _____
DATE: _____
REVISION: _____
DATE: _____
ISSUE DATE: 03/28/2025

CAD DWG FILE: COC-MO-16-23 RV22
DRAWN BY: AEM
CHECKED BY: SIS
DESIGNED BY: AEM

SHEET TITLE:

TYPICAL DETAILS

SHEET NUMBER:

S1.4

49 OF 56 SHEETS
03/28/2025



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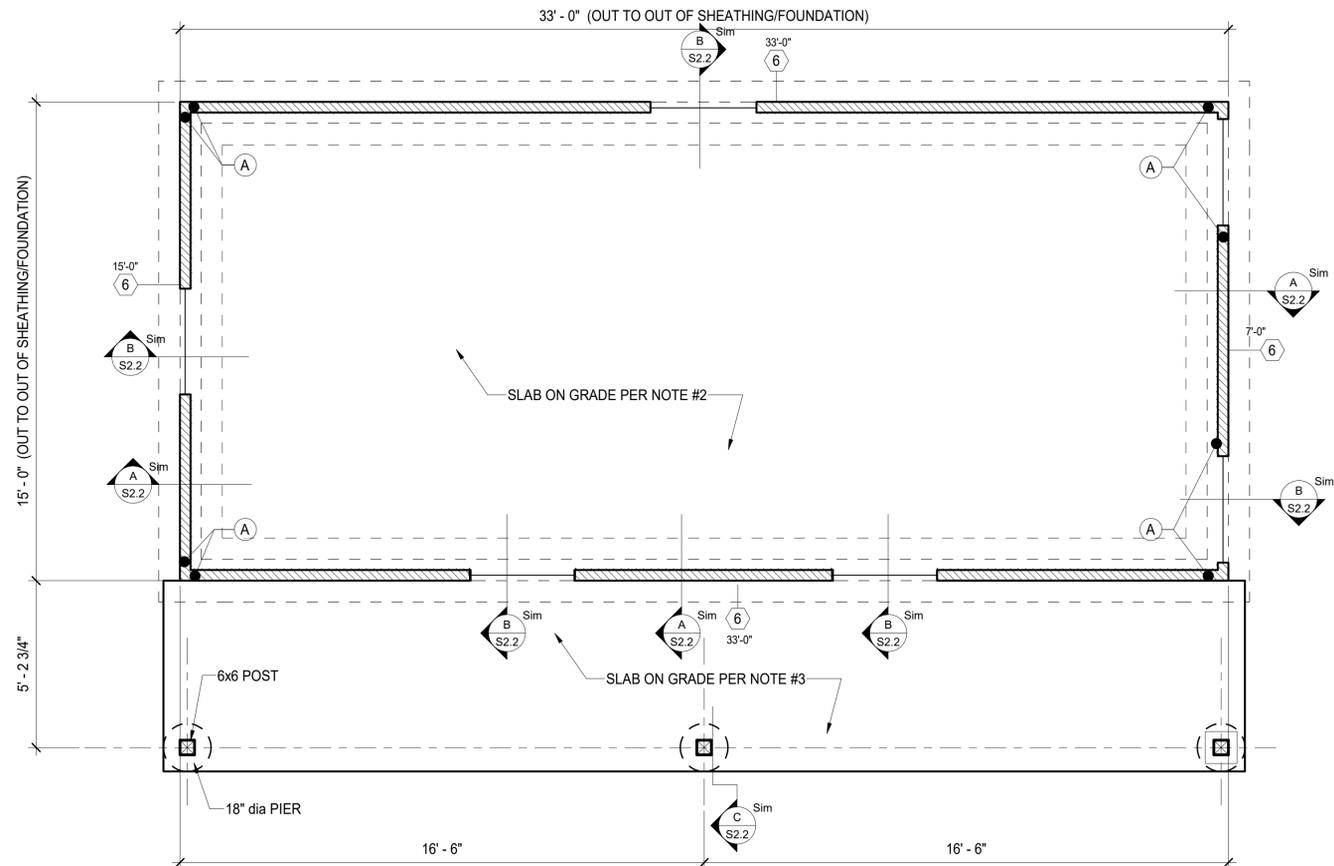
SHEET TITLE:

FOUNDATION &
FRAMING PLAN

SHEET NUMBER:

S2.1

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03/28/2025





FOUNDATION PLAN

PLAN NOTES

SCALE: 3/8" = 1'-0"

- SEE SHEETS S1.1 - S1.4 FOR GENERAL NOTES AND TYPICAL DETAILS.
- 4" CONCRETE SLAB REINFORCED WITH ONE LAYER OF 6x6 - W1.4xW1.4 WWR ON 10 MIL. POLY VAPOR BARRIER OVER 6" MINIMUM COMPACTED FREE-DRAINING GRANULAR MATERIAL. REINFORCEMENT TO BE LOCATED IN THE MIDDLE OF THE SLAB.
- 4" CONCRETE SLAB REINFORCED WITH ONE LAYER OF 6x6 - W1.4xW1.4 WWR OVER 6" MINIMUM COMPACTED FREE-DRAINING GRANULAR MATERIAL. REINFORCEMENT TO BE LOCATED IN THE MIDDLE OF THE SLAB.
- SEE ARCHITECTURAL DRAWINGS FOR DIMENSIONS, SECTIONS, AND ELEVATIONS NOT SHOWN HEREON.
- COORDINATE SIZE AND LOCATION OF ROUGH OPENINGS IN FLOOR OR WALLS WITH ARCHITECTURAL DRAWINGS.
- FOOTING STEP LOCATIONS (IF SHOWN) ARE GIVEN AS APPROXIMATE. GENERAL CONTRACTOR TO COORDINATE FINAL FOOTING STEP LOCATIONS WITH THE CIVIL DRAWINGS.
- ALL ELEVATIONS ARE REFERENCED FROM FINISHED MAIN FLOOR = 100'-0"
 - T/FTG = TOP OF FOOTING = PER SECTIONS
 - T/CONC = TOP OF CONCRETE = PER SECTIONS
- ALL EXTERIOR WALL SHEATHING NOT SPECIFIED AS "SHEAR WALL SHEATHING" IS TO BE 1/2" OSB SHEATHING AND ATTACHED PER IBC TABLE 2304.9.1 UNLESS OTHERWISE INDICATED BY ARCHITECT.

LEGEND - FOUNDATION PLAN

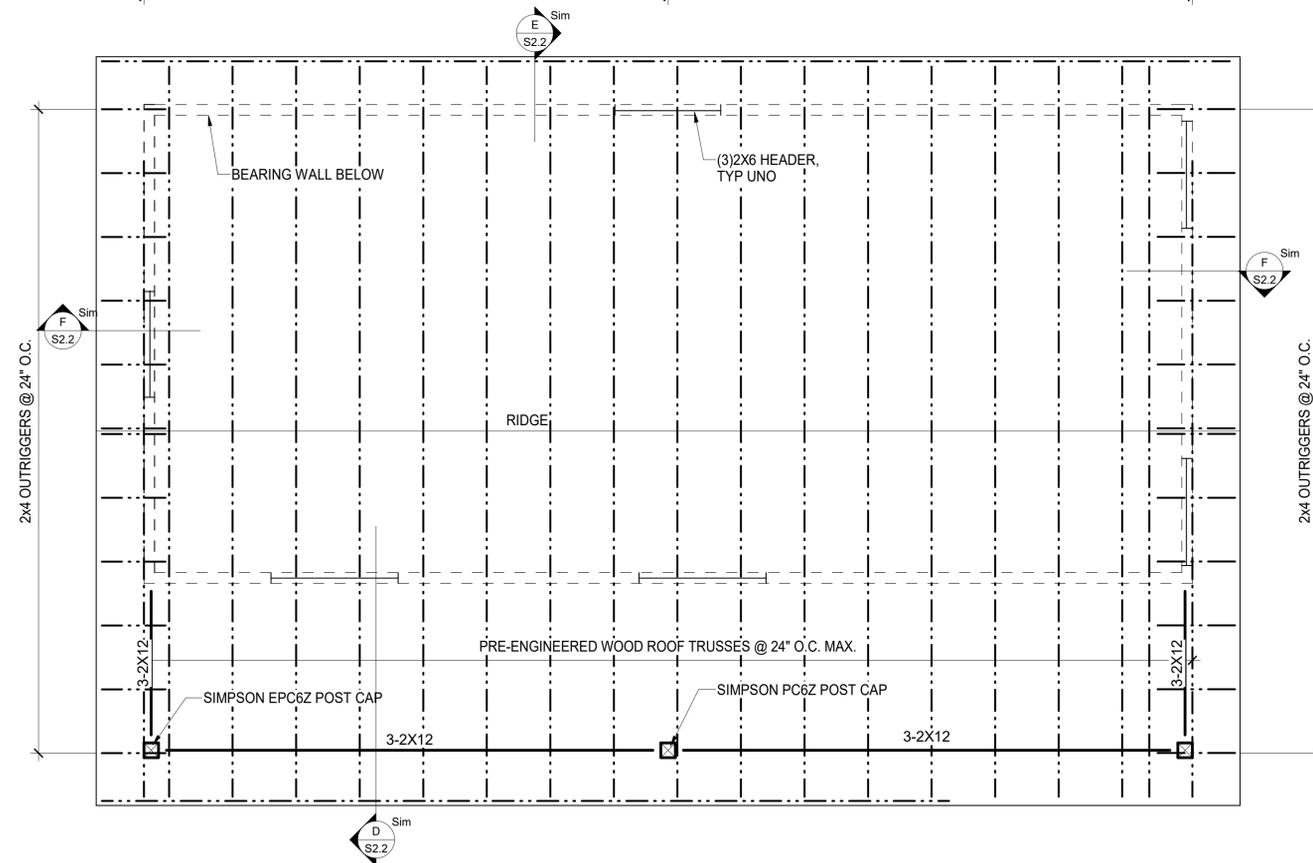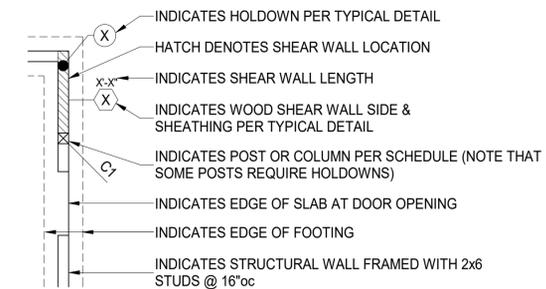


ROOF FRAMING PLAN - WOOD

PLAN NOTES

SCALE: 3/8" = 1'-0"

- SEE SHEETS S1.1 - S1.4 FOR GENERAL NOTES AND TYPICAL DETAILS.
- ROOF CONSTRUCTION: 5/8" PLYWOOD ROOF SHEATHING, ATTACHED TO SUPPORTS PER LUMBER NOTES, SCHEDULE, AND DETAILS.
- PROVIDE TRUSS BRIDGING AND SPACING PER TRUSS SUPPLIER.
- TRUSS MANUFACTURER TO COORDINATE WITH CONTRACTORS TO DETERMINE RTU AND TRANSFORMER LAYOUTS, WEIGHTS, AND FOOTPRINTS. RTU AND EXHAUST HOOD LOADS ARE TO BE IN ADDITION TO OTHER DESIGN LOADS.
- MAXIMUM TRUSS SPACING = 2'-0" UNO
- SEE ARCHITECTURAL DRAWINGS FOR DIMENSIONS, SECTIONS, AND ELEVATIONS NOT SHOWN HEREON.
- ALL ELEVATIONS ARE REFERENCED FROM FINISHED MAIN FLOOR = 100'-0"
 - TRUSS/BRG = TRUSS BEARING = 109'-1"

LEGEND - FRAMING PLAN

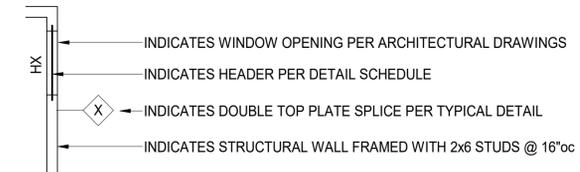



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MISSOURI STATE PARKS

NEW PREMIUM 63 SITE
LOOP CAMPGROUND

ST. FRANCOIS STATE PARK
8920 US-67N
BONNE TERRE, MO 63628

PROJECT # X2317-01
SITE # 5216
ASSET # 7815216025

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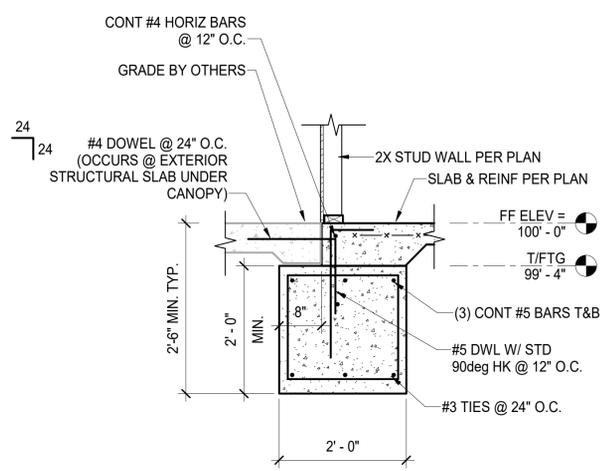
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SHEET TITLE:
**FOUNDATION &
FRAMING SECTIONS**


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S2.2


51 OF 56 SHEETS
03/28/2025




A FOUNDATION SECTION
S2.2 N.T.S.

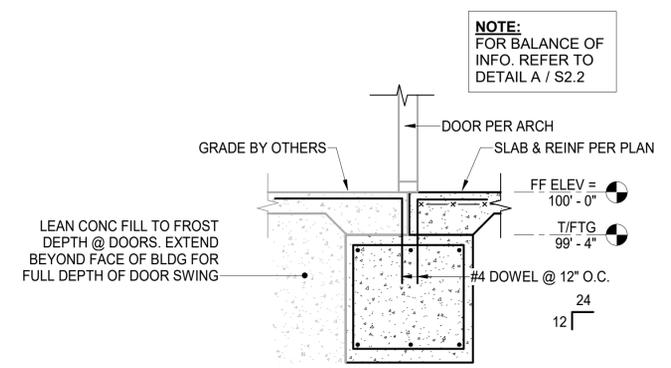


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S2.2 N.T.S.

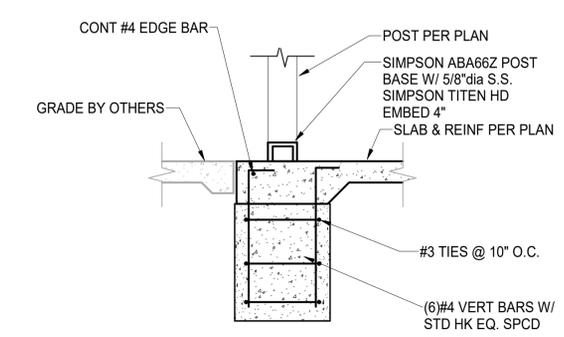


C FOUNDATION SECTION
S2.2 N.T.S.

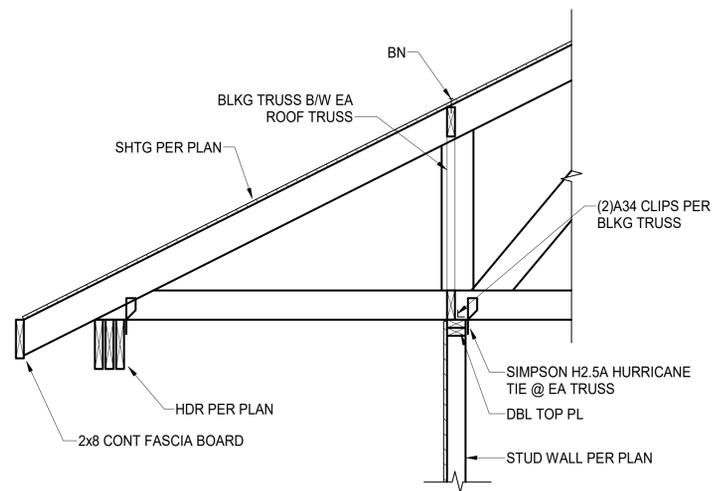

D FRAMING SECTION
S2.2 N.T.S.

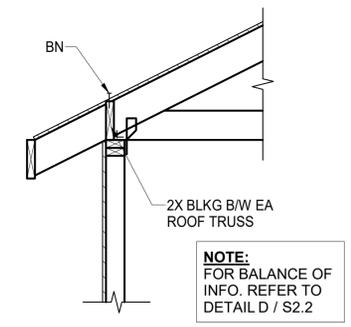


E FRAMING SECTION
S2.2 N.T.S.

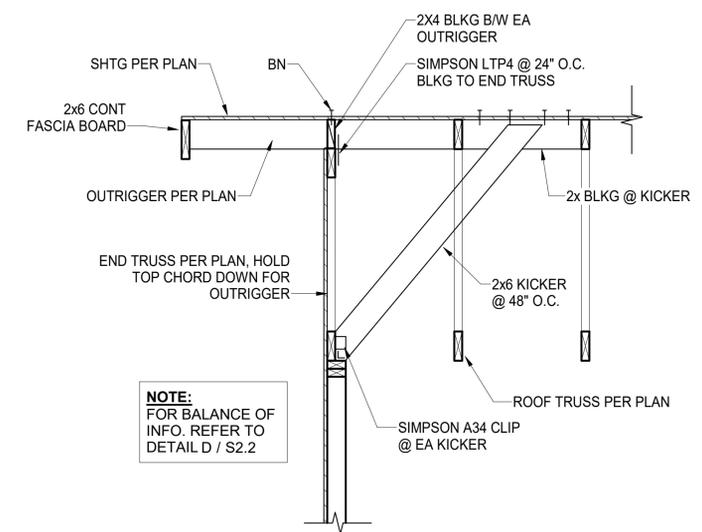

F FRAMING SECTION
S2.2 N.T.S.



03/28/25

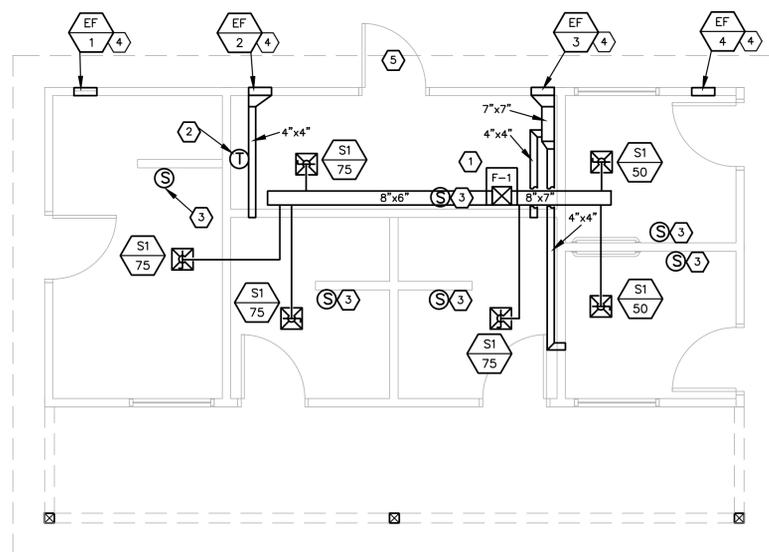

1 MECHANICAL FLOOR PLAN
M1.0 SCALE: 1/4" = 1'-0"

MECHANICAL SYMBOLS LEGEND	
—CD—	CONDENSATE DRAIN
⊖	THERMOSTAT
⊙	TEMPERATURE SENSOR
⊠	90 DEGREE ELBOW DOWN, RECT. SUPPLY DUCT
⊡	90 DEGREE ELBOW DOWN, RECT. RETURN DUCT
—WV—	FLEXIBLE DUCT
—V—	VOLUME DAMPER
⊠	CEILING SUPPLY AIR DIFFUSER
⊡	CEILING RETURN AIR GRILLE
—○—	PIPE TURNING UP
— —	UNION
S1	AIR DEVICE #
240	CFM

KEYED NOTES

- FURNISH AND INSTALL FURNACE (F-1) AS SPECIFIED IN LOCATION SHOWN. SEE FURNACE SCHEDULE FOR MORE INFORMATION.
- FURNISH AND INSTALL SEVEN-DAY PROGRAMMABLE THERMOSTAT AND RELATED WIRING TO CONTROL FURNACE. THERMOSTAT TO BE HONEYWELL MODEL TB7220. MOUNT AT 48" AFF. VERIFY LOCATION OF THERMOSTAT WITH ELEVATION ON ARCHITECTURAL DRAWINGS. VERIFY PROPER OPERATION IN FIELD.
- INSTALL INDOOR TEMPERATURE SENSOR FOR THERMOSTAT IN LOCATION INDICATED ON PLANS.
- NEW WALL-MOUNTED EXHAUST FAN (EF-1,2,3,4) WITH INTEGRAL LOUVERED EXTERIOR WALL CAP/GRILLE AS SCHEDULED AND SPECIFIED TO SERVE RESTROOMS. FAN SHALL BE WIRED AND OPERATED THROUGH THE LIGHT SWITCH. COORDINATE WITH ELECTRICAL CONTRACTOR. SEE EXHAUST FAN SCHEDULE FOR MORE INFORMATION.
- UNDERCUT MECHANICAL ROOM DOOR MINIMUM 1/4" FOR RETURN AIR TO FURNACE.

NOTE: THERMOSTAT MANUFACTURER LISTED FOR EXAMPLE PURPOSES ONLY. SEE MECHANICAL SPECIFICATIONS SECTION 235400 FOR FULL LIST OF APPROVED MANUFACTURERS.

GRILLE & DIFFUSER SCHEDULE							
MARK	MFR	MODEL	TYPE	FACE SIZE	MATL	MOUNTING	REMARKS
S1	TITUS	OMNI	SUPPLY	12"x12"	ST	CEILING	1,2,3

1. FRAME AND FACE BLADES SHALL HAVE BAKED ENAMEL OFF-WHITE FINISH.
2. COORDINATE EXACT FRAME MOUNTING TYPE WITH ARCHITECTURAL CEILING PLAN.
3. AIR DEVICE RUN-OUT SHALL BE SAME SIZE AS DIFFUSER NECK. FLEX DUCT MAXIMUM LENGTH 5'-0".

NOTE: MANUFACTURER LISTED FOR EXAMPLE PURPOSES ONLY. SEE MECHANICAL SPECIFICATIONS SECTION 233713 FOR FULL LIST OF APPROVED MANUFACTURERS.

EXHAUST FAN SCHEDULE								
MARK	MANUFACTURER	MODEL NO.	HP	RPM	CFM	WEIGHTS	VOLTS/PH	REMARKS
EF-1	BROAN	512M	0.7 A	1550	75	3	120/1	1,2
EF-2	BROAN	512M	0.7 A	1550	75	3	120/1	1,2
EF-3	BROAN	509	1.8 A	1550	150	3	120/1	1,2
EF-4	BROAN	512M	0.7 A	1550	75	3	120/1	1,2


1. VERIFY ELECTRICAL VOLTAGE AND PHASE WITH ELECTRICAL CONTRACTOR PRIOR TO ORDERING UNIT.
2. FAN TO BE CONTROLLED BY LIGHT SWITCH.

NOTE: MANUFACTURER LISTED FOR EXAMPLE PURPOSES ONLY. SEE MECHANICAL SPECIFICATIONS SECTION 233423 FOR FULL LIST OF APPROVED MANUFACTURERS.


FURNACE SCHEDULE							
MARK	MFG.	MODEL NO.	CFM	HEATING kW	VOLTS/PHASE	MCA/MOCP	REMARKS
F-1	GOODMAN	MBVC1201AA-1	400	10.0	240/1	5/15	1,2,3,4

1. PROVIDE UNIT WITH 7-DAY PROGRAMMABLE THERMOSTAT.
2. VERIFY ELECTRICAL VOLTAGE WITH ELECTRICAL CONTRACTOR PRIOR TO ORDERING.
3. PROVIDE WITH ELECTRIC HEAT KIT, INSTALL IN FIELD.
4. PROVIDE WITH SUMMER FAN SWITCH.

NOTE: MANUFACTURER LISTED FOR EXAMPLE PURPOSES ONLY. SEE MECHANICAL SPECIFICATIONS SECTION 235400 FOR FULL LIST OF APPROVED MANUFACTURERS.

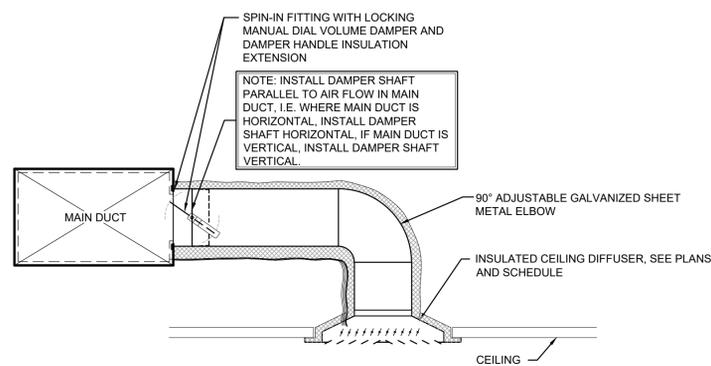

2 BRANCH DUCT - AIR GRILLE DETAIL
M1.0 SCALE: NO SCALE

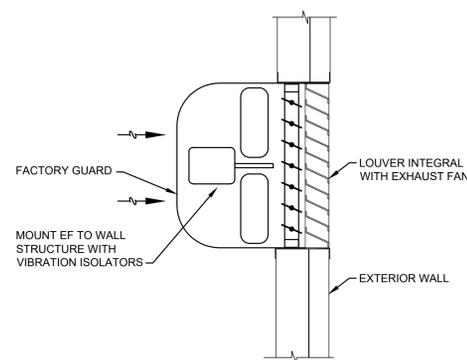

3 EXHAUST FAN DETAIL
M1.0 SCALE: NO SCALE

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ST. FRANCOIS COUNTY, MISSOURI

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CAD DWG FILE: COC-MO-16-23
DRAWN BY: ATP
CHECKED BY: MC
DESIGNED BY: ATP

SHEET TITLE:
**MECHANICAL
PLAN AND
SCHEDULES**


SHEET NUMBER:

M1.0

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PLUMBING GENERAL NOTES

1. PLUMBING CONTRACTOR SHALL ABIDE BY THE LOCAL CODES AND ORDINANCES.
2. PLUMBING CONTRACTOR SHALL FIELD VERIFY THE EXACT LOCATIONS AND SIZES OF ALL UTILITIES, INCLUDING THE DEPTHS OF ALL BELOW GRADE SANITARY SEWERS, PRIOR TO START OF WORK. THIS DRAWING IS NOT INTENDED TO INDICATE ALL EXISTING UTILITIES.
3. CONTRACTOR SHALL BE FAMILIAR WITH LANDLORD'S STANDARDS, RULES AND REGULATIONS. ALL LANDLORD'S CRITERIA SHALL BE COMPILED WITH AND INCLUDED IN THIS BID.
4. CONTRACTOR SHALL VISIT SITE PRIOR TO SUBMITTING BID AND FIELD VERIFY EXISTING CONDITIONS TO ENSURE THAT THE WORK REPRESENTED ON THE DRAWINGS AND IN THESE SPECIFICATIONS CAN BE INSTALLED AS INDICATED. CONTRACTOR SHALL TAKE ALL INTERFERENCES INTO CONSIDERATION. PROVIDE ALL NECESSARY OFFSETS TO SUIT FIELD CONDITIONS AS REQUIRED.
5. CONTRACTOR SHALL VERIFY AND COORDINATE ALL UTILITY CONNECTION POINTS, INCLUDING SIZES AND INVERTS WITH EXISTING FIELD CONDITIONS PRIOR TO START OF WORK.
6. MAKE ALL UTILITY CONNECTIONS AND INSTALLATIONS IN FULL ACCORDANCE WITH ALL UTILITY REGULATIONS. PROVIDE ALL ADDITIONAL APPURTENANCES AS REQUIRED BY UTILITY COMPANY. THE COMPLETED INSTALLATION SHALL BE IN ACCORDANCE WITH ALL APPLICABLE INDUSTRY STANDARDS OF GOOD PRACTICE AND SAFETY, AND THE MANUFACTURER'S STRICTEST RECOMMENDATIONS FOR EQUIPMENT AND PRODUCT APPLICATION AND INSTALLATION.
7. THE CONTRACTOR SHALL OBTAIN AND PAY FOR ALL PERMITS AND INSPECTIONS RELATED TO THE INSTALLATION OF THE WORK.
8. ALL WORK SHALL COMPLY WITH ALL APPLICABLE FEDERAL, STATE AND LOCAL CODES, LAWS, ACTS AND ALL AUTHORITIES HAVING JURISDICTION AND LANDLORD'S CRITERIA.
9. MAINTAIN ALL MANUFACTURER'S RECOMMENDED SERVICE CLEARANCES FOR ALL FIXTURES AND EQUIPMENT. REFER TO ARCHITECTURAL PLANS FOR EXACT LOCATIONS OF PLUMBING FIXTURES.
10. CUTTING OF ROOF AND FLASHING OF PIPE CURBS, SANITARY VENT THROUGH ROOF, ETC. SHALL BE COORDINATED WITH AND PERFORMED BY LANDLORD'S ROOFING CONTRACTOR, AT THIS CONTRACTOR'S EXPENSE, TO MAINTAIN ROOF WARRANTY. ALL VENT OUTLETS SHALL BE A MINIMUM OF 10'-0" AWAY FROM OR 3'-0" ABOVE ANY AIR INTAKES ON HVAC EQUIPMENT.
11. CONTRACTOR SHALL COORDINATE TIMES TO WORK IN SPECIFIC AREA OF THE EXISTING BUILDING WITH THE BUILDING MANAGER AND WITH THE OCCUPANTS OF THE AREA AFFECTED BY THE WORK.
12. CONTRACTOR TO VERIFY ALL EXISTING CONDITIONS AND SHALL NOTIFY THE ENGINEER OF ANY DISCREPANCIES WITH THE CONTRACT DOCUMENTS BEFORE COMMENCING ANY WORK.
13. SLEEVE AND SEAL ALL PIPE PENETRATIONS O WALLS AND FLOORS. APPLY INTUMESCENT FIRE SAFING COMPOUND AT PENETRATIONS AT FIRE RATED WALLS AND FLOORS, MAINTAINING INTEGRITY AND RATING OF FIRE SEPARATION. SLEEVES THROUGH FLOORS SHALL EXTEND 2" ABOVE FLOOR, BE GROUTED INTO PLACE AND WATERPROOFED. PIPING THROUGH EXTERIOR WALLS SHALL BE SLEEVED AND SEALED WEATHER TIGHT WITH SILICONE CAULK.
14. ALL DOMESTIC COLD, HOT AND TEMPERED WATER PIPING TO BE INSULATED WITH RIGID FIBERGLASS INSULATION WITH TYPE "ASJ" JACKET. COLD WATER PIPES TO HAVE 3/4" THICK INSULATION. DOMESTIC HOT AND TEMPERED WATER PIPES TO HAVE 1" THICK INSULATION.
15. THE P.C. IS TO INSPECT THE EXISTING SANITARY DRAIN TO VERIFY THAT IT HAS SUFFICIENT DEPTH FOR THE NEW WORK AND TO VERIFY THE DIRECTION OF FLOW. PRESSURE TEST THE EXISTING SANITARY DRAIN PRIOR TO THE START OF WORK. VERIFY THAT SEWER IS ACTIVE BY FLUSHING WITH WATER, A MINIMUM OF FIVE GALLONS PER MINUTE FOR FOUR HOURS PRIOR TO START OF WORK.

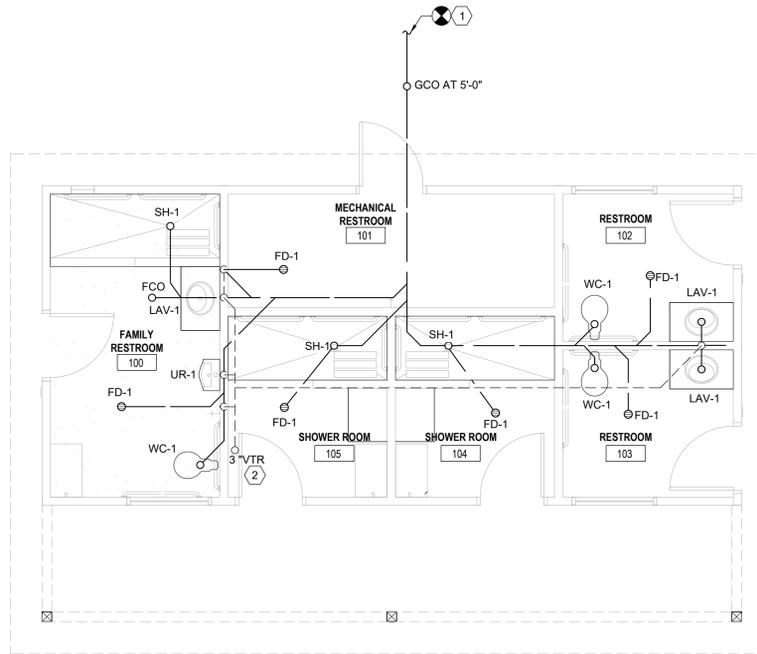

1 DWV PLAN
SCALE : 1/4" = 1'-0"

SANITARY SEWER CONDITIONS NOTE:

SANITARY SEWER PIPING SHOWN ON DRAWINGS IS DIAGRAMMATIC AND MAY DIFFER SLIGHTLY FROM ACTUAL FIELD CONDITIONS. PLUMBING CONTRACTOR (PC) SHALL COORDINATE WITH EXISTING FIELD CONDITIONS VIA A SANITARY VIDEO SURVEYSCOPE TO DETERMINE THE EXACT SIZE, LOCATION, INVERT ELEVATIONS AT THE PROPOSED CONNECTIONS TO EXISTING PLUMBING SERVICES PRIOR TO BID/CONSTRUCTION. IF ACTUAL FIELD FINDINGS VARY SIGNIFICANTLY FROM THOSE AS INDICATED ON PLANS, PC SHALL NOTIFY GENERAL CONTRACTOR (GC) IMMEDIATELY PRIOR TO STARTING ANY WORK. THE OWNER SHALL NOT BE RESPONSIBLE FOR ADDITIONAL COSTS INCURRED BY FAILED COORDINATION AFTER CONSTRUCTION HAS BEGUN. PC SHALL BE RESPONSIBLE FOR UTILIZING A REPUTABLE UTILITY LOCATING SERVICE PRIOR TO ANY EXCAVATION.

TABLE TO CALCULATE DRAINAGE FIXTURE UNITS

PLUMBING FIXTURE	DRAINAGE FIXTURE UNITS	NUMBER OF FIXTURES	TOTAL DRAINAGE FIXTURE UNITS
WATER CLOSET	3	3	9
LAVATORY	1	3	3
FLOOR DRAIN	2	3	6
TOTAL DRAINAGE UNITS			18.0
TOTAL DRAINAGE UNITS FOR ALL FIXTURES			4"

PLUMBING KEYED NOTES

- ① ROUTE NEW SANITARY WASTE PIPING TO CONNECT TO EXISTING WASTE PIPING, SEE SHEET C-108 FOR CONTINUATION.
- ② ROUTE TO CONNECT TO EXISTING SANITARY VENT PIPING THROUGH ROOF. MAINTAIN MINIMUM 10'-0" OFFSET FROM OUTSIDE AIR INTAKES.

PLUMBING FIXTURE SCHEDULE

MARK	FIXTURE	SA N.	VENT	C.W.	H.W.	REMARKS
LAV-1	UNDER MOUNT SINGLE OVAL BOWL SINK STAINLESS STEEL ADA COMPLIANT 19"L X 16" W (OR EQUIVALENT)	2"	2"	1/2"	3/4"	MODEL K-2609-MU REQUIRED ACCESSORIES K-7114-A WITH GRID STRAINERS
UR-1	URINAL - TOTO - UT447E MOUNTED AT 17" AFF MAX. ADA COMPLIANT ELONGATED RIM WITH FLOOR PEDESTAL CARRIER (OR EQUIVALENT)	2"	2"	1/2"	-	TOTO - UT447E COMPACT URINAL WITH CONCEALED INTEGRAL TRAP WASHOUT FLUSH ACTION WITH 3/4" TOP OR BACK SPUD INLET 0.5 GPF WITH ANY FLUSH VALVE SHOWN BELOW
WC-1	WALL MOUNTED KOHLER K-4325-0 WATER CLOSET - ADA (OR EQUIVALENT)	4"	2"	1 1/2"	-	KOHLER K-4325-0 KINGSTON TOILET BOWL IS PRECISION-ENGINEERED TO DELIVER SUPERIOR PERFORMANCE AT EITHER 1.28 GPF OR 1.6GPF. DEPENDING ON FLUSHOMETER.
FD-1	FLOOR DRAIN - JR SMITH 2010-A (OR EQUIVALENT)	3"	2"	-	-	CAST IRON BODY - PROVIDE WITH VANDAL RESISTANT SCREWS MEDIUM DUTY STAINLESS STEEL GRATE
SH-1	KOHLER PURIST 1.5 GPM MULTI FUNCTION HAND SHOWER PACKAGE - INCLUDES SLIDE BAR AND HOSE (OR EQUIVALENT)	2"	2"	1/2"	3/4"	THE HIGHCLIFF ULTRA TOP SPUD IS LISTED FROM 1.0 TO 1.6 GPF AND PERFORMS WELL AT EVERY FLUSH INTERVAL, MAKING IT UNIQUELY EFFECTIVE WITH DUAL FLUSH VALVES.
HB-1	HOSE BIB INTERIOR WITH CHECK VALVE (OR EQUIVALENT)	2"	2"	1/2"	-	WOODFORD - MODEL 26
HB-2	ZURN HOSE BIB INTERIOR WITH CHECK VALVE (OR EQUIVALENT)	2"	2"	1/2"	-	ZURN - Z1321-CL - HYDRANT FURNISHED WITH TYPE 304 STAINLESS STEEL FACEPLATE AND INCLUDES OPERATING KEY.
RPZBFP	REDUCED PRESSURE ZONE ASSEMBLY WATTS LF-919-QT OR EQUAL (OR EQUIVALENT)	1"	-	-	-	LEAD FREE CAST COPPER WITH QUARTER TURN CONTROLS

PLUMBING FIXTURE NOTE:

PLUMBING FIXTURE SCHEDULE MANUFACTURER AND CATALOG NUMBERS ARE SHOWN AS A DESIGN BASIS ONLY. REFER TO SPECIFICATION SECTION 220140. OTHER MANUFACTURERS MAY BE APPROVED AFTER SUBMITTAL OF A WRITTEN REQUEST.



03/28/25

CASE
Engineering Inc.

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St. Louis, MO 63026
T 636.349.1600
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CERTIFICATE OF AUTHORITY NO. 001498

OFFICE OF ADMINISTRATION
DIVISION OF FACILITIES
MANAGEMENT,
DESIGN AND CONSTRUCTION

DEPARTMENT OF
NATURAL RESOURCES
MISSOURI STATE PARKS

NEW 63 SITE
LOOP CAMPGROUND

ST. FRANCOIS STATE PARK
8920 US-67N
ST. FRANCOIS COUNTY, MISSOURI

PROJECT # X2317-01
SITE # 5216
ASSET # 7815216025

REVISION: _____
DATE: _____
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DATE: _____

ISSUE DATE: 03/28/2025

CAD DWG FILE: COC-MO-16-23
DRAWN BY: DMM
CHECKED BY: NH
DESIGNED BY: DMM

SHEET TITLE:
**PLUMBING DWV
PLAN**

SHEET NUMBER:

P1.0

53 OF 56 SHEETS
03/28/2025

PLUMBING GENERAL NOTES

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WATER SERVICE CONDITIONS NOTE:

WATER PRESSURE IS SHOWN AS DIAGRAMMATIC ONLY. CONTRACTOR SHALL VERIFY EXISTING WATER PRESSURE IN FIELD PRIOR TO ANY WORK AND PIPING ROUGH IN. IF DISCOVERED ON SITE THAT EXISTING WATER PRESSURE IS LESS THAN 68 PSI, CONTACT ENGINEER IMMEDIATELY FOR PIPING DESIGN CHANGES. IF PRESSURE IS GREATER THAN 80 PSI PROVIDE PRESSURE REDUCING VALVE AND REDUCE DOWN TO 77 PSI.

PRIOR TO WORK VERIFY INCOMING WATER QUALITY TO SCALE. WHEN INCOMING WATER IS ABOVE 3.5 GRAINS PER GALLON (60 PARTS PER MILLION) SCALE BUILD-UP WILL FORM INSIDE THE PLUMBING SYSTEM CAUSING DAMAGE TO SYSTEM COMPONENTS AND COPPER PIPE. TO AVOID DAMAGE DUE TO SCALE BUILD-UP, EITHER A WATER SOFTENER OR ANTI-SCALE DEVICE SHOULD BE INSTALLED AT POINT-OF-ENTRY. APPLICATIONS WHERE THERE IS A CONCERN FOR WATER SPOTS ON GLASS SHOWER DOORS, GLASS DISHES, VEHICLES IN CARWASHES, ETC., AND/OR THE EFFECTS OF HARD WATER ON HUMAN SKIN, A WATER SOFTENER SHOULD BE USED INSTEAD OF AN ANTI-SCALE DEVICE. ANTI-SCALE DEVICES REDUCE THE FORMATION OF SCALE IN A PLUMBING SYSTEM BUT DO NOT REMOVE THE CALCIUM AND MAGNESIUM FROM THE WATER, WHICH WILL REMAIN ONCE THE WATER HAS EVAPORATE LEAVING WATER SPOTS AND/OR DRYING OUT HUMAN SKIN. WATER SOFTENERS REMOVE CALCIUM AND MAGNESIUM FROM THE WATER BUT REQUIRE ROUTINE REFILLING OF SALT LEVELS IN THE BRINE TANK.


TABLE TO CALCULATE HOT WATER GPH			
PLUMBING FIXTURE	WATER GALLONS PER HOUR	NO. OF FIXTURES	TOTAL HOT WATER GPH
SINKS / LAVATORIES	5	3	15
SHOWER	30	3	90
TOTAL HOT WATER GALLONS PER HOUR FOR ALL FIXTURES:			105 GPH
50	GALLONS USABLE STORAGE (75% TOTAL STORAGE)		38 GALLONS
TOTAL HOT WATER GALLONS PER HOUR NEEDED FOR RECOVERY:			67.5 GPH
TEMPERATURE RISE (°F)			100 °F
GPH RECOVERY x 8.33 x TEMP. RISE		X (DEMAND FACTOR %)	TOTAL BTU NEEDED FOR RECOVERY
58,570 BTU		0.75	43,928 BTU
BTU -> KW CONVERSION			12.9 KW

TABLE TO CALCULATE SUPPLY FIXTURE UNITS			
PLUMBING FIXTURE	SUPPLY FIXTURE UNITS	NUMBER OF FIXTURES	TOTAL SUPPLY FIXTURE UNITS
WATER CLOSET FLUSH VALVE	2.5	3	7.5
LAVATORIES	1.0	3	3.0
SINKS	1.0	1	1.0
URINAL	0.0	1	.0
HOSE BIB	2.5	2	5.0
TOTAL SUPPLY FIXTURE UNITS			16.50
WATER PIPE SIZE = 1"			

WATER HEATER SCHEDULE									
MARK	MFR	MODEL	STORAGE	RECOVERY	F. RISE	VOLT/PHASE	HEAT INPUT	REMARKS	
EWH-1	AO SMITH (OR EQUIVALENT)	DRE-62-13.5	50	55	100	240/1	13.5 KW	1.2,3	

1. SET WATER HEATER TEMPERATURE TO 110°F.
 2. CONSULT MANUFACTURER PRIOR TO PURCHASE FOR EXACT MODEL AND ALL ACCESSORIES FOR A COMPLETE SYSTEM.
 3. CONFIRM VOLTAGE WITH ELECTRICAL CONTRACTOR PRIOR TO PURCHASE AND ROUGH IN.

PLUMBING FIXTURE NOTE:
 PLUMBING FIXTURE SCHEDULE MANUFACTURER AND CATALOG NUMBERS ARE SHOWN AS A DESIGN BASIS ONLY. REFER TO SPECIFICATION SECTION 223300. OTHER MANUFACTURERS MAY BE APPROVED AFTER SUBMITTAL OF A WRITTEN REQUEST.

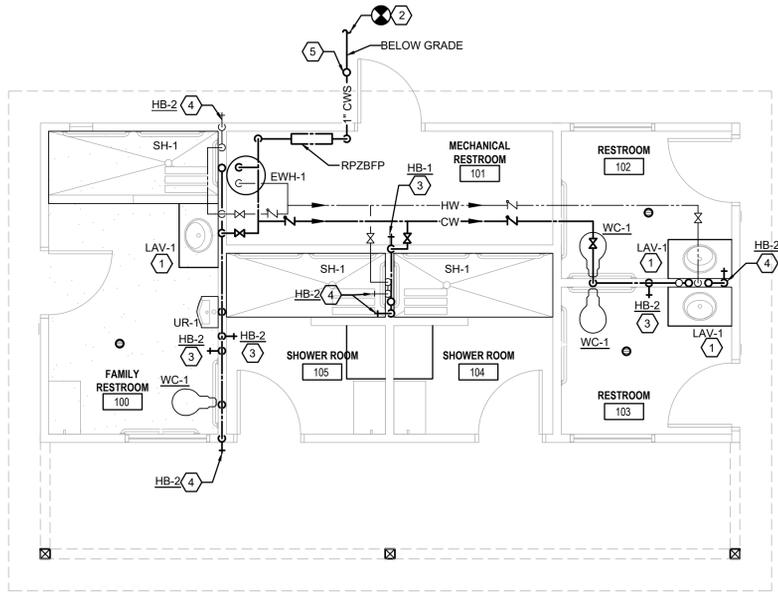

1 SUPPLY PLAN

PLUMBING KEYED NOTES	
1	INSTALL THERMOSTATIC MIXING VALVE (TMV-1) ON THIS PLUMBING FIXTURE. SEE PLUMBING FIXTURE SCHEDULE.
2	ROUTE TO CONNECT TO NEW WATER SUPPLY FOR SPACE BELOW GRADE. GC TO VERIFY SIZE AND UPSIZE AS REQUIRED. VERIFY EXACT LOCATION, DELIVERY PRESSURE, AND SIZE IN FIELD PRIOR TO ANY WORK AND WITH CIVIL DRAWINGS. WATER PIPING SIZE BASED ON 60 PSI INCOMING STATIC WATER PRESSURE. PROVIDE PRESSURE REDUCING VALVE IF PRESSURE IS OVER 80 PSI. CONTACT ENGINEER IMMEDIATELY IF LOW PRESSURE (BELOW 60 PSI) OR DISCREPANCIES ARE FOUND FOR PIPING CHANGES.
3	1/2" CW HOSE BIB.
4	HOSE BID AT LOW POINT IN PIPING FOR FREEZE PROTECTION AND WINTER DRAIN DOWN.
5	VALVE BOX AT GRADE.



03/28/25

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 DIVISION OF FACILITIES
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DEPARTMENT OF
 NATURAL RESOURCES
 MISSOURI STATE PARKS

NEW 63 SITE
 LOOP CAMPGROUND

ST. FRANCOIS STATE PARK
 8920 US-67N
 ST. FRANCOIS COUNTY, MISSOURI

PROJECT # X2317-01
 SITE # 5216
 ASSET # 7815216025

REVISION: _____
 DATE: _____
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ISSUE DATE: 03/28/2025

CAD DWG FILE: COC-MO-16-23
 DRAWN BY: DMM
 CHECKED BY: NH
 DESIGNED BY: DMM

SHEET TITLE:
**PLUMBING SUPPLY
 PLAN**

SHEET NUMBER:

P2.0

54 OF 56 SHEETS
 03/28/2025



03/28/25

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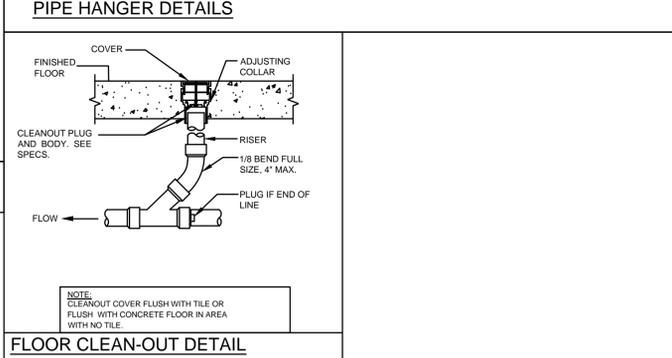
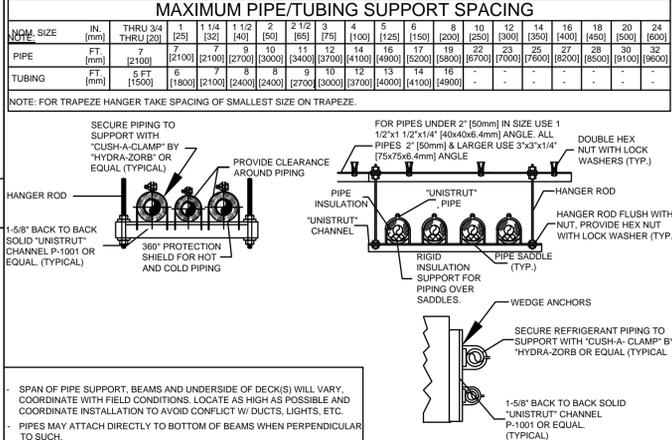
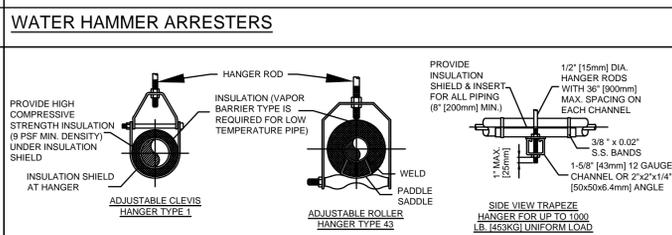
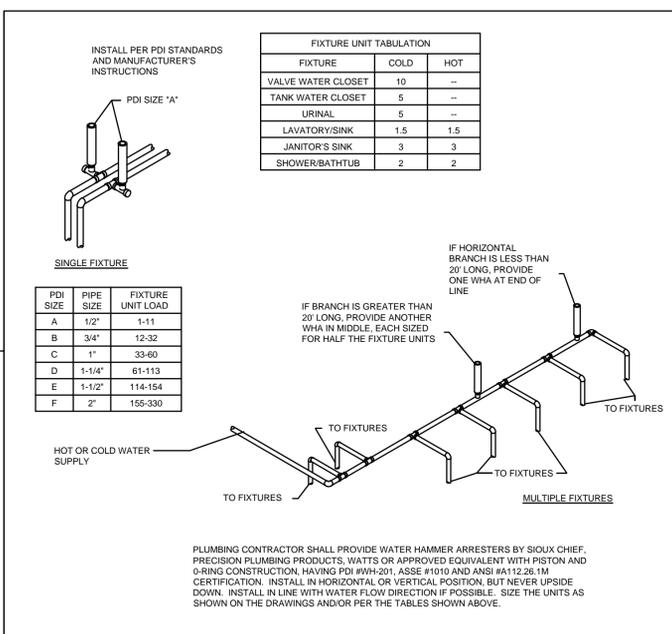
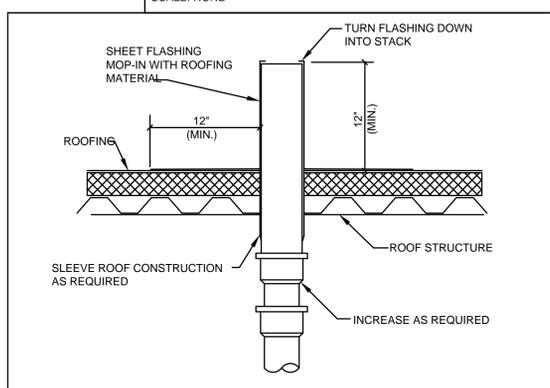
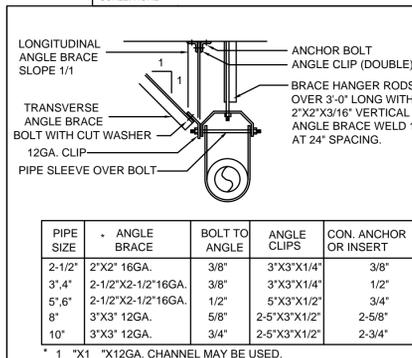
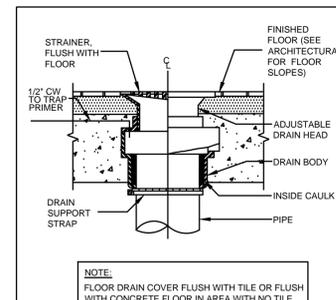
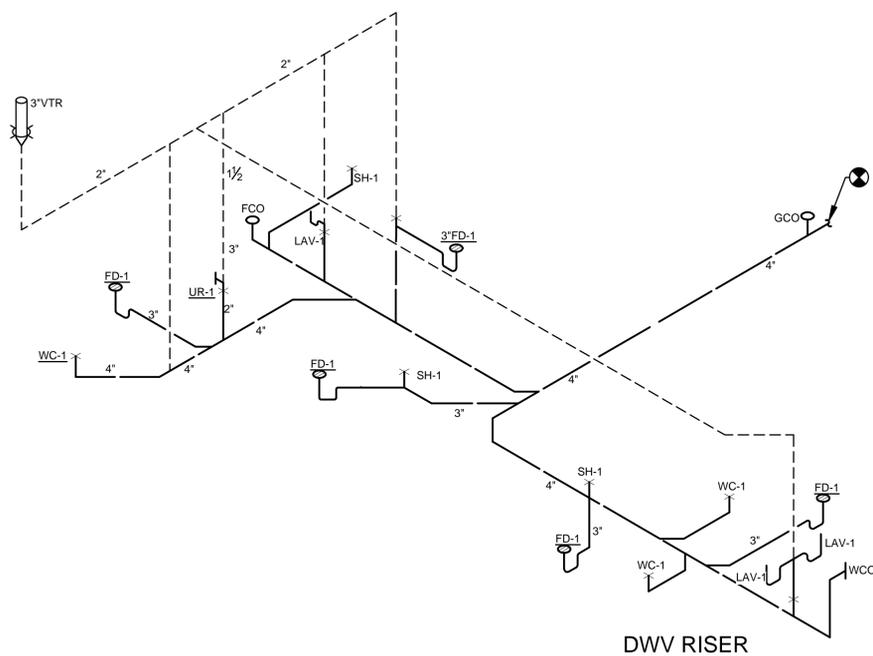
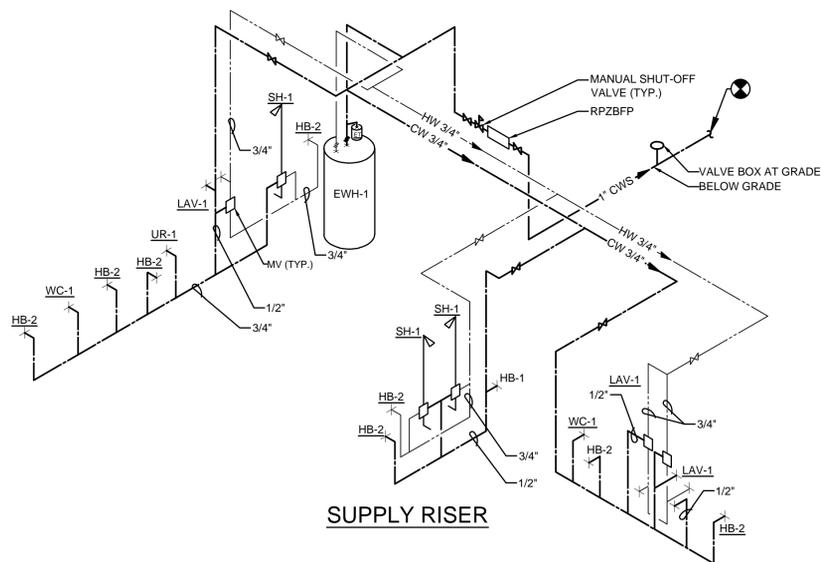
CAD DWG FILE: COC-MO-16-23
DRAWN BY: DMM
CHECKED BY: NH
DESIGNED BY: DMM

SHEET TITLE:
**PLUMBING RISERS
AND DETAILS**

SHEET NUMBER:

P3.0

55 OF 56 SHEETS
03/28/2025





03/28/25

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DRAWN BY: BDW
CHECKED BY: DRC
DESIGNED BY: BDW


SHEET TITLE:

**ELECTRICAL POWER
& LIGHTING PLAN**


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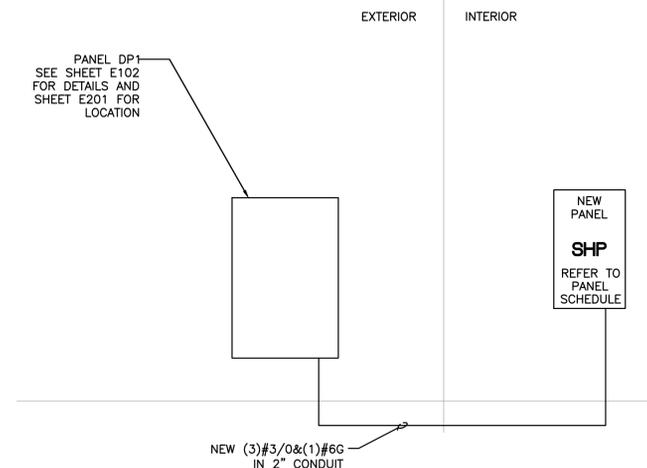
56 OF 56 SHEETS
03/28/2025



2 ELECTRICAL LIGHTING PLAN
E1-0 SCALE: 1/4" = 1'-0"

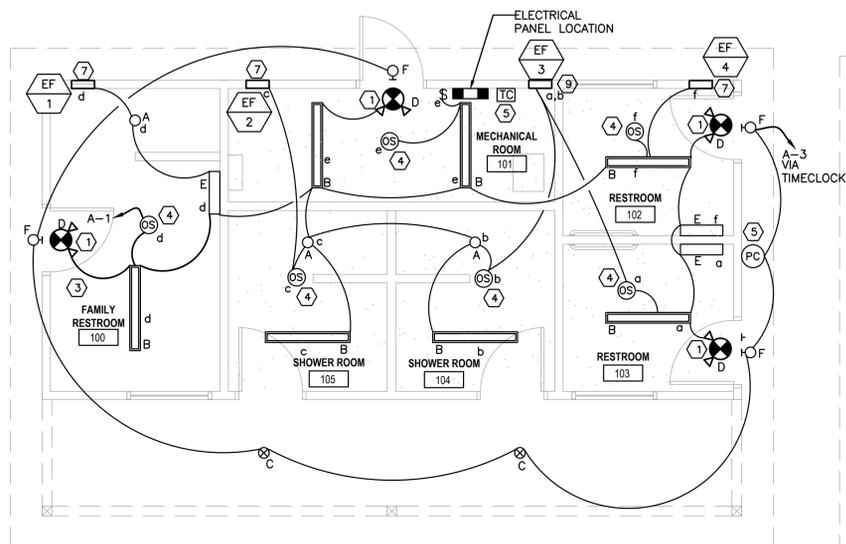

1 ELECTRICAL POWER PLAN
E1-0 SCALE: 1/4" = 1'-0"

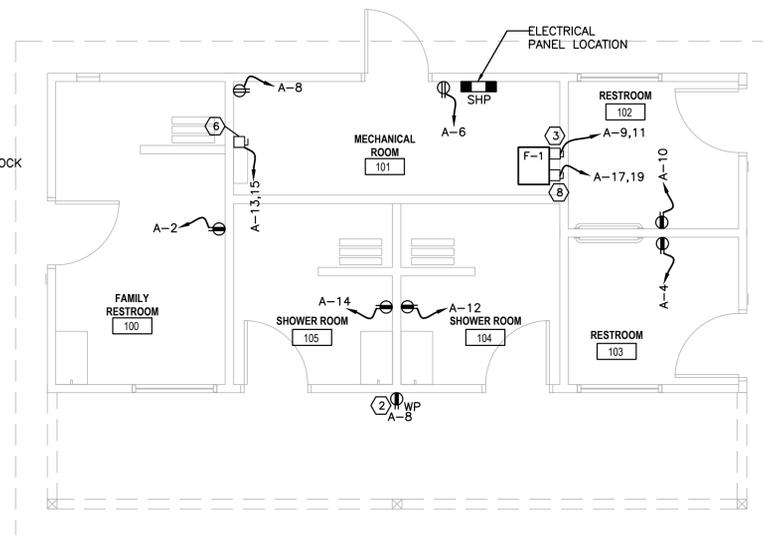

3 ONE LINE DIAGRAM
E1-0 SCALE: NTS

NEW PANEL BOARD SHP									
120/240VOLTS 1 PHASE 3 WIRE 200 AMP. BUS 42k AIC FULLY RATED									
200 AMP. MAIN CIRCUIT BREAKER FED FROM SERVICE SWITCH									
CIRCUIT NO.	TRIP NO.	LOAD SERVED	LOAD - V. A.		LOAD SERVED	NO. OF POLE	TRIP NO.	CIRCUIT NO.	LOAD SERVED
			A@	B@					
1	20	GENERAL LTG	300	180	RESTROOM REC	1	20	2	
3	20	OUTDOOR LTG	NEC	180	RESTROOM REC	1	20	4	
5	20	SPARE	---	---	MAINTENANCE REC	1	20	6	
7	20	SPARE	---	---	RECEPTACLE	1	20	8	
9	15	FURNACE UNIT	600	180	RESTROOM REC	1	20	10	
11	15	SPARE	---	---	RECEPTACLE	1	20	12	
13	80	ELECTRIC WATER HEATER	6750	180	RECEPTACLE	1	20	14	
15	15	SPARE	---	---	SPARE	1	20	16	
17	60	ELECTRIC HEAT	5000	---	SPARE	1	20	18	
19	19	SPARE	---	---	SPARE	1	20	20	
21	20	SPARE	---	---	SPARE	1	20	22	
23	20	SPARE	---	---	SPARE	1	20	24	
TOTAL			13570	12990					


LOAD DESCRIPTION	DEMAND FACTOR D.F.	VOLT - AMPS	
		CONNECTED	DEMAND
LIGHTING	1.25	400	500
RECEPTACLES	NEC	720	720
MOTORS	NEC	---	---
MISC. EQUIPMENT	1.00	200	200
WATER HEATER	1.00	13500	13500
HVAC EQUIPMENT	1.00	11200	11200
TOTAL		26020	28120

PANELBOARD LOAD = 26120 V.A.
FULL LOAD AMPS = 109 A.


LO PROVIDE LOCK-ON DEVICE TS CIRCUIT VIA TIMESCLOCK
CL VIA TRACK CURRENT LIMITER (SEE LIGHT FIXTURE SCHEDULE)
G GFI RECEPTACLE
A PROVIDE PAD-LOCK

TYPE	MANUFACTURER	CATALOG NUMBER	LAMPS		VOLTAGE	MOUNTING	WATTS	FIXTURE DESCRIPTION
			QTY.	TYPE				
A	LITHONIA	LDN6-40-15-L06-AR-LSS-MVOLT-GZ10	-	LED	120V	SURFACE MOUNTED	18	DOWNLIGHT
B	RAB	SEAL4- 40W-4000K	-	LED	120V	SURFACE MOUNTED	40	LED SURFACE WRAP
C	RAB	Disk34-6 4K	-	LED	120V	SURFACE MOUNTED	14.8	ROUND CANOPY DOWNLIGHT
D	BEST	EZXTEU2RWEM , MV, NON DIM, 4W	-	LED	120V	WALL MOUNTED	4	EXIT, SELF POWERED SINGLE/DOUBLE FACE, UNIVERSAL MOUNT
E	LUMINAIRE LED	VPF8-2FT-HP-4000K-120-CP-WHT-WET-TX/SD	-	LED	120V	WALL MOUNTED	20	2FT WALL MOUNTED LED
F	RAB	Brik17FS20 4K	-	LED	120V	WALL MOUNTED	20	EXTERIOR DECORATIVE WALLPACK

LIGHTING FIXTURE NOTE:
FIXTURE SCHEDULE MANUFACTURER AND CATALOG NUMBERS ARE SHOWN AS A DESIGN BASIS ONLY. EQUAL FIXTURES FROM COOPER, ACUITY, PHILLIPS, HUBBELL ARE APPROVED. OTHER MANUFACTURERS MAY BE APPROVED AFTER SUBMITTAL OF A WRITTEN REQUEST.

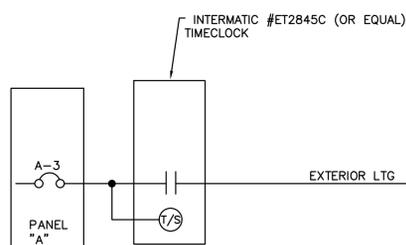

4 LIGHTING CONTROL DIAGRAM
E1-0 SCALE: NONE

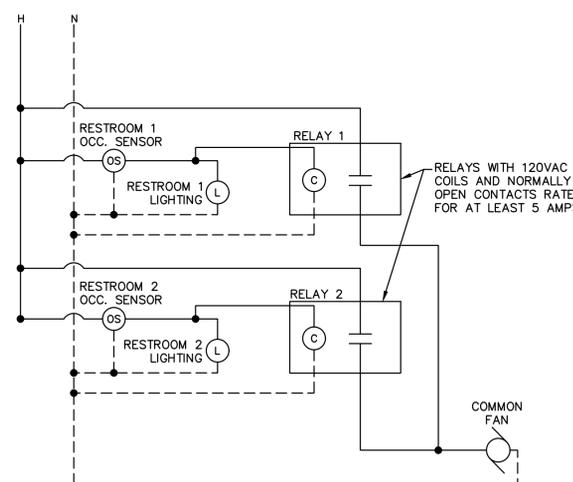

5 COMMON EXHAUST FAN WIRING DIAGRAM
E1-0 SCALE: NONE

LIGHTING PLAN GENERAL ELECTRICAL NOTES

1. PLACEMENT OF LIGHT FIXTURES SHALL BE SET AS DIMENSIONED & AS SCHEDULED.
2. LIGHT FIXTURES SHALL BE SUPPLIED AS SCHEDULED WITH NO EXCEPTIONS.
3. ALL EMERGENCY AND EXIT LIGHTING SHALL BE WIRED AHEAD OF THE SWITCHING. EMERGENCY LIGHTING SHALL BE ON THE SAME CIRCUITRY AS THE GENERAL LIGHTING IN THE AREA THEY SERVE. EMERGENCY LIGHTING WIRING SHALL BE IDENTIFIED (MARKED) PER N.E.C. 700.9. PROVIDE GENERAL LIGHTING CIRCUITS, WHICH HAVE EMERGENCY LIGHTING CONNECTIONS, WITH LOCK-OUT ON BREAKER.
4. EC TO TEST ALL LIGHTING SYSTEMS TO ENSURE PROPER CALIBRATIONS, ADJUSTMENT, PROGRAMING, AND OPERATION.
5. ALL EMERGENCY, EXIT LIGHTS IN SUPPORT AREAS SHALL BE CIRCUITED TO LIGHTING CIRCUIT SERVICING SAME AREA WITH A LOCK ON DEVICE AT THE BREAKER PER N.E.C. 700.12.

POWER PLAN GENERAL ELECTRICAL NOTES

1. EXACT LOCATION, CUT-OUTS AND MOUNTING HEIGHTS FOR WIRING DEVICES IN CASEWORK SHALL BE COORDINATED WITH OWNER'S REPRESENTATIVE PRIOR TO ROUGH-IN.
2. VERIFY ALL EXISTING CONDITIONS IN THE FIELD PRIOR TO BID. NOTIFY OWNER OF ANY DISCREPANCIES. IF ACCEPTABLE TO OWNER'S REPRESENTATIVE, EXISTING EQUIPMENT MAY BE RE-USED. IF NOT ACCEPTABLE, FURNISH AND INSTALL NEW.
3. ALL RECEPTACLES ARE TO BE MOUNTED AT +18" ABOVE FINISHED FLOOR UNLESS NOTED OTHERWISE.
4. PRIOR TO CONNECTION EC SHALL VERIFY THE VOLTAGE AND AMPERAGE REQUIREMENTS OF ALL EQUIPMENT DELIVERED TO THE SITE. EC SHALL NOTIFY OWNER OF ANY DIFFERENCE.
5. EC TO VERIFY PLUG TYPE, AMPERAGE, VOLTAGE, AND LOCATION PRIOR TO BID AND ROUGH IN.
6. EC TO VERIFY ALL POWER REQUIREMENTS WITH EQUIPMENT MANUFACTURER. PROVIDE HACR BREAKERS AS REQUIRED.
7. WHEN POSSIBLE, OUTLETS TO BE MOUNTED ABOVE BACKSPLASH FOR COUNTER TOP EQUIPMENT AND BELOW COUNTER FOR UNDER COUNTER EQUIPMENT. PROVIDE POWER BELOW COUNTER FOR FRONT SERVING LINE COUNTER TOP EQUIPMENT. SEE ARCHITECTURAL DRAWINGS FOR COUNTER TOP HEIGHTS.

POWER PLAN KEYED NOTES

1. CONNECT EXIT SIGN / REMOTE EGRESS DUAL HEAD FIXTURE AHEAD OF ALL LIGHTING CONTROLS OF GENERAL LIGHTING CIRCUIT SERVING THIS AREA.
2. EC TO PROVIDE WEATHER RESISTANT TYPE, GFI RECEPTACLE IN WEATHERPROOF WHILE IN USE COVER AT EQUIPMENT. COVER SHALL BE EXTRA DUTY RATED PER SECTION 406.9(B). CONNECT TO CIRCUIT NOTED.
3. EC TO PROVIDE 240V, 1PH, 30A DISCONNECT SWITCH FOR FURNACE MOTOR. PROVIDE (2)#12 & (1)#12G IN 3/4" CONDUIT.
4. EC TO PROVIDE CEILING MOUNTED DUAL TECHNOLOGY OCCUPANCY SENSOR FOR AUTOMATIC LIGHTING CONTROLS IN AREA SHOWN. ACUITY CMR-PDT-9 OR EQUAL
5. EC TO PROVIDE NEW ASTRONOMICAL TIMECLOCK FOR CONTROL OF EXTERIOR LIGHTING. SEE DETAIL #4 ON THIS SHEET FOR MORE INFORMATION.
6. 240V, 1P, 13.5KVA ELECTRIC WATER HEATER, EC TO COORDINATE ALL POWER REQUIREMENT WITH MANUFACTURER PRIOR TO BID. PROVIDE (2)#4 & (1)#8G IN 1" CONDUIT. EC TO PROVIDE 240V, 1P, 100A DISCONNECT SWITCH.
7. EC TO CONNECT THE RESTROOM EXHAUST FANS TO THE LOCAL LIGHTING CIRCUIT AND CONTROLS.
8. EC TO PROVIDE 240V, 1PH, 60A DISCONNECT SWITCH FOR FURNACE ELECTRIC HEAT. PROVIDE (2)#6 & (1)#8G IN 1" CONDUIT.
9. EF-3 SHALL BE WIRED SO THAT EITHER OCCUPANCY SENSOR IN SHOWER ROOM 104 OR RESTROOM 103 WILL TURN ON FAN. DETAIL #5 ON THIS SHEET.