

BOTHWELL LODGE STATE HISTORIC SITE INSTALL NEW HEATING UNIT SEDALIA, MO



OWNER: STATE OF MISSOURI
MICHAEL L. PARSON,
GOVERNOR
MISSOURI STATE PARKS

PROJECT
MANAGEMENT: OFFICE OF ADMINISTRATION
DIVISION OF FACILITIES MANAGEMENT,
DESIGN AND CONSTRUCTION

DESIGNER: KLINGNER & ASSOCIATES, P.C.


PROJECT NUMBER: X2331-01

SITE NUMBER: 5303 - BOTHWELL LODGE
STATE HISTORIC SITE

ASSET NUMBER: 7815303002 - BOTHWELL LODGE

SHEET NUMBER:

G001
SHEET 1 OF 12
SEPTEMBER 9, 2024

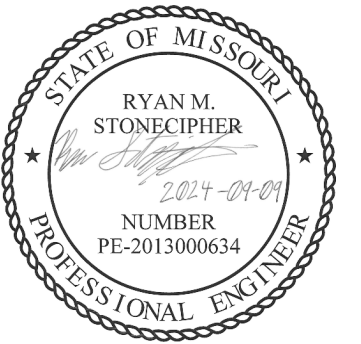

RYAN M. STONECIPHER
MO # PE-2013000634

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MISSOURI STATE CERTIFICATE OF AUTHORITY #000866

OFFICE OF ADMINISTRATION
DIVISION OF FACILITIES
MANAGEMENT,
DESIGN AND CONSTRUCTION

INSTALL NEW HEATING
UNIT

BOTHWELL LODGE STATE
HISTORIC SITE

19349 BOTHWELL STATE
PARK RD
SEDALIA, MO 65301

PROJECT # X233101
SITE # 5303
ASSET # 7815303002

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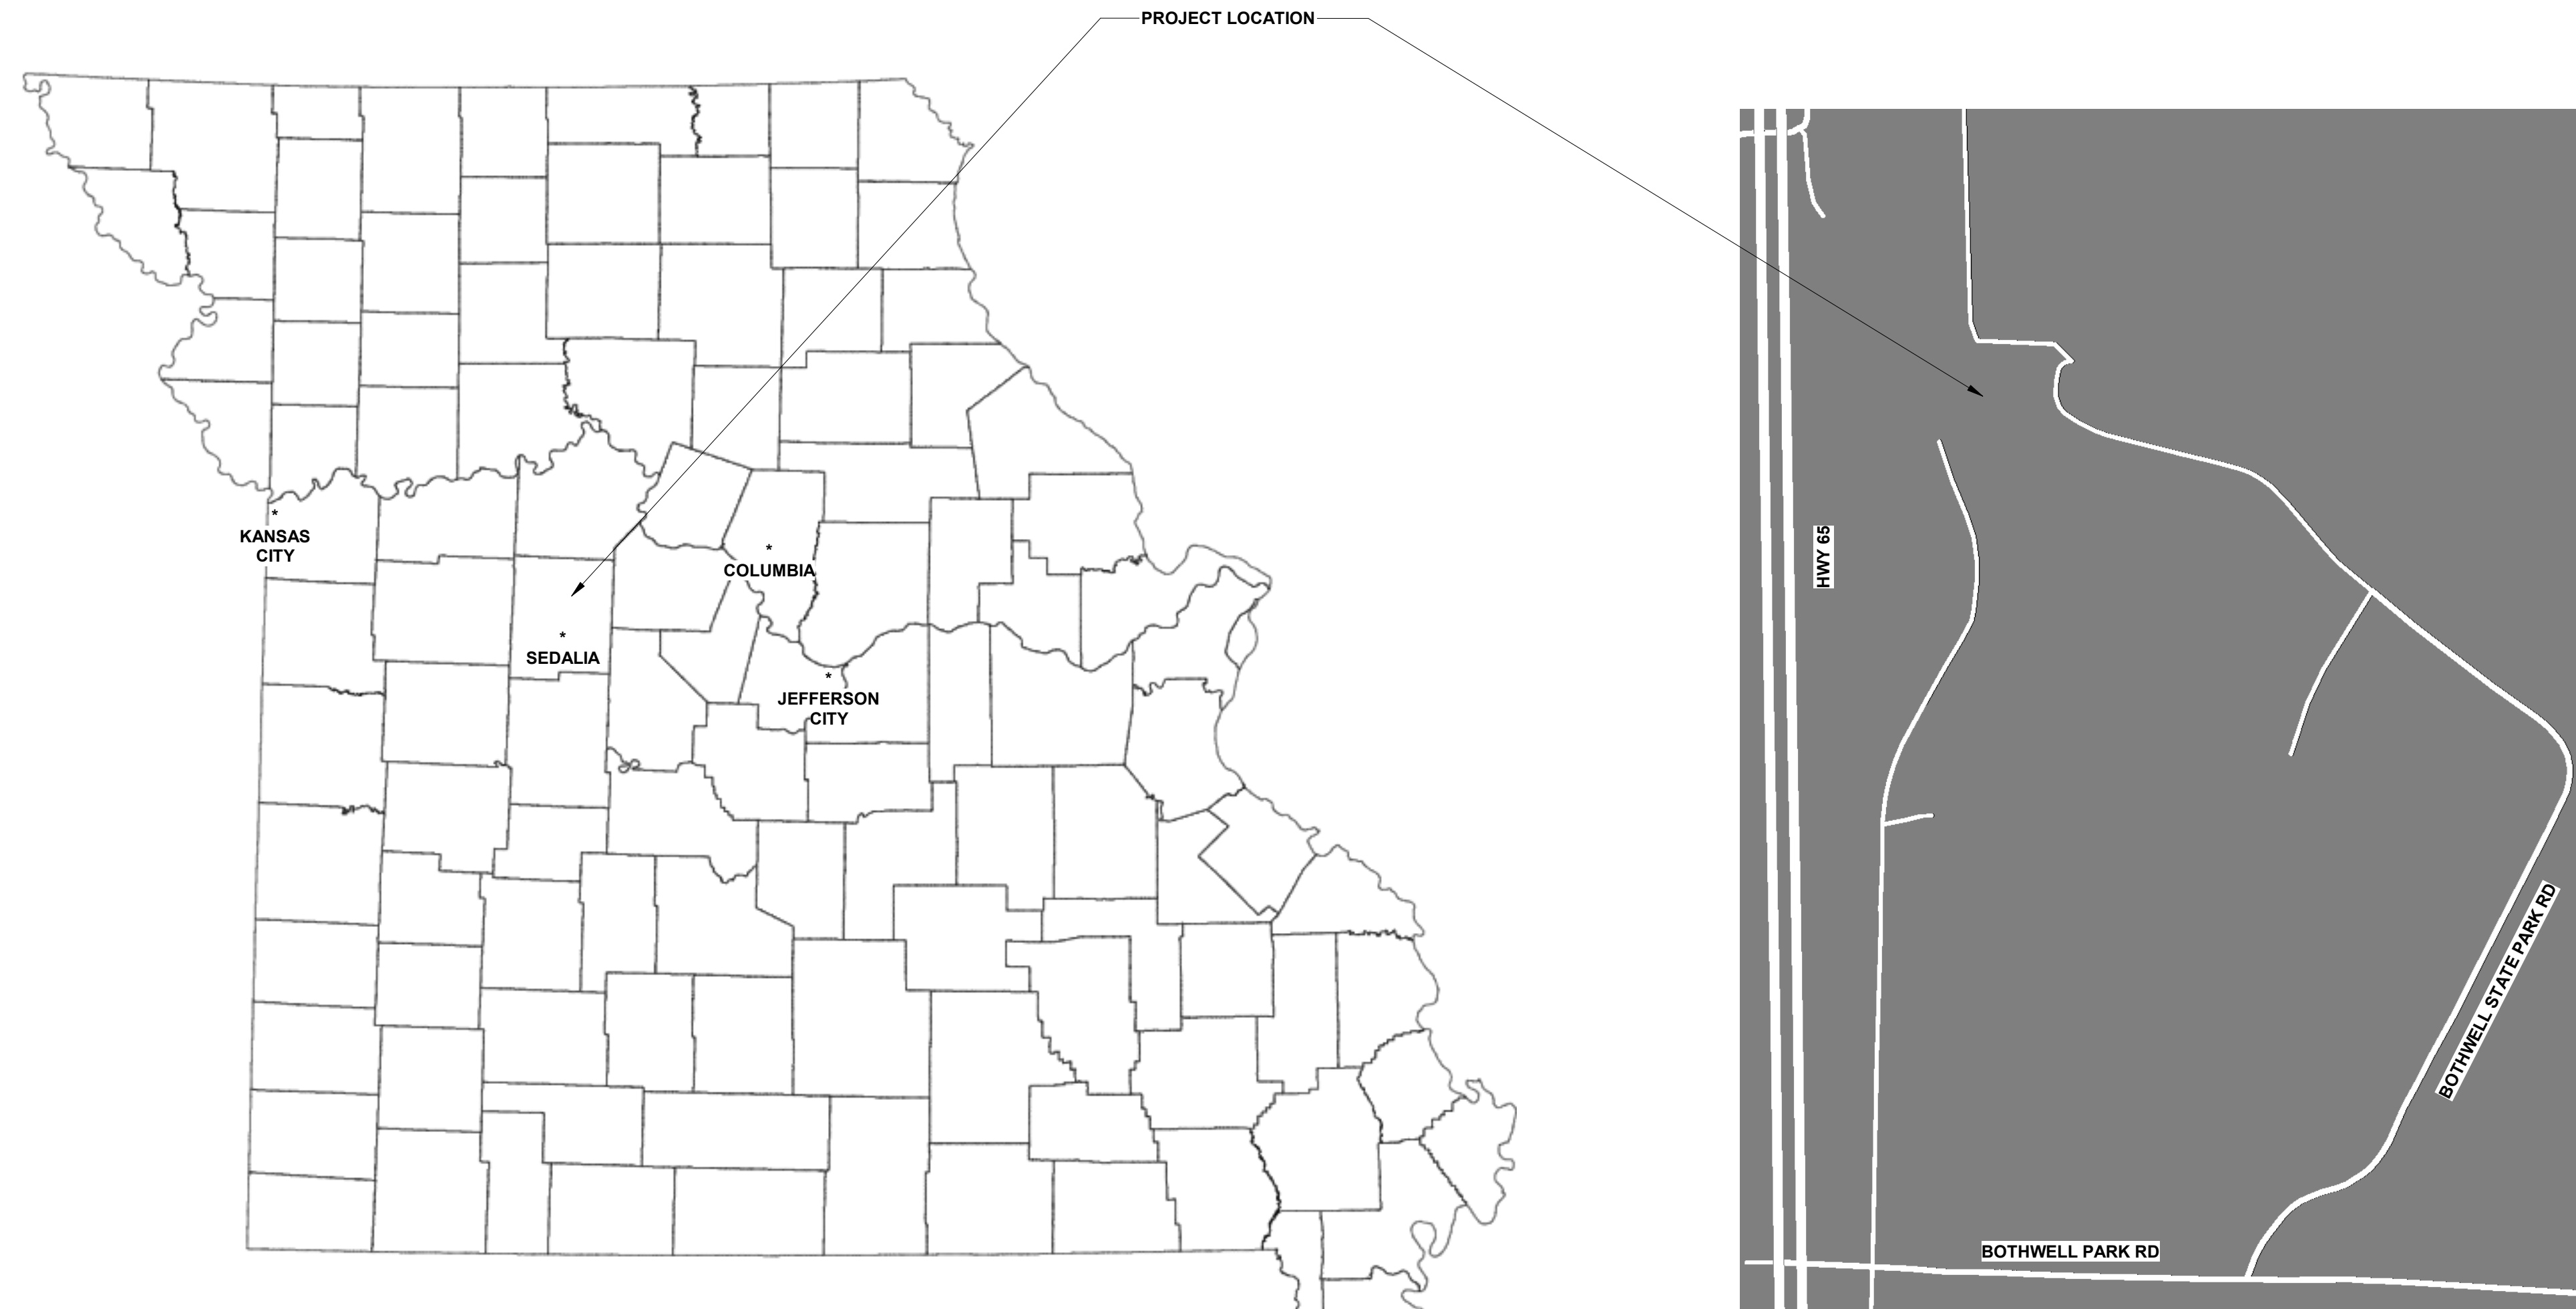
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DESIGNED BY: RMS

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INDEX PAGE

SHEET NUMBER:

G002

SHEET 2 OF 12
SEPTEMBER 9, 2024



PROJECT ADDRESS:

BOTHWELL LODGE
19349 BOTHWELL STATE PARK RD
SEDALIA, MO 65301


SHEET INDEX:

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E600	ELECTRICAL DETAILS AND SCHEDULES

GENERAL PLUMBING AND MECHANICAL NOTES:

- ALL WORK SHALL COMPLY WITH APPLICABLE LOCAL, STATE, AND NATIONAL CODES AND REGULATIONS.
- PLUMBING CONTRACTOR SHALL FURNISH AND INSTALL ALL MATERIALS, ACCESSORIES, TOOLS, EQUIPMENT, TRANSPORTATION, LABOR, SERVICES AND OPERATIONS NECESSARY FOR A COMPLETE PLUMBING SYSTEM INCLUDING FIXTURES, SANITARY SEWERS, CLEANOUTS, WATER SUPPLY PIPING, AND NATURAL GAS PIPING.
- PLUMBING CONTRACTOR SHALL OBTAIN ALL NECESSARY PERMITS AND ARRANGE FOR ALL INSPECTIONS REQUIRED BY STATE OR LOCAL AUTHORITIES.
- MATERIALS MUST BE NEW, IN FIRST CLASS CONDITION.
- WORK SHALL BE DONE BY TRAINED, EXPERIENCED, SKILLED, JOURNEYMAN UNDER AN APPROVED FULL TIME SUPERVISOR. WORK SHALL BE PERFORMED IN A NEAT WORKLIKE MANNER.
- PIPE INSTALLATION SHALL BE COORDINATED WITH OTHER TRADES.
- PIPING SHALL BE SEPARATELY HUNG AND ANCHORED, FREE TO EXPAND AND CONTRACT QUIETLY, WITHOUT IMPOSING STRAINS ON STRUCTURE, PIPING, VALVES, DEVICES, AND EQUIPMENT. PIPING SHALL BE RUN PARALLEL OR PERPENDICULAR TO BUILDING LINES.
- CONNECTIONS BETWEEN DISSIMILAR METALS SHALL BE SEPARATED BY DIELECTRIC COUPLINGS.
- CONTRACTOR SHALL PERFORM EXCAVATION REQUIRED TO INSTALL HIS WORK.
- PIPING, ETC., SHALL BE TESTED TO AT LEAST 125 PSI.
- PIPE HANGERS AND SUPPORTS SHALL MEET THE LOCAL SEISMIC REQUIREMENTS.
- PROVIDE BALL VALVE ON PIPES TO EACH GROUP OF FIXTURES OR TO EACH PIECE OF EQUIPMENT.
- PLUMBING CONTRACTOR SHALL INSTALL GAS PIPING TO WITHIN 2' OF EACH APPLIANCE AND TERMINATE WITH A GAS COCK. HVAC CONTRACTOR TO MAKE FINAL CONNECTION.
- LOCATE ALL SHUT-OFFS, CLEANOUTS, AND OTHER DEVICES REQUIRING ACCESS IN AN EASILY ACCESSIBLE AREA.
- DRAWINGS ARE SCHEMATIC AND SHOW APPROXIMATE LOCATIONS OF PIPING. EXACT LOCATIONS SHALL BE COORDINATED BY THE CONTRACTOR AND VERIFIED IN THE FIELD PRIOR TO ROUGH-IN.
- PLUMBING CONTRACTOR SHALL COORDINATE ALL PLUMBING VENTS THROUGH ROOFS WITH HVAC EQUIPMENT AND BUILDING OPENINGS TO ENSURE CODE COMPLIANCE WITH MINIMUM SEPARATION DISTANCES.
- SEE ARCHITECTURAL SHEET FOR FIRE RATED CONSTRUCTION LOCATIONS. ALL PLUMBING PENETRATIONS IN FIRE RATED CONSTRUCTION SHALL BE UL LISTED OF EQUAL OR GREATER HOUR RATING.


PLUMBING AND MECHANICAL PIPING SYMBOLS

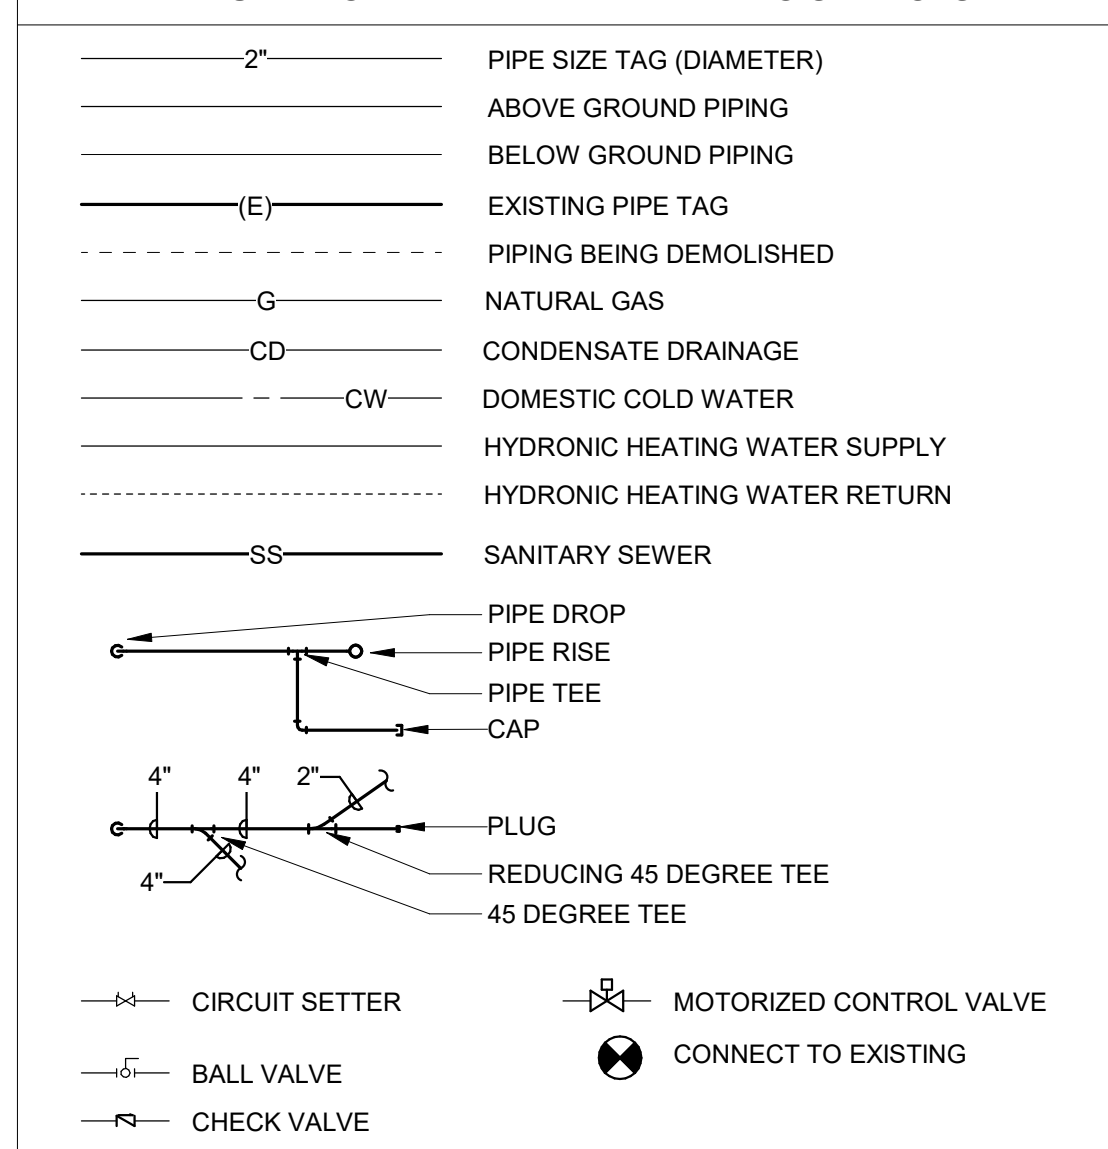

GENERAL ELECTRICAL NOTES:

- APPLICABLE STANDARDS: NFPA-70, NFPA-101, STATE BUILDING CODES, AND THE OCCUPATIONAL SAFETY AND HEALTH ACT (OSHA) OF 1971 AND ALL AMENDMENTS THERETO; EQUIPMENT, DEVICES, APPARATUS, SYSTEMS, AND INSTALLATIONS SHALL BE ENTIRELY SUITABLE AND SAFE FOR EACH INTENDED APPLICATION AND BE IN FULL COMPLIANCE WITH APPLICABLE STANDARDS, REQUIREMENTS, RULES, REGULATIONS, CODES, STATUTES, ORDINANCES, ETC., OF MUNICIPAL, COUNTY, AND STATE GOVERNMENTS, OWNER'S INSURANCE COMPANY, LOCAL UTILITIES, AND LABOR REGULATIONS. NOTHING CONTAINED IN THESE PLANS AND SPECIFICATIONS SHALL BE CONSTRUED TO CONFLICT WITH THESE LAWS, CODES, AND ORDINANCES.
- DRAWINGS ARE SCHEMATIC AND SHOW APPROXIMATE LOCATIONS OF ELECTRICAL EQUIPMENT. EXACT LOCATIONS SHALL BE COORDINATED BY THE CONTRACTOR AND VERIFIED IN THE FIELD PRIOR TO ROUGH-IN.
- INSTALLATIONS WHICH INCLUDE ELECTRICAL FIXTURES, DEVICES, CONDUIT, SWITCHES, PANELS, HANGERS, WIRE, CABLE, STANDARDS, ETC., MUST BE ENTIRELY SUITABLE FOR TEMPERATURES, HUMIDITY, DAMP AREAS, VOLTAGE, FREQUENCY, AND ALL INSTALLATION CONDITIONS ENCOUNTERED.
- INSTALLATION MUST BE ENTIRELY SAFE IN EVERY RESPECT, AND MUST NOT CREATE ANY CONDITIONS OF ANY KIND WHICH WILL BE HARMFUL TO ANY OCCUPANT OF THE BUILDING. IF CONTRACTOR BELIEVES THAT INSTALLATION WILL NOT BE SAFE FOR ALL PEOPLE, HE/SHE SHALL SO REPORT IN WRITING TO ENGINEER BEFORE ANY EQUIPMENT IS PURCHASED OR WORK IS INSTALLED, GIVING EXACT RECOMMENDATIONS, AND REASONS FOR THEM.
- GROUNDING: ALL GROUNDING SHALL BE IN STRICT ACCORDANCE WITH THE LATEST EDITION OF THE NATIONAL ELECTRICAL CODE (NEC).
- INSTALLATION OF ELECTRICAL DEVICES SHALL BE COORDINATED WITH OTHER TRADES AS NECESSARY TO PREVENT ANY CONFLICTS DURING CONSTRUCTION.
- LOW VOLTAGE CONDUIT AND JUNCTION BOXES SHALL BE INSTALLED BY THE ELECTRICAL CONTRACTOR.
- EQUIPMENT GROUNDING CONDUCTORS SHALL BE PULLED WITH ALL BRANCH CIRCUITS. CONDUIT SHALL NOT BE USED AS A GROUND U.N.O.
- ELECTRICAL CONTRACTOR SHALL FURNISH AND INSTALL ALL MATERIALS, ACCESSORIES, TOOLS, EQUIPMENT, TRANSPORTATION, LABOR, SERVICES AND OPERATIONS NECESSARY FOR A COMPLETE ELECTRICAL SYSTEM.
- ELECTRICAL CONTRACTOR SHALL OBTAIN ALL NECESSARY PERMITS AND ARRANGE FOR ALL INSPECTIONS REQUIRED BY STATE OR LOCAL AUTHORITIES.
- MATERIALS MUST BE NEW, IN FIRST CLASS CONDITION.
- CONDUIT SHALL BE SEPARATELY HUNG AND ANCHORED, FREE TO EXPAND AND CONTRACT QUIETLY, WITHOUT IMPOSING STRAINS ON STRUCTURE, DEVICES, AND EQUIPMENT. CONDUIT SHALL BE RUN PARALLEL OR PERPENDICULAR TO BUILDING LINES.
- CONTRACTOR SHALL PERFORM EXCAVATION REQUIRED TO INSTALL HIS WORK.

ELECTRICAL SYMBOLS

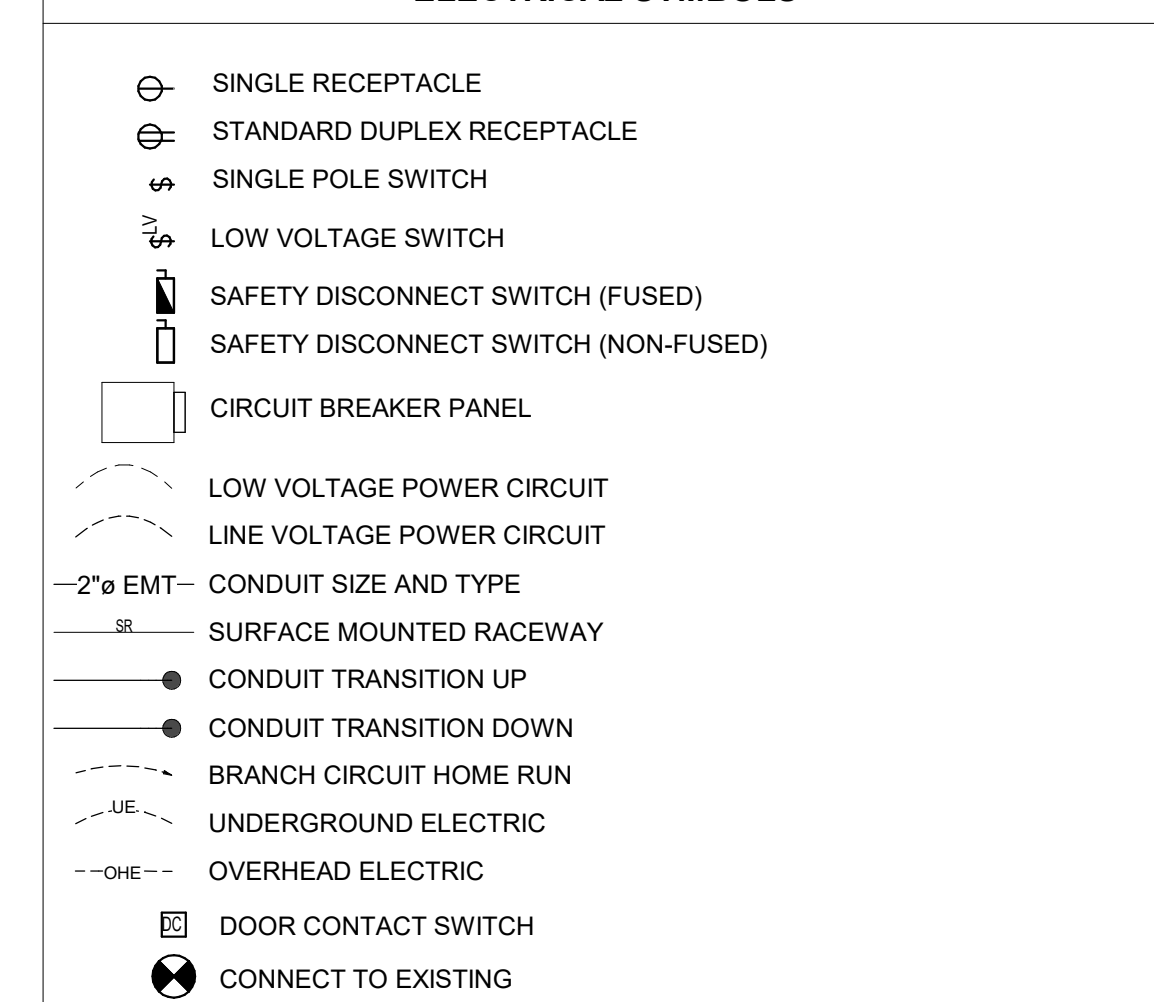



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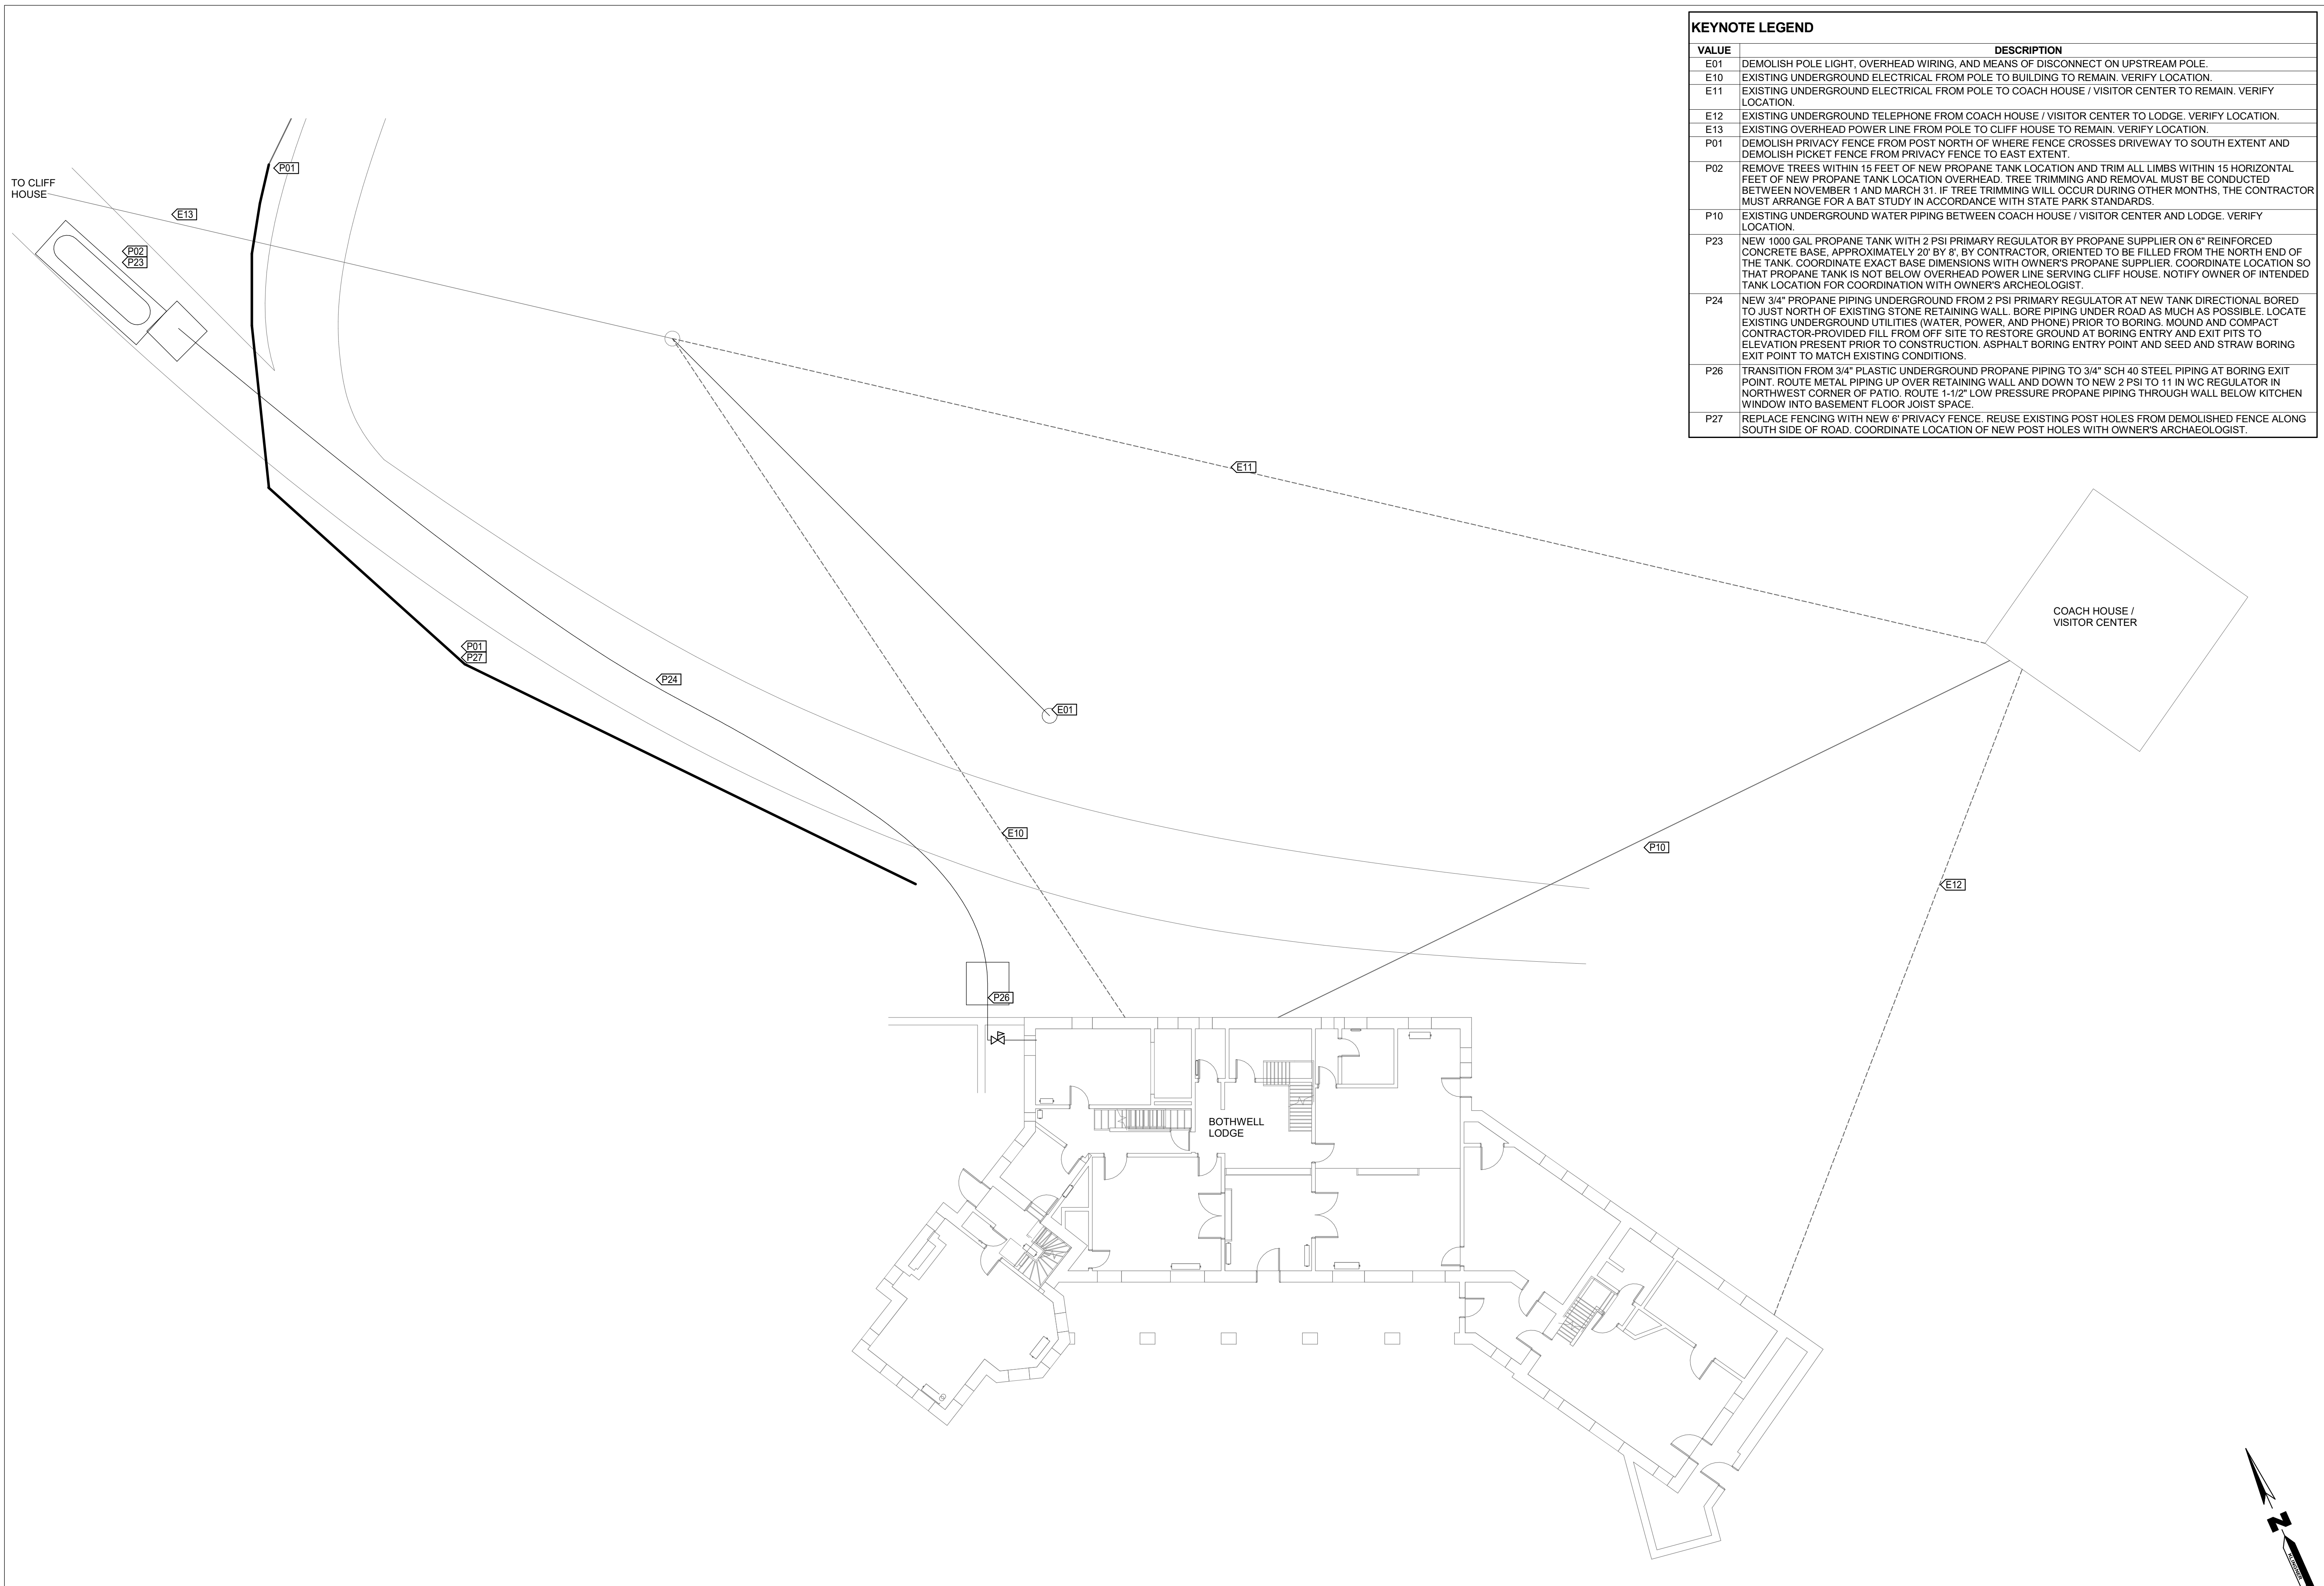
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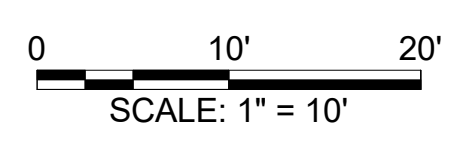
MEP100

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VALUE	DESCRIPTION
E01	DEMOLISH POLE LIGHT, OVERHEAD WIRING, AND MEANS OF DISCONNECT ON UPSTREAM POLE.
E10	EXISTING UNDERGROUND ELECTRICAL FROM POLE TO BUILDING TO REMAIN. VERIFY LOCATION.
E11	EXISTING UNDERGROUND ELECTRICAL FROM POLE TO COACH HOUSE / VISITOR CENTER TO REMAIN. VERIFY LOCATION.
E12	EXISTING UNDERGROUND TELEPHONE FROM COACH HOUSE / VISITOR CENTER TO LODGE. VERIFY LOCATION.
E13	EXISTING OVERHEAD POWER LINE FROM POLE TO CLIFF HOUSE TO REMAIN. VERIFY LOCATION.
P01	DEMOLISH PRIVACY FENCE FROM POST NORTH OF WHERE FENCE CROSSES DRIVEWAY TO SOUTH EXTENT AND DEMOLISH PICKET FENCE FROM PRIVACY FENCE TO EAST EXTENT.
P02	REMOVE TREES WITHIN 15 FEET OF NEW PROPANE TANK LOCATION AND TRIM ALL LIMBS WITHIN 15 HORIZONTAL FEET OF NEW PROPANE TANK LOCATION OVERHEAD. TREE TRIMMING AND REMOVAL MUST BE CONDUCTED BETWEEN NOVEMBER 1 AND MARCH 31. IF TREE TRIMMING WILL OCCUR DURING OTHER MONTHS, THE CONTRACTOR MUST ARRANGE FOR A BAT STUDY IN ACCORDANCE WITH STATE PARK STANDARDS.
P10	EXISTING UNDERGROUND WATER PIPING BETWEEN COACH HOUSE / VISITOR CENTER AND LODGE. VERIFY LOCATION.
P23	NEW 1000 GAL PROPANE TANK WITH 2 PSI PRIMARY REGULATOR BY PROPANE SUPPLIER ON 6" REINFORCED CONCRETE BASE, APPROXIMATELY 20' BY 8'. BY CONTRACTOR, ORIENTED TO BE FILLED FROM THE NORTH END OF THE TANK. COORDINATE EXACT BASE DIMENSIONS WITH OWNER'S PROPANE SUPPLIER. COORDINATE LOCATION SO THAT PROPANE TANK IS NOT BELOW OVERHEAD POWER LINE SERVING CLIFF HOUSE. NOTIFY OWNER OF INTENDED TANK LOCATION FOR COORDINATION WITH OWNER'S ARCHEOLOGIST.
P24	NEW 3/4" PROPANE PIPING UNDERGROUND FROM 2 PSI PRIMARY REGULATOR AT NEW TANK DIRECTIONAL BORED TO JUST NORTH OF EXISTING STONE RETAINING WALL. BORE PIPING UNDER ROAD AS MUCH AS POSSIBLE. LOCATE EXISTING UNDERGROUND UTILITIES (WATER, POWER, AND PHONE) PRIOR TO BORING. MOUND AND COMPACT CONTRACTOR-PROVIDED FILL FROM OFF SITE TO RESTORE GROUND AT BORING ENTRY AND EXIT PITS TO ELEVATION PRESENT PRIOR TO CONSTRUCTION. ASPHALT BORING ENTRY POINT AND SEED AND STRAW BORING EXIT POINT TO MATCH EXISTING CONDITIONS.
P26	TRANSITION FROM 3/4" PLASTIC UNDERGROUND PROPANE PIPING TO 3/4" SCH 40 STEEL PIPING AT BORING EXIT POINT. ROUTE METAL PIPING UP OVER RETAINING WALL AND DOWN TO NEW 2 PSI TO 11 IN WC REGULATOR IN NORTHWEST CORNER OF PATIO. ROUTE 1-1/2" LOW PRESSURE PROPANE PIPING THROUGH WALL BELOW KITCHEN WINDOW INTO BASEMENT FLOOR JOIST SPACE.
P27	REPLACE FENCING WITH NEW 6' PRIVACY FENCE. REUSE EXISTING POST HOLES FROM DEMOLISHED FENCE ALONG SOUTH SIDE OF ROAD. COORDINATE LOCATION OF NEW POST HOLES WITH OWNER'S ARCHEOLOGIST.



1 SITE MEP PLAN
1" = 10'-0"





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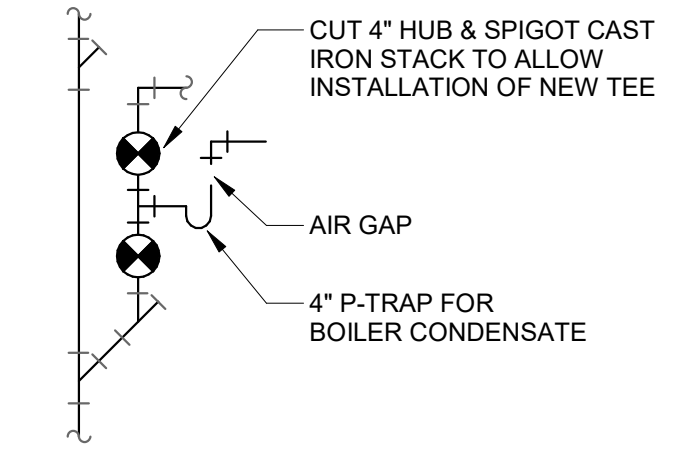
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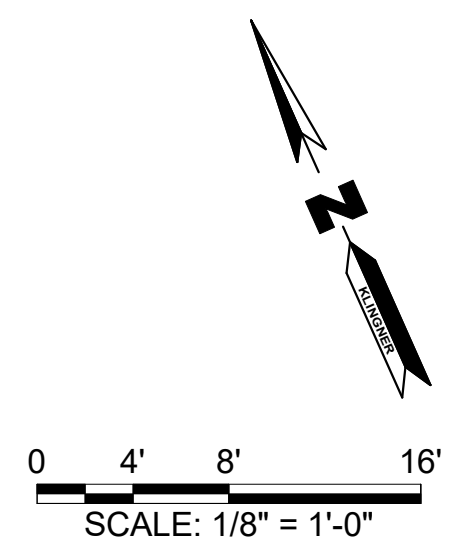
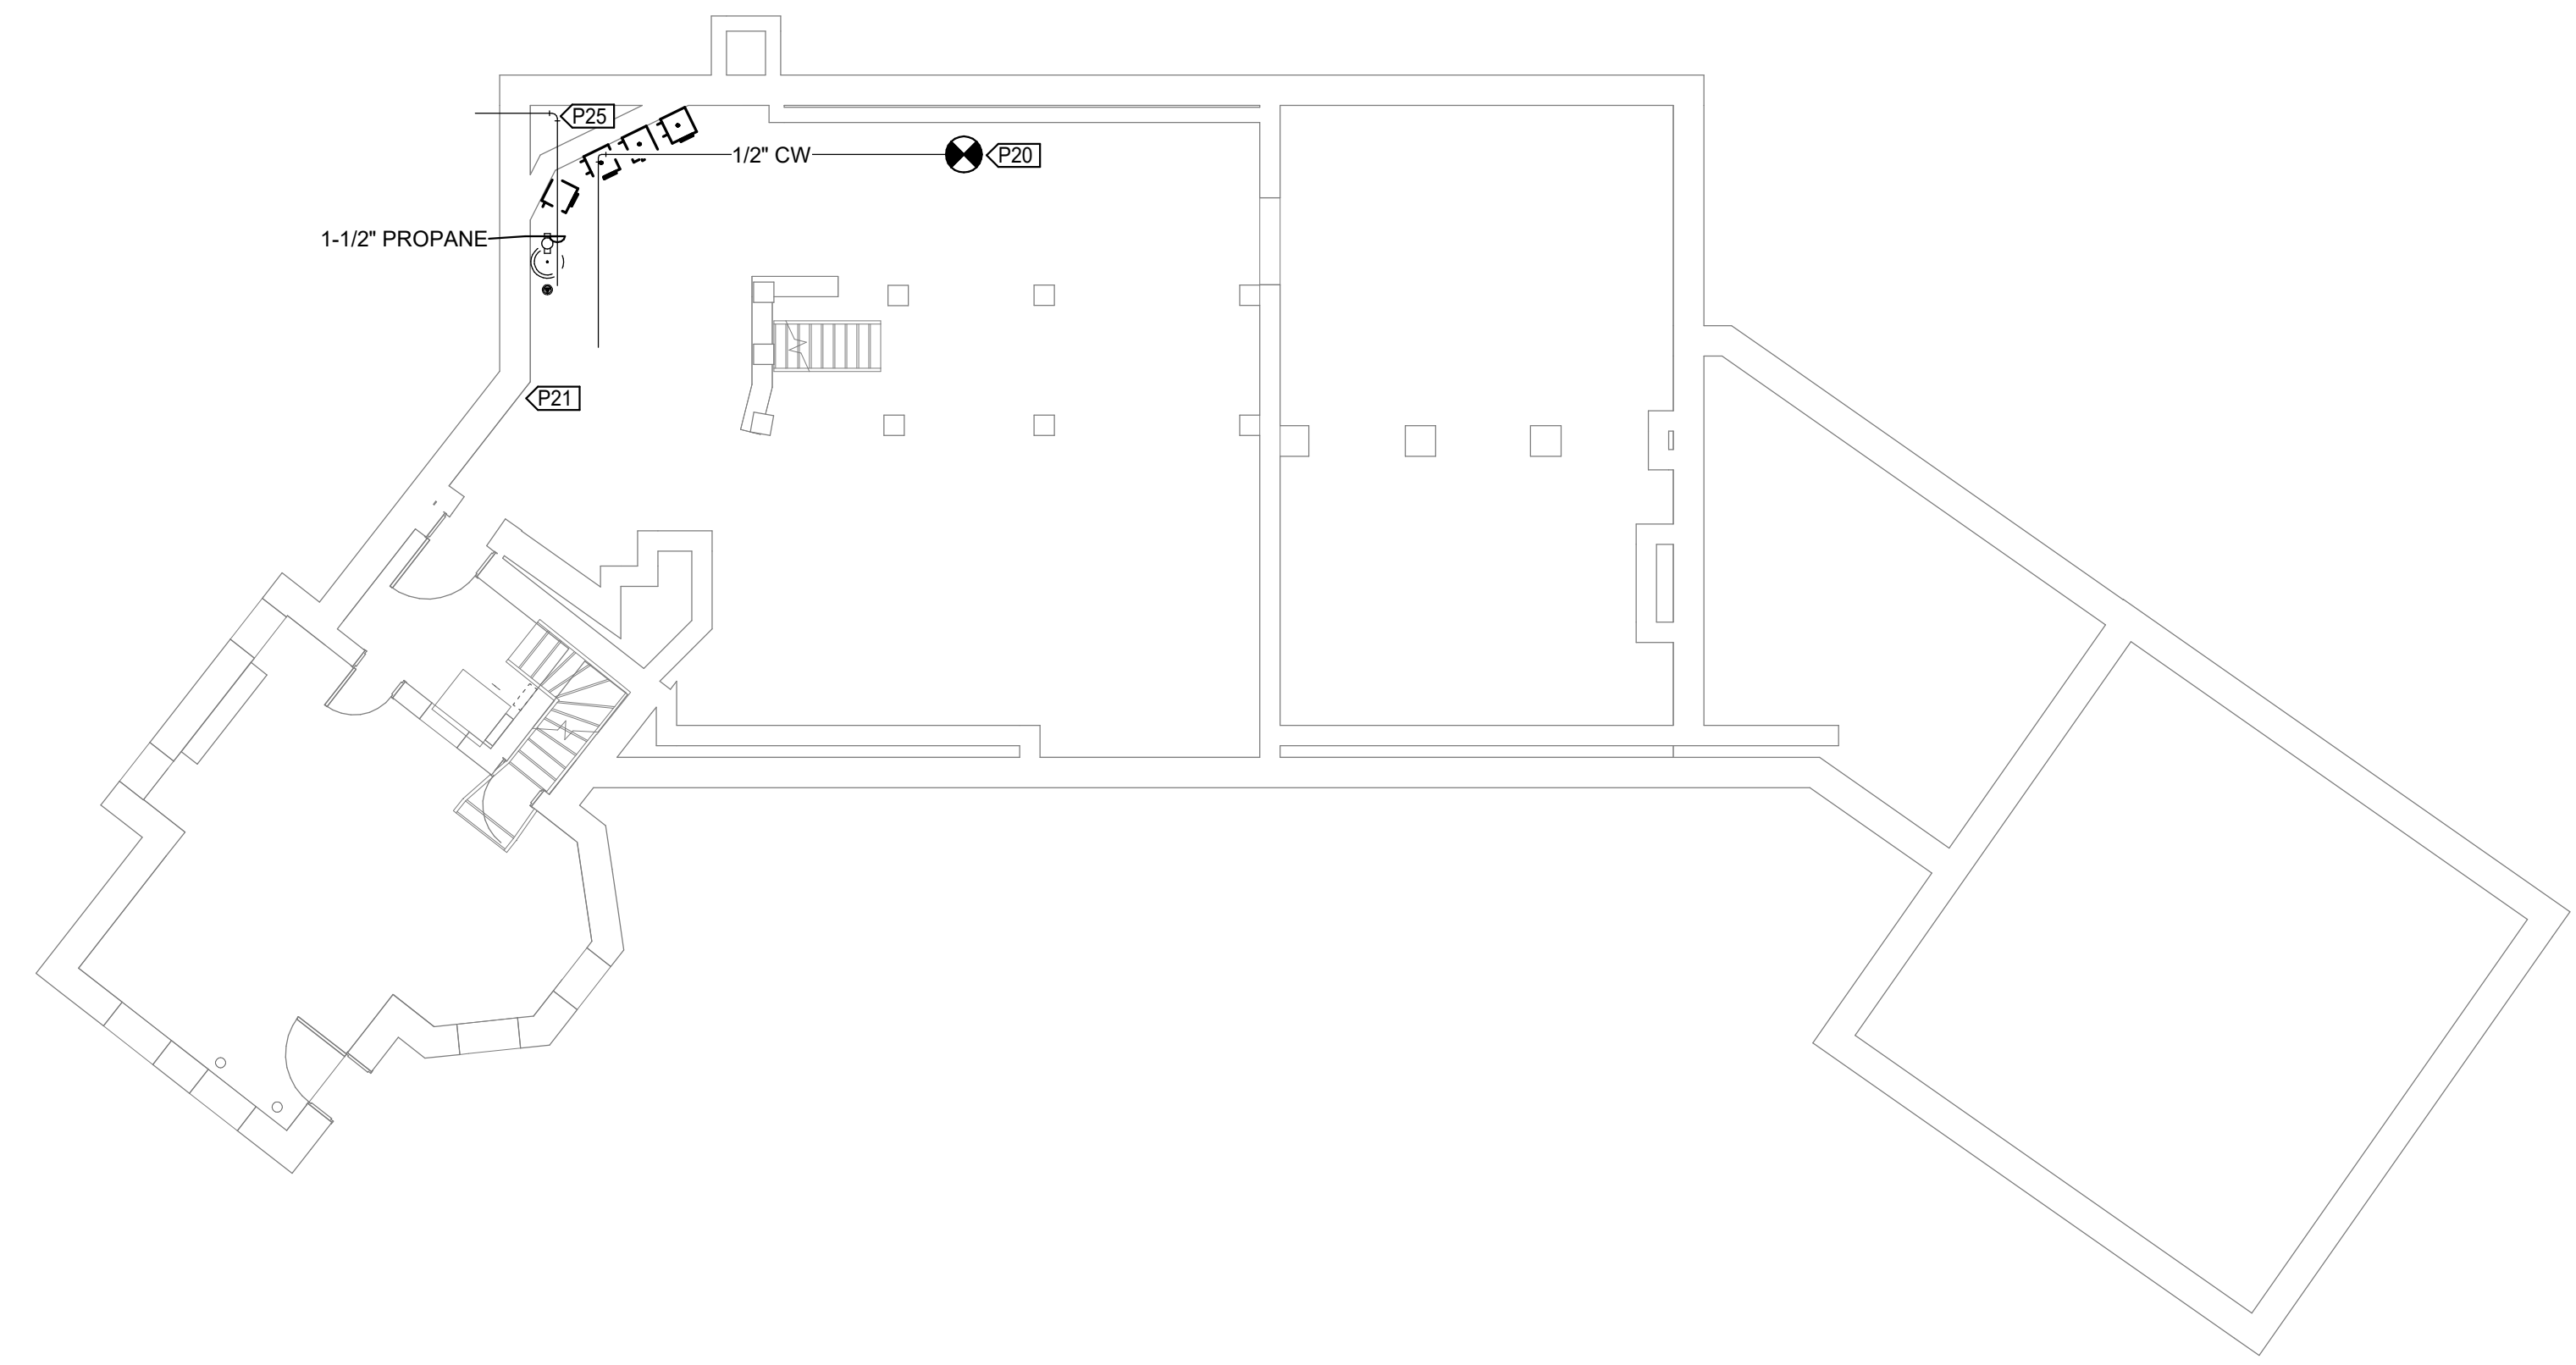
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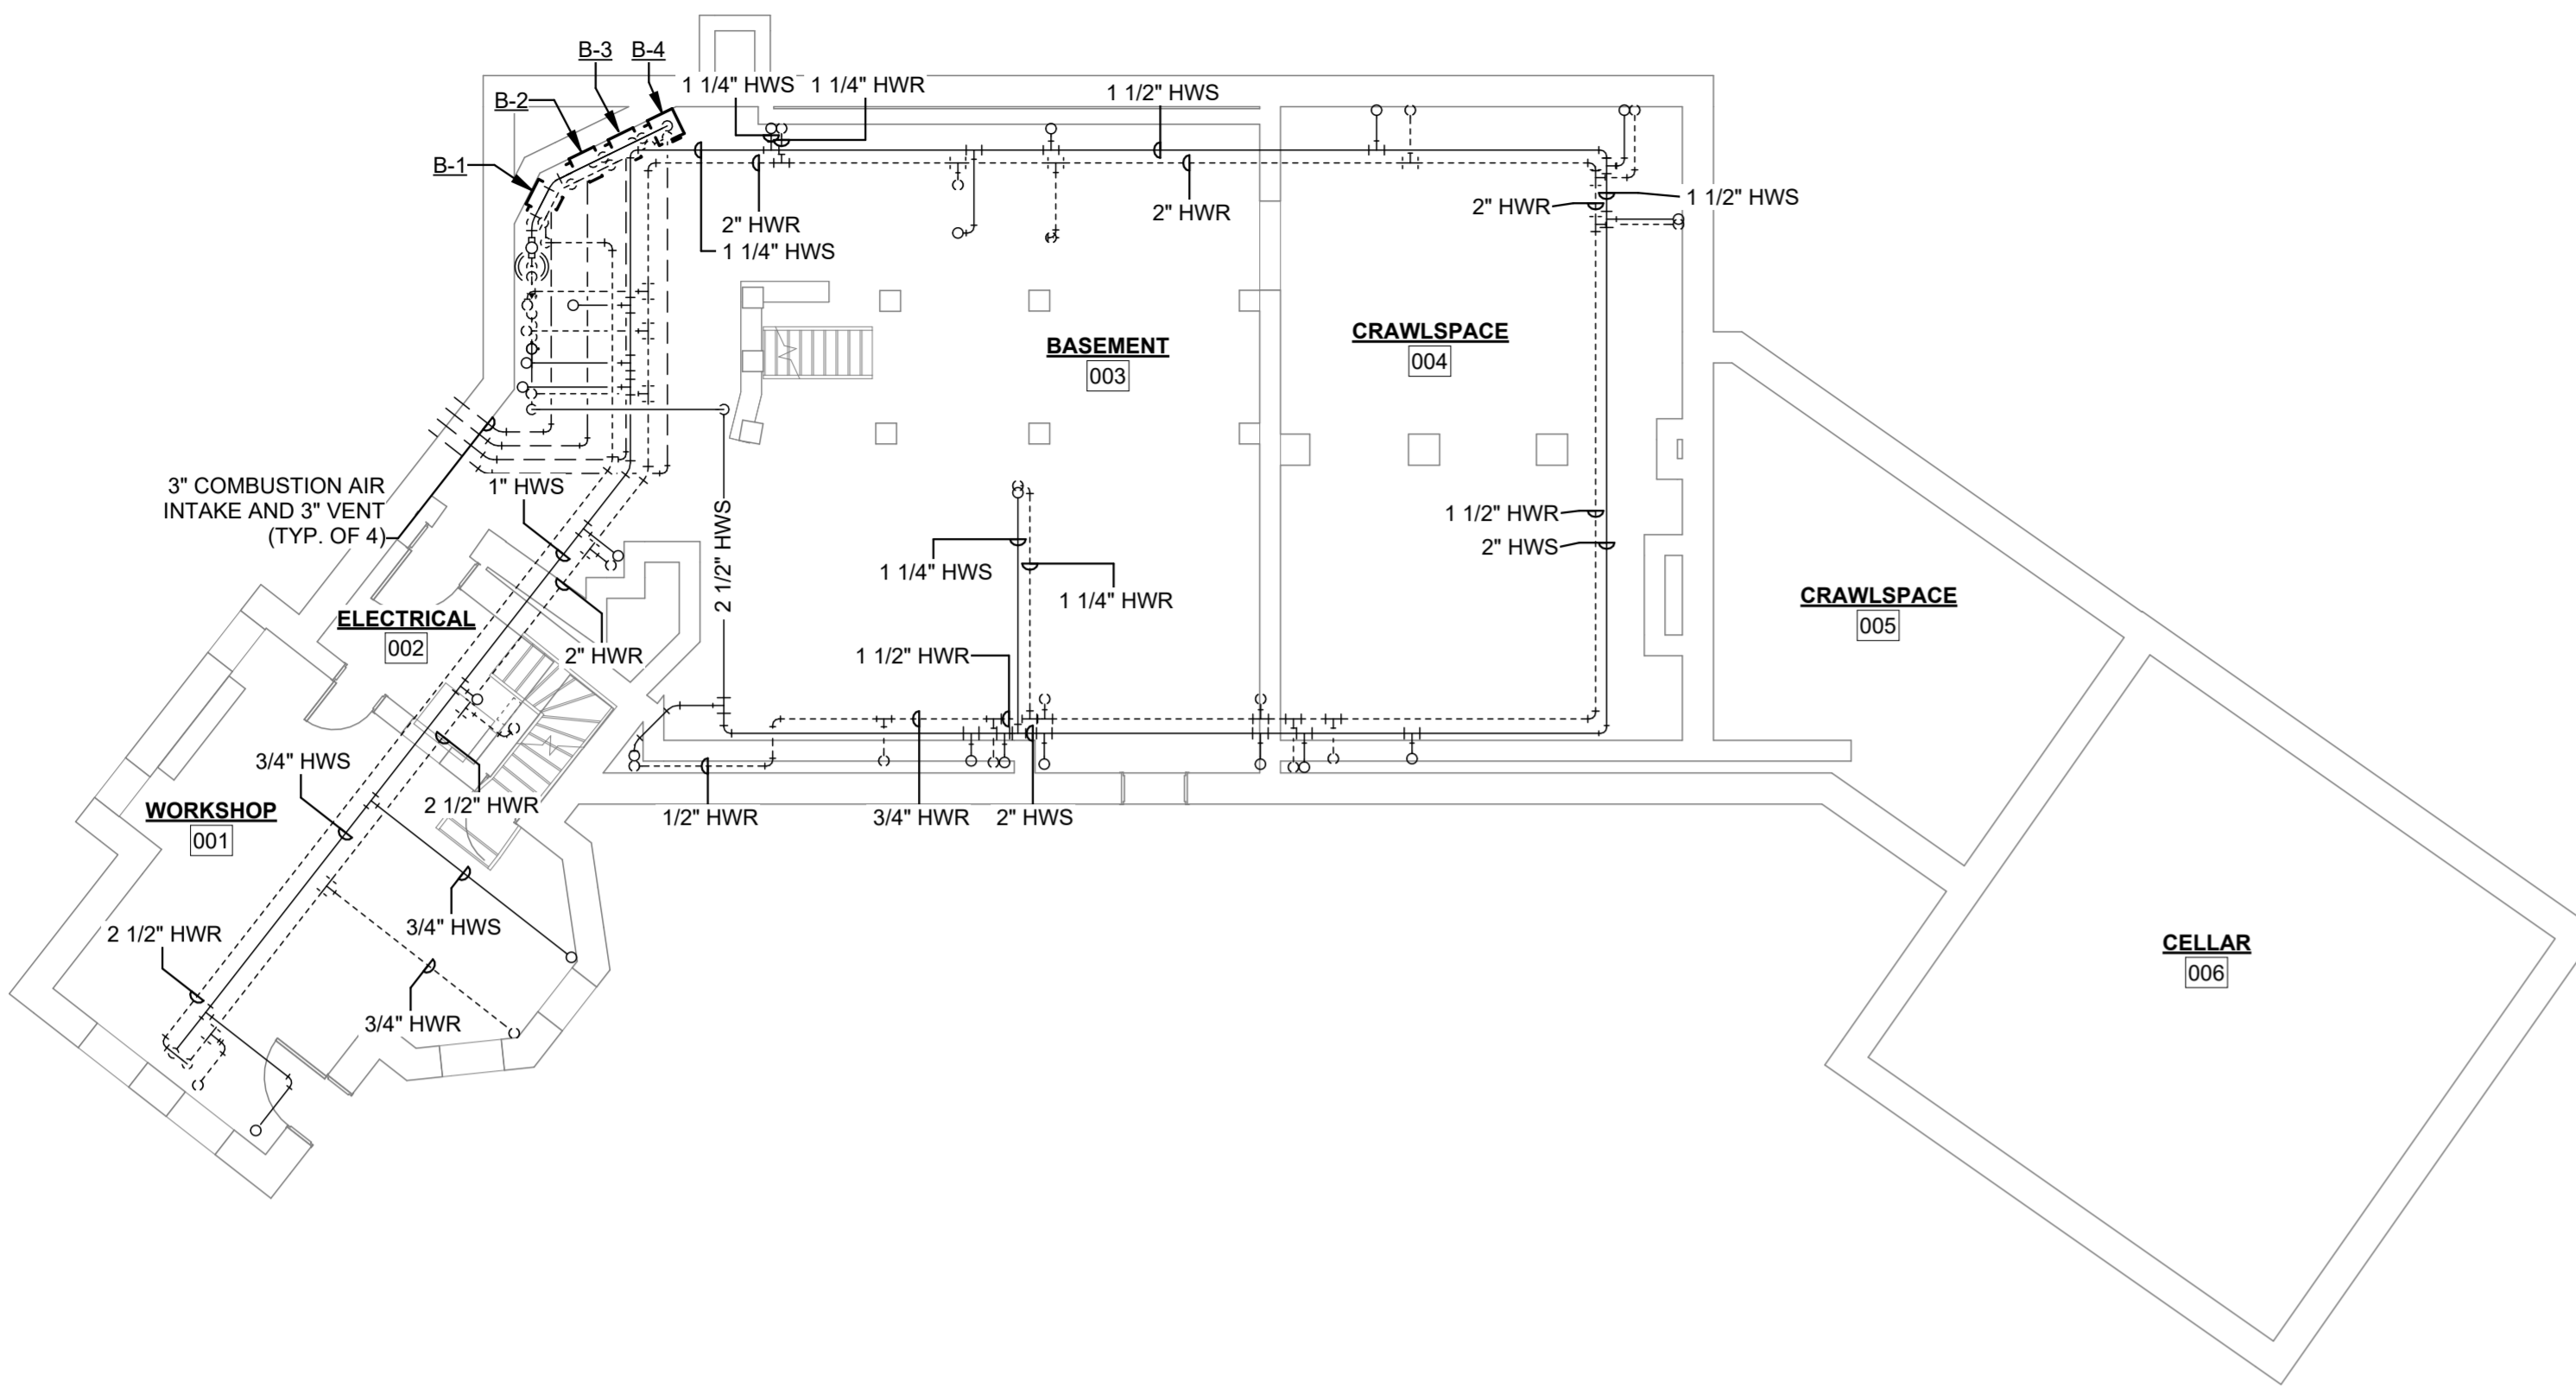
SHEET 4 OF 12
SEPTEMBER 9, 2024

KEYNOTE LEGEND	
VALUE	DESCRIPTION
P20	EXTEND 1/2" COLD WATER PIPING FROM EXISTING PIPING IN CLOSET TO NEW BACKFLOW PREVENTER FOR BOILER FEED/MAKEUP.
P21	EXTEND SANITARY PIPING FROM STACK TO NEW P-TRAP AND HUB DRAIN TO RECEIVE BOILER CONDENSATE.
P25	PROVIDE AND INSTALL 1-1/2" SCH 40 STEEL PROPANE PIPING TO NEW BOILERS TIGHT TO STRUCTURE ABOVE. PAINT YELLOW FOR IDENTIFICATION.




CONDENSATE HUB DRAIN DETAIL
NTS






VALUE	DESCRIPTION
M02	DEMOLISH ALL EXPOSED STEAM AND CONDENSATE PIPING IN BASEMENT GREATER THAN 3 FEET AWAY FROM BOILER.
M05	DRY CORE DRILL NEW OPENING FOR PIPING. REFER TO NEW WORK PLAN.
M08	UNINSTALL WINDOW AND RETURN TO OWNER. ENSURE OPENING IS COVERED AND SECURE UNTIL NEW WORK IS COMPLETED.
M10	EXISTING, ABANDONED STEAM BOILER, BOILER SPECIALTIES, AND PIPING WITHIN 3 FEET OF BOILER TO REMAIN.

2 BASEMENT MECHANICAL PLAN
1/8" = 1'-0"

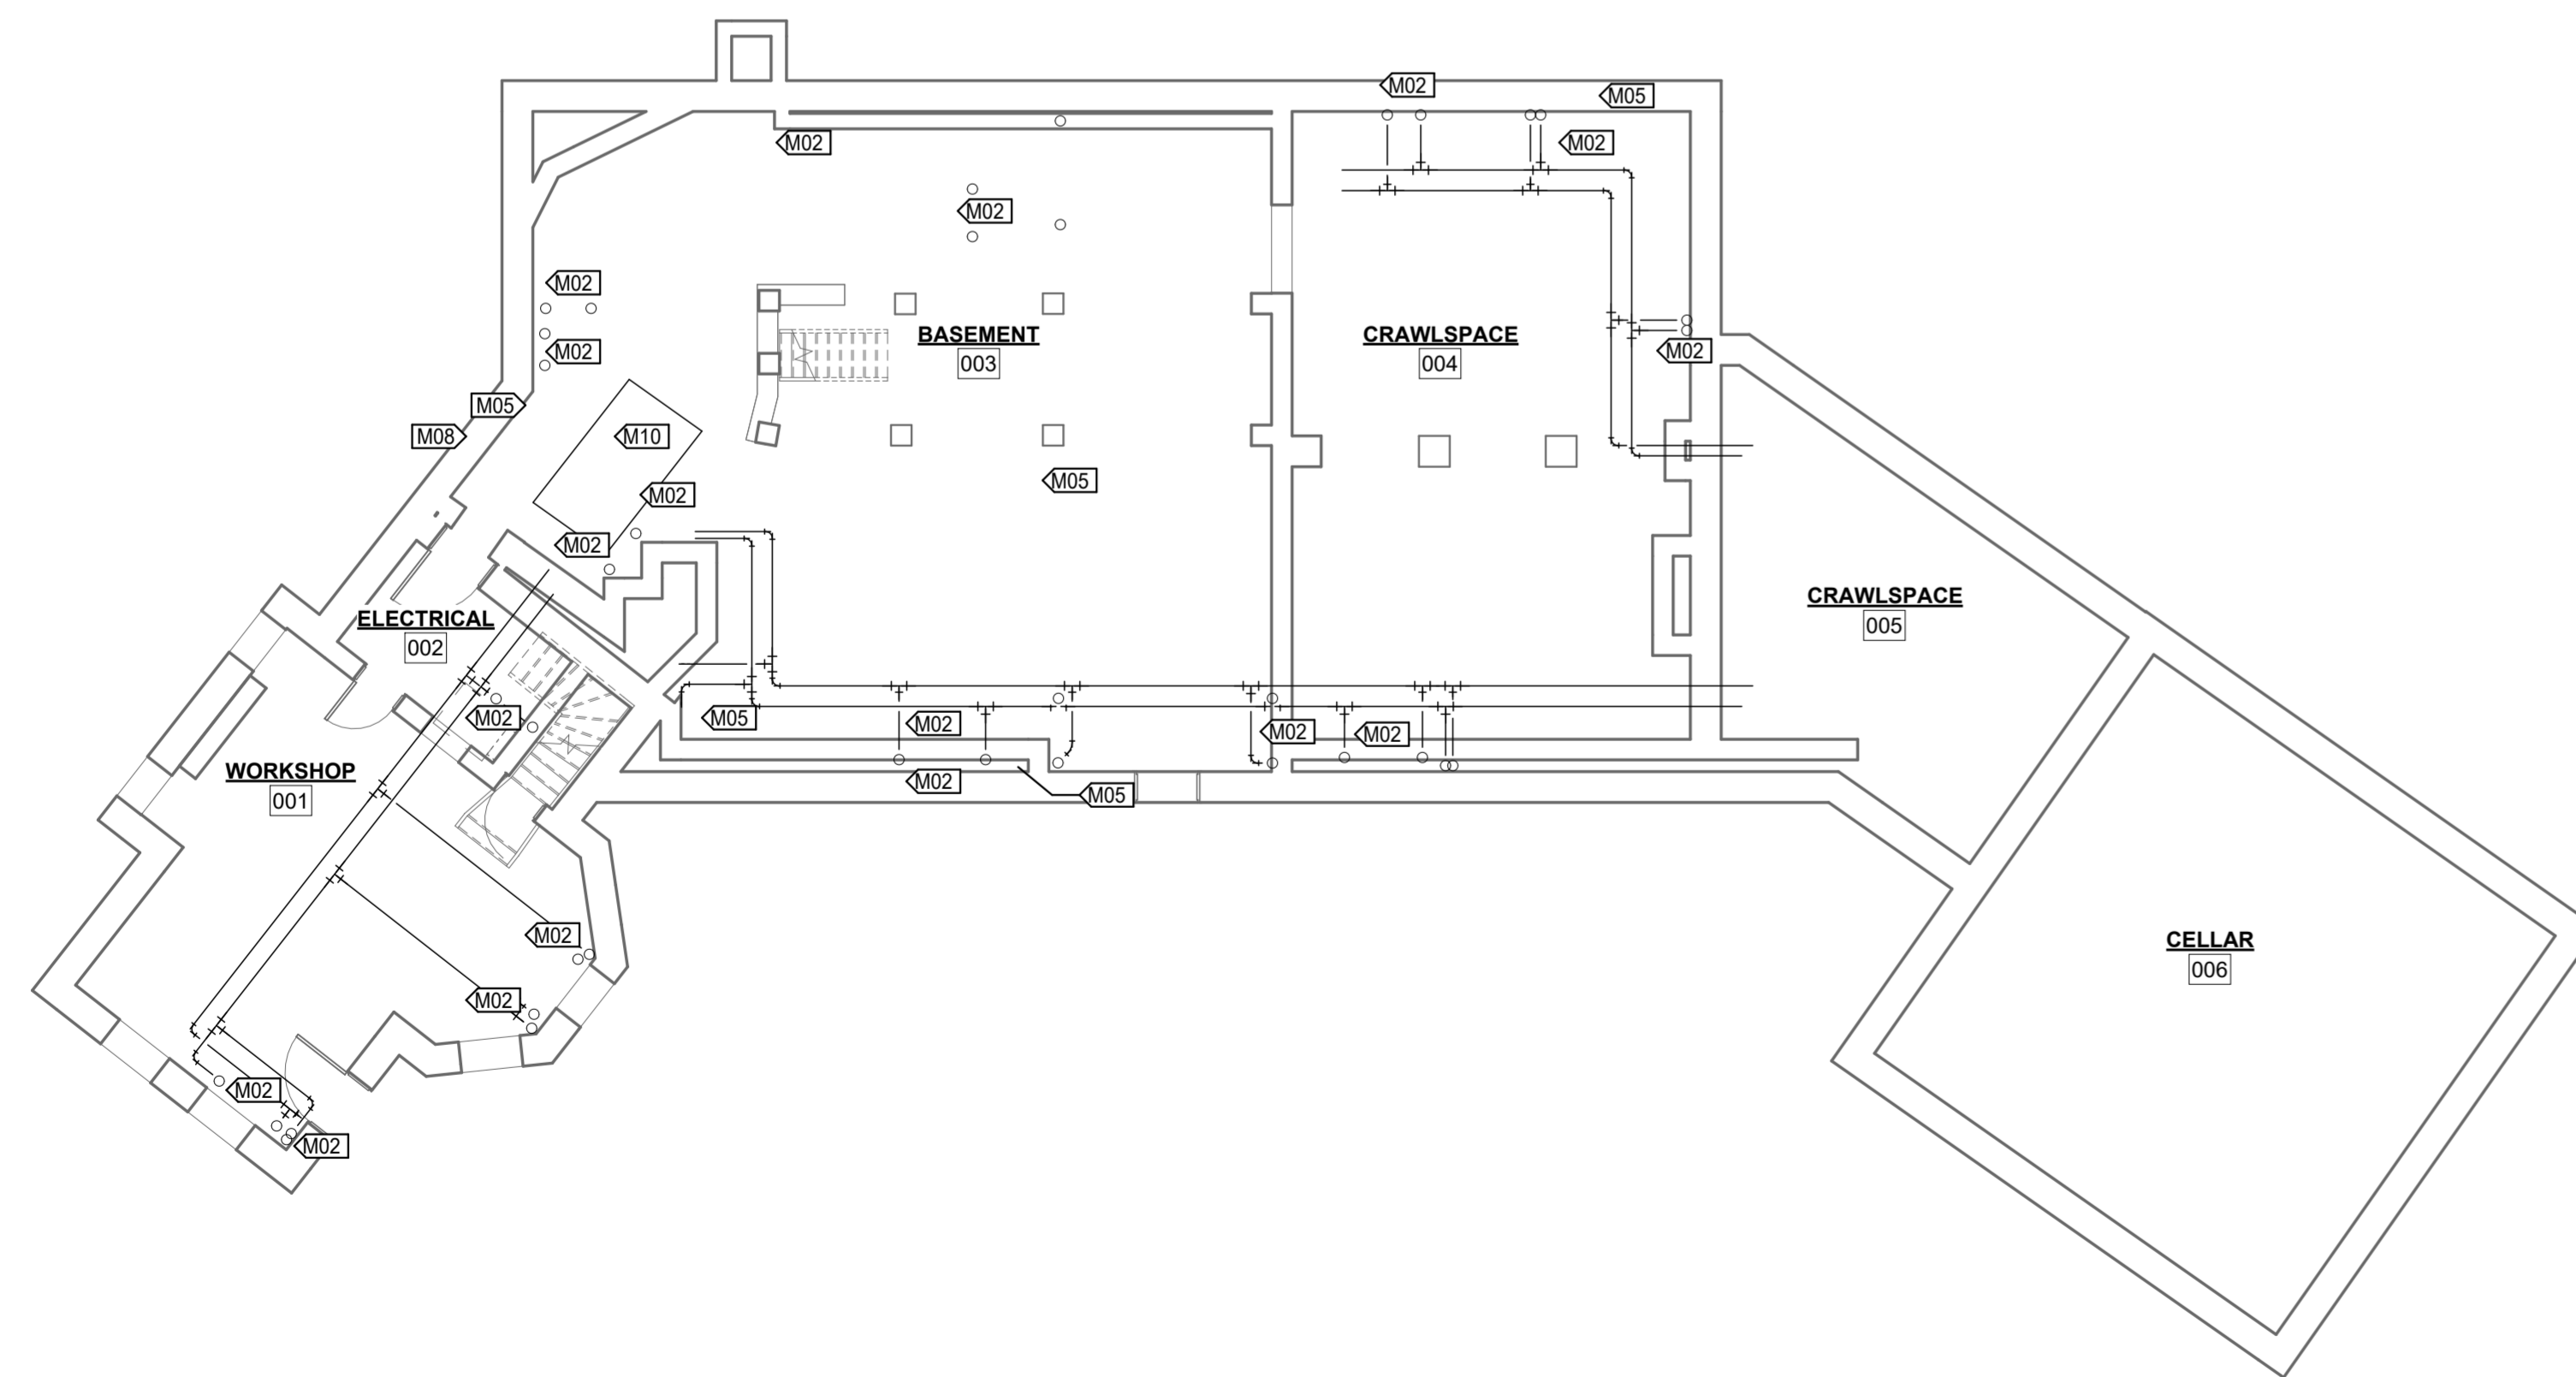

1 BASEMENT MECHANICAL DEMO PLAN
1/8" = 1'-0"

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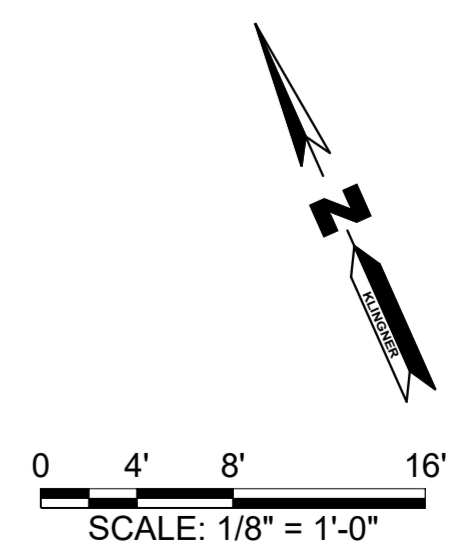
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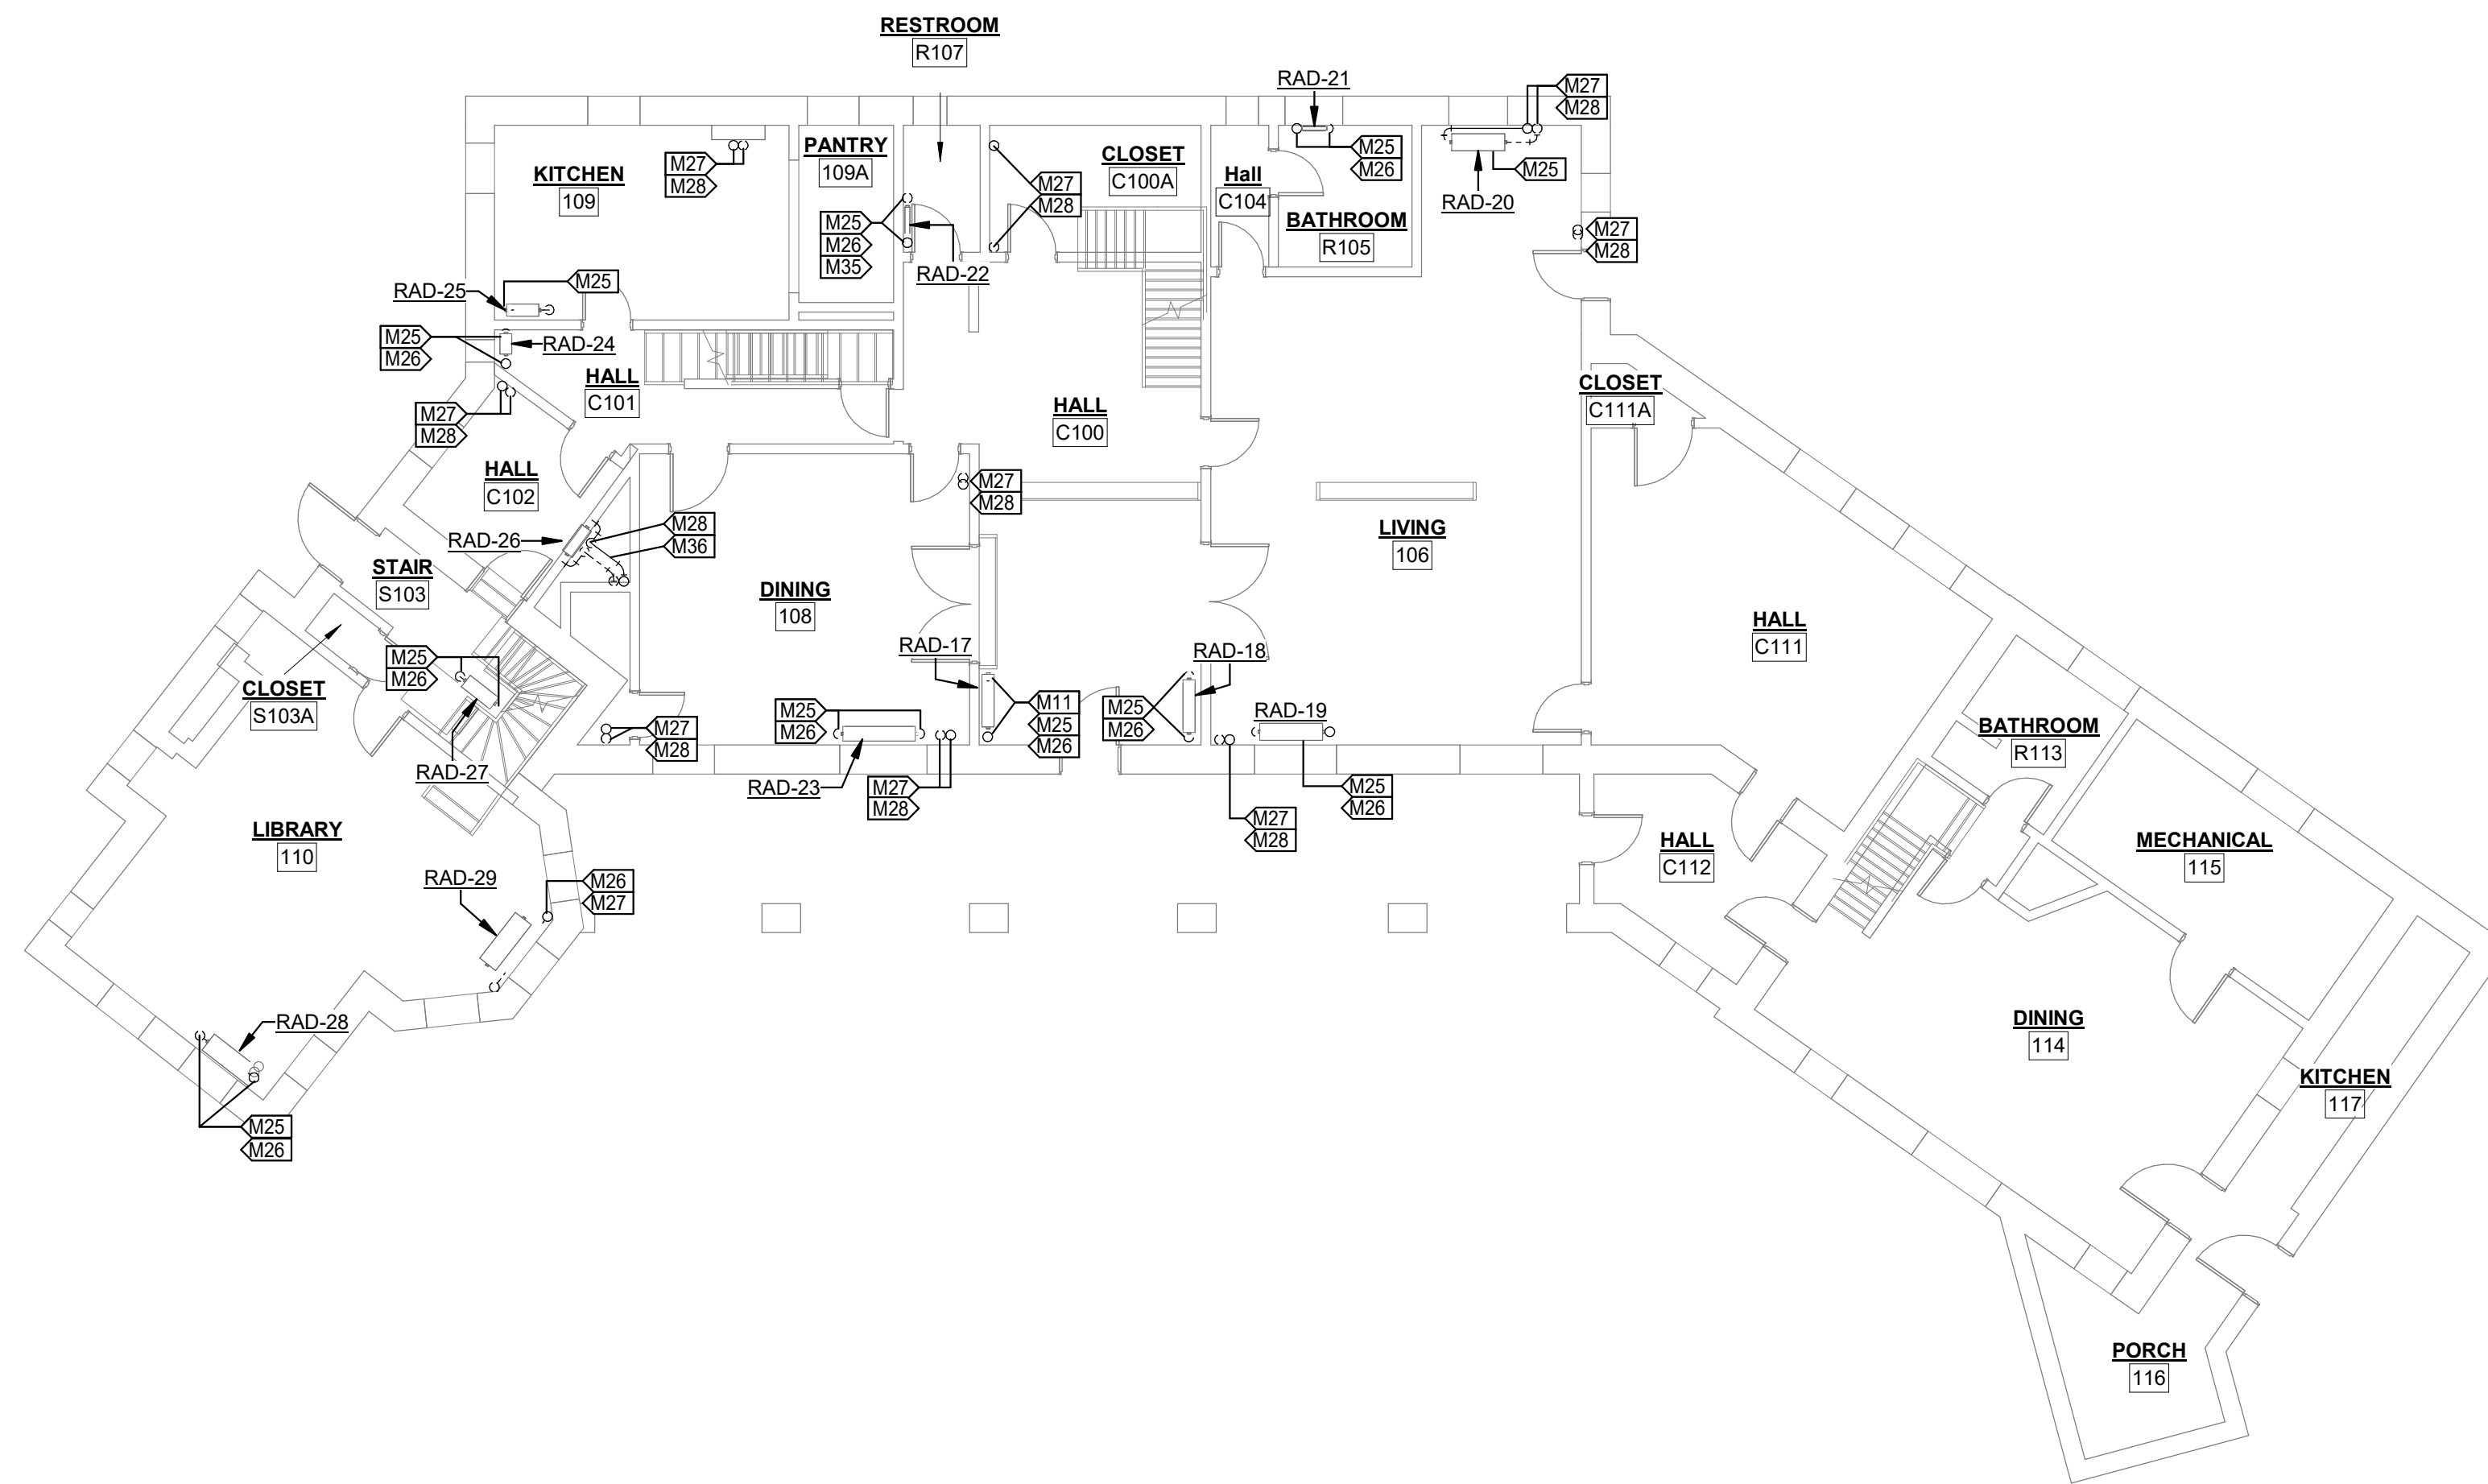
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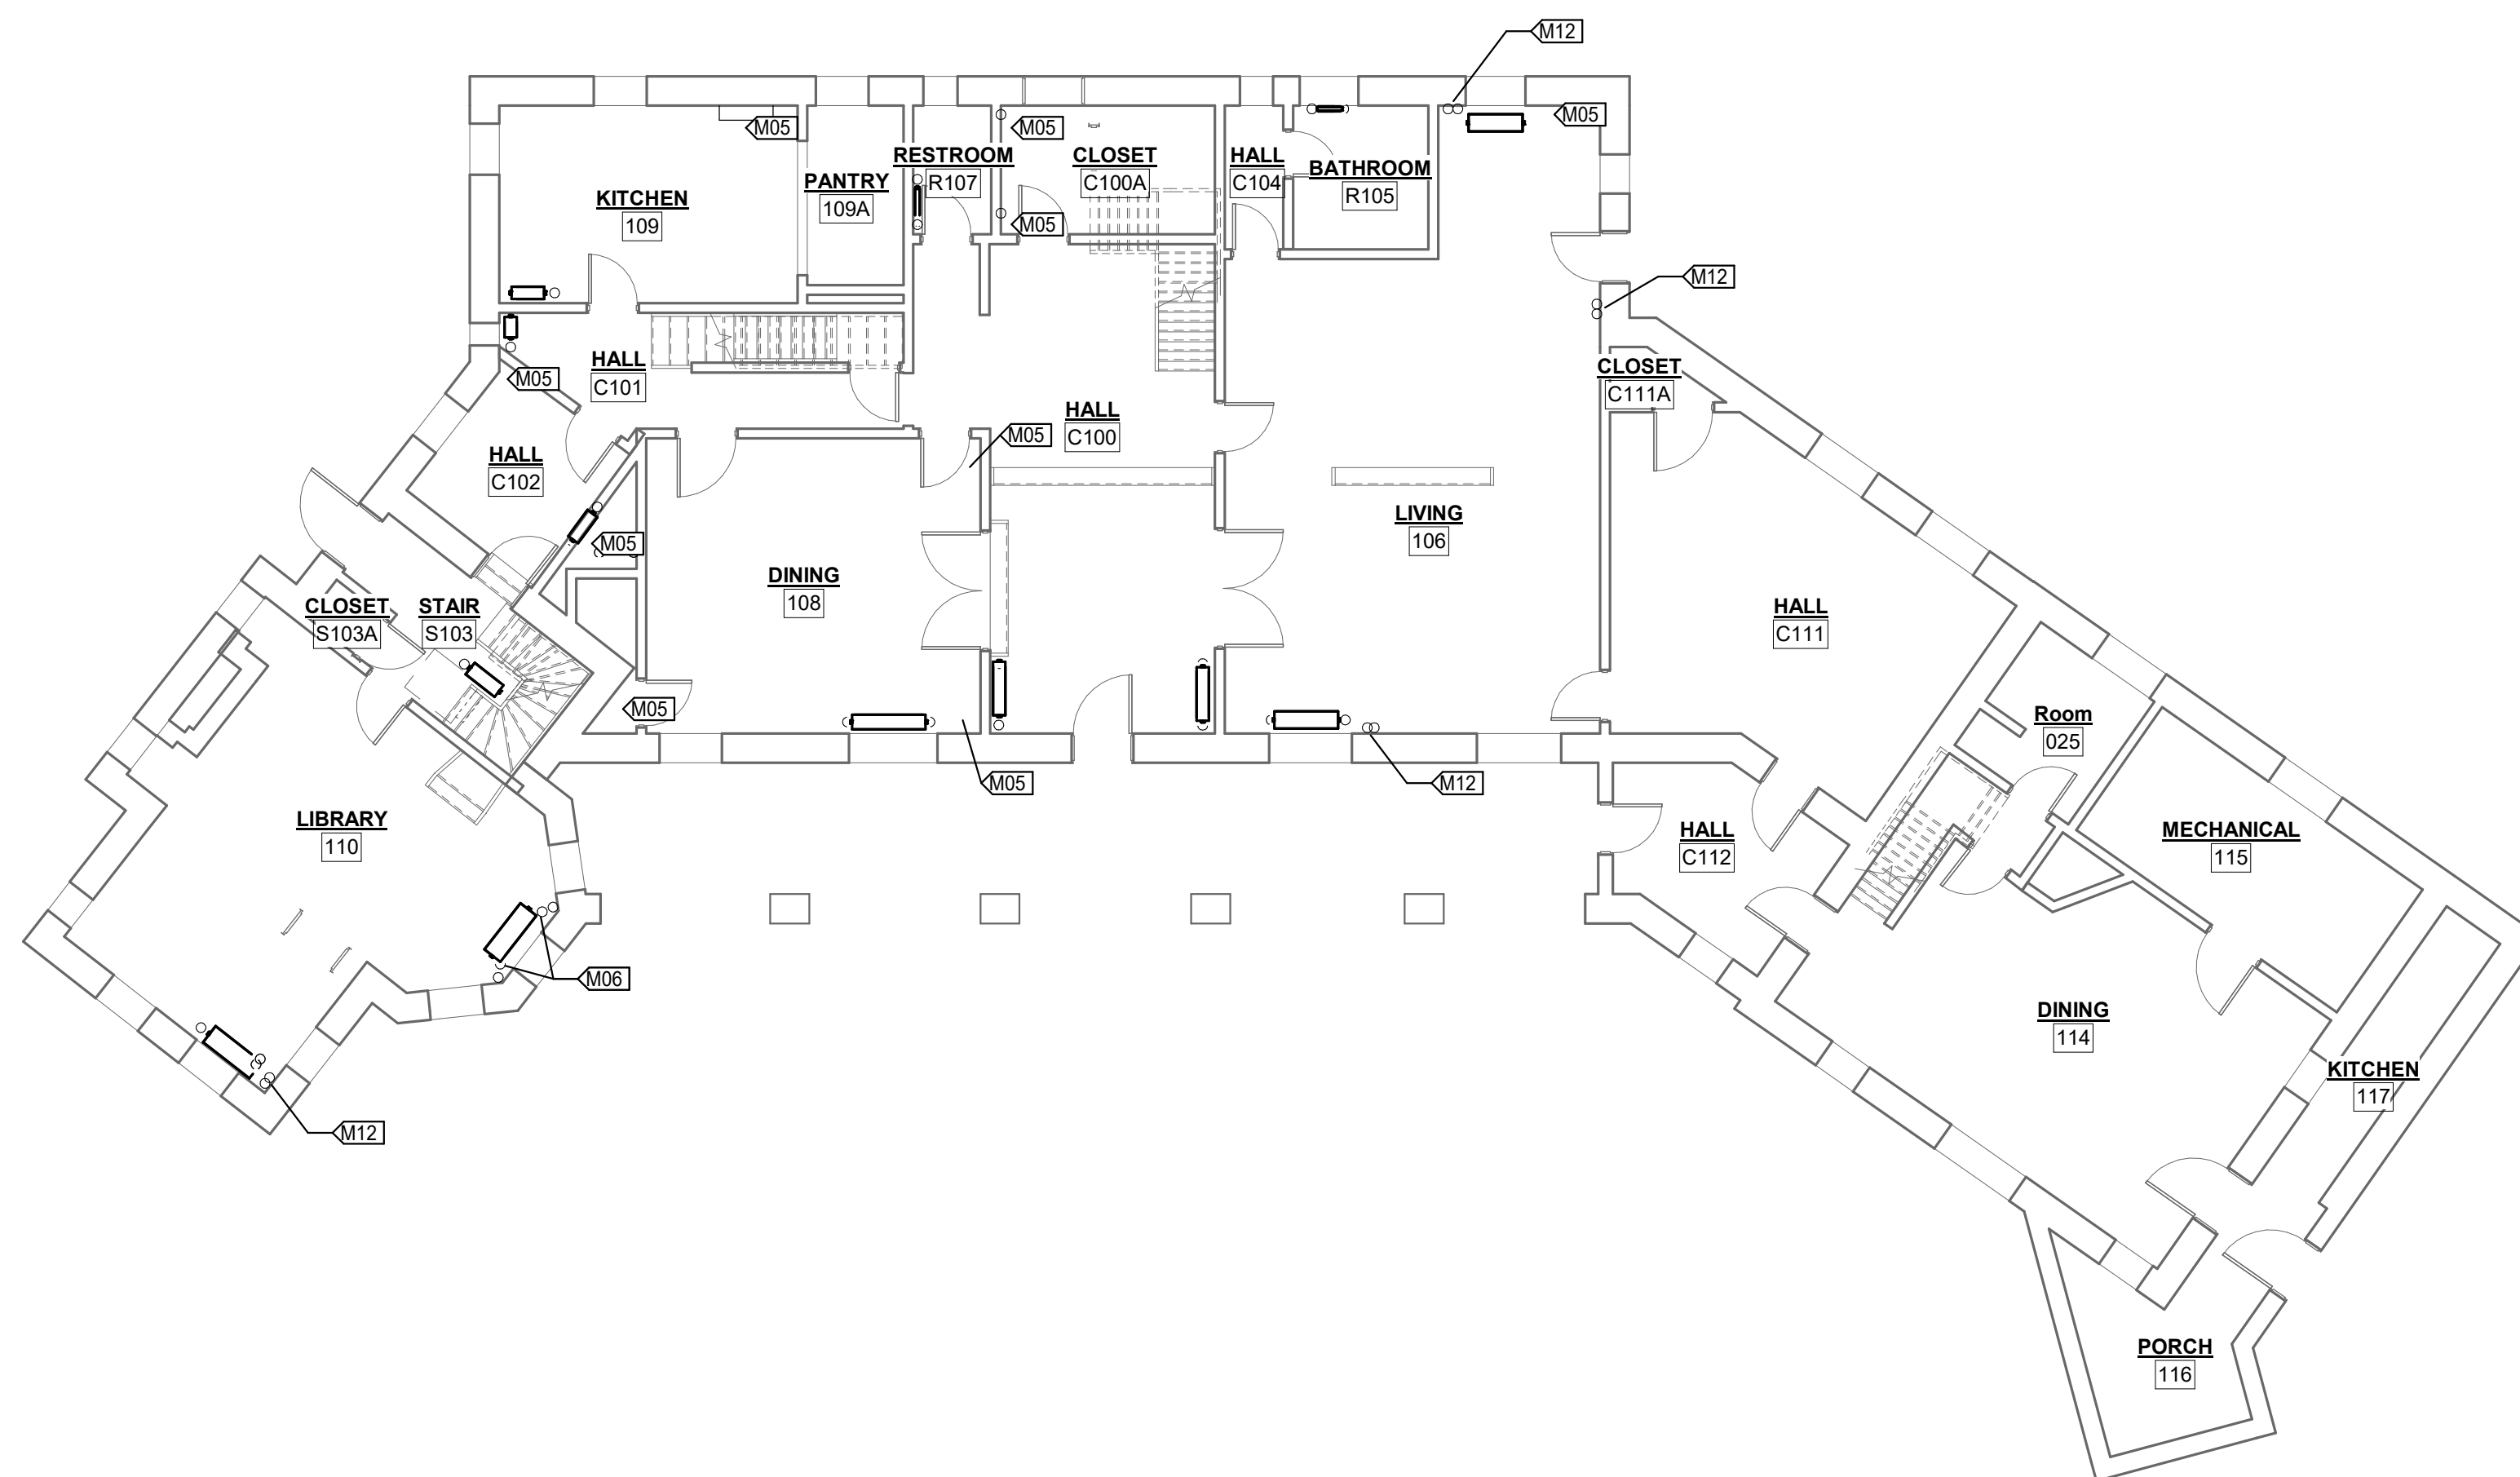
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SHEET 5 OF 12
SEPTEMBER 9, 2024

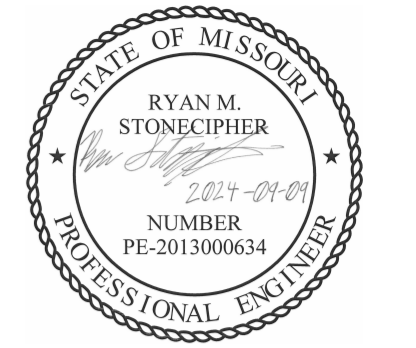



2 FIRST FLOOR MECHANICAL PLAN
1/8" = 1'-0"



1 FIRST FLOOR MECHANICAL DEMO PLAN
1/8" = 1'-0"

VALUE	DESCRIPTION
M05	DRY CORE DRILL NEW OPENING FOR PIPING. REFER TO NEW WORK PLAN.
M06	DEMOLISH EXPOSED STEAM AND CONDENSATE PIPING TO MAX. 6" ABOVE FLOOR. CAP AND ABANDON PIPING STUB. SALVAGE VALVES AND STEAM TRAPS AND RETURN TO OWNER.
M11	EXISTING RADIATOR WITH CRACKED BODY. OWNER TO REPAIR RADIATOR PRIOR TO CONTRACTOR CONNECTING TO NEW PIPING.
M12	EXISTING ABANDONED STEAM AND CONDENSATE PIPING TO REMAIN. CAP BOTTOM OF PIPING IN BASEMENT.
M25	CONNECT NEW HYDRONIC SUPPLY AND RETURN PIPING TO EXISTING RADIATOR. REFER TO DETAIL FOR ARRANGEMENT OF NEW CONTROL VALVE, LOCK SHIELD VALVE, AND AIR VENT.
M26	EXTEND NEW HYDRONIC SUPPLY AND RETURN PIPING DOWN THROUGH EXISTING FLOOR OPENING AND THROUGH CEILING BELOW. SUPPORT WITH FLOOR CLAMP.
M27	EXTEND NEW HYDRONIC SUPPLY AND RETURN PIPING FROM ABOVE DOWN TO FLOOR. ROUTE AS CLOSE TO WALL AS POSSIBLE WITHOUT EXTRA OFFSETS AT FLOOR. SUPPORT FROM WALL WITH STANDOFFS PAINTED TO MATCH EXISTING AND SUPPORT WITH FLOOR CLAMP.
M28	EXTEND NEW HYDRONIC SUPPLY AND RETURN PIPING DOWN THROUGH NEW FLOOR OPENING. SUPPORT WITH FLOOR CLAMP.
M35	HOLE SAW SHELF IN CLOSET TO CREATE OPENING FOR NEW PIPING.
M36	REFER TO DETAIL FOR PIPING TO RAD-12 AND RAD-26.

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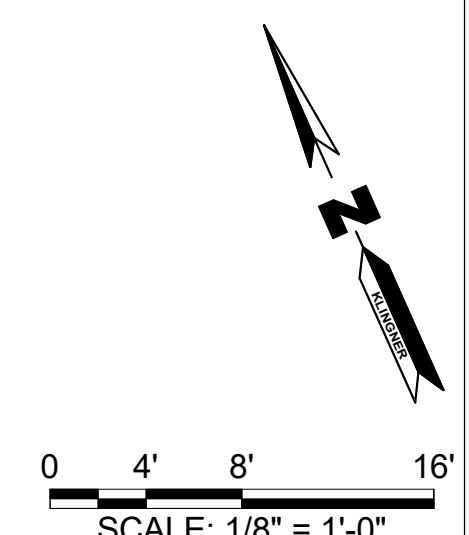
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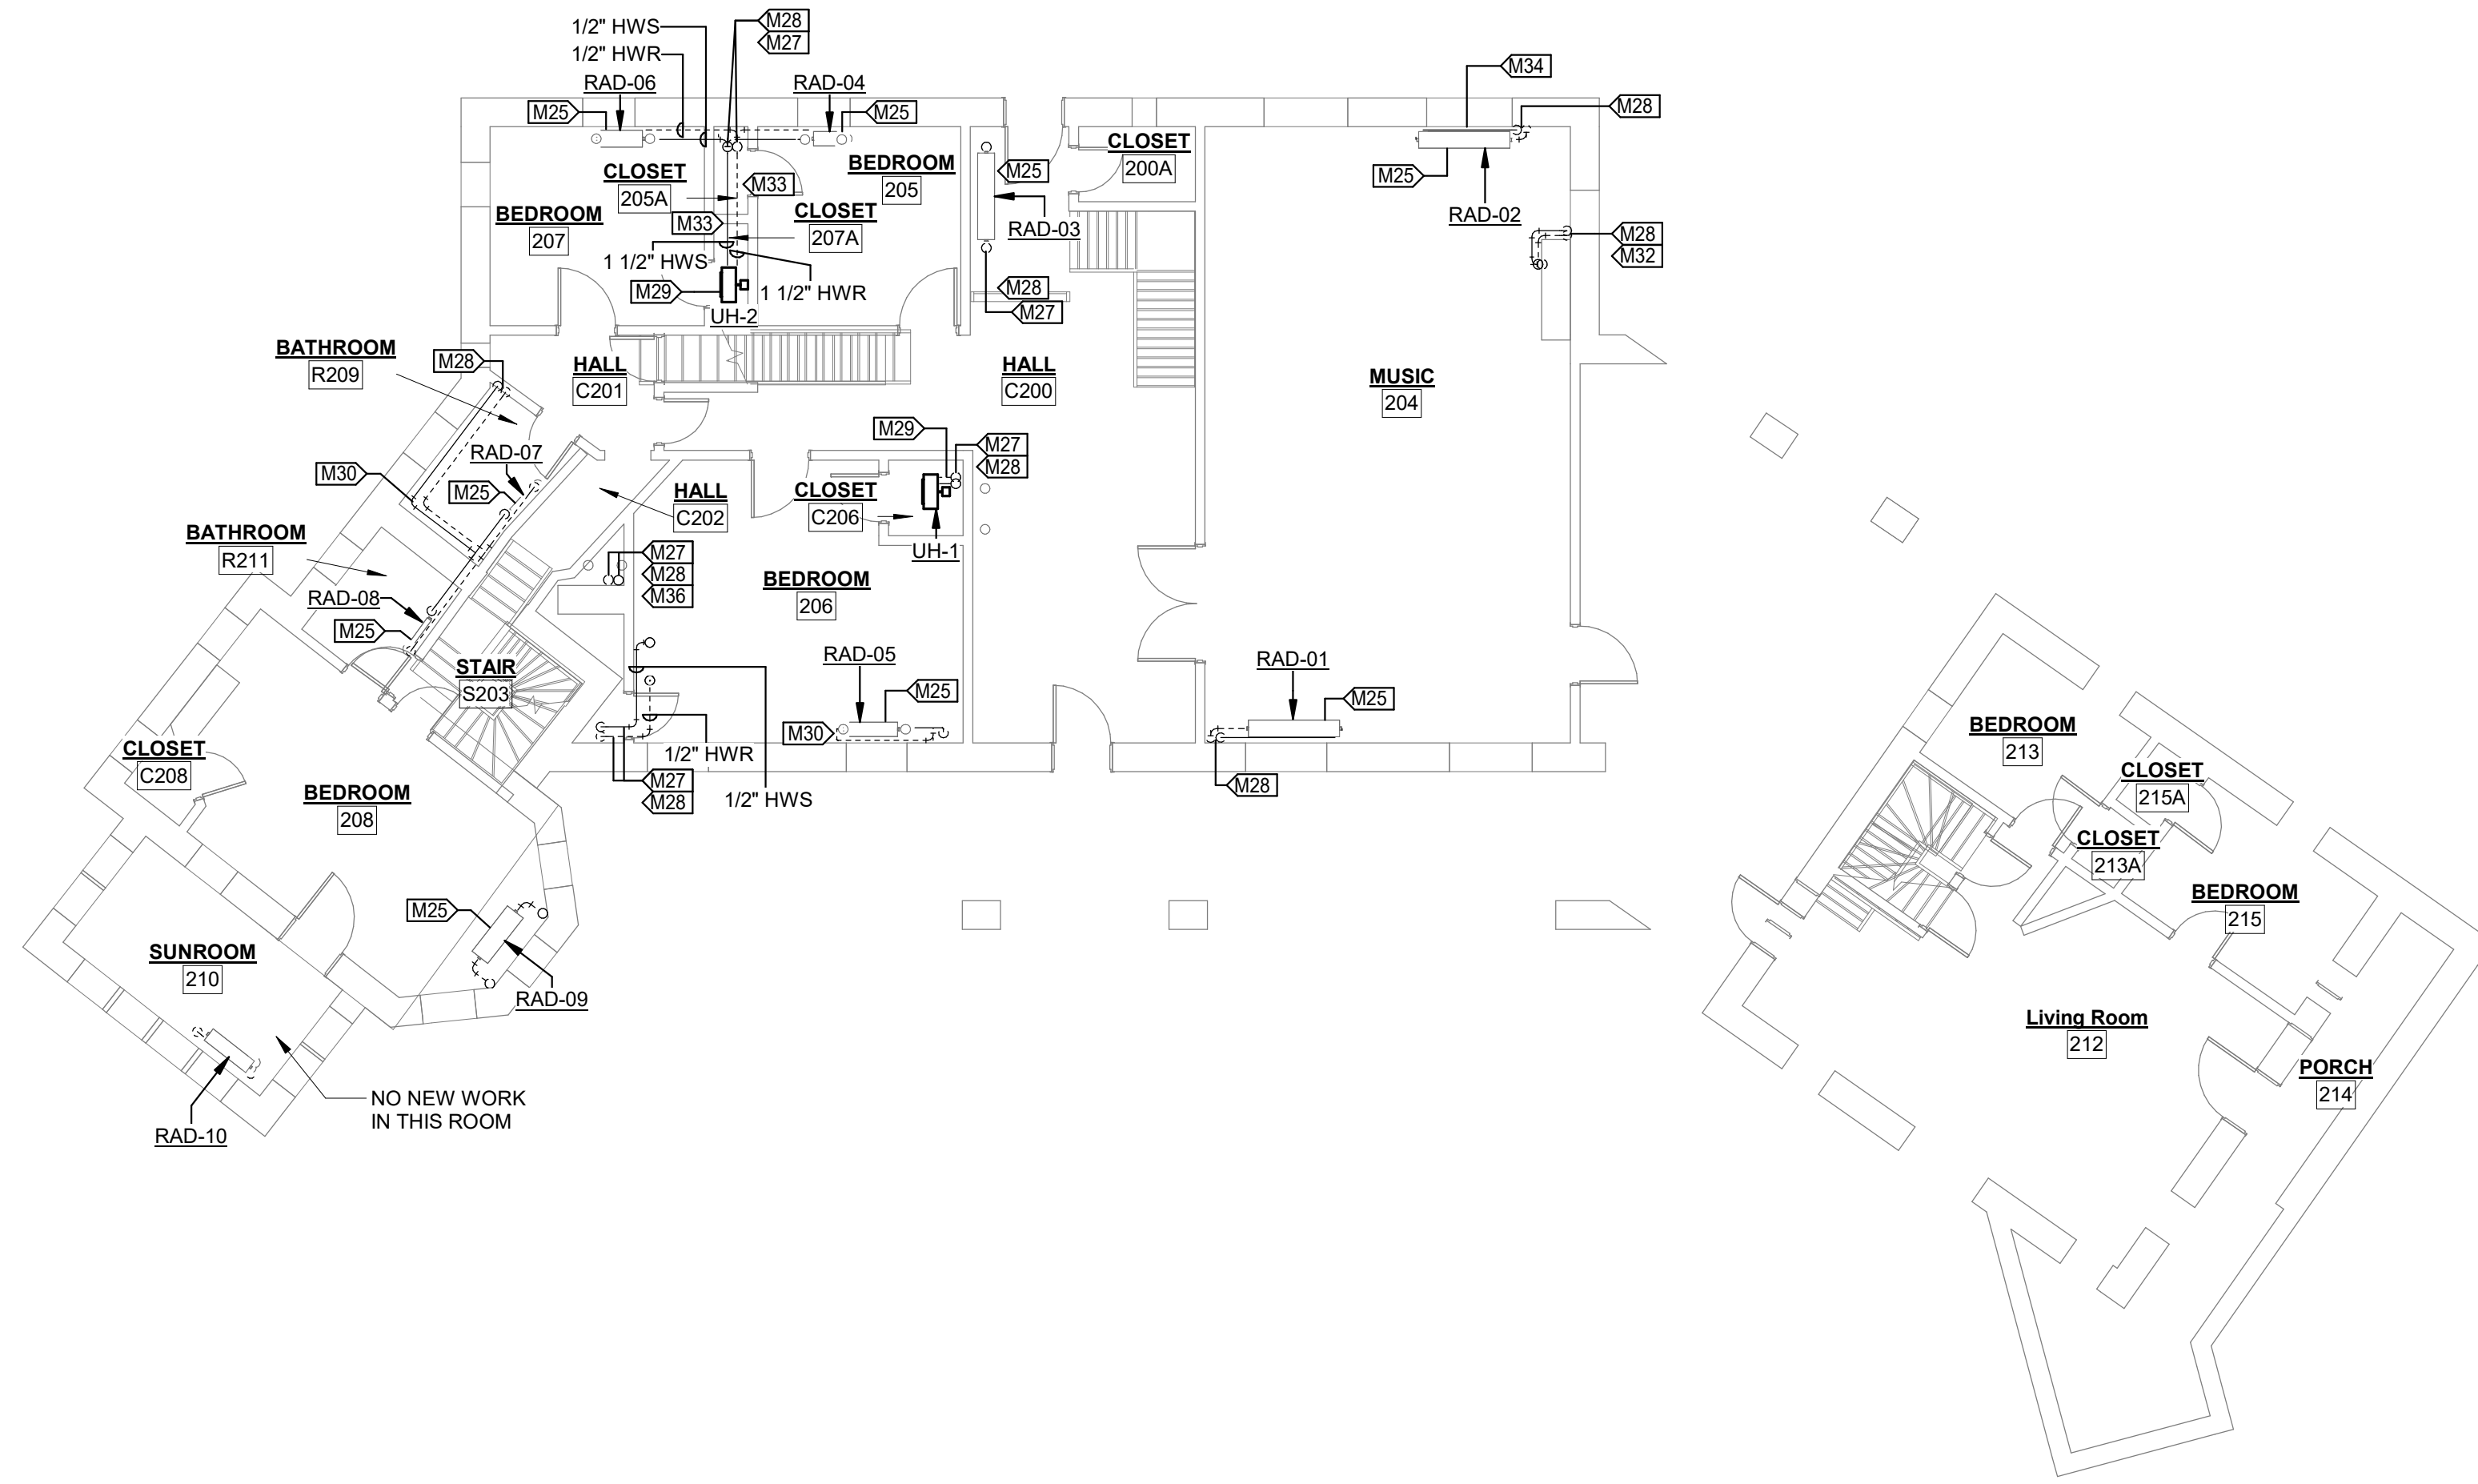
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**FIRST FLOOR
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M101


SHEET 6 OF 12
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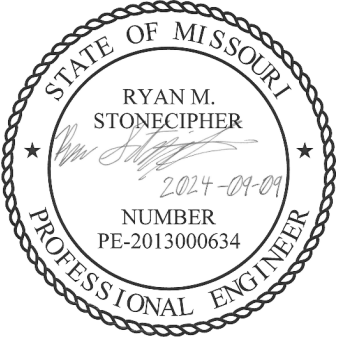
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M01	DEMOLISH EXPOSED STEAM AND CONDENSATE PIPING DOWN THROUGH FLOOR. SALVAGE VALVES AND STEAM TRAPS AND RETURN TO OWNER.
M05	DRY CORE DRILL NEW OPENING FOR PIPING. REFER TO NEW WORK PLAN.
M06	DEMOLISH EXPOSED STEAM AND CONDENSATE PIPING TO MAX. 6" ABOVE FLOOR. CAP AND ABANDON PIPING STUB. SALVAGE VALVES AND STEAM TRAPS AND RETURN TO OWNER.
M07	LIMIT EXTENTS OF WALL DEMOLITION TO MINIMIZE DAMAGE TO EXISTING PLASTERWORK "TILE" TO WITHIN AREA COVERED BY NEW PIPE ESCUTCHEON.
M25	CONNECT NEW HYDRONIC SUPPLY AND RETURN PIPING TO EXISTING RADIATOR. REFER TO DETAIL FOR ARRANGEMENT OF NEW CONTROL VALVE, LOCK SHIELD VALVE, AND AIR VENT.
M27	EXTEND NEW HYDRONIC SUPPLY AND RETURN PIPING FROM ABOVE DOWN TO FLOOR. ROUTE AS CLOSE TO WALL AS POSSIBLE WITHOUT EXTRA OFFSETS AT FLOOR. SUPPORT FROM WALL WITH STANDOFFS PAINTED TO MATCH EXISTING AND SUPPORT WITH FLOOR CLAMP.
M28	EXTEND NEW HYDRONIC SUPPLY AND RETURN PIPING DOWN THROUGH NEW FLOOR OPENING. SUPPORT WITH FLOOR CLAMP.
M29	CONNECT NEW HYDRONIC PIPING TO NEW UNIT HEATER. CONFIGURE UNIT HEATER CONTROLS FOR FAN TO BE ON WHENEVER UNIT HEATER IS POWERED.
M30	ROUTE NEW HYDRONIC PIPING TO TIGHT TO WALLS AND TO EXISTING RADIATORS. PAINT TO MATCH EXISTING WALLS.
M32	ROUTE PIPING TO RAD-16 UP WALL, WEST PAST MOLDING, SOUTH, AND UP THROUGH CEILING INTO BEDROOM 302. JOG IN PIPING MAY BE UP TO 45 DEGREES FROM VERTICAL AND FROM HORIZONTAL TO MINIMIZE FITTINGS.
M33	PAINT WALL BEHIND NEW PIPING OR THROUGH WHICH NEW PIPING PENETRATES TO MATCH ADJACENT WALLS, FROM CORNER TO CORNER AND FROM TOP OF BASEBOARD TO CEILING.
M34	PAINT WALL BEHIND RAD-02 ONLY IN AREA BEHIND RADIATOR, TOUCHED UP AND BLENDED TO MATCH THE REST OF THE SAME WALL.
M36	REFER TO DETAIL FOR PIPING TO RAD-12 AND RAD-26.

2 SECOND FLOOR MECHANICAL PLAN
1/8" = 1'-0"



1 SECOND FLOOR MECHANICAL DEMO PLAN
1/8" = 1'-0"

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OFFICE OF ADMINISTRATION
DIVISION OF FACILITIES
MANAGEMENT,
DESIGN AND CONSTRUCTION

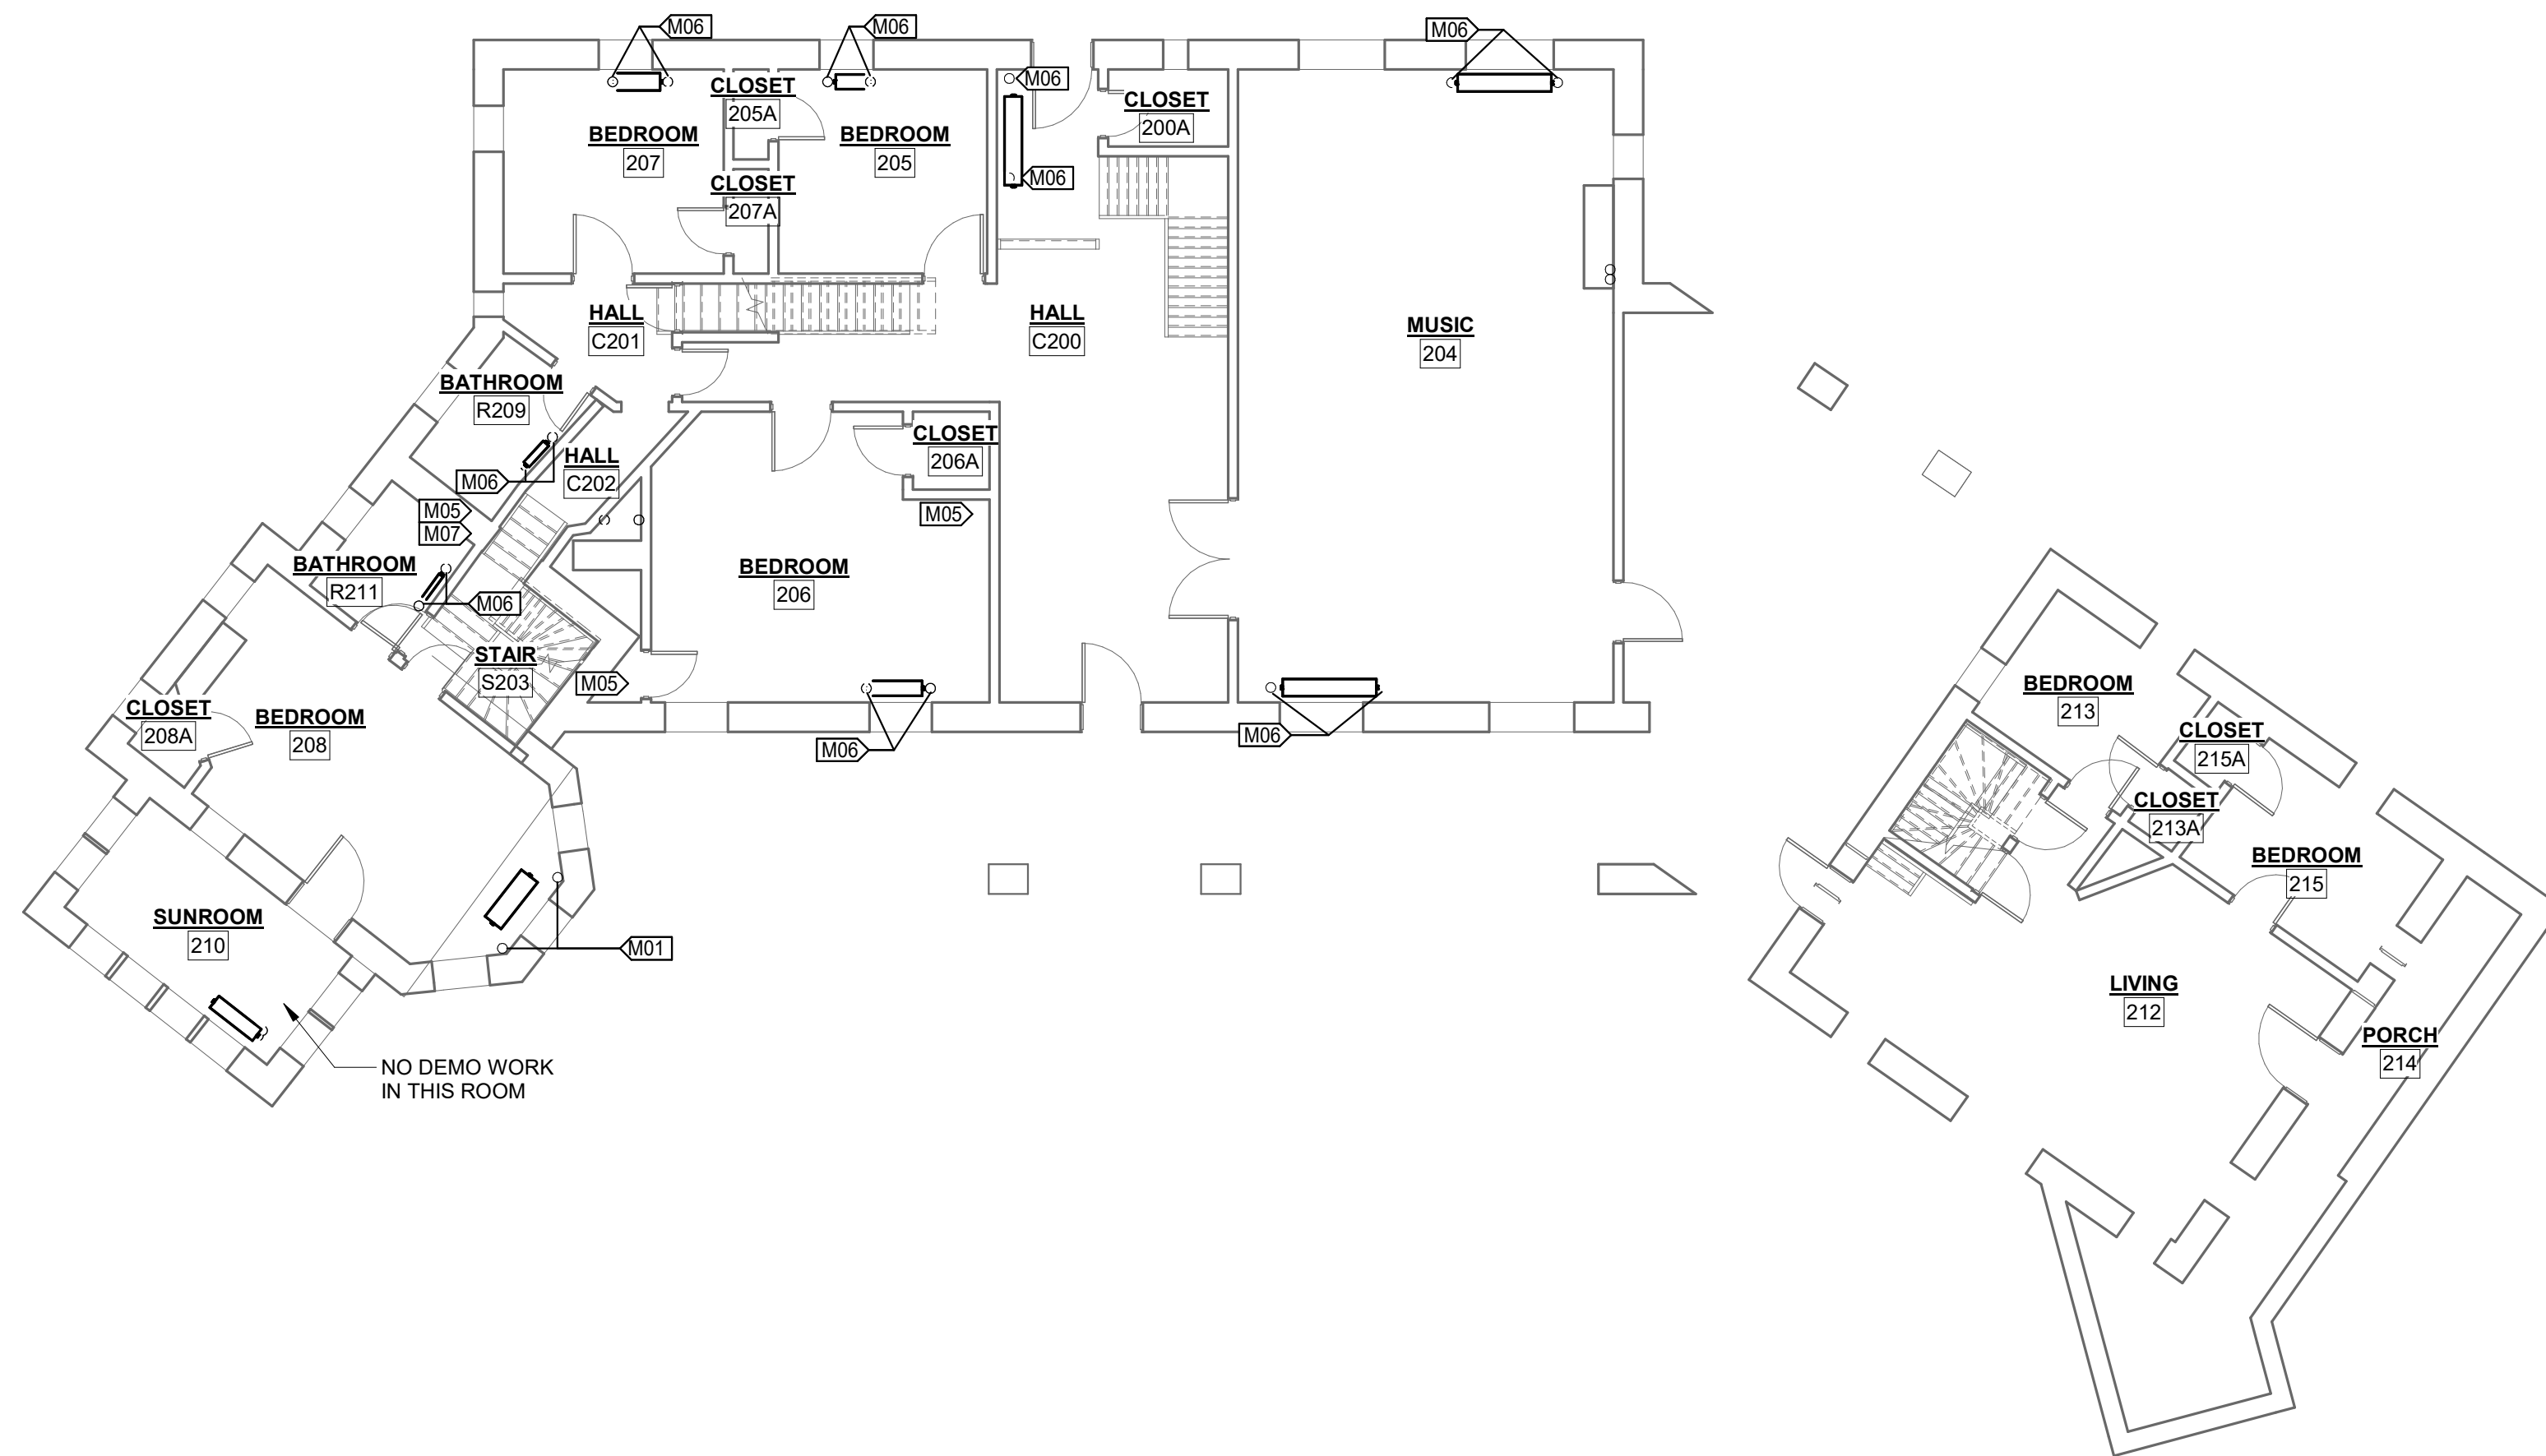INSTALL NEW HEATING
UNIT

BOTHWELL LODGE STATE
HISTORIC SITE

19349 BOTHWELL STATE
PARK RD
SEDALIA, MO 65301

PROJECT # X233101
SITE # 5303
ASSET # 7815303002

REVISION: _____
DATE: _____
REVISION: _____
DATE: _____
REVISION: _____
DATE: _____

ISSUE DATE: 09/09/2024


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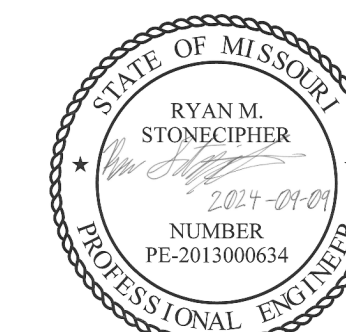
SHEET TITLE:
**SECOND FLOOR
MECHANICAL PLANS**

SHEET NUMBER:

M102

SHEET 7 OF 12
SEPTEMBER 9, 2024



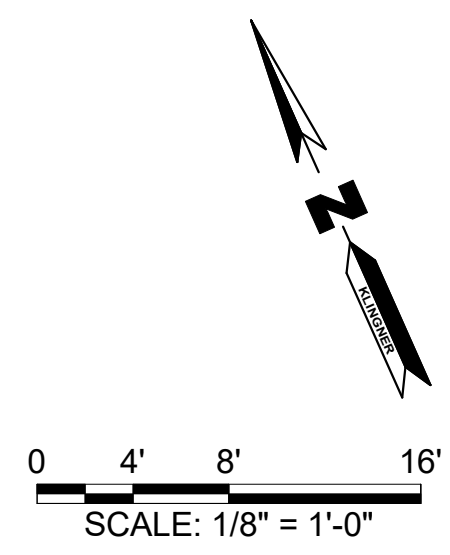

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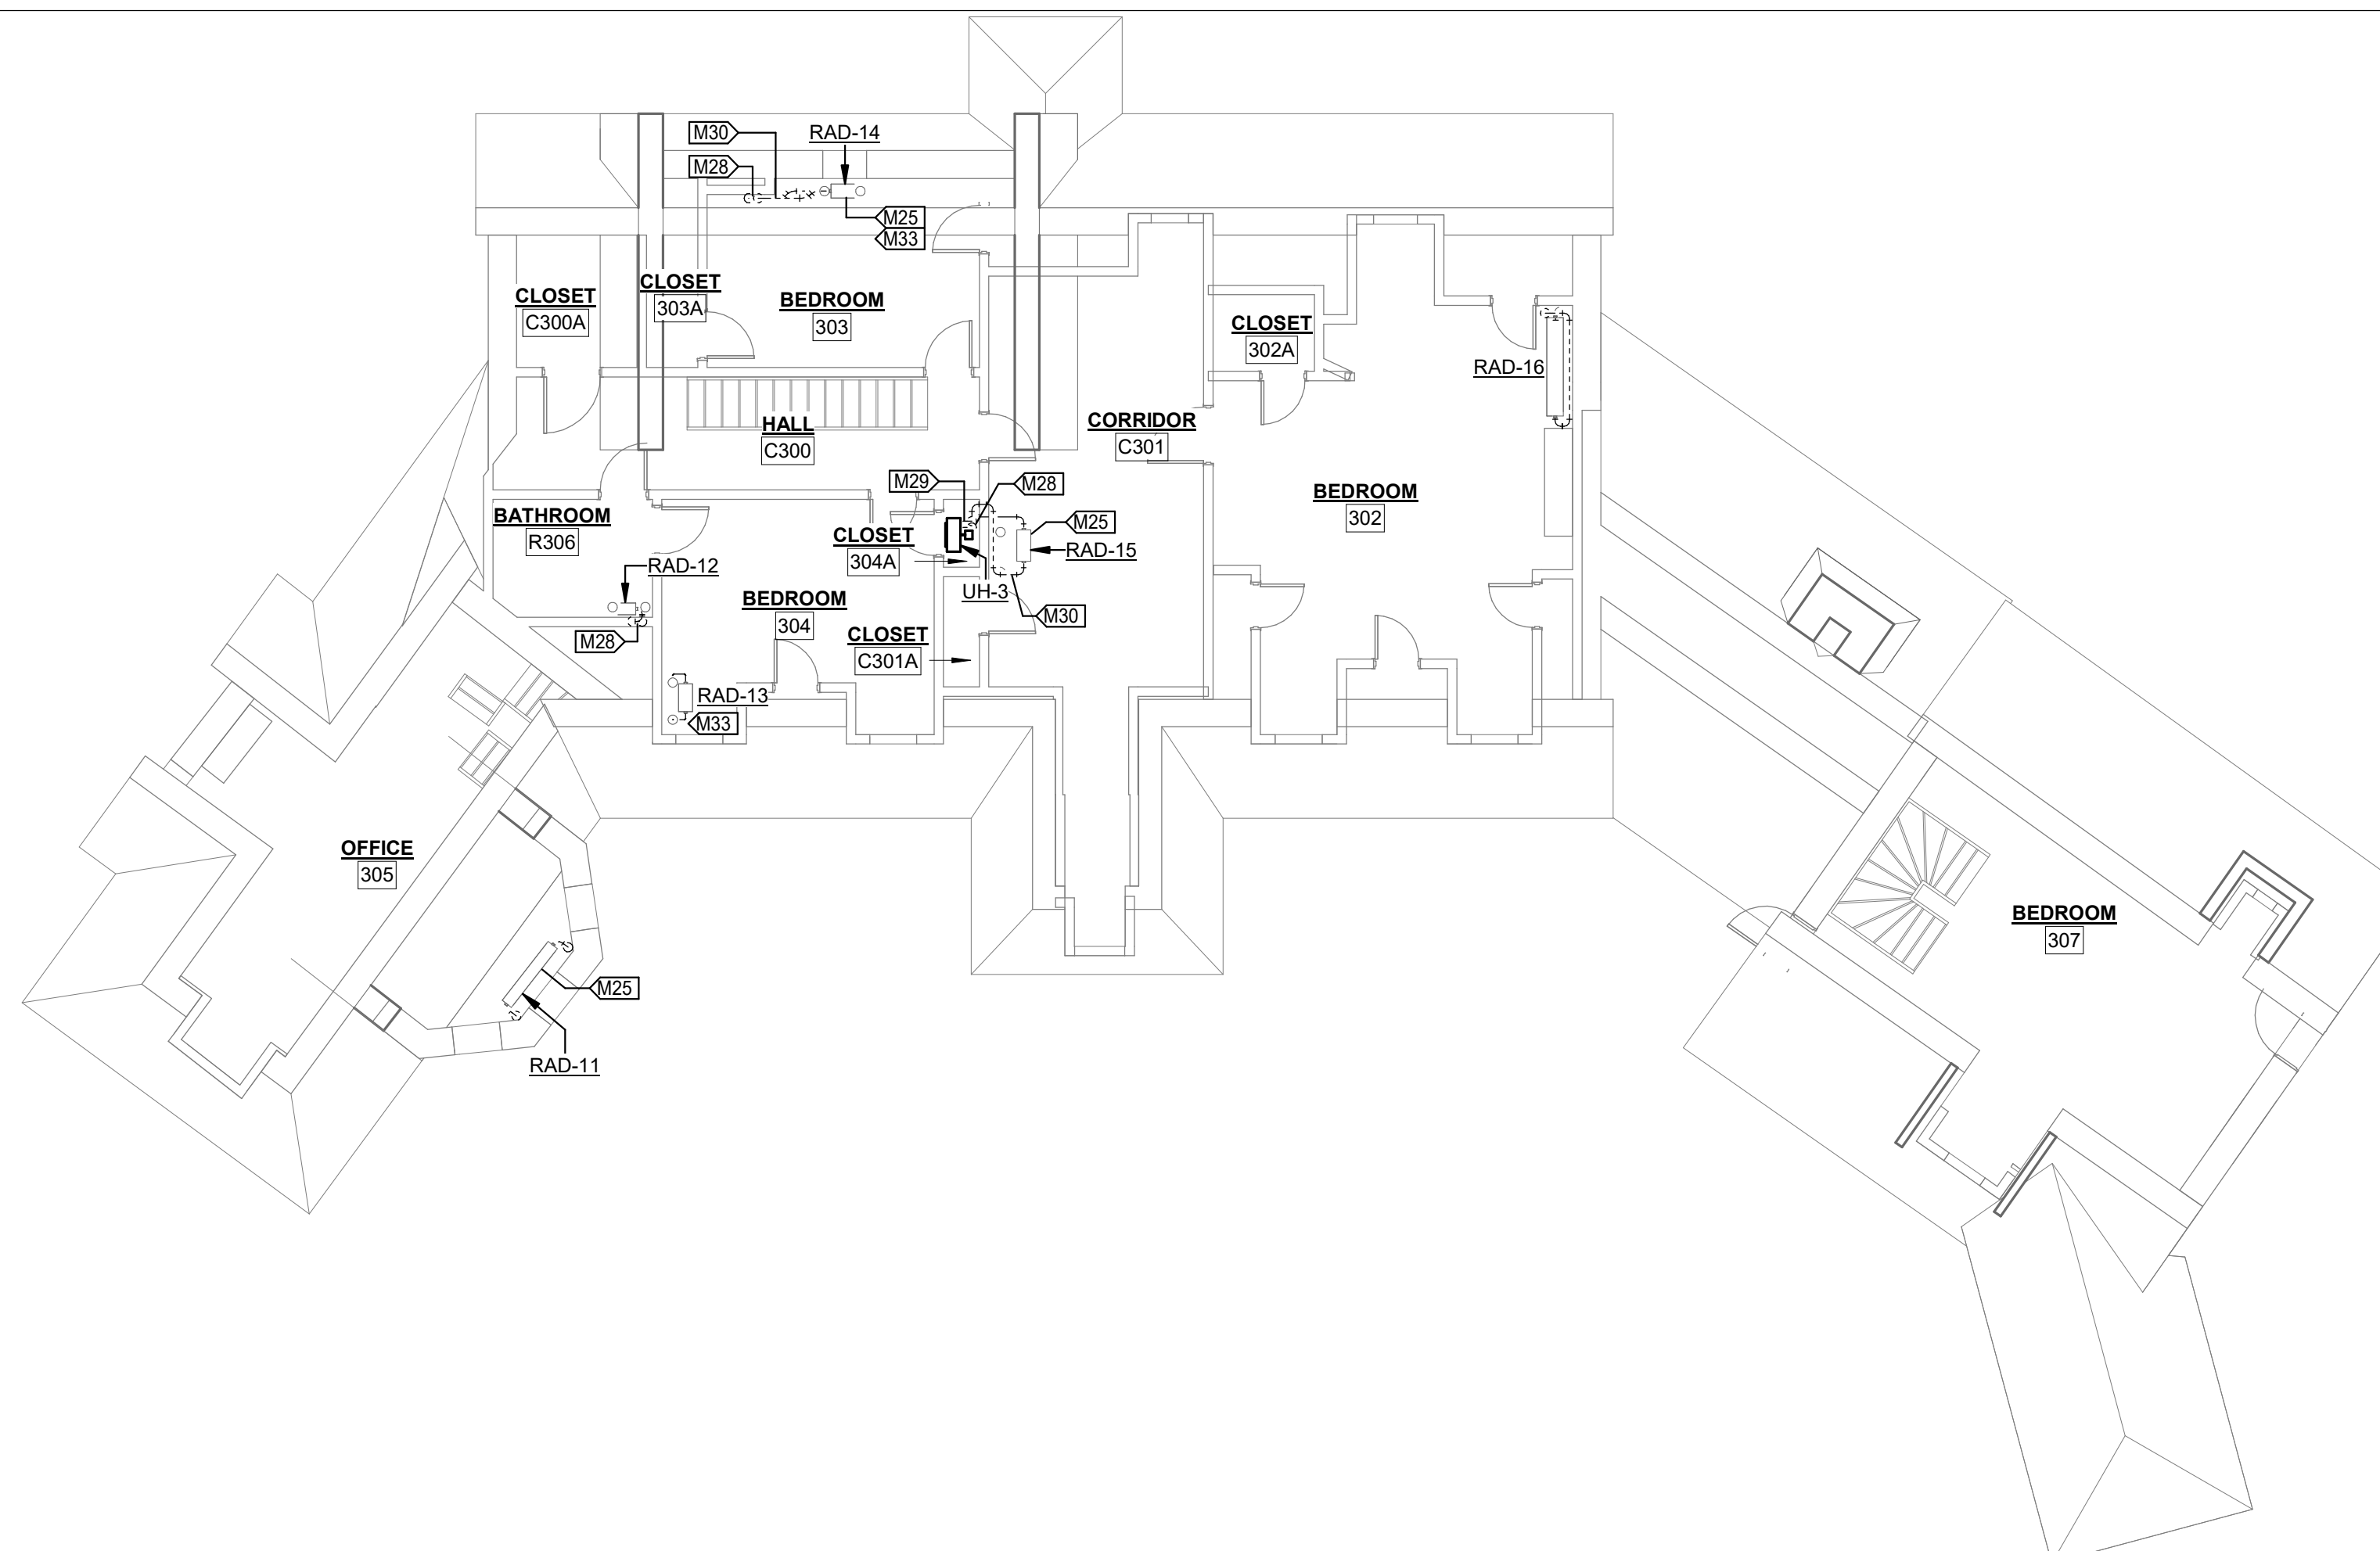
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**THIRD FLOOR
MECHANICAL PLANS**

SHEET NUMBER:


M103

SHEET 8 OF 12
SEPTEMBER 9, 2024


VALUE	DESCRIPTION
M01	DEMOLISH EXPOSED STEAM AND CONDENSATE PIPING DOWN THROUGH FLOOR. SALVAGE VALVES AND STEAM TRAPS AND RETURN TO OWNER.
M05	DRY CORE DRILL NEW OPENING FOR PIPING. REFER TO NEW WORK PLAN.
M06	DEMOLISH EXPOSED STEAM AND CONDENSATE PIPING TO MAX. 6" ABOVE FLOOR. CAP AND ABANDON PIPING STUB. SALVAGE VALVES AND STEAM TRAPS AND RETURN TO OWNER.
M07	LIMIT EXTENTS OF WALL DEMOLITION TO MINIMIZE DAMAGE TO EXISTING PLASTERWORK "TILE" TO WITHIN AREA COVERED BY NEW PIPE ESCUTCHEON.
M25	CONNECT NEW HYDRONIC SUPPLY AND RETURN PIPING TO EXISTING RADIATOR. REFER TO DETAIL FOR ARRANGEMENT OF NEW CONTROL VALVE, LOCK SHIELD VALVE, AND AIR VENT.
M28	EXTEND NEW HYDRONIC SUPPLY AND RETURN PIPING DOWN THROUGH NEW FLOOR OPENING. SUPPORT WITH FLOOR CLAMP.
M29	CONNECT NEW HYDRONIC PIPING TO NEW UNIT HEATER. CONFIGURE UNIT HEATER CONTROLS FOR FAN TO BE ON WHENEVER UNIT HEATER IS POWERED.
M30	ROUTE NEW HYDRONIC PIPING TO TIGHT TO WALLS AND TO EXISTING RADIATORS. PAINT TO MATCH EXISTING WALLS.
M33	PAINT WALL BEHIND NEW PIPING OR THROUGH WHICH NEW PIPING PENETRATES TO MATCH ADJACENT WALLS, FROM CORNER TO CORNER AND FROM TOP OF BASEBOARD TO CEILING.




2 THIRD FLOOR MECHANICAL PLAN
1/8" = 1'-0"

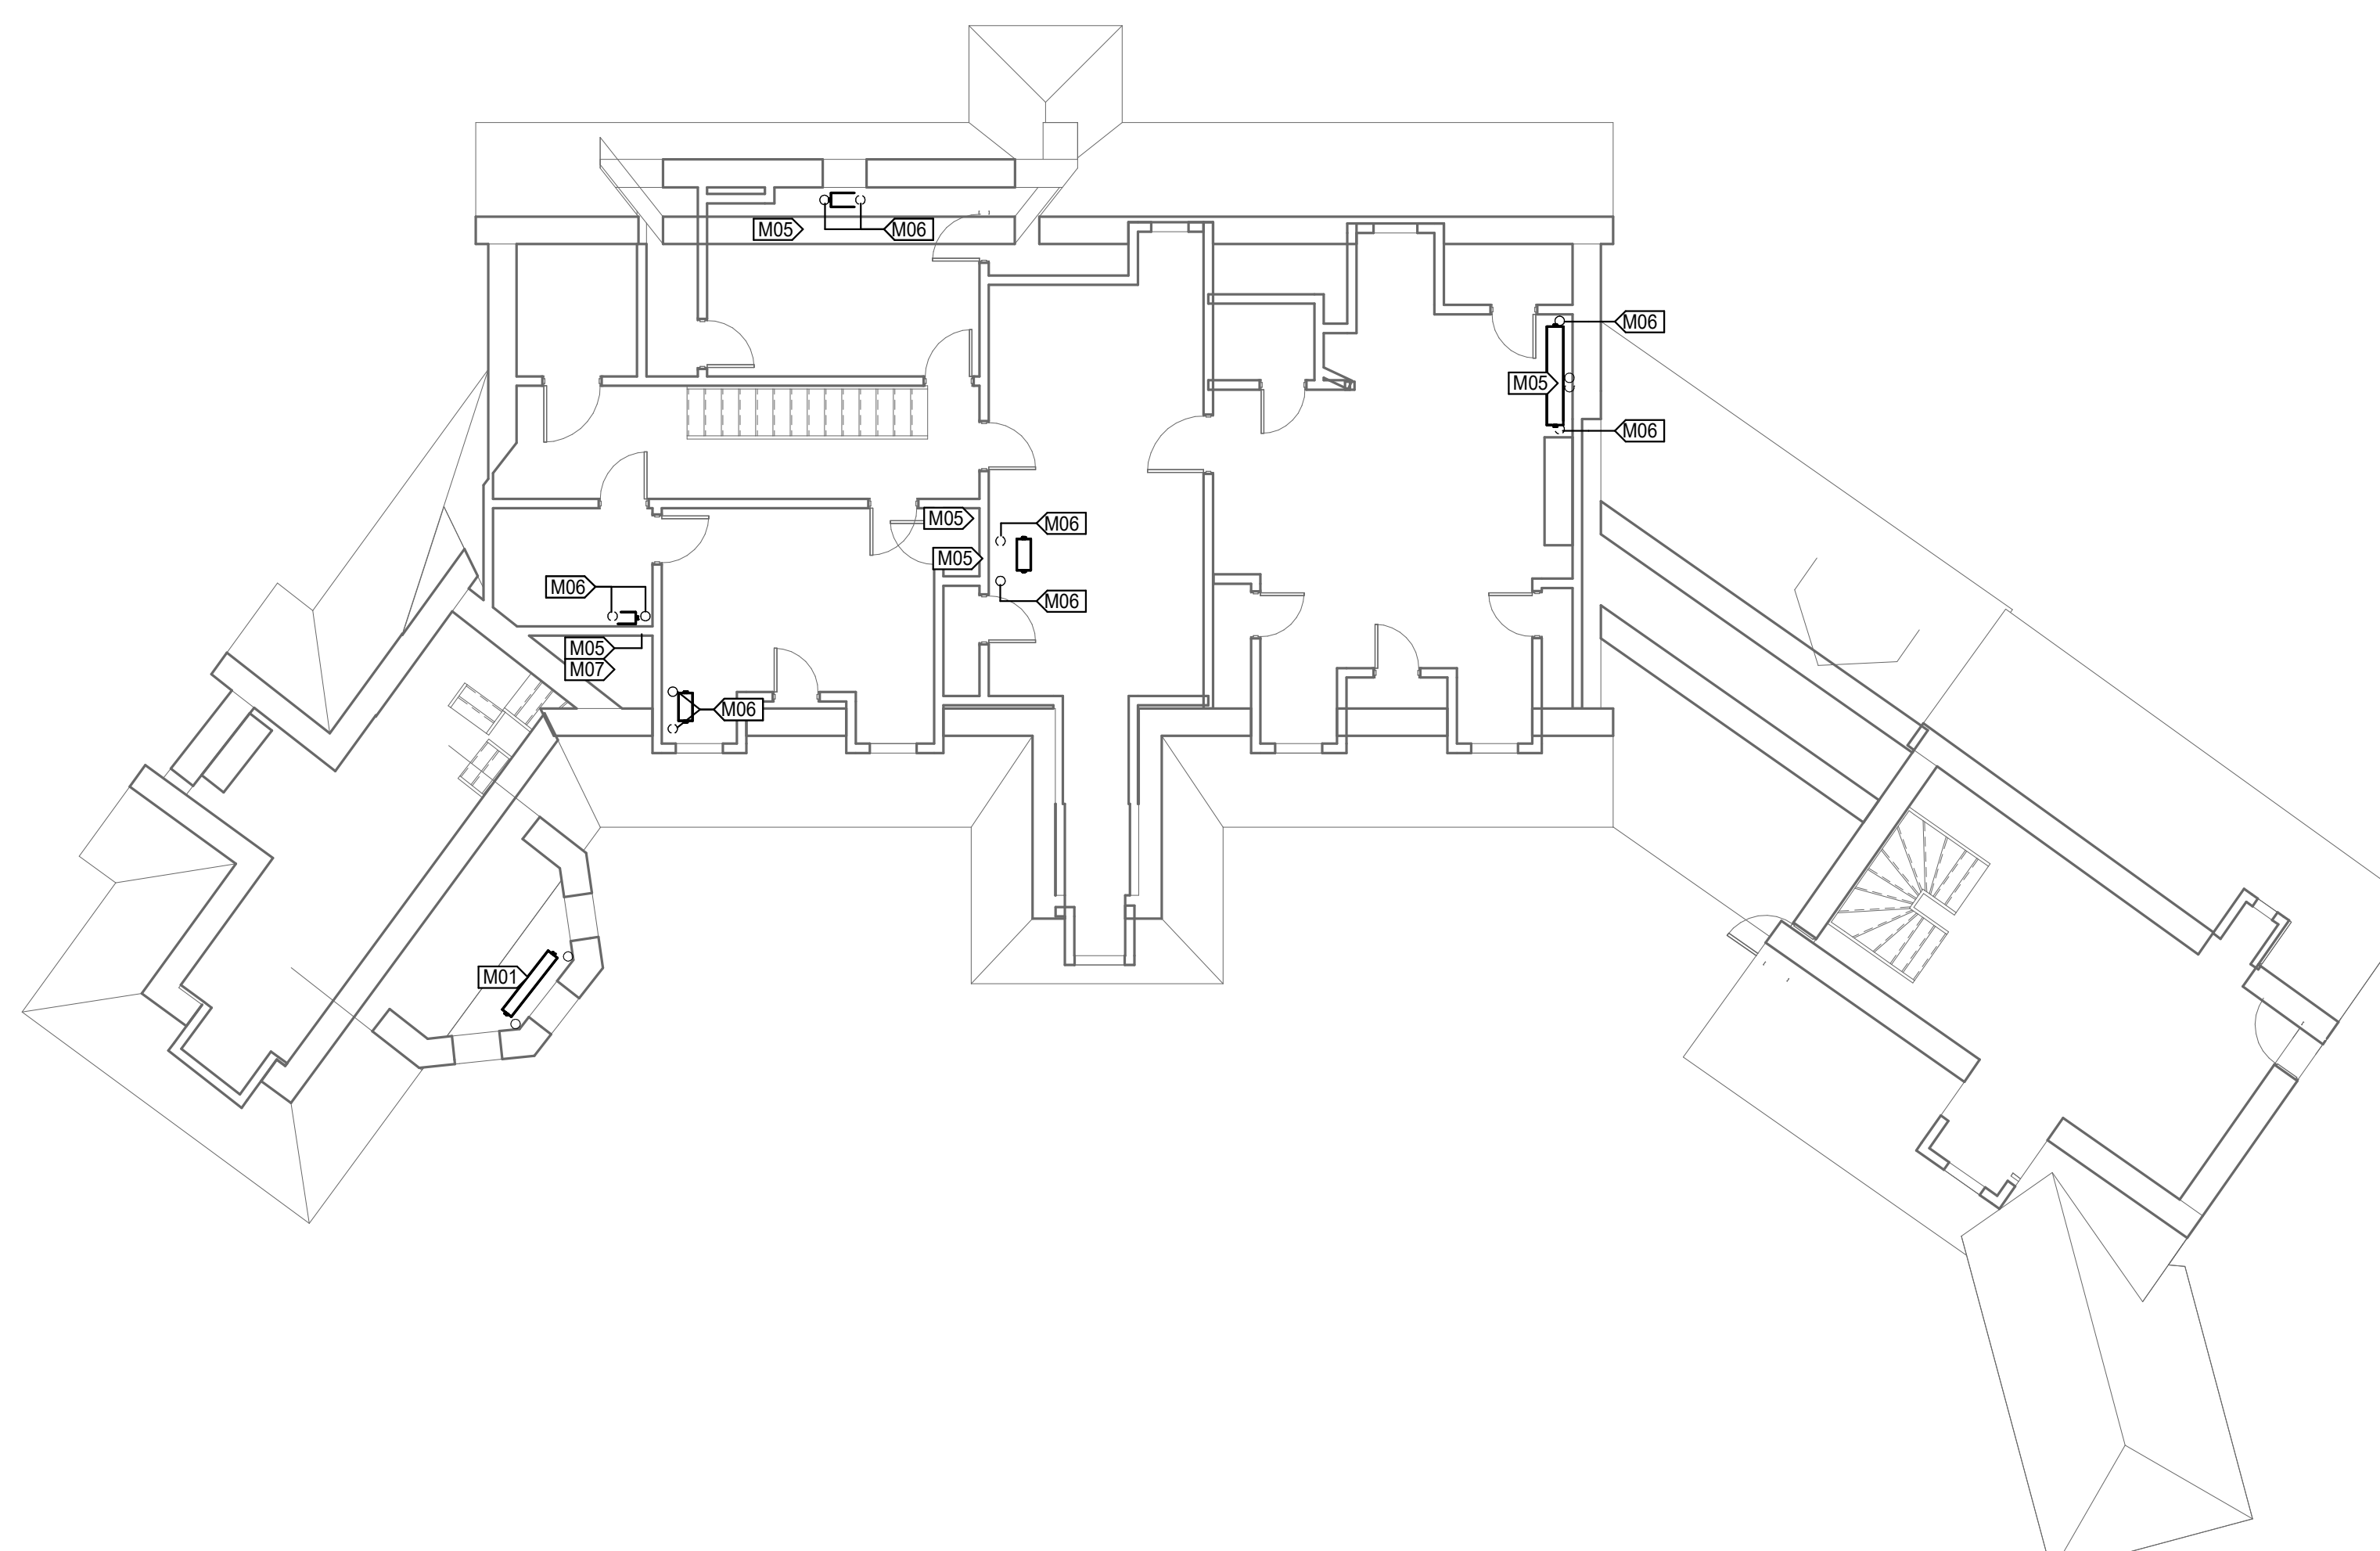


1 THIRD FLOOR MECHANICAL DEMO PLAN
1/8" = 1'-0"

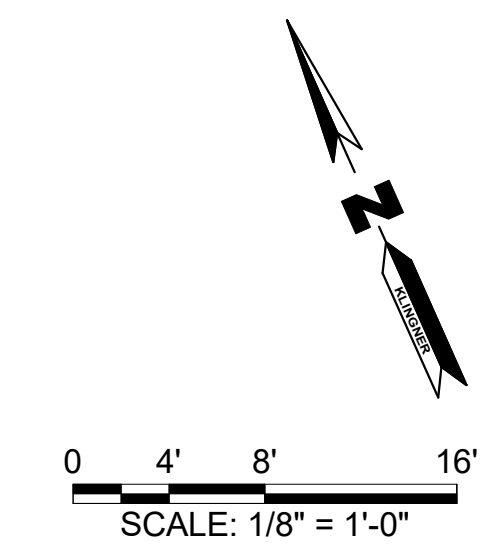


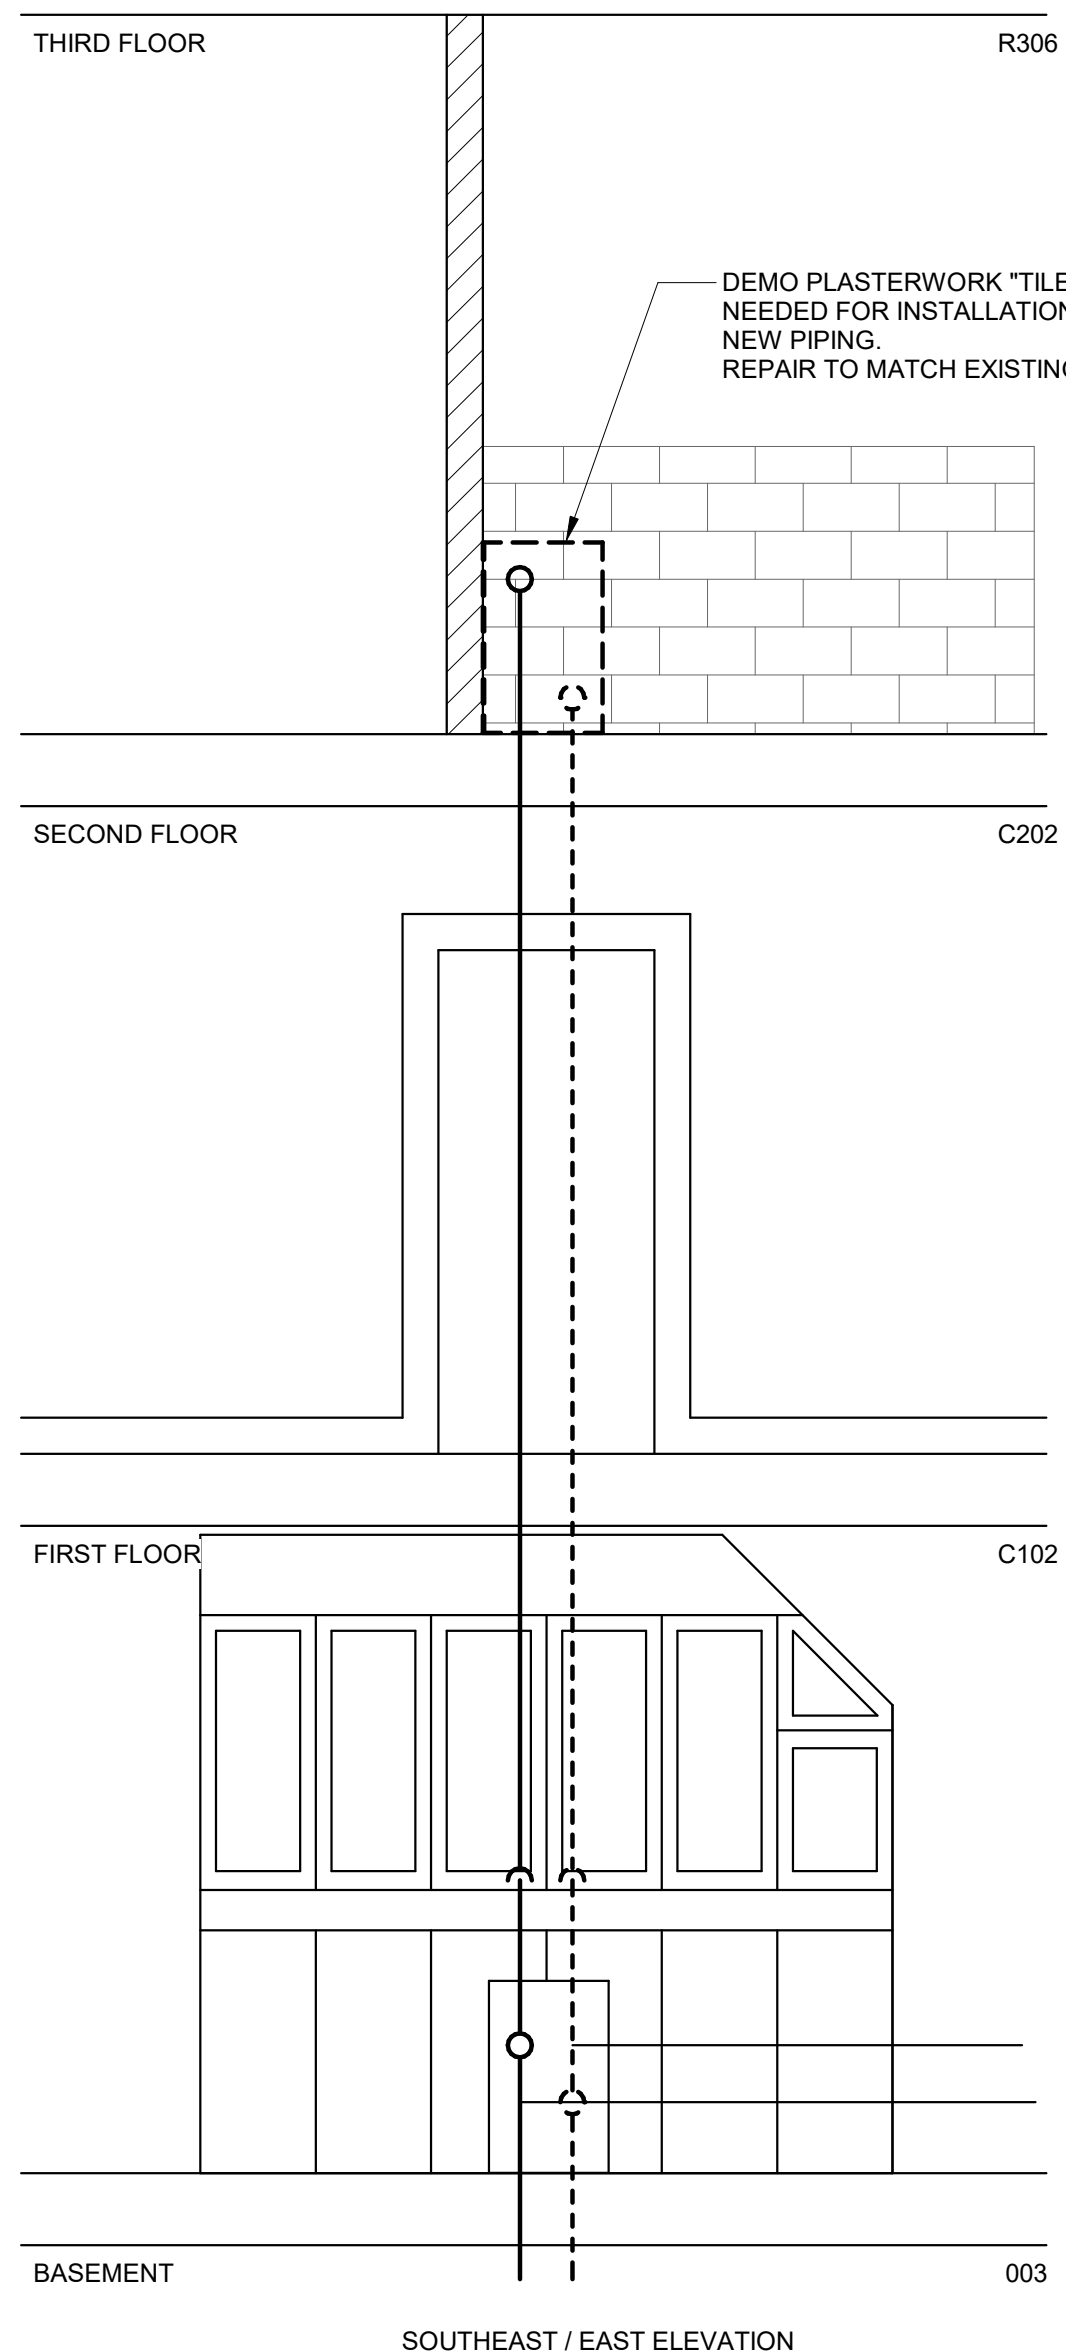


6 RAD-12 & RAD-26 PIPE ROUTING DETAILS
NTS

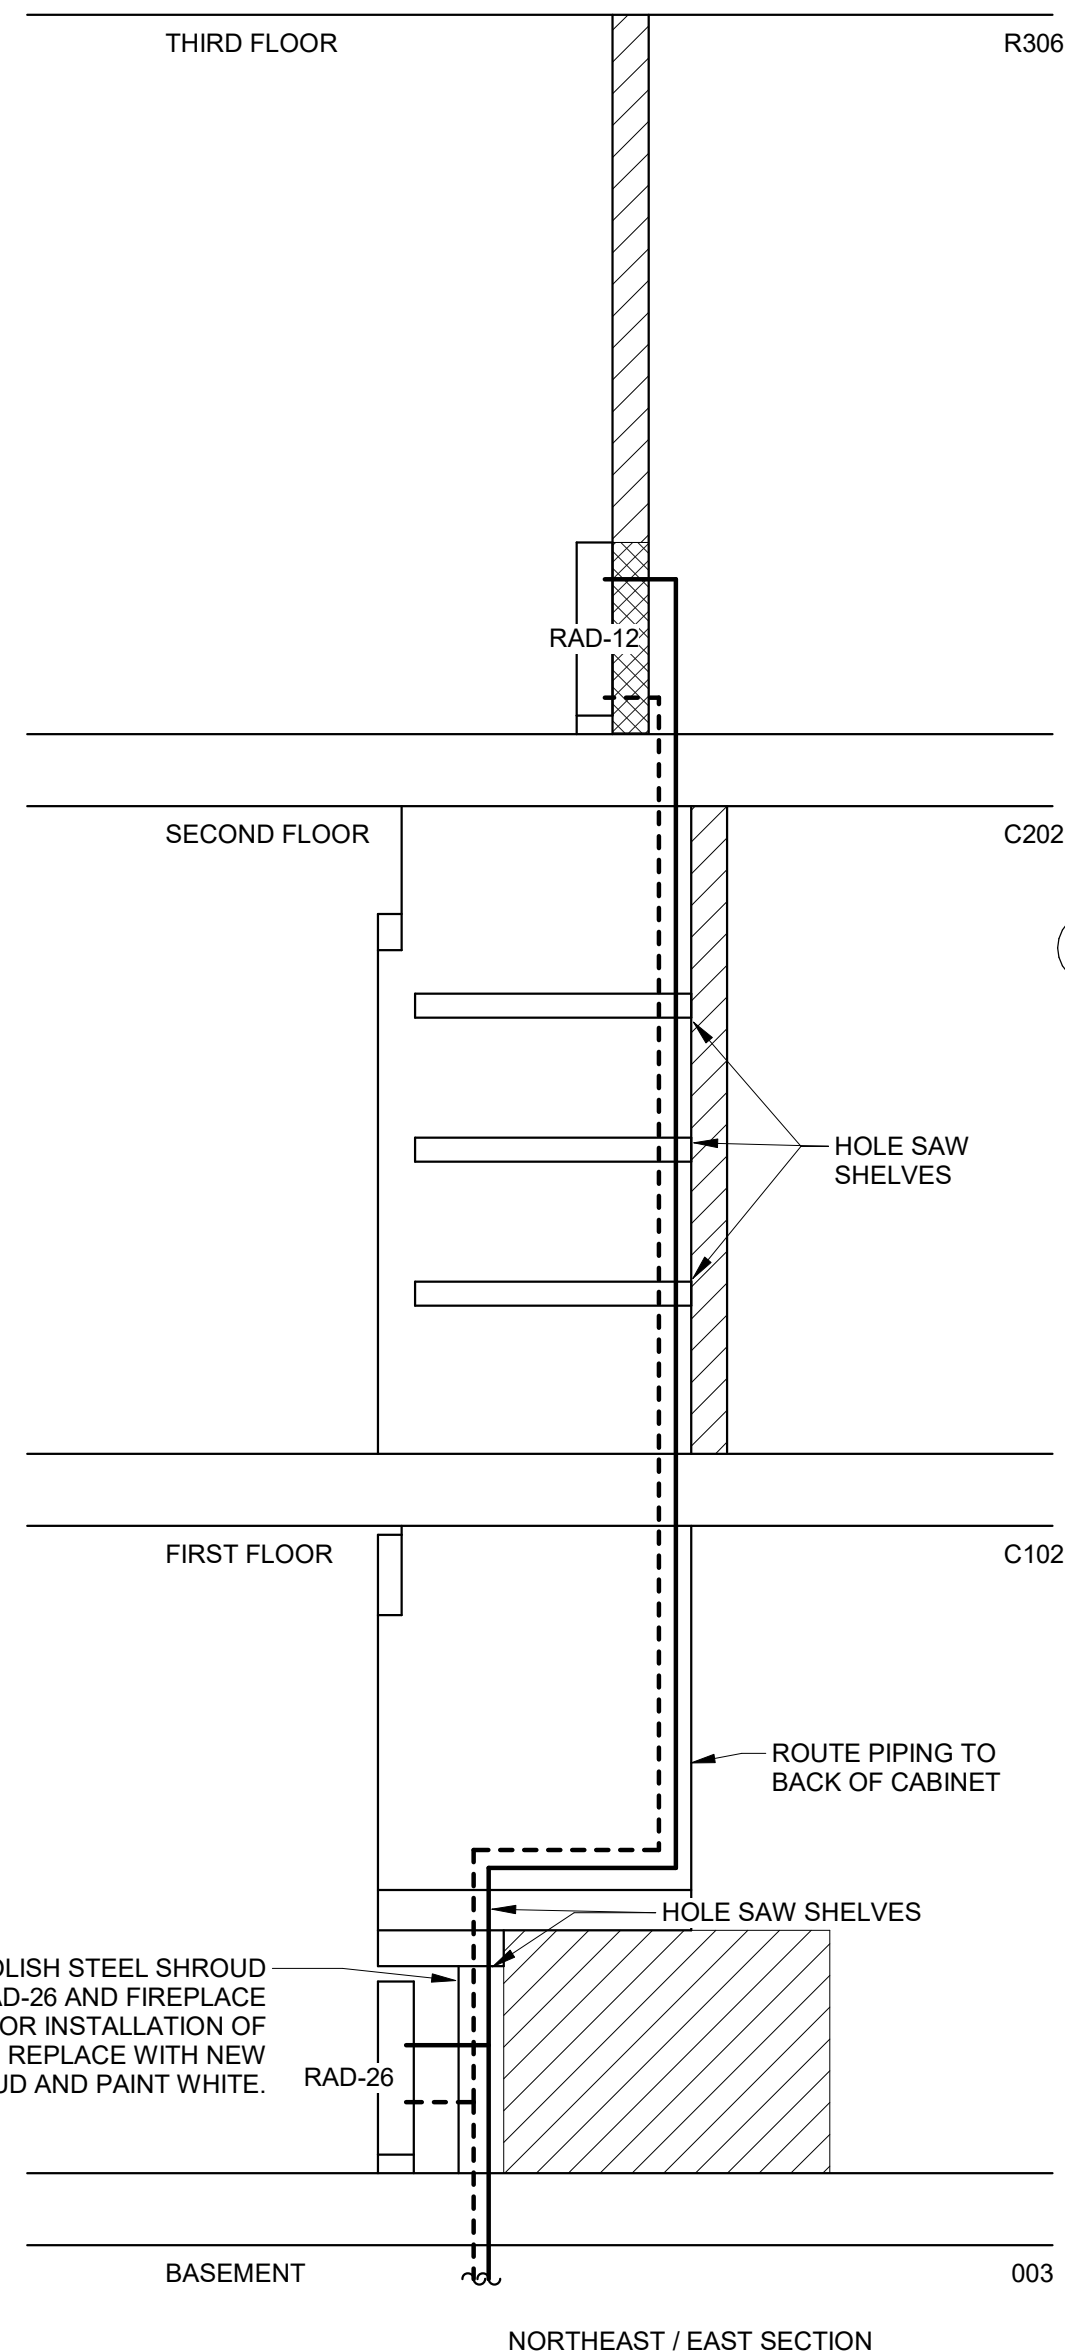


NORTHEAST / EAST SECTION

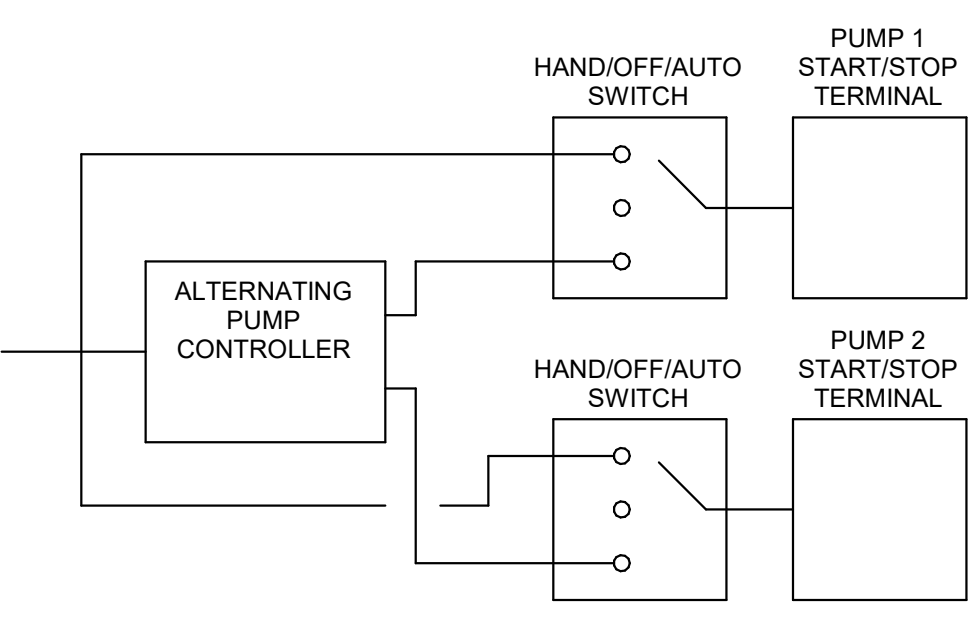

7 PUMP CONTROL DETAIL
NTS

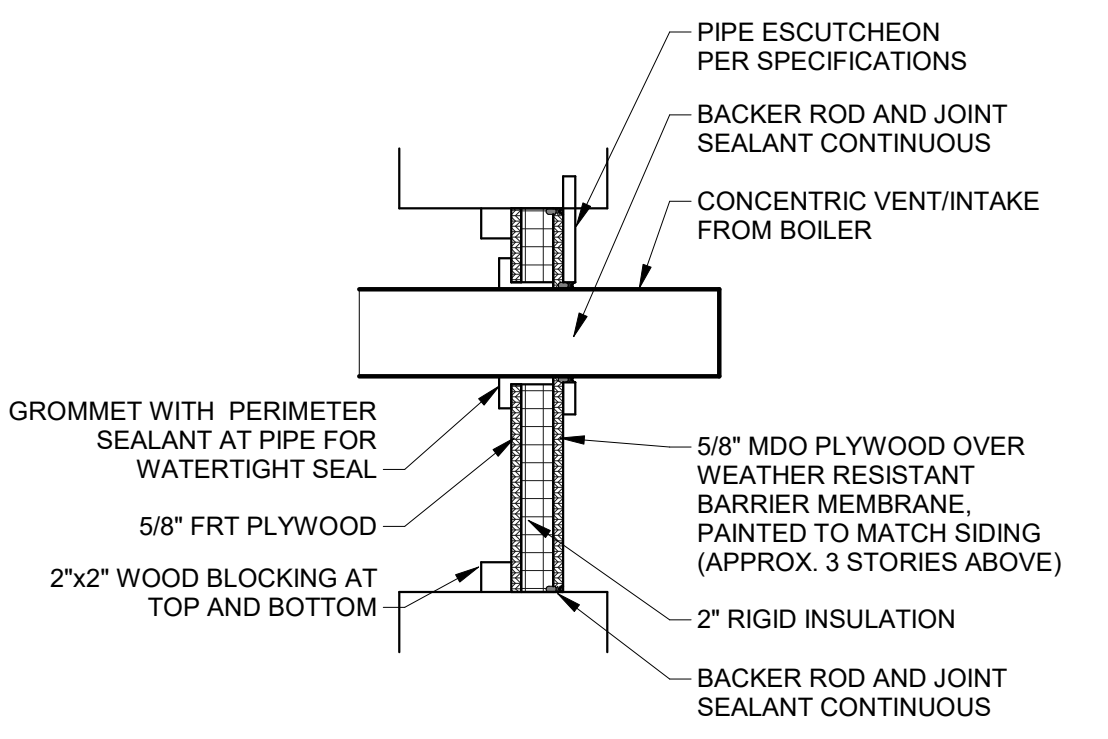

5 VENT THROUGH WINDOW OPENING DETAIL
NTS

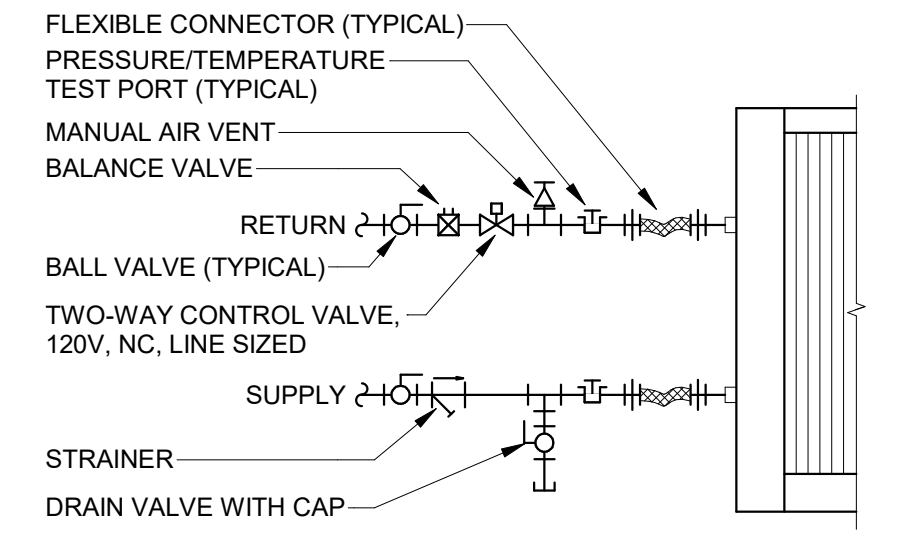


4 UNIT HEATER COIL CONNECTION DETAIL
NTS

SEQUENCE OF OPERATIONS


BOILERS
A CASCADING BOILER CONTROLLER APPROVED FOR USE BY THE BOILER MANUFACTURER SHALL STAGE AND/OR MODULATE BOILERS TO MAXIMIZE TURNDOWN AND ASSOCIATED FUEL EFFICIENCY IN RESPONSE TO CHANGES IN DEMAND. BOILERS SHALL BE CONFIGURED TO MAINTAIN A LEAVING WATER TEMPERATURE LINEARLY SET BACK BY OUTDOOR AIR TEMPERATURE, WITH A LEAVING WATER TEMPERATURE OF 90 DEG. F WHEN THE OUTDOOR AIR TEMPERATURE IS AT OR ABOVE 70 F AND A LEAVING WATER TEMPERATURE OF 180 F WHEN THE OUTDOOR AIR TEMPERATURE IS AT OR BELOW 40 F.

PUMPS
AN ALTERNATING PUMP CONTROLLER SHALL RUN ONE PUMP AT A TIME, SWITCHING PUMPS EVERY 7 DAYS (ADJUSTABLE) TO EVEN WEAR ON BOTH PUMPS. EACH PUMP SHALL HAVE A HAND/OFF/AUTO SWITCH TO ALLOW MANUAL OVERRIDE DURING PUMP MAINTENANCE OR FAILURE AND AUTOMATIC START/STOP BY THE ALTERNATING PUMP CONTROLLER DURING NORMAL OPERATION. BOTH PUMPS SHOULD BE CONFIGURED TO MAINTAIN A CONSTANT PRESSURE DIFFERENTIAL ACROSS THE PUMP CORRESPONDING TO THE MINIMUM PRESSURE REQUIRED FOR DESIGN FLOW AT ALL TERMINAL HEATING EQUIPMENT AND THE END OF LINE BYPASS. THE PRESSURE DIFFERENTIAL SET POINT SHALL BE DETERMINED BY THE T.A.B. CONTRACTOR.


RADIATORS
LOCKSHIELD VALVES AT THE RETURN SIDE OF THE RADIATOR SHALL BE USED TO BALANCE THE FLOW AT EACH RADIATOR TO

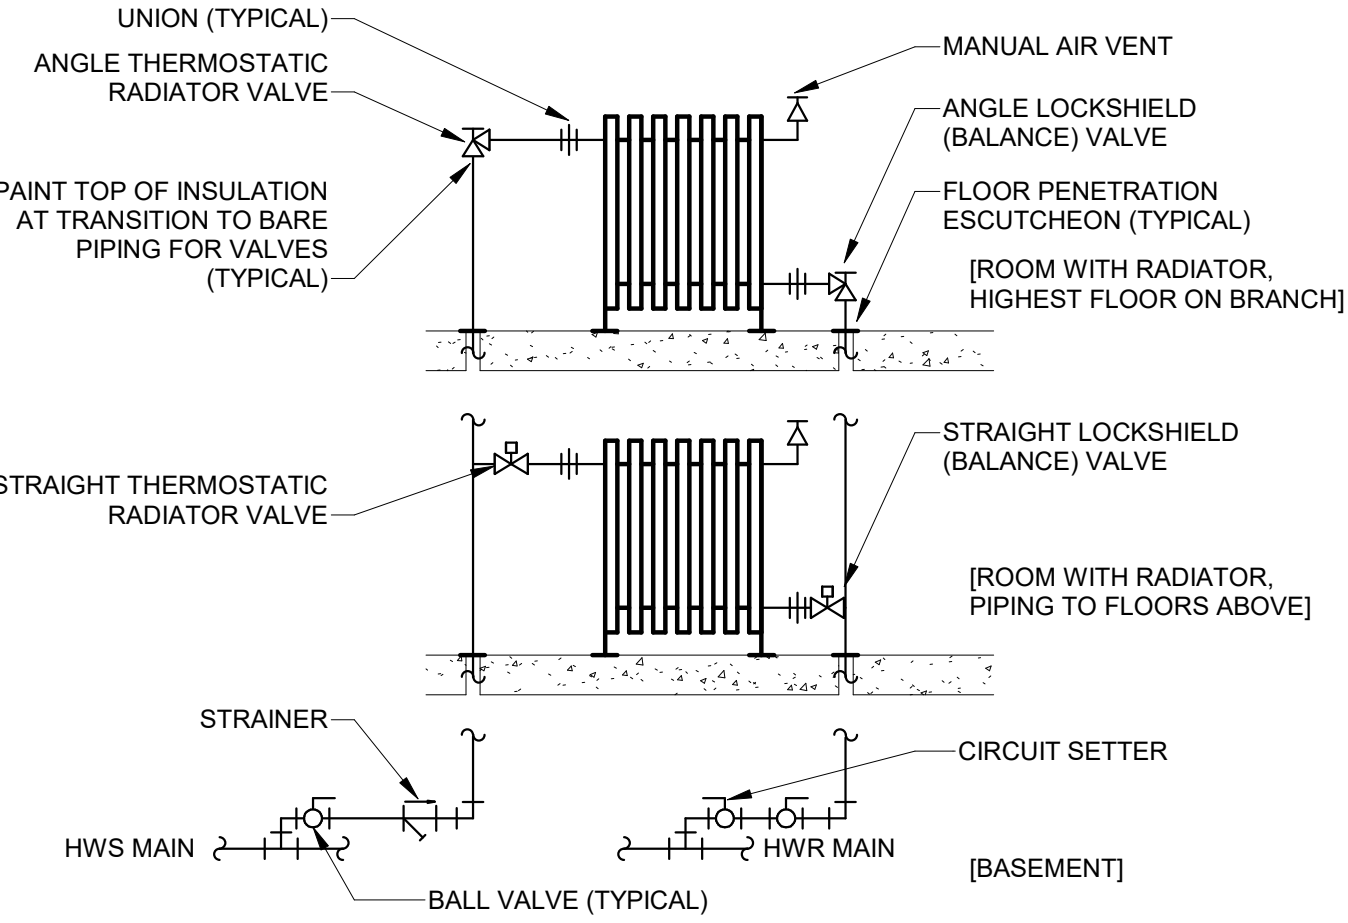

3 RADIATOR CONNECTION DETAIL (HYDRONIC)
NTS

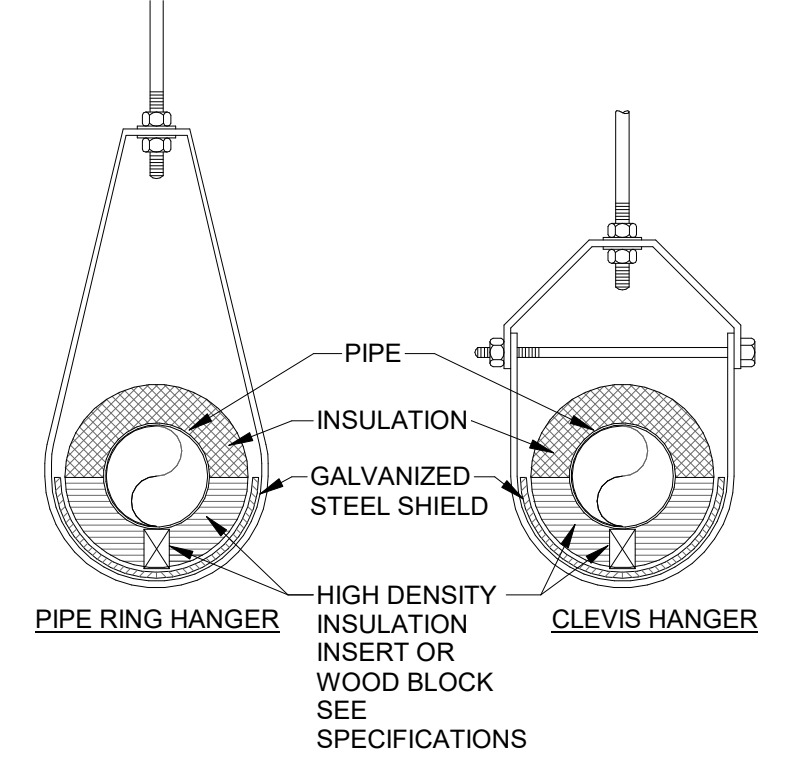

2 INSULATED PIPE AT HANGER DETAIL
NTS

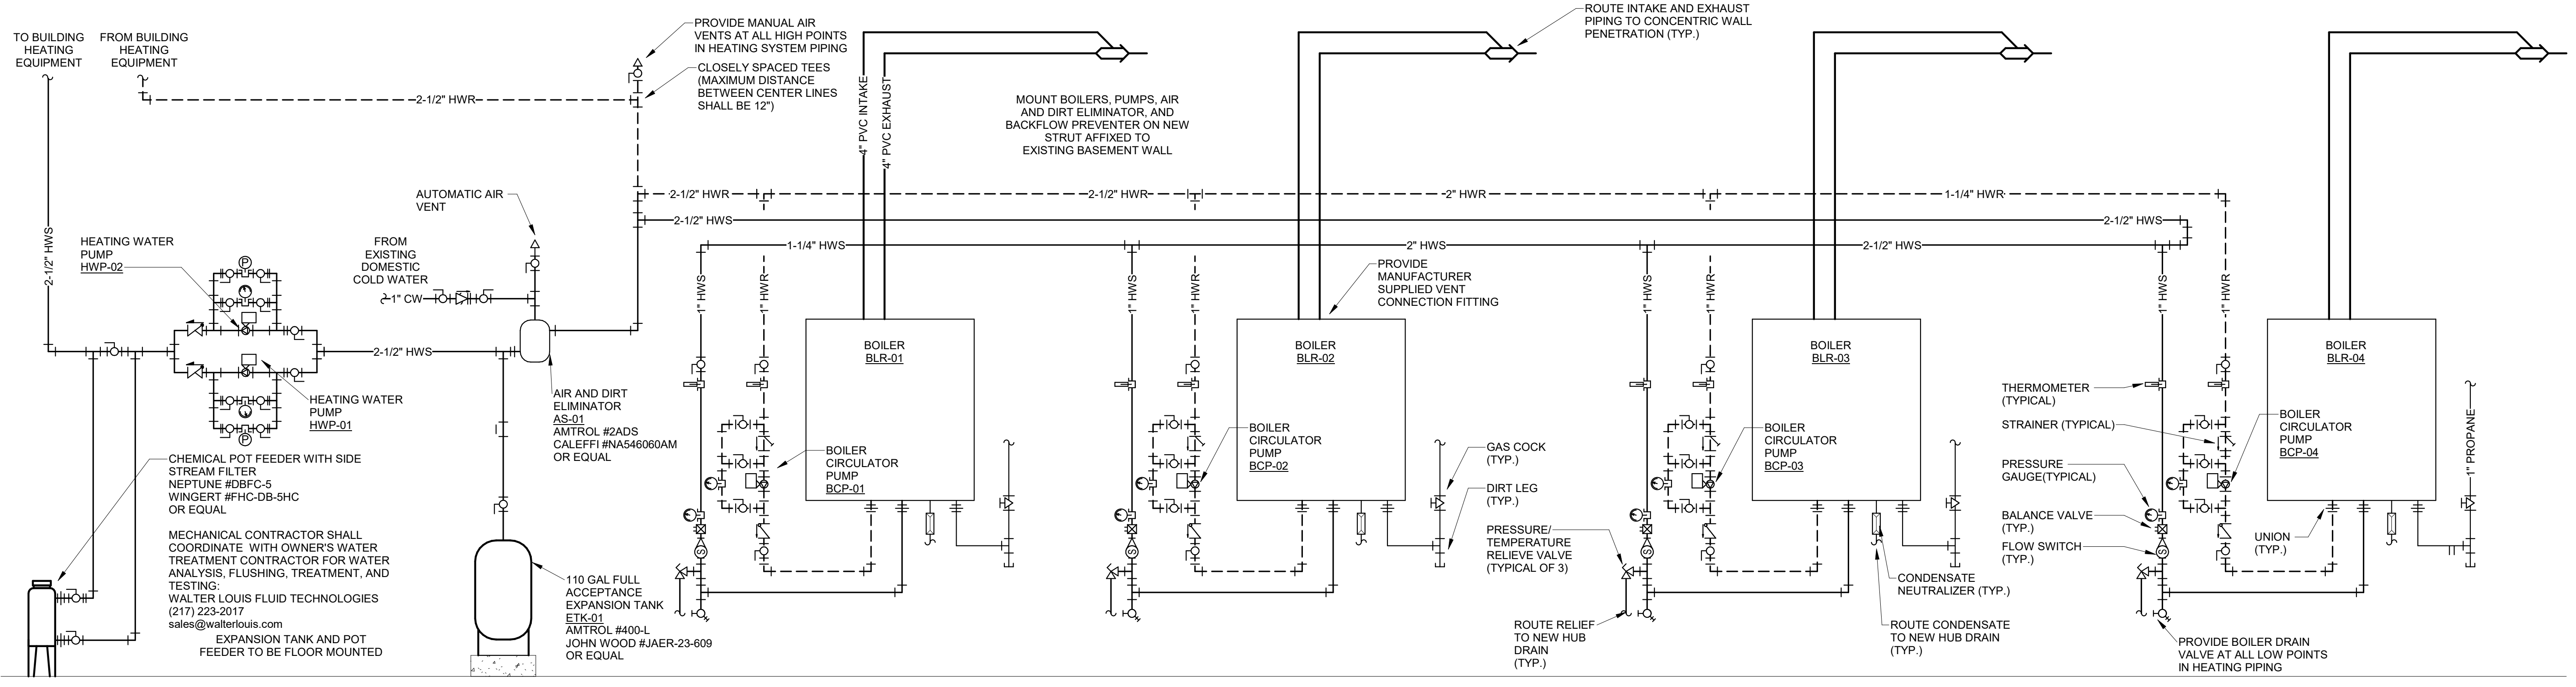

1 HYDRONIC EQUIPMENT AND PIPING GENERAL ARRANGEMENT
NTS

STATE OF MISSOURI
MICHAEL L. PARSON,
GOVERNOR



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OFFICE OF ADMINISTRATION
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DESIGN AND CONSTRUCTION

INSTALL NEW HEATING UNIT

BOTHWELL LODGE STATE HISTORIC SITE

19349 BOTHWELL STATE PARK RD
SEDALIA, MO 65301

PROJECT # X233101
SITE # 5303
ASSET # 7815303002

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DATE: _____
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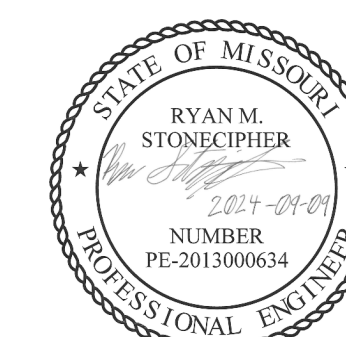
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DRAWING BY: RMS
CHECKED BY: SFD
DESIGNED BY: RMS

SHEET TITLE:
MECHANICAL DETAILS

SHEET NUMBER:

M501

SHEET 9 OF 12
SEPTEMBER 9, 2024



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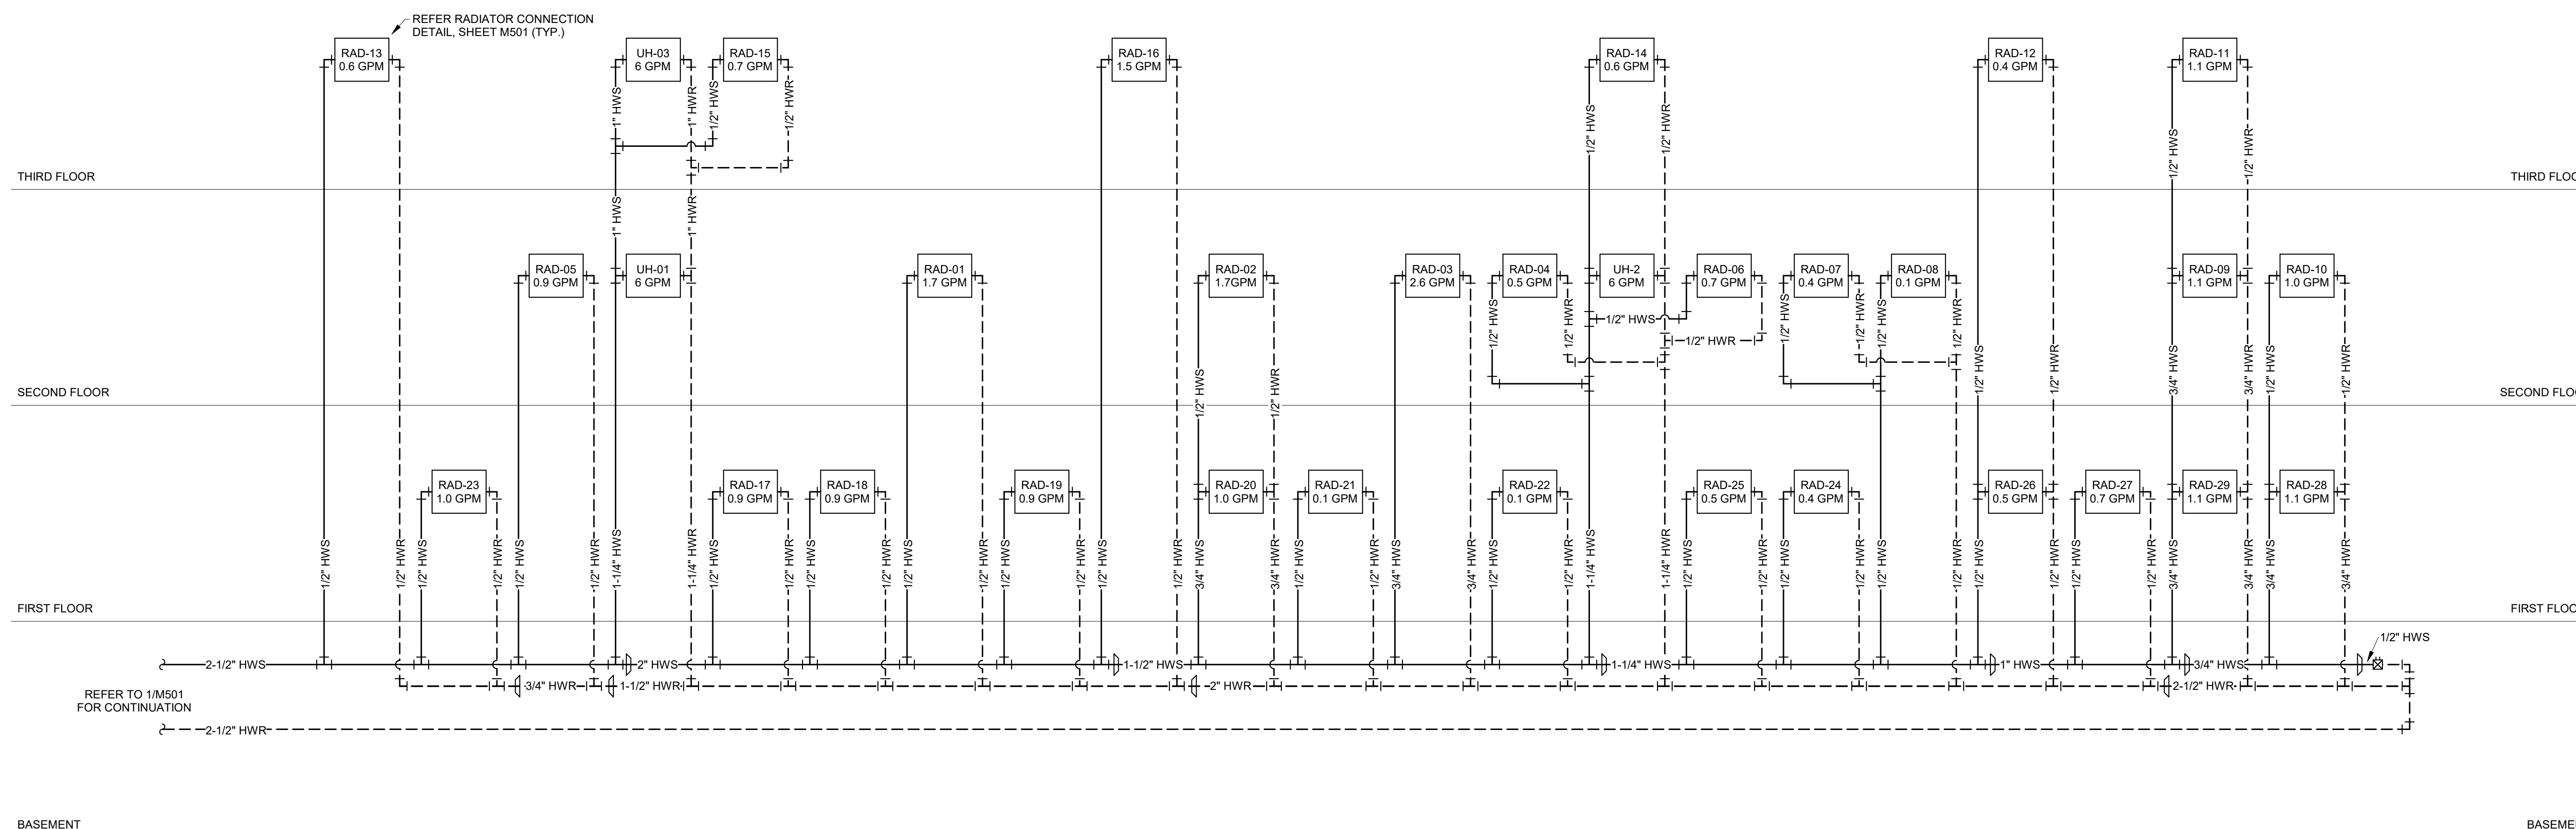
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Unit Heater Schedule											
Mark	Description	Hydronic Performance		Air Performance		Electrical			Manufacturer	Model	Notes
		Flow	Pressure Drop	Flow	Throw	Voltage	FLA	MOCP			
UH-1	Hydronic Unit Heater	6.3 GPM	1.0 ftH ₂ O	1,340 CFM	33 ft	120 V	4 A	15 A	Modine	HC 86S	
UH-2	Hydronic Unit Heater	6.3 GPM	1.0 ftH ₂ O	1,340 CFM	33 ft	120 V	4 A	15 A	Modine	HC 86S	
UH-3	Hydronic Unit Heater	6.3 GPM	1.0 ftH ₂ O	1,340 CFM	33 ft	120 V	4 A	15 A	Modine	HC 86S	

Pump Schedule										
Mark	Description	Hydronic Performance			Voltage	Full Load Amps	MOCP	Manufacturer	Model	Notes
		Flow	Dynamic Head	Static Head						
HWP-01	Wet Rotor Circulator	44.1 GPM	35 ftH ₂ O	37.5 ftH ₂ O	120 V	4.6 A	15 A	Grundfos	MAGNA3 40-180 GF	
HWP-02	Wet Rotor Circulator	44.1 GPM	35 ftH ₂ O	37.5 ftH ₂ O	120 V	4.6 A	15 A	Grundfos	MAGNA3 40-180 GF	

Boiler Schedule												
Mark	Description	Fuel Type	Gas Heat		Hydronic Performance		Electrical			Manufacturer	Model	Notes
			Input	Thermal Efficiency	Flow	Pressure Drop	Voltage	FLA	MOCP			
B-1	Condensing Propane Boiler	Propane	199,999 Btu/h	95.0%	9.9 GPM	7.9 ftH ₂ O	240 V	1.2 A	15 A	Hamilton	HWH-199	
B-2	Condensing Propane Boiler	Propane	199,999 Btu/h	95.0%	9.9 GPM	7.9 ftH ₂ O	240 V	1.2 A	15 A	Hamilton	HWH-199	
B-3	Condensing Propane Boiler	Propane	199,999 Btu/h	95.0%	9.9 GPM	7.9 ftH ₂ O	240 V	1.2 A	15 A	Hamilton	HWH-199	
B-4	Condensing Propane Boiler	Propane	199,999 Btu/h	95.0%	9.9 GPM	7.9 ftH ₂ O	240 V	1.2 A	15 A	Hamilton	HWH-199	



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SEDALIA, MO 65301

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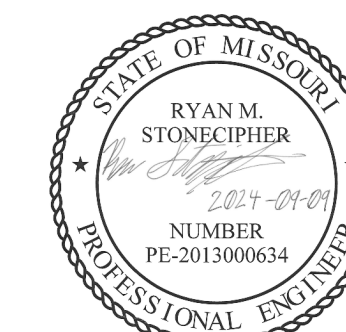
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DRAWING BY: GCS
CHECKED BY: SFD
DESIGNED BY: RMS

SHEET TITLE:
**MECHANICAL
SCHEDULES AND
HEATING SYSTEM FLOW
DIAGRAM**

SHEET NUMBER:

M701

SHEET 10 OF 12
SEPTEMBER 9, 2024




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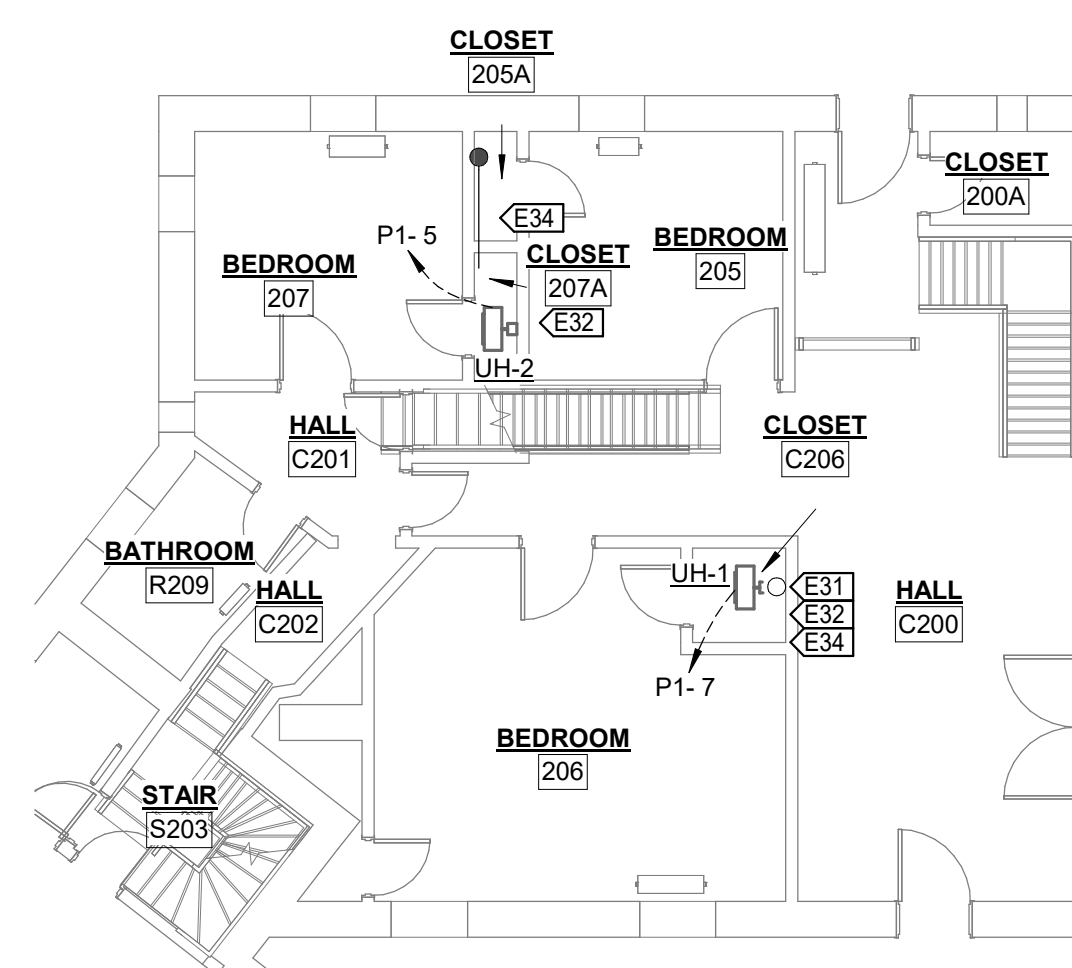
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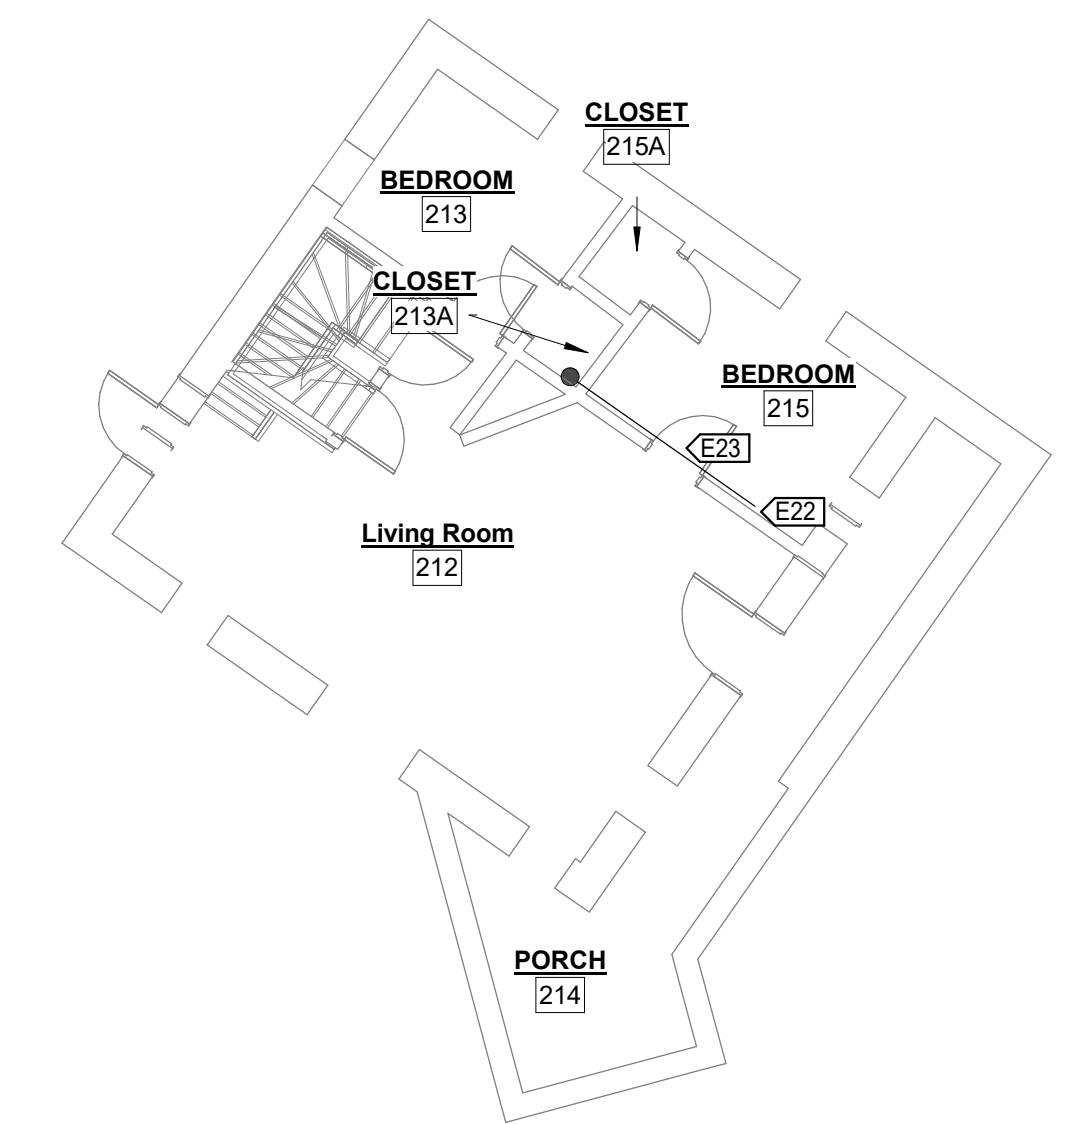
VALUE	DESCRIPTION
E20	PROVIDE AND INSTALL NEW LIGHTING CONTROL PANEL, CONTACTOR, AND POWER PACK IN EXISTING ELECTRICAL ROOM. INTERCEPT LIGHTING CIRCUITS AND REROUTE THROUGH CONTROL PANEL. INTERCEPT FEEDER TO PANEL P2 IN CENTRAL BUILDING AND REROUTE THROUGH NEW CONTACTOR. PROVIDE AND INSTALL NEW 15-1 BREAKER IN EXISTING 42 SPACE PANEL TO POWER CONTROL PANEL AND CONTACTOR. REFER TO ONE-LINE DIAGRAM.
E21	PROVIDE AND INSTALL NEW POWER PACKS IN AREA WITH EXISTING PANEL. INTERCEPT LIGHTING CIRCUITS AND REROUTE THROUGH POWER PACKS. REFER TO ONE-LINE DIAGRAM.
E22	PROVIDE AND INSTALL NEW LOW VOLTAGE SWITCH ADJACENT TO EXISTING SECURITY CONTROL PANEL TO CONTROL NON-ESSENTIAL ELECTRICAL LOADS.
E23	ROUTE (1) CAT5 CABLE IN 1/2 INCH SURFACE MOUNTED EMT FROM BELOW UP CLOSET WALL TO CEILING, THROUGH WALL, HIGH ACROSS WALL ABOVE DOOR, AND DOWN TO SWITCH. PAINT CONDUIT TO MATCH WALL.
E24	ROUTE (1) CAT5 CABLE IN 1/2 INCH SURFACE CONDUIT FROM CELLAR BELOW UP ALONG WALL OF MECHANICAL ROOM AND INTO CLOSET ABOVE.
E25	ROUTE (2) CAT5 CABLES FROM AREA WITH EXISTING PANEL IN STAIR WALL UP TO ATTIC AND DOWN EXISTING CHASE INTO CELLAR.
E26	ROUTE (1) CAT5 CABLE IN 1/2 INCH SURFACE CONDUIT FROM CHASE ABOVE THROUGH NEW FOUNDATION WALL PENETRATION INTO CRAWLSPACE, THROUGH CRAWLSPACE, THROUGH NEW FOUNDATION WALL PENETRATION FROM CRAWLSPACE INTO BASEMENT, AND INTO ELECTRICAL ROOM ADJACENT TO EXISTING CONDUITS.
E27	(1) CAT5 CABLE FROM CELLAR INTO MECHANICAL ROOM.
E28	PROVIDE AND INSTALL NEW 1/2 INCH CONDUIT WITH PULL STRING AND BUSHING ON OPEN END FROM NEAR EXISTING SECURITY PANEL DOWN INTO CELLAR BELOW.
E29	ROUTE 1/2 INCH CONDUIT WITH PULL STRING FROM CELLAR THROUGH NEW WALL PENETRATION INTO CRAWLSPACE, THROUGH CRAWLSPACE, THROUGH NEW WALL PENETRATION INTO BASEMENT, AND TO BOILER CONTROLLER.
E30	ROUTE 3/4 INCH CONDUIT UP THROUGH CEILING FOR UNIT HEATER POWER. PAINT TO MATCH WALL AND CONCEAL BY LOCATING CLOSE TO LARGER, INSULATED HYDRONIC PIPING.
E31	ROUTE 1/2 INCH CONDUIT UP THROUGH CEILING FOR UNIT HEATER POWER. PAINT TO MATCH WALL AND CONCEAL BY LOCATING CLOSE TO LARGER, INSULATED HYDRONIC PIPING.
E32	POWER UNIT HEATER AND CONTROL VALVE THROUGH NEW DOOR SWITCH, COOPER #WD1664 OR APPROVED EQUAL. REFER TO WIRING DIAGRAM.
E33	PROVIDE AND INSTALL (5) NEW 15-1 BREAKERS FOR UNIT HEATERS AND PUMPS AND (4) NEW 15-2 BREAKERS FOR BOILERS IN EXISTING 42 SPACE PANEL.
E34	ROUTE CONDUIT DOWN THROUGH NEW HOLE IN FLOOR.
E36	ROUTE NEW POWER CIRCUIT CONDUITS FROM ELECTRICAL ROOM TO BASEMENT THROUGH GAP BETWEEN TOP OF ELECTRICAL ROOM AND FLOOR STRUCTURE ABOVE.
E37	PROVIDE AND INSTALL A TOGGLE SWITCH DISCONNECT AT NEW MECHANICAL EQUIPMENT UNDER 20 AMPS.
E38	PROVIDE AND INSTALL AN EMERGENCY BOILER SHUTDOWN BUTTON MOUNTED IN THE NORTH CORNER OF ELECTRICAL ROOM JUST SOUTH OF NARROW PASSAGE.




6 THIRD FLOOR POWER PLAN - HEATERS
1/8" = 1'-0"




5 SECOND FLOOR POWER PLAN - HEATERS
1/8" = 1'-0"

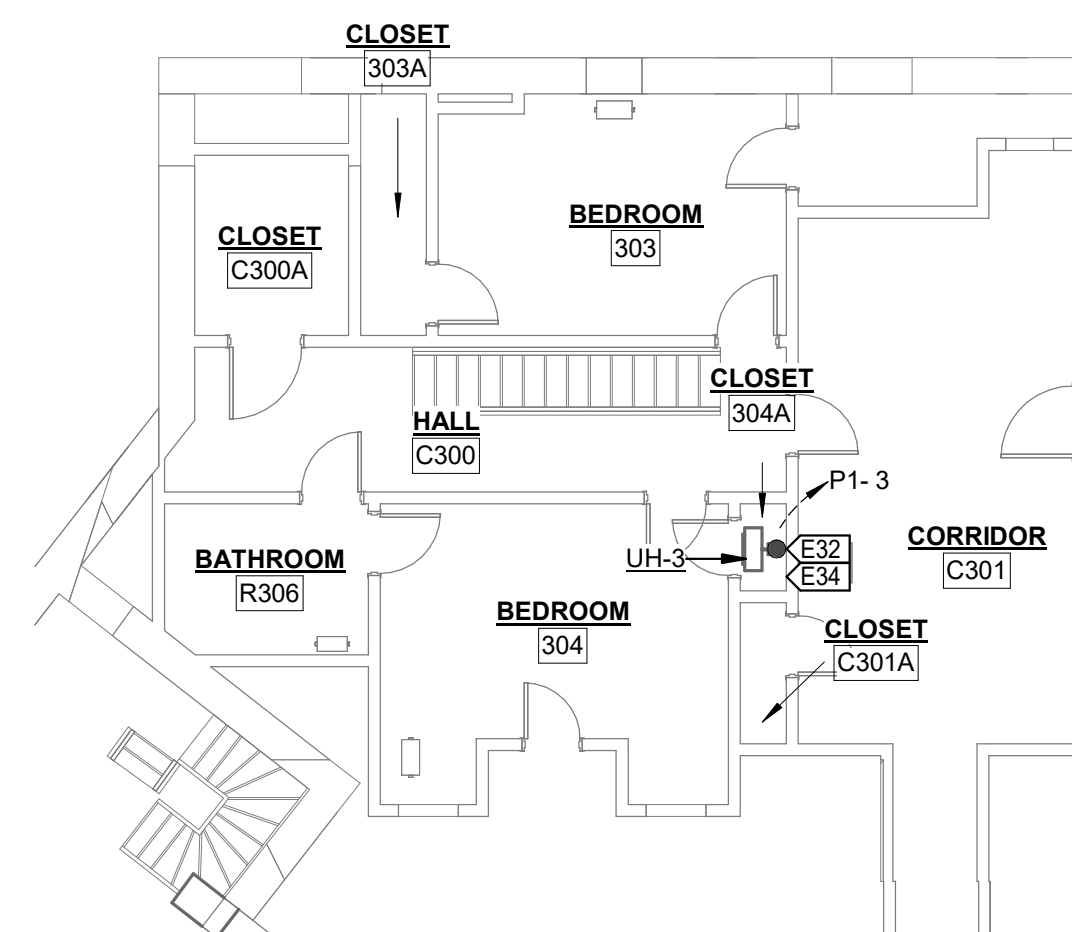


3 SECOND FLOOR POWER PLAN - CONTROLS
1/8" = 1'-0"

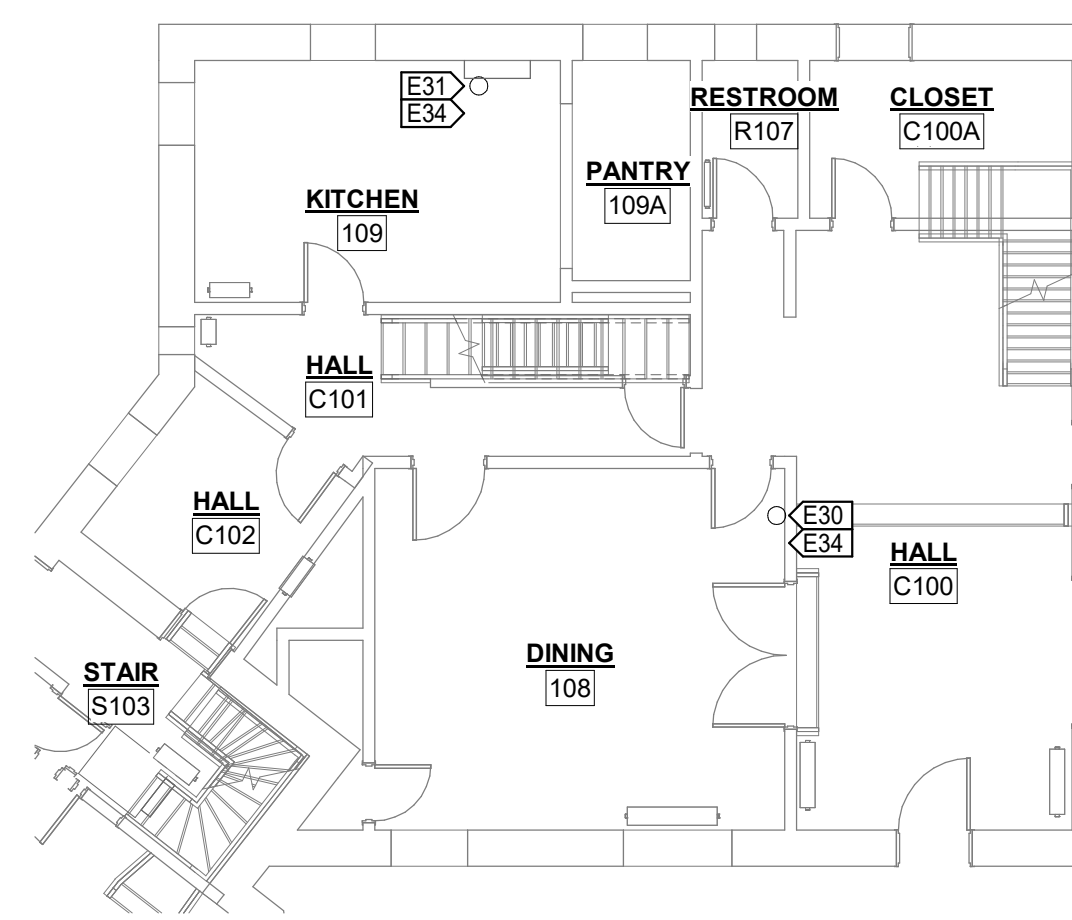

4 FIRST FLOOR POWER PLAN - HEATERS
1/8" = 1'-0"

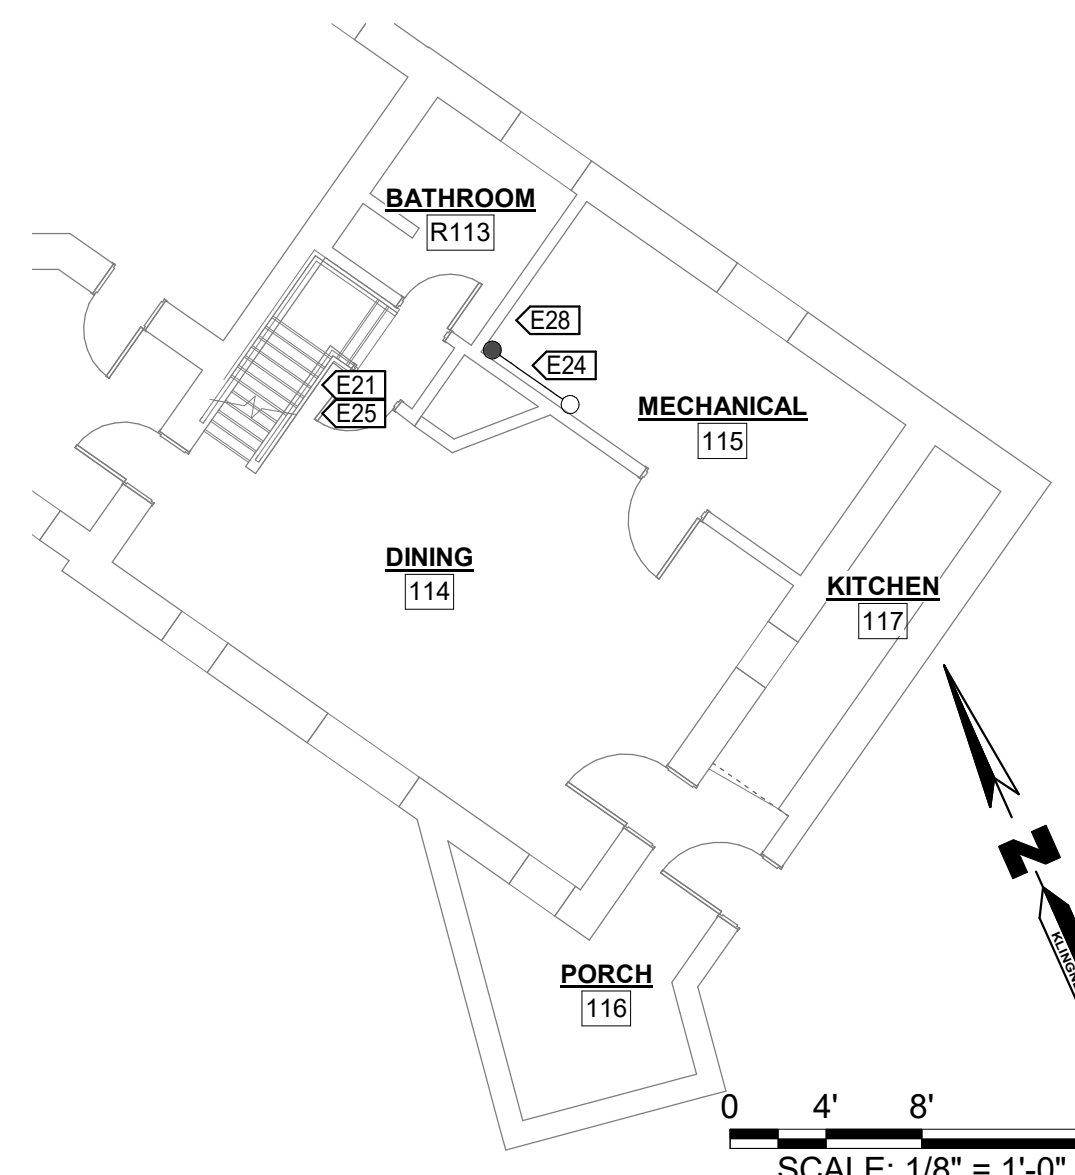

2 FIRST FLOOR POWER PLAN - CONTROLS
1/8" = 1'-0"

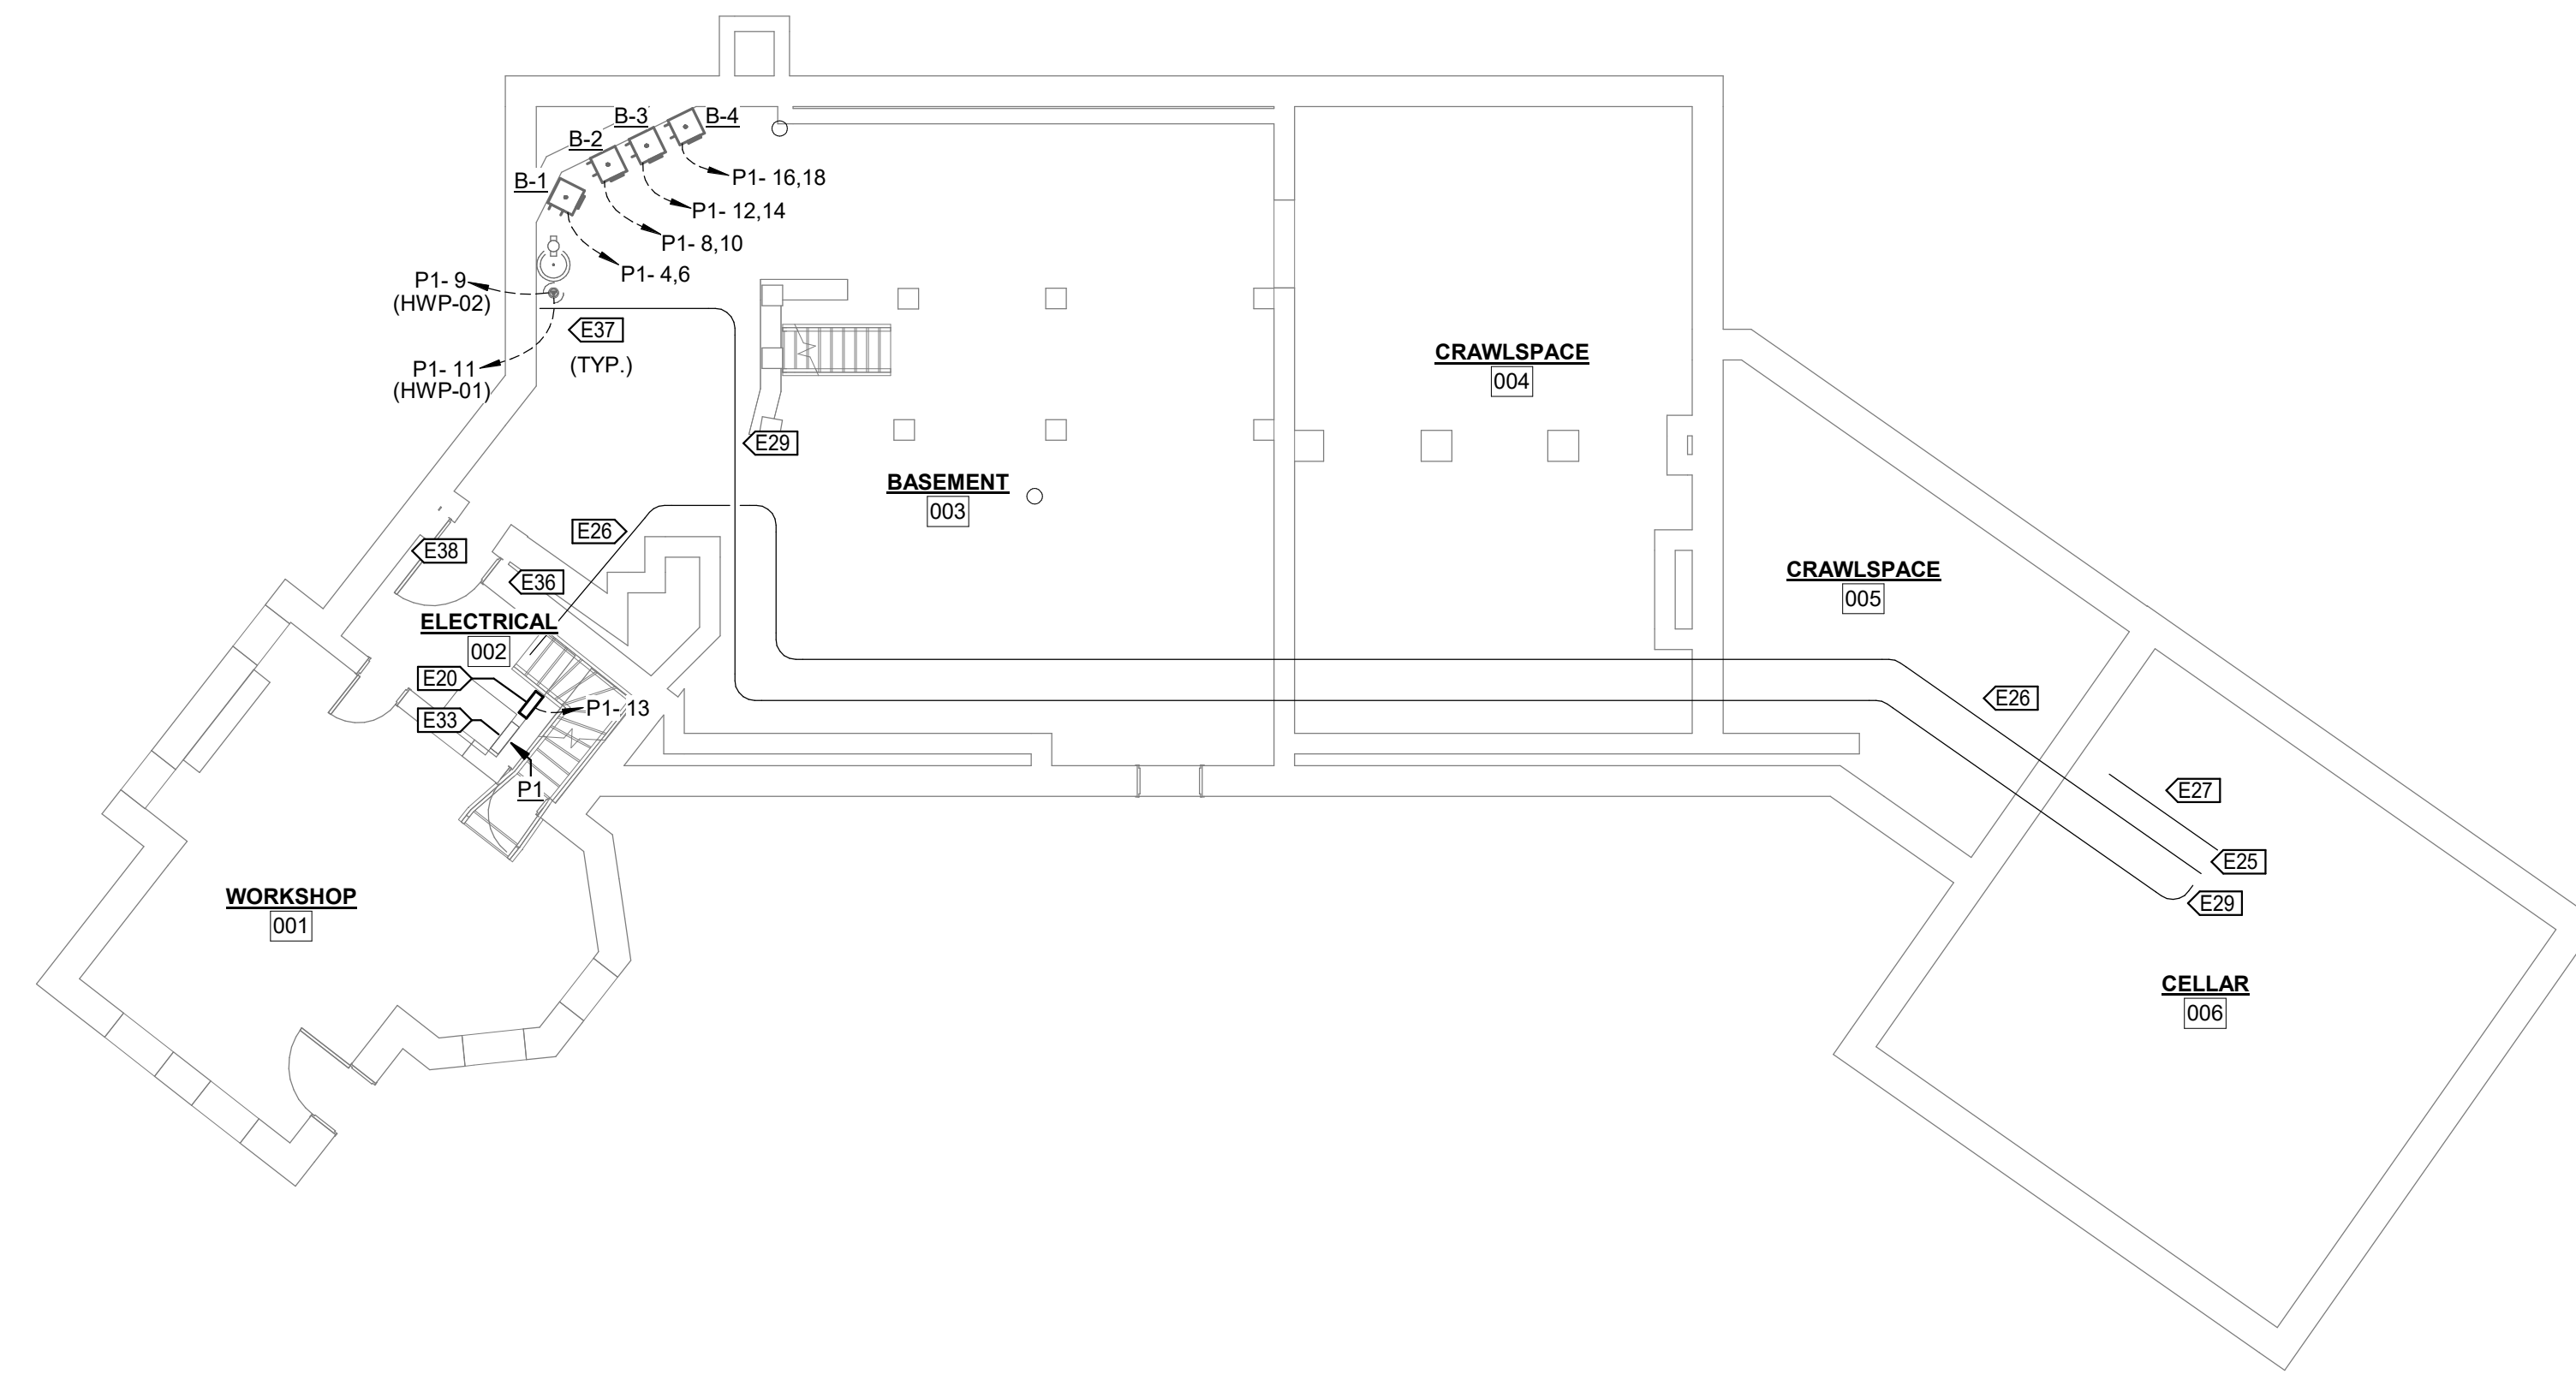

1 BASEMENT POWER PLAN
1/8" = 1'-0"

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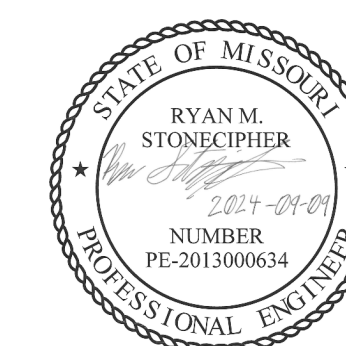
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CHECKED BY: SFD
DESIGNED BY: RMS

SHEET TITLE:
ELECTRICAL PLANS

SHEET NUMBER:

E100

SHEET 11 OF 12
SEPTEMBER 9, 2024



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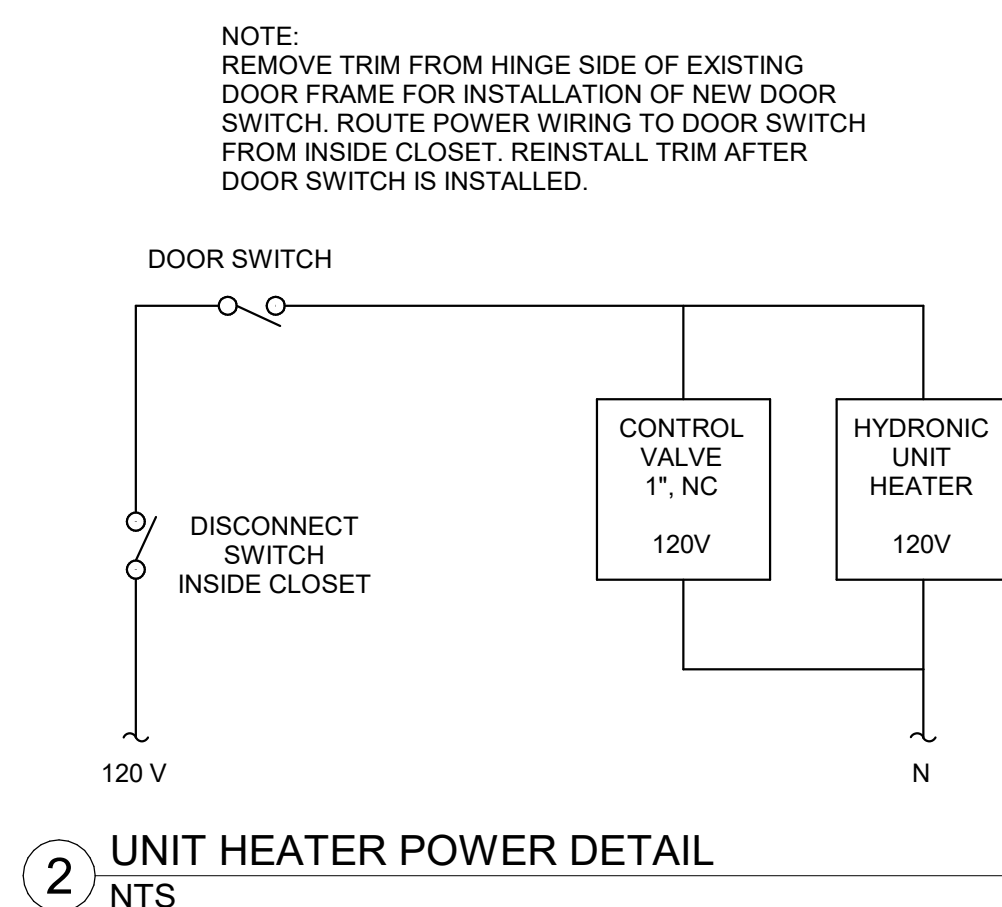
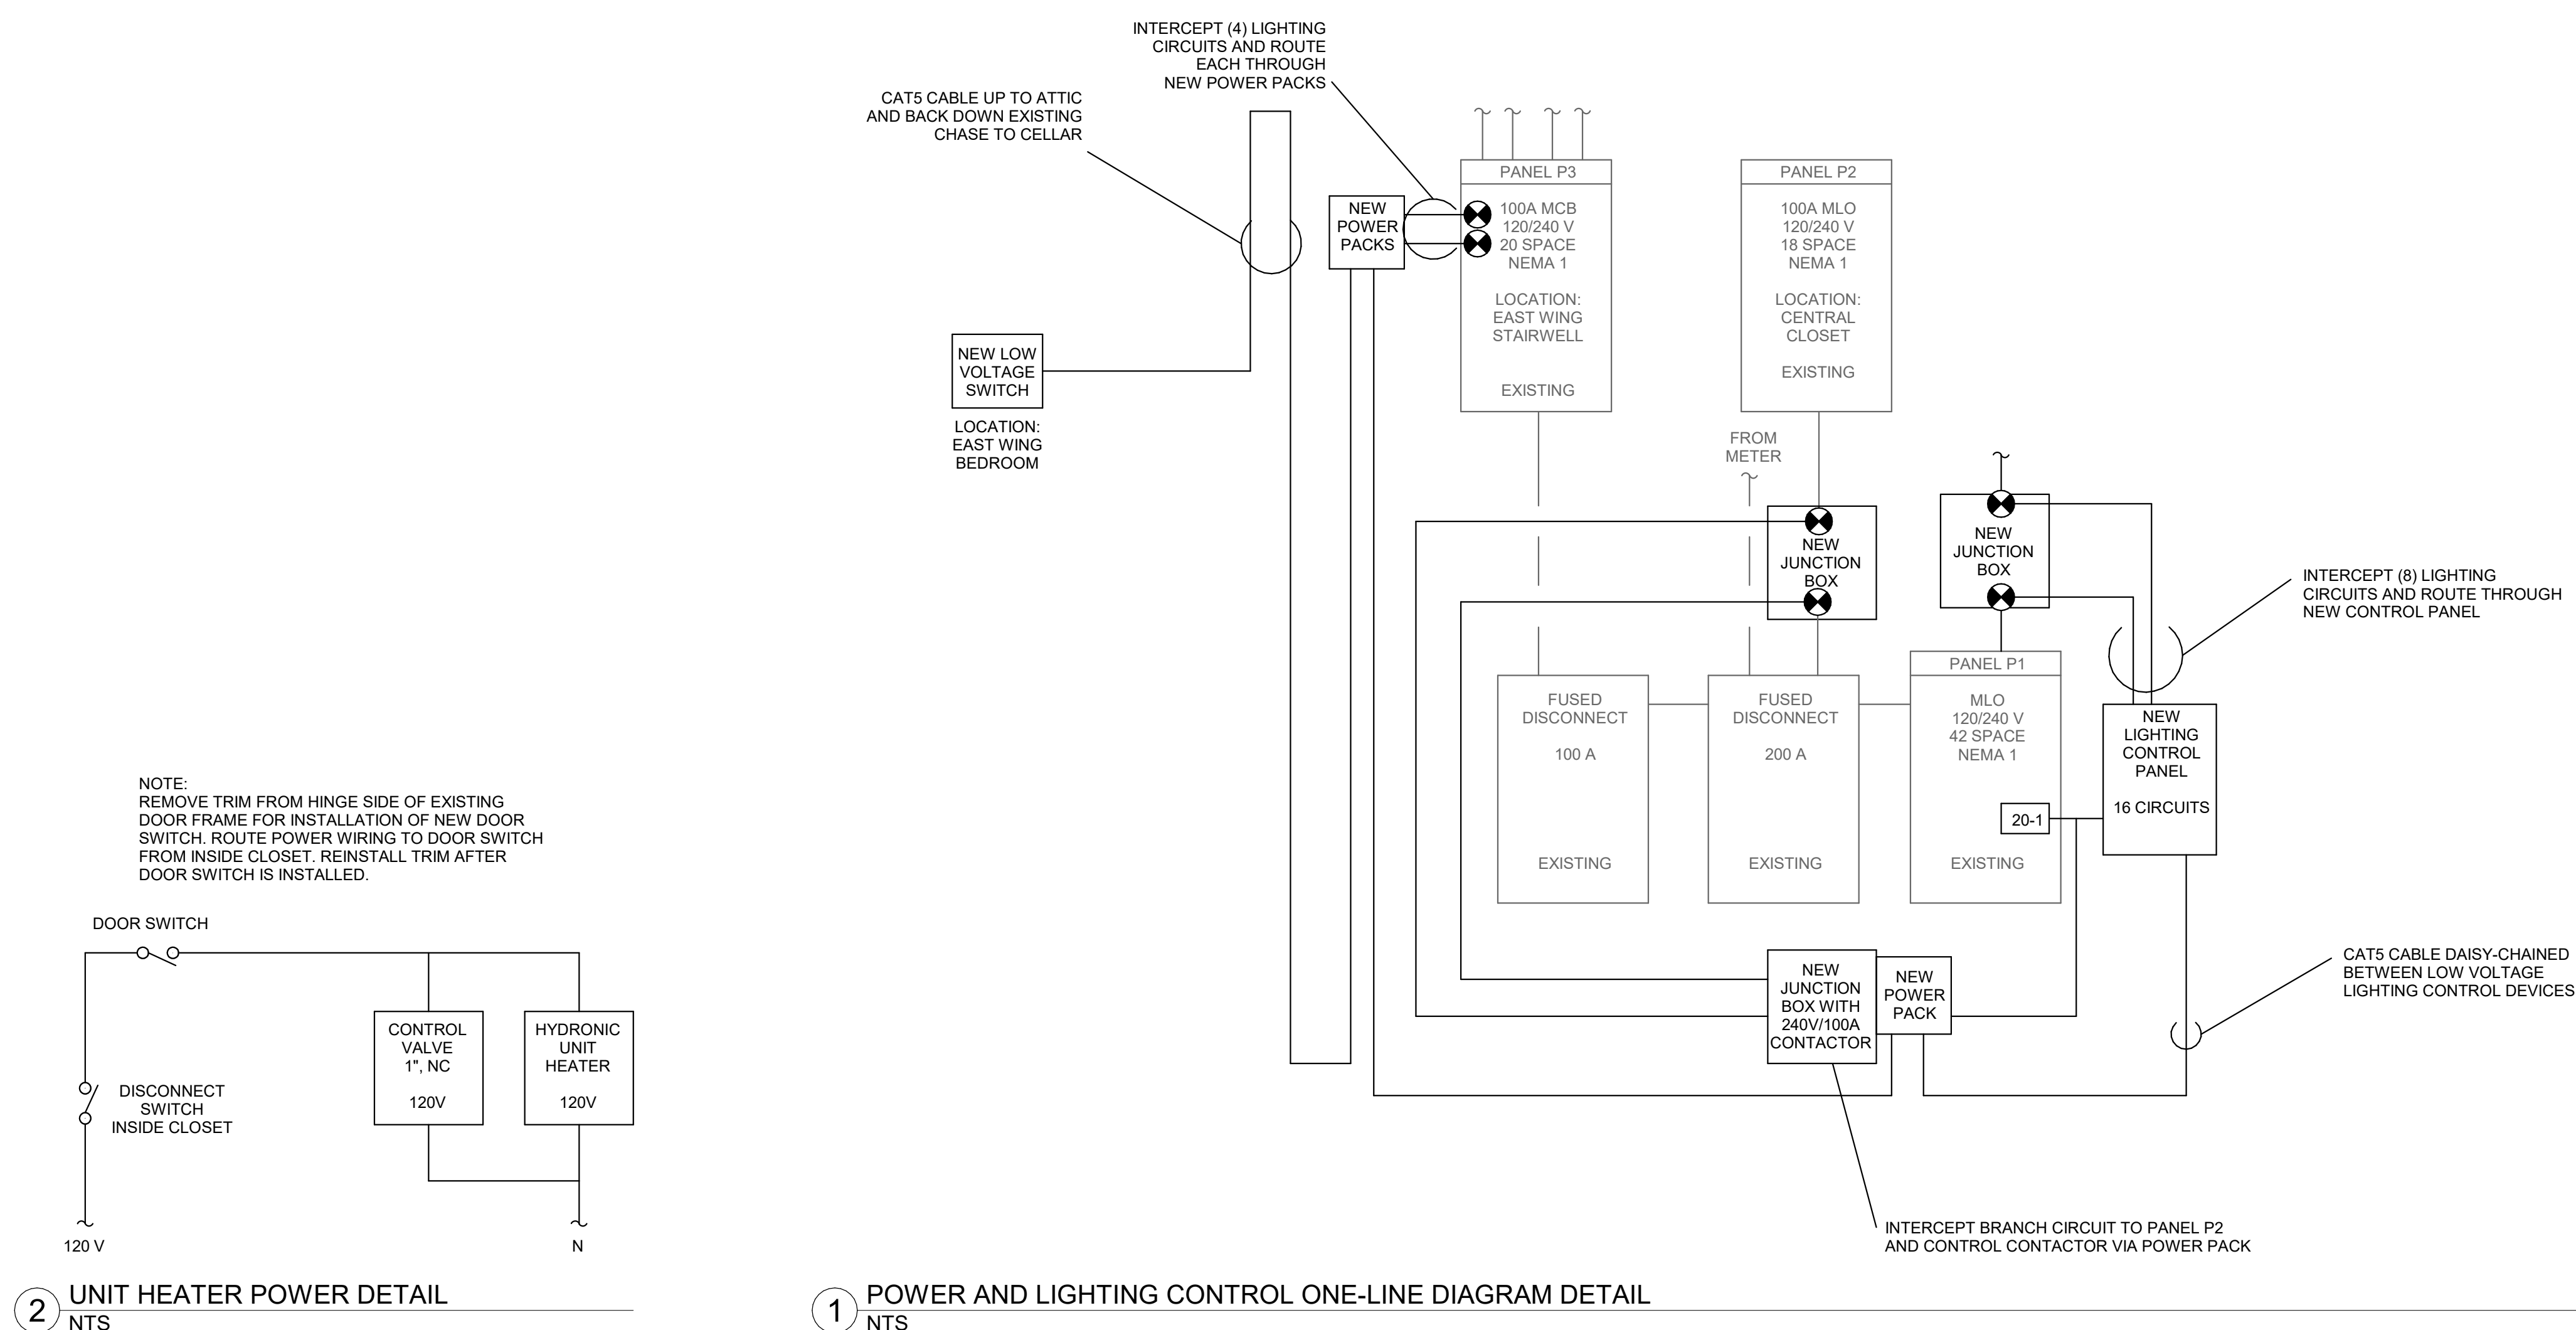
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DESIGNED BY: RMS

SHEET TITLE:
**ELECTRICAL DETAILS
AND SCHEDULES**

SHEET NUMBER:

E600

SHEET 12 OF 12
SEPTEMBER 9, 2024



1 POWER AND LIGHTING CONTROL ONE-LINE DIAGRAM DETAIL
NTS