REPLACE SIDING - MILL DILLARD MILL STATE HISTORIC SITE DAVISVILLE, MISSOURI

BID DOCUMENTS

OWNER:

STATE OF MISSOURI

MICHAEL L. PARSON,

GOVERNOR

DEPARTMENT OF

NATURAL RESOURCES

PROJECT

OFFICE OF ADMINISTRATION

MANAGEMENT: DIVISION OF FACILITIES MANAGEMENT,

DESIGN AND CONSTRUCTION

DESIGNER:

STATE OF MISSOURI - OFFICE OF ADMINISTRATION

DIVISION OF FACILITIES MANAGEMENT DESIGN

AND CONSTRUCTION: 301 W. HIGH STREET,

JEFFERSON CITY, MO. 65102

PROJECT NUMBER:

X23MP-01

ASSET NUMBER:


7815606010-MILL

11/15/2023

DILLARD MILL STATE HISTORIC SITE **Hiking Trail Hiking Trail** Mill **Parking** PARK **Picnic ENTRANCE** To Hwy. 49 (one mile) Cemetery Picnic Area THE HISTORIC DILLARD MILL (SITE OF PROJECT) Office LOW WATER CROSSING APPROX. CONTRACT LIMITS Former Huzzah Creek Bed 0 100 200 400 600 **SCALE IN FEET** Dead end **Indian Creek**



IST OF DRA	WINGS:	
ORDER	SHEET #	TITLE OF SHEET
1	G-001	TITLE SHEET
2	G-002	SITE & HIGHWAY MAPS
3	A-101	FLOOR & SCHEMATIC SITE PLAN
4	A-201	SOUTH ELEVATION
5	A-202	NORTH ELEVATION
6	A-203	EAST & WEST ELEVATIONS

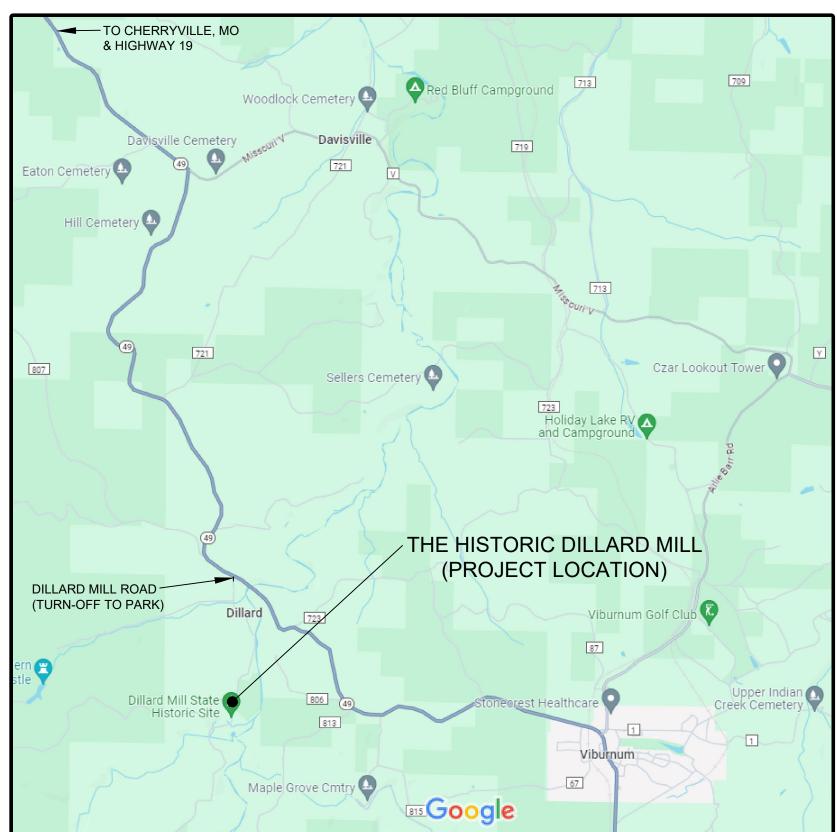

PARTIAL HIGHWAY MAP near DILLARD, MO SCALE: NOT TO SCALE

GENERAL NOTES FOR SITE MAP:

1 EXISTING CONDITIONS & DIMENSIONS AS SHOWN ON THE SITE MAP ARE APPROXIMATIONS. ACTUAL CONDITIONS & DIMENSIONS MAY VARY. CONTRACTORS SHALL VERIFY EXISTING CONDITIONS & DIMENSIONS TO THE EXTENT THAT IT WOULD MAKE A DIFFERENCE TO THEIR BID. NO EXTRA OR CREDIT WILL BE CONSIDERED BASED UPON ANY MINOR VARIATIONS.

THE SITE FEATURES SHOWN ON THIS MAP REPRESENTS THE BASIC ROADS, BUILDINGS, WATERWAYS AND GENERAL SITE FEATURES. NO TREES, SHRUBS OR TOPOGRAPHY ARE SHOWN. CONTRACTOR SHALL VERIFY EXISTING TOPOGRAPHY & VEGETATION IN THE FIELD AS NECESSARY TO DETERMINE ACCESSIBILITY NEEDED TO ACCOMPLISH THEIR WORK.

SCOPE OF WORK:

BASE BID: WORK FOR THIS PROJECT SHALL CONSIST OF FURNISHING ALL MATERIALS, LABOR AND SERVICES NECESSARY TO SCAFFOLD OR OTHERWISE ACCESS THE THREE—STORY PORTION OF THE SOUTH ELEVATION OF THE DILLARD MILL FOR THE PURPOSE OF REMOVING, REPLACING & PAINTING THE METAL SIDING AS INDICATED ON THESE DRAWINGS. (SIDING REPLACEMENT IS LIMITED TO THREE—STORY PORTION OF SOUTH ELEVATION)

ALTERNATE NO. 1: WORK FOR THIS PROJECT SHALL CONSIST OF FURNISHING ALL MATERIALS, LABOR AND SERVICES NECESSARY TO SCAFFOLD OR OTHERWISE ACCESS ALL PORTIONS OF THE DILLARD MILL FOR THE PURPOSE OF PREPARING & REPAINTING ALL PREVIOUSLY PAINTED SURFACES OF THE EXISTING METAL OR WOOD SIDINGS, FASCIA, TRIM & DOORS ON THE ENTIRE MILL ENVELOPE AS INDICATED ON THESE DRAWINGS. (THIS WORK EXCLUDES REPAIRS, PREPARATION & PAINTING OF ROOFS, FOUNDATIONS, WINDOWS, REPLACEMENT SIDING & THE ENTIRE TURBINE ROOM AS INDICATED IN ALTERNATE NO. 2.)

ALTERNATE NO. 2: WORK FOR THIS PROJECT SHALL CONSIST OF FURNISHING ALL MATERIALS, LABOR AND SERVICES NECESSARY TO SCAFFOLD OR OTHERWISE ACCESS THE TURBINE ROOM THAT EXTENDS OUT & OVER THE CREEK ON THE EAST SIDE OF THE DILLARD MILL FOR THE PURPOSE OF PREPARING & REPAINTING ALL PREVIOUSLY PAINTED PORTIONS OF THE EXISTING WOOD SIDINGS, FASCIA, TRIM AND WINDOWS AS INDICATED ON THESE DRAWINGS. (THIS WORK IS LIMITED TO SOUTH, EAST & NORTH ELEVATIONS OF THE TURBINE ROOM.)

EXTENT OF PAINTING REQUIRED UNDER SOW:

1 <u>BASE BID:</u> PAINTING IS ONLY REQUIRED FOR REPLACEMENT PRESSED BRICK SIDING ON THREE—STORY PORTION OF SOUTH ELEVATION OF MILL. PAINT SYSTEM INCLUDES THE APPLICATION OF 1 TOPCOAT OVER 1 PRIME COAT TO BARE METAL SIDING. SEE SPECIFICATIONS.

2 ALTERNATE NO. 1: REPAINTING IS REQUIRED ON ALL PREVIOUSLY PAINTED SURFACES OF THE EXISTING EXTERIOR ENVELOPE ON THE NORTH, SOUTH, EAST & WEST ELEVATIONS OF THE MILL, EXCEPT TURBINE ROOM. (SEE ALTERNATE #2) PAINTING SHALL INCLUDE EXISTING PRESSED METAL PANELS, WOOD SIDING, FASCIA, EXPOSED RAFTERS, WOOD TRIMS, DOORS, CASINGS AND ALL MISCELLANEOUS ITEMS THAT HAVE BEEN PREVIOUSLY PAINTED. DO NOT PAINT CONCRETE, STONE, BRICK MASONRY OR WINDOWS. PAINT SYSTEM INCLUDES THE APPLICATION OF 1 TOPCOAT & SPOT PRIMING OF ANY BARE METAL OR WOOD SURFACES. SEE SPECIFICATIONS.

3 ALTERNATE NO. 2: REPAINTING WORK REQUIRED ON ALL PREVIOUSLY PAINTED SURFACES OF THE EXISTING EXTERIOR ENVELOPE OF THE TURBINE ROOM THAT EXTENDS OUT & OVER THE CREEK ON THE EAST SIDE OF THE MILL. DO NOT PAINT CONCRETE, STONE, BRICK MASONRY OR WINDOWS. PAINT SYSTEM INCLUDES THE APPLICATION OF 1 TOPCOAT & SPOT PRIMING OF ANY BARE METAL OR WOOD SURFACES. SEE SPECIFICATIONS.

STATE OF MISSOURI MICHAEL L. PARSON, GOVERNOR



Brad M. Schaefer - Archite

BID DOCUMENTS

OFFICE OF ADMINISTRATION DIVISION OF FACILITIES MANAGEMENT, DESIGN AND CONSTRUCTION

DEPARTMENT OF NATURAL RESOURCES

REPLACE SIDING - MILL

DILLARD MILL STATE HISTORIC SITE 142 DILLARD MILL DRIVE DAVISVILLE, MO 65456

PROJECT # X23MP-01

ASSET # 5606 ASSET # 7815606010 - MILL

REVISION:
DATE:
REVISION:
DATE:
REVISION:
DATE:
REVISION:
DATE:
ISSUE DATE: 11/15/2023

CAD DWG FILE:X23MP-01
DRAWN BY: TEH
CHECKED BY: BMS
DESIGNED BY: TEH


SHEET TITLE:

SITE & HIGHWAY

SHEET NUMBER:

G-002

2 OF 6 SHEETS 11/15/2023

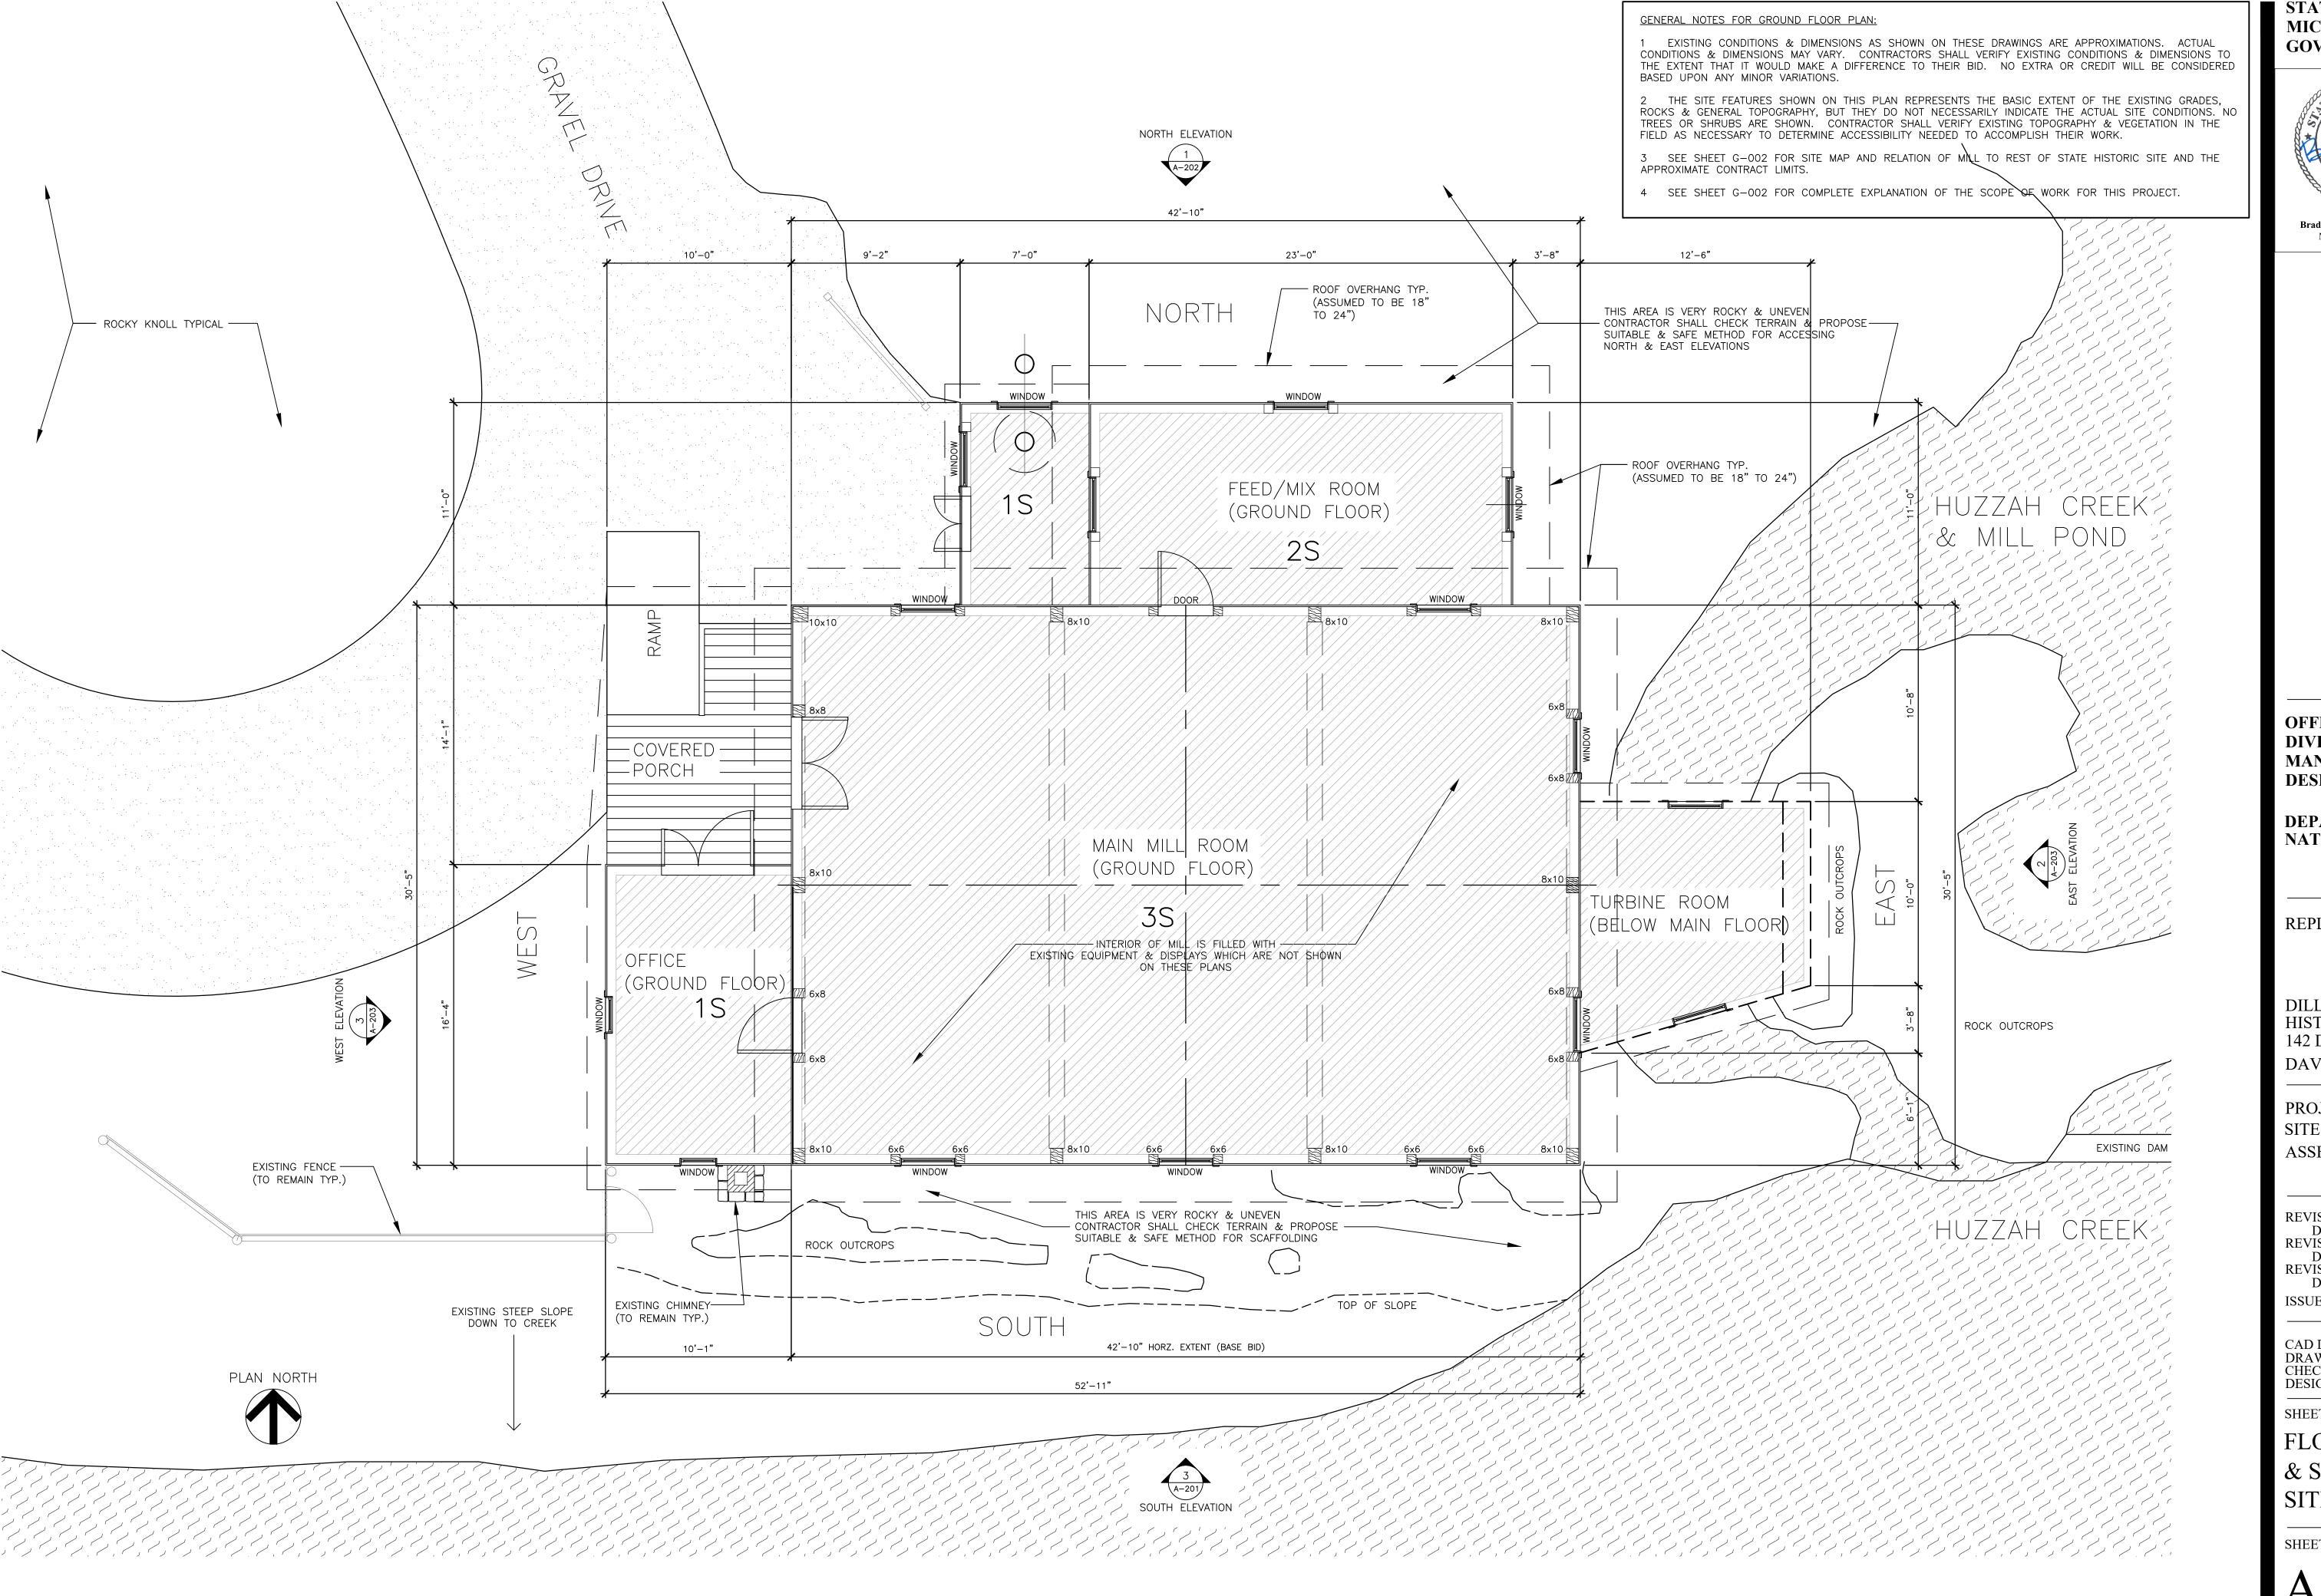

STATE OF MISSOURI MICHAEL L. PARSON, GOVERNOR



Brad M. Schaefer - Architect MO# A-2009027294

BID DOCUMENTS

OFFICE OF ADMINISTRATION DIVISION OF FACILITIES MANAGEMENT, DESIGN AND CONSTRUCTION

DEPARTMENT OF NATURAL RESOURCES

REPLACE SIDING - MILL

DILLARD MILL STATE HISTORIC SITE 142 DILLARD MILL DRIVE DAVISVILLE, MO 65456

PROJECT # X23MP-01 SITE # 5606 ASSET # 7815606010 - MILL

REVISION:
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ISSUE DATE: 11/15/2023

CAD DWG FILE:X23MP-01
DRAWN BY: TEH
CHECKED BY: BMS
DESIGNED BY: TEH

SHEET TITLE:

FLOOR PLAN & SCHEMATIC SITE PLAN


SHEET NUMBER:

A-101

3 OF 6 SHEETS 11/15/2023

GROUND FLOOR PLAN - DILLARD ROLLER MILL

SCALE: 1/4" = 1'-0"

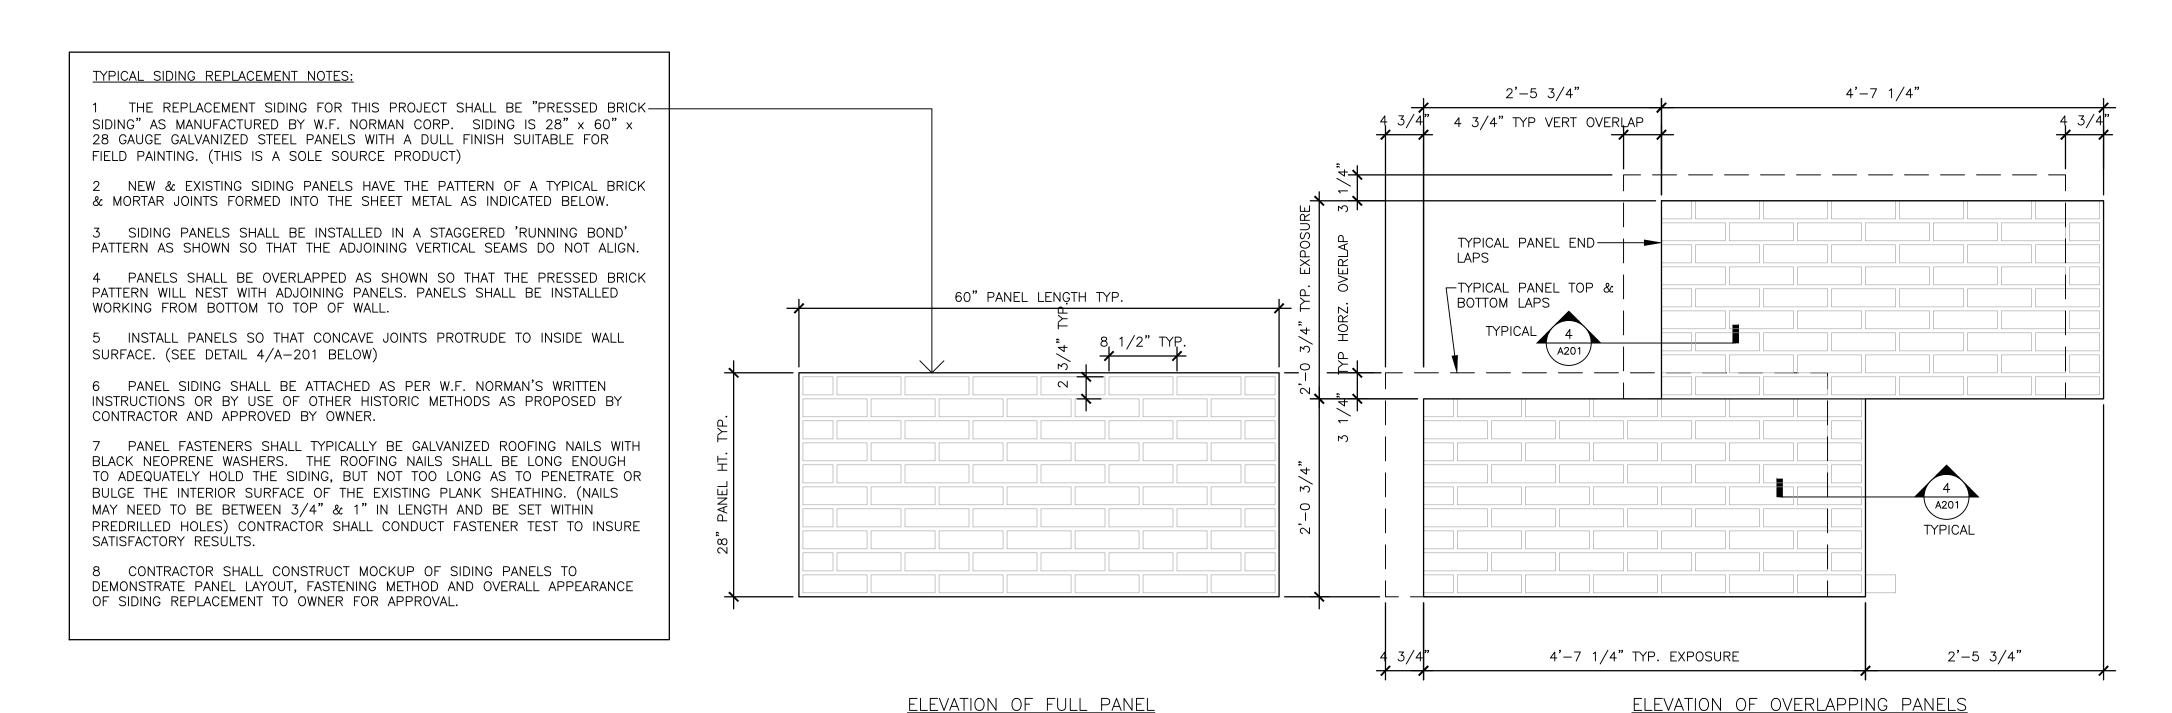


TYPICAL PRESSED BRICK SIDING PANEL

SCALE: 1" = 1'-0"

TYPICAL PANEL OVERLAPS

SCALE: 1" = 1'-0"

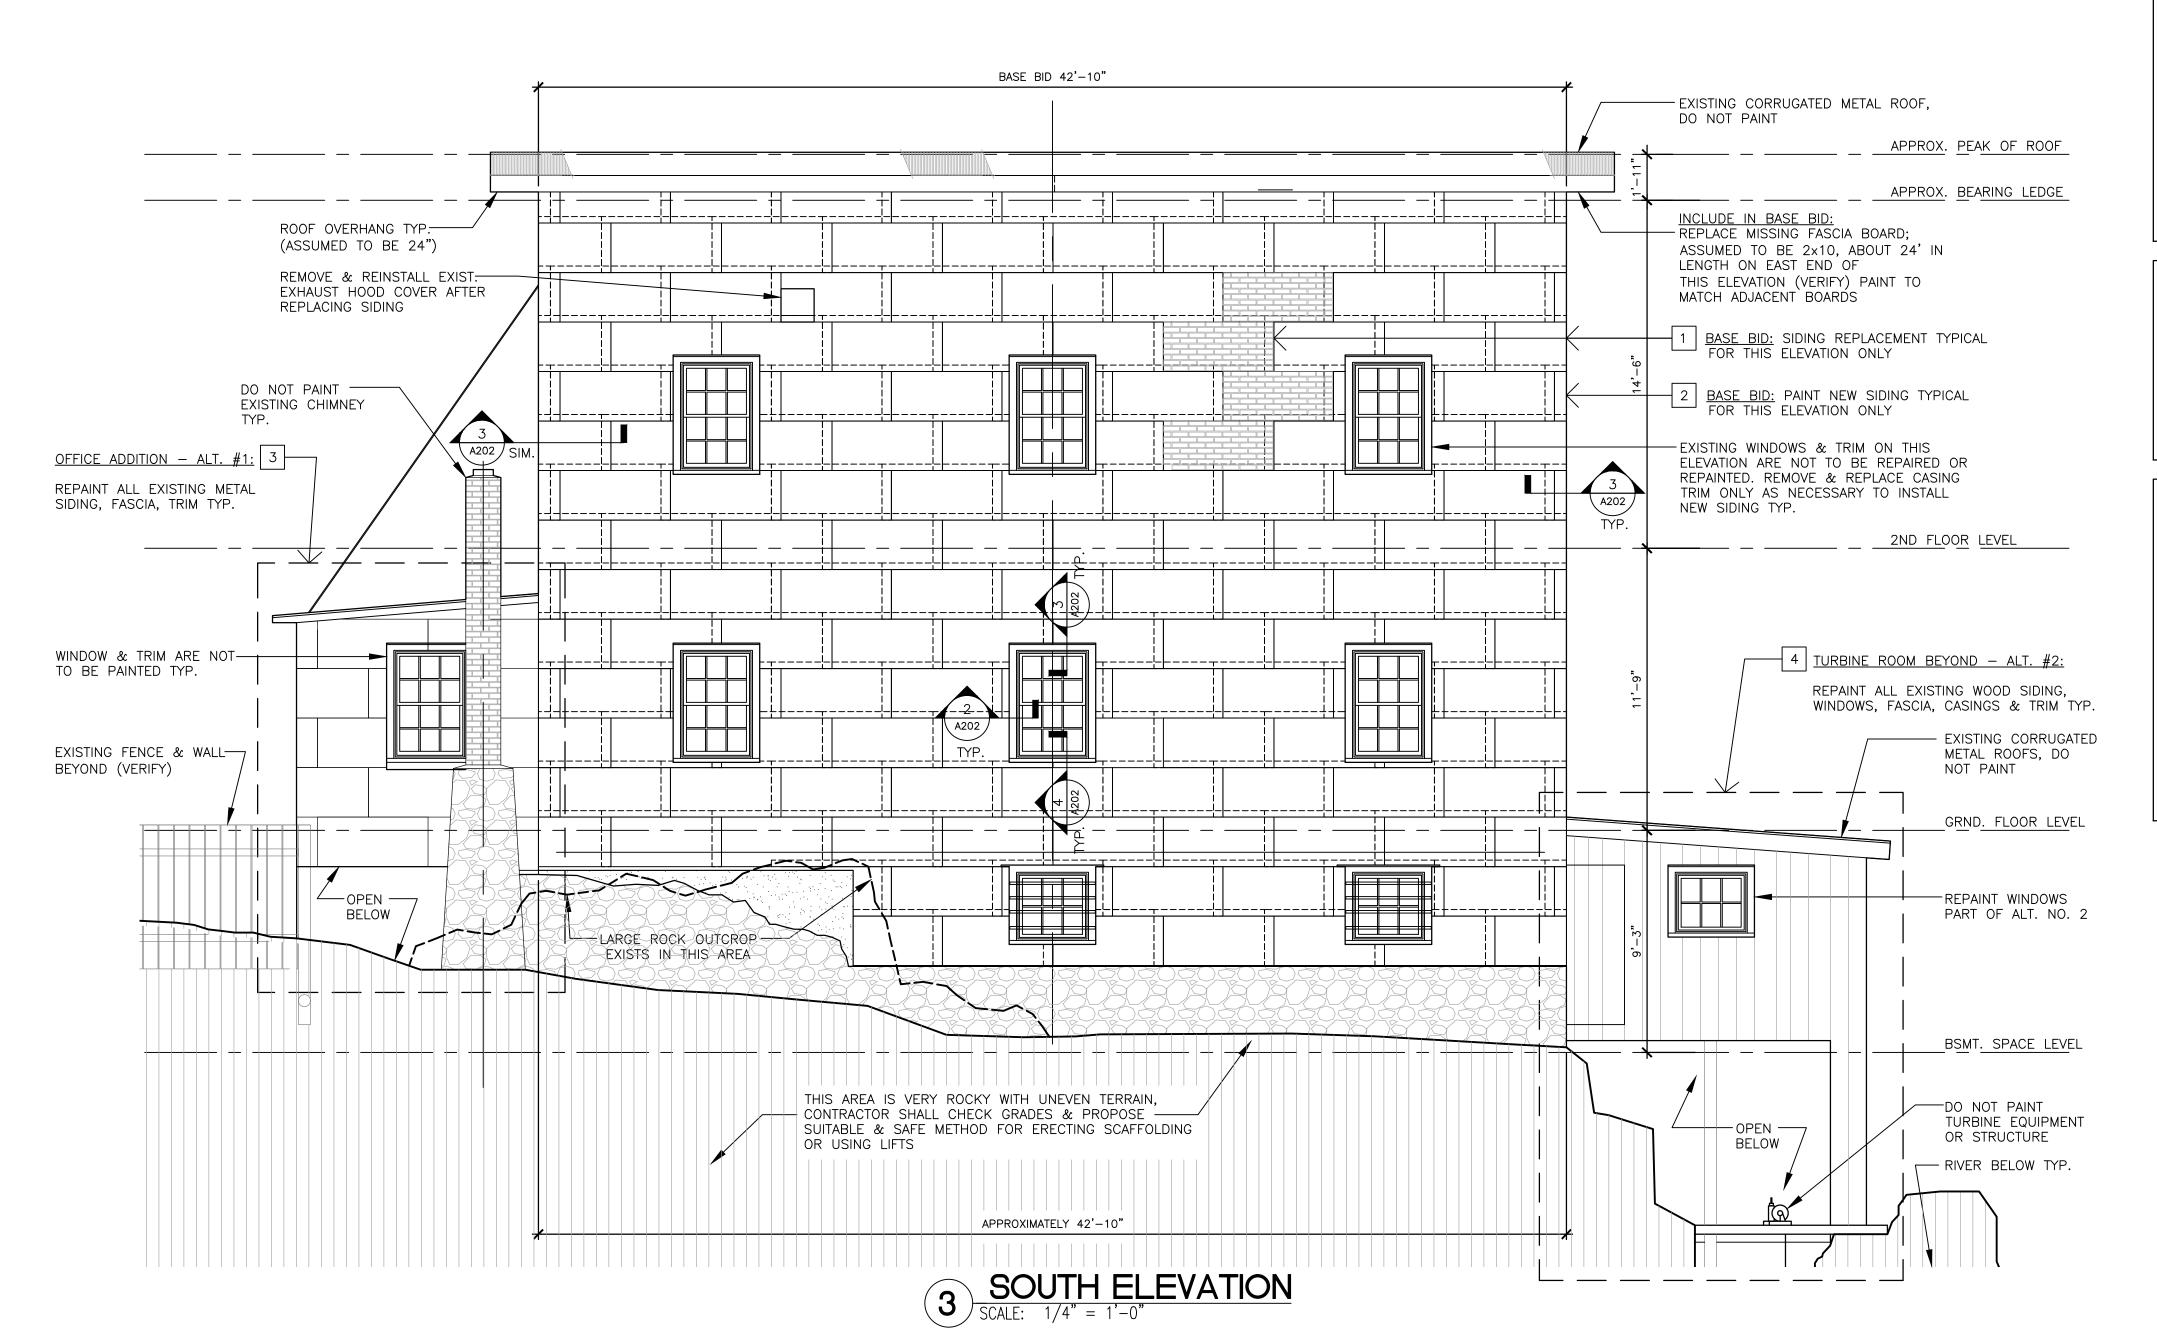

SCOPE OF WORK:

BASE BID: WORK FOR THIS PROJECT SHALL CONSIST OF FURNISHING ALL MATERIALS, LABOR AND SERVICES NECESSARY TO SCAFFOLD OR OTHERWISE ACCESS THE THREE—STORY PORTION OF THE SOUTH ELEVATION OF THE DILLARD MILL FOR THE PURPOSE OF REMOVING, REPLACING & PAINTING THE METAL SIDING AS INDICATED ON THESE DRAWINGS. (SIDING REPLACEMENT IS LIMITED TO THREE—STORY PORTION OF SOUTH ELEVATION)

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LEAD-BASED PAINT NOTE:

THE EXISTING EXTERIOR PAINT SURFACES ON THE MILL HAVE BEEN TESTED FOR LEAD—BASED PAINT BY THE DEPARTMENT OF NATURAL RESOURCES, DIVISION OF STATE PARKS AND ARE REPORTED AS BEING BELOW THE DEFINED LIMIT OF LEAD EQUAL TO OR EXCEEDING 1.0 MILLIGRAM PER SQUARE CENTIMETER OR 0.5 % BY WEIGHT FOR BEING CONSIDERED LEAD—BASED PAINT. THEREFORE, THIS PROJECT IS NOT AN ABATEMENT, NOR DOES IT REQUIRE CONTRACTORS TO BE LICENSED OR CERTIFIED TO DO RENOVATIONS OR REPAINTING. AS PER SPECIFICATIONS, CONTRACTORS SHALL TAKE GENERAL PRECAUTIONS TO PROTECT & MINIMIZE WORKERS AND BUILDING OCCUPANTS EXPOSURE DURING ALL WORK THAT WILL DISTURB THE EXISTING PAINTED SURFACES AND CREATE DUST. WHEN REMOVING SIDING OR REMOVAL OF LOOSE FLAKING PAINT, ATTEMPT TO COLLECT THE FALLING PAINT CHIPS & DEBRIS ON PLASTIC BELOW THE VERTICAL WALL SURFACES AND PROPERLY DISPOSE OF THIS WASTE.

GENERAL PROJECT NOTES:

1 THE DILLARD MILL HISTORIC DISTRICT AND THE DILLARD MILL BUILDING ITSELF ARE ON THE NATIONAL REGISTER OF HISTORIC PLACES.

THE STATE OF MISSOURI DOES NOT SPECIFY OR ENDORSE ANY PARTICULAR MEANS OR METHODS FOR SCAFFOLDING OR POSITIONING WORKERS TO ACCESS THE ELEVATIONS FOR THIS PROJECT, HOWEVER THE CONTRACTOR'S PROPOSAL SHALL SPECIFICALLY DEFINE OR INDICATE HOW THEY INTEND TO SAFELY ACCESS ALL PORTIONS OF THE VERTICAL SURFACES OF THIS BUILDING TO ACCOMPLISH ALL THE PROPOSED WORK. THE USE OF SCAFFOLDING, PLATFORMS, LADDERS, STAIRS, LIFTS, HOIST, CRANE AND OTHER CONVEYING EQUIPMENT SHALL BE ACCOMPLISHED AND MAINTAINED IN STRICT ACCORDANCE WITH OSHA AND OTHER APPLICABLE JURISDICTIONS WITHOUT DETRIMENT TO THE SITE AND ENVIRONMENT.

3 EXISTING CONDITIONS AND DIMENSIONS AS SHOWN ON THESE DRAWINGS ARE APPROXIMATIONS. ACTUAL CONDITIONS AND DIMENSIONS MAY VARY. CONTRACTORS SHALL VERIFY EXISTING CONDITIONS AND DIMENSIONS TO THE EXTENT THAT IT WOULD MAKE A DIFFERENCE TO THEIR BID. NO EXTRA OR CREDIT WILL BE CONSIDERED BASED UPON ANY MINOR VARIATIONS.

4 CONTRACTOR IS RESPONSIBLE FOR ANY INCIDENTAL DAMAGE DONE TO BUILDING AND GROUNDS DURING COURSE OF THE PROJECT AND SHALL RESTORE BUILDING AND GROUNDS TO EXISTING CONDITIONS UPON COMPLETION OF THIS PROJECT.

5 CONTRACTOR SHALL THOROUGHLY CLEAN EXTERIOR OF BUILDING AND SITE UPON COMPLETION OF PROJECT. PICK-UP, REMOVE AND PROPERLY DISPOSE OF ALL FASTENERS, DEBRIS AND SCRAP MATERIALS.

6 THE EXISTING SIDING PATTERNS ARE REPRESENTATIVE ONLY & ARE NOT INTENDED TO BE AN EXACT DEPICTION OF THE ACTUAL SIZES, CUTS & LAYOUT OF THE EXISTING METAL OR WOOD SIDING PANELS.

SELECTIVE DEMOLITION NOTES

SELECTIVE DEMOLITION ON THE SOUTH ELEVATION ONLY INCLUDES THE REMOVAL OF THE EXISTING METAL SIDING, MISCELLANEOUS FASTENERS AND ANY UNDERLAYMENTS DOWN TO THE EXISTING WOOD BOARD SHEATHING. AVOID SAW CUTTING EXISTING METAL SIDING, USE POWER SHEARS OR REMOVE WHOLE PANELS TO AVOID CREATING DUST. PROPERLY DISPOSE OF ALL EXISTING METAL SIDING, INCIDENTAL FASTENERS & MISC. WASTE. (INCLUDE THIS WORK IN THE BASE BID)

ANY ROTTEN, DAMAGED OR MISSING SHEATHING ENCOUNTERED UNDER THE SIDING SHALL BE REMOVED AND REPLACED AS APPROVED BY THE ARCHITECT ON A UNIT PRICE BASIS. ALL REMOVED MATERIALS BECOME THE PROPERTY OF THE CONTRACTOR AND SHALL BE DISPOSED OF PROPERLY. (SEE UNIT PRICES)


SOUTH ELEVATION KEYED NOTES:

BASE BID SIDING WORK: INCLUDES THE REPLACEMENT OF EXISTING SIDING ONLY ON THE 3-STORY PORTION OF THE SOUTH ELEVATION AS INDICATED HERE. NEW SIDING PANELS SHALL BE OF THE SAME TYPE, SIZES & USING SIMILAR METHODS OF OVERLAP & ATTACHMENT AS PER THE HISTORIC CONSTRUCTION. HOWEVER, SINCE MUCH OF THE EXISTING PANELS WERE APPLIED HAPHAZARDLY OR RANDOMLY, CONTRACTOR SHALL INSTALL NEW PANELS AS PER LAYOUTS, OVERLAPS & OTHER DETAILS SHOWN ON THESE DRAWINGS (SEE 1&2/A-201) VERIFY EXISTING CONDITIONS & INFORM ARCHITECT OF ANY MAJOR DISCREPANCIES BETWEEN WHAT IS PROPOSED & THE ORIGINAL CONSTRUCTION.

BASE BID PAINTING WORK; INCLUDES THE PREPARATION & PAINTING OF NEW SIDING & MISC. TRIM AS PART OF BASE BID. SEE PAINT SPECIFICATIONS; 1 — PRIME COAT & 1 — TOPCOAT TYPICAL

ALTERNATE NO. 1 WORK: INCLUDES THE PREPARATION & REPAINT OF ALL PREVIOUSLY PAINTED SURFACES CONSISTING OF EXISTING METAL OR WOOD SIDINGS, FASCIAS, TRIMS & DOORS ON THE MILL ENVELOPE AS INDICATED ON THIS ELEVATION.

ALTERNATE NO. 2 WORK: INCLUDES THE PREPARATION & REPAINT OF ALL PREVIOUSLY PAINTED SURFACES OF THE TURBINE ROOM CONSISTING OF EXISTING WOOD SIDINGS, FASCIAS, TRIMS & WINDOWS AS INDICATED ON THIS ELEVATION. (DO NOT PAINT TURBINE EQUIPMENT)

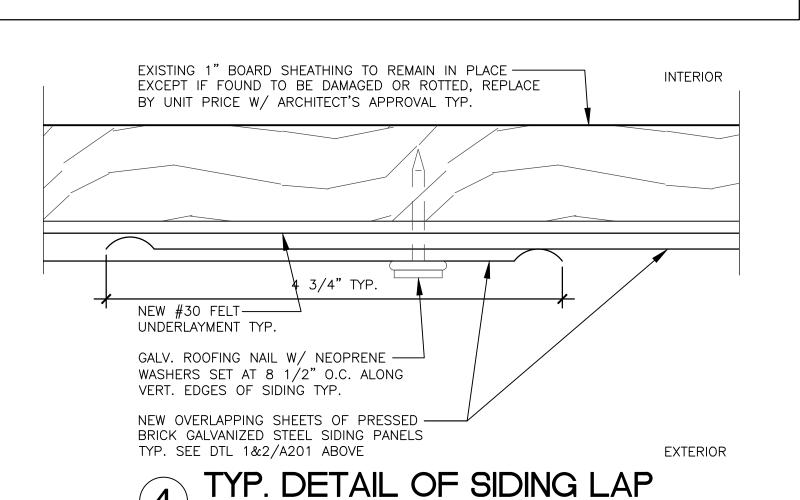

STATE OF MISSOURI MICHAEL L. PARSON, GOVERNOR



Brad M. Schaefer - Architect MO# A-2009027294

BID DOCUMENTS

OFFICE OF ADMINISTRATION DIVISION OF FACILITIES MANAGEMENT, DESIGN AND CONSTRUCTION

DEPARTMENT OF NATURAL RESOURCES

REPLACE SIDING - MILL

DILLARD MILL STATE HISTORIC SITE 142 DILLARD MILL DRIVE DAVISVILLE, MO 65456

PROJECT # X23MP-01 SITE # 5606

STIE # 5606 ASSET # 7815606010 - MILL

REVISION:
DATE:
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ICCLIE DATE 11/15/2022

ISSUE DATE: 11/15/2023

CAD DWG FILE:X23MP-01
DRAWN BY: TEH
CHECKED BY: BMS
DESIGNED BY: TEH


SHEET TITLE:

SOUTH ELEVATION

SHEET NUMBER:

A-201

4 OF 6 SHEETS 11/15/2023

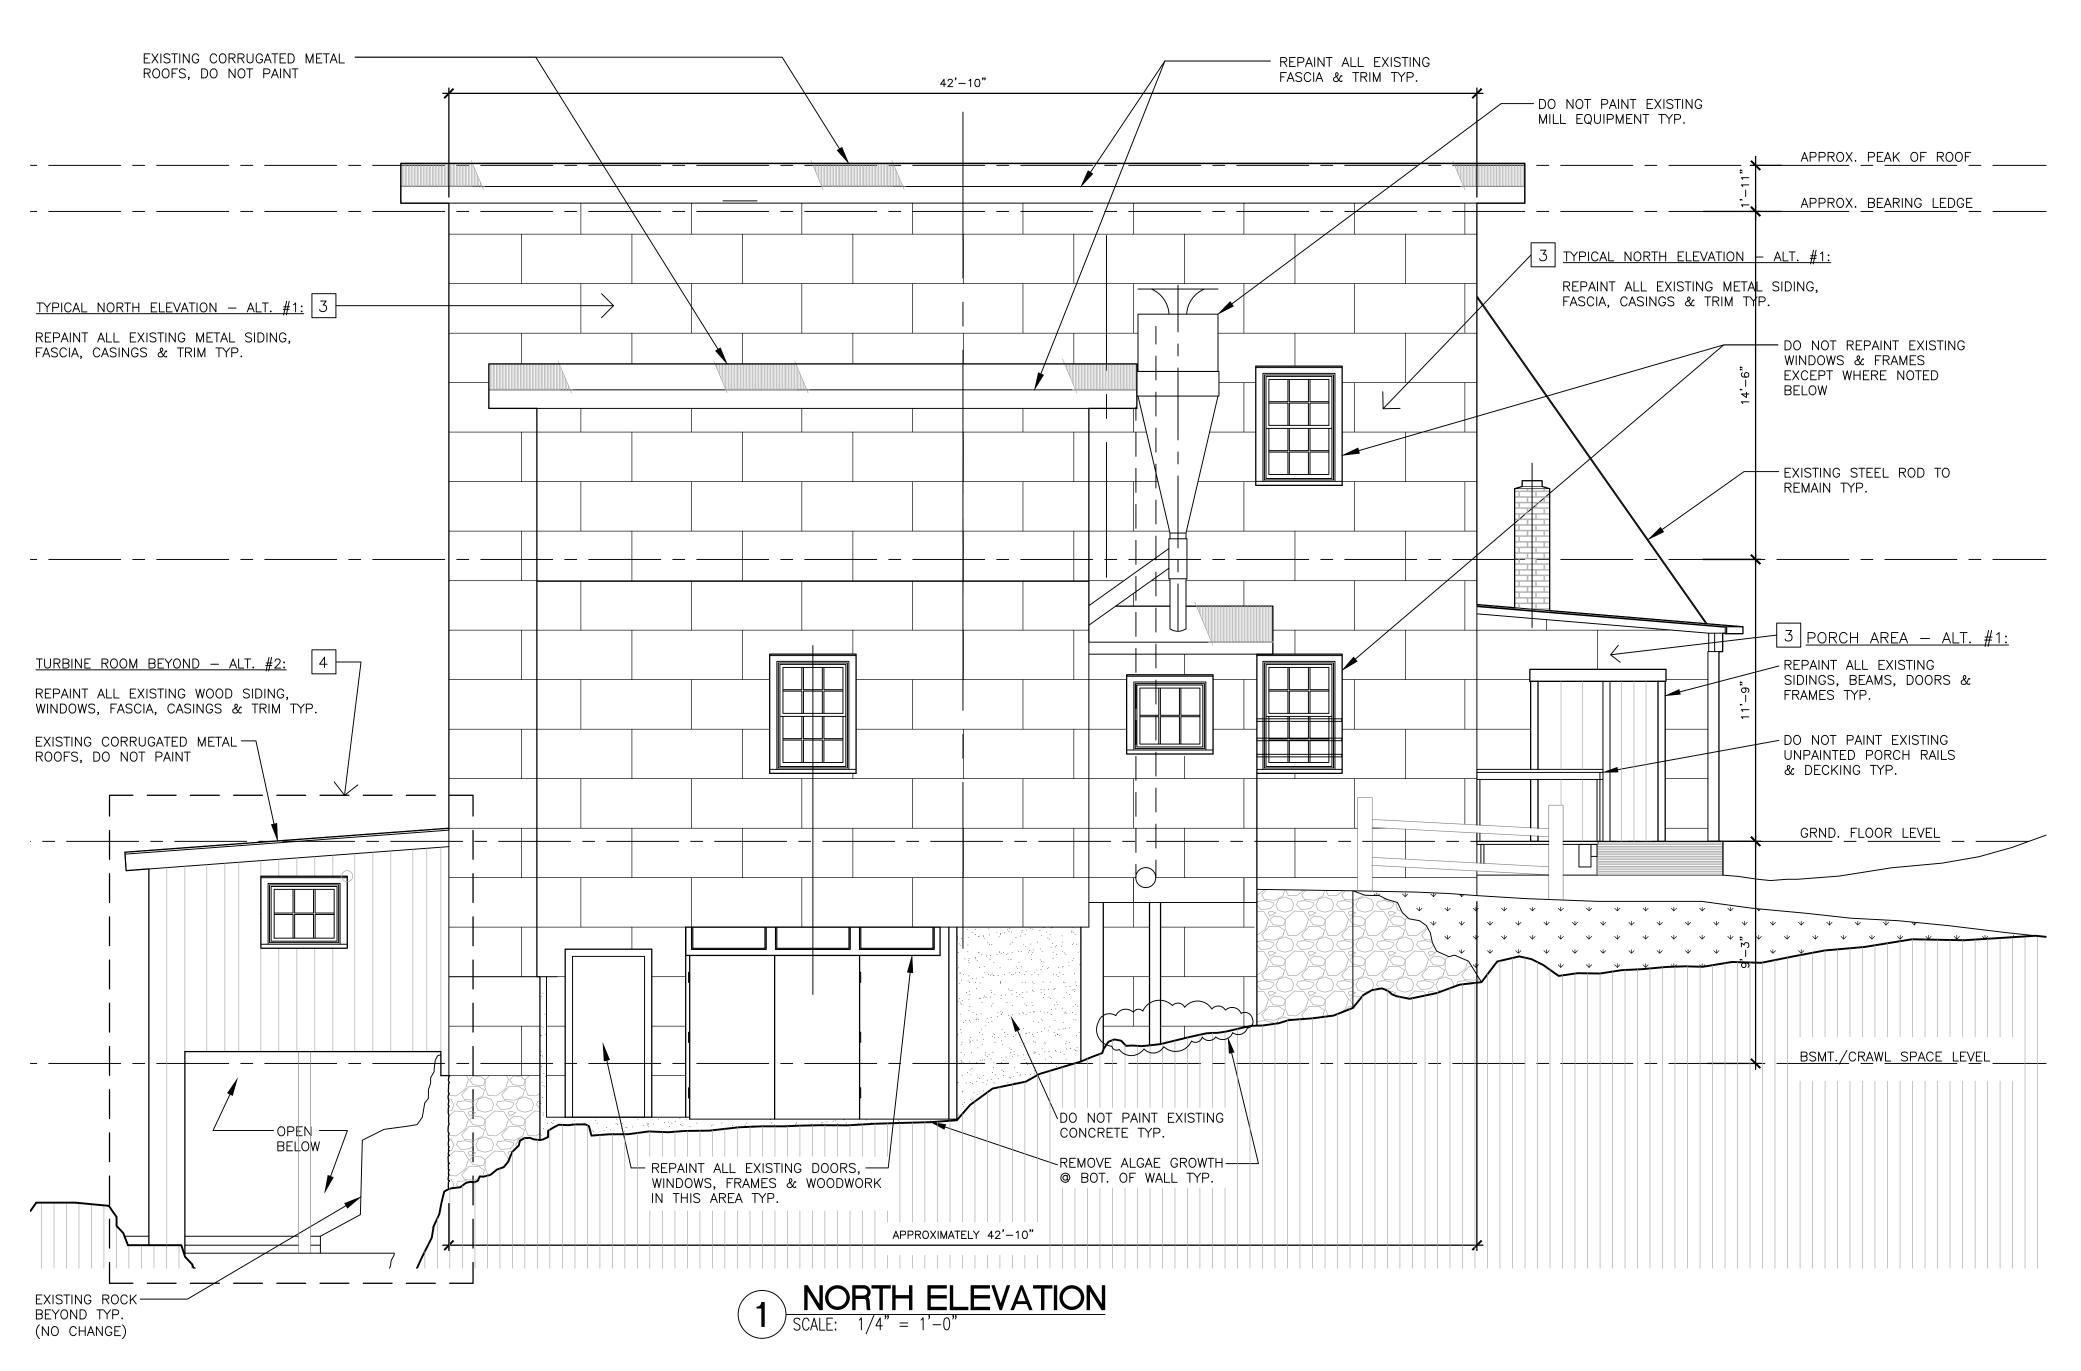

SURFACE DEGRADATION NOTE:


THE DEGREE OR AMOUNT OF THE EXISTING PAINTED SURFACE DEGRADATION VARIES SIGNIFICANTLY FROM AREA TO AREA ON THE EXTERIOR MILL ELEVATIONS. CONTRACTOR SHALL VERIFY & SATISFY THEMSELVES AS TO THE AMOUNT OF SURFACE PREPARATION NECESSARY OR REQUIRED BY THE SPECIFICATIONS FOR THESE SURFACES

NORTH ELEVATION KEYED NOTES:

- 3 <u>ALTERNATE NO. 1 WORK:</u> INCLUDES THE PREPARATION & REPAINT OF ALL PREVIOUSLY PAINTED SURFACES CONSISTING OF EXISTING METAL OR WOOD SIDINGS, FASCIAS, TRIMS & DOORS ON THE MILL ENVELOPE AS INDICATED ON THIS ELEVATION.
- ALTERNATE NO. 2 WORK: INCLUDES THE PREPARATION & REPAINT OF ALL PREVIOUSLY PAINTED SURFACES OF THE TURBINE ROOM CONSISTING OF EXISTING WOOD SIDINGS, FASCIAS, TRIMS & WINDOWS AS INDICATED ON THIS ELEVATION. (DO NOT PAINT TURBINE EQUIPMENT)

NOTE:

THESE WINDOW DETAILS PERTAIN ONLY TO WINDOWS ON THE THREE-STORY PORTION OF THE SOUTH ELEVATION

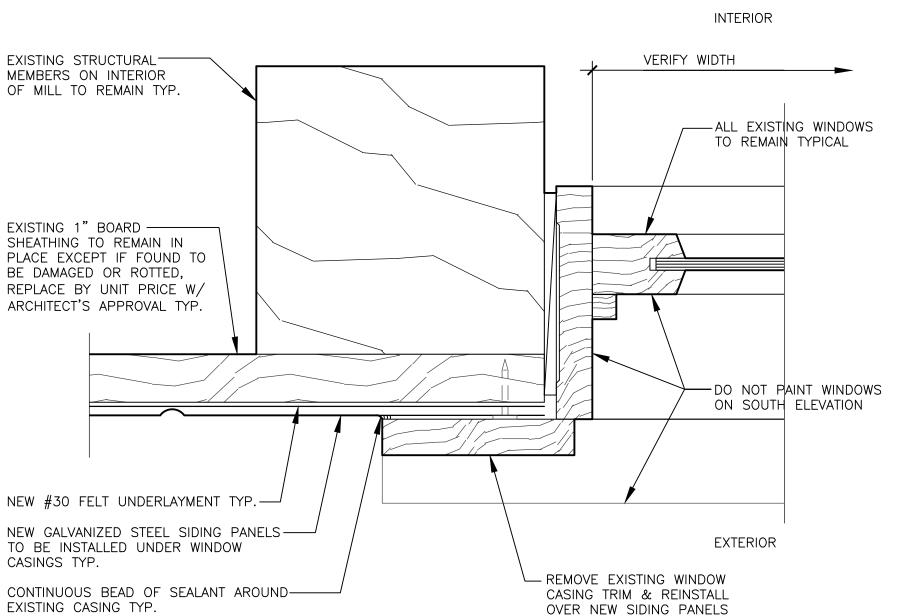

2 TYP. SOUTH WINDOW JAMB
SCALE: FULL SIZE

SCOPE OF WORK:

BASE BID: WORK FOR THIS PROJECT SHALL CONSIST OF FURNISHING ALL MATERIALS, LABOR AND SERVICES NECESSARY TO SCAFFOLD OR OTHERWISE ACCESS THE THREE—STORY PORTION OF THE SOUTH ELEVATION OF THE DILLARD MILL FOR THE PURPOSE OF REMOVING, REPLACING & PAINTING THE METAL SIDING AS INDICATED ON THESE DRAWINGS. (SIDING REPLACEMENT IS LIMITED TO THREE—STORY PORTION OF SOUTH ELEVATION)

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LEAD-BASED PAINT NOTE:

NEW SHEETS OF PRESSED BRICK———GALVANIZED STEEL SIDING PANELS TYP.

NEW #30 FELT UNDERLAYMENT - OVER EXIST. SHEATHING TYP.

VERT. EDGES OF SIDING TYP.

NEATLY BEND SIDING & — UNDERLAYMENT OUT OVER

EXIST. WATER TABLE TRIM WHERE THIS CONDITION

GALV. ROOFING NAIL W/ NEOPRENE -

WASHERS SET @ 8 1/2" O.C. ALONG

SEE DTL 1/A201

THE EXISTING EXTERIOR PAINT SURFACES ON THE MILL HAVE BEEN TESTED FOR LEAD-BASED PAINT BY THE DEPARTMENT OF NATURAL RESOURCES, DIVISION OF STATE PARKS AND ARE REPORTED AS BEING BELOW THE DEFINED LIMIT OF LEAD EQUAL TO OR EXCEEDING 1.0 MILLIGRAM PER SQUARE CENTIMETER OR 0.5 % BY WEIGHT FOR BEING CONSIDERED LEAD-BASED PAINT. THEREFORE, THIS PROJECT IS NOT AN ABATEMENT, NOR DOES IT REQUIRE CONTRACTORS TO BE LICENSED OR CERTIFIED TO DO RENOVATIONS OR REPAINTING. AS PER SPECIFICATIONS, CONTRACTORS SHALL TAKE GENERAL PRECAUTIONS TO PROTECT & MINIMIZE WORKERS AND BUILDING OCCUPANTS EXPOSURE DURING ALL WORK THAT WILL DISTURB THE EXISTING PAINTED SURFACES AND CREATE DUST. WHEN REMOVING SIDING OR REMOVAL OF LOOSE FLAKING PAINT, ATTEMPT TO COLLECT THE FALLING PAINT CHIPS & DEBRIS ON PLASTIC BELOW THE VERTICAL WALL SURFACES AND PROPERLY DISPOSE OF THIS WASTE.

LAP TYP.


-EXISTING 1" BOARD SHEATHING
TO REMAIN IN PLACE EXCEPT

IF FOUND TO BE DAMAGED OR

MISSING, REPLACE BY UNIT

PRICE W/ ARCHITECT'S


APPROVÁL TYP.

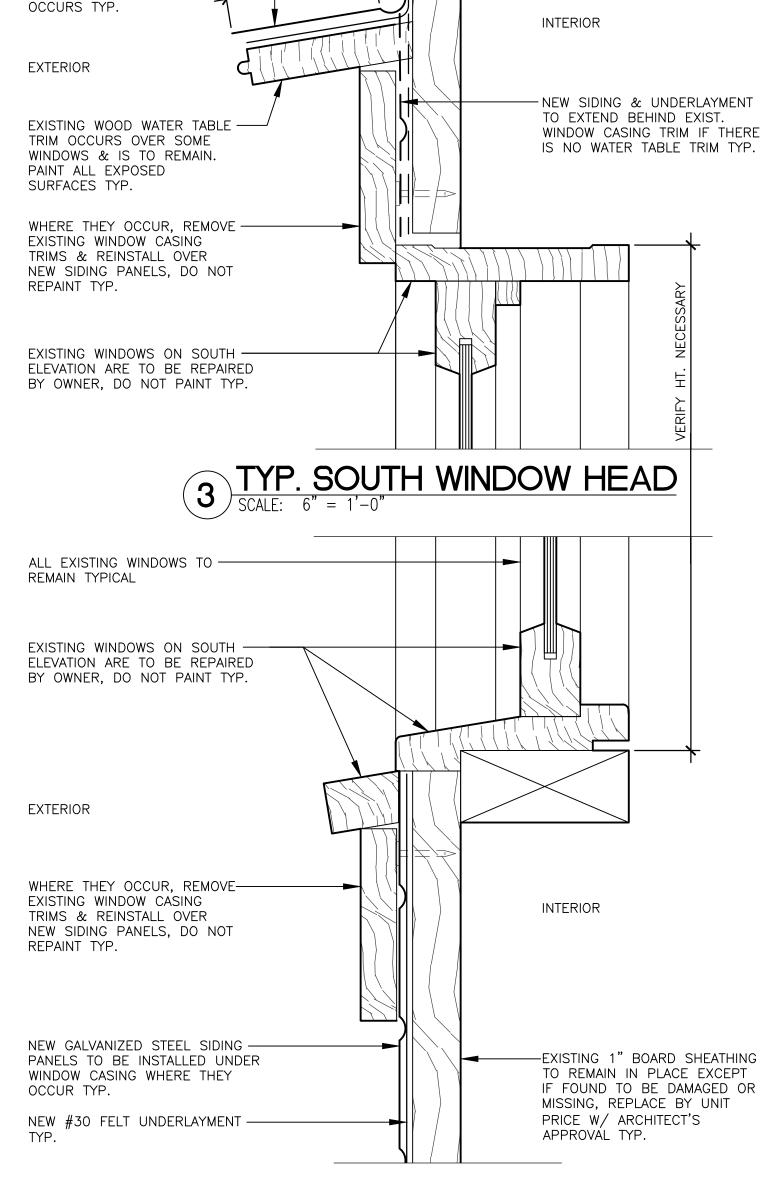

TYP. SOUTH WINDOW SILL

SCALE: FULL SIZE

STATE OF MISSOURI MICHAEL L. PARSON, GOVERNOR

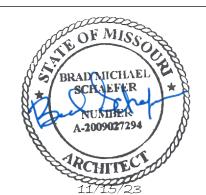

Brad M. Schaefer - Architect MO# A-2009027294

BID DOCUMENTS

OFFICE OF ADMINISTRATION DIVISION OF FACILITIES MANAGEMENT, DESIGN AND CONSTRUCTION

DEPARTMENT OF
NATURAL RESOURCES

REPLACE SIDING - MILL

DILLARD MILL STATE HISTORIC SITE 142 DILLARD MILL DRIVE DAVISVILLE, MO 65456

PROJECT # X23MP-01 SITE # 5606

ASSET # 7815606010 - MILL

REVISION:	
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DATE:	

CAD DWG FILE:X23MP-01
DRAWN BY: TEH
CHECKED BY: BMS
DESIGNED BY: TEH

ISSUE DATE: 11/15/2023

SHEET TITLE:

NORTH ELEVATION

SHEET NUMBER:

|A-202|

5 OF 6 SHEETS 11/15/2023

SURFACE DEGRADATION NOTE:

THE DEGREE OR AMOUNT OF THE EXISTING PAINTED SURFACE DEGRADATION VARIES SIGNIFICANTLY FROM AREA TO AREA ON THE EXTERIOR MILL ELEVATIONS. CONTRACTOR SHALL VERIFY & SATISFY THEMSELVES AS TO THE AMOUNT OF SURFACE PREPARATION NECESSARY OR REQUIRED BY THE SPECIFICATIONS FOR THESE SURFACES.

EAST & WEST ELEVATION KEYED NOTES:

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SCOPE OF WORK:

BASE BID: WORK FOR THIS PROJECT SHALL CONSIST OF FURNISHING ALL MATERIALS, LABOR AND SERVICES NECESSARY TO SCAFFOLD OR OTHERWISE ACCESS THE THREE—STORY PORTION OF THE SOUTH ELEVATION OF THE DILLARD MILL FOR THE PURPOSE OF REMOVING, REPLACING & PAINTING THE METAL SIDING AS INDICATED ON THESE DRAWINGS. (SIDING REPLACEMENT IS LIMITED TO THREE—STORY PORTION OF SOUTH ELEVATION)

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STATE OF MISSOURI MICHAEL L. PARSON, GOVERNOR



Brad M. Schaefer - Architect MO# A-2009027294

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DESIGNED BY: TEH

SHEET TITLE:

DATE:

EAST & WEST ELEVATIONS

SHEET NUMBER:

A-203

6 OF 6 SHEETS 11/15/2023

1 DETAIL OF SIDING © SOUTHEAST CORNER SCALE: 6" = 1'-0"

