REPLACE ROOFS - 4 BUILDINGS MOBERLY CORRECTIONAL CENTER MOBERLY, MISSOURI



OWNER:

PROJECT

STATE OF MISSOURI MICHAEL L. PARSON,

GOVERNOR

DEPARTMENT OF CORRECTIONS

OFFICE OF ADMINISTRATION

DIVISION OF FACILITIES MANAGEMENT, MANAGEMENT:

DESIGN AND CONSTRUCTION

CONNELL ARCHITECTURE, P.C.

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DESIGNER: CONNELL ARCHITECTURE, P.C.

2311 EAST WALNUT STREET SUITE B

COLUMBIA, MISSOURI 65201

PROJECT NUMBER: C1913-01


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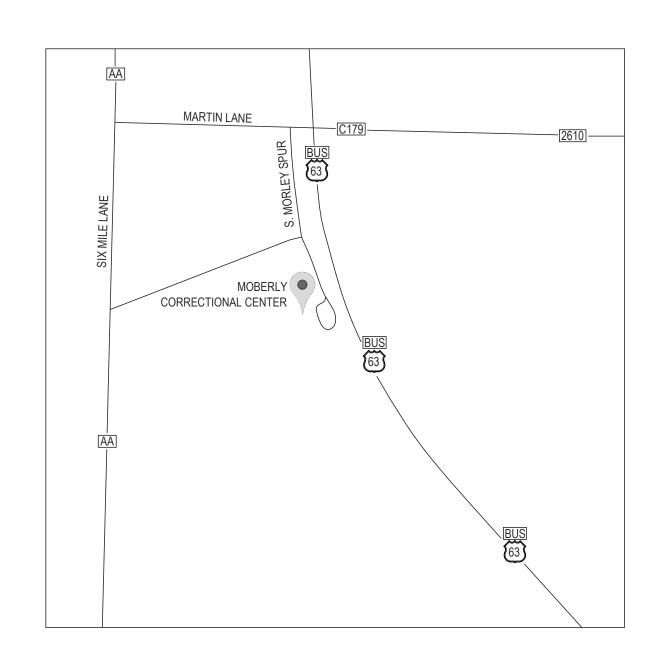
9327005022, 9327005023, ASSET NUMBERS:

7005

9327005024, 9327005029

ISSUE DATE: 11/11/2022



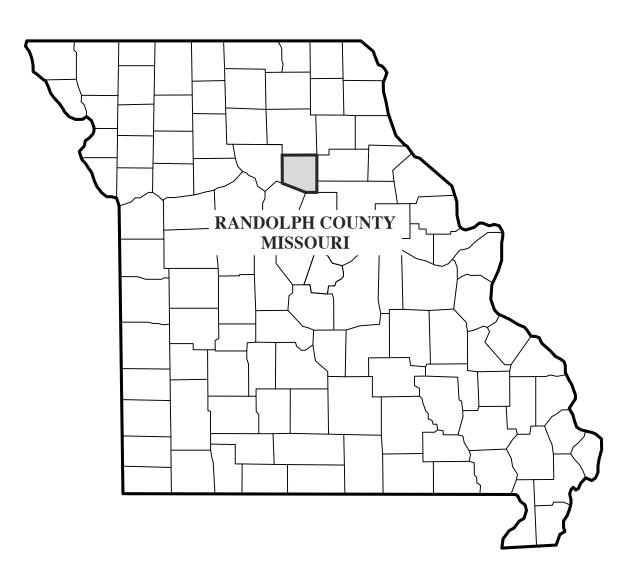








VICINITY MAP - MOBERLY CORRECTIONAL CENTER

NOT TO SCALE

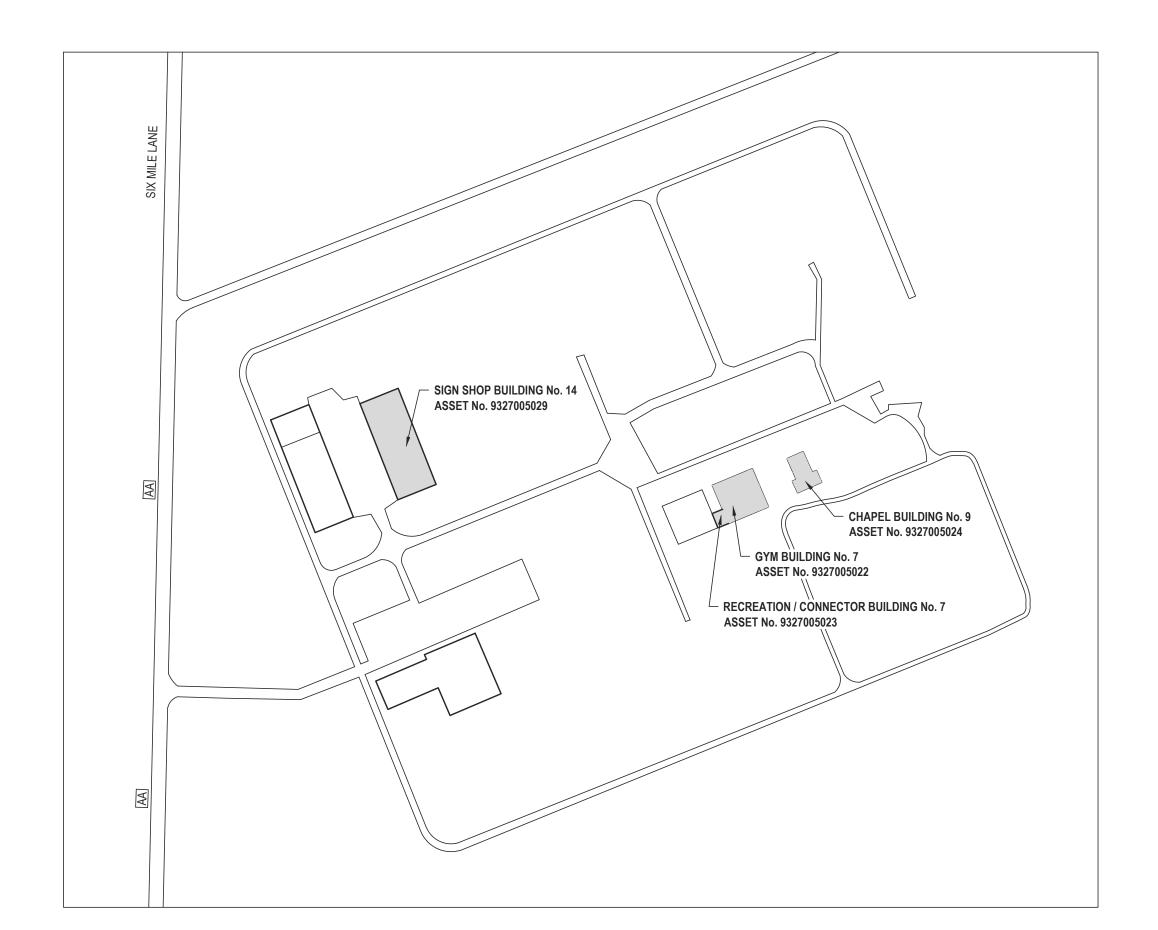

ASBESTOS CONTAINING MATERIALS

A LIMITED ASBESTOS INSPECTION WAS PERFORMED ON THE
EXISTING ROOF SYSTEMS OF ALL FOUR BUILDINGS INCLUDED IN
THE SCOPE OF THIS PROJECT.

ASBESTOS CONTAINING MATERIALS WERE NOT DETECTED ON

RECREATION / CONNECTOR & GYM BUILDING No. 7, CHAPEL BUILDING
No. 9, AND THE SIGN SHOP BUILDING No. 14.

BUILDINGS.

IN ALL INSTANCES REFER TO PROJECT MANUAL SECTION 028213 - ASBESTOS ABATEMENT FOR FULL DETAIL

ASBESTOS ABATEMENT WILL NOT BE REQUIRED ON THESE

LEAD CONTAINING MATERIALS A LIMITED LEAD INSPECTION WAS PERFORMED ON THE

A LIMITED LEAD INSPECTION WAS PERFORMED ON THE EXISTING ROOF SYSTEMS OF ALL FOUR BUILDINGS INCLUDED IN THE SCOPE OF THIS PROJECT.

LEAD CONTAINING MATERIALS WERE DETECTED ON THE CHAPE BUILDING No. 9 (LEAD FLASHING AT VENT PENETRATIONS) AND THE SIGN SHOP BUILDING No. 14 (LEAD FLASHING AT VENT PENETRATIONS).

LEAD ABATEMENT WILL BE REQUIRED ON THESE BUILDINGS.

LEAD CONTAINING MATERIALS WERE NOT DETECTED ON THE RECREATION / CONNECTOR & GYM BUILDING No. 7.

LEAD ABATEMENT WILL NOT BE REQUIRED ON THESE BUILDINGS.

IN ALL INSTANCES REFER TO PROJECT MANUAL SECTION 028333 LEAD ABATEMENT FOR FULL DETAIL

GENERAL NOTES:

IT IS THE RESPONSIBILITY OF THE GENERAL CONTRACTOR AND EACH SUBCONTRACTOR TO REVIEW THE DRAWINGS TO ASSURE COORDINATION OF ALL WORK AFFECTING EACH TRADE. FAILURE TO REVIEW ALL CONTRACT DOCUMENTS FOR APPLICABLE ITEMS OF WORK SHALL NOT RELIEVE THE RESPONSIBLE PARTY FROM PERFORMING ALL WORK REQUIRED BY THE CONTRACT DOCUMENTS.

- **DRAWINGS** THESE DRAWINGS SHALL NOT BE SCALED. REFER TO DIMENSIONS INDICATED, ACTUAL SIZES OF CONSTRUCTION ITEMS, OR OTHER METHODS OF LOCATING CONSTRUCTION. WHERE NO DIMENSION OR METHOD OF DETERMINING A LOCATION IS GIVEN, VERIFY CORRECT LOCATION WITH CONNELL ARCHITECTURE P.C. PRIOR TO INSTALLATION.
- **DIMENSIONS** DIMENSIONS ON PLANS ARE FROM FACE OF CONCRETE, MASONRY, OR FRAMING UNLESS OTHERWISE NOTED. DIMENSIONS INDICATED AS "CLEAR" SHALL BE A MINIMUM DIMENSION MEASURED FROM FACE OF FINISH MATERIALS.
- COORDINATION GENERAL CONTRACTOR SHALL COORDINATE REQUIREMENTS OF ALL TRADES TO ALLOW FOR TIMELY INCLUSION IN THE WORK SO AS NOT TO DELAY THE WORK OR THE WORK OF ANY SUBCONTRACTOR.
- EXISTING CONDITIONS THE EXISTING CONDITIONS SHOWN ON THESE DRAWINGS ARE DERIVED FROM
 OBSERVATIONS AND MEASUREMENTS TAKEN DURING SITE VISITS AND FROM ARCHIVE INFORMATION
 PROVIDED BY THE OWNER. THE CONTRACTOR SHALL VERIFY ALL EXISTING CONDITIONS ON THE JOB
 SITE AND NOTIFY CONNELL ARCHITECTURE P.C. OF DEVIATIONS FROM THESE DRAWINGS PRIOR TO
 FABRICATION AND INSTALLATION OF THE WORK.
- PRECAUTIONS CONTRACTOR SHALL IMMEDIATELY REPORT ANY UNFORESEEN CONDITIONS
 DISCOVERED IN THE WORK WHICH COULD RESULT IN DAMAGE TO THE STRUCTURE OR INJURY TO THE
 OCCUPANTS TO THE OWNER'S REPRESENTATIVE AND CONNELL ARCHITECTURE P.C. IMPLEMENT
 NECESSARY PRECAUTIONS TO PROPERLY SUPPORT THE STRUCTURE AND PROTECT THE OCCUPANTS.
- HAZARDOUS MATERIALS CONTRACTOR SHALL IMMEDIATELY REPORT THE DISCOVERY OF ANY
 HAZARDOUS MATERIALS TO THE OWNER'S REPRESENTATIVE AND CONNELL ARCHITECTURE, P.C.
- SITE UTILIZATION USE OF THE SITE FOR ANY CONSTRUCTION STAGING OR OTHER OPERATIONS SHALL BE COORDINATED WITH THE OWNER'S REPRESENTATIVE AND CONSTRUCTION ADMINISTRATOR. THE CONTRACTOR'S OPERATIONS SHALL NOT OBSTRUCT OR ADVERSELY AFFECT ANY PUBLIC RIGHT-OF-WAY OR ADJACENT PROPERTIES.
- EXIT ACCESS MAINTAIN FREE, SAFE, AND APPROVED MEANS OF EGRESS IN AND OUT OF PROJECT LOCATION AND EXISTING OCCUPIED BUILDINGS IN ACCORDANCE WITH REQUIREMENTS OF APPLICABLE REGULATORY AGENCIES.

CONTRACTOR SHALL FURNISH & INSTALL ALL ROOFING, FLASHING & INSULATION MATERIALS REQUIRED FOR A COMPLETE WATERPROOF INSTALLATION, WHETHER OR NOT ALL SUCH MATERIALS & DETAILS OF INSTALLATION HAVE BEEN SPECIFICALLY MENTIONED OR SHOWN ON THE CONSTRUCTION DRAWINGS. ALL INSTALLATION AND DETAILS TO CONFORM TO MANUFACTURER'S WRITTEN SPECIFICATIONS AND RECOMMENDATIONS.

ANY AND ALL MATERIALS NOTED "TO REMAIN" ARE EXISTING MATERIALS TO REMAIN UNLESS OTHERWISE NOTED. ANY MATERIAL NOT DESIGNATED "TO REMAIN" SHALL BE REMOVED AND DISPOSED OF IN A LEGAL MANNER, AND REPLACED WITH NEW MATERIALS UNLESS OTHERWISE NOTED.

ROOF REPLACEMENT NOTES:

- ROOF SLOPE: THE MINIMUM SLOPE ON ANY ROOF PLANE (INCLUDING SADDLES AND CRICKETS) SHALL BE 1/4" PER FOOT.
- THERMAL PERFORMANCE: THE MINIMUM AVERAGE R-VALUE FOR ANY FLAT ROOF AREA SHALL BE R-30, SLOPED ROOFS SHALL BE R-0 ON THE CHAPEL BUILDING, AND R-30 ON THE CONNECTOR / GYM ROOFS.
- WIND UPLIFT RATING: THE MEMBRANE ROOFING SYSTEM SHALL MEET THE REQUIREMENTS OF FM 1A-90.
- FIRE-RESISTANCE RATING: THE MEMBRANE ROOFING SYSTEM SHALL ACHIEVE A MINIMUM UL CLASS C WHEN TESTED PER UL 790 (ASTM E 108).

DRAWING SHEET INDEX:

ARCHITECTURAL SHEETS

G-000 COVER PAGE

1 LOCATION MAPS & DRAWING INDEX

AD-100 RECREATION / CONNECTOR & GYM BUILDING No. 7 - ROOF DEMOLITION PLAN

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SLOPED ROOF SHINGLE DETAILS

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A-100 RECREATION / CONNECTOR & GYM BUILDING No. 7 - ROOF REPLACEMENT PLAN

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A-500 FLAT ROOF TPO DETAILS

A-501 TPO ROOF DETAILS

STATE OF MISSOURI MICHAEL L. PARSON, GOVERNOR



SONNELL ARCHITECTURE, P. 311 East Walnut Street Suite 652 Solumbia, Missouri 652-2455 Cell: 573-268-61



OFFICE OF ADMINISTRATION DIVISION OF FACILITIES MANAGEMENT, DESIGN AND CONSTRUCTION

MISSOURI DEPARTMENT OF CORRECTIONS

REPLACE ROOFS - 4 BUILDINGS

MOBERLY CORRECTIONAL CENTER

5201 SOUTH MORLEY ST MOBERLY, MO 65233

PROJECT No. C1913-01 SITE No. 7005

ASSET No. 9327005022, 9327005023, 9327005024, 9327005029

REVISION:
DATE:
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ISSUE DATE: 11/11/2022

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SHEET TITLE:

LOCATION MAPS & DRAWING INDEX

SHEET NUMBER:

G-00

SHEET 2 OF 11 ISSUE DATE: 11/11/2022



GENERAL DEMOLITION NOTES: RECREATION/CONNECTOR & GYM BUILDING No. 7

- CONTRACTOR SHALL COORDINATE ALL DEMOLITION AND REMOVAL OF DEMOLITION
- MATERIALS WITH OTHER WORK SEQUENCES AND THE OWNER'S OCCUPANCY REQUIREMENTS.
- REMOVE ALL EXISTING ASPHALT SHINGLES AND UNDERLAYMENT DOWN TO SUBSTRATE NOTED TO REMAIN
- REMOVE ALL EXISTING PERIMETER METAL COPING, FLASHING, COUNTERFLASHING, SHEET METAL CLEATS, FASTENERS, AND SEALANT UNLESS OTHERWISE NOTED.
- REMOVE ALL EXISTING ROOF-TO-WALL BASE FLASHING, COUNTERFLASHING, REGLETS,
- FASTENERS AND SEALANT.
- REMOVE ALL EXISTING DAMAGED OR DETERIORATED WOOD BLOCKING, CANTS, NAILERS, GROUNDS, ETC. REMOVE ALL ABANDONED ROOF-MOUNTED ITEMS (EXHAUST FANS, VENTS, CONDUITS, PIPES, DUCTS,
- CURBS, ETC. AS NOTED ON THE ROOF DEMOLITION PLAN.
- TOTAL ROOF AREA CALCULATION DOES NOT INCLUDE ROOF-TO-WALL FLASHING AT VERTICAL SURFACES.

RECREATION / CONNECTOR & GYM BUILDING No. 7 **EXISTING ROOF CORE SAMPLE SCHEDULE**

RECREATION/CONNECTOR GABLE (SLOPED) ROOF AREA

ROOF CORE No. 1 ASPHALT SHINGLES OVER 30# FELT UNDERLAYMENT OVER 1/2" PLYWOOD NAILING SHEET OVER 3" POLYISO INSULATION BOARD OVER BASE SHEET MOPPED TO STRUCTURAL TECTUM PANEL DECK. OVERALL DEVELOPED THICKNESS = 4" (NOT INCLUDING THICKNESS OF TECTUM PANEL)

GYM GABLE (SLOPED) ROOF AREA

ROOF CORE No. 2 ASPHALT SHINGLES OVER 30# FELT UNDERLAYMENT OVER 1/2" PLYWOOD NAILING SHEET OVER MOPPED-DOWN MULTI-PLY BUILT-UP ROOF OVER STRUCTURAL GYPSUM PANEL DECK. OVERALL DEVELOPED THICKNESS = 2" (NOT INCLUDING THICKNESS OF GYPSUM PANEL)

EXISTING GYM BUILDING No. 7 ROOF FEATURE SCHEDULE MAIN (SLOPED) ROOF AREA

EXISTING RECREATION/CONNECTOR BUILDING No. 7 ROOF FEATURE SCHEDULE RECREATION / CONNECTOR ROOF AREA Description 4" Ø Cast Iron VTR Exhaust Vent Gutter 57 LF


ASBESTOS CONTAINING MATERIALS A LIMITED ASBESTOS INSPECTION WAS PERFORMED ON THE EXISTING ROOF SYSTEMS OF THE RECREATION/CONNECTOR & GYM BUILDING No. 7, AND THE LABORATORY ANALYSIS INDICATES THAT

SAMPLES **DO NOT** CONTAIN ASBESTOS. ASBESTOS ABATEMENT IS NOT REQUIRED ON THIS BUILDING.

LEAD CONTAINING MATERIALS A LIMITED LEAD INSPECTION WAS PERFORMED ON THE EXISTING ROOF SYSTEMS OF THE RECREATION/CONNECTOR & GYM BUILDING No. 7 AND THE LABORATORY ANALYSIS INDICATES THAT SAMPLES **DO NOT** CONTAIN LEAD. LEAD ABATEMENT IS NOT REQUIRED ON THIS BUILDING.

EXISTING CONDITIONS

THE EXISTING CONDITIONS SHOWN ON THESE DRAWINGS ARE DERIVED FROM OBSERVATIONS AND MEASUREMENTS TAKEN DURING SITE VISITS AND FROM ARCHIVE INFORMATION PROVIDED BY THE OWNER. THE CONTRACTOR SHALL VERIFY ALL EXISTING CONDITIONS ON THE JOB SITE.

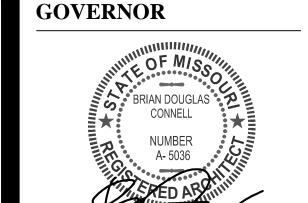

STATE OF MISSOURI

MICHAEL L. PARSON,

BRIAN DOUGLAS CONNELL ARCHITECT MO A-5036

L ARCHITE
Walnut Stree

OFFICE OF ADMINISTRATION DIVISION OF FACILITIES MANAGEMENT, DESIGN

AND CONSTRUCTION

MISSOURI DEPARTMENT OF CORRECTIONS

REPLACE ROOFS -4 BUILDINGS

MOBERLY CORRECTIONAL **CENTER**

5201 SOUTH MORLEY ST MOBERLY, MO 65233

PROJECT No. C1913-01 7005 SITE No. **ASSET No.** 9327005022,

REVISION: REVISION: DATE: REVISION: DATE:

9327005023

11/11/2022 **CAD DWG FILE:**

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DRAWN BY: BDC

CHECKED BY: BDC DESIGNED BY: BDC

SHEET TITLE:

RECREATION / CONNECTOR & GYM BUILDING No. 7 ROOF DEMOLITION PLAN

SHEET NUMBER:

SHEET 3 OF 11 **ISSUE DATE: 11/11/2022**

1. REMOVE ALL SHEET METAL GUTTERS AND DOWNSPOUTS 2. REMOVE EXISTING ROOF-TO-WALL FLASHING 3. REMOVE EXISTING ROOF-TO- WALL FLASHING AT METAL WALL PANELS

KEYED DEMOLITION NOTES: RECREATION/CONNECTOR & GYM BUILDING No. 7


4. EXISTING LOW-VOLTAGE SPEAKER WIRE TO BE RELOCATED BY OWNER 5. EXISTING COAXIAL CABLE TO BE RELOCATED BY OWNER

6. EXISTING ROOF- MOUNTED LIGHT FIXTURE - REMOVE & REINSTALL 7. EXISTING ELECTRIC CONDUIT ATTACHED TO RAKE FASCIA - REMOVE & REINSTALL

8. EXISTING 4" Ø CAST IRON VTR TO REMAIN

9. EXISTING CURB- MOUNTED EXHAUST VENT TO REMAIN

10. EXISTING ROOF-MOUNTED LIGHTNING ROD TO REMAIN

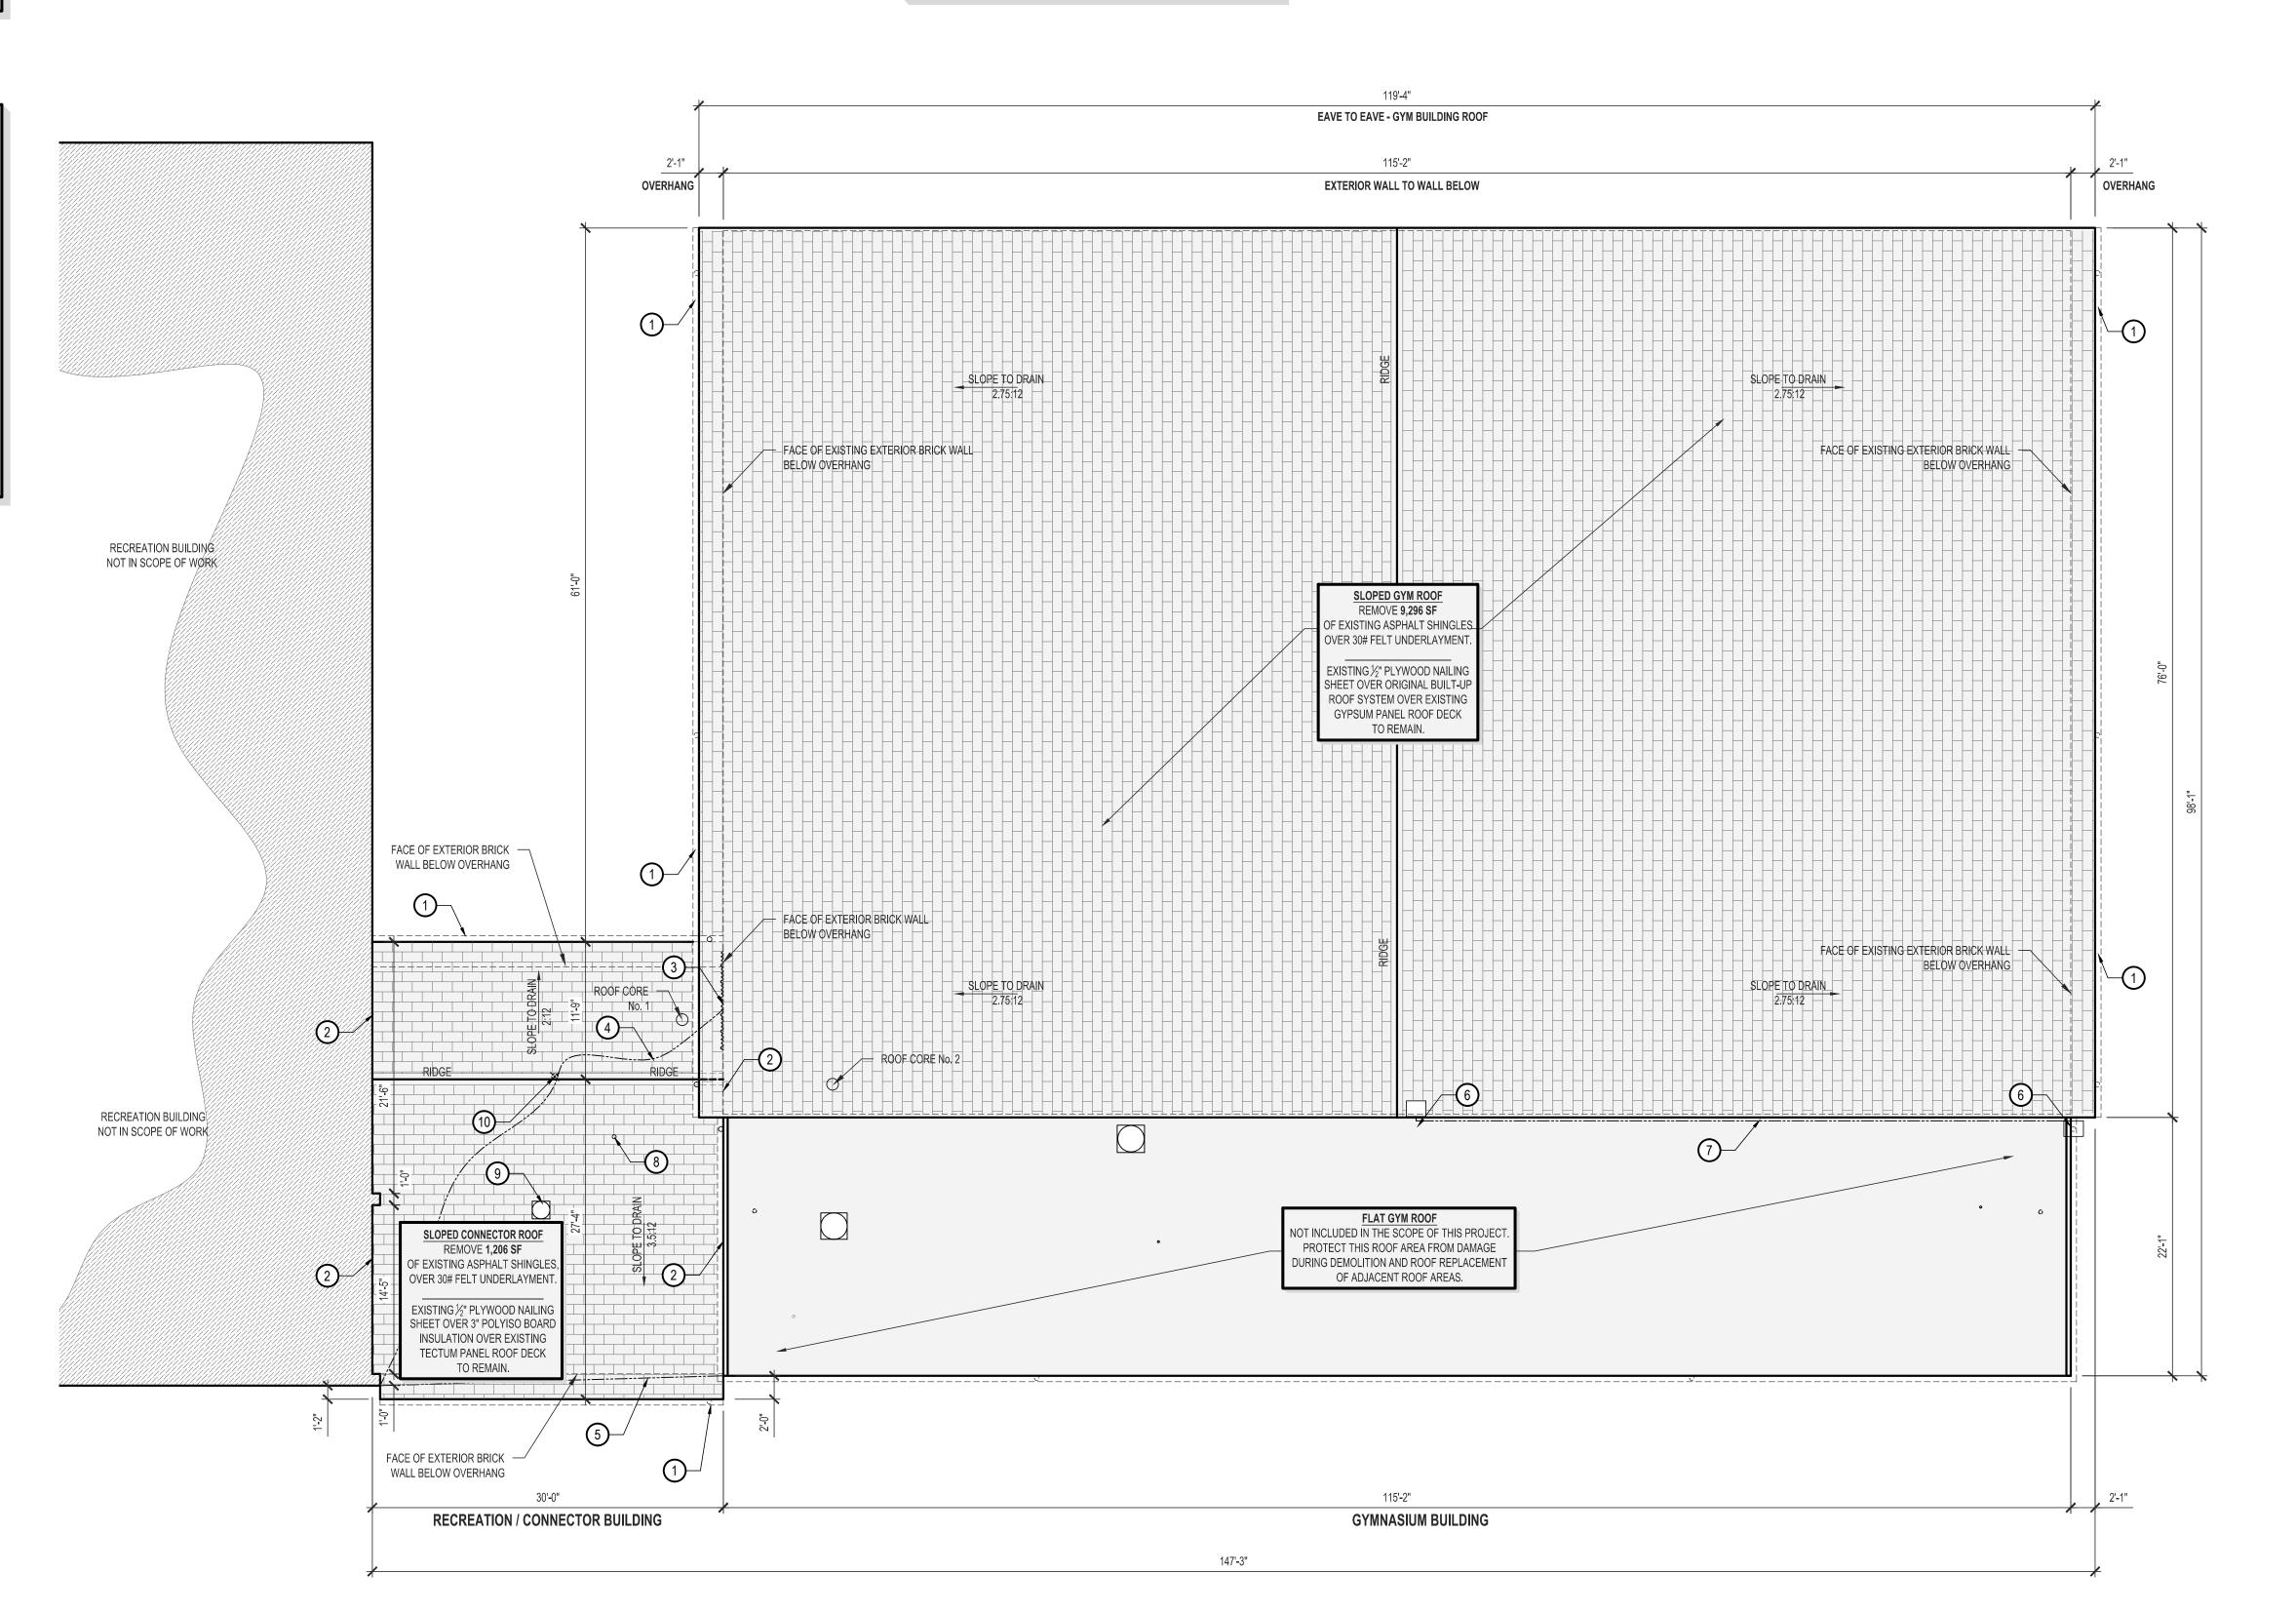











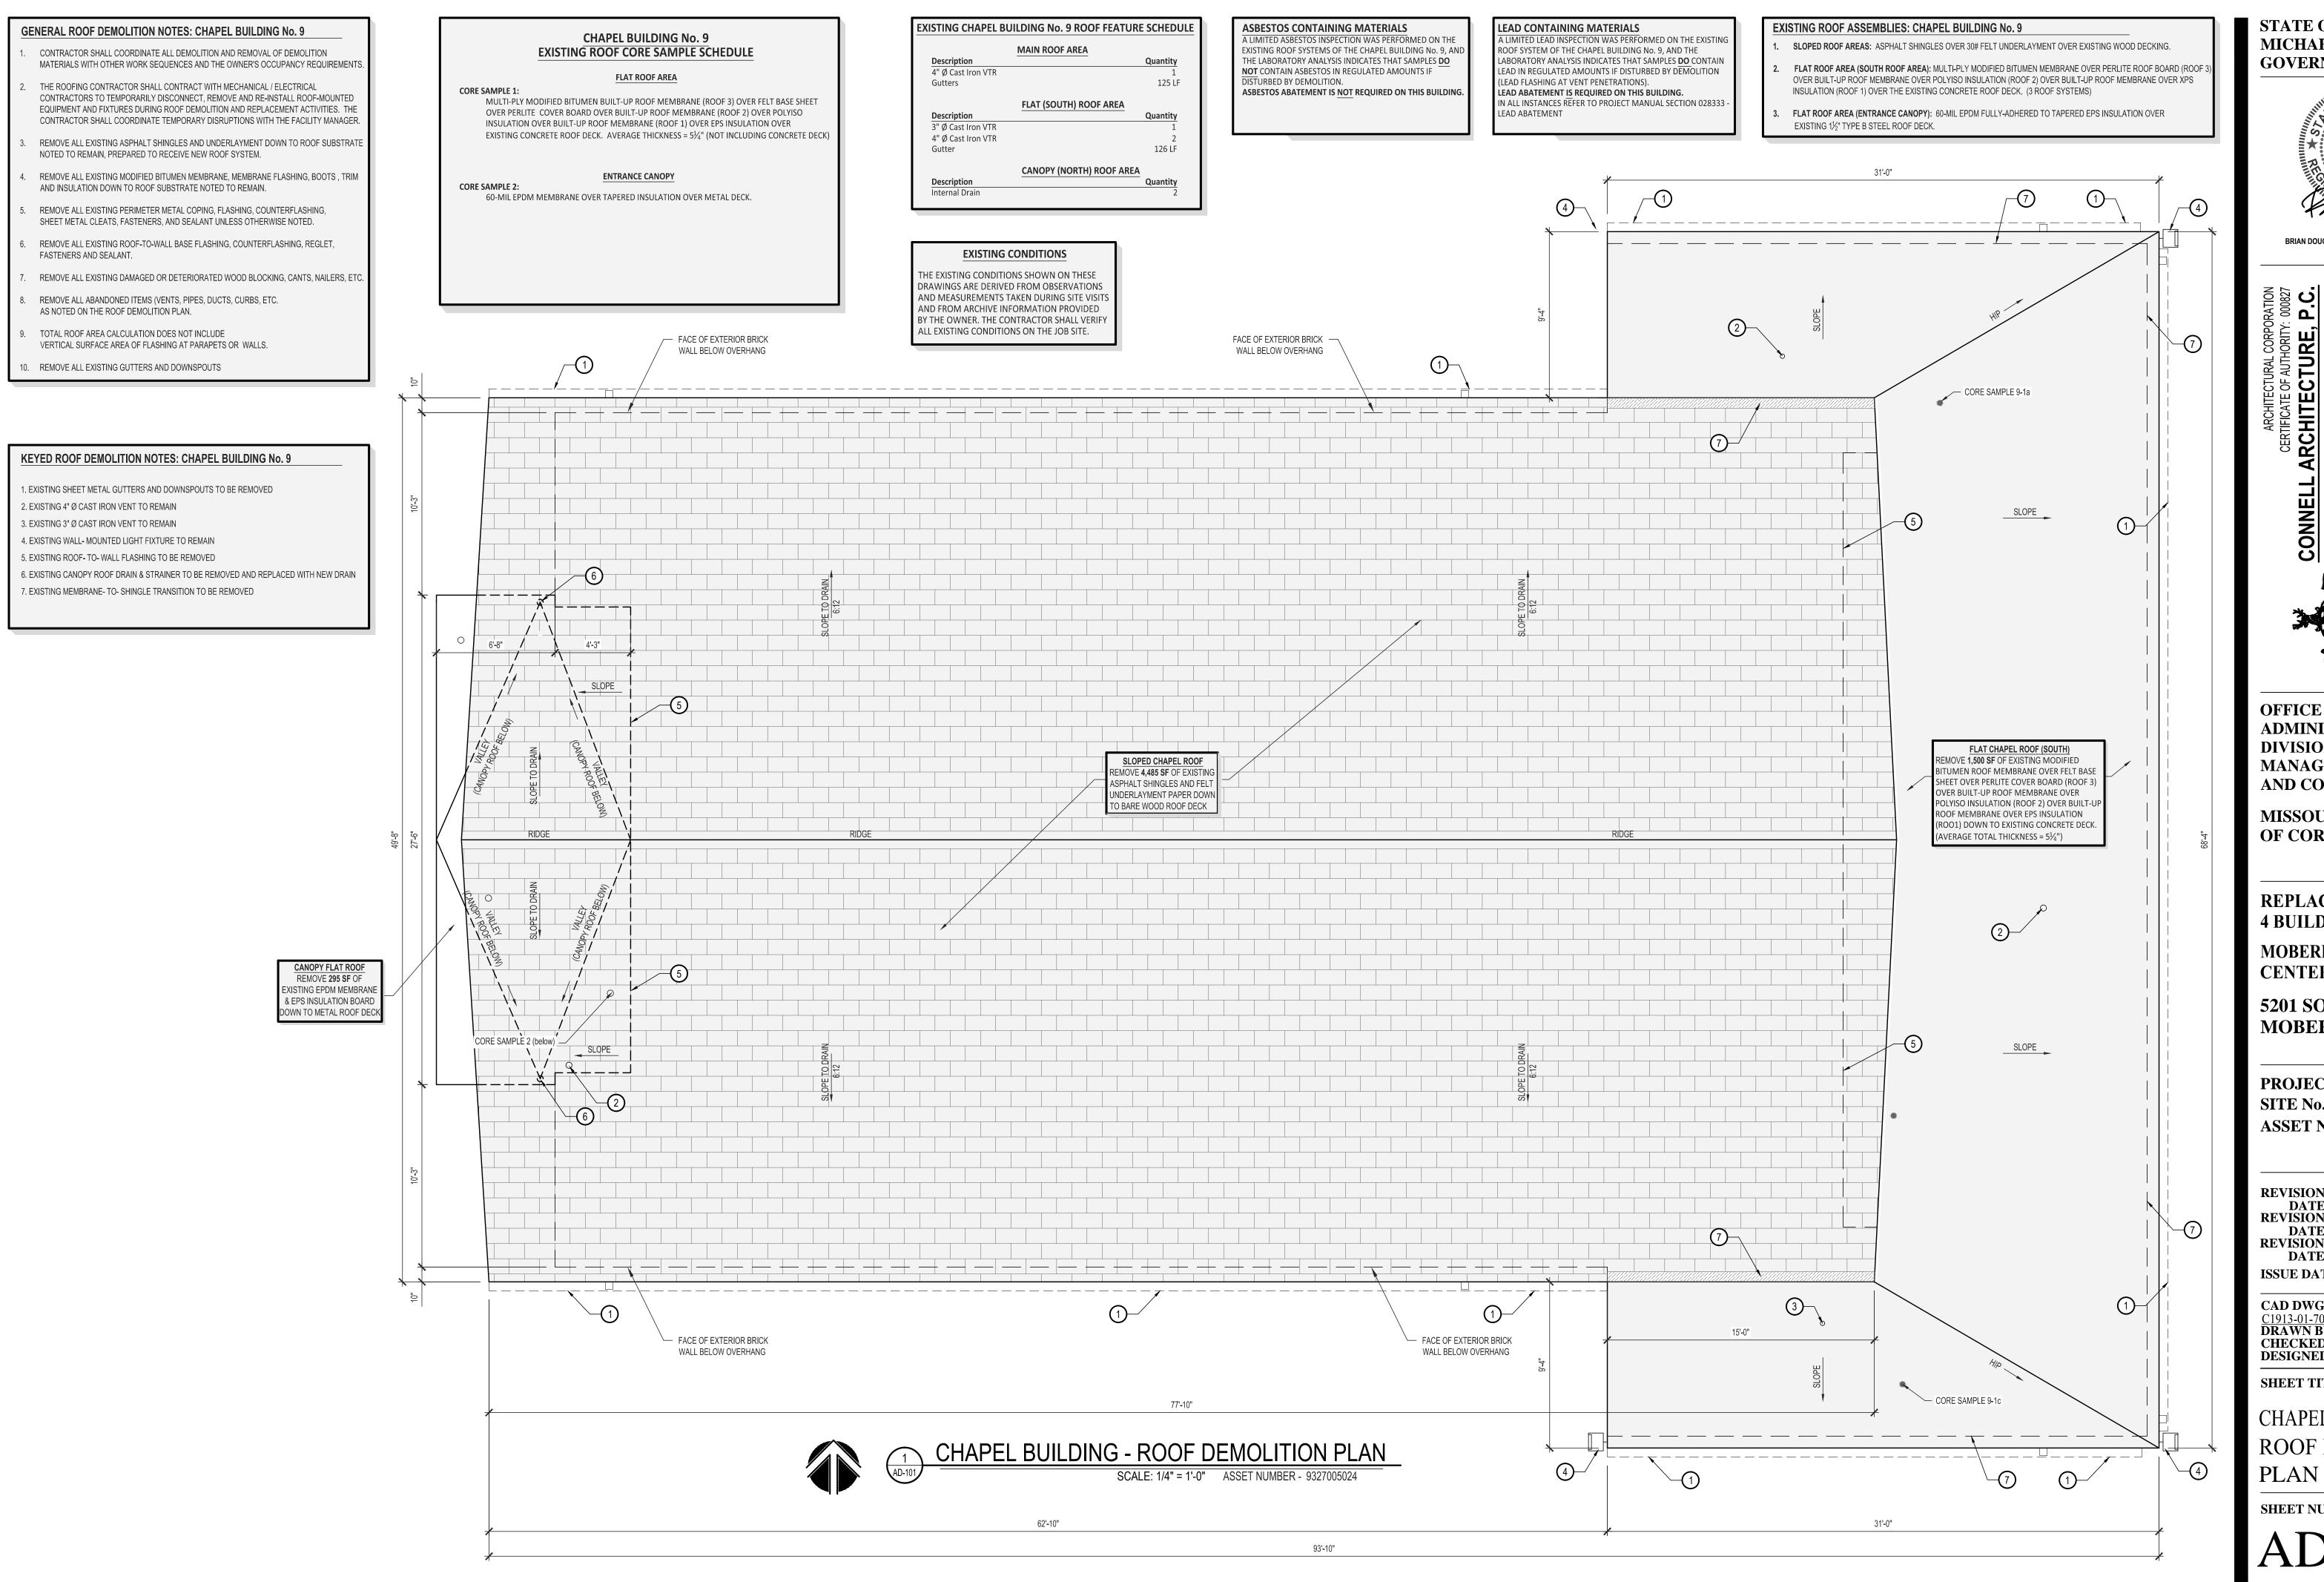

STATE OF MISSOURI MICHAEL L. PARSON, **GOVERNOR**

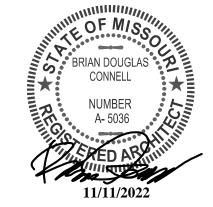

BRIAN DOUGLAS CONNELL ARCHITECT MO A-5036

OFFICE OF ADMINISTRATION DIVISION OF FACILITIES MANAGEMENT, DESIGN AND CONSTRUCTION

MISSOURI DEPARTMENT OF CORRECTIONS

REPLACE ROOFS -4 BUILDINGS

MOBERLY CORRECTIONAL **CENTER**

5201 SOUTH MORLEY ST MOBERLY, MO 65233

PROJECT No. C1913-01 SITE No. 7005 **ASSET No.** 9327005024

REVISION: REVISION: DATE: **REVISION:** DATE:

ISSUE DATE: <u>11/11/2022</u>

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SHEET TITLE:

CHAPEL BUILDING No. 9 ROOF DEMOLITION

SHEET NUMBER:

SHEET 4 OF 11 **ISSUE DATE: 11/11/2022**

GENERAL ROOF DEMOLITION NOTES - SIGN SHOP BUILDING No. 14

- CONTRACTOR SHALL COORDINATE ALL DEMOLITION AND REMOVAL OF DEMOLITION MATERIALS WITH OTHER WORK SEQUENCES AND THE OWNER'S OCCUPANCY REQUIREMENTS.
- THE ROOFING CONTRACTOR SHALL CONTRACT WITH MECHANICAL / ELECTRICAL CONTRACTORS TO TEMPORARILY DISCONNECT, REMOVE AND RE-INSTALL ROOF-MOUNTED EQUIPMENT DURING ROOF DEMOLITION AND REPLACEMENT ACTIVITIES. THE CONTRACTOR

SHALL COORDINATE TEMPORARY DISRUPTIONS WITH THE FACILITY MANAGER.

- REMOVE ALL EXISTING MEMBRANE, MEMBRANE FLASHING, BOOTS AND INSULATION DOWN TO BARE LIGHTWEIGHT CONCRETE ROOF DECK.
- EXISTING 3-COURSE METAL FASCIA REMOVE TOP COURSE, BOTTOM 2 COURSES TO REMAIN.
- REMOVE ALL EXISTING DAMAGED AND DETERIORATED 2x WOOD CANTS, NAILERS, GROUNDS, ETC.
- REMOVE ALL ABANDONED ITEMS (VENTS, PIPES, CURBS, ETC.) AS NOTED ON ROOF DEMOLITION PLAN.
- TOTAL ROOF AREA CALCULATION DOES NOT INCLUDE VERTICAL SURFACE AREA OF FLASHING AT PARAPET AND WALLS.

KEYED ROOF DEMOLITION NOTES - SIGN SHOP BUILDING No. 14

1. EXISTING ROOF DRAIN WITH 8" Ø DOME STRAINER TO REMAIN

2. EXISTING 3-COURSE METAL FASCIA - REMOVE TOP COURSE, BOTTOM 2 COURSES TO REMAIN

3. EXISTING 2x WOOD PERIMETER BLOCKING TO REMAIN

4. EXISTING 4" Ø CAST IRON VTR TO REMAIN

5. EXISTING CURB-MOUNTED EXHAUST VENT TO BE REMOVED

6. EXISTING WALL-MOUNTED EXHAUST FLUE TO REMAIN 7. EXISTING EXHAUST FLUE SUPPORT INTO PITCH POCKET (TYPICAL 4 LOCATIONS) TO REMAIN

8. EXISTING EXTERIOR EXHAUST FLUE TO REMAIN

SIGN SHOP BUILDING No. 14 **EXISTING ROOF CORE SAMPLE SCHEDULE**

MULTI-PLY MODIFIED BITUMEN OVER 1/2" PERLITE COVER BOARD OVER TAPERED POLYISO INSULATION OVER BASE SHEET OVER 2" LIGHTWEIGHT CONCRETE OVER 1½" TYPE B STEEL ROOF DECK. TOTAL THICKNESS OF EXISTING ROOF SYSTEM IS 15" AT THIS SAMPLE LOCATION (NOT INCLUDING LIGHTWEIGHT CONCRETE)

MULTI-PLY MODIFIED BITUMEN OVER 1/2" PERLITE COVER BOARD OVER TAPERED POLYISO INSULATION OVER BASE SHEET OVER 2" LIGHTWEIGHT CONCRETE OVER 1½" TYPE B STEEL ROOF DECK. TOTAL THICKNESS OF EXISTING ROOF SYSTEM IS 5" AT THIS SAMPLE LOCATION (NOT INCLUDING LIGHTWEIGHT CONCRETE)

EXISTING SIGN SHOP BUILDING No. 14 ROOF FEATURE SCHEDULE

DESCRIPTION	QUAN
4" Ø CAST IRON VTR	,
INTERNAL ROOF DRAIN	
CURB- MOUNTED EXHAUST VENT	

THE EXISTING CONDITIONS SHOWN ON THESE DRAWINGS ARE DERIVED FROM OBSERVATIONS AND MEASUREMENTS TAKEN DURING SITE VISITS AND FROM ARCHIVE INFORMATION PROVIDED BY THE OWNER. THE CONTRACTOR SHALL VERIFY ALL EXISTING CONDITIONS ON

THE JOB SITE.


EXISTING ROOF ASSEMBLY: SIGN SHOP BUILDING No. 14

FLAT ROOF AREA: MULTI-PLY MODIFIED BITUMEN MEMBRANE OVER 1/2" PERLITE COVER BOARD OVER POLYISO TAPERED INSULATION OVER BASE SHEET OVER 2"- 3" LIGHTWEIGHT CONCRETE OVER TYPE B METAL DECK. THICKNESS VARIES FROM 41/2" TO 15".

ASBESTOS CONTAINING MATERIALS A LIMITED ASBESTOS INSPECTION WAS PERFORMED ON THE EXISTING ROOF SYSTEM OF THE SIGN SHOP BUILDING No. 14, ANI THE LABORATORY ANALYSIS INDICATES THAT SAMPLES **DO NOT** CONTAIN ASBESTOS IN REGULATED AMOUNTS IF DISTURBED BY ASBESTOS ABATEMENT IS NOT REQUIRED ON THIS BUILDING

LEAD CONTAINING MATERIALS A LIMITED LEAD INSPECTION WAS PERFORMED ON THE EXISTING ROOF SYSTEM OF THE SIGN SHOP BUILDING No. 14, AND THE LABORATORY ANALYSIS INDICATES THAT SAMPLES **DO** CONTAIN LEAD IN REGULATED AMOUNTS IF DISTURBED BY DEMOLITION. LEAD ABATEMENT IS REQUIRED ON THIS BUILDING. IN ALL INSTANCES REFER TO PROJECT MANUAL SECTION 028333 -

LEAD ABATEMENT FOR FULL DETAILS.

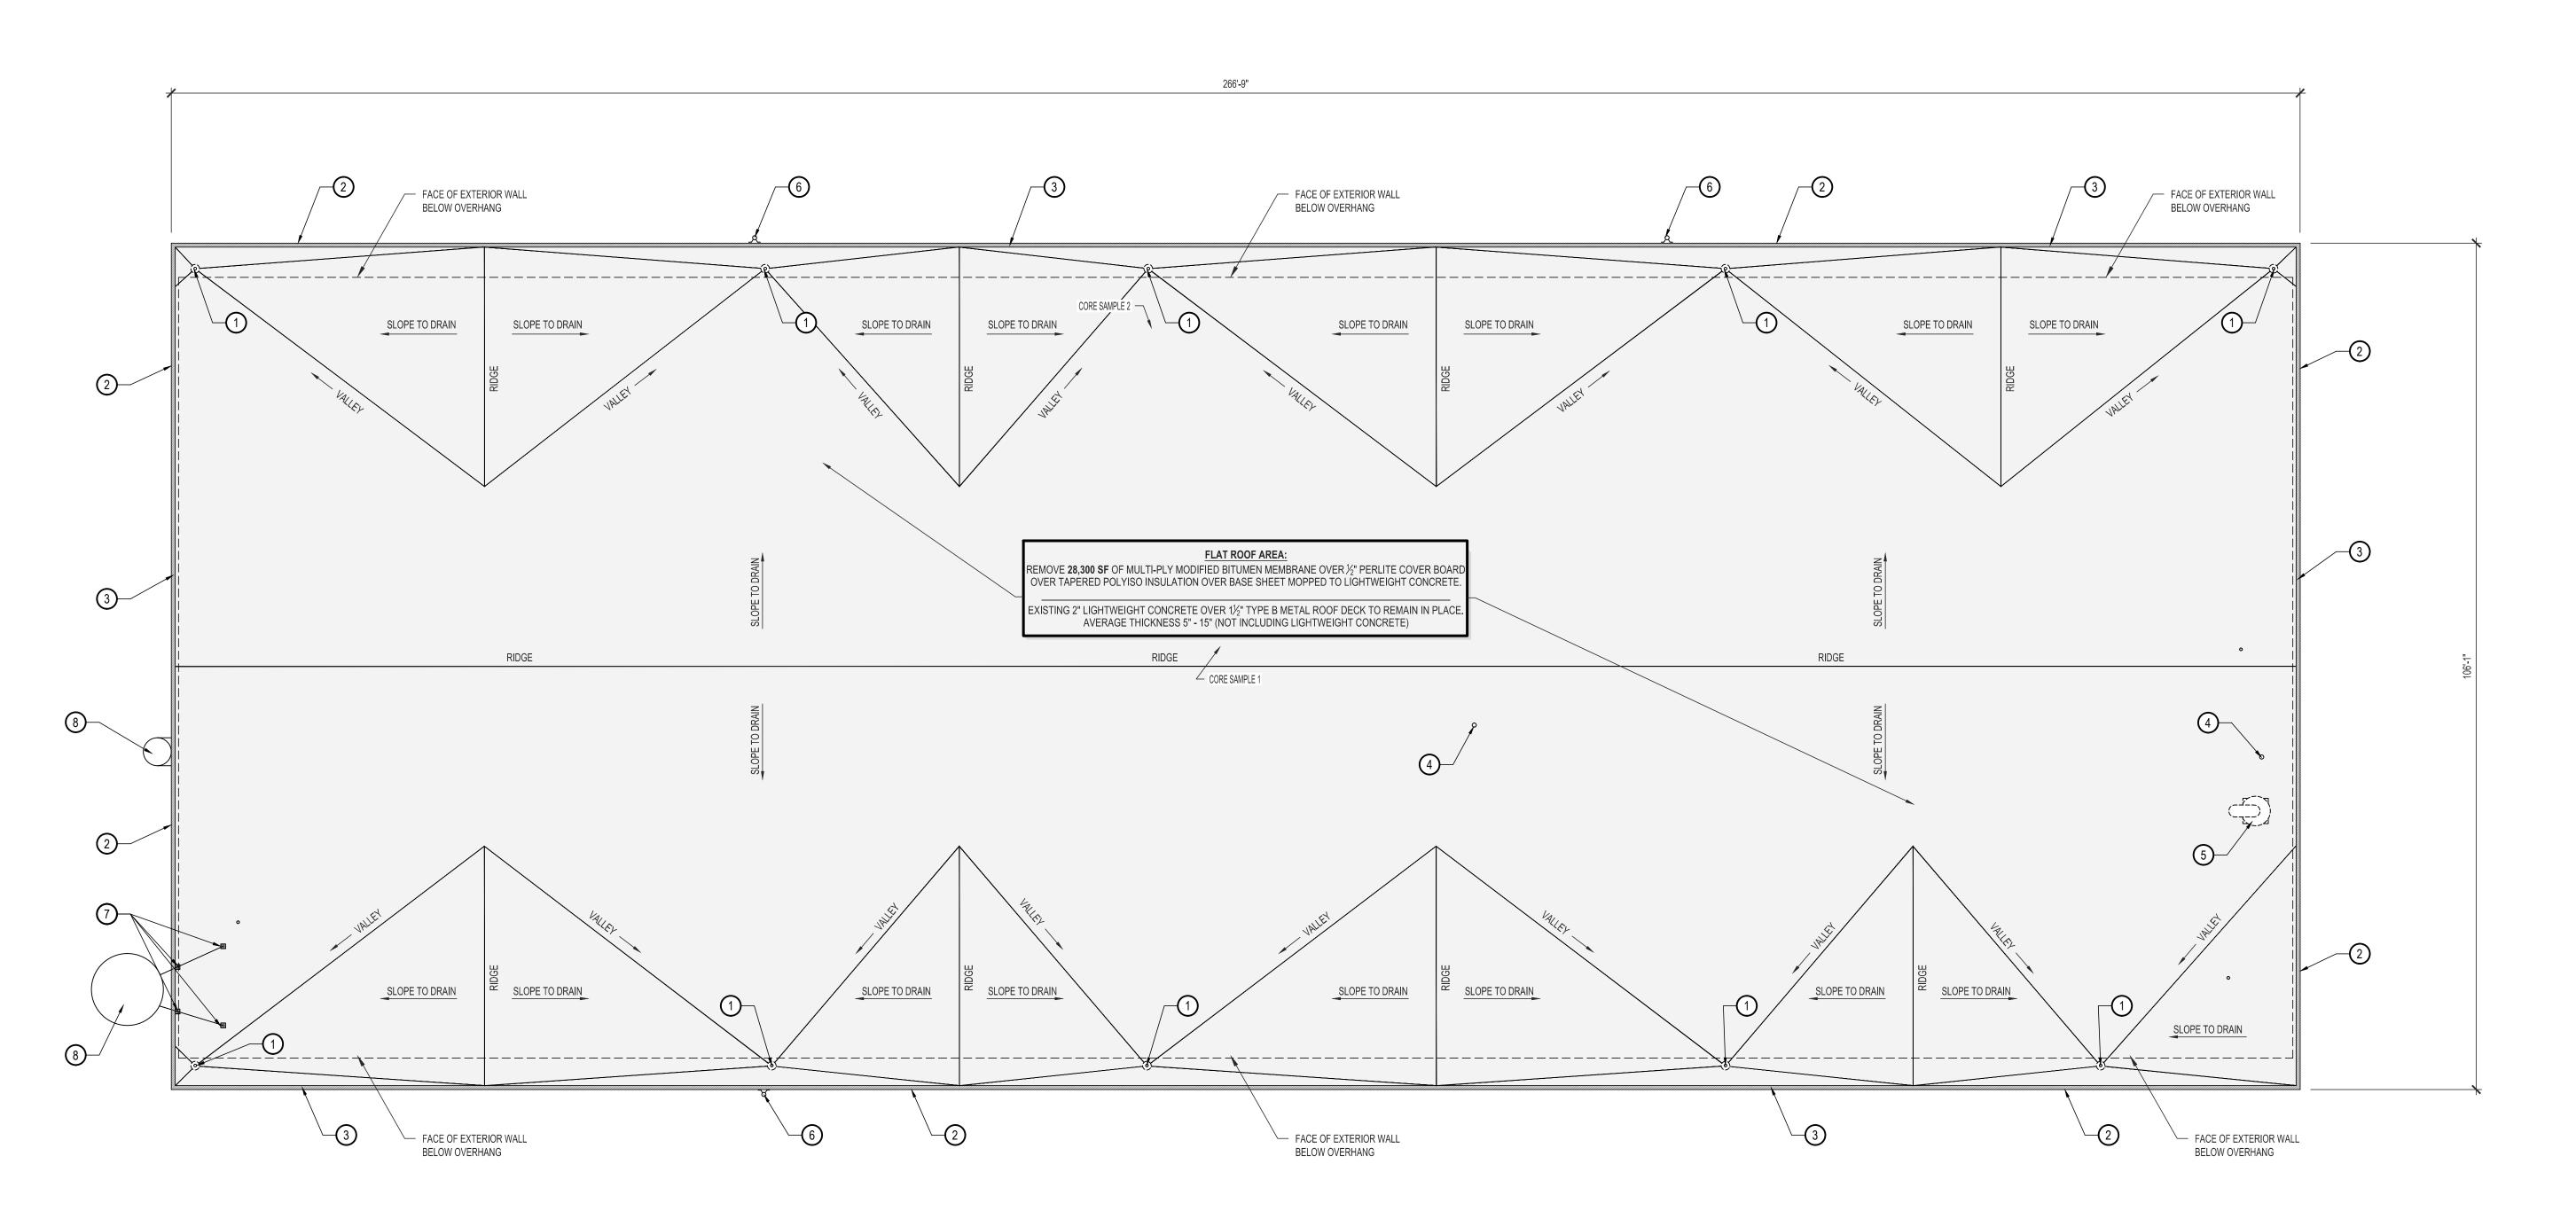





SIGN SHOP ROOF - DEMOLITION PLAN

SCALE: 3/32" = 1'-0" ASSET NUMBER - 9327005029

STATE OF MISSOURI MICHAEL L. PARSON, **GOVERNOR**



L ARCHITE Walnut Stre Missouri

OFFICE OF ADMINISTRATION

DIVISION OF FACILITIES MANAGEMENT, DESIGN AND CONSTRUCTION

MISSOURI DEPARTMENT OF CORRECTIONS

REPLACE ROOFS -4 BUILDINGS

MOBERLY CORRECTIONAL **CENTER**

5201 SOUTH MORLEY ST

MOBERLY, MO 65233

PROJECT No. C1913-01 SITE No. 7005 **ASSET No.** 9327005029

REVISION: REVISION: DATE: REVISION: DATE: ISSUE DATE: 11/11/2022

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SHEET TITLE:

SIGN SHOP BUILDING No. 14 ROOF DEMOLITION PLAN

SHEET NUMBER:

SHEET 5 OF 11 **ISSUE DATE: 11/11/2022**

KEYED ROOF REPLACEMENT NOTES: CONNECTOR & GYM BUILDING No. 7

- 1. NEW 7" TYPE-D 24-GAUGE SHEET METAL BOX GUTTER
- 2. NEW 4"x5" 24-GAUGE SHEET METAL DOWNSPOUT
- 3. NEW ROOF- TO- WALL FLASHING BELOW
- 4. NEW CRICKET AT ROOF- TO- WALL JUNCTION
- 5. EXISTING 4" Ø CAST IRON VTR EXTEND TO 18" ABOVE ROOF
- 6. RE-INSTALL EXISTING ROOF-MOUNTED LIGHT FIXTURE
- 7. RE-INSTALL ELECTRICAL CONDUIT TO FACE OF RAKE FASCIA
- 8. SNOWGUARDS NEW PRE-MOLDED TPO OUTSIDE CURB CORNER WELDED TO TPO MEMBRANE 9. EXISTING CURB- MOUNTED EXHAUST VENT
- 10. NEW FLASHING AT ROOF-TO- WALL CONDITION REFER TO DETAILS 7/A-501
- 11. NEW BUILDING IDENTIFICATION SIGNAGE REFER TO DETAIL 3/A-100 ON THIS DRAWING SHEET
- 12. RE-INSTALL EXISTING LIGHTNING ROD AT ROOF RIDGE
- 13. NEW ALUMINUM SHEET METAL WRAP OVER EXISTING WOOD RAKE FASCIA

GENERAL ROOF REPLACEMENT NOTES: CONNECTOR & GYM BUILDING No. 7

- MINIMUM FLAT ROOF SLOPE: 1/4" PER FOOT. MINIMUM AVERAGE R-VALUE R-30 (EACH ROOF AREA)
- WIND UPLIFT RATING: FM 1A-90
- FIRE-RESISTANCE RATING: UL CLASS C


EXISTING CONDITIONS

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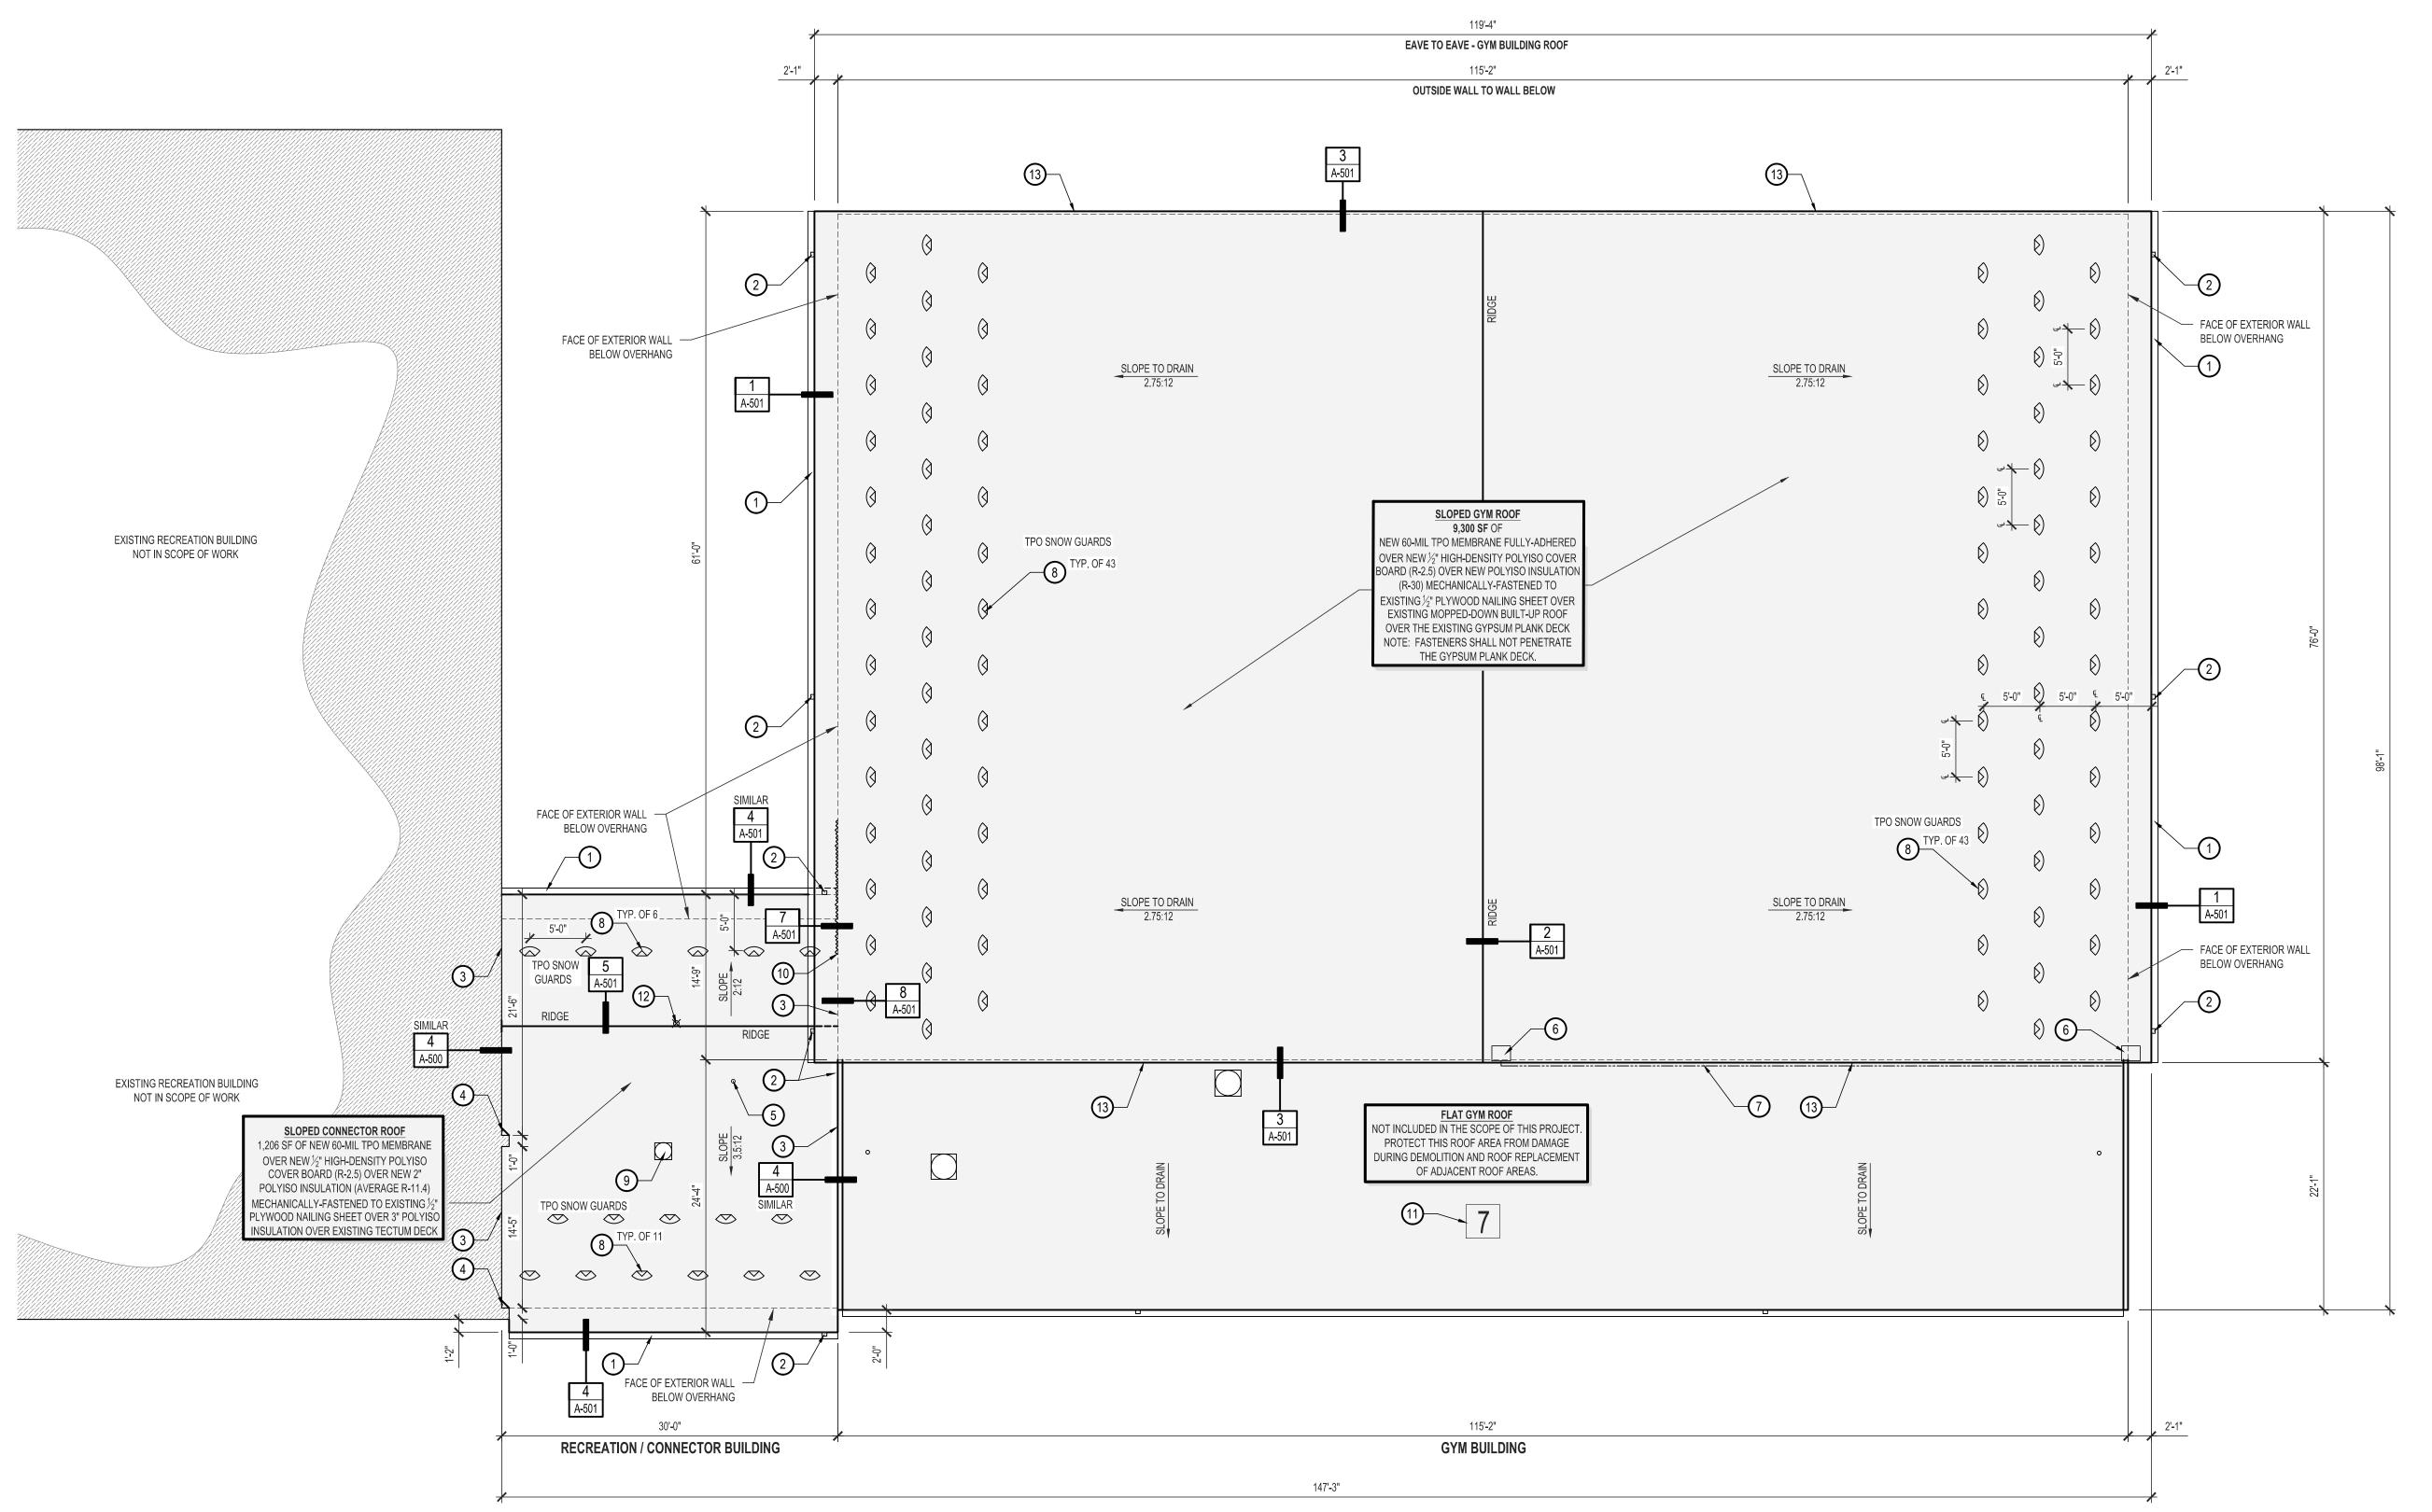
BUILDING IDENTIFICATION SIGNAGE NOTE:

. LETTERING AND BACKGROUND SHALL BE REFLECTIVE. 2. SIGN SHALL BE FABRICATED FROM 36" x 36" x .080" ALUMINUM SHEET WITH SMOOTH FINISH. 3. THE CHARACTERS (BUILDING NUMBER) SHALL BE ARIAL FONT, MINIMUM 32" HIGH WITH 3" STROKE FABRICATED FROM 3M #1178 BLACK ELECTROCUT ACRYLIC SHEET WITH PRESSURE-SENSITIVE ADHESIVE BACK APPLIED OVER REFLECTIVE BACKGROUND. 4. REFLECTIVE BACKGROUND SHALL BE 3M #3930 SILVER/WHITE HIGH INTENSITY PRISMATIC

REFLECTIVE SHEETING WITH PRESSURE-SENSITIVE ADHESIVE APPLIED TO ALUMINUM SHEET. 5. SIGN SHALL BE FULLY-ADHERED TO TPO WALK PAD LAMINATED TO THE TPO MEMBRANE WITH ADHESIVE COMPATIBLE WITH THE ROOF MEMBRANE MANUFACTURER'S WARRANTY.



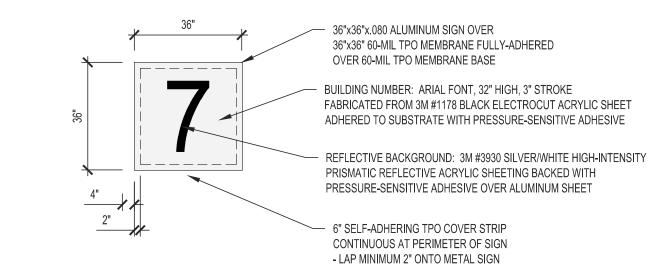






RECREATION / CONNECTOR - ROOF REPLACEMENT PLAN SCALE: 1/8" = 1'-0" ASSET NUMBER - 9327005023





STATE OF MISSOURI MICHAEL L. PARSON, **GOVERNOR**

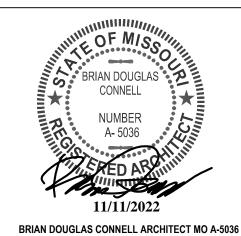

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Walnut Stree



OFFICE OF ADMINISTRATION DIVISION OF FACILITIES MANAGEMENT, DESIGN AND CONSTRUCTION

MISSOURI DEPARTMENT **OF CORRECTIONS**

REPLACE ROOFS -4 BUILDINGS

MOBERLY CORRECTIONAL **CENTER**

5201 SOUTH MORLEY ST MOBERLY, MO 65233

PROJECT No. C1913-01 7005 SITE No. **ASSET No.** 9327005022,

9327005023

REVISION: REVISION: DATE: REVISION: DATE:

ISSUE DATE: 11/11/2022

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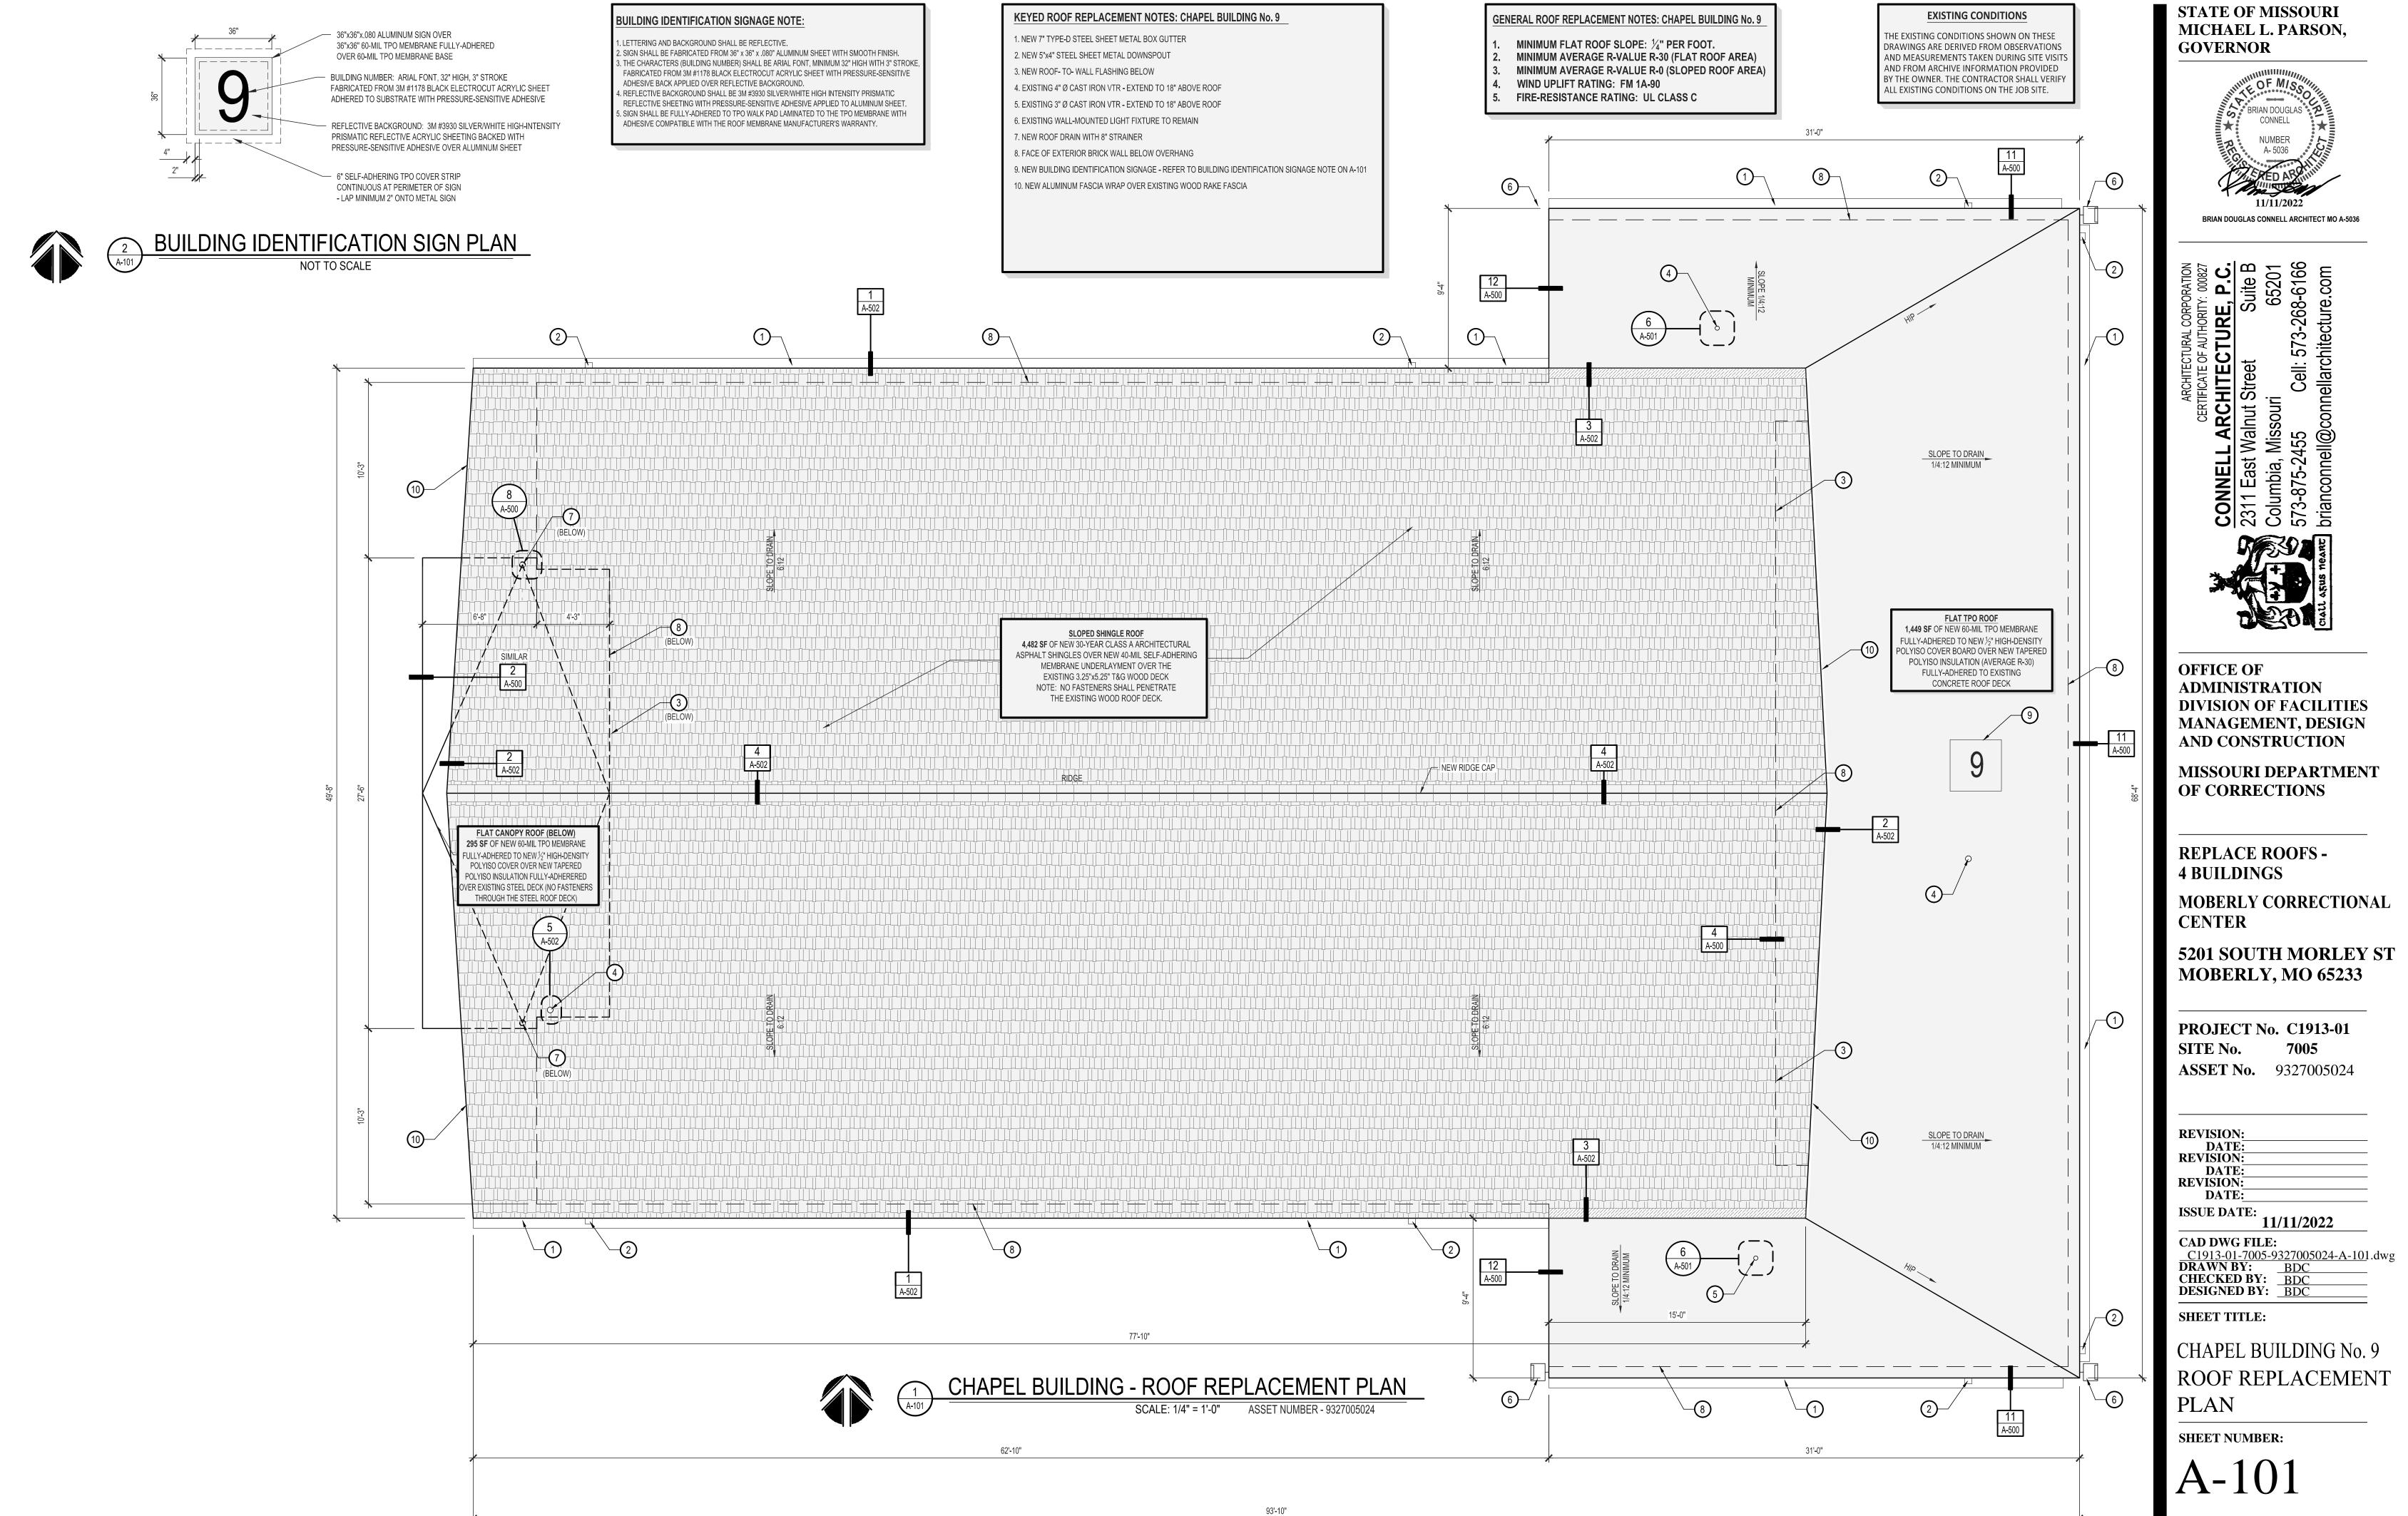
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RECREATION / CONNECTOR & GYM BUILDING No. 7 ROOF REPLACEMENT PLAN


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A-100

SHEET 6 OF 11 **ISSUE DATE: 11/11/2022**



SHEET 7 OF 11 ISSUE DATE: 11/11/2022

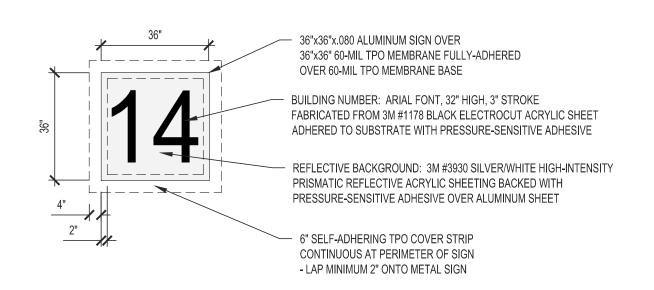

BUILDING IDENTIFICATION SIGN PLAN

NOT TO SCALE

BUILDING IDENTIFICATION SIGNAGE NOTE

2. SIGN SHALL BE FABRICATED FROM 36" x 36" x .080" ALUMINUM SHEET WITH SMOOTH FINISH. . THE CHARACTERS (BUILDING NUMBER) SHALL BE ARIAL FONT, MINIMUM 32" HIGH WITH 3" STROKI FABRICATED FROM 3M #1178 BLACK ELECTROCUT ACRYLIC SHEET WITH PRESSURE-SENSITIVE

. REFLECTIVE BACKGROUND SHALL BE 3M #3930 SILVER/WHITE HIGH INTENSITY PRISMATIC REFLECTIVE SHEETING WITH PRESSURE-SENSITIVE ADHESIVE APPLIED TO ALUMINUM SHEET. . SIGN SHALL BE FULLY-ADHERED TO TPO WALK PAD LAMINATED TO THE TPO MEMBRANE WITH ADHESIVE COMPATIBLE WITH THE ROOF MEMBRANE MANUFACTURER'S WARRANTY.

KEYED ROOF REPLACEMENT NOTES: SIGN SHOP BUILDING No. 14

1. NEW 8" Ø DOME STRAINER OVER EXISTING ROOF DRAIN

2. EXISTING PARAPET - REPLACE DAMAGED 2x4 FRAMING AS REQUIRED

3. EXISTING 4" Ø CAST IRON VTR - EXTEND TO 18" ABOVE ROOF 4. FACE OF EXTERIOR BRICK WALL BELOW OVERHANG

5. NEW BUILDING IDENTIFICATION SIGNAGE - REFER TO BUILDING IDENTIFICATION SIGNAGE NOTE ON A-103

6. EXISTING WALL-MOUNTED EXHAUST FLUE TO REMAIN

7. EXISTING EXHAUST FLUE SUPPORT INTO ROOF-MOUNTED PITCH POCKET - TYPICAL OF 4 LOCATIONS

8. EXISTING WALL-MOUNTED EXHAUST FLUE TO REMAIN


ROOF REPLACEMENT NOTES: SIGN SHOP BUILDING No. 14

- MINIMUM FLAT ROOF SLOPE: $\frac{1}{4}$ " PER FOOT.
- MINIMUM AVERAGE R-VALUE R-30 (FLAT ROOF AREA)
- WIND UPLIFT RATING: FM 1A-90 FIRE-RESISTANCE RATING: UL CLASS C

THE EXISTING CONDITIONS SHOWN ON THESE DRAWINGS ARE DERIVED FROM OBSERVATIONS AND MEASUREMENTS TAKEN DURING SITE VISITS AND FROM ARCHIVE INFORMATION PROVIDED BY THE OWNER. THE CONTRACTOR SHALL VERIFY ALL EXISTING CONDITIONS ON THE JOB SITE.

EXISTING CONDITIONS

STATE OF MISSOURI MICHAEL L. PARSON, **GOVERNOR**

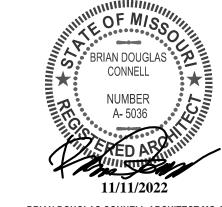

BRIAN DOUGLAS CONNELL ARCHITECT MO A-5036

L ARCHITE
Walnut Stree

OFFICE OF ADMINISTRATION DIVISION OF FACILITIES MANAGEMENT, DESIGN AND CONSTRUCTION

MISSOURI DEPARTMENT OF CORRECTIONS

REPLACE ROOFS -4 BUILDINGS

MOBERLY CORRECTIONAL **CENTER**

5201 SOUTH MORLEY ST MOBERLY, MO 65233

PROJECT No. C1913-01 7005 SITE No. **ASSET No.** 9327005029

REVISION: DATE: **REVISION:** DATE: ISSUE DATE: <u>11/11/2022</u>


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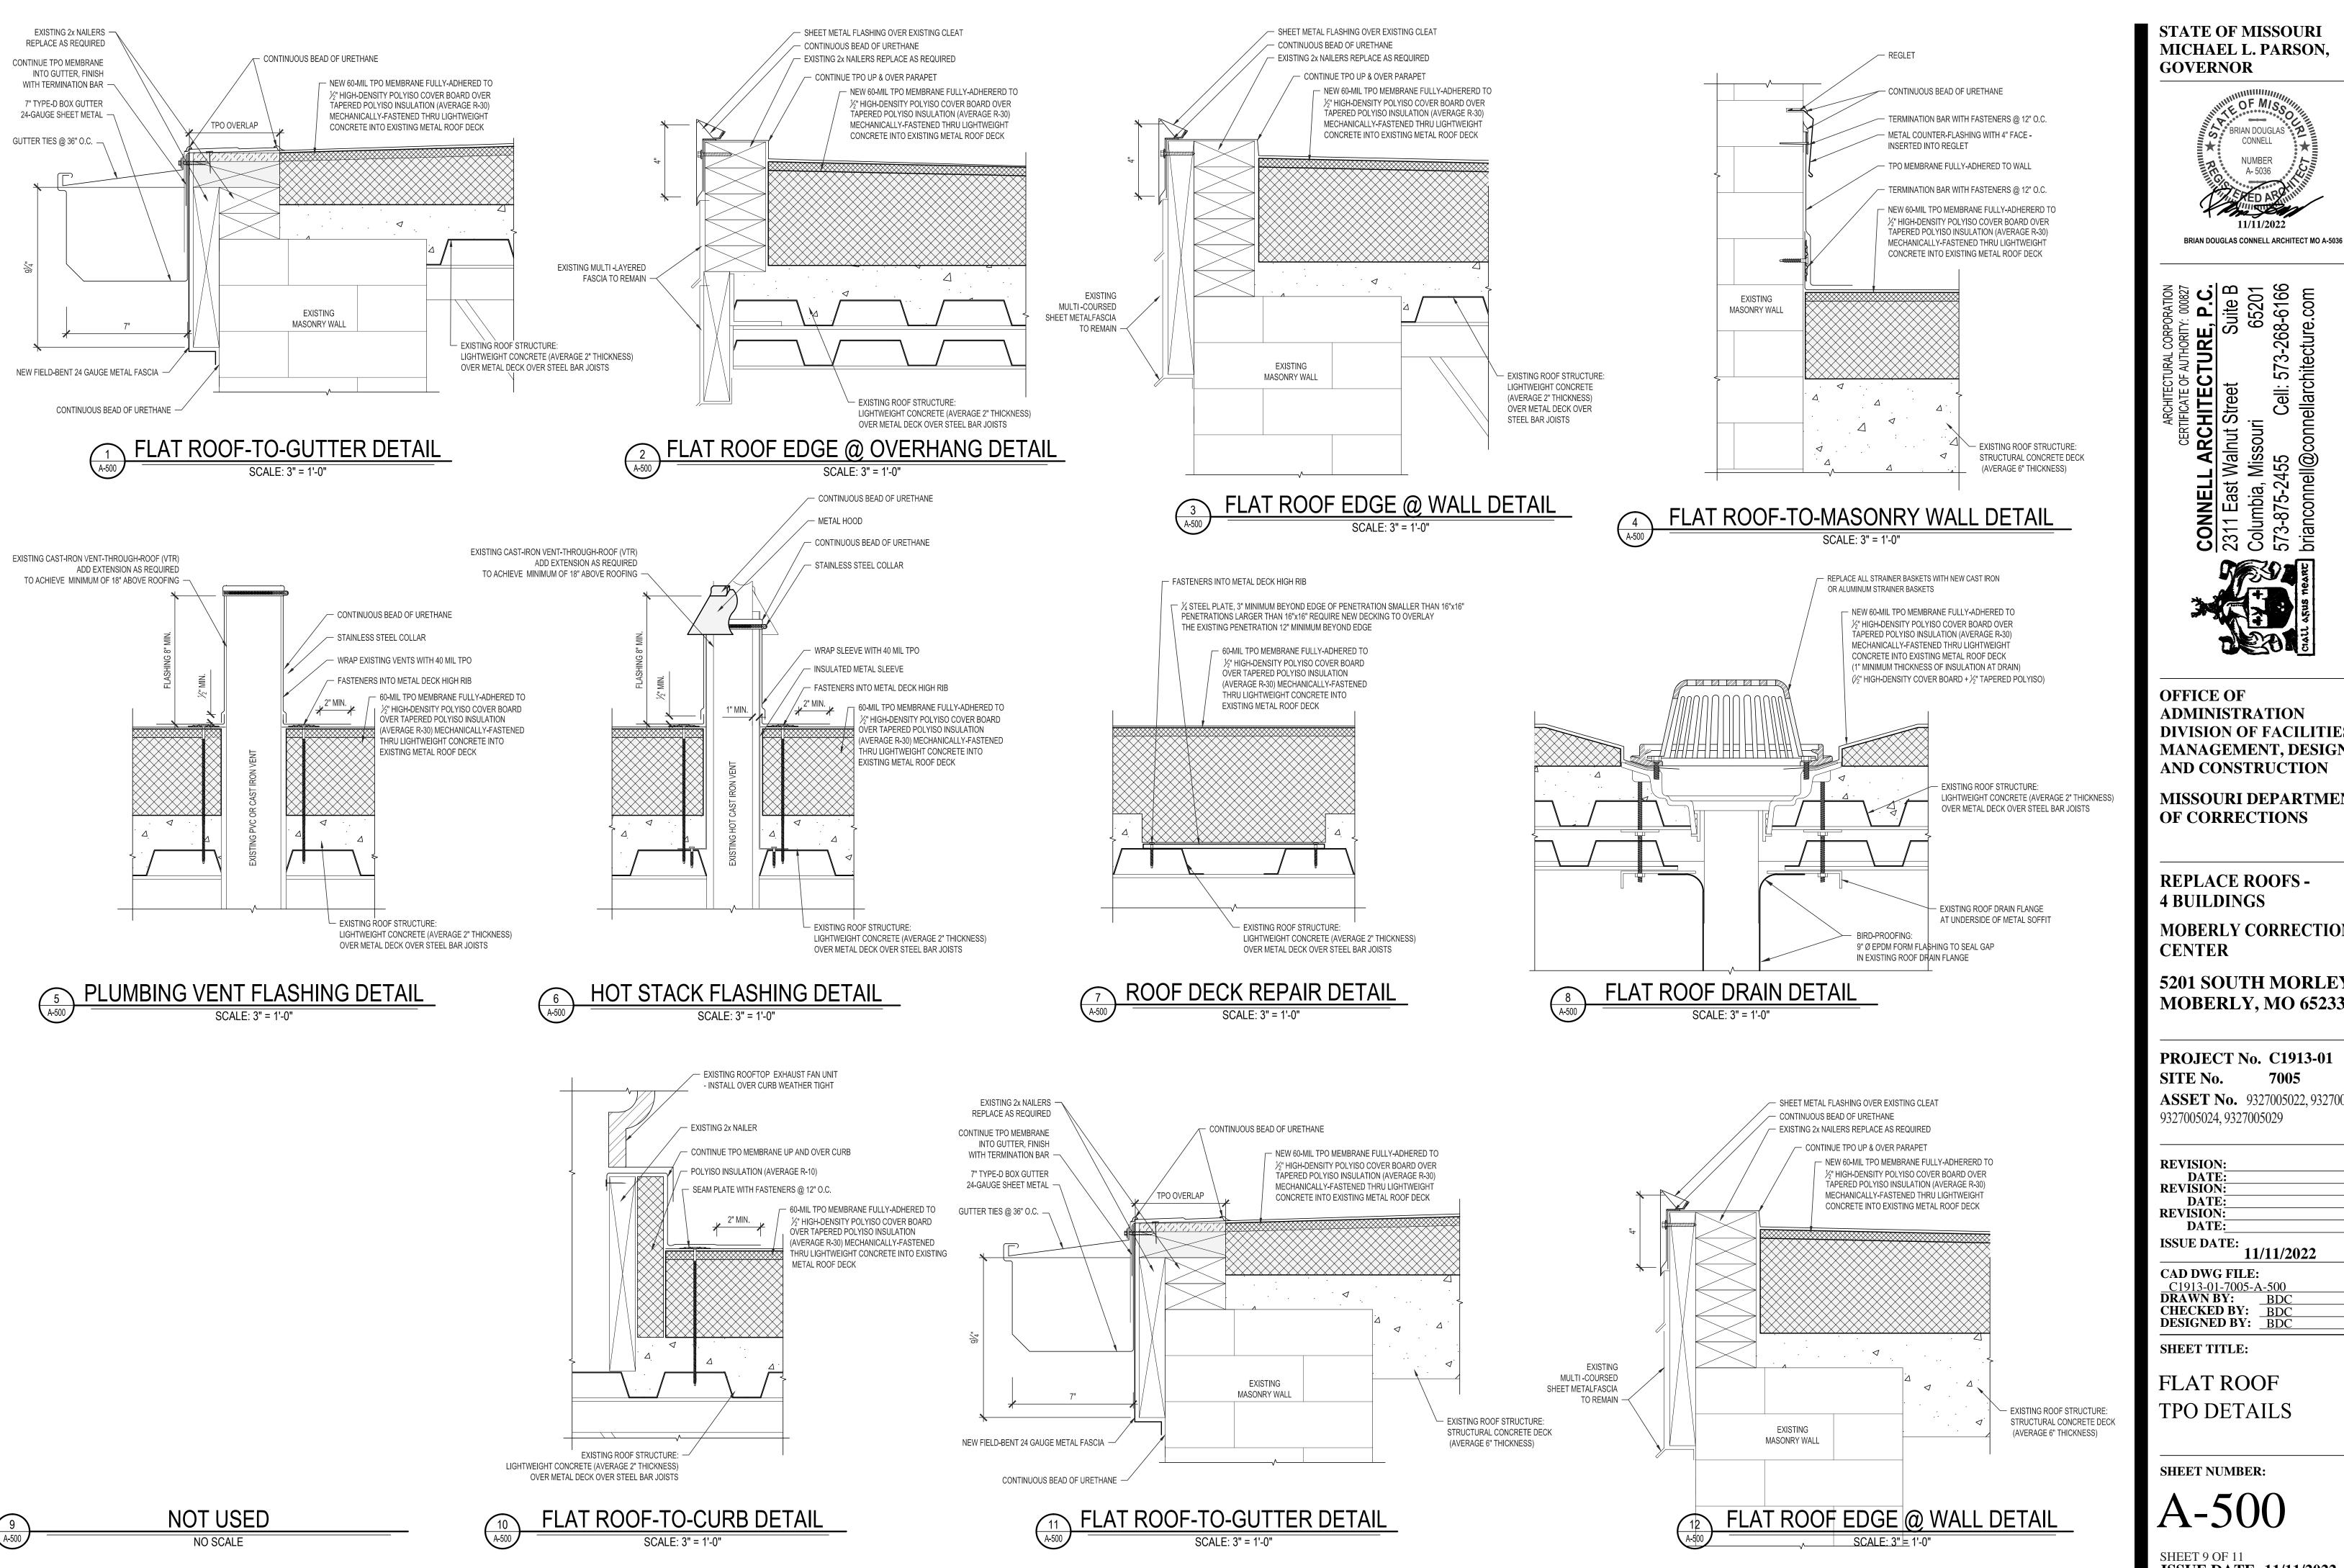
REVISION:

SIGN SHOP BUILDING No. 14 ROOF REPLACEMENT PLAN


SHEET NUMBER:

SHEET 8 OF 11 **ISSUE DATE: 11/11/2022**



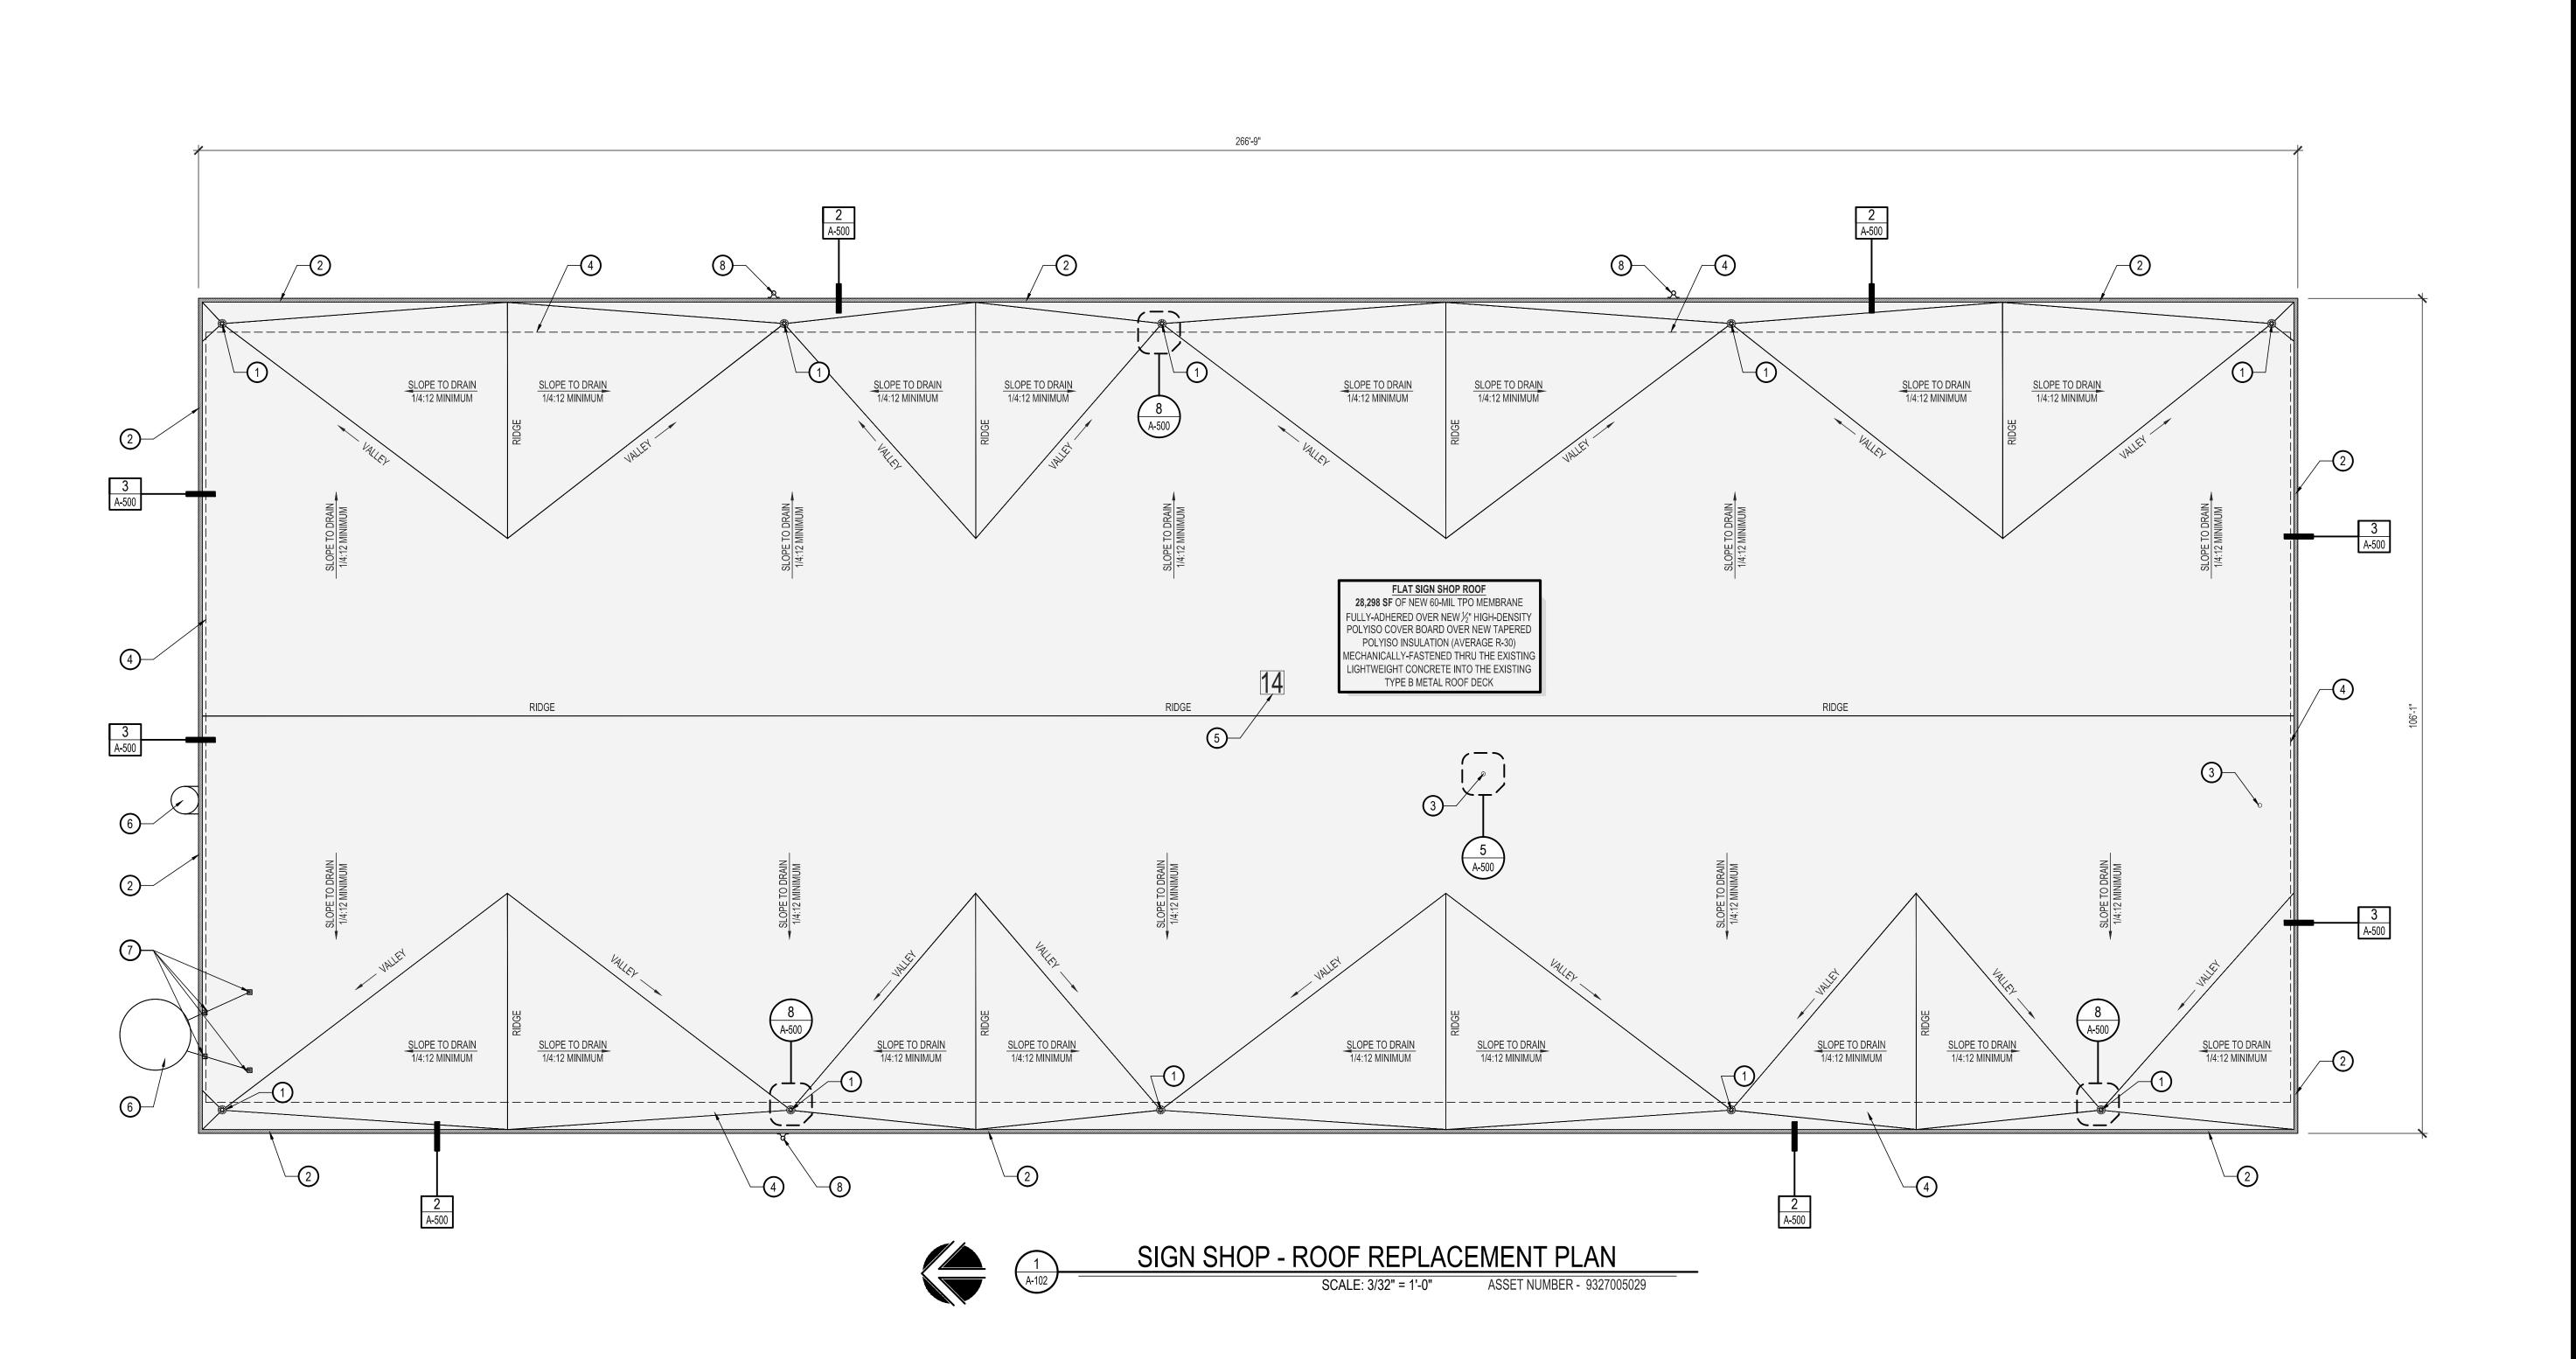

STATE OF MISSOURI MICHAEL L. PARSON, **GOVERNOR**

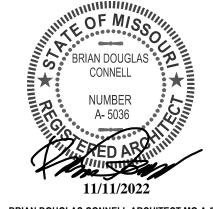

L ARCHI Walnut Str Missouri



OFFICE OF ADMINISTRATION DIVISION OF FACILITIES MANAGEMENT, DESIGN AND CONSTRUCTION

MISSOURI DEPARTMENT **OF CORRECTIONS**

REPLACE ROOFS -4 BUILDINGS

MOBERLY CORRECTIONAL

5201 SOUTH MORLEY ST MOBERLY, MO 65233

PROJECT No. C1913-01 7005

ASSET No. 9327005022, 9327005023, 9327005024, 9327005029

11/11/2022


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CHECKED BY: BDC **DESIGNED BY:** BDC


FLAT ROOF TPO DETAILS

SHEET NUMBER:

ISSUE DATE: 11/11/2022

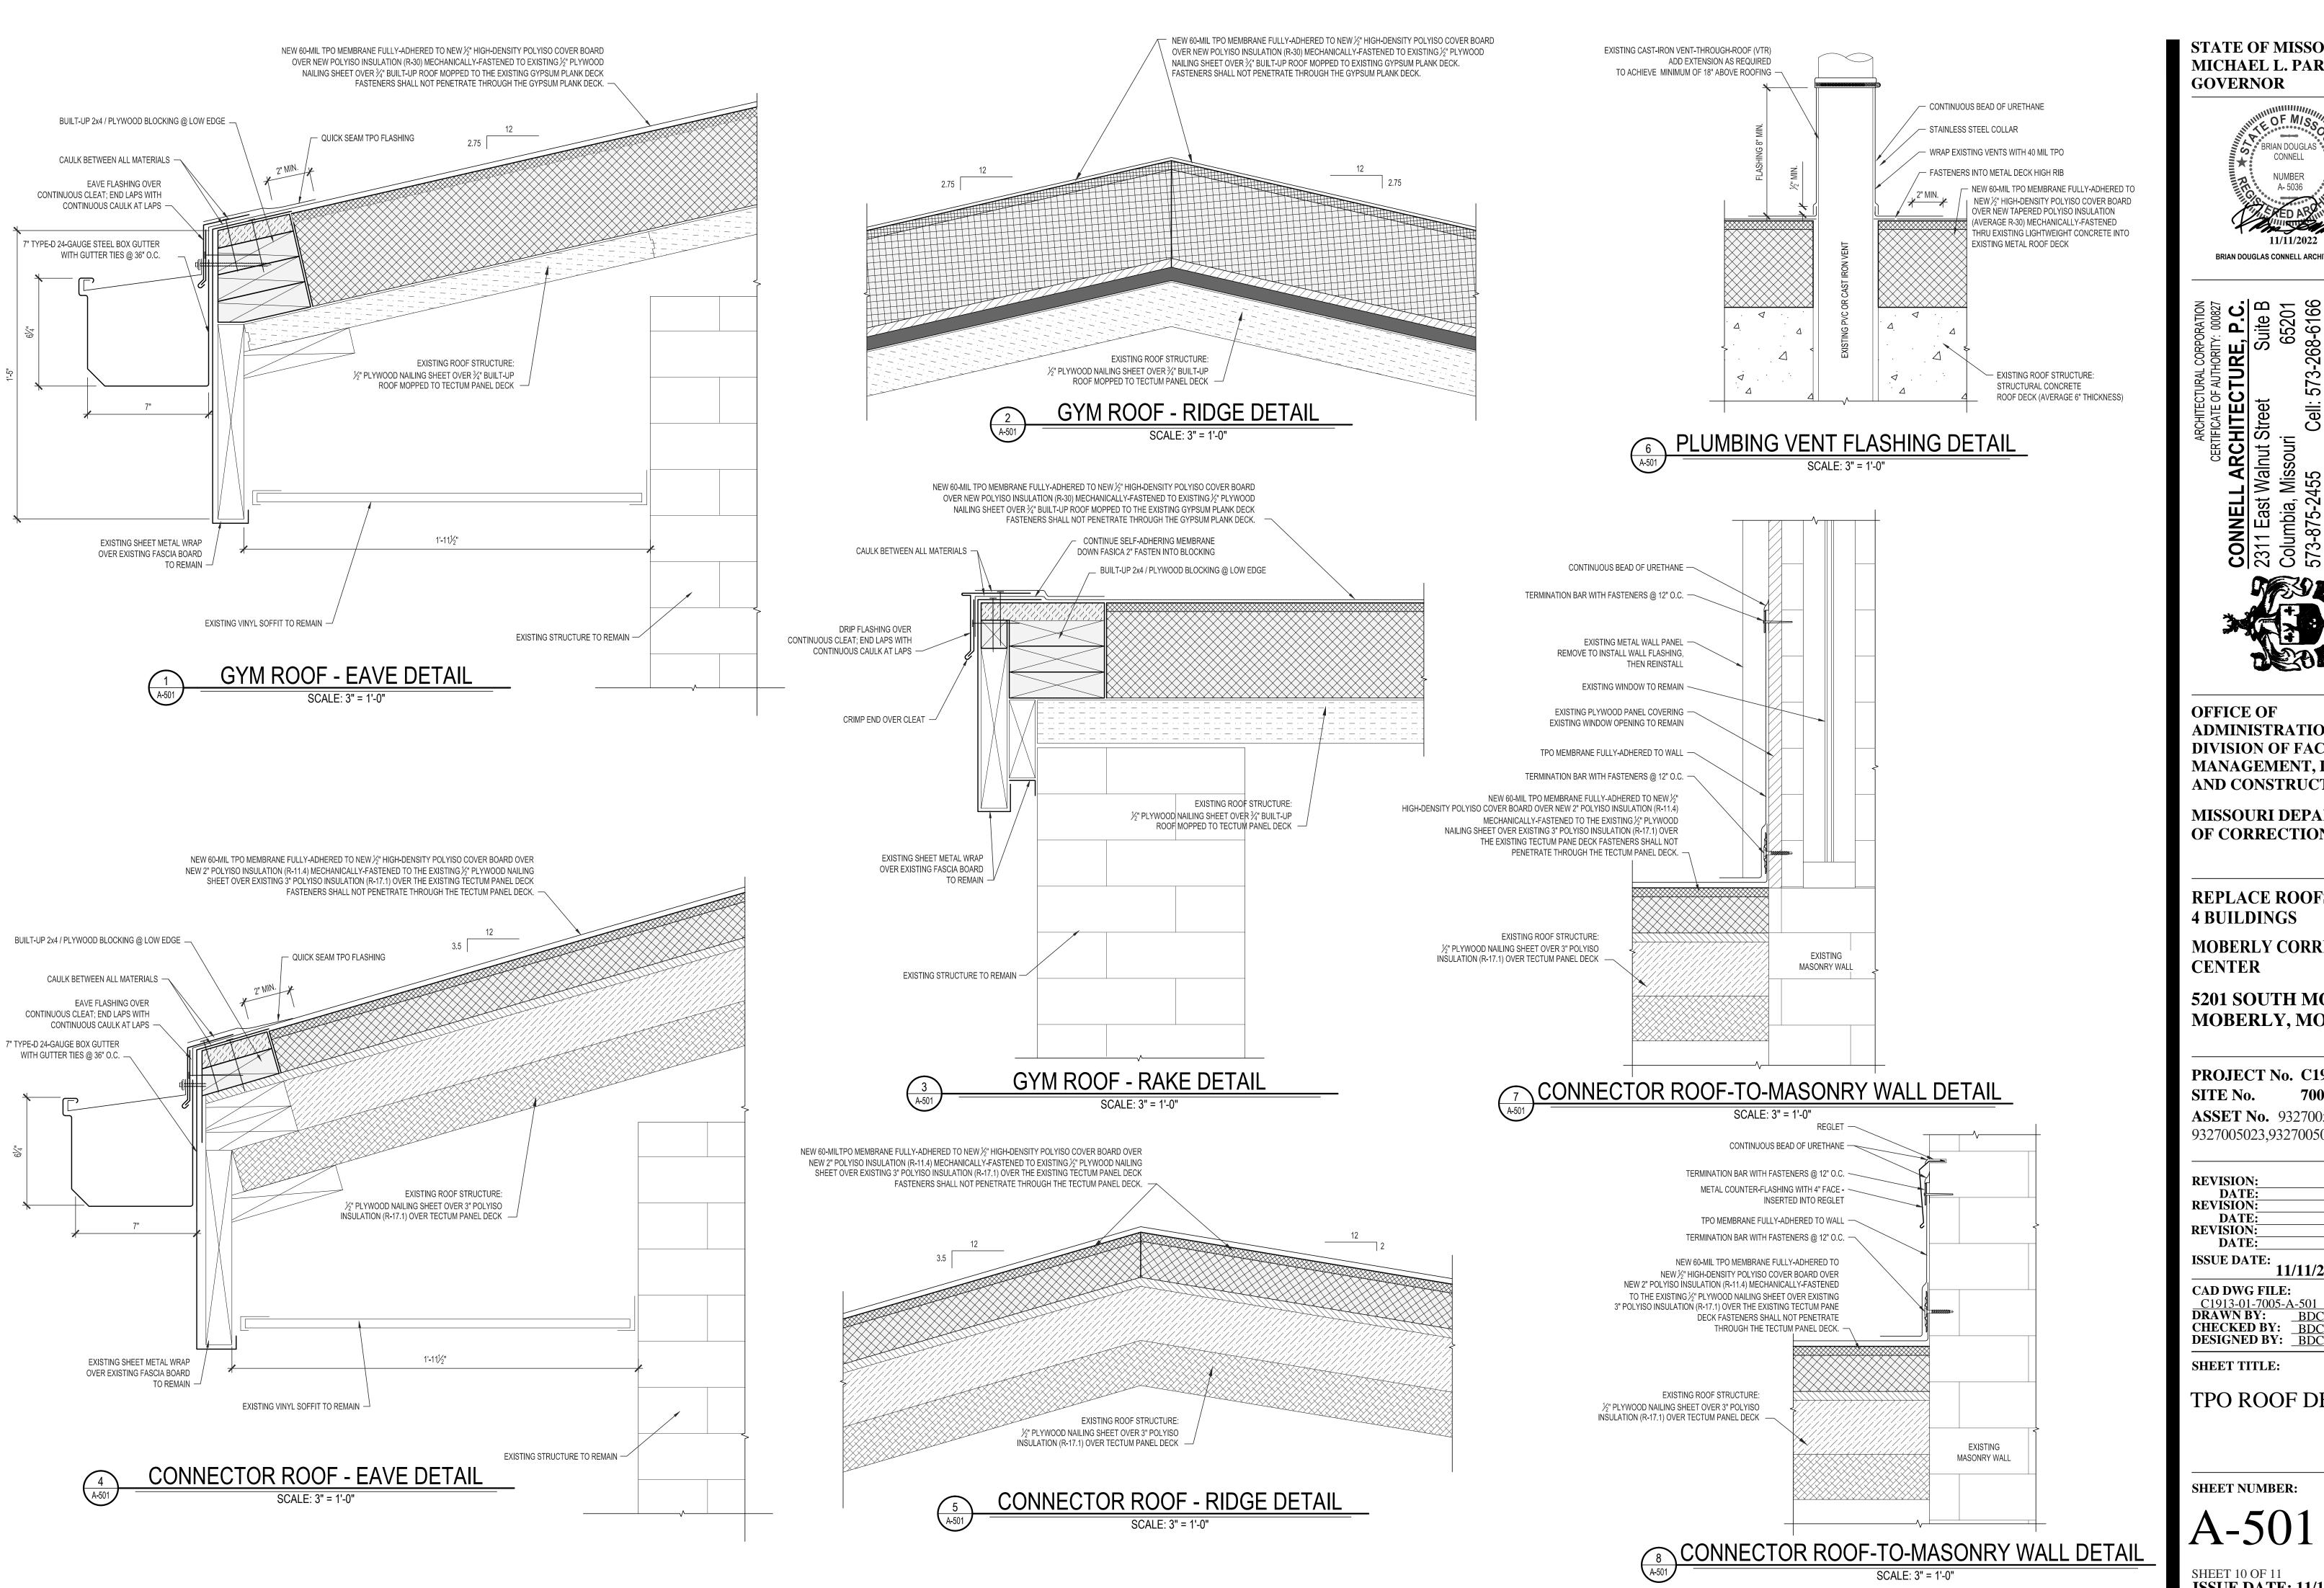

STATE OF MISSOURI MICHAEL L. PARSON, **GOVERNOR**

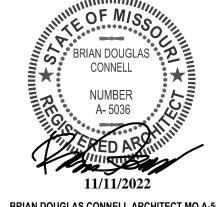

BRIAN DOUGLAS CONNELL ARCHITECT MO A-5036



OFFICE OF ADMINISTRATION DIVISION OF FACILITIES MANAGEMENT, DESIGN AND CONSTRUCTION

MISSOURI DEPARTMENT **OF CORRECTIONS**

REPLACE ROOFS -4 BUILDINGS

MOBERLY CORRECTIONAL CENTER

5201 SOUTH MORLEY ST MOBERLY, MO 65233

PROJECT No. C1913-01 7005 SITE No.

ASSET No. 9327005022 9327005023,9327005024

REVISION: REVISION: DATE: REVISION: DATE:

ISSUE DATE:

11/11/2022


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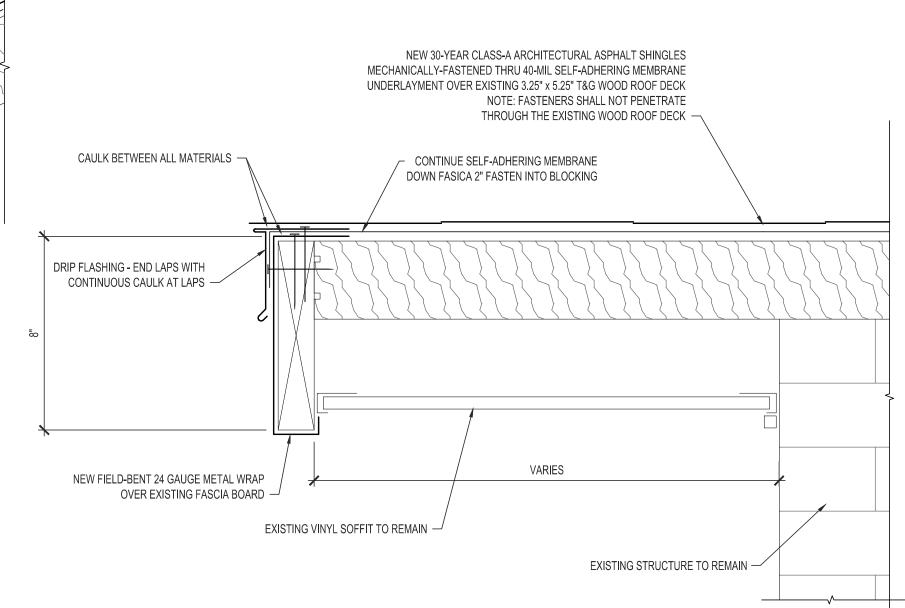
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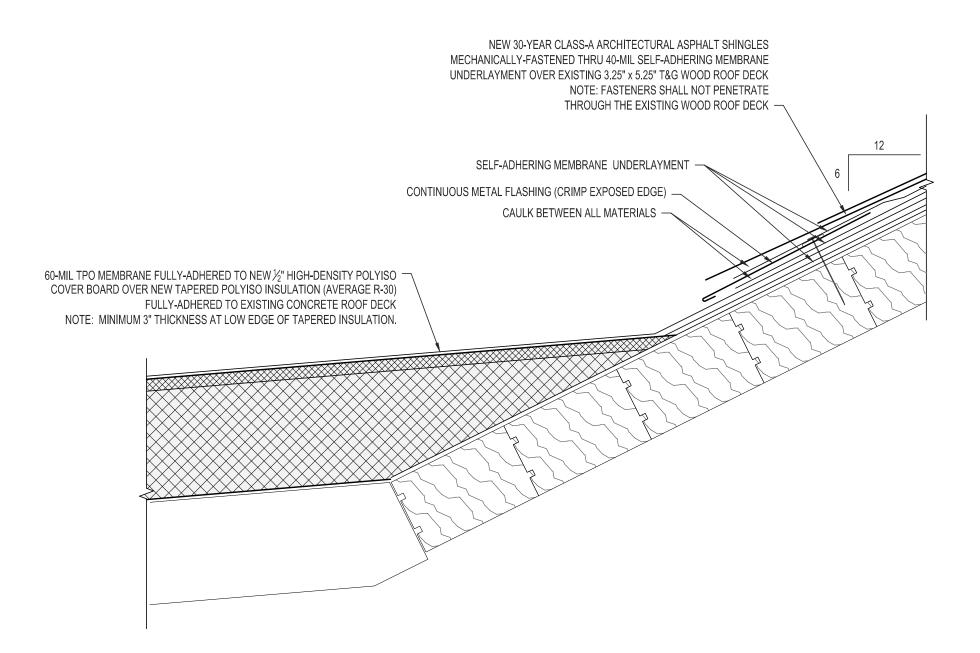
TPO ROOF DETAILS

SHEET NUMBER:

SHEET 10 OF 11 **ISSUE DATE: 11/11/2022**





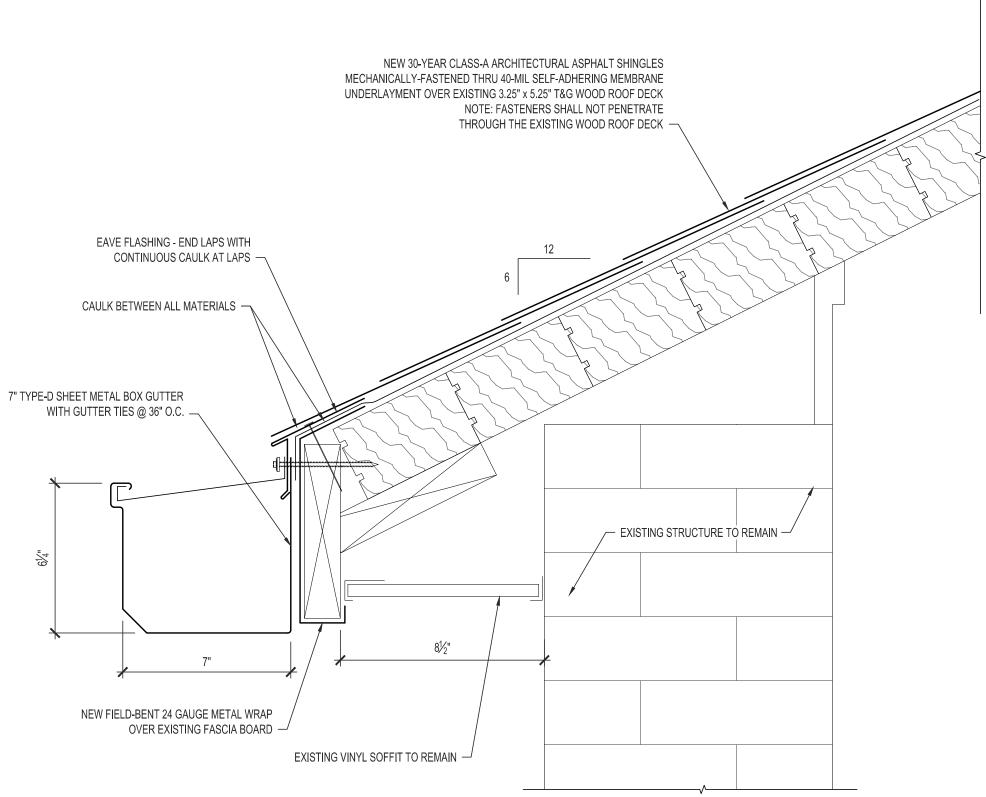


SLOPED CHAPEL ROOF - EAVE DETAIL


SCALE: 3" = 1'-0"

SLOPED CHAPEL ROOF - RAKE DETAIL

SCALE: 3" = 1'-0"

SCALE: 3" = 1'-0"

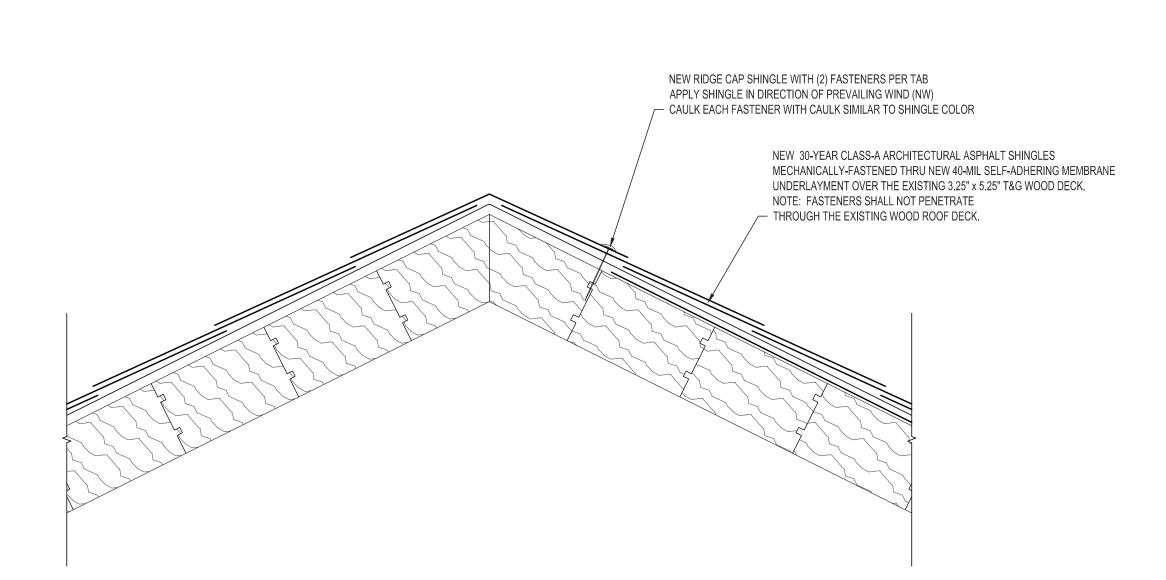

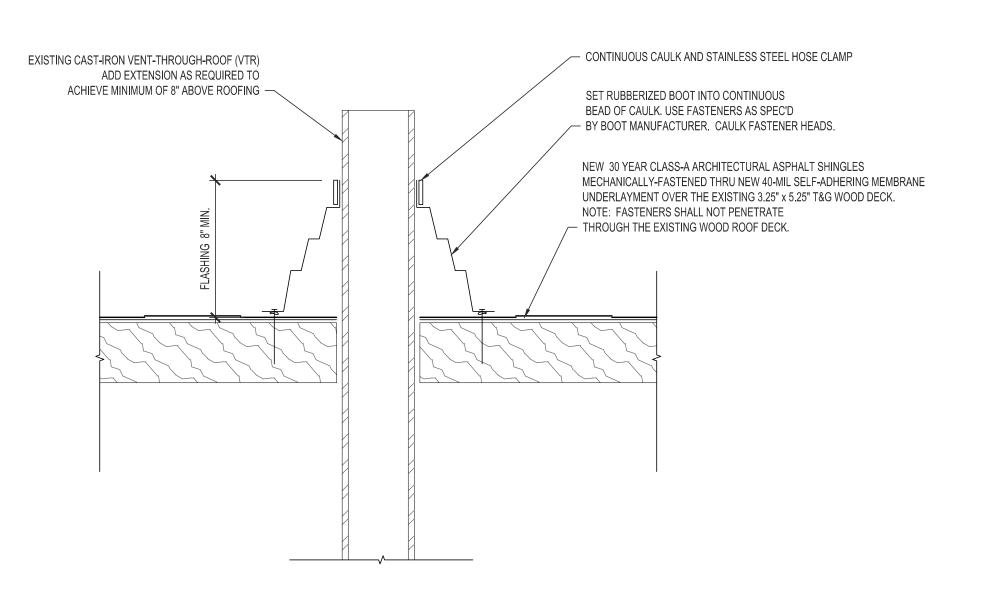


SLOPED CHAPEL ROOF - RIDGE DETAIL

SCALE: 3" = 1'-0"

SLOPED CHAPEL ROOF - VENT FLASHING DETAIL

SCALE: 3" = 1'-0"

STATE OF MISSOURI MICHAEL L. PARSON, GOVERNOR

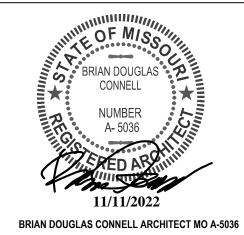

ARCHITECTURE, P.C.

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OFFICE OF
ADMINISTRATION
DIVISION OF FACILITIES
MANAGEMENT, DESIGN

AND CONSTRUCTION

MISSOURI DEPARTMENT OF CORRECTIONS

REPLACE ROOFS -4 BUILDINGS

MOBERLY CORRECTIONAL CENTER

5201 SOUTH MORLEY ST MOBERLY, MO 65233

PROJECT No. C1913-01 SITE No. 7005 ASSET No. 9327005024

REVISION:
DATE:
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DATE:
REVISION:
DATE:

ISSUE DATE: 11/11/2022

DESIGNED BY: BDC

SHEET TITLE:

SLOPED ROOF SHINGLE DETAILS

SHEET NUMBER:

A-502

SHEET 11 OF 11 ISSUE DATE: 11/11/2022