

REPLACE ROOFS MULTIPLE ASSETS OZARK CORRECTIONAL CENTER FORDLAND , MISSOURI

OWNER: STATE OF MISSOURI
MICHAEL L. PARSON,
GOVERNOR

DEPARTMENT OF
CORRECTIONS

PROJECT
MANAGEMENT: OFFICE OF ADMINISTRATION
DIVISION OF FACILITIES MANAGEMENT,
DESIGN AND CONSTRUCTION

DESIGNER: STATE OF MISSOURI - OFFICE OF ADMINISTRATION
DIVISION OF FACILITIES MANAGEMENT DESIGN
AND CONSTRUCTION: 301 W. HIGH STREET,
JEFFERSON CITY, MO. 65102


PROJECT NUMBER: C2004-01

ASSET NUMBER: 9327003025-FOOD SERVICE (BASE BID)
9327003018-RECORDS AND P&P (BASE BID)
9327003017-ADMINISTRATION (ALTERNATE #2)
9327003019-SEGREGATION (ALTERNATE #1)
9327003033-POWER PLANT (BASE BID)


SHEET NUMBER:

G-001

1 OF 7 SHEETS
MARCH 17, 2023

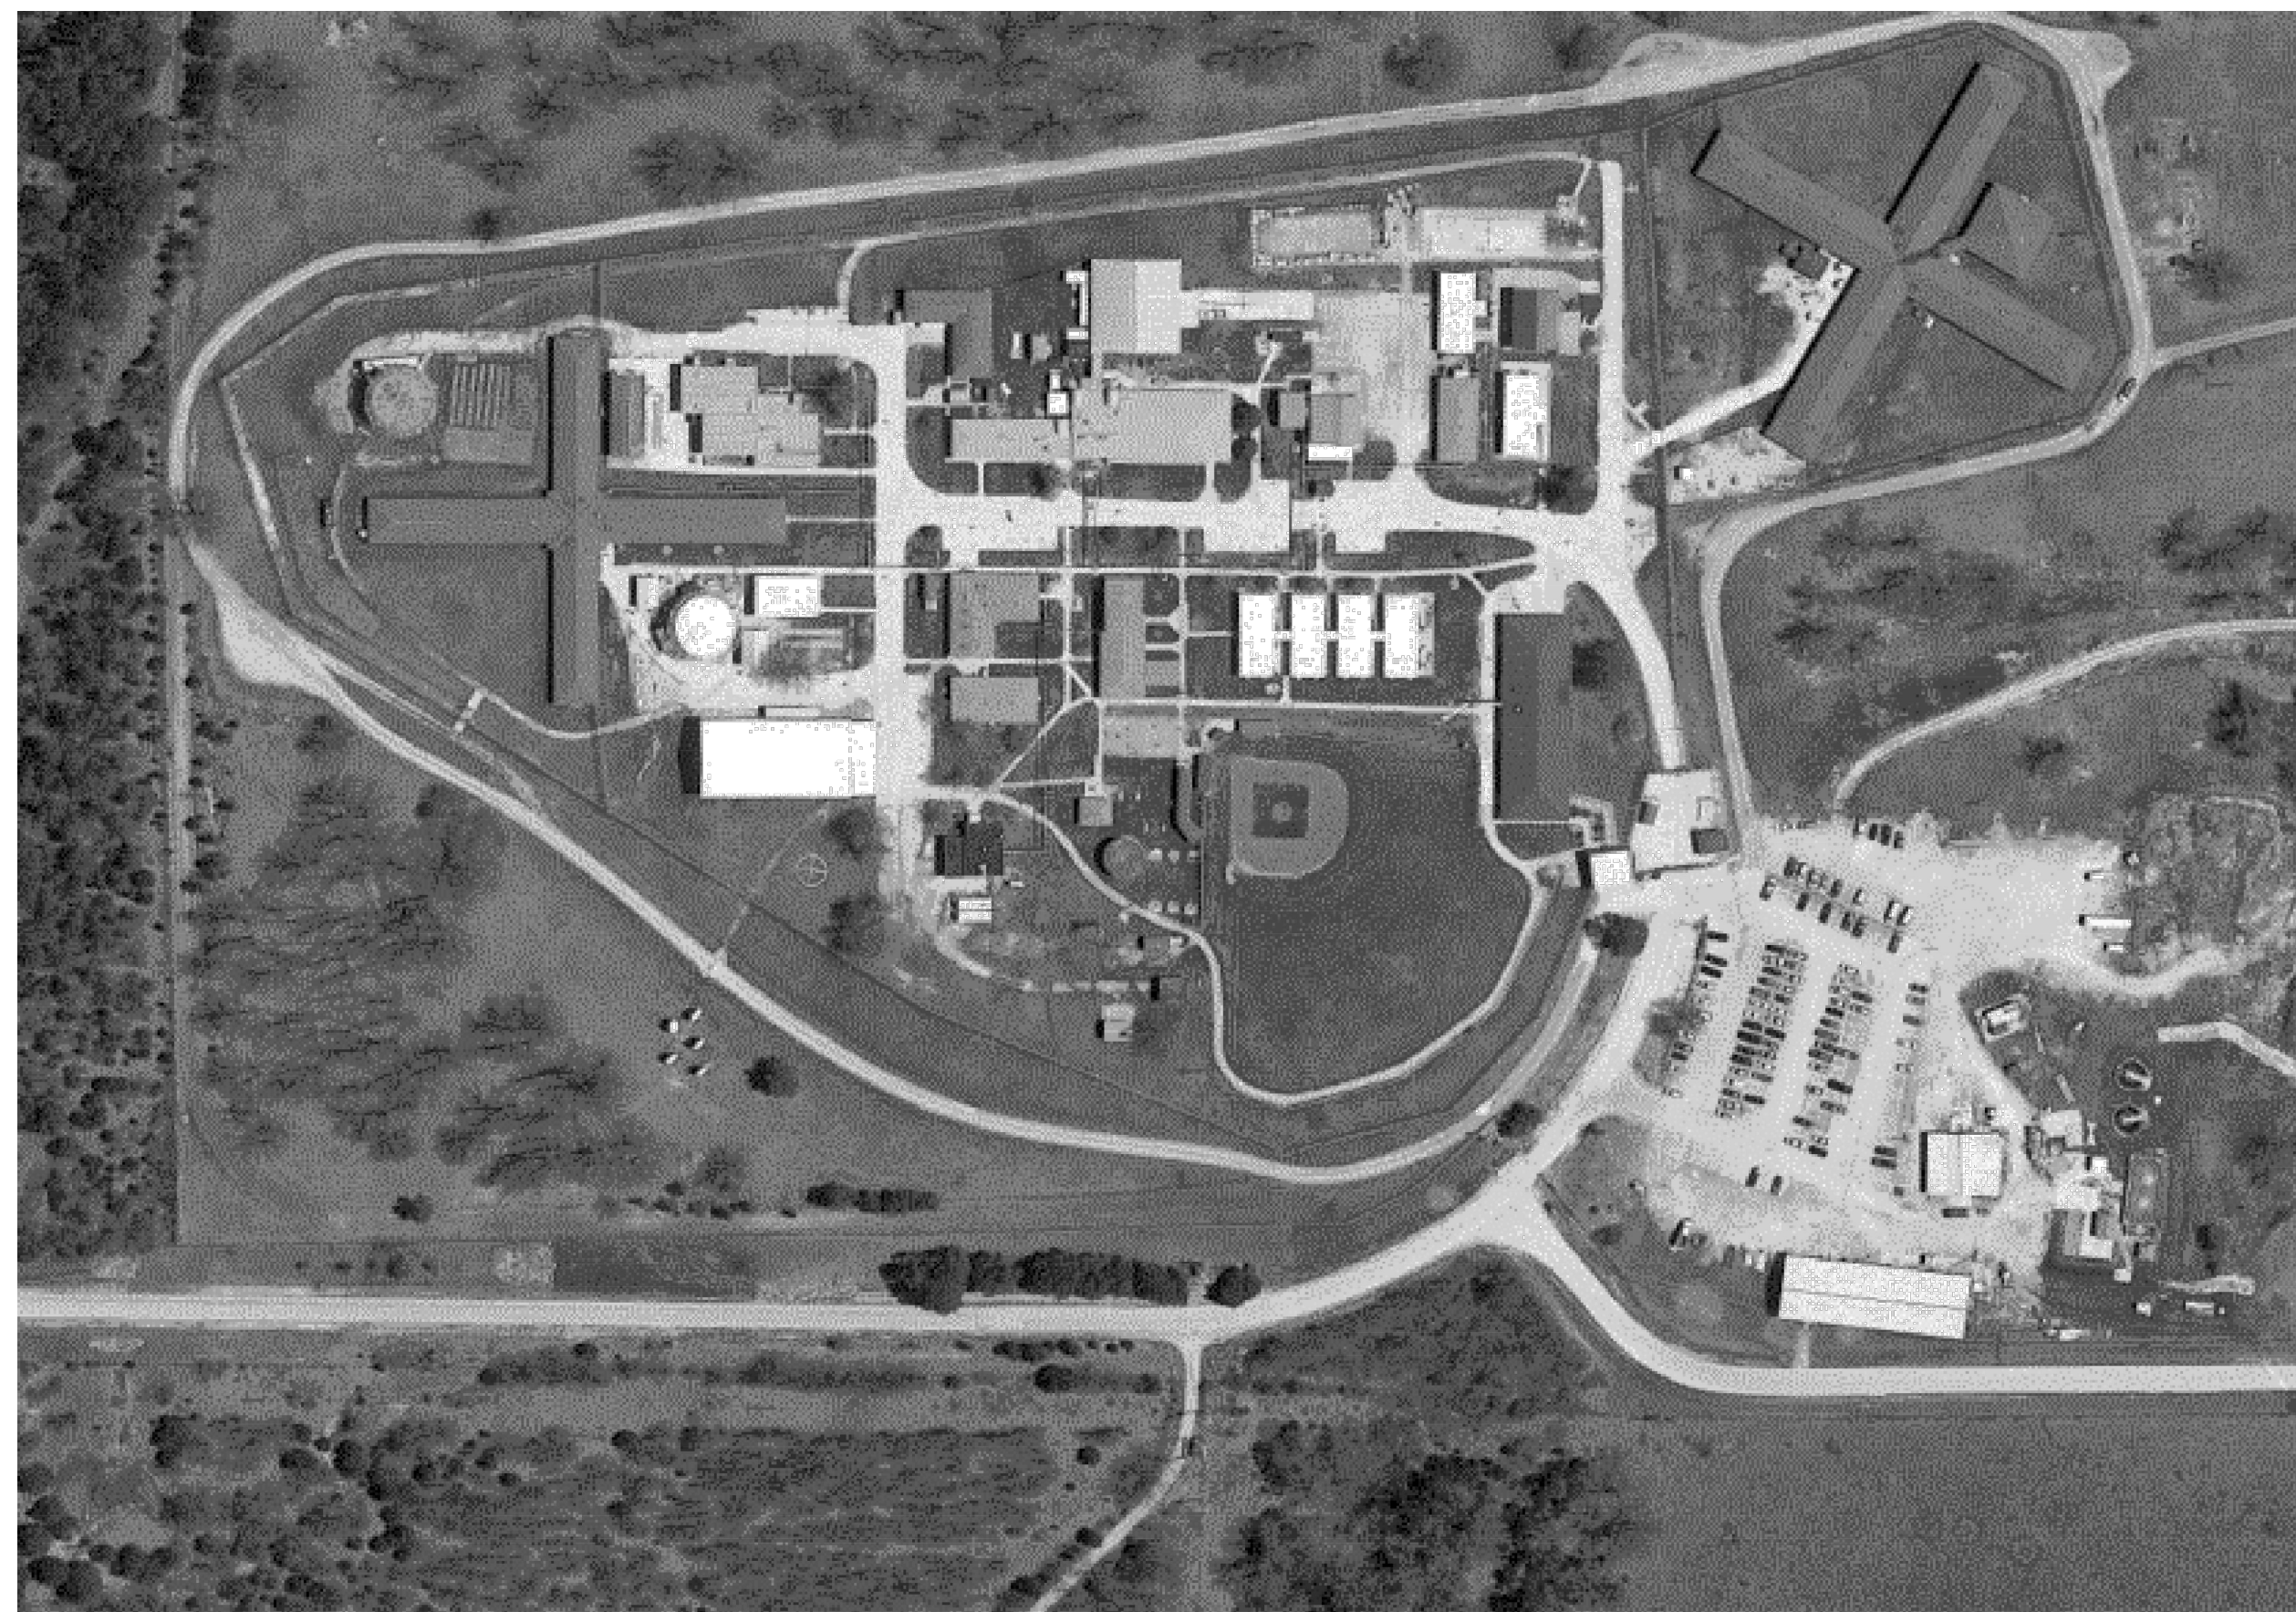

1 SITE LOCATION MAP
N.T.S.

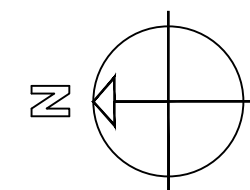


DRAWING INDEX


G-001 COVER SHEET
G-002 OVERALL SITE PLAN AND DRAWING INDEX

ARCHITECTURAL

A-101 FOOD SERVICE/RECORDS AND P&P BUILDING ROOF PLAN
A-102 SEGREGATION BUILDING ROOF PLAN
A-103 ADMINISTRATION BUILDING ROOF PLAN
A-104 POWERPLANT BUILDING ROOF PLAN
A-501 ROOF DETAILS

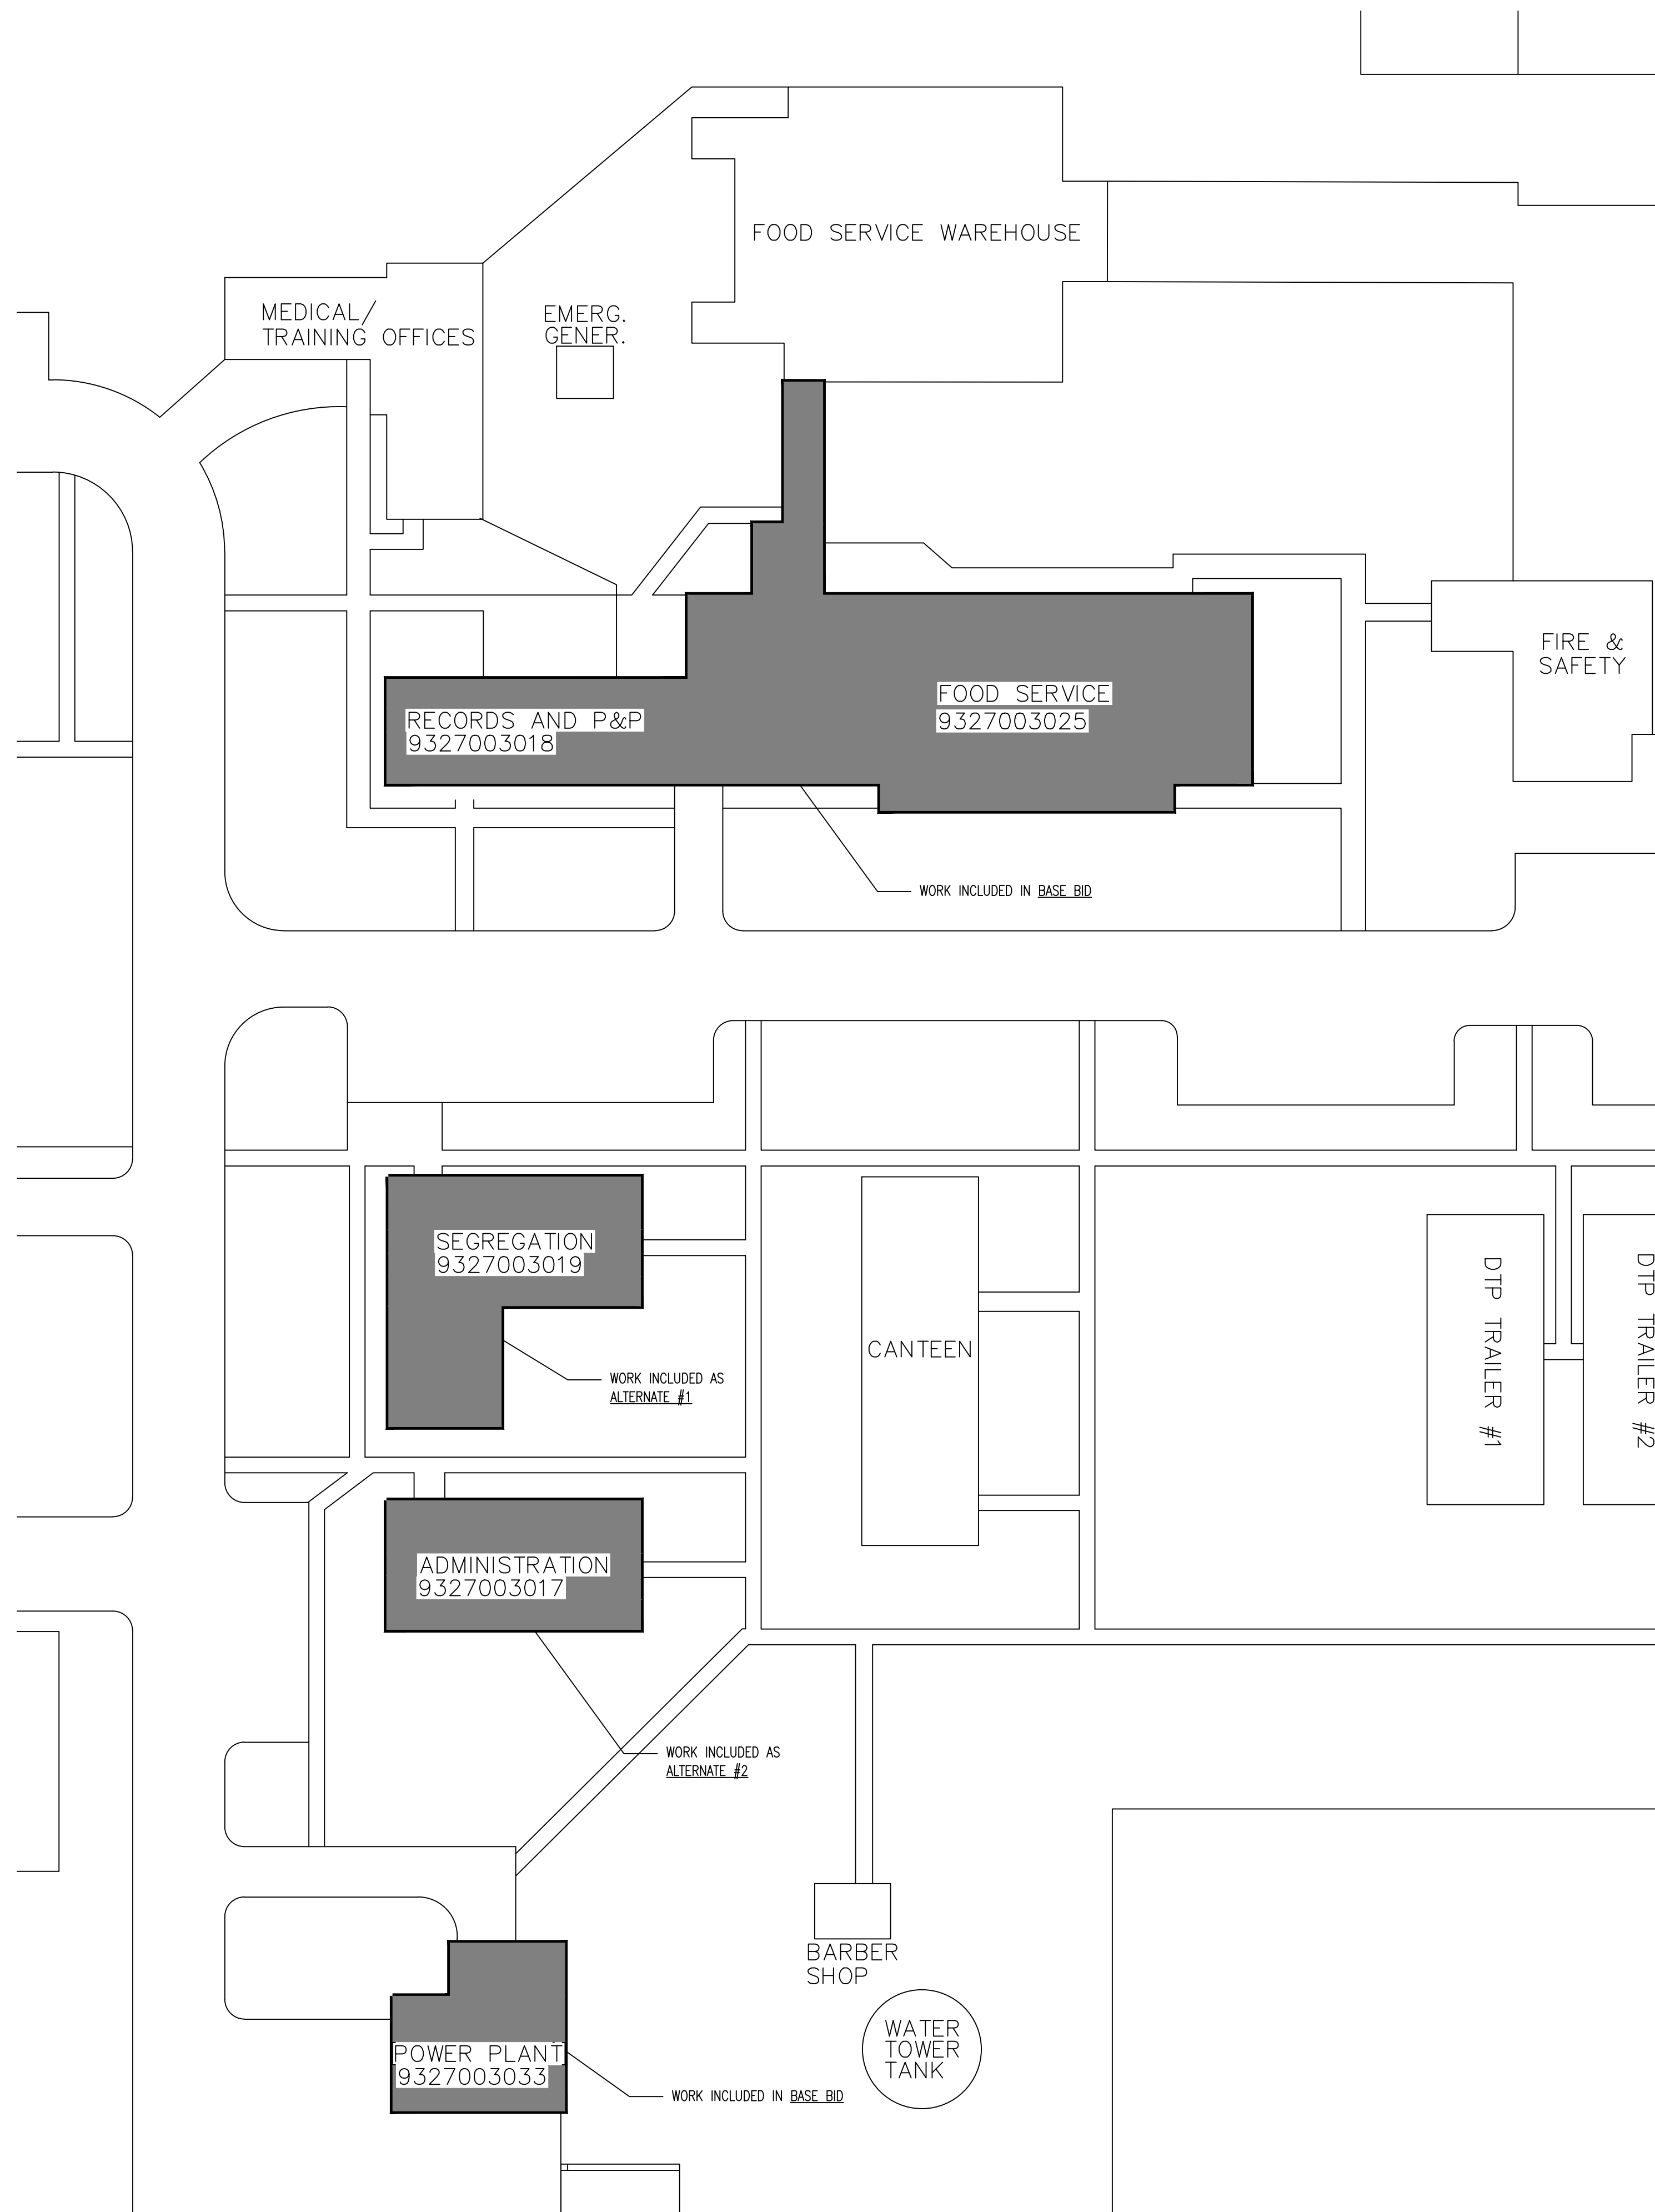

2 OVERALL SITE PLAN
N.T.S.

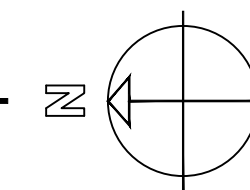

OFFICE OF ADMINISTRATION
DIVISION OF FACILITIES
MANAGEMENT,
DESIGN AND CONSTRUCTION

DEPARTMENT OF
CORRECTIONS

REPLACE ROOFS
MULTIPLE ASSETS

OZARKS CORRECTIONAL
CENTER
929 HONOR CAMP LANE
FORDLAND, MO 65652

PROJECT # C2004-01
SITE # 7003

ASSET #
9327003025-FOOD SERVICE
9327003018-RECORDS AND P&P
9327003017-ADMINISTRATION
9327003019-SEGREGATION
9327003033-POWER PLANT

REVISION: _____
DATE: _____
REVISION: _____
DATE: _____
REVISION: _____
DATE: _____

ISSUE DATE: 3/17/2023

CAD DWG FILE: CB
DRAWN BY: CB
CHECKED BY: BMS
DESIGNED BY: BMS


SHEET TITLE:

**OVERALL SITE PLAN
AND DRAWING
INDEX**

SHEET NUMBER:

G-002

2 OF 7 SHEETS
DATE: 3/17/2023

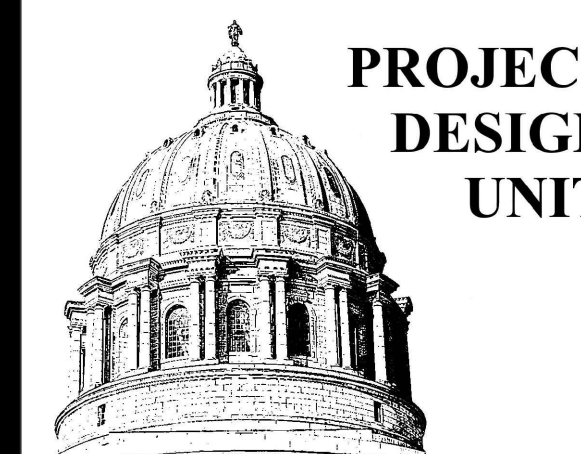

SOFFIT AND FLASHING
TO REMAIN
SIDING TO BE REMOVED
AND REPLACED.
RE: SPECIFICATIONS

3 EXISTING GABLE IMAGE
REFER TO NOTE "K"




EQUIPMENT AND FLASHING
TO REMAIN
SIDING TO BE REMOVED
AND REPLACED.
RE: SPECIFICATIONS

4 EXISTING EXHAUST PENETRATION
REFER TO NOTES "K" AND "H"



EQUIPMENT AND FLASHING
TO REMAIN
SIDING TO BE REMOVED
AND REPLACED.
RE: SPECIFICATIONS

5 EXISTING EQUIPMENT PLATFORM
REFER TO NOTES "K" AND "H"

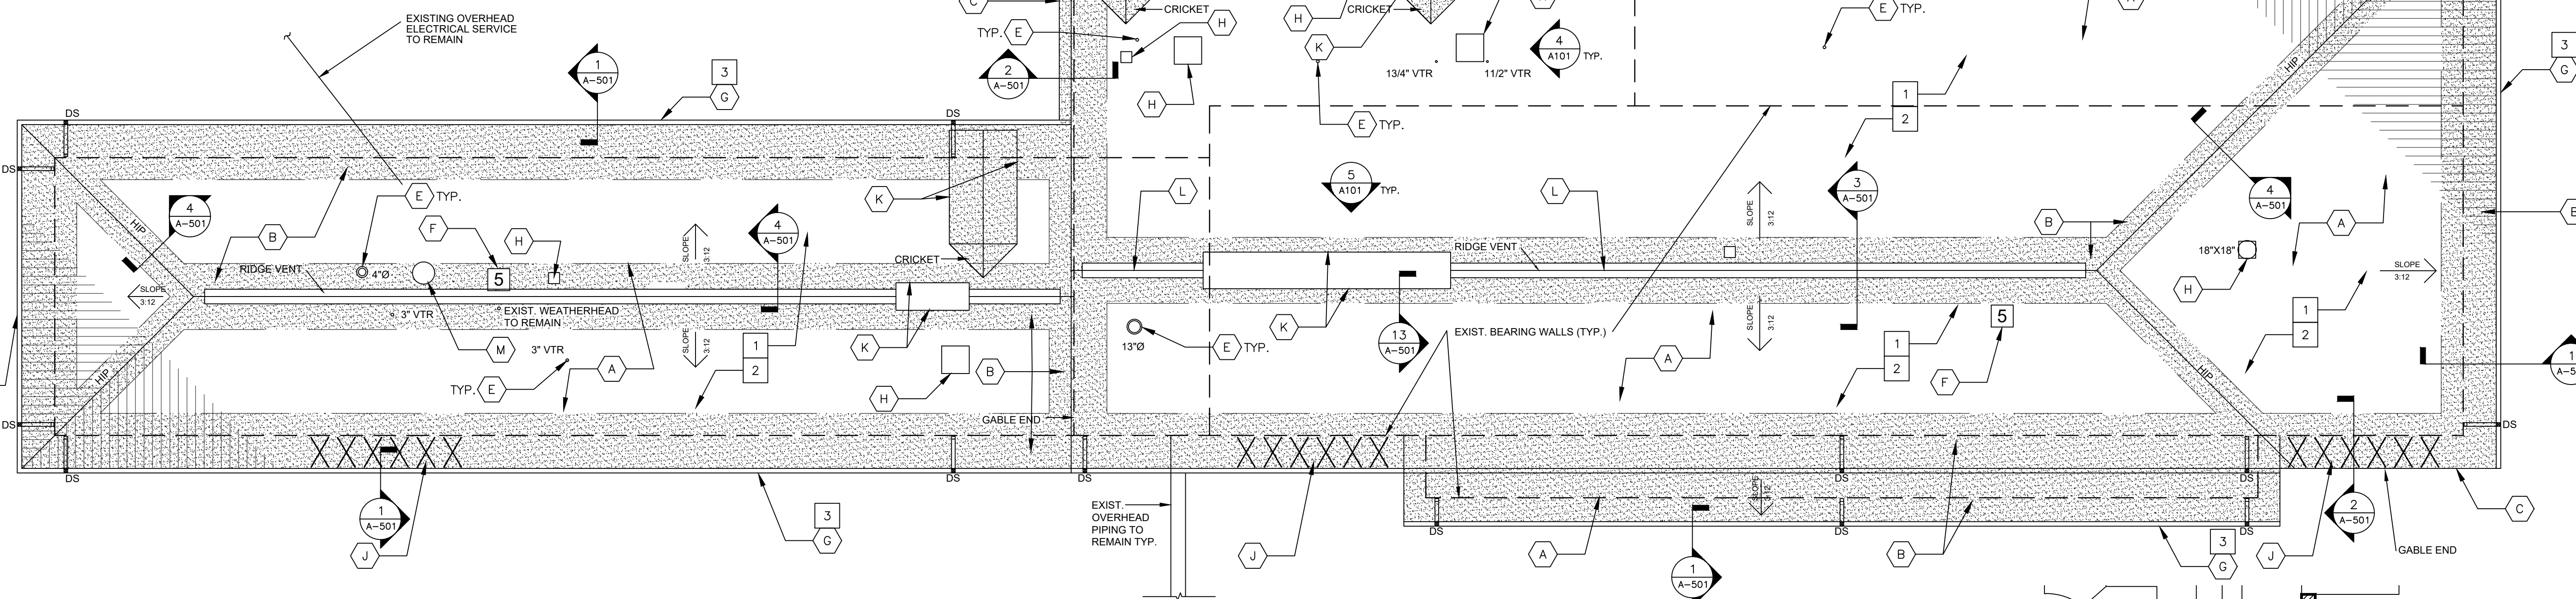

1 FOOD SERVICE/RECORDS AND P&P BUILDING ROOF PLAN
1/8" = 1'-0"

NOTE: ALL WORK INCLUDED FOR FOOD SERVICE/RECORDS P&P BUILDING WILL BE BID AS "BASE BID"

HAZARDOUS MATERIAL NOTES:

- ASBESTOS CAULK WAS IDENTIFIED. AVOID CONTACT WITH THIS ASBESTOS MATERIAL. DO NOT SCRAPE, ABRABE OR OTHERWISE IMPACT THE ASBESTOS.
- THE LOCATIONS OF WASTE DISPOSAL CONTAINERS SHALL BE FIELD VERIFIED WITH THE CORRECTIONAL CENTER AND/OR THE CORRECTIONAL CENTER'S REPRESENTATIVE.
- REFER TO SPECIFICATIONS FOR REQUIREMENTS FOR HAZARDOUS MATERIAL ABATEMENT.

GENERAL ROOFING NOTES:

- ALL ROOFING SHALL BE DONE IN ACCORDANCE WITH THE LATEST ADDITION OF THE NATIONAL ROOFING CONTRACTORS ASSOCIATION (NRCA) ROOFING MANUAL AND ASHRAE AS IT SIMILARLY RELATES TO ARCHITECTURAL METAL ROOFING AND EQUIPMENT.
- EXISTING CONDITIONS AND DIMENSIONS AS SHOWN ON THESE DRAWINGS ARE APPROXIMATIONS. ACTUAL CONDITIONS AND DIMENSIONS MAY VARY. CONTRACTORS SHALL VERIFY EXISTING CONDITIONS AND DIMENSIONS TO THE EXTENT THAT IT WOULD MAKE A DIFFERENCE TO THEIR BID. NO ADDITIONAL COST TO THE OWNER WILL BE CONSIDERED BASED UPON ANY MINOR VARIATIONS.
- THE CONTRACTOR IS TO VISIT THE SITE DURING THE BIDDING PERIOD AND IS TO ADVISE THE ARCHITECT OF ANY SITUATION OR DISCREPANCY WHICH WILL NOT ALLOW SUCCESSFUL COMPLETION OF THE WORK.
- ALL ROOF SLOPES ARE APPROXIMATELY 3:12 UNLESS OTHERWISE INDICATED ON DRAWINGS.
- DEMOLITION SHALL INCLUDE THE COMPLETE REMOVAL OF EXISTING SHINGLES, UNDERLAYMENTS, FASTENERS, & FLASHINGS AS INDICATED DOWN TO THE EXISTING WOOD DECK. PROPERLY DISPOSED OF ALL HAZARDOUS MATERIALS & ALL MATERIALS WHICH ARE NOT MEANT TO BE REUSED.
- CONTRACTOR IS RESPONSIBLE FOR ANY INCIDENTAL DAMAGE DONE TO BUILDING AND GROUNDS DURING COURSE OF DEMOLITION AND CONSTRUCTION AND SHALL RESTORE BUILDING AND GROUNDS TO EXISTING CONDITIONS UPON COMPLETION OF ROOFING PROJECT.

GENERAL ROOFING NOTES CONTINUED:

- CONTRACTOR SHALL THOROUGHLY CLEAN ROOF AND SITE UPON COMPLETION OF PROJECT. PICK-UP, REMOVE AND PROPERLY DISPOSE OF ALL FASTENERS, DEBRIS AND SCRAP MATERIALS.
- METAL HATCH PATTERN IS REPRESENTATION ONLY AND IS NOT INTENDED TO BE AN EXACT INDICATION OF THE SIZE OR COURSING OF THE NEW ROOF SYSTEM.
- ALL MANUFACTURED ARTICLES, MATERIALS AND EQUIPMENT SHALL BE APPLIED, INSTALLED, CONNECTED, ERECTED, CLEANED AND CONDITIONED AS DIRECTED BY THE MANUFACTURER, UNLESS INDICATED OTHERWISE.
- THE CONTRACTOR SHALL COORDINATE WITH THE FACILITY TO ESTABLISH PROCEDURES FOR THE CONTROLLED ENTRY OF MEN AND MATERIALS INTO THE WORK AREA AND SHALL COMPLY WITH ALL RULES AND REGULATIONS ESTABLISHED BY THE FACILITY. THE INTERRUPTION OF SECURITY AND COMMUNICATIONS WILL NOT BE PERMITTED. CONTRACTOR SHALL INFORM AND COORDINATE WITH SECURITY OFFICIALS 48 HOURS IN ADVANCE OF ANY WORK RELATED TO SECURITY OR COMMUNICATIONS.
- AT MECHANICAL/ELECTRICAL ROOF EQUIPMENT AND VENTS, PROVIDE FLASHING PER ROOFING MFG. FOR WATERTIGHT ROOF INSTALLATION.
- PROVIDE SNOW AND ICE GUARDS AT NEW STANDING SEAM METAL ROOFS AS INDICATED ON THE PLANS AND LOCATED DIRECTLY ABOVE EXIST. DOOR LOCATIONS AND 5'-0" ON EITHER SIDE OF DOOR OPENING.
- EXISTING GUTTERS AND DOWNSPOUTS TO REMAIN.


DEMOLITION KEY NOTES:


- REMOVE AND PROPERLY DISPOSE OF ALL EXISTING SHINGLES, EXISTING UNDERLAYMENTS, EXISTING FLASHINGS AND FASTENERS DOWN TO THE EXISTING WOOD DECK, UNLESS NOTED OTHERWISE.
- ONCE EXISTING ROOFING IS REMOVED, CAREFULLY INSPECT ALL EXISTING WOOD DECK FOR DAMAGE OR ROT.
- EXISTING GUTTERS AND DOWNSPOUTS TO REMAIN.

NEW ROOFING KEY NOTES:

- NEW STANDING SEAM METAL ROOFING SYSTEM, UNDERLAYMENT, AND FLASHING OVER EXIST. WOOD DECKING ON WOOD STRUCTURAL SYSTEM. PROVIDE METAL ROOFING FLASHING/ACCESSORIES AT EXISTING VENTS AND ELECTRICAL/MECHANICAL EQUIPMENT TO MATCH METAL ROOFING SYSTEM.
- HATCHING INDICATES AREAS TO PROVIDE AND INSTALL 36" WIDE STRIP OF SELF ADHERING ICE DAM UNDERLAYMENT PROTECTION MEMBRANE AT EAVES, RAKES, RIDGES, HIPS VALLEYS AND OTHER AREAS INDICATED ON THIS DRAWING AND SPECIFICATIONS. RE: DETAILS ON SHEET A-501 AND SPECIFICATIONS.
- PROVIDE AND INSTALL NEW RAKE FLASHINGS AT ALL RAKE CONDITIONS TYPICAL. RE: DETAIL 2/A-501 TYP.
- PROVIDE AND INSTALL NEW VALLEY FLASHING AT ALL EXISTING VALLEYS TYPICAL. RE: DETAIL 5/A-501 TYP.
- PROVIDE AND INSTALL NEW VENT PIPE FLASHING AS PER SPECIFICATIONS & DETAIL 6/A-501 TYP.
- ROOF NUMBER SIGNAGE SECURE TO STANDING SEAM METAL ROOF PER MANUFACTURER SO AS NOT TO VOID WARRANTY. COORDINATE SIGNAGE WITH OWNER. SHALL BE 36"x36" SQUARE. THE BUILDING NUMBER AND SHALL BE BLACK WITH A REFLECTIVE WHITE BACKGROUND. FONT SIZE SHALL FIT 36"x36" SIGN.
- EXISTING GUTTERS AND DOWNSPOUTS TO REMAIN.
- EXISTING EQUIPMENT. COORDINATE FOR REQUIRED REMOVAL/REINSTALLATION FOR ROOFING REPLACEMENT, FLASH CURBS PER ROOF MFG. RECOMMENDATIONS. RE: 8/A-501.
- PROVIDE SNOW GUARDS ABOVE DOOR AND ENTRY LOCATIONS 60" ON EITHER SIDE.
- INSTALL NEW VINYL SIDING ON VERTICAL SIDES OF GABLES AND PLATFORMS. DEMOLISH EXISTING. RE: 13/A501 AND 3/A101.
- PROVIDE AND INSTALL VENTED RIDGE VENTS. RE: 3/A501.
- EXISTING ROOF EQUIPMENT TO BE REMOVED

2 SITE KEY PLAN
N.T.S.

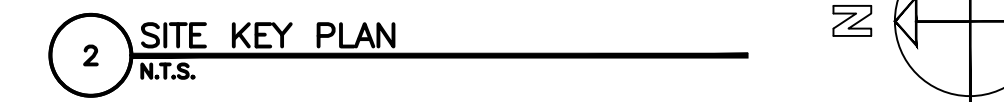


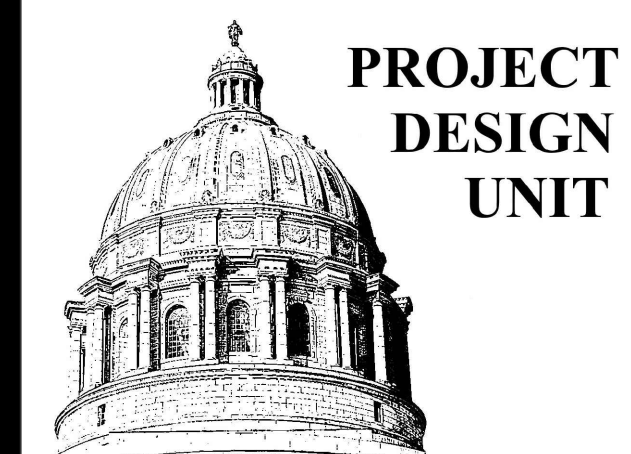

- HAZARDOUS MATERIAL NOTES:**
- ASBESTOS CAULK WAS IDENTIFIED. AVOID CONTACT WITH THIS ASBESTOS MATERIAL. DO NOT SCRAPE, ABRABE OR OTHERWISE IMPACT THE ASBESTOS.
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 - EXISTING GUTTERS AND DOWNSPOUTS TO REMAIN.

- DEMOLITION KEY NOTES:**
- REMOVE AND PROPERLY DISPOSE OF ALL EXISTING SHINGLES, EXISTING UNDERLAYMENTS, EXISTING FLASHINGS AND FASTENERS DOWN TO THE EXISTING WOOD DECK, UNLESS NOTED OTHERWISE.
 - ONCE EXISTING ROOFING IS REMOVED, CAREFULLY INSPECT ALL EXISTING WOOD DECK FOR DAMAGE OR ROT.
 - HATCHING INDICATES EXISTING GUTTERS AND DOWNSPOUTS TO BE REMOVED.
 - HATCHING INDICATES DEMOLITION OF EXISTING SKYLIGHT.
 - HATCHING INDICATES EXISTING ROOF GABLE TO BE DEMOLISHED.


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 - NEW 6"x6" PREFINISHED METAL GUTTERS AND DOWNSPOUTS TO GRADE.
 - EXISTING EQUIPMENT TO BE REMOVED INFILL LOCATION WITH 3/4" PLYWOOD DECKING SCREWED TO EXISTING STRUCTURAL SYSTEM JOISTS.
 - PROVIDE SNOW GUARDS ABOVE DOOR AND ENTRY LOCATIONS 60" ON EITHER SIDE.
 - NOT USED.
 - PROVIDE AND INSTALL VENTED RIDGE VENTS. RE: 3/A-501.
 - INFILL LOCATION WITH 3/4" PLYWOOD DECKING SCREWED TO EXISTING STRUCTURAL SYSTEM JOISTS.

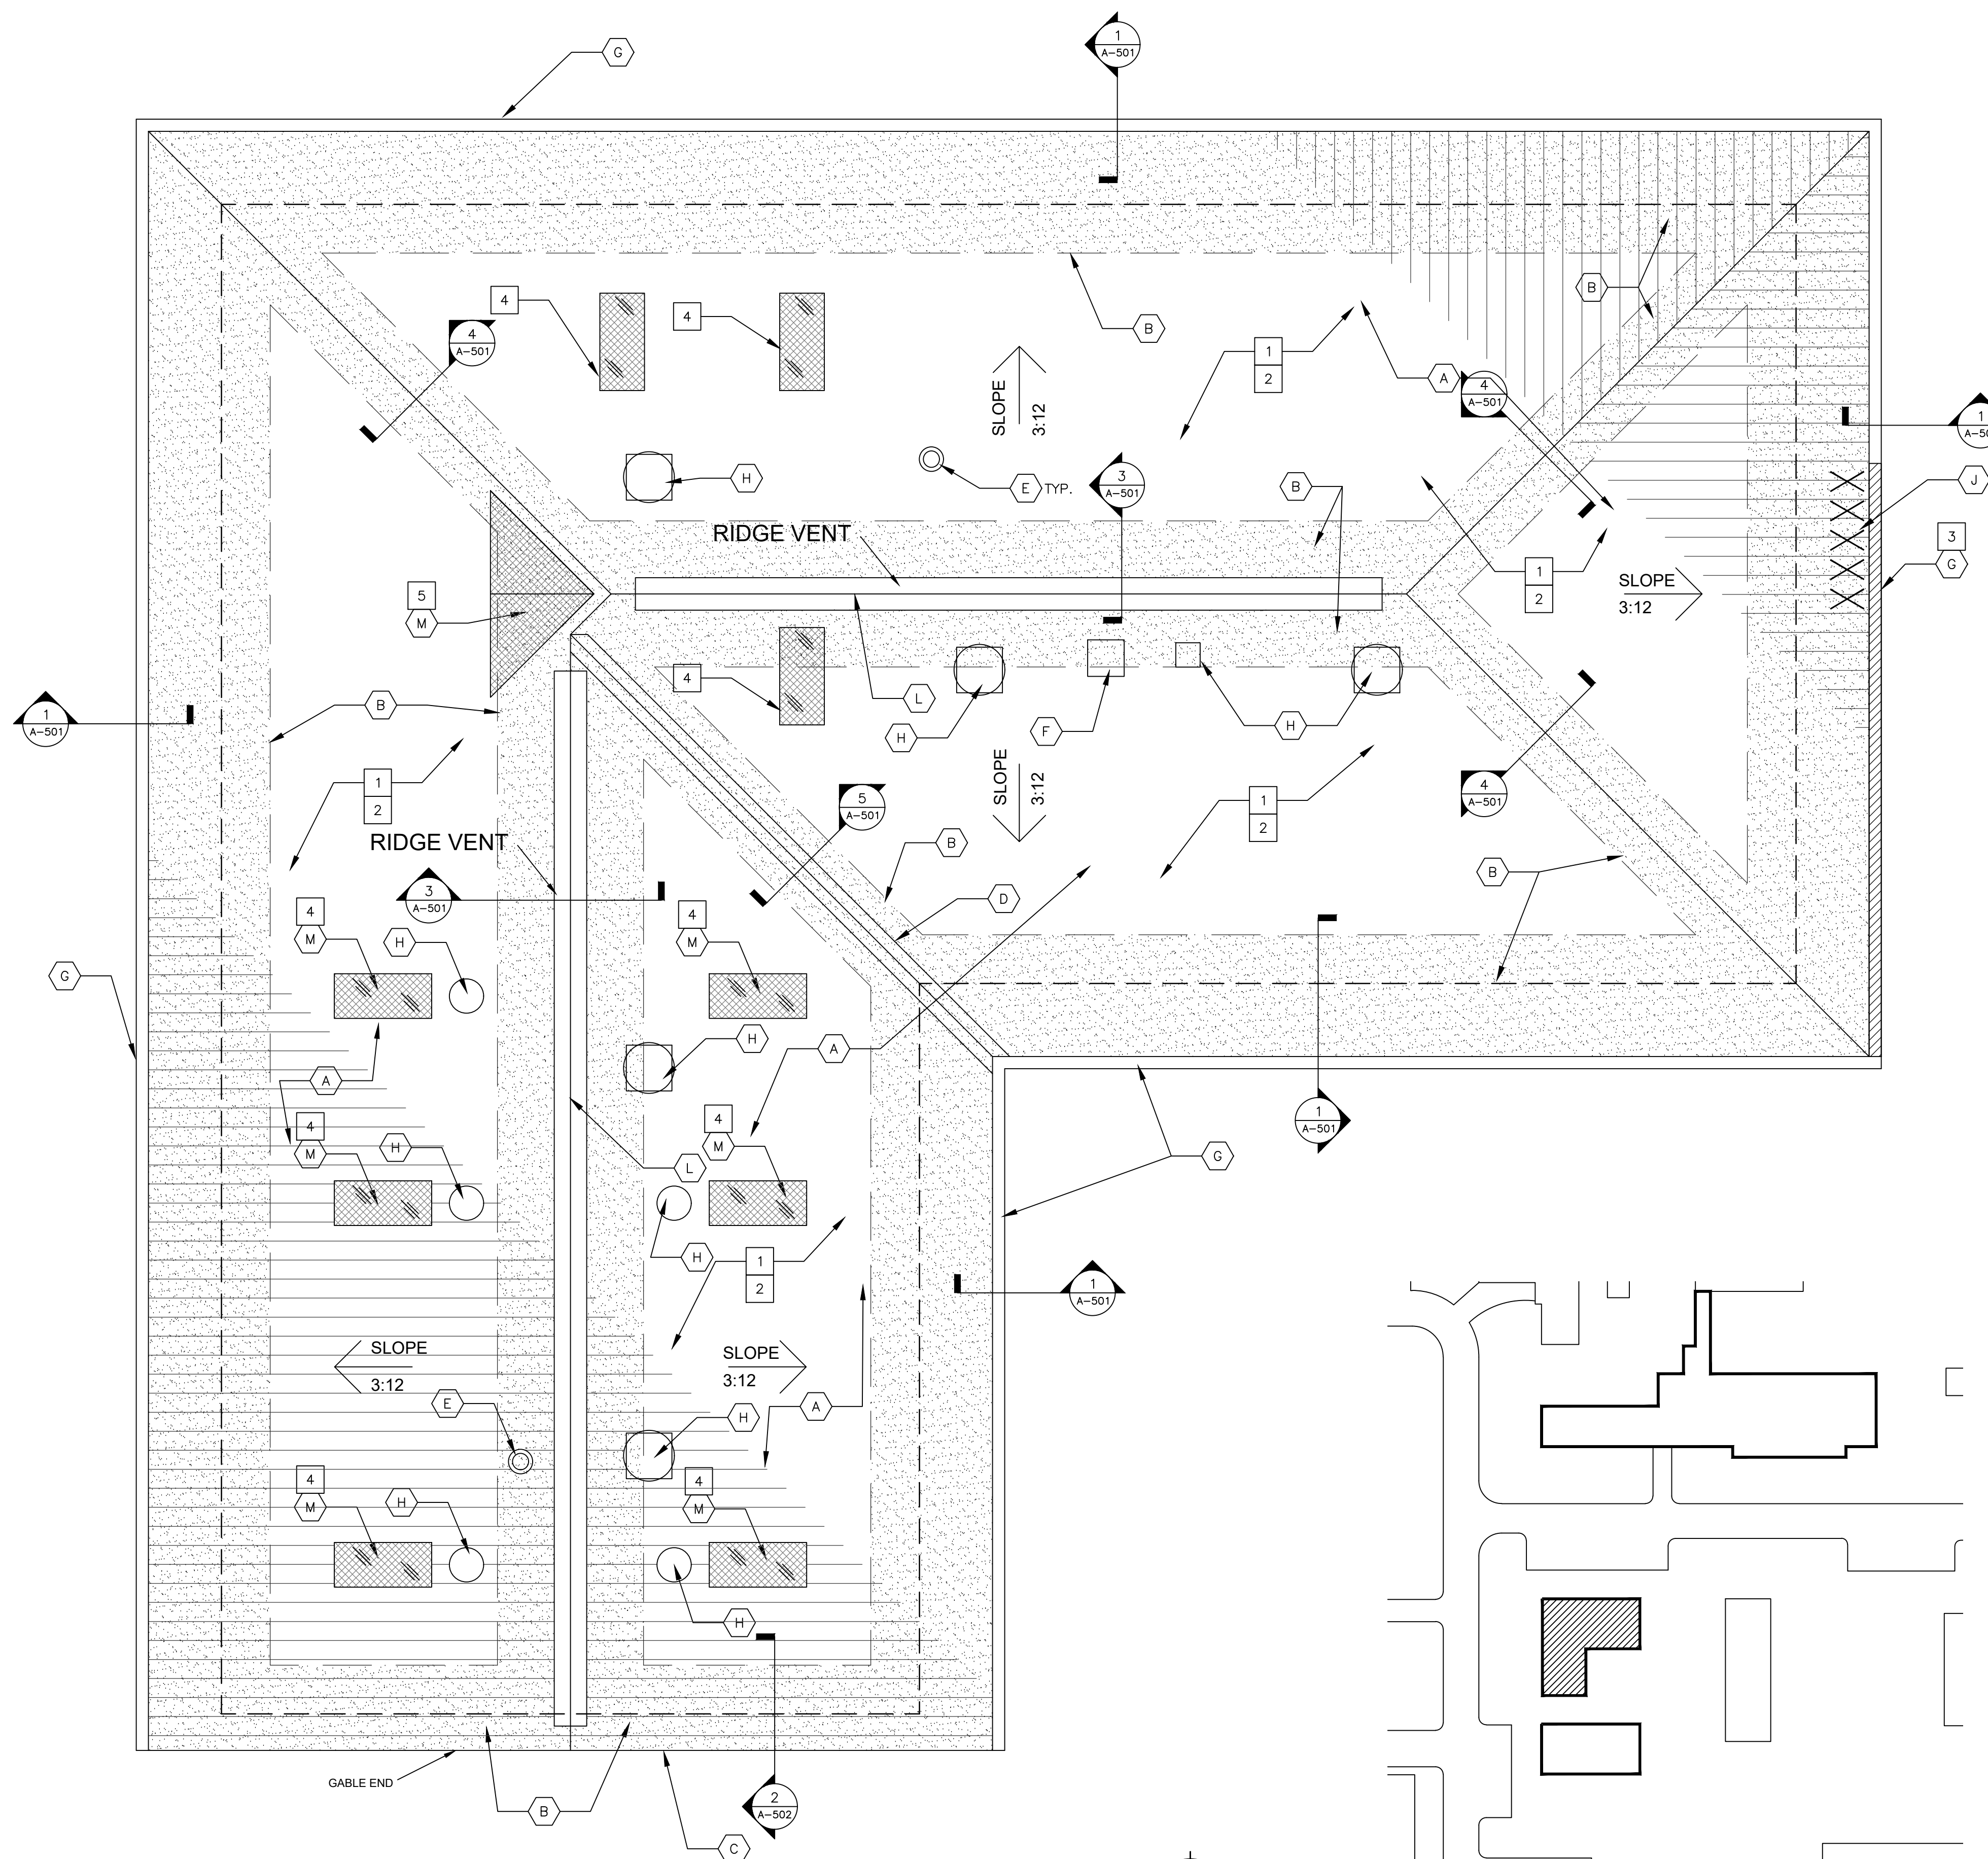


1 SEGREGATION BUILDING ROOF PLAN (ALTERNATE #1)
1/4" = 1'-0"

NOTE: ALL WORK INCLUDED FOR SEGREGATION BUILDING WILL BE BID AS "ALTERNATE #1"

2 SITE KEY PLAN
N.T.S.

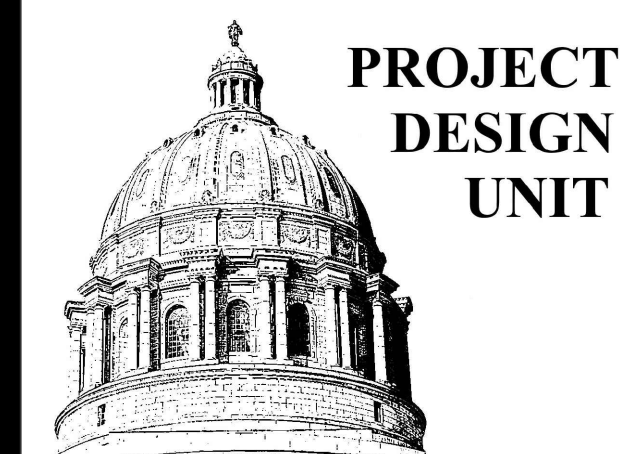


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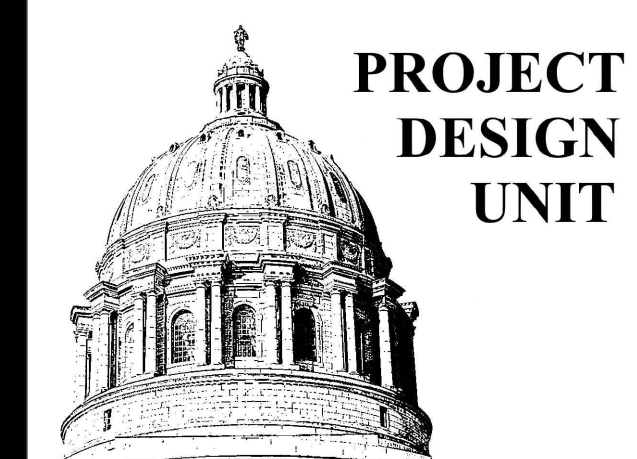
1 ADMINISTRATION BUILDING ROOF PLAN (ALTERNATE #2)
1/4" = 1'-0"

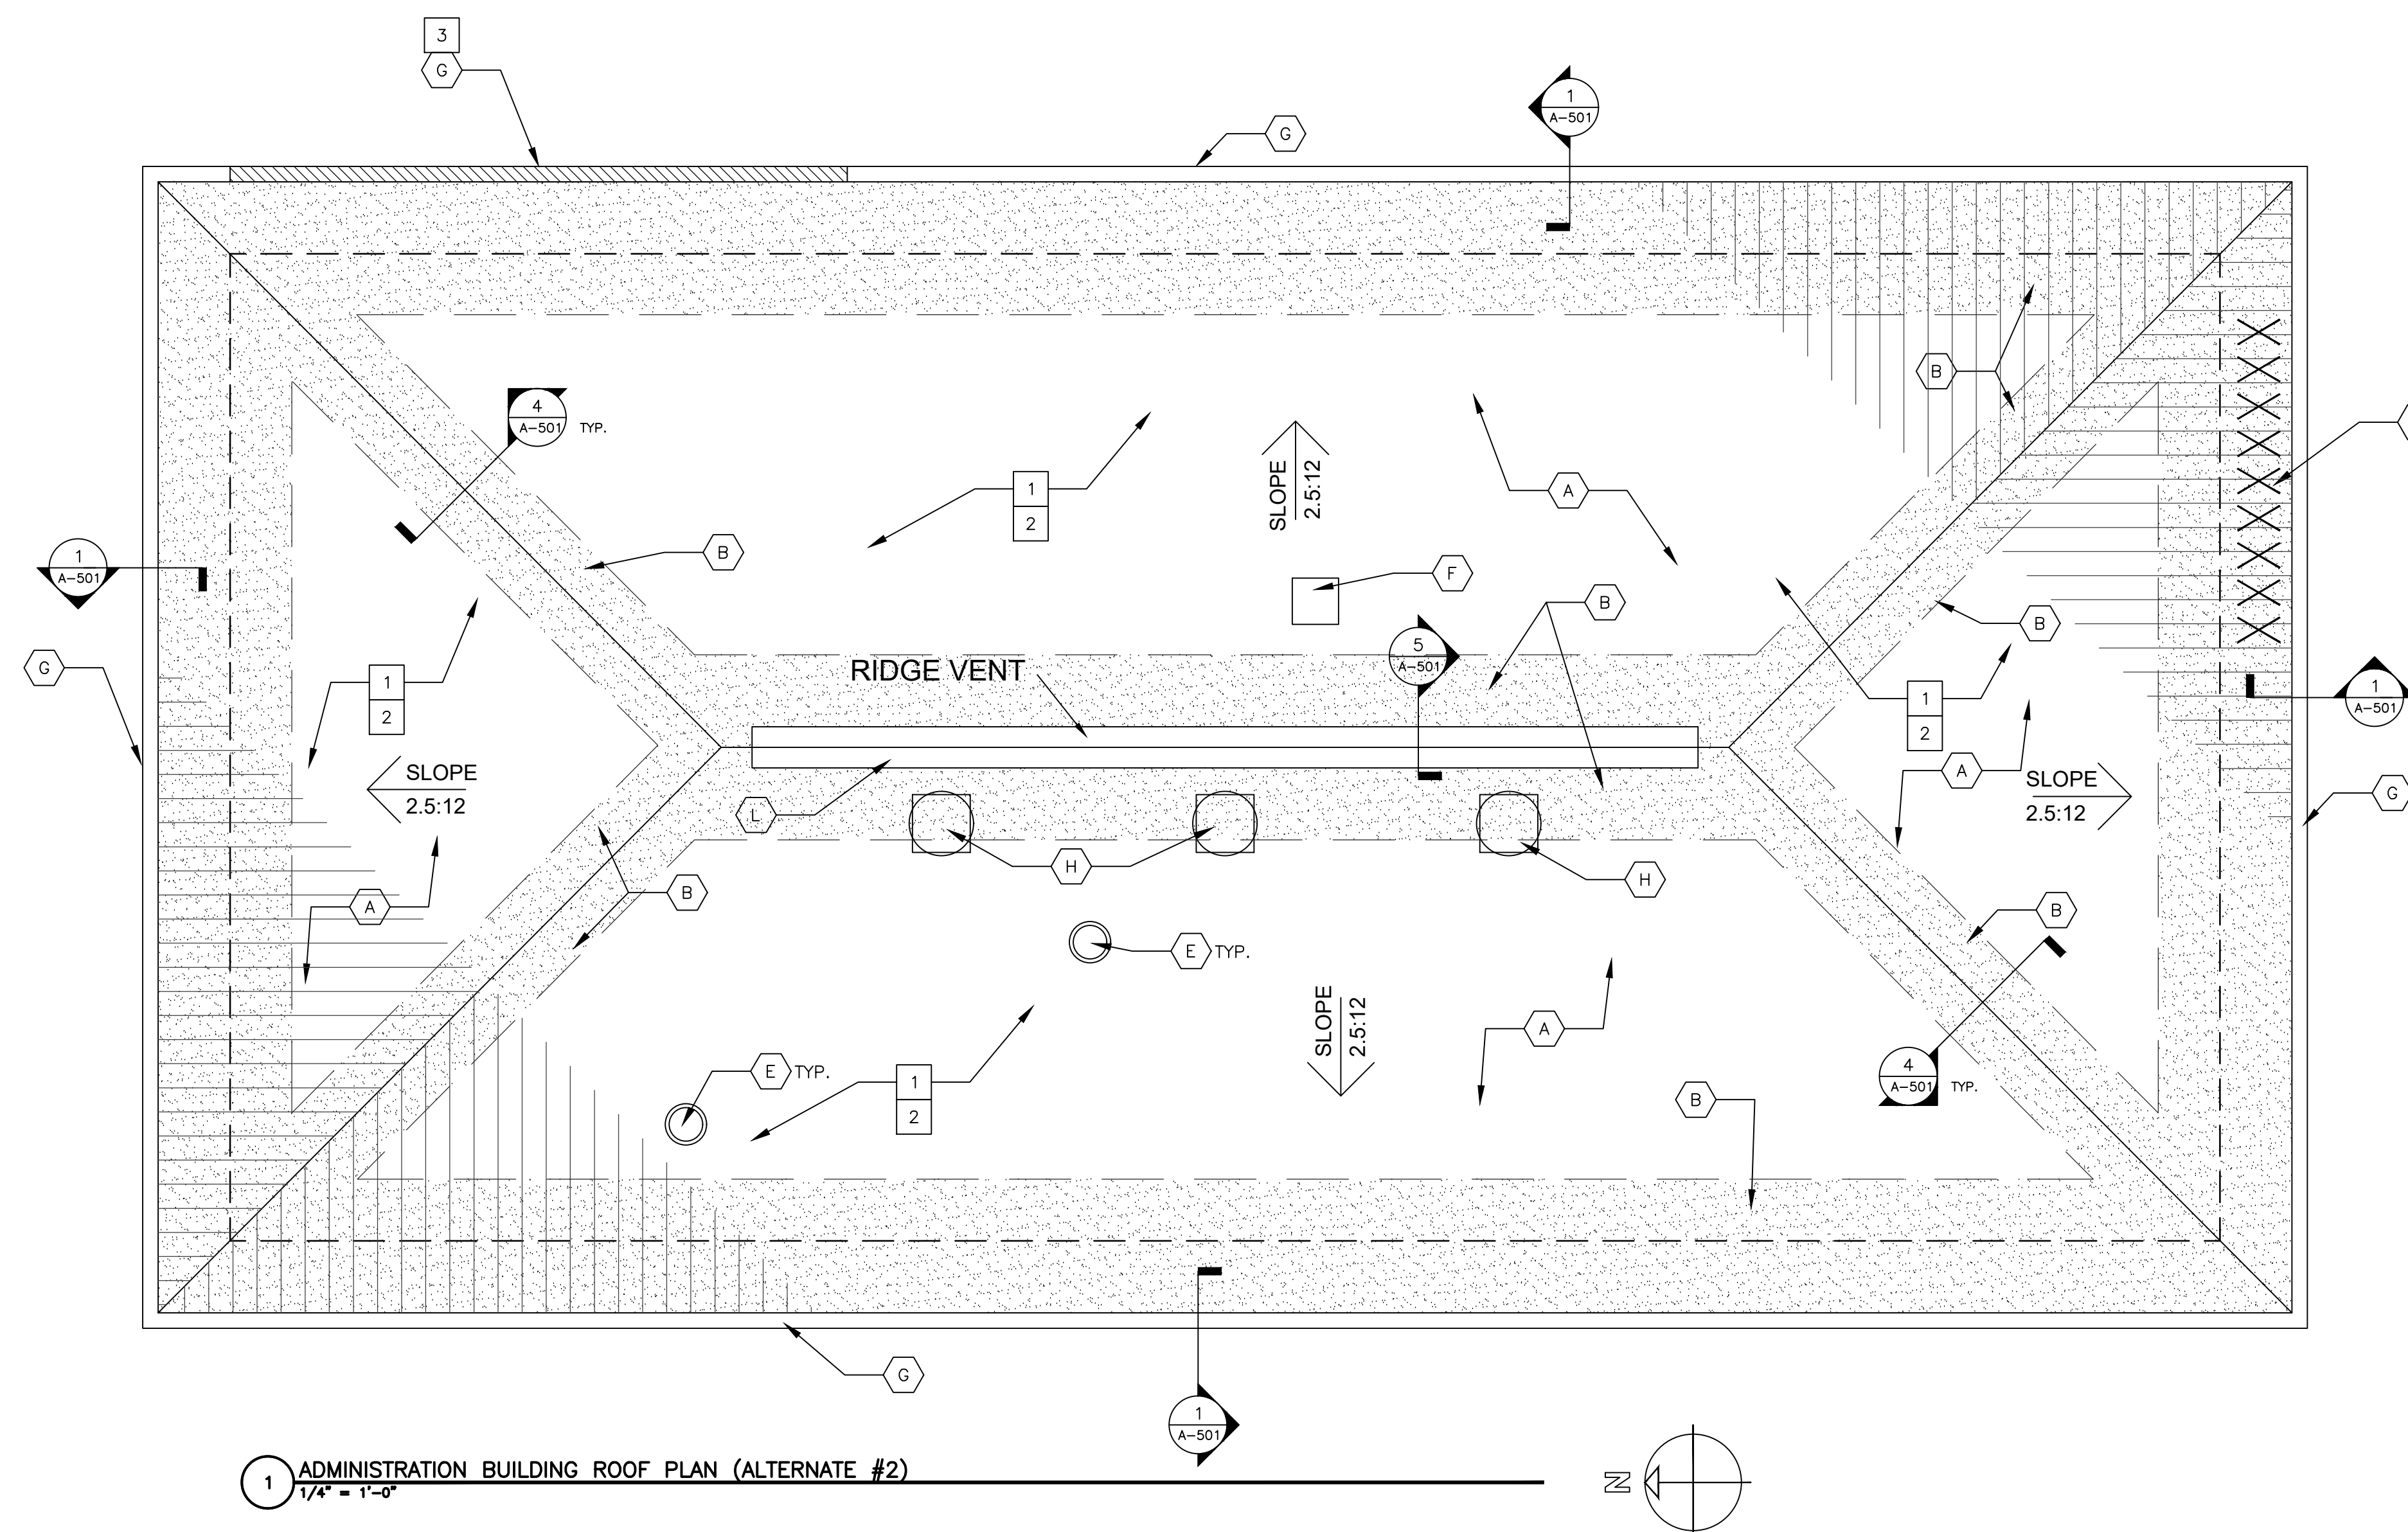- DEMOLITION KEY NOTES:**
- REMOVE AND PROPERLY DISPOSE OF ALL EXISTING SHINGLES, EXISTING UNDERLAYMENTS, EXISTING FLASHINGS AND FASTENERS DOWN TO THE EXISTING WOOD DECK, UNLESS NOTED OTHERWISE.
 - ONCE EXISTING ROOFING IS REMOVED, CAREFULLY INSPECT ALL EXISTING WOOD DECK FOR DAMAGE OR ROT.
 - HATCHING INDICATES EXISTING GUTTERS AND DOWNSPOUTS TO BE DEMOLISHED.
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 - C NOT USED.
 - D NOT USED.
 - E PROVIDE AND INSTALL NEW VENT PIPE FLASHING AS PER SPECIFICATIONS & DETAIL 6/A-501 TYP.
 - F ROOF NUMBER SIGNAGE SECURE TO STANDING SEAM METAL ROOF PER MANUFACTURER SO AS NOT TO VOID WARRANTY. COORDINATE SIGNAGE WITH OWNER. SHALL BE 36"x36" SQUARE. THE BUILDING NUMBER AND SHALL BE BLACK WITH A REFLECTIVE WHITE BACKGROUND. FONT SIZE SHALL FIT 36"x36" SIGN.
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 - J PROVIDE SNOW GUARDS ABOVE DOOR AND ENTRY LOCATIONS 60" ON EITHER SIDE.
 - K NOT USED.
 - L PROVIDE AND INSTALL VENTED RIDGE VENTS. RE: 3/A-501.



2 SITE KEY PLAN
N.T.S.

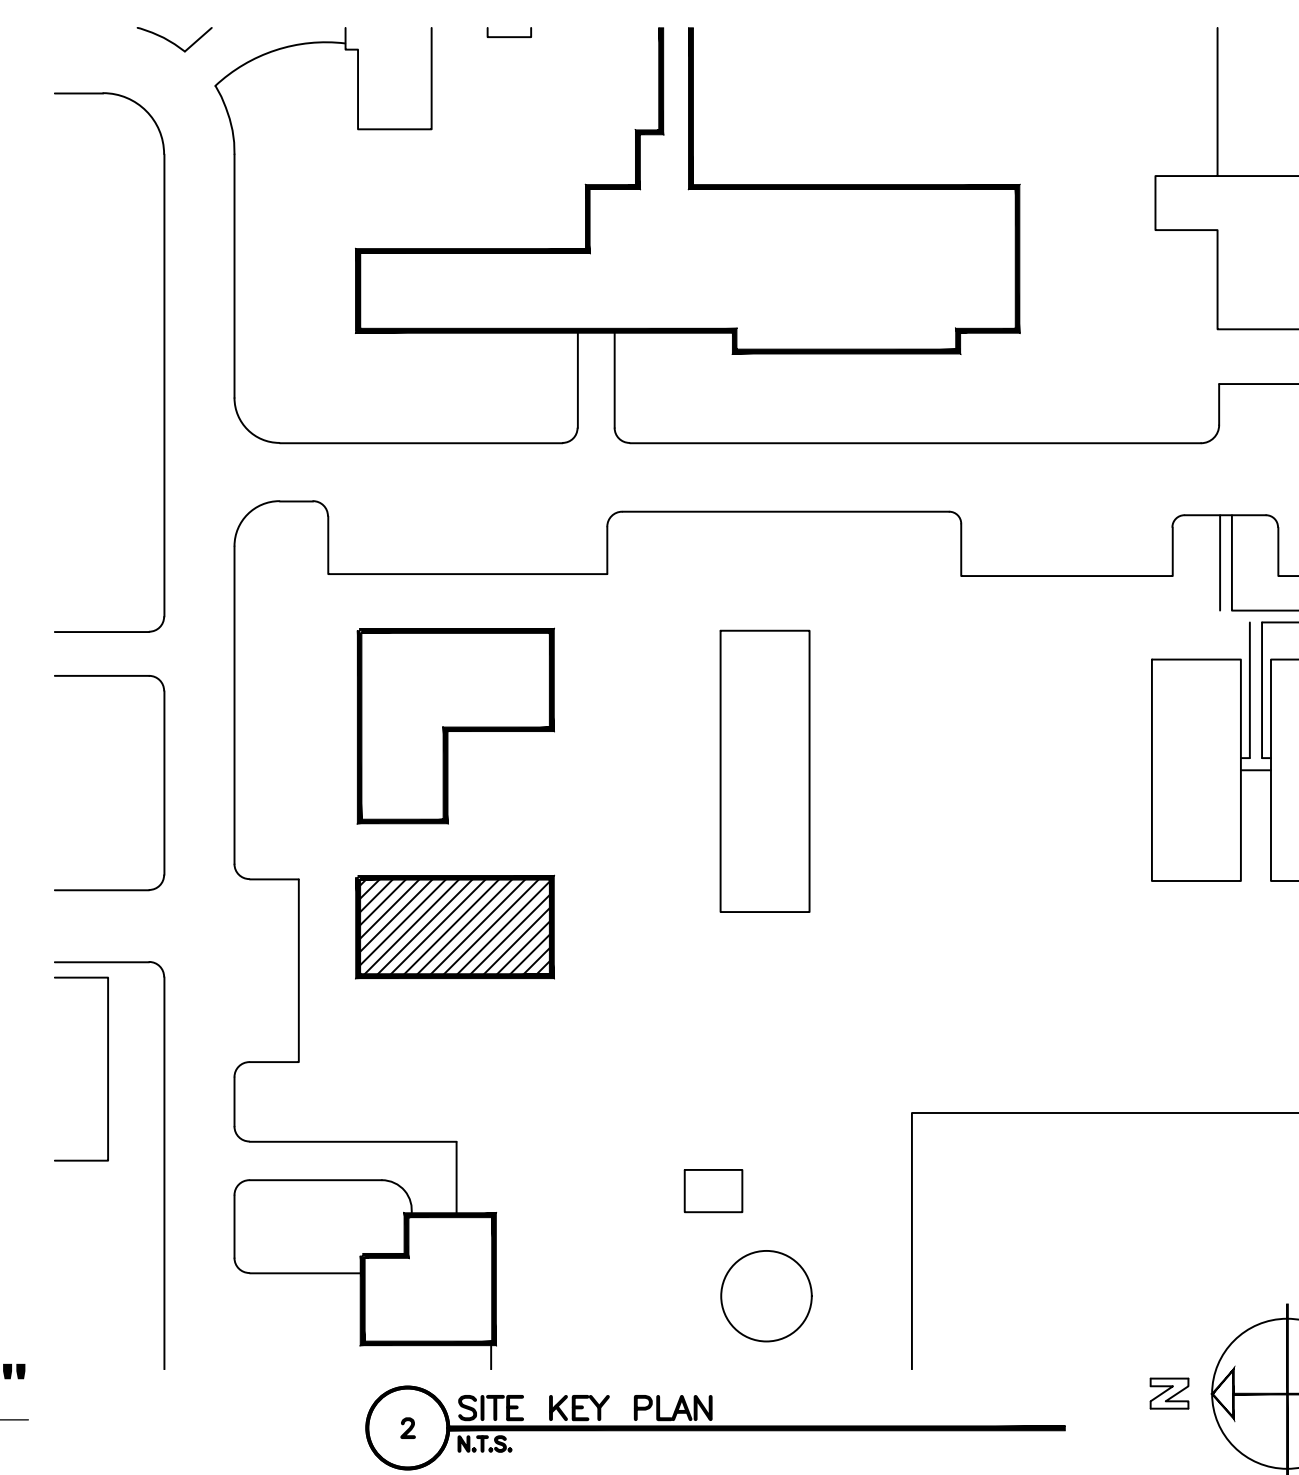NOTE: ALL WORK INCLUDED FOR ADMINISTRATION BUILDING WILL BE BID AS "ALTERNATE #2"



OFFICE OF ADMINISTRATION
DIVISION OF FACILITIES
MANAGEMENT,
DESIGN AND CONSTRUCTION

DEPARTMENT OF
CORRECTIONS

REPLACE ROOFS
MULTIPLE ASSETS
OZARKS CORRECTIONAL
CENTER
929 HONOR CAMP LANE
FORDLAND, MO 65652

PROJECT # C2004-01
SITE # 7003
ASSET #

9327003033-POWER PLANT

REVISION: _____
DATE: _____
REVISION: _____
DATE: _____
REVISION: _____
DATE: _____

ISSUE DATE: 3/17/2023

CAD DWG FILE: CB
DRAWN BY: CB
CHECKED BY: BMS
DESIGNED BY: BMS

SHEET TITLE:
**POWER
PLANT
ROOF PLAN**


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A-104


6 OF 7 SHEETS
DATE: 3/17/2023

- HAZARDOUS MATERIAL NOTES:**
- ASBESTOS CAULK WAS IDENTIFIED. AVOID CONTACT WITH THIS ASBESTOS MATERIAL. DO NOT SCRAPE, ABRADE OR OTHERWISE IMPACT THE ASBESTOS.
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- GENERAL ROOFING NOTES:**
- ALL ROOFING SHALL BE DONE IN ACCORDANCE WITH THE LATEST ADDITION OF THE NATIONAL ROOFING CONTRACTORS ASSOCIATION (NRCA) ROOFING MANUAL AND ASHRAE AS IT SIMILARLY RELATES TO ARCHITECTURAL METAL ROOFING AND EQUIPMENT.
 - EXISTING CONDITIONS AND DIMENSIONS AS SHOWN ON THESE DRAWINGS ARE APPROXIMATIONS. ACTUAL CONDITIONS AND DIMENSIONS MAY VARY. CONTRACTORS SHALL VERIFY EXISTING CONDITIONS AND DIMENSIONS TO THE EXTENT THAT IT WOULD MAKE A DIFFERENCE TO THEIR BID. NO ADDITIONAL COST TO THE OWNER WILL BE CONSIDERED BASED UPON ANY MINOR VARIATIONS.
 - THE CONTRACTOR IS TO VISIT THE SITE DURING THE BIDDING PERIOD AND IS TO ADVISE THE ARCHITECT OF ANY SITUATION OR DISCREPANCY WHICH WILL NOT ALLOW SUCCESSFUL COMPLETION OF THE WORK.
 - ALL ROOF SLOPES ARE APPROXIMATELY 1/4":12 UNLESS OTHERWISE INDICATED ON DRAWINGS.
 - DEMOLITION SHALL INCLUDE THE COMPLETE REMOVAL OF EPDM, INSULATION, COVERBOARD, UNDERLAYMENTS, FASTENERS, & FLASHINGS AS INDICATED DOWN TO THE EXISTING DECK. PROPERLY DISPOSED OF ALL HAZARDOUS MATERIALS & ALL MATERIALS WHICH ARE NOT MEANT TO BE REUSED.
 - CONTRACTOR IS RESPONSIBLE FOR ANY INCIDENTAL DAMAGE DONE TO BUILDING AND GROUNDS DURING COURSE OF DEMOLITION AND CONSTRUCTION AND SHALL RESTORE BUILDING AND GROUNDS TO EXISTING CONDITIONS UPON COMPLETION OF ROOFING PROJECT.
 - CONTRACTOR SHALL THOROUGHLY CLEAN ROOF AND SITE UPON COMPLETION OF PROJECT. PICK-UP, REMOVE AND PROPERLY DISPOSE OF ALL FASTENERS, DEBRIS AND SCRAP MATERIALS.
 - ALL MANUFACTURED ARTICLES, MATERIALS AND EQUIPMENT SHALL BE APPLIED, INSTALLED, CONNECTED, ERECTED, CLEANED AND CONDITIONED AS DIRECTED BY THE MANUFACTURER, UNLESS INDICATED OTHERWISE.
 - THE CONTRACTOR SHALL COORDINATE WITH THE FACILITY TO ESTABLISH PROCEDURES FOR THE CONTROLLED ENTRY OF MEN AND MATERIALS INTO THE WORK AREA AND SHALL COMPLY WITH ALL RULES AND REGULATIONS ESTABLISHED BY THE FACILITY. THE INTERRUPTION OF SECURITY AND COMMUNICATIONS WILL NOT BE PERMITTED. CONTRACTOR SHALL INFORM AND COORDINATE WITH SECURITY OFFICIALS 48 HOURS IN ADVANCE OF ANY WORK RELATED TO SECURITY OR COMMUNICATIONS.
 - AT MECHANICAL/ELECTRICAL ROOF EQUIPMENT AND VENTS, PROVIDE FLASHING PER ROOFING MFGFR. FOR WATERTIGHT ROOF INSTALLATION.
 - EXISTING GUTTERS AND DOWNSPOUTS TO REMAIN.

- DEMOLITION KEY NOTES:**
- REMOVE AND PROPERLY DISPOSE OF ALL EXISTING EPDM ROOF, INSULATION, COVERBOARD, EXISTING UNDERLAYMENTS, EXISTING FLASHINGS AND FASTENERS DOWN TO THE EXISTING DECK, UNLESS NOTED OTHERWISE.
 - ONCE EXISTING ROOFING IS REMOVED, CAREFULLY INSPECT ALL EXISTING DECK FOR DAMAGE OR ROT.
 - EXISTING GUTTERS AND DOWNSPOUTS TO BE REMOVED.
- NEW ROOFING KEY NOTES:**
- A ADHERE ROOF NUMBER SIGNAGE SECURE TO STANDING SEAM METAL ROOF PER MANUFACTURER SO AS NOT TO VOID WARRANTY. COORDINATE SIGNAGE WITH OWNER. SHALL BE 36"x36" SQUARE. THE BUILDING NUMBER AND SHALL BE BLACK WITH A REFLECTIVE WHITE BACKGROUND. FONT SIZE SHALL FIT 36"x36" SIGN.
 - B NEW FULLY ADHERED TPO ROOF ON COVERBOARD ON 1/4" FT TAPERED INSULATION ON AVERAGE R-30 RIGID POLYISO ROOF INSULATION. RE: 7/A-501.
 - C EXISTING GUTTER AND DOWNSPOUT TO BE REMOVED AND REINSTALLED.
 - D EXISTING EQUIPMENT, COORDINATE FOR REQUIRED REMOVAL/REINSTALLATION FOR ROOFING REPLACEMENT, FLASH CURBS PER ROOF MFGFR RECOMMENDATIONS.
 - E FLASH EXISTING VENT PIPING - TYPICAL 16 SS FLASHING. RE: 11/A-501.
 - F NEW FLASHING AND DRIP EDGE ON PERIMETER OF ROOF. TYPICAL. RE: 12/A-501.


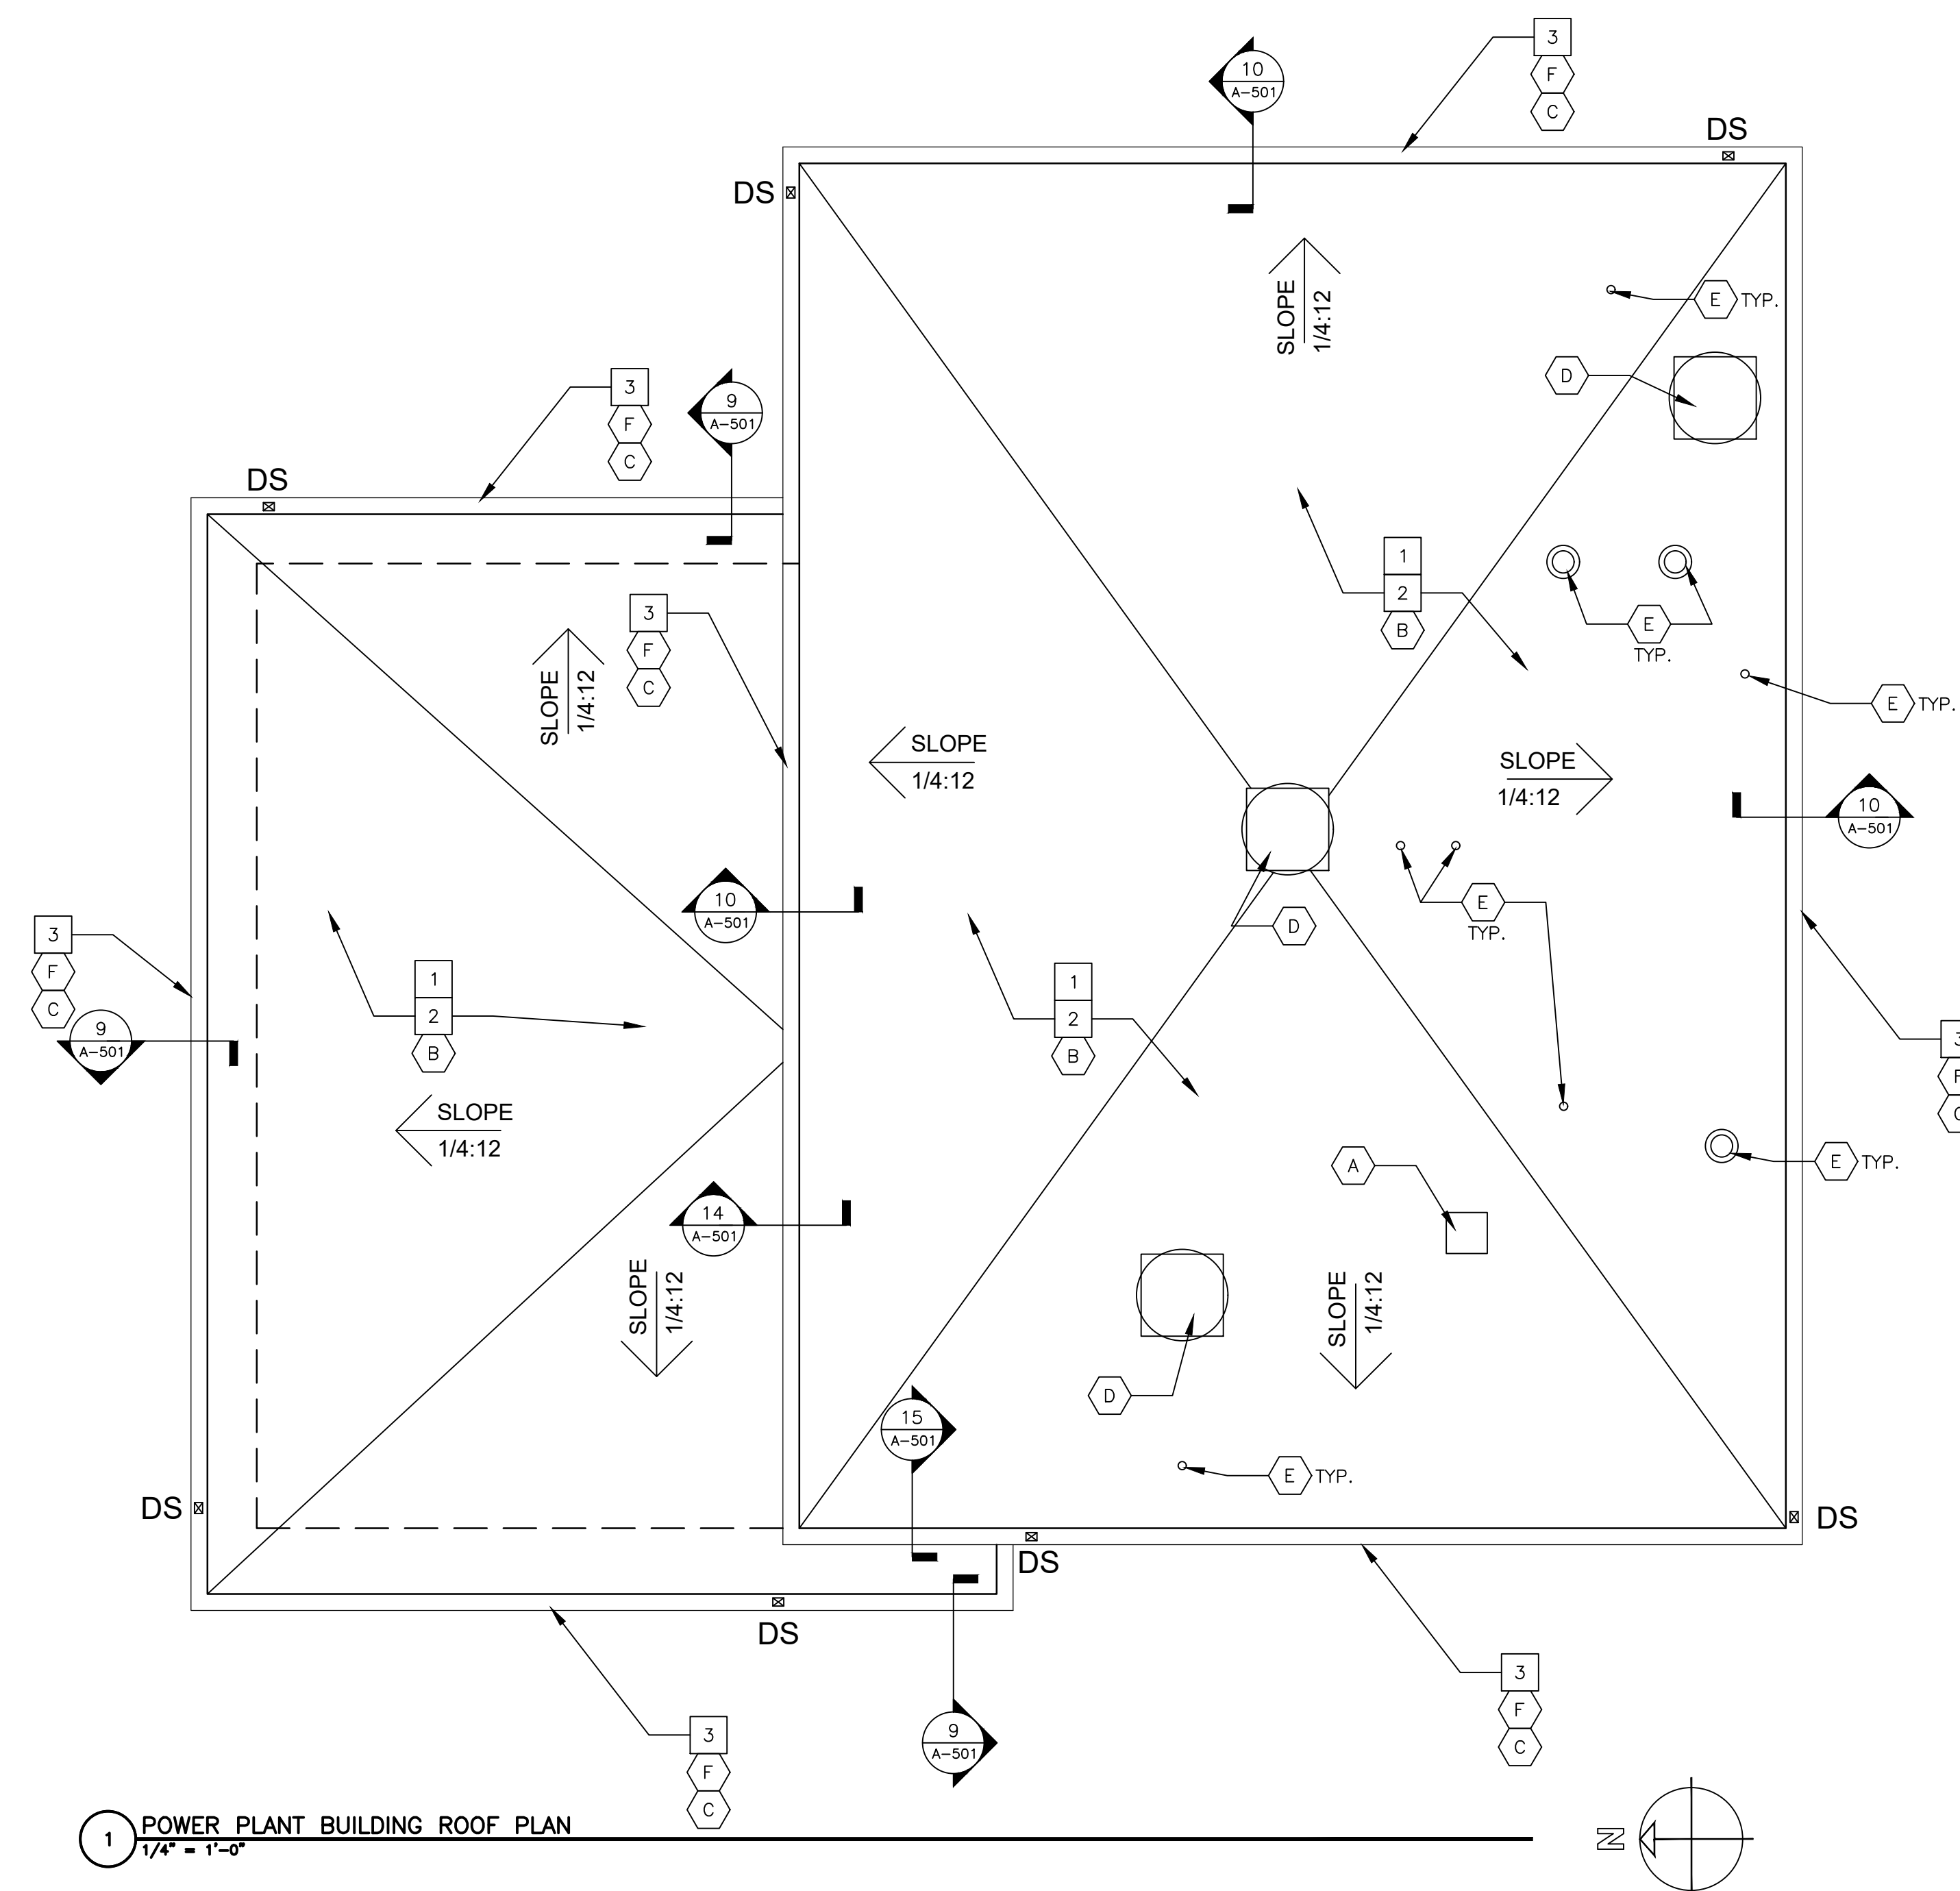


1 POWER PLANT BUILDING ROOF PLAN
1/4" = 1'-0"

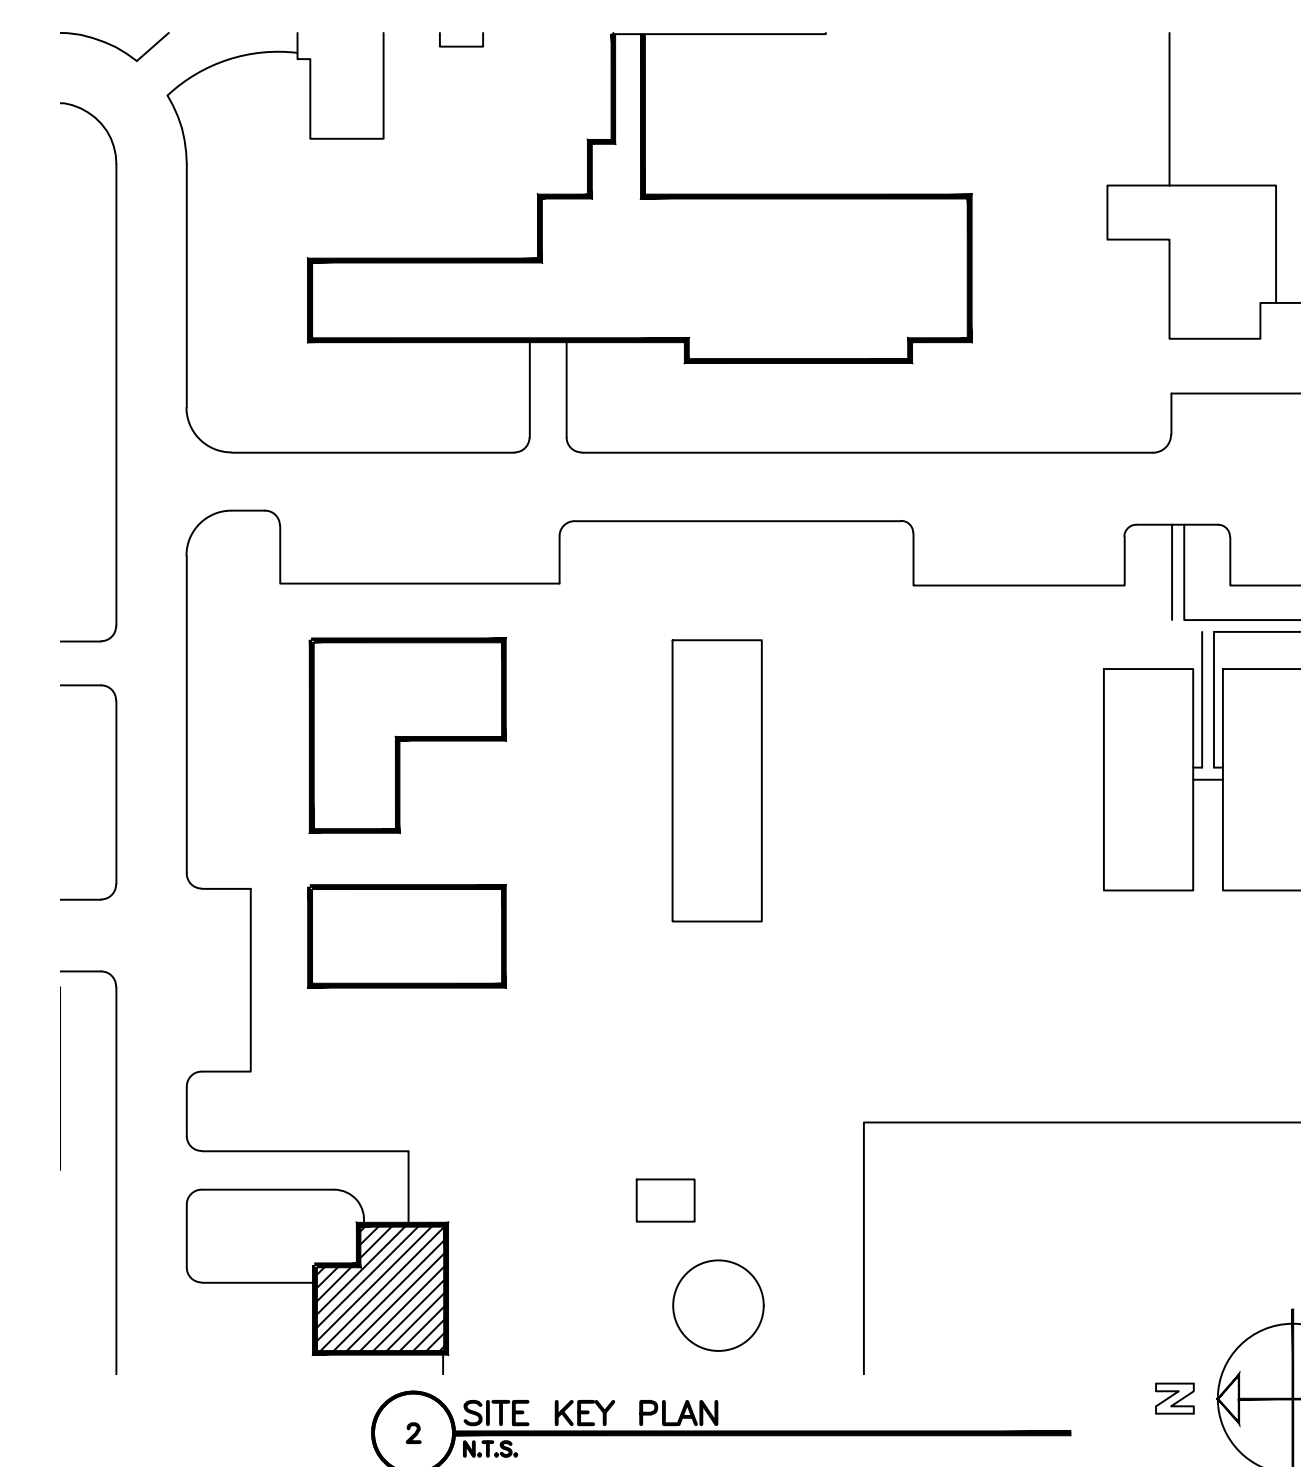


2 SITE KEY PLAN
N.T.S.


NOTE: ALL WORK INCLUDED FOR POWER PLANT BUILDING WILL BE BID AS "BASE BID"

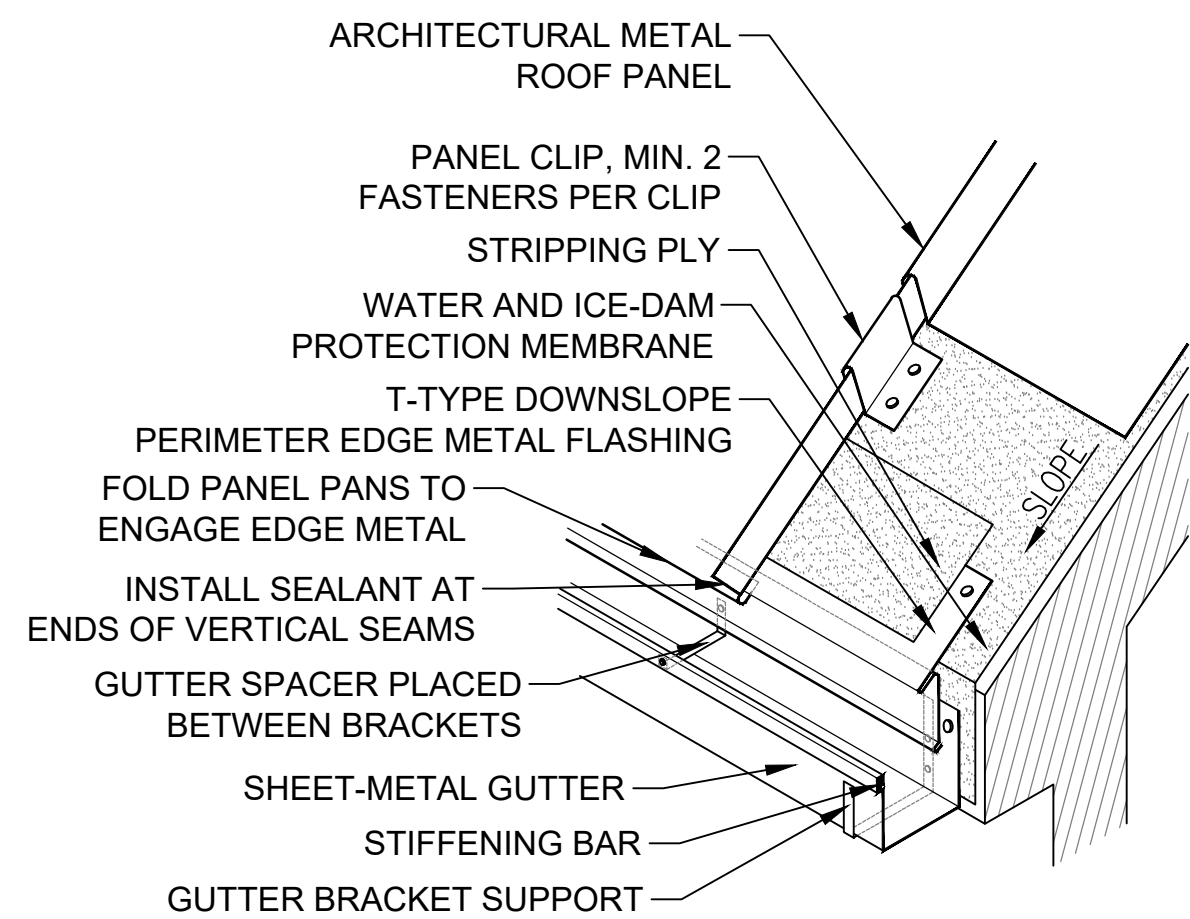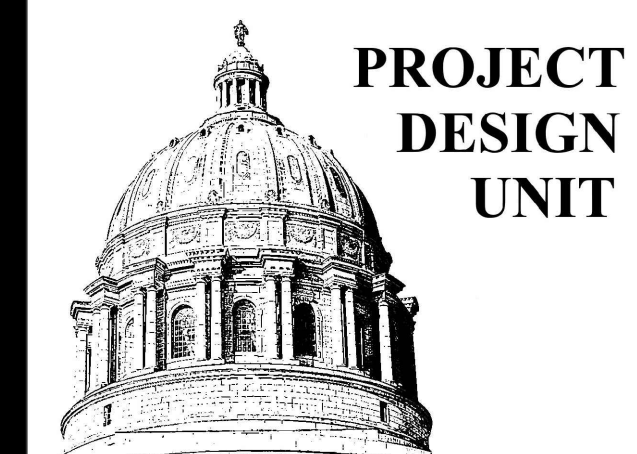


1 EAVE W/GUTTER DETAIL
SCALE: NTS

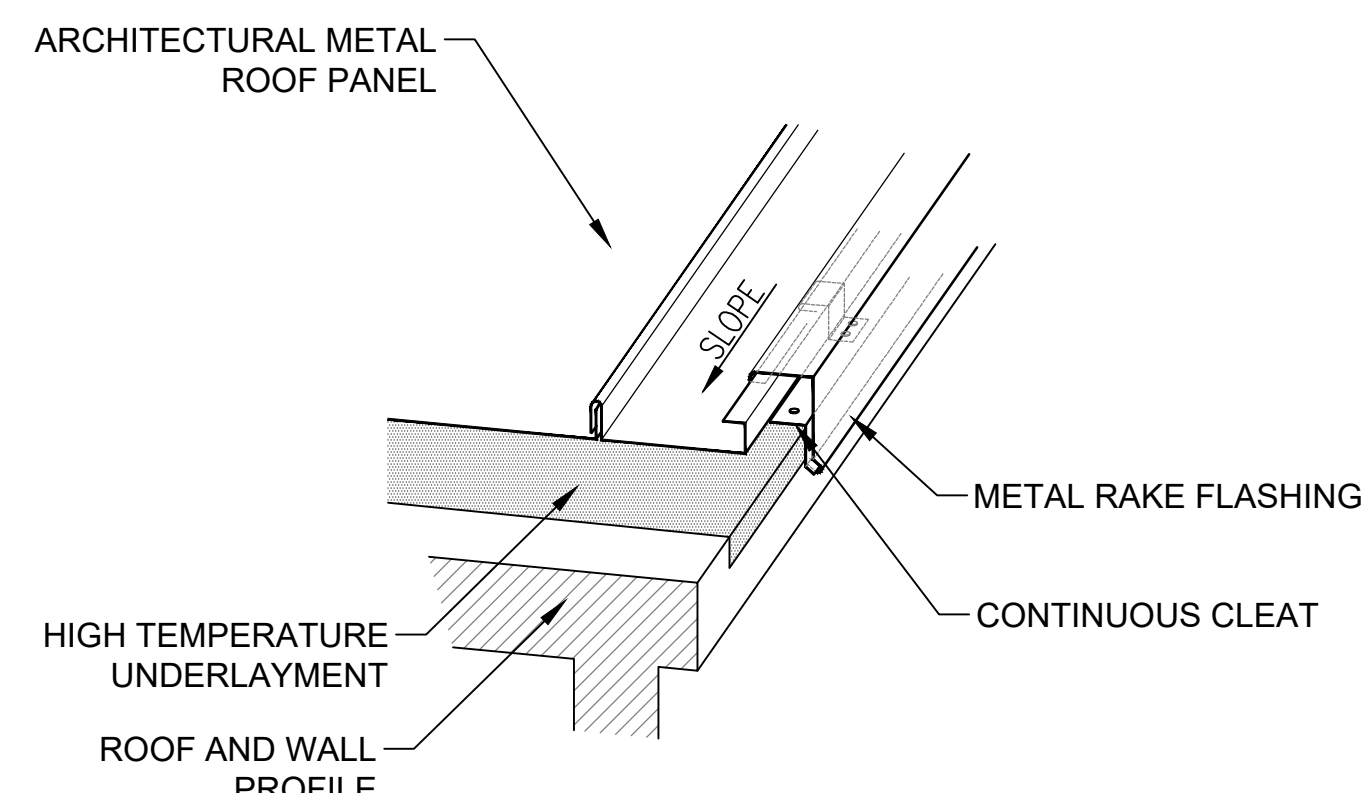


2 RAKE EDGE FLASHING
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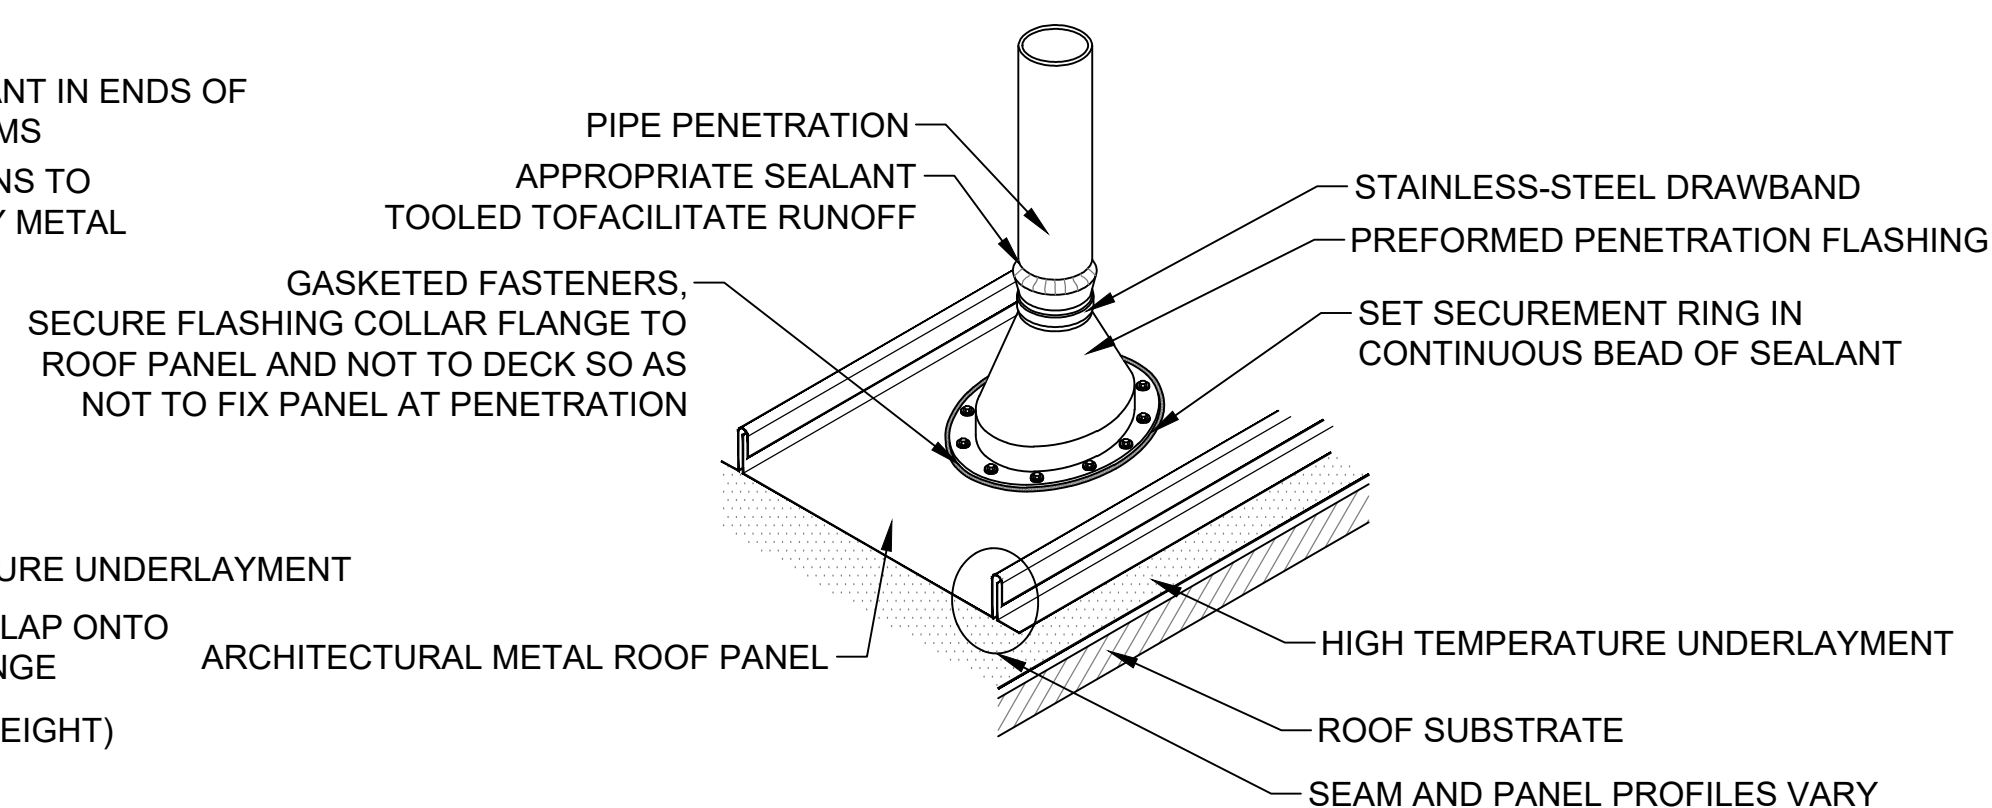
3 VENTING RIDGE CAP
SCALE: NTS

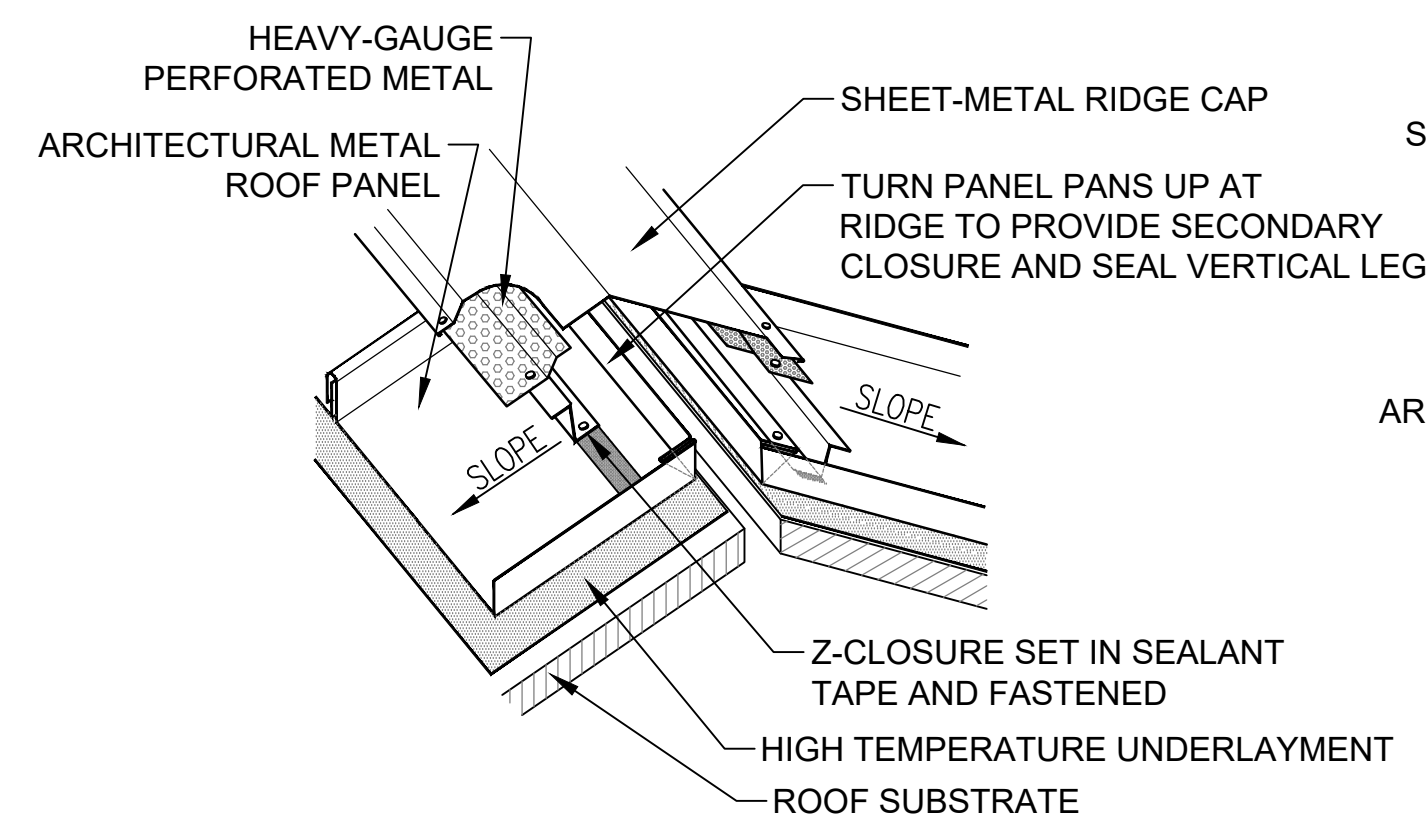


4 HIP CAP FLASHING
SCALE: NTS

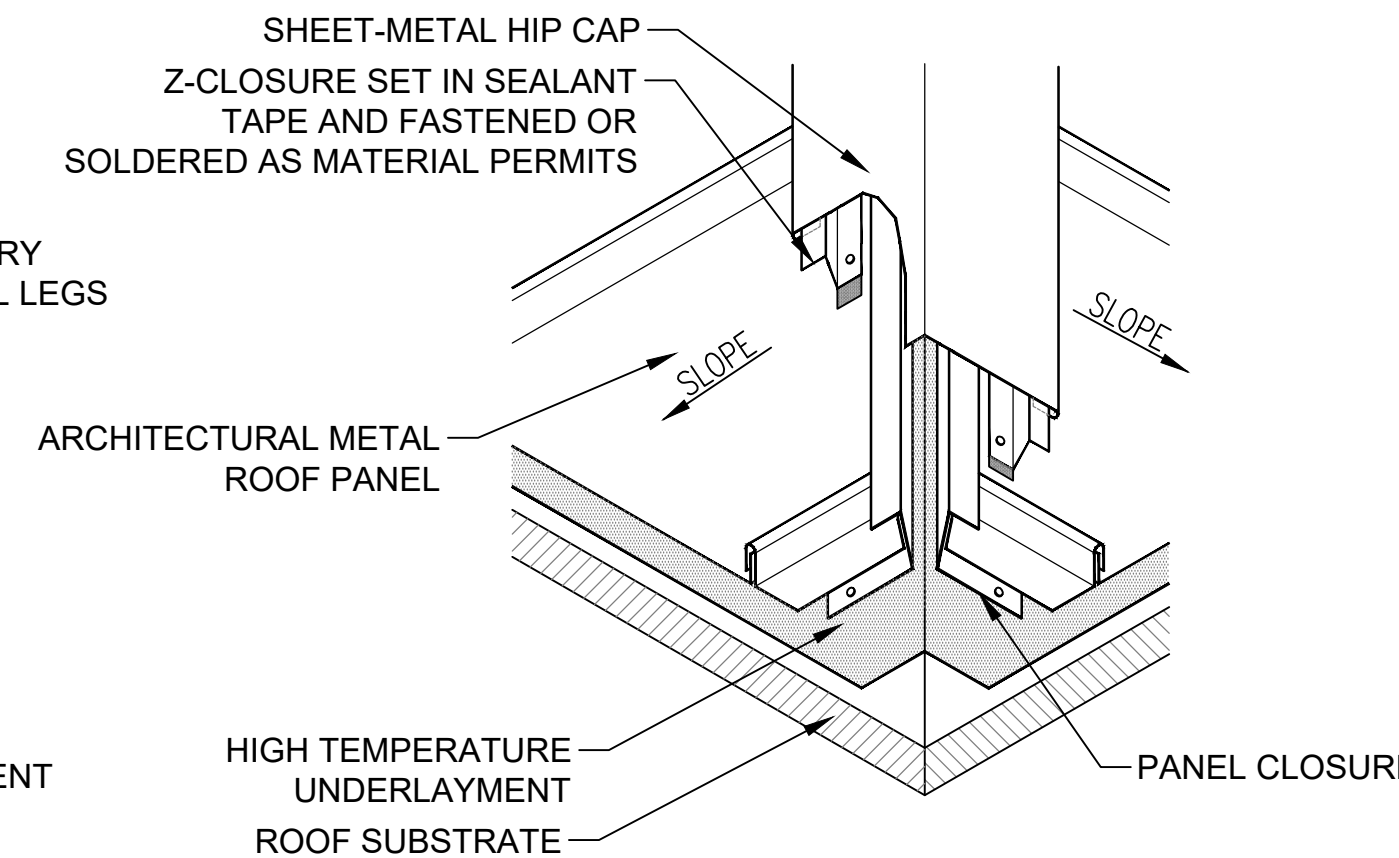


5 OPEN METAL VALLEY
SCALE: NTS

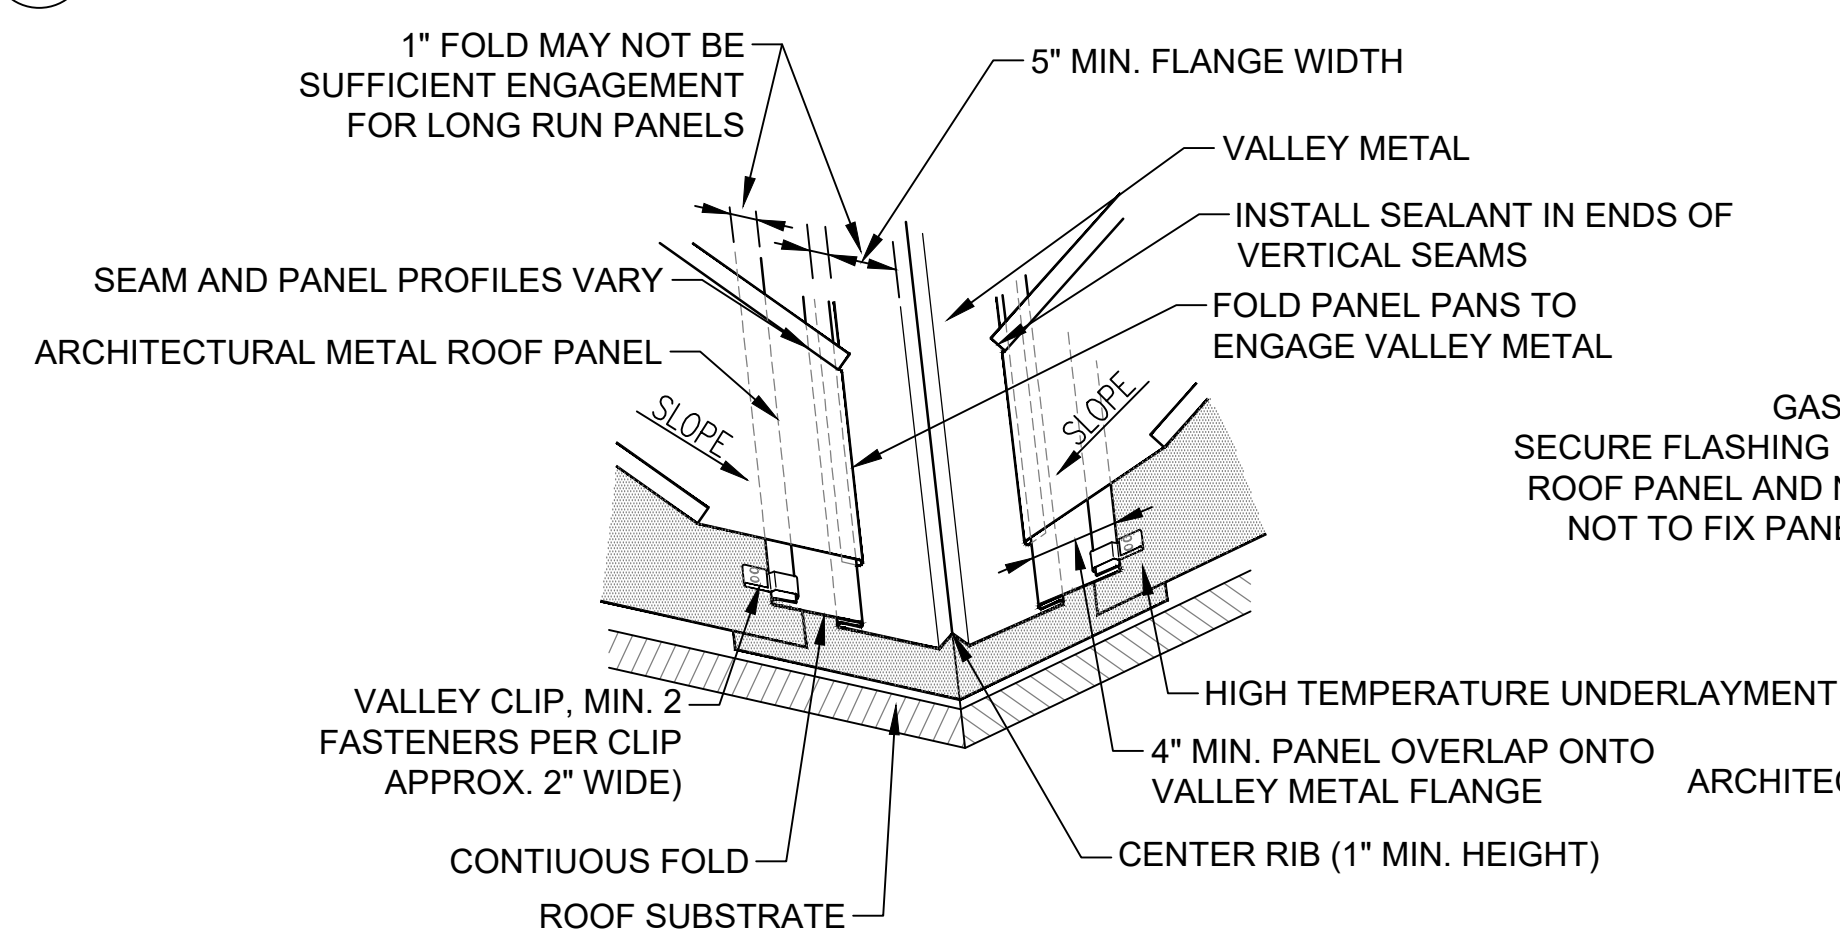


6 PIPE PENETRATION FLASHING
SCALE: NTS

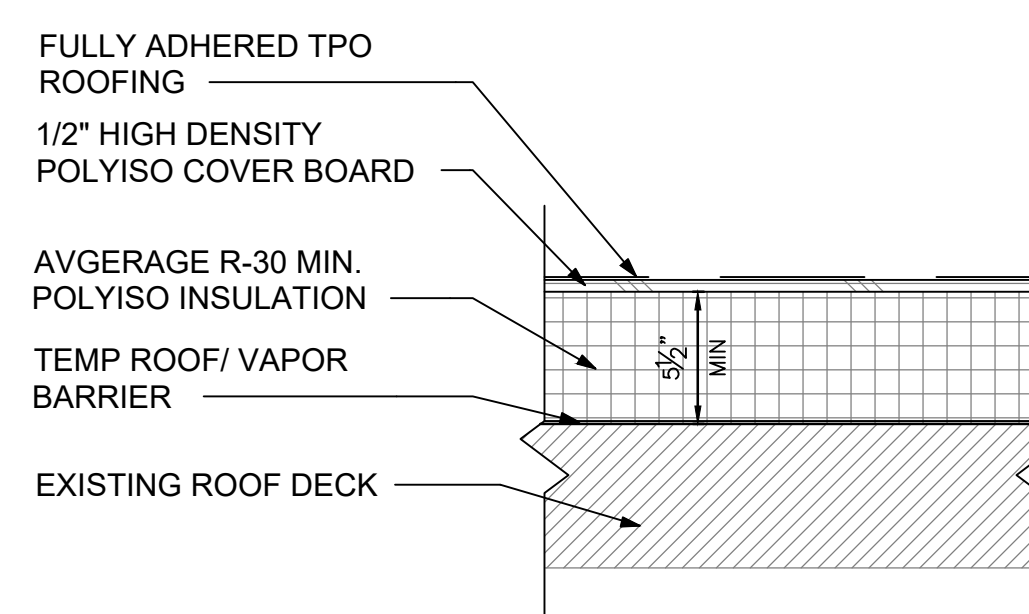


7 TYPICAL ROOF ASSEMBLY
SCALE: 1 1/2"=1'-0"

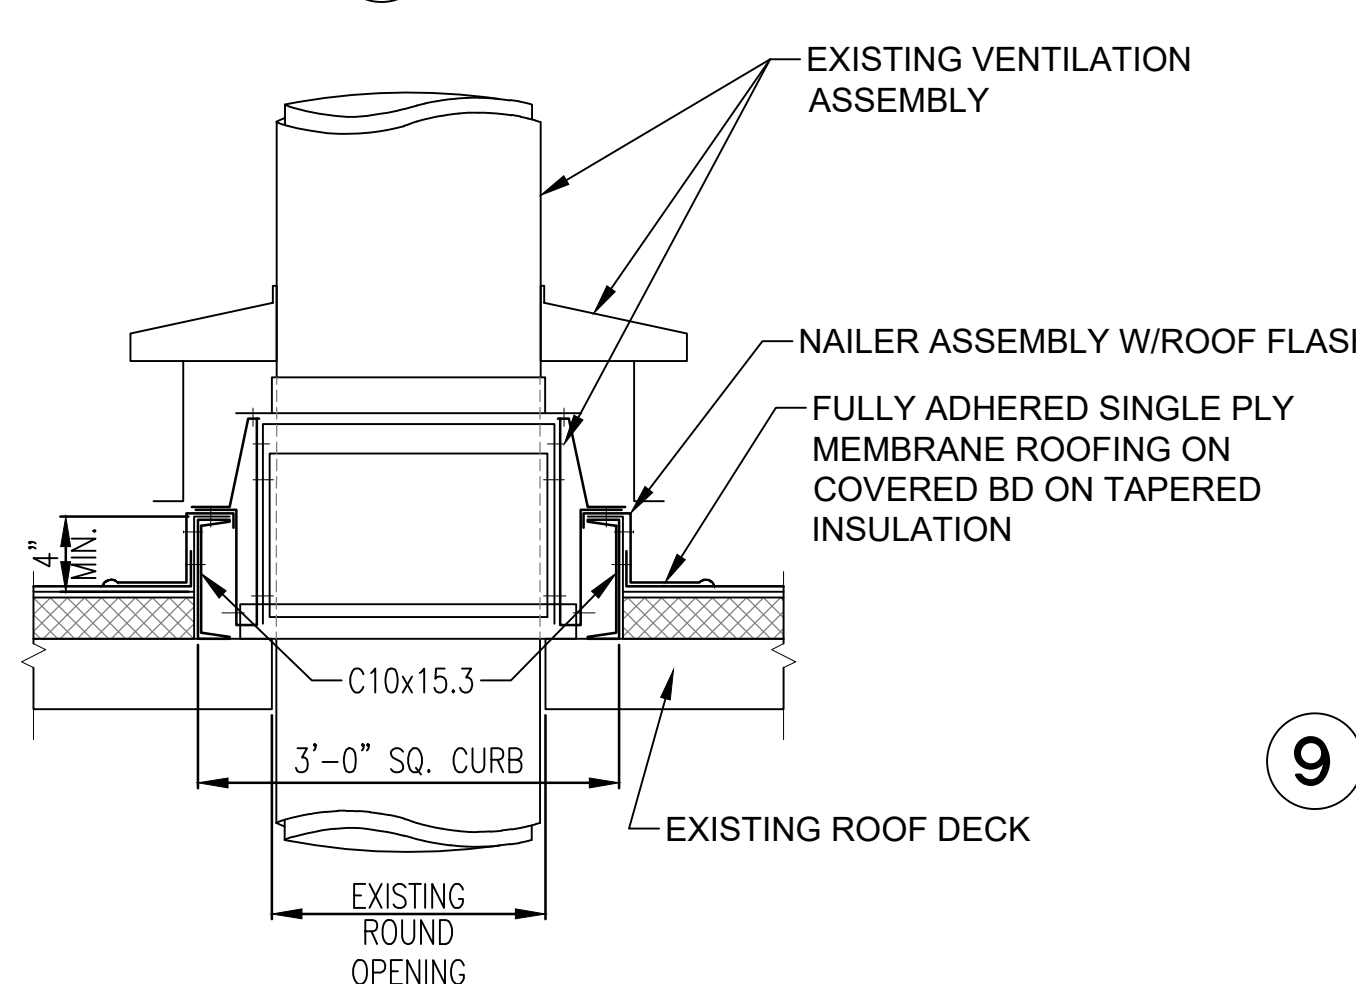


9 LOW ROOF-FASCIA/GUTTER
SCALE: NTS

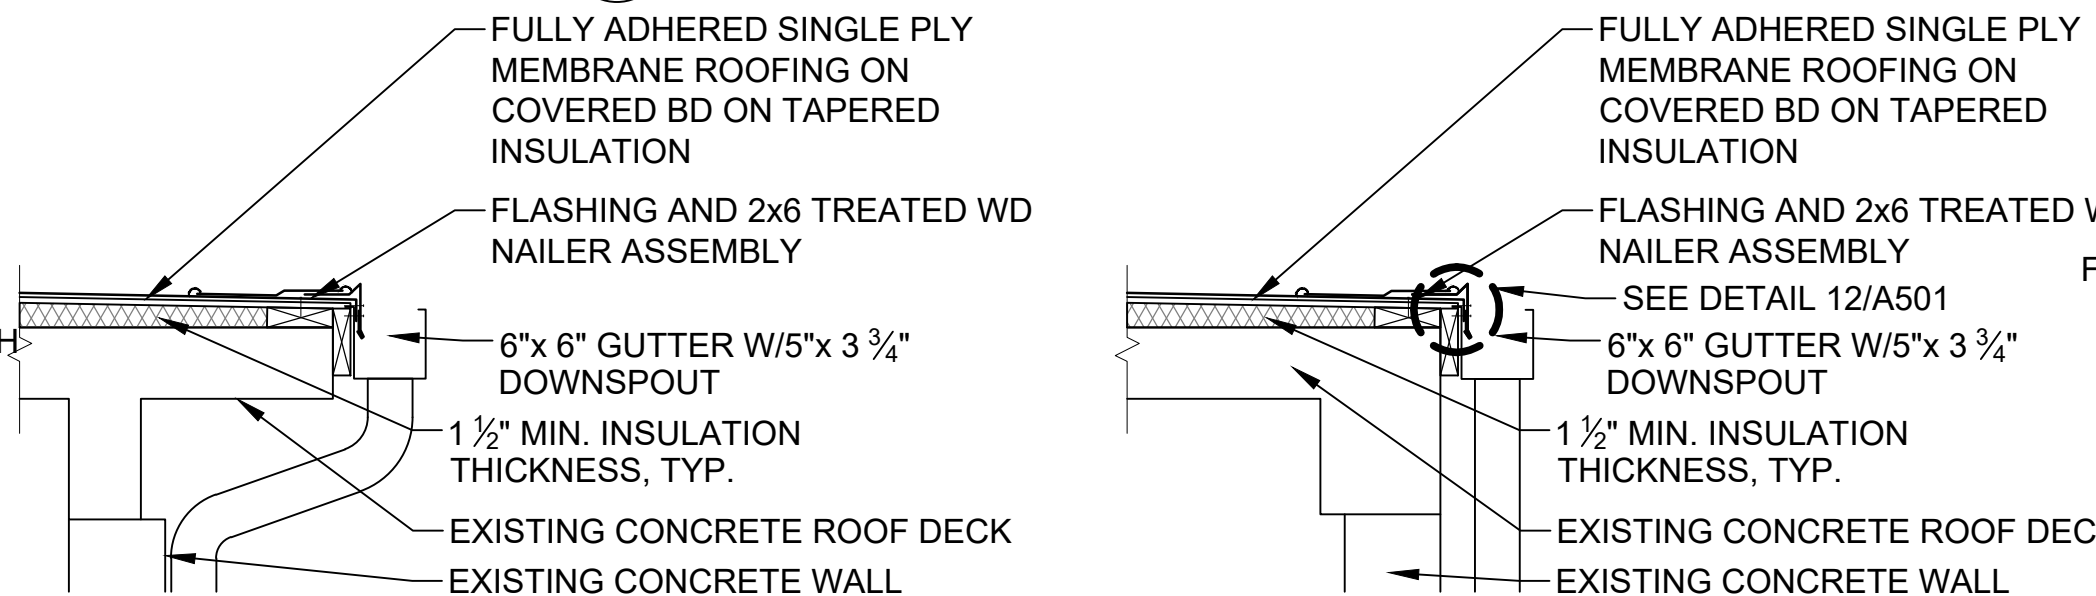

10 HIGH ROOF-FASCIA/GUTTER
SCALE: NTS

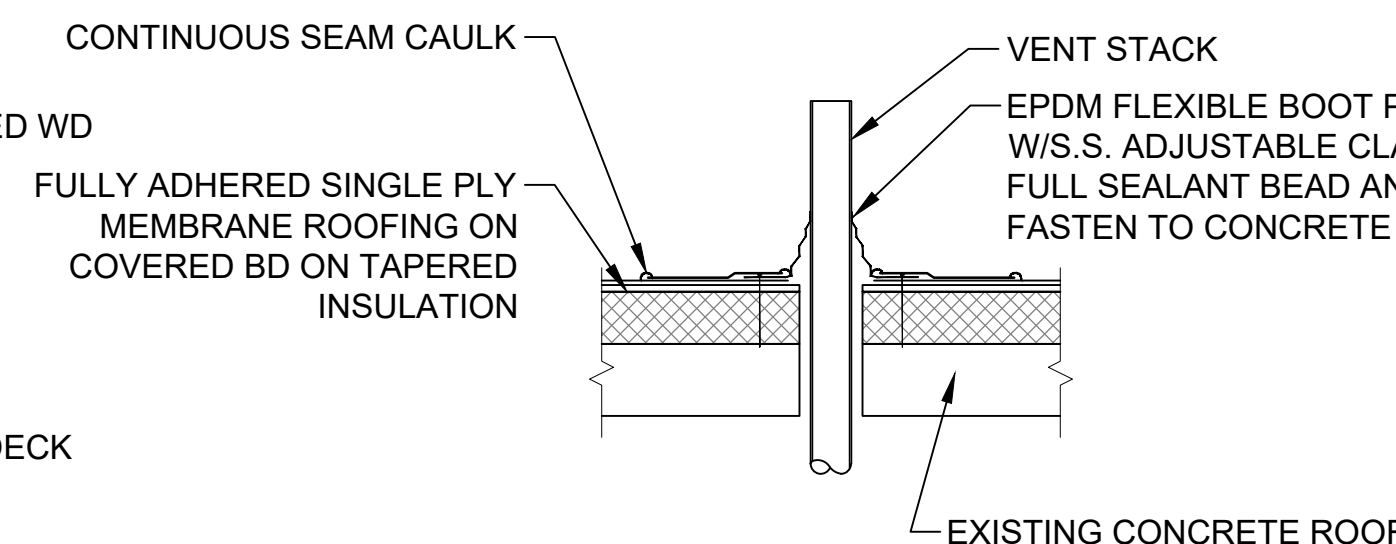


11 ROOF-PIPE PENETRATION
SCALE: NTS

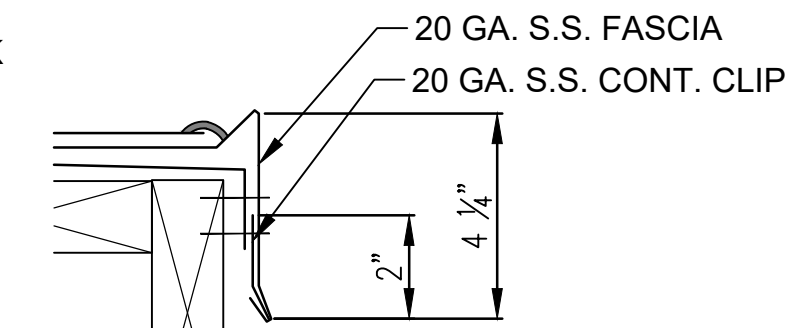


12 FASCIA DETAIL
SCALE: NTS


8 ROOF-VENT PENETRATION
SCALE: NTS

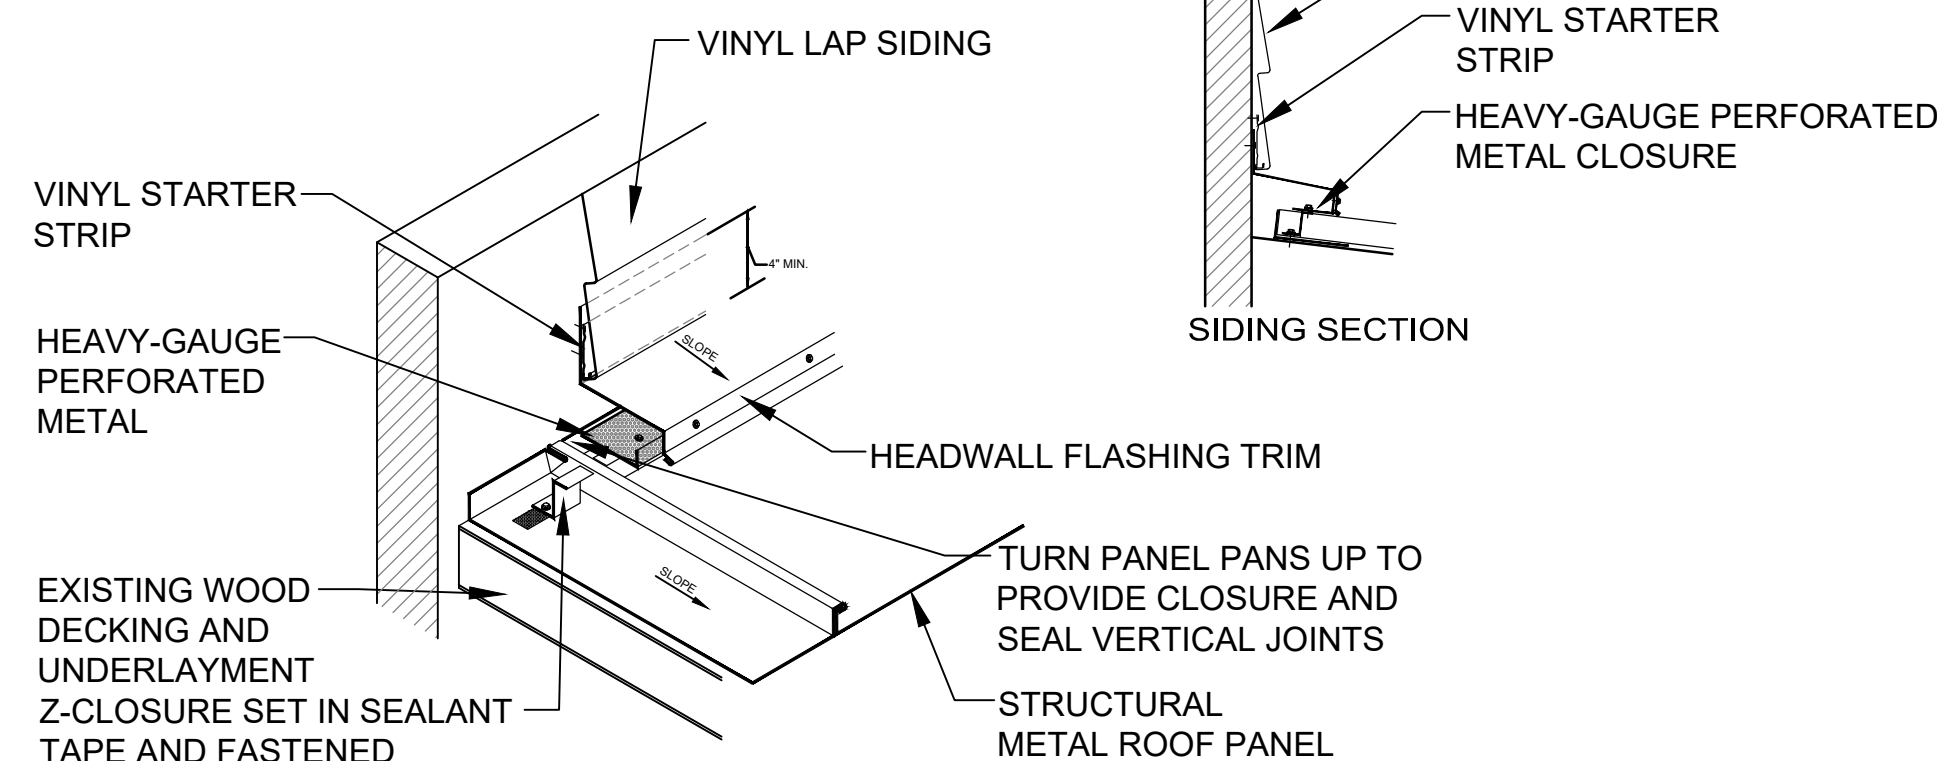

13 METAL TO SIDING DETAIL
SCALE: N.T.S.

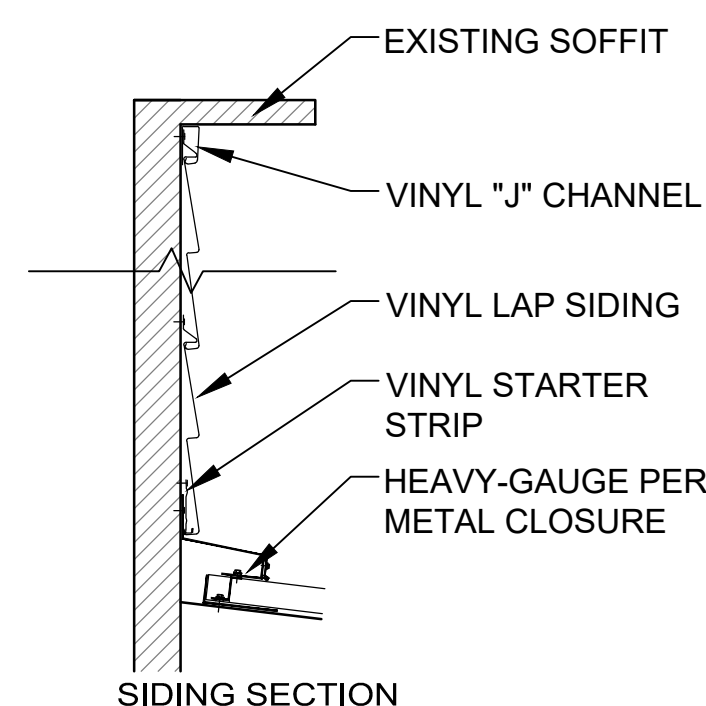

10 HIGH ROOF-FASCIA/GUTTER
SCALE: NTS

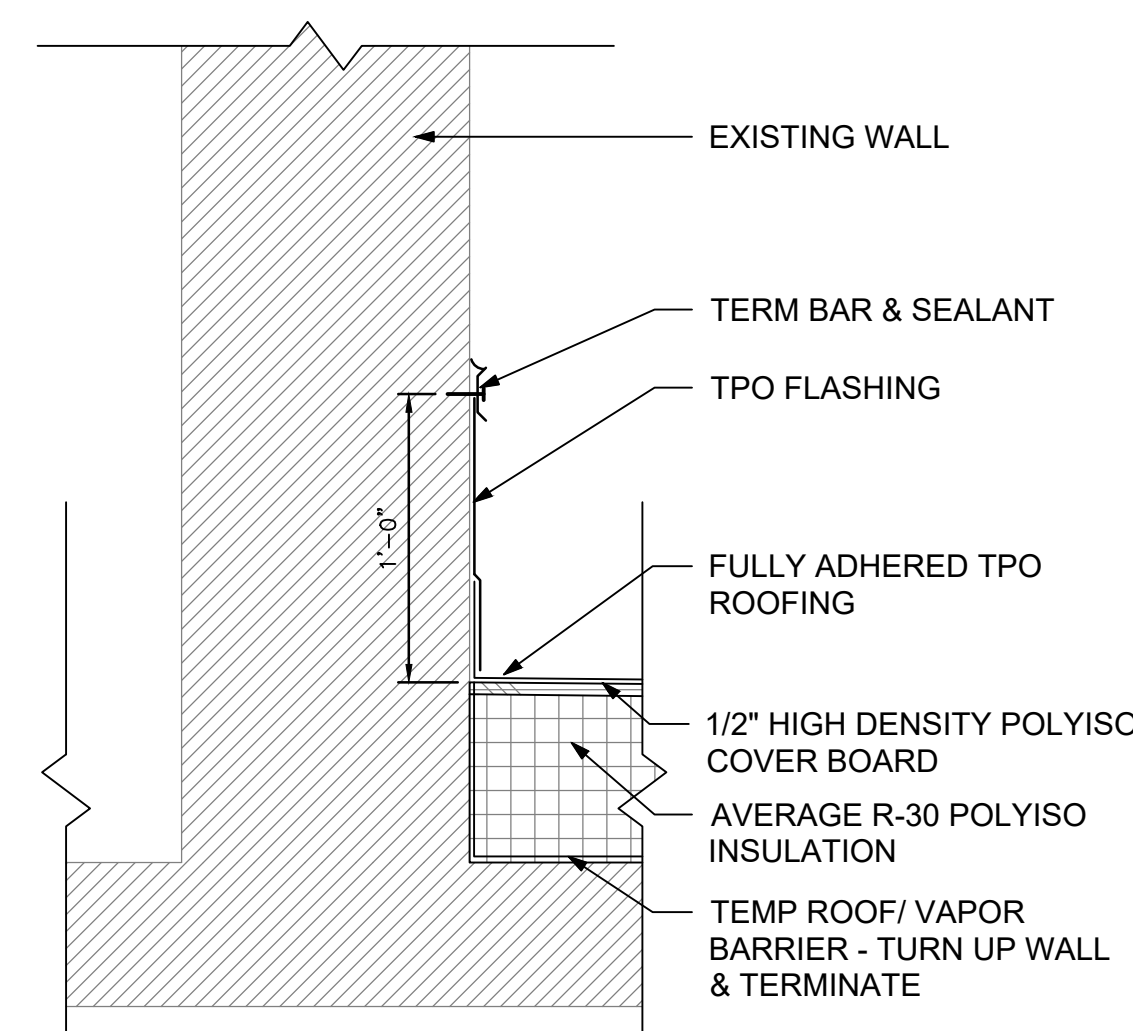

14 NEW ROOF TO WALL DETAIL
SCALE: 1 1/2"=1'-0"

OFFICE OF ADMINISTRATION
DIVISION OF FACILITIES
MANAGEMENT,
DESIGN AND CONSTRUCTION

DEPARTMENT OF
CORRECTIONS

REPLACE ROOFS
MULTIPLE ASSETS
OZARKS CORRECTIONAL
CENTER
929 HONOR CAMP LANE
FORDLAND, MO 65652

PROJECT # C2004-01
SITE # 7003

ASSET #
9327003025-FOOD SERVICE
9327003018-RECORDS AND P&P
9327003017-ADMINISTRATION
9327003019-SEGREGATION
9327003033-POWER PLANT

REVISION: _____
DATE: _____
REVISION: _____
DATE: _____
REVISION: _____
DATE: _____

ISSUE DATE: 3/17/2023

CAD DWG FILE: CB
DRAWN BY: CB
CHECKED BY: BMS
DESIGNED BY: BMS

SHEET TITLE:
ROOF DETAILS

SHEET NUMBER:

A-501

7 OF 7 SHEETS
DATE: 3/17/2023