# UPGRADE HVAC AND BAS COMMUNITY SUPERVISION CENTER MISSOURI DEPARTMENT OF CORRECTIONS ST. JOSEPH, MISSOURI

OWNER:

STATE OF MISSOURI MICHAEL L. PARSON,

**GOVERNOR** 

DEPARTMENT OF CORRECTIONS

**PROJECT MANAGEMENT:**  OFFICE OF ADMINISTRATION

DIVISION OF FACILITIES MANAGEMENT,


**DESIGN AND CONSTRUCTION** 



**VICINITY MAP** 



# **LOCATION MAP**

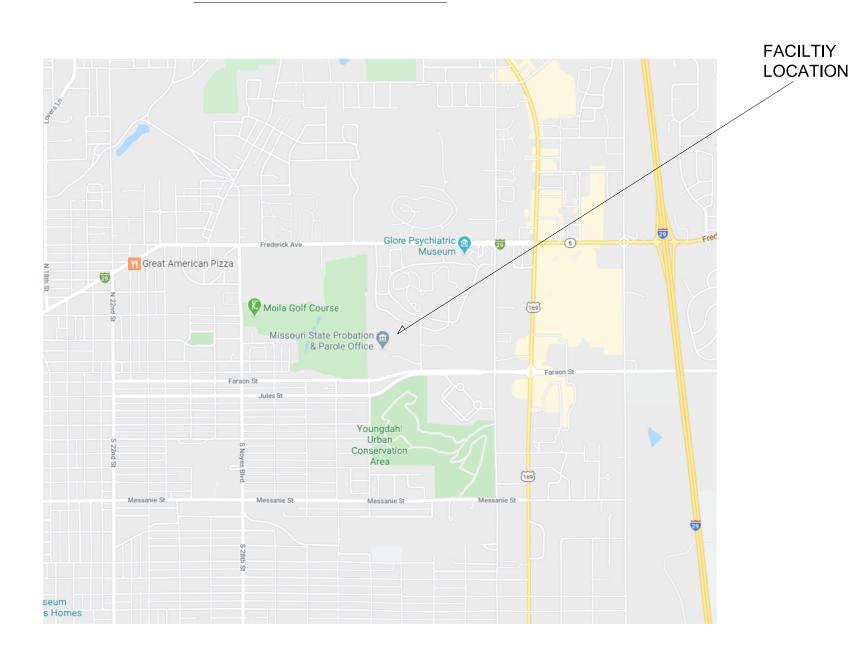

DESIGNER:

BRIC PARTNERSHIP, LLC

3701 S. LINDBERGH,

SUITE 204 ST. LOUIS, MISSOURI 63127

**PROJECT NUMBER:**  C2011-01

SITE

NUMBER:

7022

**ASSET** NUMBER:

9327022002

# DRAWING INDEX

### **GENERAL**

**COVER SHEET** 

### **MECHANICAL**

MECHANICAL LEGEND AND NOTES FIRST FLOOR PLAN - MECHANICAL DEMOLITION M-201 FIRST FLOOR PLAN - MECHANICAL **ENLARGED PLAN - MECHANICAL** M-401

M-501 MECHANICAL DETAILS CHILLED WATER SCHEMATIC M-502 M-601 MECHANICAL SCHEDULES MECHANICAL CONTROLS

### **ELECTRICAL**

**ELECTRICAL LEGEND AND NOTES** ELECTRICAL DEMOLITION FIRST FLOOR ELECTRICAL NEW WORK PLAN BRiC

**ST. LOUIS, MO 63127** PHONE: 314.725.5889 MISSOURI CERTIFICATE OF **AUTHORITY #2014035826** 

**DIVISION OF FACILITIES** MANAGEMENT, DESIGN AND **CONSTRUCTION** 

**DEPARTMENT OF** CORRECTIONS

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ST. JOSEPH COMMUNITY SUPERVISION CENTER

3305 FARAON ST. ST. JOSEPH, MO 64506

PROJECT # 2011-01 SITE # 7022

ASSET # 9327022002

**REVISION:** DATE: 10-05-2022 REVISION:

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SHEET TITLE:

**COVER** 

SHEET NUMBER:

G-000

SHEET 1 OF 12 10/05/2022

#### GENERAL NOTES (DEMOLITION)

- 1. THESE PLANS ARE DIAGRAMMATIC IN NATURE. SINCE THEY REFLECT ONLY THE AVAILABLE INFORMATION OBTAINED FROM EXISTING PLANS, SPECIFICATIONS, AND FIELD SURVEYS. THE EXACT LOCATION OF EXISTING DUCTWORK, PIPING, AND EQUIPMENT MAY DEVIATE FROM THE LOCATION INDICATED ON THESE DRAWINGS. THE CONTRACTOR SHALL BE PREPARED TO MAKE SOME ALTERATIONS TO NEW AND/OR EXISTING SERVICES TO FIT ACTUAL JOB CONDITIONS.
- DEMOLITION SHEETS INDICATE ITEMS TO BE REMOVED.
- 3. CROSS HATCHING INDICATES ITEMS TO BE

2. ITEMS SHOWN BOLD AND/OR DASHED ON THE


 OWNER HAS FIRST RIGHT OF REFUSAL FOR ALL EQUIPMENT BEING REMOVED. CONTRACTOR TO DISPOSE OF EQUIPMENT BEING REMOVED BUT NOT RETAINED BY OWNER.

#### **GENERAL NOTES (HYDRONIC)**

- 1. THE CONTRACTOR SHALL COORDINATE SYSTEM SHUT-DOWNS WITH THE FACILITY. PROVIDE A MINIMUM TWO WORKING DAY NOTICE PRIOR TO ANY SYSTEM SHUT-DOWN.
- 2. THE CONTRACTOR SHALL BE RESPONSIBLE FOR DRAINING, FILLING, AND VENTING OF ALL HYDRONIC SYSTEMS IMPACTED BY THIS PROJECT.

#### **GENERAL NOTES**

- 1. THESE PLANS ARE DIAGRAMMATIC IN NATURE SINCE THEY REFLECT ONLY THE AVAILABLE INFORMATION OBTAINED FROM EXISTING PLANS, SPECIFICATIONS, AND FIELD SURVEYS. THE EXACT LOCATION OF EXISTING PIPING, AND EQUIPMENT MAY DEVIATE FROM THE LOCATION INDICATED ON THE DRAWINGS. THE CONTRACTOR SHALL BE PREPARED TO MAKE SOME ALTERATIONS TO NEW AND/OR EXISTING SERVICES TO FIT ACTUAL JOB CONDITIONS.
- ANY HOLES LEFT IN EXISTING WALL CONSTRUCTION DUE TO DEMOLITION OR NEW WORK SHALL BE PATCHED TO MATCH EXISTING CONDITIONS.
- 3. CONTRACTOR TO FIRESTOP ALL PENETRATIONS THROUGH FIRE-RATED FLOORS AND WALLS CREATED BY DEMOLITION OR NEW WORK WITH "SPECSEAL SSS" OR EQUAL.
- 4. THE CONTRACTOR SHALL BE RESPONSIBLE FOR THE COORDINATION OF ANY FRAMING REVISIONS, EQUIPMENT LOCATIONS, ADDITION OF CONTROLS, ELECTRICAL CIRCUITING REVISIONS, ETC. THAT RESULT FROM USING EQUIPMENT OTHER THAN INDICATED ON THE DRAWINGS. APPROVAL OF THE SHOP DRAWINGS BY THE ENGINEER WILL NOT WAIVE THE CONTRACTOR OF THIS RESPONSIBILITY.
- 5. THE CONTRACTOR SHALL HAVE THE FINAL RESPONSIBILITY FOR SYSTEM START UP AND TURN OVER TO THE OWNER.
- 6. ALL ITEMS INCLUDED ON THESE DRAWINGS
  AND THE SPECIFICATIONS SHALL BE
  INCLUDED IN THE CONTRACTOR'S BID. IF THE
  CONTRACTOR DOES NOT CLEARLY
  UNDERSTAND THESE PLANS OR IS NOT SURE
  OF THEIR MEANING, THE CONTRACTOR
  SHOULD OBTAIN THE ENGINEER'S WRITTEN
  EXPLANATION AND INTERPRETATION PRIOR
  TO BID TIME. THE CONTRACTOR WILL BE
  HELD TO THE INTERPRETATION OF THE
  ENGINEER.
- 7. IT SHALL BE THE CONTRACTOR'S RESPONSIBILITY TO COORDINATE ALL TEMPERATURE CONTROL SYSTEM REQUIREMENTS.
- 8. ROUTE LINE SIZE PVC CONDENSATE DRAIN PIPING FROM AIR HANDLING UNIT TO NEAREST FLOOR DRAIN. PROVIDE TRAP AT CONNECTION TO AIR HANDLING UNIT.
- 9. ANY DAMAGE TO THE SITE (SIDEWALKS, CURBS, ETC) OR TO THE BUILDING AS A RESULT OF WORK PERFORMED UNDER THIS CONTRACT SHALL BE FIXED BY THE CONTRACTOR AT NO ADDITIONAL COST TO THE OWNER.
- 10. CONTRACTOR WILL BE RESPONSIBLE FOR ALL CUTTING AND PATCHING OF ROOFS/WALLS AND CORE DRILLS REQUIRED TO COMPLETE THEIR RESPECTIVE WORK.
- 11. THE OWNER SHALL HAVE FIRST SALVAGE RIGHTS OF EQUIPMENT AND MATERIALS REMOVED. ALL EQUIPMENT AND MATERIALS NOT CLAIMED BY THE OWNER SHALL BE REMOVED FROM THE PREMISES BY THE CONTRACTORS.
- 12. THE CONTRACTOR SHALL BE RESPONSIBLE FOR PROVIDING ANY TEMPORARY FENCING AROUND THE LIFT SITE DURING LIFTS.

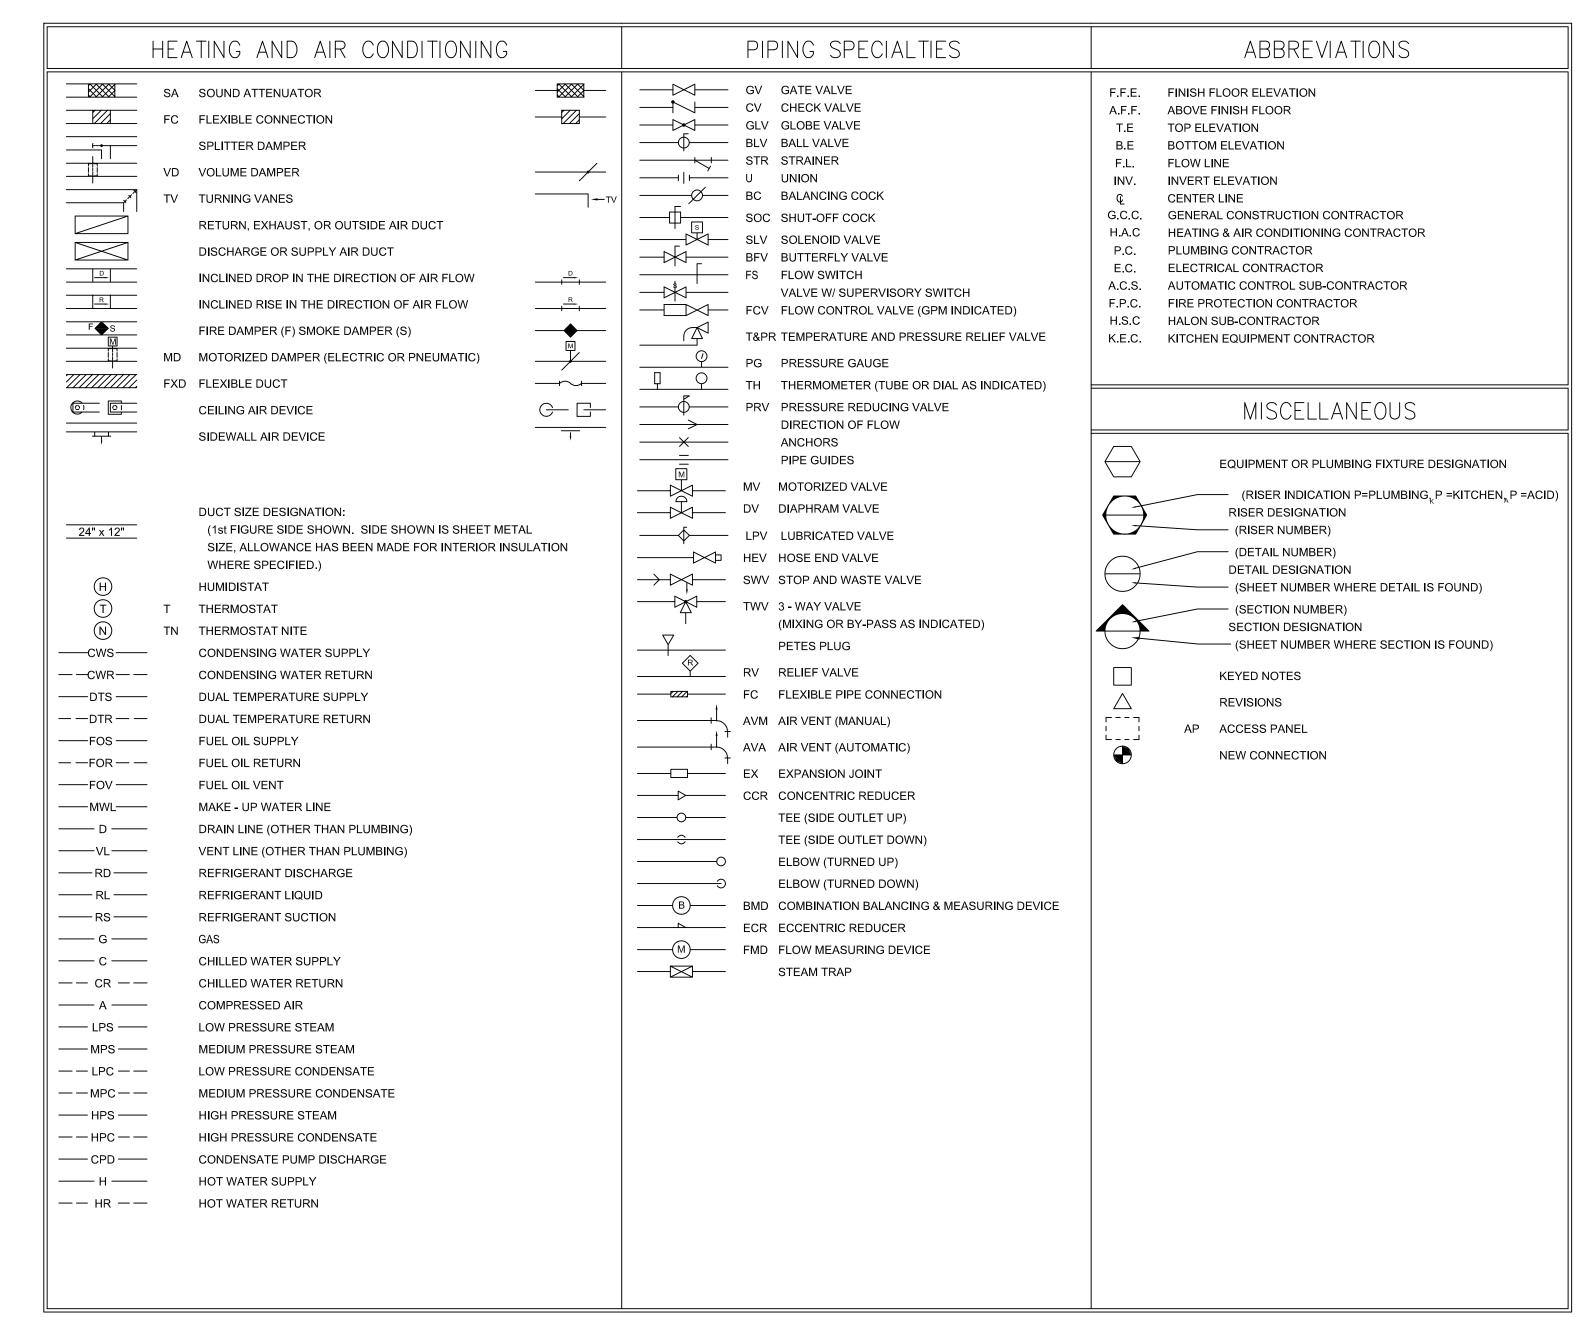

NOTE: NOT ALL SYMBOLS OR ABBREVIATIONS MAY BE USED.


PHASING NOTE:

THE JOB SHALL BE PHASED SUCH THAT ONLY ONE AIR HANDLING UNIT SHALL BE DOWN AT A TIME

IF IF THE PROJECT IS UNDER CONSTRUCTION IN THE HEATING SEASON, ALL CONDENSING UNITS CAN BE REMOVED AT THE SAME TIME.

IF THE PROJECT IS UNDER CONSTRUCTION IN THE COOLING SEASON, THE CHILLER MUST BE OPERATIONAL BEFORE CONDENSING UNITS ARE REMOVED, AND ONLY ONE HVAC ZONE MAY BE OUT OF SERVICE AT A TIME.

STATE OF MISSOURI MICHAEL L. PARSON, GOVERNOR

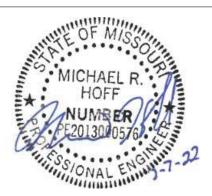

MICHAEL HOFF LICENSE #: PE2013000576 EXP: 12/31/2023



3701 S. LINDBERGH BOULEVARD SUITE 204 ST. LOUIS, MO 63127 PHONE: 314.725.5889 MISSOURI CERTIFICATE OF

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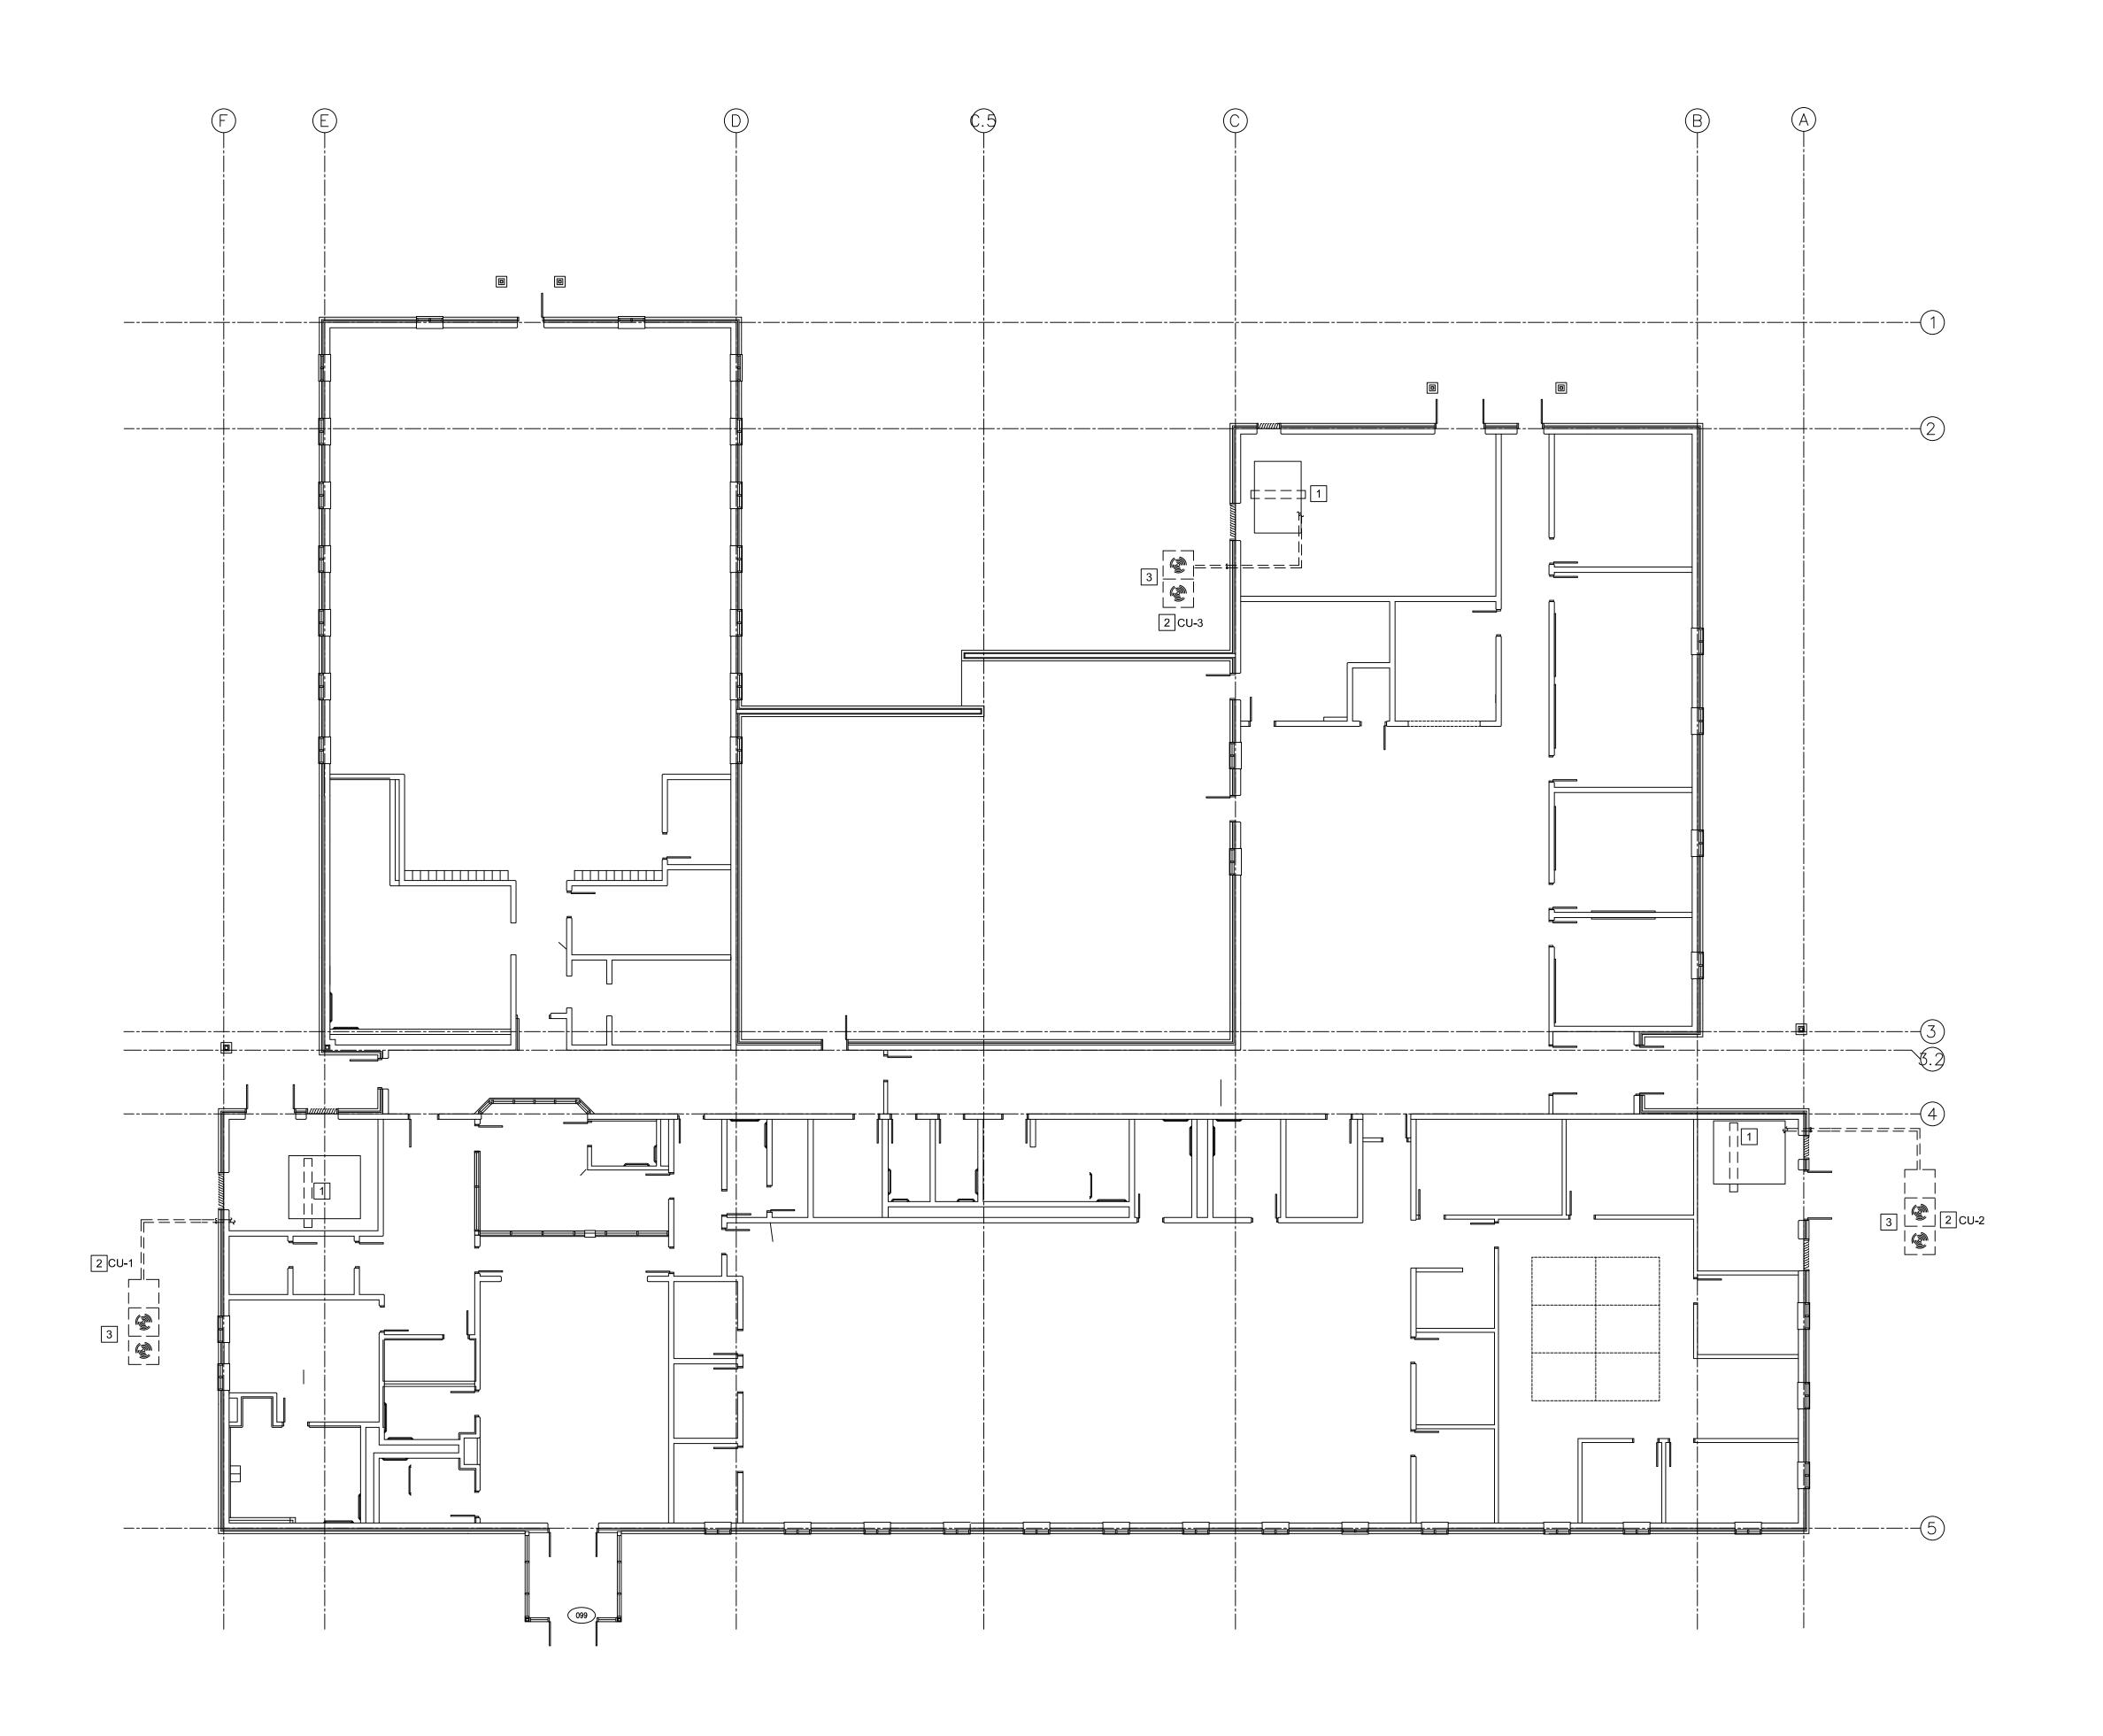
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MRH
MRH

SHEET TITLE:

MECHANICAL LEGEND AND NOTES

SHEET NUMBER:

M-UU
SHEET 2 OF 12
10/05/2022



MECHANICAL FLOOR PLAN

SCALE: 1/8" = 1'-0"


## KEYED NOTES

1 DISCONNECT AND REMOVE EXISTING DX COOLING COIL IN AIR HANDLING UNIT. A NEW CHILLED WATER COIL WILL BE INSTALLED IN THIS AIR HANDLING UNIT. SEE NEW WORK DRAWINGS.

2 DISCONNECT AND REMOVE EXISTING DX CONDENSING UNIT, AND ALL ASSOCIATED REFRIGERANT PIPING AND CONTROLS. PATCH REMAINING BUILDING OPENINGS TO MATCH EXISTING.

3 REMOVE EXISTING CONCRETE PAD. BACKFILL REMAINING HOLE. COVER WITH GRASS SEED AND STRAW

STATE OF MISSOURI MICHAEL L. PARSON, GOVERNOR

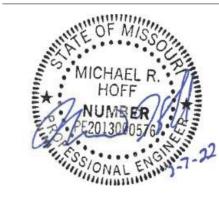

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BRiC
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CONSULTING ENGINEERS



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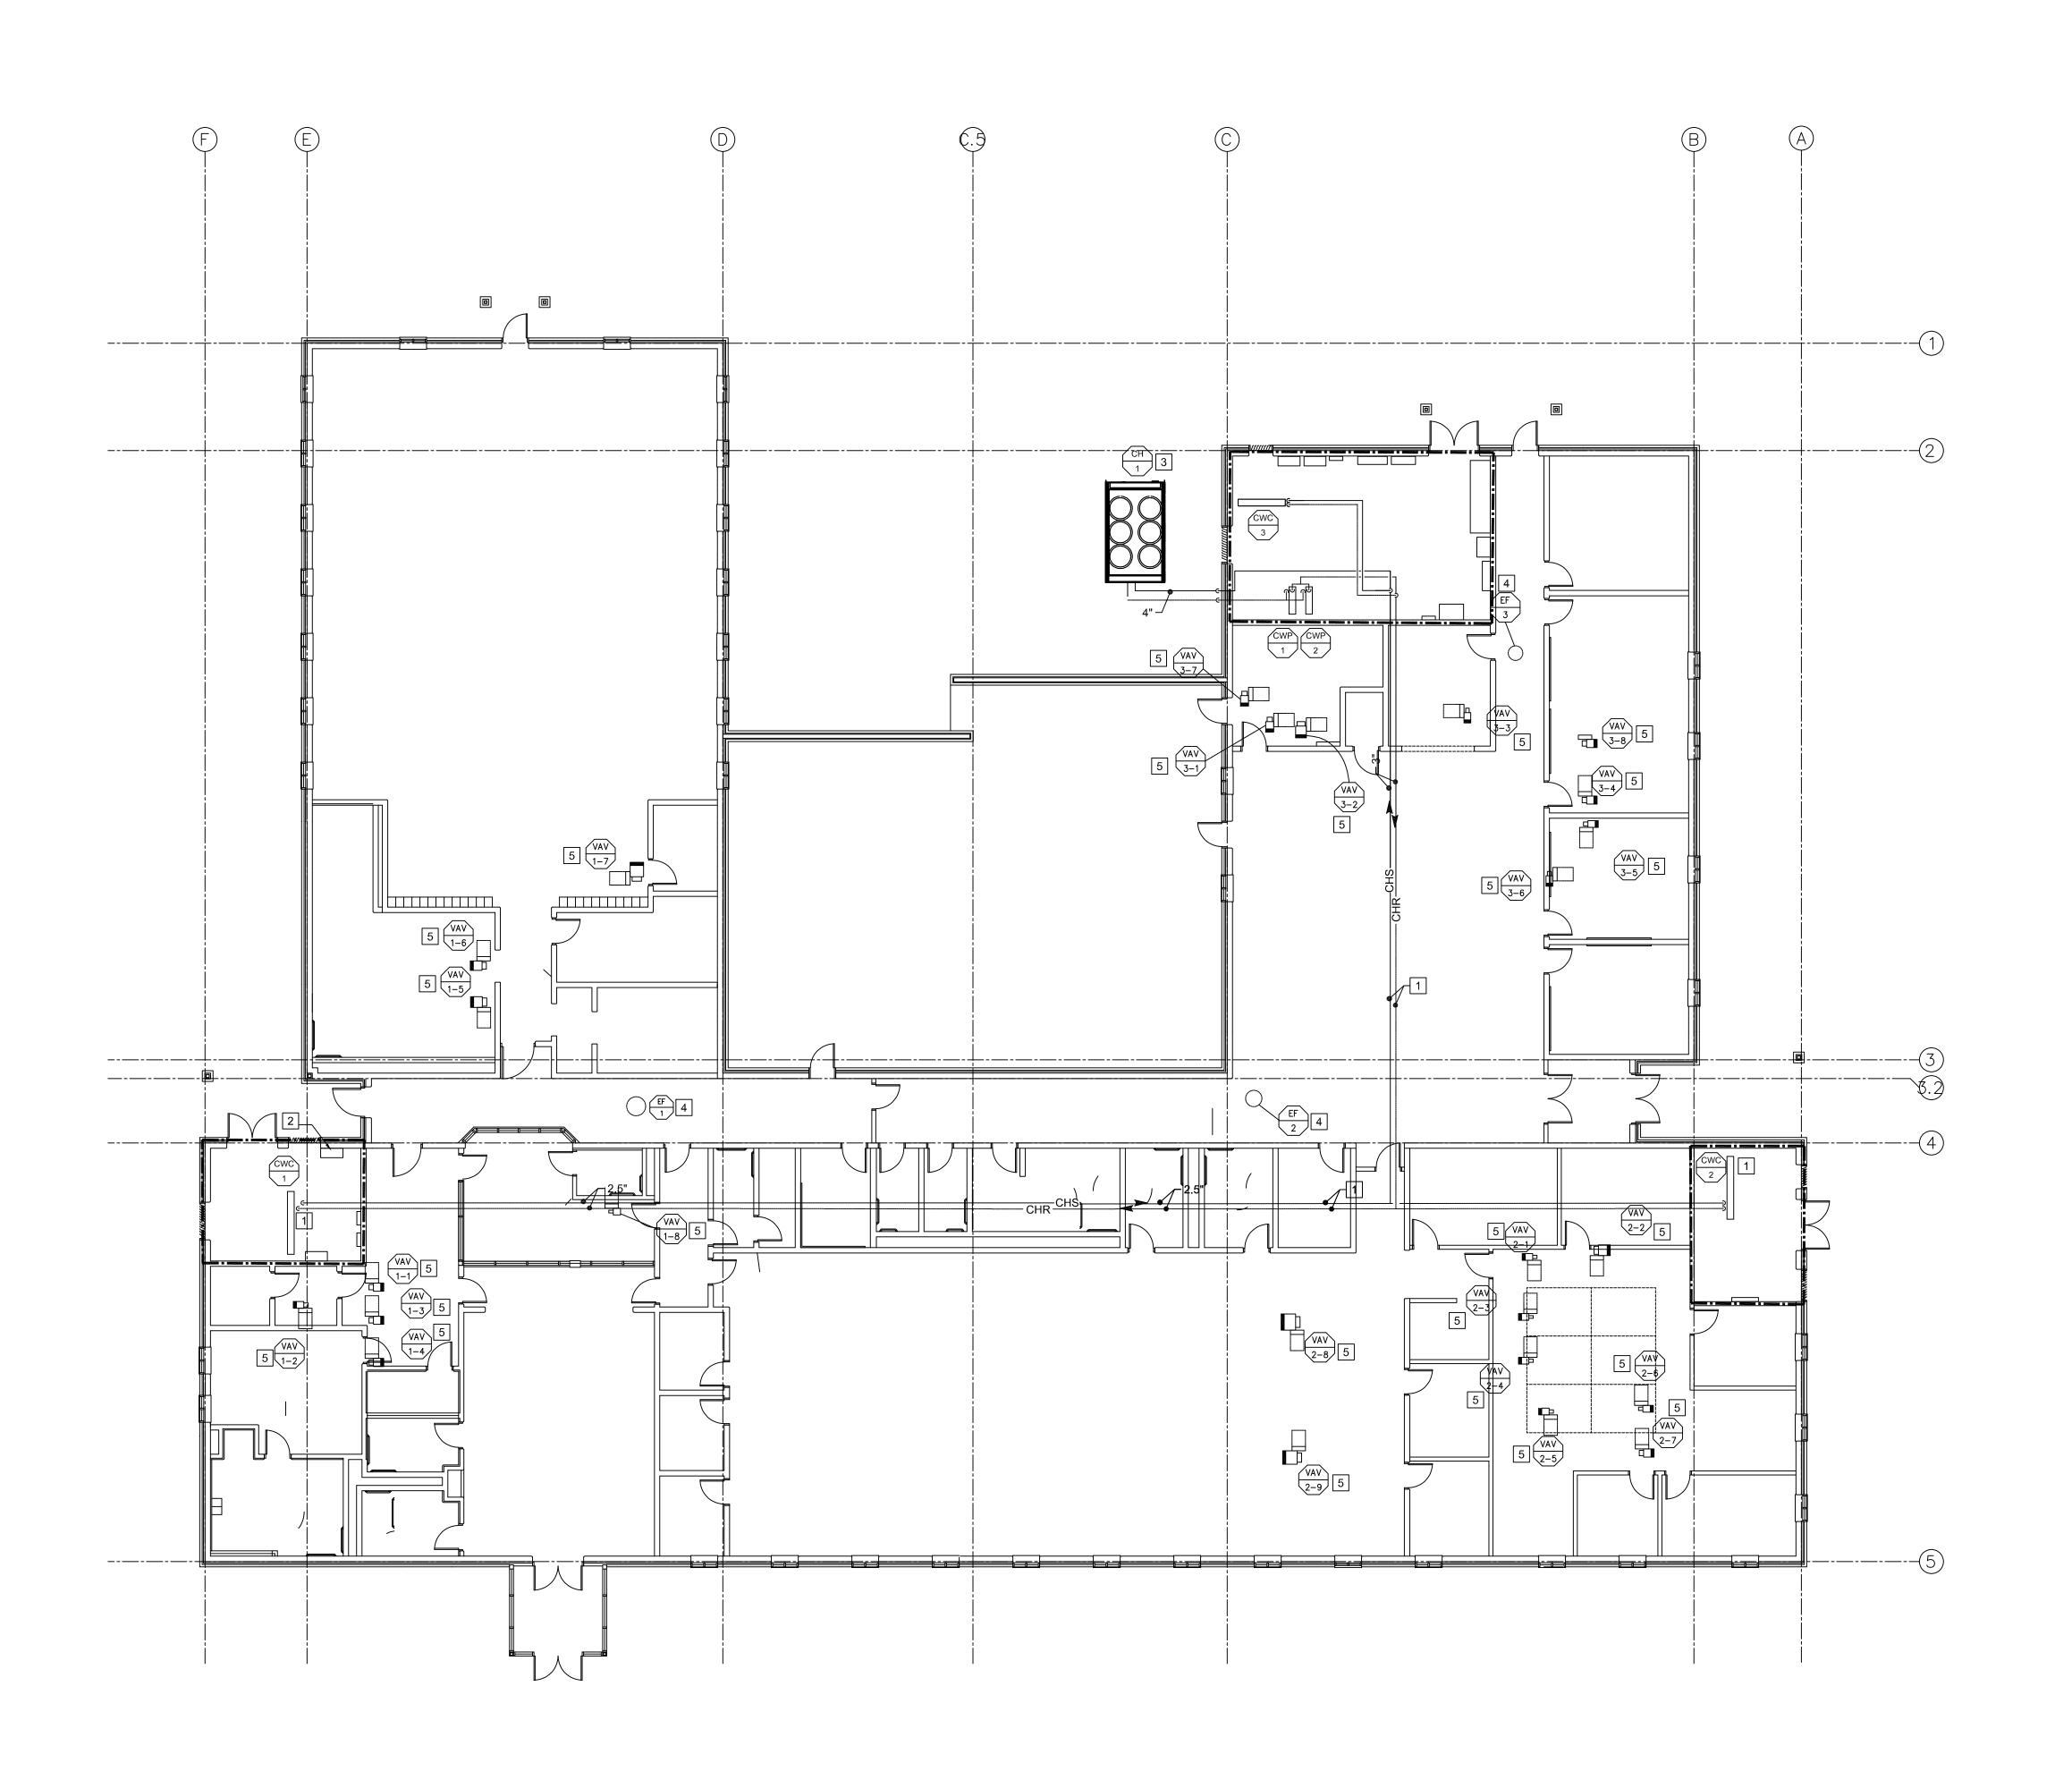
SHEET TITLE:

FIRST FLOOR MECHANICAL DEMOLITION

SHEET NUMBER:

MD-101

SHEET 3 OF 12 10/05/2022



MECHANICAL FLOOR PLAN

SCALE: 3/32" = 1'-0"

KEYED NOTES

1 CHILLED WATER PIPING ROUTED THROUGH ATTIC SPACE. SEAL WALL PENETRATIONS THROUGH FIRE WALLS TO MAINTAIN FIRE RATING.

2 SEE MECHANICAL ROOM DETAILS ON M-401

3 NEW CHILLER ON NEW CONCRETE PAD

4 CONNECT EXISTING EXHAUST FAN TO BMS

5 CONNECT EXISTING VAV TO BMS. EXSITING CONTROLLER, WIRING AND TSTAT MAY REMAIN.

STATE OF MISSOURI MICHAEL L. PARSON, GOVERNOR



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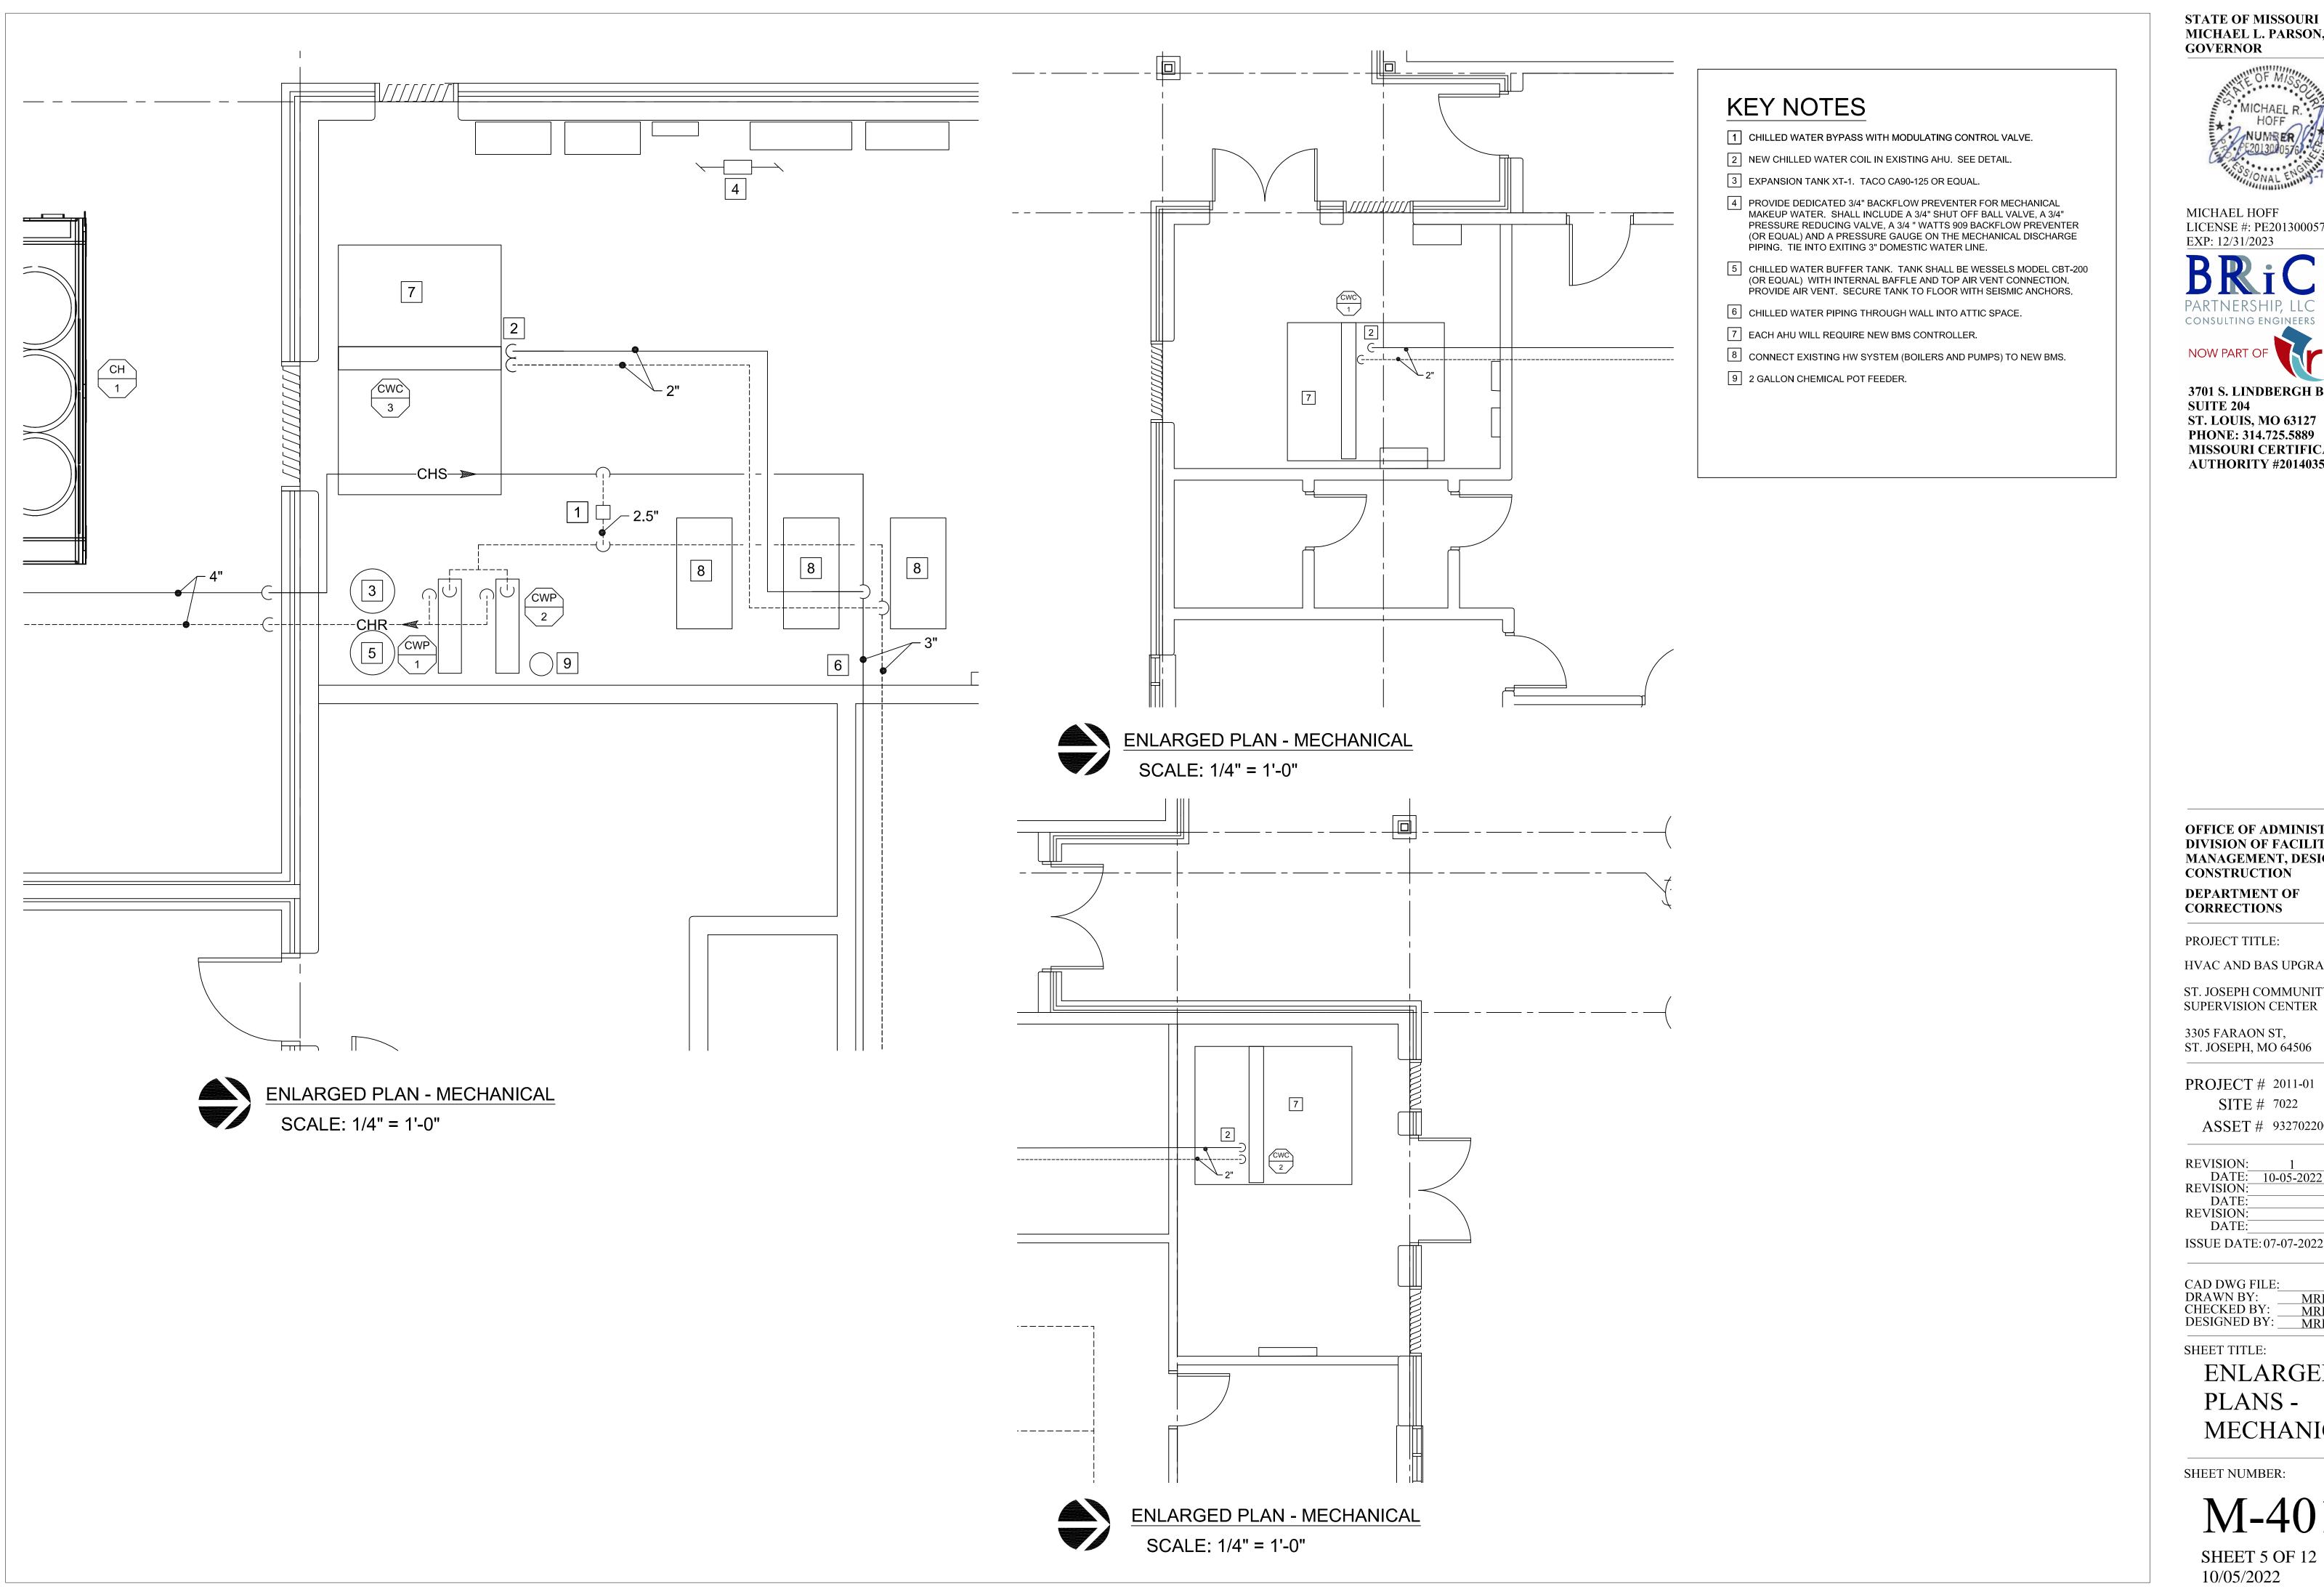
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FIRST FLOOR MECHANICAL FLOORPLAN

SHEET NUMBER:

M-201

SHEET 4 OF 12 10/05/2022



MICHAEL L. PARSON, **GOVERNOR** 



MICHAEL HOFF LICENSE #: PE2013000576 EXP: 12/31/2023



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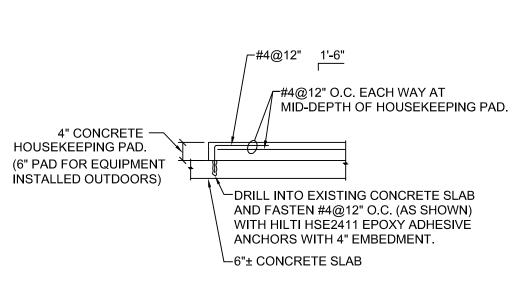
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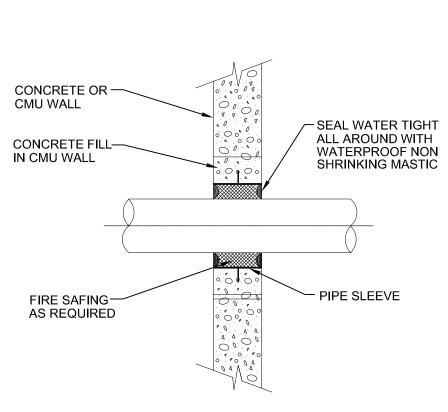
**ENLARGED** PLANS -**MECHANICAL** 

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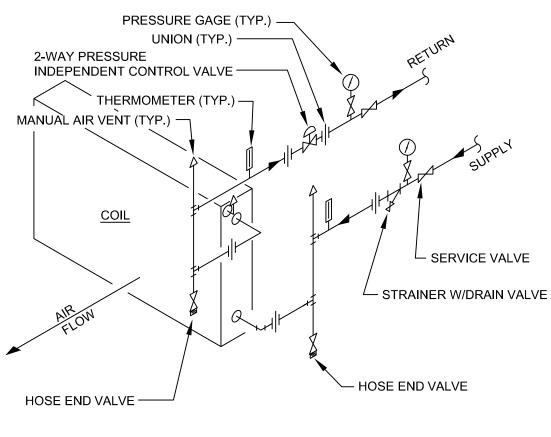
SHEET 5 OF 12 10/05/2022








PIPE PENETRATION THRU WALL



NOTE:
ARRANGE RISERS SUCH THAT COIL MAY BE REMOVED WITHOUT DISTURBING RISERS.


### **CHILLED WATER COIL DETAIL** NO SCALE

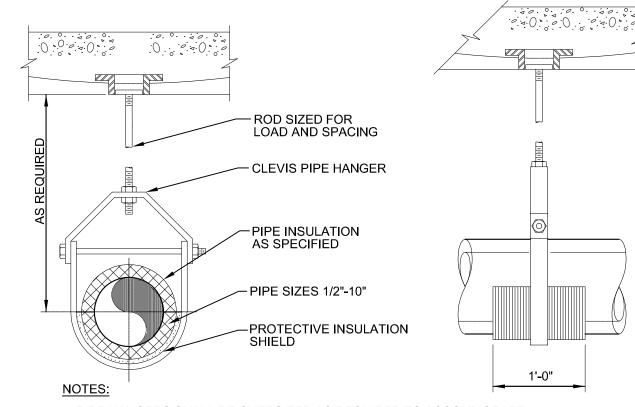

1. PIPE HANGERS SHALL BE OVERSIZED AS REQUIRED TO ACCOMMODATE. THICKNESS OF INSULATION SPECIFIED. HANGER SHALL NOT COME INTO CONTACT WITH THE INSULATION DIRECTLY, EITHER AT THE VERTICAL YOKE OR AT THE POINT OF SUPPORT. FOR REQUIREMENTS ON INSULATION SHIELD USED WITH PIPE HANGERS, SEE SPECIFICATIONS.


# PIPE HANGER DETAIL

NO SCALE

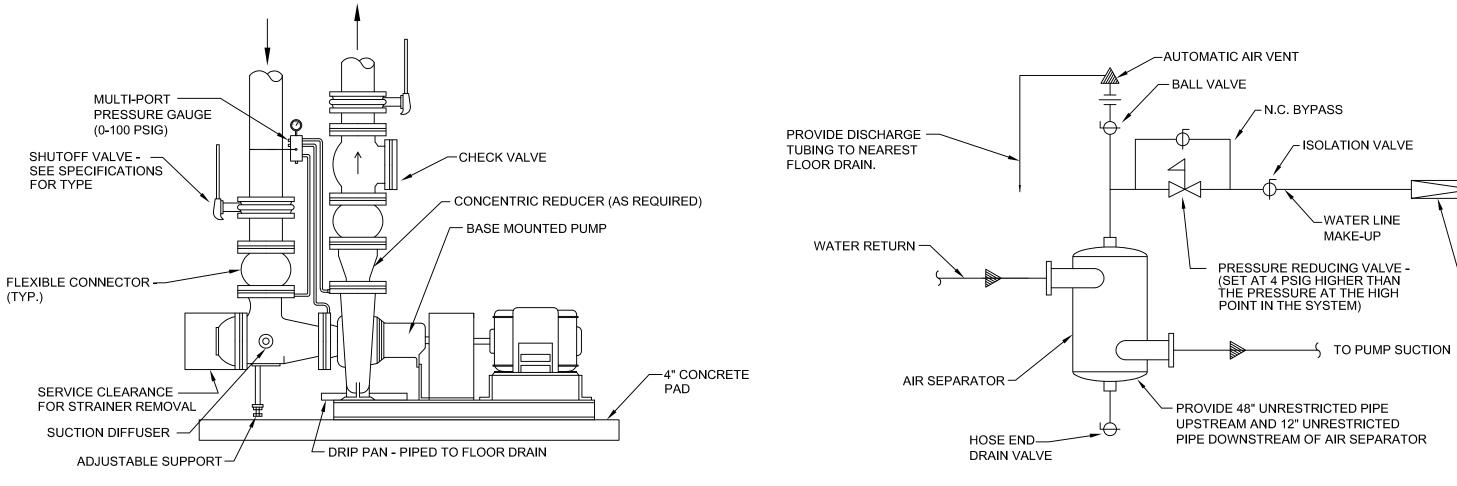


END SUCTION PUMP PIPING DETAIL




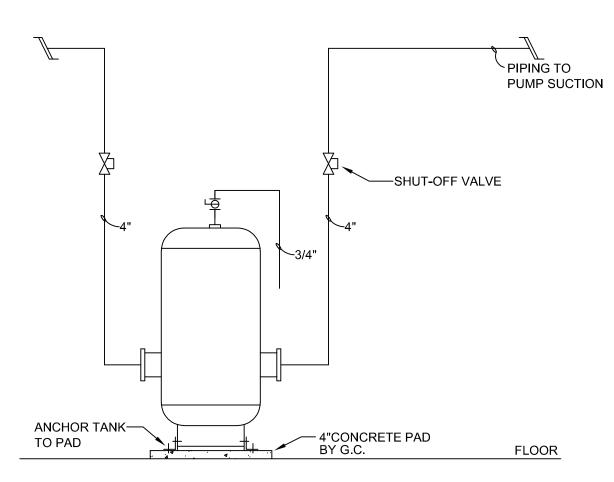

**BUFFER TANK DETAIL** NO SCALE

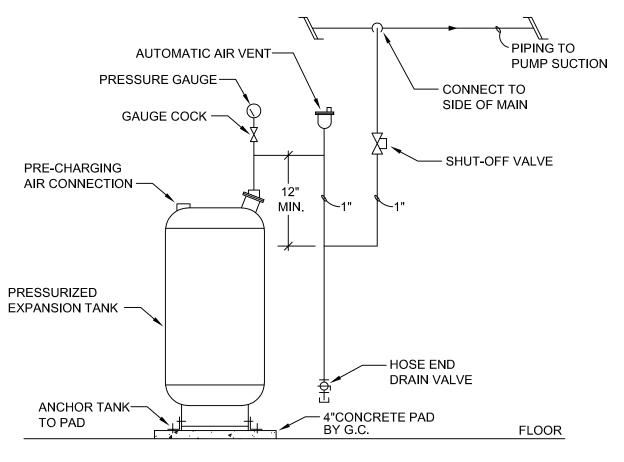

**EXPANSION TANK DETAIL** 

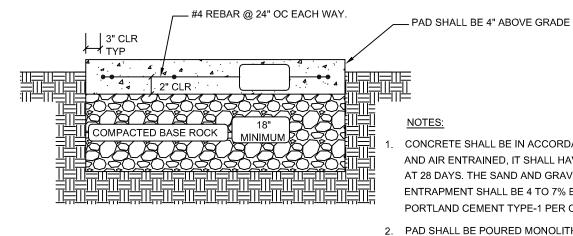

COORDINATE FINAL SIZE OF PAD

WITH EQUIPMENT TO BE PROVIDED.

PIPE TO DRAIN

REDUCED PRESSURE

BACKFLOW PREVENTER

CONCRETE SHALL BE IN ACCORDANCE WITH THE LATEST EDITION OF THE ACI CODE AND AIR ENTRAINED, IT SHALL HAVE A MINIMUM COMPRESSIVE STRENGTH OF 3000 PSI AT 28 DAYS. THE SAND AND GRAVEL ARE TO BE CLEAN AND HARD, THE AIR ENTRAPMENT SHALL BE 4 TO 7% BY VOLUME. THE MIX SHALL HAVE 5 BAGS OF

- PORTLAND CEMENT TYPE-1 PER CUBIC YARD OF CONCRETE. 2. PAD SHALL BE POURED MONOLITHICALLY, WITH NO COLD JOINTS.
- 3. NO FOOTING IS TO BE EXCAVATED WITHOUT HAVING REINFORCING AND CONCRETE READY TO PLACE WITHIN THAT WORKING DAY.
- 4. ALL REINFORCING BARS SHALL BE DEFORMED #4 BILLET STEEL CONFORMING TO ASTM A615, GRADE 60. BARS SHALL BE FREE OF ANY GREASE, RUST, OR SCALE AT THE TIME OF PLACEMENT. TIE ALL STEEL AT INTERSECTIONS. SPACING SHALL NOT EXCEED 24" ON CENTERS.
- 5. TOP SURFACES OF CONCRETE SHALL HAVE A STEEL TROWEL FINISH.

# **EQUIPMENT PAD DETAIL**

NO SCALE

STATE OF MISSOURI MICHAEL L. PARSON, **GOVERNOR** 



MICHAEL HOFF LICENSE #: PE2013000576 EXP: 12/31/2023

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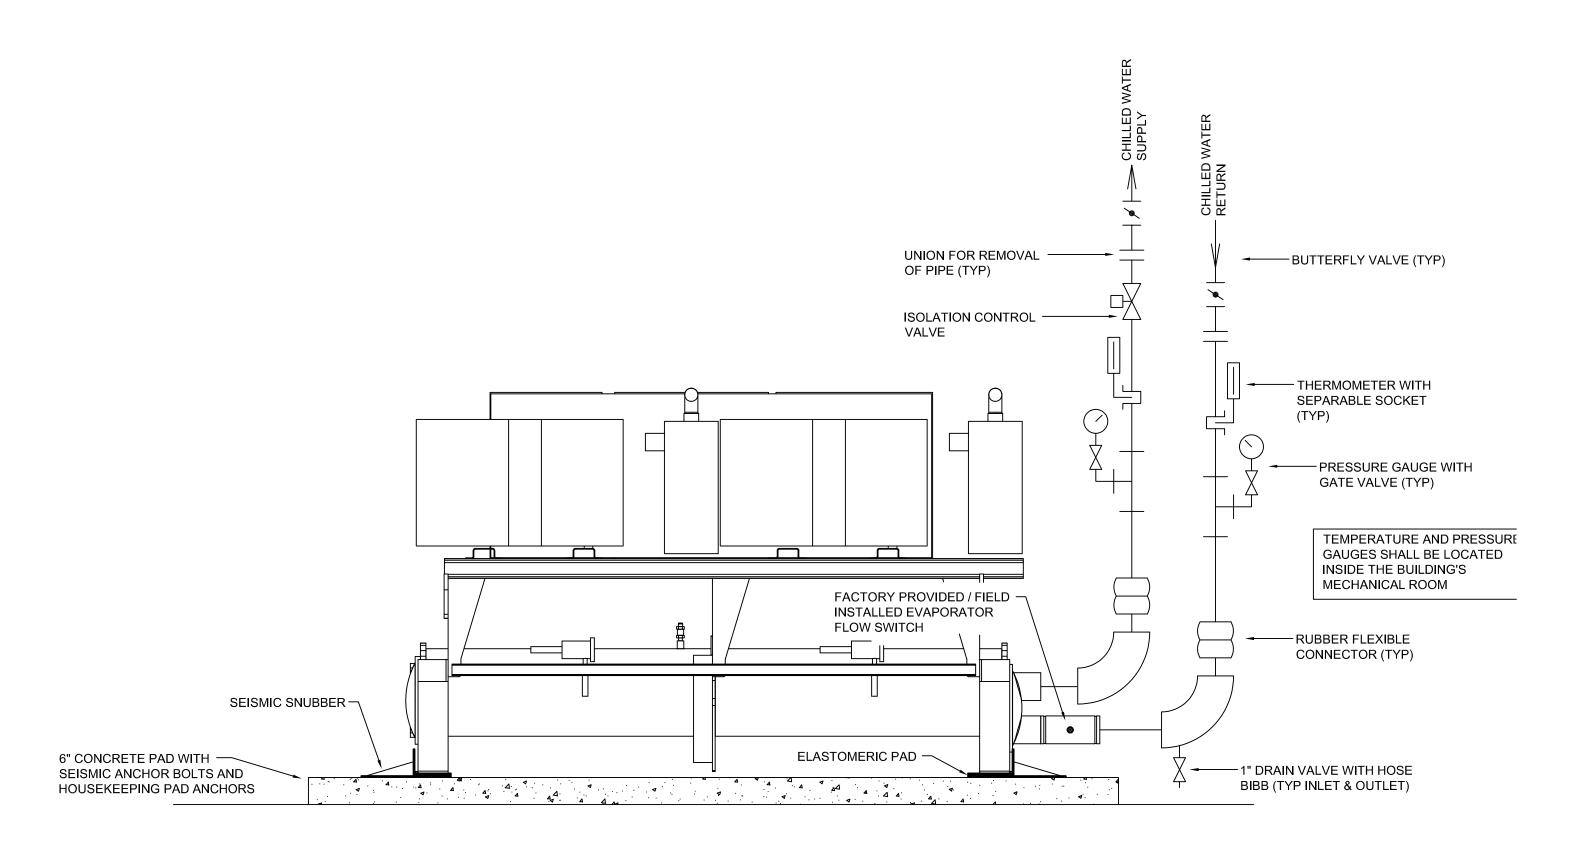
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MECHANICAL **DETAILS** 


SHEET NUMBER:

SHEET 6 OF 12

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# 1 CHILLED WATER SCHEMATIC




# CHILLED WATER PIPING SCHEMATIC

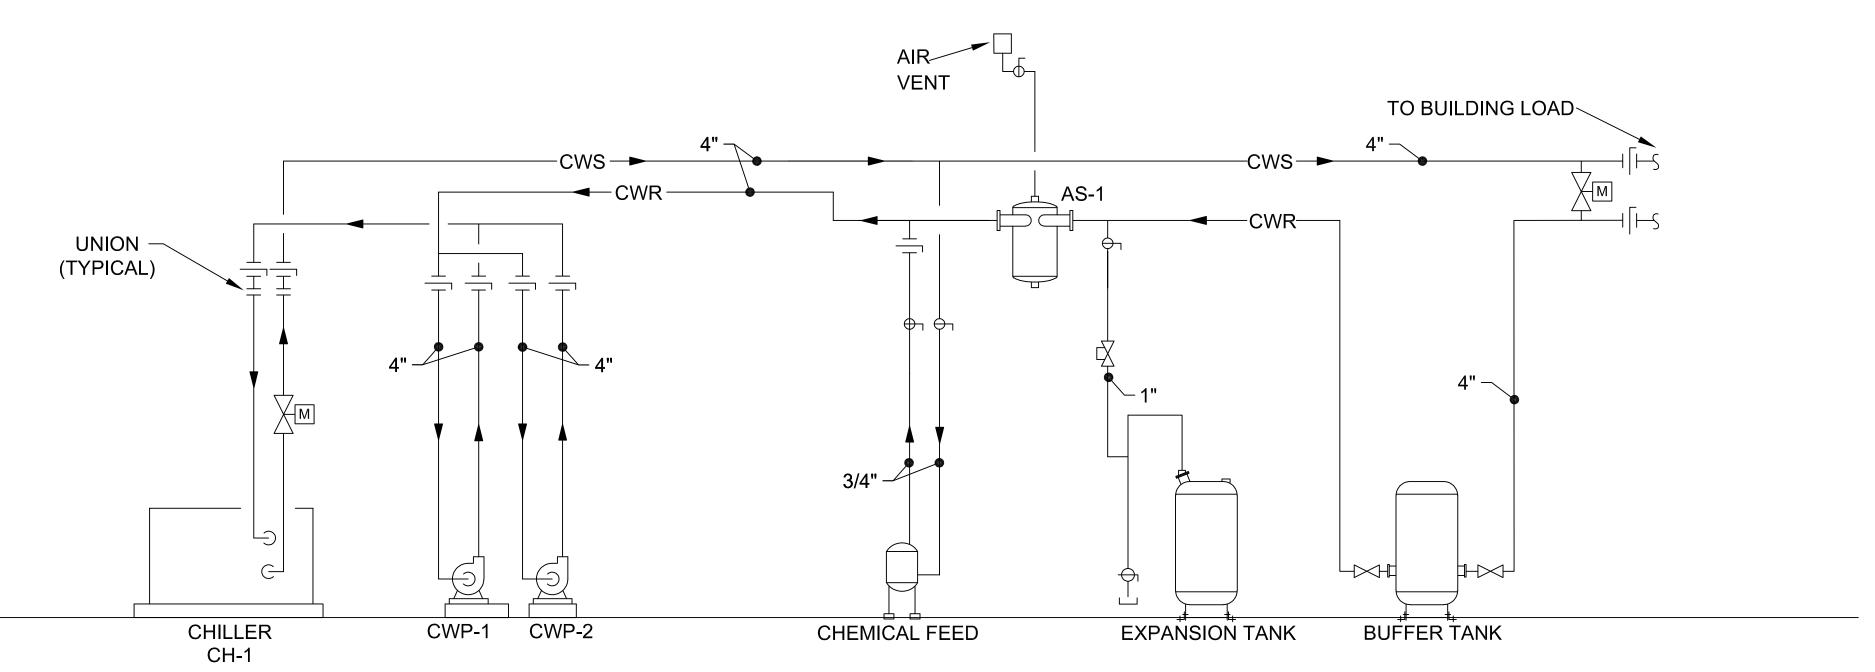NO SCALE



STATE OF MISSOURI MICHAEL L. PARSON, GOVERNOR

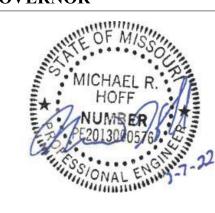

MICHAEL HOFF LICENSE #: PE2013000576 EXP: 12/31/2023



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SHEET TITLE:

CHILLED WATER

SCHEMATIC

SHEET NUMBER:

M-502
SHEET 7 OF 12

10/05/2022

							CHIL	LLE	ER SC	HEDULE									CH
				CAPACITY			EVAF	PORAT	ΓOR				COMPRES	SOR	ELE	CTRICA	۸L	FLUID	
PLAN MARK	MANUFACTURER	MODEL NO.	TONS	IPLV KW/TON	EER	WATER FLOW GPM	EWT'F LV	WT <b>'</b> F	P.D. (FT. OF HD.)	MIN. WATER FLOW GPM	QTY	TYPE	RATED-LOAD AMPS	LOCKED-ROTOR AMPS	VOLT/PH	MCA	МОР	PROPYLENE GLYCOL	NOTES
CH-1	TRANE	CGAM	60	15.4	10.7	142	54	44	24	67	4	SCROLL	50.2	351	208/3	257	300	30%	ALL

NOTES:

1) SINGLE POINT POWER CONNECTION WITH DISCONNECT.

2 MINIMUM 14 IPLV.

3 FACTORY INSTALLED THERMAL DISPERSION FLOW SWITCH ON EVAPORATOR.
 4 FACTORY CONTROL PANEL WITH TOUCHSCREEN AND BACNET INTERFACE.

(5) FACTORY INSULATION PACKAGE.

6 HIGH EFFICIENCY/PERFORMANCE.

7 STANDARD COOLING APPLICATION.8 REFRIGERANT SERVICE VALVES

9 FAN VFD CONTROL10 RATINGS BASED ON 30% POLYPROPYLENE

PRODUCT LISTED IS BASIS OF DESIGN ONLY

	CHILLED WATER COIL														ćwò							
PLAN MARK	MANUFACTURER	MODEL	AIRFLOW	TOTAL CAPACITY MBH	SENSIBLE CAPACITY MBH		LDB/LWB	FACE VELOCITY	AIR PD (WG)	H2O TEMF EWT	PERATURE LWT		H2O PD (WG)	PROP. GLYCOL	ROWS	FPI	TUBE DIAMETER	TUBE MATERIAL	FIN MATERIAL	WEIGHT	DIMENSIONS	REMARKS
CWC-1	MARLO	6W22-51-5609F-11.8-H-1.0-R-B	5800	248	213	82.1/69.1	55.0/54.3	490	0.5"	42	52	61	16.6"	30%	6	9	5/8	CU .035	AL .010	335	51"L X 33.4"H	ALL
CWC-2	MARLO	6W22-51-5609F-11.8-H-1.0-R-B	6500	305	236	82.1/69.1	55.0/54.3	490	0.5"	42	52	57	16.6"	30%	6	9	5/8	CU .035	AL .010	335	51"L X 33.4"H	ALL
CWC-3	MARLO	8W18-41-5508F-7.8-H-1.33-R-B	3900	166	139	81.8/69.1	55.0/54.3	540	0.5"	42	52	44	16.6"	30%	6	9	5/8	CU .035	AL .010	275	41"L X 28"H	ALL
1																						

NOTES

① CONTRACTOR TO VERIFY UNIT SIZES FOR COIL FIT.

2 ALTERNATE MANUFACTURERS HEATCRAFT AND USA COIL

③ COILS SELECTED BASED ON 30% PROPYLENE GLYCOL

4 CHILLED WATER COIL MEASUREMENTS ARE THE MEASUREMENTS OF THE SPECIFIC COIL SPECIFIED. THE CASE DIMENSIONS ARE LARGER AT ROUGHLY 68 X 44 FOR AHU-1,2 AND 39 X 57 FOR AHU-3 (OUTSIDE DIMENSION), BUT MUST BE VERIFIED BY CONTRACTOR.

SEE SPECIFICATIONS FOR APPROVED MANUFACTURERS

SEE SPECIFICATIONS FOR APPROVED MANUFACTURERS

PRODUCT LISTED IS BASIS OF DESIGN ONLY

PUMP SCHEDULE												
PLAN MARK	MANUFACTURER	MODEL	TYPE	GPM	HEAD IN FT	MOTOR HP	PUMP RPM	ELECTRICAL VOLT/PH	WEIGHT (lbs)	REMARKS		
CWP-1	TACO	FI2509D	BASE MOUNTED END SUCTION	155	52	5	1750	208/3	343	ALL		
CWP-2	TACO	FI2509D	BASE MOUNTED END SUCTION	155	52	5	1750	208/3	343	ALL		
NOTES:  ① VARIABLE SPEED DRIVE. ② SUCTION DIFFUSER.												

SEE SPECIFICATIONS FOR APPROVED MANUFACTURERS

PRODUCT LISTED IS BASIS OF DESIGN ONLY

(3) HEAVY DUTY BASE PLATE.

STATE OF MISSOURI MICHAEL L. PARSON, GOVERNOR



MICHAEL HOFF LICENSE #: PE2013000576



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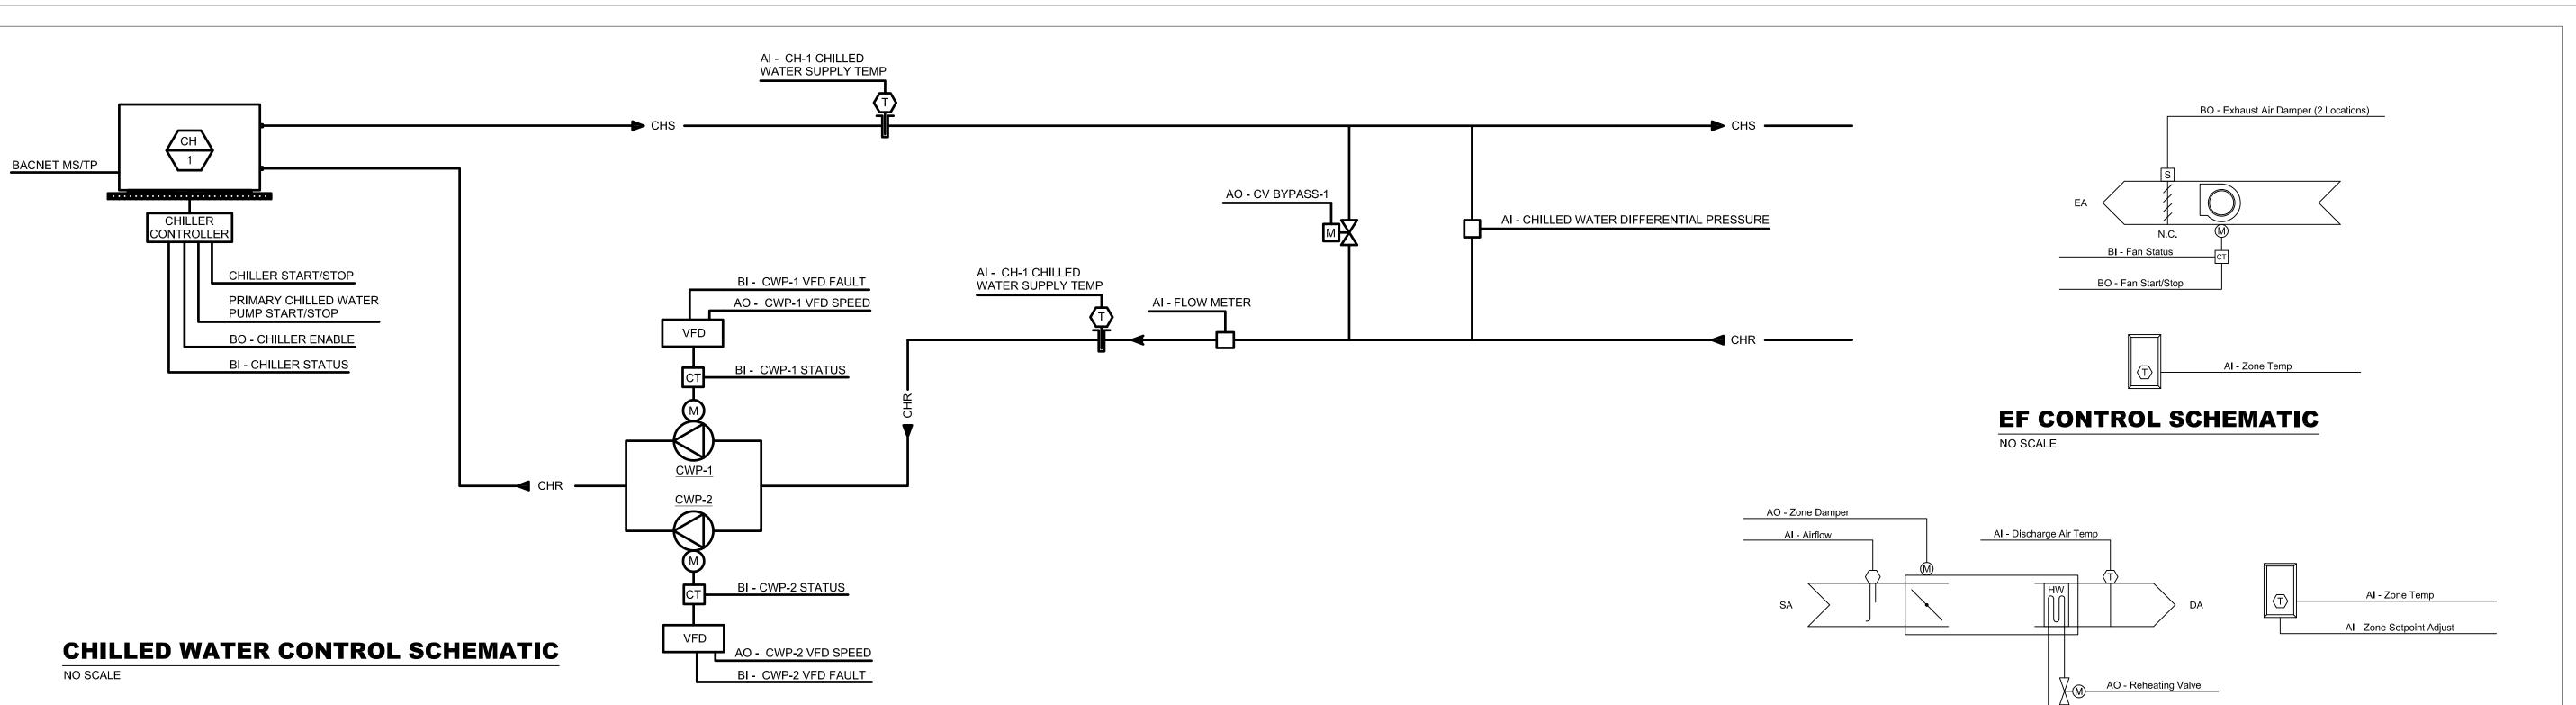
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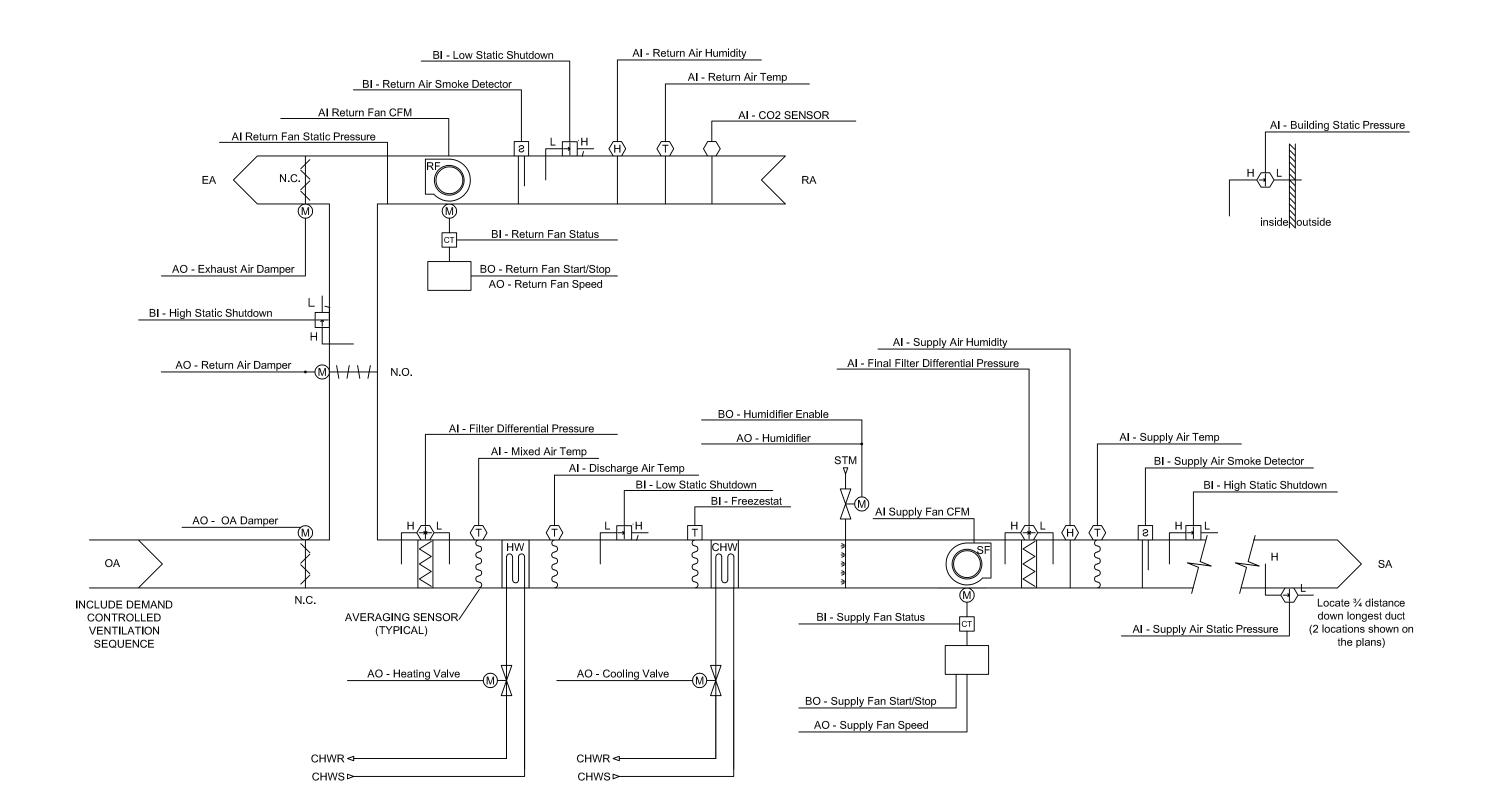
MECHANICAL SCHEDULES

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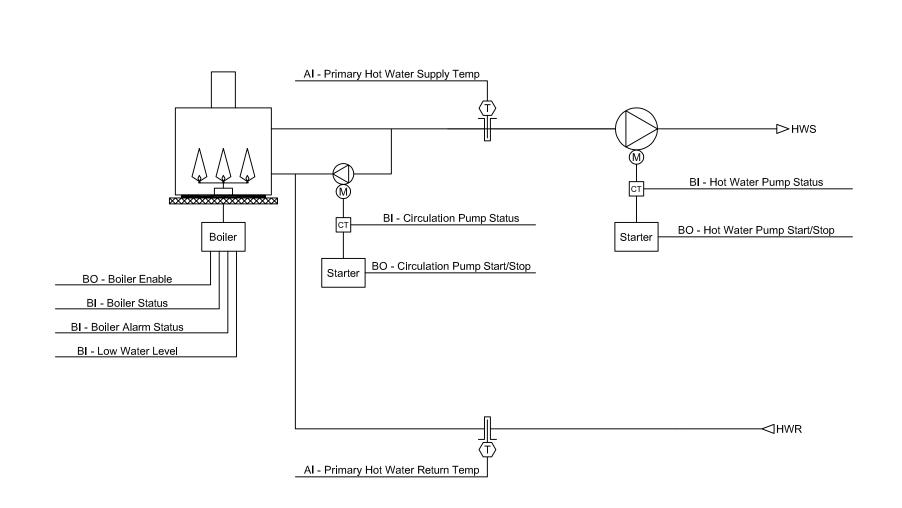
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M-601
SHEET 8 OF 12






# AHU CONTROL SCHEMATIC NO SCALE



NO SCALE

# **BOILER CONTROL SCHEMATIC**

NO SCALE

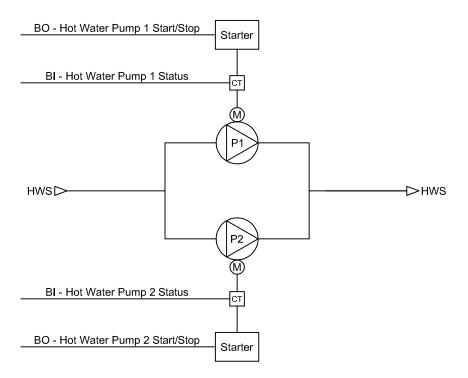


**VAV CONTROL SCHEMATIC** 

# **HWP CONTROL SCHEMATIC**

NO SCALE

**STATE OF MISSOURI** MICHAEL L. PARSON, **GOVERNOR** 

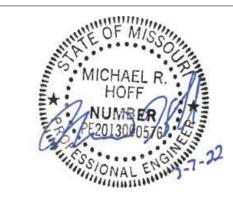

MICHAEL HOFF LICENSE #: PE2013000576



3701 S. LINDBERGH BOULEVARD **SUITE 204 ST. LOUIS, MO 63127** PHONE: 314.725.5889 MISSOURI CERTIFICATE OF **AUTHORITY #2014035826** 

OFFICE OF ADMINISTRATION DIVISION OF FACILITIES MANAGEMENT, DESIGN AND CONSTRUCTION

**DEPARTMENT OF CORRECTIONS** 

PROJECT TITLE:

HVAC AND BAS UPGRADE ST. JOSEPH COMMUNITY

SUPERVISION CENTER 3305 FARAON ST,

ST. JOSEPH, MO 64506

PROJECT # 2011-01 SITE # 7022

ASSET # 9327022002

**REVISION:** DATE: 10-05-2022 REVISION: DATE: **REVISION:** 

DATE: ISSUE DATE: 07-07-2022

CAD DWG FILE: DRAWN BY: CHECKED BY: DESIGNED BY:

SHEET TITLE:

MECHANICAL CONTROLS

SHEET NUMBER:

M-701


SHEET 9 OF 12 10/05/2022


# ELECTRICAL LEGEND AND ABBREVIATIONS (SEE SPECIFICATIONS & SCHEDULES)


NOTES: 1. NOT ALL SYMBOLS AND ABBREVIATIONS ARE USED ON THESE PLANS.

2. ALL MOUNTING HEIGHTS ARE TO CENTERLINE OF DEVICES AND EQUIPMENT U.O.N.

3. IN GENERAL, SYMBOLS SHOWN WITH LIGHT LINES DENOTE EXISTING WORK, SYMBOLS SHOWN WITH HEAVY LINES DENOTE PROPOSED WORK.

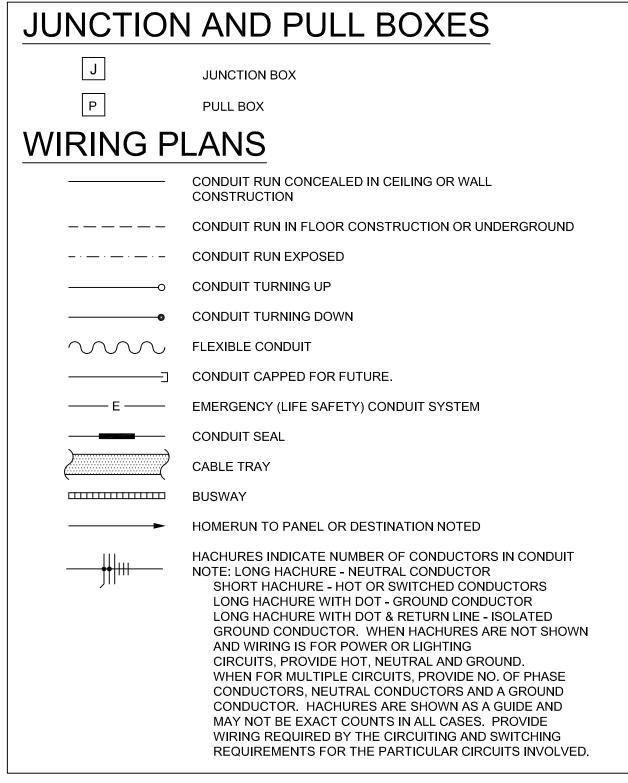

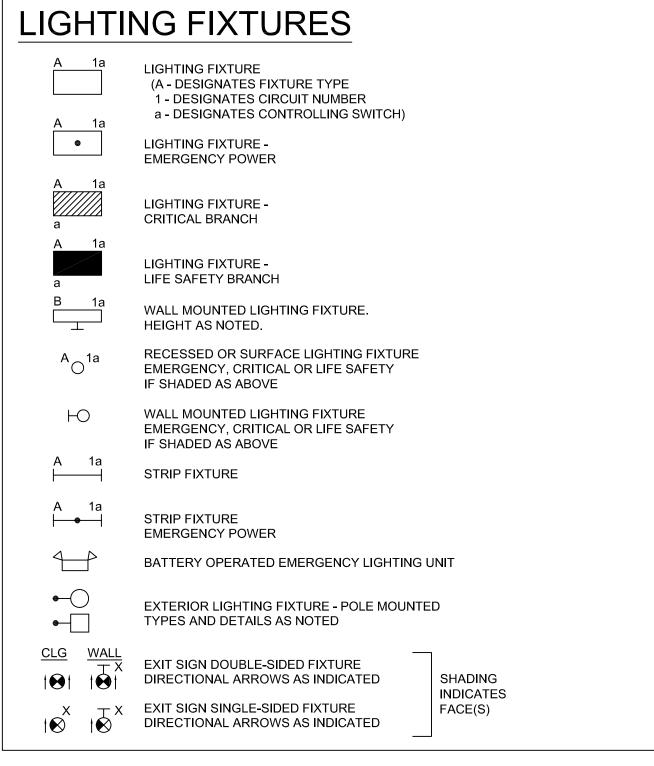

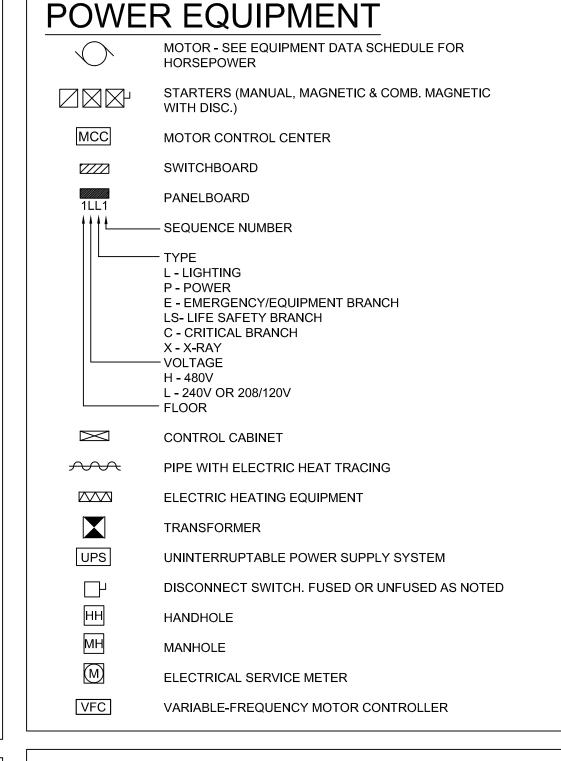


WILL BE REQUIRED.

POWER AS NOTED ON DRAWING E201.

2. IF THIS PROJECT IS UNDER CONSTRUCTION IN THE COOLING SEASON, THE NEW CHILLER

ONE CONDENSING UNIT MAY BE DISCONNECTED AT A TIME. PROVIDE TEMPORARY

MUST BE OPERATIONAL BEFORE POWER TO CONDENSING UNITS IS REMOVED, AND ONLY

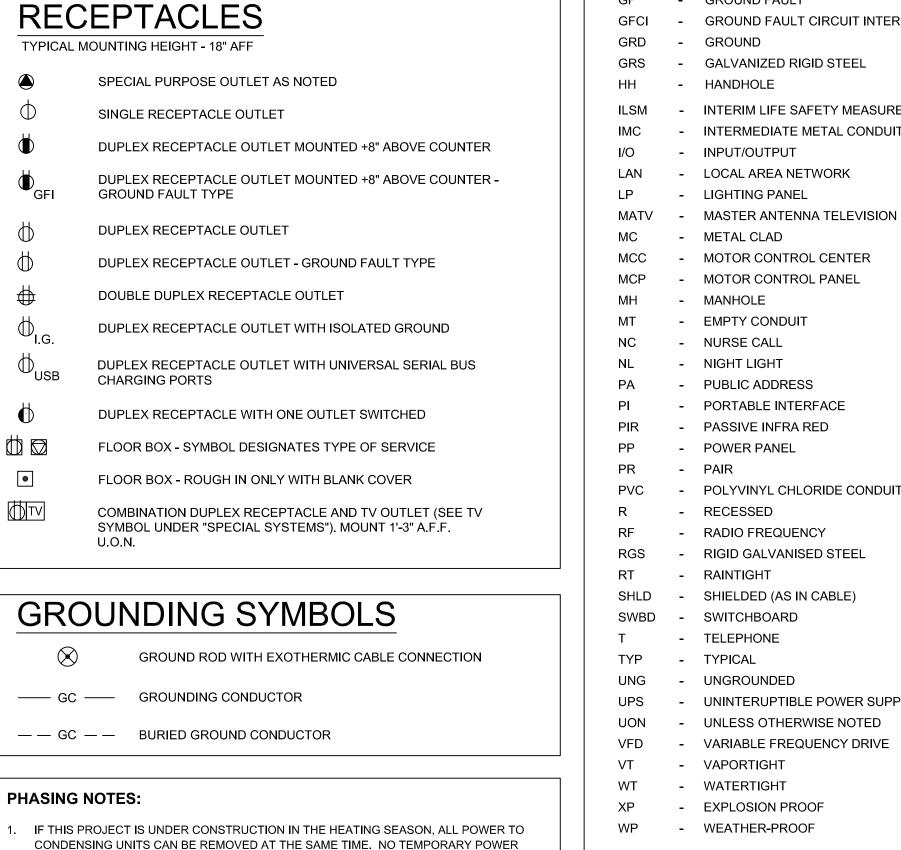

# SHEET LIST

ED-101 FIRST FLOOR ELECTRICAL DEMOLITION PLAN

# ACCESS CONTROL SYSTEM

**BELOW CEILING** CONDUIT CAMERA CIRCUIT BREAKER CONTROL CONTACTOR CLOSED CIRCUIT TELEVISION

CCW COUNTER CLOCKWISE CW CLOCKWISE DISTRIBUTED CONTROLLER UNIT

DCU DISTRIBUTION PANEL

DUSTTIGHT DRAWING

ELECTRICAL CONTRACTOR ELECTRIC OR ELECTRICAL ELECTRICAL METALLIC TUBING

EXISTING RELOCATED ETR EXISTING TO REMAIN - ELECTRIC WATER COOLER **EWC** FIRE ALARM

F/O MODEM FIBER OPTIC FUSIBLE SWITCH GENERAL CONTRACTOR

**GROUND FAULT** GROUND FAULT CIRCUIT INTERRUPTER

INTERIM LIFE SAFETY MEASURES - INTERMEDIATE METAL CONDUIT

LOCAL AREA NETWORK

MOTOR CONTROL CENTER

POLYVINYL CHLORIDE CONDUIT

 RIGID GALVANISED STEEL - SHIELDED (AS IN CABLE)

 UNINTERUPTIBLE POWER SUPPLY UNLESS OTHERWISE NOTED VARIABLE FREQUENCY DRIVE

E-001 ELECTRICAL SYMBOLS AND LEGEND E-201 FIRST FLOOR ELECTRICAL NEW WORK PLAN

# **ABBREVIATIONS**

ABOVE FINISHED FLOOR AUTOMATIC TRANSFER SWITCH CONSULTING ENGINEERS

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STATE OF MISSOURI MICHAEL L. PARSON,

> CARL V. HAUCK

NUMBER E-16688

GOVERNOR

CARL V. HAUCK, PE

LICENSE #: 016688

EXP: 12/31/2022

**OFFICE OF ADMINISTRATION DIVISION OF FACILITIES** MANAGEMENT, DESIGN AND CONSTRUCTION

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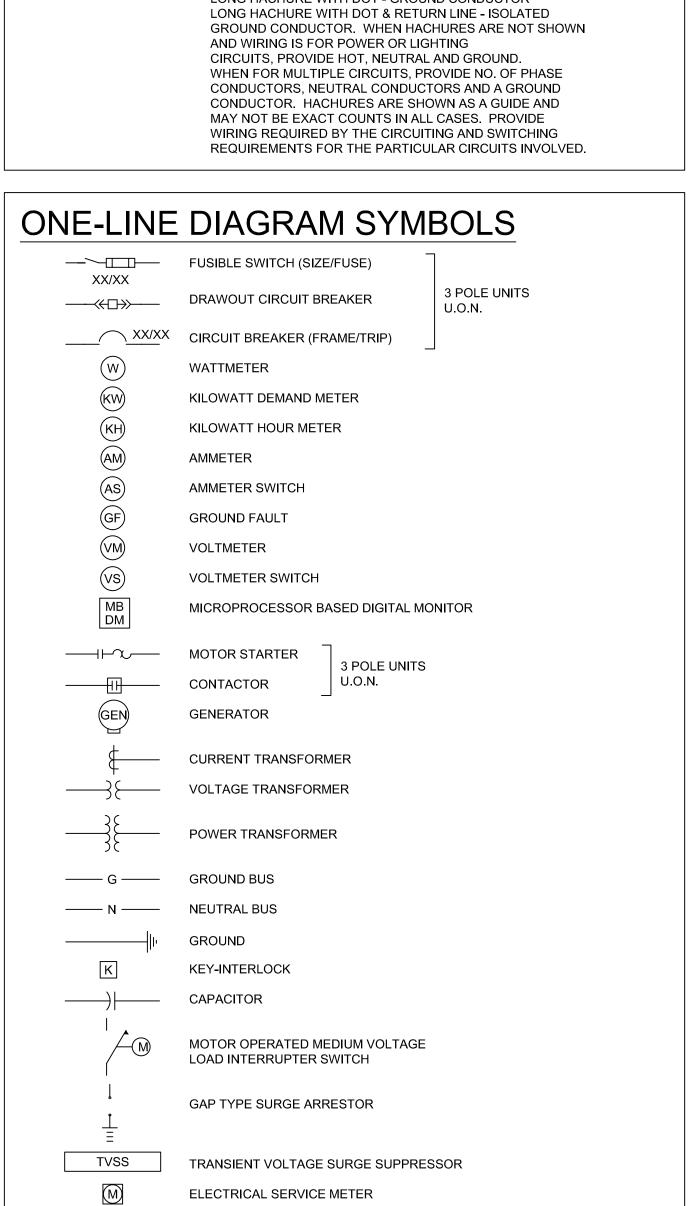
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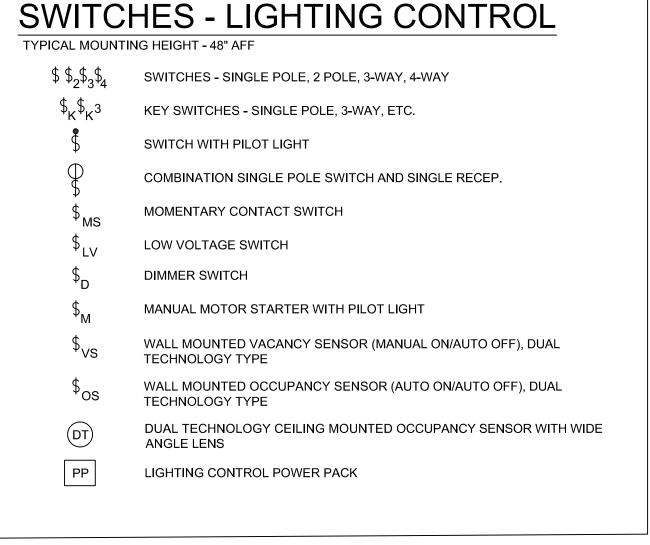
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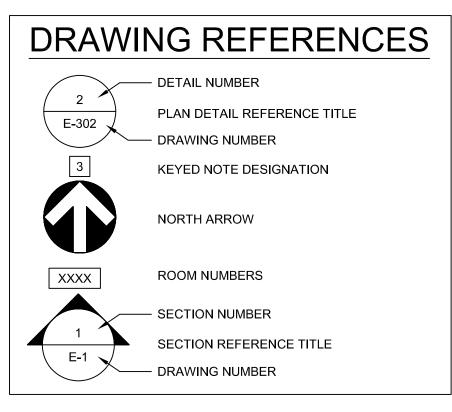
ELECTRICAL **SYMBOLS** AND LEGEND


SHEET NUMBER:

**SHEET 10 OF 12** 10/05/2022







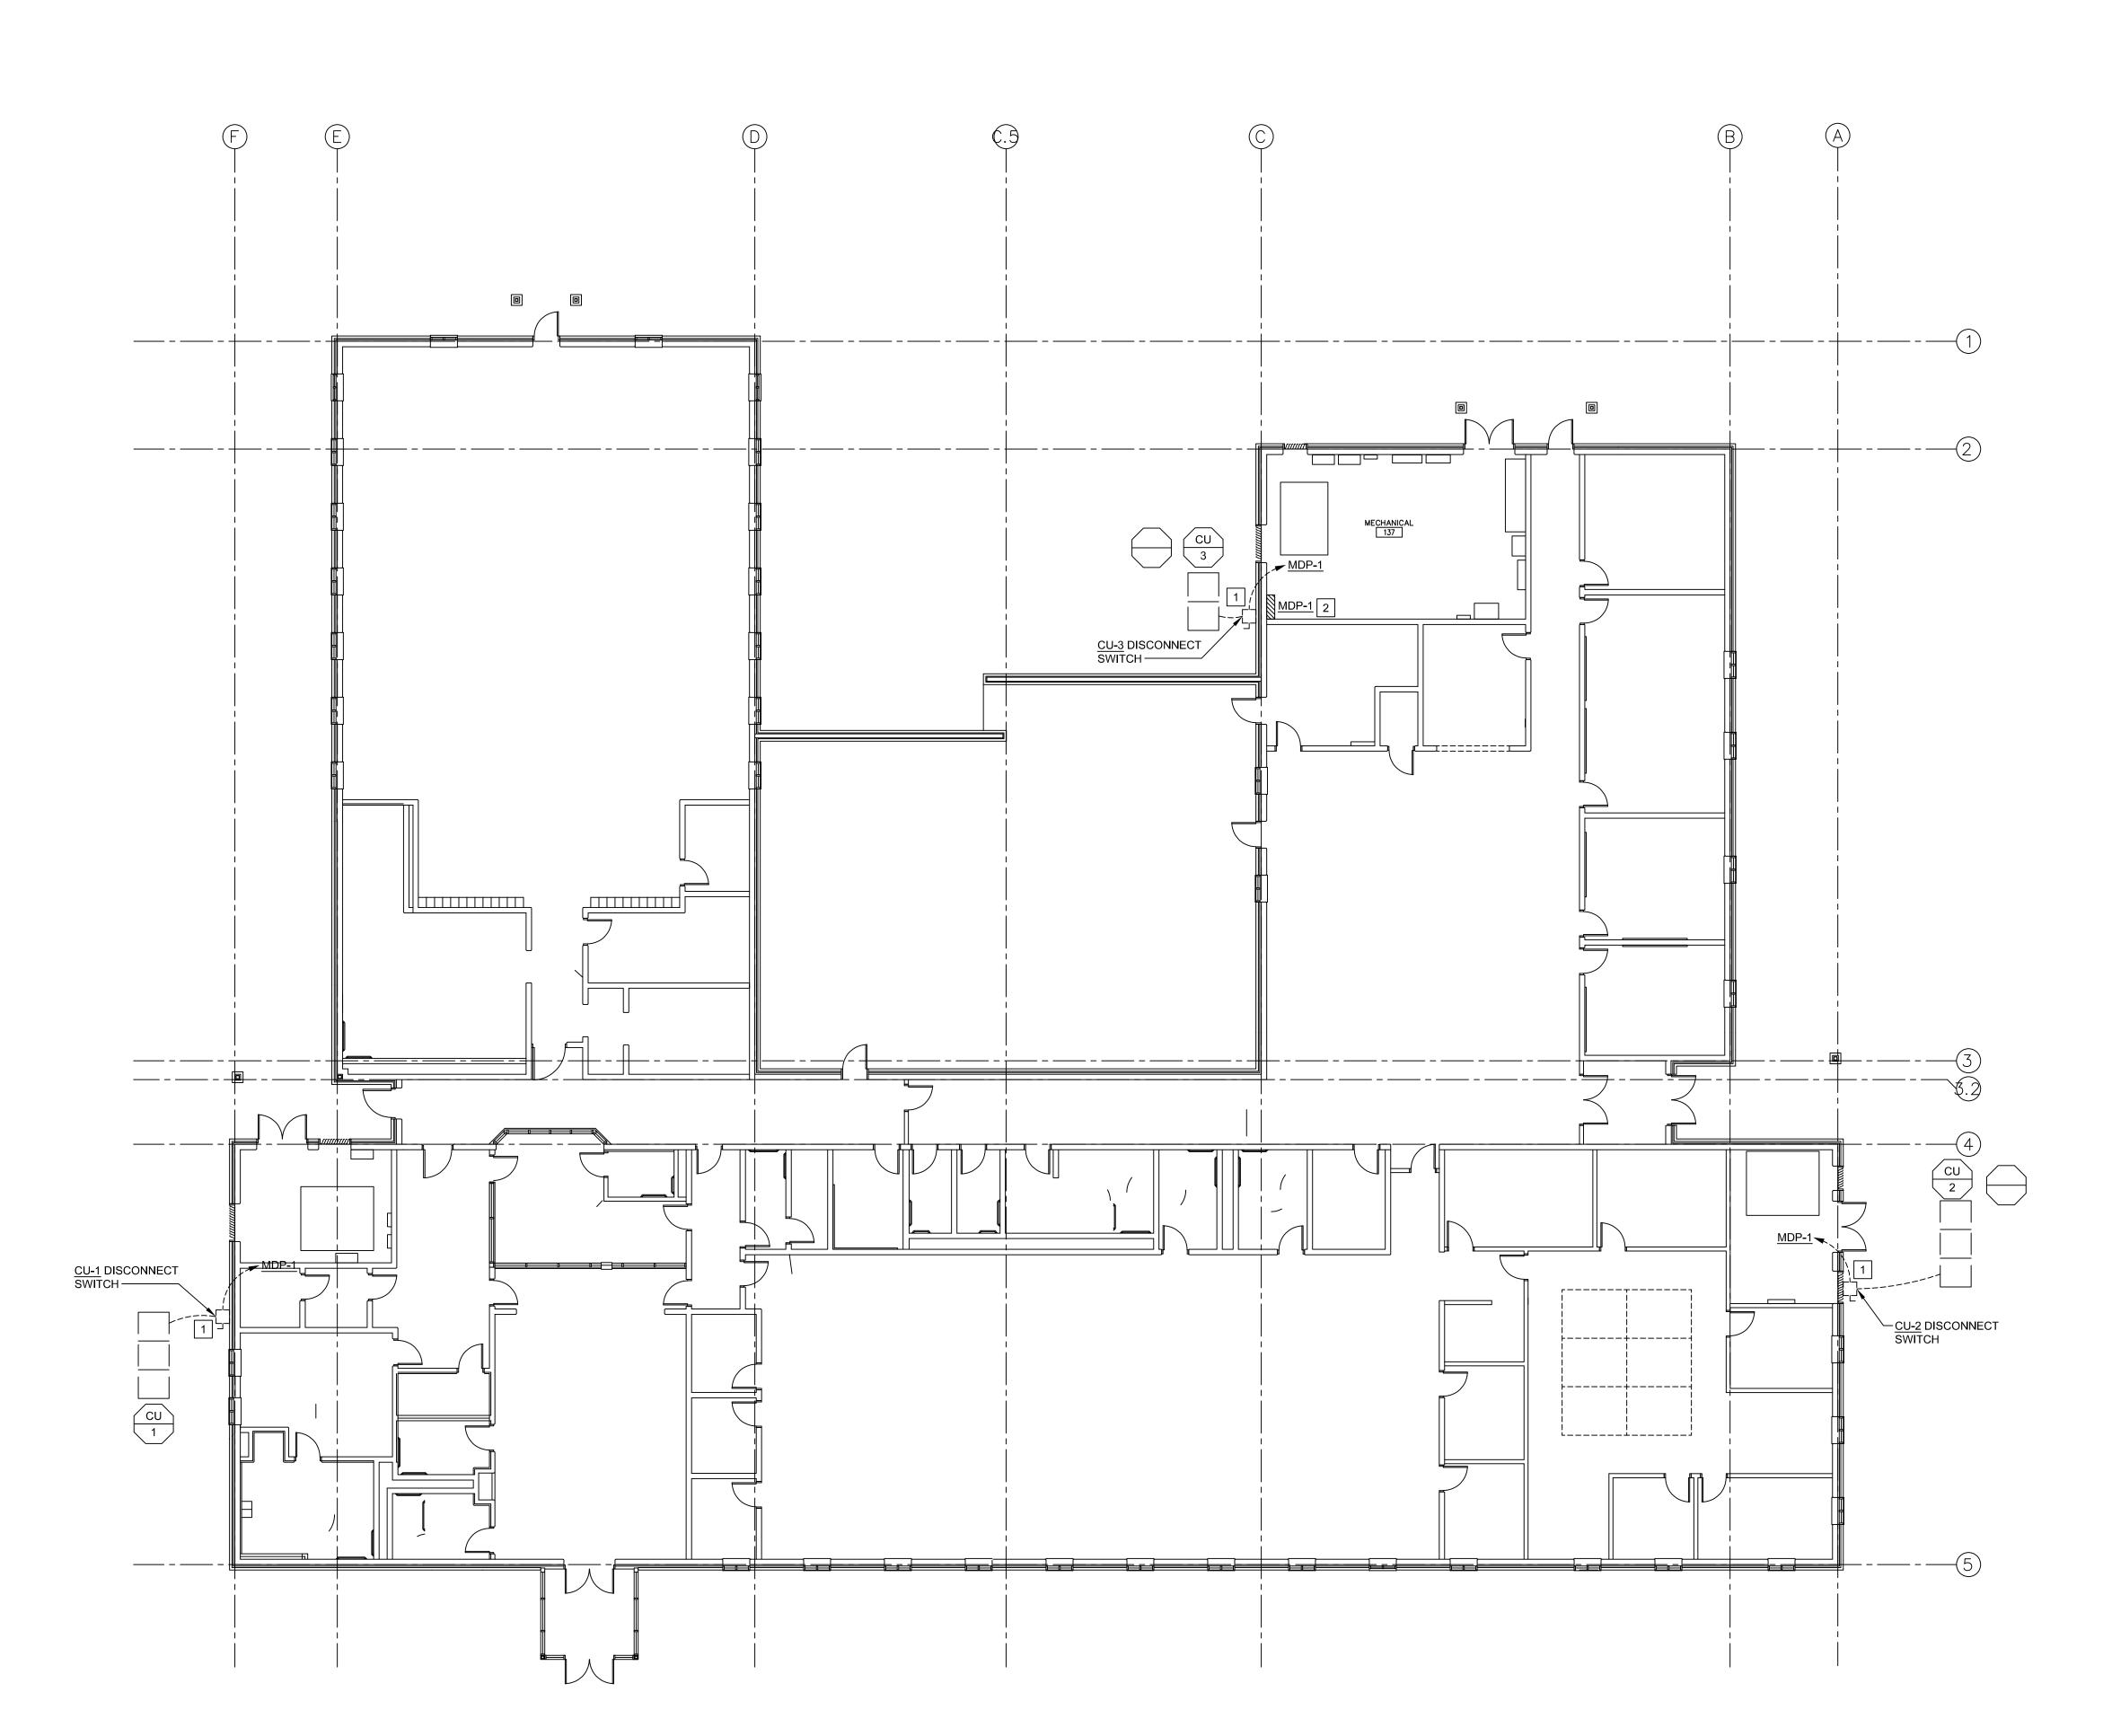

### **GENERAL NOTES:**

- 1. THE ELECTRICAL CONTRACTOR SHALL REMOVE, CAP, AND/OR RELOCATE EQUIPMENT, OUTLETS, CONDUIT, WIRE, ETC. AS MAY BECOME NECESSARY BECAUSE OF EXISTING FIELD CONDITIONS. THE CONTRACTOR SHALL BE HELD TO HAVING VISITED THE SITE AND TAKEN ALL EXISTING CONDITIONS INTO CONSIDERATION.
- 2. MAINTAIN SERVICES TO AREAS OUTSIDE DEMOLITION LIMITS. WHEN SERVICES MUST BE INTERRUPTED, INSTALL TEMPORARY SERVICES FOR AFFECTED AREAS.
- 3. IN THE DEMOLITION WORK, REMOVE ALL UNUSED WIRING AND CABLES AND UNUSED CONDUIT THAT IS EXPOSED OR WITHIN ACCESSIBLE CEILINGS WHICH IS AFFECTED BY AND IS IN THE AREA OF THE WORK OF THIS CONTRACT.
- 4. THE INTENTION OF THE ELECTRICAL DEMOLITION IS TO DISCONNECT AND REMOVE ALL ELECTRICAL WORK MADE VOID BY THE SCOPE OF THE CONSTRUCTION AND ALTERATION. FIELD VERIFY EXACT MATERIAL QUANTITIES REQUIRED TO BE REMOVED.
- 5. WHERE ELECTRICAL EQUIPMENT, CONDUIT, BOXES, AND SUPPORTING HARDWARE ARE REMOVED, PATCH, AND FINISH THE SURFACE AS REQUIRED TO MATCH THE EXISTING, UNLESS OTHERWISE NOTED.
- 6. WHERE BURIED CONDUITS EXTENDING OUT OF A CONCRETE SLAB BECOME ABANDONED, CUT AND GRIND THE CONDUITS OFF FLUSH WITH TOP OF SLAB AND PLUG WITH NON-SHRINK WATERPROOF GROUT FILL.
- 7. OWNER HAS FIRST SALVAGE RIGHTS TO ALL REMOVED MATERIALS AND EQUIPMENT. ALL MATERIAL AND EQUIPMENT NOT CLAIMED BY THE OWNER SHALL BECOME THE PROPERTY OF THE CONTRACTOR AND SHALL BE REMOVED FROM THE PROJECT SITE. COORDINATE AT PROJECT COMMENCEMENT.
- 8. ACCEPTANCE OF CONTRACT MEANS INSTALLER ACCEPTS EXISTING CONDITIONS.
- 9. CONTRACTOR SHALL COORDINATE ALL DEMOLITION WORK WITH ALL OTHER TRADES.
- 10. LEGALLY DISPOSE OF HAZARDOUS MATERIALS. COMPLY WITH ALL FEDERAL, STATE, AND LOCAL LAWS.
- 11. MODIFY EXISTING PANEL DIRECTORIES (OR REPLACE) FOR PANELS WHICH HAVE HAD ALTERATIONS TO THE CIRCUITS ORIGINATING THEREIN. DESCRIBE THE LOAD AND LOCATION.
- 12. WHERE WORK IS TO BE PERFORMED ABOVE EXISTING ACCESSIBLE CEILINGS, CONTRACTOR SHALL BE RESPONSIBLE FOR REMOVING CEILING TILES AND GRID WITHOUT DAMAGE; STORAGE OF EXISTING TILES AND GRID WHILE WORK IS BEING PERFORMED, AND INSTALLATION OF EXISTING GRID AND TILES AFTER DIVISION 26 WORK IS COMPLETED.
- 13. ALL EXISTING ELECTRICAL WORK AND ASSOCIATED RACEWAY AND WIRING WHICH HAS BEEN MADE OBSOLETE BY THE WORK AND/OR IS SHOWN DASHED ON THE ELECTRICAL DEMOLITION DRAWINGS, SHALL BE DISCONNECTED AND REMOVED, UNLESS OTHERWISE NOTED.
- 14. PLANS ARE DIAGRAMMATIC IN NATURE. THEY REFLECT THE AVAILABLE INFORMATION OBTAINED FROM FIELD OBSERVATION AND EXISTING DOCUMENTATION. ACTUAL LOCATION OF ELEMENTS AND EQUIPMENT MAY DEVIATE FROM THE LOCATIONS AND QUANTITIES SHOWN.
- 15. ALL PANELS SHOWN ARE EXISTING TO REMAIN UNLESS NOTED OTHERWISE.

### KEYED NOTES:

- REMOVE DISCONNECT, WIRING, AND ACCESSIBLE CONDUIT BACK TO PANEL MDP-1
- TURN OFF (2) 200 AMP AND (1) 100A FUSED SWITCHES PREVIOUSLY SERVING CU-1, CU-2, AND CU-3 AND LABEL SPARE. SEE PROJECT PHASING NOTE ON SHEET E-001.

STATE OF MISSOURI MICHAEL L. PARSON, GOVERNOR



CARL V. HAUCK, PE LICENSE #: 016688 EXP: 12/31/2022



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REVISION: 1
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CHECKED BY:
DESIGNED BY:
MRJ

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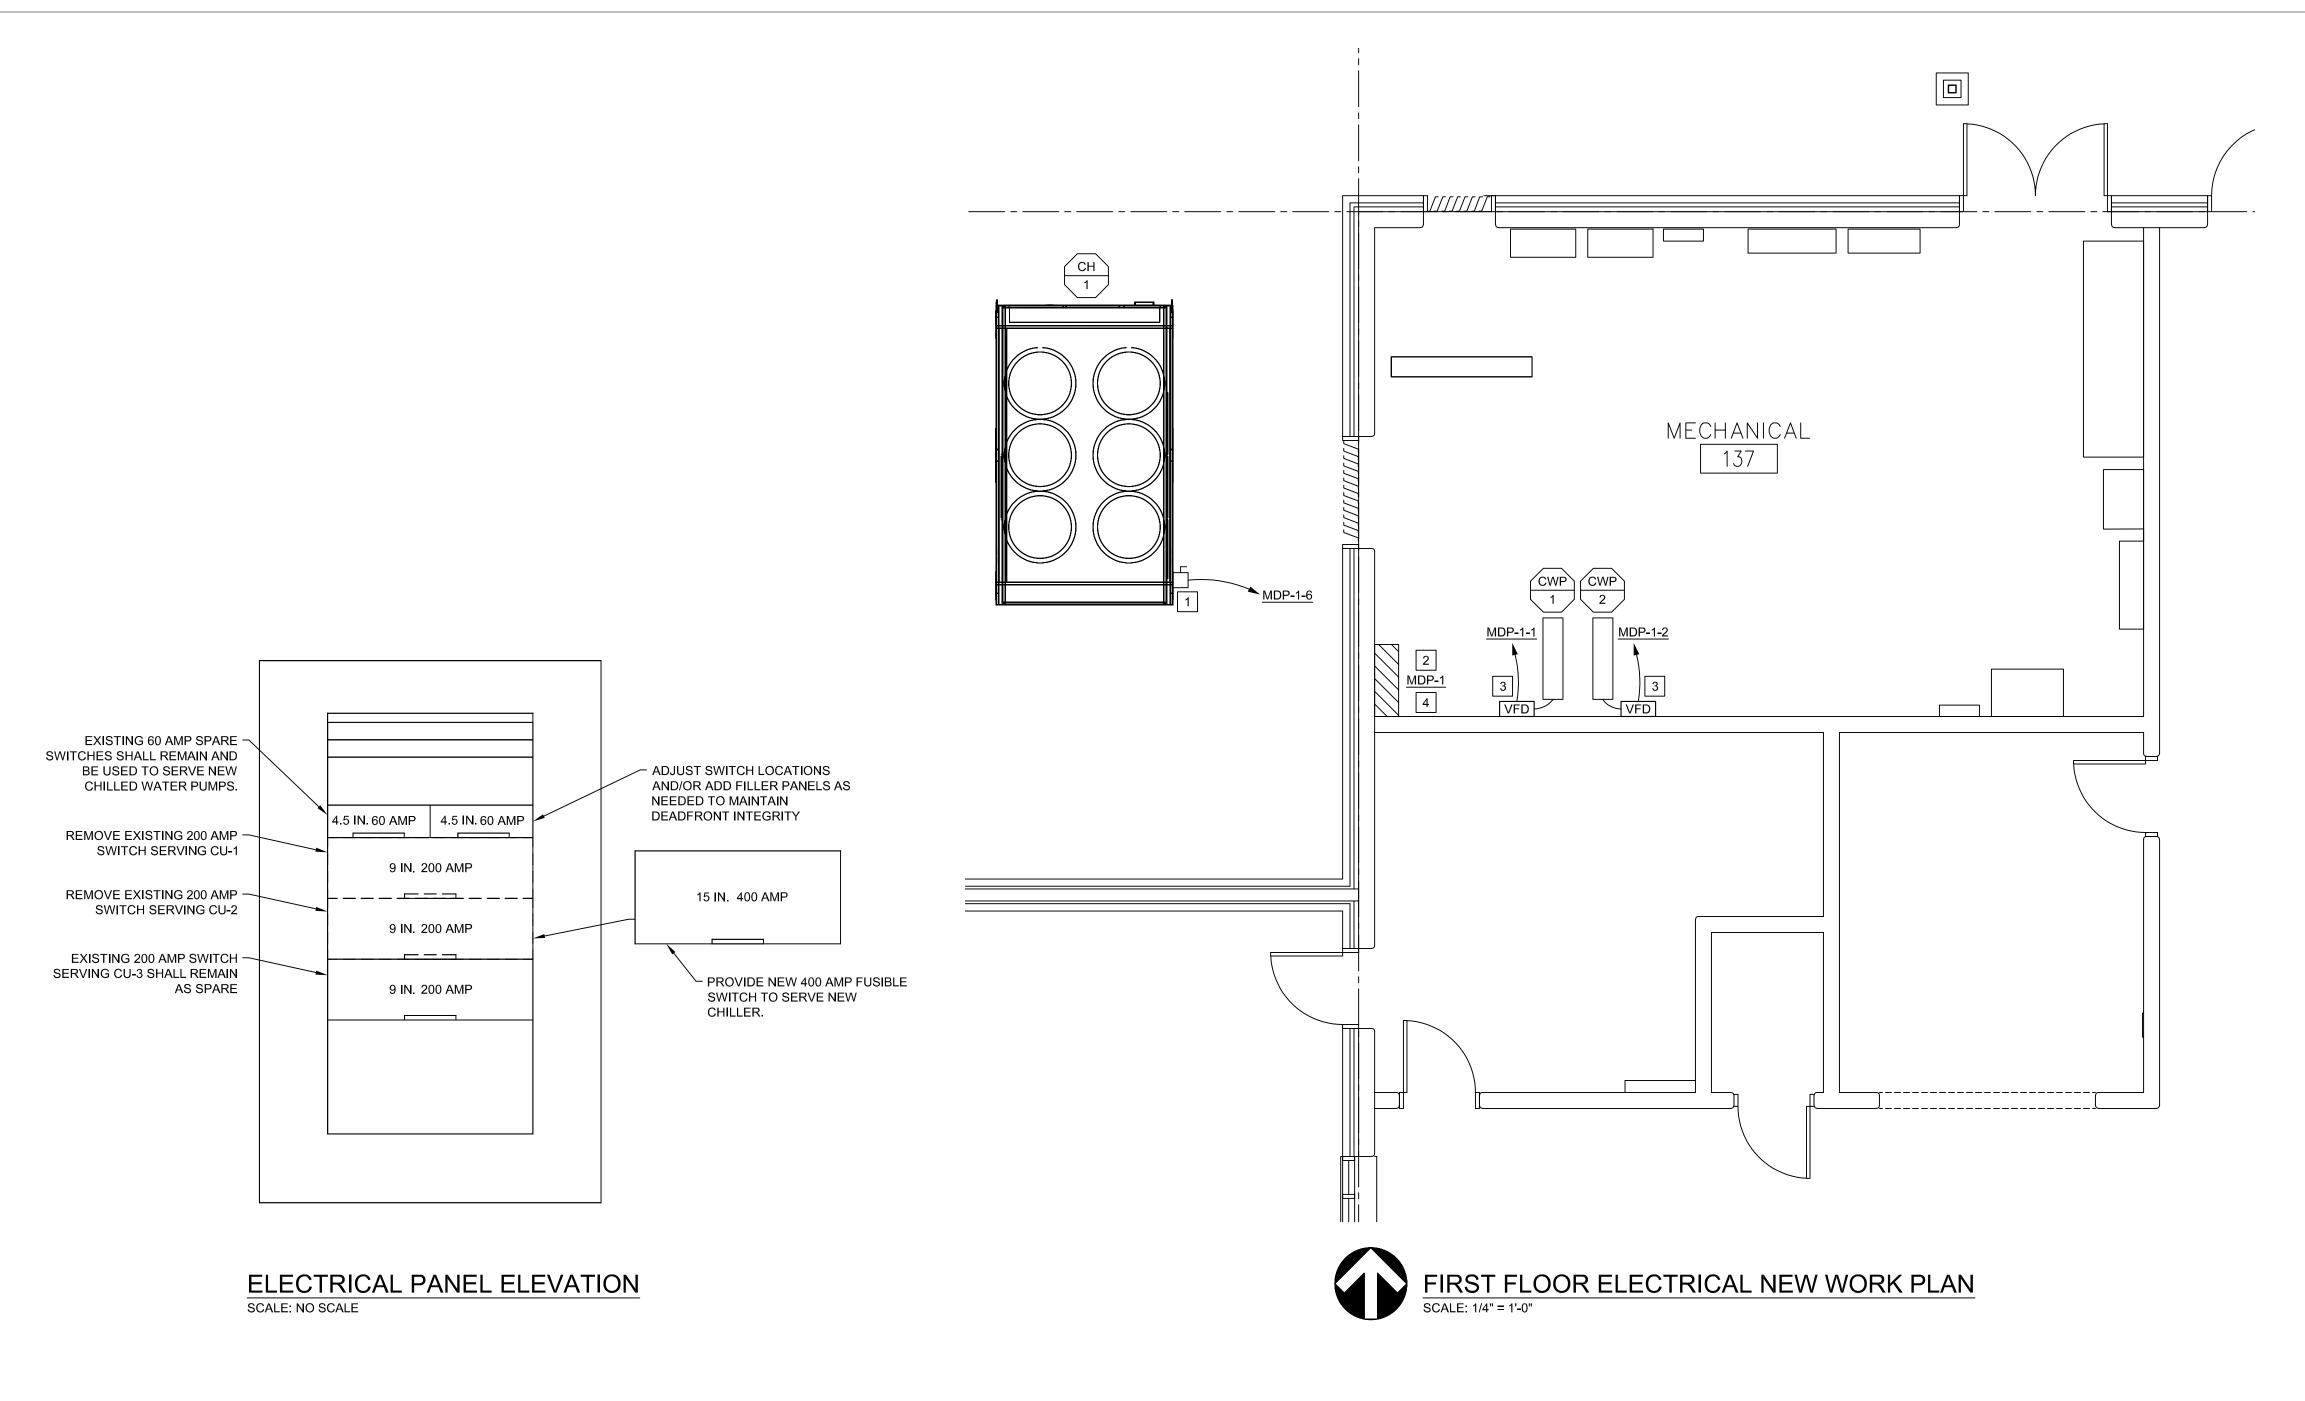
FIRST FLOOR
ELECTRICAL
DEMOLITION PLAN

SHEET NUMBER:

10/05/2022

ED-101
SHEET 11 OF 12

FIRST FLOOR ELECTRICAL DEMOLITION PLAN
SCALE: 3/32" = 1'-0"



### **GENERAL NOTES:**

- 1. ALL WORK SHALL BE IN ACCORDANCE WITH THE 2017 NATIONAL ELECTRICAL
- 2. THE ELECTRICAL DRAWINGS HAVE BEEN PREPARED UTILIZING EXISTING DRAWINGS AND BUILDING OBSERVATIONS AND MAY NOT SHOW ALL CONDITIONS. CONTRACTOR SHALL VISIT THE BUILDING PRIOR TO BID SUBMISSION AND BECOME FAMILIAR WITH ALL EXISTING CONDITIONS. CONTRACTOR WILL NOT BE ALLOWED ADDITIONAL FUNDS OR TIME DUE TO THE CONTRACTOR'S FAILURE TO BECOME FAMILIAR WITH ALL EXISTING
- 3. ACCEPTANCE OF CONTRACT MEANS INSTALLER ACCEPTS EXISTING CONDITIONS.
- 4. COORDINATE INSTALLATION WITH EXISTING CONDITIONS. FIELD VERIFY EXISTING CONDITIONS.
- 5. CONTRACTOR SHALL SCHEDULE ALL ELECTRICAL SYSTEM POWER OUTAGES WITH THE OWNER'S REPRESENTATIVE AT LEAST 7 CALENDAR DAYS IN ADVANCE OF A SHUTDOWN. DOWNTIME ON BRANCH CIRCUIT PANELBOARDS, SWITCHBOARDS, DISTRIBUTION PANELBOARDS, ETC., WHICH SERVE LOADS OUTSIDE OF THE CONSTRUCTION AREAS SHALL BE LIMITED TO A (1) HOUR (MAXIMUM) OUTAGE UNLESS OTHERWISE PERMITTED BY OWNER. MORE THAN (1) SCHEDULED OUTAGE MAY OCCUR ON EACH PIECE OF EQUIPMENT, BUT THE MAXIMUM OUTAGE TIME MUST BE MAINTAINED.
- 6. ALL PENETRATIONS THROUGH CONCRETE OR MASONRY WALLS AND FLOOR SLABS SHALL BE CORE DRILLED. AFTER CONDUITS HAVE BEEN INSTALLED, SEAL WALL AROUND CONDUIT TO MAINTAIN 2-HOUR FIRE RATING USING UL LISTED METHODS AND MATERIALS. EXTERIOR WALLS SHALL BE SEALED WATERTIGHT.
- 7. CONTRACTOR SHALL UPDATE EXISTING PANELBOARD CIRCUIT DIRECTORIES TO REFLECT ALL CHANGES MADE TO EXISTING PANELBOARDS DURING THIS
- 8. WHEN INSTALLING CIRCUIT BREAKERS IN EXISTING PANELBOARDS, MATCH EXISTING CIRCUIT BREAKER TYPES AND INTERRUPTING RATINGS.
- 9. THIS CONTRACTOR SHALL BE RESPONSIBLE FOR COORDINATING EXISTING DIVISION 26 RELATED ITEMS TO REMAIN IN PLACE WITH THE INSTALLATION OF GENERAL CONSTRUCTION WORK, DUCTWORK, PIPING, ETC. ALL ATTEMPTS SHALL BE MADE PRIOR TO THE START OF CONSTRUCTION TO AVOID THE REMOVAL AND RELOCATION OF EXISTING DIVISION 26 RELATED ITEMS WHICH ARE NOT AFFECTED BY WORK OF THIS CONTRACT.
- 10. CONTRACTOR SHALL PROVIDE A SET OF HAND MARKED RECORD DRAWINGS TO THE ENGINEER AT THE COMPLETION OF THE PROJECT INDICATING ACTUAL INSTALLED CONDITIONS. THE HAND MARKING SHALL BE CLEARLY LEGIBLE AND SHALL BE MARKED IN RED. MARKS SHALL INCLUDE ITEMS SUCH AS CIRCUITING CHANGES, DEVICE AND EQUIPMENT LOCATION CHANGES, MAJOR FEEDER AND CABLING ROUTING CHANGES, ETC.
- 11. ALL PANELS SHOWN ARE EXISTING TO REMAIN UNLESS NOTED OTHERWISE.

## **KEYED NOTES:**

- PROVIDE SINGLE POINT CONNECTION TO CH-1. INSTALL (3)#300, 1#4G, 2½"C FROM PANEL MDP-1 TO CH-1.
- 2 PROVIDE 3P-400A FUSED SWITCH WITH 300 AMP FUSES IN AVAILABLE SPACE AND INSTALL 25A FUSES IN (2) EXISTING 3P-60A FUSED SWITCHES (PROVIDE FUSE REDUCERS AS REQUIRED) IN EXISTING PANEL MDP-1 FOR CH-1, CWP-1,
- 3 PROVIDE A NEMA 1 VFD WITH INTEGRAL DISCONNECT FOR CWP-1 AND CWP-2. INSTALL (3)#12, 1#12G, 3/4"C FROM PANEL MDP-1 TO VFD AND FROM VFD TO
- 4 IF THIS PROJECT IS UNDER CONSTRUCTION IN THE COOLING SEASON, ELECTRICAL CONTRACTOR SHALL PROVIDE A TEMPORARY MEANS OF MAINTAINING POWER AND CIRCUIT PROTECTION TO THE (3) EXISTING CONDENSING UNITS. THE (2) EXISTING 3P-200A FUSED SWITCHES IN MDP-1 SHALL BE REMOVED IN ORDER TO FACILITATE THE INSTALLATION OF THE NEW 3P-400A FUSED SWITCH IN MDP-1 FOR THE NEW CHILLER CIRCUIT. TEMPORARY POWER MAY COME FROM MDP-1 BY MEANS OF TEMPORARY EXTERNAL 3P-200A FUSED DISCONNECTS. AFTER THE NEW CHILLER BECOMES OPERATIONAL THE TEMPORARY EXTERNAL FUSED DISCONNECTS SHALL BE REMOVED.

OFFICE OF ADMINISTRATION **DIVISION OF FACILITIES** MANAGEMENT, DESIGN AND CONSTRUCTION

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STATE OF MISSOURI MICHAEL L. PARSON,

CARL V.

HAUCK

NUMBER

E-16688

**GOVERNOR** 

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3701 S. LINDBERGH BOULEVARD

MISSOURI CERTIFICATE OF

**AUTHORITY #2014035826** 

EXP: 12/31/2022

**SUITE 204** 

PROJECT TITLE:

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CAD DWG FILE: DRAWN BY: CHECKED BY: CVH DESIGNED BY: MRJ

SHEET TITLE:

FIRST FLOOR **ELECTRICAL** NEW WORK PLAN

SHEET NUMBER:

**SHEET 12 OF 12** 10/05/2022

**EQUIPMENT DATA SCHEDULE** DISCONNECT SWITCH MOTOR OR STARTER FURNISH. BRANCH AT EQUIPMENT **EQUIPMENT DATA** REMARKS MARK **EQUIPMENT** TYPE NEMA ENCLOS. SWITCH/ FURNISH. INST.BY/ NEMA NEMA ENCLOS. TYPE LOCATION FROM CIRCUIT HORSE ACCESS. FURNISH. CONN.BY CONTROL HP/KW/A VOLTS/ INST.BY/ TYPE FUSE SIZE BY CONN.BY SIZE TYPE POWER PHASE | CONN.BY BY CH-1 | CHILLER **EXTERIOR** 23 257A 208/3 23/26 MDP-1 PWCP 23 23 CWP-1 PUMP 208/3 23/26 MDP-1 2 5HP MECHANICAL ROOM 137 VFC 26 26 23 CWP-2 PUMP 208/3 23/26 MDP-1 6 5HP MECHANICAL ROOM 137 VFC 26 26 23

(1) SPECIFICATION DIVISION NUMBER: DIVISION 22 - PLUMBING DIVISION 23 - MECHANICAL **DIVISION 26 - ELECTRICAL** 

(2) HORSEPOWER(HP) IS SHOWN

KILOWATTS(KW) ARE CALLED

UNLESS AMPS(A) OR

(3) REFER TO FEEDER SCHEDULE WHEN THIS COLUMN CONTAINS A FEEDER DESIGNATION INSTEAD OF CONDUCTOR SIZE.

(4) NF - NON FUSED

TOG - TOGGLE

F - FUSED

- (5) STARTER TYPE: COMB1 - COMBINATION FULL VOLTAGE NON-REVERSING MAGNETIC STARTER WITH FUSED DISCONNECT SWITCH
- COMB2 COMBINATION FULL VOLTAGE NON-REVERSING MAGNETIC STARTER WITH UNFUSED DISCONNECT SWITCH COMB3 - COMBINATION FULL VOLTAGE NON-REVERSING MAGNETIC STARTER WITH THERMAL MAGNETIC MOLDED CASE CIRCUIT
- BREAKER DISCONNECT COMB4 - COMBINATION FULL VOTLAGE NON-REVERSING MAGNETIC STARTER WITH MAGNETIC ONLY MOLDED CASE CIRCUIT BREAKER DISCONNECT
- FVNR FULL VOLTAGE NON-REVERSING MAGNETIC STARTER WITHOUT DISCONNECT
- MAN MANUAL STARTER WITH PILOT LIGHT SDS - STAR DELTA STARTER PWCP - PREWIRED CONTROL PANEL VFC - VARIABLE-FREQUENCY MOTOR CONTROLLER
- 2S2W 2 SPEED 2 WINDING 2S1W - 2 SPEED SINGLE WINDING
- (6) ACCESSORIES: HOAP - HOA WITH PILOT LIGHT PB - START/STOP PUSH BUTTON

  - (MOMENTARY CONTACT)
    - (3) MOUNT DISCONNECT SWITCH ON EQUIPMENT HOUSING (4) INTEGRAL MOTOR STARTER

(1) FIRE ALARM INTERLOCK

7 KEY TO REMARKS:

(5) INTEGRAL CONTROLLER (6) VFD PROVIDED BY AHU MANUFACTURER

(2) INTEGRAL DISCONNECT SWITCH

(7) SINGLE POINT CONNECTION

ALL MAGNETIC AND SOLID STATE STARTERS ARE TO BE EQUIPPED WITH AUXILIARY CONTACTS, PILOT LIGHTS AND FUSED CONTROL POWER TRANSFORMERS. SEE SPECIFICATIONS FOR ADDITIONAL INFORMATION.