REPLACE FLOOR AND EQUIPMENT FOOD SERVICE BUILDING OZARK CORRECTIONAL CENTER FORDLAND, MISSOURI

OWNER:

STATE OF MISSOURI

MICHAEL L. PARSON,

GOVERNOR

DEPARTMENT OF CORRECTIONS

PROJECT

OFFICE OF ADMINISTRATION

DIVISION OF FACILITIES MANAGEMENT, MANAGEMENT:

DESIGN AND CONSTRUCTION

DESIGNER:

STATE OF MISSOURI - OFFICE OF ADMINISTRATION

DIVISION OF FACILITIES MANAGEMENT DESIGN

AND CONSTRUCTION: 301 W. HIGH STREET

JEFFERSON CITY, MO. 65102

PROJECT NUMBER:


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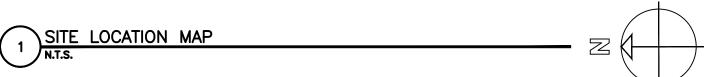
ASSET NUMBER:

9327003025 - FOOD SERVICE

9327003026 - FOOD SERVICE WAREHOUSE

1 OF 6 SHEETS JANUARY 6, 2023



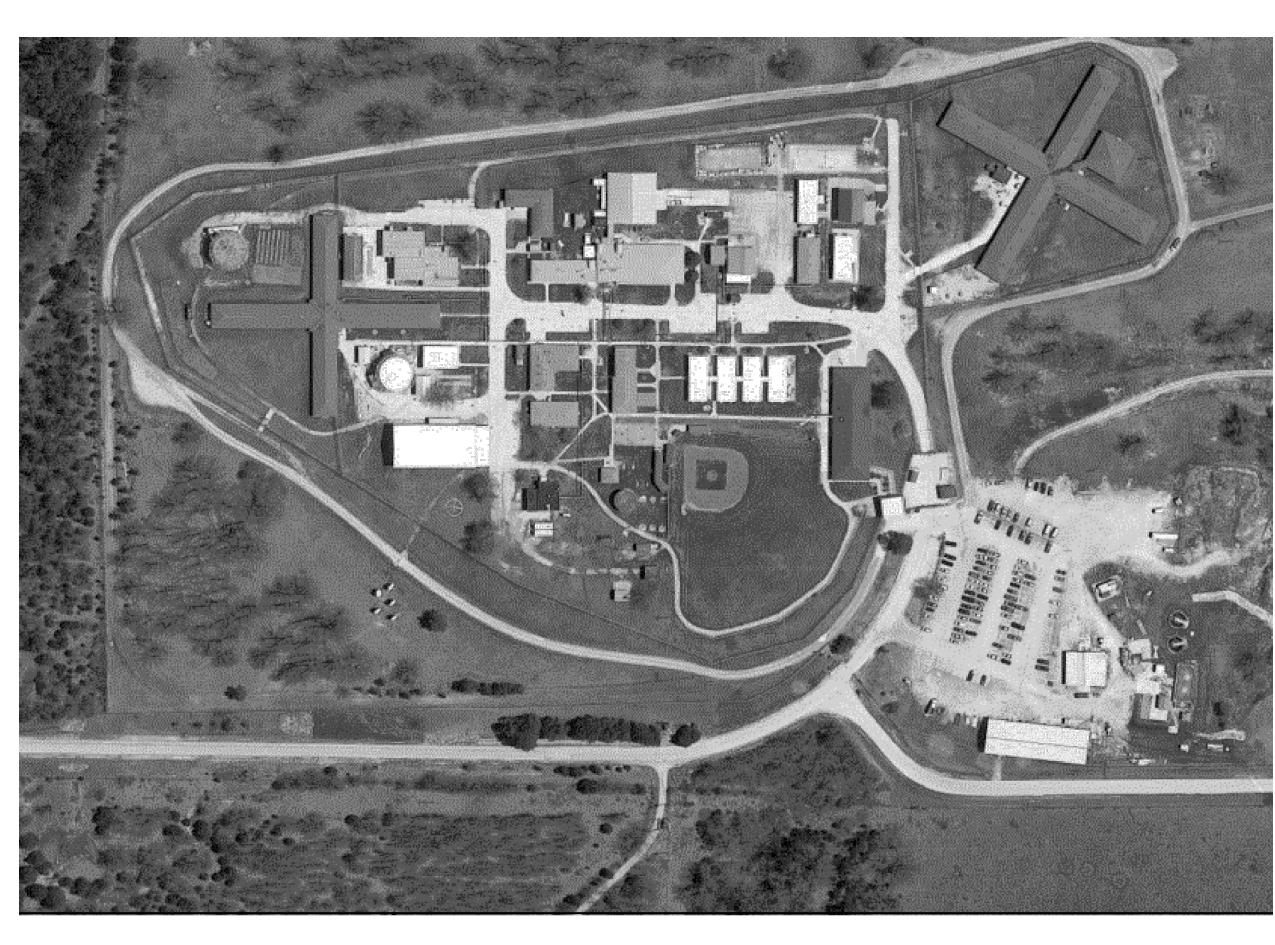


GENERAL NOTES

- 1. ALL APPLICABLE CODES AND STANDARDS COMPLIANCE SHALL BE MET, AS ADVISED BY THE ARCHITECT IN CONSULTATION WITH THE STATE OF MISSOURI'S DIVISION OF FACILITIES MANAGEMENT, DESIGN & CONSTRUCTION.
- 2. ALL DIMENSIONS ARE NOMINAL AND ARE FINISH TO FINISH OR FACE TO FACE OF CONSTRUCTION UNLESS OTHERWISE NOTED. THE CONTRACTOR SHALL VERIFY ALL DIMENSIONS. ANY DISCREPANCIES BETWEEN THE EXISTING CONDITIONS AND DRAWINGS SHALL BE BROUGHT TO THE ATTENTION OF THE ARCHITECT PRIOR TO CONSTRUCTION.
- 3. CONTRACTOR SHALL USE EXTREME CARE AND TAKE PRECAUTION DURING CONSTRUCTION SO AS NOT TO DAMAGE EXISTING ADJACENT FACILITIES. ANY DAMAGE DONE TO EXISTING
- FACILITIES DURING CONSTRUCTION SHALL BE REPAIRED TO THE SATISFACTION OF THE OWNER'S REPRESENTATIVE WITHOUT ADDITIONAL COST TO THE OWNER.
- 4. CONTRACTOR SHALL PROTECT EXISTING FINISHES AND ANY OTHER ITEMS WHICH MAY BE DAMAGED BY THE CONSTRUCTUION PROCESS. UNLESS OTHERWISE NOTED, CONTRACTOR SHALL PATCH OR REPAIR AND PAINT ALL ADJACENT SURFACES AFFECTED BY NEW CONSTRUCTION OR DEMOLITION.
- 5. CONTRACTOR SHALL REMOVE ALL TRASH AND DEBRIS FROM THE SITE ON A DAILY BASIS. COORDINATE DUMPSTER LOCATION AND ACCESS WITH THE OWNER'S REPRESENTATIVE.
- 6. OWNER WILL BE CONTINUALLY OCCUPYING THE BUILDING. NOTIFICATION 72 HOURS IN ADVANCE MUST BE GIVEN FOR ANY WORK THAT WILL AFFECT THEIR NORMAL WORKING OPERATIONS. CONTRACTOR MAY BE REQUIRED TO WORK AROUND OWNER'S SCHEDULE AND NEED; THEREFORE SOME COORDINATION OR PHASING MAY BE REQUIRED WITH MINIMUM DISRUPTION OF THE BUILDING OCCUPANTS.
- 7. SHOULD ANY DOUBT OR QUESTION ARISE WITH RESPECT TO THE TRUE MEANING OF THE DRAWINGS OR SPECIFICATIONS, REFERENCE SHALL BE MADE TO THE ARCHITECT WHOSE DECISIONS THEREON SHALL BE FINAL AND CONCLUSIVE. NO ALLEGED ORAL ADMISSION, CONDONATION, OR INADVERTENT NEGLECT ON THE PART OF THE ARCHITECT WILL BE ACCEPTED AS AN EXCUSE FOR INFERIOR WORK.
- 8. THE CONTRACTOR IS RESPONSIBLE FOR TEMPORARY DIRECTIONAL SIGNAGE AS WELL A CONSTRUCTION SIGNAGE NOTIFYING BUILDING OCCUPANTS OF CONSTRUCTION LIMITS. COORDINATE SIGNAGE WITH OWNER'S REPRESENTATIVE.
- 9. CONTRACTOR SHALL NOT ENGAGE IN ANY ACTIVITY WHICH MAY ENDANGER THE BUILDING OCCUPANTS.
- 10. CONTRACTOR IS REQUIRED PRIOR TO THE START OF CONSTRUCTION TO SURVEY THE AREAS WHICH WOULD BE AFFECTED BY THE CONSTRUCTION FOR DOCUMENTATION OF EXISTING CONDITIONS.
- 11. CONTRACTOR IS REQUIRED TO PROVIDE EQUIPMENT AND TOOLS REQUIRED OR NECESSARY FOR THE OWNER'S REPRESENTATIVE, ARCHITECT, OR ENGINEER TO REVIEW THE
- 12. CONTRACTOR SHALL AT ALL TIMES ABIDE BY THE RESTRICTIONS AND REGULATIONS OF THE DEPARTMENT OF CORRECTIONS REGARDING CONDUCT AND SECURITY MEASURES AT THE PROJECT SITE.
- 13. CONTRACTOR'S SECURITY CLEARANCE FOR ACCESS TO THE FACILITY SHALL BE ARRANGED WITH THE DOC AND OA-FMDC.

DEMOLITION NOTES

- 1. PRIOR TO COMMENCING DEMOLITION WORK, THE CONTRACTOR SHALL VERIFY LOCATIONS OF ALL UTILITIES AND MAKE PROVISIONS THAT NO INTERRUPTION OF SERVICES OCCURS.
- 2. CONTRACTOR SHALL COMPLETELY REMOVE ALL DEMOLISHED MATERIALS FROM THE SITE. ALL DEMOLISHED MATERIALS WILL BECOME PROPERTY OF THE CONTRACTOR UNLESS THEY ARE TO BE REUSED, OR AS OTHERWISE NOTED OR INSTUCTED, AND TO BE DISPOSED OF LEGALLY. REMOVE DEBRIS, RUBBISH, AND OTHER MATERIALS DAILY FROM THE CONSTRUCTION SITE. ALL REMOVED MATERIALS SHALL BE DISPOSED OF IN A LEGAL MANNER.
- 3. ALL MATERIALS NOT REQUIRED TO BE REMOVED FOR THE EXECUTION OF THE PROJECT SHALL BE LEFT IN PLACE AND PROTECTED FROM DAMAGE DURING CONSTRUCTION. ANY ITEMS DAMAGED DUE TO THIS PROJECT SHALL BE RESTORED TO THEIR ORIGINAL CONDITION AT THE CONTRACTOR'S EXPENSE.
- 4. THE OWNER ASSUMES NO RESPONSIBILITY FOR ACTUAL CONDITIONS OF ITEMS TO BE DEMOLISHED.
- 5. CUT AND REMOVE PORTIONS OF EXISTING CONSTRUCTION AS REQUIRED TO ALLOW FOR PROPER INSTALLATION OF NEW CONSTRUCTION.
- 6. AT ANY TIME OF CONSTRUCTION, IF ANY CONTRACTOR DISCOVERS HAZARDOUS MATERIALS, STOP WORK AND NOTIFY THE OWNER IMMEDIATELY.

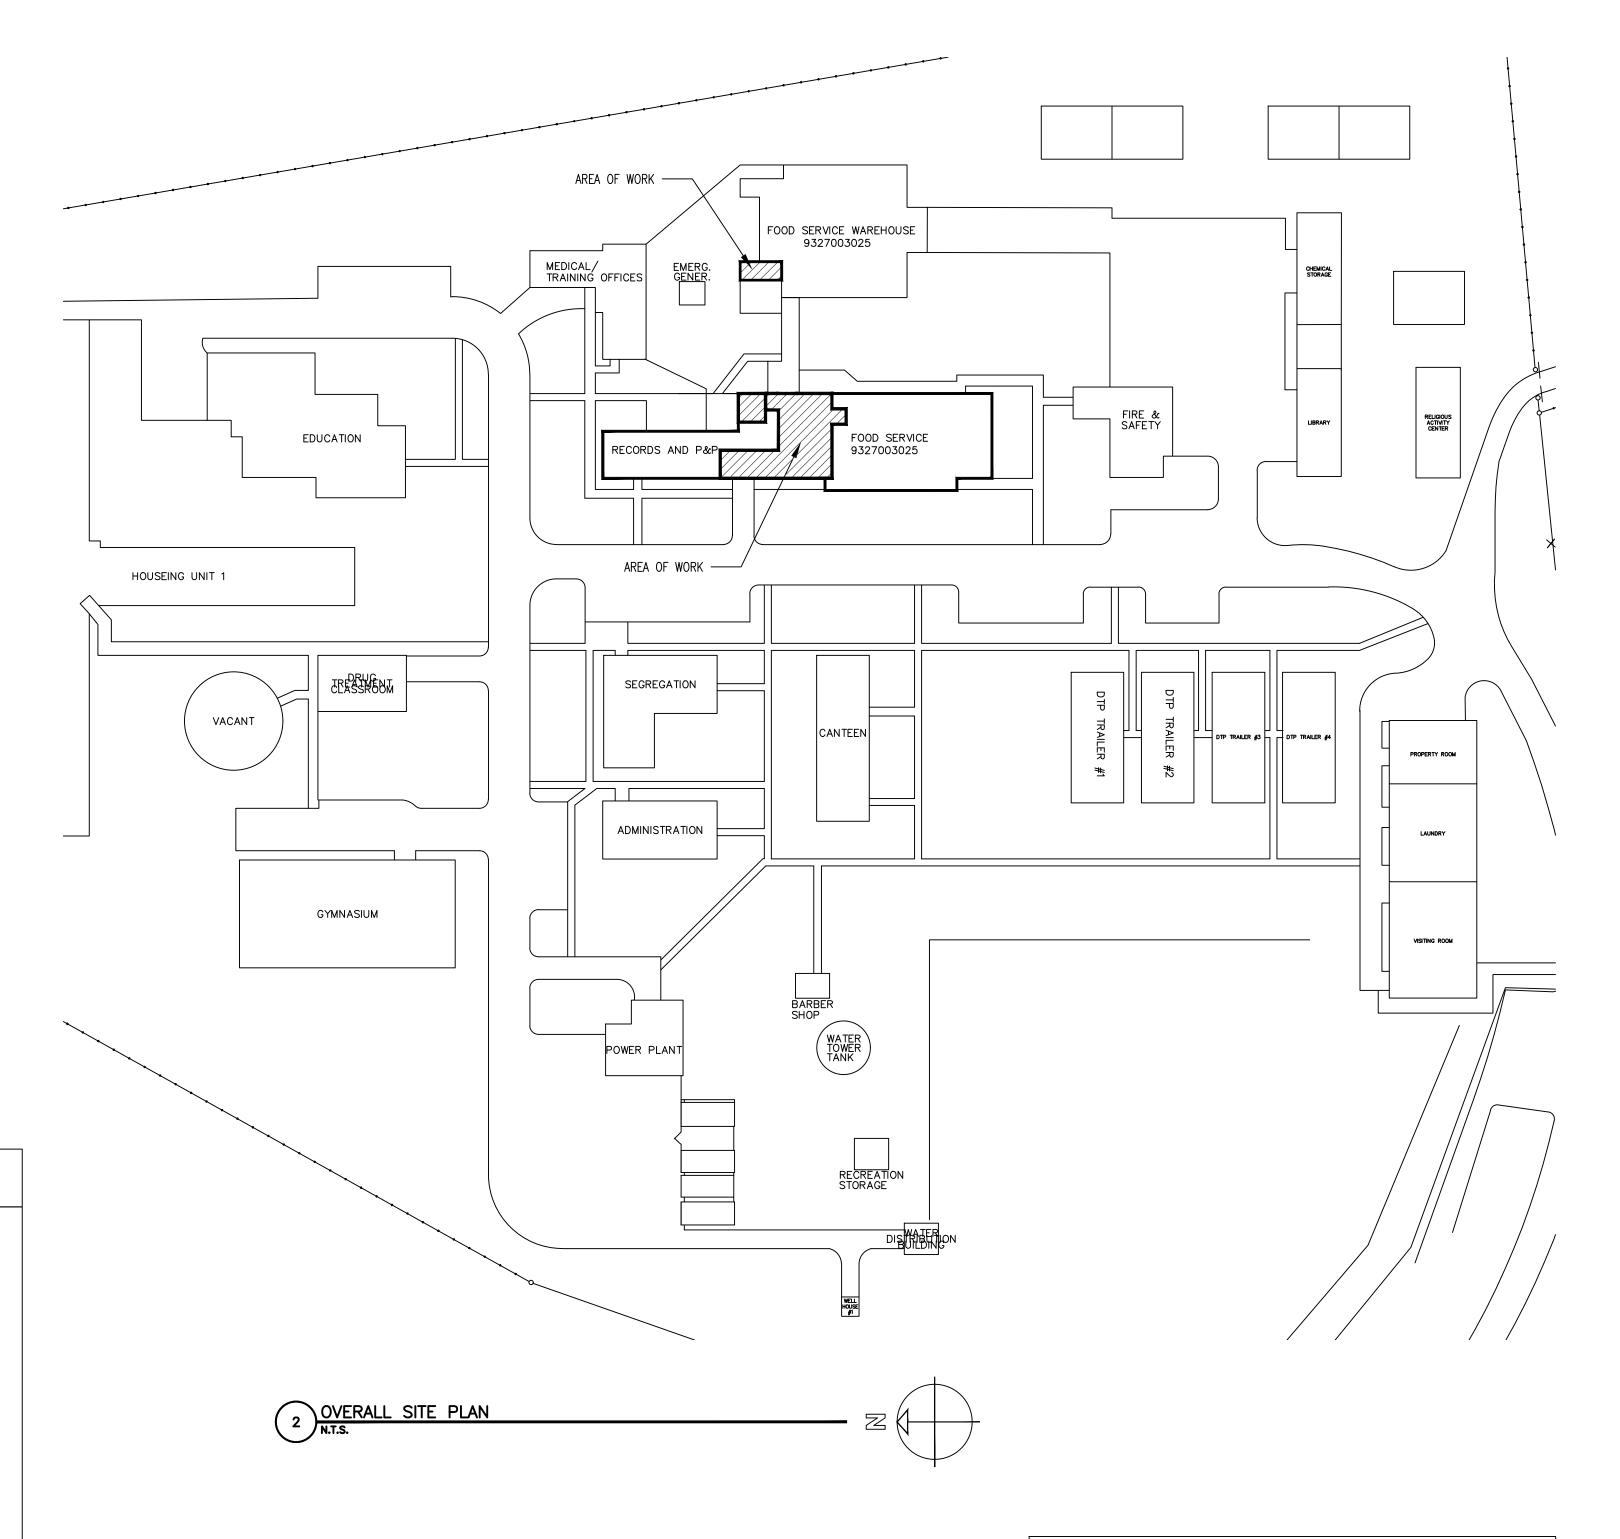

SHEET INDEX - GENERAL

O1 COVER SHEET

G-002 OVERALL SITE PLAN AND DRAWING

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SHEET INDEX - ARCHITECTURAL


A-101 DEMOLITION FLOOR PLAN (KITCHEN) A-102 RENOVATION FLOOR PLAN (KITCHEN)

A-102 RENOVATION FLOO A-501 KITCHEN DETAILS

SHEET INDEX - MECHANICAL

ME-101 REPLACE EQUIPMENT MECHANICAL & ELECTRICAL PLAN

STATE OF MISSOURI MICHAEL L. PARSON, GOVERNOR

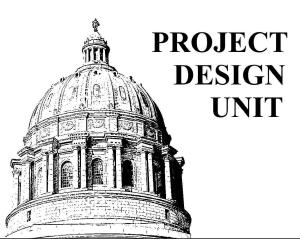

BID DOCUM

OFFICE OF ADMINISTRATION DIVISION OF FACILITIES MANAGEMENT, DESIGN AND CONSTRUCTION

DEPARTMENT OF CORRECTIONS

REPLACEMENT FLOOR AND EQUIPMENT

FOOD SERVICE BUILDING

OZARK CORRECTIONAL CENTER

929 HONOR CAMP LANE FORDLAND, MO 65652

PROJECT # C2237-01 SITE # 7003

ASSET # 93270003025 - FOOD SERVICE

93270003025 - FOOD SERVICE 93270003026 - FOOD SERVICE WAREHOUSE

CAD DWG FILE:
DRAWN BY:
CHECKED BY:
DESIGNED BY:

AND DRAWING

ISSUE DATE: 4/14/2023

SHEET TITLE:


OVERALL SITE PLAN

SHEET NUMBER:

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G-002


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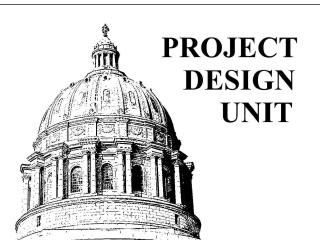
	FOOD SERVICE EQUIPM	MENT S	SCHED	ULE			
MK	DESCRIPTION	WATER	WASTE	GAS	AIR	STEAM	ELEC ⁻
(1)	HOT FOOD UNIT						Х
${2}$	COLD FOOD UNIT						Х
${\sqrt{3}}$	30" x 96" S.S. TABLE WITH UTINSIL RACK						
$\frac{\overline{4}}{4}$	30" x 72" S.S. TABLE						
$\frac{\overline{5}}{\overline{5}}$	TOASTER(TO BE RELOCATED)						Х
$\frac{\overline{6}}{6}$	30" x 48" S.S. TABLE						
$\frac{\overline{7}}{\overline{7}}$	THREE DOOR REFRIG.						Х
$\frac{\overline{8}}{8}$	STEAM KETTLE (RE: 1/A501 FOR PLAN)					Х	
$\frac{\overline{9}}{9}$	DEEP FRYER			Х			Х
$\overline{\langle 10 \rangle}$	17"x17" METAL TREAD G.C. COVER (TO BE REPLACED WITH 12 GA. S.S.)						
$\frac{}{\langle 11 \rangle}$	72" FLAT TOP GRIDDLE			Х			Х
(12)	48" x 14'-0" EXHAUST HOOD WITH SUPPRESSION SYSTEM	NOT IN	ONTR	ACT			
(13)	TEN BURNER RANGE WITH OVEN			Х			Х
$\frac{\overline{14}}{\overline{14}}$	SKITTLE COOKER (TO BE RELOCATED RE: 3/A102)			Х			Х
${\langle 15 \rangle}$	30" x 72" S.S. WORK TABLE (TO BE RELOCATED)						
<u></u>	STEAM COOKER						
${\langle 17 \rangle}$	PORTABLE BAKERS RACK						
<u></u>	30" x 96" BAKERS TABLE						
<u></u>	MIXER						Х
20	TRENCH DRAIN GRATE (RE: 1/A501)						
$\frac{\overline{21}}{\overline{21}}$	HOBART STACKED OVENS						Х
(22)	54" x 14'-0" EXHAUST HOOD WITH SUPPRESSION SYSTEM	NOT IN	CONTR	ACT			
$\overline{\langle 23 \rangle}$	STAINLESS STEEL SHELVING						
24	THREE COMP. SINK, 10'-0" LONG	Х	х				
(25)	CAN OPENER						Х
26	30" x30" S.S. TABLE						
27	30" x 72" S.S. TABLE						
28	SLICER						Х
29	FOOD PREP MACHINE						Х
30	POTATO PEELER						Х
31	THREE COMP. SINK, 8'-0" LONG	Х	Х				
32	HAND SINK	Х	Х				
33	SOILED DISH TABLE						
34	DISH MACHINE	х	х				Х
35	CLEAN DISH TABLE						
36	TWO DOOR WARMER CABINET						Х
37	4'-4" x 8'-2" EXHAUST HOOD WITH SUPPRESSION SYSTEM	SUPPR	I DINATE L ESSON I WING RE	DEVICES	PER C		l

- NOTES:

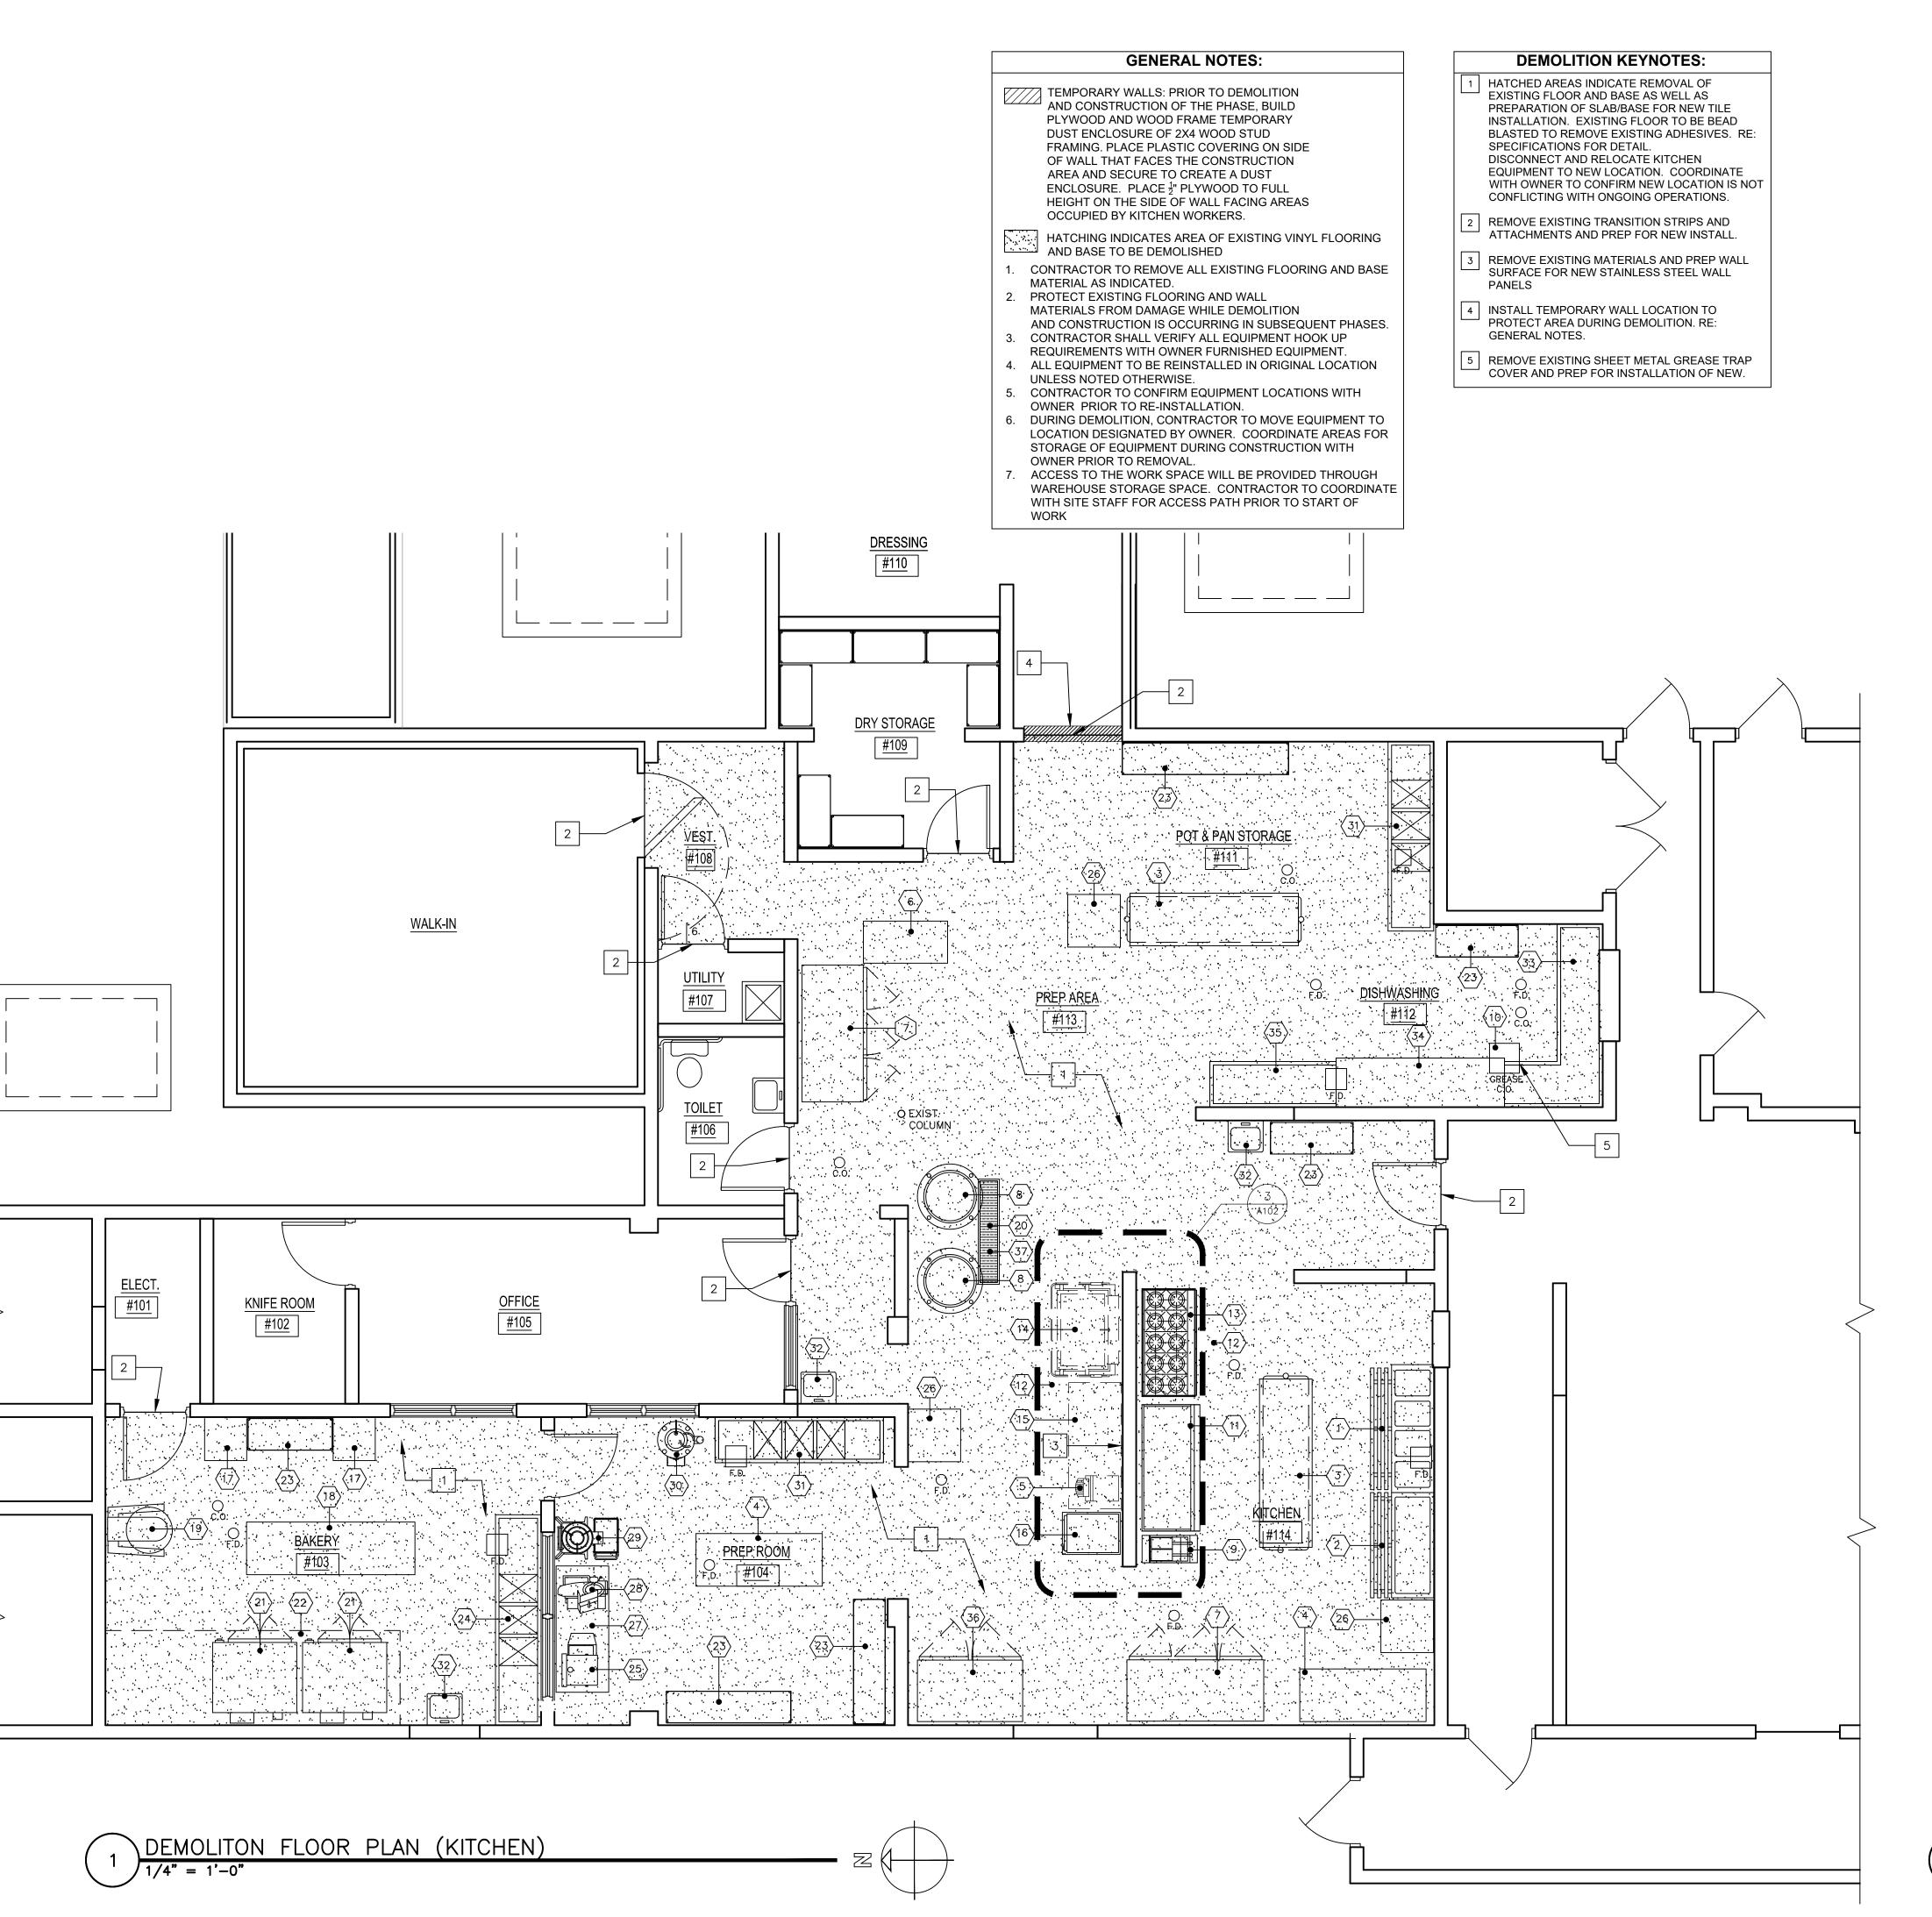 1. CONTRACTOR SHALL VERIFY ALL EQUIPMENT HOOK UP REQUIREMENTS WITH OWNER FURNISHED EQUIPMENT.
- 2. ALL EQUIPMENT TO BE REINSTALLED IN ORIGINAL LOCATION
- UNLESS NOTED OTHERWISE.
- 3. CONTRACTOR TO CONFIRM EQUIPMENT LOCATIONS WITH OWNER PRIOR TO INSTALLATION.
- 4. CONTRACTOR TO COORDINATE AREAS FOR STORAGE OF EQUIPMENT DURING CONSTRUCTION WITH OWNER PRIOR TO REMOVAL.
- 5. NATURAL GAS AND WATER SHUTOFFS ARE AT EACH ASSOCIATED EQUIPMENT. COORDINATE WITH SITE STAFF FOR ELECTRICAL
- SHUTOFF PANEL LOCATIONS.
 6. COORDINATE EXISTING ELECTRICAL HARDWIRED EQUIPMENT FOR DISCONNECTION AND REINSTALLATION TO BE DONE BY CERTIFIED ELECTRICIAN. SHUTOFF LOCATIONS TO BE COORDINATED WITH SITE
- 7. EXHAUST HOOD SUPPRESSION SYSTEM TO BE MODIFIED BY CERTIFIED INSTALLER TO COVER NEW LOCATION OF EQUIPMENT PER DRAWINGS AND PER FIRE CODE.



STATE OF MISSOURI MICHAEL L. PARSON, **GOVERNOR**

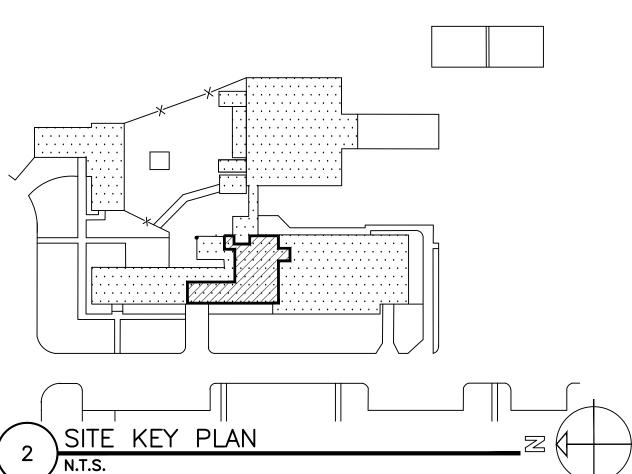

OFFICE OF ADMINISTRATION **DIVISION OF FACILITIES** MANAGEMENT, **DESIGN AND CONSTRUCTION**

DEPARTMENT OF CORRECTIONS

REPLACEMENT FLOOR AND **EQUIIPMENT**

FOOD SERVICE BUILDING

OZARK CORRECTIONAL CENTER

929 HONOR CAMP LANE FORDLAND, MO 65652

PROJECT # C2237-01 7003

ASSET# 93270003025 - FOOD SERVICE 93270003026 - FOOD SERVICE WAREHOUSE

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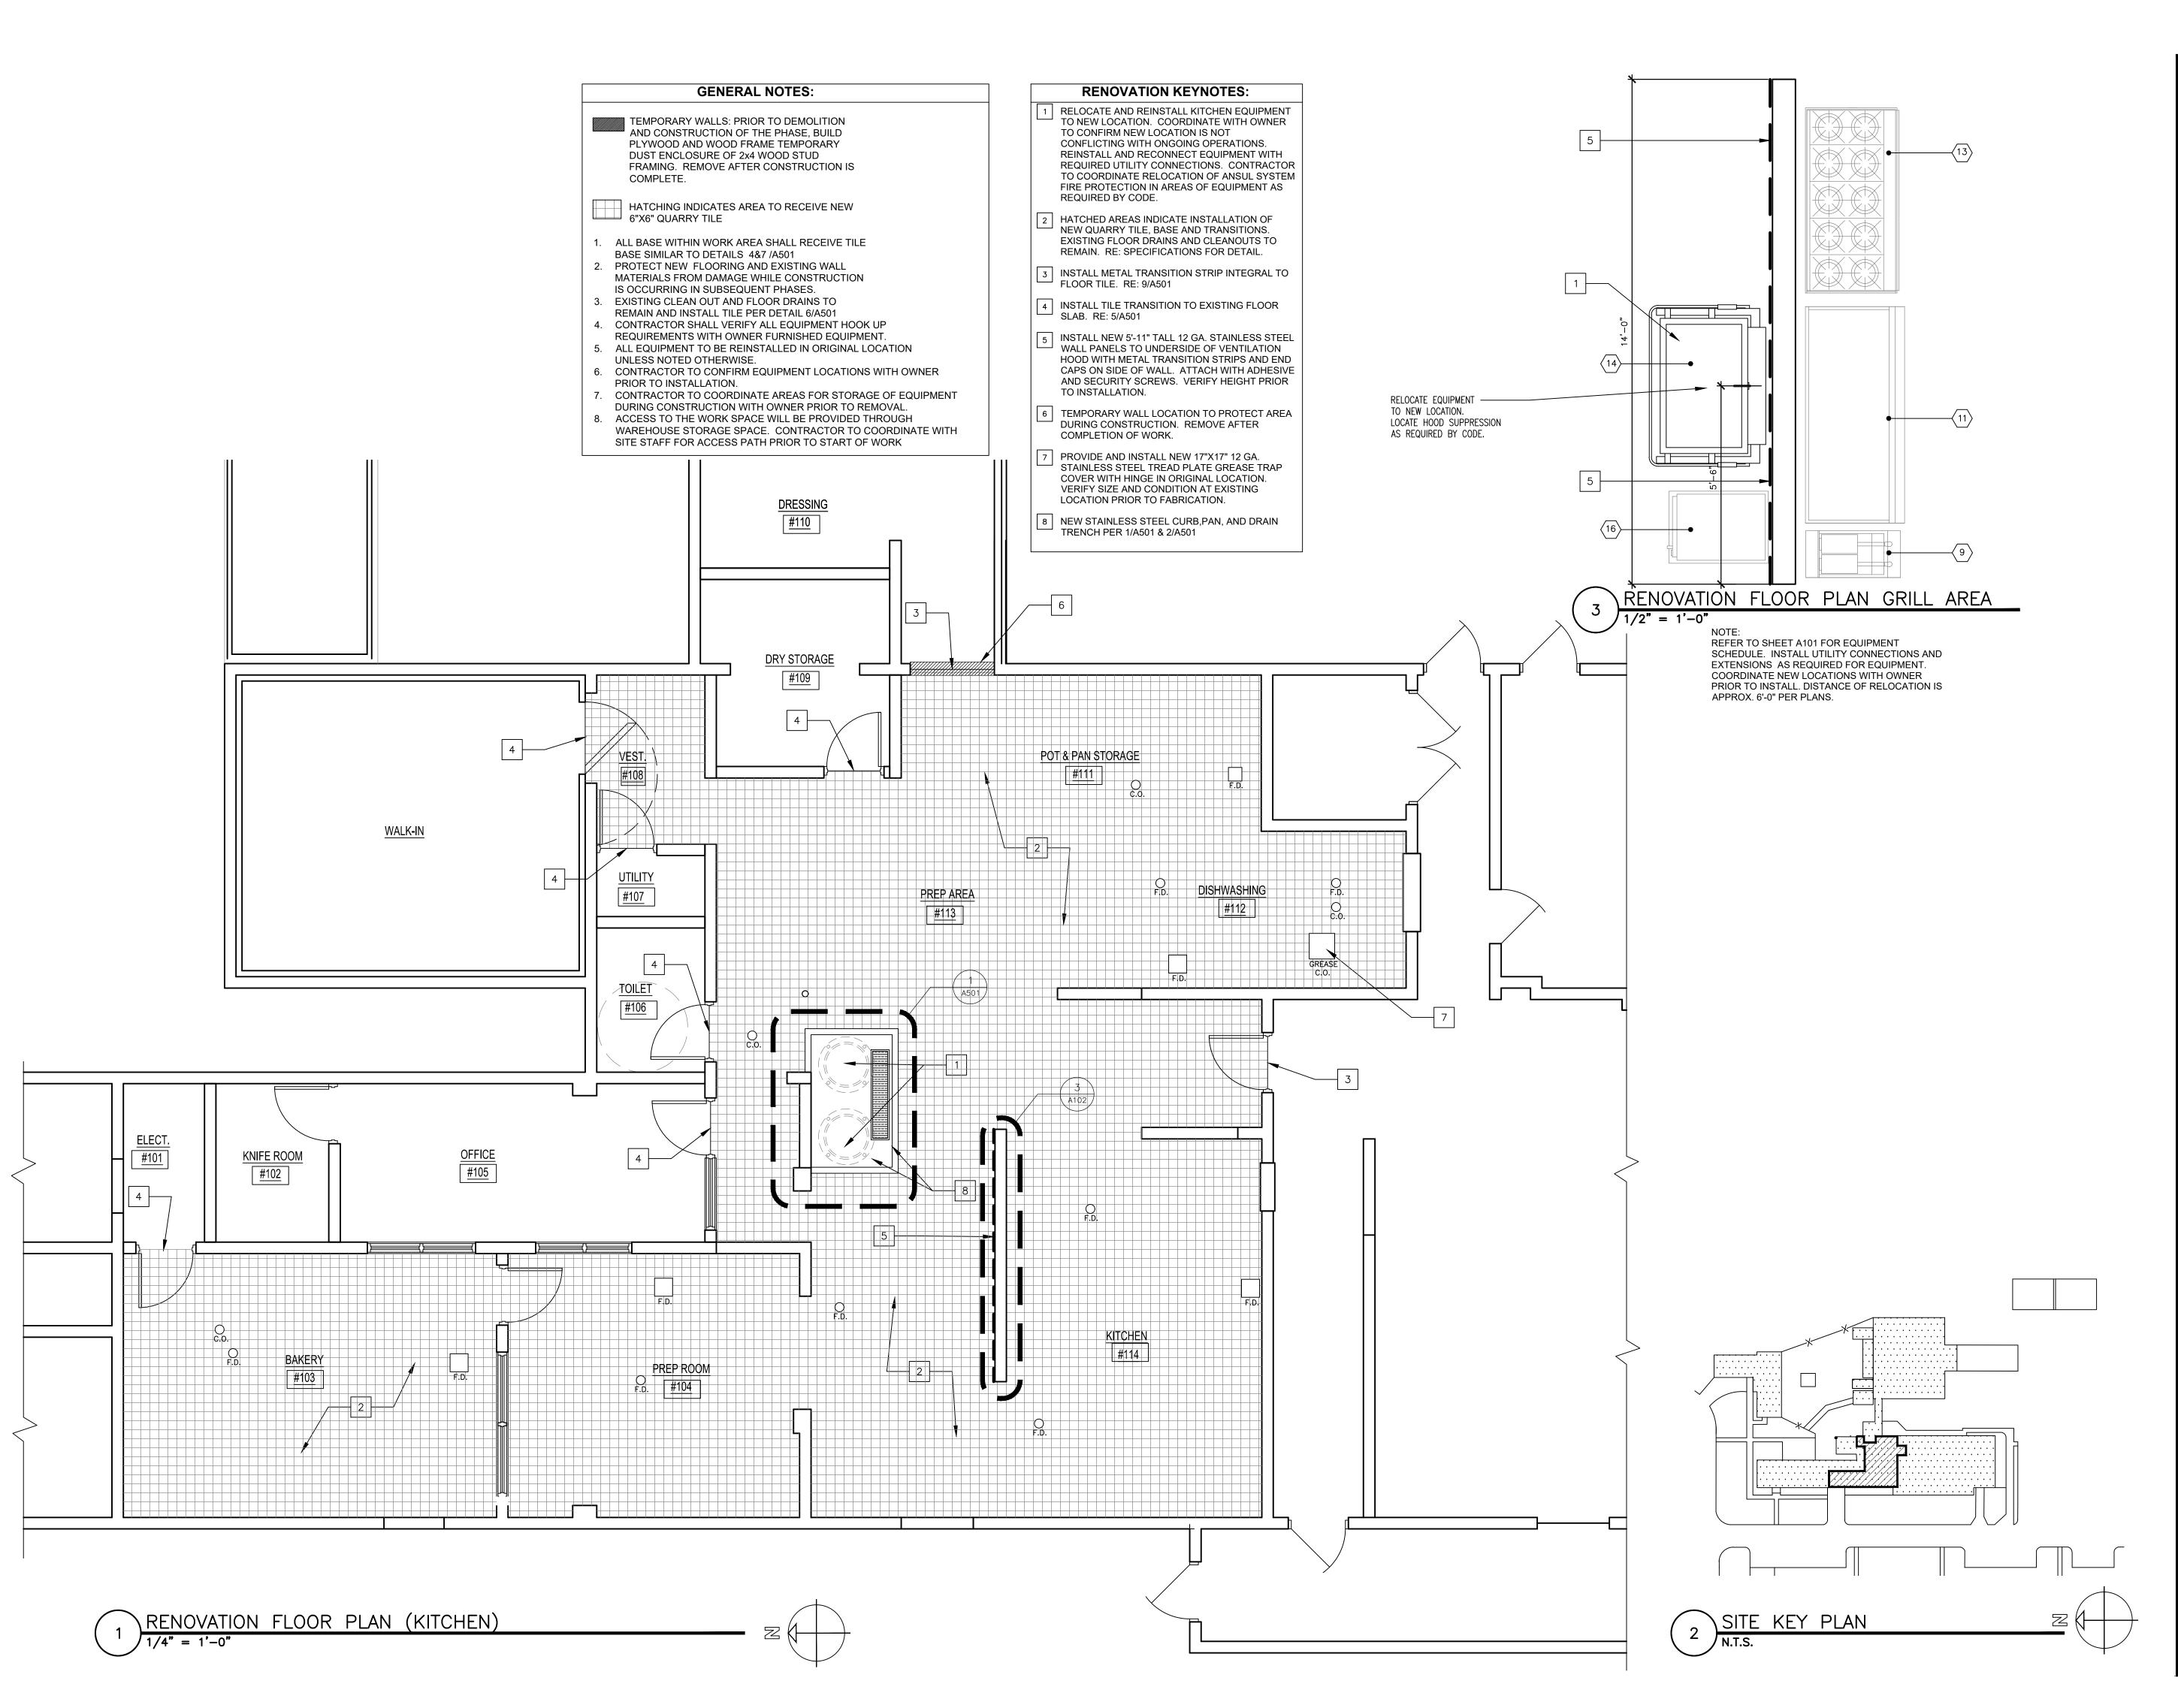
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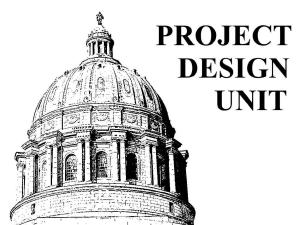
DEMOLITION FLOOR PLAN (KITCHEN)

SHEET NUMBER:

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STATE OF MISSOURI MICHAEL L. PARSON, GOVERNOR



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REPLACEMENT FLOOR AND EQUIIPMENT

FOOD SERVICE BUILDING

OZARK CORRECTIONAL CENTER 929 HONOR CAMP LANE FORDLAND, MO 65652

PROJECT # C2237-01 SITE # 7003

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93270003026 - FOOD SERVICE
WAREHOUSE

REVISION:
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REVISION:
DATE:
ISSUE DATE: 4/14/2023

CAD DWG FILE:
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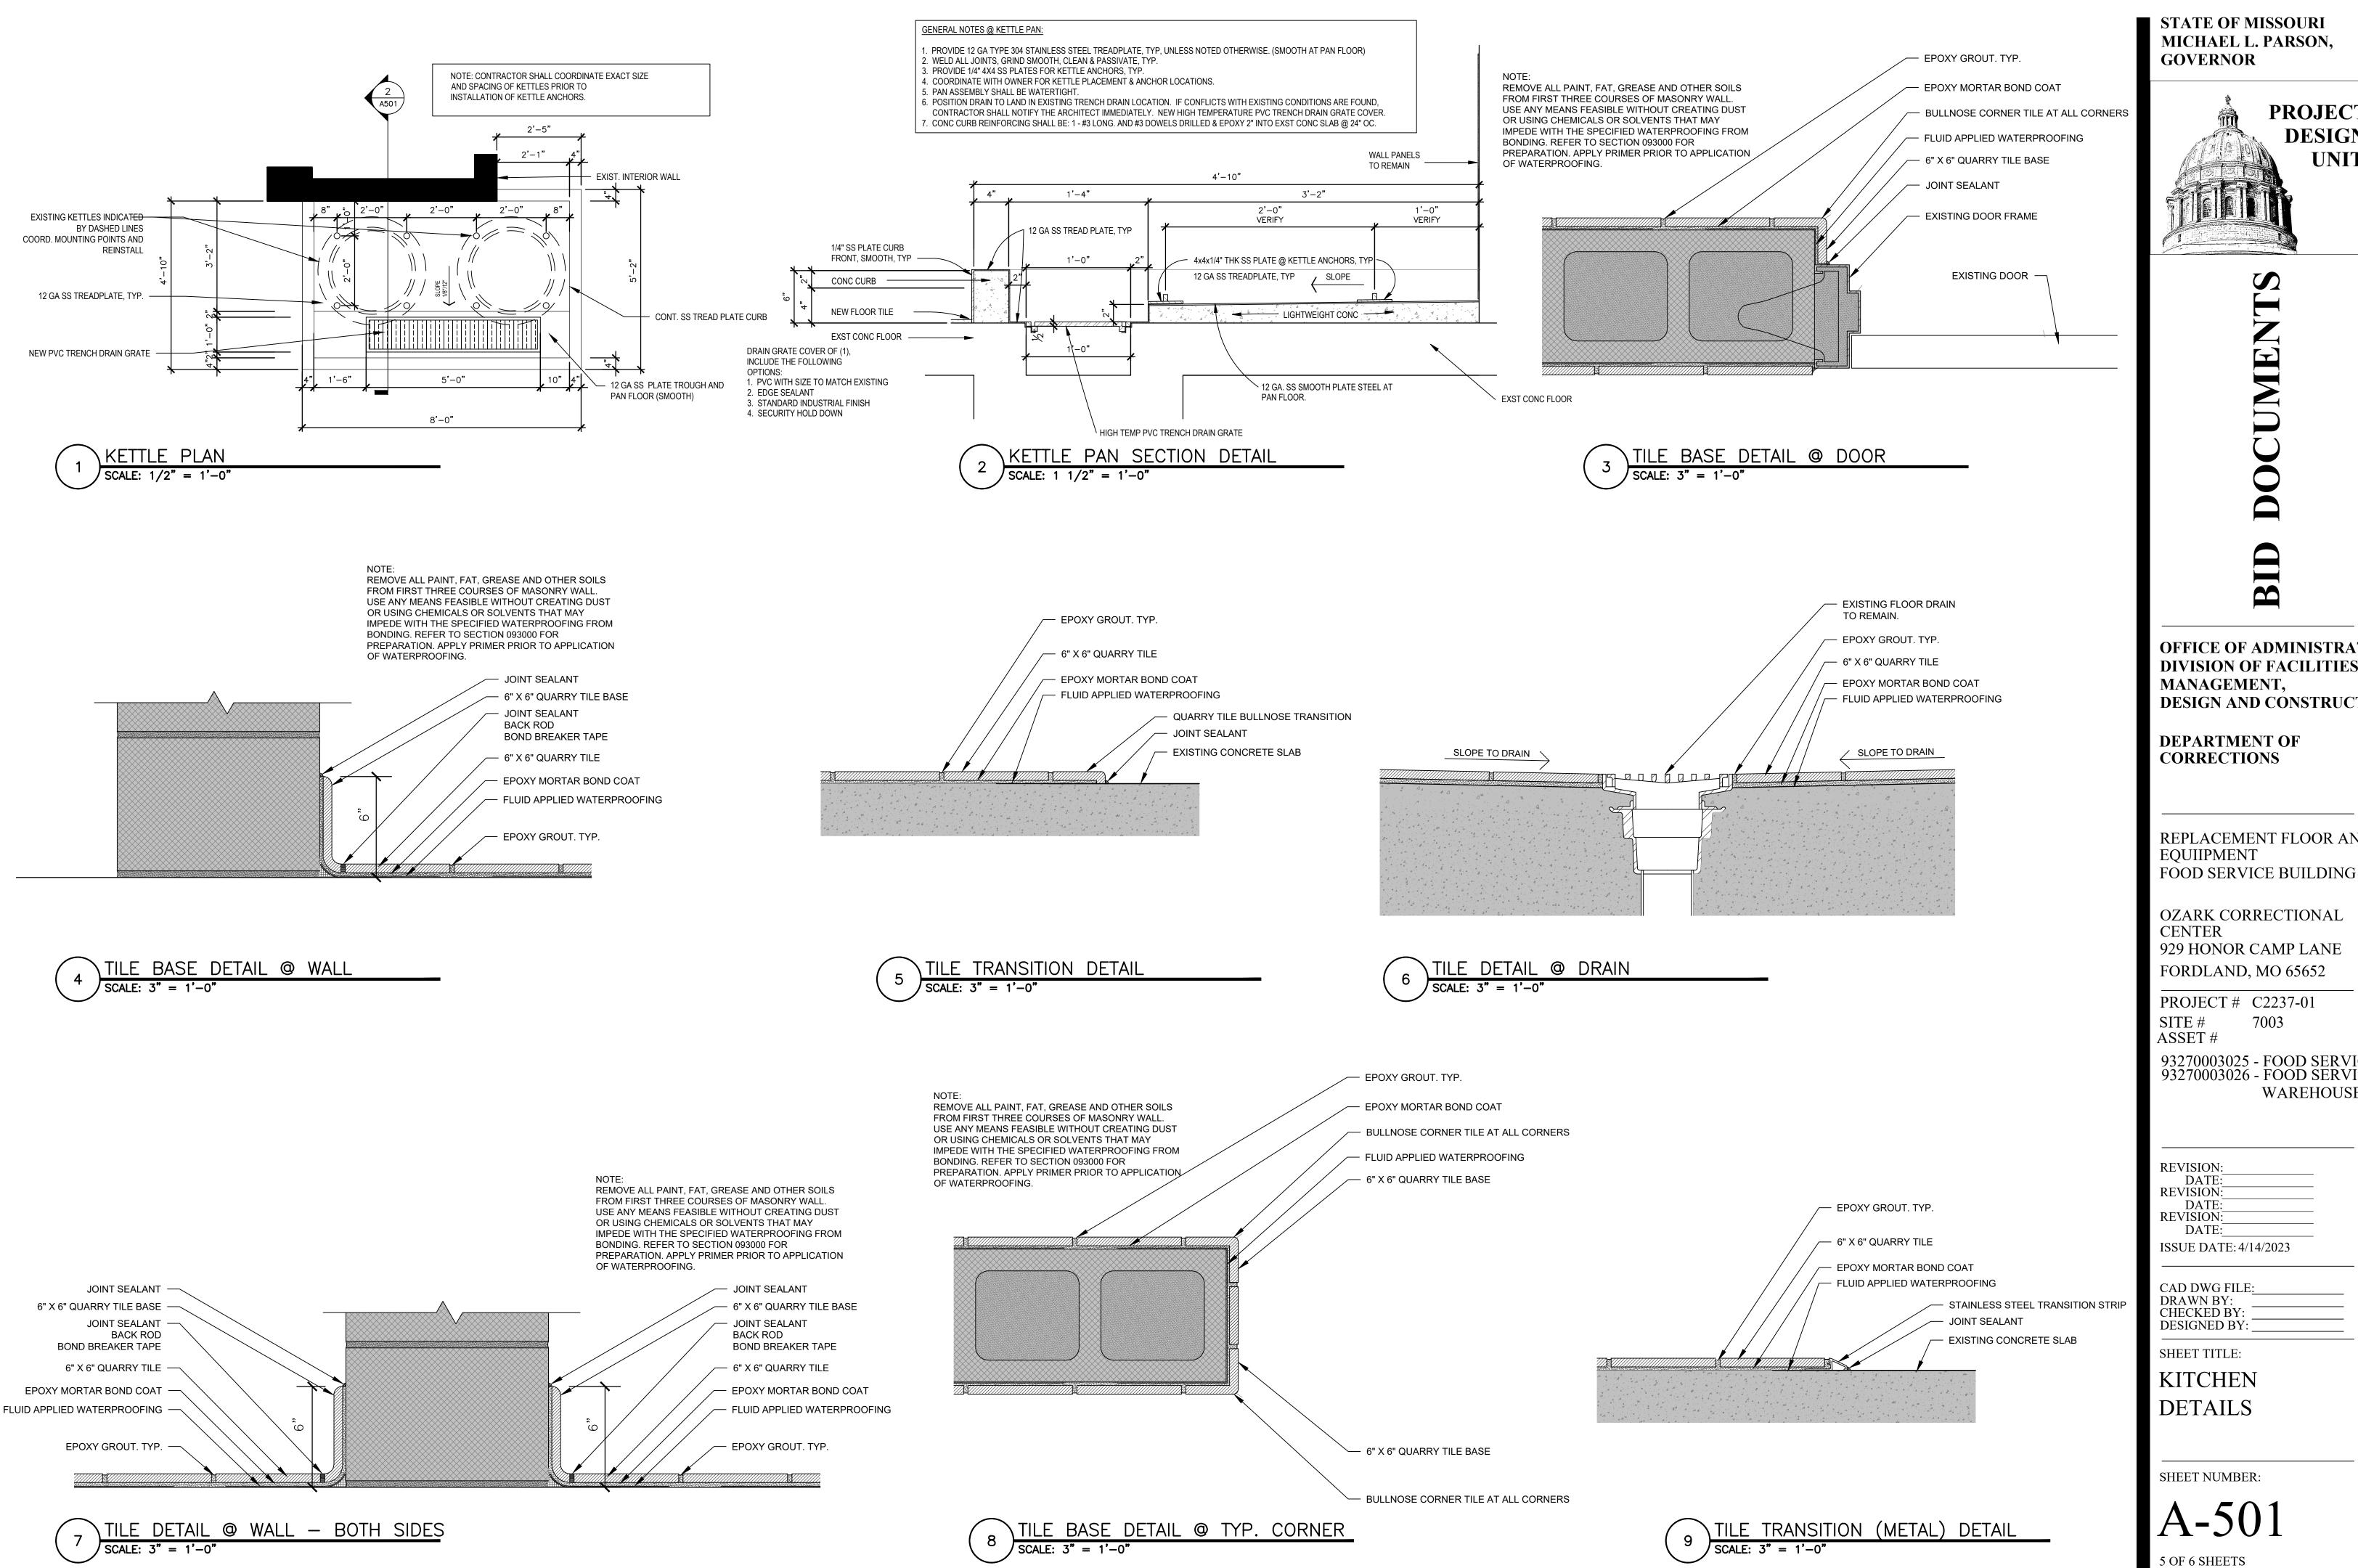
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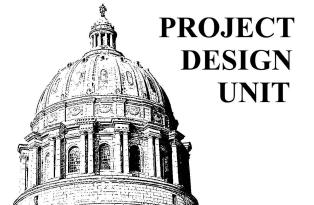
RENOVATION FLOOR PLAN (KITCHEN)

SHEET NUMBER:

A-102

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OFFICE OF ADMINISTRATION DIVISION OF FACILITIES **DESIGN AND CONSTRUCTION**

REPLACEMENT FLOOR AND

93270003025 - FOOD SERVICE 93270003026 - FOOD SERVICE WAREHOUSE

4/14/2023

REFRIGERATION SCHEDULE								
MARK	MANUFACTURER	MODEL	CAPACITY (BTUH)	REFRIGERANT	CONNECTIONS	ELECTRICAL	WEIGHT (LBS)	NOTES
CU-1	BALLY	BEZA011H8-HT3D	12,444	R-448A	3/8 LIQUID 5/8 SUCTION	208-230/3 MCA 14.1 MOP 20	285	1,2
E-1	BALLY	BLP214MA-S1D-SV+	13,836	R-448A	1/2 LIQUID 7/8 SUCTION 3/4 DRAIN	115/1 MCA 2.3 MOP 20	78	3,4
CU-2	BALLY	BEZA025H8-HT3D	21,972	R-404A	1/2 LIQUID 7/8 SUCTION	208-230/3 MCA 19.2 MOP 30	405	1,2
E-2	BALLY	BLP214MA-S1D-SV+	22,019	R-404A	3/8 LIQUID 1-1/8 SUCTION 3/4 DRAIN	115/1 MCA 4.3 MOP 20	117	3,4


HVAC	LEGEND
AA N	DEVICE SCHEDULE TAG
	NEW EQUIPMENT
	REFRIGERANT PIPE
	CONDENSATE DRAIN PIPE
	EQUIPMENT TO BE REMOVED

- 1 CAPACITY AT 24.4°F SUCTION AND 100°F OUTDOOR AMBIENT; MEETS DOE MINIMUM AWEF RATE 7.6 BTU/W-H
- PROVIDE SMART SPEED SCROLL COMPRESSOR, LIQUID LINE FILTER DRIER, SUCTION ACCUMULATOR, NON-FUSED DISCONNECT AND ALL ADDITIONAL COMPONENTS REQUIRED FOR LOW AMBIENT OPERATION
- CAPACITY AT 24.9°F EVAP TEMPERATURE AND 25°F BOX TEMPERATURE; AWEF RATE 9.0 BTU/W-H
- PROVIDE EC MOTOR, SMARTVAP+ CONTROL BOARD AND DISPLAY AND ALL REQUIRED SENSORS, ELECTRONIC EXPANSION VALVE, LIQUID LINE SOLENOID VALVE, COMPONENTS AND CONTROLS FOR AIR DEFROST; ALL ACCESSORIES ARE PRE-WIRED AND MOUNTED

HVAC	LEGEND		
DEVICE SCHEDULE TAG			
	NEW EQUIPMENT		
	REFRIGERANT PIPE		
	CONDENSATE DRAIN PIPE		
	EQUIPMENT TO BE REMOVED		

NEW WALK-IN



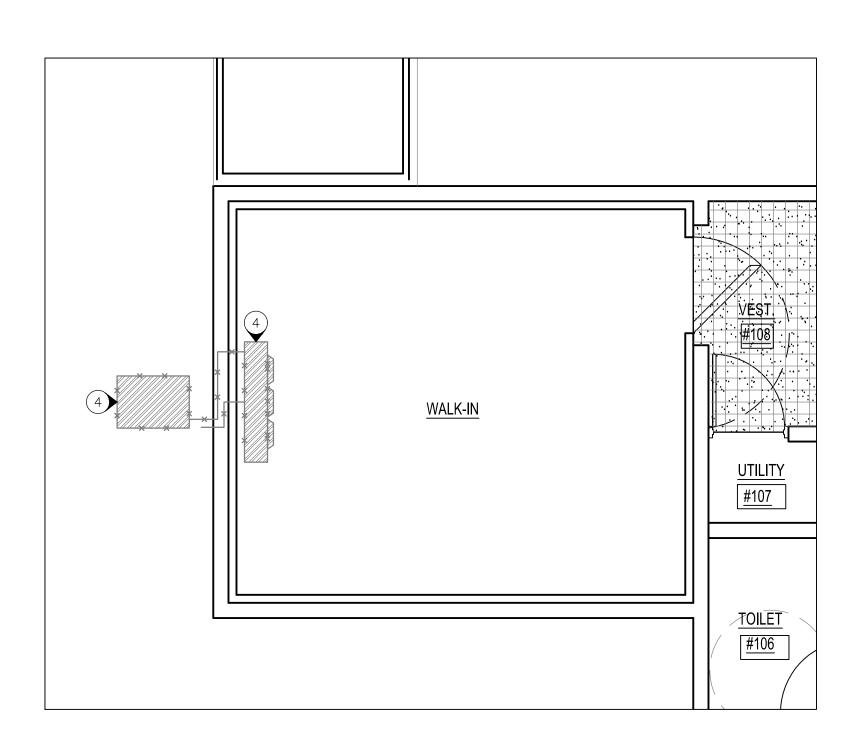


WALK IN COOLER - CONDENSER & EVAPORATOR DEMOLITION

SCALE: 1/4" = 1'-0"

WALK IN COOLER - COOLER, CONDENSER & EVAPORATOR DEMOLITION

SCALE: 1/4" = 1'-0"

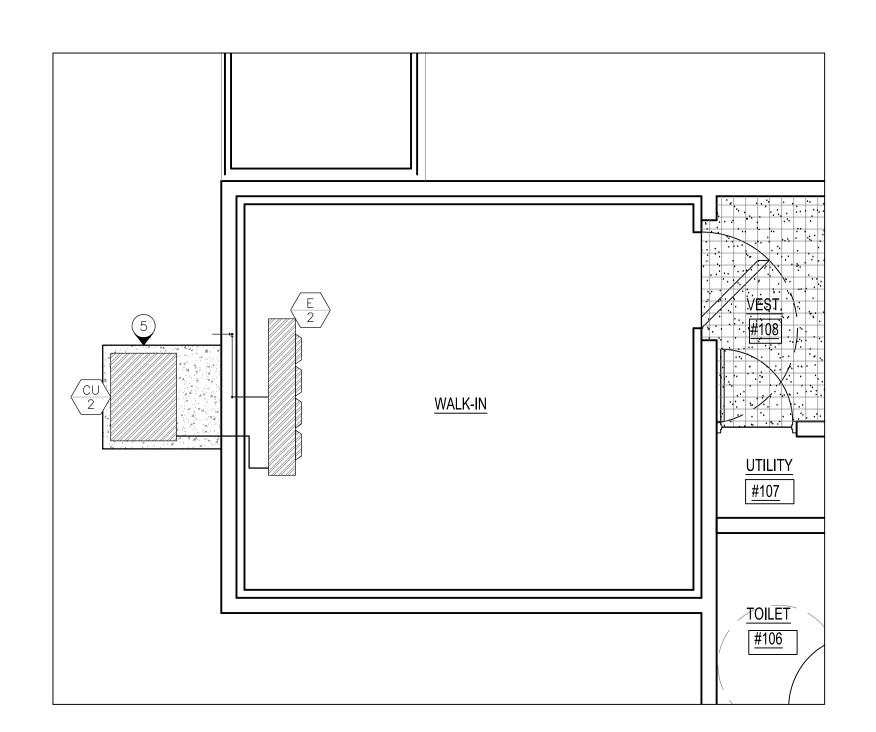

WALK IN COOLER - REPLACE CONDENSER & EVAPORATOR

SCALE: 1/4" = 1'-0"




1 ALL WORK SHALL BE IN ACCORDANCE WITH THE LATEST VERSION OF THE INTERNATIONAL MECHANICAL CODE, NATIONAL ELECTRIC CODE, ALL STATE CODES, AND ALL MANUFACTURER INSTALLATION GUIDELINES.

- 2 ELECTRICAL CONTRACTOR SHALL BE RESPONSIBLE FOR PROVIDING ALL MATERIALS REQUIRED TO COMPLETE THE WORK. ALL EXPOSED LINE VOLTAGE WIRING SHALL BE PULLED IN PROPERLY SIZED CONDUIT (EMT) WITH APPROVED FITTINGS.
- REMOVE AND DISPOSE OF EXISTING WALK IN COOLER, EVAPORATOR, CONDENSING UNIT, AND ALL ASSOCIATED CONTROLS AND REFRIGERANT AND CONDENSATE PIPE. DISCONNECT POWER FROM EQUIPMENT PRIOR TO DEMOLITION AND VERIFY WIRE SIZE AND BREAKER ARE ACCEPTABLE FOR USE WITH NEW EQUIPMENT. REPLACE WIRE AND BREAKER AS NEEDED. EXISTING CONCRETE PAD TO REMAIN FOR USE WITH NEW COOLER.
- (4) REMOVE EVAPORATOR, CONDENSING UNIT, AND ALL ASSOCIATED REFRIGERANT AND CONDENSATE PIPE. DISCONNECT POWER FROM EQUIPMENT PRIOR TO DEMOLITION AND VERIFY WIRE SIZE AND BREAKER ARE ACCEPTABLE FOR USE WITH NEW EQUIPMENT. REPLACE WIRE AND BREAKER AS
- (5) PROVIDE POURED IN PLACE CONCRETE MOUNTING PAD FOR REMOTE CONDENSING UNIT. ENSURE PAD IS LEVEL AND COMPACT SOIL UNDER PAD PRIOR TO INSTALLATION TO PREVENT SETTLING. LOCATE PAD ADJACENT TO EXISTING WALK IN COOLER PAD SUCH THAT THERE IS NO TURF BETWEEN THE PADS.
- 6 PROVIDE A TRAPPED CONDENSATE DRAIN PIPE FOR EVAPORATORS. CONDENSATE PIPE SHALL BE 0.75 INCH INSIDE DIAMETER COPPER. SLOPE PIPE IN THE DIRECTION OF DISCHARGE A MINIMUM OF 1 INCH PER FOOT. LOCATE P-TRAP OUTSIDE OF WALK IN COOLER OR PER MANUFACTURER'S INSTRUCTIONS. COORDINATE WITH ELECTRICAL CONTRACTOR TO PROVIDE HEAT TRACE FOR CONDENSATE PIPE. PROVIDE 1 INCH FLEXIBLE ELASTOMERIC CELLULAR INSULATION THAT COMPLIES WITH ASTM C534 GRADE 1. WEATHER SEAL CONDENSATE PIPE WALL PENETRATIONS AND INSTALL ALUMINUM JACKET TO INTERIOR AND EXTERIOR CONDENSATE PIPE.
- 7 INSULATE REFRIGERANT SUCTION PIPES WITH 1 INCH THICK FLEXIBLE ELASTOMERIC CELLULAR INSULATION THAT COMPLIES WITH ASTM C534 GRADE 1. THE REFRIGERANT PIPES SHALL BE SUPPORTED WITH A MAXIMUM SPAN BETWEEN HANGERS OF 5 FEET. WEATHER SEAL REFRIGERANT PIPE WALL PENETRATIONS AND INSTALL ALUMINUM JACKET TO INTERIOR AND EXTERIOR REFRIGERATE PIPE.
- (8) PREFABRICATED NSF APPROVED WALK-IN COOLER: BASIS OF DESIGN: BALLY REFRIGERATION. REFERENCE SPECIFICATIONS FOR ADDITIONAL

LOCATION WITH SITE CONDITIONS.

- EXTERIOR DIMENSIONS (NOMINAL): 19'(L) X 8'(W) X 8'-6"(H). SINGLE COMPARTMENT. CONTRACTOR IS RESPONSIBLE FOR VERIFYING FINAL DIMENSIONS OF COOLER WITH SITE CONDITIONS.
- PANELS: 4 INCH THICK FOAMED IN PLACE TYPE WITH EMBOSSED WHITE EXTERIOR AND EMBOSSED GALVALUME (26 GA) INTERIOR.
- CEILING: 4 INCH THICK, SINGLE SPAN WITH INSULATION TAPERED % INCH PER FOOT AWAY FROM BUILDING WITH MEMBRANE ROOF FOR OUTDOOR CONDITIONS. EMBOSSED GALVALUME (26 GA) INTERIOR.
- FLOOR: 6 INCH THICK WITH SMOOTH ALUMINUM (10 GA) WALKING SURFACE ADHERED TO 1/2" OSB BOARD FOAMED IN PANEL, STRUCTURAL FLOOR WITH FRP BEAMS AND REINFORCED EXTERIOR BOTTOM.
- DOOR: HINGED 36"(W) X 78"(H) DOOR WITH 36"(W) X 30"(H) 1/8 INCH DIAMOND TREAD KICKPLATE ON INTERIOR AND EXTERIOR OF DOOR. SELF-CLOSING DOOR, LOCKING DEADBOLT HANDLE. CONTRACTOR IS RESPONSIBLE FOR VERIFYING FINAL LOCATION OF DOOR AND HINGE
- LIGHTS: 1 VAPOR PROOF LED BULB ABOVE DOOR, 2 KASON LED 1809-3 LIGHT WITH STRIPS 17 INCH LONG.

STATE OF MISSOURI MICHAEL L. PARSON, **GOVERNOR**

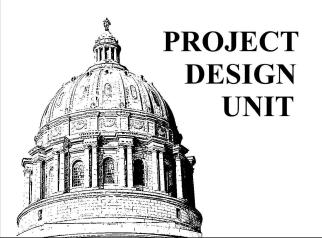

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REVISION: REVISION: **REVISION:** DATE: ISSUE DATE: 4/14/2023

CAD DWG FILE:<u>ME101_C2237.D</u>WG DRAWN BY: <u>TLS</u> CHECKED BY: TLS DESIGNED BY: TLS

SHEET TITLE:

REPLACE EQUIPMENT MECHANICAL & ELECTRICAL PLAN

SHEET NUMBER:

ME-101

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