
REPLACE ROOF, EDUCATION BUILDING No.14 BOONVILLE CORRECTIONAL CENTER BOONVILLE, MISSOURI

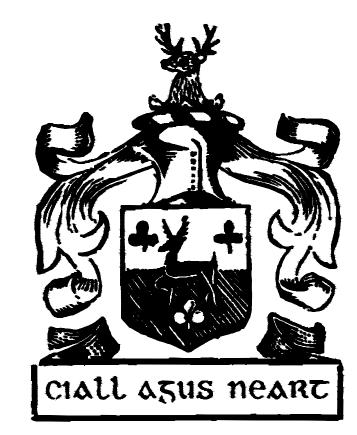

OWNER:

STATE OF MISSOURI MICHAEL L. PARSON,

GOVERNOR

DEPARTMENT OF CORRECTIONS

PROJECT OFFICE OF ADMINISTRATION

MANAGEMENT: DIVISION OF FACILITIES MANAGEMENT,

DESIGN AND CONSTRUCTION

CONNELL ARCHITECTURE, P.C.

2311 East Walnut Sreet Suite B
Columbia, Missouri 65201
573-875-2455 Cell: 573-268-6166
brianconnell@connellarchitecture.com

DESIGNER: CONNELL ARCHITECTURE, P.C.


2311 EAST WALNUT STREET SUITE B

COLUMBIA, MISSOURI 65201

PROJECT NUMBER: C2311-01

SITE NUMBER: 7002 ASSET NUMBER: 9327002024



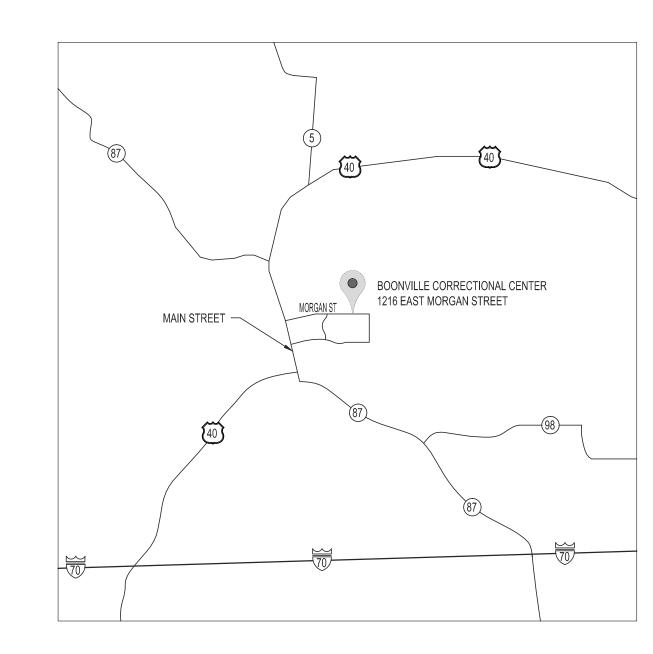













SITE NUMBER - 7002

GENERAL NOTES:

- REVIEW THE CONTRACT DOCUMENTS IT IS THE RESPONSIBILITY OF THE GENERAL CONTRACTOR AND EACH SUBCONTRACTOR TO REVIEW THE DRAWINGS TO ASSURE COORDINATION OF ALL WORK AFFECTING EACH TRADE. FAILURE TO REVIEW ALL CONTRACT DOCUMENTS FOR APPLICABLE ITEMS OF WORK SHALL NOT RELIEVE THE RESPONSIBLE PARTY FROM PERFORMING ALL WORK REQUIRED BY THE CONTRACT DOCUMENTS.
- DRAWINGS THESE DRAWINGS SHALL NOT BE SCALED. REFER TO DIMENSIONS INDICATED, ACTUAL SIZES OF CONSTRUCTION ITEMS, OR OTHER METHODS OF LOCATING OR SIZING CONSTRUCTION. WHERE NO DIMENSION OR METHOD OF DETERMINING A LOCATION OR SIZE OF ANY ITEM IS GIVEN, THE CONTRACTOR SHALL VERIFY THE CORRECT LOCATION OR SIZE OF ANY ITEM WITH CONNELL ARCHITECTURE P.C. PRIOR TO INSTALLATION.
- 3. **DIMENSIONS** DIMENSIONS ON PLANS ARE MEASURED FROM FACE OF CONCRETE, MASONRY, OR FRAMING UNLESS OTHERWISE NOTED. DIMENSIONS INDICATED AS "CLEAR" SHALL BE A MINIMUM DIMENSION MEASURED FROM THE FACE OF FINISH MATERIALS (WHERE CLEARANCES ARE CRITICAL)
- 4. COORDINATION THE CONTRACTOR SHALL COORDINATE REQUIREMENTS OF ALL TRADES TO ALLOW FOR TIMELY INCLUSION IN THE WORK SO AS NOT TO DELAY THE WORK OR THE WORK OF ANY SUBCONTRACTOR.
- **EXISTING CONDITIONS** THE EXISTING CONDITIONS SHOWN ON THESE DRAWINGS ARE DERIVED FROM OBSERVATIONS AND MEASUREMENTS TAKEN DURING SITE VISITS AND FROM ARCHIVE INFORMATION PROVIDED BY THE OWNER. THE CONTRACTOR SHALL VERIFY ALL EXISTING CONDITIONS ON THE JOB SITE, AND NOTIFY CONNELL ARCHITECTURE P.C. OF DEVIATIONS FROM THESE DRAWINGS PRIOR TO FABRICATION AND INSTALLATION OF THE WORK.
- PRECAUTIONS THE CONTRACTOR SHALL NOTIFY THE CONSTRUCTION ADMINISTRATOR AND CONNELL ARCHITECTURE P.C. IMMEDIATELY UPON DISCOVERY OF ANY UNFORESEEN CONDITIONS WHICH COULD RESULT IN DAMAGE TO THE STRUCTURE OR INJURY TO ITS OCCUPANTS. THE CONTRACTOR SHALL TAKE NECESSARY PRECAUTIONS TO PROPERLY SUPPORT THE STRUCTURE AND PROTECT THE OCCUPANTS.
- HAZARDOUS MATERIALS THE CONTRACTOR SHALL IMMEDIATELY REPORT THE DISCOVERY OF ANY HAZARDOUS MATERIALS TO THE CONSTRUCTION ADMINISTRATOR AND CONNELL ARCHITECTURE, P.C.
- 8. SITE USAGE THE CONTRACTOR'S USE OF THE SITE FOR ANY CONSTRUCTION STAGING OR OTHER OPERATIONS SHALL BE COORDINATED WITH THE OWNER AND CONSTRUCTION ADMINISTRATOR. THE CONTRACTOR'S OPERATIONS SHALL NOT OBSTRUCT OR ADVERSELY AFFECT ANY PUBLIC RIGHT-OF-WAY OR ADJACENT OWNER-OCCUPIED AREAS.
- EXIT ACCESS THE CONTRACTOR SHALL AT ALL TIMES DURING THE CONSTRUCTION PERIOD MAINTAIN UNOBSTRUCTED, SAFE, AND APPROVED MEANS OF EGRESS IN AND OUT OF PROJECT LOCATION AND EXISTING OCCUPIED BUILDINGS IN ACCORDANCE WITH REQUIREMENTS OF APPLICABLE REGULATORY AGENCIES.
- **EXISTING MATERIALS:** ANY AND ALL MATERIALS NOTED "TO REMAIN" ARE EXISTING MATERIALS TO REMAIN A PART OF THE WORK UNLESS OTHERWISE NOTED. ANY MATERIAL NOT DESIGNATED "TO REMAIN" SHALL BE REMOVED AND DISPOSED OF IN A LEGAL MANNER, AND REPLACED WITH NEW MATERIALS UNLESS OTHERWISE NOTED.

DRAWING INDEX

G-001 G-002	33.1	TION MAPS & DRAWING INDEX
AD-10	0 ROOF	DEMOLITION PLAN
A-100	ROOF	REPLACEMENT PLAN
A-200		H & EAST EXTERIOR ELEVATIONS - NRY MAINTENANCE
A-201		H & WEST EXTERIOR ELEVATIONS - NRY MAINTENANCE
A-202		TYARD EXTERIOR ELEVATIONS - NRY MAINTENANCE
A-500 A-501		& ROOF DETAILS DETAILS
A-502	ROOF	DRAINAGE DETAILS

GENERAL ROOF REPLACEMENT NOTES

- ROOF SLOPE: THE MINIMUM SLOPE ON ANY LOW-SLOPE ROOF PLANE
- WIND UPLIFT RATING: FM 1A-90
- FIRE RESISTANCE RATING: UL CLASS C.
- ROOF WARRANTY: THE NEW TPO MEMBRANE ROOF AND FLASHING SYSTEM SHALL BE WARRANTED BY THE MANUFACTURER FOR A PERIOD OF 20 YEARS FROM THE DATE OF SUBSTANTIAL COMPLETION.

LIMITED ASBESTOS INSPECTION WAS CONDUCTED ON THE EXISTING ROOF AREA AND THROUGHOUT ALL NTERIOR AREAS OF THE EDUCATION BUILDING No. 14 WHERE DEMOLITION AND CONSTRUCTION ACTIVITIES TAKEN DURING THE INVESTIGATION **DO** CONTAIN ASBESTOS. ASBESTOS ABATEMENT WILL BE REQUIRED IN AND ON ALL AREAS OF THE BUILDING WHERE ASBESTOS-CONTAINING MATERIALS MAY BE DISTURBED DURING THE COURSE OF DEMOLITION AND CONSTRUCTION ACTIVITIES.

ASBESTOS-CONTAINING MATERIALS SURVEY REPORT FOR FULL DETAIL.

LEAD CONTAINING MATERIALS

THE EDUCATION BUILDING No. 14 AND NO SUSPECT LEAD-CONTAINING MATERIALS WERE OBSERVED, XTERIOR OF THE EDUCATION BUILDING No. 14.

LIMITED LEAD INSPECTION WAS CONDUCTED THROUGHOUT ALL INTERIOR AREAS OF THE EDUCATION O CONTAIN LEAD. LEAD ABATEMENT WILL BE REQUIRED IN ALL AREAS OF THE BUILDING WHERE EAD-CONTAINING MATERIALS MAY BE DISTURBED DURING THE COURSE OF DEMOLITION AND ONSTRUCTION ACTIVITIES.

MATERIALS SURVEY REPORT FOR FULL DETAIL.

ARCHITECTURAL SHEETS

G-001 G-002	COVER SHEET LOCATION MAPS & DRAWING INDEX
AD-100	ROOF DEMOLITION PLAN
A-100	ROOF REPLACEMENT PLAN
A-200	NORTH & EAST EXTERIOR ELEVATIONS - MASONRY MAINTENANCE
A-201	SOUTH & WEST EXTERIOR ELEVATIONS - MASONRY MAINTENANCE
A-202	COURTYARD EXTERIOR ELEVATIONS - MASONRY MAINTENANCE
A-500 A-501 A-502	WALL & ROOF DETAILS ROOF DETAILS ROOF DRAINAGE DETAILS

- (INCLUDING SADDLES AND CRICKETS) SHALL BE 1/4" PER FOOT.
- THERMAL PERFORMANCE: THE MINIMUM AVERAGE R-VALUE FOR ANY ROOF AREA ON THIS PROJECT SHALL BE R-30.

ASBESTOS CONTAINING MATERIALS

EFER TO PROJECT MANUAL SECTION 028213 - ASBESTOS ABATEMENT AND APPENDIX A

A VISUAL INSPECTION FOR LEAD-CONTAINING MATERIALS WAS CONDUCTED ON THE ROOF AND EXTERIOR O HEREFORE A SAMPLING INVESTIGATION FOR LEAD-CONTAINING MATERIALS WAS NOT PERFORMED ON THE

BUILDING No. 14 WHERE DEMOLITION AND CONSTRUCTION ACTIVITIES ARE ANTICIPATED IN THE SCOPE OF HIS PROJECT. THE LABORATORY ANALYSIS INDICATES THAT SAMPLES TAKEN DURING THE INVESTIGATION


REFER TO PROJECT MANUAL SECTION 028333 - LEAD ABATEMENT AND APPENDIX B - LEAD-CONTAINING

STATE OF MISSOURI MICHAEL L. PARSON, **GOVERNOR**



3/22/2024 BRIAN DOUGLAS CONNELL ARCHITECT MO A-5036

RCHITI nut Stre

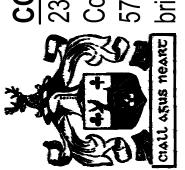

OFFICE OF ADMINISTRATION DIVISION OF FACILITIES MANAGEMENT, DESIGN AND CONSTRUCTION

MISSOURI DEPARTMENT **OF CORRECTIONS**

REPLACE ROOF **EDUCATION BLDG No. 14 BOONVILLE CORRECTIONAL**

1216 EAST MORGAN ST. BOONVILLE, MO 65233

PROJECT No. C2311-01

7002 SITE No. **ASSET No.** 9327002024

CENTER

REVISION: REVISION: DATE: REVISION: DATE:

ISSUE DATE: 3/22/2024

CAD DWG FILE: DRAWN BY: CHECKED BY: BDC **DESIGNED BY:** BDC

SHEET TITLE:

LOCATION MAPS & DRAWING INDEX

SHEET NUMBER:

2 OF 10 **ISSUE DATE: 3/22/2024**

GENERAL ROOF DEMOLITION NOTES: EDUCATION BUILDING No. 14

- CONTRACTOR SHALL COORDINATE ALL DEMOLITION AND REMOVAL OF DEMOLITION MATERIALS WITH OTHER WORK SEQUENCES AND OWNER OCCUPANCY REQUIREMENTS.
- REMOVE ALL EXISTING EPDM MEMBRANE, MEMBRANE FLASHING, BOOTS AND TRIM.
- REMOVE ALL EXISTING PERIMETER METAL COPING, FLASHING, COUNTERFLASHING, SHEET METAL CLEATS, FASTENERS, AND SEALANT.
- REMOVE ALL EXISTING ROOF-TO-WALL BASE FLASHING, COUNTERFLASHING, REGLETS, FASTENERS AND SEALANT.
- REMOVE ALL EXISTING WOOD BLOCKING, CANTS, NAILERS, GROUNDS, ETC.
- REMOVE ALL ABANDONED ITEMS (VENTS, CONDUITS, PIPES, DUCTS, CURBS, ETC. AS NOTED ON THE ROOF DEMOLITION PLAN.
- TOTAL ROOF AREA CALCULATION DOES NOT INCLUDE VERTICAL SURFACE AREA OF PARAPET WALLS OR OTHER FEATURES.

KEYED ROOF DEMOLITION NOTES: EDUCATION BUILDING No. 14

- .) REMOVE EXISTING ROOF DRAIN AND PREP ROOF PENETRATION TO RECEIVE NEW ROOF DRAIN IN EXISTING LOCATION.
- .) REMOVE EXISTING ROOF DRAIN, COVER ROOF PENETRATION WITH 24"X24" 20-GAUGE SHEET METAL PANEL ANCHORED TO CONCRETE ROOF DECK WITH 4 - $\frac{1}{4}$ "x1" TAPCONS.
- 3.) EXISTING CURB-MOUNTED EXHAUST VENT TO REMAIN
- 4.) EXISTING 4" Ø CAST IRON VTR TO REMAIN
- 5.) EXISTING ROOF HATCH TO REMAIN (CONCRETE CURB)
- 6.) CAREFULLY REMOVE EXISTING 5"x8" CAST IRON THROUGH-WALL OVERFLOW WEIR SLEEVE, REINSTALL AT UNDERSIDE OF EXISTING STONE PARAPET TO RAISE OVERFLOW WEIR OPENING
- 7.) CAREFULLY REMOVE EXISTING BRICK MASONRY FROM EXISTING THROUGH-WALL OVERFLOW WEIR OPENING UP TO UNDERSIDE OF EXISTING STONE PARAPET TO RAISE OVERFLOW WEIR OPENING
- 8.) REMOVE EXISTING ROOF TO WALL FLASHING
- .) REMOVE EXISTING SHEET METAL ROOF PANELS, LIGHT-GAUGE FRAMING, FLASHING & GUTTER

EXISTING ROOF FEATURE SCHEDULE - EDUCATION BUILDING No. 14

NORTH ROOF AREA

EAST ROOF AREA

Description
4" Cast Iron Roof Drain & Dome Strainer

Description
4" Cast Iron Roof Drain & Dome Strainer

Overflow Wiers (Thru-Wall Scuppers)

4" Cast Iron Roof Drain & Dome Strainer

Overflow Wiers (Thru-Wall Scuppers)

4" Cast Iron Roof Drain & Dome Strainer

Overflow Wiers (Thru-Wall Scuppers) Roof-Mounted HVAC Units

Exhaust Vent (Curb-Mounted)

Roof-Mounted HVAC Units

4" Ø Cast Iron VTR

4" Ø Cast Iron VTR

Roof Access Hatch

4" Ø Cast Iron VTR

4" Ø Cast Iron VTR Exhaust Vent (Curb-Mounted)

Description

Description


Ventilator Penthouse

Exhaust Vent (Curb-Mounted)

Roof-Mounted HVAC Units

Exhaust Vent (Curb-Mounted) Overflow Wiers (Thru-Wall Scuppers) Roof-Mounted HVAC Units

- 10.) EXISTING CURB-MOUNTED VENTILATION PENTHOUSE TO REMAIN
- 1.) EXISTING STONE PARAPET COPING TO REMAIN
- 2.) REMOVE EXISTING EPDM MEMBRANE AND INSULATION DOWN TO CONCRETE ROOF DECK.
- 3) REMOVE EXISTING EPDM MEMBRANE AND INSULATION DOWN TO METAL ROOF DECK.

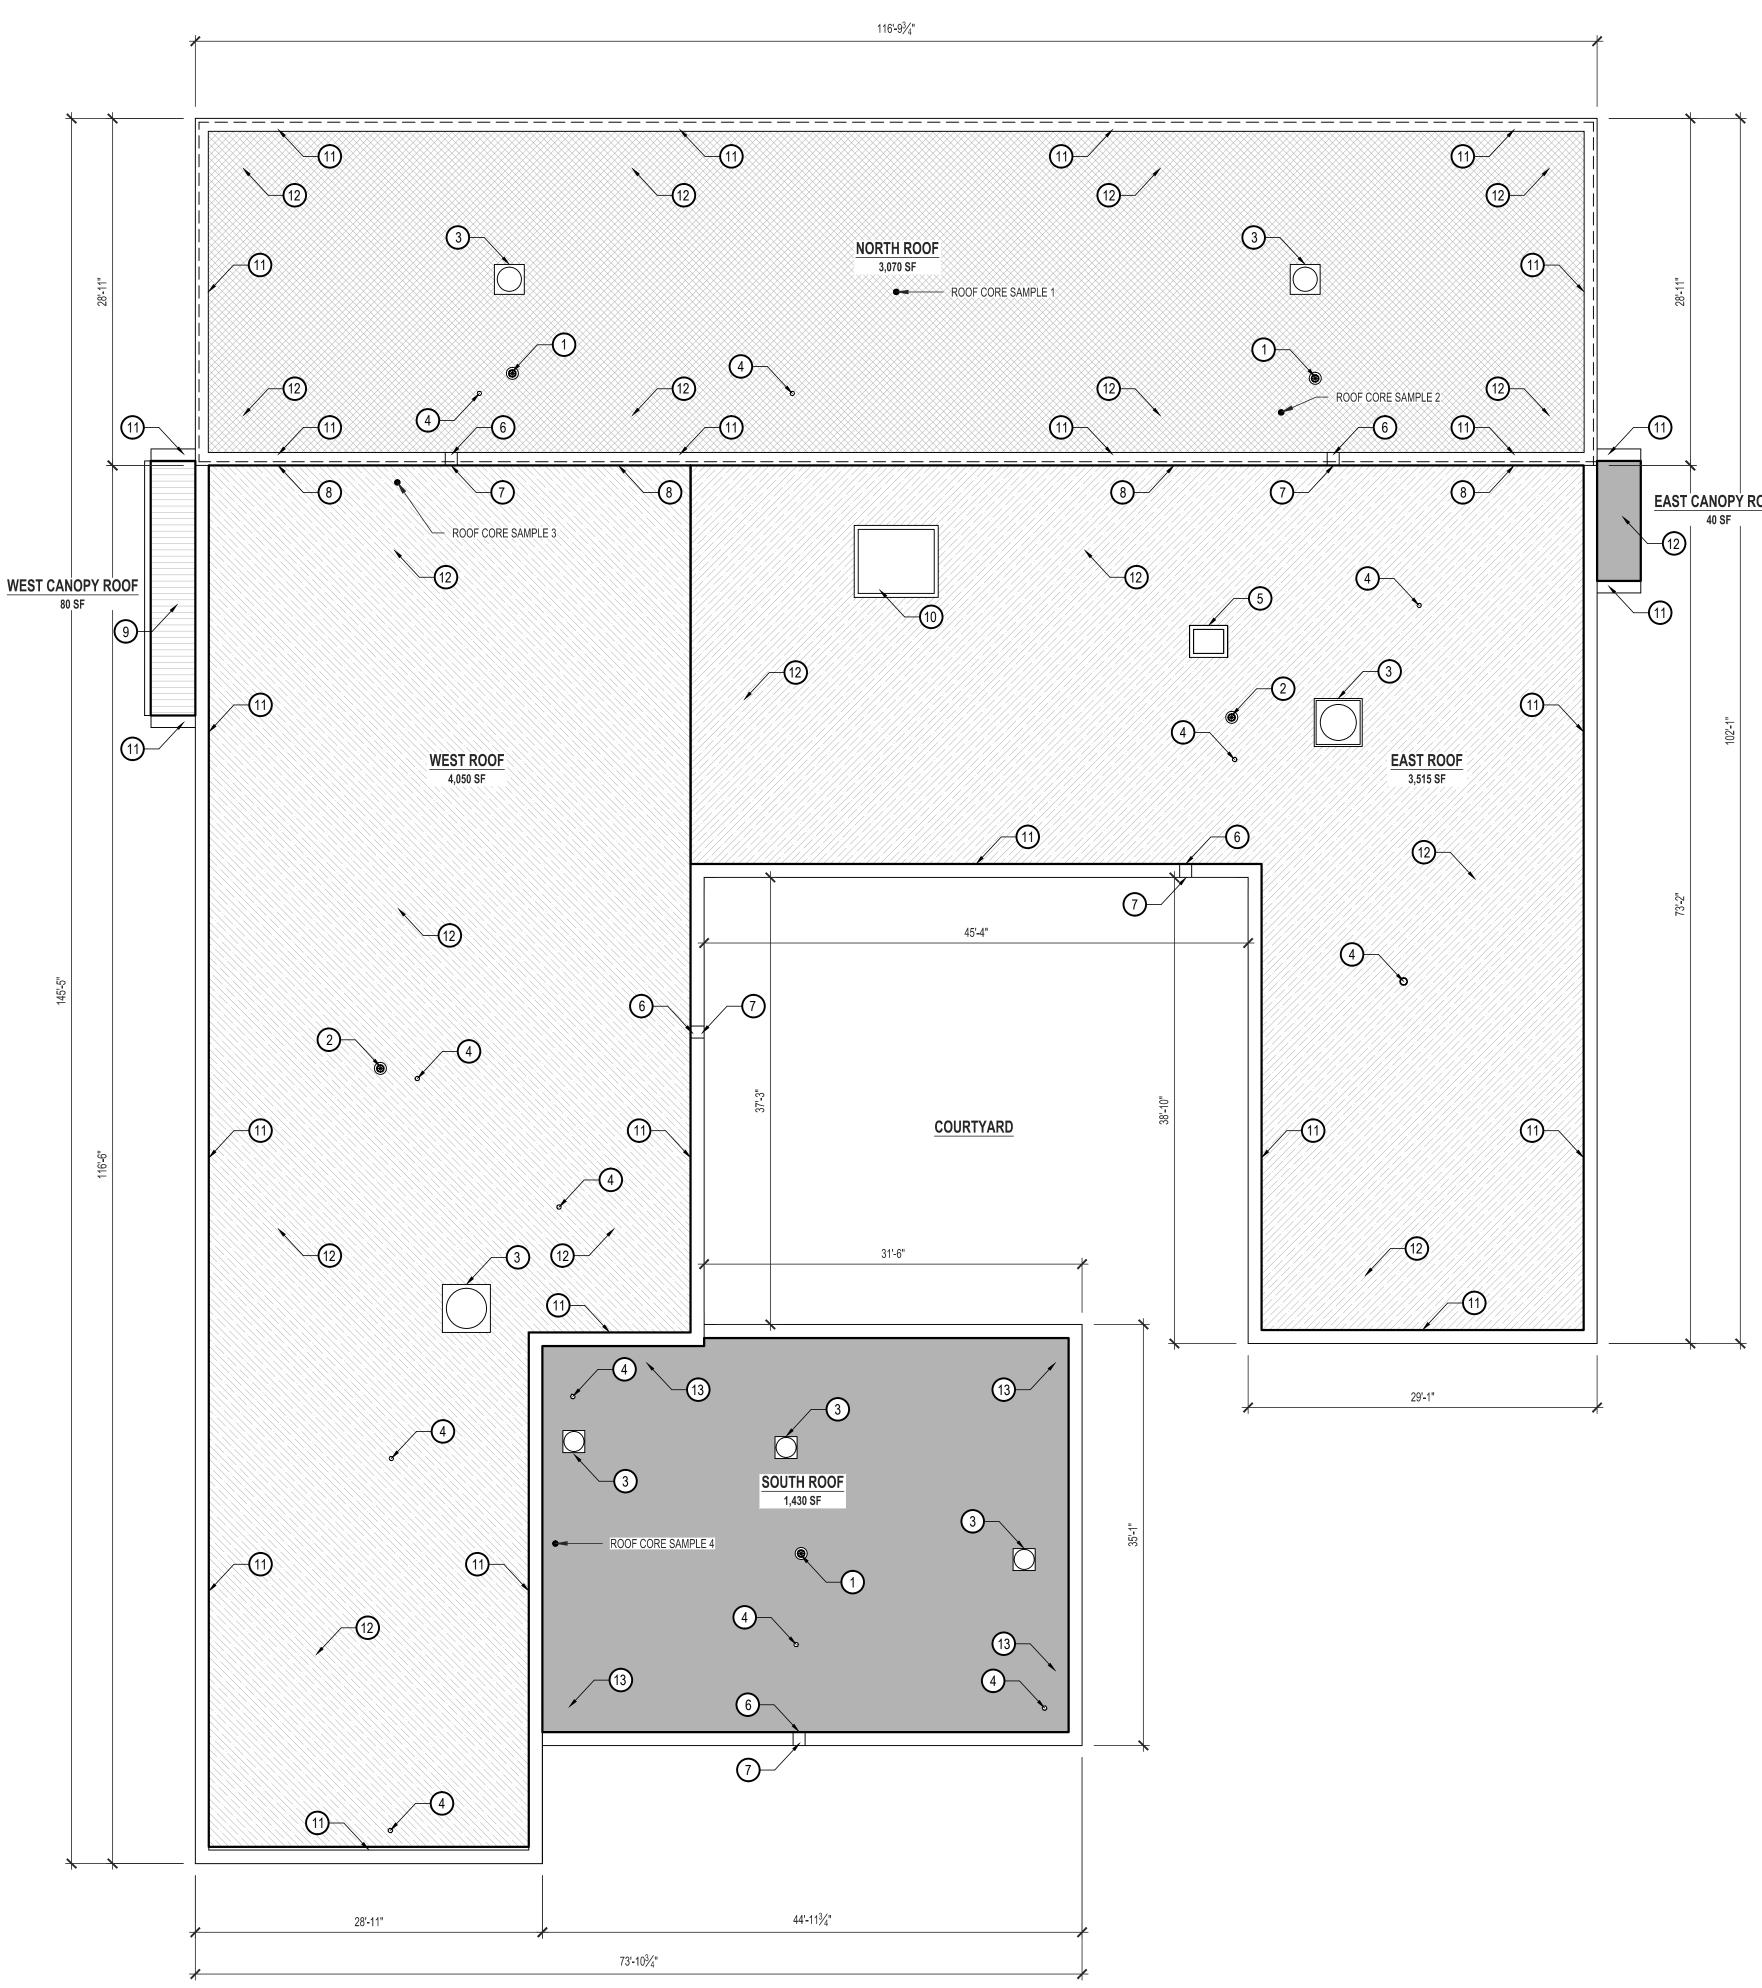

EDUCATION BUILDING No. 14 EXISTING ROOF ASSEMBLY DESCRIPTION

- THE EXISTING CONDITIONS SHOWN ON THESE DRAWINGS ARE DERIVED FROM OBSERVATIONS AND MEASUREMENTS TAKEN DURING SITE VISITS AND FROM ARCHIVE INFORMATION PROVIDED BY THE OWNER. THE CONTRACTOR SHALL VERIFY ALL EXISTING CONDITIONS ON THE JOB SITE.
- NORTH ROOF AREA (3,070 SF): 60 MIL EPDM OVER TAPERED EPS RIGID FOAM INSULATION (THICKNESS VARIES) OVER LIGHTWEIGHT CONCRETE (THICKNESS VARIES) OVER STRUCTURAL CONCRETE ROOF DECK.
- VARIES) OVER LIGHTWEIGHT CONCRETE (THICKNESS VARIES) OVER STRUCTURAL CONCRETE ROOF DECK. REFER TO CORE SAMPLE SCHEDULE BELOW FOR THICKNESS OF SUBSTRATE MATERIALS.
- SOUTH ROOF AREA (1,430 SF): 60 MIL EPDM OVER TAPERED POLYISO RIGID FOAM INSULATION OVER
- EAST CANOPY ROOF AREA (40 SF): 60 MIL EPDM OVER TAPERED POLYISO RIGID FOAM INSULATION OVER STRUCTURAL CONCRETE ROOF DECK.

REFER TO CORE SAMPLE SCHEDULE BELOW FOR THICKNESS OF SUBSTRATE MATERIALS.

WEST (FRONT) CANOPY ROOF AREA (80 SF): STANDING SEAM ROOF PANELS @ 12 / 12 SLOPE OVER LIGHT-GAUGE METAL FRAMING OVER FLAT STRUCTURAL CONCRETE ROOF DECK.

EDUCATION BUILDING No. 14 EXISTING ROOF CORE SAMPLE SCHEDULE

ROOF CORE SAMPLE 1: (TOTAL DEPTH = 9") 60 MIL EPDM OVER 6 $\frac{1}{4}$ " TAPERED EPS RIGID FOAM INSULATION OVER 2 $\frac{3}{4}$ " LIGHTWEIGHT CONCRETE OVER STRUCTURAL CONCRETE ROOF DECK.

ROOF CORE SAMPLE 2: (TOTAL DEPTH = $3\frac{1}{2}$ ")

60 MIL EPDM OVER 3 ½" LIGHTWEIGHT CONCRETE OVER STRUCTURAL CONCRETE ROOF DECK.

ROOF CORE SAMPLE 3 : (TOTAL DEPTH = 11") 60 MIL EPDM OVER 7" TAPERED EPS RIGID FOAM INSULATION OVER 2" LIGHTWEIGHT CONCRETE OVER STRUCTURAL CONCRETE ROOF DECK.

ROOF CORE SAMPLE 4: (TOTAL DEPTH = $1\frac{1}{2}$ ") 60 MIL EPDM OVER 1½" TAPERED POLYISO RIGID FOAM INSULATION OVER 1½" METAL ROOF DECK OVER

ASBESTOS CONTAINING MATERIALS

LIMITED ASBESTOS INSPECTION WAS CONDUCTED ON THE EXISTING ROOF AREA AND THROUGHOUT ALL ARE ANTICIPATED IN THE SCOPE OF THIS PROJECT. THE LABORATORY ANALYSIS INDICATES THAT SAMPLES TAKEN DURING THE INVESTIGATION **DO** CONTAIN ASBESTOS. ASBESTOS ABATEMENT WILL BE REQUIRED IN AND ON ALL AREAS OF THE BUILDING WHERE ASBESTOS-CONTAINING MATERIALS MAY BE DISTURBED DURING THE COURSE OF DEMOLITION AND CONSTRUCTION ACTIVITIES.

REFER TO PROJECT MANUAL SECTION 028213 - ASBESTOS ABATEMENT AND APPENDIX A -ASBESTOS-CONTAINING MATERIALS SURVEY REPORT FOR FULL DETAIL.

LEAD CONTAINING MATERIALS

A VISUAL INSPECTION FOR LEAD-CONTAINING MATERIALS WAS CONDUCTED ON THE ROOF AND EXTERIOR OF THE EDUCATION BUILDING No. 14 AND NO SUSPECT LEAD-CONTAINING MATERIALS WERE OBSERVED, THEREFORE A SAMPLING INVESTIGATION FOR LEAD-CONTAINING MATERIALS WAS NOT PERFORMED ON THE EXTERIOR OF THE EDUCATION BUILDING No. 14.

LIMITED LEAD INSPECTION WAS CONDUCTED THROUGHOUT ALL INTERIOR AREAS OF THE EDUCATION BUILDING No. 14 WHERE DEMOLITION AND CONSTRUCTION ACTIVITIES ARE ANTICIPATED IN THE SCOPE OF DO CONTAIN LEAD. LEAD ABATEMENT WILL BE REQUIRED IN ALL AREAS OF THE BUILDING WHERE EAD-CONTAINING MATERIALS MAY BE DISTURBED DURING THE COURSE OF DEMOLITION AND CONSTRUCTION ACTIVITIES.

REFER TO PROJECT MANUAL SECTION 028333 - LEAD ABATEMENT AND APPENDIX B - LEAD-CONTAINING MATERIALS SURVEY REPORT FOR FULL DETAIL.

STATE OF MISSOURI MICHAEL L. PARSON, **GOVERNOR**



BRIAN DOUGLAS CONNELL ARCHITECT MO A-5036

L ARCHITI Walnut Stre



OFFICE OF ADMINISTRATION DIVISION OF FACILITIES MANAGEMENT, DESIGN AND CONSTRUCTION

MISSOURI DEPARTMENT **OF CORRECTIONS**

REPLACE ROOF **EDUCATION BLDG No. 14**

BOONVILLE CORRECTIONAL CENTER

1216 EAST MORGAN ST. BOONVILLE, MO 65233

PROJECT No. C2311-01 7002 SITE No. **ASSET No.** 9327002024

REVISION: REVISION: DATE: REVISION: DATE:

ISSUE DATE: 3/22/2024


CAD DWG FILE: DRAWN BY: BDC CHECKED BY: BDC **DESIGNED BY:** BDC


SHEET TITLE:


ROOF DEMOLITION PLAN

SHEET NUMBER:

SHEET 3 OF 10 **ISSUE DATE: 3/22/2024**

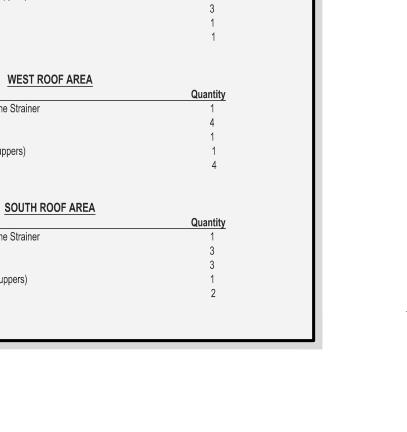

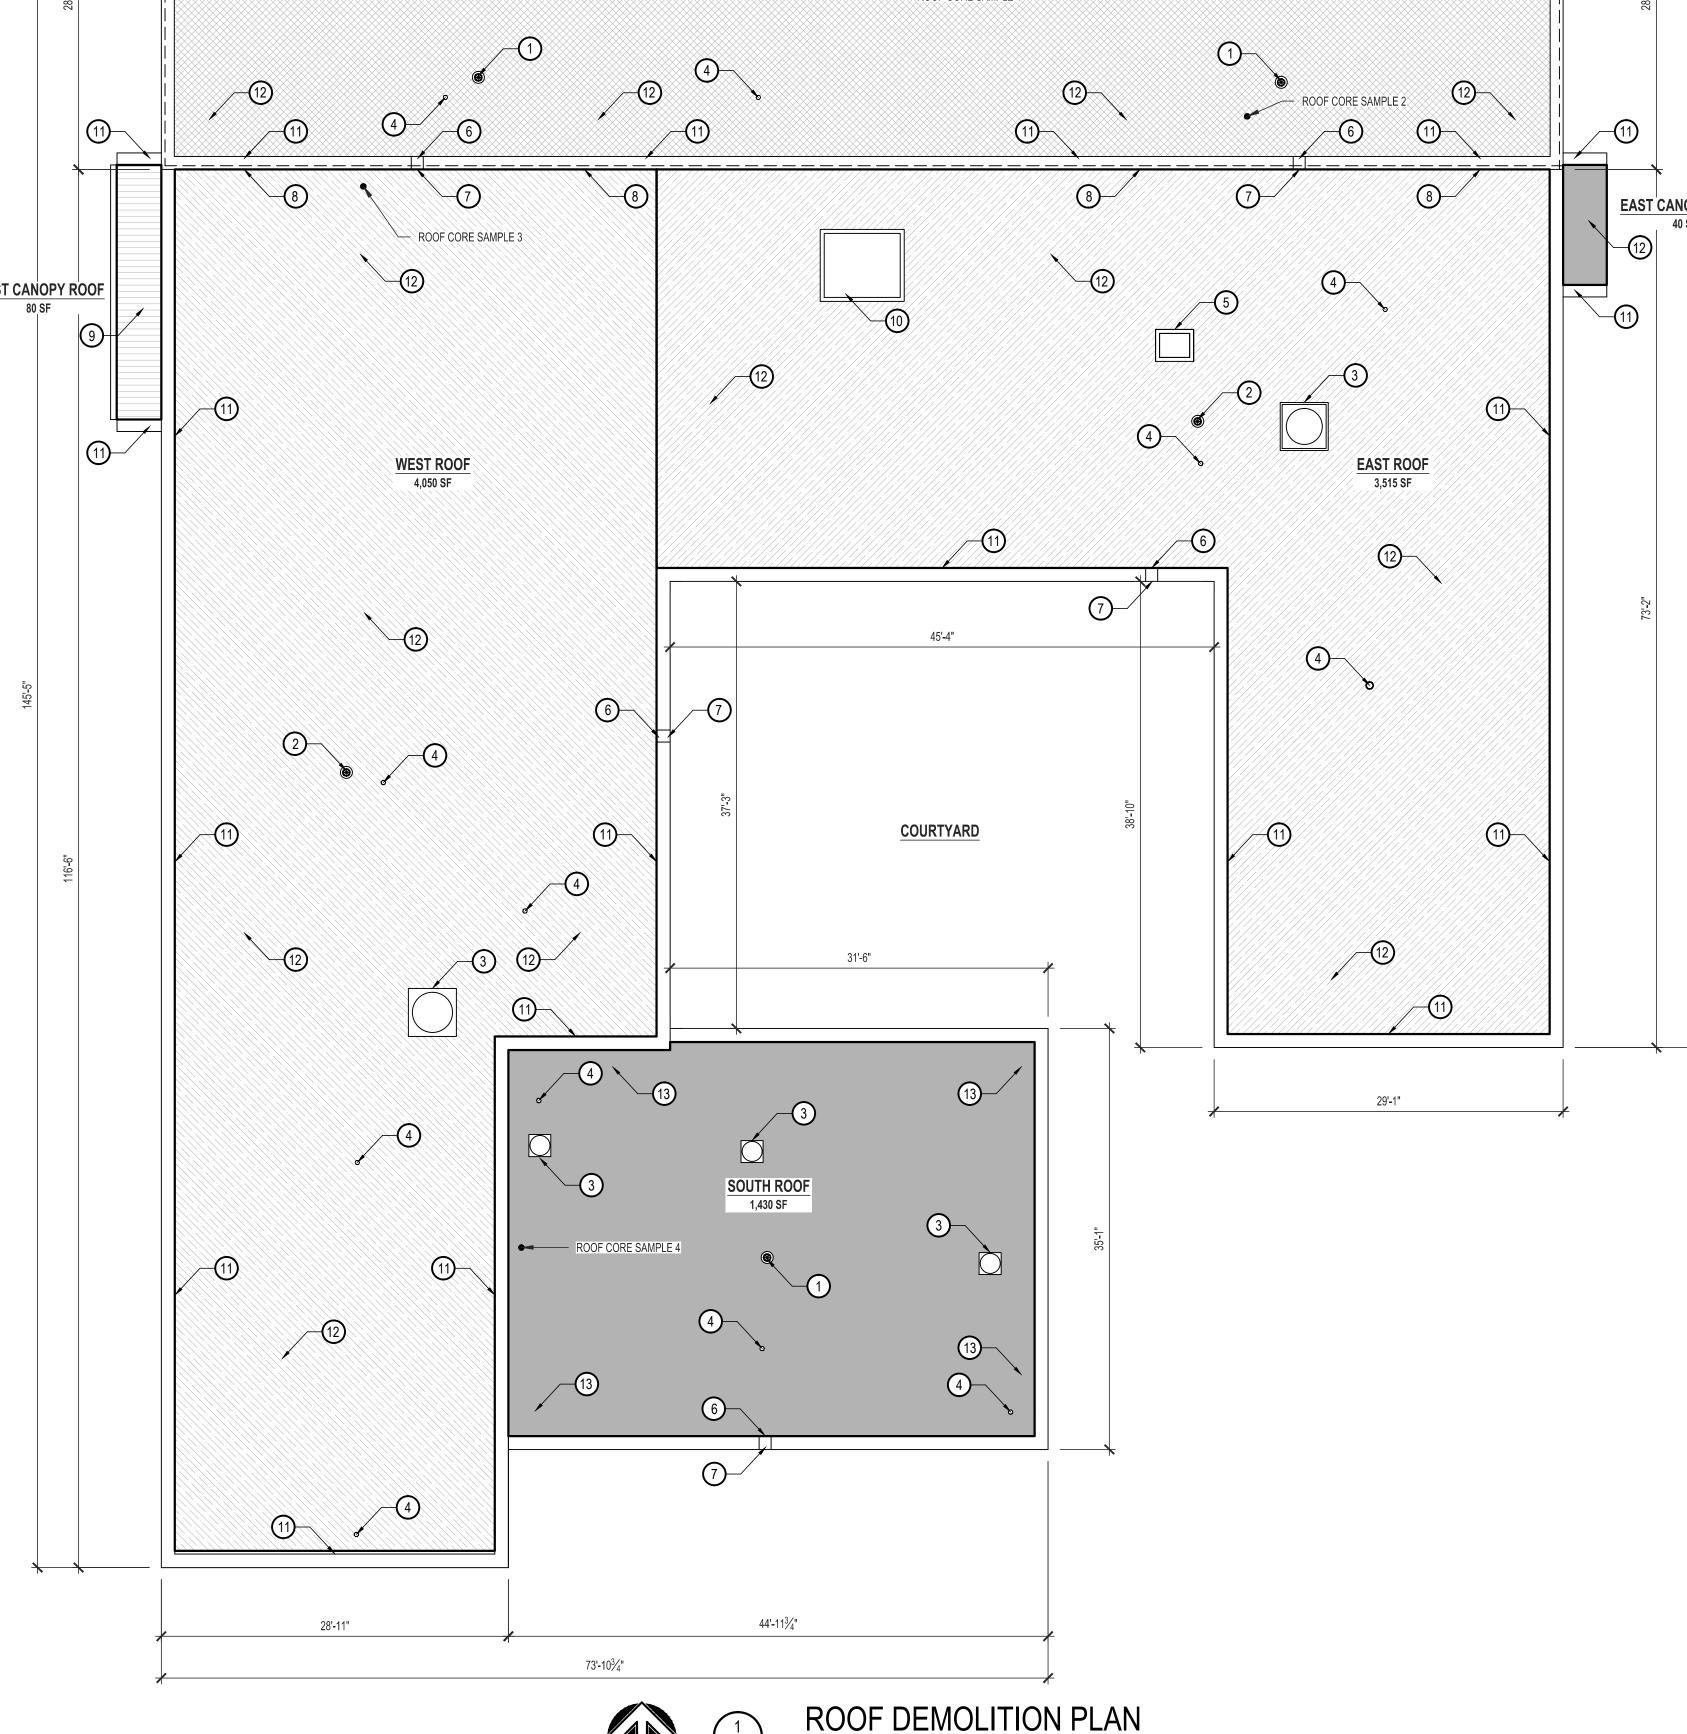

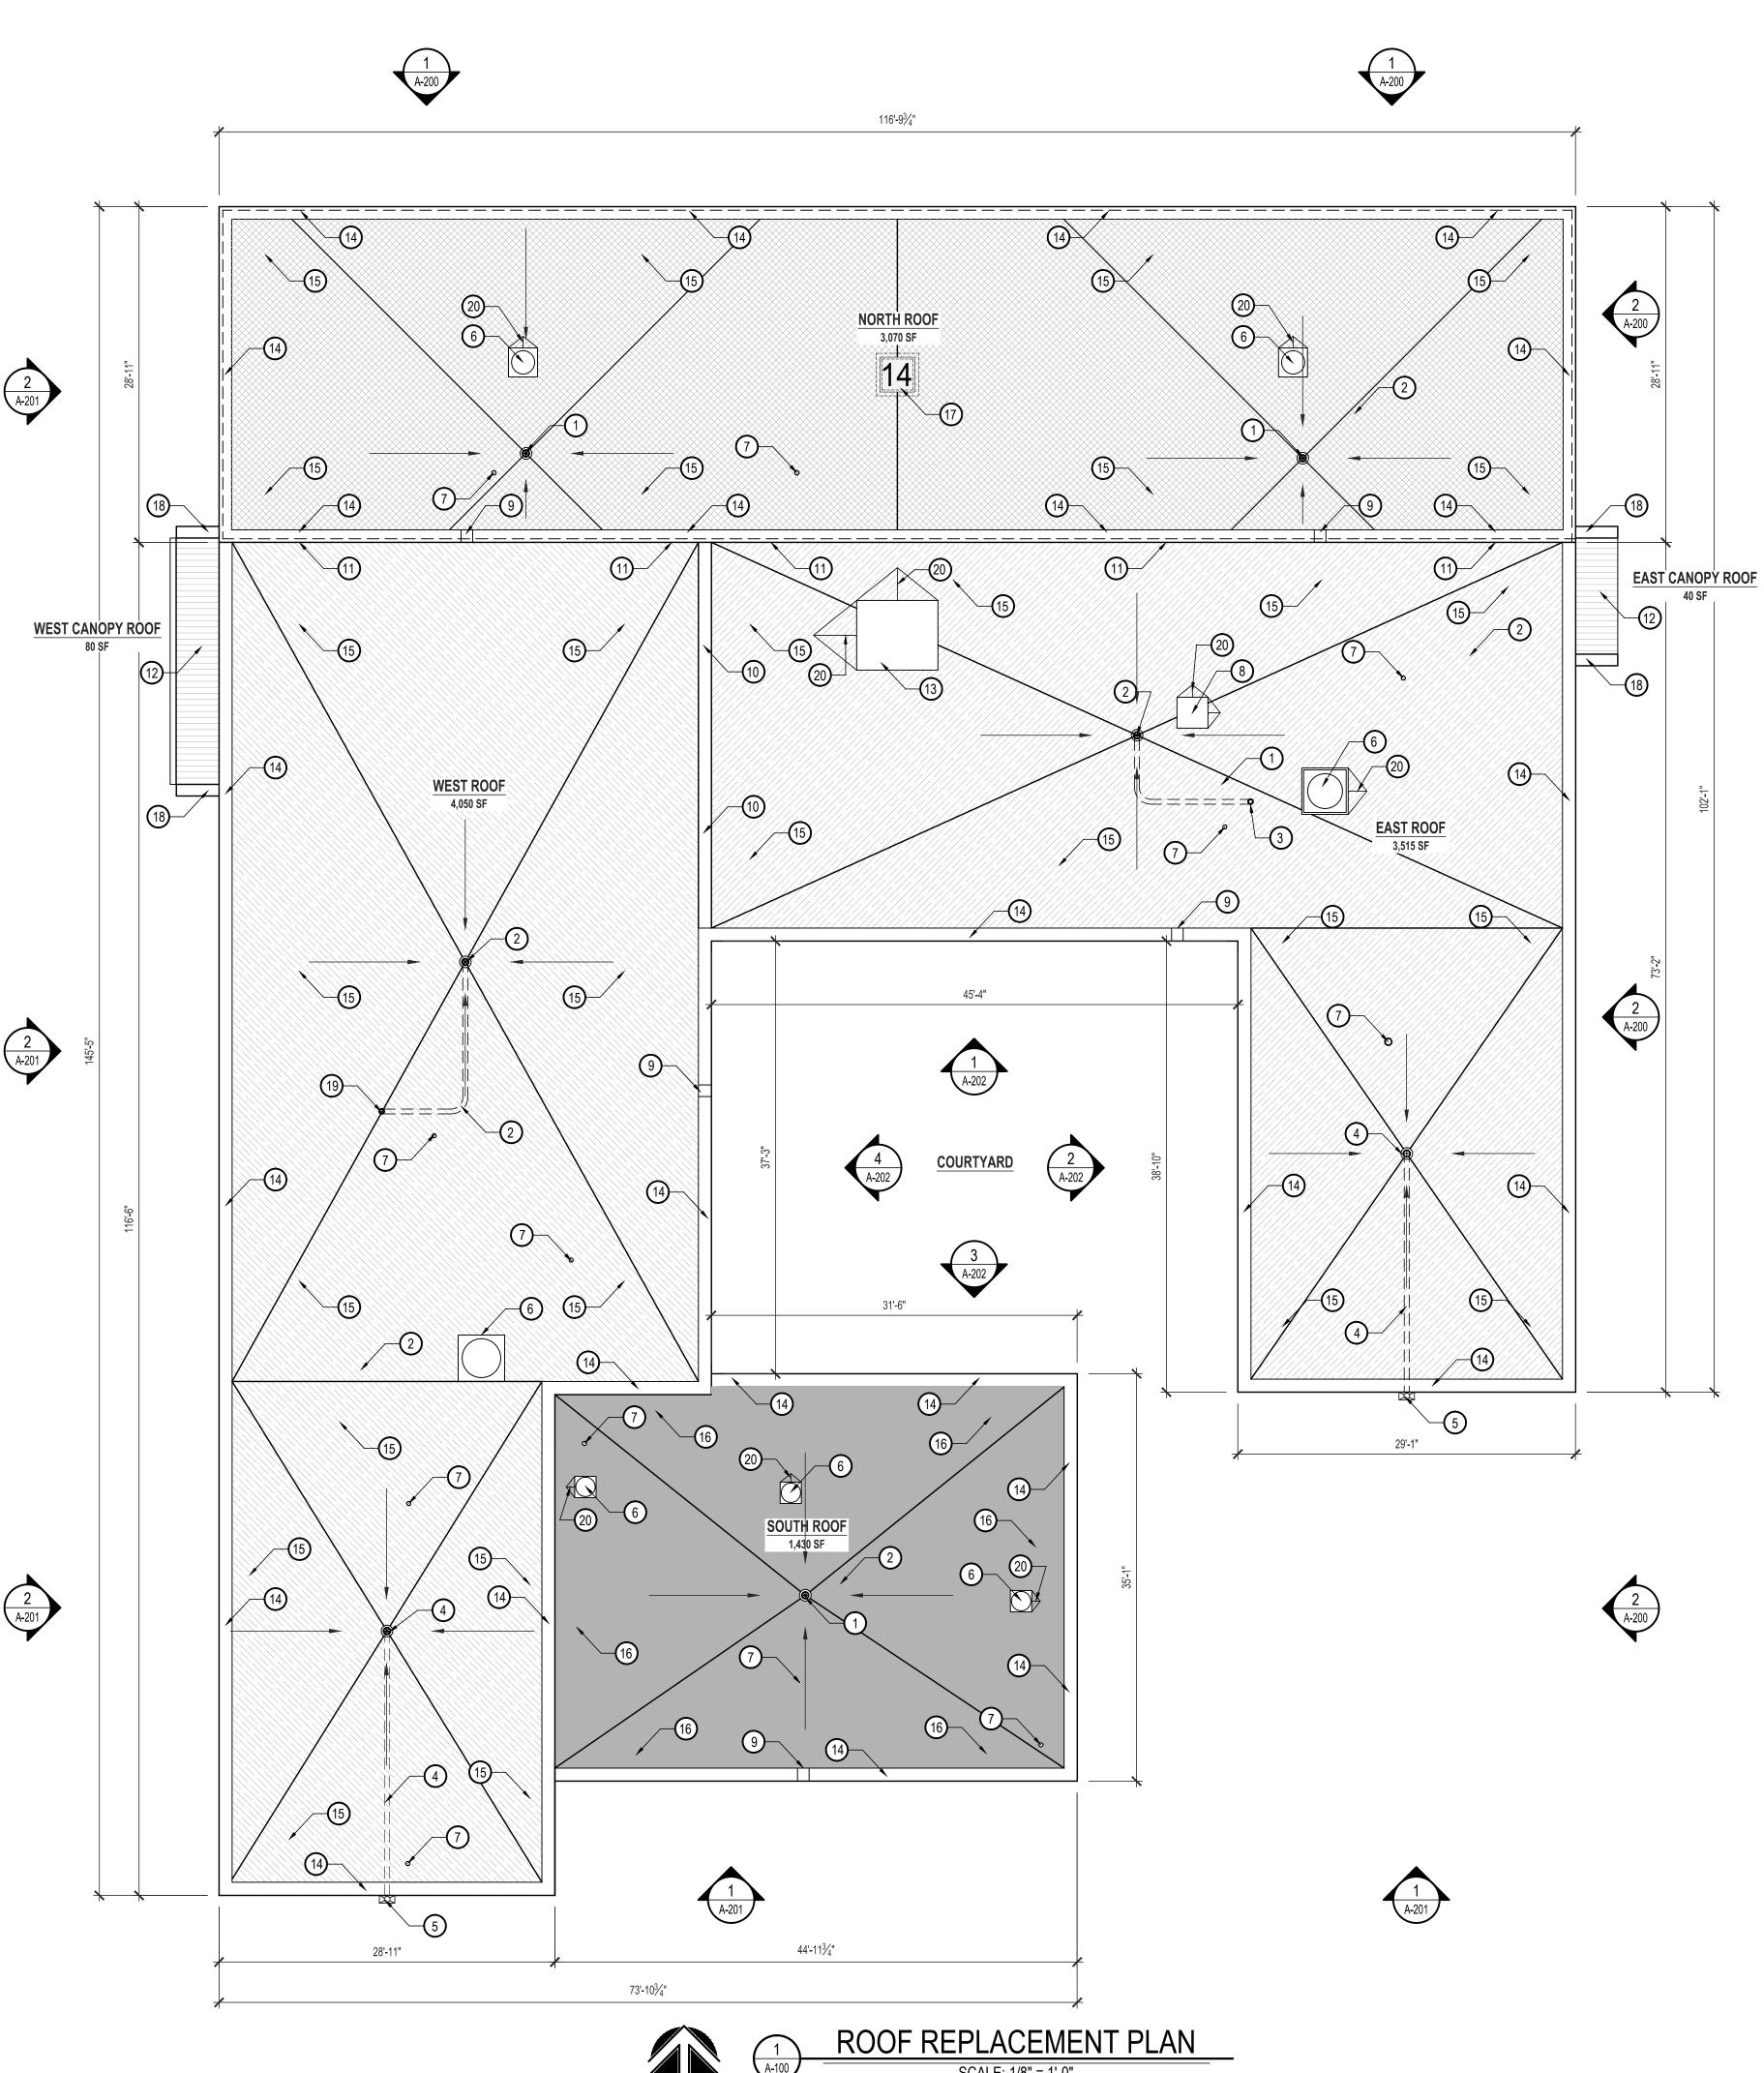

GENERAL ROOF REPLACEMENT NOTES

- ROOF SLOPE: THE MINIMUM SLOPE ON ANY LOW-SLOPE ROOF PLANE (INCLUDING SADDLES AND CRICKETS) SHALL BE $\frac{1}{4}$ " PER FOOT.
- THERMAL PERFORMANCE: THE MINIMUM AVERAGE R-VALUE FOR ANY ROOF AREA ON THIS PROJECT SHALL BE R-30.
- WIND UPLIFT RATING: FM 1A-90
- FIRE RESISTANCE RATING: UL CLASS C.
- ROOF WARRANTY: THE NEW TPO MEMBRANE ROOF AND FLASHING SYSTEM SHALL BE WARRANTED BY THE MANUFACTURER FOR A PERIOD OF 20 YEARS FROM THE DATE OF SUBSTANTIAL COMPLETION.

EDUCATION BUILDING No. 14 REPLACEMENT ROOF ASSEMBLY DESCRIPTION

- THE EXISTING CONDITIONS SHOWN ON THESE DRAWINGS ARE DERIVED FROM OBSERVATIONS AND MEASUREMENTS TAKEN DURING SITE VISITS AND FROM ARCHIVE INFORMATION PROVIDED BY THE OWNER. THE
- CONTRACTOR SHALL VERIFY ALL EXISTING CONDITIONS ON THE JOB SITE.
- NORTH ROOF AREA (3,070 SF): 60 MIL TPO MEMBRANE OVER ½" HIGH-DENSITY COVER BOARD OVER TAPERED POLYISO RIGID INSULATION (MINIMUM AVERAGE R-30) OVER OVER STRUCTURAL CONCRETE ROOF DECK.

 EAST & WEST ROOF AREAS (7,565 SF): 60 MIL TPO MEMBRANE OVER ½" HIGH-DENSITY COVER BOARD OVER
- TAPERED POLYISO RIGID INSULATION (MINIMUM AVERAGE R-30) OVER OVER STRUCTURAL CONCRETE ROOF DECK.
- SOUTH ROOF AREA (1,430 SF): 60 MIL TPO MEMBRANE OVER ½" HIGH-DENSITY COVER BOARD OVER TAPERED POLYISO RIGID INSULATION (MINIMUM AVERAGE R-30) OVER 1½" METAL DECK OVER STEEL BAR JOISTS.
- 5. WEST (FRONT) CANOPY ROOF AREA (80 SF HORIZONTAL AREA): 24 GAUGE STANDING SEAM METAL ROOF @ 12/12 SLOPE OVER 40 MIL SELF-ADHERING UNDERLAYMENT OVER ¾" PLYWOOD SUBDECK OVER LIGHT-GAUGE METAL FRAMING INSTALLED OVER EXISTING FLAT STRUCTURAL CONCRETE ROOF DECK DRAIN TO 24 GAUGE SHEET METAL GUTTER AND DOWNSPOUTS.
- EAST CANOPY ROOF AREA (40 SF HORIZONTAL AREA): 24 GAUGE STANDING SEAM METAL ROOF @ 12/12 SLOPE OVER 40 MIL SELF-ADHERING UNDERLAYMENT OVER 3/4" PLYWOOD SUBDECK OVER LIGHT-GAUGE METAL FRAMING INSTALLED OVER EXISTING FLAT STRUCTURAL CONCRETE ROOF DECK DRAIN TO 24 GAUGE SHEET METAL GUTTER AND DOWNSPOUTS.

KEYED ROOF REPLACEMENT NOTES: EDUCATION BUILDING No. 14

- (1) INSTALL NEW ROOF DRAIN TO REPLACE EXISTING ROOF DRAIN TO REMAIN IN EXISTING LOCATION CONNECT TO EXISTING 4" Ø CAST IRON HORIZONTAL AND VERTICAL DRAIN PIPING INSIDE BUILDING.
 - INSTALL NEW 4" Ø CAST IRON ROOF WITH DOME STRAINER CONNECT TO NEW 6" Ø HORIZONTAL PVC DRAIN PIPING INSTALLED AT UNDERSIDE OF CEILING CONNECT TO EXISTING VERTICAL CAST IRON ROOF DRAIN PIPING LOCATED INSIDE BUILDING (SEE NOTES 3 & 19). REFER TO DETAIL 1/A-501.
 - 3) EXISTING 5" Ø VERTICAL CAST IRON ROOF DRAIN LOCATED INSIDE BUILDING.
- 4) INSTALL NEW 4" Ø CAST IRON ROOF DRAIN WITH DOME STRAINER CONNECT TO NEW 6" Ø PVC HORIZONTAL DRAIN PIPING INSTALLED AT UNDERSIDE OF ROOF DECK TERMINATE AT NEW THROUGH-WALL NOZZLE AND DOWNSPOUT (SEE NOTE 5). REFER TO DETAILS 1/A-501 & 4/A-502.
- 5) INSTALL NEW ROOF DRAIN NOZZLE AND SHEET METAL DOWNSPOUT WITH LEADER HEAD TERMINATE DOWNSPOUT AT GRADE ON SPLASH BLOCK. REFER TO DETAIL 6/A-500.
- 6 EXISTING CURB-MOUNTED EXHAUST VENT TO REMAIN RAISE TOP OF CURB TO MINIMUM 12" ABOVE NEW ROOF SURFACE, INSTALL CURB FLASHING. REFER TO DETAIL 6/A-500.
- EXISTING 4" Ø CAST IRON VTR TO REMAIN EXTEND TOP OF VTR TO MINIMUM 12" ABOVE NEW ROOF SURFACE, INSTALL NEW BOOT FLASHING. REFER TO DETAIL 2/A-501.
- 8) EXISTING ROOF HATCH TO REMAIN (CONCRETE CURB) EXTEND TOP OF CURB TO MINIMUM 12" ABOVE
- 9 INFILL EXISTING THRU-WALL OVERFLOW WEIR (SCUPPER) OPENING IN PARAPET WALL WITH BRICK MASONRY TO MATCH EXISTING, RAISE EXISTING 5"x8" CAST IRON THRU-WALL OVERFLOW WEIR SLEEVE (SAME SIZE AS ORIGINAL) UP TO UNDERSIDE OF STONE PARAPET CAP, CONTOUR NEW TAPERED INSULATION AT SCUPPER OPENING AS REQUIRED. FLASH THRU-WALL OPENING WITH
- (10) NEW ROOF EXPANSION JOINT. REFER TO DETAIL 3/A-501.
- (11) INSTALL NEW ROOF TO WALL TPO MEMBRANE FLASHING. REFER TO DETAIL 2/A-500.


TPO MEMBRANE FLASHING. REFER TO DETAILS 1/A-502, 2/A-502, 3/A-502.

- (12) INSTALL NEW SHEET METAL ROOF PANELS, FLASHING & GUTTER. REFER TO DETAILS 5/A-501, 6/A-501.
- 13 EXISTING CURB-MOUNTED VENTILATION PENTHOUSE TO REMAIN INSTALL CURB FLASHING.
- (14) EXISTING STONE PARAPET COPING TO REMAIN EXTEND TPO MEMBRANE UP AND OVER TOP. 2/A-500.
- 15) INSTALL NEW 60 MIL TPO MEMBRANE, ½" HIGH-DENSITY COVER BOARD AND TAPERED POLYISO INSULATION (MINIMUM AVERAGE R-30) OVER EXISTING CONCRETE ROOF DECK. DETAIL 3/A-500.
- (16) INSTALL NEW 60 MIL TPO MEMBRANE, ½" HIGH-DENSITY COVER BOARD AND TAPERED POLYISO INSULATION (MINIMUM AVERAGE R-30) OVER EXISTING METAL ROOF DECK (SOUTH ROOF AREA ONLY). REFER TO DETAILS 4/A-500 & 5/A-500.
- 17) BUILDING IDENTIFICATION SIGN: BUILDING No. 14. REFER TO DETAIL 2/A-100.
- (18) EXISTING STONE PARAPET CAP AT TOP OF ENTRANCE WING WALLS TO REMAIN.
- (19) EXISTING 6" Ø VERTICAL CAST IRON ROOF DRAIN LOCATED INSIDE BUILDING.
- 20.) INSTALL TAPERED INSULATION DRAINAGE CRICKET AT ROOF CURB MIN SLOPE 1/4" PER FOOT.

BUILDING IDENTIFICATION SIGNAGE NOTE:

- LETTERING AND BACKGROUND SHALL BE REFLECTIVE.
 SIGN SHALL BE FABRICATED FROM 36" x 36" x .080" ALUMINUM SHEET WITH SMOOTH FINISH.
 THE CHARACTERS (BUILDING NUMBER) SHALL BE ARIAL FONT, MINIMUM 32" HIGH WITH 3" STROKE, FABRICATED FROM 3M #1178 BLACK ELECTROCUT ACRYLIC SHEET WITH PRESSURE-SENSITIVE ADHESIVE BACK APPLIED OVER REFLECTIVE BACKGROUND.
- 4. REFLECTIVE BACKGROUND SHALL BE 3M #3930 SILVER/WHITE HIGH INTENSITY PRISMATIC REFLECTIVE SHEETING WITH PRESSURE-SENSITIVE ADHESIVE APPLIED TO ALUMINUM SHEET.

 5. SIGN SHALL BE FULLY-ADHERED TO TPO WALK PAD LAMINATED TO THE TPO MEMBRANE WITH ADHESIVE COMPATIBLE WITH THE ROOF MEMBRANE MANUFACTURER'S WARRANTY.

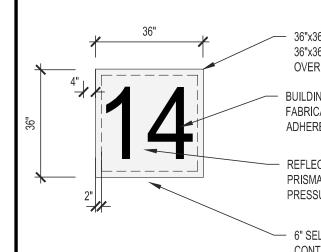

36"x36"x.080 ALUMINUM SIGN OVER
 36"x36" 60-MIL TPO MEMBRANE FULLY-ADHERED
 OVER 60-MIL TPO MEMBRANE BASE

BUILDING NUMBER: ARIAL FONT, 32" HIGH, 3" STROKE FABRICATED FROM 3M #1178 BLACK ELECTROCUT ACRYLIC SHEET ADHERED TO SUBSTRATE WITH PRESSURE-SENSITIVE ADHESIVE

REFLECTIVE BACKGROUND: 3M #3930 SILVER/WHITE HIGH-INTENSITY PRISMATIC REFLECTIVE ACRYLIC SHEETING BACKED WITH PRESSURE-SENSITIVE ADHESIVE OVER ALUMINUM SHEET

- 6" SELF-ADHERING TPO COVER STRIP CONTINUOUS AT PERIMETER OF SIGN - LAP MINIMUM 2" ONTO METAL SIGN



STATE OF MISSOURI MICHAEL L. PARSON, GOVERNOR



3/22/2024

BRIAN DOUGLAS CONNELL ARCHITECT MO A-5036

L ARCHITECTURE, P.C.
Walnut Street Suite B
Missouri 65201
455 Cell: 573-268-6166

Columbia, Mi 573-875-245

OFFICE OF ADMINISTRATION

DIVISION OF FACILITIES

MANAGEMENT, DESIGN

AND CONSTRUCTION

MISSOURI DEPARTMENT OF CORRECTIONS

REPLACE ROOF EDUCATION BLDG No. 14

BOONVILLE CORRECTIONAL CENTER

1216 EAST MORGAN ST. BOONVILLE, MO 65233

PROJECT No. C2311-01 SITE No. 7002 ASSET No. 9327002024

REVISION:
DATE:
REVISION:
DATE:
REVISION:

ISSUE DATE: 3/22/2024

DATE:

CAD DWG FILE:

C2311-01-7002-9327002024-A-100.dwg

DRAWN BY: BDC

CHECKED BY: BDC

DESIGNED BY: BDC


SHEET TITLE:

ROOF REPLACEMENT PLAN


SHEET NUMBER:

A-100

SHEET 4 OF 10 **ISSUE DATE: 3/22/2024**

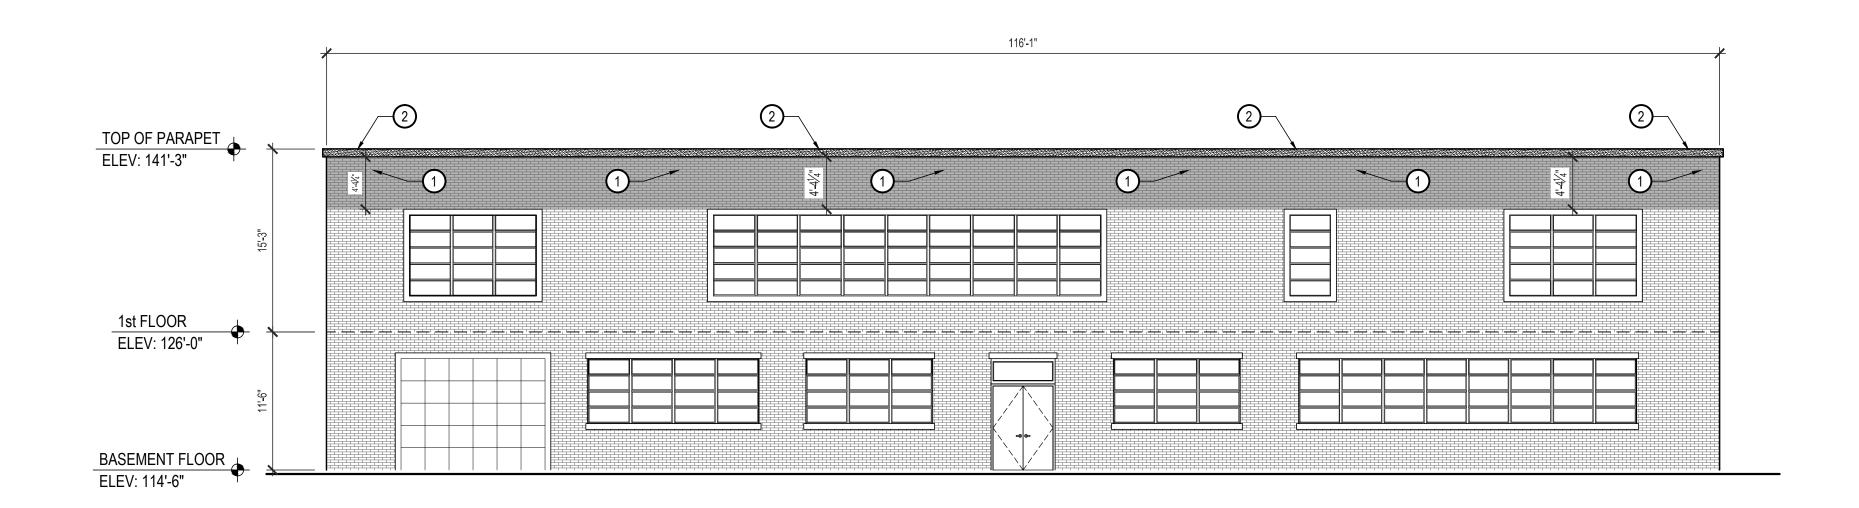



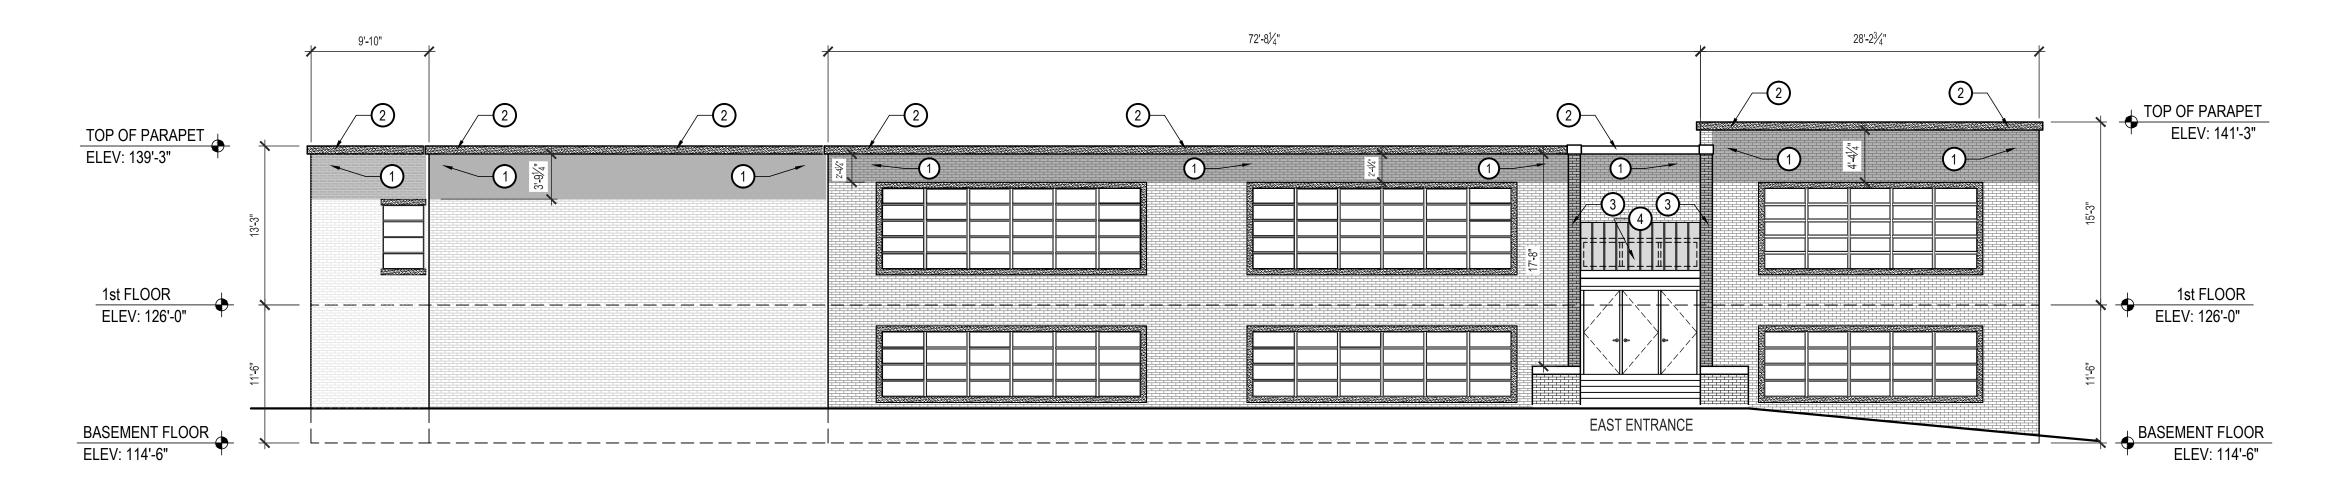



GENERAL MASONRY MAINTENANCE NOTES: EDUCATION BUILDING No. 14

- 1. CONTRACTOR SHALL COORDINATE ALL DEMOLITION AND REMOVAL OF DEMOLITION MATERIALS WITH OTHER WORK SEQUENCES AND OWNER OCCUPANCY REQUIREMENTS.
- 2. CAREFULLY GRIND OR RAKE OUT DETERIORATED MORTAR IN ALL HEAD AND BED JOINTS IN THE EXTERIOR WALL AREAS DESIGNATED FOR MASONRY MAINTENANCE, CLEAN AND PREPARE SURFACES TO RECEIVE NEW MORTAR OR SEALANT.
- 3. CAREFULLY GRIND OR RAKE OUT DETERIORATED MORTAR AND SEALANT IN ALL HEAD JOINTS IN STONE PARAPET COPING, AND PREPARE SURFACES TO RECEIVE NEW MORTAR OR SEALANT.
- CAREFULLY REMOVE AND REINSTALL OR REPLACE DETERIORATED BRICK AND STONE UNITS AS REQUIRED MAINTAIN THE INTEGRITY OF THE EXTERIOR MASONRY.
- 5. BASE BID INCLUDES 4,000 SF OF MASONRY TUCKPOINTING. REFER TO SECTION 012200 UNIT PRICES.

KEYED MASONRY MAINTENANCE NOTES: EDUCATION BUILDING No. 14

- CAREFULLY GRIND OR RAKE OUT DETERIORATED MORTAR AND SEALANT FROM ALL HEAD AND BED JOINTS IN DESIGNATED AREAS OF BRICK MASONRY TO A MINIMUM DEPTH OF ¾" OR TO SOUND MORTAR, TAKING CARE TO AVOID DAMAGING MASONRY EDGES AND SURFACES. CLEAN SURFACES AND PREPARE TO RECEIVE NEW MORTAR OR SEALANT. INSTALL NEW POINTING MORTAR TO MATCH EXISTING ADJOINING MORTAR IN COLOR, TEXTURE AND
- JOINT PROFILE TO ELIMINATE EVIDENCE OF REPLACEMENT.

 CAREFULLY GRIND OR RAKE OUT DETERIORATED MORTAR AND SEALANT FROM ALL HEAD AND BED
- JOINTS IN ALL STONE PARAPET COPING TO A MINIMUM DEPTH OF ¾" OR SOUND MORTAR, TAKING CARE TO AVOID DAMAGING STONE / MASONRY EDGES AND SURFACES. CLEAN SURFACES AND PREPARE TO RECEIVE NEW MORTAR OR SEALANT.

 INSTALL NEW BACKER ROD AND JOINT SEALANT AT ALL HEAD AND BED JOINTS IN STONE COPIING.
- ENTRANCE WING WALLS: CAREFULLY GRIND OR RAKE OUT DETERIORATED MORTAR AND SEALANT FROM ALL HEAD AND BED JOINTS IN DESIGNATED AREAS OF BRICK MASONRY TO A MINIMUM DEPTH OF 3/4" OR TO SOUND MORTAR, TAKING CARE TO AVOID DAMAGING MASONRY EDGES AND SURFACES. CLEAN SURFACES AND PREPARE TO RECEIVE NEW MORTAR OR SEALANT. INSTALL NEW POINTING MORTAR TO MATCH EXISTING ADJOINING MORTAR IN COLOR, TEXTURE AND JOINT PROFILE TO ELIMINATE EVIDENCE OF REPLACEMENT.
- (4) STANDING SEAM METAL ROOF OVER ENTRANCE CANOPIES: INSTALL NEW 24 GAUGE STANDING SEAM METAL ROOF PANELS OVER 40 MIL SELF-ADHERING UNDERLAYMENT OVER 3/4" PLYWOOD SUBDECK OVER LIGHT-GAUGE METAL FRAMING OVER EXISTING STRUCTURAL CONCRETE DECK DRAIN TO 24 GAUGE SHEET METAL GUTTER AND DOWNSPOUTS. (COVER EXISTING TRANSOM) REFER TO DETAILS 5/A-501 & 6/A-501.

STATE OF MISSOURI MICHAEL L. PARSON, GOVERNOR



3/22/2024

BRIAN DOUGLAS CONNELL ARCHITECT MO A-5036

NNELL ARCHITECTURE, P.C.

I East Walnut Street Suite B imbia, Missouri 65201

875-2455 Cell: 573-268-6166



OFFICE OF
ADMINISTRATION
DIVISION OF FACILITIES
MANAGEMENT, DESIGN
AND CONSTRUCTION

MISSOURI DEPARTMENT OF CORRECTIONS

REPLACE ROOF EDUCATION BLDG No. 14 BOONVILLE CORRECTIONAL CENTER

1216 EAST MORGAN ST. BOONVILLE, MO 65233

PROJECT No. C2311-01 SITE No. 7002 ASSET No. 9327002024

REVISION:
DATE:
REVISION:
DATE:
REVISION:
DATE:

ISSUE DATE: 3/22/2024

CAD DWG FILE:

C2311-01-7002-9327002024-A-200.dwg

DRAWN BY: BDC

CHECKED BY: BDC

DESIGNED BY: BDC


SHEET TITLE:


NORTH & EAST
EXTERIOR ELEVATIONS MASONRY MAINTENANCE

SHEET NUMBER:

A-200

SHEET 5 OF 10 ISSUE DATE: 3/22/2024

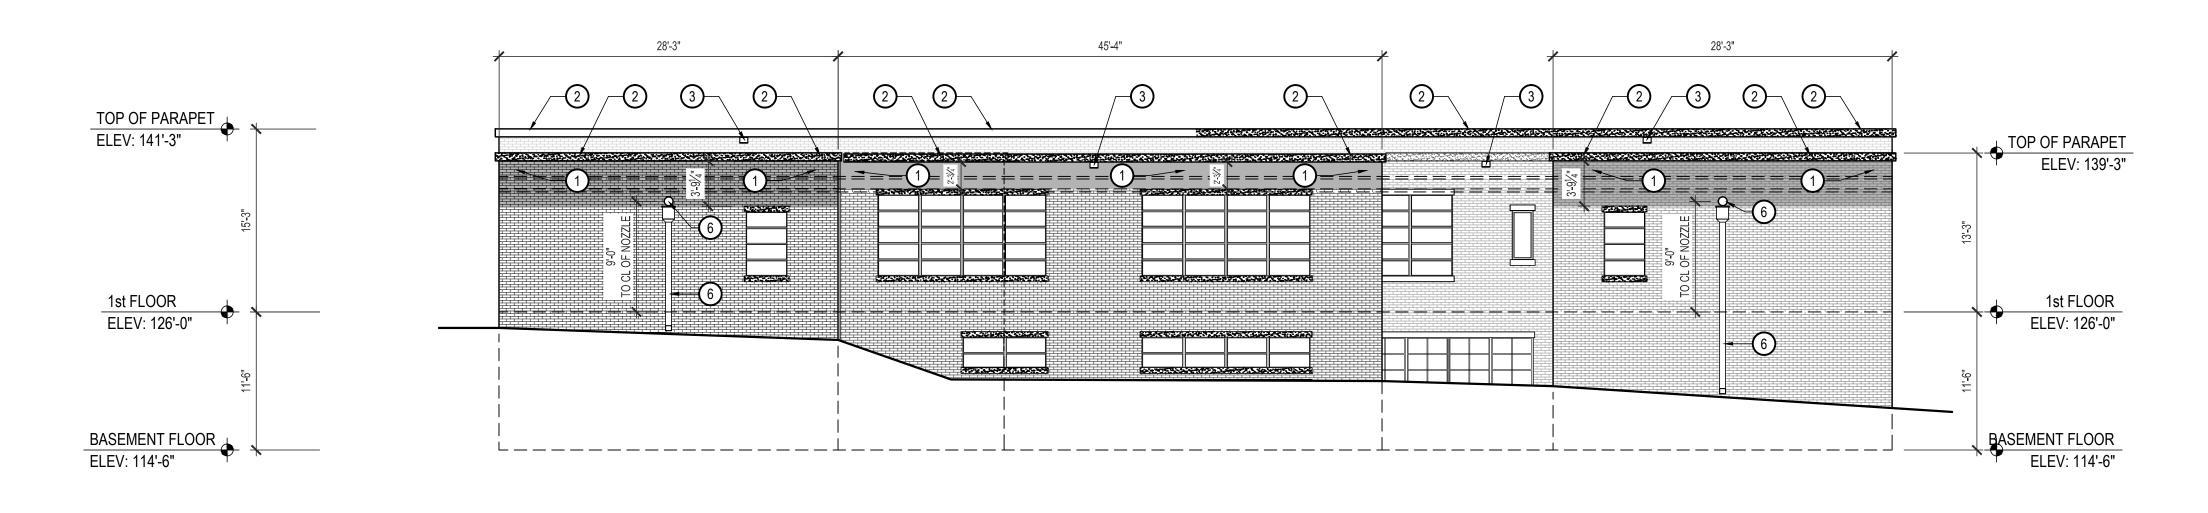

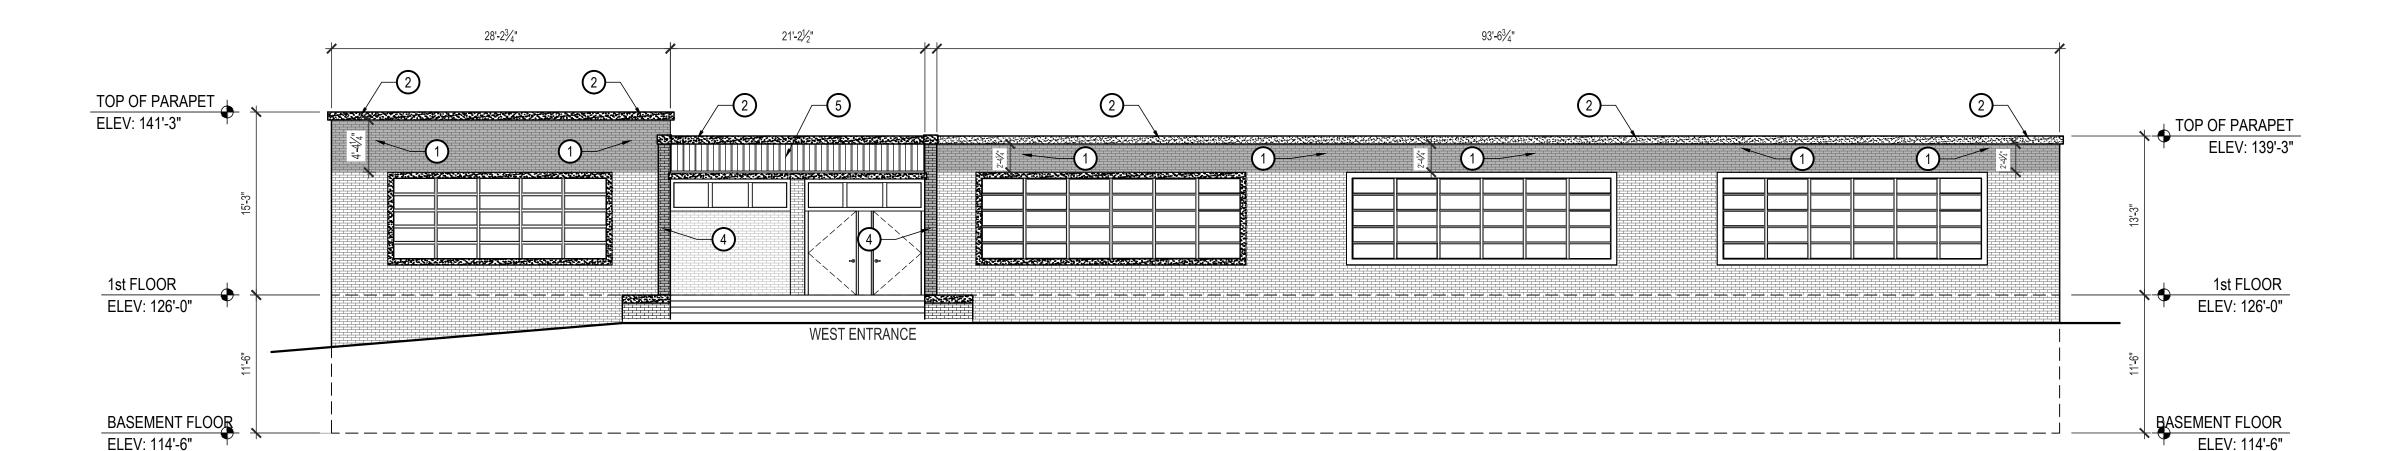

WEST EXTERIOR ELEVATION SCALE: 1/8" = 1'-0"

SOUTH EXTERIOR ELEVATION

GENERAL MASONRY MAINTENANCE NOTES: EDUCATION BUILDING No. 14

- CONTRACTOR SHALL COORDINATE ALL DEMOLITION AND REMOVAL OF DEMOLITION MATERIALS WITH OTHER WORK SEQUENCES AND OWNER OCCUPANCY REQUIREMENTS.
- CAREFULLY GRIND OR RAKE OUT DETERIORATED MORTAR IN ALL HEAD AND BED JOINTS IN THE EXTERIOR WALL AREAS DESIGNATED FOR MASONRY MAINTENANCE, CLEAN AND PREPARE SURFACES TO RECEIVE NEW MORTAR OR SEALANT.
- CAREFULLY GRIND OR RAKE OUT DETERIORATED MORTAR AND SEALANT IN ALL HEAD JOINTS IN STONE PARAPET COPING, AND PREPARE SURFACES TO RECEIVE NEW MORTAR OR SEALANT.
- CAREFULLY REMOVE AND REINSTALL OR REPLACE DETERIORATED BRICK AND STONE UNITS AS REQUIRED MAINTAIN THE INTEGRITY OF THE EXTERIOR MASONRY.
- BASE BID INCLUDES 4,000 SF OF MASONRY TUCKPOINTING. REFER TO SECTION 012200 UNIT PRICES.

KEYED MASONRY MAINTENANCE NOTES: EDUCATION BUILDING No. 14

-) CAREFULLY GRIND OR RAKE OUT DETERIORATED MORTAR AND SEALANT FROM ALL HEAD AND BED JOINTS IN DESIGNATED AREAS OF BRICK MASONRY TO A MINIMUM DEPTH OF $^3\!4$ " OR TO SOUND MORTAR, TAKING CARE TO AVOID DAMAGING MASONRY EDGES AND SURFACES. CLEAN SURFACES AND PREPARE TO RECEIVE NEW MORTAR OR SEALANT.
- INSTALL NEW POINTING MORTAR TO MATCH EXISTING ADJOINING MORTAR IN COLOR, TEXTURE AND JOINT PROFILE TO ELIMINATE EVIDENCE OF REPLACEMENT.
- CAREFULLY GRIND OR RAKE OUT DETERIORATED MORTAR AND SEALANT FROM ALL HEAD AND BED JOINTS IN ALL STONE PARAPET COPING TO A MINIMUM DEPTH OF 3/4" OR SOUND MORTAR, TAKING CARE TO AVOID DAMAGING STONE / MASONRY EDGES AND SURFACES. CLEAN SURFACES AND PREPARE TO RECEIVE NEW MORTAR OR SEALANT. INSTALL NEW BACKER ROD AND JOINT SEALANT AT ALL HEAD AND BED JOINTS IN STONE COPING.
- RAISE EXISTING 5"x8" CAST IRON THROUGH-WALL OVERFLOW WEIR SLEEVE TO UNDERSIDE OF STONE PARAPET CAP - INFILL EXISTING OPENING IN PARAPET WALL WITH BRICK MASONRY TO MATCH EXISTING ADJACENT BRICK - FLASH THROUGH-WALL OVERFLOW WEIR SLEEVE WITH TPO MEMBRANE FLASHING. REFER TO DETAILS SHEET A-502.
- ENTRANCE WING WALLS: CAREFULLY GRIND OR RAKE OUT DETERIORATED MORTAR AND SEALANT FROM ALL HEAD AND BED JOINTS IN DESIGNATED AREAS OF BRICK MASONRY TO A MINIMUM DEPTH OF $\frac{3}{4}$ " OR TO SOUND MORTAR, TAKING CARE TO AVOID DAMAGING MASONRY EDGES AND SURFACES. CLEAN SURFACES AND PREPARE TO RECEIVE NEW MORTAR OR SEALANT. INSTALL NEW POINTING MORTAR TO MATCH EXISTING ADJOINING MORTAR IN COLOR, TEXTURE AND JOINT PROFILE TO ELIMINATE EVIDENCE OF REPLACEMENT.
- STANDING SEAM METAL ROOF OVER ENTRANCE CANOPIES: INSTALL NEW 24 GAUGE STANDING SEAM METAL ROOF PANELS OVER 40 MIL SELF-ADHERING UNDERLAYMENT OVER 3/4" PLYWOOD SUBDECK OVER LIGHT-GAUGE METAL FRAMING OVER EXISTING STRUCTURAL CONCRETE DECK -DRAIN TO 24 GAUGE SHEET METAL GUTTER AND DOWNSPOUTS. (COVERS EXISTING TRANSOM). 12/12 SLOPE AT WEST ENTRANCE CANOPY, 6/12 SLOPE AT EAST ENTRANCE CANOPY. REFER TO DETAILS 5/A-501 & 6/A-501.
- INSTALL NEW THROUGH-WALL 6" Ø DOWNSPOUT NOZZLE AND PRE-FINISHED 24-GAUGE SHEET METAL LEADER HEAD AND DOWNSPOUT - TERMINATE AT GRADE ON SPLASH BLOCK. REFER TO DETAIL 4/A-502.

STATE OF MISSOURI MICHAEL L. PARSON, **GOVERNOR**



BRIAN DOUGLAS CONNELL ARCHITECT MO A-5036

VELL ARCHITEC

East Walnut Street
bia, Missouri



OFFICE OF ADMINISTRATION DIVISION OF FACILITIES MANAGEMENT, DESIGN AND CONSTRUCTION

MISSOURI DEPARTMENT OF CORRECTIONS

REPLACE ROOF EDUCATION BLDG No. 14 **BOONVILLE CORRECTIONAL CENTER**

1216 EAST MORGAN ST. BOONVILLE, MO 65233

PROJECT No. C2311-01 SITE No. 7002 **ASSET No.** 9327002024

REVISION: REVISION: DATE: **REVISION:** DATE:

ISSUE DATE: 3/22/2024

CAD DWG FILE: C2311-01-7002-9327002024-A-201.dwg **DRAWN BY:**BDC CHECKED BY: BDC **DESIGNED BY:** BDC


SHEET TITLE:


SOUTH & WEST EXTERIOR ELEVATIONS -

MASONRY MAINTENANCE

SHEET NUMBER:

SHEET 6 OF 10 **ISSUE DATE: 3/22/2024**

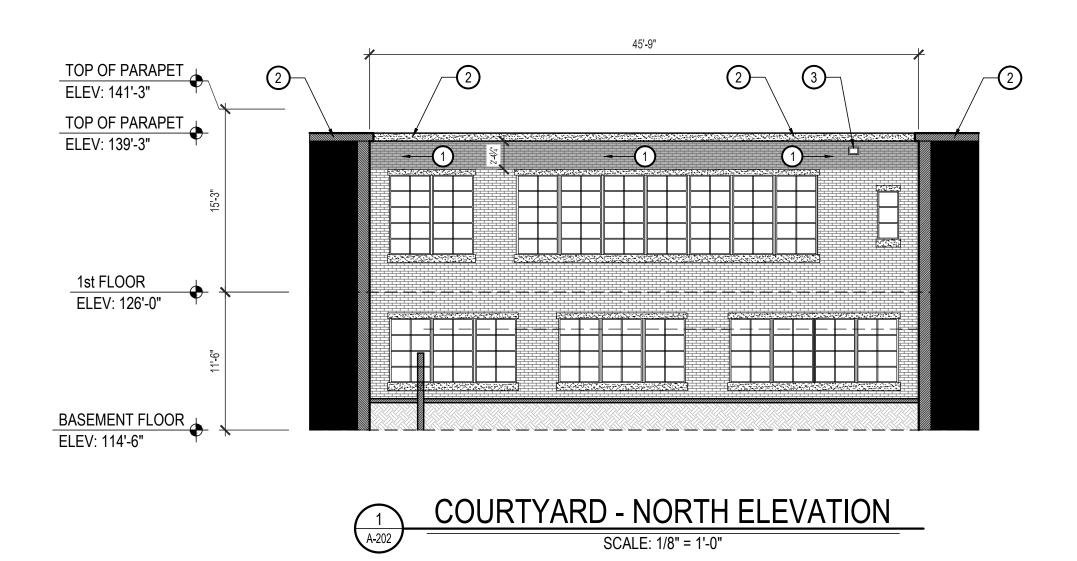

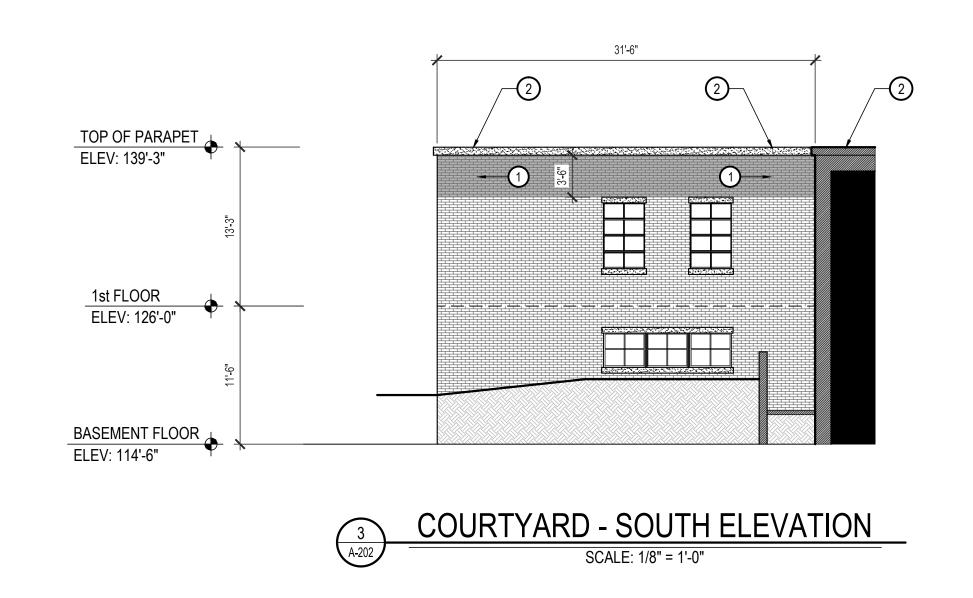

CONTRACTOR SHALL COORDINATE ALL DEMOLITION AND REMOVAL OF DEMOLITION

- 1. CONTRACTOR SHALL COORDINATE ALL DEMOLITION AND REMOVAL OF DEMOLITION MATERIALS WITH OTHER WORK SEQUENCES AND OWNER OCCUPANCY REQUIREMENTS.
- 2. CAREFULLY GRIND OR RAKE OUT DETERIORATED MORTAR IN ALL HEAD AND BED JOINTS IN THE EXTERIOR WALL AREAS DESIGNATED FOR MASONRY MAINTENANCE, CLEAN AND PREPARE SURFACES TO RECEIVE NEW MORTAR OR SEALANT.

GENERAL MASONRY MAINTENANCE NOTES: EDUCATION BUILDING No. 14

- 3. CAREFULLY GRIND OR RAKE OUT DETERIORATED MORTAR AND SEALANT IN ALL HEAD JOINTS IN STONE PARAPET COPING, AND PREPARE SURFACES TO RECEIVE NEW MORTAR OR SEALANT.
- . CAREFULLY REMOVE AND REINSTALL OR REPLACE DETERIORATED BRICK AND STONE UNITS AS
- REQUIRED MAINTAIN THE INTEGRITY OF THE EXTERIOR MASONRY.

BASE BID INCLUDES 4,000 SF OF MASONRY TUCKPOINTING. REFER TO SECTION 012200 UNIT PRICES.

KEYED MASONRY MAINTENANCE NOTES: EDUCATION BUILDING No. 14


- (1) CAREFULLY GRIND OR RAKE OUT DETERIORATED MORTAR AND SEALANT FROM ALL HEAD AND BED JOINTS IN BRICK MASONRY TO A MINIMUM DEPTH OF 3/4" OR TO SOUND MORTAR, TAKING CARE TO AVOID DAMAGING MASONRY EDGES AND SURFACES.

 CLEAN SURFACES AND PREPARE TO RECEIVE NEW MORTAR OR SEALANT.
 INSTALL NEW POINTING MORTAR TO MATCH EXISTING ADJOINING MORTAR IN COLOR, TEXTURE AND JOINT PROFILE TO ELIMINATE EVIDENCE OF REPLACEMENT.
- 2 CAREFULLY GRIND OR RAKE OUT DETERIORATED MORTAR AND SEALANT FROM ALL HEAD AND BED JOINTS IN STONE PARAPET COPING TO A MINIMUM DEPTH OF 3/4" OR SOUND MORTAR, TAKING CARE TO AVOID DAMAGING STONE / MASONRY EDGES AND SURFACES.

 CLEAN SURFACES AND PREPARE TO RECEIVE NEW MORTAR OR SEALANT.
- INSTALL NEW BACKER ROD AND JOINT SEALANT AT ALL HEAD AND BED JOINTS IN STONE COPING.
- 3 REMOVE EXISTING THROUGH-WALL SCUPPER INFILL OPENING WITH BRICK VENEER TO MATCH EXISTING ADJACENT BRICK.



SCALE: 1/8" = 1'-0"

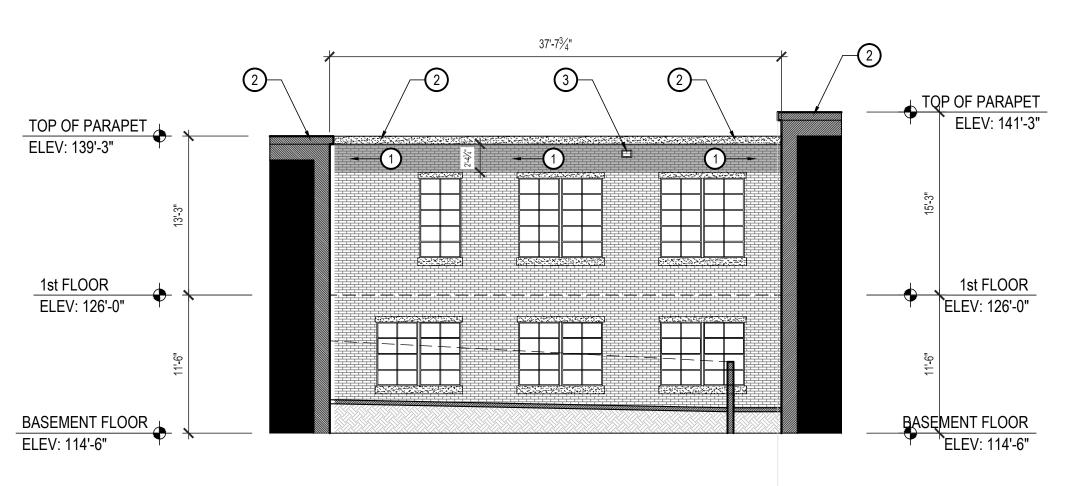



STATE OF MISSOURI MICHAEL L. PARSON, GOVERNOR



3/22/2024

BRIAN DOUGLAS CONNELL ARCHITECT MO A-5036

LL ARCHITECTURE, P.C.
t Walnut Street Suite B
, Missouri 65201
2455 Cell: 573-268-6166

2311 East Walnut Columbia, Missour 573-875-2455



OFFICE OF ADMINISTRATION DIVISION OF FACILITIES MANAGEMENT, DESIGN AND CONSTRUCTION

MISSOURI DEPARTMENT OF CORRECTIONS

REPLACE ROOF EDUCATION BLDG No. 14

BOONVILLE CORRECTIONAL CENTER

1216 EAST MORGAN ST. BOONVILLE, MO 65233

PROJECT No. C2311-01
SITE No. 7002
ASSET No. 9327002024

REVISION:
DATE:
REVISION:
DATE:
REVISION:
DATE:

ISSUE DATE: 3/22/2024

 CAD DWG FILE:

 C2311-01-7002-9327002024-A-202.dwg

 DRAWN BY:
 BDC

 CHECKED BY:
 BDC

 DESIGNED BY:
 BDC

SHEET TITLE:

COURTYARD


EXTERIOR ELEVATIONS -


MASONRY MAINTENANCE

SHEET NUMBER:

A-202


SHEET 7 OF 10 **ISSUE DATE: 3/22/2024**

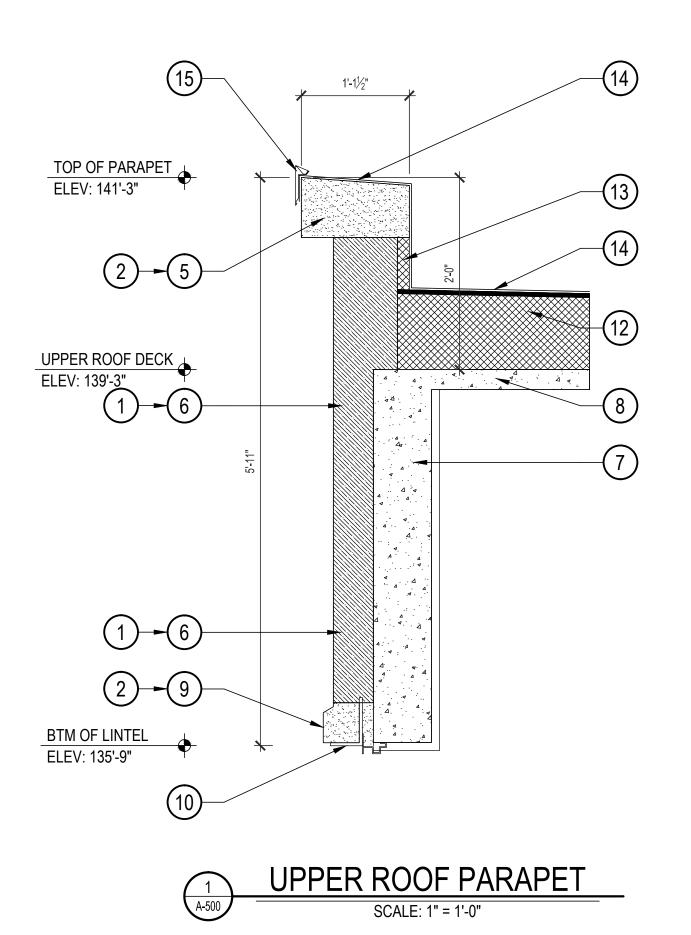

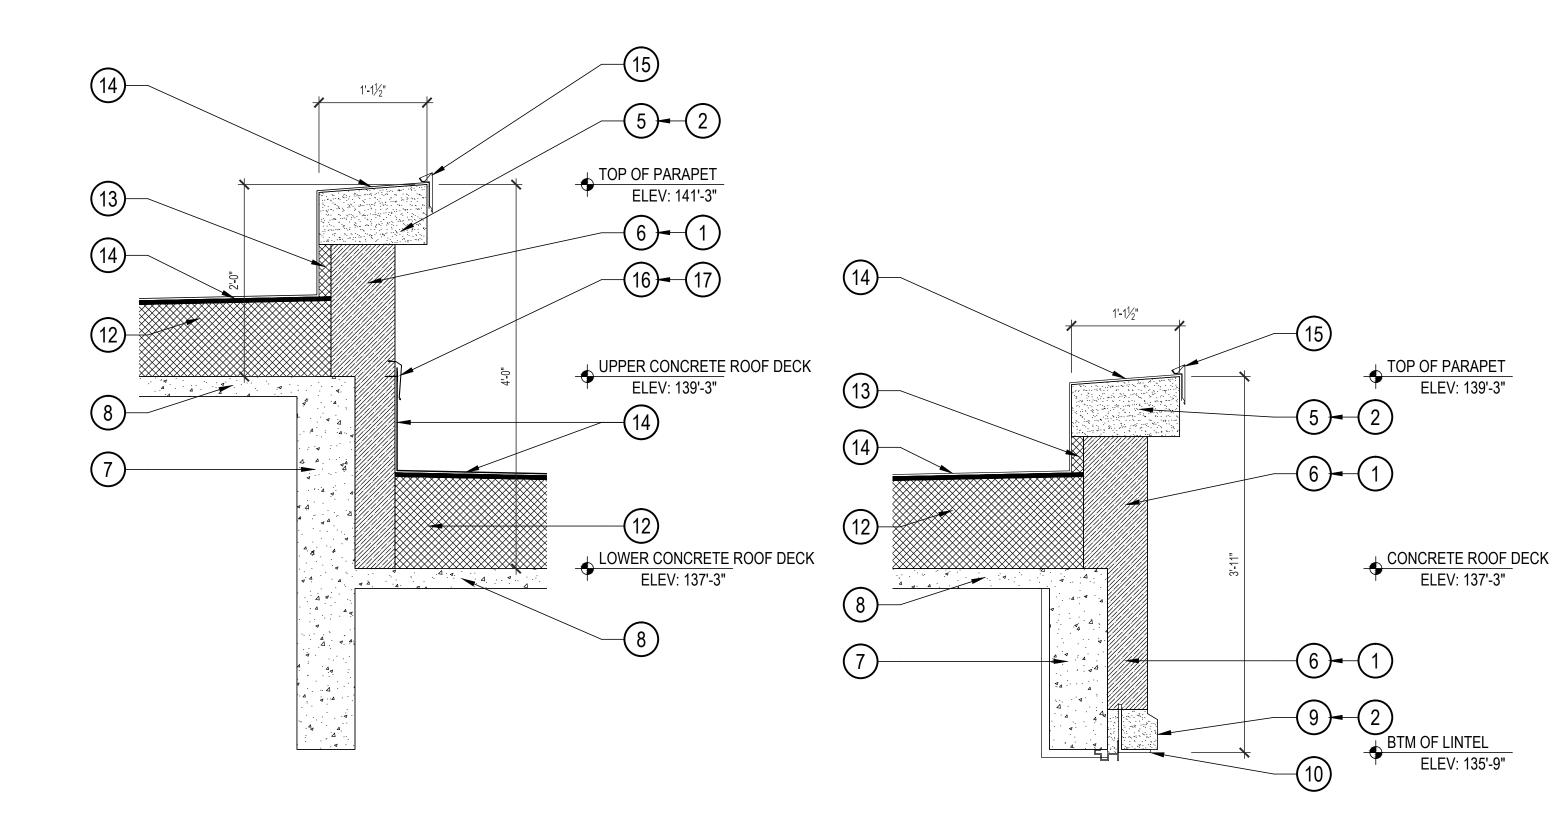


ELEV: 139'-3"

ELEV: 137'-3"

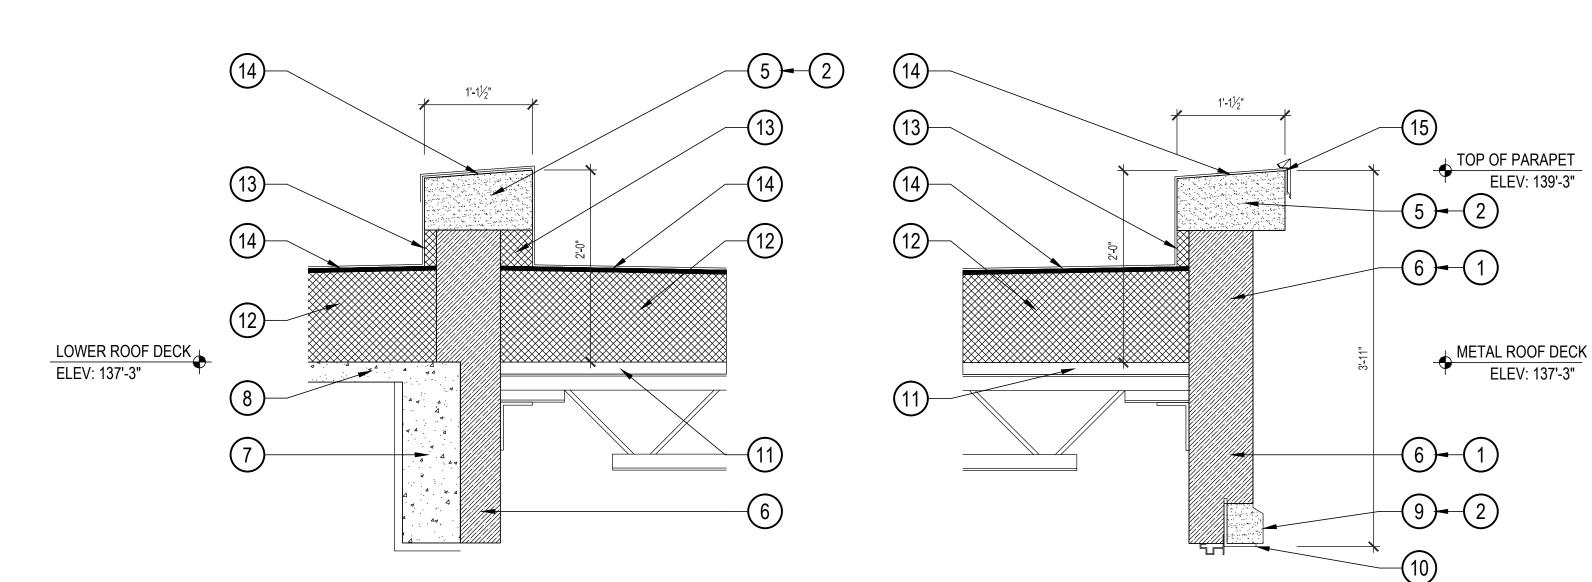

WEST / SOUTH ROOF PARAPET

SCALE: 1" = 1'-0"

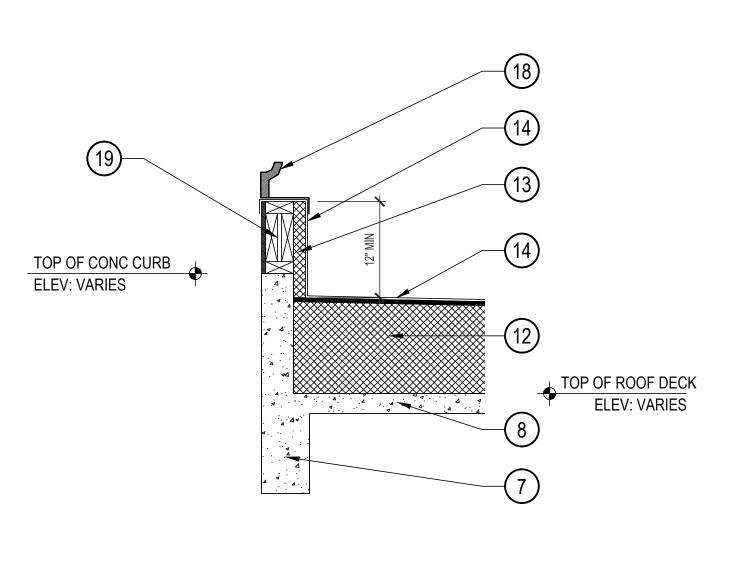

LOWER ROOF PARAPET

SOUTH ROOF PARAPET SCALE: 1" = 1'-0"

UPPER / LOWER ROOF PARAPET

ROOF CURB DETAIL SCALE: 1" = 1'-0"

GENERAL MASONRY MAINTENANCE NOTES: EDUCATION BUILDING No. 14

- CONTRACTOR SHALL COORDINATE ALL DEMOLITION AND REMOVAL OF DEMOLITION MATERIALS WITH OTHER WORK SEQUENCES AND OWNER OCCUPANCY REQUIREMENTS.
- CAREFULLY GRIND OR RAKE OUT DETERIORATED MORTAR IN ALL HEAD AND BED JOINTS IN THE EXTERIOR BRICK MASONRY WALL AREAS DESIGNATED FOR MASONRY MAINTENANCE, CLEAN AND PREPARE SURFACES TO RECEIVE NEW MORTAR OR SEALANT.
- CAREFULLY GRIND OR RAKE OUT DETERIORATED MORTAR AND SEALANT IN ALL HEAD JOINTS IN CUT STONE COPING AND WINDOW LINTELS - PREPARE SURFACES TO RECEIVE NEW MORTAR OR
- CAREFULLY REMOVE AND REINSTALL OR REPLACE DETERIORATED BRICK AND STONE UNITS AS REQUIRED MAINTAIN THE INTEGRITY OF THE EXTERIOR MASONRY.
- BASE BID INCLUDES 4,000 SF OF MASONRY TUCKPOINTING AND 100 SF OF BRICK OR STONE MASONRY UNIT REPLACEMENT. REFER TO SECTION 012200 UNIT PRICES.

KEYED MASONRY MAINTENANCE NOTES: EDUCATION BUILDING No. 14

- CAREFULLY GRIND OR RAKE OUT DETERIORATED MORTAR AND SEALANT FROM ALL HEAD AND BED JOINTS IN DESIGNATED AREAS OF BRICK MASONRY TO A MINIMUM DEPTH OF $\frac{3}{4}$ " OR TO SOUND MORTAR, TAKING CARE TO AVOID DAMAGING MASONRY EDGES AND SURFACES. CLEAN SURFACES AND PREPARE TO RECEIVE NEW MORTAR OR SEALANT. INSTALL NEW POINTING MORTAR TO MATCH EXISTING ADJOINING MORTAR IN COLOR, TEXTURE AND JOINT PROFILE TO ELIMINATE EVIDENCE OF REPLACEMENT.
- CAREFULLY GRIND OR RAKE OUT DETERIORATED MORTAR AND SEALANT FROM ALL HEAD AND BED JOINTS IN ALL STONE PARAPET COPING TO A MINIMUM DEPTH OF 3/4" OR SOUND MORTAR, TAKING CARE TO AVOID DAMAGING STONE / MASONRY EDGES AND SURFACES. CLEAN SURFACES AND PREPARE TO RECEIVE NEW MORTAR OR SEALANT. INSTALL NEW BACKER ROD AND JOINT SEALANT AT ALL HEAD AND BED JOINTS IN STONE COPIING.

KEYED ROOF REPLACEMENT NOTES: EDUCATION BUILDING No. 14

- EXISTING CUT STONE COPING CONTINUOUS AT TOP OF PARAPET.
- 6) EXISTING BRICK MASONRY PARAPET WALL.
- () EXISTING STRUCTURAL CONCRETE BEAM AT PERIMETER OF ROOF DECK OR CURB OPENING.
- 8) EXISTING STRUCTURAL REINFORCED CONCRETE ROOF DECK (2 $\frac{1}{2}$ " THICK).
- 9) EXISTING CUT STONE LINTEL CONTINUOUS AT TOP OF WINDOW OPENINGS.
- 10) EXISTING STEEL ANGLE LINTEL CONTINUOUS AT WINDOW OPENINGS.
- 11) EXISTING 1 $\frac{1}{2}$ " STEEL ROOF DECK OVER STEEL JOISTS (SOUTH ROOF ONLY).
- 2) INSTALL 1/2" HIGH-DENSITY POLYISO COVER BOARD OVER TAPERED POLYISO INSULATION (MINIMUM AVERAGE R-30) MECHANICALLY-FASTENED TO STRUCTURAL ROOF DECK.
-) INSTALL RIGID INSULATION INFILL AT VERTICAL SURFACE OF PARAPET WALL TO PROVIDE FLUSH VERTICAL SURFACE FOR TPO MEMBRANE FLASHING UP AND OVER THE TOP OF THE PARAPET.
- 14) INSTALL 60-MIL TPO MEMBRANE FULLY-ADHERED TO NEW INSULATION SYSTEM EXTEND UP AND OVER
- 15) INSTALL NEW PRE-FINISHED 24 GAUGE SHEET METAL EDGE FASCIA SYSTEM AT TOP OF PARAPET.
- 16) EXTEND NEW 60-MIL TPO ROOF MEMBRANE UP VERTICAL FACE OF PARAPET SEAL OFF WITH
- CONTINUOUS HORIZONTAL TERMINATION BAR ANCHORED INTO MASONRY.
- 7) INSTALL NEW PRE-FINISHED 24 GAUGE SHEET METAL COUNTERFLASHING INSERTED INTO CONTINOUS SHEET METAL REGLET.
- 18) CURB-MOUNTED UNIT (ROOF HATCH, VENTILATOR, EXHAUST, ETC.). EXTEND TOP OF CURB TO MINIMUM 12" ABOVE NEW ROOF SURFACE.
- (19) WOOD 2x BLOCKING AS REQUIRED TO EXTEND TOP OF CURB TO 12" MINIMUM ABOVE ROOF MEMBRANE SURFACE - INTERIOR FACE CLAD WITH 1/2" PLYWOOD FLUSH WITH CURB.

STATE OF MISSOURI MICHAEL L. PARSON, **GOVERNOR**



3/22/2024 BRIAN DOUGLAS CONNELL ARCHITECT MO A-5036

L ARCHITE
Walnut Stree



OFFICE OF ADMINISTRATION DIVISION OF FACILITIES MANAGEMENT, DESIGN AND CONSTRUCTION

MISSOURI DEPARTMENT **OF CORRECTIONS**

REPLACE ROOF **EDUCATION BLDG No. 14**

BOONVILLE CORRECTIONAL CENTER

1216 EAST MORGAN ST. BOONVILLE, MO 65233

PROJECT No. C2311-01 7002 SITE No. 9327002024 ASSET No.

REVISION: REVISION: DATE: REVISION: DATE:

ISSUE DATE: 3/22/2024


CAD DWG FILE: DRAWN BY: CHECKED BY: BDC **DESIGNED BY:** BDC


SHEET TITLE:

WALL & ROOF DETAILS

SHEET NUMBER:

SHEET 8 OF 10 **ISSUE DATE: 3/22/2024**

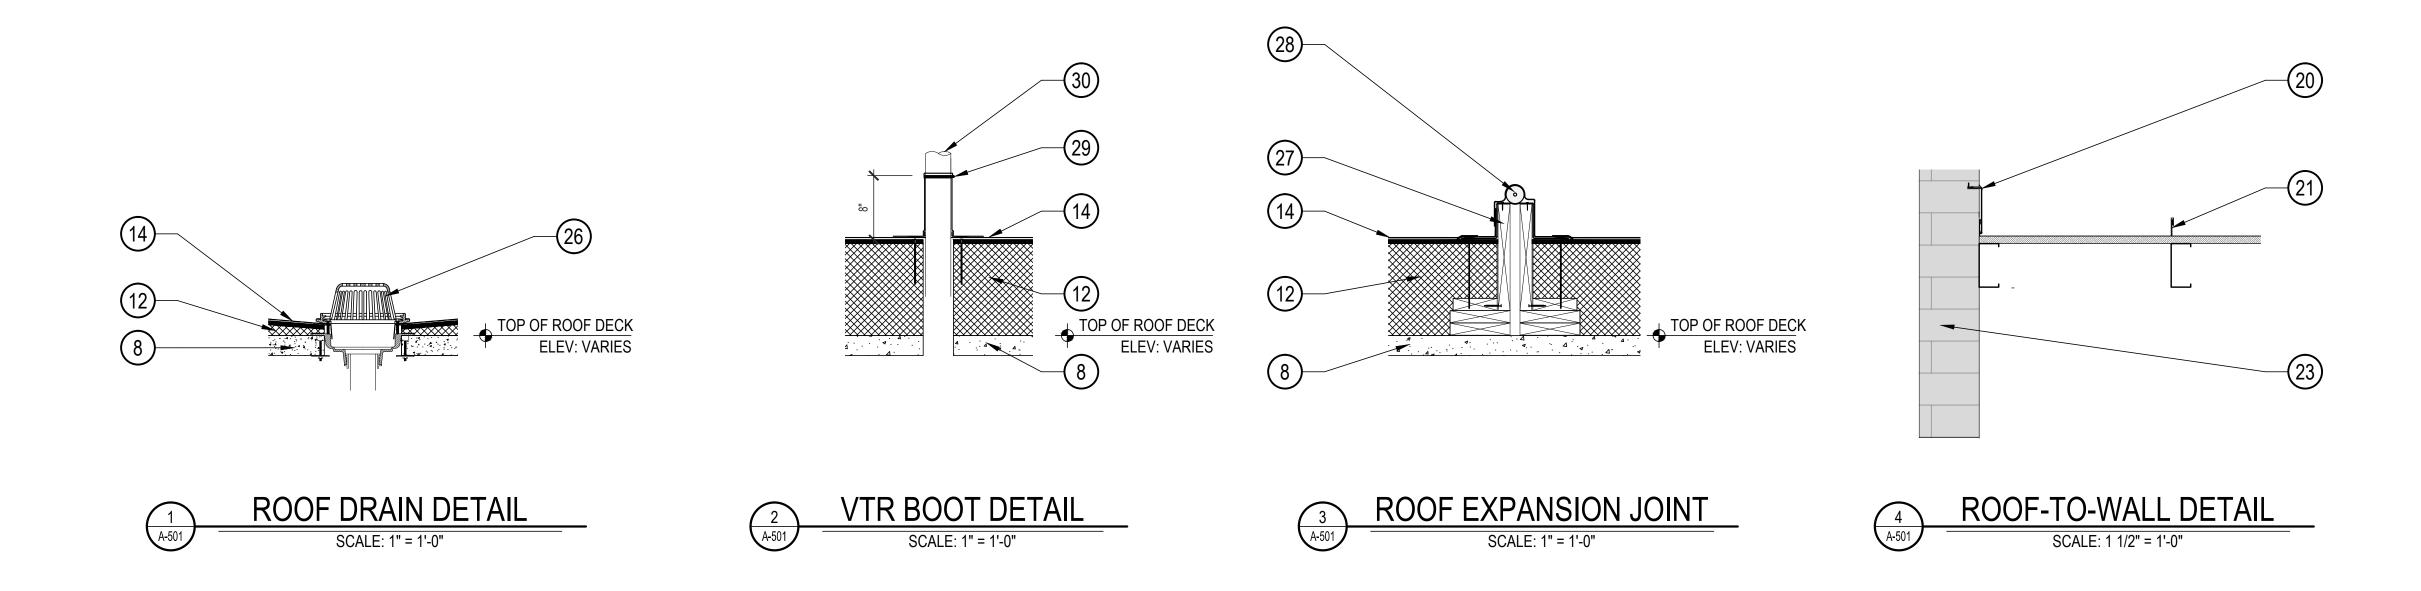

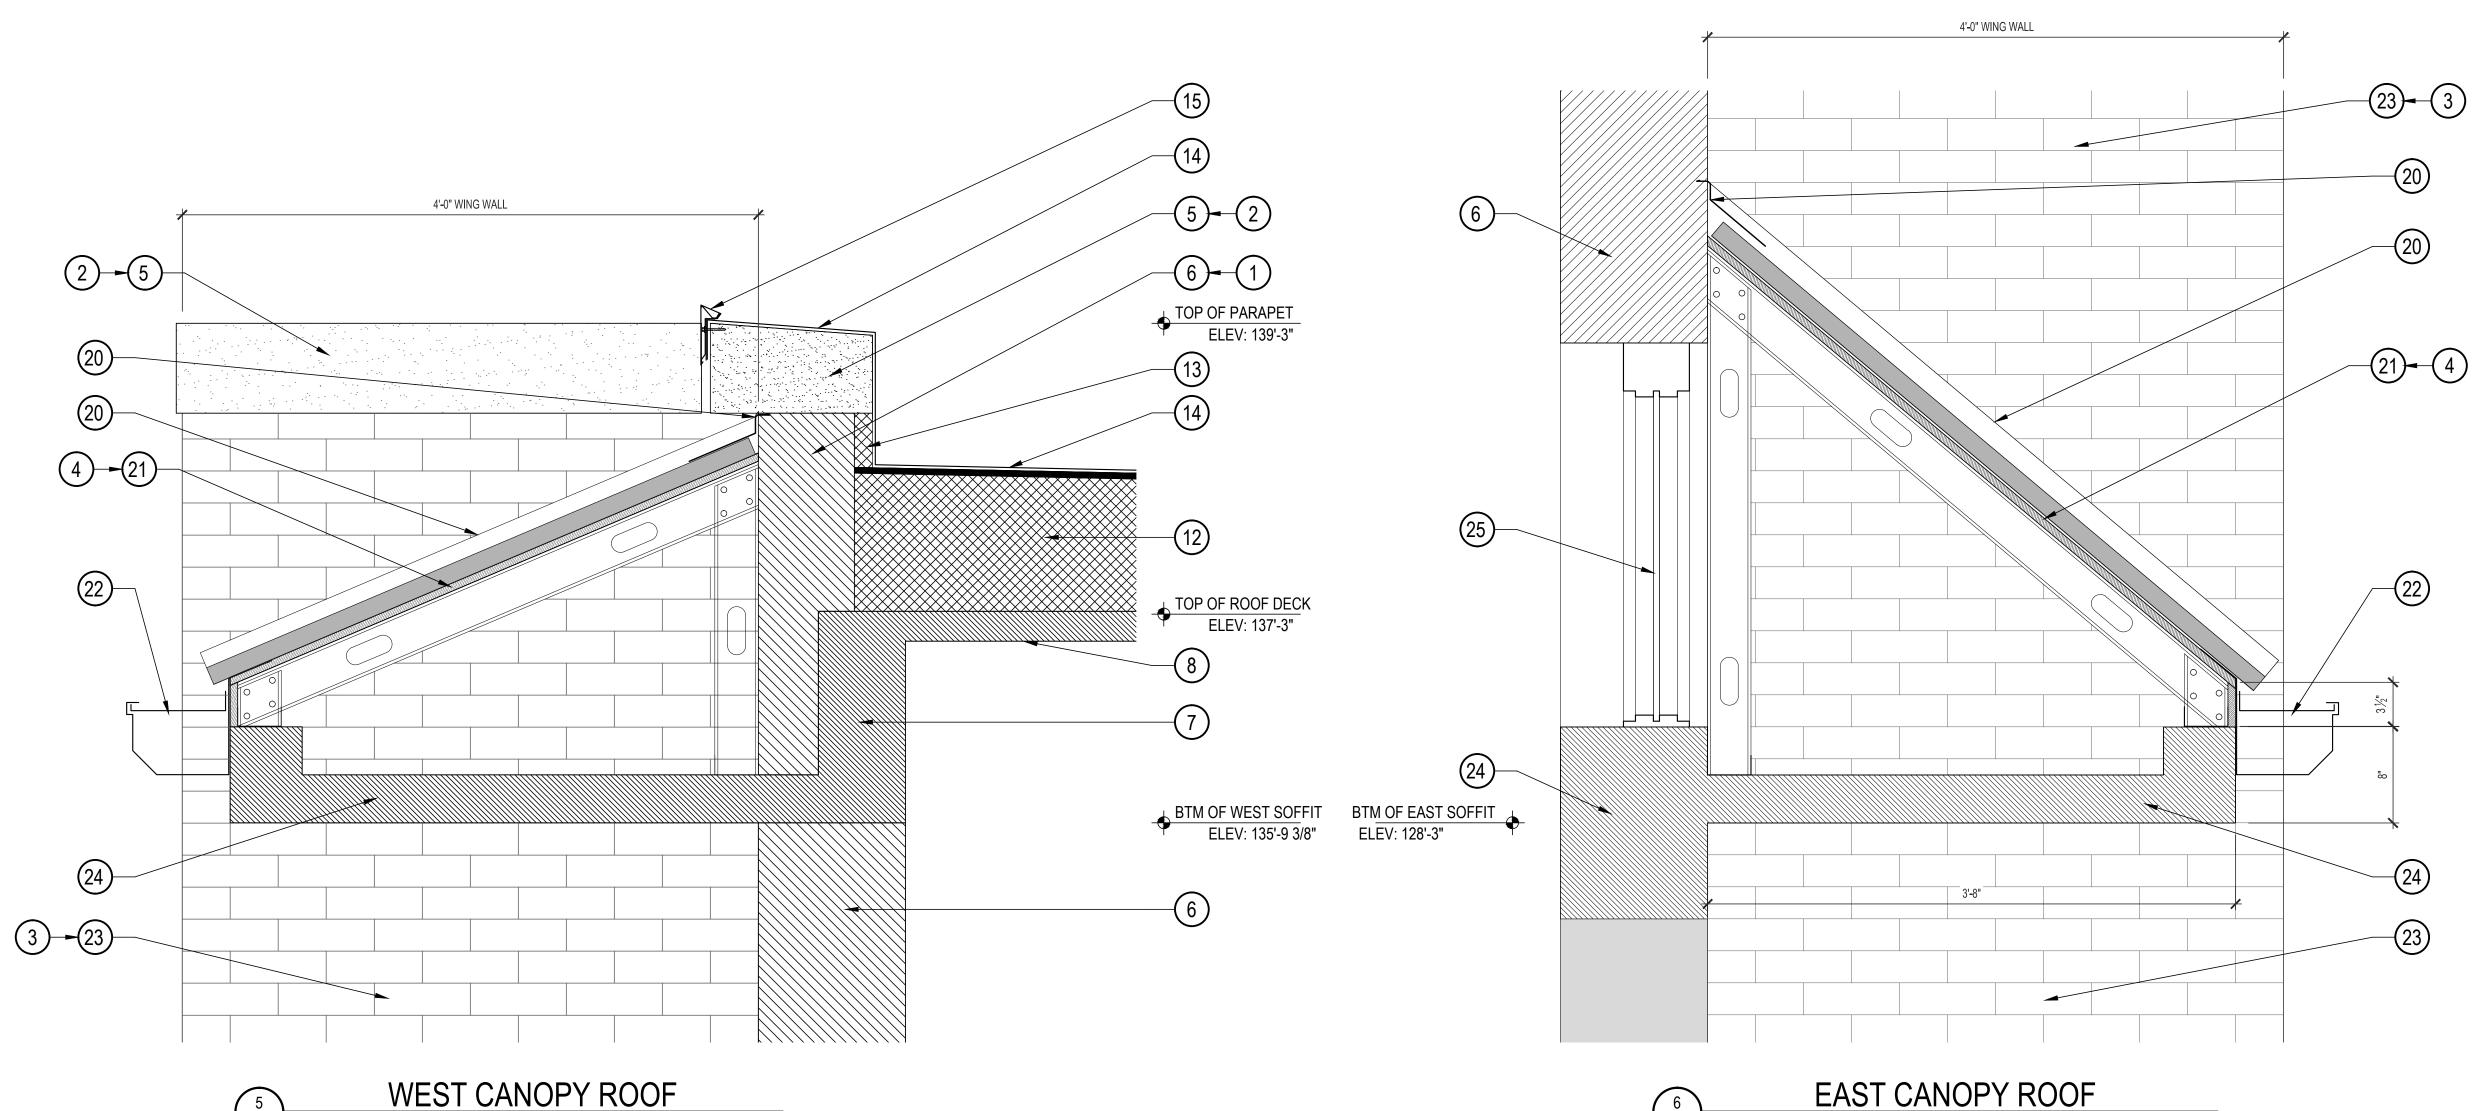

SCALE: 1 1/2" = 1'-0"

GENERAL MASONRY MAINTENANCE NOTES: EDUCATION BUILDING No. 14

- CONTRACTOR SHALL COORDINATE ALL DEMOLITION AND REMOVAL OF DEMOLITION MATERIALS WITH OTHER WORK SEQUENCES AND OWNER OCCUPANCY REQUIREMENTS.
- CAREFULLY GRIND OR RAKE OUT DETERIORATED MORTAR IN ALL HEAD AND BED JOINTS IN THE EXTERIOR BRICK MASONRY WALL AREAS DESIGNATED FOR MASONRY MAINTENANCE, CLEAN AND PREPARE SURFACES TO RECEIVE NEW MORTAR OR SEALANT.
- CAREFULLY GRIND OR RAKE OUT DETERIORATED MORTAR AND SEALANT IN ALL HEAD JOINTS IN CUT STONE COPING AND WINDOW LINTELS - PREPARE SURFACES TO RECEIVE NEW MORTAR OR
- CAREFULLY REMOVE AND REINSTALL OR REPLACE DETERIORATED BRICK AND STONE UNITS AS REQUIRED MAINTAIN THE INTEGRITY OF THE EXTERIOR MASONRY.
- BASE BID INCLUDES 4,000 SF OF MASONRY TUCKPOINTING AND 100 SF OF BRICK OR STONE MASONRY UNIT REPLACEMENT. REFER TO SECTION 012200 UNIT PRICES.

KEYED MASONRY MAINTENANCE NOTES: EDUCATION BUILDING No. 14

- CAREFULLY GRIND OR RAKE OUT DETERIORATED MORTAR AND SEALANT FROM ALL HEAD AND BED JOINTS IN DESIGNATED AREAS OF BRICK MASONRY TO A MINIMUM DEPTH OF $\frac{3}{4}$ " OR TO SOUND MORTAR, TAKING CARE TO AVOID DAMAGING MASONRY EDGES AND SURFACES. CLEAN SURFACES AND PREPARE TO RECEIVE NEW MORTAR OR SEALANT. INSTALL NEW POINTING MORTAR TO MATCH EXISTING ADJOINING MORTAR IN COLOR, TEXTURE AND JOINT PROFILE TO ELIMINATE EVIDENCE OF REPLACEMENT.
- CAREFULLY GRIND OR RAKE OUT DETERIORATED MORTAR AND SEALANT FROM ALL HEAD AND BED JOINTS IN ALL STONE PARAPET COPING TO A MINIMUM DEPTH OF 3/4" OR SOUND MORTAR, TAKING CARE TO AVOID DAMAGING STONE / MASONRY EDGES AND SURFACES. CLEAN SURFACES AND PREPARE TO RECEIVE NEW MORTAR OR SEALANT. INSTALL NEW BACKER ROD AND JOINT SEALANT AT ALL HEAD AND BED JOINTS IN STONE COPIING.
- ENTRANCE WING WALLS: CAREFULLY GRIND OR RAKE OUT DETERIORATED MORTAR AND SEALANT FROM ALL HEAD AND BED JOINTS IN DESIGNATED AREAS OF BRICK MASONRY TO A MINIMUM DEPTH OF $\frac{3}{4}$ " OR TO SOUND MORTAR, TAKING CARE TO AVOID DAMAGING MASONRY EDGES AND SURFACES. CLEAN SURFACES AND PREPARE TO RECEIVE NEW MORTAR OR SEALANT. INSTALL NEW POINTING MORTAR TO MATCH EXISTING ADJOINING MORTAR IN COLOR, TEXTURE AND JOINT PROFILE TO ELIMINATE EVIDENCE OF REPLACEMENT.
- STANDING SEAM METAL ROOF OVER ENTRANCE CANOPIES: INSTALL NEW 24 GAUGE STANDING SEAM METAL ROOF PANELS OVER 40 MIL SELF-ADHERING UNDERLAYMENT OVER 3/4" PLYWOOD SUBDECK OVER LIGHT-GAUGE METAL FRAMING OVER EXISTING STRUCTURAL CONCRETE DECK -DRAIN TO 24 GAUGE SHEET METAL GUTTER AND DOWNSPOUTS. (COVER EXISTING TRANSOM)

KEYED ROOF REPLACEMENT NOTES: EDUCATION BUILDING No. 14

- $5\,)$ EXISTING CUT STONE COPING CONTINUOUS AT TOP OF PARAPET.
- (a) EXISTING BRICK MASONRY PARAPET WALL.
- EXISTING STRUCTURAL CONCRETE BEAM AT PERIMETER OF ROOF DECK OR CURB OPENING.
- 8) EXISTING STRUCTURAL REINFORCED CONCRETE ROOF DECK (2 $\frac{1}{2}$ " THICK).
- 9 NOT USED
- (10) NOT USED
- $^{(2)}$ Install $^{(2)}$ " High-density polyiso cover board over tapered polyiso insulation (minimum AVERAGE R-30) MECHANICALLY-FASTENED TO STRUCTURAL ROOF DECK.
- 3) INSTALL RIGID INSULATION INFILL AT VERTICAL SURFACE OF PARAPET WALL TO PROVIDE FLUSH VERTICAL SURFACE FOR TPO MEMBRANE FLASHING UP AND OVER THE TOP OF THE PARAPET.
- (4) INSTALL 60-MIL TPO MEMBRANE FULLY-ADHERED TO NEW INSULATION SYSTEM EXTEND UP AND OVER $\stackrel{\frown}{}$ TOP OF PARAPET - TERMINATE UNDER NEW CONTINUOUS SHEET METAL EDGE FASCIA.
- 15) INSTALL NEW PRE-FINISHED 24 GAUGE SHEET METAL EDGE FASCIA SYSTEM AT TOP OF PARAPET.
- (16) NOT USED
- (17) NOT USED

(19) NOT USED

SCALE: 1 1/2" = 1'-0"

- 20) PRE-FINISHED 24 GAUGE SHEET METAL COUNTERFLASHING AT SLOPED ROOF-TO-WALL CONDITION -INSERT INTO SAW-CUT REGLET IN MASONRY. DETAIL 4/A-501.
- 1) PRE-FINISHED 24 GAUGE STANDING SEAM METAL ROOF PANELS OVER 40-MIL SELF-ADHERING UNDERLAYMENT OVER $^3\!4$ " EXTERIOR-GRADE PLYWOOD ROOF DECK OVER 16 GAUGE 3 $^5\!8$ " METAL STUD RAFTERS @ 16" O.C. - VERTICAL STUDS AND SILL CHANNEL ANCHORED TO EXISTING STRUCTURE.
- (22) PRE-FINISHED 24 GAUGE 8" SHEET METAL GUTTER & DOWNSPOUT.
- 23) EXISTING BRICK MASONRY WING WALL AT EACH SIDE OF EAST AND WEST ENTRANCE CANOPIES.
- (24) EXISTING STRUCTURAL CONCRETE CANOPY ROOF DECK (4" THICK). DETAILS 5/A-501 & 6/A-501.
- 25) EXISTING TRANSOM WINDOWS OVER EAST ENTRANCE CANOPY APPLY OPAQUE FILM TO INSIDE
- SURFACE OF GLAZING. DETAIL 6/A-501.
- (26) NEW 4" Ø CAST IRON ROOF DRAIN & DOME STRAINER. DETAIL 1/A-501.
- 27) NEW 2x WOOD BLOCKING AS REQUIRED TO FORM ROOF EXPANSION JOINT WHERE SHOWN -ANCHORED TO ROOF DECK.
- (28) 2" Ø COMPRESSIBLE TUBE AT TOP OF ROOF EXPANSION JOINT.
- (29) PRE-FABRICATED MEMBRANE FLASHING BOOT WITH DRAWBAND MIMIMUM 8" HEIGHT ABOVE ROOF
- (30) EXTEND EXISTING VENT PIPE A MINIMUM OF 12" ABOVE ROOF SURFACE. REFER TO DETAIL 2/A-501.

ROOF DETAILS

SHEET NUMBER:



STATE OF MISSOURI MICHAEL L. PARSON,

GOVERNOR

3/22/2024

BRIAN DOUGLAS CONNELL ARCHITECT MO A-5036

L ARCHITE Walnut Stree Missouri



OFFICE OF ADMINISTRATION DIVISION OF FACILITIES MANAGEMENT, DESIGN AND CONSTRUCTION

MISSOURI DEPARTMENT OF CORRECTIONS

REPLACE ROOF **EDUCATION BLDG No. 14 BOONVILLE CORRECTIONAL**

1216 EAST MORGAN ST. **BOONVILLE, MO 65233**

CENTER

PROJECT No. C2311-01 7002

SITE No. 9327002024 ASSET No.


REVISION:	
DATE:	
REVISION:	
DATE:	
REVISION:	
DATE:	


ISSUE DATE: 3/22/2024


CAD DWG FILE: DRAWN BY: BDC CHECKED BY: BDC

DESIGNED BY: BDC **SHEET TITLE:**

SHEET 9 OF 10 **ISSUE DATE: 3/22/2024**

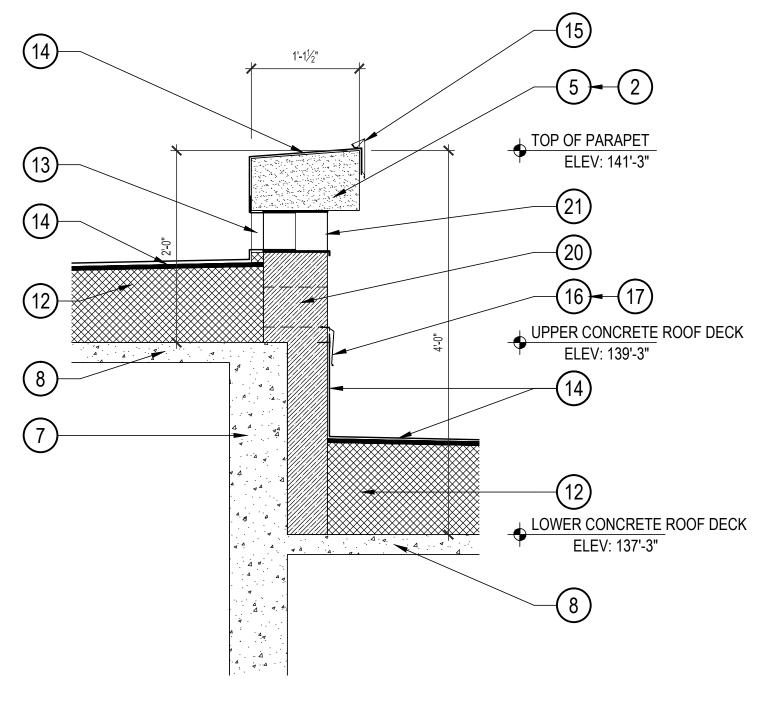

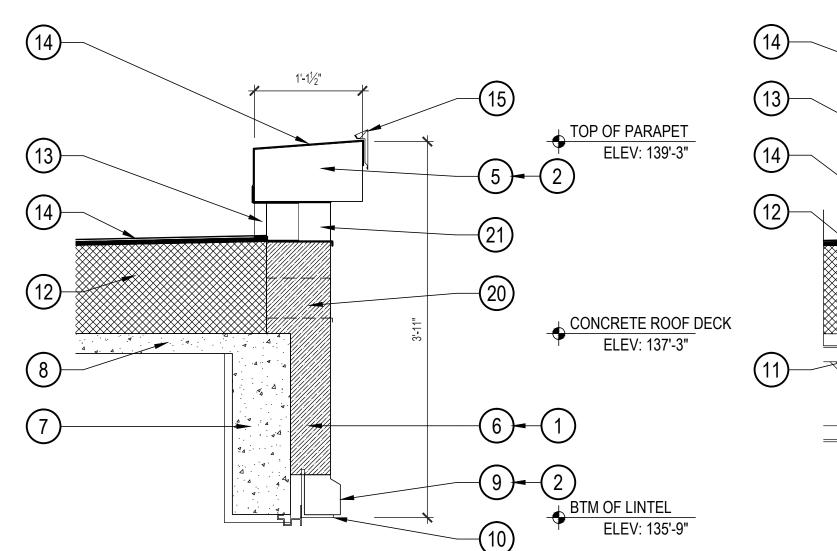


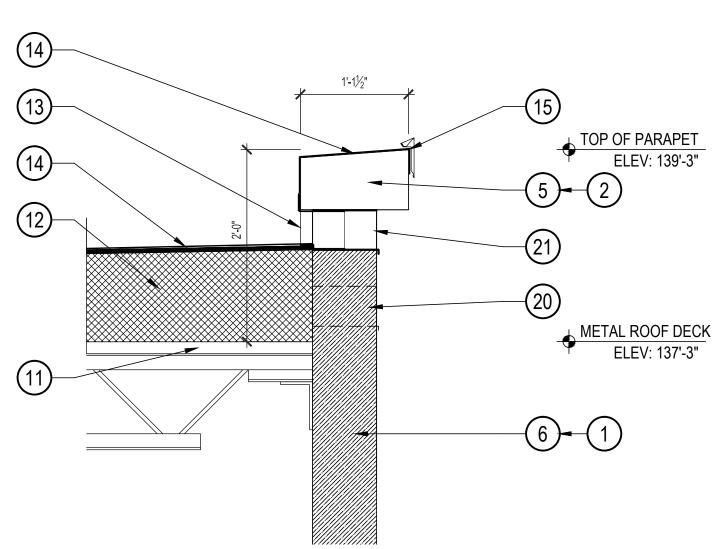






SOUTH ROOF - OVERFLOW WEIR

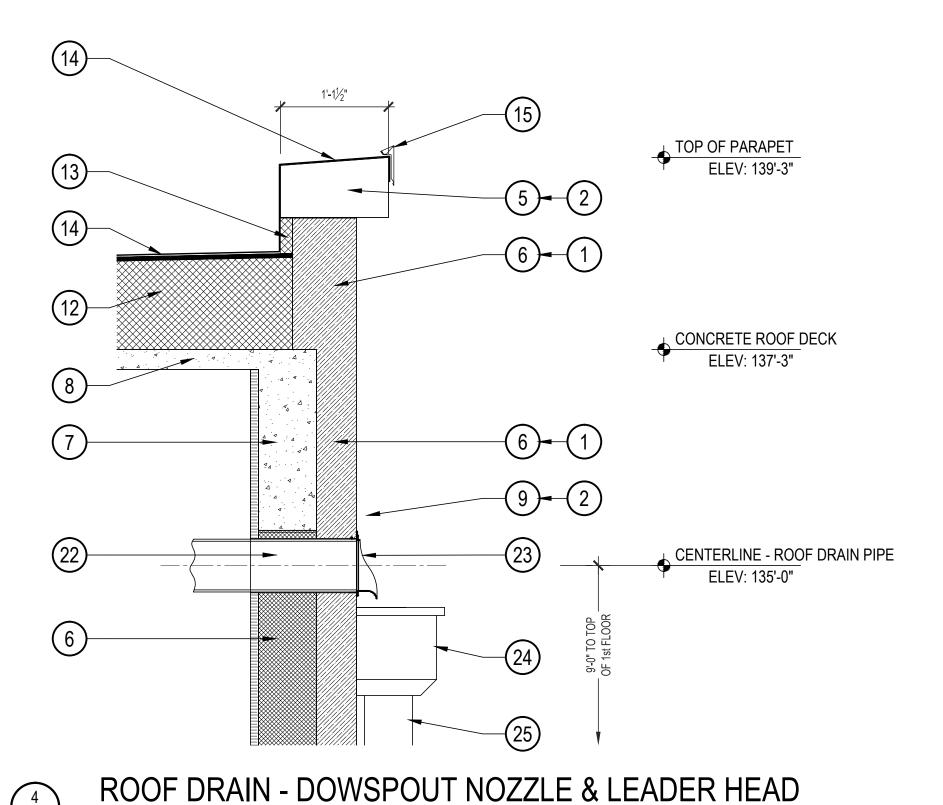

SCALE: 1" = 1'-0"

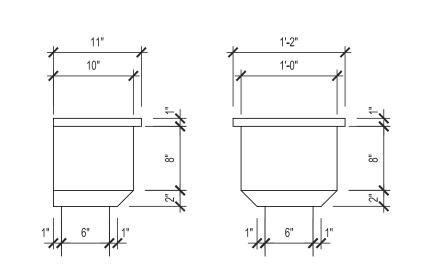

LEADER HEAD DIMENSIONS

GENERAL MASONRY MAINTENANCE NOTES: EDUCATION BUILDING No. 14

- CONTRACTOR SHALL COORDINATE ALL DEMOLITION AND REMOVAL OF DEMOLITION MATERIALS WITH OTHER WORK SEQUENCES AND OWNER OCCUPANCY REQUIREMENTS.
- CAREFULLY GRIND OR RAKE OUT DETERIORATED MORTAR IN ALL HEAD AND BED JOINTS IN THE EXTERIOR BRICK MASONRY WALL AREAS DESIGNATED FOR MASONRY MAINTENANCE, CLEAN AND PREPARE SURFACES TO RECEIVE NEW MORTAR OR SEALANT.
- CAREFULLY GRIND OR RAKE OUT DETERIORATED MORTAR AND SEALANT IN ALL HEAD JOINTS IN CUT STONE COPING AND WINDOW LINTELS - PREPARE SURFACES TO RECEIVE NEW MORTAR OR
- CAREFULLY REMOVE AND REINSTALL OR REPLACE DETERIORATED BRICK AND STONE UNITS AS REQUIRED MAINTAIN THE INTEGRITY OF THE EXTERIOR MASONRY.
- BASE BID INCLUDES 4,000 SF OF MASONRY TUCKPOINTING AND 100 SF OF BRICK OR STONE MASONRY UNIT REPLACEMENT. REFER TO SECTION 012200 UNIT PRICES.

KEYED MASONRY MAINTENANCE NOTES: EDUCATION BUILDING No. 14

- CAREFULLY GRIND OR RAKE OUT DETERIORATED MORTAR AND SEALANT FROM ALL HEAD AND BED JOINTS IN DESIGNATED AREAS OF BRICK MASONRY TO A MINIMUM DEPTH OF $\frac{3}{4}$ " OR TO SOUND MORTAR, TAKING CARE TO AVOID DAMAGING MASONRY EDGES AND SURFACES. CLEAN SURFACES AND PREPARE TO RECEIVE NEW MORTAR OR SEALANT. INSTALL NEW POINTING MORTAR TO MATCH EXISTING ADJOINING MORTAR IN COLOR, TEXTURE AND JOINT PROFILE TO ELIMINATE EVIDENCE OF REPLACEMENT.
- CAREFULLY GRIND OR RAKE OUT DETERIORATED MORTAR AND SEALANT FROM ALL HEAD AND BED JOINTS IN ALL STONE PARAPET COPING TO A MINIMUM DEPTH OF $^3\!4$ " OR SOUND MORTAR, TAKING CARE TO AVOID DAMAGING STONE / MASONRY EDGES AND SURFACES. CLEAN SURFACES AND PREPARE TO RECEIVE NEW MORTAR OR SEALANT.

INSTALL NEW BACKER ROD AND JOINT SEALANT AT ALL HEAD AND BED JOINTS IN STONE COPIING.

KEYED ROOF REPLACEMENT NOTES: EDUCATION BUILDING No. 14

- EXISTING CUT STONE COPING CONTINUOUS AT TOP OF PARAPET.
- 6) EXISTING BRICK MASONRY PARAPET WALL.
- () EXISTING STRUCTURAL CONCRETE BEAM AT PERIMETER OF ROOF DECK.
- 8) EXISTING STRUCTURAL REINFORCED CONCRETE ROOF DECK (2 $\frac{1}{2}$ " THICK).
- (9) EXISTING CUT STONE LINTEL CONTINUOUS AT TOP OF WINDOW OPENINGS.
- 10) EXISTING STEEL ANGLE LINTEL CONTINUOUS AT WINDOW OPENINGS.
- 11) EXISTING 1 $rac{1}{2}$ " STEEL ROOF DECK OVER STEEL JOISTS (SOUTH ROOF ONLY).
- 2) INSTALL ½" HIGH-DENSITY POLYISO COVER BOARD OVER TAPERED POLYISO INSULATION (MINIMUM AVERAGE R-30) MECHANICALLY-FASTENED TO STRUCTURAL ROOF DECK.
- 3) INSTALL RIGID INSULATION INFILL AT VERTICAL SURFACE OF PARAPET WALL TO PROVIDE FLUSH VERTICAL SURFACE FOR TPO MEMBRANE FLASHING UP AND OVER THE TOP OF THE PARAPET.
- 14) INSTALL 60-MIL TPO MEMBRANE FULLY-ADHERED TO NEW INSULATION SYSTEM EXTEND UP AND OVER TOP OF PARAPET - TERMINATE UNDER NEW CONTINUOUS SHEET METAL EDGE FASCIA.
- 15) INSTALL NEW PRE-FINISHED 24 GAUGE SHEET METAL EDGE FASCIA SYSTEM AT TOP OF PARAPET.
- 16) EXTEND NEW 60-MIL TPO ROOF MEMBRANE UP VERTICAL FACE OF PARAPET SEAL OFF WITH CONTINUOUS HORIZONTAL TERMINATION BAR ANCHORED INTO MASONRY.
- 17) INSTALL NEW PRE-FINISHED 24 GAUGE SHEET METAL COUNTERFLASHING INSERTED INTO CONTINOUS SHEET METAL REGLET.
- (18) NOT USED ON THIS SHEET.
- (19) NOT USED ON THIS SHEET
- 20) REMOVE EXISTING 5"x 8" CAST IRON THROUGH-WALL OVERFLOW WEIR SLEEVE, INFILL OPENING WITH BRICK MASONRY TO MATCH ADJACENT.
- 21) INSTALL EXISTING 5"x 8" CAST IRON THROUGH-WALL OVERFLOW WEIR SLEEVE AT UNDERSIDE OF STONE PARAPET CAP. EXTEND TPO MEMBRANE FLASHING AND COUNTERFLASHING FROM ROOF AND PARAPET INTO OVERFLOW WEIR SLEEVE.
- 22.) 6" Ø PVC ROOF DRAIN PIPING EXTENDED FROM ROOF DRAIN OUTLET TO DOWNSPOUT NOZZLE INLET @ $\frac{1}{2}$ " PER FT MINIMUM SLOPE TO DRAIN. PIPE SUPPORTS ANCHORED TO UNDERSIDE OF ROOF DECK PER SECTION 221005. WRAP ENTIRE PIPE LENGTH FROM ROOF DRAIN OUTLET TO DOWNSPOUT NOZZLE INLET WITH 1" INSULATION PER SECTION 220719.
- 23.) 6" Ø THROUGH-WALL DOWNSPOUT NOZZLE, CAST NICKEL-BRONZE BODY & FLANGE, PVC SLIP-ON INLET, MASONRY ANCHOR BOLTS BY MANUFACTURER.
- 24.) PRE-FINISHED 24-GAUGE SHEET METAL LEADER HEAD TOP FLANGE MOUNTED 2" BELOW FLOWLINE OF DOWNSPOUT NOZZLE.
- (25.) 6"x 6" PRE-FINISHED 24-GAUGE SHEET METAL DOWNSPOUT, STRAPS @ 48" O.C. TURN OUT 90 ° ONTO SPLASHBLOCK AT GRADE.

STATE OF MISSOURI MICHAEL L. PARSON, **GOVERNOR**



3/22/2024 BRIAN DOUGLAS CONNELL ARCHITECT MO A-5036

L ARCHITE
Walnut Stree



OFFICE OF ADMINISTRATION DIVISION OF FACILITIES MANAGEMENT, DESIGN AND CONSTRUCTION

MISSOURI DEPARTMENT **OF CORRECTIONS**

REPLACE ROOF EDUCATION BLDG No. 14

BOONVILLE CORRECTIONAL CENTER

1216 EAST MORGAN ST. BOONVILLE, MO 65233

PROJECT No. C2311-01 SITE No. 7002 **ASSET No.** 9327002024

REVISION: REVISION: DATE: REVISION:

DATE: ISSUE DATE: 3/22/2024

CAD DWG FILE: DRAWN BY: BDC CHECKED BY: BDC **DESIGNED BY:** BDC

SHEET TITLE:

ROOF DRAINAGE DETAILS

SHEET NUMBER:

SHEET 10 OF 10 ISSUE DATE: 3/22/2024