INSTALL NEW EMERGENCY BACKUP SYSTEM TRANSITION CENTER OF ST.LOUIS



St. Louis

6 South Old Orchard St. Louis, MO 63119

+1 800.404.7677 hello@introba.com www.introba.com

OWNER:

STATE OF MISSOURI

MIKE KEHOE, GOVERNOR

DEPARTMENT OF CORRECTIONS

PROJECT

OFFICE OF ADMINISTRATION

MANAGEMENT: DIVISION OF FACILITIES MANAGEMENT,

DESIGN AND CONSTRUCTION



DESIGNER:

GARY FISCHER

PROJECT NUMBER:

SITE NUMBER: FACILITY NUMBER:

7026 9327026001

C2407-01

LEGEND AND ABBREVIATIONS (SEE SPECIFICATIONS & SCHEDULES)

NOTES: 1. ALL SYMBOLS AND ABBREVIATIONS ARE NOT NECESSARILY USED ON THESE PLANS.

2. IN GENERAL, SYMBOLS SHOWN WITH LIGHT LINES DENOTE EXISTING WORK. SYMBOLS SHOWN WITH HEAVY LINES DENOTE NEW WORK.

DRAWING INDEX

NUMBER TITLE

G-00 COVER SHEET

E-00 ELECTRICAL SYMBOLS AND LEGEND

E-10 EXISTING SITE PLAN
E-11 MOVE SERVICE SITE AND ENLARGED PLAN

E-50 ELECTRICAL DETAIL

E-51 ELECTRICAL DETAIL

E-60 DEMO EXISTING ONE-LINE

NEW WORK ONE-LINE

PHASING

CONTRACTOR TO INSTALL ALL GENERATOR EQUIPMENT, CONDUITS, FEEDERS, AND AMEREN CONDUITS PRIOR TO SWITCH OVER TO NEW SERVICES.

CONTRACTOR TO COORDINATE WITH END USER POWER OUTAGE 3 WEEKS IN ADVANCE.

BUILDING POWER OUTAGE LIMITED TO 8 HOURS MAX.
CONTRACTOR TO PROVIDE STAFF TO DO THE AMEREN SIDE
SWITCH OVER AND PROVIDE THE STAFF FOR THE MAIN SSB
SWITCH OVER.

DRAWING REFERENCES PLAN DETAIL REFERENCE TITLE KEYED NOTE DESIGNATION NORTH ARROW ABBREVIATIONS : ABOVE FINISHED FLOOR CONDUIT : ELECTRICAL CONTRACTOR : EXISTING RELOCATED ER : EXISTING TO REMAIN E.D. : GENERAL CONTRACTOR GROUND GND : GROUND TYP. : TYPICAL : UNLESS OTHERWISE NOTED U.O.N. EXISTING TO REMAIN OR NEW WORK BY OTHERS (LIGHT, SOLID LINE) NEW WORK BY THIS CONTRACTOR (DARK, SOLID LINE) _____ EXISTING TO BE REMOVED BY THIS CONTRACTOR (DARK, DASHED LINE, DEMOLITION PLANS) 2-HOUR FIRE RATED WALL

POWER EQUIPMENT

PANELBOARD (SURFACE)

PANELBOARD (FLUSH)

GENERAL NOTES

- MAKE ALL INSTALLATIONS IN ACCORDANCE WITH THE AMERICANS WITH DISABILITIES ACT ACCESSIBILITY GUIDELINES (ADAAG).
- 2. COORDINATE EXACT EQUIPMENT LOCATIONS WITH EXISTING CONDITIONS. EQUIPMENT LOCATIONS SHOWN ON ELECTRICAL PLANS ARE DIAGRAMMATICAL ONLY AND MIGHT NOT BE EXACT.
- CONCEAL ALL CONDUIT IN WALLS, PARTITIONS, ABOVE CEILINGS, ETC. UNLESS
 OTHERWISE INDICATED ON THE PLANS OR IN THE SPECIFICATIONS. CONDUIT ROUTED IN
 MECHANICAL ROOMS, ELECTRICAL ROOMS, AND STORAGE ROOMS WITHOUT CEILINGS MAY
 BE ROUTED EXPOSED.
- 4. REPAIR ALL OPENINGS MADE IN EXISTING WALLS, PARTITIONS, ETC TO ACCOMMODATE WORK OF THIS DISCIPLINE TO MATCH THE SURROUNDING CONDITIONS, USING WORKERS QUALIFIED IN THE APPROPRIATE TRADE. APPROPRIATELY GROUT OR SEAL ALL CONDUITS THROUGH WALLS.
- 5. ALL MATERIALS USED TO SEAL PENETRATIONS OF FIRE RATED WALLS AND FLOORS MUST HAVE BEEN TESTED AND CERTIFIED AS A SYSTEM PER ASTM E814 STANDARDS FOR FIRE TESTS OF THROUGH—PENETRATION FIRESTOPS.
- 6. REPLACE OR REINSTALL ALL PORTIONS OF THE BUILDING (CEILING TILES, WALLS, ETC) REMOVED TO ACCOMMODATE THE INSTALLATION OF ANY FIRE ALARM DEVICE, EQUIPMENT, ETC., USING WORKERS QUALIFIED IN THE APPROPRIATE TRADE.
- . TAKE PHOTOS OF ANY EXISTING CEILING TILE OR WALLS THAT ARE DAMAGED PRIOR TO THE COMMENCEMENT OF WORK. ANY DAMAGED WALLS OR CEILING SUSPECTED OF BEING DAMAGED DURING THE CONSTRUCTION OF THIS PROJECT WILL BE REPLACED/REPAIRED BY CONTRACTOR.

DEMOLITION NOTES

- 1. REMOVE, CAP AND RELOCATE EQUIPMENT, DEVICES, CONDUIT, WIRE, ETC., AS SHOWN AND SPECIFIED ON DRAWINGS, AND AS MAY BECOME NECESSARY BECAUSE OF EXISTING FIELD CONDITIONS. FAILURE TO VISIT THE SITE AND TO TAKE ALL EXISTING CONDITIONS INTO ACCOUNT WILL NOT ALLOW FOR CHANGES TO THE SCOPE OF WORK.
- 2. MAINTAIN CIRCUIT CONTINUITY TO ALL EXISTING FIXTURES, EQUIPMENT, OUTLETS, ETC., TO REMAIN IN USE WHETHER NOTED ON THE PLANS OR NOT. FIELD VERIFY EXISTING ITEMS TO REMAIN IN USE. RECONNECT RACEWAYS AND WIRING FOR EXISTING CIRCUITS WHICH MUST BE RE—ROUTED OR WHICH ARE PARTIALLY ABANDONED TO POWER THE REMAINING OUTLETS ON THE CIRCUIT.
- 3. FOR ALL WORK SHOWN TO BE REMOVED DURING THE DEMOLITION PHASE, REMOVE ALL WIRING AND CABLES BACK TO THEIR SOURCE UNLESS NOTED OTHERWISE TO BE RE-USED FOR NEW WORK. REMOVE ALL UNUSED CONDUIT THAT IS EXPOSED OR ABOVE ACCESSIBLE CEILINGS WHICH IS AFFECTED BY OR IS IN THE AREA OF THE DEMOLITION WORK.
- 4. WHERE EQUIPMENT, DEVICES, CONDUIT, BOXES, AND SUPPORTING HARDWARE ARE REMOVED, PATCH AND FINISH THE SURFACE AS REQUIRED TO MATCH THE EXISTING, USING WORKERS QUALIFIED IN THE APPROPRIATE TRADE.
- 5. TAKE ALL REMOVED MATERIALS FROM THE PROJECT SITE, EXCEPT FOR THOSE TO BE RELOCATED, STORED, OR TURNED OVER TO THE USING AGENCY.
- 6. ACCEPTANCE OF CONTRACT MEANS INSTALLER ACCEPTS EXISTING CONDITIONS.
- 7. PROVIDE A BLANK COVER PLATE WHERE A FLUSH DEVICE IS BEING REMOVED FROM WALLS THAT ARE TO REMAIN. MATCH THE COLOR, MATERIAL AND FIRE RATING TO THE EXISTING SURFACE IN THE ROOM OR SPACE.
- 8. LEGALLY DISPOSE OF HAZARDOUS MATERIALS OR OTHER EQUIPMENT CONTAINING PCBS. COMPLY WITH ALL FEDERAL, STATE, AND LOCAL LAWS.
- 9. MODIFY EXISTING PANEL DIRECTORIES (OR REPLACE) FOR PANELBOARDS WHICH HAVE HAD ALTERATIONS TO THE CIRCUITS ORIGINATING THEREIN. DESCRIBE THE LOAD AND LOCATION. TYPE, DO NOT HAND LETTER NEW PANELBOARD DIRECTORIES.
- 10. PATCH OR FILL ANY EXPOSED GAP BETWEEN CONDUIT AND WALL WERE NEW HOLES ARE DRILLED IN EXISTING WALLS.
- 11. PAINT TO A MINIMUM OF 1 FT ALL SIDE OF PATCH OR REMOVED SURFACE CONDUIT.

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DEPARTMENT OF CORRECTIONS

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TRANSITION CENTER OF ST. LOUIS 1621 N. 1ST STREET ST. LOUIS, MO 63102

PROJECT # C2407-01 SITE # 7026 FACILITY # 9327026001

REVISION:
DATE:
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REVISION:
DATE:
ISSUE DATE: 3/13/2025

CAD DWG FILE:E-00
DRAWN BY:
CHECKED BY:
DESIGNED BY:

SHEET TITLE:

ELECTRICAL SYMBOLS AND LEGEND

SHEET NUMBER:

E-00

02 OF 08 SHEETS 03/13/2025





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ISSUE DATE: 3/13/2025

CAD DWG FILE:E-10
DRAWN BY: AO
CHECKED BY: GF
DESIGNED BY: AO

SHEET TITLE:


EXISTING SITE PLAN

SHEET NUMBER:

E-10

03 OF 08 SHEETS 03/13/2025


707-61-6

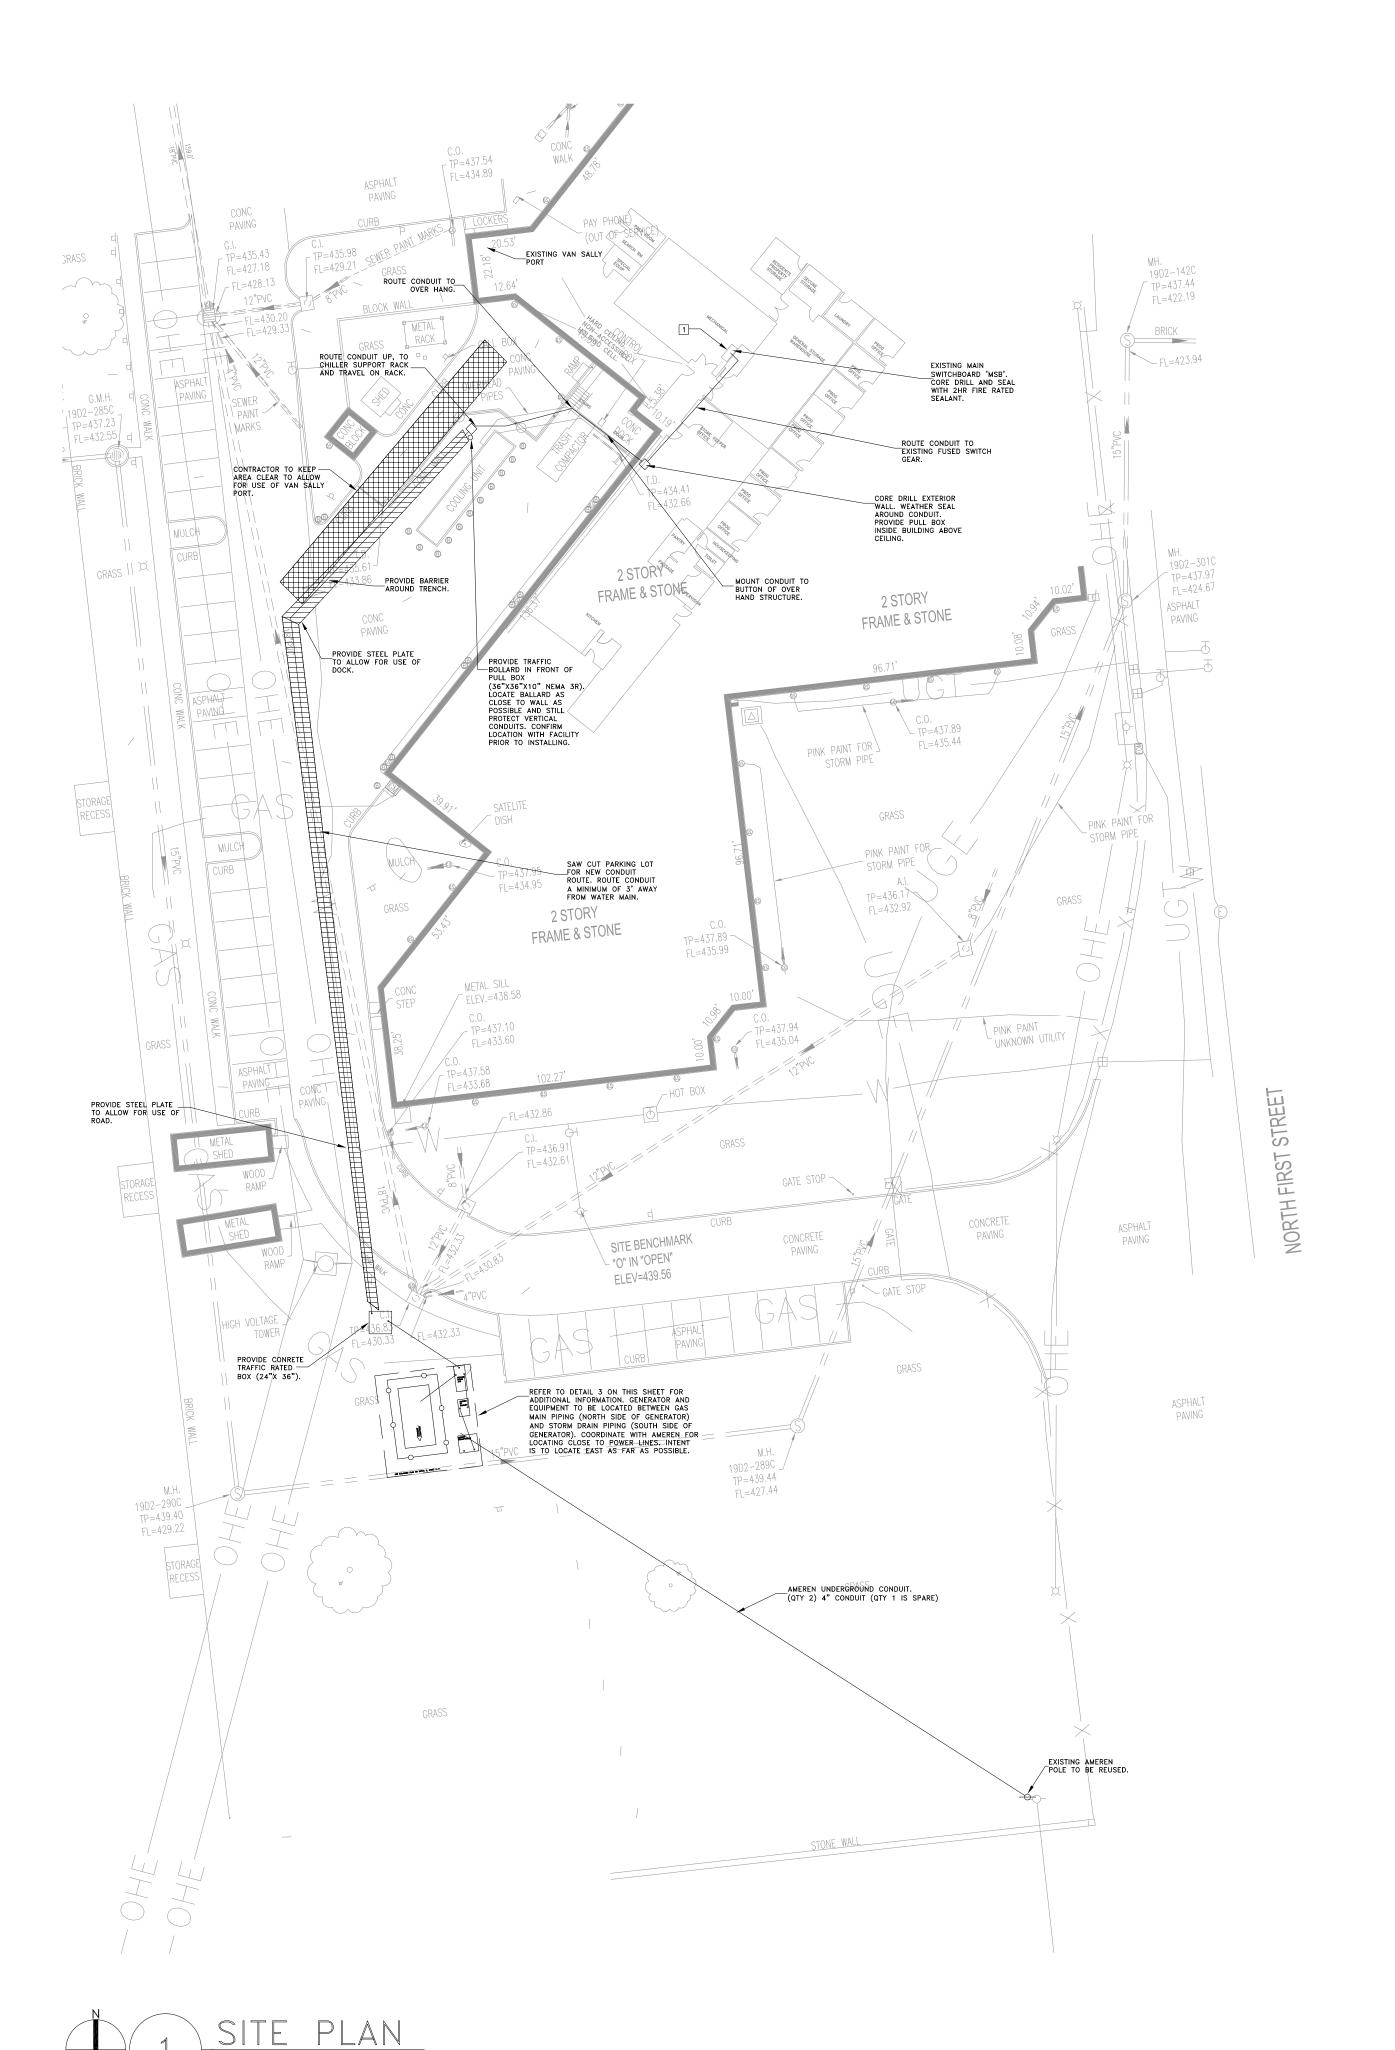


GENERAL NOTES:

. REFER TO DETAILS ON SHEET E-50 FOR TRENCHING REQUIREMENTS.

- CONTRACTOR TO PROVIDE PERMANENT LABEL ON MAIN ELECTRICAL EQUIPMENT TO READ "MAIN SERVICE DISCONNECT LOCATED AT ATS NEXT TO GENERATOR".
- PROVIDE TRANSFORMER CONCRETE PAD. REFER TO DETAIL 3 ON SHEET E-50 FOR EXAMPLE OF PAD. PAD SHALL MEET AMEREN STANDARDS.
- PROVIDE CONCRETE PAD FOR GENERATOR. REFER TO DETAIL 4 ON SHEET E-50 GENERATOR AND FUEL TANK. REFER TO SPEC SECTION 20 08 00 FOR SEISMIC REQUIREMENTS. GENERATOR PAD SHALL BE SIZED FOR THE GENERATOR AND THE RAISED ACCESS PLATFORM.
- 4. PROVIDE CONCRETE PAD FOR ATS, PANELBOARD, AND METER.
- PROVIDE 3 FOOT WIDE, METAL RAISED ACCESS PLATFORM ON EACH SIDE OF THE GENERATOR MOUNTED TO CONCRETE PAD. PROVIDE HAND RAILS AND STAIRS. COORDINATE WITH HAND RAIL AND STAIRS WITH GENERATOR ACCESS DOORS. PLATFORM SHALL BE SELF SUPPORTING AND ANCHORED TO PAD.

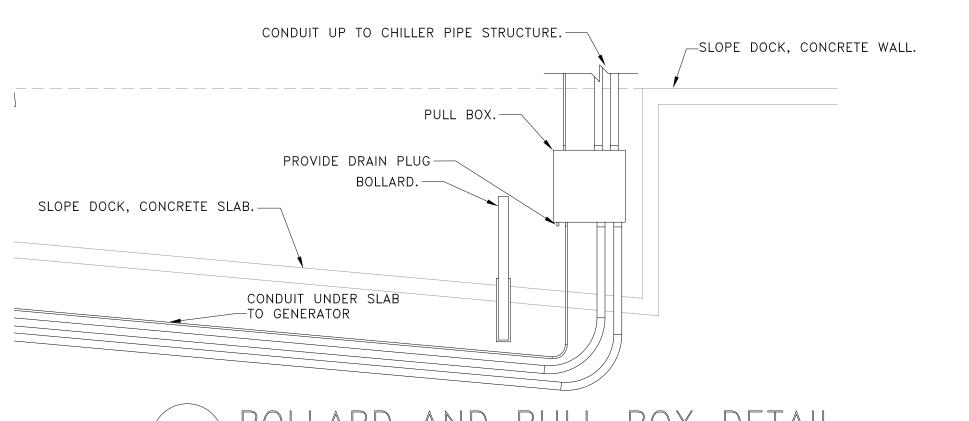

BOLLARD AND PULL BOX DETAIL SCALE: NOT TO SCALE

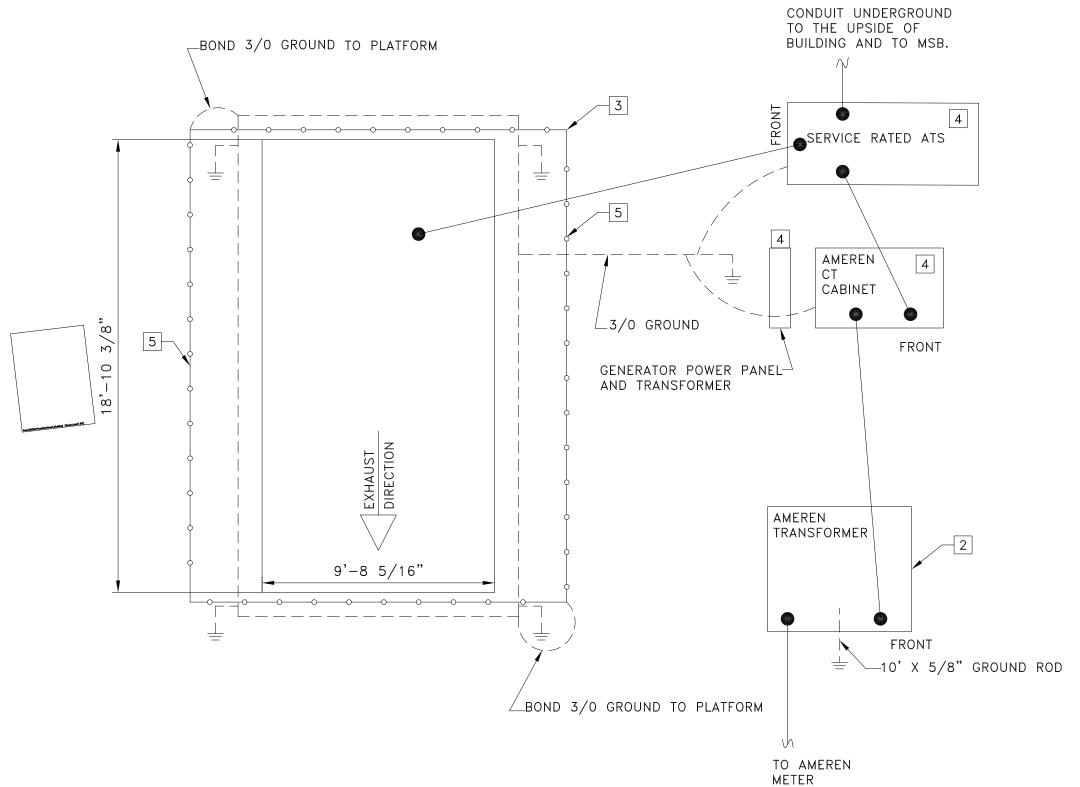

3 ENLARGED PLAN DETAIL — GENERATOR SCALE: 1/4" = 1' - 0"

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REVISION:
DATE:
ISSUE DATE: 3/13/2025

CAD DWG FILE:E-1 DRAWN BY: \overline{AO} CHECKED BY: GF


SHEET TITLE:

DESIGNED BY: AO

MOVE SERVICE SITE AND ENLARGED PLAN

SHEET NUMBER:

04 OF 08 SHEETS 03/13/2025

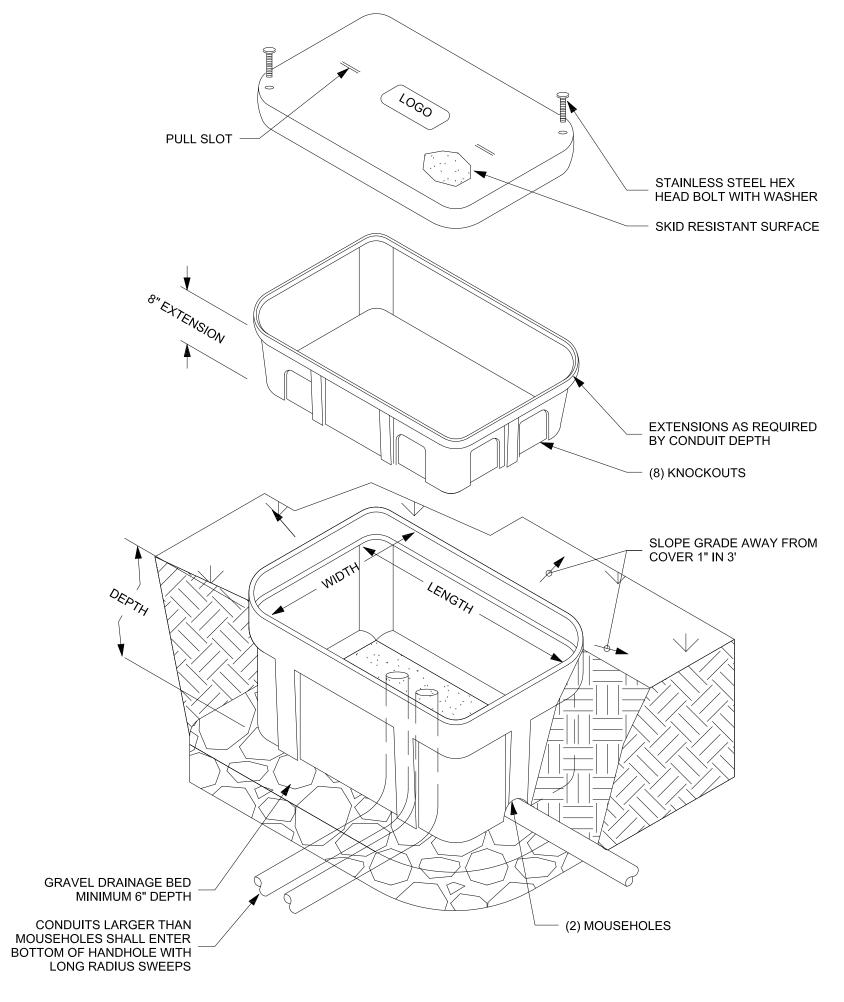

ALL DIMENSIONS ARE NOMINAL INSIDE CLEARANCES. 2. TRAFFIC RATING TIER 15.

1/2 INCH CHAMFER —

APPROXIMATE GRADE-

3" ABOVE GRADE


12 INCHES

PAD DETAIL

SCALE: 1" = 1'-0"

MINIMAL



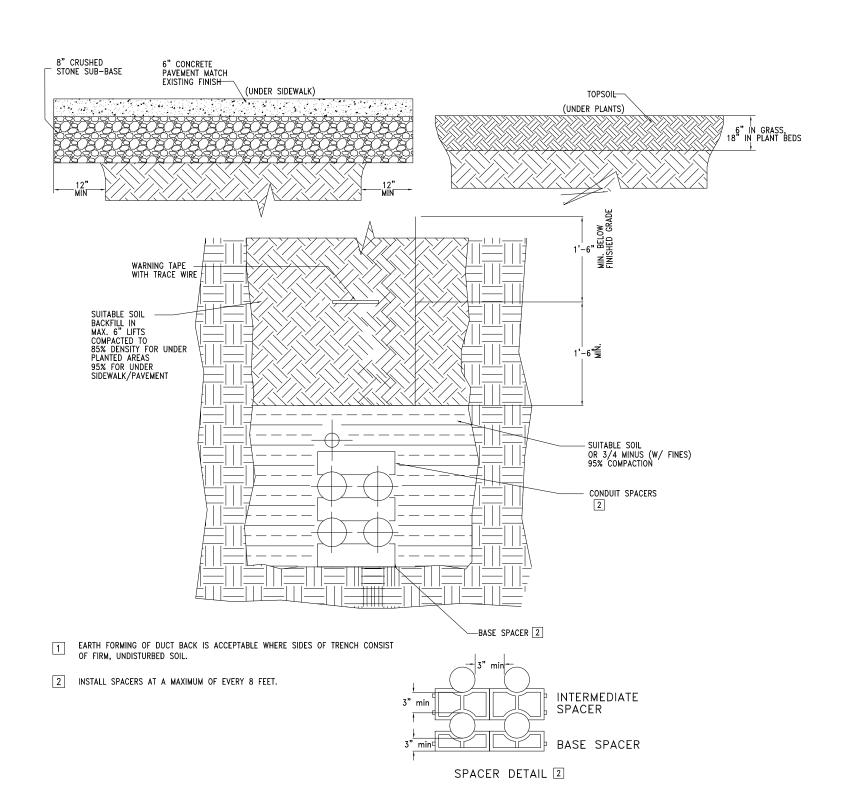


SCALE: NOT TO SCALE


NEW CONC. EXISTING

PAD

CONC. PAD

CONCRETE DUCTBANK DETAIL

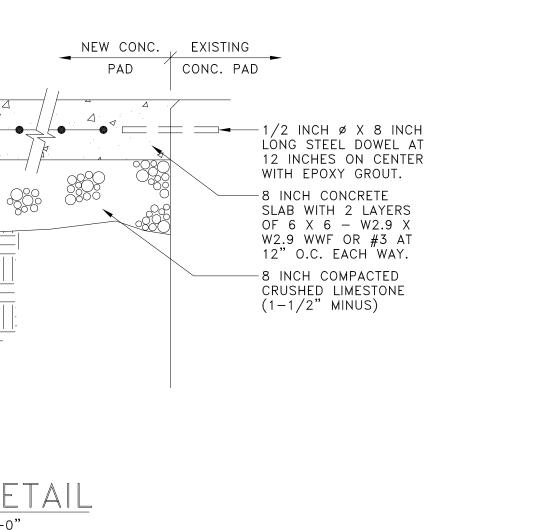


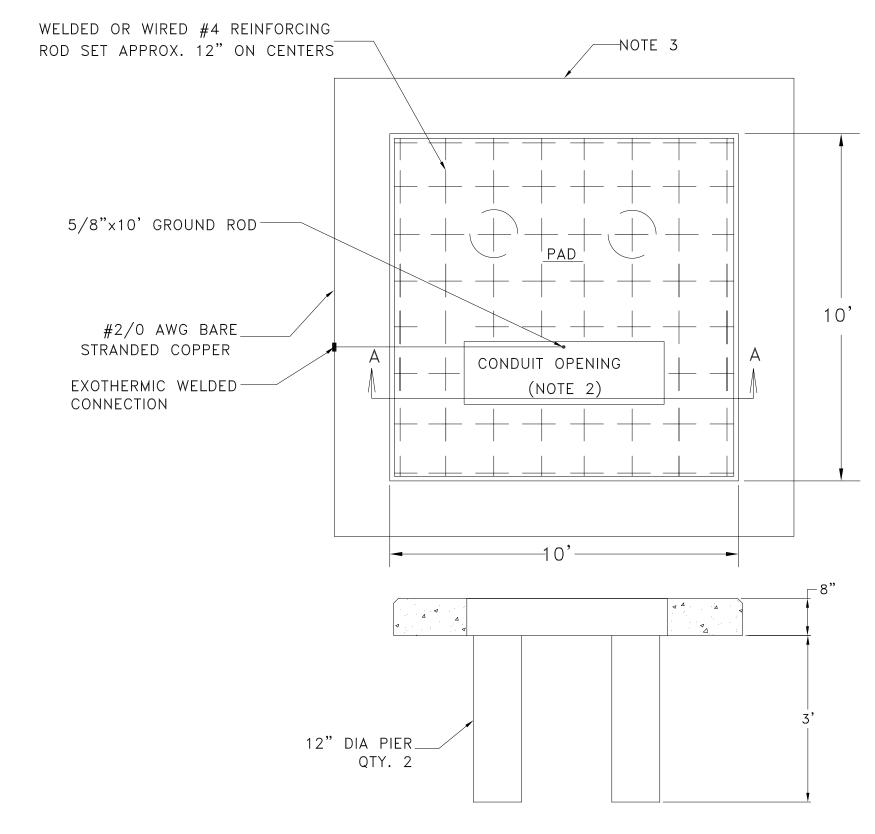

SECTION "A-A"

- REINFORCED CONCRETE PAD SHALL BE CONSTRUCTED IN ACCORDANCE WITH CSI STANDARD SPECIFICATIONS FOR REINFORCED CONCRETE, LATEST EDITION.
- 2. CONDUITS SHOULD BE CAREFULLY LOCATED IN CONDUIT OPENING SO THEY WILL NOT INTERFERE WITH TRANSFORMER HIGH & LOW VOLTAGE COMPARTMENT DIVIDER OR OIL DRAINAGE VALVE.
- 3. GROUND LOOP TO BE INSTALLED 12" OUT AND 12" DEEP WITH EXOTHERMIC CONNECTIONS.
- 4. 8 FT. MINIMUM CLEARANCE IN FRONT OF TRANSFORMER. CONFIRM CLEARANCE PRIOR TO INSTALLATIONS.
- 5. PROVIDE DETAIL 3/E-11 TO AMEREN MARKED UP WITH WORKING CLEARANCE DIMENSIONS FOR AMEREN'S ACCEPTANCE.

TRANSFORMER PAVEMENT DETAIL SCALE: NOT TO SCALE

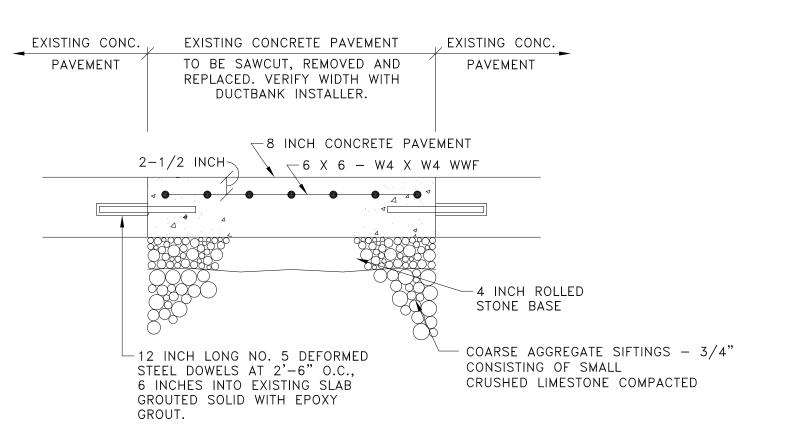

DRIVEWAY CONCRETE PAVEMENT DETAIL $^{/}$ SCALE: 1" = 1'-0"

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REVISION:
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ISSUE DATE: 3/13/2025

CAD DWG FILE:E-50 DRAWN BY: AO CHECKED BY: GF DESIGNED BY: AO

SHEET TITLE:

ELECTRICAL **DETAIL**

SHEET NUMBER:


05 OF 08 SHEETS 03/13/2025

NOTES:

1. POST BARRICADES WILL BE PAINTED WITH ONE PRIME COAT OF RED OXIDE (PAINT NO.1), ONE FINISH COAT OF DULL BLACK ENAMEL PER VA SPECIFICATIONS, AND STRIPES CONSISTING OF 4" [102mm] BANDS OF YELLOW REFLECTORIZED TAPE WILL BE USED UNLESS OTHERWISE SPECIFIED ON THE PLANS.

 FINISH COLOR COMBINATIONS, OTHER THAN THAT SPECIFIED ABOVE, WILL BE SUBMITTED TO THE AGENCY FOR APPROVAL.



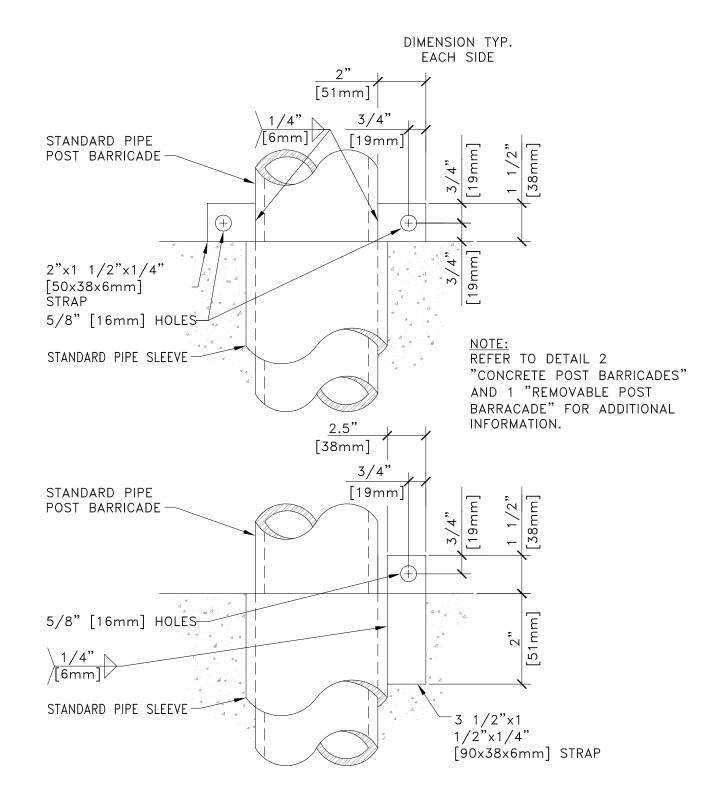

2 REMOVABLE POST BARRICADE — STRAP DETAIL
SCALE: NOT TO SCALE

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PROJECT # C2407-01 SITE # 7026

FACILITY # 9327026001

REVISION:
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REVISION:
DATE:

ISSUE DATE: 3/13/2025

CAD DWG FILE:E-51
DRAWN BY: AO
CHECKED BY: GF
DESIGNED BY: AO

SHEET TITLE:

ELECTRICAL DETAIL

SHEET NUMBER:

E-51

06 OF 08 SHEETS 03/13/2025

- 2. DEMO AND REPLACE C.T. WIRING.
- 3. DEMO AMEREN METER CABINET.

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REVISION:
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REVISION:

ISSUE DATE: 3/13/2025

CAD DWG FILE:E-60
DRAWN BY: AO
CHECKED BY: GF
DESIGNED BY: AO


SHEET TITLE:

EXISTING
ONE-LINE
DIAGRAM

SHEET NUMBER:

E-60

07 OF 08 SHEETS 03/13/2025

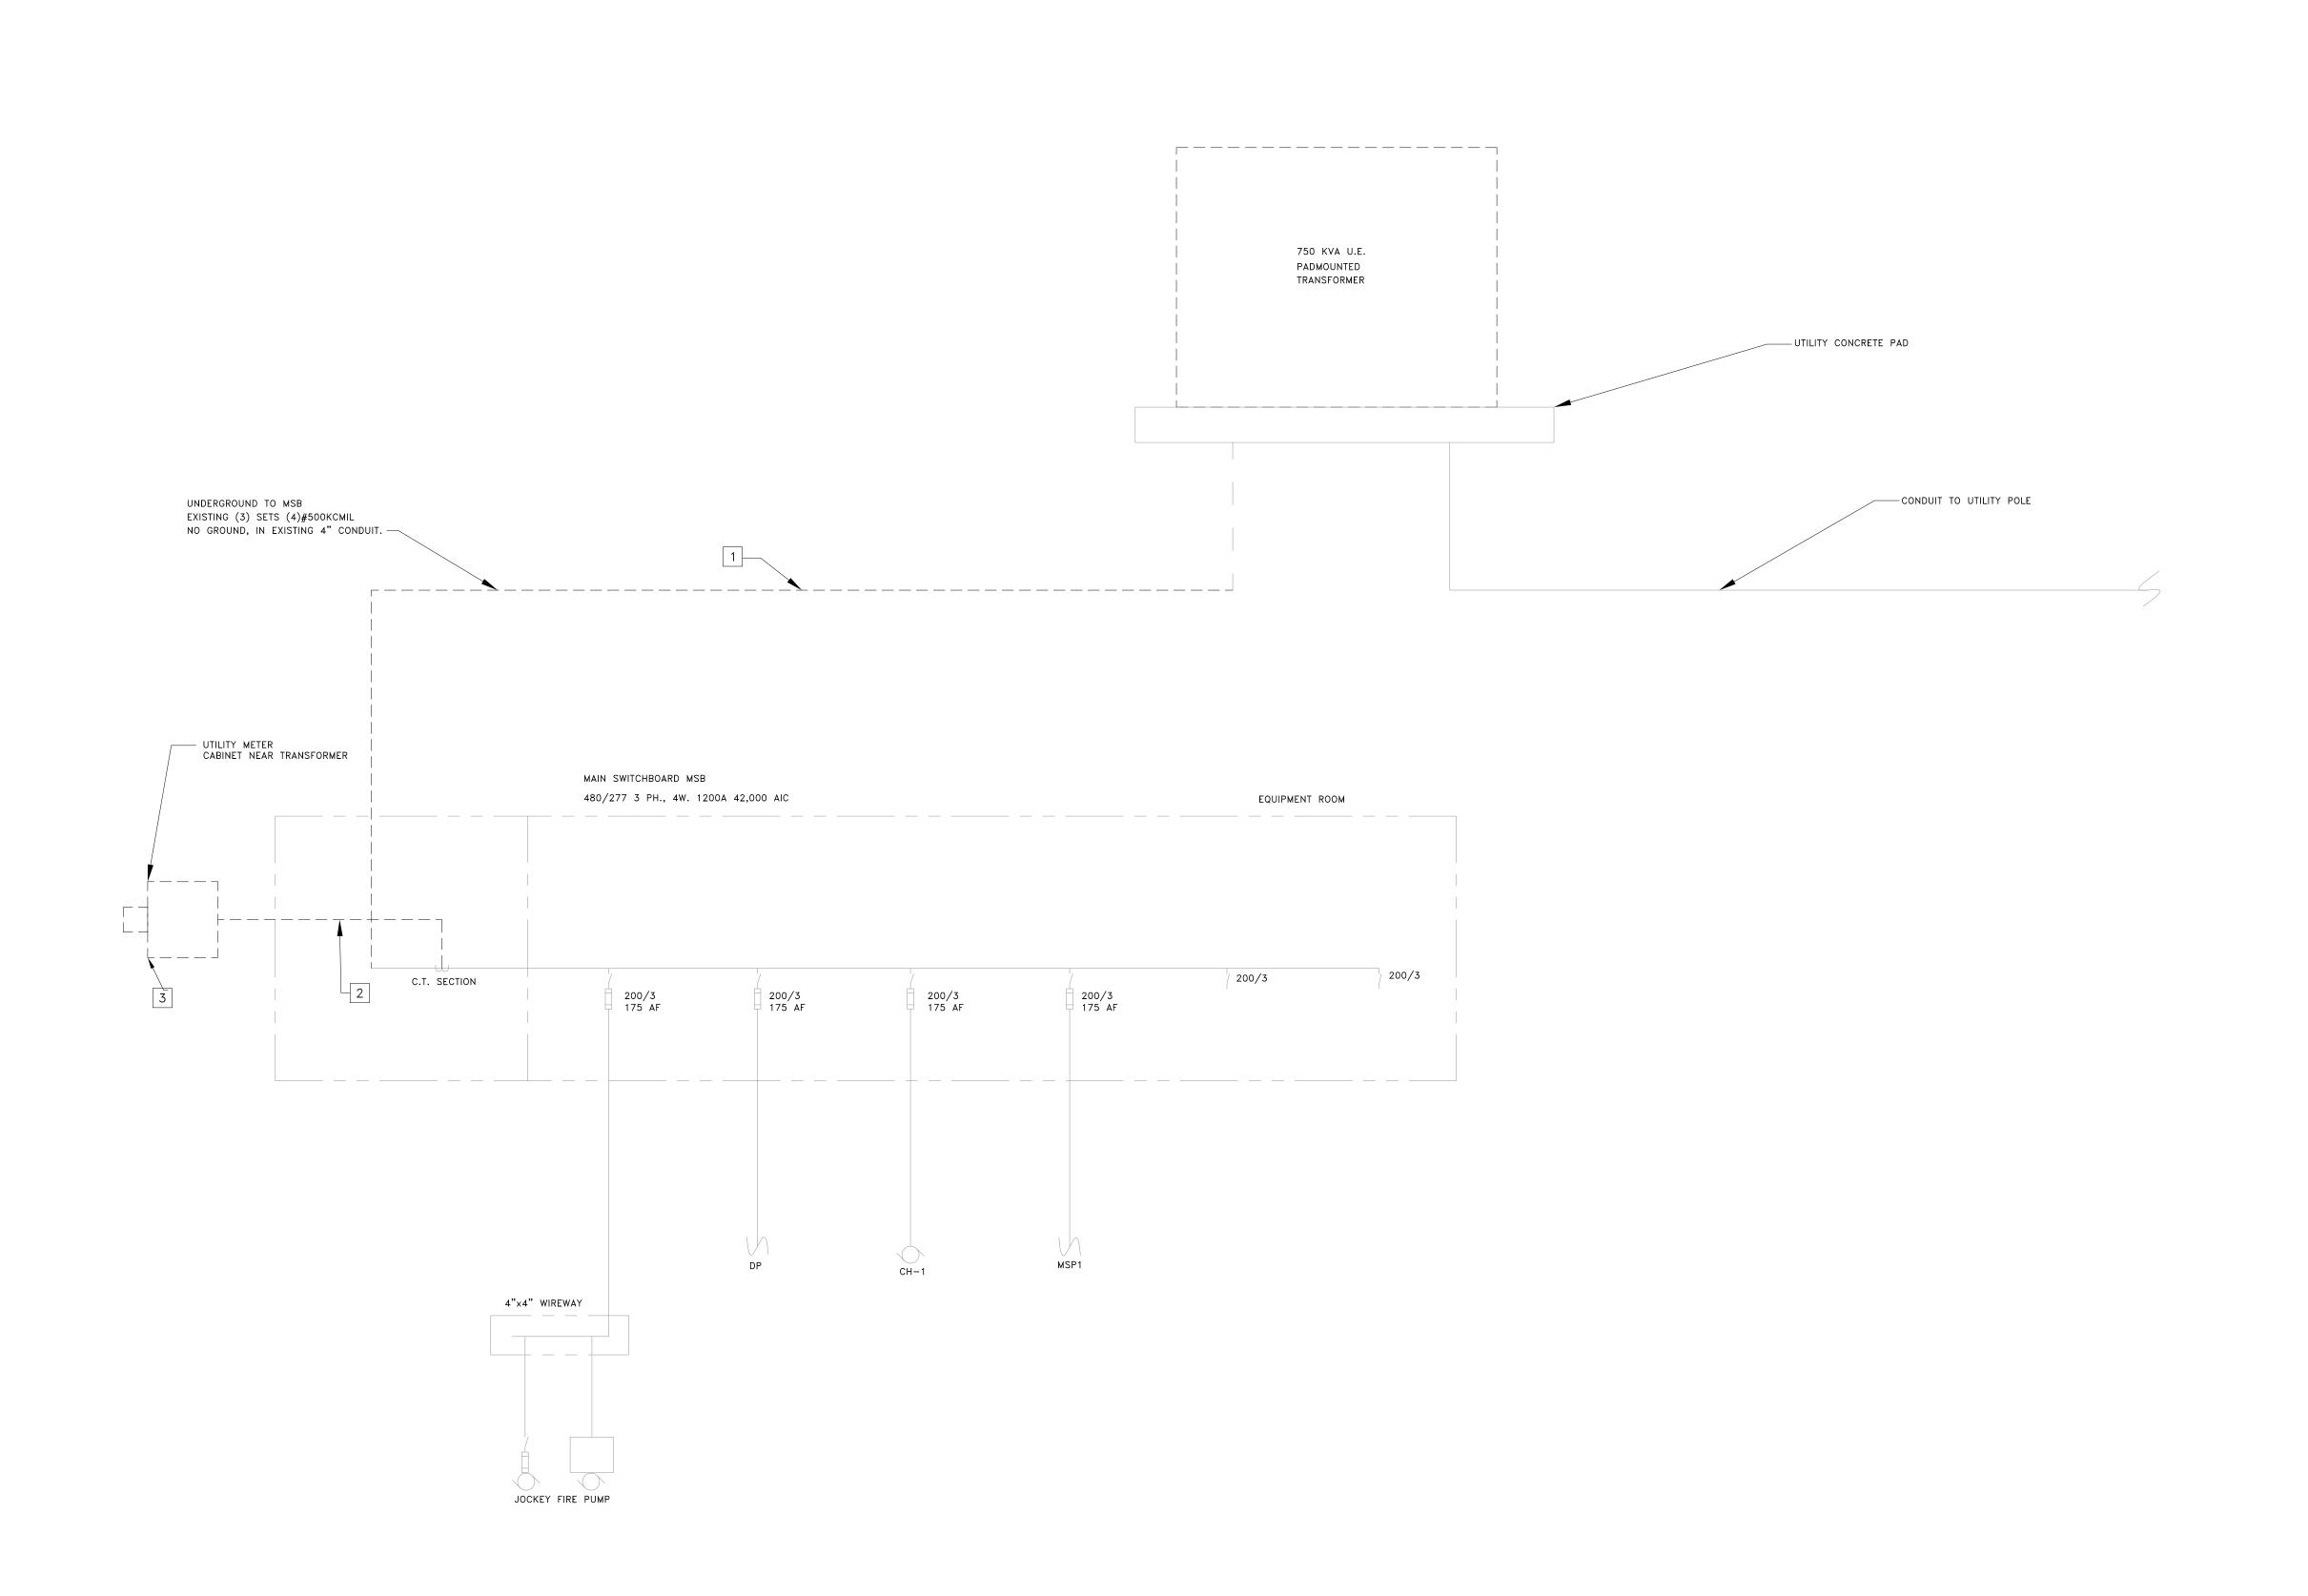


EXISTING ONE-LINE DIAGRAM

	Lo	ad Ce	enter	Pan	el: G	ienei	rato	r			
	Location: GENERATOR Supply From: DP1 Mounting: SURFACE Enclosure: NEMA 3R		Volts: 240V/120V Phases: 1 Wires: 3						A.I.C. Rating: 10KAIC Mains Type: MCB Mains Rating: 60 A MCB Rating: 60 A		
СКТ	Circuit Description	Trip	Poles	A (VA)	B (VA)	Poles	Trip		Circuit D	escription	СКТ
1	GFCI	20 A	1	180		1	20 A	SPARE		<u>.</u>	2
3	BATTERY CHARGER	20 A	1		720	1	20 A	SPARE			4
5	JACKET WATER HEATER	20 A	1	252		1	20 A	SPARE			6
7	JACKET WATER HEATER	20 A	1		252	1	20 A	SPARE			8
9	ALTERNATOR HEATER	20 A	1	1800		1	20 A	SPARE			10
11	ALTERNATOR HEATER	20 A	1		1800	1	20 A	SPARE			12
	Total Load VA: Total Amps:										
	Panel Totals									Totals	
	Total Conn. Load: 5004 VA								tal Conn.:		
Total Est. Demand: 5310 VA								i otal Est.	. Demand:	22.13 A	

NOTE: PANEL BOARD SHOP DRAWING WILL BE REVIEWED ONCE GENERATOR HAS BEEN SUBMITTED. PANEL NEEDS TO BE COORDINATED WITH GENERATOR MISCELLANEOUS LOADS.



- 1. CONTRACTOR TO REMOVE NEUTRAL AND GROUND BOND AT MSB.
- 2. CONTRACTOR TO BOND NEUTRAL AND GROUND AT AUTOMATIC TRANSFER SWITCH.
- 3. REPLACE EXISTING UNUSED LOCKED OUT CIRCUIT BREAKER WITH 30 AMP 2 POLE BREAKER. REMOVE ABANDONED CABLE. PROVIDE PANEL BLANK TO FILL IN ENCLOSURE HOLE AS REQUIRED. CUTLER-HAMMER, POW-R-LINE, PRL4.
- 4. ROUTE CONDUIT FROM LOAD CENTER PANEL TO GENERATOR BATTERY CHARGER.
- 5. ROUTE CONDUIT FROM LOAD CENTER PANEL TO GENERATOR JACKET WATER
 HEATER
- 6. ROUTE CONDUIT FROM LOAD CENTER PANEL TO GENERATOR ALTERNATOR
- PROVIDE ALTERNATE FOR CLOSED TRANSITION. PROVIDE SHUNT TRIP BREAKER TO OPEN SERVICE BREAKER AFTER 2 SECONDS IF ATS FAILS TO CLOSE TRANSFER.

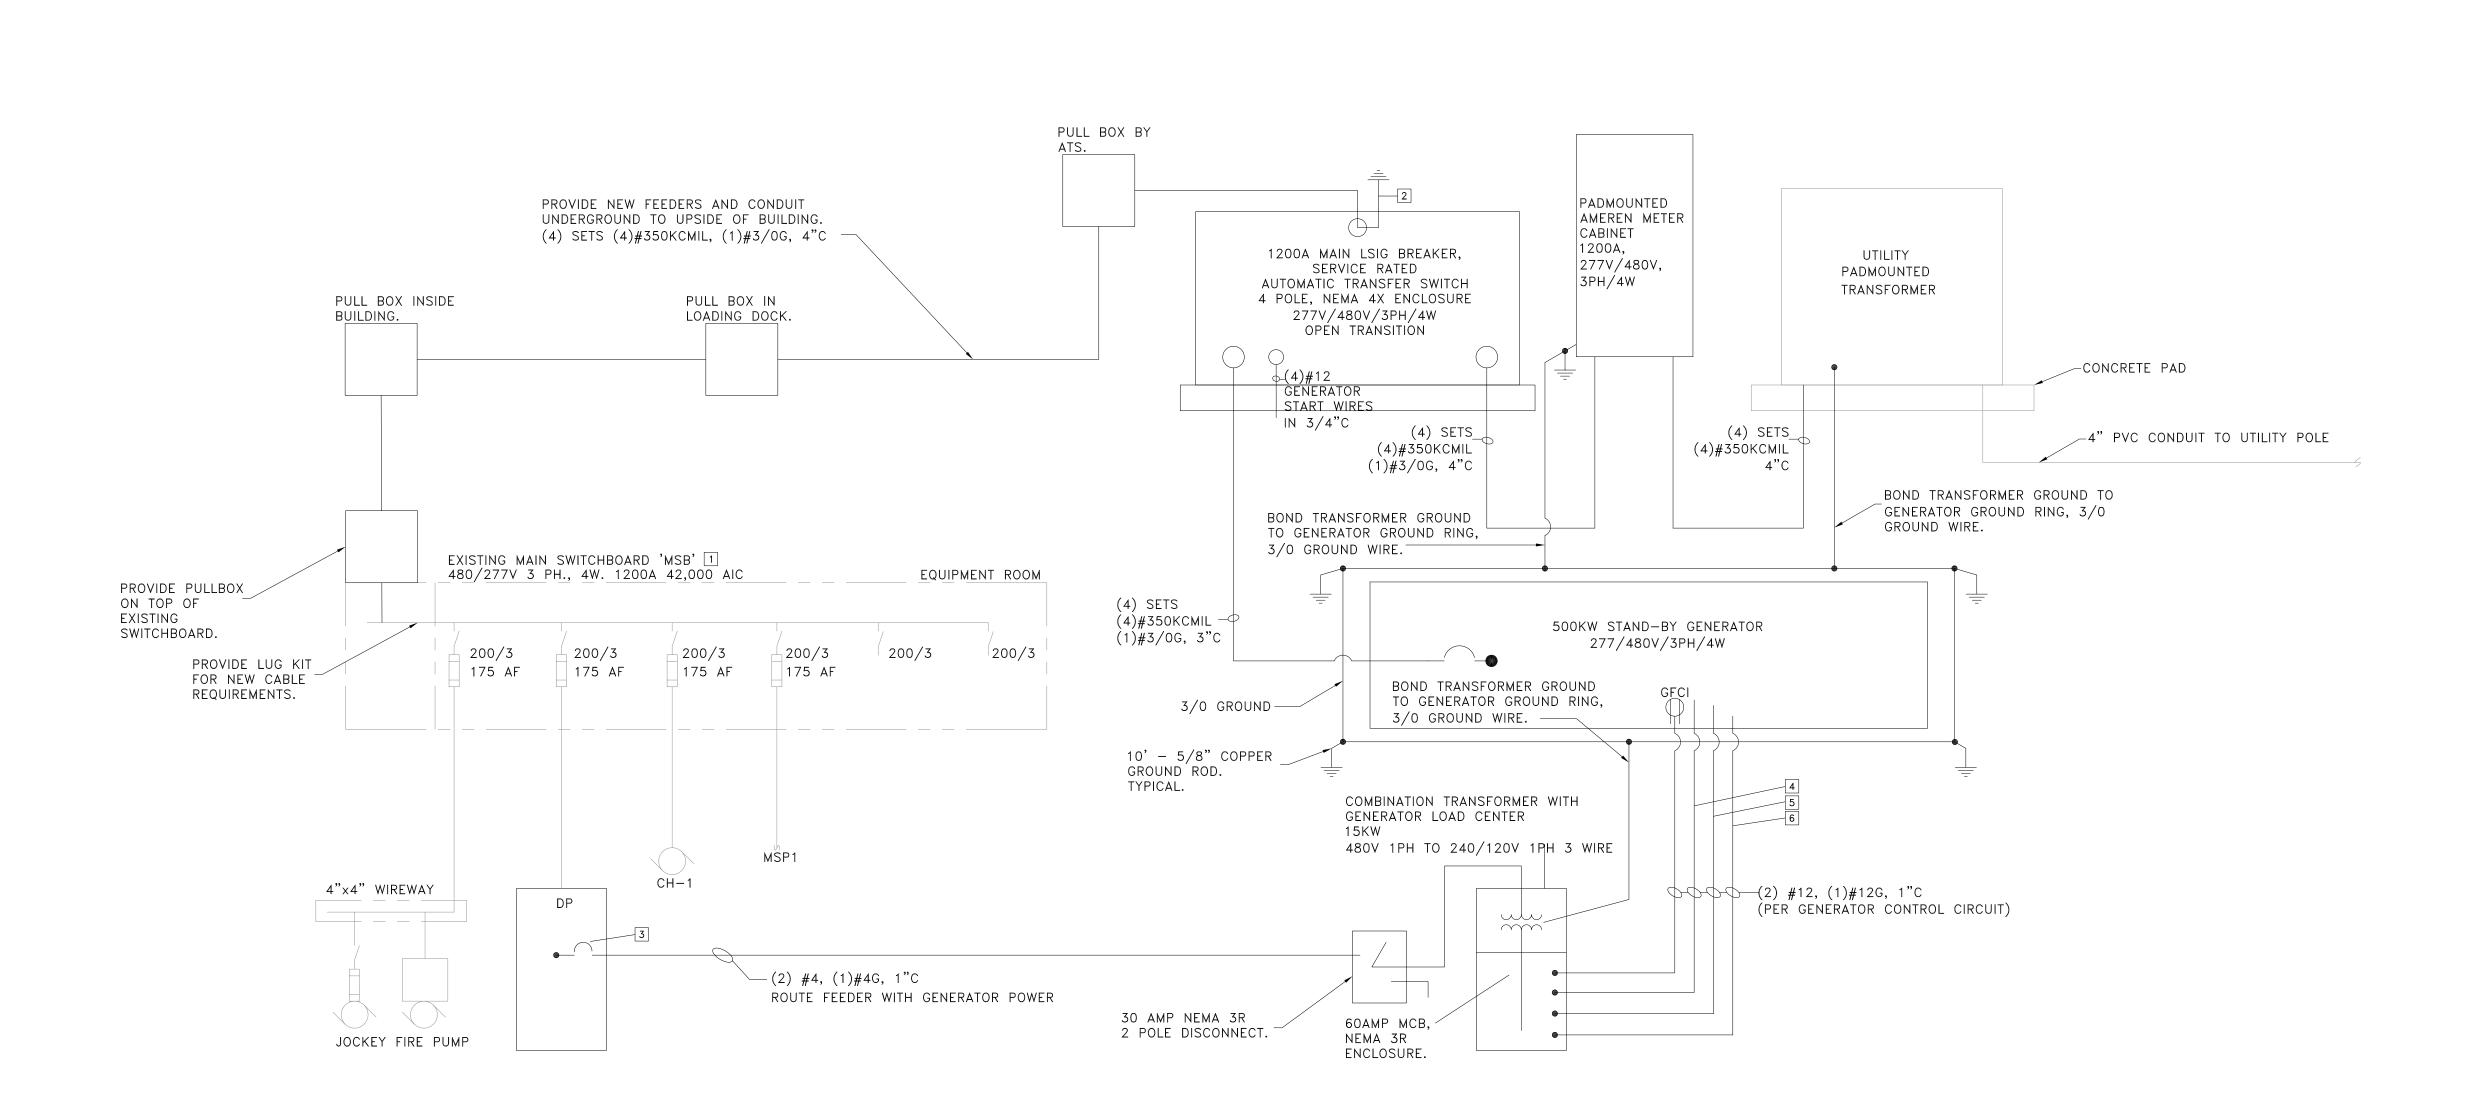

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ISSUE DATE: 3/13/2025

CAD DWG FILE:E-61
DRAWN BY: AO
CHECKED BY: GF
DESIGNED BY: AO

SHEET TITLE:

NEW ONE-LINE DIAGRAM

SHEET NUMBER:

E-61

08 OF 08 SHEETS 03/13/2025