IMPROVEMENTS TO EXTERIOR PLAYGROUND & COURTYARD, NEW DAWN SCHOOL (Sikeston, Missouri)



Engineers | Architects | Surveyors | Scientists

OWNER: STATE OF MISSOURI

MICHAEL L. PARSON,

GOVERNOR

DEPARTMENT OF

ELEMENTARY AND SECONDARY EDUCATION

PROJECT OFFICE OF ADMINISTRATION

MANAGEMENT: DIVISION OF FACILITIES MANAGEMENT,

DESIGN AND CONSTRUCTION

DESIGNER:

FARNSWORTH GROUP

PROJECT NUMBER:

E2408-01

SITE NUMBER:

2043

FACILITY NUMBER: 5012043003 FACILITY

5012043001 PLAYGROUND

SYMBOLS LEGEND

EXISTING DECIDUOUS TREE EXISTING STORM DOWNSPOUT EXISTING CLEAN OUT EXISTING SANITARY MANHOLE EXISTING STORM INLET EXISTING LIGHT EXISTING ELECTRICAL METER EXISTING ELECTRICAL OUTLET \sim EXISTING ELECTRICAL BOX EXISTING COMMUNICATIONS PEDESTAL EXISTING UTILITY HANDHOLE NEW SANITARY SEWER MANHOLE

LINE LEGEND

X 5' CONTOUR	-505	
X 1' CONTOUR 		
X STORM SEWER	— ST ————	- ST
X SANITARY SEWER	— SA ———	- SA
INISH 5' CONTOUR	505 —	
INISH 1' CONTOUR	504 ———	
EW STORM SEWER	— ST ———	-ST
EW SANITARY SEWER	— SA ———	- SA
ROSION CONTROL BARRIEF		
EW CHAIN LINK FENCE		
<u> </u>		

NEW DEMOLITION KEYED NOTE DESIGNATOR

SET PER ARCHITECT

NEW STORM SEWER MANHOLE

NEW FINISH SPOT ELEVATION

NEW FINISH SPOT ELEVATION

NEW STORM SEWER STRUCTURE

NEW LAYOUT AND HARDSCAPE KEYED NOTE DESIGNATOR


NEW GRADING KEYED NOTE DESIGNATOR



42.76

432.2

NEW CONCRETE SIDEWALK PAVEMENT AND BASE

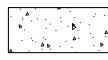

NEW CONCRETE PAVEMENT AND BASE



EXISTING CONCRETE PAVEMENT AND BASE TO BE REMOVED

ABBREVIATIONS

EX	EXISTING	ELEV	ELEVATION
TYP	TYPICAL	MB	MAILBOX
TBR	TO BE REMOVED	FP	FLAG POLE
TR	TO REMAIN	FO	FIBER OPTIC
TBREL	TO BE RELOCATED	DS	DOWNSPOUT
TBR&REL	TO BE RELOCATED	CO	CLEANOUT
ME	MATCH EXISTING	MH	MANHOLE
ВМ	BENCHMARK	SAN	SANITARY
COR	CORNER	ST	STORM
PB	PLAT BOOK	FL	FLOW LINE
DB	DEED BOOK	PVC	POLYVINYL
PG	PAGE		CHLORIDE PIPE
(S)	SURVEYED	CMP	CORRUGATED
(R)	RECORD		METAL PIPE
N	NORTH	RCP	REINFORCED CONCRETE PIPE
S	SOUTH		CONCINETE THE
W	WEST	UTIL	UTILITY
E	EAST FFFT	STM	STEAM
S.F.	SQUARE FEET	UG	UNDERGROUND
BLDG	BUILDING	TBA	TO BE ABANDONE
CONC	CONCRETE		

GENERAL NOTES

- 1. ALL EXISTING IMPROVEMENTS SHALL REMAIN UNLESS NOTED OTHERWISE
- 2. THE CONTRACTOR SHALL KEEP ALL ACCESS ROADS FREE FROM MUD AND DEBRIS AT ALL TIMES.
- 3. THE CONTRACTOR SHALL SAWCUT ALL EDGES OF EXISTING PAVEMENT THAT IS TO BE REMOVED. THE CONTRACTOR SHALL TAKE SPECIAL CARE TO CREATE A SMOOTH WORKING EDGE AND TO PLACE BACKFILL AND PAVEMENT SUCH THAT SETTLEMENT DOES NOT OCCUR.
- 4. ALL MATERIALS AND WORKMANSHIP ASSOCIATED WITH THE STORM AND SANITARY SEWER CONSTRUCTION SHALL CONFORM TO THE LATEST STANDARDS SPECIFICATIONS FOR MISSOURI STANDARD SPECIFICATION FOR HIGHWAY CONSTRUCTION.
- 5. ALL DISTURBED AREAS SHALL BE RESTORED WITH SEED. REFER TO TURF SPECIFICATIONS FOR SEEDING.
- 6. THE EXISTING UTILITIES SHOWN HEREON ARE FROM INFORMATION PROVIDED BY THE OWNER AND UTILITY COMPANIES AND MUST BE CONSIDERED AS APPROXIMATE. THE CONTRACTOR SHALL BE RESPONSIBLE FOR DETERMINING THE EXACT LOCATIONS OF PUBLIC AND PRIVATE UTILITIES.
- 7. THE CONTRACTOR SHALL ASSUME COMPLETE RESPONSIBILITY FOR CONTROLLING ALL SILTATION AND EROSION OF THE PROJECT AREA. THE CONTRACTOR SHALL USE WHATEVER MEANS NECESSARY TO CONTROL EROSION AND SILTATION INCLUDING BUT NOT LIMITED TO SILTATION FABRIC FENCES CONTROL SHALL COMMENCE WITH GRADING AND BE MAINTAINED THROUGHOUT THE PROJECT UNTIL ACCEPTANCE OF THE WORK BY THE OWNER AND/OR THE STATE OF MISSOURI. THE CONTRACTOR'S RESPONSIBILITIES INCLUDE ALL DESIGN AND IMPLEMENTATION AS REQUIRED TO PREVENT EROSION AND THE DEPOSITING OF SILT. THE OWNER AND/OR STATE MAY AT THEIR OPTION DIRECT THE CONTRACTOR I HIS METHODS AS DEEMED FIT TO PROTECT PROPERTY AND IMPROVEMENTS. ANY DEPOSITING OF SILT OR MUD ON NEW OR EXISTING PAVEMENT OR IN NEW OR EXISTING STORM SEWERS OR SWALES SHALL BE REMOVED AFTER EACH RAIN AND AFFECTED AREAS CLEANED TO THE SATISFACTION OF THE OWNER AND/OR STATE.
- 8. ALL EXISTING UNDERGROUND IMPROVEMENTS SHALL REMAIN UNLESS NOTED OTHERWISE.
- 9. BACKFILL ALL UTILITY TRENCHES UNDER PAVEMENT WITH GRANULAR MATERIAL
- 10. THE CONTRACTOR SHALL BE RESPONSIBLE FOR VERIFYING TOPS AND FLOWLINES OF ALL EXISTING SEWERS PRIOR TO COMMENCING WORK.
- 11. ABANDONMENT OF SEWERS SHALL CONFORM TO THE STATE OF MISSOURI DNR SPECIFICATIONS.
- 12. EXISTING UTILITY POLES SHALL NOT BE DISTURBED. COORDINATE WITH AMEREN UE IF BRACING IS REQUIRED DURING EXCAVATION.
- 13. THE CONTRACTOR SHALL MAINTAIN CONSTRUCTION FENCE AROUND ALL OPEN EXCAVATION AT ALL TIMES.
- 14. THE CONTRACTOR SHALL BE RESPONSIBLE FOR ALL REQUIRED CONSTRUCTION STAKING AND LAYOUT

Utility Contacts

<u>ELECTRIC</u> SIKESTON BMU 107 E MALONE AVE. SIKESTON, MO 63801 573-471-3328

SANITARY & STORM SEWERS SIKESTON LIGHT & WATER CO 138 N PRAIRIE ST. SIKESTON, MO 63801 573-471-3328

LIBERTY UTILITIES 1024 LINN ST. SIKESTON, MO 63801

SIKESTON LIGHT & WATER CO 138 N PRAIRIE ST. SIKESTON, MO 63801 573-471-3328




<u>TELEPHONE</u>

AT&T-MISSOURI

800-499-7928

PROJECT LOCATION

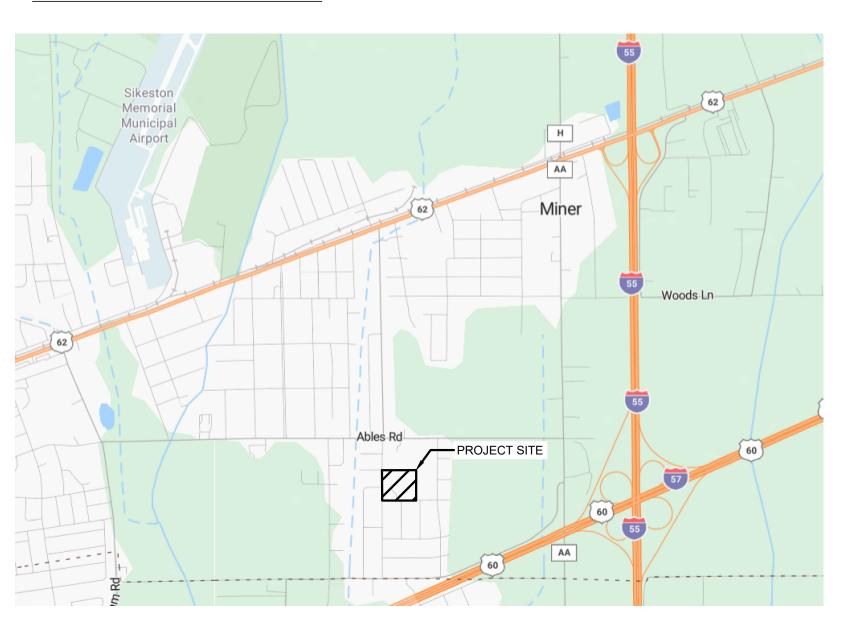

SHEET INDEX:

G-001 - COVER SHEET

C-001 - CIVIL GENERAL NOTES

C-002 - EXISTING CONDITIONS AND DEMOLITION PLAN

C-003 - LAYOUT AND HARDSCAPE PLAN

C-004 - JOINTING PLAN C-005 - GRADING PLAN

C-006 - DETAILS

C-007 - DETAILS


C-008 - DETAILS

C-009 - HISTORICAL STRUCTURAL PLANS

C-010 - HISTORICAL STRUCTURAL DETAILS

C-011 - ACCESS ROUTE - COURTYARD

STATE OF MISSOURI MICHAEL L. PARSON, GOVERNOR

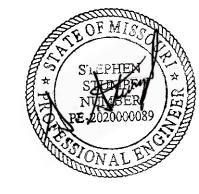

DATE: 10/04/2024



GROUP 20 ALLEN AVENUE, SUITE 200 ST LOUIS, MISSOURI 63119

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DEPARTMENT OF ELEMENTARY AND SECONDARY EDUCATION

IMPROVEMENTS TO EXTERIOR -PLAYGROUND & **COURTYARD NEW DAWN STATE** SCHOOL

SIKESTON, MISSOURI

PROJECT #.: E2408-01 SITE #.: 2043

ASSET #.: 5012043001 - PLAYGROUND

5012043003 - FACILITY # DATE: DESCRIPTION:


DRAWN BY: MLG CHECKED BY: SAS **DESIGNED BY: SAS**

SHEET TITLE:

CIVIL GENERAL NOTES

SHEET NUMBER:

SHEET 2 of 12 ISSUE DATE: OCTOBER 04, 2024

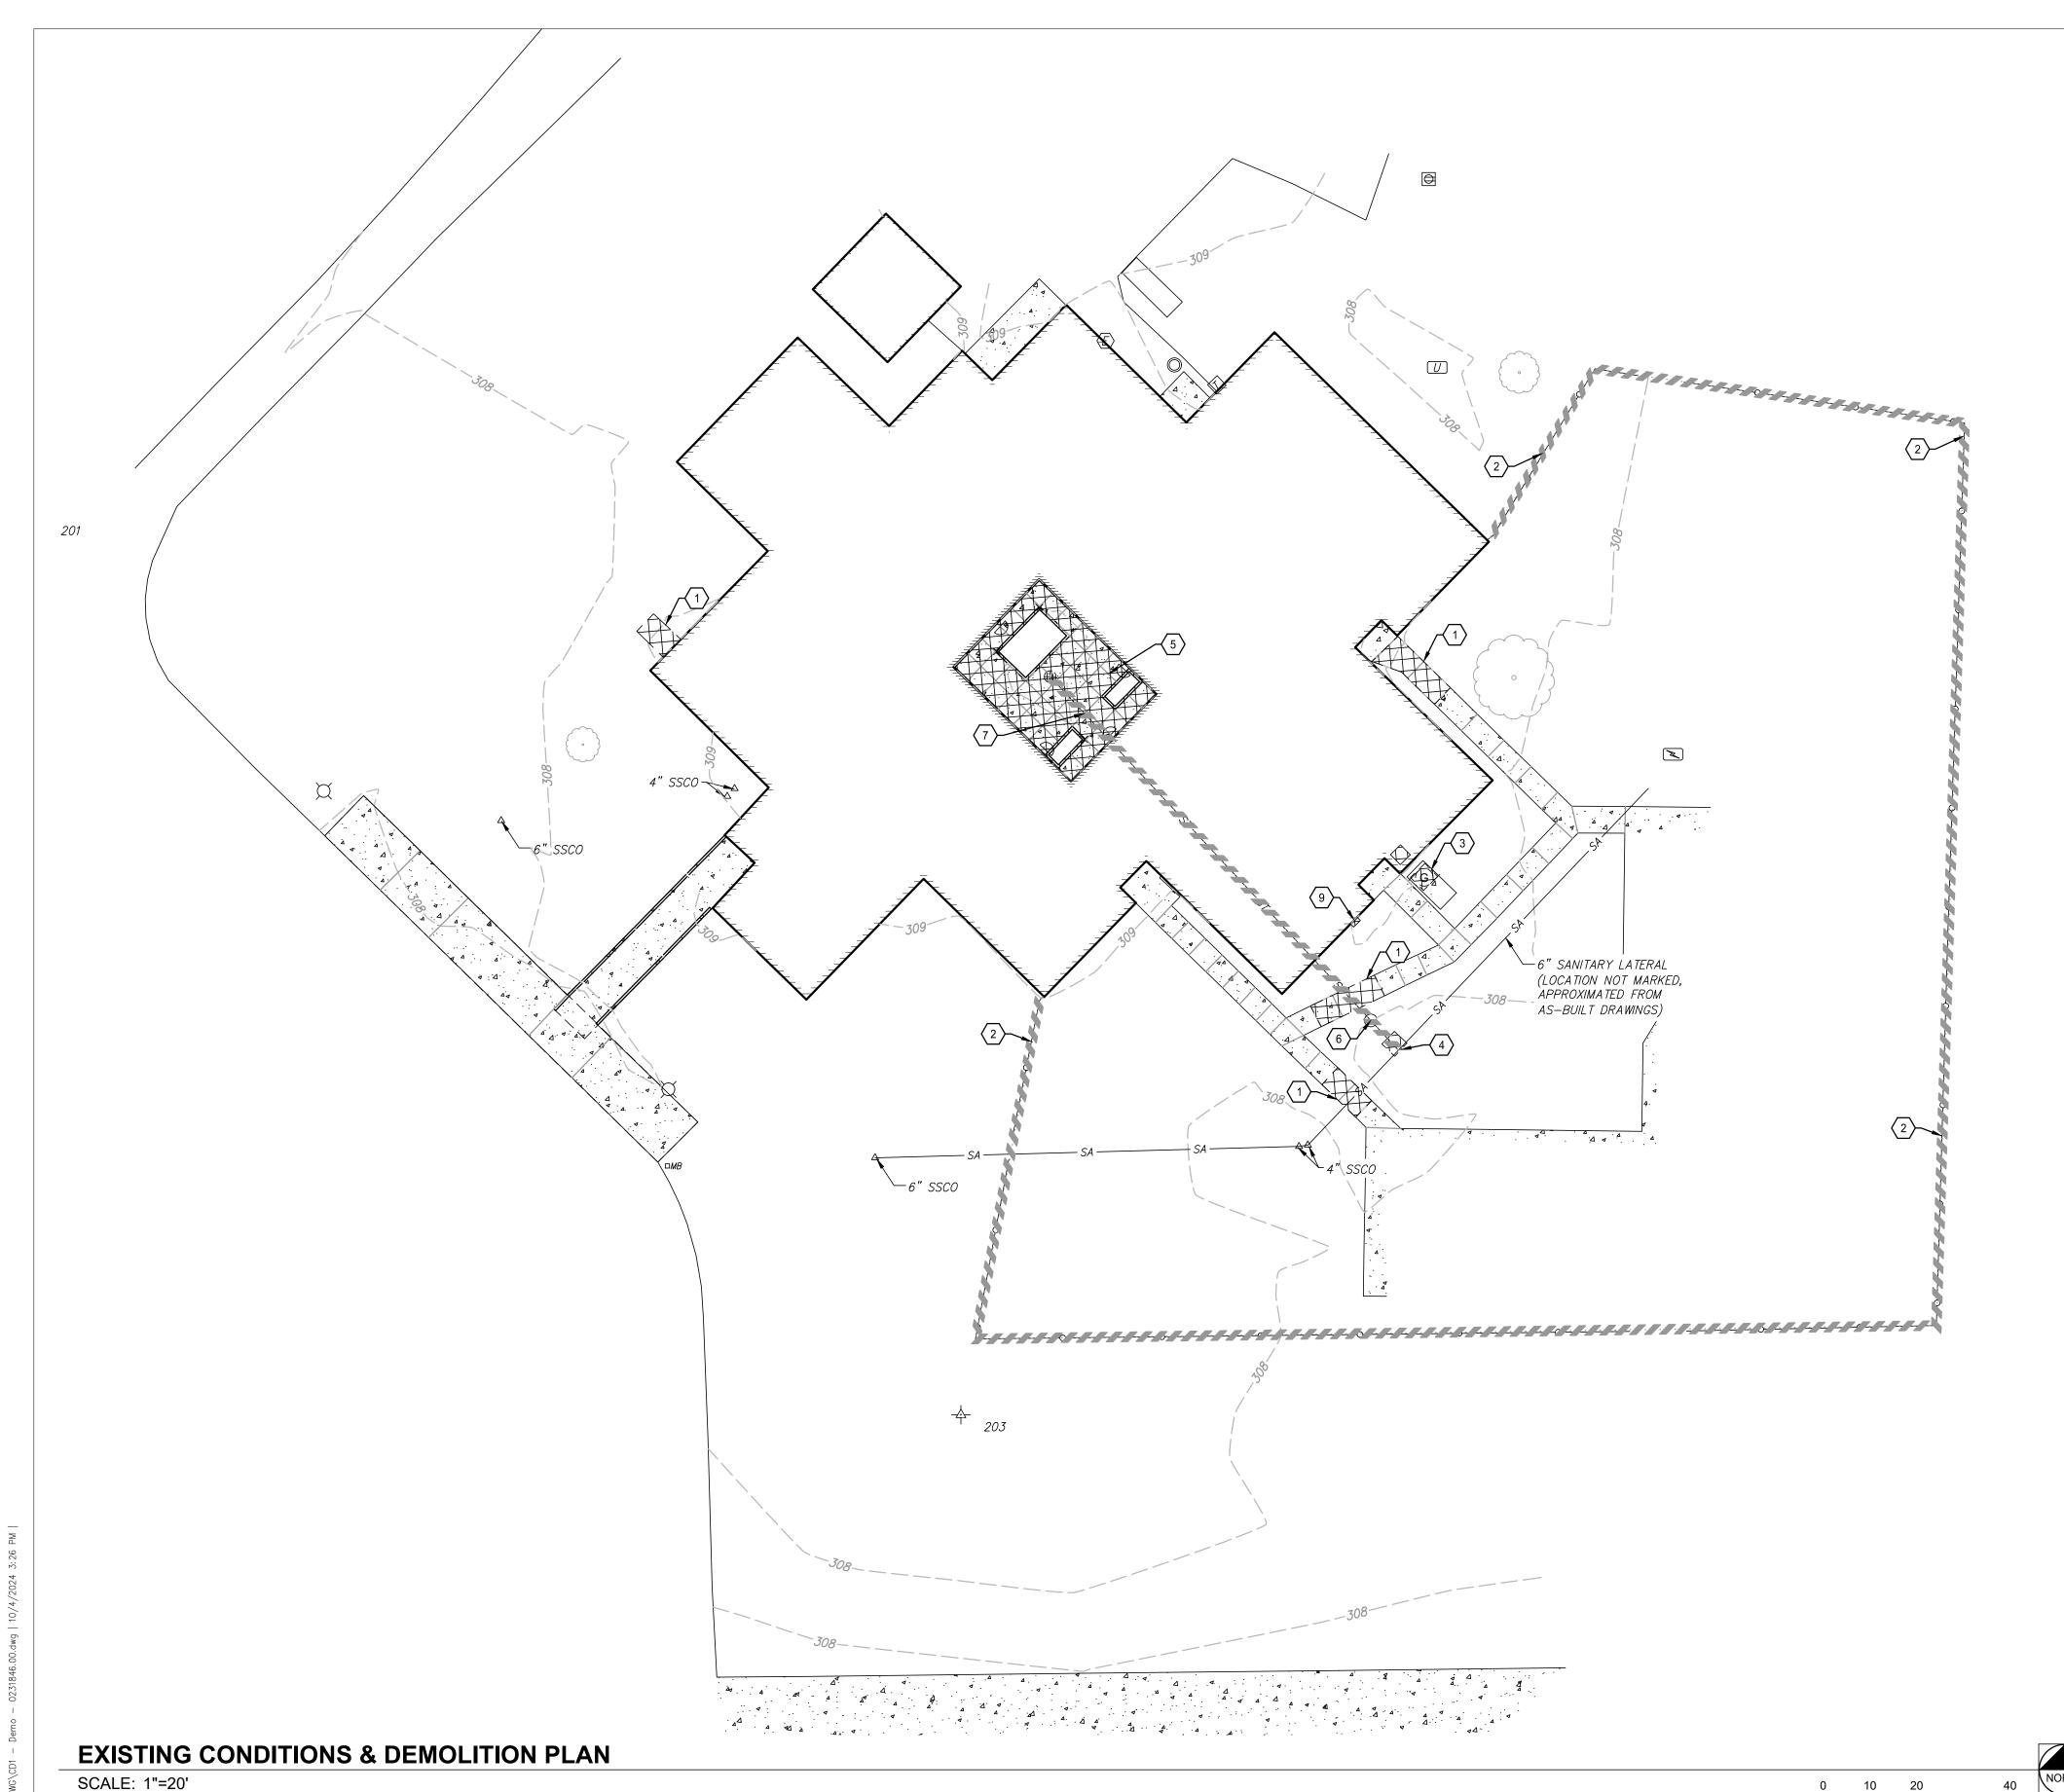

SITE DEMOLITION NOTES:

- 1. EXISTING UTILITIES TO REMAIN, WHICH ARE DAMAGED BY THE CONTRACTOR DURING CONSTRUCTION, SHALL BE REPAIRED AND/OR REPLACED WITHOUT ADDITIONAL COMPENSATION. CONFLICTS WITH PROPOSED CONSTRUCTION AND UTILITIES TO REMAIN ARE TO BE BROUGHT TO THE IMMEDIATE ATTENTION OF THE CONSTRUCTION MANAGER FOR COORDINATION WITH THE OWNER'S REPRESENTATIVE, ENGINEER, AND UTILITY COMPANY.
- 2. NO DEMOLITION OR CONSTRUCTION ACTIVITIES SHALL TAKE PLACE WITHIN PUBLIC RIGHT-OF-WAY UNTIL ALL PERMITS ARE SECURED.
- 3. ALL PAVEMENT TO BE REMOVED SHALL BE SAWCUT FULL DEPTH.
- 4. CONTRACTOR SHALL EMPLOY ALL MEASURES NECESSARY DURING DEMOLITION TO CONTROL EROSION AND INSURE THAT SEDIMENT DOES NOT LEAVE THE SITE. TRACKING OF DIRT ONTO PUBLIC STREETS AND EXISTING PARKING LOT SHALL BE CLEANED IMMEDIATELY, AND ALL SEDIMENT AND EROSION CONTROL ITEMS SHALL BE INSTALLED PRIOR TO CLEARING AND DEMOLITION WORK.
- 5. CONTRACTOR IS RESPONSIBLE FOR VERIFYING EXISTING SITE CONDITIONS AND BECOMING FAMILIAR WITH ALL CONSTRUCTION DOCUMENTS.
- 6. ITEMS INDICATED TO BE REMOVED SHALL BE COMPLETELY REMOVED UNLESS INDICATED OTHERWISE.
- 7. ALL TREES AND BRUSH INDICATED TO BE REMOVED SHALL BE REMOVED COMPLETELY, INCLUDING ROOT BALLS.
- 8. UNLESS OTHERWISE IDENTIFIED AND/OR NOTED ON THE DEMOLITION PLAN, CONTRACTOR SHALL FULLY DEMOLISH, REMOVE, AND LAWFULLY DISPOSE OF ANY AND ALL RELATED APPURTENANCES FROM EXISTING BUILDINGS AT THIS SITE AND PROPERTY. CONTRACTOR SHALL PROCURE ALL NECESSARY PERMITS AND APPROVALS FOR SUCH DEMOLITION WORK (BOTH INSIDE THE PROPERTY LINE AND IN THE PUBLIC RIGHT-OF-WAY) PRIOR TO COMMENCING ANY DEMOLITION OPERATIONS.
- 9. CONTRACTOR SHALL FULLY PROTECT ALL SURROUNDING PROPERTIES FROM ANY AND ALL DAMAGE DURING DEMOLITION OPERATIONS; AND SHALL BE FULLY RESPONSIBLE FOR REPAIRING (TO A CONDITION ACCEPTABLE TO THE OWNER AND ARCHITECT) ANY AND ALL DAMAGE THAT DOES OCCUR.
- 10. CONTRACTOR SHALL PROVIDE ALL NECESSARY TRAFFIC CONTROLS AND RELATED APPURTENANCES THAT ARE REQUIRED BY ANY APPLICABLE CODES AND ORDINANCES, DURING ALL DEMOLITION OPERATIONS.
- 11. CONTRACTOR SHALL BE FULLY RESPONSIBLE FOR THE SAFETY AND SECURITY OF THE PROJECT SITE AND ITS SURROUNDINGS DURING DEMOLITION OPERATIONS.
- 12. ALL DEMOLISHED EXISTING MATERIALS, SYSTEMS, AND CONSTRUCTIONS SHALL BE DISPOSED OF IN A LAWFUL MANNER, AND WRITTEN RECORDS OF THE FINAL DESTINATION FOR THESE MATERIALS, SYSTEMS, AND CONSTRUCTIONS (INCLUDING ANY IDENTIFIED HAZARDOUS ITEMS) SHALL BE PROVIDED TO THE OWNER AND ARCHITECT.
- 13. EXISTING SITE SHALL BE CLEANED ON A DAILY BASIS THROUGHOUT THE DURATION OF DEMOLITIONS OPERATIONS; AND NO DEBRIS OR PRODUCTS OF DEMOLITION SHALL BE ALLOWED TO ACCUMULATE OUTSIDE THE BOUNDARIES OF THE SITE.
- 14. CONTRACTOR SHALL FULLY COORDINATE ALL PROJECT DEMOLITION OPERATIONS.

KEYED NOTES (X)

SCALE: 1"=20'

U.S. SURVEY FEET

- DEMOVE CIDEWALK TO THE NEADEST TO
- 2. REMOVE CHAIN LINK FENCE. COORDINATE WITH NEW FENCE CONSTRUCTION TO KEEP A CONTINUOUS FENCE OPERATING AT
- ALL TIMES. FOUNDATIONS MAY BE CUT 1 FOOT BELOW GRADE AND LEFT IN PLACE.

 3. REMOVE EXISTING GENERATOR AND HOUSING. ALL WIRE SHALL BE SAFELY TERMINATED AND REMOVED. CONCRETE PAD SHALL REMAIN IN PLACE. ANY PROTRUDING CONDUITS SHALL BE CUT FLUSH WITH THE CONCRETE AND CAPPED.
- REMOVE CONCRETE PAD. REMOVE PVC PIPE TO STORM STRUCTURE.
 REMOVE CONCRETE AS NEEDED FOR CONSTRUCTION OR AS DIRECTED BY THE CONSTRUCTION MANAGER. CONCRETE SHALL BE REMOVED TO THE NEAREST JOINT.
- 6. REMOVE CONCRETE STORM STRUCTURE. REMOVE ALL PUMPS AND APPURTENANCES. REMOVE ALL WIRES TO THE CONTROL PANEL AND DISCONNECT. CONTRACTOR MAY ABANDON THE STRUCTURE BY BREAKING THE STRUCTURE BOTTOM, REMOVING THE TOP TWO FEET OF THE STRUCTURE AND FILLING IN THE STRUCTURE WITH 1-INCH CLEAN AGGREGATE. THE TOP TWO FEET SHALL BE TOP SOIL.
- REMOVE STORM SEWER AS NEEDED FOR THE WORK. REMAINING PIPE SHALL BE CAPPED AND FILLED WITH GROUT.
 REMOVE AUTOMATIC TRANSFER SWITCH. ALL WIRE SHALL BE SAFELY TERMINATED AND CONDUITS SHALL BE CAPPED AND
- PULLED.

 9. REMOVE CONTROL PANEL. ALL WIRE FROM CONTROL TO WET WELL SHALL BE SAFELY TERMINATED.

STATE OF MISSOURI MICHAEL L. PARSON, GOVERNOR



DATE: 10/04/2024



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SIKESTON, MISSOURI

PROJECT #.: E2408-01 SITE #.: 2043

ASSET #.: 5012043001 - PLAYGROUND 5012043003 - FACILITY

DATE: DESCRIPTION:

DRAWN BY: MLG CHECKED BY: SAS DESIGNED BY: SAS


SHEET TITLE:

EXISTING
CONDITIONS AND
DEMOLITION PLAN

SHEET NUMBER:

G-002

SHEET 3 of 12 ISSUE DATE: OCTOBER 04, 2024

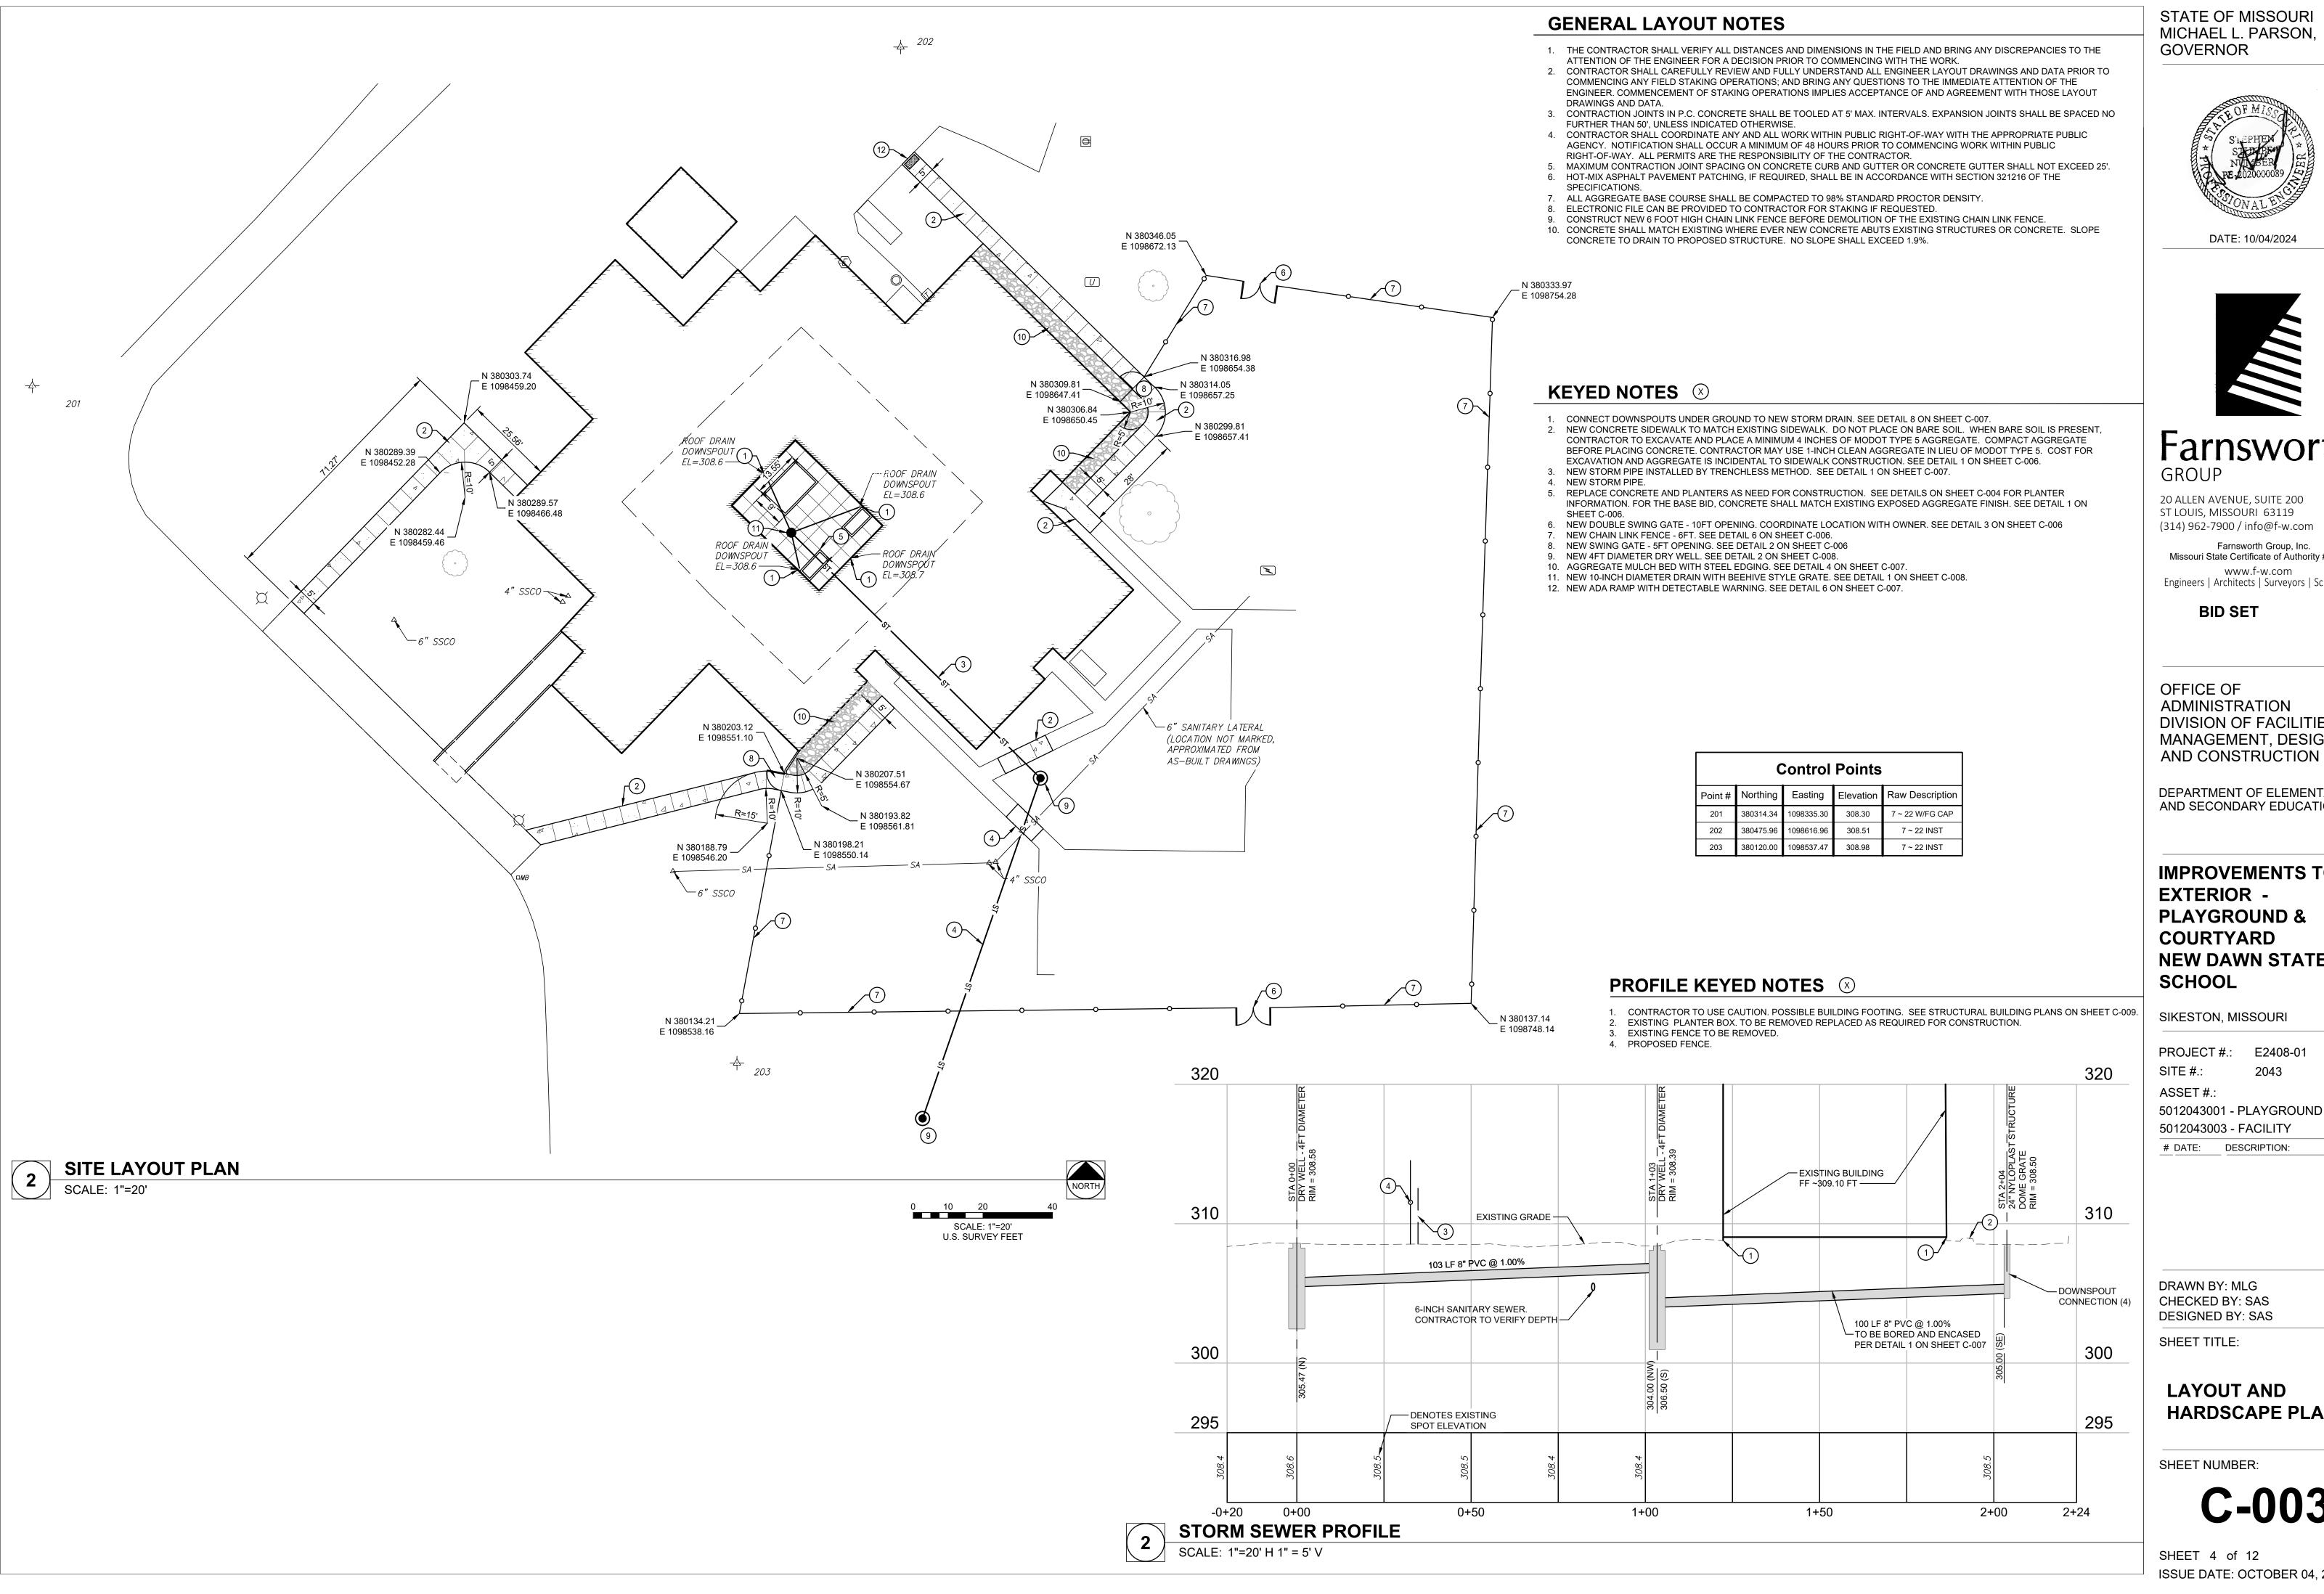

STATE OF MISSOURI MICHAEL L. PARSON, GOVERNOR



DATE: 10/04/2024



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SIKESTON, MISSOURI

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ASSET #.:

5012043001 - PLAYGROUND 5012043003 - FACILITY

SHEET TITLE:

LAYOUT AND HARDSCAPE PLAN

SHEET NUMBER:

C-003


SHEET 4 of 12 ISSUE DATE: OCTOBER 04, 2024




STATE OF MISSOURI MICHAEL L. PARSON,

GOVERNOR

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Type A Expansion Joint

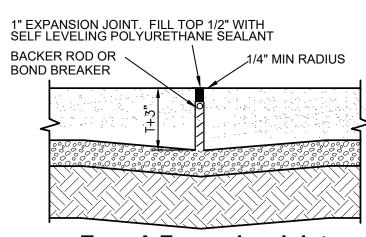

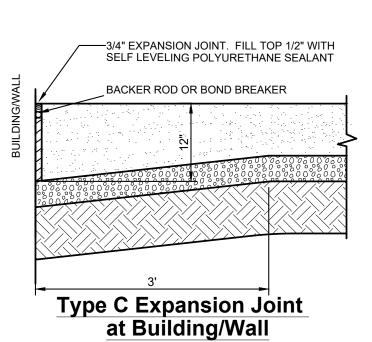

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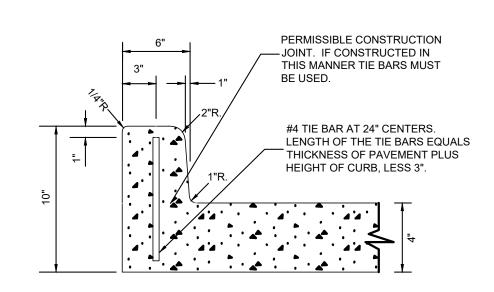
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Typical Concrete Pavement Joint Details

SCALE: Not To Scale



Concrete Planter Box

SCALE: Not To Scale

IMPROVEMENTS TO EXTERIOR -PLAYGROUND & COURTYARD **NEW DAWN STATE** SCHOOL

SIKESTON, MISSOURI

PROJECT #.: E2408-01 2043 SITE #.: ASSET #.:

5012043001 - PLAYGROUND 5012043003 - FACILITY

DATE: DESCRIPTION:

DRAWN BY: MLG CHECKED BY: SAS DESIGNED BY: SAS

SHEET TITLE:

JOINTING PLAN

SHEET NUMBER:


SCALE: 1"=5' U.S. SURVEY FEET

SHEET 5 of 12 ISSUE DATE: OCTOBER 04, 2024

JOINTING PLAN

SCALE: 1"= 5'



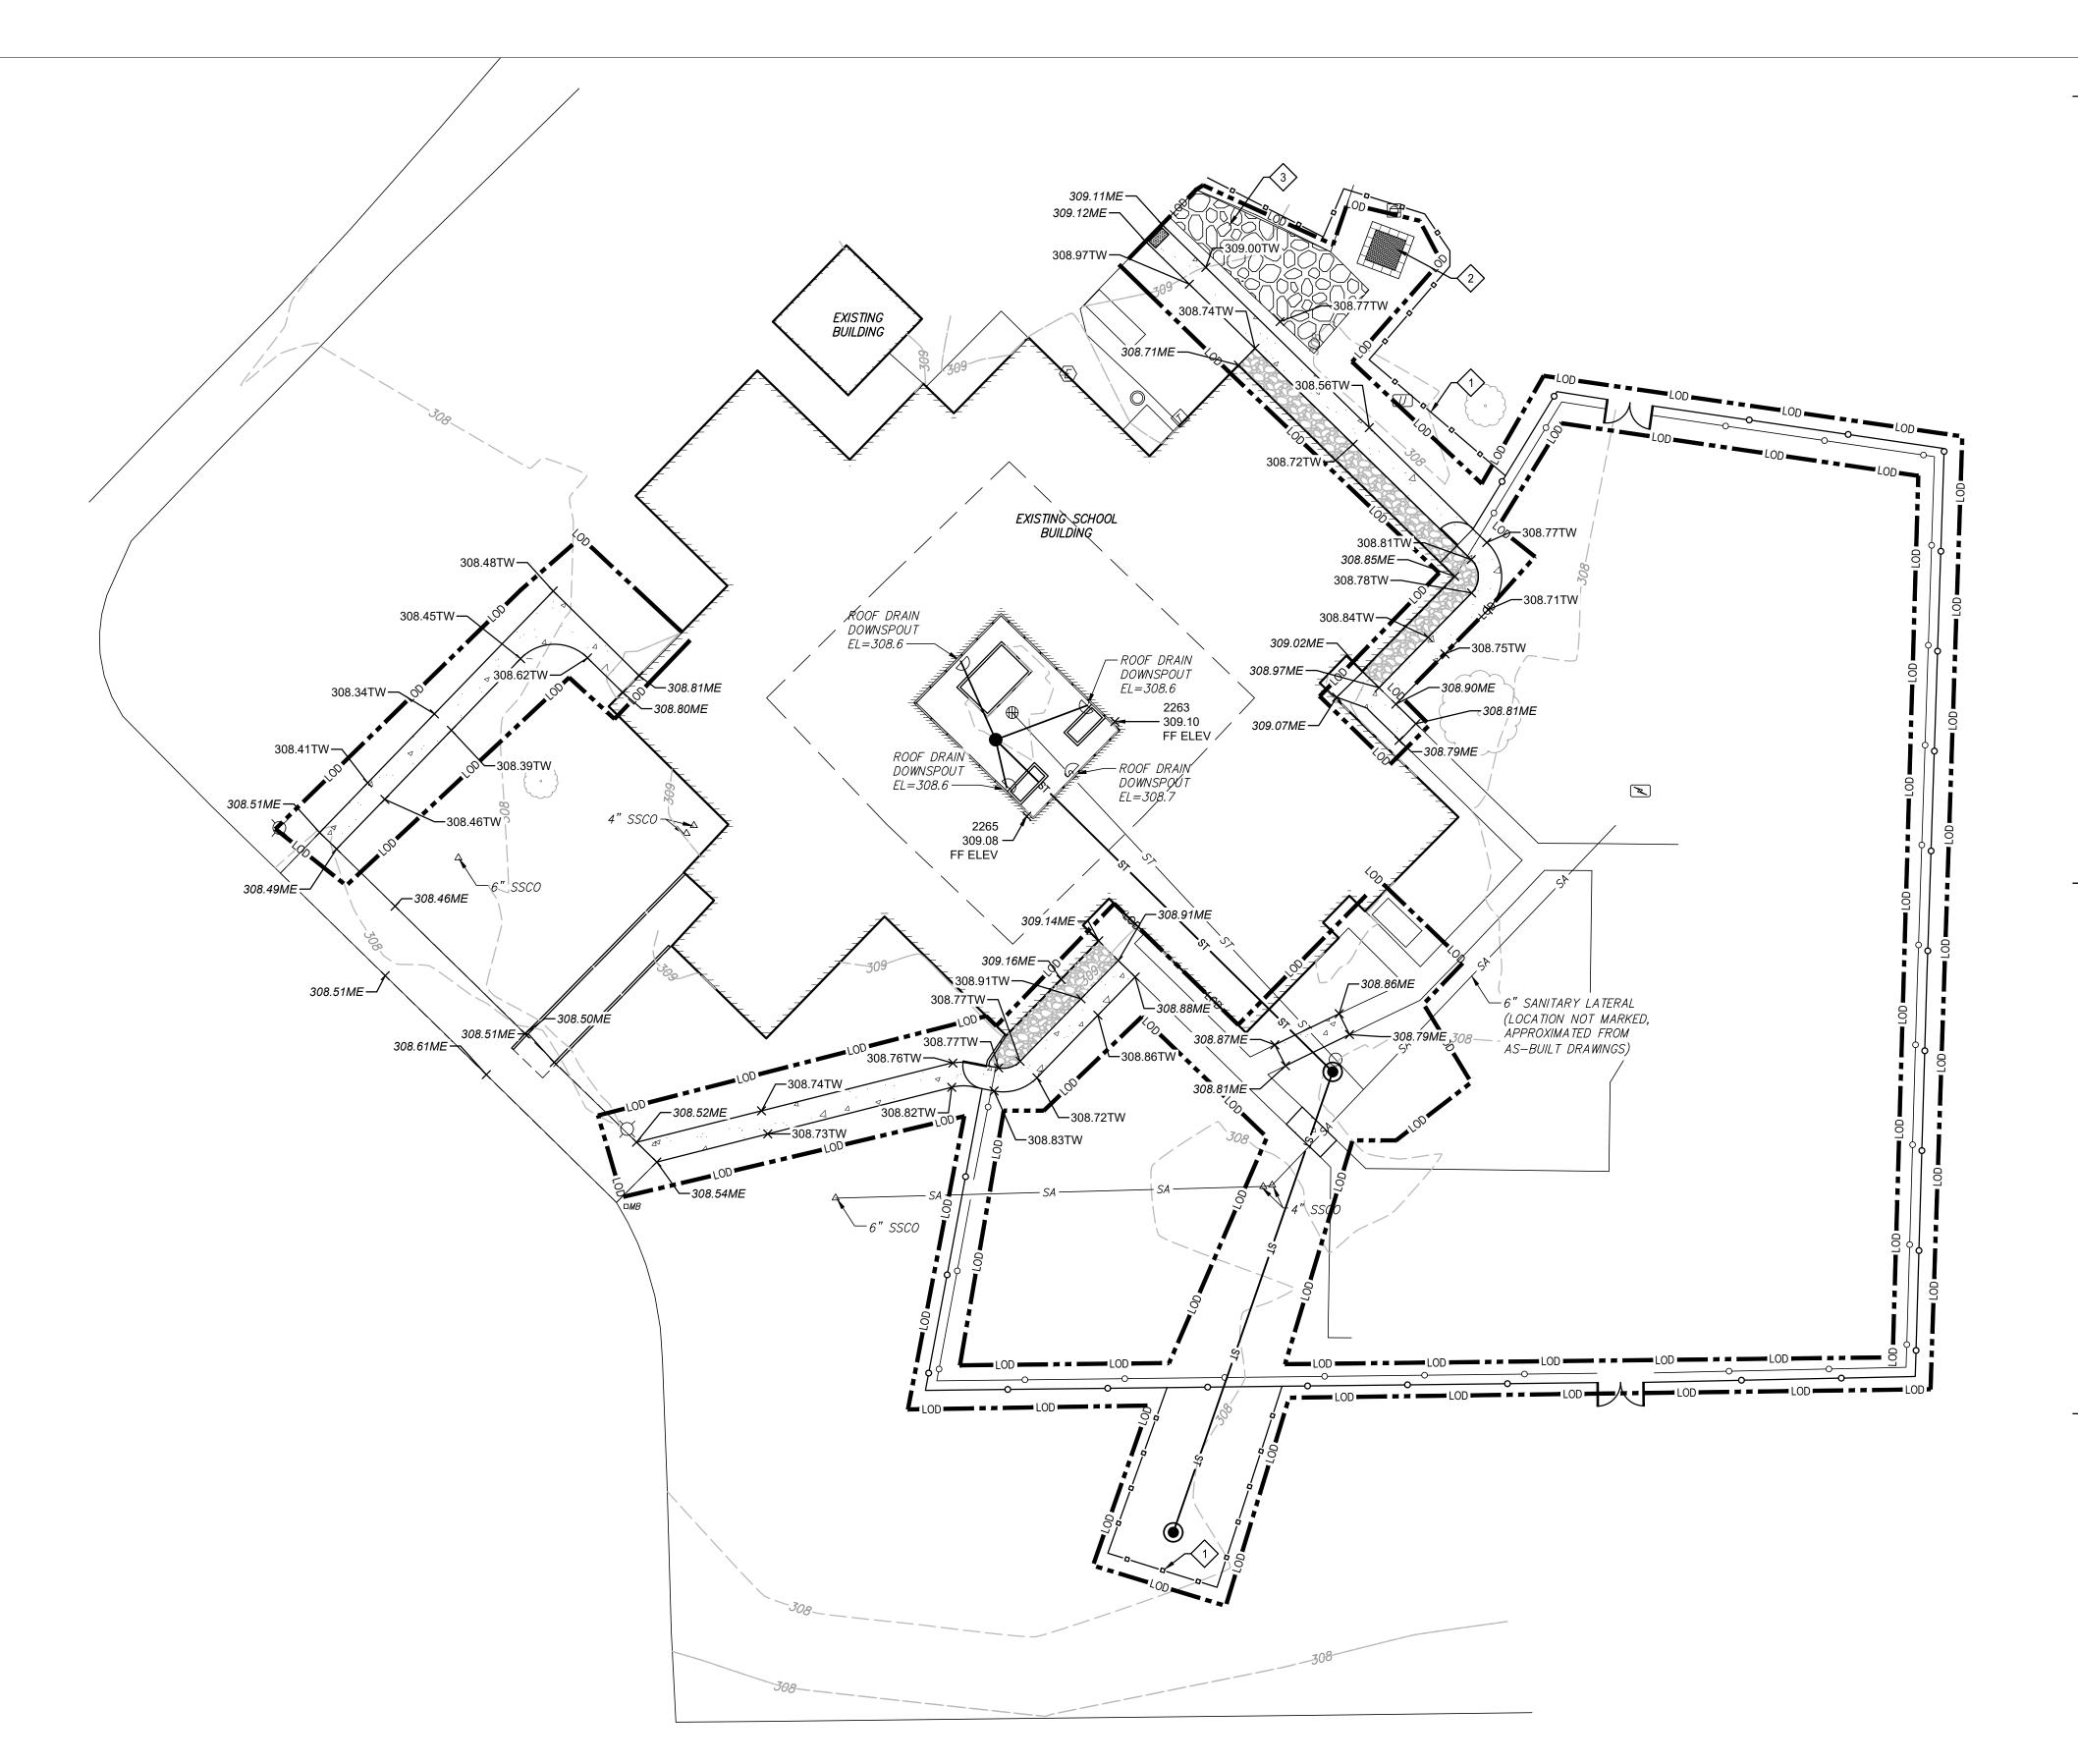

GENERAL NOTES


- CONTRACTOR SHALL ENSURE SITE GRADES AWAY FROM THE BUILDING OVER SIDEWALKS.
- SIDEWALKS SHALL MAINTAIN CROSS SLOPES LESS THAN 2% AND RAMP SLOPE LESS THAN 8%. SIDEWALKS SHALL MAINTAIN RUNNING SLOPES LESS THAN 5%.
- REMOVE AND REPLACE FENCE AT SAME BASE ELEVATIONS.
- PERMANENT STABILIZATION SHALL INCLUDE THE SEEDING OR SODDING OF LAWN AREAS DISTURBED AND PAVED SURFACE COURSE FOR ROADWAYS AND PARKING. ALL PERMANENT SEEDING SHALL TAKE PLACE IMMEDIATELY FOLLOWING FINAL GRADING OPERATIONS IN ANY COMPLETED AREA WITHIN THE CONSTRUCTION LIMITS.


2. CONCRETE WASHOUT. REFER TO DETAIL 3 ON SHEET C-007. CONCRETE WASHOUT TO BE REMOVED AND RESTORED AFTER

3. THE CONTRACTOR SHALL PROVIDE A STABILIZED CONSTRUCTION ENTRANCE IN ACCORDANCE WITH THE DETAIL 5 ON SHEET C-007 AT LOCATIONS INDICATED ON THE PLANS TO HELP REDUCE VEHICLE TRACKING OF SEDIMENTS. ANY EXCESS MUD,

DIRT, OR ROCK TRACKED ONTO EXISTING STREETS WILL BE CHECKED FOR DAILY AND REMOVED AS NECESSARY.

CONSTRUCTION ENTRANCE TO BE REMOVED AND RESTORED AFTER CONSTRUCTION ACTIVITIES.

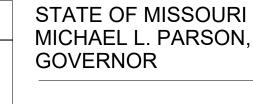

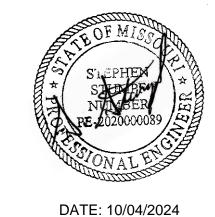



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SIKESTON, MISSOURI

PROJECT #.: E2408-01 2043 SITE #.:

DATE: DESCRIPTION:

ASSET #.: 5012043001 - PLAYGROUND 5012043003 - FACILITY

DRAWN BY: MLG CHECKED BY: SAS

DESIGNED BY: SAS

SHEET TITLE:

GRADING PLAN

SHEET NUMBER:

SHEET 6 of 12 ISSUE DATE: OCTOBER 04, 2024


DISTURBED AREA


KEYED NOTES \otimes


1. SILT FENCE PLACEMENT. SEE DETAIL 4 ON SHEET C-006.


LIMIT OF DISTURBANCE = 18,003 SQFT = 0.41 ACRES NEW IMPERVIOUS AREA = 1,814.8 SQFT = 0.04 ACRES

GRADING PLAN SCALE: 1"=20'

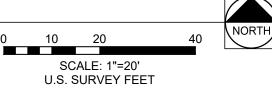

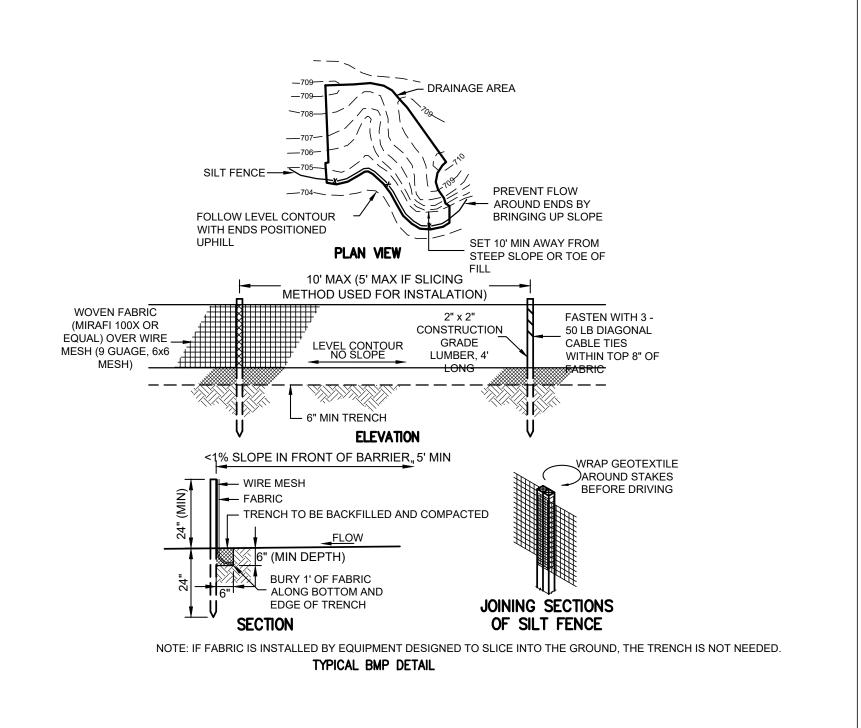

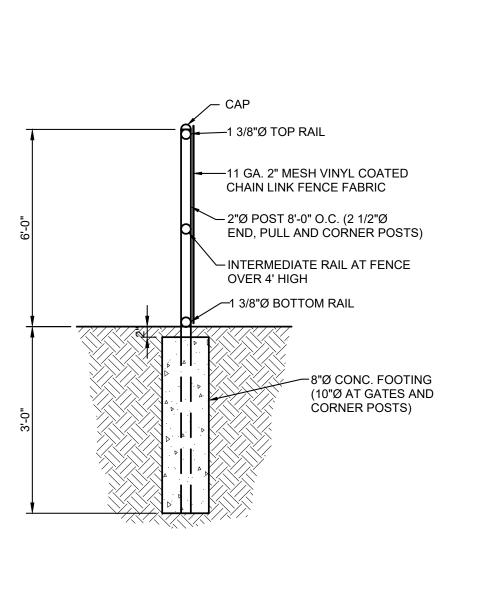

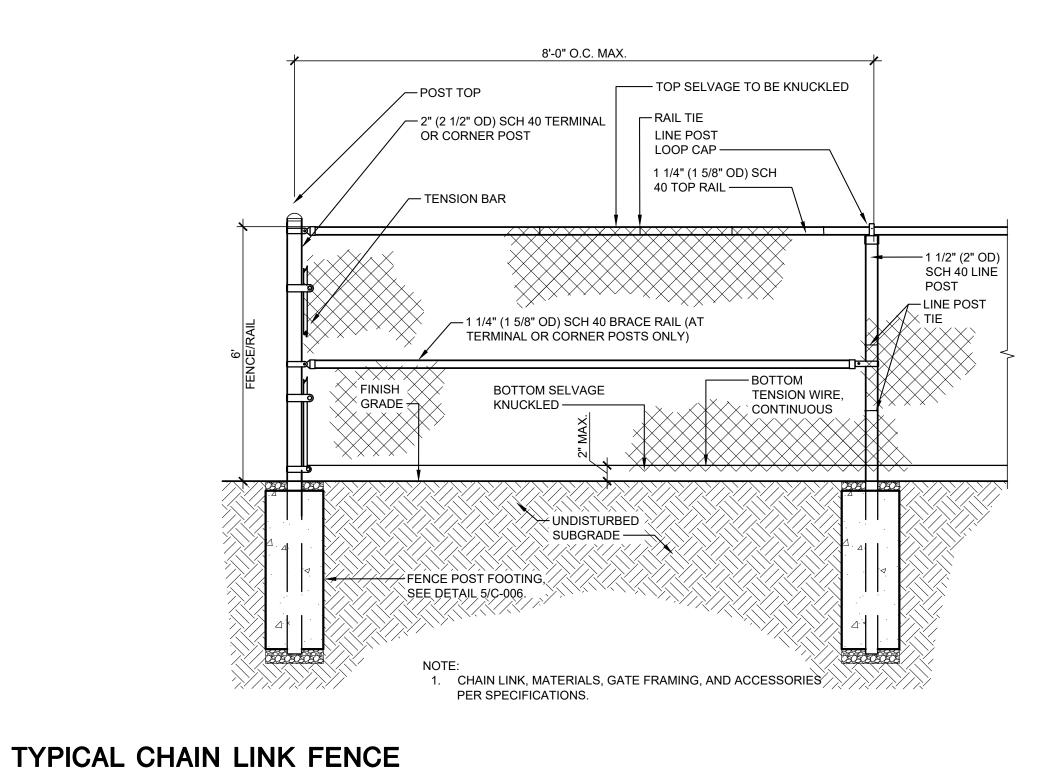

GATE PLAN

SEE PLANS

— ALL JOINTS WELDED TO

MAKE A SOLID FRAME

1'-0"

LATCH/HINGE POST

— FULCRUM LATCH

W/ STRIKE STRAP

2" SQ GATE FRAME (TYP. 4 SIDES)

TENSION BAR (TYP. 4 SIDES)

1'-0"

- CHAIN LINK FABRIC/MESH

DROP BAR. PROVIDE SLEEVES

CLOSED AND OPEN POSITIONS.

TO ENGAGE DROP ROD @

CONCRETE FOOTING

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5012043003 - FACILITY # DATE: DESCRIPTION:

DRAWN BY: MLG

CHECKED BY: SAS **DESIGNED BY: SAS**

SHEET TITLE:


DETAILS

SHEET NUMBER:

SHEET 7 of 12 ISSUE DATE: OCTOBER 04, 2024




Scale: Not To Scale Scale: Not To Scale

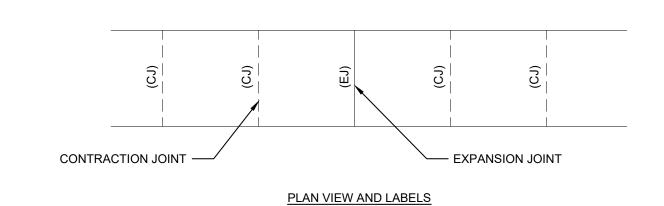


½" X 1½" TOOLED JOINT OR SAW JOINT (SEE PLAN FOR JOINT TYPE & SPACING) ———

CONTRACTION JOINT (CJ)

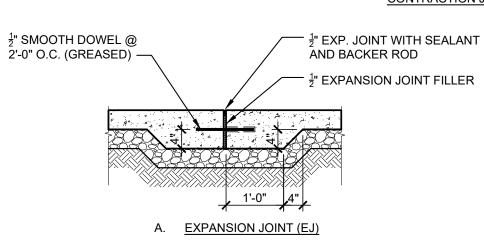

B. <u>4" TO 4" DOWEL</u>

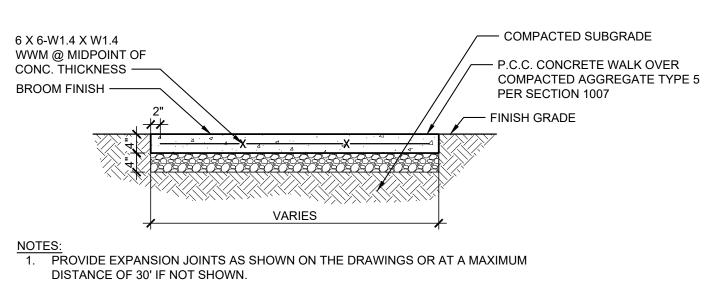

DISTANCE OF 30' IF NOT SHOWN. 2. PROVIDE EXPANSION JOINTS @ INTERSECTIONS WITH STRUCTURES AND

ABRUPT CHANGES. 3. PROVIDE CONTRACTION JOINTS AS SHOWN.

CONCRETE WALKWAY SECTION

GATE PLAN SEE PLANS 2 1/2" (3" OD) SS40 - POST TOP HINGE POST, TYP. — 21/2" — LATCH POST - 2" X 9 GA (CORE WIRE) CHAIN LINK FABRIC/MESH — FULCRUM LATCH W/ STRIKE STRAP — 2" GATE FRAME (TYP. 4 SIDES) - TENSION BAR (TYP. 4 SIDES) CONCRETE FOOTING, SEE DETAIL 5/C-006. ALL JOINTS WELDED TO MAKE Á SŐLÍÐ FRÁME 🛚

NOTES: 1. PROVIDE SELF-CLOSING AND SELF-LATCHING GATE HINGES AND LATCHES.

2. FOR ADDITIONAL INFORMATION REGARDING THE CHAIN LINK FENCE GATE CONSTRUCTION, SEE SPEC 32 3113.


TYPICAL CONCRETE WALKWAY SECTION

Scale: Not To Scale


SILT FENCE

Scale: Not To Scale

TYPICAL CHAIN LINK SINGLE SWING GATE Scale: Not To Scale

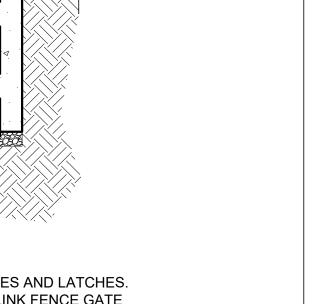


TYPICAL CHAIN LINK DOUBLE SWING GATE Scale: Not To Scale

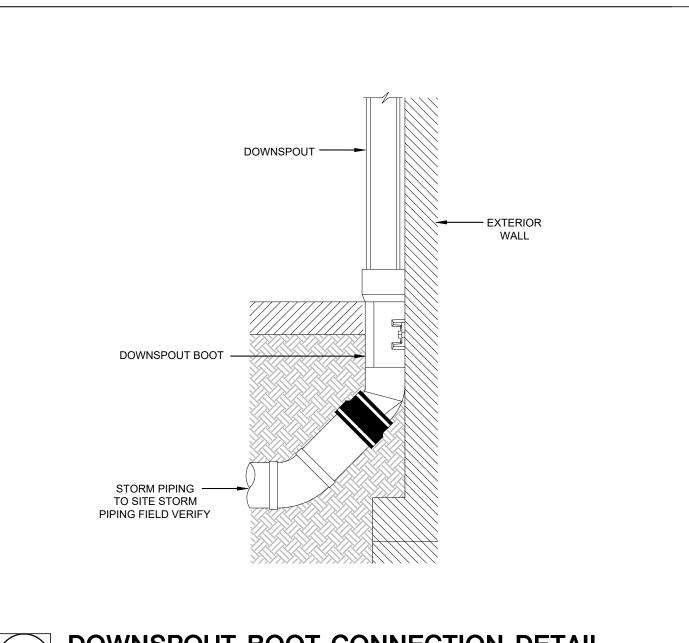




Scale: NOT TO SCALE

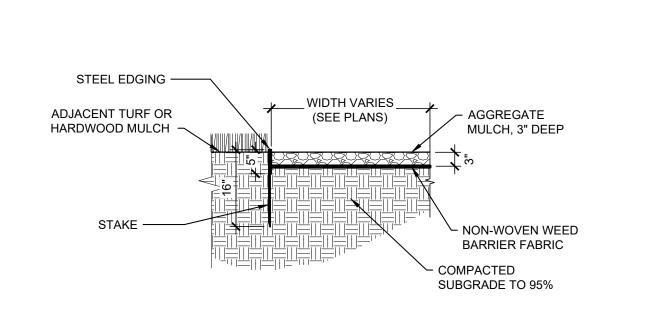

STEEL EDGING AT AGGREGATE MULCH BED


TYPICAL STORMWATER BORE AND ENCASEMENT


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5 CONSTRUCTION ENTRANCE

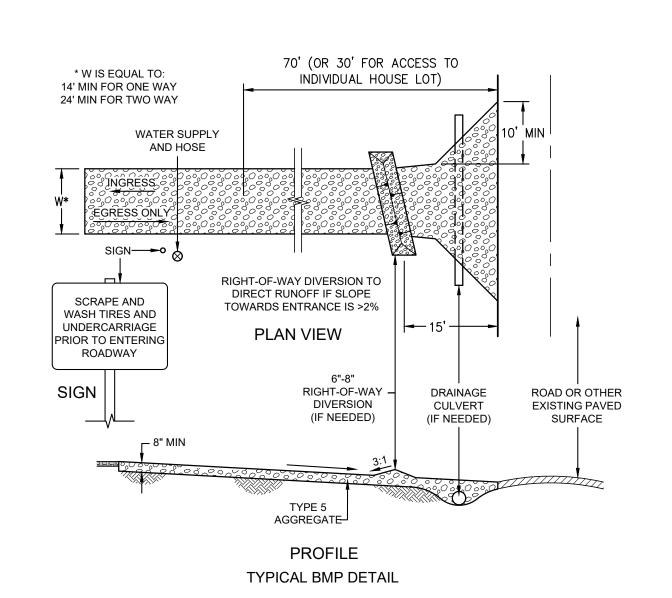Scale: Not To Scale







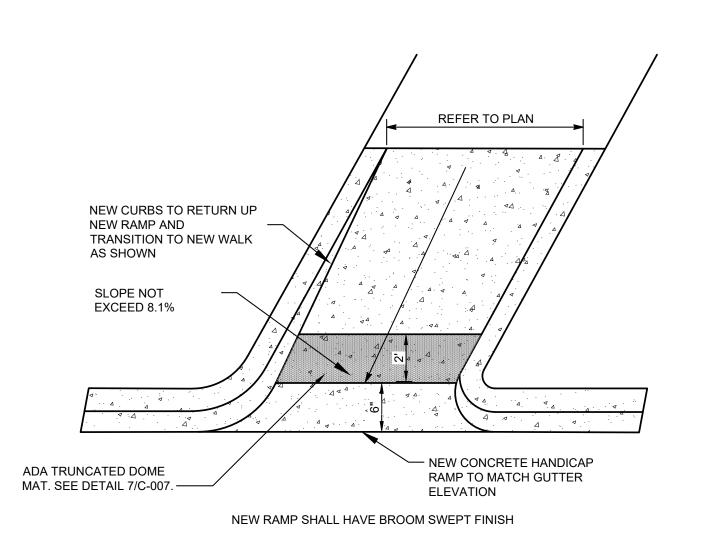

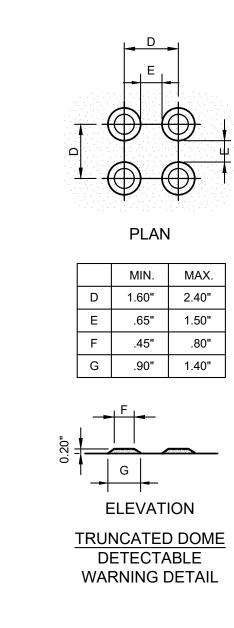
CONCRETE HANDICAP RAMP DETAIL Not To Scale



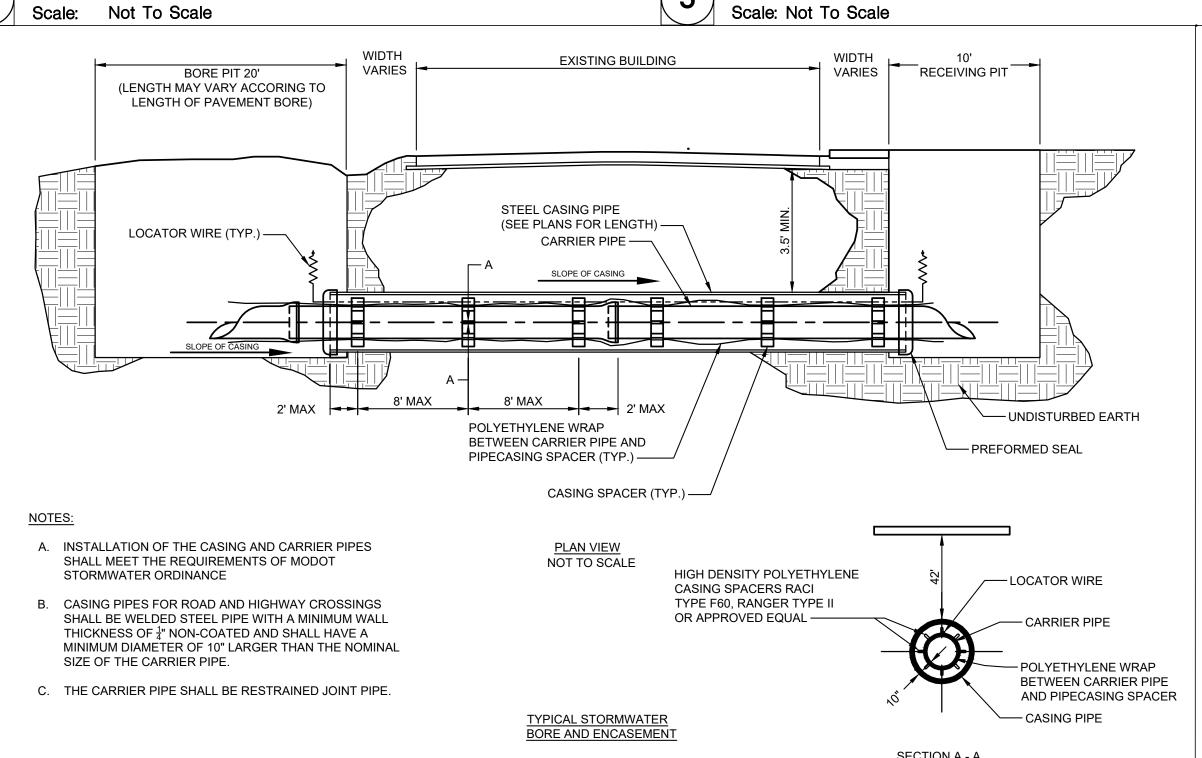

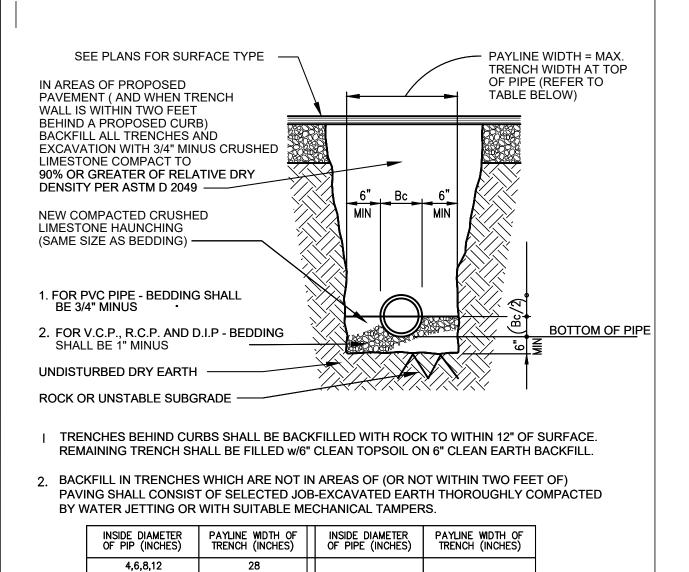

UTILITY TRENCH

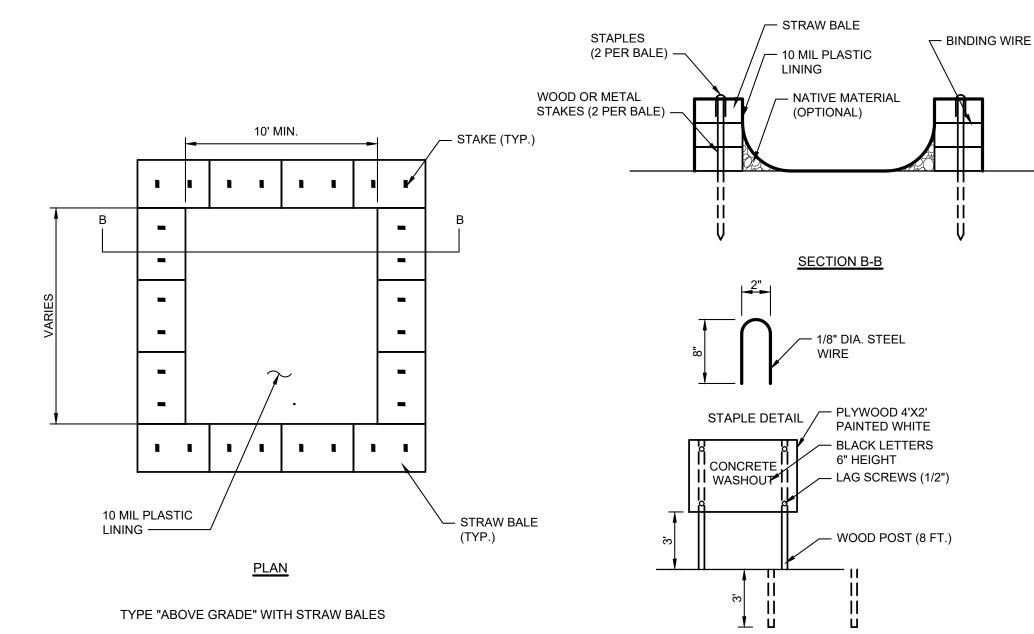

CONCRETE WASHOUT SIGN DETAIL (OR EQUIVALENT) CONCRETE WASHOUT DETAIL Scale: NOT TO SCALE

STATE OF MISSOURI MICHAEL L. PARSON, GOVERNOR



DATE: 10/04/2024



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DEPARTMENT OF ELEMENTARY AND SECONDARY EDUCATION

IMPROVEMENTS TO EXTERIOR -**PLAYGROUND & COURTYARD NEW DAWN STATE** SCHOOL

SIKESTON, MISSOURI

PROJECT #.: E2408-01 SITE #.: 2043 ASSET #.:

5012043001 - PLAYGROUND 5012043003 - FACILITY

DATE: DESCRIPTION:


DRAWN BY: MLG CHECKED BY: SAS **DESIGNED BY: SAS**


SHEET TITLE:

DETAILS

SHEET NUMBER:

SHEET 8 of 12 ISSUE DATE: OCTOBER 04, 2024

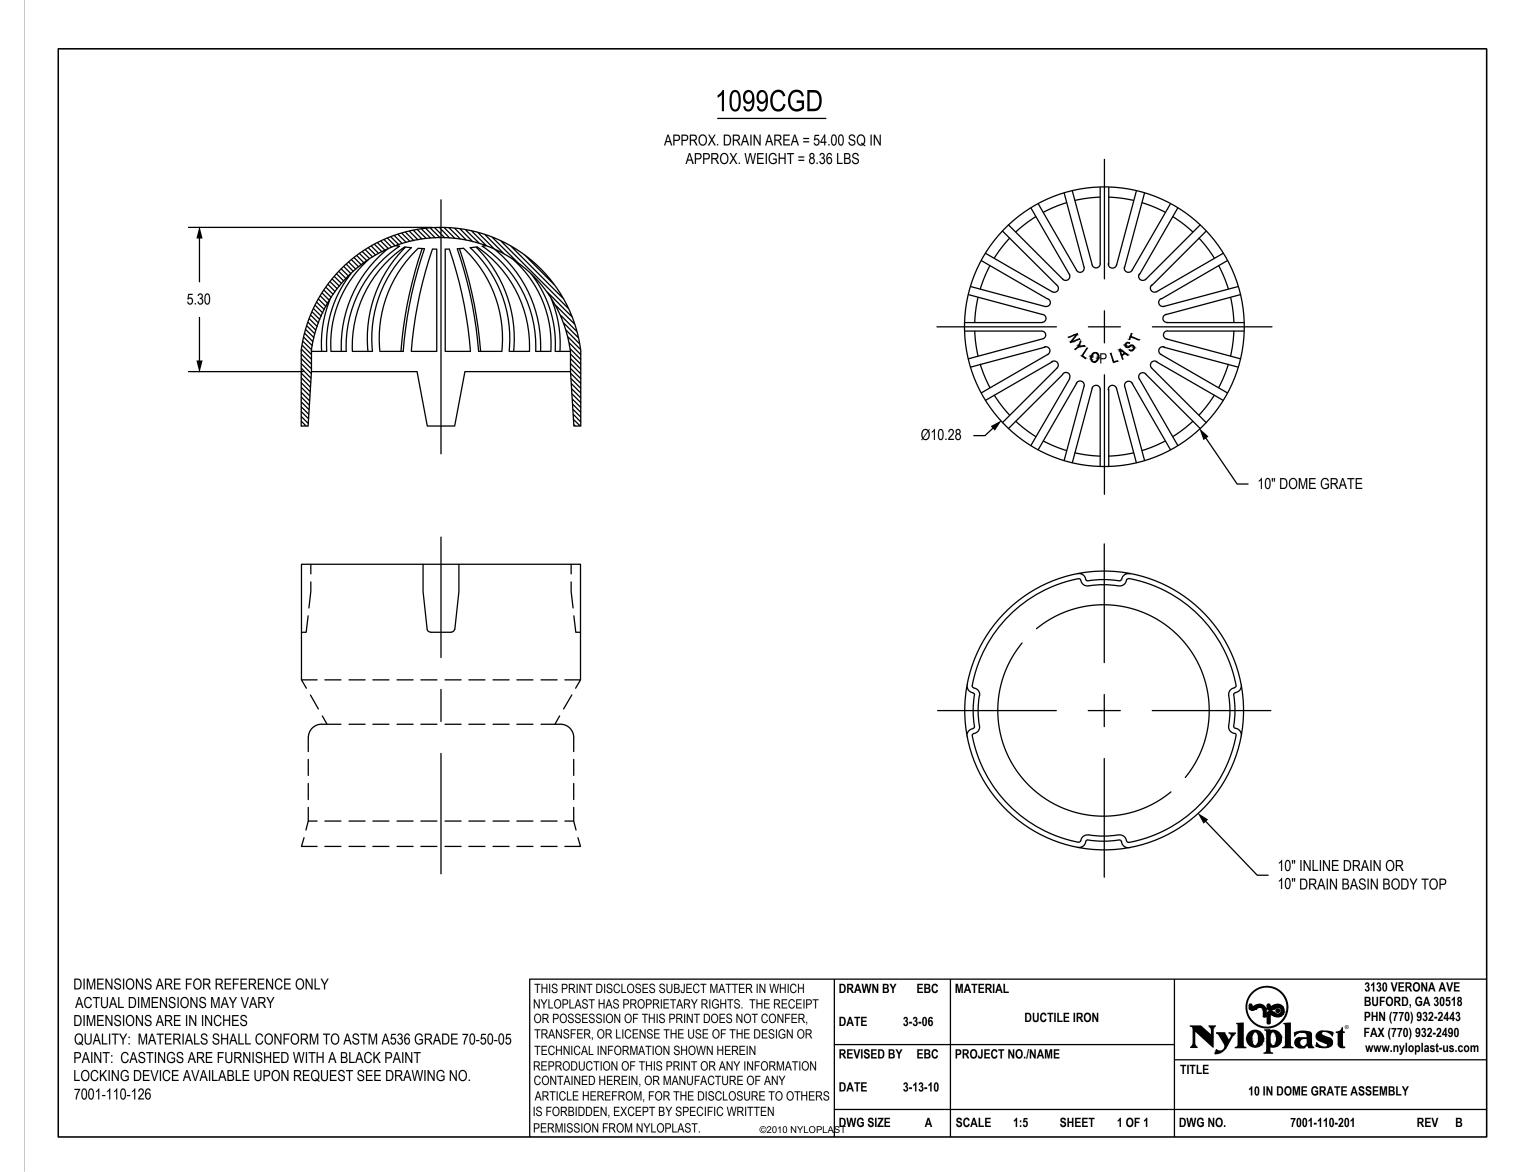

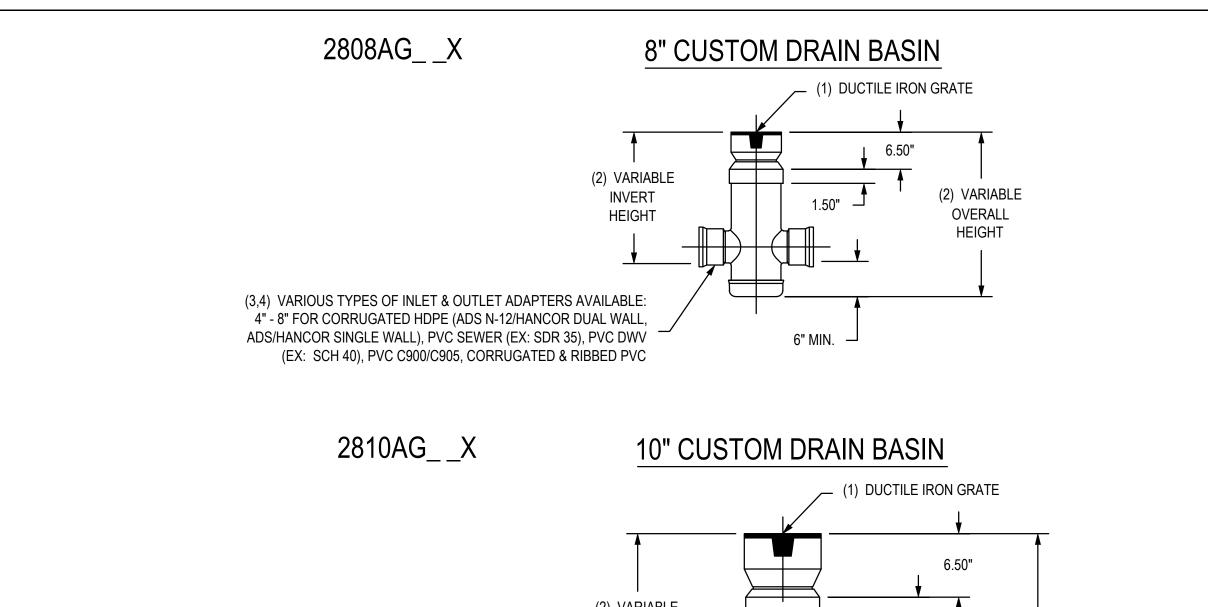

(2) VARIABLE INVERT HEIGHT

(3,4) VARIOUS TYPES OF INLET & OUTLET ADAPTERS AVAILABLE:
4" - 10" FOR CORRUGATED HDPE (ADS N-12/HANCOR DUAL WALL, ADS/HANCOR SINGLE WALL), PVC SEWER (EX: SDR 35), PVC DWV (EX: SCH 40), PVC C900/C905, CORRUGATED & RIBBED PVC

- 1 GRATES/SOLID COVER SHALL BE DUCTILE IRON PER ASTM A536 GRADE
- 70-50-05, WITH THE EXCEPTION OF THE BRONZE GRATE.

 2 CUSTOM DRAIN BASIN TO BE CUSTOM MANUFACTURED ACCORDING
 BLAN DETAILS DISERS ARE NEEDED FOR BASINS OVER 84" DUE TO
- SHIPPING RESTRICTIONS. SEE DRAWING NO. 7001-110-065

 3 DRAINAGE CONNECTION STUB JOINT TIGHTNESS SHALL CONFORM TO
- ASTM D3212 FOR CORRUGATED HDPE (ADS & HANCOR DUAL WALL) & SDR 35 PVC

 4 STANDARD DRAIN BASIN HAS FIXED ADAPTER LOCATIONS OF 0° & 180° CUSTOM DRAIN BASIN ADAPTERS CAN BE MOUNTED ON ANY ANGLE
- 0° TO 360°. TO DETERMINE MINIMUM ANGLE BETWEEN ADAPTERS SEE DRAWING NO. 7001-110-012.
- 5 DIMENSIONS ARE FOR REFERENCE ONLY ACTUAL DIMENSIONS MAY VARY

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MATERIAL

3130 VERONA AVE
BUFORD, GA 30518
PHN (770) 932-2443
FAX (770) 932-2440
www.nyloplast-us.cc
TITLE

8 IN & 10 IN DRAIN BASIN DESIGN DETAILS

REV G

3130 VERONA AVE
BUFORD, GA 30518
PHN (770) 932-2443
FAX (770) 932-2490
www.nyloplast-us.com

DESIGN DETAILS

MANAGEMENT, DESIGN
AND CONSTRUCTION

DEPARTMENT OF ELEMENTARY
AND SECONDARY EDUCATION

IMPROVEMENTS TO EXTERIOR -

STATE OF MISSOURI MICHAEL L. PARSON,

DATE: 10/04/2024

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DIVISION OF FACILITIES

OFFICE OF

GROUP

GOVERNOR

PLAYGROUND &
COURTYARD
NEW DAWN STATE
SCHOOL

SIKESTON, MISSOURI

PROJECT #.: E2408-01 SITE #.: 2043

ASSET #.: 5012043001 - PLAYGROUND

5012043001 - PLAYGROUN 5012043003 - FACILITY

DATE: DESCRIPTION:

DRAWN BY: MLG CHECKED BY: SAS DESIGNED BY: SAS

SHEET TITLE:

DETAILS


SHEET NUMBER:

C-008

SHEET 9 of 12 ISSUE DATE: OCTOBER 04, 2024



Scale: Not To Scale

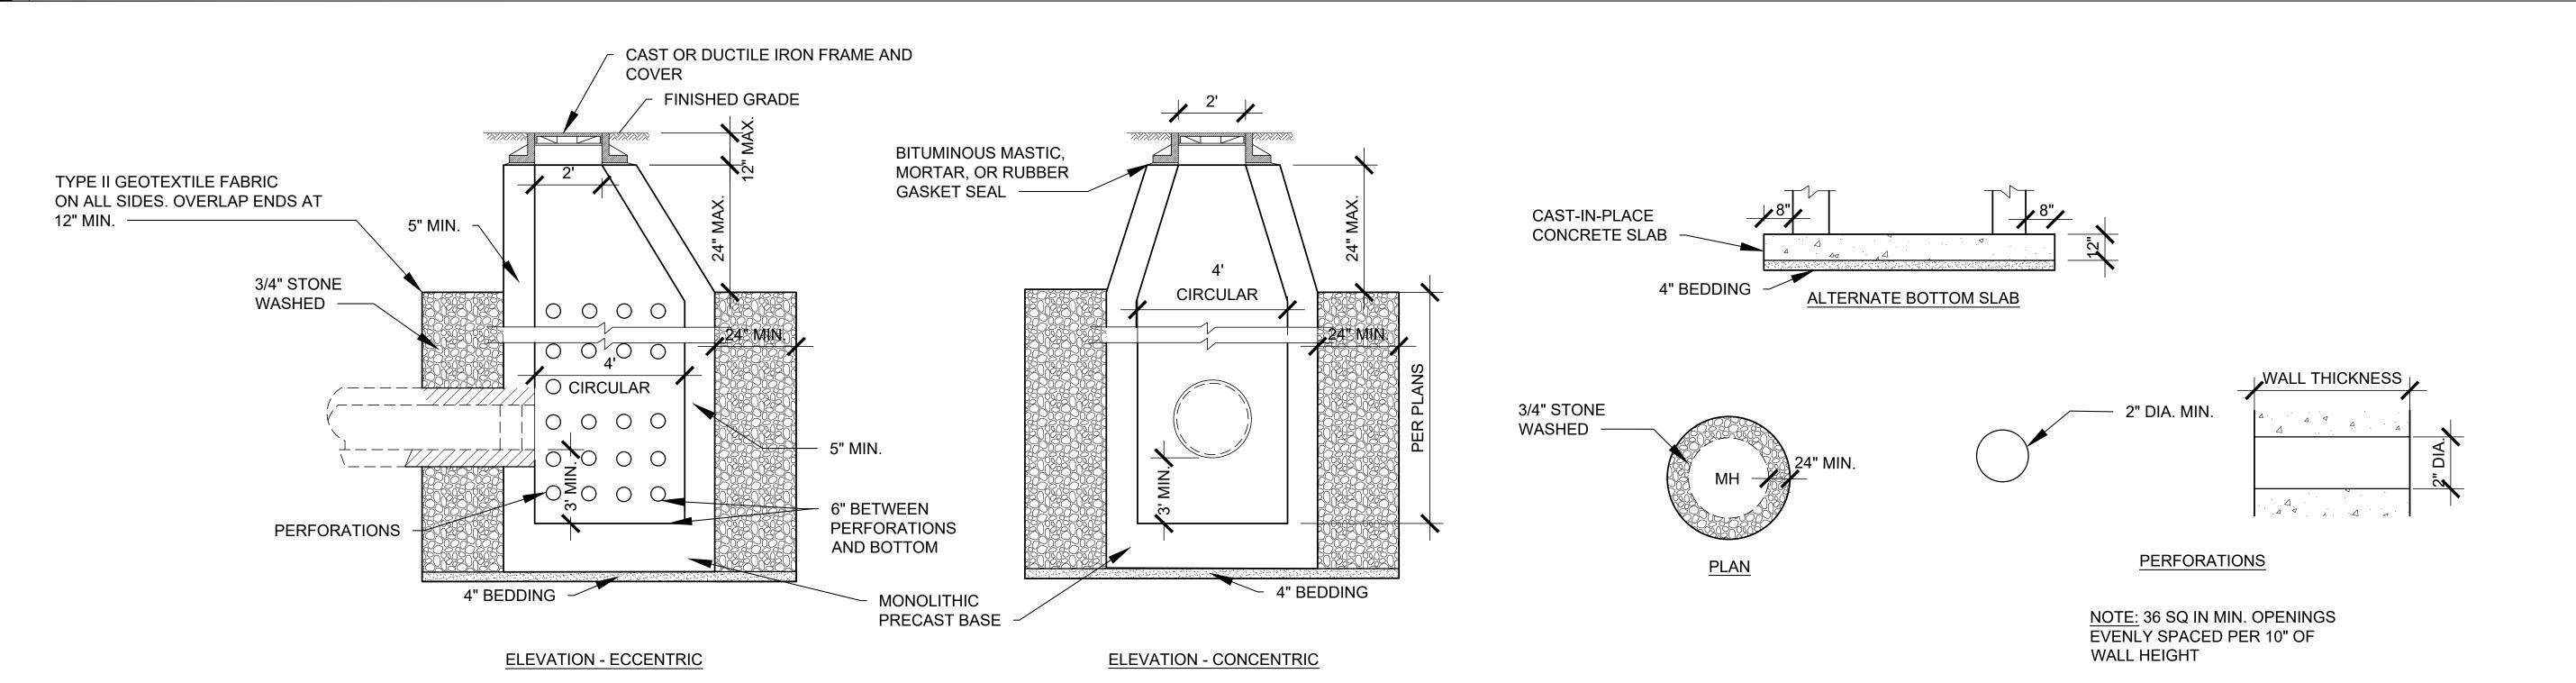


NOTES:

I. FOR GENERAL NOTES SEE SHEET S-2
2. FOR FOOTING & COLUMN SCHEDULE SEE SHEET 3-2
3. ROMAN NUMERALS INDICATE COLUMN & FOOTING MARK
4. FINISHED FLOOR ELEV +0:0" (FOR REFERENCE ONLY)

GENERAL BLUEPRINT NOTES

BLUEPRINT FOR REFERENCE USE ONLY.
 FIELD VERIFY EXISTING CONDITIONS.

STATE OF MISSOURI MICHAEL L. PARSON, GOVERNOR

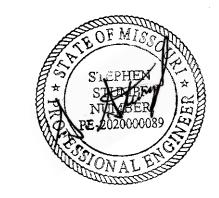

DATE: 10/04/2024



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SIKESTON, MISSOURI

PROJECT #.: E2408-01 SITE #.: 2043

ASSET #.: 5012043001 - PLAYGROUND 5012043003 - FACILITY

DATE: DESCRIPTION:

DRAWN BY: MLG CHECKED BY: SAS DESIGNED BY: SAS

SHEET TITLE:

HISTORICAL
STRUCTURAL PLANS


SHEET NUMBER:

C-009

SHEET 10 of 12 ISSUE DATE: OCTOBER 04, 2024

ORIGINAL STRUCTURAL BLUEPRINT

Scale: Not to Scale

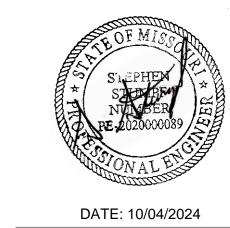



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DATE: DESCRIPTION:

DRAWN BY: MLG CHECKED BY: SAS DESIGNED BY: SAS


SHEET TITLE:

HISTORICAL STRUCTURAL DETAILS

SHEET NUMBER:

6-010

SHEET 11 of 12 ISSUE DATE: OCTOBER 04, 2024

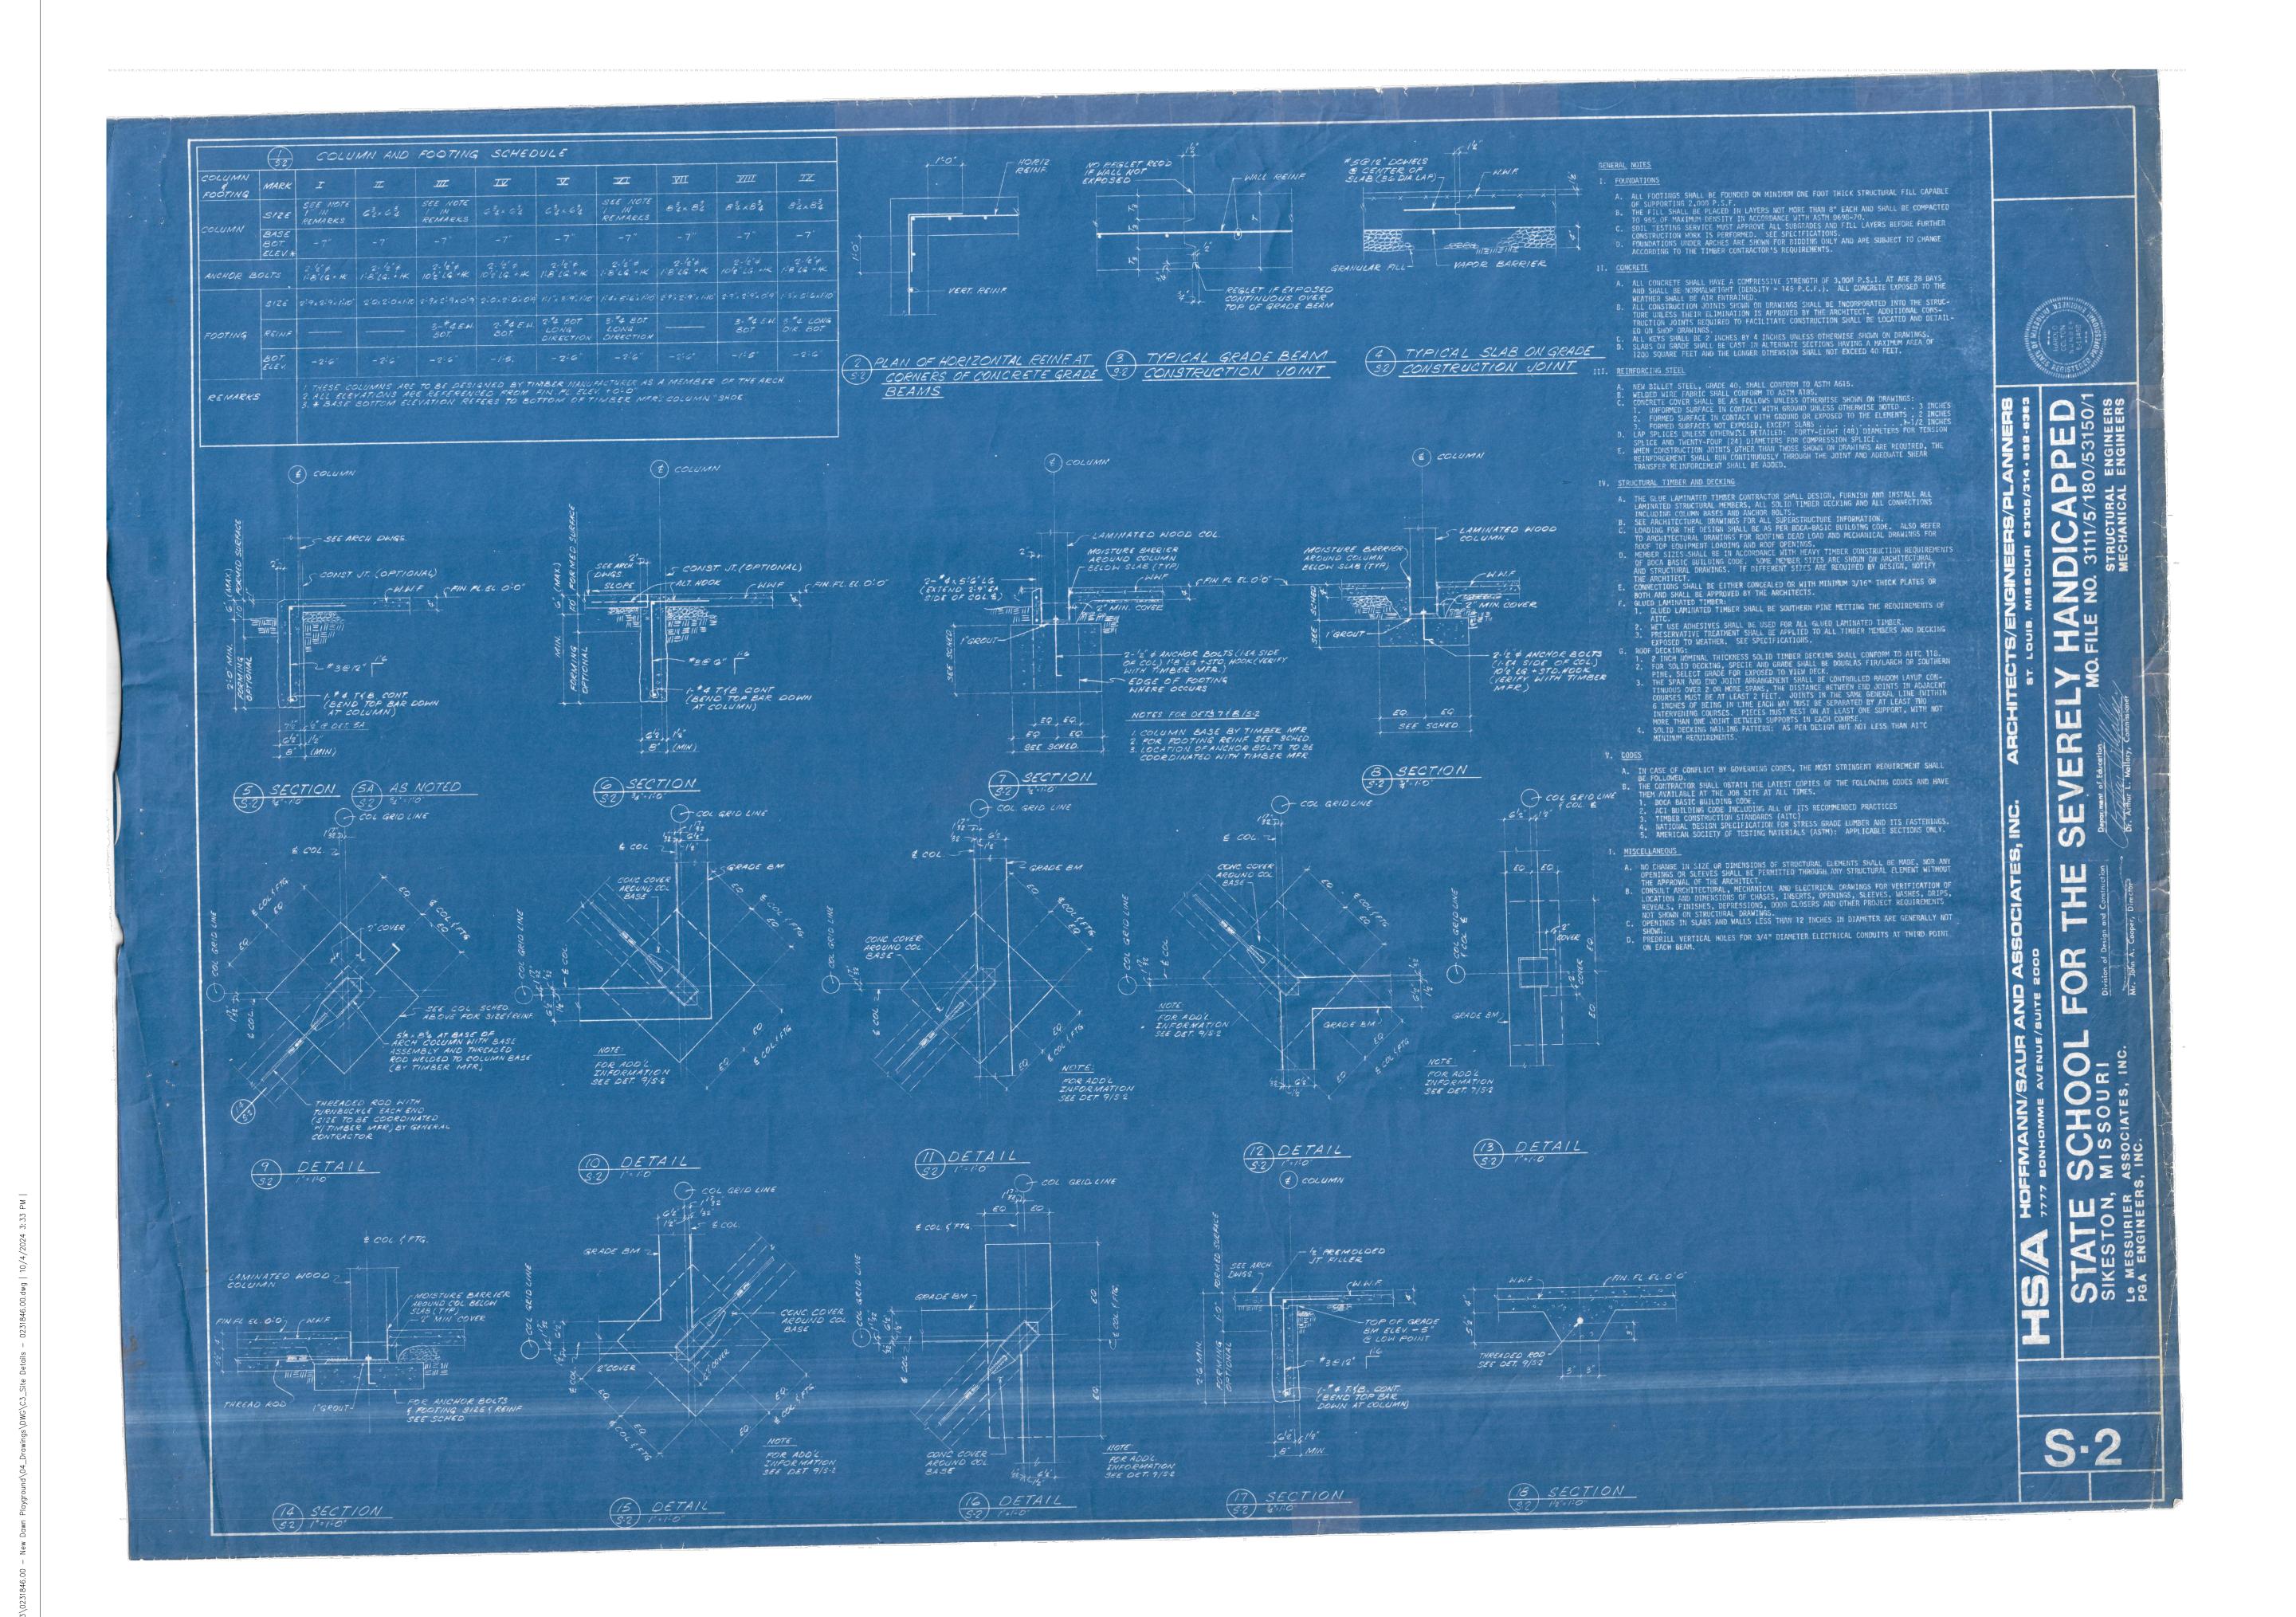

STATE OF MISSOURI MICHAEL L. PARSON, GOVERNOR



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SIKESTON, MISSOURI

PROJECT #.: E2408-01 SITE #.: 2043

ASSET #.: 5012043001 - PLAYGROUND 5012043003 - FACILITY

DATE: DESCRIPTION:

DRAWN BY: MLG CHECKED BY: SAS DESIGNED BY: SAS

SHEET TITLE:

ACCESS ROUTE - COURTYARD

SHEET NUMBER:

C-011

SHEET 12 of 12 ISSUE DATE: OCTOBER 04, 2024

