INTERIOR & EXTERIOR RENOVATIONS SHORTHORN BARN MISSOURI STATE FAIRGROUNDS SEDALIA, MO



OWNER:

STATE OF MISSOURI MICHAEL L. PARSON,

GOVERNOR

DEPARTMENT OF AGRICULTURE MISSOURI STATE FAIRGROUNDS

PROJECT
MANAGEMENT:

OFFICE OF ADMINISTRATION

DIVISION OF FACILITIES

MANAGEMENT,

DESIGN AND CONSTRUCTION

DESIGNER:


ROBERT ROLLINGS ARCHITECTS, LLC

PROJECT NUMBER:

F2205-01

SITE NUMBER: ASSET NUMBER:

1501 3511501048

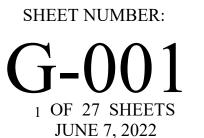

GENERAL NOTES ARE INTENDED TO SUPPLEMENT THE DRAWINGS AND SPECIFICATIONS. NOT ALL NOTES APPLY TO THIS PROJECT. SPECIFIC TRADE NOTES TAKE PRECEDENCE OVER THESE GENERAL NOTES.

1. DESIGN LOADS:

- A: BUILDING CODE 2018 IBC B: ROOF LIVE LOAD - 20 PSF
- C: GROUND SNOW LOAD 20 PSF D: WIND SPEED BASIC - 120 MPH

NOTE: THESE DRAWINGS ARE FOR THIS SPECIFIC BUILDING AND NO OTHER USE IS AUTHORIZED. SEE ARCHITECTURAL AND MECHANICAL DRAWINGS FOR EMBEDDED ITEMS NOT SHOWN HEREIN AND TO VERIFY SIZE AND LOCATION OF ALL OPENINGS. BEFORE EXECUTING ANYTHING HEREIN SHOWN, THE CONTRACTOR SHALL EXAMINE ACTUAL JOB CONDITIONS AND REPORT TO THE ARCHITECT ANY ERROR, OMISSION, OR DIFFICULTY AFFECTING THE WORK.

NOTE:

THESE DRAWINGS, ALONG WITH THE PROJECT SPECIFICATIONS, REPRESENT A UNIFIED SET OF CONSTRUCTION DOCUMENTS. ALL BIDDERS SHALL BE RESPONSIBLE FOR FAMILIARIZING THEMSELVES WITH ALL DRAWINGS IN THIS SET, REGARDLESS OF SHEET NUMBER AND DISCIPLINE, AND SHALL BE RESPONSIBLE FOR COORDINATING THEIR WORK WITH THE WORK OF OTHER TRADES. ANY APPARENT DISCREPANCIES BETWEEN DRAWINGS OR BETWEEN THE DRAWINGS AND SPECIFICATIONS SHALL BE BROUGHT TO THE ATTENTION OF THE ARCHITECT PRIOR TO BIDDING.

DO NOT BID FROM PARTIAL SETS OF BID DOCUMENTS.


BY SUBMITTING A BID, BIDDERS REPRESENT THAT THEY HAVE VISITED THE SITE, BECOME FAMILIAR WITH THE BID DOCUMENTS IN THEIR ENTIRETY AND WITH LOCAL CONDITIONS UNDER WHICH THE WORKS IS TO BE PERFORMED AND HAVE CORRELATED THE BIDDER'S PERSONAL OBSERVATIONS WITH THE REQUIREMENTS OF THE CONTRACT DOCUMENTS.








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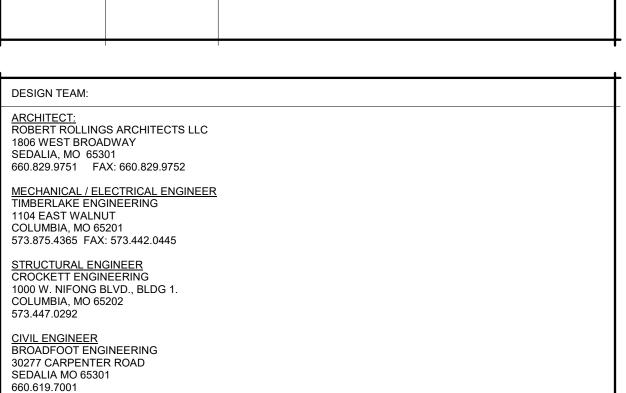
2 SITE MAP, SEDALIA, MO NOT TO SCALE



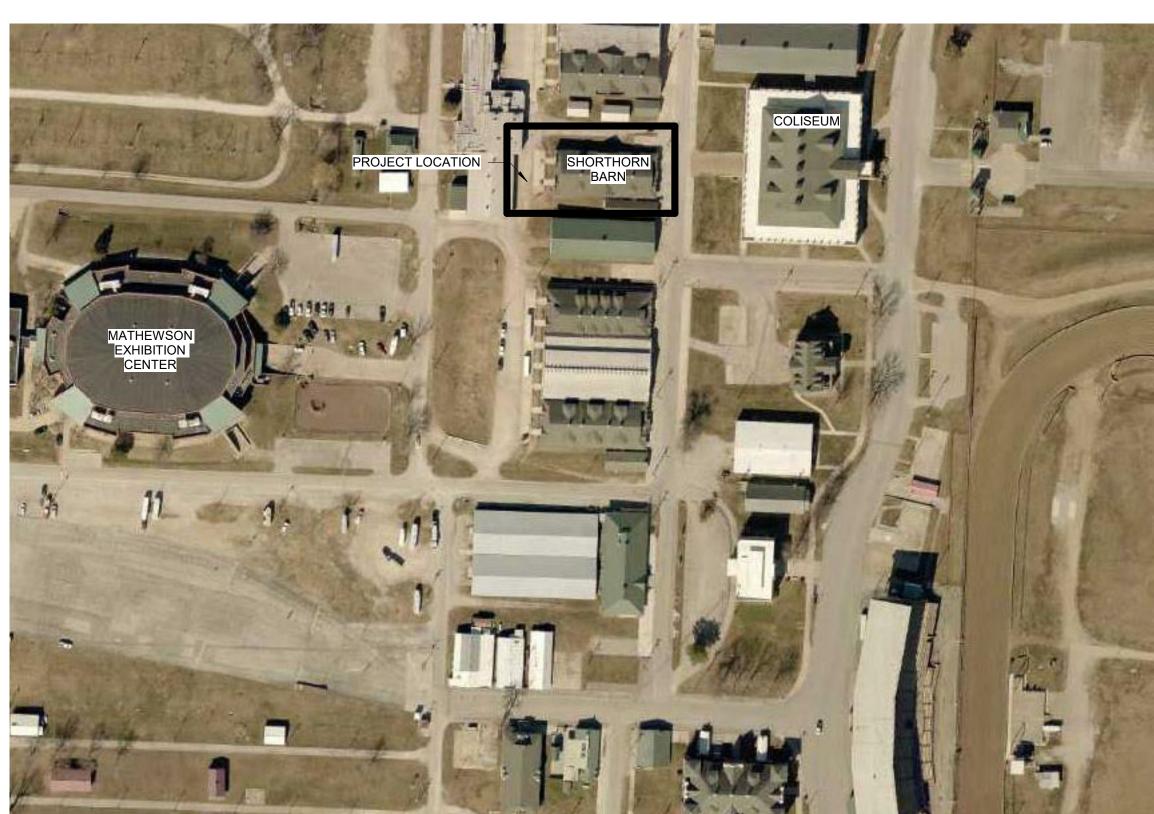

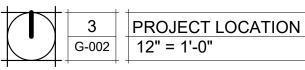

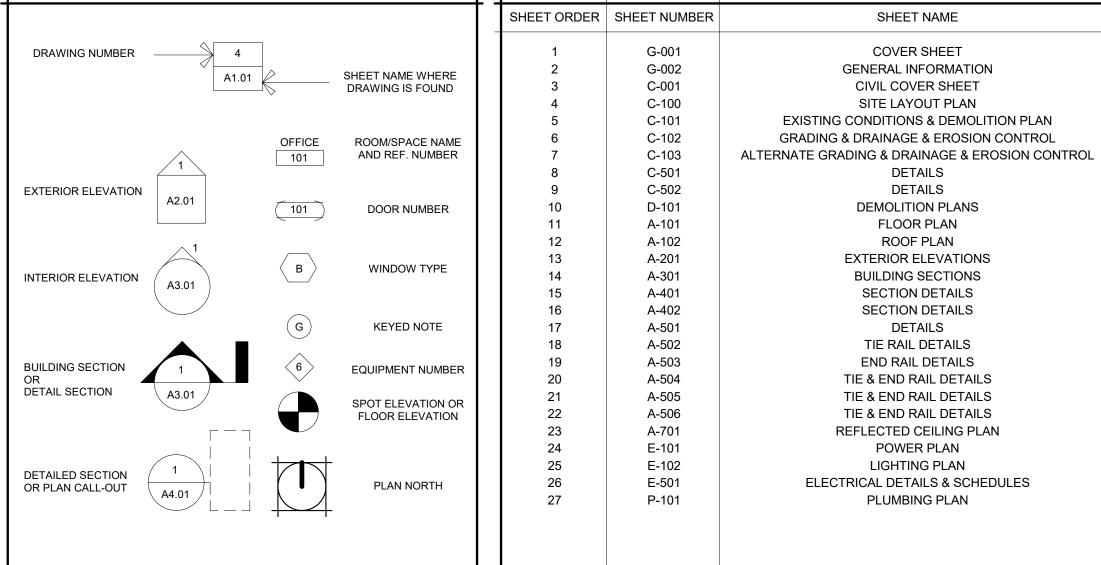

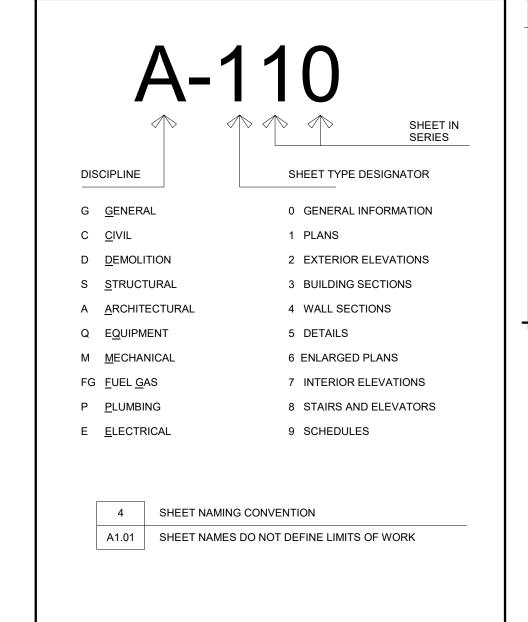

STATE OF MISSOURI MICHAEL L. PARSON, GOVERNOR



06.27.22



cobert Rollings with tects LLC

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OFFICE OF ADMINISTRATION
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MANAGEMENT DESIGN AND
CONSTRUCTION
INTERIOR & EXTERIOR

RENOVATIONS - SHORTHORN

MISSOURI STATE FAIRGROUNDS 2503 W. 16TH ST SEDALIA, MO 65301

PROJECT # F2205-01 SITE # 1501

ASSET # 3511501048

REVISION:___ DATE:

REVISION:_____ DATE:

REVISION:___ DATE:__

ISSUE DATE: 06/29/2022 BID DOCUMENTS

CAD DWG FILE:

F2205-01-1501-3511501048-G-02

DRAWN BY: AMK
CHECKED BY: RDR
DESIGNED BY: AMK

SHEET TITLE:

GENERAL INFORMATION

SHEET NUMBER:

G-002

SHEET 2 OF 27

CONSTRUCTION NOTES

- 1. THE CONTRACTOR IS RESPONSIBLE FOR VERIFYING THE LOCATION OF EXISTING UTILITIES. CONTRACTOR SHALL REPAIR ALL UTILITIES DAMAGED BY CONTRACTOR'S ACTIVITIES AT NO EXPENSE TO THE OWNER.
- 2. CONTRACTOR IS RESPONSIBLE FOR SITE SAFETY.
- 3. ALL WORK WITHIN CITY RIGHT OF WAY SHALL BE DONE IN ACCORDANCE WITH CITY OF WARRENSBURG STANDARD DETAILS AND SPECIFICATIONS.
- 4. CONTRACTOR IS RESPONSIBLE FOR IMPLEMENTING BEST MANAGEMENT PRACTICE (BMP'S) AS SHOWN ON THE PLANS. BMP'S SHALL ME MAINTAINED AT ALL TIMES.
- 5. CONTRACTOR SHALL MAINTAIN ALL EROSION CONTROL MEASURES. REFER TO GRADING BID SET FOR
- 6. ALL PUBLIC ROADS MUST BE KEPT CLEAN AT ALL TIMES.
- 7. CONTRACTOR IS RESPONSIBLE FOR PATCHING ALL STREETS DAMAGED BY CONSTRUCTION ACTIVITIES OR
- 8. CONTRACTOR SHALL NOT INTERRUPT THE OWNERS CURRENT OPERATIONS.
- 9. CONTRACTOR SHALL BE RESPONSIBLE CONTROLLING DUST FROM JOBSITE ACTIVITIES.
- 10. ADJUST VALVE COVERS & UTILITY BOXES AS NECESSARY TO PROVIDE SMOOTH SURFACE.
- 11. ALL STORM PIPE OUTLETS TO HAVE RODENT SCREENS/ANIMAL BARRIERS.
- 12. ALL STORM STRUCTURES NYOPLAST UNLESS OTHERWISE SIZES NOTED FOR CONCRETE STRUCTURE.
- 13. ALL PIPE LENGTHS AND FLOW LINES TO CENTER OF STRUCTURE.

CONSTRUCTION QUALITY ASSURANCE REQUIREMENTS:

- 1. THE OWNER IS RESPONSIBLE FOR PROVIDING QUALITY ASSURANCE COMPACTION TESTING OF SUBGRADES AND CONTROLLED FILL MATERIALS AND FIELD SAMPLING AND TESTING.
- 2. STRIP A MINIMUM OF 12 INCHES OF TOPSOIL AND ROOT ZONES FROM ALL AREAS TO RECEIVE FILL.
- 3. ALL SITE FILL SHALL BE CONSTRUCTED IN UNIFORM HORIZONTAL LIFTS WITH A MAXIMUM LOOSE THICKNESS OF 8 INCHES.
- 4. ALL SUBGRADE SURFACES AND CONTROLLED FILL ARE TO BE COMPACTED TO A MINIMUM OF 95 PERCENT OF MAXIMUM DRY DENSITY AS DETERMINED IN ACCORDANCE WITH ASTM D 689 "STANDARD" PROCTOR, AT A MOISTURE CONTENT BETWEEN 1 PERCENTAGE POINTS BELOW AND 5 PERCENTAGE POINTS ABOVE OPTIMUM MOISTURE CONTENT AS DETERMINED IN ACCORDANCE WITH ASTM D 698.
- 5. COMPACTION TESTS SHALL BE CONDUCTED IN ACCORDANCE WITH THE METHODS OF ASTM D 6938 OR
- 6. COMPACTION TESTS SHALL BE CONDUCTED AT THE RATE OF ONE TEST PER 10,000 SQUARE FEET OF SUBGRADE SURFACE AREA OR CONTROLLED FILL SURFACE AREA, WITH NO LESS THAN 2 TESTS PER EACH DAY'S SUBGRADE SURFACE AREA AND NOT LESS THAN 2 TESTS PER LIFT OF CONTROLLED FILL.

DEMOLITION NOTES:

- 1. CONTRACTOR SHALL COORDINATE ALL DEMOLITION WITH OWNER AND UTILITIES.
- 2. ALL OTHER ITEMS SHALL BE PROTECTED.
- 3. CONTRACTOR SHALL HAUL DISPOSAL ITEMS TO AN APPROVED LOCATION.

UTILITY NOTES

- 1. CONTRACTOR SHALL REFERENCE MEP PLANS FOR ADDITIONAL SITE UTILITY INFORMATION, INCLUDING UTILITY SERVICE CONNECTIONS TO ITM AND SIGNS.
- 2. ALL CONSTRUCTION SHALL MEET APPLICABLE FEDERAL, STATE, AND LOCAL UTILITY REGULATIONS AND SPECIFICATIONS, MORE SPECIFICALLY CITY OF SEDALIA AND MISSOURI STATE REQUIREMENTS.
- 3. INSTALL CLEANOUTS AT ALL CHANGES IN ALIGNMENT AND AT A MAXIMUM SPACING OF 100 FEET.
- 4. CONTRACTOR IS RESPONSIBLE FOR ALL APPLICABLE FEES INCLUDING FOR BRINGING WATER TO SITE, TAPPING, INSTALLATION OF SERVICE LINE, PITS, BACKFLOW PREVENTER AND OTHER APPLICABLE REQUIREMENTS.
- 5. CUTTING AND REPAIRING/REPLACING STREET IS THE RESPONSIBILITY OF THE CONTRACTOR.
- 6. PIPE MATERIAL SHALL BE HDPE OR POLY OR OTHER MATERIAL APPROVED BY THE LOCAL WATER DEPARTMENT.
- 7. PIPE MATERIAL SHALL BE PVC OR POLY OR OTHER MATERIAL APPROVED BY THE LOCAL WATER DEPARTMENT.
- 8. ELECTRIC CONDUIT BY CONTRACTOR.
- 9. THE CONTRACTOR SHALL BE RESPONSIBLE FOR DETERMINING THE LOCATION OF EXISTING UTILITIES, AND FIELD VERIFY EXISTING FACILITY ALIGNMENTS, DEPTHS, AND ANGLES BEFORE BEGINNING WORK.

TEMPORARY TRAFFIC CONTROL NOTES:

- 1. ALL TRAFFIC CONTROL SHALL BE PER CURRENT MUTCD REQUIREMENTS AND SHALL BE THE RESPONSIBILITY OF THE CONTRACTOR. A TRAFFIC CONTROL PLAN WILL BE REQUIRED FOR ANY WORK WITHIN THE RIGHT-OF-WAY.
- 2. ALL TRAFFIC CONTROL DEVICES AND TEMPORARY TRAFFIC CONTROL PLANS SHALL BE IN ACCORDANCE WITH THE MOST RECENT EDITION OF THE MANUAL ON UNIFORM TRAFFIC CONTROL DEVICES
- 3. THE CONTRACTOR IS SOLELY RESPONSIBLE FOR JOB SITE, WORKER, AND TRAFFIC SAFETY.

ALL UTILITIES SHOWN ARE BASED ON MARKINGS BY THE RESPECTIVE UTILITY COMPANIES, THE OWNERS, AND BY OBSERVABLE SURFACE STRUCTURES, AS FOUND IN THE FIELD.

PRIVATE WATER LINES WERE NOT MARKED BEYOND THE WATER METERS, AND IN SOME CASES, THE WATER COMPANY DID NOT MARK WATER MAINS, WHERE STRUCTURES WOULD INDICATE ONE EXISTED (i.e. FIRE HYDRANT OR WATER VALVE).

PRIVATE SANITARY SEWER LINES WERE NOT MARKED, BUT OBSERVABLE CLEAN-OUTS WERE LOCATED IN THE FIELD, AND ARE SHOWN. NO PUBLIC SEWER WAS MARKED WITHIN THE PROJECT LIMITS.

PRIVATE ELECTRIC, TELEPHONE, AND CATV LINES WERE NOT MARKED; BUT OBSERVABLE PRIVATE UTILITIES WERE LOCATED IN THE FIELD, AND ARE SHOWN.

ALL UTILITIES SHOULD BE LOCATED AND VERIFIED BEFORE ANY CONSTRUCTION SHOULD

PROPERTY OWNER


STATE OF MISSOURI S LIMIT SEDALIA, MO 65301

FLOODPLAIN NOTE

THIS PROPERTY IS LOCATED IN ZONE "X" AREAS DETERMINED TO BE OUTSIDE THE 0.2% ANNUAL CHANCE FLOODPLAIN, AS SHOWN BY FLOOD INSURANCE RATE MAP NUMBER 2902830005C, DATED JANUARY 5, 1996.

SURVEY CONTROL POINTS

POINT #	<u>NORTH</u>	<u>EAST</u>	ELEVATION	<u>DESCRIPTION</u>
CP1	1042769.29	1423566.59	865.42	HALF&CAP WEST OF DONNELLY ARENA
CP2	1042863.26	1423872.32	869.75	HALF CAP WEST OF COLISEUM CL CORRIDOR
CP5	1042860.46	1423635.55	862.88	SPIKE CL CORRIDOR NW OF DONNELLY ARENA
CP6	1042989.61	1423638.92	861.57	SPIKE IN PAVE EAST OF WOODS CENTER
CP304	1042926.74	1423737.92	868.79	INSIDE BUILDING NEAR CENTER OF NORTH AISLE

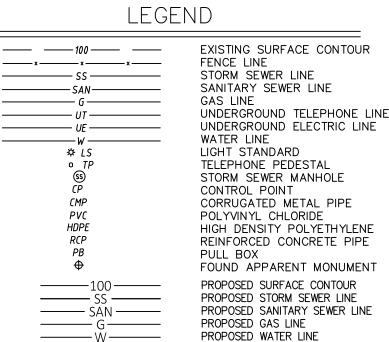

REINFORCED CONCRETE PIPE FOUND APPARENT MONUMENT PROPOSED SURFACE CONTOUR PROPOSED STORM SEWER LINE PROPOSED SANITARY SEWER LINE PROPOSED GAS LINE PROPOSED WATER LINE PROPOSED UNDERGROUND ELECTRIC LINE ———UE——— SILT FENCE

PROPOSED BASE BID CONCRETE PAVEMENT

MICHAEL L. PARSON, **GOVERNOR**

STATE OF MISSOURI



Theron J. Broadfoot, PE-2009015435 MO CERTIFICATE OF AUTHORITY # 2018030429



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#2000151304 OFFICE OF ADMINISTRATION DIVISION OF FACILITIES MANAGEMENT DESIGN AND CONSTRUCTION

INTERIOR & EXTERIOR RENOVATIONS - SHORTHORN BARN

MISSOURI STATE **FAIRGROUNDS** 2503 W. 16TH ST SEDALIA, MO 65301 PROJECT # F2205-01

SITE # 1501 ASSET # 3511501048

> **REVISION:** DATE:

REVISION: DATE:

REVISION: DATE:

PROPOSED ALTERNATE 3 CONCRETE PAVEMENT

ISSUE DATE: 06/29/2022 **CONSTRUCTION DRAWINGS**

CAD DWG FILE: F2205-01-1501-3511501048-GC-03


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CIVIL COVER SHEET

SHEET NUMBER:

SHEET 3 OF 27



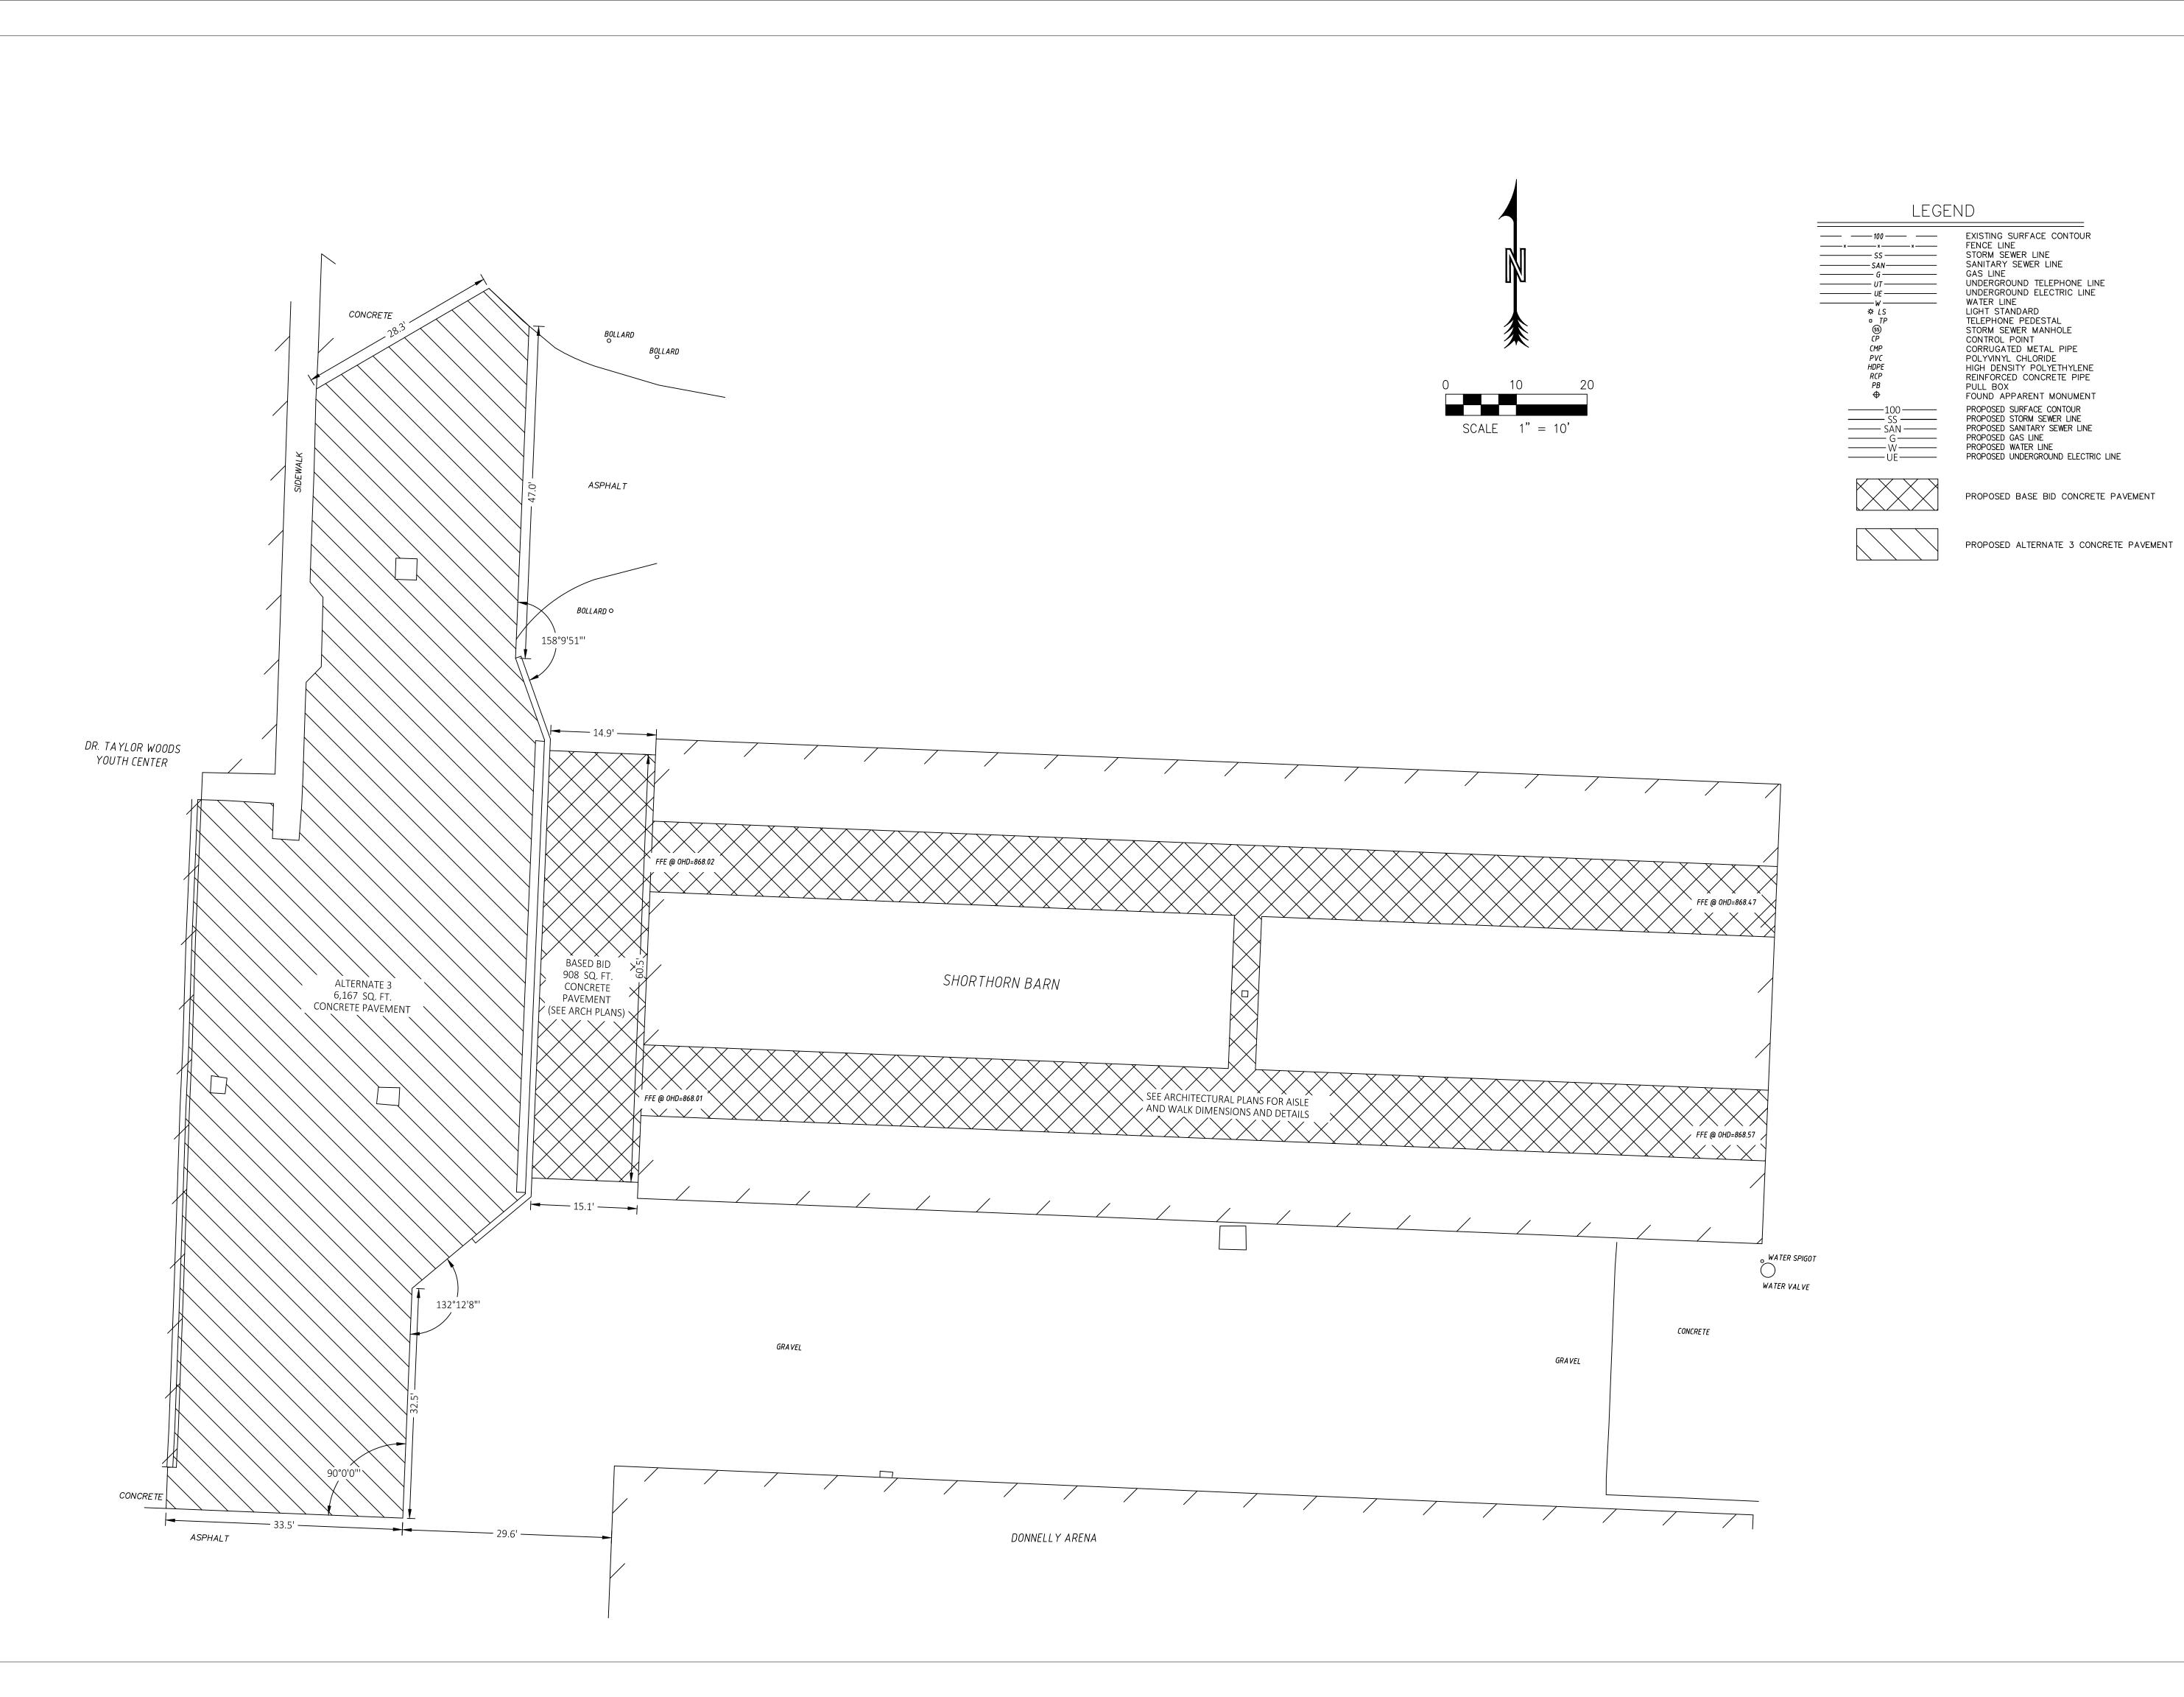

Theron J. Broadfoot, PE-2009015435 JUNE 29, 2
MO CERTIFICATE OF AUTHORITY # 2018030429



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DIVISION OF FACILITIES
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RENOVATIONS - SHORTHORN BARN MISSOURI STATE

FAIRGROUNDS 2503 W. 16TH ST SEDALIA, MO 65301 PROJECT # F2205-01

SITE # 1501 ASSET # 3511501048 REVISION:

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DATE:

REVISION:____ DATE:

ISSUE DATE: 06/29/2022 CONSTRUCTION DRAWINGS

CAD DWG FILE: F2205-01-1501-3511501048-C-SP-04

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CHECKED BY: TJB
DESIGNED BY: TJB


SHEET TITLE:

SITE LAYOUT PLAN

SHEET NUMBER:

C-100

SHEET 4 OF 27

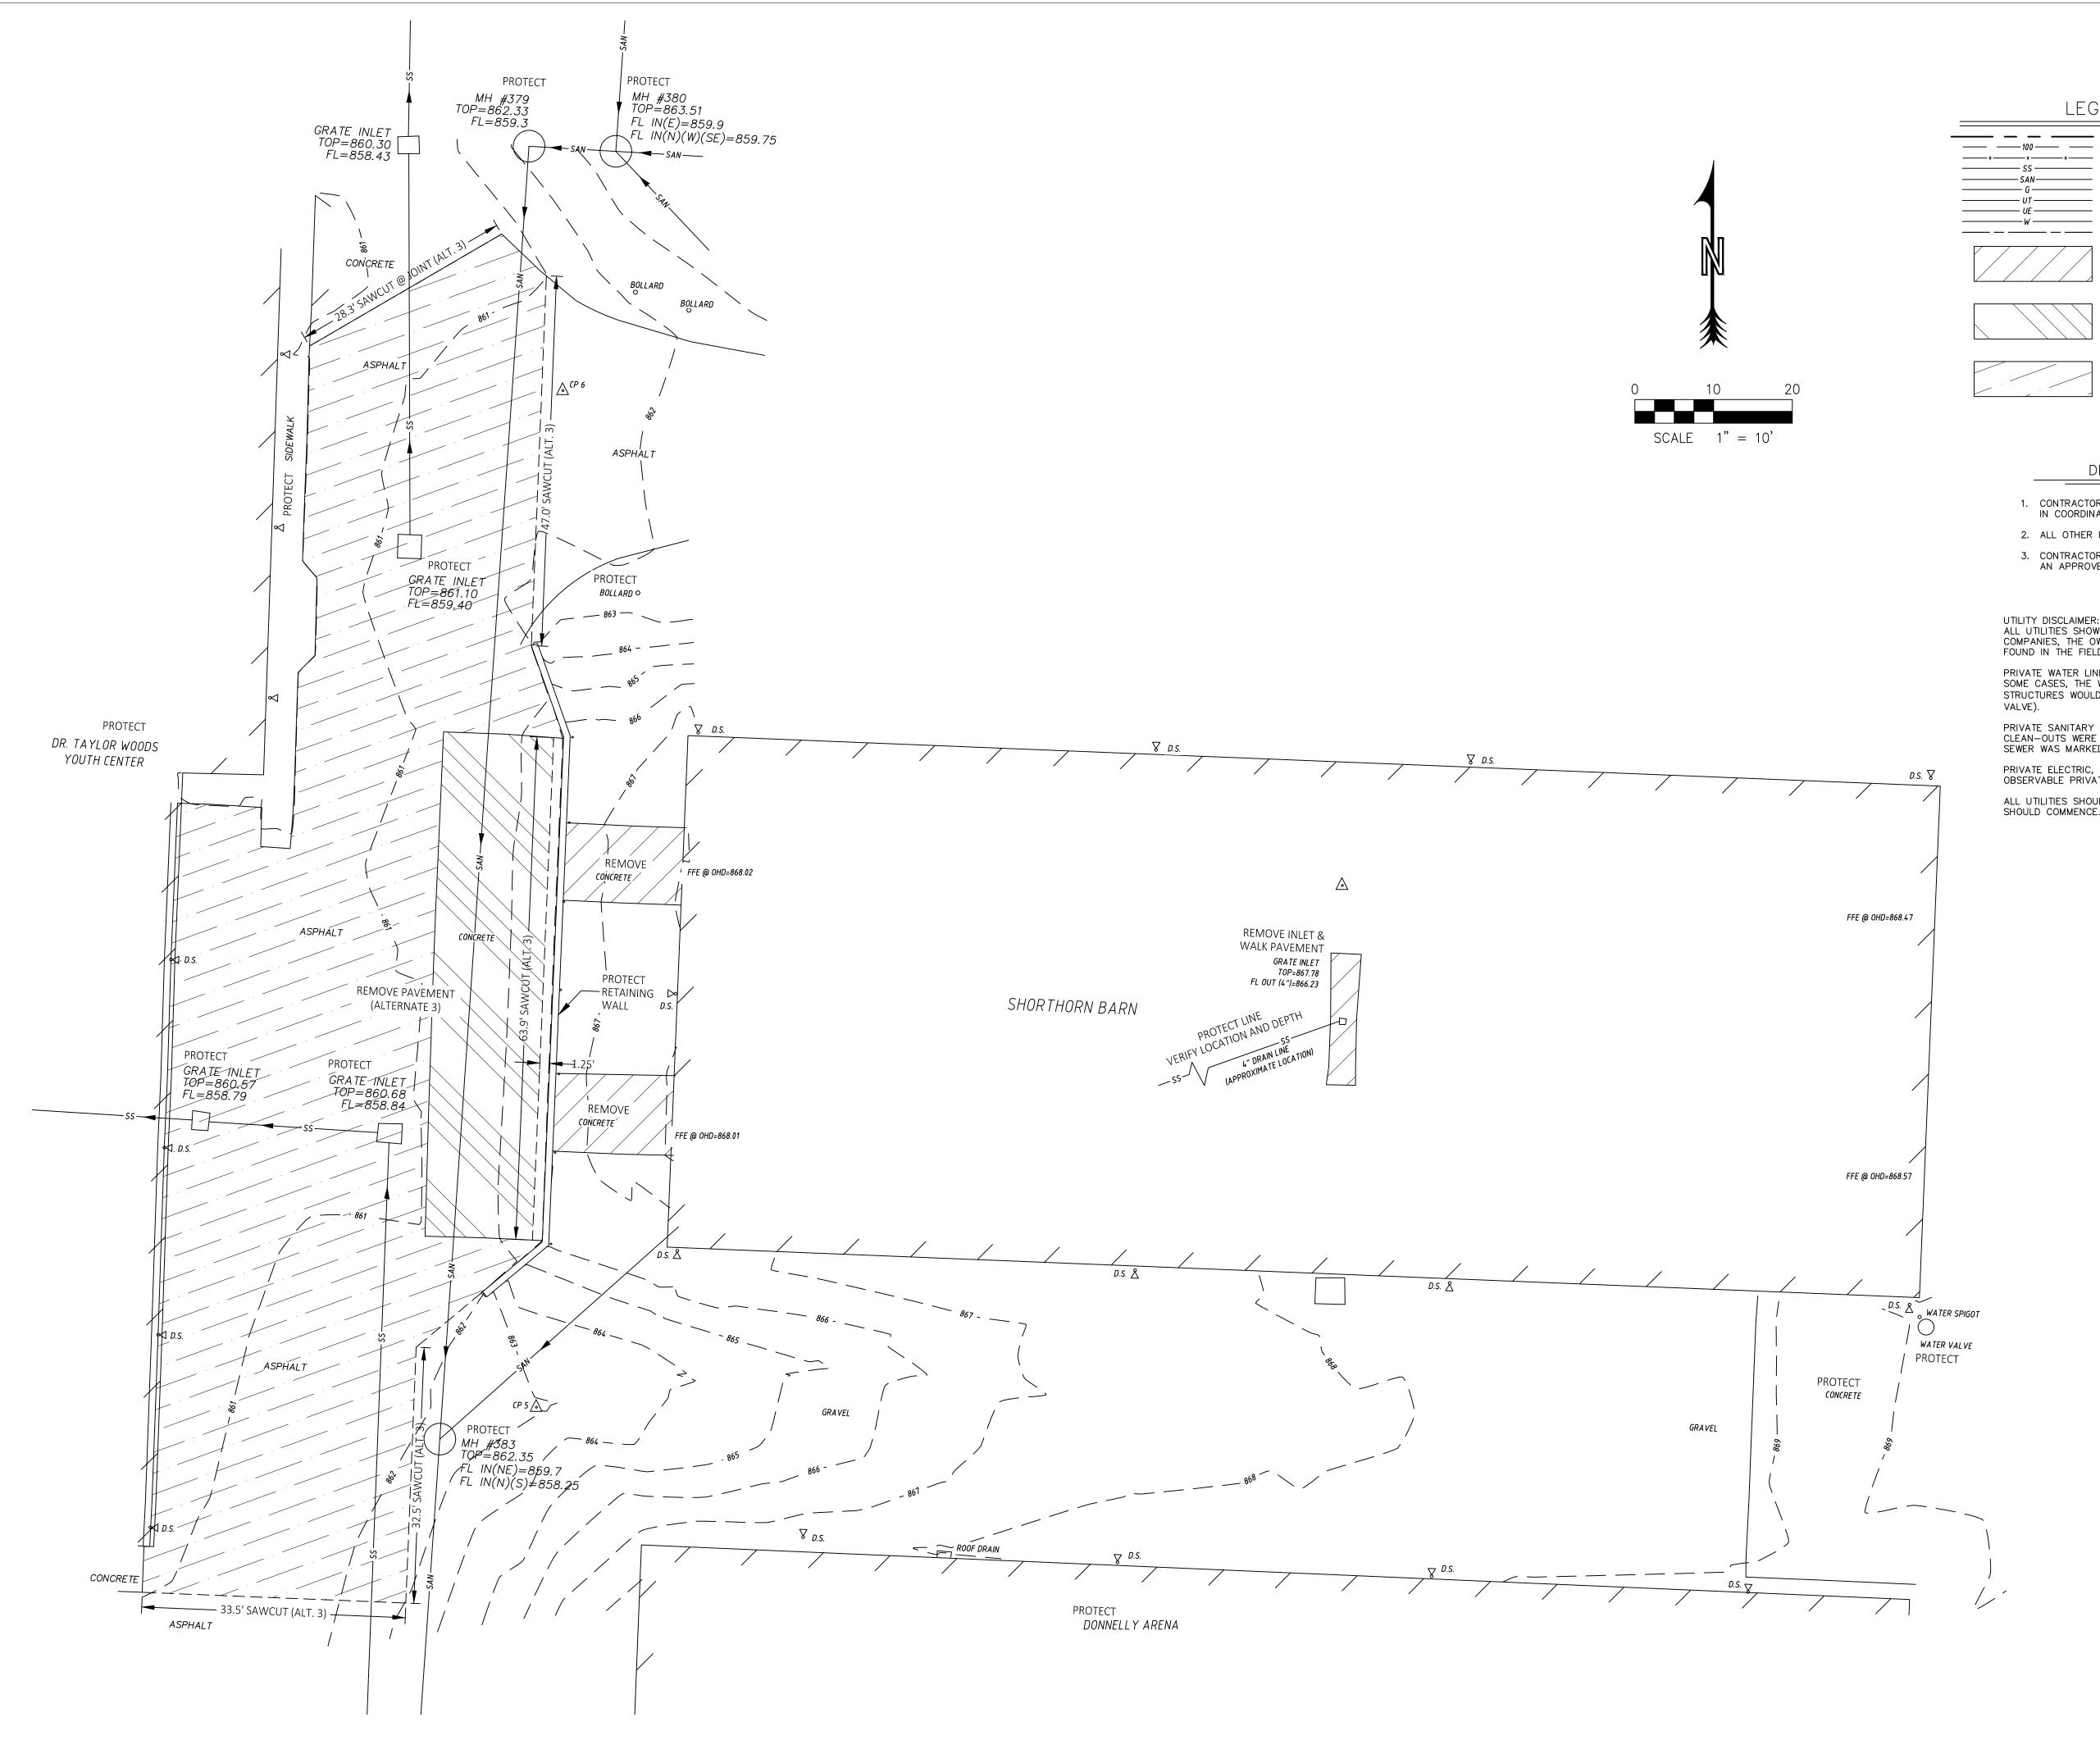

LEGEND

PROPERTY LINE (APPROXIMATE)
EXISTING SURFACE CONTOUR FENCE LINE STORM SEWER LINE SANITARY SEWER LINE GAS LINE UNDERGROUND TELEPHONE LINE UNDERGROUND ELECTRIC LINE WATER LINE SILT FENCE

BASE BID DEMOLITION/ REMOVE CONCRETE PAVEMENT

ALTERNATE 3 BID DEMOLITION/ REMOVE CONCRETE PAVEMENT

ALTERNATE 3 BID DEMOLITION/ REMOVE ASPHALT PAVEMENT

DEMOLITION NOTES

- 1. CONTRACTOR SHALL DEMOLITION PER PLANS AND IN COORDINATION WITH OWNER AND UTILITIES.
- 2. ALL OTHER ITEMS SHALL BE PROTECTED.
- CONTRACTOR SHALL HAUL DISPOSAL ITEMS TO AN APPROVED LOCATION.

UTILITY DISCLAIMER:
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STATE OF MISSOURI MICHAEL L. PARSON, **GOVERNOR**



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OFFICE OF ADMINISTRATION DIVISION OF FACILITIES MANAGEMENT DESIGN AND CONSTRUCTION

#2000151304

INTERIOR & EXTERIOR **RENOVATIONS - SHORTHORN** BARN

MISSOURI STATE **FAIRGROUNDS** 2503 W. 16TH ST SEDALIA, MO 65301

PROJECT # F2205-01 SITE # 1501 ASSET # 3511501048

REVISION: DATE:

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REVISION: DATE:

ISSUE DATE: 06/29/2022 **CONSTRUCTION DRAWINGS**

CAD DWG FILE: F2205-01-1501-3511501048-C-SP-05


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SHEET TITLE:

EXISTING CONDITIONS & **DEMOLITION PLAN**

SHEET NUMBER:

SHEET 5 OF 27



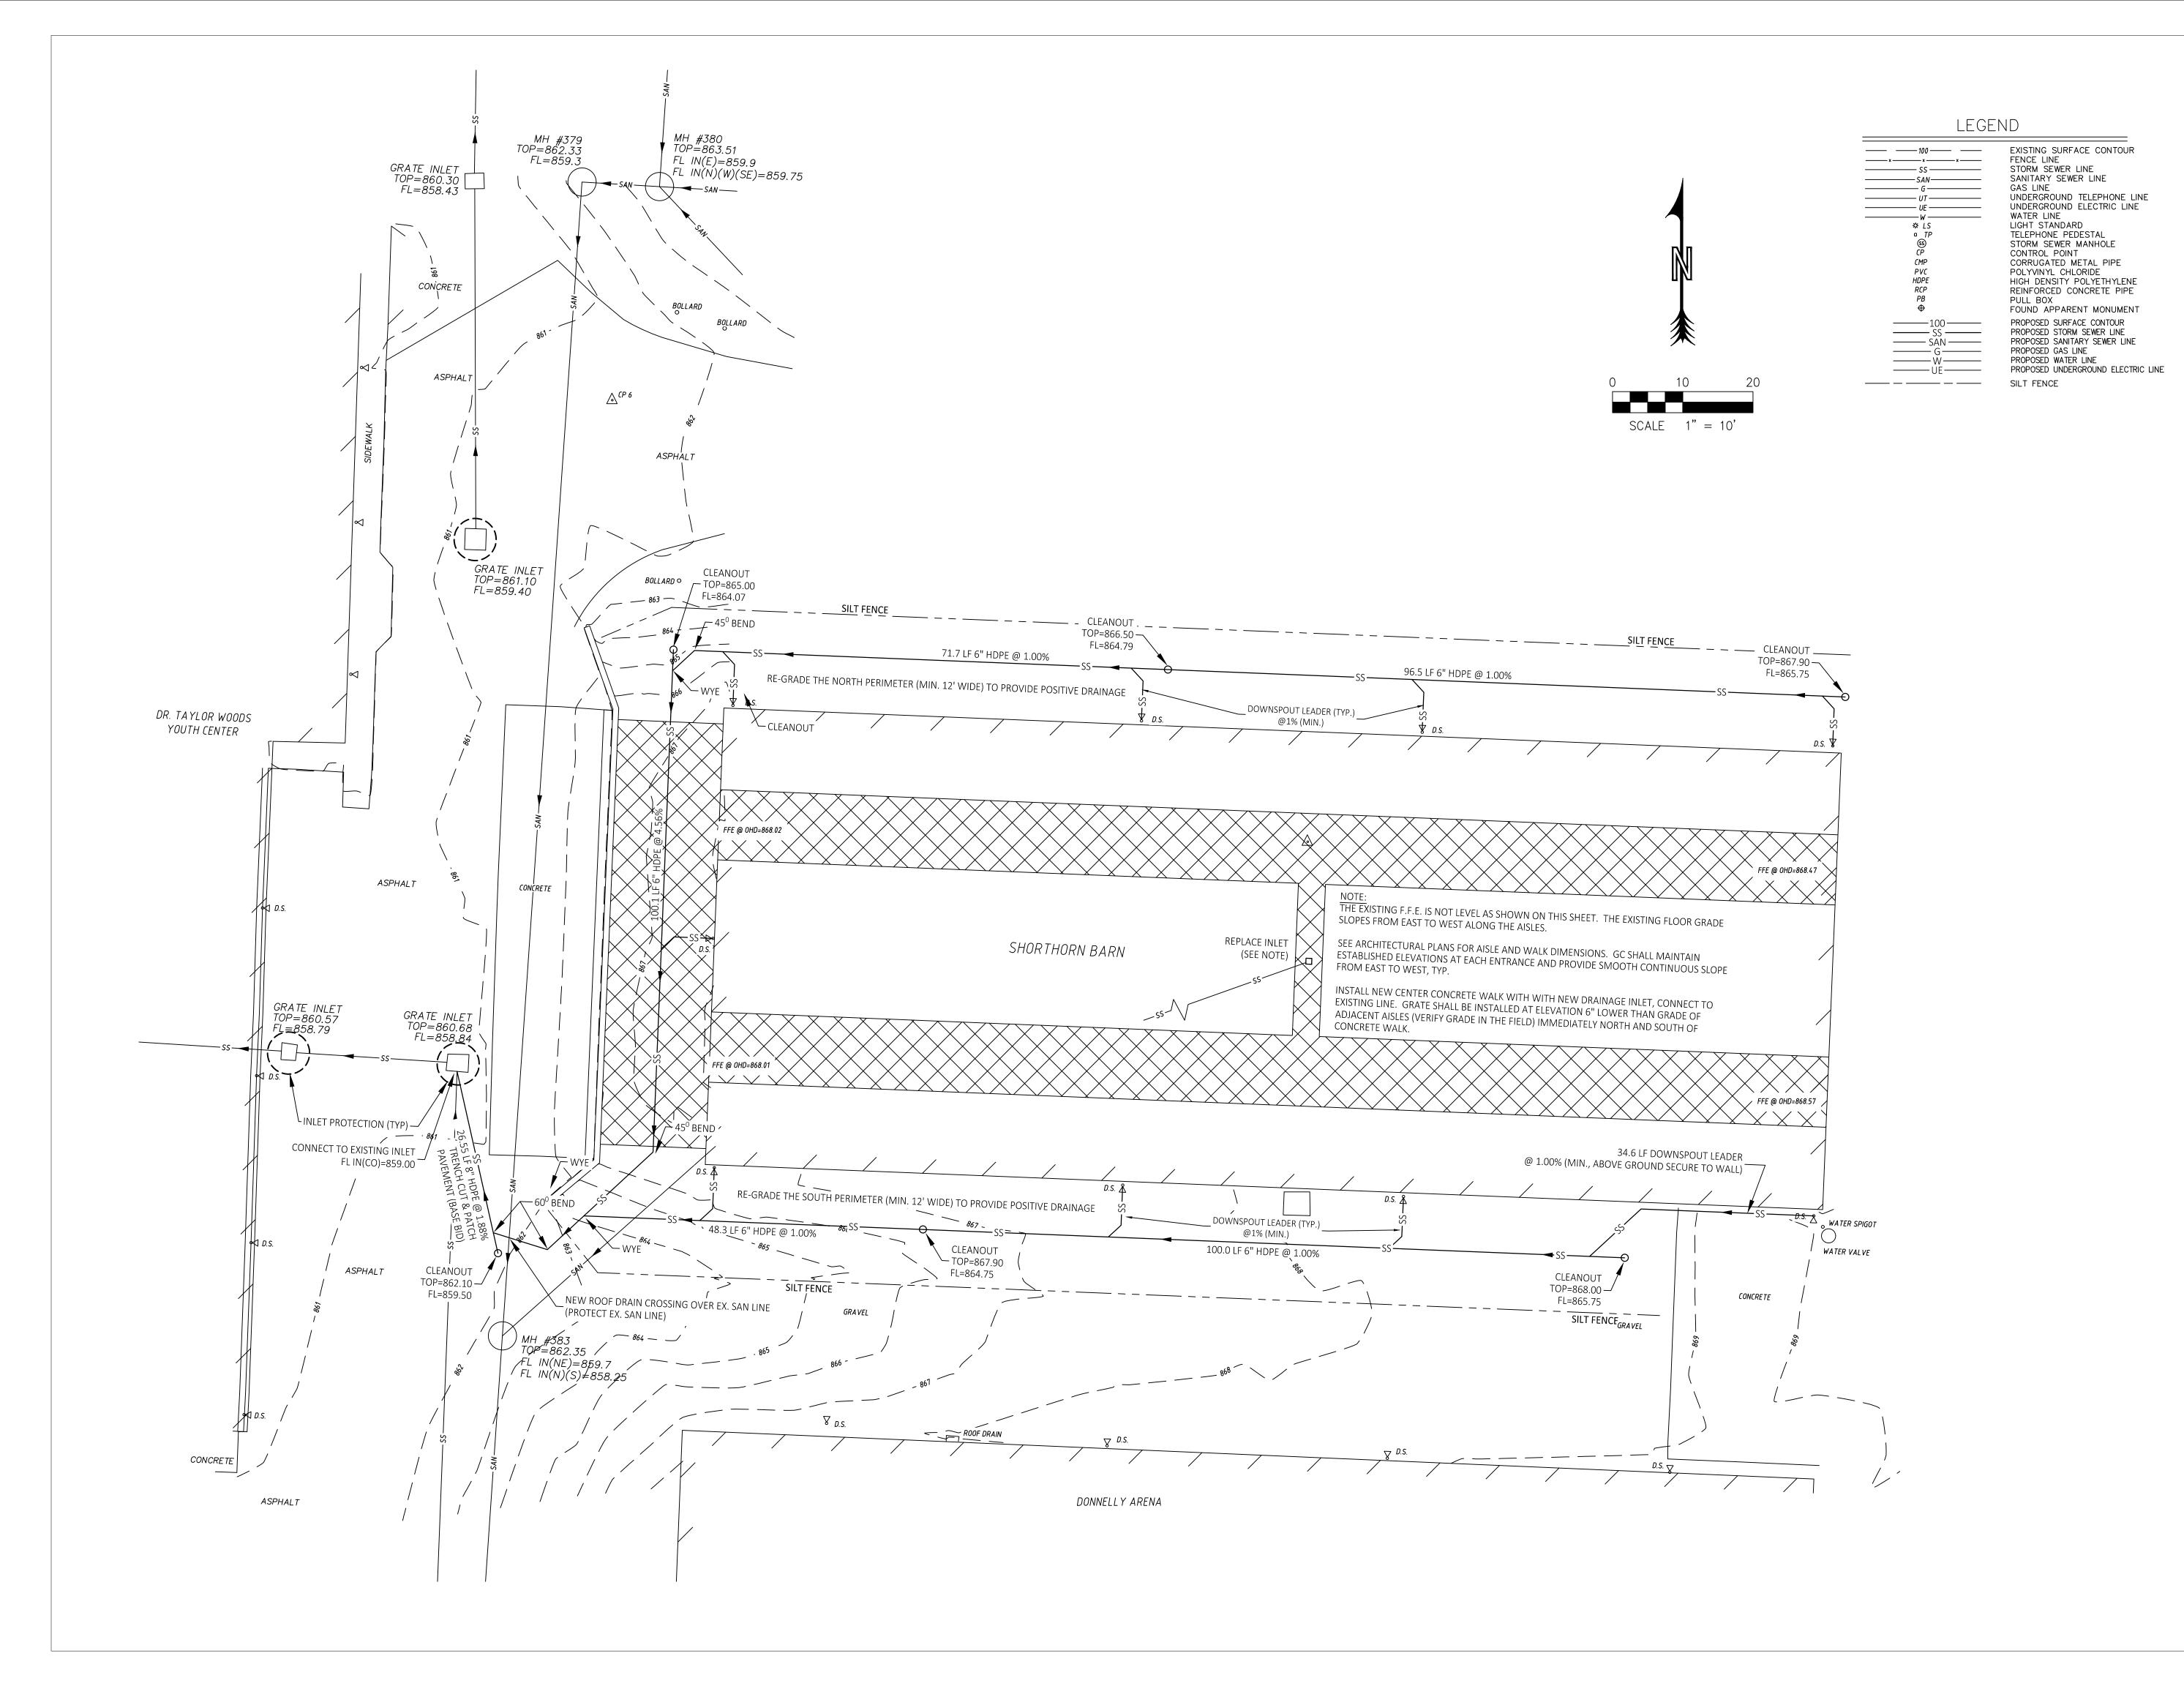

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INTERIOR & EXTERIOR RENOVATIONS - SHORTHORN BARN MISSOURI STATE

FAIRGROUNDS 2503 W. 16TH ST SEDALIA, MO 65301 PROJECT # F2205-01

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CAD DWG FILE: F2205-01-1501-3511501048-C-SP-06


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SHEET TITLE:

GRADING & DRAINAGE & **EROSION CONTROL**

SHEET NUMBER:

SHEET 6 OF 27



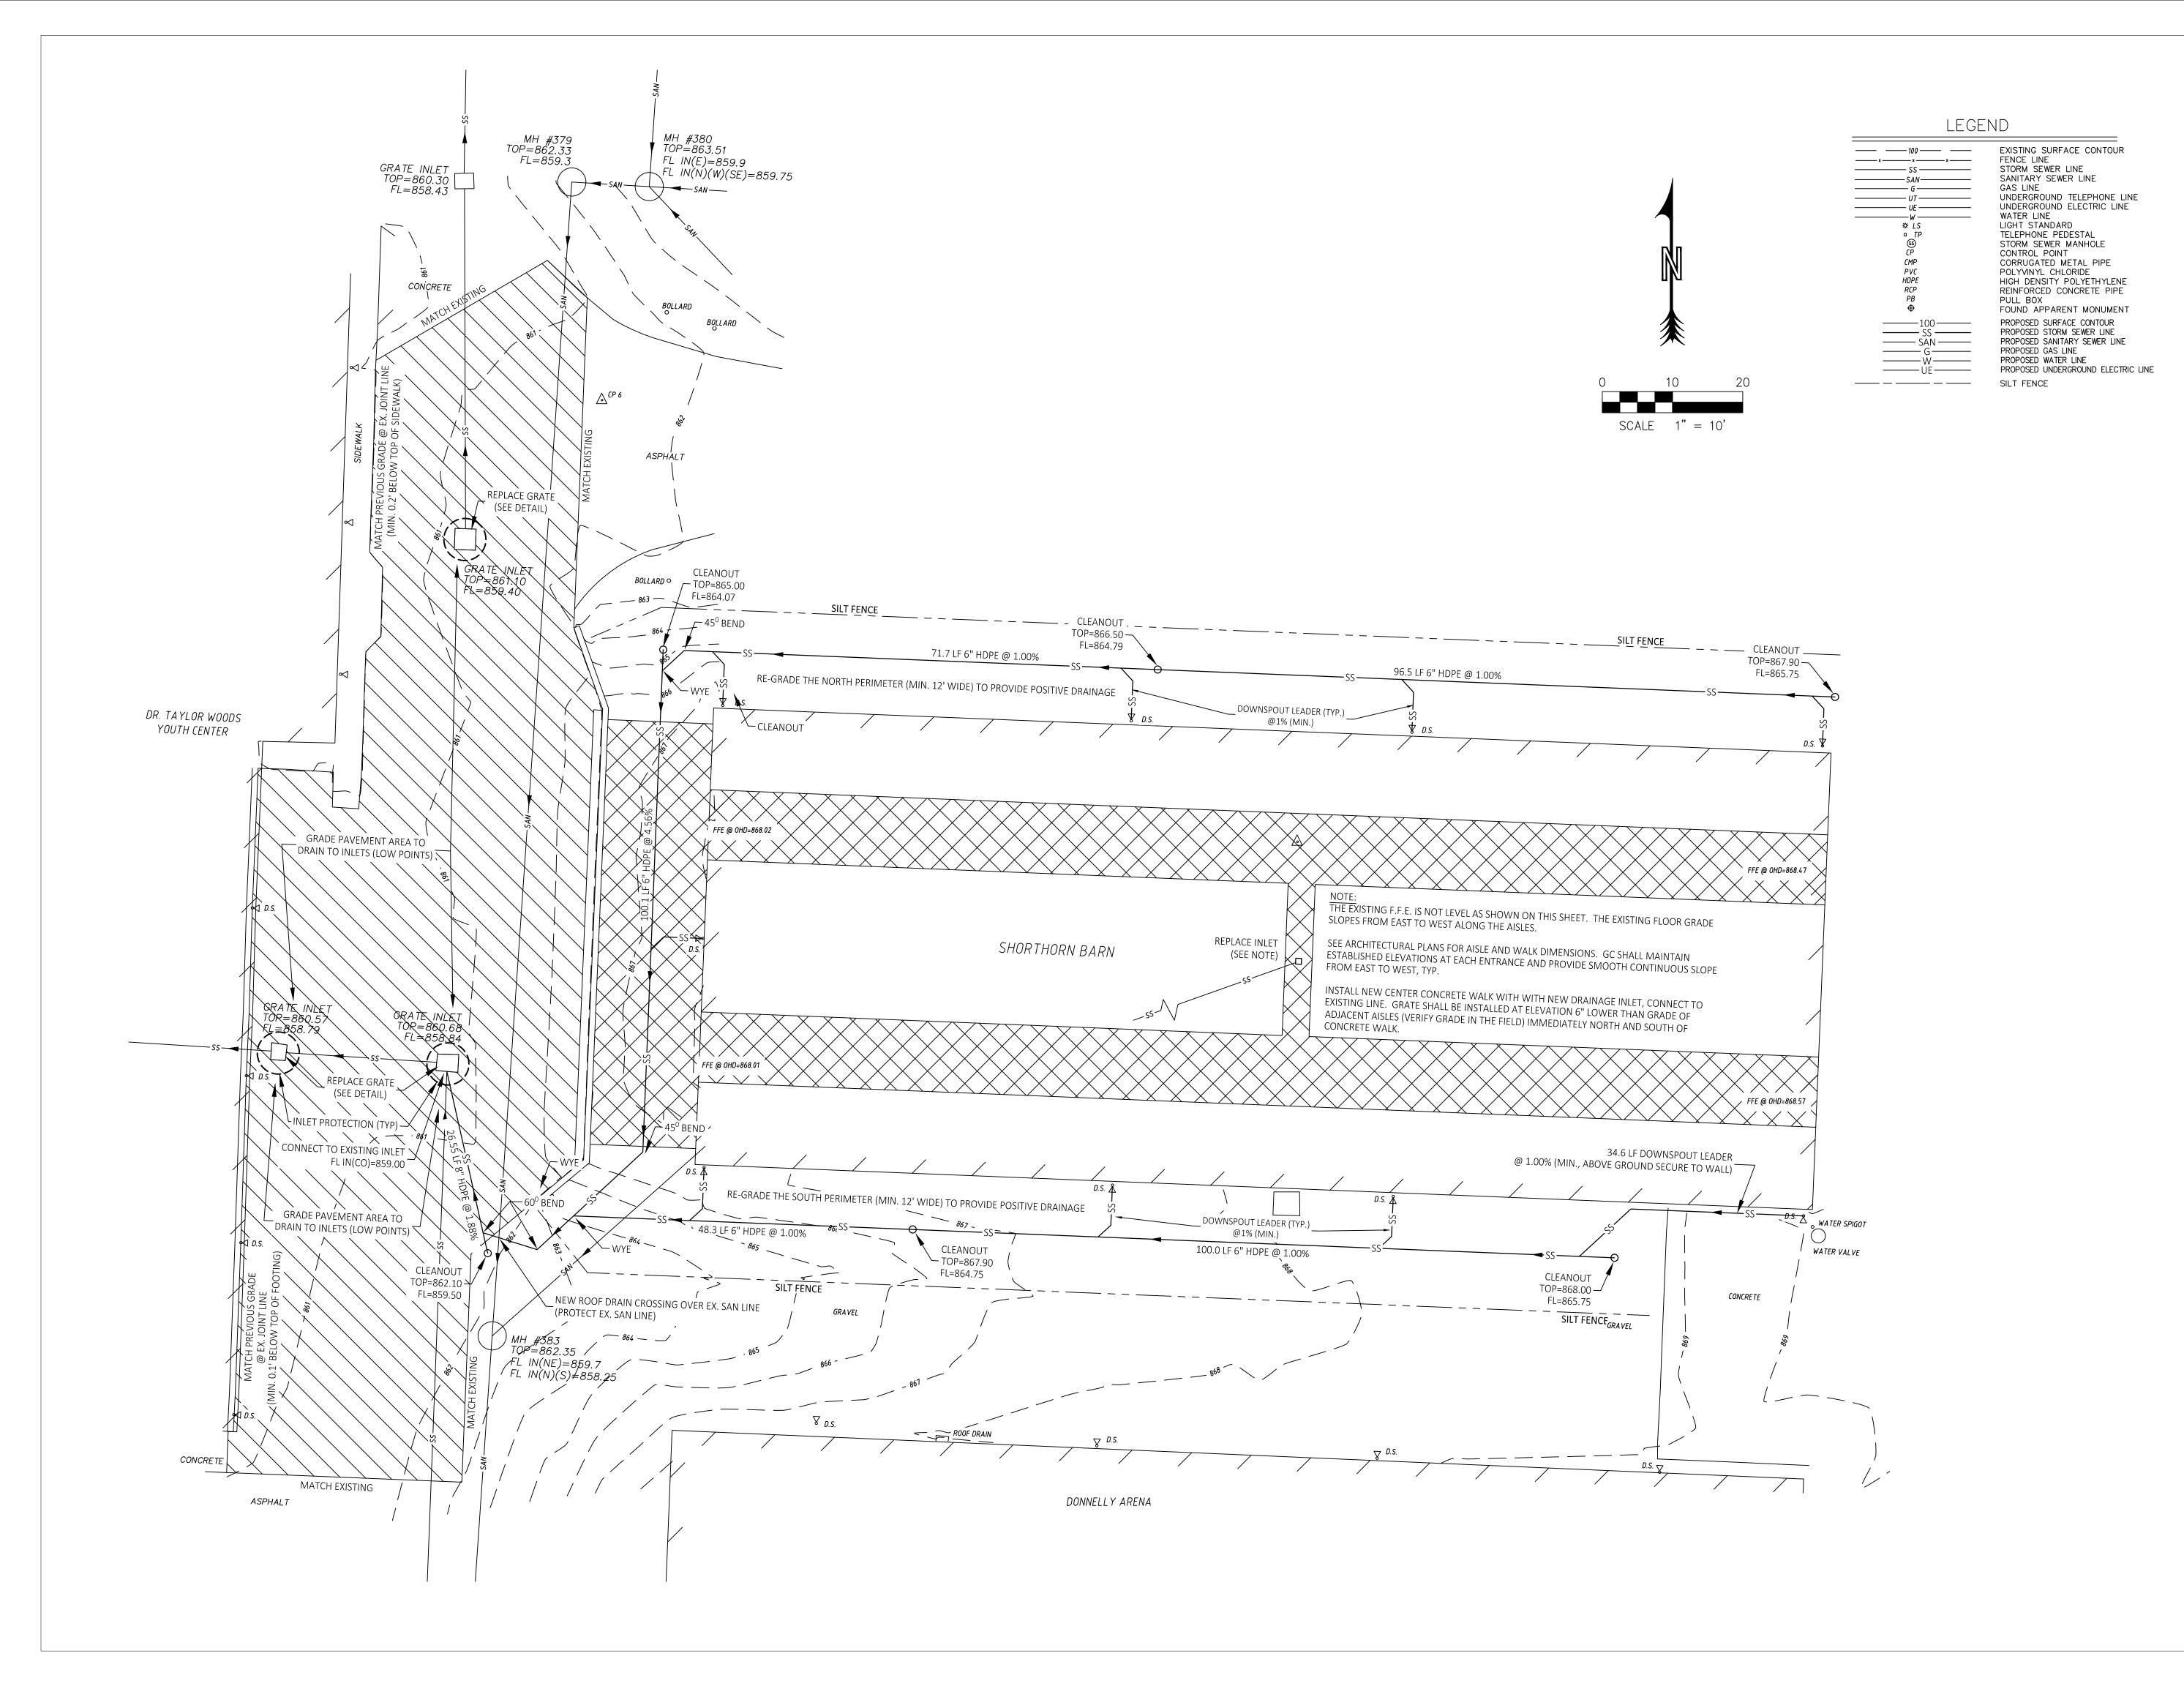

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OFFICE OF ADMINISTRATION

BARN MISSOURI STATE FAIRGROUNDS 2503 W. 16TH ST SEDALIA, MO 65301

PROJECT # F2205-01 SITE # 1501 ASSET # 3511501048

REVISION: DATE:_

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REVISION:_ DATE:_

ISSUE DATE: 06/29/2022 CONSTRUCTION DRAWINGS

CAD DWG FILE: F2205-01-1501-3511501048-C-SP-07

DRAWN BY: TJB
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DESIGNED BY: TJB


SHEET TITLE:

ALTERNATE GRADING & DRAINAGE & EROSION CONTROL PLAN

SHEET NUMBER:


C-103

SHEET 7 OF 27

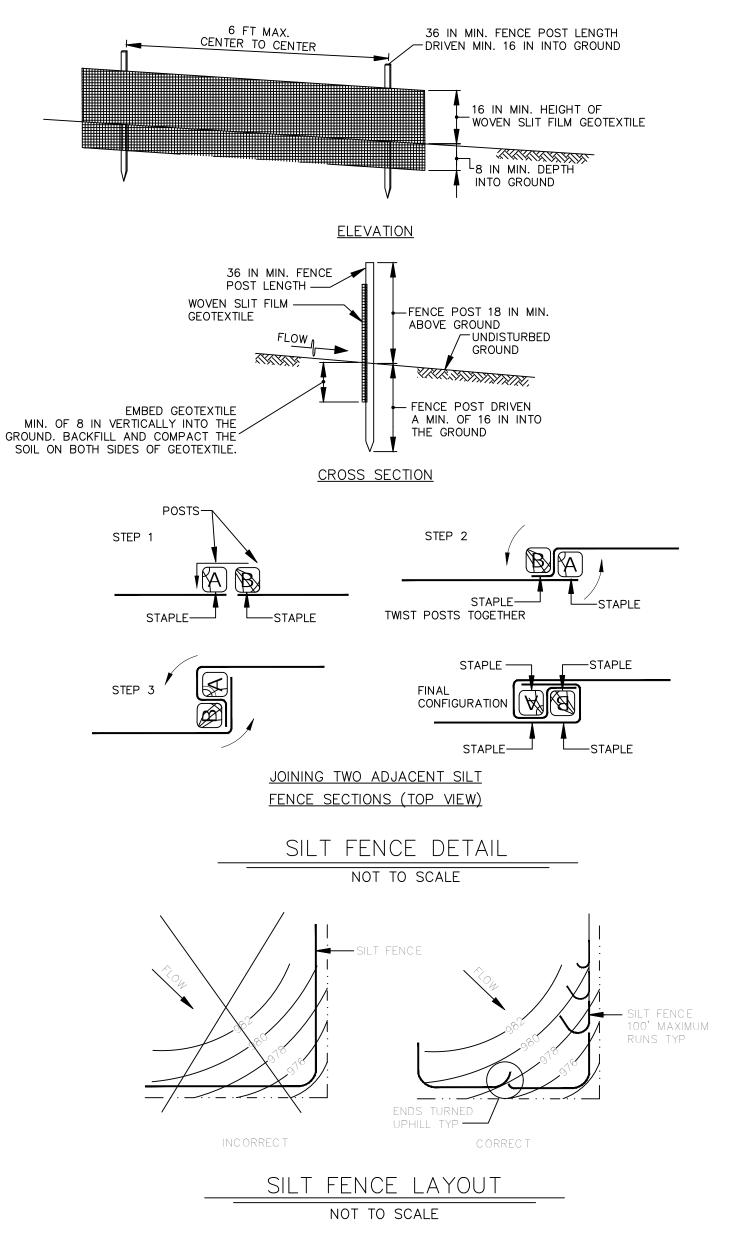

SILT FENCE SPECIFICATIONS

- 1. USE WOOD POSTS $1\frac{3}{4}$ X $1\frac{3}{4}$ \pm $\frac{1}{6}$ INCH (MINIMUM) SQUARE CUT OF SOUND QUALITY HARDWOOD. AS AN ALTERNATIVE TO WOODEN POST USE STANDARD "T" OR "U" SECTION STEEL POSTS WEIGHING NOT LESS THAN 1 POUND PER LINEAR FOOT.
- 2. USE 36 INCH MINIMUM POSTS DRIVEN 16 INCH MINIMUM INTO GROUND NO MORE THAN 6 FEET APART.
- 3. USE WOVEN SLIT FILM GEOTEXTILE AS SPECIFIED IN SECTION H-1 MATERIALS AND FASTEN GEOTEXTILE SECURELY TO UPSLOPE SIDE OF FENCE POSTS WITH WIRE TIES OR STAPLES AT TOP AND MID-SECTION.
- 4. PROVIDE MANUFACTURER CERTIFICATION TO THE AUTHORIZED REPRESENTATIVE OF THE INSPECTION/ENFORCEMENT AUTHORITY SHOWING THAT THE GEOTEXTILE USED MEETS THE REQUIREMENTS IN
- 5. EMBED GEOTEXTILE A MINIMUM OF 8 INCHES VERTICALLY INTO THE GROUND. BACKFILL AND COMPACT THE SOIL ON BOTH SIDES OF FABRIC.
- 6. WHERE TWO SECTIONS OF GEOTEXTILE ADJOIN: OVERLAP, TWIST, AND STAPLE TO POST IN ACCORDANCE WITH THIS DETAIL.
- 7. EXTEND BOTH ENDS OF THE SILT FENCE A MINIMUM OF FIVE HORIZONTAL FEET UPSLOPE AT 45 DEGREES TO THE MAIN FENCE ALIGNMENT TO PREVENT RUNOFF FROM GOING AROUND THE ENDS OF
- 8. REMOVE ACCUMULATED SEDIMENT AND DEBRIS WHEN BULGES DEVELOP IN SILT FENCE OR WHEN SEDIMENT REACHES 25% OF FENCE HEIGHT. REPLACE GEOTEXTILE IF TORN. IF UNDERMINING OCCURS, REINSTALL

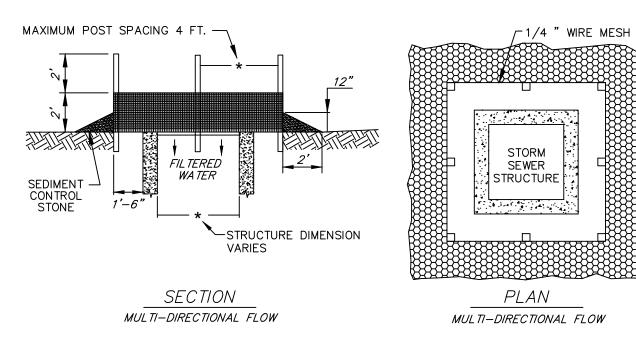


1. SEDIMENT CONTROL STONE SHALL BE 3/4" WASHED STONE. 2. WIRE MESH SHALL BE HARDWARE CLOTH 23 GAUGE MIN. AND SHALL HAVE 1/4 INCH MESH

3. TOP OF WIRE MESH SHALL BE A MINIMUM OF ONE FOOT BELOW THE SHOULDER OR ANY DIVERSION 4. STEEL POST SHALL BE 5 FT. IN HEIGHT, BE INSTALLED 1.5 FT. DEEP MINIMUM, AND BE OF THE SELF-FASTENER ANGLE STEEL TYPE. 5. WOOD POST SHALL BE 6 FT. IN HEIGHT, BE INSTALLED TO 1.5 FT. DEEP MINIMUM, AND BE 3

INCHES IN DIAMETER. 6. POST SPACING SHALL BE A MAXIMUM OF 4 FT.

> INLET PROTECTION NOT TO SCALE

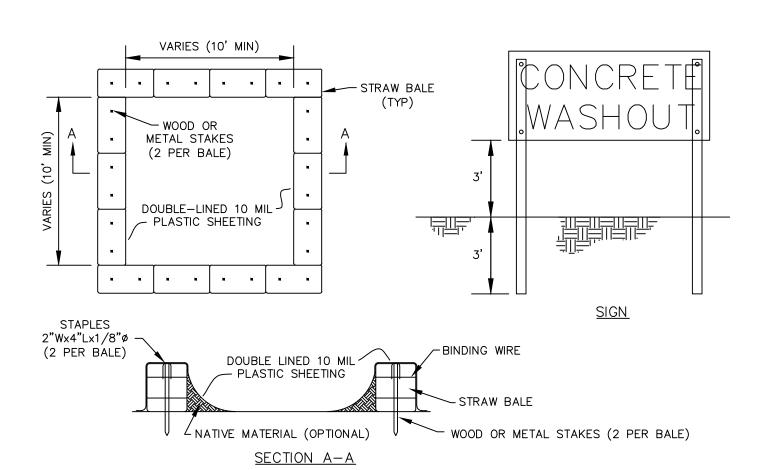



1. ALL CONCRETE WASTE MATERIAL, INCLUDING WASHOUT WATER, SHALL BE TOTALLY CONTAINED. 2. SEE SWPPP FOR MORE DETAILS.

- 3. UPON PROJECT COMPLETION CONTRACTOR SHALL REMOVE AND DISPOSE OF ALL CONCRETE WASTE FROM THE OWNER'S PROPERTY PER ALL APPLICABLE SOLID WASTE REGULATIONS.
- 4. CONSTRUCT SIGN OF WEATHER PROOF MATERIALS OF A SIZE EASILY READABLE BY CONCRETE TRUCK DRIVERS. PLACE
- SIGN WITHIN 10' OF WASHOUT. 5. CONTRACTOR SHALL CONTAIN WASHOUT WATERS AT ALL TIMES.

CONCRETE WASHOUT AREA

NOT TO SCALE

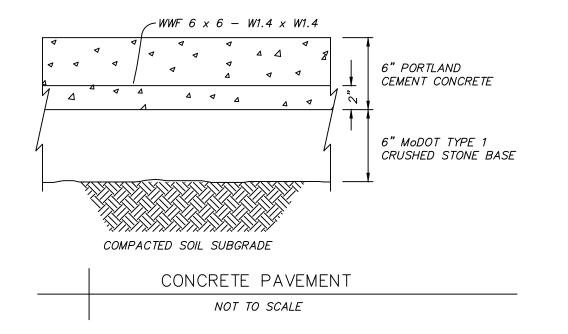

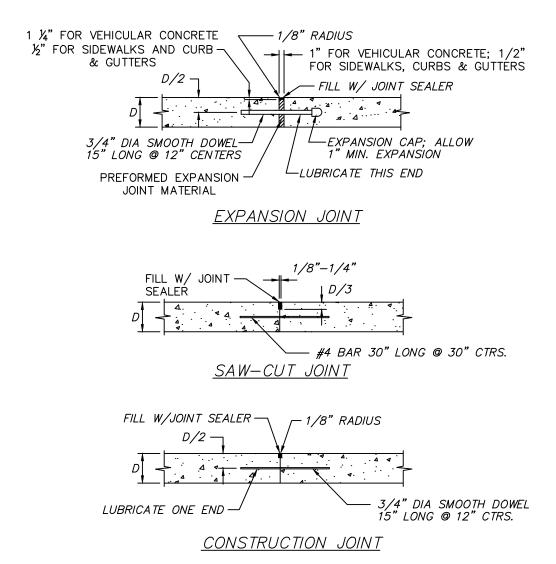

1. PRIOR TO CONSTRUCTION, CONTRACTOR SHALL SUBMIT A PAVEMENT JOINT PLAN OF ALL

CONCRETE PAVEMENT FOR APPROVAL. 2. CONCRETE PAVEMENT SHALL HAVE SAW-CUT OR CONSTRUCTION JOINTS EVERY 10 FEET FOR 4 INCH THICK PAVEMENT, 12 FEET FOR 5 INCH THICK PAVEMENT, AND 15 FEET FOR 6 INCH THICK PAVEMENT OR GREATER. PANELS SHALL BE CUT SUCH THAT PANELS ARE NEARLY SQUARE AND DO NOT EXCEED 1.4 LENGTH TO WIDTH RATIO. EXPANSION JOINTS SHALL BE PROVIDED AT ALL FIXED STRUCTURES, SUCH AS: LIGHT STANDARD FOUNDATIONS, SEWER STRUCTURES, BUILDINGS, WALLS, BOTTOM OF STAIRS, ROOF DRAINS, ETC., AND EVERY 150 FEET MAXIMUM. DOWEL BARS SHALL BE PROVIDED AT TRANSVERSE JOINTS IN ALL HEAVY DUTY PAVEMENT.

3. THIS DETAIL APPLIES TO ALL CONCRETE PAVEMENT FOR PARKING LOTS, DRIVE/ACCESS AISLES, CURBS & GUTTERS, AND SIDEWALKS.

- 4. ALL 9 INCH THINK HEAVY DUTY CONCRETE PAVEMENT SHALL HAVE JOINTS PER MODOT DETAILS, INCLUDING 1.25 INCH SMOOTH DOWELS WITH DOWEL SUPPORT BASKETS PER MODOT DETAIL AND LONGITUDINAL JOINTS WITH #5 X 30" TIE BARS.
- INCLUDE BAR WITH TRANSVERSE SAW-CUT JOINTS FOR HEAVY DUTY PAVEMENT. OMIT BAR WITH SAW-CUT JOINTS FOR STANDARD DUTY PAVEMENT AND SIDEWALKS.
- PROVIDE CONSTRUCTION JOINT AT END OF DAYS WORK OR IF CONCRETE PLACEMENT IS SUSPENDED FOR MORE THAN 30 MINUTES.
- 7. SAW-CUT JOINTS SHALL BE CUT WITHIN 12 HOURS OF INITIAL SET OF CONCRETE. RAVELED JOINTS WILL NOT BE ACCEPTED.
- 8. ELASTOMERIC POLYURETHANE JOINT SEALANT IS REQUIRED FOR ALL JOINTS AND SHALL BE LIGHT

9. OMIT DOWEL BARS FOR EXPANSION JOINTS AT BUILDINGS, LIGHT STANDARDS, AND ROOF DRAINS.

CONCRETE PAVEMENT JOINTS NOT TO SCALE

STATE OF MISSOURI MICHAEL L. PARSON, **GOVERNOR**



Theron J. Broadfoot, PE-2009015435 MO CERTIFICATE OF AUTHORITY # 2018030429

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INTERIOR & EXTERIOR RENOVATIONS - SHORTHORN BARN

MISSOURI STATE **FAIRGROUNDS** 2503 W. 16TH ST SEDALIA, MO 65301

PROJECT # F2205-01 SITE # 1501

ASSET # 3511501048 **REVISION:**

DATE: **REVISION:** DATE:

REVISION: DATE:

ISSUE DATE: 06/29/2022 **CONSTRUCTION DRAWINGS**

CAD DWG FILE: F2205-01-1501-3511501048-C-DT-08


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DETAILS

SHEET NUMBER:

SHEET 8 OF 27




NON-TRAFFIC INSTALLATION

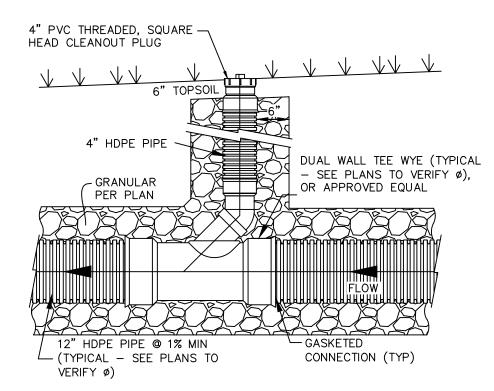- 1. SEE PLANS TO DETERMINE IF FITTINGS AND JOINTS ARE SOIL TIGHT (ST) OR WATER TIGHT (WT).
- 2. INSTALL ALL PIPING PER SEPARATE DETAIL OR MANUFACTURER'S WRITTEN INSTRUCTIONS
- 3. THIS DETAIL IS FOR GENERAL LAYOUT PURPOSES ONLY. ADDITIONAL COUPLERS, GASKETS, FITTINGS, ETC. MAY BE NECESSARY PER MANUFACTURER'S REQUIREMENTS.
- 4. CLEAN OUT PLUG SHALL BE SET FLUSH WITH FINISH GRADE. 5. TWO WAY CLEANOUT CONSTRUCTION SHALL INCLUDE INSTALLATION OF TWO
- CLEANOUTS AS SHOWN WITHIN 5' OF EACH OTHER, TEE WYE'S INSTALLED IN OPPOSITE DIRECTIONS. 6. SDR35 PVC PIPE MAY BE SUBSTITUTED FOR ANY HDPE PIPE UP TO 15" DIAMETER.
- 1. SEE PLANS TO DETERMINE IF FITTINGS AND JOINTS ARE SOIL TIGHT (ST) OR WATER TIGHT (WT).
- 2. INSTALL ALL PIPING PER SEPARATE DETAIL OR MANUFACTURER'S WRITTEN
- INSTRUCTIONS. 3. THIS DETAIL IS FOR GENERAL LAYOUT PURPOSES ONLY. ADDITIONAL COUPLERS,
- 4. CAST IRON TOP SHALL BE SET FLUSH WITH FINISH GRADE. CONCRETE SHALL BE 4,000 PSI MIX, MINIMUM.
- TWO WAY CLEANOUT CONSTRUCTION SHALL INCLUDE INSTALLATION OF TWO
- OPPOSITE DIRECTIONS.

HDPE STORM SEWER CLEANOUT

NOT TO SCALE

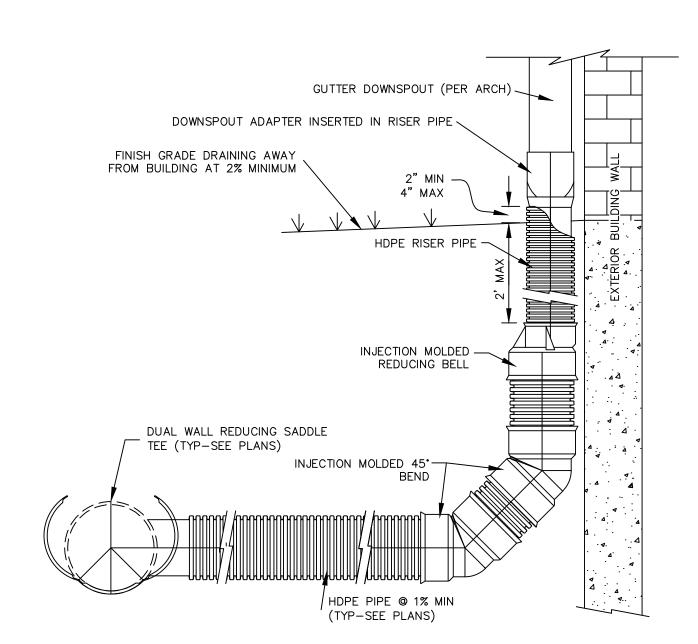


1. SEE PLANS TO DETERMINE IF FITTINGS AND JOINTS ARE SOIL TIGHT (ST) OR WATER TIGHT (WT).

- 2. INSTALL ALL PIPING PER SEPARATE DETAIL OR MANUFACTURER'S WRITTEN INSTRUCTIONS. 3. THIS DETAIL IS FOR GENERAL LAYOUT PURPOSES ONLY. ADDITIONAL COUPLERS, GASKETS, FITTINGS, ETC. MAY BE NECESSARY PER MANUFACTURER'S REQUIREMENTS.
- 4. IF GUTTER DOWNSPOUT SIZE EXCEEDS THE LARGEST AVAILABLE HANCOR DOWNSPOUT ADAPTER, THE HDPE PIPE SIZE SHALL BE INCREASED TO ACCOMMODATE THE DOWNSPOUT AND THE DOWNSPOUT ADAPTER SHALL BE REPLACED WITH AN HDPE END CAP PREFABRICATED OR CUT TO FIT THE DOWNSPOUT GUTTER AND UPSIZED HDPE PIPE. CAP/PIPE SHALL
- BE INSTALLED SO CAP IS 2" ABOVE FINISHED GRADE, MINIMUM. 5. SDR35 PVC PIPE MAY BE SUBSTITUTED FOR ANY HDPE PIPE UP TO 15" IN DIAMETER


GUTTER DOWNSPOUT CONNECTION

NOT TO SCALE

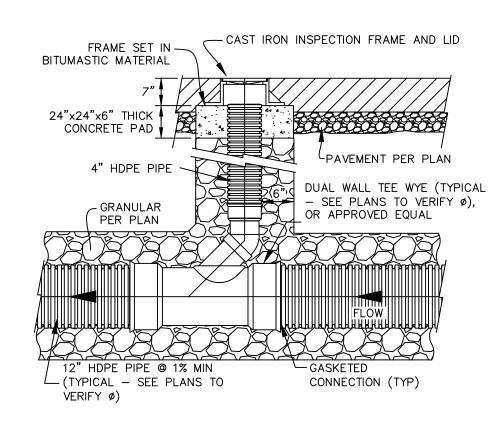

TRAFFIC/PAVED INSTALLATION

- GASKETS, FITTINGS, ETC. MAY BE NECESSARY PER MANUFACTURER'S REQUIREMENTS.
- CLEANOUTS AS SHOWN WITHIN 5' OF EACH OTHER, TEE WYE'S INSTALLED IN
- 7. SDR35 PVC PIPE MAY BE SUBSTITUTED FOR ANY HDPE PIPE UP TO 15" DIAMETER.

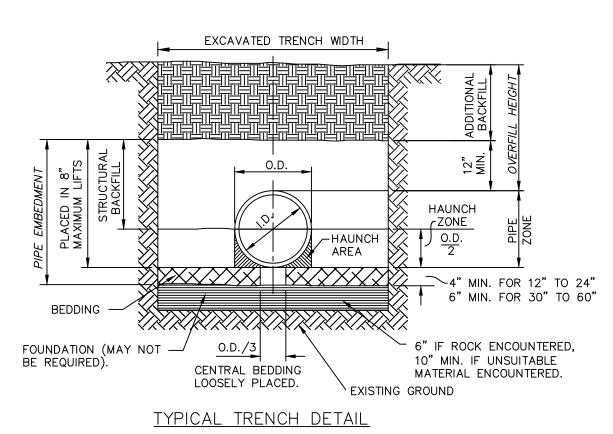

BACKFILL NOTES: 1. BEDDING, HAUNCH, AND STRUCTURAL BACKFILL SHALL BE IN CONFORMANCE WITH AASHTO M145 A1 OR A-3 COMPACTED TO A MINIMUM OF 95% OF THE MAXIMUM DRY DENSITY AS DEFINED BY ASTM D698.

- 2. ALL PIPE INSTALLATION SHALL BE IN ACCORDANCE WITH THE MANUFACTURER'S RECOMMENDATIONS AND ASTM D2321 LATEST ADDITION.
- 3. HAUNCH, STRUCTURAL, AND ADDITIONAL BACKFILL SHALL BE PLACED IN LIFTS NOT TO EXCEED 8 INCHES AND COMPACTED TO 95% OF THE MAXIMUM DRY DENSITY AS DEFINED BY ASTM D698.

		-	TABLE II		
	MINIMU	IM COVER F	FOR CONST	RUCTION LO	DADS
	PIPE DIA. (IN.)	MINIMUM C	COVER (FT) FOI (THOUSANDS	R INDICATED A OF POUNDS)	XLE LOADS
		18-50	50-75	75–110	110-150
	12-36	2.0	2.5	3.0	3.0
	42-48	3.0	3.0	3.5	4.0
(THE CONTRACTOR COVER REQUIRED SITUATIONS THE	TO AVOID DAM	IAGE TO THE F	PIPE. IN UNPA	VED

STEEL FRAME & GRATE OR APPROVED EQUAL

─ H-20 LOAD RATED

3'-0"

GRATE

SECURED TO EXISTING CONCRETE BOX.

2. GRATE SHALL BE H-20 LOAD RATED.

GRATE FOR APPROVAL.

1. ENSURE THE NEW REPLACEMENT GRATE IS PROPERLY

3. GRATE MAXIMUM OPENING SIZE SHALL BE 1.5" WIDE.

ALTERNATE 3 STORM INLET GRATE REPLACEMENT DETAIL

NOT TO SCALE

4. CONTRACTOR SHALL SUBMIT SHOP DRAWINGS OF STEEL

SITUATIONS, THE SURFACE MUST BE MAINTAINED TO A LEVEL AND NON-RUTTED CONDITION.

_		LEGEND
O.D. H MIN.	= = =	NORMAL INSIDE DIAMETER OF PIPE. OUTSIDE DIAMETER OF PIPE. FILL COVER HEIGHT OVER PIPE (FEET MINIMUM MAXIMUM UNDISTURBED SOIL

CONSTRUCTION SEQUENCE: 1. PLACE BEDDING MATERIAL TO GRADE. . COMPACT BEDDING OUTSIDE THE MIDDLE THIRD OF THE PIPE.

. INSTALL PIPE TO GRADE. 4. PLACE AND COMPACT THE HAUNCH AREA UP TO THE SPRINGLINE. 5. COMPLETE BACKFILL ACCORDING TO SPECIFICATIONS.

TABLE III

15 16

PARALLEL PIPE INSTALLATION

S = MINIMUM PIPE SEPARATION (IN) BETWEEN OUTSIDE WALLS OF PIPES.

X = MINIMUM SEPARATION BETWEEN TRENCH

WALL AND OUTSIDE WALL OF PIPE.

					TAE	BLE I					
		CC	DRRUGATI	ED HDPE	AND PO	LYVINYL C	HLORIDE C	IRCULAR F	PIPE		
005015150	Ī	HDPE MAX	POLYVINYL CHLORIDE MAX OVERFILL HEIGHT* (FT)		ADS N-12, N-12 ST, AND N-12 WT PIPE						
SPECIFIED DIA OF PIPE (IN.)	MIN OVERFILL HEIGHT (FT)	OVERFILL HEIGHT* (FT)			VIRGIN RESIN (AASHTO M294) OVERFILL HEIGHT* (FT)			ENGINEERED COMPOUND (RECYCLED, ASTM F2648) OVERFILL HEIGHT* (FT)			TRENCH WIDTH
L (\dots.)		, ,	SDR 35#	SDR 26#	CLASS 1**	CLASS 2**	CLASS 3**	CLASS 1**	CLASS 2**	CLASS 3**	(IN.)
12	2	26	15	30	43	29	21	27	19	12	34
15	2	28	15	30	45	30	22	27	20	13	39
18	2	24	15	30	40	27	19	25	18	11	44
24	2	20	15	30	36	25	17	22	16	12	55
30	2.5	17	N/A	N/A	29	21	15	16	12	6	67
36	2.5	19	N/A	N/A	34	23	16	21	15	10	76
42	2.5	19	N/A	N/A	31	23	16	17	13	7	84
48	2.5	17	N/A	N/A	30	20	14	18	13	10	95
54	2.5	9	N/A	N/A	33	22	15	N/A	N/A	N/A	104
60	2.5	9	N/A	N/A	33	22	15	20	15	10	113

TABLE ASSUMES STANDARD PROCTOR DENSITY OF 95% * MAXIMUM OVERFILL MEASURED FROM THE TOP OF PIPE TO SURFACE

- ** CLASS 1 CRUSHED ROCK, ANGULAR; AASHTO M43 5, 6, 56, 57, 67 ** CLASS 2 - CLEAN, COURSE GRAINED SOILS TO BORDERLINE CLEAN FINES; AASHTO M43 - 5, 6, 56, 57, 67; AASHTO M145 - A1, A3
- ** CLASS 3 COURSE GRAINED SOILS WITH FINES AND INORGANIC FINE-GRAINED SOILS; AASHTO M43 GRAVEL AND SAND WITH <10% FINES; AASHTO M145 - A-2-4, A-2-5, A-2-6, A-4, OR A-6 WITH >30% RETAINED ON #200 SIEVE
- ** REFER TO CURRENT ADS INC. DRAINAGE HANDBOOK FOR A COMPLETE LISTING OF SUITABLE MATERIALS # PER ASTM D-3034 FOR PIPE UP TO 15" AND ASTM F679 OVER 15"

EMBEDMENT OF PLASTIC STORM SEWER PIPE

NOT TO SCALE

STATE OF MISSOURI MICHAEL L. PARSON, **GOVERNOR**





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OFFICE OF ADMINISTRATION DIVISION OF FACILITIES MANAGEMENT DESIGN AND CONSTRUCTION

#2000151304

INTERIOR & EXTERIOR RENOVATIONS - SHORTHORN BARN

MISSOURI STATE **FAIRGROUNDS** 2503 W. 16TH ST SEDALIA, MO 65301

PROJECT # F2205-01 SITE # 1501 ASSET # 3511501048

REVISION: DATE:

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ISSUE DATE: 06/29/2022 **CONSTRUCTION DRAWINGS**

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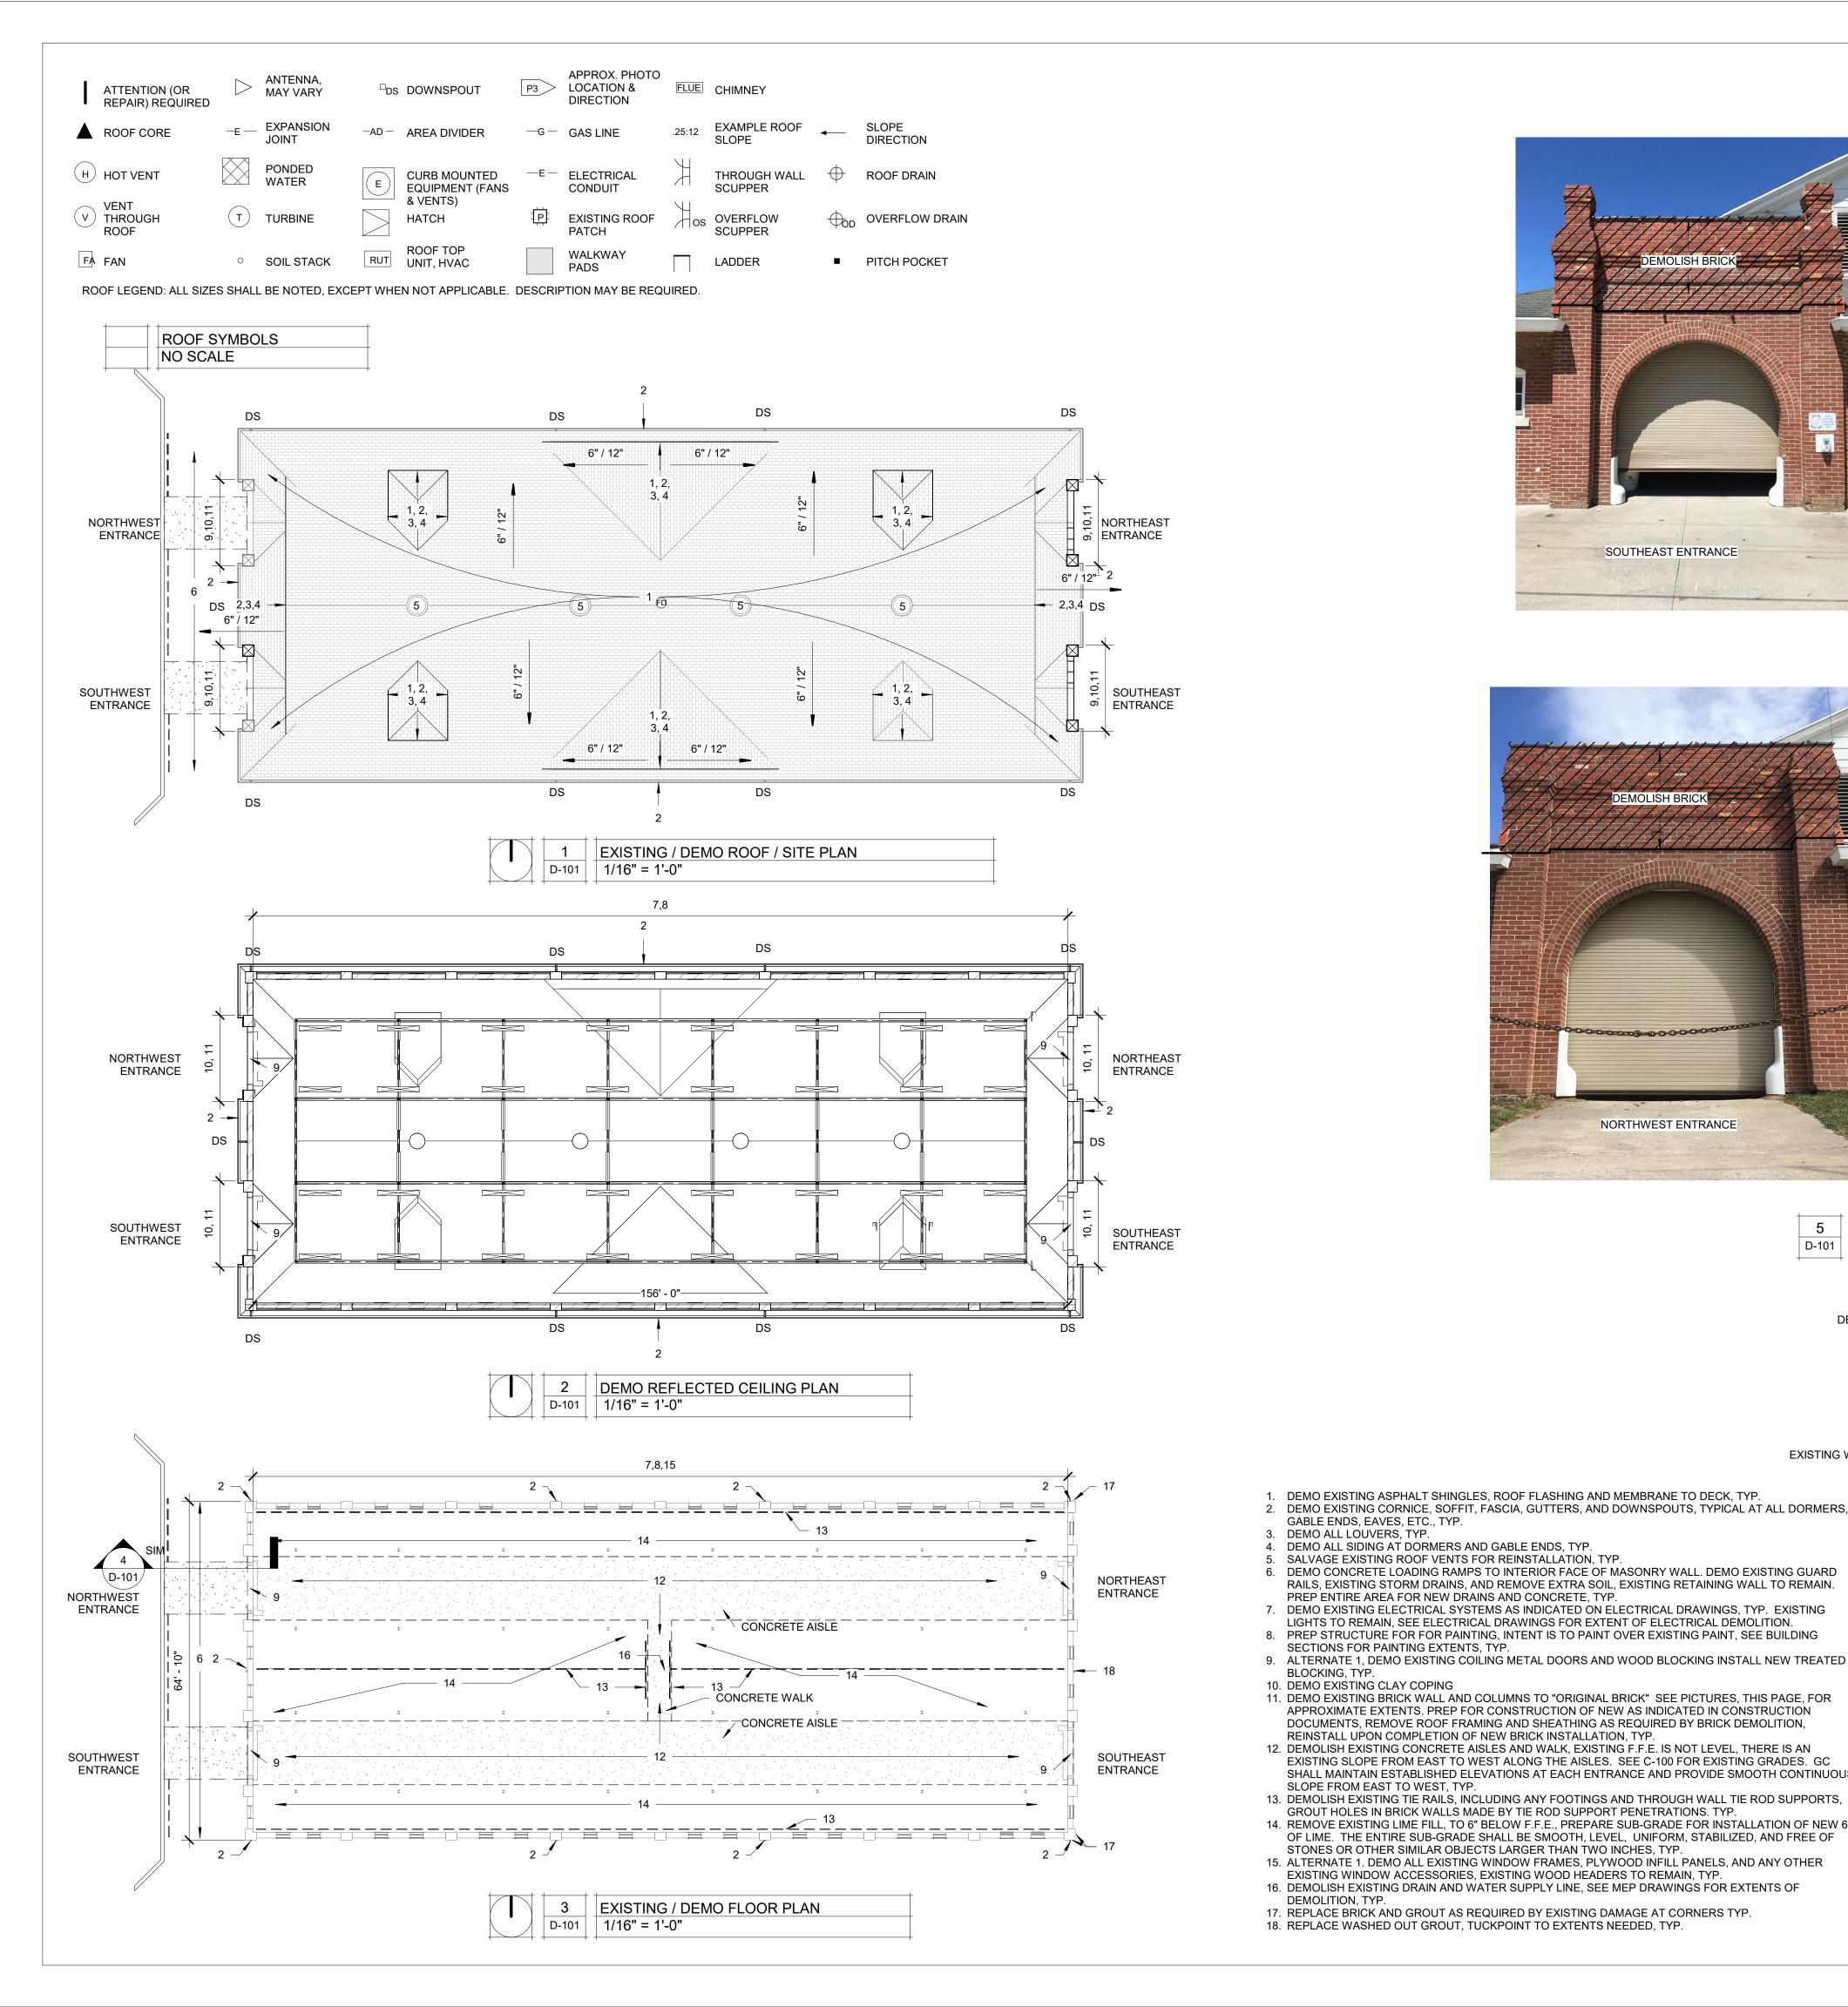
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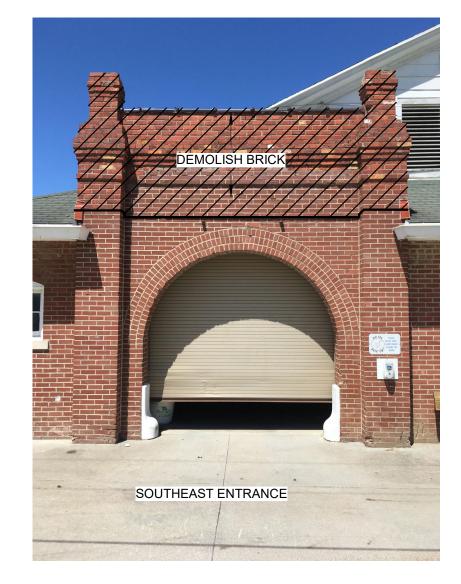
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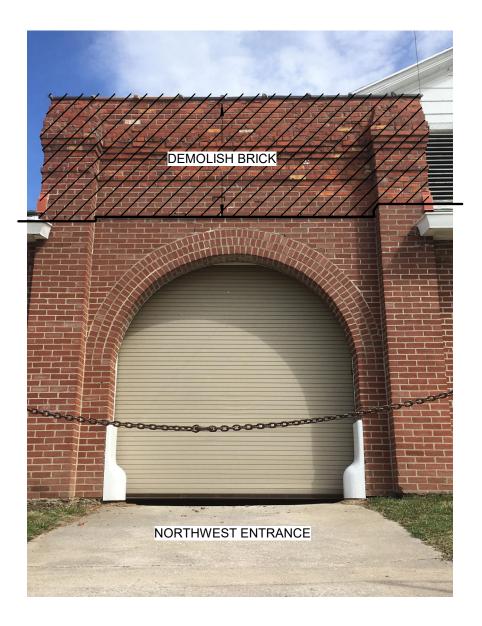
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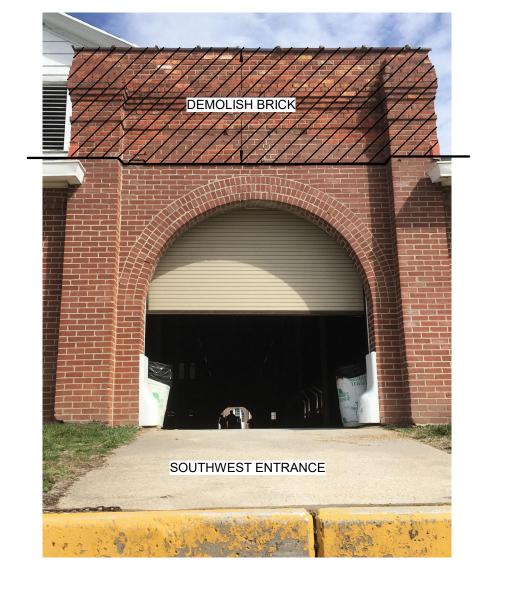
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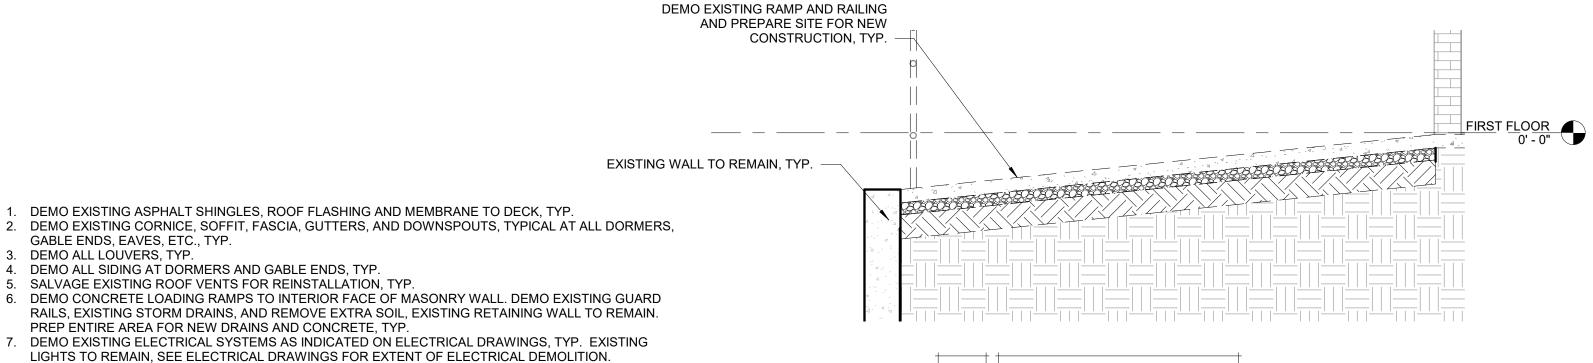








5 PORTAL DEMO EXTENTS D-101 3/4" = 1'-0"



4 RAMP DEMO DETAIL D-101 | 3/8" = 1'-0"







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RENOVATIONS - SHORTHORN

MISSOURI STATE FAIRGROUNDS 2503 W. 16TH ST

SEDALIA, MO 65301 PROJECT # F2205-01

SITE # 1501 ASSET # 3511501048

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ISSUE DATE: 06/29/2022 **BID DOCUMENTS**


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SHEET NUMBER:

SHEET 10 OF 27





06.29.22

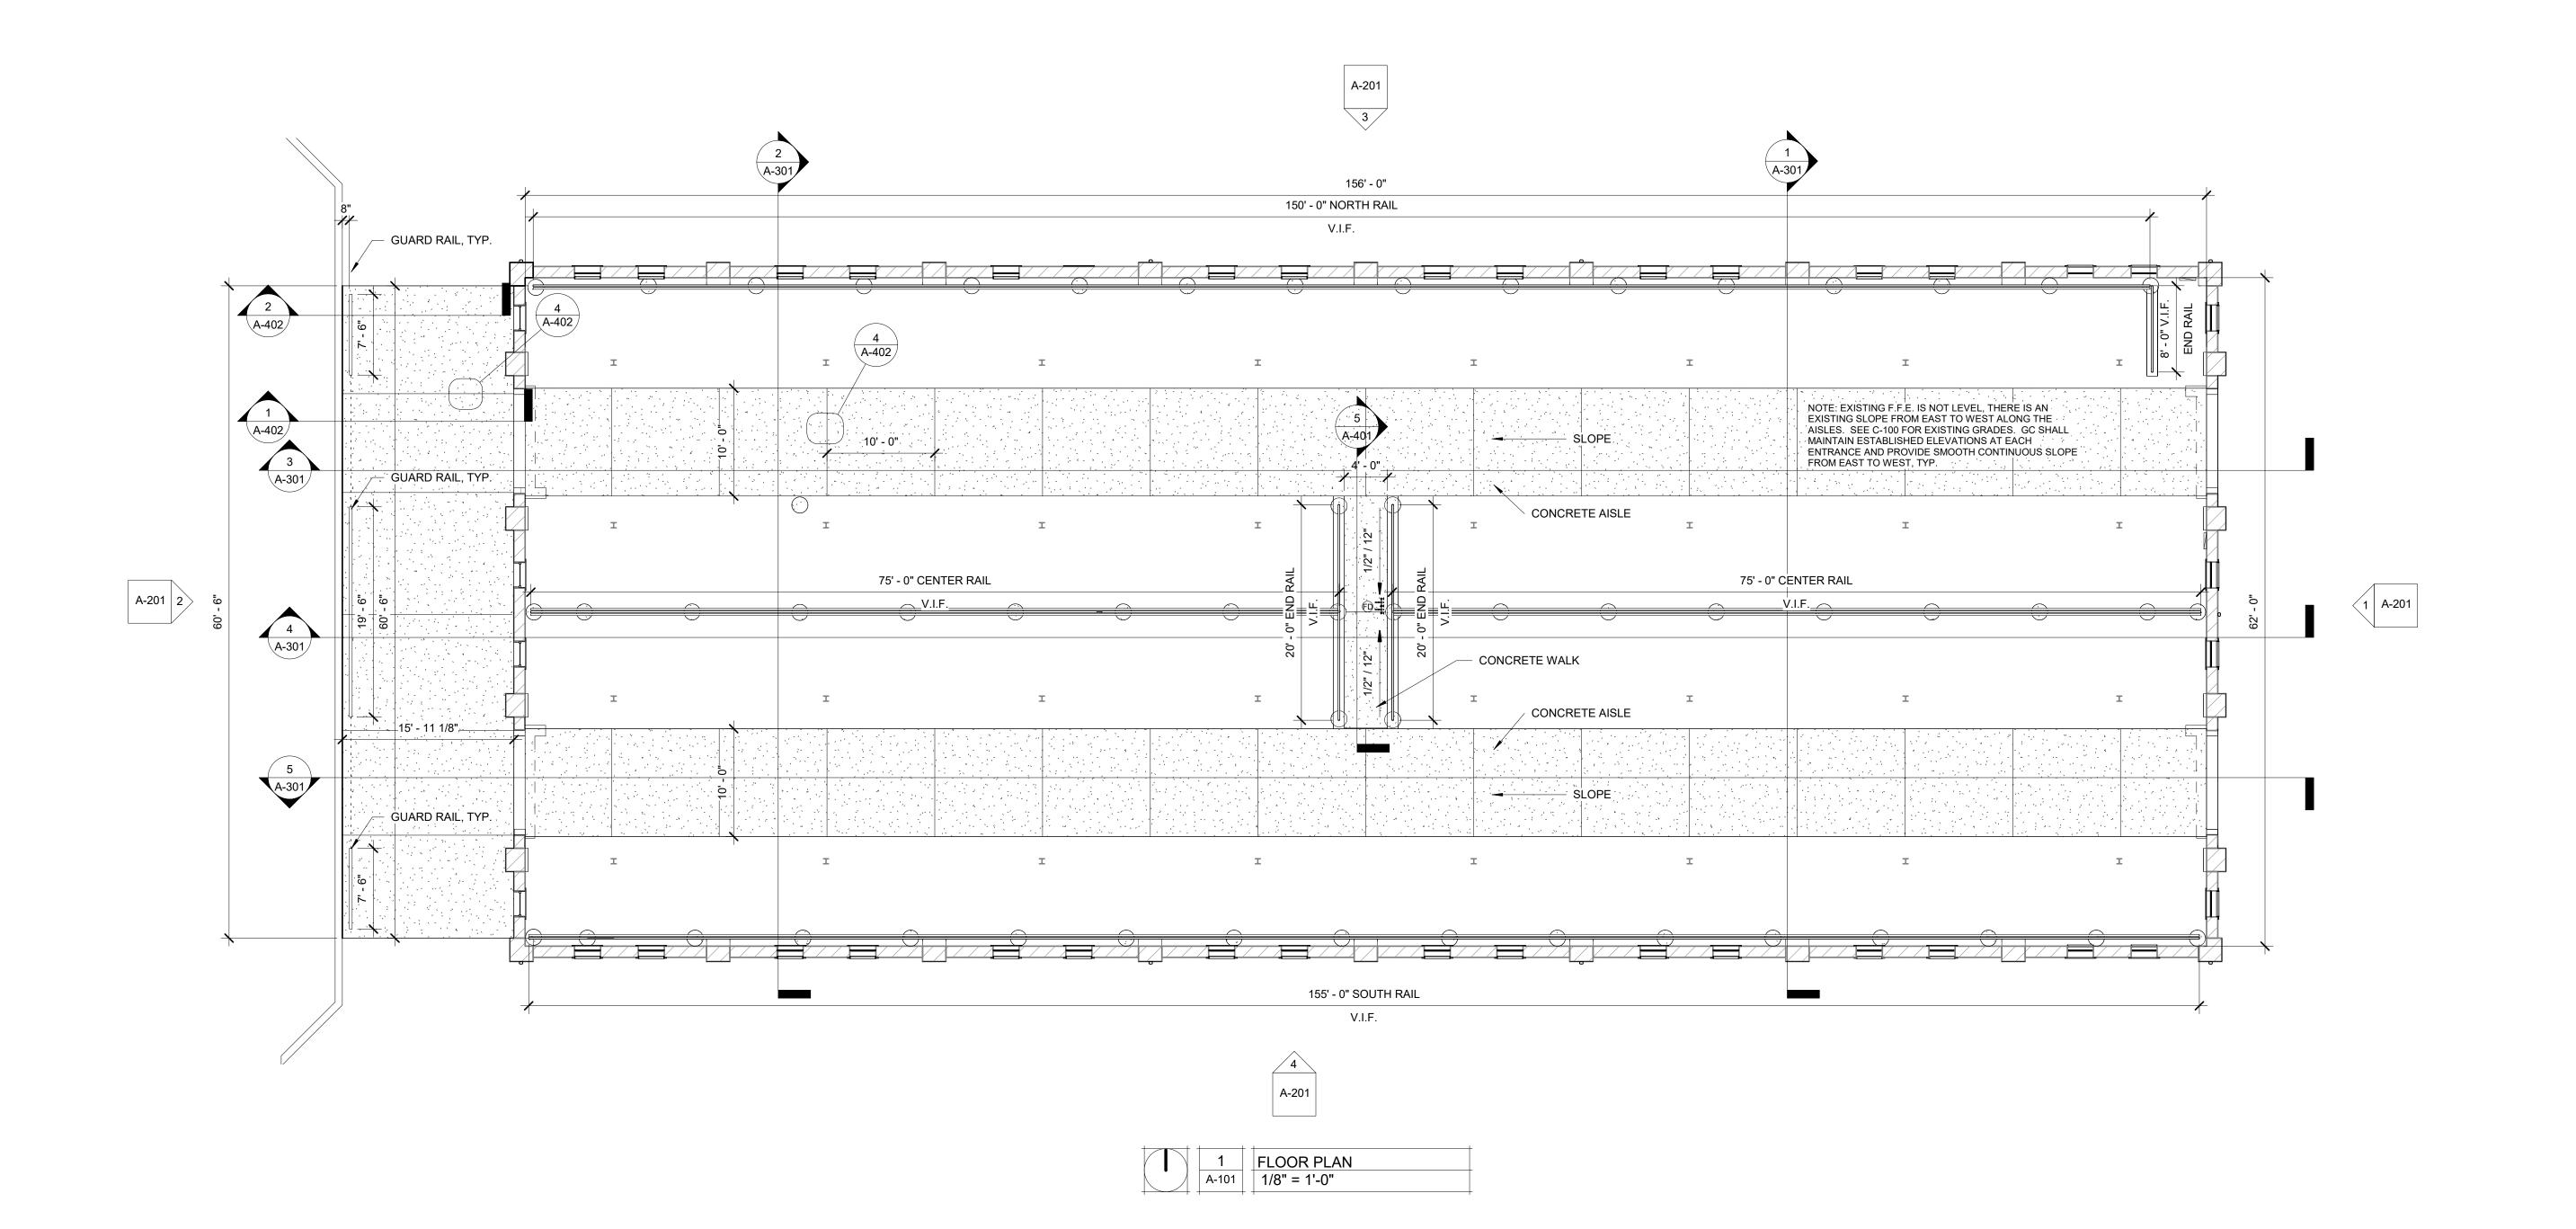

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INTERIOR & EXTERIOR RENOVATIONS - SHORTHORN BARN

MISSOURI STATE FAIRGROUNDS 2503 W. 16TH ST SEDALIA, MO 65301

PROJECT # F2205-01 SITE # 1501 ASSET # 3511501048

REVISION: DATE:

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ISSUE DATE: 06/29/2022 BID DOCUMENTS

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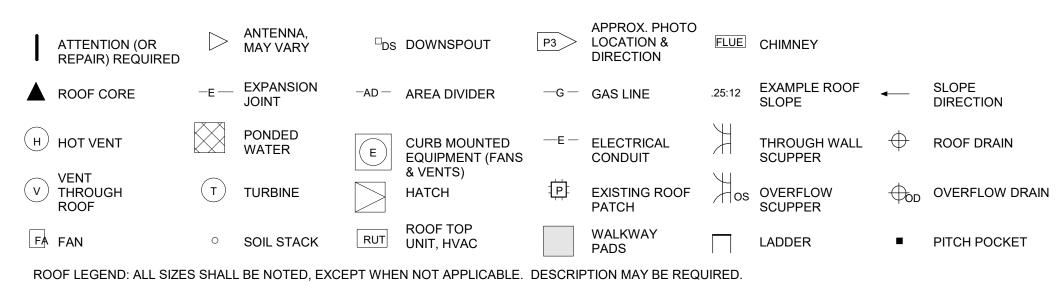
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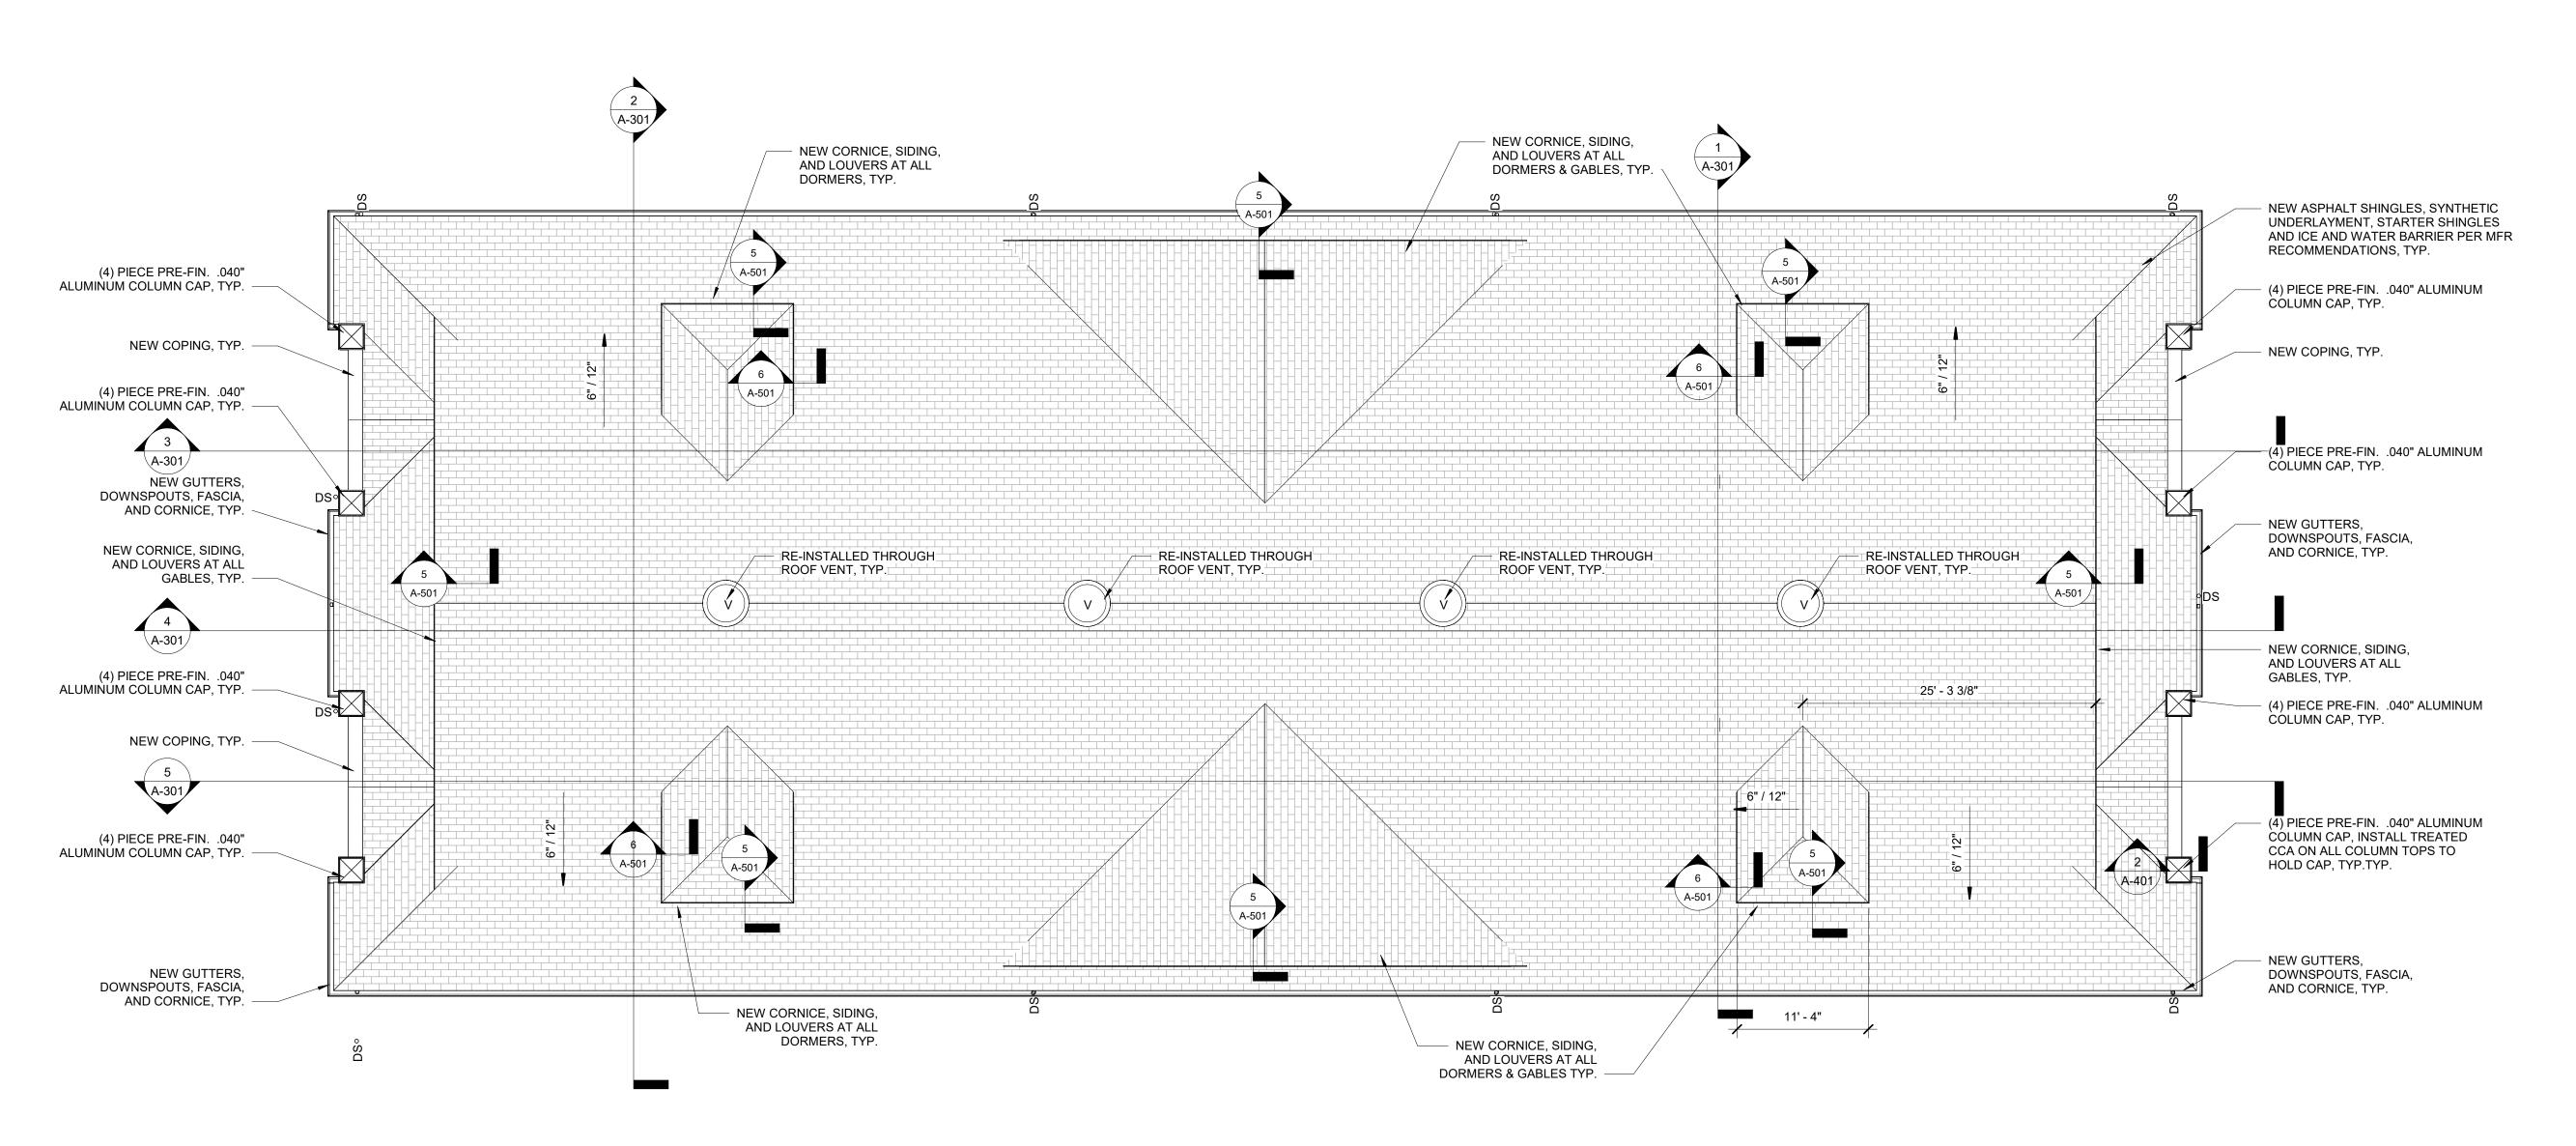
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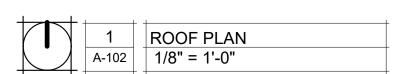
A-101

SHEET 11 OF 27



ROOF SYMBOLS
NO SCALE





STATE OF MISSOURI MICHAEL L. PARSON, GOVERNOR



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INTERIOR & EXTERIOR
RENOVATIONS - SHORTHORN

MISSOURI STATE FAIRGROUNDS 2503 W. 16TH ST SEDALIA, MO 65301

PROJECT # F2205-01 SITE # 1501 ASSET # 3511501048

REVISION: DATE:

DATE:

REVISION:

REVISION:_ DATE:_

ISSUE DATE: 06/29/2022 BID DOCUMENTS

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CHECKED BY: RDR

DESIGNED BY: AMK


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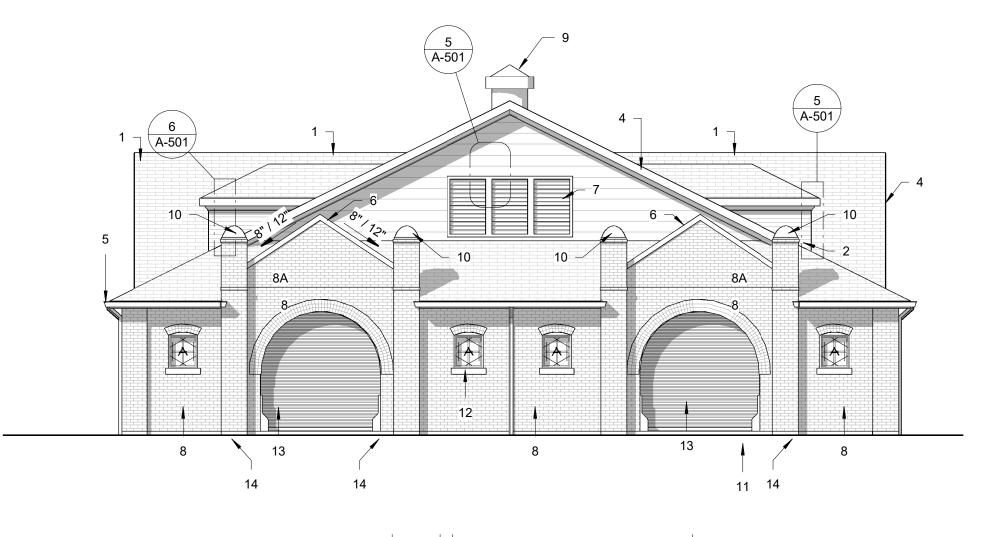
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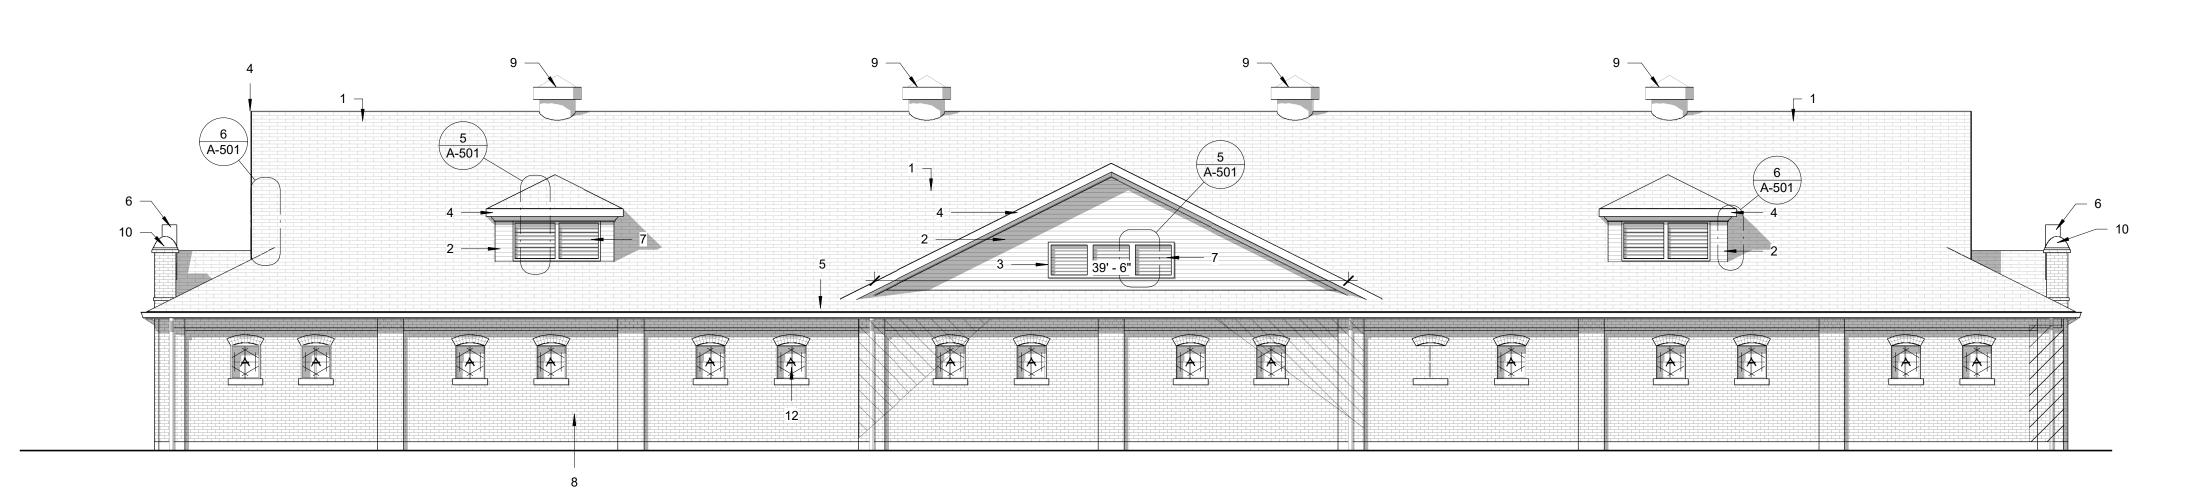
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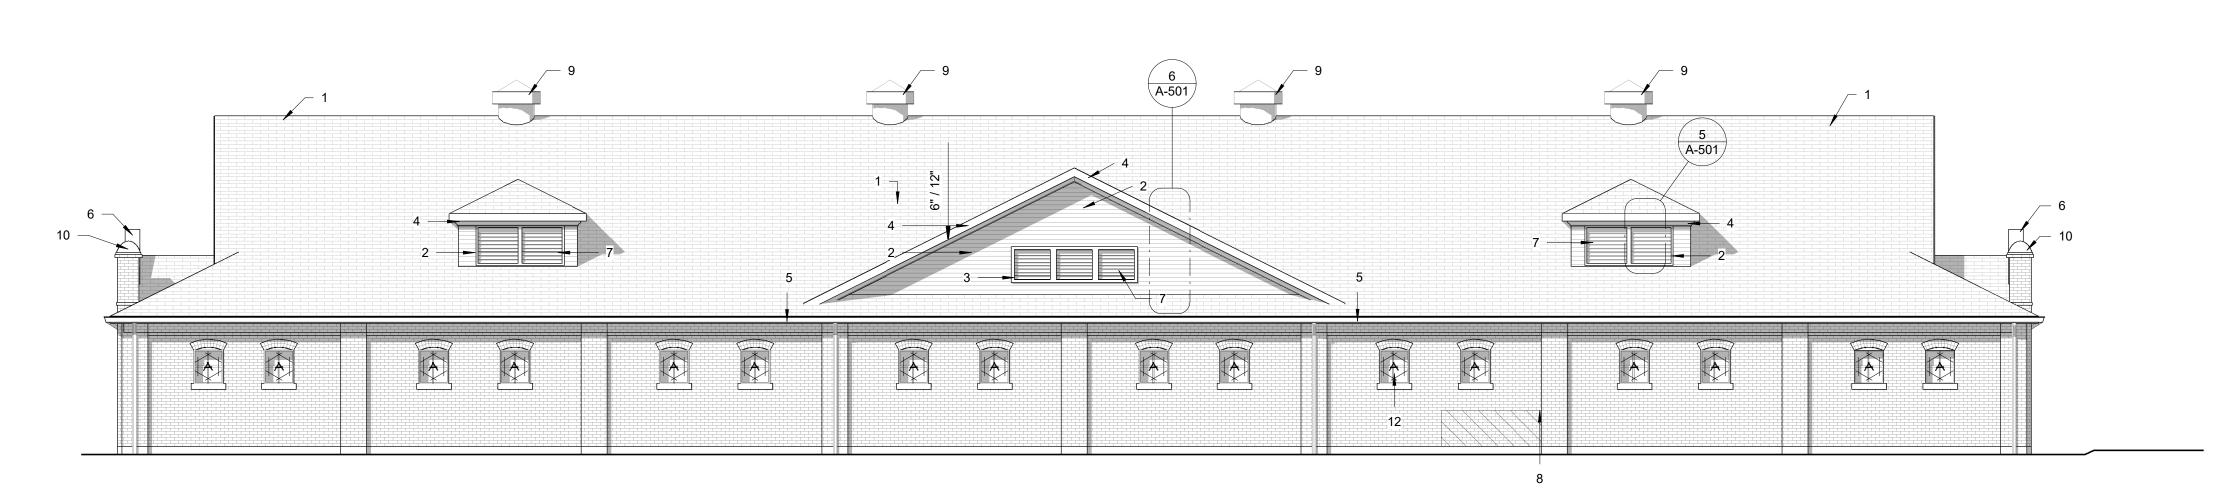




2 WEST ELEVATION 1/8" = 1'-0"



3 NORTH ELEVATION A-201 1/8" = 1'-0"

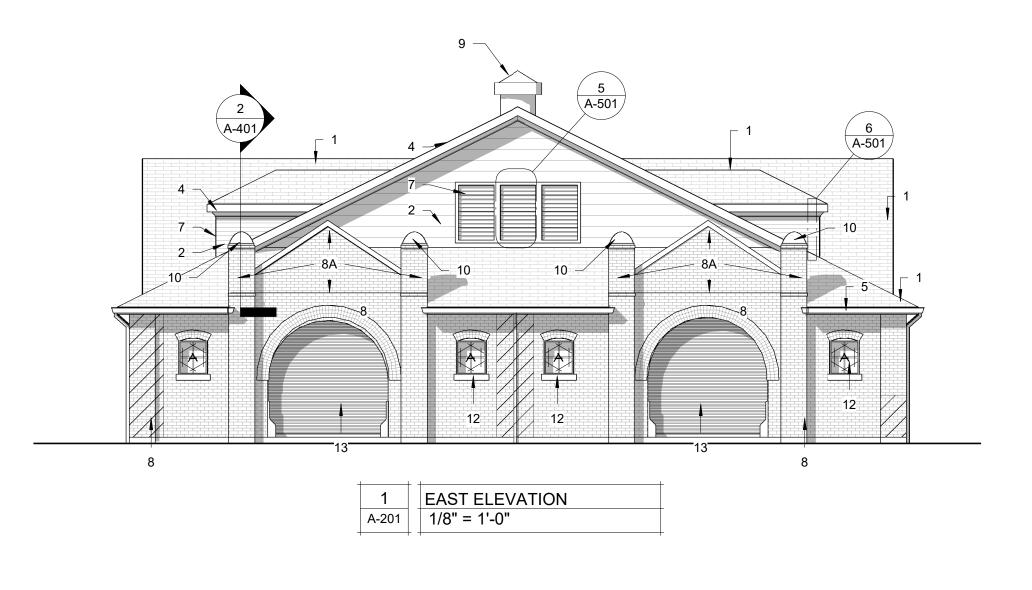

4 SOUTH ELEVATION A-201 1/8" = 1'-0"

ELEVATION TAG KEY:
NOTE: NOT ALL COMMENTS MAY APPEAR ON ALL VIEWS
1. ASPHALT SHINGLES

FIBER CEMENT SIDING
 FIBER CEMENT TRIM BOARD

4. PRE-FIN. METAL CORNICE, SOFFIT, FASCIA 5. GUTTERS & DOWNSPOUTS 6. PRE-FIN. METAL COPING

7. PRE-FIN. ALUMINUM LOUVERS 8. EXISTING BRICK A. NEW BRICK

9. EXISTING ROOF VENTS - REINSTALLED 10. METAL COLUMN CAP

11. CONTINUOUS CONCRETE LOADING RAMP

12. NEW WINDOWS
13. NEW OVERHEAD DOORS
14. METAL GUARD RAILS W/ (2) CHAINS ACROSS OPENINGS.



APPROXIMATE AREAS REQUIRING TUCKPOINTING & / OR BRICK REPAIR

APPROXIMATE AREAS REQUIRING MASONRY CLEANING

STATE OF MISSOURI MICHAEL L. PARSON, **GOVERNOR**





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INTERIOR & EXTERIOR RENOVATIONS - SHORTHORN

MISSOURI STATE FAIRGROUNDS 2503 W. 16TH ST SEDALIA, MO 65301

PROJECT # F2205-01 SITE # 1501 ASSET # 3511501048

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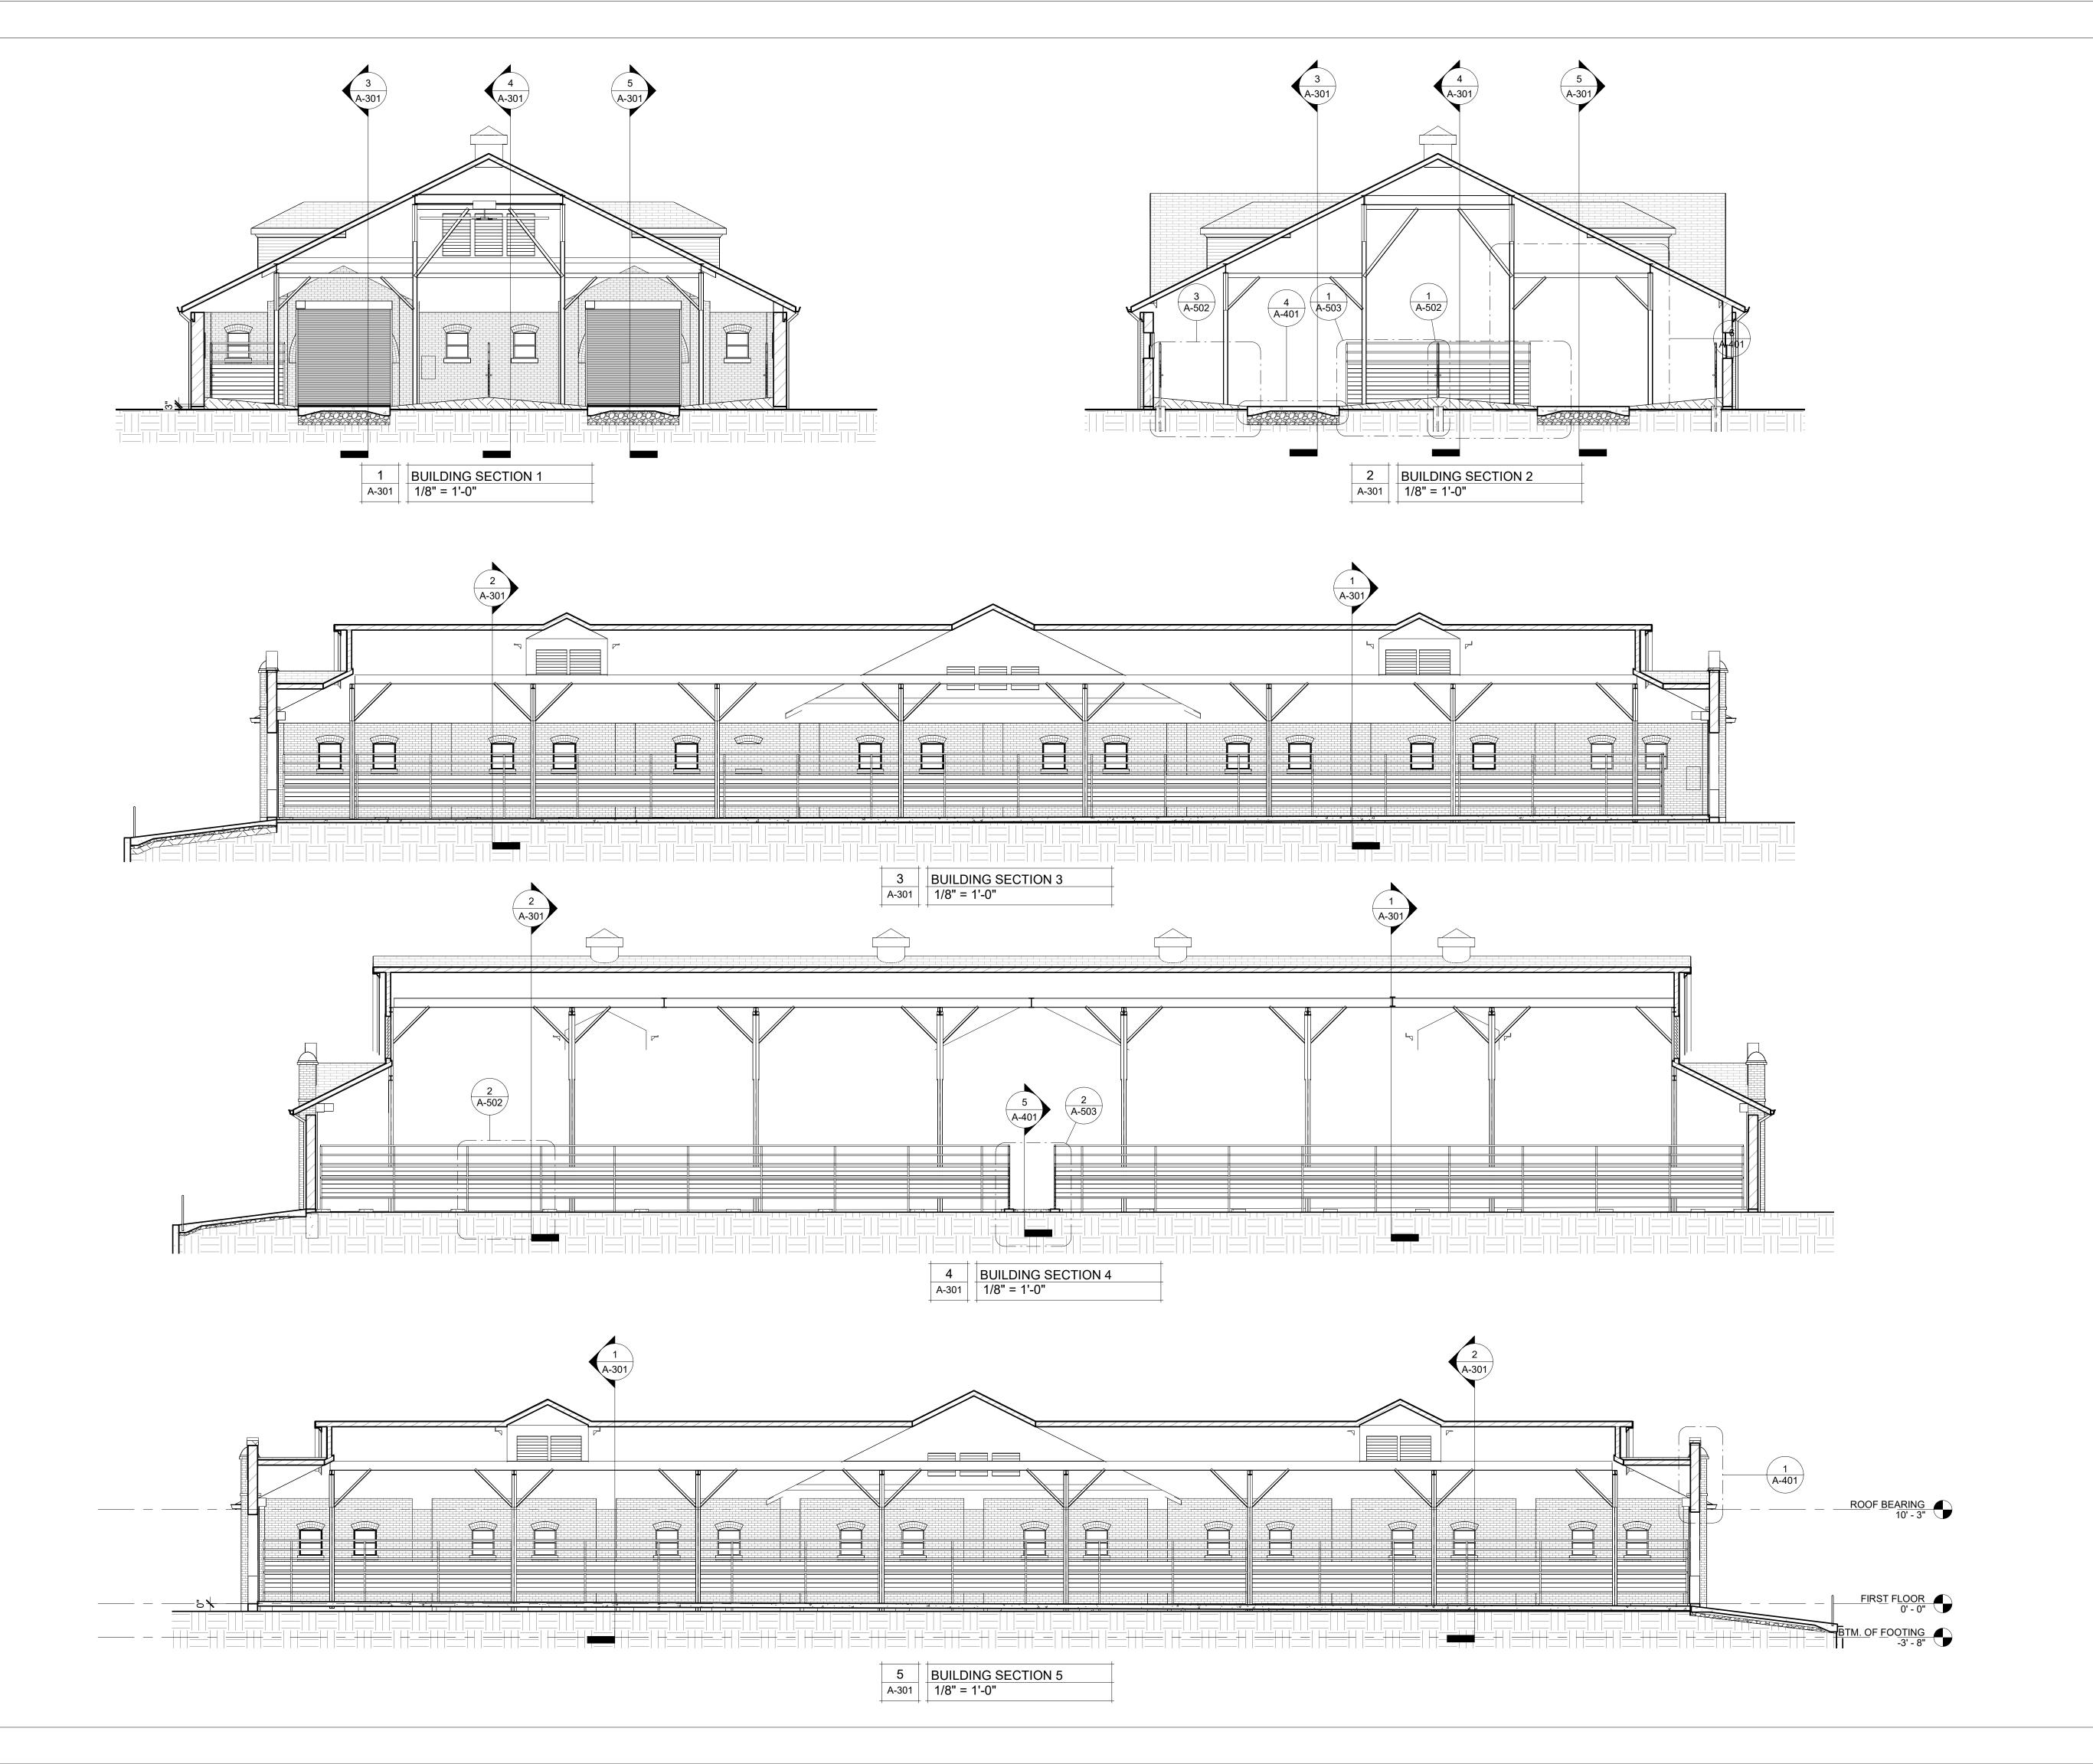
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EXTERIOR ELEVATIONS

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RENOVATIONS - SHORTHORN
BARN
MISSOURI STATE

FAIRGROUNDS 2503 W. 16TH ST SEDALIA, MO 65301 PROJECT # F2205-01

SITE # 1501 ASSET # 3511501048

REVISION: DATE:

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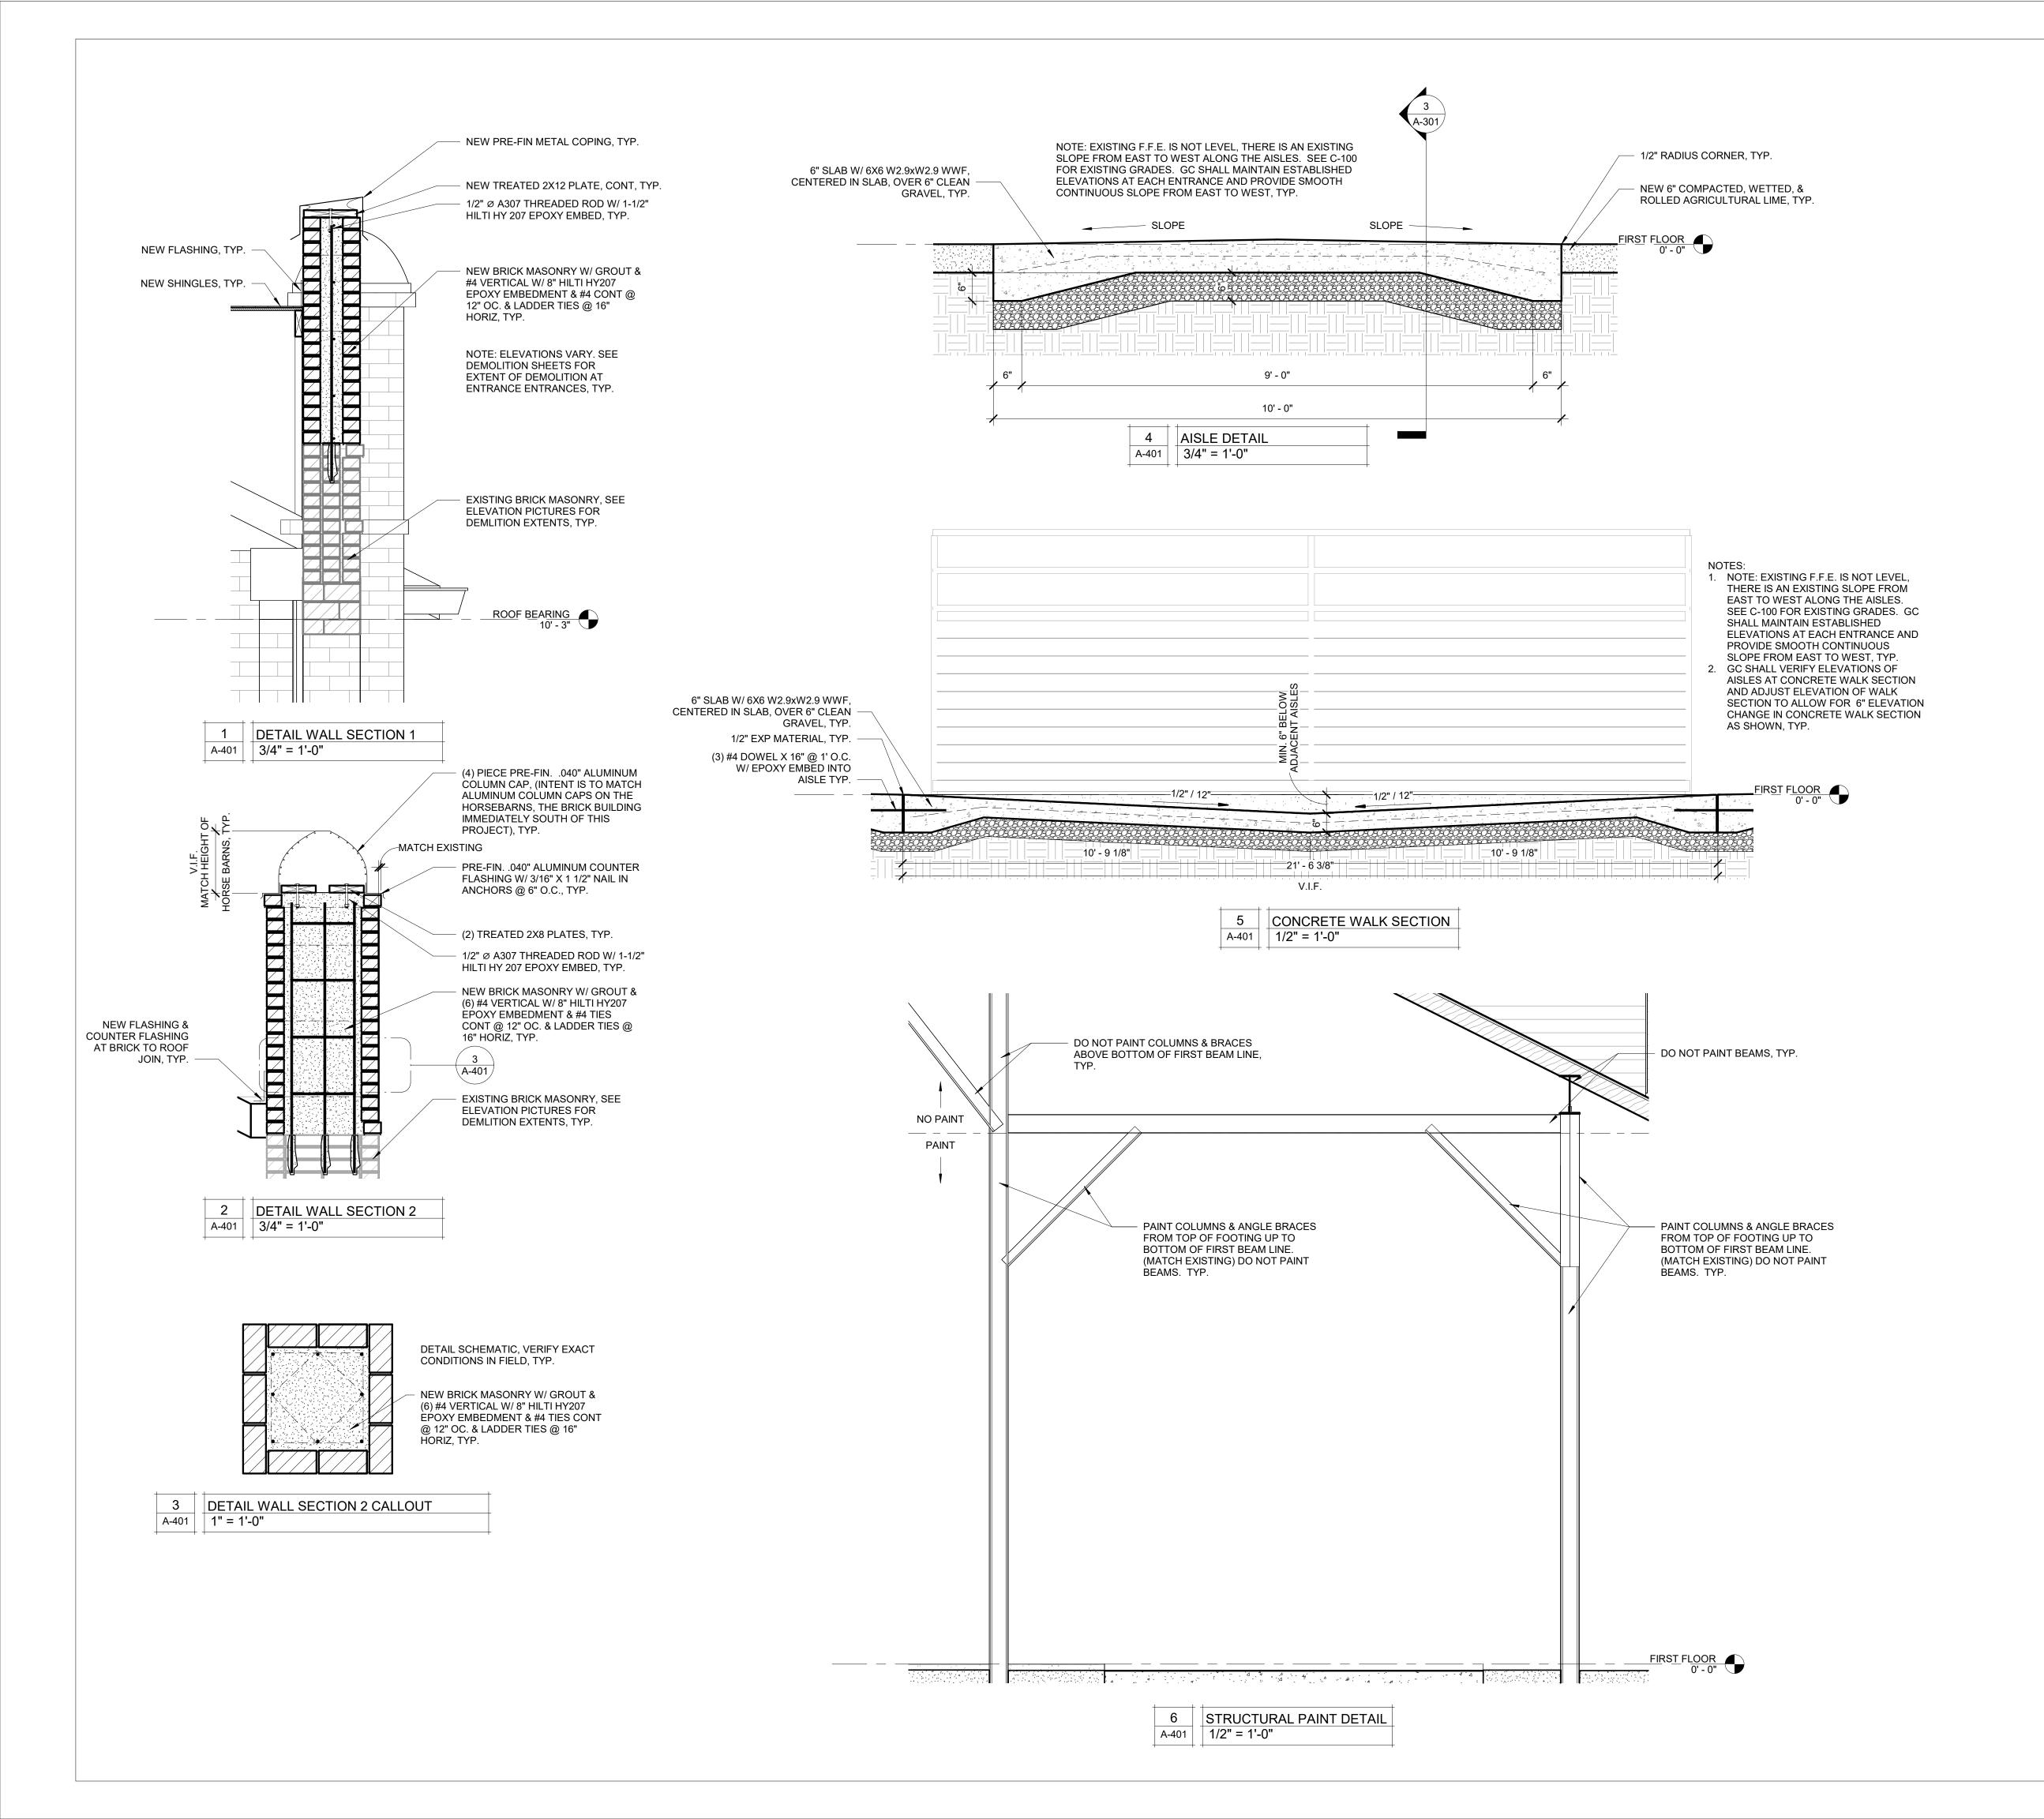
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BUILDING SECTIONS

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A-30

SHEET 14 OF 27





06.29.22



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INTERIOR & EXTERIOR

RENOVATIONS - SHORTHORN BARN MISSOURI STATE FAIRGROUNDS

2503 W. 16TH ST SEDALIA, MO 65301 PROJECT # F2205-01

SITE # 1501 ASSET # 3511501048

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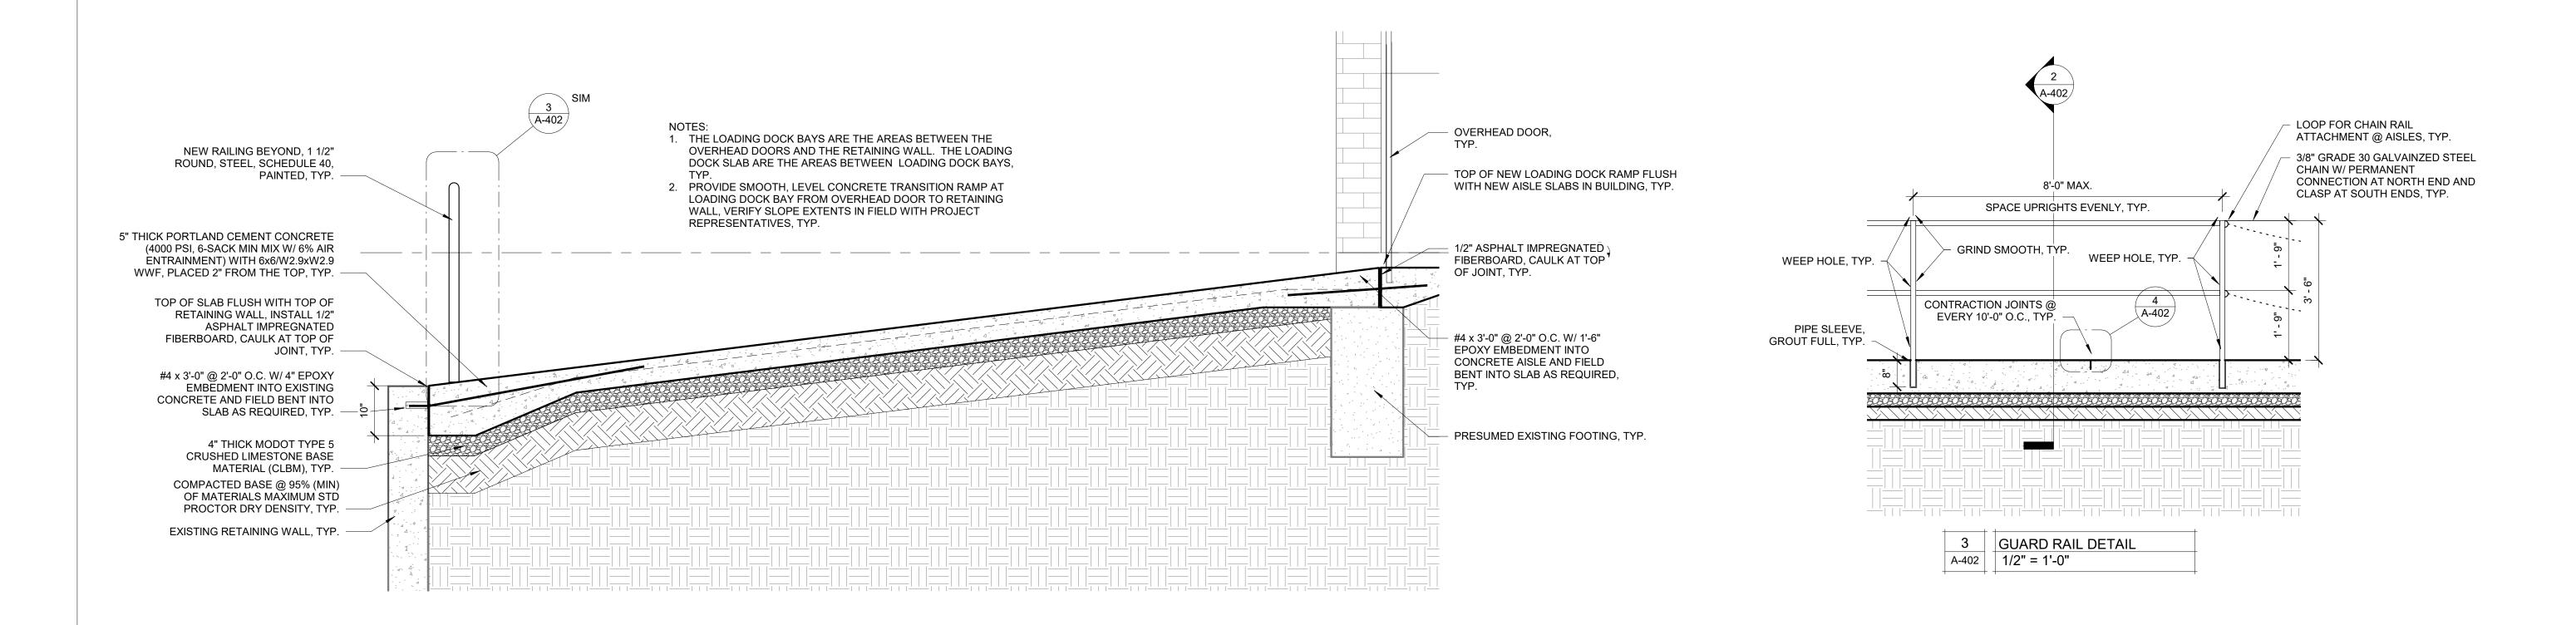
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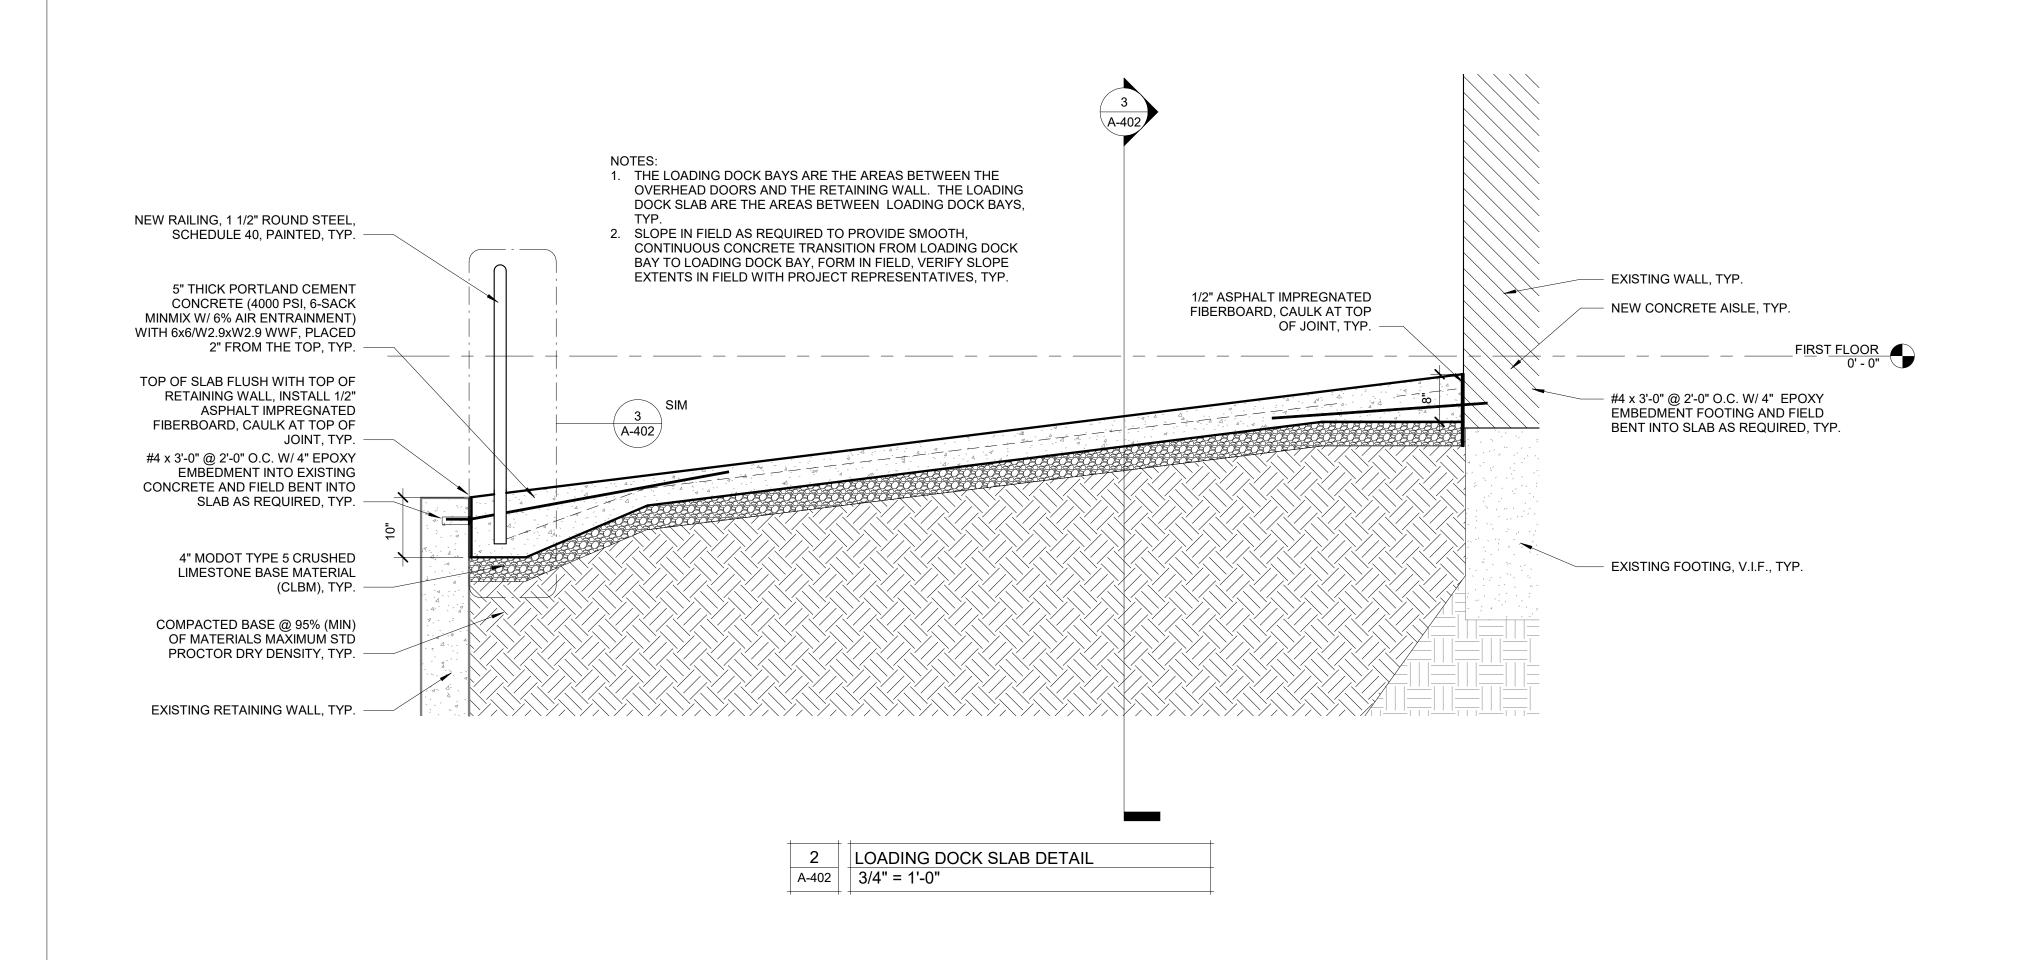
SECTION DETAILS

SHEET NUMBER:

A-40


SHEET 15 OF 27





1 LOADING DOCK BAY DETAIL

A-402 3/4" = 1'-0"

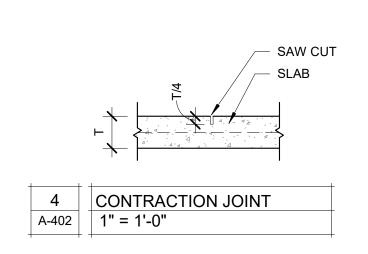

STATE OF MISSOURI MICHAEL L. PARSON, GOVERNOR



06.29.22



Architects LLC
1806 West Broadway Boulevard



J-SQUARED
ENGINEERING
OO BLUFF CREEK DR. STE.

2400 BLUFF CREEK DR. STE. 101 COLUMBIA, MO 65203 573.234.4492



Broadfoot Engineeing, LLC 30277 Carpenter Road Sedalia, MO 65301 Phone: 660-619-7001 broadfooteng@yahoo.com

COACUETS

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www.crockettengineering.com
Crockett Engineering Consultants, LLC
Missouri Certificate of Authority
#2000151304

OFFICE OF ADMINISTRATION
DIVISION OF FACILITIES
MANAGEMENT DESIGN AND
CONSTRUCTION
INTERIOR & EXTERIOR
RENOVATIONS - SHORTHORN

BARN MISSOURI STATE FAIRGROUNDS 2503 W. 16TH ST SEDALIA, MO 65301

PROJECT # F2205-01 SITE # 1501

ASSET # 3511501048

REVISION:
DATE:

REVISION:

DATE:

REVISION:____ DATE:

ISSUE DATE: 06/29/2022
BID DOCUMENTS

CAD DWG FILE: F2205-01-1501-3511501048-A-SC-16

DRAWN BY: AMK
CHECKED BY: RDR
DESIGNED BY: AMK


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SECTION DETAILS


SHEET NUMBER:

A-402

SHEET 16 OF 27



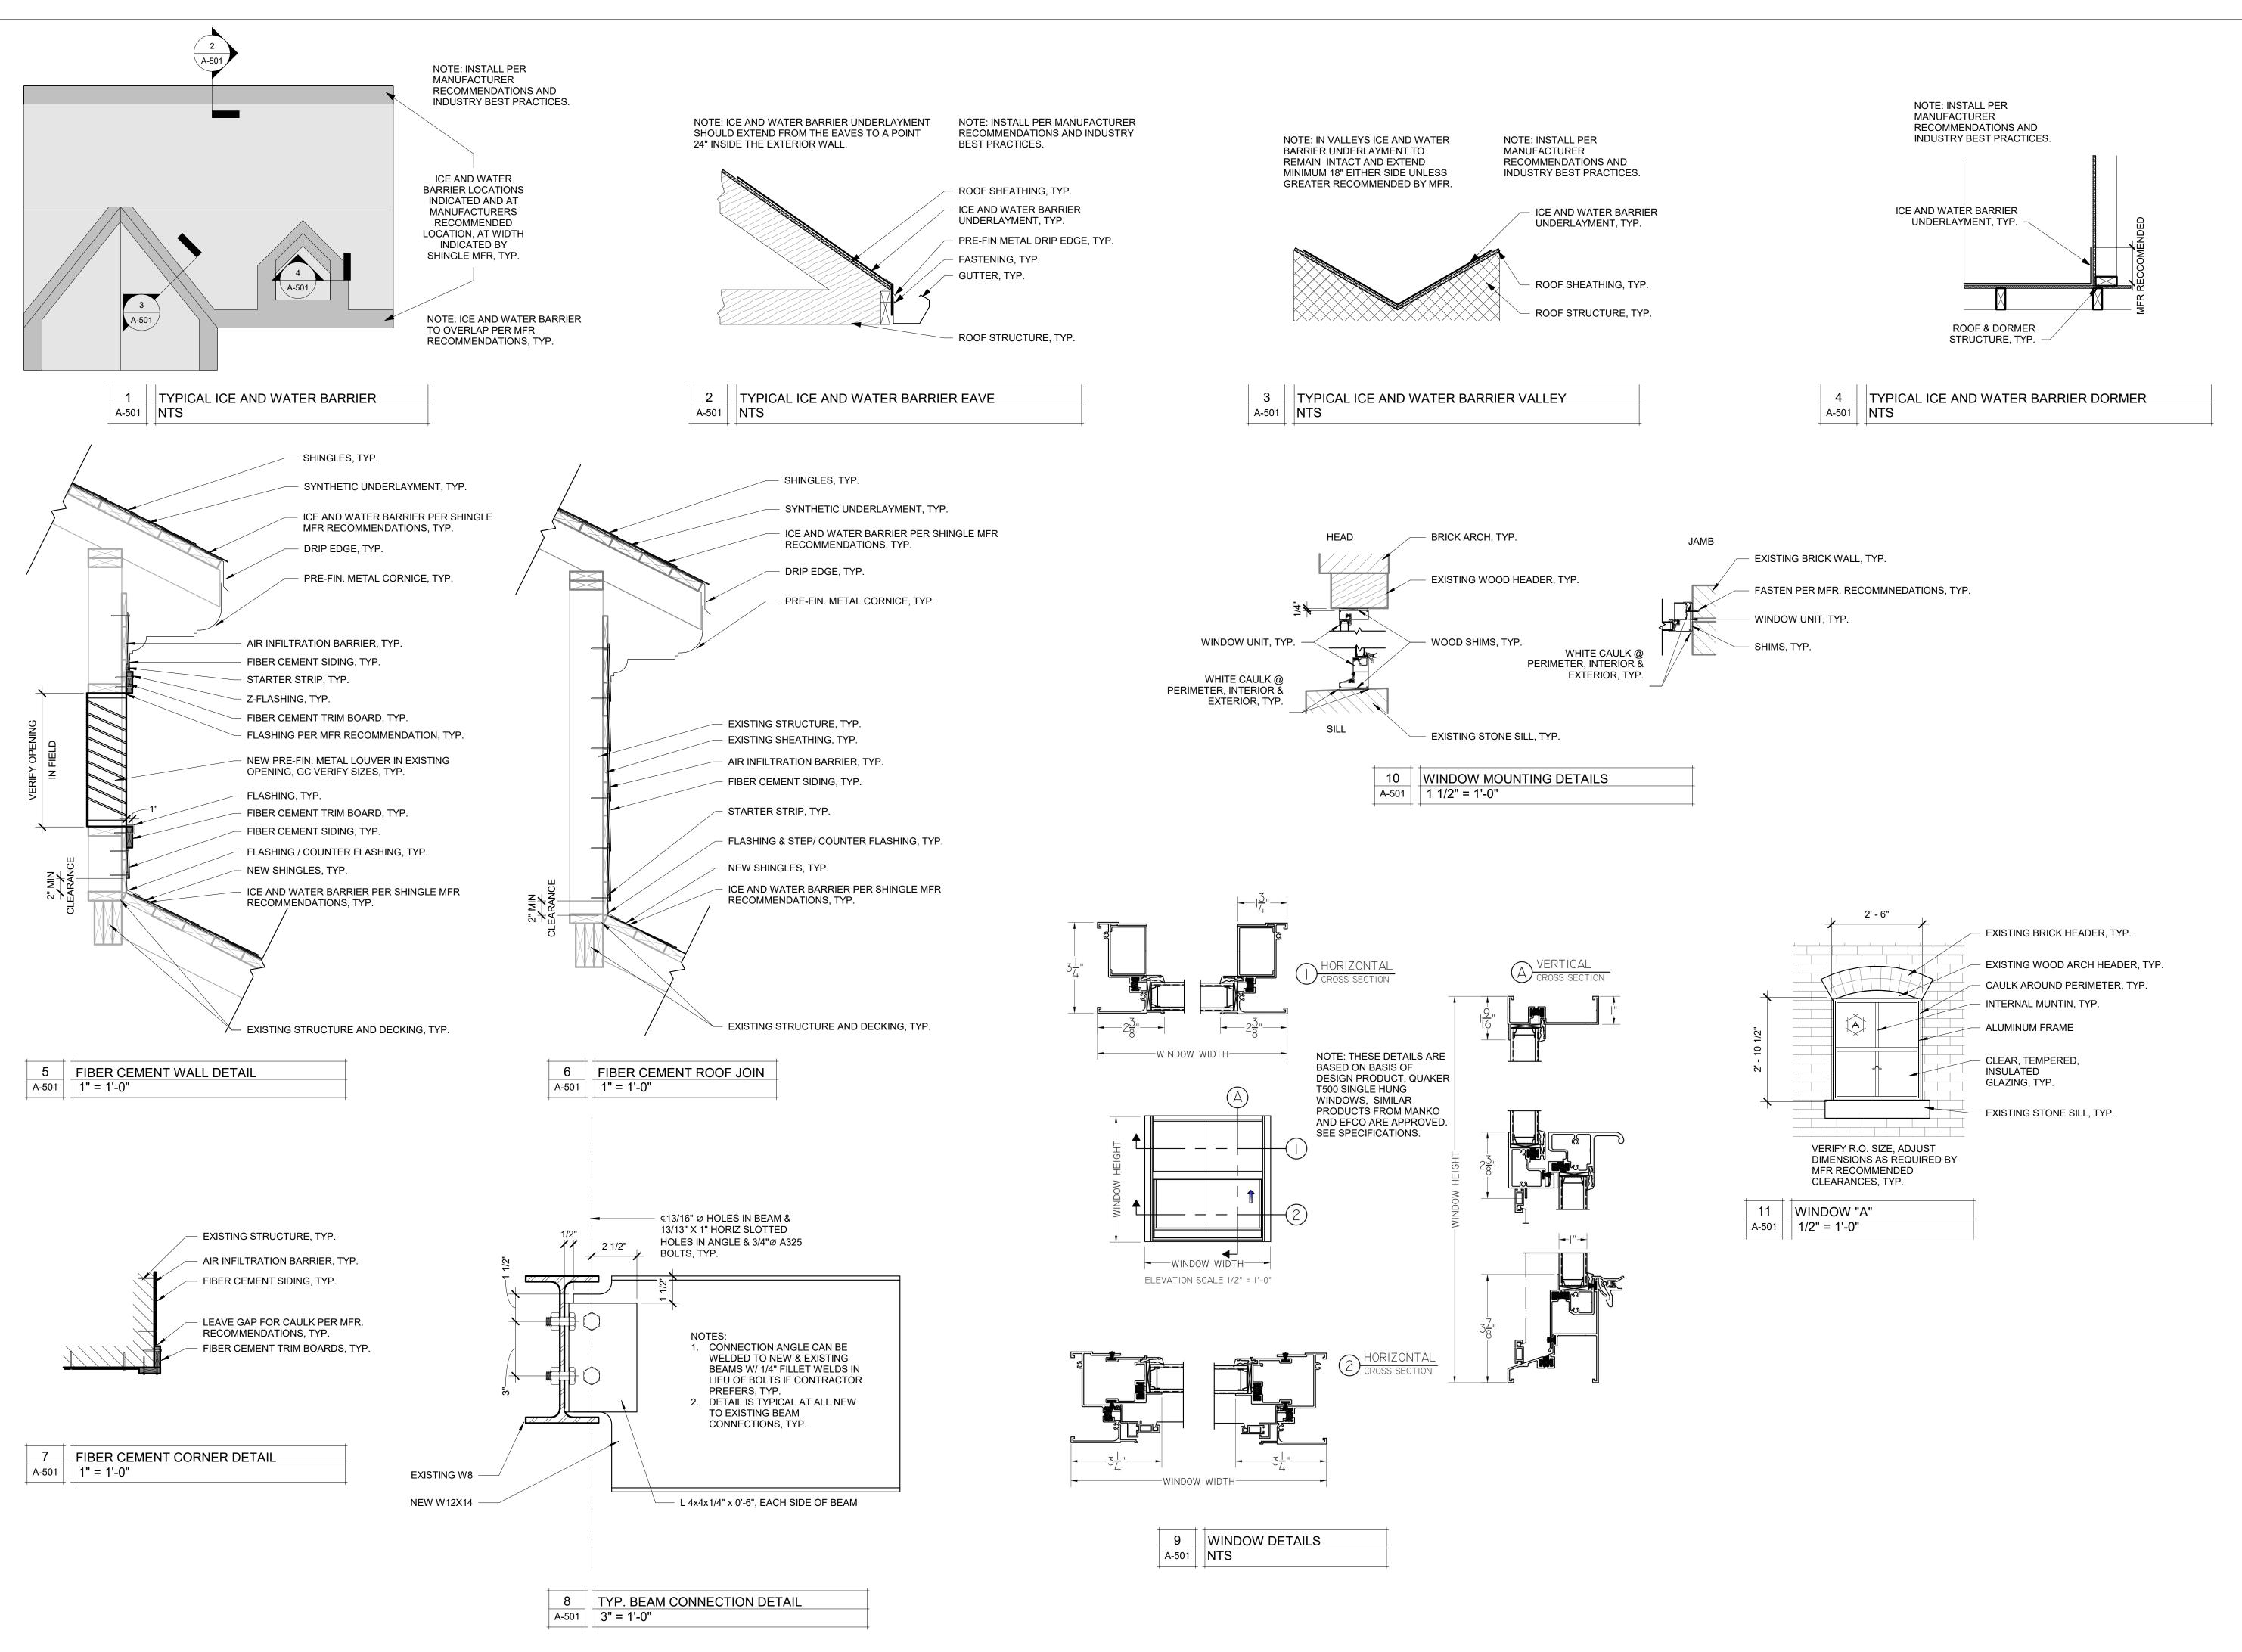

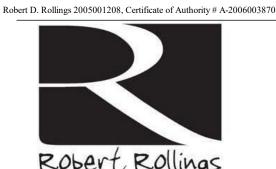

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OFFICE OF ADMINISTRATION DIVISION OF FACILITIES MANAGEMENT DESIGN AND CONSTRUCTION INTERIOR & EXTERIOR RENOVATIONS - SHORTHORN

BARN MISSOURI STATE **FAIRGROUNDS** 2503 W. 16TH ST SEDALIA, MO 65301

PROJECT # F2205-01 SITE # 1501 ASSET # 3511501048

REVISION: DATE:

REVISION: DATE:

REVISION: DATE:

ISSUE DATE: 06/29/2022 **BID DOCUMENTS**


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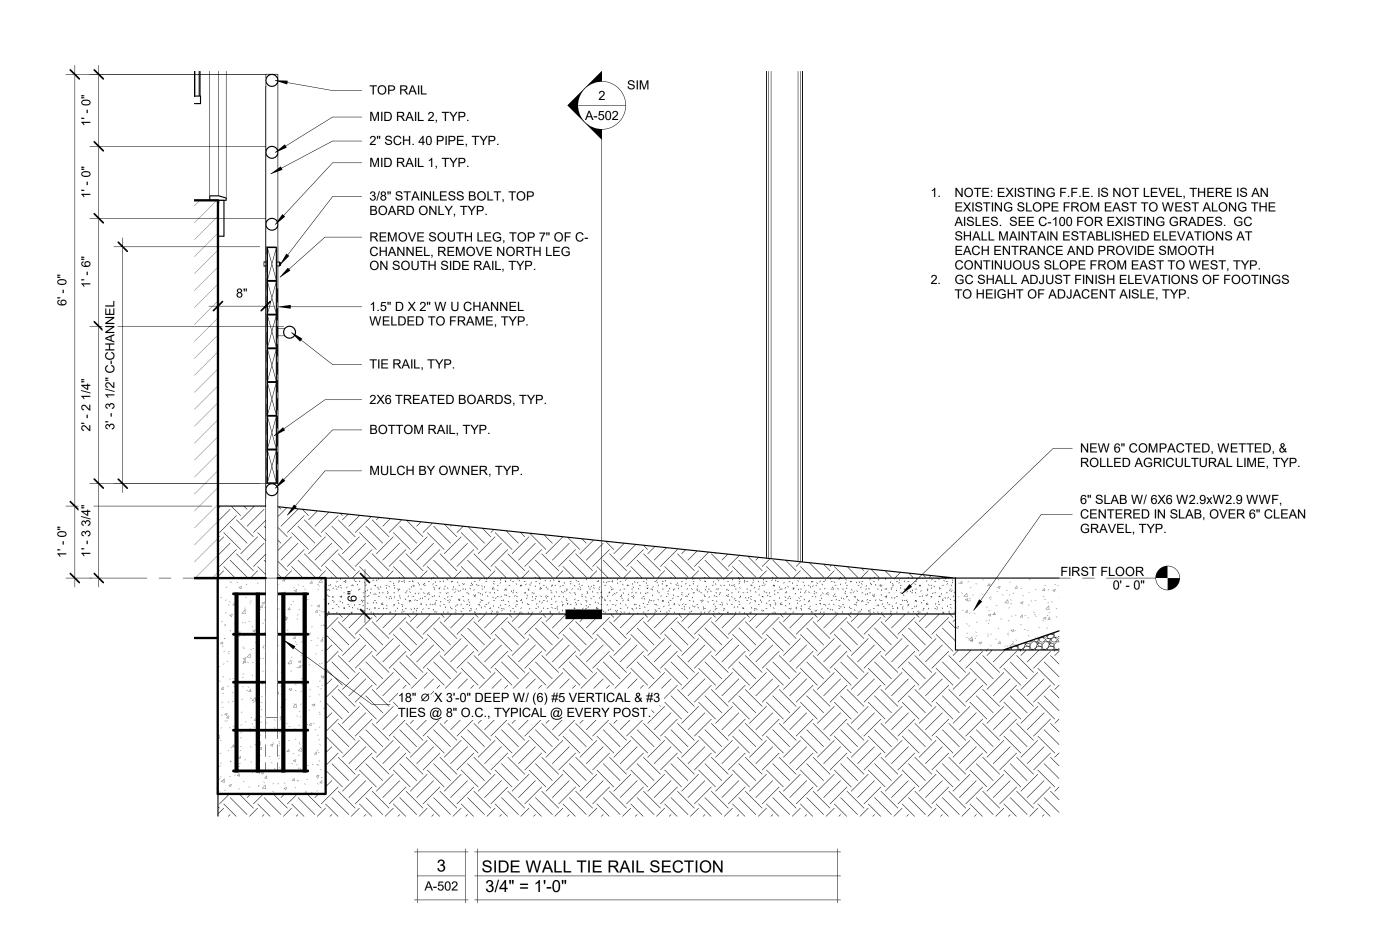
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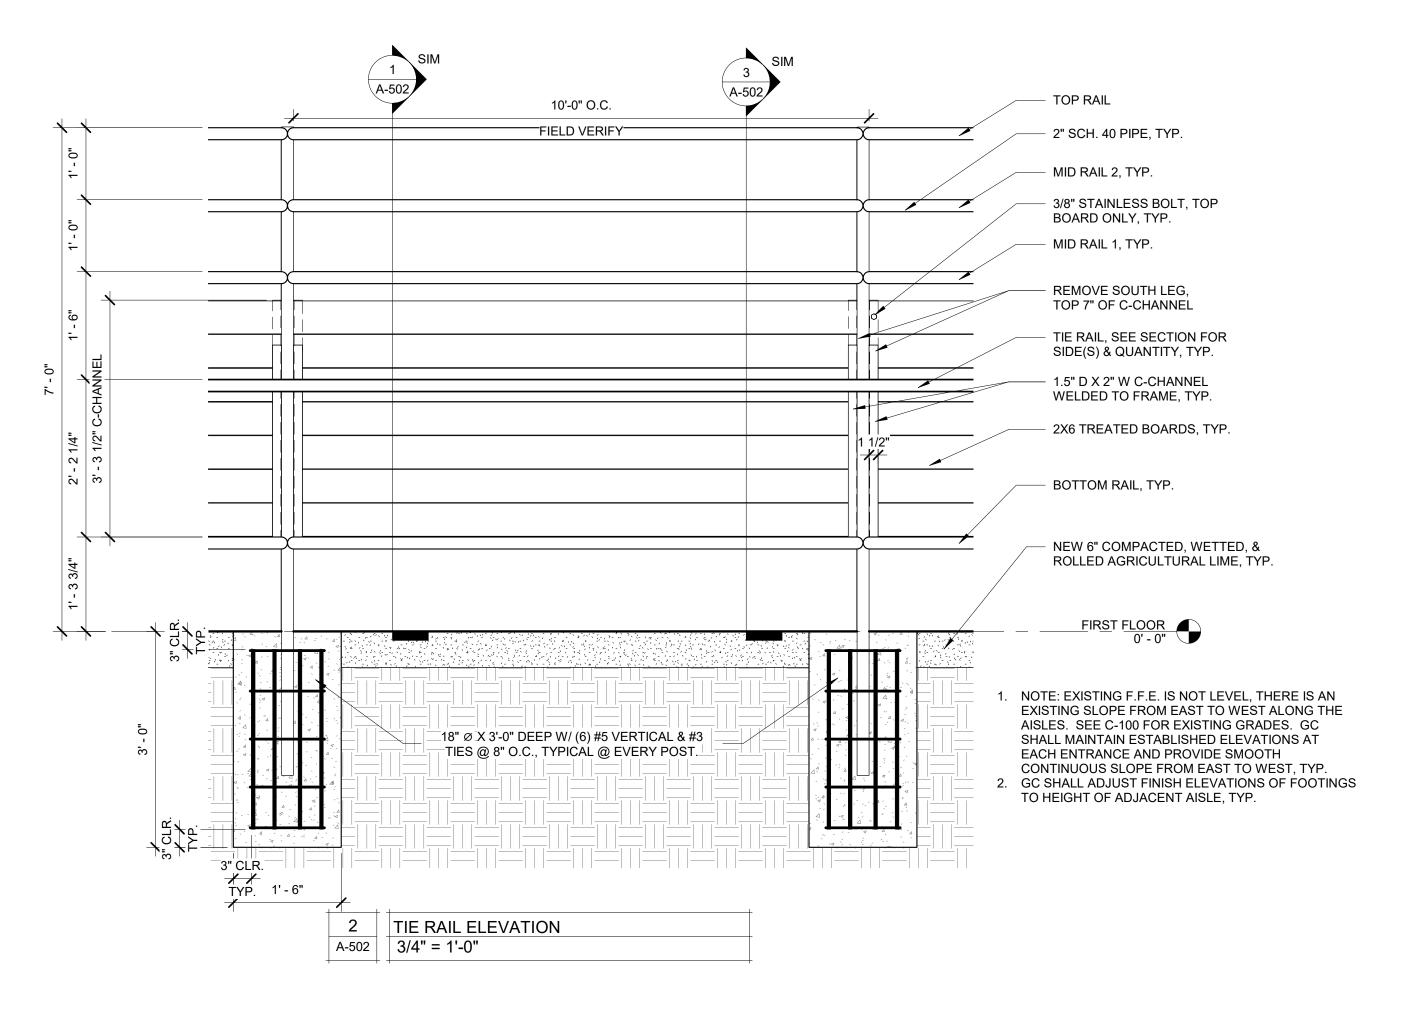
DETAILS

SHEET NUMBER:

SHEET 17 OF 27





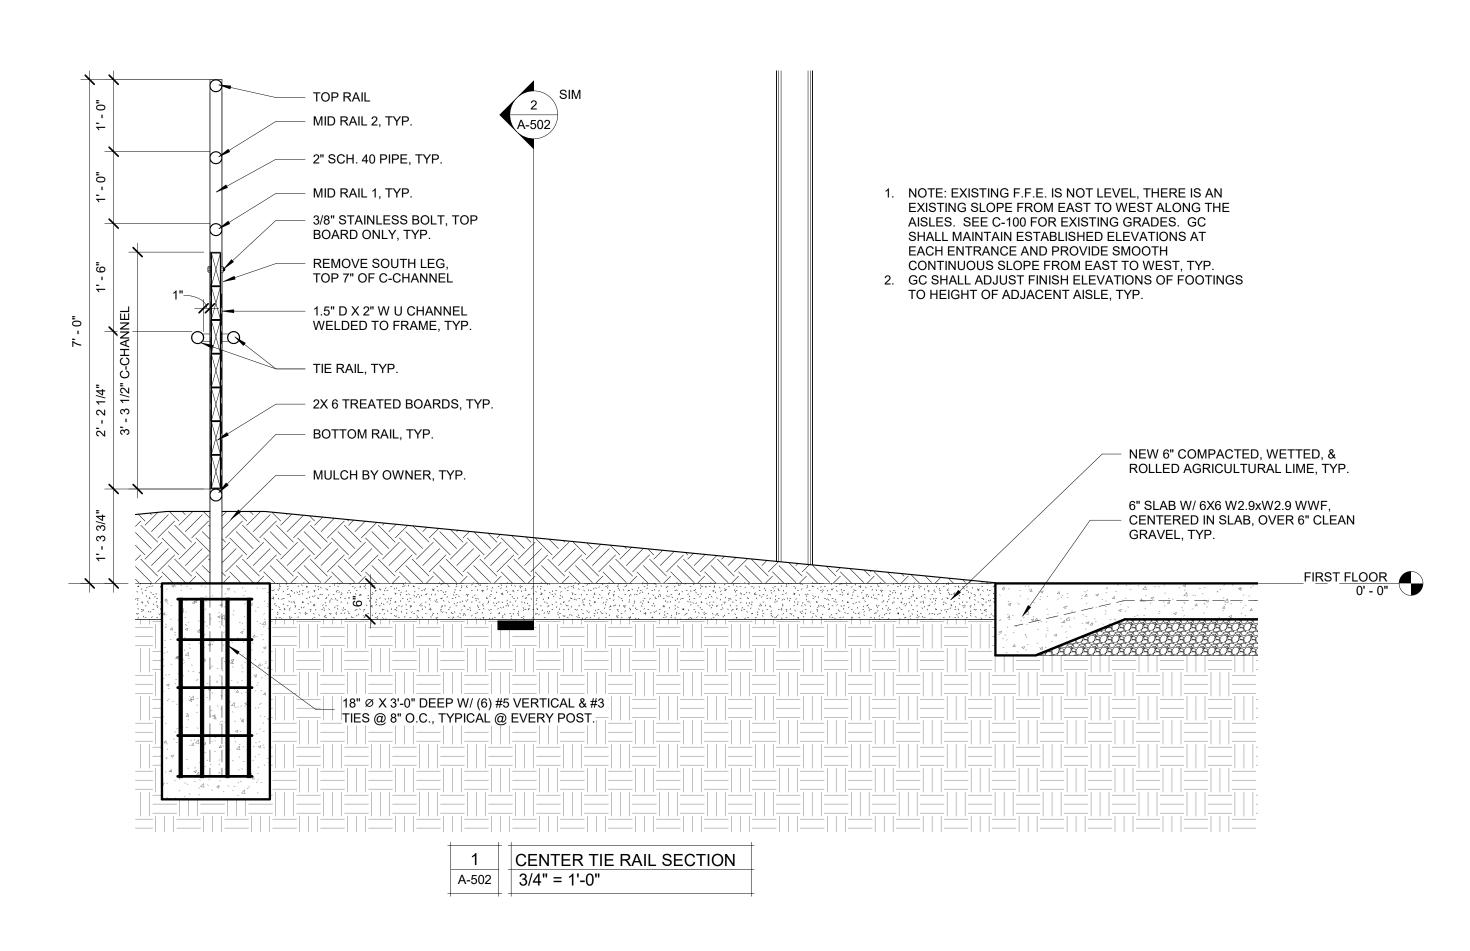



06.29.22



Robert Rollings Architects LLC 1806 West Broadway Boulevard



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INTERIOR & EXTERIOR

RENOVATIONS - SHORTHORN

BARN MISSOURI STATE FAIRGROUNDS 2503 W. 16TH ST SEDALIA, MO 65301

PROJECT # F2205-01 SITE # 1501

ASSET # 3511501048

REVISION: DATE:

REVISION: DATE:

REVISION:_ DATE:

ISSUE DATE: 06/29/2022 BID DOCUMENTS

CAD DWG FILE:

F2205-01-1501-3511501048-A-DT-18

DRAWN BY: AMK

CHECKED BY: RDR

DESIGNED BY: AMK


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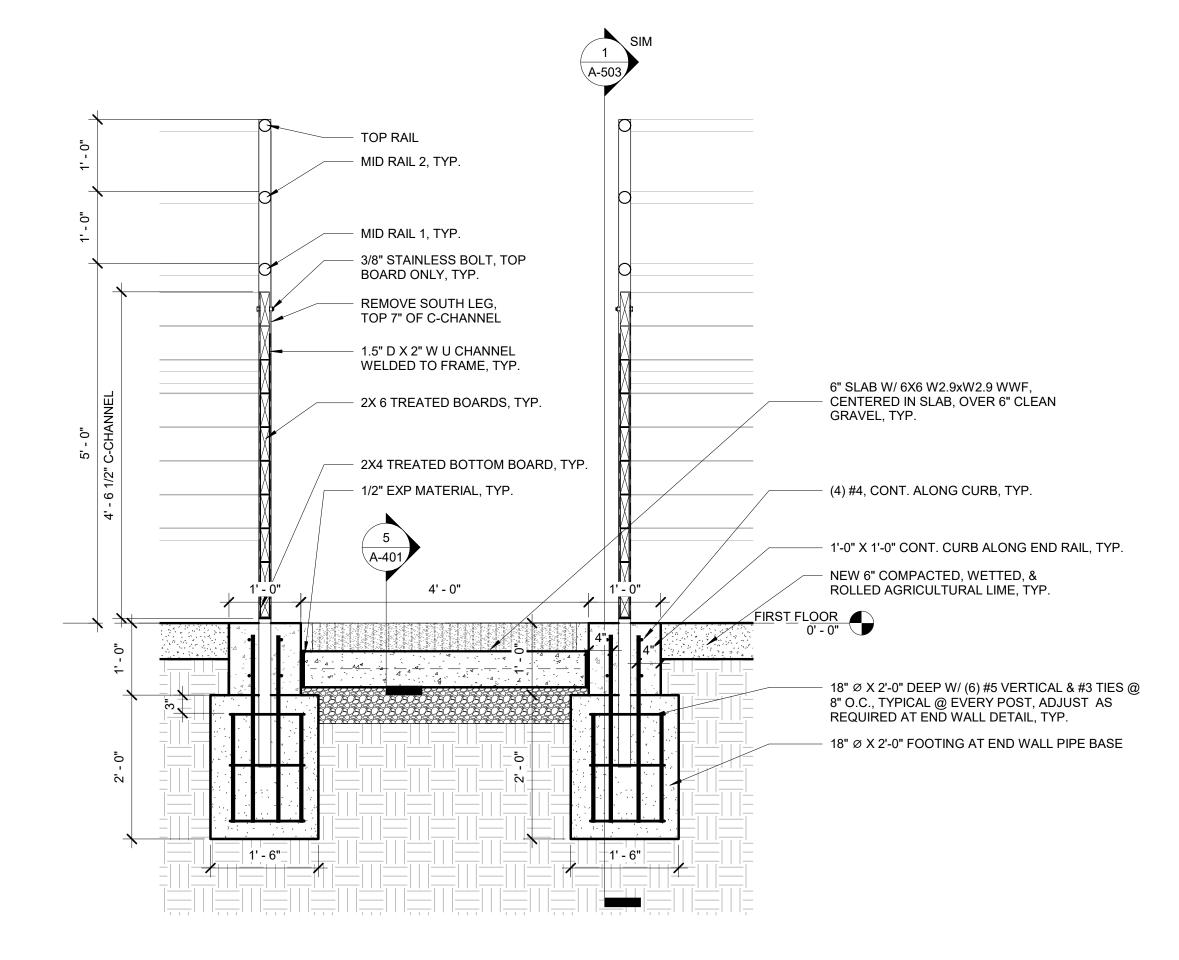
TIE RAIL DETAILS

SHEET NUMBER:

A-502

SHEET 18 OF 27



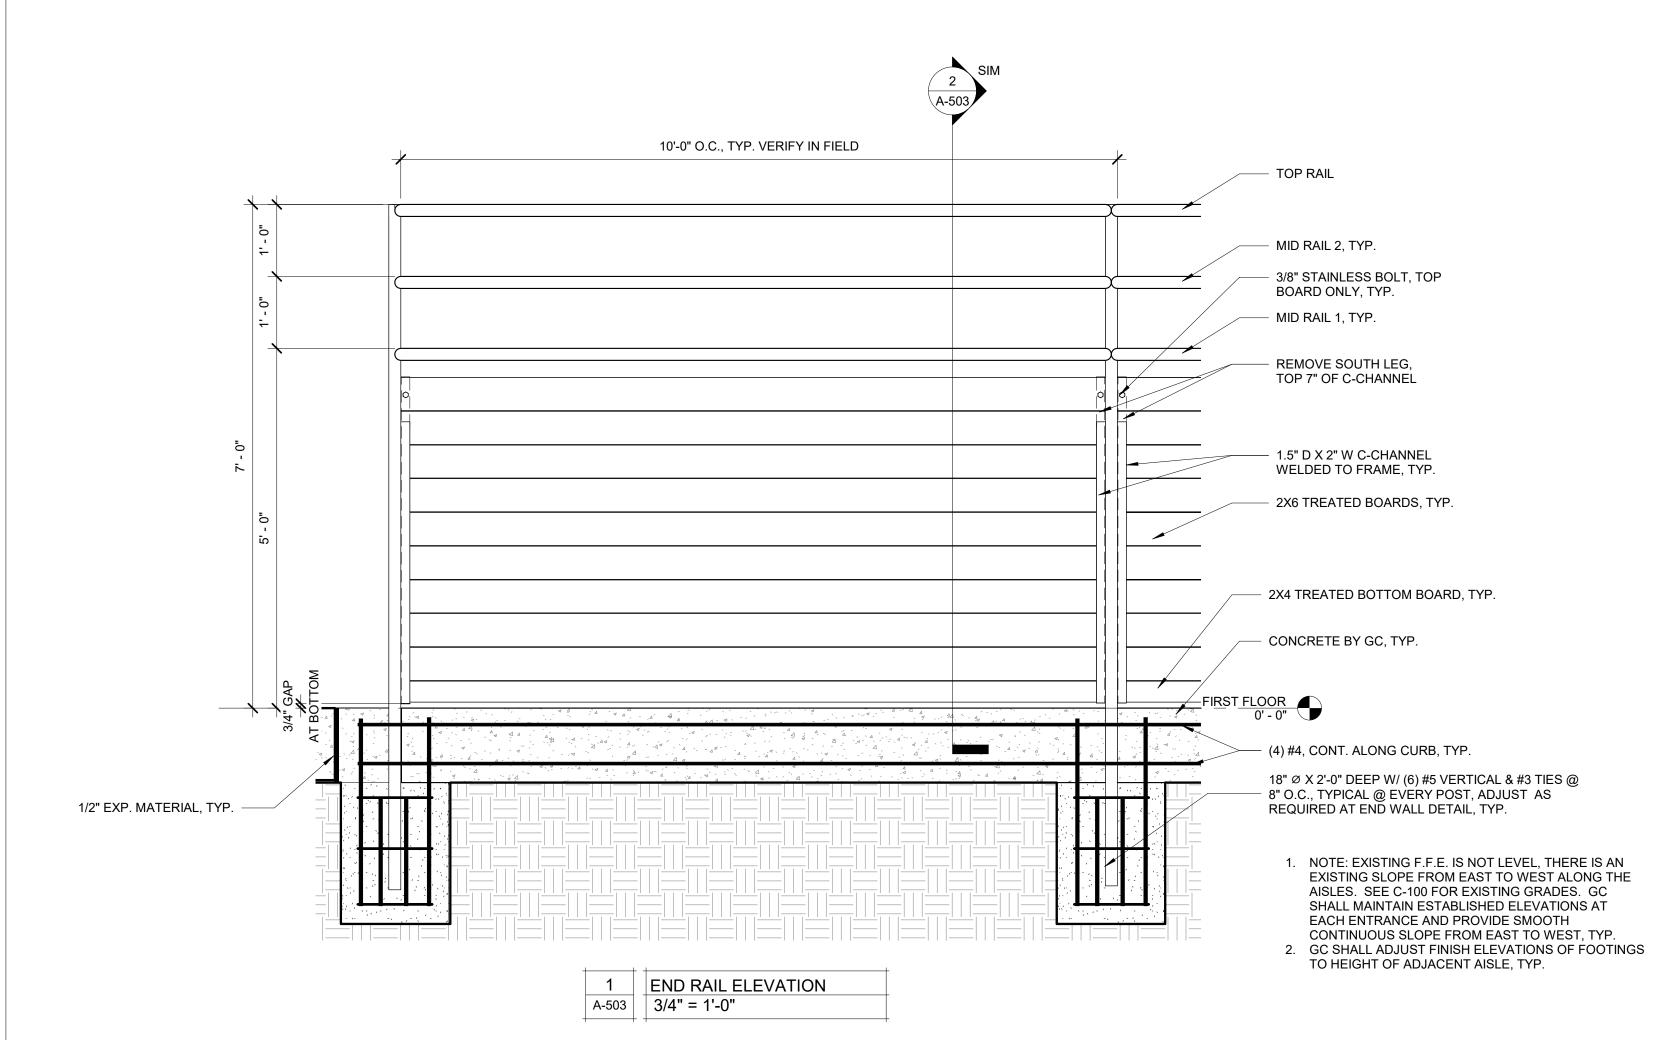

2 END RAIL SECTION 3/4" = 1'-0"

STATE OF MISSOURI MICHAEL L. PARSON, **GOVERNOR**





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RENOVATIONS - SHORTHORN MISSOURI STATE FAIRGROUNDS

PROJECT # F2205-01 SITE # 1501 ASSET # 3511501048

2503 W. 16TH ST SEDALIA, MO 65301

REVISION: DATE:

REVISION: DATE:

REVISION: DATE:

ISSUE DATE: 06/29/2022 **BID DOCUMENTS** CAD DWG FILE:


F2205-01-1501-3511501048-A-DT-19 DRAWN BY: AMK
CHECKED BY: RDR
DESIGNED BY: AMK

SHEET TITLE:

END RAIL DETAILS

SHEET NUMBER:

SHEET 19 OF 27

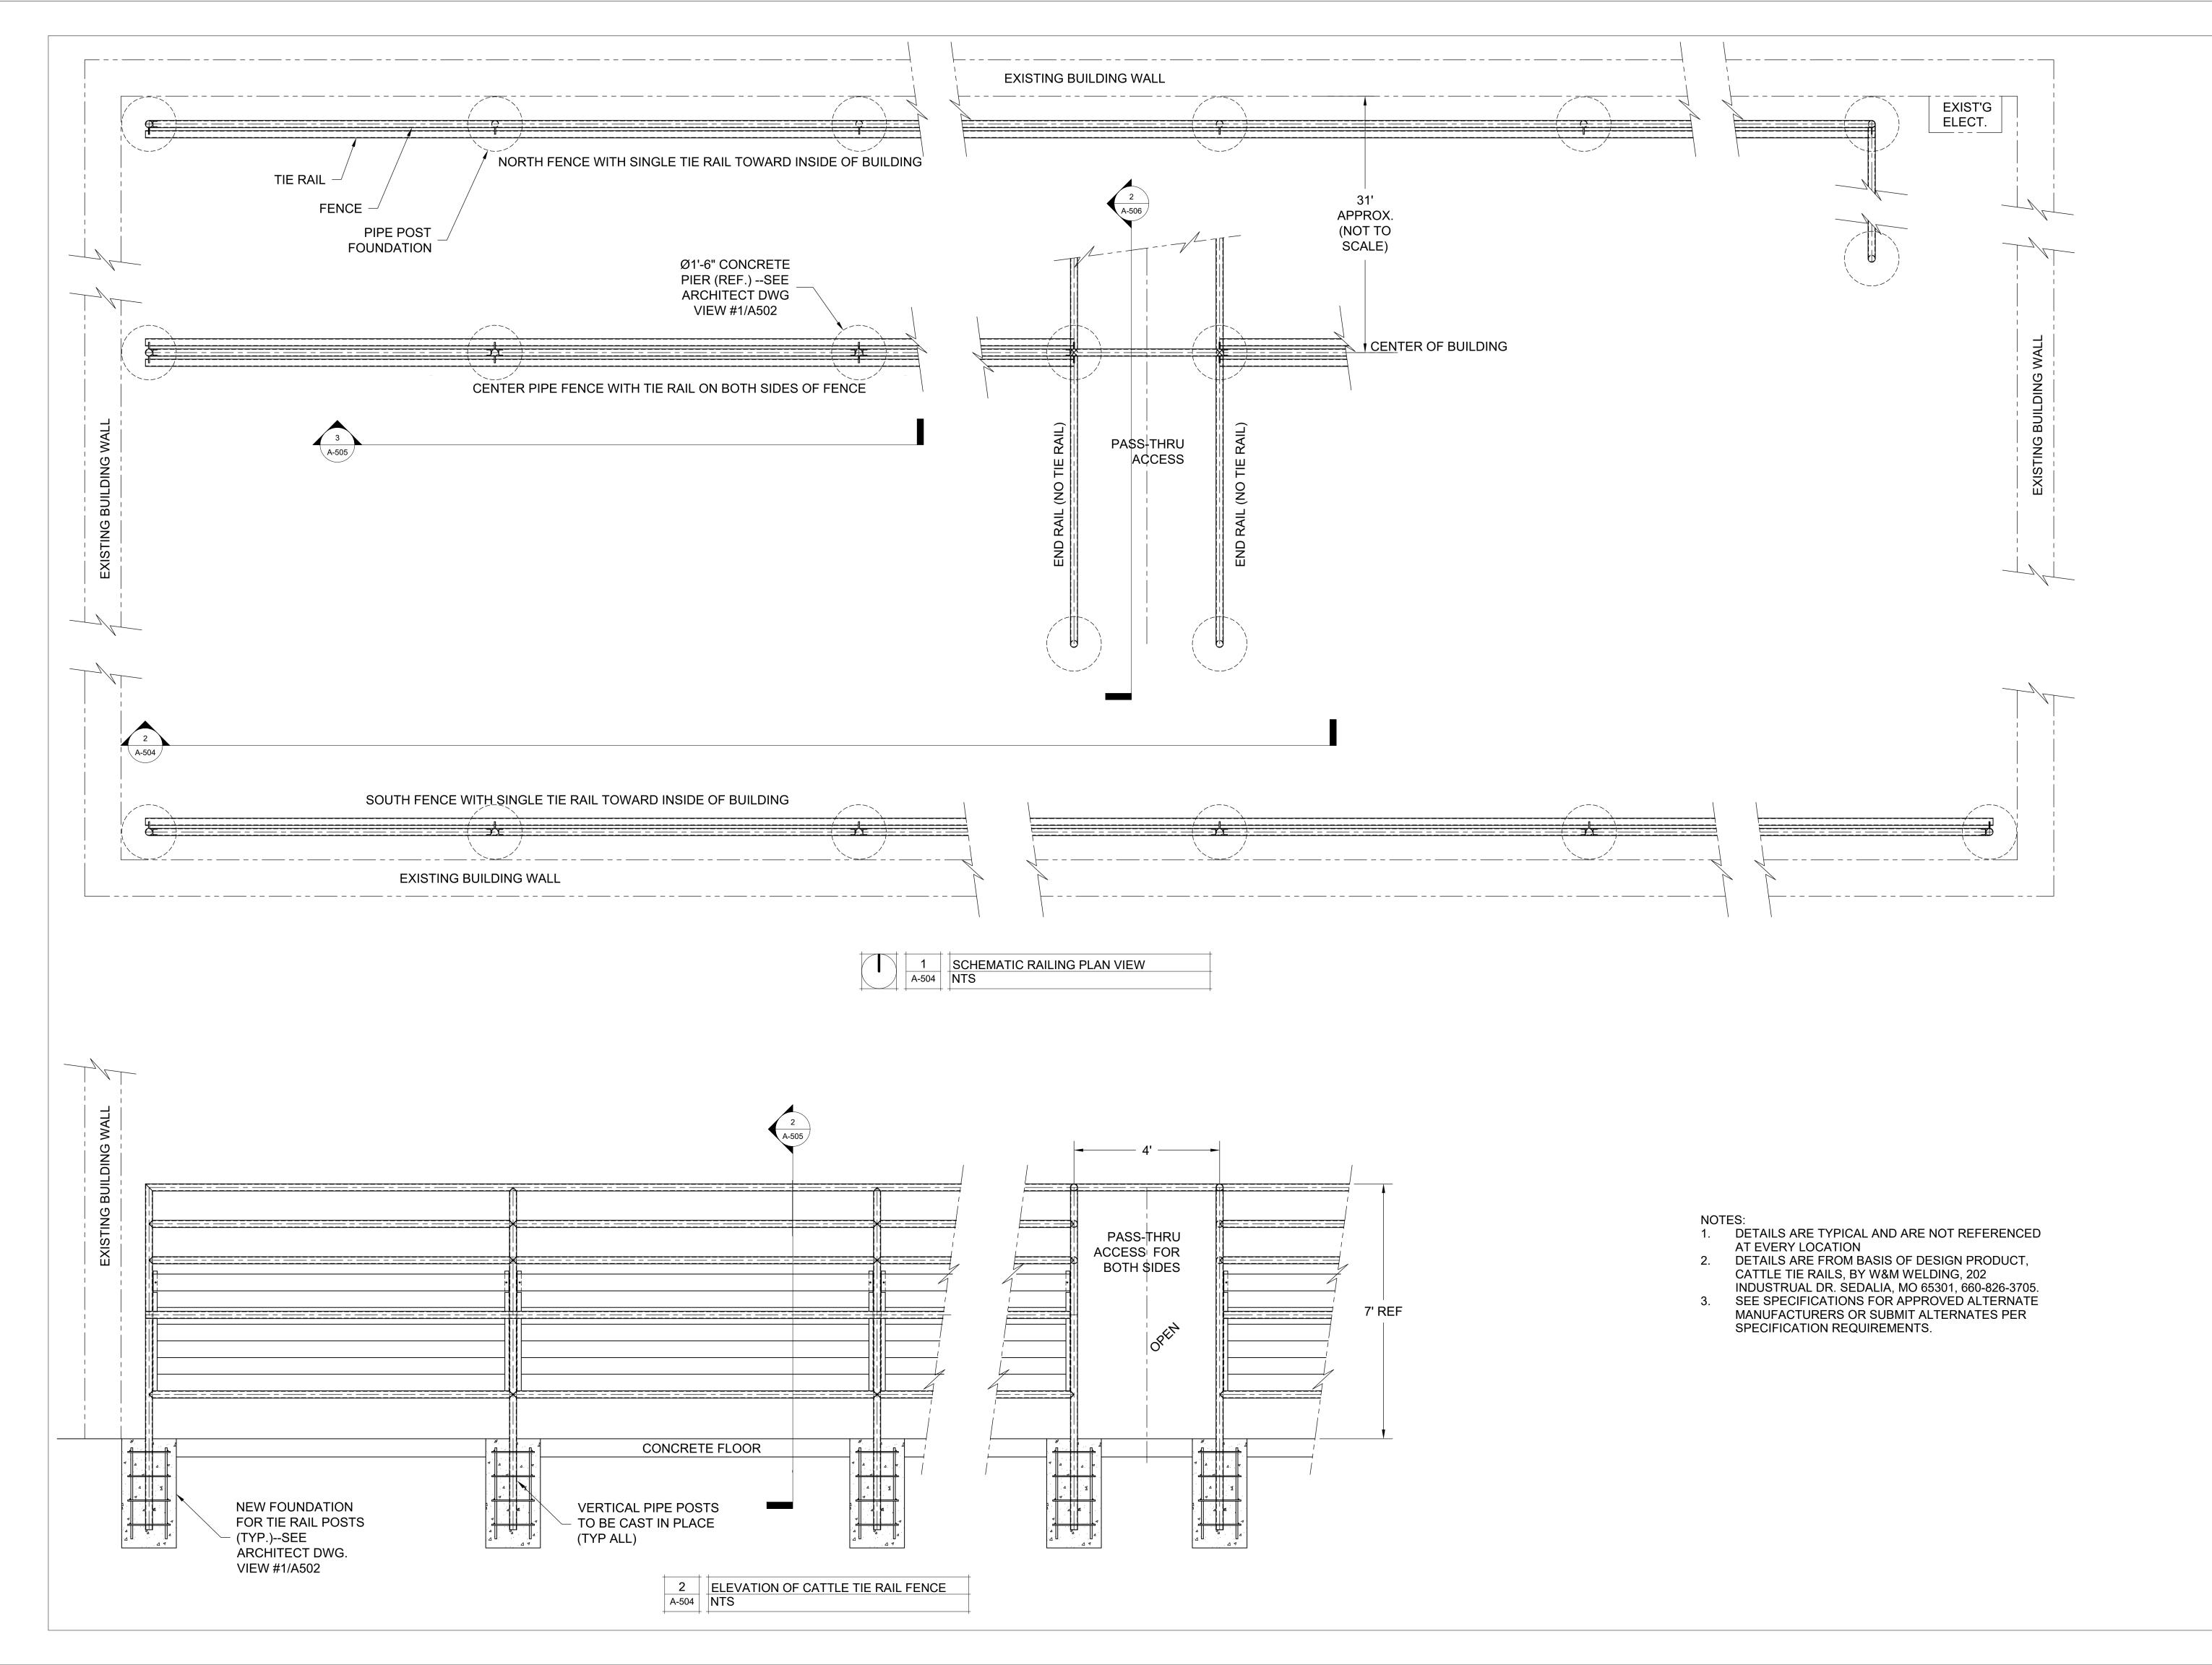



06.29.22



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Sedalia, MO 65301 660.829.9751

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INTERIOR & EXTERIOR

RENOVATIONS - SHORTHORN
BARN
MISSOURI STATE

FAIRGROUNDS 2503 W. 16TH ST SEDALIA, MO 65301

PROJECT # F2205-01 SITE # 1501 ASSET # 3511501048

REVISION: DATE:

REVISION:_ DATE:

ISSUE DATE: 06/29/2022 BID DOCUMENTS

CAD DWG FILE:
F2205-01-1501-3511501048-A-DT-20

DRAWN BY: AMK
CHECKED BY: RDR
DESIGNED BY: AMK


SHEET TITLE:

TIE & END RAIL DETAILS

SHEET NUMBER:

A-504

SHEET 20 OF 27

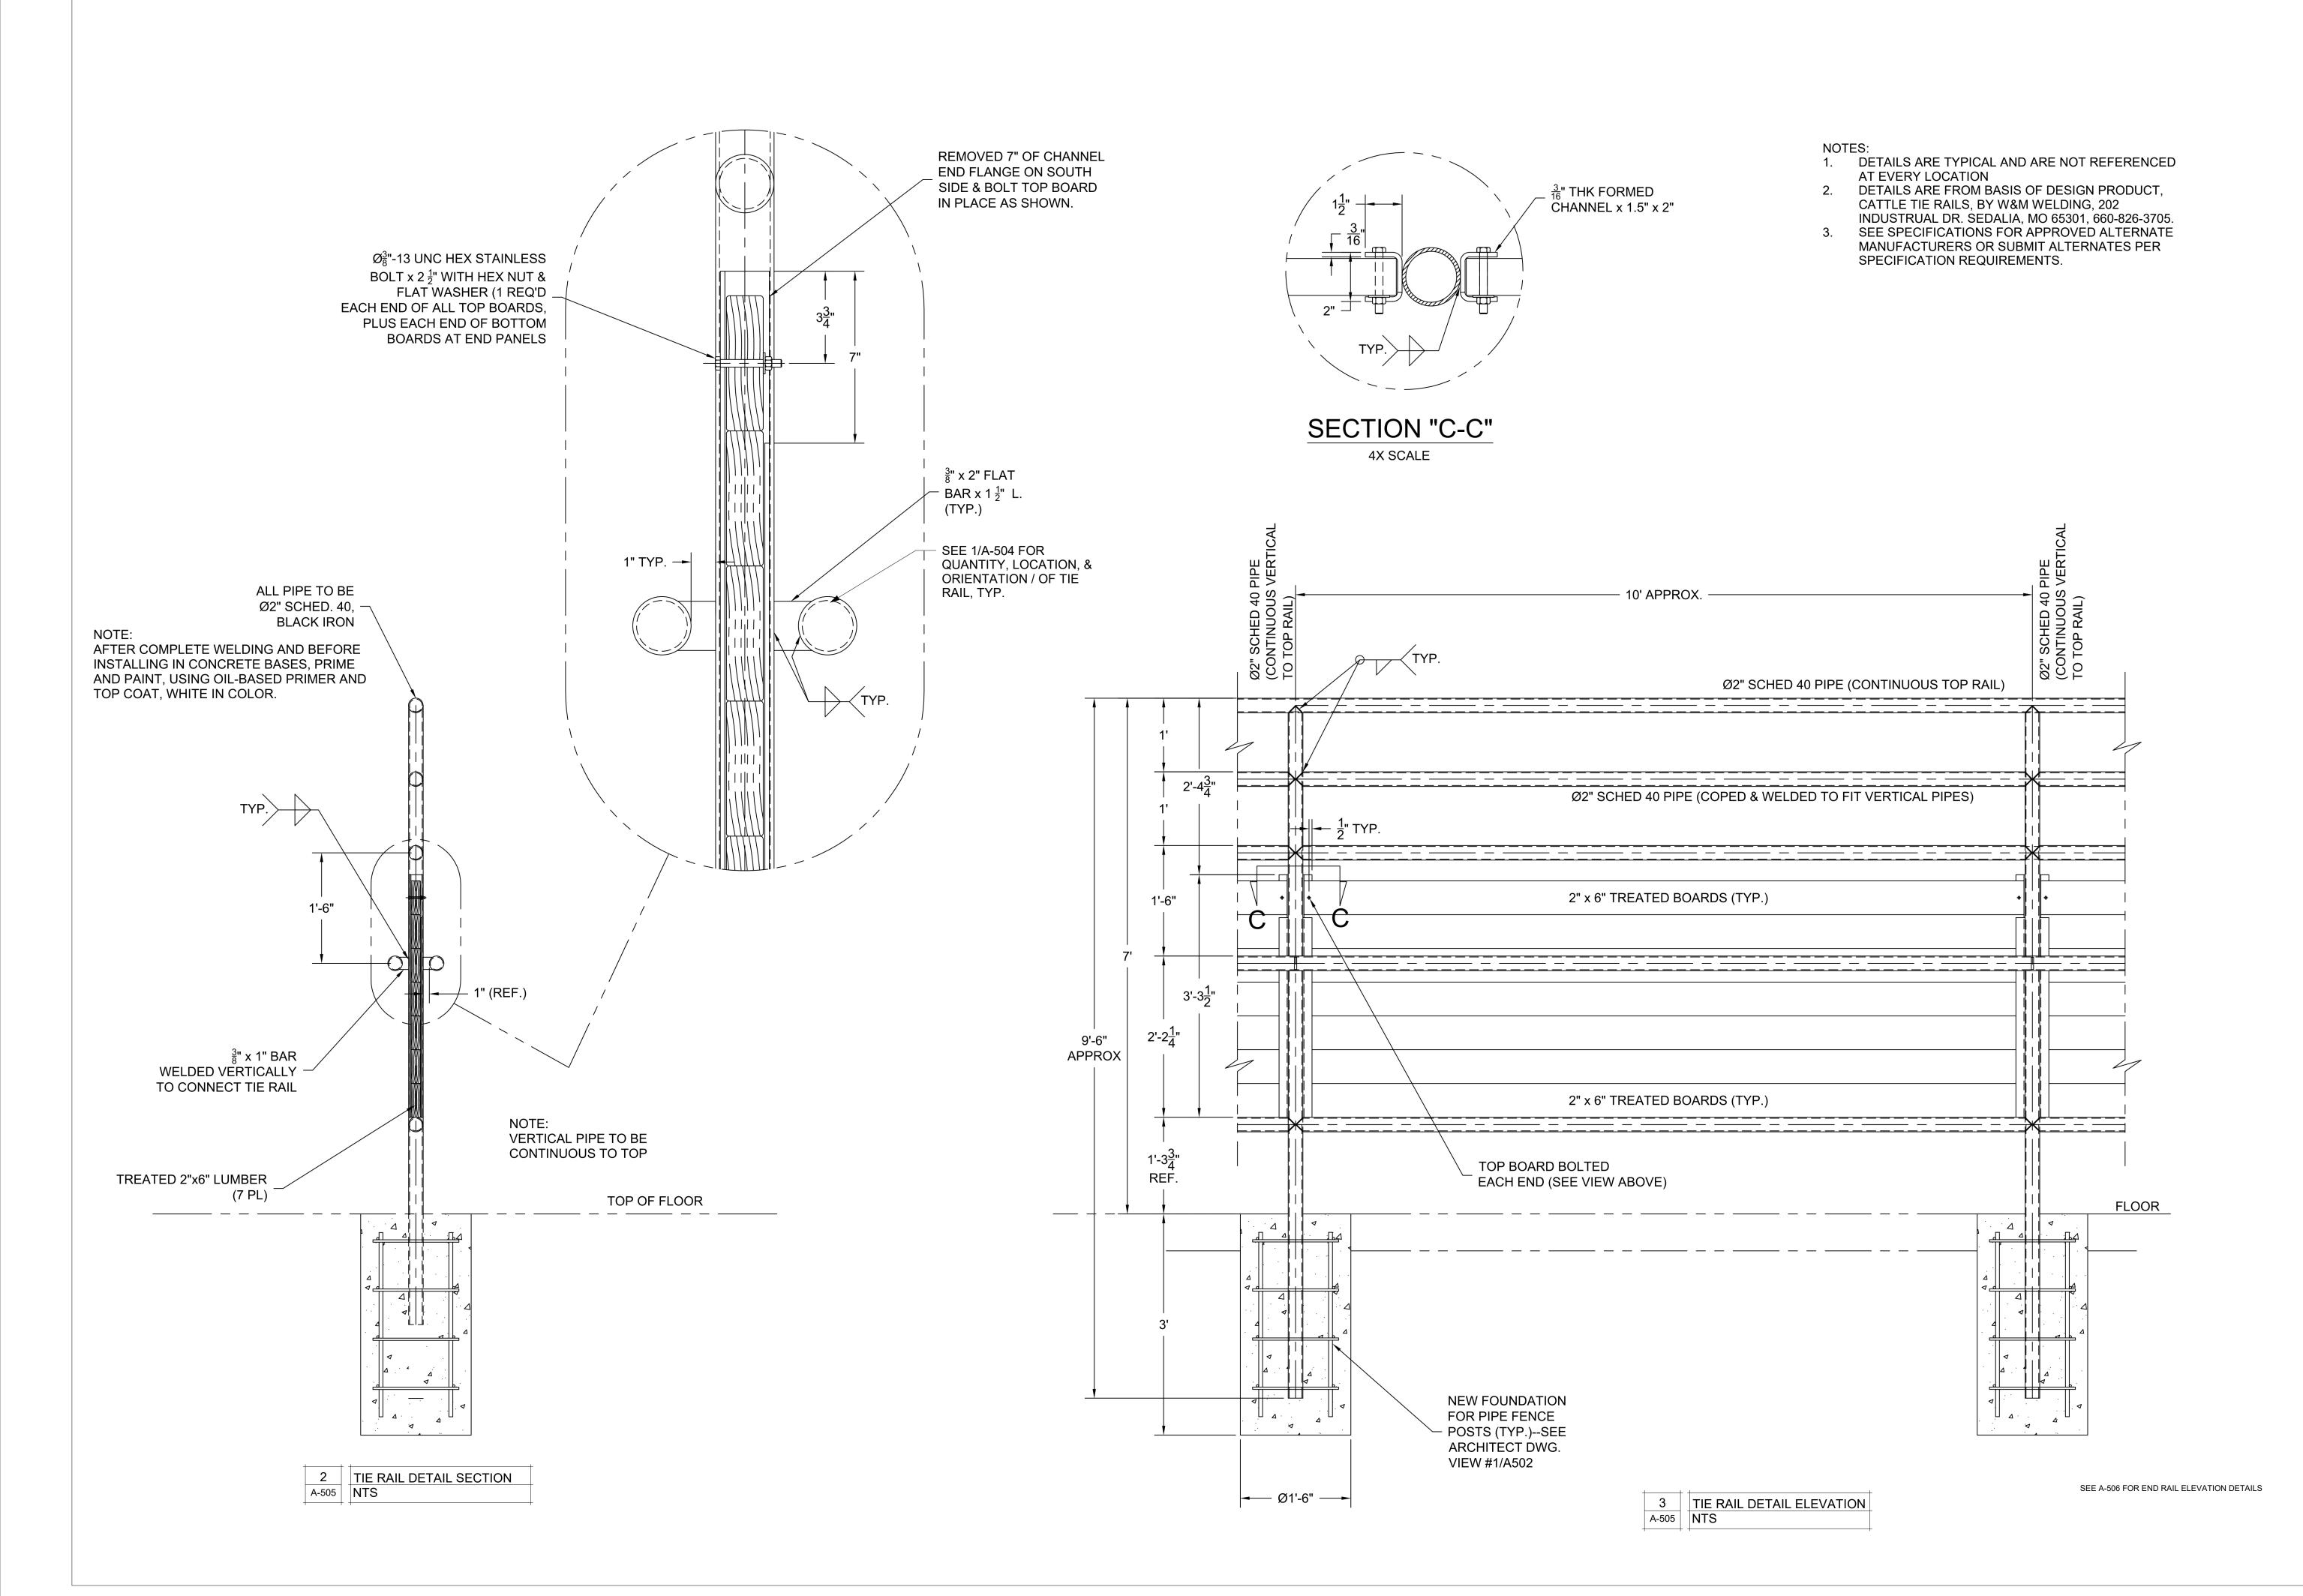



06.29.22



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OFFICE OF ADMINISTRATION DIVISION OF FACILITIES MANAGEMENT DESIGN AND CONSTRUCTION INTERIOR & EXTERIOR

RENOVATIONS - SHORTHORN BARN MISSOURI STATE

FAIRGROUNDS 2503 W. 16TH ST SEDALIA, MO 65301 PROJECT # F2205-01

SITE # 1501 ASSET # 3511501048

REVISION: DATE:

REVISION: DATE:

REVISION: DATE:

ISSUE DATE: 06/29/2022 BID DOCUMENTS

CAD DWG FILE:

F2205-01-1501-3511501048-A-DT-21

DRAWN BY: AMK

CHECKED BY: RDR

DESIGNED BY: AMK


SHEET TITLE:

TIE & END RAIL DETAILS

SHEET NUMBER:

A-505

SHEET 21 OF 27

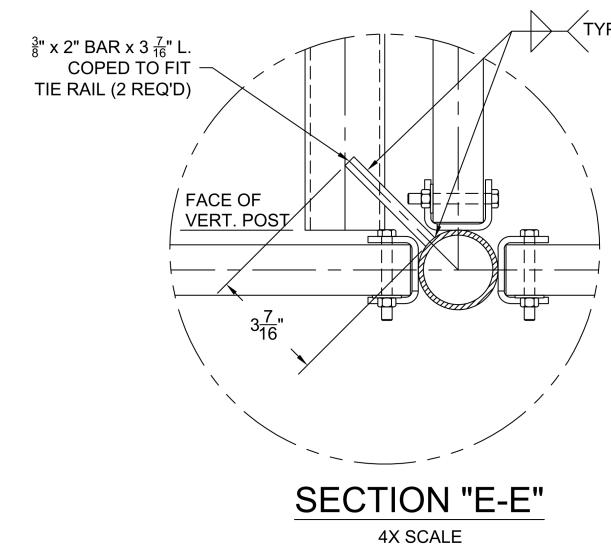

- 1. DETAILS ARE TYPICAL AND ARE NOT REFERENCED
- AT EVERY LOCATION
- 2. DETAILS ARE FROM BASIS OF DESIGN PRODUCT, CATTLE TIE RAILS, BY W&M WELDING, 202
- INDUSTRUAL DR. SEDALIA, MO 65301, 660-826-3705. 3. SEE SPECIFICATIONS FOR APPROVED ALTERNATE MANUFACTURERS OR SUBMIT ALTERNATES PER SPECIFICATION REQUIREMENTS.

Sedalia, MO 65301 660.829.9751

STATE OF MISSOURI MICHAEL L. PARSON,

GOVERNOR



Robert D. Rollings 2005001208, Certificate of Authority # A-2006003870

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OFFICE OF ADMINISTRATION DIVISION OF FACILITIES MANAGEMENT DESIGN AND CONSTRUCTION **INTERIOR & EXTERIOR**

RENOVATIONS - SHORTHORN

MISSOURI STATE **FAIRGROUNDS** 2503 W. 16TH ST SEDALIA, MO 65301

PROJECT # F2205-01 SITE # 1501 ASSET # 3511501048

DATE:

REVISION:

REVISION: DATE:

REVISION: DATE:

ISSUE DATE: 06/29/2022 **BID DOCUMENTS**


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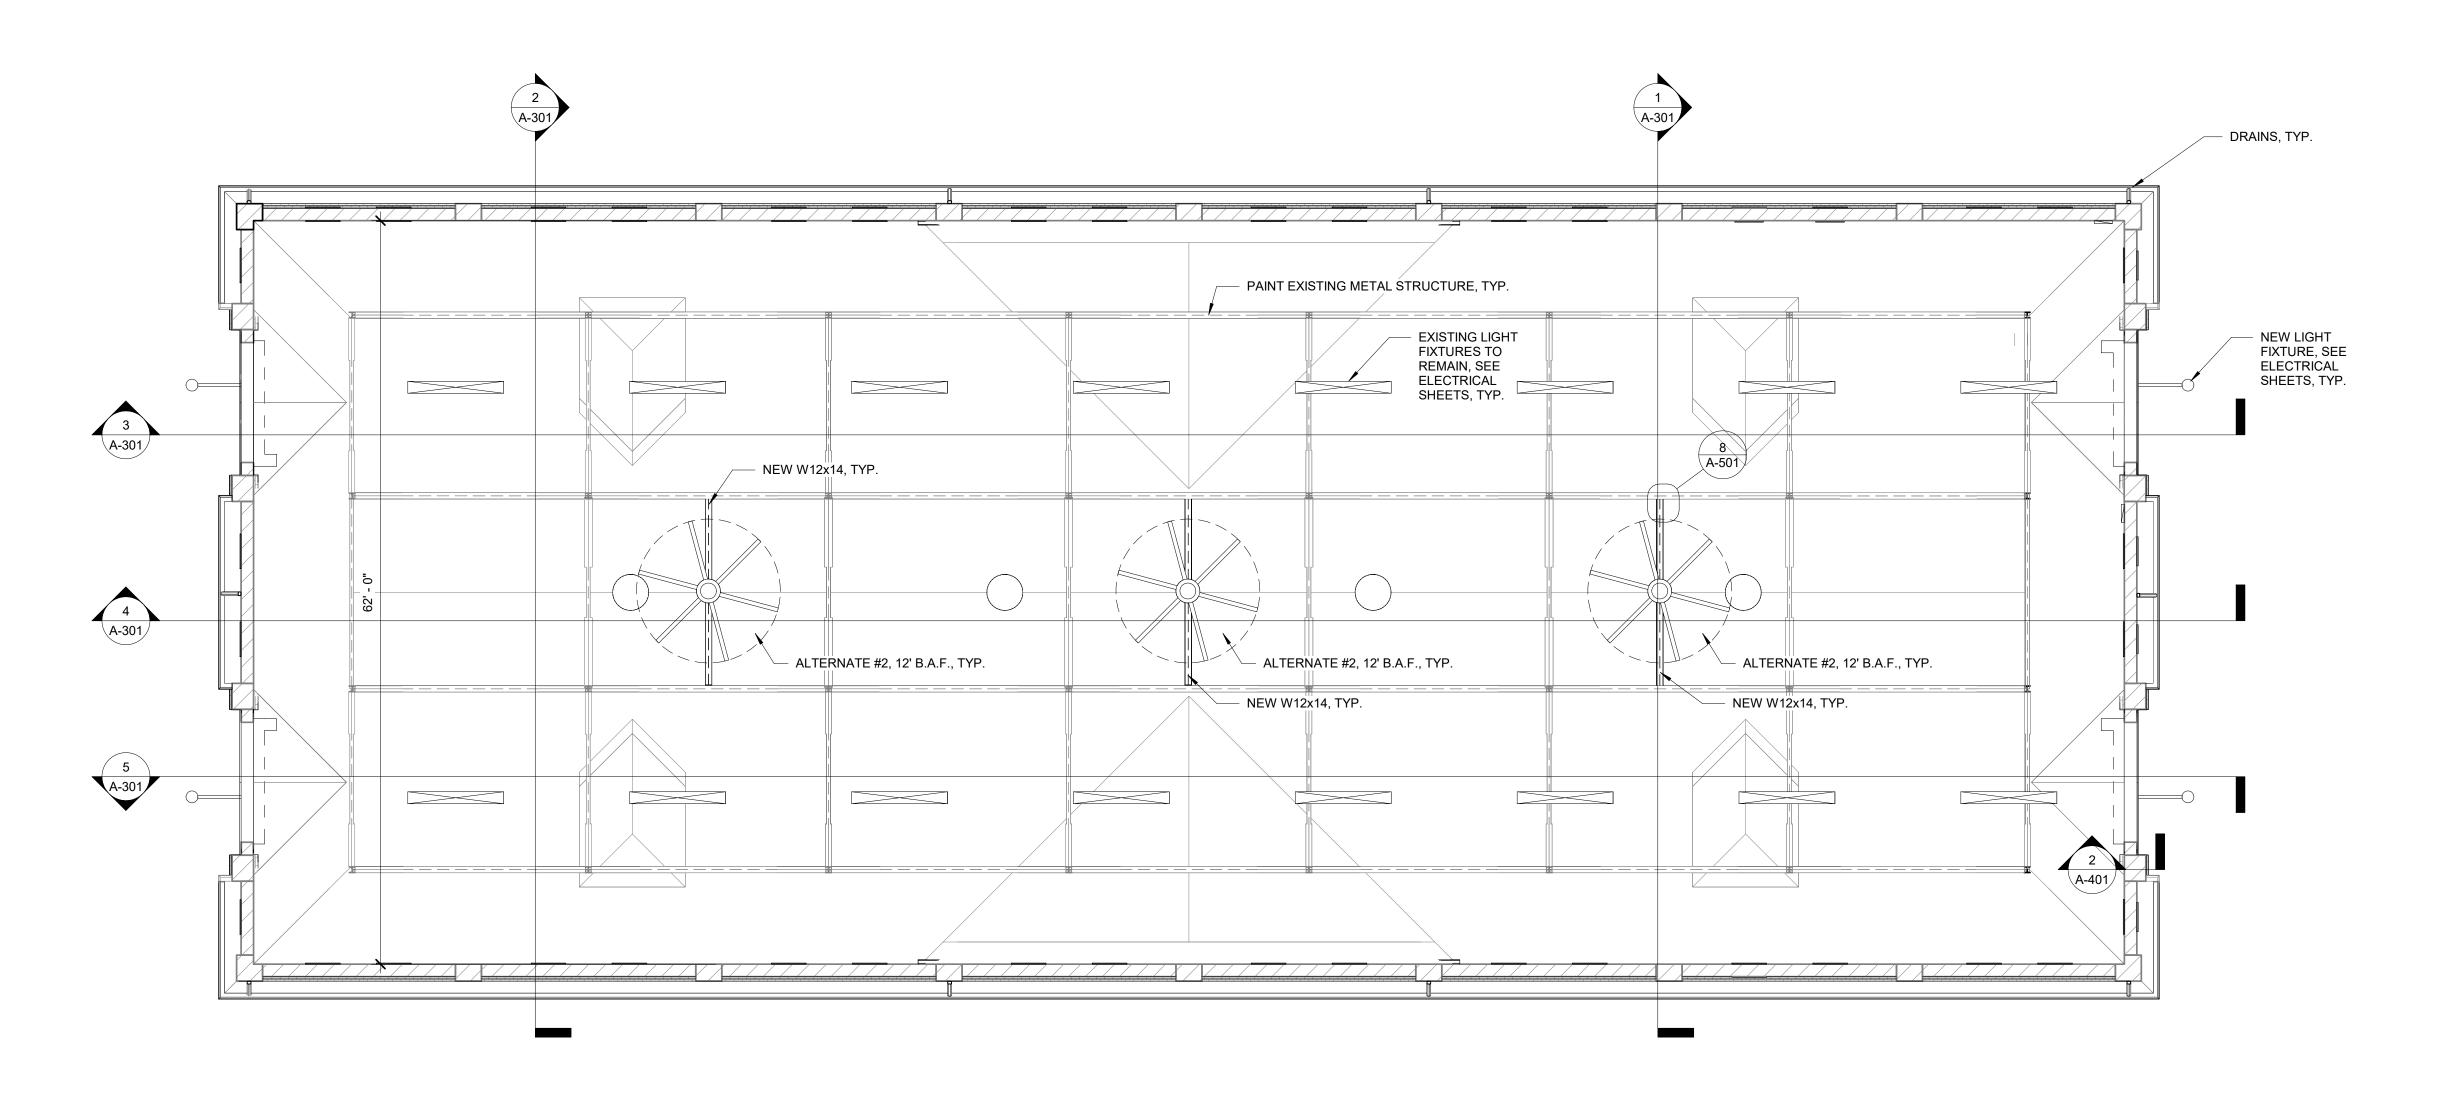
SHEET TITLE:

TIE & END RAIL **DETAILS**

SHEET NUMBER:

SHEET 22 OF 27



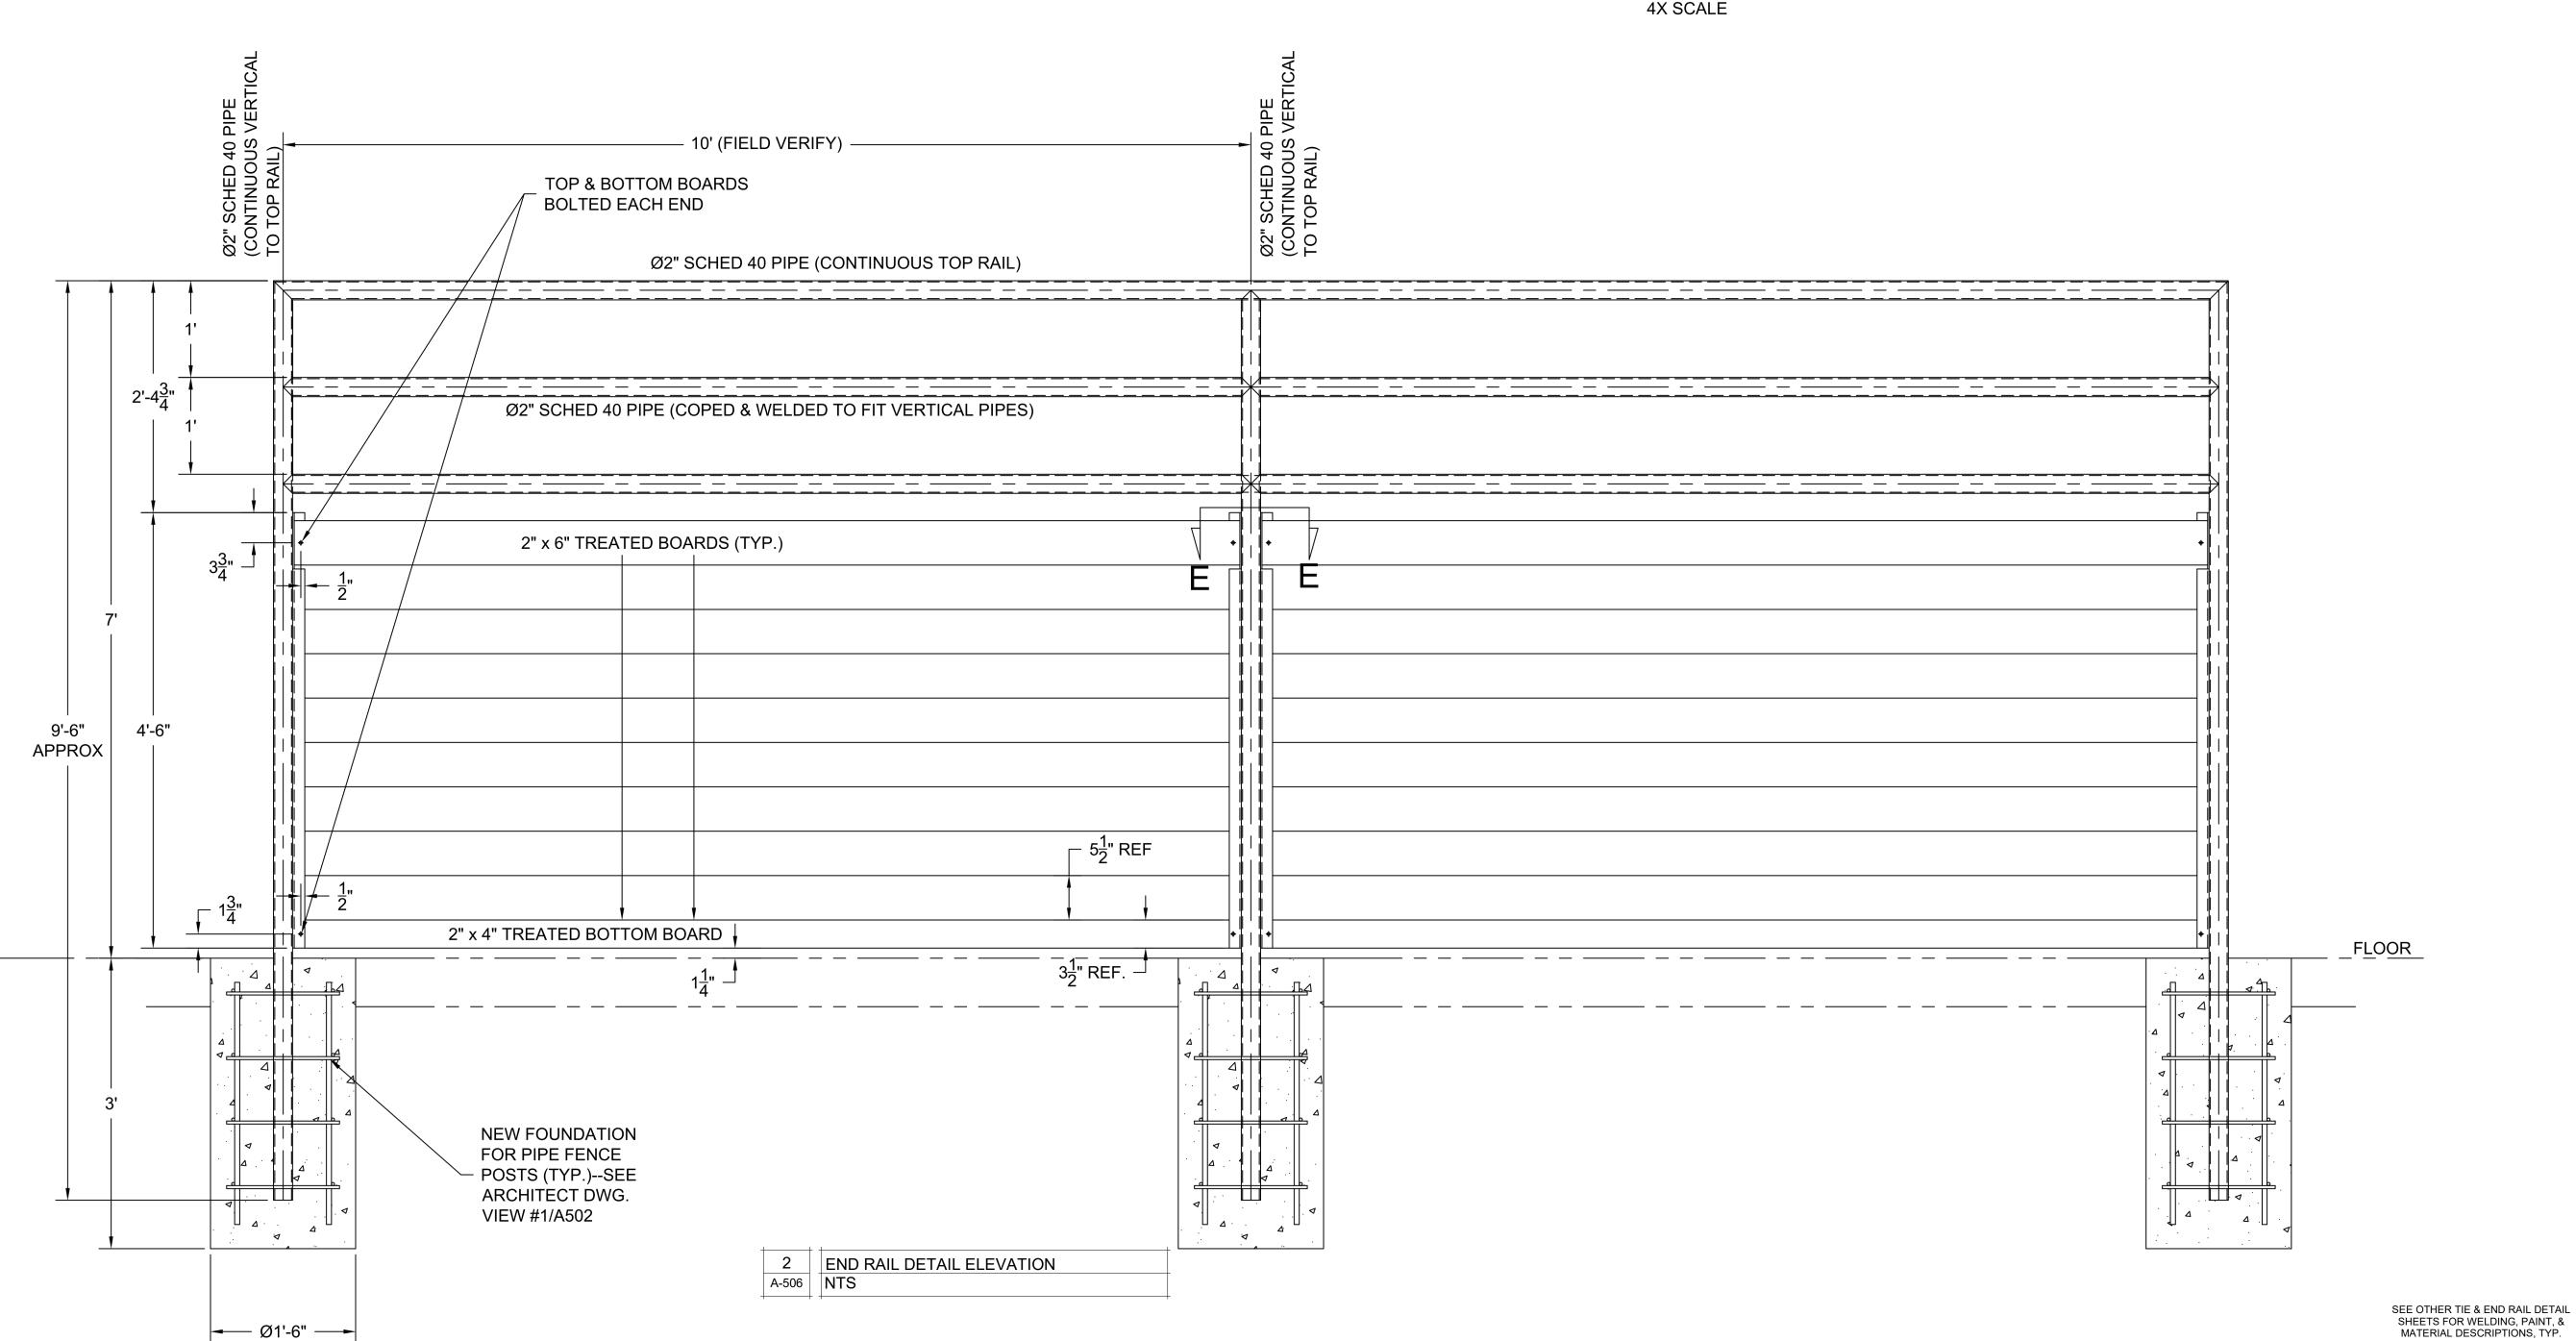


1 REFLECTED CEILING PLAN 1/8" = 1'-0"

STATE OF MISSOURI MICHAEL L. PARSON, GOVERNOR



06.29.22

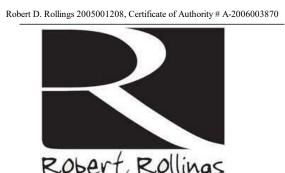

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OFFICE OF ADMINISTRATION
DIVISION OF FACILITIES
MANAGEMENT DESIGN AND
CONSTRUCTION
INTERIOR & EXTERIOR

INTERIOR & EXTERIOR RENOVATIONS - SHORTHORN BARN MISSOURI STATE

FAIRGROUNDS 2503 W. 16TH ST SEDALIA, MO 65301 PROJECT # F2205-01

SITE # 1501 ASSET # 3511501048

REVISION: DATE: REVISION:

REVISION:_ DATE:

DATE:

ISSUE DATE: 06/29/2022 BID DOCUMENTS

CAD DWG FILE:

F2205-01-1501-3511501048-A-RC-23

DRAWN BY: AMK

CHECKED BY: RDR

DESIGNED BY: AMK

SHEET TITLE:

REFLECTED CEILING PLAN

SHEET NUMBER:

A-701

SHEET 23 OF 27

GENERAL NOTES

- 1. REFER TO SHEET E501 FOR ADDITIONAL POWER DETAILS, SCHEDULES, ETC.
- 2. ELECTRICAL CONTRACTOR TO REMOVE/UNINSTALL ANY/ALL PORTIONS OF UNUSED CONDUIT/CONDUCTORS ON MAIN LEVEL BACK TO ELECTRICAL PANEL. REMOVE/UNINSTALL ANY/ALL PORTIONS OF UNUSED CONDUIT/CONDUCTORS. FIELD VERIFY **EXACT QUANTITIES & LOCATIONS.**
- 3. ALL EXPOSED CONDUIT, FASTENERS, AND BOXES SHALL BE PAINTED.
- 4. EXISTING SOUND SYSTEM SPEAKERS AND ASSOCIATED WIRING TO REMAIN. IF REMOVAL & RELOCATION IS REQUIRED DUE TO ANY PORTION OF THE RENOVATION, GC SHALL REMOVE SPEAKERS & STORE IN A LOCATION ON SITE DETERMINED BY MISSOURI STATE FAIRGROUNDS. DISCONNECTED WIRES FROM SPEAKERS SHALL BE COILED TO A LOCATION THAT WILL NOT BE DISRUPTED BY CONSTRUCTION & COORDINATED WITH THE MISSOURI STATE FAIRGROUNDS. MISSOURI STATE FAIRGROUNDS WILL REINSTALL SPEAKERS & WIRE UPON COMPLETION OF THE PROJECT / WORK IN THE AREA.
- 5. ALL RECEPTACLES SHALL BE GFCI PROTECTED BY GFCI CIRCUIT BREAKERS.

KEY NOTES

- (1) BACK TO BACK DUPLEX RECEPTACLE AND CONDUIT SHALL BE MOUNTED ON TOP RAIL OF RAILING STRUCTURE. SEE DETAIL FOR MORE INFORMATION.
- REPLACE EXISTING 200A PANEL WITH NEW 120/240V, 1-PHASE, 400A, MCB, NEMA 3R, 84 CIRCUIT PANEL WITH GROUND BAR.
- (3) EXISTING QUAD ON COLUMN SHALL REMAIN (FED FROM PANEL 'XP1').

ELECTRICAL SYMBOL LEGEND

_____ CIRCUIT WIRING

→ PX-XX CIRCUIT TAG

GFCI DUPLEX CONVENIENCE RECEPTACLE

INDICATES MOUNTING HEIGHT TO BOTTOM OF BOX (STANDARD @ 18" AFF UNLESS NOTED OTHERWISE) "WP" = WEATHERPROOF OUTDOOR RECEPTACLE

"AW" = ABOVE WINDOW RECEPTACLE "AC" = ABOVE CEILING RECEPTACLE "EX" = EXISTING RECEPTACLE TO REMAIN



REFFERENCED CODES IN EFFECT

2018 INTERNATIONAL ENERGY CONSERVATION CODE

2018 INTERNATIONAL MECHANICAL CODE

2018 INTERNATIONAL PLUMBING CODE

2018 INTERNATIONAL FUEL GAS CODE

2018 INTERNATIONAL FIRE CODE

2017 NATIONAL ELECTRIC CODE



POWER PLAN

SCALE: 1/8" = 1'-0"

STATE OF MISSOURI MICHAEL L. PARSON, **GOVERNOR**



KEATON E. LEISINGER, PE - 2021035875 MO CERTIFICATE OF AUTHORITY # 2018029680



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EXISTING PANEL TO REMAIN. -

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CONSTRUCTION INTERIOR & EXTERIOR **RENOVATIONS - SHORTHORN** BARN

MISSOURI STATE

FAIRGROUNDS 2503 W. 16TH ST SEDALIA, MO 65301 PROJECT # F2205-01

SITE # 1501 ASSET # 3511501048 **REVISION:**

DATE:

REVISION: DATE:

REVISION:

DATE: ISSUE DATE: 06/29/2022

BID DOCUMENTS

CAD DWG FILE: F2205-01-1501-3511501048-E-FP-24.dwg DRAWN BY: KEL
CHECKED BY: JAP
DESIGNED BY: KEL

SHEET TITLE:

POWER PLAN

SHEET NUMBER:

E-101

SHEET 24OF 27

GENERAL NOTES

- 1. REFER TO SHEET E501 FOR ADDITIONAL LIGHTING DETAILS, SCHEDULES, ETC.
- 2. ALL LIGHTING FIXTURES LABELED 'EX' SHALL BE EXISTING TO REMAIN UNLESS NOTED OTHERWISE.

KEY NOTES

CEILING FAN CONTROLLER LOCATION. BASE BID: PROVIDE (1) ½" CONDUIT WITH PULL STRING FROM FANS TO CONTROLLER LOCATION. ALTERNATE BID #2: PROVIDE (1) CAT 5 CABLE FROM FANS TO CONTROLLER AND PROTECTIVE COVER FOR FAN CONTROLLER. VERIFY CONTROL WIRE WITH CEILING FAN MANUFACTURER.

BASE BID: PROVIDE POWER FOR CEILING FAN. ALTERNATE BID #2: PROVIDE AND INSTALL CEILING FAN.

(3) EXTERIOR LIGHT FIXTURES SHALL BE CONTROLLED BY PHOTOCELL MOUNTED ON EXTERIOR OF BUILDING.

LIGHTING PLAN SYMBOL LEGEND


LIGHT FIXTURE

- 'X1' = FIXTURE TAG / REFER TO SCHEDULE - 'EM' = EMERGENCY BATTERY BACKUP

- 'EX' = EXISTING LIGHT FIXTURE TO REMAIN

LIGHT SWITCH (3-WAY OR 4-WAY IF NOTED)

CIRCUIT WIRING

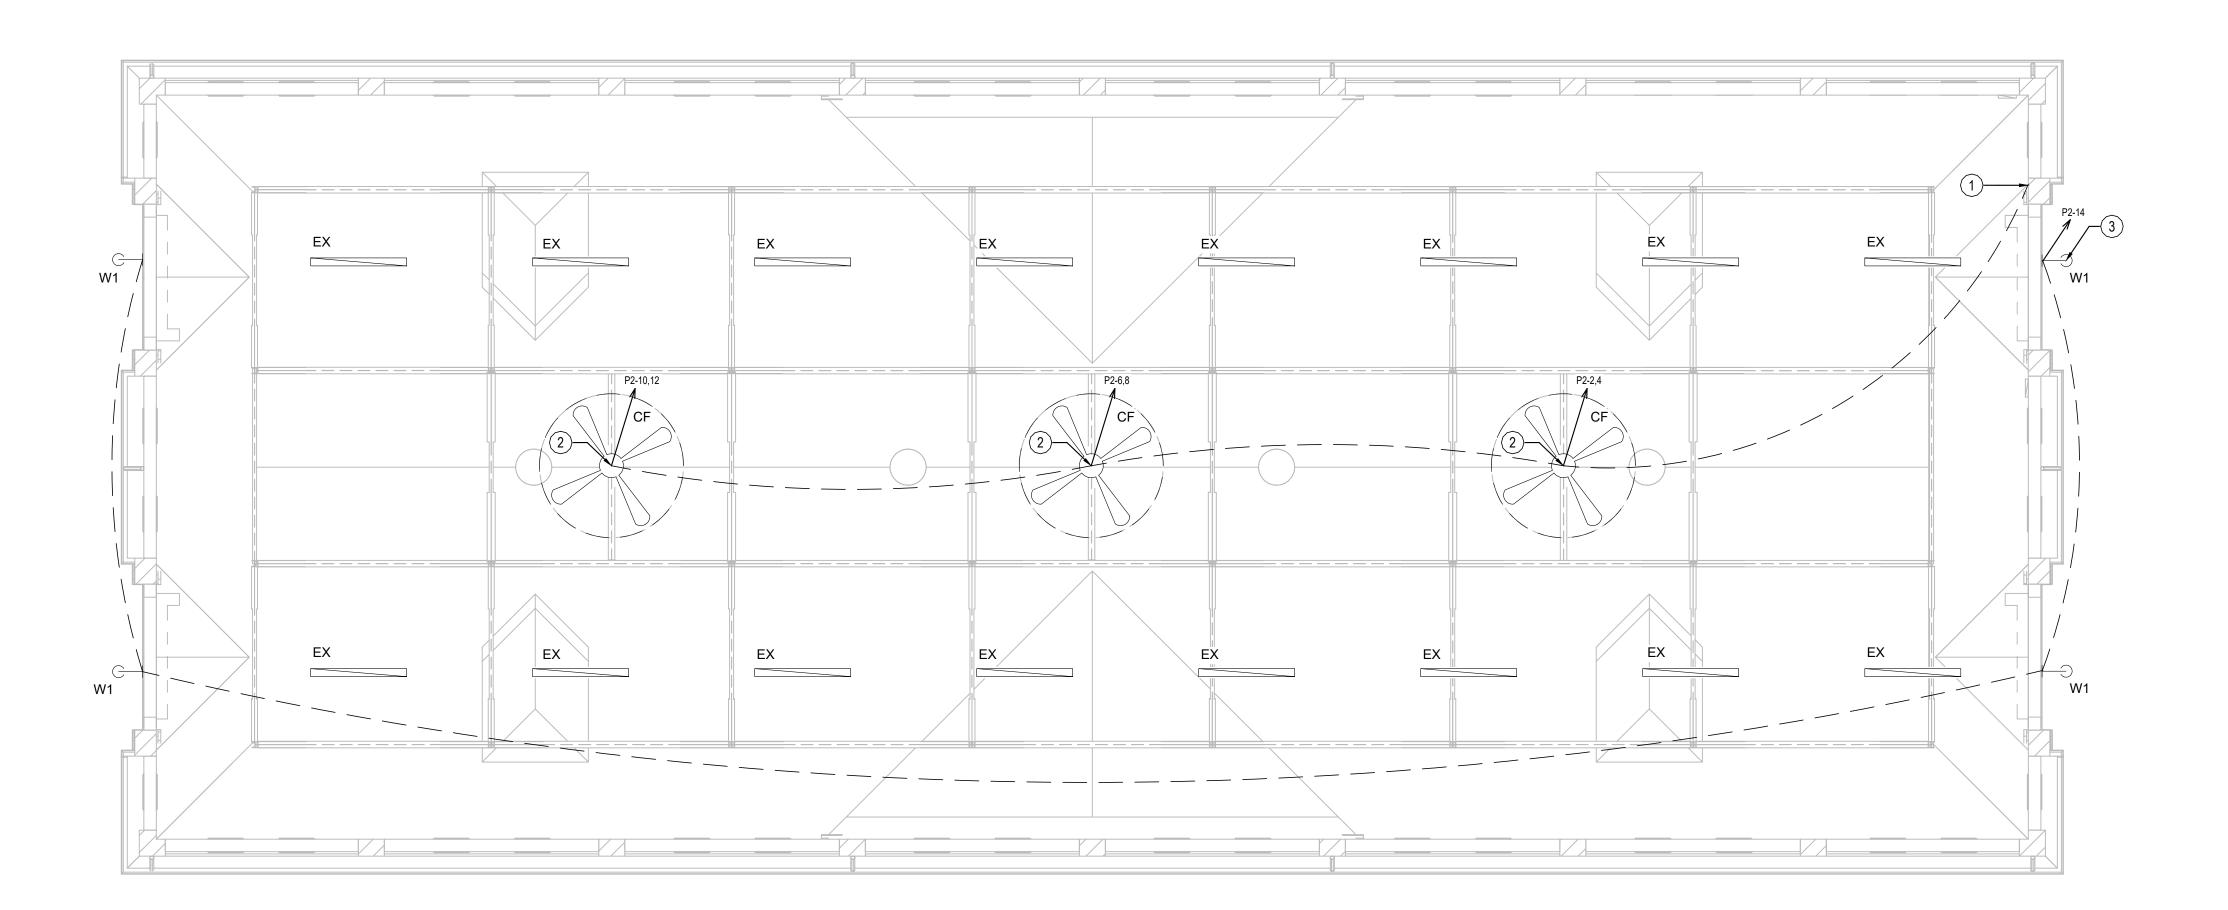

MANUFACTURER

(OR EQUAL)

HALO

2. ALTERNATE BID #2

W1

MODEL NUMBER

(OR EQUAL)

PFX4-12

AL3150

4. SEE SPECIFICATIONS FOR ALTERNATE PRE-APPROVED PRODUCTS.

DESCRIPTION

12' CEILING FAN

WALL LIGHT

3. MOUNT LIGHT FIXTURE WITH CONDUIT IN ORDER TO EXTEND LIGHT FIXTURE AWAY FROM FACE OF THE BUILDING BY 2 FT.

1. VERIFY LIGHT FIXTURE FINISHES WITH OWNER / ARCHITECT PRIOR TO INSTALLATION

LIGHT FIXTURE SCHEDULE

MOUNTING

BEAM MOUNT

WALL MOUNT @ 12' AFF



LIGHTING PLAN

SCALE: 1/8" = 1'-0"

STATE OF MISSOURI MICHAEL L. PARSON, **GOVERNOR**



WATTS

2880

1,2,4

VOLTS

240 / 1

120

CCT (°K)


5000

OUTPUT

3500



1806 West Broadway Boulevard Sedalia, MO 65301 660.829.9751

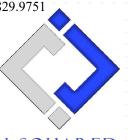

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DIVISION OF FACILITIES MANAGEMENT DESIGN AND CONSTRUCTION INTERIOR & EXTERIOR

RENOVATIONS - SHORTHORN **BARN** MISSOURI STATE FAIRGROUNDS

2503 W. 16TH ST SEDALIA, MO 65301 PROJECT # F2205-01

SITE # 1501 ASSET # 3511501048 **REVISION:**

REVISION: DATE:

DATE:

REVISION: DATE:

ISSUE DATE: 06/29/2022 **BID DOCUMENTS**

CAD DWG FILE: F2205-01-1501-3511501048-E-FP-25.dwg DRAWN BY: KEL
CHECKED BY: JAP
DESIGNED BY: KEL

SHEET TITLE:

LIGHTING PLAN

SHEET NUMBER:

SHEET 25OF 27


	VOLTAGE	T DANE	SIZE	T MOU	NTING	AIC RATING		
	VOLTAGE	PANEL	- SIZE	IVIOUI	VIING	AIC RATING	PHASE "A" LOAD	184.2
	120/240	400A	MCB	SUR	FACE	10,000	PHASE "B" LOAD	183
	NEMA RATING: 3R	1						
CIRCUIT NUMBER	DESCRIPTION	BREAKER SIZE	AMPS	PHASE	AMPS	BREAKER SIZE	DESCRIPTION	CIRCUIT NUMBER
1	NORTH WALL QUAD RECEPTS. *	20-1	6	Α	12	20-2	CEILING FAN	2
3	NORTH WALL QUAD RECEPTS. *	20-1	6	В	12	-	-	4
5	NORTH WALL QUAD RECEPTS. *	20-1	6	Α	12	20-2	CEILING FAN	6
7	NORTH WALL QUAD RECEPTS. *	20-1	6	В	12	-	-	8
9	NORTH WALL QUAD RECEPTS. *	20-1	6	А	12	20-2	CEILING FAN	10
11	NORTH WALL QUAD RECEPTS. *	20-1	6	В	12	-	-	12
13	NORTH WALL QUAD RECEPTS. *	20-1	6	Α	1.2	20-1	EXTERIOR LIGHTING	14
15	NORTH WALL QUAD RECEPTS. *	20-1	6	В	6	20-1	SOUTH WALL QUAD RECEPTS. *	16
17	NORTH WALL QUAD RECEPTS. *	20-1	6	А	6	20-1	SOUTH WALL QUAD RECEPTS. *	18
19	NORTH WALL QUAD RECEPTS. *	20-1	6	В	6	20-1	SOUTH WALL QUAD RECEPTS. *	20
21	NORTH WALL QUAD RECEPTS. *	20-1	6	Α	6	20-1	SOUTH WALL QUAD RECEPTS. *	22
23	NORTH WALL QUAD RECEPTS. *	20-1	6	В	6	20-1	SOUTH WALL QUAD RECEPTS. *	24
25	NORTH WALL QUAD RECEPTS. *	20-1	3	А	6	20-1	SOUTH WALL QUAD RECEPTS. *	26
27	CENTER FENCE QUAD RECEPTS. *	20-1	6	В	6	20-1	SOUTH WALL QUAD RECEPTS. *	28
29	CENTER FENCE QUAD RECEPTS. *	20-1	6	А	6	20-1	SOUTH WALL QUAD RECEPTS. *	30
31	CENTER FENCE QUAD RECEPTS. *	20-1	6	В	6	20-1	SOUTH WALL QUAD RECEPTS. *	32
33	CENTER FENCE QUAD RECEPTS. *	20-1	6	А	6	20-1	SOUTH WALL QUAD RECEPTS. *	34
35	CENTER FENCE QUAD RECEPTS. *	20-1	6	В	6	20-1	SOUTH WALL QUAD RECEPTS. *	36
37	CENTER FENCE QUAD RECEPTS. *	20-1	6	Α	6	20-1	SOUTH WALL QUAD RECEPTS. *	38
39	CENTER FENCE QUAD RECEPTS. *	20-1	6	В	3	20-1	SOUTH WALL QUAD RECEPTS. *	40
41	CENTER FENCE QUAD RECEPTS. *	20-1	6	А		20-1	SPARE	42
43	CENTER FENCE QUAD RECEPTS. *	20-1	6	В		20-1	SPARE	44
45	CENTER FENCE QUAD RECEPTS. *	20-1	6	Α		20-1	SPARE	46
47	CENTER FENCE QUAD RECEPTS. *	20-1	6	В		20-1	SPARE	48
49	CENTER FENCE QUAD RECEPTS. *	20-1	6	А		20-1	SPARE	50
51	CENTER FENCE QUAD RECEPTS. *	20-1	6	В		20-1	SPARE	52
53	CENTER FENCE QUAD RECEPTS. *	20-1	6	А		20-1	SPARE	54
55	CENTER FENCE QUAD RECEPTS. *	20-1	6	В		20-1	SPARE	56
57	CENTER FENCE QUAD RECEPTS. *	20-1	6	А		20-1	SPARE	58
59	CENTER FENCE QUAD RECEPTS. *	20-1	6	В		20-1	SPARE	60
61	CENTER FENCE QUAD RECEPTS. *	20-1	6	A		20-1	SPARE	62
63	CENTER FENCE QUAD RECEPTS. *	20-1	6	В		20-1	SPARE	64
65	CENTER FENCE QUAD RECEPTS. *	20-1	6	А		20-1	SPARE	66
67	CENTER FENCE QUAD RECEPTS. *	20-1	6	В		20-1	SPARE	68
69	CENTER FENCE QUAD RECEPTS. *	20-1	6	A		20-1	SPARE	70
71	CENTER FENCE QUAD RECEPTS. *	20-1	6	В		20-1	SPARE	72
73	CENTER FENCE QUAD RECEPTS. *	20-1	6	A		20-1	SPARE	74
75	SPARE	20-1	•	В		20-1	SPARE	76
77	SPARE	20-1		A		20-1	SPARE	78
79	SPARE	20-1		В		20-1	SPARE	80
81	SPARE	20-1		A		20-1	SPARE	82
83	SPARE	20-1		В		20-1	SPARE	84


A: PANEL SHALL BE EQUAL TO SQUARE D MODEL "NQ"


B: ELECTRICIAN SHALL VERIFY BREAKER WITH EQUIPMENT PRIOR TO PURCHASE & INSTALL.

AFTER COMPLETION OF WORK, ELECTRICAN SHALL PROVIDE A TYPE WRITTEN PANEL DIRECTORY IN NEW PANEL. CIRCUITS SHALL BE LABLED WITH STALL NUMBERS. COORDINATE WITH JASON MOORE MISSOURI STATE FAIR

D: *SHALL INDICATE GFCI CIRCUIT BREAKER.

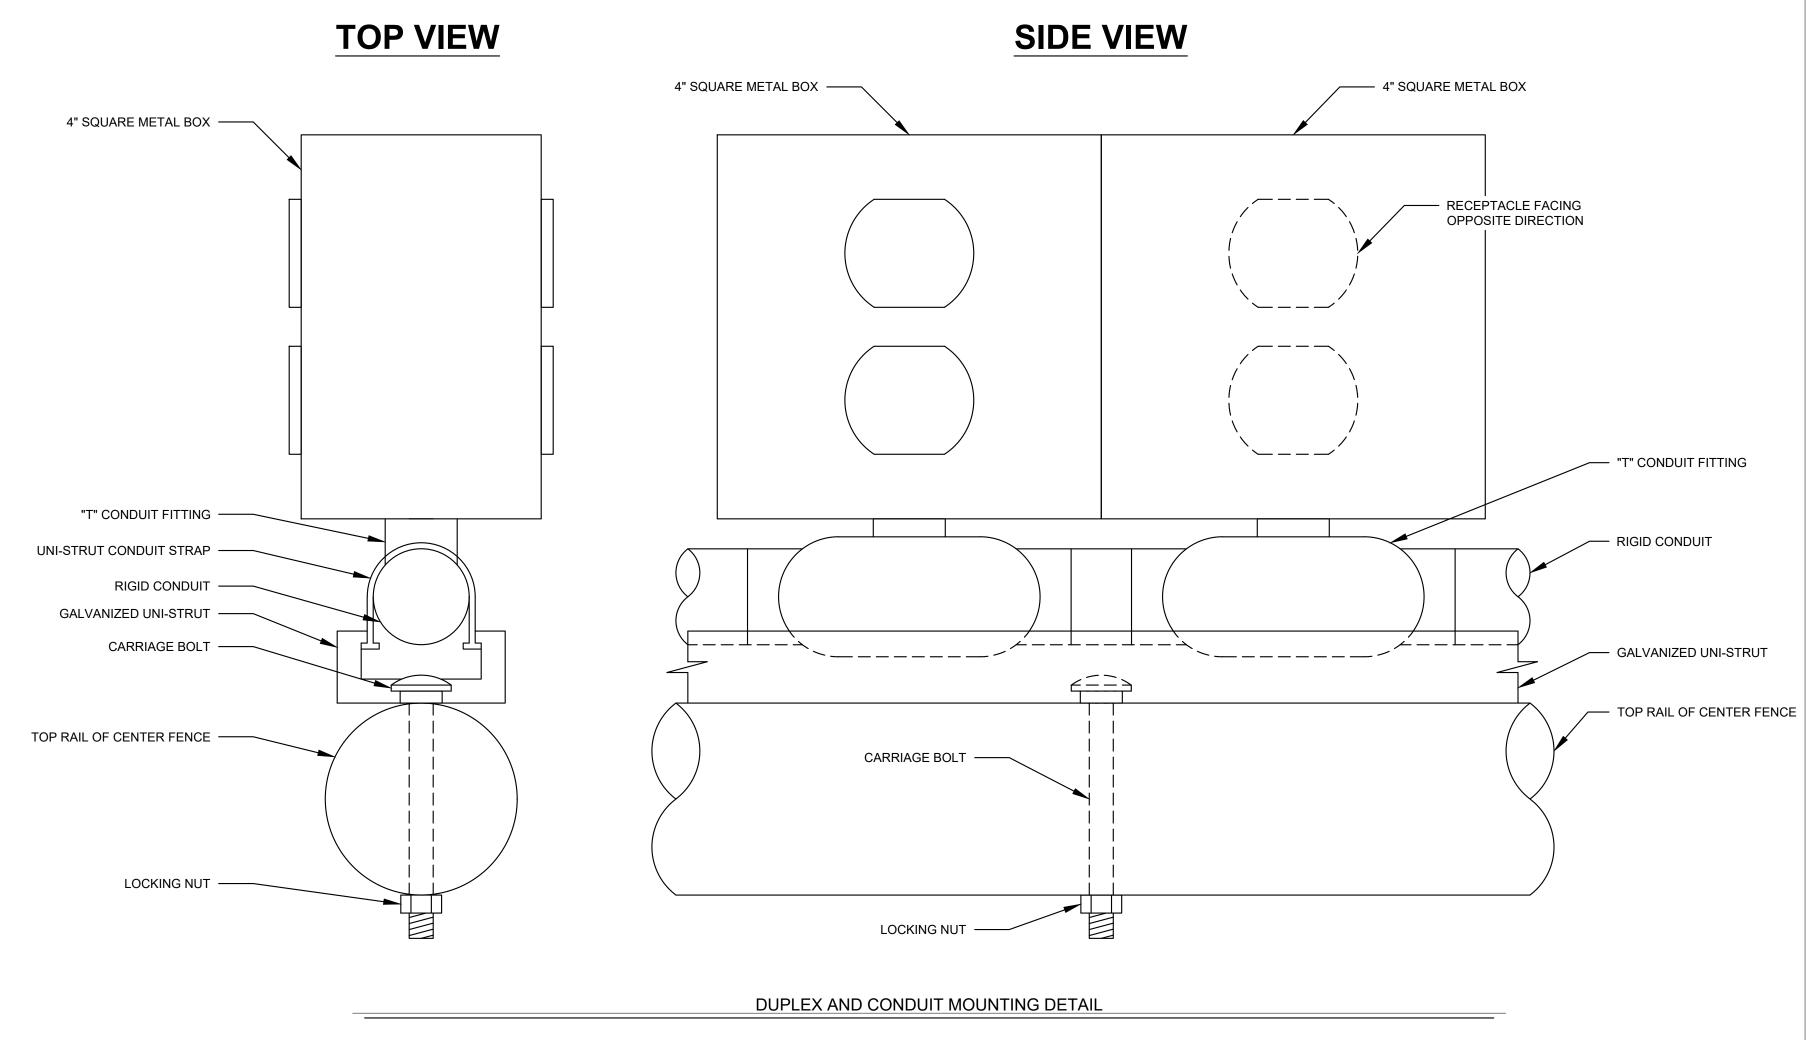

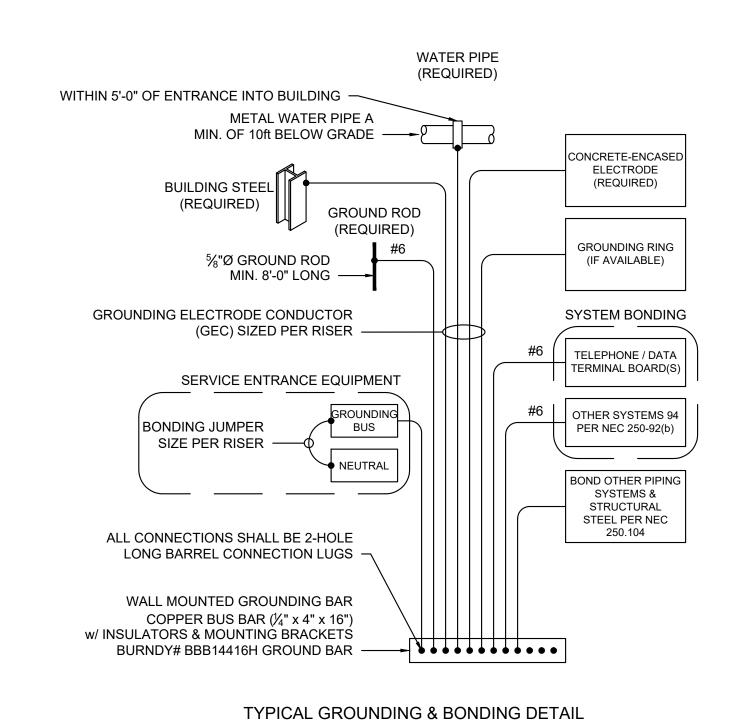

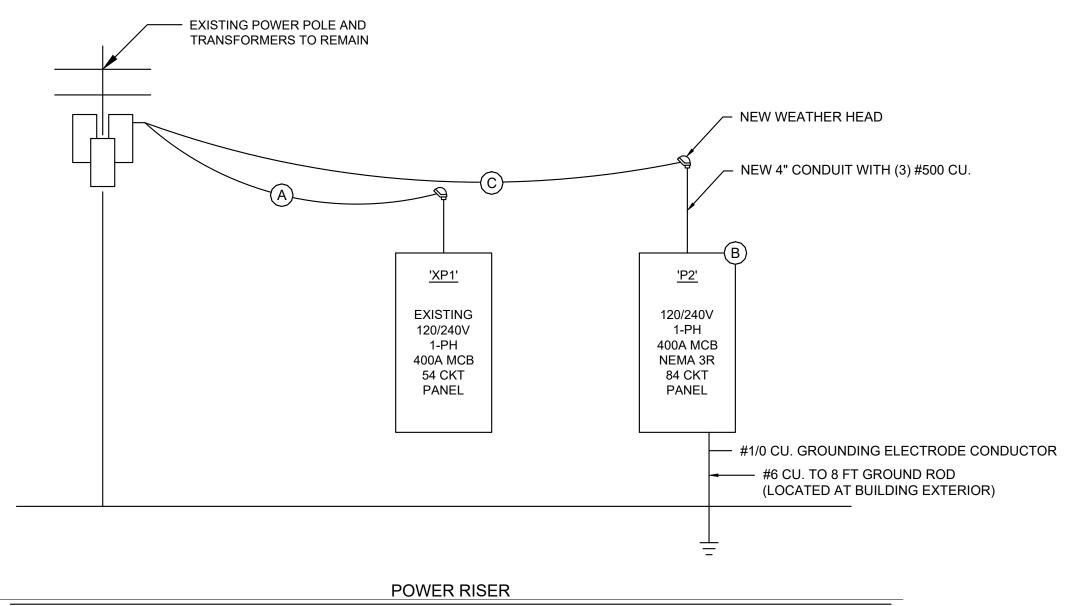

(A) EXISTING CONDUCTORS TO REMAIN.

(B) REPLACE EXISTING PANEL WITH NEW PANEL AS SHOWN.

© COORDINATE WITH POWER COMPANY ON NEW 400A SERVICE CONNECTION TO POLE MOUNTED TRANSFORMER.

STATE OF MISSOURI MICHAEL L. PARSON, **GOVERNOR**



KEATON E. LEISINGER, PE - 2021035875 MO CERTIFICATE OF AUTHORITY # 2018029680



1806 West Broadway Boulevard Sedalia, MO 65301 660.829.9751



ENGINEERING 2400 BLUFF CREEK DR. STE. 101 COLUMBIA, MO 65203 573.234.4492



Broadfoot Engineeing, LLC 30277 Carpenter Road Sedalia, MO 65301 Phone: 660-619-7001 broadfooteng@yahoo.com

ENGINEERING CONSULTANTS 1000 W. Nifong Blvd., Bldg. 1. Columbia, Missouri 65202 (573) 447-0292

www.crockettengineering.com Crockett Engineering Consultants, LLC Missouri Certificate of Authority #2000151304

DIVISION OF FACILITIES MANAGEMENT DESIGN AND CONSTRUCTION INTERIOR & EXTERIOR RENOVATIONS - SHORTHORN BARN

OFFICE OF ADMINISTRATION

MISSOURI STATE **FAIRGROUNDS** 2503 W. 16TH ST SEDALIA, MO 65301

PROJECT # F2205-01 SITE # 1501 ASSET # 3511501048

REVISION: DATE:

> **REVISION:** DATE:

REVISION: DATE:

ISSUE DATE: 06/29/2022 **BID DOCUMENTS**

CAD DWG FILE: F2205-01-1501-3511501048-E-DT-26.dwg DRAWN BY: KEL CHECKED BY: JAP
DESIGNED BY: KEL

SHEET TITLE:

ELECTRICAL DETAILS & SCHEDULES

SHEET NUMBER:

E-501

SHEET 26OF 27

KEY NOTES

1 REPLACE GALVANIZED WATER LINE WITH NEW 1" CTS PEX PIPING OR 1" COPPER BACK TO SHUT-OFF VALVE.

2 APPROXIMATE LOCATION OF SHUT-OFF VALVE.

REPLACE EXISTING FLOOR GRATE WITH NEW AS SHOWN. CONNECT TO EXISTING SANITARY LINE.

PLUMBING SYMBOL LEGEND

COLD WATER LINE PIPING TURNED DOWN / TURNED UP TIE INTO EXISTING

I	I	I	I	I	I	I	I
I	I	I	I		I	I	I
I	I	I	I	FG / YH +	I	I	I
I	I	I	I	I	1	I	I





PLUMBING PLAN

SCALE: 1/8" = 1'-0"

STATE OF MISSOURI MICHAEL L. PARSON, **GOVERNOR**

PLUMBING FIXTURE SCHEDULE

1. VERIFY NECESSARY FIXTURES MEET ADA REQUIREMENTS WITH ARCHITECT PRIOR TO INSTALLATION

3. OTHER ACCEPTABLE MANUFACTURES BUT NOT LIMITED TO RITCHIE, SIMMONS, & MERRILL

4. OTHER ACCEPTABLE MANUFACTURES BUT NOT LIMITED TO JR SMITH, ZURN, & ACO

DESCRIPTION

FLOOR GRATE

2. 12"x12" CATCHBASIN WITH CAST IORN GRATE

NOTES:

YARD HYDRANT

MANUFACTURER

(OR EQUAL)

WOODFORD

MODEL

(OR EQUAL)

1200-1213

1,2,4

1,3



KEATON E. LEISINGER, PE - 2021035875 MO CERTIFICATE OF AUTHORITY # 2018029680



1806 West Broadway Boulevard



J-SQUARED ENGINEERING 2400 BLUFF CREEK DR. STE. 101 COLUMBIA, MO 65203 573.234.4492



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OFFICE OF ADMINISTRATION DIVISION OF FACILITIES MANAGEMENT DESIGN AND CONSTRUCTION

INTERIOR & EXTERIOR RENOVATIONS - SHORTHORN BARN MISSOURI STATE

FAIRGROUNDS 2503 W. 16TH ST SEDALIA, MO 65301 PROJECT # F2205-01

SITE # 1501 ASSET # 3511501048 **REVISION:**

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CAD DWG FILE: F2205-01-1501-3511501048-P-FP-27.dwg DRAWN BY: KEL
CHECKED BY: JAP
DESIGNED BY: KEL

SHEET TITLE:

PLUMBING PLAN

SHEET NUMBER:

P-101

SHEET 27 OF 27