
NEW COMFORT STATION

Missouri State Fairgrounds (MSF) Sedalia, Missouri

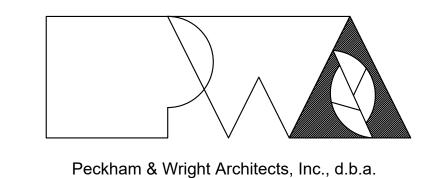

PWArchitects, Inc.

2120 Forum Blvd., Ste 101 Columbia, Missouri 65203 Ph:(573) 449-2683 Fax:(573) 442-6213

OWNER:

STATE OF MISSOURI MICHAEL L. PARSON,

GOVERNOR

OFFICE OF ADMINISTRATION

DIVISION OF FACILITIES MANAGEMENT,

DESIGN AND CONSTRUCTION

PROJECT

OFFICE OF ADMINISTRATION

MANAGEMENT: DIVISION (

DIVISION OF FACILITIES MANAGEMENT,

DESIGN AND CONSTRUCTION

DESIGNER:

PWArchitects, Inc.

2120 Forum Blvd., Ste. 101

Columbia, Missouri 65203

PROJECT NUMBER:

FMDC Project No. F2206-01


SITE NUMBER:

1501

ASSET NUMBER:

3511501146

OFFICE OF ADMINISTRATION
DIVISION OF FACILITIES MANAGEMENT,
DESIGN AND CONSTRUCTION

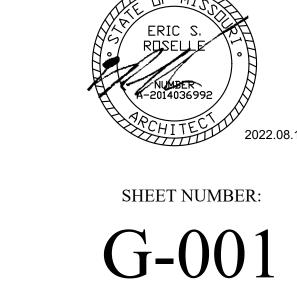

1 OF 20 SHEETS August 10, 2022

US 65 Brianna Boulevard Margaret Avenue Shopping MO Y West 16th Street 6th Street West 16th Street → MO Y West 16th Street → FAIRGROUNDS ADJACENT TO DIRECTOR'S PAVILION State Fairground Maple Street Country C

LOCATION MAP

SCALE: N.T.S.

LIST OF ALTERNATES

A. ALTERNATE 1 - CONTRACTOR-INSTALLED PLUMBING FIXTURES AND TOILET **ACCESSORIES:**

CONTRACTOR TO:

- a. PROVIDE AND INSTALL PLUMBING FIXTURES TO INCLUDE WATER CLOSETS AND FLUSH VALVES, URINALS AND FLUSH VALVES, LAVATORIES, AND FAUCETS.
- b. PROVIDE AND INSTALL TOILET ACCESSORIES AS NOTED IN THE "RESTROOM ACCESSORY SCHEDULE" INCLUDED ON SHEETS A-101AND A-301.
- 2. BASE BID: TO INCLUDE ROUGH-IN AND WALL-HUNG BRACKETS FOR THE WATER CLOSETS, URINALS, AND LAVATORIES. OWNER TO PROVIDE AND INSTALL ALL TOILET ACCESSORIES.

B. ALTERNATE 2 - WATER HEATER, EXTERIOR LIGHTING, INTERIOR LIGHTING, TOILET **PARTITIONS, EPOXY COATING:**

CONTRACTOR TO:

- a. PROVIDE AND INSTALL WATER HEATER WITH WALL KIT AS SHOWN AND NOTED ON SHEET P-101.
- b. PROVIDE AND INSTALL ALL EXTERIOR AND INTERIOR LIGHT FIXTURES AS SHOWN AND NOTED ON SHEET E-101.
- c. PROVIDE AND INSTALL HDPE TOILET COMPARTMENT DOOR/PILASTER ASSEMBLIES (INCLUDING HARDWARE), AS SHOWN ON SHEETS A-101 AND
- d. PROVIDE AND INSTALL EPOXY WALL COATING PNT-01, AS SHOWN THE INTERIOR FINISH LEGEND ON SHEET A-601.

2. BASE BID:

SYMBOL LEGEND

SCALE: NTS

- a. PROVIDE ALL PLUMBING AND ELECTRICAL ROUGH-IN FOR FUTURE WATER HEATER AND WALL KIT TO BE INSTALLED BY OWNER; PROVIDE BLANK PLATE AT JUNCTION BOX; TEMPORARILY CAP PLUMBING PIPES.
- b. PROVIDE ALL ELECTRICAL ROUGH-IN FOR FUTURE EXTERIOR AND INTERIOR LIGHT FIXTURES TO BE INSTALLED BY OWNER. PROVIDE BLANK PLATES AT JUNCTION BOXES.
- c. DO NOT PROVIDE HDPE TOILET PARTITIONS.
- d. CMU TO REMAIN EXPOSED; WALLS WILL BE FINISHED AND PAINTED BY

C. ALTERNATE 3 - STANDING SEAM METAL ROOFING SYSTEM:

- 1. PROVIDE STANDING SEAM METAL ROOF AND ASSOCIATED FLASHING CHANGES.
- 2. BASE BID: TO INCLUDE COMPOSITION SHINGLE ROOF SYSTEM.


D. <u>ALTERNATE 4</u> - ADDITIONAL CONCRETE PAVING; SEED AND MULCH:

1. PAVE THE AREA LOCATED BETWEEN THE TWO ENTRY WALKS LEADING TO THE COMFORT STATION. PAVING TO EXTEND FROM THE EDGE OF THE DIRECTOR'S PAVILION TO THE COMFORT STATION.

FINE-GRADE, SEED, AND MULCH ALL DISTURBED AREAS WITHIN THE LIMITS OF DISTURBANCE AS NOTED ON SHEET C100.

2. BASE BID: TO INCLUDE THE SIDEWALKS ONLY; AREA BETWEEN THE WALKS TO BE "FINE-GRADED", AS NOTED ON DRAWING SHEET C-100.

FINE-GRADE ALL DISTURBED AREAS WITHIN THE LIMITS OF DISTURBANCE AS NOTED ON SHEET C100.

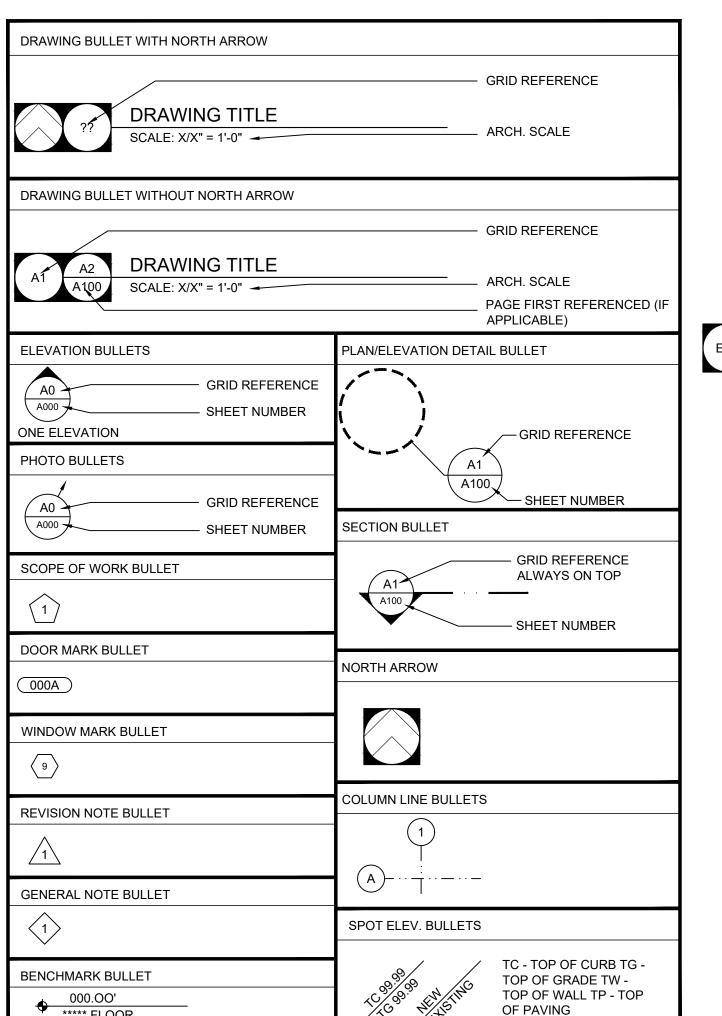

Code Summary 2018 International Building Code (IBC) Code Requirement Main Use Group(s) [IBC] 903.2 No Automatic Sprinklers [IBC] 602 Type 3B Minimum Construction Classification Floor Area - Area (Square Feet) per Floor Permitted - 'U' use [IBC] T. 506.2 8,500 SF (Non-sprinkled, 'NS') - Area (Square Feet) per Floor - First Floor Total Area ('U' use) Number of Stories [IBC] T. 504.4 2 Stories (Non-sprinkled, 'NS') - Stories Permitted - 'U' Stories Maximum Height - Max. Height (Ft.) Permitted - 'U' [IBC] T. 504.3 55'-0" (Non-sprinkled, 'NS') - Max. Height (Ft.) [IBC] T. 1017.2 Travel Distance - 'U' use 300'-0" Maximum

(Non-sprinkled)

LIST OF DRAWINGS

LOCATION PLAN, LEGENDS, DRAWING INDEX, LIFE SAFETY G-101 C-100 GENERAL CIVIL INFORMATION SITE AND UTILITY PLAN C-101 GRADING AND EROSION CONTROL PLAN C-102 C-103 CONSTRUCTION DETAILS CONSTRUCTION DETAILS C-104 GENERAL STRUCTURAL DATA FOUNDATION PLAN AND DETAILS S-300 ROOF FRAMING PLAN AND DETAILS TYPICAL MASONRY DETAILS FLOOR PLAN, ROOF PLAN, & DETAILS **ELEVATIONS & DETAILS** SECTIONS & DETAILS A-301 **SECTIONS & DETAILS** A-302 SCHEDULES & DETAILS A-601 MEP SITE UTILITIES PLAN HVAC PLAN ELECTRICAL PLANS



PLUMBING PLANS

SMALL SCALE LARGE SCALE MASONRY ELEVATION CONCRETE MASONRY UNIT **ELEVATION** CONCRETE SECTION **GYPSUM** SECTION BOARD **ELEVATION** PLAN, SECTION CMU/CAVITY/DOOR FRAME PLAN, SECTION, MISCELLANEOUS ITEMS: AS NOTED ON EACH SHEET **ELEVATION** PLAN, INSULATION SECTION ROOF SHINGLES **ELEVATION** CONTINUOUS WOOD FRAMING SECTION BLOCKING SECTION PLAN, PLYWOOD SECTION **EXISTING** PLAN, SECTION

MATERIAL LEGEND

SCALE: NTS

OFFICE OF ADMINISTRATION DIVISION OF FACILITIES MANAGEMENT, **DESIGN AND CONSTRUCTION**

STATE OF MISSOURI

MICHAEL L. PARSON,

GOVERNOR

Peckham & Wright Architects, Inc., d.b.a. PWArchitects, Inc.

2120 Forum Blvd., Ste. 101 Columbia, Missouri 65203 PWArchitects.com | 573.449.2683

Peckham & Wright Architects an Architectural Corporation

Missouri State Certificate of Authority No. 000244

gNEW COMFORT STATION

MISSOURI STATE FAIRGROUNDS (MSF) 2503 W. 16TH St. SEDALIA, MO

PROJECT # F2206-01

ASSET#

3511501146

REVISION: DATE: **REVISION: REVISION:** DATE:

CAD DWG FILE:G-10 DRAWN BY: CHECKED BY: ER DESIGNED BY: ER

ISSUE DATE: 08/10/2022

SHEET TITLE:

LOCATION PLAN, LEGENDS, DRAWING INDEX, LIFE SAFETY

SHEET NUMBER:

MISSOURI STATE FAIRGROUNDS - COMFORT STATION

SEDALIA, PETTIS COUNTY, MISSOURI

PROJECT BENCHMARK:

TBM #1 - BENCH TIE, SW CORNER OF THE GRAVEL INTERSECTION NW OF THE PAVILION

ELEVATION = 887.46

FLOOD PLAIN STATEMENT:

NO PART OF THIS TRACT IS LOCATED WITHIN THE 500-YEAR FLOODPLAIN AS PER THE CITY OF SEDALIA FIRM MAP #2902830001C DATED 01/05/1996.

UTILITY COMPANIES:

LOCATES: MISSOURI ONE CALL INC. 1022 B NORTHEAST DRIVE JEFFERSON CITY, MO 65109

1-800-344-7483



TELEPHONE: CHARTER COMMUNICATIONS 210 W. 7TH STREET SEDALIA, MO 65301

NATURAL GAS: LIBERTY UTILITIES 602 S JOPLIN AVE JOPLIN, MO 64801 1-800-424-0427

866-874-2398

CABLE TELEVISION: 5903 E. RED BRIDGE ROAD

KANSAS CITY, MO 64134

877-219-3898

WATER:

SEDALIA WATER DEPARTMENT 111 WEST 4TH STREET SEDALIA, MO 65301 660-826-1234

SANITARY SEWER: CITY OF SEDALIA 200 SOUTH OSAGE AVE. SEDALIA, MO 65301

660-827-3000

660-530-5617

ELECTRIC: MISSOURI STATE FAIRGROUNDS CONTRACTOR

GENERAL NOTES:

ALL STREET, STORM DRAIN, AND SANITARY SEWER CONSTRUCTION TO BE IN ACCORDANCE WITH THE CITY OF SEDALIA AND MISSOURI STATE FAIRGROUND'S GUIDANCE AND SPECIFICATIONS.

CONTRACTOR WILL BE RESPONSIBLE FOR PLACEMENT AND MAINTENANCE OF TRAFFIC CONTROL DEVICES NECESSARY TO COMPLETE THEIR PORTION OF WORK. THE DEVICES AND METHODS EMPLOYED WILL COMPLY WITH THE CURRENT VERSION OF THE MANUAL ON UNIFORM TRAFFIC CONTROL DEVICES.

EXISTING UTILITIES SHOWN FOR REFERENCE ONLY. CONTRACTOR SHALL COORDINATE LOCATES (HORIZONTAL AND VERTICAL) PRIOR

ALL EXCAVATION TO BE IN ACCORDANCE WITH SECTIONS 319.010-319.050, REVISED STATUTES OF THE STATE OF MISSOURI. SUCH COMPLIANCE SHALL NOT, HOWEVER, EXCUSE ANY PERSON MAKING ANY EXCAVATION FROM DOING SO IN A CAREFUL AND PRUDENT MANNER, NOR SHALL IT EXCUSE SUCH PERSON FROM LIABILITY FOR ANY DAMAGE OR INJURY TO UNDERGROUND UTILITIES

NUMBER G19478 DATED OCTOBER 21ST, 2019 BY CROCKETT GTL.

ALL SLOPES ARE 3:1 OR FLATTER UNLESS OTHERWISE NOTED.

IT IS THE INTENT OF THESE PLANS TO COMPLY WITH THE REQUIREMENTS OF THE MODNR CLEAN WATER COMMISSION.

ALL DISTURBED AREAS WITHIN THE "LIMITS OF DISTURBANCE" SHALL BE FINE GRADED. (SEEDING AND MULCHING BY OTHERS).

THE CONTRACTOR IS RESPONSIBLE FOR MAINTAINING ALL EROSION CONTROL DEVICES AND REMOVING THEM ONCE THE SITE IS

ALL SERVICE LATERALS SHALL BE INSTALLED AT 1.0% (MIN.) GRADE.

ALL EXCAVATION WITHIN 10' OF THE STREET PAVEMENT SHALL BE BACKFILLED WITH GRANULAR MATERIAL. REFER TO PIPE EMBEDMENT DETAILS.

ALL SEWERLINES SHALL BE CONSTRUCTED AT LEAST 10 FEET HORIZONTALLY, EDGE TO EDGE, FROM ANY WATERLINE AND AT LEAST 24 INCHES VERTICALLY BETWEEN THE OUTSIDE LIMITS OF THE SANITARY SEWER AND WATERLINE. FOR CONDITIONS OTHER THAN THOSE IDENTIFIED ABOVE, CONTACT THE ENGINEER FOR SPECIFIC INSTRUCTIONS.

ALL HDPE PIPE SHALL BE INSTALLED PER MANUFACTURER'S RECOMMENDATIONS. REFER TO DETAIL FOR PIPE BEDDING REQUIREMENTS.

LAND DISTURBANCE SITES SHOULD BE INSPECTED ON A REGULAR SCHEDULE AND WITHIN A REASONABLE TIME PERIOD (NOT TO EXCEED 48 HOURS) FOLLOWING HEAVY RAINS. REGULARLY SCHEDULED INSPECTIONS SHALL BE AT A MINIMUM OF ONCE PER WEEK. ANY DEFICIENCIES SHALL BE NOTED IN A WEEKLY REPORT OF THE INSPECTION AND CORRECTED WITHIN SEVEN CALENDAR DAYS OF THE REPORT.

ALL UTILITY LINES SHALL BE BACKFILLED W/ GRANULAR AND COMPACTED EARTH BACKFILL.

ESTIMATED AREA OF DISTURBANCE IS 0.20 ACRES.

MISSOURI DNR LAND DISTURBANCE PERMIT NOT REQUIRED.

ALTERNATE #4 GENERAL NOTES:

FINE-GRADE, SEED, AND MULCH ALL DISTURBED AREAS WITHIN THE LIMITS OF DISTURBANCE

LEGEND OF SYMBOLS:

OUTER STREAM BUFFER

 $\cdot \quad \Rightarrow \cdot \quad \Rightarrow \cdot \quad \mathsf{SWALE}$

	OTTINDOLO.	
	EXISTING CURB	FF=XXX.
	PROPOSED CURB	XXX.XX TO
	RIP RAP	(XXX.XX TI
23	EXISTING STRUCTURE	XXX.XX F
~~~~	EXISTING TREELINE	(XXX.XX TV
~~~~	PROPOSED TREELINE	$(\chi\chi)$
000	EDGE OF WATERWAY	
w	EXISTING WATERLINE	$\langle X \rangle$
w	PROPOSED WATERLINE	
—— G ——	EXISTING GAS LINE	X
G	PROPOSED GAS LINE	H.P.
UT	EXISTING UNDERGROUND TELEPHONE	L.P.
VTV	EXISTING UNDERGROUND CABLE TELEVISION	
— — – HVE— — —	EXISTING HIGH VOLTAGE ELECTRIC	-0
—— OE ——	EXISTING OVERHEAD ELECTRIC	Ø GV
— — —UE— — —	EXISTING UNDERGROUND ELECTRIC	SV N
——— OETV ———	EXISTING OVERHEAD ELEC. & TV	×
— — OETVT — —	EXISTING OVERHEAD ELEC., TV & TELE.	©
—— s ——	EXISTING SANITARY SEWER	W
s	PROPOSED SANITARY SEWER	Ϋ
XXX	EXISTING MINOR CONTOUR	0
XXX	EXISTING MAJOR CONTOUR	- -•
XXX	PROPOSED MINOR CONTOUR	—•
XXX	PROPOSED MAJOR CONTOUR	®
	100 YEAR FLOOD PLAIN	AC
тппппп	FLOODWAY	
	ORDINARY HIGH WATER MARK	ET
	STREAM SIDE BUFFER	E

PROPOSED TOP OF CURB ELEVATION PROPOSED TOP OF PAVEMENT ELEVATION PROPOSED FINISH GRADE ELEVATION STORM SEWER STRUCTURE LABEL SANITARY SEWER STRUCTURE LABEL HIGH POINT LOW POINT EXISTING SIGNS EXISTING POWER POLE EXISTING GAS VALVE EXISTING WATER VALVE EXISTING GAS METER EXISTING WATER METER EXISTING FIRE HYDRANT MANHOLE EXISTING SANITARY SEWER LATERAL PROPOSED SANITARY SEWER LATERAL PROPOSED TRACER WIRE TEST STATION BOX EXISTING AIR CONDITIONER

EXISTING TELEPHONE PEDESTAL

EXISTING ELECTRIC METER

EXISTING LIGHT POLE

EXISTING GUY WIRE

EXISTING ELECTRICAL TRANSFORMER

FINISH FLOOR OF STRUCTURE

STATE OF MISSOURI MICHAEL L. PARSON, GOVERNOR





www.crockettengineering.com

Crockett Engineering Consultants, LLC Missouri Certificate of Authority #2000151301

OFFICE OF ADMINISTRATION DIVISION OF FACILITIES MANAGEMENT, **DESIGN AND CONSTRUCTION**

NEW COMFORT STATION

MISSOURI STATE FAIRGROUNDS (MSF) 2503 W. 16TH St. SEDALIA, MO

PROJECT # F2206-01 1501 3511501146 ASSET#


REVISION: DATE: **REVISION:** DATE: **REVISION**: DATE: ISSUE DATE: 08/10/2022

CAD DWG FILE:C-100 DRAWN BY: KRM CHECKED BY: TDC DESIGNED BY: KRM

SHEET TITLE:

GENERAL CIVIL **INFORMATION**

SHEET NUMBER:

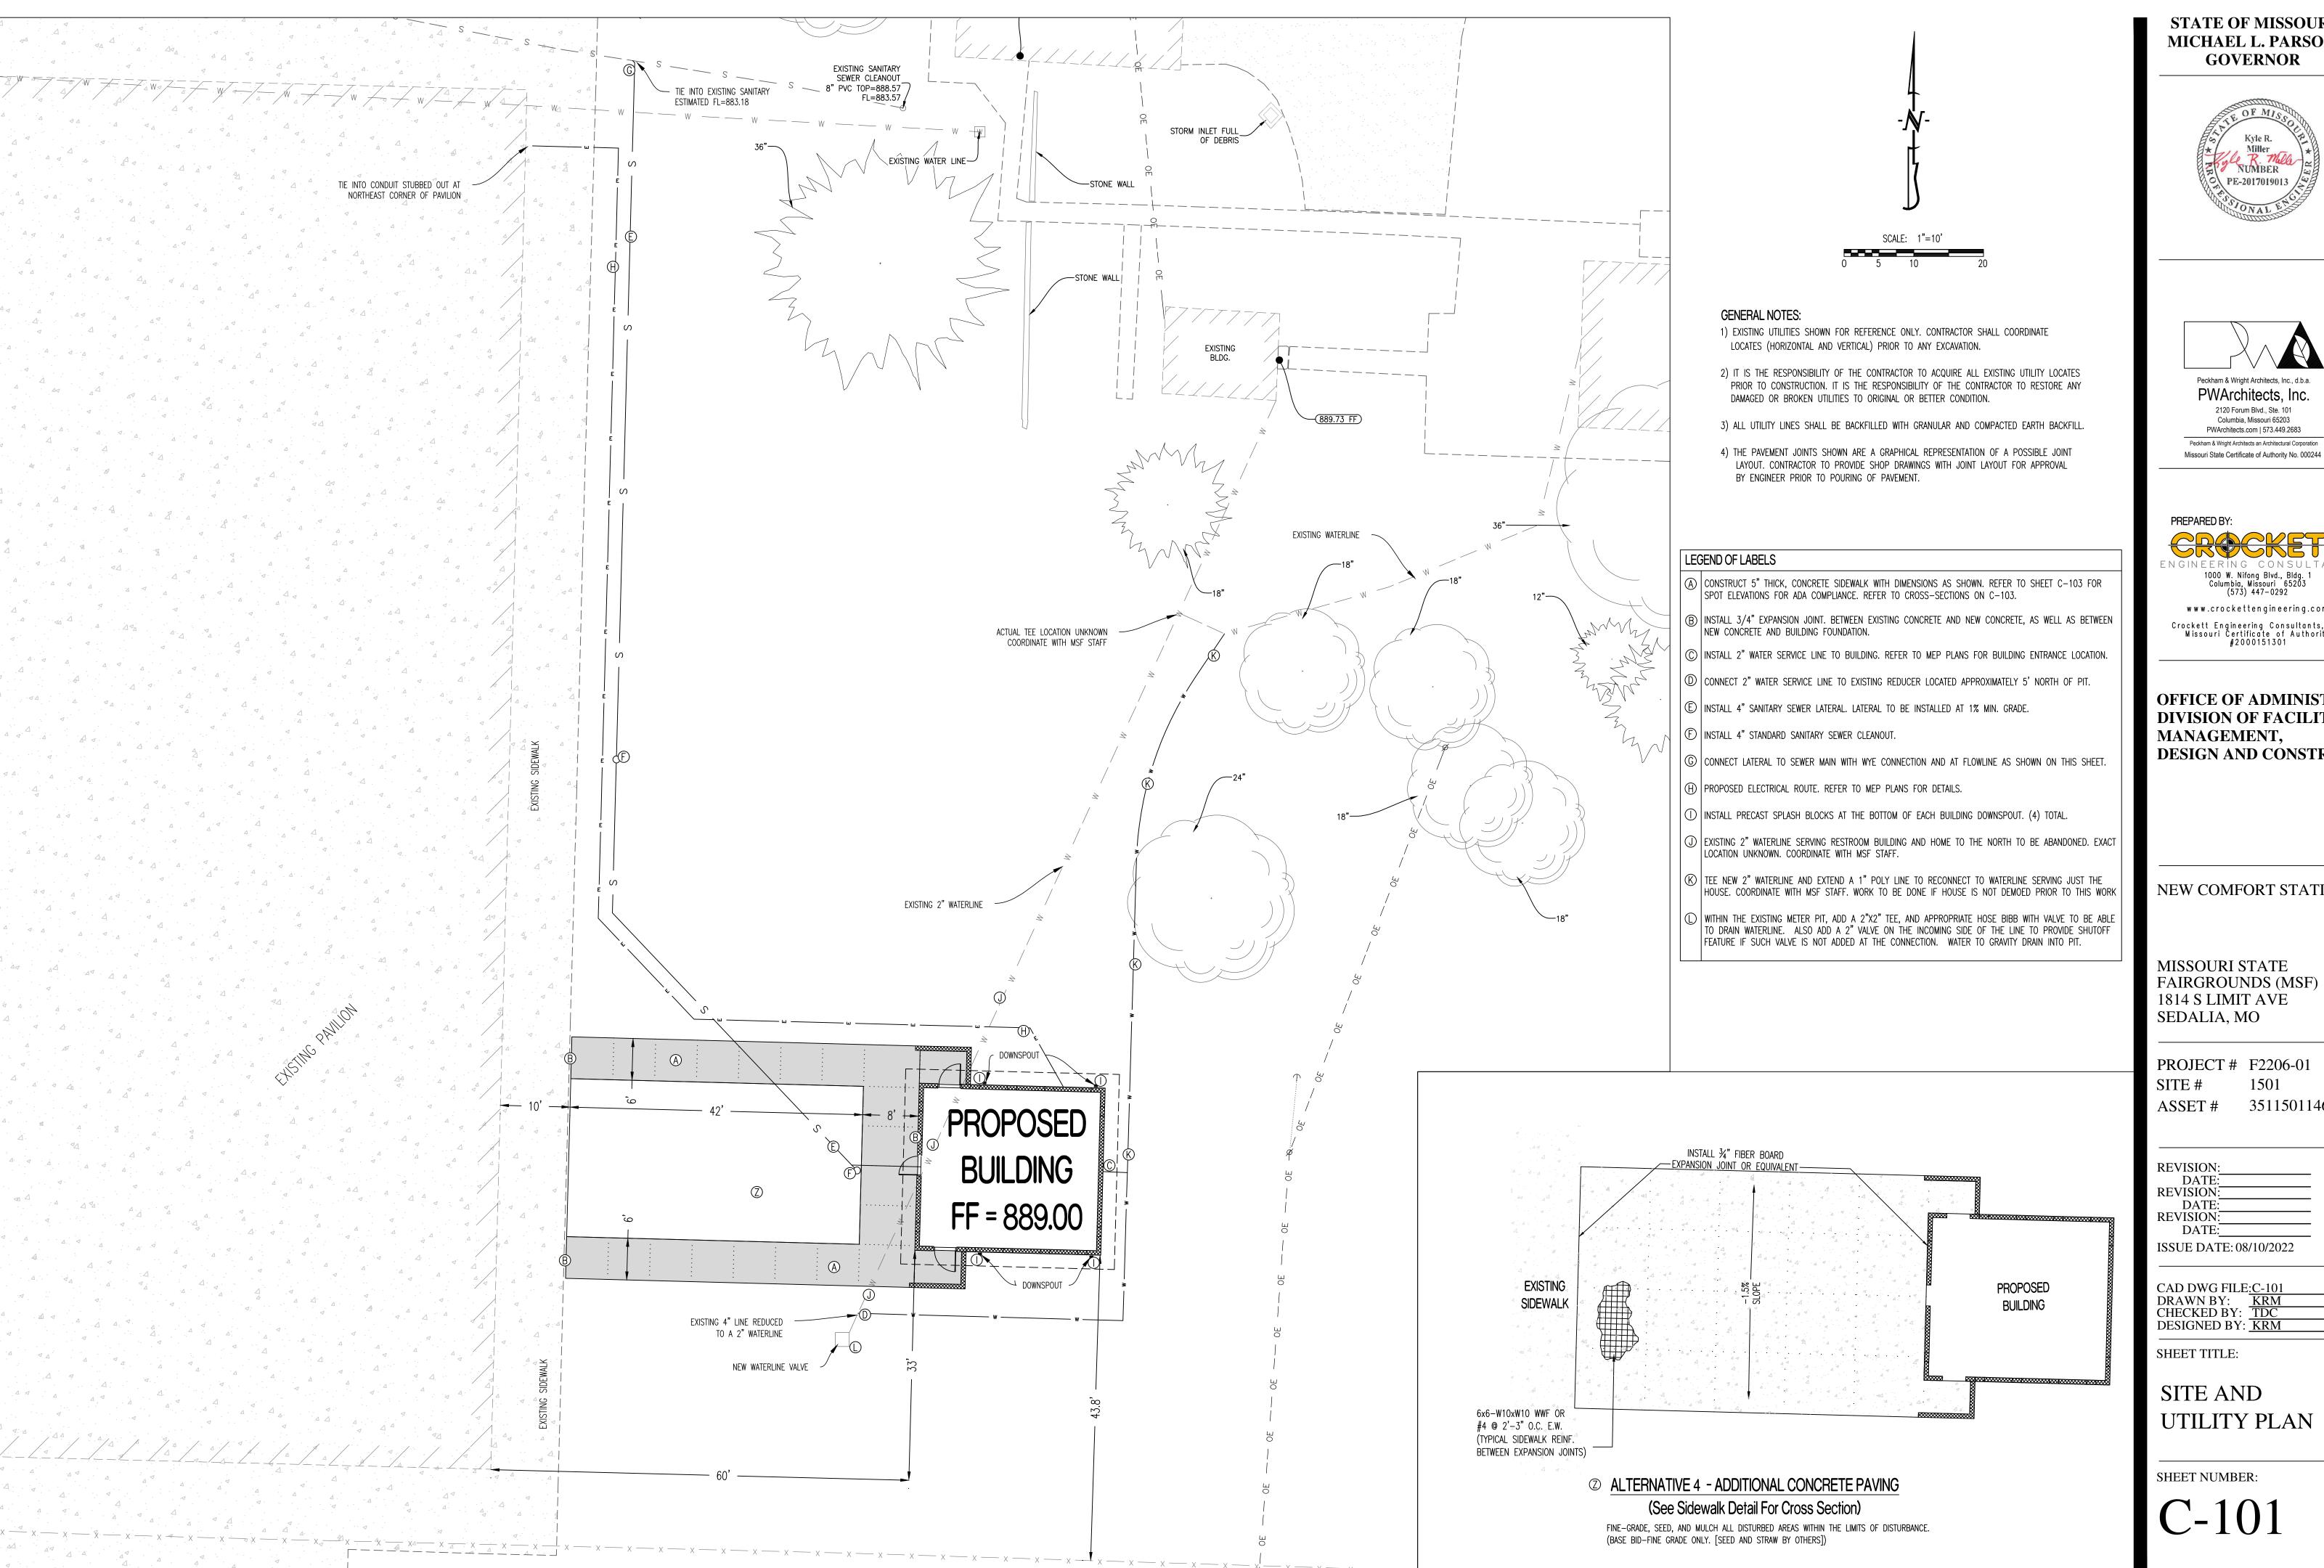

STATE OF MISSOURI MICHAEL L. PARSON, **GOVERNOR**





1000 W. Nifong Blvd., Bldg. 1 Columbia, Missouri 65203 (573) 447-0292

www.crockettengineering.com Crockett Engineering Consultants, LLC Missouri Certificate of Authority #2000151301

OFFICE OF ADMINISTRATION DIVISION OF FACILITIES MANAGEMENT, **DESIGN AND CONSTRUCTION**

NEW COMFORT STATION

MISSOURI STATE FAIRGROUNDS (MSF) 1814 S LIMIT AVE SEDALIA, MO

PROJECT # F2206-01 3511501146 ASSET#

REVISION: DATE: **REVISION:** DATE: **REVISION**: DATE: ISSUE DATE: 08/10/2022


CAD DWG FILE:C-101 DRAWN BY: KRM CHECKED BY: TDC DESIGNED BY: KRM

SHEET TITLE:

SITE AND UTILITY PLAN

SHEET NUMBER:

C-101

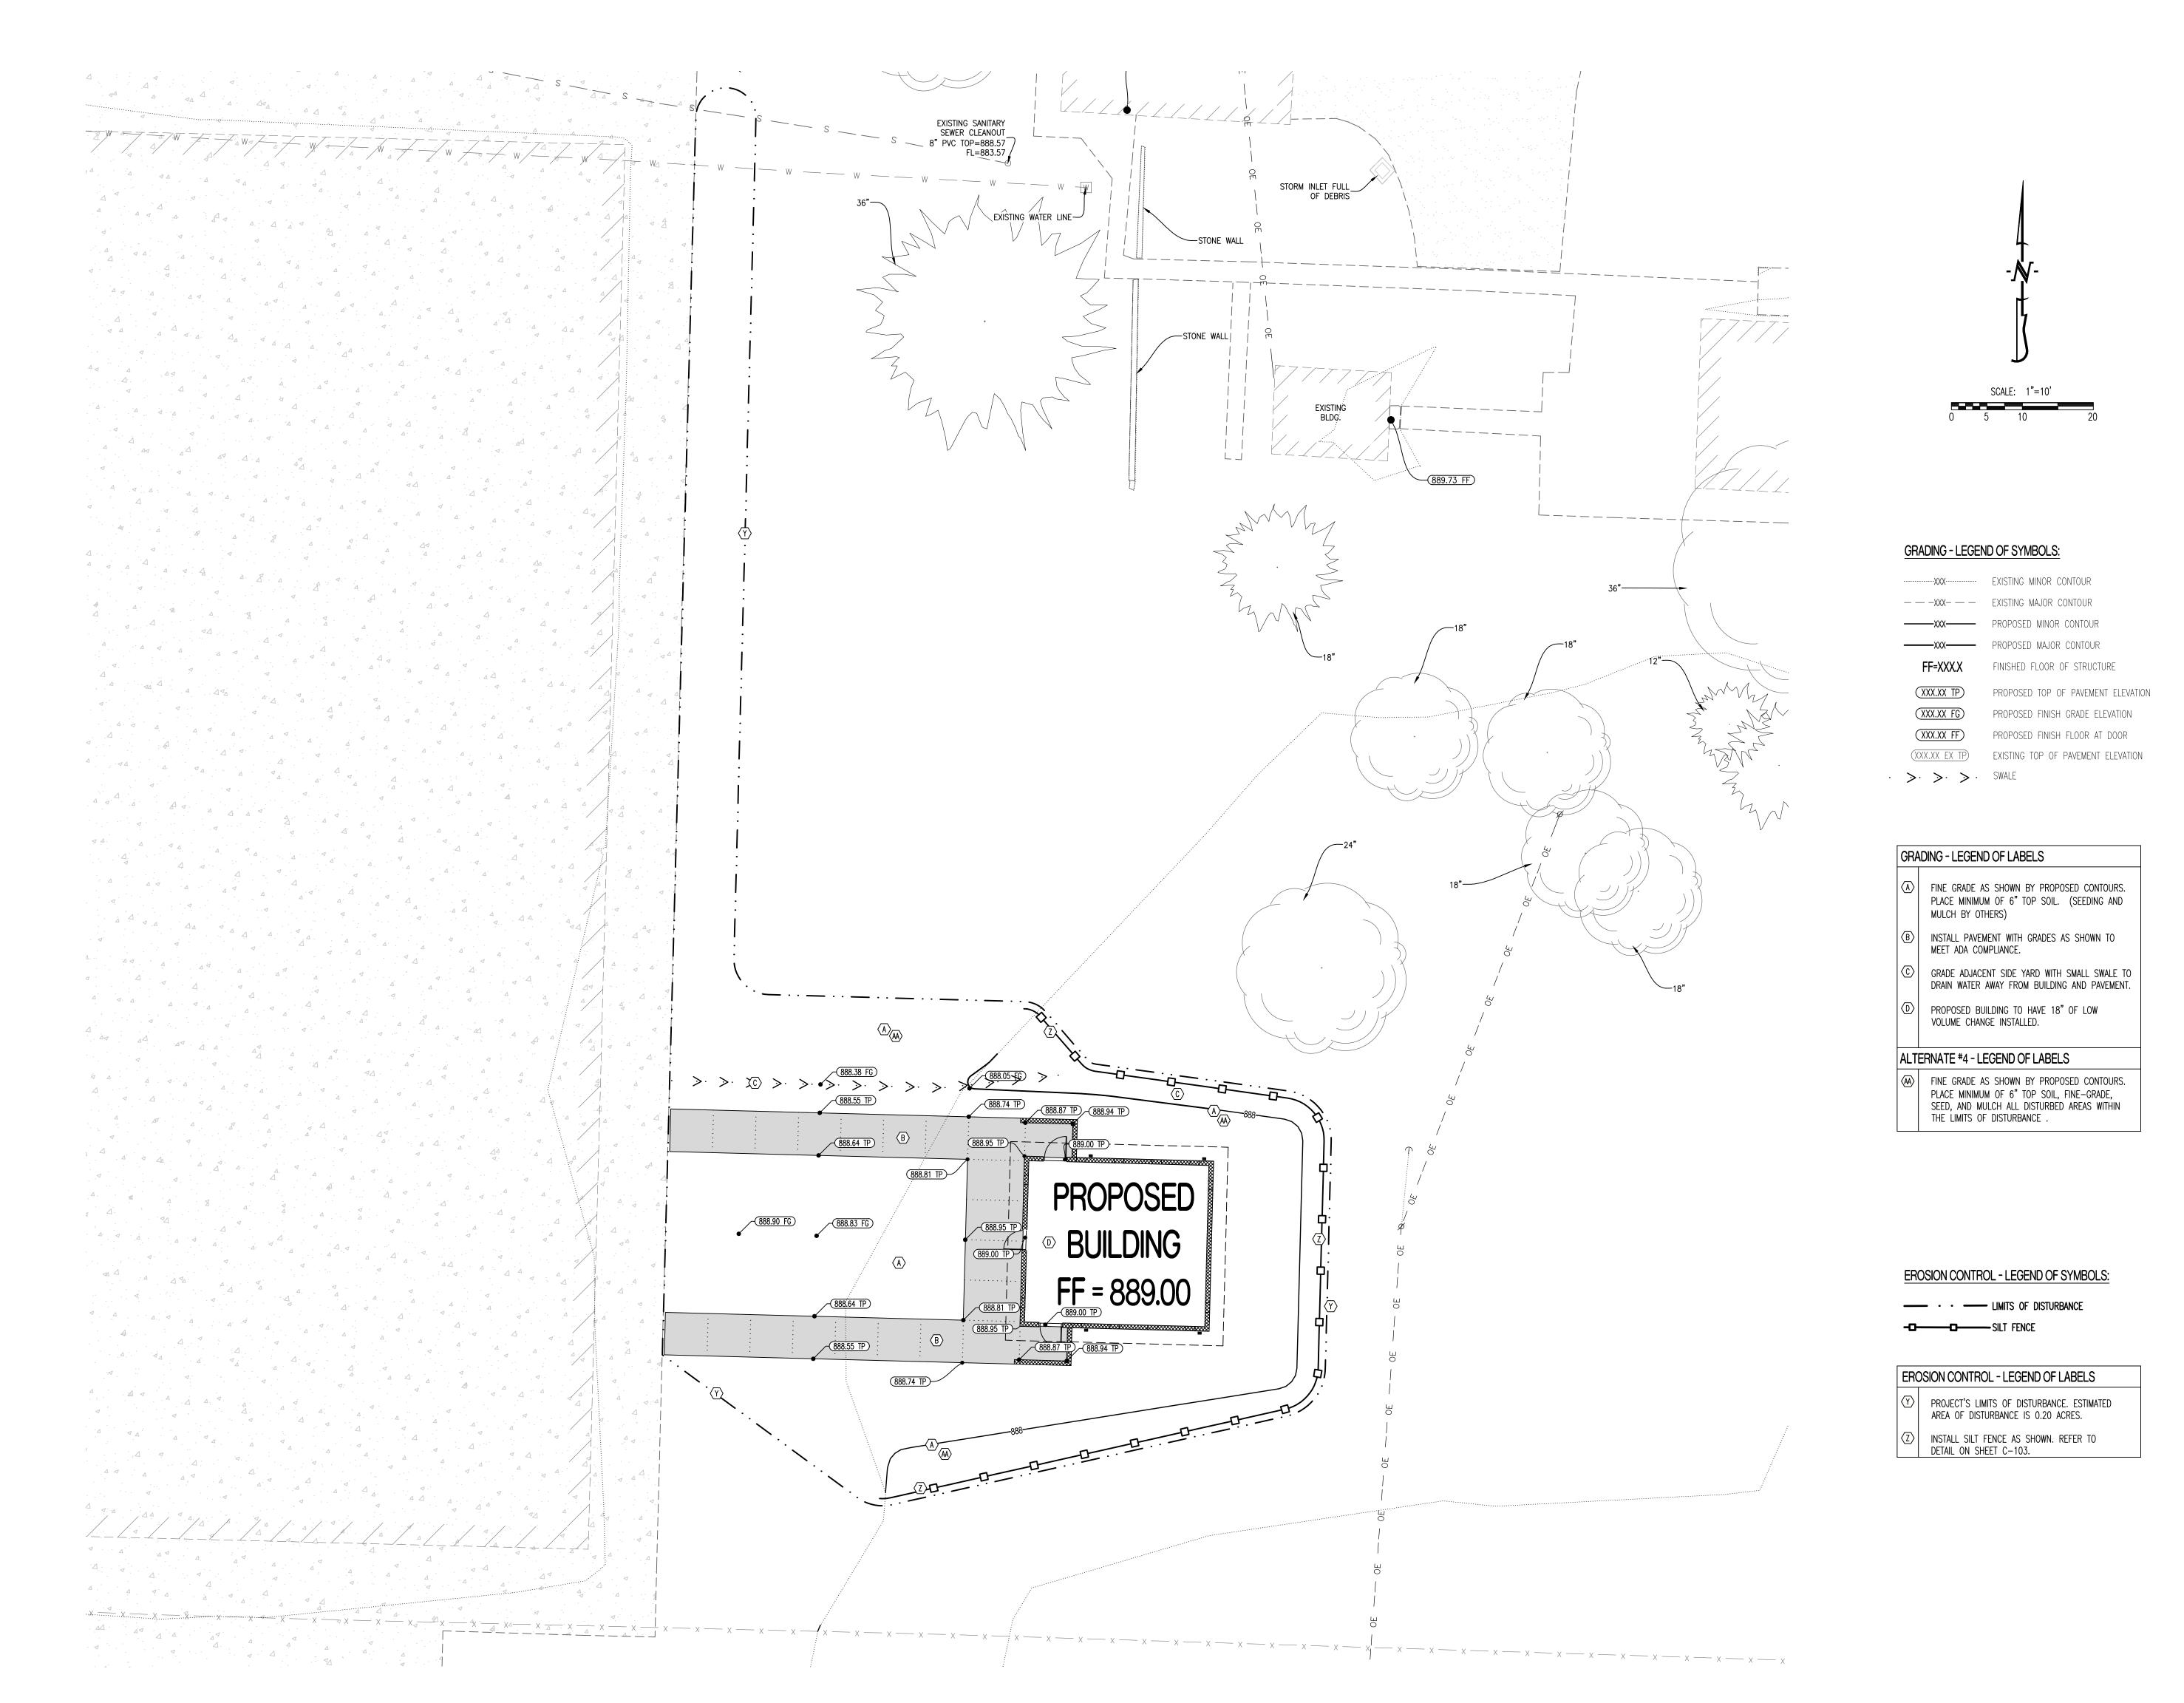

STATE OF MISSOURI MICHAEL L. PARSON, GOVERNOR





PREPARED BY: ENGINEERING CONSULTANTS 1000 W. Nifong Blvd., Bldg. 1 Columbia, Missouri 65203 (573) 447-0292

www.crockettengineering.com

Crockett Engineering Consultants, LLC
Missouri Certificate of Authority
#2000151301

OFFICE OF ADMINISTRATION DIVISION OF FACILITIES MANAGEMENT, DESIGN AND CONSTRUCTION

NEW COMFORT STATION

MISSOURI STATE FAIRGROUNDS (MSF) 1814 S LIMIT AVE SEDALIA, MO

PROJECT # F2206-01 SITE # 1501 ASSET # 3511501146

REVISION:
DATE:
REVISION:
DATE:
REVISION:
DATE:
ISSUE DATE: 08/10/2022

CAD DWG FILE:C-102	
DRAWN BY: KRM	
CHECKED BY: TDC	
DESIGNED BY: KRM	


SHEET TITLE:


GRADING AND EROSION CONTROL PLAN

SHEET NUMBER:


C-102

EROSION CONTROL DETAIL PAVEMENT DETAILS

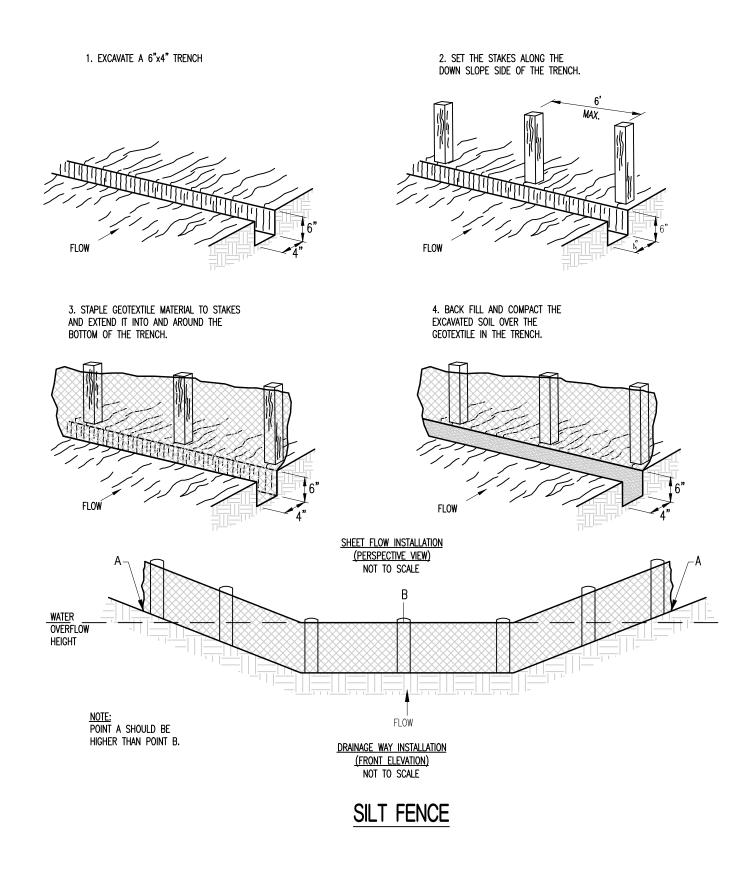

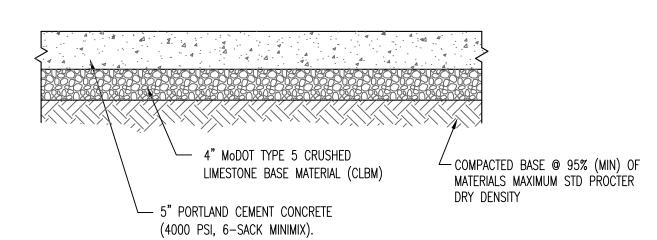


TYPICAL CONCRETE SIDEWALK PAVEMENT CROSS SECTION

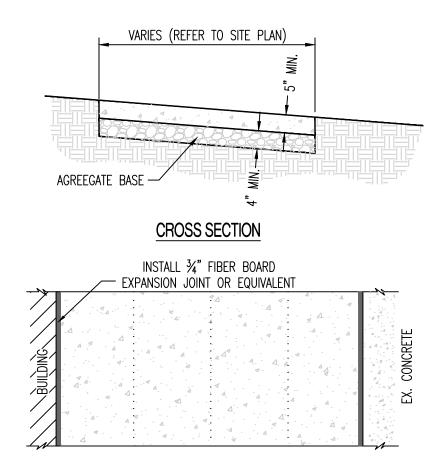


TYPICAL LOCATION OF EXPANSION JOINT AT BUILDING/CURB

1. SIDEWALK SHALL BE 5" THICK CLASS A CONCRETE ON 4" AGGREGATE BASE. 3. INSTALL 3/4 EXPANSION JOINT BETWEEN BUILDING AND NEW CONCRETE.


TYPICAL CONCRETE SIDEWALK

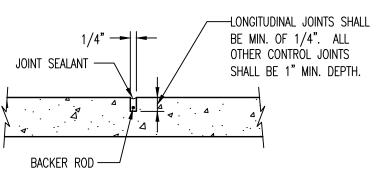

CONTROL JOINT

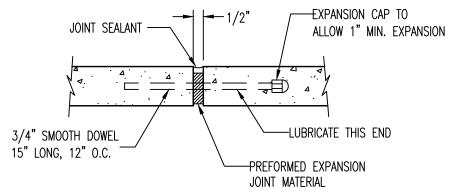

EXPANSION JOINT

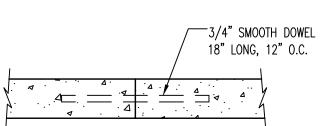

TRANSVERSE CONSTRUCTION JOINT

NOTE: SEE SPECIFICATIONS - 1000.01B THRU 1000.01D.

SIDEWALK JOINT DETAILS (1000.03)

STATE OF MISSOURI MICHAEL L. PARSON, **GOVERNOR**







OFFICE OF ADMINISTRATION DIVISION OF FACILITIES MANAGEMENT, DESIGN AND CONSTRUCTION

NEW COMFORT STATION

MISSOURI STATE FAIRGROUNDS (MSF) 1814 S LIMIT AVE SEDALIA, MO

PROJECT # F2206-01 1501 3511501146 ASSET#


REVISION: DATE: **REVISION:** DATE: **REVISION:** DATE: ISSUE DATE: 08/10/2022

CAD DWG FILE:C-103
DRAWN BY: KRM
CHECKED BY: TDC DESIGNED BY: KRM

SHEET TITLE:

CONSTRUCTION **DETAILS**


SHEET NUMBER:

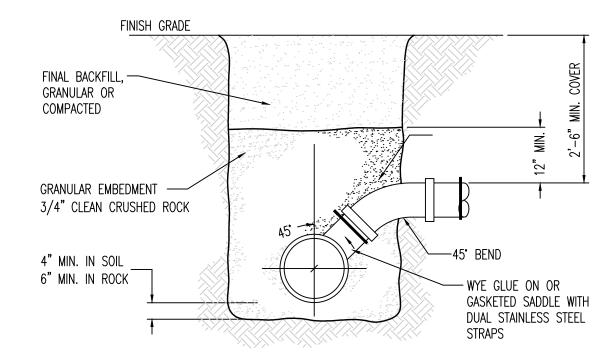

NOTES:

1. VCP PIPES SHALL NOT BE TAPPED. REPLACE SECTION OF VCP WITH PVC AND FITTING.


STANDARD SERVICE CONNECTION DETAIL - WYE DETAIL

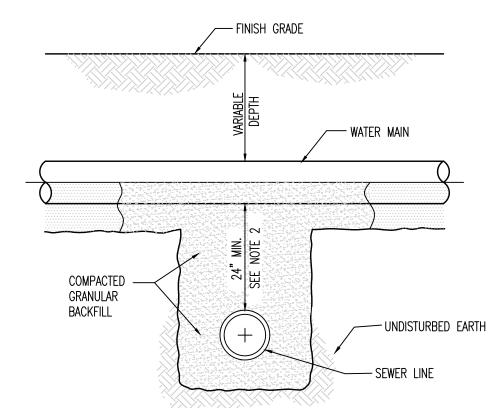


NOTES:

- 1. SEWERS CROSSING WATER MAINS SHALL BE LAID TO PROVIDE A VERTICAL SEPARATION THAT IS NO LESS THAN 24 INCHES BETWEEN THE OUTSIDE OF THE WATER MAIN AND THE OUTSIDE OF THE SEWER MAIN.
- 2. THE CROSSING SHALL BE ARRANGED SO THAT THE SEWER LINE CROSSES BELOW THE WATER LINE. CROSSINGS IN WHICH THE SEWER LINE IS ABOVE THE WATER LINE WILL ONLY BE APPROVED ON A CASE BY CASE BASIS.
- 3. THE CROSSING SHALL BE ARRANGED SO THAT THE ENDS OF A FULL JOINT OF PIPE WILL BE EQUIDISTANT FROM THE WATER MAIN AND AS FAR AS POSSIBLE FROM THE WATER MAIN JOINTS.
- 4. IF THE VERTICAL SEPARATION BETWEEN THE WATER MAIN AND SEWER MAIN IS LESS THAN 18 INCHES, THE SEWER MAIN SHALL BE D.I.P. OR PRESSURE RATED PVC PIPE WITH A PRESSURE RATING THAT IS EQUAL TO OR GREATER THAN THE WATER MAIN. THE D.I.P. OR PRESSURE RATED P.V.C. MUST BE EXTENDED A DISTANCE 10 FEET ON BOTH SIDES OF THE WATER MAIN. THE TRANSITION BETWEEN PIPE MATERIALS SHALL BE ACCOMPLISHED WITH A RESTRAINED MECHANICAL TYPE JOINT OR FITTING. FLEXIBLE TYPE (FERNCO) FITTINGS ARE NOT ACCEPTABLE.
- 5. PRESSURE SEWER LINE AND WATER LINE CROSSINGS SHALL BE REVIEWED ON A CASE BY CASE BASIS.

GRAVITY SEWER AND WATER LINE CROSSING

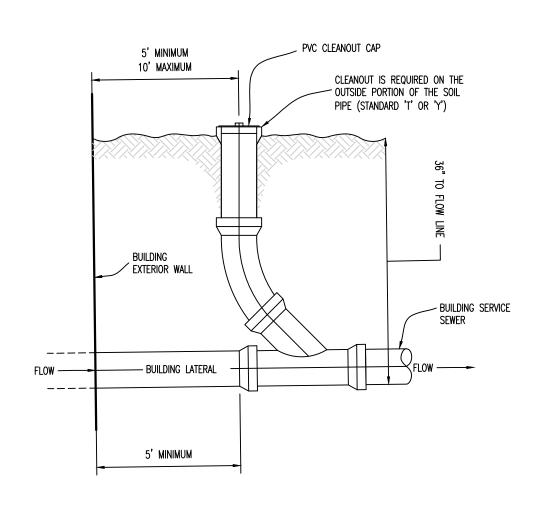

STANDARD SANITARY CLEANOUT

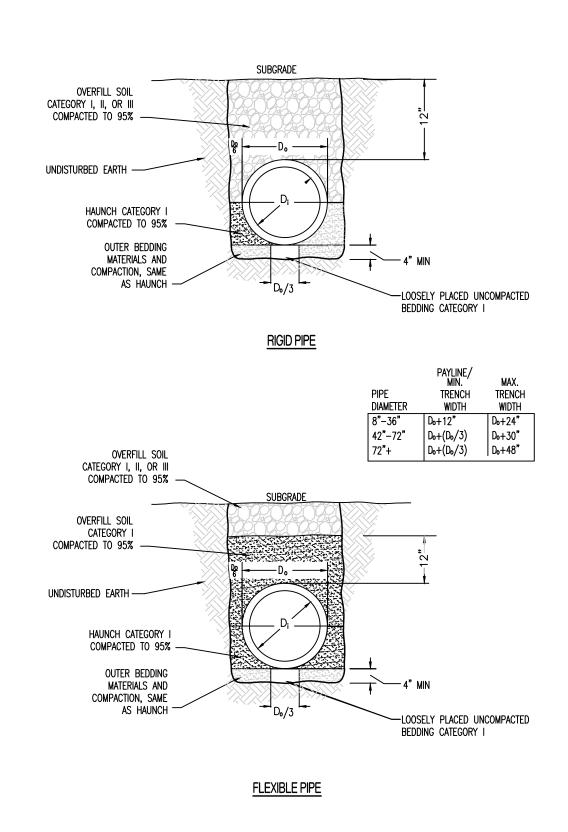

PIPE EMBEDMENT DETAIL

STATE OF MISSOURI MICHAEL L. PARSON, GOVERNOR







OFFICE OF ADMINISTRATION DIVISION OF FACILITIES MANAGEMENT, DESIGN AND CONSTRUCTION

NEW COMFORT STATION

MISSOURI STATE FAIRGROUNDS (MSF) 1814 S LIMIT AVE SEDALIA, MO

PROJECT # F2206-01 SITE # 1501 ASSET # 3511501146

REVISION:
DATE:
REVISION:
DATE:
REVISION:
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REVISION:
DATE:
ISSUE DATE: 08/10/2022

CAD DWG FILE:C-102
DRAWN BY: KRM
CHECKED BY: TDC
DESIGNED BY: KRM

SHEET TITLE:

CONSTRUCTION DETAILS

SHEET NUMBER:

C-104

Missouri State Fair - Comfort Station

Sedalia, Pettis County, Missouri

GENERAL NOTES

ELEVATION DATUM
SEE ARCHITECTURAL DRAWINGS OR SITE PLAN FOR FINISH FLOOR ELEVATIONS

DESIGN SPECIFICATIONS
2018 INTERNATIONAL BUILDING CODE

EARTHWOF

EARTHWORK OPERATIONS SHALL BE PERFORMED UNDER THE DIRECTION OF A PROFESSIONAL TESTING AGENCY TO ASSURE COMPLIANCE WITH THE RECOMMENDATIONS OF THE SOILS REPORT BY CROCKETT GTL DATED NOVEMBER 3, 2020.

CONCRET

CONCRETE WORK SHALL CONFORM TO ALL REQUIREMENTS OF THE CURRENT ACI 301, SPECIFICATIONS FOR STRUCTURAL CONCRETE FOR BUILDINGS, ACI 318 BUILDING CODE REQUIREMENTS FOR STRUCTURAL CONCRETE, ACI 305 SPECIFICATIONS FOR HOT WATER CONCRETE, AND ACI 306 SPECIFICATIONS FOR COLD WEATHER CONCRETE, WITH THE FOLLOWING ADDITIONAL REQUIREMENTS:

1. CONCRETE SHALL DEVELOP THE FOLLOWING 28—DAY MINIMUM COMPRESSIVE STRENGTH:

FOUNDATIONS - 3,000 PSI
CAST-IN-PLACE WALLS - 3,500 PSI
FLOOR SLAB - 4,000 PSI

2. ALL FOOTINGS SHALL BEAR ON UNDISTURBED SOIL OR ENGINEERED FILL.

3. CHLORIDE— BASED ADMIXTURES ARE PROHIBITED IN ALL REINFORCED CONCRETE.
4. REINFORCING STEEL SHALL CONFORM TO ASTM A615, A616, OR A617, GRADE 60.

5. ALL CONTINUOUS REINFORCING STEEL THAT MEETS AT A CORNER SHALL BE TIED TOGETHER WITH A CORNER BAR THAT HAS SUFFICIENT LAP DISTANCE IN EACH DIRECTION

6. CONTINUOUS REINFORCING BARS LAP LENGTH SHALL BE A MINIMUM OF 48 BAR DIAMETERS UNLESS

7. CONCRETE SLUMP SHALL BE A MAXIMUM OF 4" +/- 1" (ASTM C- 143) AS DELIVERED IN THE FIELD. CONTRACTOR MAY USE CHEMICAL ADMIXTURES TO ATTAIN A MAXIMUM SLUMP OF 8" FOR WORKABILITY. NO WATER MAY BE ADDED TO THE CONCRETE MIX ON SITE UNLESS WATER IS WITHHELD AT THE BATCHING FACILITY. IF WATER IS WITHHELD AT THE BATCHING FACILITY IT SHOULD BE REFLECTED ON THE LOAD TICKET. THE TOTAL AMOUNT OF WATER IN THE MIX SHALL NOT EXCEED WHAT IS NOTED ON THE APPROVED MIXED. THIS SHALL BE NOTED IN THE SPECIAL INSPECTOR'S RECORDS.

8. CONCRETE EXPOSED TO WEATHER, VEHICLES, AND/OR DEICING CHEMICALS SHALL BE AIR—ENTRAINED WITH 6% (+/-) 1.5% ENTRAINED AIR BY VOLUME AT POINT OF DISCHARGE. DO NOT ALLOW AIR CONTENT OF TROWELED FINISHED FLOORS TO EXCEED 3%.

9. SUBMIT CONCRETE MIX PROPORTIONS PRIOR TO START OF WORK. DO NOT BEGIN CONCRETE PRODUCTION UNTIL MIXES HAVE BEEN REVIEWED AND ARE ACCEPTABLE TO THE ENGINEER.

10.READY MIX CONCRETE SHALL COMPLY WITH REQUIREMENTS OF ASTM C94.

11.CONCRETE WORK EXECUTION

A. CONSTRUCT FORMS TO CORRECT SIZE, SHAPE, ALIGNMENT, ELEVATION AND POSITION; AND TO SUPPORT VERTICAL AND LATERAL LOADS.

B. POSITION, SUPPORT, AND SECURE REINFORCEMENT AGAINST DISPLACEMENT. MINIMUM CONCRETE COVER FOR REINFORCEMENT SHALL BE, UNLESS NOTED OTHERWISE ON THE DRAWINGS:

CAST AGAINST AND EXPOSED TO EARTH.......3 INCHES EXPOSED TO EARTH OR WEATHER.......2 INCHES

NOT EXPOSED TO WEATHER OR
IN CONTACT WITH EARTH.....

FINISHING WITHOUT DISLODGING AGGREGATE.

D. STEEL TROWEL FINISH ALL INTERIOR CONCRETE SLABS, BROOM FINISH ALL EXTERIOR CONCRETE

E. CURE ALL CONCRETE IN COMPLIANCE WITH ACI 301, USING A LIQUID TYPE MEMBRANE, NON-RESIDUAL, CURING COMPOUND COMPLYING WITH ASTM C309. ASSURE COMPATIBILITY WITH FINISH FLOOR COVERING.

MASONE

MASONRY WORK SHALL CONFORM TO ALL REQUIREMENTS OF THE CURRENT ACI 530.1 SPECIFICATIONS FOR MASONRY STRUCTURES WITH THE FOLLOWING ADDITIONAL REQUIREMENTS:

- 1. HOLLOW MASONRY BLOCK SHALL CONFORM TO ASTM C90 REGULAR WEIGHT GRADE N1.
- 2. COURSE GROUT SHALL CONFORM TO ASTM C476 WITH A MAXIMUM AGGREGATE SIZE OF 3/8" AND A MINIMUM COMPRESSIVE STRENGTH OF 2,500 PSI.
- 3. MORTAR SHALL BE TYPE S CONFORMING TO ASTM C270. AVERAGE COMPRESSIVE STRENGTH IS 2,000
- 4. MINIMUM 28-DAY COMPRESSIVE STRENGTH OF MASONRY; f'm = 2,000 PSI.
- 5. WIRE REINFORCING SHALL CONFORM TO ASTM A82, STANDARD TRUSS—TYPE DUR—O—WALL REINFORCING (OR APPROVED EQUAL) AND SHALL BE PLACED CONTINUOUSLY IN ALTERNATE HORIZONTAL MORTAR
- 6. REINFORCING STEEL SHALL CONFORM TO ASTM A615, A616, OR A617, GRADE 60. THE MINIMUM LAP
- FOR SPLICES SHALL BE 48 BAR DIAMETERS. PROVIDE DUR-0-WAL REBAR POSITIONERS.

 7. ALL STEEL LINTELS TO BE A36 STEEL OR A992 GRADE 50. ALL LINTELS TO BE HOT DIPPED
- 8. INTERSECTING STRUCTURAL WALLS SHALL BE ANCHORED BY STEEL CONNECTORS SPACED VERTICALLY AT 48" O.C. MAXIMUM. THE CONNECTORS SHALL CONFORM TO ASTM A36 AND SHALL HAVE A MINIMUM SECTION OF 1/4" x 11/2". THEY SHALL BE 28" LONG WITH 2" AT EACH END BENT AT 90 DEGREES TO FORM A "U" OR "Z" SHAPE. ALL CELLS ABOVE AND BELOW THE ANCHOR SHALL BE GROUTED, AND THE BENT ENDS OF THE CONNECTORS SHALL BE EMBEDDED IN THE GROUT, 2' MIN.
- 9. EXPANSION JOINTS SHALL BE PROVIDED IN CMU BLOCK WALLS FULL HEIGHT OF WALL AT INTERVALS NOT EXCEEDING 24'-0". NOT CLOSER THAN 2'-0" FROM OPENINGS JOINT REINFORCING SHALL BE SEVERED AT EXPANSION JOINT LOCATIONS, HOWEVER BOND BEAM REINFORCING SHALL BE CONTINUOUS THROUGH THE JOINT
- 10. BOND BEAMS OR GROUTED CELLS ARE REQUIRED AT ALL CONNECTIONS TO CMU.

HEADED MASONRY ANCHORS

- 1. ALL HEADED CONCRETE ANCHORS SHALL MEET THE REQUIREMENTS OF THE CODE-CITED EDITION OF ACI 318 APPENDIX "D" AND AWS D1.1.
- HEADED STUDS HAVE BEEN DESIGNED AS TYPE "B" ANCHORS (f_{ut}= 65,000 psi, f_y= 51,000 psi).
 EMBEDMENT DEPTH IS DEFINED AS THE DISTANCE FROM THE OUTSIDE FACE OF THE EMBEDMENT PLATE TO THE INSIDE FACE OF THE STUD HEAD.
- 4. EQUIVALENT ANCHORS MAY BE SUBMITTED FOR THE ENGINEER'S APPROVAL.

DEFORMED BAR ANCHORS

- 1. ALL DEFORMED BAR ANCHORS SHALL MEET THE REQUIREMENTS OF THE CODE—CITED EDITION OF ACI 318 APPENDIX "D" AND AWS D1.1.
- 2. DEFORMED BAR ANCHORS HAVE BEEN DESIGNED AS TYPE "C" ANCHORS (f_{ut}= 80,000 psi, f_y= 70,000 psi, & MANUFACTURED IN CONFORMANCE WITH ASTM A496).
- 3. EQUIVALENT ANCHORS MAY BE SUBMITTED FOR THE ENGINEER'S APPROVAL.

PREFABRICATED WOOD TRUSSES

- 1. FLOOR & ROOF TRUSSES SHALL BE DESIGNED IN ACCORDANCE WITH THE TRUSS PLATE INSTITUTE (TPI) DESIGN SPECIFICATION FOR METAL PLATE CONNECTED WOOD TRUSSES, AND THE ANSI/NF&PA NATIONAL DESIGN SPECIFICATION (NDS) FOR WOOD CONSTRUCTION.
- PROVIDE TEMPORARY AND PERMANENT BRACING ON ALL TRUSSES, AS REQUIRED TO PROVIDE MEMBER AND TRUSS STABILITY.
- 3. FLOOR & ROOF TRUSSES SHALL BE DESIGNED AND CONSTRUCTED FOR A MAXIMUM TOTAL LOAD DEFLECTION OF L/360 AND TO SAFELY SUPPORT THE FOLLOWING LOADS:
- A. DEAD, LIVE, SNOW, WIND, EARTHQUAKE: SEE PROJECT DESIGN DATA ON COVER SHEET.B. MECHANICAL PIPE LOAD: TRUSSES SHALL BE DESIGNED FOR A CONCENTRATED LOAD OF 250
- LBS HUNG ANYWHERE ALONG THE BOTTOM CHORD.

 C. OVER-FRAMING LOAD: TRUSSES SHALL ALSO BE DESIGNED TO SUPPORT ADDITIONAL OVERBUILD
- FRAMING, SUCH AS THAT WHICH FORMS VALLEYS AND HIPS ON ROOFS.

 D. DRIFTED SNOW LOAD: TRUSSES SHALL BE DESIGNED TO SUPPORT DRIFTED SNOW LOADS IN ACCORDANCE WITH THE APPROPRIATE BUILDING CODE.
- E. IN-PLANE LATERAL LOADS: TRUSSES SHALL BE DESIGNED TO SUPPORT ANY LATERAL LOADS CARRIED AXIALLY IN THE PLANE OF THE TRUSS, AS SHOWN ON THE PLANS.
- 4. GABLED END TRUSSES SHALL HAVE VERTICAL MEMBERS SPACED AT 16" O.C. MAXIMUM.
- 4. GABLED END TRUSSES SHALL HAVE VERTICAL MEMBERS SPACED AT 16 O.C. MAXIMUM

 5. SUBMITTALS SHALL INCLUDE THE FOLLOWING:
 - A. SHOP DRAWINGS PREPARED UNDER THE SUPERVISION OF, AND SIGNED AND SEALED BY, A PROFESSIONAL ENGINEER REGISTERED IN THE STATE WHERE THE PROJECT IS BUILT. THESE DRAWINGS SHALL INDICATE SPECIES, GRADE, AND SIZES OF LUMBER TO BE USED; PITCH, SPAN, CAMBER, CONFIGURATION, AND SPACING FOR EACH TYPE OF TRUSS REQUIRED; TYPE, SIZE, MATERIAL, FINISH, AND LOCATION OF METAL CONNECTOR PLATES; AND BEARING DETAILS. SHOW TRUSS LAYOUT AND ALL REQUIRED TEMPORARY AND PERMANENT BRACING AFFECTING THE STRUCTURAL CAPACITY OF THE TRUSSES.

PROVIDE COMPLETE ENGINEERING DESIGN CALCULATIONS THAT INCLUDE DESIGN VALUES, DESIGN ANALYSIS INDICATING LOADING, ASSUMED ALLOWABLE STRESSES, STRESS DIAGRAMS, AND CALCULATIONS, AND ANY OTHER INFORMATION NEEDED FOR REVIEW. THE CALCULATIONS SHALL HAVE BEEN SIGNED AND SEALED BY A QUALIFIED PROFESSIONAL ENGINEER WHO IS REGISTERED IN THE STATE WHERE THE PROJECT IS BUILT AND WHO IS RESPONSIBLE FOR PREPARATION OF THE CALCULATIONS.

SPECIAL INSPECTIONS

THE FOLLOWING ITEMS REQUIRE SPECIAL INSPECTION IN ACCORDANCE WITH CHAPTER 17 OF THE INTERNATIONAL BUILDING CODE.

- a. CONCRETE GROUT DESIGN MIX (PERIODIC)
- b. PLACING OF CONCRETE AND REINFORCING STEEL (CONTINUOUS OF CONCRETE SAMPLING / PERIODIC OF REINFORCING)
- c. BOLTS & ANCHORS EMBEDDED IN CONCRETE (PERIODIC)
- d. STRUCTURAL STEEL FABRICATIONS (UNLESS AISC APPROVED)


 (PERIODIC)
- e. STRUCTURAL STEEL BOLTING & WELDING (PERIODIC)
- f. POST INSTALLED ANCHORS IN CONCRETE (CONTINUOUS)
 q. IN—SITU SOILS, EXCAVATIONS, FILLING & COMPACTION (PERIODIC)
- h. MASONRY AND REINFORCING STEEL (CONTINUOUS ON CELL GROUTING / PERIODIC ON PEINFORCING)
- REINFORCING)
- i. WOOD FRAMING:
- i.a. SHEAR WALLS; WALL SIZE, CONFIGURATION, BLOCKING, PANEL GRADE, PANEL THICKNESS, AND FASTENING. (PERIODIC)
- i.b. DIAPHRAGMS (FLOOR AND ROOF SHEATHING); SIZE, CONFIGURATION, BLOCKING, PANEL GRADE, PANEL THICKNESS, AND FASTENING. (PERIODIC)
- i.c. FRAMING MEMBERS AND DETAILS (PERIODIC)
- i.d. MATERIAL GRADE (PERIODIC)
- i.e. CONNECTIONS; HANGERS, HOLD DOWNS, BUILT-UP COLUMNS, BUILT-UP BEAMS (PERIODIC)
- i.f. PRE-ENGINEERED TRUSSES; FRAMING, CONNECTIONS, BRIDGING (PERIODIC)

THE CONTRACTOR SHALL REQUEST SPECIAL INSPECTION OF THE ITEMS LISTED ABOVE PRIOR TO THOSE ITEMS BECOMING INACCESSIBLE AND UNOBSERVABLE DUE TO PROGRESSION OF THE WORK.

DESIGN DATA 2018 INTERNATIONAL BUILDING CODE / ASCE 7-16 **BUILDING OCCUPANCY CATEGORY ROOF LOAD DATA** LIVELOAD 8.0 ROOFING, SHEATHING, & INSULATION 7.0 MECHANICAL ALLOWANCE TRUSSES/STRUCTURE TOTAL TO WALLS 40 lbs/sq.ft ROOF SNOW LOAD DATA* (*UNBALANCED & DRIFTING SNOW TO BE DETERMINED IN ADDITION TO UNIFORM LOAD, WHERE APPLICABLE) 20 lbs/sq.ft $C_e =$ $C_t =$ WIND DESIGN DATA 115 M.P.H. (IBC 1609.3.1) RISK CATEGOR' **EXPOSURE** INTERNAL PRESSURE COEFFICIENT = DIRECTIONAL PROCEDURE (MWFRS - ASCE 7-10, CH 27; C&C - ASCE 7-10, CH 30, PART 4) MAXIMUM COMPONENTS & CLADDING WIND EARTHQUAKE DESIGN DATA RISK CATEGORY 0.137 0.084 SITECLASS 0.119 SDS= 0.084 SEISMIC DESIGN CATEGORY BASIC SEISMIC-FORCE-RESISTING SYSTEM = INTERMEDIATE REINFORCED MASONRY SHEAR BEARING WALLS 3.50 OMEGA: 2.50 2.25 V = 0.034WDESIGN BASE SHEAR EQUIVALENT LATERAL FORCE PROCEDURE NET ALLOWABLE SOIL BEARING 2,100 CONTINUOUS/2,500 PAD lbs/sq.ft

INDEX OF SHEETS	
COVER / GENERAL STRUCTURAL DATA	S-100
FOUNDATION PLAN & DETAILS	S-200
ROOF FRAMING PLAN & DETAILS	S-300
ROOF FRAMING DETAILS	S-310

STATE OF MISSOURI MICHAEL L. PARSON, GOVERNOR

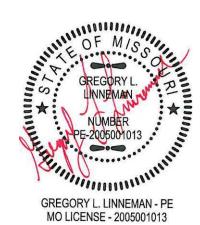





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OFFICE OF ADMINISTRATION DIVISION OF FACILITIES MANAGEMENT, DESIGN AND CONSTRUCTION

NEW COMFORT STATION

MISSOURI STATE FAIRGROUNDS (MSF) 2503 W. 16TH St.

PROJECT # F2206-01 SITE # 1501

3511501139

SEDALIA, MO

REVISION:
DATE:
REVISION:
DATE:
REVISION:
DATE:
DATE:

CAD DWG FILE:
DRAWN BY: SEH
CHECKED BY: GLL
DESIGNED BY: GLL

ISSUE DATE: 08/10/2022

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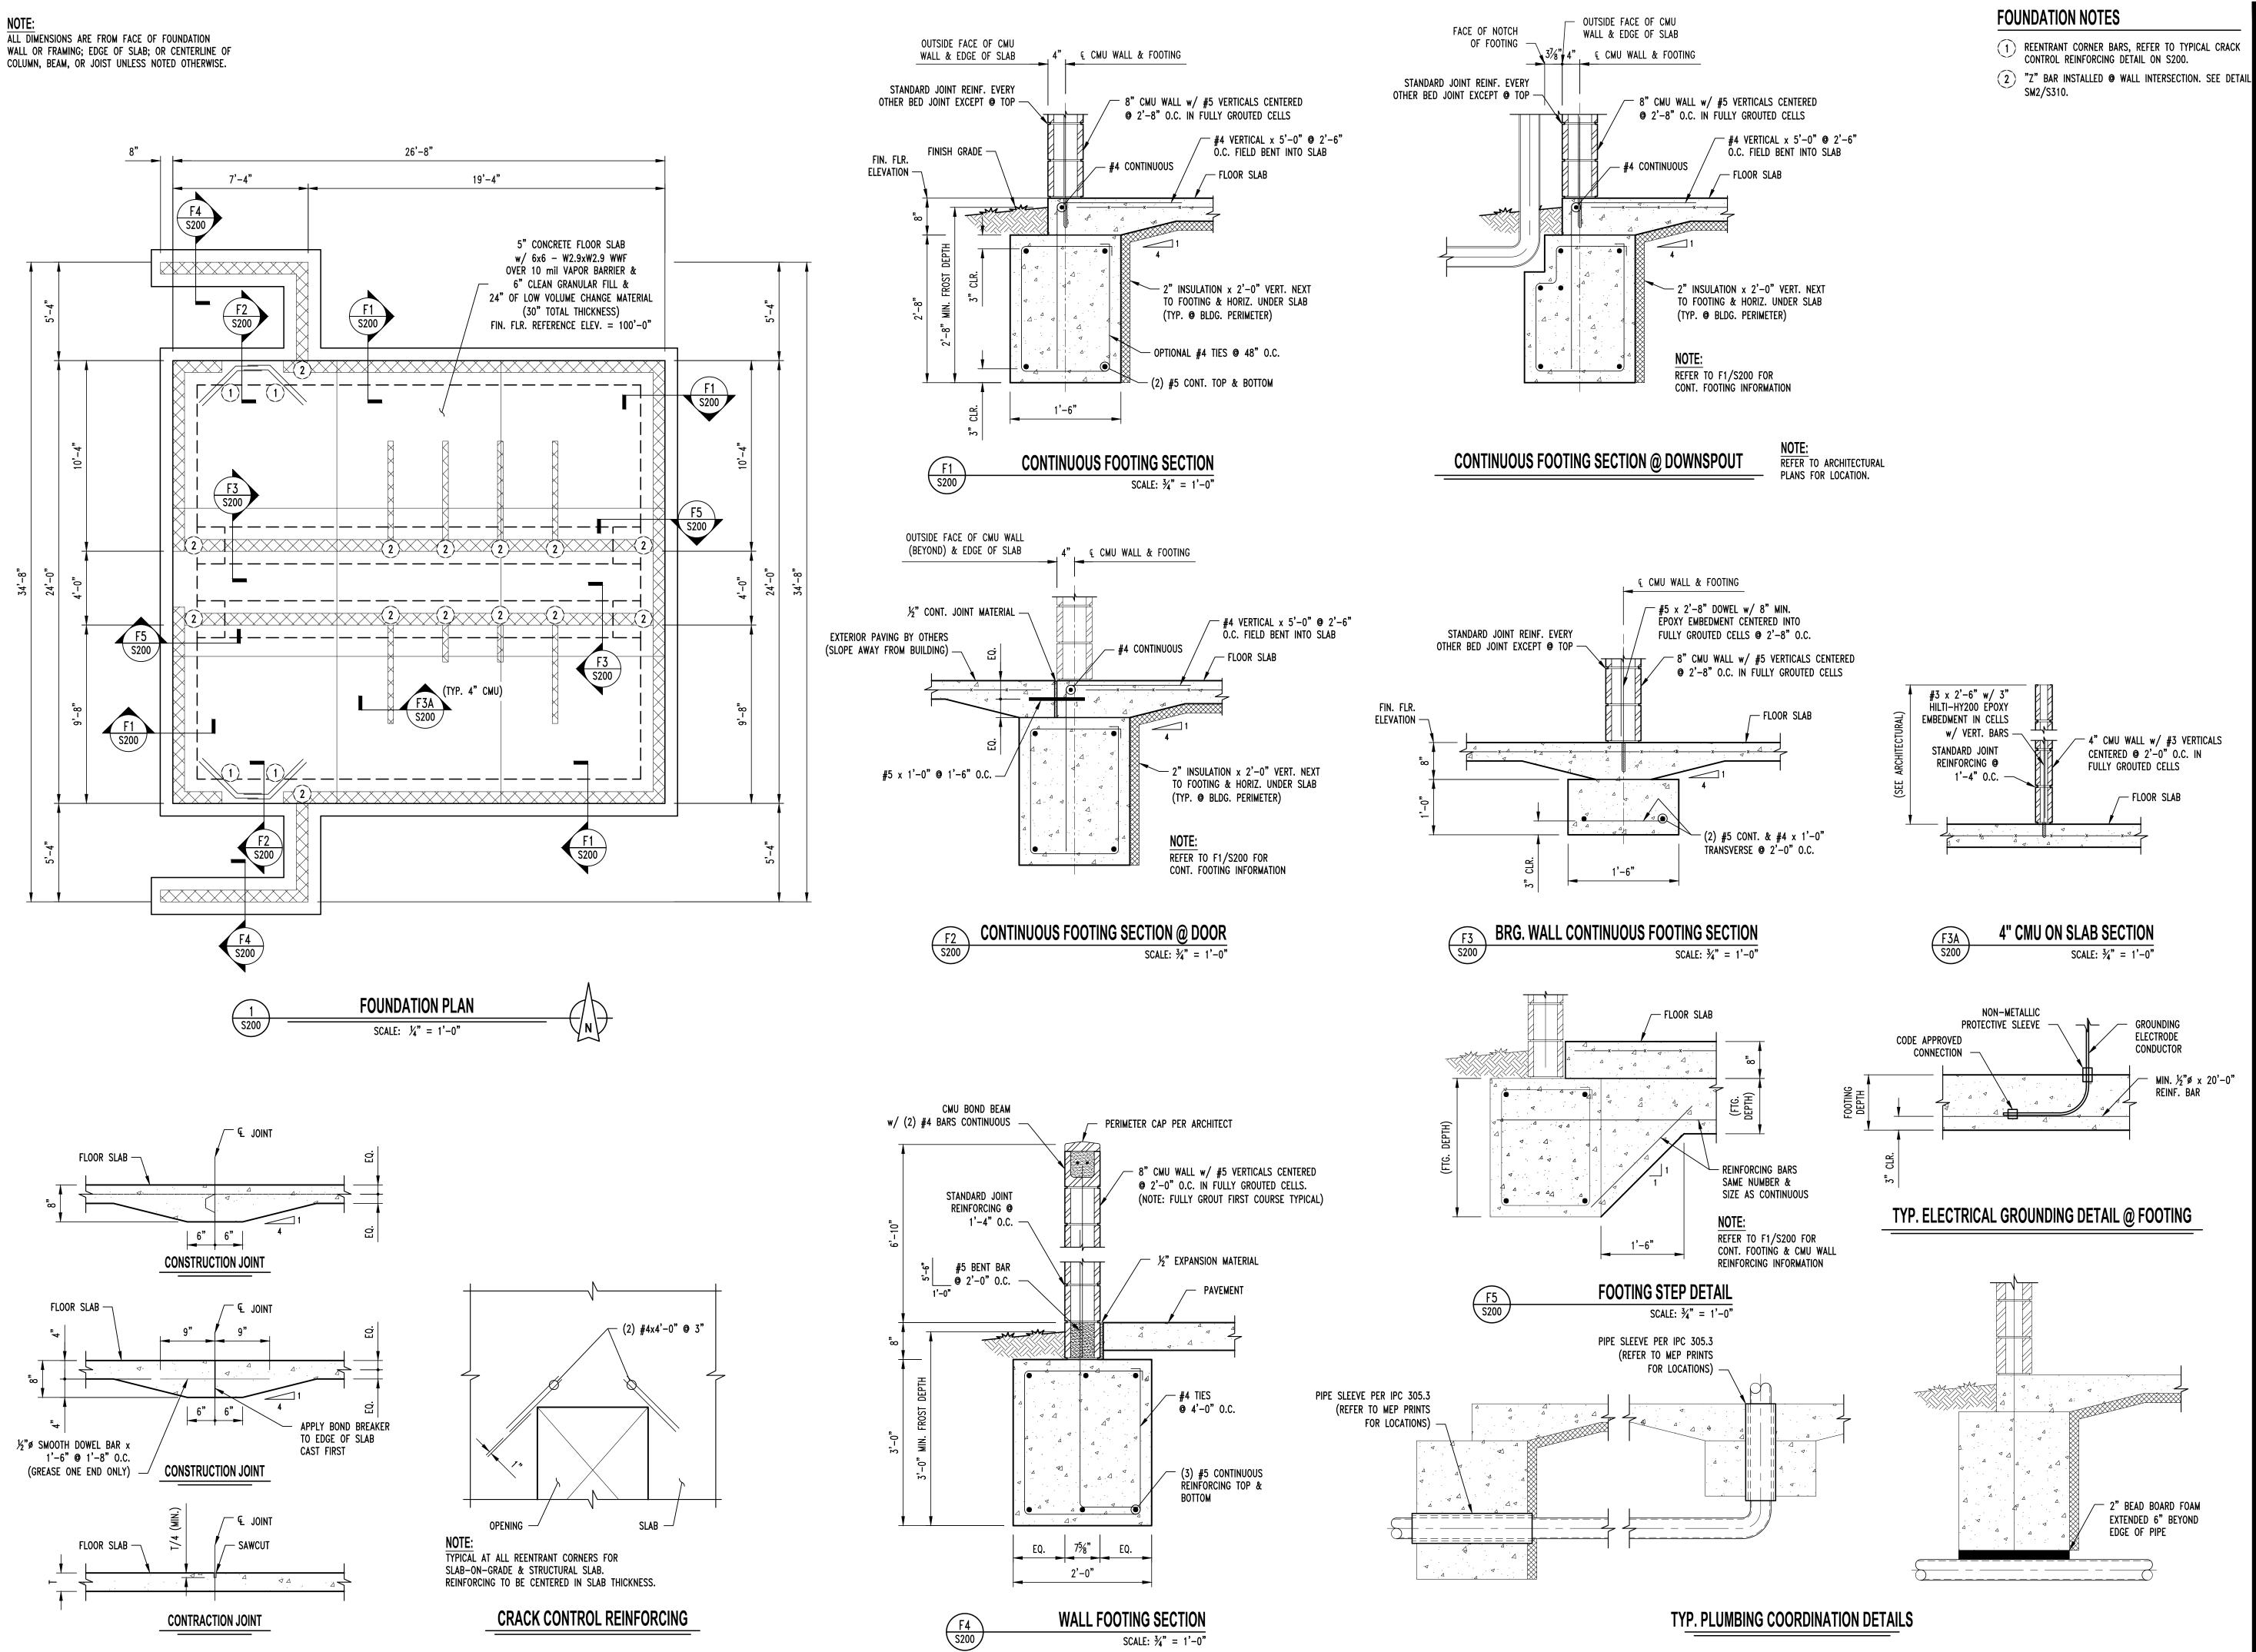
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SHEET NUMBER:

S-100

8 OF 20 SHEETS


08/10/2022



SCALE: $\frac{3}{4}$ " = 1'-0"



STATE OF MISSOURI

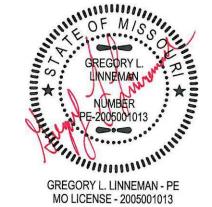





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ENGINEERING CONSULTANTS 1000 W. Nifong Blvd., Bldg. 1 Columbia, Missouri 65203

OFFICE OF ADMINISTRATION DIVISION OF FACILITIES

DESIGN AND CONSTRUCTION

NEW COMFORT STATION

MISSOURI STATE FAIRGROUNDS (MSF) 2503 W. 16TH St. SEDALIA, MO

MANAGEMENT,

PROJECT # F2206-01 1501 3511501139

REVISION: DATE REVISION DATE **REVISION:**

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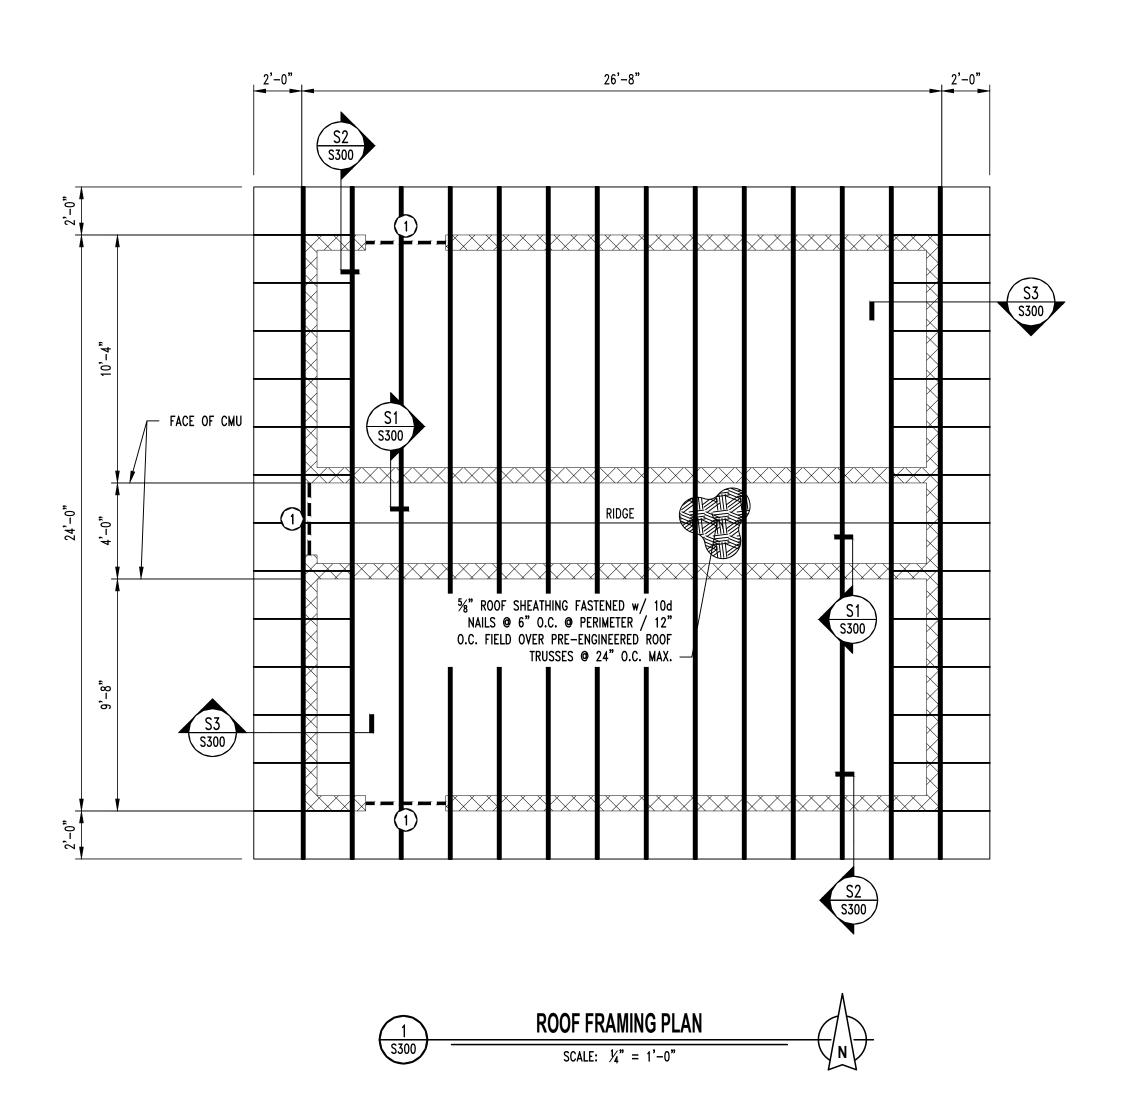
ISSUE DATE: 08/10/2022


DESIGNED BY: GLI SHEET TITLE:

FOUNDATION PLAN & DETAILS


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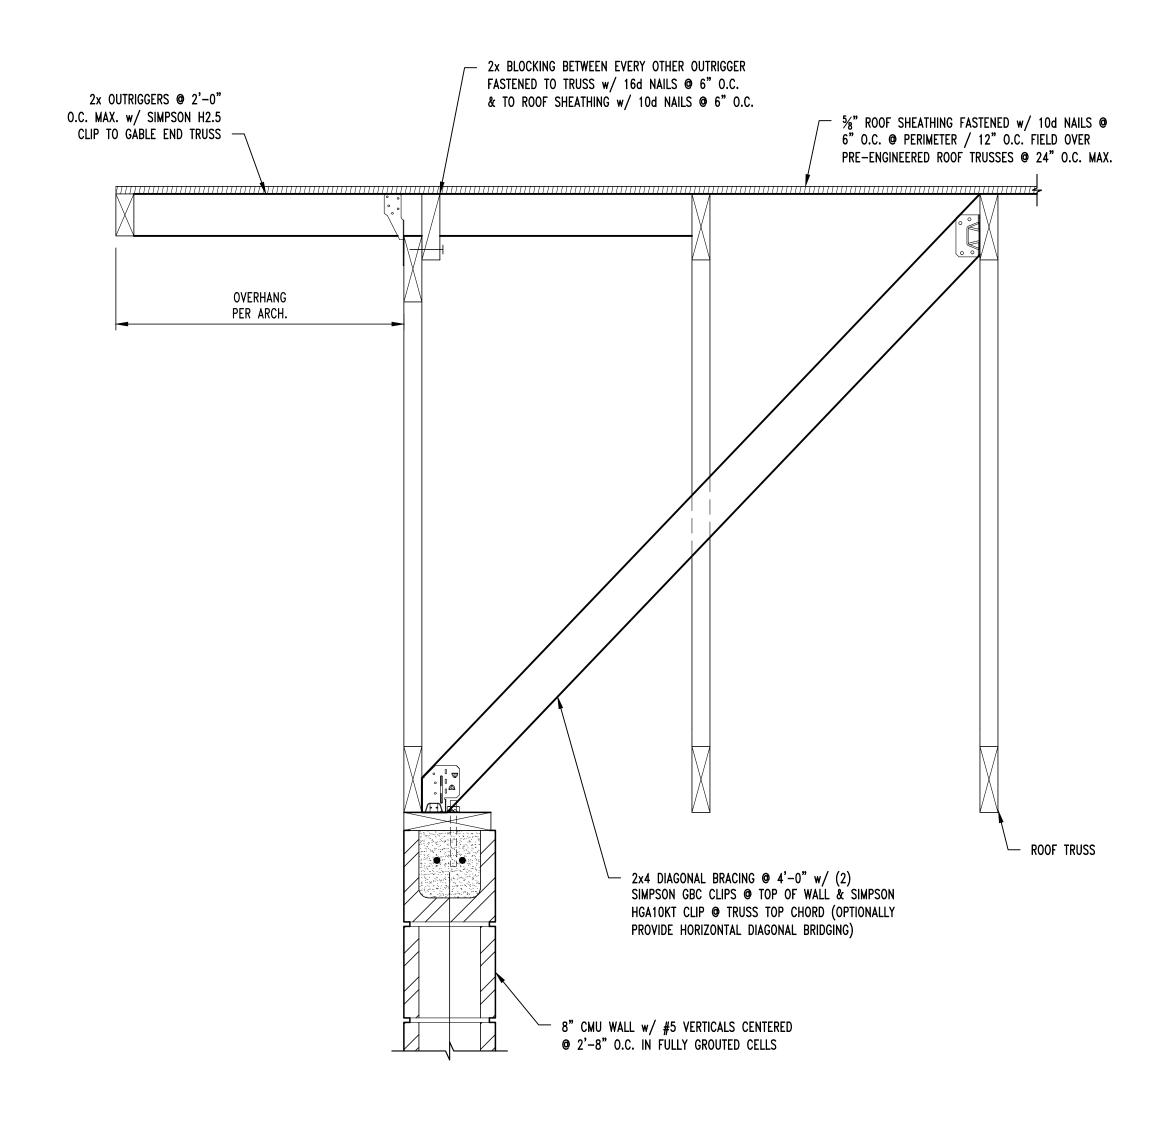
1) CMU LINTEL. REFER TO DETAIL SM1 SHEET S310.





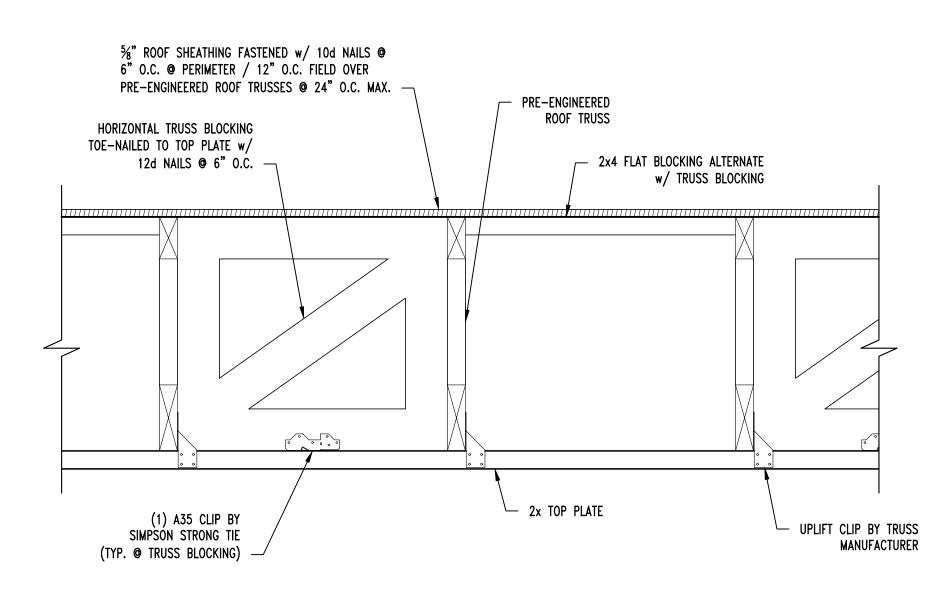




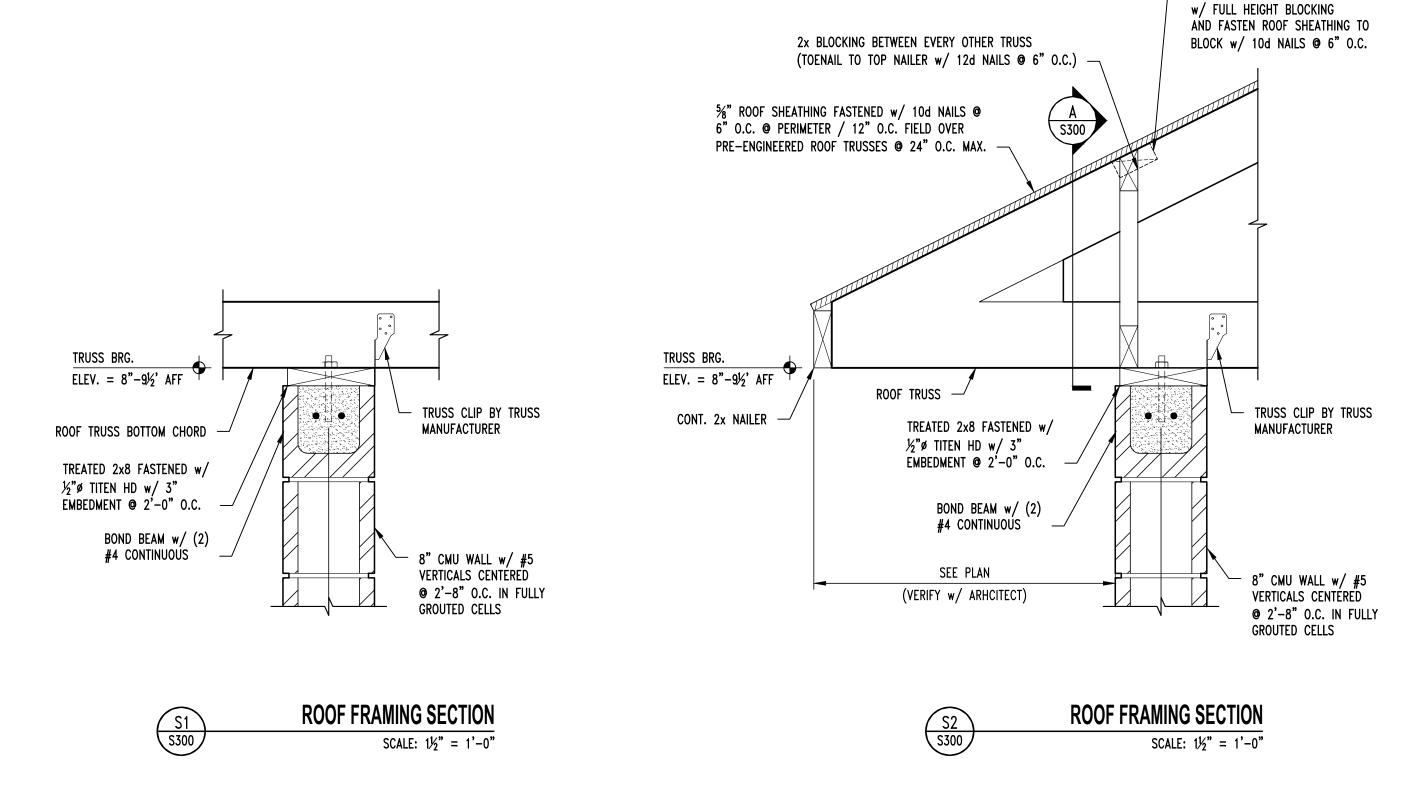



STATE OF MISSOURI MICHAEL L. PARSON, GOVERNOR

ALTERNATE 2x4 FLAT BLOCKING

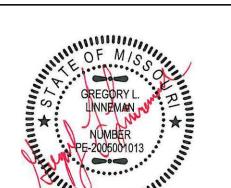

GREGORY L. LINNEMAN - PE MO LICENSE - 2005001013

Peckham & Wright Architects, Inc., d.b.a.

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NEW COMFORT STATION

MISSOURI STATE FAIRGROUNDS (MSF) 2503 W. 16TH St. SEDALIA, MO

PROJECT # F2206-01 SITE # 1501 ASSET # 3511501139

REVISION:
DATE:
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ISSUE DATE: 08/10/2022


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DRAWN BY: SEH
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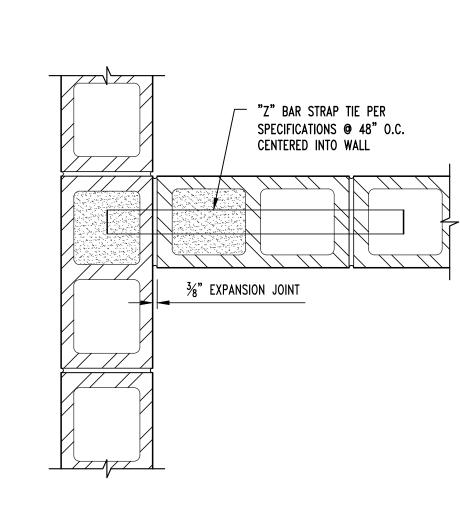
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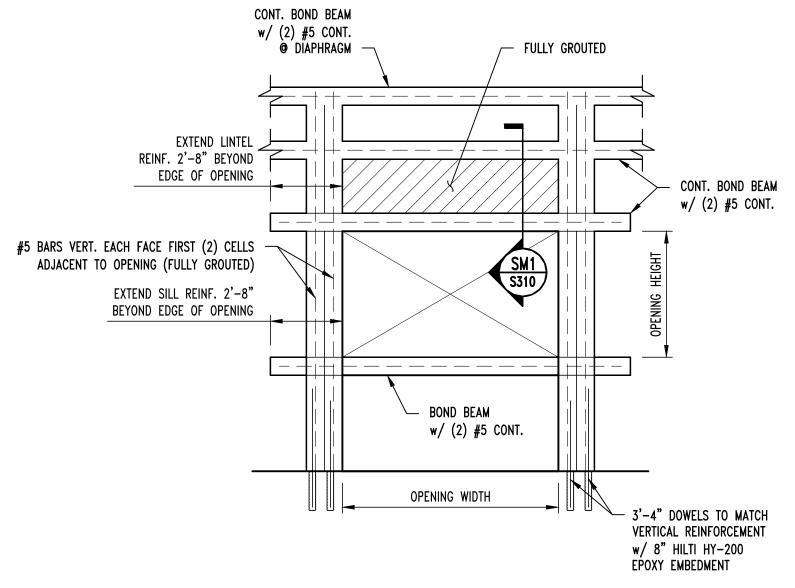
ROOF FRAMING PLAN & DETAILS


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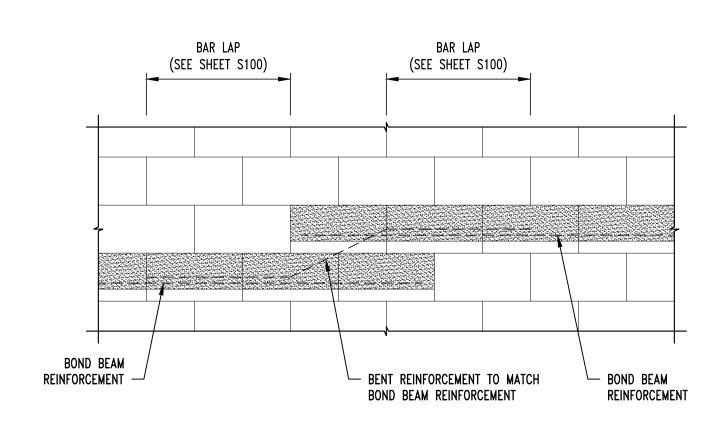







TYPICAL MASONRY OPENING REINFORCEMENT

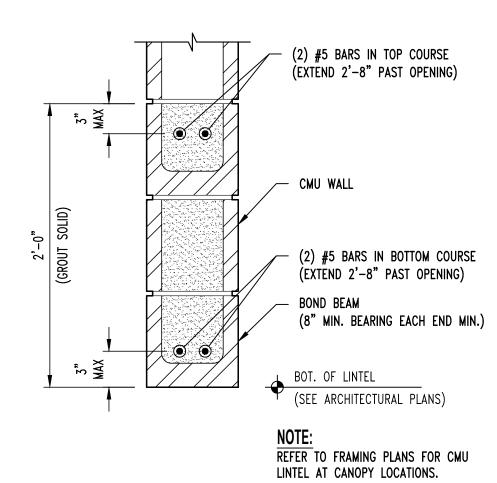TYPICAL CMU WALL VERT REINFORCING

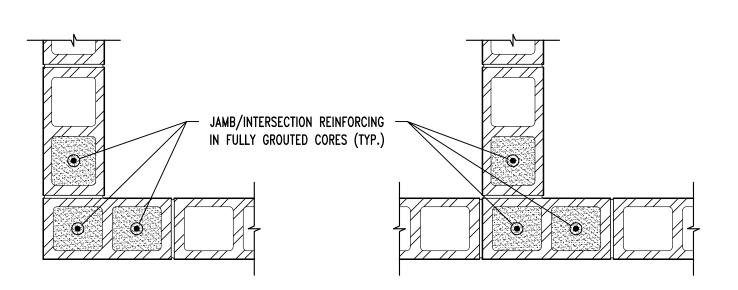

TYPICAL STEP IN BOND BEAM



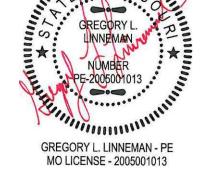

STATE OF MISSOURI MICHAEL L. PARSON, **GOVERNOR**





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OFFICE OF ADMINISTRATION DIVISION OF FACILITIES MANAGEMENT, **DESIGN AND CONSTRUCTION**

NEW COMFORT STATION

MISSOURI STATE FAIRGROUNDS (MSF) 2503 W. 16TH St. SEDALIA, MO

PROJECT # F2206-01 1501 ASSET # 3511501139

REVISION: DATE: REVISION: DATE: **REVISION:** DATE:


ISSUE DATE: 08/10/2022

CAD DWG FILE: DRAWN BY: SEH CHECKED BY: $\overline{\text{GLL}}$ DESIGNED BY: GLL

SHEET TITLE:

TYPICAL MASONRY DETAILS

SHEET NUMBER:

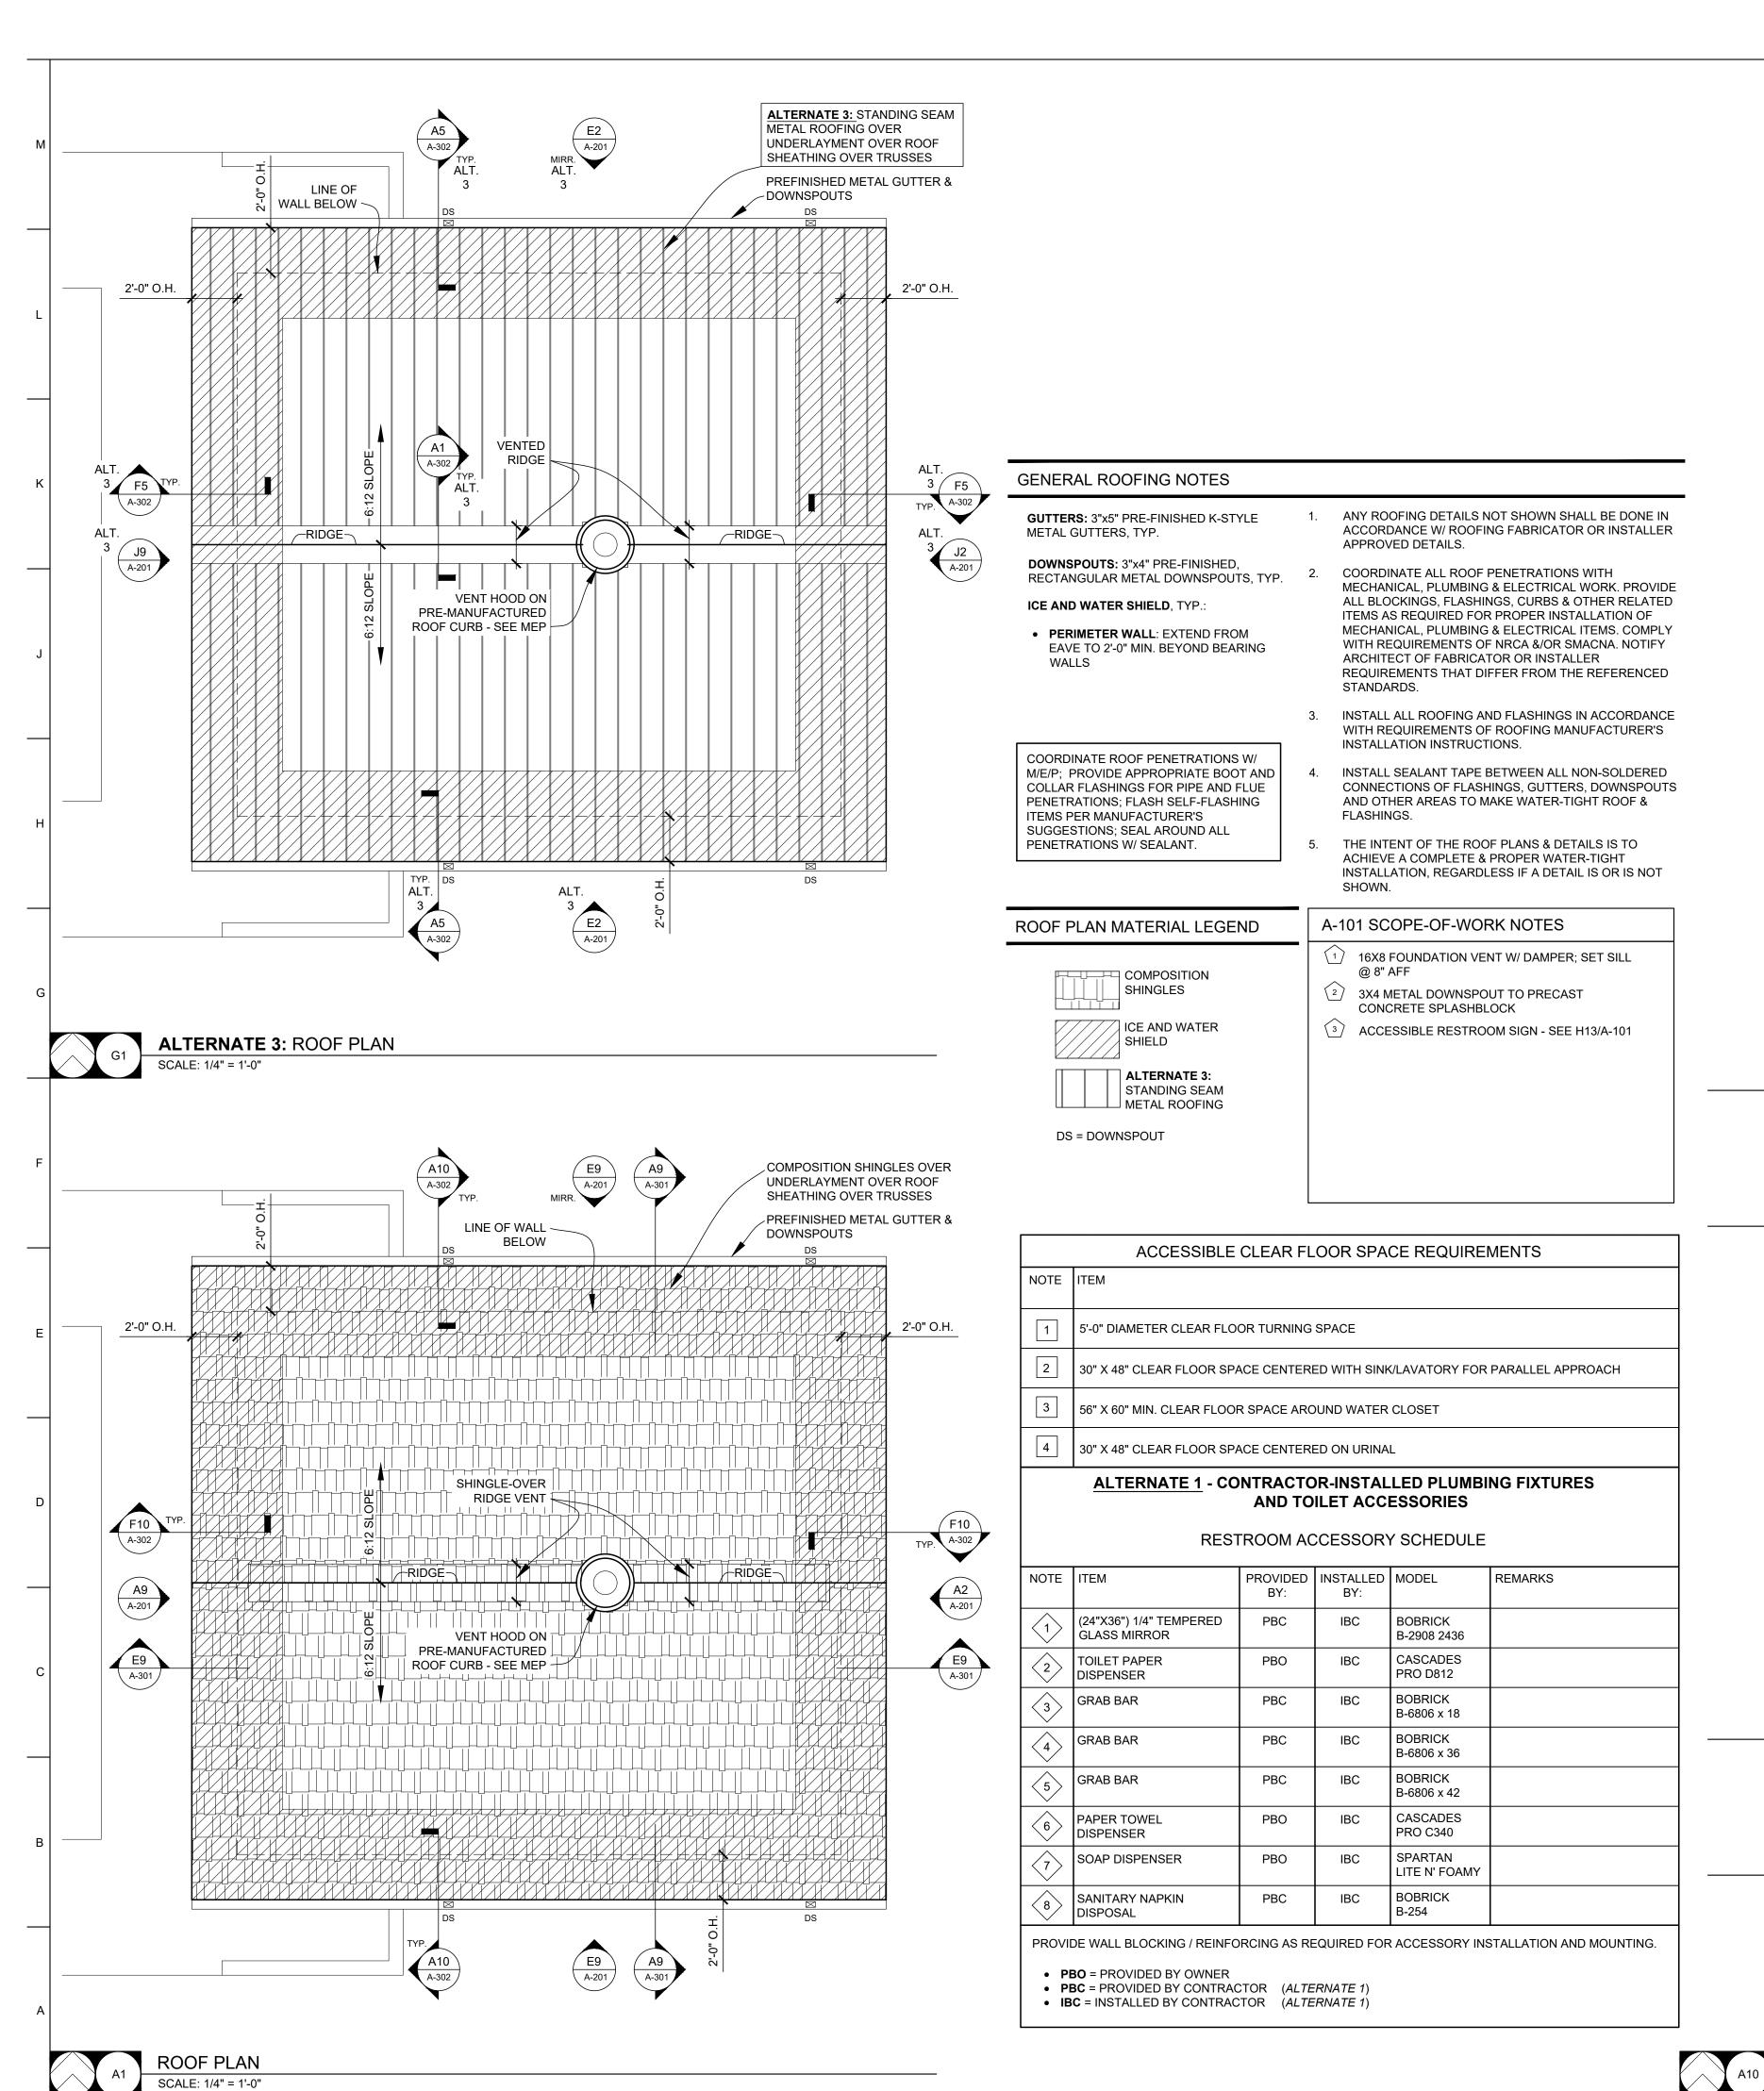

FLOOR PLAN PARTITION TYPE KEY

STRUCTURAL

8" SPLIT-FACE CMU WALL - SEE STRUCTURAL



FLOOR PLAN


SCALE: 1/4" = 1'-0"

4" CMU PARTITION WALL @ 6'-8" TALL, TYP. 8" CMU WALL - SEE


- FIELD VERIFY ALL DIMENSIONS AND WORK. NOTIFY ARCHITECT OF ANY ARCHITECT PRIOR TO PROCEEDING WITH
- AFFECTED BY SAME.
- LOCATE DOOR OPENINGS WHICH ARE NOT DIMENSIONED OTHERWISE, CENTERED IN WALL AND 6" FROM FINISH WALL TO FINISH
- 4. COORDINATE ALL FLOOR DRAINS AND OTHER REFERENCED MECHANICAL,

- **GENERAL FLOOR PLAN NOTES**
- CONDITIONS PRIOR TO EXECUTING ANY DIMENSIONS OR WORK DIFFERING FROM THAT SHOWN, FOR CLARIFICATION BY THE
- VERIFY ALL ROUGH OPENINGS FOR DOORS LOUVERS, EQUIPMENT, & OTHER "BUILT-IN" ITEMS PRIOR TO EXECUTION OF ANY WORK
- ELECTRICAL, OR PLUMBING ITEMS W/ M.E.P.

- 5. COORDINATE ALL REQUIRED UTILITIES
 - WITH EQUIPMENT MANUFACTURER.
 - ALL DIMENSIONS ARE TO FACE OF STUD OR MASONRY - UNLESS OTHERWISE NOTED.
 - DO NOT SCALE DRAWINGS WHERE DIMENSIONAL DISCREPANCIES ARE ENCOUNTERED NOTIFY ARCHITECT PRIOR TO PROCEEDING WITH THE WORK.
 - COORDINATE HEIGHTS OF OUTLETS & SWITCHING WITH ALL ARCHITECTURAL ITEMS. SEE M/E DRAWINGS FOR LOCATIONS.

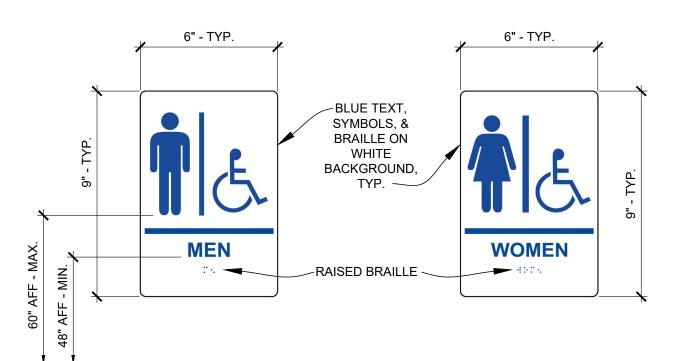

ACCESSIBLE RESTROOM SIGNS SCALE: N.T.S.

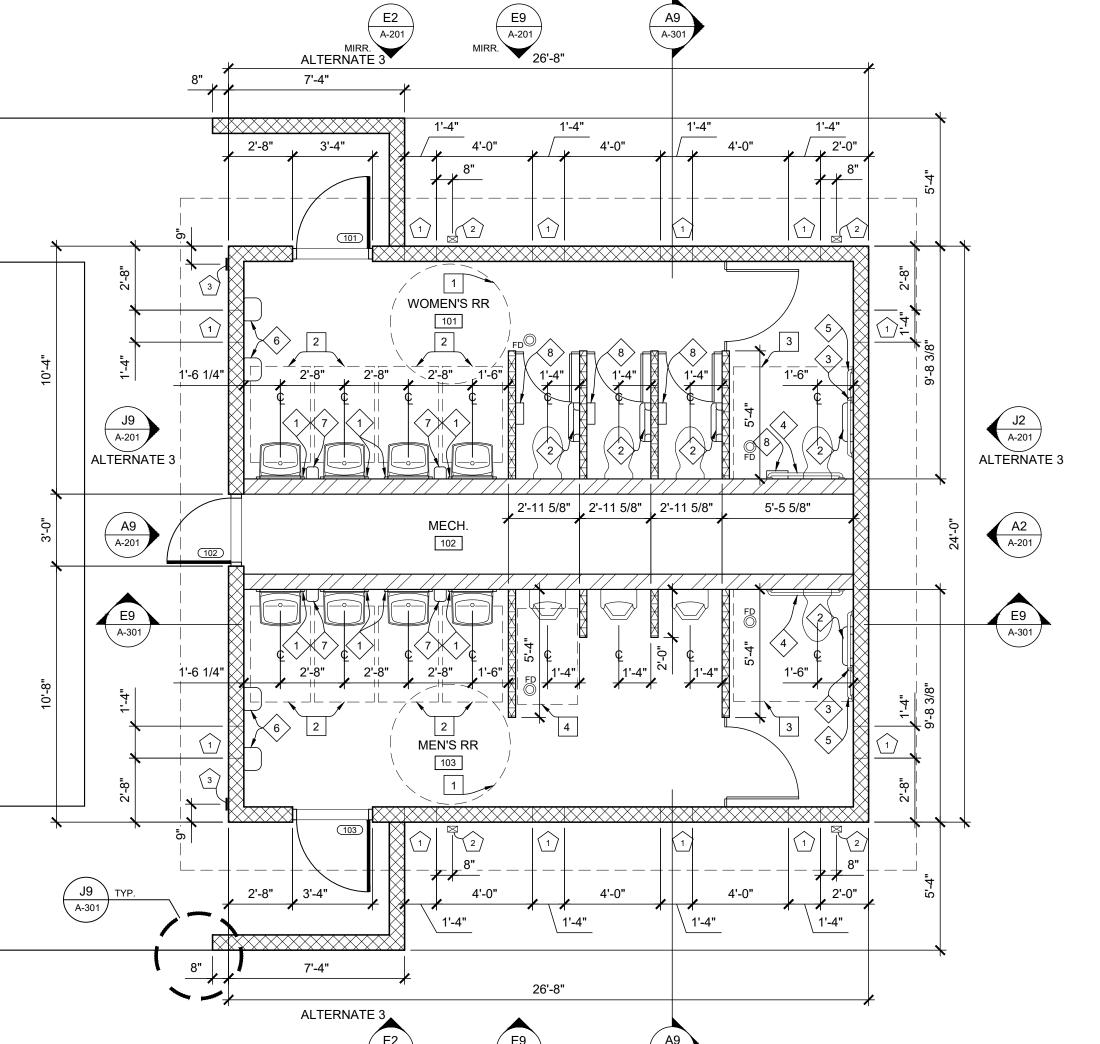

OFFICE OF ADMINISTRATION DIVISION OF FACILITIES MANAGEMENT, **DESIGN AND CONSTRUCTION**

STATE OF MISSOURI MICHAEL L. PARSON,

GOVERNOR

Peckham & Wright Architects, Inc., d.b.a.

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NEW COMFORT STATION

MISSOURI STATE FAIRGROUNDS (MSF) 2503 W. 16TH St.

SEDALIA, MO

PROJECT # F2206-01

3511501146

REVISION:

ASSET#

REVISION: **REVISION:**

DATE:

ISSUE DATE: 08/10/2022


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DESIGNED BY: ER

SHEET TITLE: FLOOR PLAN, ROOF PLAN,

SHEET NUMBER:

& DETAILS

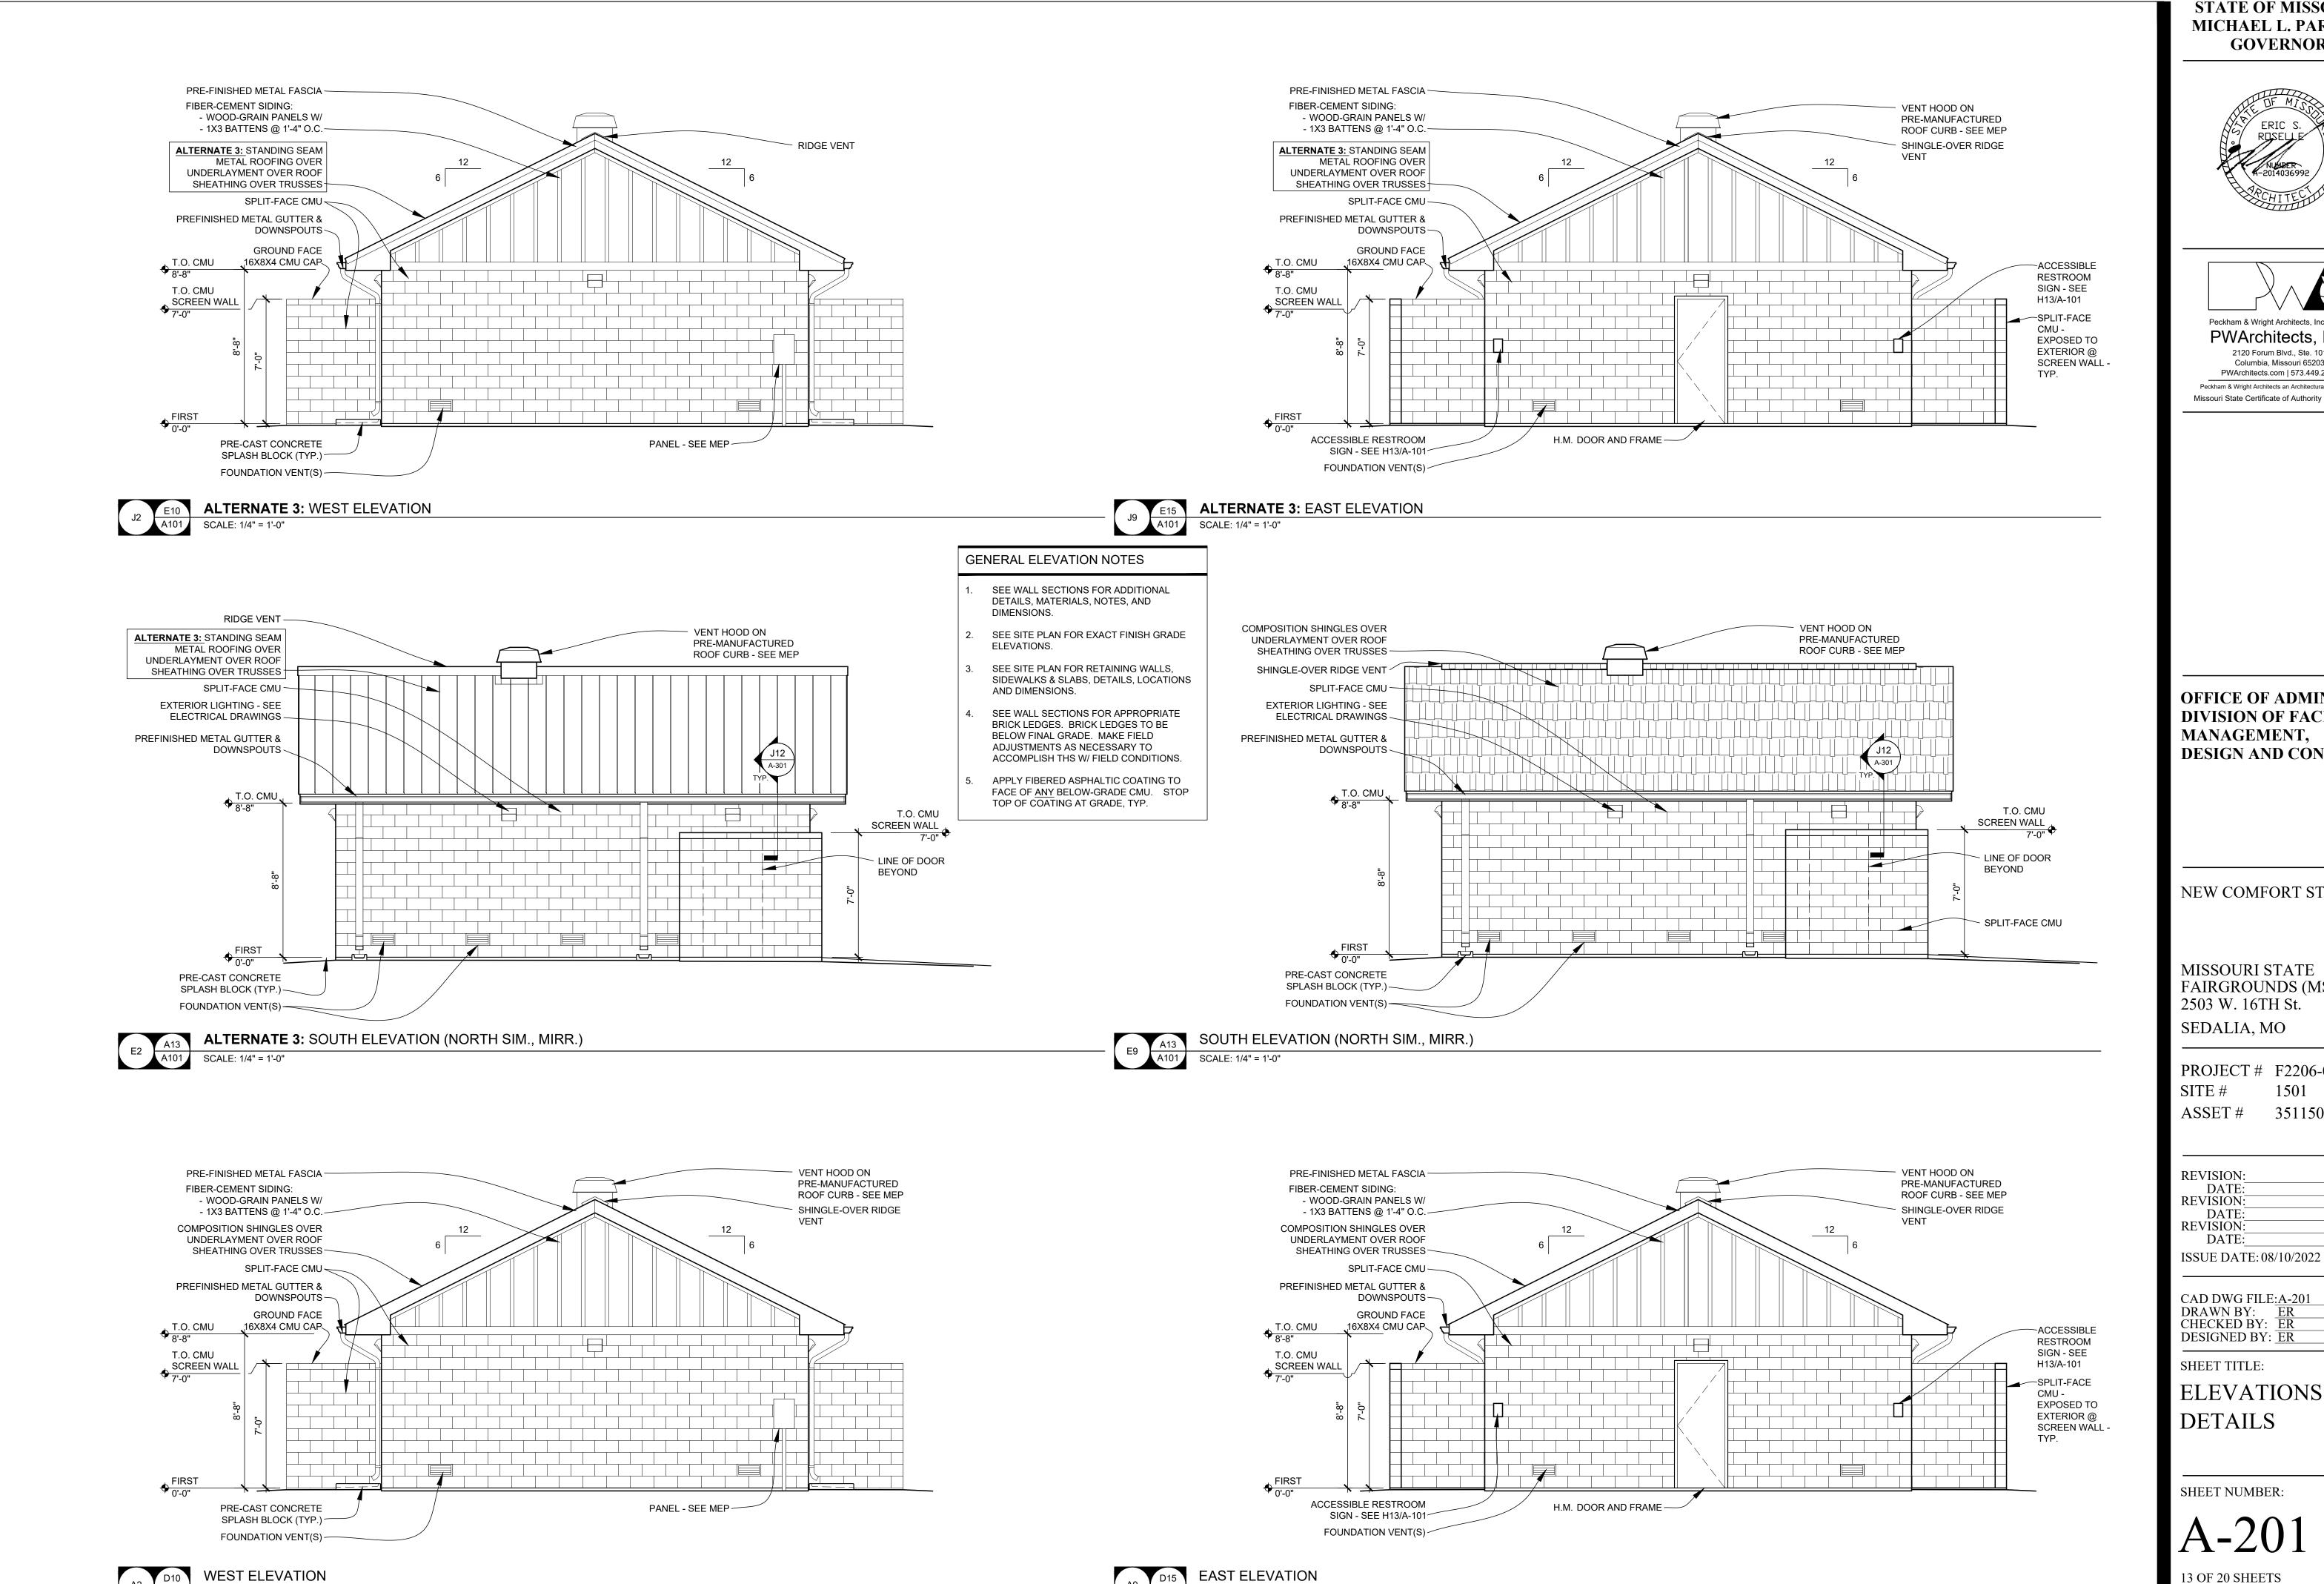

SCALE: 1/4" = 1'-0"

SCALE: 1/4" = 1'-0"

STATE OF MISSOURI MICHAEL L. PARSON, **GOVERNOR**





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OFFICE OF ADMINISTRATION DIVISION OF FACILITIES MANAGEMENT, **DESIGN AND CONSTRUCTION**

NEW COMFORT STATION

MISSOURI STATE FAIRGROUNDS (MSF) 2503 W. 16TH St. SEDALIA, MO

PROJECT # F2206-01 3511501146 ASSET#


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SHEET NUMBER:




SCALE: 1/4" = 1'-0"

SCALE: 1" = 1'-0"

STATE OF MISSOURI MICHAEL L. PARSON,

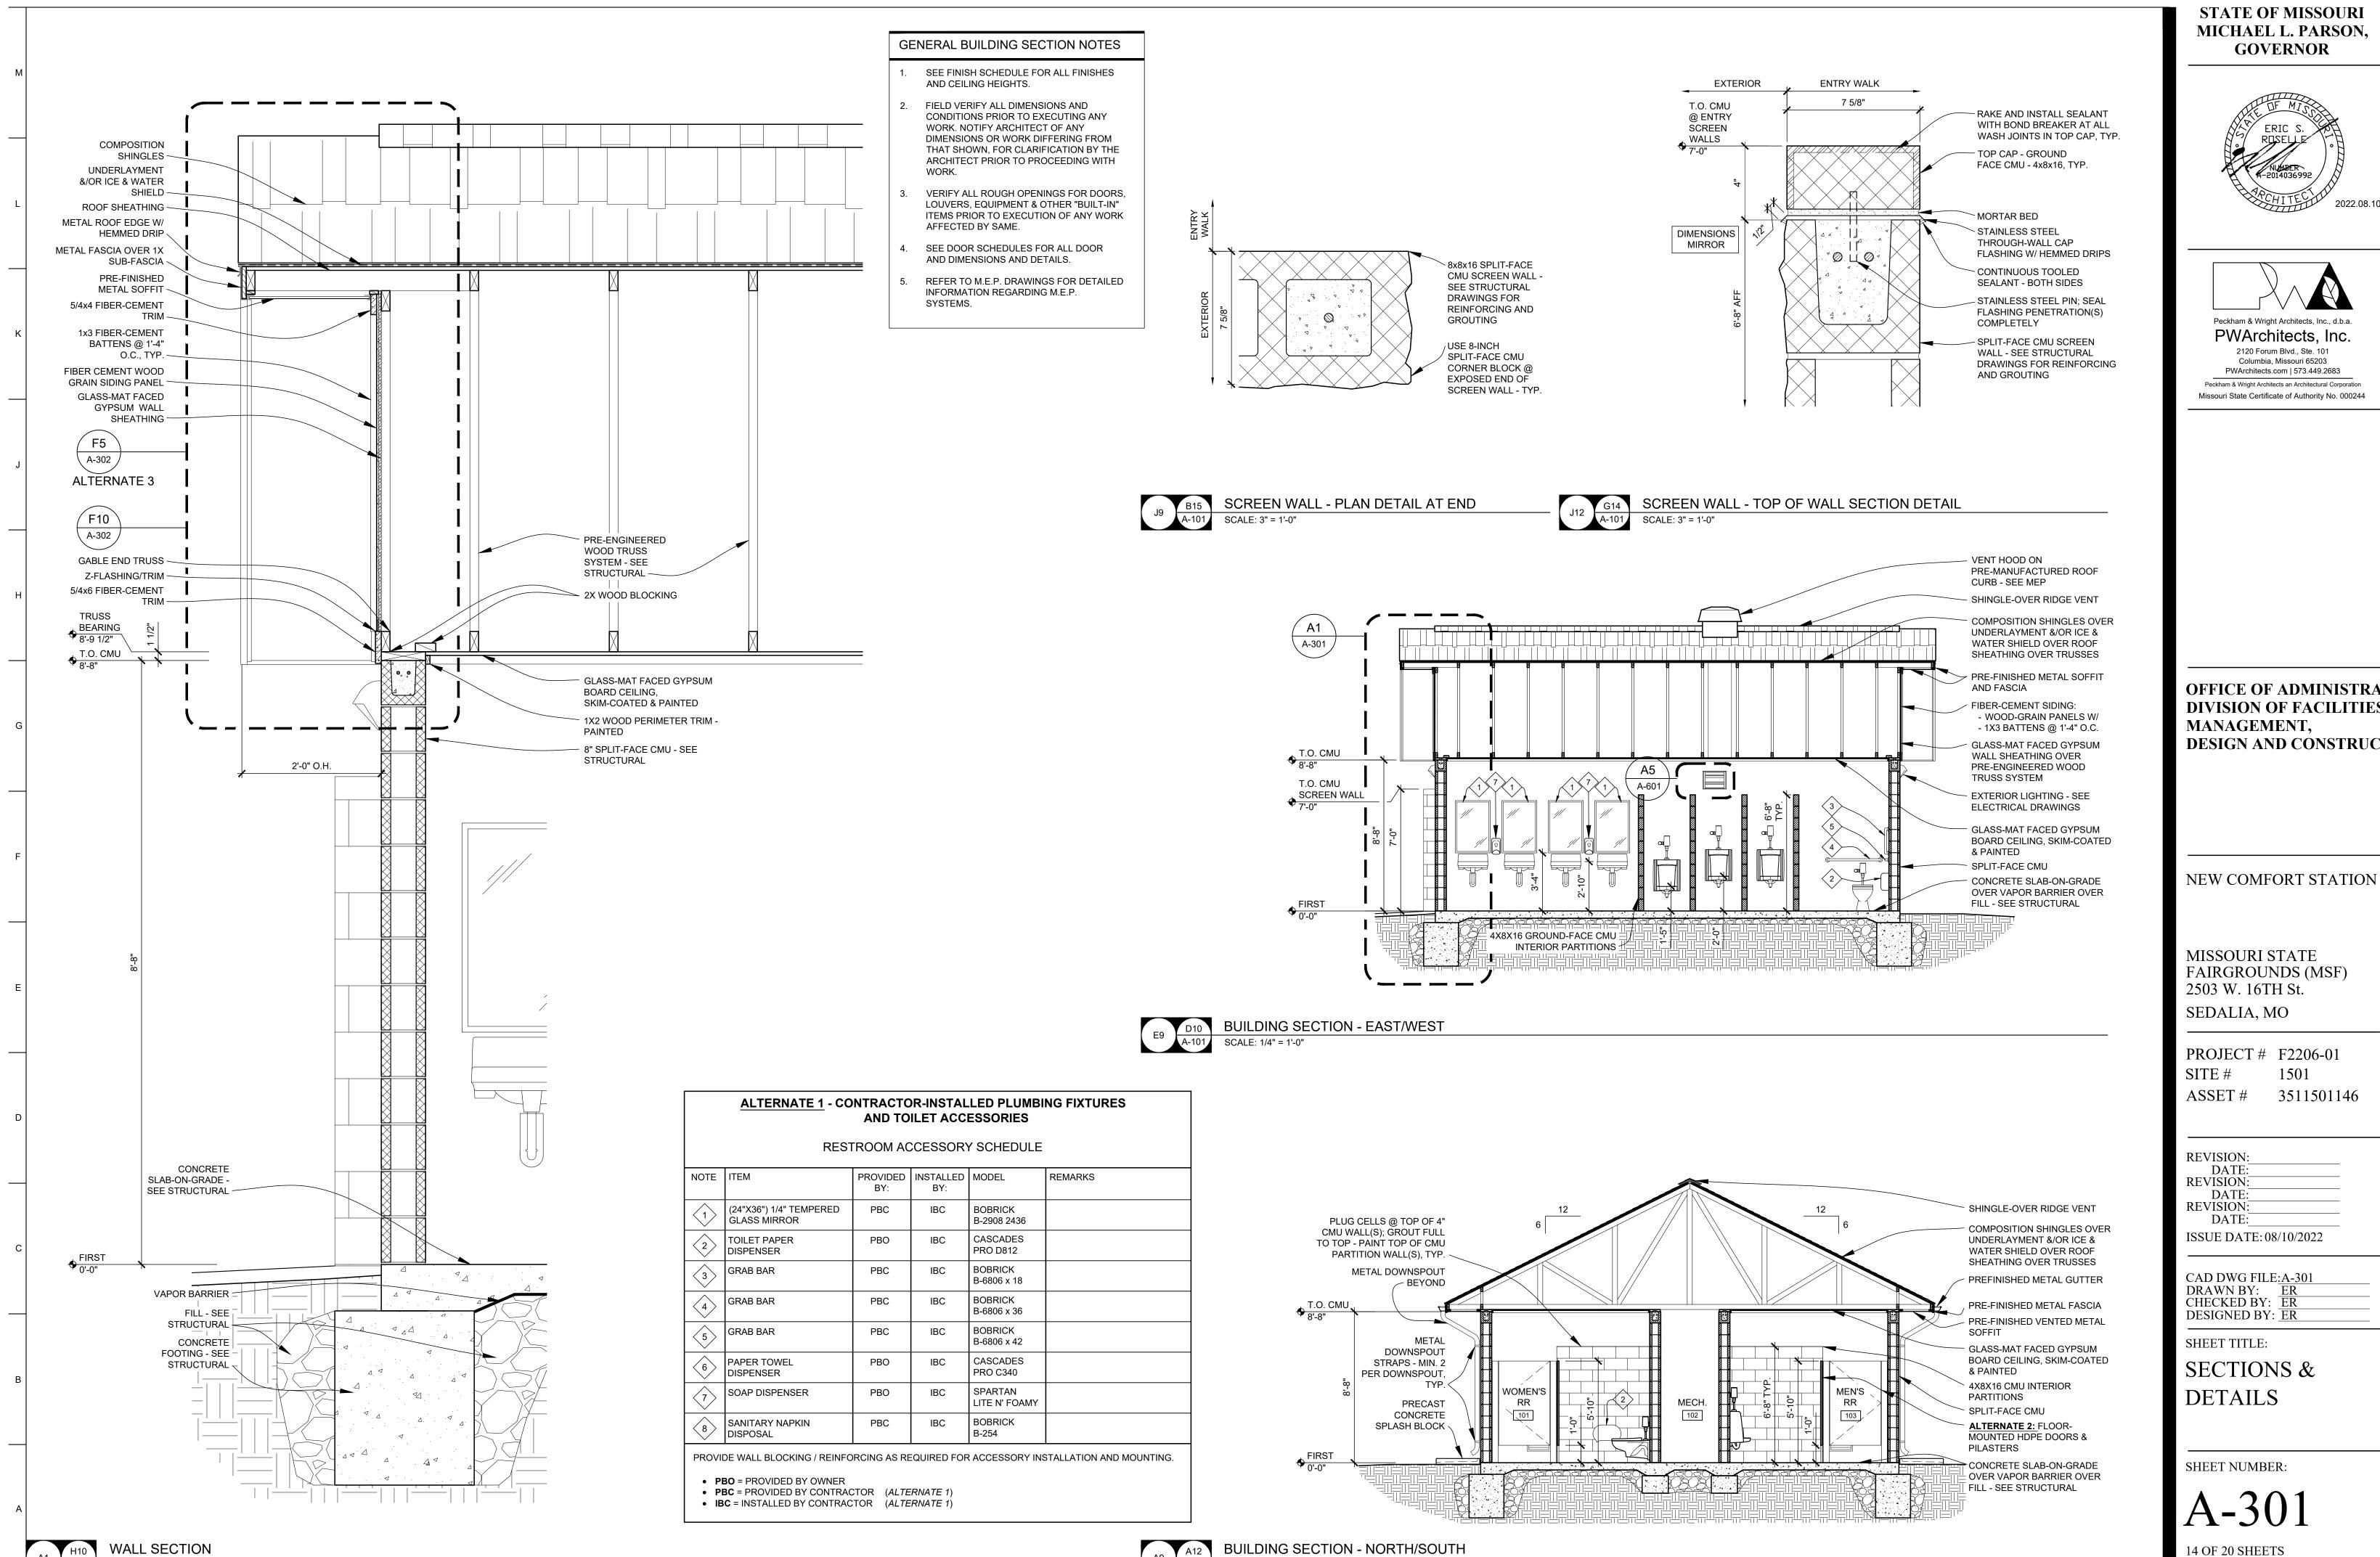

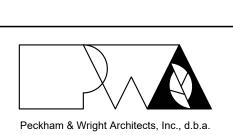



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OFFICE OF ADMINISTRATION **DIVISION OF FACILITIES DESIGN AND CONSTRUCTION**

MISSOURI STATE FAIRGROUNDS (MSF)

PROJECT # F2206-01



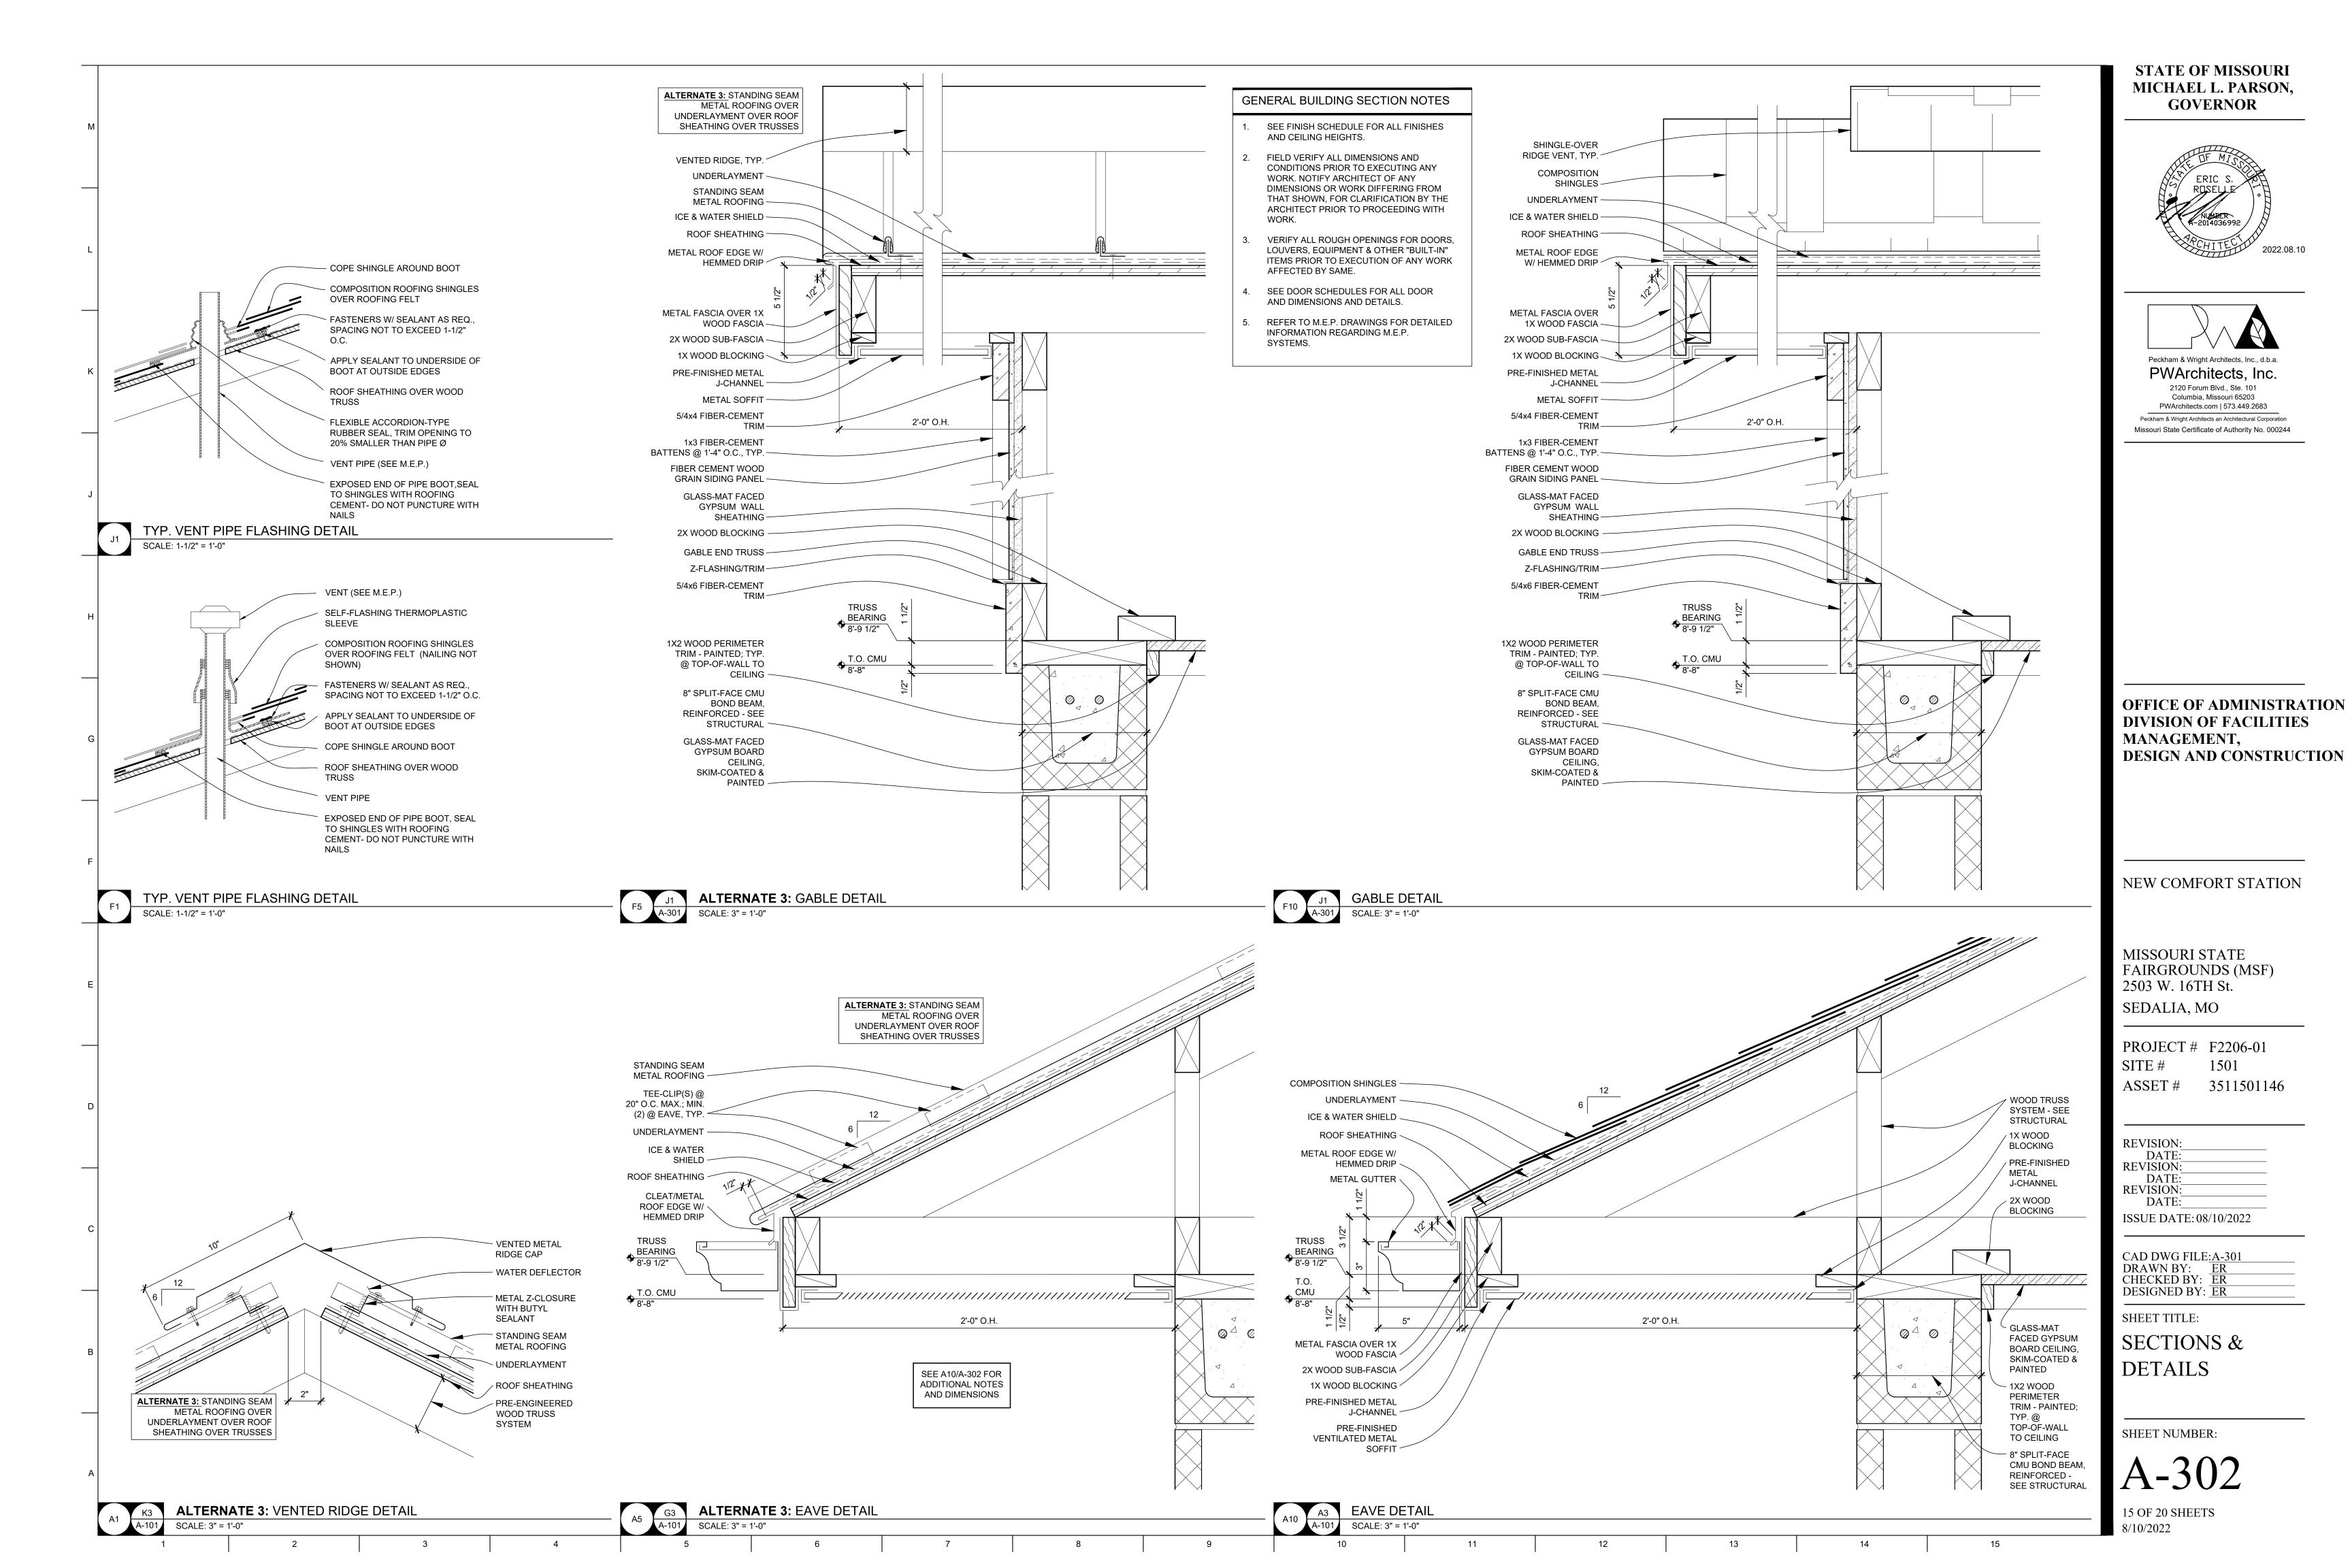

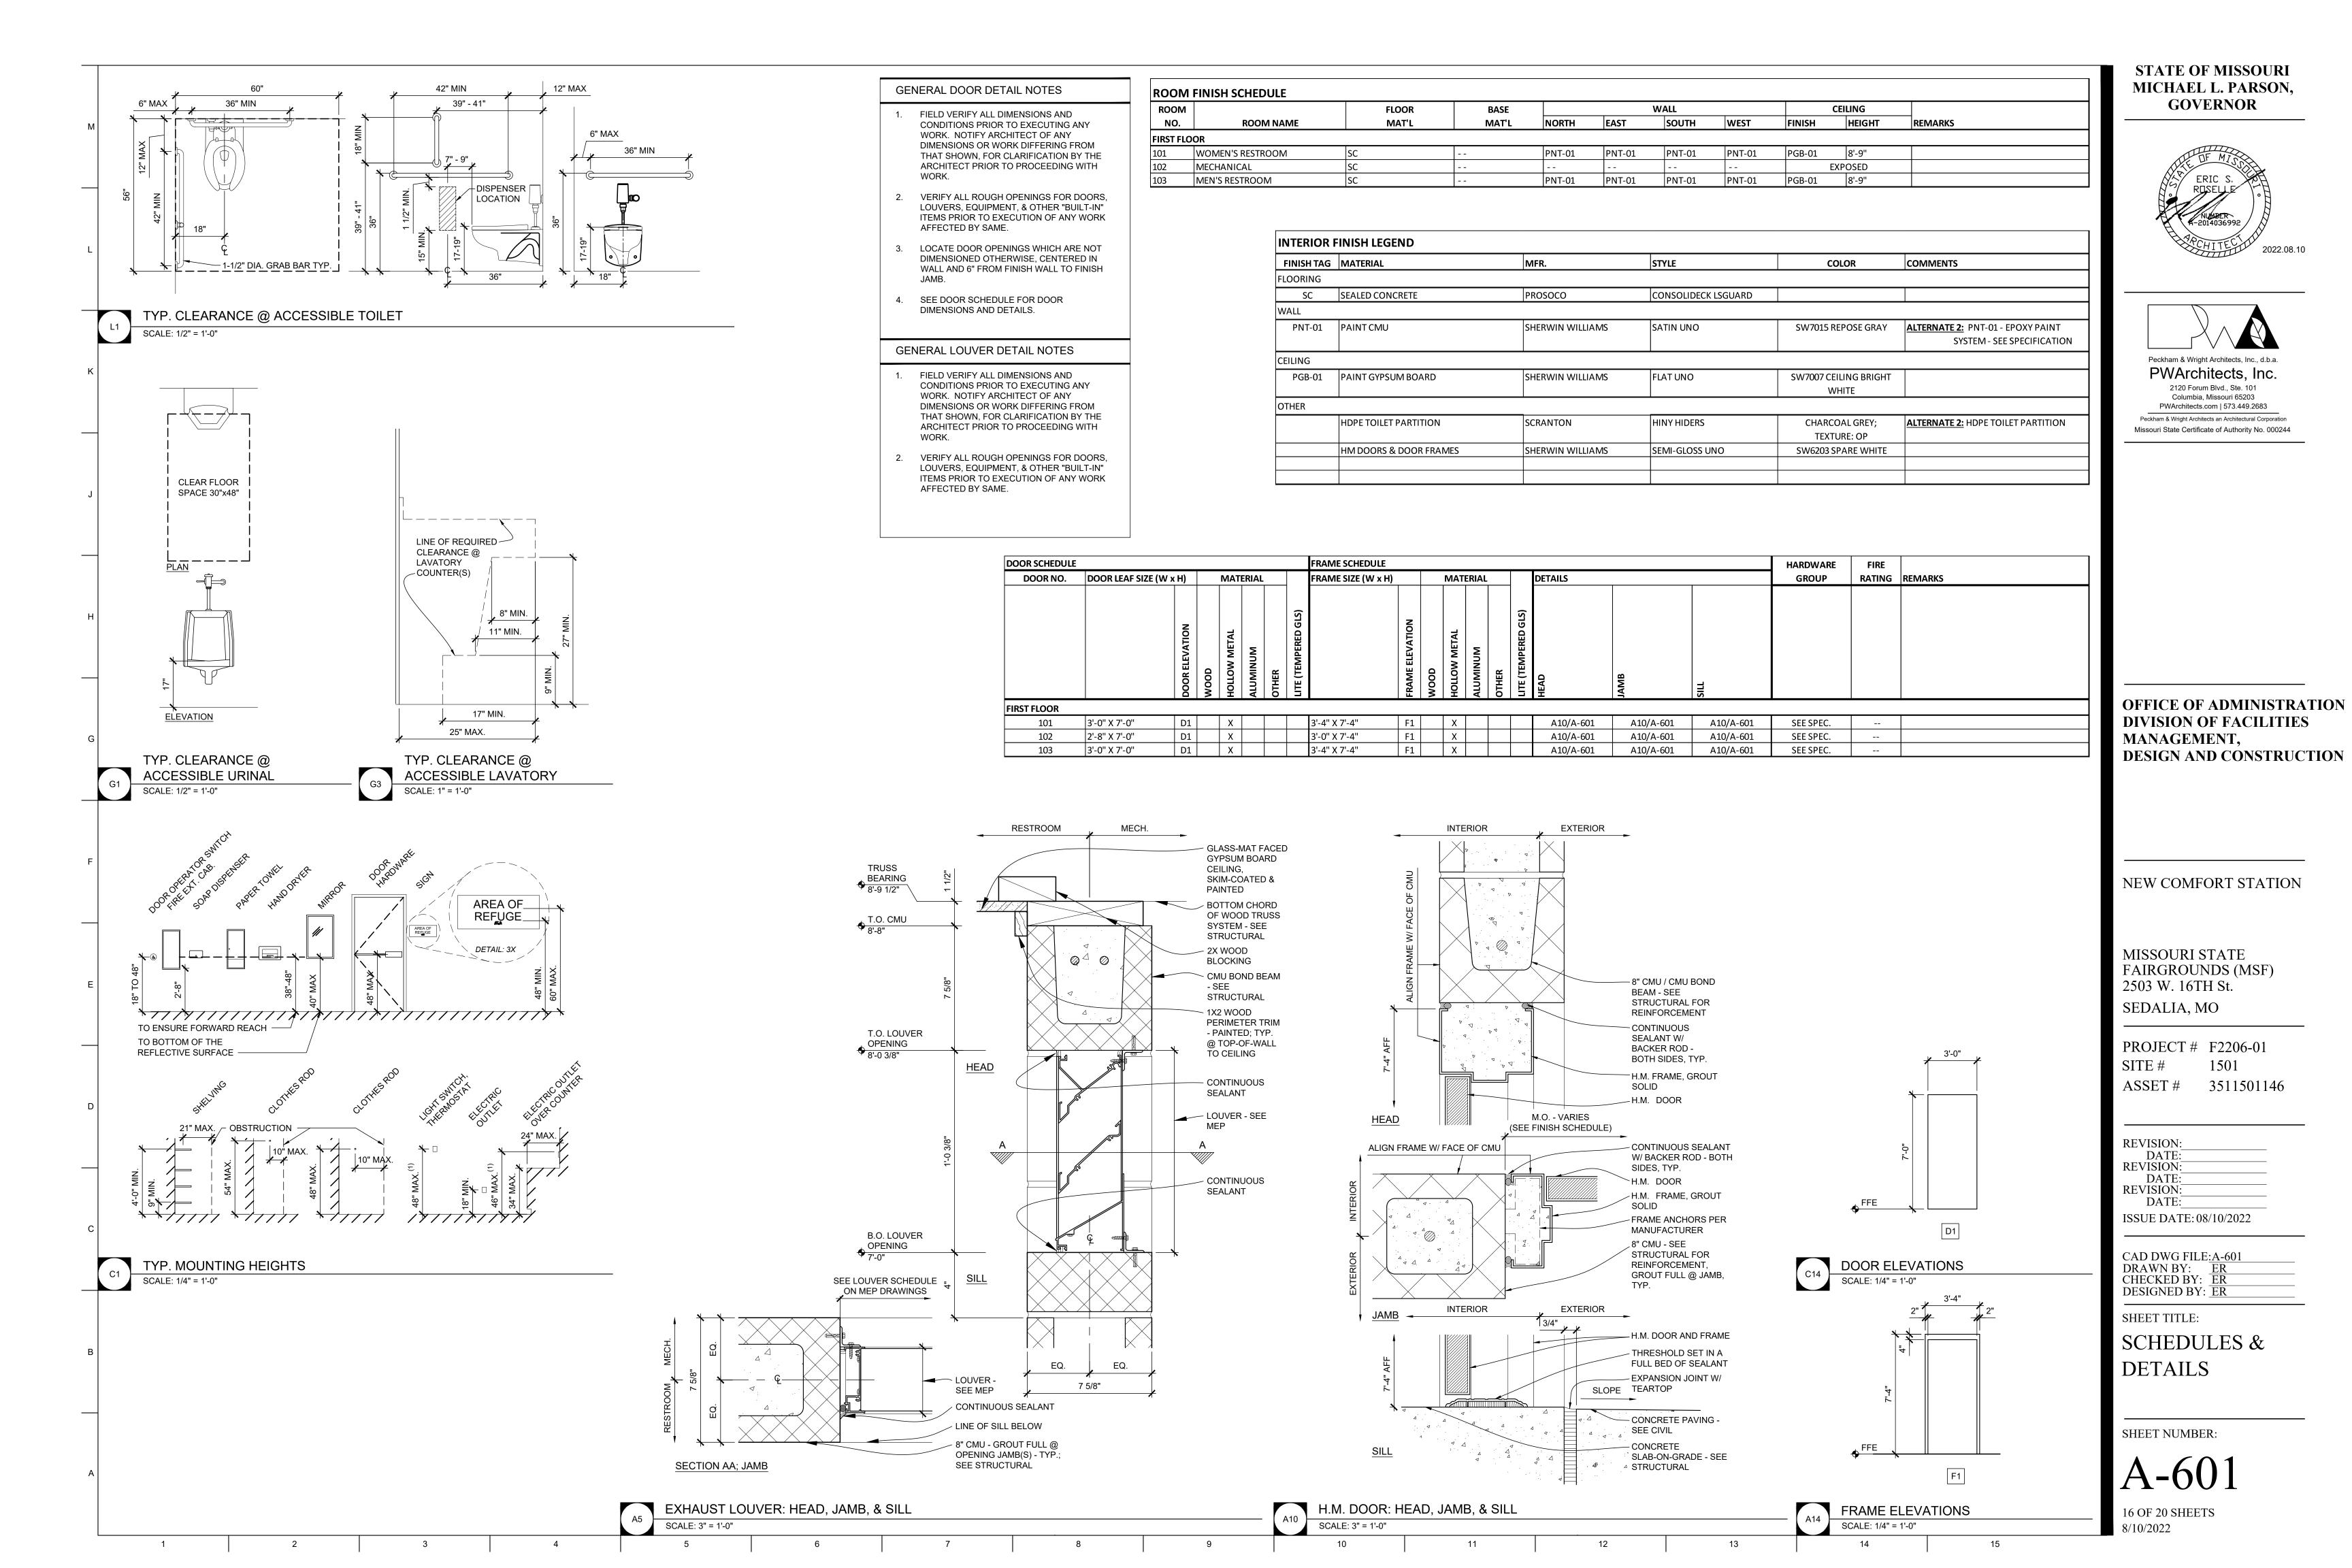GENERAL MEP SPECIFICATIONS

- 1. IT IS THE RESPONSIBILITY OF THE CONTRACTOR TO REVIEW AND UNDERSTAND ALL DRAWINGS AND SPECIFICATIONS IN THE CONTRACT DOCUMENTS. EACH CONTRACTOR IS RESPONSIBLE FOR ALL WORK ASSOCIATED WITH HIS TRADE REGARDLESS OF WHERE THE WORK IS DEPICTED IN THE DRAWINGS OR SPECIFICATIONS.
- 2. THE LAYOUT OF SYSTEMS SHOWN ON PLANS ARE APPROXIMATE AND WILL NEED TO BE COORDINATED IN FIELD. THE CONTRACTOR SHALL INCLUDE THIS COORDINATION IN HIS SCOPE AND INCLUDE ALL COSTS OF MODIFYING THE LAYOUT AS REQUIRED IN HIS BID.
- 3. THE CONTRACTOR IS RESPONSIBLE FOR PROVIDING ALL NECESSARY PARTS AND LABOR TO PRODUCE A COMPLETE AND FULLY OPERATIONAL SYSTEM UNLESS STATED OTHERWISE ON
- 4. ALL MATERIALS TO BE NEW, FIRST CLASS, AND INSTALLED PER MANUFACTURE'S PUBLISHED INSTRUCTIONS.
- 5. ALL WORK SHALL BE PERFORMED IN COMPLIANCE WITH LOCALLY ADOPTED CODES AND ORDINANCES.
- 6. CONTRACTOR IS RESPONSIBLE FOR COORDINATING EQUIPMENT LOCATIONS AND SYSTEM ROUTING WITH OTHER TRADES PRIOR TO INSTALLATION.
- 7. CONTRACTOR TO GUARANTEE ALL MATERIALS AND WORKMANSHIP FOR A PERIOD OF ONE YEAR
- FROM THE DATE THE PROJECT IS TURN OVER TO THE OWNER, UNLESS NOTED OTHERWISE. 8. CONTRACTOR IS TO INCLUDE IN THEIR SCOPE THE COST OF ALL PERMITS, INSPECTIONS,
- METERING, AND TAPS ASSOCIATED WITH THEIR WORK. 9. CONTRACTOR IS RESPONSIBLE FOR ALL EXCAVATION, CUTTING, CORING, PATCHING, AND
- BACKFILL REQUIRED TO COMPLETE THEIR WORK, UNLESS NOTED OTHERWISE.
- 10. THESE PLANS ARE NOT TO BE SCALED. SEE ARCHITECTURAL PLANS FOR DIMENSIONS. WHERE THERE IS A CONFLICT BETWEEN ARCHITECTURAL DIMENSIONS AND MEP DIMENSION,
- ARCHITECTURAL SHALL GOVERN. 11. SEE DISCIPLINE SHEETS FOR ADDITIONAL DISCIPLINE SPECIFIC SPECIFICATIONS.

REFERENCED CODES IN EFFECT


2018 INTERNATIONAL MECHANICAL CODE

2018 INTERNATIONAL PLUMBING CODE

2018 INTERNATIONAL FUEL GAS CODE

2018 INTERNATIONAL FIRE CODE 2017 NATIONAL ELECTRIC CODE


2018 INTERNATIONAL ENERGY CONSERVATION CODE

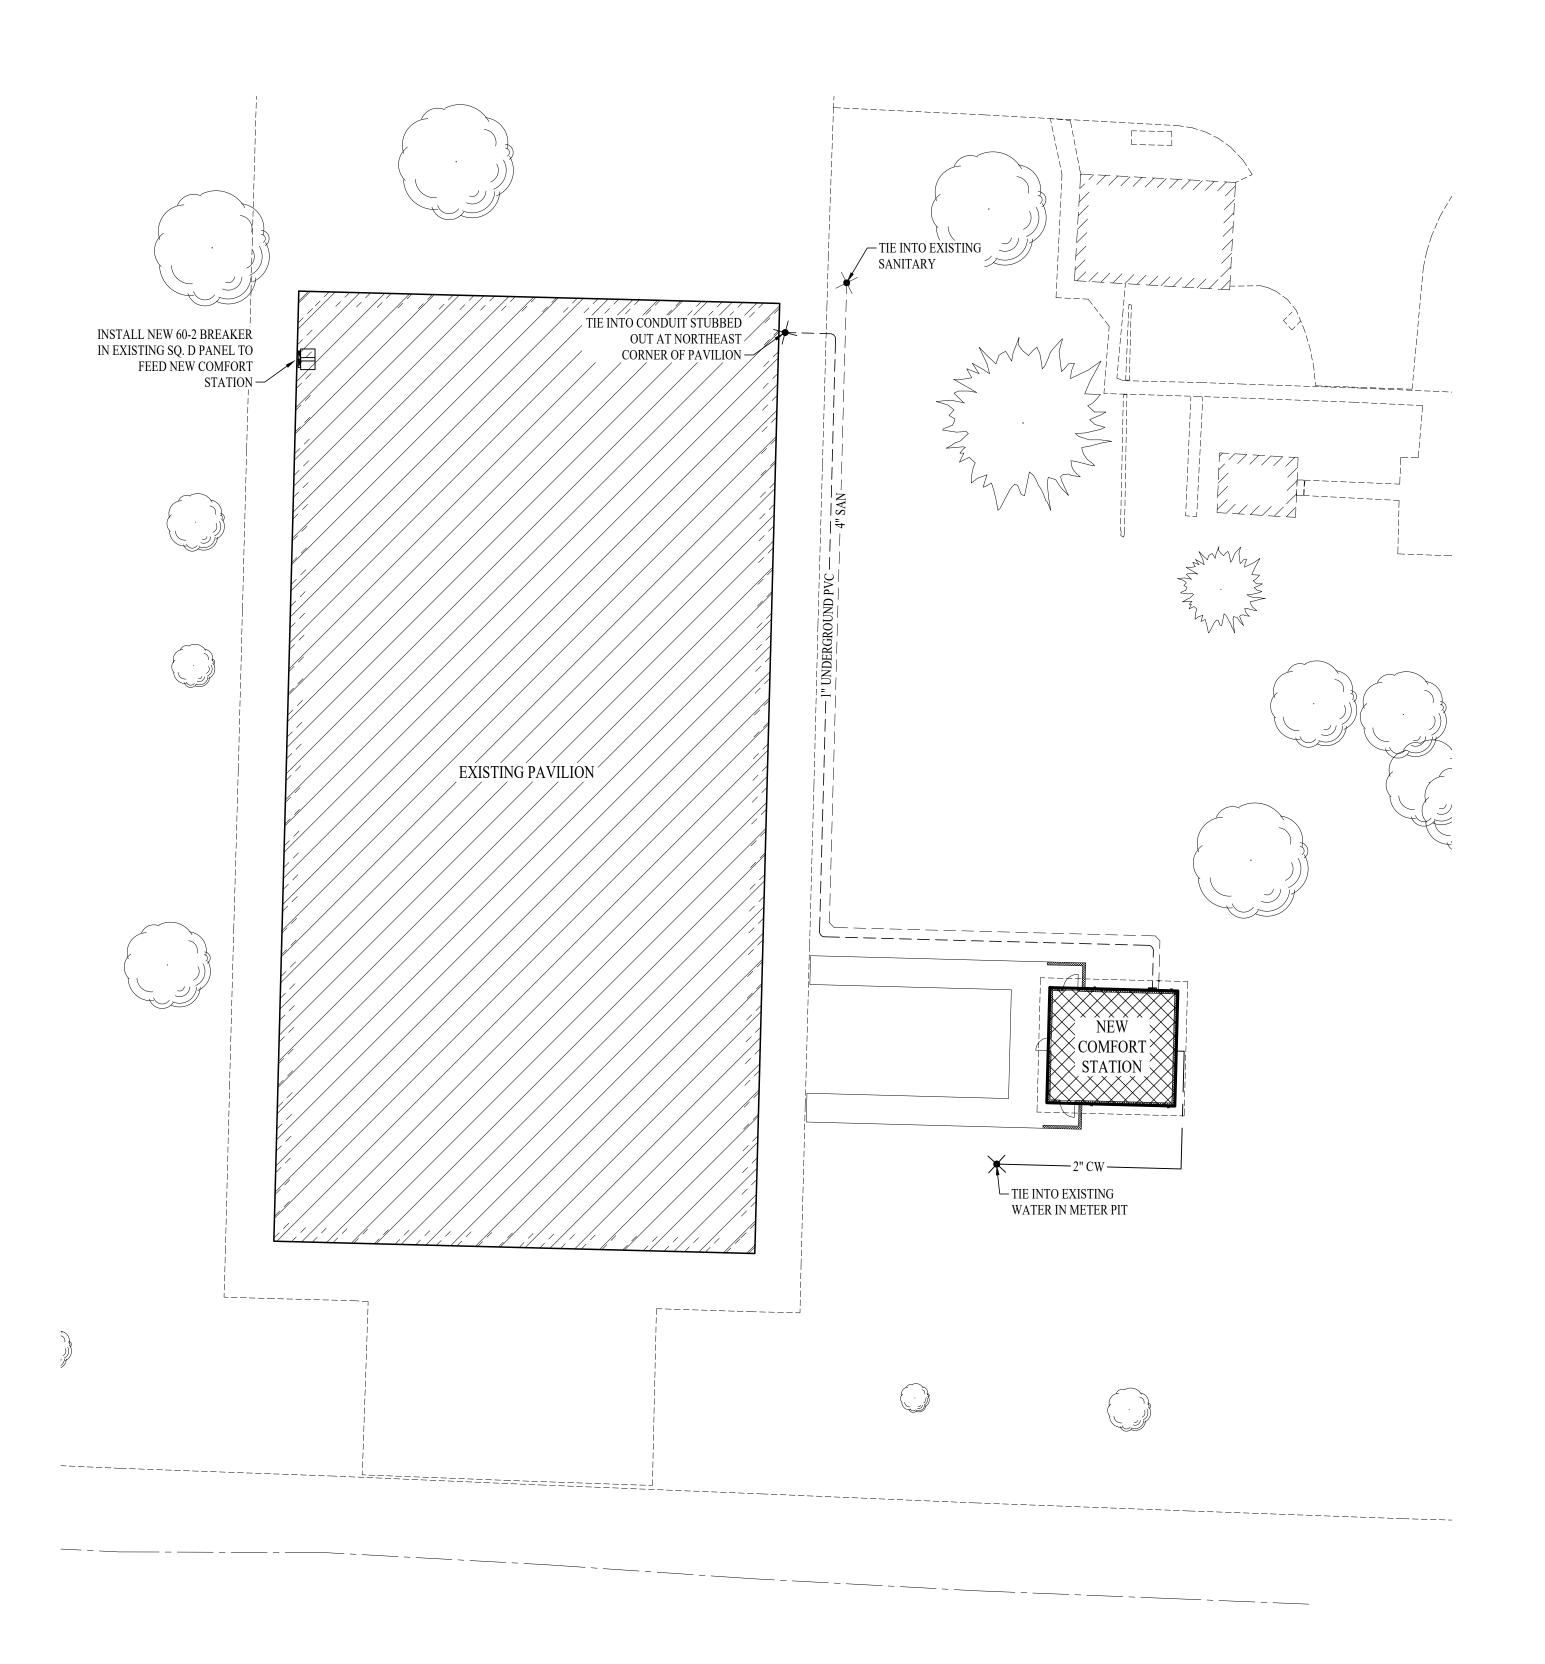

MEP SITE PLAN

SCALE: 1'' = 20 ft

STATE OF MISSOURI MICHAEL L. PARSON, **GOVERNOR**

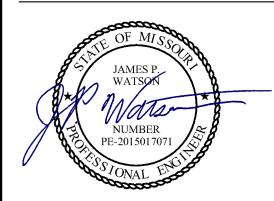


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OFFICE OF ADMINISTRATION DIVISION OF FACILITIES MANAGEMENT, **DESIGN AND** CONSTRUCTION

NEW COMFORT STATION

MISSOURI STATE FAIRGROUNDS (MSF) 2503 W. 16th St. SEDALIA, MO

F2206-01

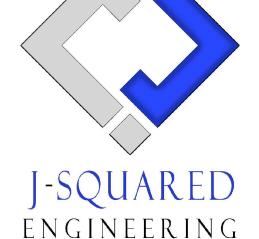1501

PROJECT# SITE# ASSET# 35111501147

REVISION: REVISION: **REVISION:** DATE: ISSUE DATE: 08/10/2022

CAD DWG FILE: J20736 DRAWN BY: DET CHECKED BY: JPW DESIGNED BY: JAP

SHEET TITLE:

MEP SITE UTILITIES PLAN

SHEET NUMBER:

17 OF 20 SHEETS

HVAC PLAN SYMBOL LEGEND

EQUIPMENT TYPE (REFER TO EQUIPMENT SCHEDULE)

EQUIPMENT REFERENCE NUMBER


DIFFUSER/GRILLE TYPE (REFER TO SCHEDULE)

CUBIC FEET PER MINUTE (CFM) / FACE SIZE

EXHAUST DUCTWORK


		FAN SCH	EDULE				
TAG	EQUIDMENT DESCRIPTION	TYDE	AIRFLOW		ELECTRICAI	د	NOTES
IAG	EQUIPMENT DESCRIPTION	TYPE	(CFM)	VOLTS/PH	MCA	OCP	NULES
EF-1	EXHAUST FAN	INLINE	1200	120	4	20	1
NOTES:							
1.	EQUAL TO SOLER & PALAU TD SERI	ES (FLOW RATED A	AT 0.375" ESP))			

AIR DEVICE SCHEDULE							
TAG	SERVICE	MANUFACTURER (OR EQUAL)	MODEL (OR EQUAL)	SIZE	COLOR/ FINISH	NOTES	
L1	EXHAUST	POTTORFF	EFJ-445	AS INDICATED	PRIMED	PAINT TO MATCH WALL	
NOTES:							
1.	VERIFY AIR I	DEVICE FINISHES WITH C	WNER/ARCHITECT	Γ PRIOR TO INSTAI	LATION		

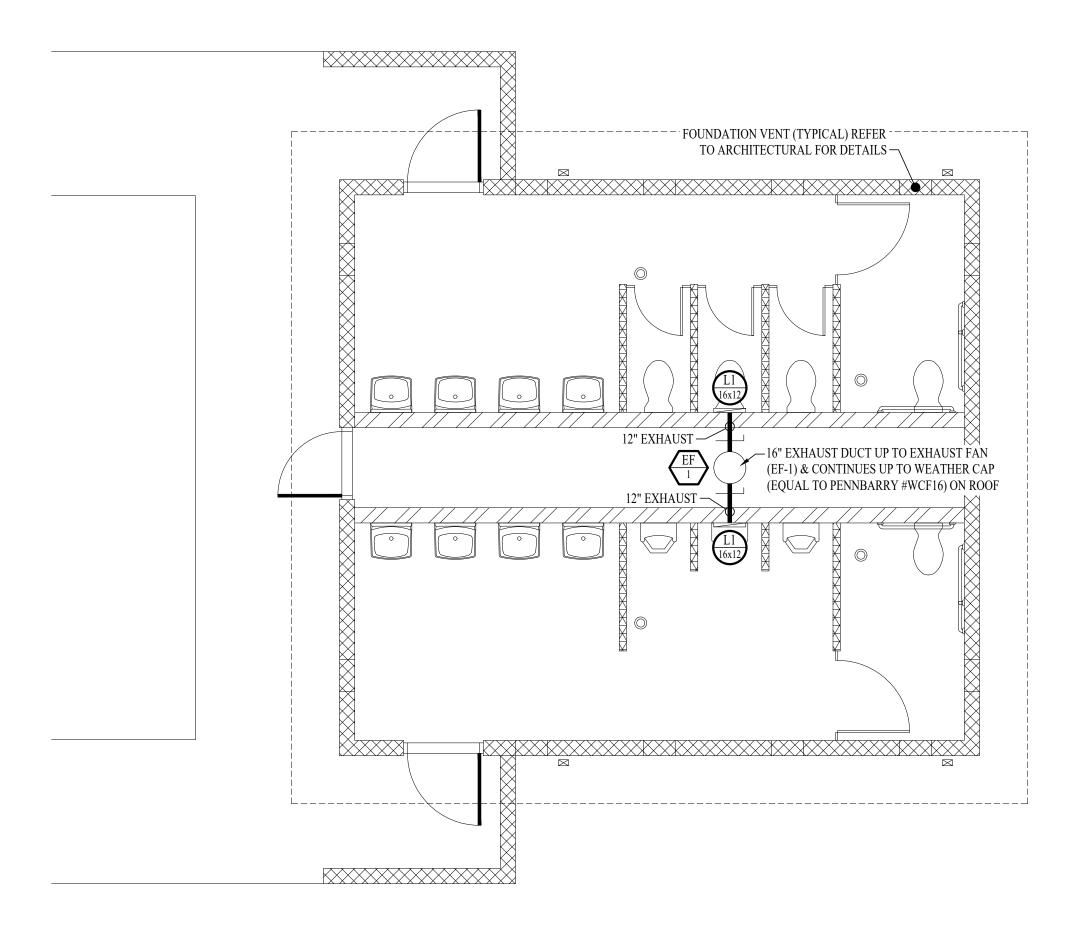



STATE OF MISSOURI MICHAEL L. PARSON, **GOVERNOR**

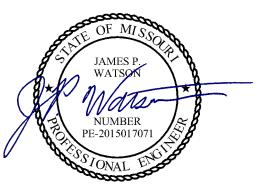


August 10th, 2022 James Watson, P.E. PE-2015017071 MO Certificate of Authority # 2018029680



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Missouri State Certificate of Authority No. 000244

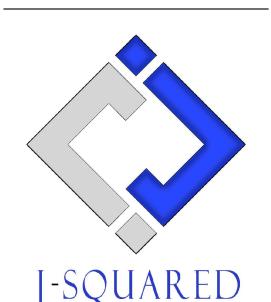

OFFICE OF ADMINISTRATION **DIVISION OF FACILITIES** MANAGEMENT, **DESIGN AND**

NEW COMFORT STATION

CONSTRUCTION

MISSOURI STATE FAIRGROUNDS (MSF) 2503 W. 16th St. SEDALIA, MO

PROJECT # ASSET#

F2206-01 1501 35111501147

REVISION: DATE: REVISION: DATE: REVISION: DATE: ISSUE DATE: 08/10/2022

CAD DWG FILE: J20736
DRAWN BY: DET
CHECKED BY: JPW
DESIGNED BY: JAP

SHEET TITLE:

HVAC PLAN

SHEET NUMBER:

ELECTRICAL PLANS SYMBOL LEGEND

_ _ _ CIRCUIT WIRING

→ PX-XX CIRCUIT TAG

GFCI DUPLEX CONVENIENCE RECEPTACLE INDICATES MOUNTING HEIGHT TO BOTTOM OF BOX (STANDARD @ 18" AFF UNLESS NOTED OTHERWISE)

"WP" = WEATHERPROOF OUTDOOR RECEPTACLE "AW" = ABOVE WINDOW RECEPTACLE

"AC" = ABOVE CEILING RECEPTACLE "EX" = EXISTING RECEPTACLE TO REMAIN

"X1" INDICATES FIXTURE TYPE (REFER TO SCHEDULE) LIGHTING FIXTURE "EM" INDICATES EMERGENCY BATTERY BACKUP

"NL" INDICATES UN-SWITCHED NIGHT LIGHT

SWITCH (WALL MOUNTED)

 $\bullet \qquad 3 = 3\text{-WAY}$ $\bullet \qquad 4 = 4\text{-WAY}$

 OP = PASSIVE INFRARED OCCUPANCY SENSOR OU = ULTRASONIC OCCUPANCY SENSOR

• OT = DUAL-TECHNOLOGY OCCUPANCY SENSOR

• VP = PASSIVE INFRARED VACANCY SENSOR VU = ULTRASONIC VACANCY SENSOR

• VT = DUAL-TECHNOLOGY VACANCY SENSOR

• M = MOMENTARY SWITCH • SS = SCENE SWITCH

SWITCH (CEILING MOUNTED)

SEE "SWITCH (WALL MOUNTED)" FOR TYPE DESIGNATIONS

POWER PLAN KEY NOTES:

- (1) WIRE EXTERIOR LIGHTS THRU PHOTOCELL MOUNTED ON BUILDING EXTERIOR RAKE BOARD. PHOTOCELL TO FACE NORTH.
- (2) CONTRACTOR TO PROVIDE & INSTALL RELAY / CONTACTOR TO ISOLATE LIGHTING CIRCUIT FROM MEN'S RESTROOM LIGHTING FROM WOMEN'S RESTROOM LIGHTING. BOTH SHALL TURN ON

ALTERNATE #1 - CONTRACTOR-INSTALLED PLUMBING FIXTURES & TOILET ACCESSORIES:

- 1. CONTRACTOR TO:
- a. PROVIDED & INSTALL PLUMBING FIXTURES TO INCLUDE WATER CLOSETS & FLUSH VALVES, URINALS & FLUSH VALVES, LAVATORIES & FAUCETS. b. CONTRACTOR PROVIDED & INSTALLED TOILET ACCESSORIES AS NOTED IN THE "RESTROOM
- ACCESSORY SCHEDULE INCLUDED ON SHEETS A-101 & A-301.
- a. CONTRACTOR TO INCLUDE ROUGH-IN & WALL-HUNG BRACKETS FOR THE WATER CLOSETS, URINALS, & LAVATORIES. OWNER TO PROVIDE & INSTALL ALL TOILET ACCESSORIES.

ALTERNATE #2 - WATER HEATER, EXTERIOR LIGHTING, INTERIOR LIGHTING, TOILET PARTITIONS, & EPOXY COATING:

- a. CONTRACTOR TO PROVIDE AND INSTALL WATER HEATER WITH WALL KITS AS SHOWN AND
- b. CONTRACTOR TO PROVIDE AND INSTALL ALL EXTERIOR AND INTERIOR LIGHTING FIXTURES AS
- SHOWN AND NOTED ON SHEET E-101. c. CONTRACTOR TO PROVIDE AND INSTALL HDPE TOILET COMPARTMENT DOOR/PILASTER
- ASSEMBLIES (INCLUDING HARDWARE) AS SHOWN ON SHEETS A-101 AND A-301. d. CONTRACTOR TO PROVIDE AND INSTALL EPOXY WALL COATING PNT-01, AS SHOWN THE
- INTERIOR FINISH LEGEND ON SHEET A-601.
- - a. PROVIDE ALL PLUMBING AND ELECTRICAL ROUGH-IN FOR FUTURE WATER HEATER AND WALL KIT TO BE INSTALLED BY OWNER. PROVIDE BLANK PLATE AT JUNCTION BOX; TEMPORARILY
 - b. PROVIDE ALL ELECTRICAL ROUGH-IN FOR FUTURE EXTERIOR AND INTERIOR LIGHTING
- FIXTURES TO BE INSTALLED BY OWNER.PROVIDE BLANK PLATES AT JUNCTION BOXES. c. DO NOT PROVIDE HDPE TOILET PARTITIONS.

d. CMU TO REMAIN EXPOSED; WALLS WILL BE FINISHED AND PAINTED BY OWNER.

	VOLTAGE		PANEL SIZE MOUNTING AI		AIC RATING					
	120/208V		120/208V						PHASE"A" LOAD	18.5
	120/200V		120/208V		MCB	SUR	FACE	22,000	PHASE "B" LOAD	11
	NEMA RATING: 3R									
CIRCUIT NUMBER	DESCRIPTION	BREAKER SIZE	AMPS	PHASE	AMPS	BREAKER SIZE	DESCRIPTION	CIRCUIT NUMBER		
1	WOMEN'S RESTROOM RECEPTS	20-1	3	A	3	20-1	MEN'S RESTROOM RECEPTS	2		
3	MECH & EXTERIOR RECEPTS	20-1	3	В	8	20-1	LIGHTS AND EXHUAST FAN	4		
5	SPARE	20-1		A	12.5	20-1	WATER HEATER	6		
7	SPARE	20-1		В				8		
9	SPARE	20-1		A				10		
11	SPARE	20-1		В				12		
13	SPARE	20-1		A				14		
15	SPARE	20-1		В				16		

MODEL NUMBER

(OR EQUAL)

HVSL8-4-LD42SD-40-UNV-C-EDC1

XTOR2B-W

1. VERIFY LIGHT FIXTURE FINISHES WITH OWNER / ARCHITECT PRIOR TO INSTALLATION

MANUFACTURER

(OR EQUAL)

FAIL-SAFE

LUMARK

TAG

WP

NOTES:

A: PANEL SHALL BE EQUAL TO SQUARE D MODEL "QO"

DESCRIPTION

VANDAL RESISTANT STRIP

FULL CUTOFF WALL PACK

- ELECTRICIAN SHALL VERIFY BREAKER WITH EQUIPMENT PRIOR TO PURCHASE & INSTALL.
- AFTER COMPLETION OF WORK, ELECTRICAN SHALL PROVIDE A TYPE WRITTEN PANEL DIRECTORY IN NEW PANEL.

LIGHT FIXTURE SCHEDULE

MOUNTING

SURFACE

SURFACE

LUMEN

OUTPUT

1400

4000

4000

PANEL 'P1' SCHEDULE


VOLTS

UNV


UNV

WATTS

NOTES

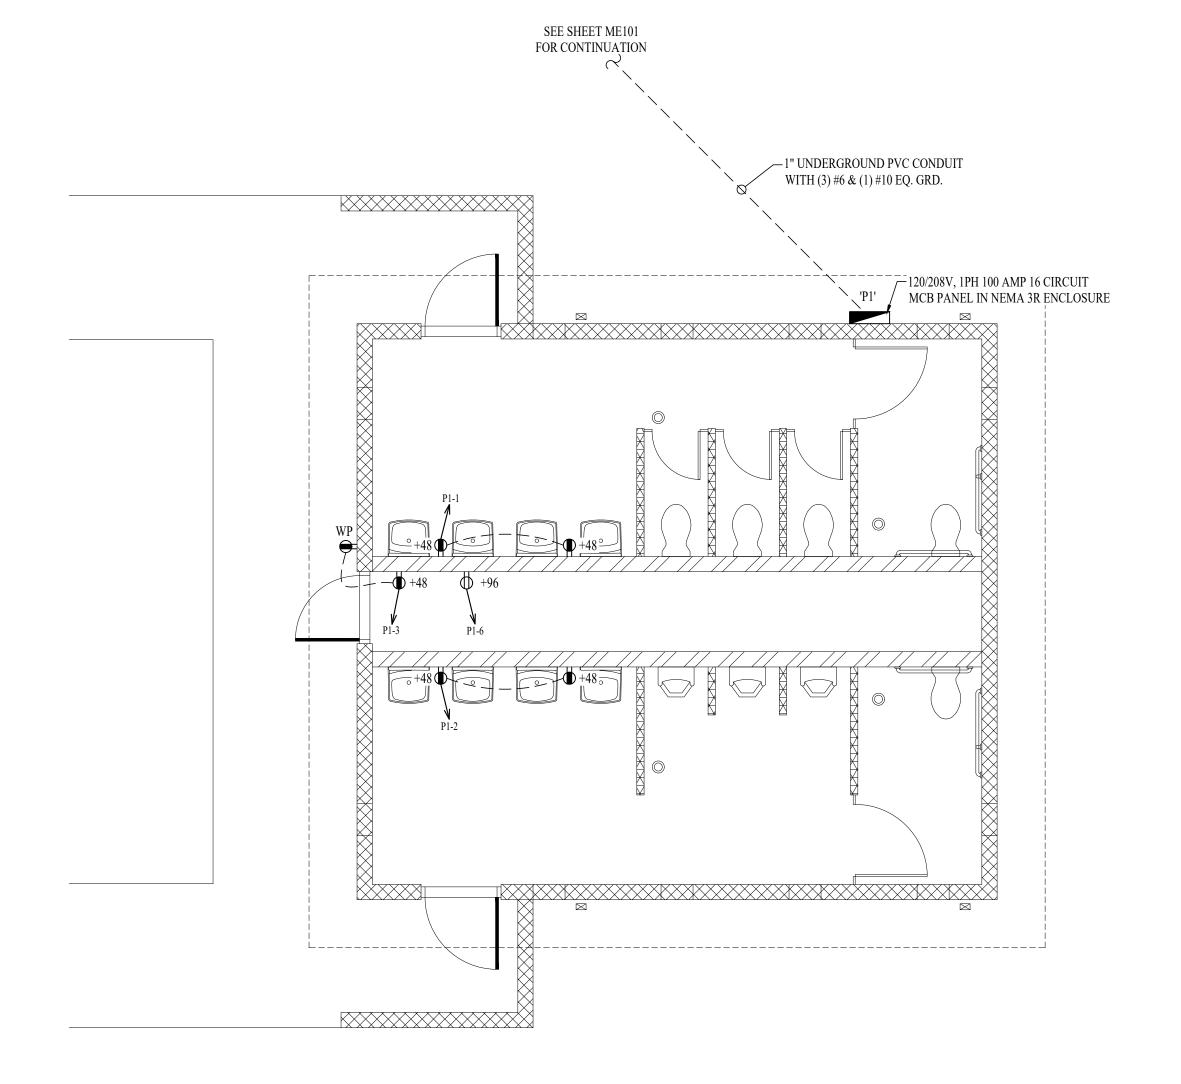




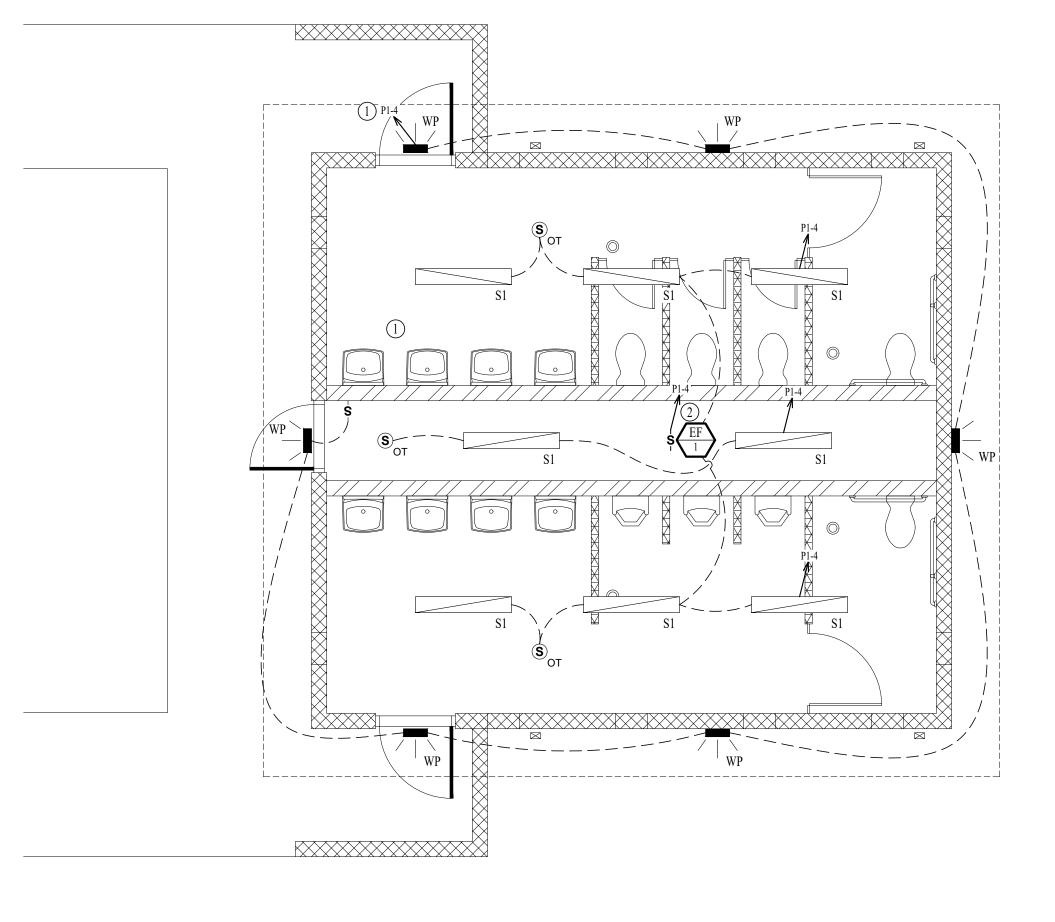




STATE OF MISSOURI MICHAEL L. PARSON, **GOVERNOR**

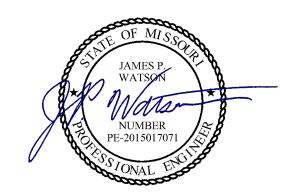

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MISSOURI STATE FAIRGROUNDS (MSF) 2503 W. 16th St. SEDALIA, MO

F2206-01

1501

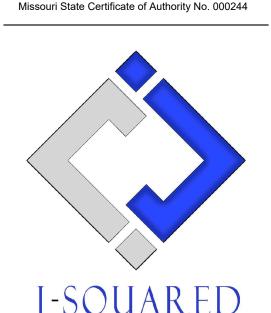PROJECT# 35111501147 ASSET#

REVISION: REVISION: REVISION: DATE:

ISSUE DATE: 08/10/2022

CAD DWG FILE: J20736 DRAWN BY: DET CHECKED BY: JPW DESIGNED BY: JAP

SHEET TITLE:

ELECTRICAL PLANS

SHEET NUMBER:

19 OF 20 SHEETS

08/10/2022

PLUMBING PLANS SYMBOL LEGEND

---- SANITARY SEWER PIPING
----- VENT PIPING

— COLD WATER PIPING

HOT WATER PIPING

PIPING TURNED DOWN / TURNED UP

TIE INTO EXISTING

SANITARY SEWER PLAN GENERAL NOTES:

- 1. PLUMBING SYSTEM TO BE INSTALLED FOR WINTERIZATION. CONTRACTOR SHALL INSTALL LOW POINT DRAINS ON BOTH COLD & HOT WATER PIPING.
- 2. DOMESTIC WATER LINES SHALL BE HELD TIGHT TO WALLS & AT 8'-0" A.F.F. TO ALLOW ACCESS IN CHASE.

ALTERNATE #1 - CONTRACTOR-INSTALLED PLUMBING FIXTURES & TOILET ACCESSORIES:

- 1. CONTRACTOR TO:
- a. PROVIDED & INSTALL PLUMBING FIXTURES TO INCLUDE WATER CLOSETS & FLUSH VALVES,
- URINALS & FLUSH VALVES, LAVATORIES & FAUCETS.

 CONTRACTOR PROVIDED & INSTALLED TOILET ACCESSORIES AS NOTED IN THE "RESTR
- b. CONTRACTOR PROVIDED & INSTALLED TOILET ACCESSORIES AS NOTED IN THE "RESTROOM ACCESSORY SCHEDULE INCLUDED ON SHEETS A-101 & A-301.
- 2. BASE BID:
- a. CONTRACTOR TO INCLUDE ROUGH-IN & WALL-HUNG BRACKETS FOR THE WATER CLOSETS, URINALS, & LAVATORIES. OWNER TO PROVIDE & INSTALL ALL TOILET ACCESSORIES.

ALTERNATE #2 - WATER HEATER, EXTERIOR LIGHTING, INTERIOR LIGHTING, TOILET PARTITIONS, & EPOXY COATING:

- 1. CONTRACTOR 7
- a. CONTRACTOR TO PROVIDE AND INSTALL WATER HEATER WITH WALL KITS AS SHOWN AND NOTED ON THIS SHEET.
- b. CONTRACTOR TO PROVIDE AND INSTALL ALL EXTERIOR AND INTERIOR LIGHTING FIXTURES AS
- SHOWN AND NOTED ON SHEET E-101.
 c. CONTRACTOR TO PROVIDE AND INSTALL HDPE TOILET COMPARTMENT DOOR/PILASTER
- ASSEMBLIES (INCLUDING HARDWARE) AS SHOWN ON SHEETS A-101 AND A-301.
- d. CONTRACTOR TO PROVIDE AND INSTALL EPOXY WALL COATING PNT-01, AS SHOWN THE INTERIOR FINISH LEGEND ON SHEET A-601.
- 2. BASE BID:

 a. PROVIDE ALL PLUMBING AND ELECTRICAL ROUGH-IN FOR FUTURE WATER HEATER AND WALL KIT TO BE INSTALLED BY OWNER. PROVIDE BLANK PLATE AT JUNCTION BOX; TEMPORARILY CAP PLUMBING PIPES.
- b. PROVIDE ALL ELECTRICAL ROUGH-IN FOR FUTURE EXTERIOR AND INTERIOR LIGHTING
- FIXTURES TO BE INSTALLED BY OWNER.PROVIDE BLANK PLATES AT JUNCTION BOXES. c. DO NOT PROVIDE HDPE TOILET PARTITIONS.

d. CMU TO REMAIN EXPOSED; WALLS WILL BE FINISHED AND PAINTED BY OWNER.


SSE SHEET MEIO)
FOR CONTINUATION

FOR CONTINUATI



TAG	DESCRIPTION	MANUFACTURER (OR EQUAL)	MODEL (OR EQUAL)	NOTES
FCO	FLOOR CLEANOUT	ZURN	1400	
FD	FLOOR DRAIN	ZURN	Z415-BZ	WITH Z1072 TRAP SEAL
LAV	LA VA TORY (WALL HUNG W/MANUAL FA UCET)	AMERICAN STANDARD	0355.012	WITH ZURN Z81104-XL FAUCET, 1/4 TURN STOPS, BRAIDED STAINLESS STEEL SUPPLIES, AND TRUBRO LAV GUARD 2, AND TMV
TMV	THERMOSTATIC MIXING VALVE - POINT OF USE	WATTS	LFUSG	
UR	URINAL - MANUAL FLUSH	AMERICAN STANDARD	6550.001	WITH ZURN Z6003A V-W S1 MANUAL FLUSH VALVE (1.0 GPM/FLUSH)
WC1	WATER CLOSET - ADA HEIGHT WALL HUNG WITH MANUAL FLUSH VALVE	AMERICAN STANDARD	2859	WITH ZURN Z6000A V-WS1 MANUAL FLUSH VALVE (1.6 GPM/FLUSH) AND CHURC 9500SSCT SELF SUSTAINING SEAT
WC2	WATER CLOSET - STANDARD HEIGHT WALL HUNG WITH MANUAL FLUSH VALVE	AMERICAN STANDARD	2859	WITH ZURN Z6000A V-WS1 MANUAL FLUSH VALVE (1.6 GPM/FLUSH) AND CHURC 9500SSCT SELF SUSTAINING SEAT
WH	WATER HEATER	RUUD	ESGP20	20 GALLON, 120V, 1500W, WITH HOLDRITE#30-SWHP-WM WALL MOUNT KIT. PROVIDE WITH CORD & PLUG
HB	HOSE BIBB	WOODFORD	MODEL 14	"P" INLET - 10" WALL

FIXTURE		SANITAR	Y PIPING	SUPPLYPIPING		
ТҰРЕ	TYPICAL ABBREVIATION	WASTE CONNECTION	VENT CONNECTION	COLD WATER CONNECTION	HOT WATER CONNECTION	
DRINKING FOUNTAIN	DF	1-1/2"	1-1/4"	1/2"	=1	
FLOOR DRAIN	FD	3"	2"	v	-1	
HAND / HAIR SINK	HS / SK	2"	1-1/4"	1/2"	1/2"	
HOSE BIBB	HB	ı	-	3/4"	-	
LAVATORY	LAV	1-1/2"	1-1/4"	1/2"	1/2"	
MOP SINK	MS	3"	1-1/2"	1/2"	1/2"	
ICE MAKER OUTLET BOX	REF	ji.	1	1/2"	ī	
SHOWER	SH	3"	1-1/2"	1/2"	1/2"	
URINAL	UR	2"	1-1/4"	3/4"	-1	
WATER CLOSET (FLUSH TANK)	WC	3"	2"	1/2"	-	
WATER CLOSET (FLUSH VALVE)	WC	3"	2"	1"	-	

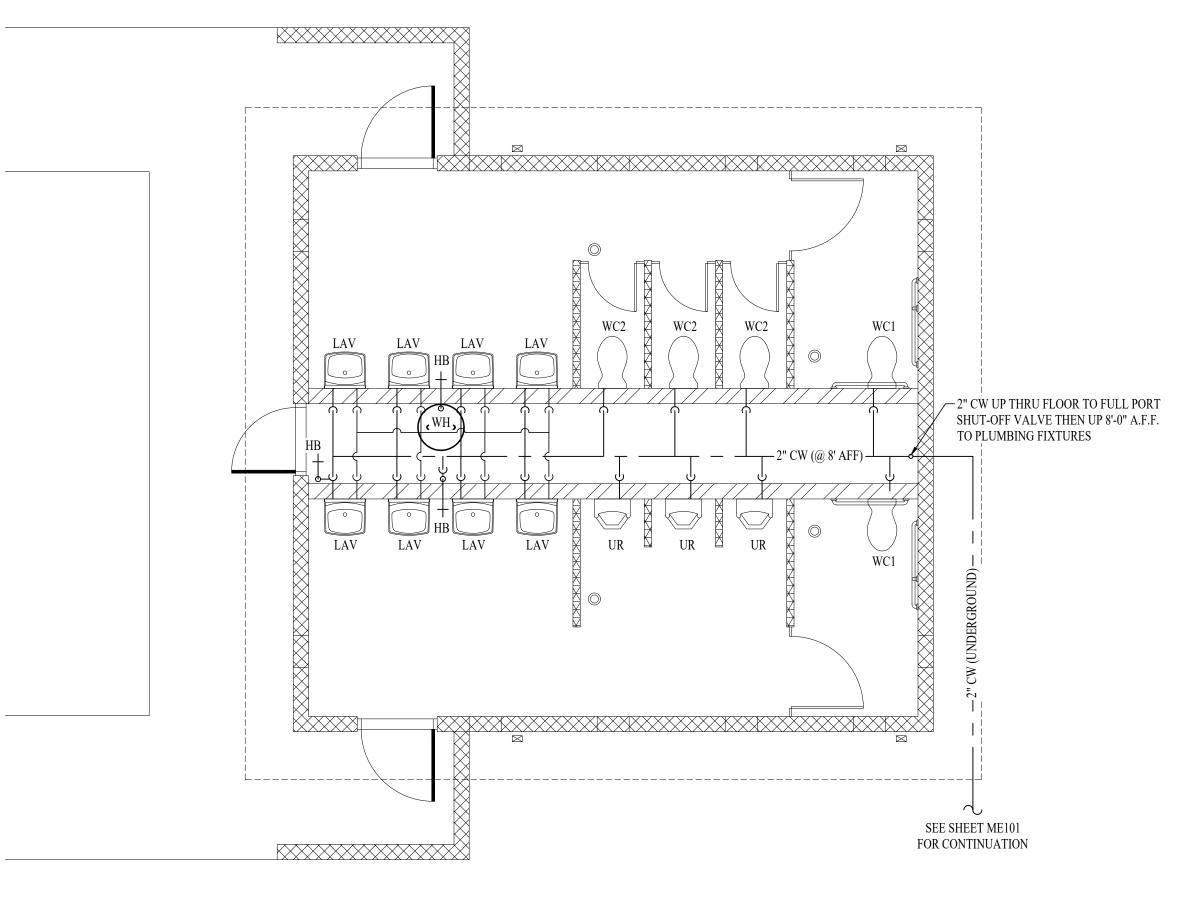



STATE OF MISSOURI MICHAEL L. PARSON, GOVERNOR



James Watson, P.E. August 10th, 20 PE-2015017071 MO Certificate of Authority # 2018029680



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NEW COMFORT STATION

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PROJECT # SITE # ASSET #

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PLUMBING PLANS

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P-10