
NEW COMFORT STATION Missouri State Fairgrounds (MSF) Sedalia, Missouri

OWNER:

STATE OF MISSOURI MICHAEL L. PARSON, GOVERNOR

OFFICE OF ADMINISTRATION DIVISION OF FACILITIES MANAGEMENT, DESIGN AND CONSTRUCTION

PROJECTOFFICE OF ADMINISTRATIONMANAGEMENT:DIVISION OF FACILITIES MANAGEMENT,DESIGN AND CONSTRUCTION

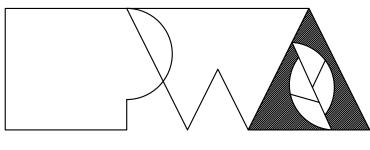

Peckham & Wright Architects, Inc., d.b.a.

PWArchitects, Inc.

2120 Forum Blvd., Ste 101 Columbia, Missouri 65203 Ph:(573) 449-2683 Fax:(573) 442-6213

DESIGNER: PWArchitects, Inc. 2120 Forum Blvd., Ste. 101 Columbia, Missouri 65203


PROJECT NUMBER: FMDC Project No. F2206-01

SITE NUMBER:1501ASSET NUMBER:3511501146

OFFICE OF ADMINISTRATION DIVISION OF FACILITIES MANAGEMENT, DESIGN AND CONSTRUCTION



SHEET NUMBER: G-001 1 OF 20 SHEETS September 22, 2023

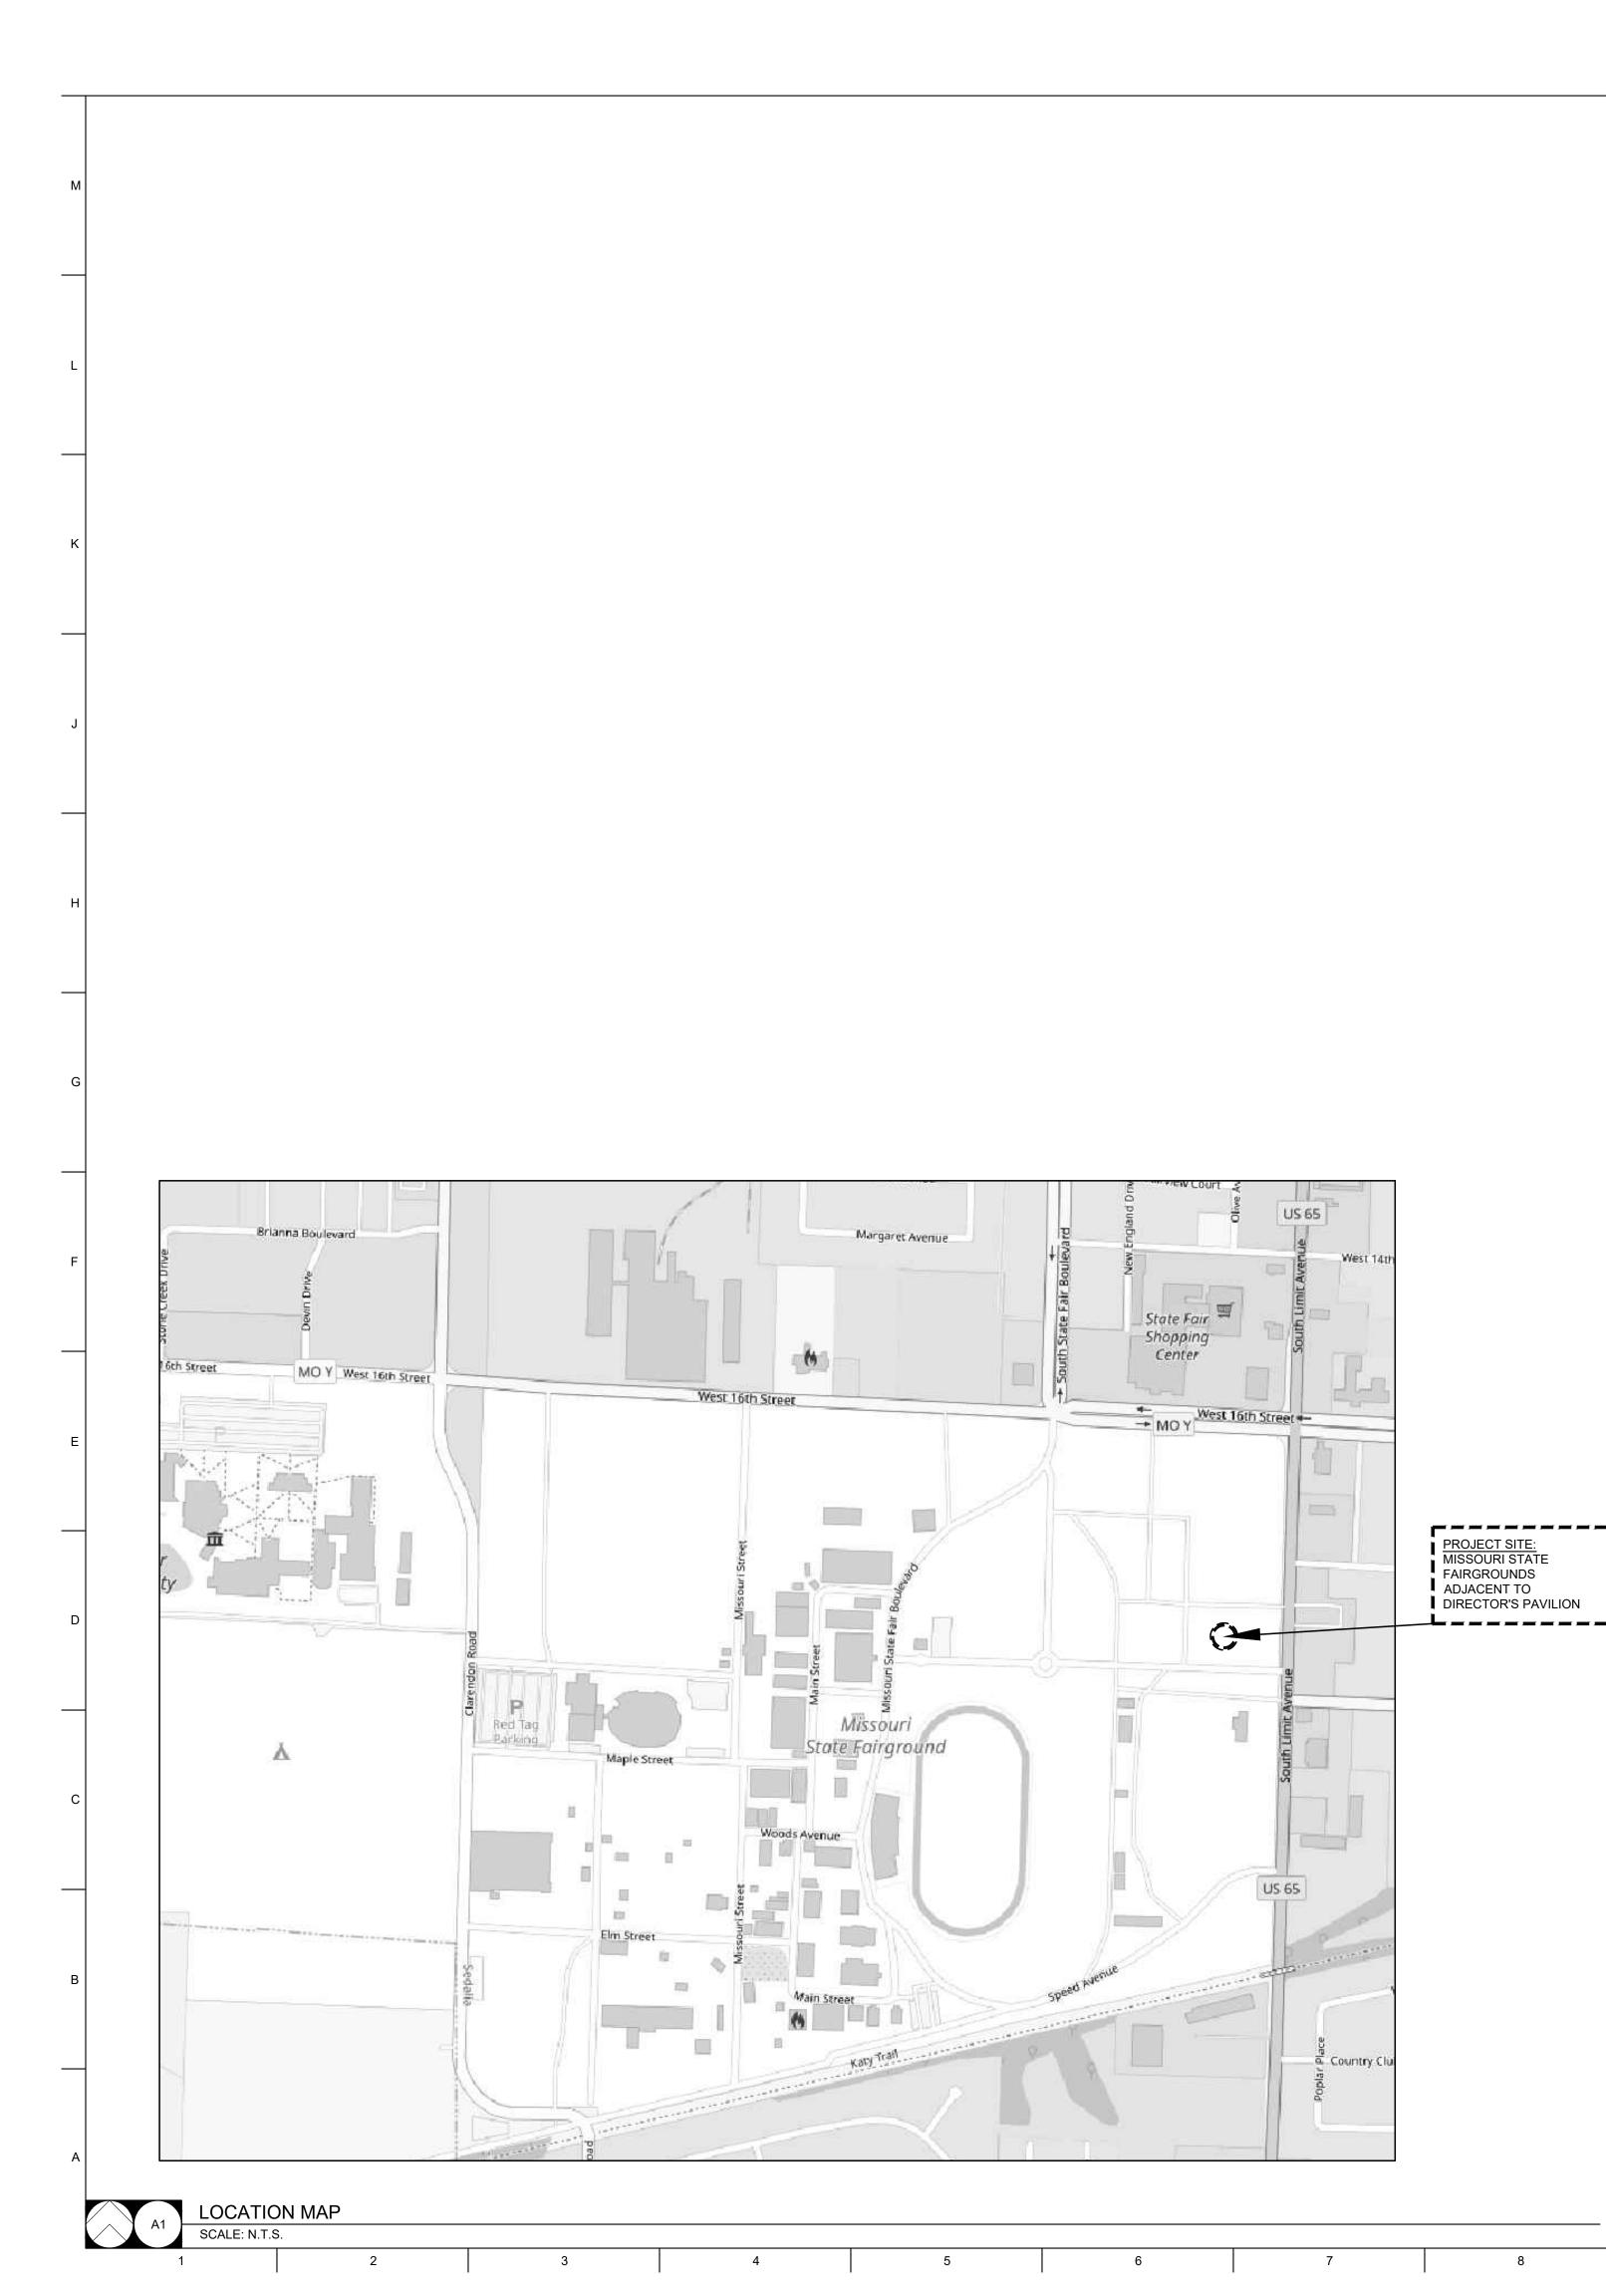

Code Summary Code Require Main Use Gro Automatic Sp Minimum Con Floor Area - Area (Squ - Area (Squ

Number of Sto - Stories Pe - Stories Maximum Hei

- Max. Heig - Max. Heig Travel Distanc

A. ALTERNATE 1 - CONTRACTOR-INSTALLED PLUMBING FIXTURES AND TOILET ACCESSORIES:

1. CONTRACTOR TO:

- a. PROVIDE AND INSTALL PLUMBING FIXTURES TO INCLUDE WATER CLOSETS AND FLUSH VALVES, URINALS AND FLUSH VALVES, LAVATORIES, AND FAUCETS.
- b. PROVIDE AND INSTALL TOILET ACCESSORIES AS NOTED IN THE "RESTROOM ACCESSORY SCHEDULE" INCLUDED ON SHEETS A-101AND A-301.
- 2. BASE BID: TO INCLUDE ROUGH-IN AND WALL-HUNG BRACKETS FOR THE WATER CLOSETS, URINALS, AND LAVATORIES. OWNER TO PROVIDE AND INSTALL ALL TOILET ACCESSORIES.

B. ALTERNATE 2 - WATER HEATER, EXTERIOR LIGHTING, INTERIOR LIGHTING, TOILET PARTITIONS, EPOXY COATING:

1. CONTRACTOR TO:

- a. PROVIDE AND INSTALL WATER HEATER WITH WALL KIT AS SHOWN AND NOTED ON SHEET P-101. b. PROVIDE AND INSTALL ALL EXTERIOR AND INTERIOR LIGHT FIXTURES AS
- SHOWN AND NOTED ON SHEET E-101. c. PROVIDE AND INSTALL HDPE TOILET COMPARTMENT DOOR/PILASTER
- ASSEMBLIES (INCLUDING HARDWARE), AS SHOWN ON SHEETS A-101 AND A-301. d. PROVIDE AND INSTALL EPOXY WALL COATING PNT-01, AS SHOWN THE
- INTERIOR FINISH LEGEND ON SHEET A-601.

2. BASE BID:

- a. PROVIDE ALL PLUMBING AND ELECTRICAL ROUGH-IN FOR FUTURE WATER HEATER AND WALL KIT TO BE INSTALLED BY OWNER; PROVIDE BLANK PLATE AT JUNCTION BOX; TEMPORARILY CAP PLUMBING PIPES.
- b. PROVIDE ALL ELECTRICAL ROUGH-IN FOR FUTURE EXTERIOR AND INTERIOR LIGHT FIXTURES TO BE INSTALLED BY OWNER. PROVIDE BLANK PLATES AT JUNCTION BOXES.
- c. DO NOT PROVIDE HDPE TOILET PARTITIONS.
- d. CMU TO REMAIN EXPOSED; WALLS WILL BE FINISHED AND PAINTED BY OWNER.


C. ALTERNATE 3 - STANDING SEAM METAL ROOFING SYSTEM:

- 1. PROVIDE STANDING SEAM METAL ROOF AND ASSOCIATED FLASHING CHANGES.
- 2. BASE BID: TO INCLUDE COMPOSITION SHINGLE ROOF SYSTEM.

D. ALTERNATE 4 - ADDITIONAL CONCRETE PAVING; SEED AND MULCH:

- 1. PAVE THE AREA LOCATED BETWEEN THE TWO ENTRY WALKS LEADING TO THE COMFORT STATION. PAVING TO EXTEND FROM THE EDGE OF THE DIRECTOR'S PAVILION TO THE COMFORT STATION.
- FINE-GRADE, SEED, AND MULCH ALL DISTURBED AREAS WITHIN THE LIMITS OF DISTURBANCE AS NOTED ON SHEET C100.
- 2. BASE BID: TO INCLUDE THE SIDEWALKS ONLY; AREA BETWEEN THE WALKS TO BE "FINE-GRADED", AS NOTED ON DRAWING SHEET C-100.


FINE-GRADE ALL DISTURBED AREAS WITHIN THE LIMITS OF DISTURBANCE AS NOTED ON SHEET C100.

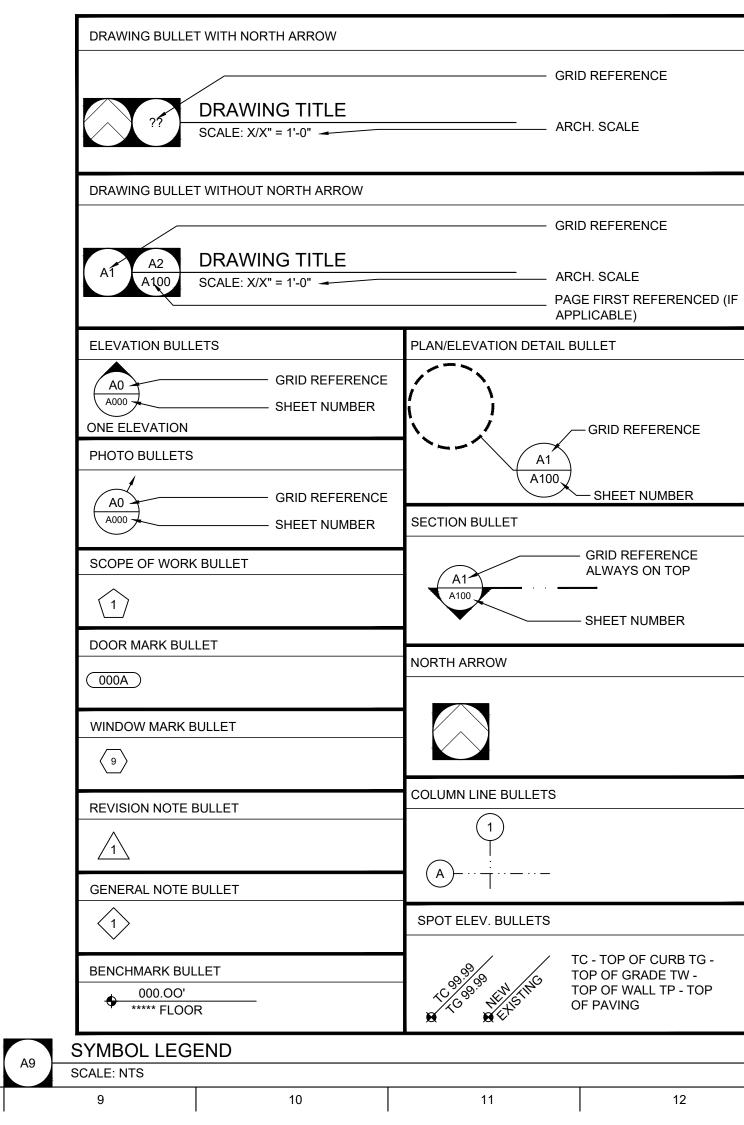

8

bae Caninary		
de Requirement		2018 International Building Code (IBC)
ain Use Group(s)	[IBC] 312	Utility U
tomatic Sprinklers	[IBC] 903.2	No
nimum Construction Classification	<i>[IBC]</i> 602	Туре 3В
oor Area		
- Area (Square Feet) per Floor Permitted - 'U' use	<i>[IBC]</i> T. 506.2	8,500 SF (Non-sprinkled, 'NS')
- Area (Square Feet) per Floor		
- First Floor Total Area ('U' use)		650 SF
mber of Stories		
- Stories Permitted - 'U'	<i>[IBC]</i> T. 504.4	2 Stories (Non-sprinkled, 'NS')
- Stories		1 Stories
aximum Height		
- Max. Height (Ft.) Permitted - 'U'	<i>[IBC]</i> T. 504.3	55'-0" (Non-sprink led, 'NS')
- Max. Height (Ft.)		16'-6''
avel Distance	<i>[IBC]</i> T. 1017.2	
- 'U' use		300'-0" Maximum (Non-sprinkled)

STATE OF MISSOURI MICHAEL L. PARSON, GOVERNOR

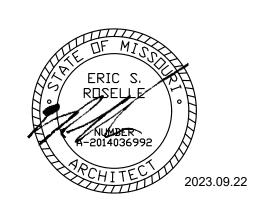



Peckham & Wright Architects, Inc., d.b.a. PWArchitects, Inc. 2120 Forum Blvd., Ste. 101 Columbia, Missouri 65203 PWArchitects.com | 573.449.2683 Peckham & Wright Architects an Architectural Corporation Missouri State Certificate of Authority No. 000244

OFFICE OF ADMINISTRATION DIVISION OF FACILITIES MANAGEMENT, **DESIGN AND CONSTRUCTION**

NEW COMFORT STATION

MISSOURI STATE FAIRGROUNDS (MSF) 2503 W. 16TH St. SEDALIA, MO

PROJECT # F2206-01 1501 SITE # 3511501146 ASSET #

REVISION: DATE: **REVISION:** DATE: **REVISION:** DATE: ISSUE DATE: 09/22/2023

CAD DWG FILE:G-10 DRAWN BY: ER CHECKED BY: ER DESIGNED BY: ER

SHEET TITLE:

LOCATION PLAN, LEGENDS, DRAWING INDEX, LIFE SAFETY

SHEET NUMBER:

G-101 2 OF 20 SHEETS 09/22/2023

LIST OF DRAWINGS

G-001 G-101	COVER SHEET LOCATION PLAN, LEGENDS, DRAWING INDEX, LIFE SAFETY
C-100 C-101 C-102 C-103 C-104	GENERAL CIVIL INFORMATION SITE AND UTILITY PLAN GRADING AND EROSION CONTROL PLAN CONSTRUCTION DETAILS CONSTRUCTION DETAILS
S-100 S-200 S-300 S-310	GENERAL STRUCTURAL DATA FOUNDATION PLAN AND DETAILS ROOF FRAMING PLAN AND DETAILS TYPICAL MASONRY DETAILS
A-101 A-201 A-301 A-302 A-601	FLOOR PLAN, ROOF PLAN, & DETAILS ELEVATIONS & DETAILS SECTIONS & DETAILS SECTIONS & DETAILS SCHEDULES & DETAILS
ME-101	MEP SITE UTILITIES PLAN
M-101	HVAC PLAN
E-101	ELECTRICAL PLANS
P-101	PLUMBING PLANS

E13 DRAWING INDEX SCALE: NTS

LARGE SCALE SMALL SCALE PLAN, SECTION BRICK MASONRY UNIT CONCRETE PLAN, SECTION MASONRY UNIT ELEVATION PLAN, CONCRETE SECTION PLAN, GYPSUM SECTION BOARD ELEVATION PLAN, SECTION GROUTED AREA OF: CMU/CAVITY/DOOR FRAME PLAN, SECTION, MISCELLANEOUS ITEMS: AS NOTED ON EACH SHEET ELEVATION PLAN, INSULATION SECTION ╷╨┝┤║╶╨┾ ╿╶╢╵┍┙┍ PLAN, ROOF SHINGLES ELEVATION CONTINUOUS PLAN, WOOD FRAMING SECTION PLAN, WOOD BLOCKING SECTION PLAN, PLYWOOD SECTION EXISTING PLAN, BUILDING SECTION

14

A13 MATERIAL LEGEND SCALE: NTS 13

15

MISSOURI STATE FAIRGROUNDS - COMFORT STATION

SEDALIA, PETTIS COUNTY, MISSOURI

PROJECT BENCHMARK:

TBM #1 - BENCH TIE, SW CORNER OF THE GRAVEL INTERSECTION NW OF THE PAVILION

ELEVATION = 887.46'

FLOOD PLAIN STATEMENT:

NO PART OF THIS TRACT IS LOCATED WITHIN THE 500-YEAR FLOODPLAIN AS PER THE CITY OF SEDALIA FIRM MAP #2902830001C DATED 01/05/1996.

UTILITY COMPANIES:

LOCATES:

MISSOURI ONE CALL INC. 1022 B NORTHEAST DRIVE JEFFERSON CITY, MO 65109 1-800-344-7483



TELEPHONE: CHARTER COMMUNICATIONS 210 W. 7TH STREET SEDALIA, MO 65301 866-874-2398

NATURAL GAS: LIBERTY UTILITIES 602 S JOPLIN AVE JOPLIN, MO 64801 1-800-424-0427

CABLE TELEVISION:

AT&T 5903 E. RED BRIDGE ROAD KANSAS CITY, MO 64134 877-219-3898

WATER: SEDALIA WATER DEPARTMENT 111 WEST 4TH STREET SEDALIA, MO 65301 660-826-1234

SANITARY SEWER: CITY OF SEDALIA 200 SOUTH OSAGE AVE. SEDALIA, MO 65301 660-827-3000

ELECTRIC: MISSOURI STATE FAIRGROUNDS CONTRACTOR 660-530-5617

GENERAL NOTES:

STABILIZED.

ALL STREET, STORM DRAIN, AND SANITARY SEWER CONSTRUCTION TO BE IN ACCORDANCE WITH THE CITY OF SEDALIA AND MISSOURI STATE FAIRGROUND'S GUIDANCE AND SPECIFICATIONS.

CONTRACTOR WILL BE RESPONSIBLE FOR PLACEMENT AND MAINTENANCE OF TRAFFIC CONTROL DEVICES NECESSARY TO COMPLETE THEIR PORTION OF WORK. THE DEVICES AND METHODS EMPLOYED WILL COMPLY WITH THE CURRENT VERSION OF THE MANUAL ON UNIFORM TRAFFIC CONTROL DEVICES.

EXISTING UTILITIES SHOWN FOR REFERENCE ONLY. CONTRACTOR SHALL COORDINATE LOCATES (HORIZONTAL AND VERTICAL) PRIOR TO ANY EXCAVATION.

ALL EXCAVATION TO BE IN ACCORDANCE WITH SECTIONS 319.010-319.050, REVISED STATUTES OF THE STATE OF MISSOURI. SUCH COMPLIANCE SHALL NOT, HOWEVER, EXCUSE ANY PERSON MAKING ANY EXCAVATION FROM DOING SO IN A CAREFUL AND PRUDENT MANNER, NOR SHALL IT EXCUSE SUCH PERSON FROM LIABILITY FOR ANY DAMAGE OR INJURY TO UNDERGROUND UTILITIES RESULTING FROM THE EXCAVATION.

A GEOTECHNICAL EVALUATION HAS BEEN PERFORMED BY CROCKETT GEOTECHNICAL TESTING LAB (GTL). REFER TO REPORT NUMBER G19478 DATED OCTOBER 21ST, 2019 BY CROCKETT GTL.

ALL SLOPES ARE 3:1 OR FLATTER UNLESS OTHERWISE NOTED.

IT IS THE INTENT OF THESE PLANS TO COMPLY WITH THE REQUIREMENTS OF THE MODNR CLEAN WATER COMMISSION.

ALL DISTURBED AREAS WITHIN THE "LIMITS OF DISTURBANCE" SHALL BE FINE GRADED. (SEEDING AND MULCHING BY OTHERS). THE CONTRACTOR IS RESPONSIBLE FOR MAINTAINING ALL EROSION CONTROL DEVICES AND REMOVING THEM ONCE THE SITE IS

ALL SERVICE LATERALS SHALL BE INSTALLED AT 1.0% (MIN.) GRADE.

ALL EXCAVATION WITHIN 10' OF THE STREET PAVEMENT SHALL BE BACKFILLED WITH GRANULAR MATERIAL. REFER TO PIPE EMBEDMENT DETAILS.

ALL SEWERLINES SHALL BE CONSTRUCTED AT LEAST 10 FEET HORIZONTALLY, EDGE TO EDGE, FROM ANY WATERLINE AND AT LEAST 24 INCHES VERTICALLY BETWEEN THE OUTSIDE LIMITS OF THE SANITARY SEWER AND WATERLINE. FOR CONDITIONS OTHER THAN THOSE IDENTIFIED ABOVE, CONTACT THE ENGINEER FOR SPECIFIC INSTRUCTIONS.

ALL HDPE PIPE SHALL BE INSTALLED PER MANUFACTURER'S RECOMMENDATIONS. REFER TO DETAIL FOR PIPE BEDDING REQUIREMENTS.

LAND DISTURBANCE SITES SHOULD BE INSPECTED ON A REGULAR SCHEDULE AND WITHIN A REASONABLE TIME PERIOD (NOT TO EXCEED 48 HOURS) FOLLOWING HEAVY RAINS. REGULARLY SCHEDULED INSPECTIONS SHALL BE AT A MINIMUM OF ONCE PER WEEK. ANY DEFICIENCIES SHALL BE NOTED IN A WEEKLY REPORT OF THE INSPECTION AND CORRECTED WITHIN SEVEN CALENDAR DAYS OF THE REPORT.

ALL UTILITY LINES SHALL BE BACKFILLED W/ GRANULAR AND COMPACTED EARTH BACKFILL.

ESTIMATED AREA OF DISTURBANCE IS 0.20 ACRES.

MISSOURI DNR LAND DISTURBANCE PERMIT NOT REQUIRED.

ALTERNATE #4 GENERAL NOTES:

FINE-GRADE, SEED, AND MULCH ALL DISTURBED AREAS WITHIN THE LIMITS OF DISTURBANCE

LEGEND OF SYMBOLS:

	EXISTING CURB	FF=XXX.X
	PROPOSED CURB	(XXX.XX TC)
	RIP RAP	(XXX.XX TP)
63	EXISTING STRUCTURE	(XXX.XX FG)
\sim	EXISTING TREELINE	(XXX.XX TW)
\sim	PROPOSED TREELINE	XX
000	EDGE OF WATERWAY	$\overline{\langle \mathbf{v} \rangle}$
— — w — —	EXISTING WATERLINE	$\langle X \rangle$
w	PROPOSED WATERLINE	(V)
—— G ——	EXISTING GAS LINE	X
G	PROPOSED GAS LINE	H.P.
— — — UT — — —	EXISTING UNDERGROUND TELEPHONE	L.P.
— — —UTV — — —	EXISTING UNDERGROUND CABLE TELEVISION	<u> </u>
— — - HVE- — —	EXISTING HIGH VOLTAGE ELECTRIC	ø
—— OE ——	EXISTING OVERHEAD ELECTRIC	Š
— — — UE — — —	EXISTING UNDERGROUND ELECTRIC	\bowtie
——————————————————————————————————————	EXISTING OVERHEAD ELEC. & TV	©
— — OETVT — —	EXISTING OVERHEAD ELEC., TV & TELE.	W N
—— s ——	EXISTING SANITARY SEWER	т М
s	PROPOSED SANITARY SEWER	Ø
XXX	EXISTING MINOR CONTOUR	
XXX	EXISTING MAJOR CONTOUR	
XXX	PROPOSED MINOR CONTOUR	
XXX	PROPOSED MAJOR CONTOUR	
	100 YEAR FLOOD PLAIN	AC
<u>+++++++++</u>	FLOODWAY	
	ORDINARY HIGH WATER MARK	Ē
	STREAM SIDE BUFFER	E
	OUTER STREAM BUFFER	×
\gg $>$ $>$ $>$ $>$	SWALE	\rightarrow

FINISH FLOOR OF STRUCTURE PROPOSED TOP OF CURB ELEVATION PROPOSED TOP OF PAVEMENT ELEVATION PROPOSED FINISH GRADE ELEVATION PROPOSED TOP OF WALL LOT NUMBER STORM SEWER STRUCTURE LABEL SANITARY SEWER STRUCTURE LABEL HIGH POINT LOW POINT EXISTING SIGNS EXISTING POWER POLE EXISTING GAS VALVE EXISTING WATER VALVE EXISTING GAS METER EXISTING WATER METER EXISTING FIRE HYDRANT MANHOLE EXISTING SANITARY SEWER LATERAL PROPOSED SANITARY SEWER LATERAL PROPOSED TRACER WIRE TEST STATION BOX EXISTING AIR CONDITIONER EXISTING TELEPHONE PEDESTAL

EXISTING ELECTRICAL TRANSFORMER EXISTING ELECTRIC METER

EXISTING LIGHT POLE

EXISTING GUY WIRE

MICHAEL L. PARSON, GOVERNOR

STATE OF MISSOURI





PWArchitects, Inc. 2120 Forum Blvd., Ste. 101 Columbia, Missouri 65203 PWArchitects.com | 573.449.2683 Peckham & Wright Architects an Architectural Corporatio Missouri State Certificate of Authority No. 000244

PREPARED BY:

NGINFFRING CONSULTANT: 1000 W. Nifong Blvd., Bldg. Columbia, Missouri 65203 (573) 447-0292 www.crockettengineering.com Crockett Engineering Consultants, LLC Missouri Certificate of Authority #2000151301

OFFICE OF ADMINISTRATION DIVISION OF FACILITIES MANAGEMENT, **DESIGN AND CONSTRUCTION**

NEW COMFORT STATION

MISSOURI STATE FAIRGROUNDS (MSF) 1814 S LIMIT AVE SEDALIA, MO

PROJECT #	F2206-01
SITE #	1501
ASSET #	3511501140

REVISION: DATE: **REVISION**: DATE: REVISION DATE: ISSUE DATE: 09/22/2023

CAD DWG FILE:C-100


DRAWN BY:	KRM
CHECKED BY:	TDC
DESIGNED BY:	KRM


SHEET TITLE: GENERAL CIVIL

INFORMATION

SHEET NUMBER:


SHEET 3 OF 20 09/22/2023

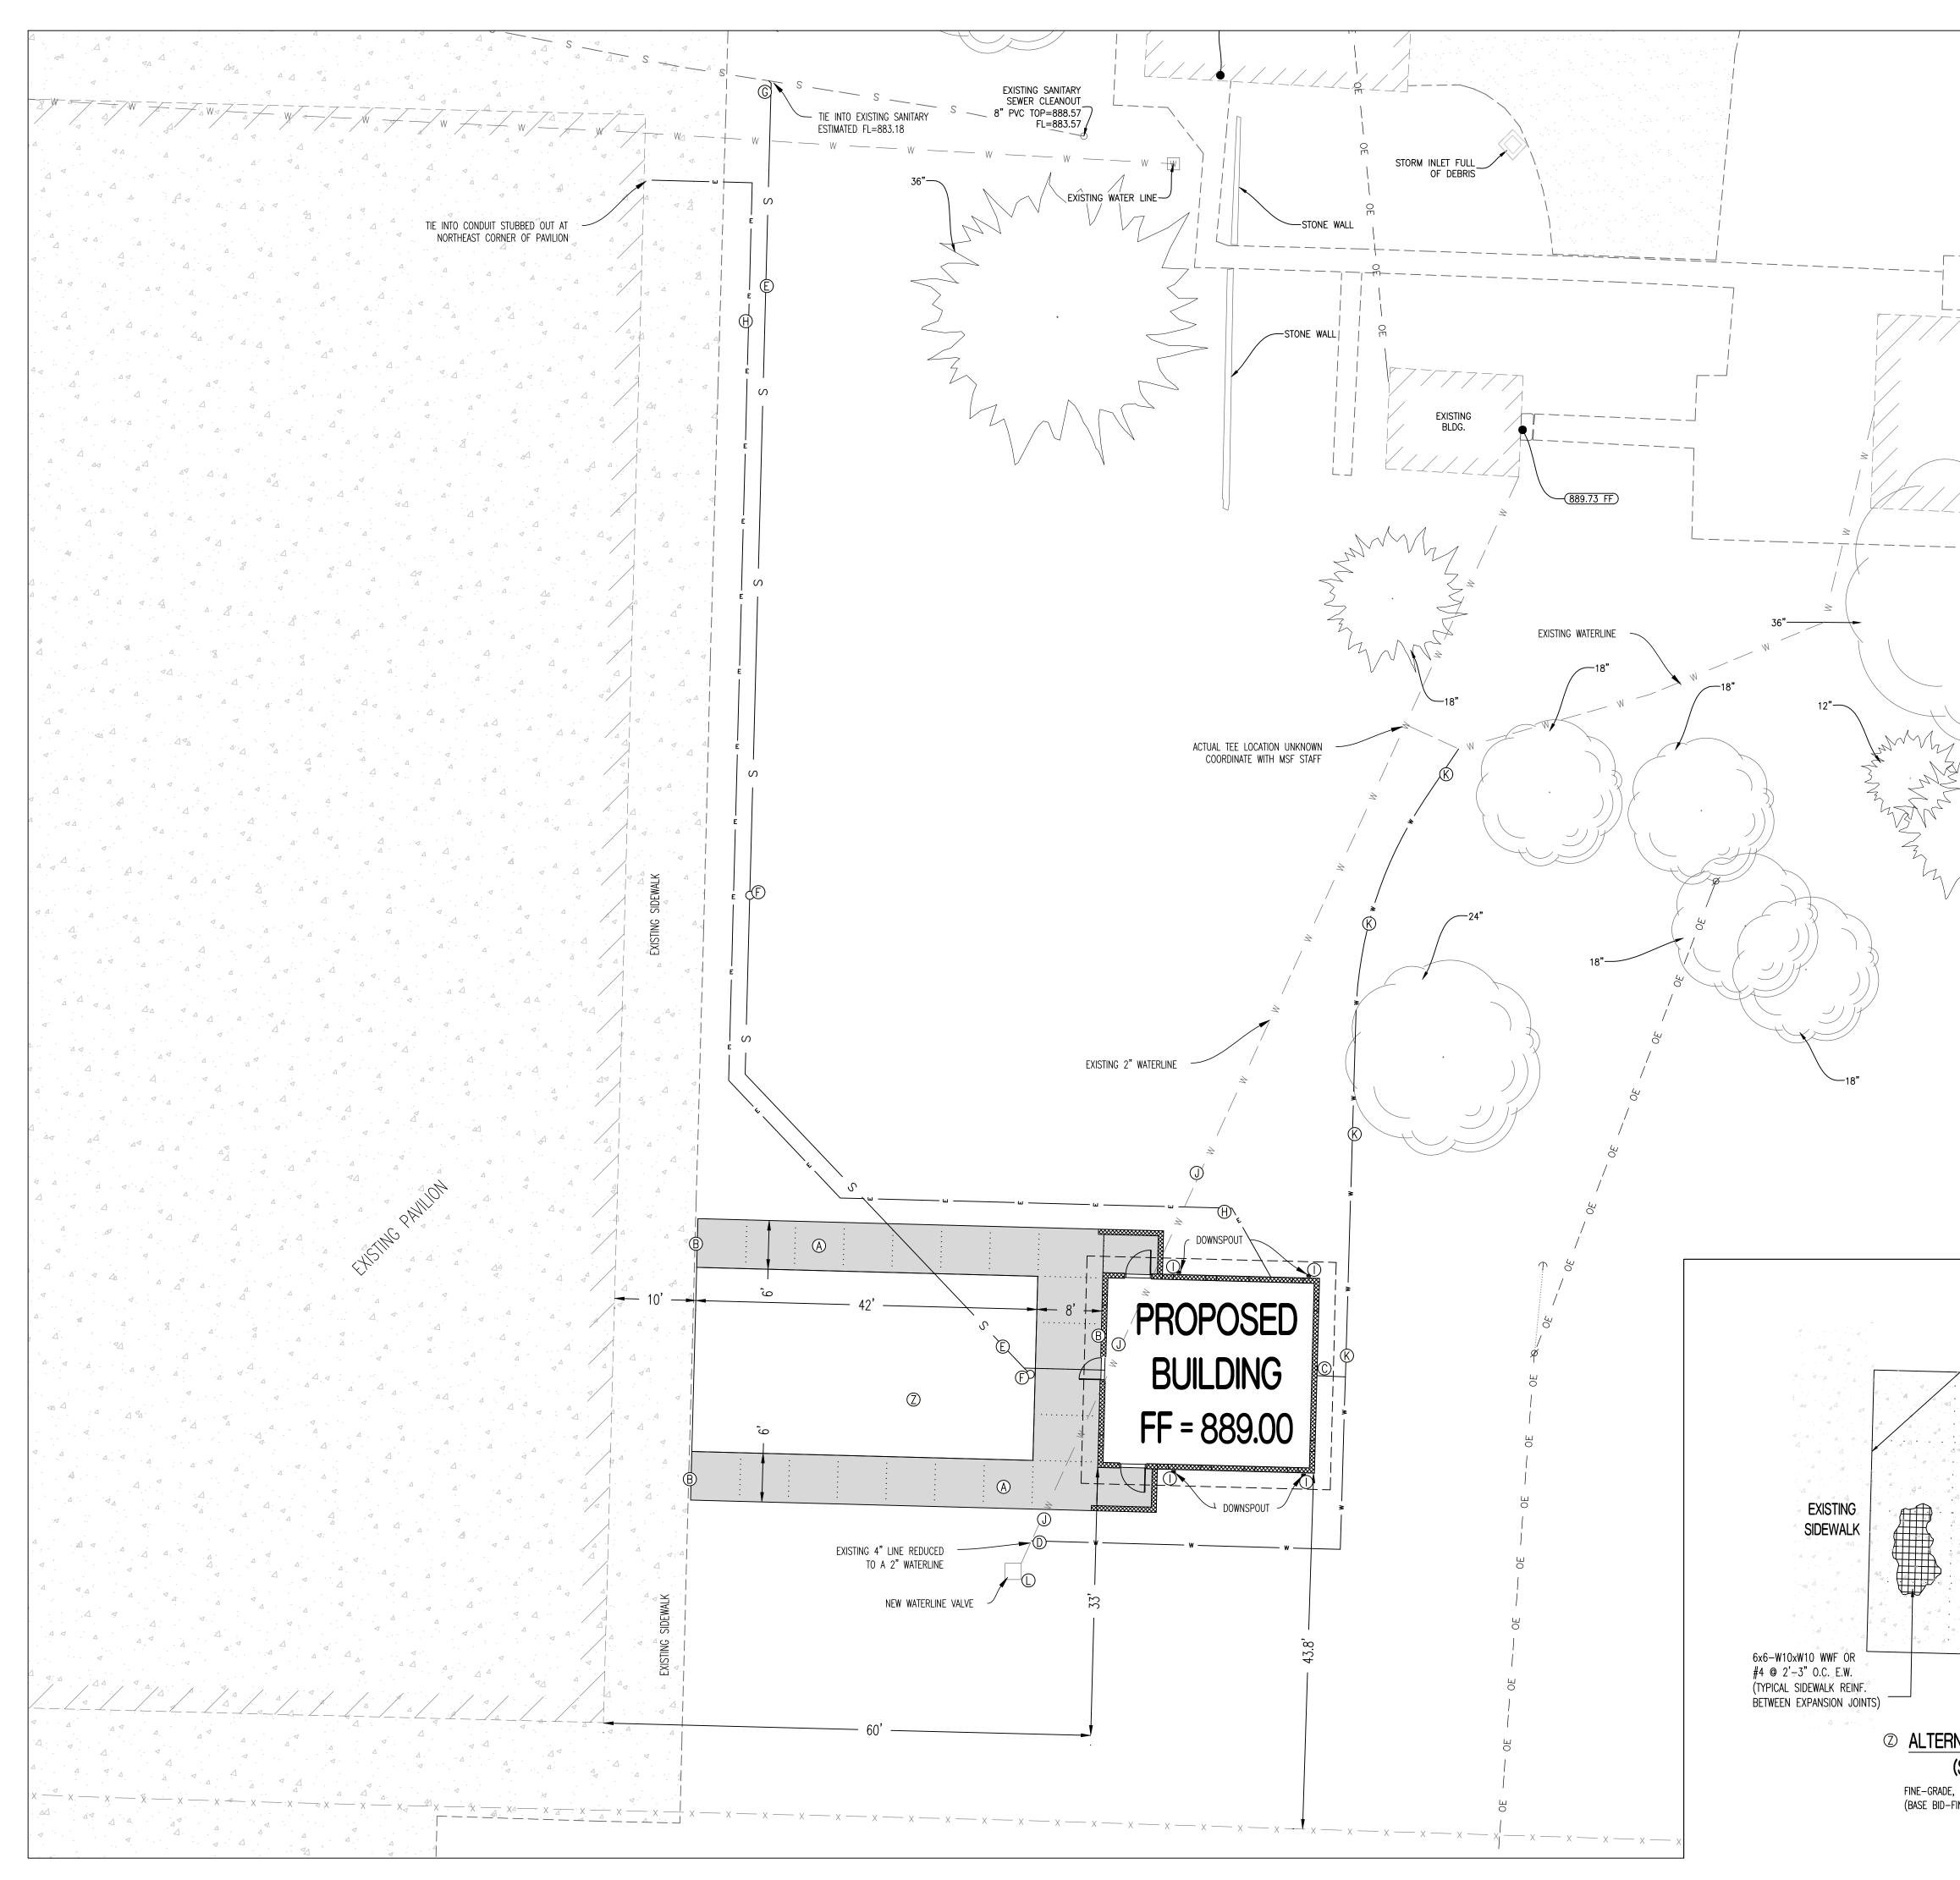

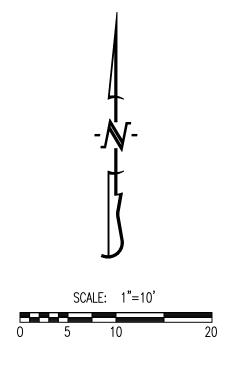


GENERAL NOTES:

- 1) EXISTING UTILITIES SHOWN FOR REFERENCE ONLY. CONTRACTOR SHALL COORDINATE LOCATES (HORIZONTAL AND VERTICAL) PRIOR TO ANY EXCAVATION.
- 2) IT IS THE RESPONSIBILITY OF THE CONTRACTOR TO ACQUIRE ALL EXISTING UTILITY LOCATES PRIOR TO CONSTRUCTION. IT IS THE RESPONSIBILITY OF THE CONTRACTOR TO RESTORE ANY DAMAGED OR BROKEN UTILITIES TO ORIGINAL OR BETTER CONDITION.
- 3) ALL UTILITY LINES SHALL BE BACKFILLED WITH GRANULAR AND COMPACTED EARTH BACKFILL.
- 4) THE PAVEMENT JOINTS SHOWN ARE A GRAPHICAL REPRESENTATION OF A POSSIBLE JOINT LAYOUT. CONTRACTOR TO PROVIDE SHOP DRAWINGS WITH JOINT LAYOUT FOR APPROVAL BY ENGINEER PRIOR TO POURING OF PAVEMENT.

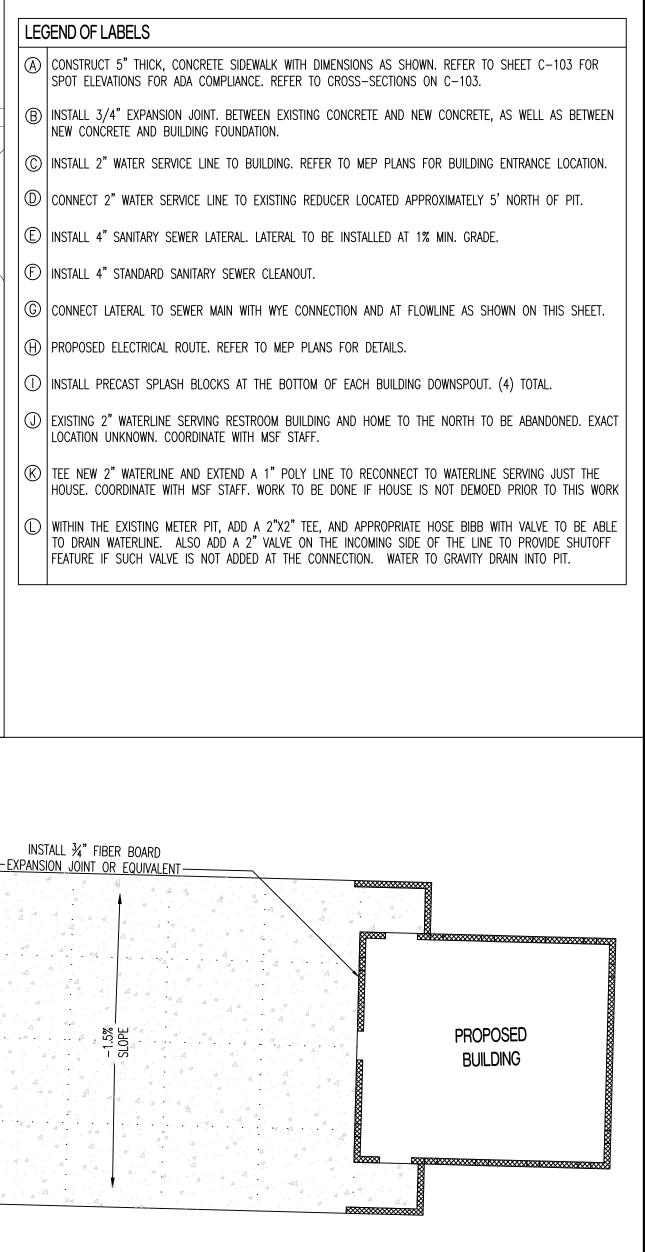


ALTERNATIVE 4 - ADDITIONAL CONCRETE PAVING
 (See Sidewalk Detail For Cross Section)
 FINE-GRADE, SEED, AND MULCH ALL DISTURBED AREAS WITHIN THE LIMITS OF DISTURBANCE.
 (BASE BID-FINE GRADE ONLY. [SEED AND STRAW BY OTHERS])

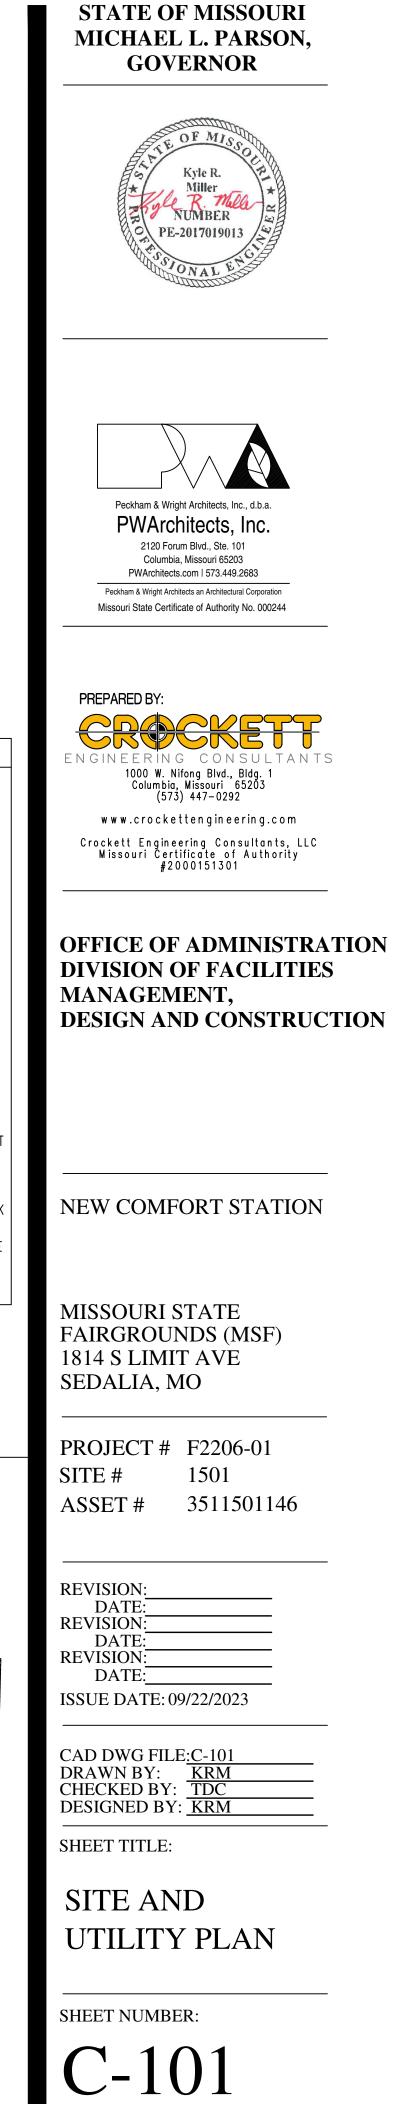

SHEET 4 OF 20

09/22/2023



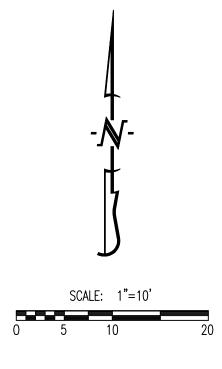

GRADING - LEGEND OF SYMBOLS:

······XXX······	EXISTING
— — —XXX— — —	EXISTING
XXX	PROPOSI
XXX	PROPOSI
FF=XXX.X	FINISHEE
(XXX.XX TP)	PROPOS
(XXX.XX FG)	PROPOS
(XXX.XX FF)	PROPOS
(XXX.XX EX TP)	EXISTING
$\cdot \gg \cdot \gg \cdot \gg \cdot$	SWALE

EXISTING MINOR CONTOUR EXISTING MAJOR CONTOUR PROPOSED MINOR CONTOUR PROPOSED MAJOR CONTOUR FINISHED FLOOR OF STRUCTURE PROPOSED TOP OF PAVEMENT ELEVATION PROPOSED FINISH GRADE ELEVATION PROPOSED FINISH FLOOR AT DOOR EXISTING TOP OF PAVEMENT ELEVATION SWALE

GRA	ADING - LEGEND OF LABELS				
A	FINE GRADE AS SHOWN BY PROPOSED CONTOURS. PLACE MINIMUM OF 6" TOP SOIL. (SEEDING AND MULCH BY OTHERS)				
B	INSTALL PAVEMENT WITH GRADES AS SHOWN TO MEET ADA COMPLIANCE.				
0	GRADE ADJACENT SIDE YARD WITH SMALL SWALE T DRAIN WATER AWAY FROM BUILDING AND PAVEMENT				
0	PROPOSED BUILDING TO HAVE 18" OF LOW VOLUME CHANGE INSTALLED.				
ALTERNATE #4 - LEGEND OF LABELS					

FINE GRADE AS SHOWN BY PROPOSED CONTOURS. PLACE MINIMUM OF 6" TOP SOIL, FINE-GRADE, SEED, AND MULCH ALL DISTURBED AREAS WITHIN THE LIMITS OF DISTURBANCE .

EROSION CONTROL - LEGEND OF SYMBOLS:

	•	•	 LIMITS	0F	DISTURBANCE
-0		-0-	SILT F	enc	E

EROSION CONTROL - LEGEND OF LABELS

$\langle \mathbf{Y} \rangle$	PROJECT'S LIMITS OF DISTURBANCE. ESTIMATED AREA OF DISTURBANCE IS 0.20 ACRES.
Z	INSTALL SILT FENCE AS SHOWN. REFER TO DETAIL ON SHEET C–103.


CONSISTENCE OF ADMINISTRATION OFFICE OF ADMIN
DIVISION OF FACILITIES MANAGEMENT, DESIGN AND CONSTRUCTION NEW COMFORT STATION MISSOURI STATE FAIRGROUNDS (MSF) 1814 S LIMIT AVE SEDALIA, MO PROJECT # F2206-01 SITE # 1501 ASSET # 3511501146 REVISION: DATE: REVISION: DATE: SSUE DATE: 09/22/2023
MISSOURI STATE FAIRGROUNDS (MSF) 1814 S LIMIT AVE SEDALIA, MO PROJECT # F2206-01 SITE # 1501 ASSET # 3511501146 REVISION: DATE: REVISION: DATE: SSUE DATE: 09/22/2023
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SITE # 1501 ASSET # 3511501146 REVISION:
DATE: REVISION: DATE: REVISION: DATE: DATE: SSUE DATE: 09/22/2023
CAD DWG FILE <u>:C-102</u> DRAWN BY: <u>KRM</u> CHECKED BY: <u>TDC</u> DESIGNED BY: <u>KRM</u>
GRADING AND

STATE OF MISSOURI

SHEET NUMBER:

09/22/2023

C-102 SHEET 5 OF 20 EROSION CONTROL DETAIL

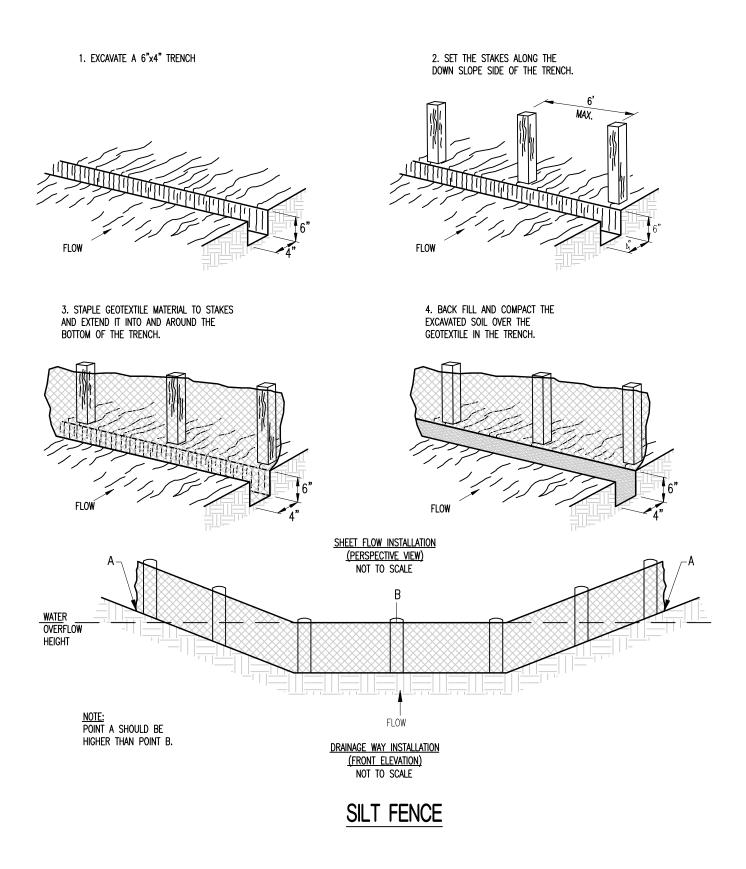



NOTE:

TYPICAL CONCRETE SIDEWALK PAVEMENT CROSS SECTION

LIMESTONE BASE MATERIAL (CLBM)


KIKIKIKIK KIKIKIK

COMPACTED BASE @ 95% (MIN) OF MATERIALS MAXIMUM STD PROCTER DRY DENSITY

└── 4" MoDOT TYPE 5 CRUSHED

- 5" PORTLAND CEMENT CONCRETE


(4000 PSI, 6-SACK MINIMIX).

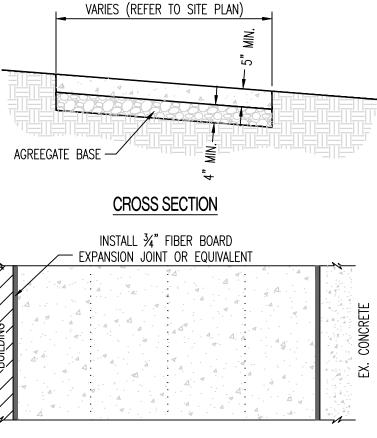

TYPICAL LOCATION OF EXPANSION JOINT AT BUILDING/CURB


1. SIDEWALK SHALL BE 5" THICK CLASS A CONCRETE ON 4" AGGREGATE BASE. 3. INSTALL 3/4 EXPANSION JOINT BETWEEN BUILDING AND NEW CONCRETE.

TYPICAL CONCRETE SIDEWALK

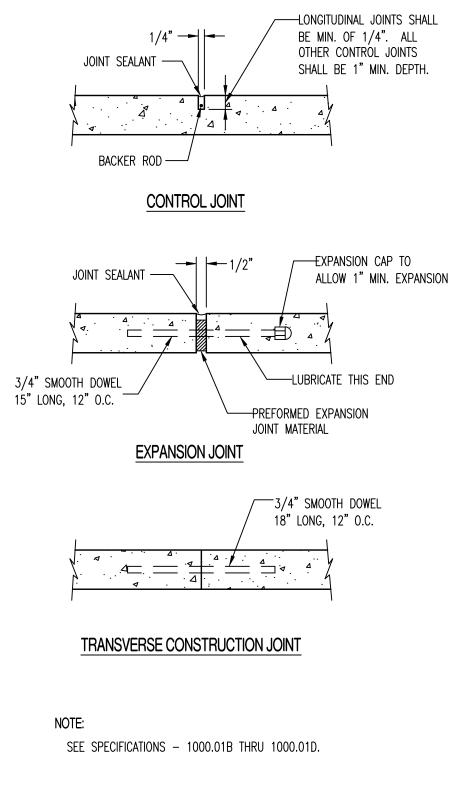


SIDEWALK JOINT DETAILS (1000.03)

	GOVERNOR
	Kyle R. Miller NUMBER PE-2017019013
	Peckham & Wright Architects, Inc., d.b.a. PWArchitects, Inc. 2120 Forum Blvd., Ste. 101 Ochembia Minocuri (S2000
	Columbia, Missouri 65203 PWArchitects.com 573.449.2683 Peckham & Wright Architects an Architectural Corporation Missouri State Certificate of Authority No. 000244
ENG	EPARED BY: DINEERING CONSULTANTS 1000 W. Nifong Blvd., Bldg. 1 Columbia, Missouri 65203 (573) 447-0292 www.crockettengineering.com
	ockett Engineering Consultants, LLC Missouri Certificate of Authority #2000151301
	W COMFORT STATION
NEV	
MIS FAI 1814	SSOURI STATE RGROUNDS (MSF) 4 S LIMIT AVE DALIA, MO
MIS FAI 1814 SEI PRO SITI	RGROUNDS (MSF) 4 S LIMIT AVE DALIA, MO DJECT # F2206-01
MIS FAI 1814 SED PRO SITT ASS REV REV REV	RGROUNDS (MSF) 4 S LIMIT AVE DALIA, MO DJECT # F2206-01 E # 1501
MIS FAI 1814 SED PRC SITI ASS REV REV REV REV REV ISSU CAD DRA CHE DES SHEI CC	RGROUNDS (MSF) 4 S LIMIT AVE DALIA, MO DJECT # F2206-01 E # 1501 SET # 3511501146 ISION: DATE: ISION: DATE: ISION: DATE: ISION: DATE: ISION:

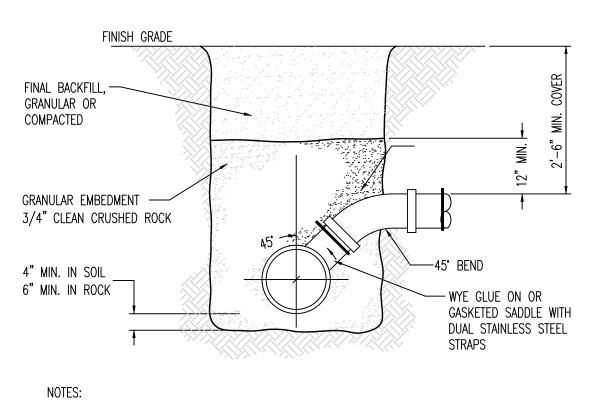


1. VCP PIPES SHALL NOT BE TAPPED. REPLACE SECTION OF VCP WITH PVC AND FITTING.


STANDARD SERVICE CONNECTION DETAIL -WYE DETAIL

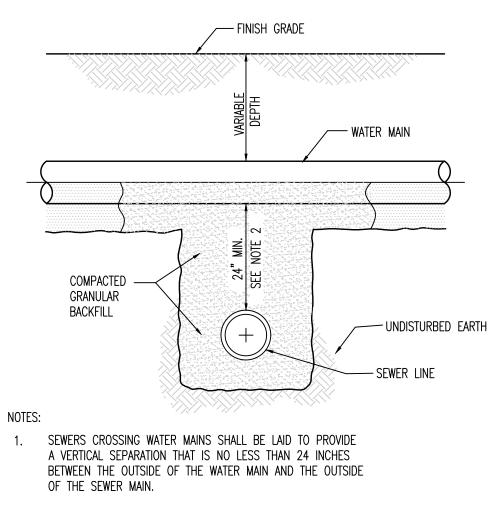

- 2. THE CROSSING SHALL BE ARRANGED SO THAT THE SEWER LINE CROSSES BELOW THE WATER LINE. CROSSINGS IN WHICH THE SEWER LINE IS ABOVE THE WATER LINE WILL ONLY BE APPROVED ON A CASE BY CASE BASIS.
- 3. THE CROSSING SHALL BE ARRANGED SO THAT THE ENDS OF A FULL JOINT OF PIPE WILL BE EQUIDISTANT FROM THE WATER MAIN AND AS FAR AS POSSIBLE FROM THE WATER MAIN JOINTS.
- 4. IF THE VERTICAL SEPARATION BETWEEN THE WATER MAIN AND SEWER MAIN IS LESS THAN 18 INCHES, THE SEWER MAIN SHALL BE D.I.P. OR PRESSURE RATED PVC PIPE WITH A PRESSURE RATING THAT IS EQUAL TO OR GREATER THAN THE WATER MAIN. THE D.I.P. OR PRESSURE RATED P.V.C. MUST BE EXTENDED A DISTANCE 10 FEET ON BOTH SIDES OF THE WATER MAIN. THE TRANSITION BETWEEN PIPE MATERIALS SHALL BE ACCOMPLISHED WITH A RESTRAINED MECHANICAL TYPE JOINT OR FITTING. FLEXIBLE TYPE (FERNCO) FITTINGS ARE NOT ACCEPTABLE.
- 5. PRESSURE SEWER LINE AND WATER LINE CROSSINGS SHALL BE REVIEWED ON A CASE BY CASE BASIS.

GRAVITY SEWER AND WATER LINE CROSSING

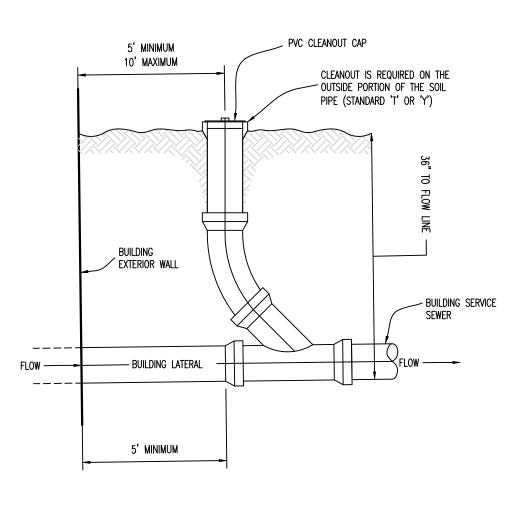

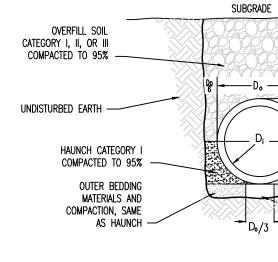

OVERFILL SOIL CATEGORY I, II, OR III COMPACTED TO 95% OVERFILL SOIL CATEGORY I COMPACTED TO 95% -____D。 UNDISTURBED EARTH ------HAUNCH CATEGORY I COMPACTED TO 95% -OUTER BEDDING MATERIALS AND COMPACTION, SAME as haunch —


FLEXIBLE PIPE


PIPE EMBEDMENT DETAIL

STANDARD SANITARY CLEANOUT

— 4" MIN -LOOSELY PLACED UNCOMPACTED BEDDING CATEGORY I

<u>RIGID PIPE</u>

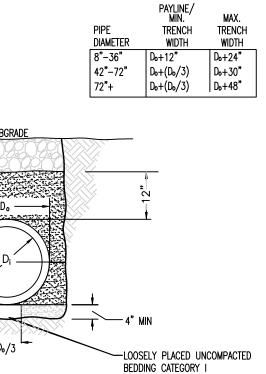

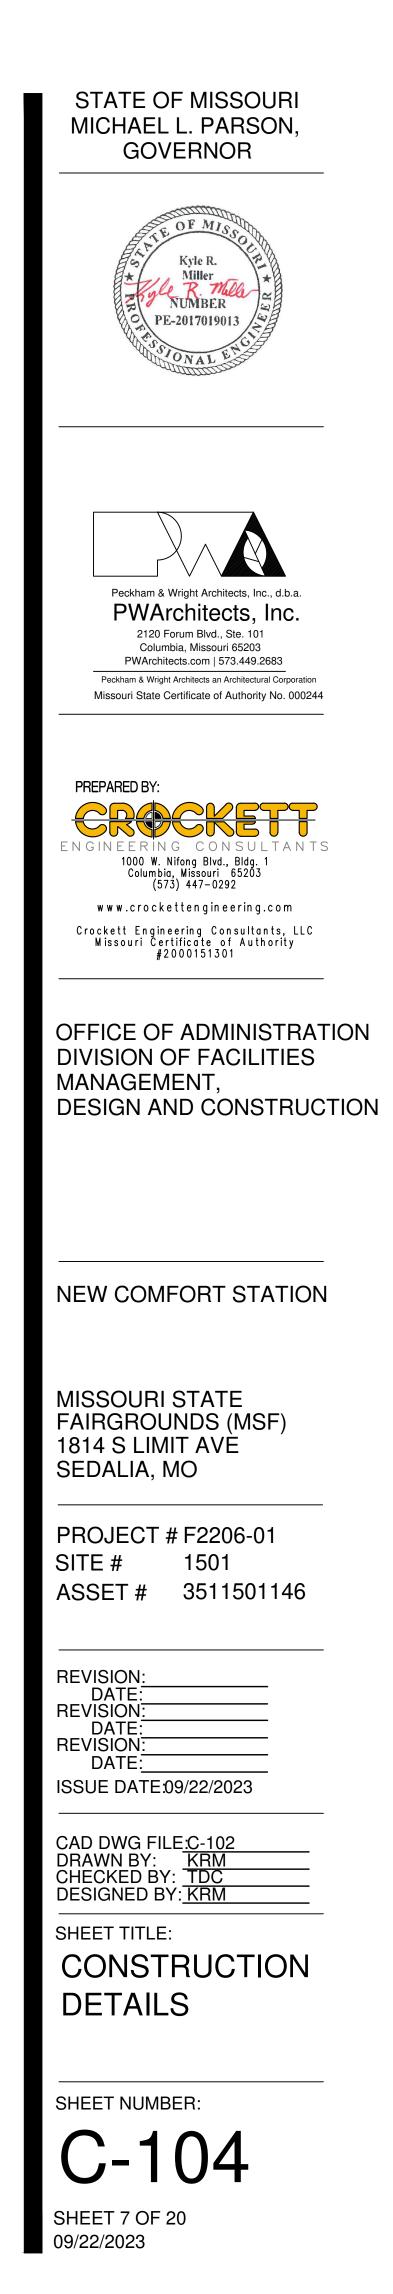

Missouri State Fair - Comfort Station

GENERAL NOTES

ELEVATION DATUM

SEE ARCHITECTURAL DRAWINGS OR SITE PLAN FOR FINISH FLOOR ELEVATIONS

DESIGN SPECIFICATIONS 2018 INTERNATIONAL BUILDING CODE

EARTHWORK

EARTHWORK OPERATIONS SHALL BE PERFORMED UNDER THE DIRECTION OF A PROFESSIONAL TESTING AGENCY TO ASSURE COMPLIANCE WITH THE RECOMMENDATIONS OF THE SOILS REPORT BY CROCKETT GTL DATED NOVEMBER 3, 2020.

CONCRETE

CONCRETE WORK SHALL CONFORM TO ALL REQUIREMENTS OF THE CURRENT ACI 301. SPECIFICATIONS FOR STRUCTURAL CONCRETE FOR BUILDINGS, ACI 318 BUILDING CODE REQUIREMENTS FOR STRUCTURAL CONCRETE, ACI 305 SPECIFICATIONS FOR HOT WATER CONCRETE, AND ACI 306 SPECIFICATIONS FOR COLD WEATHER CONCRETE, WITH THE FOLLOWING ADDITIONAL REQUIREMENTS:

1.	CONCRETE SHALL DEVELOP	THE	FOLLOWING	28-DAY	MINIMUM	COMPRESSIVE	STRENGTH:
	FOUNDATIONS			-	3,000 PS	SI	
	CAST-IN-PLACE WALLS			-	3,500 PS	SI	
	FLOOR SLAB			-	4,000 PS	SI	

- EXTERIOR SLABS, WALLS AND CURBS 4,000 PSI
- 2. ALL FOOTINGS SHALL BEAR ON UNDISTURBED SOIL OR ENGINEERED FILL. 3. CHLORIDE— BASED ADMIXTURES ARE PROHIBITED IN ALL REINFORCED CONCRETE
- 4. REINFORCING STEEL SHALL CONFORM TO ASTM A615, A616, OR A617, GRADE 60.
- 5. ALL CONTINUOUS REINFORCING STEEL THAT MEETS AT A CORNER SHALL BE TIED TOGETHER WITH A CORNER BAR THAT HAS SUFFICIENT LAP DISTANCE IN EACH DIRECTION
- 6. CONTINUOUS REINFORCING BARS LAP LENGTH SHALL BE A MINIMUM OF 48 BAR DIAMETERS UNLESS NOTED OTHERWISE
- 7. CONCRETE SLUMP SHALL BE A MAXIMUM OF $4^{"} + / 1^{"}$ (ASTM C- 143) AS DELIVERED IN THE FIELD. CONTRACTOR MAY USE CHEMICAL ADMIXTURES TO ATTAIN A MAXIMUM SLUMP OF 8" FOR WORKABILITY. NO WATER MAY BE ADDED TO THE CONCRETE MIX ON SITE UNLESS WATER IS WITHHELD AT THE BATCHING FACILITY. IF WATER IS WITHHELD AT THE BATCHING FACILITY IT SHOULD BE REFLECTED ON THE LOAD TICKET. THE TOTAL AMOUNT OF WATER IN THE MIX SHALL NOT EXCEED WHAT IS NOTED ON THE APPROVED MIXED. THIS SHALL BE NOTED IN THE SPECIAL INSPECTOR'S RECORDS.
- 8. CONCRETE EXPOSED TO WEATHER, VEHICLES, AND/OR DEICING CHEMICALS SHALL BE AIR-ENTRAINED WITH 6% (+/-) 1.5% ENTRAINED AIR BY VOLUME AT POINT OF DISCHARGE. DO NOT ALLOW AIR CONTENT OF TROWELED FINISHED FLOORS TO EXCEED 3%.

9. SUBMIT CONCRETE MIX PROPORTIONS PRIOR TO START OF WORK. DO NOT BEGIN CONCRETE PRODUCTION UNTIL MIXES HAVE BEEN REVIEWED AND ARE ACCEPTABLE TO THE ENGINEER. 10.READY MIX CONCRETE SHALL COMPLY WITH REQUIREMENTS OF ASTM C94.

- 11.CONCRETE WORK EXECUTION A. CONSTRUCT FORMS TO CORRECT SIZE, SHAPE, ALIGNMENT, ELEVATION AND POSITION; AND TO SUPPORT VERTICAL AND LATERAL LOADS.
- B. POSITION, SUPPORT, AND SECURE REINFORCEMENT AGAINST DISPLACEMENT, MINIMUM CONCRETE COVER FOR REINFORCEMENT SHALL BE, UNLESS NOTED OTHERWISE ON THE DRAWINGS:

NOT EXPOSED TO WEATHER OR

- IN CONTACT WITH EARTH......1 1/2 INCHES C. PROVIDE CONTROL JOINTS IN SLABS-ON-GRADE AT NOT GREATER THAN 15 FEET ON CENTER IN EACH DIRECTION. SAW CUT CONTROL JOINTS MINIMUM 1/4 OF SLAB DEPTH, AS SOON AFTER SLAB FINISHING WITHOUT DISLODGING AGGREGATE. D. STEEL TROWEL FINISH ALL INTERIOR CONCRETE SLABS, BROOM FINISH ALL EXTERIOR CONCRETE
- SLABS. E. CURE ALL CONCRETE IN COMPLIANCE WITH ACI 301, USING A LIQUID TYPE MEMBRANE,
- NON-RESIDUAL, CURING COMPOUND COMPLYING WITH ASTM C309. ASSURE COMPATIBILITY WITH FINISH FLOOR COVERING.

MASONRY

MASONRY STRUCTURES WITH THE FOLLOWING ADDITIONAL REQUIREMENTS:

- 1. HOLLOW MASONRY BLOCK SHALL CONFORM TO ASTM C90 REGULAR WEIGHT GRADE N1. 2. COURSE GROUT SHALL CONFORM TO ASTM C476 WITH A MAXIMUM AGGREGATE SIZE OF 3/8" AND A MINIMUM COMPRESSIVE STRENGTH OF 2,500 PSI.
- 3. MORTAR SHALL BE TYPE S CONFORMING TO ASTM C270. AVERAGE COMPRESSIVE STRENGTH IS 2,000 PSI
- 4. MINIMUM 28-DAY COMPRESSIVE STRENGTH OF MASONRY; f'm = 2,000 PSI. 5. WIRE REINFORCING SHALL CONFORM TO ASTM A82, STANDARD TRUSS-TYPE DUR-O-WALL REINFORCING (OR APPROVED EQUAL) AND SHALL BE PLACED CONTINUOUSLY IN ALTERNATE HORIZONTAL MORTAR JOINTS
- 6. REINFORCING STEEL SHALL CONFORM TO ASTM A615, A616, OR A617, GRADE 60. THE MINIMUM LAP FOR SPLICES SHALL BE 48 BAR DIAMETERS. PROVIDE DUR-0-WAL REBAR POSITIONERS. 7. ALL STEEL LINTELS TO BE A36 STEEL OR A992 GRADE 50. ALL LINTELS TO BE HOT DIPPED
- GALVANIZED.
- 8. INTERSECTING STRUCTURAL WALLS SHALL BE ANCHORED BY STEEL CONNECTORS SPACED VERTICALLY AT 48" O.C. MAXIMUM. THE CONNECTORS SHALL CONFORM TO ASTM A36 AND SHALL HAVE A MINIMUM SECTION OF 1/4" x 11/4". THEY SHALL BE 28" LONG WITH 2" AT EACH END BENT AT 90 DEGREES TO FORM A "U" OR "Z" SHAPE. ALL CELLS ABOVE AND BELOW THE ANCHOR SHALL BE GROUTED, AND THE BENT ENDS OF THE CONNECTORS SHALL BE EMBEDDED IN THE GROUT, 2' MIN.). EXPANSION JOINTS SHALL BE PROVIDED IN CMU BLOCK WALLS FULL HEIGHT OF WALL AT INTERVALS
- THROUGH THE JOINT.

HEADED MASONRY ANCHORS

- 318 APPENDIX "D" AND AWS D1.1.
- 2. HEADED STUDS HAVE BEEN DESIGNED AS TYPE "B" ANCHORS (f_{tt} = 65,000 psi, f_{y} = 51,000 psi). 3. EMBEDMENT DEPTH IS DEFINED AS THE DISTANCE FROM THE OUTSIDE FACE OF THE EMBEDMENT PLATE TO THE INSIDE FACE OF THE STUD HEAD. 4. EQUIVALENT ANCHORS MAY BE SUBMITTED FOR THE ENGINEER'S APPROVAL.

DEFORMED BAR ANCHORS

- 1. ALL DEFORMED BAR ANCHORS SHALL MEET THE REQUIREMENTS OF THE CODE-CITED EDITION OF ACI
- 318 APPENDIX "D" AND AWS D1.1.
- 2. DEFORMED BAR ANCHORS HAVE BEEN DESIGNED AS TYPE "C" ANCHORS (f_{ut} = 80,000 psi, f_y = 70,000 psi, & MANUFACTURED IN CONFORMANCE WITH ASTM A496). 3. EQUIVALENT ANCHORS MAY BE SUBMITTED FOR THE ENGINEER'S APPROVAL.

Sedalia, Pettis County, Missouri

MASONRY WORK SHALL CONFORM TO ALL REQUIREMENTS OF THE CURRENT ACI 530.1 SPECIFICATIONS FOR

NOT EXCEEDING 24'-O". NOT CLOSER THAN 2'-O" FROM OPENINGS JOINT REINFORCING SHALL BE SEVERED AT EXPANSION JOINT LOCATIONS, HOWEVER BOND BEAM REINFORCING SHALL BE CONTINUOUS

10. BOND BEAMS OR GROUTED CELLS ARE REQUIRED AT ALL CONNECTIONS TO CMU.

1. ALL HEADED CONCRETE ANCHORS SHALL MEET THE REQUIREMENTS OF THE CODE-CITED EDITION OF ACI

PREFABRICATED WOOD TRUSSES

- 1. FLOOR & ROOF TRUSSES SHALL BE DESIGNED IN ACCORDANCE WITH THE TRUSS PLATE INSTITUTE (TPI) DESIGN SPECIFICATION FOR METAL PLATE CONNECTED WOOD TRUSSES, AND THE ANSI/NF&PA
- NATIONAL DESIGN SPECIFICATION (NDS) FOR WOOD CONSTRUCTION. 2. PROVIDE TEMPORARY AND PERMANENT BRACING ON ALL TRUSSES, AS REQUIRED TO PROVIDE MEMBER AND TRUSS STABILITY.
- 3. FLOOR & ROOF TRUSSES SHALL BE DESIGNED AND CONSTRUCTED FOR A MAXIMUM TOTAL LOAD DEFLECTION OF L/360 AND TO SAFELY SUPPORT THE FOLLOWING LOADS: A. DEAD, LIVE, SNOW, WIND, EARTHQUAKE: SEE PROJECT DESIGN DATA ON COVER SHEET.
- B. MECHANICAL PIPE LOAD: TRUSSES SHALL BE DESIGNED FOR A CONCENTRATED LOAD OF 250 LBS HUNG ANYWHERE ALONG THE BOTTOM CHORD.
- C. OVER-FRAMING LOAD: TRUSSES SHALL ALSO BE DESIGNED TO SUPPORT ADDITIONAL OVERBUILD FRAMING, SUCH AS THAT WHICH FORMS VALLEYS AND HIPS ON ROOFS.
- D. DRIFTED SNOW LOAD: TRUSSES SHALL BE DESIGNED TO SUPPORT DRIFTED SNOW LOADS IN ACCORDANCE WITH THE APPROPRIATE BUILDING CODE.
- E. IN-PLANE LATERAL LOADS: TRUSSES SHALL BE DESIGNED TO SUPPORT ANY LATERAL LOADS CARRIED AXIALLY IN THE PLANE OF THE TRUSS, AS SHOWN ON THE PLANS.
- 4. GABLED END TRUSSES SHALL HAVE VERTICAL MEMBERS SPACED AT 16" O.C. MAXIMUM
- 5. SUBMITTALS SHALL INCLUDE THE FOLLOWING:
- A. SHOP DRAWINGS PREPARED UNDER THE SUPERVISION OF. AND SIGNED AND SEALED BY. A PROFESSIONAL ENGINEER REGISTERED IN THE STATE WHERE THE PROJECT IS BUILT. THESE DRAWINGS SHALL INDICATE SPECIES, GRADE, AND SIZES OF LUMBER TO BE USED; PITCH, SPAN, CAMBER, CONFIGURATION, AND SPACING FOR EACH TYPE OF TRUSS REQUIRED; TYPE, SIZE, MATERIAL, FINISH, AND LOCATION OF METAL CONNECTOR PLATES; AND BEARING DETAILS. SHOW TRUSS LAYOUT AND ALL REQUIRED TEMPORARY AND PERMANENT BRACING AFFECTING THE STRUCTURAL CAPACITY OF THE TRUSSES.

PROVIDE COMPLETE ENGINEERING DESIGN CALCULATIONS THAT INCLUDE DESIGN VALUES, DESIGN ANALYSIS INDICATING LOADING, ASSUMED ALLOWABLE STRESSES, STRESS DIAGRAMS, AND CALCULATIONS, AND ANY OTHER INFORMATION NEEDED FOR REVIEW. THE CALCULATIONS SHALL HAVE BEEN SIGNED AND SEALED BY A QUALIFIED PROFESSIONAL ENGINEER WHO IS REGISTERED IN THE STATE WHERE THE PROJECT IS BUILT AND WHO IS RESPONSIBLE FOR PREPARATION OF THE CALCULATIONS.

SPECIAL INSPECTIONS

THE FOLLOWING ITEMS REQUIRE SPECIAL INSPECTION IN ACCORDANCE WITH CHAPTER 17 OF THE INTERNATIONAL BUILDING CODE.

- a. CONCRETE GROUT DESIGN MIX (PERIODIC)
- b. PLACING OF CONCRETE AND REINFORCING STEEL (CONTINUOUS OF CONCRETE SAMPLING / PERIODIC OF REINFORCING)
- c. BOLTS & ANCHORS EMBEDDED IN CONCRETE (PERIODIC)
- d. STRUCTURAL STEEL FABRICATIONS (UNLESS AISC APPROVED)
- (PERIODIC)
- e. STRUCTURAL STEEL BOLTING & WELDING (PERIODIC)
- f. POST INSTALLED ANCHORS IN CONCRETE (CONTINUOUS)
- g. IN-SITU SOILS, EXCAVATIONS, FILLING & COMPACTION (PERIODIC)
- h. MASONRY AND REINFORCING STEEL (CONTINUOUS ON CELL GROUTING / PERIODIC ON
- REINFORCING)
- i. WOOD FRAMING:
- i.a. SHEAR WALLS; WALL SIZE, CONFIGURATION, BLOCKING, PANEL GRADE, PANEL THICKNESS, AND FASTENING. (PERIODIC)
- i.b. DIAPHRAGMS (FLOOR AND ROOF SHEATHING); SIZE, CONFIGURATION, BLOCKING, PANEL GRADE, PANEL THICKNESS, AND FASTENING. (PERIODIC)
- i.c. FRAMING MEMBERS AND DETAILS (PERIODIC)
- i.d. MATERIAL GRADE (PERIODIC)
- i.e. CONNECTIONS; HANGERS, HOLD DOWNS, BUILT-UP COLUMNS, BUILT-UP BEAMS (PERIODIC) i.f. PRE-ENGINEERED TRUSSES; FRAMING, CONNECTIONS, BRIDGING (PERIODIC)


THE CONTRACTOR SHALL REQUEST SPECIAL INSPECTION OF THE ITEMS LISTED ABOVE PRIOR TO THOSE ITEMS BECOMING INACCESSIBLE AND UNOBSERVABLE DUE TO PROGRESSION OF THE WORK.

DE	SIGNDATA
2018 INTERNATIONAL BUILDING CODE / AS	<u>CE 7-16</u>
BUILDING OCCUPANCY CATEGORY	I
ROOF LOAD DATA	
LIVELOAD	20
ROOFING, SHEATHING, & INSULATION	8.0
MECHANICAL ALLOWANCE	7.0
TRUSSES/STRUCTURE	5.0
TOTAL TO WALLS	40 lbs/sq.ft
ROOF SNOW LOAD DATA* (*UNBALANCE IN ADDITION T	D & DRIFTING SNOW TO BE DETERMINED O UNIFORM LOAD, WHERE APPLICABLE)
p _g =	20 lbs/sq.ft
C _e =	1.0
/ _s =	1.0
<i>C</i> ₁ =	11
WIND DESIGN DATA	
V _{ult} =	115 M.P.H. (IBC 1609.3.1)
RISK CATEGORY	I
EXPOSURE	С
INTERNAL PRESSURE COEFFICIENT =	± 0.18
DIRECTIONAL PROCEDURE (MWFRS - AS	SCE 7-10, CH 27; C&C - ASCE 7-10, CH 30, PART 4)
MAXIMUM COMPONENTS & CLADDING W	IND +40/-40 lbs/sq.ft
EARTHQUAKE DESIGN DATA	
RISK CATEGORY	I
/ _E =	1.0
S _S =	0.137
<i>S</i> ₁ =	0.084
SITECLASS	С
S _{DS} =	0.119
S _{D1} =	0.084
SEISMIC DESIGN CATEGORY	В
BASIC SEISMIC-FORCE-RESISTING SYST INTERMEDIATE REINFORCED MAS	
R =	3.50
OMEGA=	2.50
$C_d =$	2.25
DESIGN BASE SHEAR	V= 0.034W
EQUIVALENT LATERAL FORCE PROCED	JRE
NET ALLOWABLE SOIL BEARING	2,100 CONTINUOUS/2,500 PAD lbs/sq.ft


INDEX OF SHEETS	
COVER / GENERAL STRUCTURAL DATA	S-100
FOUNDATION PLAN & DETAILS	S-200
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ROOF FRAMING DETAILS	S-310

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OFFICE OF ADMINISTRATION DIVISION OF FACILITIES MANAGEMENT, DESIGN AND CONSTRUCTION
NEW COMFORT STATION
NEW COMFORT STATION MISSOURI STATE FAIRGROUNDS (MSF) 2503 W. 16TH St. SEDALIA, MO PROJECT # F2206-01 SITE # 1501 ASSET # 3511501139
MISSOURI STATE FAIRGROUNDS (MSF) 2503 W. 16TH St. SEDALIA, MO PROJECT # F2206-01 SITE # 1501 ASSET # 3511501139 REVISION: DATE: REVISION: DATE: REVISION: DATE: REVISION: DATE: ISSUE DATE: 09/22/2023
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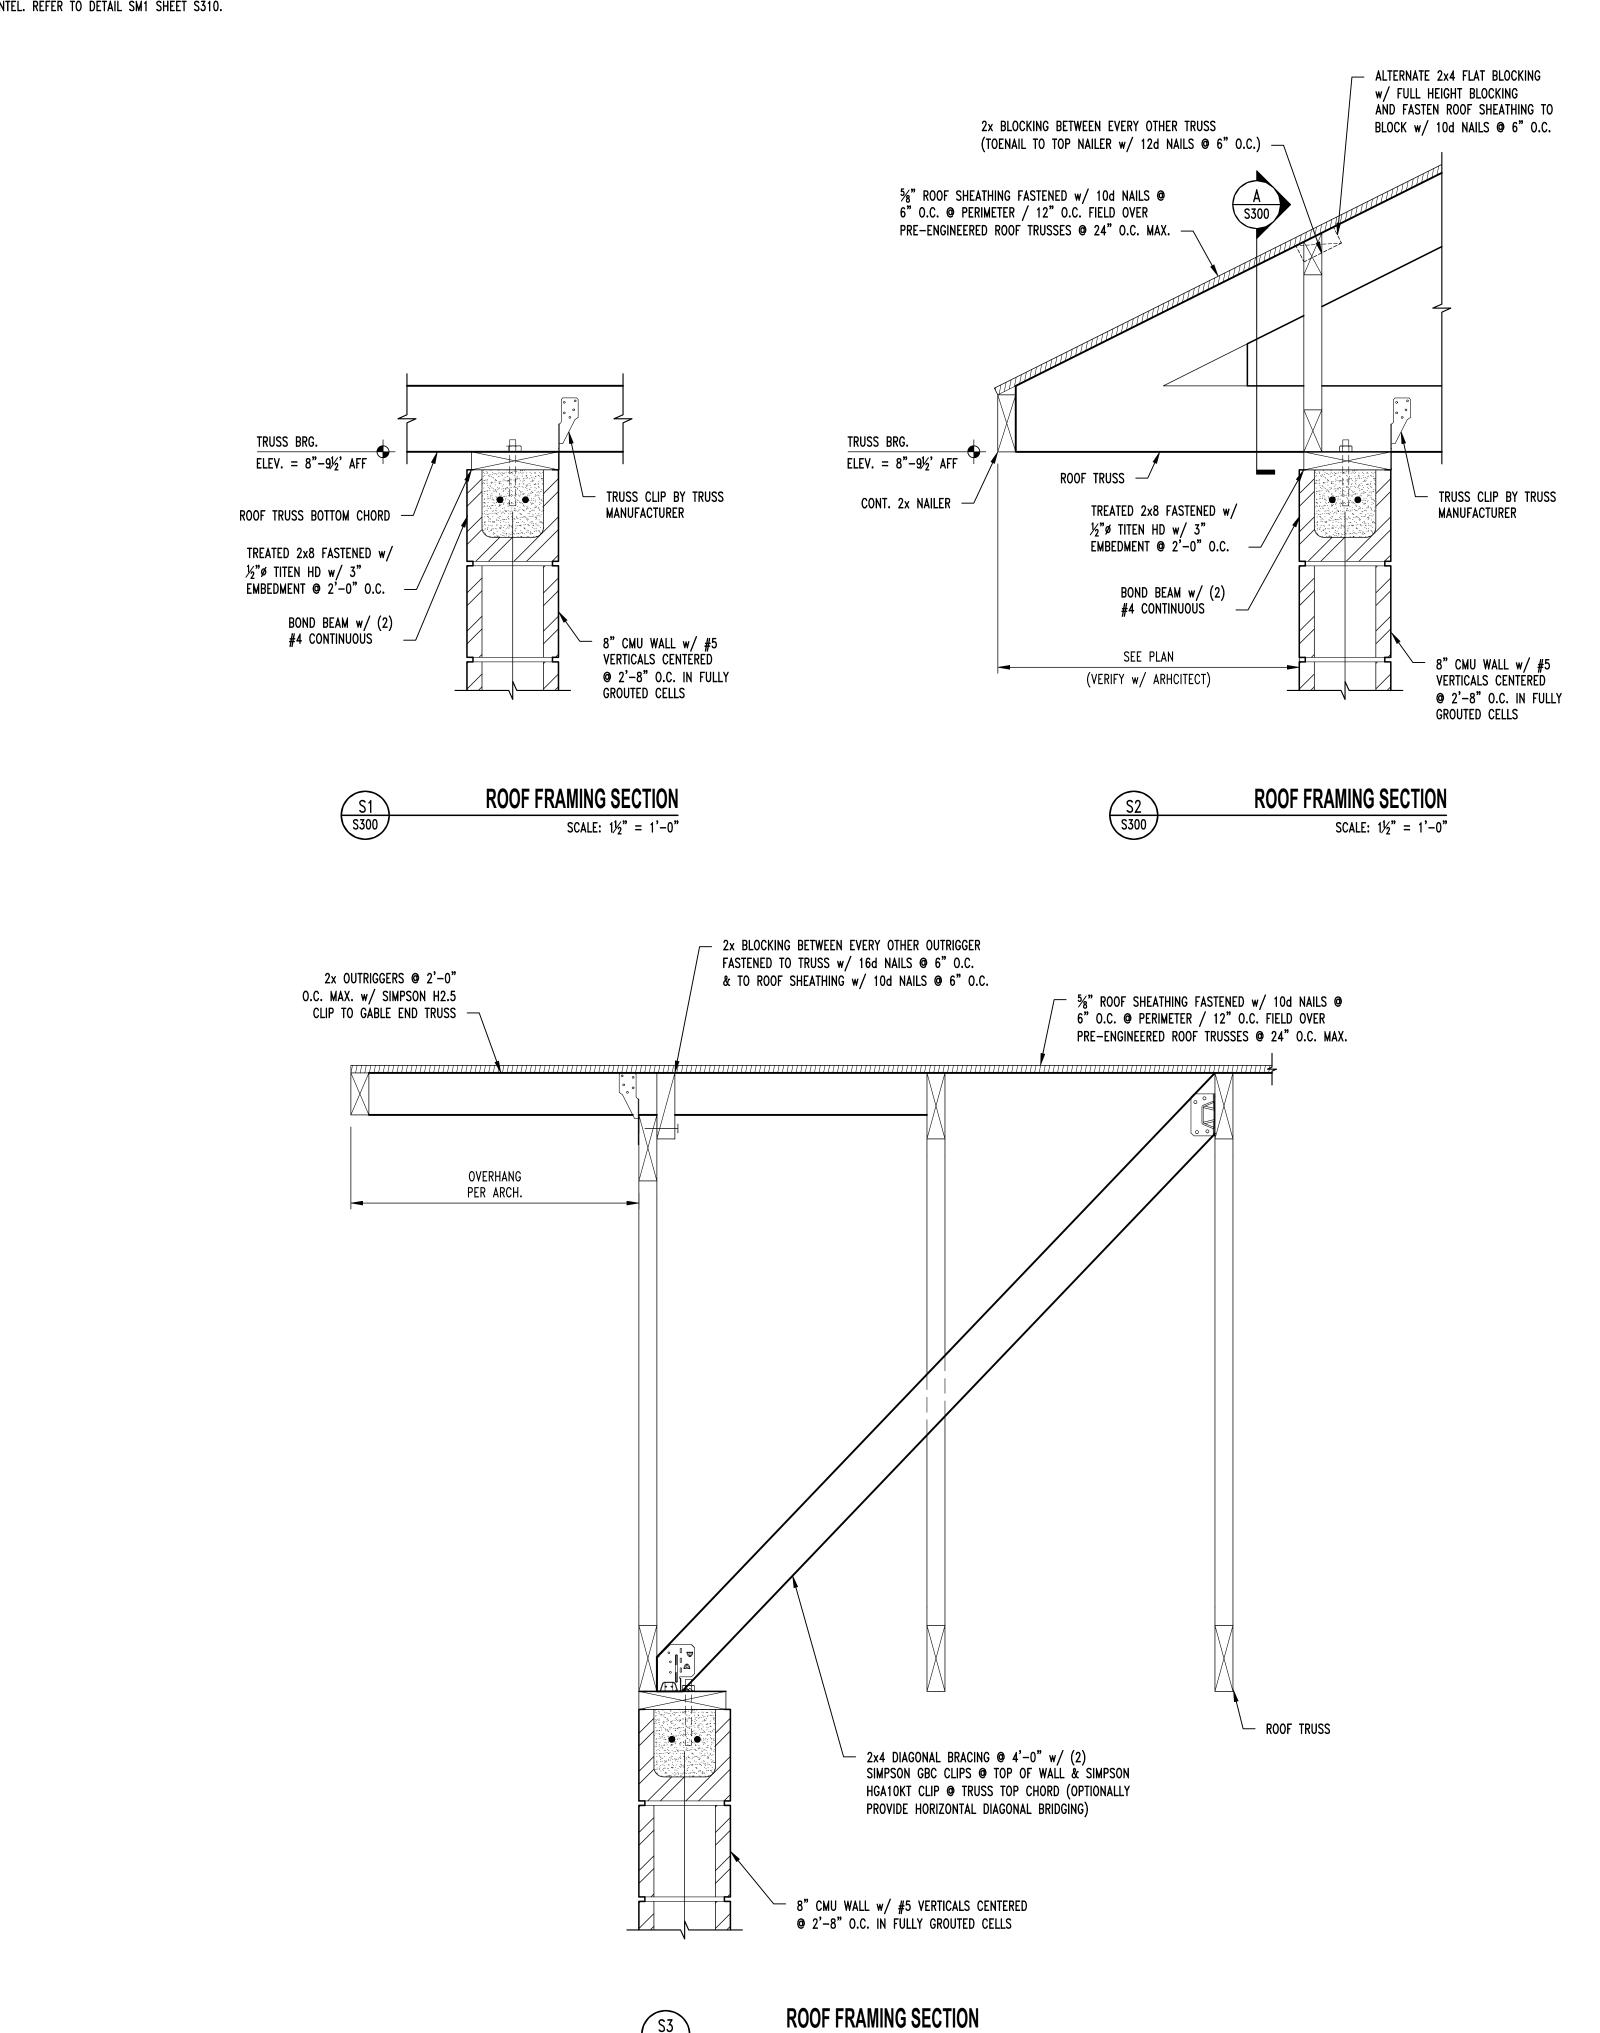
09/22/2023

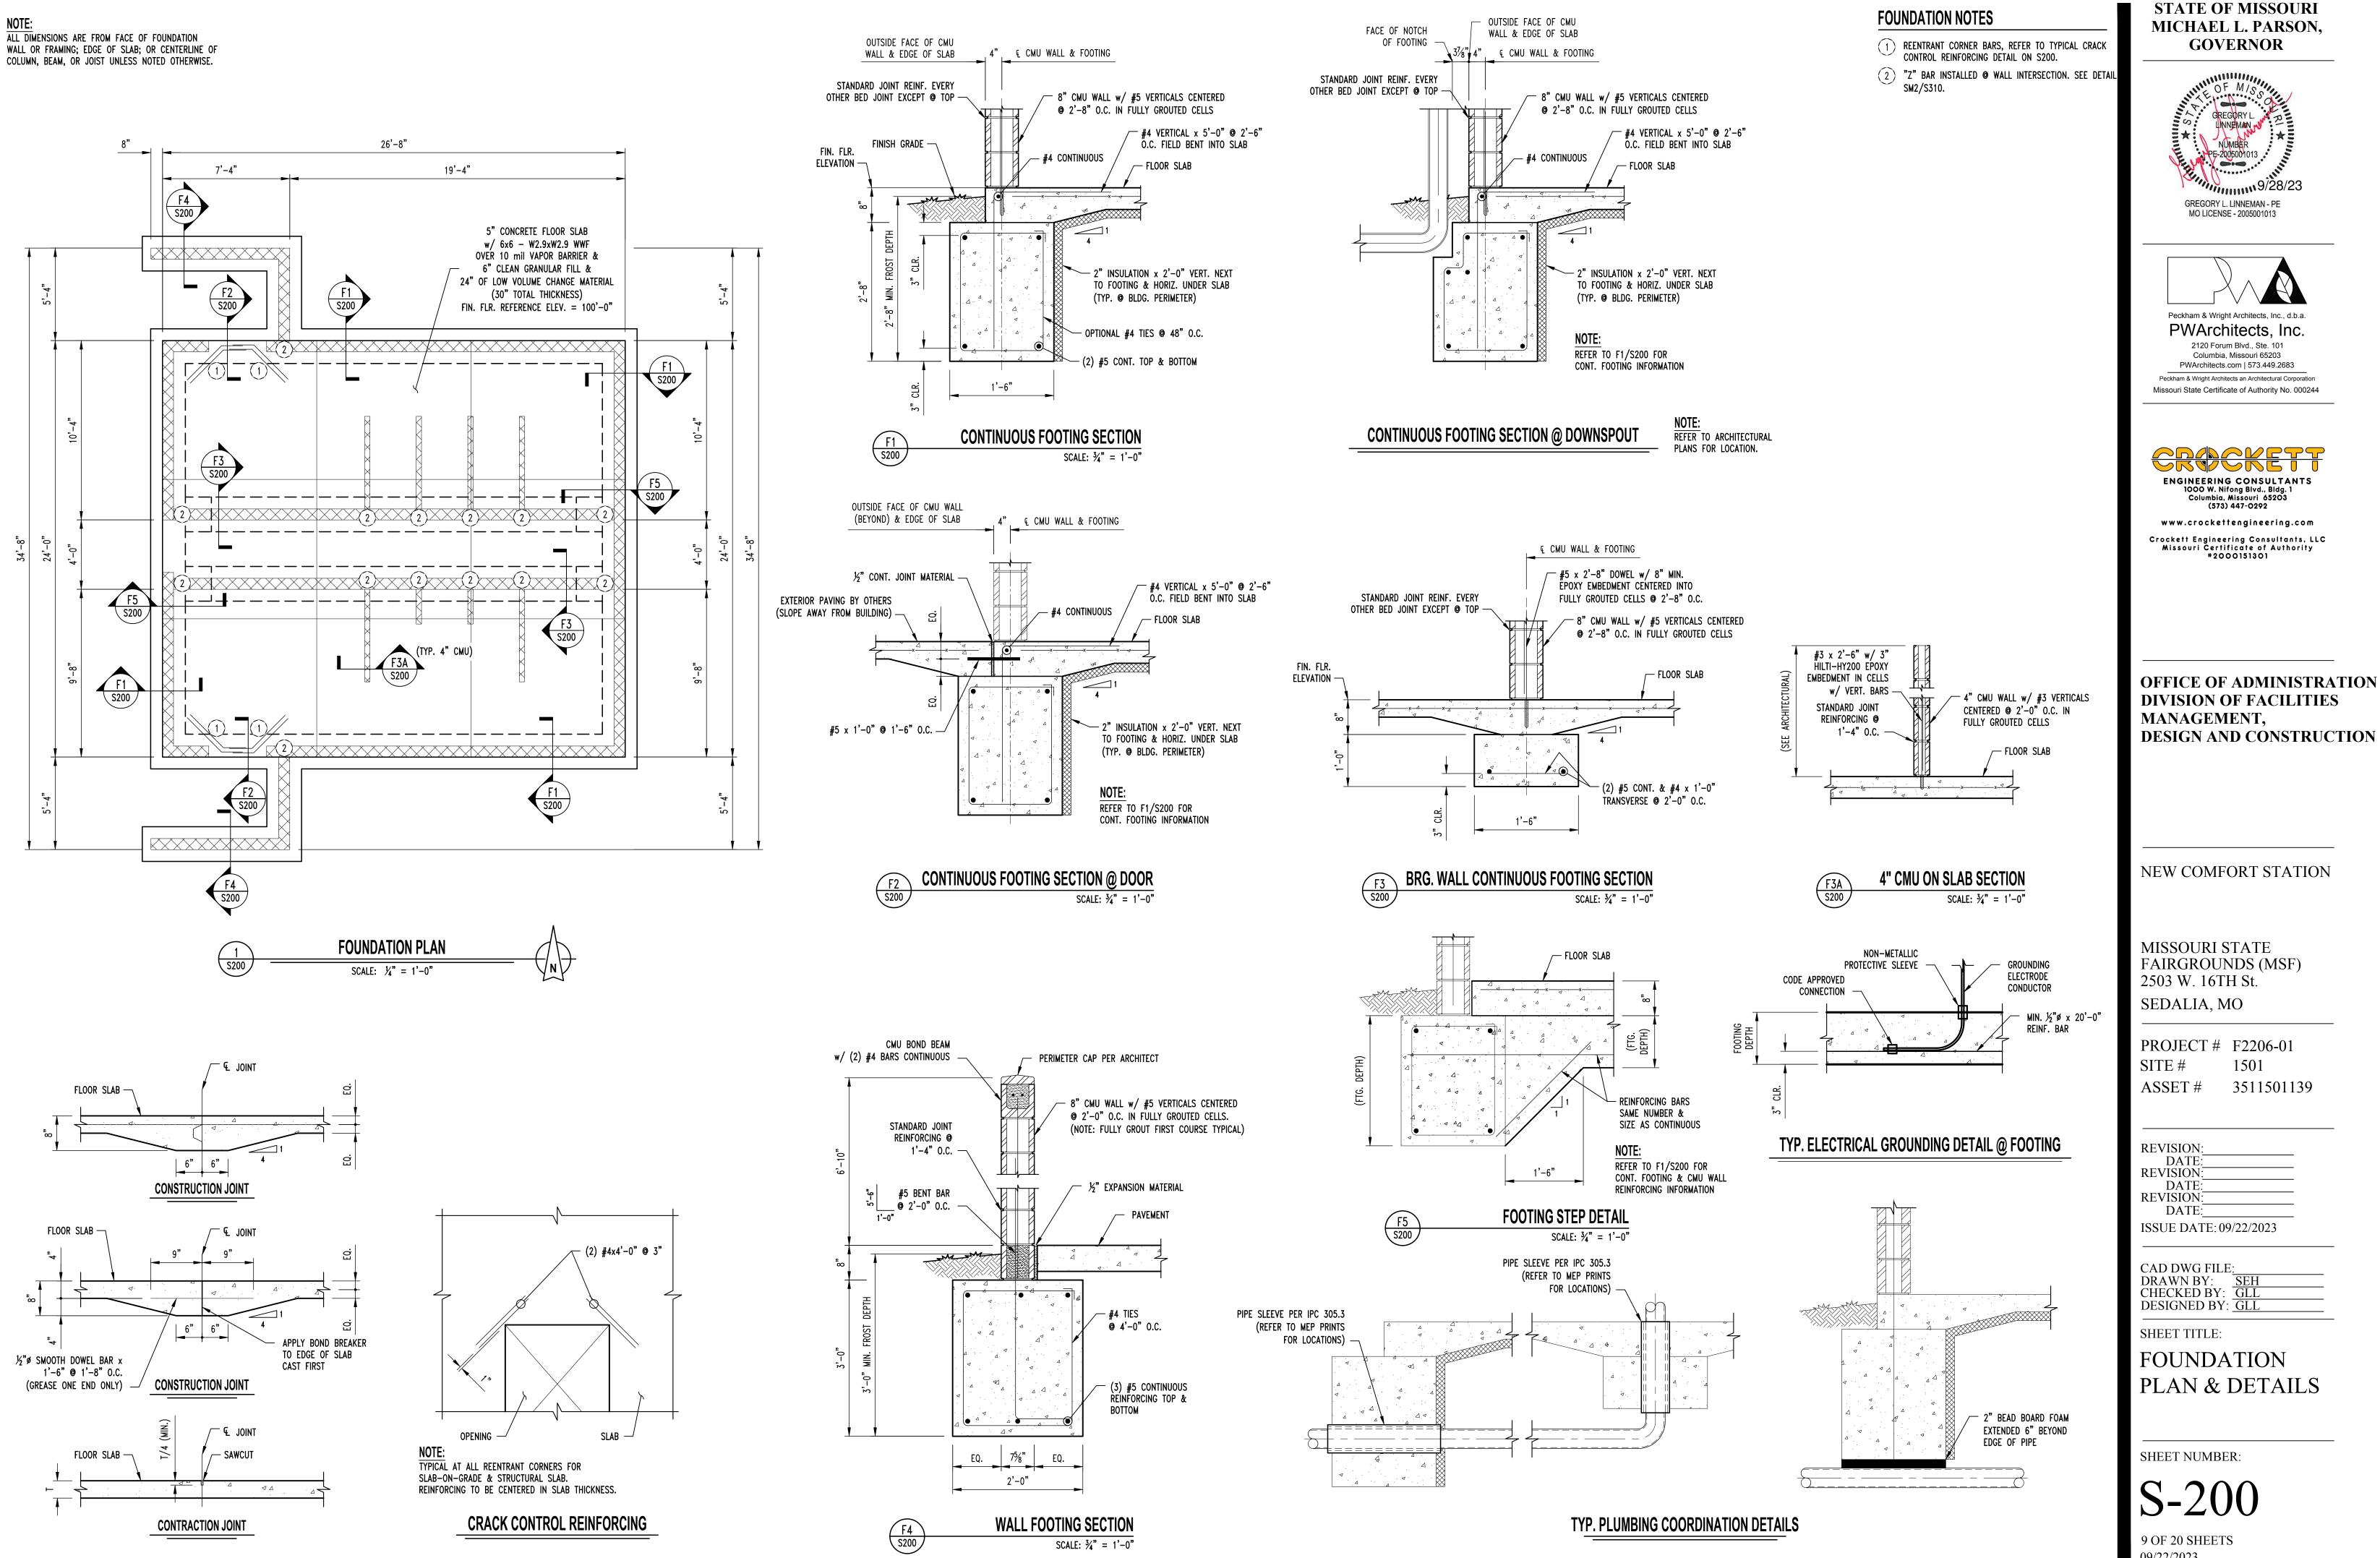

TYP. TRUSS BLOCKING SECTION A S300 SCALE: $1\frac{1}{2}$ " = 1'-0"


FRAMING NOTES

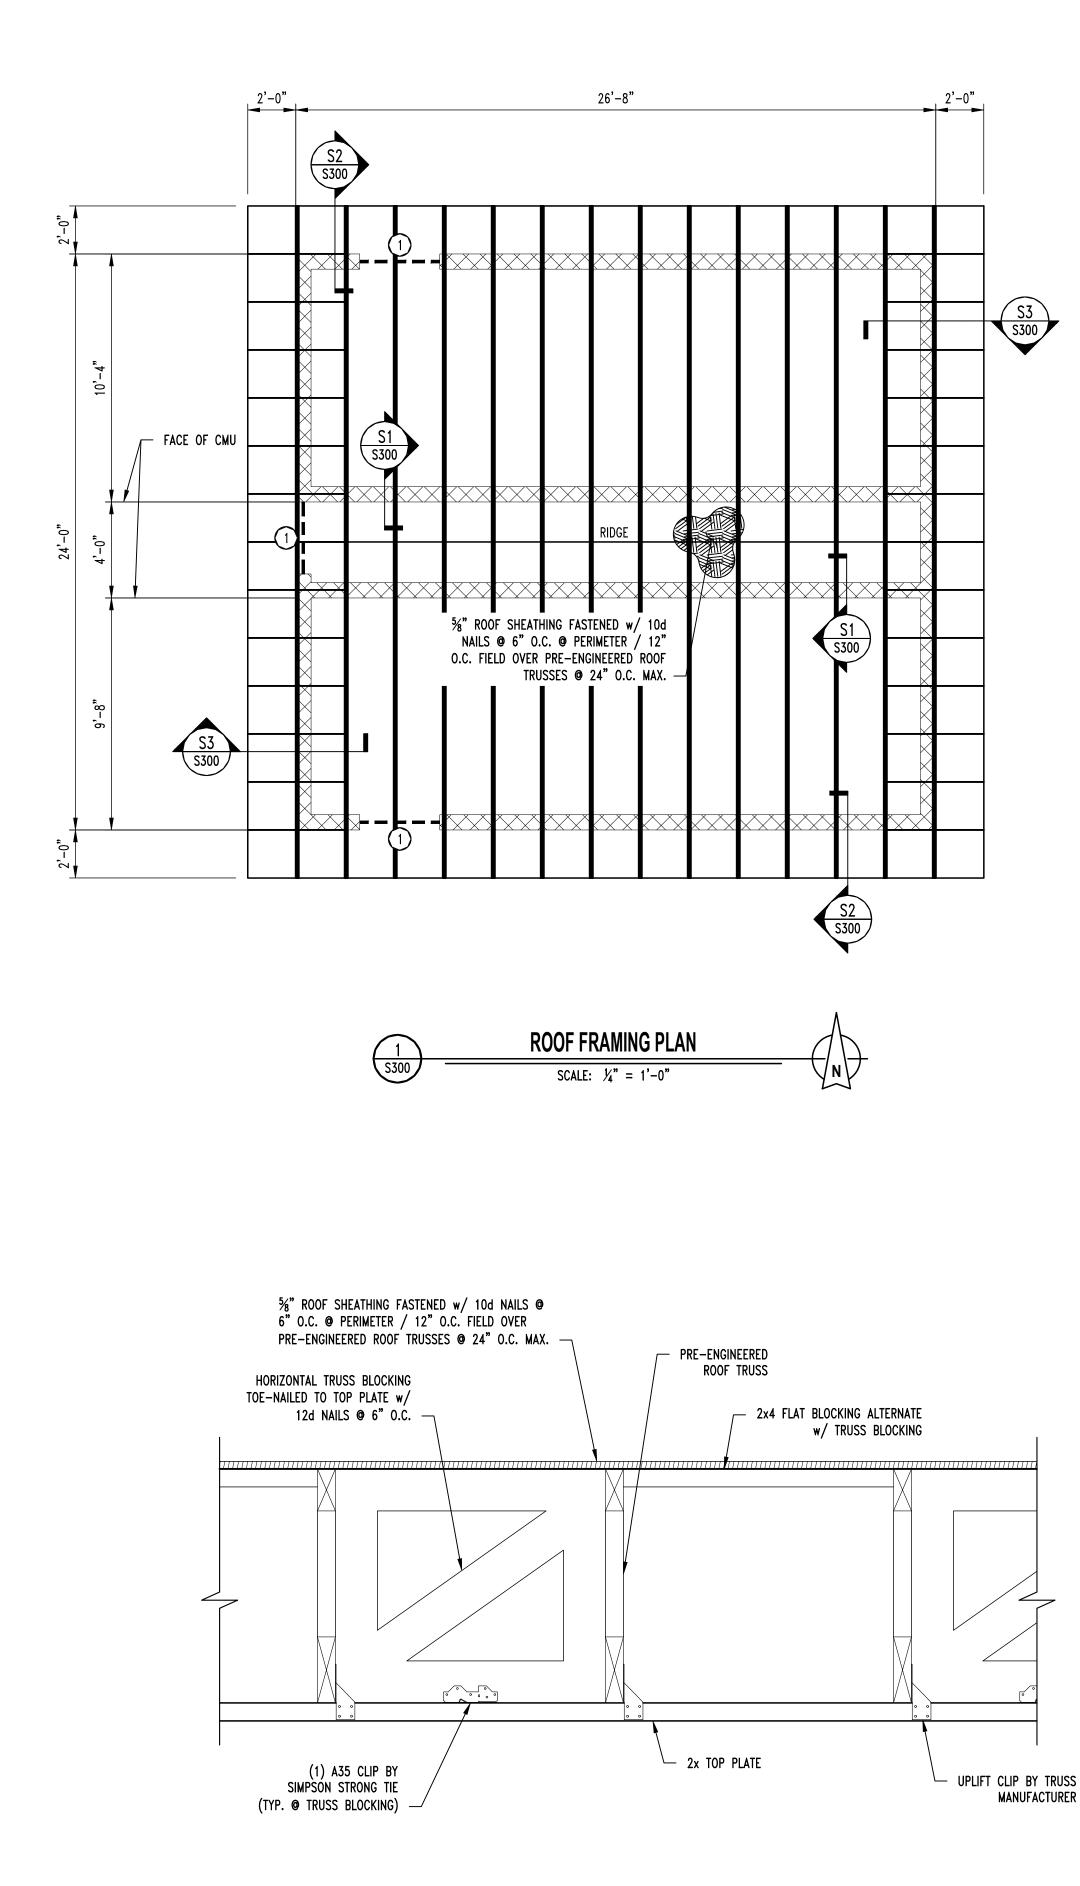
(1) CMU LINTEL. REFER TO DETAIL SM1 SHEET S310.



S3 S300

SCALE: $1\frac{1}{2}$ " = 1'-0"

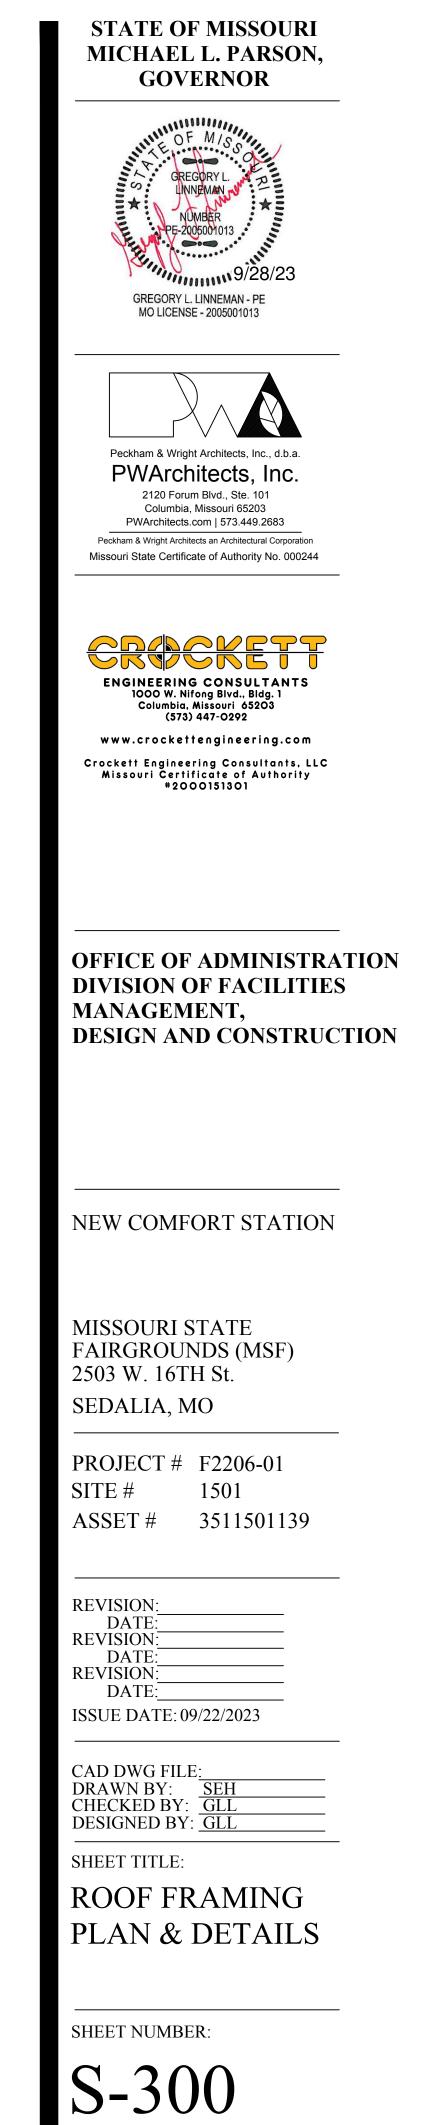


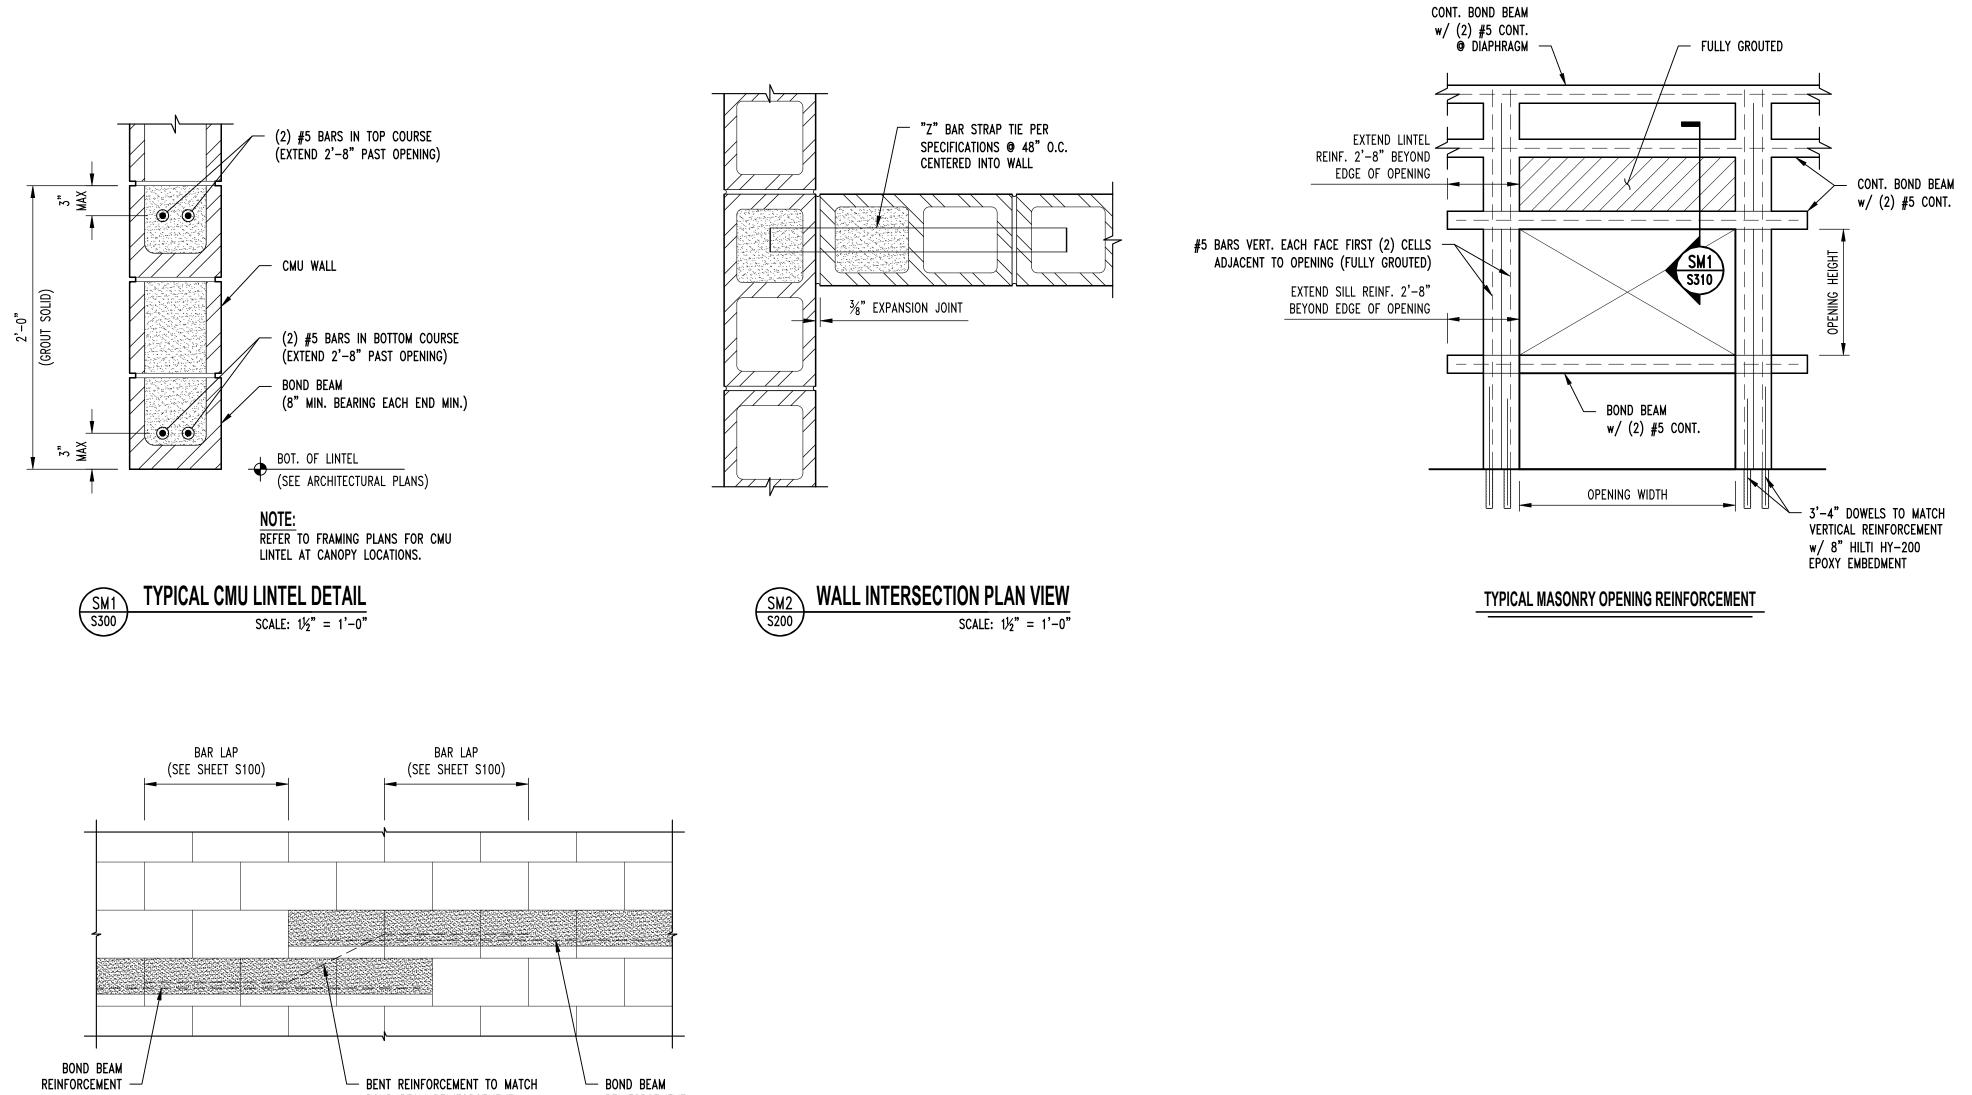


TYPICAL STEP IN BOND BEAM ____

└── BENT REINFORCEMENT TO MATCH BOND BEAM REINFORCEMENT


└── BOND BEAM REINFORCEMENT

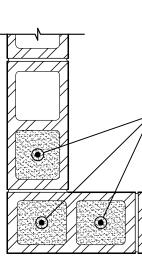

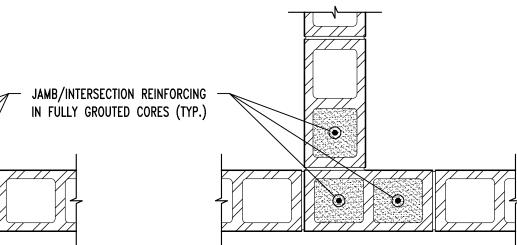


TYPICAL CMU WALL VERT REINFORCING ____

STATE OF MISSOURI MICHAEL L. PARSON, GOVERNOR
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CAD DWG FILE. DRAWN BY: <u>SEH</u> CHECKED BY: <u>GLL</u> DESIGNED BY: <u>GLL</u> SHEET TITLE: TYPICAL MASONRY DETAILS
Sheet number: $S-310$

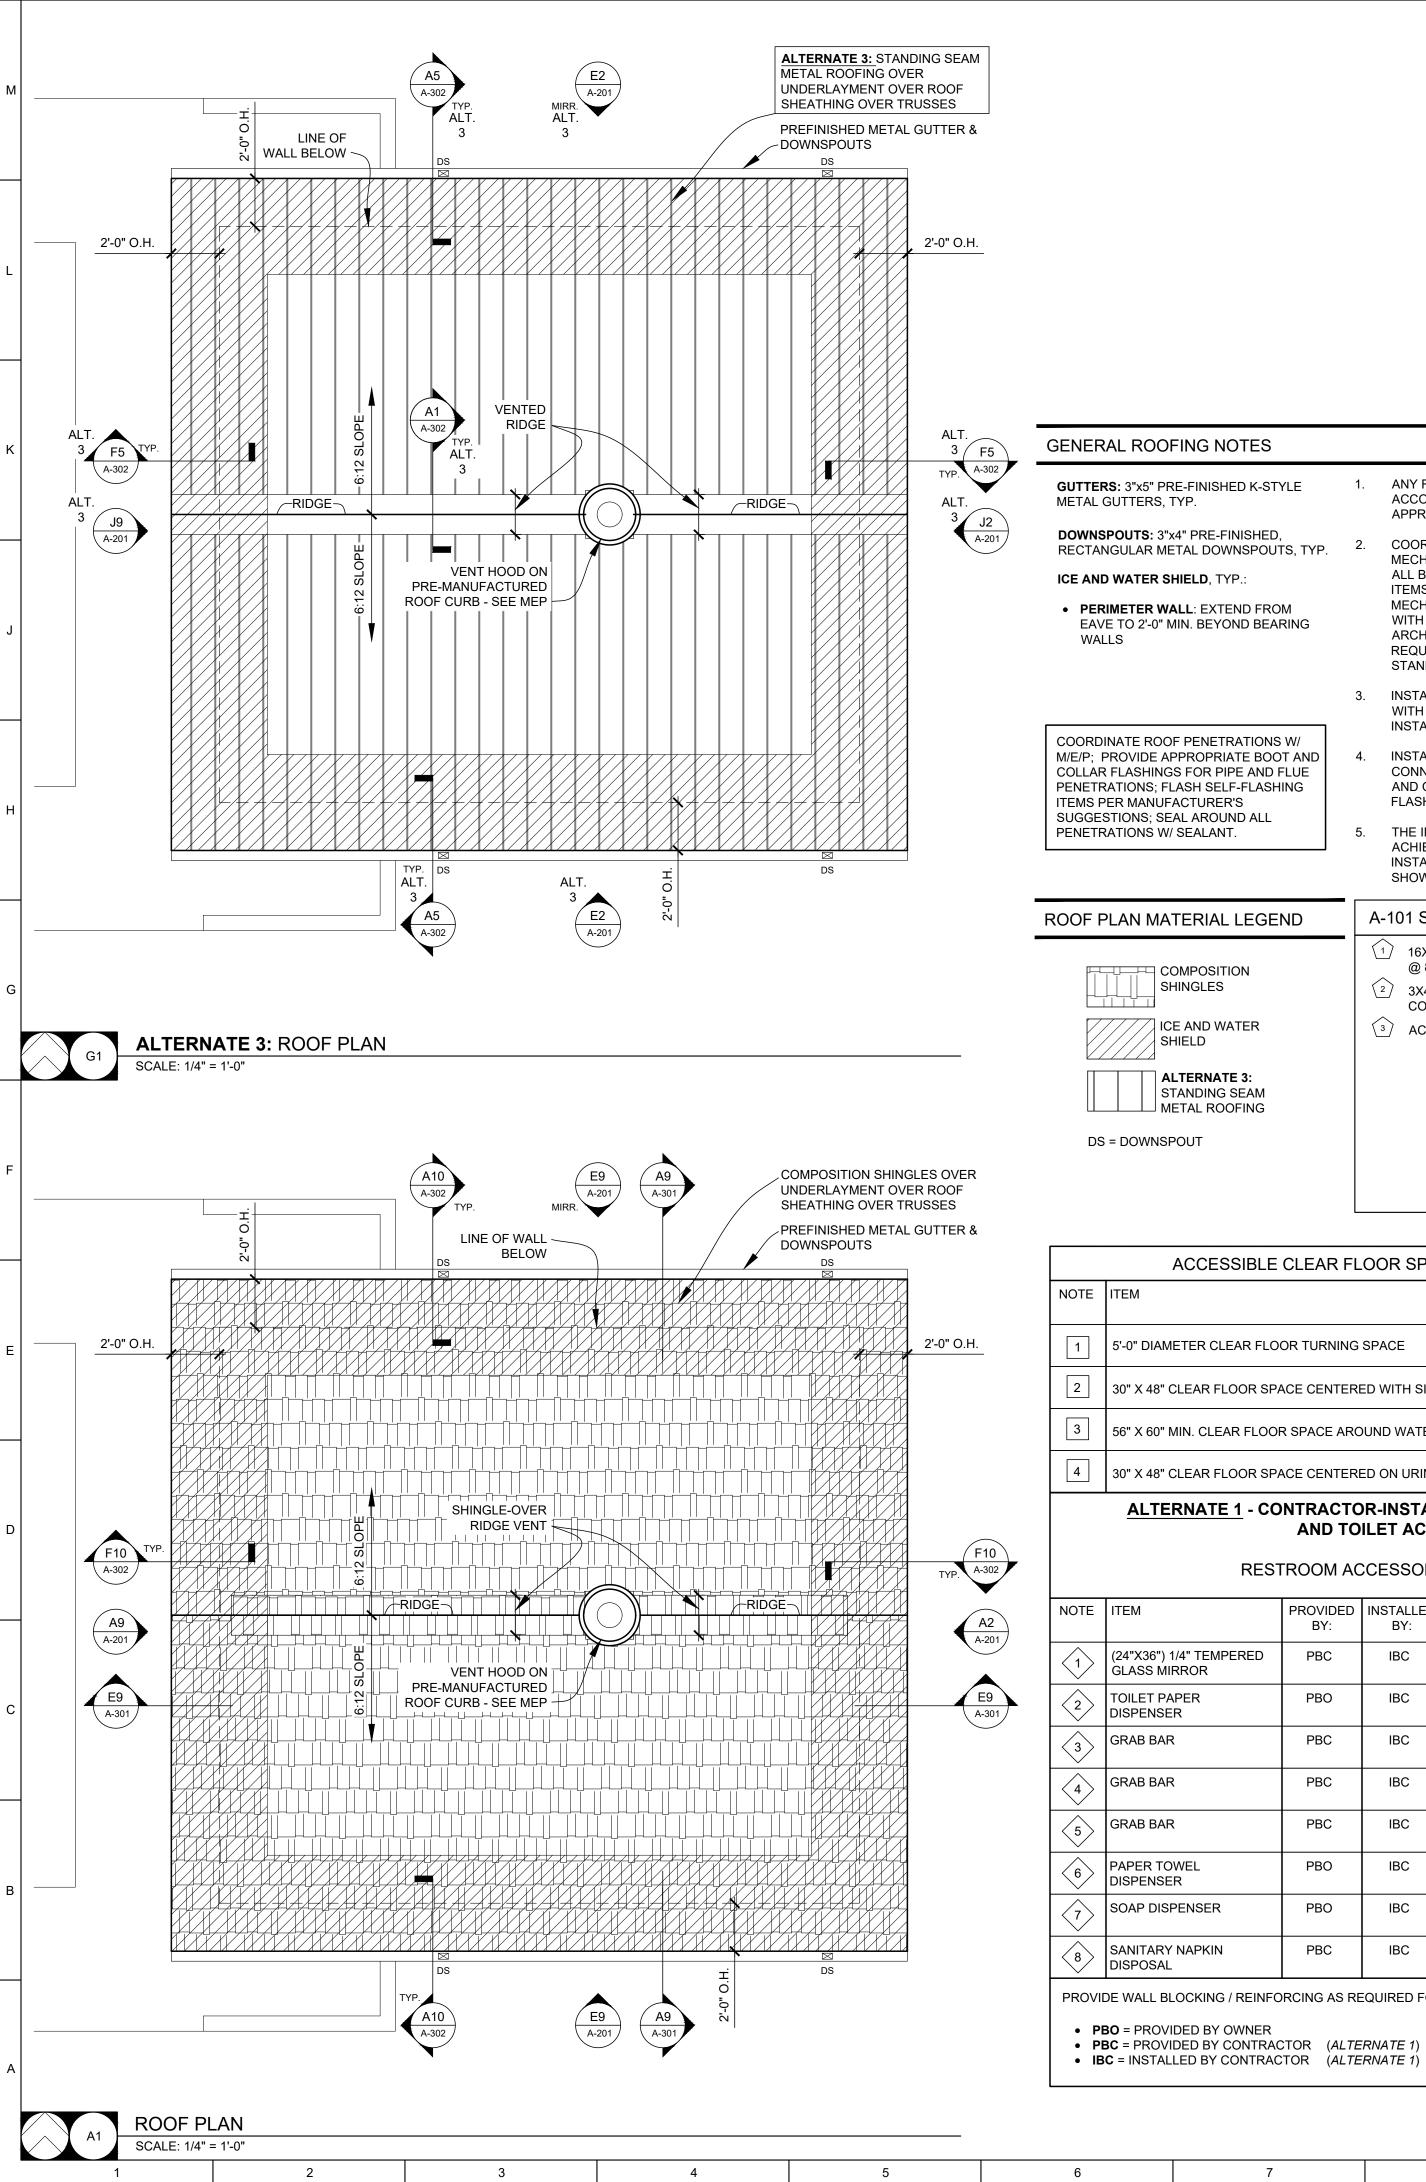

FLOOR PLAN PARTITION TYPE KEY

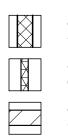

8" SPLIT-FACE CMU WALL - SEE STRUCTURAL

4" CMU PARTITION WALL @ 6'-8" TALL, TYP. 8" CMU WALL - SEE STRUCTURAL

ETAL GUTTERS, TYP.	
DWNSPOUTS: 3"x4" PRE-FINISHED, ECTANGULAR METAL DOWNSPOUTS, TYP.	2.
E AND WATER SHIELD, TYP.:	
PERIMETER WALL : EXTEND FROM EAVE TO 2'-0" MIN. BEYOND BEARING WALLS	
	3.
DORDINATE ROOF PENETRATIONS W/ E/P; PROVIDE APPROPRIATE BOOT AND DLLAR FLASHINGS FOR PIPE AND FLUE ENETRATIONS; FLASH SELF-FLASHING EMS PER MANUFACTURER'S JGGESTIONS; SEAL AROUND ALL ENETRATIONS W/ SEALANT.	4. 5.
OF PLAN MATERIAL LEGEND	
	-

ANY ROOFING DETAILS NOT SHOWN SHALL BE DONE IN ACCORDANCE W/ ROOFING FABRICATOR OR INSTALLER APPROVED DETAILS.

COORDINATE ALL ROOF PENETRATIONS WITH MECHANICAL, PLUMBING & ELECTRICAL WORK. PROVIDE ALL BLOCKINGS, FLASHINGS, CURBS & OTHER RELATED ITEMS AS REQUIRED FOR PROPER INSTALLATION OF MECHANICAL, PLUMBING & ELECTRICAL ITEMS. COMPLY WITH REQUIREMENTS OF NRCA &/OR SMACNA. NOTIFY ARCHITECT OF FABRICATOR OR INSTALLER REQUIREMENTS THAT DIFFER FROM THE REFERENCED STANDARDS.

INSTALL ALL ROOFING AND FLASHINGS IN ACCORDANCE WITH REQUIREMENTS OF ROOFING MANUFACTURER'S INSTALLATION INSTRUCTIONS.

- INSTALL SEALANT TAPE BETWEEN ALL NON-SOLDERED CONNECTIONS OF FLASHINGS, GUTTERS, DOWNSPOUTS AND OTHER AREAS TO MAKE WATER-TIGHT ROOF & FLASHINGS. THE INTENT OF THE ROOF PLANS & DETAILS IS TO
- ACHIEVE A COMPLETE & PROPER WATER-TIGHT INSTALLATION, REGARDLESS IF A DETAIL IS OR IS NOT SHOWN.

A-101 SCOPE-OF-WORK NOTES

- 1) 16X8 FOUNDATION VENT W/ DAMPER; SET SILL @ 8" AFF
- $\left< \frac{2}{2} \right>$ 3X4 METAL DOWNSPOUT TO PRECAST CONCRETE SPLASHBLOCK
- (3) ACCESSIBLE RESTROOM SIGN SEE H13/A-101

	ALTERNATE 1 - CONTRACTOR-INSTALLED PLUMBING FIXTURES
4	30" X 48" CLEAR FLOOR SPACE CENTERED ON URINAL
3	56" X 60" MIN. CLEAR FLOOR SPACE AROUND WATER CLOSET
2	30" X 48" CLEAR FLOOR SPACE CENTERED WITH SINK/LAVATORY FOR PARALLEL APPROACH
1	5'-0" DIAMETER CLEAR FLOOR TURNING SPACE
DTE	ITEM
	ACCESSIBLE CLEAR FLOOR SPACE REQUIREMENTS


AND TOILET ACCESSORIES

RESTROOM ACCESSORY SCHEDULE

OTE	ITEM	PROVIDED BY:	INSTALLED BY:	MODEL	REMARKS
	(24"X36") 1/4" TEMPERED GLASS MIRROR	PBC	IBC		
2	TOILET PAPER DISPENSER	PBO	IBC		
3	GRAB BAR	PBC	IBC	BOBRICK B-6806 x 18	
4	GRAB BAR	PBC	IBC	BOBRICK B-6806 x 36	
5	GRAB BAR	PBC	IBC	BOBRICK B-6806 x 42	
6	PAPER TOWEL DISPENSER	PBO	IBC	CASCADES PRO C340	
7	SOAP DISPENSER	PBO	IBC	SPARTAN LITE N' FOAMY	
8	SANITARY NAPKIN DISPOSAL	PBC	IBC	BOBRICK B-254	

PROVIDE WALL BLOCKING / REINFORCING AS REQUIRED FOR ACCESSORY INSTALLATION AND MOUNTING.

8

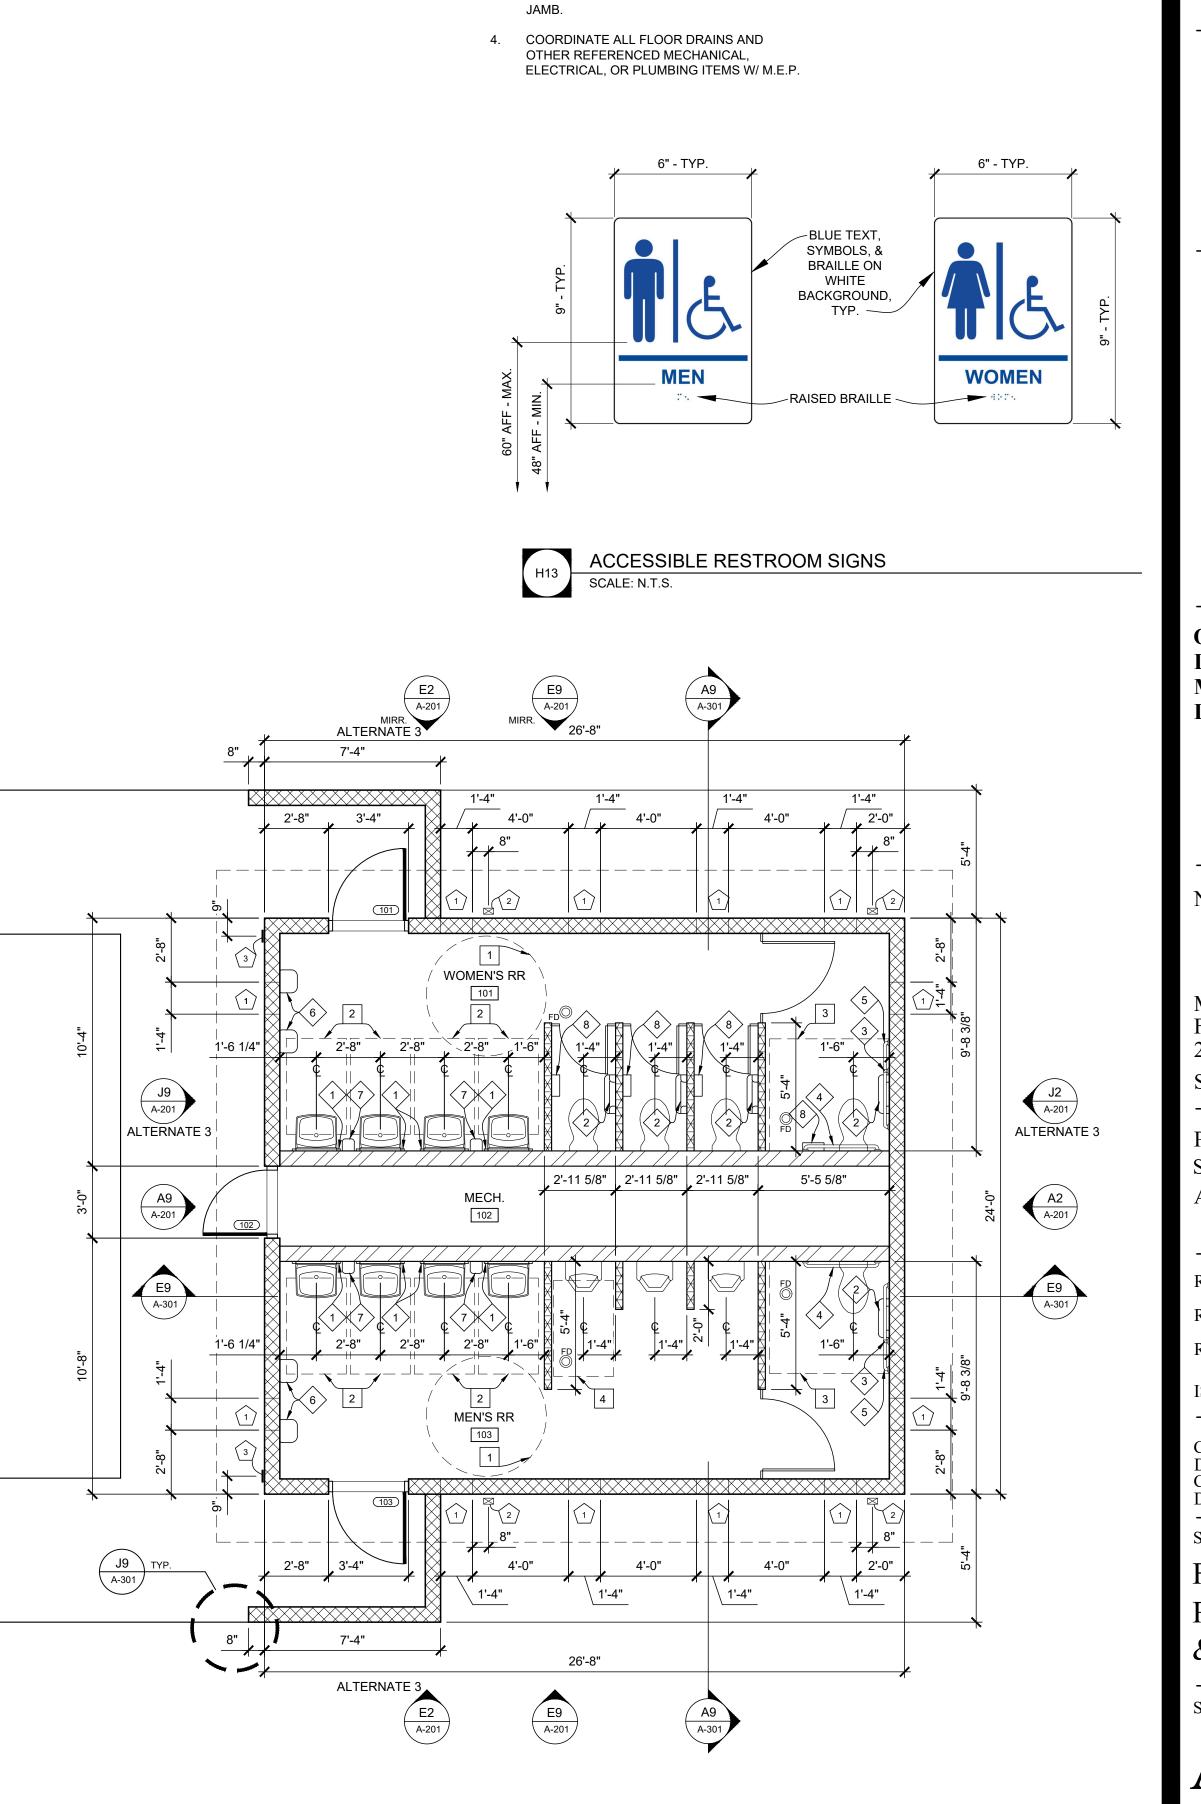



10

9

13

GENERAL FLOOR PLAN NOTES

- FIELD VERIFY ALL DIMENSIONS AND CONDITIONS PRIOR TO EXECUTING ANY WORK. NOTIFY ARCHITECT OF ANY DIMENSIONS OR WORK DIFFERING FROM THAT SHOWN, FOR CLARIFICATION BY THE ARCHITECT PRIOR TO PROCEEDING WITH WORK.
- VERIFY ALL ROUGH OPENINGS FOR DOORS, LOUVERS, EQUIPMENT, & OTHER "BUILT-IN" ITEMS PRIOR TO EXECUTION OF ANY WORK AFFECTED BY SAME.
- 3. LOCATE DOOR OPENINGS WHICH ARE NOT DIMENSIONED OTHERWISE, CENTERED IN WALL AND 6" FROM FINISH WALL TO FINISH
- 5. COORDINATE ALL REQUIRED UTILITIES WITH EQUIPMENT MANUFACTURER.
- ALL DIMENSIONS ARE TO FACE OF STUD -6. OR MASONRY - UNLESS OTHERWISE NOTED.
- DO NOT SCALE DRAWINGS WHERE 7. DIMENSIONAL DISCREPANCIES ARE ENCOUNTERED NOTIFY ARCHITECT PRIOR TO PROCEEDING WITH THE WORK.
- COORDINATE HEIGHTS OF OUTLETS & SWITCHING WITH ALL ARCHITECTURAL ITEMS. SEE M/E DRAWINGS FOR LOCATIONS.

STATE OF MISSOURI MICHAEL L. PARSON, GOVERNOR





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OFFICE OF ADMINISTRATION DIVISION OF FACILITIES MANAGEMENT, **DESIGN AND CONSTRUCTION**

NEW COMFORT STATION

MISSOURI STATE FAIRGROUNDS (MSF) 2503 W. 16TH St. SEDALIA, MO

F2206-01
1501
3511501146

REVISION: DATE: **REVISION:** DATE: **REVISION:** DATE: ISSUE DATE: 09/22/2023

CAD DWG FILE:A-101 DRAWN BY: ER CHECKED BY: ER DESIGNED BY: ER


SHEET TITLE: FLOOR PLAN, ROOF PLAN, & DETAILS


SHEET NUMBER:

[A-10]12 OF 20 SHEETS 09/22/2023


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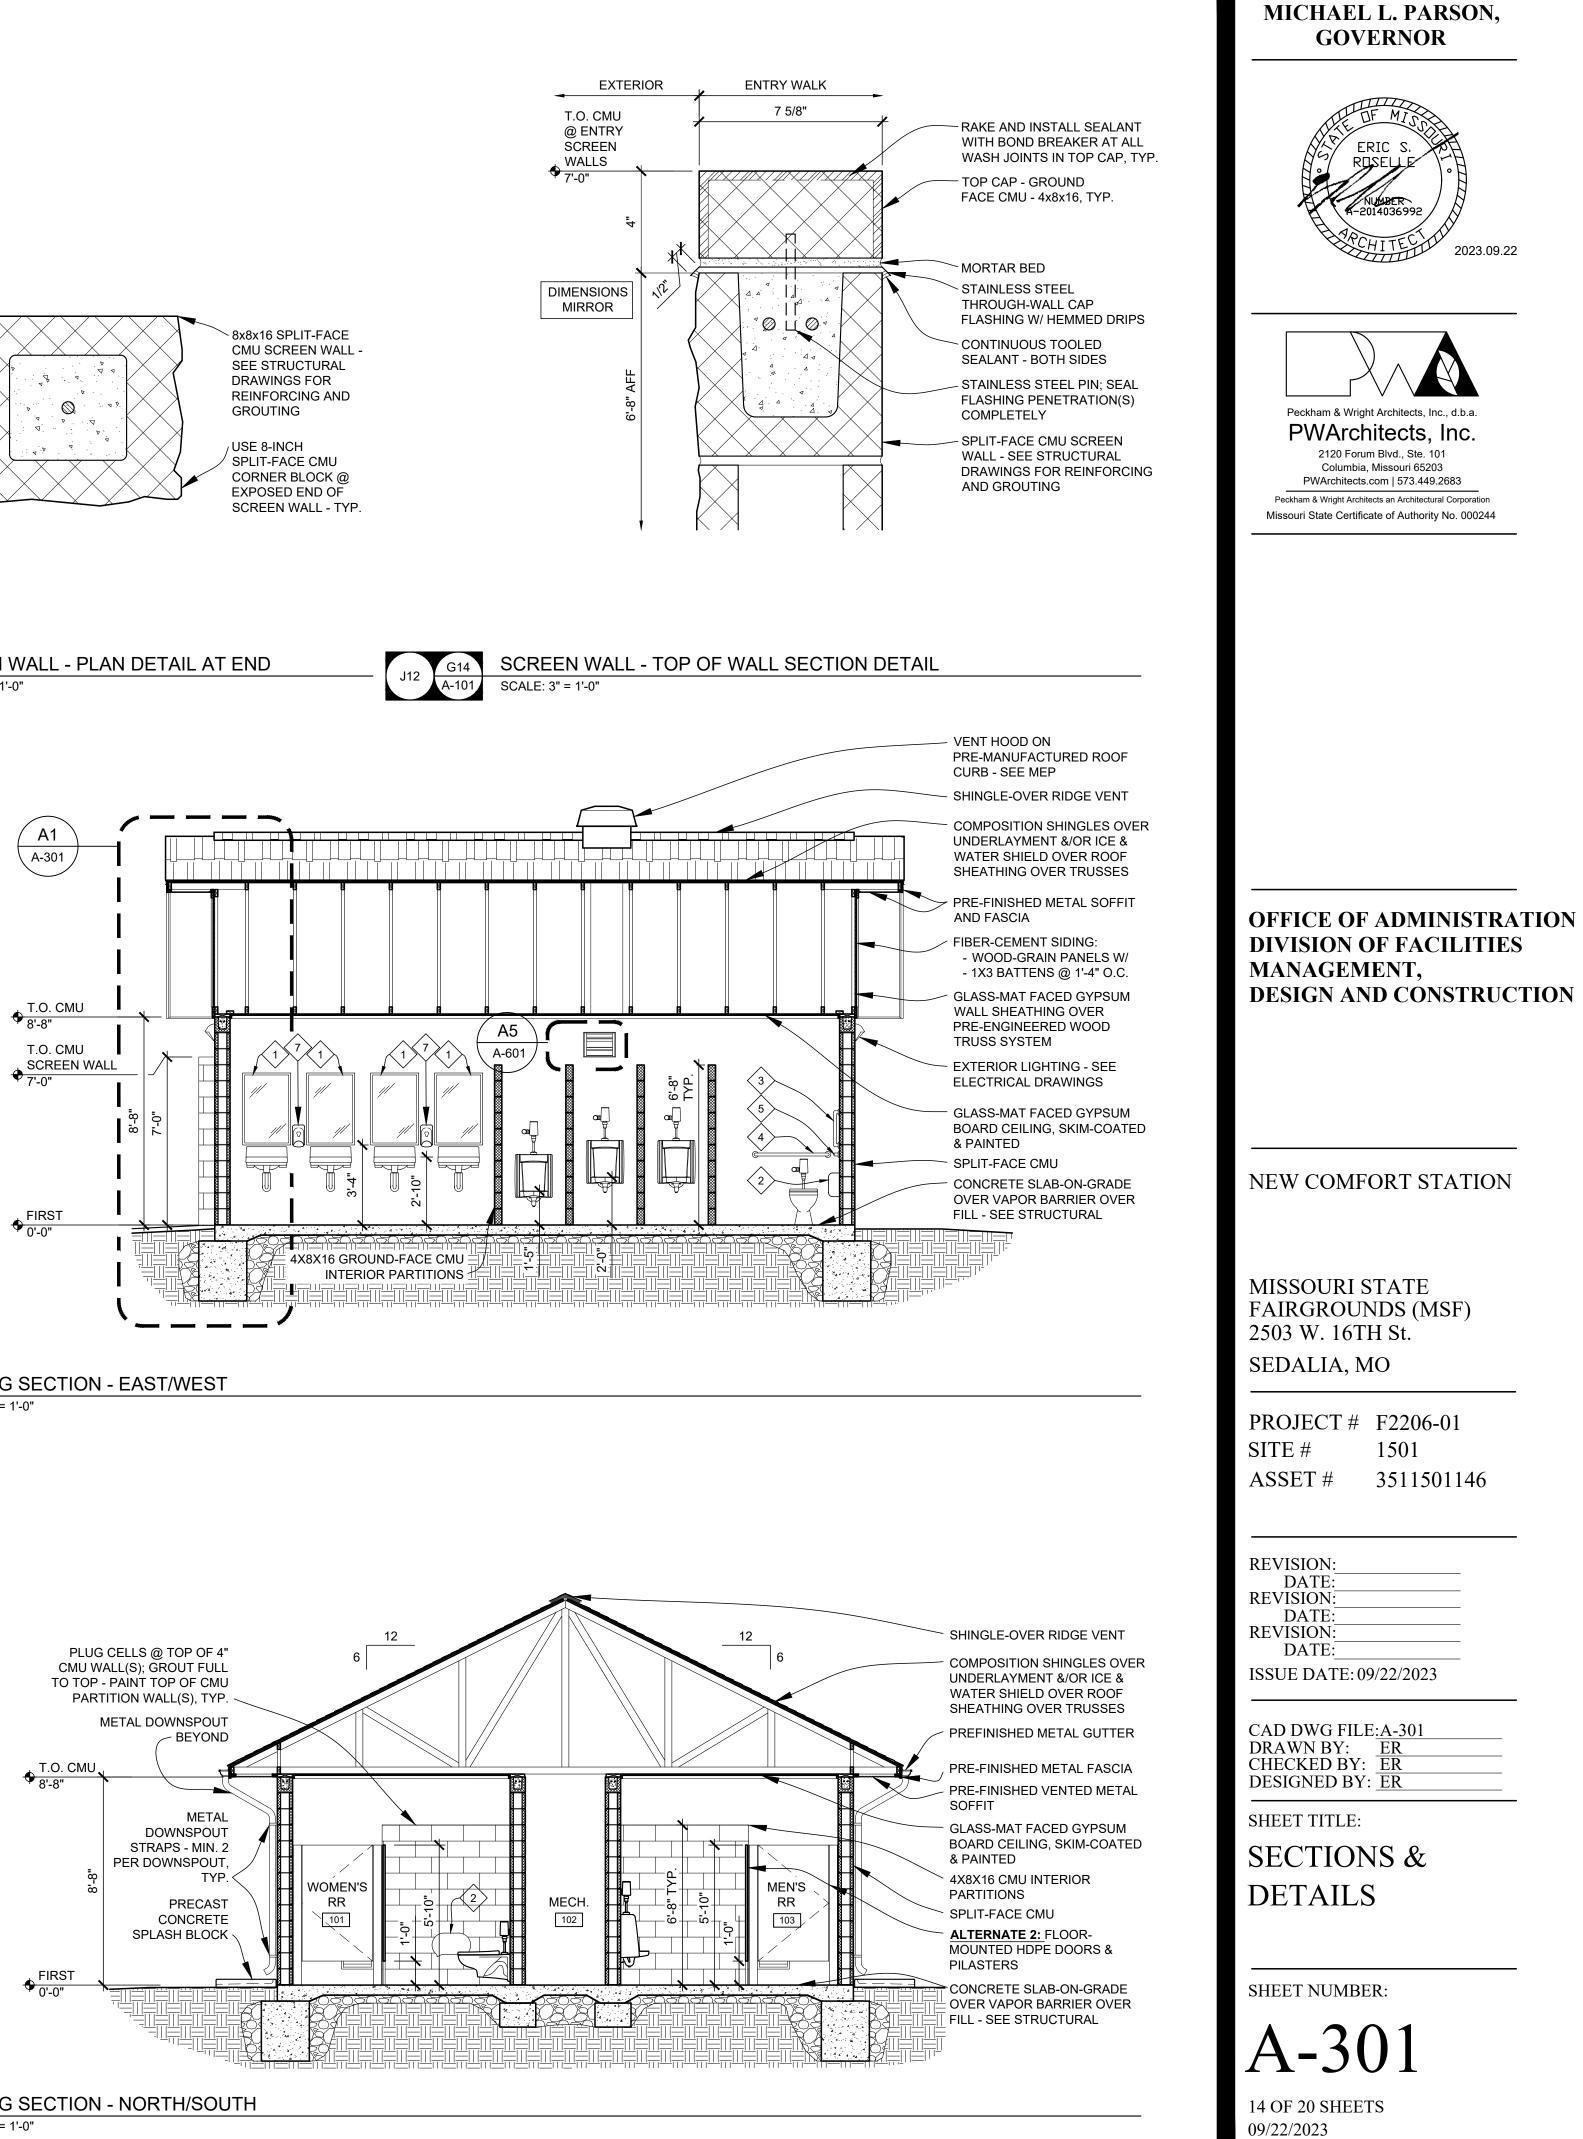
GENERAL BUILDING SECTION NOTES



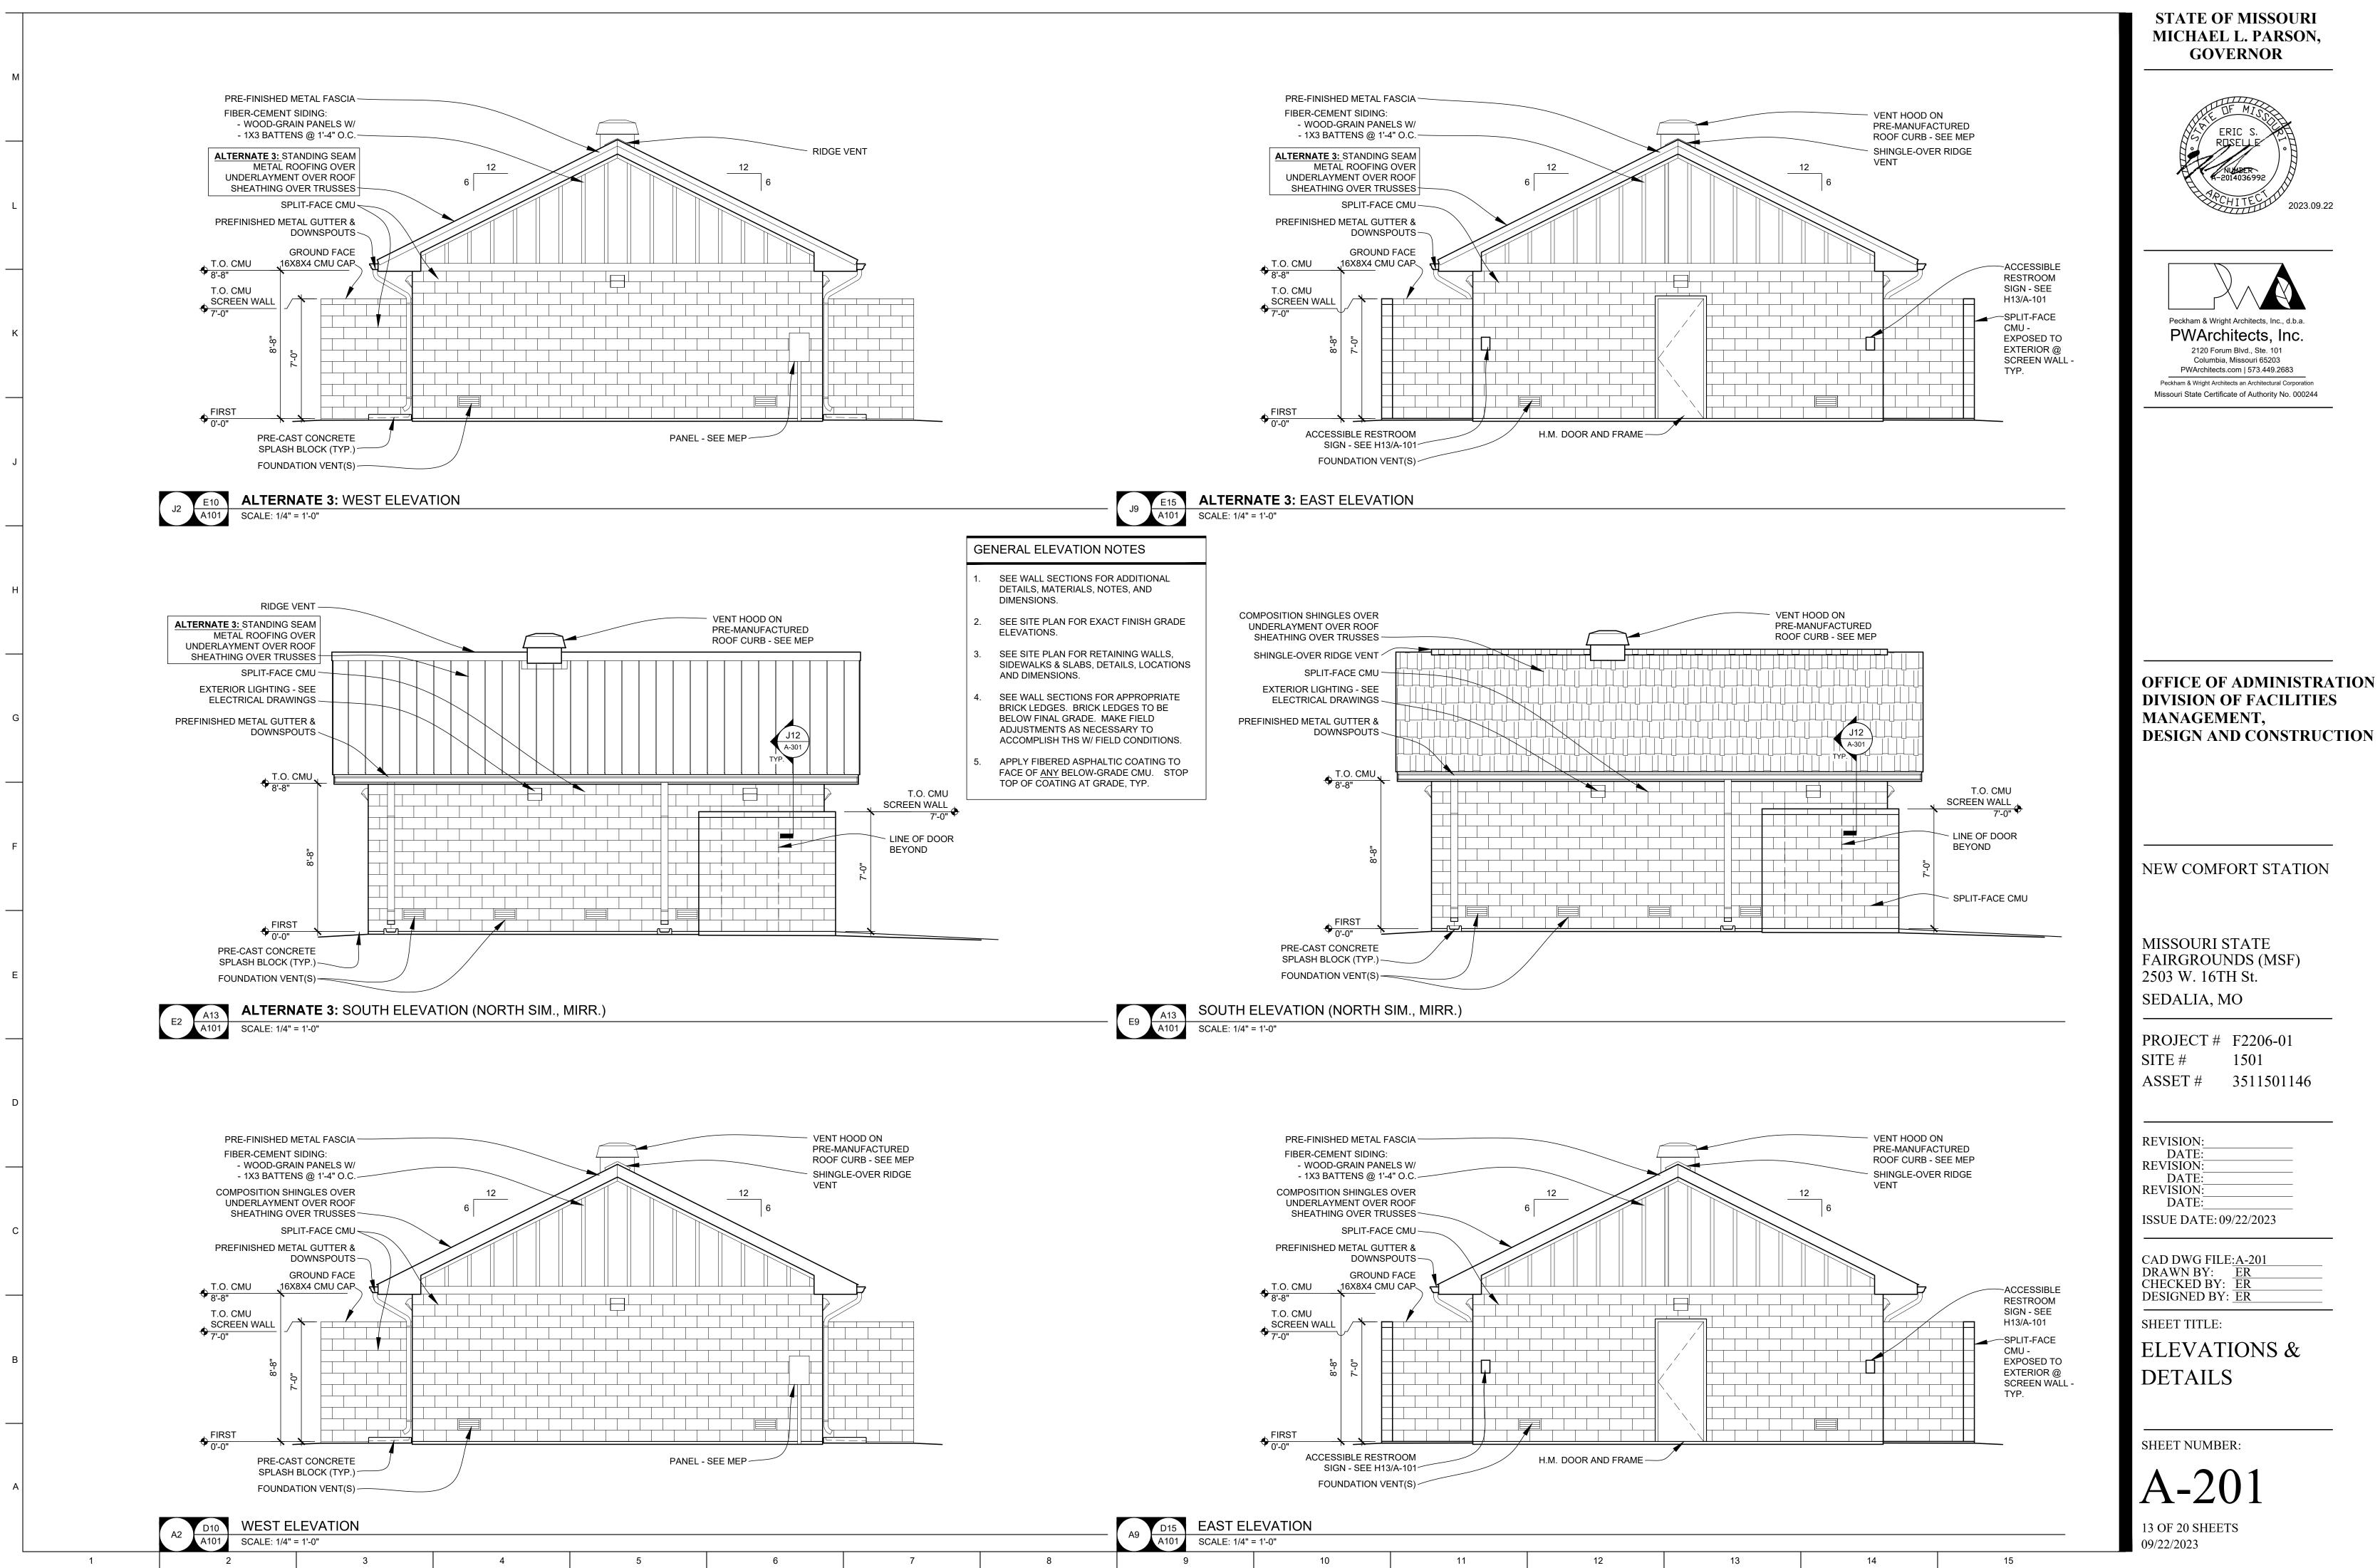

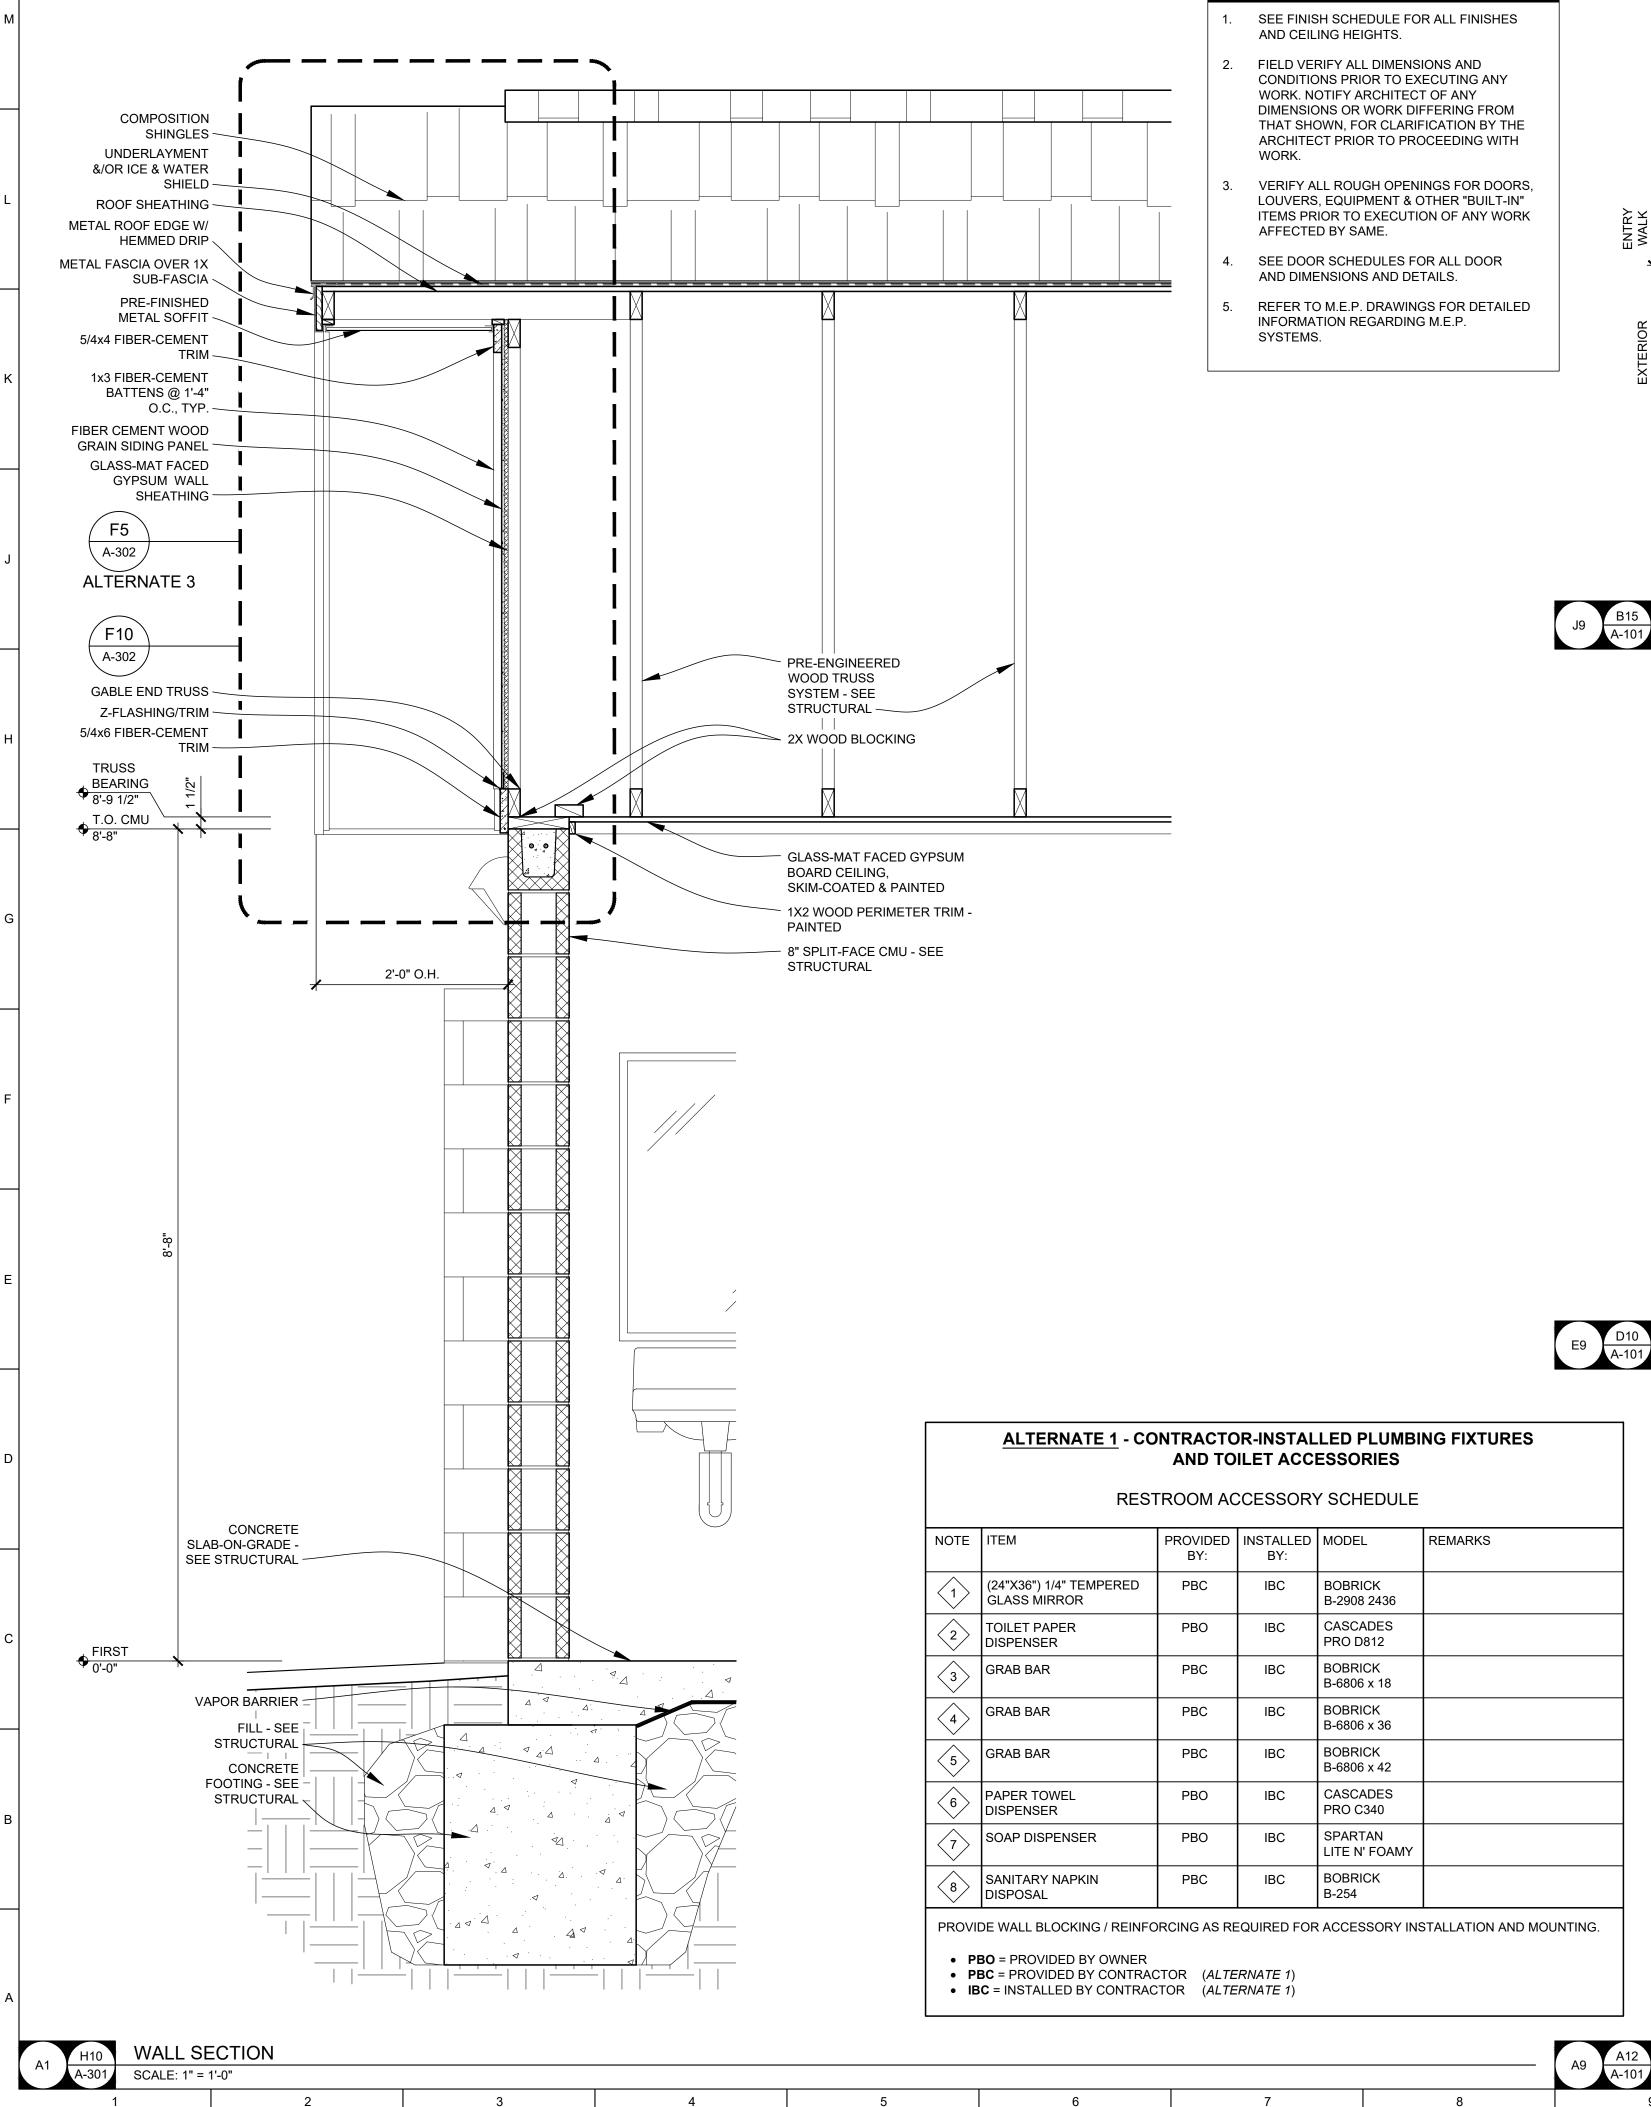J9 B15 SCREEN WALL - PLAN DETAIL AT END A-101 SCALE: 3" = 1'-0"



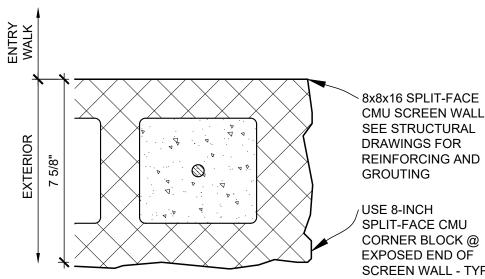


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STATE OF MISSOURI



E9 D10 BUILDING SECTION - EAST/WEST A-101 SCALE: 1/4" = 1'-0"





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GE	NERAL DOOR DETAIL NOTES
1.	FIELD VERIFY ALL DIMENSIONS AND CONDITIONS PRIOR TO EXECUTING ANY WORK. NOTIFY ARCHITECT OF ANY DIMENSIONS OR WORK DIFFERING FROM THAT SHOWN, FOR CLARIFICATION BY THE ARCHITECT PRIOR TO PROCEEDING WITH WORK.
2.	VERIFY ALL ROUGH OPENINGS FOR DOORS, LOUVERS, EQUIPMENT, & OTHER "BUILT-IN" ITEMS PRIOR TO EXECUTION OF ANY WORK AFFECTED BY SAME.
3.	LOCATE DOOR OPENINGS WHICH ARE NOT DIMENSIONED OTHERWISE, CENTERED IN WALL AND 6" FROM FINISH WALL TO FINISH JAMB.

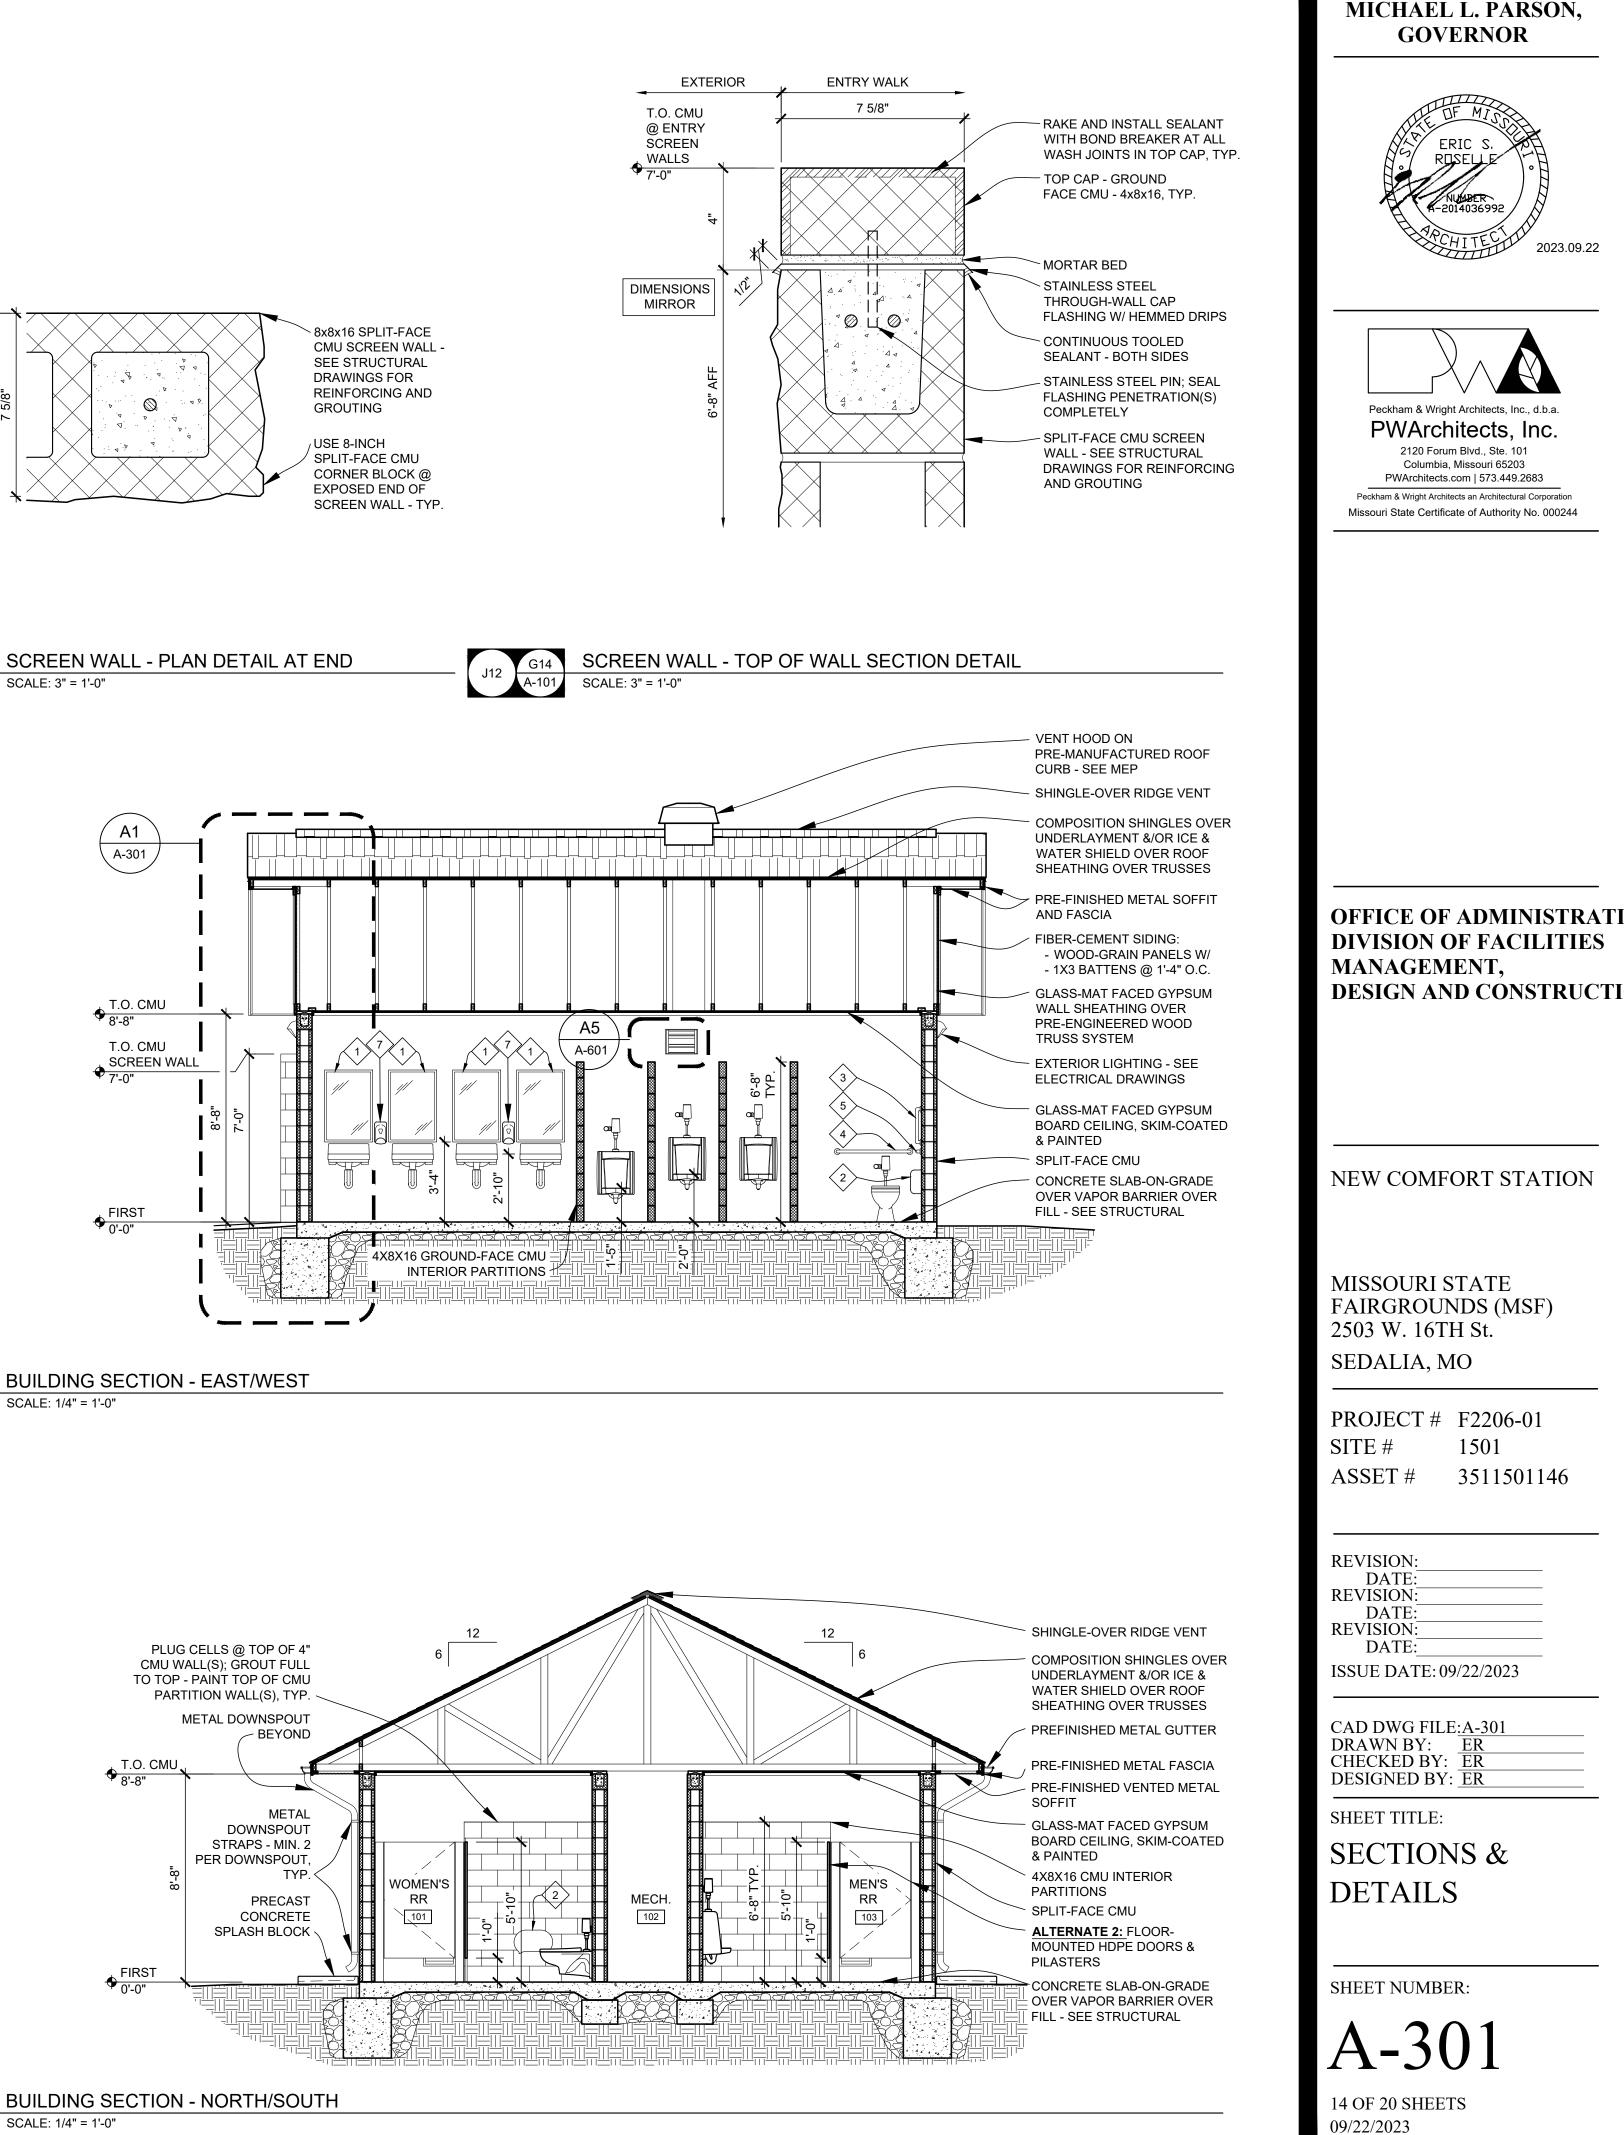4. SEE DOOR SCHEDULE FOR DOOR DIMENSIONS AND DETAILS.

GENERAL LOUVER DETAIL NOTES

WORK.

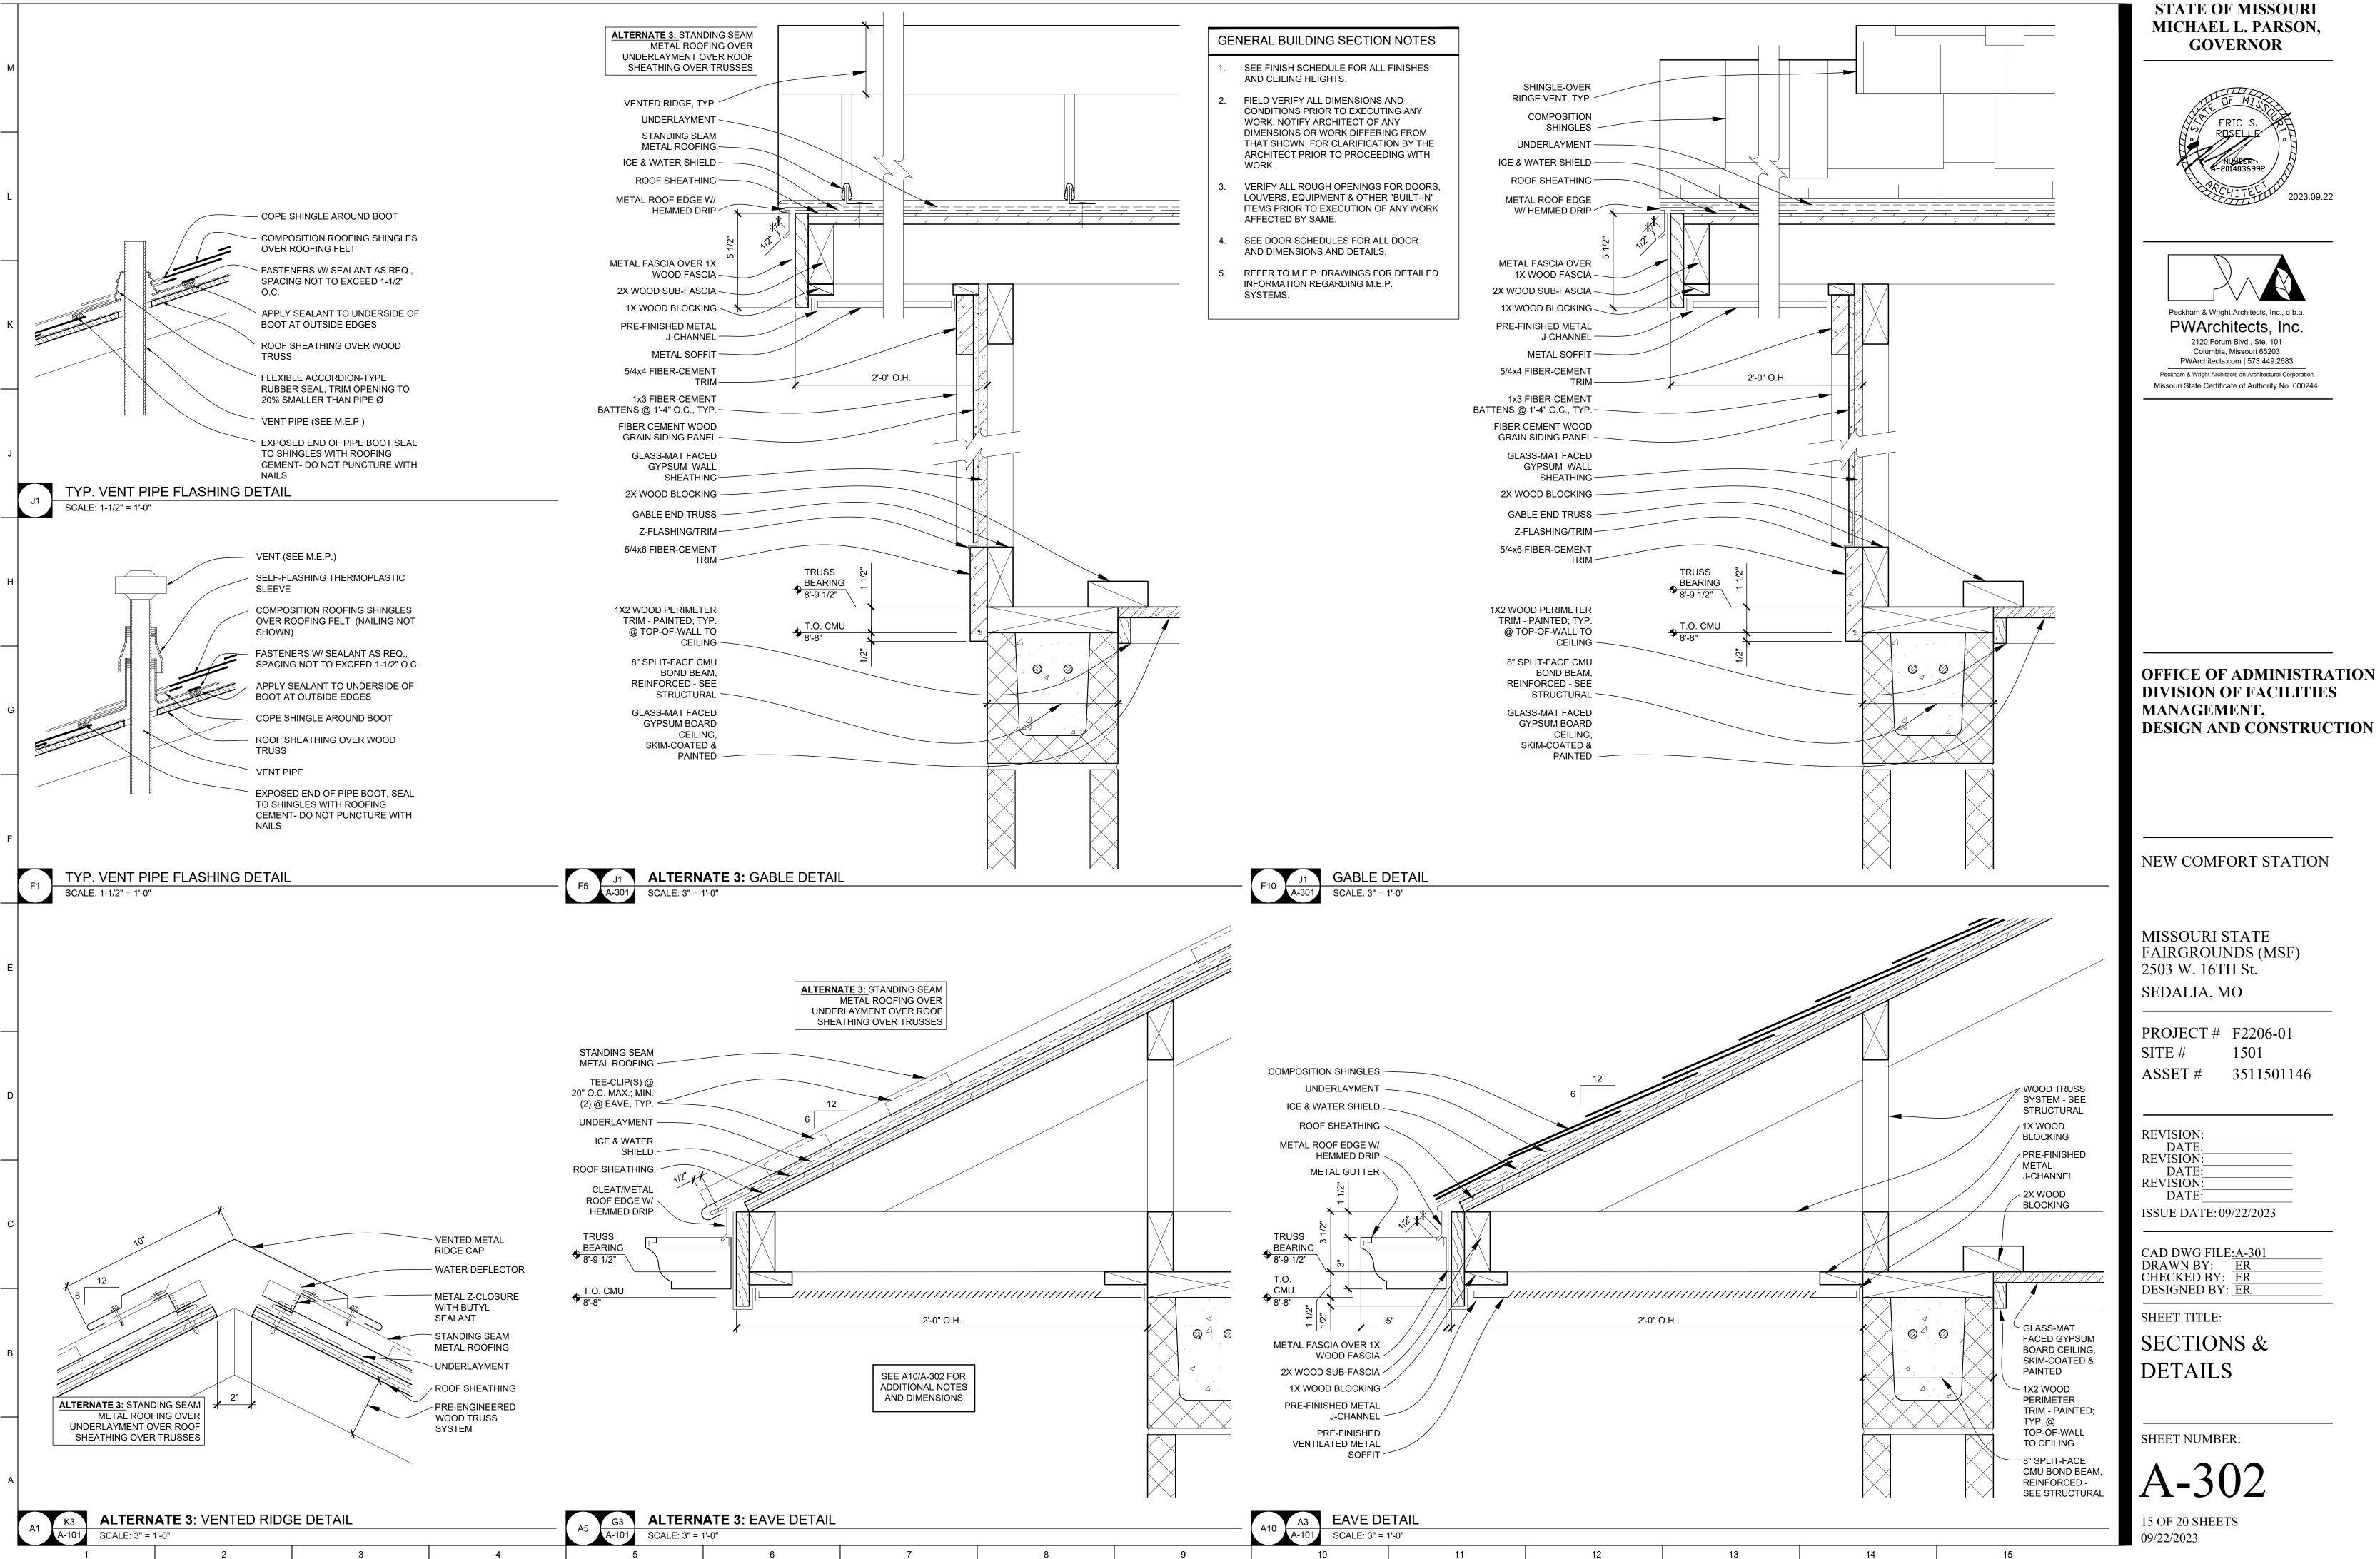AFFECTED BY SAME.

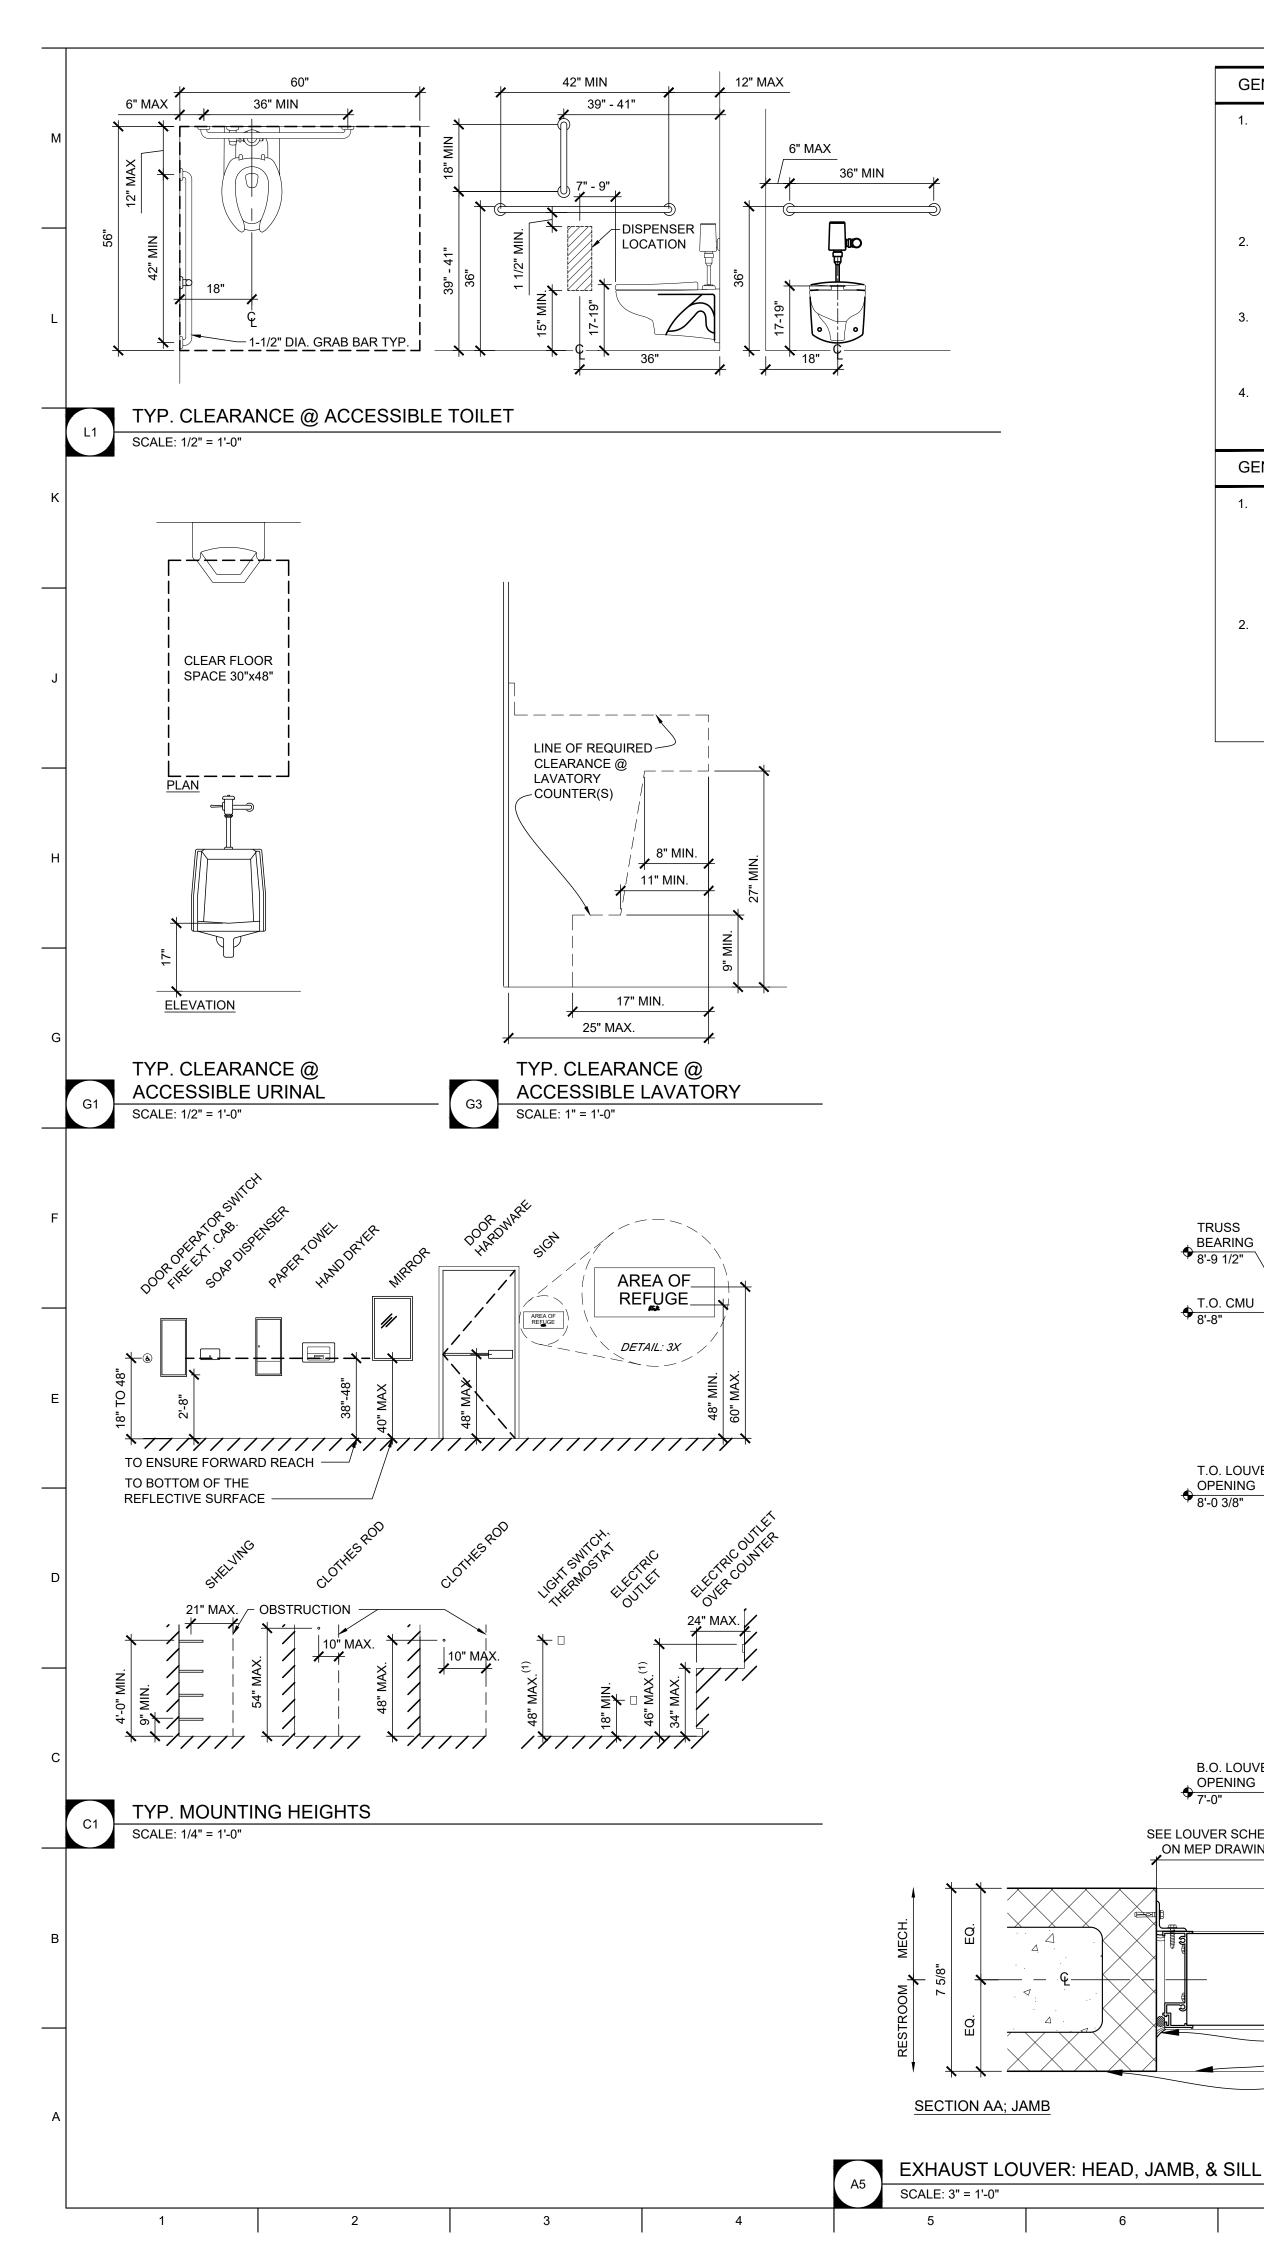FIELD VERIFY ALL DIMENSIONS AND CONDITIONS PRIOR TO EXECUTING ANY

WORK. NOTIFY ARCHITECT OF ANY

DIMENSIONS OR WORK DIFFERING FROM

THAT SHOWN, FOR CLARIFICATION BY THE


ARCHITECT PRIOR TO PROCEEDING WITH


VERIFY ALL ROUGH OPENINGS FOR DOORS, LOUVERS, EQUIPMENT, & OTHER "BUILT-IN" ITEMS PRIOR TO EXECUTION OF ANY WORK

ROOM	OM FINISH SCHEDULE														
ROOM		FLOOR	BASE			WALL		CE	ILING						
NO.	ROOM NAME	MAT'L	MAT'L	NORTH	EAST	SOUTH	WEST	FINISH	HEIGHT	REMARKS					
FIRST FLO	DOR														
101	WOMEN'S RESTROOM	SC		PNT-01	PNT-01	PNT-01	PNT-01	PGB-01	8'-9"						
.02	MECHANICAL	SC						EXI	POSED						
103	MEN'S RESTROOM	SC		PNT-01	PNT-01	PNT-01	PNT-01	PGB-01	8'-9"						

INTERIOR	FINISH LEGEND				
FINISH TAG	MATERIAL	MFR.	STYLE	COLOR	COMMENTS
FLOORING					
SC	SEALED CONCRETE	PROSOCO	CONSOLIDECK LSGUARD		
WALL					
PNT-01	PAINT CMU	SHERWIN WILLIAMS	SATIN UNO	SW7015 REPOSE GRAY	ALTERNATE 2: PNT-01 - EPOXY PAINT SYSTEM - SEE SPECIFICATION
CEILING	·		·		·
PGB-01	PAINT GYPSUM BOARD	SHERWIN WILLIAMS	FLAT UNO	SW7007 CEILING BRIGHT WHITE	
OTHER					
	HDPE TOILET PARTITION	SCRANTON	HINY HIDERS	CHARCOAL GREY; TEXTURE: OP	ALTERNATE 2: HDPE TOILET PARTITION
	HM DOORS & DOOR FRAMES	SHERWIN WILLIAMS	SEMI-GLOSS UNO	SW6203 SPARE WHITE	


DOOR SCHEDULE					FRAME SCHEDULE	<u> </u>								HARDWARE	FIRE						
DOOR NO.	DOOR LEAF SIZE (W	J x H)		MATE	ERIAI	<u> </u>		FRAME SIZE (W x H	RAME SIZE (W x H)				MATERIAL			TAILS			GROUP	RATING	REMARKS
		DOOR ELEVATION	MOOD	Hollow Metal	ALUMINUM	OTHER	LITE (TEMPERED GLS)		FRAME ELEVATION	WOOD	Hollow Metal	ALUMINUM	OTHER	LITE (TEMPERED GLS)	5		JAMB	SILL			
FIRST FLOOR																					
101	3'-0" X 7'-0"	D1	ر	X	1		·	3'-4" X 7'-4"	F1		X					A10/A-601	A10/A-601	A10/A-601	SEE SPEC.		
102	2'-8" X 7'-0"	D1		X	1,	· ['	· ['	3'-0" X 7'-4"	F1		X					A10/A-601	A10/A-601	A10/A-601	SEE SPEC.		
103	3'-0" X 7'-0"	D1	1	X	1	,	·	3'-4" X 7'-4"	F1		X					A10/A-601	A10/A-601	A10/A-601	SEE SPEC.		

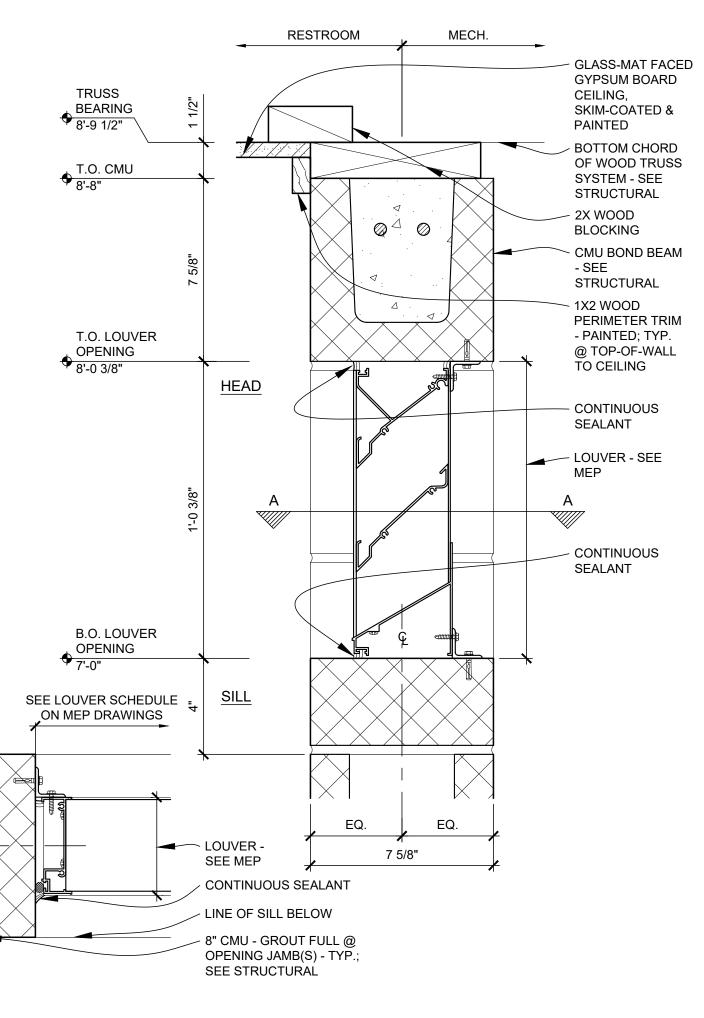


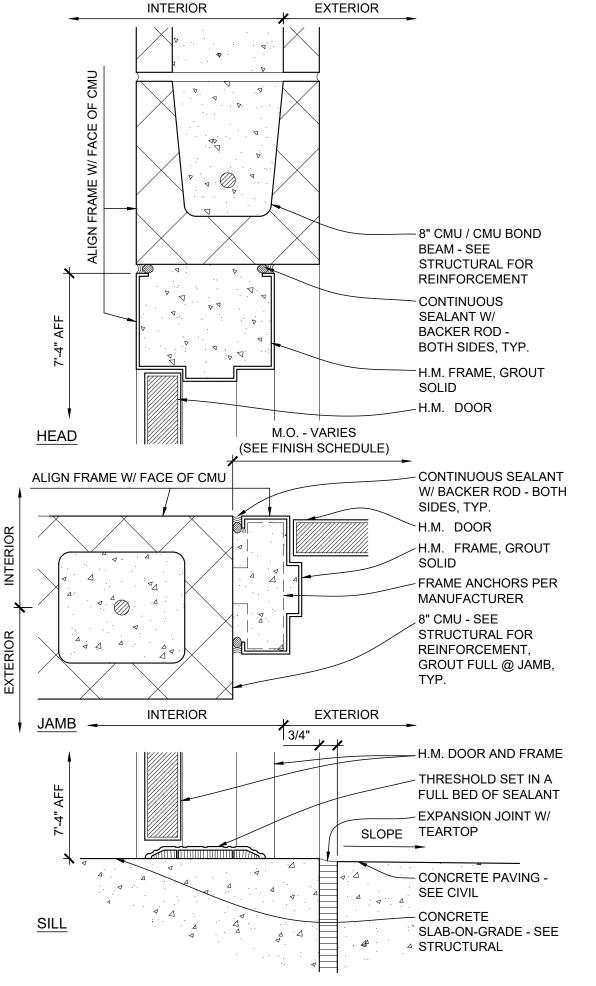

11

13

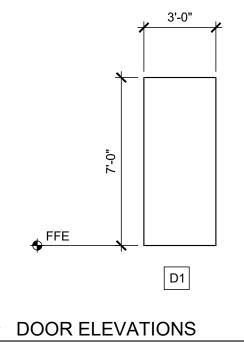

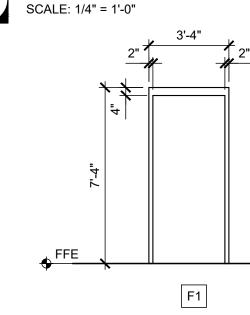

C14

A14 FRAME ELEVATIONS SCALE: 1/4" = 1'-0" 14

15

STATE OF MISSOURI MICHAEL L. PARSON, GOVERNOR 2023.09.22



Peckham & Wright Architects, Inc., d.b.a. PWArchitects, Inc. 2120 Forum Blvd., Ste. 101 Columbia, Missouri 65203 PWArchitects.com | 573.449.2683 Peckham & Wright Architects an Architectural Corporation Missouri State Certificate of Authority No. 000244

OFFICE OF ADMINISTRATION DIVISION OF FACILITIES MANAGEMENT, **DESIGN AND CONSTRUCTION**

NEW COMFORT STATION

MISSOURI STATE FAIRGROUNDS (MSF) 2503 W. 16TH St. SEDALIA, MO

PROJECT # F2206-01 1501 SITE # 3511501146 ASSET #

REVISION: DATE: **REVISION:** DATE: **REVISION**: DATE: ISSUE DATE: 09/22/2023

CAD DWG FILE:A-601 DRAWN BY: CHECKED BY: ER

SHEET TITLE: SCHEDULES & DETAILS

DESIGNED BY: ER

SHEET NUMBER:



GENERAL MEP SPECIFICATIONS

- 1. IT IS THE RESPONSIBILITY OF THE CONTRACTOR TO REVIEW AND UNDERSTAND ALL DRAWINGS AND SPECIFICATIONS IN THE CONTRACT DOCUMENTS. EACH CONTRACTOR IS RESPONSIBLE FOR ALL WORK ASSOCIATED WITH HIS TRADE REGARDLESS OF WHERE THE WORK IS DEPICTED IN THE DRAWINGS OR SPECIFICATIONS.
- 2. THE LAYOUT OF SYSTEMS SHOWN ON PLANS ARE APPROXIMATE AND WILL NEED TO BE COORDINATED IN FIELD. THE CONTRACTOR SHALL INCLUDE THIS COORDINATION IN HIS SCOPE AND INCLUDE ALL COSTS OF MODIFYING THE LAYOUT AS REQUIRED IN HIS BID.
- 3. THE CONTRACTOR IS RESPONSIBLE FOR PROVIDING ALL NECESSARY PARTS AND LABOR TO PRODUCE A COMPLETE AND FULLY OPERATIONAL SYSTEM UNLESS STATED OTHERWISE ON PLANS.
- 4. ALL MATERIALS TO BE NEW, FIRST CLASS, AND INSTALLED PER MANUFACTURE'S PUBLISHED INSTRUCTIONS.
- 5. ALL WORK SHALL BE PERFORMED IN COMPLIANCE WITH LOCALLY ADOPTED CODES AND ORDINANCES.
- 6. CONTRACTOR IS RESPONSIBLE FOR COORDINATING EQUIPMENT LOCATIONS AND SYSTEM ROUTING WITH OTHER TRADES PRIOR TO INSTALLATION.
- 7. CONTRACTOR TO GUARANTEE ALL MATERIALS AND WORKMANSHIP FOR A PERIOD OF ONE YEAR FROM THE DATE THE PROJECT IS TURN OVER TO THE OWNER, UNLESS NOTED OTHERWISE.
- 8. CONTRACTOR IS TO INCLUDE IN THEIR SCOPE THE COST OF ALL PERMITS, INSPECTIONS, METERING, AND TAPS ASSOCIATED WITH THEIR WORK.
- 9. CONTRACTOR IS RESPONSIBLE FOR ALL EXCAVATION, CUTTING, CORING, PATCHING, AND
- BACKFILL REQUIRED TO COMPLETE THEIR WORK, UNLESS NOTED OTHERWISE. 10. THESE PLANS ARE NOT TO BE SCALED. SEE ARCHITECTURAL PLANS FOR DIMENSIONS. WHERE THERE IS A CONFLICT BETWEEN ARCHITECTURAL DIMENSIONS AND MEP DIMENSION, ARCHITECTURAL SHALL GOVERN.
- 11. SEE DISCIPLINE SHEETS FOR ADDITIONAL DISCIPLINE SPECIFIC SPECIFICATIONS.

REFERENCED CODES IN EFFECT

2018 INTERNATIONAL MECHANICAL CODE


2018 INTERNATIONAL PLUMBING CODE

2018 INTERNATIONAL FUEL GAS CODE

2018 INTERNATIONAL FIRE CODE

2017 NATIONAL ELECTRIC CODE

2018 INTERNATIONAL ENERGY CONSERVATION CODE

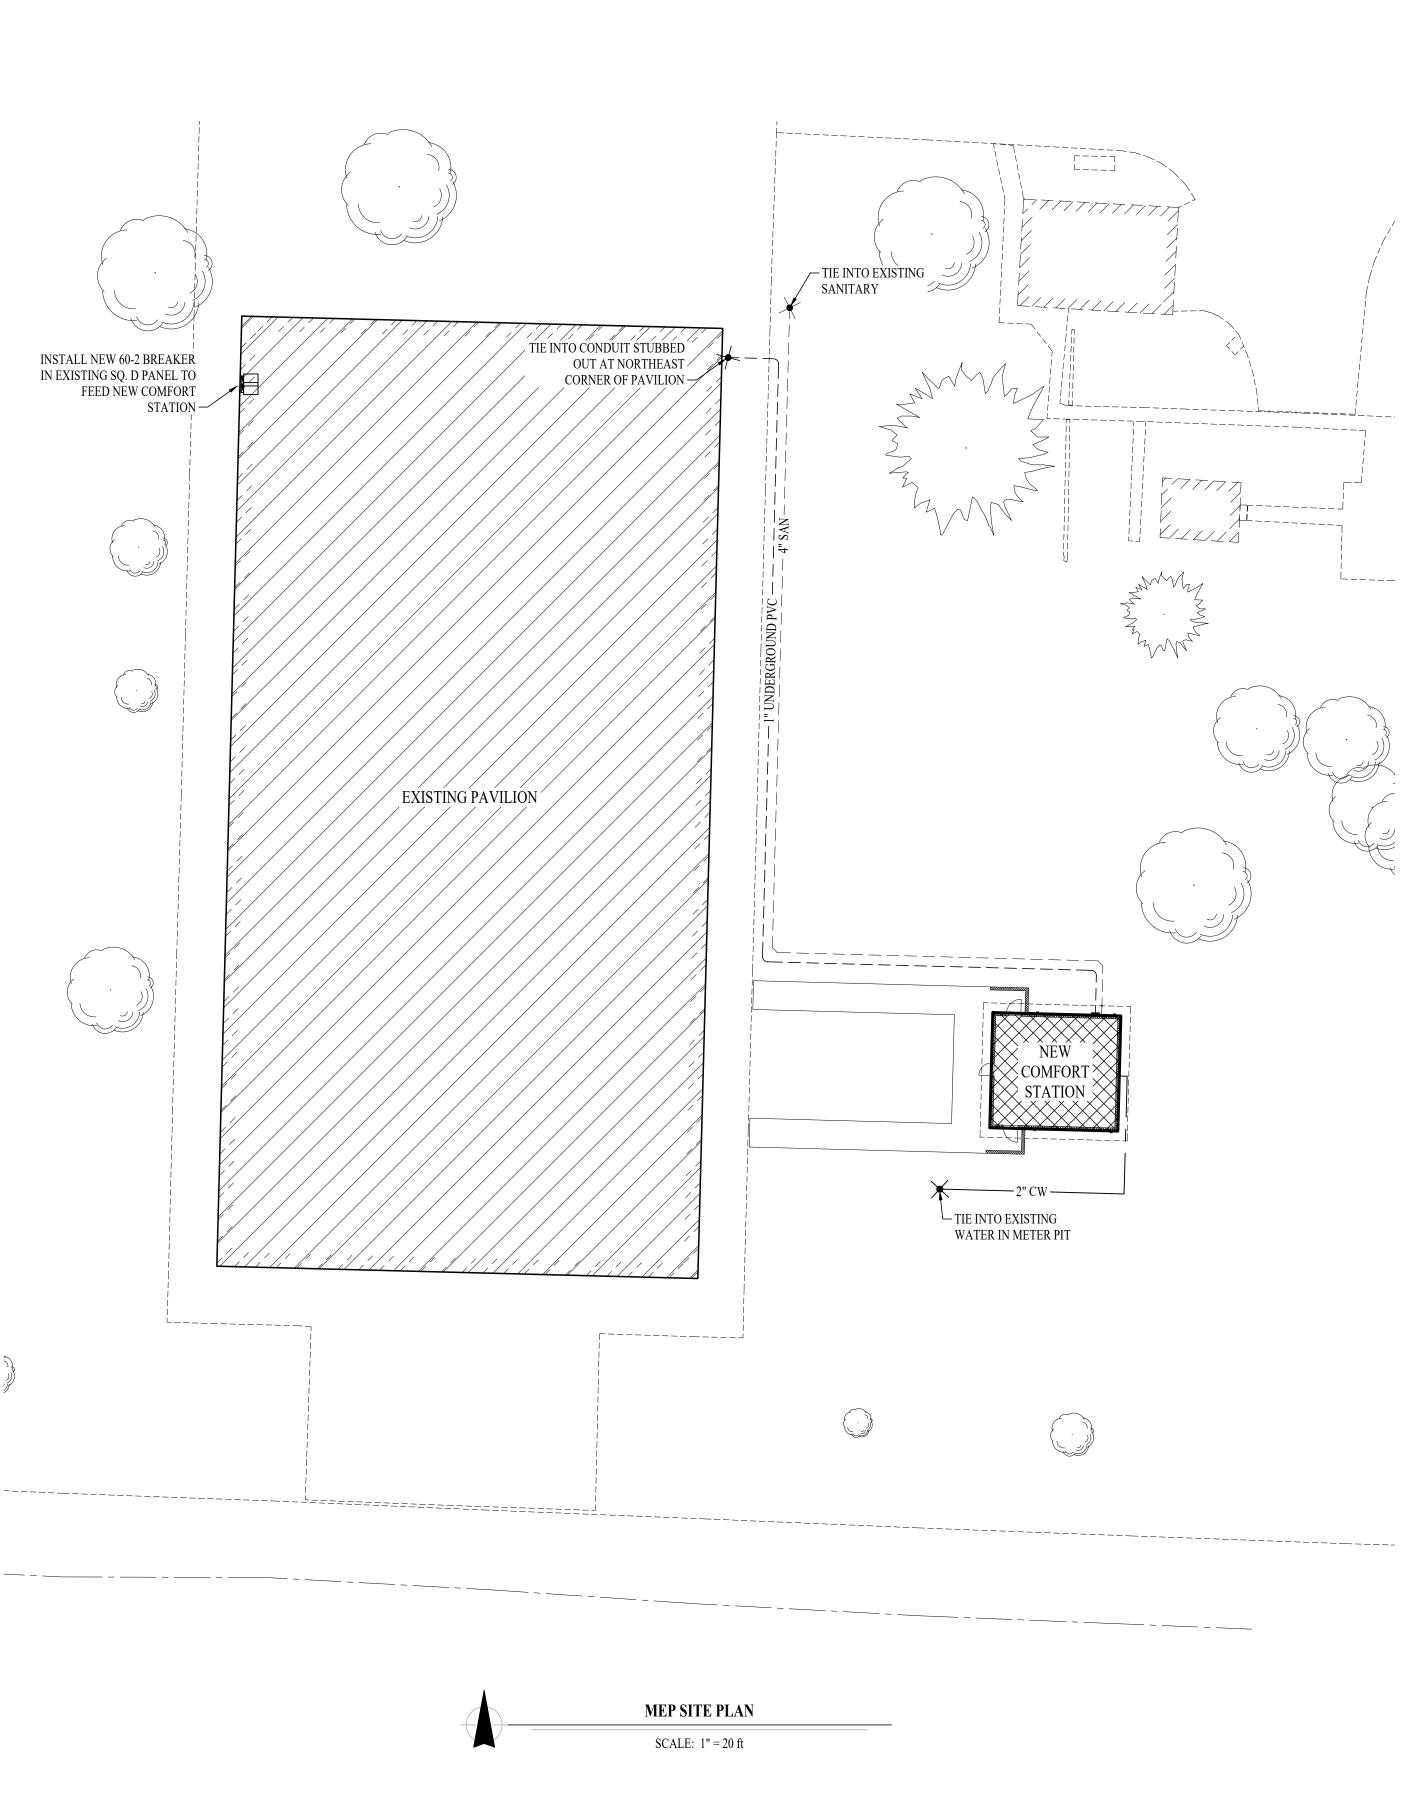



HVAC PLAN SYMBOL LEGEND



 X
 EQUIPMENT TYPE (REFER TO EQUIPMENT SCHEDULE)


 #
 EQUIPMENT REFERENCE NUMBER

 X
 Image: Cubic feet per minute (CFM) / Face size

EXHAUST DUCTWORK

			LECTRICAI	1	NOTES
TION TYPE	(CFM)	VOLTS/PH	MCA	ОСР	NOTES
INLINE	1200	120	4	20	1
	INLINE				

		А	IR DEVICE	SCHEDUL	E	
TAG	SERVICE	MANUFACTURER (OR EQUAL)	MODEL (OR EQUAL)	SIZE	COLOR/ FINISH	NOTES
L1	EXHAUST	POTTORFF	EFJ-445	AS INDICATED	PRIMED	PAINT TO MATCH WALL
NOTES: 1.	VERIFYAIRI	DEVICE FINISHES WITH C	WNER/ARCHITECT	F PRIOR TO INSTAI	LATION	

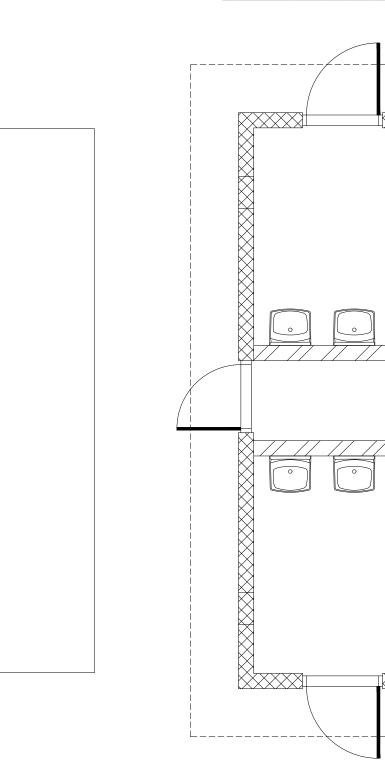




--- FOUNDATION VENT (TYPICAL) REFER ----TO ARCHITECTURAL FOR DETAILS \bowtie L116x1212" EXHAUST — $\left(\frac{EF}{1} \right)^{\ell}$ - 16" EXHAUST DUCT UP TO EXHAUST FAN (EF-1) & CONTINUES UP TO WEATHER CAP (EQUAL TO PENNBARRY #WCF16) ON ROOF 12" EXHAUST — /<u>{___</u>___ L1 16x12

HVAC PLAN

SCALE: 1/4" = 1'-0"

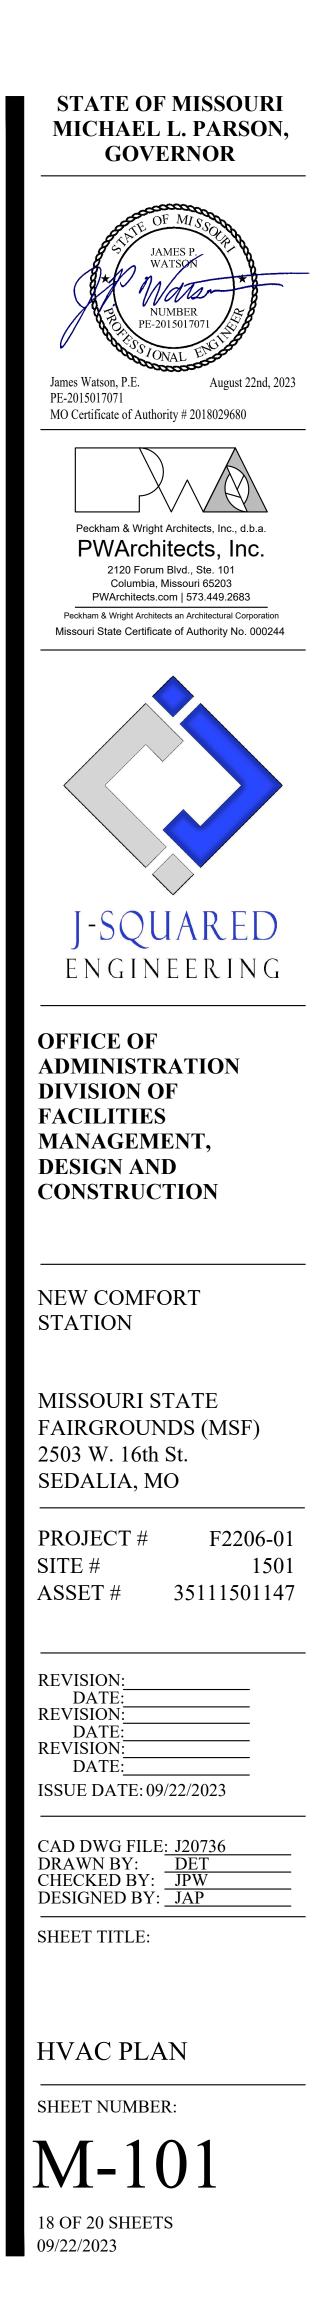

• VP = PASSIVE INFRARED VACANCY SENSOR

• VT = DUAL-TECHNOLOGY VACANCY SENSOR

• SEE "SWITCH (WALL MOUNTED)" FOR TYPE DESIGNATIONS

• VU = ULTRASONIC VACANCY SENSOR

• M = MOMENTARY SWITCH

SWITCH (CEILING MOUNTED)

• SS = SCENE SWITCH

- SWITCH TYPE:


\$x

	CIRCUIT WIRING	(1) WIRE EXTERIOR LIGHTS THRU PHOTOCELL MOUNTED ON PHOTOCELL TO FACE NORTH.
── > PX-XX	CIRCUIT TAG	(2) CONTRACTOR TO PROVIDE & INSTALL RELAY / CONTACT MEN'S RESTROOM LIGHTING FROM WOMEN'S RESTROOM EXHAUST FAN.
XX +42	GFCI DUPLEX CONVENIENCE RECEPTACLE	ALTERNATE #1 - CONTRACTOR-INSTALLED PLUMBING
	 INDICATES MOUNTING HEIGHT TO BOTTOM OF BOX (STANDARD @ 18" AFF UNLESS NOTED OTHERWISE) 	1. CONTRACTOR TO:
	 "WP" = WEATHERPROOF OUTDOOR RECEPTACLE "AW" = ABOVE WINDOW RECEPTACLE "AC" = ABOVE CEILING RECEPTACLE "EX" = EXISTING RECEPTACLE TO REMAIN 	 a. PROVIDED & INSTALL PLUMBING FIXTURES TO INCLUDE WA' URINALS & FLUSH VALVES, LAVATORIES & FAUCETS. b. CONTRACTOR PROVIDED & INSTALLED TOILET ACCESSORIES ACCESSORY SCHEDULE INCLUDED ON SHEETS A-101 & A-301. 2. BASE BID: a. CONTRACTOR TO INCLUDE ROUGH-IN & WALL-HUNG BRACKED
X1 -	— "X1" INDICATES FIXTURE TYPE (REFER TO SCHEDULE)	URINALS, & LAVATORIES. OWNER TO PROVIDE & INSTALL AL
\circ	LIGHTING FIXTURE	ALTERNATE #2 - WATER HEATER,EXTERIOR LIGHTING
EM -	— "EM" INDICATES EMERGENCY BATTERY BACKUP	
NL -	— "NL" INDICATES UN-SWITCHED NIGHT LIGHT	 CONTRACTOR TO: a. CONTRACTOR TO PROVIDE AND INSTALL WATER HEATER WITNOTED ON THIS SHEET.
Ś	SWITCH (WALL MOUNTED)	 b. CONTRACTOR TO PROVIDE AND INSTALL ALL EXTERIOR AND SHOWN AND NOTED ON SHEET E-101.
	— SWITCH TYPE:	c. CONTRACTOR TO PROVIDE AND INSTALL HDPE TOILET COMP
	• $3 = 3$ -WAY	ASSEMBLIES (INCLUDING HARDWARE) AS SHOWN ON
	 4 = 4-WAY OP = PASSIVE INFRARED OCCUPANCY SENSOR 	d. CONTRACTOR TO PROVIDE AND INSTALL EPOXY WALL COAT INTERIOR FINISH LEGEND ON SHEET A-601.
	 OU = ULTRASONIC OCCUPANCY SENSOR OU = ULTRASONIC OCCUPANCY SENSOR 	2. BASE BID:
	 OT = DUAL-TECHNOLOGY OCCUPANCY SENSOR DT = DUAL-TECHNOLOGY OCCUPANCY SENSOR 	a. PROVIDE ALL PLUMBING AND ELECTRICAL ROUGH-IN FOR FU

a. PROVIDE ALL PLUMBING AND ELECTRICAL ROUGH-IN FOR FUTURE WATER HEATER AND WALL KIT TO BE INSTALLED BY OWNER. PROVIDE BLANK PLATE AT JUNCTION BOX; TEMPORARILY CAP PLUMBING PIPES.

POWER PLAN KEY NOTES:

- b. PROVIDE ALL ELECTRICAL ROUGH-IN FOR FUTURE EXTERIOR AND INTERIOR LIGHTING
- FIXTURES TO BE INSTALLED BY OWNER.PROVIDE BLANK PLATES AT JUNCTION BOXES. c. DO NOT PROVIDE HDPE TOILET PARTITIONS.
- d. CMU TO REMAIN EXPOSED; WALLS WILL BE FINISHED AND PAINTED BY OWNER.

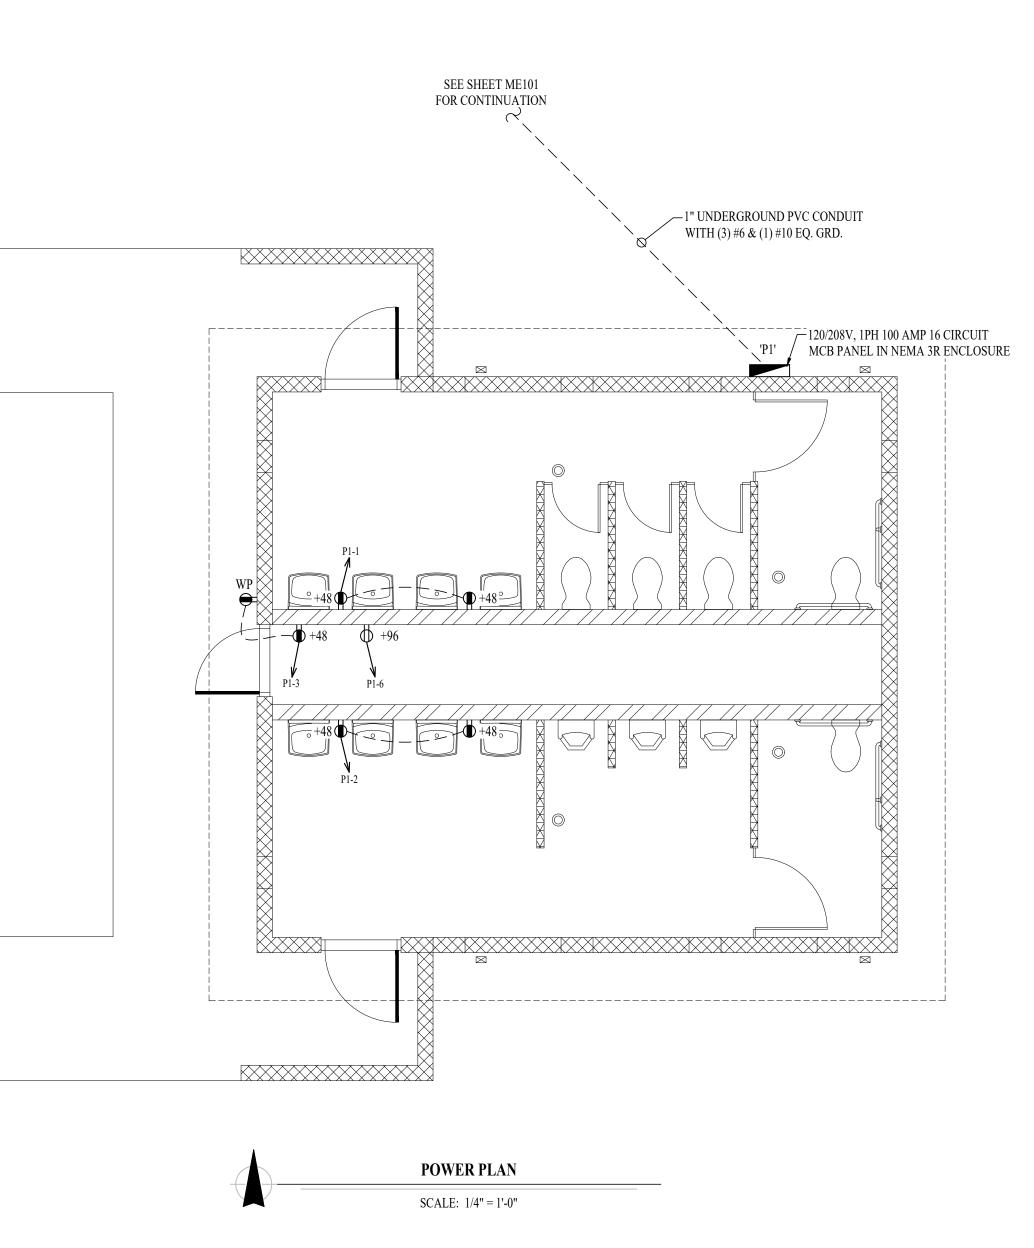

ON BUILDING EXTERIOR RAKE BOARD.

CTOR TO ISOLATE LIGHTING CIRCUIT FROM

OM LIGHTING. BOTH SHALL TURN ON

ING FIXTURES & TOILET ACCESSORIES:

WATER CLOSETS & FLUSH VALVES,

IES AS NOTED IN THE "RESTROOM

CKETS FOR THE WATER CLOSETS, ALL TOILET ACCESSORIES.

ING, INTERIOR LIGHTING, TOILET PARTITIONS, & EPOXY COATING:

WITH WALL KITS AS SHOWN AND

ND INTERIOR LIGHTING FIXTURES AS

MPARTMENT DOOR/PILASTER ON SHEETS A-101 AND A-301.

ATING PNT-01, AS SHOWN THE


			LIGHT F	IXTURE SCHEI	DULE					
TAG	MANUFACTURER (OR EQUAL)	MODEL NUMBER (OR EQUAL)	DES CRIPTION	MOUNTING	LUMEN OUTPUT	CCT (°K)	CRI	VOLTS	WATTS	NOTES
S1	FAIL-SAFE	HVSL8-4-LD42SD-40-UNV-C-EDC1	VANDAL RESISTANT STRIP	SURFACE	3495	4000	80	UNV	34	
WP	LUMARK	XTOR2B-W	FULL CUTOFF WALL PACK	SURFACE	1400	4000	70	UNV	18	
NOTES:										

1. VERIFY LIGHT FIXTURE FINISHES WITH OWNER / ARCHITECT PRIOR TO INSTALLATION

]	PANEL	'P1' SCH	IEDUL	E		
	VOLTAGE	PANE	L SIZE	MOU	NTING	AIC RATING		
	120/208V	100A	MCB	SURI	FACE	22,000	PHASE "A" LOAD PHASE "B" LOAD	18.5 11
	NEMA RATING: 3R							
CIRCUIT NUMBER	DES CRIPTION	BREAKER SIZE	AMPS	PHASE	AMPS	BREAKER SIZE	DES CRIPTION	CIRCUIT NUMBER
1	WOMEN'S RESTROOM RECEPTS	20-1	3	А	3	20-1	MEN'S RESTROOM RECEPTS	2
3	MECH & EXTERIOR RECEPTS	20-1	3	В	8	20-1	LIGHTS AND EXHUAST FAN	4
5	SPARE	20-1		А	12.5	20-1	WATER HEATER	6
7	SPARE	20-1		В				8
9	SPARE	20-1		А				10
11	SPARE	20-1		В				12
13	SPARE	20-1		А				14
15	SPARE	20-1		В				16

A: PANEL SHALL BE EQUAL TO SQUARE D MODEL "QO"


ELECTRICIAN SHALL VERIFY BREAKER WITH EQUIPMENT PRIOR TO PURCHASE & INSTALL. B: AFTER COMPLETION OF WORK, ELECTRICAN SHALL PROVIDE A TYPE WRITTEN PANEL DIRECTORY IN NEW PANEL. C:

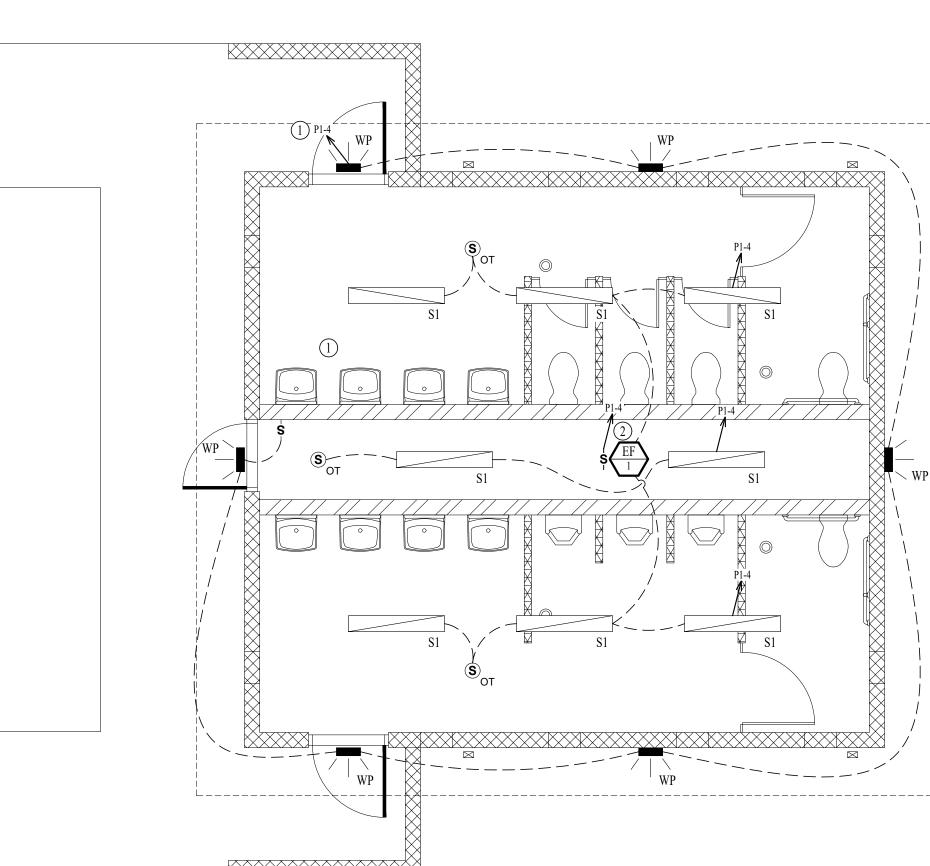



LIGHTING PLAN

SCALE: 1/4" = 1'-0"

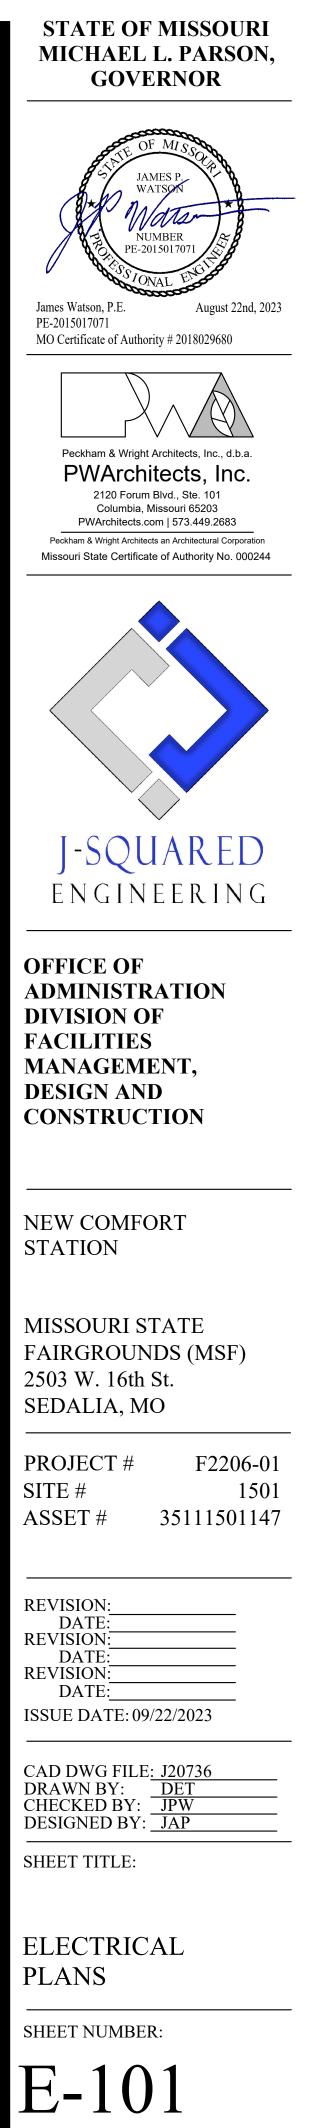

PLUMBING PLANS SYMBOL LEGEND

	SANITARY SEWER PIPING
	VENT PIPING
	COLD WATER PIPING
	HOT WATER PIPING
o	PIPING TURNED DOWN / TURNED UP
$\left(\star \right)$	TIE INTO EXISTING

SANITARY SEWER PLAN GENERAL NOTES:


- 1. PLUMBING SYSTEM TO BE INSTALLED FOR WINTERIZATION. C POINT DRAINS ON BOTH COLD & HOT WATER PIPING. 2. DOMESTIC WATER LINES SHALL BE HELD TIGHT TO WALLS & AT 8'-0" A.F.F. TO ALLOW ACCESS IN
- CHASE.

ALTERNATE #1 - CONTRACTOR-INSTALLED PLUMBING FIXTURES & TOILET ACCESSORIES:

- 1. CONTRACTOR TO: a. PROVIDED & INSTALL PLUMBING FIXTURES TO INCLUDE WATER CLOSETS & FLUSH VALVES, URINALS & FLUSH VALVES, LAVATORIES & FAUCETS. b. CONTRACTOR PROVIDED & INSTALLED TOILET ACCESSORIES AS NOTED IN THE "RESTROOM
- ACCESSORY SCHEDULE INCLUDED ON SHEETS A-101 & A-301. 2. BASE BID:

ALTERNATE #2 - WATER HEATER, EXTERIOR LIGHTING, INTERIOR LIGHTING, TOILET PARTITIONS, & EPOXY COATING:

- 1. CONTRACTOR TO: a. CONTRACTOR TO PROVIDE AND INSTALL WATER HEATER WITH WALL KITS AS SHOWN AND NOTED ON THIS SHEET.
 - b. CONTRACTOR TO PROVIDE AND INSTALL ALL EXTERIOR AND INTERIOR LIGHTING FIXTURES AS SHOWN AND NOTED ON SHEET E-101.
- c. CONTRACTOR TO PROVIDE AND INSTALL HDPE TOILET COMPARTMENT DOOR/PILASTER
- ASSEMBLIES (INCLUDING HARDWARE) AS SHOWN ON SHEETS A-101 AND A-301. d. CONTRACTOR TO PROVIDE AND INSTALL EPOXY WALL COATING PNT-01, AS SHOWN THE INTERIOR FINISH LEGEND ON SHEET A-601.
- 2. BASE BID: a. PROVIDE ALL PLUMBING AND ELECTRICAL ROUGH-IN FOR FUTURE WATER HEATER AND WALL KIT TO BE INSTALLED BY OWNER. PROVIDE BLANK PLATE AT JUNCTION BOX; TEMPORARILY CAP PLUMBING PIPES.
- b. PROVIDE ALL ELECTRICAL ROUGH-IN FOR FUTURE EXTERIOR AND INTERIOR LIGHTING
- FIXTURES TO BE INSTALLED BY OWNER. PROVIDE BLANK PLATES AT JUNCTION BOXES. c. DO NOT PROVIDE HDPE TOILET PARTITIONS.
- d. CMU TO REMAIN EXPOSED; WALLS WILL BE FINISHED AND PAINTED BY OWNER.

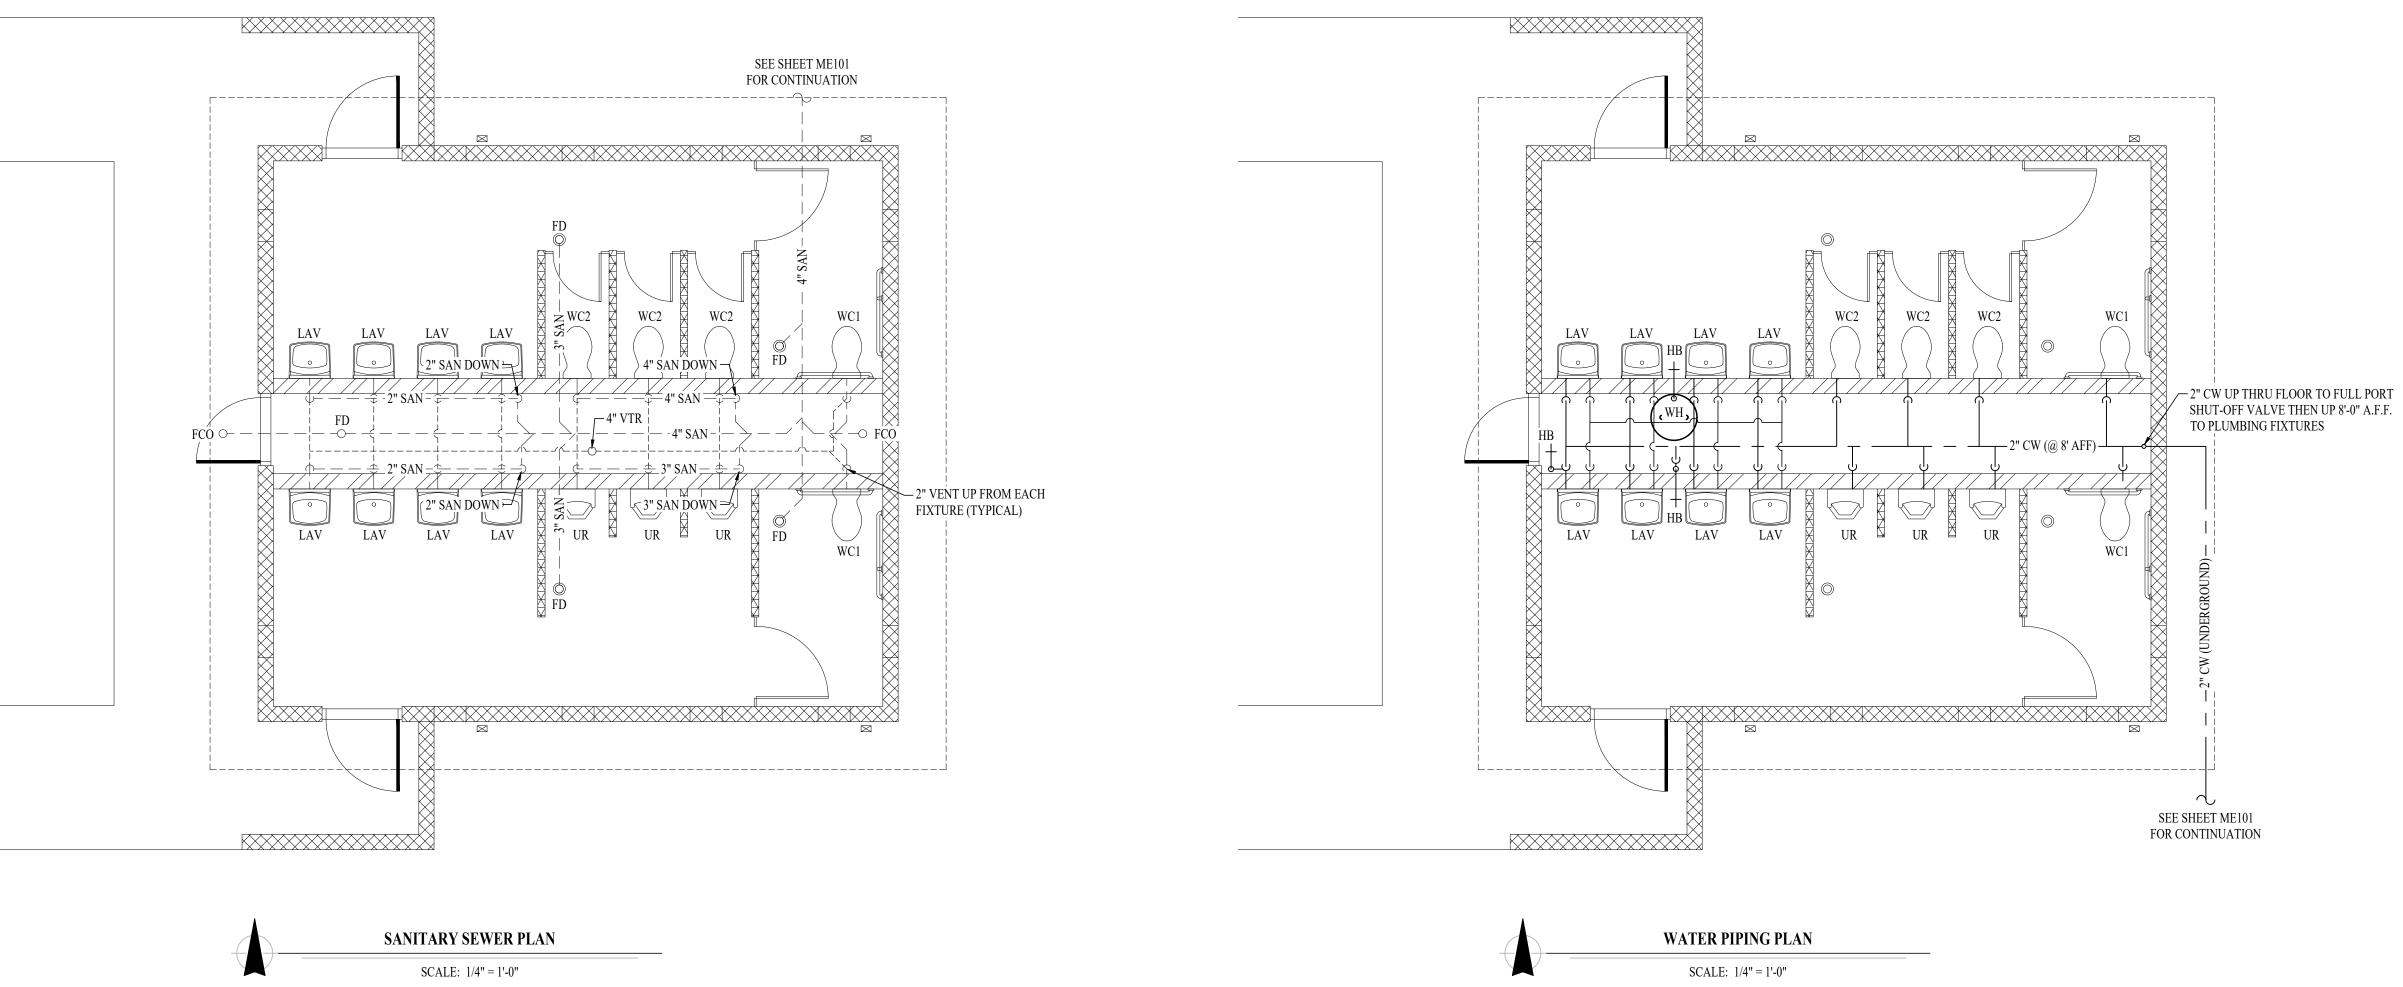

CONTRACTOR SHALL INSTALL LOW	

a. CONTRACTOR TO INCLUDE ROUGH-IN & WALL-HUNG BRACKETS FOR THE WATER CLOSETS, URINALS, & LAVATORIES. OWNER TO PROVIDE & INSTALL ALL TOILET ACCESSORIES.

		PLUMBING F	TIXTURE S	CHEDULE
TAG	DESCRIPTION	MANUFACTURER (OR EQUAL)	MODEL (OR EQUAL)	NOTES
FCO	FLOOR CLEANOUT	ZURN	1400	
FD	FLOOR DRAIN	ZURN	Z415-BZ	WITH Z1072 TRAP SEAL
LAV	LAVATORY (WALL HUNG W/MANUAL FAUCET)	AMERICAN STANDARD	0355.012	WITH ZURN Z81104-XL FAUCET, 1/4 TURN STOPS, BRAIDED STAINLESS STEEL SUPPLIES, AND TRUBRO LAV GUARD 2, AND TMV
TMV	THERMOSTATIC MIXING VALVE - POINT OF USE	WATTS	LFUSG	
UR	URINAL - MANUAL FLUSH	AMERICAN STANDARD	6550.001	WITH ZURN Z6003A V-WS1 MANUAL FLUSH VALVE (1.0 GPM/FLUSH)
WC1	WATER CLOSET - ADA HEIGHT WALL HUNG WITH MANUAL FLUSH VALVE	AMERICAN STANDARD	2859	WITH ZURN Z6000A V-WS1 MANUAL FLUSH VALVE (1.6 GPM/FLUSH) AND CHURCH 9500SSCT SELF SUSTAINING SEA T
WC2	WATER CLOSET - STANDARD HEIGHT WALL HUNG WITH MANUAL FLUSH VALVE	AMERICAN STANDARD	2859	WITH ZURN Z6000A V-WS1 MANUAL FLUSH VALVE (1.6 GPM/FLUSH) AND CHURCH 9500SSCT SELF SUSTAINING SEA T
WH	WATER HEATER	RUUD	ESG₽20	20 GALLON, 120V, 1500W, WITH HOLDRITE#30-SWHP-WM WALL MOUNT KIT. PROVIDE WITH CORD & PLUG
HB	HOSE BIBB	WOODFORD	MODEL 14	"P" INLET - 10" WALL
NOTES: 1.	VERIFY NECESSARY FIXTURES MEET ADA REQU	IREMENTS WITH ARCHITECT P	RIOR TO INSTALLATIO	ON

FIXTURE		SANITAR	RY PIPING	SUPPLY	PIPING
ТҮРЕ	TYPICAL ABBREVIATION	WASTE CONNECTION	VENT CONNECTION	COLD WATER CONNECTION	HOT WATER CONNECTION
DRINKING FOUNTAIN	DF	1-1/2"	1-1/4"	1/2"	-1
FLOOR DRAIN	FD	3"	2"	-	-
HAND / HAIR SINK	HS / SK	2"	1-1/4"	1/2"	1/2"
HOSE BIBB	HB	-	-	3/4"	-
LAVATORY	LAV	1-1/2"	1-1/4"	1/2"	1/2"
MOP SINK	MS	3"	1-1/2"	1/2"	1/2"
ICE MAKER OUTLET BOX	REF	1	-	1/2"	-
SHOWER	SH	3"	1-1/2"	1/2"	1/2"
URINAL	UR	2"	1-1/4"	3/4"	-
WATER CLOSET (FLUSH TANK)	WC	3"	2"	1/2"	-
WATER CLOSET (FLUSH VALVE)	WC	3"	2"	1"	-

	STE OF MISSOR
L.	JAMES P. WATSON
	* Water
	NUMBER PE-2015017071
V	WESSTONAL ENCLAS
James Wa PE-20150	
	$\lambda \wedge A$
Pec	kham & Wright Architects, Inc., d.b.a.
	WArchitects, Inc.
ſ	2120 Forum Blvd., Ste. 101 Columbia, Missouri 65203 PWArchitects.com 573.449.2683
Peckhar	n & Wright Architects an Architectural Corporation State Certificate of Authority No. 000244
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OFFI ADMI DIVIS FACI MANA DESI	CE OF INISTRATION
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OFFI ADMI DIVIS FACI MAN DESI CONS	CE OF INISTRATION SION OF LITIES AGEMENT, GN AND STRUCTION COMFORT ION
OFFIC ADMI DIVIS FACI MAN DESIC CONS	CE OF INISTRATION SION OF LITIES AGEMENT, GN AND STRUCTION COMFORT ION
OFFIC ADMI DIVIS FACI MAN DESIC CONS NEW STAT	CE OF INISTRATION SION OF LITIES AGEMENT, GN AND STRUCTION COMFORT ION
OFFI ADMI DIVIS FACI MAN DESI CONS NEW STAT	CE OF INISTRATION SION OF LITIES AGEMENT, GN AND STRUCTION COMFORT ION DURI STATE GROUNDS (MSF)
OFFI ADMI DIVIS FACI MAN DESI CONS NEW STAT MISSO FAIRO 2503 V SEDA	CE OF INISTRATION SION OF LITIES AGEMENT, GN AND STRUCTION COMFORT ION DURI STATE GROUNDS (MSF) V. 16th St. LIA, MO
OFFI ADMI DIVIS FACI MAN DESI CONS NEW STAT	CE OF INISTRATION SION OF LITIES AGEMENT, GN AND STRUCTION COMFORT ION DURI STATE GROUNDS (MSF) V. 16th St. LIA, MO ECT # F2206-01
OFFI ADMI DIVIS FACI MANA DESI CONS 	CE OF INISTRATION SION OF LITIES AGEMENT, GN AND STRUCTION COMFORT ION OURI STATE GROUNDS (MSF) V. 16th St. LIA, MO ECT # F2206-01 # 1501
OFFI ADMI DIVIS FACI MANA DESI CONS 	CE OF INISTRATION SION OF LITIES AGEMENT, GN AND STRUCTION COMFORT ION OURI STATE GROUNDS (MSF) V. 16th St. LIA, MO ECT # F2206-01 # 1501
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PLUMBING PLANS

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