UPGRADE ELECTRICAL AND RESTROOMS, GRANDSTAND MISSOURI STATE FAIRGROUNDS SEDALIA, MO



OWNER:

STATE OF MISSOURI MICHAEL L. PARSON,

GOVERNOR

DEPARTMENT OF AGRICULTURE MISSOURI STATE FAIRGROUNDS

PROJECT

OFFICE OF ADMINISTRATION

MANAGEMENT: DIVISION OF FACILITIES MANAGEMENT,

DESIGN AND CONSTRUCTION

DESIGNER:

ROBERT ROLLINGS ARCHITECTS, LLC

PROJECT NUMBER:

F2304-01

SITE NUMBER: ASSET NUMBER:


1501 351150101

3511501018

THESE DRAWINGS, ALONG WITH THE PROJECT SPECIFICATIONS, REPRESENT A UNIFIED SET OF CONSTRUCTION DOCUMENTS. ALL BIDDERS SHALL BE RESPONSIBLE FOR FAMILIARIZING THEMSELVES WITH ALL DRAWINGS IN THIS SET, REGARDLESS OF SHEET NUMBER AND DISCIPLINE, AND SHALL BE RESPONSIBLE FOR COORDINATING THEIR WORK WITH THE WORK OF OTHER TRADES. ANY APPARENT DISCREPANCIES BETWEEN DRAWINGS OR BETWEEN THE DRAWINGS AND SPECIFICATIONS SHALL BE BROUGHT TO THE ATTENTION OF THE ARCHITECT PRIOR TO BIDDING.


DO NOT BID FROM PARTIAL SETS OF BID DOCUMENTS.


BY SUBMITTING A BID, BIDDERS REPRESENT THAT THEY HAVE VISITED THE SITE, BECOME FAMILIAR WITH THE BID DOCUMENTS IN THEIR ENTIRETY AND WITH LOCAL CONDITIONS UNDER WHICH THE WORKS IS TO BE PERFORMED AND HAVE CORRELATED THE BIDDER'S PERSONAL OBSERVATIONS WITH THE REQUIREMENTS OF THE CONTRACT DOCUMENTS.

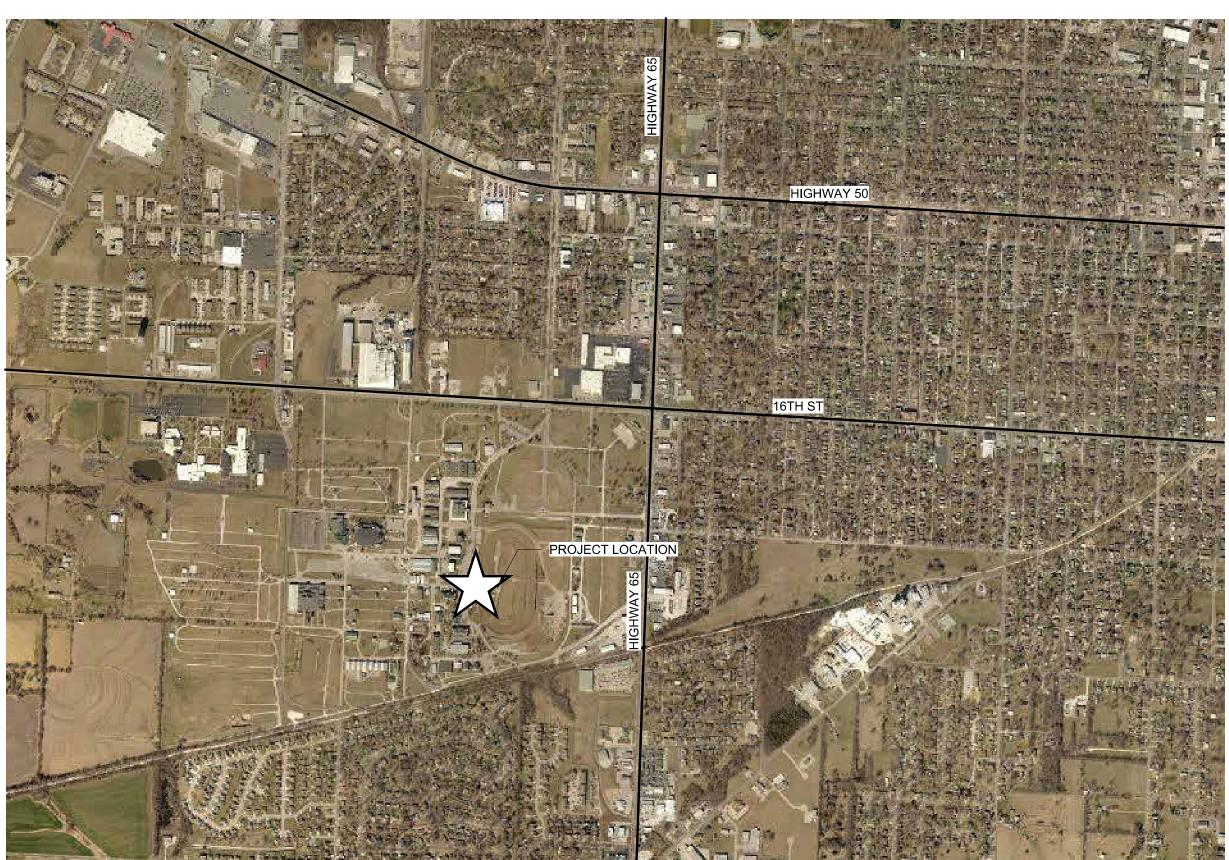






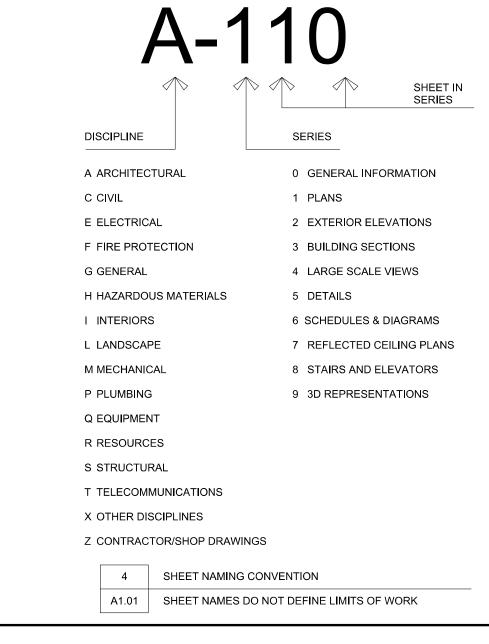

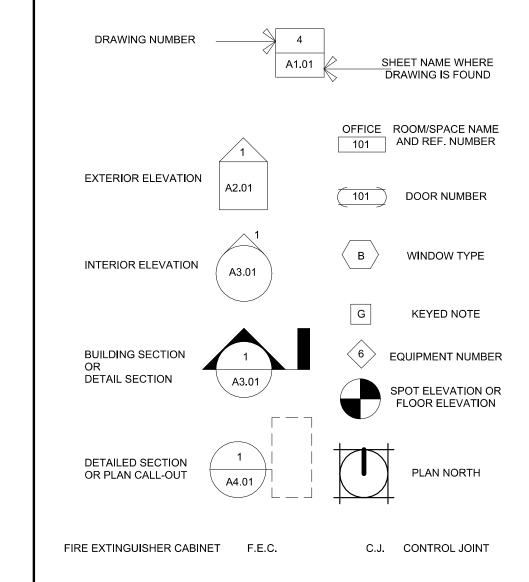

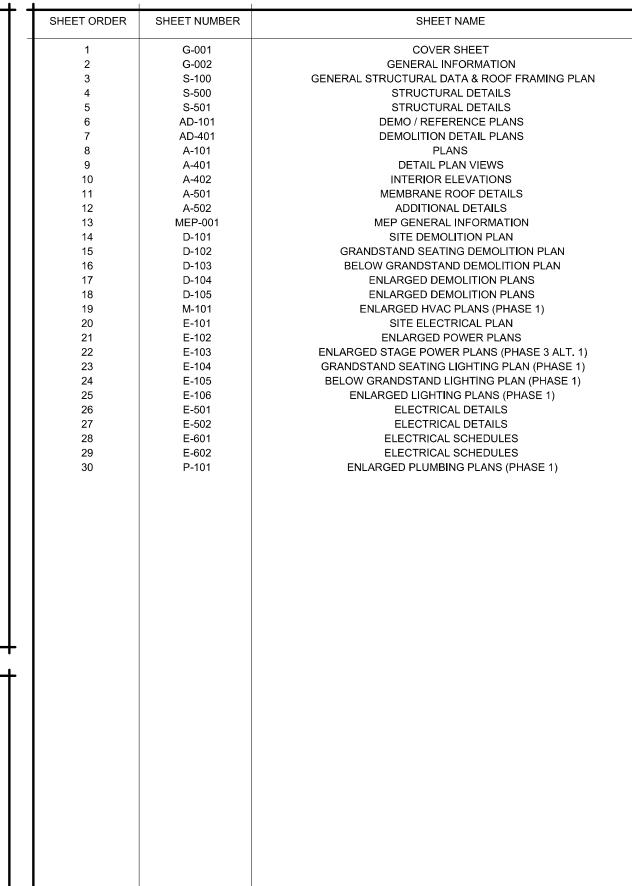


DESIGN TEAM:
ARCHITECT:
ROBERT ROLLINGS ARCHITECTS LLC 1806 WEST BROADWAY SEDALIA, MO 65301 660.829.9751 FAX: 660.829.9752
MECHANICAL / ELECTRICAL ENGINEER J-SQUARED ENGINEERING 2401 BERNADETTE DR. SUITE 201 COLUMBIA, MO 65203 573.234.4492
STRUCTURAL ENGINEER CROCKETT ENGINEERING 1000 W. NIFONG BLVD. BLDG. 1 COLUMBIA, MO 65202 573.447.0292

STATE OF MISSOURI MICHAEL L. PARSON, **GOVERNOR**



Robert D. Rollings 2005001208, Certificate of Authority # A-2006003870

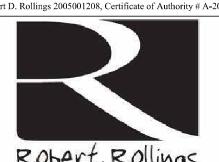

1806 West Broadway Boulevard Sedalia, MO 65301 660.829.9751



ENGINEERING 2400 BLUFF CREEK DR. STE. 101 COLUMBIA, MO 65203

573.234.4492

ENGINEERING CONSULTANTS 1000 W. Nifong Blvd., Bldg. 1. Columbia, Missouri 65202 (573) 447-0292 www.crockettengineering.com Crockett Engineering Consultants, LLC Missouri Certificate of Authority

OFFICE OF ADMINISTRATION DIVISION OF FACILITIES MANAGEMENT DESIGN AND CONSTRUCTION

UPGRADE ELECTRICAL AND RESTROOMS, GRANDSTAND

MISSOURI STATE FAIRGROUNDS 2503 W. 16TH ST. SEDALIA, MO 65301

PROJECT # T2304-01 SITE # 1501 ASSET # 3511501018

REVISION: DATE:

REVISION:

DATE:

REVISION: DATE:

ISSUE DATE: 11/29/2023 **BID DOCUMENTS**

CAD DWG FILE: G-02
DRAWN BY: AMK
CHECKED BY: RDR
DESIGNED BY: AMK


SHEET TITLE:

GENERAL INFORMATION

SHEET NUMBER:

G-002

SHEET 2 OF 30 ISSUE DATE: 11/29/23

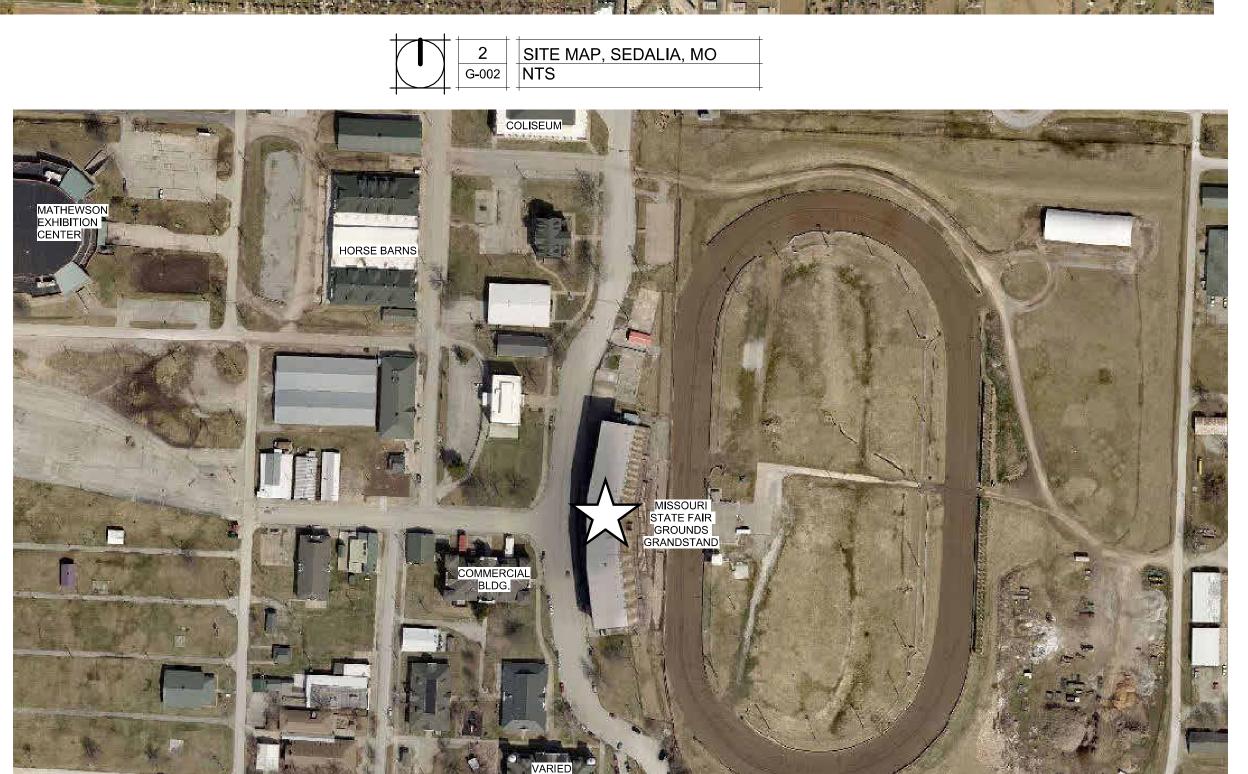

GENERAL NOTES

ELEVATION DATUM
SEE ARCHITECTURAL DRAWINGS OR SITE PLAN FOR FINISH FLOOR ELEVATIONS

DESIGN SPECIFICATIONS

2018 INTERNATIONAL BUILDING CODE

CONCRETE

CONCRETE WORK SHALL CONFORM TO ALL REQUIREMENTS OF THE CURRENT ACI 301, SPECIFICATIONS FOR STRUCTURAL CONCRETE FOR BUILDINGS, ACI 318 BUILDING CODE REQUIREMENTS FOR STRUCTURAL CONCRETE, ACI 305 SPECIFICATIONS FOR HOT WATER CONCRETE, AND ACI 306 SPECIFICATIONS FOR COLD WEATHER CONCRETE, WITH THE FOLLOWING ADDITIONAL REQUIREMENTS:

1. CONCRETE SHALL DEVELOP THE FOLLOWING 28—DAY MINIMUM COMPRESSIVE STRENGTH:

FOUNDATIONS - 3,000 PSI CAST-IN-PLACE WALLS - 3,500 PSI

FLOOR SLAB - 4,000 PSI
EYTERIOR SLARS WALLS AND CLIRRS - 4,000 PSI

EXTERIOR SLABS, WALLS AND CURBS — 4,000 PSI
2. ALL FOOTINGS SHALL BEAR ON UNDISTURBED SOIL OR ENGINEERED FILL.

3. CHLORIDE— BASED ADMIXTURES ARE PROHIBITED IN ALL REINFORCED CONCRETE.

4. REINFORCING STEEL SHALL CONFORM TO ASTM A615, A616, OR A617, GRADE 60.
5. ALL CONTINUOUS REINFORCING STEEL THAT MEETS AT A CORNER SHALL BE TIED TOGETHER WITH A

CORNER BAR THAT HAS SUFFICIENT LAP DISTANCE IN EACH DIRECTION
6. CONTINUOUS REINFORCING BARS LAP LENGTH SHALL BE A MINIMUM OF 48 BAR DIAMETERS UNLESS

NOTED OTHERWISE

7. CONCRETE SLUMP SHALL BE A MAXIMUM OF 4" +/- 1" (ASTM C- 143) AS DELIVERED IN THE FIELD.

CONTRACTOR MAY USE CHEMICAL ADMITTURES TO ATTAIN A MAXIMUM SLUMP OF 8" FOR WORKARILITY.

CONTRACTOR MAY USE CHEMICAL ADMIXTURES TO ATTAIN A MAXIMUM SLUMP OF 8" FOR WORKABILITY.

NO WATER MAY BE ADDED TO THE CONCRETE MIX ON SITE UNLESS WATER IS WITHHELD AT THE

BATCHING FACILITY. IF WATER IS WITHHELD AT THE BATCHING FACILITY IT SHOULD BE REFLECTED ON

THE LOAD TICKET. THE TOTAL AMOUNT OF WATER IN THE MIX SHALL NOT EXCEED WHAT IS NOTED ON

THE LOAD TICKET. THE TOTAL AMOUNT OF WATER IN THE MIX SHALL NOT EXCEED WHAT IS NOTED ON THE APPROVED MIXED. THIS SHALL BE NOTED IN THE SPECIAL INSPECTOR'S RECORDS.

8. CONCRETE EXPOSED TO WEATHER, VEHICLES, AND/OR DEICING CHEMICALS SHALL BE AIR—ENTRAINED

WITH 6% (+/-) 1.5% ENTRAINED AIR BY VOLUME AT POINT OF DISCHARGE. DO NOT ALLOW AIR CONTENT OF TROWELED FINISHED FLOORS TO EXCEED 3%.

9. SUBMIT CONCRETE MIX PROPORTIONS PRIOR TO START OF WORK. DO NOT BEGIN CONCRETE

9. SUBMIT CONCRETE MIX PROPORTIONS PRIOR TO START OF WORK. DO NOT BEGIN CONCRETE PRODUCTION UNTIL MIXES HAVE BEEN REVIEWED AND ARE ACCEPTABLE TO THE ENGINEER. 10.READY MIX CONCRETE SHALL COMPLY WITH REQUIREMENTS OF ASTM C94.

11.CONCRETE WORK EXECUTION

A. CONSTRUCT FORMS TO CORRECT SIZE, SHAPE, ALIGNMENT, ELEVATION AND POSITION; AND TO

EXPOSED TO EARTH OR WEATHER......2 INCHES NOT EXPOSED TO WEATHER OR

IN CONTACT WITH EARTH......1 ½ INCHES

C. PROVIDE CONTROL JOINTS IN SLABS-ON-GRADE AT NOT GREATER THAN 15 FEET ON CENTER IN EACH DIRECTION. SAW CUT CONTROL JOINTS MINIMUM 1/4 OF SLAB DEPTH, AS SOON AFTER SLAB

FINISHING WITHOUT DISLODGING AGGREGATE.

D. STEEL TROWEL FINISH ALL INTERIOR CONCRETE SLABS, BROOM FINISH ALL EXTERIOR CONCRETE

E. CURE ALL CONCRETE IN COMPLIANCE WITH ACI 301, USING A LIQUID TYPE MEMBRANE, NON-RESIDUAL, CURING COMPOUND COMPLYING WITH ASTM C309. ASSURE COMPATIBILITY WITH FINISH FLOOR COVERING.

STRUCTURAL STEEL

- 1. FABRICATION AND ERECTION OF STRUCTURAL STEEL SHALL BE IN ACCORDANCE WITH THE CURRENT EDITION OF THE AISC SPECIFICATIONS FOR STRUCTURAL STEEL BUILDINGS, THE AISC CODE OF STANDARD PROCESS AND CURRENT OSHA STANDARDS
- PRACTICE FOR STEEL BUILDINGS AND BRIDGES AND CURRENT OSHA STANDARDS.

 2. WIDE FLANGE SHAPES SHALL CONFORM TO ASTM A992. STRUCTURAL TUBES SHALL CONFORM TO ASTM A500 GRADE B. ALL OTHER STRUCTURAL STEEL SHALL CONFORM TO ASTM A36.
- 3. BOLTS, UNLESS OTHERWISE SHOWN, SHALL CONFORM TO ASTM A325-N,
- SIZE AS PER PLAN.
 4. ANCHOR BOLTS, UNLESS OTHERWISE SHOWN, SHALL CONFORM TO
- ASTM F1554 GRADE 36.
- 5. SPLICING OF STRUCTURAL STEEL IS PROHIBITED EXCEPT AS DETAILED.
- 6. ALL STRUCTURAL AND MISCELLANEOUS STEEL ITEMS SHALL RECEIVE ONE COAT OF "IRONCLAD RETARDO RUST INHIBITIVE PAINT 163" (BENJAMIN MOORE) OR APPROVED EQUAL UNLESS OTHERWISE INDICATED IN THE SPECIFICATIONS. ALL STEEL SURFACES EMBEDDED IN CONCRETE SHALL NOT BE PAINTED. PREPARATION OF STEEL SURFACES SHALL MEET THE REQUIREMENTS OF THE STEEL STRUCTURES
- PAINTING COUNCIL (SSPC-SP1) AND THE REMOVAL OF GREASE AND OIL BY SOLVENT CLEANING (SSPC-SP1) AND THE REMOVAL OF MILL SCALE, RUST, WELD FLUX AND SLAG BY HAND TOOL CLEANING (SSPC-SP2). PRIMER SHALL BE APPLIED AT THE MANUFACTURER'S RECOMMENDED RATE BUT NOT LESS THAN ONE GALLON PER 400 SQ.FT. THEREBY DEPOSITING A DRY FILM THICKNESS OF NOT LESS
- THAN 1.5 MILS. ANY SCARRED AREAS SHALL BE TOUCHED UP WITH THE SAME PAINT AFTER ERECTION.


 7. ALL WELDING SHALL BE DONE BY QUALIFIED WELDERS IN ACCORDANCE WITH THE CURRENT EDITION OF THE AWS STRUCTURAL WELDING CODE. WELDING ELECTRODES SHALL BE E70XX.


SPECIAL INSPECTIONS

THE FOLLOWING ITEMS REQUIRE SPECIAL INSPECTION IN ACCORDANCE WITH CHAPTER 17 OF THE INTERNATIONAL BUILDING CODE. IT IS THE GENERAL CONTRACTOR'S RESPONSIBILITY TO HIRE & ENSURE THE FOLLOWING INSPECTIONS HAVE BEEN PERFORMED ON THE PROJECT.

- a. CONCRETE GROUT DESIGN MIX (PERIODIC)
- b. PLACING OF CONCRETE AND REINFORCING STEEL (CONTINUOUS OF CONCRETE SAMPLING /
- PERIODIC OF REINFORCING)
- c. STRUCTURAL STEEL FABRICATIONS (UNLESS AISC APPROVED)
- (PERIODIC)
- d. STRUCTURAL STEEL BOLTING & WELDING (PERIODIC)

THE CONTRACTOR SHALL REQUEST SPECIAL INSPECTION OF THE ITEMS LISTED ABOVE PRIOR TO THOSE ITEMS BECOMING INACCESSIBLE AND UNOBSERVABLE DUE TO PROGRESSION OF THE WORK.

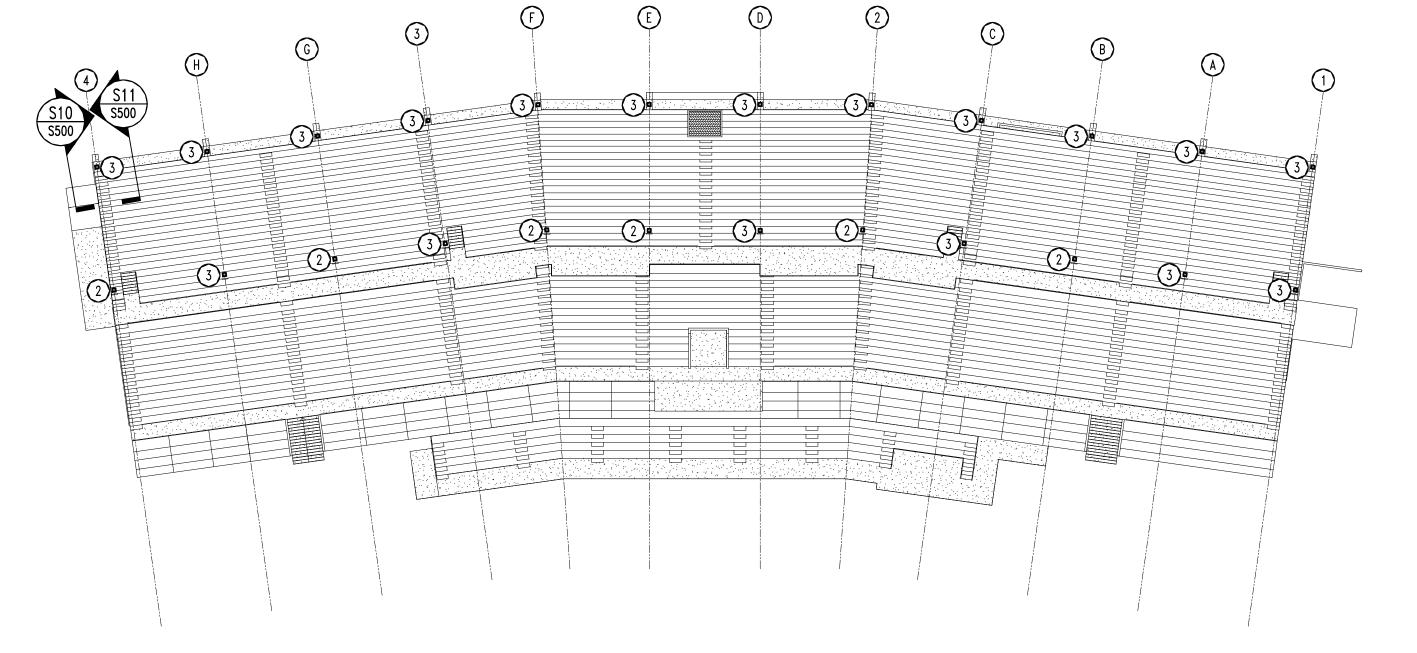

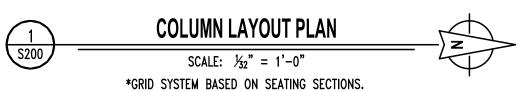

REPAIR NOTES

- CONTRACTORS RESPONSIBILITY TO VISIT SITE PRIOR
 TO BIDDING TO UNDERSTAND COMPLEXITY OF ACCESS
 FOR COLUMN REPAIRS.
- 2) REPAIR COLUMN AS SHOWN IN DETAIL S1/S500.
- 3 INSTALL WEEP IN BASE OF COLUMN AS SHOWN IN DETAIL S1/S200. (ANGLE REINFORCING NOT REQUIRED AT THIS LOCATION.)

STATE OF MISSOURI MICHAEL L. PARSON, GOVERNOR



Robert Rollings Architects LLC 1806 West Broadway Boulevard Sedalia, MO 65301 660.829.9751

Robert D. Rollings 2005001208, Certificate of Authority # A-2006003870



CROCKETT

ENGINEERING CONSULTANTS
1000 W. Nifong Blvd., Bldg. 1.
Columbia, Missouri 65202
(573) 447-0292
www.crockettengineering.com
Crockett Engineering Consultants, LLC
Missouri Certificate of Authority
#2000151304

OFFICE OF ADMINISTRATION DIVISION OF FACILITIES MANAGEMENT DESIGN AND CONSTRUCTION

UPGRADE ELECTRICAL AND RESTROOMS, GRANDSTAND

MISSOURI STATE FAIRGROUNDS 2503 W. 16TH ST. SEDALIA, MO 65301

SITE # 1501 ASSET # 3511501018 REVISION: DATE:

PROJECT # T2304-01

REVISION:____ DATE:

REVISION:___ DATE:___

ISSUE DATE: 11/29/2023
BID DOCUMENTS

CAD DWG FILE:
DRAWN BY: SEH
CHECKED BY: JWV
DESIGNED BY: JWV


SHEET TITLE:


GENERAL STRUCTURAL DATA & PLAN

SHEET NUMBER:

S-100

SHEET 3 OF 30 11/29/2023

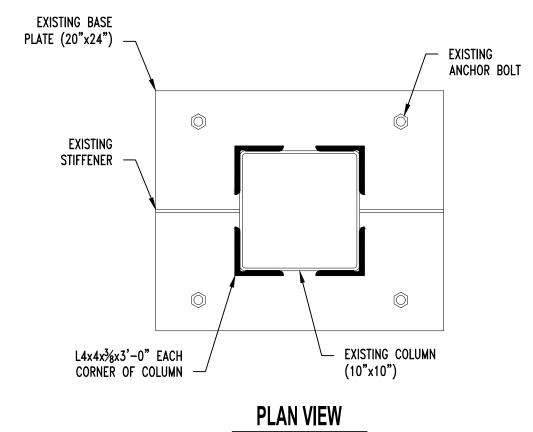

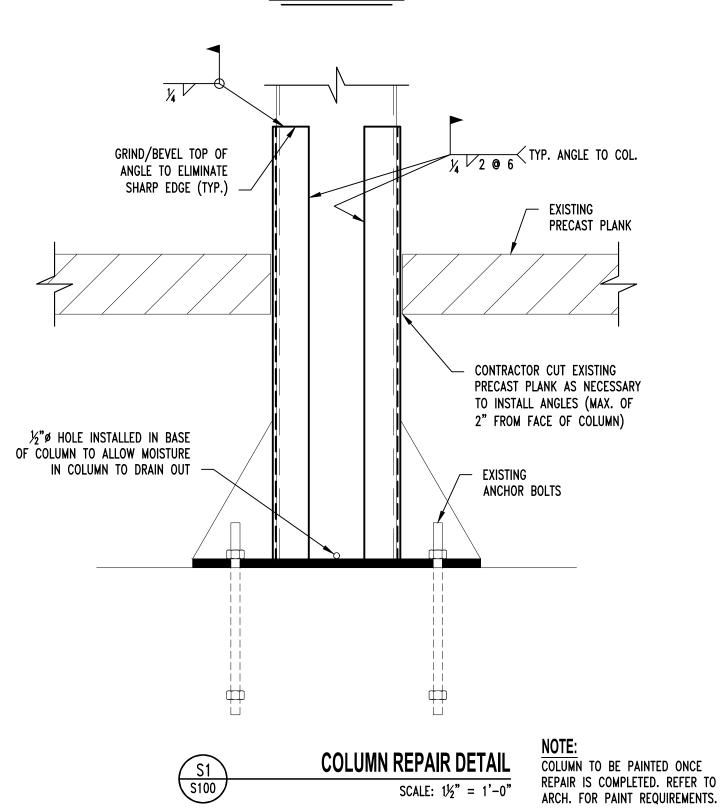


COLUMN REPAIR DETAIL



CONCRETE SUPPORT AT GRID LINE 4 (NORTH FACE)

SCALE: $1\frac{1}{2}$ " = 1'-0"

CRACKED/SPALLED
CONCRETE; REFER TO
SHEET S501 FOR
NECESSARY REPAIRS

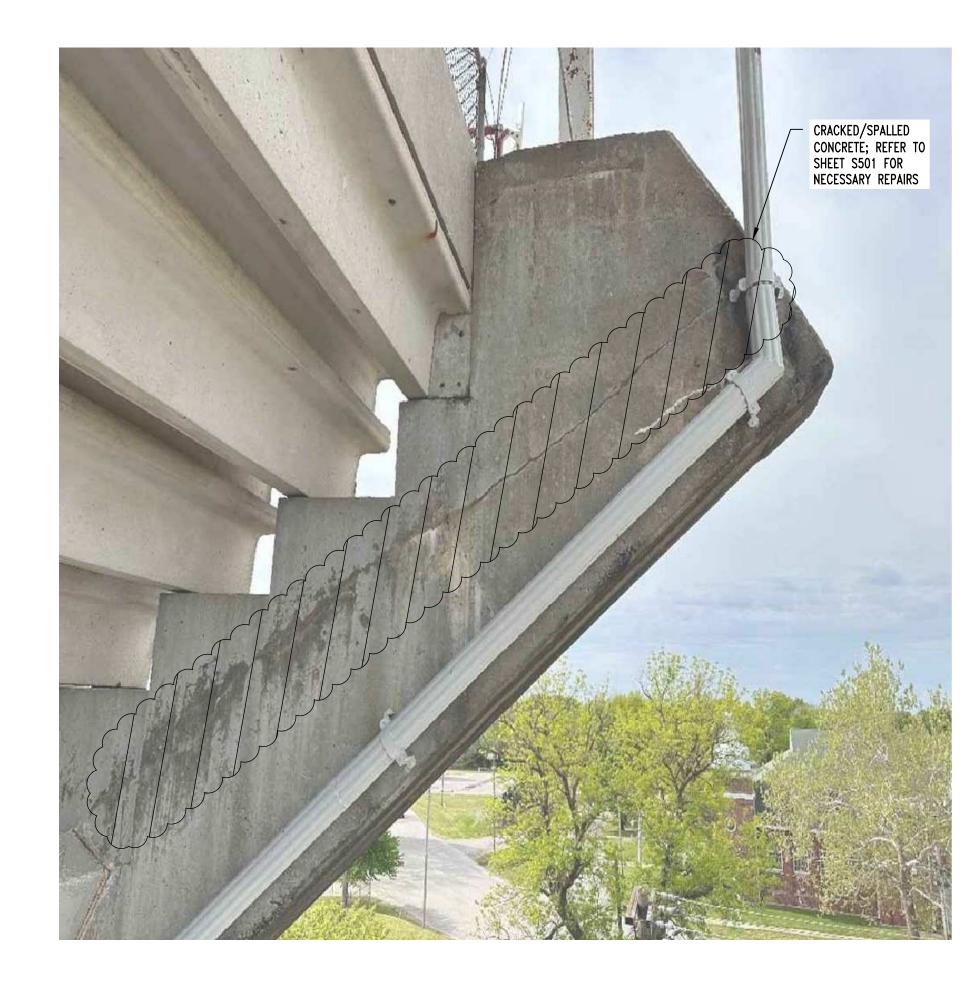


CONCRETE SUPPORT AT GRID LINE 4 (SOUTH FACE) SCALE: 1½" = 1'-0"

STATE OF MISSOURI MICHAEL L. PARSON, **GOVERNOR**



Robert D. Rollings 2005001208, Certificate of Authority # A-2006003870

1806 West Broadway Boulevard Sedalia, MO 65301 660.829.9751

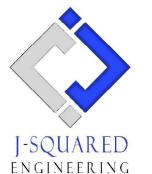

ENGINEERING 2400 BLUFF CREEK DR. STE. 101 COLUMBIA, MO 65203 573.234.4492

ENGINEERING CONSULTANTS
1000 W. Nifong Blvd., Bldg. 1.
Columbia, Missouri 65202
(573) 447-0292
www.crockettengineering.com Crockett Engineering Consultants, LLC Missouri Certificate of Authority #2000151304

OFFICE OF ADMINISTRATION DIVISION OF FACILITIES MANAGEMENT DESIGN AND CONSTRUCTION

UPGRADE ELECTRICAL AND RESTROOMS, GRANDSTAND **MISSOURI STATE FAIRGROUNDS**

PROJECT # T2304-01 SITE # 1501

ASSET # 3511501018

2503 W. 16TH ST. SEDALIA, MO 65301

REVISION: DATE:

REVISION: DATE:

REVISION: DATE:

> ISSUE DATE: 11/29/2023 **BID DOCUMENTS**

CAD DWG FILE:
DRAWN BY: SEH
CHECKED BY: JWV
DESIGNED BY: JWV


SHEET TITLE:

STRUCTURAL **DETAILS**


SHEET NUMBER:

S-500

SHEET 4 OF 30 11/29/2023

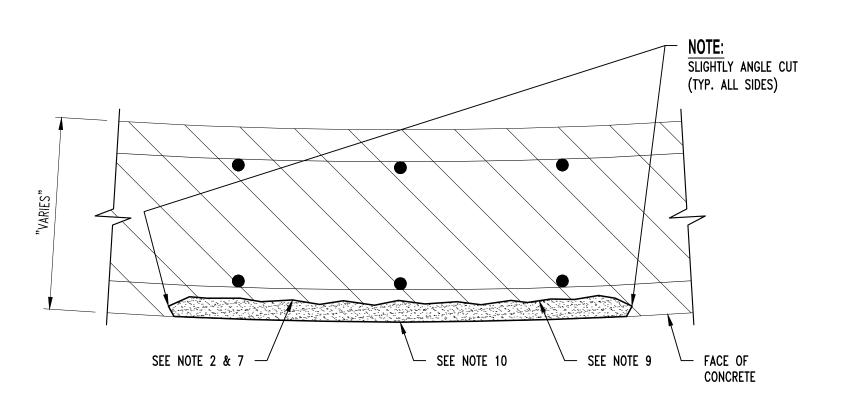


SURFACE SPALL REPAIR DETAIL APPLIES TO SURFACE SPALLS WITH NO REINFORCEMENT EXPOSED.

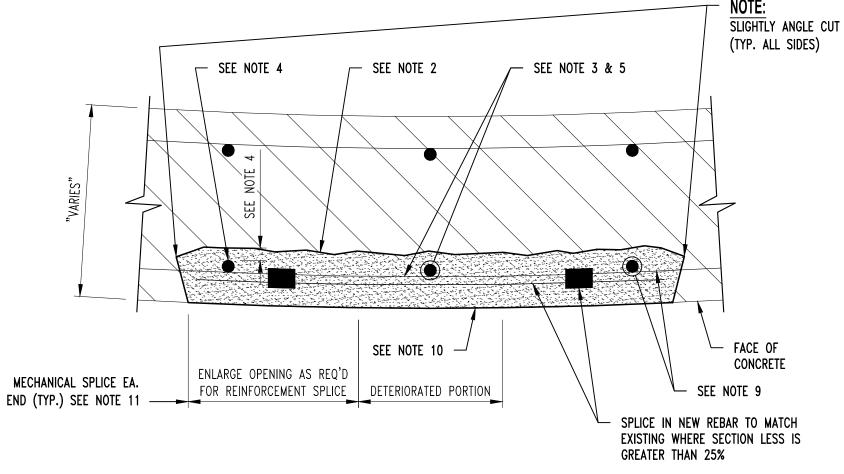

DEEP SPALL w/ REINFORCEMENT SECTION LOSS GREATER THAN OR EQUAL TO 25% DETAIL APPLIES TO SURFACE SPALLS

MINIMUM NOMINAL **BAR SIZE** ALLOWABLE DIAMETER (IN.) DIAMETER (IN. 0.375 0.325 0.500 0.433 0.625 0.541 0.750 0.650 0.875 0.758 1.000 0.866 1.128 0.977 #10 1.270 1.100

REINFORCED BAR DIAMETER TABLE

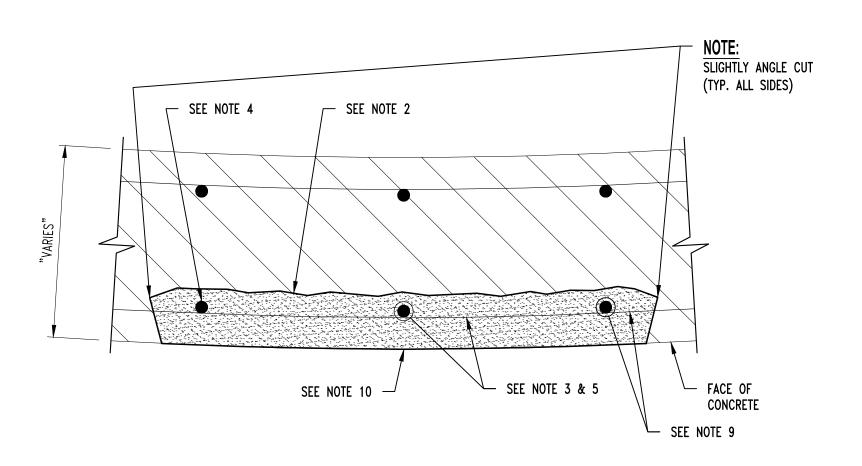

FACE OF CONCRETE SEE NOTE 12 & 13


DEEP SPALL w/ REINFORCEMENT SECTION LOSS LESS THAN OR EQUAL TO 25%


DETAIL APPLIES TO SURFACE SPALLS WITH REINFORCEMENT EXPOSED.

CRACK REPAIR

DETAIL APPLIES TO CRACKS LARGER THAN 0.03".



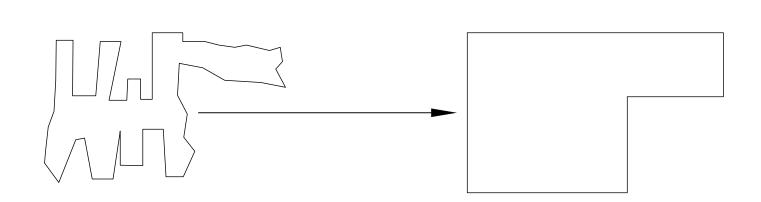

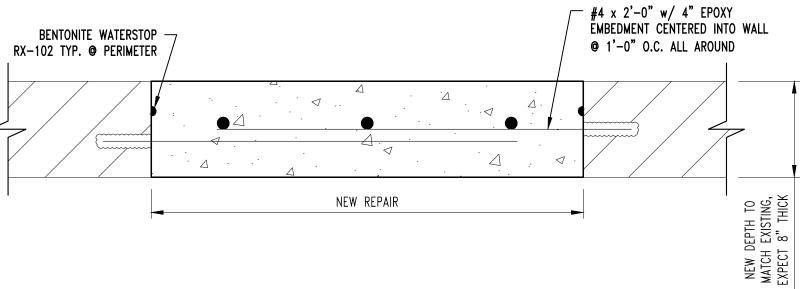

DETERIORATED CONCRETE SURFACE REPAIR

REPAIR CONFIGURATIONS TO BE KEPT AS SIMPLE AS POSSIBLE. 2. CORNERS MUST BE SQUARED TO AVOID FEATHERED EDGES.

FULL DEPTH REPAIR DETAIL


CONCRETE REPAIR NOTES

- 1) PRIOR TO PERFORMING ANY CONCRETE REPAIRS, CONTRACTOR SHALL EXAMINE THE ENTIRE CONCRETE SURFACE BY SOUNDING TO DETECT ANY DEFICIENCIES NOT SHOWN ON THE CONTRACT DOCUMENTS. IF DEFICIENCIES ARE DETECTED, MARK OUTLINE ON CONCRETE SURFACE AND NOTIFY OWNER'S REPRESENTATIVE. PROVIDE OWNER'S REPRESENTATIVE WITH APPROXIMATE SIZE AND LOCATION OF EACH DEFICIENCY NOTED.
- 2) REMOVE ALL LOOSE AND DETERIORATED CONCRETE. CHIP OUT AND PATCH AREA ½" MIN. BEYOND SPALLED SURFACE. AT BOUNDARIES OF DETERIORATED CONCRETE, SAWCUT BOUNDARY TO A MINIMUM DEPTH OF $\frac{3}{4}$ ". DO NOT FEATHER EDGES.
- CARE SHOULD BE EXERCISED NOT TO DAMAGE EXISTING REINFORCING STEEL DURING CONCRETE REMOVAL. CONCRETE REMOVAL SHALL EXTEND TO WHERE BAR IS WELL BONDED TO SURROUNDING SOUND CONCRETE. CARE SHALL BE EXERCISED NOT TO DAMAGE THE BAR'S BOND TO SURROUNDING CONCRETE. IF BOND BETWEEN BAR AND CONCRETE IS BROKEN, UNDERCUTTING OF THE BAR IS REQUIRED AS SPECIFIED IN ITEM 4 BELOW.
- (3) IF HALF OF THE THICKNESS OF THE REINFORCEMENT BAR OR MORE IS EXPOSED PROVIDE A MINIMUM OF 1/2" CLEARANCE BETWEEN EXPOSED REINFORCEMENT AND SURROUNDING CONCRETE FOR HAND APPLIED REPAIR MATERIALS AND A MINIMUM OF 1" CLEARANCE FOR SPRAY APPLIED REPAIR MATERIALS.
- (4) MECHANICALLY CLEAN STEEL BY SANDBLASTING OR WIRE BRUSH TO WHITE METAL CONDITION TO REMOVE CORROSION. AFTER CLEANING REINFORCING STEEL, MEASURE DIAMETER AT NARROWEST POINT. IF SECTION LOSS IS GREATER THAN 25% (SEE "REINFORCING BAR DIAMETER TABLE" ON THIS SHEET) ADD NEW REINFORCING BAR MATCHING SIZE OF EXISTING. MAINTAIN A MINIMUM OF 11/3" CONCRETE COVER AT ALL NEW AND EXISTING REINFORCEMENT, ANY REINFORCEMENT TO BE DRILLED AND GROUTED INTO EXISTING CONCRETE SHALL USE HILTI HIT HY 200 MAX EPOXY ADHESIVE (OR APPROVED EQUAL).
- 5 SCARIFY CONCRETE SURFACE TO OBTAIN CONCRETE SURFACE PROFILE ROUGHENED.
- 6) MINIMUM DEPTH OF PATCH TO BE 3/8".
- 7) SUBSTRATE SHOULD BE SATURATED SURFACE DRY (SSD) WITH NO STANDING WATER DURING APPLICATION.
- (8) APPLY CONCRETE PRIMER TO SUBSTRATE PER MANUFACTURERS SPECIFICATIONS. APPLY TWO COATS OF ANTI-CORROSION COATING PER MANUFACTURERS SPECIFICATIONS TO ALL EXPOSED REINFORCEMENT ALLOWING TO PROPERLY DRY BETWEEN COATS. SIKA FERROGARD 901 OR APPROVED EQUAL.
- (9) WHILE CONCRETE PRIMER IS STILL WET, APPLY PATCH MATERIAL PER MANUFACTURERS SPECIFICATIONS. FOR APPLICATIONS GREATER THAN 1" IN DEPTH, APPLY PATCH MATERIAL IN LIFTS. SCORE THE TOP SURFACE OF EACH LIFT AND ALLOW EACH LIFT TO REACH FINAL SET THEN REPEAT FROM STEP 8.
- (10) PROVIDE MECHANICAL SPLICE CAPABLE OF DEVELOPING 125% Fy. MAINTAIN A MINIMUM OF 11/2" CONCRETE COVER AT ALL NEW AND EXISTING REINFORCEMENT.
- CLEAN CRACK SURFACES AND REMOVE ANY FOREIGN MATTER AND DEPOSITS.
- (12) INSTALL POLYMER MODIFIED CEMENTITIOUS PATCHING MATERIAL PER MANUFACTURERS SPECIFICATION AND TOOL SURFACE TO MATCH SURROUNDING SURFACE. SIKATOP-123 OR APPROVED EQUAL.


STATE OF MISSOURI MICHAEL L. PARSON, **GOVERNOR**



Robert D. Rollings 2005001208, Certificate of Authority # A-2006003870

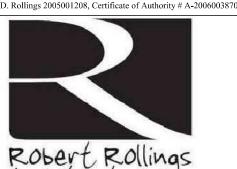

ArchitectsLLC 1806 West Broadway Boulevard Sedalia, MO 65301 660.829.9751

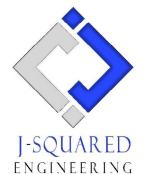

2400 BLUFF CREEK DR. STE. 101 COLUMBIA, MO 65203 573.234.4492

CROCKETT

ENGINEERING CONSULTANTS 1000 W. Nifong Blvd., Bldg. 1. Columbia, Missouri 65202 (573) 447-0292 www.crockettengineering.com Crockett Engineering Consultants, LLC Missouri Certificate of Authority #2000151304

OFFICE OF ADMINISTRATION DIVISION OF FACILITIES MANAGEMENT DESIGN AND CONSTRUCTION

UPGRADE ELECTRICAL AND RESTROOMS, GRANDSTAND

MISSOURI STATE **FAIRGROUNDS** 2503 W. 16TH ST. SEDALIA, MO 65301

PROJECT # T2304-01 SITE # 1501 ASSET # 3511501018

DATE:

REVISION:

REVISION: DATE:

REVISION: DATE:

ISSUE DATE: 11/29/2023 **BID DOCUMENTS**

CAD DWG FILE: DRAWN BY: SEH CHECKED BY: JWV DESIGNED BY: JWV


SHEET TITLE:

STRUCTURAL **DETAILS**

SHEET NUMBER:

S-501

SHEET 5 OF 30 11/29/2023

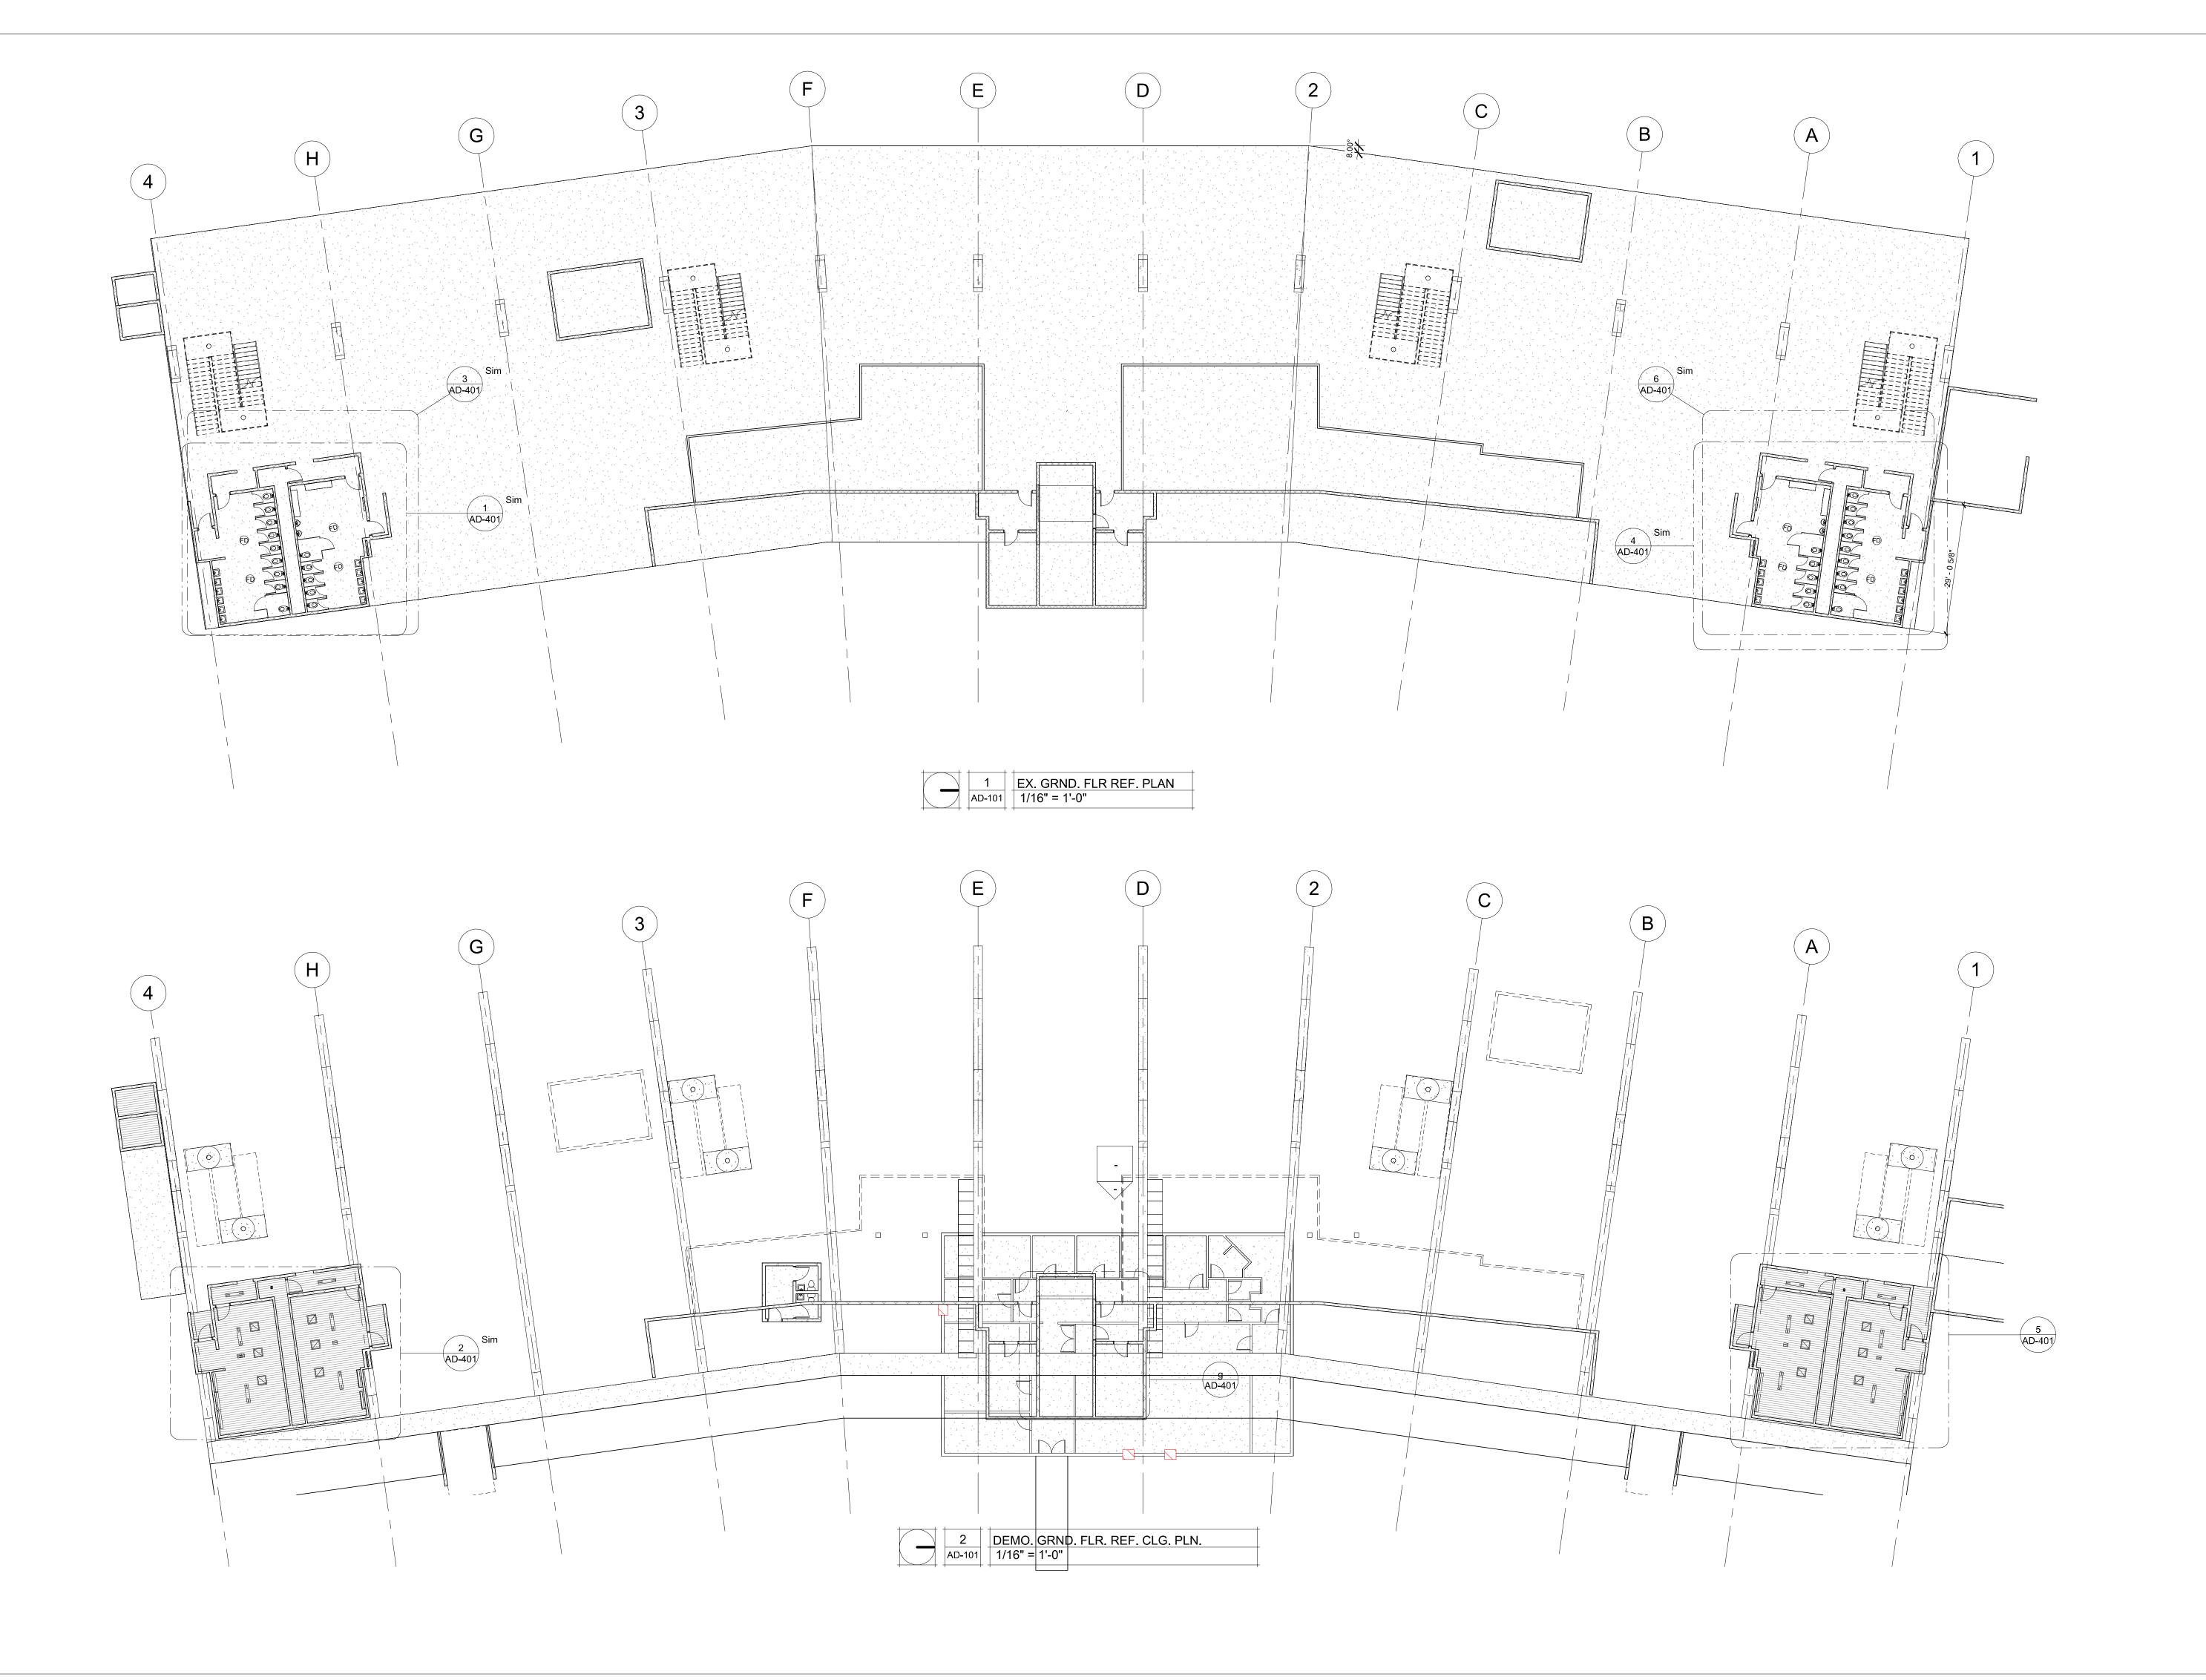



Robert D. Rollings 2005001208, Certificate of Authority # A-2006003870



Robert Rollings Architects LLC 1806 West Broadway Boulevard Sedalia, MO 65301 660.829.9751



ENGINEERING 2400 BLUFF CREEK DR. STE. 101 COLUMBIA, MO 65203 573.234.4492

CROCKETT

ENGINEERING CONSULTANTS
1000 W. Nifong Blvd., Bldg. 1.
Columbia, Missouri 65202
(573) 447-0292
www.crockettengineering.com
Crockett Engineering Consultants, LLC
Missouri Certificate of Authority
#2000151304

OFFICE OF ADMINISTRATION DIVISION OF FACILITIES MANAGEMENT DESIGN AND CONSTRUCTION

UPGRADE ELECTRICAL AND RESTROOMS, GRANDSTAND

MISSOURI STATE FAIRGROUNDS 2503 W. 16TH ST. SEDALIA, MO 65301

PROJECT # T2304-01 SITE # 1501 ASSET # 3511501018

REVISION: DATE:

REVISION:_ DATE:

REVISION:_ DATE:

ISSUE DATE: 11/29/2023
BID DOCUMENTS

CAD DWG FILE: A-DP-06
DRAWN BY: AMK
CHECKED BY: RDR
DESIGNED BY: AMK


SHEET TITLE:

DEMO / REFERENCE PLANS

SHEET NUMBER:

AD-101

SHEET 6 OF 30 ISSUE DATE: 11/29/23

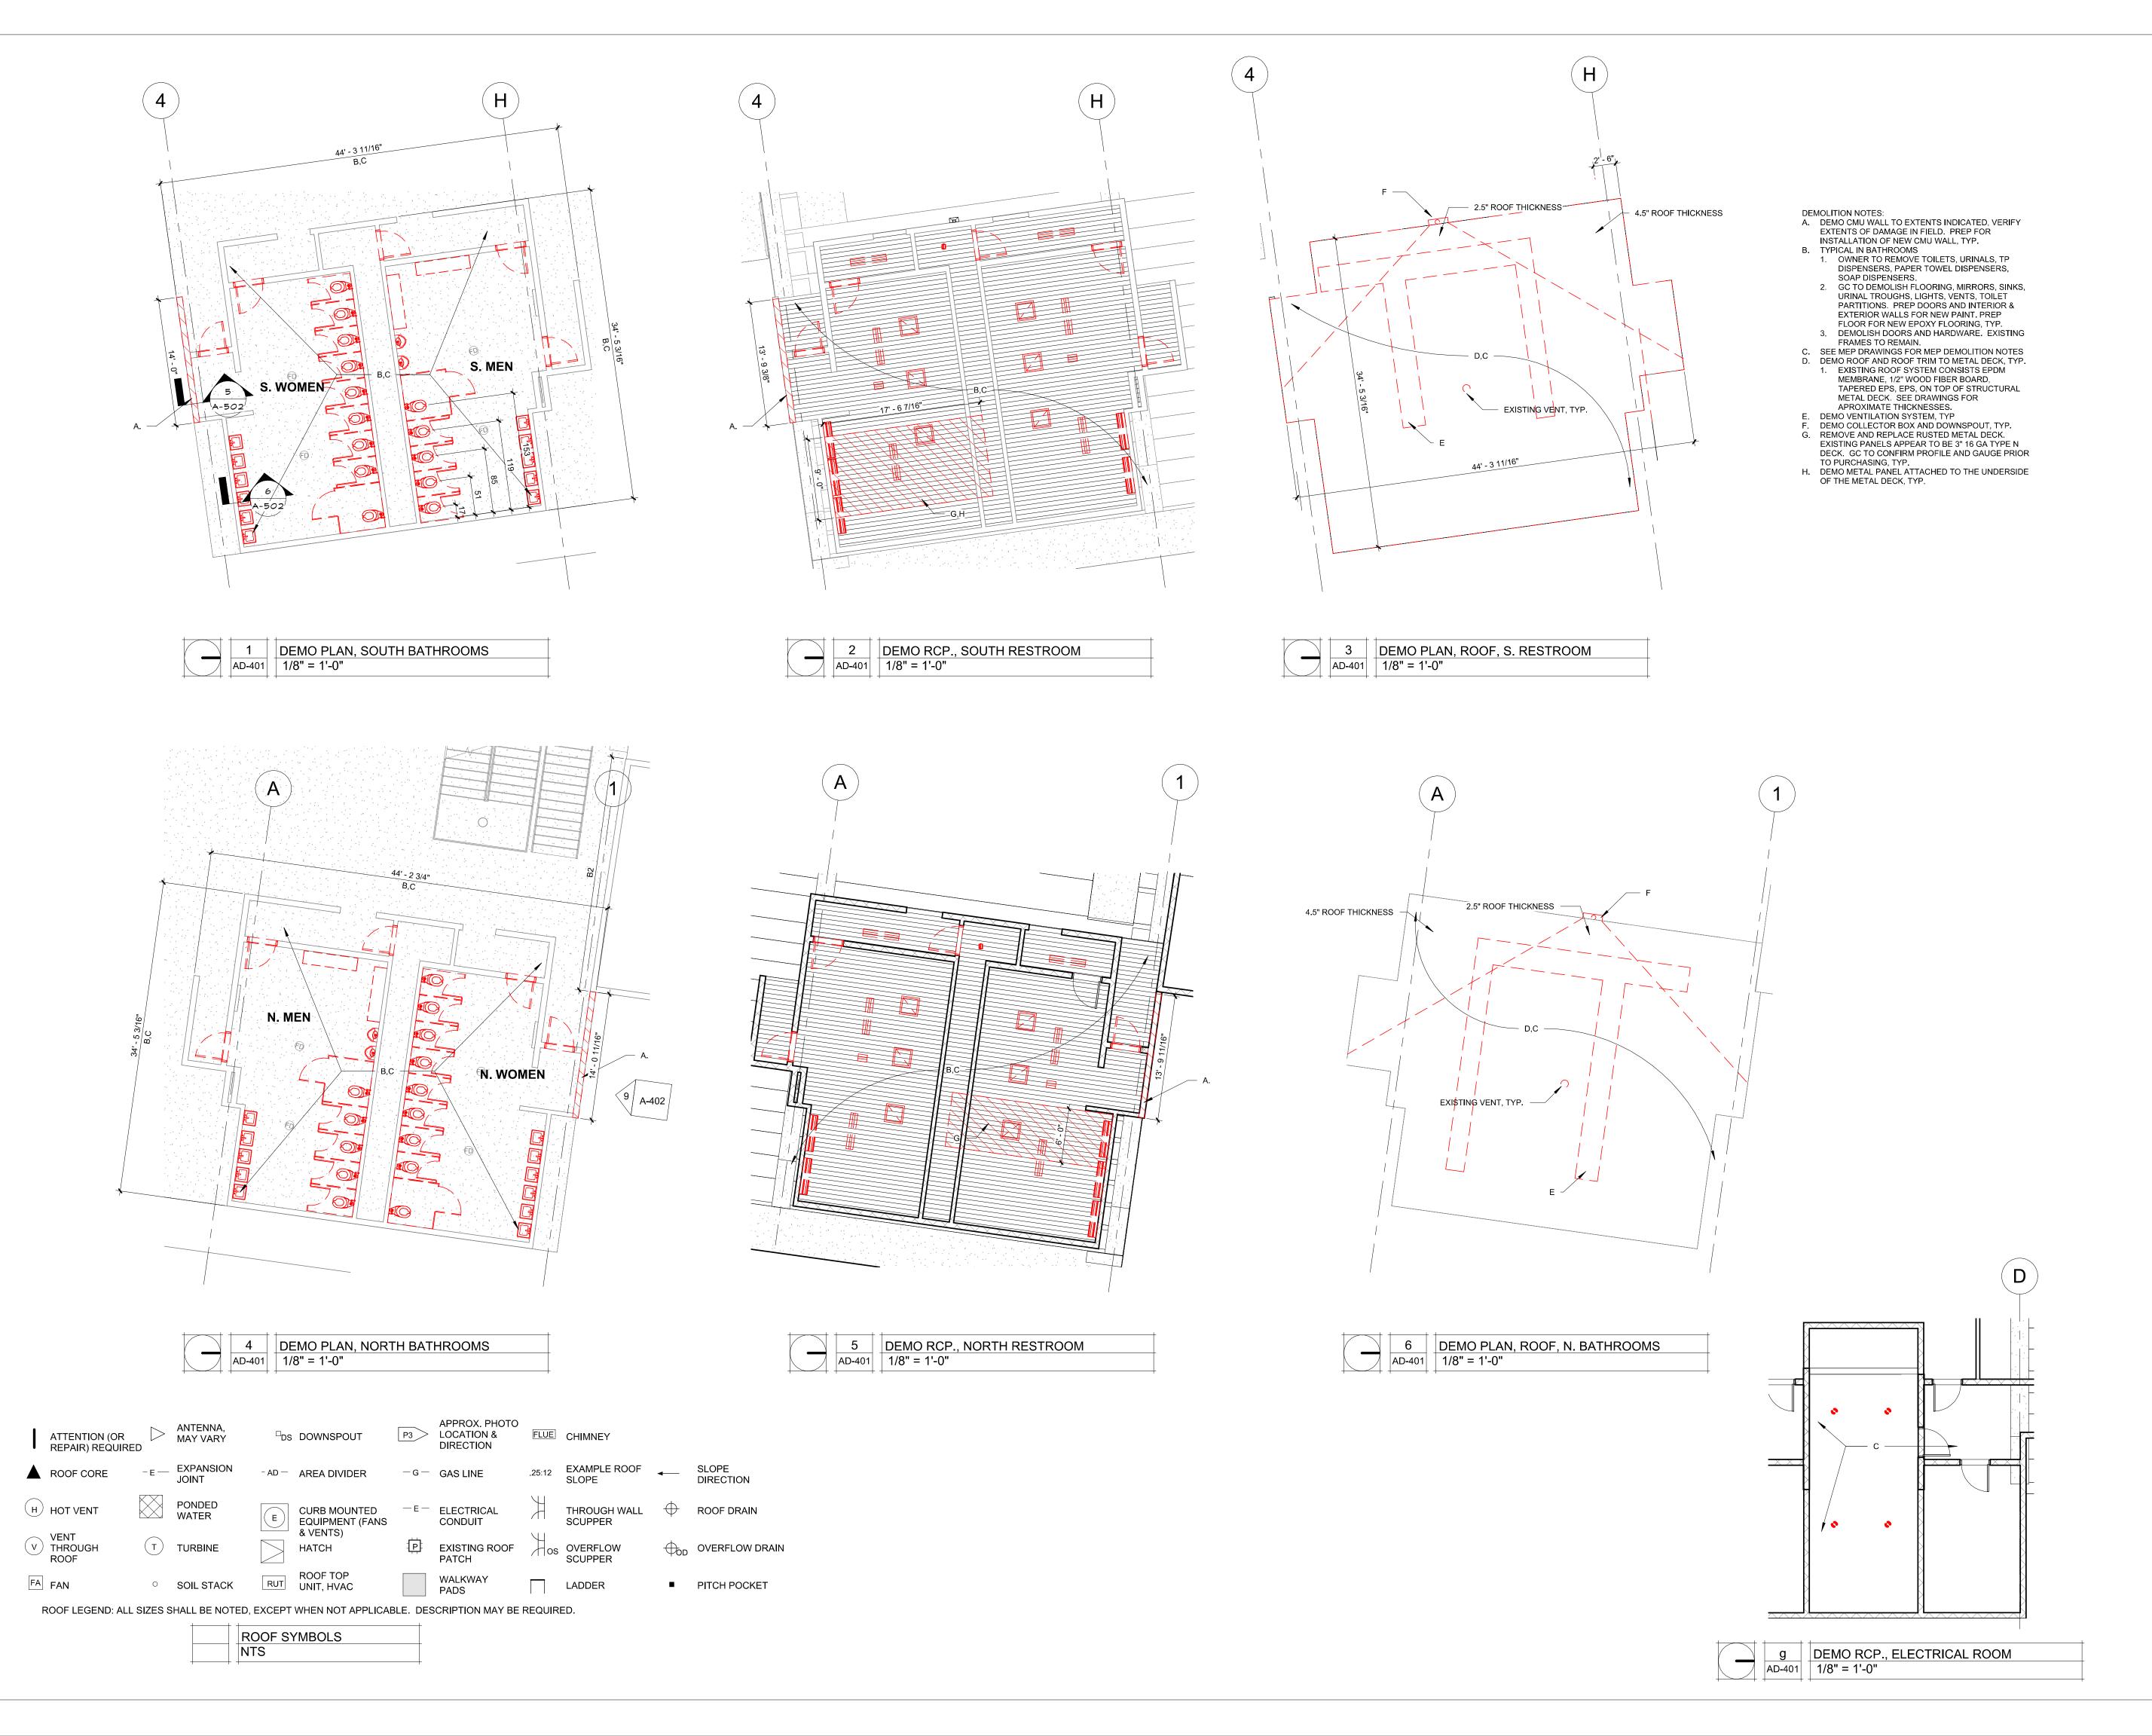



Robert D. Rollings 2005001208, Certificate of Authority # A-2006003870



Robert Rollings Architects LLC 1806 West Broadway Boulevard Sedalia, MO 65301 660.829.9751



ENGINEERING 2400 BLUFF CREEK DR. STE. 101 COLUMBIA, MO 65203

573.234.4492

CRUCKETT

ENGINEERING CONSULTANTS
1000 W. Nifong Blvd., Bldg. 1.
Columbia, Missouri 65202
(573) 447-0292
www.crockettengineering.com
Crockett Engineering Consultants, LLC
Missouri Certificate of Authority

OFFICE OF ADMINISTRATION DIVISION OF FACILITIES MANAGEMENT DESIGN AND CONSTRUCTION

UPGRADE ELECTRICAL AND RESTROOMS, GRANDSTAND

MISSOURI STATE FAIRGROUNDS 2503 W. 16TH ST. SEDALIA, MO 65301

PROJECT # T2304-01 SITE # 1501 ASSET # 3511501018

REVISION:_ DATE:_

REVISION:_ DATE:_

REVISION:____ DATE:___

ISSUE DATE: 11/29/2023
BID DOCUMENTS

CAD DWG FILE: A-DP-07
DRAWN BY: AMK
CHECKED BY: RDR
DESIGNED BY: AMK


SHEET TITLE:

DEMOLITION DETAIL PLANS

SHEET NUMBER:

AD-401

SHEET 7 OF 30 ISSUE DATE: 11/29/23

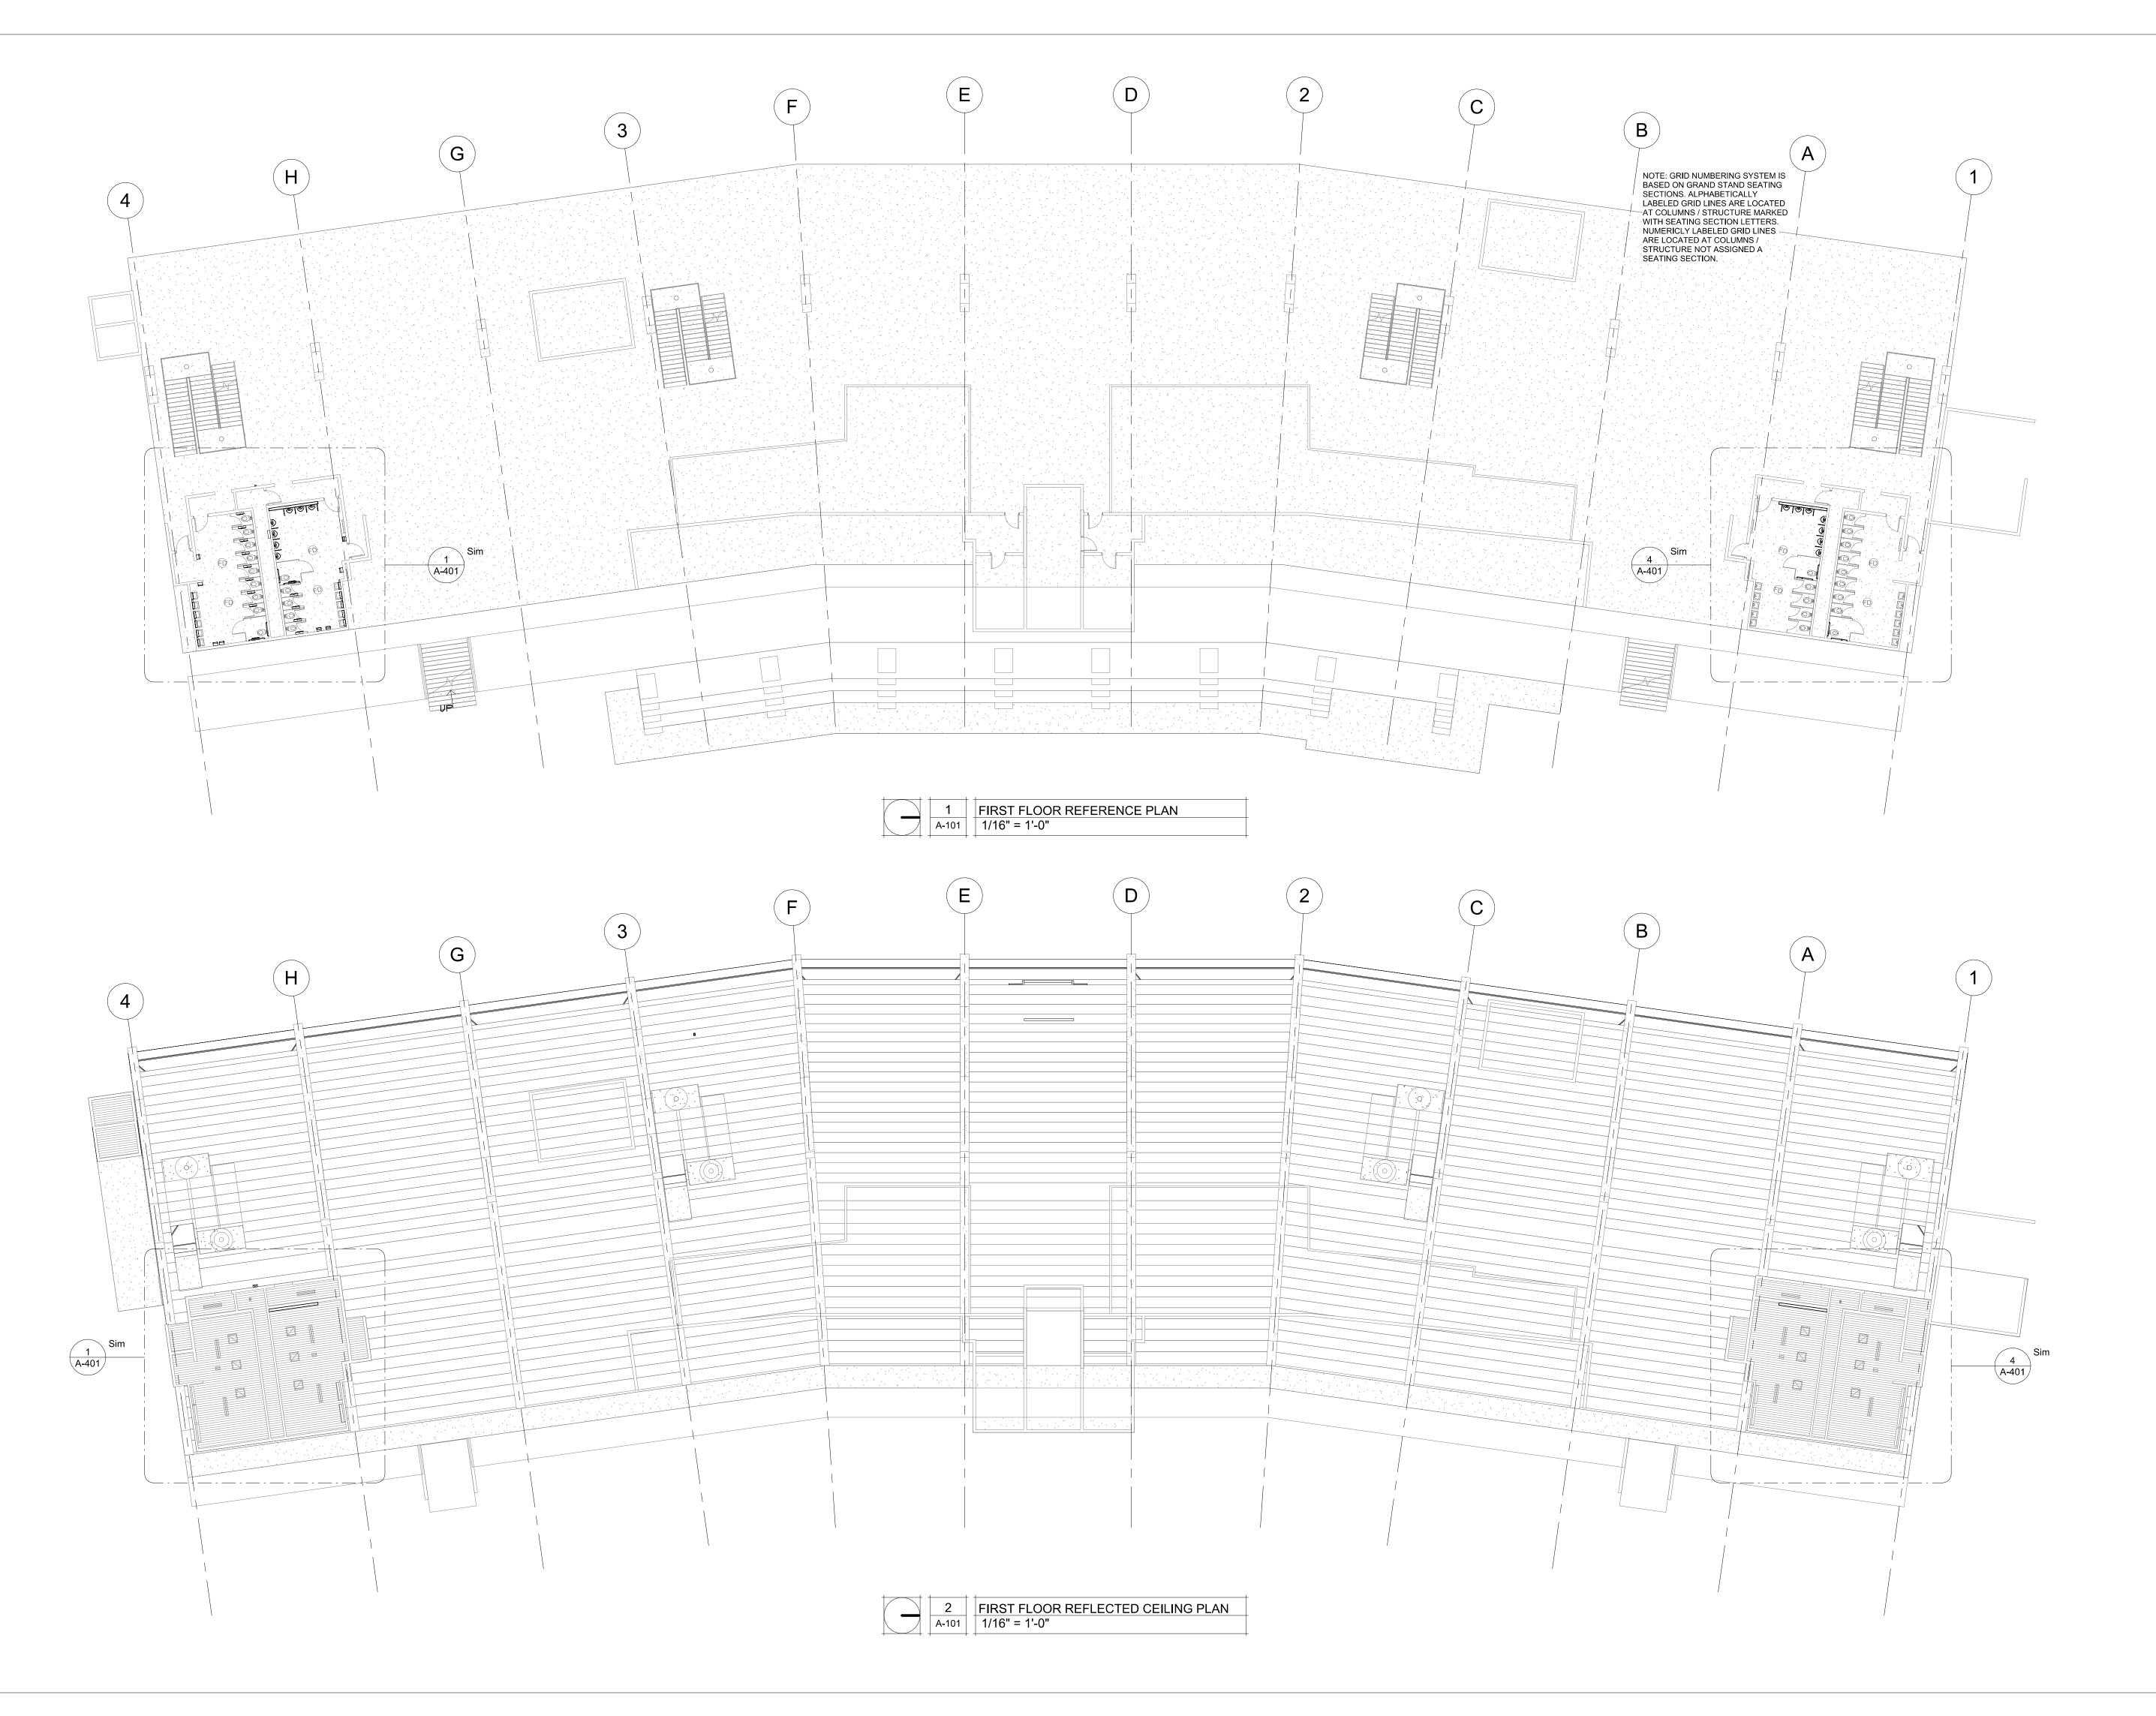



11. 21.67



Robert Rollings Architects LLC 1806 West Broadway Boulevard Sedalia, MO 65301 660.829.9751



ENGINEERING 2400 BLUFF CREEK DR. STE. 101 COLUMBIA, MO 65203

573.234.4492

CRUCKET

ENGINEERING CONSULTANTS
1000 W. Nifong Blvd., Bldg. 1.
Columbia, Missouri 65202
(573) 447-0292
www.crockettengineering.com
Crockett Engineering Consultants, LLC
Missouri Certificate of Authority
#2000151304

OFFICE OF ADMINISTRATION DIVISION OF FACILITIES MANAGEMENT DESIGN AND CONSTRUCTION

UPGRADE ELECTRICAL AND RESTROOMS, GRANDSTAND

MISSOURI STATE FAIRGROUNDS 2503 W. 16TH ST. SEDALIA, MO 65301

PROJECT # T2304-01 SITE # 1501 ASSET # 3511501018

REVISION: DATE:

REVISION: DATE:

REVISION:_ DATE:

ISSUE DATE: 11/29/2023
BID DOCUMENTS

CAD DWG FILE: A-FP-08
DRAWN BY: AMK
CHECKED BY: RDR
DESIGNED BY: AMK


SHEET TITLE:


PLANS


SHEET NUMBER:

A-10

SHEET 8 OF 30 ISSUE DATE: 11/29/23

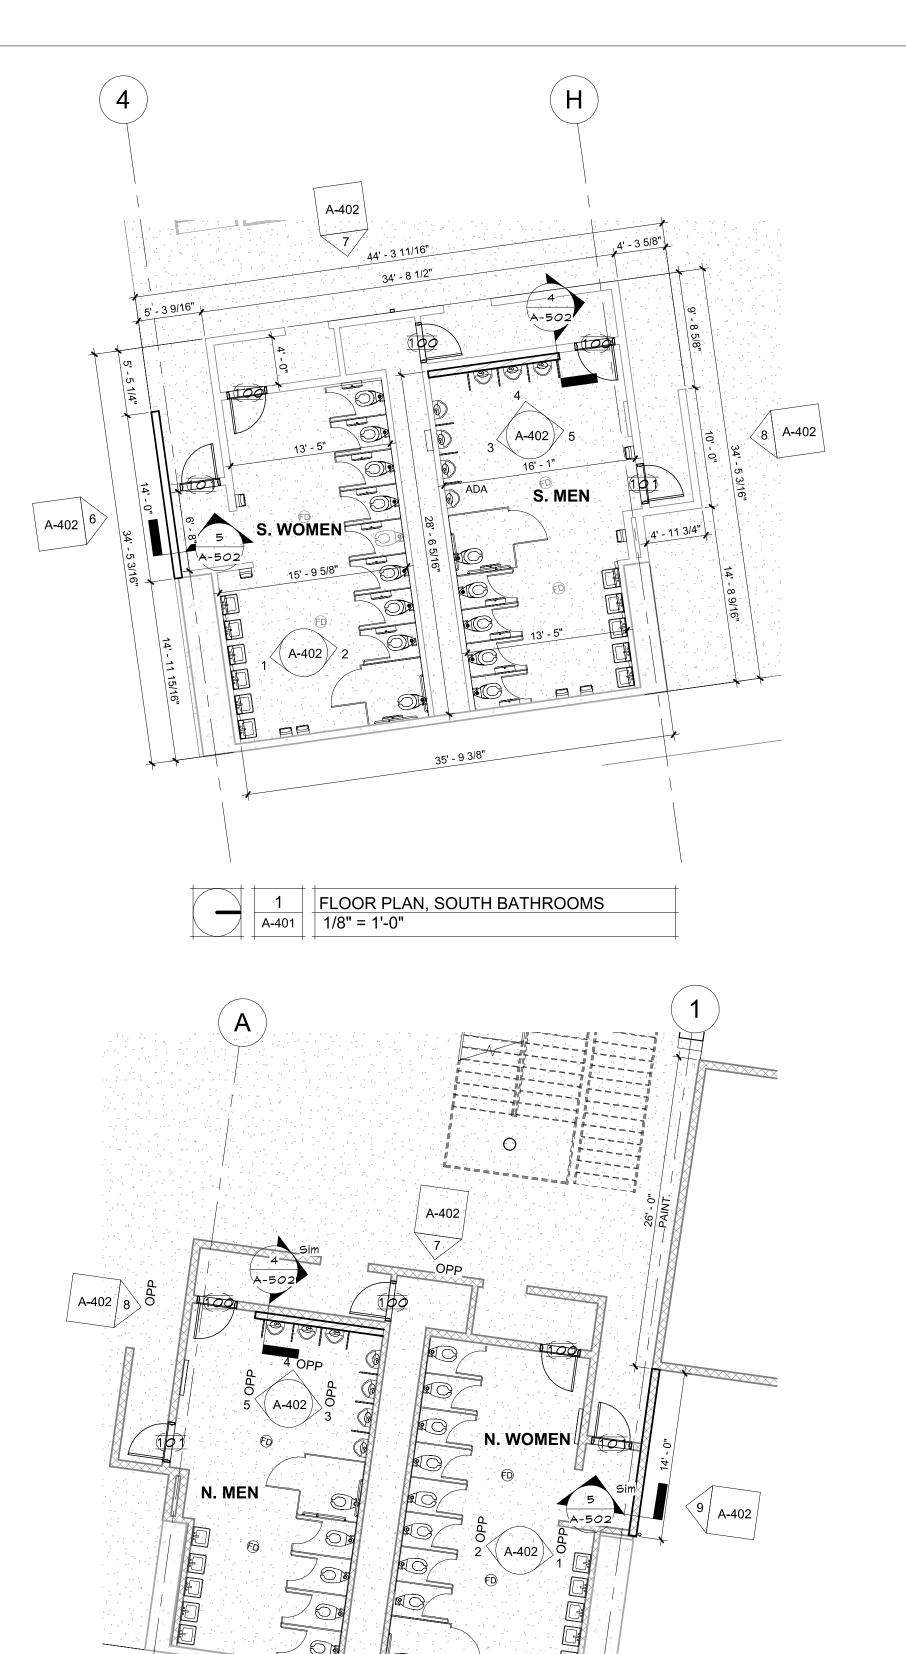

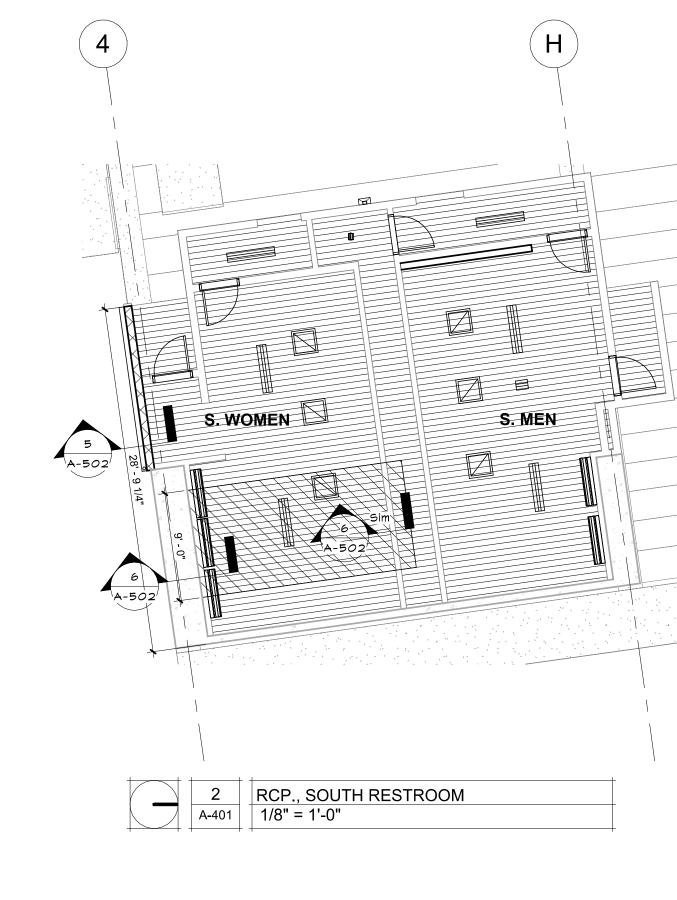


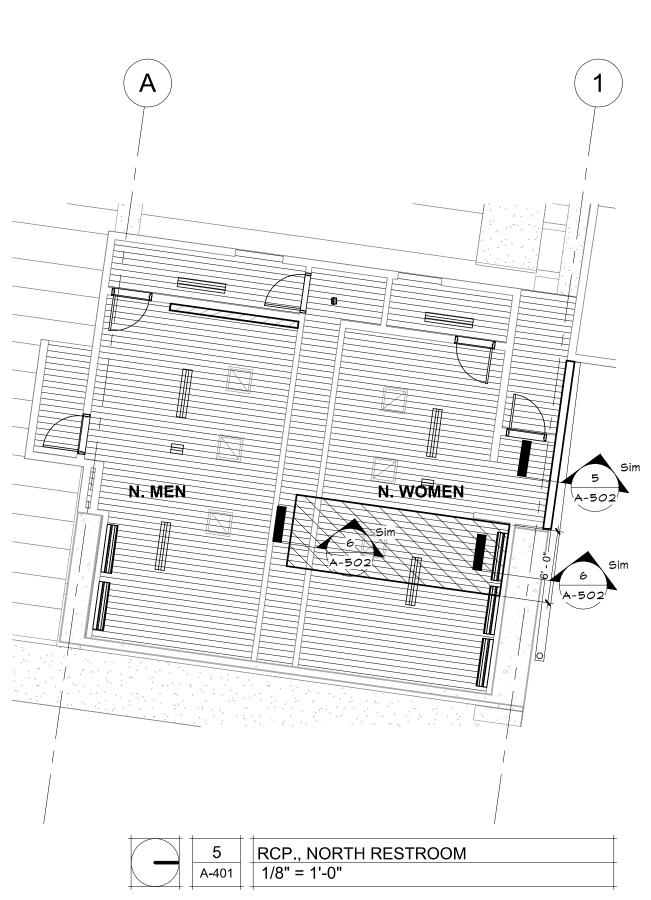


		FINISH SC	CHEDULE		
ROOM	ROOM NAME	FLOOR FINISH	BASE FINISH	INTERIOR WALL FINISH	EXTERIOR WALL FINISH
100	S. WOMEN	EPOXY	EPOXY	EPOXY PAINT	EPOXY PAINT
101	S. MEN	EPOXY	EPOXY	EPOXY PAINT	EPOXY PAINT
102	N. MEN	EPOXY	EPOXY	EPOXY PAINT	EPOXY PAINT
103	N WOMEN	FPOXY	FPOXY	FPOXY PAINT	FPOXY PAINT

4 FLOOR PLAN, NORTH BATHROOMS 1/8" = 1'-0"

			DOOR SC	HEDULE		
MARK	WIDTH	HEIGHT	DOOR MATERIAL	DOOR TYPE	DOOR FINISH	HARDWARE
100	3' - 0"	7' - 0"	14 GA REINFORCED	FLAT PANEL	PAINT	Α
101	3' - 0"	7' - 0"	14 GA REINFORCED	FLAT PANEL	PAINT	В

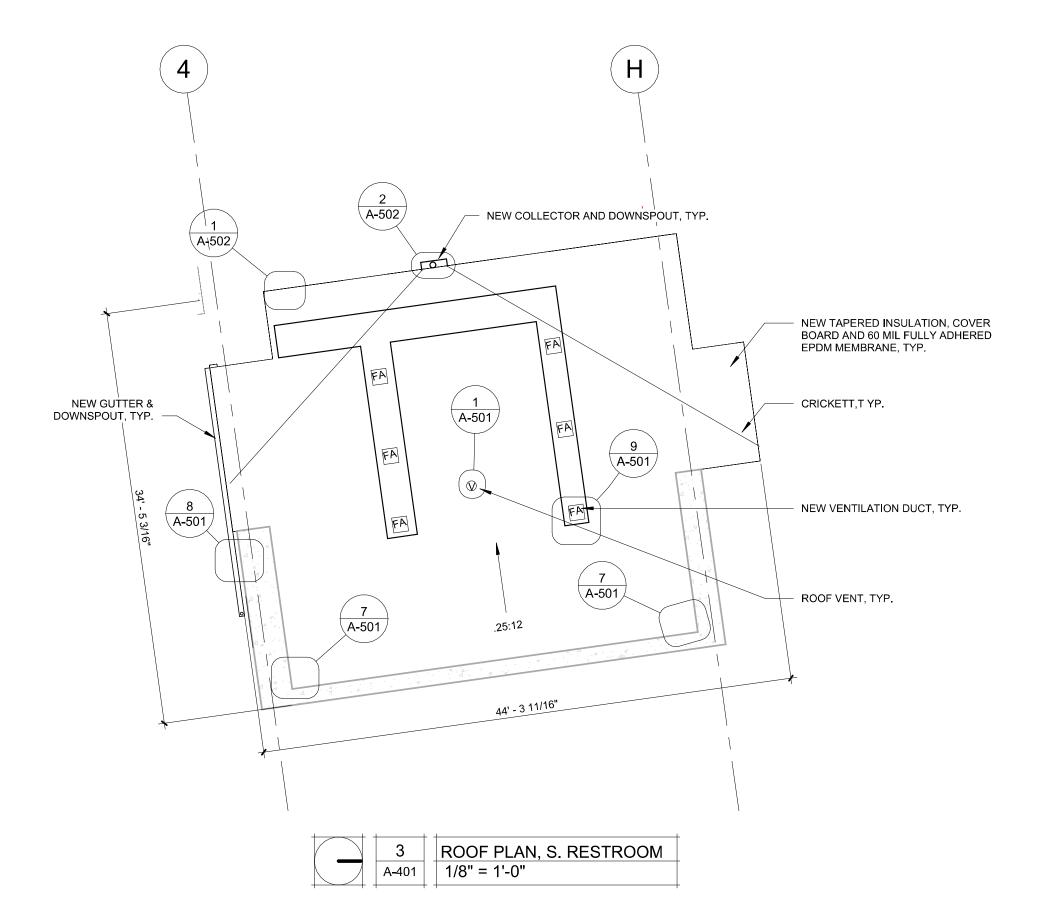

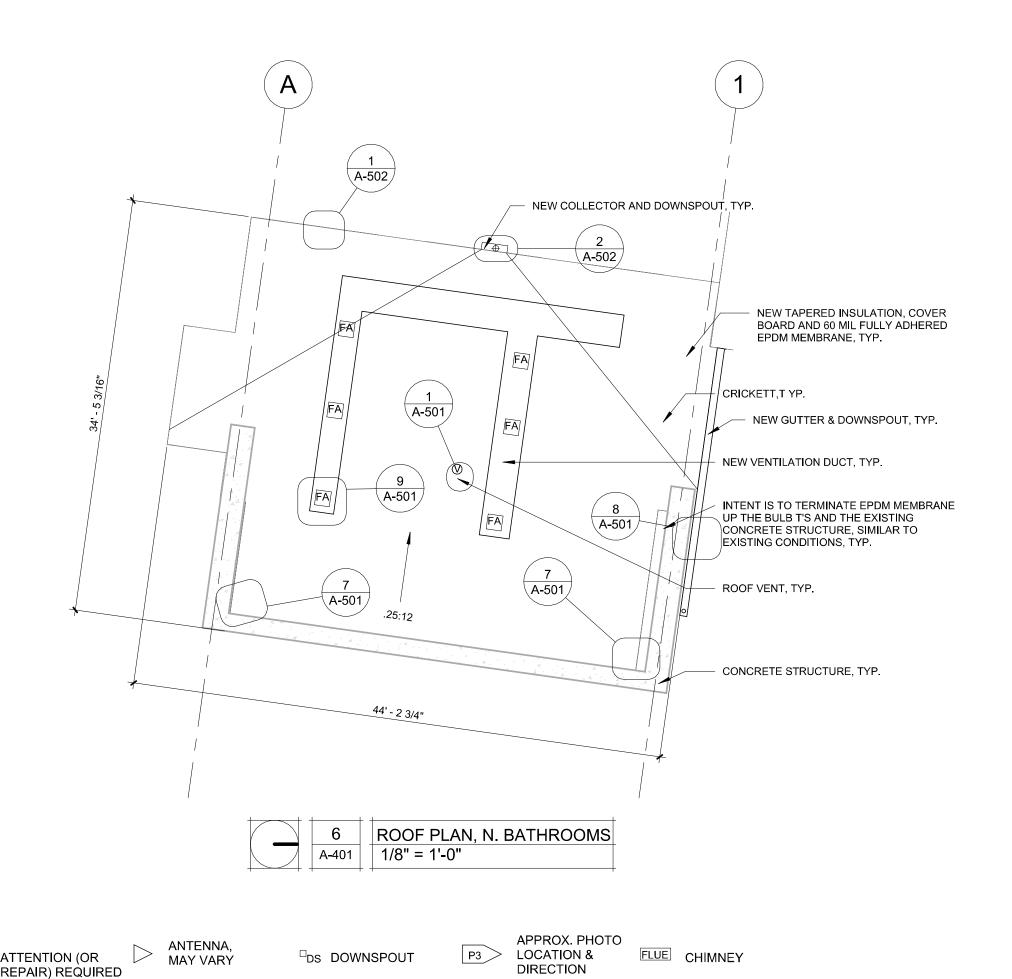

-e- electrical

EXISTING ROOF PATCH

□DS DOWNSPOUT

CURB MOUNTED EQUIPMENT (FANS & VENTS)

ROOF TOP UNIT, HVAC

ROOF LEGEND: ALL SIZES SHALL BE NOTED, EXCEPT WHEN NOT APPLICABLE. DESCRIPTION MAY BE REQUIRED.

ATTENTION (OR REPAIR) REQUIRED

T TURBINE

SOIL STACK


ROOF CORE

H HOT VENT

VENT THROUGH ROOF

STATE OF MISSOURI MICHAEL L. PARSON, **GOVERNOR**



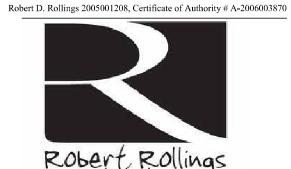

ArchitectsLLC 1806 West Broadway Boulevard Sedalia, MO 65301 660.829.9751



J-SQUARED ENGINEERING

2400 BLUFF CREEK DR. STE. 101 COLUMBIA, MO 65203 573.234.4492

ENGINEERING CONSULTANTS 1000 W. Nifong Blvd., Bldg. 1. Columbia, Missouri 65202 (573) 447**-**0292 www.crockettengineering.com Crockett Engineering Consultants, LLC Missouri Certificate of Authority

OFFICE OF ADMINISTRATION DIVISION OF FACILITIES MANAGEMENT DESIGN AND CONSTRUCTION

UPGRADE ELECTRICAL AND RESTROOMS, GRANDSTAND

MISSOURI STATE **FAIRGROUNDS** 2503 W. 16TH ST. SEDALIA, MO 65301

PROJECT # T2304-01 SITE # 1501 ASSET # 3511501018

REVISION: DATE:

REVISION: DATE:

REVISION: DATE:

ISSUE DATE: 11/29/2023 **BID DOCUMENTS**

CAD DWG FILE: A-FP-09
DRAWN BY: AMK
CHECKED BY: RDR
DESIGNED BY: AMK

SHEET TITLE:

SLOPE DIRECTION

OD OVERFLOW DRAIN

PITCH POCKET

ROOF DRAIN


THROUGH WALL

os OVERFLOW SCUPPER

DETAIL PLAN VIEWS

SHEET NUMBER:

SHEET 9 OF 30 ISSUE DATE: 11/29/23

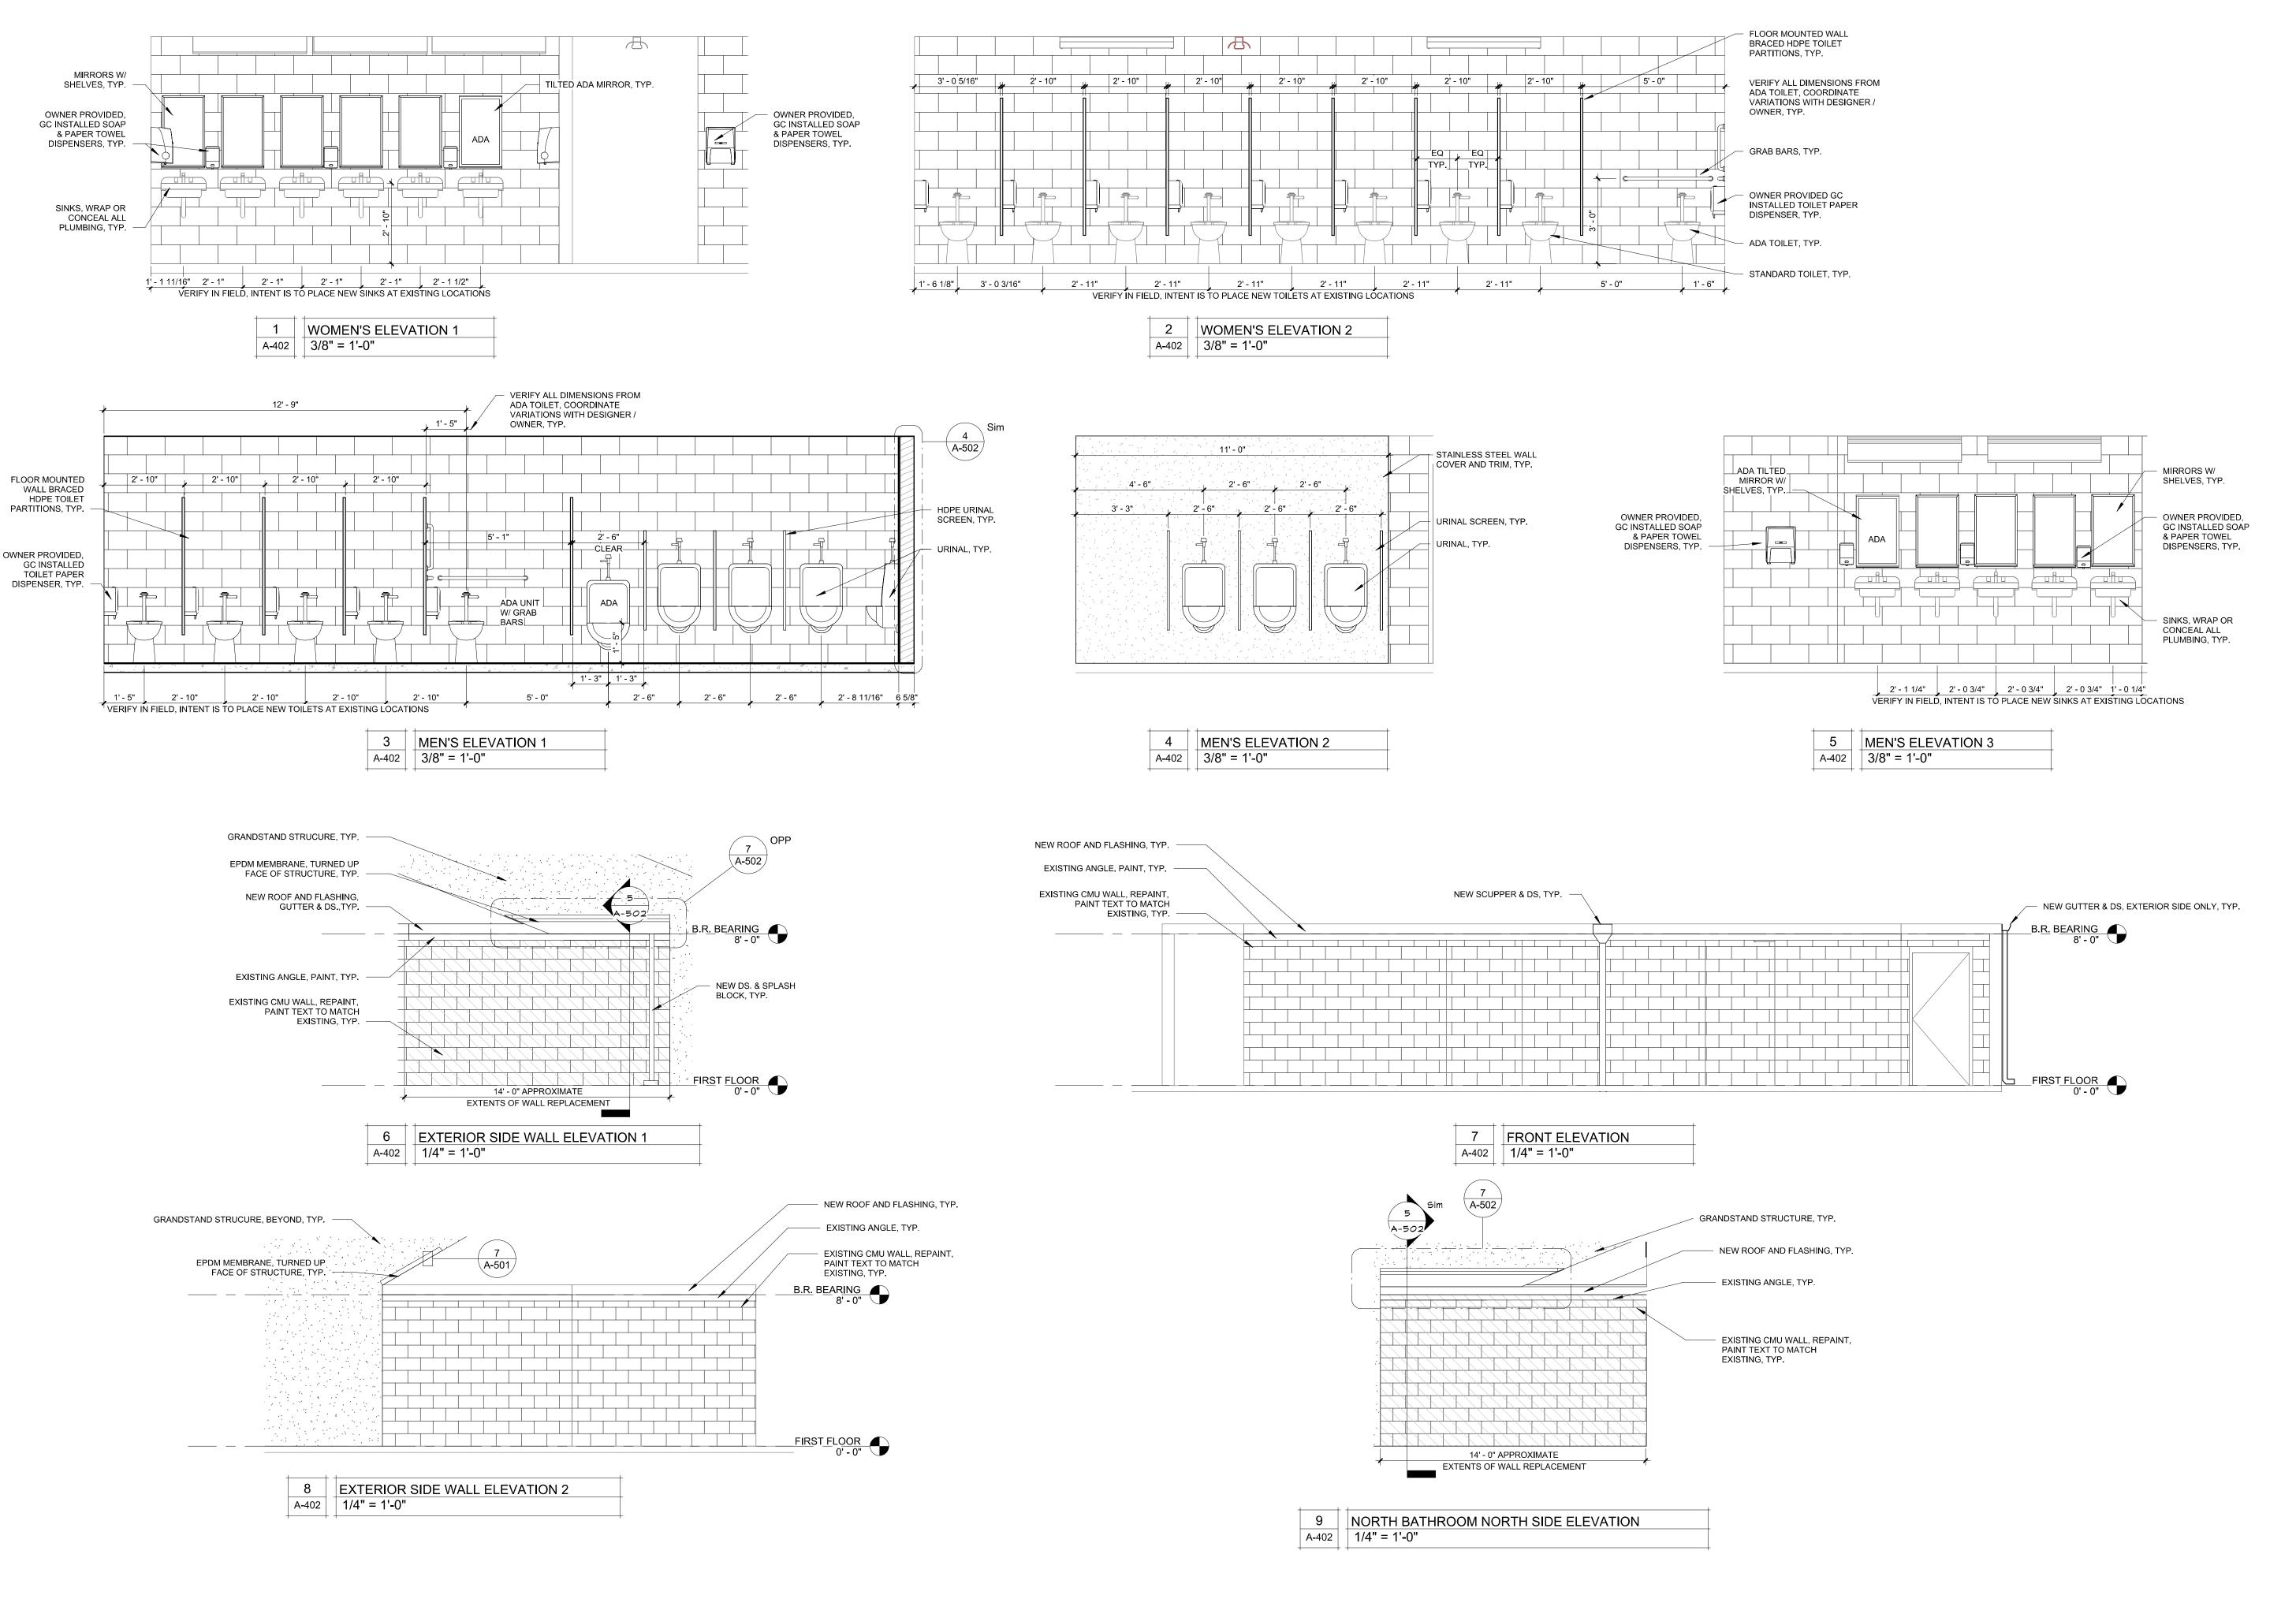



Robert D. Rollings 2005001208, Certificate of Authority # A-2006003870

Robert Rollings Architects LLC 1806 West Broadway Boulevard Sedalia, MO 65301 660.829.9751



ENGINEERING 2400 BLUFF CREEK DR. STE. 101 COLUMBIA, MO 65203 573.234.4492

CRUCKETI

ENGINEERING CONSULTANTS
1000 W. Nifong Blvd., Bldg. 1.
Columbia, Missouri 65202
(573) 447-0292
www.crockettengineering.com
Crockett Engineering Consultants, LLC
Missouri Certificate of Authority
#2000151304

OFFICE OF ADMINISTRATION DIVISION OF FACILITIES MANAGEMENT DESIGN AND CONSTRUCTION

UPGRADE ELECTRICAL AND RESTROOMS, GRANDSTAND

MISSOURI STATE FAIRGROUNDS 2503 W. 16TH ST. SEDALIA, MO 65301

PROJECT # T2304-01 SITE # 1501 ASSET # 3511501018

REVISION: DATE:

REVISION: DATE:

REVISION:

DATE:

ISSUE DATE: 11/29/2023
BID DOCUMENTS

CAD DWG FILE: A-EL-10
DRAWN BY: AMK
CHECKED BY: RDR
DESIGNED BY: AMK


SHEET TITLE:

INTERIOR ELEVATIONS

SHEET NUMBER:

A-402

SHEET 10 OF 30 ISSUE DATE: 11/29/23

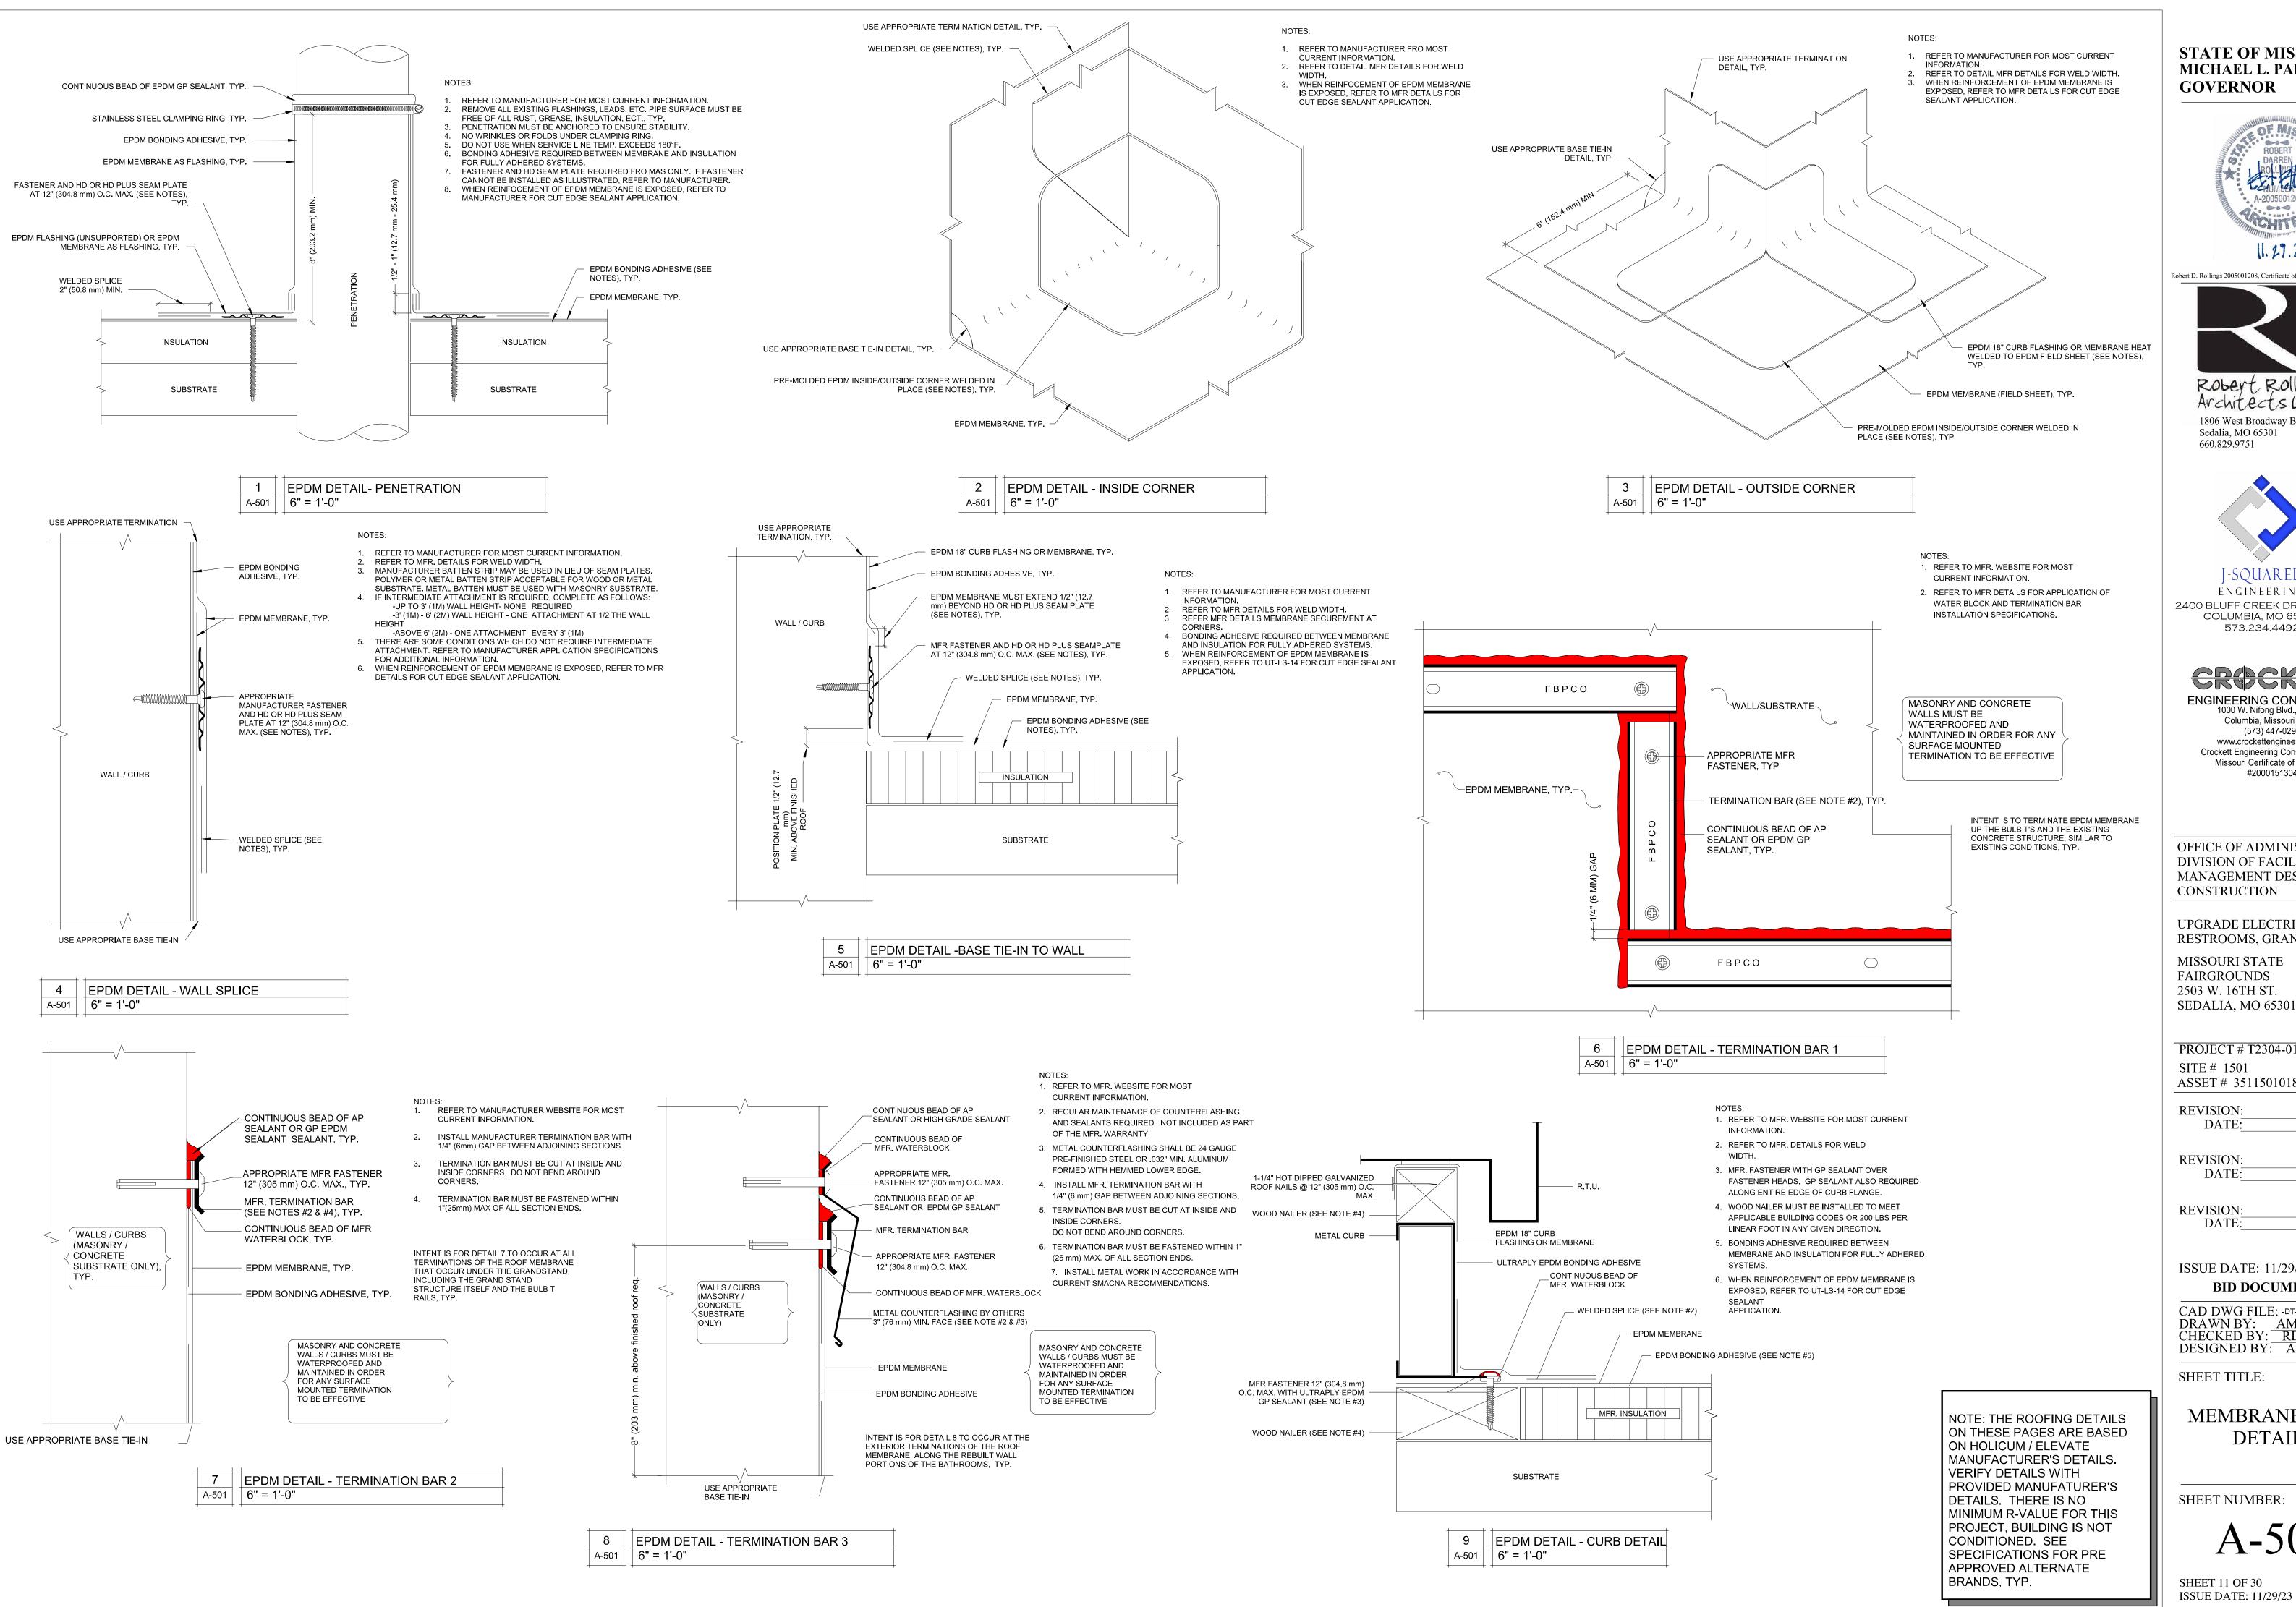



Robert D. Rollings 2005001208, Certificate of Authority # A-2006003870



1806 West Broadway Boulevard Sedalia, MO 65301 660.829.9751



ENGINEERING 2400 BLUFF CREEK DR. STE. 101 COLUMBIA, MO 65203 573.234.4492

ENGINEERING CONSULTANTS 1000 W. Nifong Blvd., Bldg. 1 Columbia, Missouri 65202 (573) 447-0292 www.crockettengineering.com Crockett Engineering Consultants, LLC Missouri Certificate of Authority

OFFICE OF ADMINISTRATION DIVISION OF FACILITIES MANAGEMENT DESIGN AND CONSTRUCTION

UPGRADE ELECTRICAL AND RESTROOMS, GRANDSTAND

MISSOURI STATE **FAIRGROUNDS** 2503 W. 16TH ST.

PROJECT # T2304-01 SITE # 1501 ASSET # 3511501018

REVISION: DATE:

REVISION:

DATE:

REVISION:

DATE:

ISSUE DATE: 11/29/2023 **BID DOCUMENTS**


CAD DWG FILE: -DT-11 DRAWN BY: AMK CHECKED BY: RDR DESIGNED BY: AMK

SHEET TITLE:

MEMBRANE ROOF **DETAILS**

SHEET NUMBER:

SHEET 11 OF 30 ISSUE DATE: 11/29/23

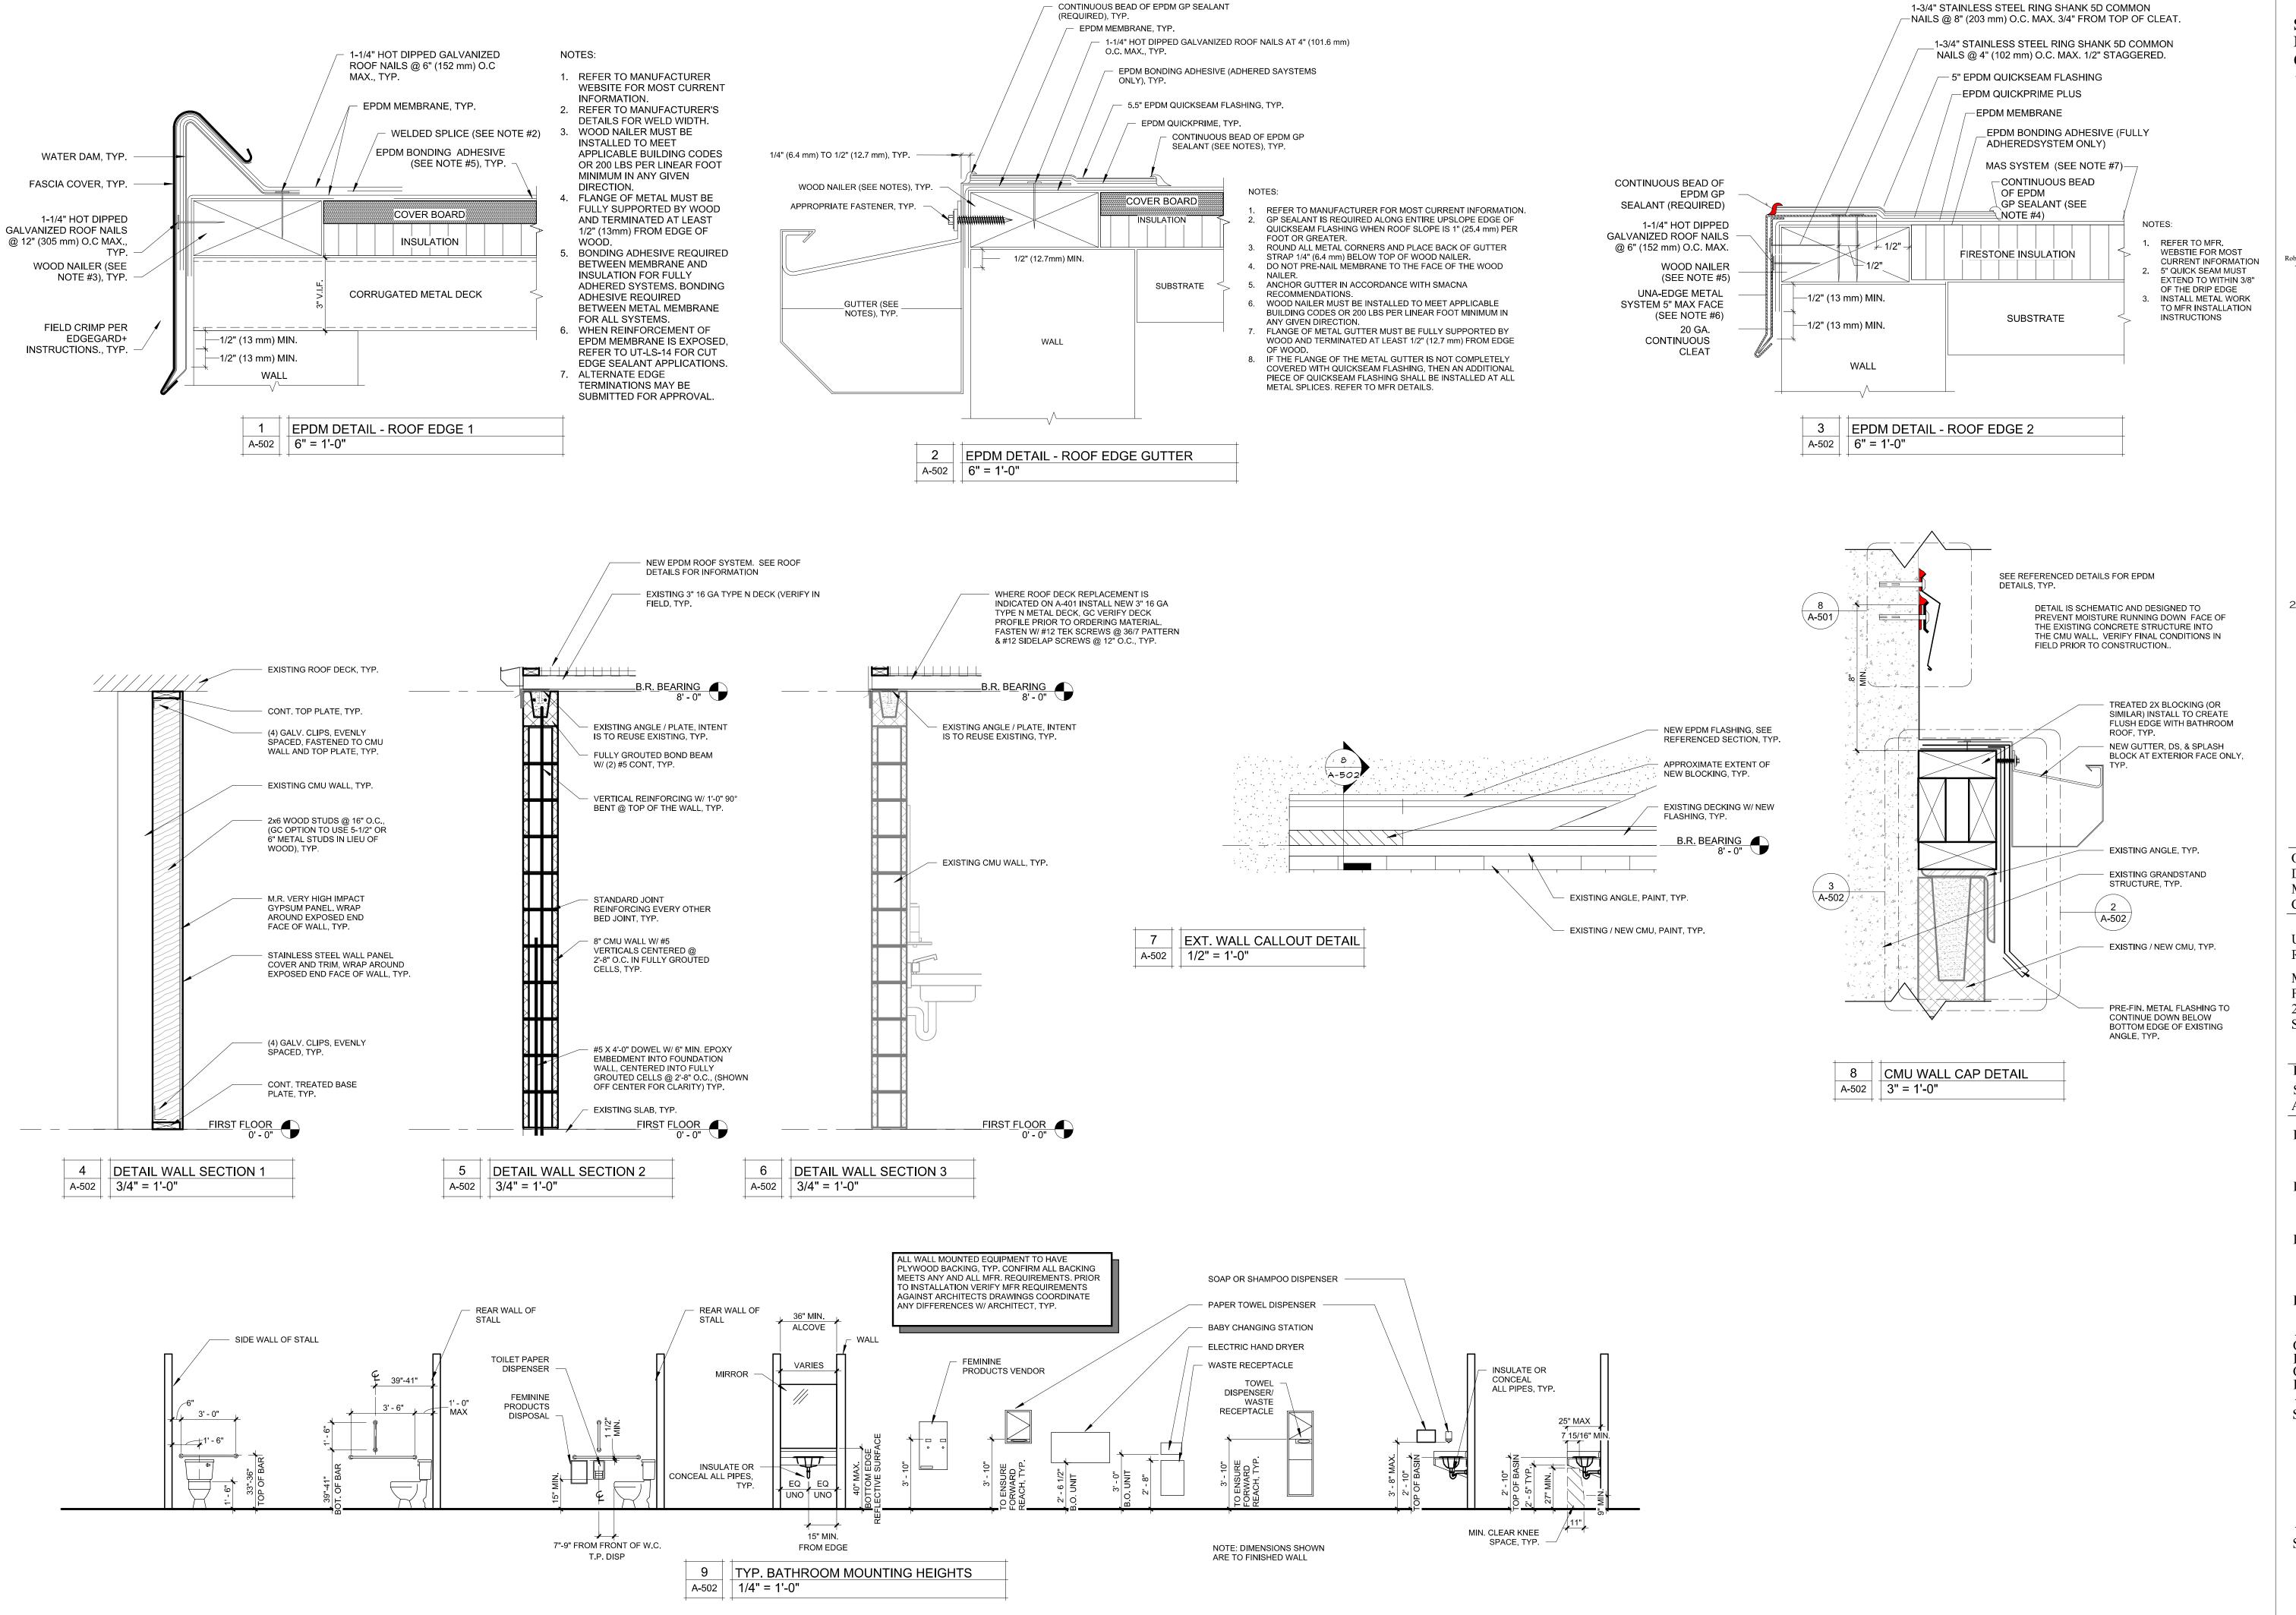



Robert D. Rollings 2005001208, Certificate of Authority # A-2006003870



Architects LLC 1806 West Broadway Boulevard Sedalia, MO 65301 660.829.9751



ENGINEERING 2400 BLUFF CREEK DR. STE. 101 COLUMBIA, MO 65203 573.234.4492

CACKETT

ENGINEERING CONSULTANTS
1000 W. Nifong Blvd., Bldg. 1.
Columbia, Missouri 65202
(573) 447-0292
www.crockettengineering.com
Crockett Engineering Consultants, LLC
Missouri Certificate of Authority

OFFICE OF ADMINISTRATION DIVISION OF FACILITIES MANAGEMENT DESIGN AND CONSTRUCTION

UPGRADE ELECTRICAL AND RESTROOMS, GRANDSTAND

MISSOURI STATE FAIRGROUNDS 2503 W. 16TH ST. SEDALIA, MO 65301

PROJECT # T2304-01 SITE # 1501 ASSET # 3511501018

REVISION: DATE:

REVISION:___ DATE:__

ISSUE DATE: 11/29/2023
BID DOCUMENTS

CAD DWG FILE: A-DT-12
DRAWN BY: AMK
CHECKED BY: RDR
DESIGNED BY: AMK

SHEET TITLE:

ADDITIONAL DETAILS

SHEET NUMBER:

A-502

SHEET 12 OF 30 ISSUE DATE: 11/29/23

GENERAL MEP SPECIFICATIONS

- IT IS THE RESPONSIBILITY OF THE CONTRACTOR TO REVIEW AND UNDERSTAND ALL DRAWINGS AND SPECIFICATIONS IN THE CONTRACT DOCUMENTS. EACH CONTRACTOR IS RESPONSIBLE FOR ALL WORK ASSOCIATED WITH HIS TRADE REGARDLESS OF WHERE THE WORK IS DEPICTED IN THE DRAWINGS OR SPECIFICATIONS.
- 2. THE LAYOUT OF SYSTEMS SHOWN ON PLANS ARE APPROXIMATE AND WILL NEED TO BE COORDINATED IN FIELD. THE CONTRACTOR SHALL INCLUDE THIS COORDINATION IN HIS SCOPE AND INCLUDE ALL COSTS OF MODIFYING THE LAYOUT AS REQUIRED IN HIS BID.
- 3. THE CONTRACTOR IS RESPONSIBLE FOR PROVIDING ALL NECESSARY PARTS AND LABOR TO PRODUCE A COMPLETE AND FULLY OPERATIONAL SYSTEM UNLESS STATED OTHERWISE ON PLANS.
- 4. ALL MATERIALS TO BE NEW, FIRST CLASS, AND INSTALLED PER MANUFACTURE'S PUBLISHED INSTRUCTIONS.
- 5. ALL WORK SHALL BE PERFORMED IN COMPLIANCE WITH LOCALLY ADOPTED CODES AND ORDINANCES.
- 6. CONTRACTOR IS RESPONSIBLE FOR TO COORDINATE EQUIPMENT LOCATIONS AND SYSTEM ROUTING WITH OTHER TRADES PRIOR TO INSTALLATION.
- 7. CONTRACTOR TO GUARANTEE ALL MATERIALS AND WORKMANSHIP FOR A PERIOD OF ONE YEAR FROM THE DATE THE PROJECT IS TURN OVER TO THE OWNER, UNLESS NOTED OTHERWISE.
- FROM THE DATE THE PROJECT IS TURN OVER TO THE OWNER, UNLESS NOTED OTHERWISE.

 8. CONTRACTOR IS TO INCLUDE IN HIS SCOPE THE COST OF ALL PERMITS, INSPECTIONS, METERING,
- AND TAPS ASSOCIATED WITH HIS WORK.

 9. CONTRACTOR IS RESPONSIBLE FOR ALL EXCAVATION, CUTTING, CORING, PATCHING, AND BACKFILL
- REQUIRED TO COMPLETE HIS WORK, UNLESS NOTED OTHERWISE.

 10. THESE PLANS ARE NOT TO BE SCALED. SEE ARCHITECTURAL PLANS FOR DIMENSIONS. WHERE
- THERE IS A CONFLICT BETWEEN ARCHITECTURAL DIMENSIONS AND MEP DIMENSION,
- ARCHITECTURAL SHALL GOVERN.

 11. SEE DISCIPLINE SHEETS FOR ADDITIONAL DISCIPLINE SPECIFIC SPECIFICATIONS.

REFERENCED CODES IN EFFECT

2015 INTERNATIONAL MECHANICAL CODE

2015 INTERNATIONAL PLUMBING CODE

2015 INTERNATIONAL FUEL GAS CODE

2015 INTERNATIONAL FIRE CODE

2017 NATIONAL ELECTRIC CODE

SHEET LIST TABLE

E-502

E-601

E-602

P-101

Sheet Number Sheet Title MEP-001 MEP GENERAL INFORMATION D-101 SITE DEMOLITION PLAN D-102 GRANDSTAND SEATING DEMOLITION PLAN D-103 BELOW GRANDSTAND DEMOLITION PLAN D-104 ENLARGED DEMOLITION PLANS D-105 ENLARGED DEMOLITION PLAN M-101 ENLARGED HVAC PLANS (PHASE 1) E-101 SITE ELECTRICAL PLAN E-102 **ENLARGED POWER PLANS** E-103 ENLARGED STAGE POWER PLAN (PHASE 3 ALT. 1) GRANDSTAND SEATING LIGHTING PLAN (PHASE 1) E-104 E-105 BELOW GRANDSTAND LIGHTING PLAN (PHASE 1) **ENLARGED LIGHTING PLANS (PHASE 1)** E-106 E-501 ELECTRICAL DETAILS

ELECTRICAL DETAILS

ELECTRICAL SCHEDULES


ELECTRICAL SCHEDULES

ENLARGED PLUMBING PLANS (PHASE 1)


STATE OF MISSOURI MICHAEL L. PARSON, GOVERNOR



Keaton E. Leisinger, P.E. PE-2021035875 MO Certificate of Authority # 2018029680

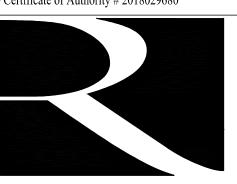

1806 West Broadway Boulevard Sedalia, MO 65301 660.829.9751

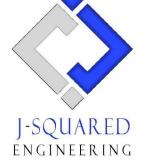

J-SQUARED ENGINEERING 2400 BLUFF CREEK DR. STE. 101 COLUMBIA, MO 65203 573.234.4492

CROCKETT

ENGINEERING CONSULTANTS
1000 W. Nifong Blvd., Bldg. 1.
Columbia, Missouri 65202
(573) 447-0292
www.crockettengineering.com
Crockett Engineering Consultants, LLC
Missouri Certificate of Authority
#2000151304

OFFICE OF ADMINISTRATION DIVISION OF FACILITIES MANAGEMENT DESIGN AND CONSTRUCTION

UPGRADE ELECTRICAL AND RESTROOMS, GRANDSTAND

MISSOURI STATE FAIRGROUNDS 2503 W. 16TH ST. SEDALIA, MO 65301

PROJECT # T2304-01

SITE # 1501
ASSET # 3511501018

REVISION:
DATE:

REVISION:

ISSUE DATE: 11/29/2023

BID DOCUMENTS

CAD DWG FILE:
DRAWN BY: RXM
CHECKED BY: JAP
DESIGNED BY: KEL

DATE:

REVISION: DATE:

SHEET TITLE:

MEP GENERAL INFORMATION

SHEET NUMBER:

MEP-001


SHEET 13 OF 30 11/29/2023


DEMOLITION PLAN GENERAL NOTES:

- 1. SEE SHEETS E-501, E-502, E-601 & E-602 FOR ADDITIONAL ELECTRICAL
- NOTES, DETAILS, & SCHEDULES. 2. SEE SHEET M-501 FOR ADDITIONAL HVAC NOTES, DETAILS, &
- 3. SEE SHEET P-501 FOR ADDITIONAL PLUMBING NOTES, DETAILS, & SCHEDULES.
- 4. ALL EQUIPMENT LABELED 'EX' OR 'EXISTING' SHALL BE EXISTING TO REMAIN UNLESS OTHERWISE NOTED.

DEMOLITION PLAN KEY NOTES:

- (1) PHASE 2: DEMOLISH PANEL & PREP FOR NEW PANEL INSTALLATION.
- (2) PHASE 1: DEMOLISH HANGING PRESS BOX & ALL ASSOCIATED
- ELECTRICAL & HVAC EQUIPMENT & WIRING.
- (3) PHASE 3/ALTERNATE 1: DEMOLISH DISCONNECT.
- (4) PHASE 3/ALTERNATE 1: DEMOLISH CONDUIT AND CONDUCTORS.
- (5) PHASE 3/ALTERNATE 1: DEMOLISH PANEL & ROUTE EXISTING CIRCUITS THAT ARE TO REMAIN TO NEW PANEL CONNECTION LOCATED UNDER THE STAGE.
- (6) PHASE 1: REPLACE EXISTING 600A DISCONNECT WITH NEW DOUBLE THROW 600A DISCONNECT. SEE STAGE POWER RISER (PHASE 1) FOR MORE DETAILS.

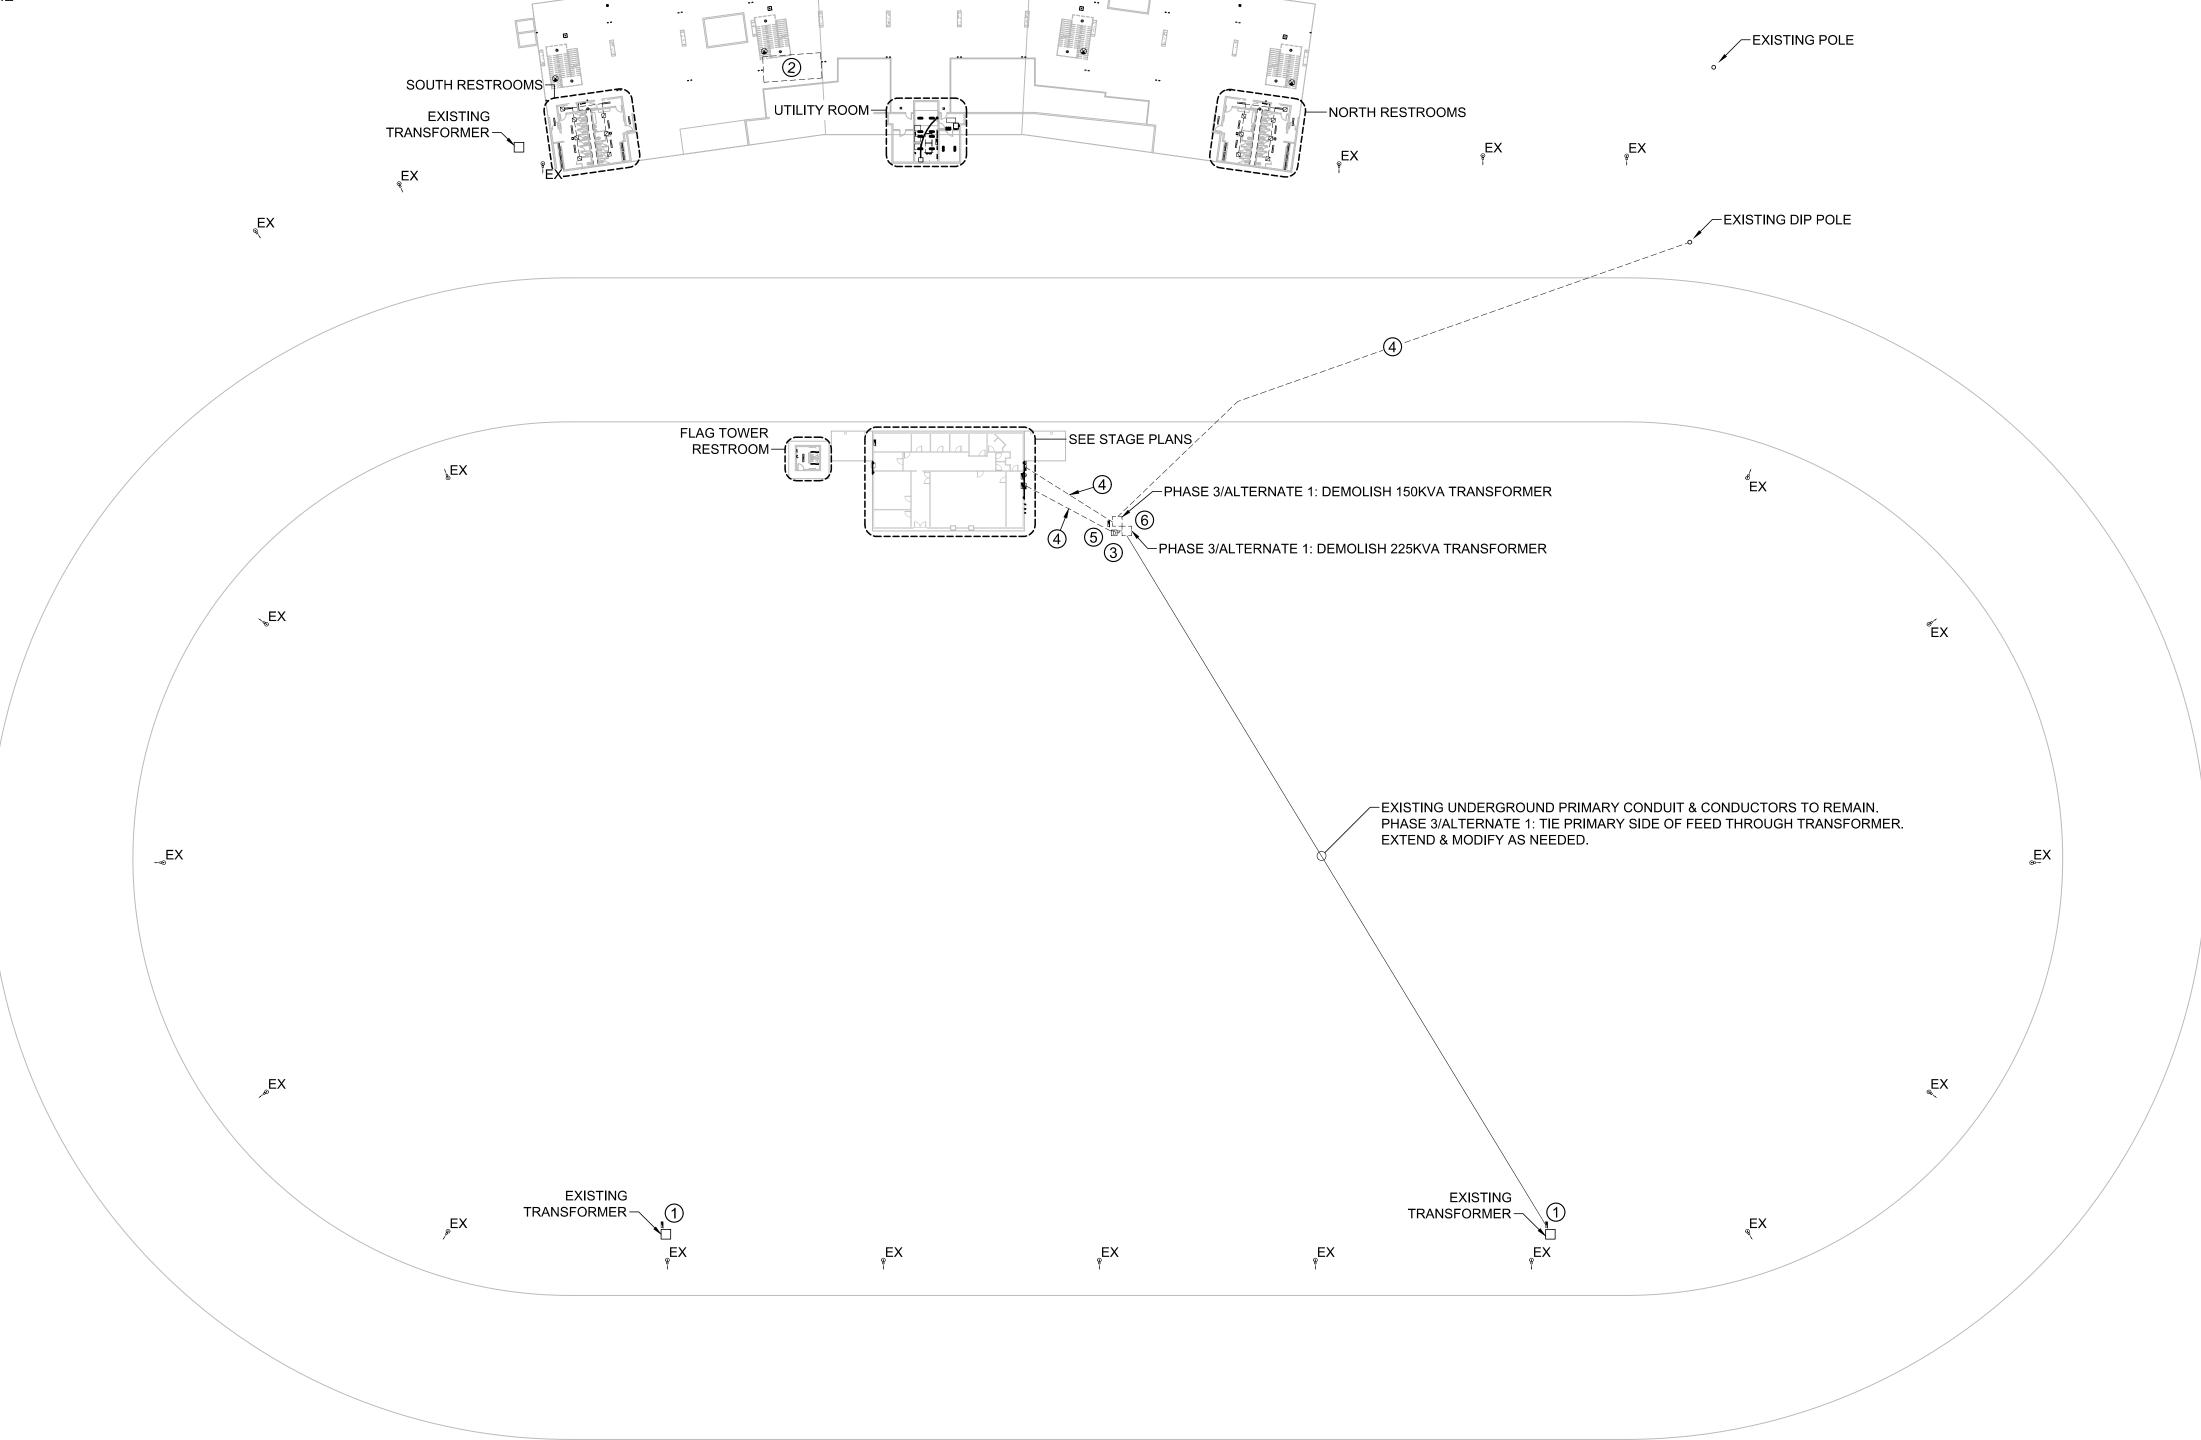

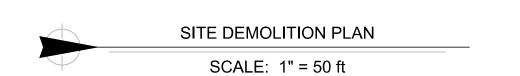

STATE OF MISSOURI MICHAEL L. PARSON, **GOVERNOR**



Keaton E. Leisinger, P.E. PE-2021035875



1806 West Broadway Boulevard Sedalia, MO 65301 660.829.9751



ENGINEERING 2400 BLUFF CREEK DR. STE. 101 COLUMBIA, MO 65203 573.234.4492

ENGINEERING CONSULTANTS 1000 W. Nifong Blvd., Bldg. 1. Columbia, Missouri 65202 (573) 447-0292 www.crockettengineering.com Crockett Engineering Consultants, LLC Missouri Certificate of Authority #2000151304

OFFICE OF ADMINISTRATION DIVISION OF FACILITIES MANAGEMENT DESIGN AND CONSTRUCTION

UPGRADE ELECTRICAL AND RESTROOMS, GRANDSTAND MISSOURI STATE

FAIRGROUNDS 2503 W. 16TH ST. SEDALIA, MO 65301

PROJECT # T2304-01 SITE # 1501 ASSET # 3511501018

REVISION: DATE:

REVISION: DATE:

REVISION:

DATE:

ISSUE DATE: 11/29/2023 **BID DOCUMENTS**

CAD DWG FILE:
DRAWN BY: RXM
CHECKED BY: JAP
DESIGNED BY: KEL

SHEET TITLE:

SITE DEMOLITION PLAN

SHEET NUMBER:

SHEET 14 OF 30 11/29/2023


DEMOLITION PLAN GENERAL NOTES:

- 1. SEE SHEETS E-501, E-502, E-601 & E-602 FOR ADDITIONAL ELECTRICAL NOTES, DETAILS, & SCHEDULES.
- 2. SEE SHEET M-501 FOR ADDITIONAL HVAC NOTES, DETAILS, &
- SCHEDULES.
 3. SEE SHEET P-501 FOR ADDITIONAL PLUMBING NOTES, DETAILS, &
- SCHEDULES.
 4. ALL EQUIPMENT LABELED 'EX' OR 'EXISTING' SHALL BE EXISTING TO

DEMOLITION PLAN KEY NOTES:

REMAIN UNLESS OTHERWISE NOTED.

- 1) PHASE 1: DEMOLISH LIGHT FIXTURE IN PLACE & PREP FOR NEW FIXTURE CONNECTION.
- ② PHASE 1: EXISTING BOX & CIRCUIT TO REMAIN. LIGHT FIXTURE WITHIN BOX SHALL BE DEMOLISHED & PREPARED FOR NEW FIXTURE INSTALLATION. SEE FIXTURE (F2) DETAIL.
- ③ PHASE 1: DEMOLISH PANEL IN SOUND BOOTH & PREP FOR NEW PANEL INSTALLATION.

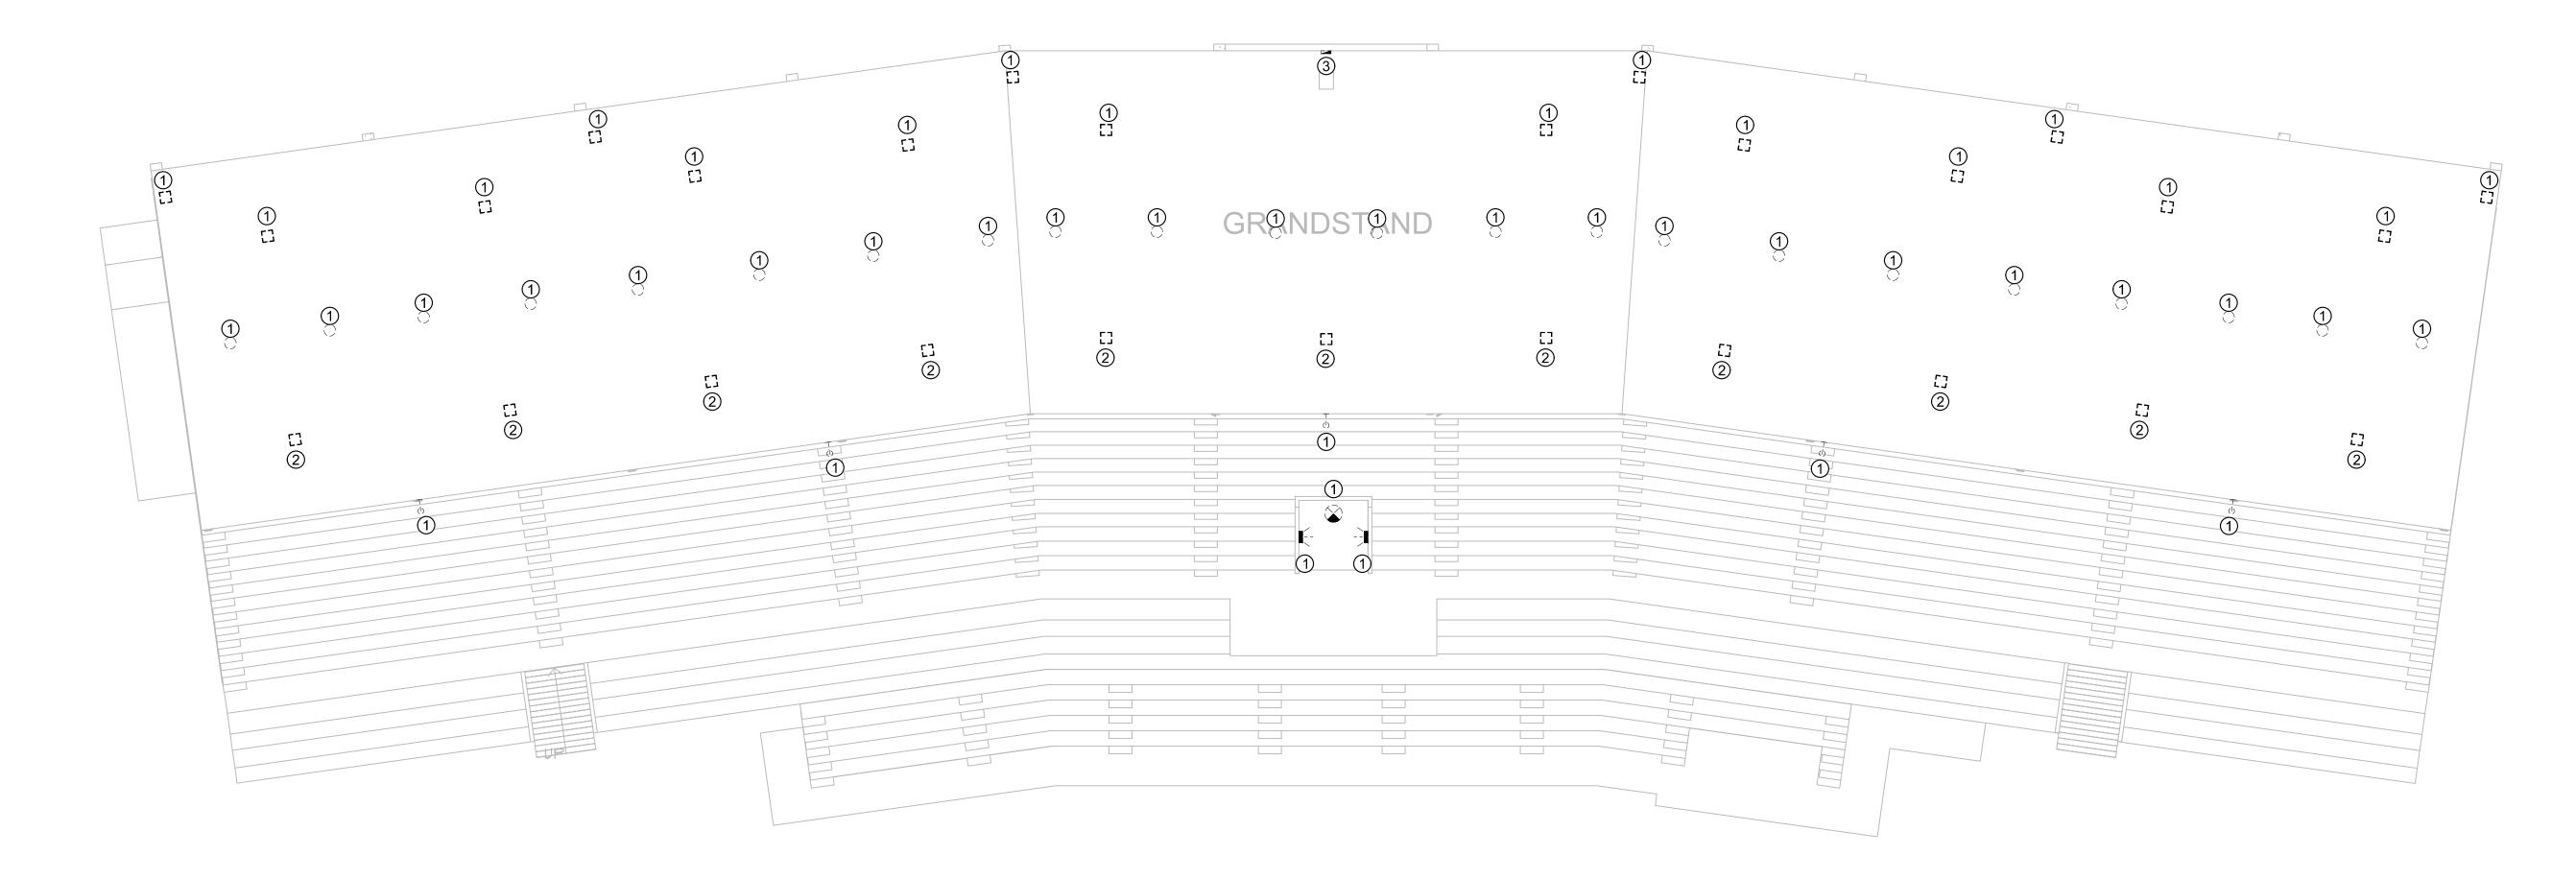




STATE OF MISSOURI MICHAEL L. PARSON, GOVERNOR



Keaton E. Leisinger, P.E. PE-2021035875

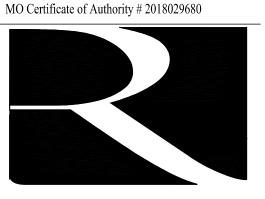

1806 West Broadway Boulevard Sedalia, MO 65301 660.829.9751



J-SQUARED ENGINEERING 2400 BLUFF CREEK DR. STE. 101 COLUMBIA, MO 65203 573.234.4492

CROCKETT

ENGINEERING CONSULTANTS
1000 W. Nifong Blvd., Bldg. 1.
Columbia, Missouri 65202
(573) 447-0292
www.crockettengineering.com
Crockett Engineering Consultants, LLC
Missouri Certificate of Authority
#2000151304

OFFICE OF ADMINISTRATION DIVISION OF FACILITIES MANAGEMENT DESIGN AND CONSTRUCTION

UPGRADE ELECTRICAL AND RESTROOMS, GRANDSTAND

MISSOURI STATE FAIRGROUNDS 2503 W. 16TH ST. SEDALIA, MO 65301

PROJECT # T2304-01 SITE # 1501 ASSET # 3511501018

REVISION:_ DATE:

REVISION:_ DATE:

REVISION:_ DATE:_

ISSUE DATE: 11/29/2023

BID DOCUMENTS

CAD DWG FILE:
DRAWN BY: RXM
CHECKED BY: JAP
DESIGNED BY: KEL

SHEET TITLE:
GRANDSTAND
SEATING
DEMOLITION
PLAN

SHEET NUMBER:

D-102

SHEET 15 OF 30 11/29/2023

BELOW GRANDSTAND DEMOLITION PLAN SCALE: 1/16" = 1'-0"

SEE UTILITY ROOM DEMO PLAN

SEE SOUTH BATHROOM

DEMO PLAN

DEMOLITION PLAN GENERAL NOTES:

- 1. SEE SHEETS E-501,E-502 E-601 & E-602 FOR ADDITIONAL ELECTRICAL NOTES. DETAILS & SCHEDULES
- NOTES, DETAILS, & SCHEDULES.
- 2. SEE SHEET M-501 FOR ADDITIONAL HVAC NOTES, DETAILS, & SCHEDULES
- SEE SHEET P-501 FOR ADDITIONAL PLUMBING NOTES, DETAILS, & SCHEDULES.
- 4. ALL EQUIPMENT LABELED 'EX' OR 'EXISTING' SHALL BE EXISTING TO REMAIN UNLESS OTHERWISE NOTED.

DEMOLITION PLAN KEY NOTES:

SEE NORTH BATHROOM DEMO PLAN

1) PHASE 1: DEMOLISH LIGHT FIXTURE IN PLACE & PREP FOR NEW FIXTURE CONNECTION.

STATE OF MISSOURI MICHAEL L. PARSON, GOVERNOR



Keaton E. Leisinger, P.E. PE-2021035875



1806 West Broadway Boulevard Sedalia, MO 65301 660.829.9751



J-SQUARED ENGINEERING 2400 BLUFF CREEK DR. STE. 101 COLUMBIA, MO 65203 573.234.4492

CROCKETT

ENGINEERING CONSULTANTS
1000 W. Nifong Blvd., Bldg. 1.
Columbia, Missouri 65202
(573) 447-0292
www.crockettengineering.com
Crockett Engineering Consultants, LLC
Missouri Certificate of Authority
#2000151304

OFFICE OF ADMINISTRATION DIVISION OF FACILITIES MANAGEMENT DESIGN AND CONSTRUCTION

UPGRADE ELECTRICAL AND RESTROOMS, GRANDSTAND

MISSOURI STATE FAIRGROUNDS 2503 W. 16TH ST. SEDALIA, MO 65301

PROJECT # T2304-01 SITE # 1501 ASSET # 3511501018

REVISION:_ DATE:

REVISION:_ DATE:

REVISION:_____DATE:

ISSUE DATE: 11/29/2023

BID DOCUMENTS

CAD DWG FILE:
DRAWN BY: RXM
CHECKED BY: JAP
DESIGNED BY: KEL

SHEET TITLE:
BELOW
GRANDSTAND
DEMOLITION
PLAN

SHEET NUMBER:

D-103

SHEET 16 OF 30 11/29/2023

DEMOLITION PLAN GENERAL NOTES:

- 1. SEE SHEETS E-501, E-502, E-601 & E-602 FOR ADDITIONAL ELECTRICAL
- NOTES, DETAILS, & SCHEDULES.

 2 SEE SHEET M-501 FOR ADDITIONAL HVAC NOTES, DETAILS &
- 2. SEE SHEET M-501 FOR ADDITIONAL HVAC NOTES, DETAILS, &
- 3. SEE SHEET P-501 FOR ADDITIONAL PLUMBING NOTES, DETAILS, & SCHEDULES.
- 4. ALL EQUIPMENT LABELED 'EX' OR 'EXISTING' SHALL BE EXISTING TO REMAIN UNLESS OTHERWISE NOTED.

DEMOLITION PLAN KEY NOTES:


- 1 PHASE 1: DEMOLISH LIGHT FIXTURE & ASSOCIATED WIRING BACK TO
- (2) PHASE 1: DEMOLISH GRILLE & ASSOCIATED DUCTWORK ON ROOF.
- ③ PHASE 1: DEMOLISH LAVATORY & ASSOCIATED COLD WATER PIPING BACK TO MAIN CONNECTION.
- 4 PHASE 1: OWNER TO REMOVE FIXTURE. CONTRACTOR TO DEMOLISH
- COLD WATER LINE BACK TO MAIN CONNECTION.
- (5) PHASE 1: DEMOLISH ELECTRIC PANEL.
- 6 PHASE 1: DEMOLISH COLD WATER MAIN BACK TO THIS LOCATION. LEAVE

(8) PHASE 1: DEMOLISH ALL VENT PIPING IN CHASE. LEAVE ENOUGH EXISTING

- ENOUGH EXISTING PIPE FOR NEW PIPE TO TIE INTO.
- 7 PHASE 1: DEMOLISH URINAL TROFF & ASSOCIATED SANITARY, VENT, & COLD WATER PIPING.
- PIPE FOR NEW PIPE TO TIE INTO.

 (9) PHASE 1: DEMOLISH FAN & ASSOCIATED CONTROL SWITCH.
- (1) PHASE 2: DEMOLISH PANEL & PREP FOR NEW PANEL INSTALLATION.
- (1) PHASE 2: DEMOLISH STEP DOWN TRANSFORMER.
- (2) PHASE 1: DEMOLISH LIGHT FIXTURE IN PLACE & PREP FOR NEW FIXTURE CONNECTION.
- (13) PHASE 2: EXISTING SWITCH AND SO CORD TO BE RELOCATED. SEE
- LIGHTING CONTROL DETAILS FOR MORE INFORMATION.
- (4) EXISTING LIGHTING CONTACTOR TO REMAIN.



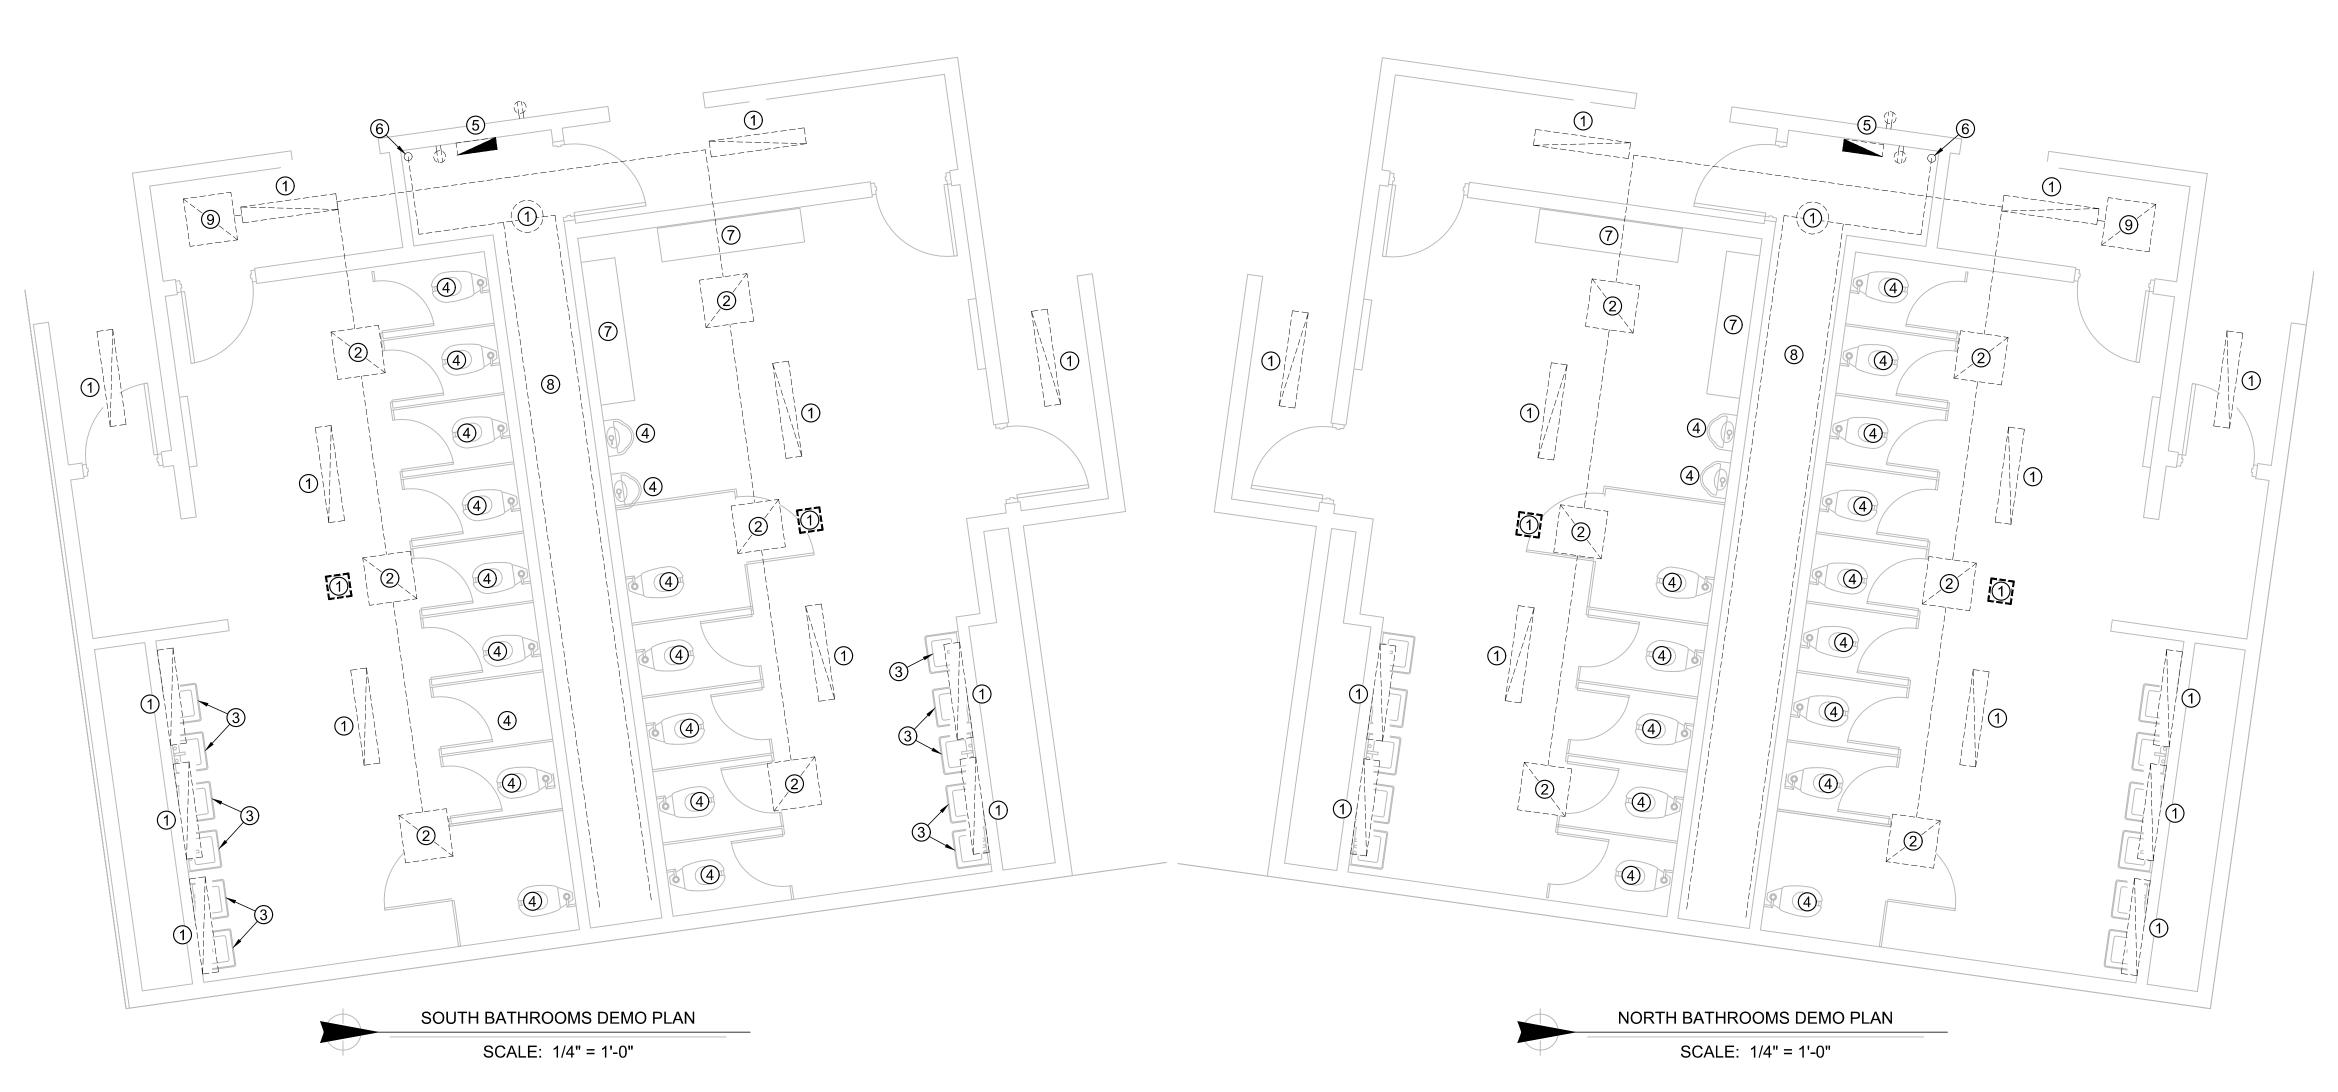

STATE OF MISSOURI MICHAEL L. PARSON, GOVERNOR



Keaton E. Leisinger, P.E. PE-2021035875



1806 West Broadway Boulevard Sedalia, MO 65301 660.829.9751



J-SQUARED ENGINEERING 2400 BLUFF CREEK DR. STE. 101 COLUMBIA, MO 65203 573.234.4492

CROCKETT

ENGINEERING CONSULTANTS
1000 W. Nifong Blvd., Bldg. 1.
Columbia, Missouri 65202
(573) 447-0292
www.crockettengineering.com
Crockett Engineering Consultants, LLC
Missouri Certificate of Authority
#2000151304

OFFICE OF ADMINISTRATION DIVISION OF FACILITIES MANAGEMENT DESIGN AND CONSTRUCTION

UPGRADE ELECTRICAL AND RESTROOMS, GRANDSTAND

MISSOURI STATE FAIRGROUNDS 2503 W. 16TH ST. SEDALIA, MO 65301

PROJECT # T2304-01

SITE # 1501 ASSET # 3511501018 REVISION: DATE:

DATE:

REVISION:

DATE:

REVISION:

ISSUE DATE: 11/29/2023
BID DOCUMENTS

CAD DWG FILE:
DRAWN BY:
CHECKED BY:
DESIGNED BY:
KEL

SHEET TITLE:

ENLARGED
DEMOLITION
PLANS

SHEET NUMBER:

D-104

SHEET 17 OF 30 11/29/2023

DEMOLITION PLAN GENERAL NOTES:


- 1. SEE SHEETS E-501, E-502 E-601 & E-602 FOR ADDITIONAL ELECTRICAL NOTES, DETAILS, & SCHEDULES
- NOTES, DETAILS, & SCHEDULES.
 2. SEE SHEET M-501 FOR ADDITIONAL HVAC NOTES, DETAILS, &
- 3. SEE SHEET P-501 FOR ADDITIONAL PLUMBING NOTES, DETAILS, &
- 4. ALL EQUIPMENT LABELED 'EX' OR 'EXISTING' SHALL BE EXISTING TO REMAIN UNLESS OTHERWISE NOTED.

DEMOLITION PLAN KEY NOTES:

SCHEDULES.

- 1) PHASE 3/ALTERNATE 1: DEMOLISH RECEPTACLE & ASSOCIATED CONDUIT & CONDUCTORS.
- ② PHASE 3/ALTERNATE 1: DEMOLISH PANEL & ASSOCIATED CONDUIT & CONDUCTORS BACK TO TRANSFORMER AND PREPARE FOR NEW STAGE SERVICE.
- ③ PHASE 3/ALTERNATE 1: DEMOLISH DISCONNECT & ASSOCIATED CONDUIT & CONDUCTORS BACK TO PANEL.
- (4) PHASE 3/ALTERNATE 1: DEMOLISH PANEL. PREPARE ALL EXISTING BRANCH CIRCUITS FOR NEW PANEL RECONNECTION.
- 5 PHASE 3/ALTERNATE 1: DEMOLISH PANEL & ASSOCIATED CONDUIT &
- CONDUCTORS BACK TO MAIN DISTRIBUTION PANEL.

 (6) PHASE 1: REPLACE EXISTING 800A DISCONNECT WITH DOUBLE THROW DISCONNECT. SEE STAGE POWER RISER (PHASE 1) FOR MORE DETAILS. PHASE 3/ALTERNATE 1: SALVAGE 800A DISCONNECT TO OWNER & DEMOLISH ASSOCIATED CONDUIT & CONDUCTORS BACK TO TRANSFORMER AND PREPARE FOR NEW STAGE SERVICE.

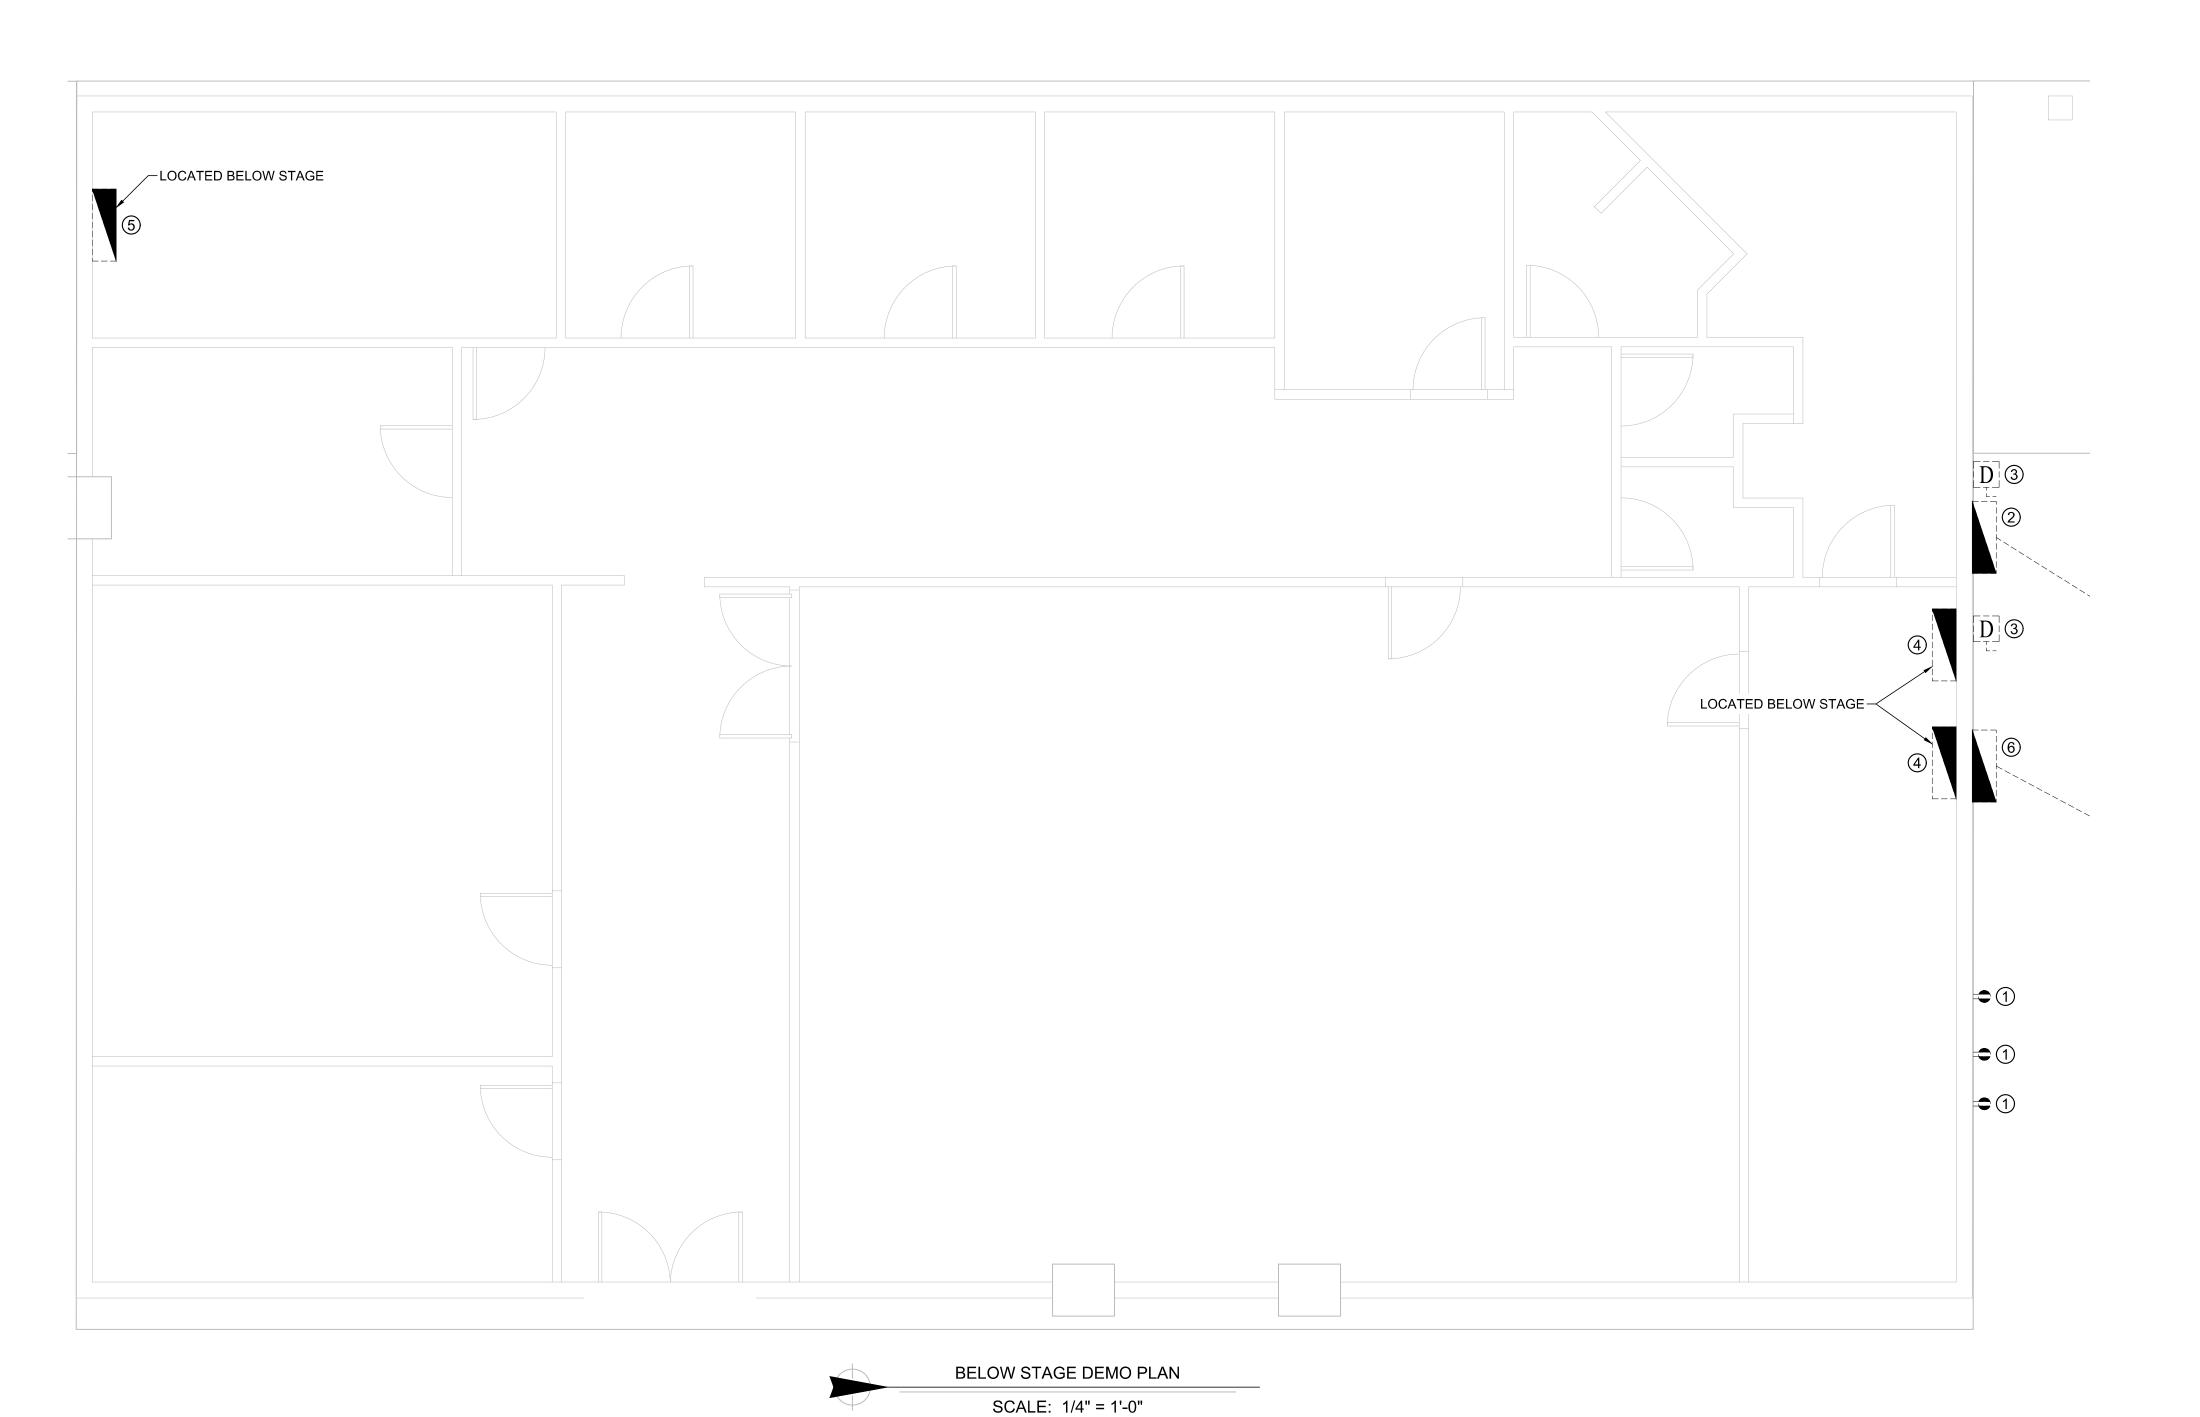



STATE OF MISSOURI



Keaton E. Leisinger, P.E.
PE-2021035875
MO Contificate of Authority # 2015



1806 West Broadway Boulevard Sedalia, MO 65301 660.829.9751



J-SQUARED
ENGINEERING
2400 BLUFF CREEK DR. STE. 101
COLUMBIA, MO 65203
573.234.4492

CROCKETT

ENGINEERING CONSULTANTS
1000 W. Nifong Blvd., Bldg. 1.
Columbia, Missouri 65202
(573) 447-0292
www.crockettengineering.com
Crockett Engineering Consultants, LLC
Missouri Certificate of Authority
#2000151304

OFFICE OF ADMINISTRATION DIVISION OF FACILITIES MANAGEMENT DESIGN AND CONSTRUCTION

UPGRADE ELECTRICAL AND RESTROOMS, GRANDSTAND

MISSOURI STATE FAIRGROUNDS 2503 W. 16TH ST. SEDALIA, MO 65301

PROJECT # T2304-01 SITE # 1501 ASSET # 3511501018

REVISION: DATE:

REVISION:___ DATE:__

REVISION:

DATE:

ISSUE DATE: 11/29/2023

BID DOCUMENTS

CAD DWG FILE:

CAD DWG FILE:
DRAWN BY: RXM
CHECKED BY: JAP
DESIGNED BY: KEL

SHEET TITLE:

ENLARGED DEMOLITION PLAN

SHEET NUMBER:

D-105

SHEET 18 OF 30 11/29/2023

HVAC PLAN SYMBOL LEGEND

X EQUIPMENT TYPE (REFER TO EQUIPMENT SCHEDULE)

EQUIPMENT REFERENCE NUMBER

DIFFUSER/GRILLE TYPE (REFER TO SCHEDULE)

CUBIC FEET PER MINUTE (CFM) / FACE SIZE

SUPPLY DUCTWORK

RETURN DUCTWORK

EXHAUST DUCTWORK

OUTSIDE AIR DUCTWORK

✓✓✓✓ FLEX DUCT

VENT / COMBUSTION AIR

TIE INTO EXISTING

SUPPLY DIFFUSER (HATCH INDICATES "NO FLOW ZONE")

RETURN DIFFUSER

BALANCE DAMPER

THERMOSTAT

HVAC PLAN GENERAL NOTES:

1. ALL DUCTWORK SHALL BE MOUNTED ON ROOF. SEE DUCTWORK DETAILS.

HVAC PLAN KEY NOTES:

(1) REUSE EXISTING ROOF PENETRATION. PROVIDE NEW GRILLE AS SHOWN.

- (2) MOUNT FAN ON FLOOR WITH RUBBER INSULATORS. FAN TO DISCHARGE OUT EXISTING WALL OPENING. CONTRACTOR TO BLOCK OFF OPENING NT USED BY FAN
- (3) EXHAUST FAN TO BE CONTROLLED BY OCCUPANCY SENSOR & COOLING ONLY THERMOSTAT WIRED IN PARALLEL. PROVIDE VANDAL RESISTANT COVER FOR THERMOSTAT & SWITCH.

EF-1.1 UTILITY FAN S&P CM-16 3,600 1" 208 / 3 11 20 22"x32"x37" 120 1 EF-1.2 UTILITY FAN S & P CM-16 3,600 1" 208 / 3 11 20 22"x32"x37" 120 1		EXHAUST FAN SCHEDULE											
EF-1.1 UTILITY FAN S.P. VOLT/PH MCA OCP DIM. WEIGHT EF-1.2 UTILITY FAN S.B.P. CM-16 3,600 1" 208 / 3 11 20 22"x32"x37" 120 1 EF-1.2 UTILITY FAN S.B.P. CM-16 3,600 1" 208 / 3 11 20 22"x32"x37" 120 1	TAG EQUIPMENT TYPE	MANUFACTURER	MODEL	FL	WC	E	LECTRICAL	-	PHYS	ICAL	NOTES		
EF-1.2 UTILITY FAN S & P CM-16 3,600 1" 208 / 3 11 20 22"x32"x37" 120 1		LQOIFMENT TIPL	(OR EQUAL)	(OR EQUAL)	CFM	S.P.	VOLT/PH	MCA	OCP	DIM.	WEIGHT	NOTES	
	EF-1.1	UTILITY FAN	S&P	CM-16	3,600	1"	208 / 3	11	20	22"x32"x37"	120	1,2	
EF-2 UTILITY FAN S & P CFD-12 2.000 0.5" 208 / 3 7 20 27"x27"x21" 82 1	EF-1.2	UTILITY FAN	S&P	CM-16	3,600	1"	208 / 3	11	20	22"x32"x37"	120	1,2	
	EF-2	UTILITY FAN	S&P	CFD-12	2,000	0.5"	208 / 3	7	20	27"x27"x21"	82	1,2	


NOTES: WITH SPEED CONTROLLER

2. HORIZONTAL DISCHARGE.


	AIR DEVICE SCHEDULE									
TAG	SERVICE	MANUFACTURER (OR EQUAL)	MODEL (OR EQUAL)	SIZE	COLOR / FINISH	NOTES				
E1	EXHAUST	PRICE	80	AS INDICATED	WHITE	1				
T1	TRANSFER	TITUS	T-700	AS INDICATED	PRIMED	1,2				

NOTES: 1. VERIFY AIR DEVICE FINISHES WITH OWNER/ARCHITECT PRIOR TO INSTALLATION

2. PAINT TO MATCH DOOR COLOR.

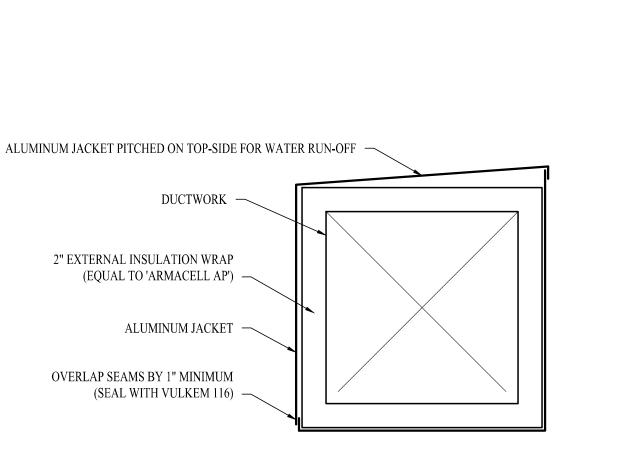


BUILDING EXTERIOR DUCT SECTION DETAIL

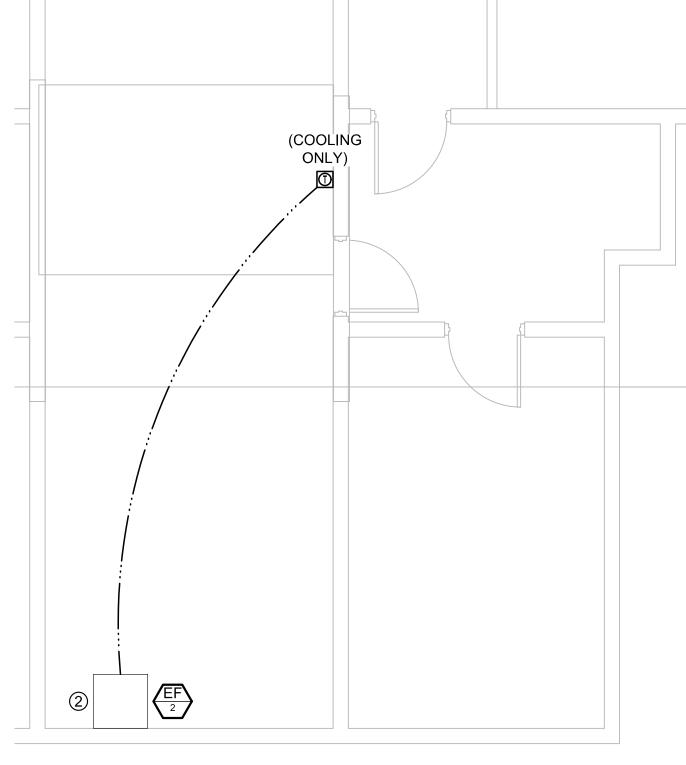

UTILITY ROOM HVAC PLAN

SCALE: 1/4" = 1'-0"

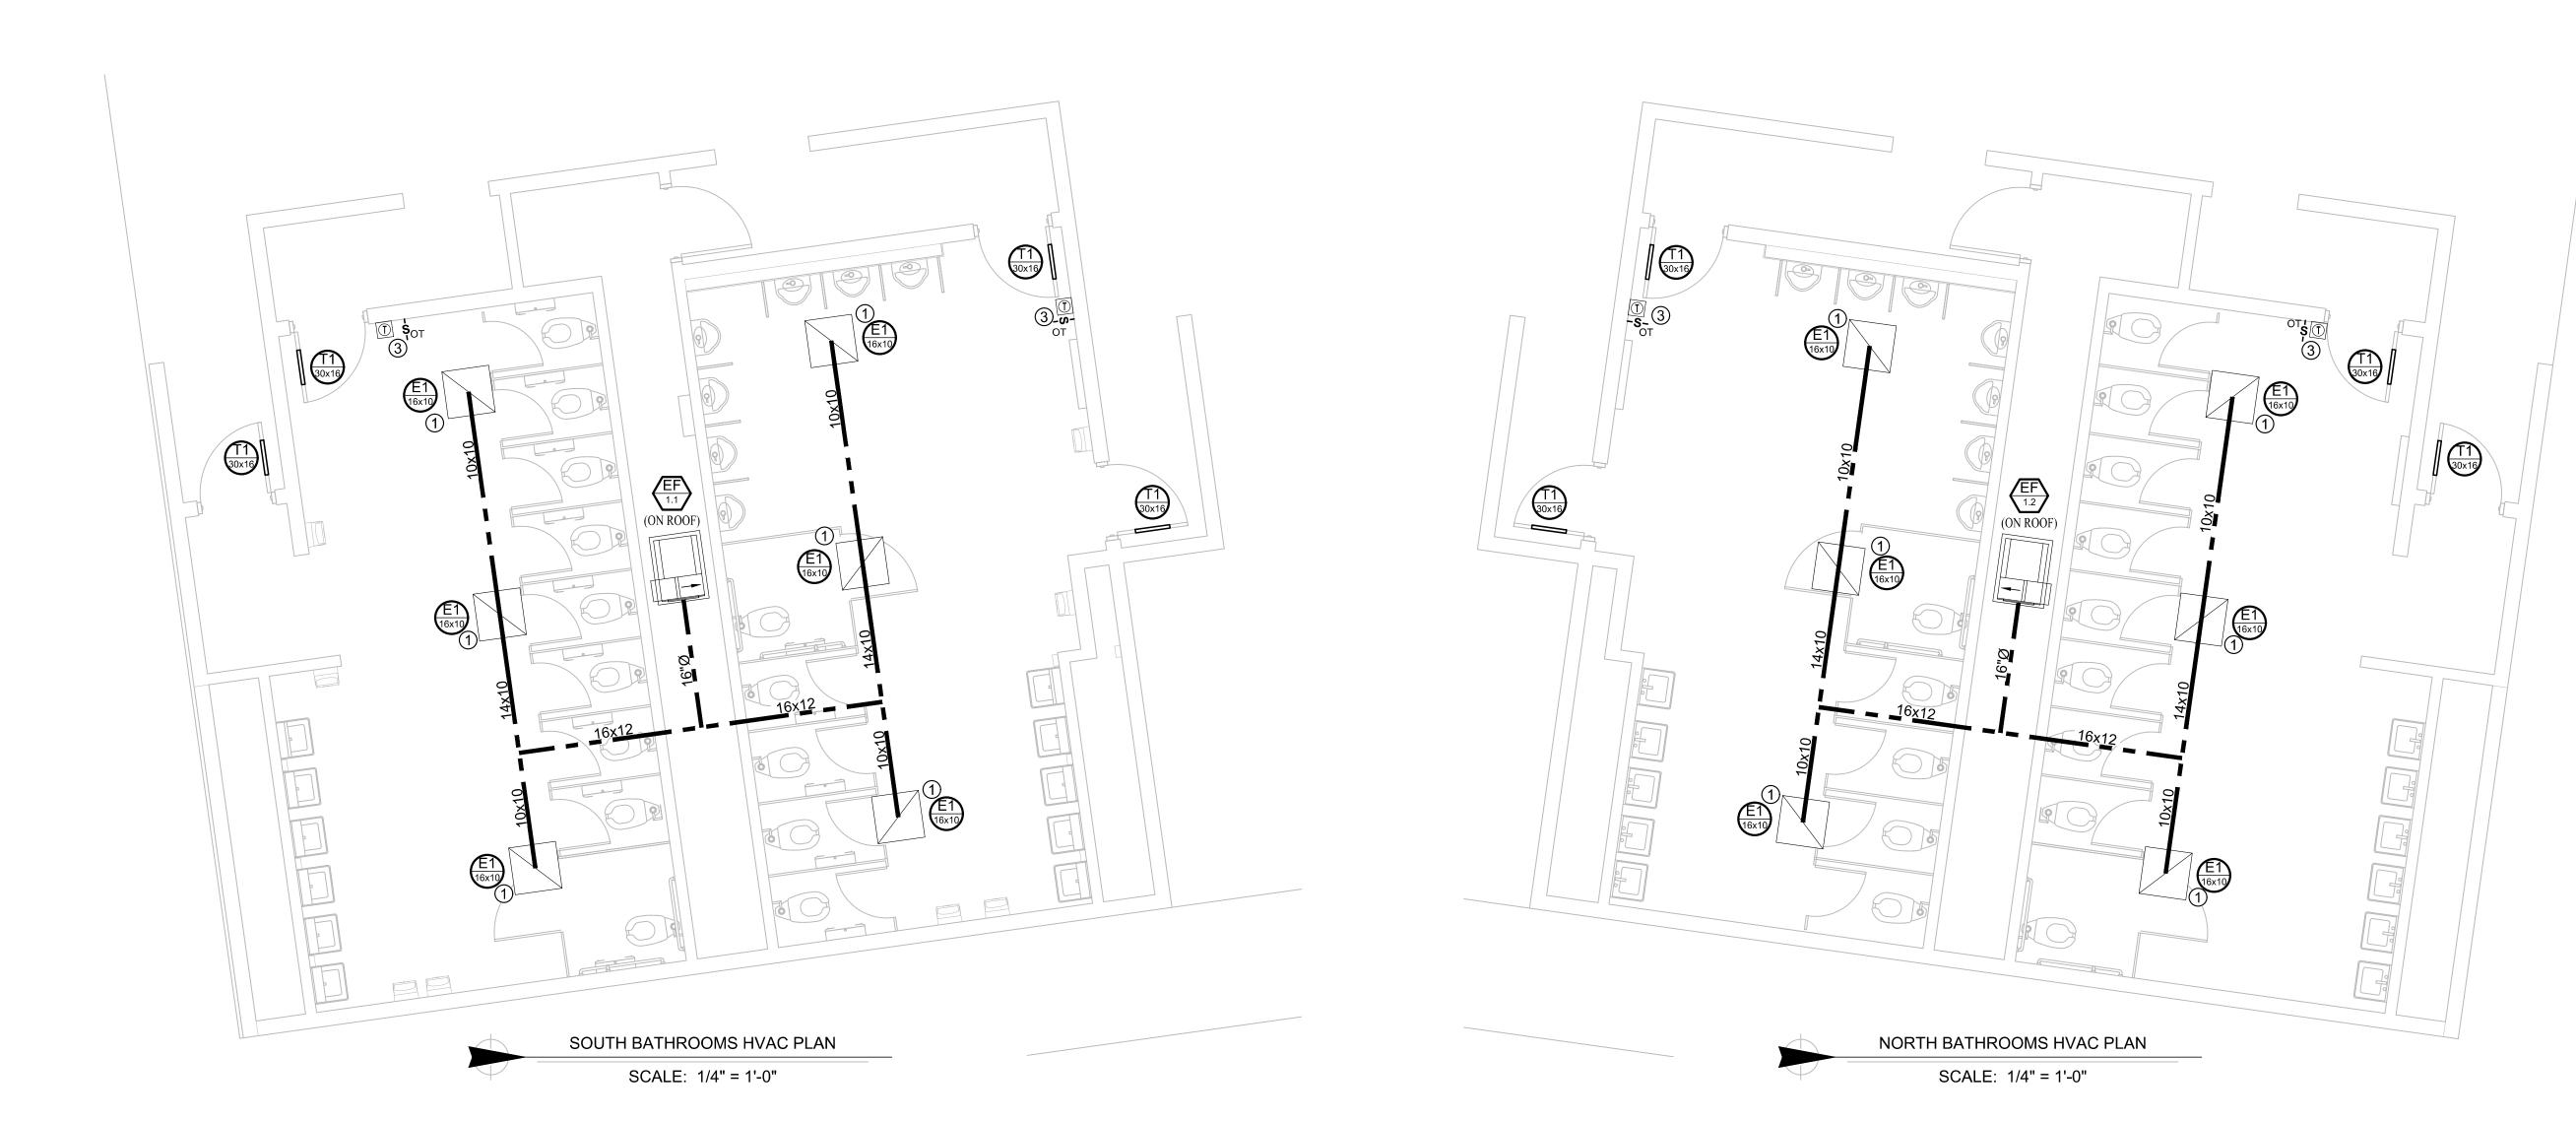

STATE OF MISSOURI MICHAEL L. PARSON, **GOVERNOR**



Keaton E. Leisinger, P.E. PE-2021035875



1806 West Broadway Boulevard Sedalia, MO 65301 660.829.9751



J-SQUARED ENGINEERING 2400 BLUFF CREEK DR. STE. 101 COLUMBIA, MO 65203 573.234.4492

ENGINEERING CONSULTANTS 1000 W. Nifong Blvd., Bldg. 1. Columbia, Missouri 65202 (573) 447-0292 www.crockettengineering.com Crockett Engineering Consultants, LLC Missouri Certificate of Authority #2000151304

OFFICE OF ADMINISTRATION DIVISION OF FACILITIES
MANAGEMENT DESIGN AND
CONSTRUCTION

UPGRADE ELECTRICAL AND RESTROOMS, GRANDSTAND

MISSOURI STATE FAIRGROUNDS 2503 W. 16TH ST. SEDALIA, MO 65301

PROJECT # T2304-01 SITE # 1501 ASSET # 3511501018 REVISION:

REVISION: DATE:

DATE:

REVISION: DATE:

ISSUE DATE: 11/29/2023

BID DOCUMENTS

CAD DWG FILE:
DRAWN BY:
CHECKED BY:
DESIGNED BY:
KEL

SHEET TITLE:

ENLARGED HVAC PLANS (PHASE 1)

SHEET NUMBER:


SHEET 19 OF 30 11/29/2023

POWER PLAN GENERAL NOTES:

- 1. SEE SHEETS E-501, E-502, E-601 & E-602 FOR ELECTRICAL NOTES, DETAILS, &
- SCHEDULES.
- 2. ALL EQUIPMENT LABELED "EX" OR "EXISTING" SHALL BE EXISTING TO REMAIN UNLESS OTHERWISE NOTED.

POWER PLAN KEY NOTES:

- (1) PHASE 1: PROVIDE & INSTALL NEW PANEL. SEE PANEL SCHEDULE &
- POWER RISER FOR MORE DETAILS.
- ② EXISTING CONDUIT & CONDUCTORS TO REMAIN.
- ③ PHASE 2: PROVIDE & INSTALL NEW PANEL. SEE PANEL SCHEDULE & POWER RISER FOR MORE DETAILS.
- (4) PHASE 3/ALTERNATE 1: PROVIDE & INSTALL NEW 300kVA TRANSFORMER.
- (5) PHASE 3/ALTERNATE 1: SEE POWER RISER FOR CONDUIT & CONDUCTOR
- SIZE AND FURTHER INFORMATION.
- ⑥ PHASE 1: PROVIDE & INSTALL NEW 600A & 800A, 120/208Y, NEMA 3R, DOUBLE THROW DISCONNECTS. SEE STAGE POWER RISER (PHASE 1) FOR MORE INFORMATION.

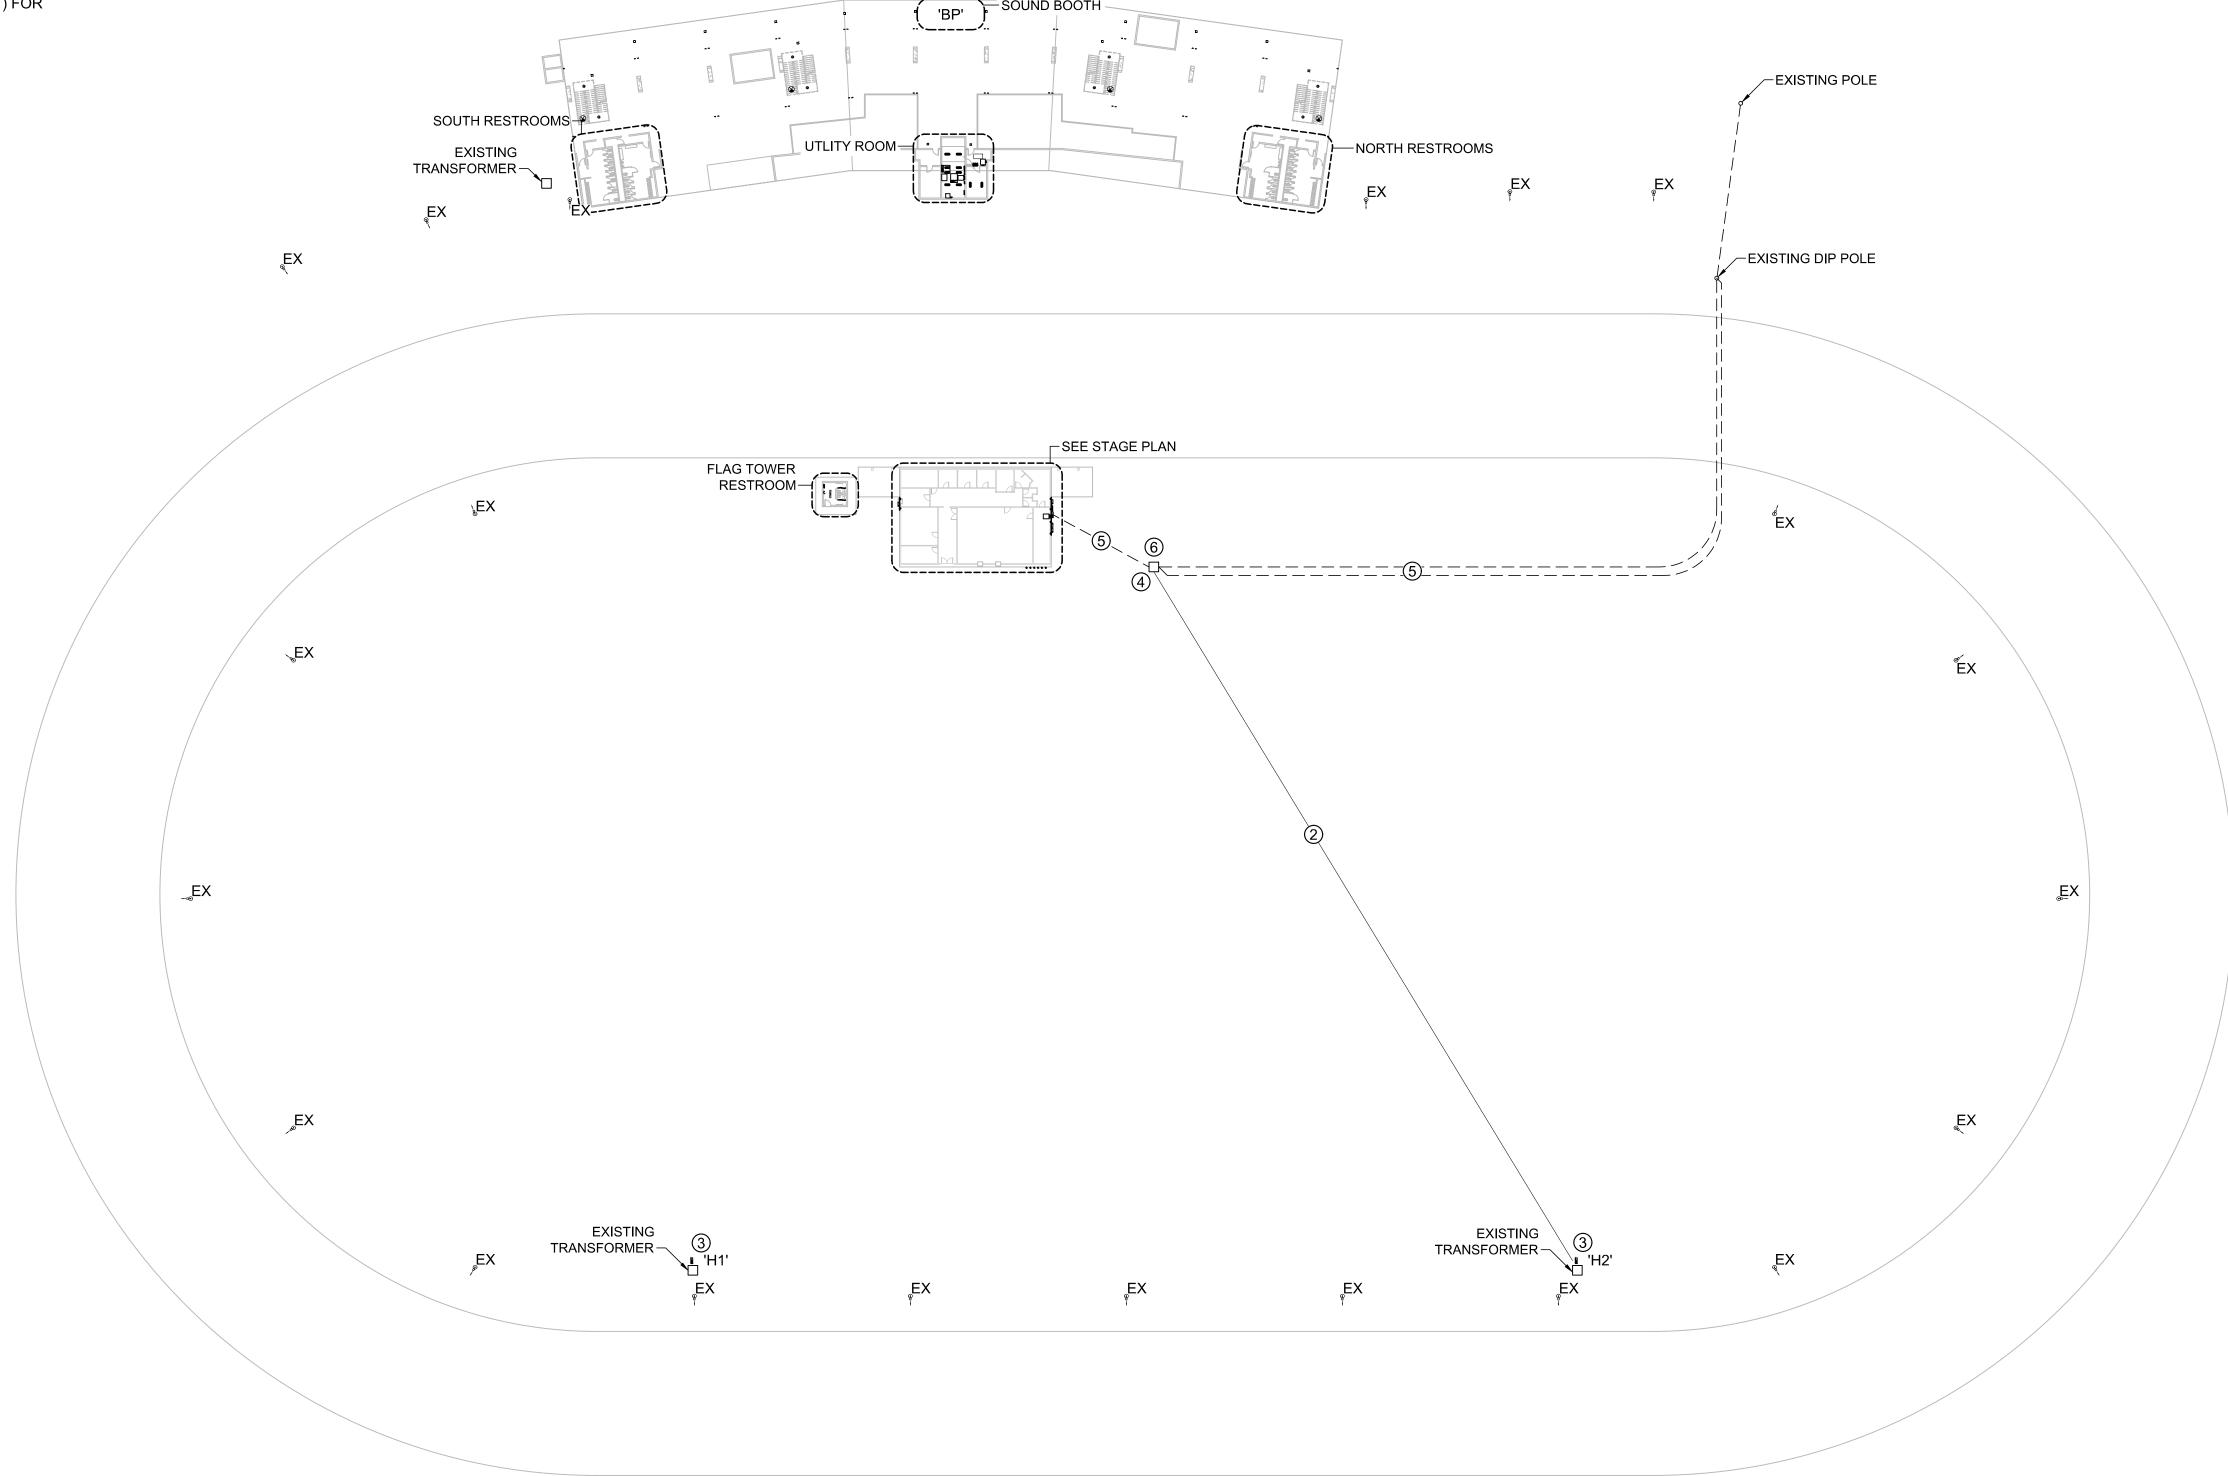



STATE OF MISSOURI MICHAEL L. PARSON, GOVERNOR



Keaton E. Leisinger, P.E.
PE-2021035875
MO Contificate of Authority # 201802



1806 West Broadway Boulevard Sedalia, MO 65301 660.829.9751



J-SQUARED
ENGINEERING
2400 BLUFF CREEK DR. STE. 101
COLUMBIA, MO 65203
573.234.4492

CROCKET TO THE PROPERTY OF THE

ENGINEERING CONSULTANTS
1000 W. Nifong Blvd., Bldg. 1.
Columbia, Missouri 65202
(573) 447-0292
www.crockettengineering.com
Crockett Engineering Consultants, LLC
Missouri Certificate of Authority
#2000151304

OFFICE OF ADMINISTRATION DIVISION OF FACILITIES MANAGEMENT DESIGN AND CONSTRUCTION

UPGRADE ELECTRICAL AND RESTROOMS, GRANDSTAND MISSOURI STATE

FAIRGROUNDS 2503 W. 16TH ST. SEDALIA, MO 65301

PROJECT # T2304-01 SITE # 1501 ASSET # 3511501018

DATE:_ REVISION:

REVISION:

DATE:

ISSUE DATE: 11/29/2023

BID DOCUMENTS

CAD DWG FILE:
DRAWN BY: RXM
CHECKED BY: JAP
DESIGNED BY: KEL

SHEET TITLE:

SITE ELECTRICAL PLAN

SHEET NUMBER:

E-101

SHEET 20 OF 30 11/29/2023

POWER PLAN SYMBOL LEGEND ____ CIRCUIT WIRING \longrightarrow PX-XX CIRCUIT TAG JUNCTION BOX XX⊕+42 RECEPTACLE INDICATES MOUNTING HEIGHT TO BOTTOM OF BOX (STANDARD @ 18" AFF UNLESS NOTED OTHERWISE) "WP" = WEATHERPROOF OUTDOOR RECEPTACLE "AW" = ABOVE WINDOW RECEPTACLE "AC" = ABOVE CEILING RECEPTACLE "EX" = EXISTING RECEPTACLE TO REMAIN GFCI DUPLEX CONVENIENCE RECEPTACLE 208V RECEPTACLE

QUADPLEX CONVENIENCE RECEPTACLE


- USB OUTLET WITH USB-A & USB-C CHARGING PORT
- DATA / PHONE JACK BOX WITH 1" CONDUIT & PULL STRING) UP TO CEILING SPACE (STANDARD @ 18" AFF UNLESS NOTED OTHERWISE)
- WIRELESS ACCESS POINT, CEILING MOUNTED
- FLOOR RECEPTACLE
- **1** FLOOR DATA
- DISCONNECT
- **FUSED DISCONNECT**
- **FUSED SWITCH**
- STARTER / DISCONNECT
- TIE INTO EXISTING

POWER PLAN GENERAL NOTES:


- 1. SEE SHEETS E-501, E-502, E-601 & E-602 FOR ELECTRICAL NOTES, DETAILS, & SCHEDULES.
- 2. ALL EQUIPMENT LABELED "EX" OR "EXISTING" SHALL BE EXISTING TO REMAIN UNLESS OTHERWISE NOTED.
- CONTRACTOR IS RESPONSIBLE FOR ANY AND ALL CONDUIT & CONDUCTOR MODIFICATIONS OR EXTENSIONS NECESSARY FOR A FULLY FUNCTIONAL ELECTRICAL SYSTEM.

POWER PLAN KEY NOTES:


- (1) PHASE 1: PROVIDE & INSTALL NEW PANEL. SEE PANEL SCHEDULE &
- POWER RISERS FOR MORE DETAILS. (2) EXISTING PANEL TO REMAIN.
- (3) PHASE 2: PROVIDE & INSTALL NEW 800A, 120/208V, 3Ø DISCONNECT.
- (4) PHASE 2: PROVIDE & INSTALL NEW PANEL. SEE PANEL SCHEDULE & POWER RISERS FOR MORE DETAILS.
- (5) PHASE 2: NEW STEP DOWN TRANSFORMER. SEE POWER RISER FOR MORE DETAILS.
- (6) PHASE 2: (2) EXISTING CONTACTORS AND CONTROL SWITCHES TO BE RELOCATED HERE. PROVIDE & INSTALL (1) NEW LIGHTING CONTACTOR. SEE LIGHTING CONTROL DETAILS FOR FURTHER INFORMATION.
- (7) EXISTING LIGHTING CONTACTOR TO REMAIN.
- (8) PHASE 2: PROVIDE & INSTALL UNISTRUT STRUCTURE FOR PANEL

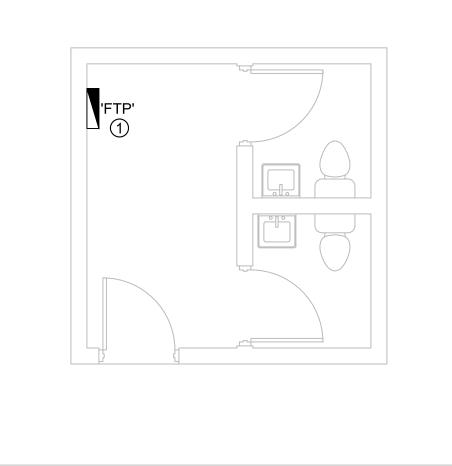



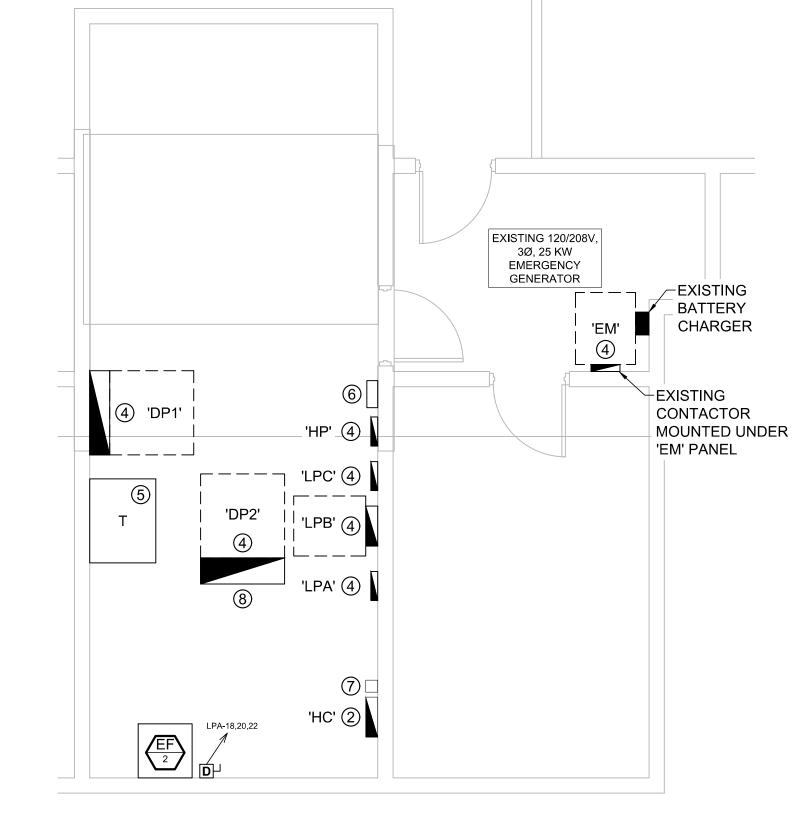

UTILITY ROOM POWER PLAN SCALE: 1/4" = 1'-0"

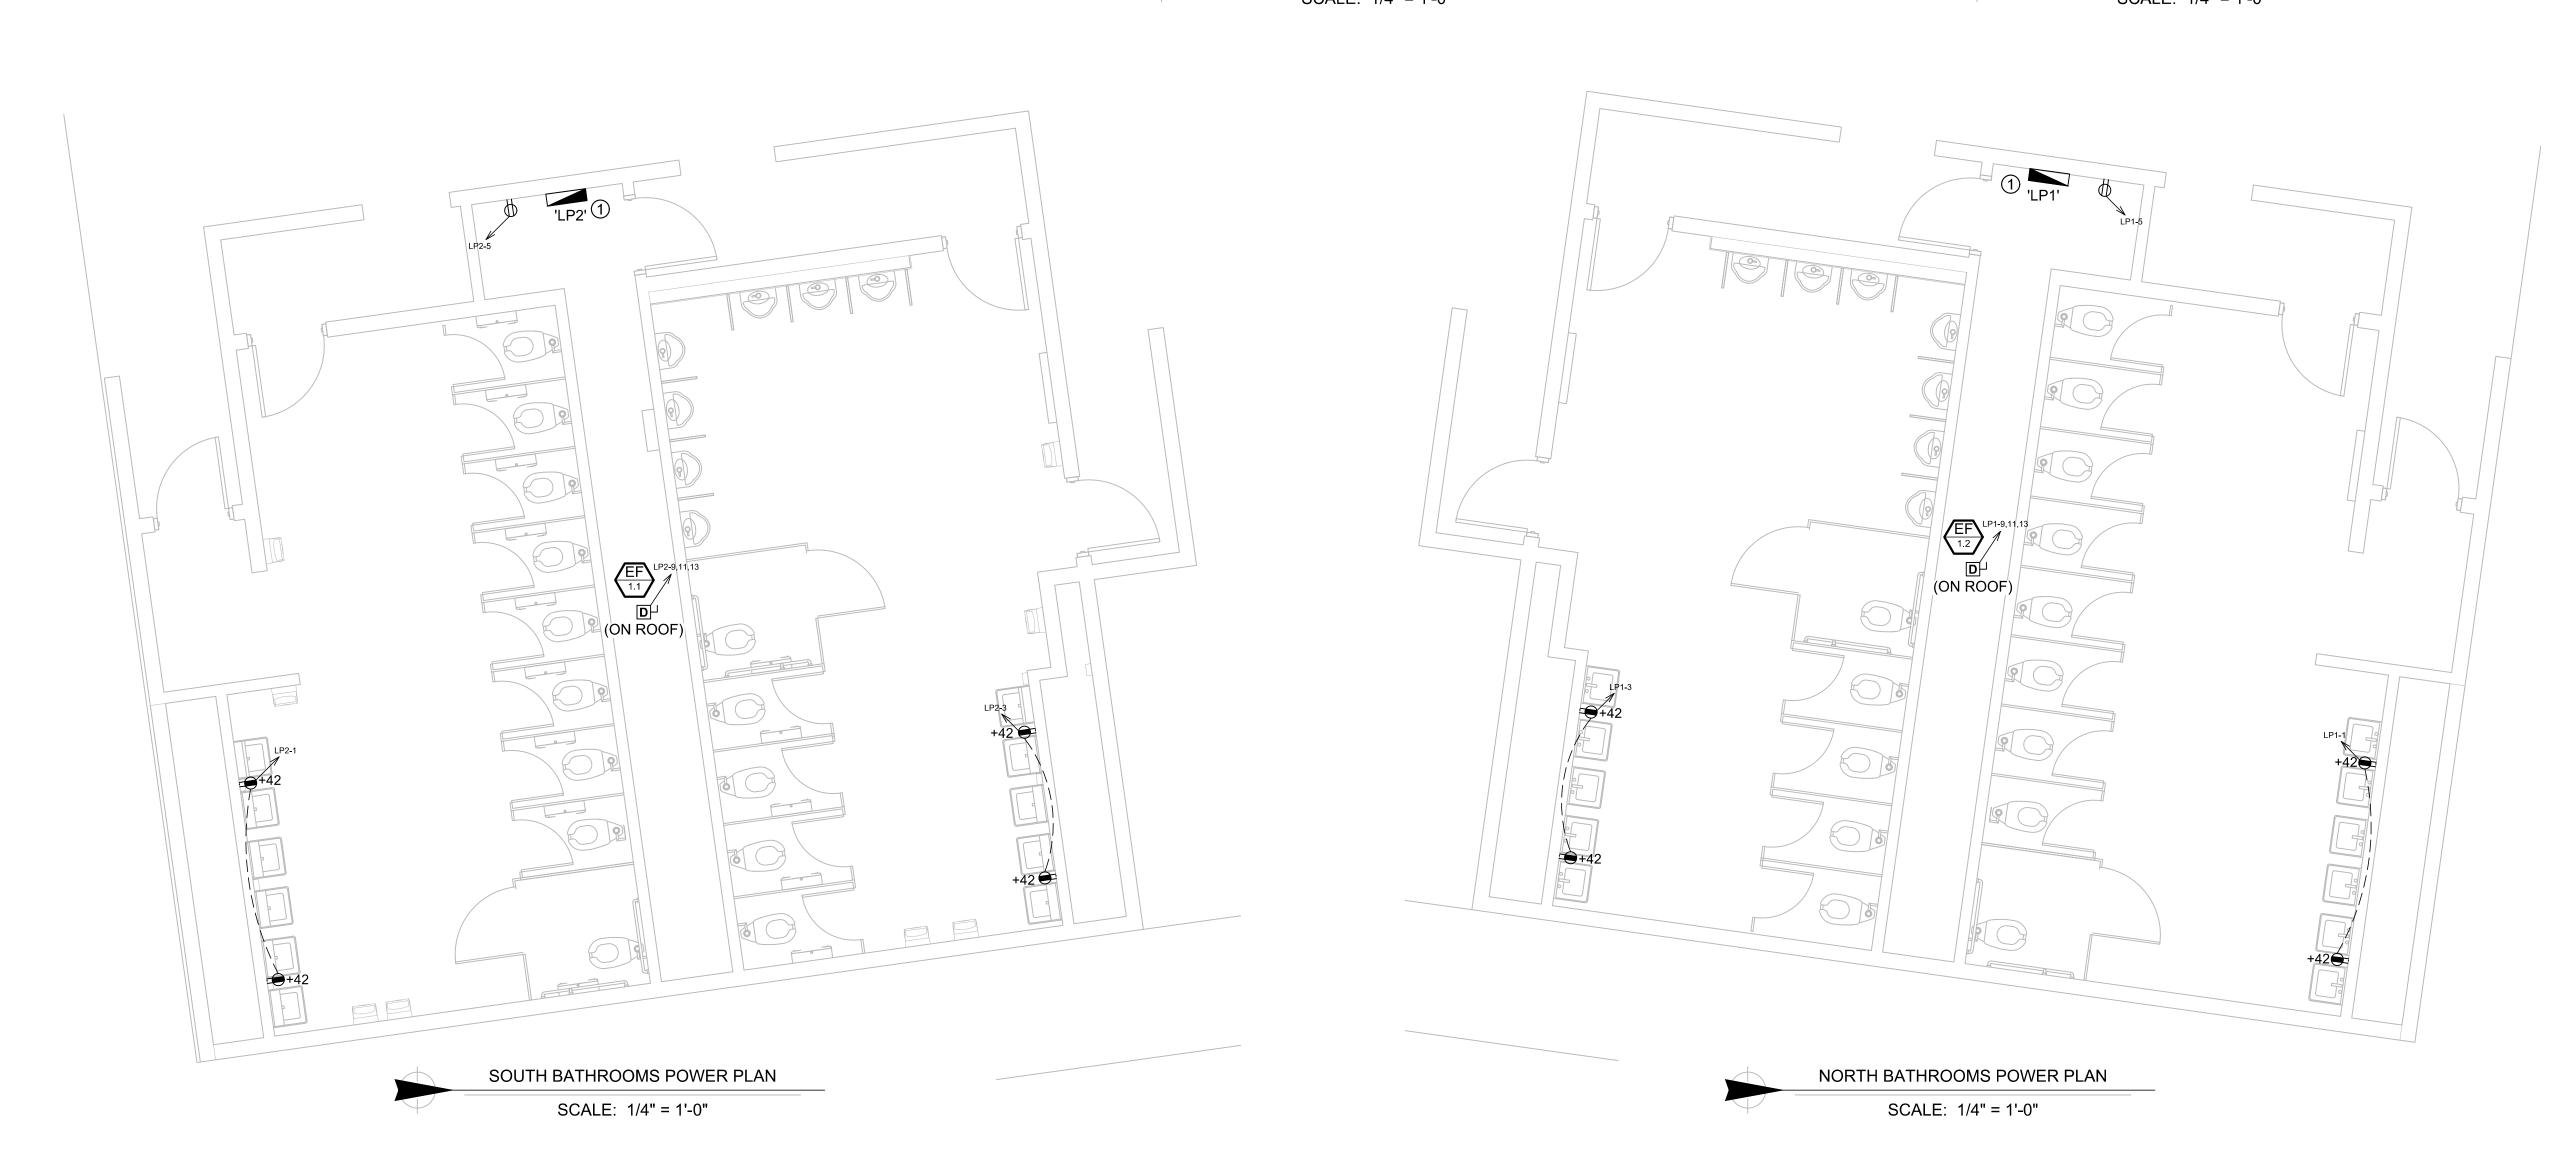

STATE OF MISSOURI MICHAEL L. PARSON, **GOVERNOR**



Keaton E. Leisinger, P.E. PE-2021035875



1806 West Broadway Boulevard Sedalia, MO 65301 660.829.9751



J-SQUARED ENGINEERING 2400 BLUFF CREEK DR. STE. 101 COLUMBIA, MO 65203 573.234.4492

ENGINEERING CONSULTANTS 1000 W. Nifong Blvd., Bldg. 1. Columbia, Missouri 65202 (573) 447-0292 www.crockettengineering.com Crockett Engineering Consultants, LLC Missouri Certificate of Authority #2000151304

OFFICE OF ADMINISTRATION DIVISION OF FACILITIES MANAGEMENT DESIGN AND CONSTRUCTION

UPGRADE ELECTRICAL AND RESTROOMS, GRANDSTAND MISSOURI STATE

FAIRGROUNDS 2503 W. 16TH ST. SEDALIA, MO 65301

PROJECT # T2304-01 SITE # 1501 ASSET # 3511501018

REVISION: DATE:

REVISION: DATE:

REVISION: DATE:

ISSUE DATE: 11/29/2023

BID DOCUMENTS

CAD DWG FILE:
DRAWN BY:
CHECKED BY:
DESIGNED BY:
KEL

SHEET TITLE:

ENLARGED POWER PLANS

SHEET NUMBER:

E-102

SHEET 21 OF 30 11/29/2023

POWER PLAN SYMBOL LEGEND ____ CIRCUIT WIRING DATA / PHONE JACK BOX WITH 1" CONDUIT & PULL STRING) UP TO CEILING SPACE ——>PX-XX CIRCUIT TAG (STANDARD @ 18" AFF UNLESS NOTED OTHERWISE) JUNCTION BOX WIRELESS ACCESS POINT, CEILING MOUNTED RECEPTACLE FLOOR RECEPTACLE INDICATES MOUNTING HEIGHT TO BOTTOM OF BOX (STANDARD @ 18" AFF UNLESS NOTED OTHERWISE) FLOOR DATA "WP" = WEATHERPROOF OUTDOOR RECEPTACLE "AW" = ABOVE WINDOW RECEPTACLE DISCONNECT "AC" = ABOVE CEILING RECEPTACLE "EX" = EXISTING RECEPTACLE TO REMAIN FUSED DISCONNECT GFCI DUPLEX CONVENIENCE RECEPTACLE **FUSED SWITCH** 208V RECEPTACLE STARTER / DISCONNECT

TIE INTO EXISTING

QUADPLEX CONVENIENCE RECEPTACLE

WITH USB-A & USB-C CHARGING PORT


USB OUTLET

POWER PLAN GENERAL NOTES:

- 1. SEE SHEETS E-501, E-502, E-601 & E-602 FOR ELECTRICAL NOTES, DETAILS, &
- SCHEDULES. 2. ALL EQUIPMENT LABELED "EX" OR "EXISTING" SHALL BE EXISTING TO REMAIN UNLESS OTHERWISE NOTED.

POWER PLAN KEY NOTES:

(1) PHASE 3/ALTERNATE 1: 50A BUS PLUG MOUNTED TO BACK OF STAGE PLATFORM.

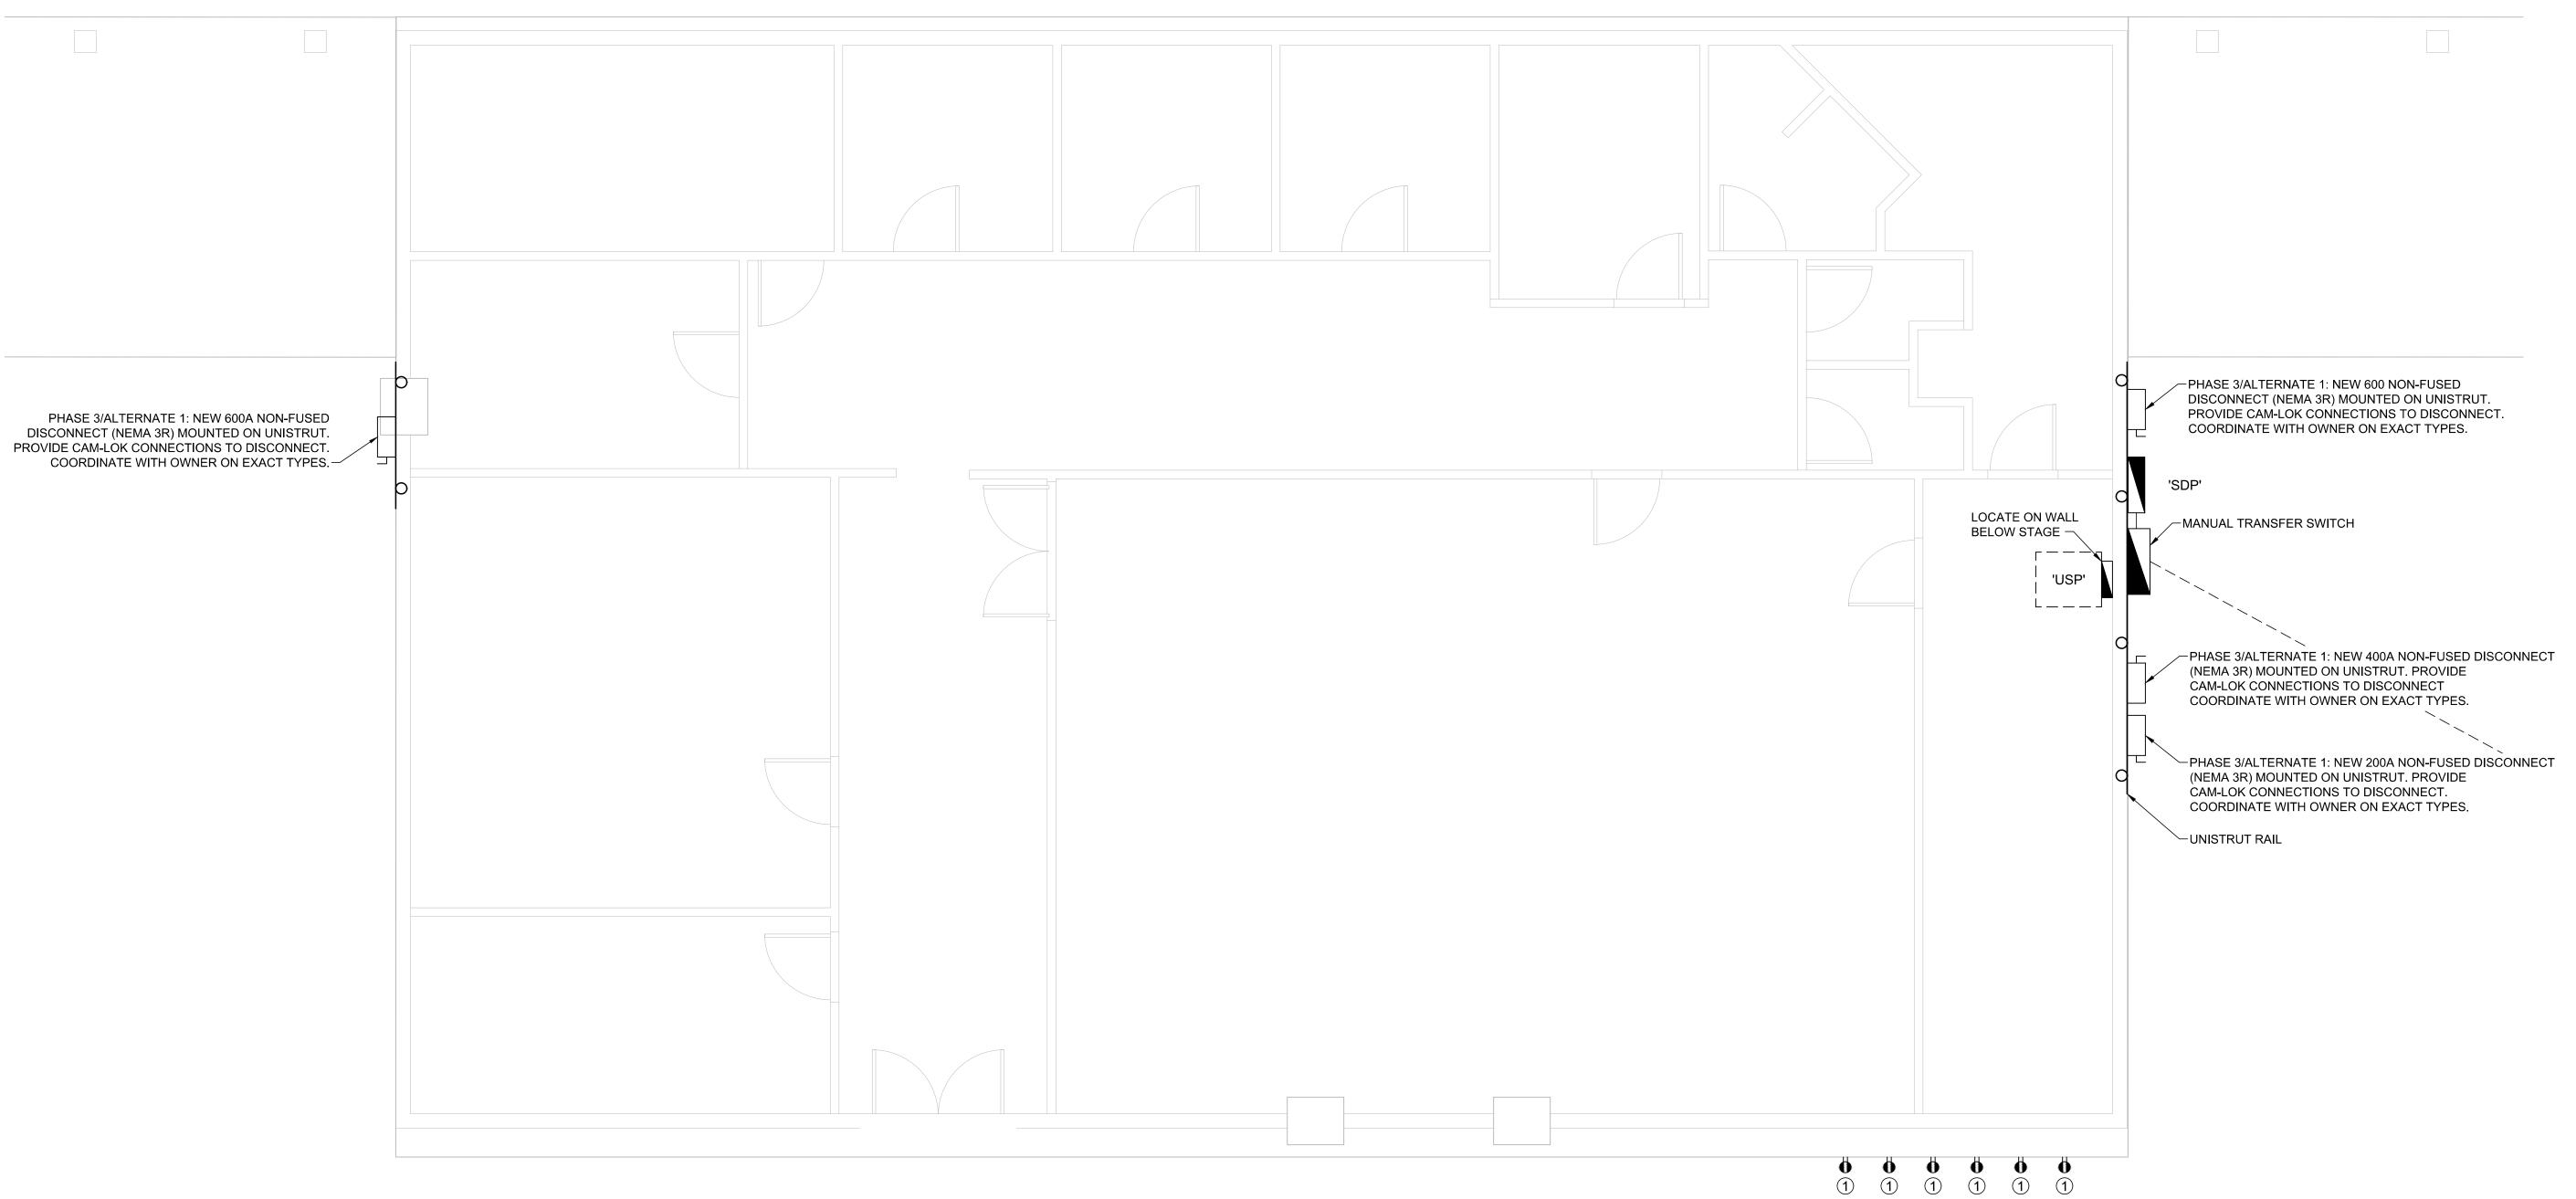


STAGE POWER PLAN

SCALE: 1/4" = 1'-0"


STATE OF MISSOURI MICHAEL L. PARSON, **GOVERNOR**



Keaton E. Leisinger, P.E. PE-2021035875

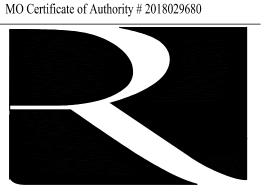

1806 West Broadway Boulevard Sedalia, MO 65301 660.829.9751

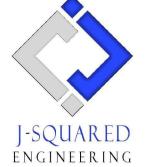

2400 BLUFF CREEK DR. STE. 101 COLUMBIA, MO 65203 573.234.4492

ENGINEERING CONSULTANTS 1000 W. Nifong Blvd., Bldg. 1. Columbia, Missouri 65202 (573) 447-0292 www.crockettengineering.com Crockett Engineering Consultants, LLC Missouri Certificate of Authority #2000151304

OFFICE OF ADMINISTRATION DIVISION OF FACILITIES MANAGEMENT DESIGN AND CONSTRUCTION

UPGRADE ELECTRICAL AND RESTROOMS, GRANDSTAND

MISSOURI STATE **FAIRGROUNDS** 2503 W. 16TH ST. SEDALIA, MO 65301

PROJECT # T2304-01 SITE # 1501 ASSET # 3511501018

REVISION: DATE:

REVISION: DATE:

REVISION:

DATE:

ISSUE DATE: 11/29/2023 **BID DOCUMENTS**

CAD DWG FILE:
DRAWN BY: RXM
CHECKED BY: JAP
DESIGNED BY: KEL

SHEET TITLE:

ENLARGED STAGE POWER PLAN (PHASE 3 ALT. 1)

SHEET NUMBER:

E-103

SHEET 22 OF 30 11/29/2023

LIGHTING PLAN SYMBOL LEGEND

X1 - "X1" INDICATES FIXTURE TYPE (REFER TO SCHEDULE)

LIGHTING FIXTURE

"EM" INDICATES EMERGENCY BATTERY BACKUP

— "NL" INDICATES UN-SWITCHED NIGHT LIGHT

E.

EXIT LIGHT

─INDICATES REQUIRED REMOTE HEAD

EMERGENCY EGRESS LIGHTSWITCH (WALL MOUNTED)

SWITCH (WALL

SWITCH TYPE:

• 3 = 3-WAY

• 4 = 4-WAY

OP = PASSIVE INFRARED OCCUPANCY SENSOR

OU = ULTRASONIC OCCUPANCY SENSOR
 OT = DUAL-TECHNOLOGY OCCUPANCY SENSOR

VP = PASSIVE INFRARED VACANCY SENSOR
 VU = ULTRASONIC VACANCY SENSOR

VU = DETRASONIC VACANCY SENSOR
 VT = DUAL-TECHNOLOGY VACANCY SENSOR

M = MOMENTARY SWITCH

• SS = SCENE SWITCH

DIMMER SWITCH (WALL MOUNTED)

- SWITCH TYPE:

SEE "SWITCH (WALL MOUNTED)" FOR TYPE DESIGNATIONS

SWITCH TYPE:

SEE "SWITCH (WALL MOUNTED)" FOR TYPE DESIGNATIONS


LIGHTING PLAN GENERAL NOTES:


- 1. SEE SHEETS E-501, E-502, E-601 & E-602 FOR ADDITIONAL ELECTRICAL
- NOTES, DETAILS, & SCHEDULES.
- 2. ALL NEW LIGHT FIXTURES ARE ONE FOR ONE REPLACEMENTS.
- RECONNECT TO EXISTING CIRCUIT.

 3. EXISTING GRANDSTAND LIGHTING CIRCUITS TO BE CONTROLLED BY NEW LIGHTING CONTACTOR IN UTILITY ROOM. SEE LIGHTING CONTROL DETAILS FOR MORE INFORMATION.

LIGHTING PLAN KEY NOTES:

- (1) AIM FIXTURE TOWARD GRANDSTAND EXIT WALKWAYS.
- (2) AIM FIXTURE UPWARD TOWARD GRANDSTAND CANOPY.
- (3) AIM FIXTURE TOWARD UNCOVERED GRANDSTAND SEATING AREA.

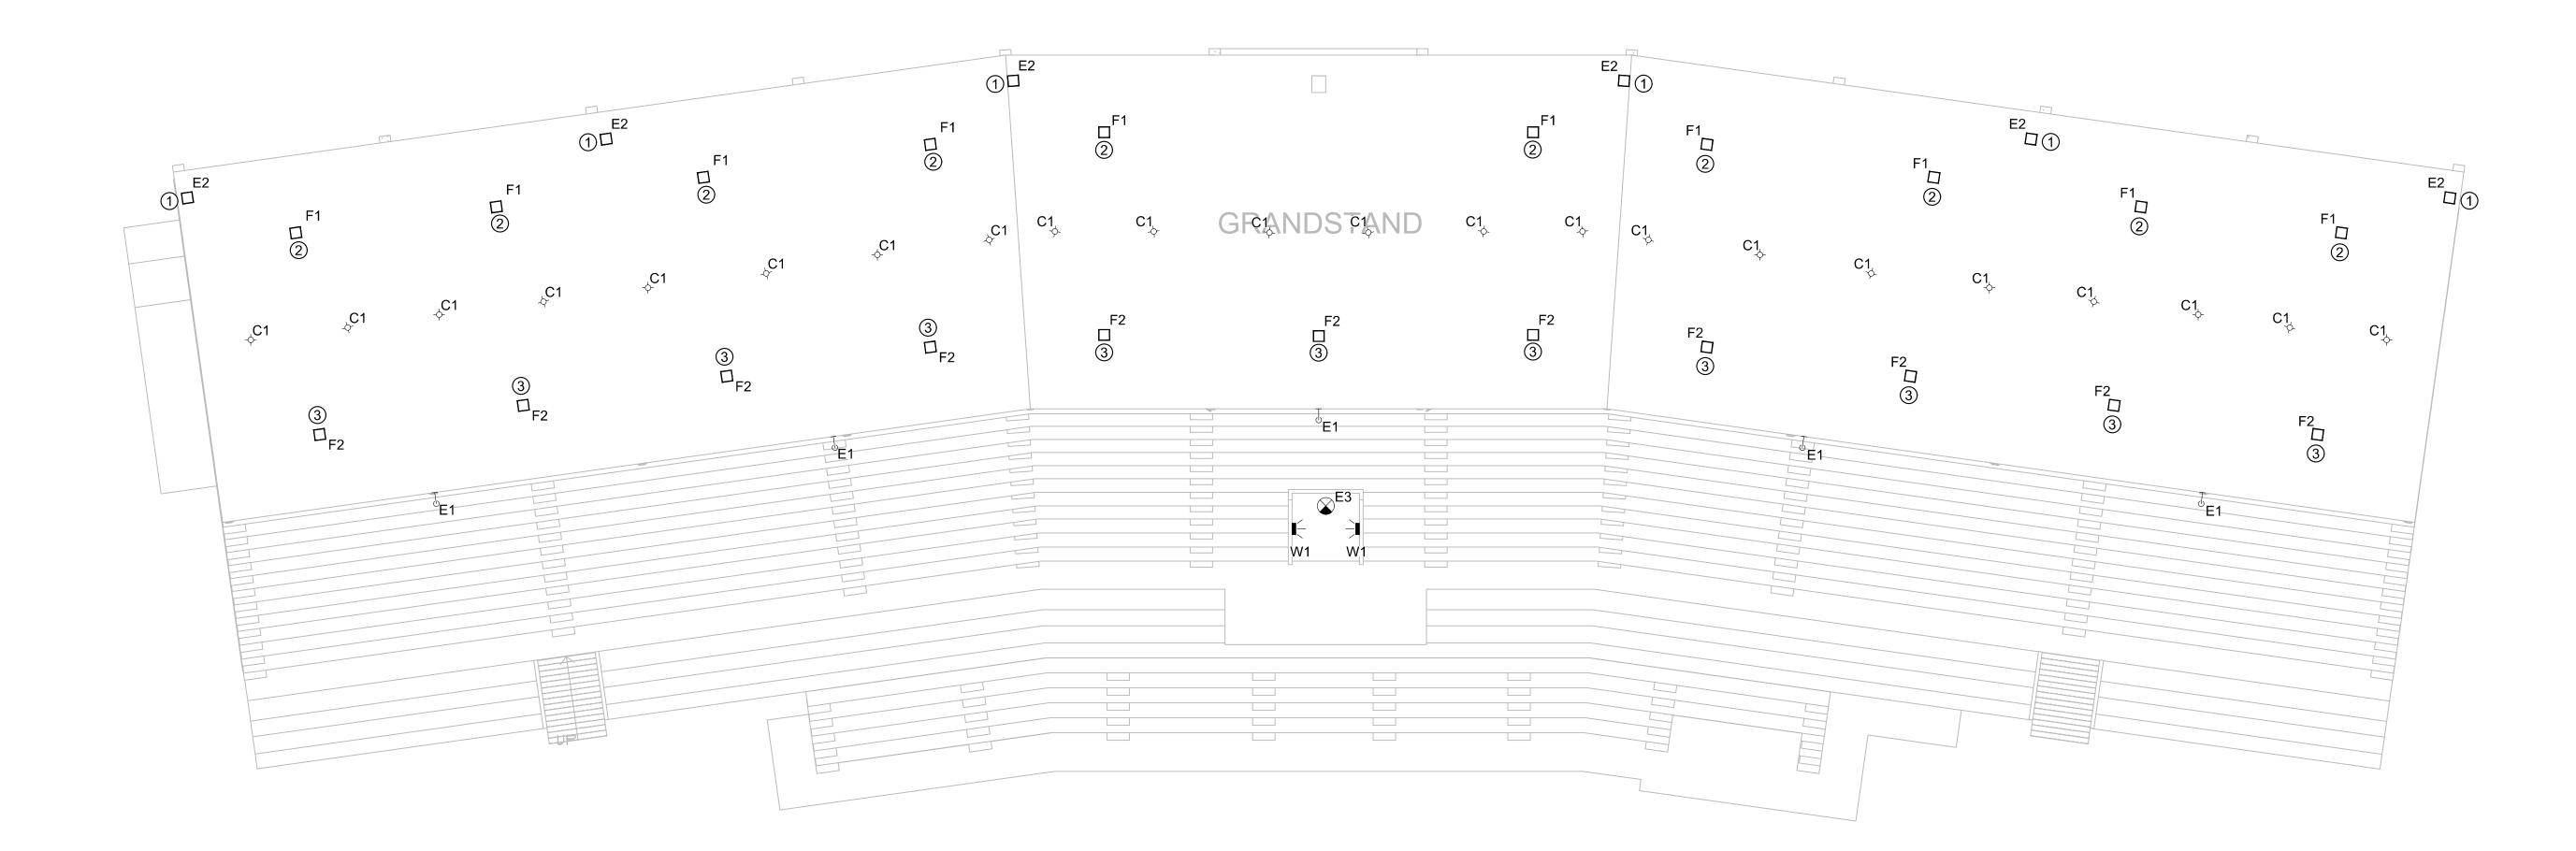

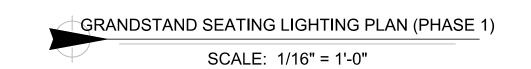

STATE OF MISSOURI MICHAEL L. PARSON, GOVERNOR



Keaton E. Leisinger, P.E. PE-2021035875



1806 West Broadway Boulevard Sedalia, MO 65301 660.829.9751



J-SQUARED ENGINEERING 2400 BLUFF CREEK DR. STE. 101 COLUMBIA, MO 65203 573.234.4492

CROCKETT

ENGINEERING CONSULTANTS
1000 W. Nifong Blvd., Bldg. 1.
Columbia, Missouri 65202
(573) 447-0292
www.crockettengineering.com
Crockett Engineering Consultants, LLC
Missouri Certificate of Authority
#2000151304

OFFICE OF ADMINISTRATION DIVISION OF FACILITIES MANAGEMENT DESIGN AND CONSTRUCTION

UPGRADE ELECTRICAL AND RESTROOMS, GRANDSTAND MISSOURI STATE FAIRGROUNDS

PROJECT # T2304-01 SITE # 1501 ASSET # 3511501018

2503 W. 16TH ST. SEDALIA, MO 65301

REVISION:_ DATE:

REVISION:_ DATE:

REVISION:____ DATE:___

ISSUE DATE: 11/29/2023

BID DOCUMENTS

CAD DWG FILE:
DRAWN BY: RXM
CHECKED BY: JAP
DESIGNED BY: KEL

SHEET TITLE:
GRANDSTAND
SEATING
LIGHTING PLAN
(PHASE 1)

SHEET NUMBER:

E-104

SHEET 23 OF 30 11/29/2023

LIGHTING PLAN SYMBOL LEGEND

X1 - "X1" INDICATES FIXTURE TYPE (REFER TO SCHEDULE) LIGHTING FIXTURE

"EM" INDICATES EMERGENCY BATTERY BACKUP — "NL" INDICATES UN-SWITCHED NIGHT LIGHT

EXIT LIGHT

-INDICATES REQUIRED REMOTE HEAD

EMERGENCY EGRESS LIGHT SWITCH (WALL MOUNTED)

SWITCH TYPE:

• 3 = 3-WAY • 4 = 4-WAY

OP = PASSIVE INFRARED OCCUPANCY SENSOR

• OU = ULTRASONIC OCCUPANCY SENSOR • OT = DUAL-TECHNOLOGY OCCUPANCY SENSOR

VP = PASSIVE INFRARED VACANCY SENSOR

 VU = ULTRASONIC VACANCY SENSOR VT = DUAL-TECHNOLOGY VACANCY SENSOR

 M = MOMENTARY SWITCH SS = SCENE SWITCH

DIMMER SWITCH (WALL MOUNTED) SWITCH TYPE:


SEE "SWITCH (WALL MOUNTED)" FOR TYPE DESIGNATIONS

SWITCH (CEILING MOUNTED)

SEE "SWITCH (WALL MOUNTED)" FOR TYPE DESIGNATIONS

LIGHTING PLAN GENERAL NOTES:

- 1. SEE SHEETS E-501, E-502, E-601 & E-602 FOR ADDITIONAL ELECTRICAL
- NOTES, DETAILS, & SCHEDULES.
- 2. ALL NEW LIGHT FIXTURES ARE ONE FOR ONE REPLACEMENTS.
- RECONNECT TO EXISTING CIRCUIT.
- EXISTING GRANDSTAND LIGHTING CIRCUITS TO BE CONTROLLED BY NEW LIGHTING CONTACTOR IN UTILITY ROOM.

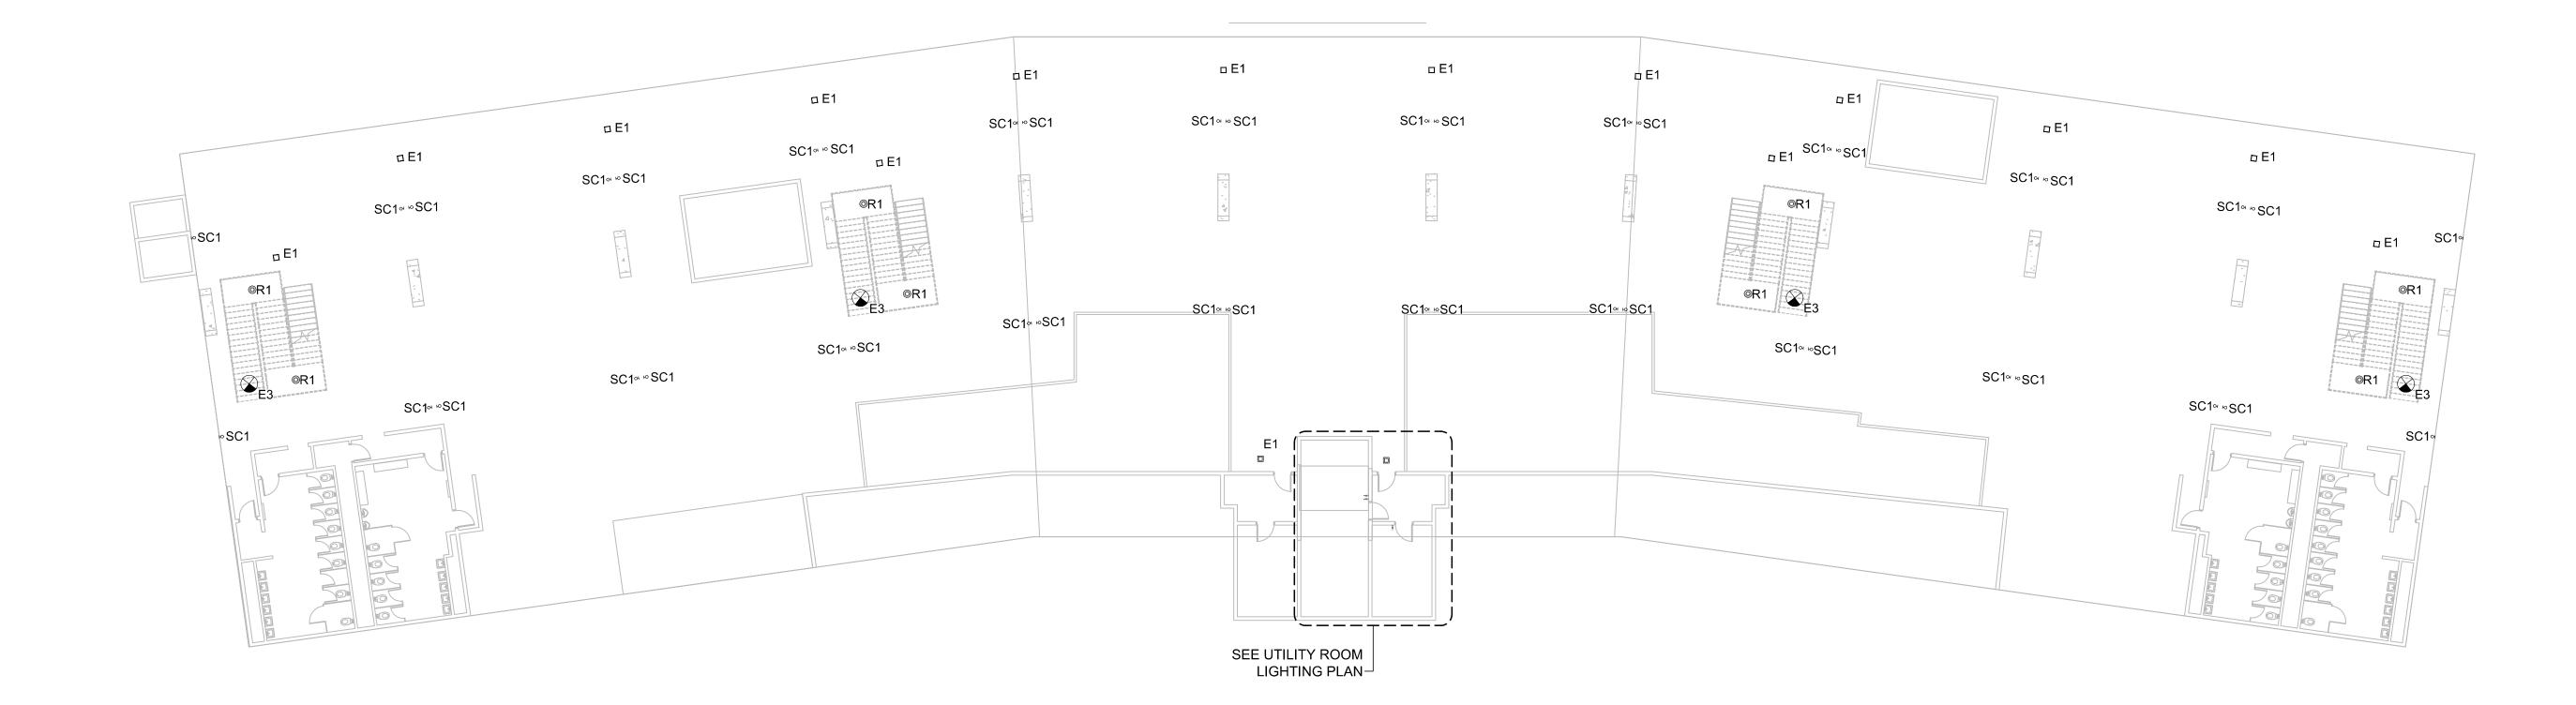





STATE OF MISSOURI MICHAEL L. PARSON, **GOVERNOR**



Keaton E. Leisinger, P.E. PE-2021035875 MO Certificate of Authority # 2018029680

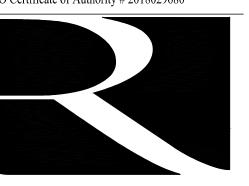

1806 West Broadway Boulevard Sedalia, MO 65301 660.829.9751

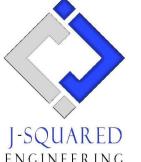

ENGINEERING 2400 BLUFF CREEK DR. STE. 101 COLUMBIA, MO 65203 573.234.4492

ENGINEERING CONSULTANTS 1000 W. Nifong Blvd., Bldg. 1. Columbia, Missouri 65202 (573) 447-0292 www.crockettengineering.com Crockett Engineering Consultants, LLC Missouri Certificate of Authority #2000151304

OFFICE OF ADMINISTRATION DIVISION OF FACILITIES MANAGEMENT DESIGN AND CONSTRUCTION

UPGRADE ELECTRICAL AND RESTROOMS, GRANDSTAND MISSOURI STATE **FAIRGROUNDS**

PROJECT # T2304-01 SITE # 1501 ASSET # 3511501018

2503 W. 16TH ST.

SEDALIA, MO 65301

REVISION: DATE:

REVISION: DATE:

REVISION: DATE:

ISSUE DATE: 11/29/2023 **BID DOCUMENTS**

CAD DWG FILE:
DRAWN BY: RXM
CHECKED BY: JAP
DESIGNED BY: KEL

SHEET TITLE: BELOW GRANDSTAND LIGHTING PLAN (PHASE 1)

SHEET NUMBER:

SHEET 24 OF 30 11/29/2023

LIGHTING PLAN SYMBOL LEGEND LIGHTING PLAN GENERAL NOTES: 1. SEE SHEETS E-501, E-502, E-601 & E-602 FOR ADDITIONAL ELECTRICAL X1 - "X1" INDICATES FIXTURE TYPE (REFER TO SCHEDULE) NOTES, DETAILS, & SCHEDULES. LIGHTING FIXTURE "EM" INDICATES EMERGENCY BATTERY BACKUP · "NL" INDICATES UN-SWITCHED NIGHT LIGHT EXIT LIGHT LIGHTING PLAN KEY NOTES: -INDICATES REQUIRED REMOTE HEAD (1) TIE INTO EXISTING LIGHTING CIRCUIT. **EMERGENCY EGRESS LIGHT** (2) TIE INTO EXISTING EMERGENCY LIGHTING CIRCUIT. SWITCH (WALL MOUNTED) (3) EXISTING ROOM LIGHT SWITCH TO REMAIN. SWITCH TYPE: (4) PHASE 2: EXISTING CONTACTOR CONTROL SWITCH TO BE RELOCATED. 3 = 3-WAY SEE UTILITY ROOM DETAIL FOR MORE INFORMATION. • 4 = 4-WAY OP = PASSIVE INFRARED OCCUPANCY SENSOR • OU = ULTRASONIC OCCUPANCY SENSOR • OT = DUAL-TECHNOLOGY OCCUPANCY SENSOR

VP = PASSIVE INFRARED VACANCY SENSOR

VT = DUAL-TECHNOLOGY VACANCY SENSOR

SEE "SWITCH (WALL MOUNTED)" FOR TYPE DESIGNATIONS


SEE "SWITCH (WALL MOUNTED)" FOR TYPE DESIGNATIONS

VU = ULTRASONIC VACANCY SENSOR

DIMMER SWITCH (WALL MOUNTED)


M = MOMENTARY SWITCHSS = SCENE SWITCH

SWITCH (CEILING MOUNTED)

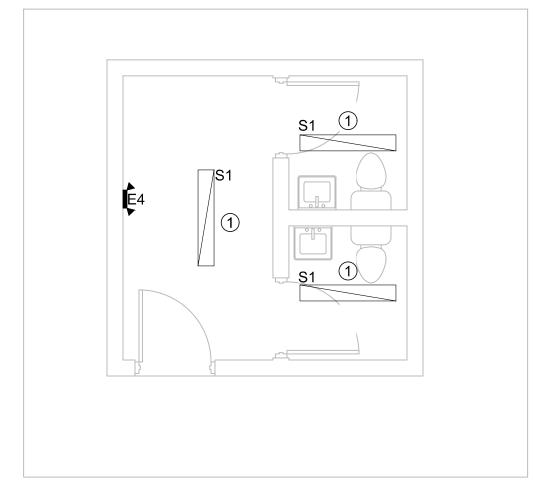


FLAG TOWER LIGHTING PLAN

SCALE: 1/4" = 1'-0"

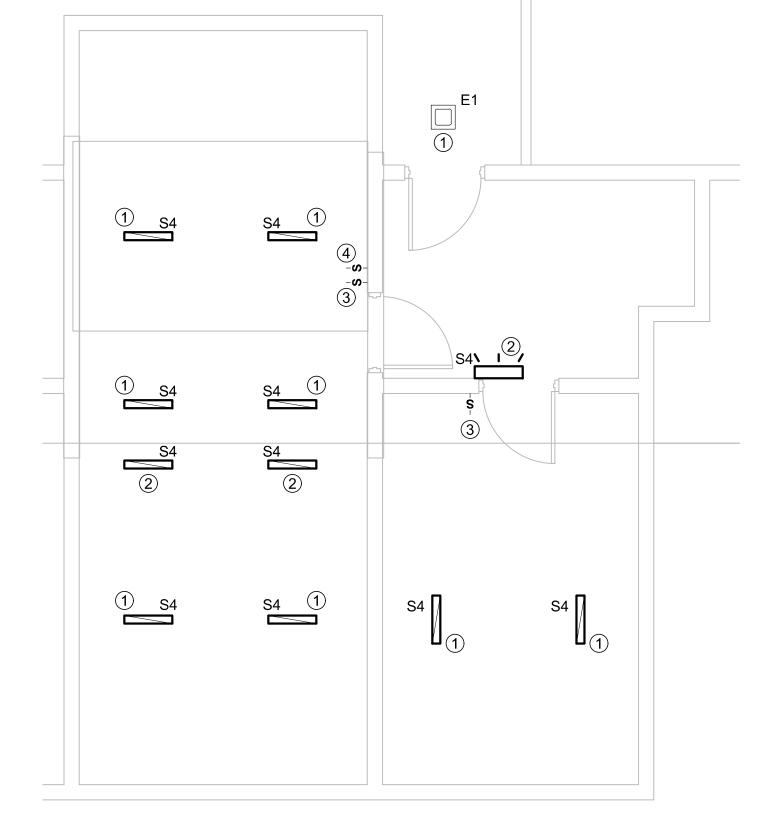

UTILITY ROOM LIGHTING PLAN

SCALE: 1/4" = 1'-0"

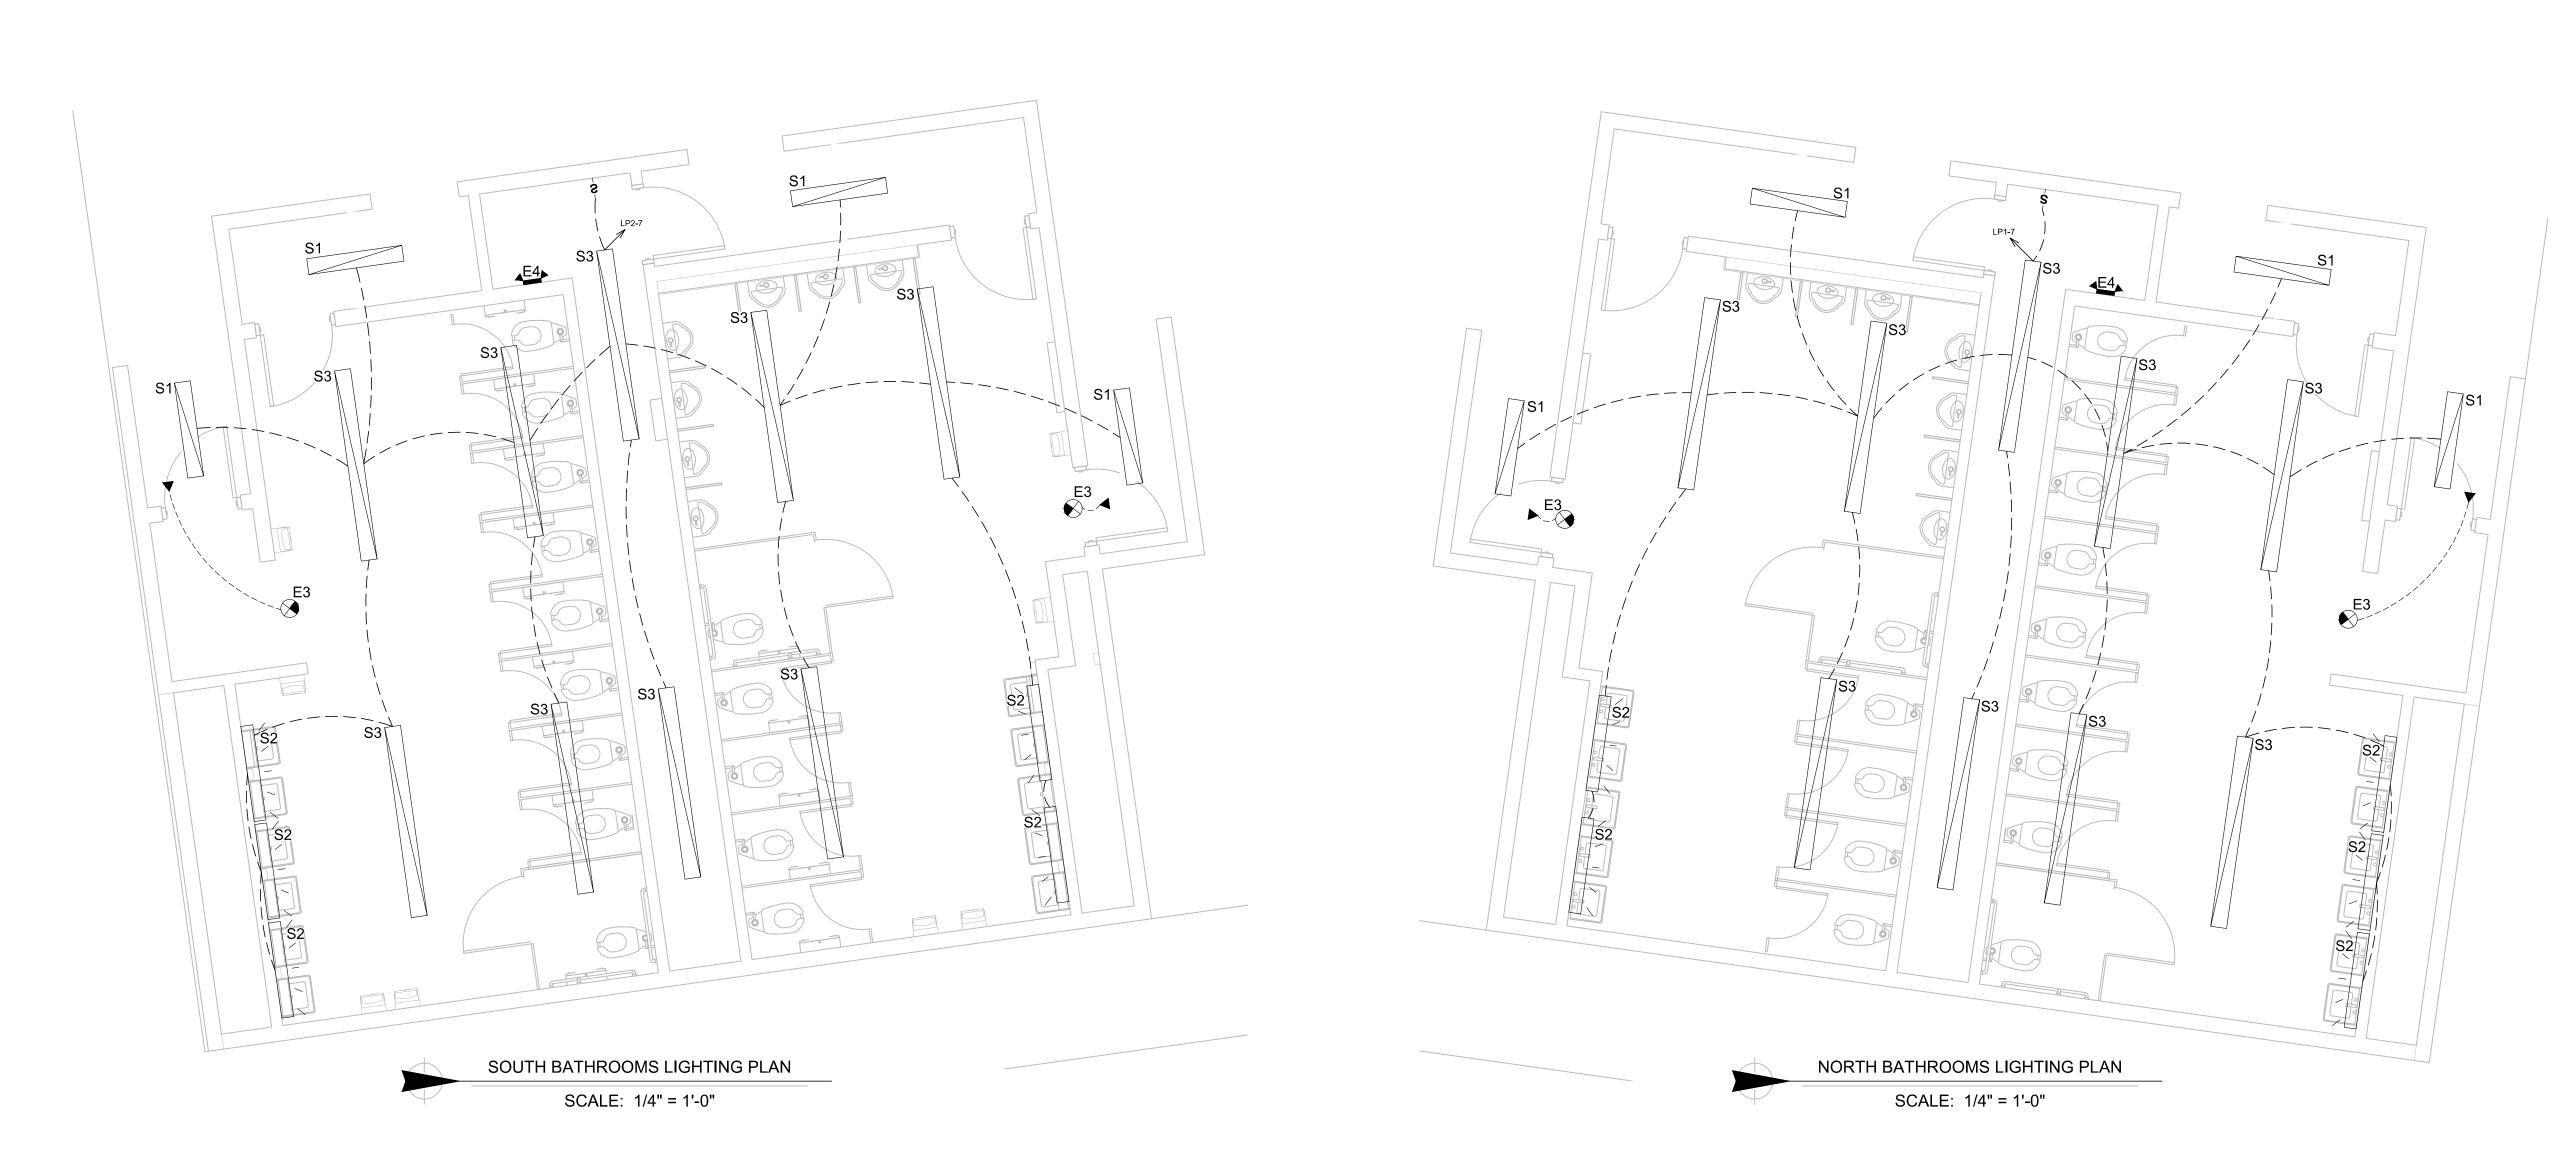

STATE OF MISSOURI MICHAEL L. PARSON, GOVERNOR



Keaton E. Leisinger, P.E. PE-2021035875



1806 West Broadway Boulevard Sedalia, MO 65301 660.829.9751



J-SQUARED ENGINEERING 2400 BLUFF CREEK DR. STE. 101 COLUMBIA, MO 65203 573.234.4492

CROCKETT

ENGINEERING CONSULTANTS
1000 W. Nifong Blvd., Bldg. 1.
Columbia, Missouri 65202
(573) 447-0292
www.crockettengineering.com
Crockett Engineering Consultants, LLC
Missouri Certificate of Authority
#2000151304

OFFICE OF ADMINISTRATION DIVISION OF FACILITIES MANAGEMENT DESIGN AND CONSTRUCTION

UPGRADE ELECTRICAL AND RESTROOMS, GRANDSTAND

MISSOURI STATE FAIRGROUNDS 2503 W. 16TH ST. SEDALIA, MO 65301

PROJECT # T2304-01 SITE # 1501 ASSET # 3511501018 REVISION:

DATE:

REVISION:

DATE: REVISION:

DATE:

ISSUE DATE: 11/29/2023

BID DOCUMENTS

CAD DWG FILE:
DRAWN BY: RXM
CHECKED BY: JAP
DESIGNED BY: KEL

SHEET TITLE:

ENLARGED LIGHTING PLANS (PHASE 1)

SHEET NUMBER:

E-106


SHEET 25 OF 30 11/29/2023


POWER RISER GENERAL NOTES:

- 1. CONTRACTOR IS RESPONSIBLE FOR ANY CONDUIT & CONDUCTOR MODIFICATIONS & EXTENSIONS
- NECESSARY FOR A FULLY FUNCTIONAL ELECTRIC SYSTEM.
- 2. CONTRACTOR SHALL INCLUDE IN BID 1,000 FT OF #12 THHN, #10 THHN, AND #8 THHN.
- 3. CONTRACTOR SHALL ALSO INCLUDE IN BID 100 FT OF $\frac{3}{4}$ " AND 1" CONDUIT.
- 4. CONTRACTOR SHALL PROVIDE UNIT PRICE PER FOOT FOR #12 THHN, #10 THHN, AND #8 THHN IN $\frac{3}{4}$ " OR 1" CONDUIT.


POWER RISER KEY NOTES:

- (1) EXISTING CONDUIT & CONDUCTORS TO REMAIN.
- (2) (2) 4" CONDUITS, EACH WITH (4) #350 CU & (1) #1 CU GRD.
- (3) 4" CONDUITS WITH (4) #500 CU & (1) #3 CU GRD.
- 4) 2 ½" CONDUITS WITH (4) #3/O CU & (1) #6 CU GRD.
- (5) (4) 4" CONDUITS WITH (4) #350 CU & (1) #3/O CU GRD.
- 6) (2) 4" CONDUITS WITH (4) #500 CU & (1) #2/O CU GRD.
- 7 PRIMARY CONDUCTORS SHALL MEET THE FOLLOWING SPECIFICATIONS. 3/0 URD CABLE, CLASS B STRAND, WITH A WATER BLOCKING STRAND FILLER TO SEAL AND FILL THE SPACE BETWEEN THE STRANDS, TO HAVE AN EXTENDED THERMO SETTING SEMI CONDUCTING CONDUCTOR SHIELD WHICH IS FREE STRIPPING FROM THE CONDUCTOR AND BONDED TO THE INSULATION, 220 MIL TREE RETARDANT UCC4202 OR BOREALIS 4212 INSULATION, EXTRUDED THERMOSETTING SEMI CONDUCTING INSULATION WITH CONTROLLED ADHESION TO THE INSULATION HAVING A REDUCED CONCENTRIC NEUTRAL OF 11-14AWG. BARE COPPER NEUTRAL WIRES & OVERALL ENCAPSULATING JACKET OF LINEAR LOW DENSITY POLYETHYLENE EXTRUDED TO FILL IN THE SPACE BETWEEN NEUTRAL WIRES, JACKET MUST BE FREE STRIPPING FROM THE UNDERLYING INSULATION SHIELD. CABLE TO BE TANDEM EXTRUDED & DRY CURED. CABLE TO BE CONSTRUCTED PER ICEA S-94-649, ICEA S-97-682 AND AEIC CS8.
- (8) FORMERLY POWER FOR HANGING ANNOUNCER BOOTH PANEL.
- (9) REPLACE EXISTING DISCONNECT WITH NEW 600A, 120/208Y, 3Ø, NEMA 3R, DOUBLE THROW DISCONNECT FOR STAND BY GENERATOR CONNECTION.
- 10 REPLACE EXISTING DISCONNECT WITH NEW 800A, 120/208Y, 3Ø, NEMA 3R, DOUBLE THROW DISCONNECT FOR STANDBY GENERATOR CONNECTION.

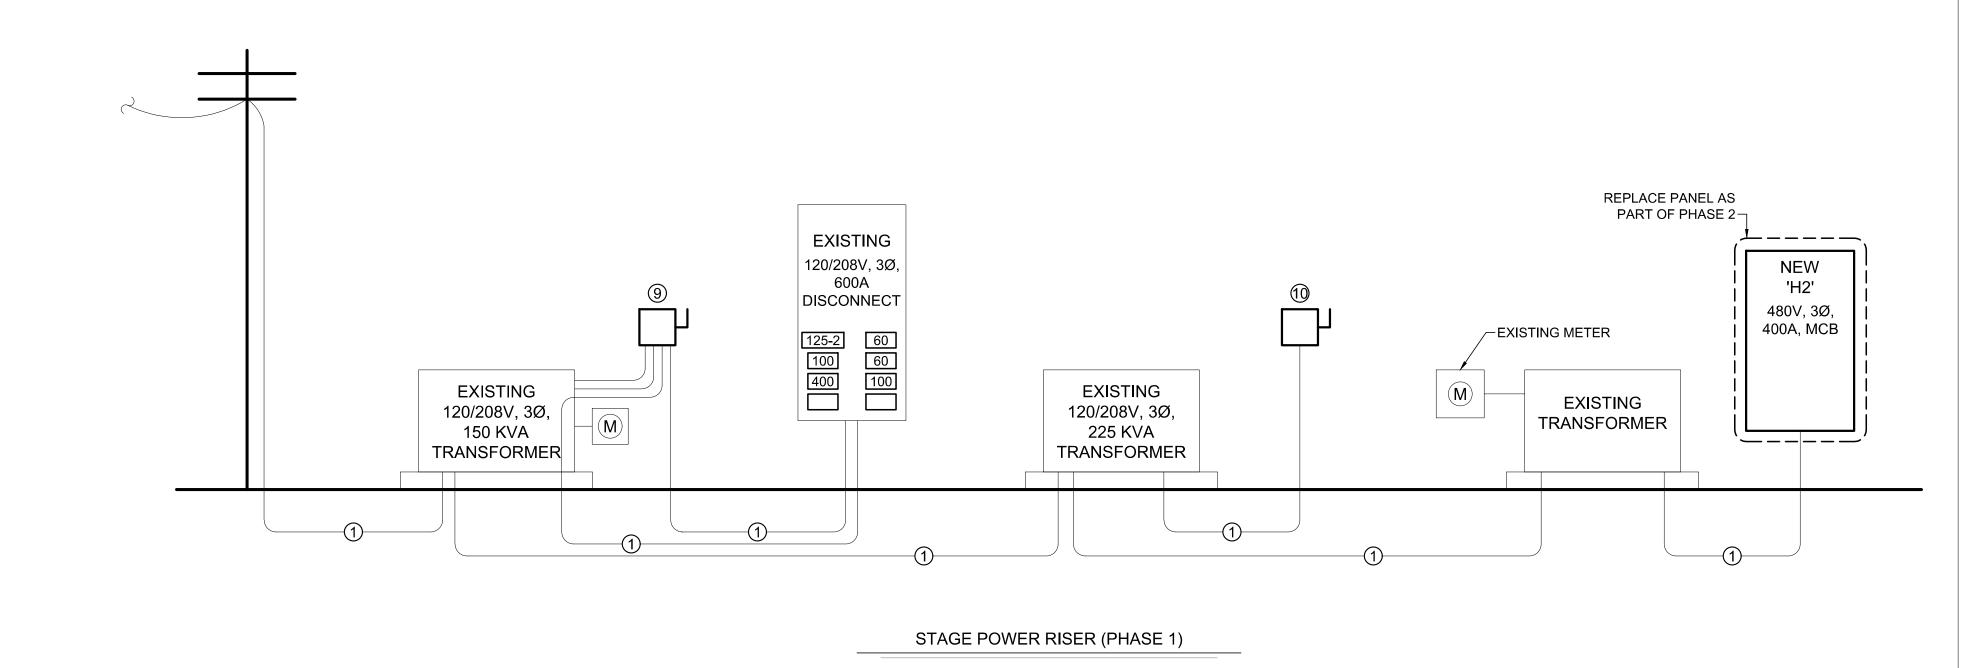

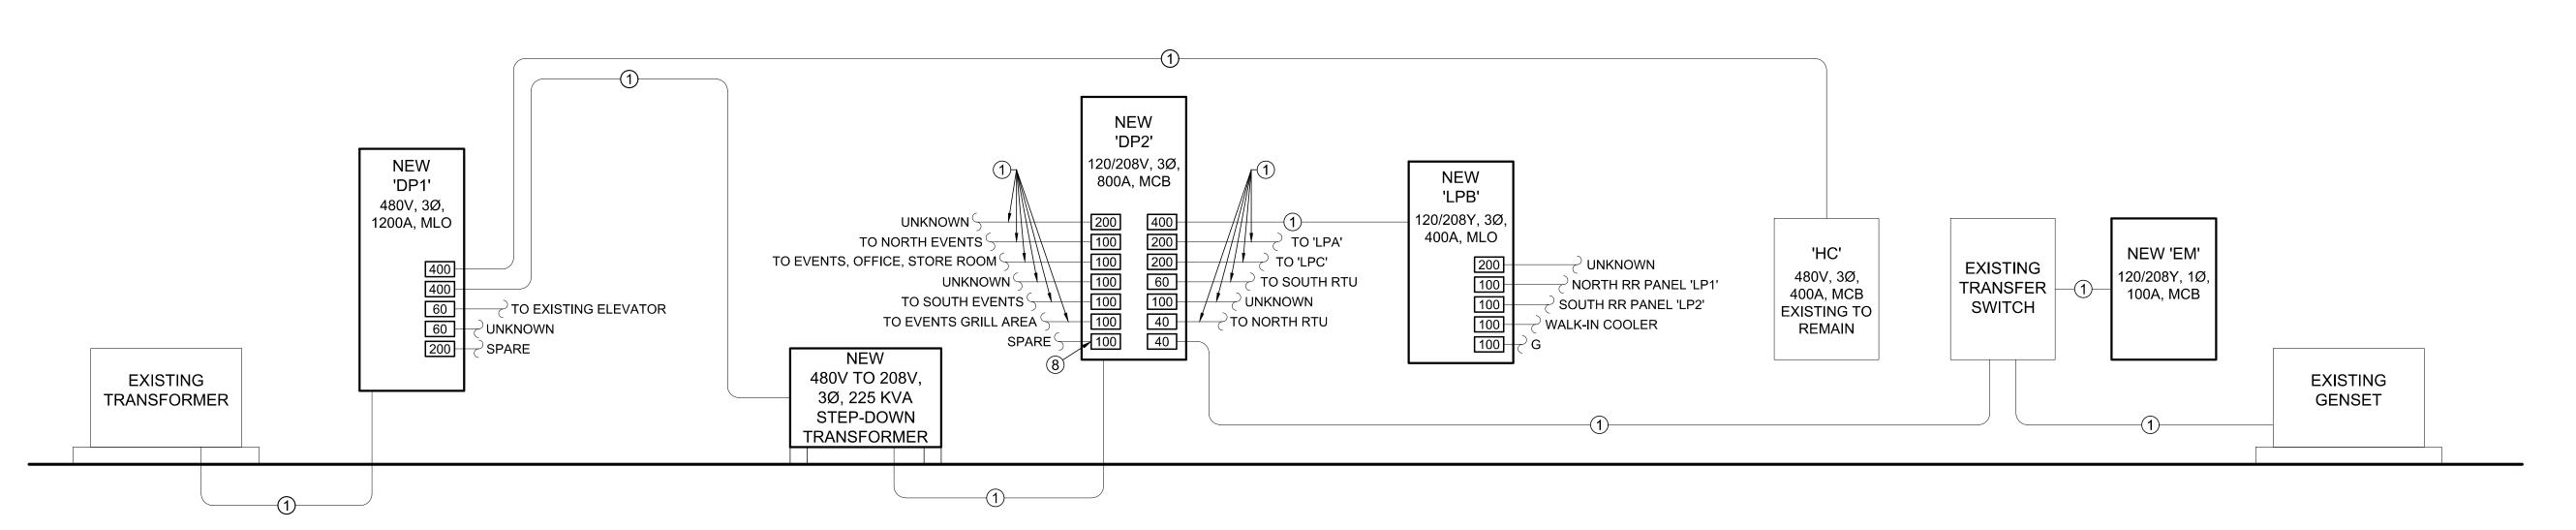

GRANDSTAND POWER RISER (PHASE 2)

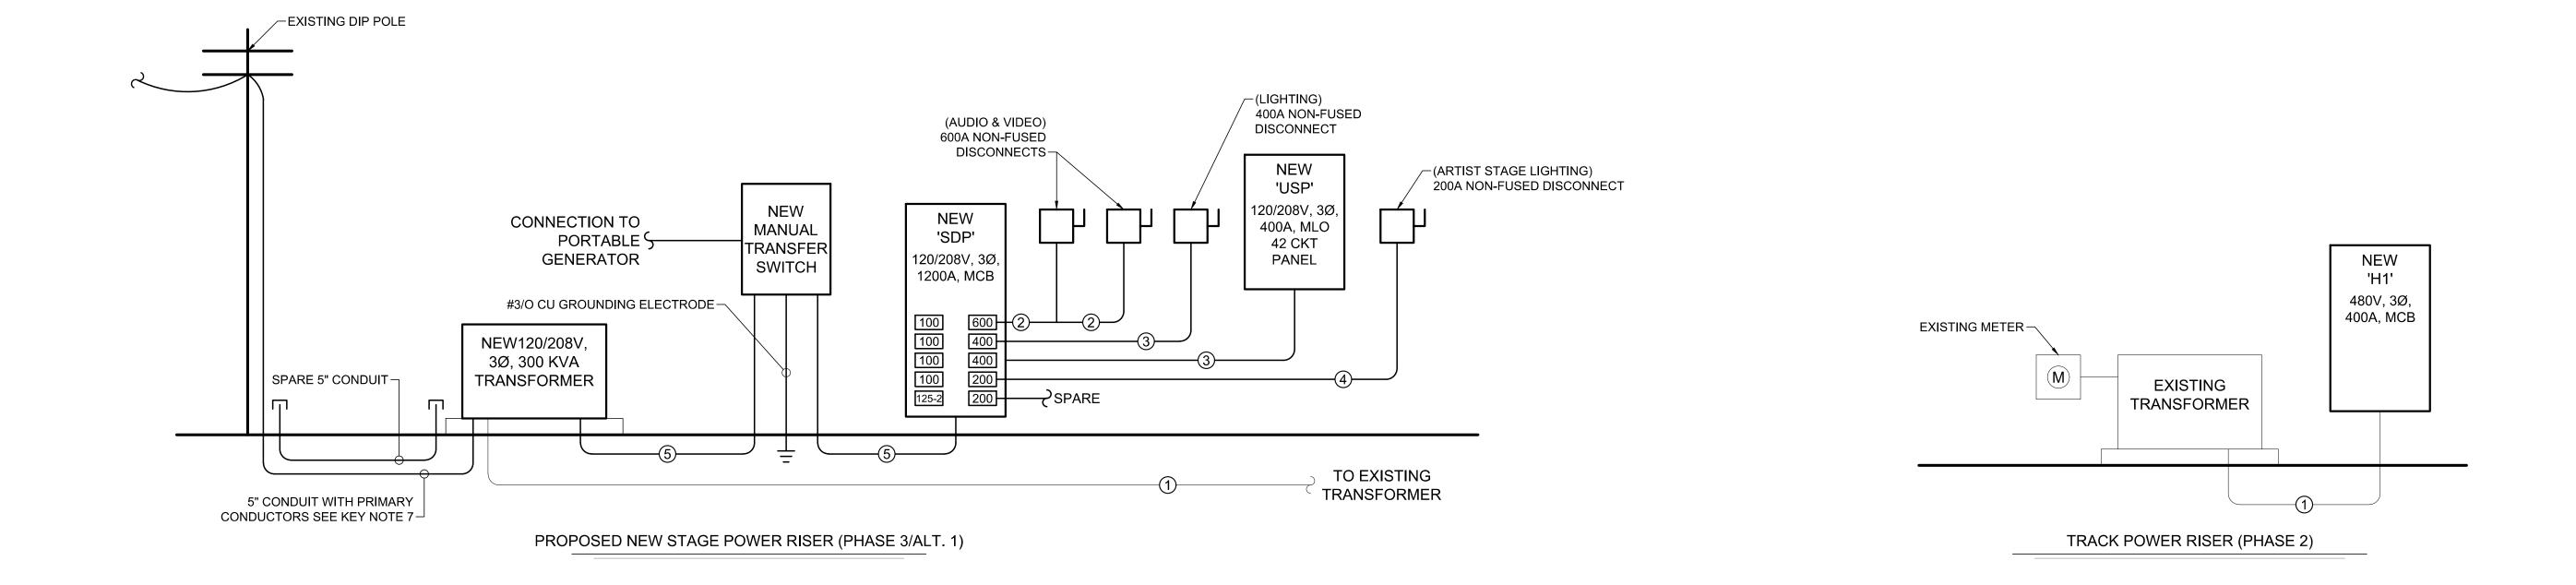

STATE OF MISSOURI MICHAEL L. PARSON, GOVERNOR



Keaton E. Leisinger, P.E. PE-2021035875



1806 West Broadway Boulevard Sedalia, MO 65301 660.829.9751



J-SQUARED ENGINEERING 2400 BLUFF CREEK DR. STE. 101 COLUMBIA, MO 65203 573.234.4492

CROCKETT

ENGINEERING CONSULTANTS
1000 W. Nifong Blvd., Bldg. 1.
Columbia, Missouri 65202
(573) 447-0292
www.crockettengineering.com
Crockett Engineering Consultants, LLC
Missouri Certificate of Authority
#2000151304

OFFICE OF ADMINISTRATION DIVISION OF FACILITIES MANAGEMENT DESIGN AND CONSTRUCTION

UPGRADE ELECTRICAL AND RESTROOMS, GRANDSTAND MISSOURI STATE FAIRGROUNDS

PROJECT # T2304-01
SITE # 1501
ASSET # 3511501018

2503 W. 16TH ST. SEDALIA, MO 65301

REVISION:____ DATE:____

REVISION:

DATE: ______

DATE:

ISSUE DATE: 11/29/2023

BID DOCUMENTS

CAD DWG FILE:
DRAWN BY: RXM
CHECKED BY: JAP
DESIGNED BY: KEL

SHEET TITLE:

ELECTRICAL DETAILS

SHEET NUMBER:

E-50


SHEET 26 OF 30 11/29/2023

			LIGHT FIXTURE SO	CHEDULE						
TAG	MANUFACTURER (OR EQUAL)	MODEL NUMBER (OR EQUAL)	DESCRIPTION	MOUNTING	LUMEN OUTPUT	сст (°К)	CRI	VOLTS	WATTS	NOTES
C1	LUMARK	RPGC25S-POSITION 0	EXTERIOR LED AREA LIGHT	SURFACE	7800	4000	70	120	63	1
E1	LUMARK	NFFLD-S-C15-UNV-66-KNC-CB	LED FLOODLIGHT	KNUCKLE MOUNT	5700	4000	70	120	51	1
E2	LUMARK	NFFLD-S-C15-UNV-66-KNC-WH	LED FLOODLIGHT	KNUCKLE MOUNT	5700	4000	70	120	51	1
E3	MULE	CWL-1-R-WH WITH R-ASRLED-2-WP	EXTERIOR EXIT LIGHT WITH HEADS WITH EXTERIOR REMOTE HEAD	WALL / CEILING	-	-	-	UNV	5	1,2
E4	RPLIGHTING	REL20	EXTERIOR EGRESS LIGHT	WALL	-	-	-	UNV	1	1
F1	LUMARK	NFFLD-S-C15-UNV-66-KNC-WH	LED FLOODLIGHT	KNUCKLE MOUNT	5700	4000	70	120	51	1
F2	LUMARK	NFFLD-S-C15-UNV-66-T-WH	LED FLOODLIGHT	SEE NOTES	5700	4000	70	120	51	1,3
R1	LUMARK	RPGC25S-POSITION 1	EXTERIOR LED AREA LIGHT	SURFACE	7800	4000	70	120	50	1
S1	FAIL-SAFE	4APVTLD-SL3C3	4' VAPOR TIGHT LED STRIP	SURFACE	5900	3500	80	120	46	1
S2	FAIL-SAFE	4APVTLD-SL3C3	4' VAPOR TIGHT LED STRIP	WALL ABOVE MIRROR	5900	3500	80	120	46	1
S3	FAIL-SAFE	8APVTLD-SL3C3	8' VAPOR TIGHT LED STRIP	SURFACE	8700	3500	80	120	60	1
S4	METALUX	2SNX-SL3-UNV-L835-CD1-U	2' LED STRIP LIGHT	SURFACE	2000	3500	80	120	14	1,4
SC1	HALO	CTKRV2B-SR-CARETAKER	EXTERIOR LED AREA LIGHT	SURFACE	7000	4000	70	120	50	1
W1	LUMARK	XTOR1B-W	EXTERIOR LED WALL PACK	WALL	1400	4000	70	120	12	1


- 1. VERIFY LIGHT FIXTURE FINISHES WITH OWNER / ARCHITECT PRIOR TO INSTALLATION
- 3. CONTRACTOR TO PROVIDE CUSTOM FABRICATED BOX WITH F2 FIXTURE MOUNTED ON IT. SEE FIXTURE F2 DETAIL.
- 4. SELECTABLE LIGHT FIXTURE. CONTRACTOR TO SET FIXTURE TO VALUES REFLECTED ON THE LIGHTING SCHEDULE.

UTILITY ROOM NORTH WALL ELEVATION KEY NOTES:

- (1) RELOCATED EXISTING LIGHTING CONTACTOR
- (2) NEW LIGHTING CONTACTOR TO CONTROL CIRCUITS LPC-9, LPC-11. LPC-13.
- (3) NEW OR RELOCATED LIGHTING CONTACTOR CONTROL SWITCHES. PERMANENTLY LABEL SWITCH WITH AREA WHERE LIGHTS ARE LOCATED.
- (4) RELOCATED EMERGENCY LIGHT SWITCH.
- (5) EXISTING UTILITY ROOM LIGHT SWITCH.

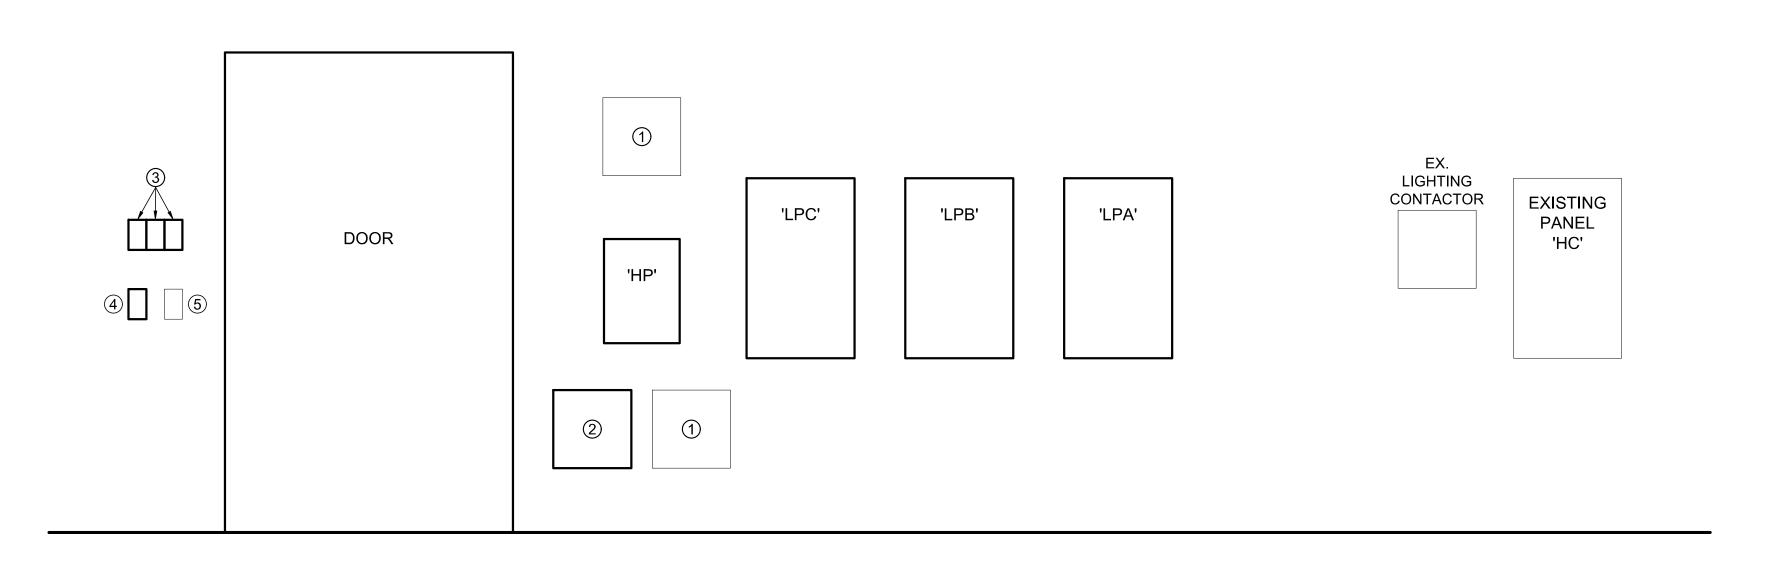

UTILITY ROOM NORTH WALL ELEVATION

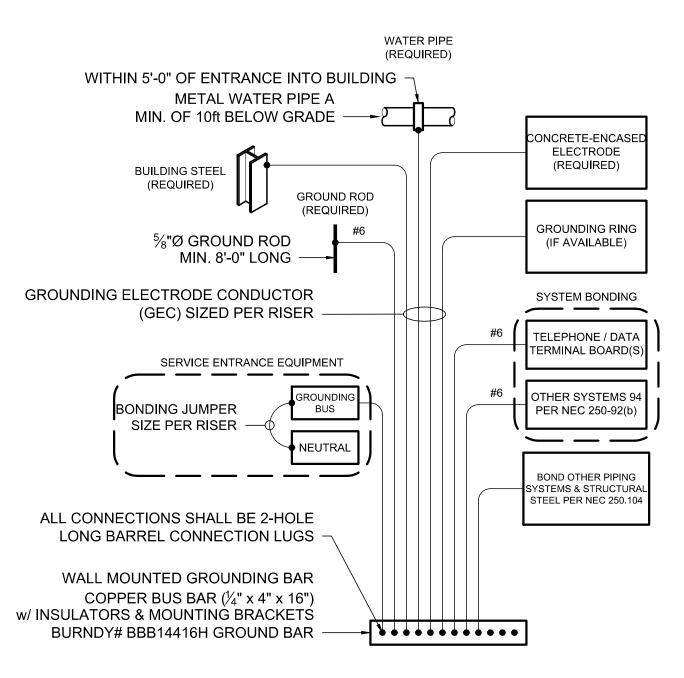

TYPICAL GROUNDING & BONDING DETAIL

STATE OF MISSOURI MICHAEL L. PARSON, **GOVERNOR**



Keaton E. Leisinger, P.E. PE-2021035875



1806 West Broadway Boulevard Sedalia, MO 65301 660.829.9751



J-SQUARED ENGINEERING 2400 BLUFF CREEK DR. STE. 101 COLUMBIA, MO 65203 573.234.4492

ENGINEERING CONSULTANTS 1000 W. Nifong Blvd., Bldg. 1. Columbia, Missouri 65202 www.crockettengineering.com Crockett Engineering Consultants, LLC Missouri Certificate of Authority #2000151304

OFFICE OF ADMINISTRATION DIVISION OF FACILITIES MANAGEMENT DESIGN AND CONSTRUCTION

UPGRADE ELECTRICAL AND RESTROOMS, GRANDSTAND

MISSOURI STATE **FAIRGROUNDS** 2503 W. 16TH ST. SEDALIA, MO 65301

PROJECT # T2304-01

SITE # 1501
ASSET # 3511501018
REVISION:
DATE:
REVISION:
DATE:
REVISION:

ISSUE DATE: 11/29/2023

DATE:

BID DOCUMENTS CAD DWG FILE:
DRAWN BY: RXM
CHECKED BY: JAP
DESIGNED BY: KEL

SHEET TITLE:

ELECTRICAL DETAILS

SHEET NUMBER:

SHEET 27 OF 30 11/29/2023

	VOLTAGE	PANEL SIZE		MOUNTING		AIC RATING		
	120/208						PHASE "A" LOAD	0
NEMA RATING: 3R		100A I	MLO	SURFACE		10,000	PHASE "B" LOAD	0
]				PHASE "C" LOAD	0
CIRCUIT NUMBER	DESCRIPTION	BREAKER SIZE	AMPS	PHASE	AMPS	BREAKER SIZE	DESCRIPTION	CIRCUI [*] NUMBEI
1	FIRST FLOOR / RECEPTS	20-1		Α		30-1	RACE TRACK SIGNAL LIGHTS	2
3	FIRST FLOOR / RECEPTS	20-1		В		20-1	RESTROOM LIGHTS	4
5	FIRST & SECOND FLOOR / LIGHTS	20-1		С		30-1	ICE MACHINE	6
7	SECOND FLOOR / RECEPTS	20-1		Α		30-1	30 AMP PLUG	8
9	SECOND FLOOR / RECEPTS	20-1		В		30-1	LIGHT NORTH SIDE ALLEYWAY	10
11	FLAG LIGHT	20-1		С		30-1	OUTSIDE RECEPTS UNDER STEPS	12
13	VIDEO	70-2		Α		30-2	SEWER PUMP	14
15	-	-		В		-	-	16
17	SPARE	20-1		С		20-1	SPARE	18
19	SPARE	20-1		Α		20-1	SPARE	20
21	SPARE	20-1		В		20-1	SPARE	22
23	SPARE	20-1		С		20-1	SPARE	24
25	SPARE	20-1		Α		20-1	SPARE	26
27	SPARE	20-1		В		20-1	SPARE	28
29	SPARE	20-1		С		20-1	SPARE	30

A: PANEL SHALL BE EQUAL TO SQUARE D MODEL "QO". ITALLICS INDICATE EXISTING CIRCUIT TO BE RECONNECTED TO NEW PANEL.

- B: ELECTRICIAN SHALL VERIFY BREAKER WITH EQUIPMENT PRIOR TO PURCHASE & INSTALL.
- C: A FTER COMPLETION OF WORK, ELECTRICAN SHALL PROVIDE A TYPE WRITTEN PANEL DIRECTORY IN NEW PANEL.

	PANEL 'EM' SCHEDULE											
	VOLTAGE	PANEL	SIZE	MOU	NTING	AIC RATING						
120/208							PHASE "A" LOAD	0				
		100A	МСВ	SURF	SURFACE		PHASE "B" LOAD	0				
	NEMA RATING: 3R					PHASE "C" LOAD	0					
CIRCUIT NUMBER	DESCRIPTION	BREAKER SIZE	AMPS	PHASE	AMPS	BREAKER SIZE	DESCRIPTION	CIRCUIT NUMBER				
1	UNKNOWN	20-1		Α		20-1	UNKNOWN	2				
3	UNKNOWN	20-1		В		20-1	UNKNOWN	4				
5	UNKNOWN	20-1		С		20-1	UNKNOWN	6				
7	UNKNOWN	20-1		Α		20-1	UNKNOWN	8				
9	UNKNOWN	20-1		В		20-1	UNKNOWN	10				
11	UNKNOWN	20-1		С		20-1	UNKNOWN	12				
13	UNKNOWN	20-1		Α		20-1	UNKNOWN	14				
15	UNKNOWN	20-1		В		20-1	PNC RM LIGHTS	16				
17	UNKNOWN	20-1		С		20-1	UNKNOWN	18				

- A: PANEL SHALL BE EQUAL TO SQUARE D MODEL "QO". ITALLICS INDICATE EXISTING CIRCUIT TO BE RECONNECTED TO NEW PANEL.
- B: ELECTRICIAN SHALL VERIFY BREAKER WITH EQUIPMENT PRIOR TO PURCHASE & INSTALL.
- C: A FTER COMPLETION OF WORK, ELECTRICAN SHALL PROVIDE A TYPE WRITTEN PANEL DIRECTORY IN NEW PANEL.

	PANEL 'H1' SCHEDULE											
VOLTAGE	PANEL SIZE		MOU	NTING	AIC RATING							
277/480	400A MLO SURFACE				PHASE "A" LOAD	120						
2777400			14,000	PHASE "B" LOAD	120							
NEMA RATING: 3R		1				PHASE "C" LOAD	120					
DESCRIPTION	BREAKER SIZE	AMPS	PHASE	AMPS	BREAKER SIZE	DESCRIPTION						
EXISTING TRACK POLE LIGHTS	125-3	75	Α	45	60-3	EXISTING TRACK POLE LIGHTS						
-	-	75	В	45	-	-						
-	-	75	С	45	-	-						
BLANK			Α			BLANK						
BLANK			В			BLANK						
BLANK			С			BLANK						
BLANK			Α			BLANK						
BLANK			В			BLANK						
BLANK			С			BLANK						

- A: PANEL SHALL BE EQUAL TO SQUARE D "I-LINE" SERIES FOR 208V / "NF" SERIES FOR 480V. ITALLICS INDICATE EXISTING CIRCUIT TO BE RECONNECTED TO NEW PANEL.
- ELECTRICIAN SHALL VERIFY BREAKER WITH EQUIPMENT PRIOR TO PURCHASE & INSTALL.
- C: AFTER COMPLETION OF WORK, ELECTRICAN SHALL PROVIDE A TYPE WRITTEN PANEL DIRECTORY IN NEW PANEL.

PANEL 'H2' SCHEDULE										
VOLTAGE	PANEL SIZE		MOU	NTING	AIC RATING					
277/480	400A MLO SURFACE 14,				PHASE "A" LOAD	101				
2111400			14,000	PHASE "B" LOAD	101					
NEMA RATING: 3R					PHASE "C" LOAD	101				
DESCRIPTION	BREAKER SIZE	AMPS	PHASE	AMPS	BREAKER SIZE	DESCRIPTION				
EXISTING TRACK POLE LIGHTS	125-3	71	Α	30	50-3	EXISTING TRACK POLE LIGHTS				
-	-	71	В	30	-	-				
-	-	71	С	30	-	-				
BLANK			Α			BLANK				
BLANK			В			BLANK				
BLANK			С			BLANK				
BLANK			Α			BLANK				
BLANK			В			BLANK				
BLANK			С			BLANK				

- A: PANEL SHALL BE EQUAL TO SQUARE D "I-LINE" SERIES FOR 208V / "NF" SERIES FOR 480V. ITALLICS INDICATE EXISTING CIRCUIT TO BE RECONNECTED TO NEW PANEL.
- B: ELECTRICIAN SHALL VERIFY BREAKER WITH EQUIPMENT PRIOR TO PURCHASE & INSTALL.
- C: AFTER COMPLETION OF WORK, ELECTRICAN SHALL PROVIDE A TYPE WRITTEN PANEL DIRECTORY IN NEW PANEL.

	VOLTAGE	PANEL SIZE		MOUNTING		AIC RATING	PHASE "A" LOAD	
	400/000						PHASE "A" LOAD	200
	120/208		400A MLO		FACE	10,000	PHASE "B" LOAD	200
	NEMA RATING: 3R						PHASE "C" LOAD	200
CIRCUIT NUMBER	DESCRIPTION	BREAKER SIZE	AMPS	PHASE	AMPS	BREAKER SIZE	DESCRIPTION	CIRCU NUMBI
1	EXISTING WATER HEATER	30-2	20	А		30-2	UNKNOWN	2
3	-	-	20	В		-	-	4
5	EXISTING AIR CONDITIONER	30-2	20	С		20-1	UNKNOWN	6
7	-	-	20	Α		20-1	UNKNOWN	8
9	EXISTING AIR CONDITIONER	30-2	20	В		20-1	UNKNOWN	10
11	-	-	20	С		30-1	UNKNOWN	12
13	LOUNGE AREA / LIGHTS & RECEPTS.	20-1		Α		20-1	UNKNOWN	14
15	LOUNGE AREA / LIGHTS & RECEPTS.	30-1		В		20-1	UNKNOWN	16
17	UTILITY ROOM/LIGHTS & RECEPTS.	20-1		С		30-1	UNKNOWN	18
19	KITCHEN / RECEPTS.	20-1		Α		20-1	PUMP NORTH EAST	20
21	EAST WALL / RECEPTS	20-1		В		20-1	UNKNOWN	22
23	KITCHEN / RECEPTS.	20-1		С	40	50-2	BUS PLUG	24
25	KITCHEN / RECEPTS.	20-1		А	40	-	-	26
27	UKNOWN	20-2		В	40	50-2	BUS PLUG	28
29	-	-		С	40	-	-	30
31	BUS PLUG	50-2	40	А	40	50-2	BUS PLUG	32
33	-	-	40	В	40	-	-	34
35	SPARE	20-1		С	40	50-2	BUS PLUG	36
37	SPARE	20-1		А	40	-	-	38
39	SPARE	20-1		В	40	50-2	BUS PLUG	40
41	SPARE	20-1		С	40	-	-	42

- A: PANEL SHALL BE EQUAL TO SQUARE D MODEL "QO". ITALLICS INDICATE EXISTING CIRCUIT TO BE RECONNECTED TO NEW PANEL.
- B: ELECTRICIAN SHALL VERIFY BREAKER WITH EQUIPMENT PRIOR TO PURCHASE & INSTALL.
- C: AFTER COMPLETION OF WORK, ELECTRICAN SHALL PROVIDE A TYPE WRITTEN PANEL DIRECTORY IN NEW PANEL.

		PA	NEL 'L	.P1' S0	CHEDU	JLE		
	VOLTAGE	PANEL	SIZE	MOU	NTING	AIC RATING		
	120/208						PHASE "A" LOAD	22
	NEMA RATING: 3R		MLO	SURF	FACE	10,000	PHASE "B" LOAD	14
]				PHASE "C" LOAD	12.5
CIRCUIT NUMBER	DESCRIPTION	BREAKER SIZE	AMPS	PHASE	AMPS	BREAKER SIZE	DESCRIPTION	CIRCUIT NUMBER
1	WOMENS / GFCI RECEPTS	20-1	3	Α		100-2	NORTH COOLER	2
3	MENS / GFCI RECEPTS	20-1	3	В		-	-	4
5	MECH ROOM / RECEPT	20-1	1.5	С		60-3	NORTH CENTRAL COOLER	6
7	LIGHTING	20-1	8	Α		-	-	8
9	RESTROOM FAN	20-3	11	В		-	~	10
11	-	-	11	С		20-1	SPARE	12
13	-	-	11	Α		20-1	SPARE	14
15	SPARE	20-1		В		20-1	SPARE	16
17	SPARE	20-1		С		20-1	SPARE	18
19	SPARE	20-1		Α		20-1	SPARE	20
21	SPARE	20-1		В		20-1	SPARE	22
23	SPARE	20-1		С		20-1	SPARE	24

- A: PANEL SHALL BE EQUAL TO SQUARE D MODEL "QO". ITALLICS INDICATE EXISTING CIRCUIT TO BE RECONNECTED TO NEW PANEL.
- B: ELECTRICIAN SHALL VERIFY BREAKER WITH EQUIPMENT PRIOR TO PURCHASE & INSTALL.
- C: AFTER COMPLETION OF WORK, ELECTRICAN SHALL PROVIDE A TYPE WRITTEN PANEL DIRECTORY IN NEW PANEL.

		PA	NEL 'L	.P2' S0	CHEDU	JLE		
	VOLTAGE	PANEL	PANEL SIZE		MOUNTING			
	120/208						PHASE "A" LOAD	22
	120/208	100A	MLO	SURF	FACE	10,000	PHASE "B" LOAD	14
	NEMA RATING: 3R		1				PHASE "C" LOAD	12.5
CIRCUIT NUMBER	DESCRIPTION	BREAKER SIZE	AMPS	PHASE	AMPS	BREAKER SIZE	DESCRIPTION	CIRCUIT NUMBER
1	WOMENS / GFCI RECEPTS	20-1	3	Α		100-3	SOUTH WEST COOLER	2
3	MENS / GFCI RECEPTS	20-1	3	В		-	-	4
5	MECH ROOM / RECEPT	20-1	1.5	С		60-2	COOLER	6
7	LIGHTING	20-1	8	Α		-	-	8
9	RESTROOM FAN	20-3	11	В		20-1	SPARE	10
11	-	-	11	С		20-1	SPARE	12
13	-	-	11	Α		20-1	SPARE	14
15	SPARE	20-1		В		20-1	SPARE	16
17	SPARE	20-1		С		20-1	SPARE	18
19	SPARE	20-1		Α		20-1	SPARE	20
21	SPARE	20-1		В		20-1	SPARE	22
23	SPARE	20-1		С		20-1	SPARE	24

- A: PANEL SHALL BE EQUAL TO SQUARE D MODEL "QO". ITALLICS INDICATE EXISTING CIRCUIT TO BE RECONNECTED TO NEW PANEL.
- B: ELECTRICIAN SHALL VERIFY BREAKER WITH EQUIPMENT PRIOR TO PURCHASE & INSTALL.
- C: AFTER COMPLETION OF WORK, ELECTRICAN SHALL PROVIDE A TYPE WRITTEN PANEL DIRECTORY IN NEW PANEL.


STATE OF MISSOURI MICHAEL L. PARSON, **GOVERNOR**



Keaton E. Leisinger, P.E. PE-2021035875 MO Certificate of Authority # 2018029680



1806 West Broadway Boulevard Sedalia, MO 65301 660.829.9751

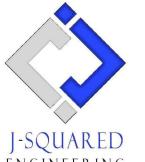

ENGINEERING 2400 BLUFF CREEK DR. STE. 101 COLUMBIA, MO 65203 573.234.4492

ENGINEERING CONSULTANTS 1000 W. Nifong Blvd., Bldg. 1. Columbia, Missouri 65202 (573) 447-0292 www.crockettengineering.com Crockett Engineering Consultants, LLC Missouri Certificate of Authority #2000151304

OFFICE OF ADMINISTRATION DIVISION OF FACILITIES MANAGEMENT DESIGN AND CONSTRUCTION

UPGRADE ELECTRICAL AND RESTROOMS, GRANDSTAND

MISSOURI STATE **FAIRGROUNDS** 2503 W. 16TH ST. SEDALIA, MO 65301

PROJECT # T2304-01 SITE # 1501 ASSET # 3511501018

REVISION: DATE:

REVISION: DATE:

REVISION: DATE:

ISSUE DATE: 11/29/2023

BID DOCUMENTS

CAD DWG FILE:
DRAWN BY: RXM
CHECKED BY: JAP
DESIGNED BY: KEL

SHEET TITLE:

ELECTRICAL SCHEDULES

SHEET NUMBER:

SHEET 28 OF 30 11/29/2023

VOLTAGE	PANEL	PANEL SIZE MOUNTING AI		AIC RATING		
120/208						PHASE "A" LOAD
	A008	MCB	SUR	-ACE	22,000	PHASE "B" LOAD
NEMA RATING: 3R						PHASE "C" LOAD
DESCRIPTION	BREAKER SIZE	AMPS	PHASE	AMPS	BREAKER SIZE	DESCRIPTION
UNKNOWN CONNECTION	200-3		Α		200-3	PANEL 'LPA'
-	-		В		-	-
-	-		С		-	-
NORTH CONCESSIONS PANEL	100-3		Α		200-3 <i>PANEL</i>	PANEL 'LPC'
-	-		В		-	-
-	-		С		-	-
NORTH CENTER CONCESSIONS PANEL	100-3		Α		400-3	PANEL 'LPB'
-	-		В		-	<u>-</u>
-	-		С		-	-
PHOTO FINISH PANEL	100-3		A		100-3	UNKNOWN CONNECTION
-	-		В		-	<u>-</u>
-	-		С		-	
SOUTH CONCESSIONS PANEL	100-3		A		60-3	SOUTH CONCESSION RTU
-	-		В		-	-
- COUTU CENTED CONCESSIONS	- 100.3		С		- 40.2	NORTH CONCESSION BY
SOUTH CENTER CONCESSIONS	100-3		A		40-3	NORTH CONCESSION RTU
-	-		B C		-	
- UNKNOWN CONNECTION	100-3		A		40-3	STARTER CONTROLLER CONNECTION
UNINDVIN CONNECTION	100-3		В		40-3	STARTER CONTROLLER CONNECTION

- A: PANEL SHALL BE EQUAL TO SQUARE D "I-LINE" SERIES FOR 208V / "NF" SERIES FOR 480V. ITALLICS INDICATE EXISTING CIRCUIT TO BE RECONNECTED TO NEW PANEL.
- B: ELECTRICIAN SHALL VERIFY BREAKER WITH EQUIPMENT PRIOR TO PURCHASE & INSTALL.
- C: A FTER COMPLETION OF WORK, ELECTRICAN SHALL PROVIDE A TYPE WRITTEN PANEL DIRECTORY IN NEW PANEL.

		PA	NEL 'L	PA' S	CHEDI	JLE		
	VOLTAGE	PANEL	PANEL SIZE		NTING	AIC RATING		
	120/208						PHASE "A" LOAD	7
	120/200	200A I	MLO	SURFACE		22,000	PHASE "B" LOAD	7
	NEMA RATING: 3R						PHASE "C" LOAD	7
CIRCUIT NUMBER	DESCRIPTION	BREAKER SIZE	AMPS	PHASE	AMPS	BREAKER SIZE	DESCRIPTION	CIRCUIT NUMBER
1	UNKNOWN CONNECTION	20-1		А		20-1	UNKNOWN CONNECTION	2
3	UNKNOWN CONNECTION	20-1		В		20-1	UNKNOWN CONNECTION	4
5	SPARE	20-1		С		20-1	UNKNOWN CONNECTION	6
7	SPARE	20-1		Α		20-1	UNKNOWN CONNECTION	8
9	SPARE	20-1		В		20-1	UNKNOWN CONNECTION	10
11	SPARE	20-1		С		20-1	UNKNOWN CONNECTION	12
13	SPARE	20-1		Α		20-1	UNKNOWN CONNECTION	14
15	SPARE	20-1		В		20-1	UNKNOWN CONNECTION	16
17	SPARE	20-1		С	7	20-3	EXHAUST FAN (EF-2)	18
19	SPARE	20-1		Α	7	-	-	20
21	SPARE	60-2		В	7	-	-	22
23	-	-		С		20-1	SPARE	24
25	UNKNOWN CONNECTION	50-1		Α		50-1	SPARE	26
27	UNKNOWN CONNECTION	50-1		В		100-2	SPARE	28
29	UNKNOWN CONNECTION	50-1		С		-	-	30
31	UNKNOWN CONNECTION	50-1		Α		100-2	UNKNOWN CONNECTION	32
33	UNKNOWN CONNECTION	50-1		В		-	-	34
35	UNKNOWN CONNECTION	50-1		С		50-1	UNKNOWN CONNECTION	36
37	UNKNOWN CONNECTION	50-1		Α		50-1	UNKNOWN CONNECTION	38
39	UNKNOWN CONNECTION	50-1		В		50-1	UNKNOWN CONNECTION	40
41	BLANK			С		50-1	UNKNOWN CONNECTION	42

- A: PANEL SHALL BE EQUAL TO SQUARE DIMODEL "QO". ITALLICS INDICATE EXISTING CIRCUIT TO BE RECONNECTED TO NEW PANEL.
- B: ELECTRICIAN SHALL VERIFY BREAKER WITH EQUIPMENT PRIOR TO PURCHASE & INSTALL.
- C: A FTER COMPLETION OF WORK, ELECTRICAN SHALL PROVIDE A TYPE WRITTEN PANEL DIRECTORY IN NEW PANEL.

		PA	NEL 'L	.PC' S	CHED	ULE		
	VOLTAGE	PANEL	SIZE	MOU	NTING	AIC RATING		
	120/208						PHASE "A" LOAD	0
	120/206	200A I	MLO	SURI	FACE	22,000	PHASE "B" LOAD	0
	NEMA RATING: 3R						PHASE "C" LOAD	0
CIRCUIT NUMBER	DESCRIPTION	BREAKER SIZE	AMPS	PHASE	AMPS	BREAKER SIZE	DESCRIPTION	CIRCUIT NUMBER
1	LIGHTING PANEL	100-2		Α		20-1	ROW 1	2
3	-	-		В		20-1	ROW 4	4
5	CONTACTOR POWER	20-1		С		20-1	ROW 5	6
7	HP SODIUM LIGHT	20-1		Α		20-1	ROW 2	8
9	CANOPY FLOOD LIGHTS	20-1		В		20-1	ROW 8	10
11	CANOPY FLOOD LIGHTS	20-1		С		20-1	ROW 6	12
13	CANOPY FLOOD LIGHTS	20-1		Α		20-1	ROW 7	14
15	FAN	20-1		В		20-1	ROW 3	16
17	CONTROL ROOM LIGHTS	20-1		С		20-1	ROW 9	18
19	SPARE	20-1		Α		20-1	ROW 10	20
21	SPARE	20-1		В		20-1	ROW 11	22
23	SPARE	20-1		С		20-1	ROW 12	24
25	SPARE	20-1		Α		20-1	BOX LIGHT (OFF)	26
27	SPARE	20-1		В		20-1	BOX LIGHT (OFF)	28
29	SPARE	20-1		С		20-1	BOX LIGHT (OFF)	30
31	SPARE	20-1		Α		20-1	SPARE	32
33	SPARE	20-1		В		20-1	BATTERY CHARGER	34
35	ELEVATOR LIGHT	20-1		С		20-1	BLOCK HEATER	36
37	SPARE	20-1		Α		20-1	SPARE	38
39	SPARE	20-1		В		20-1	SPARE	40
41	SPARE	20-1		С		20-1	SPARE	42

- A: PANEL SHALL BE EQUAL TO SQUARE D MODEL "QO". ITALLICS INDICATE EXISTING CIRCUIT TO BE RECONNECTED TO NEW PANEL.
- B: ELECTRICIAN SHALL VERIFY BREAKER WITH EQUIPMENT PRIOR TO PURCHASE & INSTALL.
- C: A FTER COMPLETION OF WORK, ELECTRICA'N SHALL PROVIDE A TYPE WRITTEN PANEL DIRECTORY IN NEW PANEL.

VOLTAGE	PANEL	SIZE	MOUN	MOUNTING				
277/480						PHASE "A" LOAD	С	
	1200A	MCB	SURF	FACE	14,000	PHASE "B" LOAD	C	
NEMA RATING: 3R						PHASE "C" LOAD	(
DESCRIPTION	BREAKER SIZE	AMPS	PHASE	AMPS	BREAKER SIZE	DESCRIPTION		
STEPDOWN TRANSFORMER TO PANEL 'DP2'	400-3		А		60-3	EXISTING ELEVATOR		
-	-		В		-	-		
-	-		C		-	-		
STEPDOWN TRANSFORMER TO FUSED DISCONNECT	400-3		Α		60-3	UNKNOWN CONNECTION		
-	-		В		-	-		
-	-		C		-	-		
EXISTING PANEL 'HC'	400-3		Α		200-3	SPARE		
-	-		В		-	-		
-	-		С		-	-		

A: PANEL SHALL BE EQUAL TO SQUARE D"I-LINE" SERIES FOR 208V / "NF" SERIES FOR 480V. ITALLICS INDICATE EXISTING CIRCUIT TO BE RECONNECTED TO NEW PANEL.

- B: ELECTRICIAN SHALL VERIFY BREAKER WITH EQUIPMENT PRIOR TO PURCHASE & INSTALL. C: AFTER COMPLETION OF WORK, ELECTRICAN SHALL PROVIDE A TYPE WRITTEN PANEL DIRECTORY IN NEW PANEL.

VOLTAGE	PANEL	SIZE	MOUNTING		AIC RATING	
120/208	1200A MCB BREAKER AMPS SIZE		SURFACE PHASE AMPS		22,000	PHASE "A" LOAD PHASE "B" LOAD
NEMA RATING: 3R					,	PHASE "C" LOAD
DESCRIPTION					BREAKER SIZE	DESCRIPTION
(2) NON-FUSED DISCONNECTS (NORTH & SOUTH)	600-3	350	А	200	400-3	UNDER STAGE PANEL 'USP'
-	-	350	В	200	-	-
-	-	350	С	200	-	-
STAGE LIGHTING / NON-FUSED DISCONNECT	400-3	250	Α		100-3	UKNOWN CONNECTION
-	-	250	В		-	-
-	-	250	С		-	-
UKNOWN CONNECTION	100-3		А		100-3	UKNOWN CONNECTION
-	-		В		-	-
-	-		С		-	-
UKNOWN CONNECTION	100-3		А	160	200-3	ARTIST STAGE LIGHTING DISCONNECT
-	-		В	160	-	-
-	-		С	160	-	-
UKNOWN CONNECTION	125-2		А		200-3	SPARE
-	-		В		-	-
- BLANK	-		С		-	<u>-</u>

- A: PAINEL SHALL BE EQUAL TO SQUARE D"I-LINE" SERIES FOR 208V / "NF" SERIES FOR 480V. ITALLICS INDICATE EXISTING CIRCUIT TO BE RECONNCETED TO NEW PAINEL.
- B: ELECTRICIAN SHALL VERIFY BREAKER WITH EQUIPMENT PRIOR TO PURCHASE & INSTALL.
- C: AFTER COMPLETION OF WORK, ELECTRICAN SHALL PROVIDE A TYPE WRITTEN PANEL DIRECTORY IN NEW PANEL.

		PA	NEL 'L	.PB' S	CHED	JLE		
	VOLTAGE	PANEL	SIZE	MOU	NTING	AIC RATING		
	420/200						PHASE "A" LOAD	0
	120/208		MLO	SURF	ACE	22,000	PHASE "B" LOAD	0
	NEMA RATING: 3R	7					PHASE "C" LOAD	0
CIRCUIT NUMBER	DESCRIPTION	BREAKER SIZE	AMPS	PHASE	AMPS	BREAKER SIZE	DESCRIPTION	CIRCUIT NUMBER
1	UNKNOWN	200-3		Α		100-3	SOUTH RESTROOM (LP2)	2
3	-	-		В		-	-	4
5	-	-		С		-	-	6
7	NORTH RESTROOM (LP1)	100-3		Α		100-3	BOOTH OR WALK-IN COOLER	8
9	-	-		В		-	-	10
11	-	-		С		-	-	12
13	G	100-3		Α			BLANK	14
15	-	-		В			BLANK	16
17	-	-		С			BLANK	18
NOTES:			•					

A: PANEL SHALL BE EQUAL TO SQUARE D MODEL "QO". ITALLICS INDICATE EXISTING CIRCUIT TO BE RECONNETED TO NEW PANEL.

- B: ELECTRICIAN SHALL VERIFY BREAKER WITH EQUIPMENT PRIOR TO PURCHASE & INSTALL.
- C: A FTER COMPLETION OF WORK, ELECTRICAN SHALL PROVIDE A TYPE WRITTEN PANEL DIRECTORY IN NEW PANEL.

		P.A	NEL'	HP' SC	HEDU	ILE		
	VOLTAGE		PANEL SIZE		MOUNTING			
	120/208 NEMA RATING: 3R		100A MCB		SURFACE		PHASE "A" LOAD PHASE "B" LOAD	
				33.4.7.62		10,000		
CIRCUIT NUMBER	DESCRIPTION	BREAKER SIZE	AMPS	PHASE	AMPS	BREAKER SIZE	DESCRIPTION	CIRCUIT NUMBER
1	CENTER LIGHTS	20-1		Α		20-1	UNKNOWN	2
3	SOUTH SOFFIT LIGHTS	20-1		В		20-1	NORTH CENTER LIGHTS	4
5	SOUTH CENTER LIGHTS	20-1		Α		30-2	LIGHTING CONTACTOR	6
7	SOUTH CENTER SOFFIT LIGHTS	30-1		В		-	-	8
9	BLANK			Α			BLANK	10
11	BLANK			В			BLANK	12
13	BLANK			Α			BLANK	14
15	BLANK			В			BLANK	16
17	BLANK			Α			BLANK	18
19	BLANK			В			BLANK	20

- A: PAINEL SHALL BE EQUAL TO SQUARE DIMODEL "QO". ITALLICS INDICATE EXISTING CIRCUIT TO BE RECONNECTED TO NEW PAINEL.
- B: ELECTRICIAN SHALL VERIFY BREAKER WITH EQUIPMENT PRIOR TO PURCHASE & INSTALL.
- C: AFTER COMPLETION OF WORK, ELECTRICAN SHALL PROVIDE A TYPE WRITTEN PANEL DIRECTORY IN NEW PANEL.

STATE OF MISSOURI MICHAEL L. PARSON, **GOVERNOR**



Keaton E. Leisinger, P.E. PE-2021035875 MO Certificate of Authority # 2018029680



1806 West Broadway Boulevard Sedalia, MO 65301 660.829.9751



J-SQUARED ENGINEERING 2400 BLUFF CREEK DR. STE. 101 COLUMBIA, MO 65203 573.234.4492

ENGINEERING CONSULTANTS 1000 W. Nifong Blvd., Bldg. 1. Columbia, Missouri 65202 www.crockettengineering.com Crockett Engineering Consultants, LLC Missouri Certificate of Authority #2000151304

OFFICE OF ADMINISTRATION DIVISION OF FACILITIES MANAGEMENT DESIGN AND CONSTRUCTION

UPGRADE ELECTRICAL AND RESTROOMS, GRANDSTAND MISSOURI STATE

SEDALIA, MO 65301 PROJECT # T2304-01

FAIRGROUNDS 2503 W. 16TH ST.

ASSET # 3511501018 **REVISION:**

DATE:

SITE # 1501

REVISION:

REVISION:

DATE:

ISSUE DATE: 11/29/2023

BID DOCUMENTS

CAD DWG FILE:
DRAWN BY: RXM
CHECKED BY: JAP
DESIGNED BY: KEL

SHEET TITLE:

ELECTRICAL SCHEDULES

SHEET NUMBER:

SHEET 29 OF 30 11/29/2023

PLUMBING PLANS SYMBOL LEGEND

---- SANITARY SEWER PIPING

---- VENT PIPING

— — — COLD WATER PIPING

→ ○ PIPING TURNED DOWN / TURNED UP


TIE INTO EXISTING

PLUMBING PLAN GENERAL NOTES:

- PLUMBING SYSTEM TO BE INSTALLED FOR WINTERIZATION.
 CONTRACTOR SHALL INSTALL LOW POINT DRAINS ON COLD WATER
 PIPING.
- 2. DOMESTIC WATER LINES SHALL BE SURFACE MOUNT & HELD TIGHT TO WALLS & ROOF.

PLUMBING PLAN KEY NOTES:

- ① RECONNECT NEW PLUMBING FIXTURE TO EXISTING CW, HW, & SANITARY CONNECTIONS.
- ② RECONNECT NEW VENT PIPING TO EXISTING VENT CONNECTION AT
- (3) PROVIDE NEW SANITARY CONNECTION INTO EXISTING SANITARY LINE IN PIPE CHASE.
- (4) PROVIDE BALL VALVE & SCHRADER VALVE FOR WINTERIZATION. SEE OUTDOOR WATER SUPPLY BLOW-DOWN DETAIL.

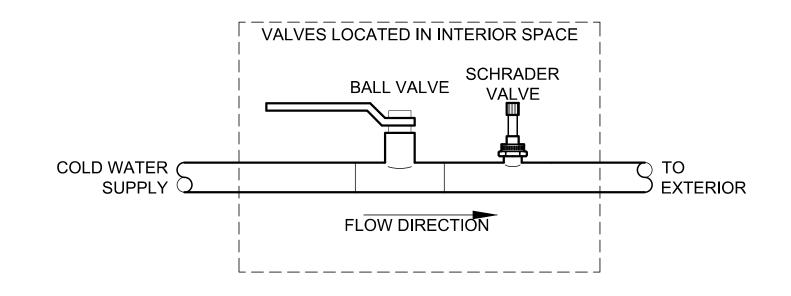

OUTDOOR WATER SUPPLY BLOW-DOWN DETAIL


	PLUMBING FIXTURE SCHEDULE										
TAG	DESCRIPTION	MANUFACTURER (OR EQUAL)	MODEL (OR EQUAL)	NOTES							
FPHB	FROST PROOF HOSE BIB	WOODFORD	MODEL 67								
HB	HOSE BIB	JR SMITH	5670-H	INTEROR HOSE BIB WITH VACUUM BREAKER							
LAV1	LAVATORY (WALL HUNG W/MANUAL FAUCET)	AMERICAN STANDARD	0356041.020	WITH ZURN Z86300-XL-3M FAUCET, 1/4 TURN STOP, BRAIDED STAINLESS STEEL SUPPLY, AND TRUBRO LAV GUARD 2							
UR1	URINAL - MANUAL FLUSH	AMERICAN STANDARD	6590001.020	WITH ZURN Z6003AV-WS1 MANUAL FLUSH VALVE (1.0 GPM/FLUSH)							
WC1	WATER CLOSET - STANDARD HEIGHT - MANUAL FLUSH VALVE	AMERICAN STANDARD	2234.001	WITH ZURN Z6000AV-WS1 MANUAL FLUSH VALVE (1.6 GPM/FLUSH) AND CHURCH 9500SSCT SELF SUSTAINING SEAT							
WC2	WATER CLOSET - ADA HEIGHT - MANUAL FLUSH VALVE	AMERICAN STANDARD	3043.001	WITH ZURN Z6000AV-WS1 MANUAL FLUSH VALVE (1.6 GPM/FLUSH) AND CHURCH 9500SSCT SELF SUSTAINING SEAT							
WC3	WATER CLOSET - ADA HEIGHT - TANK	AMERICAN STANDARD	215AA.004	WITH CHURCH 7200SLEC SEAT AND COVER, STAINLESS BRAIDED SUPPLY, AND 1/4 TURN SHUT-OFF.							

1. VERIFY NECESSARY FIXTURES MEET ADA REQUIREMENTS WITH ARCHITECT PRIOR TO INSTALLATION

FIXTURE		SANITAR	Y PIPING	SUPPLY PIPING		
TYPE	TYPICAL ABBREVIATION	WASTE CONNECTION	VENT CONNECTION	COLD WATER CONNECTION	HOT WATER CONNECTION	
DRINKING FOUNTAIN	DF	1-1/2"	1-1/4"	1/2"	-	
FLOOR DRAIN	FD	3"	2"	-	-	
HAND / HAIR SINK	HS / SK	2"	1-1/4"	1/2"	1/2"	
HOSE BIBB	НВ	-	-	3/4"	-	
LAVATORY	LAV	1-1/2"	1-1/4"	1/2"	1/2"	
MOP SINK	MS	3"	1-1/2"	1/2"	1/2"	
ICE MAKER OUTLET BOX	REF	-	-	1/2"	-	
SHOWER	SH	3"	1-1/2"	1/2"	1/2"	
URINAL	UR	2"	1-1/4"	3/4"	-	
WATER CLOSET (FLUSH TANK)	WC	3"	2"	1/2"	_	
WATER CLOSET (FLUSH VALVE)	WC	3"	2"	1"	-	

NOTES:

1. SIZES SHOWN ABOVE ARE TYPICAL UNLESS NOTED OTHERWISE ON PLANS

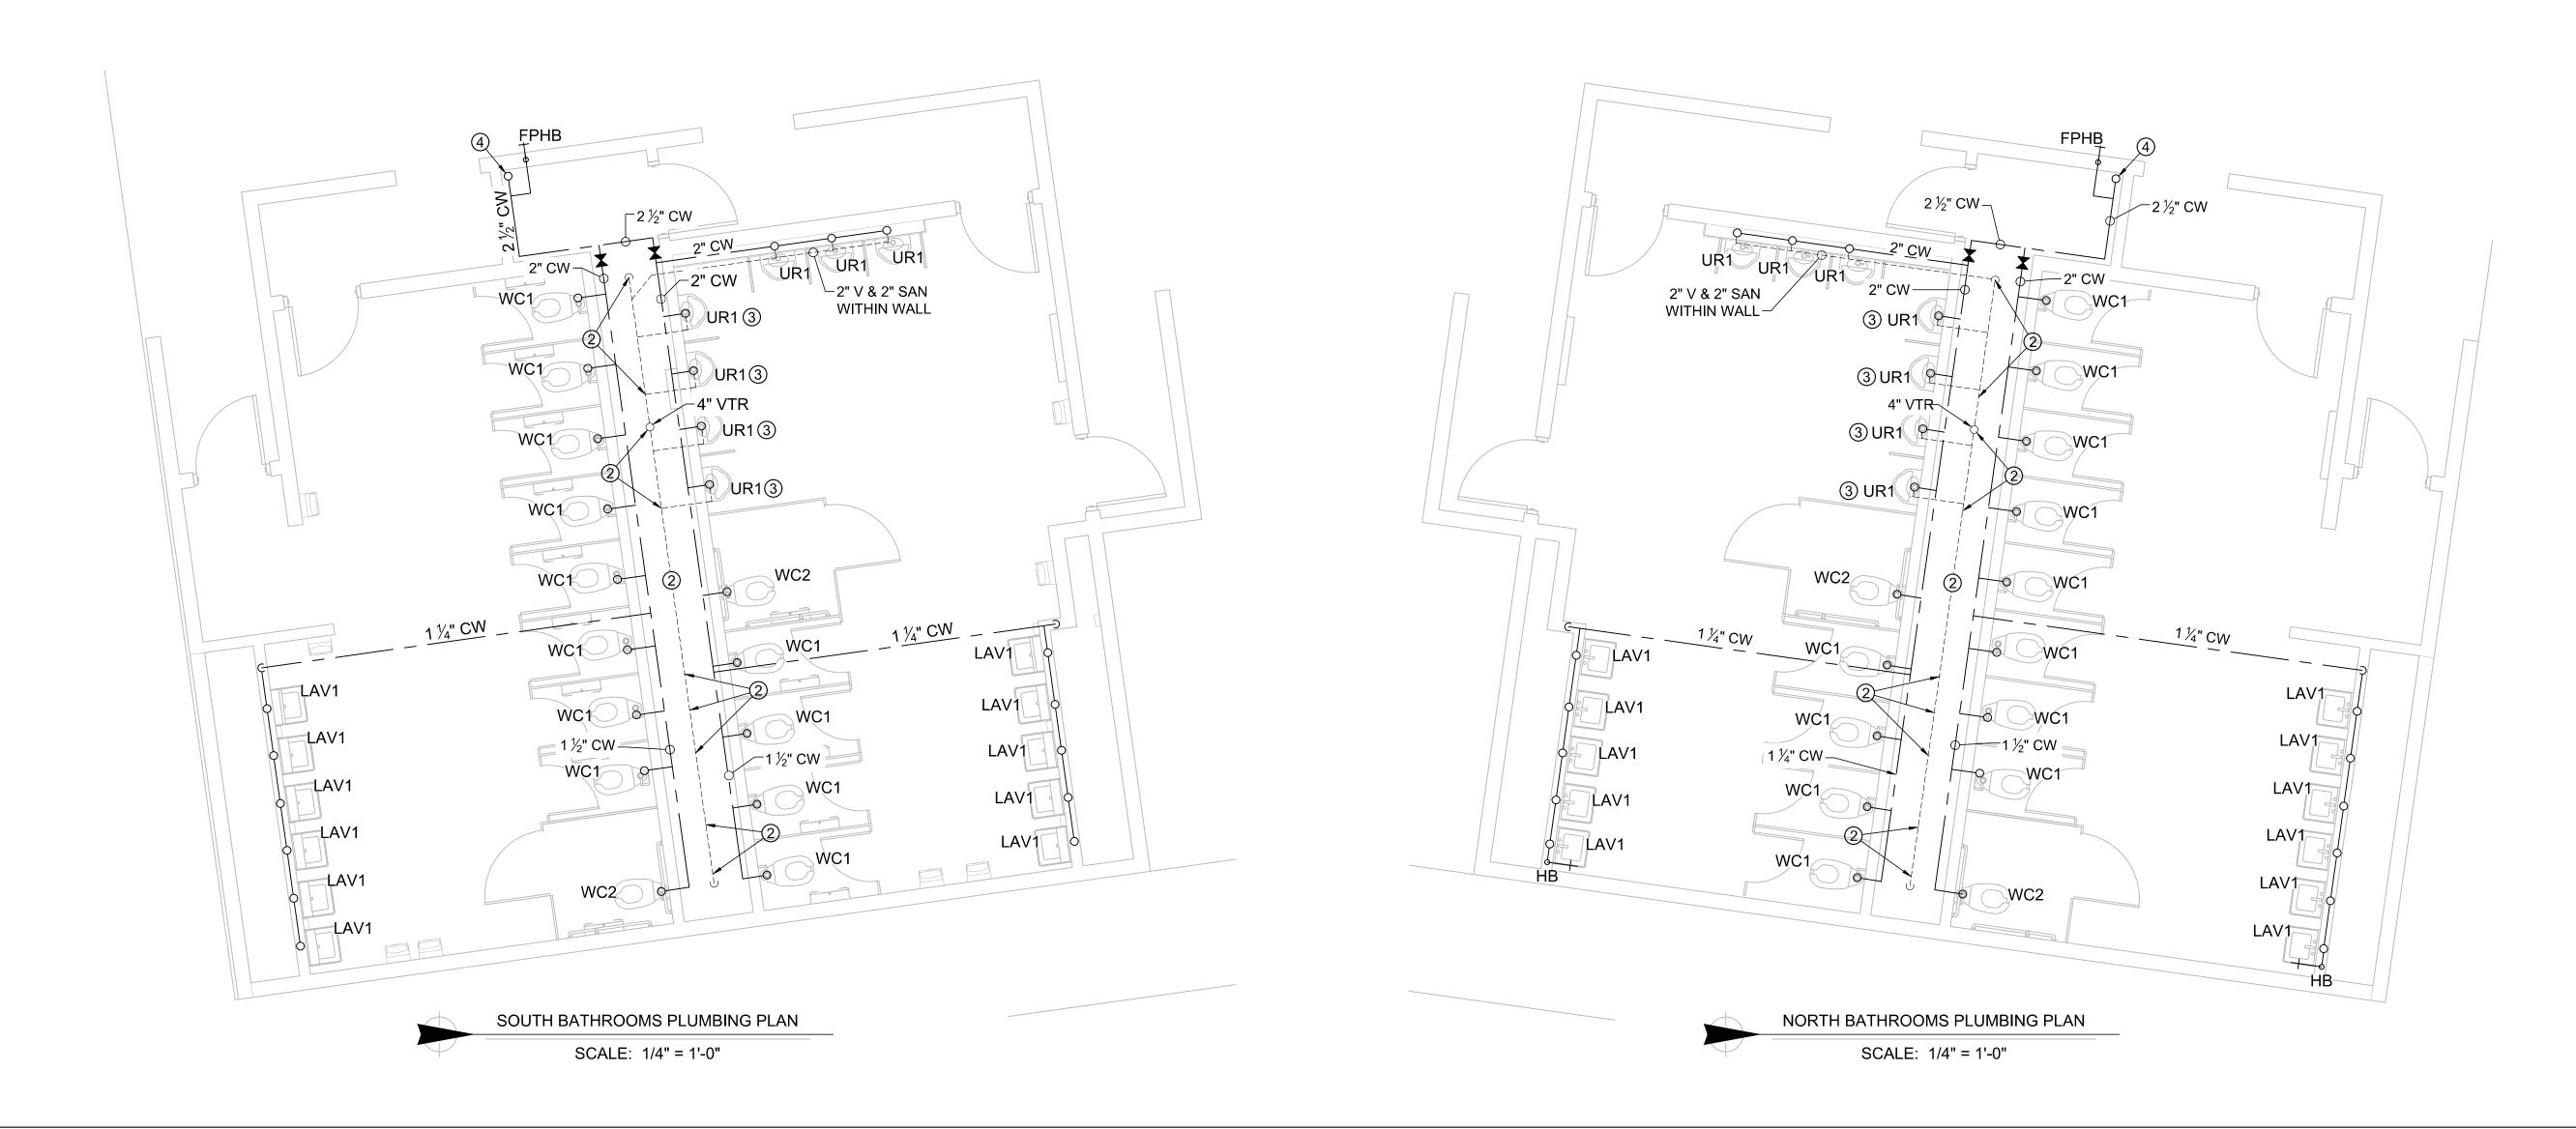

STATE OF MISSOURI MICHAEL L. PARSON, GOVERNOR



Keaton E. Leisinger, P.E. PE-2021035875



1806 West Broadway Boulevard Sedalia, MO 65301 660.829.9751



J-SQUARED ENGINEERING 2400 BLUFF CREEK DR. STE. 101 COLUMBIA, MO 65203 573.234.4492

CROCKETT

ENGINEERING CONSULTANTS
1000 W. Nifong Blvd., Bldg. 1.
Columbia, Missouri 65202
(573) 447-0292
www.crockettengineering.com
Crockett Engineering Consultants, LLC
Missouri Certificate of Authority
#2000151304

OFFICE OF ADMINISTRATION DIVISION OF FACILITIES MANAGEMENT DESIGN AND CONSTRUCTION

UPGRADE ELECTRICAL AND RESTROOMS, GRANDSTAND MISSOURI STATE

FAIRGROUNDS 2503 W. 16TH ST. SEDALIA, MO 65301

PROJECT # T2304-01

SITE # 1501 ASSET # 3511501018 REVISION: DATE:

REVISION:__ DATE:__

REVISION:

DATE:

ISSUE DATE: 11/29/2023

BID DOCUMENTS

CAD DWG FILE:
DRAWN BY:
CHECKED BY:
DESIGNED BY:
KEL

SHEET TITLE:

ENLARGED
PLUMBING
PLANS (PHASE 1)

SHEET NUMBER:

P-10

SHEET 30 OF 30 11/29/2023