# NEW DIRECTOR'S HOUSE MISSOURI STATE FAIRGROUNDS

# SEDALIA, MO



OWNER:

STATE OF MISSOURI

MIKE KEHOE, GOVERNOR

DEPARTMENT OF AGRICULTURE MISSOURI STATE FAIRGROUNDS

PROJECT

OFFICE OF ADMINISTRATION

MANAGEMENT: DIVISION OF FACILITIES MANAGEMENT,

DESIGN AND CONSTRUCTION

DESIGNER:

ROBERT ROLLINGS ARCHITECTS, LLC

PROJECT NUMBER:

F2402-01

SITE NUMBER: ASSET NUMBER:


1501

3511501149


THESE DRAWINGS, ALONG WITH THE PROJECT SPECIFICATIONS, REPRESENT A UNIFIED SET OF CONSTRUCTION DOCUMENTS. ALL BIDDERS SHALL BE RESPONSIBLE FOR FAMILIARIZING THEMSELVES WITH ALL DRAWINGS IN THIS SET, REGARDLESS OF SHEET NUMBER AND DISCIPLINE, AND SHALL BE RESPONSIBLE FOR COORDINATING THEIR WORK WITH THE WORK OF OTHER TRADES. ANY APPARENT DISCREPANCIES BETWEEN DRAWINGS OR BETWEEN THE DRAWINGS AND SPECIFICATIONS SHALL BE BROUGHT TO THE ATTENTION OF THE ARCHITECT PRIOR TO BIDDING.

DO NOT BID FROM PARTIAL SETS OF BID DOCUMENTS.


BY SUBMITTING A BID, BIDDERS REPRESENT THAT THEY HAVE VISITED THE SITE, BECOME FAMILIAR WITH THE BID DOCUMENTS IN THEIR ENTIRETY AND WITH LOCAL CONDITIONS UNDER WHICH THE WORKS IS TO BE PERFORMED AND HAVE CORRELATED THE BIDDER'S PERSONAL OBSERVATIONS WITH THE REQUIREMENTS OF THE CONTRACT DOCUMENTS.

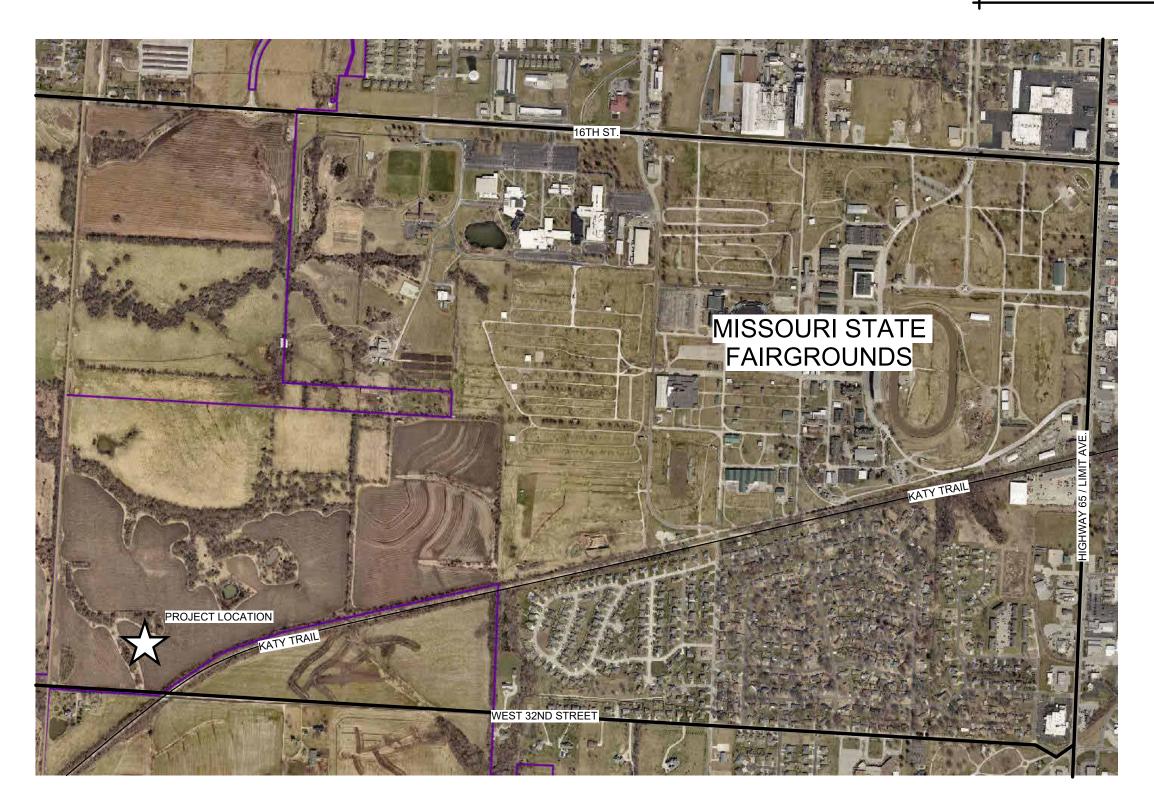



3 PROJECT LOCATION G-002 1 1/2" = 1'-0"

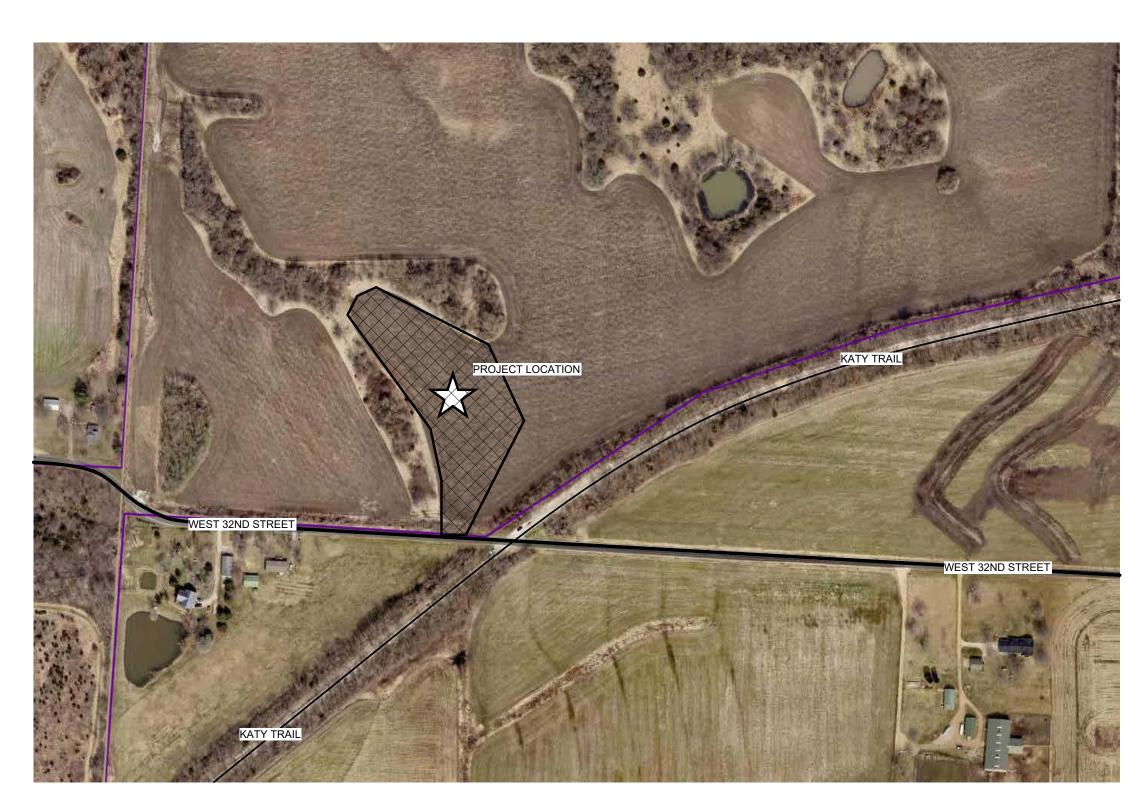

2 PROJECT SITE 1 1/2" = 1'-0"

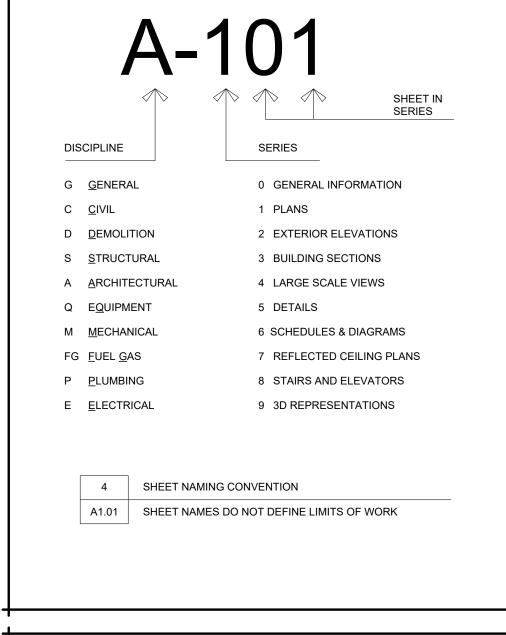


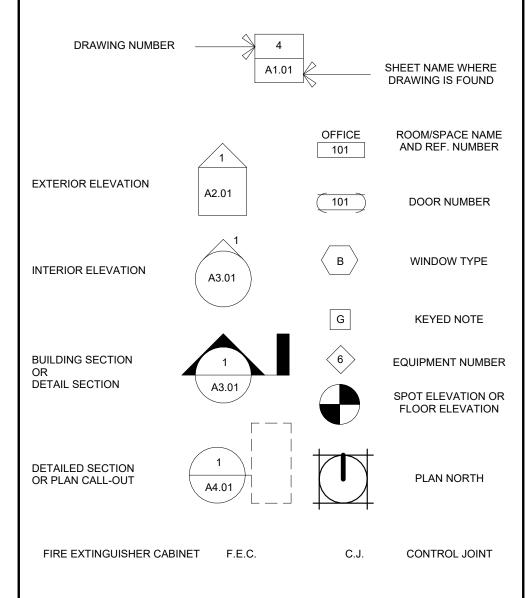

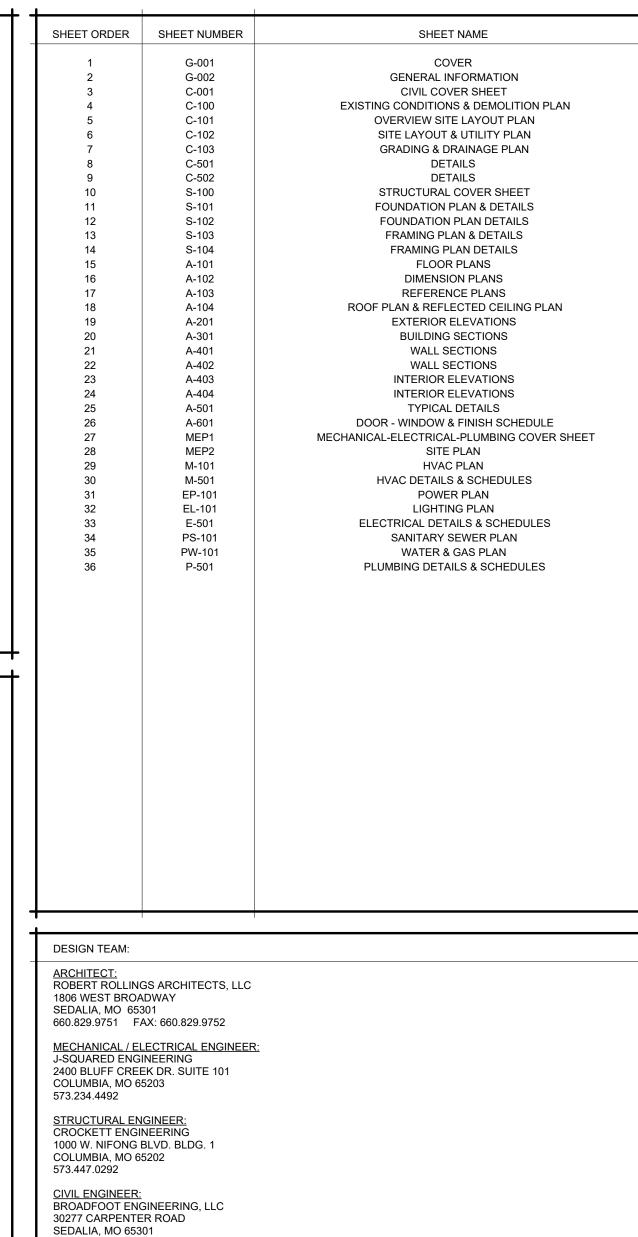





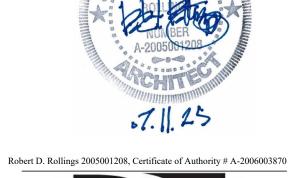





FAX: 660 829 9752

### J-SQUARED **ENGINEERING**

2400 BLUFF CREEK DR. STE. 101 COLUMBIA, MO 65201 573.234.4492 phone www.j-squaredeng.com



Broadfoot Engineering, LLC 30277 Carpenter Road Sedalia, MO 65301 Phone: 660-619-7001 broadfooteng@yahoo.com

ENGINEERING CONSULTANTS 1000 W. Nifong Blvd., Bldg. 1. Columbia, Missouri 65202 (573) 447-0292 www.crockettengineering.com Crockett Engineering Consultants, LLC Missouri Certificate of Authority #2000151304

OFFICE OF ADMINISTRATION DIVISION OF FACILITIES MANAGEMENT DESIGN AND CONSTRUCTION

### DIRECTOR'S HOUSE

MISSOURI STATE FAIRGROUNDS 2503 W. 16TH ST SEDALIA, MO 65301 PROJECT # F2402-01

SITE # 1501 ASSET # 3511501149

**REVISION:** 

REVISION:

**REVISION**: DATE:

ISSUE DATE: 7/11/2025 **BID DOCUMENTS** 

CAD DWG FILE: G-O-02
DRAWN BY: AMK
CHECKED BY: RDR
DESIGNED BY: AMK

SHEET TITLE:


**GENERAL INFORMATION** 

SHEET NUMBER:

PAGE 2 OF 36 7/11/2025

# MISSOURI STATE FAIRGROUNDS - DIRECTOR'S HOUSE

### SEDALIA, PETTIS COUNTY, MISSOURI

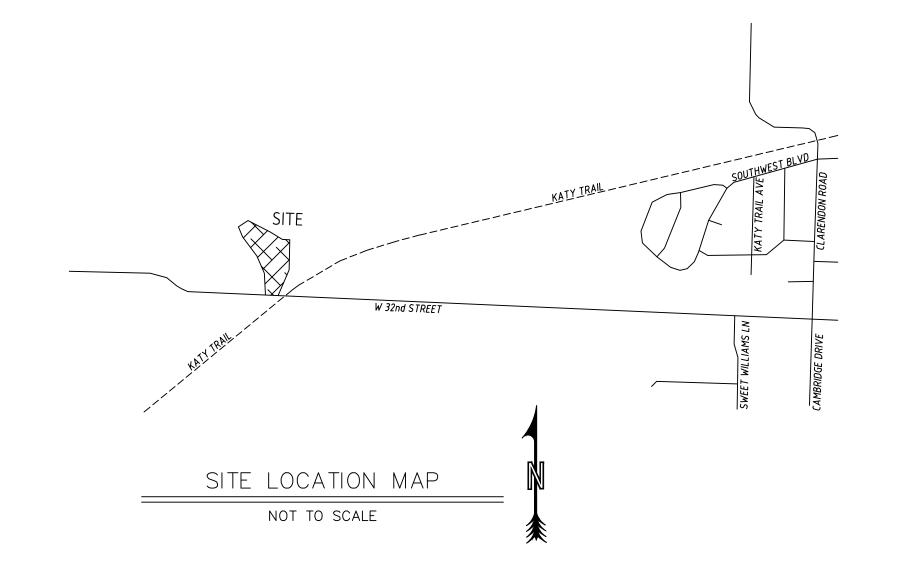

### PROPERTY OWNER

STATE FAIR OF MISSOURI BY AND THROUGH THE STATE FAIR COMMISSION SEDALIA, MISSOURI 65301

### FLOODPLAIN NOTE

THIS PROPERTY IS LOCATED IN ZONE "X" AREAS DETERMINED TO BE OUTSIDE THE 0.2% ANNUAL CHANCE FLOODPLAIN, AS SHOWN BY FLOOD INSURANCE RATE MAP NUMBER 29159C0292D & 29159C0291D, DATED NOVEMBER 30, 2023.

### SEWER DESIGN NOTE

THE PROPOSED SEPTIC SYSTEM SHOWN ON THIS SITE PLAN IS FOR COORDINATION PURPOSES ONLY. NOTE THAT THE PROPOSED SEPTIC SYSTEM SHALL BE DESIGNED, PERMITTED, AND INSTALLED BY THE GENERAL CONTRACTOR.

	SURVEY	CONTROL	POINTS	
POINT #	NORTH	EAST	ELEVATION	DESCRIPTION

CONTROL POINT (SPIKE) LOCATED NEAR WEST BRUSH LINE, SEE SHEET C-102. 1417461.85 CONTROL POINT (SPIKE) LOCATED ON KATY TRAIL, APPROXIMATELY 1039208.98 1417766.98 856.00 13 FEET NORTH OF W 32nd EDGE OF PAVEMENT, SEE SHEET C-102.

**CONSTRUCTION NOTES** 

1. THE CONTRACTOR IS RESPONSIBLE FOR VERIFYING THE LOCATION OF EXISTING UTILITIES. CONTRACTOR SHALL REPAIR ALL UTILITIES DAMAGED BY CONTRACTOR'S ACTIVITIES AT NO EXPENSE TO THE OWNER.

- CONTRACTOR IS RESPONSIBLE FOR SITE SAFETY.
- 3. CONTRACTOR IS RESPONSIBLE FOR IMPLEMENTING BEST MANAGEMENT PRACTICE (BMP'S) AS SHOWN ON THE PLANS. BMP'S SHALL BE MAINTAINED AT ALL TIMES.
- 4. CONTRACTOR SHALL MAINTAIN ALL EROSION CONTROL MEASURES. REFER TO GRADING BID SET FOR
- 5. ALL PUBLIC ROADS MUST BE KEPT CLEAN AT ALL TIMES.
- 6. CONTRACTOR IS RESPONSIBLE FOR PATCHING ALL STREETS DAMAGED BY CONSTRUCTION ACTIVITIES OR
- 7. CONTRACTOR SHALL NOT INTERRUPT THE OWNERS CURRENT OPERATIONS.
- 8. CONTRACTOR SHALL BE RESPONSIBLE CONTROLLING DUST FROM JOBSITE ACTIVITIES.
- 9. ADJUST VALVE COVERS & UTILITY BOXES AS NECESSARY TO PROVIDE SMOOTH SURFACE.
- 10. ALL STORM PIPE OUTLETS TO HAVE RODENT SCREENS/ANIMAL BARRIERS.
- 11. ALL PIPE LENGTHS AND FLOW LINES TO CENTER OF STRUCTURE.
- 12. THE CONTRACTOR SHALL BE RESPONSIBLE FOR DETERMINING THE LOCATION OF EXISTING UTILITIES, AND FIELD VERIFY EXISTING FACILITY ALIGNMENTS. DEPTHS. AND ANGLES BEFORE BEGINNING WORK.
- 13. CUTTING AND REPAIRING/REPLACING STREET IS THE RESPONSIBILITY OF THE CONTRACTOR.

### CONSTRUCTION QUALITY ASSURANCE REQUIREMENTS:

- .. THE OWNER IS RESPONSIBLE FOR PROVIDING QUALITY ASSURANCE COMPACTION TESTING OF SUBGRADES AND CONTROLLED FILL MATERIALS AND FIELD SAMPLING AND TESTING.
- 2. STRIP A MINIMUM OF 12 INCHES OF TOPSOIL AND ROOT ZONES FROM ALL AREAS TO RECEIVE FILL.
- 3. ALL SITE FILL SHALL BE CONSTRUCTED IN UNIFORM HORIZONTAL LIFTS WITH A MAXIMUM LOOSE THICKNESS OF 8 INCHES.
- 4. ALL SUBGRADE SURFACES AND CONTROLLED FILL ARE TO BE COMPACTED TO A MINIMUM OF 95 PERCENT OF MAXIMUM DRY DENSITY AS DETERMINED IN ACCORDANCE WITH ASTM D 689 "STANDARD" PROCTOR, AT A MOISTURE CONTENT BETWEEN 1 PERCENTAGE POINTS BELOW AND 5 PERCENTAGE POINTS ABOVE OPTIMUM MOISTURE CONTENT AS DETERMINED IN ACCORDANCE WITH ASTM D 698.
- 5. COMPACTION TESTS SHALL BE CONDUCTED IN ACCORDANCE WITH THE METHODS OF ASTM D 6938 OR
- 6. COMPACTION TESTS SHALL BE CONDUCTED AT THE RATE OF ONE TEST PER 10,000 SQUARE FEET OF SUBGRADE SURFACE AREA OR CONTROLLED FILL SURFACE AREA, WITH NO LESS THAN 2 TESTS PER EACH DAY'S SUBGRADE SURFACE AREA AND NOT LESS THAN 2 TESTS PER LIFT OF CONTROLLED FILL.

### **DEMOLITION NOTES:**

- 1. CONTRACTOR SHALL COORDINATE ALL DEMOLITION WITH OWNER AND UTILITIES.
- 2. ALL OTHER ITEMS SHALL BE PROTECTED.
- 3. CONTRACTOR SHALL HAUL DISPOSAL ITEMS TO AN APPROVED LOCATION.

### TEMPORARY TRAFFIC CONTROL NOTES:

- 1. ALL TRAFFIC CONTROL SHALL BE PER CURRENT MUTCD REQUIREMENTS AND SHALL BE THE RESPONSIBILITY OF THE CONTRACTOR. A TRAFFIC CONTROL PLAN WILL BE REQUIRED FOR ANY WORK WITHIN THE RIGHT-OF-WAY.
- 2. ALL TRAFFIC CONTROL DEVICES AND TEMPORARY TRAFFIC CONTROL PLANS SHALL BE IN ACCORDANCE WITH THE MOST RECENT EDITION OF THE MANUAL ON UNIFORM TRAFFIC CONTROL DEVICES
- THE CONTRACTOR IS SOLELY RESPONSIBLE FOR JOB SITE, WORKER, AND TRAFFIC SAFETY.

### SWPPP NOTES:

- CONTRACTOR SHALL FOLLOW STORM WATER POLLUTION PREVENTION PLAN (SWPPP) AND ADHERE TO ALL TERMS & CONDITIONS AS OUTLINED IN THE GENERAL N.P.D.E.S. PERMIT FOR STORM WATER DISCHARGE ASSOCIATED WITH CONSTRUCTION ACTIVITIES. A COPY OF THIS PLAN AND PERMIT SHALL REMAIN ON SITE THROUGHOUT CONSTRUCTION.
- NO LAND CLEARING OR GRADING SHALL BEGIN UNTIL ALL EROSION CONTROL MEASURES HAVE BEEN INSTALLED AND APPROVAL HAS BEEN RECEIVED FROM ALL GOVERNING AUTHORITIES. CONTRACTOR SHALL UTILIZE TOPSOIL FROM SITE IN LANDSCAPED AREAS WITH ANY EXCESS BEING PLACED AS DIRECTED BY OWNER ON THE SFCC PROPERTY.
- IMMEDIATELY UPON COMPLETION OF FINISH GRADING IN EACH AREA, ALL LANDSCAPING AREAS SHALL BE SEEDED AND MULCHED.
- 4. SHOULD CONSTRUCTION STOP FOR LONGER THAN 14 DAYS, THE SITE SHALL BE SEEDED AS SPECIFIED
- THIS PLAN SHALL NOT BE CONSIDERED ALL INCLUSIVE AS THE CONTRACTOR SHALL TAKE ALL
- NECESSARY PRECAUTIONS TO PREVENT SOIL SEDIMENT FROM LEAVING THE SITE.
- 6. CONTRACTOR SHALL COMPLY WITH ALL STATE AND LOCAL ORDINANCES THAT APPLY.
- 7. ADDITIONAL EROSION AND SEDIMENT CONTROL MEASURES SHALL BE INSTALLED IF DEEMED NECESSARY BY ON SITE INSPECTION.
- 8. CONTRACTOR SHALL BE RESPONSIBLE TO TAKE WHATEVER MEANS NECESSARY TO ESTABLISH PERMANENT SOIL STABILIZATION.
- 9. ALL SLOPES GREATER THAN 3:1 SHALL BE REINFORCED BY NORTH AMERICAN GREEN P300 PERMANENT TURF REINFORCEMENT MAT OR APPROVED EQUAL.
- 10. CONTRACTOR SHALL REMOVE ALL TRASH, DEBRIS, TREES & BRUSH AND OTHER MATERIAL CREATED AS A RESULT OF THE CONSTRUCTION WORK AND THE SITE SHALL BE RETURNED TO ITS ORIGINAL CONDITION.
- 11. ALL PERIMETER LANDSCAPED AREAS SHALL BE GRASS COVERED.
- 12. IN ORDER TO TERMINATE A STATE OPERATING PERMIT THE MISSOURI DEPARTMENT OF NATURAL RESOURCES (MDNR) REQUIRES THAT THE PERMITTEE SUBMIT A COMPLETED FORM H (INCLUDED WITH THE APPROVED PERMIT) TO THE MDNR. A PERMIT IS ELIGIBLE FOR TERMINATION WHEN EITHER PERENNIAL VEGETATION, PAVEMENT, BUILDINGS, OR STRUCTURES USING PERMANENT MATERIALS COVER ALL AREAS THAT HAVE BEEN DISTURBED. VEGETATIVE COVER SHALL BE AT LEAST 70% OF FULLY ESTABLISHED PLANT DENSITY OVER 100% OF THE DISTURBED AREA. A COPY OF FORM H SHOULD BE SUBMITTED TO THE CITY AT WHICH TIME THE CITY WILL REMOVE THE PROJECT FROM ITS INSPECTION SCHEDULE.
- 13. LAND DISTURBANCE SITES SHOULD BE INSPECTED ON A REGULAR SCHEDULE AND WITHIN A REASONABLE TIME PERIOD (NOT TO EXCEED 48 HOURS) FOLLOWING HEAVY RAINS. REGULARLY SCHEDULED INSPECTIONS SHALL BE AT A MINIMUM OF ONCE PER WEEK. ANY DEFICIENCIES SHALL BE NOTED IN A WEEKLY REPORT OF THE INSPECTION AND CORRECTED WITH SEVEN CALENDAR DAYS OF THE REPORT. CONTRACTORS ARE REQUIRED TO SUBMIT TO CITY INSPECTION STAFF COPIES OF THEIR INSPECTION REPORTS REQUIRED BY THE STORMWATER POLLUTION PREVENTION PLAN (SWPPP) ON A MONTHLY BASIS.
- 14. THE SITE CONTRACTOR SHALL INCLUDE MAINTENANCE OF ALL BMP'S PART OF HIS/HER CONTRACT AND SHALL BE RESPONSIBLE FOR THE PROJECT UNTIL THE NPDES PERMIT IS TERMINATED.

### **GENERAL UTILITY NOTES**

- 1. CONTRACTOR SHALL REFERENCE MEP PLANS FOR ADDITIONAL SITE UTILITY INFORMATION, INCLUDING UTILITY SERVICE CONNECTIONS TO BUILDING.
- 2. ALL CONSTRUCTION SHALL MEET APPLICABLE FEDERAL, STATE, AND LOCAL UTILITY REGULATIONS AND SPECIFICATIONS.
- 3. FOR PRIVATE SEWER, MAINTAIN 1.05% FALL AT ALL TIMES.
- 4. FOR PRIVATE SEWER, PIPE MATERIAL SHALL BE PVC SCH 40.
- 5. INSTALL CLEANOUTS AT ALL CHANGES IN ALIGNMENT AND AT A MAXIMUM SPACING OF 100 FEET.
- 6. ELECTRIC CONDUIT BY CONTRACTOR.

### **WATERLINE NOTES:**

- 1. CONTRACTOR IS RESPONSIBLE FOR ALL APPLICABLE FEES INCLUDING FOR BRINGING WATER TO SITE. TAPPING.INSTALLATION OF SERVICE LINE. PITS. BACKFLOW PREVENTER AND OTHER APPLICABLE
- 2. PIPE MATERIAL SHALL BE HDPE, PVC, OR POLY OR OTHER MATERIAL APPROVED BY CITY OF SEDALIA WATER DEPARTMENT.
- 3. ALL OPENINGS SHALL BE CLOSED WITH WATERTIGHT PLUGS WHEN PIPE LAYING IS STOPPED. INCLUDING REST BREAKS, MEALS AND THE END OF THE DAY.
- 4. ALL VALVES SHALL BE FULLY CLOSED DURING INSTALLATION AND CONSTRUCTION OF THE MAIN. VALVES TO BE OPERATED BY SEDALIA WATER DEPARTMENT EMPLOYEES ONLY.
- 5. THE CONTRACTOR SHALL PROVIDE AND INSTALL VALVE OPERATING NUT EXTENSIONS FOR ALL OPERATING NUTS 6 FEET OR DEEPER BELOW FINISH GRADE IN ORDER TO EXTEND THE OPERATING NUT TO WITHIN 30 INCHES OF THE FINISH SURFACE.
- 6. PROVIDE 18 INCH MINIMUM VERTICAL SEPARATION BETWEEN WATER MAIN AND ANY SEWER CROSSINGS.
- 7. WATER LINE DESIGN IS BASED ON 20 FOOT PIPE LENGTHS, 3.1 DEGREE MAXIMUM JOINT DEFLECTION. (MINIMUM PIPE RADII IS 370 FEET) MINIMUM 42 INCHES OF COVER OVER PIPE, OR 42 INCHES BELOW STREET PAVEMENT ELEVATION, WHICHEVER IS GREATER. UNLESS NOTED OTHERWISE.
- 8. AS NOTED ON THE PLANS, TRENCH BACKFILL SHALL BE COMPACTED TO A MINIMUM OF 95% STANDARD PROCTOR DENSITY PER ASTM D 698 FOR COHESIVE SOILS AND GRANULAR MATERIAL WITH A MOISTURE DENSITY RELATIONSHIP. CLEAN ROCK BACKFILL SHALL BE COMPACTED TO 70% RELATIVE DENSITY PER ASTM D 4253 AND 4254 IN 4 INCH THICK LIFTS.
- 9. THE CONTRACTOR SHALL FURNISH ANY BENDS OR FITTINGS NECESSARY TO ASSURE PROPER HORIZONTAL AND VERTICAL ALIGNMENT AT CONNECTIONS TO EXISTING MAINS. ALL WATER PIPE JOINTS IN CASINGS SHALL HAVE RESTRAINED JOINTS.

### UTILITY NOTES

THE LOCATIONS, SIZES, AND MATERIAL TYPES OF UNDERGROUND UTILITIES INDICATED ON THE PLAT, NOT VISIBLE OR APPARENT FROM THE SURFACE, ARE SHOWN IN THEIR APPROXIMATE LOCATIONS FROM A MISSOURI ONE CALL SYSTEM LOCATE, CONSTRUCTION PLANS OR UTILITY COMPANY RECORDS AND WERE NOT VERIFIED IN THE FIELD.

SEDALIA WATER DEPARTMENT 200 S. OSAGE AVE. SEDALIA, MO 65301 CONTACT: BRENDA ARDREY 660-827-3000

ELECTRIC **EVERGY** ERIK HARDING 660-620-7745

LIBERTY UTILITIES CALL UTILITY FOR INFO. TELECOMMUNICATIONS

SANITARY SEWER SEDALIA PUBLIC WORKS DEPARTMENT 200 S. OSAGE AVE. SEDALIA, MO 65301 CONTACT: BRENDA ARDREY 660-827-3000

STORM SEWER SEDALIA PUBLIC WORKS DEPARTMENT 200 S. OSAGE AVE. SEDALIA, MO 65301 CONTACT: BRENDA ARDREY 660-827-3000

LEGEND

EXISTING SURFACE CONTOUR

UNDERGROUND TELEPHONE LINE UNDERGROUND ELECTRIC LINE

CORRUGATED METAL PIPE POLYVINYL CHLORIDE HIGH DENSITY POLYETHYLENE REINFORCED CONCRETE PIPE

FOUND APPARENT MONUMENT PROPOSED SURFACE CONTOUR PROPOSED STORM SEWER LINE PROPOSED SANITARY SEWER LINE

PROPOSED UNDERGROUND ELECTRIC LINE

FINISH GRADE ELEVATION (ADD 800

PROPOSED CONCRETE PAVEMENT

PROPOSED CONCRETE SIDEWALK / PATIO

SHORTENED DIGIT DISPLAY)

FENCE LINE

GAS LINE

WATER LINE LIGHT STANDARD TELEPHONE PEDESTAL STORM SEWER MANHOLE

CONTROL POINT

PROPOSED GAS LINE PROPOSED WATER LINE

PULL BOX

SILT FENCE

STORM SEWER LINE

SANITARY SEWER LINE

HIGHWAY/STREET DEPARTMENT PETTIS COUNTY



ALL UTILITIES SHOWN ARE BASED ON MARKINGS BY THE RESPECTIVE UTILITY COMPANIES, THE OWNERS, AND BY OBSERVABLE SURFACE STRUCTURES, AS FOUND IN THE FIELD.

PRIVATE WATER LINES WERE NOT MARKED BEYOND THE WATER METERS, AND IN SOME CASES, THE WATER COMPANY DID NOT MARK WATER MAINS, WHERE STRUCTURES WOULD INDICATE ONE EXISTED (i.e. FIRE HYDRANT OR WATER VALVE).

PRIVATE SANITARY SEWER LINES WERE NOT MARKED, BUT OBSERVABLE CLEAN-OUTS WERE LOCATED IN THE FIELD, AND ARE SHOWN. NO PUBLIC SEWER WAS MARKED WITHIN THE PROJECT LIMITS. PRIVATE ELECTRIC, TELEPHONE, AND CATV LINES WERE NOT MARKED; BUT OBSERVABLE PRIVATE UTILITIES WERE LOCATED IN THE FIELD, AND ARE SHOWN.

ALL UTILITIES SHOULD BE LOCATED AND VERIFIED BEFORE ANY CONSTRUCTION SHOULD COMMENCE.

### SHEET SET

C-001 - CIVIL COVER SHEET C-100 - EXISTING CONDITIONS & DEMOLITION PLAN

C-102 - SITE LAYOUT & UTILITY PLAN

C-501 - DETAILS

SHEET NUMBER:

CIVIL COVER SHEET

**STATE OF MISSOURI** 

JULY 11, 2025

MIKE KEHOE

**GOVERNOR** 

sedalia,

Fax:

MO Phone: 660. 829. 9751

J-SQUARED

ENGINEERING

2400 BLUFF CREEK DR. SUITE 101 COLUMBIA, MO 65201 573.234.4492

Broadfoot Engineering, LLC

ENGINEERING CONSULTANTS

Columbia, Missouri 65202

www.crockettengineering.com

Crockett Engineering Consultants, LL0

Missouri Certificate of Authority

#2000151304

OFFICE OF ADMINISTRATION

MANAGEMENT DESIGN AND

DIVISION OF FACILITIES

CONSTRUCTION

DIRECTOR'S HOUSE

MISSOURI STATE

SEDALIA, MO 65301

PROJECT # F2402-01

ASSET # 3511501149

FAIRGROUNDS

2503 W. 16TH ST

SITE # 1501

**REVISION:** 

**REVISION:** 

**REVISION:** 

DATE:

DATE:

DATE:

ISSUE DATE: 7/11/2025

**BID DOCUMENTS** 

DESIGNED BY: TJB

CAD DWG FILE: DRAWN BY: TJB CHECKED BY: TJB

SHEET TITLE:

(573) 447-0292

30277 Carpenter Road

Sedalia, MO 65301

Phone: 660-619-7001

broadfooteng@yahoo.com

660. BZ9. 975Z

PAGE 3 OF 36 7/11/2025

C-101 - OVERVIEW SITE LAYOUT PLAN

C-103 - GRADING & DRAINAGE PLAN

C-502 - DETAILS





JULY 11, 2025



SCALE 1" = 30'

EXISTING SURFACE CONTOUR

UNDERGROUND TELEPHONE LINE UNDERGROUND ELECTRIC LINE

FENCE LINE
STORM SEWER LINE
SANITARY SEWER LINE

GAS LINE

WATER LINE

SILT FENCE

DEMOLITION NOTES

EROSION CONTROL NOTES

FROM LEAVING THE SITE.


1. CONTRACTOR SHALL INSTALL PERIMETER SILT

FENCE AS NECESSARY TO PREVENT SEDIMENT

IN COORDINATION WITH OWNER AND UTILITIES.

LEGEND

ArchitectsLLC S. Lamine Sedalia, Mo 65301 Phone: 660. 829. 9751

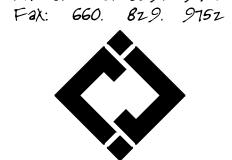

J-SQUARED ENGINEERING 2400 BLUFF CREEK DR. SUITE 101 COLUMBIA, MO 65201 573.234.4492



Broadfoot Engineering, LLC 30277 Carpenter Road Sedalia, MO 65301 Phone: 660-619-7001 broadfooteng@yahoo.com

**ENGINEERING CONSULTANTS** 1000 W. Nifong Blvd., Bldg. 1. Columbia, Missouri 65202 (573) 447-0292 www.crockettengineering.com Crockett Engineering Consultants, LLC Missouri Certificate of Authority #2000151304

OFFICE OF ADMINISTRATION DIVISION OF FACILITIES MANAGEMENT DESIGN AND CONSTRUCTION

DIRECTOR'S HOUSE

MISSOURI STATE FAIRGROUNDS 2503 W. 16TH ST SEDALIA, MO 65301 PROJECT # F2402-01

SITE # 1501 ASSET # 3511501149

REVISION: DATE:

**REVISION:** 

DATE:

**REVISION:** 

ISSUE DATE: 7/11/2025

**BID DOCUMENTS** 


CAD DWG FILE: DRAWN BY: TJB CHECKED BY: TJB DESIGNED BY: TJB

SHEET TITLE:

**EXISTING** CONDITIONS & **DEMOLITION PLAN** 

SHEET NUMBER:

PAGE 4 OF 36 7/11/2025

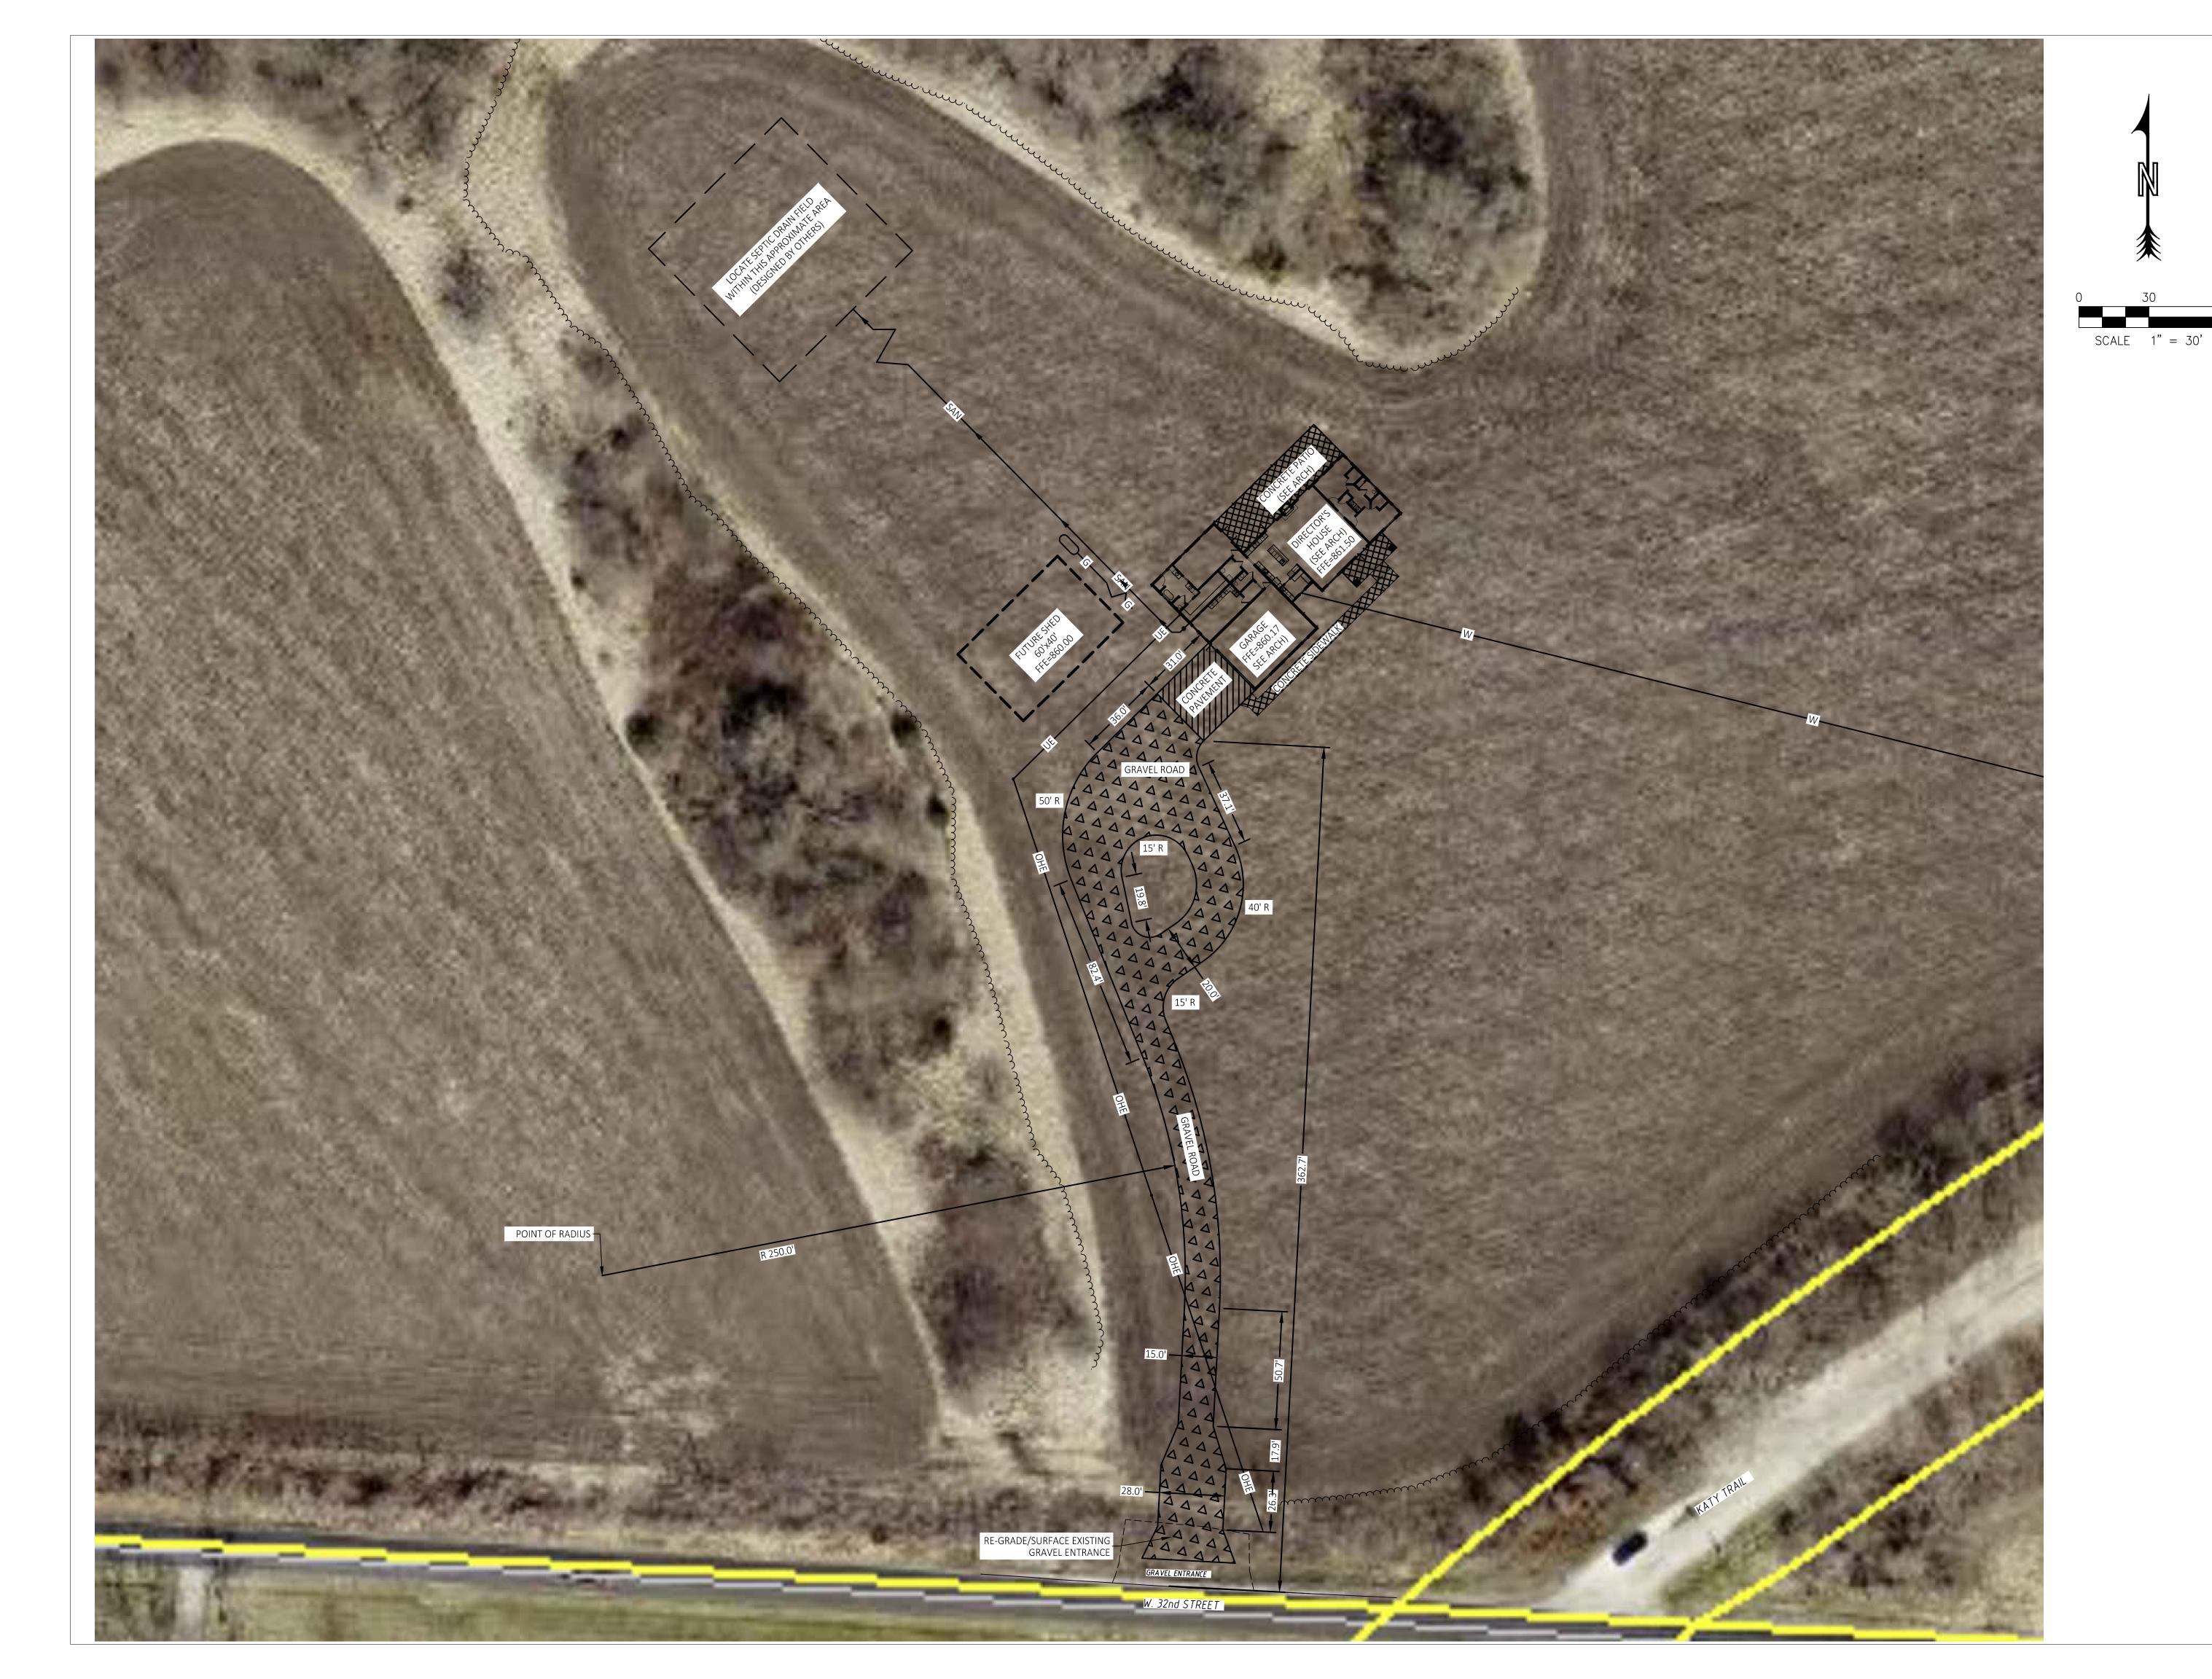



Theron J. Broadfoot, PE-2009015435 JULY 11, 2025 MO CERTIFICATE OF AUTHORITY # 2018030429



Architects LLC 208 S. Lamine Sedalia, Mo 65301 Phone: 660. 829. 9751 Fax: 660. 829. 9752



J-SQUARED
ENGINEERING
2400 BLUFF CREEK DR. SUITE 101
COLUMBIA, MO 65201
573.234.4492



Broadfoot Engineering, LLC 30277 Carpenter Road Sedalia, MO 65301 Phone: 660-619-7001 broadfooteng@yahoo.com

### **CROCKET**

ENGINEERING CONSULTANTS
1000 W. Nifong Blvd., Bldg. 1.
Columbia, Missouri 65202
(573) 447-0292
www.crockettengineering.com
Crockett Engineering Consultants, LLC
Missouri Certificate of Authority
#2000151304

OFFICE OF ADMINISTRATION
DIVISION OF FACILITIES
MANAGEMENT DESIGN AND
CONSTRUCTION

DIRECTOR'S HOUSE

MISSOURI STATE FAIRGROUNDS 2503 W. 16TH ST SEDALIA, MO 65301 PROJECT # F2402-01

SITE # 1501 ASSET # 3511501149

REVISION: \_\_\_\_\_ DATE: \_\_\_\_

REVISION:\_\_\_\_ DATE:\_\_\_

REVISION:\_\_\_ DATE:\_\_\_

ISSUE DATE: 7/11/2025
BID DOCUMENTS

CAD DWG FILE:
DRAWN BY:
CHECKED BY:
TJB
DESIGNED BY:
TJB


SHEET TITLE:

OVERVIEW SITE LAYOUT PLAN


SHEET NUMBER:

C-101

PAGE 5 OF 36 7/11/2025

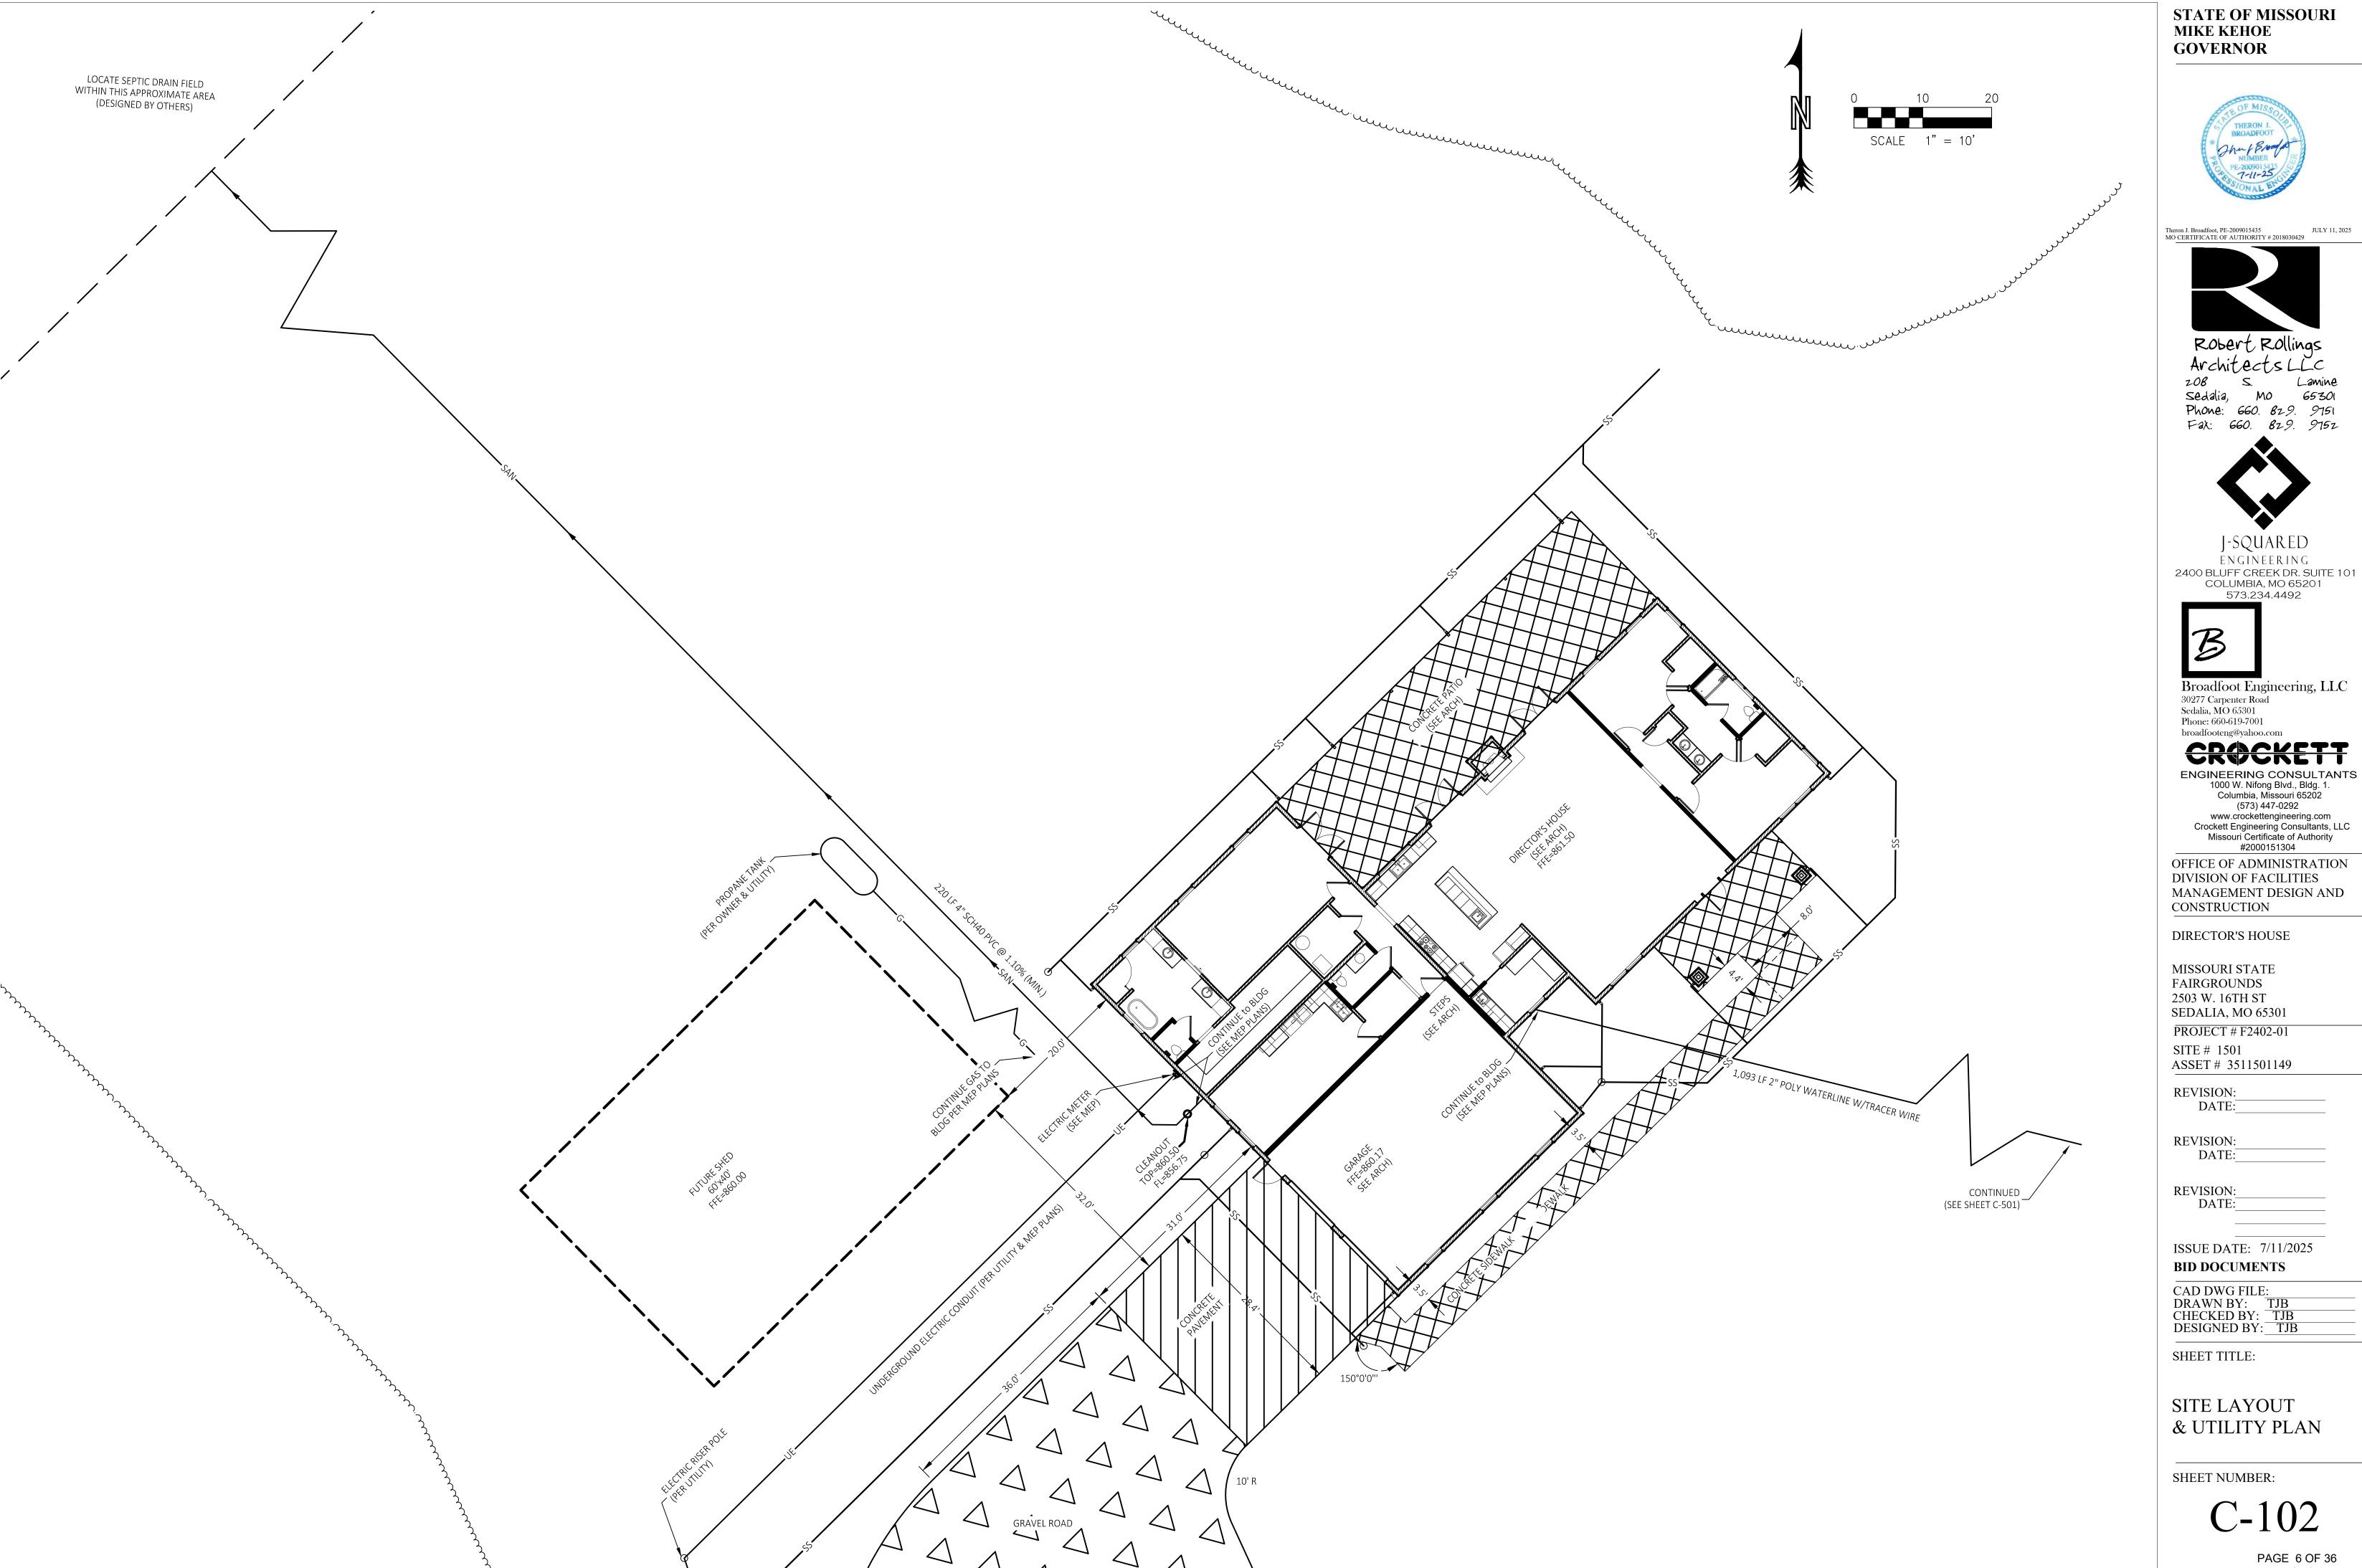

PAGE 6 OF 36 7/11/2025

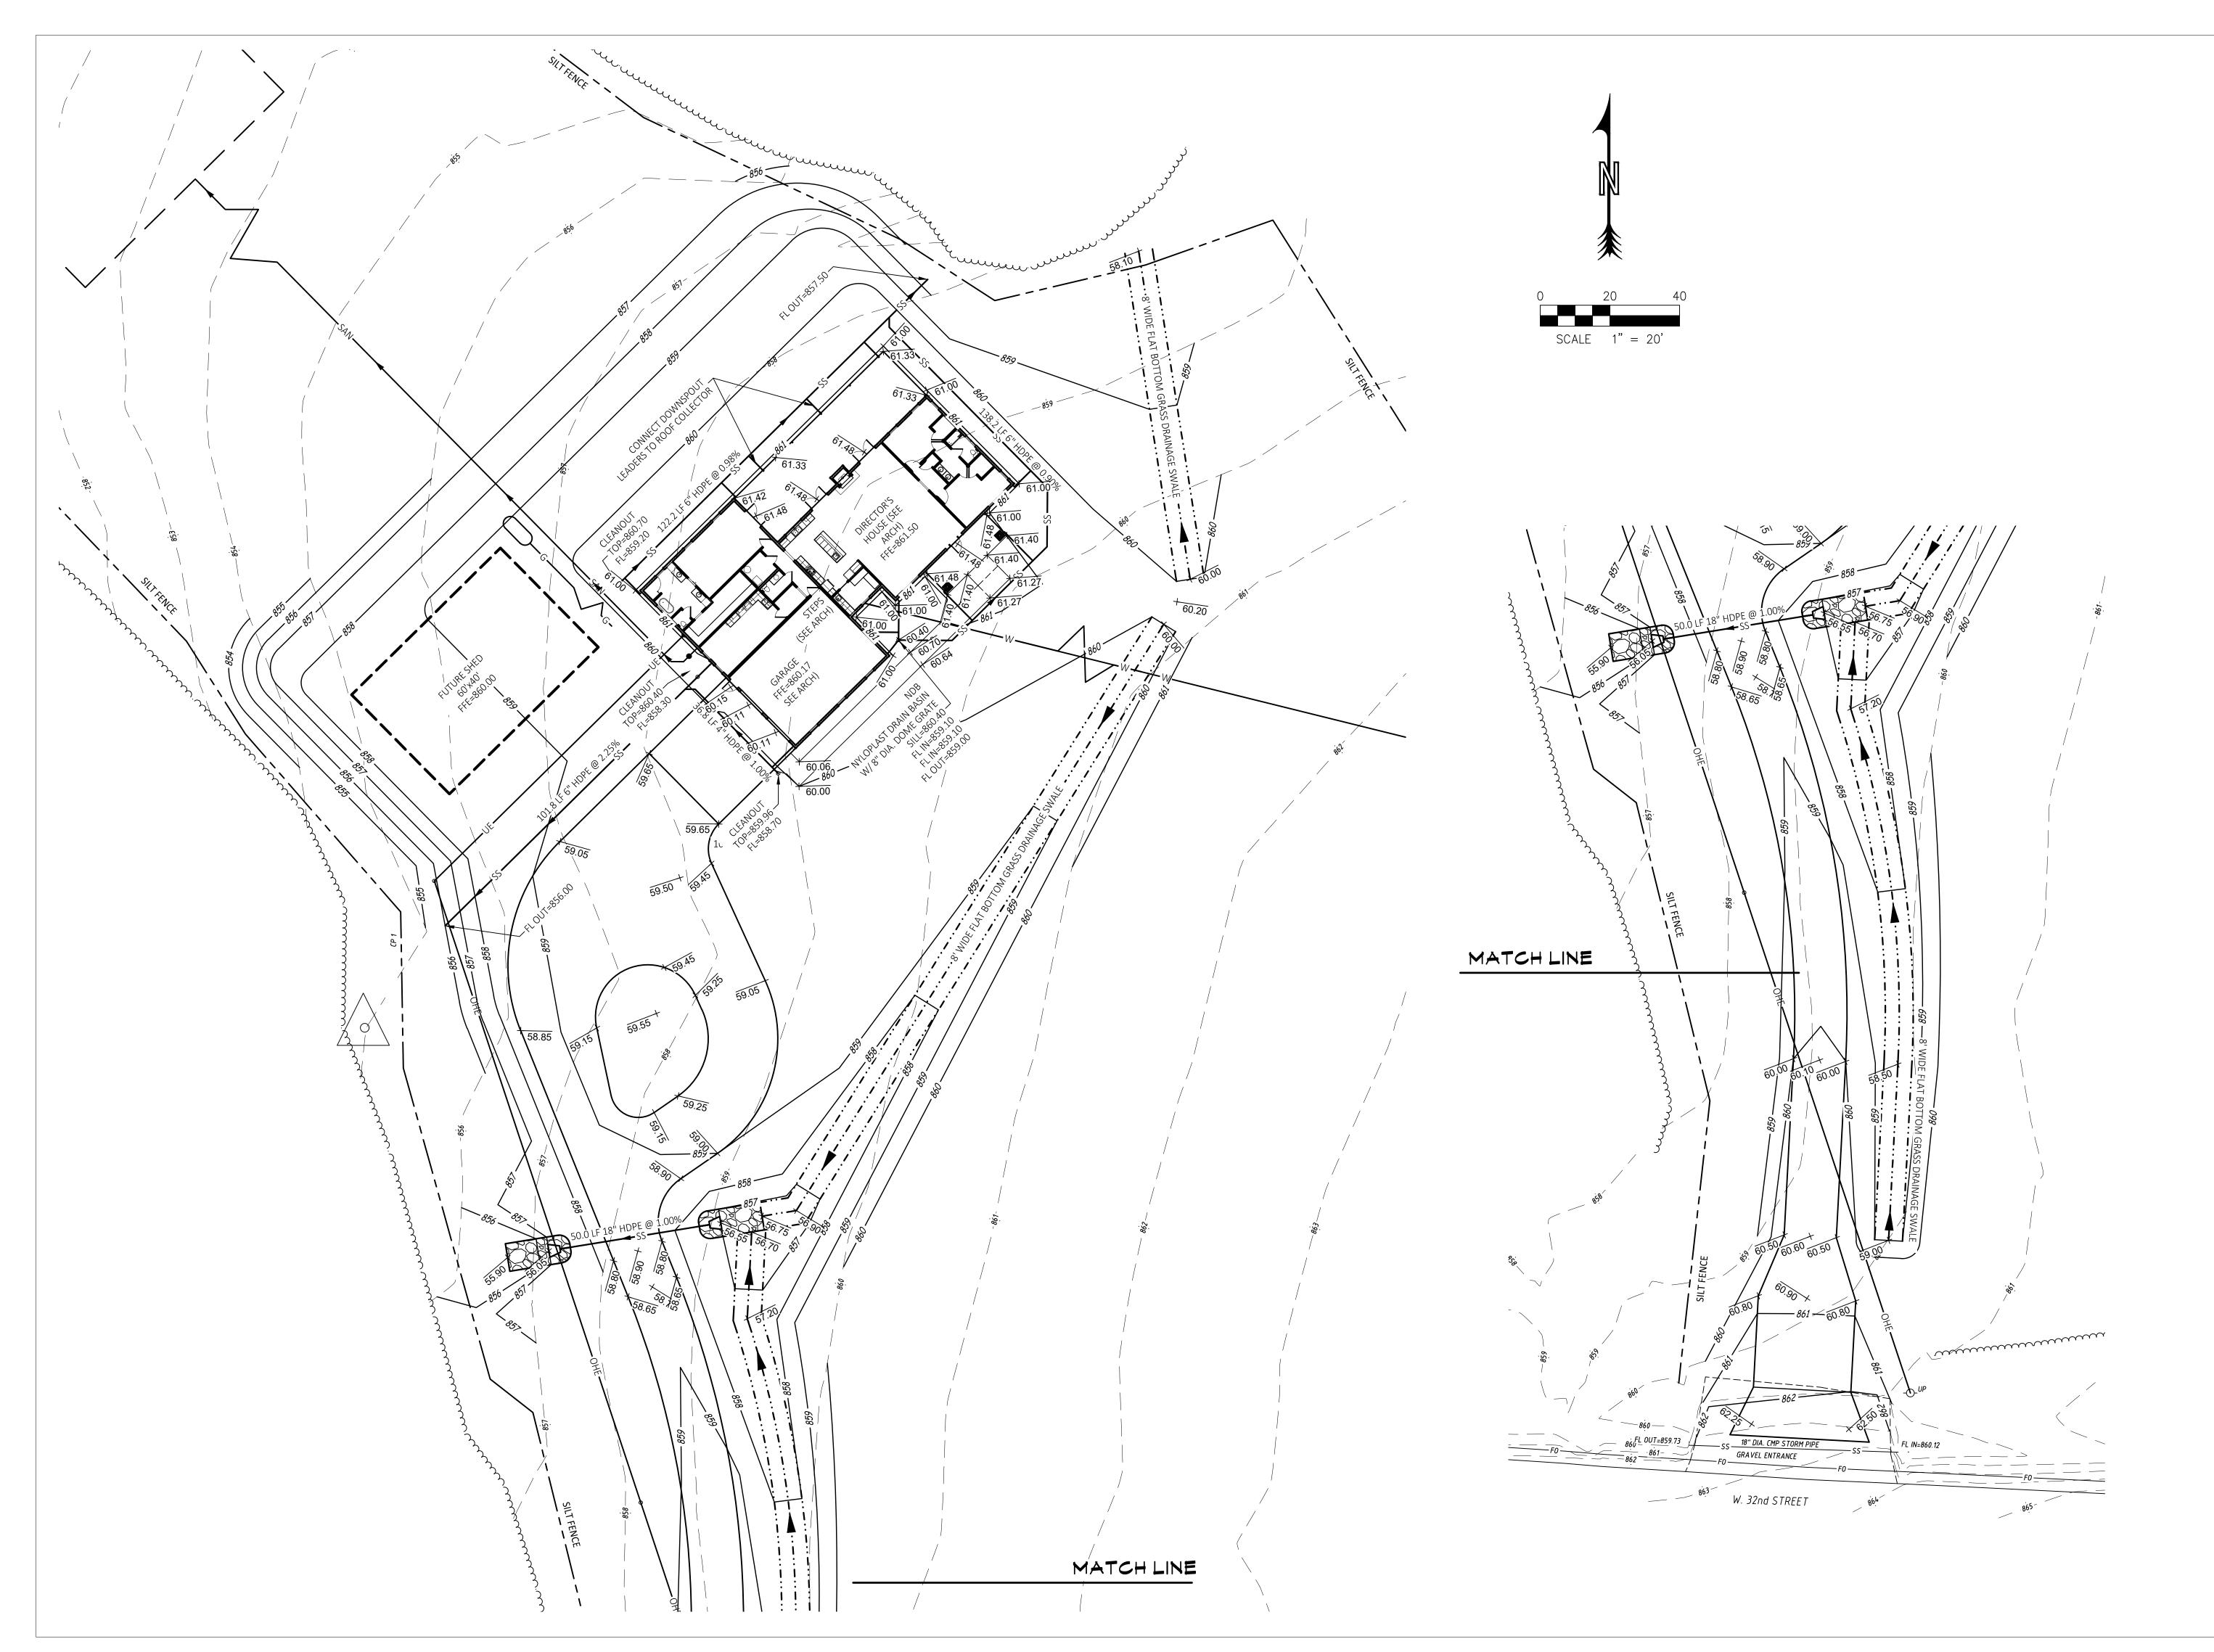



Theron J. Broadfoot, PE-2009015435 JULY 11, 2025 MO CERTIFICATE OF AUTHORITY # 2018030429



Architects LLC 208 S. Lamine Sedalia, Mo 65301 Phone: 660. 829. 9751 Fax: 660. 829. 9752



J-SQUARED
ENGINEERING
2400 BLUFF CREEK DR. SUITE 101
COLUMBIA, MO 65201
573.234.4492



Broadfoot Engineering, LLC 30277 Carpenter Road Sedalia, MO 65301 Phone: 660-619-7001 broadfooteng@yahoo.com

### **CROCKET**

ENGINEERING CONSULTANTS
1000 W. Nifong Blvd., Bldg. 1.
Columbia, Missouri 65202
(573) 447-0292
www.crockettengineering.com
Crockett Engineering Consultants, LLC
Missouri Certificate of Authority
#2000151304

OFFICE OF ADMINISTRATION DIVISION OF FACILITIES MANAGEMENT DESIGN AND CONSTRUCTION

DIRECTOR'S HOUSE

MISSOURI STATE FAIRGROUNDS 2503 W. 16TH ST SEDALIA, MO 65301 PROJECT # F2402-01

SITE # 1501 ASSET # 3511501149

DATE:\_ REVISION:

**REVISION:** 

DATE:\_

REVISION:\_\_\_\_\_ DATE:\_\_\_\_\_

ISSUE DATE: 7/11/2025
BID DOCUMENTS

CAD DWG FILE:
DRAWN BY: TJB
CHECKED BY: TJB
DESIGNED BY: TJB


SHEET TITLE:

GRADING &
DRAINAGE PLAN

SHEET NUMBER:

C-103

PAGE 7 OF 36 7/11/2025

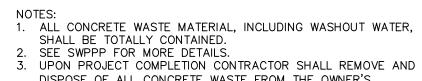

- DISPOSE OF ALL CONCRETE WASTE FROM THE OWNER'S PROPERTY PER ALL APPLICABLE SOLID WASTE REGULATIONS. 4. CONSTRUCT SIGN OF WEATHER PROOF MATERIALS OF A SIZE EASILY READABLE BY CONCRETE TRUCK DRIVERS. PLACE SIGN
- WITHIN 10' OF WASHOUT. 5. CONTRACTOR SHALL CONTAIN WASHOUT WATERS AT ALL TIMES.

36 IN MIN. FENCE POST LENGTH

INTO GROUND

-UNDISTURBED

GROUND

-FENCE POST 18 IN MIN.

VIII.

- FENCE POST DRIVEN

THE GROUND

STEP 2

TWIST POSTS TOGETHER

A MIN. OF 16 IN INTO

STAPLE-

STAPLE -

CONFIGURATION

\_\_\_\_STAPLE

O' MAXIMUM

ABOVE GROUND

**ELEVATION** 

CROSS SECTION

JOINING TWO ADJACENT SILT

FENCE SECTIONS (TOP VIEW)

SILT FENCE DETAI

SILT FENCE LAYOUT

NOT TO SCALE

1. USE WOOD POSTS  $1\frac{3}{4}$  X  $1\frac{3}{4}$   $\pm$   $\frac{1}{6}$  INCH (MINIMUM) SQUARE CUT OF SOUND QUALITY HARDWOOD. AS AN ALTERNATIVE TO WOODEN POST USE STANDARD "T" OR "U" SECTION STEEL POSTS WEIGHING NOT LESS

2. USE 36 INCH MINIMUM POSTS DRIVEN 16 INCH MINIMUM INTO GROUND NO MORE THAN 6 FEET APART.

3. USE WOVEN SLIT FILM GEOTEXTILE AS SPECIFIED IN SECTION H-1 MATERIALS AND FASTEN GEOTEXTILE

6. WHERE TWO SECTIONS OF GEOTEXTILE ADJOIN: OVERLAP, TWIST, AND STAPLE TO POST IN ACCORDANCE

45 DEGREES TO THE MAIN FENCE ALIGNMENT TO PREVENT RUNOFF FROM GOING AROUND THE ENDS OF

8. REMOVE ACCUMULATED SEDIMENT AND DEBRIS WHEN BULGES DEVELOP IN SILT FENCE OR WHEN SEDIMENT

REACHES 25% OF FENCE HEIGHT. REPLACE GEOTEXTILE IF TORN. IF UNDERMINING OCCURS, REINSTALL

7. EXTEND BOTH ENDS OF THE SILT FENCE A MINIMUM OF FIVE HORIZONTAL FEET UPSLOPE AT

4. PROVIDE MANUFACTURER CERTIFICATION TO THE AUTHORIZED REPRESENTATIVE OF THE

SECURELY TO UPSLOPE SIDE OF FENCE POSTS WITH WIRE TIES OR STAPLES AT TOP AND MID-SECTION.

NOT TO SCALE

-DRIVEN MIN. 16 IN INTO GROUND

16 IN MIN. HEIGHT OF

WOVEN SLIT FILM GEOTEXTILE

6 FT MAX.

CENTER TO CENTER

36 IN MIN. FENCE

FLOW \_\_\_

POST LENGTH ——

KKKK.

WOVEN SLIT FILM ---

GEOTEXTILE

EMBED GEOTEXTILE

MIN. OF 8 IN VERTICALLY INTO THE

STEP 1

STEP 3

SILT FENCE SPECIFICATIONS

SECTION H-1 MATERIALS.


WITH THIS DETAIL.

SOIL ON BOTH SIDES OF FABRIC.

THAN 1 POUND PER LINEAR FOOT.


GROUND. BACKFILL AND COMPACT THE

SOIL ON BOTH SIDES OF GEOTEXTILE.

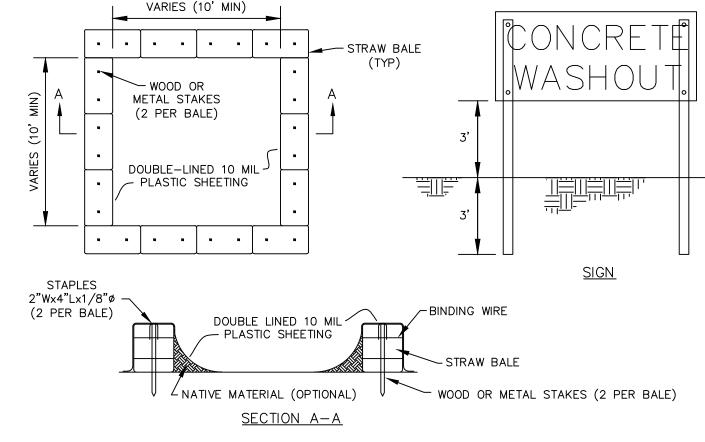

### CONCRETE WASHOUT AREA


### NOT TO SCALE

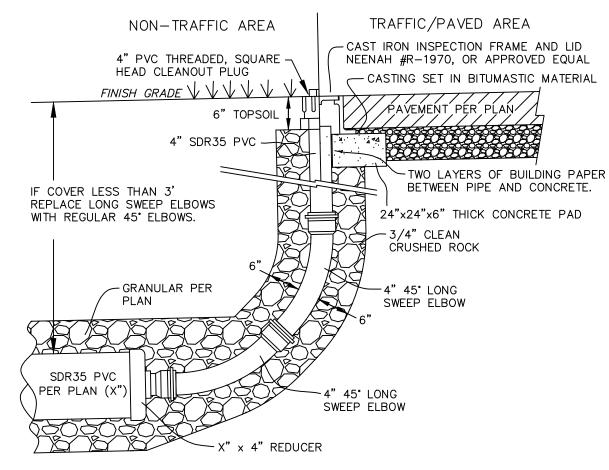


- 1. ALL PIPE & FITTINGS SHALL BE WATER TIGHT, GASKETED, SDR35 PVC. 2. INSTALL ALL PIPING PER SEPARATE DETAIL OR MANUFACTURER'S WRITTEN
- 3. THIS DETAIL IS FOR GENERAL LAYOUT PURPOSES ONLY. ADDITIONAL COUPLERS,
- GASKETS, FITTINGS, ETC. MAY BE NECESSARY PER MANUFACTURER'S 4. TOP SHALL BE SET FLUSH WITH FINISH GRADE.

PVC END-OF-LINE STORM SEWER CLEANOUT

### NOT TO SCALE

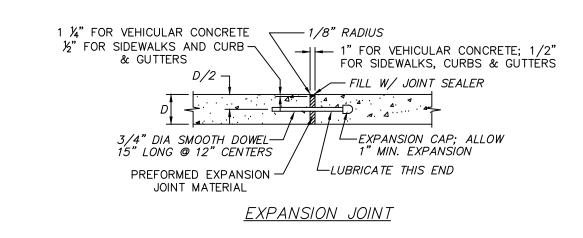

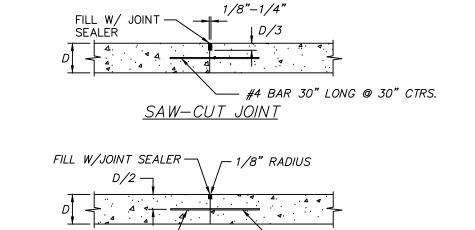

### **CONSTRUCTION JOINT**

3/4" DIA SMOOTH DOWEL

15" LONG @ 12" CTRS.

1. PRIOR TO CONSTRUCTION, CONTRACTOR SHALL SUBMIT A PAVEMENT JOINT PLAN OF ALL CONCRETE PAVEMENT FOR APPROVAL. 2. CONCRETE PAVEMENT SHALL HAVE SAW-CUT OR CONSTRUCTION JOINTS EVERY 10 FEET FOR 4

LUBRICATE ONE END


- INSPECTION/ENFORCEMENT AUTHORITY SHOWING THAT THE GEOTEXTILE USED MEETS THE REQUIREMENTS IN INCH THICK PAVEMENT, 12 FEET FOR 5 INCH THICK PAVEMENT, AND 15 FEET FOR 6 INCH THICK PAVEMENT OR GREATER. PANELS SHALL BE CUT SUCH THAT PANELS ARE NEARLY SQUARE AND DO NOT EXCEED 1.4 LENGTH TO WIDTH RATIO. EXPANSION JOINTS SHALL BE PROVIDED AT ALL 5. EMBED GEOTEXTILE A MINIMUM OF 8 INCHES VERTICALLY INTO THE GROUND. BACKFILL AND COMPACT THE FIXED STRUCTURES, SUCH AS: LIGHT STANDARD FOUNDATIONS, SEWER STRUCTURES, BUILDINGS, WALLS, BOTTOM OF STAIRS, ROOF DRAINS, ETC., AND EVERY 150 FEET MAXIMUM. DOWEL BARS SHALL BE PROVIDED AT TRANSVERSE JOINTS IN ALL HEAVY DUTY PAVEMENT.
  - 3. THIS DETAIL APPLIES TO ALL CONCRETE PAVEMENT FOR PARKING LOTS, DRIVE/ACCESS AISLES, CURBS & GUTTERS, AND SIDEWALKS. 4. ALL 9 INCH THINK HEAVY DUTY CONCRETE PAVEMENT SHALL HAVE JOINTS PER MODOT DETAILS, INCLUDING 1.25 INCH SMOOTH DOWELS WITH DOWEL SUPPORT BASKETS PER MODOT DETAIL AND
  - LONGITUDINAL JOINTS WITH #5 X 30" TIE BARS. 5. INCLUDE BAR WITH TRANSVERSE SAW-CUT JOINTS FOR HEAVY DUTY PAVEMENT. OMIT BAR WITH
  - SAW-CUT JOINTS FOR STANDARD DUTY PAVEMENT AND SIDEWALKS. 6. PROVIDE CONSTRUCTION JOINT AT END OF DAYS WORK OR IF CONCRETE PLACEMENT IS
  - SUSPENDED FOR MORE THAN 30 MINUTES. 7. SAW-CUT JOINTS SHALL BE CUT WITHIN 12 HOURS OF INITIAL SET OF CONCRETE. RAVELED JOINTS
  - WILL NOT BE ACCEPTED. 8. ELASTOMERIC POLYURETHANE JOINT SEALANT IS REQUIRED FOR ALL JOINTS AND SHALL BE LIGHT

  - 9. OMIT DOWEL BARS FOR EXPANSION JOINTS AT BUILDINGS, LIGHT STANDARDS, AND ROOF DRAINS.


CONCRETE PAVEMENT JOINTS

NOT TO SCALE

MIN. TRENCH WIDTH PIPE DIA. + 18" PIPE DIA. + 10" 8"-10" 12"-36" PIPE DIA. + 12"

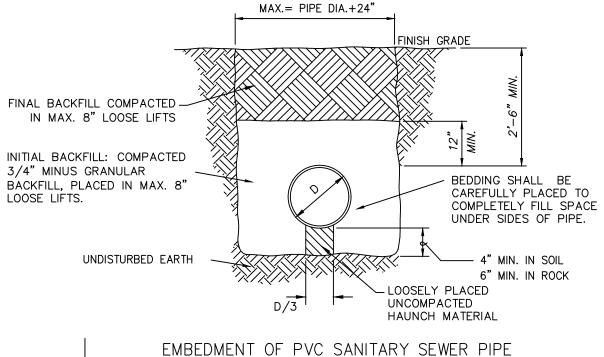


NOT TO SCALE

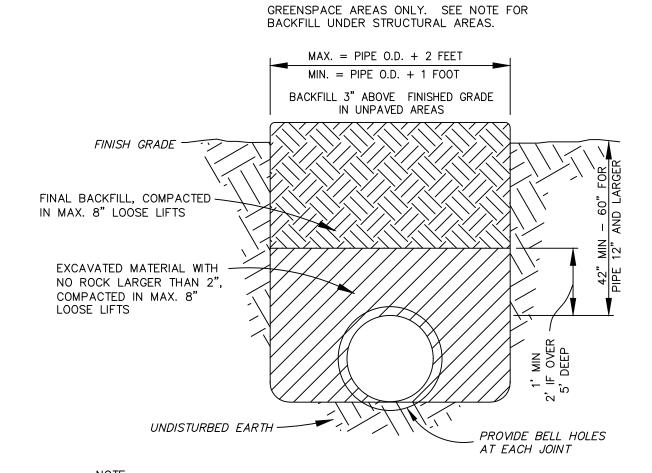

ALL TRENCHES UNDER PAVEMENT, BUILDINGS, RETAINING WALLS, OR OTHER STRUCTURAL AREAS SHALL BE BACKFILLED AND COMPACTED WITH CONTROLLED ENGINEERED FILL PER THE PROJECT SPECIFICATIONS.

> PVC WATER PIPE EMBEDMENT DETAIL NOT TO SCALE

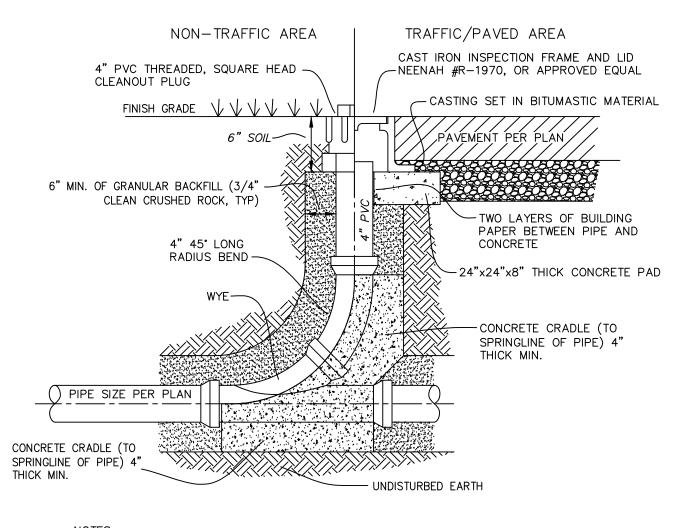

1. ALL PIPE & FITTINGS SHALL BE WATER TIGHT, GASKETED, SDR35 PVC. 2. INSTALL ALL PIPING PER SEPARATE DETAIL OR MANUFACTURER'S WRITTEN

- INSTRUCTIONS 3. THIS DETAIL IS FOR GENERAL LAYOUT PURPOSES ONLY. ADDITIONAL COUPLERS, GASKETS, FITTINGS, ETC. MAY BE NECESSARY PER MANUFACTURER'S REQUIREMENTS
- 4. TOP SHALL BE SET FLUSH WITH FINISH GRADE. 5. INSTALL IN THE DIRECTION OF FLOW AS SHOWN UNLESS OTHERWISE INDICATED IN

IN-LINE SANITARY SEWER CLEANOUT

NOT TO SCALE

CONNECT TO EXISTING WATER MAIN INSTALL 2-INCH WATER METER & VALVE (COORDINATE W/SEDALIA WATER DEPARTMENT)

**STATE OF MISSOURI** MIKE KEHOE **GOVERNOR** 



Theron J. Broadfoot, PE-2009015435 JULY 11, 2025



Sedalia, MO 65301 Phone: 660. 829. 9751 660. 829. 9752 Fax:



J-SQUARED ENGINEERING 2400 BLUFF CREEK DR. SUITE 101 COLUMBIA, MO 65201



Broadfoot Engineering, LLC 30277 Carpenter Road Sedalia, MO 65301 Phone: 660-619-7001

# CROCKET'

broadfooteng@yahoo.com

**ENGINEERING CONSULTANTS** 1000 W. Nifong Blvd., Bldg. 1 Columbia, Missouri 65202 (573) 447-0292 www.crockettengineering.com Crockett Engineering Consultants, LLC Missouri Certificate of Authority

#2000151304 OFFICE OF ADMINISTRATION DIVISION OF FACILITIES MANAGEMENT DESIGN AND CONSTRUCTION

**DIRECTOR'S HOUSE** 

MISSOURI STATE FAIRGROUNDS 2503 W. 16TH ST SEDALIA, MO 65301 PROJECT # F2402-01

SITE # 1501 ASSET # 3511501149

**REVISION:** DATE:

**REVISION:** 

DATE:

**REVISION:** DATE:

ISSUE DATE: 7/11/2025 **BID DOCUMENTS** 

CAD DWG FILE: DRAWN BY: TJB CHECKED BY: TJB DESIGNED BY: TJB

SHEET TITLE:


**DETAILS** 

SHEET NUMBER:


PAGE 8 OF 36 7/11/2025

WATER LINE PLAN

SCALE 1"=100'

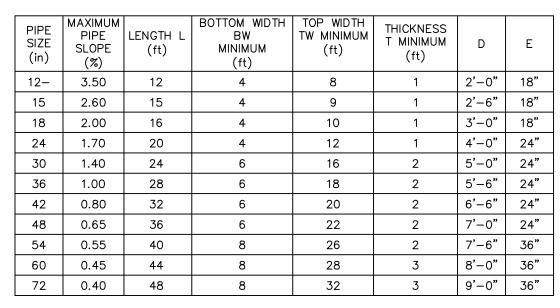


- 1. RIP RAP SHALL BE MODOT TYPE 1 ROCK BLANKET: 40% OF THE MASS SHALL BE PIECES HAVING A VOLUME OF ONE CUBIC FOOT OR MORE. ROCK MUST BE ANGULAR,
- 2. ROCK LINER FABRIC SHALL CONSIST OF A NON-WOVEN POLYPROPYLENE TYPE

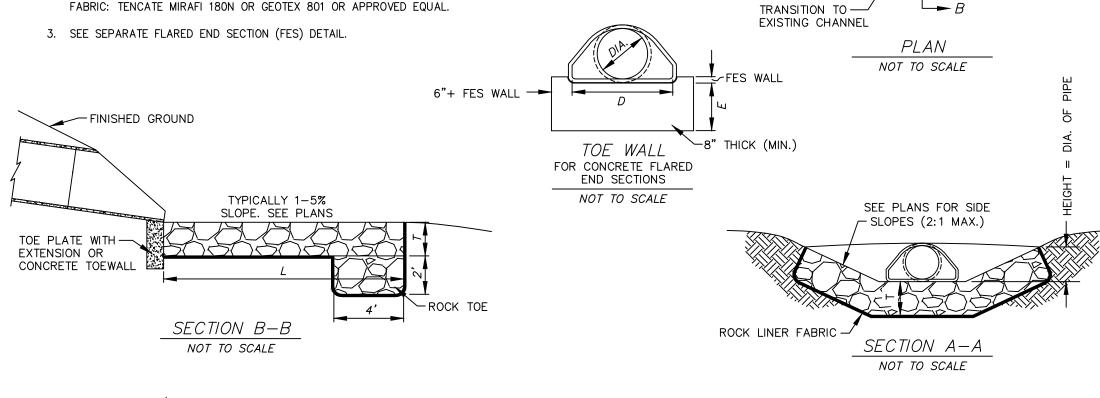

RIP RAP FOR FLARED END SECTIONS

NOT TO SCALE

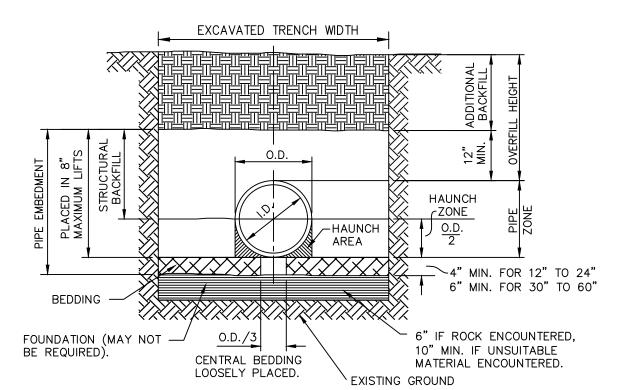

TYPICAL TRENCH DETAIL

### BACKFILL NOTES: 1. BEDDING, HAUNCH, AND STRUCTURAL BACKFILL SHALL BE IN CONFORMANCE WITH AASHTO M145 A1 OR A-3 COMPACTED TO A MINIMUM OF 95% OF THE MAXIMUM DRY DENSITY AS DEFINED BY ASTM D698.

- 2. ALL PIPE INSTALLATION SHALL BE IN ACCORDANCE WITH THE MANUFACTURER'S RECOMMENDATIONS AND ASTM D2321 LATEST ADDITION.
- 3. HAUNCH, STRUCTURAL, AND ADDITIONAL BACKFILL SHALL BE PLACED IN LIFTS NOT TO EXCEED 8 INCHES AND COMPACTED TO 95% OF THE MAXIMUM DRY DENSITY AS DEFINED BY ASTM D698.

		-	TABLE II							
MINIMUM COVER FOR CONSTRUCTION LOADS										
	PIPE DIA. (IN.)	MINIMUM COVER (FT) FOR INDICATED AXLE LOADS (THOUSANDS OF POUNDS)								
		18-50	50-75	75–110	110-150					
	12-36	2.0	2.5	3.0	3.0					
	42-48	3.0	3.0	3.5	4.0					

- B

WRAP ROCK AROUND

END SECTION.

THICKNESS=1.5'

THE CONTRACTOR SHALL PROVIDE MINIMUM COVER PLUS ANY ADDITIONAL COVER REQUIRED TO AVOID DAMAGE TO THE PIPE. IN UNPAVED SITUATIONS, THE SURFACE MUST BE MAINTAINED TO A LEVEL AND NON-RUTTED CONDITION.

_	LEGEND
O.D H MIN	= NORMAL INSIDE DIAMETER OF PIPE. = OUTSIDE DIAMETER OF PIPE. = FILL COVER HEIGHT OVER PIPE (FEET). = MINIMUM (= MAXIMUM = UNDISTURBED SOIL

- CONSTRUCTION SEQUENCE:
- PLACE BEDDING MATERIAL TO GRADE. COMPACT BEDDING OUTSIDE THE MIDDLE THIRD OF THE PIPE. INSTALL PIPE TO GRADE.
- PLACE AND COMPACT THE HAUNCH AREA UP TO THE SPRINGLINE. 5. COMPLETE BACKFILL ACCORDING TO SPECIFICATIONS.

TABLE III

PARALLEL PIPE INSTALLATION

S = MINIMUM PIPE SEPARATION (IN)

BETWEEN OUTSIDE WALLS OF PIPES.

X = MINIMUM SEPARATION BETWEEN TRENCH


WALL AND OUTSIDE WALL OF PIPE.

					TAE	BLE I								
	CORRUGATED HDPE AND POLYVINYL CHLORIDE CIRCULAR PIPE													
SPECIFIED DIA OF PIPE (IN.)	MIN OVERFILL HEIGHT (FT)	HDPE MAX OVERFILL HEIGHT* (FT)	POLYVINYL MAX OV HEIGHT	VERFILL * (FT)	OVE	RESIN (AASH ERFILL HEIGH	[* (FT)	ENGINEERE ASTM F264	TRENCH WIDTH					
, ,			SDR 35#	SDR 26#	CLASS 1**	CLASS 2**	CLASS 3**	CLASS 1**	CLASS 2**	CLASS 3**	(IN.)			
12	2	26	15	30	43	29	21	27	19	12	34			
15	2	28	15	30	45	30	22	27	20	13	39			
18	2	24	15	30	40	27	19	25	18	11	44			
24	2	20	15	30	36	25	17	22	16	12	55			
30	2.5	17	N/A	N/A	29	21	15	16	12	6	67			
36	2.5	19	N/A	N/A	34	23	16	21	15	10	76			
42	2.5	19	N/A	N/A	31	23	16	17	13	7	84			
48	2.5	17	N/A	N/A	30	20	14	18	13	10	95			
54	2.5	9	N/A	N/A	33	22	15	N/A	N/A	N/A	104			
60	2.5	9	N/A	N/A	33	22	15	20	15	10	113			

- TABLE ASSUMES STANDARD PROCTOR DENSITY OF 95% MAXIMUM OVERFILL MEASURED FROM THE TOP OF PIPE TO SURFACE
- \*\* CLASS 1 CRUSHED ROCK, ANGULAR; AASHTO M43 5, 6, 56, 57, 67 \*\* CLASS 2 - CLEAN, COURSÉ GRAINED SOILS TO BORDERLINE CLEAN FINES; AASHTO M43 - 5, 6, 56, 57, 67; AASHTO M145 - A1, A3 \*\* CLASS 3 - COURSE GRAINED SOILS WITH FINES AND INORGANIC FINE-GRAINED SOILS; AASHTO M43 - GRAVEL AND SAND WITH <10% FINES;
- AASHTO M145 A-2-4, A-2-5, A-2-6, A-4, OR A-6 WITH >30% RETAINED ON #200 SIEVE \*\* REFER TO CURRENT ADS INC. DRAINAGE HANDBOOK FOR A COMPLETE LISTING OF SUITABLE MATERIALS
- # PER ASTM D-3034 FOR PIPE UP TO 15" AND ASTM F679 OVER 15"


EMBEDMENT OF PLASTIC STORM SEWER PIPE


NOT TO SCALE

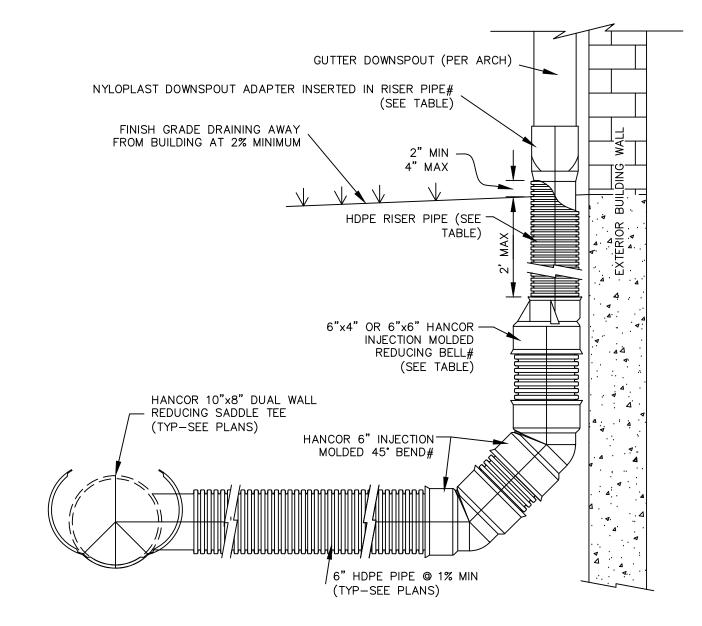


GUTTER DOWNSPOUT (INCHES)	DOWNSPOUT ADAPTER (INCHES)	NYLOPLAST DOWNSPOUT ADAPTER ID	RISER PIPE Ø (INCHES)
4 X 4 4 X 6 6 X 6 6 X 8 8 X 8	4 X 4 X 4 4 X 6 X 6 6 X 6 X 6 6 X 6 X 8 8 X 8 X 8	TECHNICAL DWG NO. 0444FH TECHNICAL DWG NO. 0466FH TECHNICAL DWG NO. 0666FH TECHNICAL DWG NO. 0668FH TECHNICAL DWG NO. 0888FH	4 6 6 8* 8*


- \* INJECTION MOLDED REDUCING BELL NOT NECESSARY # OR APPROVED EQUAL
- 1. SEE PLANS TO DETERMINE IF FITTINGS AND JOINTS ARE SOIL TIGHT (ST) OR WATER TIGHT (WT).
- 2. INSTALL ALL PIPING PER SEPARATE DETAIL OR MANUFACTURER'S WRITTEN INSTRUCTIONS. 3. THIS DETAIL IS FOR GENERAL LAYOUT PURPOSES ONLY. ADDITIONAL COUPLERS, GASKETS, FITTINGS, ETC. MAY BE
- NECESSARY PER MANUFACTURER'S REQUIREMENTS. 4. IF GUTTER DOWNSPOUT SIZE EXCEEDS THE LARGEST AVAILABLE HANCOR DOWNSPOUT ADAPTER, THE HDPE PIPE SIZE SHALL BE INCREASED TO ACCOMMODATE THE DOWNSPOUT AND THE DOWNSPOUT ADAPTER SHALL BE REPLACED WITH AN HDPE END CAP PREFABRICATED OR CUT TO FIT THE DOWNSPOUT GUTTER AND UPSIZED HDPE PIPE. CAP/PIPE SHALL
- BE INSTALLED SO CAP IS 2" ABOVE FINISHED GRADE, MINIMUM. 5. SDR35 PVC PIPE MAY BE SUBSTITUTED FOR ANY HDPE PIPE UP TO 15" IN DIAMETER

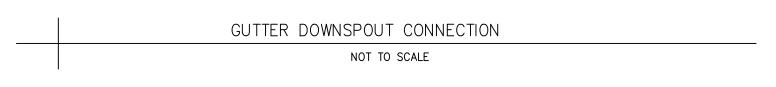


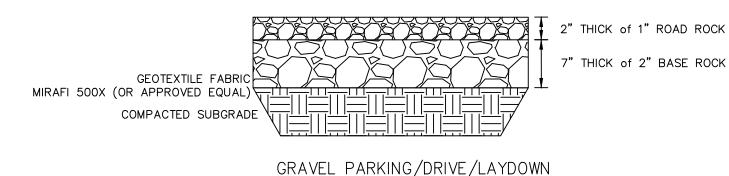

NOT TO SCALE

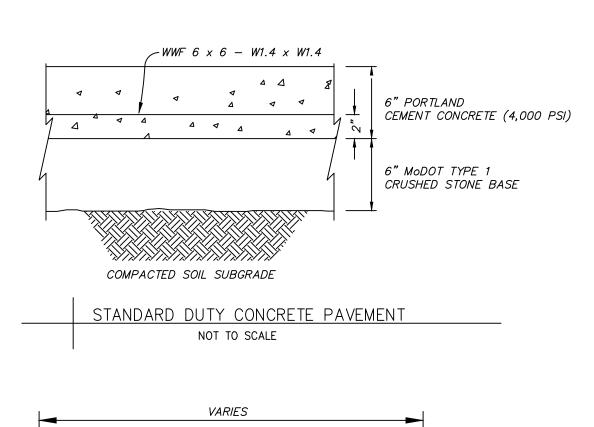


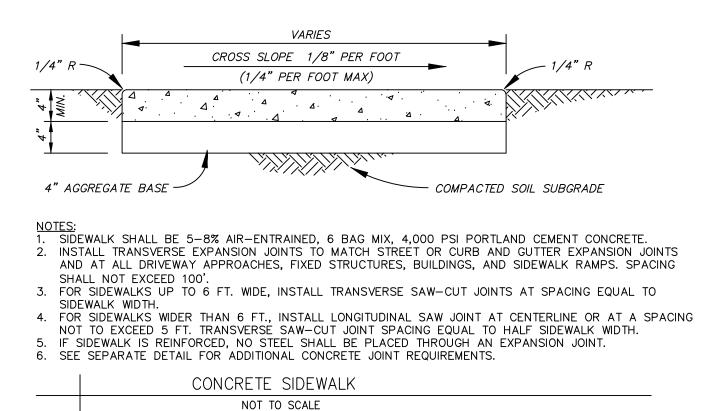

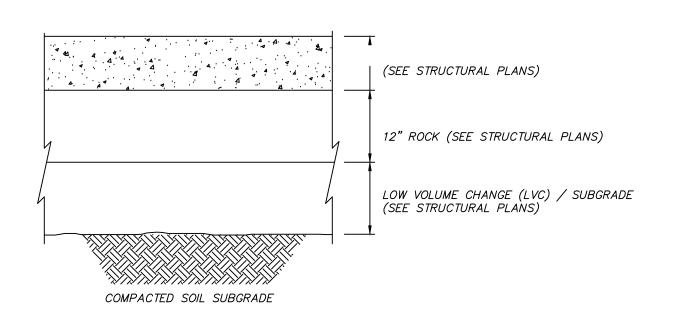

BUILDING (INTERIOR) PAD

NOT TO SCALE

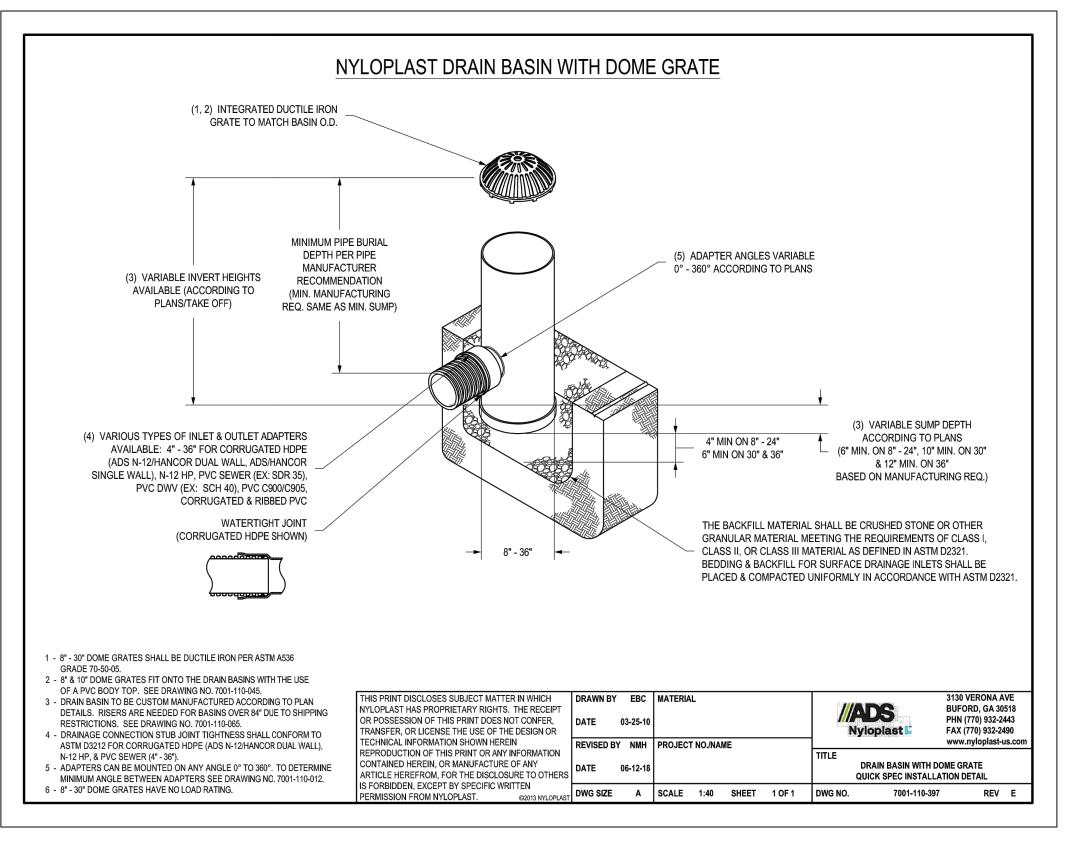

### **STATE OF MISSOURI** MIKE KEHOE **GOVERNOR**



Theron J. Broadfoot, PE-2009015435 JULY 11, 2025



sedalia, MO 65301 Phone: 660. 829. 9751 660. BZ9. 975Z Fax:



**I-SQUARED** ENGINEERING 2400 BLUFF CREEK DR. SUITE 101 COLUMBIA, MO 65201



Broadfoot Engineering, LLC 30277 Carpenter Road Sedalia, MO 65301 Phone: 660-619-7001

# broadfooteng@yahoo.com

**ENGINEERING CONSULTANTS** 1000 W. Nifong Blvd., Bldg. 1 Columbia, Missouri 65202 (573) 447-0292 www.crockettengineering.com Crockett Engineering Consultants, LLC Missouri Certificate of Authority

#2000151304 OFFICE OF ADMINISTRATION DIVISION OF FACILITIES MANAGEMENT DESIGN AND CONSTRUCTION

DIRECTOR'S HOUSE

MISSOURI STATE FAIRGROUNDS 2503 W. 16TH ST SEDALIA, MO 65301

PROJECT # F2402-01 SITE # 1501 ASSET # 3511501149

**REVISION:** DATE:

**REVISION:** 

**REVISION:** 

DATE:

ISSUE DATE: 7/11/2025

**BID DOCUMENTS** 

CAD DWG FILE: DRAWN BY: TJB CHECKED BY: TJB DESIGNED BY: TJB

SHEET TITLE:

**DETAILS** 

SHEET NUMBER:

PAGE 9 OF 36 7/11/2025

### GENERAL NOTES

### **ELEVATION DATUM**

SEE ARCHITECTURAL DRAWINGS OR SITE PLAN FOR FINISH FLOOR ELEVATIONS

### DESIGN SPECIFICATIONS

2021 INTERNATIONAL BUILDING CODE

### **EARTHWOF**

EARTHWORK OPERATIONS SHALL BE PERFORMED UNDER THE DIRECTION OF A PROFESSIONAL TESTING AGENCY TO ASSURE COMPLIANCE WITH THE RECOMMENDATIONS OF THE SOILS REPORT.

### CONCRETE

CONCRETE WORK SHALL CONFORM TO ALL REQUIREMENTS OF THE CURRENT ACI 301, SPECIFICATIONS FOR STRUCTURAL CONCRETE FOR BUILDINGS, ACI 318 BUILDING CODE REQUIREMENTS FOR STRUCTURAL CONCRETE, ACI 305 SPECIFICATIONS FOR HOT WATER CONCRETE, AND ACI 306 SPECIFICATIONS FOR COLD WEATHER CONCRETE, WITH THE FOLLOWING ADDITIONAL REQUIREMENTS:

- 1. CONCRETE SHALL DEVELOP THE FOLLOWING 28—DAY MINIMUM COMPRESSIVE STRENGTH:

  FOUNDATIONS

   3.000 PSI
- FOUNDATIONS 3,000 PSI CAST-IN-PLACE WALLS - 3,500 PSI
- FLOOR SLABS 4,000 PSI
- EXTERIOR SLABS, WALLS AND CURBS 4,000 PSI
  2. ALL FOOTINGS SHALL BEAR ON UNDISTURBED SOIL OR ENGINEERED FILL.
- 3. CHLORIDE— BASED ADMIXTURES ARE PROHIBITED IN ALL REINFORCED CONCRETE.
- 4. REINFORCING STEEL SHALL CONFORM TO ASTM A615, A616, OR A617, GRADE 60.5. ALL CONTINUOUS REINFORCING STEEL THAT MEETS AT A CORNER SHALL BE TIED TOGETHER WITH A CORNER BAR THAT HAS SUFFICIENT LAP DISTANCE IN EACH DIRECTION
- 6. CONTINUOUS REINFORCING BARS LAP LENGTH SHALL BE A MINIMUM OF 48 BAR DIAMETERS UNLESS NOTED OTHERWISE
- 7. CONCRETE SLUMP SHALL BE A MAXIMUM OF 4"+/-1" (ASTM C-143) AS DELIVERED IN THE FIELD. CONTRACTOR MAY USE CHEMICAL ADMIXTURES TO ATTAIN A MAXIMUM SLUMP OF 8" FOR WORKABILITY. NO WATER MAY BE ADDED TO THE CONCRETE MIX ON SITE UNLESS WATER IS WITHHELD AT THE BATCHING FACILITY. IF WATER IS WITHHELD AT THE BATCHING FACILITY IT SHOULD BE REFLECTED ON THE LOAD TICKET. THE TOTAL AMOUNT OF WATER IN THE MIX SHALL NOT EXCEED WHAT IS NOTED ON
- THE APPROVED MIXED. THIS SHALL BE NOTED IN THE SPECIAL INSPECTOR'S RECORDS.

  8. CONCRETE EXPOSED TO WEATHER, VEHICLES, AND/OR DEICING CHEMICALS SHALL BE AIR—ENTRAINED WITH 6% (+/-) 1.5% ENTRAINED AIR BY VOLUME AT POINT OF DISCHARGE. DO NOT ALLOW AIR
- CONTENT OF TROWELED FINISHED FLOORS TO EXCEED 3%.

  9. SUBMIT CONCRETE MIX PROPORTIONS PRIOR TO START OF WORK. DO NOT BEGIN CONCRETE PRODUCTION UNTIL MIXES HAVE BEEN REVIEWED AND ARE ACCEPTABLE TO THE ENGINEER.

  10.READY MIX CONCRETE SHALL COMPLY WITH REQUIREMENTS OF ASTM C94.
- 11.CONCRETE WORK EXECUTION

  A. CONSTRUCT FORMS TO CORRECT SIZE, SHAPE, ALIGNMENT, ELEVATION AND POSITION; AND TO

- FINISHING WITHOUT DISLODGING AGGREGATE.

  D. STEEL TROWEL FINISH ALL INTERIOR CONCRETE SLABS, BROOM FINISH ALL EXTERIOR CONCRETE
- SLABS.

  E. CURE ALL CONCRETE IN COMPLIANCE WITH ACI 301, USING A LIQUID TYPE MEMBRANE, NON-RESIDUAL, CURING COMPOUND COMPLYING WITH ASTM C309. ASSURE COMPATIBILITY WITH FINISH FLOOR COVERING.

### POST-INSTALLED ANCHORS

- 1. ALL POST-INSTALLED ANCHORS SHALL MEET THE REQUIREMENTS OF THE CODE-CITED EDITION OF ACI 318, APPENDIX "D", AND SHALL BE ACCEPTABLE FOR BOTH CRACKED AND UNCRACKED CONCRETE.
- 2. EXPANSION ANCHORS HAVE BEEN DESIGNED AS HILTI KWIK BOLT TZ ANCHORS, UNLESS NOTED OTHERWISE.
- 3. ADHESIVE ANCHORS HAVE BEEN DESIGNED TO USE HILTI HIT HY 200 ADHESIVE IN CONCRETE OR SOLID MASONRY, UNLESS NOTED OTHERWISE.
- 4. EQUIVALENT ANCHORS MAY BE SUBMITTED FOR THE ENGINEER'S APPROVAL. SUBMITTALS ARE THE CONTRACTOR'S RESPONSIBILITY AND MUST INCLUDE EVALUATION REPORTS FROM THE INTERNATIONAL CONFERENCE OF BUILDING OFFICIALS (ICBO).
- 5. EMBEDMENT DEPTH IS DEFINED AS THE DISTANCE FROM THE SURFACE OF THE LOAD—BEARING BASE MATERIAL TO THE DEEPEST PART OF THE ANCHOR AFTER THE ANCHOR HAS BEEN DRIVEN INTO THE HOLE BUT NOT YET EXPANDED.
- 6. ADHESIVE ANCHORS SHALL BE ACCEPTABLE FOR LONG—TERM LOADING. WHEN BASE MATERIAL TEMPERATURES ARE BELOW 40 DEG F, ONLY NON—EPOXY—BASED ADHESIVES SHALL BE USED.
- 7. POST-INSTALLED ANCHORS SHALL ONLY BE USED WHERE SPECIFIED ON THE DRAWINGS. THE CONTRACTOR SHALL OBTAIN APPROVAL FROM THE ENGINEER PRIOR TO USING POST-INSTALLED ANCHORS FOR MISSING OR MISPLACED CAST-IN-PLANE ANCHORS. CARE SHALL BE TAKEN TO AVOID CONFLICTS WITH EXISTING REINFORCING BARS. HOLES SHALL BE DRILLED AND CLEANED PER ANCHOR MANUFACTURER'S SPECIFICATIONS.
- 8. STAINLESS STEEL ANCHORS ARE REQUIRED AT ALL PERMANENTLY EXPOSED WEATHER CONDITIONS.

### TIMBER

TIMBER WORK SHALL CONFORM TO ALL REQUIREMENTS OF THE CURRENT ANSI/AWC NATIONAL DESIGN SPECIFICATION (NDS) FOR WOOD CONSTRUCTION WITH 2015 NDS SUPPLEMENT FOR WOOD CONSTRUCTION, WITH THE FOLLOWING SUPPLEMENTAL REQUIREMENTS:

- 1. FOR COMMON MEMBER SIZES, THE SPECIES AND GRADES SHALL BE AS FOLLOWS, UNLESS NOTED OTHERWISE:
  - A. 2X4 SPF No.1/No.2
  - B. 2X6 SPF No.1/No.2
  - C. 2X8 DF-L No.2
  - D. 2X10 DF-L S.S.
  - E. 2X12 DF-L S.S.

EQUIVALENT (OR BETTER) GRADES & SPECIES MAY BE SUBMITTED FOR THE ENGINEER'S APPROVAL.

- 2. SIZES SHOWN FOR LUMBER ARE NOMINAL SIZES.
- 3. TIMBER EXPOSED TO WEATHER OR GROUND, OR IN CONTACT WITH CONCRETE OR MASONRY SHALL BE PRESSURE—IMPREGNATED BY AN APPROVED PROCESS AND PRESERVATIVE.
- 4. SPLICING OF JOISTS, STUDS, OR HEADERS IS PROHIBITED EXCEPT AS SHOWN.
- 5. BOLTS SHALL CONFORM TO ASTM A307. HOLES SHALL BE DRILLED PER SECTION 12.1.3 OF THE 2015 ANSI/AWC NDS FOR WOOD CONSTRUCTION NDS SUPPLEMENT.
- 6. LAG SCREWS AND WOOD SCREWS SHALL BE INSTALLED PER SECTIONS 12.1.4 & 12.1.5 RESPECTIVELY,
- OF THE 2015 ANSI/AWC NDS FOR WOOD CONSTRUCTION WITH 2015 NDS SUPPLEMENT.
- 7. COMMON NAILS SHALL BE USED, UNLESS NOTED OTHERWISE. IN ADDITION, NAILS SHALL BE GALVANIZED, IF EXPOSED TO WEATHER OR MOISTURE. TOE—NAILS SHALL BE DRIVEN PER SECTION 12.1.6.3 OF THE 2015 ANSI/AWC NDS FOR WOOD CONSTRUCTION WITH 2015 NDS SUPPLEMENT.
- 8. FASTENING SHALL BE PER THE IBC MINIMUM FASTENING SCHEDULE, TABLE 2304.10.1, UNLESS NOTED OTHERWISE.
- 9. CONNECTIONS/CONNECTORS SHALL BE INSTALLED PER MANUFACTURER'S SPECIFICATIONS.

### PREFABRICATED WOOD TRUSSES

- 1. FLOOR & ROOF TRUSSES SHALL BE DESIGNED IN ACCORDANCE WITH THE TRUSS PLATE INSTITUTE (TPI) DESIGN SPECIFICATION FOR METAL PLATE CONNECTED WOOD TRUSSES, AND THE ANSI/NF&PA NATIONAL DESIGN SPECIFICATION (NDS) FOR WOOD CONSTRUCTION.
- 2. PROVIDE TEMPORARY AND PERMANENT BRACING ON ALL TRUSSES, AS REQUIRED TO PROVIDE MEMBER
- 3. FLOOR & ROOF TRUSSES SHALL BE DESIGNED AND CONSTRUCTED FOR A MAXIMUM TOTAL LOAD DEFLECTION OF L/360 AND TO SAFELY SUPPORT THE FOLLOWING LOADS:
- A. DEAD, LIVÉ, SNOW, WIND, EARTHQUAKE: SEE PROJECT DESIGN DATA ON COVER SHEET. B. MECHANICAL PIPE LOAD: TRUSSES SHALL BE DESIGNED FOR A CONCENTRATED LOAD OF 250
- LBS HUNG ANYWHERE ALONG THE BOTTOM CHORD.

  C. OVER-FRAMING LOAD: TRUSSES SHALL ALSO BE DESIGNED TO SUPPORT ADDITIONAL OVERBUILD
- FRAMING, SUCH AS THAT WHICH FORMS VALLEYS AND HIPS ON ROOFS.

  D. DRIFTED SNOW LOAD: TRUSSES SHALL BE DESIGNED TO SUPPORT DRIFTED SNOW LOADS IN
- ACCORDANCE WITH THE APPROPRIATE BUILDING CODE.

  E. IN-PLANE LATERAL LOADS: TRUSSES SHALL BE DESIGNED TO SUPPORT ANY LATERAL LOADS
- CARRIED AXIALLY IN THE PLANE OF THE TRUSS, AS SHOWN ON THE PLANS.
- 4. GABLED END TRUSSES SHALL HAVE VERTICAL MEMBERS SPACED AT 16" O.C. MAXIMUM.
  5. SUBMITTALS SHALL INCLUDE THE FOLLOWING:
- A. SHOP DRAWINGS PREPARED UNDER THE SUPERVISION OF, AND SIGNED AND SEALED BY, A PROFESSIONAL ENGINEER REGISTERED IN THE STATE WHERE THE PROJECT IS BUILT. THESE DRAWINGS SHALL INDICATE SPECIES, GRADE, AND SIZES OF LUMBER TO BE USED; PITCH, SPAN, CAMBER, CONFIGURATION, AND SPACING FOR EACH TYPE OF TRUSS REQUIRED; TYPE, SIZE, MATERIAL, FINISH, AND LOCATION OF METAL CONNECTOR PLATES; AND BEARING DETAILS. SHOW TRUSS LAYOUT AND ALL REQUIRED TEMPORARY AND PERMANENT BRACING AFFECTING THE STRUCTURAL CAPACITY OF THE TRUSSES.

PROVIDE COMPLETE ENGINEERING DESIGN CALCULATIONS THAT INCLUDE DESIGN VALUES, DESIGN ANALYSIS INDICATING LOADING, ASSUMED ALLOWABLE STRESSES, STRESS DIAGRAMS, AND CALCULATIONS, AND ANY OTHER INFORMATION NEEDED FOR REVIEW. THE CALCULATIONS SHALL HAVE BEEN SIGNED AND SEALED BY A QUALIFIED PROFESSIONAL ENGINEER WHO IS REGISTERED IN THE STATE WHERE THE PROJECT IS BUILT AND WHO IS RESPONSIBLE FOR PREPARATION OF THE CALCULATIONS.


### SPECIAL INSPECTIONS

THE FOLLOWING ITEMS REQUIRE SPECIAL INSPECTION IN ACCORDANCE WITH CHAPTER 17 OF THE INTERNATIONAL BUILDING CODE.


- a. CONCRETE GROUT DESIGN MIX (PERIODIC)
- PLACING OF CONCRETE AND REINFORCING STEEL (CONTINUOUS OF CONCRETE SAMPLING / PERIODIC OF REINFORCING)
- c. BOLTS & ANCHORS EMBEDDED IN CONCRETE (PERIODIC)
- d. STRUCTURAL STEEL FABRICATIONS (UNLESS AISC APPROVED)
  (PERIODIC)
- e. STRUCTURAL STEEL BOLTING & WELDING (PERIODIC)
- f. POST INSTALLED ANCHORS IN CONCRETE (CONTINUOUS)
- g. IN-SITU SOILS, EXCAVATIONS, FILLING & COMPACTION (PERIODIC)
- h. WOOD FRAMING:
- h.a. SHEAR WALLS; WALL SIZE, CONFIGURATION, BLOCKING, PANEL GRADE, PANEL THICKNESS, AND FASTENING. (PERIODIC)
- h.b. DIAPHRAGMS (FLOOR AND ROOF SHEATHING); SIZE, CONFIGURATION, BLOCKING, PANEL
- GRADE, PANEL THICKNESS, AND FASTENING. (PERIODIC)
- h.c. FRAMING MEMBERS AND DETAILS (PERIODIC)
- h.d. MATERIAL GRADE (PERIODIC)
- h.e. CONNECTIONS; HANGERS, HOLD DOWNS, BUILT-UP COLUMNS, BUILT-UP BEAMS (PERIODIC)
- h.f. PRE-ENGINEERED TRUSSES; FRAMING, CONNECTIONS, BRIDGING (PERIODIC)
- THE CONTRACTOR SHALL PROVIDE SPECIAL INSPECTION OF THE ITEMS LISTED ABOVE PRIOR TO THOSE ITEMS BECOMING INACCESSIBLE AND UNOBSERVABLE DUE TO PROGRESSION OF THE WORK

### **DESIGN DATA** 2021 INTERNATIONAL BUILDING CODE / ASCE 7-16 **BUILDING OCCUPANCY CATEGORY ROOF LOAD DATA** LIVE LOAD ASPHALT SHINGLES + FELT 5/8" OSB ROOF SHEATHING PRE-ENGINEERED WOOD TRUSSES @ 2'-0" O.C INSULATION (BLOWN) MECHANICAL ALLOWANCE 5/8" GYP. CEILING SOLAR TOTAL TO TRUSSES 40 lbs/sq.ft RAIN LOADING 15 MINUTE RAIN INTENSIT 6.5 in/hr 60 MINUTE RAIN INTENSITY 3.27 in/hr (\*UNBALANCED & DRIFTING SNOW TO BE DETERMINED IN ADDITION TO UNIFORM LOAD, WHERE APPLICABLE) 20 lbs/sq.ft C e = $C_t =$ 14.00 lbs/sq.ft $p_f =$ WIND DESIGN DATA 109 M.P.H. (3-SECOND GUST) RISK CATEGORY EXPOSURE INTERNAL PRESSURE COEFFICIENT = ± 0.18 DIRECTIONAL PROCEDURE (MWFRS - ASCE 7, CH 27; C&C - ASCE 7, CH 30, PART 4) MAXIMUM COMPONENTS & CLADDING WIND +/-33.54 lbs/sq.ft EARTHQUAKE DESIGN DATA RISK CATEGORY 0.136 SITE CLASS 0.145 S n1 = 0.133 BASIC SEISMIC-FORCE-RESISTING SYSTEM : LIGHT-FRAME (WOOD) WALLS SHEATHED WITH WOOD STRUCTURAL PANELS RATED FOR SHEAR $\Omega_o =$ DESIGN BASE SHEAR EQUIVALENT LATERAL FORCE PROCEDURE (\*\*ASSUMED PER IBC TABLE 1806.2, PRESUMPTIVE LOAD-BEARING VALUES)

STATE OF MISSOURI MIKE KEHOE, GOVERNOR

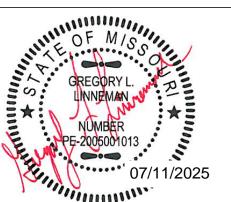


GREGORY L. LINNEMAN - PE MO LICENSE - 2005001013 Rollings 2005001208, Certificate of Authority # A-200

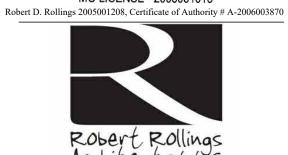

Architects LLC 208 S. Lamine SEDALTA, MO 65301 PHONE: 660 829 9752



J-SQUARED ENGINEERING 2400 BLUFF CREEK DR. STE. 101 COLUMBIA, MO 65201 573.234.4492 phone

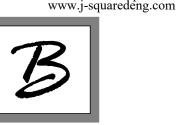

Broadfoot Engineering, LLC 30277 Carpenter Road Sedalia, MO 65301 Phone: 660-619-7001 broadfooteng@yahoo.com

# ENGINEERING CONSULTANTS

1000 W. Nifong Blvd., Bldg. 1.
Columbia, Missouri 65202
(573) 447-0292
www.crockettengineering.com
Crockett Engineering Consultants, LLC
Missouri Certificate of Authority
#2000151304

OFFICE OF ADMINISTRATION DIVISION OF FACILITIES MANAGEMENT DESIGN AND CONSTRUCTION

DIRECTOR'S HOUSE

MISSOURI STATE FAIRGROUNDS 2503 W. 16TH ST SEDALIA, MO 65301

PROJECT # F2402-01 SITE # 1501 ASSET # 3511501149

> REVISION: DATE:

> > REVISION:

DATE:

REVISION:

DATE:

ISSUE DATE: 7/11/2025

**BID DOCUMENTS** 

CAD DWG FILE: S-O-10
DRAWN BY: AMK
CHECKED BY: RDR
DESIGNED BY: AMK


SHEET TITLE:

STRUCTURAL COVER SHEET

SHEET NUMBER:


S-100

PAGE 10 OF 36 7/11/2025

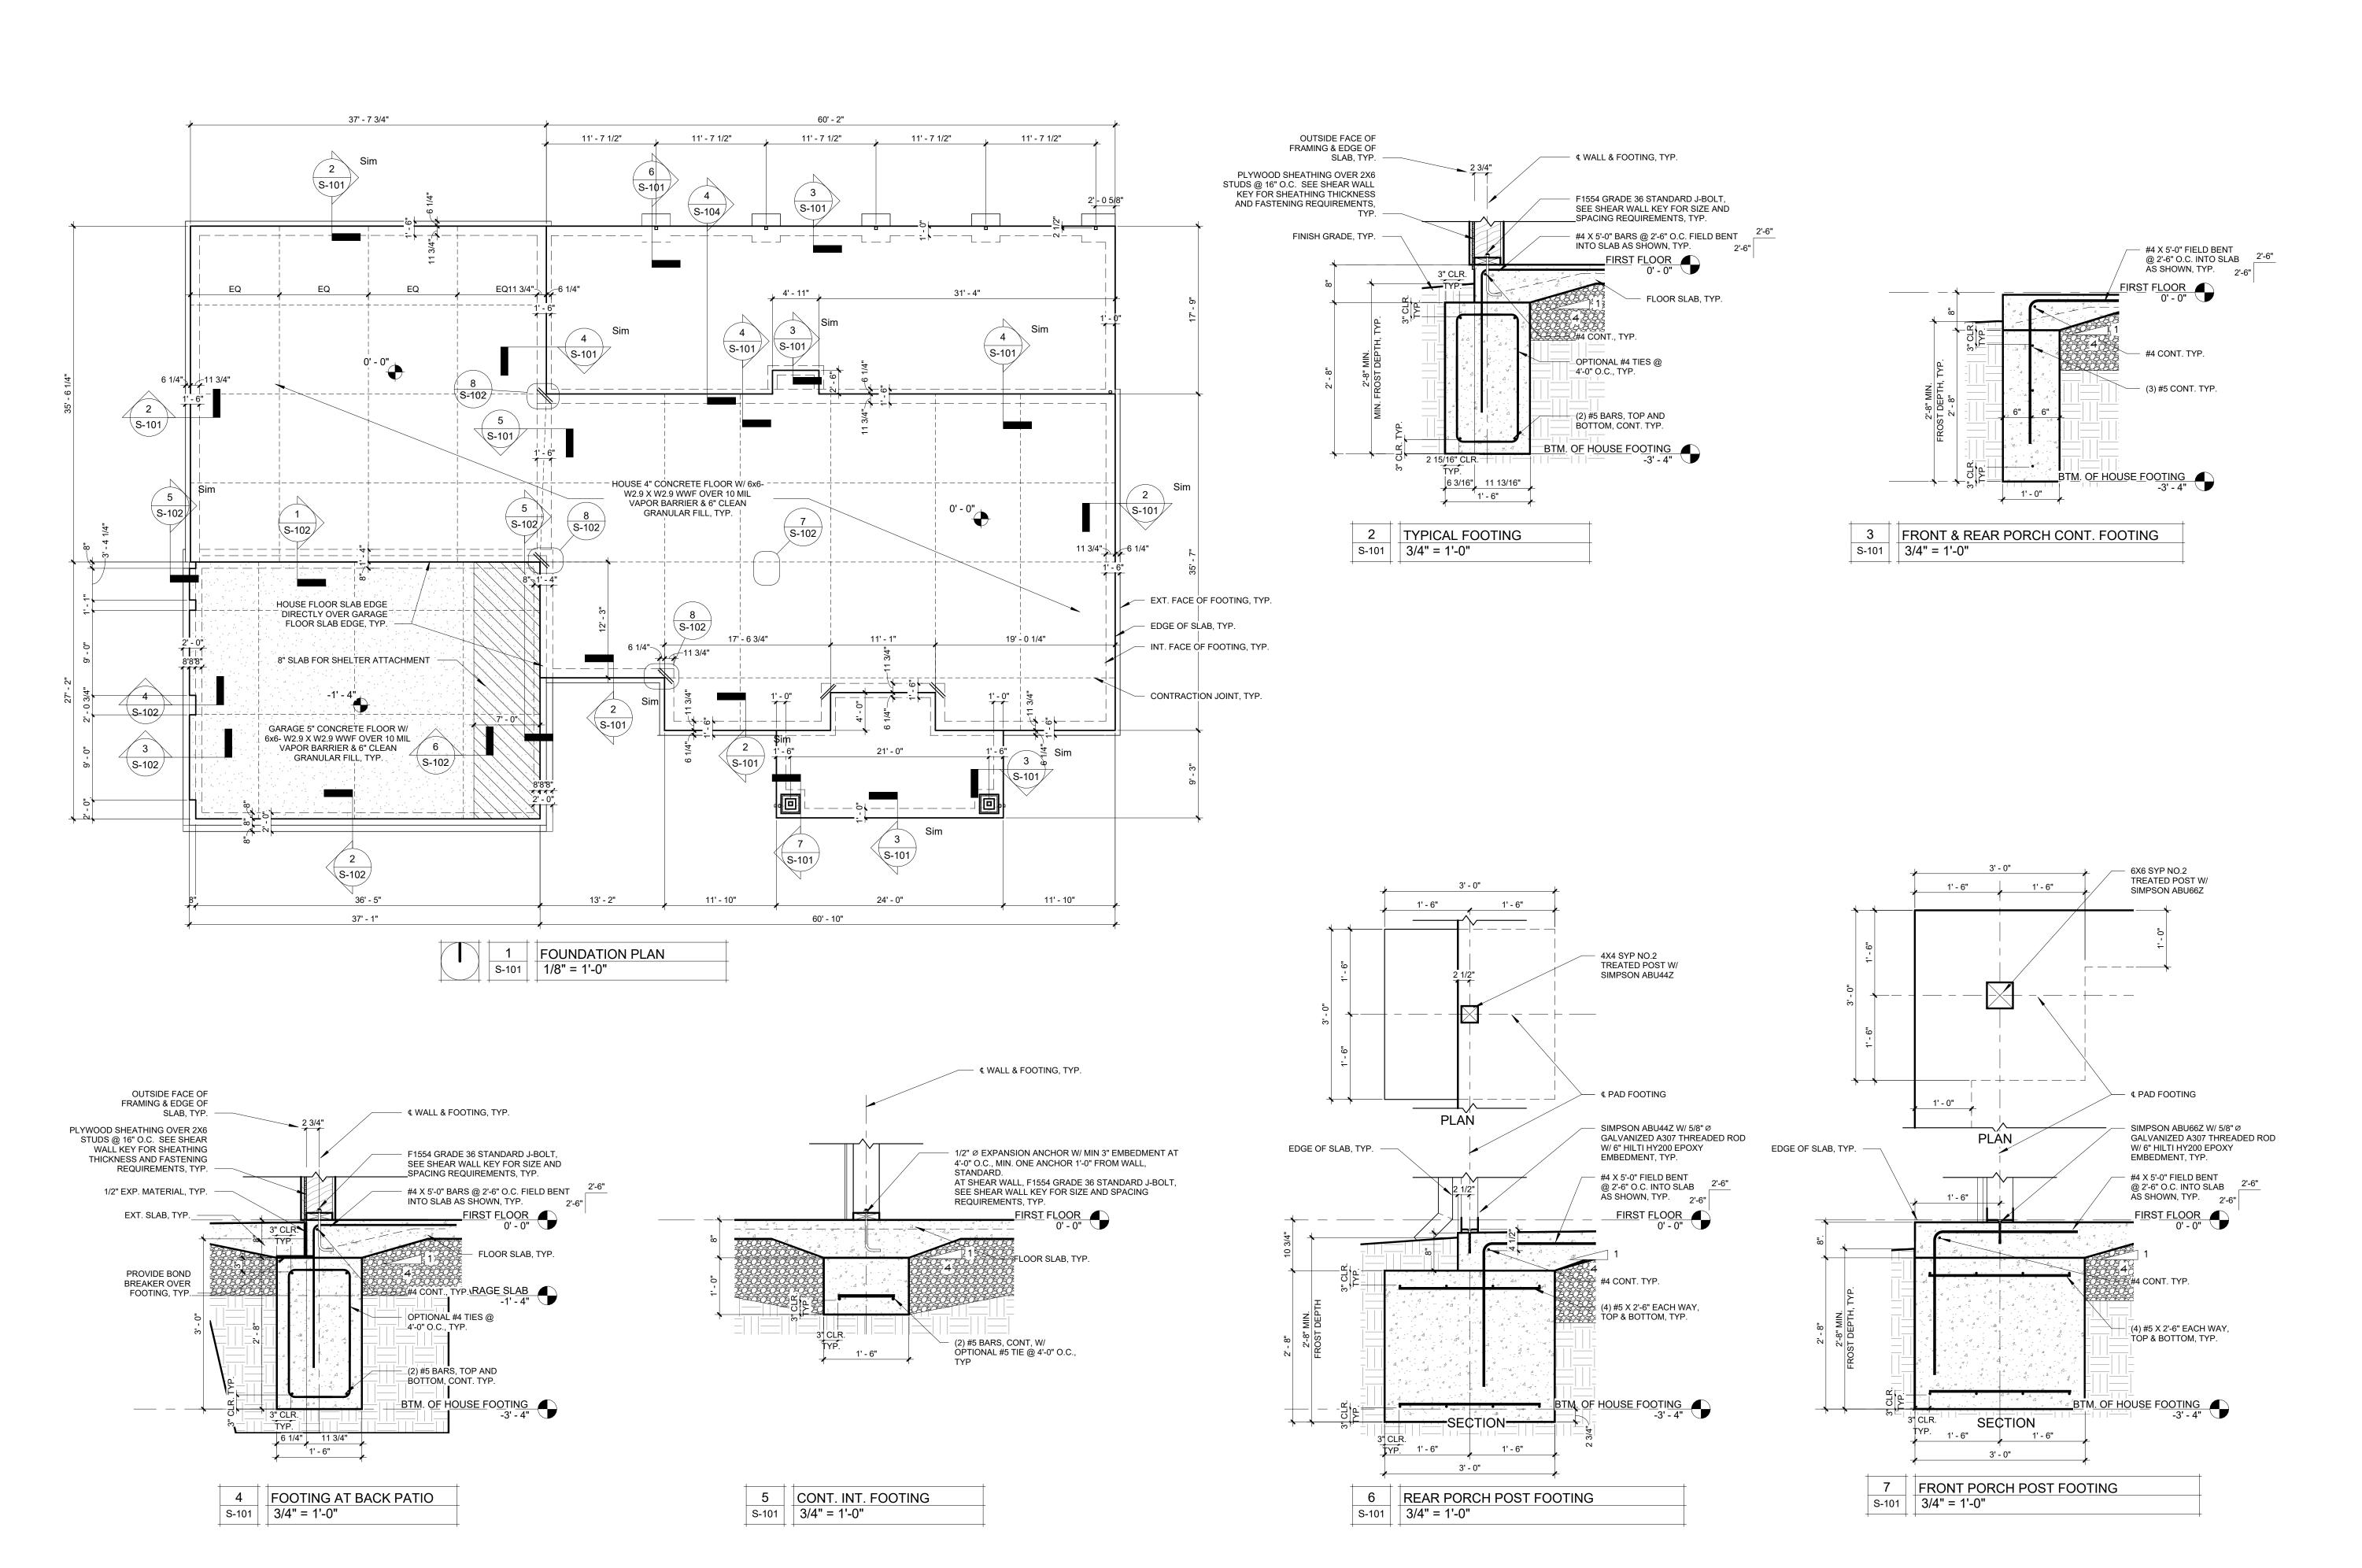



GREGORY L. LINNEMAN - PE MO LICENSE - 2005001013

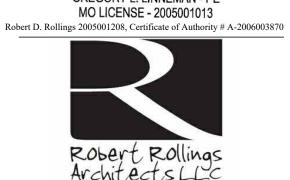

S. Lamine SEDALTA, MO 65301 PHONE: 660 829 9751 FAX: 660 829 9752



J-SQUARED **ENGINEERING** 

2400 BLUFF CREEK DR. STE. 101 COLUMBIA, MO 65201 573.234.4492 phone www.j-squaredeng.com



Broadfoot Engineering, LLC 30277 Carpenter Road Sedalia, MO 65301 Phone: 660-619-7001 broadfooteng@yahoo.com

ENGINEERING CONSULTANTS 1000 W. Nifong Blvd., Bldg. 1. Columbia, Missouri 65202 (573) 447-0292 www.crockettengineering.com Crockett Engineering Consultants, LLC Missouri Certificate of Authority #2000151304

OFFICE OF ADMINISTRATION DIVISION OF FACILITIES MANAGEMENT DESIGN AND CONSTRUCTION

**DIRECTOR'S HOUSE** 

MISSOURI STATE FAIRGROUNDS 2503 W. 16TH ST SEDALIA, MO 65301 PROJECT # F2402-01

SITE # 1501 ASSET # 3511501149

**REVISION:** DATE:

REVISION: DATE:

**REVISION:** DATE:

ISSUE DATE: 7/11/2025 **BID DOCUMENTS** 


CAD DWG FILE: S-FP-11 DRAWN BY: AMK CHECKED BY: RDR DESIGNED BY: AMK

SHEET TITLE:

FOUNDATION PLAN & DETAILS

SHEET NUMBER:

PAGE 11 OF 36 7/11/2025

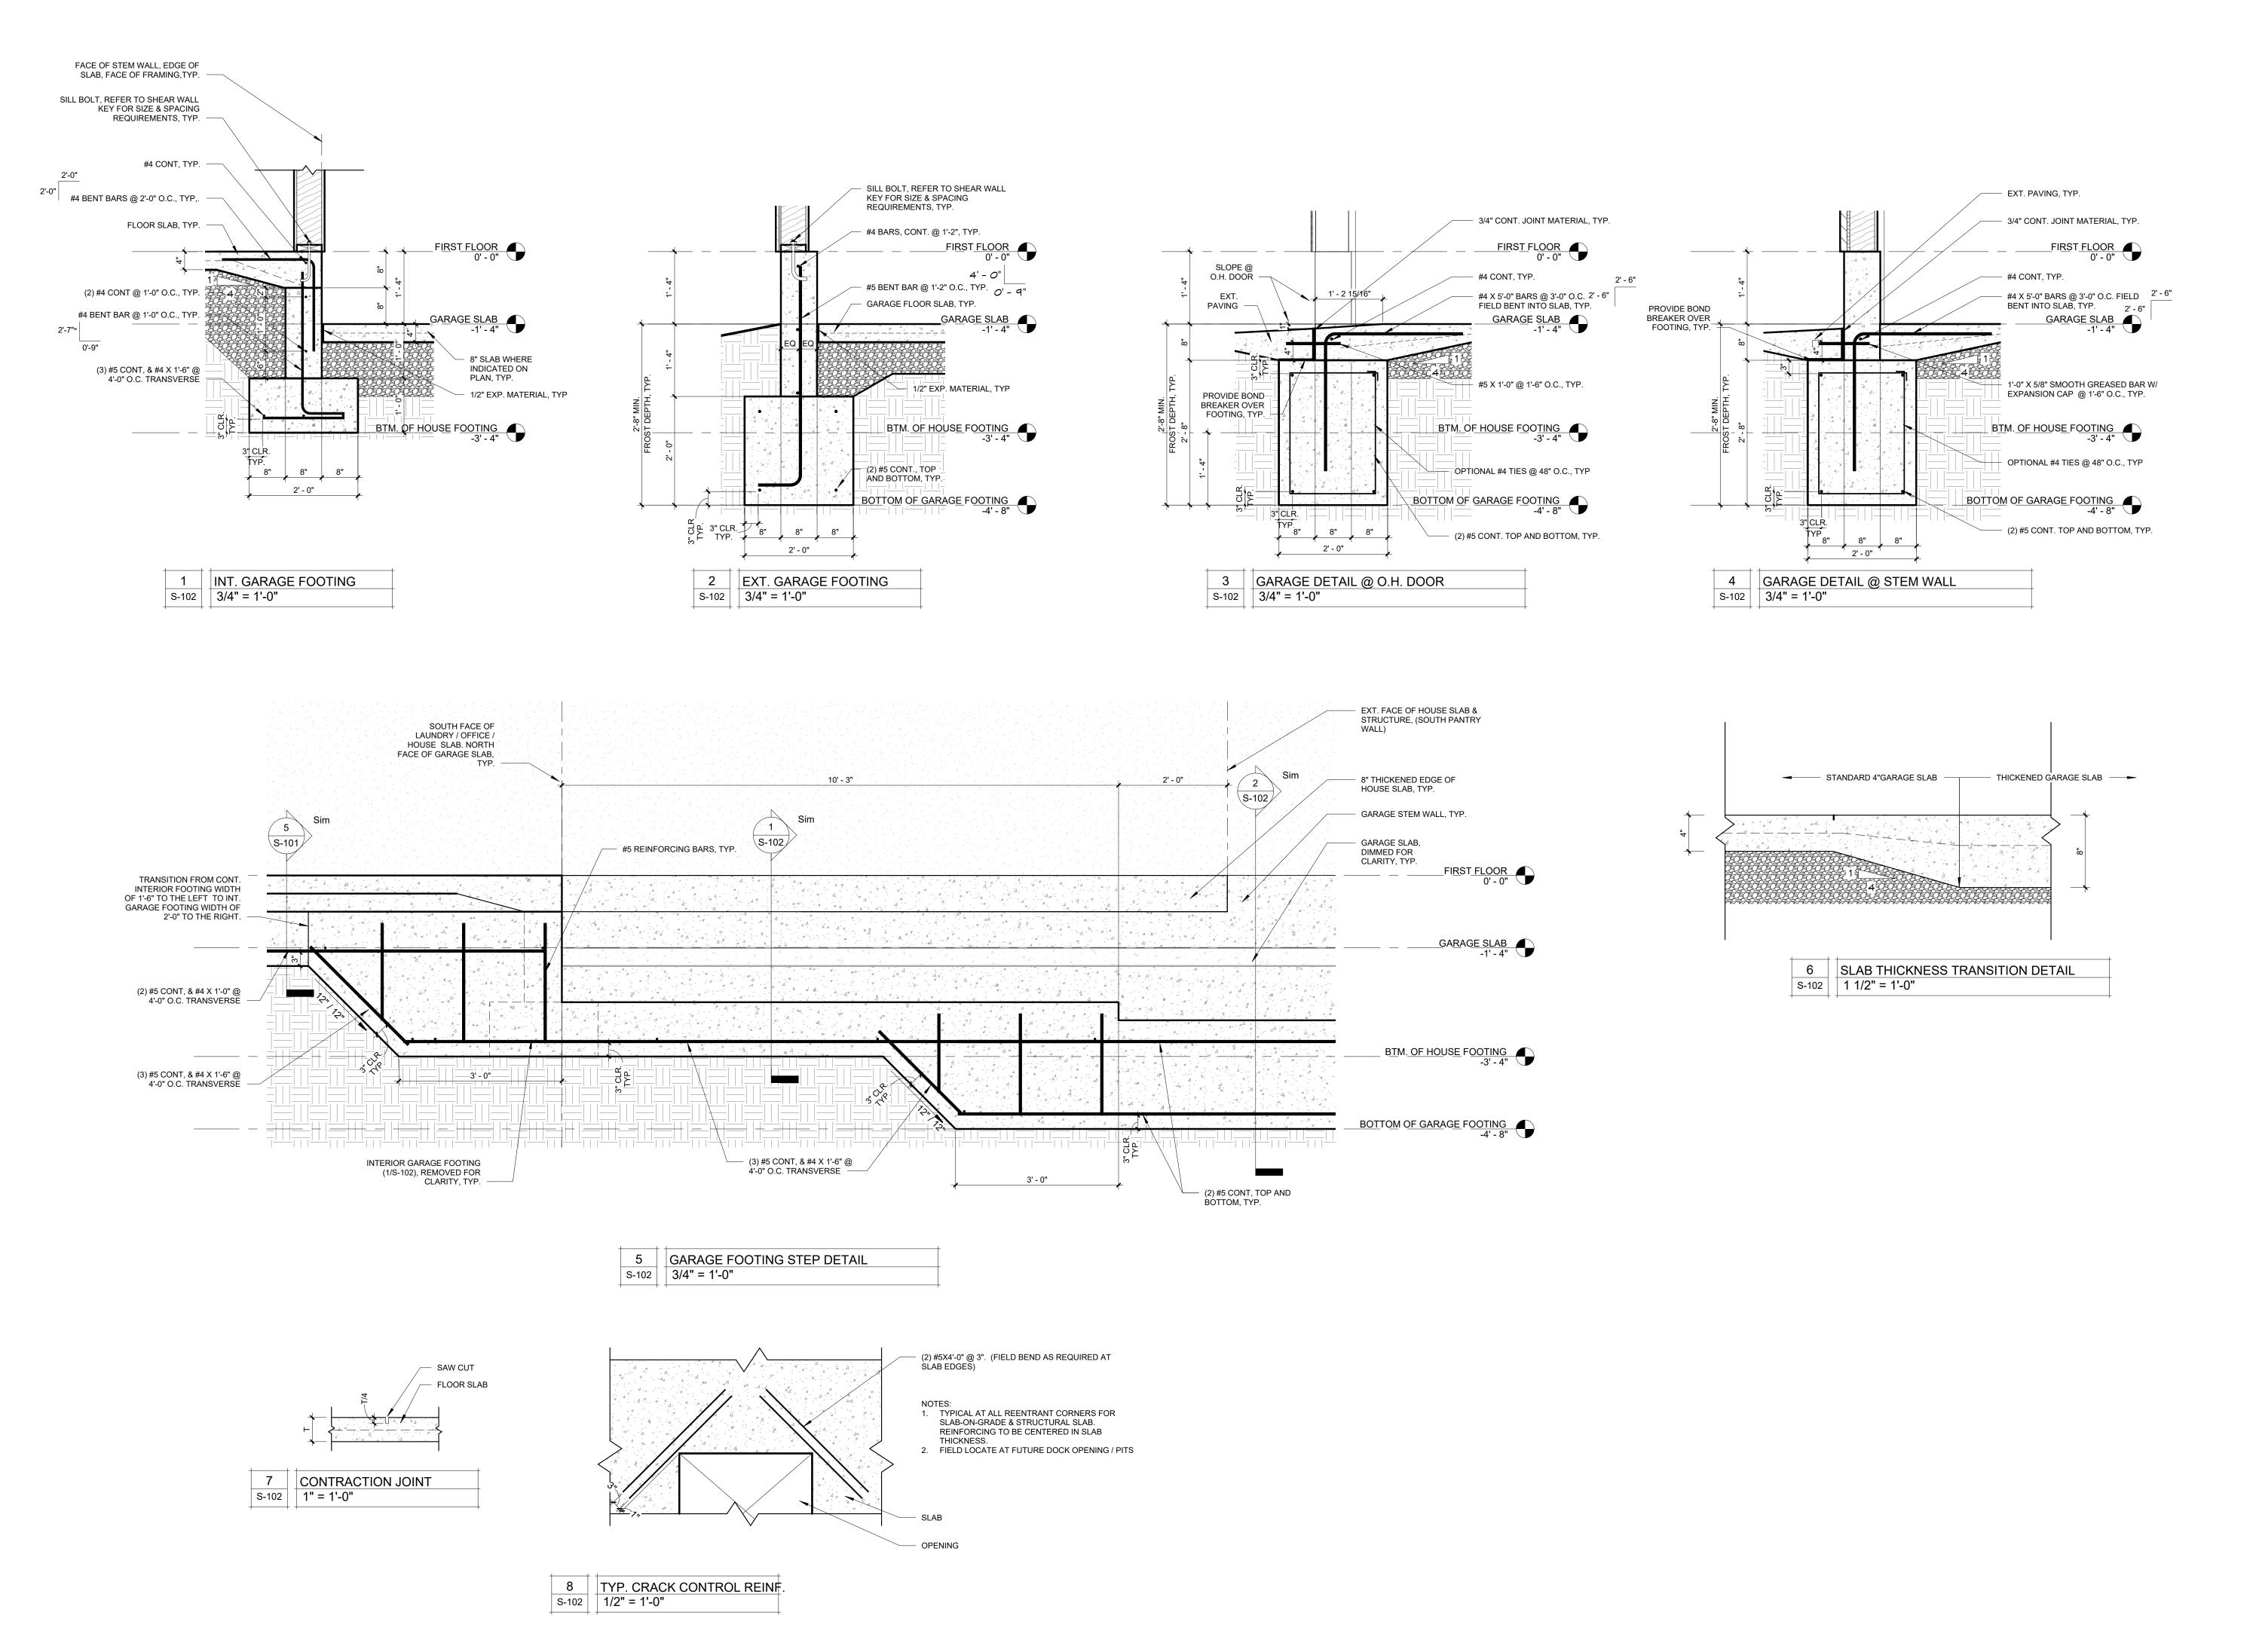



GREGORY L. LINNEMAN - PE MO LICENSE - 2005001013



Robert Rollings Architects LLC 208 S. Lamine SEDALTA, MO 65301 PHONE: 660 829 9751 FAX: 660 829 9752



# J-SQUARED ENGINEERING

2400 BLUFF CREEK DR. STE. 101 COLUMBIA, MO 65201 573.234.4492 phone www.j-squaredeng.com



Broadfoot Engineering, LLC 30277 Carpenter Road Sedalia, MO 65301 Phone: 660-619-7001 broadfooteng@yahoo.com

# ENGINEERING CONSULTAN

ENGINEERING CONSULTANTS
1000 W. Nifong Blvd., Bldg. 1.
Columbia, Missouri 65202
(573) 447-0292
www.crockettengineering.com
Crockett Engineering Consultants, LLC
Missouri Certificate of Authority
#2000151304

OFFICE OF ADMINISTRATION DIVISION OF FACILITIES MANAGEMENT DESIGN AND CONSTRUCTION

### DIRECTOR'S HOUSE

MISSOURI STATE
FAIRGROUNDS
2503 W. 16TH ST
SEDALIA, MO 65301
PROJECT # F2402-01

SITE # 1501 ASSET # 3511501149

REVISION: DATE:

REVISION: DATE:

REVISION: DATE:

ISSUE DATE: 7/11/2025
BID DOCUMENTS

CAD DWG FILE: S-DT-12
DRAWN BY: AMK
CHECKED BY: RDR
DESIGNED BY: AMK


SHEET TITLE:

FOUNDATION PLAN DETAILS

SHEET NUMBER:

S-102

PAGE 12 OF 36 7/11/2025

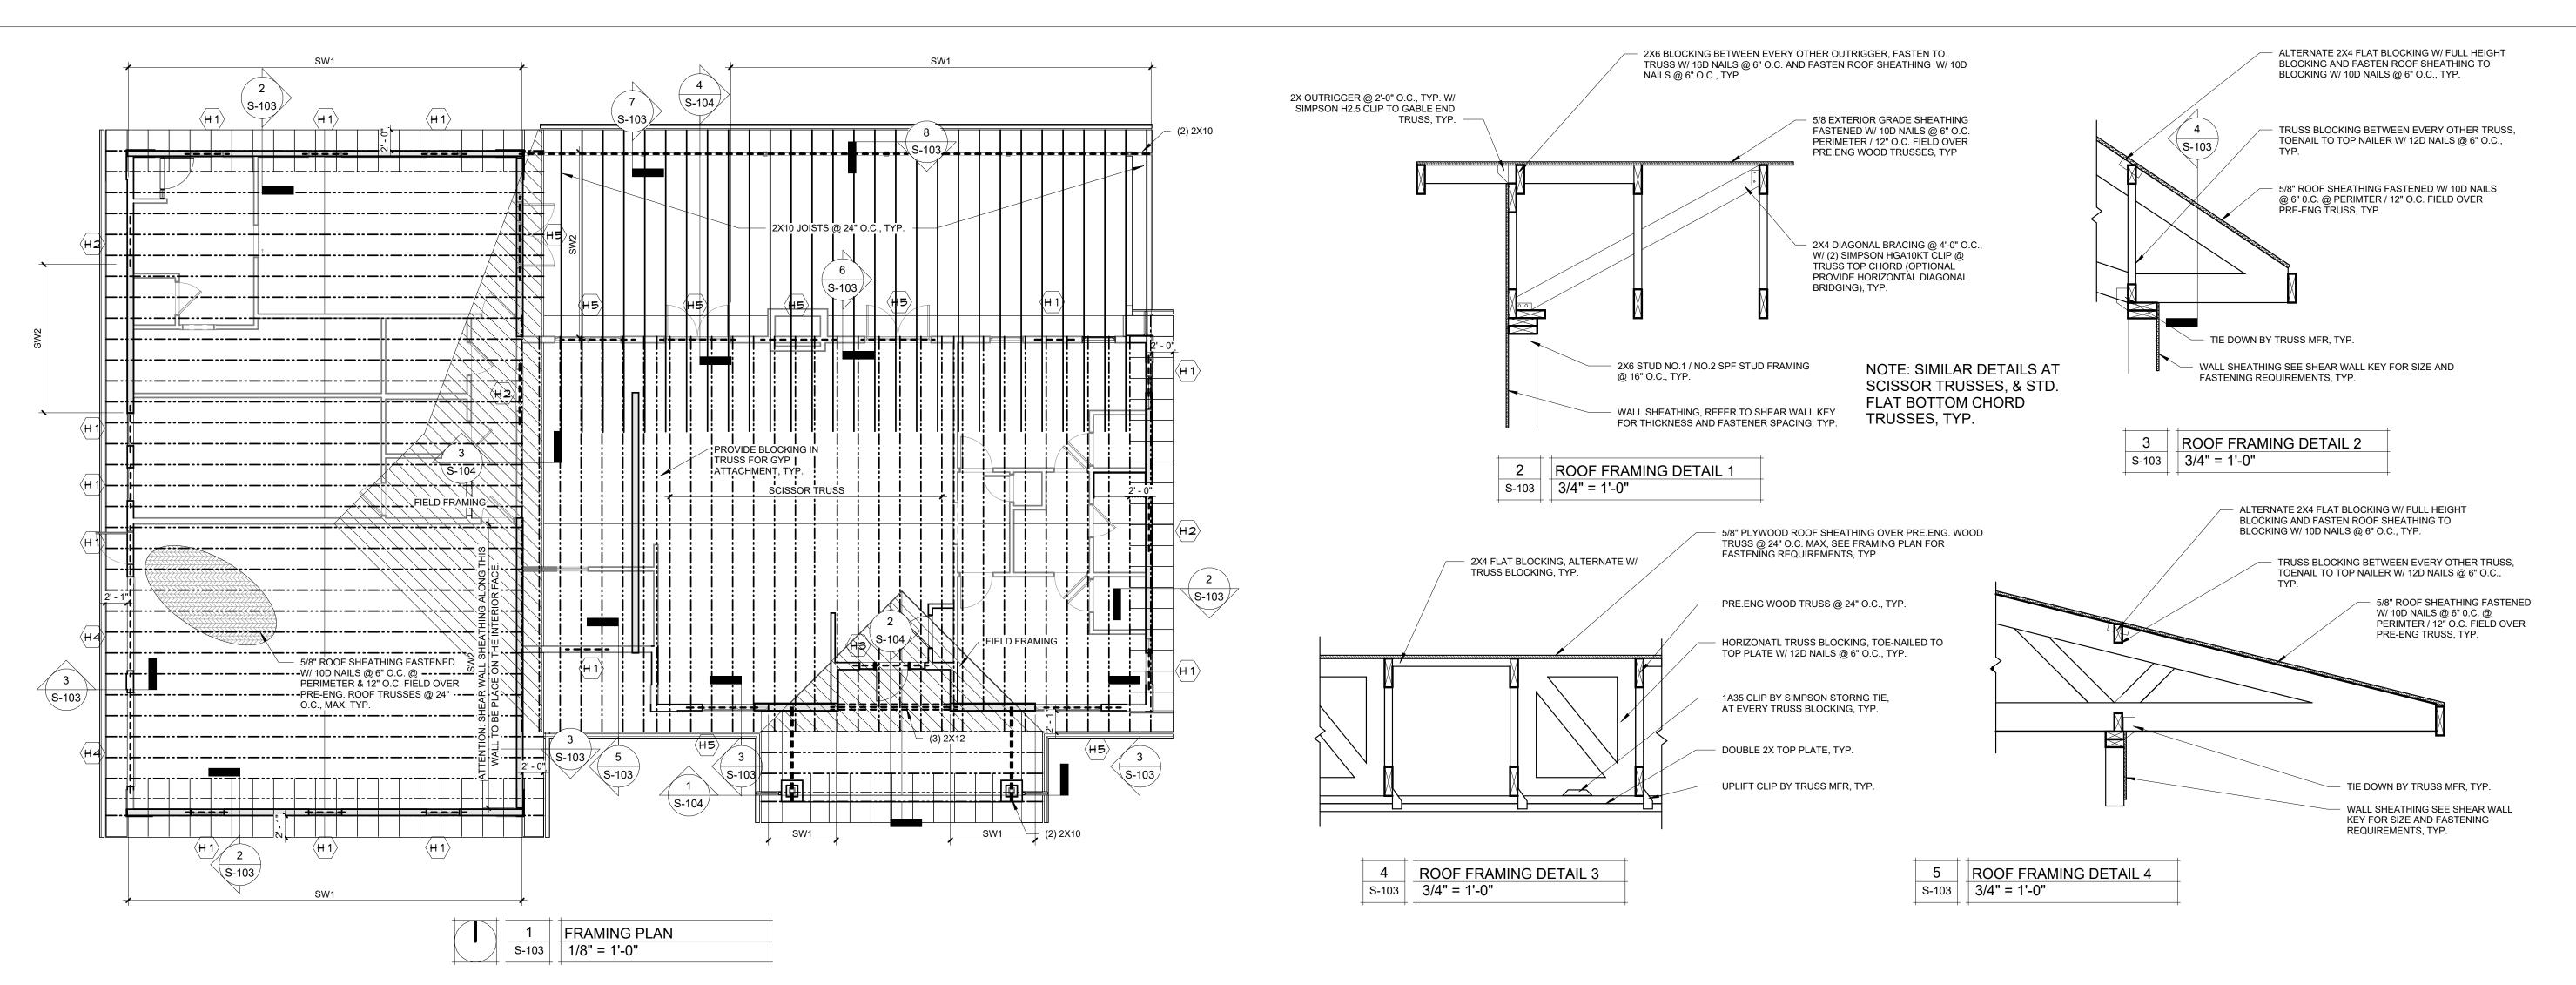

### SHEAR WALL KEY

• 7/16" OSB SHEATHING FASTENED WITH 8D NAILS @ 2" O.C. @ PERIMETER / 12" O.C. FIELD (NOTE: THIS SHEET FASTENING PATTERN REQUIRES 3X OR DOUBLE 2X FRAMING MEMBERS WHERE SHEETS MEET)


- 1/2" DIAMETER F1554 GRADE 36 STANDARD "J" BOLTS W/ 7" EMBEDMENT @ 1'-6" O.C. REQUIRES SIMPSON HTT4 HOLDOWN FASTENED TO 2-PLY
- STUDS W/ (18) 10D NAILS W/ 5/8" DIAMETER A307 THREADED ROD W/ 16" TOTAL (8" INTO FOOTING) SIMPSON "AT-XP" EPOXY EMBEDMENT AT EACH END OF THE SHEAR WALL


- 7/16" OSB SHEATHING FASTENED WITH 8D NAILS @ 2" O.C. @ PERIMETER / 12" O.C. FIELD (NOTE: THIS SHEET FASTENING PATTERN REQUIRES 3X OR DOUBLE 2X FRAMING MEMBERS
  - WHERE SHEETS MEET) 1/2" DIAMETER F1554 GRADE 36 STANDARD "J" BOLTS W/ 7" EMBEDMENT @ 2'-0" O.C.
  - REQUIRES SIMPSON LTTP2 HOLDOWN FASTENED TO SINGLE PLY STUD W/ (12) 0.148 X 1-1/2" NAILS W/ 5/8" DIAMETER A307 THREADED ROD W/ 16" TOTAL (8" INTO FOOTING) SIMPSON "AT-XP" EPOXY EMBEDMENT AT EACH END OF THE SHEAR WALL

# SW3 SHEAR WALL (TYPICAL UNLESS NOTED) 7/16" OSB SHEATHING FASTENED WITH 8D NAILS @ 4" O.C. @ PERIODER / 12" O.C. FIELD


- 1/2" DIAMETER F1554 GRADE 36 STANDARD "J" BOLTS W/ 7"
- EMBEDMENT @ 3'-0" O.C. NO HOLDDOWNS REQUIRED

HEADER SCHEDULE												
LABEL	HEADER	CRIPPLE/JACK	JAMB/KING									
"H1"	2 Ply 2x6 SPF #2	Single Ply 2x6 SPF #2	Single Ply 2x6 SPF #2									
"H2"	2 Ply 2x8 Doug. Fir #2	Single Ply 2x6 SPF #2	Single Ply 2x6 SPF #2									
"H3"	2 Ply 2x10 Doug. Fir Sel. Struct.	2 Ply 2x6 SPF #2	2 Ply 2x6 SPF #2									
"H4"	3 Ply 2x10 Doug. Fir Sel. Struct.	2 Ply 2x6 SPF #2	2 Ply 2x6 SPF #2									

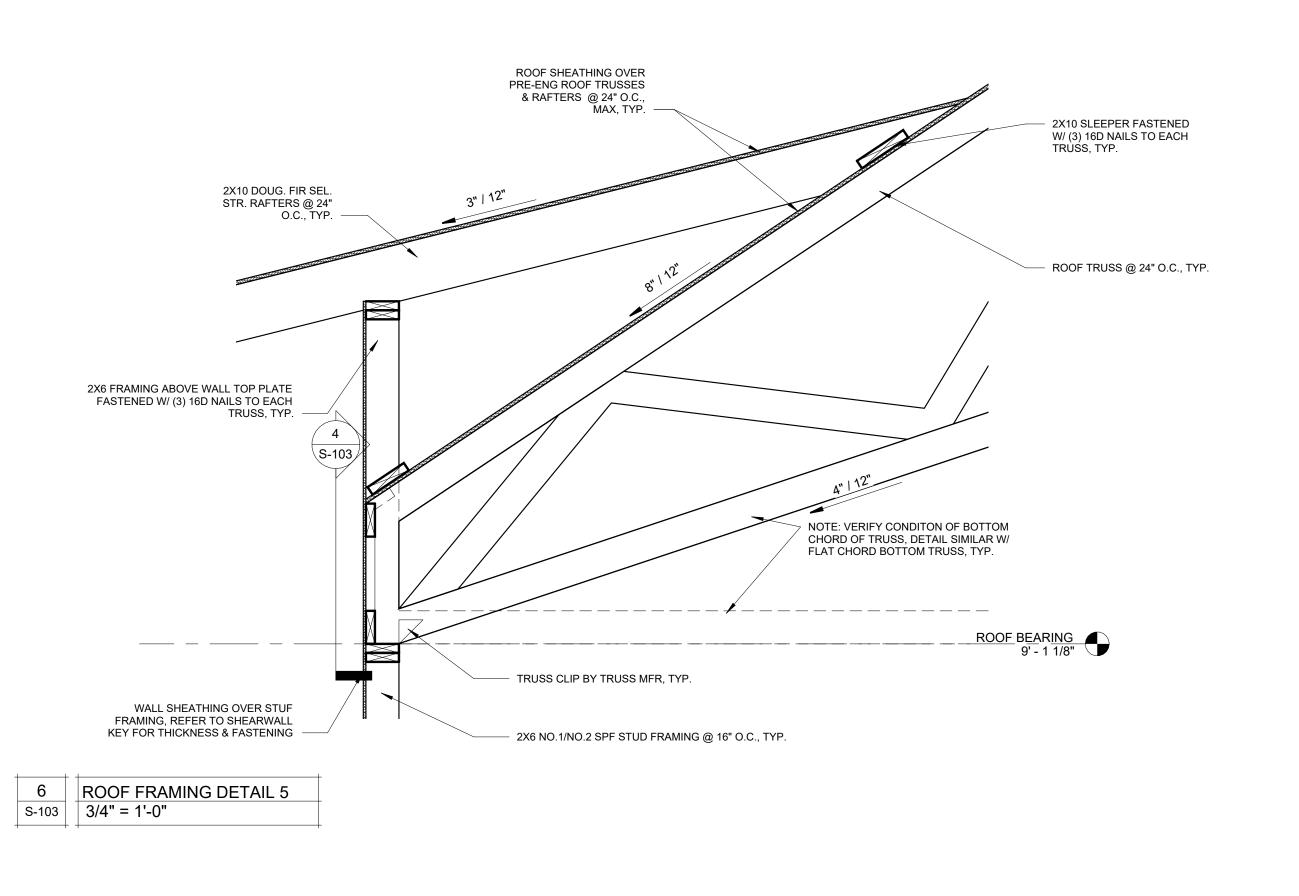

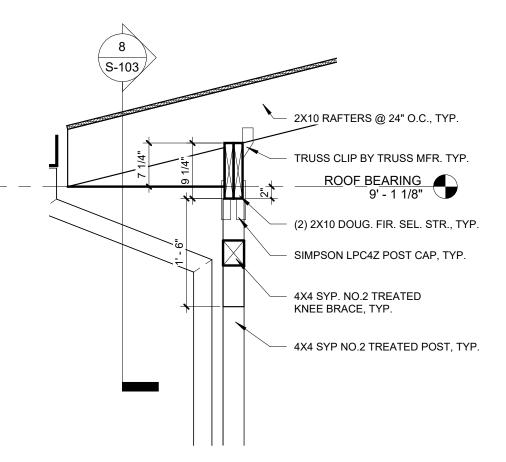



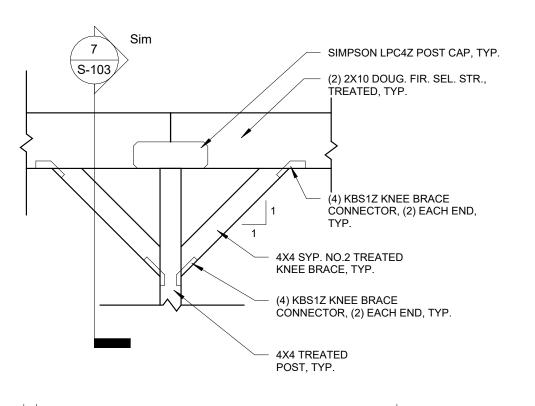


8 BEAM TO POST FRAMING SECTION S-103 3/4" = 1'-0"

**STATE OF MISSOURI** MIKE KEHOE, **GOVERNOR** 



GREGORY L. LINNEMAN - PE MO LICENSE - 2005001013

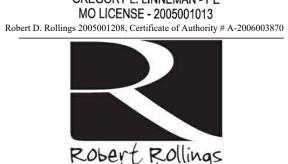

S. Lamine SEDALTA, MO 65301 PHONE: 660 829 9751 FAX: 660 829 9752



### J-SQUARED **ENGINEERING**

2400 BLUFF CREEK DR. STE. 101 COLUMBIA, MO 65201 573.234.4492 phone www.j-squaredeng.com



Broadfoot Engineering, LLC 30277 Carpenter Road Sedalia, MO 65301 Phone: 660-619-7001 broadfooteng@yahoo.com

**ENGINEERING CONSULTANTS** 1000 W. Nifong Blvd., Bldg. 1 Columbia, Missouri 65202 (573) 447-0292 www.crockettengineering.com Crockett Engineering Consultants, LLC Missouri Certificate of Authority #2000151304

OFFICE OF ADMINISTRATION DIVISION OF FACILITIES MANAGEMENT DESIGN AND CONSTRUCTION

**DIRECTOR'S HOUSE** 

MISSOURI STATE FAIRGROUNDS 2503 W. 16TH ST SEDALIA, MO 65301

PROJECT # F2402-01 SITE # 1501 ASSET # 3511501149

**REVISION:** DATE:

**REVISION** DATE:

REVISION: DATE:

ISSUE DATE: 7/11/2025 **BID DOCUMENTS** 


CAD DWG FILE: S-RP-13 DRAWN BY: AMK CHECKED BY: RDR DESIGNED BY: AMK


SHEET TITLE:

FRAMING PLAN & **DETAILS** 

SHEET NUMBER:


PAGE 13 OF 36 7/11/2025

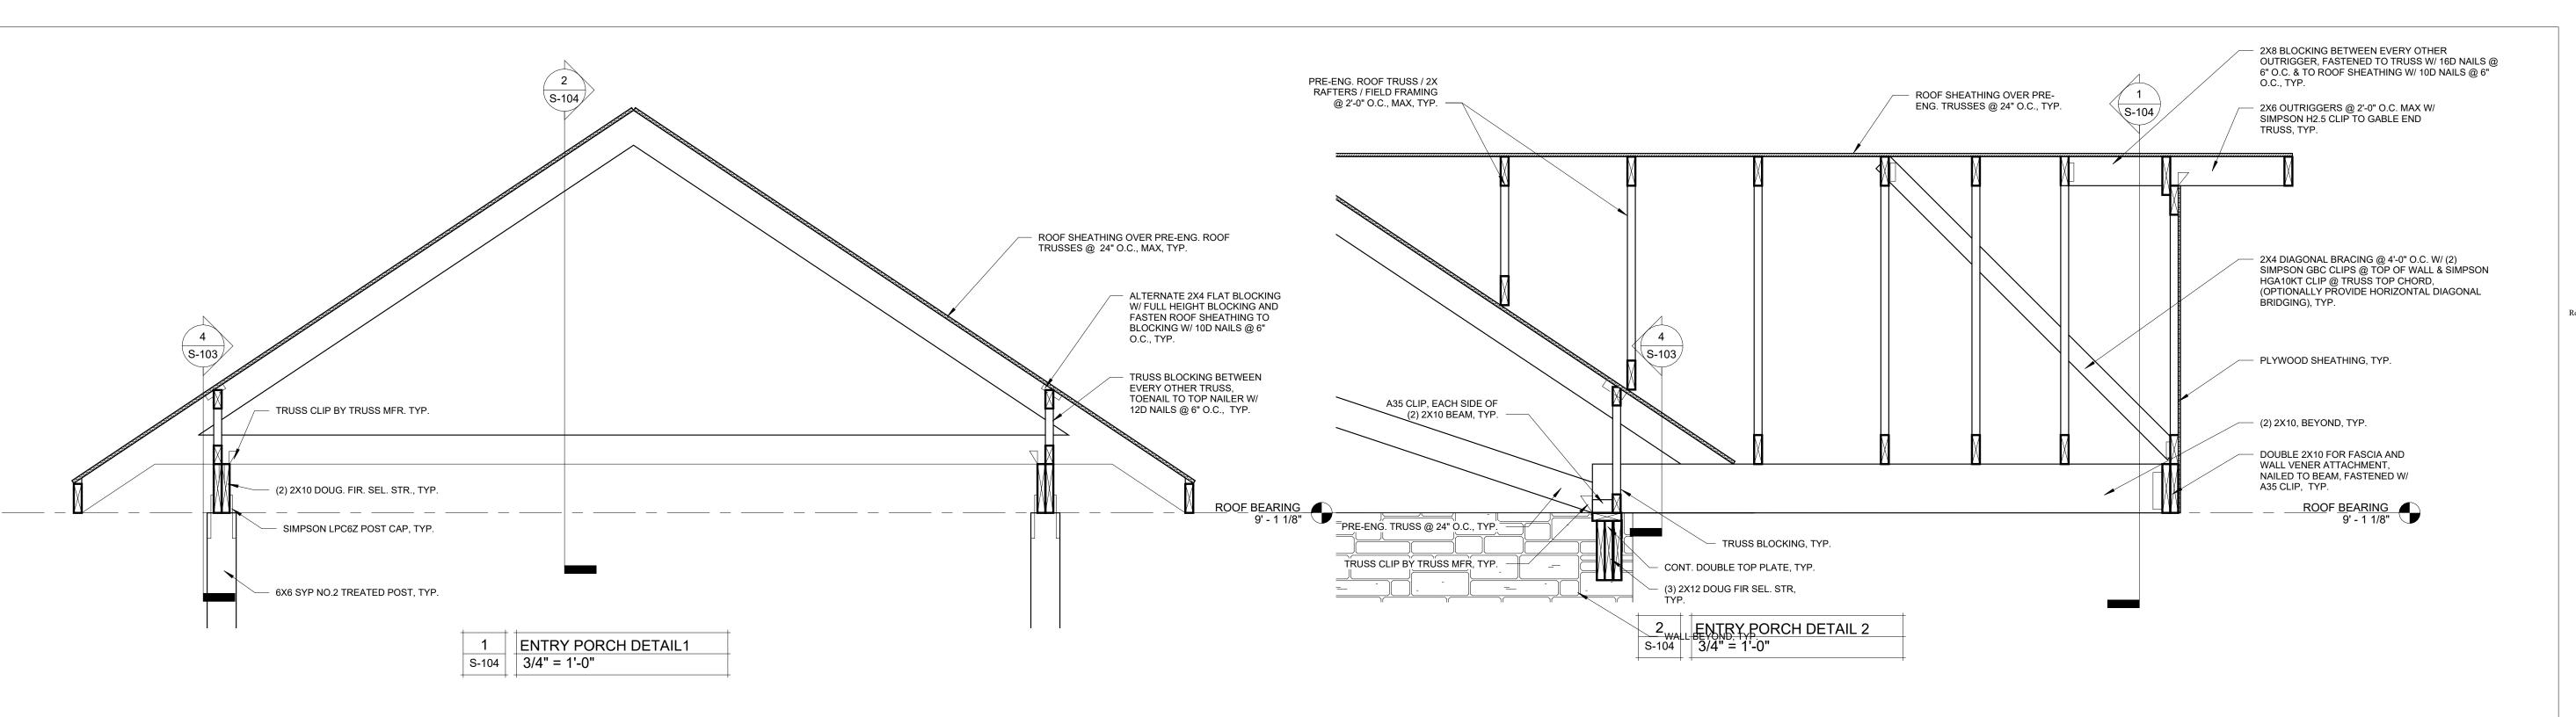

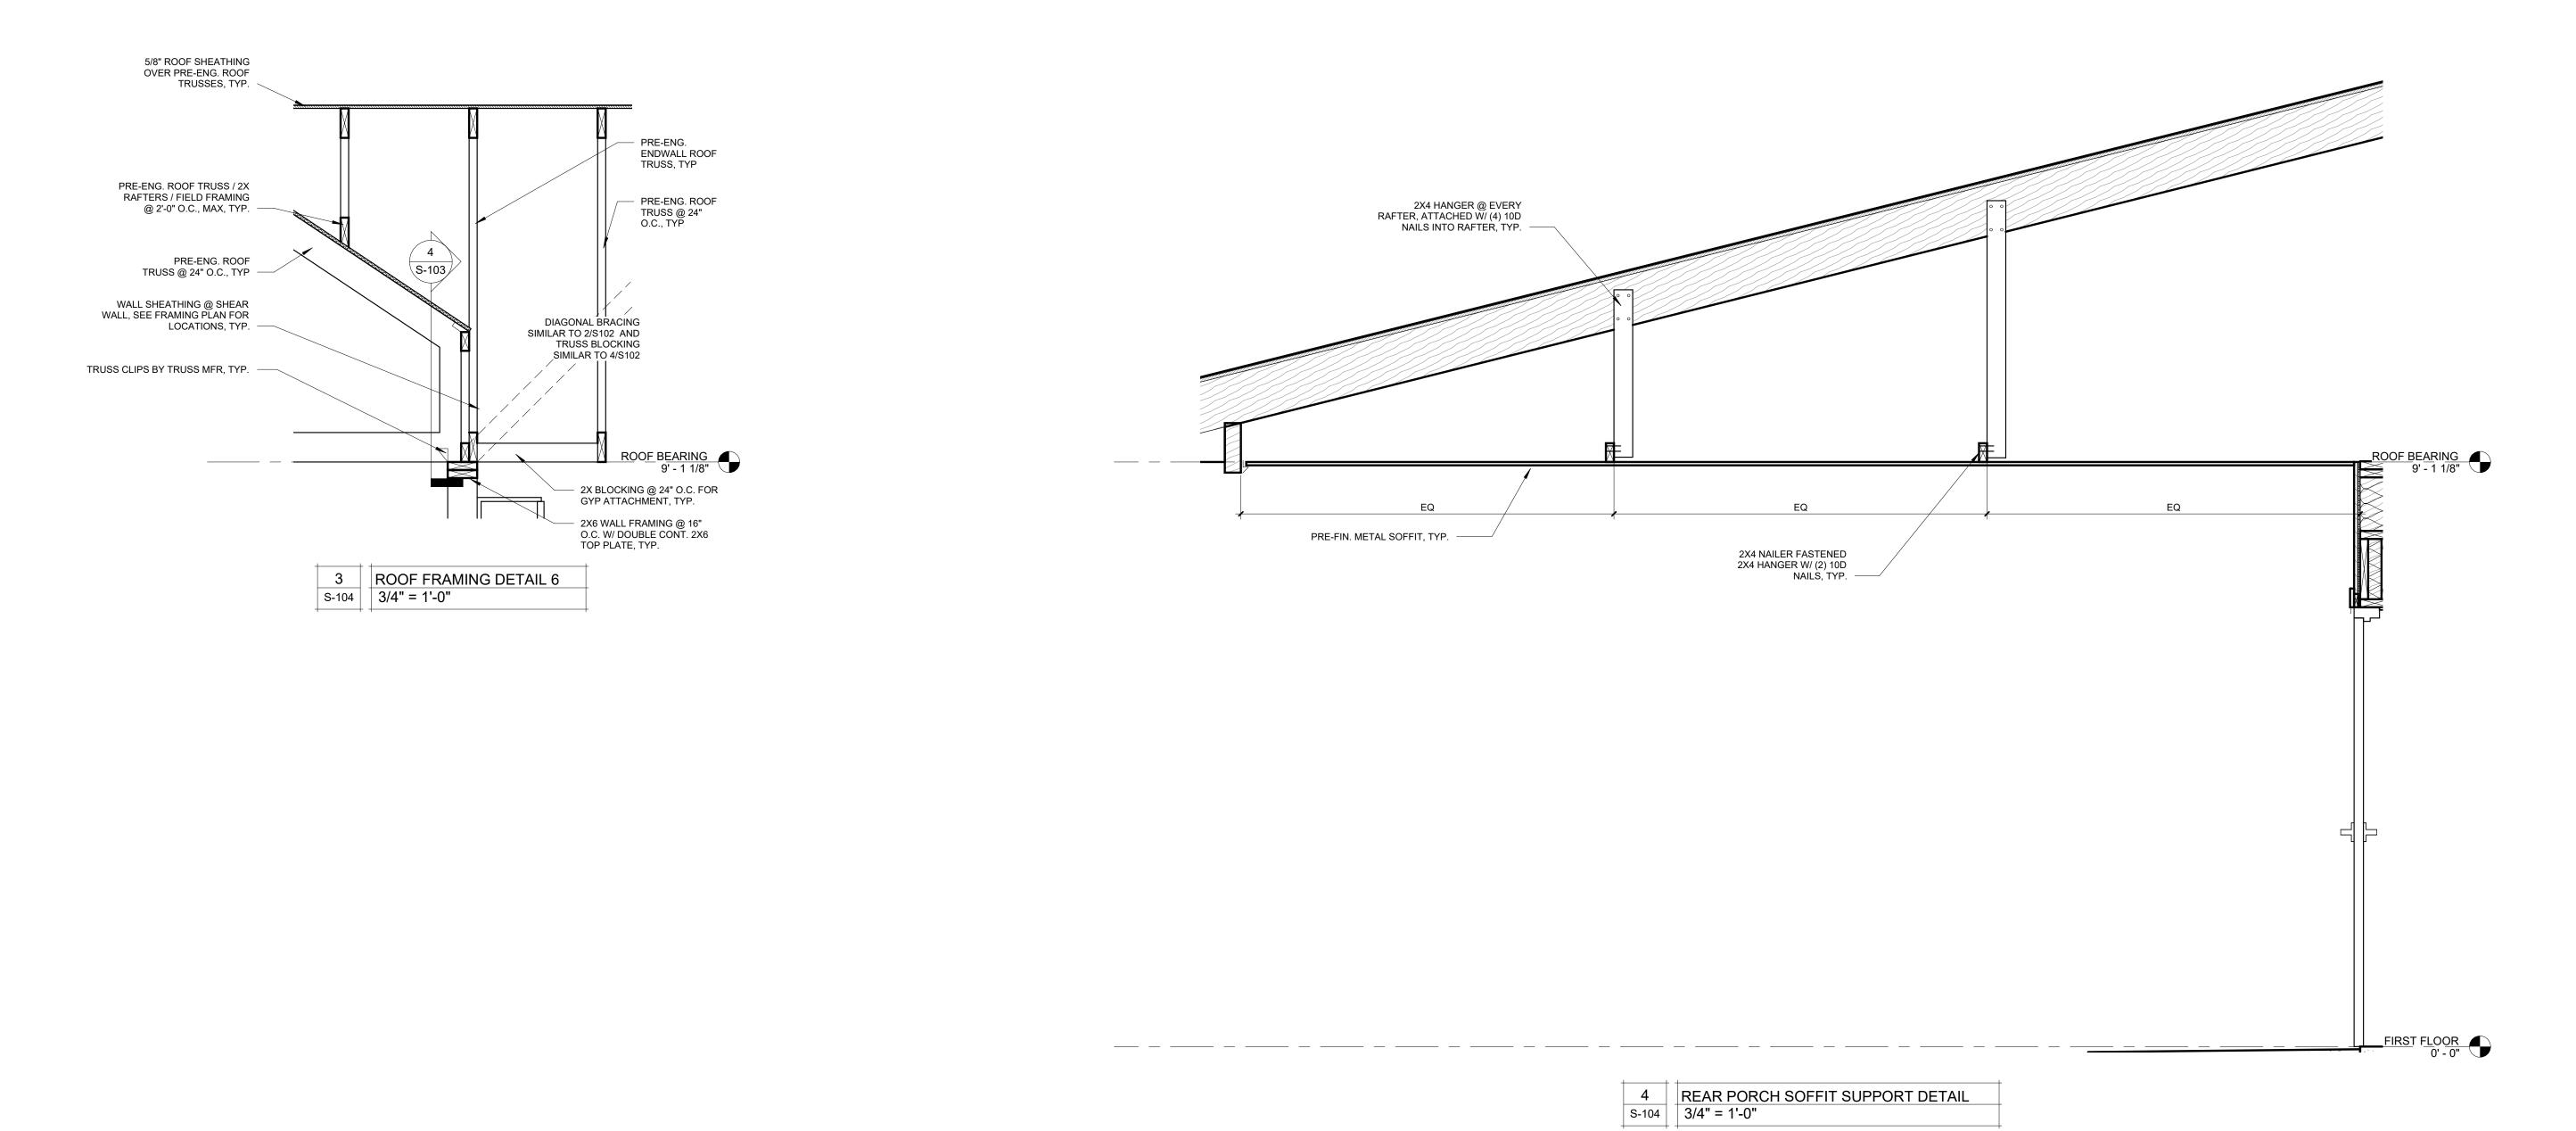



GREGORY L. LINNEMAN - PE MO LICENSE - 2005001013

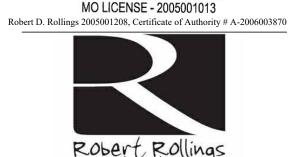

Robert Rollings Architects LLC 208 S. Lamine SEDALTA, MO 65301 PHONE: 660 829 9751 FAX: 660 829 9752



# J-SQUARED ENGINEERING

2400 BLUFF CREEK DR. STE. 101 COLUMBIA, MO 65201 573.234.4492 phone www.j-squaredeng.com



Broadfoot Engineering, LLC 30277 Carpenter Road Sedalia, MO 65301 Phone: 660-619-7001 broadfooteng@yahoo.com

### CRUCKETT

ENGINEERING CONSULTANTS
1000 W. Nifong Blvd., Bldg. 1.
Columbia, Missouri 65202
(573) 447-0292
www.crockettengineering.com
Crockett Engineering Consultants, LLC
Missouri Certificate of Authority
#2000151304

OFFICE OF ADMINISTRATION DIVISION OF FACILITIES MANAGEMENT DESIGN AND CONSTRUCTION

### DIRECTOR'S HOUSE

MISSOURI STATE FAIRGROUNDS 2503 W. 16TH ST SEDALIA, MO 65301 PROJECT # F2402-01

SITE # 1501 ASSET # 3511501149

REVISION:\_\_\_\_\_ DATE:\_\_\_

REVISION:\_\_\_\_\_ DATE:

REVISION: DATE:

ISSUE DATE: 7/11/2025
BID DOCUMENTS

CAD DWG FILE: S-DT-14
DRAWN BY: AMK
CHECKED BY: RDR
DESIGNED BY: AMK


SHEET TITLE:

FRAMING PLAN DETAILS

SHEET NUMBER:

S-104

PAGE 14 OF 36 7/11/2025

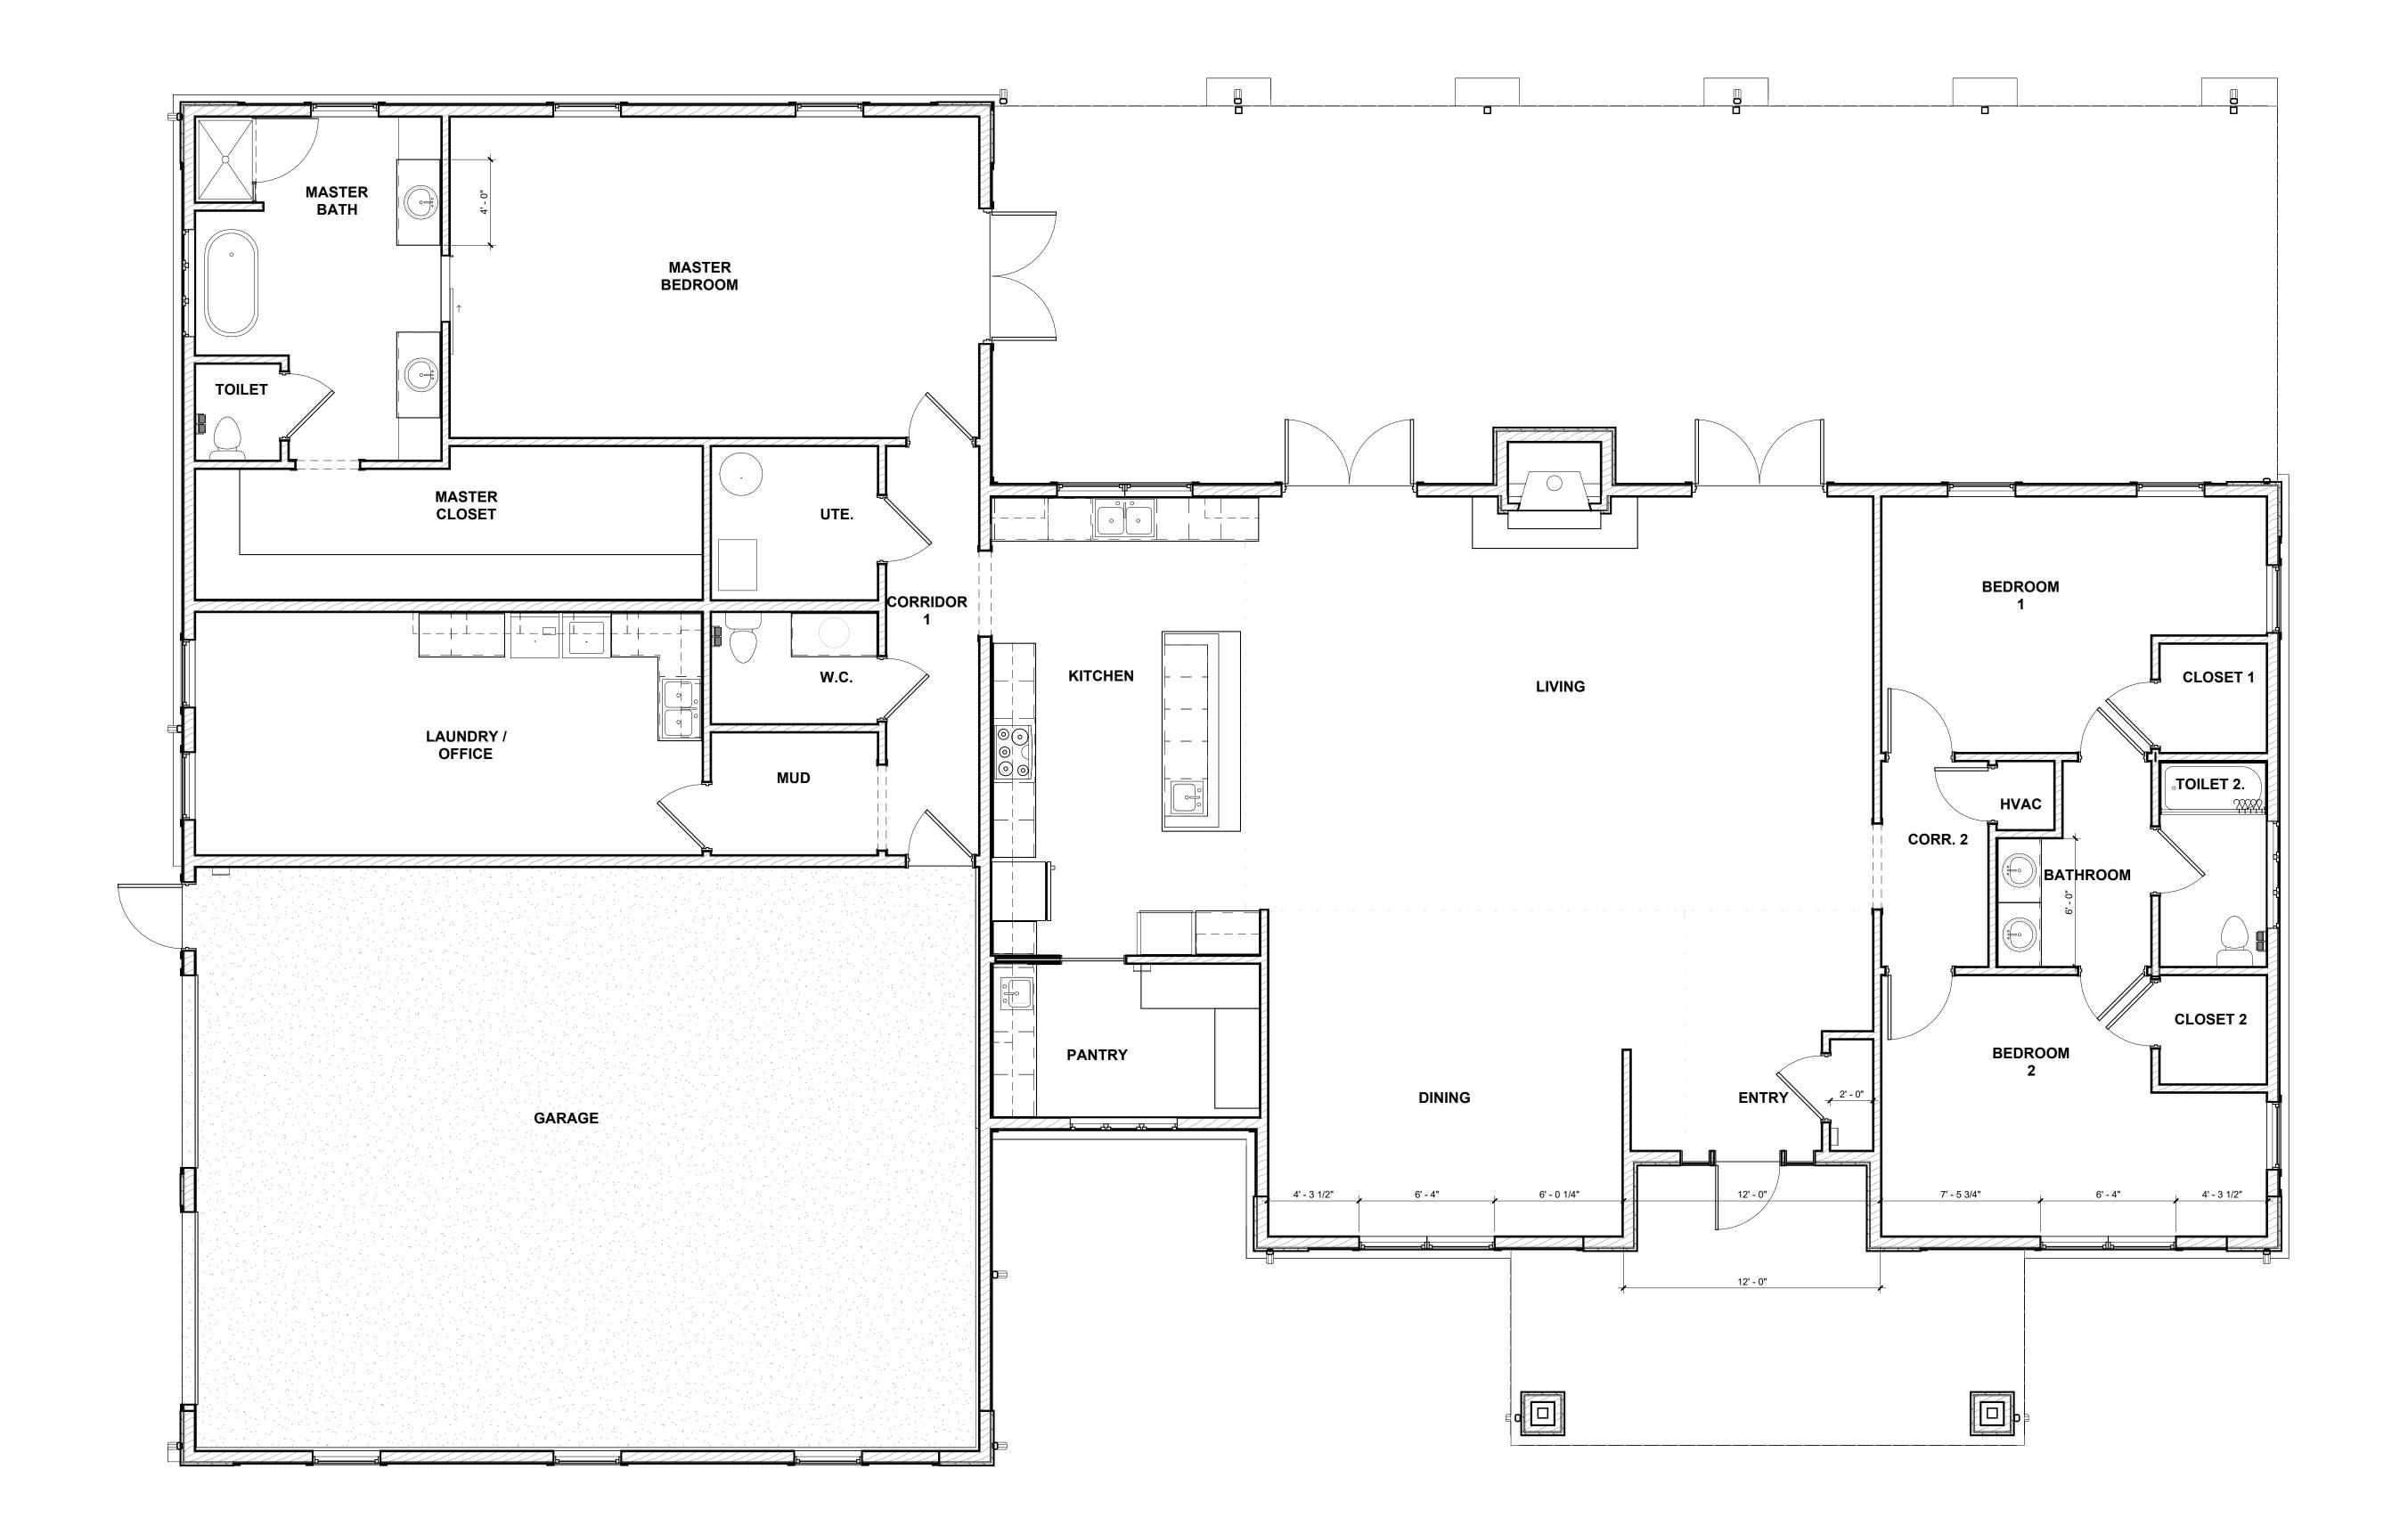





Robert D. Rollings 2005001208, Certificate of Authority # A-2006003870



Architects LLC 208 S. Lamine SEDALTA, MO 65301 PHONE: 660 829 9751 FAX: 660 829 9752



### J-SQUARED ENGINEERING

2400 BLUFF CREEK DR. STE. 101 COLUMBIA, MO 65201 573.234.4492 phone www.j-squaredeng.com



Broadfoot Engineering, LLC 30277 Carpenter Road Sedalia, MO 65301 Phone: 660-619-7001 broadfooteng@yahoo.com

### CRUCKET

ENGINEERING CONSULTANTS
1000 W. Nifong Blvd., Bldg. 1.
Columbia, Missouri 65202
(573) 447-0292
www.crockettengineering.com
Crockett Engineering Consultants, LLC
Missouri Certificate of Authority
#2000151304

OFFICE OF ADMINISTRATION DIVISION OF FACILITIES MANAGEMENT DESIGN AND CONSTRUCTION

### DIRECTOR'S HOUSE

MISSOURI STATE FAIRGROUNDS 2503 W. 16TH ST SEDALIA, MO 65301 PROJECT # F2402-01

SITE # 1501 ASSET # 3511501149

REVISION: DATE:

REVISION: DATE:

REVISION: DATE:

ISSUE DATE: 7/11/2025
BID DOCUMENTS

CAD DWG FILE: A-FP-15
DRAWN BY: AMK
CHECKED BY: RDR
DESIGNED BY: AMK


SHEET TITLE:

FLOOR PLANS

SHEET NUMBER:

A-101

PAGE 15 OF 36 7/11/2025

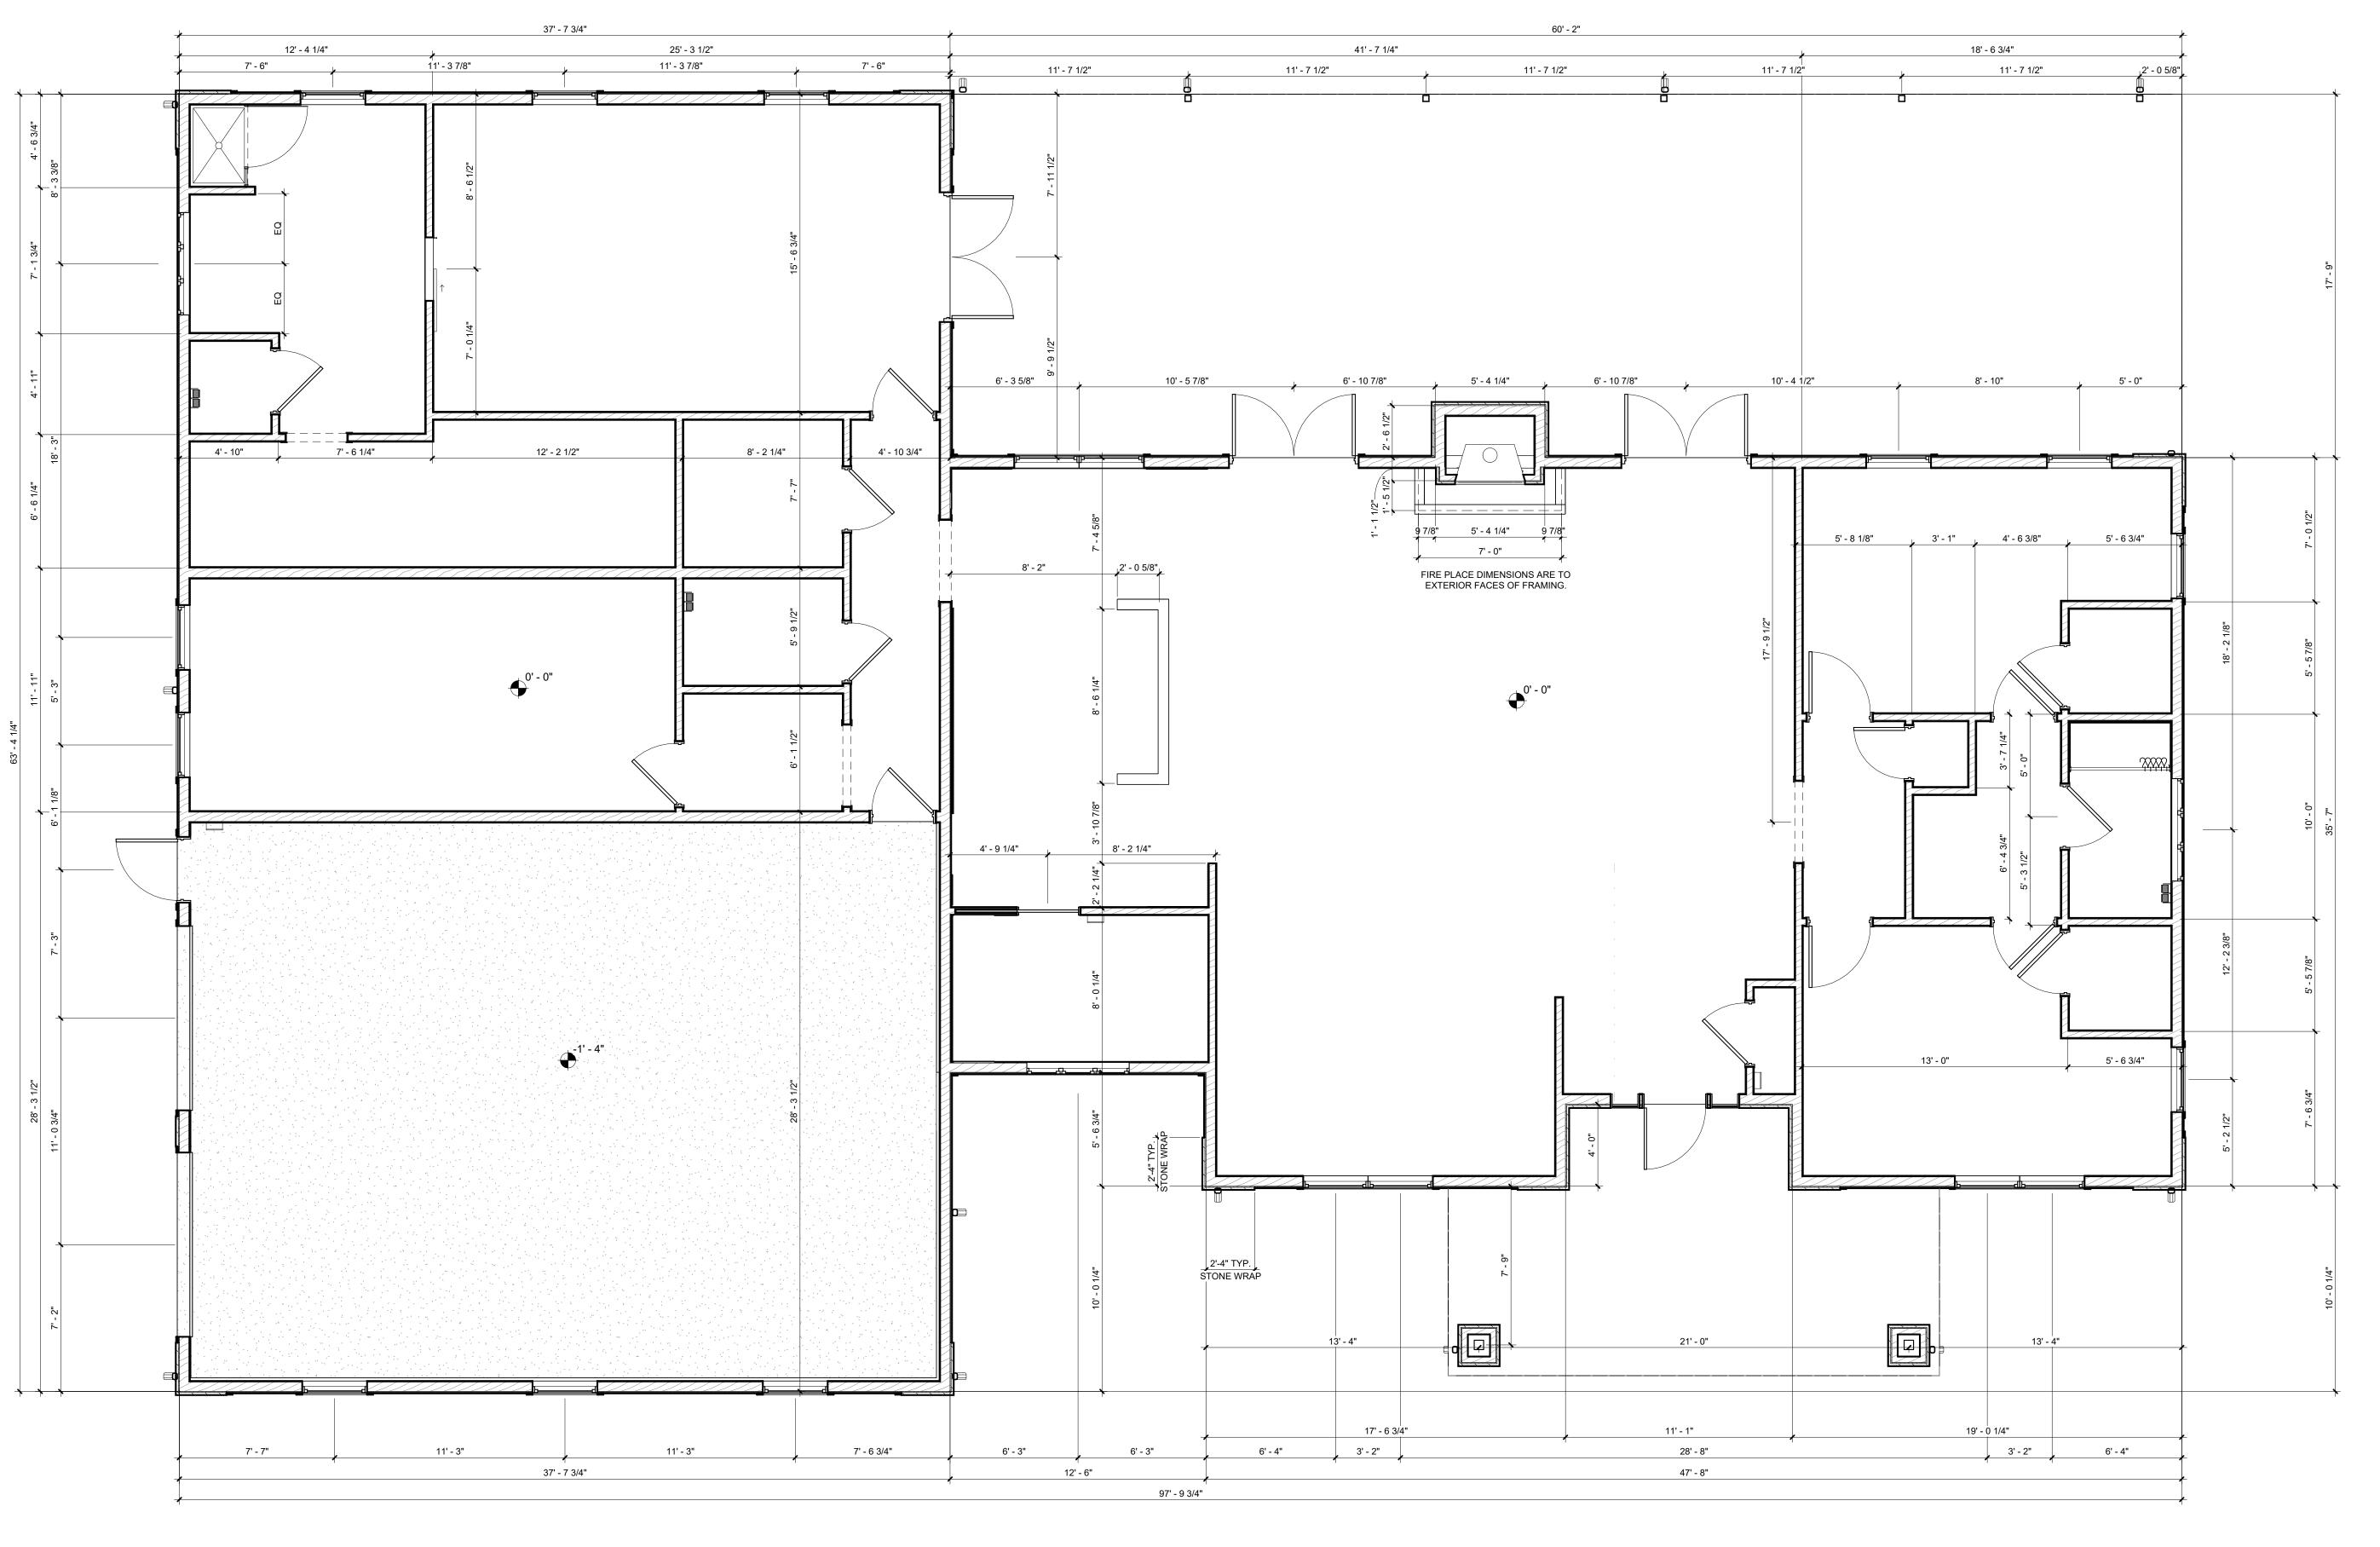

1 FIRST FLOOR DIMENSION PLAN
1/4" = 1'-0"

NOTE:
ALL DIMENSIONS ARE TO EXTERIOR
FACE OF EXTERIOR FRAMING, NORTH
AND EAST FACES OF INTERIOR
FRAMING, AND CENTER LINE OF
COLUMNS, TYP.

STATE OF MISSOURI MIKE KEHOE, GOVERNOR



Robert D. Rollings 2005001208, Certificate of Authority # A-2006003870



Architects LLC 208 S. Lamine SEDALTA, MO 65301 PHONE: 660 829 9752



# J-SQUARED ENGINEERING

2400 BLUFF CREEK DR. STE. 101 COLUMBIA, MO 65201 573.234.4492 phone www.j-squaredeng.com



Broadfoot Engineering, LLC 30277 Carpenter Road Sedalia, MO 65301 Phone: 660-619-7001 broadfooteng@yahoo.com

### CRUCKET

ENGINEERING CONSULTANTS
1000 W. Nifong Blvd., Bldg. 1.
Columbia, Missouri 65202
(573) 447-0292
www.crockettengineering.com
Crockett Engineering Consultants, LLC
Missouri Certificate of Authority
#2000151304

OFFICE OF ADMINISTRATION DIVISION OF FACILITIES MANAGEMENT DESIGN AND CONSTRUCTION

### DIRECTOR'S HOUSE

MISSOURI STATE FAIRGROUNDS 2503 W. 16TH ST SEDALIA, MO 65301 PROJECT # F2402-01

SITE # 1501 ASSET # 3511501149

REVISION: DATE:

REVISION: DATE:

REVISION: DATE:

ISSUE DATE: 7/11/2025
BID DOCUMENTS

CAD DWG FILE: A-FP-16
DRAWN BY: AMK
CHECKED BY: RDR
DESIGNED BY: AMK


SHEET TITLE:

DIMENSION PLANS


SHEET NUMBER:

A-102

PAGE 16 OF 36 7/11/2025

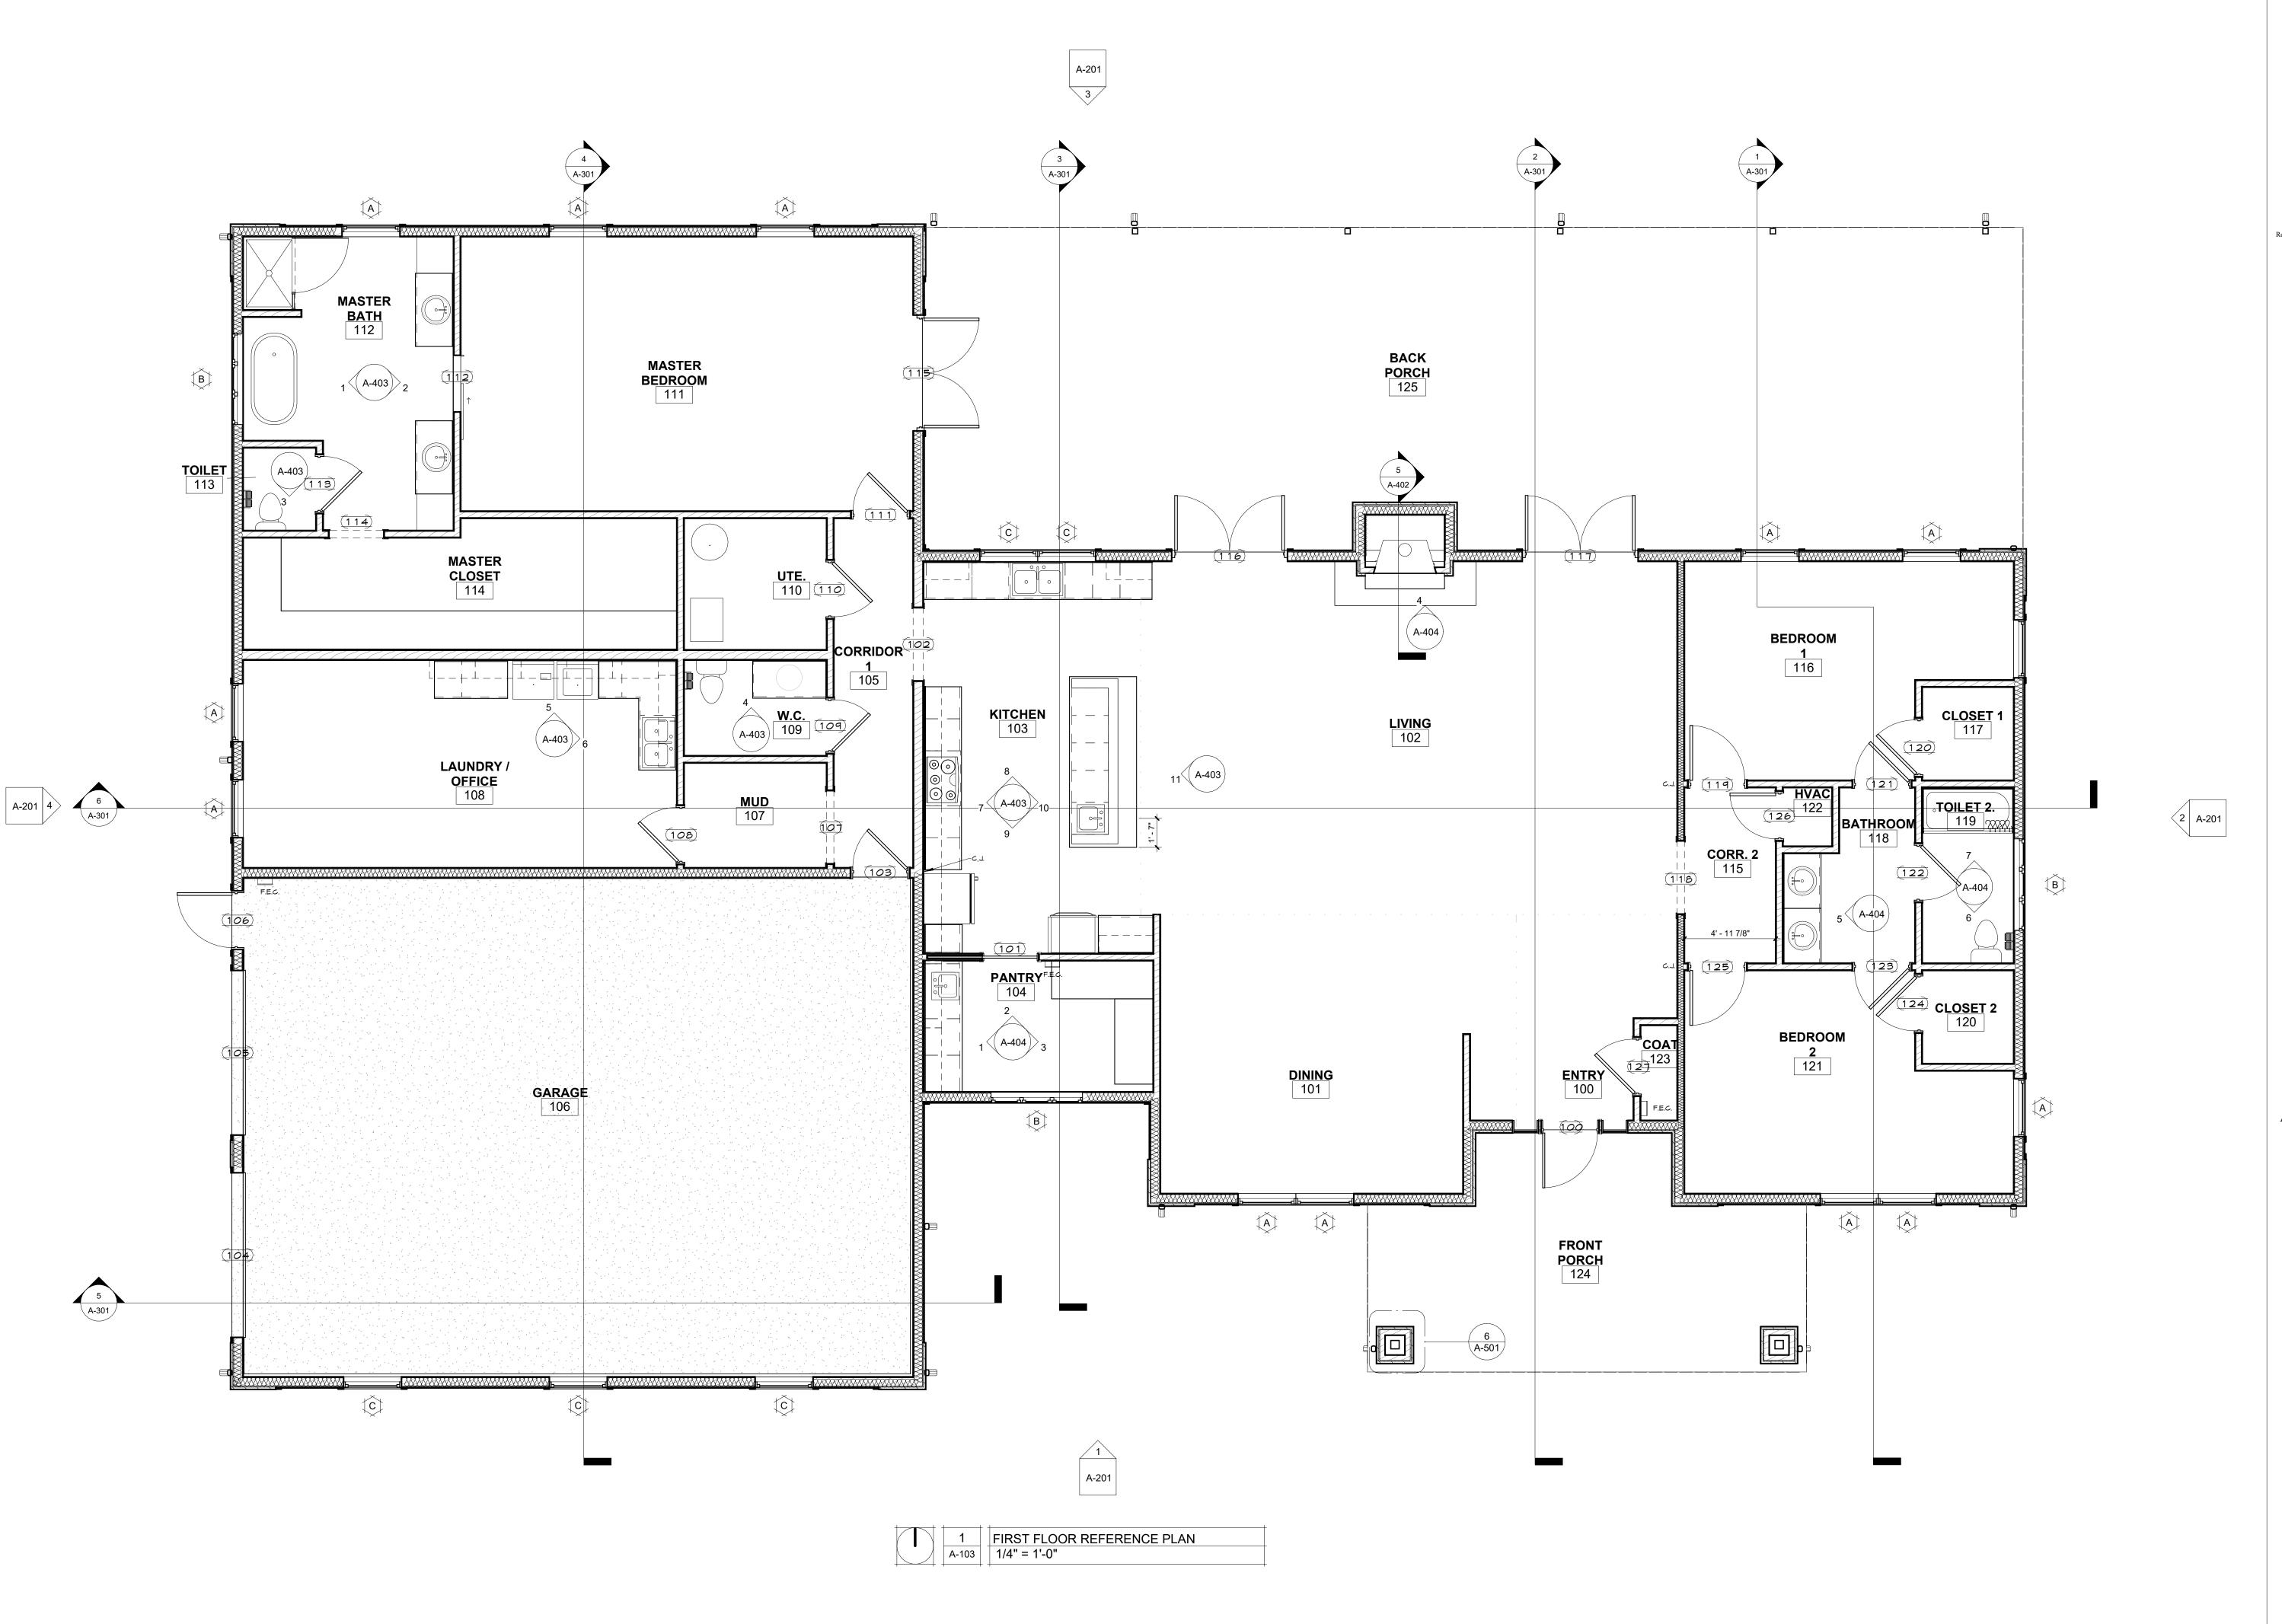



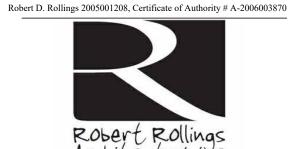

SEDALTA, MO 65301 PHONE: 660 829 9751



### J-SQUARED **ENGINEERING**

2400 BLUFF CREEK DR. STE. 101 COLUMBIA, MO 65201 573.234.4492 phone www.j-squaredeng.com



Broadfoot Engineering, LLC 30277 Carpenter Road Sedalia, MO 65301 Phone: 660-619-7001 broadfooteng@yahoo.com

ENGINEERING CONSULTANTS 1000 W. Nifong Blvd., Bldg. 1. Columbia, Missouri 65202 (573) 447-0292 www.crockettengineering.com
Crockett Engineering Consultants, LLC
Missouri Certificate of Authority
#2000151304

OFFICE OF ADMINISTRATION DIVISION OF FACILITIES MANAGEMENT DESIGN AND CONSTRUCTION

DIRECTOR'S HOUSE

MISSOURI STATE FAIRGROUNDS 2503 W. 16TH ST SEDALIA, MO 65301 PROJECT # F2402-01

SITE # 1501 ASSET # 3511501149

REVISION: DATE:

REVISION: DATE:

REVISION: DATE:

ISSUE DATE: 7/11/2025 **BID DOCUMENTS** 


CAD DWG FILE: A-FP-17
DRAWN BY: AMK
CHECKED BY: RDR
DESIGNED BY: AMK


SHEET TITLE:

REFERENCE PLANS

SHEET NUMBER:

PAGE 17 OF 36 7/11/2025

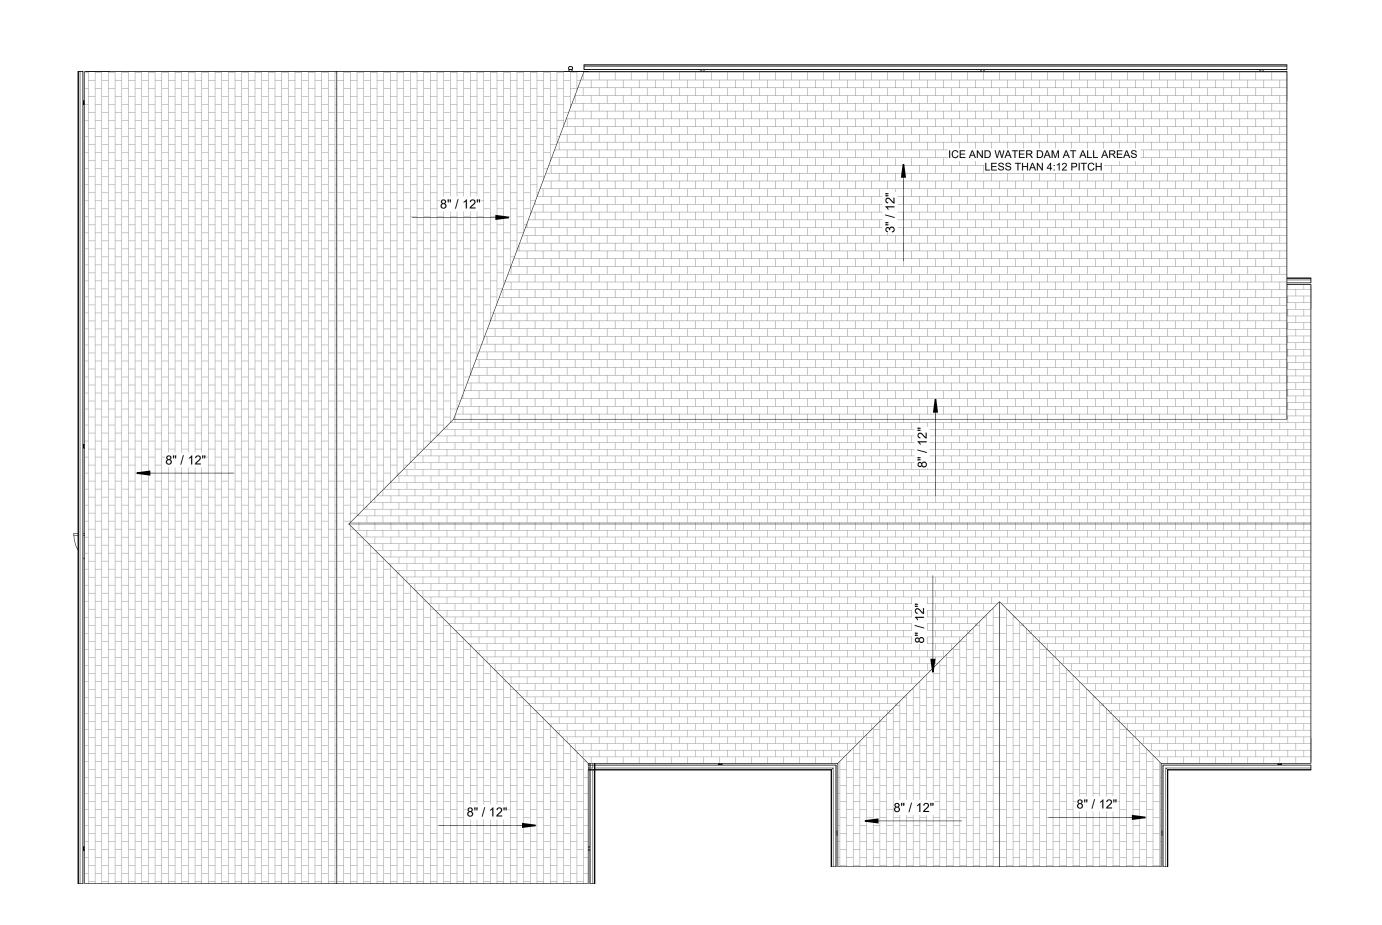

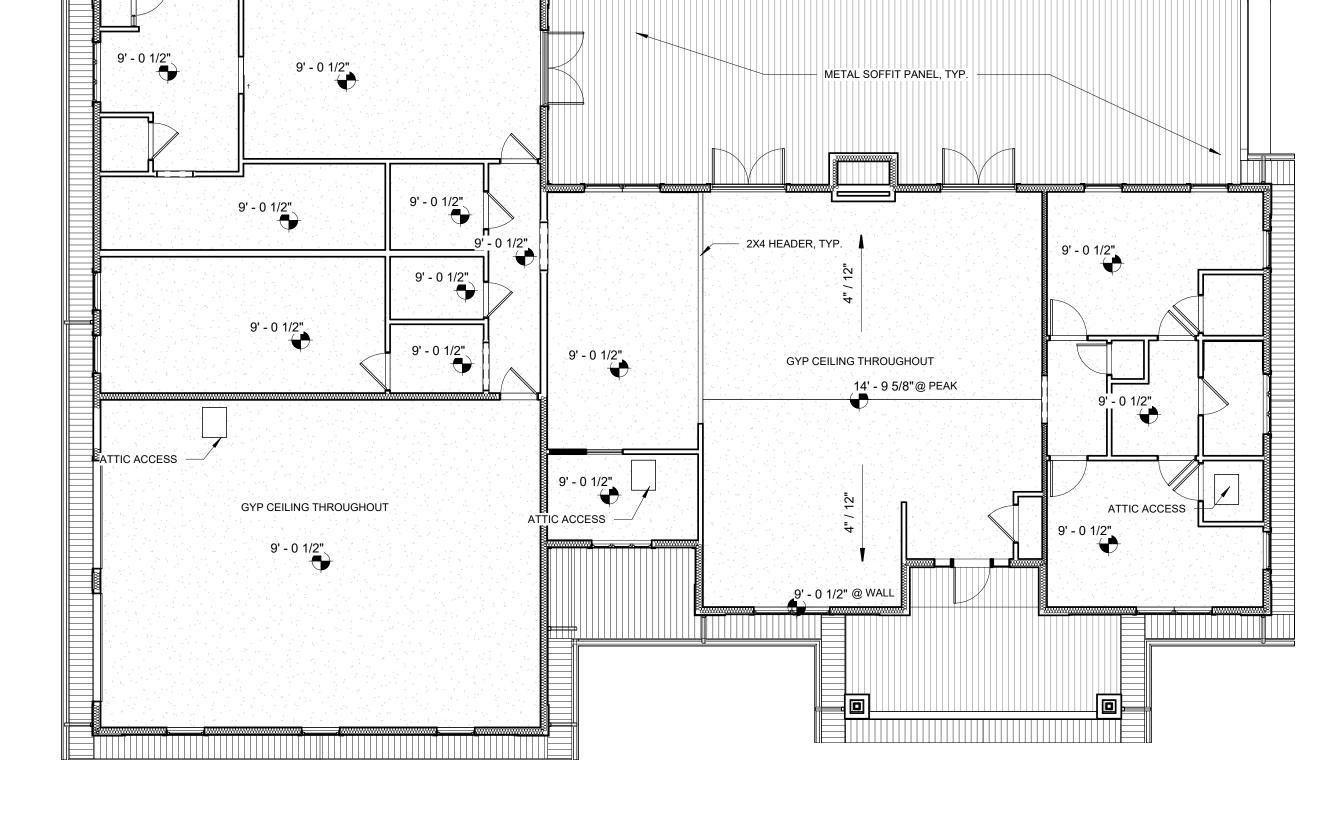


11' - 7 1/2"

11' - 6 3/8"

11' - 7 1/2"

11' - 7 1/2"


2 A-104 REFLECTED CEILING PLAN
1/8" = 1'-0"

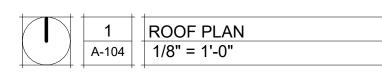

STATE OF MISSOURI MIKE KEHOE, **GOVERNOR** 



Robert D. Rollings 2005001208, Certificate of Authority # A-2006003870

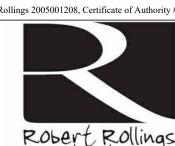

SEDALTA, MO 65301 PHONE: 660 829 9751 FAX: 660 829 9752



J-SQUARED **ENGINEERING** 2400 BLUFF CREEK DR. STE. 101

COLUMBIA, MO 65201 573.234.4492 phone www.j-squaredeng.com

Broadfoot Engineering, LLC 30277 Carpenter Road Sedalia, MO 65301 Phone: 660-619-7001 broadfooteng@yahoo.com

ENGINEERING CONSULTANTS 1000 W. Nifong Blvd., Bldg. 1. Columbia, Missouri 65202 (573) 447-0292 www.crockettengineering.com
Crockett Engineering Consultants, LLC
Missouri Certificate of Authority
#2000151304

OFFICE OF ADMINISTRATION DIVISION OF FACILITIES MANAGEMENT DESIGN AND CONSTRUCTION

DIRECTOR'S HOUSE

MISSOURI STATE **FAIRGROUNDS** 2503 W. 16TH ST SEDALIA, MO 65301 PROJECT # F2402-01

SITE # 1501 ASSET # 3511501149

**REVISION:** DATE:

REVISION:

REVISION: DATE:

ISSUE DATE: 7/11/2025 **BID DOCUMENTS** 


CAD DWG FILE: A-RP-18
DRAWN BY: AMK
CHECKED BY: RDR
DESIGNED BY: AMK

SHEET TITLE:


ROOF PLAN & REFLECTED CEILING **PLAN** 


SHEET NUMBER:

PAGE 18 OF 36 7/11/2025

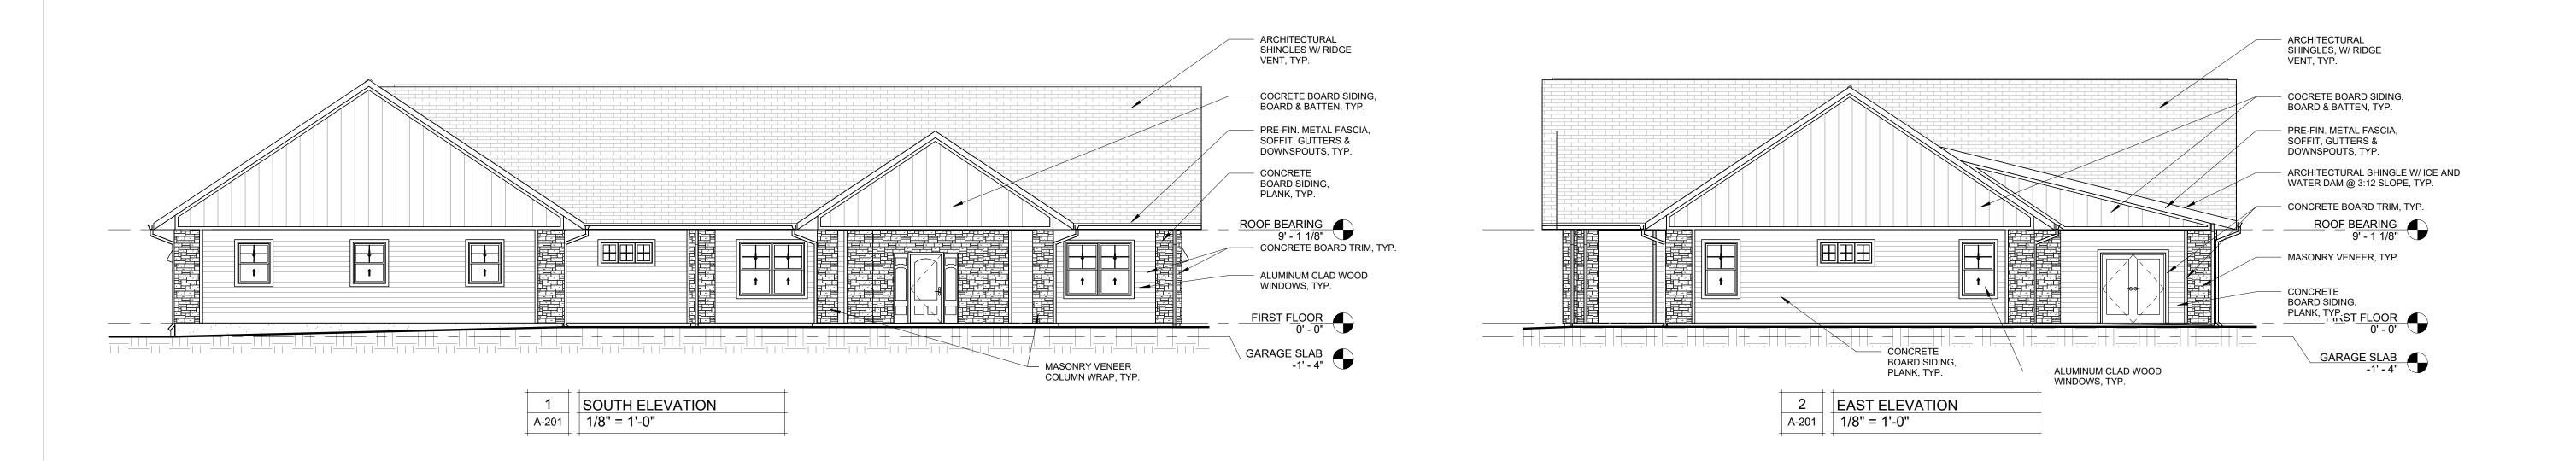




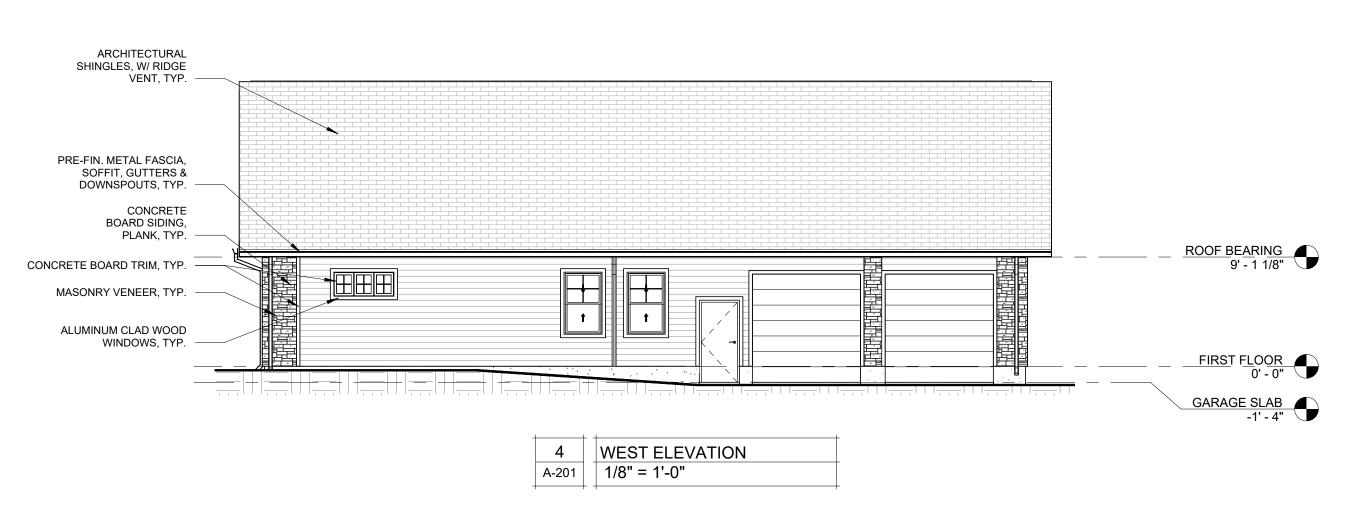

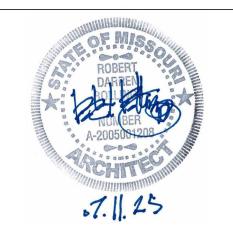

Robert D. Rollings 2005001208, Certificate of Authority # A-2006003870

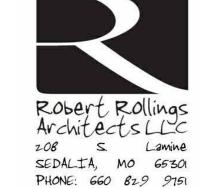



J-SQUARED
ENGINEERING
2400 BLUFF CREEK DR. STE. 101
COLUMBIA, MO 65201
573.234.4492 phone
www.j-squaredeng.com



Broadfoot Engineering, LLC 30277 Carpenter Road Sedalia, MO 65301 Phone: 660-619-7001 broadfooteng@yahoo.com

# CRUCKET

ENGINEERING CONSULTANTS
1000 W. Nifong Blvd., Bldg. 1.
Columbia, Missouri 65202
(573) 447-0292
www.crockettengineering.com
Crockett Engineering Consultants, LLC
Missouri Certificate of Authority
#2000151304

OFFICE OF ADMINISTRATION DIVISION OF FACILITIES MANAGEMENT DESIGN AND CONSTRUCTION

### DIRECTOR'S HOUSE

MISSOURI STATE FAIRGROUNDS 2503 W. 16TH ST SEDALIA, MO 65301 PROJECT # F2402-01

SITE # 1501 ASSET # 3511501149

REVISION: DATE:

REVISION: DATE:

REVISION:\_\_\_\_\_ DATE:\_\_\_

ISSUE DATE: 7/11/2025
BID DOCUMENTS

CAD DWG FILE: A-EL-19
DRAWN BY: AMK
CHECKED BY: RDR
DESIGNED BY: AMK


SHEET TITLE:

EXTERIOR ELEVATIONS


SHEET NUMBER:

A-201


PAGE 19 OF 36 7/11/2025

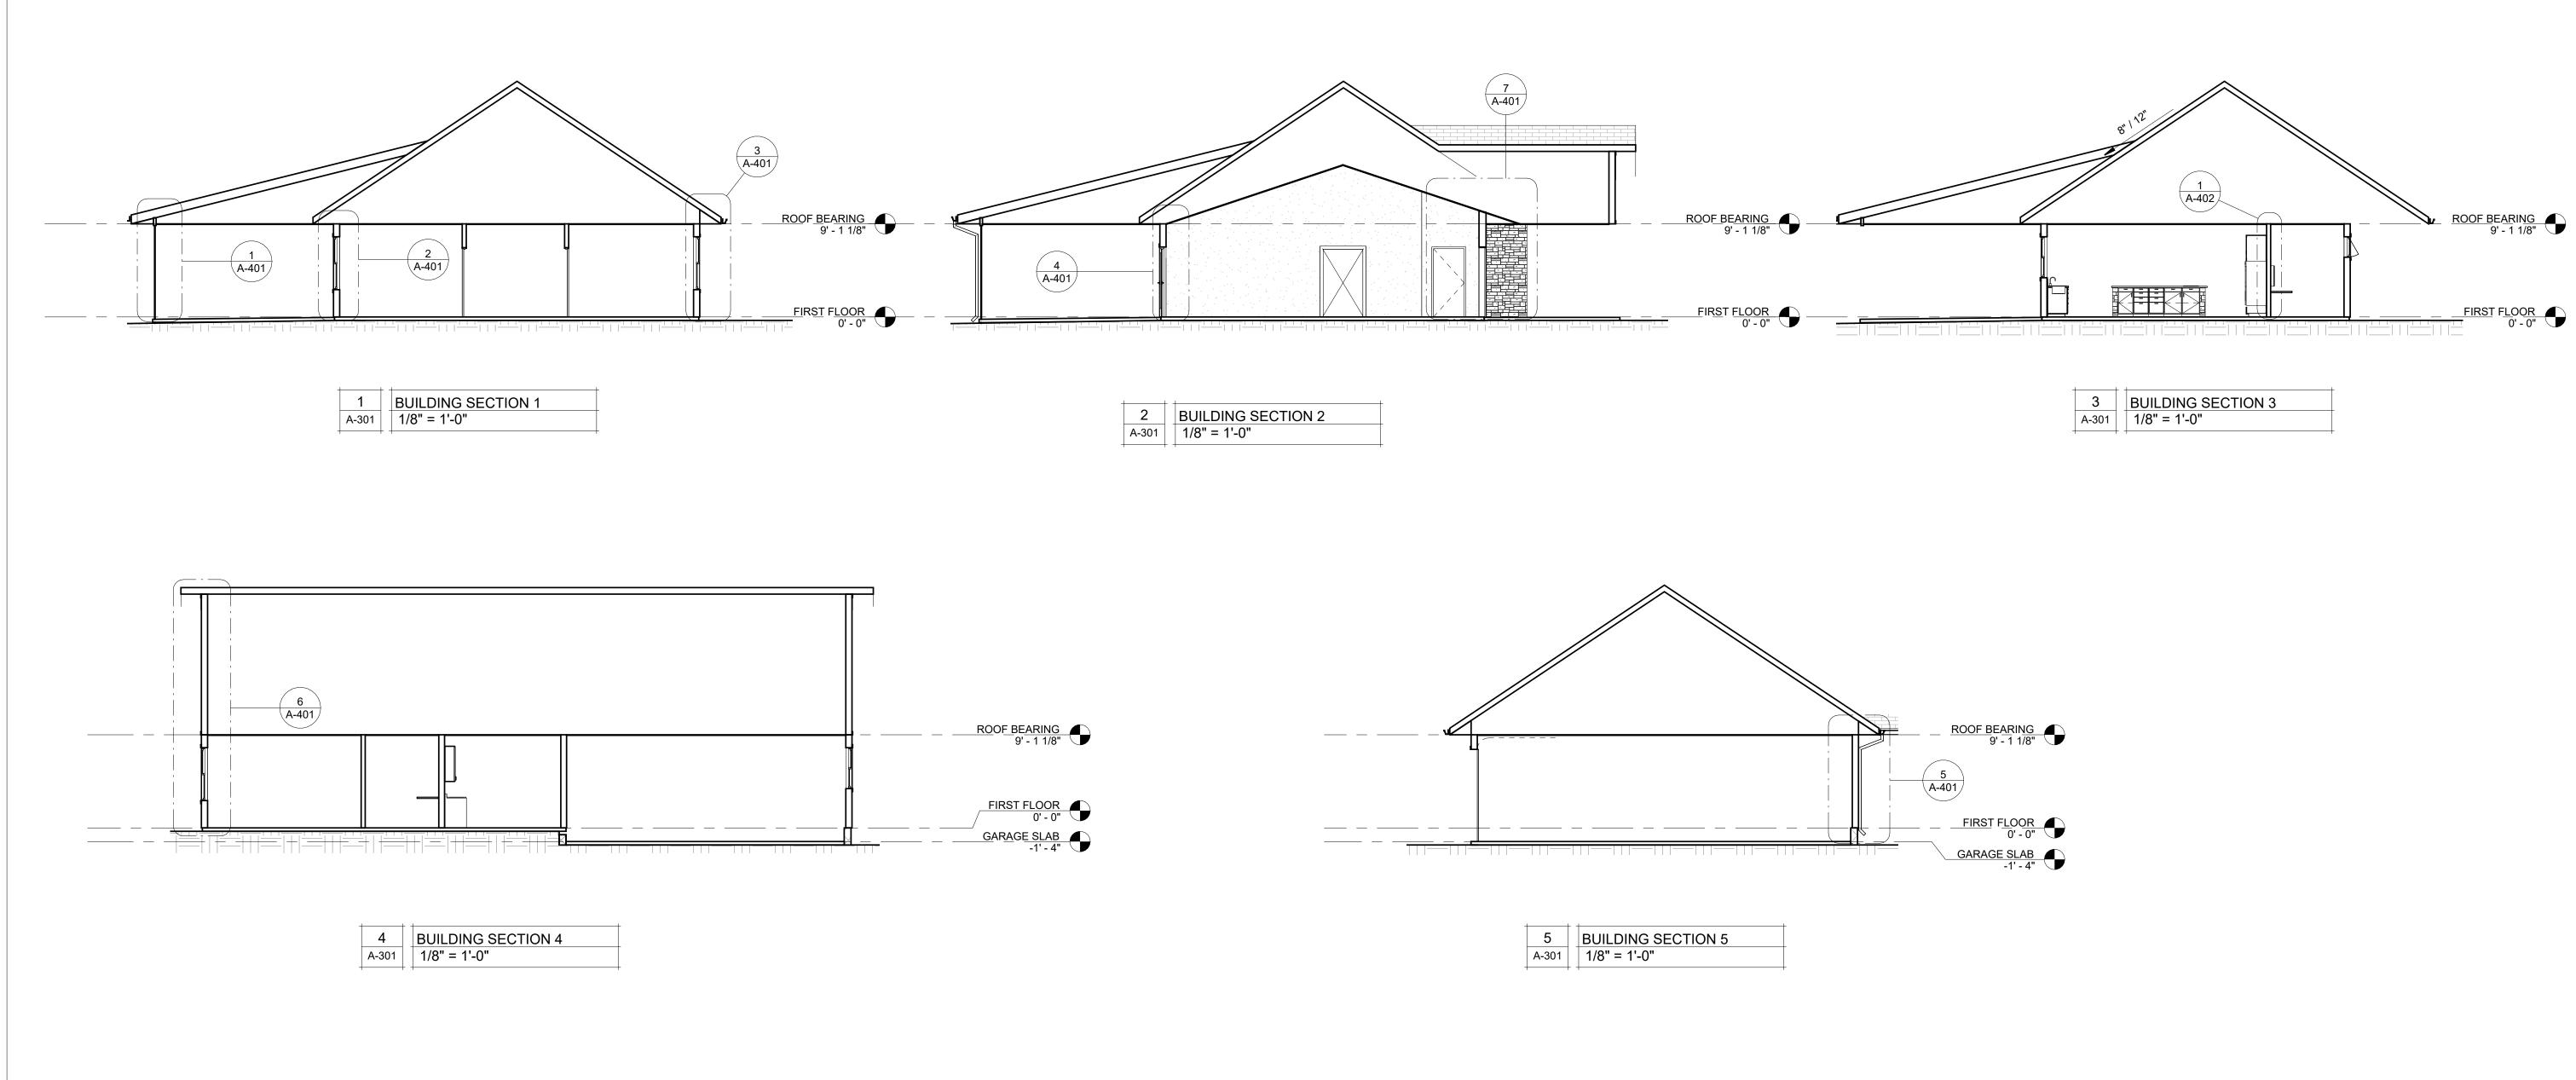


NOTE: BUILDING SECTIONS ARE SCHEMATIC. SEE WALL SECTIONS FOR DETAILS, T YP.

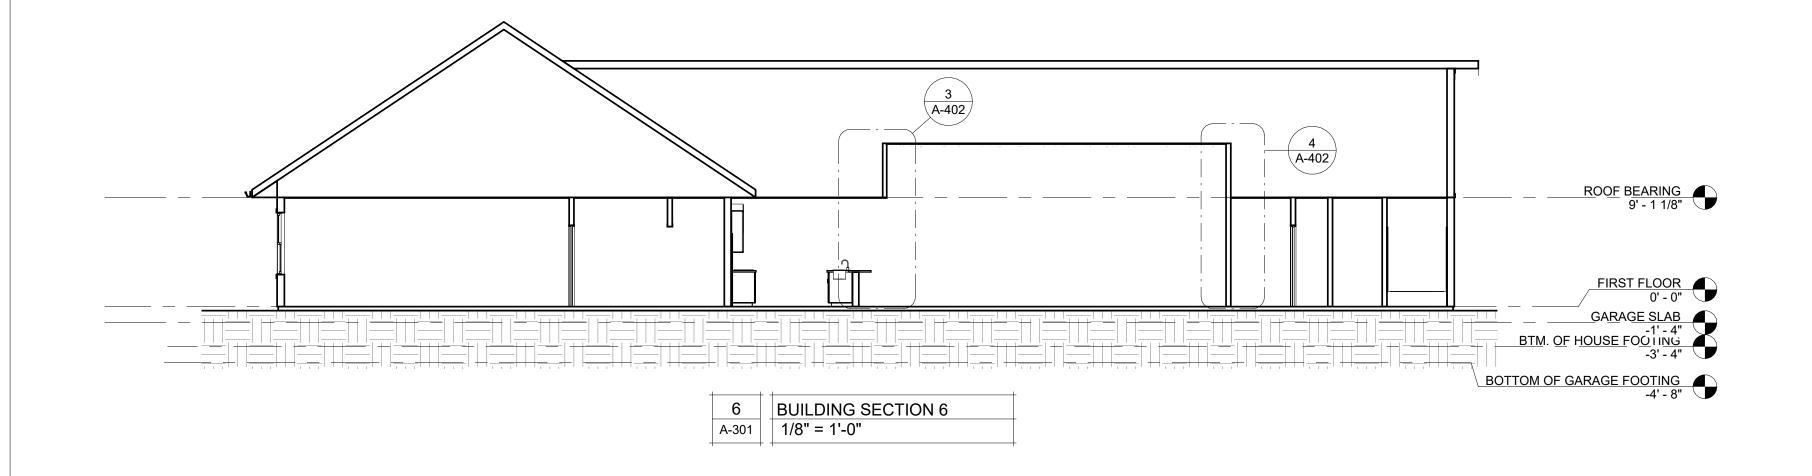

### STATE OF MISSOURI MIKE KEHOE, **GOVERNOR**

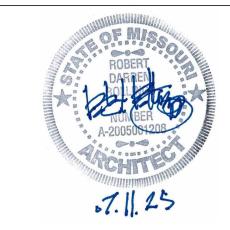

Robert D. Rollings 2005001208, Certificate of Authority # A-2006003870

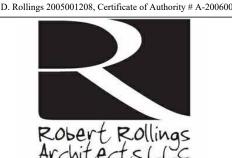

SEDALTA, MO 65301 PHONE: 660 829 9751 FAX: 660 829 9752



### J-SQUARED **ENGINEERING**

2400 BLUFF CREEK DR. STE. 101 COLUMBIA, MO 65201 573.234.4492 phone www.j-squaredeng.com



Broadfoot Engineering, LLC 30277 Carpenter Road Sedalia, MO 65301 Phone: 660-619-7001 broadfooteng@yahoo.com

ENGINEERING CONSULTANTS 1000 W. Nifong Blvd., Bldg. 1. Columbia, Missouri 65202 (573) 447-0292 www.crockettengineering.com Crockett Engineering Consultants, LLC Missouri Certificate of Authority #2000151304

OFFICE OF ADMINISTRATION DIVISION OF FACILITIES MANAGEMENT DESIGN AND CONSTRUCTION

### DIRECTOR'S HOUSE

MISSOURI STATE **FAIRGROUNDS** 2503 W. 16TH ST SEDALIA, MO 65301 PROJECT # F2402-01

SITE # 1501 ASSET # 3511501149

REVISION:
$DATE \cdot \overline{}$

REVISION:

**REVISION**:

DATE:

### ISSUE DATE: 7/11/2025 **BID DOCUMENTS**


CAD DWG FILE: A-SC-20
DRAWN BY: AMK
CHECKED BY: RDR
DESIGNED BY: AMK


SHEET TITLE:

### **BUILDING SECTIONS**

SHEET NUMBER:

PAGE 20 OF 36 7/11/2025

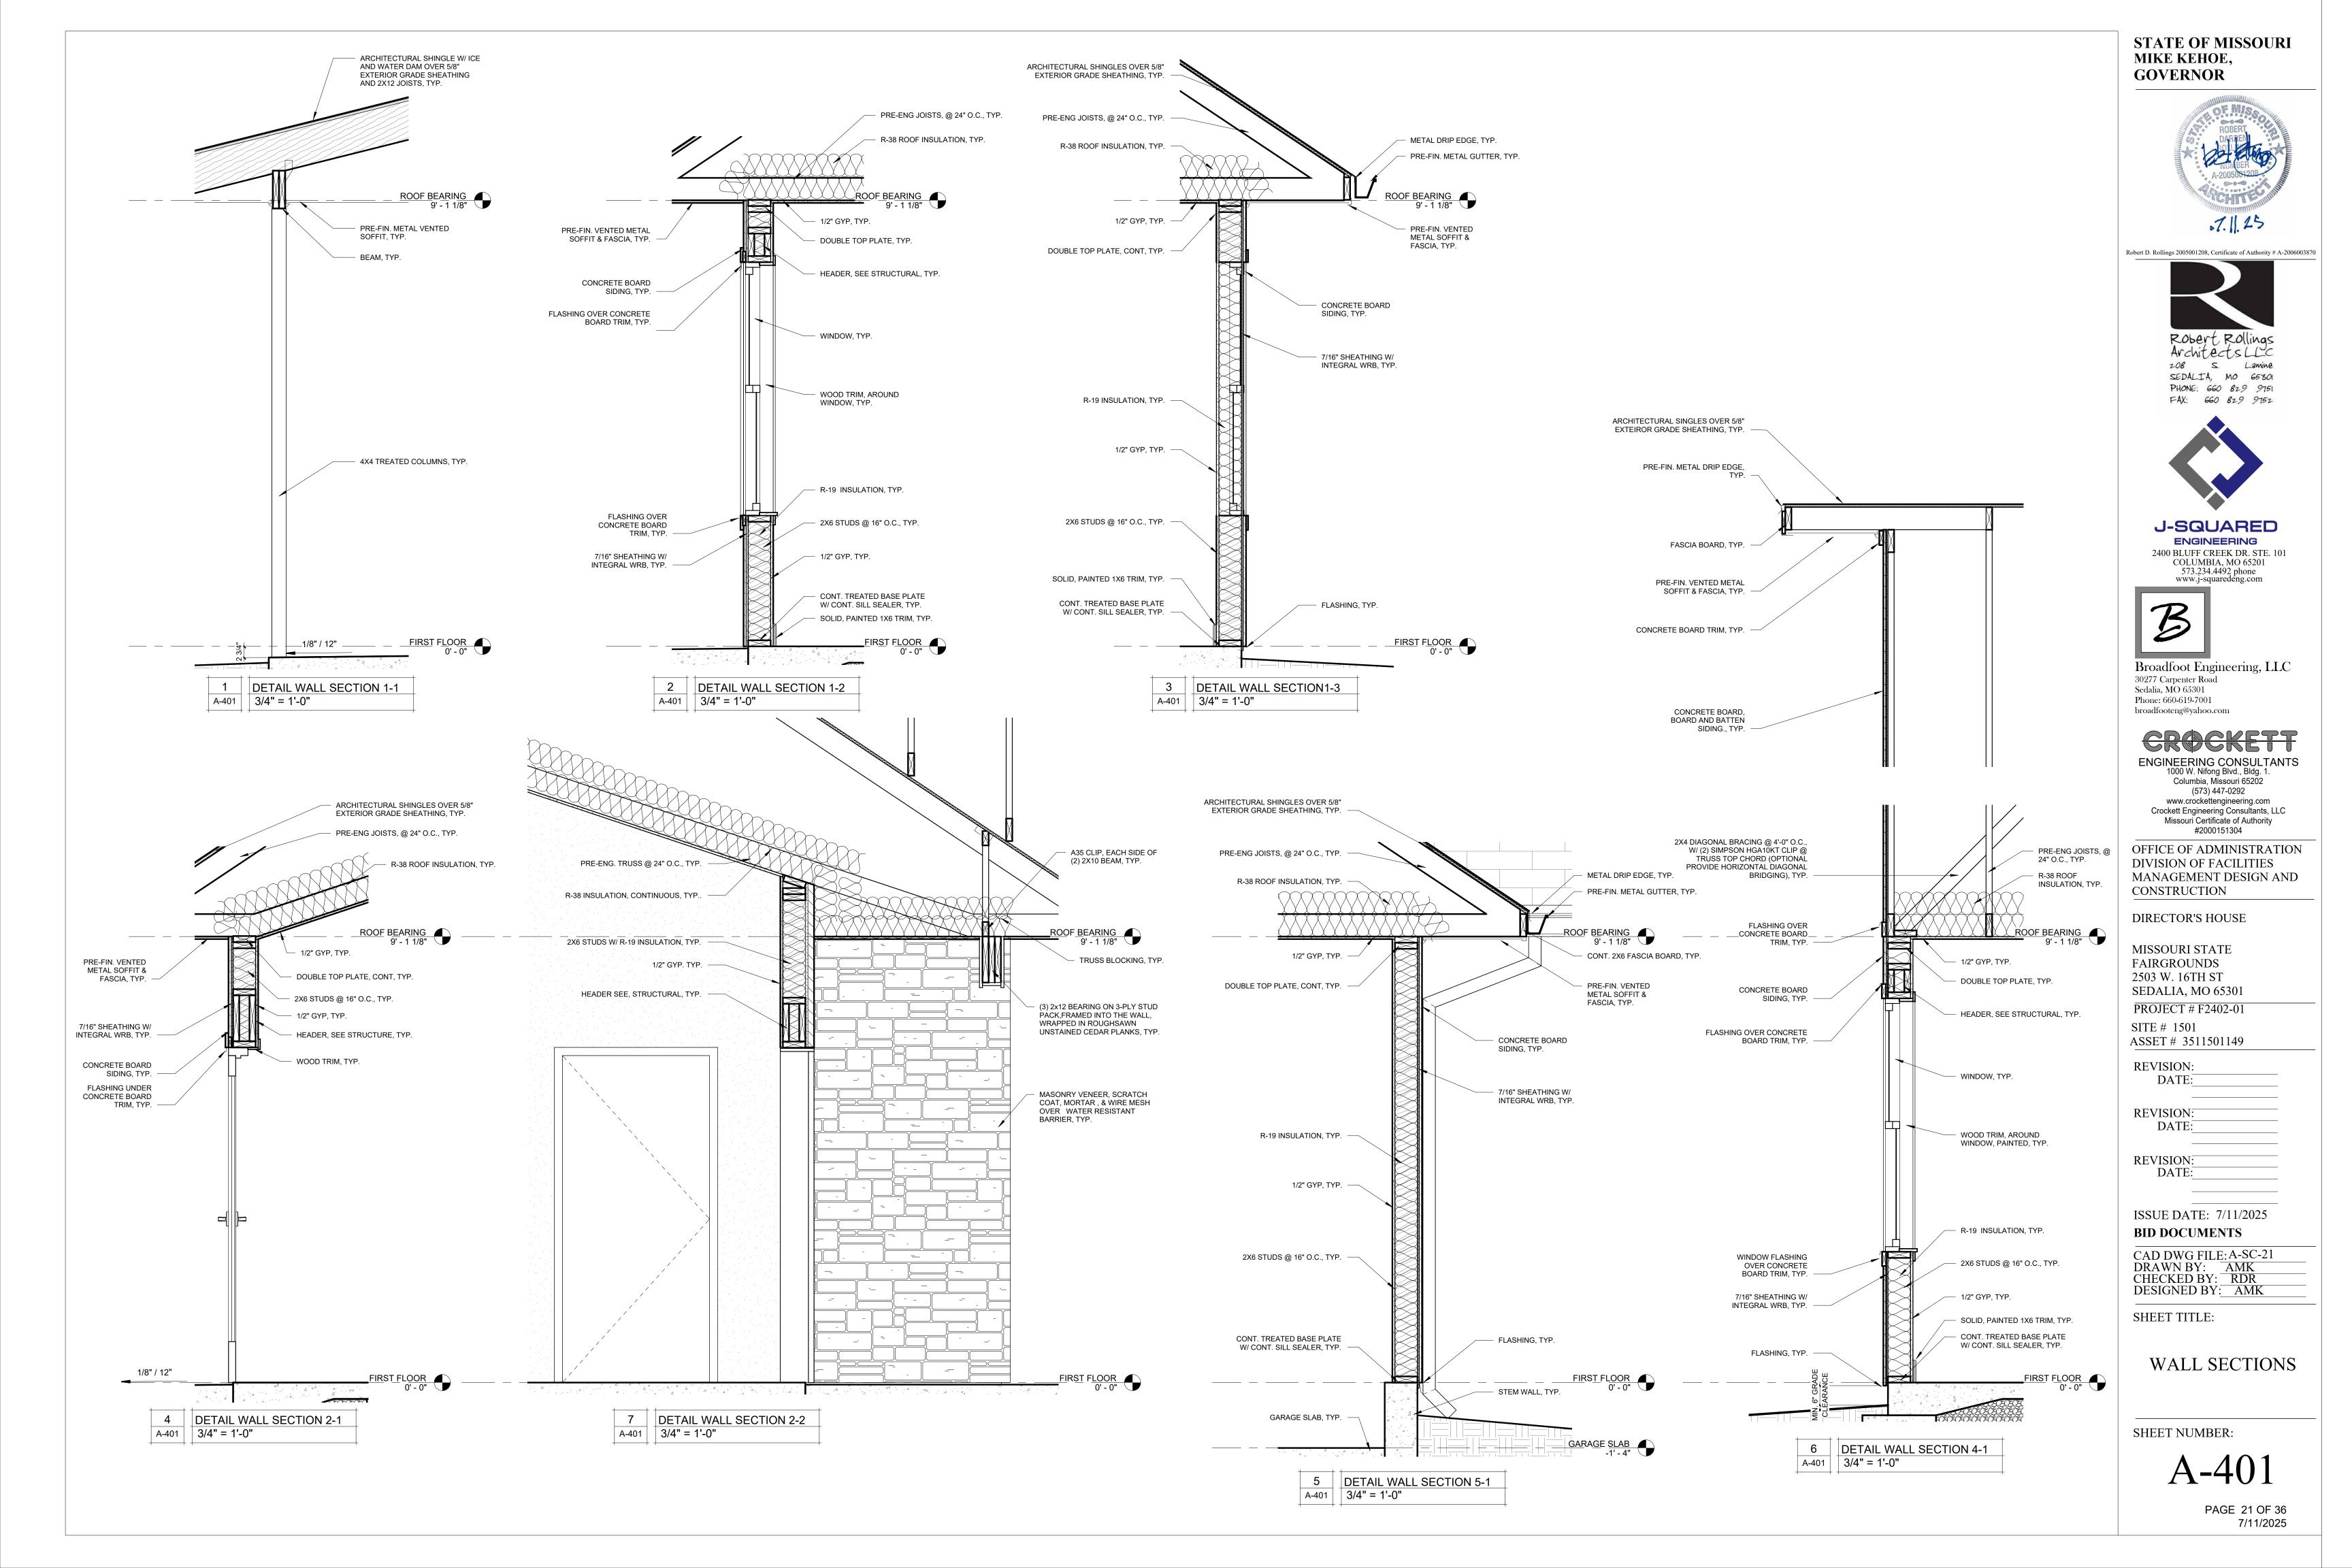

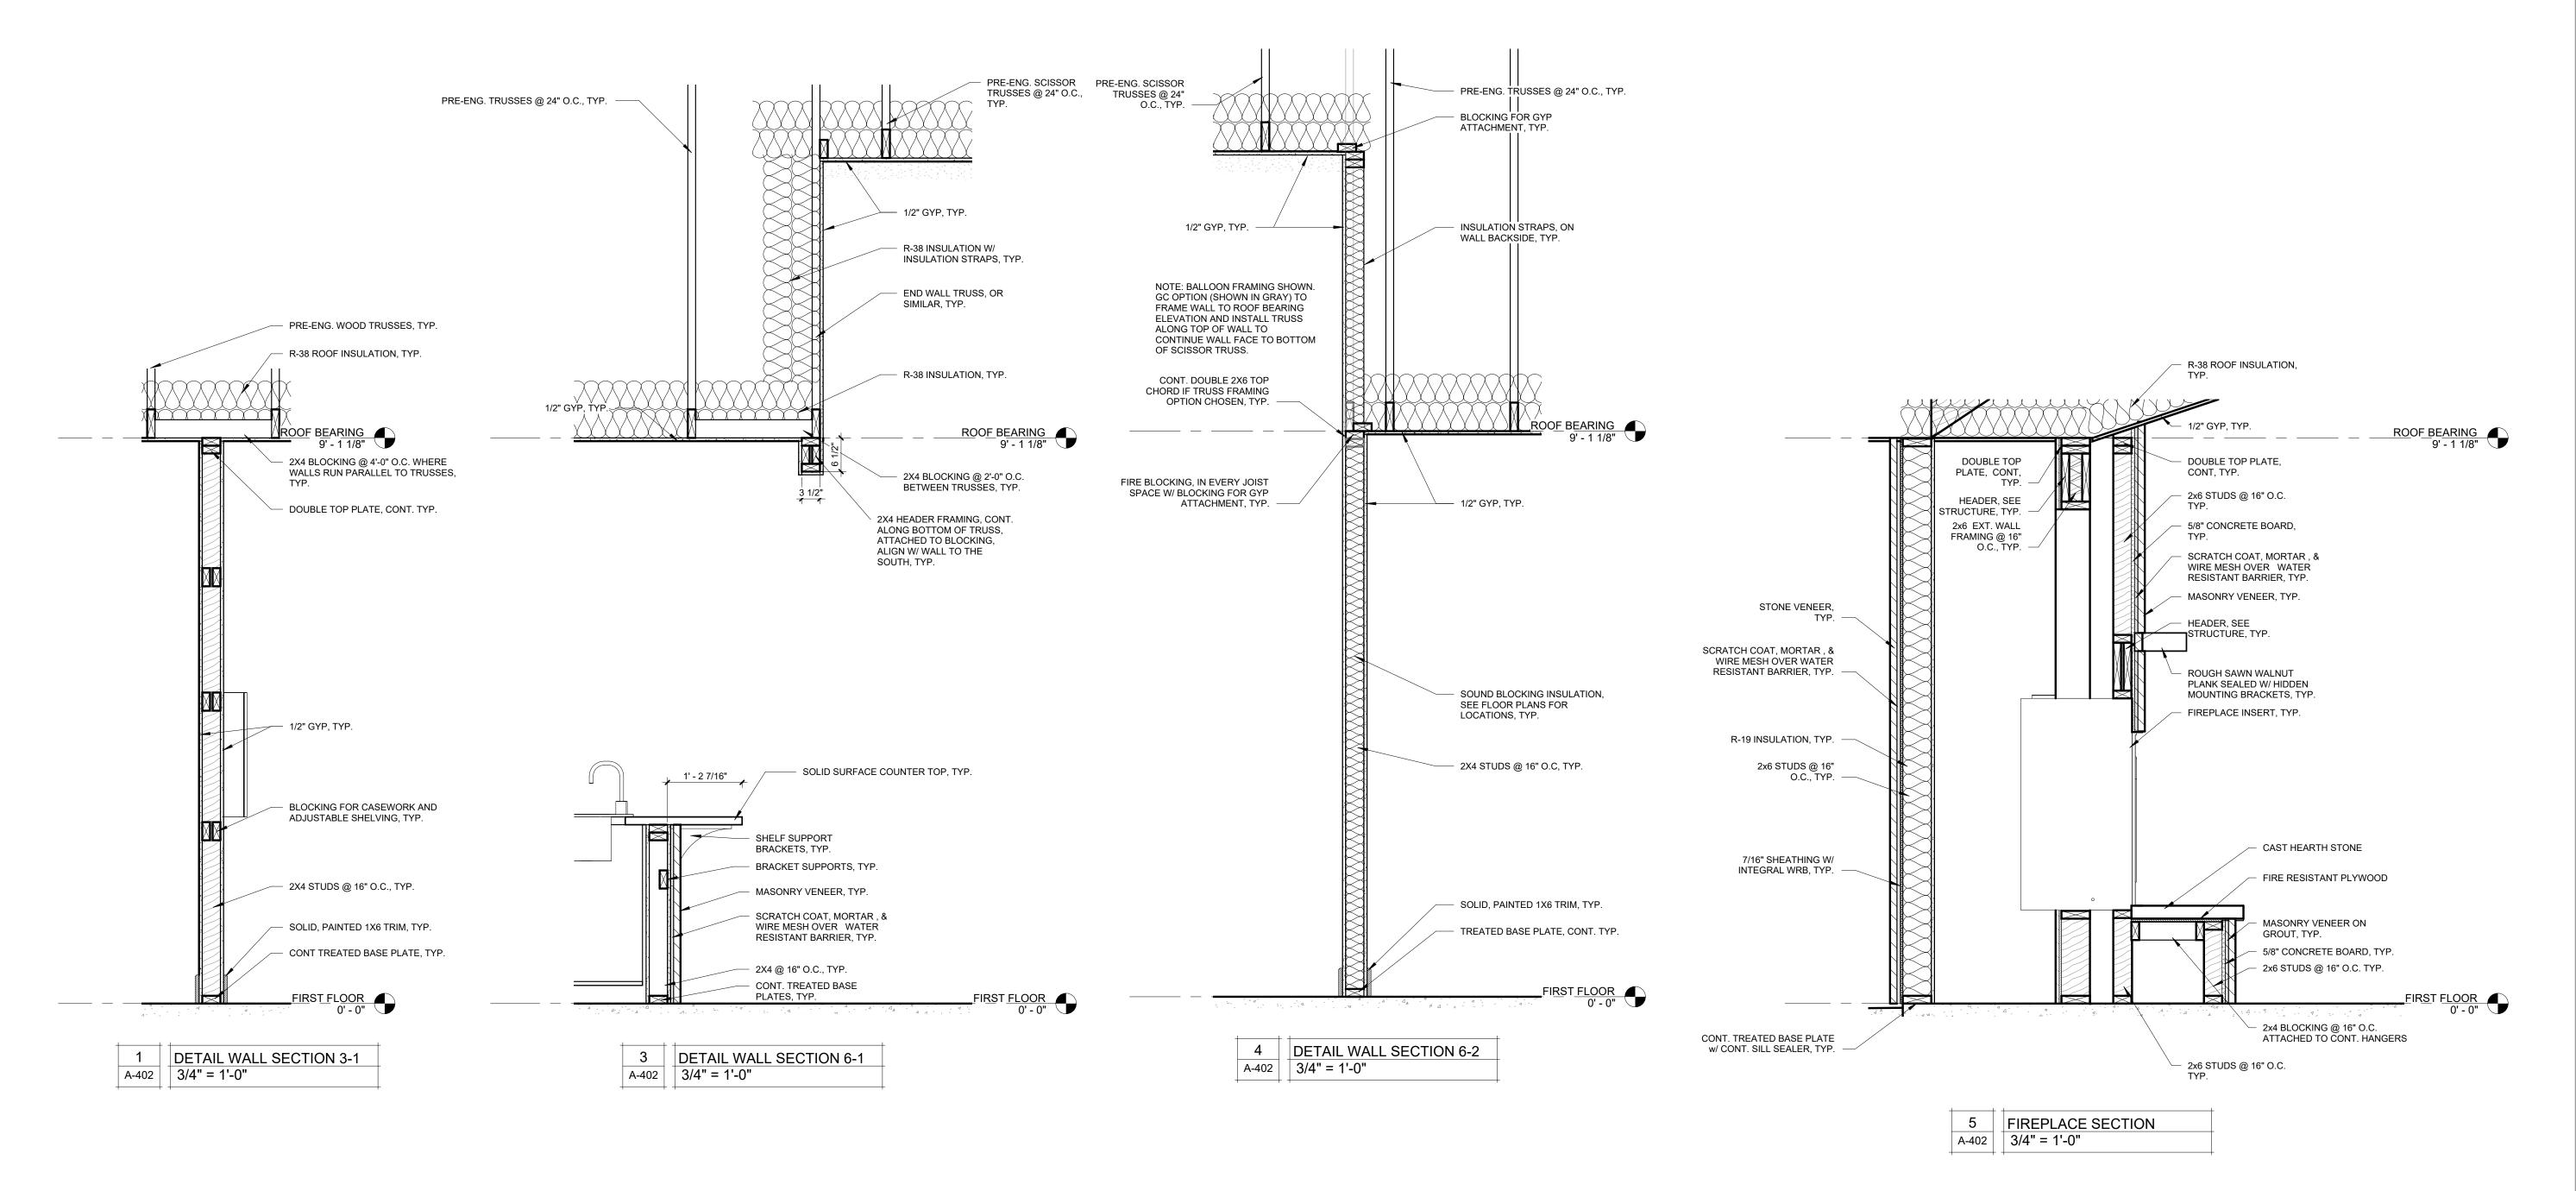



Robert D. Rollings 2005001208, Certificate of Authority # A-2006003870



PHONE: 660 829 9751



### J-SQUARED **ENGINEERING** 2400 BLUFF CREEK DR. STE. 101

COLUMBIA, MO 65201 573.234.4492 phone www.j-squaredeng.com



Broadfoot Engineering, LLC 30277 Carpenter Road Sedalia, MO 65301 Phone: 660-619-7001 broadfooteng@yahoo.com

ENGINEERING CONSULTANTS 1000 W. Nifong Blvd., Bldg. 1. Columbia, Missouri 65202 (573) 447-0292 www.crockettengineering.com Crockett Engineering Consultants, LLC Missouri Certificate of Authority #2000151304

OFFICE OF ADMINISTRATION DIVISION OF FACILITIES MANAGEMENT DESIGN AND CONSTRUCTION

### DIRECTOR'S HOUSE

MISSOURI STATE **FAIRGROUNDS** 2503 W. 16TH ST SEDALIA, MO 65301 PROJECT # F2402-01

SITE # 1501 ASSET # 3511501149

**REVISION:** DATE:

**REVISION:** DATE:

REVISION:

DATE:

ISSUE DATE: 7/11/2025 **BID DOCUMENTS** 


CAD DWG FILE: A-SC-22 DRAWN BY: AMK CHECKED BY: RDR DESIGNED BY: AMK

SHEET TITLE:

WALL SECTIONS

SHEET NUMBER:

PAGE 22 OF 36 7/11/2025

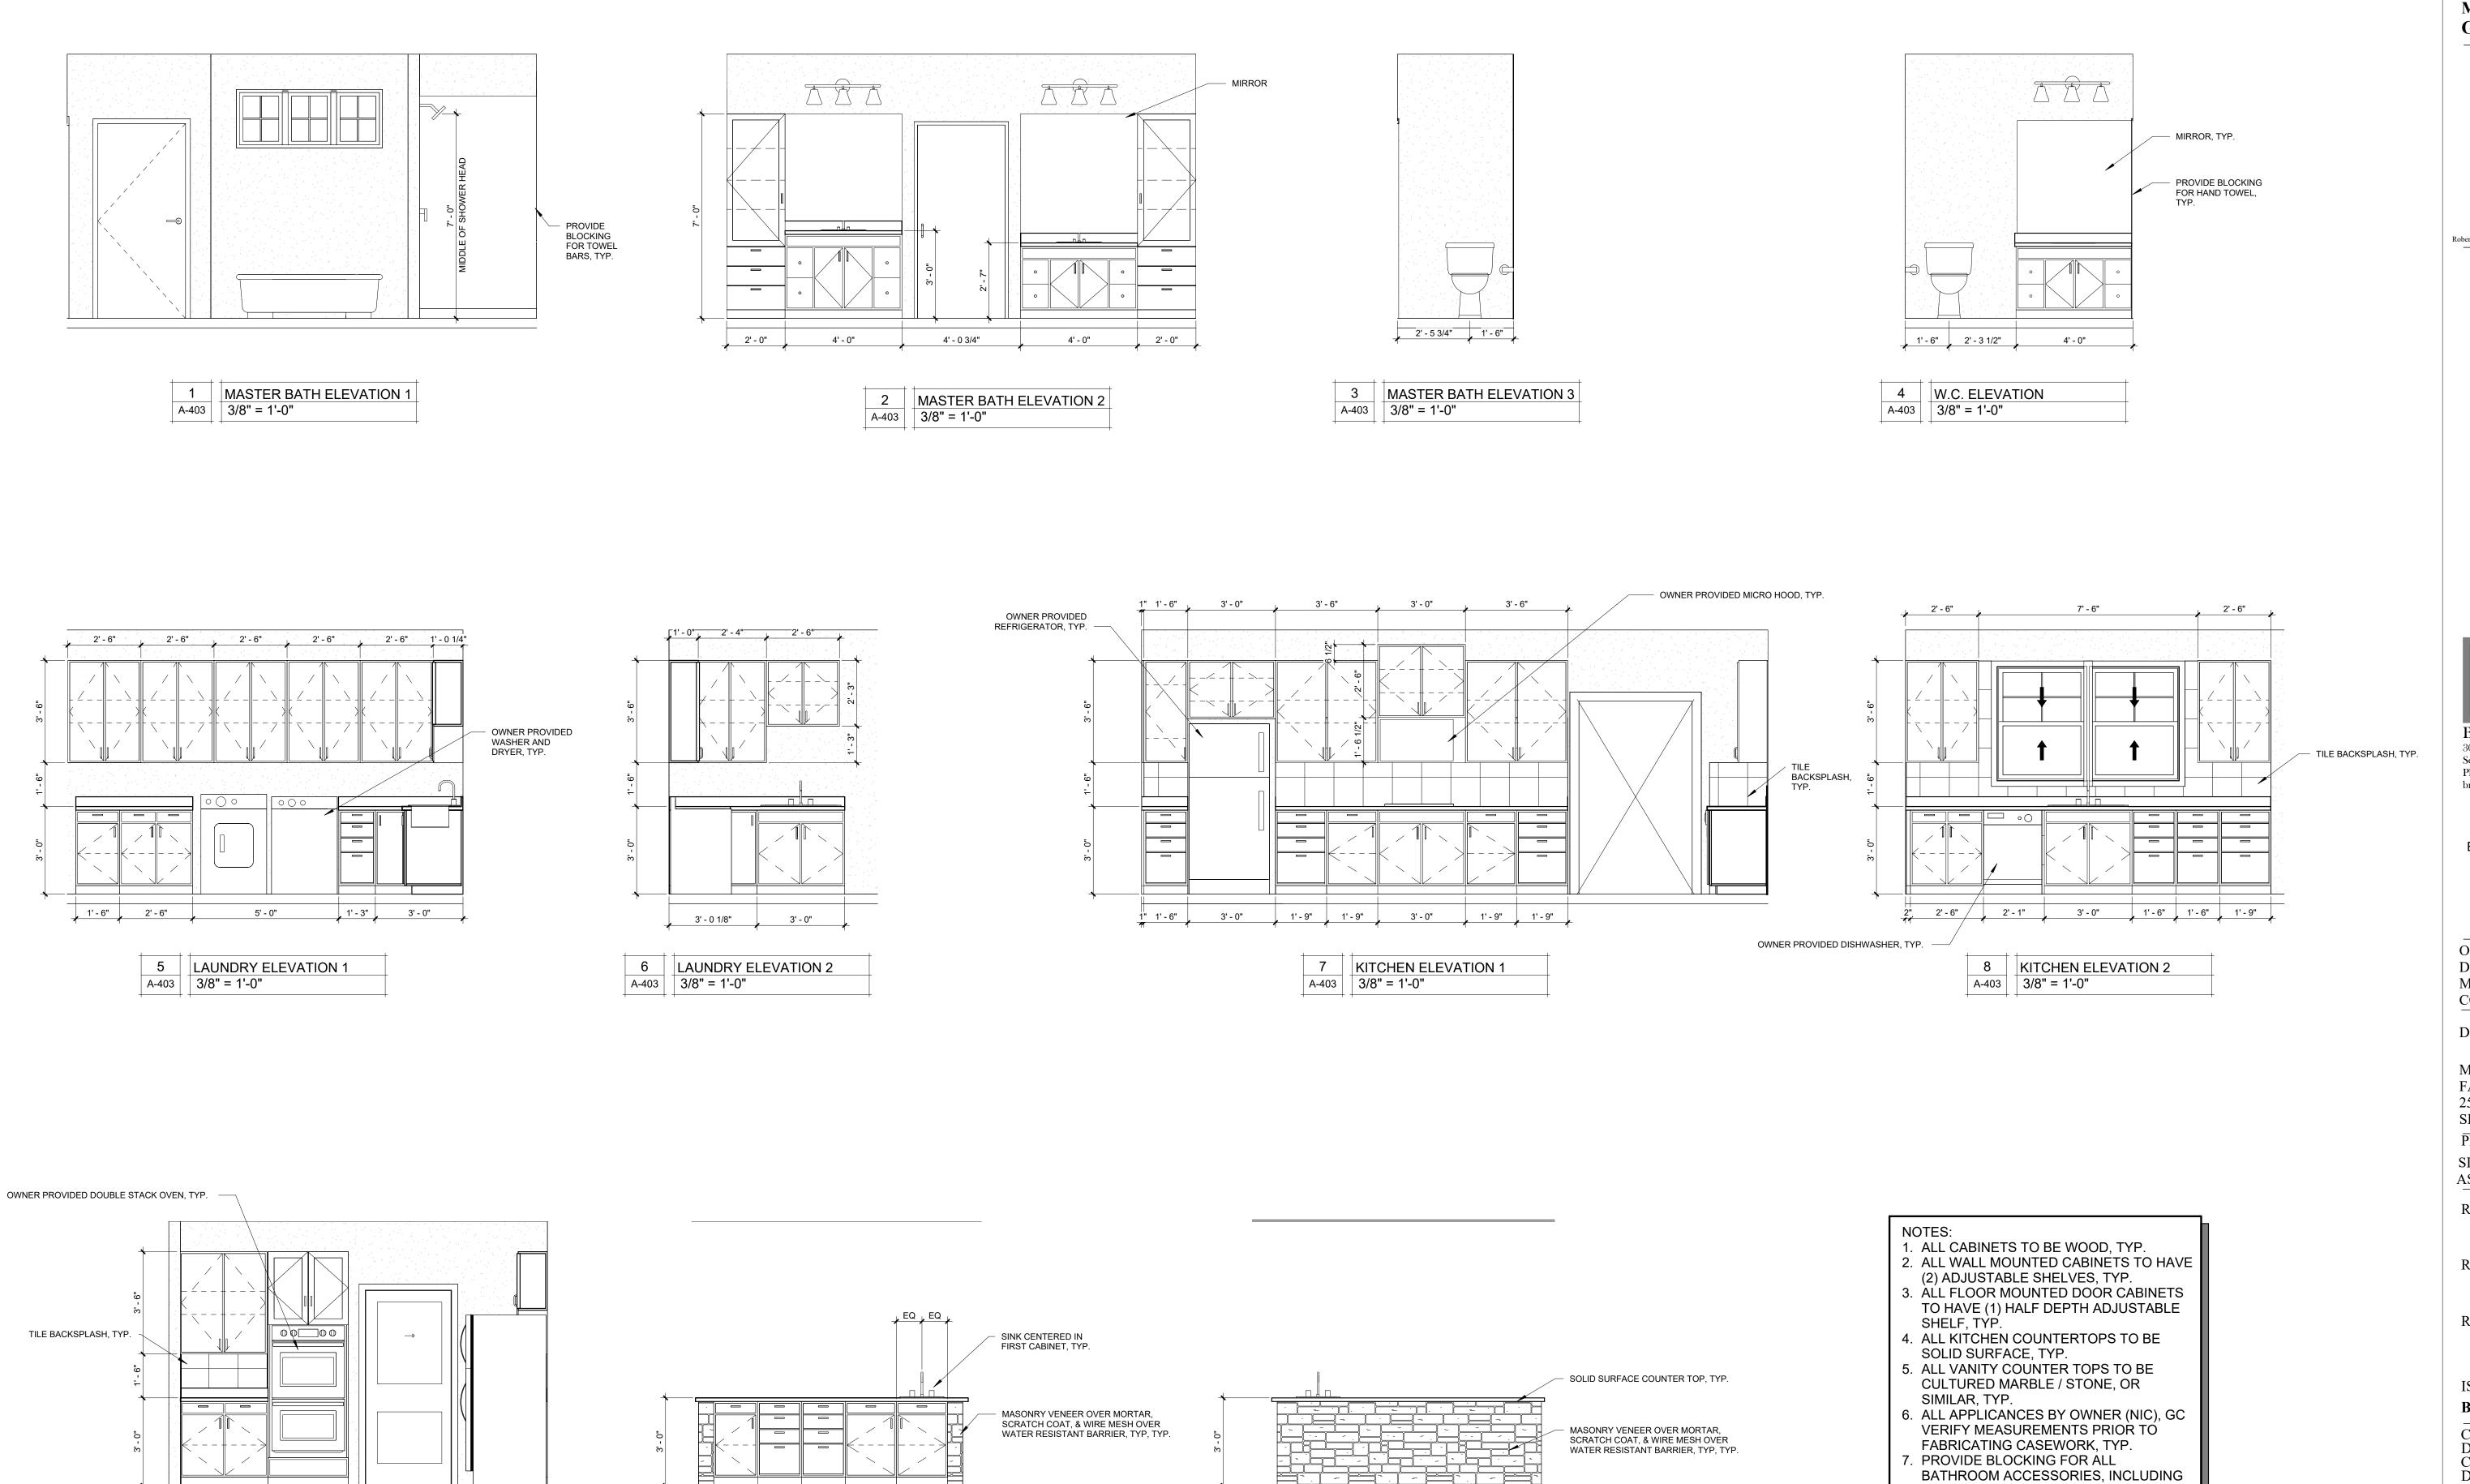

1'-6" 1'-6" 1'-9" 1'-9"

10 KITCHEN ISLAND ELEVATION 1

A-403 3/8" = 1'-0"

6' - 9 3/4"

9 KITCHEN ELEVATION 3


A-403 3/8" = 1'-0"

9' - 0 1/2"

11 KITCHEN ISLAND ELEVATION 2

A-403 3/8" = 1'-0"

STATE OF MISSOURI MIKE KEHOE, GOVERNOR

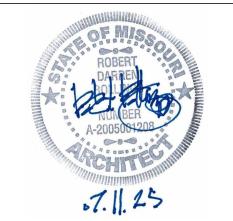

Robert D. Rollings 2005001208, Certificate of Authority # A-2006003870



Architects LLC 208 S. Lamine SEDALTA, MO 65301 PHONE: 660 829 9751 FAX: 660 829 9752



J-SQUARED
ENGINEERING
2400 BLUFF CREEK DR. STE. 101



Broadfoot Engineering, LLC 30277 Carpenter Road Sedalia, MO 65301 Phone: 660-619-7001 broadfooteng@yahoo.com

# CRUCKETT

ENGINEERING CONSULTANTS
1000 W. Nifong Blvd., Bldg. 1.
Columbia, Missouri 65202
(573) 447-0292
www.crockettengineering.com
Crockett Engineering Consultants, LLC
Missouri Certificate of Authority
#2000151304

OFFICE OF ADMINISTRATION DIVISION OF FACILITIES MANAGEMENT DESIGN AND CONSTRUCTION

### DIRECTOR'S HOUSE

MISSOURI STATE FAIRGROUNDS 2503 W. 16TH ST SEDALIA, MO 65301 PROJECT # F2402-01

SITE # 1501 ASSET # 3511501149

REVISION: DATE:

REVISION: DATE:

REVISION:

DATE:

ISSUE DATE: 7/11/2025

BID DOCUMENTS

CAD DWG FILE: A-EL-23
DRAWN BY: AMK
CHECKED BY: RDR
DESIGNED BY: AMK

SHEET TITLE:

TOWEL BARS, TOILET PAPER


DISPENSERS, ETC.


INTERIOR ELEVATIONS


SHEET NUMBER:


A-403

PAGE 23 OF 36 7/11/2025

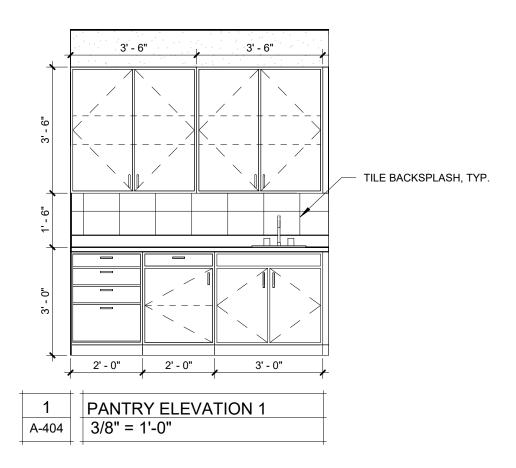


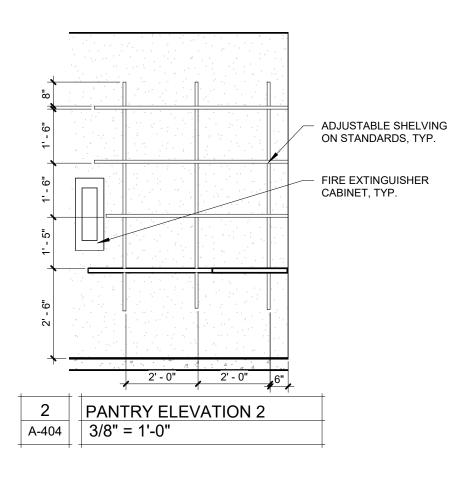


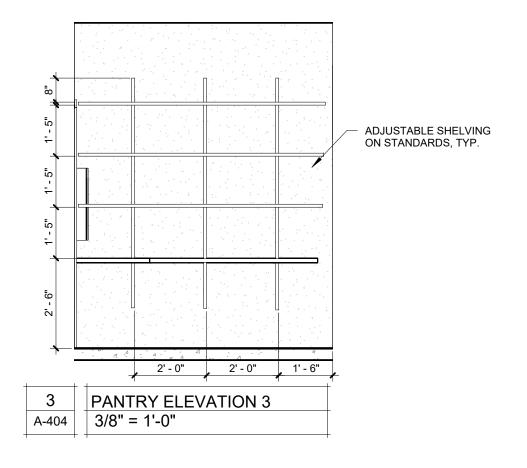


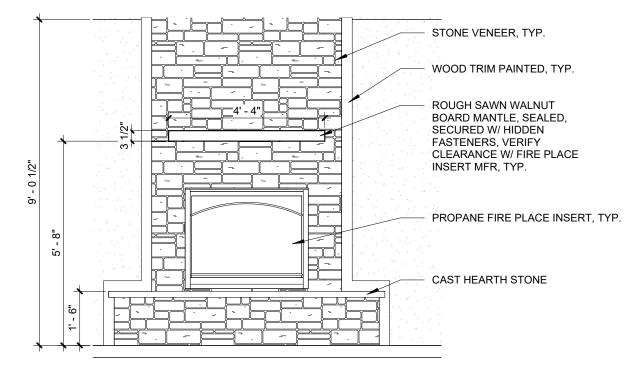

4 FIREPLACE ELEVATION 3/8" = 1'-0" A-404

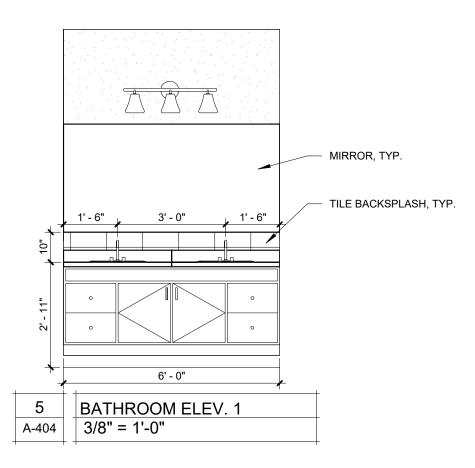

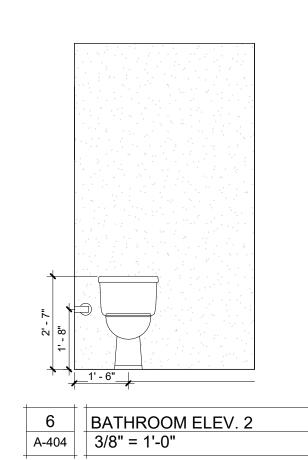

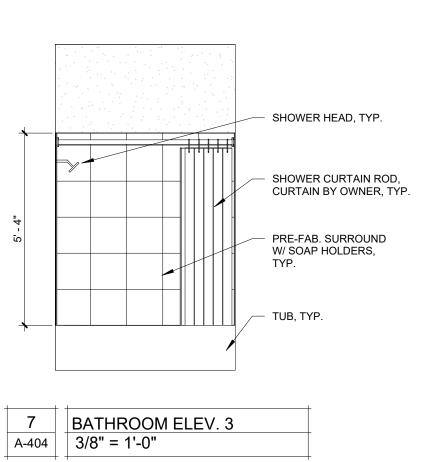

- 1. ALL CABINETS TO BE WOOD, TYP.
- 2. ALL WALL MOUNTED CABINETS TO HAVE (2) ADJUSTABLE SHELVES, TYP.
- 3. ALL FLOOR MOUNTED DOOR CABINETS TO HAVE (1) HALF DEPTH ADJUSTABLE SHELF, TYP.
- 4. ALL KITCHEN COUNTERTOPS TO BE
- SOLID SURFACE, TYP.
- 5. ALL VANITY COUNTER TOPS TO BE CULTURED MARBLE / STONE, OR SIMILAR, TYP.
- 6. ALL APPLICANCES BY OWNER (NIC), GC
- VERIFY MEASUREMENTS PRIOR TO FABRICATING CASEWORK, TYP.
- 7. PROVIDE BLOCKING FOR ALL BATHROOM ACCESSORIES, INCLUDING TOWEL BARS, TOILET PAPER DISPENSERS, ETC.

### STATE OF MISSOURI MIKE KEHOE, **GOVERNOR**



Robert D. Rollings 2005001208, Certificate of Authority # A-2006003870



208 S. Lamine SEDALTA, MO 65301 PHONE: 660 829 9751 FAX: 660 829 9752



J-SQUARED **ENGINEERING** 2400 BLUFF CREEK DR. STE. 101 COLUMBIA, MO 65201



Broadfoot Engineering, LLC 30277 Carpenter Road Sedalia, MO 65301 Phone: 660-619-7001 broadfooteng@yahoo.com

ENGINEERING CONSULTANTS 1000 W. Nifong Blvd., Bldg. 1. Columbia, Missouri 65202 (573) 447-0292 www.crockettengineering.com Crockett Engineering Consultants, LLC Missouri Certificate of Authority #2000151304

OFFICE OF ADMINISTRATION DIVISION OF FACILITIES MANAGEMENT DESIGN AND CONSTRUCTION

### DIRECTOR'S HOUSE

MISSOURI STATE **FAIRGROUNDS** 2503 W. 16TH ST SEDALIA, MO 65301 PROJECT # F2402-01

SITE # 1501 ASSET # 3511501149

**REVISION:** DATE:

**REVISION:** 

DATE:

REVISION: DATE:

ISSUE DATE: 7/11/2025

**BID DOCUMENTS** 


CAD DWG FILE: A-EL-24
DRAWN BY: AMK
CHECKED BY: RDR DESIGNED BY: AMK

SHEET TITLE:

**INTERIOR ELEVATIONS** 

SHEET NUMBER:

PAGE 24 OF 36 7/11/2025

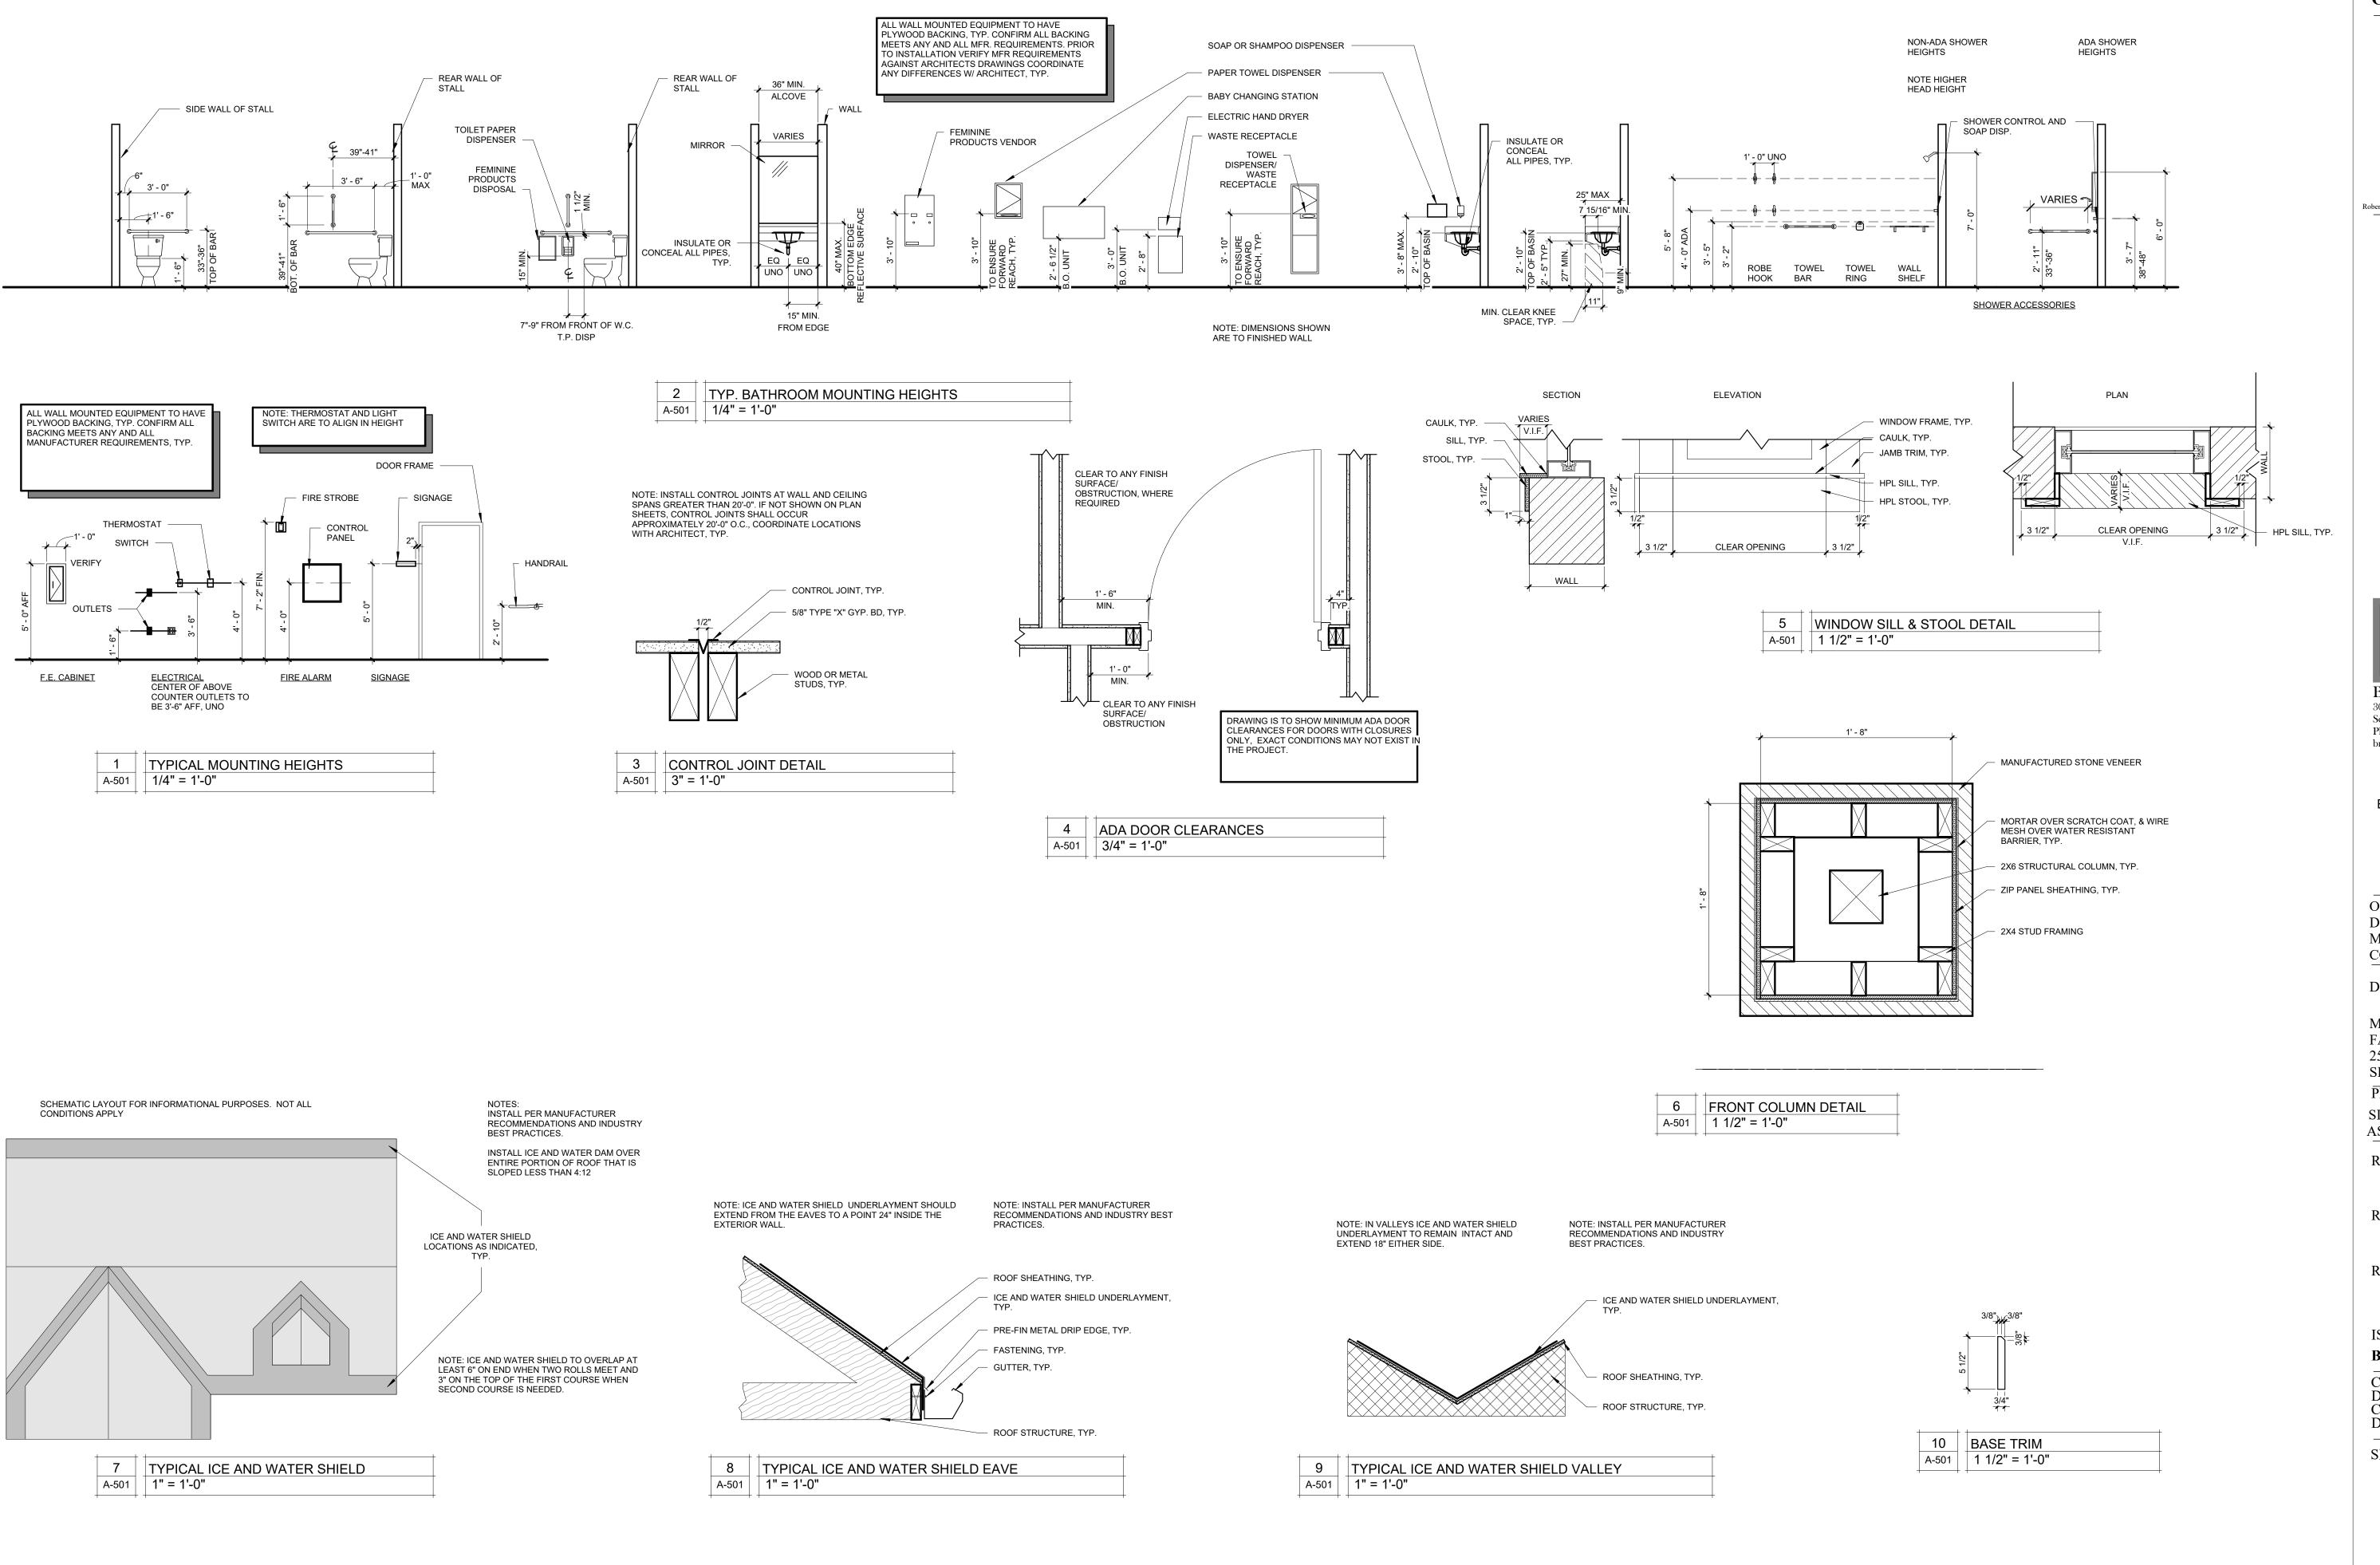



Robert D. Rollings 2005001208, Certificate of Authority # A-2006003870



SEDALTA, MO 65301 PHONE: 660 829 9751 FAX: 660 829 9752



J-SQUARED **ENGINEERING** 2400 BLUFF CREEK DR. STE. 101

COLUMBIA, MO 65201



Broadfoot Engineering, LLC 30277 Carpenter Road Sedalia, MO 65301 Phone: 660-619-7001 broadfooteng@yahoo.com

ENGINEERING CONSULTANTS 1000 W. Nifong Blvd., Bldg. 1. Columbia, Missouri 65202 (573) 447-0292 www.crockettengineering.com Crockett Engineering Consultants, LLC Missouri Certificate of Authority #2000151304

OFFICE OF ADMINISTRATION DIVISION OF FACILITIES MANAGEMENT DESIGN AND CONSTRUCTION

### DIRECTOR'S HOUSE

MISSOURI STATE FAIRGROUNDS 2503 W. 16TH ST SEDALIA, MO 65301 PROJECT # F2402-01

SITE # 1501 ASSET # 3511501149

**REVISION:** DATE:

**REVISION** 

**REVISION:** DATE:

ISSUE DATE: 7/11/2025 **BID DOCUMENTS** 

CAD DWG FILE: A-DT-25
DRAWN BY: AMK
CHECKED BY: RDR DESIGNED BY: AMK


SHEET TITLE:


TYPICAL DETAILS


SHEET NUMBER:

PAGE 25 OF 36 7/11/2025

							OOR SCHE	EDULE		
MARK	WIDTH	HEIGHT	DOOR MATERIAL	DOOR TYPE	DOOR FINISH	FRAME MATERIAL	FRAME TYPE	FRAME FINISH	NOTES	HARDWARE
100	3' - 0"	6' - 8"	ALU CLAD WOOD	Α	PAINT	HM / WOOD	BB	PAINT		RESIDENTAIL ENTRY W/ DEADBOLT
101	3' - 0"	6' - 8"	SCW		PAINT	WOOD	AA	PAINT	POCKET	POCKET DOOR
102	4' - 0"	6' - 8"	NA NA	В	NA NA	WOOD	AA	PAINT	CASED OPENING	NA NA
103	3' - 0"	6' - 8"	ALU CLAD WOOD	C	PAINT	HM / WOOD	AA	PAINT	0,1022 01 2111110	RESIDENTIAL ENTRY
104	9' - 0"	9' - 0"	HMI	F	MFR PAINT	HM / WOOD	AA	PAINT	OVERHEAD SECTIONAL	
105	9' - 0"	9' - 0"	HMI	 F	MFR PAINT	HM / WOOD	AA	PAINT	OVERHEAD SECTIONAL	
106	3' - 0"	6' - 8"	ALU CLAD WOOD	C	PAINT	HM / WOOD	AA	PAINT	012.4.12.12 020110111.12	RESIDENTAIL ENTRY W/ DEADBOLT
107	4' - 0"	6' - 8"	NA	В	NA	WOOD	AA	PAINT	CASED OPENING	NA
108	3' - 0"	6' - 8"	SCW	C	PAINT	WOOD	AA	PAINT	0.12=2 0.12	PASSAGE
109	2' - 10"	6' - 8"	SCW	С	PAINT	WOOD	AA	PAINT		PRIVACY
110	3' - 0"	6' - 8"	SCW	С	PAINT	WOOD	AA	PAINT		PASSAGE
111	3' - 0"	6' - 8"	SCW	С	PAINT	WOOD	AA	PAINT		PRIVACY
112	3' - 0"	6' - 8"	SCI	F	PAINT	WOOD / METAL	AA	PAINT	BARN STYLE SLIDER	BARN STYLE SLIDING
113	3' - 0"	6' - 8"	SCW	С	PAINT	WOOD	AA	PAINT		PRIVACY
114	3' - 0"	6' - 8"	NA	В	NA	WOOD	AA	PAINT	CASED OPENING	NA
115	6' - 0"	6' - 8"	ALU CLAD WOOD	D	PAINT	HM	AA	PAINT		RESIDENTAIL ENTRY W/ DEADBOLT 1 PANEL W/ PUSH BOLT, TOP AND BOTT
116	6' - 0"	6' - 8"	ALU CLAD WOOD	D	PAINT	HM	AA	PAINT		RESIDENTAIL ENTRY W/ DEADBOLT 1 PANEL W/ PUSH BOLT, TOP AND BOTT
117	6' - 0"	6' - 8"	ALU CLAD WOOD	D	PAINT	HM	AA	PAINT		RESIDENTAIL ENTRY W/ DEADBOLT 1 PANEL W/ PUSH BOLT, TOP AND BOTT
118	4' - 0"	6' - 8"	NA	В	NA	WOOD	AA	PAINT	CASED OPENING	NA
119	3' - 0"	6' - 8"	SCW	С	PAINT	WOOD	AA	PAINT		PRIVACY
120	3' - 0"	6' - 8"	SCW	С	PAINT	WOOD	AA	PAINT		PASSAGE
121	3' - 0"	6' - 8"	SCW	С	PAINT	WOOD	AA	PAINT		PASSAGE
122	3' - 0"	6' - 8"	SCW	С	PAINT	WOOD	AA	PAINT		PRIVACY
123	3' - 0"	6' - 8"	SCW	С	PAINT	WOOD	AA	PAINT		PASSAGE
124	3' - 0"	6' - 8"	SCW	С	PAINT	WOOD	AA	PAINT		PASSAGE
125	3' - 0"	6' - 8"	SCW	С	PAINT	WOOD	AA	PAINT		PRIVACY
126	2' - 6"	6' - 8"	SCW	С	PAINT	WOOD	AA	PAINT		PASSAGE
127	3' - 0"	6' - 8"	SCW	С	PAINT	WOOD	AA	PAINT		PASSAGE
128	2' - 11 1/2"	6' - 10"	GLASS	С	GLASS	METAL	AA	SS	SHOWER	PUSH PULL, VERIFY WIDTH IN FIELD

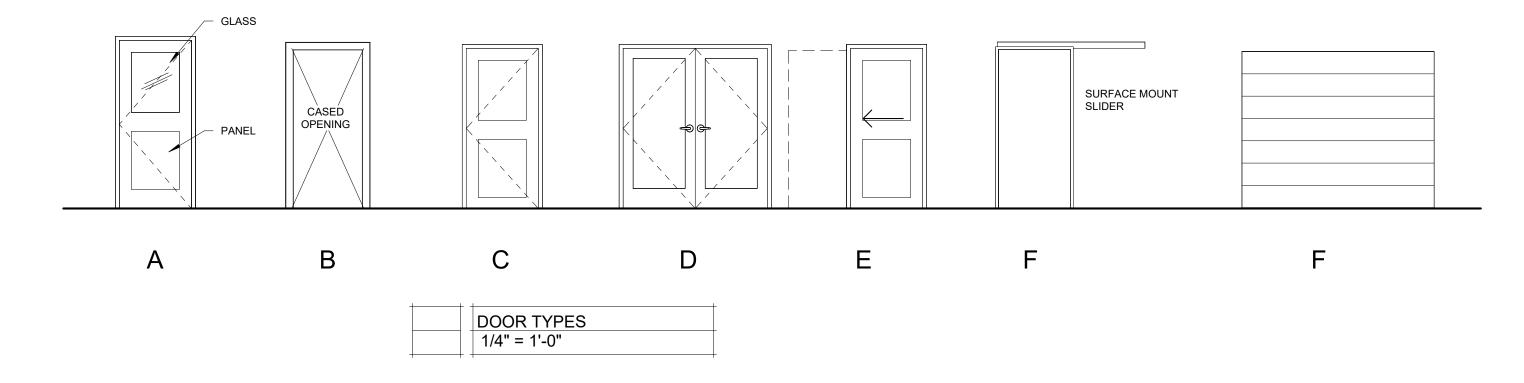

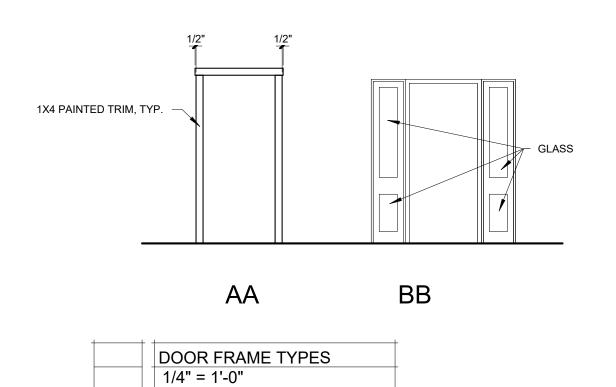

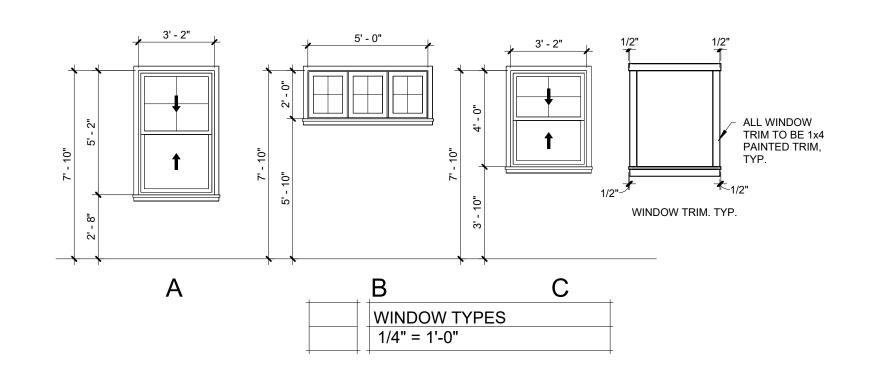

						FINISH S	CHE	DULE			
				FL	.OORIN	<b>G</b>	WALL	FINISH		LING IISH	
ROOM	ROOM NAME	LVT PLANK	SEALED CONCRETE	SHEET CARPET	12"X12" CERAMIC TILE	MOSAIC FLOOR TILE	GYPSUM BOARD PAINTED	CERAMIC TILE WAINSCOT	PREFIN. METAL SOFFIT	GYPSUM BOARD PAINTED	COMMENTS
100	ENTRY				Х		Х			Х	VAULTED CEILING
101	DINING				Х		Х			Х	VAULTED CEILING
102	LIVING			Х			Х			Х	VAULTED CEILING
103	KITCHEN				Х		Х	Х		Х	
104	PANTRY				Х		Х	Х		X	
105	CORRIDOR 1	Х					Х			Х	
106	GARAGE		Х				Х			Х	
107	MUD	Х					Х			Х	
108	LAUNDRY / OFFICE	Х					Х			Х	
109	W.C.					X	Х			Х	
110	UTE.	Х					Х			Х	
111	MASTER BEDROOM			Х			Х			Х	
112	MASTER BATH					X	Х			Х	
113	TOILET					Х	Х			Х	
114	MASTER CLOSET			Х			Х			Х	
115	CORR. 2			Х			Х			Х	
116	BEDROOM 1			Х			Х			Х	
117	CLOSET 1			Х			X			Х	
118	BATHROOM					Х	Х	Х		Х	
119	TOILET 2.					Х	Х	Х		Х	
120	CLOSET 2			Х			Х			Х	
121	BEDROOM 2			Х			Х			Х	
122	HVAC	X					Х			Х	
123	COAT	X					Х			Х	
124	FRONT PORCH								Χ		
125	BACK PORCH								Χ		



Robert D. Rollings 2005001208, Certificate of Authority # A-2006003870



Architects LLC 208 S. Lamine SEDALTA, MO 65301 PHONE: 660 829 9752



### J-SQUARED ENGINEERING 2400 BLUFF CREEK DR. STE. 101 COLUMBIA, MO 65201 573.234.4492 phone www.j-squaredeng.com



Broadfoot Engineering, LLC 30277 Carpenter Road Sedalia, MO 65301 Phone: 660-619-7001 broadfooteng@yahoo.com

ENGINEERING CONSULTANTS
1000 W. Nifong Blvd., Bldg. 1.
Columbia, Missouri 65202
(573) 447-0292
www.crockettengineering.com
Crockett Engineering Consultants, LLC
Missouri Certificate of Authority
#2000151304

OFFICE OF ADMINISTRATION DIVISION OF FACILITIES MANAGEMENT DESIGN AND CONSTRUCTION

### DIRECTOR'S HOUSE

MISSOURI STATE FAIRGROUNDS 2503 W. 16TH ST SEDALIA, MO 65301 PROJECT # F2402-01

SITE # 1501 ASSET # 3511501149

REVISION:\_ DATE:\_

DATE:\_\_\_\_ REVISION:\_

DATE:

**REVISION:** 

ISSUE DATE: 7/11/2025

BID DOCUMENTS

CAD DWG FILE: A-SH-26
DRAWN BY: AMK
CHECKED BY: RDR
DESIGNED BY: AMK


SHEET TITLE:

DOOR - WINDOW & FINISH SCHEDULE

SHEET NUMBER:

A-60

PAGE 26 OF 36 7/11/2025

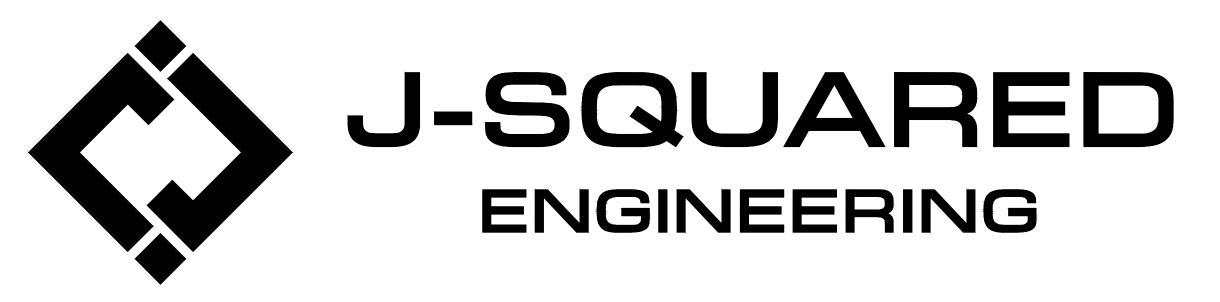

MECHANICAL - ELECTRICAL - PLUMBING DESIGN DRAWINGS FOR:

# 2402 Directors House

32nd St. Sedalia, MO

### **GENERAL MEP SPECIFICATIONS**

### 1. GENERAL

ALL WORK SHALL BE PERFORMED IN COMPLIANCE WITH LOCALLY ADOPTED CODES AND ORDINANCES.

IT IS THE RESPONSIBILITY OF CONTRACTOR TO REVIEW AND UNDERSTAND ALL DRAWINGS AND SPECIFICATIONS IN CONTRACT DOCUMENTS. EACH CONTRACTOR IS RESPONSIBLE FOR ALL WORK ASSOCIATED WITH THEIR DRAWINGS OR SPECIFICATIONS.

LAYOUT OF SYSTEMS SHOWN ON PLANS ARE APPROXIMATE AND SCHEMATIC IN NATURE. ALL SYSTEMS WILL NEED TO BE FIELD-COORDINATED. CONTRACTOR SHALL INCLUDE THIS COORDINATION IN THEIR SCOPE AND INCLUDE ALL COSTS OF MODIFYING LAYOUT AS REQUIRED IN THEIR BID. PLANS ARE NOT INTENDED TO BE SHOP DRAWINGS FROM WHICH MATERIALS CAN BE ORDERED, FABRICATED, OR INSTALLED WITHOUT ADDITIONAL FIELD MEASUREMENTS AND COORDINATION.

NOT ALL SPECIFIC PIECES AND COMPONENTS OF EACH SYSTEM ARE DETAILED OR OUTLINED ON PLANS. CONTRACTOR IS RESPONSIBLE FOR PROVIDING ALL NECESSARY PARTS AND LABOR TO PRODUCE A COMPLETE AND FULLY OPERATIONAL SYSTEM UNLESS STATED OTHERWISE ON PLANS. CONTRACTOR IS TO PROVIDE AND INCLUDE ALL EQUIPMENT AND MATERIAL NEEDED TO COMPLETE WORK ASSOCIATED WITH THEIR BID UNLESS ANY ITEMS ARE SPECIFICALLY NOTED ON PLANS AS PROVIDED BY OTHERS. ALL MATERIALS TO BE NEW, FIRST CLASS, AND INSTALLED PER MANUFACTURER'S PUBLISHED INSTRUCTIONS.

WHERE CONFLICTS EXIST BETWEEN MEP PLANS AND CIVIL, ARCHITECTURAL, OR STRUCTURAL PLANS, NOTIFY MEP ENGINEER OF DISCREPANCIES FOR CLARIFICATION PRIOR TO PERFORMING ANY WORK THAT MAY CONTRADICT INFORMATION ELSEWHERE IN THE PROJECT PLANS.

THESE PLANS ARE NOT TO BE SCALED. SEE ARCHITECTURAL PLANS FOR DIMENSIONS. WHERE THERE IS A CONFLICT BETWEEN ARCHITECTURAL DIMENSIONS AND MEP DIMENSIONS, ARCHITECTURAL SHALL GOVERN. CONTRACTOR IS TO INCLUDE IN THEIR SCOPE THE COST OF ALL PERMITS,

INSPECTIONS, METERING, TAPS, ETC. ASSOCIATED WITH THEIR WORK. CONTRACTOR IS RESPONSIBLE FOR ALL EXCAVATION, CUTTING, CORING, PATCHING, AND BACKFILL REQUIRED TO COMPLETE THEIR WORK, UNLESS

NOTED OTHERWISE ON PLANS. SPECIFIC EQUIPMENT MANUFACTURERS AND/OR MODEL NUMBERS LISTED ON PLANS ARE TO ESTABLISH A BASIS-OF-DESIGN FOR QUALITY AND PERFORMANCE, VERIFY THAT SUBSTITUTIONS WILL BE ACCEPTABLE PRIOR TO PURCHASE & INSTALLATION.

1.10. NOTIFY ENGINEER OF ANY MAJOR PLAN DISCREPANCIES OR CONFLICTS PRIOR TO PROVIDING BIDS OR COMPLETING ANY WORK.

1.11. SEE DISCIPLINE SHEETS FOR ADDITIONAL TRADE SPECIFIC

1.12. WHERE SHUTDOWN OF ANY EXISTING UTILITY OR SERVICE TO BUILDING IS REQUIRED FOR COMPLETION OF WORK, COORDINATE OUTAGE WITH OWNER AS TO NOT DISRUPT TYPICAL OPERATIONS.

### 2. WORKMANSHIP

2.1. SYSTEMS SHALL BE INSTALLED IN A FIRST-CLASS MANNER USING BEST

ACCEPTABLE METHODS AND PRACTICES. ALL SYSTEMS SHALL BE INSTALLED PARALLEL OR PERPENDICULAR TO

BUILDING ORIENTATION. COMPONENTS SHALL BE INSTALLED LEVEL AND PLUMB WITH ATTENTION GIVEN TO OVERALL AESTHETICS. CONTRACTOR IS RESPONSIBLE FOR COORDINATING EQUIPMENT

LOCATIONS AND SYSTEM ROUTING WITH OTHER TRADES PRIOR TO INSTALLATION.

CONTRACTOR TO GUARANTEE ALL MATERIALS AND WORKMANSHIP FOR A PERIOD OF ONE YEAR FROM THE DATE THE COMPLETED PROJECT IS

RELEASED TO THE OWNER, UNLESS NOTED OTHERWISE ON PLANS. DURING INSTALLATION OF MATERIALS OR ACTIVITIES IN NEW WORK SCOPE, AVOID DAMAGING EXISTING SURFACES AND EQUIPMENT TO REMAIN. ANY DAMAGE TO EXISTING SURFACES OR EQUIPMENT SHALL BE CORRECTED AT NO COST TO OWNER.

### REFERENCED CODES IN EFFECT

PROJECT HAS BEEN DESIGNED IN COMPLIANCE WITH THE FOLLOWING CODES LISTED BELOW, BUT THIS IS NOT AN EXHAUSTIVE LIST. PROJECT SHALL COMPLY WITH ALL APPLICABLE CODES, STANDARDS, AND LOCAL REQUIREMENTS

2015 INTERNATIONAL MECHANICAL CODE

2015 INTERNATIONAL PLUMBING CODE

• 2015 INTERNATIONAL FUEL GAS CODE 2015 INTERNATIONAL FIRE CODE

 2017 NATIONAL ELECTRIC CODE 2015 INTERNATIONAL RESIDENTIAL CODE

### **Sheet List Table**

### **Sheet Number Sheet Title**

MECHANICAL ELECTRICAL PLUMBING COVER SHEET

**SITE PLAN** 

M101 **HVAC PLAN** 

**HVAC DETAILS & SCHEDULES** 

EP101 **POWER PLAN** 

EL101 LIGHTING PLAN

> **ELECTRICAL DETAILS & SCHEDULES** SANITARY SEWER PLAN

**WATER & GAS PLAN** PW101


PLUMBING DETAILS AND SCHEDULES

STATE OF MISSOURI MIKE KEHOE **GOVERNOR** 



KEATON E. LEISINGER, PE - 2021035875



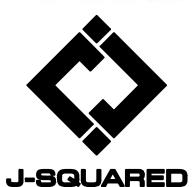

**ENGINEERING** 2400 BLUFF CREEK DR. STE. COLUMBIA, MO 65201 573.234.4492 phone www.j-squaredeng.com



Broadfoot Engineeing, LLC 30277 Carpenter Road Sedalia, MO 65301 Phone: 660-619-7001 broadfooteng@yahoo.com

www.crockettengineering.com Crockett Engineering Consultants, LLC Missouri Certificate of Authority #2000151304

OFFICE OF ADMINISTRATION DIVISION OF FACILITIES MANAGEMENT DESIGN AND CONSTRUCTION

DIRECTOR'S HOUSE

MISSOURI STATE FAIRGROUNDS 2503 W. 16TH ST SEDALIA, MO 65301

PROJECT # F2402-01 SITE # 1501 ASSET # 3511501149

**REVISION:** DATE:

**REVISION:** 

**REVISION:** 

DATE:

DATE:

ISSUE DATE: 7/11/2025

**BID DOCUMENTS** 

CAD DWG FILE: DRAWN BY: RXM CHECKED BY: JAP DESIGNED BY: KEL


SHEET TITLE:

**MECHANICAL ELECTRICAL PLUMBING COVER SHEET** 

SHEET NUMBER:

PAGE 27 OF 36 7/11/2025

### SITE PLAN SYMBOL LEGEND

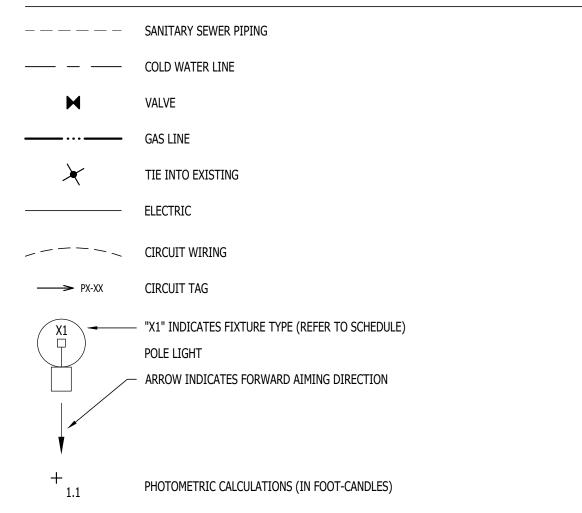

### SITE UTILITIES PLAN GENERAL NOTES:


1. REFER TO CIVIL PLANS FOR EXACT UTILITY LOCATIONS, CONNECTIONS, DETAILS, ETC.

### SITE UTILITIES PLAN KEY NOTES:

1) SEE CIVIL SITE PLAN FOR CONTINUATION AND METER LOCATION.

(2) (1) 2" UNDERGROUND PVC CONDUIT WITH PULL-STRING FROM PANEL 'P1' TO THIS LOCATION FOR FUTURE SHED ELECTRICAL CONNECTION.

(3) UNDERGROUND PROPANE LINE INSTALLED BY PROPANE SUPPLIER. CONTRACTOR TO PROVIDE & INSTALL 10 PSI TO 11" WC REGULATOR.

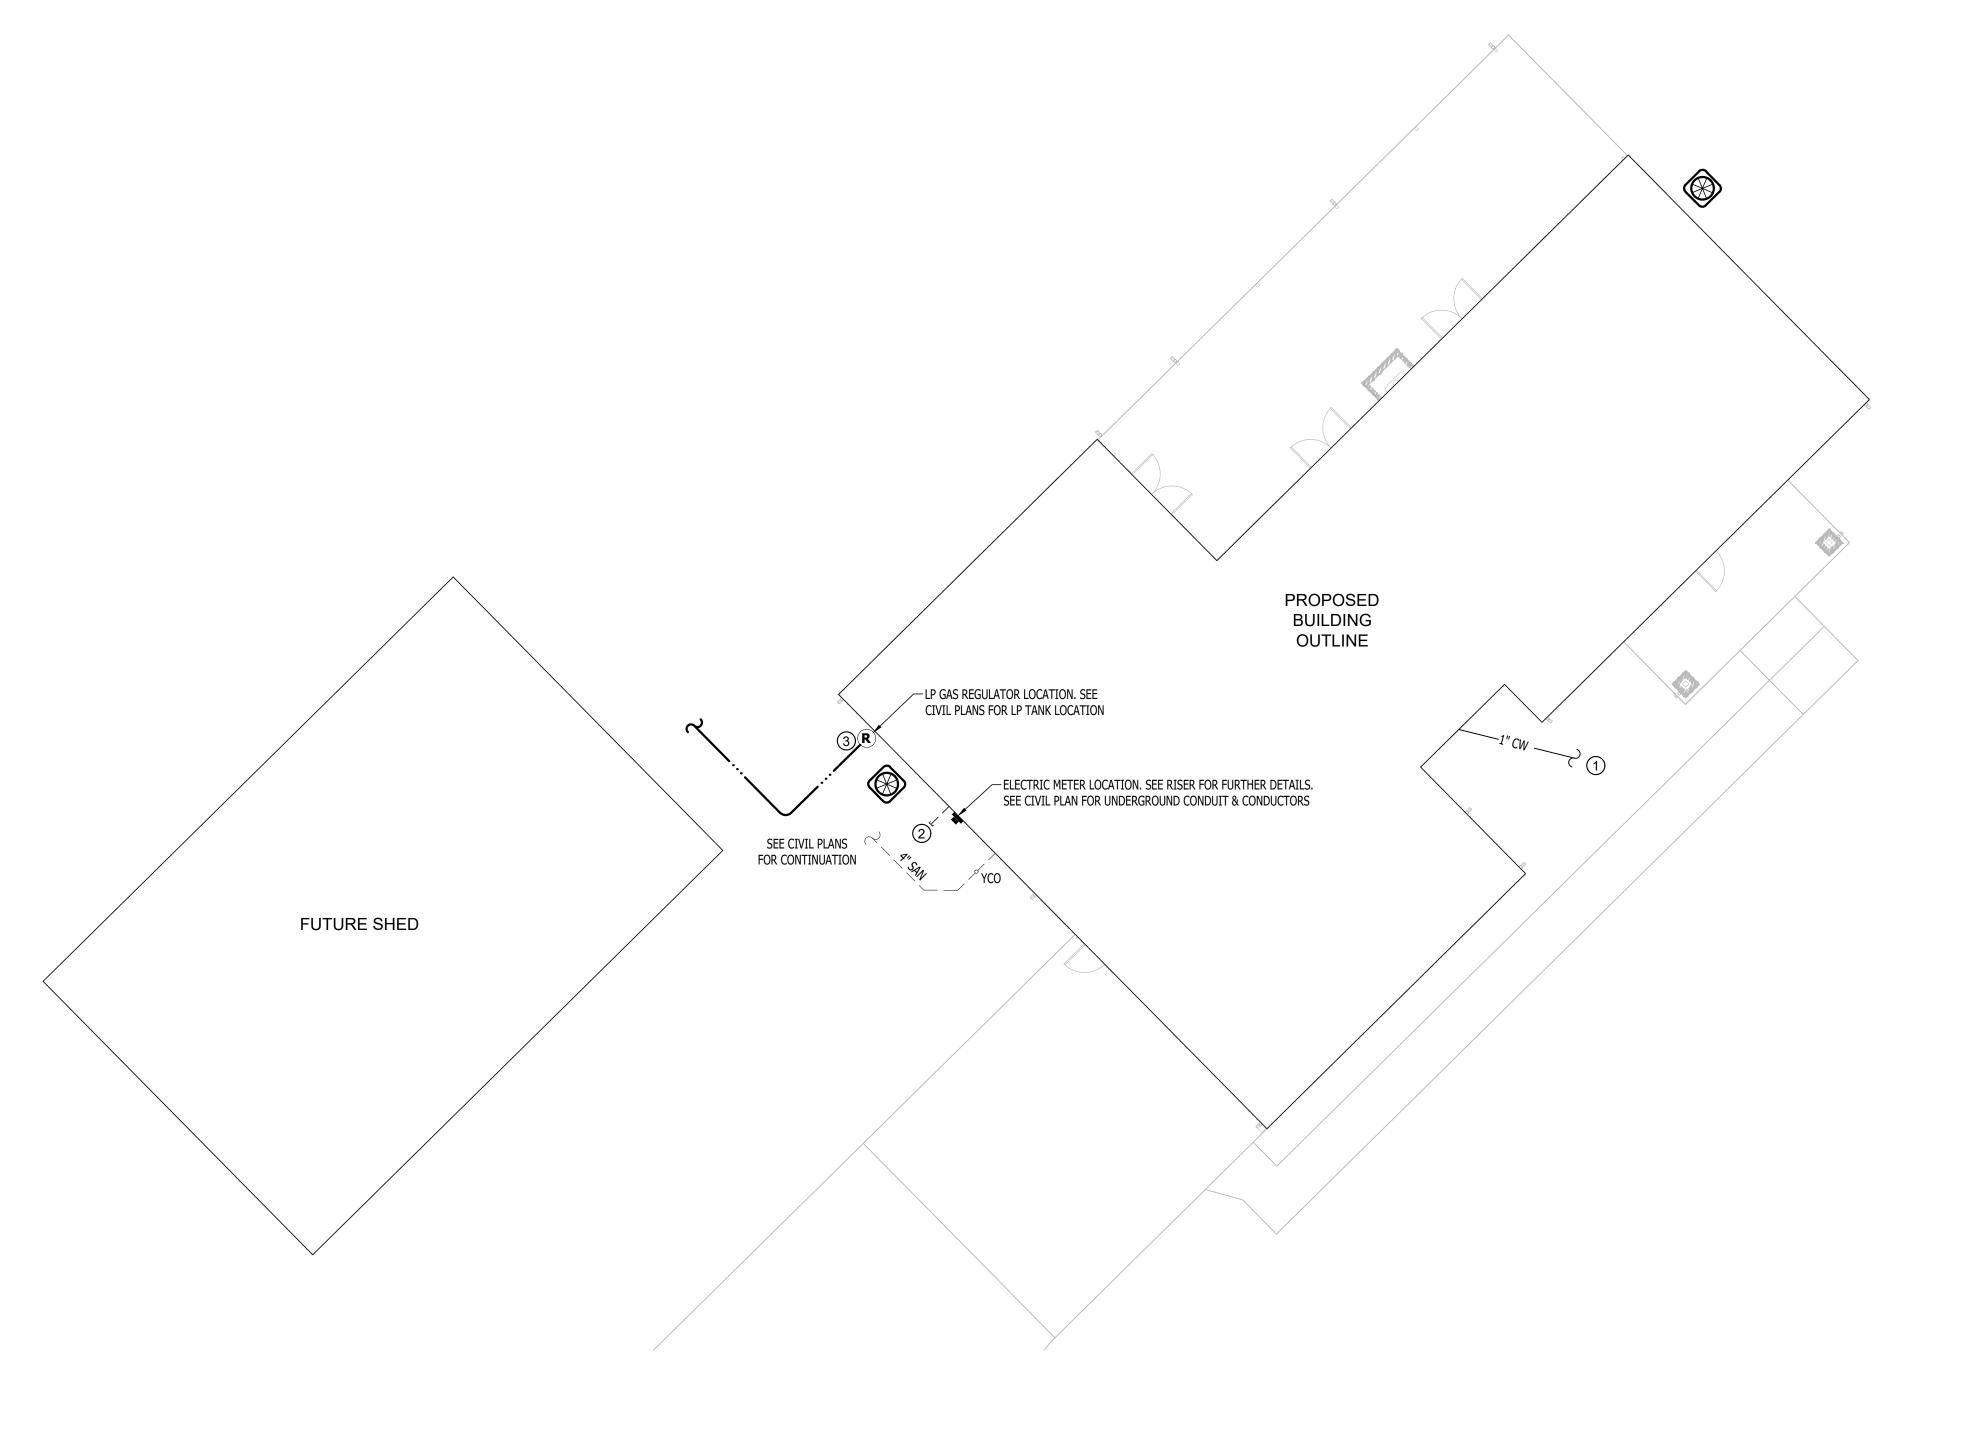



### STATE OF MISSOURI MIKE KEHOE **GOVERNOR**



KEATON E. LEISINGER, PE - 2021035875 MO CERTIFICATE OF AUTHORITY # 2018029680



SEDALTA, MO 65301 PHONE: 660 829 9751 FAX: 660 829 9752



J-SQUARED **ENGINEERING** 2400 BLUFF CREEK DR. STE. 101 COLUMBIA, MO 65201



Broadfoot Engineeing, LLC 30277 Carpenter Road Sedalia, MO 65301 Phone: 660-619-7001 broadfooteng@yahoo.com

ENGINEERING CONSULTANTS 1000 W. Nifong Blvd., Bldg. 1. Columbia, Missouri 65202 (573) 447-0292 www.crockettengineering.com Crockett Engineering Consultants, LLC

Missouri Certificate of Authority #2000151304 OFFICE OF ADMINISTRATION DIVISION OF FACILITIES MANAGEMENT DESIGN AND CONSTRUCTION

DIRECTOR'S HOUSE

MISSOURI STATE FAIRGROUNDS 2503 W. 16TH ST SEDALIA, MO 65301

PROJECT # F2402-01 SITE # 1501 ASSET # 3511501149

**REVISION:** DATE:

**REVISION:** DATE:

**REVISION:** 

ISSUE DATE: 7/11/2025

**BID DOCUMENTS** 

CAD DWG FILE:
DRAWN BY: RXM
CHECKED BY: JAP
DESIGNED BY: KEL


SHEET TITLE:

SITE PLAN

SHEET NUMBER:

MEP2

PAGE 28 OF 36 7/11/2025

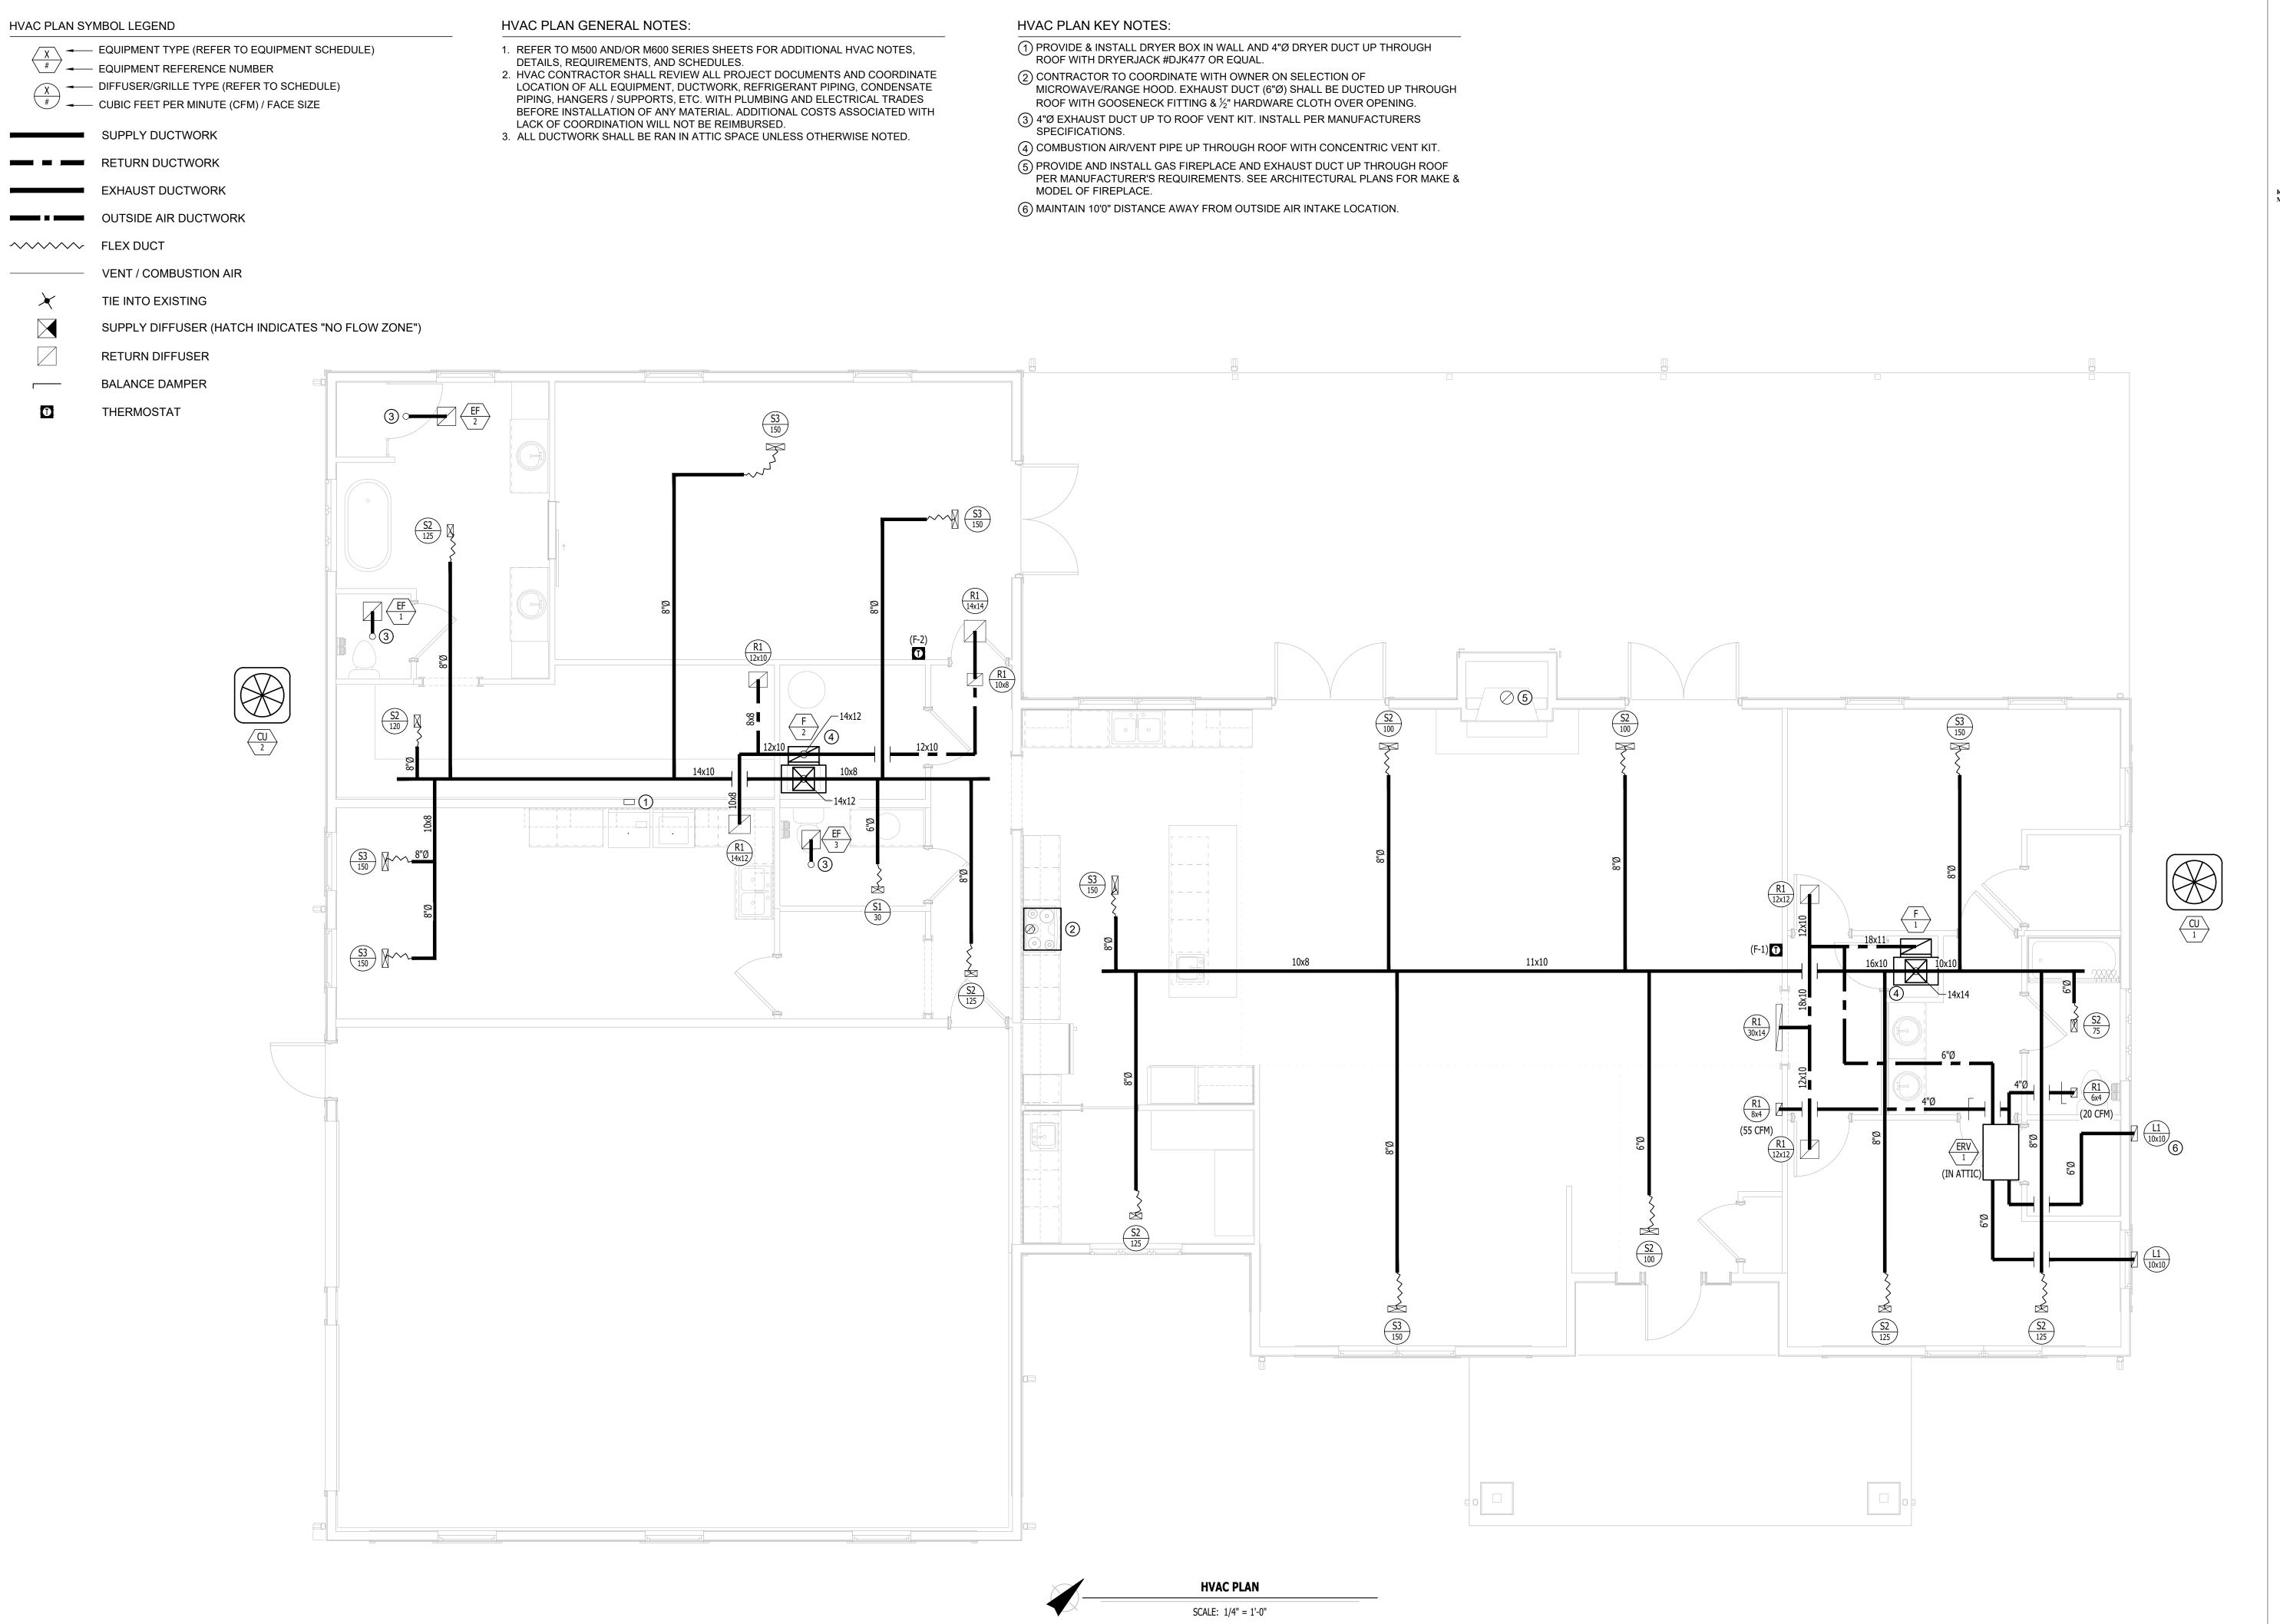




KEATON E. LEISINGER, PE - 2021035875 MO CERTIFICATE OF AUTHORITY # 2018029680



Architects LLC 208 S. Lamine SEDALTA, MO 65301 PHONE: 660 829 9751 FAX: 660 829 9752

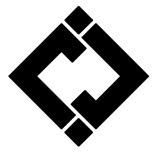

J-SQUARED ENGINEERING 2400 BLUFF CREEK DR. STE. 101 COLUMBIA, MO 65201 573.234.4492 phone www.j-squaredeng.com



Broadfoot Engineeing, LLC 30277 Carpenter Road Sedalia, MO 65301 Phone: 660-619-7001 broadfooteng@yahoo.com

### <del>CROCKET 1</del>

ENGINEERING CONSULTANTS
1000 W. Nifong Blvd., Bldg. 1.
Columbia, Missouri 65202
(573) 447-0292
www.crockettengineering.com
Crockett Engineering Consultants, LLC
Missouri Certificate of Authority
#2000151304

OFFICE OF ADMINISTRATION DIVISION OF FACILITIES MANAGEMENT DESIGN AND CONSTRUCTION

DIRECTOR'S HOUSE

MISSOURI STATE FAIRGROUNDS 2503 W. 16TH ST SEDALIA, MO 65301 PROJECT # F2402-01

SITE # 1501 ASSET # 3511501149

REVISION:\_\_\_\_ DATE:\_\_

**REVISION:** 

DATE: \_\_\_\_\_

DATE:

ISSUE DATE: 7/11/2025

ISSUE DATE: 7/11/20
BID DOCUMENTS

CAD DWG FILE:
DRAWN BY: RXM
CHECKED BY: JAP
DESIGNED BY: KEL

SHEET TITLE:

**HVAC PLAN** 

SHEET NUMBER:

**M101** 

PAGE 29 OF 36 7/11/2025

	HVAC SCHEDULE														
TAC	EQUIPMENT	SIZE		TOTAL	E.S.P.	HEA TING		COOLING (IA: 80 DB/67 WB, OA: 95 DB)			ELECTRICAL			NOTES	
TAG	DESCRIPTION	I (TONS) ORIENTATION	AIRFLOW (CFM)	(in. H20)	GAS INPUT (KBTU)	MIN. A FUE EFF. (%)	SENSIBLE (KBTU)	TOTAL (KBTU)	MIN EFF. (SEER2)	VOLTS/PH	MCA	ОСР	NOTES		
F-1	FURNACE	3.0	UPFLOW	1200	0.5	60	90	-	-	-	120	10	20	1	
CU-1	CONDENSING UNIT	3.0	-	-		-	-	25	33.7	13.4	240/1	18	30	2	
F-2	FURNACE	2.5	UPFLOW	1000	0.5	60	90	-	-	-	120	10	20	1	
CU-2	CONDENSING UNIT	2.5	-	-		-	-	21.9	31.5	13.4	240/1	16	25	2	
ERV-1	ENERGY RECOVERY UNIT	-	HORIZONTAL	75	0.75	68%	EFF		53% EFF		120	1	15	3	

### 1. PROVIDE AND INSTALL 7 DAY PROGRAMABLE HONEYWELL THERMOSTAT. COORDINATE EXACT MOUNTING LOCATION WITH OWNER.

- 2. WITH FACTORY HAIL GUARD.
- 3. EQUAL TO RENEWAIRE #SL75H. ERV SHALL RUN CONTINUOSLY PER IRC SECTION 1507.

EXHAUST FAN SCHEDULE													
T1.C	FOLEDMENT TYPE	MA NUFA CTURER	MODEL	R.	ow wc		ELECTRICAL	-	PHYSICAL	NOTEC			
TAG	EQUIPMENT TYPE	(OR EQUAL)	(OR EQUAL)	CFM	S.P.	VOLT/PH	MCA	ОСР	DIM.	NOTES			
EF-1	IN-CEILING EXHAUST FAN	BROAN	688	50	1/10"	120 / 1	1	15	7x8x4	1,2			
EF-2	IN-CEILING EXHAUST FAN	BROAN	688	50	1/10"	120 / 1	1	15	7x8x4	1,2			
EF-3	IN-CEILING EXHAUST FAN	BROAN	688	50	1/10"	120 / 1	1	15	7x8x4	1,2			

### NOTES

- 1. WITH BACKDRAFT DAMPER
- 2. WITH ROOF VENT KIT M# RVK1A.


		AIR DEVI	CE SCHE	DULE		
TAG	SERVICE	MA NUFA CTURER (OR EQUAL)	MODEL (OR EQUAL)	SIZE	COLOR / FINISH	NOTES
L1	OA/EX	POTTORFF	EFD-445	10x10	PRIMED	1,3
R1	RETURN	HART & COOLEY	672	SEE PLANS	WHITE	1
S1	SUPPLY	HART & COOLEY	682	8x4	WHITE	1,2
S2	SUPPLY	HART & COOLEY	682	12x6	WHITE	1,2
S3	SUPPLY	HART & COOLEY	682	14x8	WHITE	1,2
NOTES:						

- 1. VERIFY AIR DEVICE FINISHES WITH OWNER/ARCHITECT PRIOR TO INSTALLATION
- 2. SEE PLANS FOR AIRFLOW
- 3. PAINT TO MATCH EXTERIOR.


= INSIDE

DIFFUSER NECK SIZING SCHEDULE				
AIRFLOW (CFM)	NECK SIZE (in)			
0 - 120	6"			
120 - 210	8"			
210 - 325	10"			
325 - 470	12"			
470 - 640	14"			


= INSULATION /////// = OUTSIDE

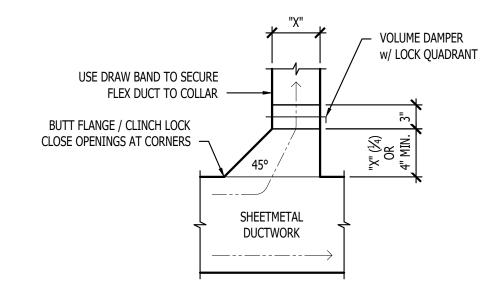


TYPICAL 45° TAKEOFF DETAIL

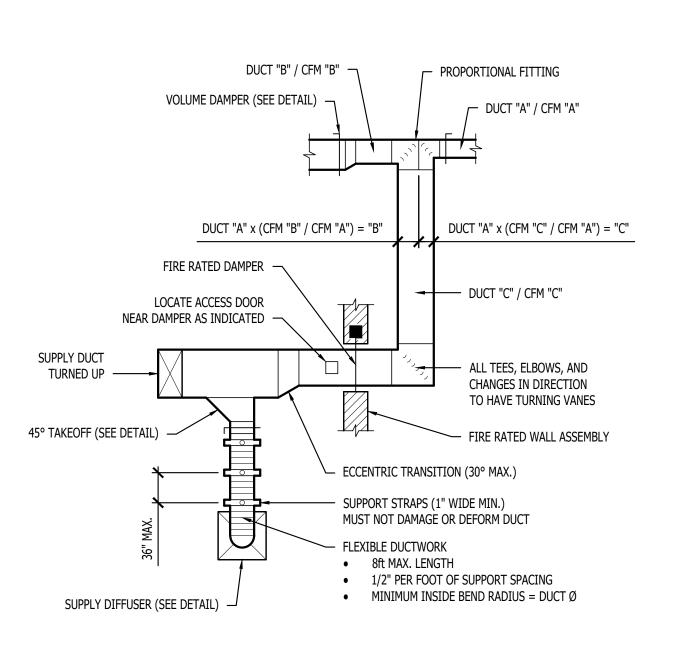

TYPICAL DUCTWORK DETAIL

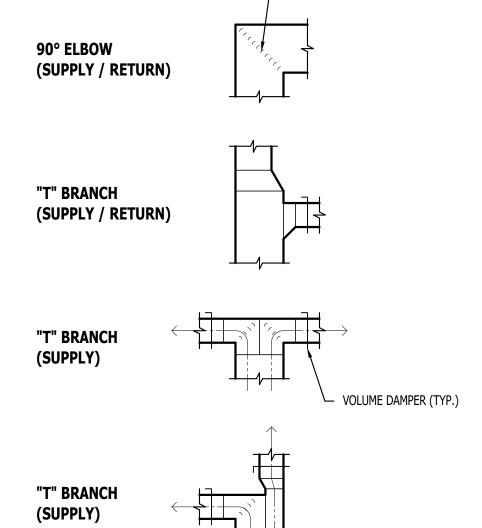

TURNING VANES (TYP.)

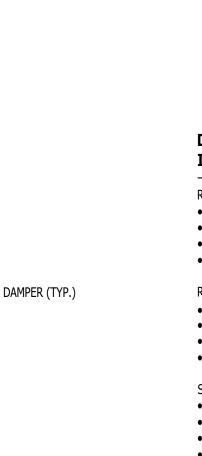

TYPICAL DUCTWORK FITTINGS DETAIL




**DUCT INSIDE THERMAL ENVELOPE DUCT OUTSIDE THERMAL ENVELOPE** INSULATION REQUIREMENTS INSULATION REQUIREMENTS RECTANGULAR RECTANGULAR SUPPLY = 1" LINER • SUPPLY = 1" LINER &  $1\frac{1}{2}$ " WRAP 1" LINER NONE • RETURN = 1" LINER & 1½" WRAP RETURN = • EXHAUST = 1½" WRAP NONE EXHAUST = 2" WRAP OUTSIDE AIR = • OUTSIDE AIR = ROUND ROUND 1½" WRAP NONE NONE SUPPLY =RETURN = SUPPLY = 2" WRAP • RETURN = 2" WRAP EXHAUST = EXHAUST = 1½" WRAP OUTSIDE AIR = OUTSIDE AIR = 2" WRAP NONE NONE NONE SUPPLY = 2" WRAP SUPPLY = RETURN = 2" WRAP RETURN = NONE EXHAUST = EXHAUST = 1½" WRAP OUTSIDE AIR = 2" WRAP OUTSIDE AIR = NONE

TYPICAL BUILDING INTERIOR DUCT INSULATION DIAGRAM

### STATE OF MISSOURI MIKE KEHOE GOVERNOR



KEATON E. LEISINGER, PE - 2021035875 MO CERTIFICATE OF AUTHORITY # 2018029680

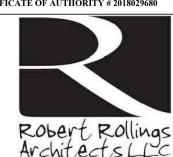

Avenitects LLC 208 S. Lamine SEDALTA, MO 65301 PHONE: 660 829 9752



J-SQUARED ENGINEERING 2400 BLUFF CREEK DR. STE. 101 COLUMBIA, MO 65201 573.234.4492 phone www.j-squaredeng.com



Broadfoot Engineeing, LLC 30277 Carpenter Road Sedalia, MO 65301 Phone: 660-619-7001 broadfooteng@yahoo.com

# ENGINEERING CONSULTANTS 1000 W. Nifong Blvd., Bldg. 1.

1000 W. Nifong Blvd., Bldg. 1.
Columbia, Missouri 65202
(573) 447-0292
www.crockettengineering.com
Crockett Engineering Consultants, LLC
Missouri Certificate of Authority

#2000151304

OFFICE OF ADMINISTRATION
DIVISION OF FACILITIES
MANAGEMENT DESIGN AND

DIRECTOR'S HOUSE

CONSTRUCTION

MISSOURI STATE FAIRGROUNDS 2503 W. 16TH ST SEDALIA, MO 65301

PROJECT # F2402-01 SITE # 1501 ASSET # 3511501149

REVISION:\_ DATE:\_

REVISION:\_\_\_\_\_DATE:\_\_\_\_

ISSUE DATE: 7/11/2025

BID DOCUMENTS

CAD DWG FILE:

CAD DWG FILE:
DRAWN BY: RXM
CHECKED BY: JAP
DESIGNED BY: KEL


SHEET TITLE:

HVAC
DETAILS &
SCHEDULES

SHEET NUMBER:

M501

PAGE 30 OF 36 7/11/2025

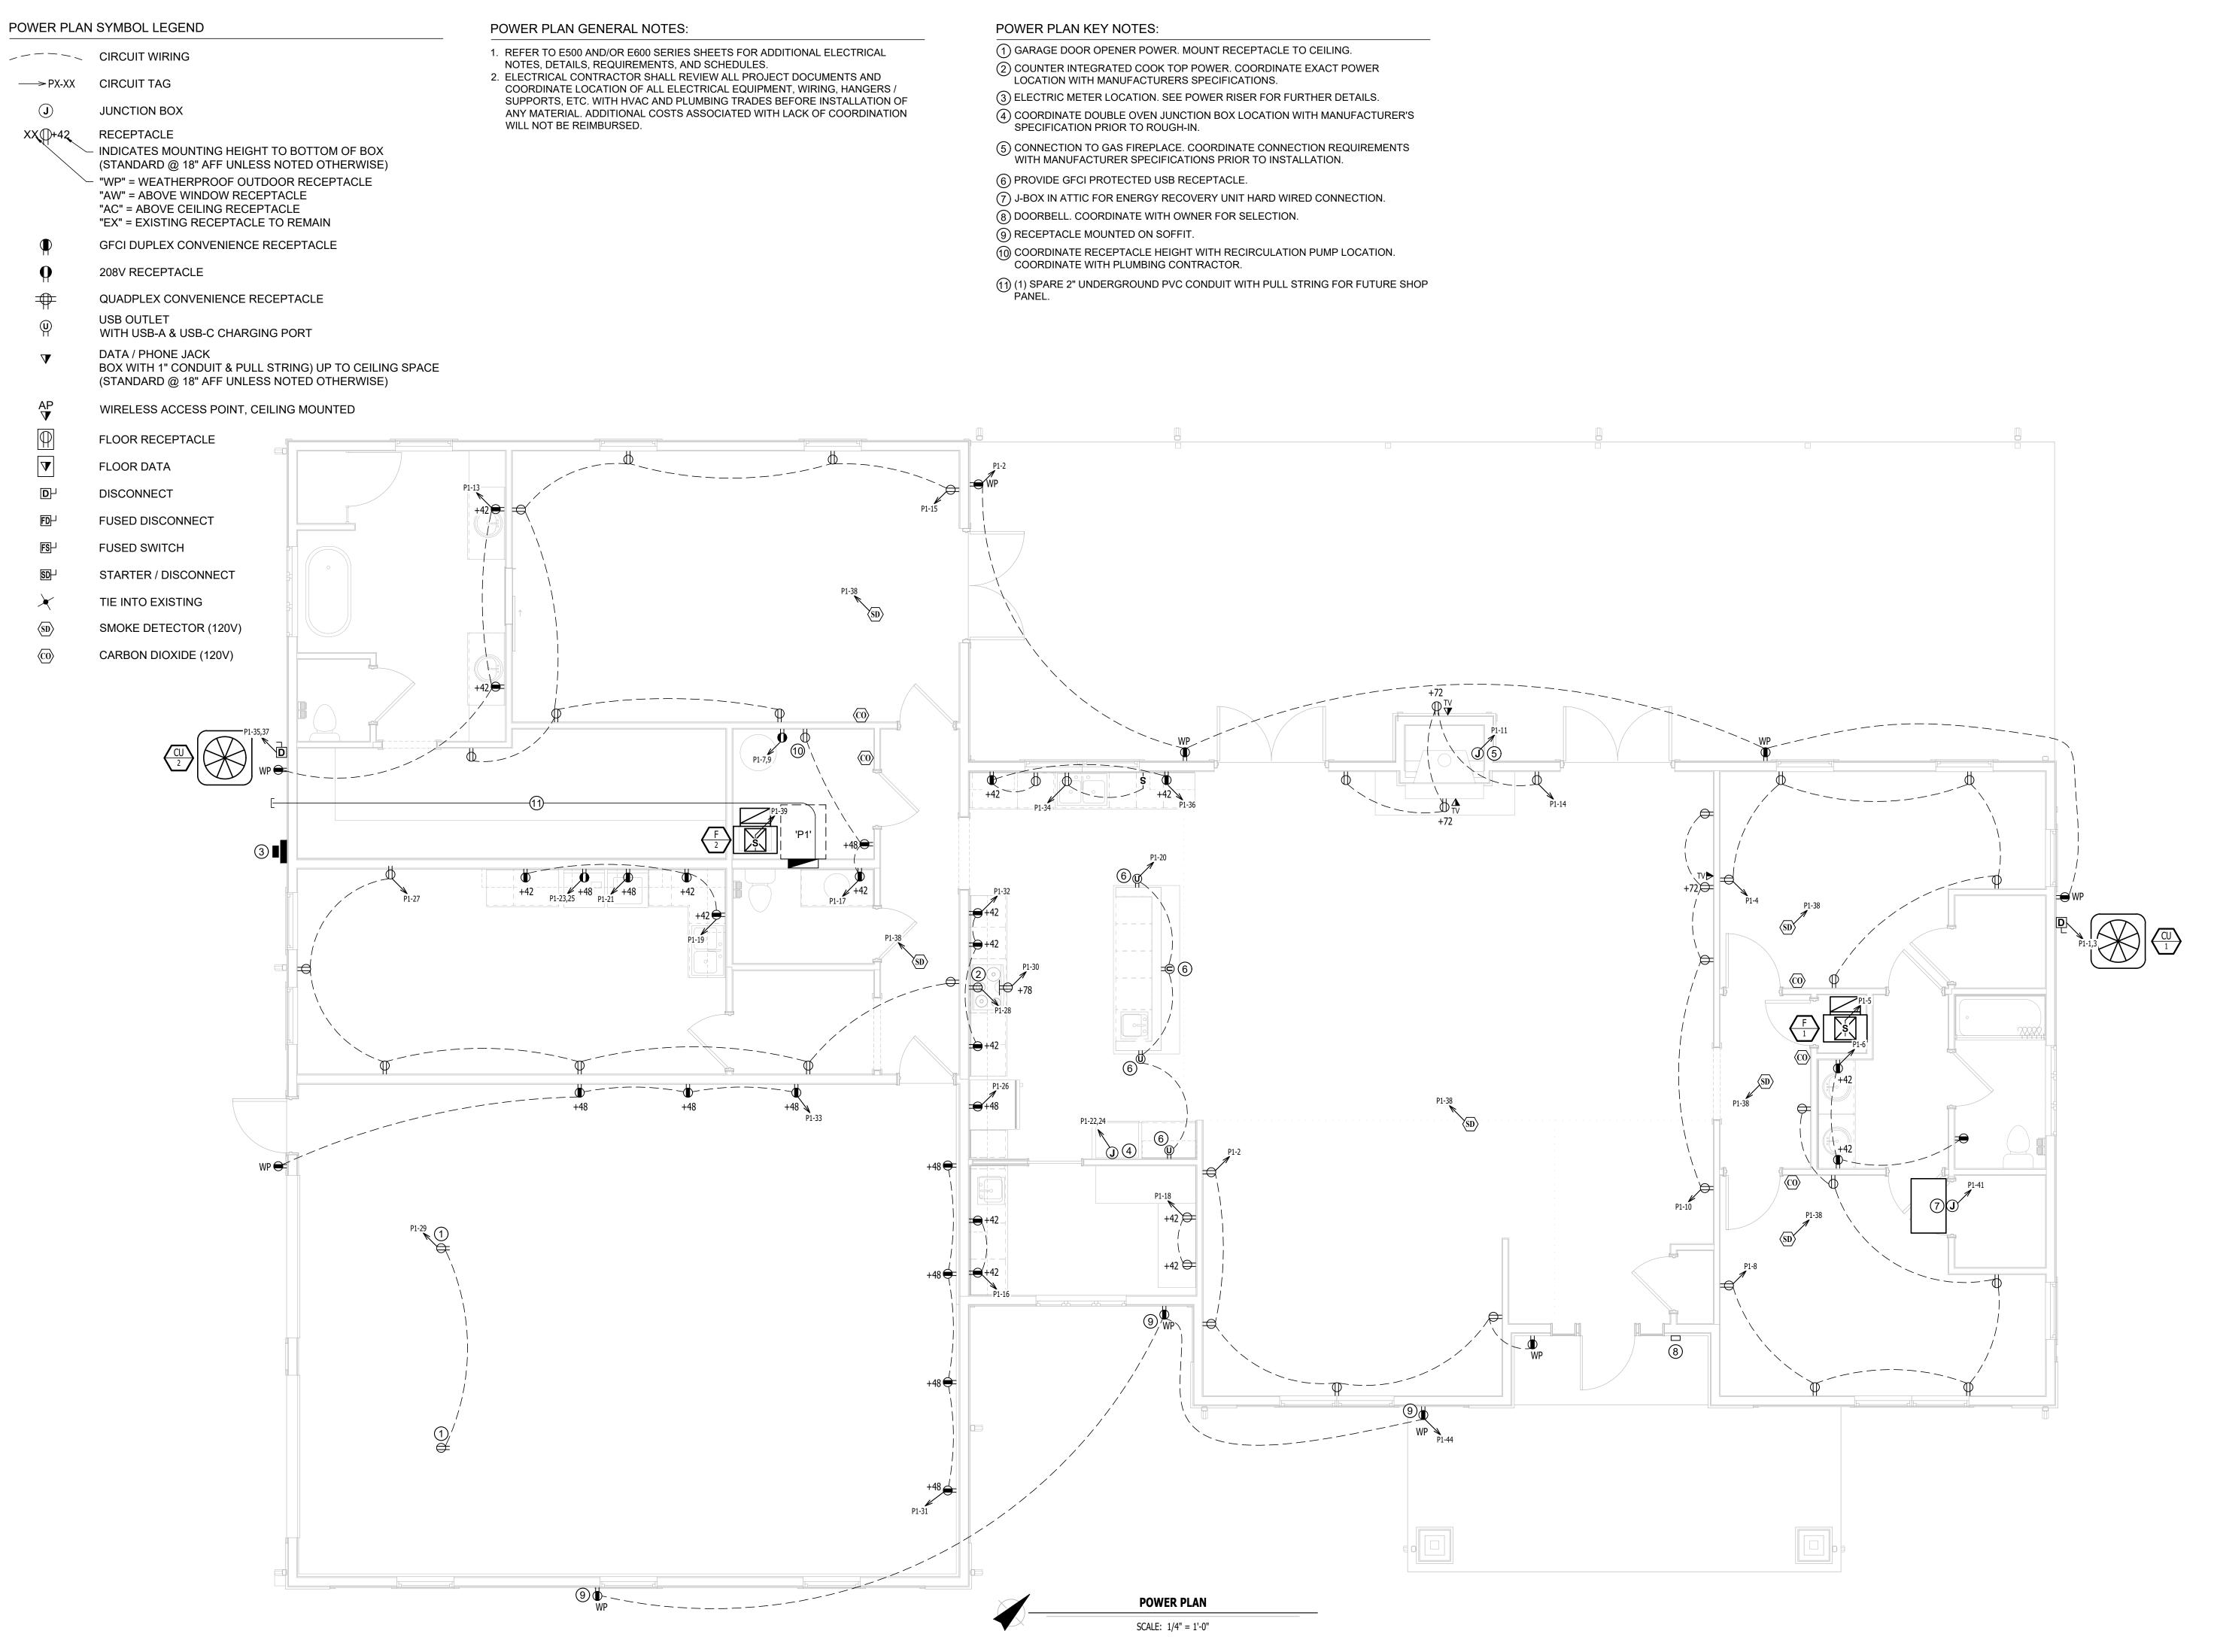



KEATON E. LEISINGER, PE - 2021035875 MO CERTIFICATE OF AUTHORITY # 2018029680



SEDALTA, MO 65301 PHONE: 660 829 9751 FAX: 660 829 9752



J-SQUARED ENGINEERING 2400 BLUFF CREEK DR. STE. 101 COLUMBIA, MO 65201 573.234.4492 phone www.j-squaredeng.com



Broadfoot Engineeing, LLC 30277 Carpenter Road Sedalia, MO 65301 Phone: 660-619-7001 broadfooteng@yahoo.com

ENGINEERING CONSULTANTS 1000 W. Nifong Blvd., Bldg. 1. Columbia, Missouri 65202 (573) 447-0292 www.crockettengineering.com Crockett Engineering Consultants, LLC Missouri Certificate of Authority #2000151304

OFFICE OF ADMINISTRATION DIVISION OF FACILITIES MANAGEMENT DESIGN AND CONSTRUCTION

DIRECTOR'S HOUSE

MISSOURI STATE FAIRGROUNDS 2503 W. 16TH ST SEDALIA, MO 65301 PROJECT # F2402-01

SITE # 1501 ASSET # 3511501149

**REVISION:** 

**REVISION:** DATE:

**REVISION:** 

ISSUE DATE: 7/11/2025

**BID DOCUMENTS** CAD DWG FILE:
DRAWN BY:
CHECKED BY:
DESIGNED BY:
KEL


SHEET TITLE:

**POWER PLAN** 

SHEET NUMBER:

**EP101** 

PAGE 31 OF 36 7/11/2025

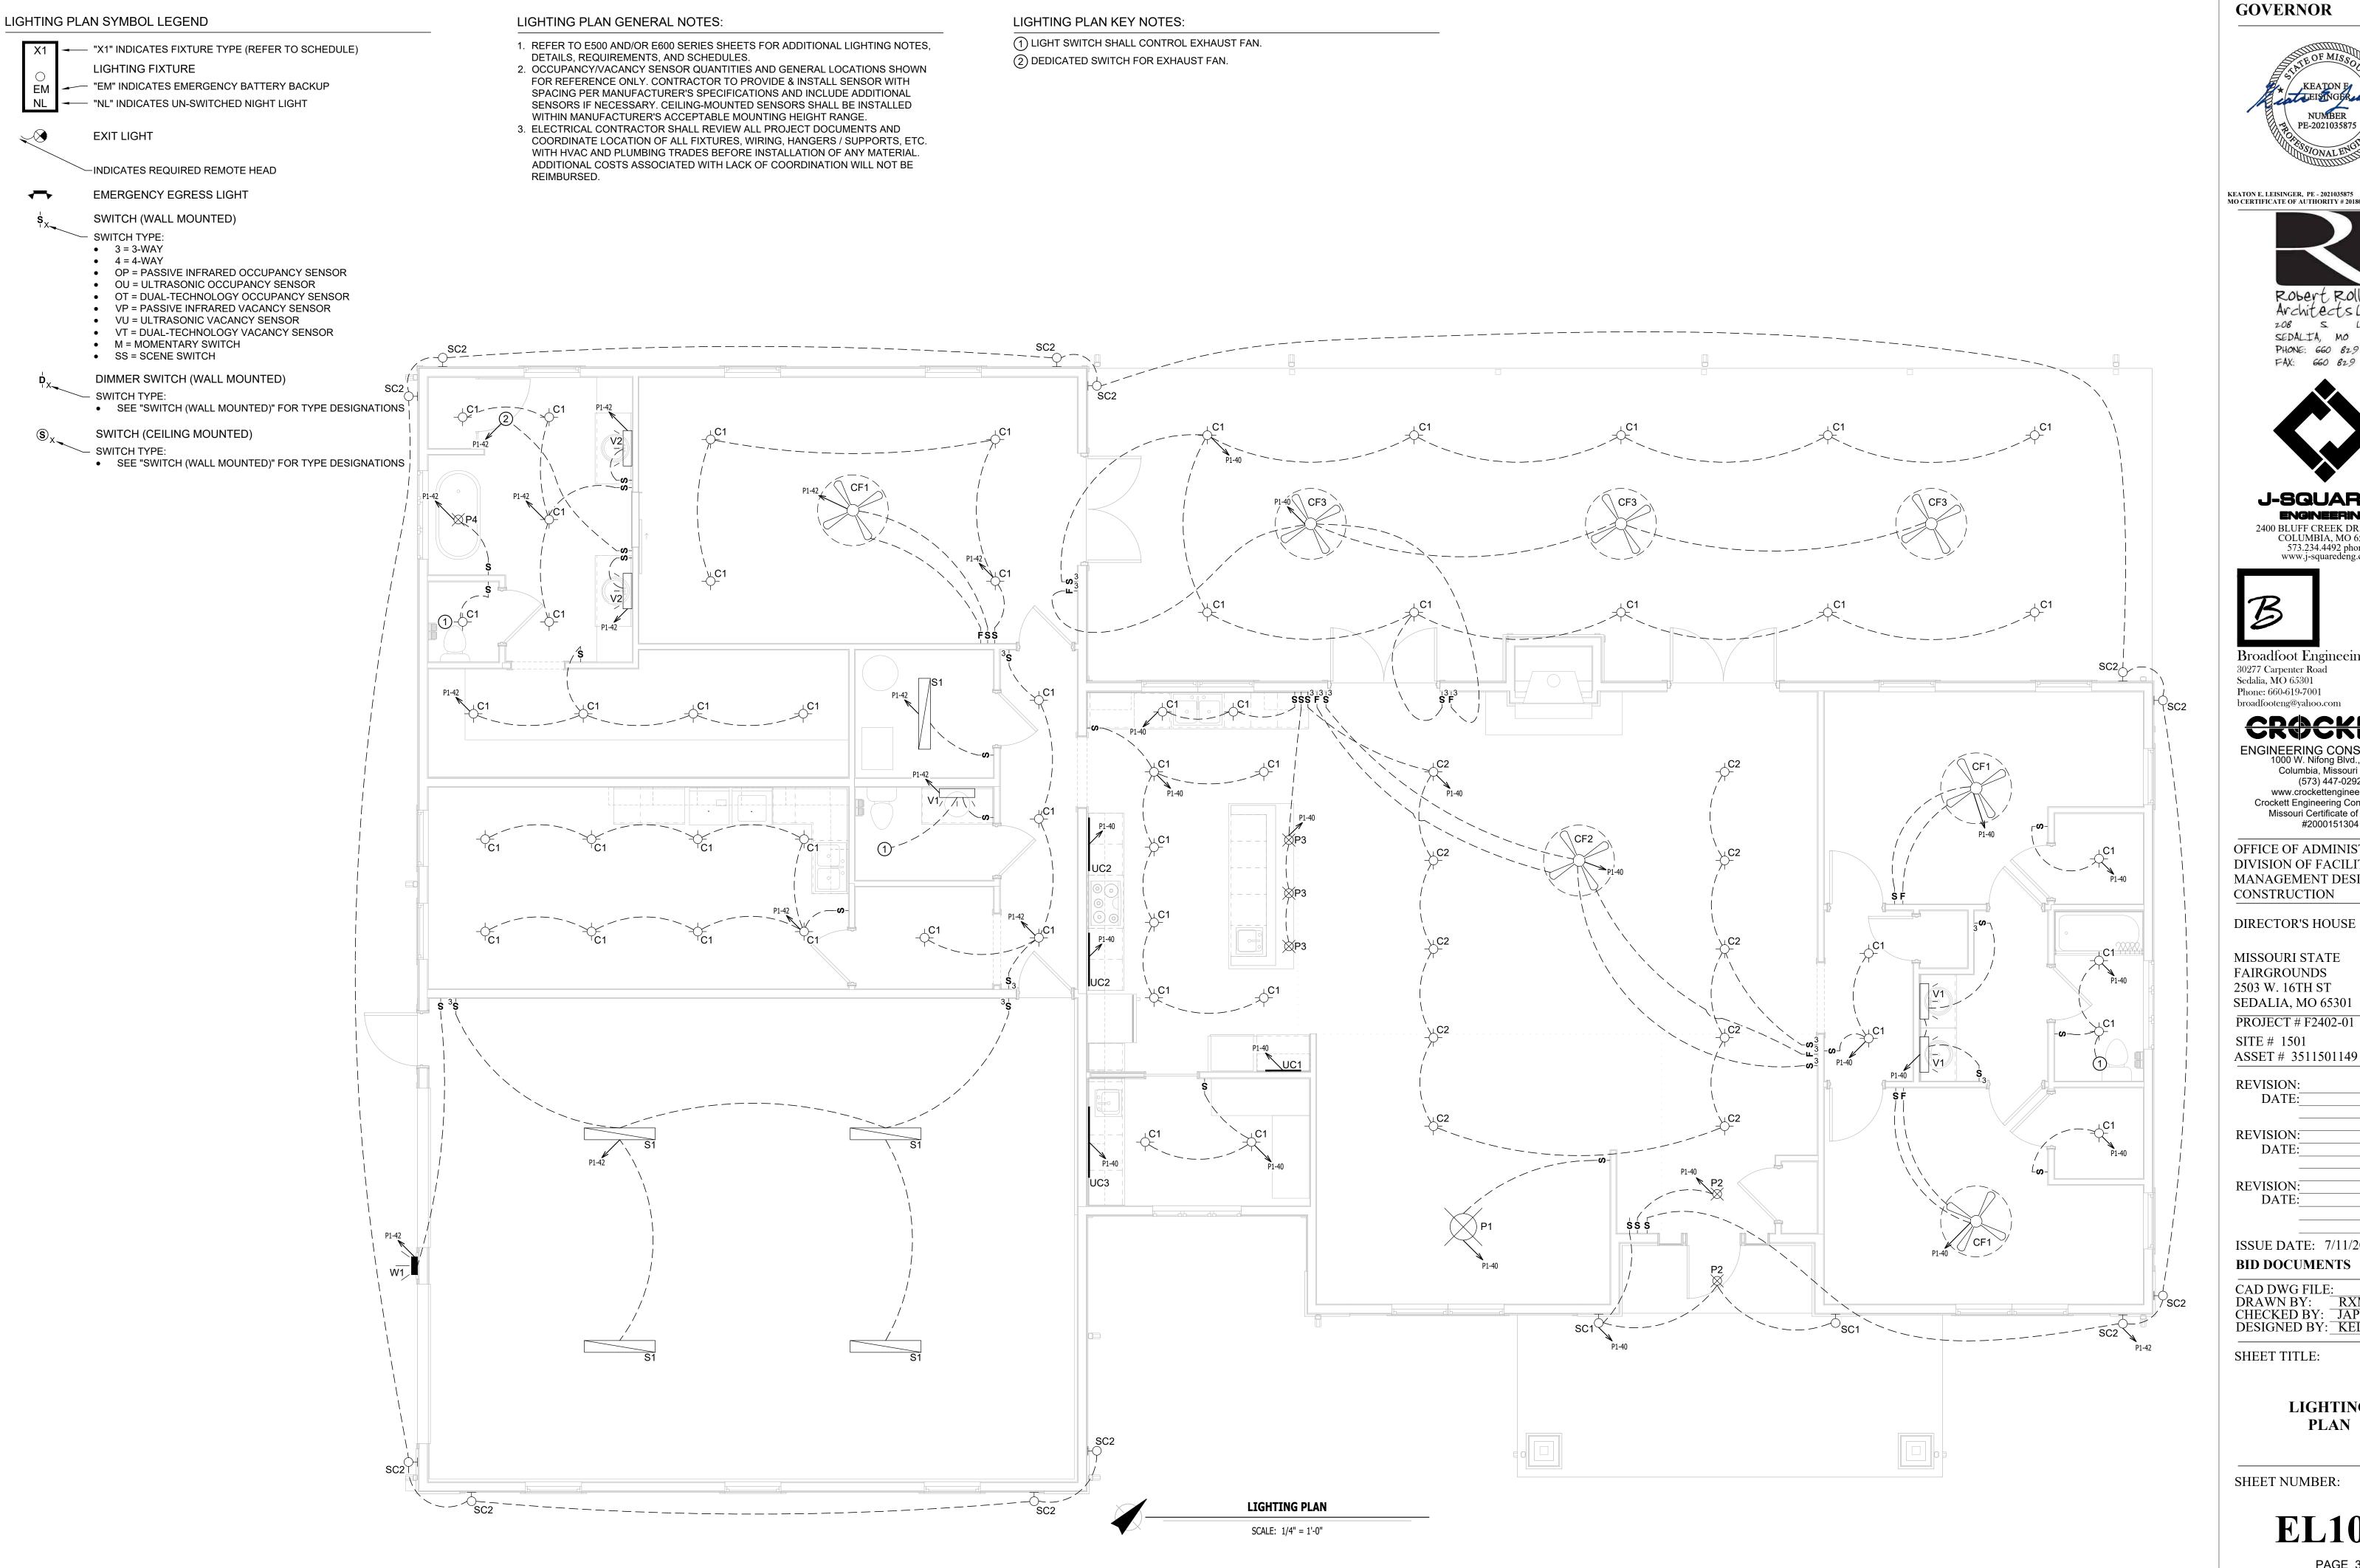



KEATON E. LEISINGER, PE - 2021035875 MO CERTIFICATE OF AUTHORITY # 2018029680



SEDALTA, MO 65301 PHONE: 660 829 9751 FAX: 660 829 9752



J-SQUARED **ENGINEERING** 2400 BLUFF CREEK DR. STE. 101 COLUMBIA, MO 65201 573.234.4492 phone www.j-squaredeng.com



Broadfoot Engineeing, LLC 30277 Carpenter Road Sedalia, MO 65301 Phone: 660-619-7001

ENGINEERING CONSULTANTS 1000 W. Nifong Blvd., Bldg. 1. Columbia, Missouri 65202 (573) 447-0292 www.crockettengineering.com Crockett Engineering Consultants, LLC

Missouri Certificate of Authority #2000151304 OFFICE OF ADMINISTRATION DIVISION OF FACILITIES MANAGEMENT DESIGN AND

MISSOURI STATE FAIRGROUNDS 2503 W. 16TH ST SEDALIA, MO 65301 PROJECT # F2402-01

SITE # 1501 ASSET # 3511501149

**REVISION:** 

**REVISION:** DATE:

**REVISION:** 

ISSUE DATE: 7/11/2025

**BID DOCUMENTS** 

CAD DWG FILE:
DRAWN BY:
CHECKED BY:
DESIGNED BY:
KEL

SHEET TITLE:


LIGHTING **PLAN** 

SHEET NUMBER:


**EL101** 

PAGE 32 OF 36 7/11/2025

LIGHT FIXTURE SCHEDULE											
TAG	MANUFACTURER (OR EQUAL)	MODEL NUMBER (OR EQUAL)	MOUNTING	LUMEN OUTPUT	CCT (°K)	CRI	VOLTAGE	WATTS	DIMMING	NOTES	
C1	HALO	SMD4R-6-9S-WH	4" Round Led	SURFACE	700	3000	90	120	10	120V	
C2	HALO	RA4LS9FSD2W1EWHDM	4" ROUND LED ADJUSTABLE CAN	RECESSED	600	3000	90	120	6	120V	WITH CANLESS MOUNTING FRAMES
CF1	HUNTER	51223	44" FAN WITH LIGHT KIT	SURFACE	1500	3000	80	120	50	120V	
CF2	HUNTER	52615	60" FAN WITH LIGHT KIT	SURFACE	1500	3000	80	120	50	120V	WITH FAN AND LIGHT WALL CONTROLLER
CF3	HUNTER	59471	54" OUTDOOR FAN WITH LIGHT KIT	SURFACE	900	3000	80	120	70	120V	WITH FAN AND LIGHT WALL CONTROLLER
P1	VISUAL COMFORT & CO.	CHC 2156GI	DECORATIVE PENDANT	PENDANT	-	3000	80	120	50	120V	
P2	VISUAL COMFORT & CO.	CHC 1408GI-SG	DECORATIVE PENDANT	PENDANT	-	3000	80	120	50	120V	
P3	VISUAL COMFORT & CO.	CHC 2165AB	DECORATIVE PENDANT	PENDANT	-	3000	80	120	50	120V	
P4	VISUAL COMFORT & CO.	CC1254PN	DECORATIVE PENDANT	PENDANT	-	3000	80	120	50	120V	
P5	VISUAL COMFORT & CO.	OL14408SBL	DECORATIVE PENDANT	PENDANT	-	4000	70	120	60	-	
S1	METALUX	4SLSTP4040DD-120V	4' LINEAR	SURFACE	5000	4000	80	120	40	0-10V	
SC1	VISUAL COMFORT & CO.	OL15402TXB	DECORATIVE SCONCE	WALL	400	4000	70	120	60	-	
SC2	VISUAL COMFORT & CO.	OL15400TXB	DECORATIVE SCONCE	WALL	400	4000	70	120	75	-	
UC1	HALO	HU30M-SCTD-24-P	24" LED UNDERCABINET FIXTURE	SURFACE	670	3000	90	120	10	-	UNDERCOUNTER MOUNTED
UC2	HALO	HU30M-SCTD-36-P	36" LED UNDERCABINET FIXTURE	SURFACE	915	3000	90	120	13	-	UNDERCOUNTER MOUNTED
UC3	HALO	HU30M-SCTD-48-P	48" LED UNDERCABINET FIXTURE	SURFACE	1250	3000	90	120	18	-	UNDERCOUNTER MOUNTED
V1	VISUAL COMFORT & CO.	VS24403ORB	VANITY	WALL	2400	3000	90	120	30	-	MOUNTED ABOVE MIRROR
V2	VISUAL COMFORT & CO.	VS24304ORB	VANITY	WALL	3200	3000	90	120	40	-	MOUNTED ABOVE MIRROR
W1	HALO	WXPS40UNVDBZ	LED WALL PACK	WALL	3700	4000	70	120	30	-	MOUNTED ABOVE GARAGE DOOR

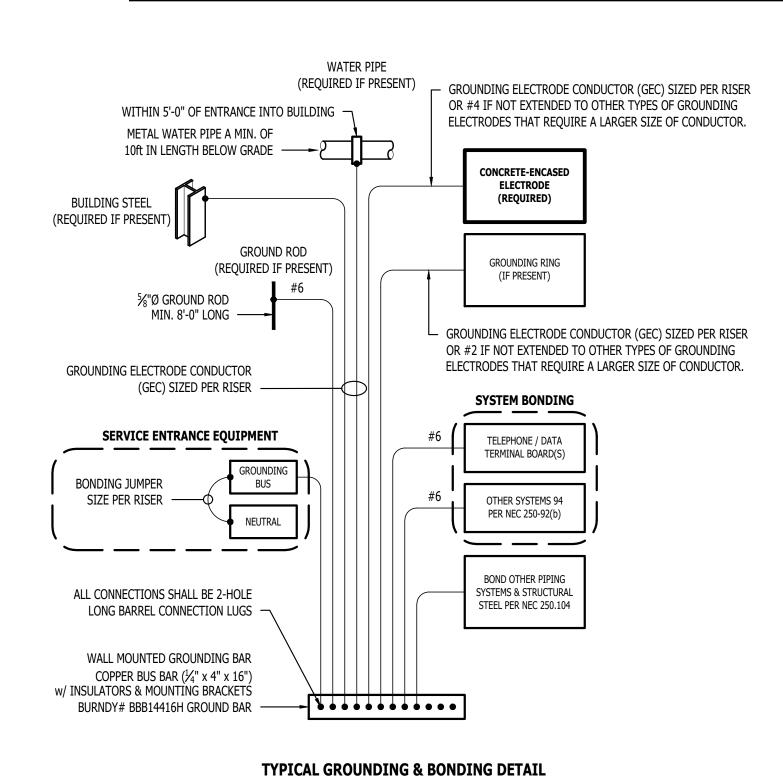

1. VERIFY LIGHT FIXTURE FINISHES WITH OWNER / ARCHITECT PRIOR TO INSTALLATION.

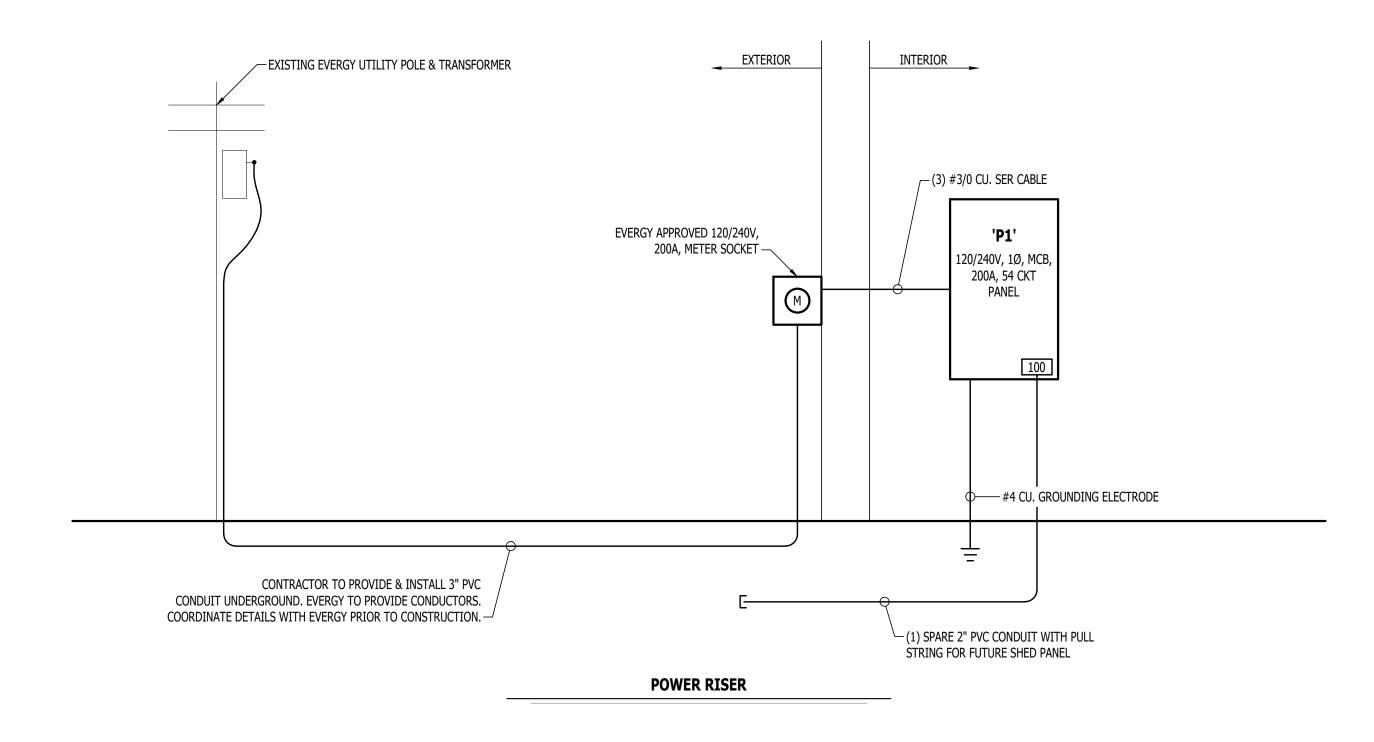

			ГА	ITLL	P1' S0		<u> </u>		
PANEL SPECIFICATIONS								TOTAL CONNECTED	LOAD
VOLTA GE: 120/240V 1-PH NEMA RATING: 1									07 AMPS
AMPACITY: 200A MCB PANEL MOUNTING: RECESSED								PHA SE "B" LOAD: 210	0.8 AMPS
A IC-RA	ATING: 10kA								•
CIRCUIT NUMBER	DESCRI	PTION	BREAKER SIZE	AMPS	PHASE	AMPS	BREAKER SIZE	DESCRIPTION	CIRCUI NUMBEI
1	CONDENSING	UNIT (CU-1)	30-2	18	Α	7.5	20-1*	OUTDOOR / WP RECEPTS	2
3	-		-	18	В	7.5	20-1*	BEDROOM 1 / RECEPTS	4
5	FURNAC	E (F-1)	20-1	10	Α	4.5	20-1*	BATHROOM / GFCI RECEPTS	6
7	WATER I	HEATER	30-2	20	В	9	20-1*	BEDROOM 2 / RECEPTS	8
9	-		-	20	Α	7.5	20-1*	LIVING ROOM / RECEPTS	10
11	GAS FIREPLA	CE POWER	20-1	1	В	7.5	20-1*	LIVING ROOM / RECEPTS	12
13	MASTER BED / R	ESTROOM GFCI	20-1*	4.5	Α	6	20-1*	LIVING ROOM / RECEPTS	14
15	MASTER BED	•	20-1*	10.5	В	3	20-1*	PANTRY / GFCI RECEPTS	16
17	HALL RESTRO	OOM / GFCI	20-1*	3	Α	4.5	20-1*	PANTRY / FUTURE REF	18
19	LAUNDRY / COUNTI	ER GFCI RECEPTS	20-1*	4.5	В	6	20-1*	KITCHEN / ISLAND GFCI RECEPTS	20
21	Laundry / Clo	THES WASHER	20-1	8	Α	35	40-2	KITCHEN / OVEN	22
23	Laundry / Clo	OTHES DRYER	30-2	20	В	35	-	-	24
25	-		-	20	Α	5	20-1*	KITCHEN / REF	26
27	Laundry /	RECEPTS	20-1*	9	В	5	20-1*	KITCHEN / COOKTOP	28
29	GARAGE / DOOF	R OPERATORS	20-1	8	Α	3	20-1*	KITCHEN / RANGE HOOD MICROWAVE	30
31	GARAGE /		20-1	6	В	4.5	20-1*	KITCHEN / COUNTER GFCI RECEPTS	32
33	GARAGE /	RECEPTS	20-1	6	Α	5	20-1*	KITCHEN / DISP & DISHWASHER	34
35	CONDENSING	UNIT (CU-2)	25-2	16	В	3	20-1*	KITCHEN / COUNTER GFCI RECEPTS	36
37	-		-	16	Α	1	20-1	SMOKE DETECTORS	38
39	FURNAC		20-1	10	В	10.8	20-1*	LIGHTING	40
41	ENERGY RECOVER	· · ·	20-1	1	Α	13.5	20-1*	LIGHTING	42
43	SPA		20-1		В	4.5	20-1*	EXTERIOR SOFFIT LIGHTING	44
45	SPA		20-1		Α		20-1	SPARE	46
47	SPA		20-1		В		20-1	SPARE	48
49	SPA		20-1		Α		100-3	FURTURE SHOP PANEL	50
51	SPA		20-1		В		-	-	52
53	SPA	RE	20-1		Α		-	-	54


### A: PANEL SHALL BE EQUAL TO SQUARE D MODEL "QO"

- B: ELECTRICIAN SHALL VERIFY EXACT EQUIPMENT OVERCURRENT PROTECTION REQUIREMENTS PRIOR TO PURCHASE & INSTALLATION OF EQUIPMENT.
- C: AFTER COMPLETION OF WORK, ELECTRICAN SHALL PROVIDE A TYPE WRITTEN PANEL DIRECTORY IN NEW PANEL.
- D: \* SHALL INDICATE AFCI PROTECTED BREAKER TO BE INSTALLED.
- E: PANEL SIZE HAS BEEN DETERMINED USING NEC SECTION 220 DEMAND CALCULATIONS. (CALCULATED 114A PER PHASE)

STATE OF MISSOURI MIKE KEHOE GOVERNOR



KEATON E. LEISINGER, PE - 2021035875 MO CERTIFICATE OF AUTHORITY # 2018029680

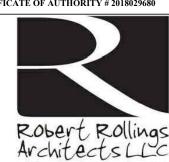

Architects LLC 208 S. Lamine SEDALTA, MO 65301 PHONE: 660 829 9752



J-SQUARED ENGINEERING 2400 BLUFF CREEK DR. STE. 101 COLUMBIA, MO 65201 573.234.4492 phone www.j-squaredeng.com



Broadfoot Engineeing, LLC 30277 Carpenter Road Sedalia, MO 65301 Phone: 660-619-7001 broadfooteng@yahoo.com

# CROCKET

ENGINEERING CONSULTANTS
1000 W. Nifong Blvd., Bldg. 1.
Columbia, Missouri 65202
(573) 447-0292
www.crockettengineering.com
Crockett Engineering Consultants, LLC
Missouri Certificate of Authority

#2000151304

OFFICE OF ADMINISTRATION
DIVISION OF FACILITIES
MANAGEMENT DESIGN AND
CONSTRUCTION

DIRECTOR'S HOUSE

MISSOURI STATE FAIRGROUNDS 2503 W. 16TH ST SEDALIA, MO 65301

PROJECT # F2402-01 SITE # 1501

ASSET # 3511501149

REVISION:

DATE:

REVISION:

DATE:\_

REVISION: DATE:

ISSUE DATE: 7/11/2025

BID DOCUMENTS

CAD DWG FILE:
DRAWN BY: RXM
CHECKED BY: JAP
DESIGNED BY: KEL

SHEET TITLE:

ELECTRICAL DETAILS & SCHEDULES

SHEET NUMBER:

E501

PAGE 33 OF 36 7/11/2025 SANITARY SEWER PLAN SYMBOL LEGEND

— — — — SANITARY SEWER PIPING

---- VENT PIPING

PIPING TURNED DOWN / TURNED UP

TIE INTO EXISTING

SANITARY SEWER PLAN GENERAL NOTES:

- 1. REFER TO P500 AND/OR P600 SERIES SHEETS FOR ADDITIONAL PLUMBING NOTES, DETAILS,
- REQUIREMENTS, AND SCHEDULES.

  2. PLUMBING CONTRACTOR SHALL REVIEW ALL PROJECT DOCUMENTS AND COORDINATE LOCATION OF ALL EQUIPMENT, PIPING, HANGERS / SUPPORTS, ETC. WITH HVAC AND ELECTRICAL TRADES BEFORE INSTALLATION OF ANY MATERIAL. ADDITIONAL COSTS ASSOCIATED WITH LACK OF COORDINATION WILL NOT BE REIMBURSED.

SANITARY SEWER PLAN KEY NOTES:

- 1) VENT PIPE IN WALL BELOW WINDOW.
- (2) CONNECT DISHWASHER TO GARBAGE DISPOSAL.




STATE OF MISSOURI

MIKE KEHOE GOVERNOR

KEATON E. LEISINGER, PE - 2021035875 MO CERTIFICATE OF AUTHORITY # 2018029680



Architects LLC 208 S. Lamine SEDALTA, MO 65301 PHONE: 660 829 9751 FAX: 660 829 9752

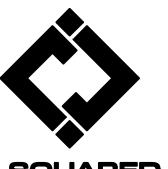

J-SQUARED ENGINEERING 2400 BLUFF CREEK DR. STE. 101 COLUMBIA, MO 65201 573.234.4492 phone www.j-squaredeng.com



Broadfoot Engineeing, LLC 30277 Carpenter Road Sedalia, MO 65301 Phone: 660-619-7001 broadfooteng@yahoo.com

# **CROCKET**

ENGINEERING CONSULTANTS
1000 W. Nifong Blvd., Bldg. 1.
Columbia, Missouri 65202
(573) 447-0292
www.crockettengineering.com
Crockett Engineering Consultants, LLC
Missouri Certificate of Authority
#2000151304

OFFICE OF ADMINISTRATION DIVISION OF FACILITIES MANAGEMENT DESIGN AND CONSTRUCTION

DIRECTOR'S HOUSE

MISSOURI STATE FAIRGROUNDS 2503 W. 16TH ST SEDALIA, MO 65301

PROJECT # F2402-01 SITE # 1501 ASSET # 3511501149

REVISION: DATE:\_

REVISION: DATE:

REVISION: DATE:

ISSUE DATE: 7/11/2025
BID DOCUMENTS

CAD DWG FILE:
DRAWN BY: RXM
CHECKED BY: JAP
DESIGNED BY: KEL


SHEET TITLE:

SANITARY SEWER PLAN

SHEET NUMBER:

**PS101** 

PAGE 34 OF 36 7/11/2025

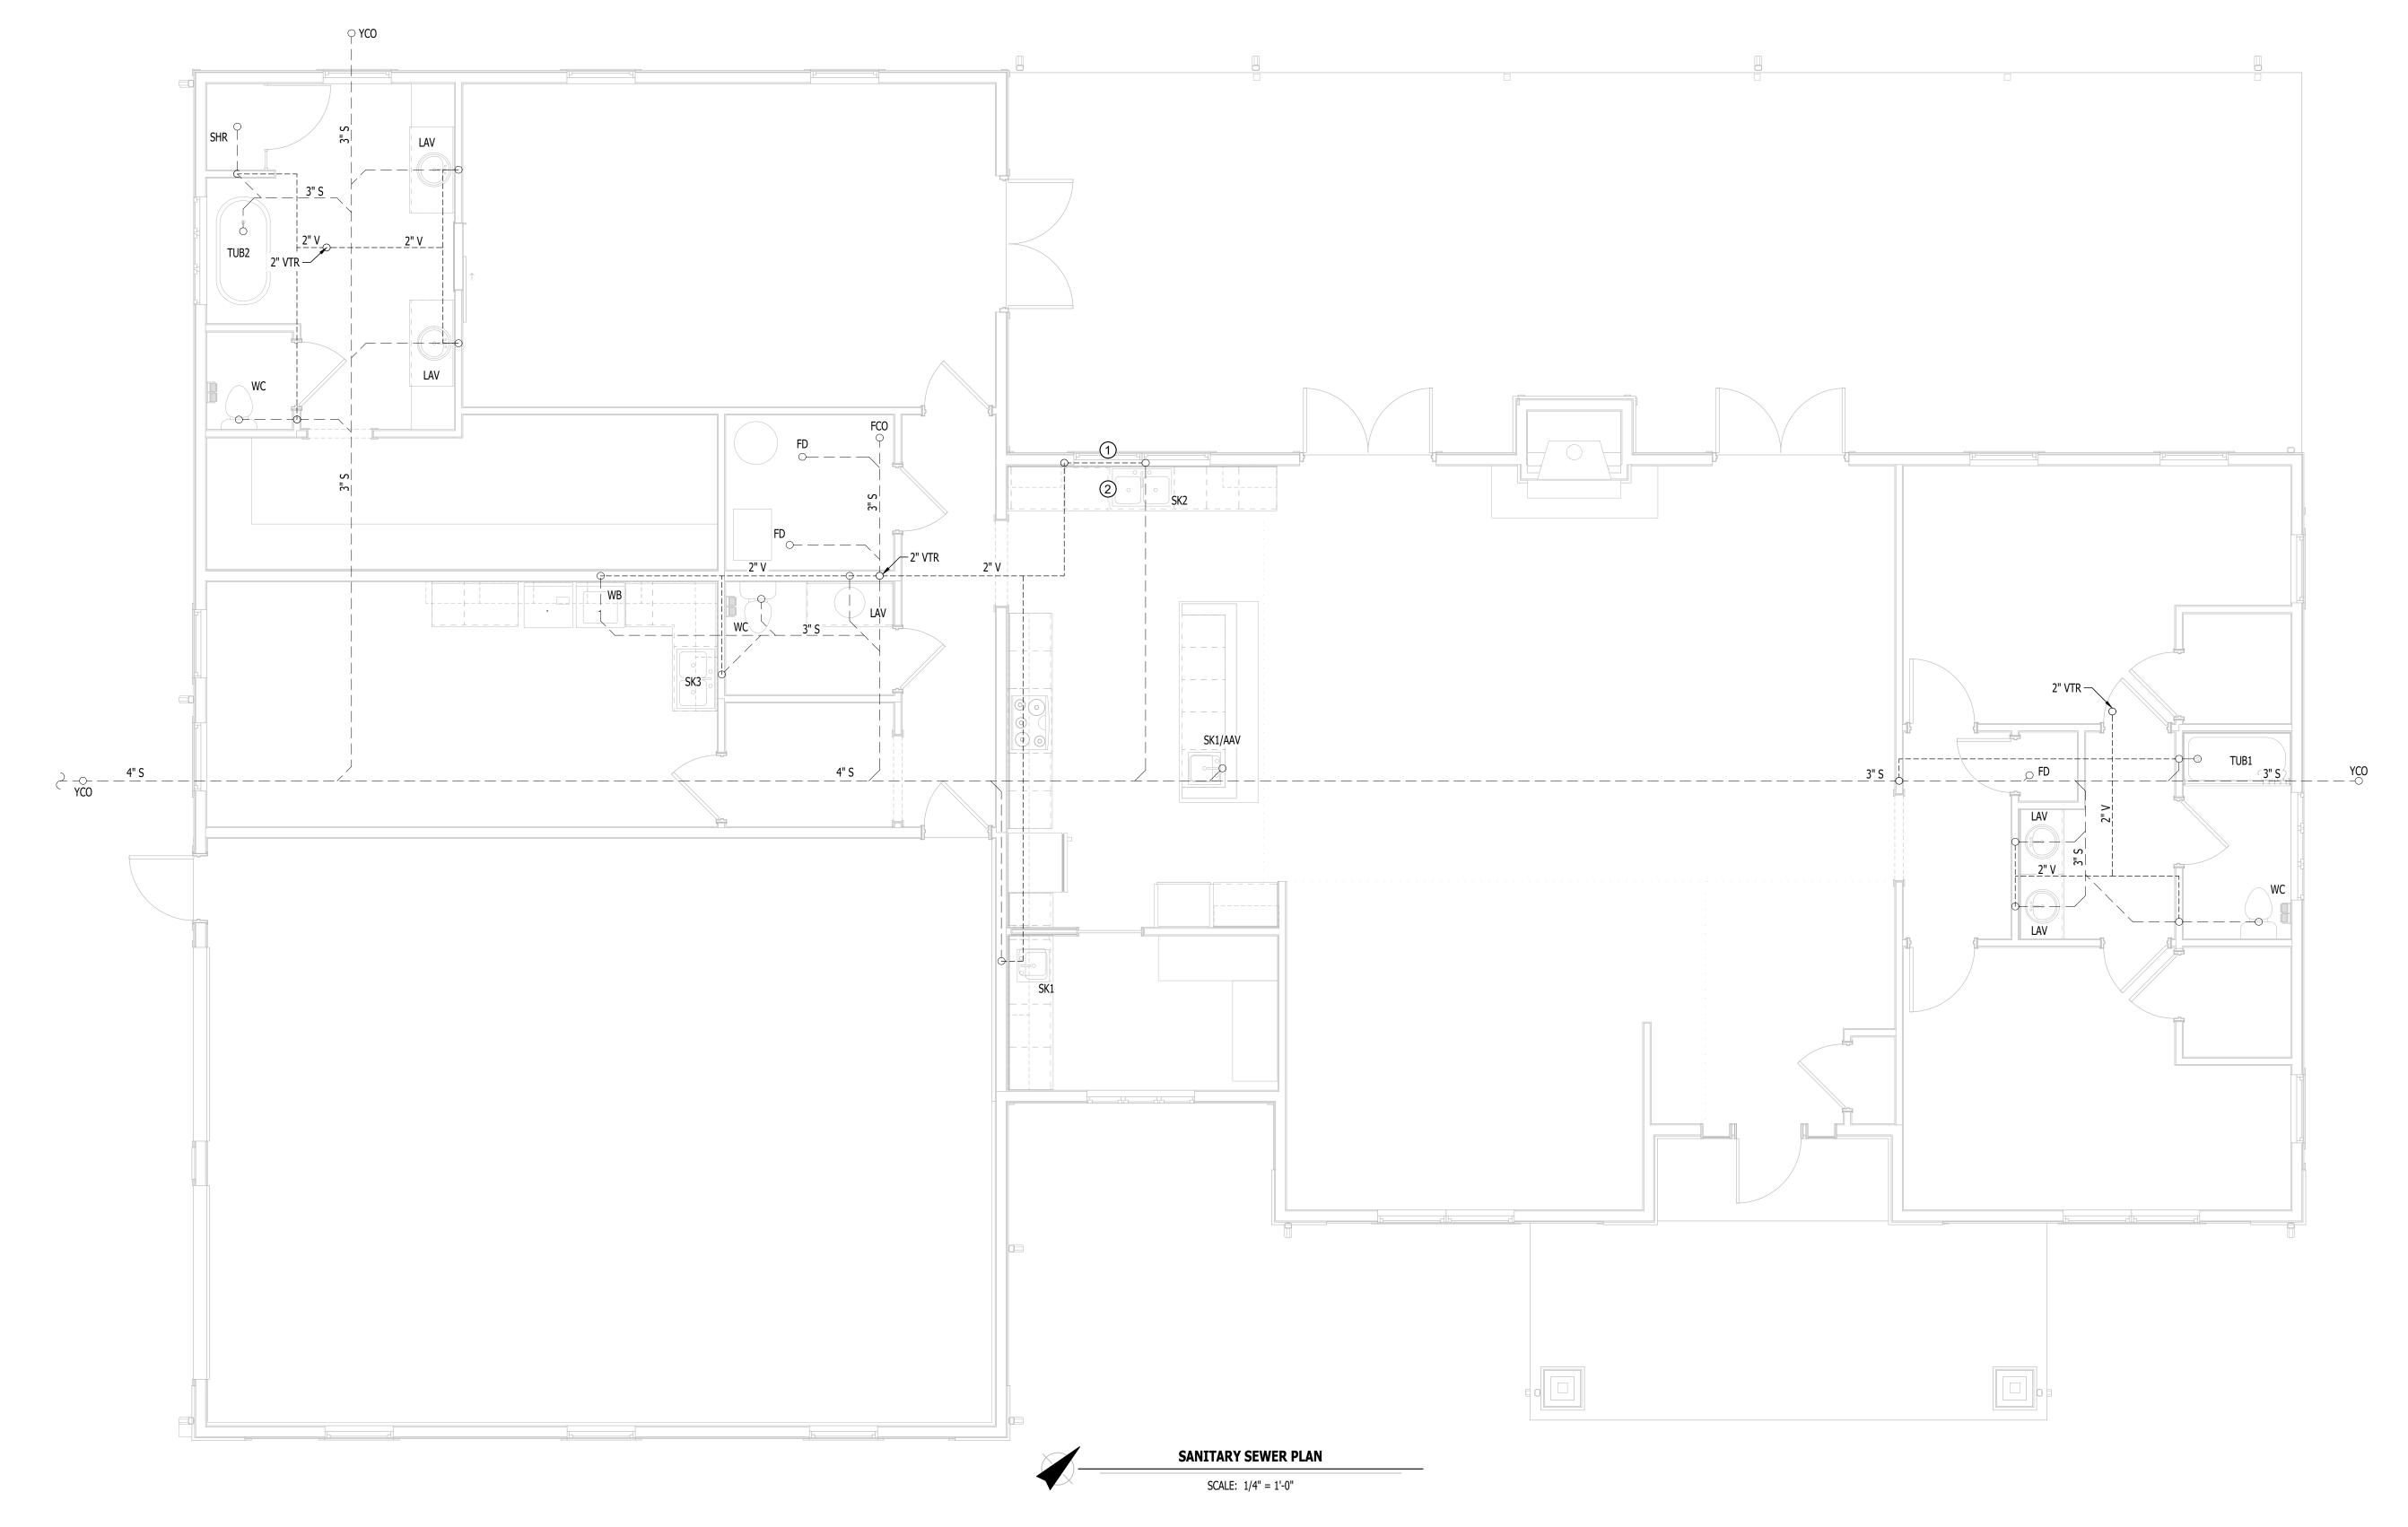

# WATER & GAS PLAN SYMBOL LEGEND COLD WATER LINE

— — COLD WATER LINE

HOT WATER LINE

HOT WATER RECIRCULATION LINE

**⋈** VALVE

• PUMF

—— PIPING TURNED DOWN / TURNED UP


TIE INTO EXISTING

### WATER & GAS PLAN GENERAL NOTES:

- 1. REFER TO P500 AND/OR P600 SERIES SHEETS FOR ADDITIONAL PLUMBING NOTES,
- DETAILS, REQUIREMENTS, AND SCHEDULES.
- 2. PLUMBING CONTRACTOR SHALL REVIEW ALL PROJECT DOCUMENTS AND COORDINATE LOCATION OF ALL EQUIPMENT, PIPING, HANGERS / SUPPORTS, ETC. WITH HVAC AND ELECTRICAL TRADES BEFORE INSTALLATION OF ANY MATERIAL. ADDITIONAL COSTS ASSOCIATED WITH LACK OF COORDINATION WILL NOT BE REIMBURSED.
- 3. ALL HOT, COLD & HOT WATER RECIRCULATION LINES SHALL BE INSTALLED UNDERGROUND UNLESS OTHERWISE NOTED.
- 4. ALL GAS PIPING LOCATED IN ATTIC UNLESS OTHERWISE NOTED.

### WATER & GAS PLAN KEY NOTES:

- 1" WATER SERVICE UP FROM UNDER FLOOR WITH SHUT OFF VALVE ABOVE FLOOR. CONNECT TO WATER HEATER IN MECHANICAL ROOM & CONTINUE TO ROUTE UNDER FLOOR FOR DISTRIBUTION TO PLUMBING FIXTURES AS SHOWN.
- 2 LP TANK REGULATOR. TOTAL CONNECTED GAS LOAD = 149,000 BTU.
- 3 GAS FIREPLACE. CONNECTED LOAD = 29,000 BTU.
- (4) CONNECT HOT WATER LINE TO DISH WASHER.
- (5) WATER SOFTENER BY OWNER.
- 6 HOT & COLD WATER BRANCH SHUT-OFF VALVES WITHIN MECHANICAL ROOM. SEE WATER SERVICE & WATER HEATER DETAIL FOR FURTHER INFORMATION.
- 7 INSTALL COMFORT VALVE AT THIS FIXTURE PER MANUFACTURERS SPECIFICATIONS.

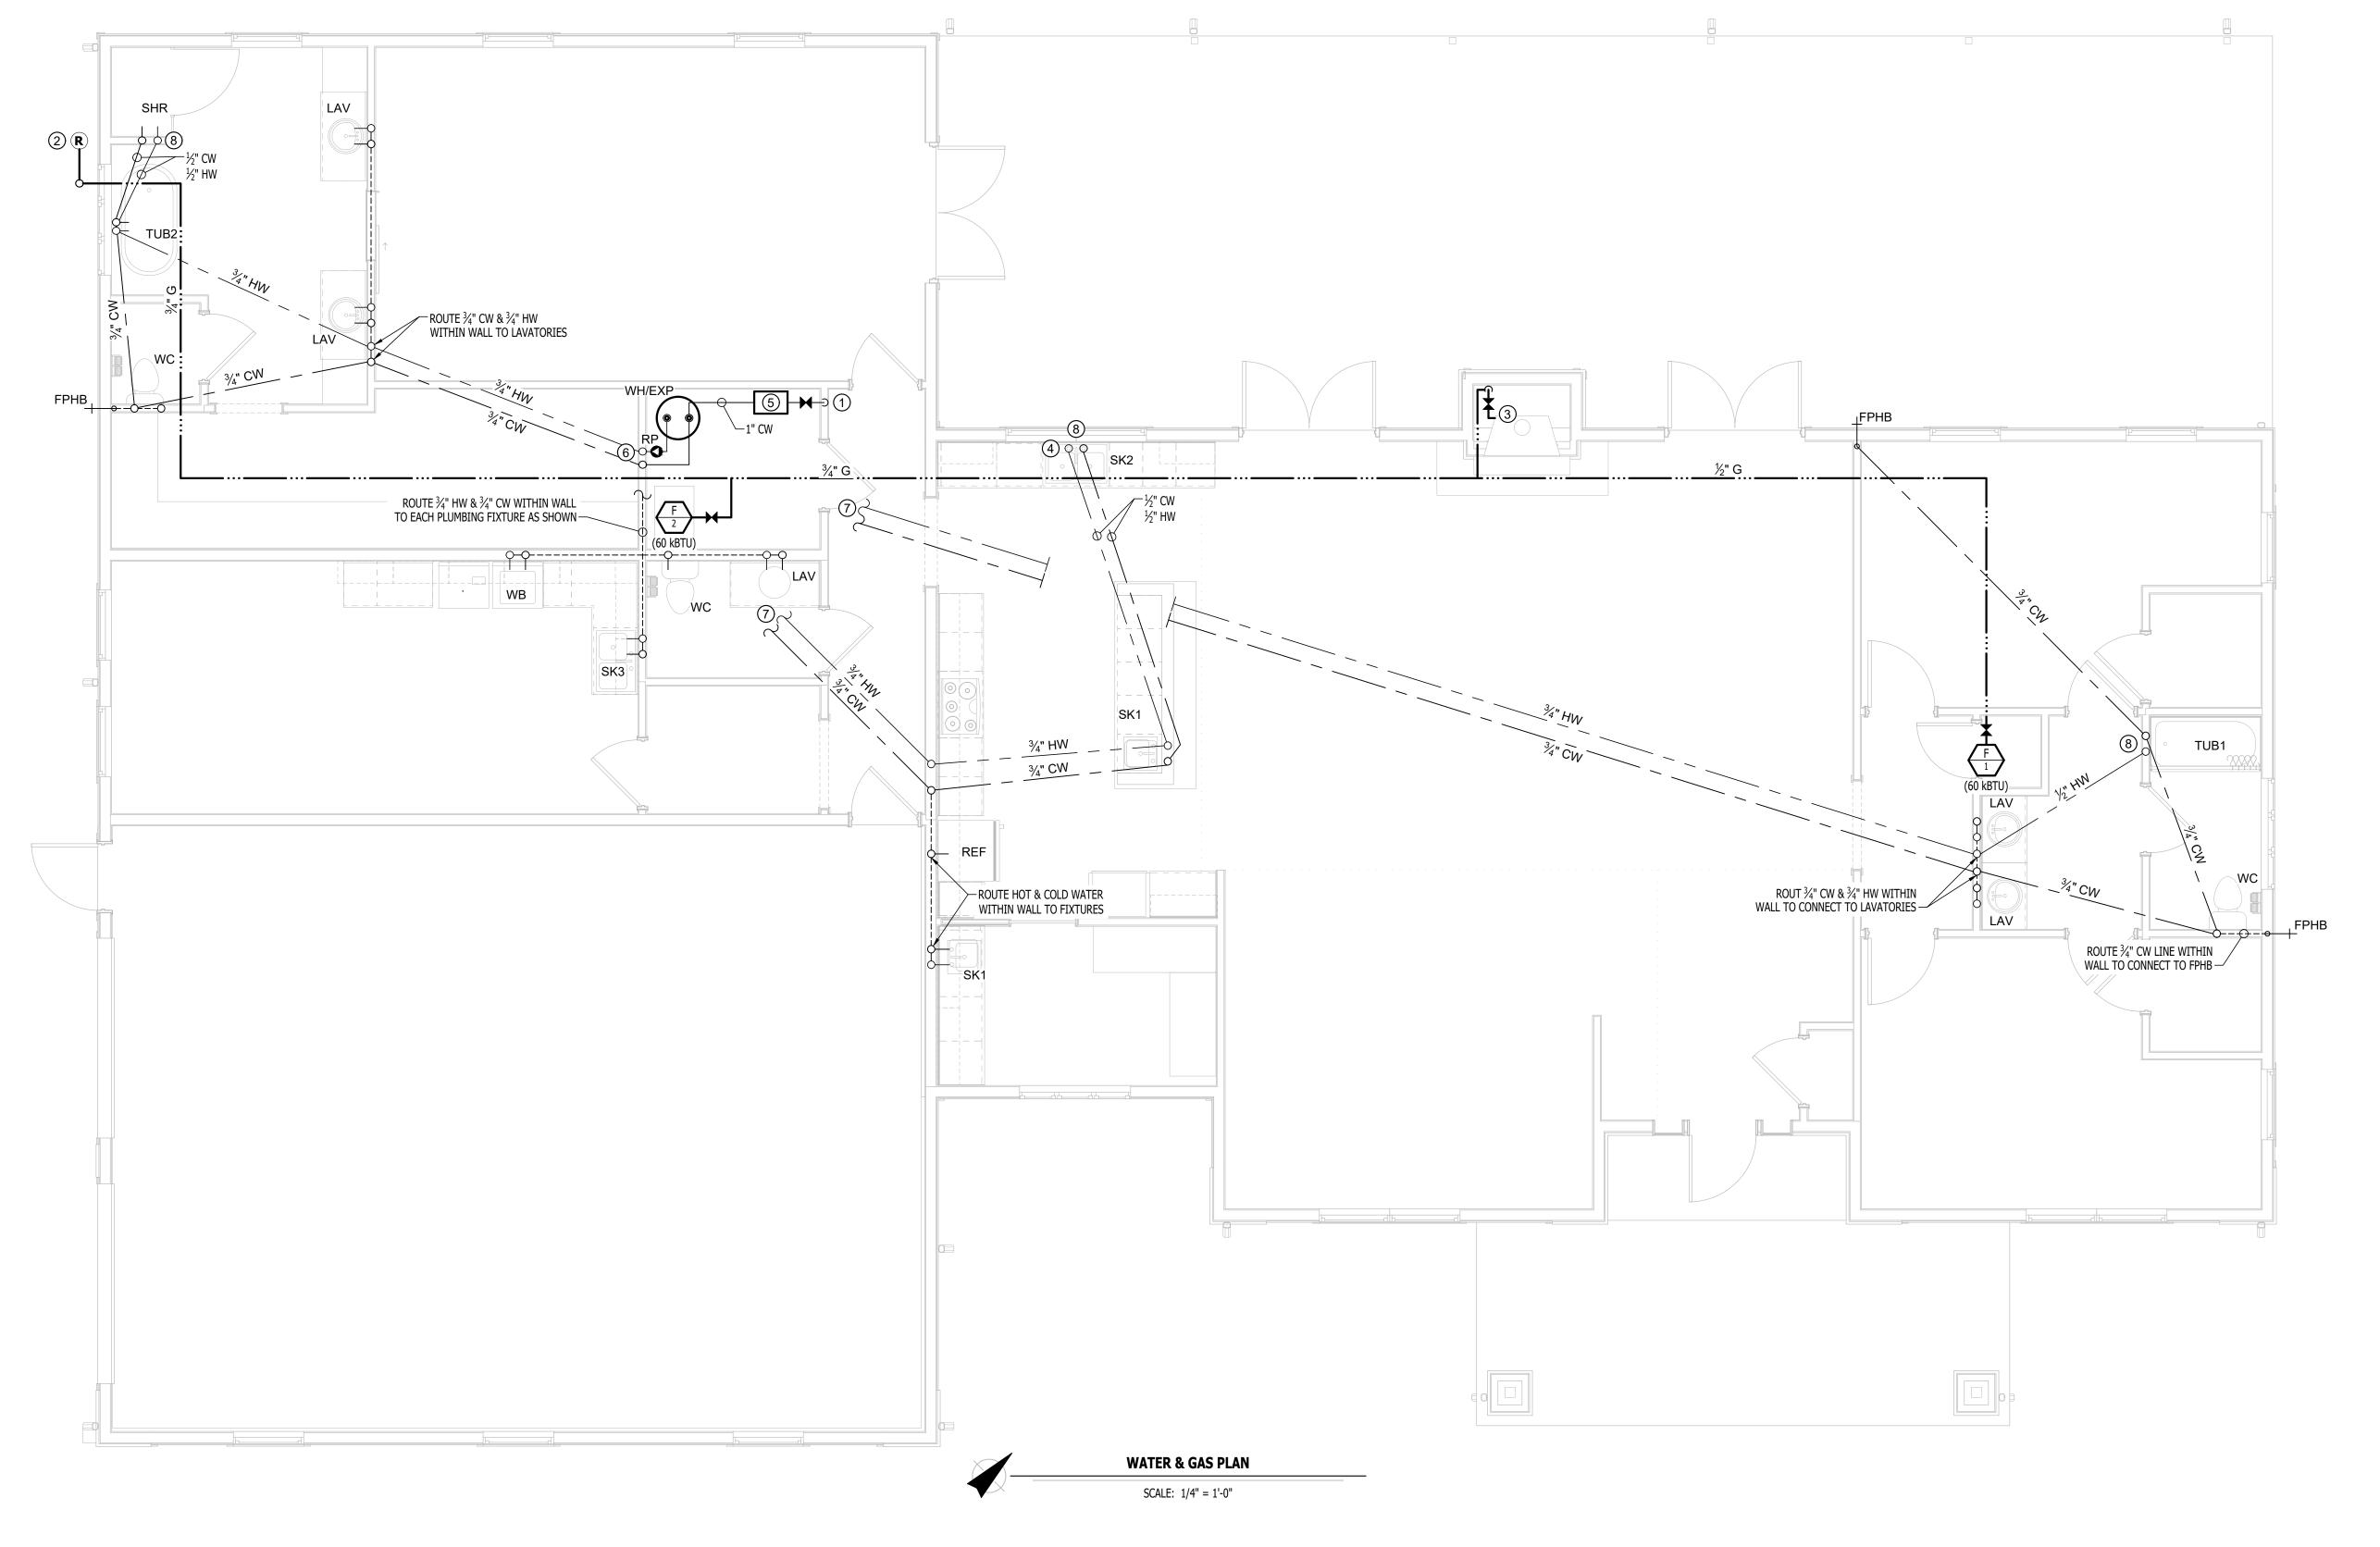

### STATE OF MISSOURI MIKE KEHOE GOVERNOR



KEATON E. LEISINGER, PE - 2021035875 MO CERTIFICATE OF AUTHORITY # 2018029680



Architects LLC 208 S. Lamine SEDALTA, MO 65301 PHONE: 660 829 9752



J-SQUARED ENGINEERING 2400 BLUFF CREEK DR. STE. 101 COLUMBIA, MO 65201

573.234.4492 phone www.j-squaredeng.com



Broadfoot Engineeing, LLC 30277 Carpenter Road Sedalia, MO 65301 Phone: 660-619-7001 broadfooteng@yahoo.com

### CROCKET

ENGINEERING CONSULTANTS
1000 W. Nifong Blvd., Bldg. 1.
Columbia, Missouri 65202
(573) 447-0292
www.crockettengineering.com
Crockett Engineering Consultants, LLC

Missouri Certificate of Authority
#2000151304

OFFICE OF ADMINISTRATION
DIVISION OF FACILITIES
MANAGEMENT DESIGN AND

DIRECTOR'S HOUSE

CONSTRUCTION

MISSOURI STATE FAIRGROUNDS 2503 W. 16TH ST SEDALIA, MO 65301 PROJECT # F2402-01

SITE # 1501 ASSET # 3511501149

REVISION: DATE:

REVISION: DATE:

REVISION: \_\_\_\_\_\_ DATE: \_\_\_\_\_

ISSUE DATE: 7/11/2025
BID DOCUMENTS

CAD DWG FILE:
DRAWN BY:
CHECKED BY:
DESIGNED BY:
KEL

SHEET TITLE:

WATER & GAS PLAN


SHEET NUMBER:

**PW101** 

PAGE 35 OF 36 7/11/2025

### WATER SERVICE & WATER HEATER KEY NOTES:

- 1) HOT & COLD SHUT OFF VALVES TO LAUNDRY/OFFICE & W.C. PLUMBING FIXTURES.
- 2) HOT & COLD WATER SHUT OFF VALVES TO MASTER BATHROOM PLUMBING FIXTURES.
- (3) HOT & COLD WATER SHUT OFF VALVES TO KITCHEN PLUMBING FIXTURES.
- (4) HOT & COLD WATER SHUT OFF VALVES TO SHARED BATHROOM PLUMBING FIXTURES.

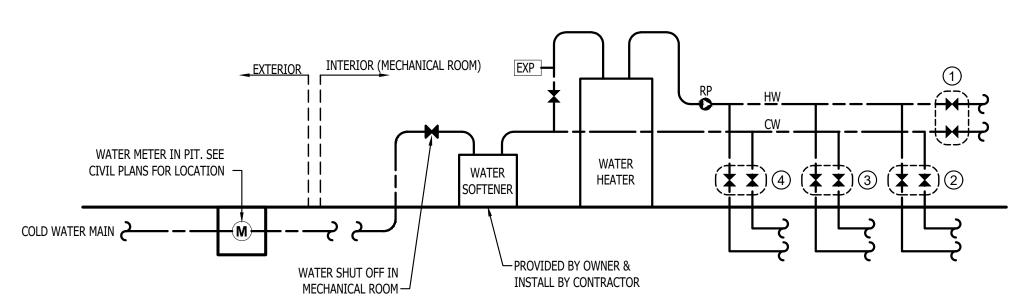

WATER SERVICE & WATER HEATER DETAIL


	PLUMBING FIXTURE SCHEDULE								
TAG	DESCRIPTION	MANUFACTURER (OR EQUAL)	MODEL (OR EQUAL)	NOTES					
AAV	AIR ADMITTANCE VALVE	OATEY	39020	1.5" - 6 DFU MAX					
EXP	EXPANSION TANK	WATTS	PLT-5						
FD	FLOOR DRAIN	ZURN	Z415-BZ	WITH Z1072 TRAP SEAL					
FPHB	FROST PROOF HOSE BIB	WOODFORD	MODEL 19						
LAV	LAVATORY (DROP-IN W/ MANUAL FAUCET)	AMERICAN STANDARD	0475.028	WITH MOEN #84537 FAUCET, 1/4 TURN STOPS, AND BRAIDED STAINLESS STEEL SUPPLIES					
REF	REFRIGERATOR BOX	SIOUX CHIEF	696-G1000						
RP	RECIRCULATION PUMP	GRUNDFOS	UP15-10 SU7P/TLC	WITH TIMER AND COMFORT VAVLES (PROVIDE 3 VALVES IN TOTAL, ONE FOR EACH HOT WATER BRANCH)					
SHR	SHOWER	AQUATIC	1483OSL-WH	WITH MOEN #UT33322 SHOWER TRIM KIT AND SHOWER VAVLE. PROVIDE COMPATIBLE DOOR BY SHOWER SURROUND PROVIDER.					
SK1	SINGLE COMPARTMENT SINK (22x19x7)	ELKAY	LR2219	WITH TWO HANDLED ZURN Z871C4-XL FAUCET					
SK2	DOUBLE COMPARTMENT SINK W/DISPOSAL (33x22x7)	ELKAY	CR3322	WITH TWO HANDLED ZURN Z871C4-XL FAUCET AND INSINKERATOR BADGER 1 DISPOSAL WITH POWER CORD					
SK3	DOUBLE COMPARTMENT SINK (33x22x7)	ELKAY	CR3322	WITH TWO HANDLED ZURN Z871C4-XL FAUCET					
TUB1	TUB & SHOWER	AQUATIC	2603302PL-WH	WITH MOEN ESSIE #82330 TUB/SHOWER TRIM KIT AND POSI-TEMP SHOWER VALVE					
TUB2	TUB	MISENO	MNO6732SFSO	WITH MISENO #MNO15TFCP TUB FILLER FAUCET					
WB	Washer Box	OATEY	38529	WASHER BOX W/ 1/4 TURN VALVES					
WC	WATER CLOSET - STANDARD HEIGHT - TANK	AMERICAN STANDARD	215CA.004	WITH CHURCH 7200SLEC SEAT AND COVER, STAINLESS BRAIDED SUPPLY, AND 1/4 TURN SHUT-OFF.					
WH	WATER HEATER	RUUD	PROE50 M2 RU95	50 GALLON, 240V, 4500W					
YCO	YARD CLEAN OUT	ZURN	Z1400						
NOTES:		-							

1.	VERIFY NECESSARY FIXTURES MEET ADA REQUIREMENTS WITH ARCHITECT PRIOR TO INSTALLATION.
_	


2. VERIFY FIXTURE FINISHES WITH	OWNER / ARCHITECT
---------------------------------	-------------------

FIXTURE		SA NITA F	Y PIPING	SUPPLY PIPING		
ТҮРЕ	TYPICAL ABBREVIATION	WASTE CONNECTION	VENT CONNECTION	COLD WATER CONNECTION	HOT WATER CONNECTION	
DRINKING FOUNTAIN	DF	1-1/2"	1-1/4"	1/2"	-	
FLOOR DRAIN	FD	3"	2"	-	-	
HAND / HAIR SINK	HS / SK	2"	1-1/4"	1/2"	1/2"	
HOSE BIBB	НВ	-	-	3/4"	-	
LAVATORY	LAV	1-1/2"	1-1/4"	1/2"	1/2"	
MOP SINK	MS	3"	1-1/2"	1/2"	1/2"	
ICE MAKER OUTLET BOX	REF	-	-	1/2"	-	
SHOWER	SH	3"	1-1/2"	1/2"	1/2"	
URINAL	UR	2"	1-1/4"	3/4"	-	
WATER CLOSET (FLUSH TANK)	WC	3"	2"	1/2"	-	
WATER CLOSET (FLUSH VALVE)	WC	3"	2"	1"	-	


1. SIZES SHOWN ABOVE ARE TYPICAL UNLESS NOTED OTHERWISE ON PLANS

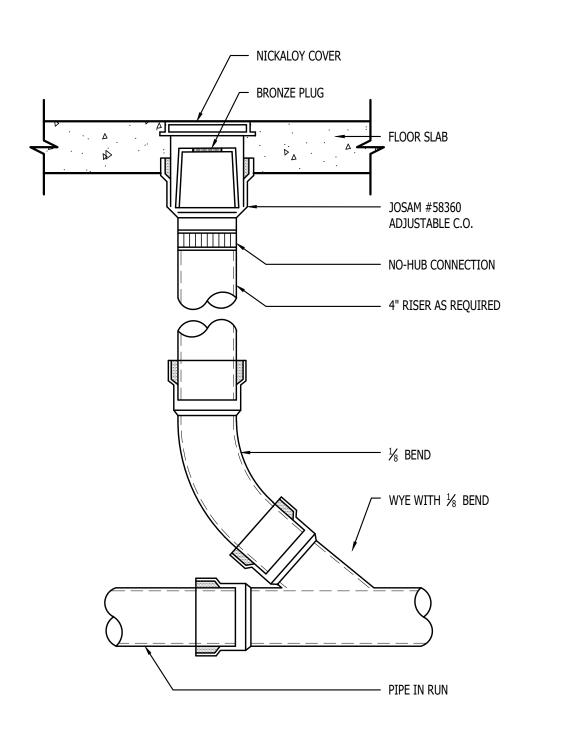



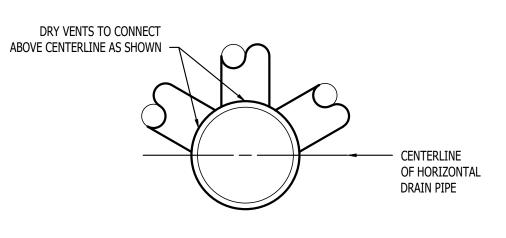

DRY VENT DETAIL

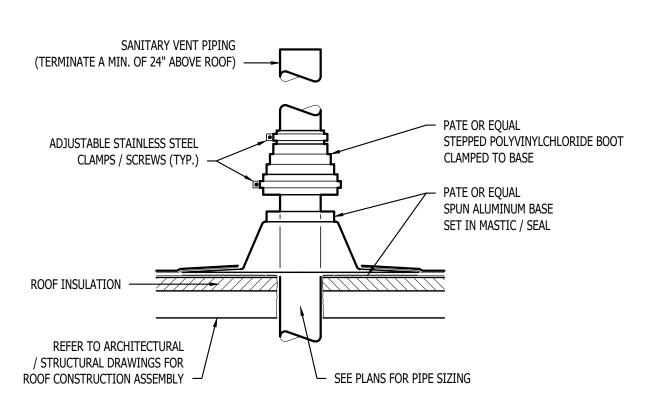

SANITARY VENT THRU ROOF DETAIL

### STATE OF MISSOURI MIKE KEHOE GOVERNOR



KEATON E. LEISINGER, PE - 2021035875 MO CERTIFICATE OF AUTHORITY # 2018029680



Architects LLC 208 S. Lamine SEDALTA, MO 65301 PHONE: 660 829 9751 FAX: 660 829 9752



J-SQUARED ENGINEERING 2400 BLUFF CREEK DR. STE. 101 COLUMBIA, MO 65201 573.234.4492 phone www.j-squaredeng.com



Broadfoot Engineeing, LLC 30277 Carpenter Road Sedalia, MO 65301 Phone: 660-619-7001 broadfooteng@yahoo.com

### ENGINEERING CONSULTANTS 1000 W. Nifong Blvd., Bldg. 1.

Columbia, Missouri 65202 (573) 447-0292 www.crockettengineering.com Crockett Engineering Consultants, LLC Missouri Certificate of Authority #2000151304

OFFICE OF ADMINISTRATION DIVISION OF FACILITIES MANAGEMENT DESIGN AND CONSTRUCTION

DIRECTOR'S HOUSE

MISSOURI STATE FAIRGROUNDS 2503 W. 16TH ST SEDALIA, MO 65301 PROJECT # F2402-01

SITE # 1501 ASSET # 3511501149

REVISION:\_ DATE:

REVISION:\_\_\_\_\_\_DATE:\_\_\_\_

REVISION:\_\_\_\_\_ DATE:\_\_\_\_

ISSUE DATE: 7/11/2025

**BID DOCUMENTS** 

CAD DWG FILE:
DRAWN BY: RXM
CHECKED BY: JAP
DESIGNED BY: KEL

SHEET TITLE:

PLUMBING
DETAILS
AND
SCHEDULES

SHEET NUMBER:

P501

PAGE 36 OF 36 7/11/2025