
# NEW COMFORT STATION AT SWINE PAVILION Missouri State Fairgrounds (MSF) Sedalia, Missouri

OWNER:

STATE OF MISSOURI MICHAEL L. PARSON, GOVERNOR

DEPARTMENT OF AGRICULTURE MISSOURI STATE FAIRGROUNDS

PROJECTOFFICE OF ADMINISTRATIONMANAGEMENT:DIVISION OF FACILITIES MANAGEMENT,DESIGN AND CONSTRUCTION

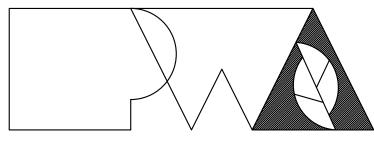

Peckham & Wright Architects, Inc., d.b.a.

## PWArchitects, Inc.


2120 Forum Blvd., Ste 101 Columbia, Missouri 65203 Ph:(573) 449-2683 Fax:(573) 442-6213

DESIGNER: PWArchitects, Inc. 2120 Forum Blvd., Ste. 101 Columbia, Missouri 65203

PROJECT NUMBER: F2406-01

SITE NUMBER:1501ASSET NUMBER:3511501037

OFFICE OF ADMINISTRATION DIVISION OF FACILITIES MANAGEMENT, DESIGN AND CONSTRUCTION

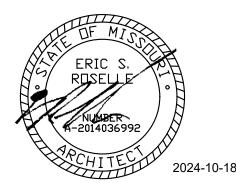

sheet number: G-001

1 OF 33 SHEETS October 18, 2024

#### LIST OF ALTERNATES

#### A. ALTERNATE 1 - SHOWER ROOMS ADDITION

1. CONSTRUCT SHOWER ROOM ADDITION ON WEST END OF BUILDING.

#### 2. TO INCLUDE:

- a. ROUGH-IN AND WALL-HUNG BRACKETS FOR THE ALTERNATE 1 WATER CLOSETS, SHOWERS, AND LAVATORIES.
- b. SHOWER ENCLOSURE(S) AND DRAIN(S).
- c. OWNER TO PROVIDE AND INSTALL ALL ALTERNATE 1 TOILET ACCESSORIES.

## B. <u>ALTERNATE 2</u> - CONTRACTOR-INSTALLED PLUMBING FIXTURES AND TOILET ACCESSORIES:

- 1. CONTRACTOR TO:
- a. PROVIDE AND INSTALL PLUMBING FIXTURES TO INCLUDE WATER CLOSETS AND FLUSH VALVES, URINALS AND FLUSH VALVES, SHOWER VALVES, SHOWER HEADS, LAVATORIES, AND FAUCETS.
- b. PROVIDE AND INSTALL TOILET ACCESSORIES AS NOTED IN THE "RESTROOM ACCESSORY SCHEDULE" INCLUDED ON SHEETS A-101, A-102, A-301, AND A-302.

#### 2. BASE BID: TO INCLUDE:

- a. ROUGH-IN AND WALL-HUNG BRACKETS FOR THE WATER CLOSETS, URINALS, SHOWERS, AND LAVATORIES.
- b. SHOWER ENCLOSURE AND DRAIN.
- c. OWNER TO PROVIDE AND INSTALL ALL TOILET ACCESSORIES.

#### SPECIAL SCHEDULING REQUIREMENTS

- 1. SUBSTANTIAL COMPLETION DATE FOR BASE BID WORK IS JULY 15, 2025.
- 2. IF ALTERNATE 1 IS ACCEPTED:

- SUBSTANTIAL COMPLETION DATE FOR BASE BID AND ALTERNATE 1 **SHELL** IS JULY 15, 2025. - SUBSTANTIAL COMPLETION DATE FOR THE REMAINING BUILDING WORK IS OCTOBER 31, 2025. - THE BUILDING SHELL MUST BE COMPLETE WITH DOOR HARDWARE INSTALLED BY JULY 15, 2025.

#### 3. IF ANY OTHER ALTERNATES ARE ACCEPTED:

- SUBSTANTIAL COMPLETION DATE FOR BASE BID AND ACCEPTED ALTERNATE(S) IS OCTOBER 31, 2025.

#### 4. NO WORK DATES INCLUDE:

- AUGUST 7, 2025 - AUGUST 17, 2025: MISSOURI STATE FAIR

- NO WORK PERMITTED DURING THE PERIODS NOTED ABOVE EXCEPT BY PRIOR ARRANGEMENT WITH THE OWNER'S REPRESENTATIVE. THE JOB SITE MUST BE SECURED DURING THESE PERIODS.

#### C. ALTERNATE 3 - WATER HEATER, EXTERIOR LIGHTING, INTE EPOXY COATING:

#### 1. CONTRACTOR TO:


- a. PROVIDE AND INSTALL WATER HEATER WITH WALL P-101.
- b. PROVIDE AND INSTALL ALL EXTERIOR AND INTERIO NOTED ON SHEET E-101.
- c. PROVIDE AND INSTALL HDPE TOILET COMPARTMEN (INCLUDING HARDWARE), AS SHOWN ON SHEETS A-
- d. PROVIDE AND INSTALL EPOXY WALL COATING PNT-LEGEND ON SHEET A-601.

#### 2. BASE BID:

- a. PROVIDE ALL PLUMBING AND ELECTRICAL ROUGH-WALL KIT TO BE INSTALLED BY OWNER; PROVIDE BI TEMPORARILY CAP PLUMBING PIPES.
- b. PROVIDE ALL ELECTRICAL ROUGH-IN FOR FUTURE FIXTURES TO BE INSTALLED BY OWNER. PROVIDE
- c. DO NOT PROVIDE HDPE TOILET PARTITIONS.
- d. CMU TO REMAIN EXPOSED; WALLS WILL BE FINISHE

### D. ALTERNATE 4 - STANDING SEAM METAL ROOFING SYSTEM

- 1. PROVIDE STANDING SEAM METAL ROOF AND ASSOCIAT
- 2. BASE BID: TO INCLUDE COMPOSITION SHINGLE ROOF

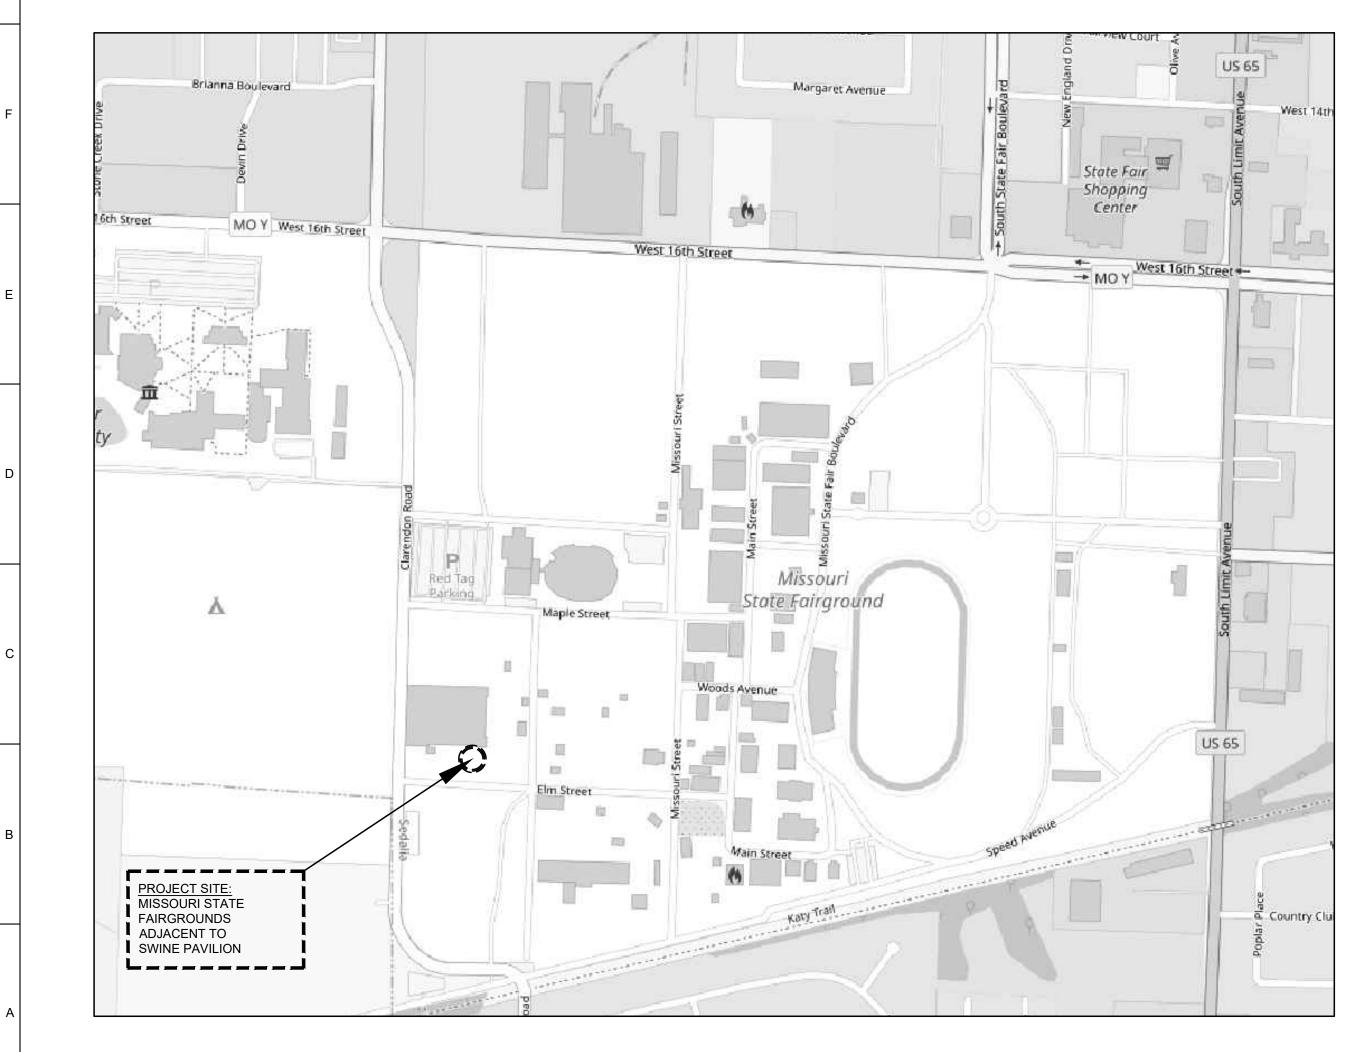

4


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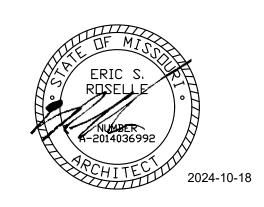
ITERIOR LIGHTING, TOILET PARTITIONS,	G-001	COVER SHEET
, ,	G-101	LOCATION PLAN, LEGENDS, DRAWING INDEX, LIFE SAFETY
	C-100	CIVIL PLAN COVER SHEET
LL KIT AS SHOWN AND NOTED ON SHEET	C-101	DEMOLITION, SITE & UTILITY PLAN
LE RITAS SHOWIN AND NOTED ON SHEET	C-102	EROSION CONTROL & GRADING PLAN
	C-103	STORM SEWER PLAN & PROFILE, AND STORM SEWER DETAILS
IOR LIGHT FIXTURES AS SHOWN AND	C-104	CONSTRUCTION DETAILS
	C-105	ALTERNATE #1 - GRADING, SITE, AND STORM PROFILE PLAN
ENT DOOR/PILASTER ASSEMBLIES	S-100	GENERAL STRUCTURAL DATA
A-101 AND A-301.	S-200	FOUNDATION PLAN
	S-200 S-210	FOUNDATION DETAILS
IT-01, AS SHOWN THE INTERIOR FINISH	S-210	FOUNDATION DETAILS
	S-300	ROOF FRAMING PLAN
	S-310	ROOF FRAMING DETAILS
	S-311	TYPICAL MASONRY DETAILS
H-IN FOR FUTURE WATER HEATER AND	0.011	
BLANK PLATE AT JUNCTION BOX;	A-101	FLOOR PLAN & DETAILS
	A-102	ALTERNATE 1: FLOOR PLAN & DETAILS
RE EXTERIOR AND INTERIOR LIGHT	A-110	ROOF PLANS & DETAILS
E BLANK PLATES AT JUNCTION BOXES.	A-120	REFLECTED CEILING PLANS & DETAILS
	A-201	ELEVATIONS & DETAILS
	A-202	ELEVATIONS & DETAILS
HED AND PAINTED BY OWNER.	A-301	SECTIONS & DETAILS
HED AND FAINTED DI OWNER.	A-302	SECTIONS & DETAILS
	A-303	SECTIONS & DETAILS
	A-601	SCHEDULES & DETAILS
EM:		
IATED FLASHING CHANGES.	ME-101	MEP SITE UTILITIES PLAN
	M-101	HVAC PLAN
OF SYSTEM.		
	E-101	POWER PLAN
	E-102	LIGHTING PLAN
	E-501	ELECTRICAL DETAILS & SCHEDULES
	P-101	SANITARY SEWER PLAN
	P-102	WATER PIPING PLAN
	P-501	PLUMBING DETAILS & SCHEDULES

LIST OF DRAWINGS



Code Summary		
Code Requirement		2018 International Building Code (IBC)
Main Use Group(s)	[IBC] 312	Utility U
Automatic Sprinklers	[IBC] 903.2	No
Minimum Construction Classification	[IBC] 602	Type 3B
Floor Area		
- Area (Square Feet) per Floor Permitted - 'U' use	[IBC] T. 506.2	8,500 SF (Non-sprinkled, 'NS')
- Area (Square Feet) per Floor		
- First Floor Total Area ('U' use)		1,184 SF (Includes Atlemate 1)
Number of Stories		
- Stories Permitted - 'U'	[IBC] T. 504.4	2 Stories (Non-sprinkled, 'NS')
- Stories		1 Stories
Maximum Height		
- Max. Height (Ft.) Permitted - 'U'	[IBC] T. 504.3	55'-0" (Non-sprinkled, 'NS')
- Proposed. Height (Ft.)		16'-6"
Travel Distance	<i>[IBC]</i> T. 1017.2	
- 'U' use		300'-0" Maximum (Non-sprinkled)

#### **STATE OF MISSOURI MICHAEL L. PARSON,** GOVERNOR

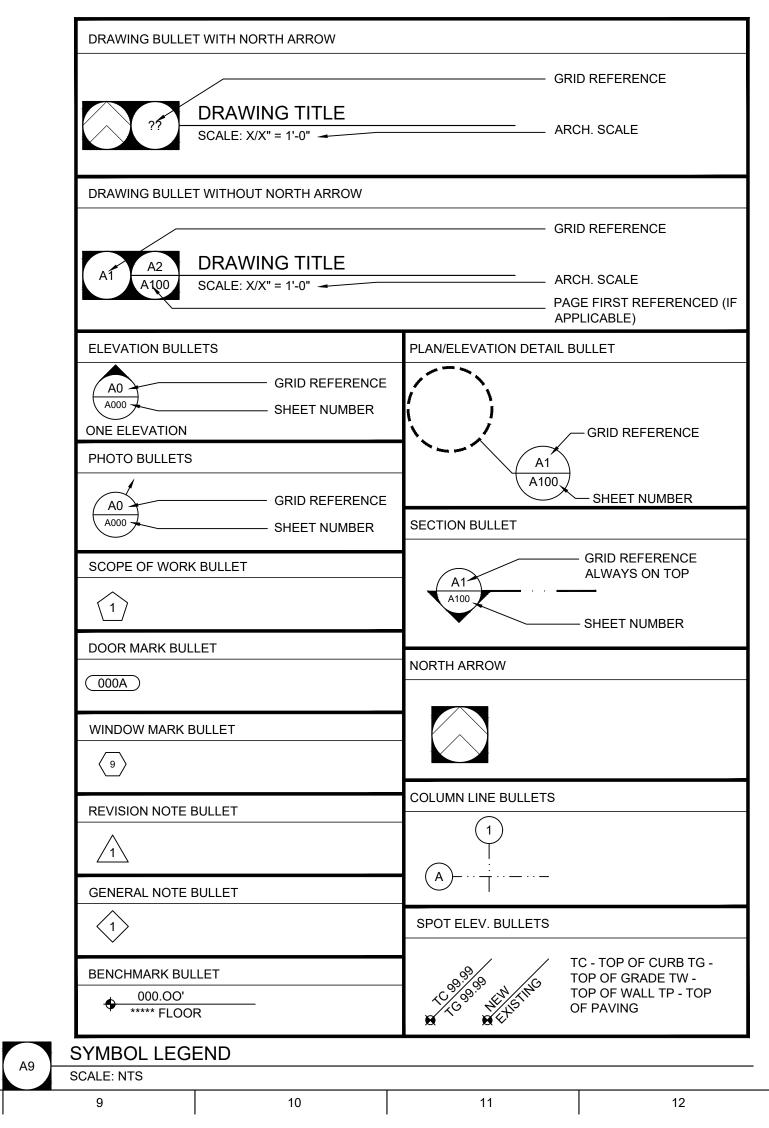



PWArchitects, Inc. 2120 Forum Blvd., Ste. 101 Columbia, Missouri 65203 PWArchitects.com | 573.449.2683 Peckham & Wright Architects an Architectural Corporatio Missouri State Certificate of Authority No. 000244

### **OFFICE OF** ADMINISTRATION **DIVISION OF FACILITIES** MANAGEMENT, **DESIGN AND** CONSTRUCTION

## NEW COMFORT STATION AT SWINE PAVILION

MISSOURI STATE FAIRGROUNDS (MSF) 2503 W. 16TH St. SEDALIA, MO

PROJECT # F2406-01 SITE # 1501 3511501037 ASSET #

REVISION:
DATE:
REVISION:
DATE:
REVISION:
DATE:
ISSUE DATE: 2024-10-18

CAD DWG FILE:G-10 DRAWN BY: CHECKED BY:

DESIGNED BY: ER SHEET TITLE:

LOCATION PLAN, LEGENDS, DRAWING INDEX, LIFE SAFETY

SHEET NUMBER:

[G-10]2 OF 33 SHEETS 2024-10-18

LARGE S	SCALE	SMALL S	SCALE
BRICK MASONRY UNIT			PLAN, SECTION ELEVATION
CONCRETE MASONRY UNIT			PLAN, SECTION ELEVATION
CONCRETE			PLAN, SECTION
GYPSUM BOARD			PLAN, SECTION
	••••		ELEVATION
GROUTED AREA OF: CMU/CAVITY/DOOR FRAME			PLAN, SECTION
MISCELLANEOUS ITEMS: AS NOTED ON EACH SHEET			PLAN, SECTION, ELEVATION
INSULATION			PLAN, SECTION
ROOF SHINGLES	╶╫ <del>┇╓</del> ╶╫ ┎╫╌╫╴╢╴╢╴╢		PLAN, ELEVATION
CONTINUOUS WOOD FRAMING			PLAN, SECTION
WOOD BLOCKING			PLAN, SECTION
PLYWOOD			PLAN, SECTION
EXISTING BUILDING			PLAN, SECTION

15

# MISSOURI STATE FAIRGROUNDS -**COMFORT STATION AT SWINE PAVILION**

## **PROJECT BENCHMARK:**

TBM #1 - CHISELED SQUARE AT THE SOUTHEAST CORNER OF THE EXISTING TRANSFORMER PAD LOCATED AT THE SOUTHEAST CORNER OF THE SWINE PAVILION ELEVATION = 884.90'

## FLOOD PLAIN STATEMENT:

NO PART OF THIS TRACT IS LOCATED WITHIN THE 500-YEAR FLOODPLAIN AS PER THE CITY OF SEDALIA FIRM MAP #2902830001C DATED 01/05/1996.

## UTILITY COMPANIES:

LOCATES:

MISSOURI ONE CALL INC. 1022 B NORTHEAST DRIVE JEFFERSON CITY, MO 65109 1-800-344-7483



SEDALIA WATER DEPARTMENT 111 WEST 4TH STREET SEDALIA, MO 65301 660-826-1234

WATER:

SANITARY SEWER: CITY OF SEDALIA 200 SOUTH OSAGE AVE. SEDALIA, MO 65301 660-827-3000

ELECTRIC: MISSOURI STATE FAIRGROUNDS CONTRACTOR 660-530-5617

TELEPHONE: CHARTER COMMUNICATIONS 210 W. 7TH STREET SEDALIA, MO 65301 866-874-2398

NATURAL GAS: LIBERTY UTILITIES 602 S JOPLIN AVE JOPLIN, MO 64801 1-800-424-0427

CABLE TELEVISION:

AT&T 5903 E. RED BRIDGE ROAD KANSAS CITY, MO 64134 877-219-3898

# SEDALIA, PETTIS COUNTY, MISSOURI

## **GENERAL NOTES:**

ALL STREET, STORM DRAIN, AND SANITARY SEWER CONSTRUCTION TO BE IN ACCORDANCE WITH THE CITY OF SEDALIA AND MISSOURI STATE FAIRGROUND'S GUIDANCE AND SPECIFICATIONS.

CONTRACTOR WILL BE RESPONSIBLE FOR PLACEMENT AND MAINTENANCE OF TRAFFIC CONTROL DEVICES NECESSARY TO COMPLETE THEIR PORTION OF WORK. THE DEVICES AND METHODS EMPLOYED WILL COMPLY WITH THE CURRENT VERSION OF THE MANUAL ON UNIFORM TRAFFIC CONTROL DEVICES.

EXISTING UTILITIES SHOWN FOR REFERENCE ONLY. CONTRACTOR SHALL COORDINATE LOCATES (HORIZONTAL AND VERTICAL) PRIOR TO ANY EXCAVATION.

ALL EXCAVATION TO BE IN ACCORDANCE WITH SECTIONS 319.010-319.050, REVISED STATUTES OF THE STATE OF MISSOURI. SUCH COMPLIANCE SHALL NOT, HOWEVER, EXCUSE ANY PERSON MAKING ANY EXCAVATION FROM DOING SO IN A CAREFUL AND PRUDENT MANNER, NOR SHALL IT EXCUSE SUCH PERSON FROM LIABILITY FOR ANY DAMAGE OR INJURY TO UNDERGROUND UTILITIES RESULTING FROM THE EXCAVATION.

A GEOTECHNICAL EVALUATION HAS BEEN PERFORMED BY CROCKETT GEOTECHNICAL TESTING LAB (GTL). REFER TO REPORT NUMBER G241077 DATED JUNE 27TH, 2024 BY CROCKETT GTL.

ALL SLOPES ARE 3:1 OR FLATTER UNLESS OTHERWISE NOTED.

IT IS THE INTENT OF THESE PLANS TO COMPLY WITH THE REQUIREMENTS OF THE MODNR CLEAN WATER COMMISSION.

THE CONTRACTOR IS RESPONSIBLE FOR MAINTAINING ALL EROSION CONTROL DEVICES AND REMOVING THEM ONCE THE SITE IS STABILIZED.

CONTRACTOR TO FINE-GRADE, SEED, AND MULCH ALL DISTURBED AREAS WITHIN THE LIMITS OF DISTURBANCE

ALL SERVICE LATERALS SHALL BE INSTALLED AT 1.0% (MIN.) GRADE.

ALL EXCAVATION WITHIN 10' OF THE STREET PAVEMENT SHALL BE BACKFILLED WITH GRANULAR MATERIAL. REFER TO PIPE EMBEDMENT DETAILS.

ALL SEWERLINES SHALL BE CONSTRUCTED AT LEAST 10 FEET HORIZONTALLY. EDGE TO EDGE, FROM ANY WATERLINE AND AT LEAST 24 INCHES VERTICALLY BETWEEN THE OUTSIDE LIMITS OF THE SANITARY SEWER AND WATERLINE. FOR CONDITIONS OTHER THAN THOSE IDENTIFIED ABOVE, CONTACT THE ENGINEER FOR SPECIFIC INSTRUCTIONS.

ALL HDPE PIPE SHALL BE INSTALLED PER MANUFACTURER'S RECOMMENDATIONS. REFER TO DETAIL FOR PIPE BEDDING REQUIREMENTS.

LAND DISTURBANCE SITES SHOULD BE INSPECTED ON A REGULAR SCHEDULE AND WITHIN A REASONABLE TIME PERIOD (NOT TO EXCEED 48 HOURS) FOLLOWING HEAVY RAINS. REGULARLY SCHEDULED INSPECTIONS SHALL BE AT A MINIMUM OF ONCE PER WEEK. ANY DEFICIENCIES SHALL BE NOTED IN A WEEKLY REPORT OF THE INSPECTION AND CORRECTED WITHIN SEVEN CALENDAR DAYS OF THE REPORT.

ALL UTILITY LINES SHALL BE BACKFILLED W/ GRANULAR AND COMPACTED EARTH BACKFILL.

ESTIMATED AREA OF DISTURBANCE IS 0.40 ACRES.

MISSOURI DNR LAND DISTURBANCE PERMIT NOT REQUIRED.

## LEGEND OF SYMBOLS:

· >·

= = = = = EXISTING CURB

	EXISTING CURB	
	PROPOSED CURB	(
	RIP RAP	(
63	EXISTING STRUCTURE	(
$\sim$	EXISTING TREELINE	(
$\sim$	PROPOSED TREELINE	
000	EDGE OF WATERWAY	
— — w — —	EXISTING WATERLINE	
w	PROPOSED WATERLINE	
—— G ——	EXISTING GAS LINE	
G	PROPOSED GAS LINE	
— — — UT — — —	EXISTING UNDERGROUND TELEPHONE	
— — — UTV — — —	EXISTING UNDERGROUND CABLE TELEVISION	
— — – HVE – — —	EXISTING HIGH VOLTAGE ELECTRIC	
—— OE ——	EXISTING OVERHEAD ELECTRIC	
— — —UE — — —	EXISTING UNDERGROUND ELECTRIC	
——————————————————————————————————————	EXISTING OVERHEAD ELEC. & TV	
— — OETVT — —	EXISTING OVERHEAD ELEC., TV & TELE.	
—— s ——	EXISTING SANITARY SEWER	
S	PROPOSED SANITARY SEWER	
	EXISTING MINOR CONTOUR	
<b>B</b>	EXISTING MAJOR CONTOUR	
	PROPOSED MINOR CONTOUR	
<b>B</b>	PROPOSED MAJOR CONTOUR	
	100 YEAR FLOOD PLAIN	
+++++++++++++++++++++++++++++++++++++++	FLOODWAY	
	ORDINARY HIGH WATER MARK	
	STREAM SIDE BUFFER	
	OUTER STREAM BUFFER	
$\gg \cdot  \gg \cdot  \gg \cdot$	SWALE	

FF=XXX.X FINISH FLOOR OF STRUCTURE (XXX.XX TC (XXX.XX TP) (XXX.XX FG) (XXX.XX TW) XX LOT NUMBER  $\langle X \rangle$ ( X ) H.P. HIGH POINT LOW POINT -0 W MANHOLE \_\_\_\_ (TB AC ET

PROPOSED TOP OF CURB ELEVATION PROPOSED TOP OF PAVEMENT ELEVATION PROPOSED FINISH GRADE ELEVATION PROPOSED TOP OF WALL STORM SEWER STRUCTURE LABEL SANITARY SEWER STRUCTURE LABEL EXISTING SIGNS EXISTING POWER POLE EXISTING GAS VALVE EXISTING WATER VALVE EXISTING GAS METER EXISTING WATER METER EXISTING FIRE HYDRANT EXISTING SANITARY SEWER LATERAL PROPOSED SANITARY SEWER LATERAL PROPOSED TRACER WIRE TEST STATION BOX

EXISTING AIR CONDITIONER EXISTING TELEPHONE PEDESTAL EXISTING ELECTRICAL TRANSFORMER EXISTING ELECTRIC METER

EXISTING LIGHT POLE

EXISTING GUY WIRE



KYLE R. MILLER MO LICENSE-2017019013

PWArchitects, Inc.

Columbia, Missouri 65203 PWArchitects.com | 573.449.2683 . Missouri State Certificate of Authority No. 000244

ENGINEERING CONSULTANTS 1000 W. Nifong Blvd., Bldg. 1 Columbia, Missouri 65203 (573) 447-0292

## MICHAEL L. PARSON, GOVERNOR

**STATE OF MISSOURI** 

www.crockettengineering.com Crockett Engineering Consultants, LLC Missouri Certificate of Authority #2000151301

**OFFICE OF ADMINISTRATION DIVISION OF FACILITIES** MANAGEMENT, **DESIGN AND** CONSTRUCTION

## NEW COMFORT STATION AT SWINE PAVILION

MISSOURI STATE FAIRGROUNDS (MSF) 2503 W. 16TH St. SEDALIA, MO

PROJECT # F2406-01 SITE # 1501 3511501037 ASSET #


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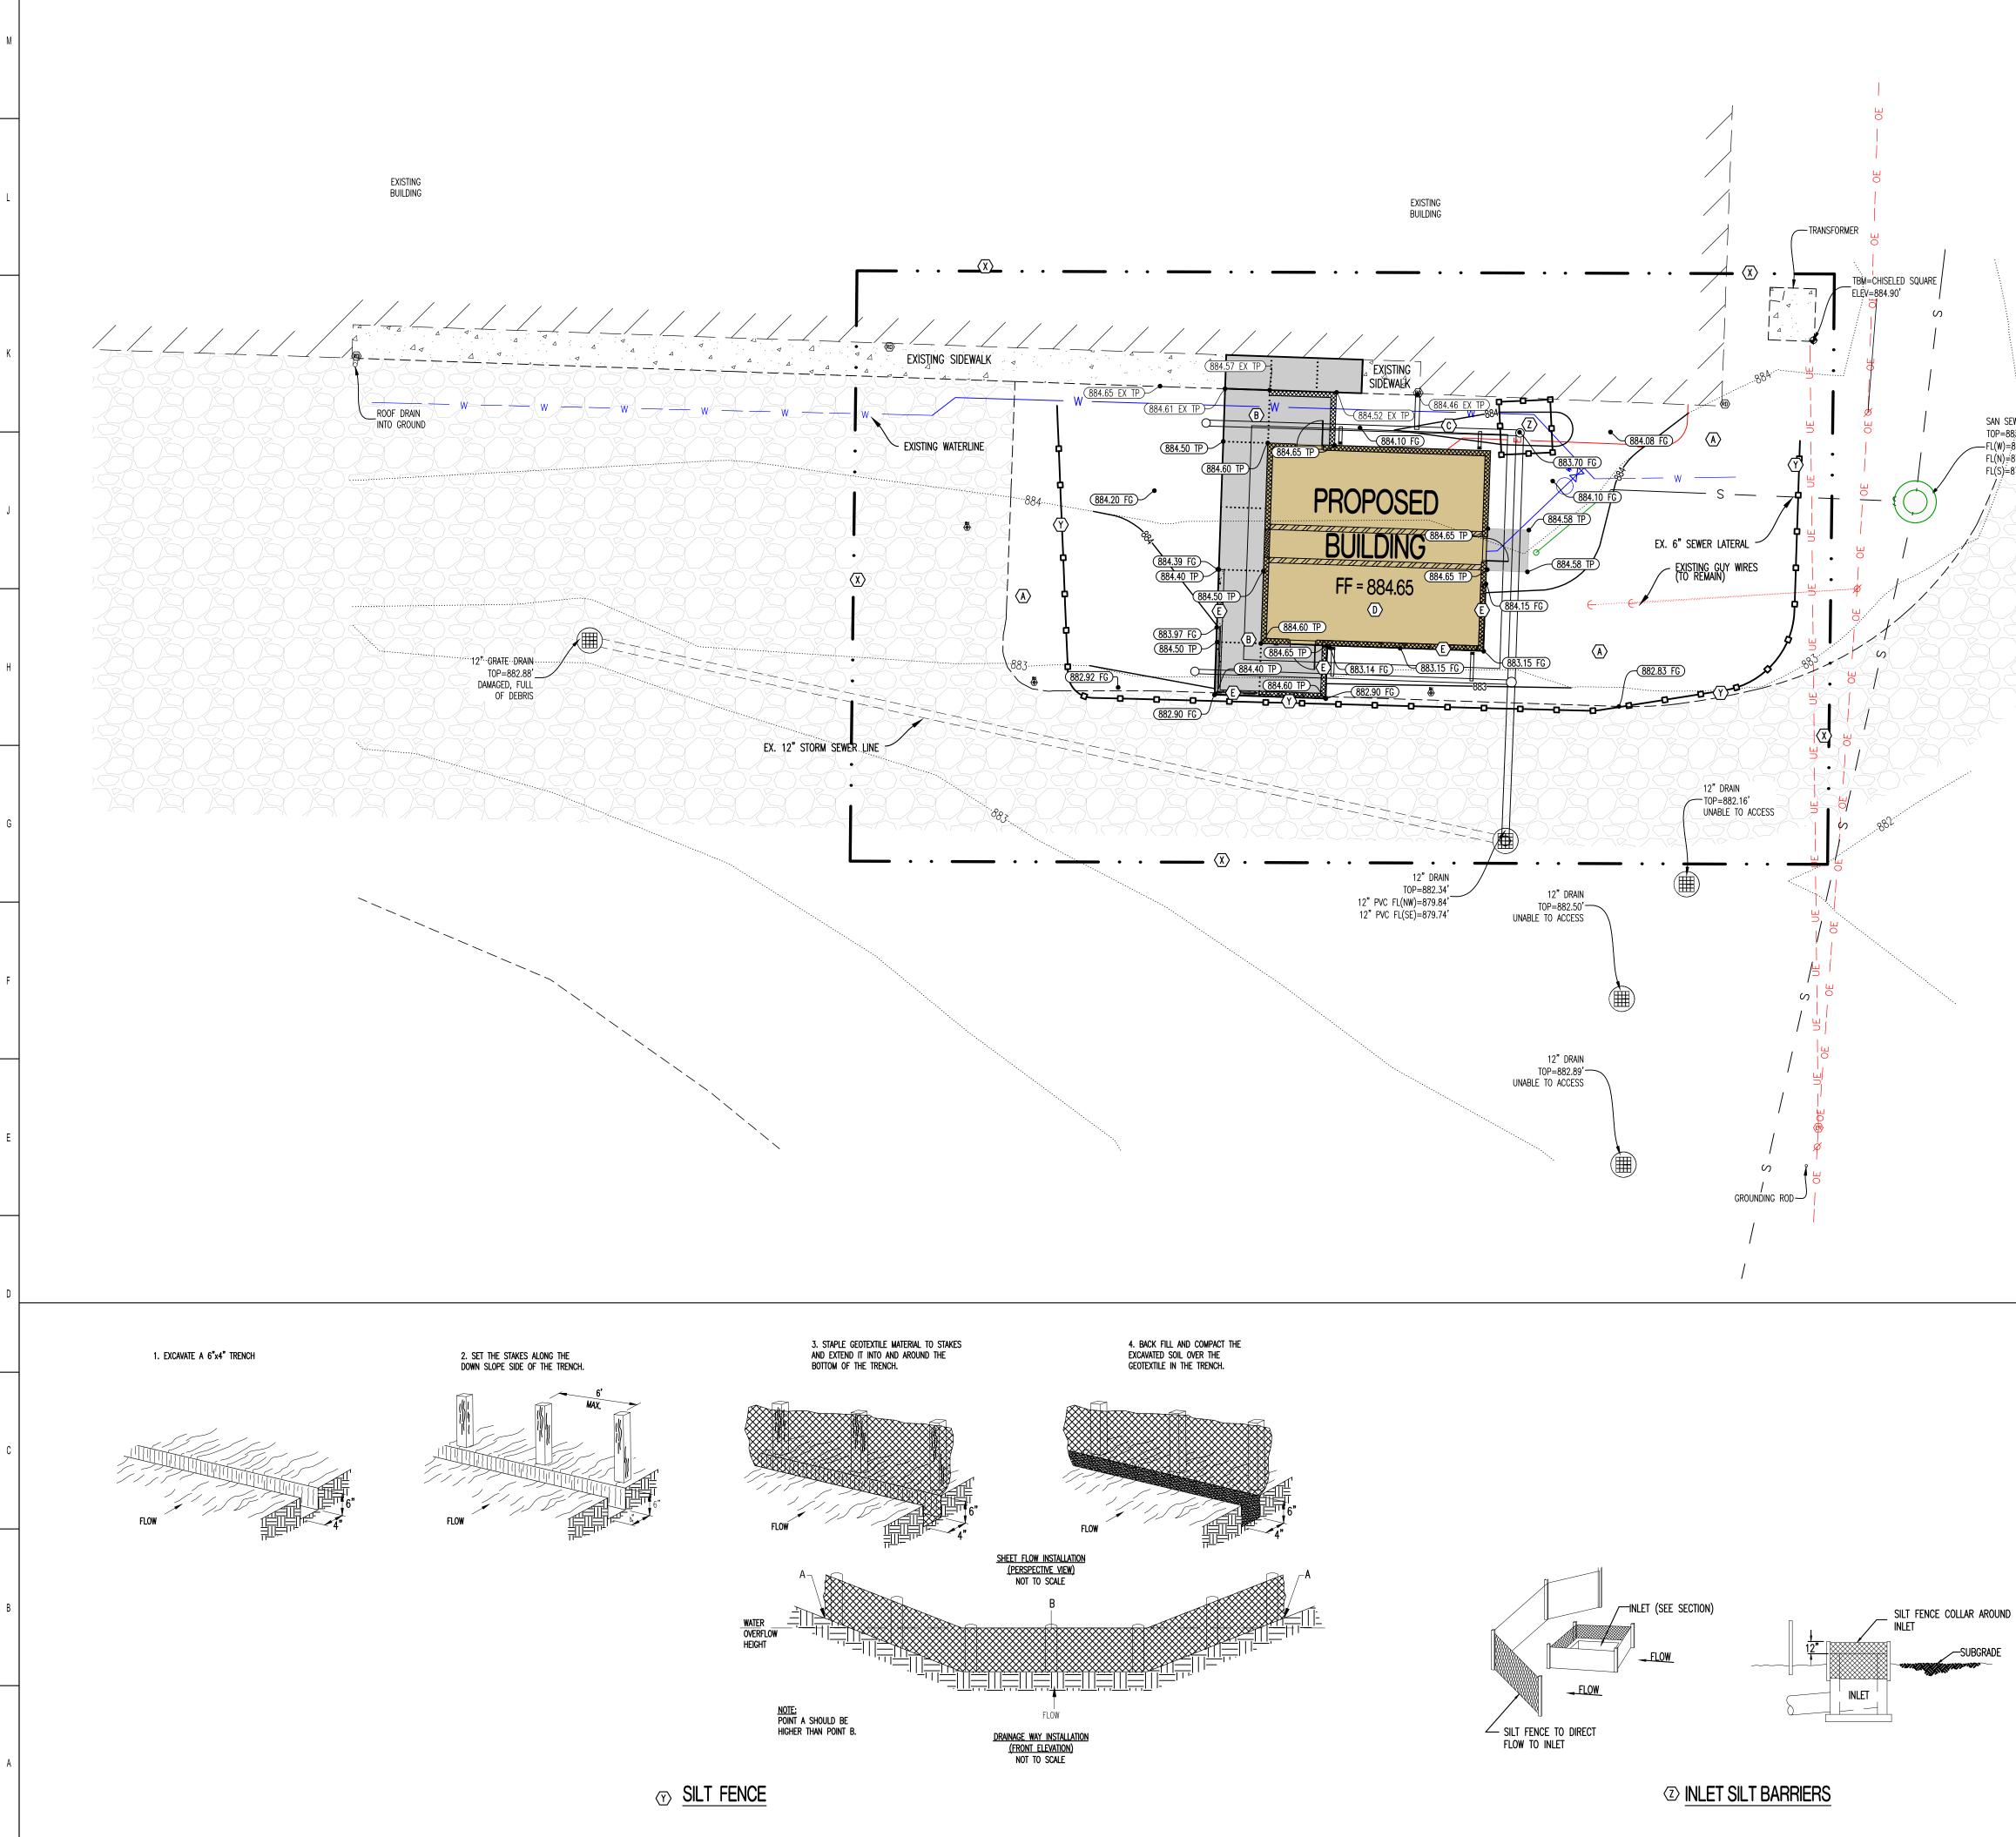
SHEET TITLE: CIVIL PLAN COVER SHEET

SHEET NUMBER:

3 OF 33 SHEETS 2024-10-18



	STATE OF MISSOURI MICHAEL L. PARSON, GOVERNOR
SCALE: $1''=10'$ 5 = 10 = 20	<image/> <section-header><text><section-header><text><text><text><text></text></text></text></text></section-header></text></section-header>
	ENGINEERING CONSULTANTS 1000 W. Nifong Blvd., Bldg. 1 Columbia, Missouri 65203 (573) 447-0292 www.crockettengineering.com Crockett Engineering Consultants, LLC Missouri Certificate of Authority #2000151301
LABELS CT 5" THICK, REINFORCED, CONCRETE SIDEWALK WITH DIMENSIONS AS SHOWN. REFER TO SHEET C-102 " ELEVATIONS. REFER TO CONCRETE CROSS-SECTIONS ON C-104. ALL CONCRETE TO BE ADA T. (MAXIMUM SLOPE OF THE PAVEMENT SHALL NOT EXCEED 1:50 IN ALL DIRECTIONS. ). CONTRACTOR RE ALL NEW PAVEMENT HAS STORMWATER RUNOFF THAT FLOWS AWAY FROM BUILDING. " EXPANSION JOINT. BETWEEN EXISTING CONCRETE AND NEW CONCRETE. " EXPANSION JOINT BETWEEN NEW CONCRETE AND BUILDING FOUNDATION. D NEW COMFORT STATION BUILDING. REFER TO ARCHITECTURAL PLANS FOR BUILDING DETAILS AND AL PLANS FOR FOUNDATION AND LVC INFORMATION.	OFFICE OF ADMINISTRATION DIVISION OF FACILITIES MANAGEMENT, DESIGN AND CONSTRUCTION
TEM WALL ALONG SOUTH PORTION OF BUILDING. SEE SHEET C-102 FOR ELEVATIONS AND STRUCTURAL ETS FOR DETAILS. 'X5' PAD OUTSIDE OF EAST DOOR. REFER TO CONCRETE CROSS SECTION ON C-104. OR TO CONNECT NEW CONCRETE BY DOWELING INTO EXISTING CONCRETE SIDEWALK USING 18" LONG ON 18" CENTERS. SEE CONSTRUCTION JOINT DETAIL ON C-104.	NEW COMFORT STATION AT SWINE PAVILION
D APPROXIMATELY 85' OF WATER LINE AROUND BUILDING AS SHOWN WITH BENDS. CONTRACTOR TO ID USE SAME SIZE LINE. MATER METER PIT, ADD A 2.5"x2.5" TEE FOR CONNECTION, & APPROPRIATE HOSE BIBB WITH VALVE TO TO DRAIN WATERLINE. ALSO ADD A 2.5" VALVE ON THE INCOMING SIDE OF THE LINE TO PROVIDE FEATURE IF SUCH VALVE IS NOT ADDED AT THE CONNECTION. WATER TO GRAVITY DRAIN INTO PIT. EE CONNECTION WITH GATE VALVE IN BOX TO SURFACE AND EXTEND 2.5" WATERLINE FROM RELOCATED	MISSOURI STATE FAIRGROUNDS (MSF) 2503 W. 16TH St. SEDALIA, MO
2' OF 4" SANITARY SEWER LATERAL. LATERAL TO BE INSTALLED AT 1% MIN. GRADE. CONNECT TO ATERAL AS SHOWN. "STANDARD SANITARY SEWER CLEANOUT 6' OUTSIDE OF PROPOSED BUILDING. FLOWLINE AT CLEANOUT "BELOW FINISHED GRADE	PROJECT # F2406-01 SITE # 1501 ASSET # 3511501146
D ELECTRICAL ROUTE. REFER TO MEP PLANS FOR MORE DETAILS. CONTRACTOR TO INSTALL 1-1/4" FOR ELECTRIC SERVICE. " DOWNSPOUT PIPE TO CONNECTOR STORM PIPE. " ROOF DRAIN DOWNSPOUT PIPE FROM SWINE BUILDING AND WYE INTO CONNECTOR STORM PIPE. PROPOSE STORM SEWER LINE INTO EXISTING STORM DRAIN. CORE FOR CONNECTION AND GROUT CLOSED.	REVISION: DATE: REVISION: DATE: REVISION: DATE: DATE: ISSUE DATE: 2024-10-18
D STORM SEWER LINE. REFER TO SHEET C-103 FOR PROFILE AND DETAILS. EDESTRIAN GUARDRAIL ON TOP OF WALL. REFER TO ARCHITECTURAL DRAWINGS FOR RAIL INFORMATION.	CAD DWG FILE:C-101 DRAWN BY: <u>KM</u> CHECKED BY: <u>TC</u> DESIGNED BY: <u>KM</u>
G UTILITIES SHOWN FOR REFERENCE ONLY. CONTRACTOR SHALL COORDINATE LOCATES (HORIZONTAL RTICAL) PRIOR TO ANY EXCAVATION. HE RESPONSIBILITY OF THE CONTRACTOR TO ACQUIRE ALL EXISTING UTILITY LOCATES PRIOR TO JCTION. IT IS THE RESPONSIBILITY OF THE CONTRACTOR TO RESTORE ANY DAMAGED OR BROKEN TO ORIGINAL OR BETTER CONDITION.	SHEET TITLE: DEMOLITION,SITE & UTILITY PLAN
LITY LINES SHALL BE BACKFILLED WITH GRANULAR AND COMPACTED EARTH BACKFILL. VEMENT JOINTS SHOWN ARE A GRAPHICAL REPRESENTATION OF A POSSIBLE JOINT CONTRACTOR TO PROVIDE SHOP DRAWINGS WITH JOINT LAYOUT FOR APPROVAL GINEER PRIOR TO POURING OF PAVEMENT.	SHEET NUMBER:
WNSPOUTS TO BE CONNECTED TO STORMWATER COLLECTOR UNDER DRAINS. $\frac{1}{2}$ " EXPANSION JOINT WITH REMOVABLE CAULK STRIP ANYWHERE CONCRETE PAVING OR SIDEWLAK BUILDING. PROVIDE LIMESTONE COLOR ELASTOMERIC JOINT SEALANT	<b>C-101</b> 4 OF 33 SHEETS 2024-10-18

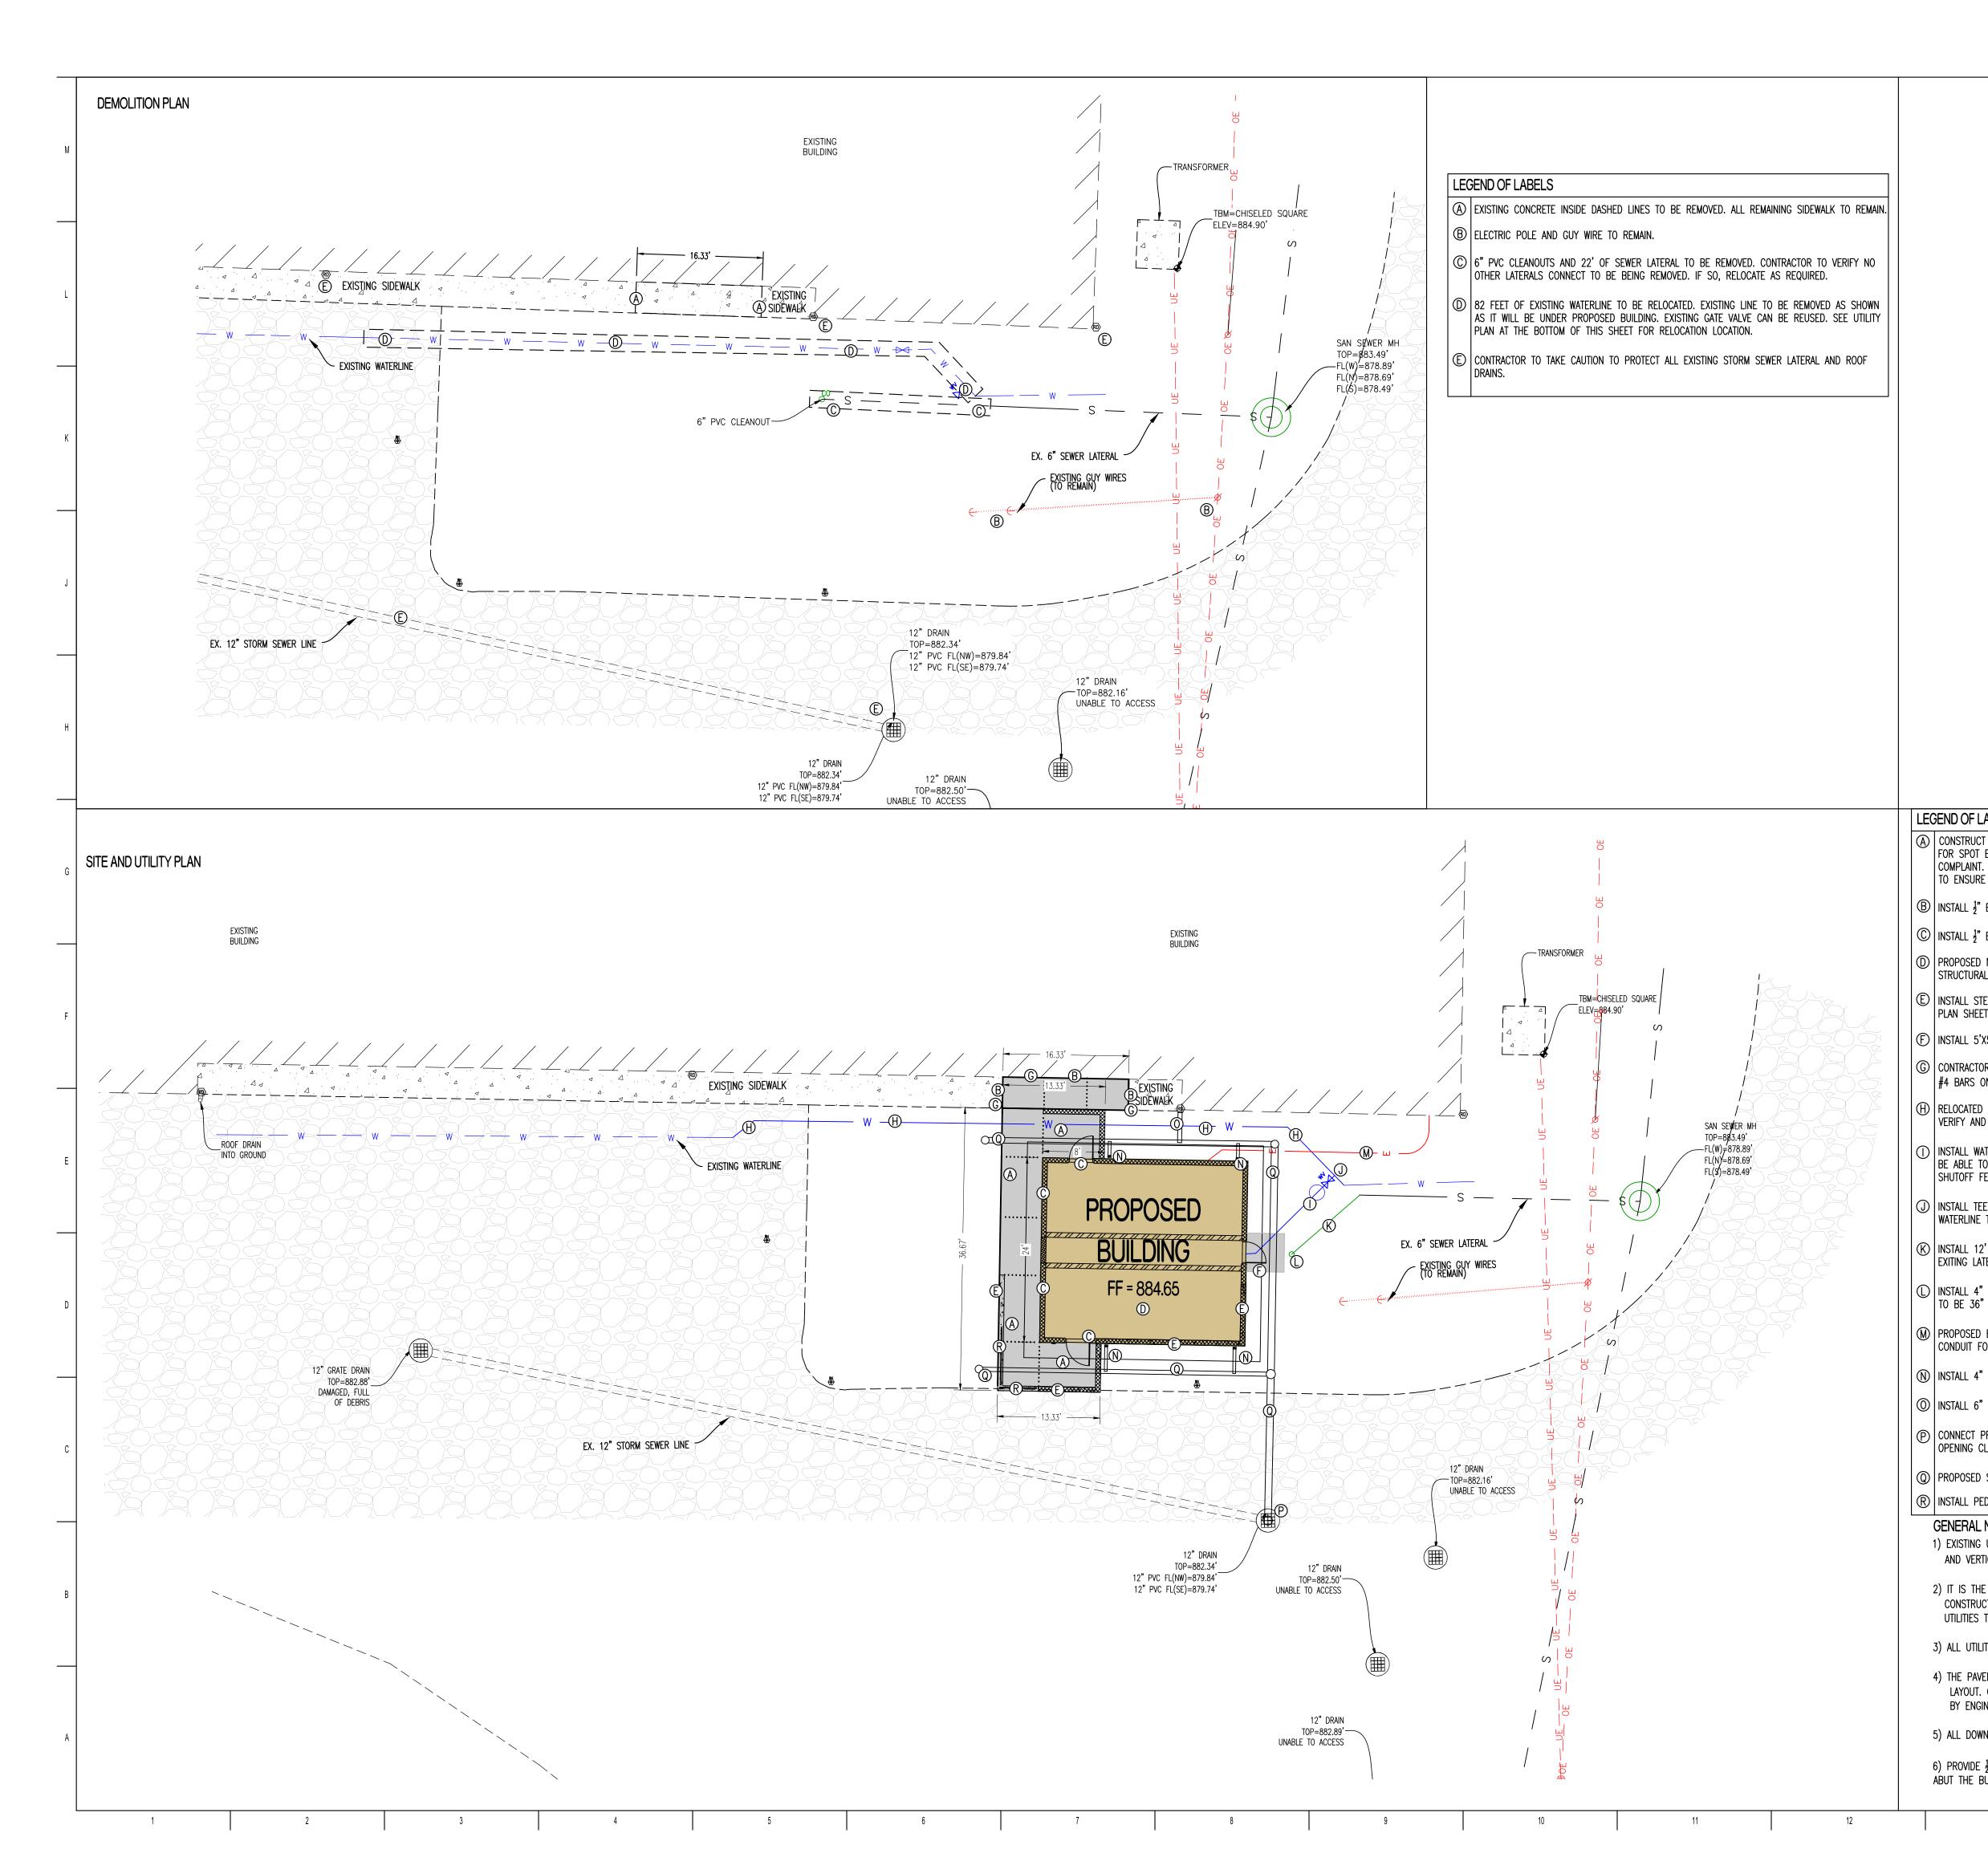

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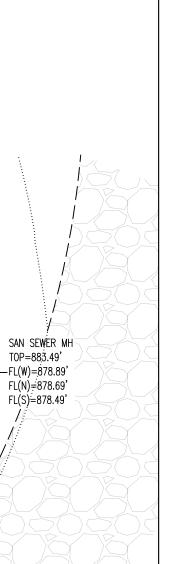
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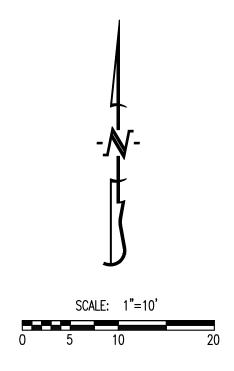
11

12

13

10





#### **GRADING - LEGEND OF SYMBOLS:**

······XXX ······	EXISTING MINOR CONTOUR
— — — XXX— — —	EXISTING MAJOR CONTOUR
XXX	PROPOSED MINOR CONTOUR
XXX	PROPOSED MAJOR CONTOUR
FF=XXX.X	FINISHED FLOOR OF STRUCTURE
(XXX.XX TP)	PROPOSED TOP OF PAVEMENT ELEVATION
(XXX.XX FG)	PROPOSED FINISH GRADE ELEVATION
XXX.XX FF	PROPOSED FINISH FLOOR AT DOOR
(XXX.XX TW)	PROPOSED FINISHED GRADE AT TOP OF WALL
(XXX.XX EX TP)	EXISTING TOP OF PAVEMENT ELEVATION

#### GRADING - LEGEND OF LABELS

- FINE GRADE AS SHOWN BY PROPOSED CONTOURS. PLACE MINIMUM OF 6" TOP SOIL. INSTALL PAVEMENT WITH GRADES AS SHOWN TO MEET ADA COMPLIANCE.
- GRADE ADJACENT SIDE YARD WITH SMALL SWALE TO DRAIN WATER AWAY FROM BUILDING AND TO INLET.
- REFER TO STRUCTURAL DETAILS FOR LVC MATERIAL
- INSTALL STEM WALL ALONG SOUTH SIDE OF BUILDING AS SHOWN. SEE STRUCTURAL DETAILS FOR WALL INFORMATION.

#### **GRADING - GENERAL NOTES**

- 1) FINISHED GRADE OUTSIDE OF BUILDING TO BE 6" BELOW FINISHED FLOOR ELEVATION.
- 2) ALL PAVEMENT TO BE ADA COMPLAINT(SLOPE OF THE PAVEMENT AT ALL ACCESSIBLE PARKING STALLS SHALL NOT EXCEED 1:50 IN ALL DIRECTIONS.)
- 3) ALL STORMWATER RUNOFF TO BE GRADES TO FLOW AWAY FROM BUILDING AND DIRECTED TO THE SOUTH.

#### EROSION CONTROL - LEGEND OF SYMBOLS:

$\langle X \rangle$	—	•	•	
$\langle \mathbf{Y} \rangle$	-0		-0	SILT FENCE

#### EROSION CONTROL - LEGEND OF LABELS

$\boxtimes$	PROJECT'S LIMITS OF DISTURBANCE. ESTIMATED AREA OF DISTURBANCE IS 0.40 ACRES.
$\heartsuit$	INSTALL SILT FENCE AS SHOWN. REFER TO DETAIL ON THIS SHEET.
	WRAP SILT FENCE AROUND INLET FOR INLET PROTECTION AS SHOWN. REFER TO DETAIL ON

15

THIS SHEET.

14

STATE OF MISSOURI MICHAEL L. PARSON, GOVERNOR



KYLE R. MILLER MO LICENSE-2017019013



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Peckham & Wright Architects an Architectural C Missouri State Certificate of Authority No. 000244

## ENGINEERING CONSULTANTS 1000 W. Nifong Blvd., Bldg. 1 Columbia, Missouri 65203 (573) 447–0292 www.crockettengineering.com

Crockett Engineering Consultants, LLC Missouri Certificate of Authority #2000151301

#### **OFFICE OF** ADMINISTRATION **DIVISION OF FACILITIES** MANAGEMENT, **DESIGN AND** CONSTRUCTION

## NEW COMFORT STATION AT SWINE PAVILION

MISSOURI STATE FAIRGROUNDS (MSF) 2503 W. 16TH St. SEDALIA, MO

PROJECT # F2406-01 1501 SITE # ASSET # 3511501146

#### **REVISION:** DATE: **REVISION**: DATE: **REVISION**: DATE:

ISSUE DATE: 2024-10-18


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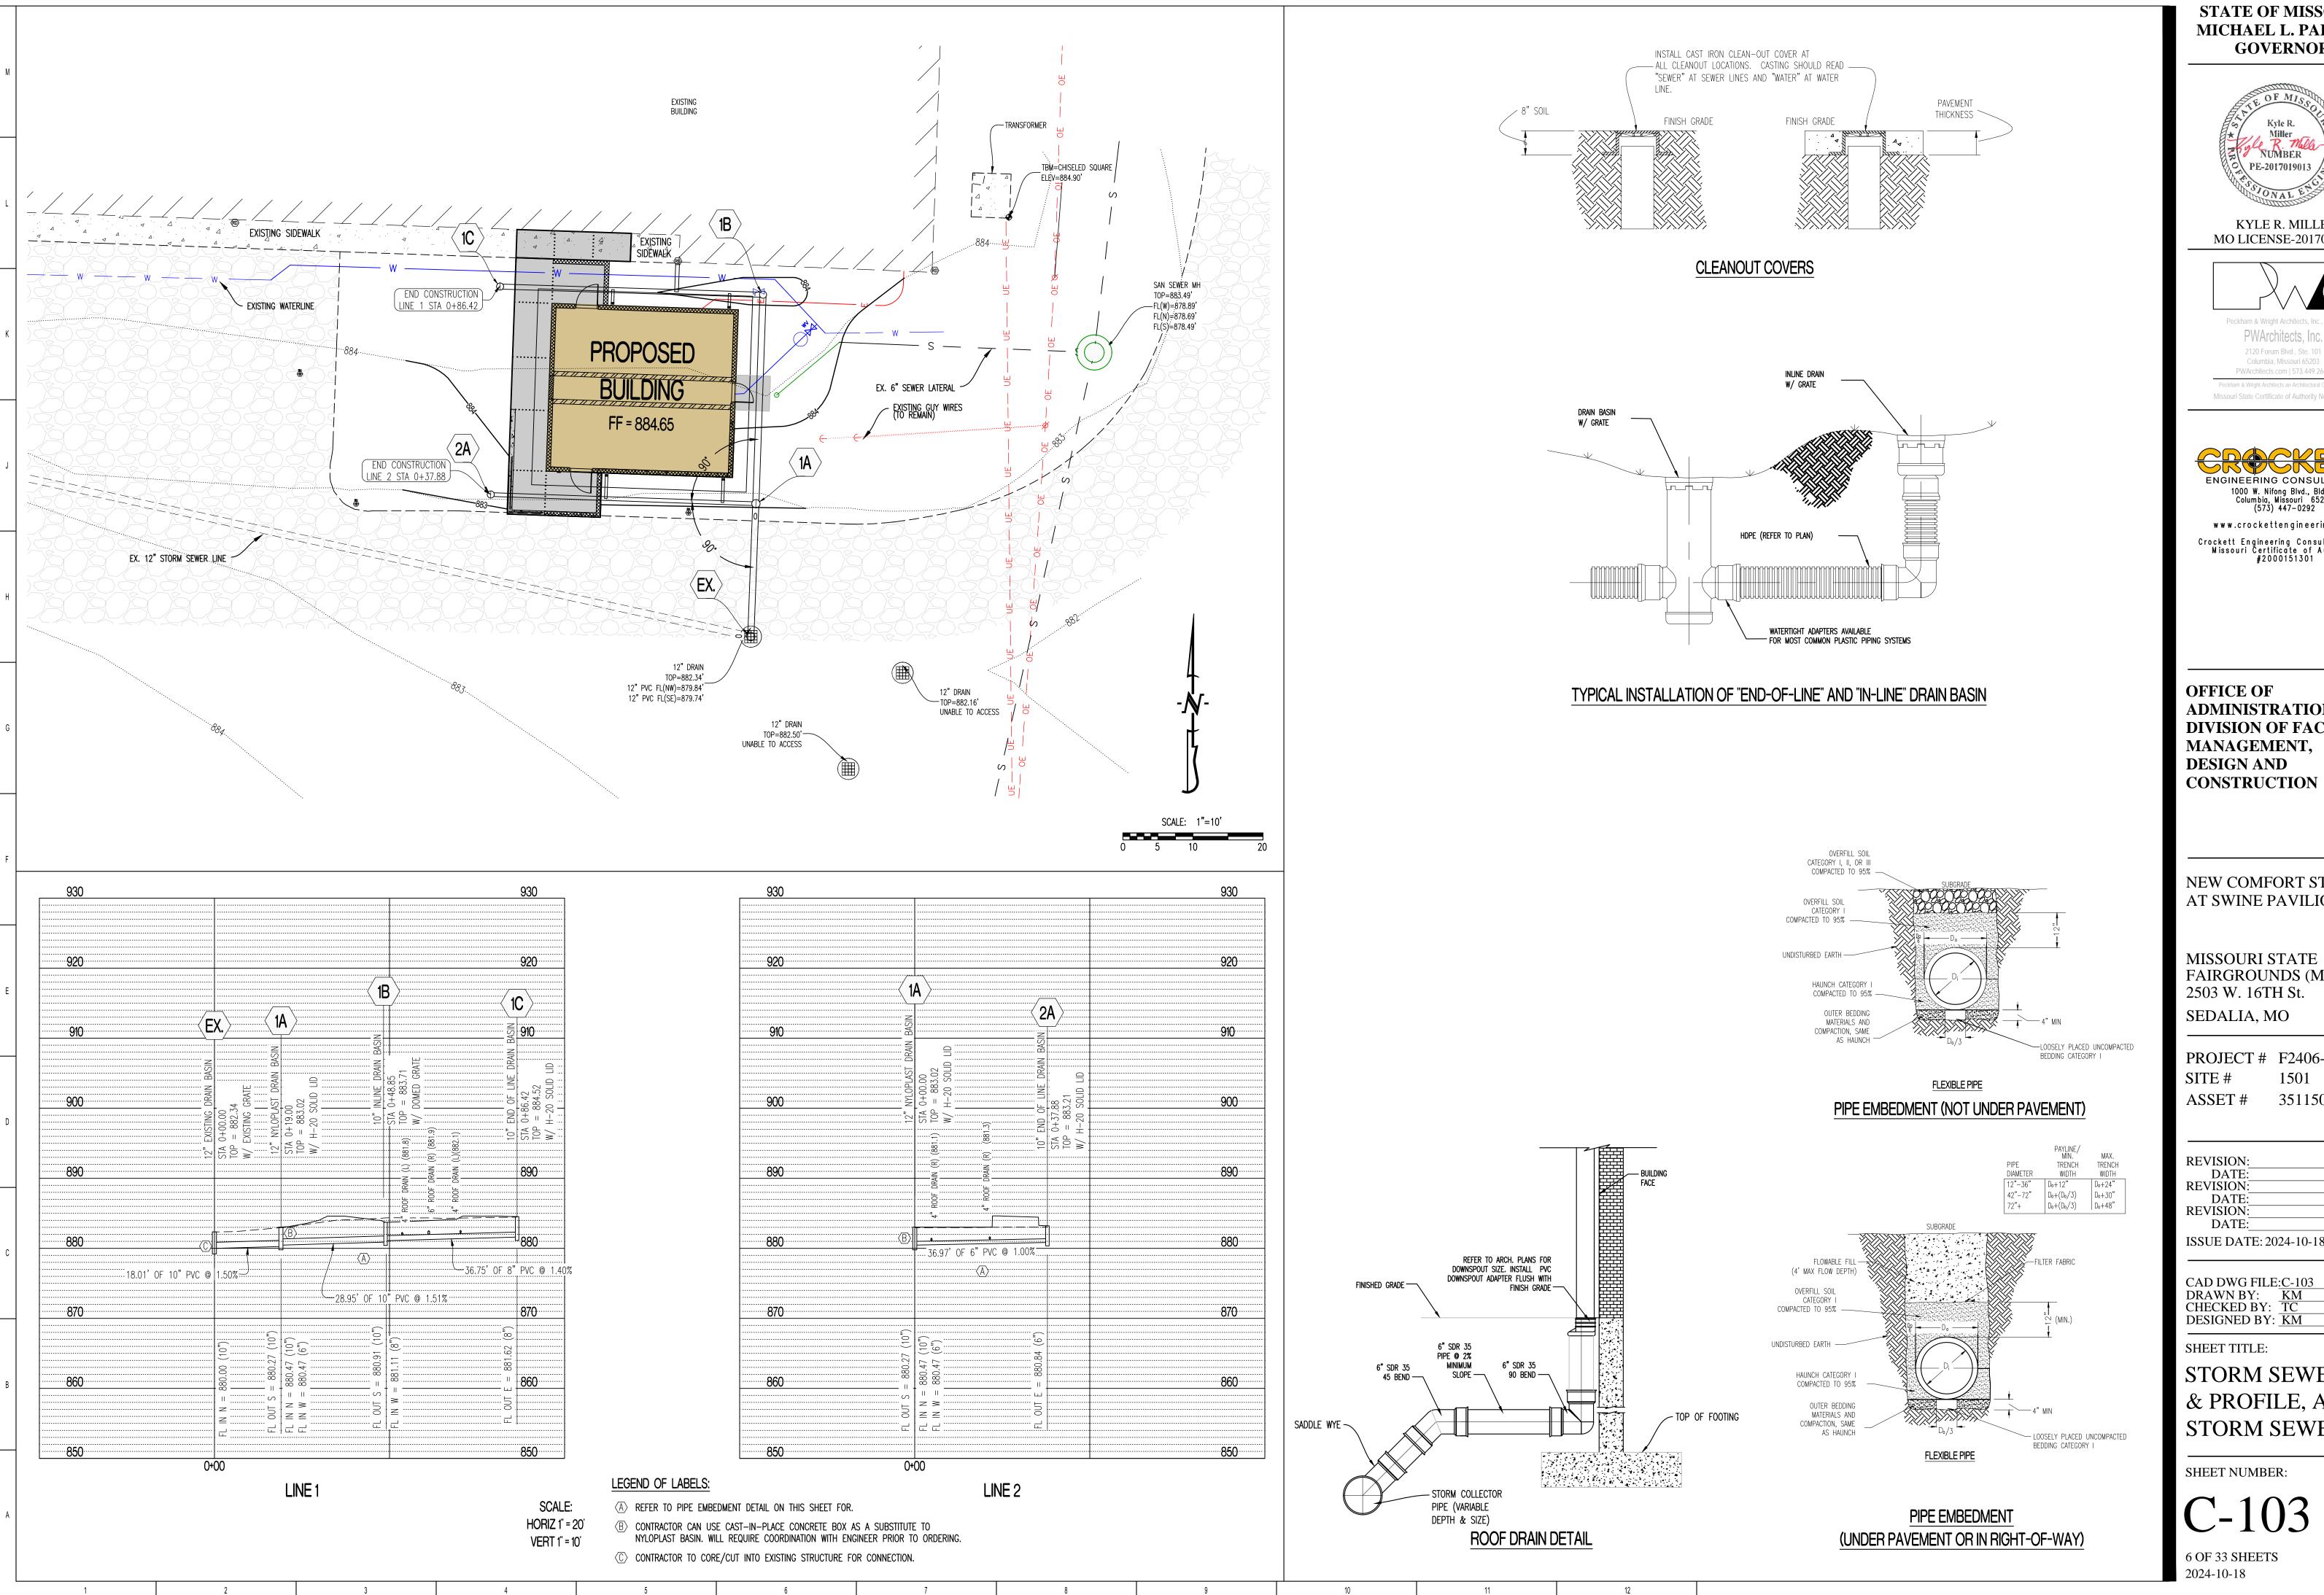
## SHEET TITLE:


EROSION CONTROL & **GRADING PLAN** 


#### SHEET NUMBER:

C-102 5 OF 33 SHEETS 2024-10-18



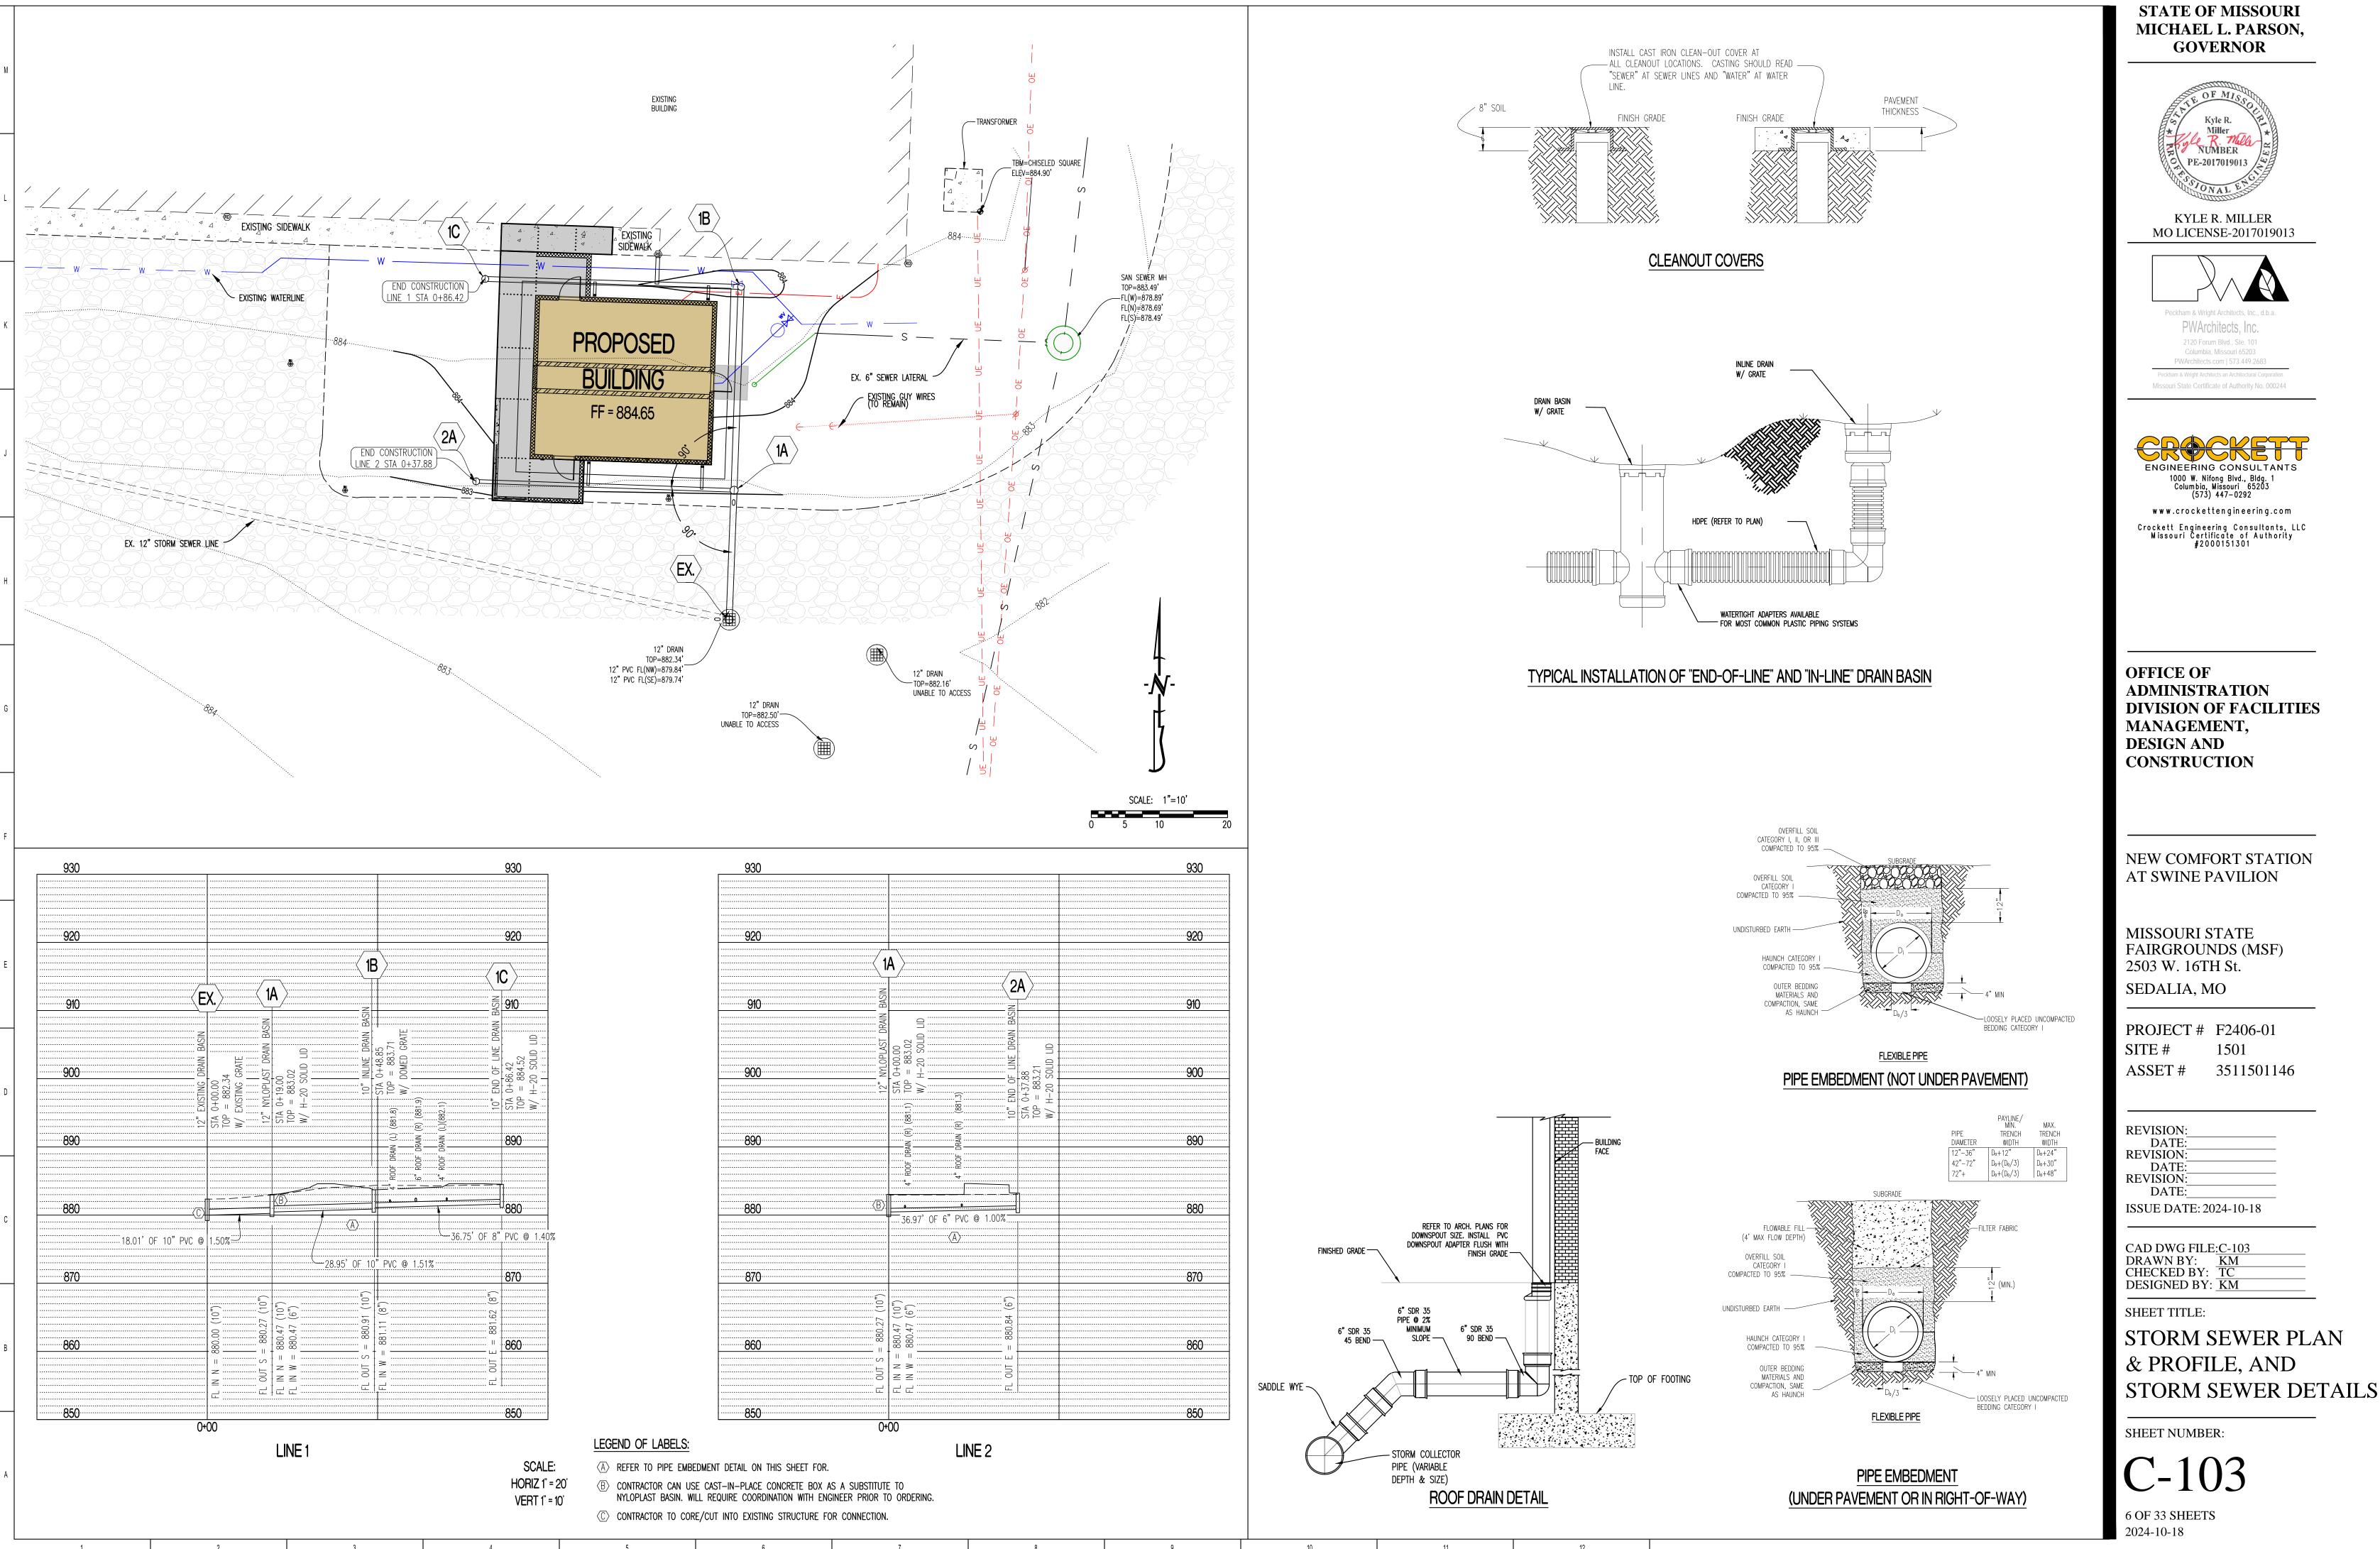

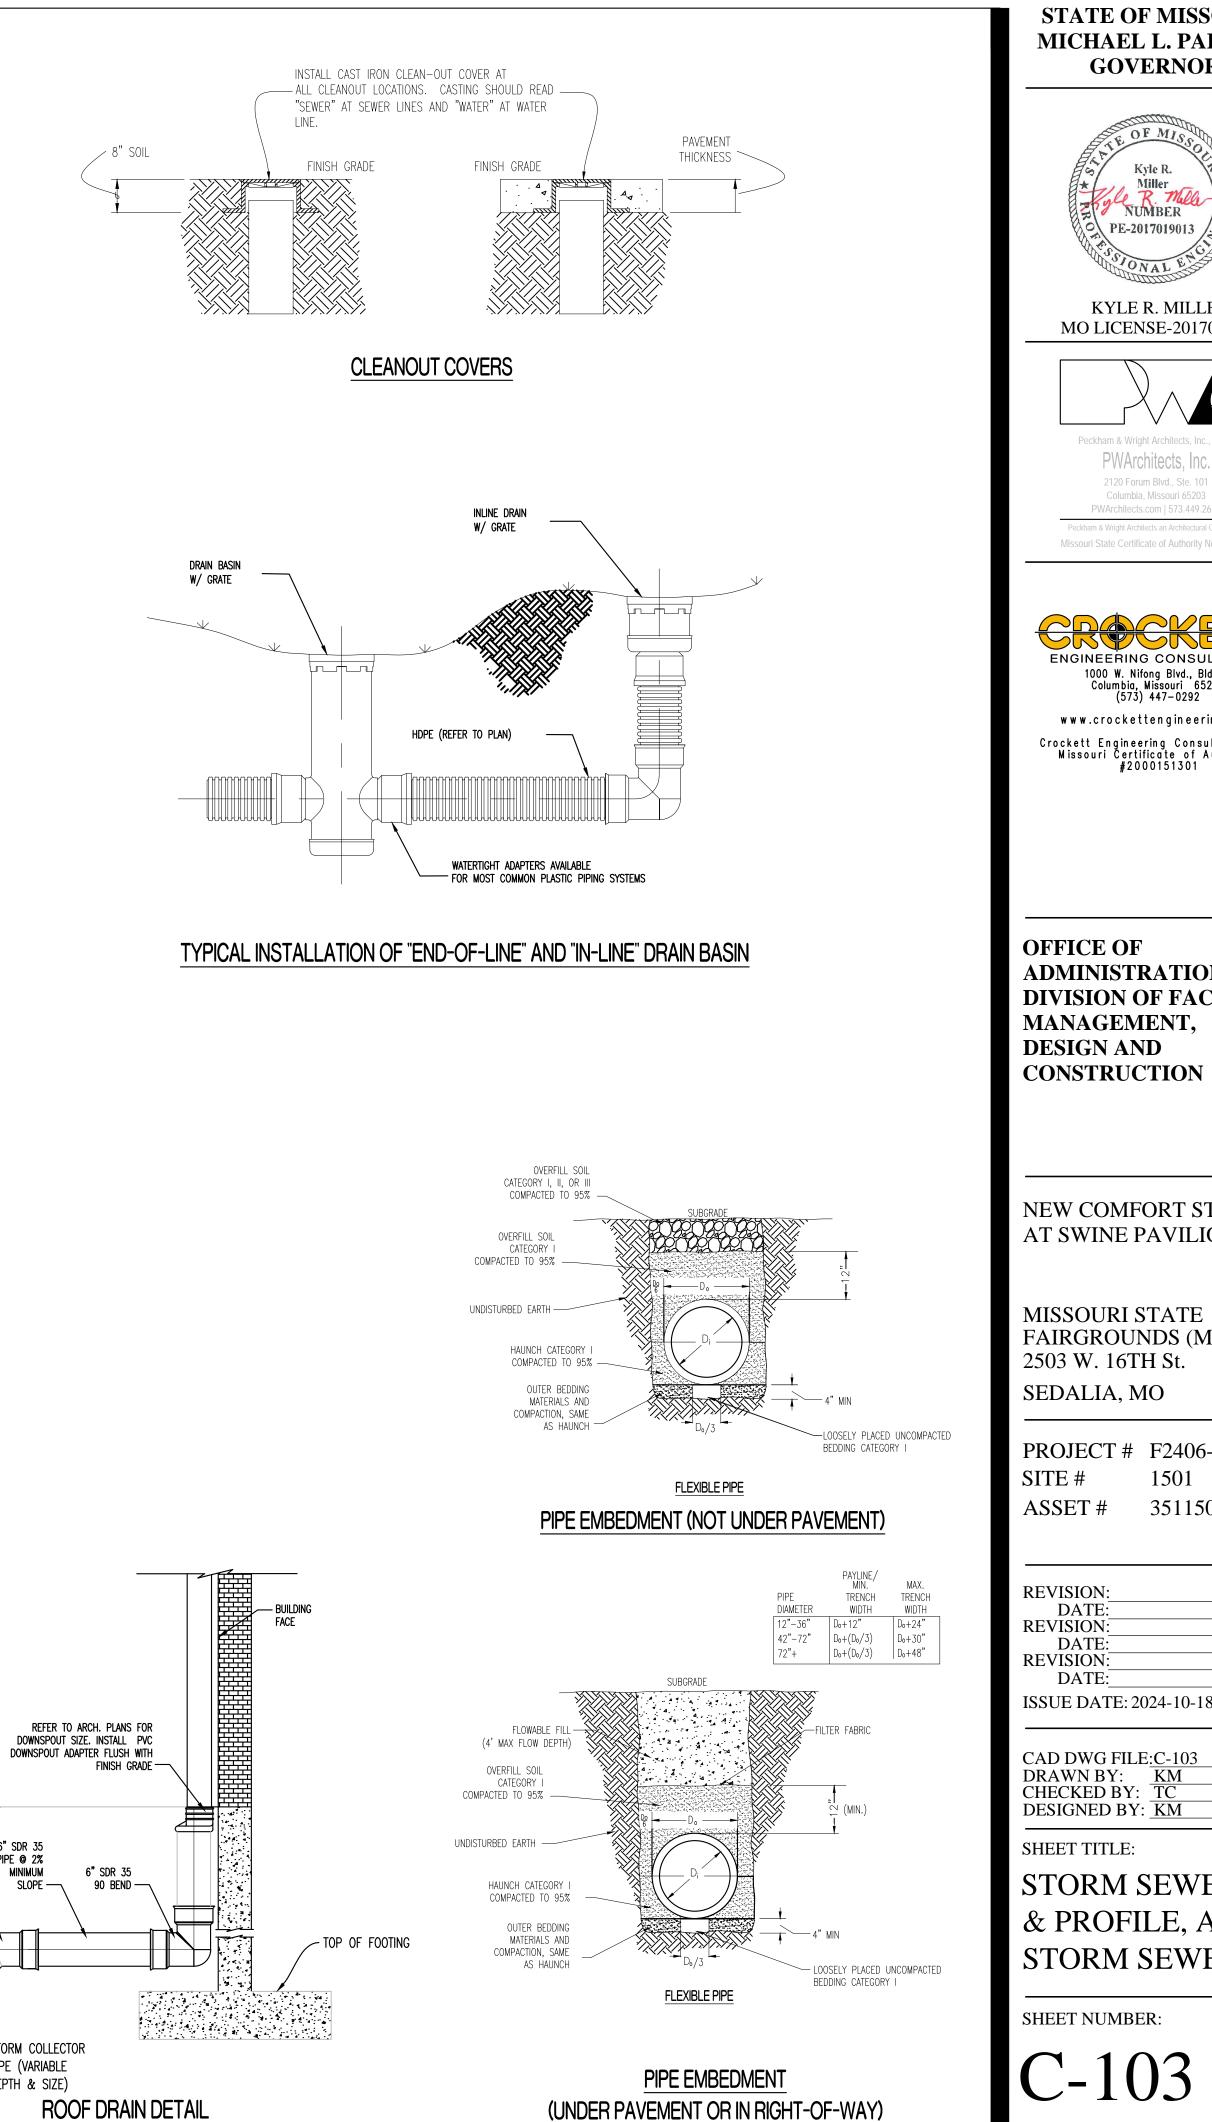

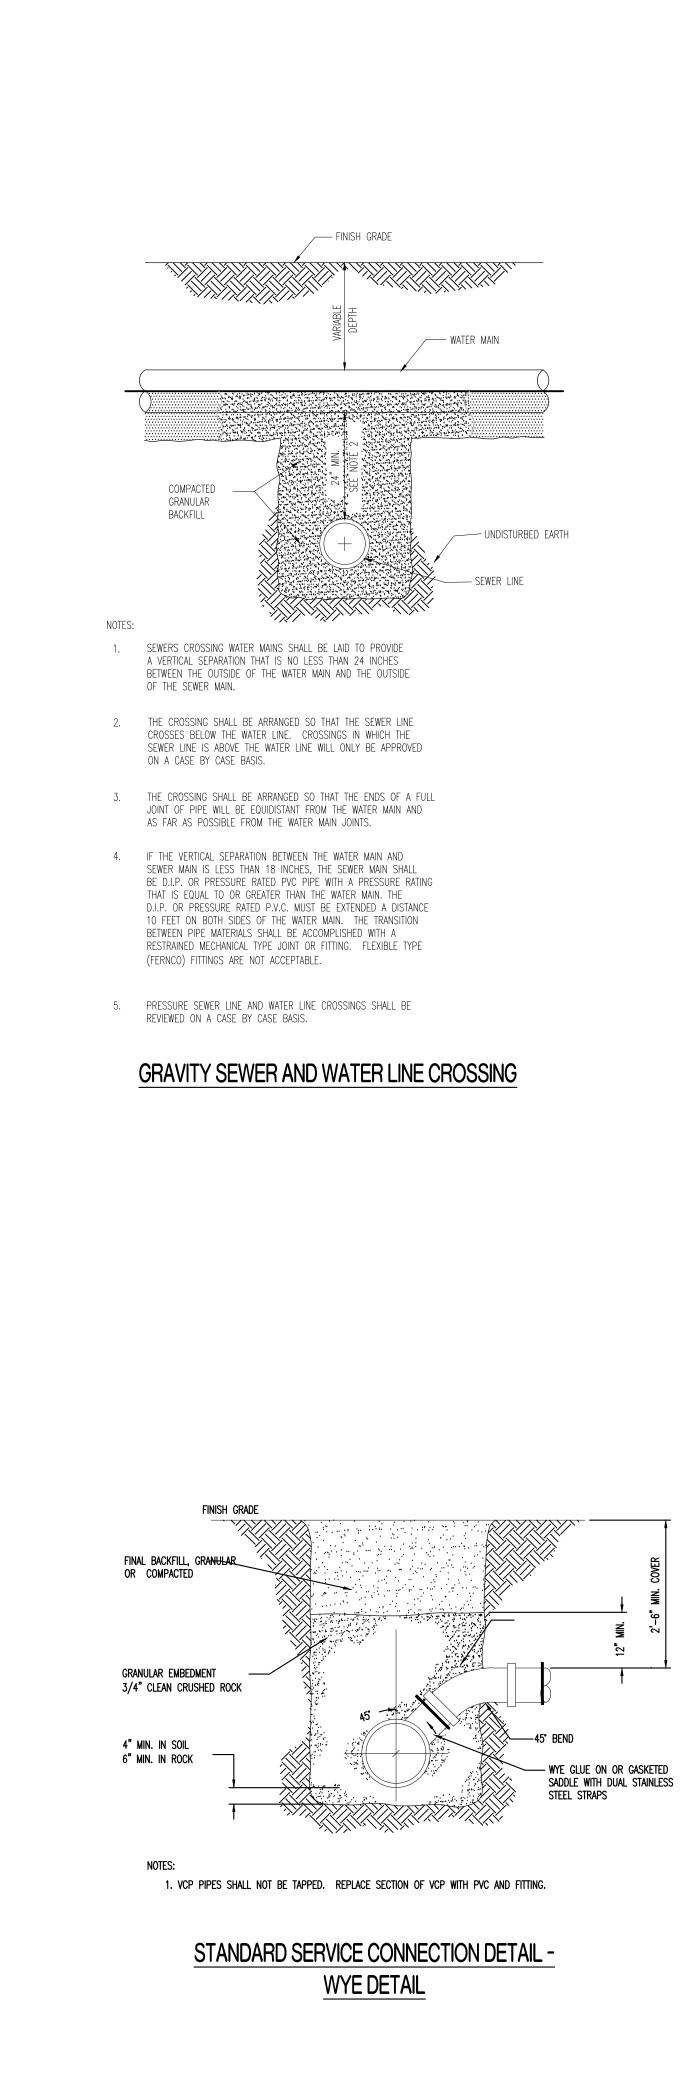


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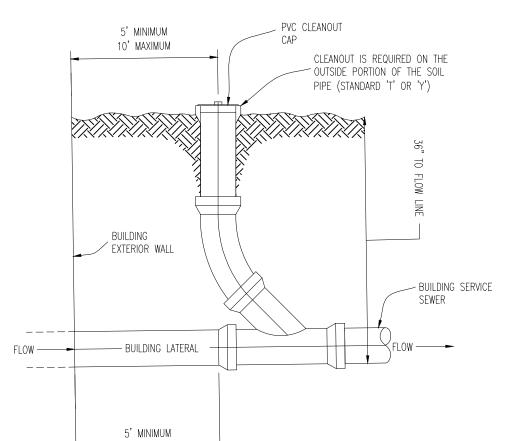
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PAVEMENT DETAILS



## TYPICAL CONCRETE SIDEWALK PAVEMENT CROSS SECTION

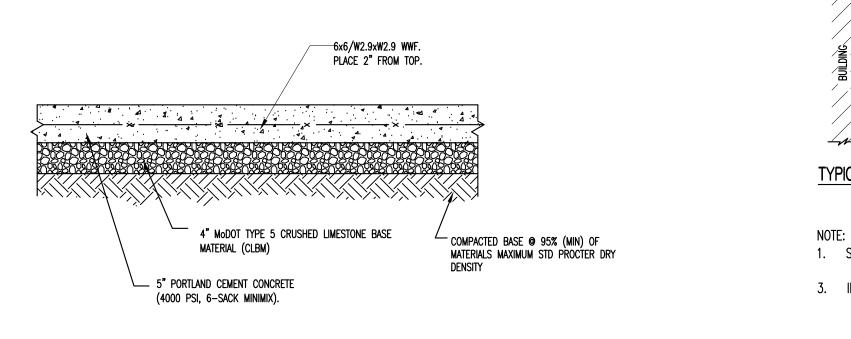


## STANDARD SANITARY CLEANOUT

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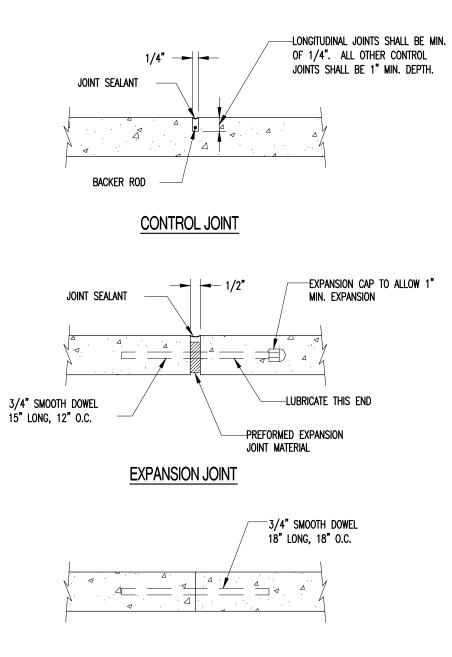
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TYPICAL LOCATION OF EXPANSION JOINT AT BUILDING/CURB

1. SIDEWALK SHALL BE 5" THICK CLASS A CONCRETE ON 4" AGGREGATE BASE. 3. INSTALL 1/2" EXPANSION JOINT BETWEEN BUILDING AND NEW CONCRETE.

## TYPICAL CONCRETE SIDEWALK

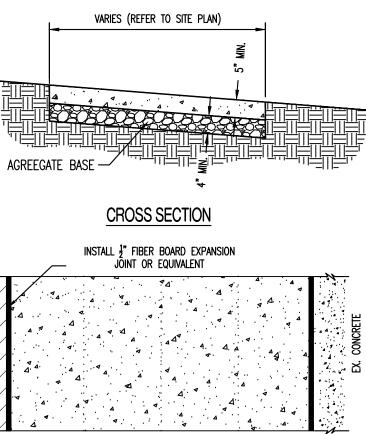

TRANSVERSE CONSTRUCTION JOINT

## SIDEWALK JOINT DETAILS


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**C-104** 



· · · · · · XXX· · · · · · · · · · · ·	EXISTING MINOR CONTOUR			
- — -XXX - — -	- EXISTING MAJOR CONTOUR			
XXX				
XXX	PROPOSED MAJOR CONTOUR			
FF=XXX.X	FINISHED FLOOR OF STRUCTURE			
(XXX.XX TP)	PROPOSED TOP OF PAVEMENT ELEVATION			
(XXX.XX FG)	PROPOSED FINISH GRADE ELEVATION			
(XXX.XX FF)	PROPOSED FINISH FLOOR AT DOOR			
(XXX.XX TW)	PROPOSED FINISHED GRADE AT TOP OF WALL			
(XXX.XX EX TP)	EXISTING TOP OF PAVEMENT ELEVATION			

	LEG	GEND OF LABELS
	A	CONSTRUCT 5" THICK, REINFORCED, CONCRETE SIDEWALK W $C-104$ . ALL CONCRETE TO BE ADA COMPLAINT. (MAXIMUM S HAS STORMWATER RUNOFF THAT FLOWS AWAY FROM BUILDIN
	₿	INSTALL <sup>1</sup> / <sub>2</sub> EXPANSION JOINT. BETWEEN EXISTING CONCRETE
	©	INSTALL $\frac{1}{2}$ " EXPANSION JOINT BETWEEN NEW CONCRETE AND
(	$\bigcirc$	PROPOSED NEW COMFORT STATION BUILDING. REFER TO AR
	E	INSTALL STEM WALL ALONG SOUTH PORTION OF BUILDING. S
-	Ð	INSTALL 5'X5' PAD OUTSIDE OF EAST DOOR. REFER TO COM
-	G	CONTRACTOR TO CONNECT NEW CONCRETE BY DOWELING IN
2	$\oplus$	RELOCATED APPROXIMATELY 85' OF WATER LINE AROUND BU
2	0	INSTALL WATER METER PIT, ADD A 2.5"X2.5" TEE FOR CONNINC SIDE OF THE LINE TO PROVIDE SHUTOFF FEATURE
	J	INSTALL TEE CONNECTION WITH GATE VALVE IN BOX TO SUF DETAILS AND BUILDING ENTRANCE LOCATION.
2	$\bigotimes$	INSTALL 12' OF 4" SANITARY SEWER LATERAL. LATERAL TO
2	$\square$	INSTALL 4" STANDARD SANITARY SEWER CLEANOUT 6' OUTSI
	(M)	PROPOSED ELECTRICAL ROUTE. REFER TO MEP PLANS FOR
	$(\mathbb{N})$	INSTALL 4" DOWNSPOUT PIPE TO CONNECTOR STORM PIPE.
	0	INSTALL 6" ROOF DRAIN DOWNSPOUT PIPE FROM SWINE BU
	P	CONNECT PROPOSE STORM SEWER LINE INTO EXISTING STOP
	0	PROPOSED STORM SEWER LINE. REFER TO SHEET C-103 F
	R	INSTALL PEDESTRIAN GUARDRAIL ON TOP OF WALL. REFER 1
	S	INSTALL P" PVC DRAIN TO SURFACE OF SIDEWALK WITH PET

WITH DIMENSIONS AS SHOWN. REFER TO SHEET C-102 FOR SPOT ELEVATIONS. REFER TO CONCRETE CROSS-SECTIONS ON SLOPE OF THE PAVEMENT SHALL NOT EXCEED 1:50 IN ALL DIRECTIONS. ). CONTRACTOR TO ENSURE ALL NEW PAVEMENT

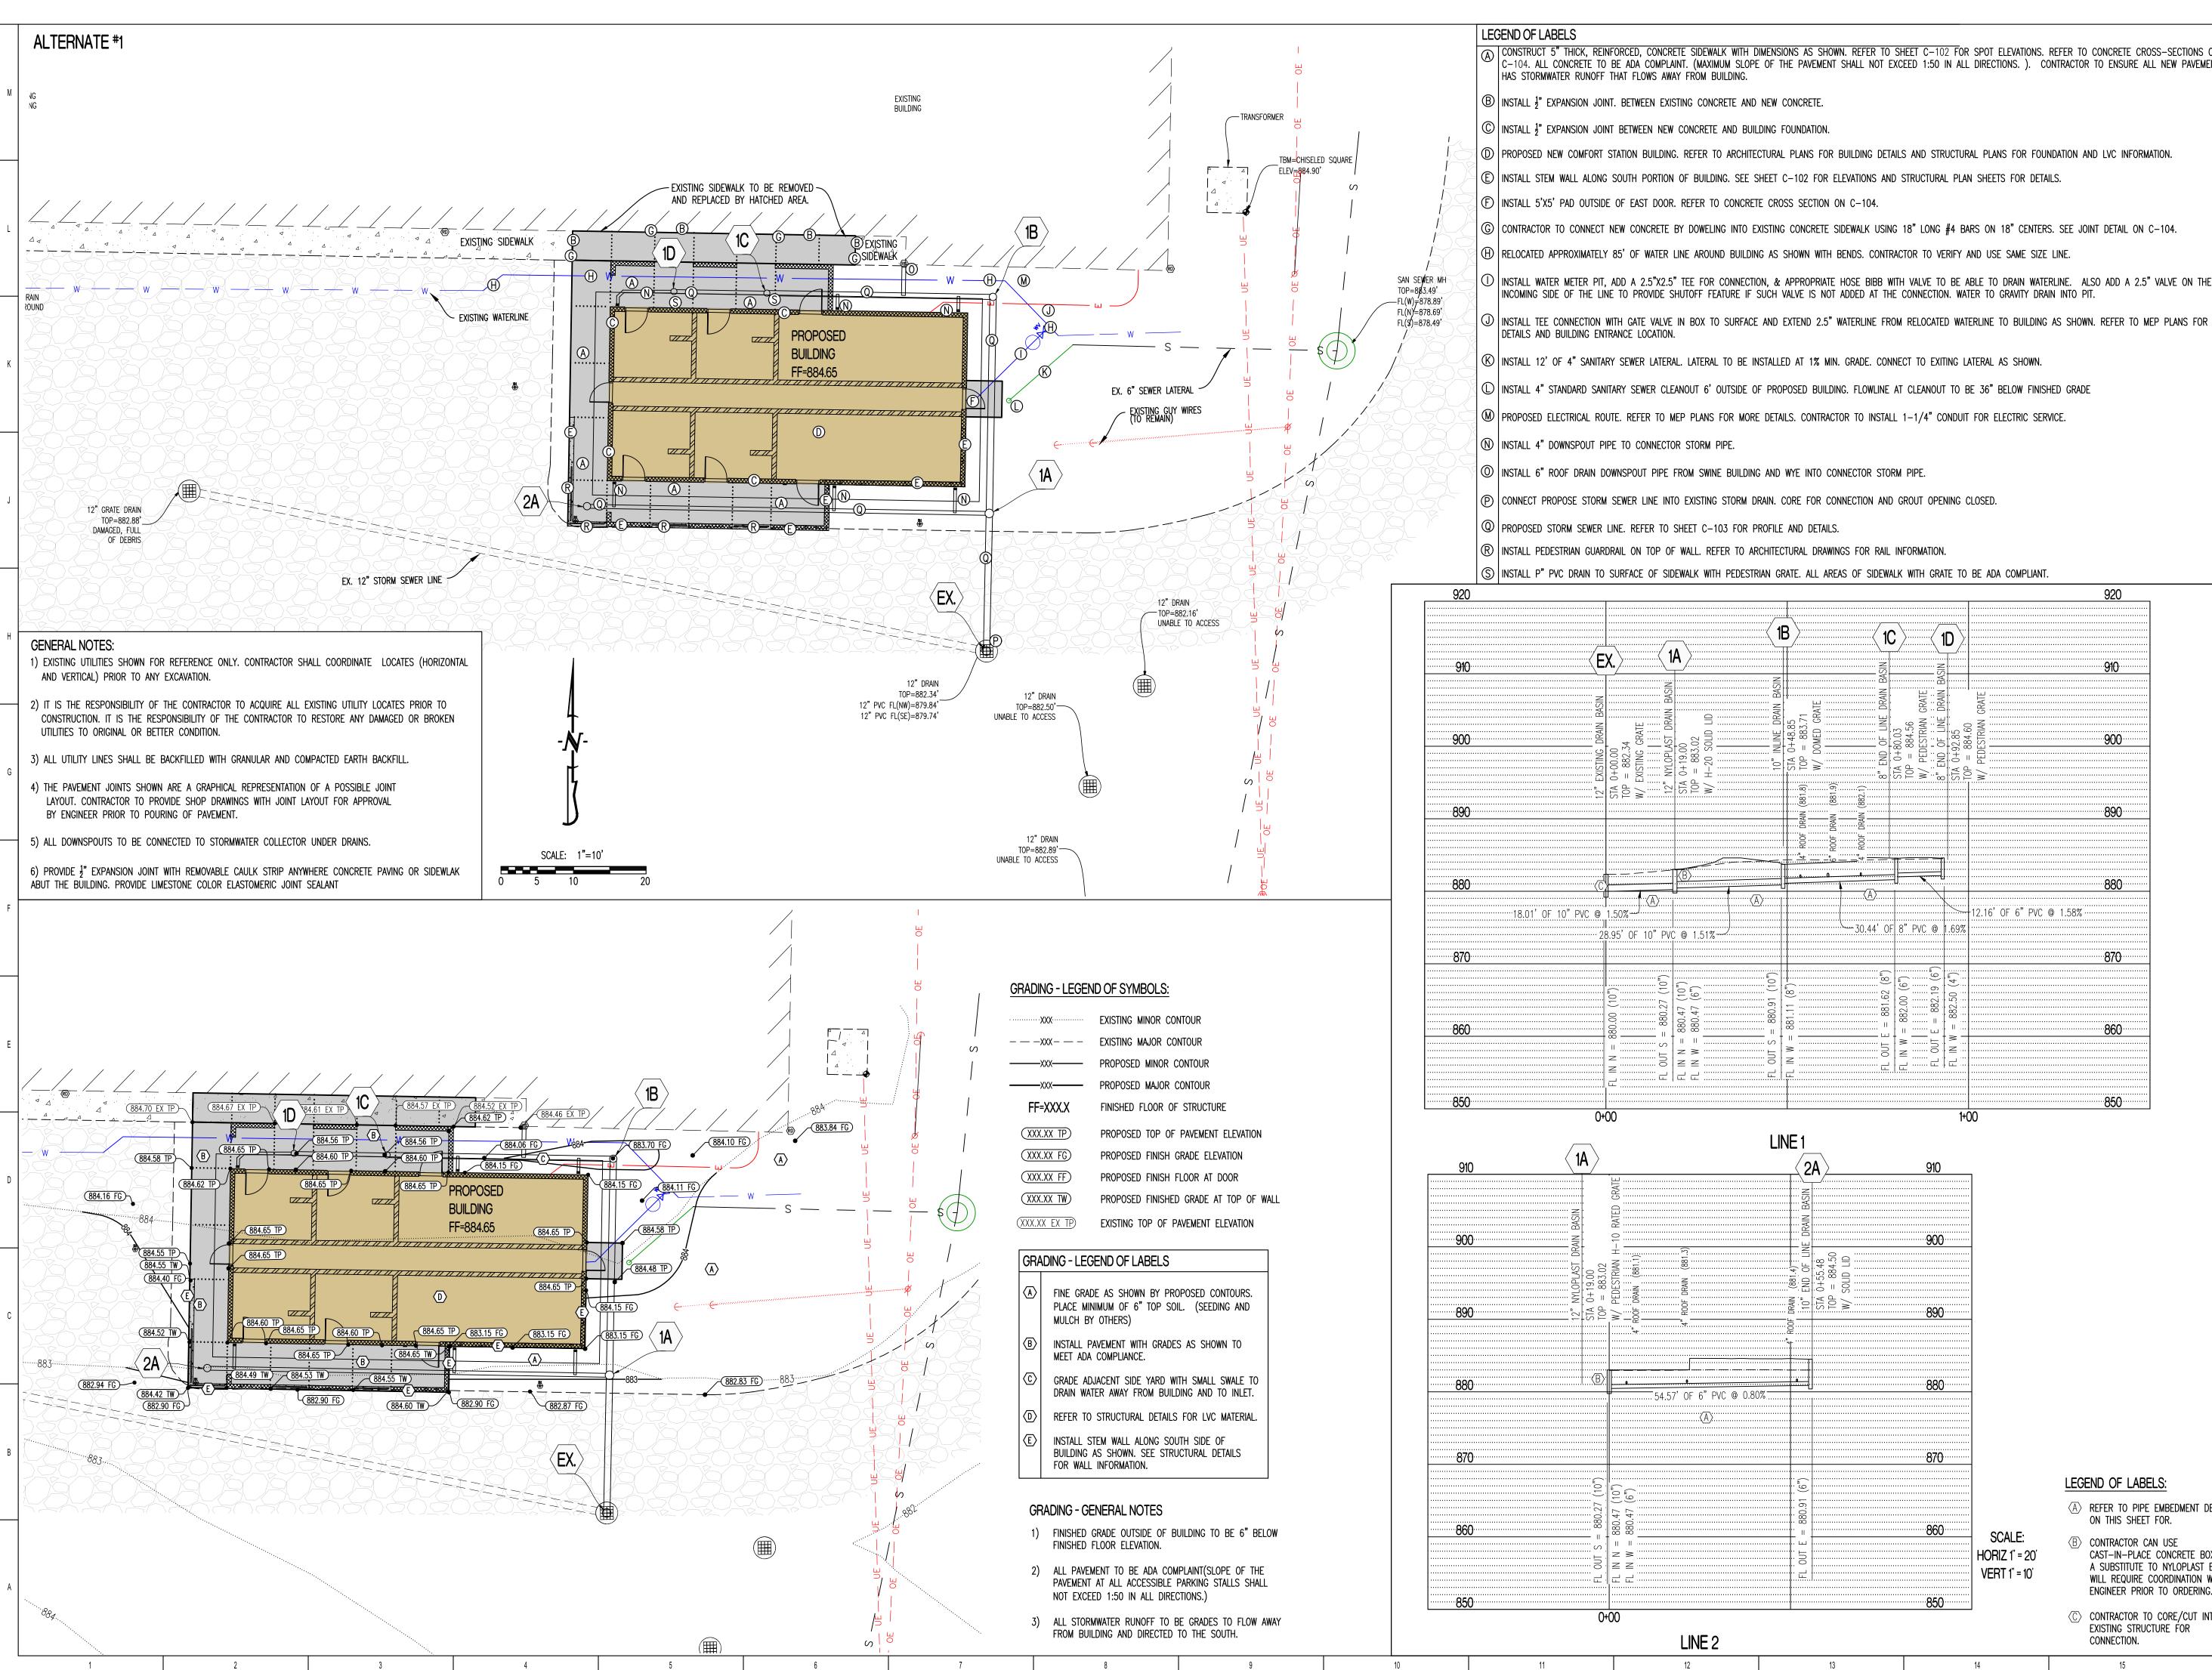ARCHITECTURAL PLANS FOR BUILDING DETAILS AND STRUCTURAL PLANS FOR FOUNDATION AND LVC INFORMATION.


INTO EXISTING CONCRETE SIDEWALK USING 18" LONG #4 BARS ON 18" CENTERS. SEE JOINT DETAIL ON C-104.

NNECTION, & APPROPRIATE HOSE BIBB WITH VALVE TO BE ABLE TO DRAIN WATERLINE. ALSO ADD A 2.5" VALVE ON THE

LEGEND OF LABELS:

- (A) REFER TO PIPE EMBEDMENT DETAIL ON THIS SHEET FOR.
- $\langle \mathbb{B} \rangle$  contractor can use CAST-IN-PLACE CONCRETE BOX AS A SUBSTITUTE TO NYLOPLAST BASIN. WILL REQUIRE COORDINATION WITH ENGINEER PRIOR TO ORDERING.
- ⟨C⟩ CONTRACTOR TO CORE/CUT INTO EXISTING STRUCTURE FOR

#### **STATE OF MISSOURI** MICHAEL L. PARSON, GOVERNOR

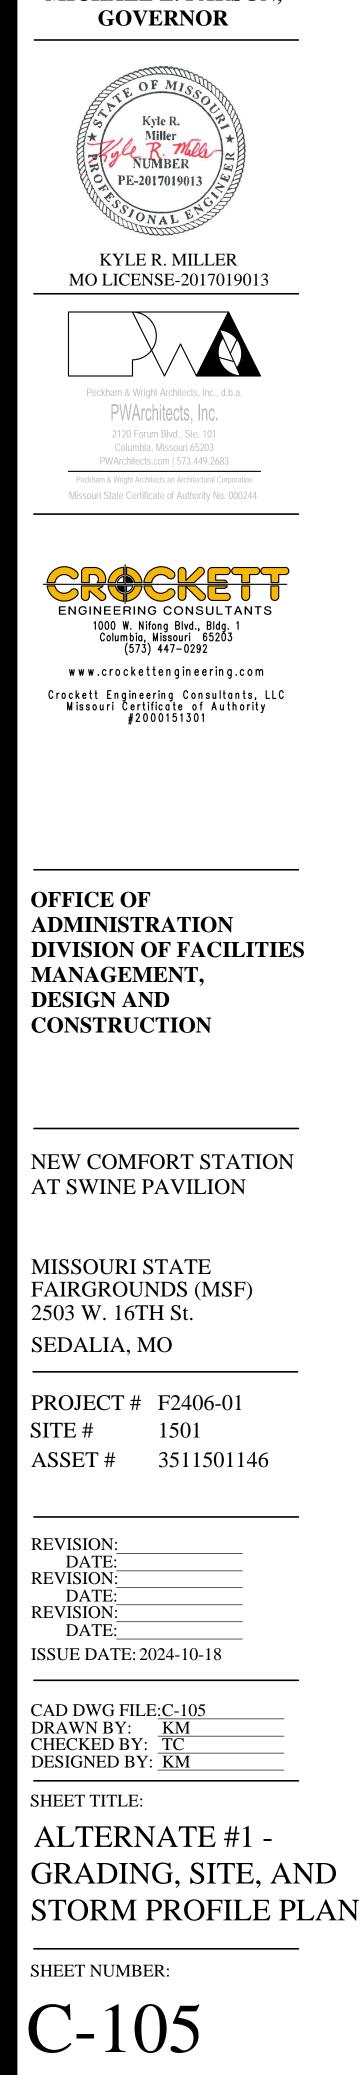

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# Missouri State Fair - Comfort Station

#### GENERAL NOTES

#### ELEVATION DATUM

SEE ARCHITECTURAL DRAWINGS OR SITE PLAN FOR FINISH FLOOR ELEVATIONS

DESIGN SPECIFICATIONS 2018 INTERNATIONAL BUILDING CODE

EARTHWORK

EARTHWORK OPERATIONS SHALL BE PERFORMED UNDER THE DIRECTION OF A PROFESSIONAL TESTING AGENCY TO ASSURE COMPLIANCE WITH THE RECOMMENDATIONS OF THE SOILS REPORT BY CROCKETT GTL DATED JUNE 27, 2024.

#### CONCRETE

CONCRETE WORK SHALL CONFORM TO ALL REQUIREMENTS OF THE CURRENT ACI 301. SPECIFICATIONS FOR STRUCTURAL CONCRETE FOR BUILDINGS, ACI 318 BUILDING CODE REQUIREMENTS FOR STRUCTURAL CONCRETE, ACI 305 SPECIFICATIONS FOR HOT WATER CONCRETE, AND ACI 306 SPECIFICATIONS FOR COLD WEATHER CONCRETE, WITH THE FOLLOWING ADDITIONAL REQUIREMENTS:

1.	CONCRETE SHALL DEVELOP	THE FOLLOWING	28-DAY	MINIMUM COMPRESSIVE STRENGTH:
	FOUNDATIONS		-	3,000 PSI
	CAST-IN-PLACE WALLS		-	3,500 PSI
	FLOOR SLAB		_	4.000 PSI

- EXTERIOR SLABS, WALLS AND CURBS 4,000 PSI
- 2. ALL FOOTINGS SHALL BEAR ON UNDISTURBED SOIL OR ENGINEERED FILL. 3 CHLORIDE— BASED ADMIXTURES ARE PROHIBITED IN ALL REINFORCED CONCRETE
- 4. REINFORCING STEEL SHALL CONFORM TO ASTM A615, A616, OR A617, GRADE 60.
- 5. ALL CONTINUOUS REINFORCING STEEL THAT MEETS AT A CORNER SHALL BE TIED TOGETHER WITH A
- CORNER BAR THAT HAS SUFFICIENT LAP DISTANCE IN EACH DIRECTION 6. CONTINUOUS REINFORCING BARS LAP LENGTH SHALL BE A MINIMUM OF 48 BAR DIAMETERS UNLESS NOTED OTHERWISE
- 7. CONCRETE SLUMP SHALL BE A MAXIMUM OF  $4^{"} + / 1^{"}$  (ASTM C- 143) AS DELIVERED IN THE FIELD. CONTRACTOR MAY USE CHEMICAL ADMIXTURES TO ATTAIN A MAXIMUM SLUMP OF 8" FOR WORKABILITY. NO WATER MAY BE ADDED TO THE CONCRETE MIX ON SITE UNLESS WATER IS WITHHELD AT THE BATCHING FACILITY. IF WATER IS WITHHELD AT THE BATCHING FACILITY IT SHOULD BE REFLECTED ON THE LOAD TICKET. THE TOTAL AMOUNT OF WATER IN THE MIX SHALL NOT EXCEED WHAT IS NOTED ON THE APPROVED MIXED. THIS SHALL BE NOTED IN THE SPECIAL INSPECTOR'S RECORDS.
- 8. CONCRETE EXPOSED TO WEATHER, VEHICLES, AND/OR DEICING CHEMICALS SHALL BE AIR-ENTRAINED WITH 6% (+/-) 1.5% ENTRAINED AIR BY VOLUME AT POINT OF DISCHARGE. DO NOT ALLOW AIR CONTENT OF TRÓWELED FINISHED FLOORS TO EXCEED 3%.

9. SUBMIT CONCRETE MIX PROPORTIONS PRIOR TO START OF WORK. DO NOT BEGIN CONCRETE PRODUCTION UNTIL MIXES HAVE BEEN REVIEWED AND ARE ACCEPTABLE TO THE ENGINEER. 10.READY MIX CONCRETE SHALL COMPLY WITH REQUIREMENTS OF ASTM C94. 11.CONCRETE WORK EXECUTION

- A. CONSTRUCT FORMS TO CORRECT SIZE, SHAPE, ALIGNMENT, ELEVATION AND POSITION; AND TO SUPPORT VERTICAL AND LATERAL LOADS. B. POSITION, SUPPORT, AND SECURE REINFORCEMENT AGAINST DISPLACEMENT. MINIMUM CONCRETE
- COVER FOR REINFORCEMENT SHALL BE, UNLESS NOTED OTHERWISE ON THE DRAWINGS:

  - NOT EXPOSED TO WEATHER OR
- IN CONTACT WITH EARTH .... ....1 ½ INCHES C. PROVIDE CONTROL JOINTS IN SLABS-ON-GRADE AT NOT GREATER THAN 15 FEET ON CENTER IN EACH DIRECTION. SAW CUT CONTROL JOINTS MINIMUM 1/4 OF SLAB DEPTH, AS SOON AFTER SLAB FINISHING WITHOUT DISLODGING AGGREGATE. D. STEEL TROWEL FINISH ALL INTERIOR CONCRETE SLABS, BROOM FINISH ALL EXTERIOR CONCRETE
- SLABS. E. CURE ALL CONCRETE IN COMPLIANCE WITH ACI 301, USING A LIQUID TYPE MEMBRANE,
- NON-RESIDUAL, CURING COMPOUND COMPLYING WITH ASTM C309. ASSURE COMPATIBILITY WITH FINISH FLOOR COVERING.

#### MASONRY

MASONRY WORK SHALL CONFORM TO ALL REQUIREMENTS OF THE CURRENT ACI 530.1 SPECIFICATIONS FOR MASONRY STRUCTURES WITH THE FOLLOWING ADDITIONAL REQUIREMENTS:

- 1. HOLLOW MASONRY BLOCK SHALL CONFORM TO ASTM C90 REGULAR WEIGHT GRADE N1. 2. COURSE GROUT SHALL CONFORM TO ASTM C476 WITH A MAXIMUM AGGREGATE SIZE OF 3/8" AND A MINIMUM COMPRESSIVE STRENGTH OF 2,500 PSI.
- 3. MORTAR SHALL BE TYPE S CONFORMING TO ASTM C270. AVERAGE COMPRESSIVE STRENGTH IS 2,000 PSI
- 4. MINIMUM 28-DAY COMPRESSIVE STRENGTH OF MASONRY; f'm = 2,000 PSI. 5. WIRE REINFORCING SHALL CONFORM TO ASTM A82, STANDARD TRUSS-TYPE DUR-O-WALL REINFORCING (OR APPROVED EQUAL) AND SHALL BE PLACED CONTINUOUSLY IN ALTERNATE HORIZONTAL MORTAR JOINTS
- 6. REINFORCING STEEL SHALL CONFORM TO ASTM A615, A616, OR A617, GRADE 60. THE MINIMUM LAP FOR SPLICES SHALL BE 48 BAR DIAMETERS. PROVIDE DUR-O-WAL REBAR POSITIONERS. 7. ALL STEEL LINTELS TO BE A36 STEEL OR A992 GRADE 50. ALL LINTELS TO BE HOT DIPPED
- GALVANIZED.
- 8. INTERSECTING STRUCTURAL WALLS SHALL BE ANCHORED BY STEEL CONNECTORS SPACED VERTICALLY AT 48" O.C. MAXIMUM. THE CONNECTORS SHALL CONFORM TO ASTM A36 AND SHALL HAVE A MINIMUM SECTION OF ¼" x 11/3". THEY SHALL BE 28" LONG WITH 2" AT EACH END BENT AT 90 DEGREES TO FORM A "U" OR "Z" SHAPE. ALL CELLS ABOVE AND BELOW THE ANCHOR SHALL BE GROUTED, AND THE BENT ENDS OF THE CONNECTORS SHALL BE EMBEDDED IN THE GROUT, 2' MIN. 9. EXPANSION JOINTS SHALL BE PROVIDED IN CMU BLOCK WALLS FULL HEIGHT OF WALL AT INTERVALS
- NOT EXCEEDING 24'-0". NOT CLOSER THAN 2'-0" FROM OPENINGS JOINT REINFORCING SHALL BE SEVERED AT EXPANSION JOINT LOCATIONS, HOWEVER BOND BEAM REINFORCING SHALL BE CONTINUOUS THROUGH THE JOINT.

#### HEADED MASONRY ANCHORS

- 318 APPENDIX "D" AND AWS D1.1.
- 2. HEADED STUDS HAVE BEEN DESIGNED AS TYPE "B" ANCHORS ( $f_{tt}$ = 65,000 psi,  $f_{y}$ = 51,000 psi). 3. EMBEDMENT DEPTH IS DEFINED AS THE DISTANCE FROM THE OUTSIDE FACE OF THE EMBEDMENT PLATE TO THE INSIDE FACE OF THE STUD HEAD. 4. EQUIVALENT ANCHORS MAY BE SUBMITTED FOR THE ENGINEER'S APPROVAL.

#### DEFORMED BAR ANCHORS

- 1. ALL DEFORMED BAR ANCHORS SHALL MEET THE REQUIREMENTS OF THE CODE-CITED EDITION OF ACI
- 318 APPENDIX "D" AND AWS D1.1. 2. DEFORMED BAR ANCHORS HAVE BEEN DESIGNED AS TYPE "C" ANCHORS ( $f_{ut}$ = 80,000 psi,  $f_v$ = 70.000 psi, & MANUFACTURED IN CONFORMANCE WITH ASTM A496). 3. EQUIVALENT ANCHORS MAY BE SUBMITTED FOR THE ENGINEER'S APPROVAL.

#### TIMBER

WITH THE FOLLOWING SUPPLEMENTAL REQUIREMENTS:

•	OTHERWI		BER SIZES, THE S
	Α.	2X4	SPF No.1/No.2
	В.	2X6	SPF No.1/No.2
	С.	2X8	DF-L No.2
	D.	2X10	DF-L S.S.
	E.	2X12	DF-L S.S.

- EQUIVALENT (OR BETTER) GRADES & SPECIES MAY BE SUBMITTED FOR THE ENGINEER'S APPROVAL.
- 2. SIZES SHOWN FOR LUMBER ARE NOMINAL SIZES. 3. TIMBER EXPOSED TO WEATHER OR GROUND, OR IN CONTACT WITH CONCRETE OR MASONRY SHALL BE PRESSURE-IMPREGNATED BY AN APPROVED PROCESS AND PRESERVATIVE. 4. SPLICING OF JOISTS, STUDS, OR HEADERS IS PROHIBITED EXCEPT AS SHOWN.

- 5. BOLTS SHALL CONFORM TO ASTM A307. HOLES SHALL BE DRILLED PER SECTION 12.1.3 OF THE 2018 ANSI/AWC NDS FOR WOOD CONSTRUCTION NDS SUPPLEMENT.
- 6. LAG SCREWS AND WOOD SCREWS SHALL BE INSTALLED PER SECTIONS 12.1.4 & 12.1.5 RESPECTIVELY, OF THE 2018 ANSI/AWC NDS FOR WOOD CONSTRUCTION WITH 2018 NDS SUPPLEMENT.
- 7. COMMON NAILS SHALL BE USED. UNLESS NOTED OTHERWISE. IN ADDITION. NAILS SHALL BE GALVANIZED, IF EXPOSED TO WEATHER OR MOISTURE. TOE-NAILS SHALL BE DRIVEN PER SECTION
- 12.1.6.3 OF THE 2018 ANSI/AWC NDS FOR WOOD CONSTRUCTION WITH 2018 NDS SUPPLEMENT. 8. FASTENING SHALL BE PER THE IBC MINIMUM FASTENING SCHEDULE, TABLE 2304.10.1, UNLESS NOTED
- OTHERWISE. 9. CONNECTIONS/CONNECTORS SHALL BE INSTALLED PER MANUFACTURER'S SPECIFICATIONS.

# Sedalia, Pettis County, Missouri

10. BOND BEAMS OR GROUTED CELLS ARE REQUIRED AT ALL CONNECTIONS TO CMU.

1. ALL HEADED CONCRETE ANCHORS SHALL MEET THE REQUIREMENTS OF THE CODE-CITED EDITION OF ACI

- TIMBER WORK SHALL CONFORM TO ALL REQUIREMENTS OF THE CURRENT ANSI/AWC NATIONAL DESIGN SPECIFICATION (NDS) FOR WOOD CONSTRUCTION WITH 2018 NDS SUPPLEMENT FOR WOOD CONSTRUCTION,
- 1 FOR COMMON MEMBER SIZES. THE SPECIES AND GRADES SHALL BE AS FOLLOWS, UNLESS NOTED

#### PREFABRICATED WOOD TRUSSES

- 1. FLOOR & ROOF TRUSSES SHALL BE DESIGNED IN ACCORDANCE WITH THE TRUSS PLATE INSTITUTE (TPI) DESIGN SPECIFICATION FOR METAL PLATE CONNECTED WOOD TRUSSES, AND THE ANSI/NF&PA
- NATIONAL DESIGN SPECIFICATION (NDS) FOR WOOD CONSTRUCTION. 2. PROVIDE TEMPORARY AND PERMANENT BRACING ON ALL TRUSSES, AS REQUIRED TO PROVIDE MEMBER AND TRUSS STABILITY
- 3. FLOOR & ROOF TRUSSES SHALL BE DESIGNED AND CONSTRUCTED FOR A MAXIMUM TOTAL LOAD DEFLECTION OF L/360 AND TO SAFELY SUPPORT THE FOLLOWING LOADS: A. DEAD, LIVE, SNOW, WIND, EARTHQUAKE: SEE PROJECT DESIGN DATA ON COVER SHEET.
- B. MECHANICAL PIPE LOAD: TRUSSES SHALL BE DESIGNED FOR A CONCENTRATED LOAD OF 250 LBS HUNG ANYWHERE ALONG THE BOTTOM CHORD.
- C. OVER-FRAMING LOAD: TRUSSES SHALL ALSO BE DESIGNED TO SUPPORT ADDITIONAL OVERBUILD FRAMING, SUCH AS THAT WHICH FORMS VALLEYS AND HIPS ON ROOFS.
- D. DRIFTED SNOW LOAD: TRUSSES SHALL BE DESIGNED TO SUPPORT DRIFTED SNOW LOADS IN ACCORDANCE WITH THE APPROPRIATE BUILDING CODE.
- E. IN-PLANE LATERAL LOADS: TRUSSES SHALL BE DESIGNED TO SUPPORT ANY LATERAL LOADS CARRIED AXIALLY IN THE PLANE OF THE TRUSS, AS SHOWN ON THE PLANS.
- 4. GABLED END TRUSSES SHALL HAVE VERTICAL MEMBERS SPACED AT 16" O.C. MAXIMUM
- 5. SUBMITTALS SHALL INCLUDE THE FOLLOWING:
- A. SHOP DRAWINGS PREPARED UNDER THE SUPERVISION OF, AND SIGNED AND SEALED BY, A PROFESSIONAL ENGINEER REGISTERED IN THE STATE WHERE THE PROJECT IS BUILT. THESE DRAWINGS SHALL INDICATE SPECIES, GRADE, AND SIZES OF LUMBER TO BE USED; PITCH, SPAN, CAMBER, CONFIGURATION, AND SPACING FOR EACH TYPE OF TRUSS REQUIRED; TYPE, SIZE, MATERIAL, FINISH, AND LOCATION OF METAL CONNECTOR PLATES; AND BEARING DETAILS. SHOW TRUSS LAYOUT AND ALL REQUIRED TEMPORARY AND PERMANENT BRACING AFFECTING THE STRUCTURAL CAPACITY OF THE TRUSSES.


PROVIDE COMPLETE ENGINEERING DESIGN CALCULATIONS THAT INCLUDE DESIGN VALUES, DESIGN ANALYSIS INDICATING LOADING, ASSUMED ALLOWABLE STRESSES, STRESS DIAGRAMS, AND CALCULATIONS, AND ANY OTHER INFORMATION NEEDED FOR REVIEW. THE CALCULATIONS SHALL HAVE BEEN SIGNED AND SEALED BY A QUALIFIED PROFESSIONAL ENGINEER WHO IS REGISTERED IN THE STATE WHERE THE PROJECT IS BUILT AND WHO IS RESPONSIBLE FOR PREPARATION OF THE CALCULATIONS.


#### SPECIAL INSPECTIONS


THE FOLLOWING ITEMS REQUIRE SPECIAL INSPECTION IN ACCORDANCE WITH CHAPTER 17 OF THE INTERNATIONAL BUILDING CODE.

- a. CONCRETE GROUT DESIGN MIX (PERIODIC)
- b. PLACING OF CONCRETE AND REINFORCING STEEL (CONTINUOUS OF CONCRETE SAMPLING / PERIODIC OF REINFORCING)
- c. BOLTS & ANCHORS EMBEDDED IN CONCRETE (PERIODIC)
- d. STRUCTURAL STEEL FABRICATIONS (UNLESS AISC APPROVED)
- (PERIODIC)
- e. STRUCTURAL STEEL BOLTING & WELDING (PERIODIC)
- f. POST INSTALLED ANCHORS IN CONCRETE (CONTINUOUS)
- q. IN-SITU SOILS, EXCAVATIONS, FILLING & COMPACTION (PERIODIC)
- h. MASONRY AND REINFORCING STEEL (CONTINUOUS ON CELL GROUTING / PERIODIC ON
- REINFORCING)
- i. WOOD FRAMING:
- i.a. SHEAR WALLS; WALL SIZE, CONFIGURATION, BLOCKING, PANEL GRADE, PANEL THICKNESS, AND FASTENING. (PERIODIC)
- i.b. DIAPHRAGMS (FLOOR AND ROOF SHEATHING); SIZE, CONFIGURATION, BLOCKING, PANEL GRADE, PANEL THICKNESS, AND FASTENING. (PERIODIC)
- i.c. FRAMING MEMBERS AND DETAILS (PERIODIC)
- i.d. MATERIAL GRADE (PERIODIC)
- i.e. CONNECTIONS; HANGERS, HOLD DOWNS, BUILT-UP COLUMNS, BUILT-UP BEAMS (PERIODIC)
- i.f. PRE-ENGINEERED TRUSSES; FRAMING, CONNECTIONS, BRIDGING (PERIODIC)

THE CONTRACTOR SHALL REQUEST SPECIAL INSPECTION OF THE ITEMS LISTED ABOVE PRIOR TO THOSE ITEMS BECOMING INACCESSIBLE AND UNOBSERVABLE DUE TO PROGRESSION OF THE WORK.

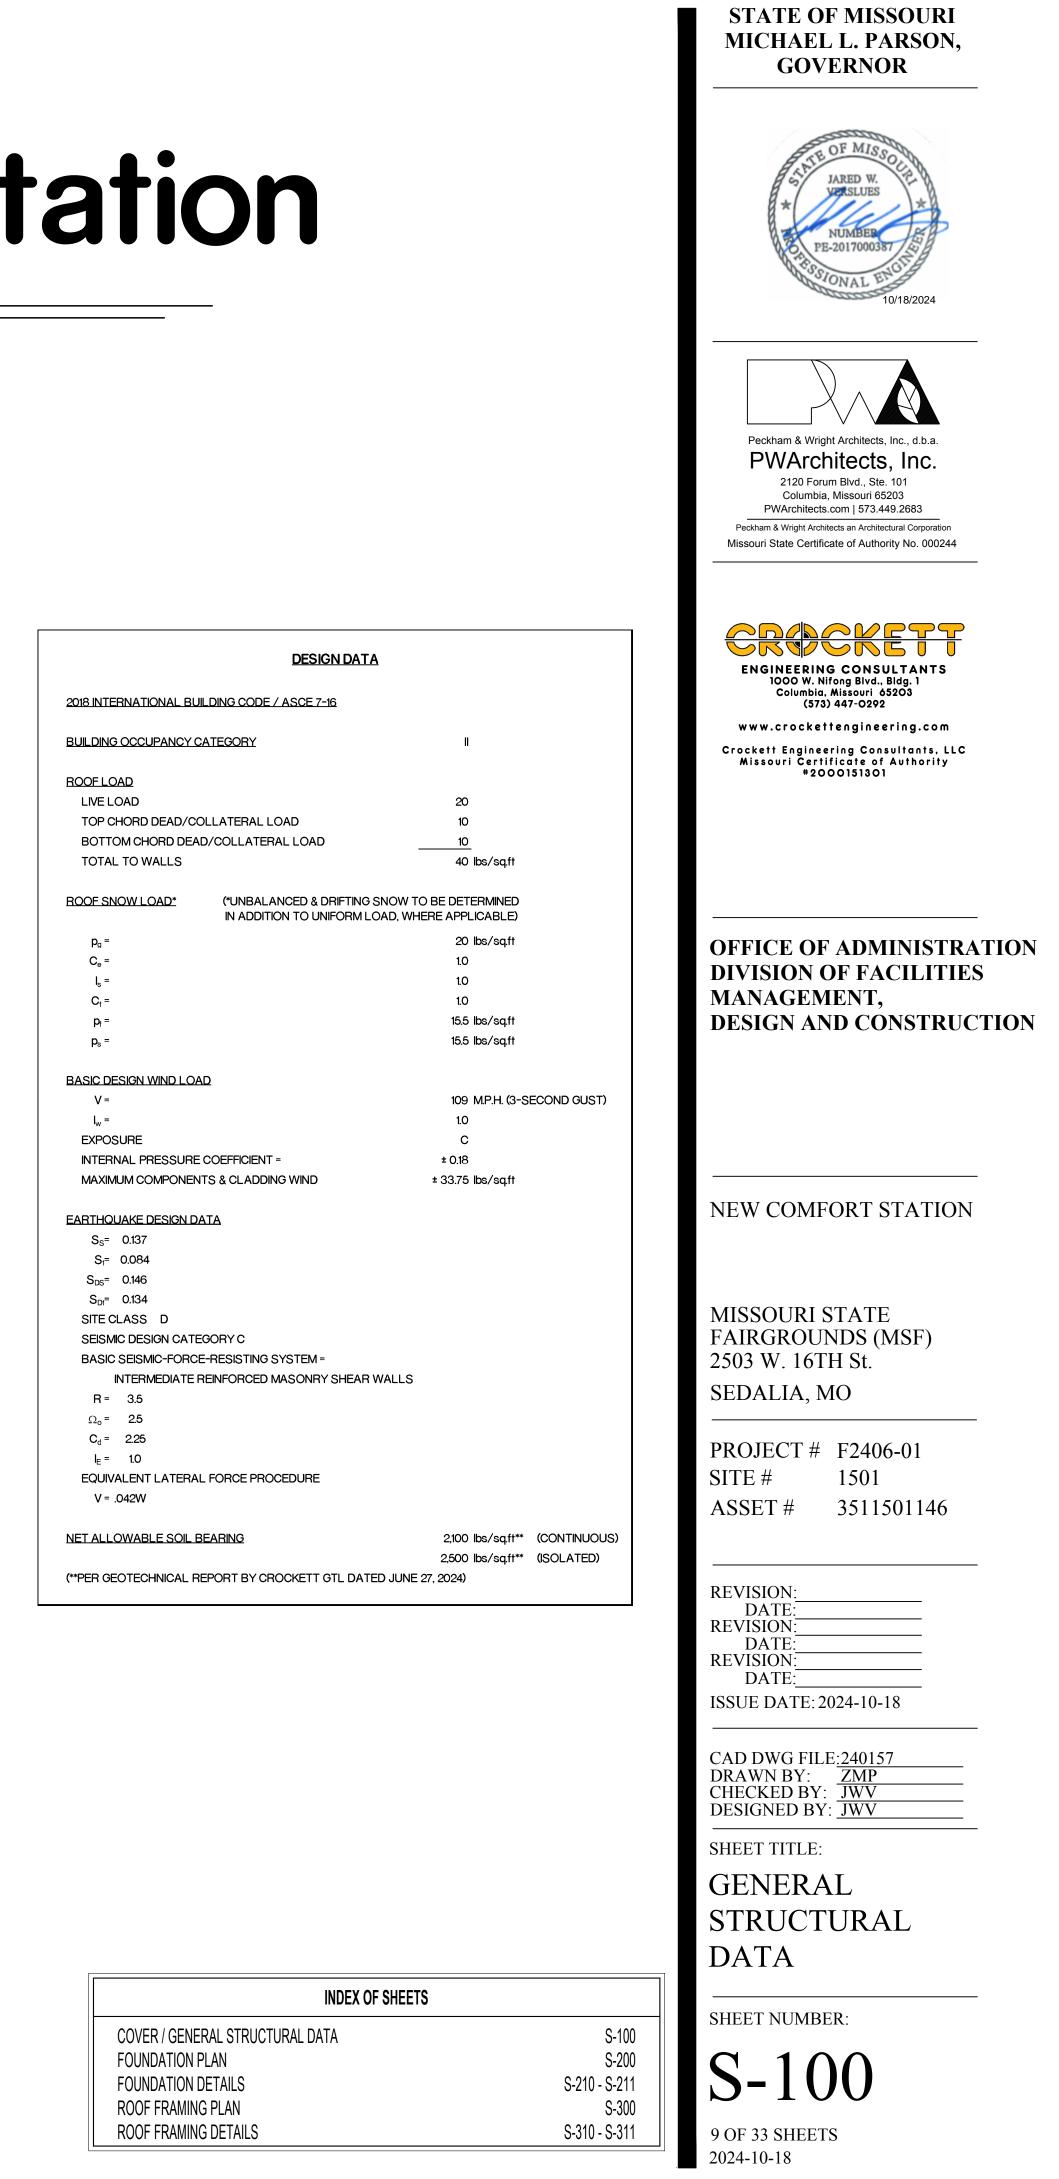

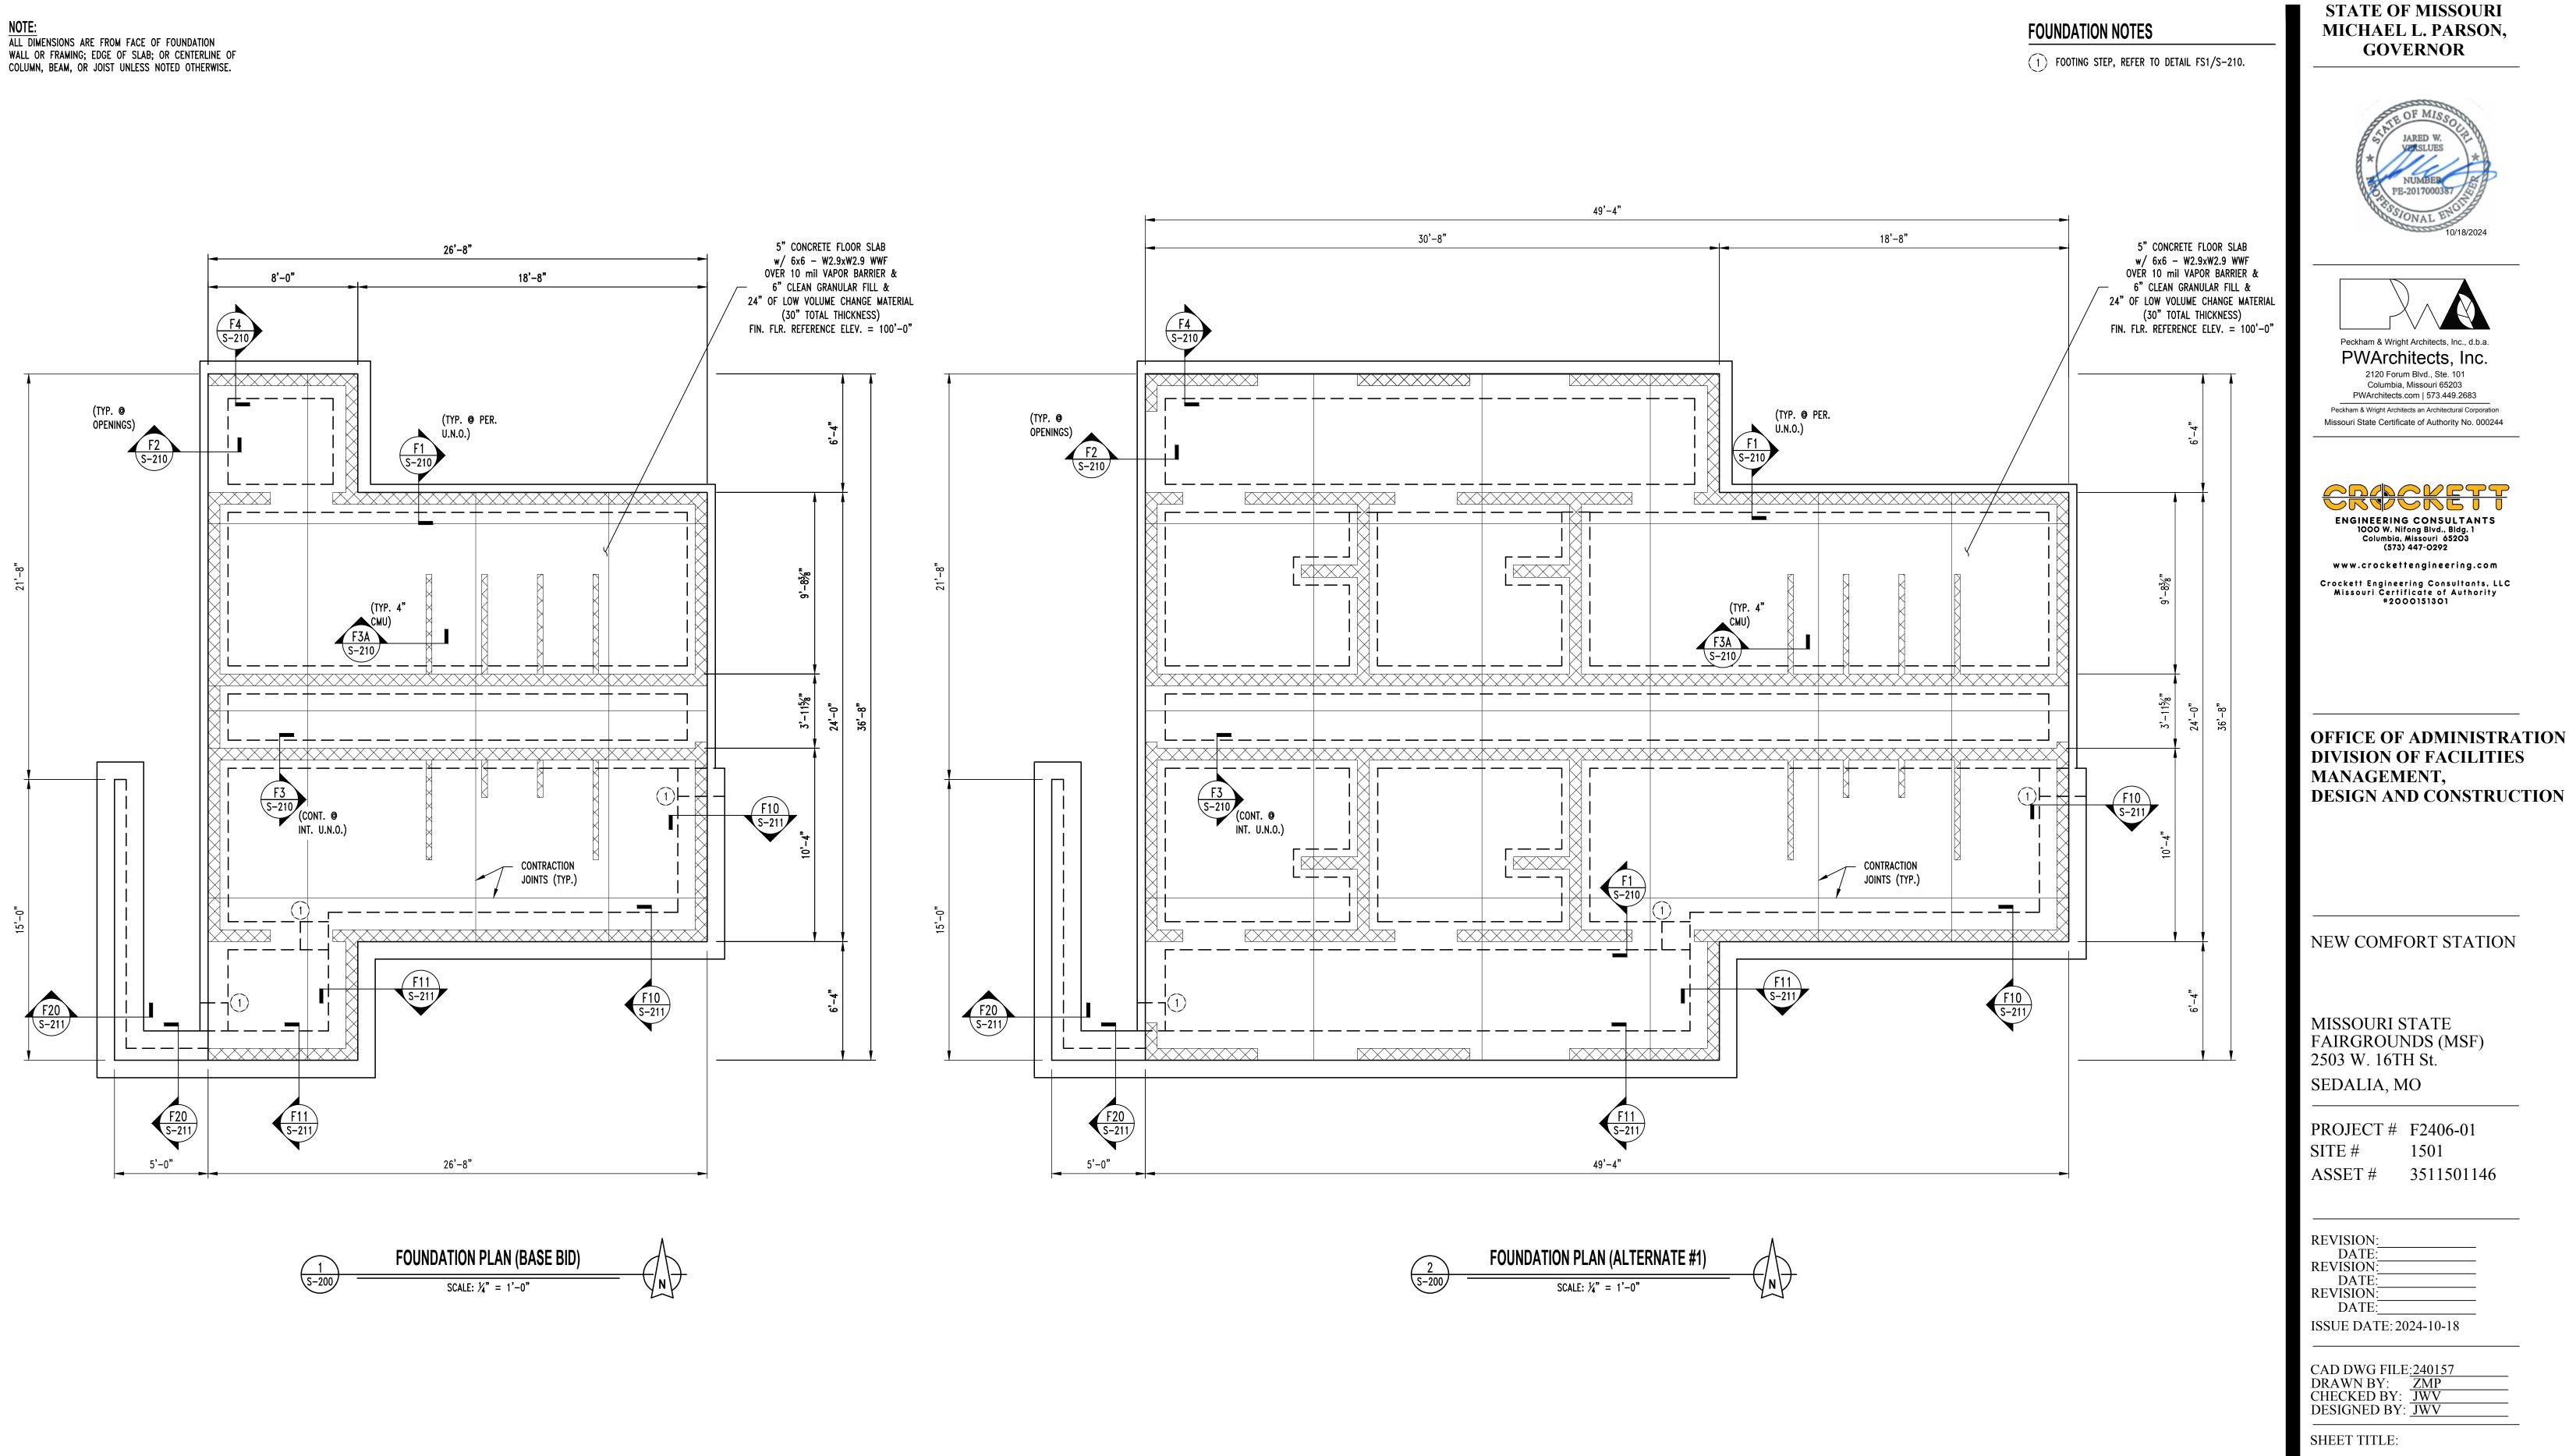

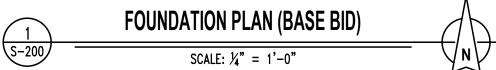



FOUNDATION PLAN


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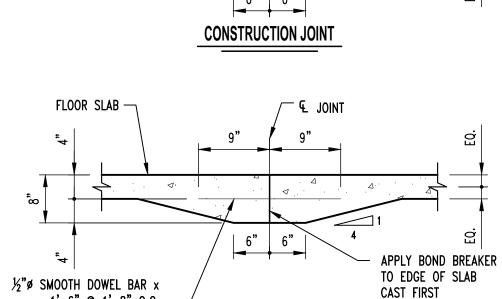
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TYP. PLUMBING COORDINATION DETAILS





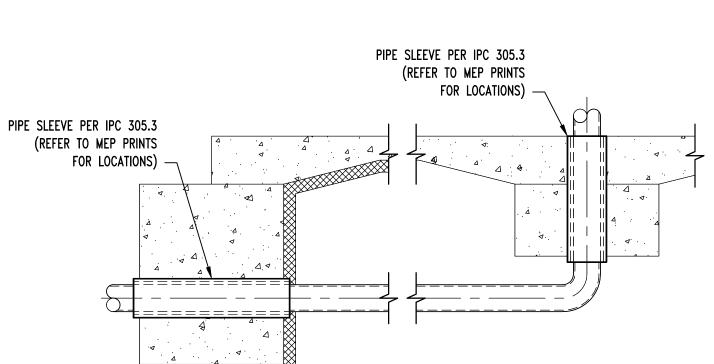

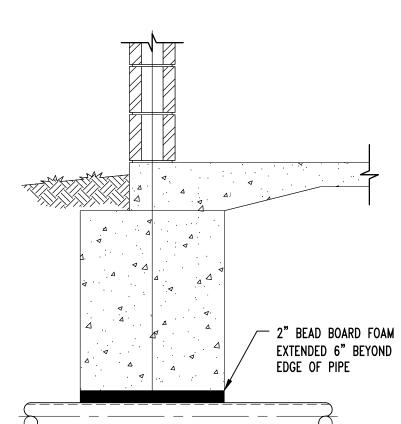

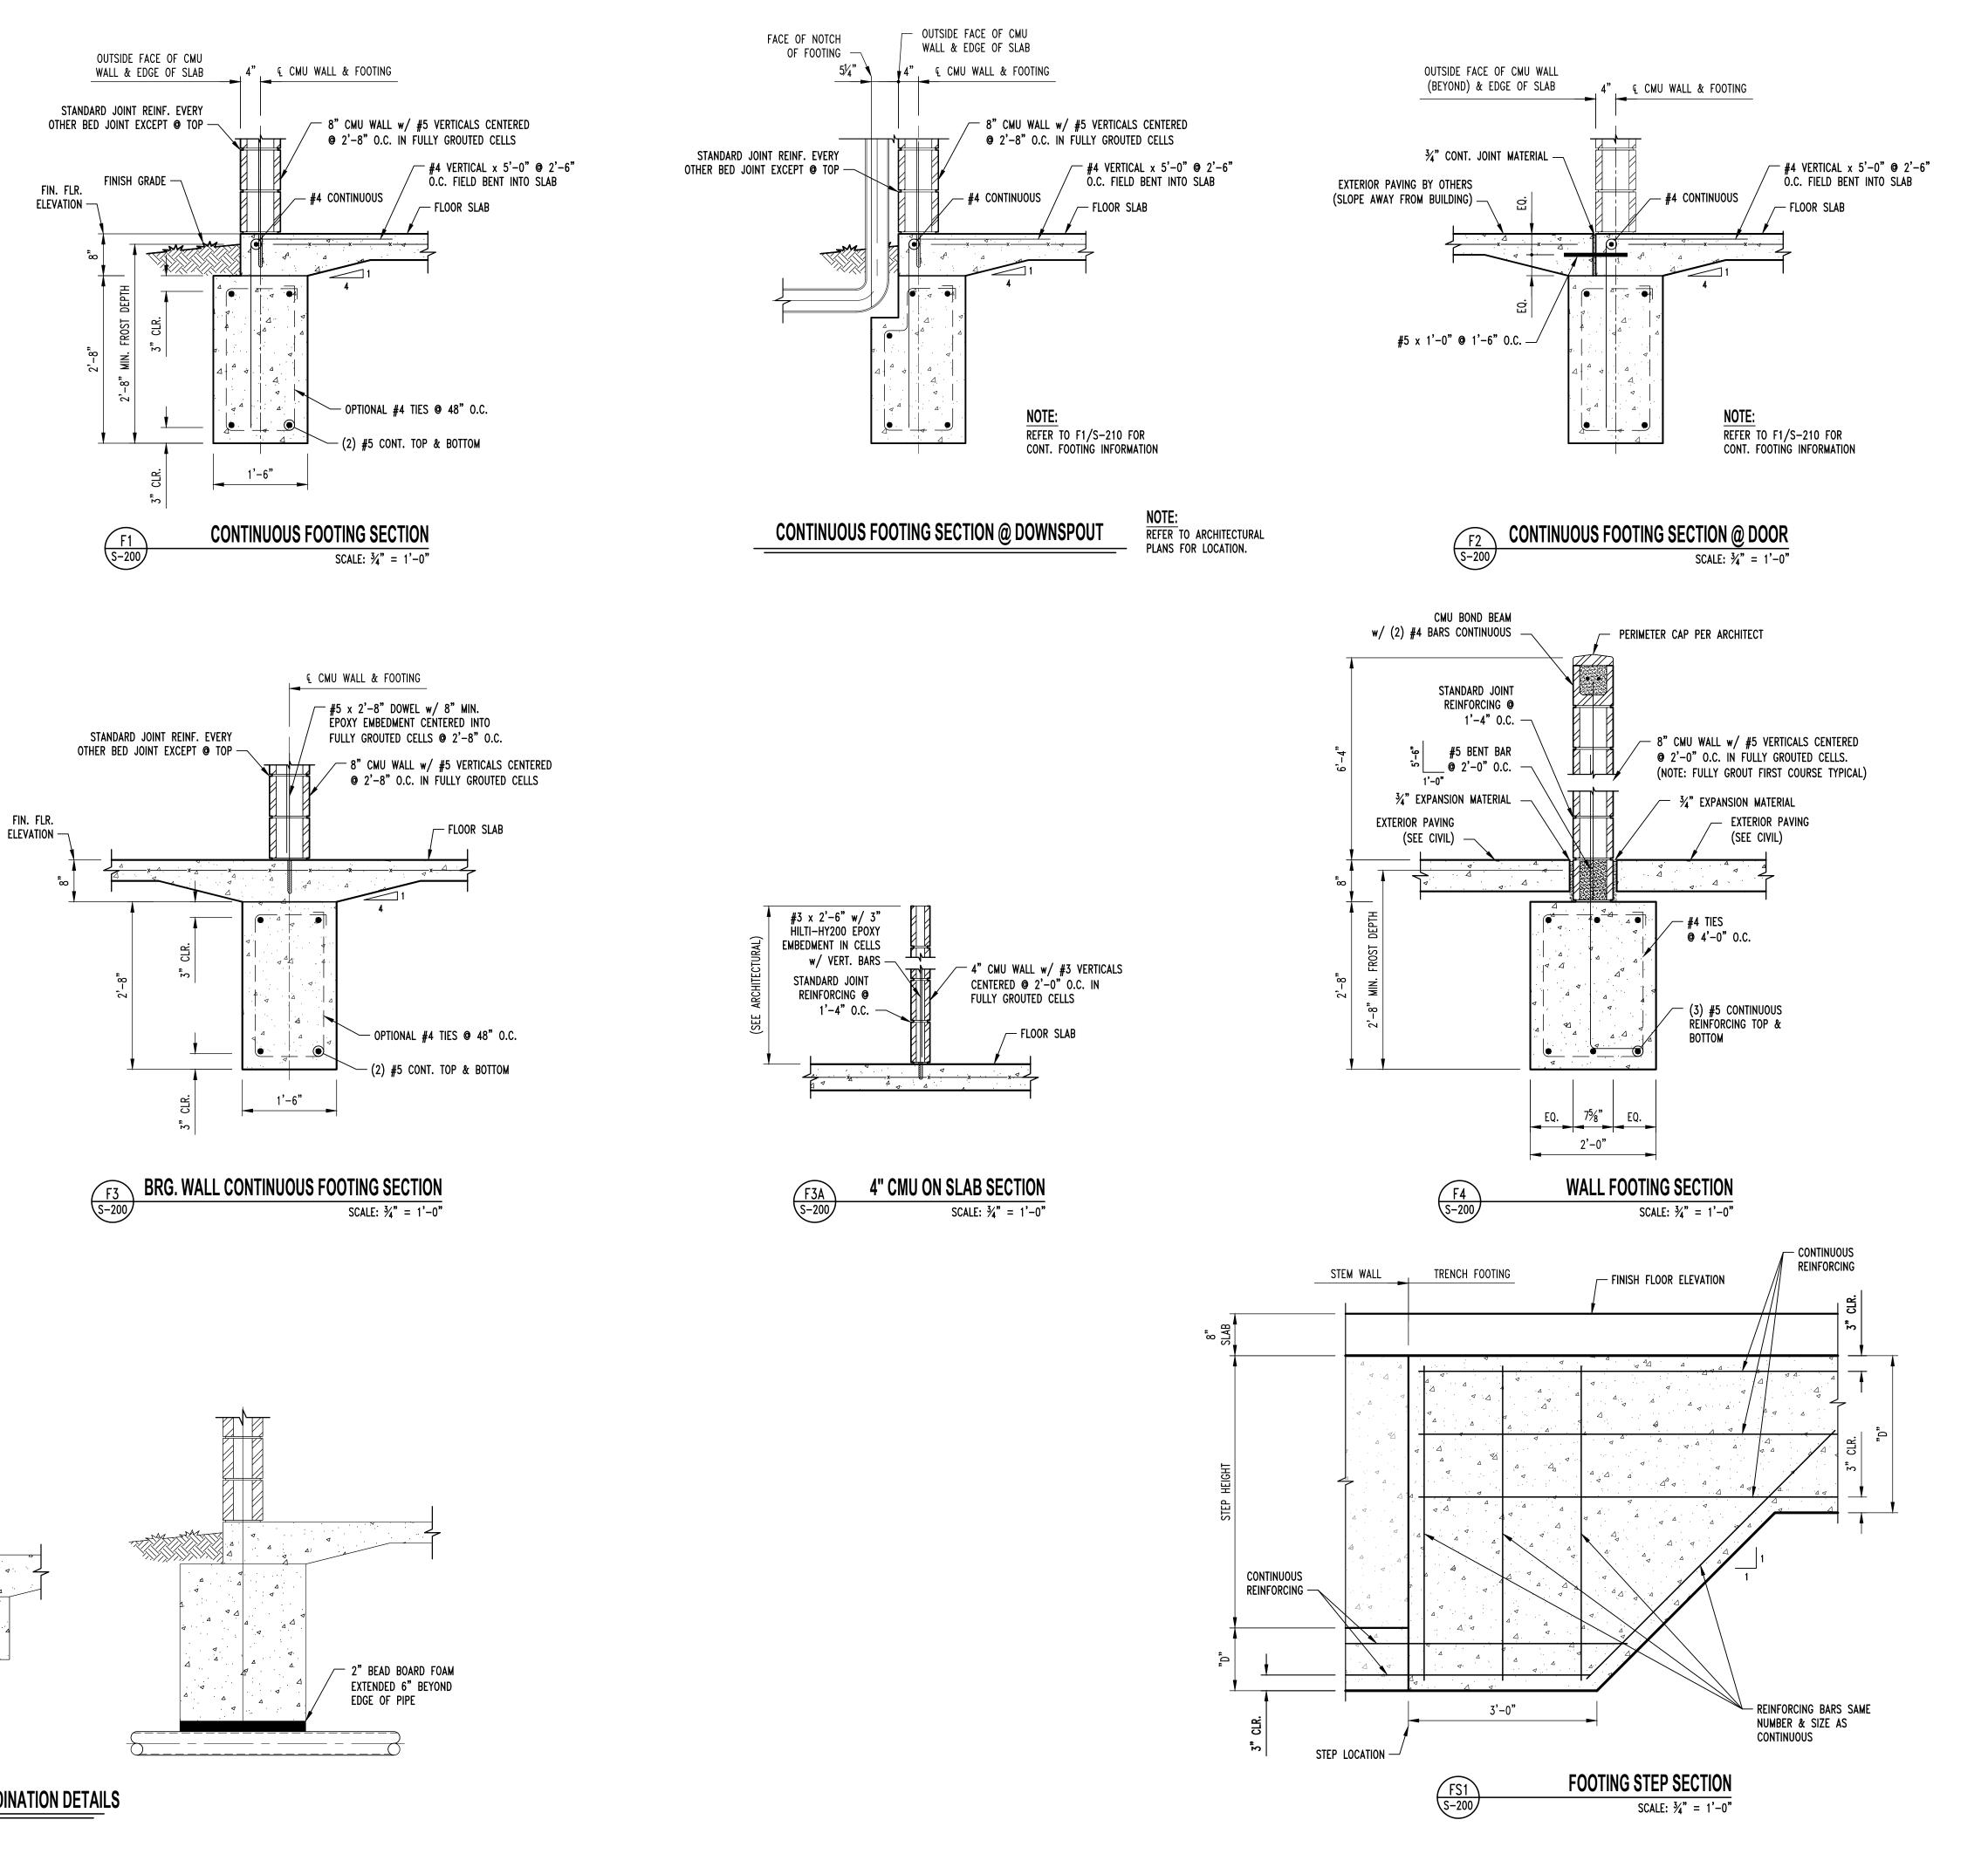CONSTRUCTION JOINT

**CONTRACTION JOINT** 

TYP. ELECTRICAL GROUNDING DETAIL @ FOOTING

\_\_\_\_\_

NON-METALLIC PROTECTIVE SLEEVE -

€ JOINT

- SAWCUT

 $\triangleleft \Delta$ 

GROUNDING

ELECTRODE

CONDUCTOR

- MIN. ½"ø x 20'-0" REINF. BAR

1'-6" @ 1'-8" O.C.

(GREASE ONE END ONLY)  $-\!\!/$ 

FLOOR SLAB


CODE APPROVED

CONNECTION


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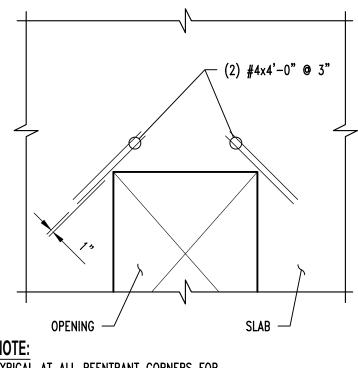
DEPTH


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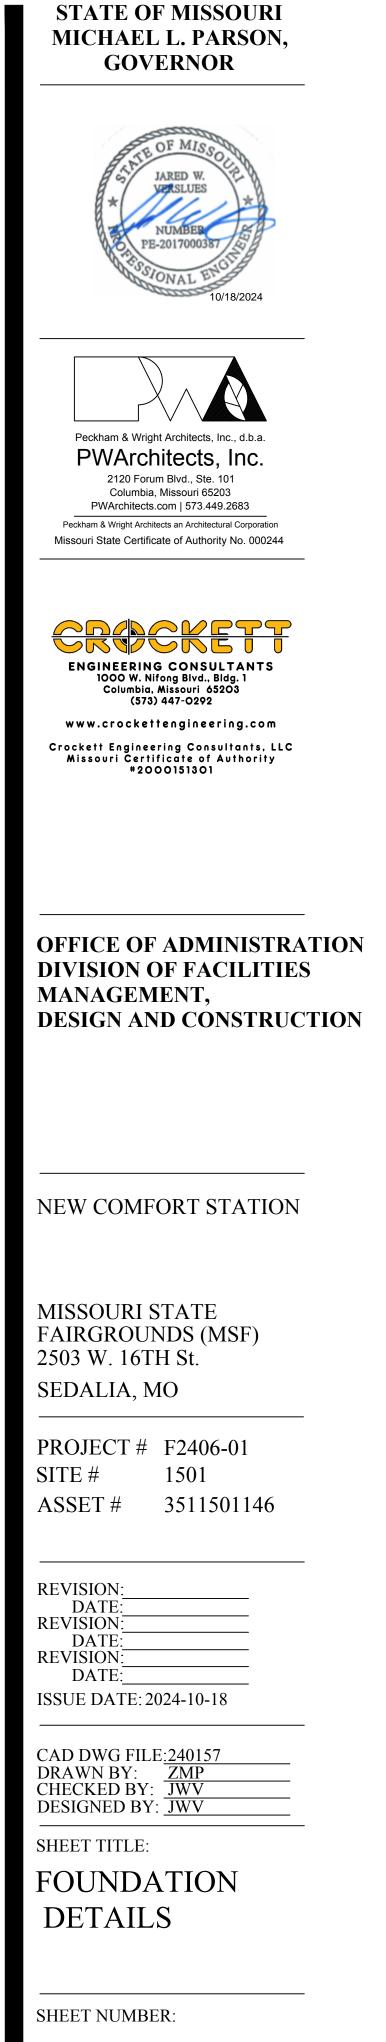


CRACK CONTROL REINFORCING

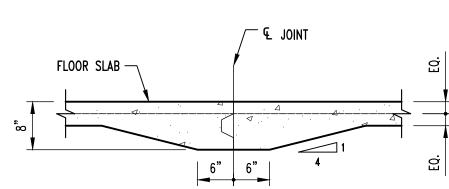





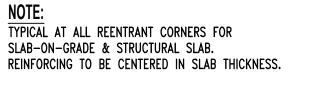


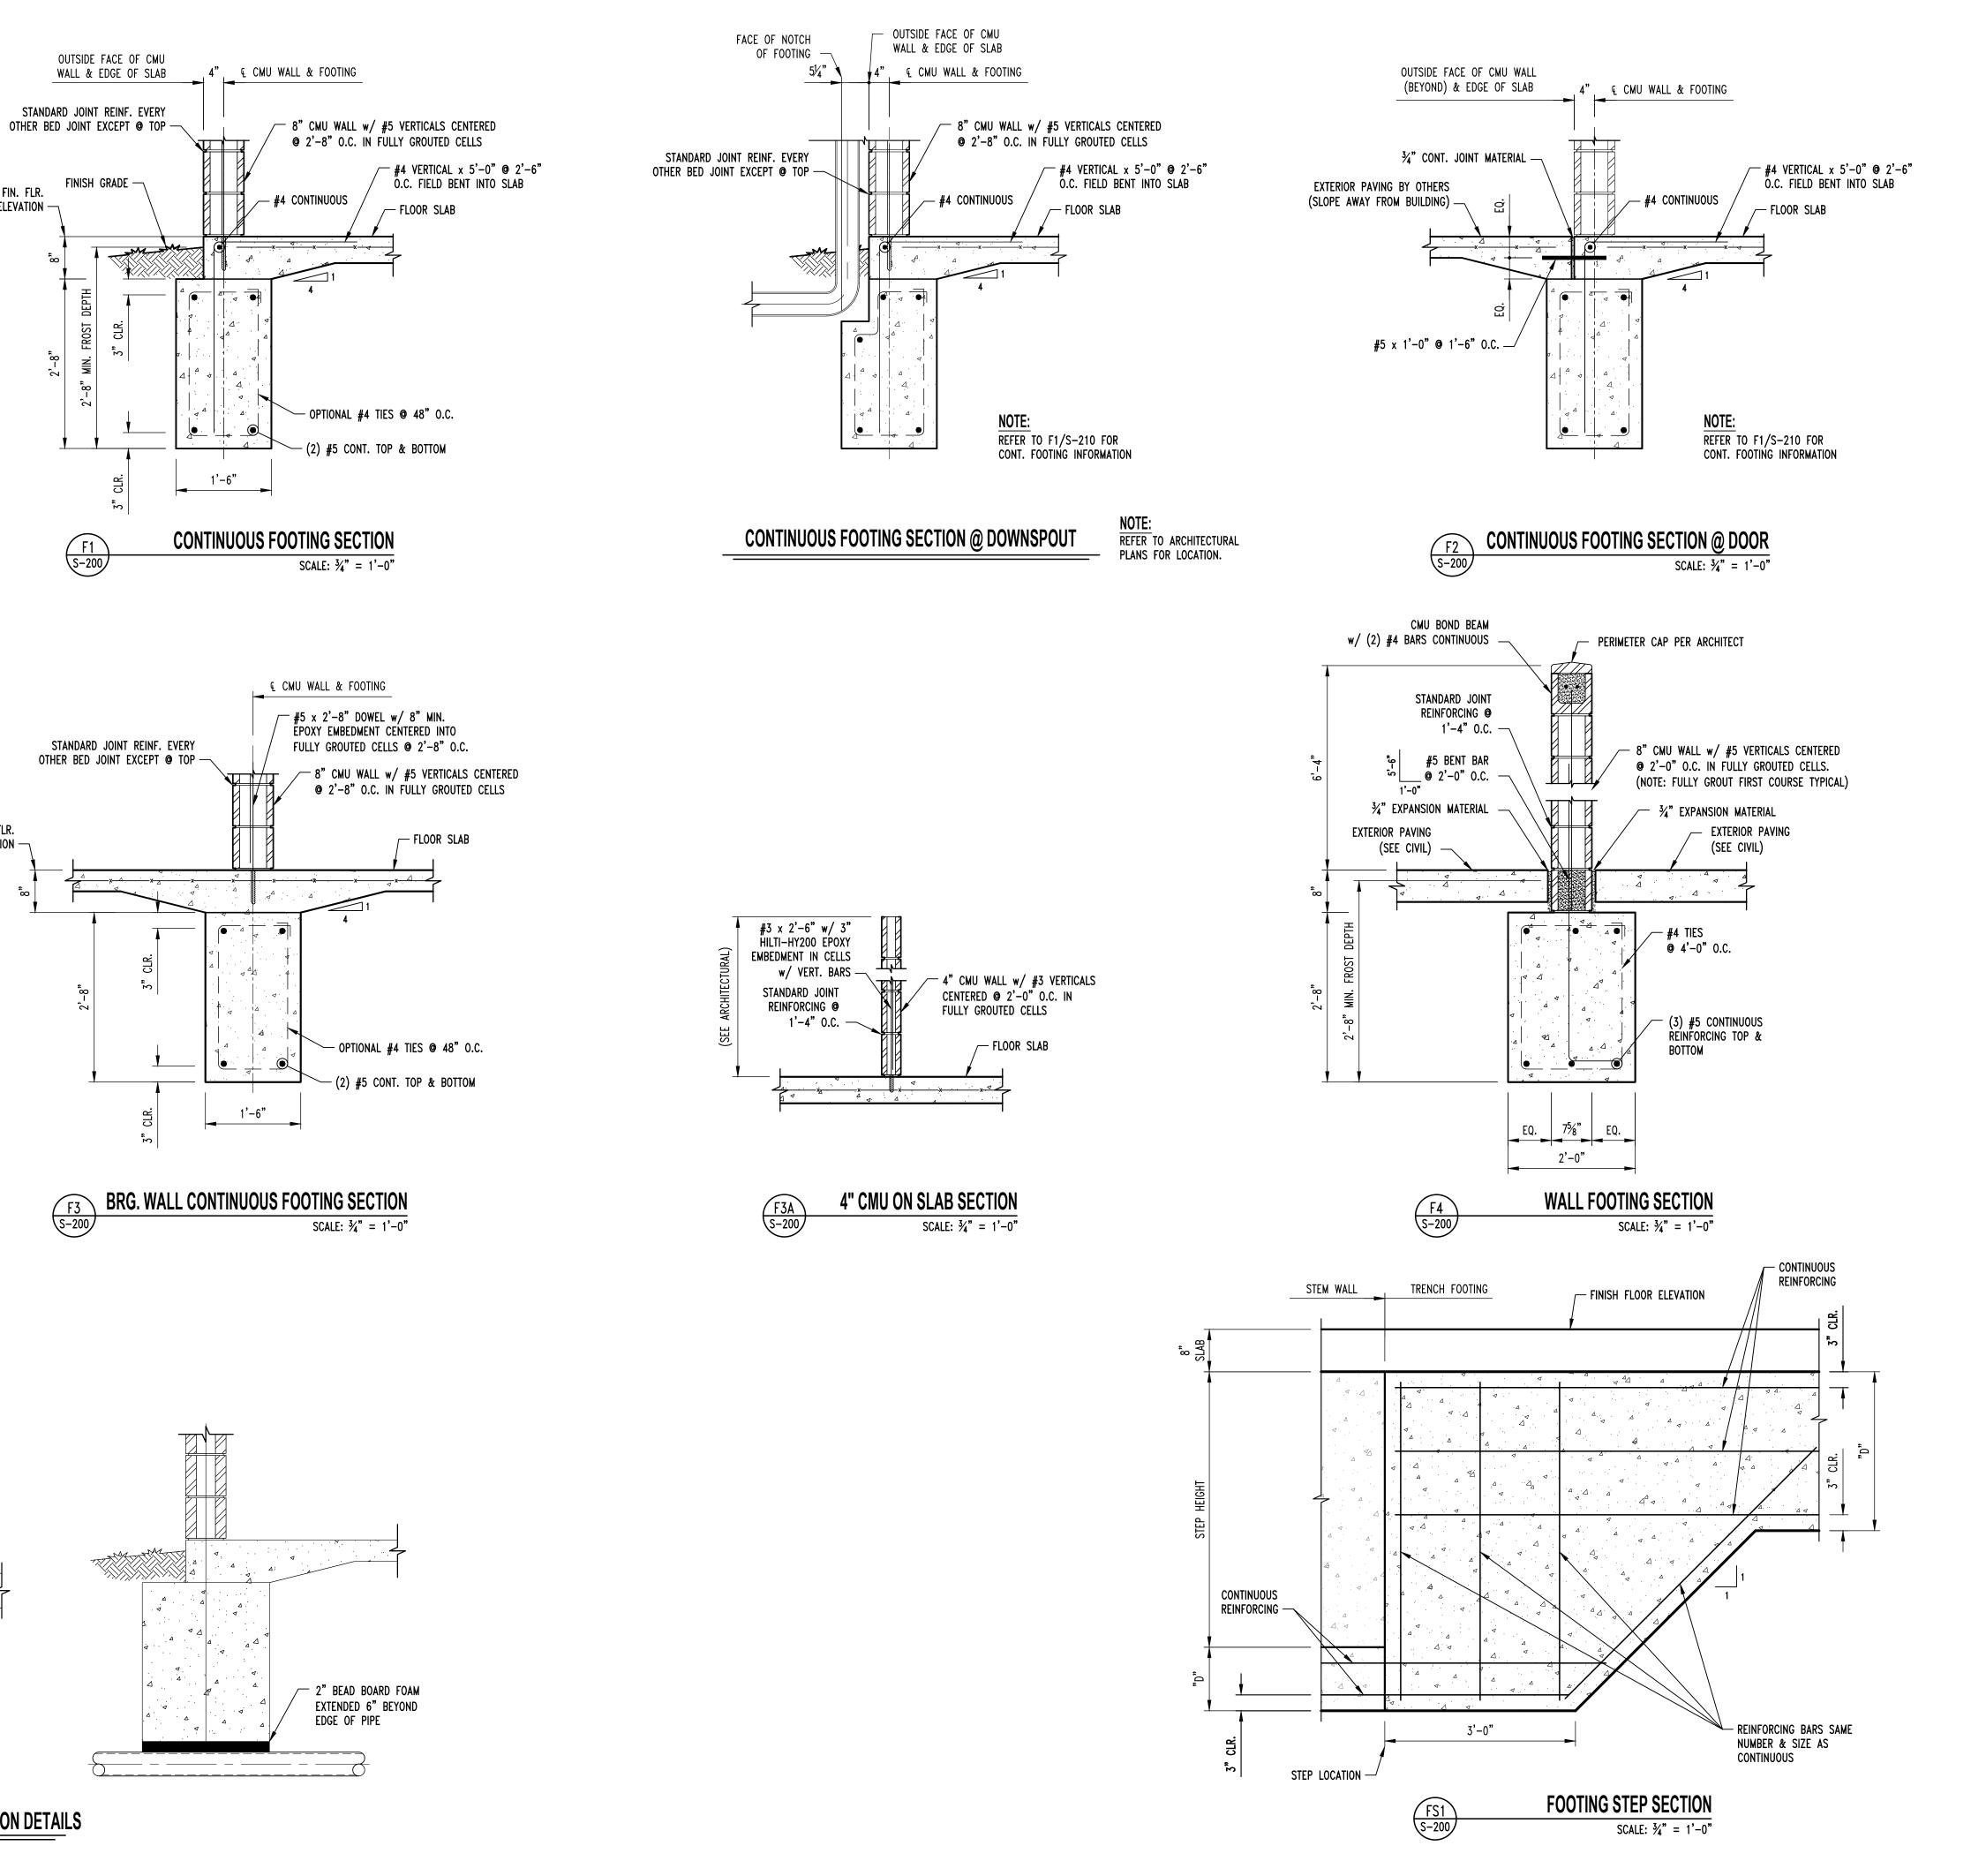

S-210 11 OF 33 SHEETS 2024-10-18

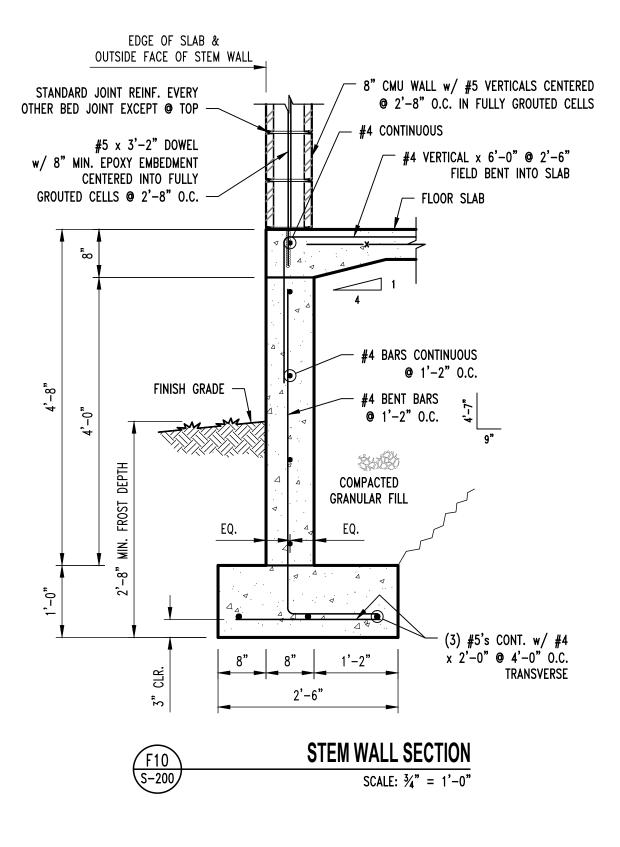

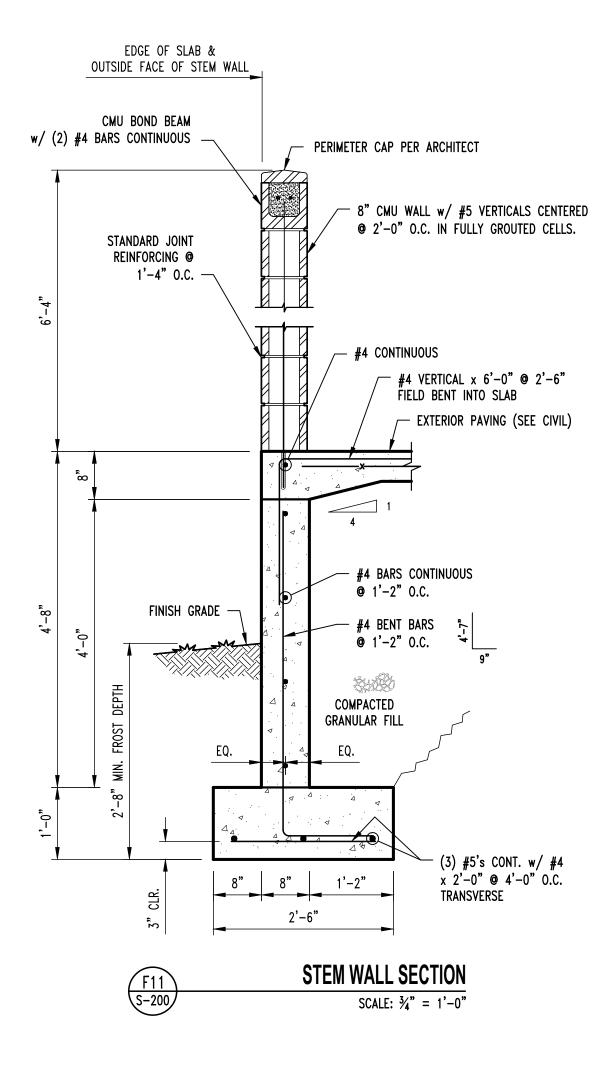

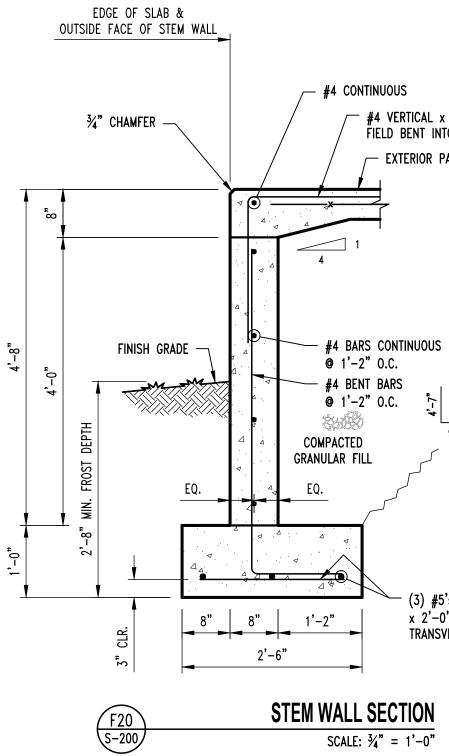

- #4 VERTICAL x 6'-0" @ 2'-6" FIELD BENT INTO SLAB - EXTERIOR PAVING (SEE CIVIL)

4'-7"

── (3) #5's CONT. w/ #4 x 2'−0" @ 4'−0" O.C. TRANSVERSE

## **STATE OF MISSOURI** MICHAEL L. PARSON, GOVERNOR





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## ENGINEERING CONSULTANTS 1000 W. Nifong Blvd., Bldg. 1 Columbia, Missouri 65203 (573) 447-0292

www.crockettengineering.com

Crockett Engineering Consultants, LLC Missouri Certificate of Authority #2000151301

## **OFFICE OF ADMINISTRATION DIVISION OF FACILITIES** MANAGEMENT, **DESIGN AND CONSTRUCTION**

## NEW COMFORT STATION

MISSOURI STATE FAIRGROUNDS (MSF) 2503 W. 16TH St. SEDALIA, MO

PROJECT # F2406-01 SITE # 1501 ASSET # 3511501146

#### **REVISION:** DATE:

**REVISION**: DATE: **REVISION:** DATE:

ISSUE DATE: 2024-10-18

CAD DWG FILE:240157 DRAWN BY: ZMP DRAWN BY: ZMP CHECKED BY: JWV DESIGNED BY: JWV


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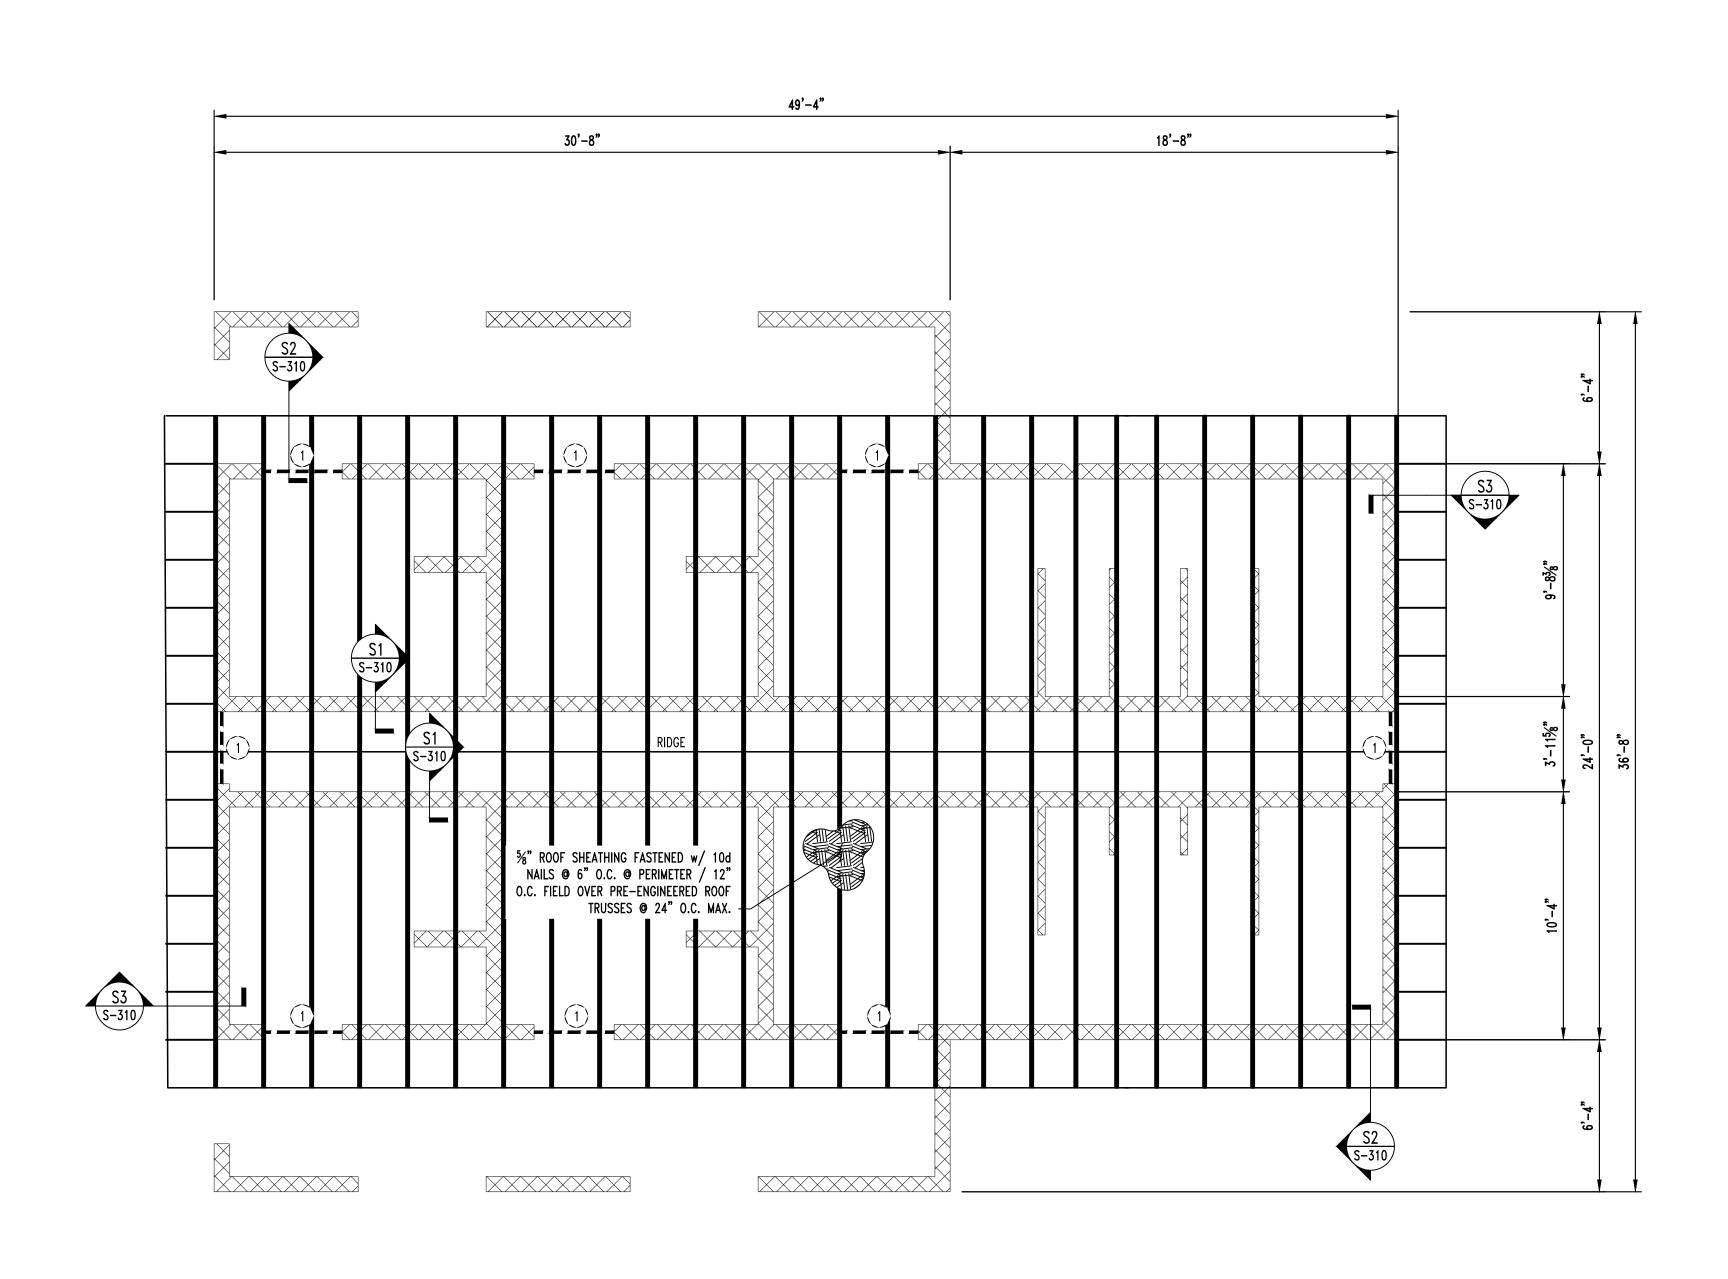
FOUNDATION DETAILS


SHEET NUMBER:

**S-211** 12 OF 33 SHEETS 2024-10-18

NOTE: ALL DIMENSIONS ARE FROM FACE OF FOUNDATION WALL OR FRAMING; EDGE OF SLAB; OR CENTERLINE OF COLUMN, BEAM, OR JOIST UNLESS NOTED OTHERWISE.




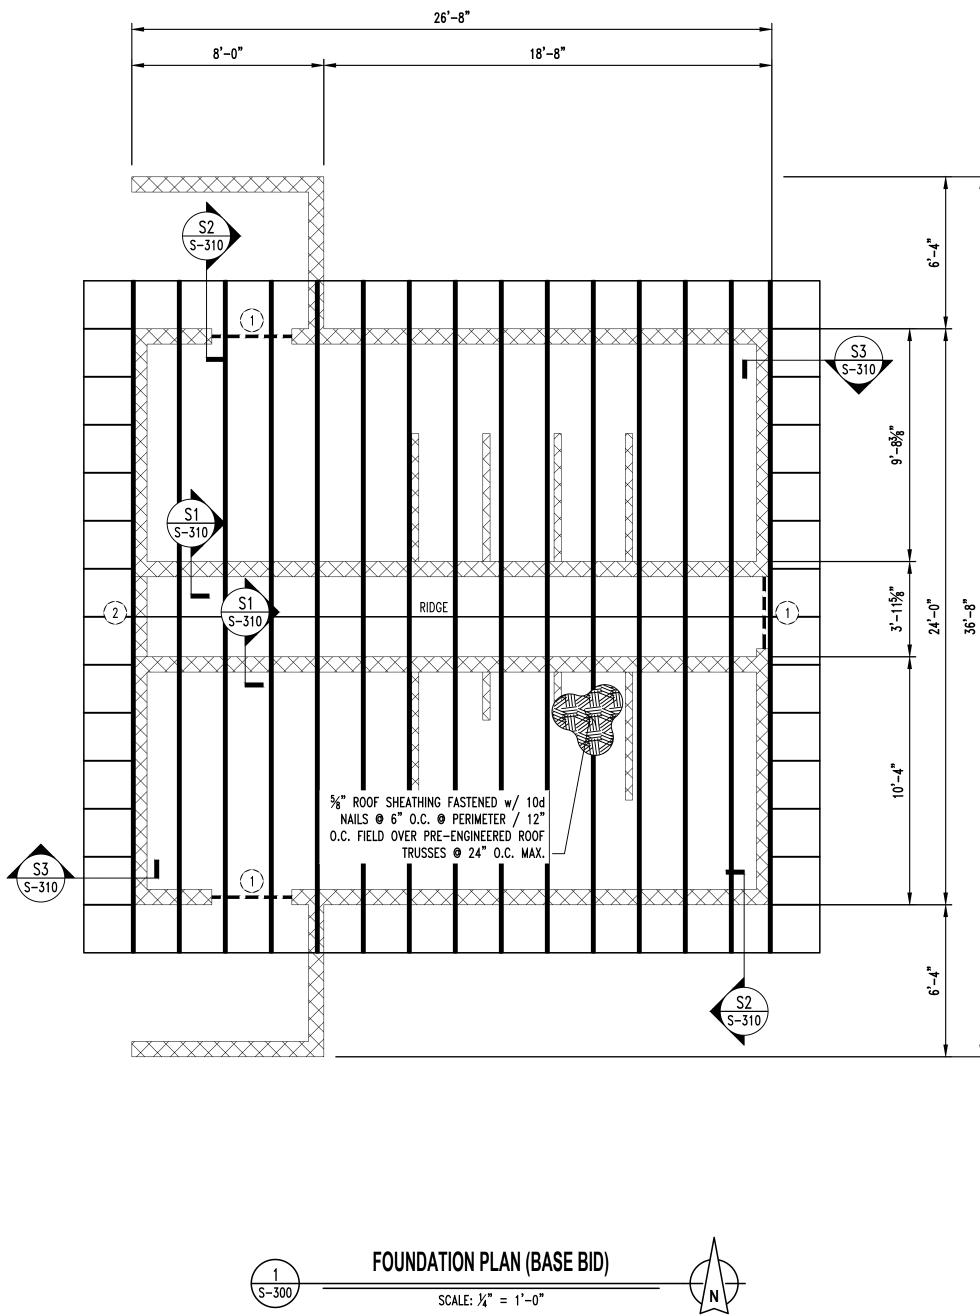

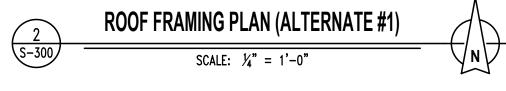

## FRAMING NOTES

- (1) CMU LINTEL. REFER TO DETAIL SM1 SHEET S-311.
- (2) INSTALL LINTEL FOR FUTURE OPENINGS. REFER TO ARCHITECTURAL DRAWINGS FOR DIMENSIONS.

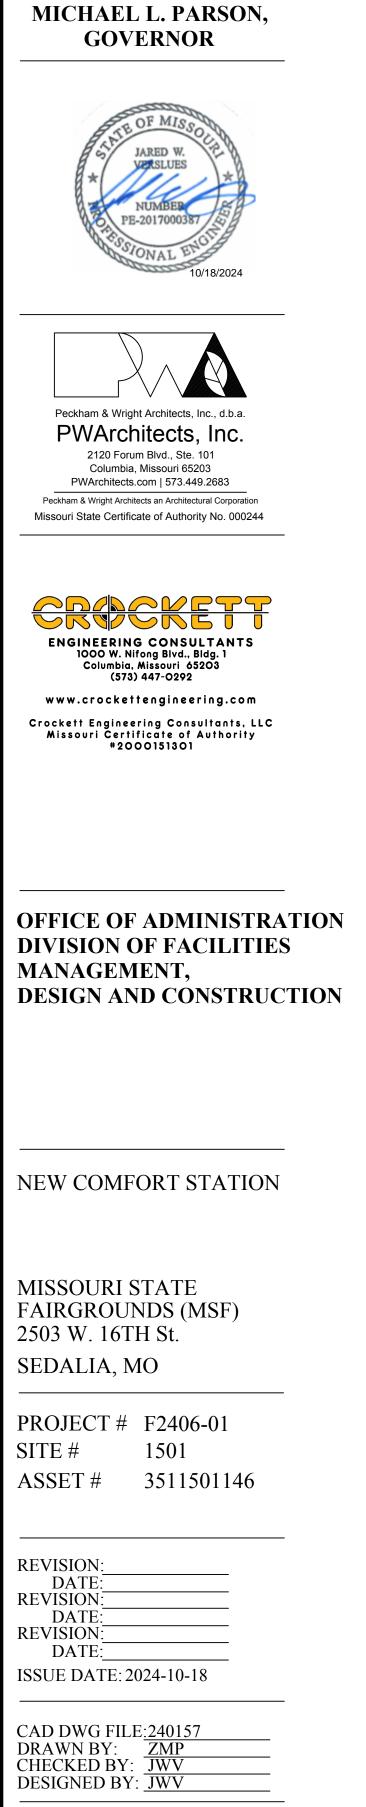

**STATE OF MISSOURI** 

SHEET TITLE:

ROOF FRAMING PLAN


SHEET NUMBER:


**S-300** 13 OF 33 SHEETS 2024-10-18


TRUSS BRG.


ELEV. =  $8"-9\frac{1}{2}'$  AFF


CONT. 2x NAILER --

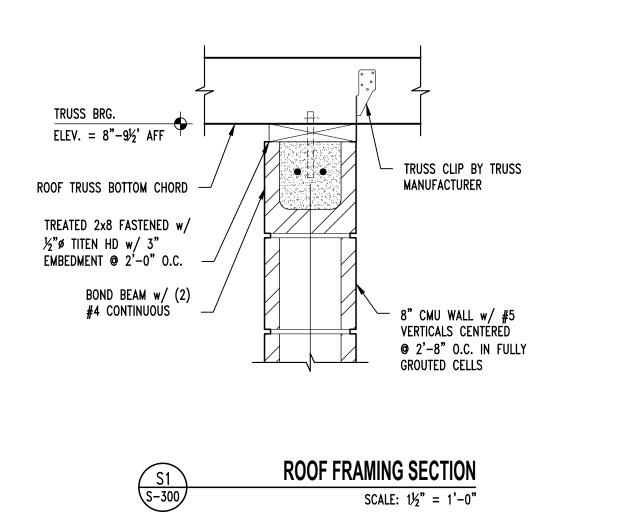


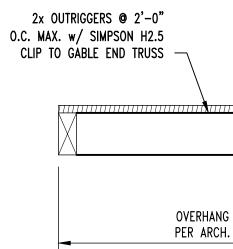

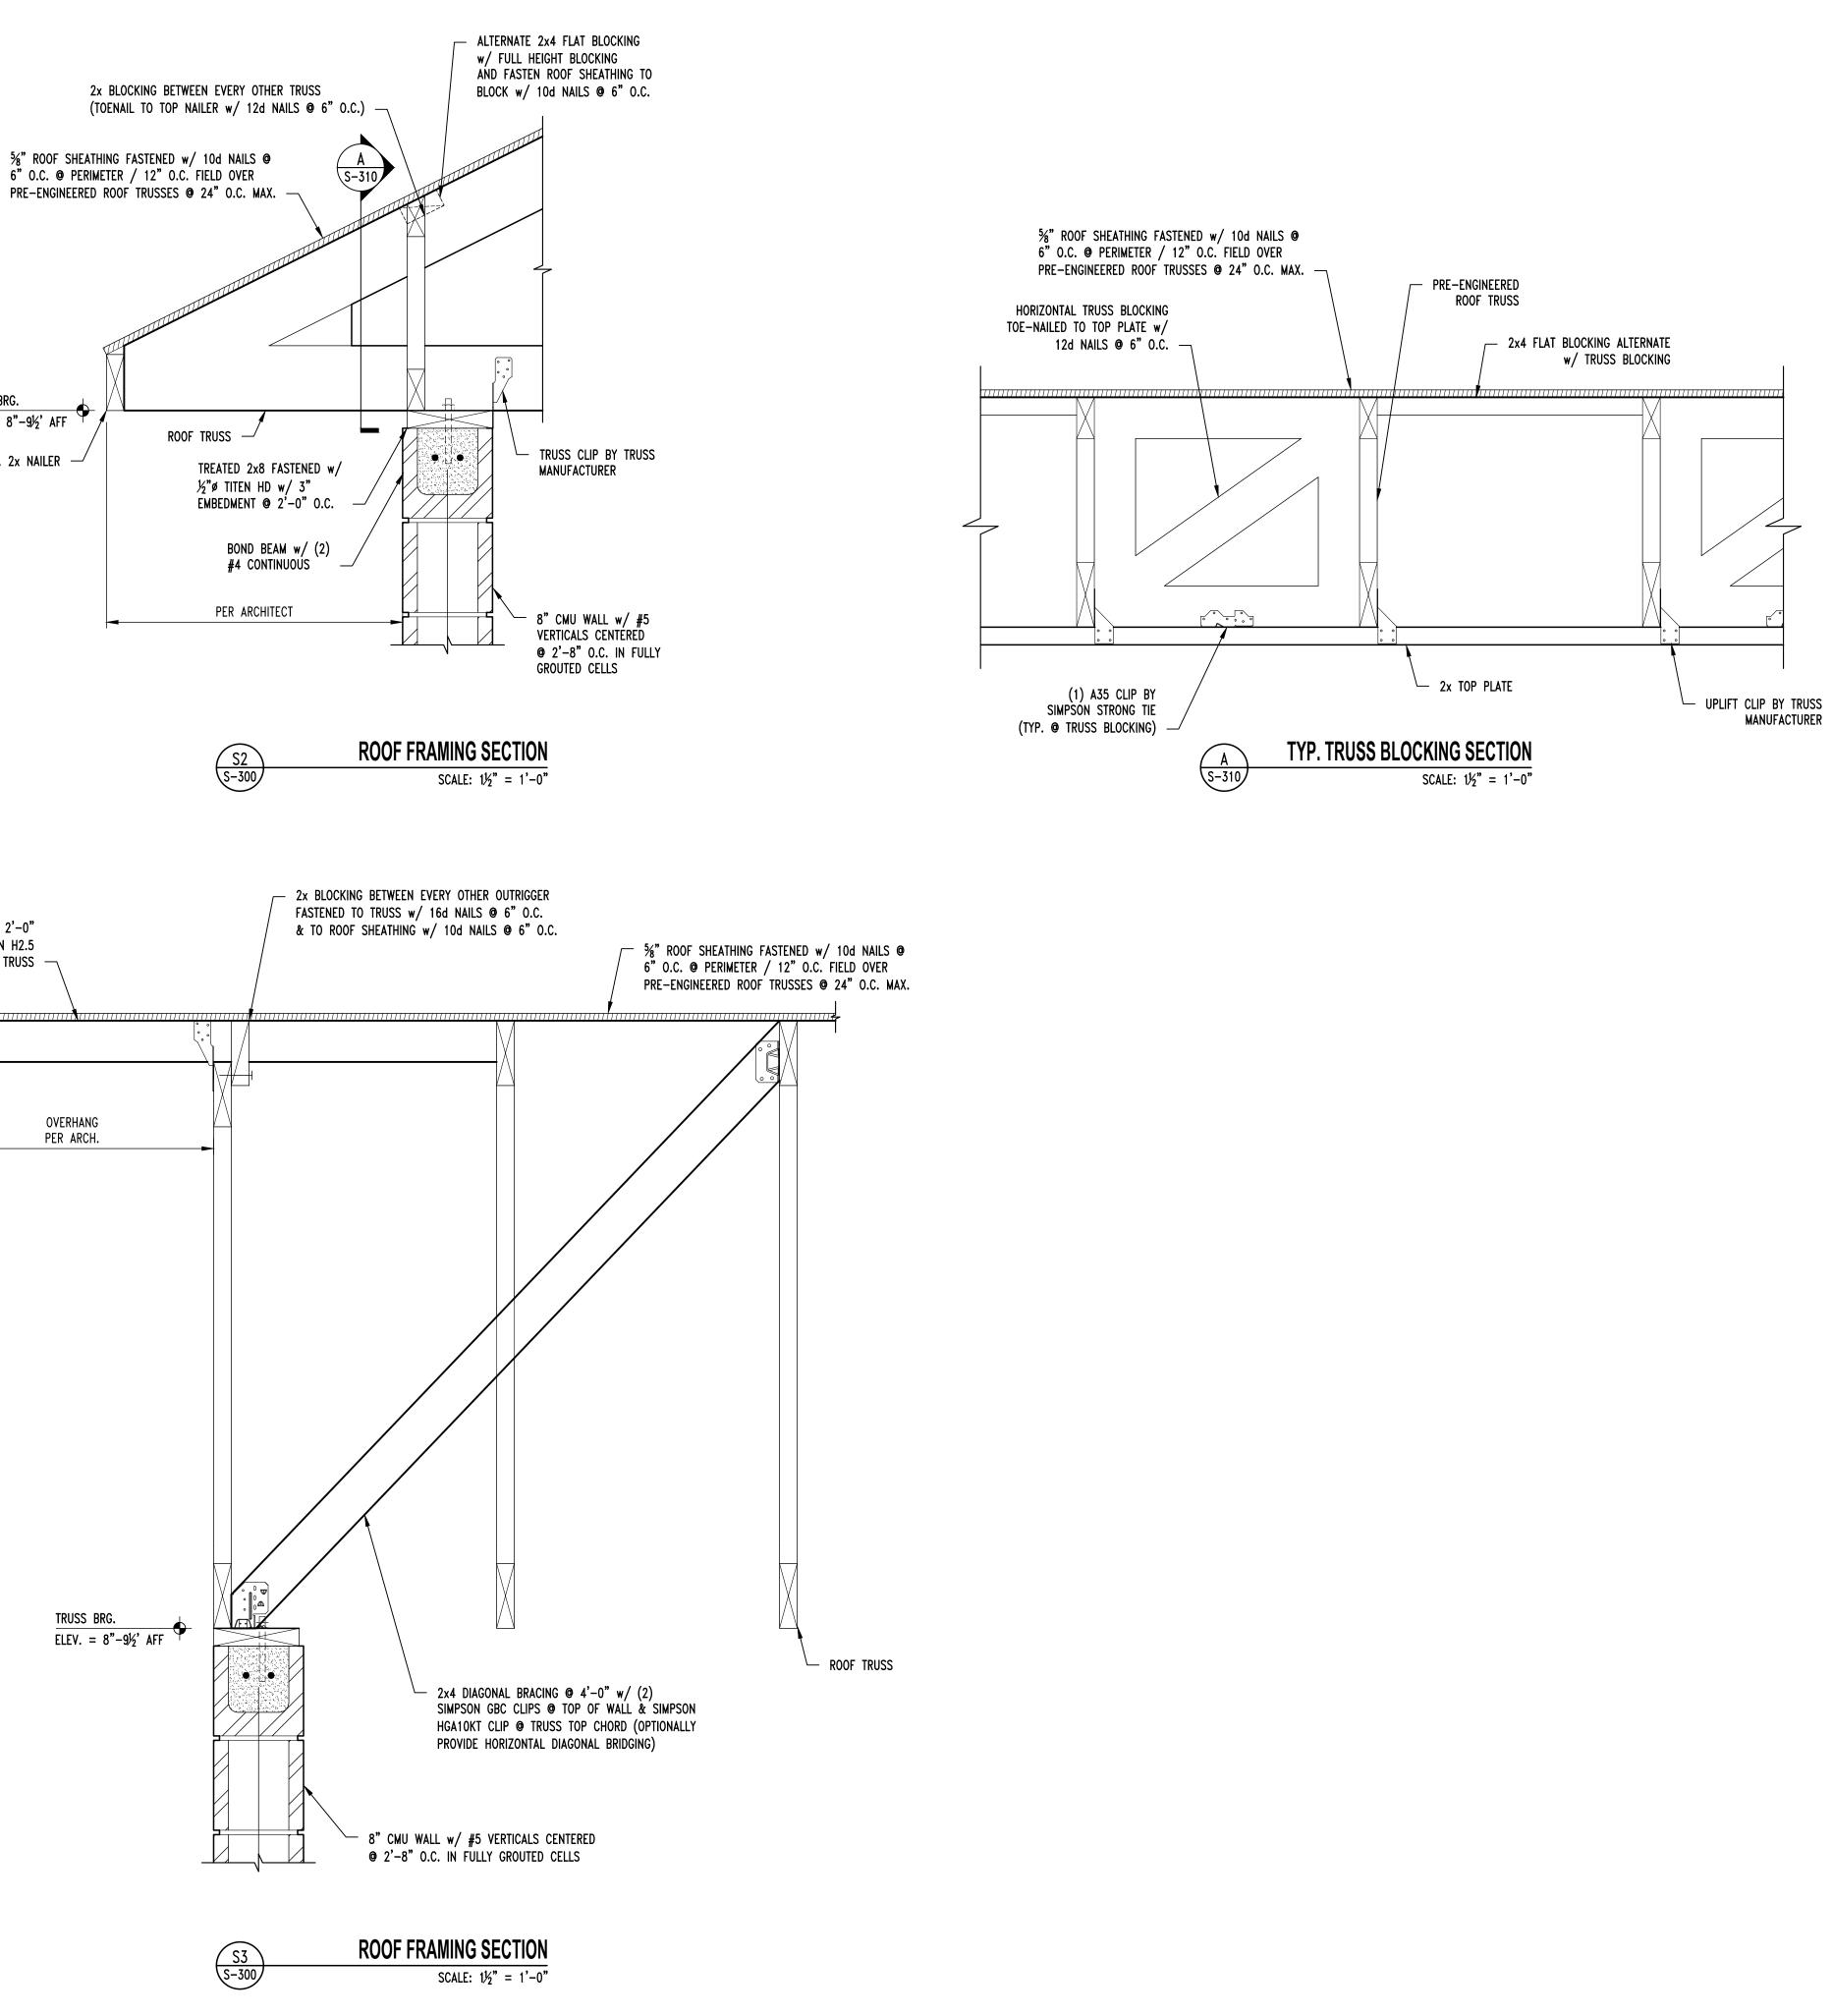

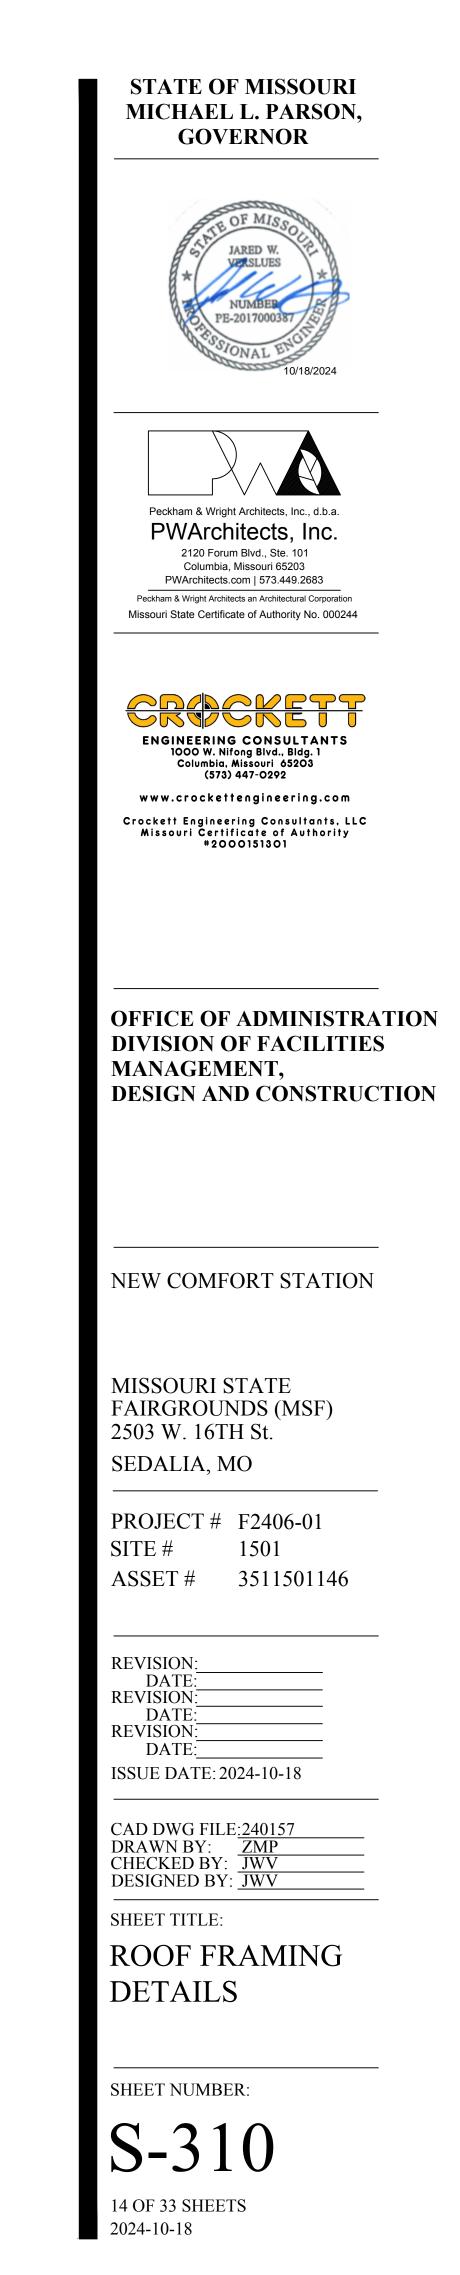

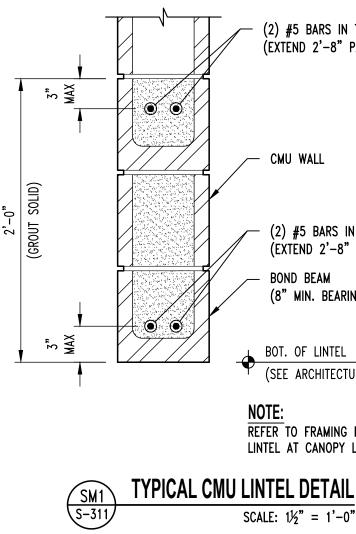

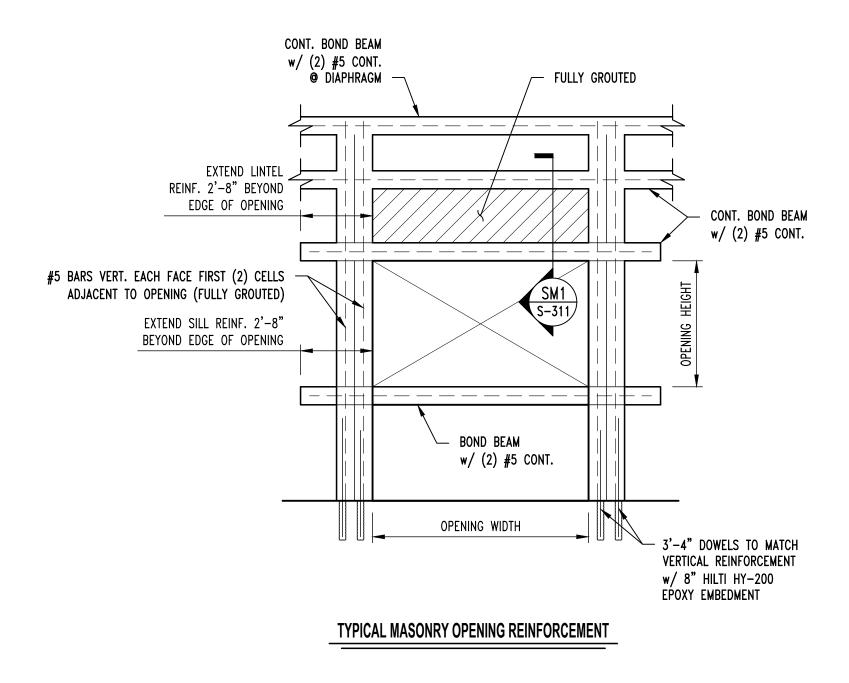

(2) #5 BARS IN TOP COURSE (EXTEND 2'-8" PAST OPENING)

- CMU WALL


(2) #5 BARS IN BOTTOM COURSE (EXTEND 2'-8" PAST OPENING)

BOND BEAM (8" MIN. BEARING EACH END MIN.)


BOT. OF LINTEL (SEE ARCHITECTURAL PLANS)


REFER TO FRAMING PLANS FOR CMU LINTEL AT CANOPY LOCATIONS.

SCALE:  $1\frac{1}{2}$ " = 1'-0"

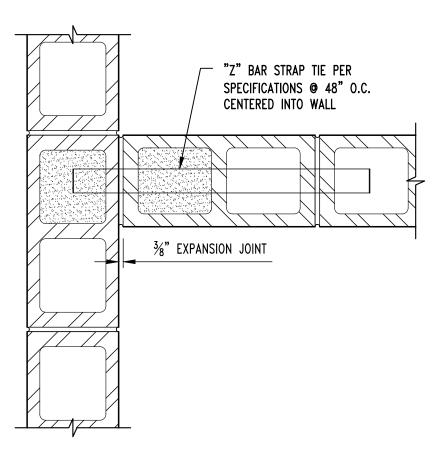




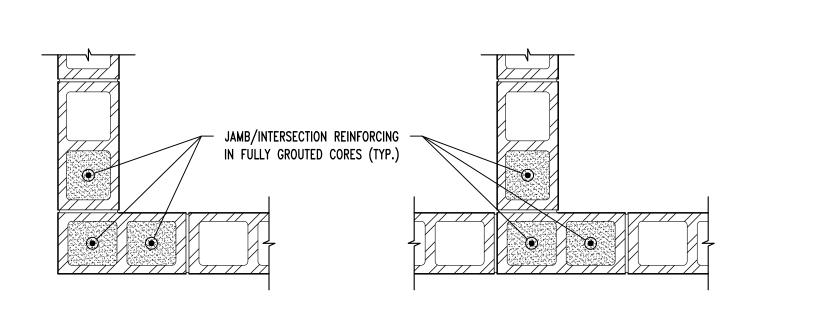

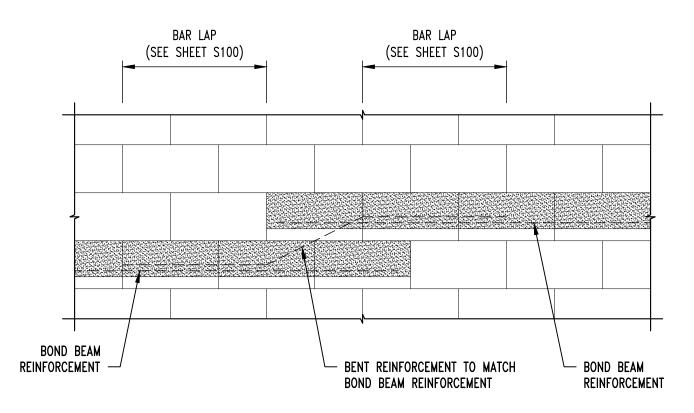

TYPICAL CMU WALL VERT REINFORCING

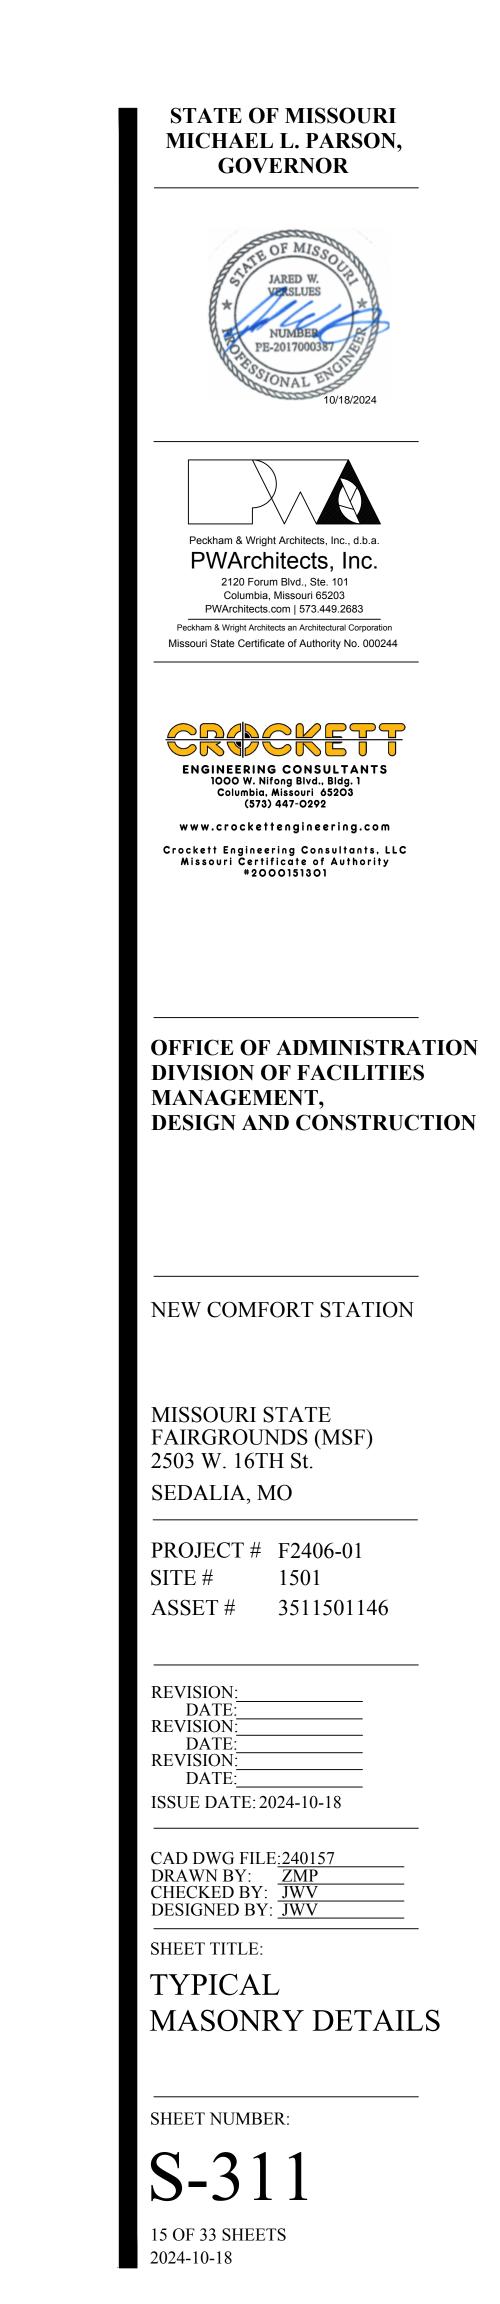



	16X8 FO @ 8" AFF
2	3X4 MET TO DRAI <u>REQUIR</u> I
3	NOT USE
4	ACCESS


	ALTERNATE 2 - CONTRACTOR-INSTALLED PLUMBING FIXTURES AND TOILET ACCESSORIES					
RESTROOM ACCESSORY SCHEDULE						
NOTE	ITEM	PROVIDED BY:	INSTALLED BY:	MODEL	REMARKS	
	(24"X36") 1/4" TEMPERED GLASS MIRROR	PBC	IBC	BOBRICK B-2908 2436		
2	TOILET PAPER DISPENSER	РВО	IBC	CASCADES PRO D812		
3	GRAB BAR	PBC	IBC	BOBRICK B-6806 x 18		
4	GRAB BAR	PBC	IBC	BOBRICK B-6806 x 36		
5	GRAB BAR	PBC	IBC	BOBRICK B-6806 x 42		
6	PAPER TOWEL DISPENSER	РВО	IBC	CASCADES PRO C340		
	SOAP DISPENSER	РВО	IBC	SPARTAN LITE N' FOAMY		
8	SANITARY NAPKIN DISPOSAL	PBC	IBC	BOBRICK B-254		
9	CLOTHES HOOK	PBC	IBC	BOBRICK B-233	MOUNT AT 46" AFF TO TOP OF HOOK	
	GRAB BAR	PBC	IBC	BOBRICK B-6806 x 24		
	GRAB BAR	PBC	IBC	BOBRICK B-6806 x 48		
<ul> <li>PROVIDE WALL BLOCKING / REINFORCING AS REQUIRED FOR ACCESSORY INSTALLATION AND MOUNTING.</li> <li>PBO = PROVIDED BY OWNER</li> </ul>						


**PBO** = PROVIDED BY OWNER **PBC** = PROVIDED BY CONTRACTOR

• **IBC** = INSTALLED BY CONTRACTOR

	ACCESSIBLE CLEAR FLOOR SPACE REQUIREMENTS					
NOTE	ITEM					
1	5'-0" DIAMETER CLEAR FLOOR TURNING SPACE					
2	30" X 48" CLEAR FLOOR SPACE CENTERED WITH SINK/LAVATORY FOR PARALLEL APPROACH					
3	56" X 60" MIN. CLEAR FLOOR SPACE AROUND WATER CLOSET					
4	30" X 48" CLEAR FLOOR SPACE CENTERED ON URINAL					
5	30" X 60" CLEAR FLOOR SPACE CENTERED ON ROLL-IN SHOWER					



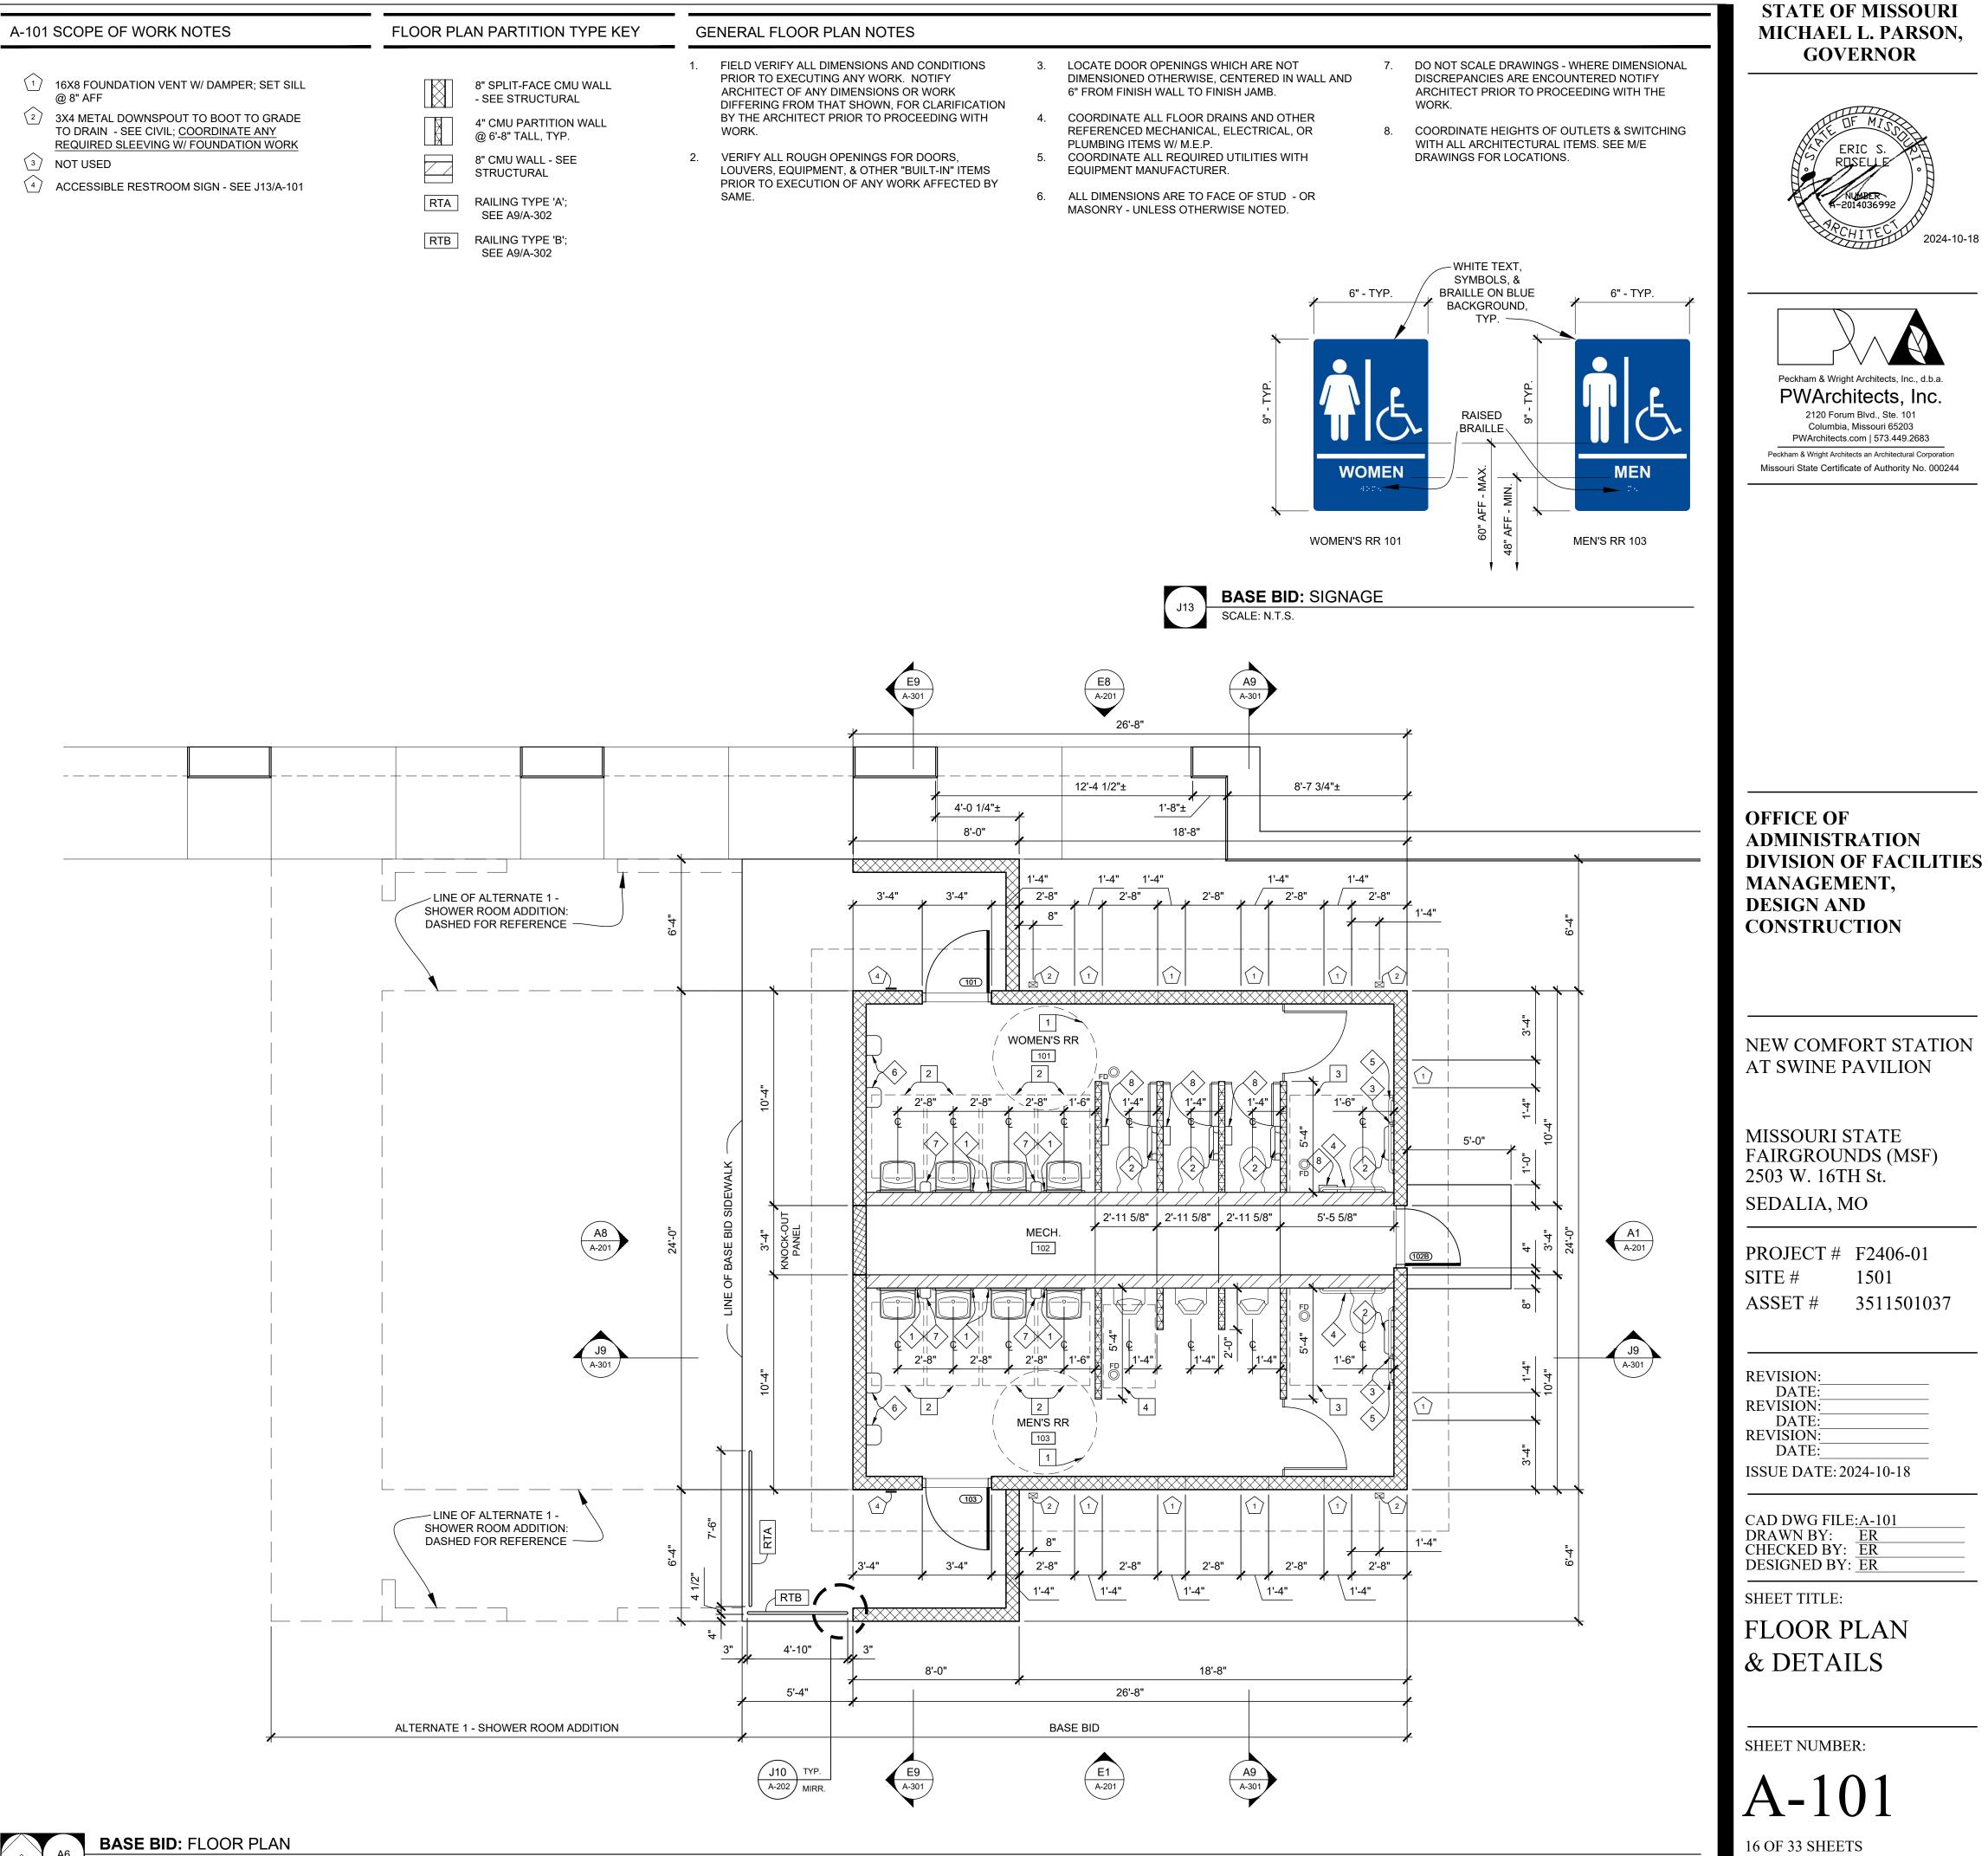

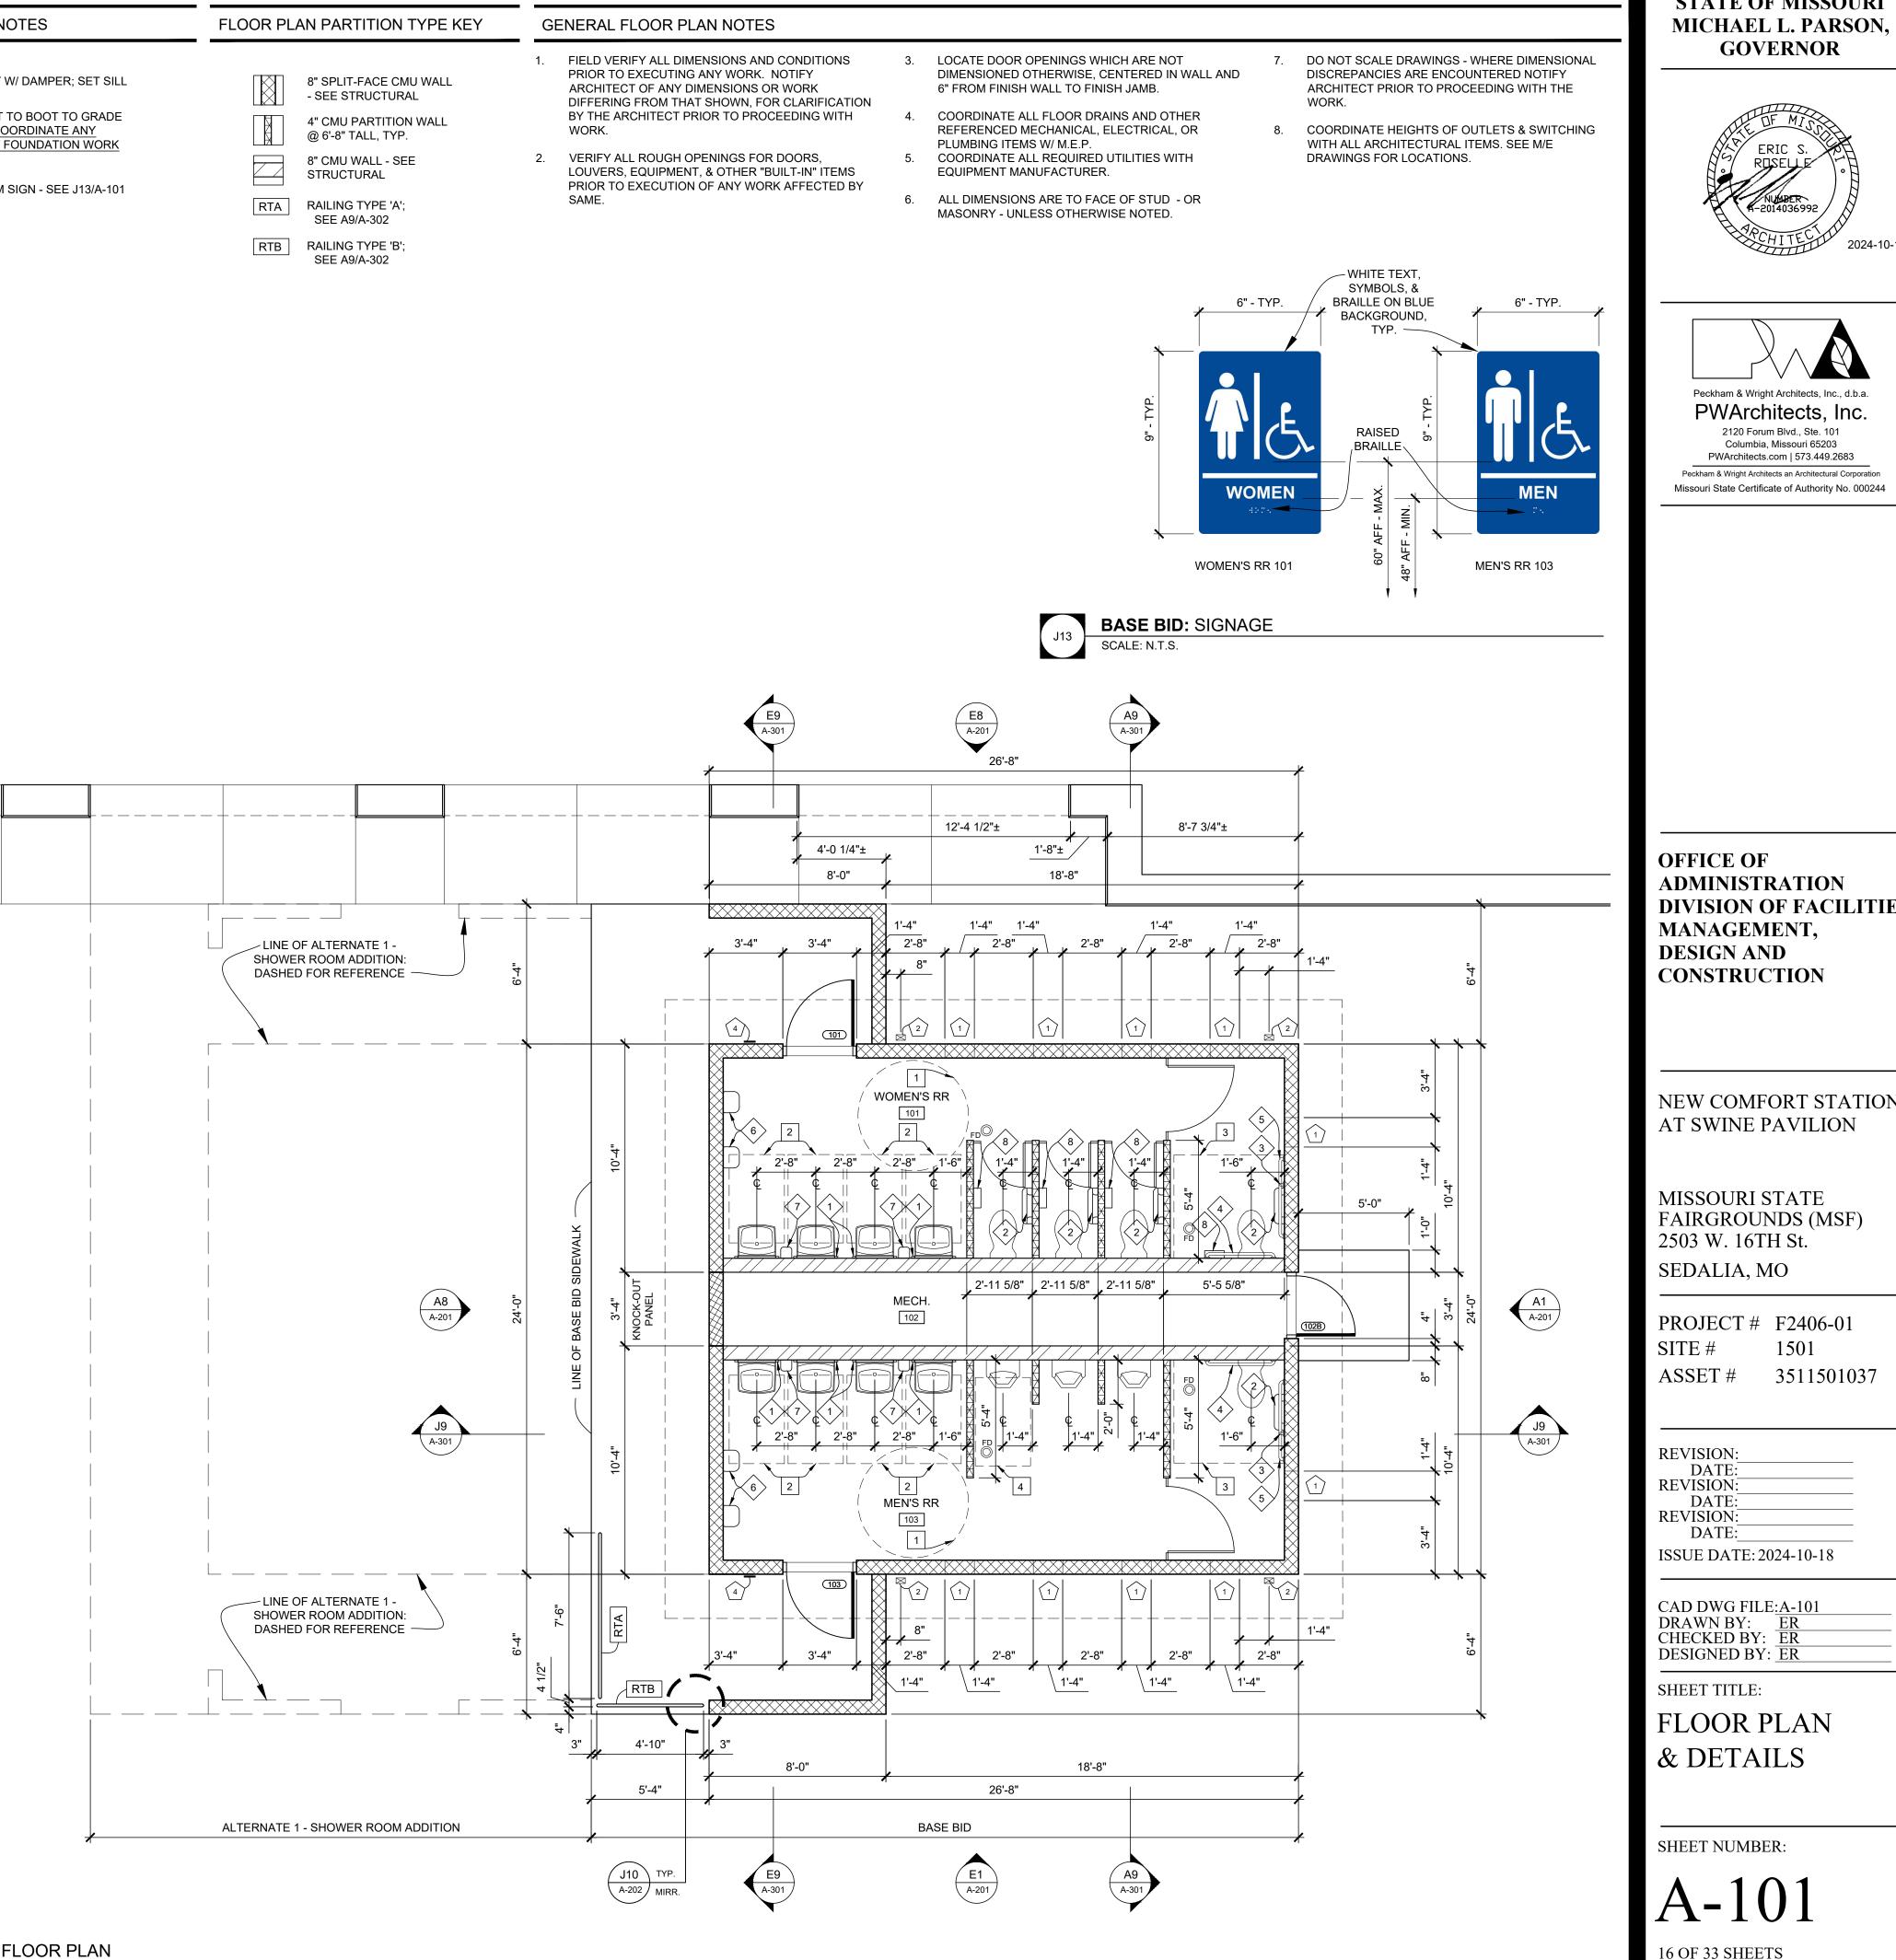

BASE BID: FLOOR PLAN

7	8	9	10	11	12

2024-10-18

	16X8 FOI @ 8" AFF
2	3X4 MET TO DRAI <u>REQUIRE</u>
3	COORDII TO ENSU ENTRY.
4	ACCESS
5	ACCESS SIGN - SI
6	ACCESS SIGN - SI
7	MEN'S R J8/A-102
8	WOMEN'

ALTERNATE 2 - CONTRACTOR-INSTALLED PLUMBING FIXTURES							
	AND TOILET ACCESSORIES						
RESTROOM ACCESSORY SCHEDULE							
NOTE	ITEM	PROVIDED BY:	INSTALLED BY:	MODEL	REMARKS		
	(24"X36") 1/4" TEMPERED GLASS MIRROR	PBC	IBC	BOBRICK B-2908 2436			
2	TOILET PAPER DISPENSER	РВО	IBC	CASCADES PRO D812			
3	GRAB BAR	PBC	IBC	BOBRICK B-6806 x 18			
4	GRAB BAR	PBC	IBC	BOBRICK B-6806 x 36			
5	GRAB BAR	PBC	IBC	BOBRICK B-6806 x 42			
6	PAPER TOWEL DISPENSER	РВО	IBC	CASCADES PRO C340			
	SOAP DISPENSER	РВО	IBC	SPARTAN LITE N' FOAMY			
$\langle \infty \rangle$	SANITARY NAPKIN DISPOSAL	PBC	IBC	BOBRICK B-254			
9	CLOTHES HOOK	PBC	IBC	BOBRICK B-233	MOUNT AT 46" AFF TO TOP OF HOOK		
	GRAB BAR	PBC	IBC	BOBRICK B-6806 x 24			
	GRAB BAR	PBC	IBC	BOBRICK B-6806 x 48			
PROVIDE WALL BLOCKING / REINFORCING AS REQUIRED FOR ACCESSORY INSTALLATION AND MOUNTING.							

• **PBO** = PROVIDED BY OWNER • **PBC** = PROVIDED BY CONTRACTOR

1


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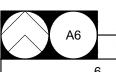
• **IBC** = INSTALLED BY CONTRACTOR

ACCESSIBLE CLEAR FLOOR SPACE REQUIREMENTS NOTE ITEM 5'-0" DIAMETER CLEAR FLOOR TURNING SPACE 30" X 48" CLEAR FLOOR SPACE CENTERED WITH SINK/LAVATORY FOR PARALLEL APPROACH 56" X 60" MIN. CLEAR FLOOR SPACE AROUND WATER CLOSET 30" X 48" CLEAR FLOOR SPACE CENTERED ON URINAL | 4 | 5 30" X 60" CLEAR FLOOR SPACE CENTERED ON ROLL-IN SHOWER

4

3



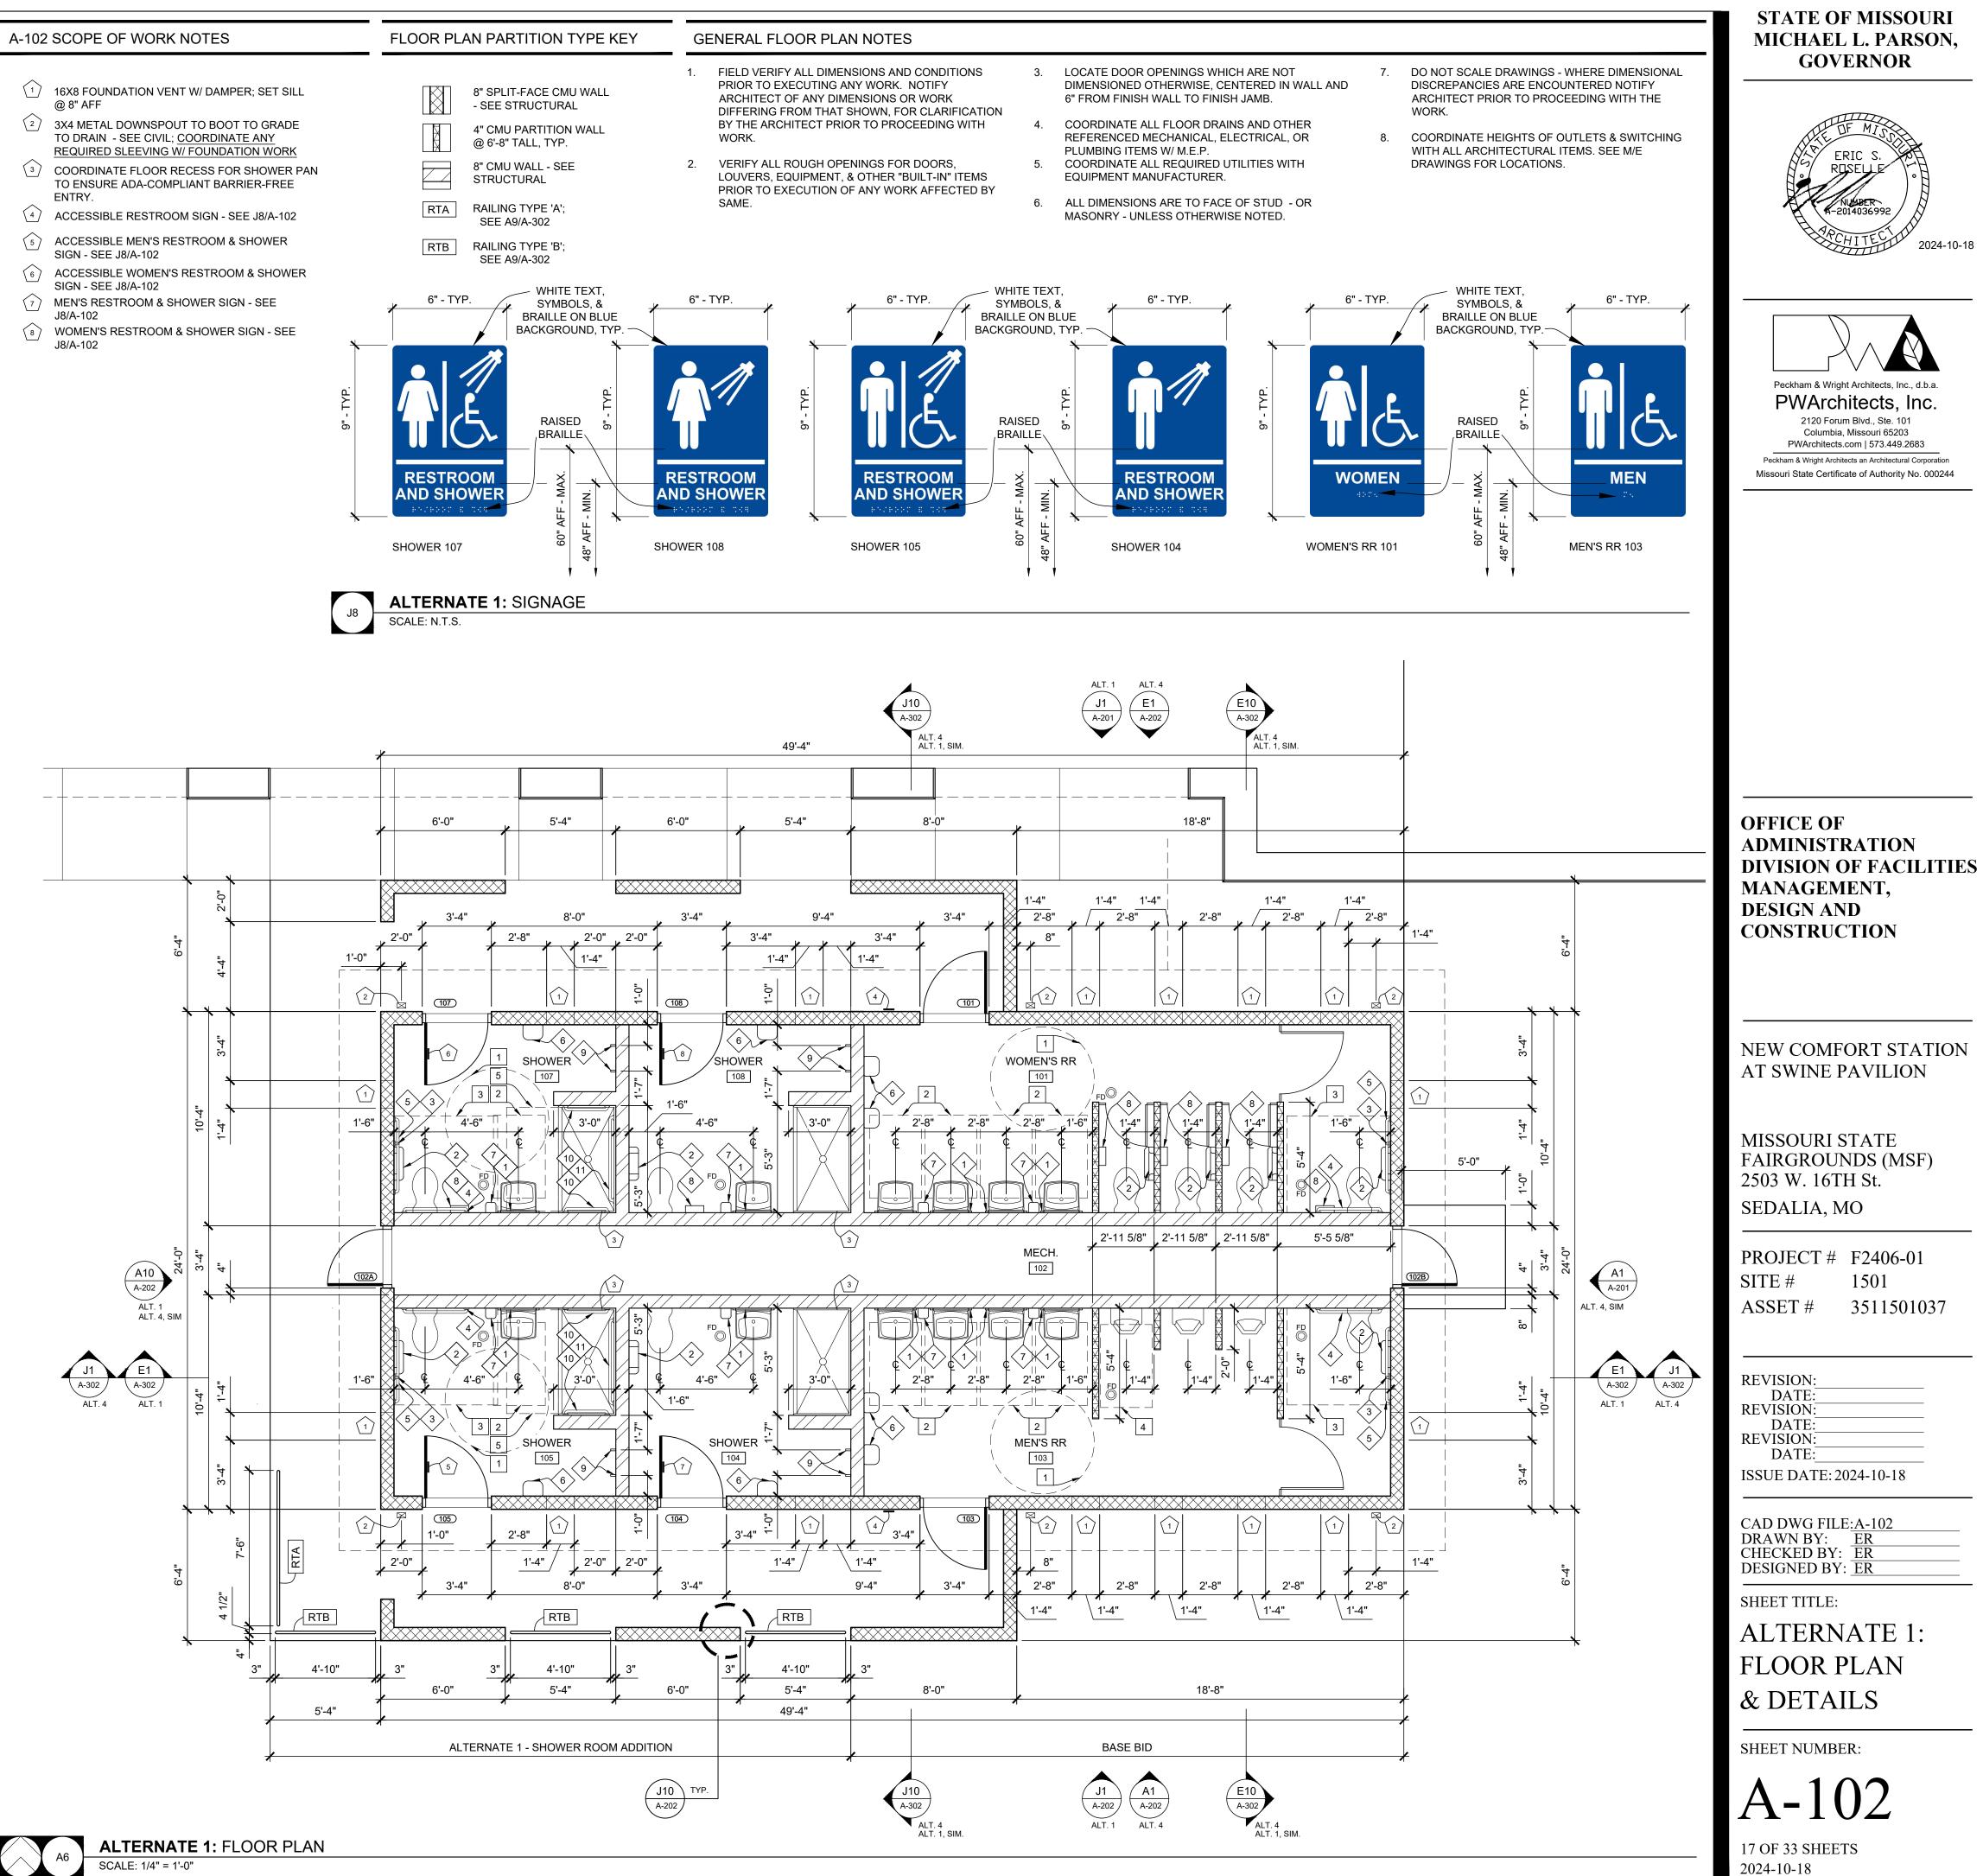

5


11 8 10

12

13

14

15

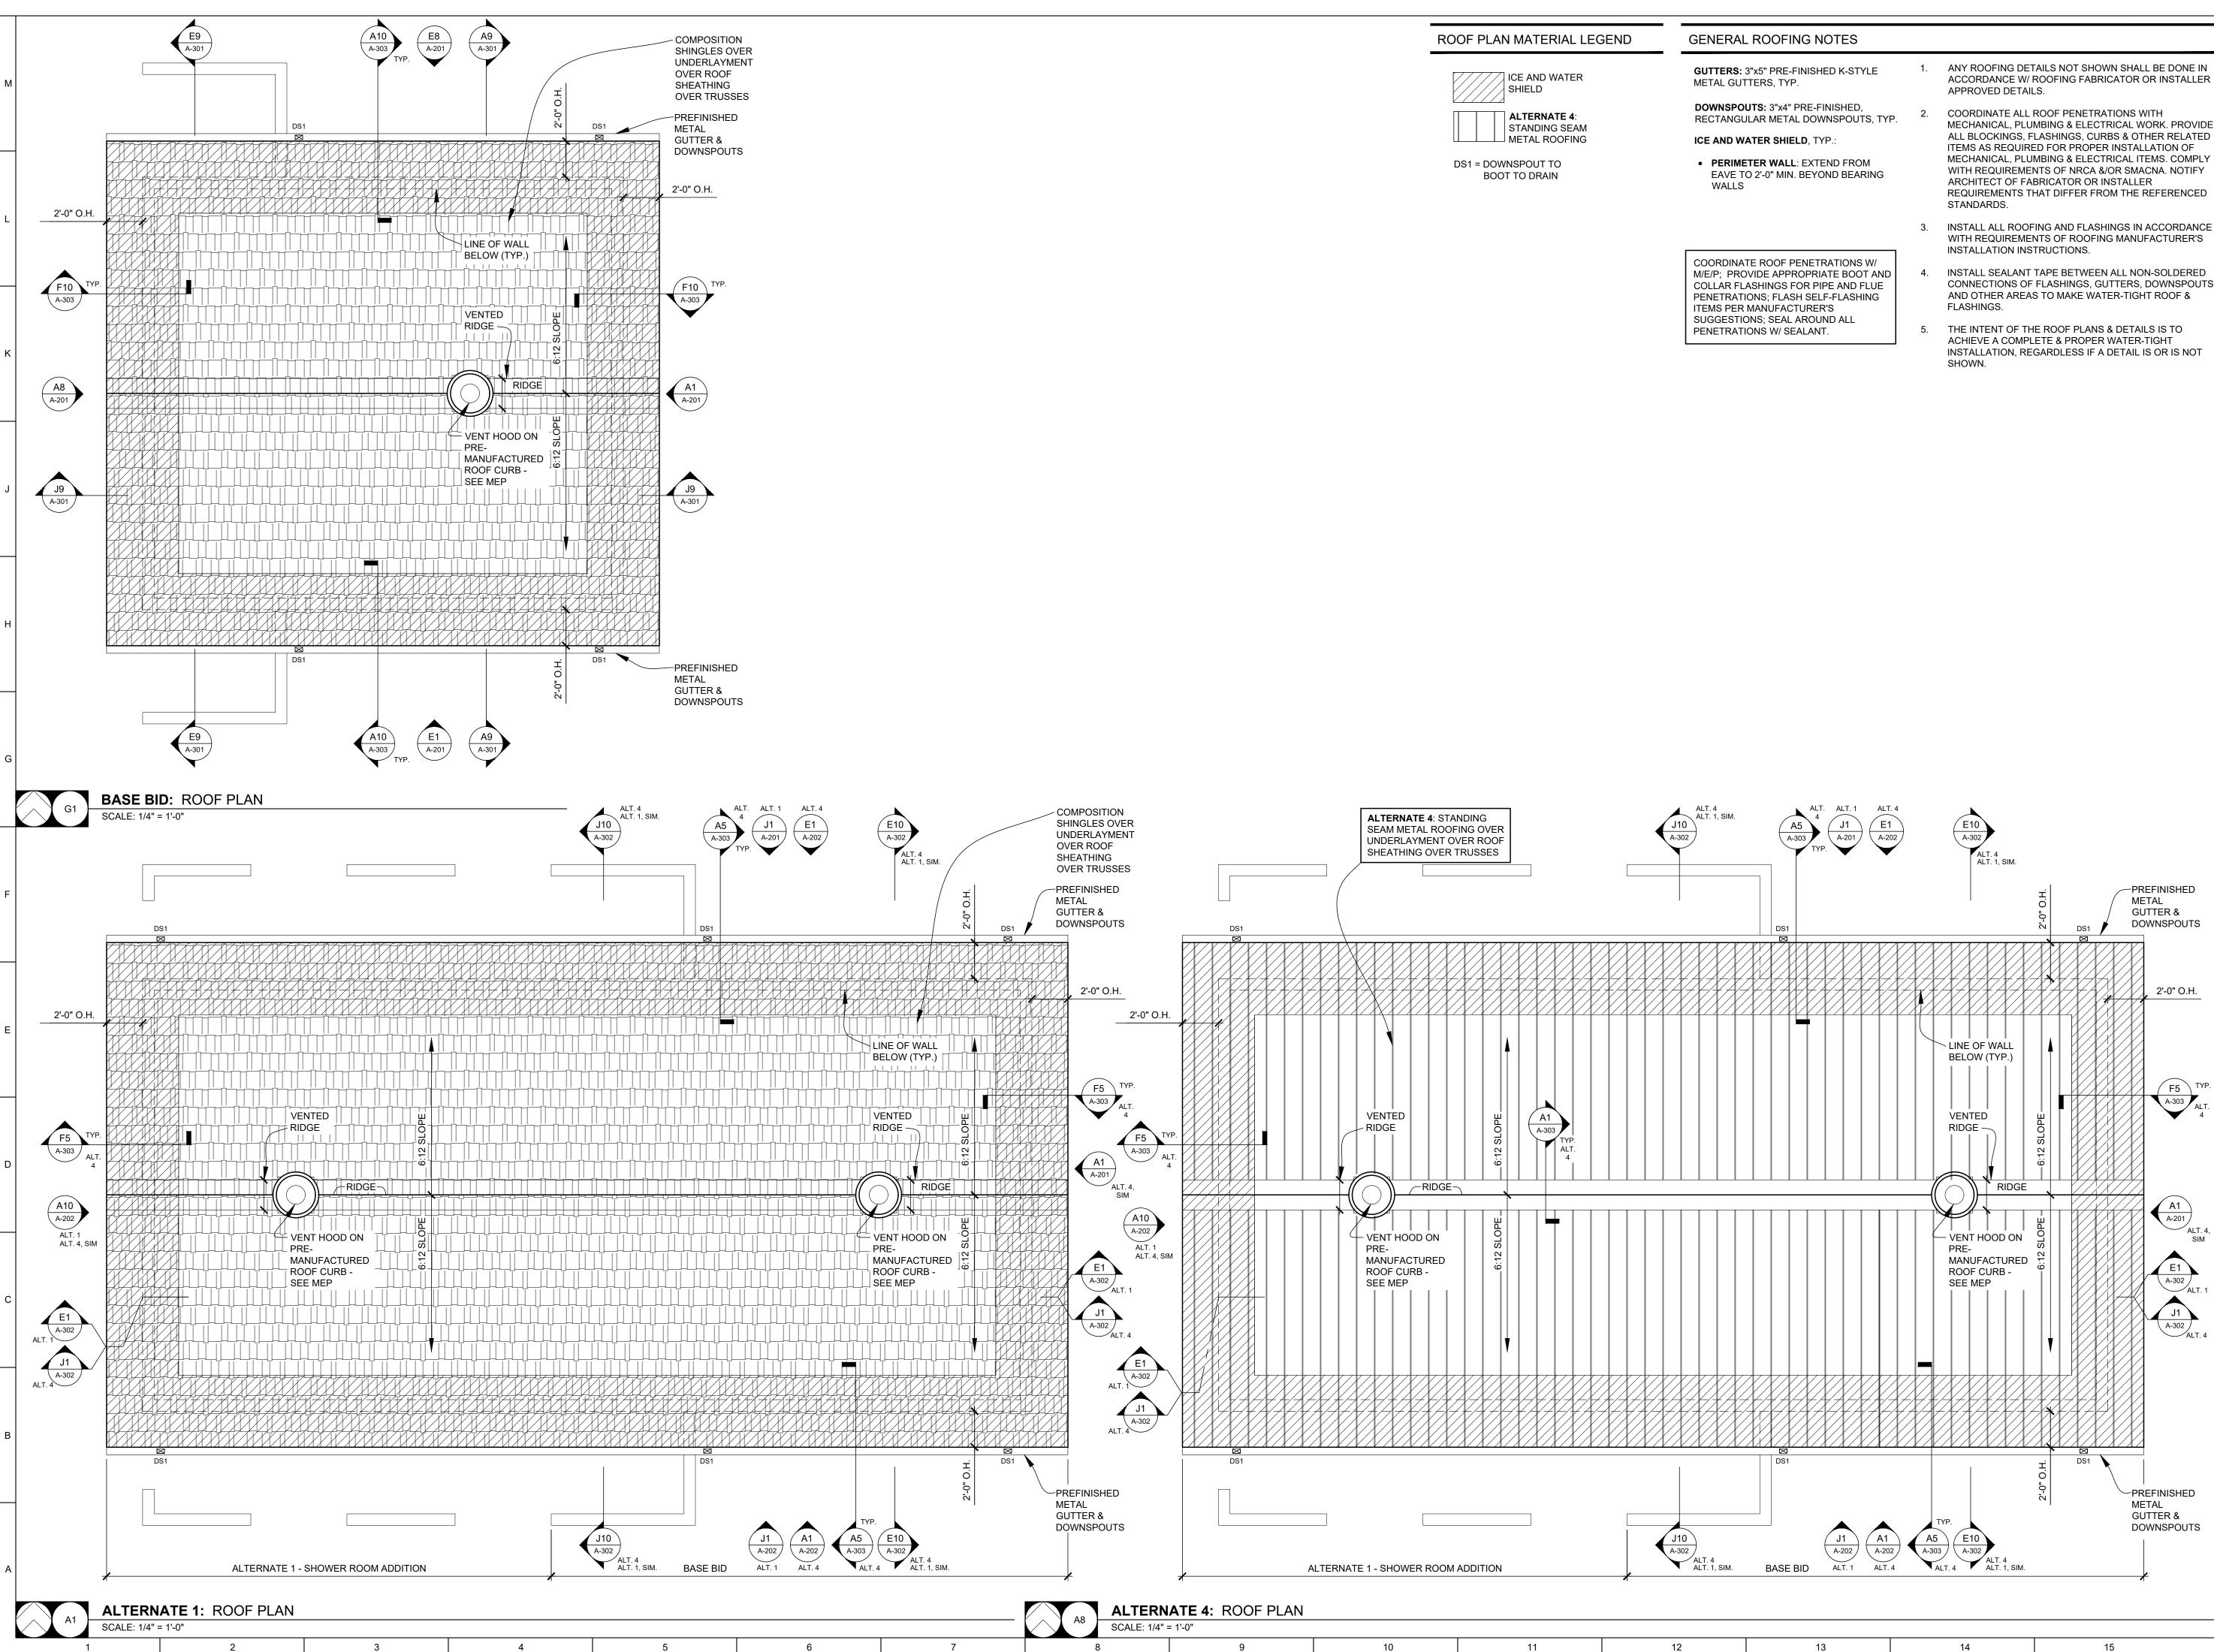

ROOF PLAN MATERIAL LEGEND	
ICE AND WATER SHIELD	
ALTERNATE 4: STANDING SEAM METAL ROOFING	


11

12

14

- ACCORDANCE W/ ROOFING FABRICATOR OR INSTALLER
- MECHANICAL, PLUMBING & ELECTRICAL WORK. PROVIDE ALL BLOCKINGS, FLASHINGS, CURBS & OTHER RELATED
- INSTALL SEALANT TAPE BETWEEN ALL NON-SOLDERED CONNECTIONS OF FLASHINGS, GUTTERS, DOWNSPOUTS

### **STATE OF MISSOURI** MICHAEL L. PARSON, GOVERNOR

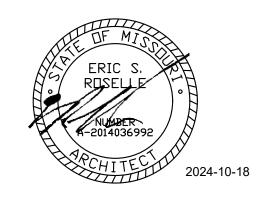



PWArchitects, Inc. 2120 Forum Blvd., Ste. 101 Columbia, Missouri 65203 PWArchitects.com | 573.449.2683 Peckham & Wright Architects an Architectural Corporation Missouri State Certificate of Authority No. 000244



## NEW COMFORT STATION AT SWINE PAVILION

## MISSOURI STATE FAIRGROUNDS (MSF) 2503 W. 16TH St. SEDALIA, MO

PROJECT #	F2406-01
SITE #	1501
ASSET #	3511501037


<b>REVISION:</b>
DATE:
REVISION:
DATE:
REVISION:
DATE:
ISSUE DATE: 2024-10-18

CAD DWG FILE:<u>A-110</u> DRAWN BY: <u>ER</u> CHECKED BY: <u>ER</u> DESIGNED BY: <u>ER</u>

SHEET TITLE: ROOF PLAN & DETAILS

SHEET NUMBER:


18 OF 33 SHEETS 2024-10-18

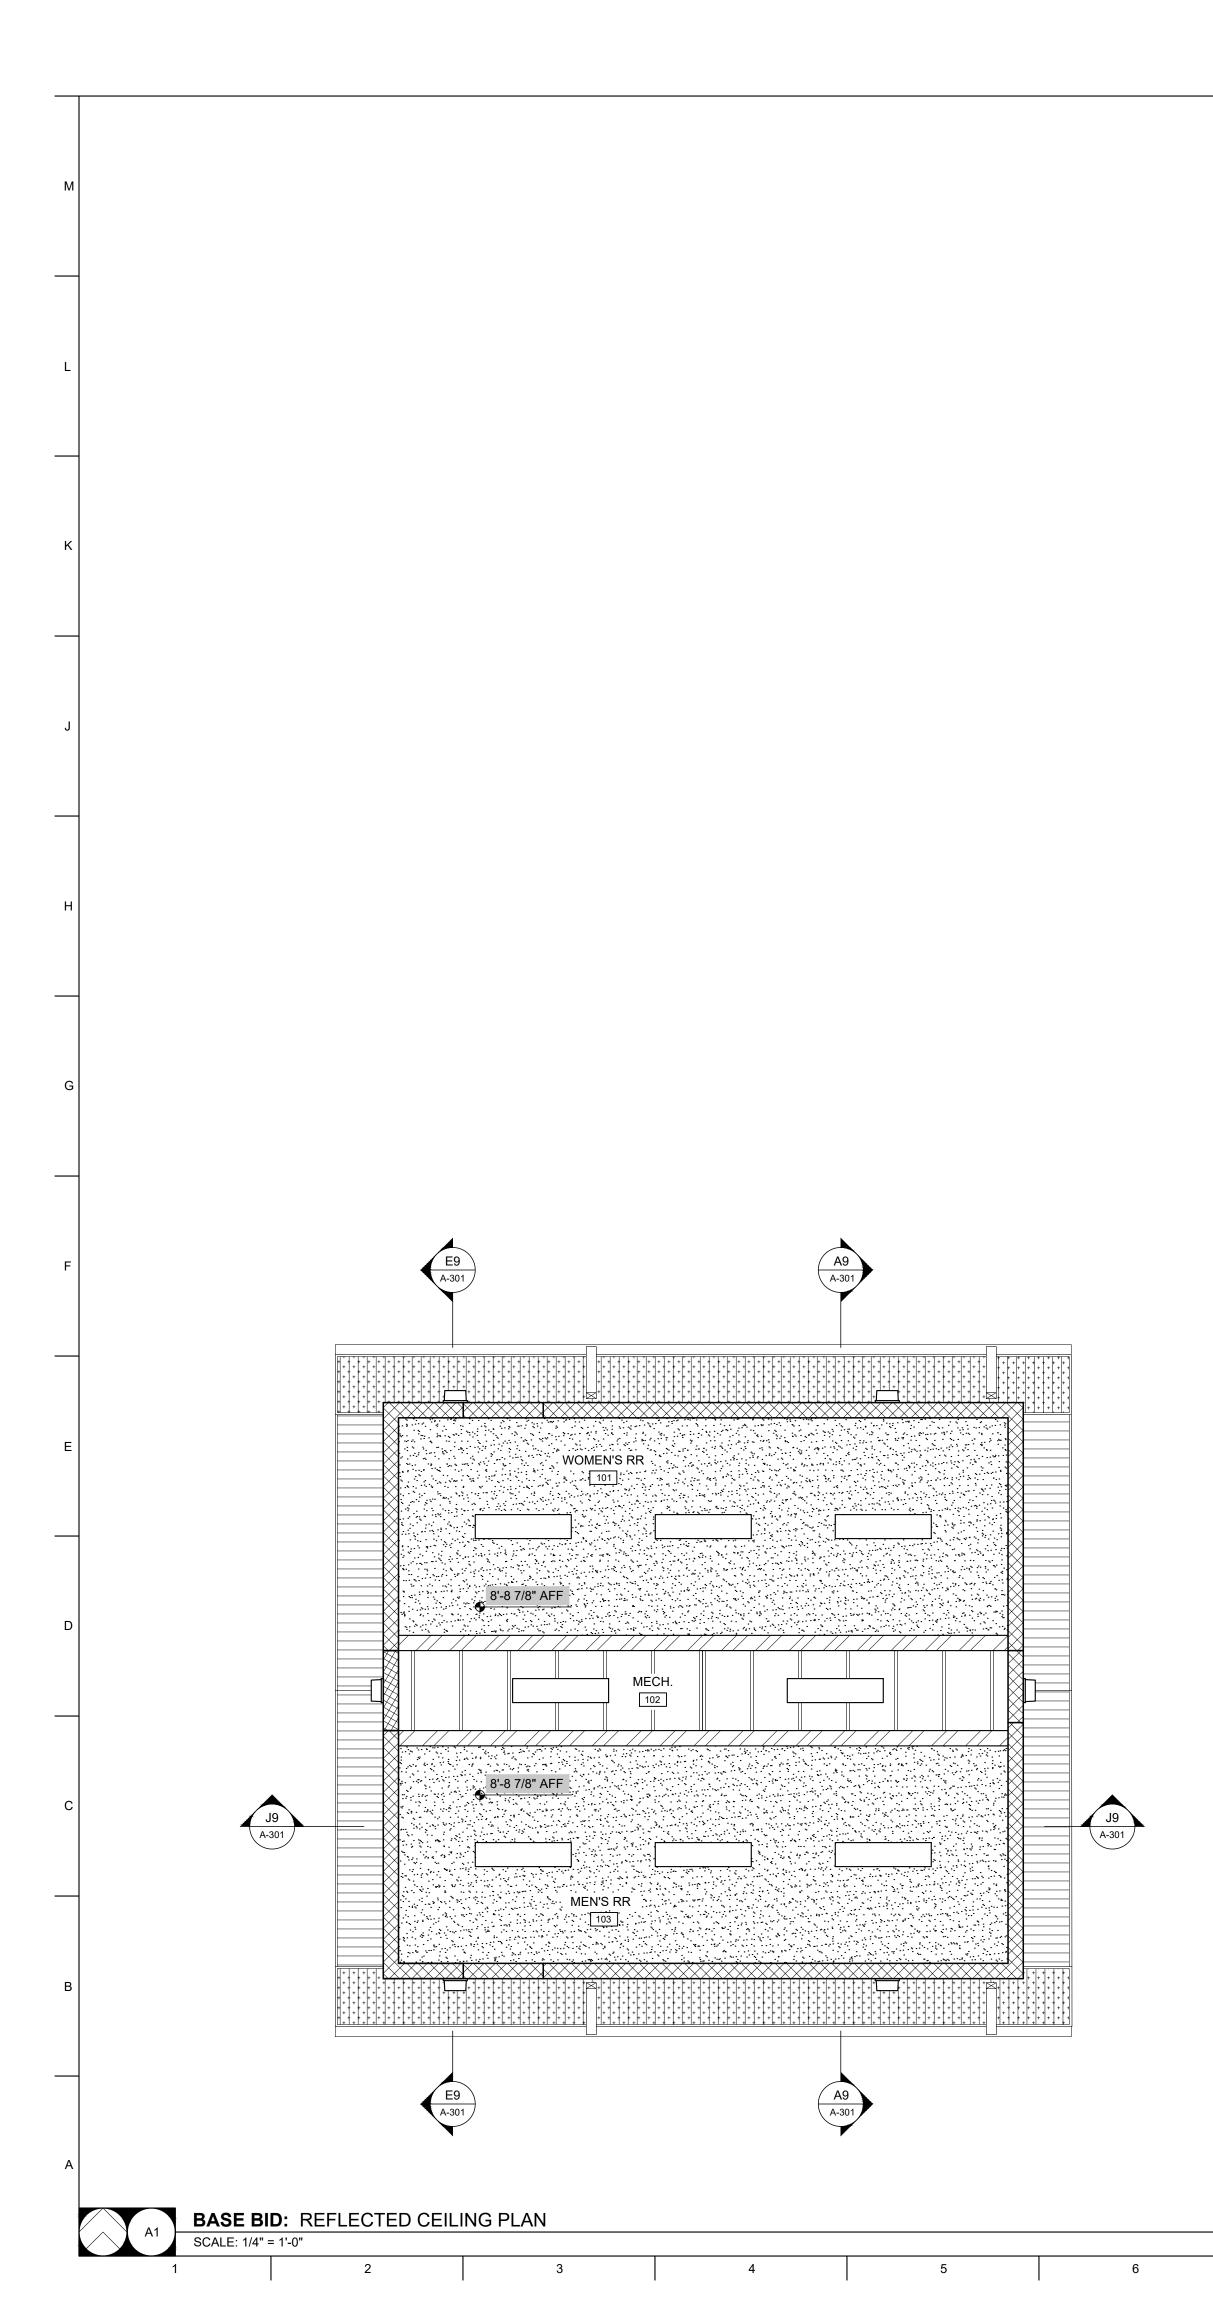

REFLECTED CEILING PLAN LEGEND				
	GLASS-MAT FACED GYPSUM BOARD CEILING, SKIM-COATED & PAINTED			
	METAL SOFFIT - VENTED			
	METAL SOFFIT - NON-VENTED			
	OPEN TO ABOVE (EXPOSED STRUCTURE)			
	CMU WALLS - SEE A-101			
	LIGHT FIXTURE - SEE MEP			
	LIGHT FIXTURE - SEE MEP			

ALT. 4 ALT. 1, SIM. SHOWER SHOWER WOMEN'S RR 108 . 107 . . . 101 . 8'-8 7/8" AFF SHOWER SHOWER MEN'S RR 103 104 105 ┝╺╢┥┹┝╈┝╚┝╡┙╡┥╪┝╪╹┥┥╡┶╞┶╞╵┥╡┥╡╞┝╪┙┥╡╴┝╞┍┥┙┥╴┝┝┝┙┥┥┝┝┝┝╵┥╕┥╴┥┶┝┶┝┥┥┥╴┥┝┝┝╵┥┑┥╴┥┝┝┝╶┥┥╸╴ ╶┙┥┶┶┶┝╘┥╡┙╡┼╞┶╎┥┥┥╡┶┝╘╵┥┥┥┶┝┶┥┥╕╴┝┝┍┥┙┥╴┝┝╵╸┙┙┥┾┝╵┝╵┥╕┥╴┥╴┥╴┥╴┥╴┥╴┥╴┥╴┥╴┥╴╸╴╴ ╴┙╴┹┶┶╘┝╵╡┥┥┥┼╞┶╎╴┥┥┥╴╴┝╴┝╸┥╸┥╴┥╴┝╴┝╴┙┥╴╴┝╴╵╸╵┙╵┥╴┝╴┝╸╵╸┥╴┥╴┥╴┙╴┙╴┙╴╴╴┝╴┝╴╵╸╴╴╸╴╸╴╴╴╴ 

ALTERNATE 1 - SHOWER ROOM ADDITION

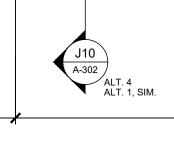

12

A-302

MECH.

102

BASE BID

13



E1 A-302 ALT. 1 J1 A-302 ALT. 4

7

A8	ALIERN	AIE 1: REFLECTED			
Ao	SCALE: 1/4" =	= 1'-0"			
8	3	9	10	11	

#### GENERAL REFLECTED CEILING PLAN NOTES

FIELD VERIFY ALL DIMENSIONS AND CONDITIONS PRIOR TO EXECUTING ANY WORK. NOTIFY ARCHITECT OF ANY DIMENSIONS OR WORK DIFFERING FROM THAT SHOWN, FOR CLARIFICATION BY THE ARCHITECT PRIOR TO PROCEEDING WITH WORK.

1

- VERIFY ALL ROUGH OPENINGS FOR DOORS, 2. LOUVERS, EQUIPMENT, & OTHER "BUILT-IN" ITEMS PRIOR TO EXECUTION OF ANY WORK AFFECTED BY SAME.
- 3. LOCATE DOOR OPENINGS WHICH ARE NOT DIMENSIONED OTHERWISE, CENTERED IN WALL AND 6" FROM FINISH WALL TO FINISH JAMB. 4. COORDINATE ALL FLOOR DRAINS AND
- OTHER REFERENCED MECHANICAL, ELECTRICAL, OR PLUMBING ITEMS W/ M.E.P.

E10 A-302 ALT. 4 ALT. 1, SIM.


E10 A-302

ALT. 4 ALT. 1, SIM.

14

- 5. COORDINATE ALL REQUIRED UTILITIES WITH EQUIPMENT MANUFACTURER.
- 6. ALL DIMENSIONS ARE TO FACE OF STUD -OR MASONRY - UNLESS OTHERWISE NOTED.
- 7. DO NOT SCALE DRAWINGS - WHERE DIMENSIONAL DISCREPANCIES ARE ENCOUNTERED NOTIFY ARCHITECT PRIOR TO PROCEEDING WITH THE WORK.
- COORDINATE HEIGHTS OF OUTLETS & 8. SWITCHING WITH ALL ARCHITECTURAL ITEMS. SEE M/E DRAWINGS FOR LOCATIONS.

#### **STATE OF MISSOURI** MICHAEL L. PARSON, GOVERNOR

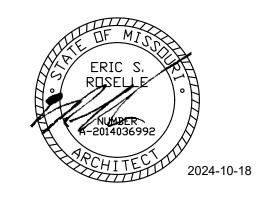



PWArchitects, Inc. 2120 Forum Blvd., Ste. 101 Columbia, Missouri 65203 PWArchitects.com | 573.449.2683 Peckham & Wright Architects an Architectural Corporation Missouri State Certificate of Authority No. 000244

#### **OFFICE OF** ADMINISTRATION **DIVISION OF FACILITIES** MANAGEMENT, **DESIGN AND** CONSTRUCTION

## NEW COMFORT STATION AT SWINE PAVILION

MISSOURI STATE FAIRGROUNDS (MSF) 2503 W. 16TH St. SEDALIA, MO

PROJECT #	F2406-01
SITE #	1501
ASSET #	3511501037

<b>REVISION:</b>
DATE:
REVISION:
DATE:
REVISION:
DATE:
ISSUE DATE: 2024-10-18

CAD DWG FILE:<u>A-120</u> DRAWN BY: <u>ER</u> CHECKED BY: <u>ER</u> DESIGNED BY: <u>ER</u>

E1 A-302 ALT. 1


J1 A-302 ALT. 4

15

SHEET TITLE: REFLECTED **CEILING PLANS** & DETAILS

SHEET NUMBER:

A-120 19 OF 33 SHEETS 2024-10-18

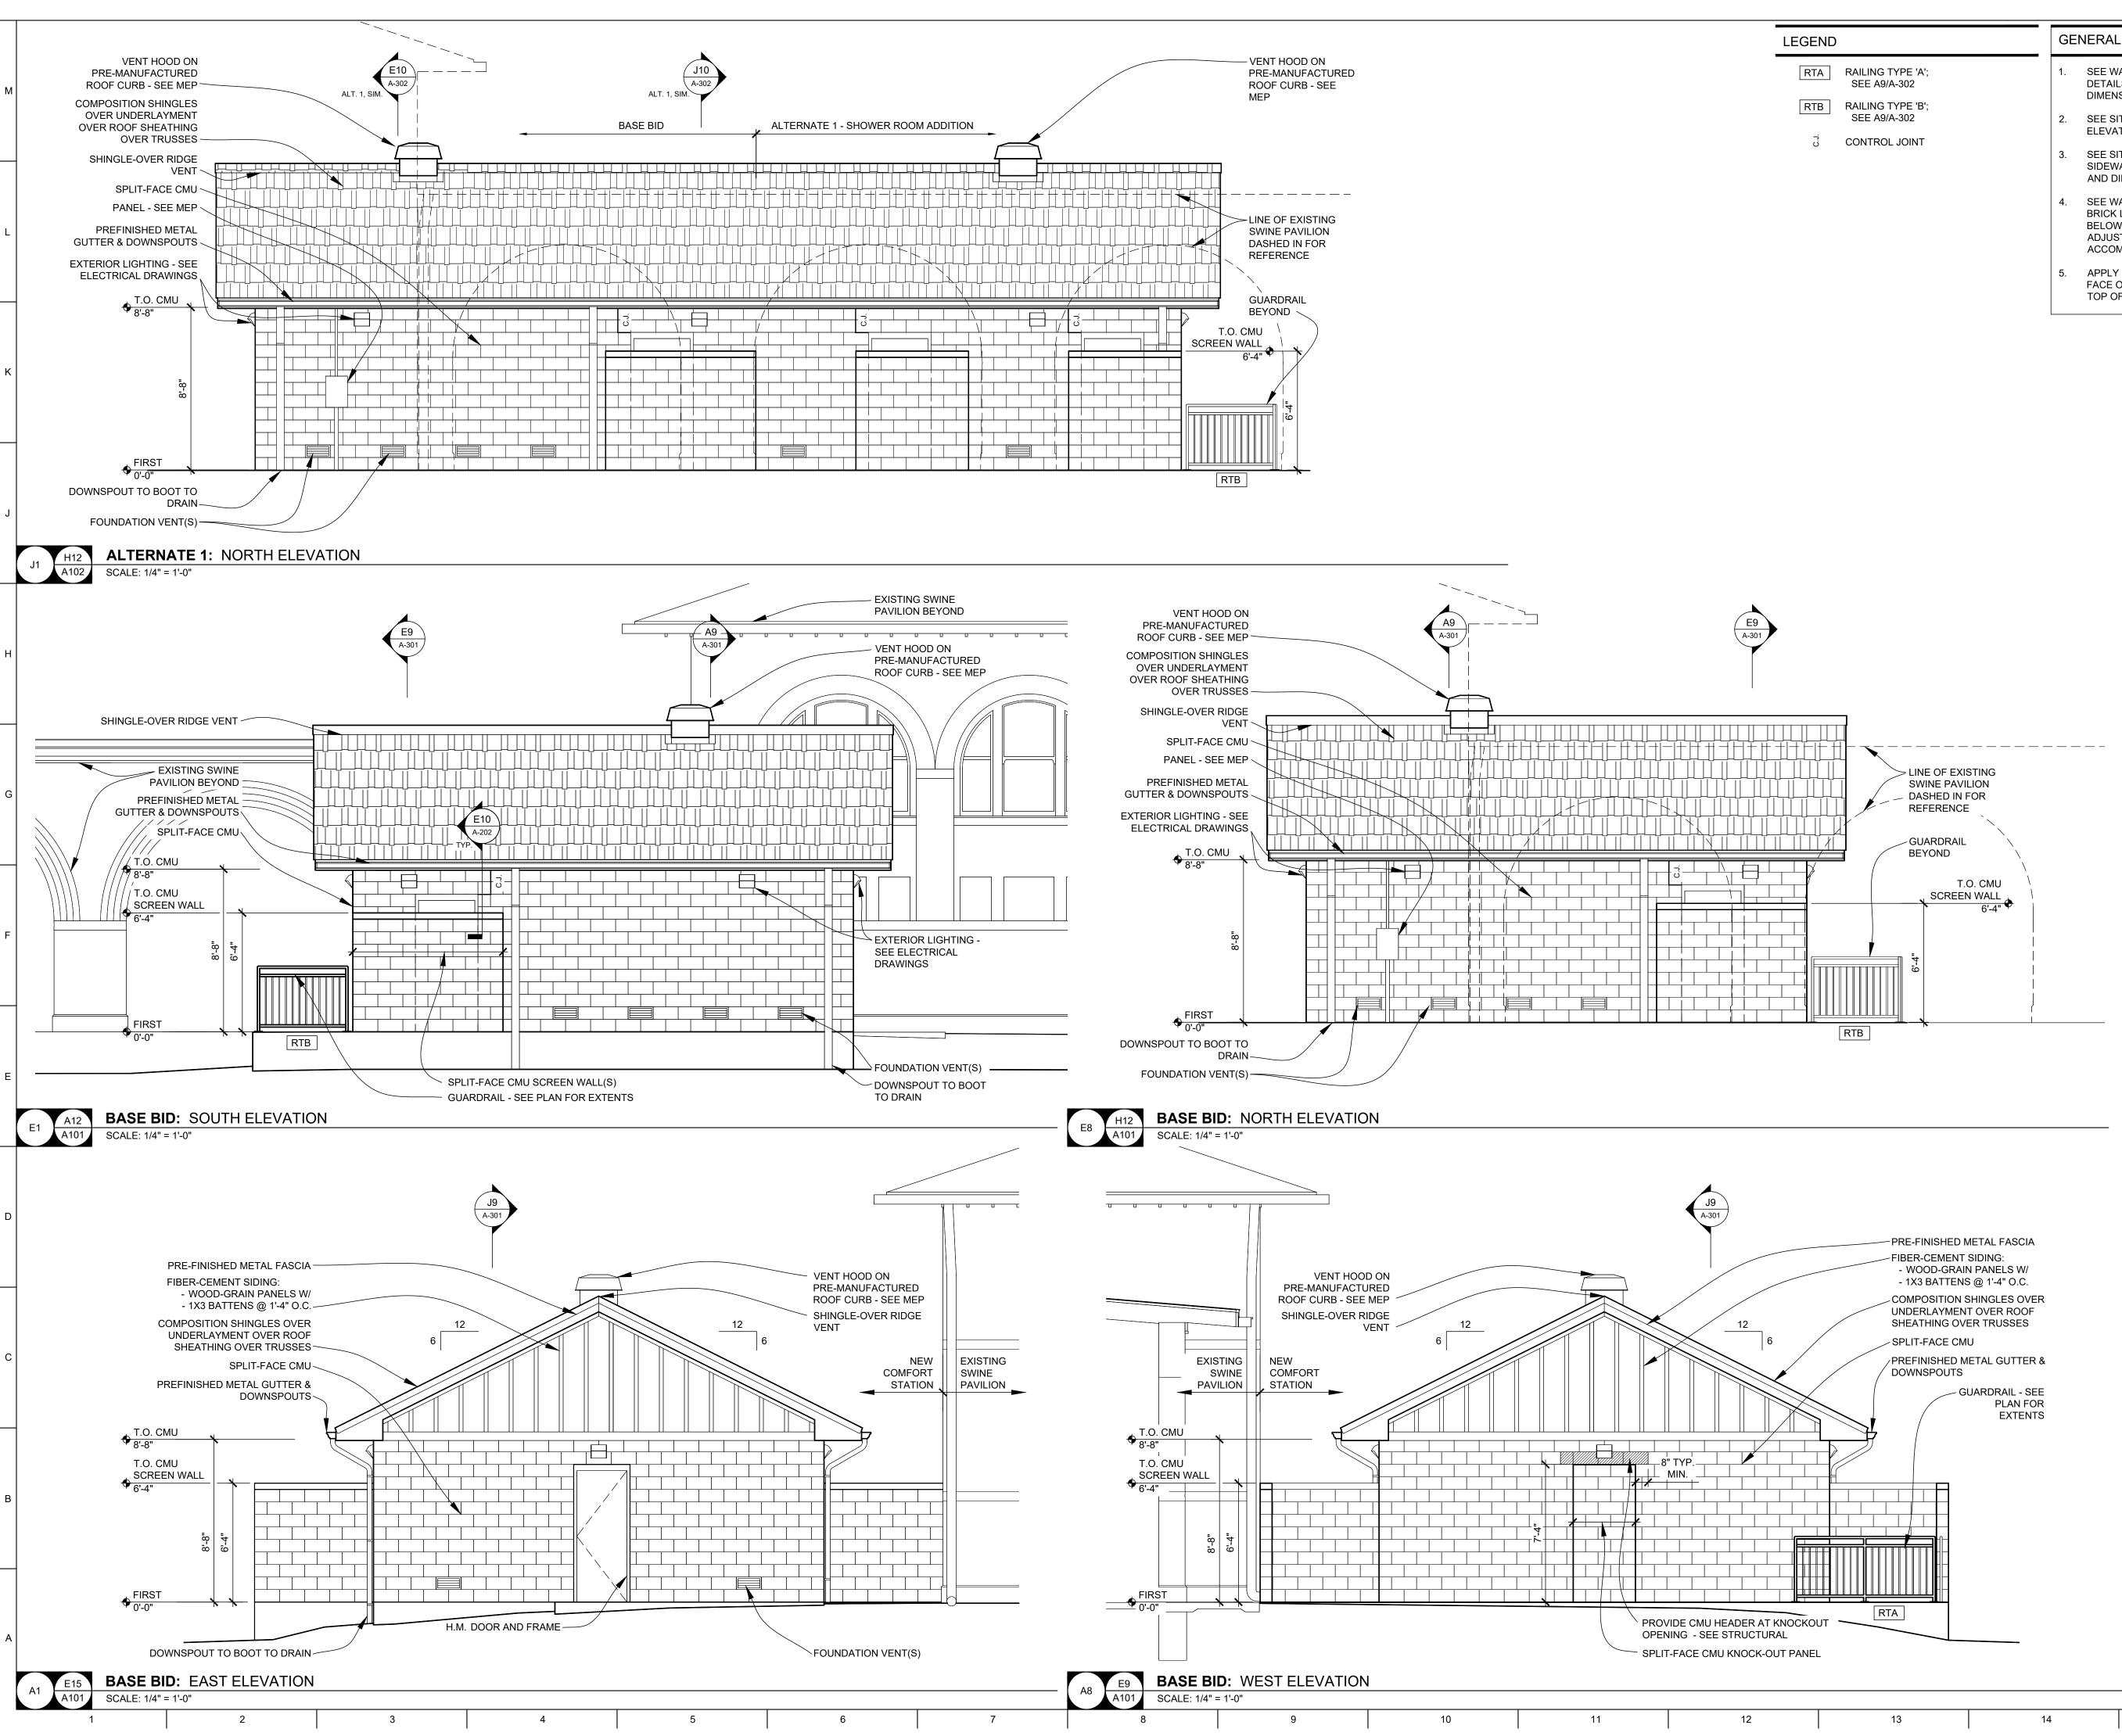

GEND	
RTA	RAILING SEE A9/
RTB	RAILING


#### GENERAL ELEVATION NOTES

SEE WALL SECTIONS FOR ADDITIONAL DETAILS, MATERIALS, NOTES, AND DIMENSIONS.

- SEE SITE PLAN FOR EXACT FINISH GRADE ELEVATIONS.
- SEE SITE PLAN FOR RETAINING WALLS, SIDEWALKS & SLABS, DETAILS, LOCATIONS AND DIMENSIONS.
- SEE WALL SECTIONS FOR APPROPRIATE BRICK LEDGES. BRICK LEDGES TO BE BELOW FINAL GRADE. MAKE FIELD ADJUSTMENTS AS NECESSARY TO ACCOMPLISH THS W/ FIELD CONDITIONS.
- APPLY FIBERED ASPHALTIC COATING TO FACE OF ANY BELOW-GRADE CMU. STOP TOP OF COATING AT GRADE, TYP.

15

### **STATE OF MISSOURI** MICHAEL L. PARSON, GOVERNOR

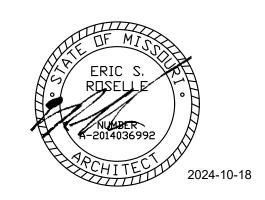



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### **OFFICE OF** ADMINISTRATION **DIVISION OF FACILITIES** MANAGEMENT, **DESIGN AND** CONSTRUCTION

## NEW COMFORT STATION AT SWINE PAVILION

MISSOURI STATE FAIRGROUNDS (MSF) 2503 W. 16TH St. SEDALIA, MO

PROJECT # F2406-01 SITE # 1501 3511501137 ASSET #

#### **REVISION:** DATE **REVISION:** DATE: **REVISION:** DATE:


ISSUE DATE: 2024-10-18

CAD DWG FILE:A-201 DRAWN BY: CHECKED BY: DESIGNED BY: ER

SHEET TITLE: **ELEVATIONS &** DETAILS

SHEET NUMBER:

A-20 20 OF 33 SHEETS 2024-10-18

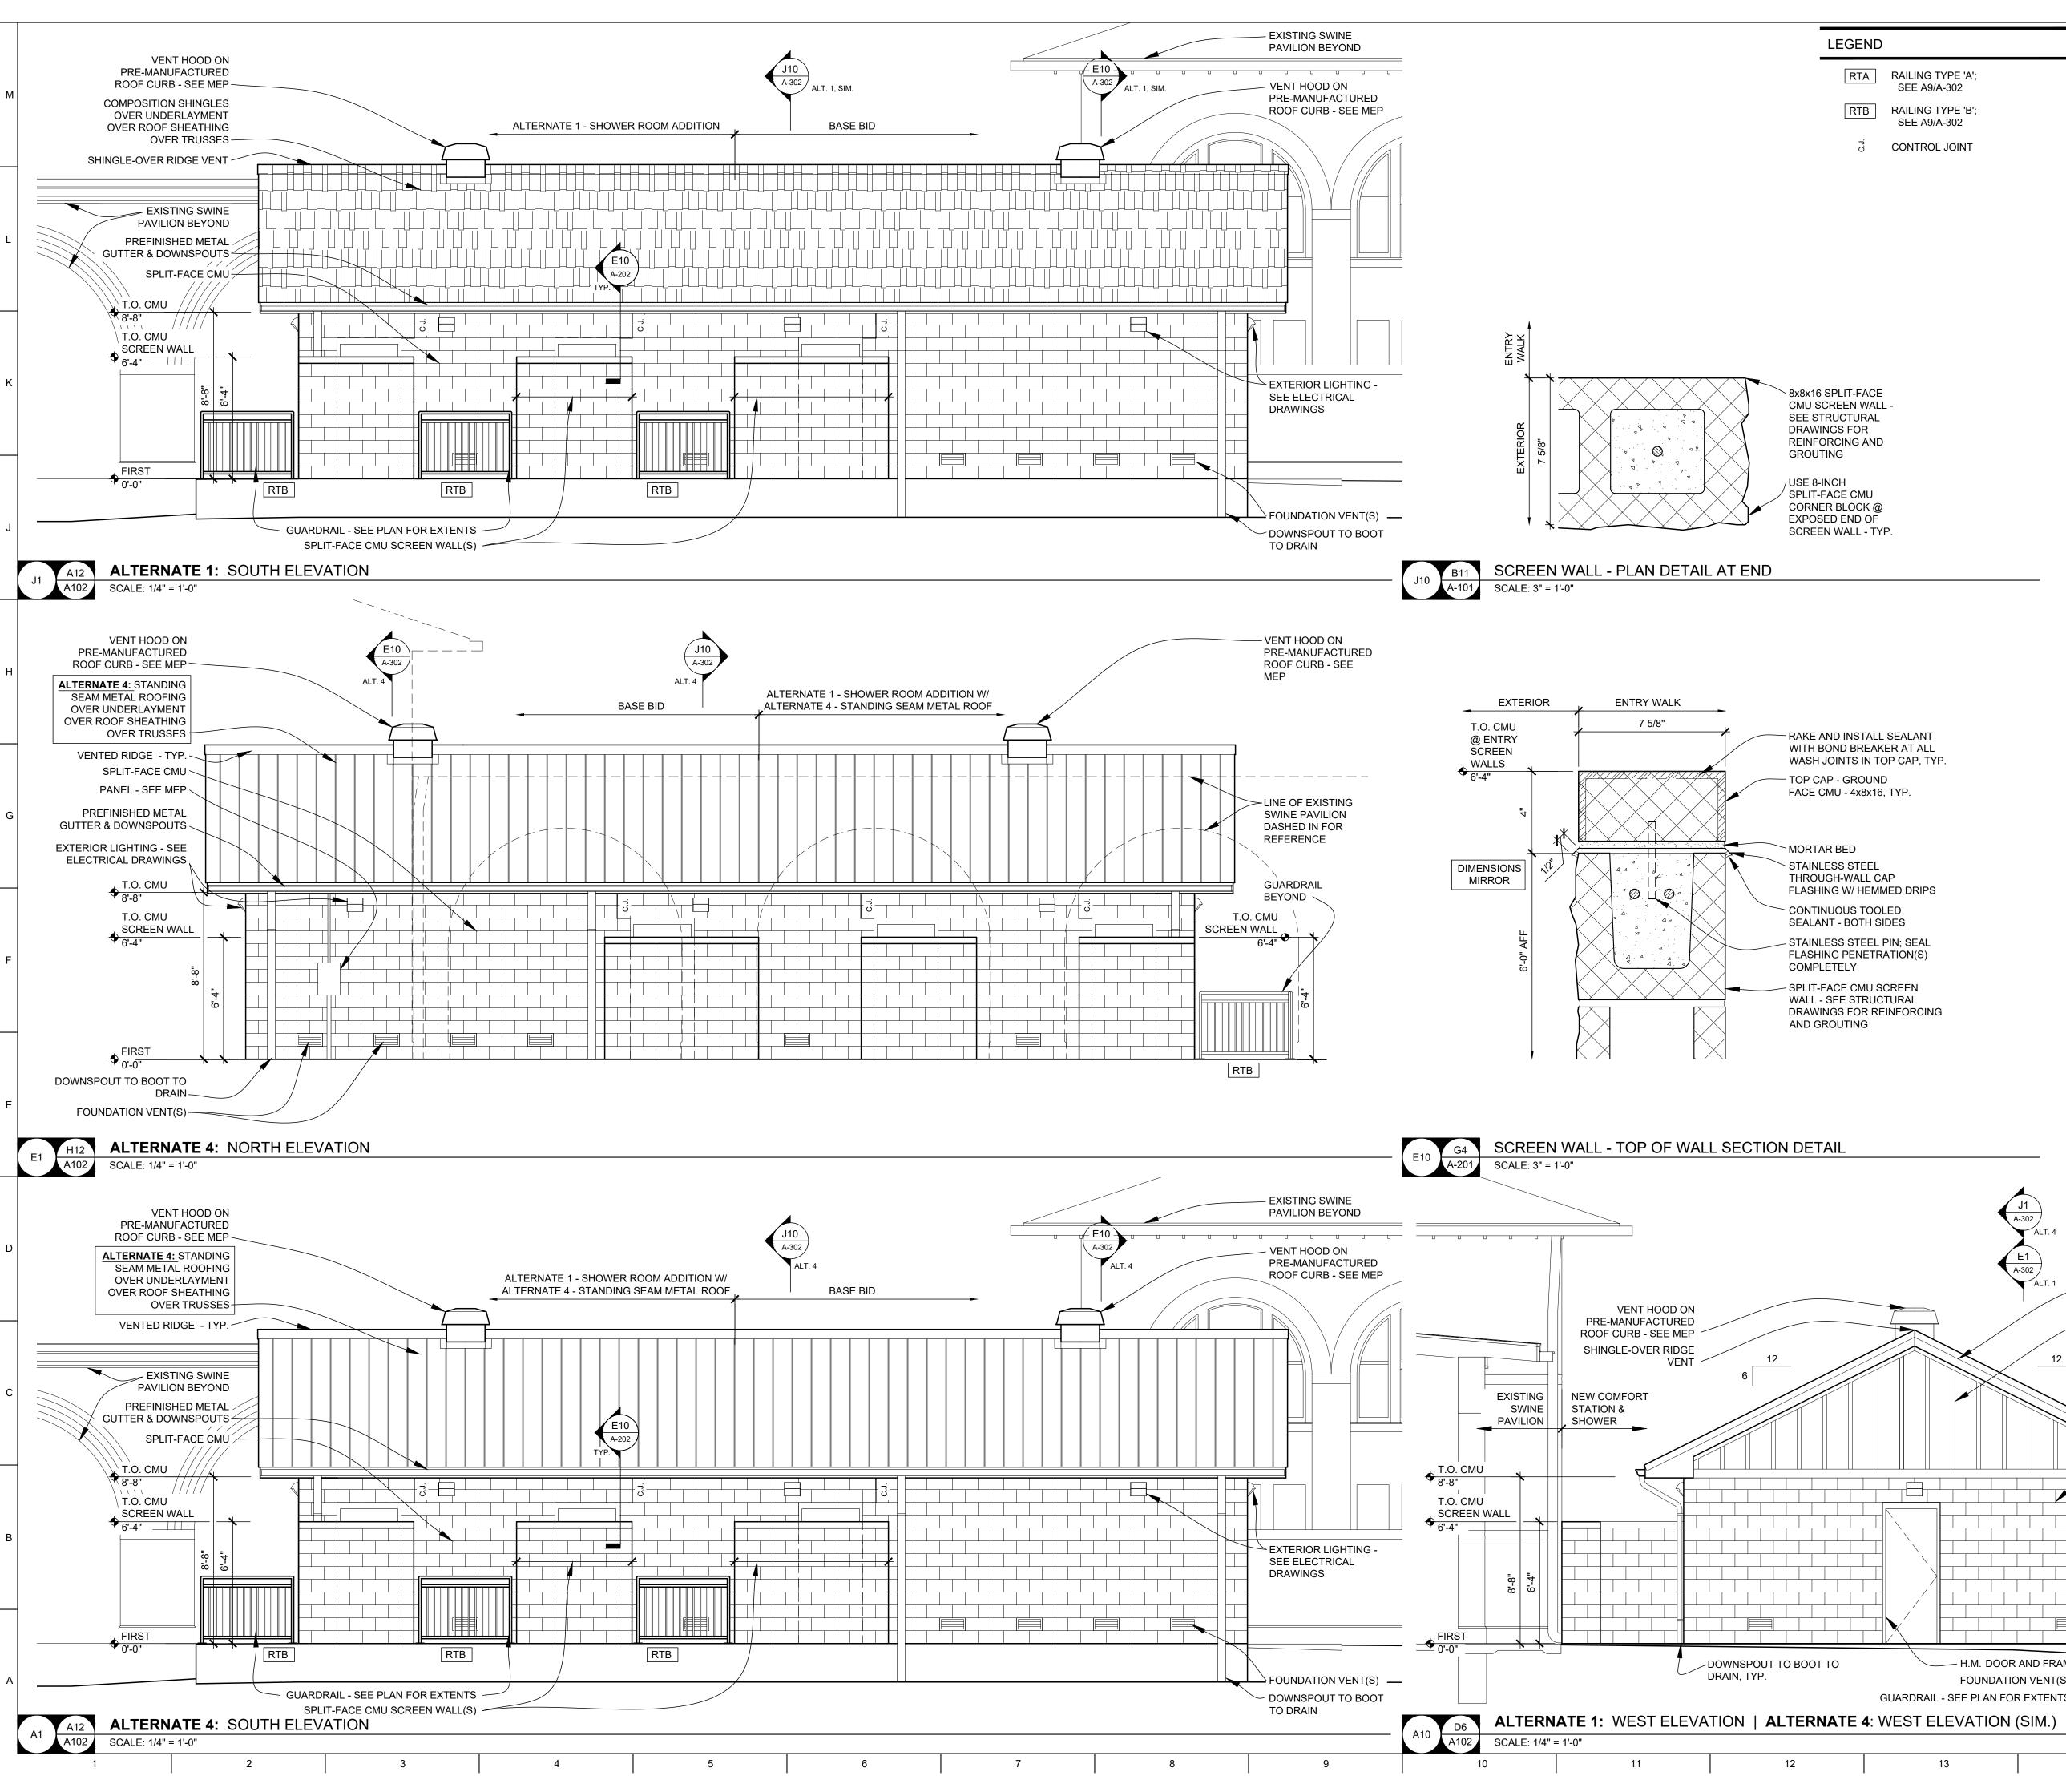


LEGEND	GENERAL ELEVATION NOTES	STATE OF MISSOURI MICHAEL L. PARSON,
RTA RAILING TYPE 'A'; SEE A9/A-302	1. SEE WALL SECTIONS FOR ADDITIONAL DETAILS, MATERIALS, NOTES, AND DIMENSIONS.	GOVERNOR
RTBRAILING TYPE 'B'; SEE A9/A-302 $\vec{3}$ CONTROL JOINT	<ol> <li>SEE SITE PLAN FOR EXACT FINISH GRADE ELEVATIONS.</li> </ol>	HE DF MISS
O CONTROL JOINT	3. SEE SITE PLAN FOR RETAINING WALLS, SIDEWALKS & SLABS, DETAILS, LOCATIONS AND DIMENSIONS.	ERIC S. RESELLE
	4. SEE WALL SECTIONS FOR APPROPRIATE BRICK LEDGES. BRICK LEDGES TO BE BELOW FINAL GRADE. MAKE FIELD ADJUSTMENTS AS NECESSARY TO	PCHITECTIC 2024-10-18
	<ul> <li>ACCOMPLISH THS W/ FIELD CONDITIONS.</li> <li>5. APPLY FIBERED ASPHALTIC COATING TO FACE OF <u>ANY</u> BELOW-GRADE CMU. STOP</li> </ul>	
	TOP OF COATING AT GRADE, TYP.	
SPLIT-FACE		Peckham & Wright Architects, Inc., d.b.a. PWArchitects, Inc.
CREEN WALL - IRUCTURAL NGS FOR DRCING AND		2120 Forum Blvd., Ste. 101 Columbia, Missouri 65203 PWArchitects.com   573.449.2683 Peckham & Wright Architects an Architectural Corporation
TING		Missouri State Certificate of Authority No. 000244
FACE CMU ER BLOCK @ BED END OF EN WALL - TYP.		
AND INSTALL SEALANT 30ND BREAKER AT ALL JOINTS IN TOP CAP, TYP. AP - GROUND		OFFICE OF
CMU - 4x8x16, TYP.		ADMINISTRATION DIVISION OF FACILITIES
AR BED LESS STEEL JGH-WALL CAP		MANAGEMENT, DESIGN AND CONSTRUCTION
ING W/ HEMMED DRIPS NUOUS TOOLED NT - BOTH SIDES		CONSTRUCTION
LESS STEEL PIN; SEAL ING PENETRATION(S) LETELY		
FACE CMU SCREEN · SEE STRUCTURAL ·NGS FOR REINFORCING ROUTING		NEW COMFORT STATION AT SWINE PAVILION
ROUTING		MISSOURI STATE
		FAIRGROUNDS (MSF) 2503 W. 16TH St.
AIL		SEDALIA, MO
J1 A-302		PROJECT #F2406-01SITE #1501ASSET #3511501137
ALT. 4 E1 A-302	PRE-FINISHED METAL FASCIA	
ALT. 1	FIBER-CEMENT SIDING: - WOOD-GRAIN PANELS W/ - 1X3 BATTENS @ 1'-4" O.C.	REVISION: DATE: REVISION:
	COMPOSITION SHINGLES OVER UNDERLAYMENT OVER ROOF SHEATHING OVER TRUSSES	DATE: REVISION: DATE:
6	SPLIT-FACE CMU PREFINISHED METAL	ISSUE DATE: 2024-10-18
	GUTTER & DOWNSPOUTS	CAD DWG FILE:A-202 DRAWN BY: ER CHECKED BY: ER DESIGNED BY: ER
		SHEET TITLE: ELEVATIONS &
		DETAILS
TO H.M. DOOR AND FRAME		SHEET NUMBER:
FOUNDATION VENT(S)		A-202


21 OF 33 SHEETS 2024-10-18

15

14

13

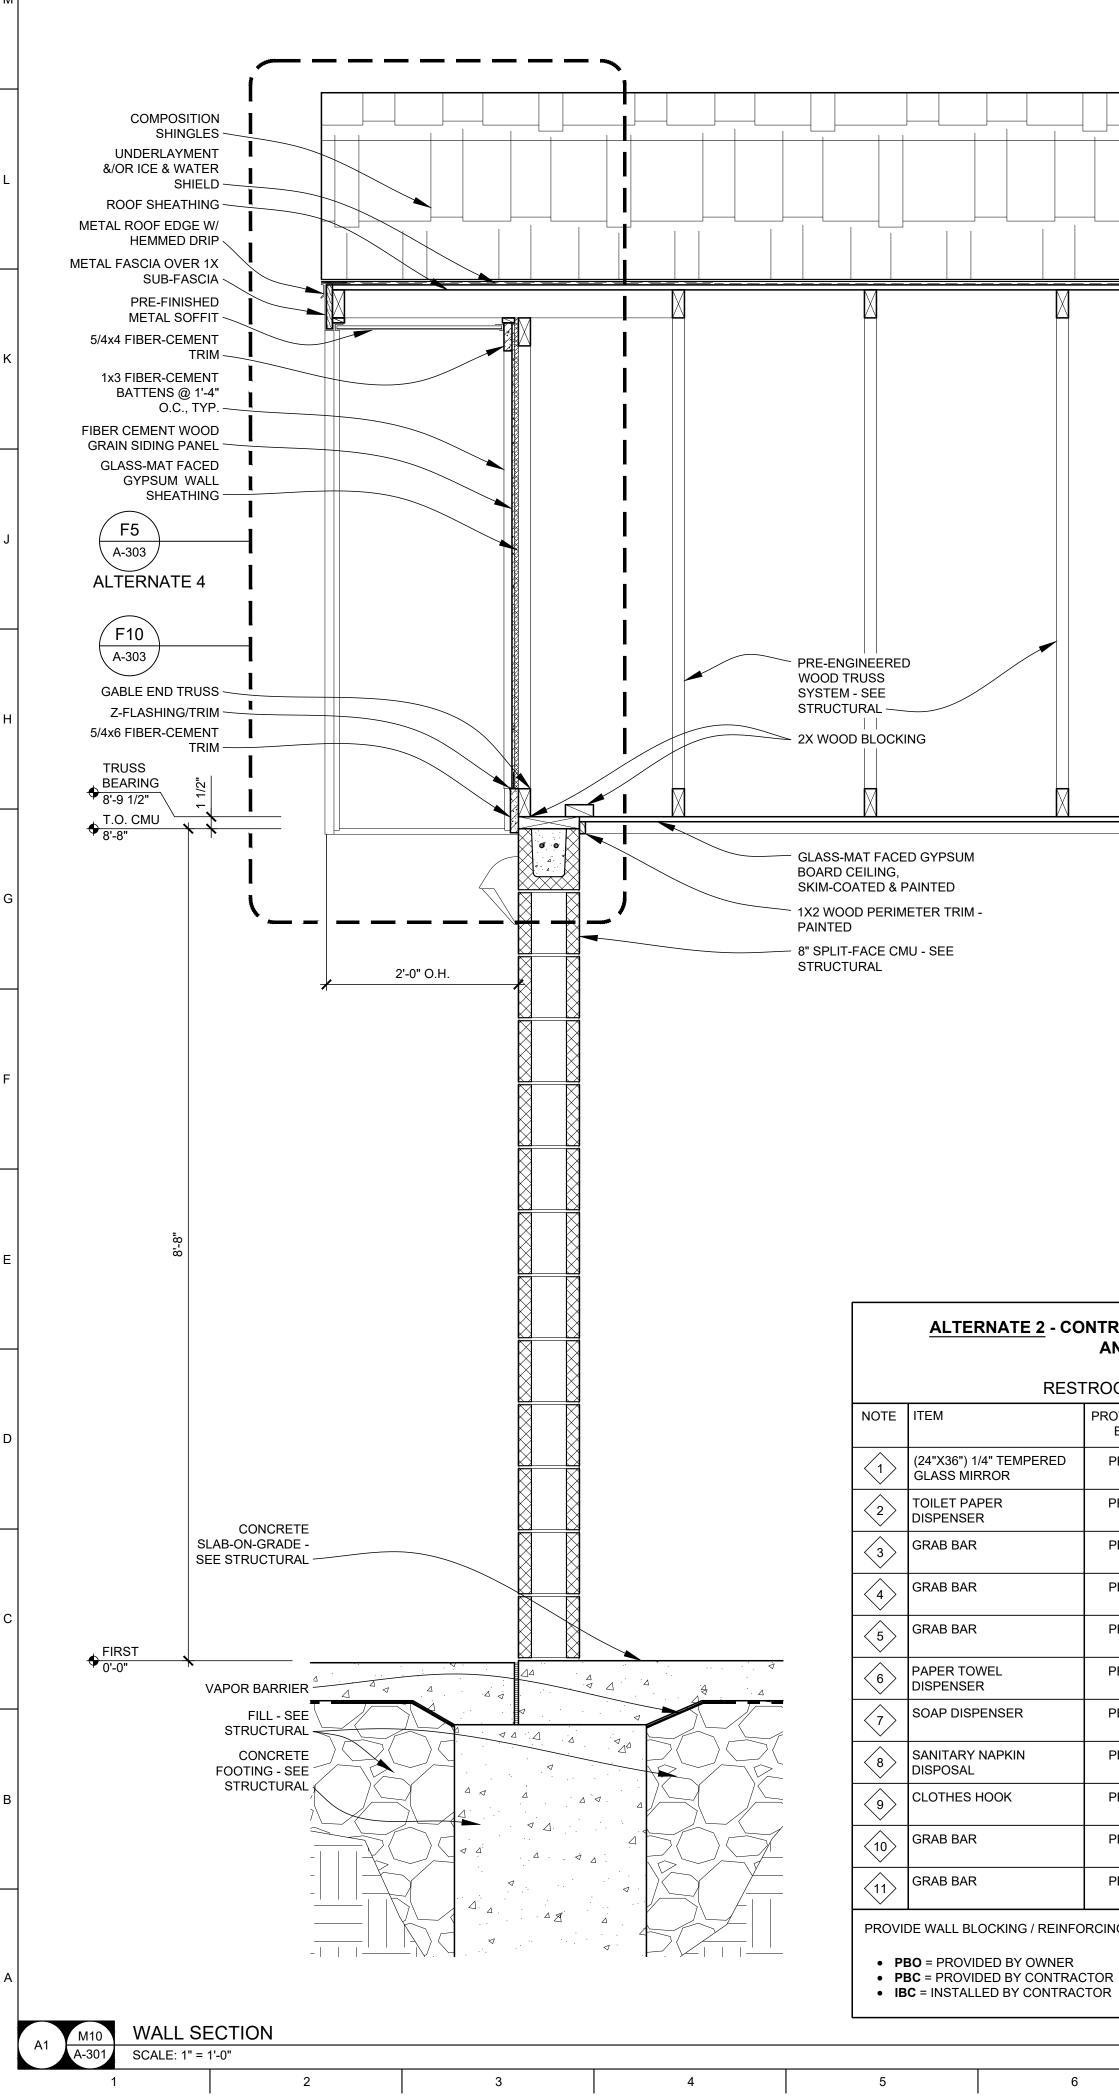

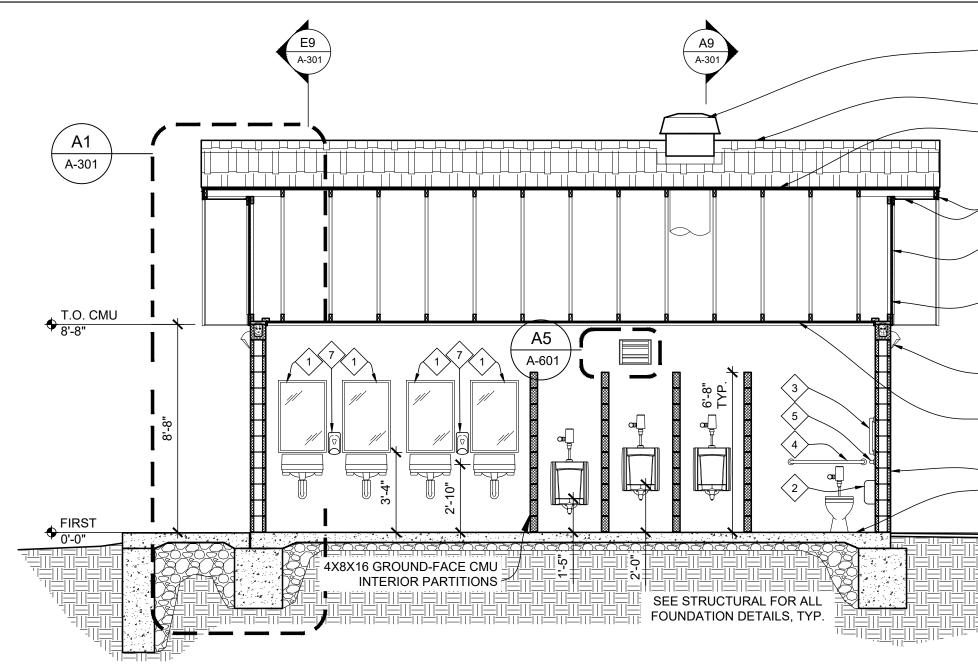



## J9 D9 BASE BID: BUILDING SECTION - EAST/WEST A-101 SCALE: 1/4" = 1'-0"



SEE FINISH SCHEDULE FOR ALL FINISHES

- AND CEILING HEIGHTS. FIELD VERIFY ALL DIMENSIONS AND 2 CONDITIONS PRIOR TO EXECUTING ANY WORK. NOTIFY ARCHITECT OF ANY DIMENSIONS OR WORK DIFFERING FROM THAT SHOWN, FOR CLARIFICATION BY THE
- WORK. VERIFY ALL ROUGH OPENINGS FOR DOORS, LOUVERS, EQUIPMENT & OTHER "BUILT-IN" ITEMS PRIOR TO EXECUTION OF ANY WORK AFFECTED BY SAME.

ARCHITECT PRIOR TO PROCEEDING WITH

- SEE DOOR SCHEDULES FOR ALL DOOR AND DIMENSIONS AND DETAILS.
- REFER TO M.E.P. DRAWINGS FOR DETAILED INFORMATION REGARDING M.E.P. SYSTEMS.


### SHINGLE-OVER RIDGE VENT 12 COMPOSITION SHINGLES OVER UNDERLAYMENT &/OR ICE & WATER SHIELD OVER ROOF SHEATHING OVER TRUSSES T.O. CMU <del>•</del> 8'-8" SPLIT-FACE CMU T.O. CMU SCREEN WALL <sup>♥</sup> 6'-4" MEN'S RR 103 FIRST <del>•</del>0'-0" GUARDRAIL SEE STRUCTURAL FOR ALL FOUNDATION DETAILS, TYP.

## ALTERNATE 2 - CONTRACTOR-INSTALLED PLUMBING FIXTURES AND TOILET ACCESSORIES

OOM ACCESSORY	SCHEDULE

PROVIDED BY:	INSTALLED BY:	MODEL	REMARKS
PBC	IBC	BOBRICK B-2908 2436	
PBO	IBC	CASCADES PRO D812	
PBC	IBC	BOBRICK B-6806 x 18	
PBC	IBC	BOBRICK B-6806 x 36	
PBC	IBC	BOBRICK B-6806 x 42	
РВО	IBC	CASCADES PRO C340	
РВО	IBC	SPARTAN LITE N' FOAMY	
PBC	IBC	BOBRICK B-254	
PBC	IBC	BOBRICK B-233	
PBC	IBC	BOBRICK B-6806 x 24	
PBC	IBC	BOBRICK B-6806 x 48	

PROVIDE WALL BLOCKING / REINFORCING AS REQUIRED FOR ACCESSORY INSTALLATION AND MOUNTING.

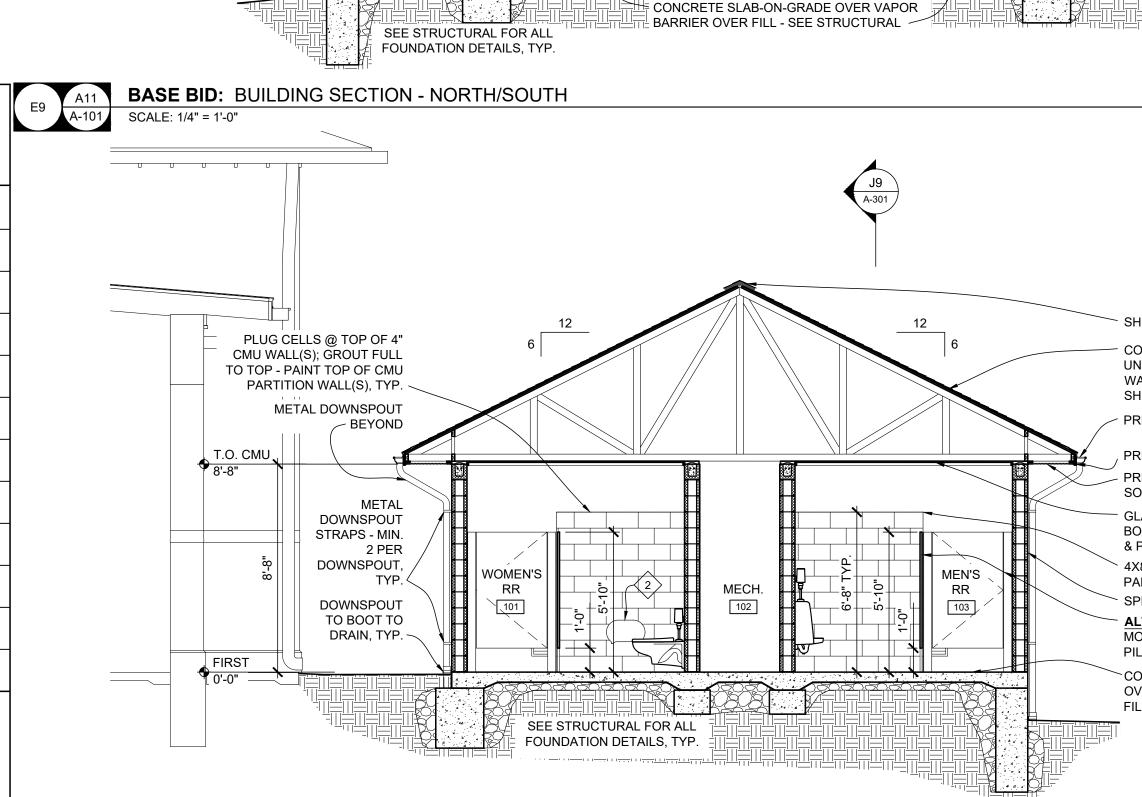

12



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11

10

VENT HOOD ON PRE-MANUFACTURED ROOF CURB - SEE MEP

SHINGLE-OVER RIDGE VENT

COMPOSITION SHINGLES OVER UNDERLAYMENT &/OR ICE & WATER SHIELD OVER ROOF SHEATHING OVER TRUSSES

PRE-FINISHED METAL SOFFIT AND FASCIA

FIBER-CEMENT SIDING: - WOOD-GRAIN PANELS W/


- 1X3 BATTENS @ 1'-4" O.C. GLASS-MAT FACED GYPSUM WALL SHEATHING OVER PRE-ENGINEERED WOOD TRUSS SYSTEM


- EXTERIOR LIGHTING - SEE ELECTRICAL DRAWINGS

GLASS-MAT FACED GYPSUM BOARD CEILING, SKIM-COATED & PAINTED


SPLIT-FACE CMU CONCRETE SLAB-ON-GRADE OVER VAPOR BARRIER OVER FILL - SEE STRUCTURAL



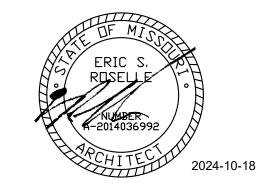

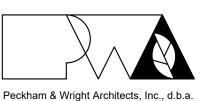

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SHINGLE-OVER RIDGE VENT

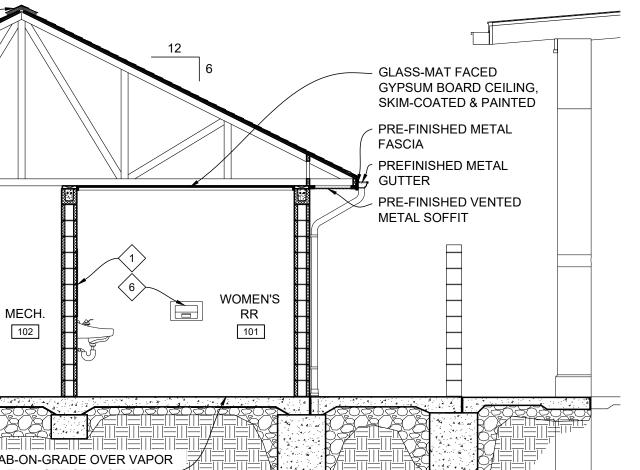COMPOSITION SHINGLES OVER UNDERLAYMENT &/OR ICE & WATER SHIELD OVER ROOF SHEATHING OVER TRUSSES PREFINISHED METAL GUTTER

, PRE-FINISHED METAL FASCIA PRE-FINISHED VENTED METAL SOFFIT

GLASS-MAT FACED GYPSUM BOARD CEILING, SKIM-COATED & PAINTED 4X8X16 CMU INTERIOR

PARTITIONS SPLIT-FACE CMU

ALTERNATE 2: FLOOR-MOUNTED HDPE DOORS & PILASTERS

CONCRETE SLAB-ON-GRADE OVER VAPOR BARRIER OVER FILL - SEE STRUCTURAL

### **OFFICE OF** ADMINISTRATION **DIVISION OF FACILITIES** MANAGEMENT, **DESIGN AND** CONSTRUCTION

## NEW COMFORT STATION AT SWINE PAVILION

MISSOURI STATE FAIRGROUNDS (MSF) 2503 W. 16TH St. SEDALIA, MO

PROJECT # F2406-01 SITE # 1501 ASSET # 3511501037


**REVISION:** DATE **REVISION:** DATE: **REVISION:** DATE: ISSUE DATE: 2024-10-18


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SHEET TITLE: **SECTIONS &** DETAILS


SHEET NUMBER:

A-30 22 OF 33 SHEETS 2024-10-18




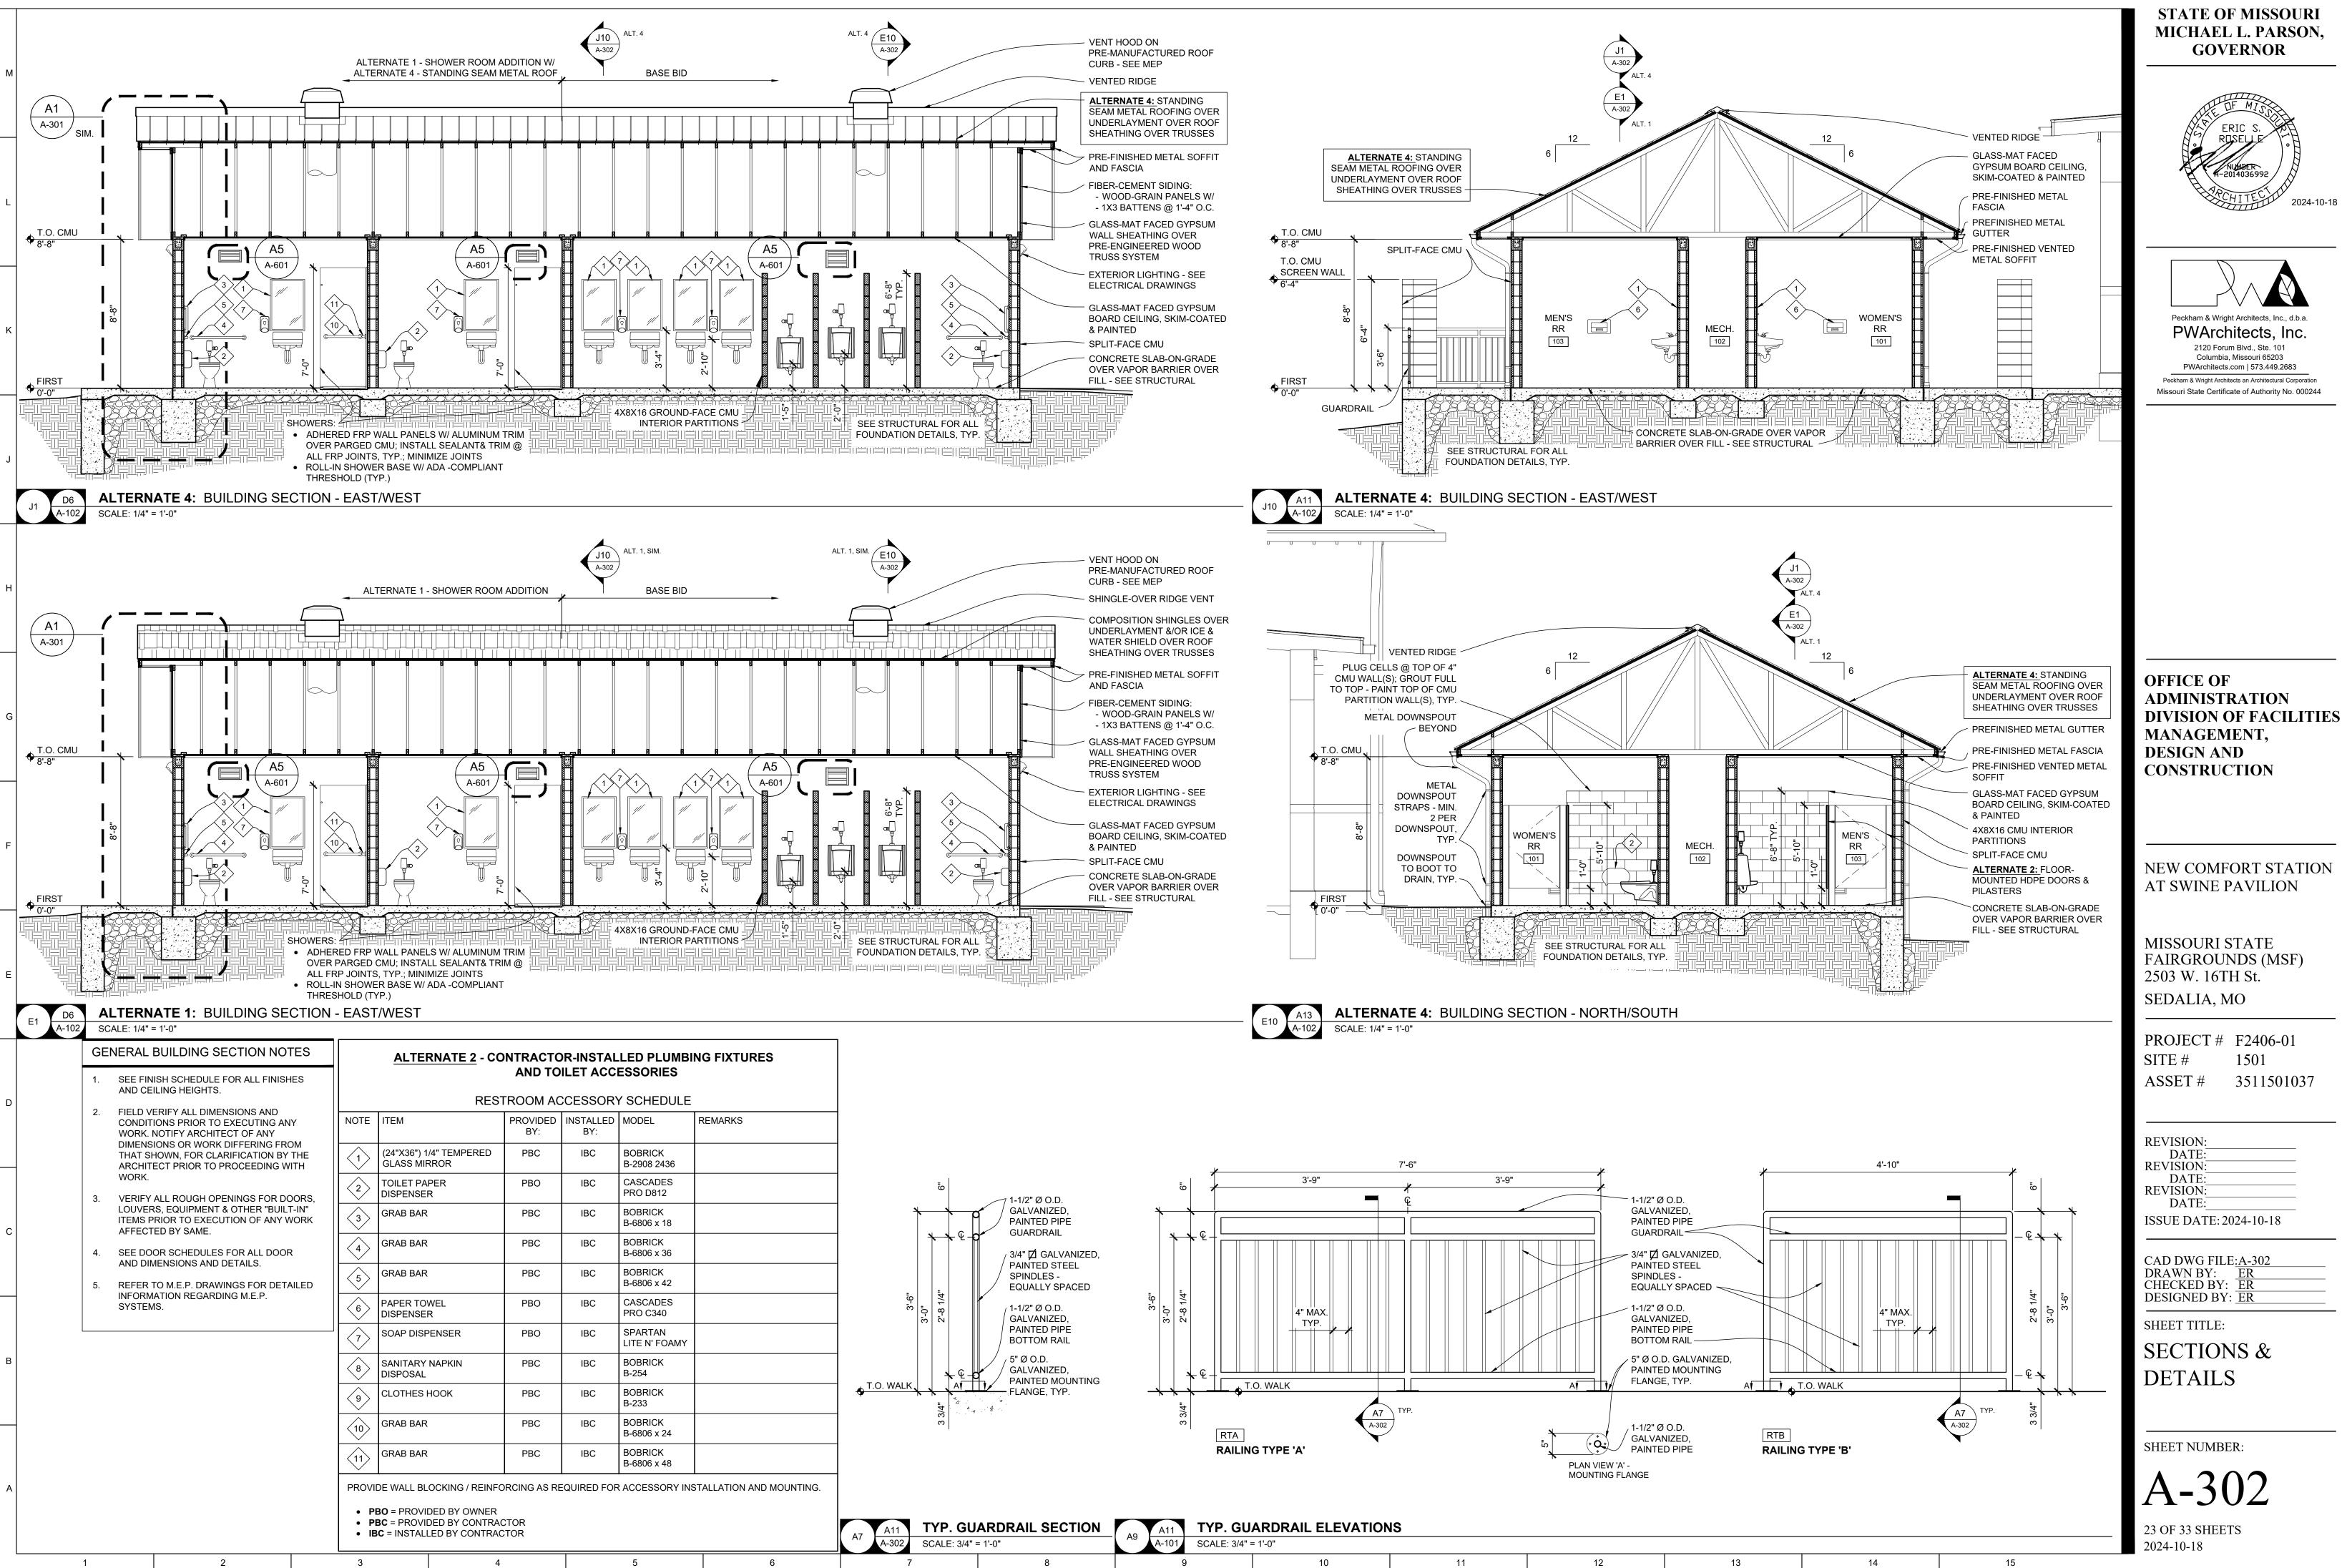


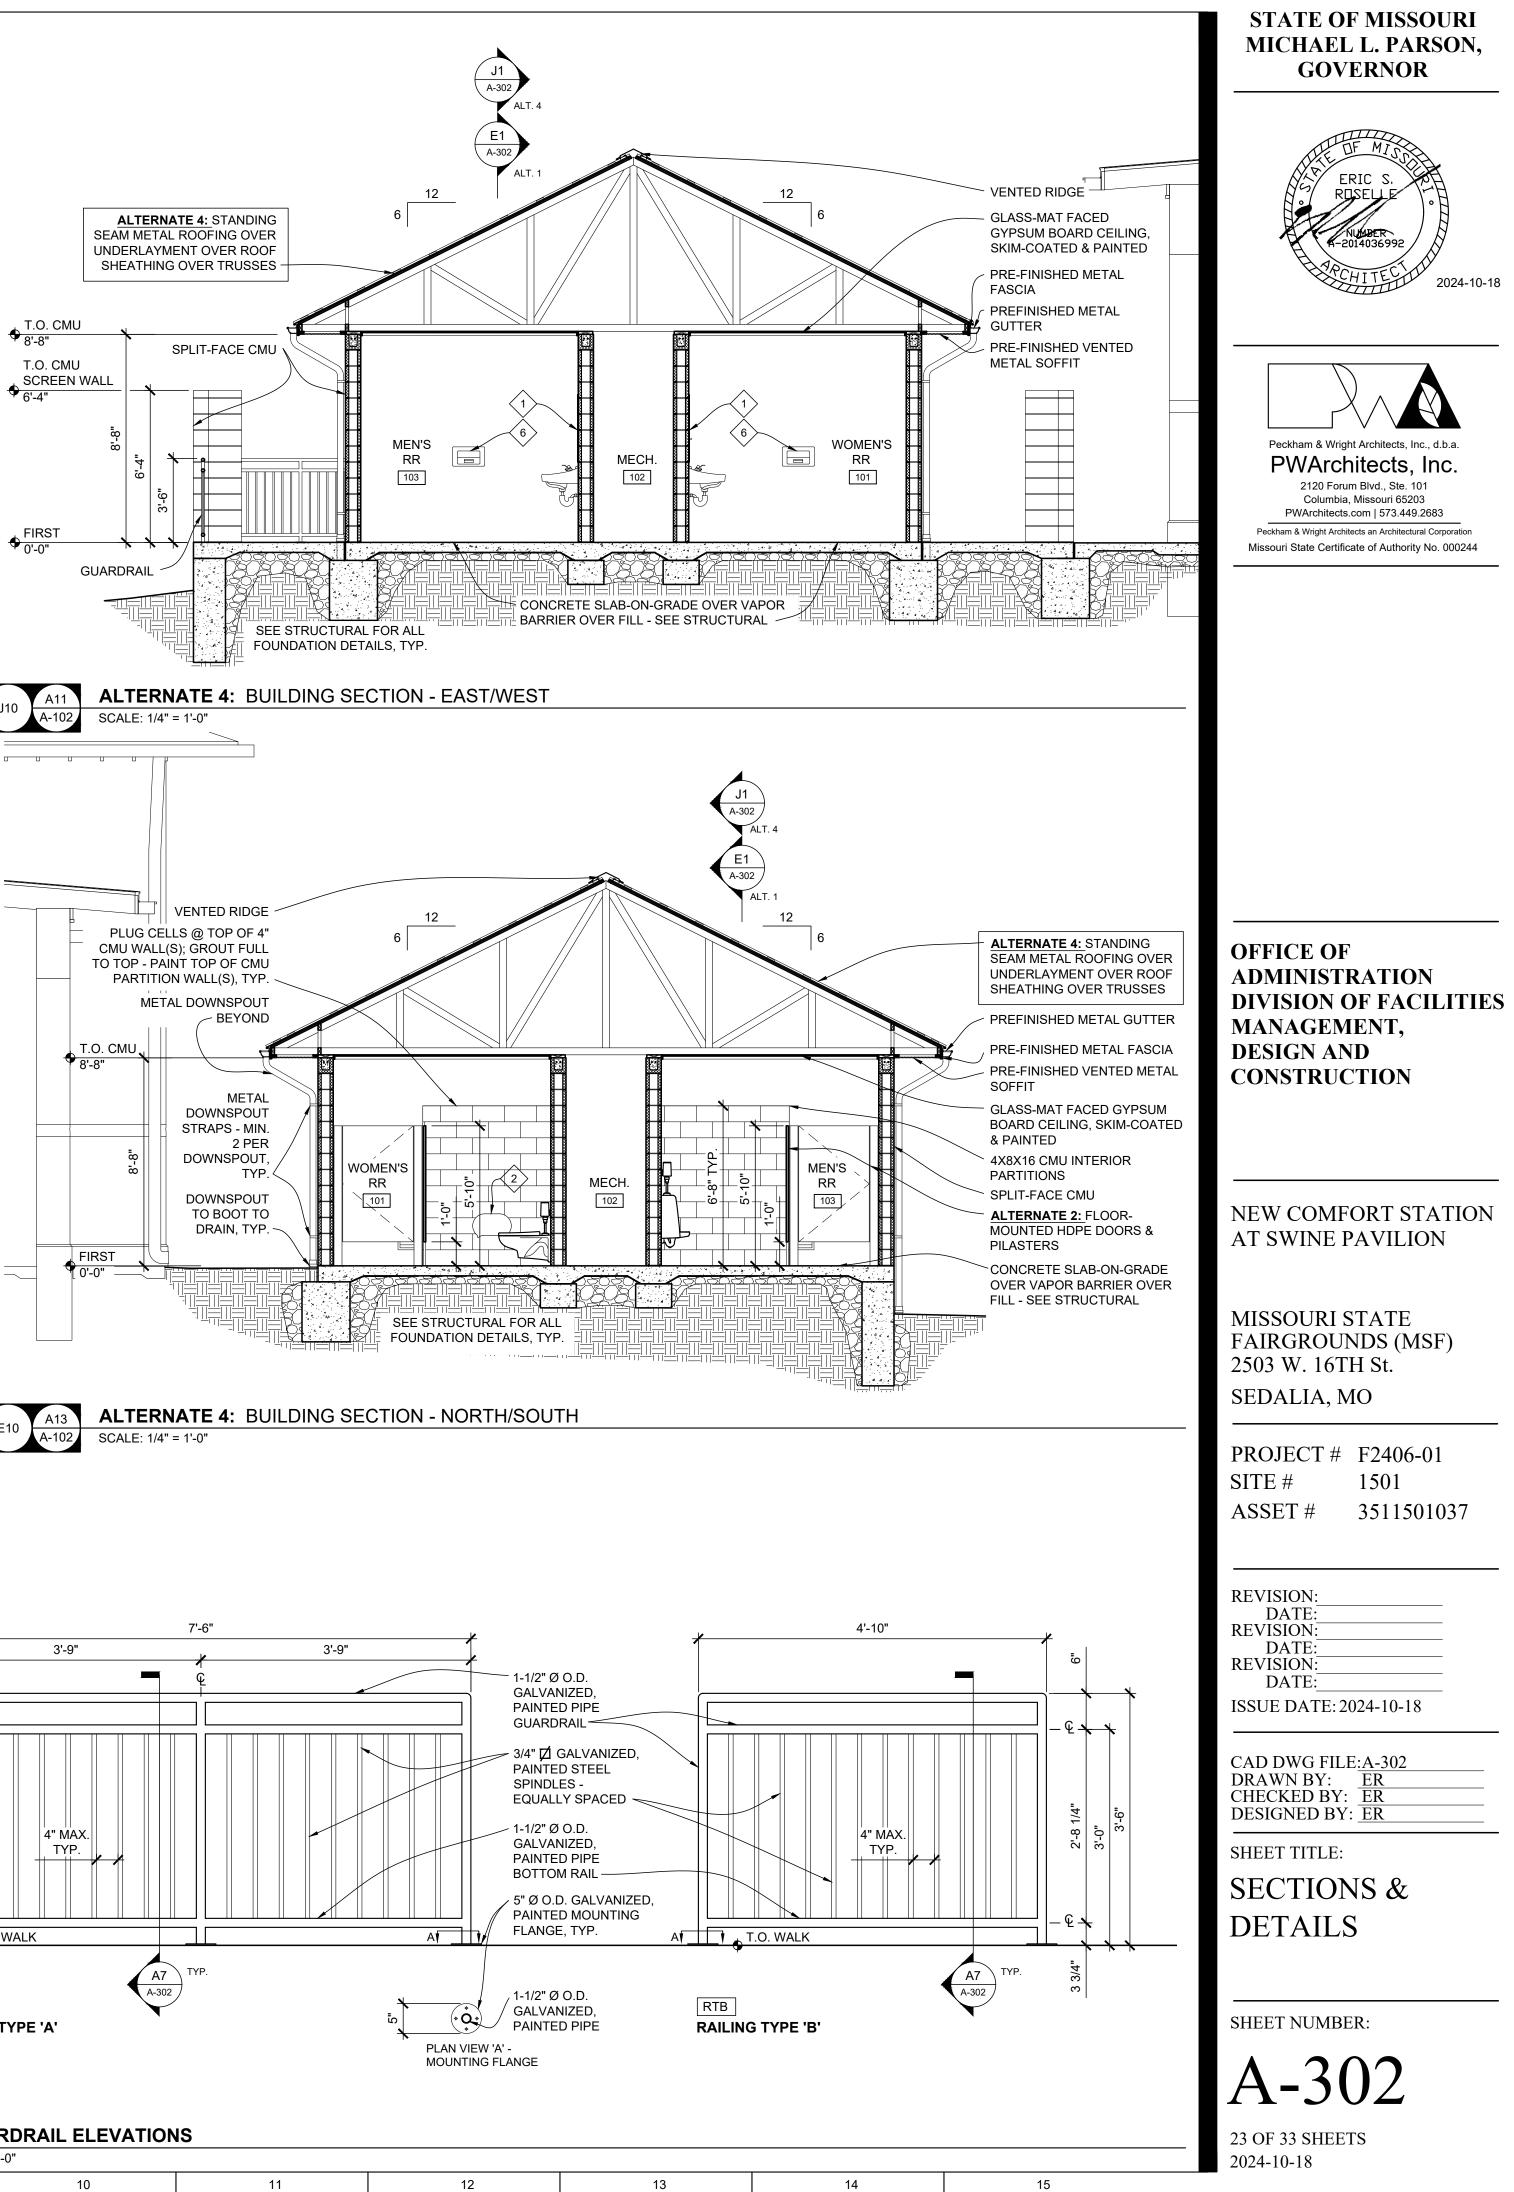

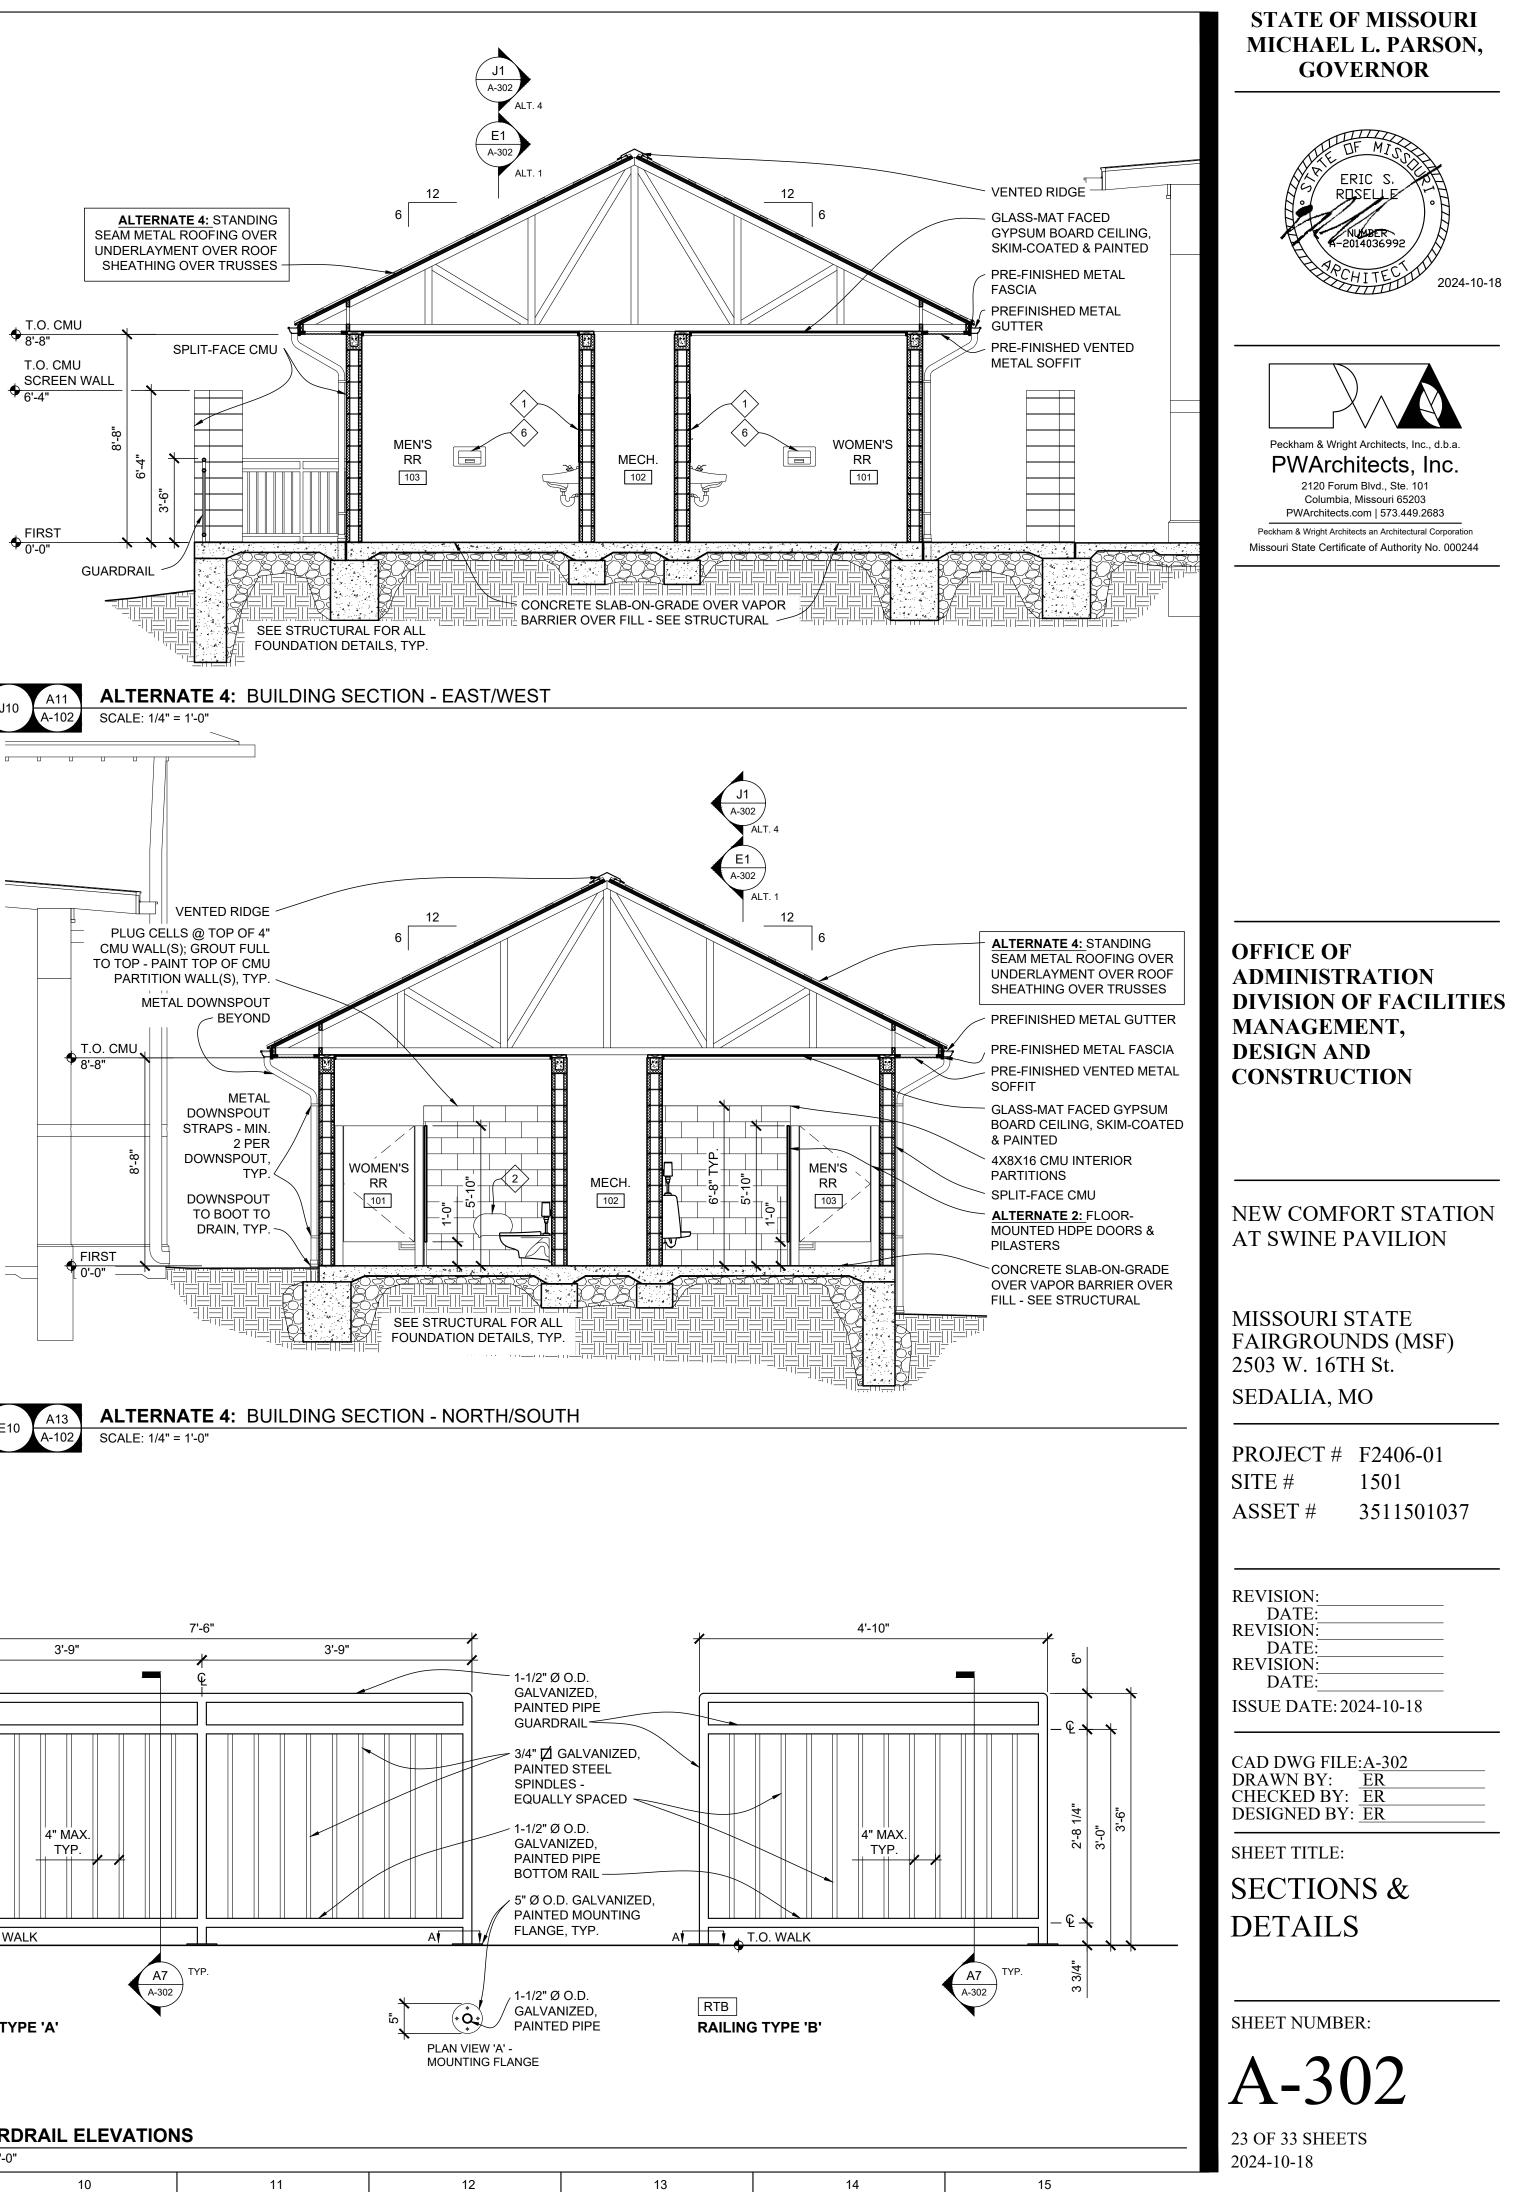



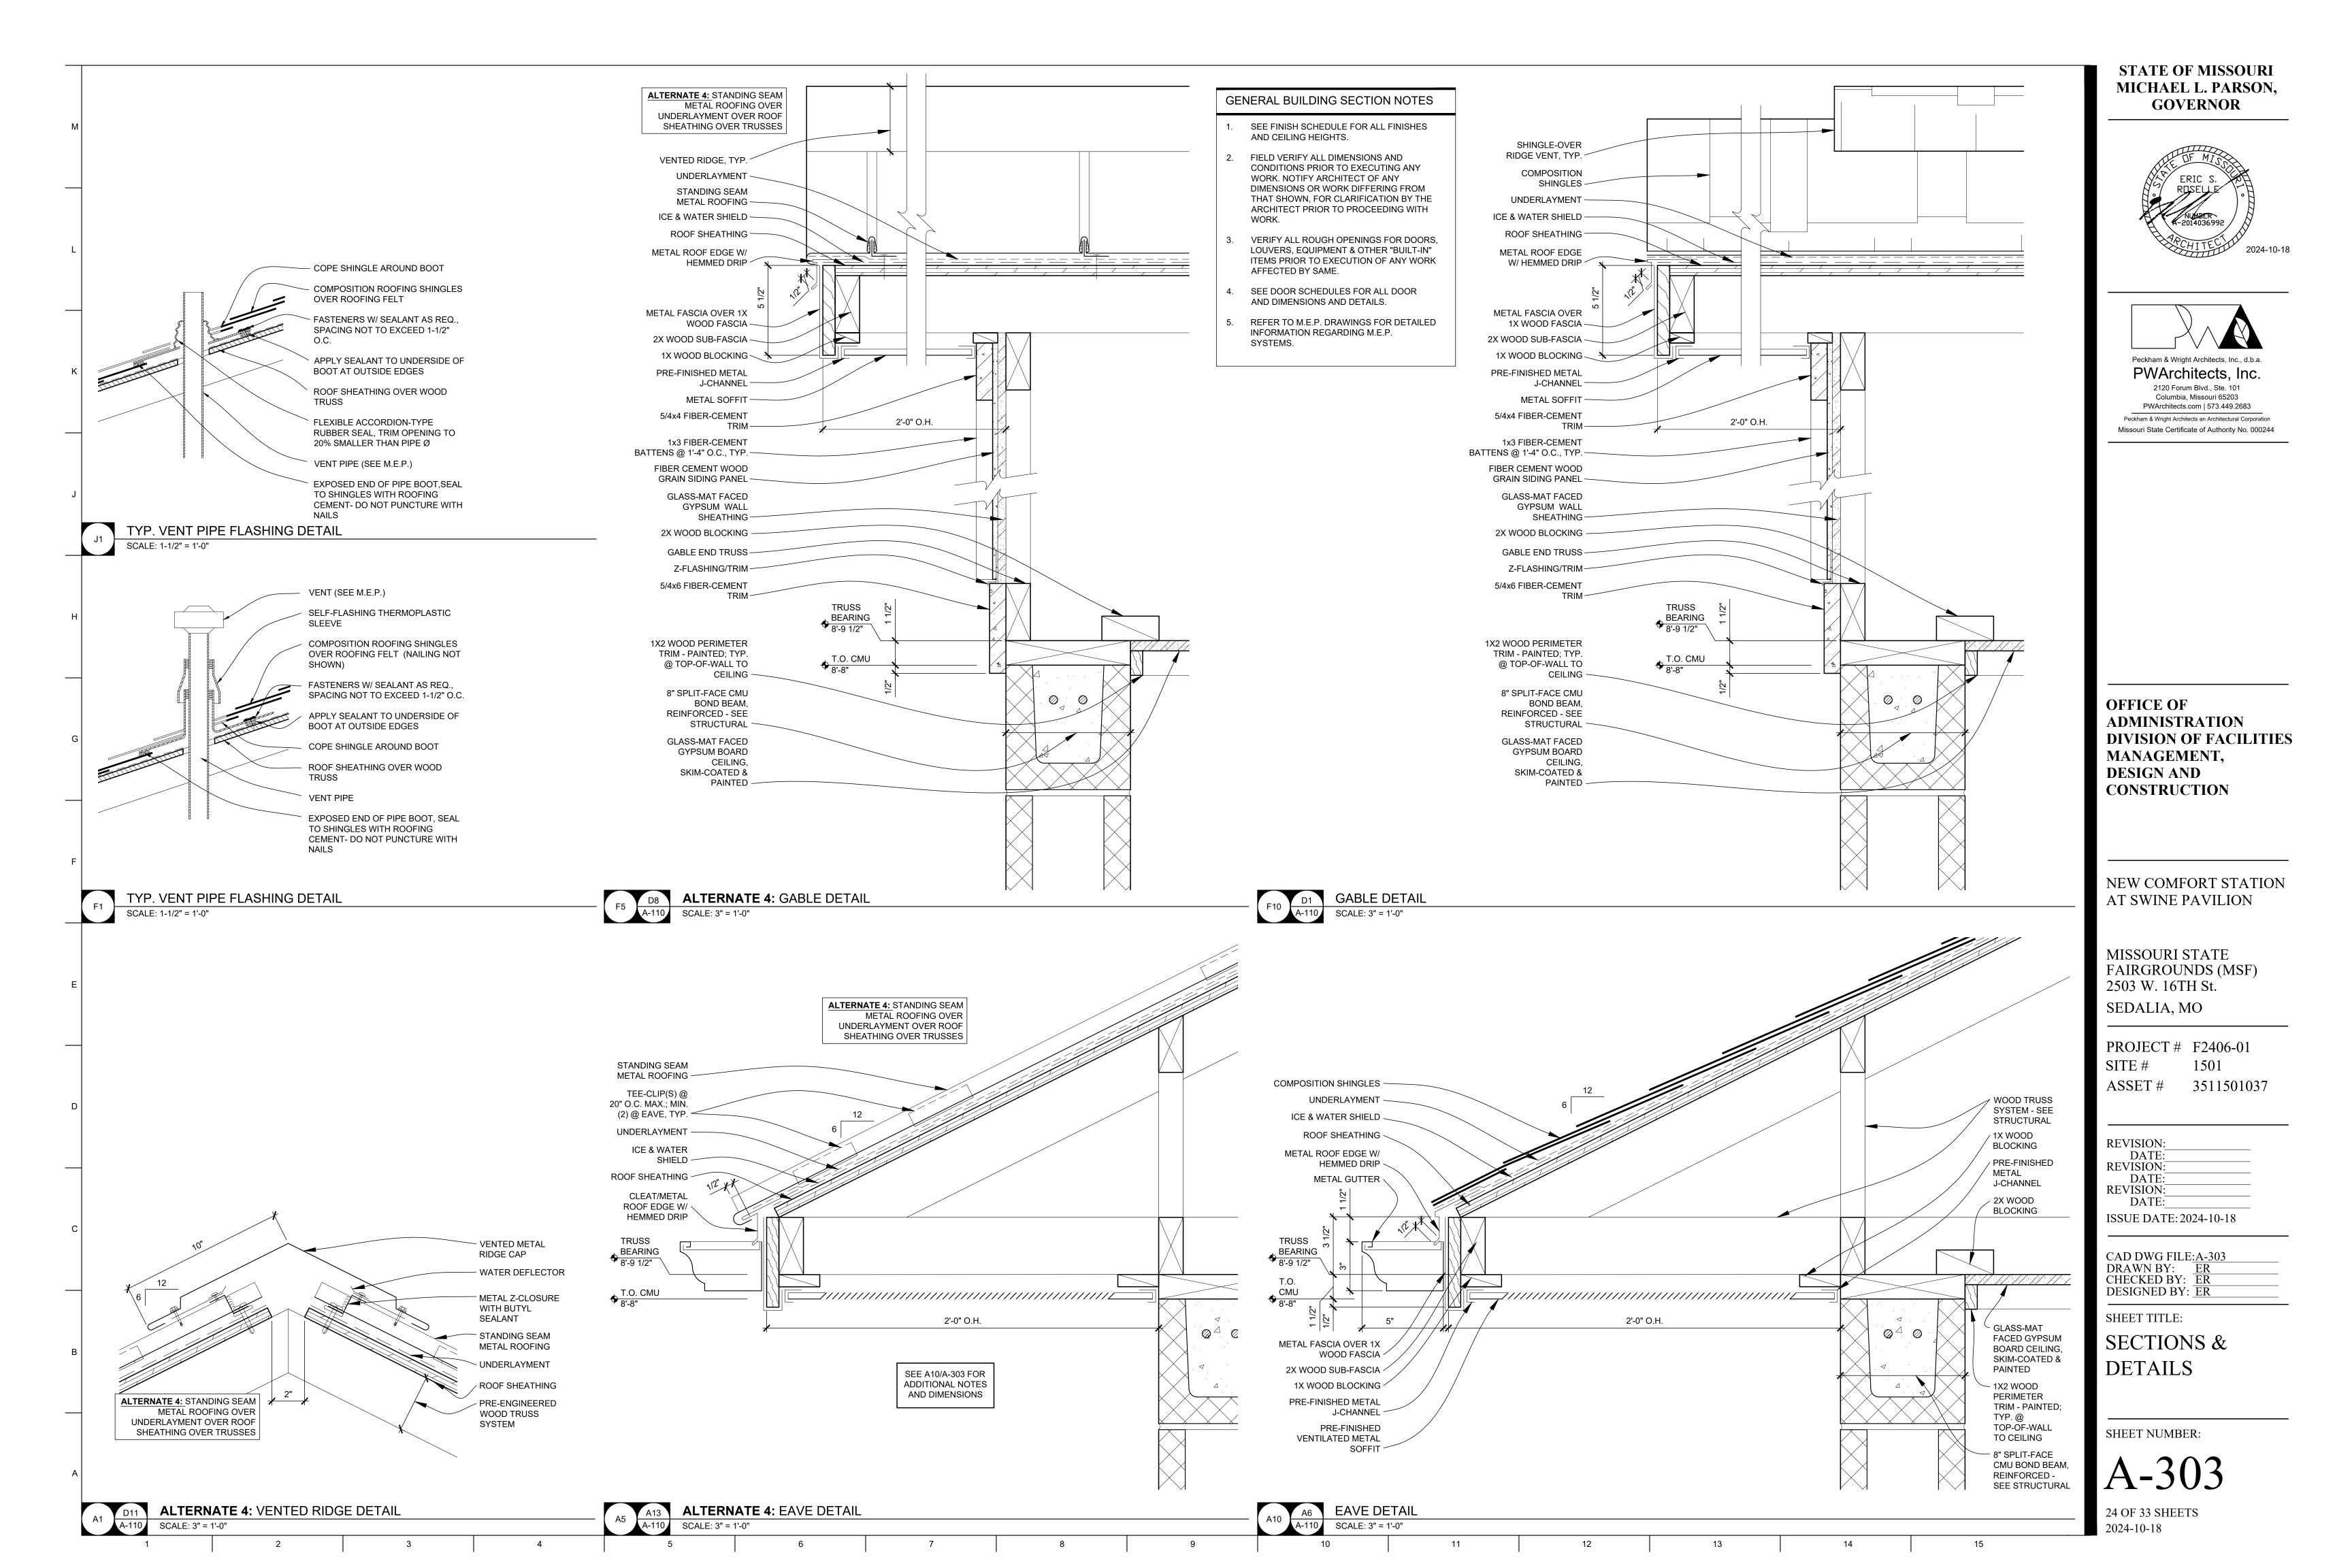

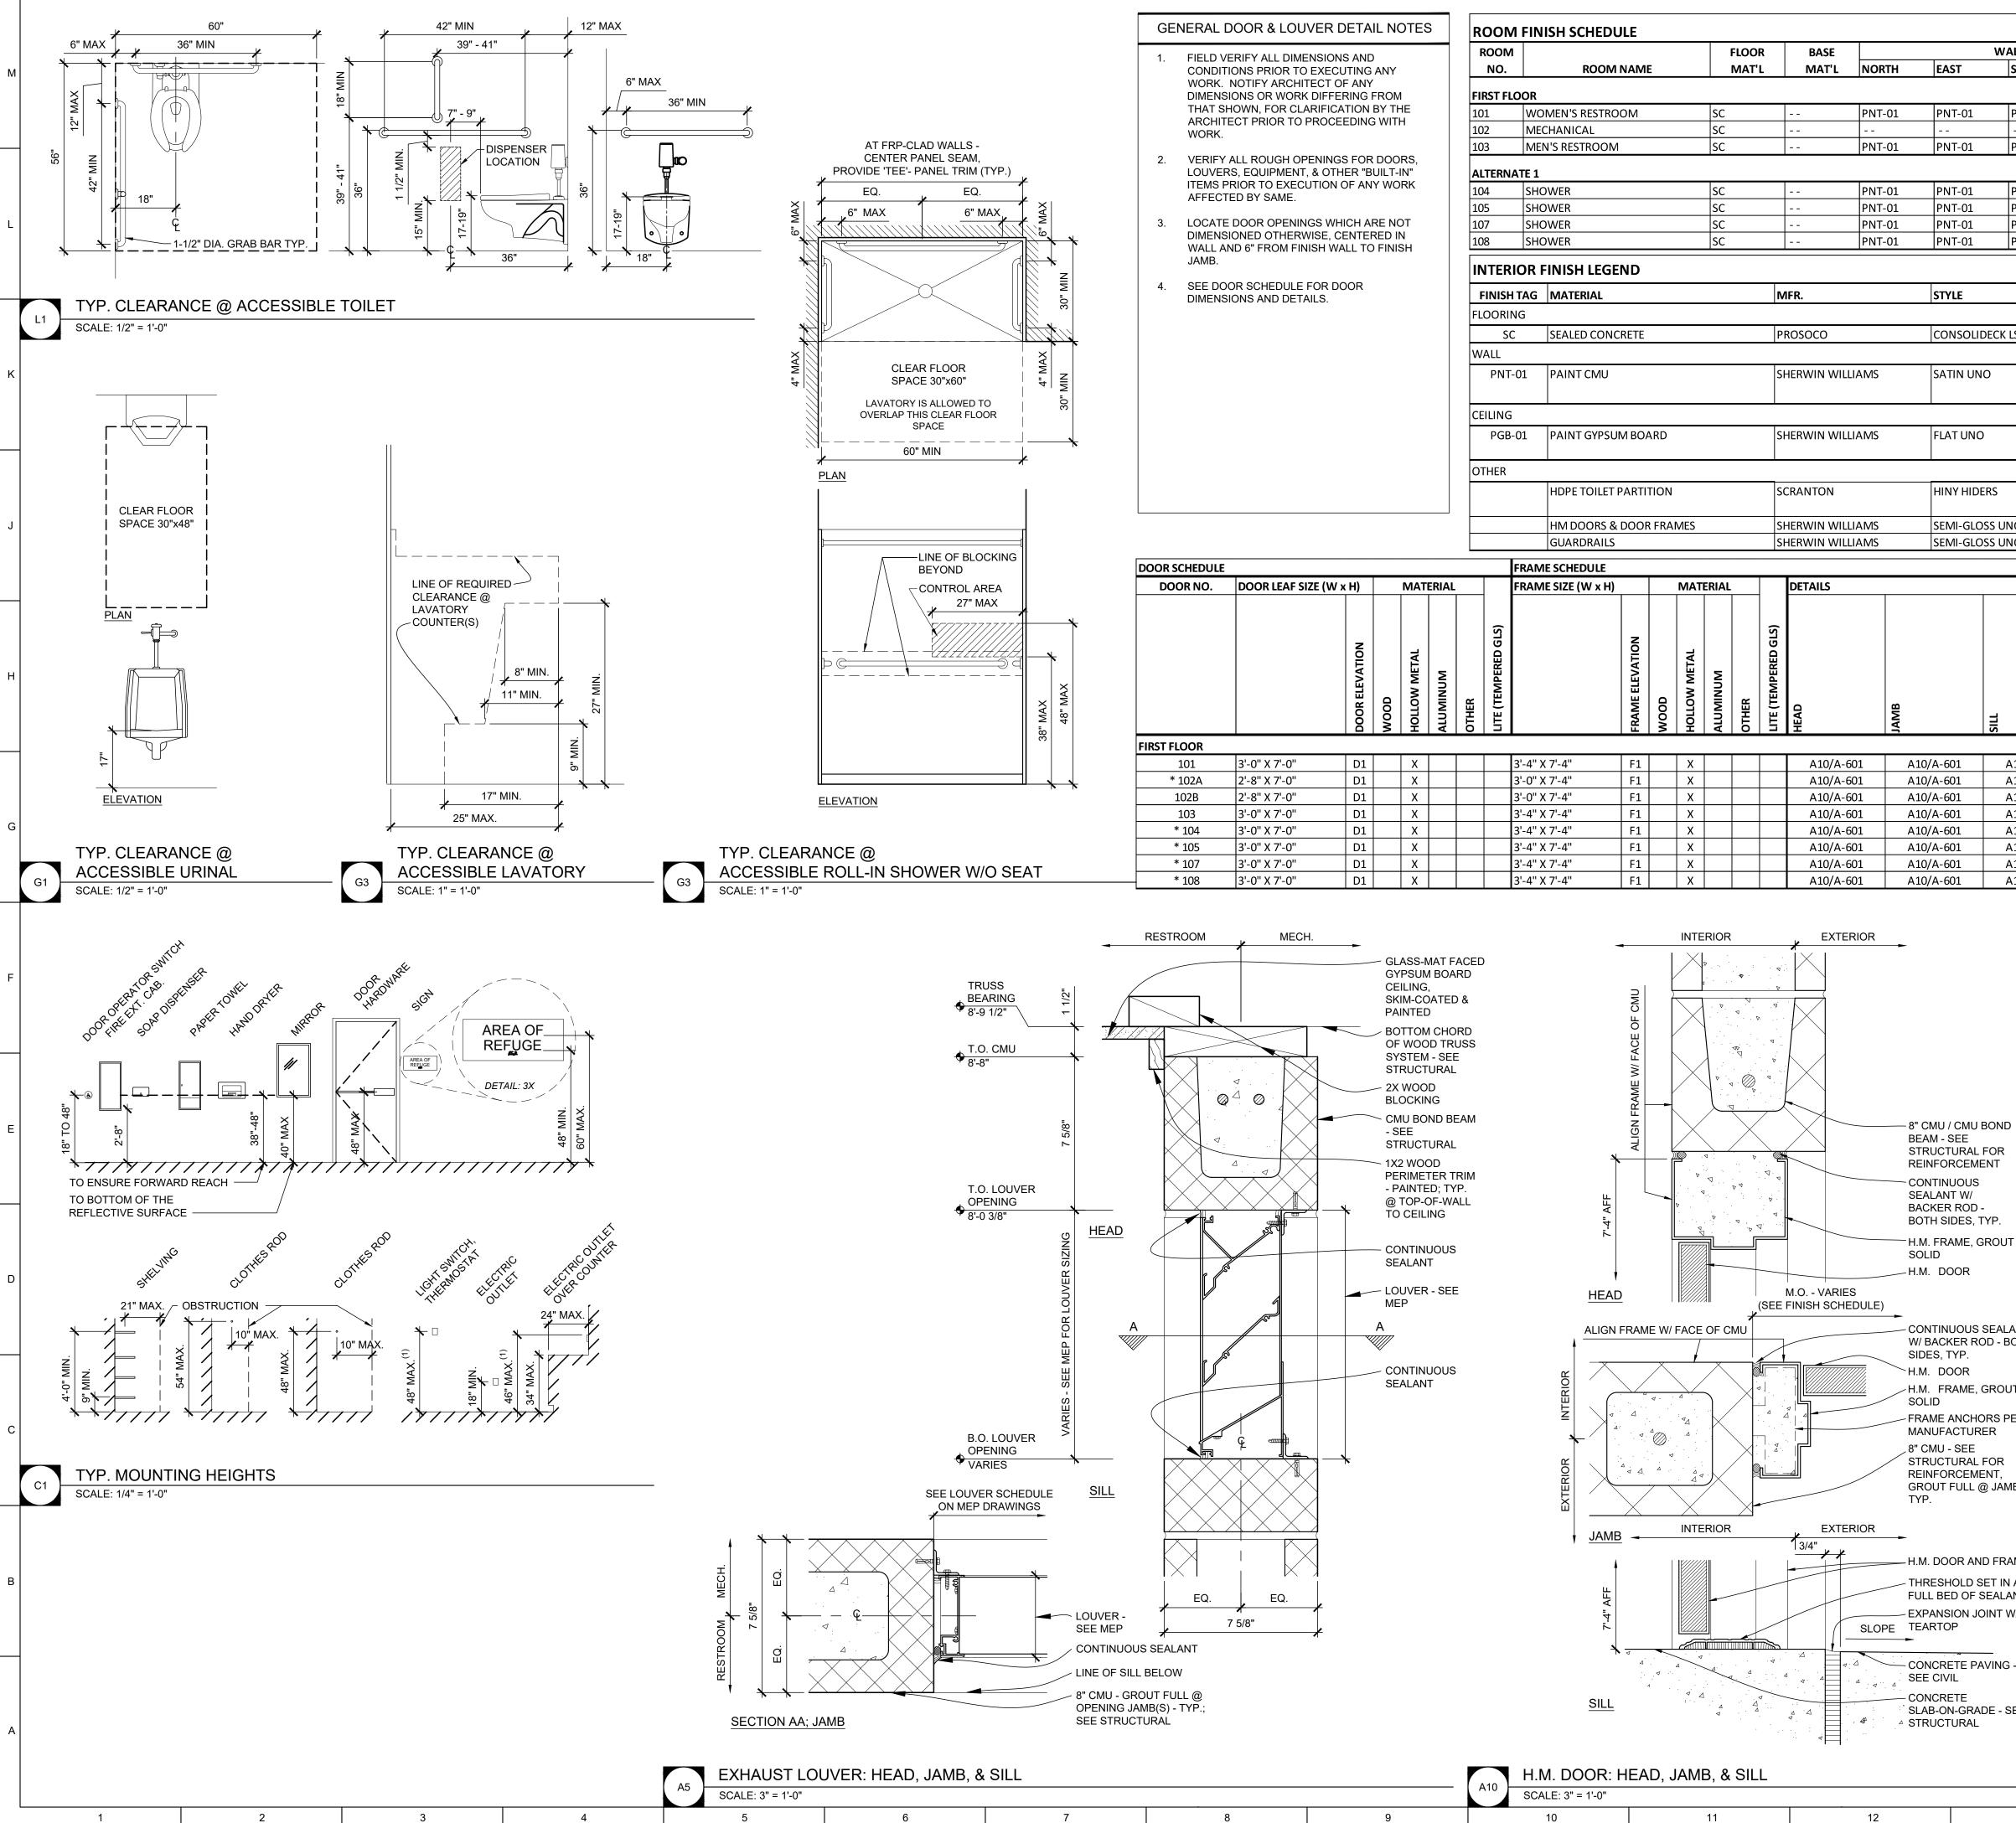

	WALL			CEILING		
EAST	SOUTH	WEST	FIN	ISH HE	IGHT	REMARKS
		•	<b>I</b>	l l		
PNT-01	PNT-01	PNT-01	PGB	3-01 8'-9	<del>)</del> "	
				EXPOSE		
PNT-01	PNT-01	PNT-01	PGB			
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					-	
CONSOLI	DECK LSGUARD					
SATIN UN		S\\/701E		SE GRAY		
	10	500/015	REPU	SEGRAY		RNATE 3: PNT-01 - EPOXY PAINT SYSTEM - SEE SPECIFICATION
						SYSTEMI-SEE SPECIFICATION
FLAT UNC	)			G BRIGHT -		
			WHITE	<u> </u>		
		CUAR			ALTER	
HINY HID	ERS			GREY;	ALIE	RNATE 3: HDPE TOILET PARTITION
			KTURE:			
SEMI-GLC						
SEMI-GLC		5006258	IRICO	RN BLACK		
		HARDWA		FIRE		
		GROUP	)	RATING	REMA	RKS
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)/A_601	A10/A 601		-			
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)/A-601 )/A-601	A10/A-601	SEE SPEC				
)/A-601 )/A-601	A10/A-601	SEE SPEC				
)/A-601 )/A-601	A10/A-601	SEE SPEC			* ^1 -	ERNATE 1
D/A-601 D/A-601	A10/A-601	SEE SPEC				ERNATE 1
)/A-601 )/A-601	A10/A-601	SEE SPEC				ERNATE 1
)/A-601 )/A-601	A10/A-601	SEE SPEC				ERNATE 1
7 A-001	A10/A-001					

BEAM - SEE STRUCTURAL FOR REINFORCEMENT - CONTINUOUS SEALANT W/ BACKER ROD -BOTH SIDES, TYP. -H.M. FRAME, GROUT


- CONTINUOUS SEALANT W/ BACKER ROD - BOTH SIDES, TYP. H.M. DOOR - H.M. FRAME, GROUT - FRAME ANCHORS PER MANUFACTURER

8" CMU - SEE STRUCTURAL FOR REINFORCEMENT, GROUT FULL @ JAMB,

- H.M. DOOR AND FRAME THRESHOLD SET IN A FULL BED OF SEALANT - EXPANSION JOINT W/

- CONCRETE PAVING -SEE CIVIL - CONCRETE SLAB-ON-GRADE - SEE


13

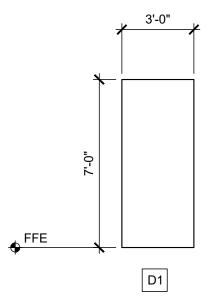

C14 DOOR ELEVATIONS SCALE: 1/4" = 1'-0"


SCALE: 1/4" = 1'-0"


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15

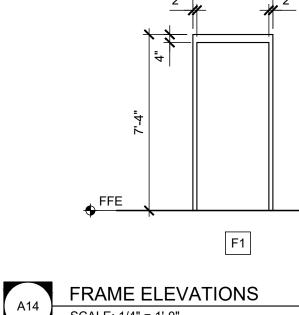**STATE OF MISSOURI** MICHAEL L. PARSON, GOVERNOR



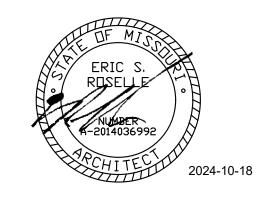

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NEW COMFORT STATION AT SWINE PAVILION

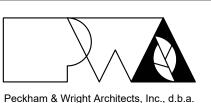MISSOURI STATE FAIRGROUNDS (MSF) 2503 W. 16TH St. SEDALIA, MO

PROJECT # F2406-01 SITE # 1501 3511501037 ASSET #

**REVISION:** DATE **REVISION:** DATE: **REVISION:** DATE: ISSUE DATE: 2024-10-18

CAD DWG FILE:A-601 DRAWN BY: CHECKED BY: DESIGNED BY: ER

SHEET TITLE: SCHEDULES & DETAILS

SHEET NUMBER:

25 OF 33 SHEETS 2024-10-18

GENERAL MEP SPECIFICATIONS

- 1. IT IS THE RESPONSIBILITY OF THE CONTRACTOR TO REVIEW AND UNDERSTAND ALL DRAWINGS AND SPECIFICATIONS IN THE CONTRACT DOCUMENTS. EACH CONTRACTOR IS RESPONSIBLE FOR ALL WORK ASSOCIATED WITH HIS TRADE REGARDLESS OF WHERE THE WORK IS DEPICTED IN THE DRAWINGS OR SPECIFICATIONS.
- THE LAYOUT OF SYSTEMS SHOWN ON PLANS ARE APPROXIMATE AND WILL NEED TO BE COORDINATED IN FIELD. THE CONTRACTOR SHALL INCLUDE THIS COORDINATION IN HIS SCOPE AND INCLUDE ALL COSTS OF MODIFYING THE LAYOUT AS REQUIRED IN HIS BID.
- 3. THE CONTRACTOR IS RESPONSIBLE FOR PROVIDING ALL NECESSARY PARTS AND LABOR TO PRODUCE A
- COMPLETE AND FULLY OPERATIONAL SYSTEM UNLESS STATED OTHERWISE ON PLANS. 4. ALL MATERIALS TO BE NEW, FIRST CLASS, AND INSTALLED PER MANUFACTURE'S PUBLISHED INSTRUCTIONS.
- ALL WORK SHALL BE PERFORMED IN COMPLIANCE WITH LOCALLY ADOPTED CODES AND ORDINANCES.
   CONTRACTOR IS RESPONSIBLE FOR COORDINATING EQUIPMENT LOCATIONS AND SYSTEM ROUTING WITH
- OTHER TRADES PRIOR TO INSTALLATION.
   CONTRACTOR TO GUARANTEE ALL MATERIALS AND WORKMANSHIP FOR A PERIOD OF ONE YEAR FROM THE
- DATE THE PROJECT IS TURN OVER TO THE OWNER, UNLESS NOTED OTHERWISE. 8. CONTRACTOR IS TO INCLUDE IN THEIR SCOPE THE COST OF ALL PERMITS, INSPECTIONS, METERING, AND
- TAPS ASSOCIATED WITH THEIR WORK. 9. CONTRACTOR IS RESPONSIBLE FOR ALL EXCAVATION, CUTTING, CORING, PATCHING, AND BACKFILL REQUIRED
- TO COMPLETE THEIR WORK, UNLESS NOTED OTHERWISE.
- 10. THESE PLANS ARE NOT TO BE SCALED. SEE ARCHITECTURAL PLANS FOR DIMENSIONS. WHERE THERE IS A CONFLICT BETWEEN ARCHITECTURAL DIMENSIONS AND MEP DIMENSION, ARCHITECTURAL SHALL GOVERN.
- 11. SEE DISCIPLINE SHEETS FOR ADDITIONAL DISCIPLINE SPECIFIC SPECIFICATIONS.

REFERENCED CODES IN EFFECT

2018 INTERNATIONAL MECHANICAL CODE


2018 INTERNATIONAL PLUMBING CODE


2018 INTERNATIONAL FUEL GAS CODE

2018 INTERNATIONAL FIRE CODE

2017 NATIONAL ELECTRIC CODE

2018 INTERNATIONAL ENERGY CONSERVATION CODE

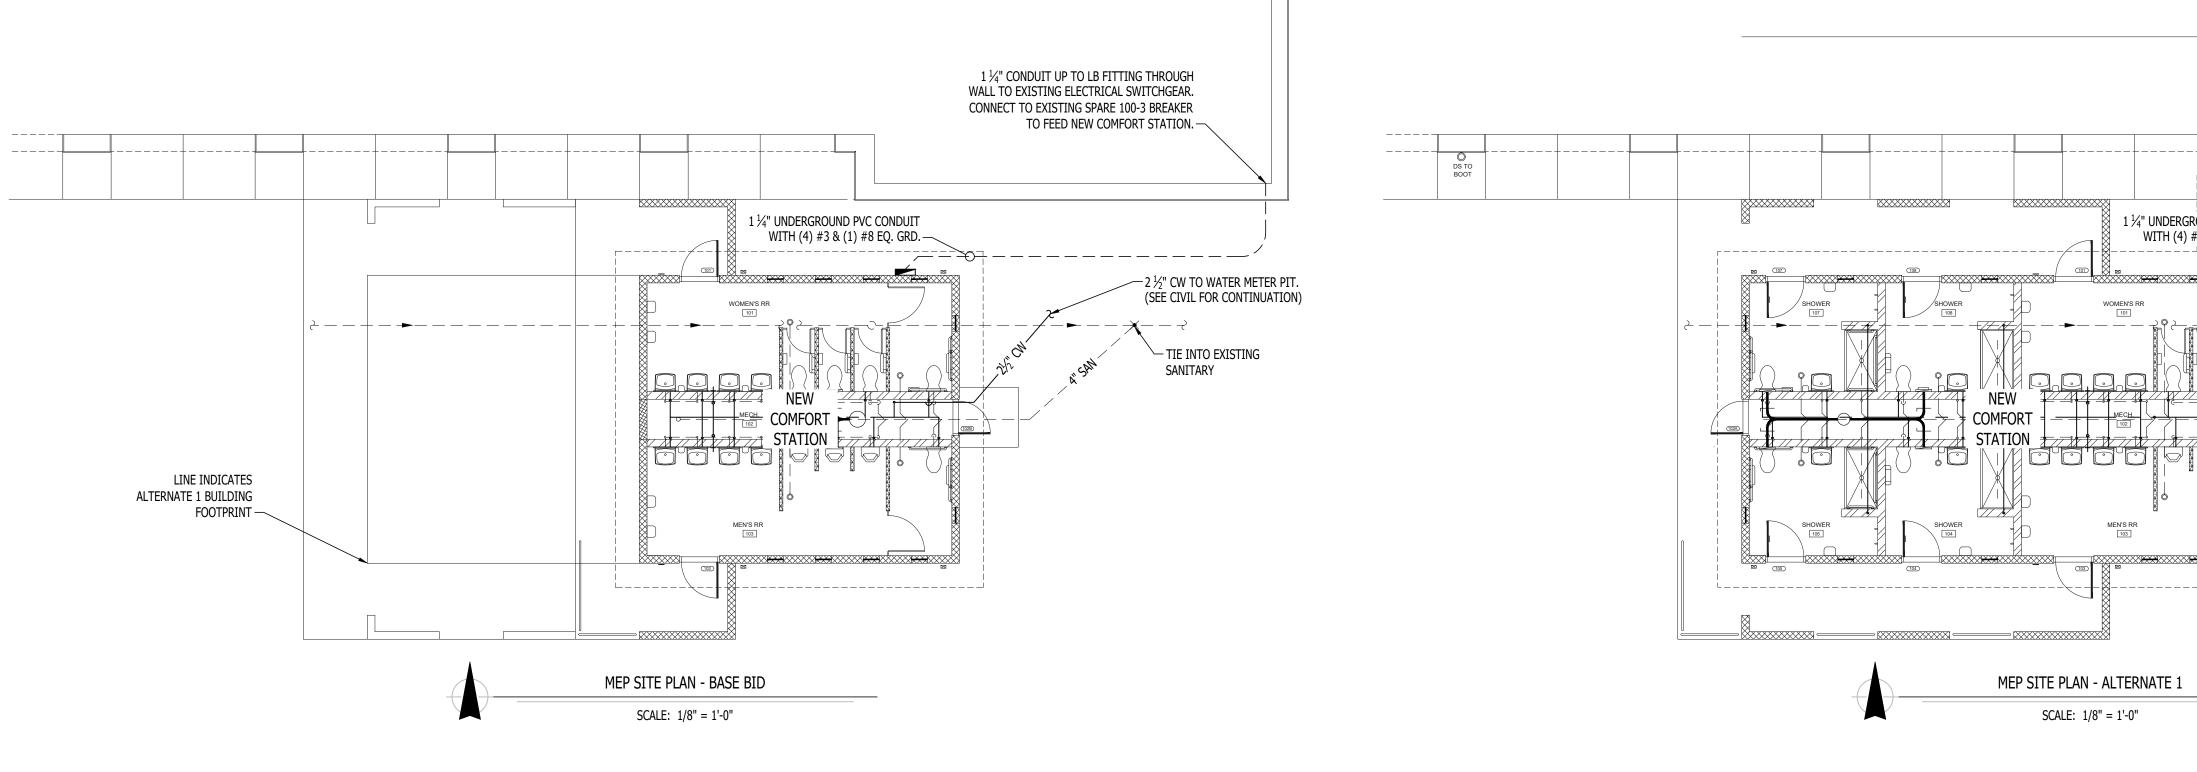

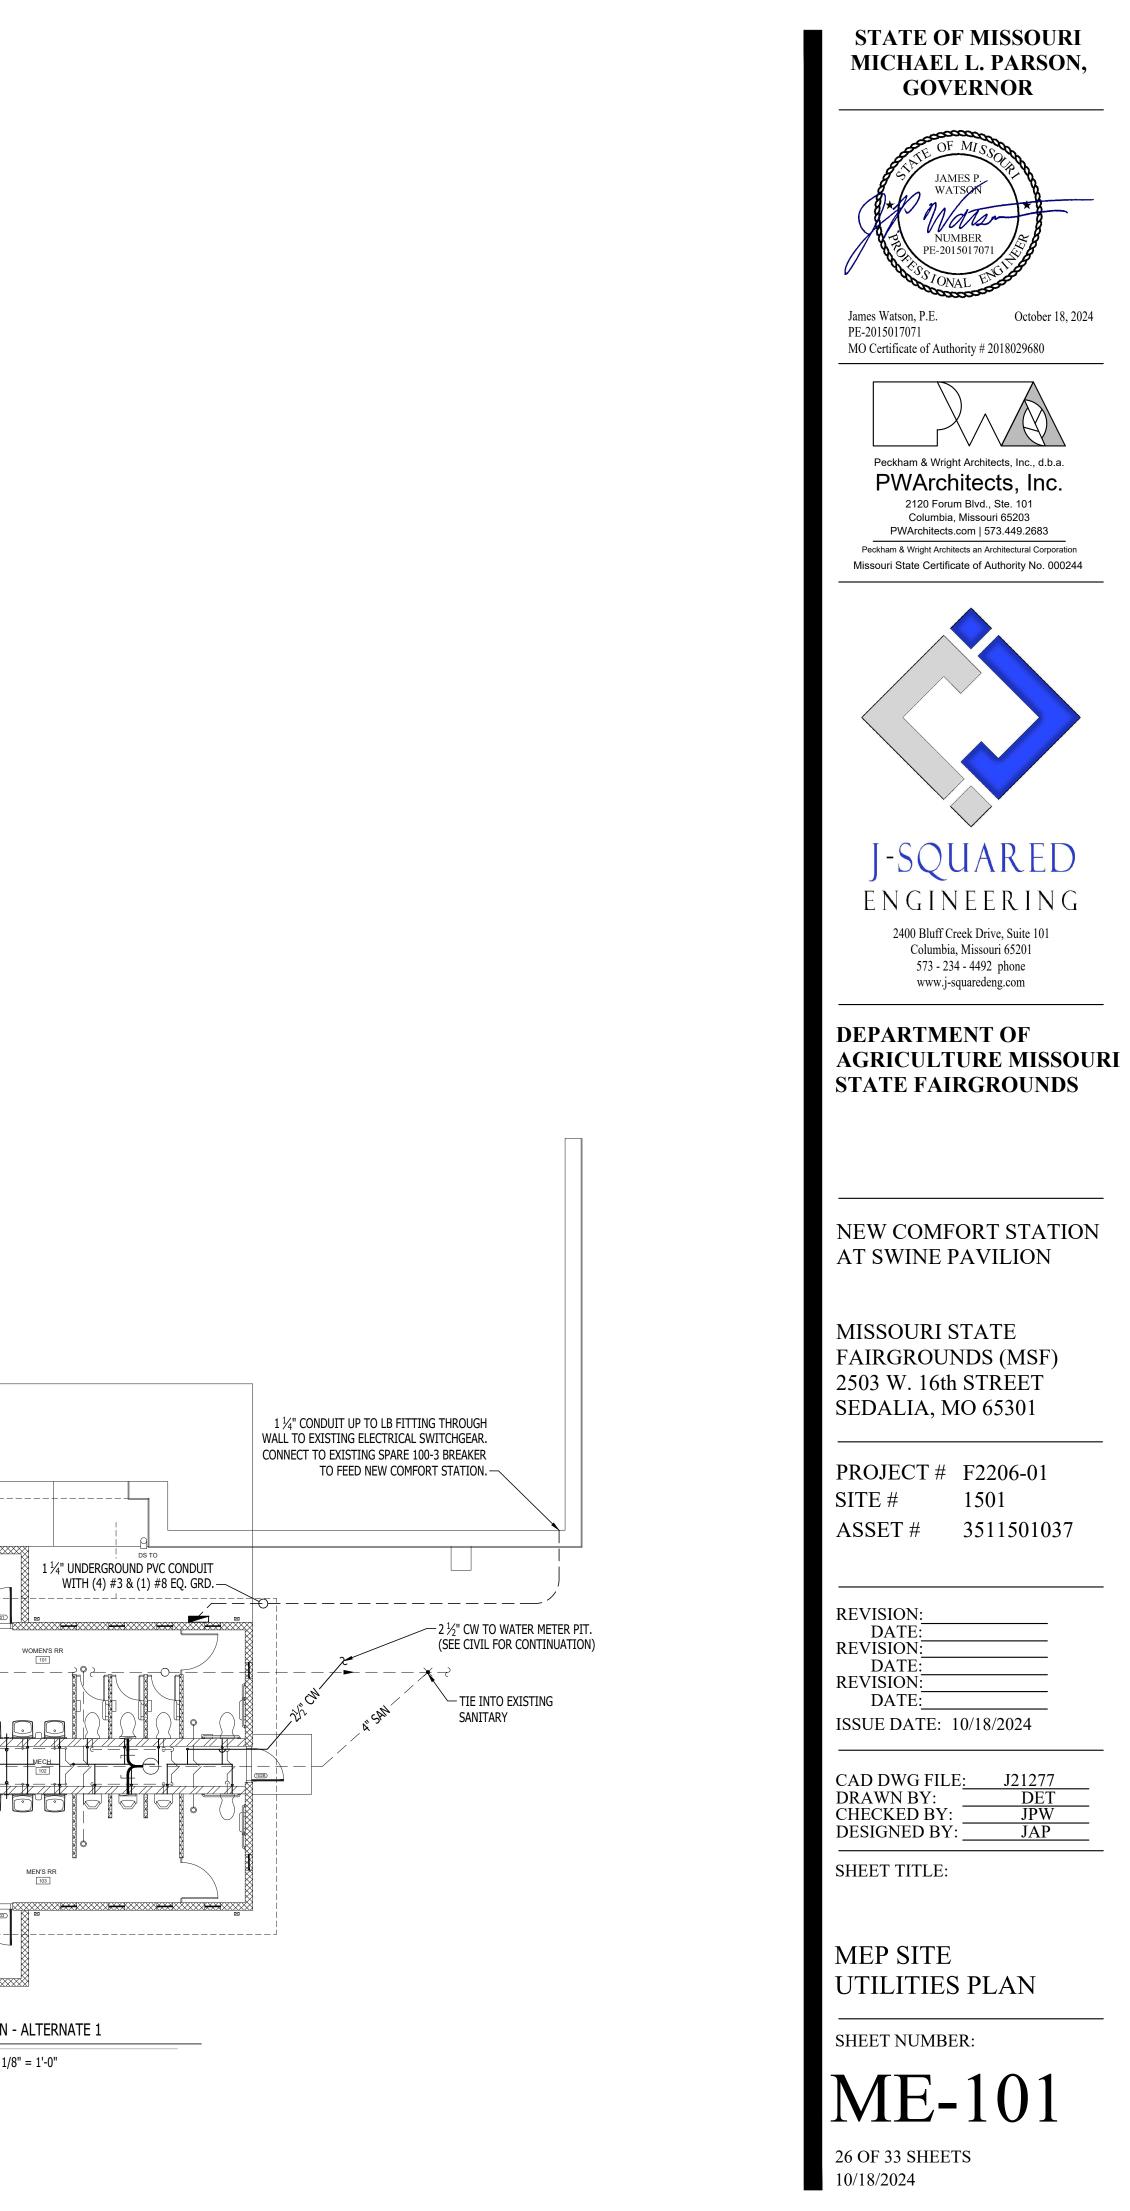

#### HVAC PLAN SYMBOL LEGEND

- X EQUIPMENT TYPE (REFER TO EQUIPMENT SCHEDULE)
- EQUIPMENT REFERENCE NUMBER
- The provide the provided and the provide

EXHAUST DUCTWORK

UBIC FEET PER MINUTE (CFM) / FACE SIZE

#### LIST OF ALTERNATES

#### A. ALTERNATE 1 - SHOWER ROOMS ADDITION

- 1. CONSTRUCT SHOWER ROOM ADDITION ON WEST END OF BUILDING.
- 2. TO INCLUDE:
- a. ROUGH-IN AND WALL-HUNG BRACKETS FOR THE ALTERNATE 1 WATER CLOSETS, SHOWERS, AND LAVATORIES.
- b. SHOWER ENCLOSURE(S) AND DRAIN(S).
- c. OWNER TO PROVIDE AND INSTALL ALL ALTERNATE 1 TOILET ACCESSORIES.

#### B. <u>ALTERNATE 2</u> - CONTRACTOR-INSTALLED PLUMBING FIXTURES AND TOILET ACCESSORIES:

- 1. CONTRACTOR TO:
- a. PROVIDE AND INSTALL PLUMBING FIXTURES TO INCLUDE WATER CLOSETS AND FLUSH VALVES, URINALS AND FLUSH VALVES, SHOWER VALVES, SHOWER HEADS, LAVATORIES, AND FAUCETS.
- b. PROVIDE AND INSTALL TOILET ACCESSORIES AS NOTED IN THE "RESTROOM ACCESSORY SCHEDULE" INCLUDED ON SHEETS A-101 AND A-301.
- 2. BASE BID: TO INCLUDE:

a. ROUGH-IN AND WALL-HUNG BRACKETS FOR THE WATER CLOSETS, URINALS, SHOWERS, AND LAVATORIES.


- b. SHOWER ENCLOSURE AND DRAIN.
- c. OWNER TO PROVIDE AND INSTALL ALL TOILET ACCESSORIES.

#### **ALTERNATE 3** - WATER HEATER, EXTERIOR LIGHTING, INTERIOR EPOXY COATING:

- 1. CONTRACTOR TO:
- a. PROVIDE AND INSTALL WATER HEATER WITH WALL KIT AS SHOWN AND NOTED ON SHEET P-101.
- E-101.
- c. PROVIDE AND INSTALL HDPE TOILET COMPARTMENT DOOR/PILASTER ASSEMBLIES (INCLUDING
- HARDWARE), AS SHOWN ON SHEETS A-101 AND A-301. d. PROVIDE AND INSTALL EPOXY WALL COATING PNT-01, AS SHOWN THE INTERIOR FINISH LEGEND ON
- SHEET A-601. 2. BASE BID:
- a. PROVIDE ALL PLUMBING AND ELECTRICAL ROUGH-IN FOR FUTURE WATER HEATER AND WALL KIT TO BE
- INSTALLED BY OWNER; PROVIDE BLANK PLATE AT JUNCTION BOX; TEMPORARILY CAP PLUMBING PIPES.
- b. PROVIDE ALL ELECTRICAL ROUGH-IN FOR FUTURE EXTERIOR AND INTERIOR LIGHT FIXTURES TO BE INSTALLED BY OWNER. PROVIDE BLANK PLATES AT JUNCTION BOXES.
- c. DO NOT PROVIDE HDPE TOILET PARTITIONS.
- d. CMU TO REMAIN EXPOSED; WALLS WILL BE FINISHED AND PAINTED BY OWNER.

#### D. ALTERNATE 4 - STANDING SEAM METAL ROOFING SYSTEM:

- 1. PROVIDE STANDING SEAM METAL ROOF AND ASSOCIATED FLASHING CHANGES.
- 2. BASE BID: TO INCLUDE COMPOSITION SHINGLE ROOF SYSTEM.

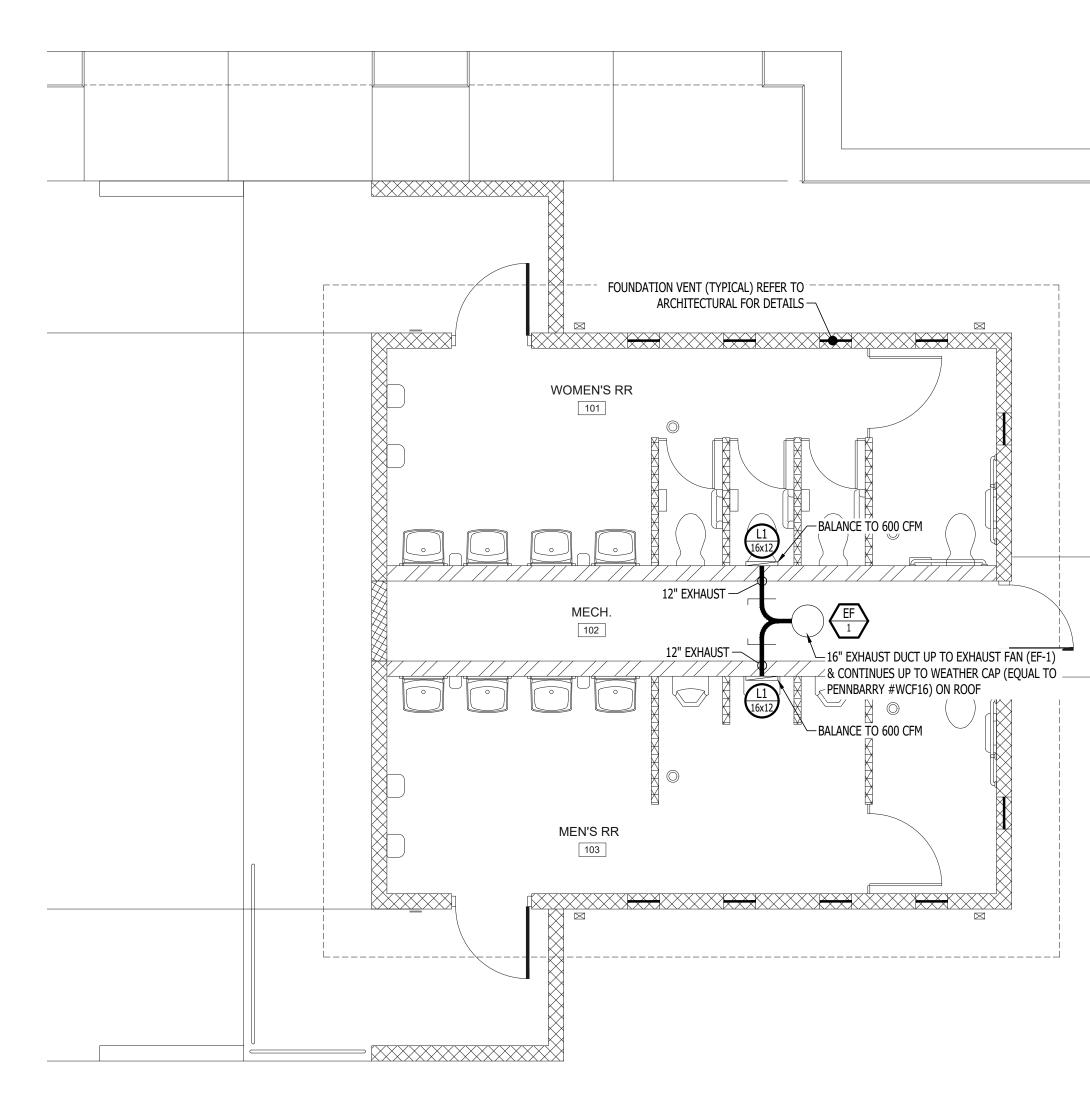

HVAC PLAN - BASE BID SCALE: 1/4" = 1'-0"

	EXHAUST FAN SCHEDULE										
TAG	EQUIPMENT TYPE	MA NUFA CTURER	MODEL	R.	W		ELECTRICA L	1	PHYS	ICAL	NOTES
IAG	EQUIPMENT ITPE	(OR EQUAL)	(OR EQUAL)	CFM	S.P.	VOLT/PH	MCA	OCP	DIM.	WEIGHT	NOTES
EF-1	IN-LINE EXHAUST FAN	SOLER & PALAU	TD-MIXVENT 355	1200	3/8"	120 / 1	3.9	15	18x17x19	68	1,2
EF-2	IN-LINE EXHAUST FAN	SOLER & PALAU	TD-MIXVENT 200	900	3/8"	120 / 1	0.8	15	12x10x10	13	1,2
NOTES:											

1. WITH BACKDRAFT DAMPER


2. WITH SPEED CONTROLLER

3. WITH SUSPENSION PLATFORM AND INLET FLEX CONNECTION

R	LIGHTING,	TOILET	PARTITIONS


MANU TAG SERVICE (OR EXHAUST POT L1 NOTES: 1. VERIFY AIR DEVICE FINISHES WITH OWNER/ARCHITECT PRIOR TO INSTALLATION


b. PROVIDE AND INSTALL ALL EXTERIOR AND INTERIOR LIGHT FIXTURES AS SHOWN AND NOTED ON SHEET

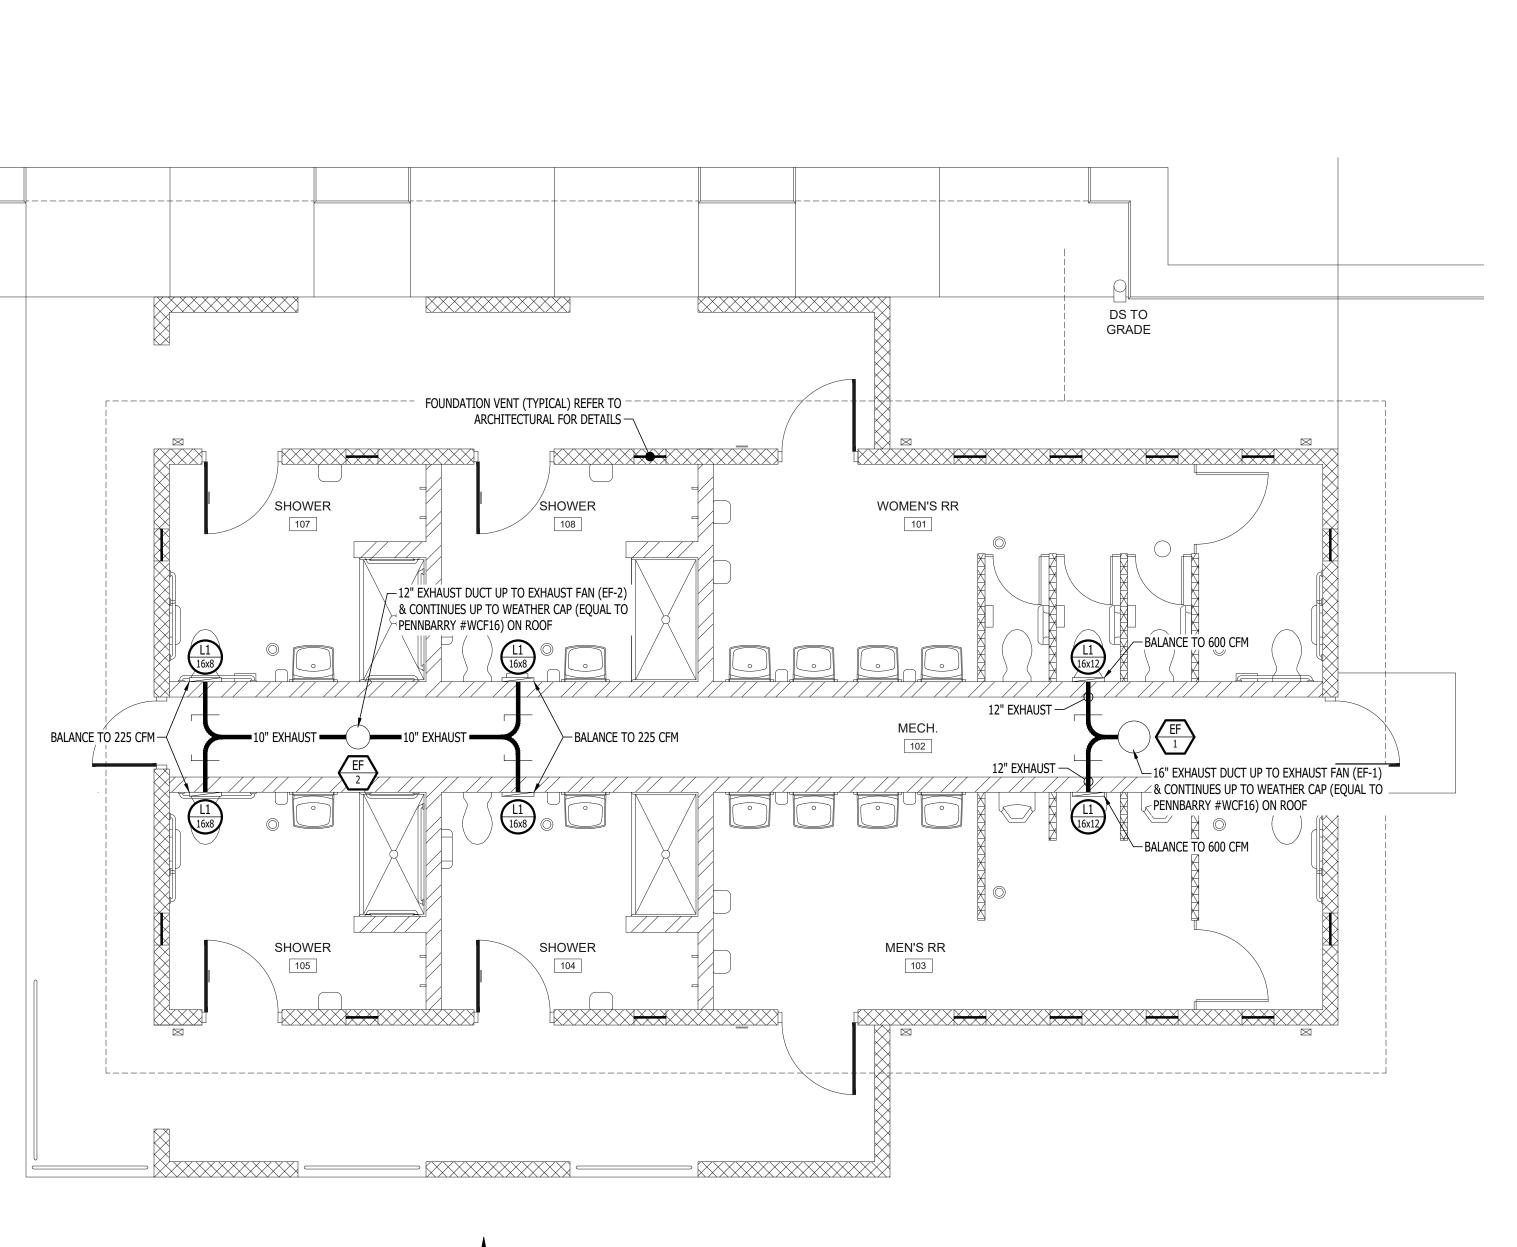

HVAC PLAN - ALTERNATE 1

A	AIR DEVICE SCHEDULE												
FACTURER EQUAL)	MODEL (OR EQUAL)	SIZE	COLOR / FINISH	NOTES									
TTORFF	EFJ-445	AS INDICATED	PRIMED	PAINT TO MATCH WALL									
	R/ARCHITECT P		ATION										

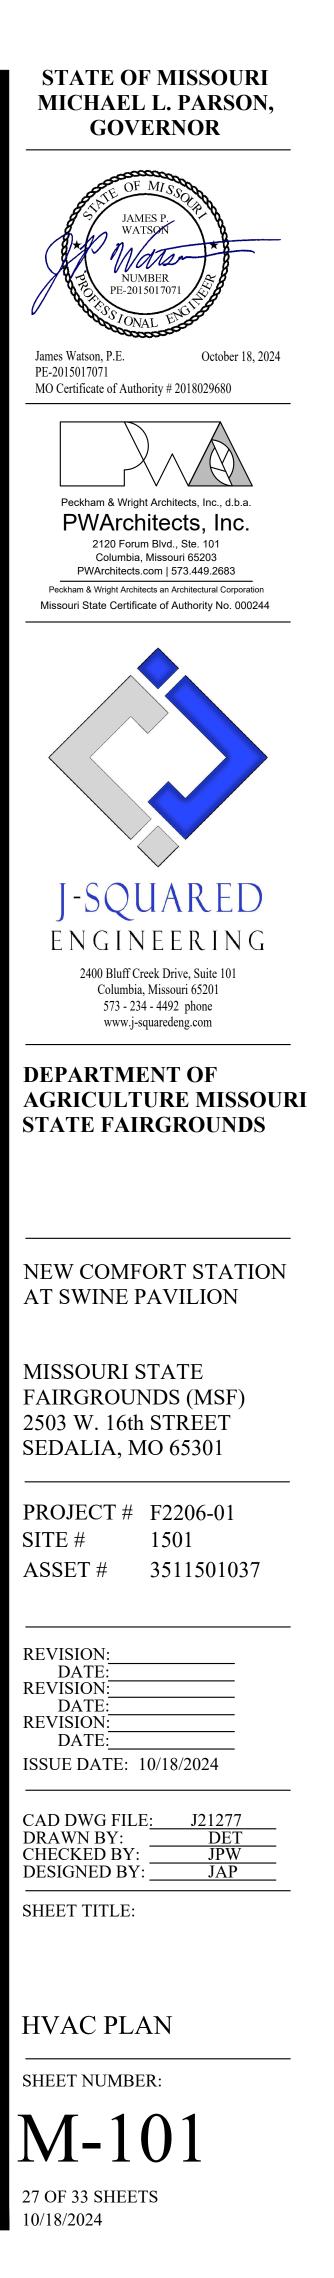

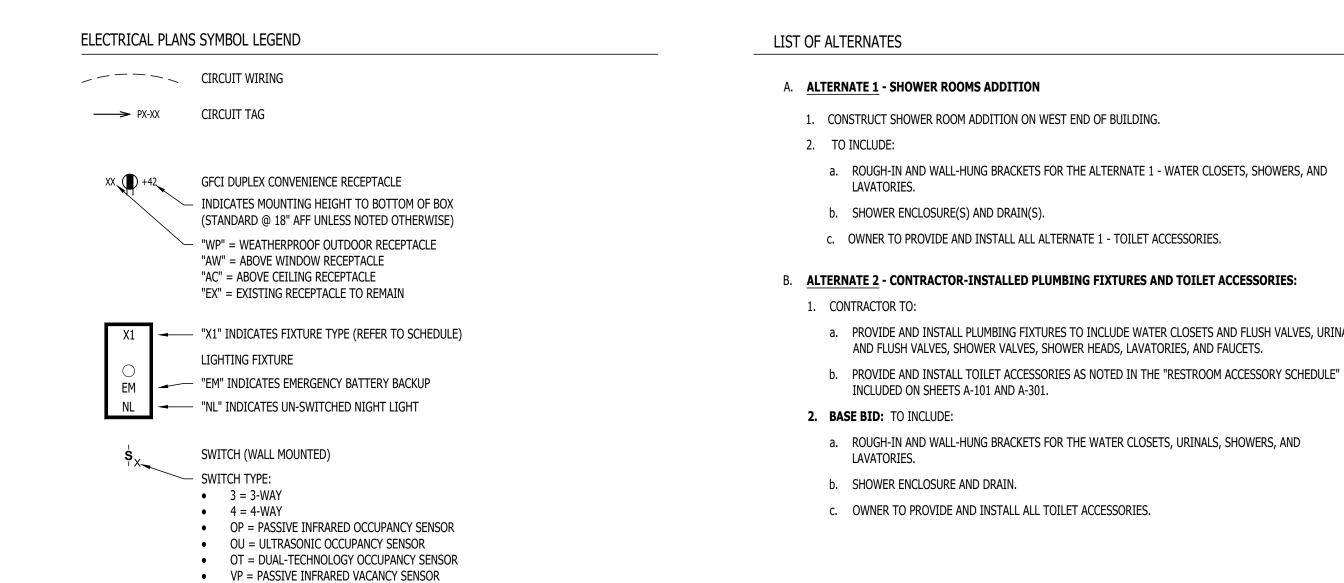

POWER PLAN KEY NOTES:

SWITCH TYPE:

®<sub>x</sub>、

• VU = ULTRASONIC VACANCY SENSOR VT = DUAL-TECHNOLOGY VACANCY SENSOR

 M = MOMENTARY SWITCH SS = SCENE SWITCH


SWITCH (CEILING MOUNTED)

(1) WIRE EXTERIOR LIGHTS THRU PHOTOCELL MOUNTED ON BUILDING EXTERIOR RAKE BOARD. PHOTOCELL TO FACE NORTH.

SEE "SWITCH (WALL MOUNTED)" FOR TYPE DESIGNATIONS

(2) CONTRACTOR TO PROVIDE & INSTALL RELAY / CONTACTOR(S) TO ISOLATE LIGHTING CIRCUIT FROM MEN'S RESTROOM LIGHTING FROM WOMEN'S RESTROOM LIGHTING. BOTH SHALL TURN ON EXHAUST FAN (EF-1).

(3) CONTRACTOR TO PROVIDE & INSTALL RELAY / CONTACTOR(S) TO ISOLATE LIGHTING CIRCUITS FROM INDIVIDUAL SHOWER ROOMS SO THAT ANY OF THE (4) WILL TURN ON EXHAUST FAN (EF-2) WHEN ENERGIZED.

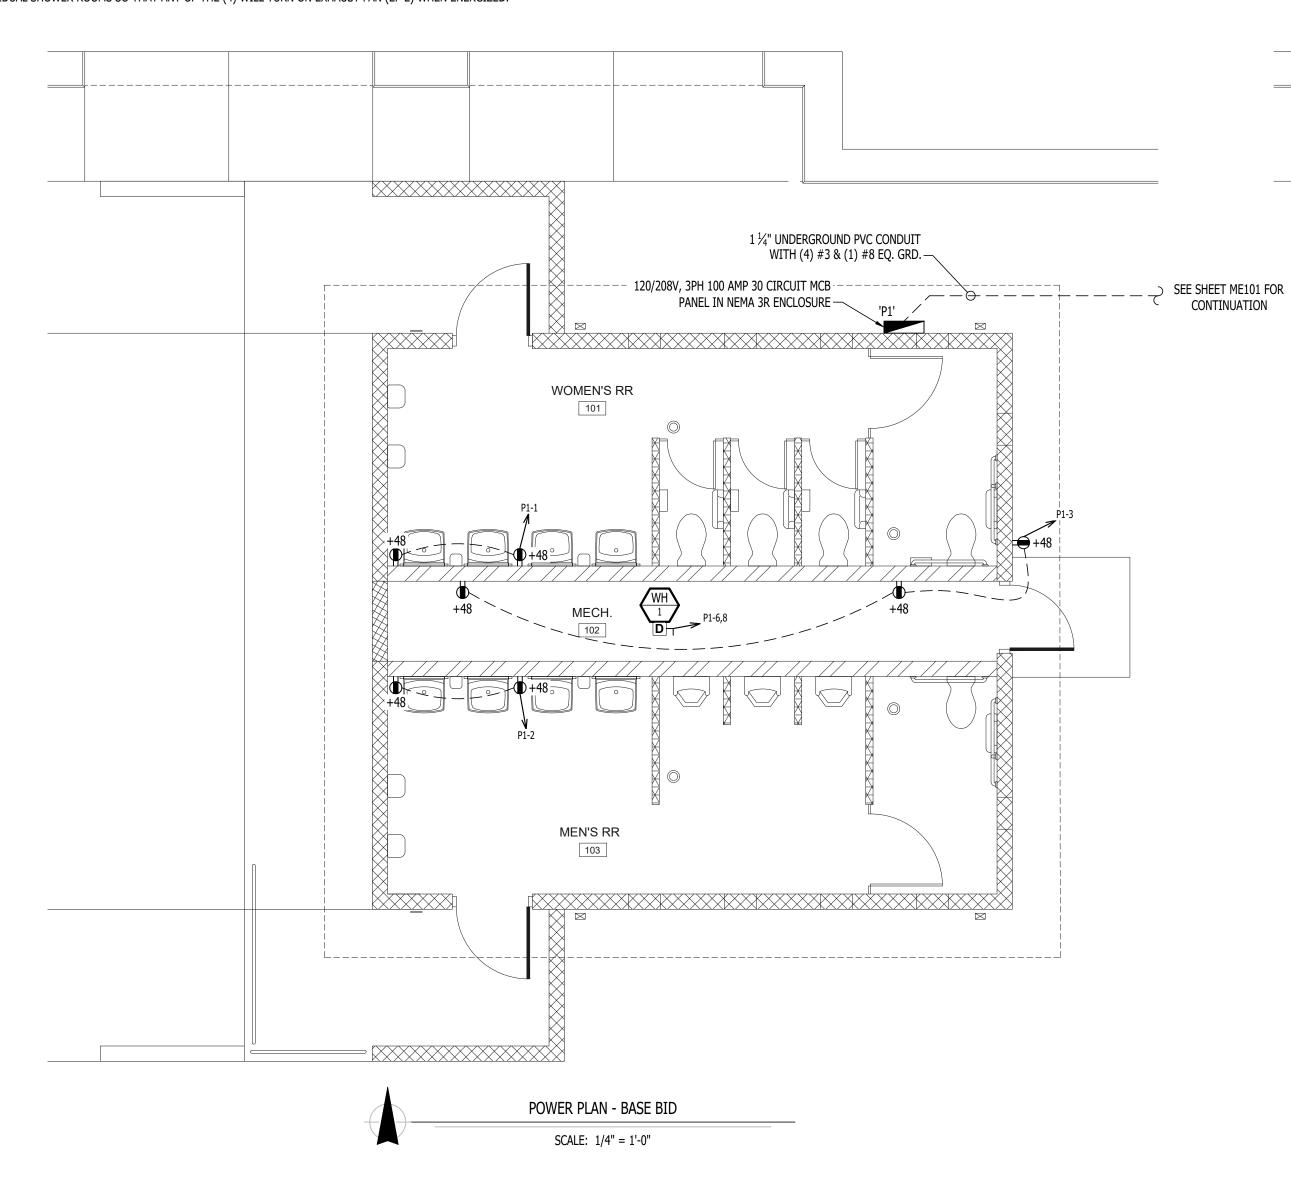

a. ROUGH-IN AND WALL-HUNG BRACKETS FOR THE ALTERNATE 1 - WATER CLOSETS, SHOWERS, AND

a. PROVIDE AND INSTALL PLUMBING FIXTURES TO INCLUDE WATER CLOSETS AND FLUSH VALVES, URINALS AND FLUSH VALVES, SHOWER VALVES, SHOWER HEADS, LAVATORIES, AND FAUCETS.

a. ROUGH-IN AND WALL-HUNG BRACKETS FOR THE WATER CLOSETS, URINALS, SHOWERS, AND

#### ALTERNATE 3 - WATER HEATER, EXTERIOR LIGHTING, INTERIOR LIGHTING, TOILET PARTITIONS, EPOXY COATING:

1. CONTRACTOR TO:


- a. PROVIDE AND INSTALL WATER HEATER WITH WALL KIT AS SHOWN AND NOTED ON SHEET P-101.
- b. PROVIDE AND INSTALL ALL EXTERIOR AND INTERIOR LIGHT FIXTURES AS SHOWN AND NOTED ON SHEET E-101.
- HARDWARE), AS SHOWN ON SHEETS A-101 AND A-301.
- d. PROVIDE AND INSTALL EPOXY WALL COATING PNT-01, AS SHOWN THE INTERIOR FINISH LEGEND ON SHEET A-601.


#### 2. BASE BID:


- a. PROVIDE ALL PLUMBING AND ELECTRICAL ROUGH-IN FOR FUTURE WATER HEATER AND WALL KIT TO BE INSTALLED BY OWNER; PROVIDE BLANK PLATE AT JUNCTION BOX; TEMPORARILY CAP PLUMBING PIPES.
- c. DO NOT PROVIDE HDPE TOILET PARTITIONS.
- d. CMU TO REMAIN EXPOSED; WALLS WILL BE FINISHED AND PAINTED BY OWNER.

#### D. ALTERNATE 4 - STANDING SEAM METAL ROOFING SYSTEM:

- 1. PROVIDE STANDING SEAM METAL ROOF AND ASSOCIATED FLASHING CHANGES.
- BASE BID: TO INCLUDE COMPOSITION SHINGLE ROOF SYSTEM.

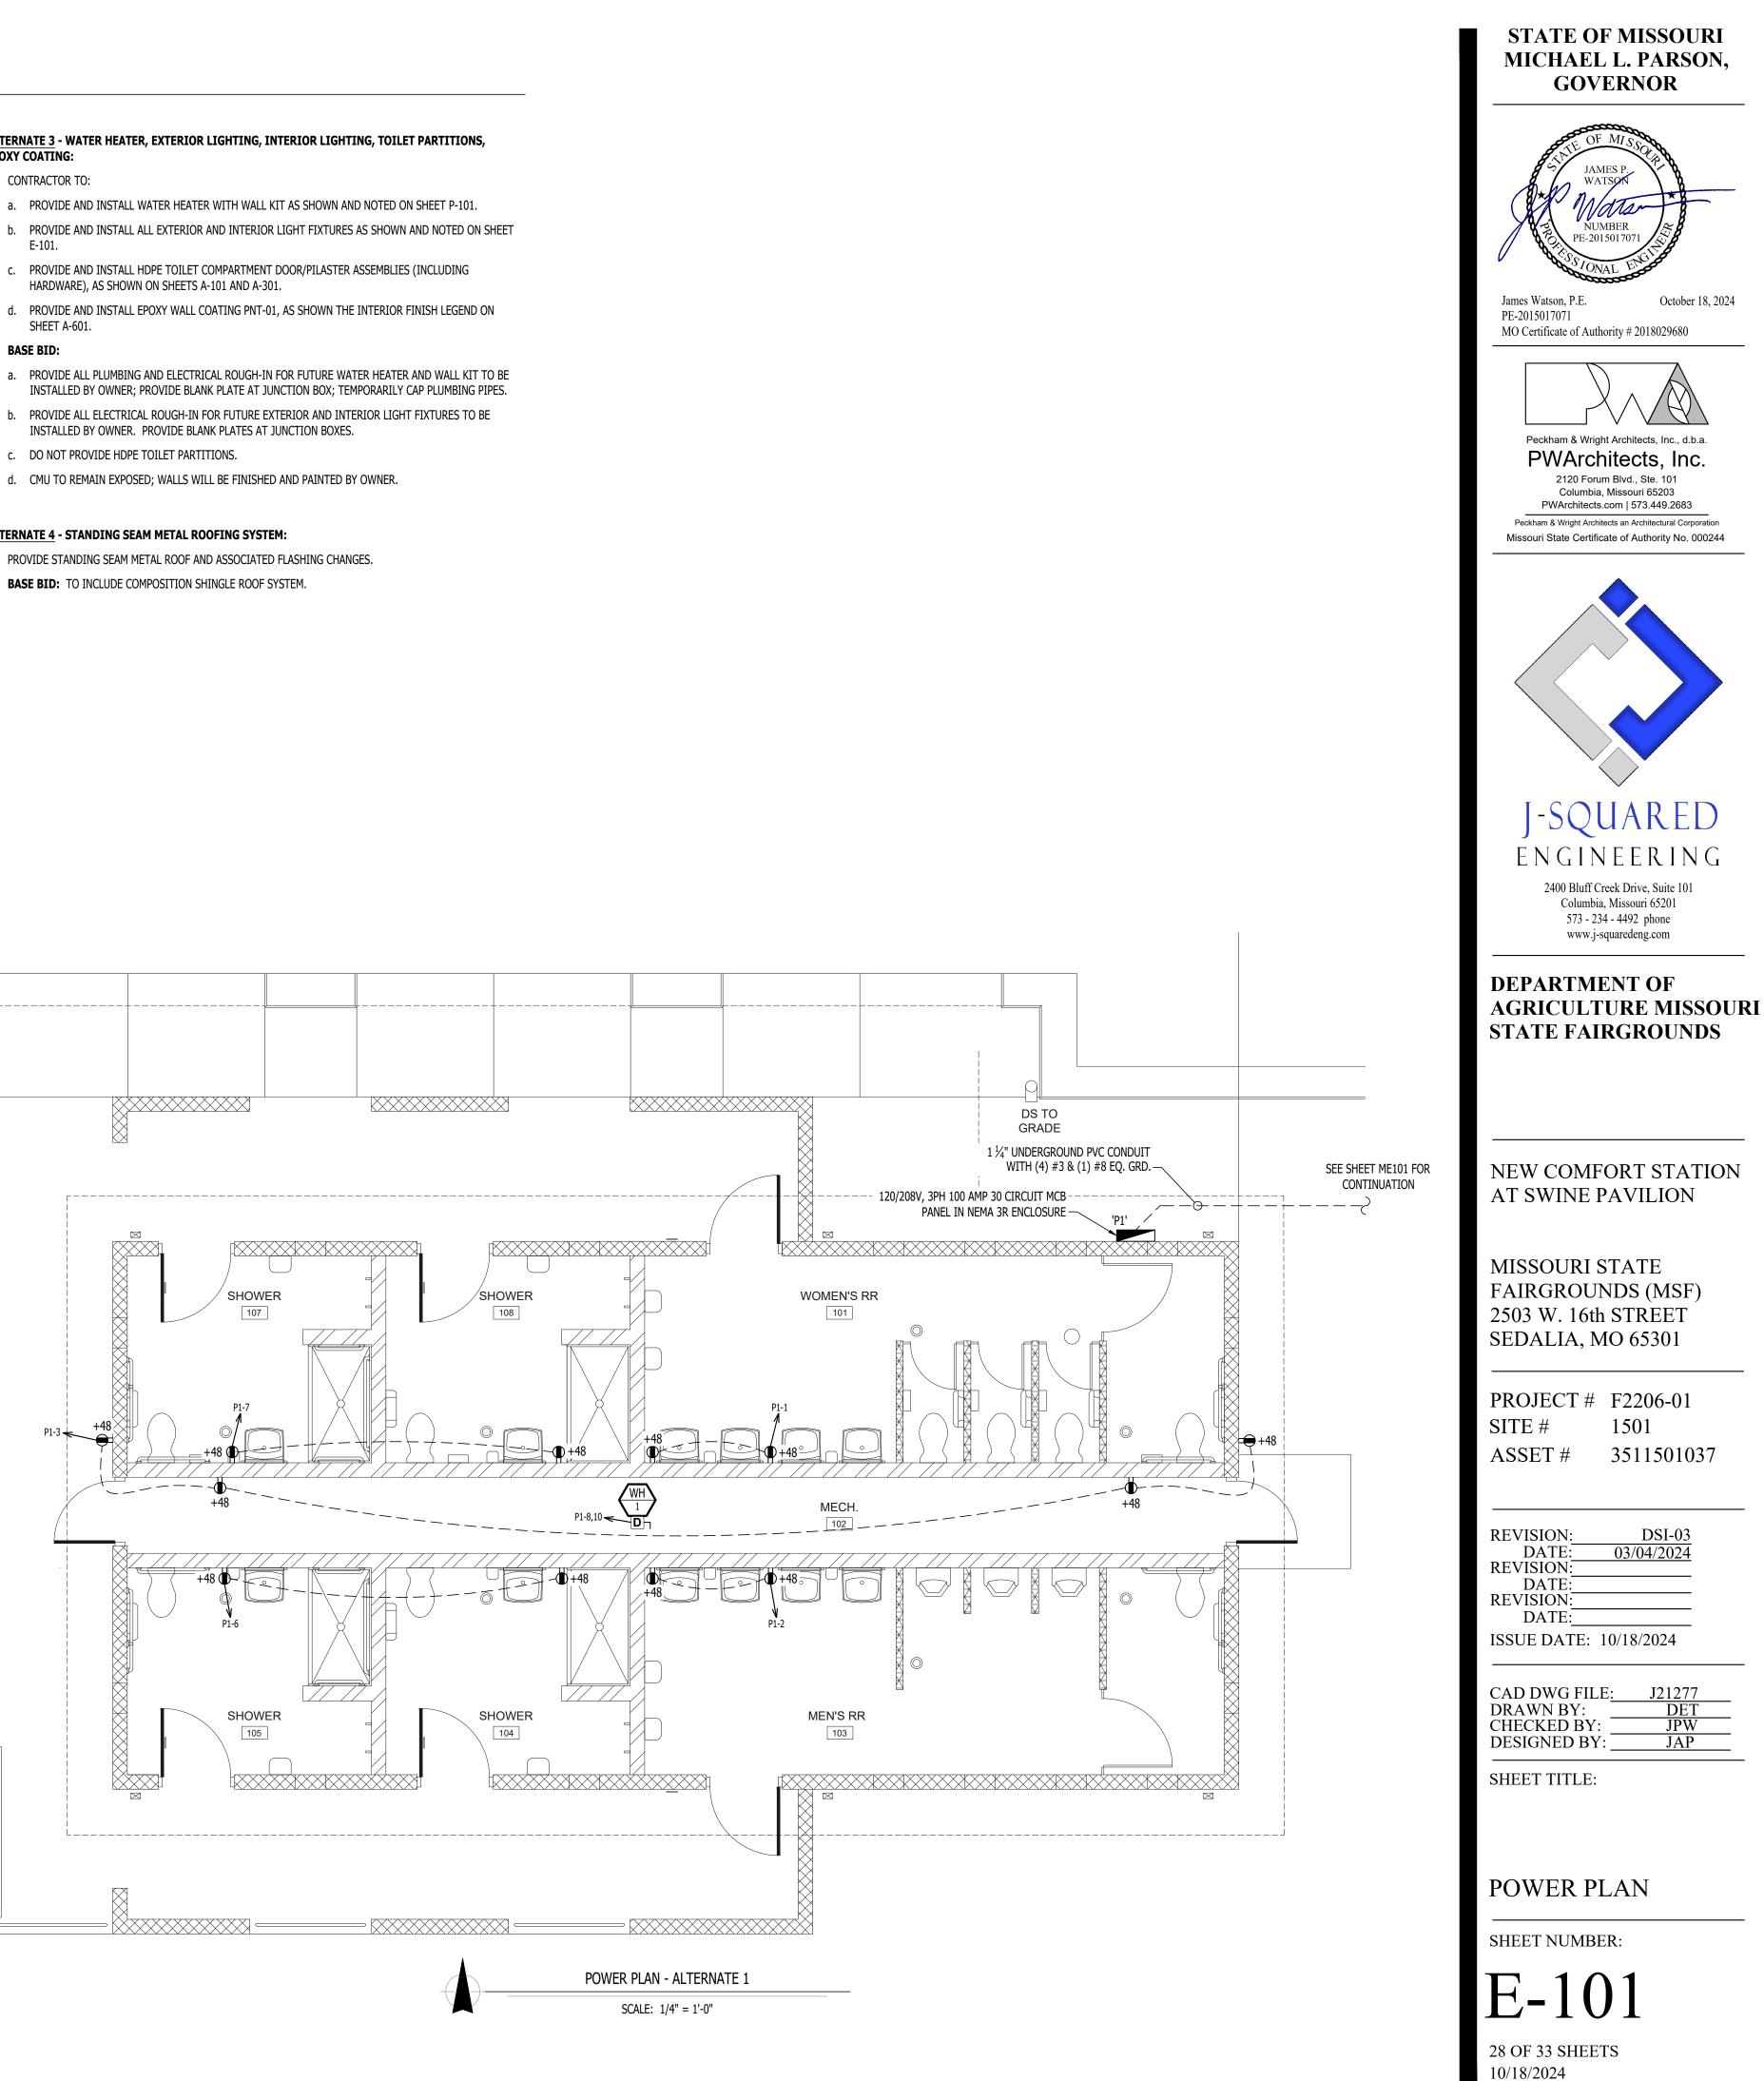

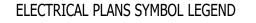

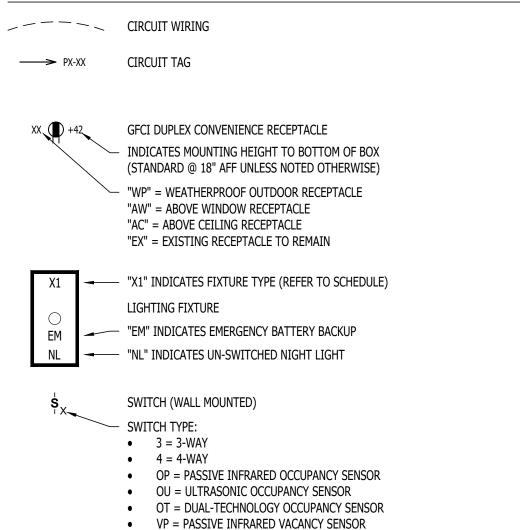

• VU = ULTRASONIC VACANCY SENSOR VT = DUAL-TECHNOLOGY VACANCY SENSOR

SEE "SWITCH (WALL MOUNTED)" FOR TYPE DESIGNATIONS

(1) WIRE EXTERIOR LIGHTS THRU PHOTOCELL MOUNTED ON BUILDING EXTERIOR RAKE BOARD. PHOTOCELL TO FACE

(2) CONTRACTOR TO PROVIDE & INSTALL RELAY / CONTACTOR(S) TO ISOLATE LIGHTING CIRCUIT FROM MEN'S RESTROOM LIGHTING FROM WOMEN'S RESTROOM LIGHTING. BOTH SHALL TURN ON EXHAUST FAN (EF-1).

(3) CONTRACTOR TO PROVIDE & INSTALL RELAY / CONTACTOR(S) TO ISOLATE LIGHTING CIRCUITS FROM

• M = MOMENTARY SWITCH SS = SCENE SWITCH

SWITCH (CEILING MOUNTED)

SWITCH TYPE:

\$x

NORTH.

LIGHTING PLAN KEY NOTES:


LIST OF ALTERNATES

#### A. <u>ALTERNATE 1</u> - SHOWER ROOMS ADDITION

- 1. CONSTRUCT SHOWER ROOM ADDITION ON WEST END OF BUILDING.
- 2. TO INCLUDE:
- LAVATORIES.
- b. SHOWER ENCLOSURE(S) AND DRAIN(S).
- c. OWNER TO PROVIDE AND INSTALL ALL ALTERNATE 1 TOILET ACCESSORIES.

#### B. <u>ALTERNATE 2</u> - CONTRACTOR-INSTALLED PLUMBING FIXTURES AND TOILET ACCESSORIES:

- 1. CONTRACTOR TO:
- AND FLUSH VALVES, SHOWER VALVES, SHOWER HEADS, LAVATORIES, AND FAUCETS.
- b. PROVIDE AND INSTALL TOILET ACCESSORIES AS NOTED IN THE "RESTROOM ACCESSORY SCHEDULE"
- INCLUDED ON SHEETS A-101 AND A-301.
- 2. BASE BID: TO INCLUDE:
- a. ROUGH-IN AND WALL-HUNG BRACKETS FOR THE WATER CLOSETS, URINALS, SHOWERS, AND LAVATORIES.
- b. SHOWER ENCLOSURE AND DRAIN.
- c. OWNER TO PROVIDE AND INSTALL ALL TOILET ACCESSORIES.

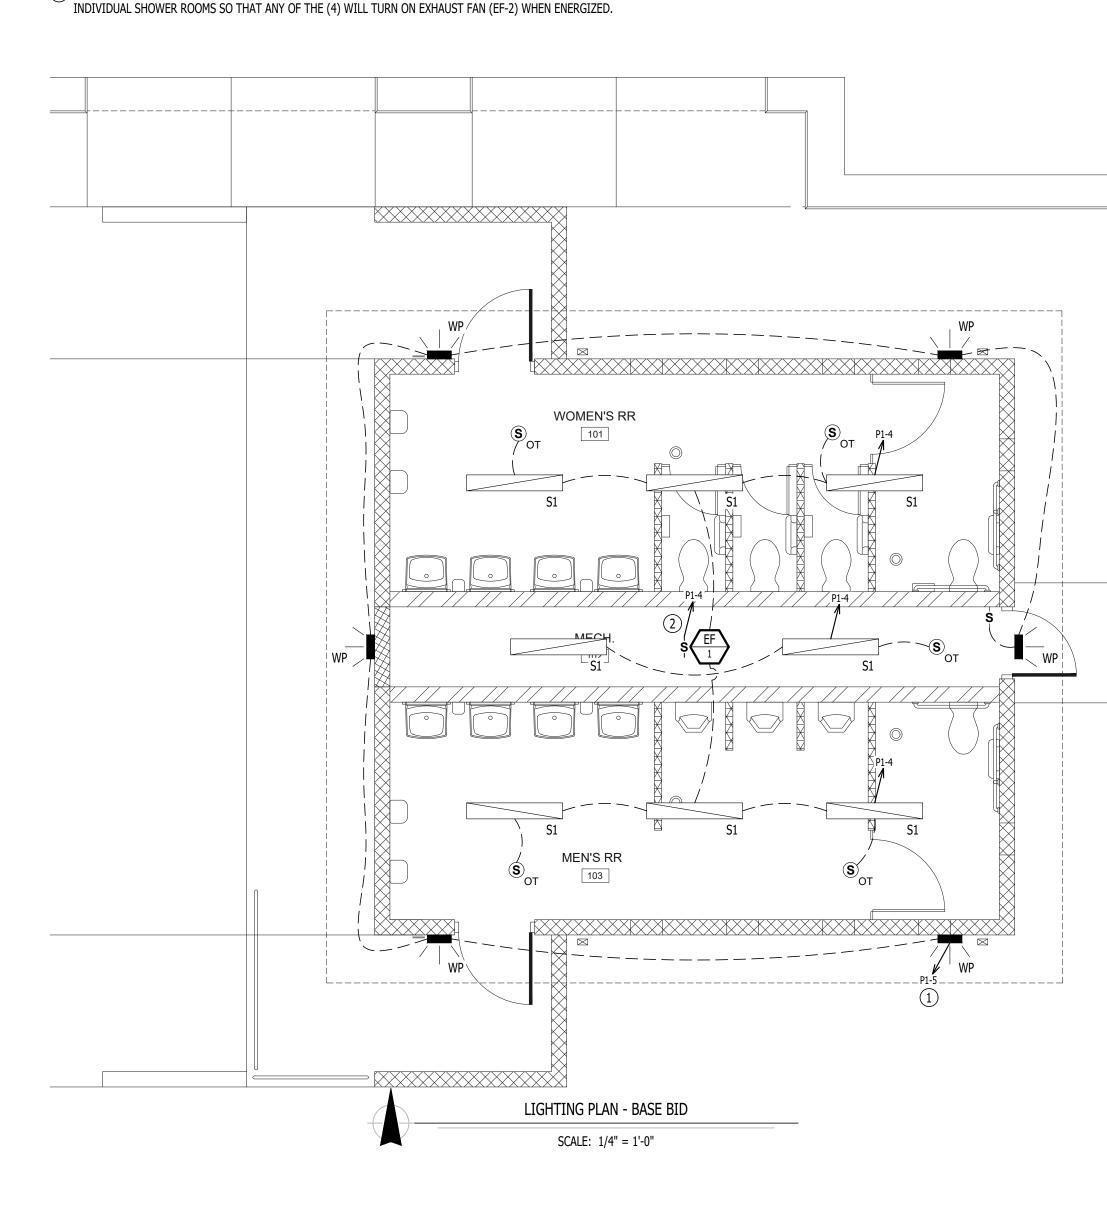

a. ROUGH-IN AND WALL-HUNG BRACKETS FOR THE ALTERNATE 1 - WATER CLOSETS, SHOWERS, AND

a. PROVIDE AND INSTALL PLUMBING FIXTURES TO INCLUDE WATER CLOSETS AND FLUSH VALVES, URINALS

#### ALTERNATE 3 - WATER HEATER, EXTERIOR LIGHTING, INTERIOR LIGHTING, TOILET PARTITIONS, **EPOXY COATING:**

1. CONTRACTOR TO:


- a. PROVIDE AND INSTALL WATER HEATER WITH WALL KIT AS SHOWN AND NOTED ON SHEET P-101.
- b. PROVIDE AND INSTALL ALL EXTERIOR AND INTERIOR LIGHT FIXTURES AS SHOWN AND NOTED ON SHEET E-101.
- c. PROVIDE AND INSTALL HDPE TOILET COMPARTMENT DOOR/PILASTER ASSEMBLIES (INCLUDING HARDWARE), AS SHOWN ON SHEETS A-101 AND A-301.
- d. PROVIDE AND INSTALL EPOXY WALL COATING PNT-01, AS SHOWN THE INTERIOR FINISH LEGEND ON SHEET A-601.


#### 2. BASE BID:

- a. PROVIDE ALL PLUMBING AND ELECTRICAL ROUGH-IN FOR FUTURE WATER HEATER AND WALL KIT TO BE INSTALLED BY OWNER; PROVIDE BLANK PLATE AT JUNCTION BOX; TEMPORARILY CAP PLUMBING PIPES.
- b. PROVIDE ALL ELECTRICAL ROUGH-IN FOR FUTURE EXTERIOR AND INTERIOR LIGHT FIXTURES TO BE INSTALLED BY OWNER. PROVIDE BLANK PLATES AT JUNCTION BOXES.
- c. DO NOT PROVIDE HDPE TOILET PARTITIONS.
- d. CMU TO REMAIN EXPOSED; WALLS WILL BE FINISHED AND PAINTED BY OWNER.

#### D. ALTERNATE 4 - STANDING SEAM METAL ROOFING SYSTEM:

- 1. PROVIDE STANDING SEAM METAL ROOF AND ASSOCIATED FLASHING CHANGES.
- BASE BID: TO INCLUDE COMPOSITION SHINGLE ROOF SYSTEM.

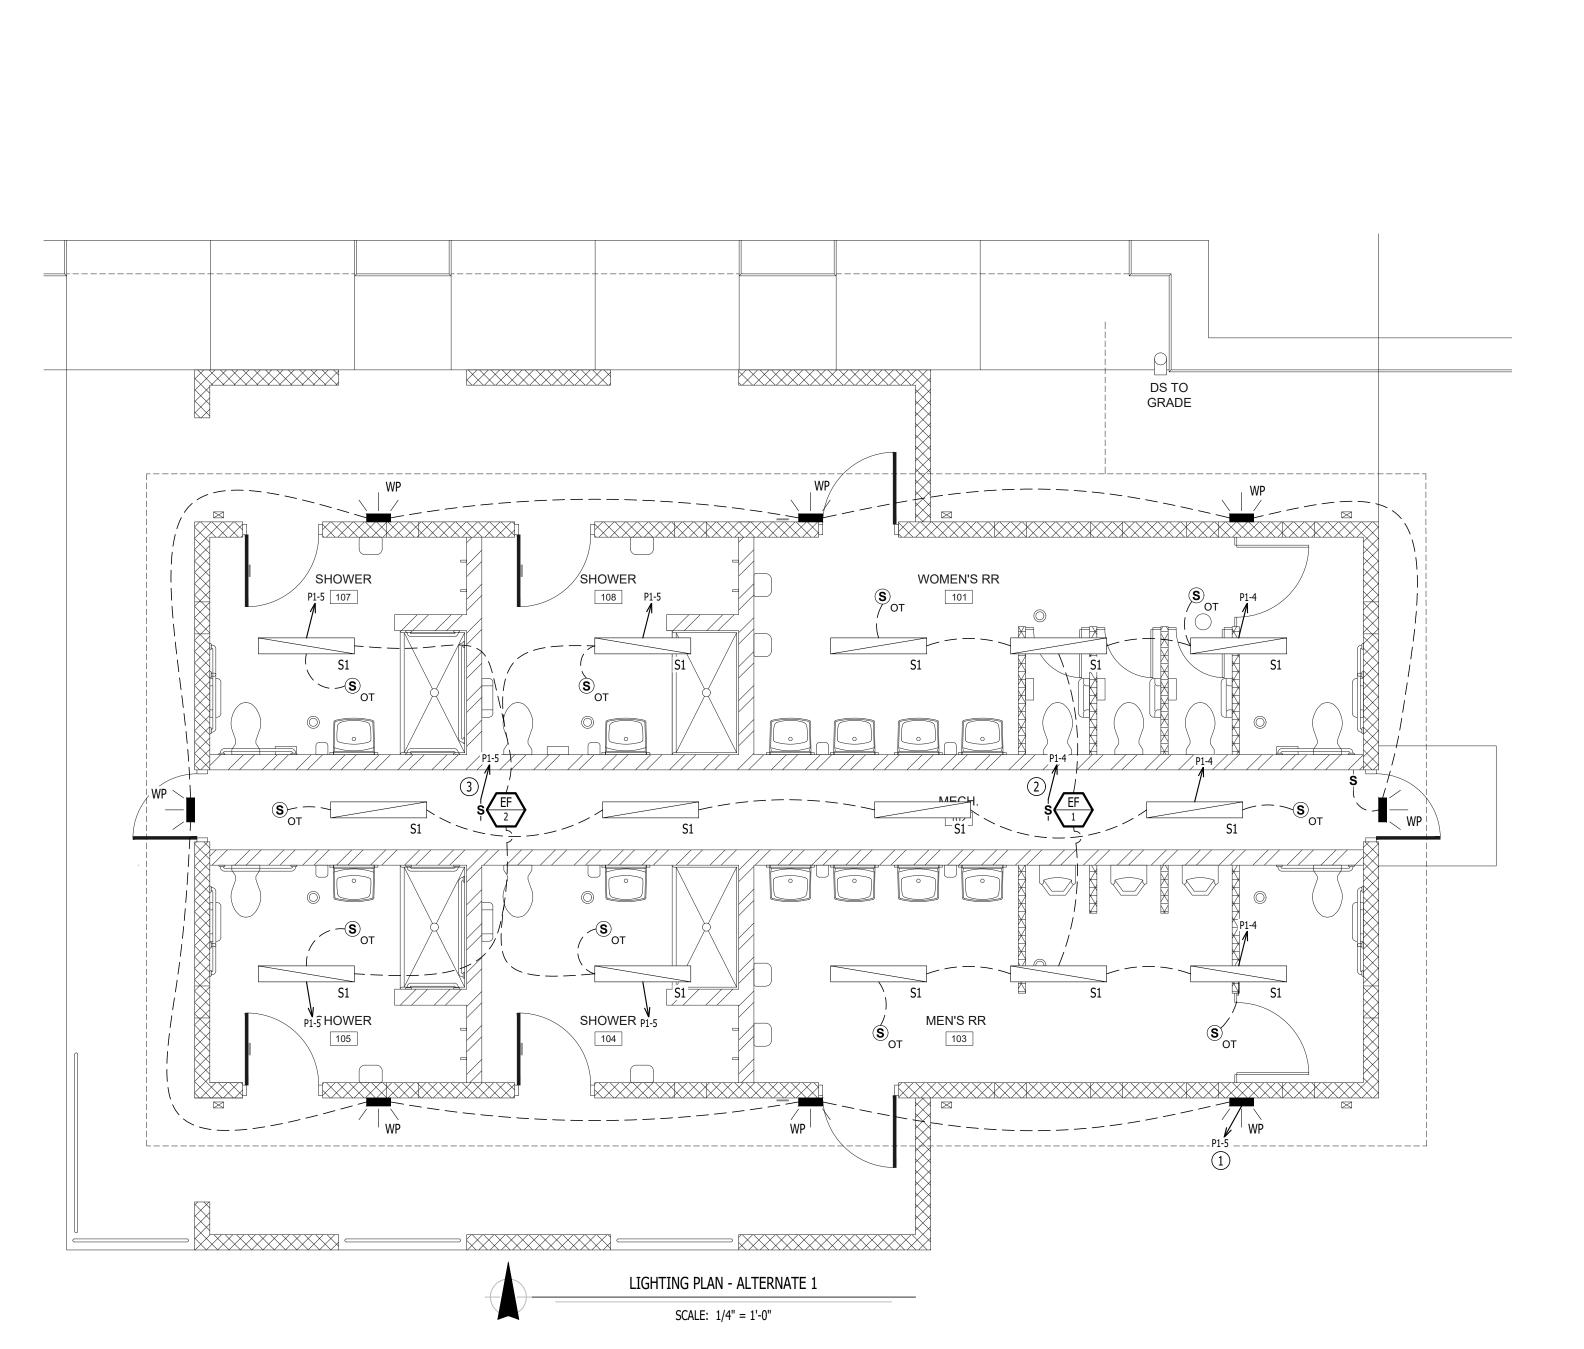

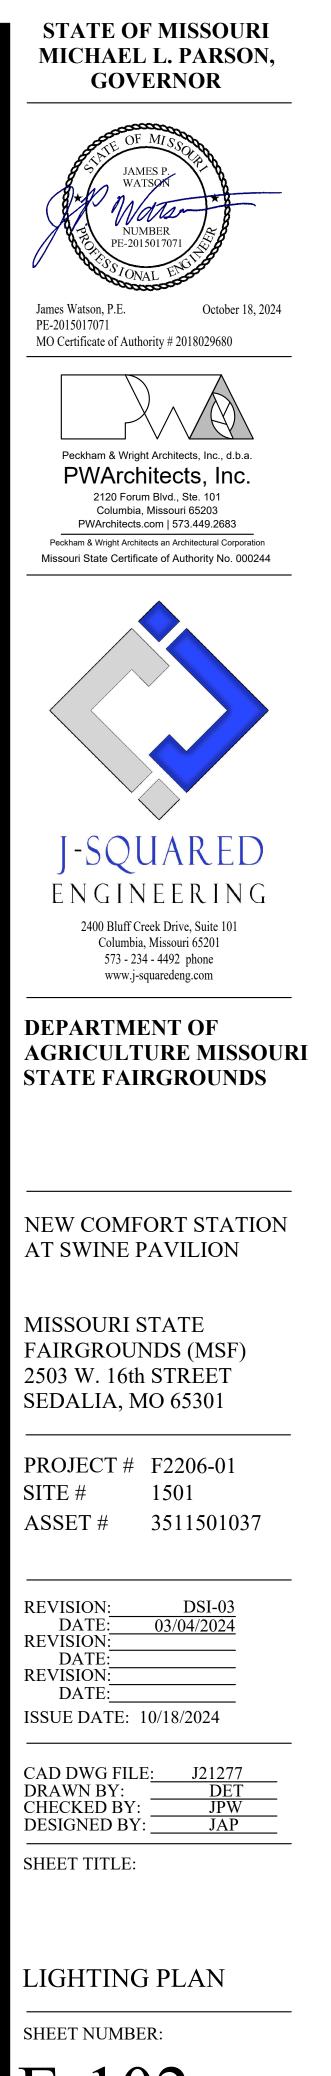

E-102

29 OF 33 SHEETS 10/18/2024

	PANEL S	SPECIFICA TIONS							TOTAL CONNEC	ted lo	AD
VC	DLTAGE: 120/208V 3-PH	NEMA RAT	<b>TING:</b> 3R						PHA SE "A" LOA D:	27.6	AMPS
AMP	PACITY: 100A MCB	PANEL MOUN	TING: SURFACE						PHASE "B" LOAD:	11.5	AMP
AIC-RATING: 22kA								PHASE "C" LOAD:	22.5	AMPS	
CIRCUIT NUMBER	DESCRI	PTION	BREAKER SIZE	AMPS	PHASE	AMPS	BREAKER SIZE	ſ	DESCRIPTION		
1	WOMEN'S	RECEPTS.	20-1	3	A	3	20-1	М	EN'S RECEPTS.		2
3	MECH & EXTER	IOR RECEPTS.	20-1	4.5	В	7	20-1	MENS/WO	MENS LIGHTING & EF-1		4
5	EXTERIOR	LIGHTING	20-1	0.9	C	21.6	30-2	WAT	ER HEATER (WH1)		6
7	SPA	RE	20-1		A	21.6	-	-			8
9	SPA	RE	20-1		В		20-1	SPARE			10
11	SPA	RE	20-1		С		20-1	SPARE			12
13	SPA	RE	20-1		А		20-1	SPARE			14
15	SPA	RE	20-1		В		20-1		SPARE		16
17	SPA	RE	20-1		C		20-1		SPARE		18
19	OPI	EN			А				OPEN		20
21	OPI	EN			В				OPEN		22
23	OPI	EN			C				OPEN		24
25	OPI	EN			А				OPEN		26
27	OPI	EN			В			OPEN			28
29	OPI	EN			C			OPEN			30
	. Shall be equal to squ Rician Shall Verify ex	-		TECTION	I REQUIRE	MENTS P	RIOR TO PURCE	HASE & INSTALL	ATION OF EQUIPMENT.		

#### DANEL DI COUEDULE (DACE DID)

	PANEL S	SPECIFICATIONS						ТС	TAL CONNECTER	) LOA	D
VOLTAGE: 120/208V 3-PH NEMA RATING: 3R								PHASE	"A" LOAD:	30.6	AMPS
AMPACITY: 100A MCB PANEL MOUNTING			SURFACE					PHASE	"B" LOA D:	34.6	AMPS
AIC-I	Rating: 22ka			-				PHASE	"C" LOA D:	6.1	AMPS
CIRCUIT DESCRIPTION		BREAKER SIZE	AMPS	PHASE	AMPS	BREA KER SIZE	DESCRIPTION			CIRCUI NUMBE	
1	WOMEN'S F	RECEPTS.	20-1	3	A	3	20-1	MEN'S RECEP	TS.		2
3	MECH & EXTER	IOR RECEPTS.	20-1	6	В	7	20-1	MENS/WOMENS LIGHTING & EF-1			4
5	SHOWER & EXTERIO	R LIGHTING & EF-2	20-1	3.1	C	3	20-1	SHOWER 104 & 105 RECEPTS.			6
7	SHOWER 107 & 108 RECEPTS.		20-1	3	A	21.6	30-2	WATER HEATER (WH1)			8
9	SPARE		20-1		В	21.6	-				10
11	SPARE		20-1		C		20-1	SPARE			12
13	SPARE		20-1		A		20-1	SPARE			14
15	SPA	RE	20-1		В		20-1	SPARE			16
17	SPA	RE	20-1		C		20-1	SPARE			18
19	OPE	EN			A			OPEN			20
21	OPE	EN			В			OPEN			22
23	OPE	EN			С			OPEN			24
25	OPE	EN			A			OPEN			26
27	OPE	EN			В			OPEN			28
29	OPE	EN			С			OPEN			30

A: PANEL SHALL BE EQUAL TO SQUARE D MODEL "QO"

B: ELECTRICIAN SHALL VERIFY EXACT EQUIPMENT OVERCURRENT PROTECTION REQUIREMENTS PRIOR TO PURCHASE & INSTALLATION OF EQUIPMENT. C: AFTER COMPLETION OF WORK, ELECTRICAN SHALL PROVIDE A TYPE WRITTEN PANEL DIRECTORY IN NEW PANEL.

LIGHT FIXTURE SCHEDULE											
TAG	MA NUFA CTURER (OR EQUAL)	MODEL NUMBER (OR EQUAL)	DESCRIPTION	MOUNTING	lumen Output	ССТ (°К)	CRI	VOLTAGE	WATTS	DIMMING	NOTES
S1	FAIL-SAFE	HVSL8-4-LD4-2STD-40-UNV-C-EDC1	VANDAL RESISTANT STRIP	SURFACE	3,495	4000	80	UNV	34	-	
WP	WP         LUMARK         XTOR2B-W         FULL CUT-OFF WALL PACK         SURFACE         1,400         4000         70         UNV         18         0-10V										
NOTES:	NOTES:										

1. VERIFY LIGHT FIXTURE FINISHES WITH OWNER / ARCHITECT PRIOR TO INSTALLATION.


2. REFER TO ARCHITECTURAL REFLECTED CEILING PLAN FOR CEILING TYPES THROUGHOUT. COORDINATE EXACT MOUNTING DETAILS WITH GENERAL CONTRACTOR.

DETAILS &	STATE OF MISSOURI MICHAEL L. PARSON, GOVERNOR
PWArchitects, Inc. 2120 Forum Bivd., Ste. 101 Columbia, Missouri 65203 Peatham & Wright Architects on Architectural Corporation Missouri State Certificate of Authority No. 000244	James Watson, P.E. PE-2015017071 James Watson, P.E. PE-2015017071
ENGINEERING 2400 Bluff Creek Drive, Suite 101 Columbia, Missouri 65201 573 - 234 - 4492 phone www.j-squaredeng.com DEPARTMENT OF AGRICULTURE MISSOUF STATE FAIRGROUNDS STATE FAIRGROUNDS MISSOURI STATE FAIRGROUNDS (MSF) 2503 W. 16th STREET SEDALIA, MO 65301  PROJECT # F2206-01 SITE # 1501 ASSET # 3511501037  REVISION: REVISION: DATE: ISSUE DATE: 10/18/2024  CAD DWG FILE: J21277 DRAWN BY: ISSUE DATE: 10/18/2024  CAD DWG FILE: J21277 DRAWN BY: SHEET TITLE: ELECTRICAL DETAILS & SCHEDULES	PWArchitects, Inc. 2120 Forum Blvd., Ste. 101 Columbia, Missouri 65203 PWArchitects.com   573.449.2683 Peckham & Wright Architects an Architectural Corporation
E N G I N E E R I N G 2400 Bluff Creek Drive, Suite 101 Columbia, Missouri 65201 573 - 234 - 4492 phone www.j-squaredeng.com DEPARTMENT OF AGRICULTURE MISSOUF STATE FAIRGROUNDS STATE FAIRGROUNDS MISSOURI STATE FAIRGROUNDS (MSF) 2503 W. 16th STREET SEDALIA, MO 65301  PROJECT # F2206-01 SITE # 1501 ASSET # 3511501037  REVISION: DATE: DATE: ISSUE DATE: 10/18/2024  CAD DWG FILE: J21277 DRAWN BY: DATE: ISSUE DATE: 10/18/2024  CAD DWG FILE: J21277 DRAWN BY: SCHEDULES  ELECTRICAL DETAILS & SCHEDULES	
AGRICULTURE MISSOUF STATE FAIRGROUNDS STATE FAIRGROUNDS NEW COMFORT STATION AT SWINE PAVILION MISSOURI STATE FAIRGROUNDS (MSF) 2503 W. 16th STREET SEDALIA, MO 65301 	ENGINEERING 2400 Bluff Creek Drive, Suite 101 Columbia, Missouri 65201 573 - 234 - 4492 phone
AT SWINE PAVILION MISSOURI STATE FAIRGROUNDS (MSF) 2503 W. 16th STREET SEDALIA, MO 65301 PROJECT # F2206-01 SITE # 1501 ASSET # 3511501037 REVISION: DSI-03 DATE: 03/04/2024 REVISION: DATE: I0/18/2024 REVISION: DATE: I0/18/2024 CAD DWG FILE: J21277 DRAWN BY: DET CHECKED BY: JPW DESIGNED BY: JAP SHEET TITLE: ELECTRICAL DETAILS & SCHEDULES	AGRICULTURE MISSOUR
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DRAWN BY: DET CHECKED BY: JPW DESIGNED BY: JAP SHEET TITLE: ELECTRICAL DETAILS & SCHEDULES	DATE: 03/04/2024 REVISION: DATE: REVISION: DATE: DATE:
DETAILS & SCHEDULES	DRAWN BY: DET CHECKED BY: JPW DESIGNED BY: JAP
SHEET NUMBER:	ELECTRICAL DETAILS & SCHEDULES

E-501 30 OF 33 SHEETS 10/18/2024

	SANITARY SEWER PIPING
	VENT PIPING
	COLD WATER PIPING
	HOT WATER PIPING
o	PIPING TURNED DOWN / TURNED
<	TIE INTO EXISTING

- LAVATORIES.

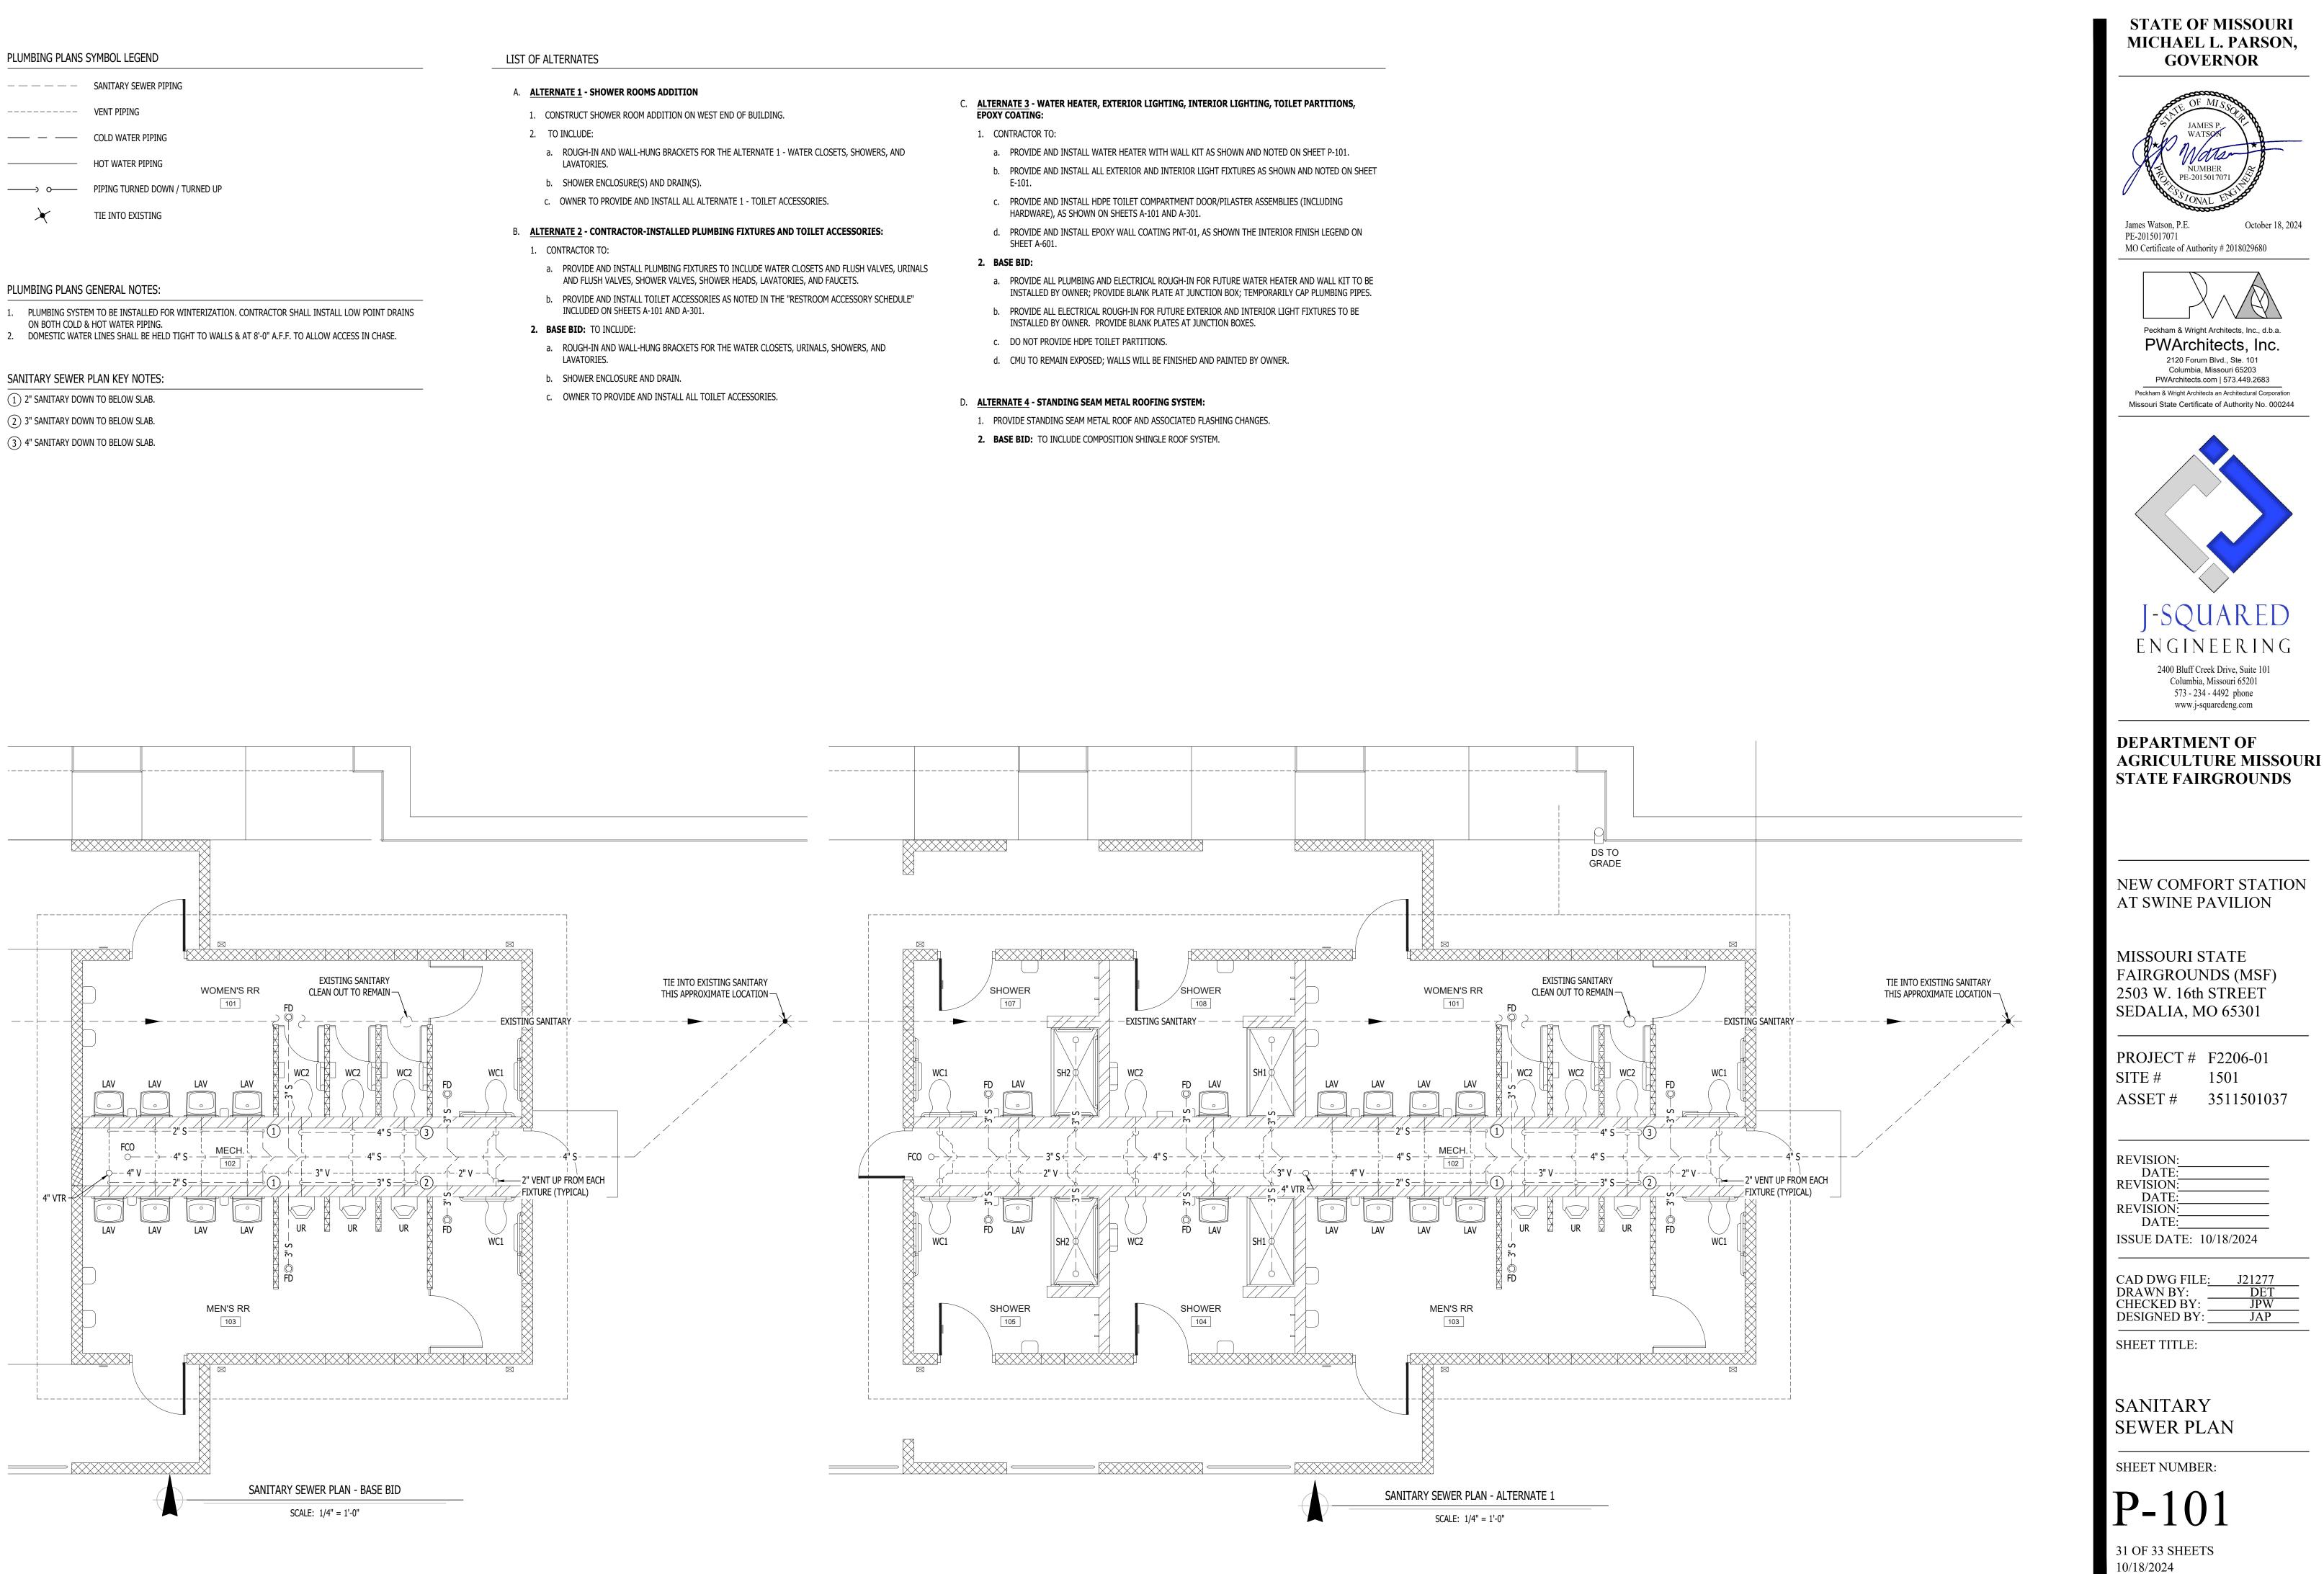

PLUMBING PLANS GENERAL NOTES:

- 1. PLUMBING SYSTEM TO BE INSTALLED FOR WINTERIZATION. CONTRACTOR SHALL INSTALL LOW POINT DRAINS
- ON BOTH COLD & HOT WATER PIPING. 2. DOMESTIC WATER LINES SHALL BE HELD TIGHT TO WALLS & AT 8'-0" A.F.F. TO ALLOW ACCESS IN CHASE.

WATER PIPING PLAN KEY NOTES:

(1) New 2<sup>1</sup>/<sub>2</sub>" CW UP THRU FLOOR TO FULL PORT SHUT-OFF VALVE THEN UP TO 8'-0" A.F.F. TO PLUMBING FIXTURES AS SHOWN.


#### LIST OF ALTERNATES

#### A. ALTERNATE 1 - SHOWER ROOMS ADDITION

- 1. CONSTRUCT SHOWER ROOM ADDITION ON WEST END OF BUILDING. 2. TO INCLUDE:
- LAVATORIES.
- b. SHOWER ENCLOSURE(S) AND DRAIN(S).
- c. OWNER TO PROVIDE AND INSTALL ALL ALTERNATE 1 TOILET ACCESSORIES.

## B. ALTERNATE 2 - CONTRACTOR-INSTALLED PLUMBING FIXTURES AND TOILET ACCESSORIES:

- 1. CONTRACTOR TO:
- b. PROVIDE AND INSTALL TOILET ACCESSORIES AS NOTED IN THE "RESTROOM ACCESSORY SCHEDULE"
- INCLUDED ON SHEETS A-101 AND A-301.
- 2. BASE BID: TO INCLUDE:
- LAVATORIES.
- b. SHOWER ENCLOSURE AND DRAIN.
- c. OWNER TO PROVIDE AND INSTALL ALL TOILET ACCESSORIES.

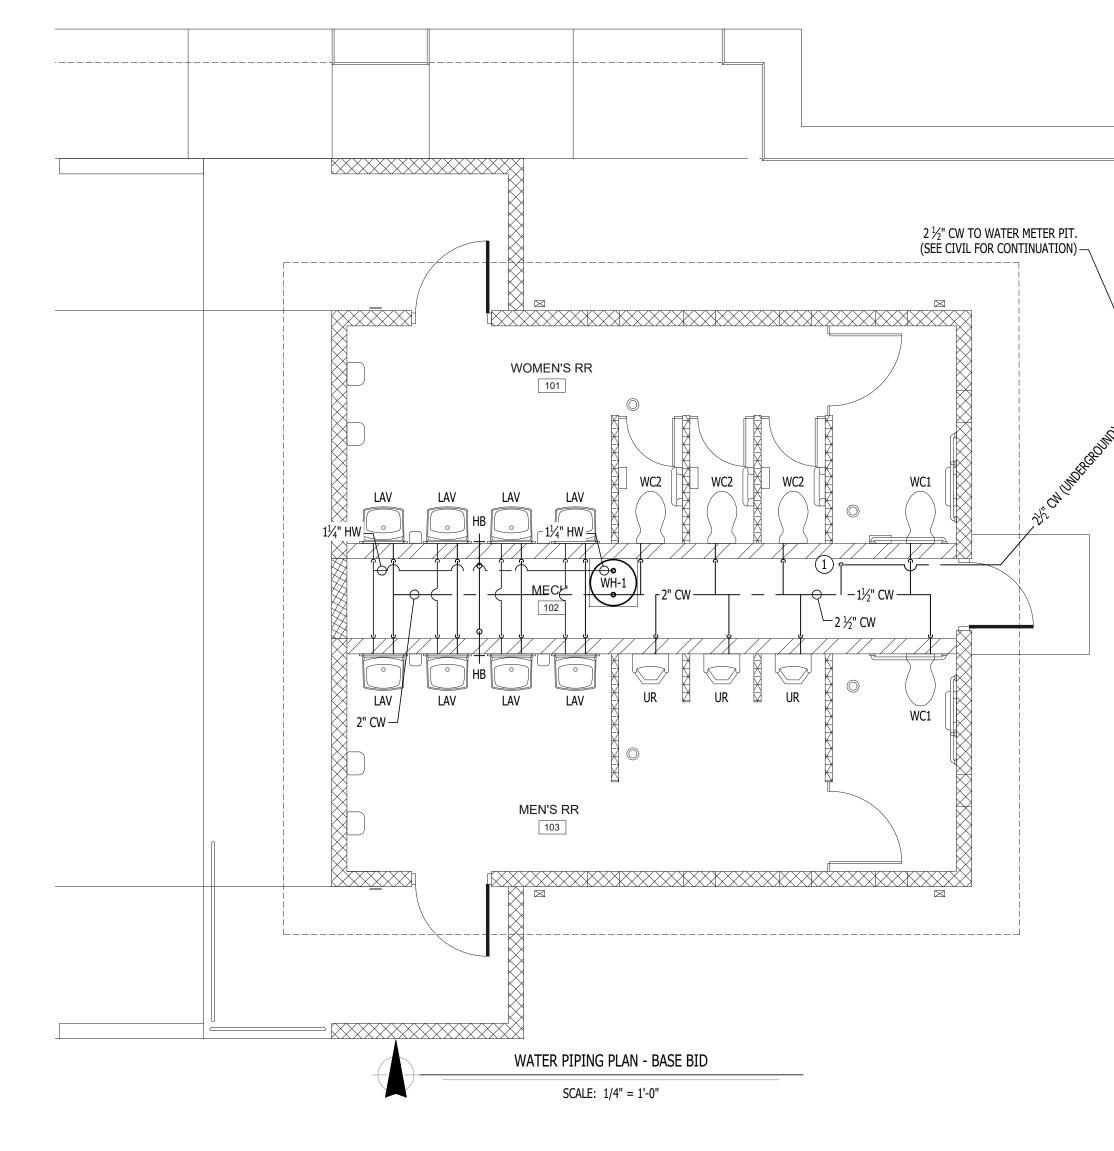


a. ROUGH-IN AND WALL-HUNG BRACKETS FOR THE ALTERNATE 1 - WATER CLOSETS, SHOWERS, AND

a. PROVIDE AND INSTALL PLUMBING FIXTURES TO INCLUDE WATER CLOSETS AND FLUSH VALVES, URINALS AND FLUSH VALVES, SHOWER VALVES, SHOWER HEADS, LAVATORIES, AND FAUCETS.

a. ROUGH-IN AND WALL-HUNG BRACKETS FOR THE WATER CLOSETS, URINALS, SHOWERS, AND


- E-101.

- INSTALLED BY OWNER; PROVIDE BLANK PLATE AT JUNCTION BOX; TEMPORARILY CAP PLUMBING PIPES.
- INSTALLED BY OWNER. PROVIDE BLANK PLATES AT JUNCTION BOXES.

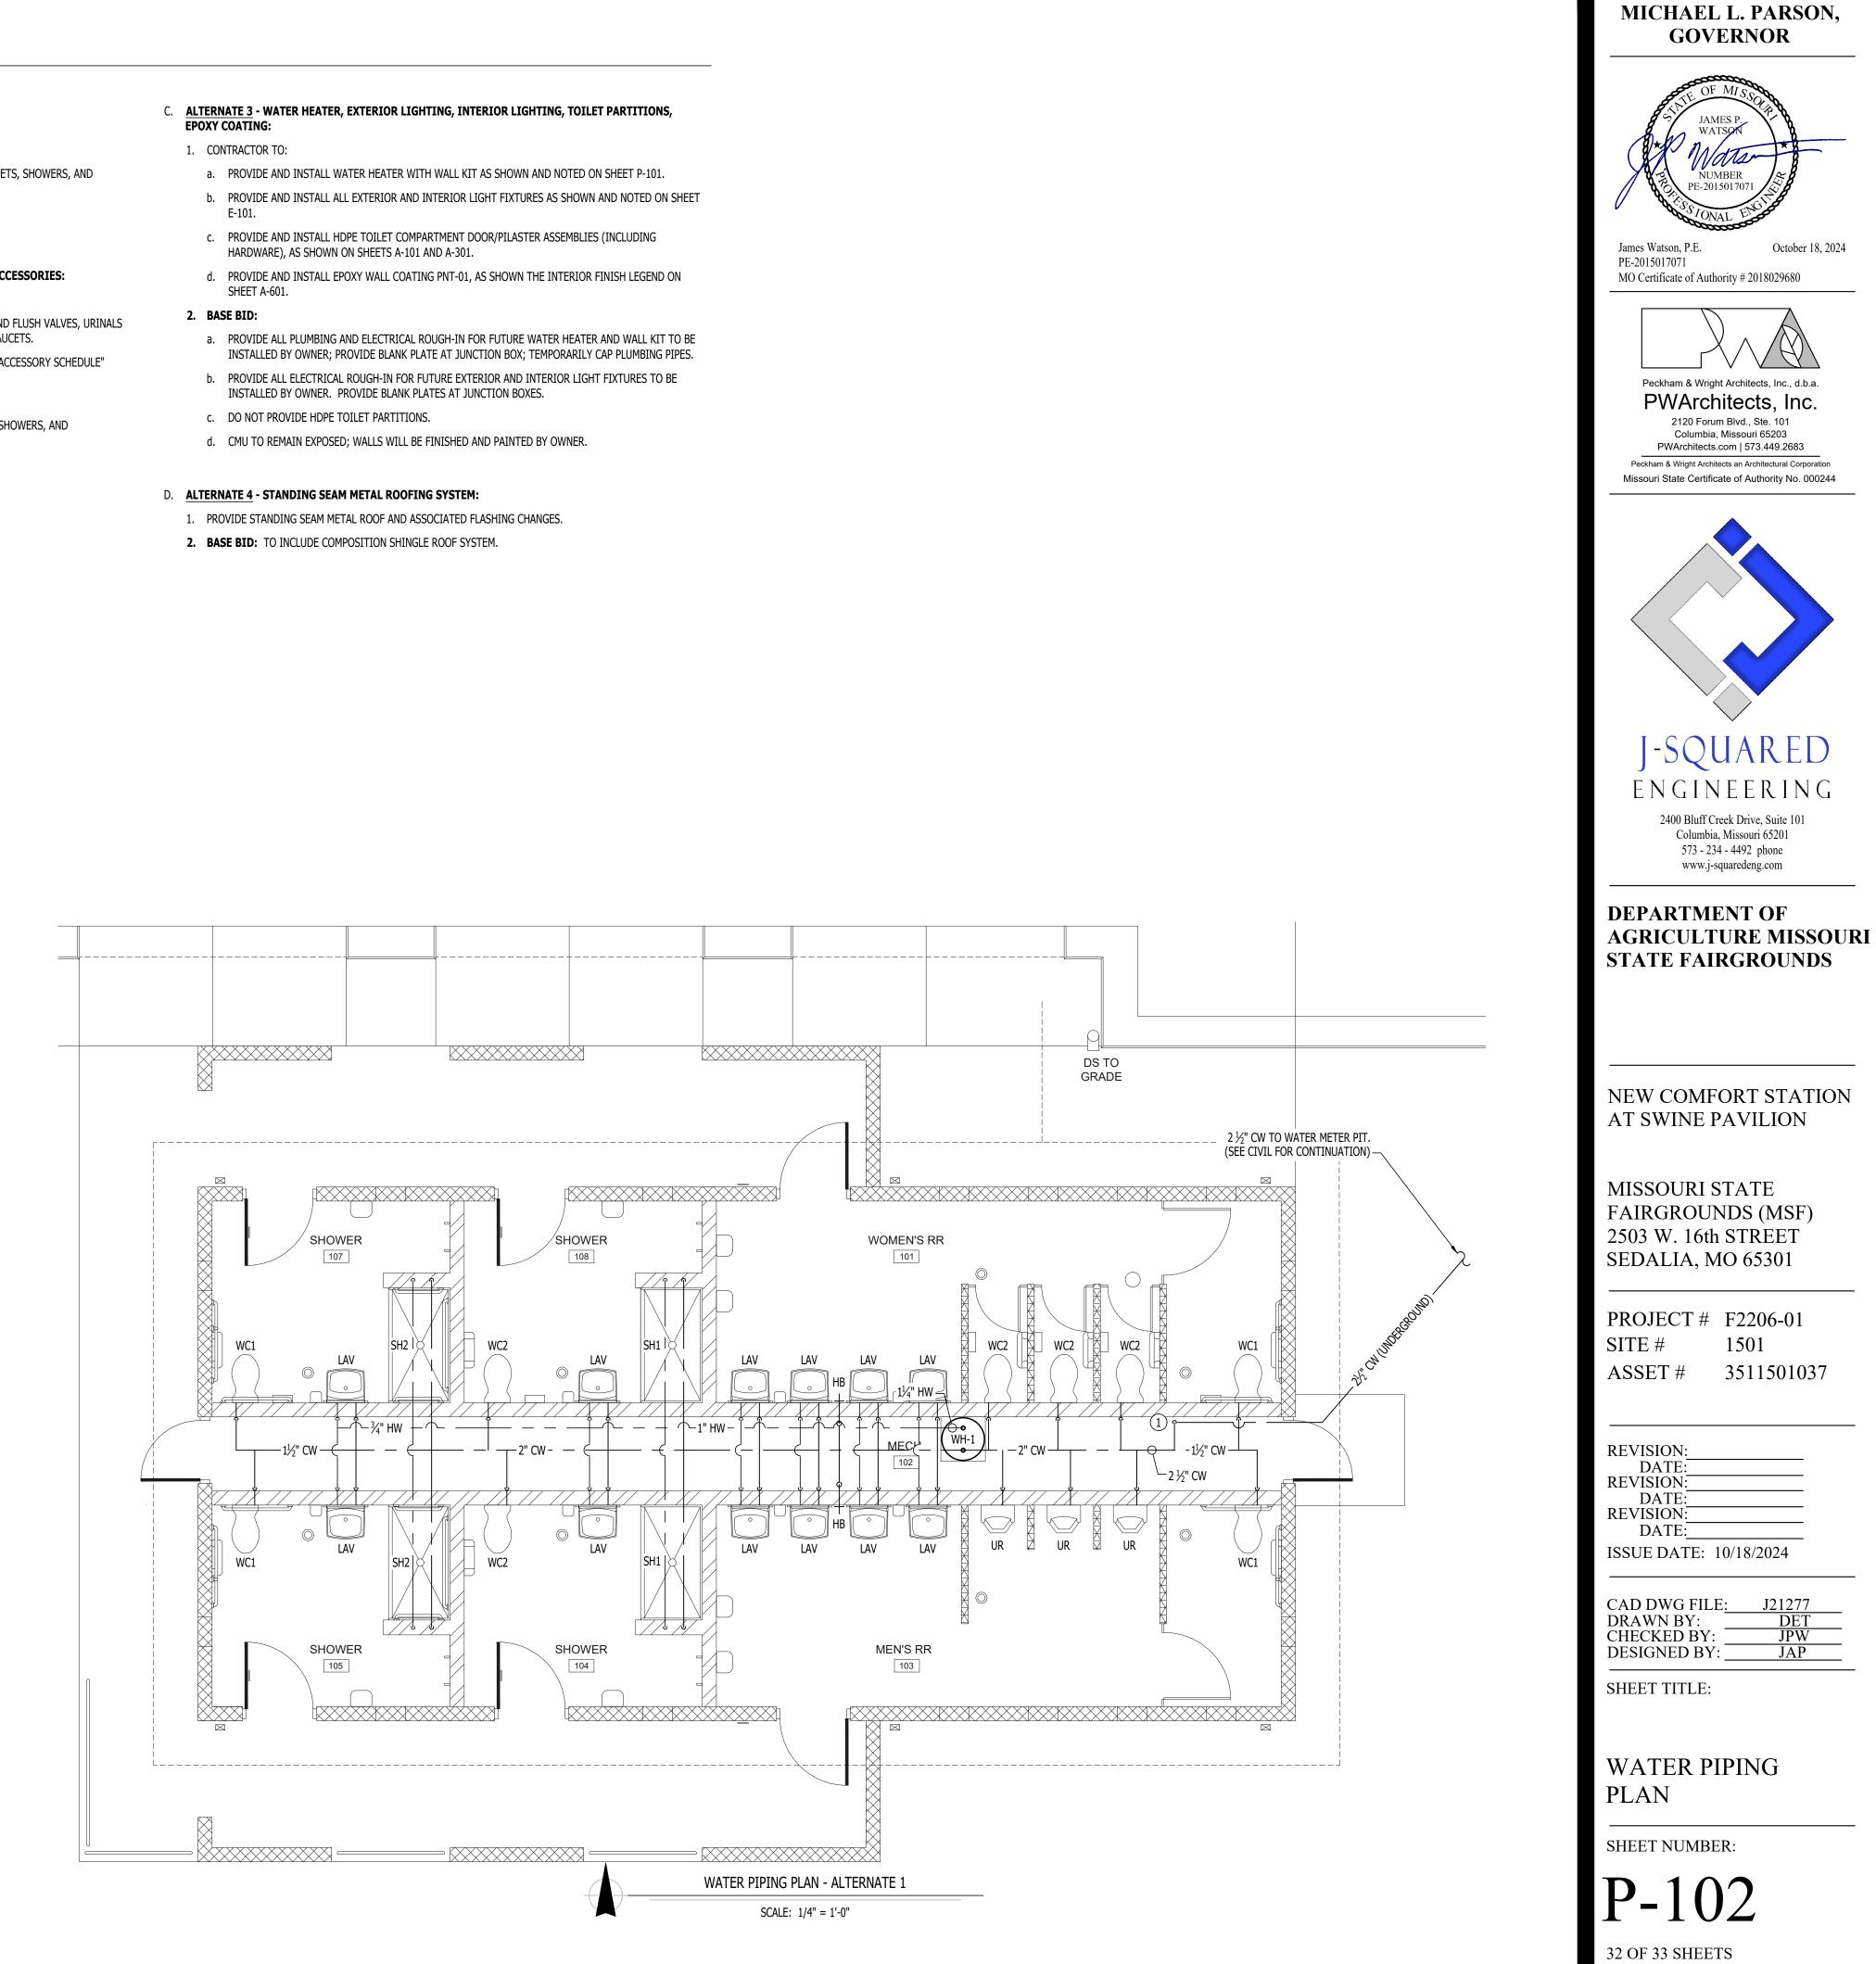


**STATE OF MISSOURI** 


10/18/2024

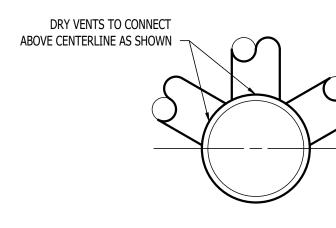

DRY VENT DETAIL

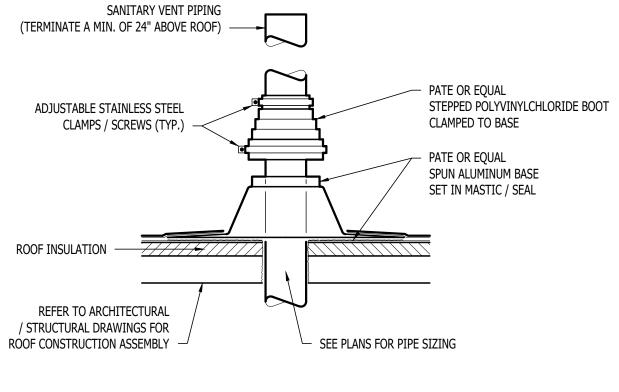


SANITARY VENT THRU ROOF DETAIL

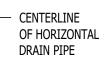

FIXTURE	SA NITA R	Y PIPING	SUPPLY PIPING		
ТҮРЕ	TYPICAL ABBREVIATION	WASTE CONNECTION	VENT CONNECTION	COLD WATER CONNECTION	HOT WATER CONNECTION
DRINKING FOUNTAIN	DF	1-1/2"	1-1/4"	1/2"	-
FLOOR DRAIN	FD	3"	2"	-	-
HAND / HAIR SINK	HS / SK	2"	1-1/4"	1/2"	1/2"
HOSE BIBB	HB	-	-	3/4"	-
LAVATORY	LAV	1-1/2"	1-1/4"	1/2"	1/2"
MOP SINK	MS	3"	1-1/2"	1/2"	1/2"
ICE MAKER OUTLET BOX	REF	-	-	1/2"	-
SHOWER	SH	3"	1-1/2"	1/2"	1/2"
URINAL	UR	2"	1-1/4"	3/4"	-
WATER CLOSET (FLUSH TANK)	WC	3"	2"	1/2"	-
WATER CLOSET (FLUSH VALVE)	WC	3"	2"	1"	-
NOTES: 1. SIZES SHOWN ABOVE ARE	TYPICAL UNLESS NO	)TED OTHERWISE	ON PLANS		

TAG	DESCRIPTION	MA NUFA CTURER (OR EQUA L)	MODEL (OR EQUAL)	NOTES
FCO	FLOOR CLEAN OUT	ZURN	Z1400	
FD	FLOOR DRAIN	ZURN	Z415-BZ	WITH ZURN #Z1072 TRAP SEAL
LAV	LAVATORY (WALL HUNG w/ MANUAL FAUCET)	AMERICAN STANDARD	0355.012	WITH ZURN #Z81104-XL FAUCET, 1/4 TURN STOPS, BRAIDED STAINLESS STEEL SUPPLIES & TRUBRO LAV GUARD 2, AND 'TMV'
SH1	SHOWER	AQUARIUS	MPB 6232 BF 1.0 *-WHT	WITH MOEN #TL182 SHOWER VALVE AND TRIM KIT AND 'TMV'
SH2	ADA SHOWER	AQUARIUS	MPB 6232 BF 1.0 *-WHT	ACCESSIBLE SHOWER WITH GRAB-BARS, SEAT, MOEN #8346 SHOWER VALVE AND HAND-HELD SHOWER SYSTEM, AND 'TMV'
TMV	THERMOSTATIC MIXING VALVE (POINT OF USE)	WATTS	LFUSG	
UR	URINAL (MANUAL FLUSH)	AMERICAN STANDARD	6550.001	WITH ZURN #Z6003AV-WS1 MANUAL FLUSH VALVE (1.0 GPM/FLUSH)
WC1	WATER CLOSET (ADA HEIGHT WALL HUNG w/ MANUAL FLUSH)	AMERICAN STANDARD	2859	WITH ZURN #Z6000AV-WS1 MANUAL FLUSH VALVE (1.6 GPM/FLUSH) & CHURCH #9500SSCT SELF-SUSTAINING SEAT
WC2	WATER CLOSET (STANDARD HEIGHT WALL HUNG w/ MANUAL FLUSH)	AMERICAN STANDARD	2859	WITH ZURN #Z6000AV-WS1 MANUAL FLUSH VALVE (1.6 GPM/FLUSH) & CHURCH #9500SSCT SELF-SUSTAINING SEAT
WH1	WATER HEATER	A.O. SMITH	DEL-40	38 GALLON, 208V 1-PH, 4500W, WITH HOLDRITE #50-SWHP-WM WALL MOUNT KIT
HB	HOSE BIBB	WOODFORD	MODEL 14	"P" INLET - 10" WALL
NOTES: 1. VERIF	FY NECESSARY FIXTURES MEET ADA REQUIREMENTS WITH AF	RCHITECT PRIOR TO INSTALL	ATION.	

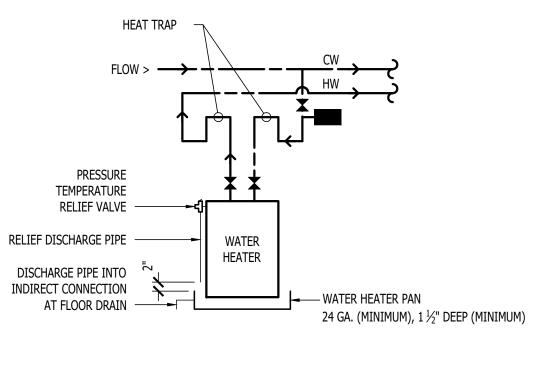

WATER HEATER DETAIL

