# Electrical Service Replacement Benton Hall Nevada Habilitation Center Nevada, MO

FOR CONSTRUCTION

OWNER: STATE OF MISSOURI

MICHAEL L. PARSON,

GOVERNOR

PROJECT

OFFICE OF ADMINISTRATION

MANAGEMENT:

DIVISION OF FACILITIES MANAGEMENT,

DESIGN AND CONSTRUCTION

DESIGNER:


LANKFORD FENDLER + ASSOCIATES

BNB DESIGN, LLC

PROJECT NUMBER: M2114-01

SITE NUMBER: 7351

FACILITY NUMBER: 6517351009

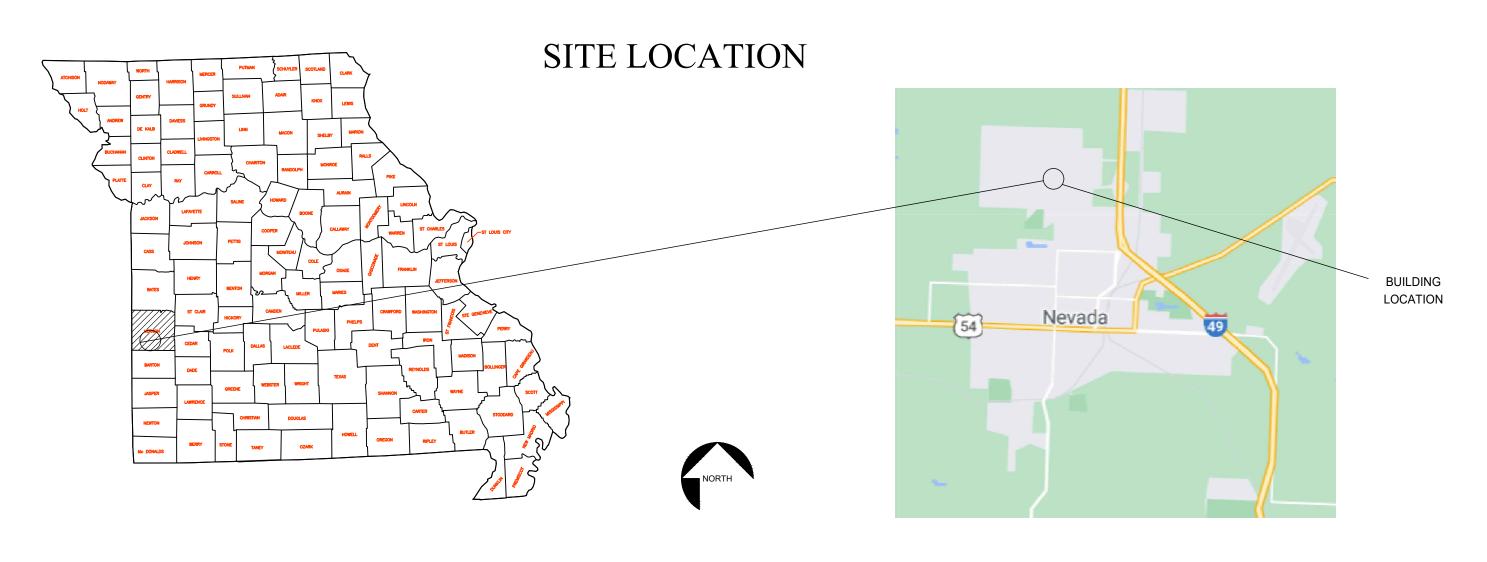



Mechanical & Plumbing Engineer of Record
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Electrical Engineer of Record
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Lankford Fendler

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STATE OF MISSOURI MICHAEL L. PARSON, GOVERNOR





OFFICE OF ADMINISTRATION DIVISION OF FACILITIES MANAGEMENT, DESIGN AND CONSTRUCTION

ELECTRICAL SERVICE REPLACEMENT

BENTON HALL
NEVADA HABILITATION
CENTER
NEVADA, MO

PROJECT # M-2114-01 SITE # 7351 FACILITY # 6517351009

REVISION:	
DATE:	_
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ISSUE DATE: 08/22/2022	

CAD DWG FILE: AS NOTED
DRAWN BY: BCD
CHECKED BY: AWL
DESIGNED BY: BCD

SHEET TITLE:

Cover Sheet

SHEET NUMBER:

G-001

THE FOLLOWING NOTES ARE AS A COURTESY AND DO IN NO WAY ABSOLVE THE CONTRACTOR FROM ANY FEDERAL, STATE, LOCAL, GUIDELINES AND ANY REQUIREMENTS AS LISTED IN THE SPECIFICATIONS.

HAZARDOUS MATERIALS GENERAL NOTES

ALL MATERIALS CONSIDERED OR SUSPECTED TO CONTAIN, MOLD, ASBESTOS, LEAD, PCBS, MERCURY OR OTHER KNOWN HAZARDOUS MATERIALS WILL BE HANDLED REMOVED AND DISPOSED OF ACCORDING TO ALL LOCAL, STATE, & FEDERAL REGULATIONS. GC SHOULD REFERENCE THE LIMITED ASBESTOS CONTAINING MATERIALS SAMPLING REPORT FOUND IN THE SPECIFICATION MANUAL



#### DRAWING INDEX

SHEET NO.

OF 12 G-001

2 OF 12 G-002 INDEX OF DRAWINGS & GENERAL NOTES

**ARCHITECTURAL** 

3 OF 12 A-100 DEMOMOLITION PLAN & DETAILS

**MECHANICAL** 

5 OF 12 M-100 FIRST FLOOR PLAN - MECHANICAL

PLUMBING

LOWER LEVEL PLUMBING DEMOLITION OF 12 P-100 LOWER LEVEL PLUMBING NEW WORK OF 12 P-101

OF 12 E-001 SITE PLAN ELECTRICAL OF 12 E-100 FIRST FLOOR PLAN - ELECTRICAL LOWER LEVEL - ELECTRICAL 11 OF 12 E-200 ELECTRICAL SCHEDULES

ELECTRICAL ONE LINE DIAGRAMS



2019 INTERNATIONAL BUILDING CODE NFPA 101, LIFE SAFETY CODE, 2019

SPRINKLED: YES

ACTUAL AREA: 35,812 SF


# FIRE RESISTIVE REQUIREMENTS (IBC TABLE 601 & 602)

STRUCTURAL FRAME: EXTERIOR BEARING WALLS: O HR INTERIOR BEARING WALLS: O HR **EXTERIOR NONBEARING WALLS:** O HR INTERIOR NONBEARING WALLS: O HR FLOOR CONSTRUCTION: O HR ROOF CONSTRUCTION: O HR

OCCUPANT LOAD: HAS NOT INCREASED WITH THE MODIFICATIONS IN THIS CONTRACT



### PARTIAL CODE REVIEW

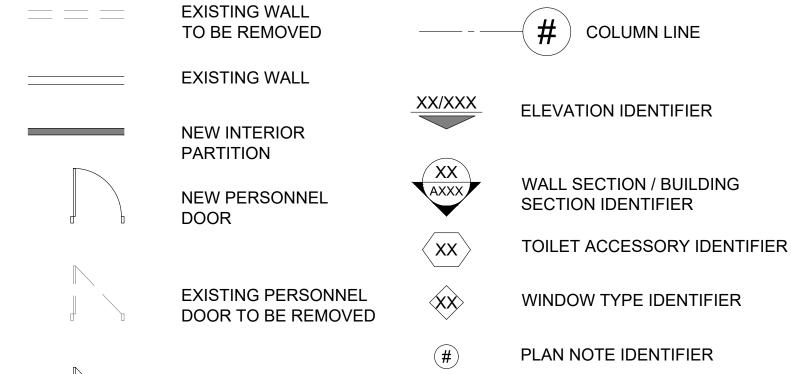



SYMBOLS

XX/XXX

PERSONNEL DOOR DOOR NUMBER

DETAIL IDENTIFIER

**EXISTING PERSONNEL** 

DOOR TO REMAIN



SHEET NUMBER:

STATE OF MISSOURI MICHAEL L. PARSON, **GOVERNOR** 

> 1730 Walnut Street Kansas City, Missouri 64108 1915 Frederick Avenue, St. Joseph, Missouri 64501

Phone: 816.221.1411 | Fax: 816.221.1429

LANKFORD | FENDLER + ASSOCIATES, CONSULTING ENGINEERS, INC.

OFFICE OF ADMINISTRATION

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DIVISION OF FACILITIES

MANAGEMENT,

ELECTRICAL

**BENTON HALL** 

NEVADA, MO

CENTER

**REVISION:** 

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CAD DWG FILE:AS NOTED
DRAWN BY: BCD
CHECKED BY: AWL

Index of Drawings &

General Notes

DESIGNED BY: BCD

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2 OF 12 SHEETS 08/22/2022



DISC SHT DESCRIPTION

**GENERAL** 

COVER SHEET

4 OF 12 A-101 FLOOR & REFLECTED CEILING PLANS

**ELECTRICAL** 

10 OF 12 E-101

12 OF 12 E-201



#### APPLICABLE CODES AND STANDARDS

2017 NATIONAL ELECTRIC CODE (NEC) NFPA 70

OCCUPANCY CLASSIFICATION


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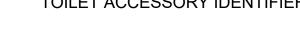
I-1/ACCESSORY SPACES

ALLOWABLE / ACTUAL HEIGHT & AREA (IBC TABLE 503) CONSTRUCTION TYPE: TYPE II-B

ALLOWABLE HEIGHT: 4 STORY, 75 FT 1 STORY ACTUAL HEIGHT: ALLOWABLE AREA (PER STORY): 40,000 SF/FLOOR






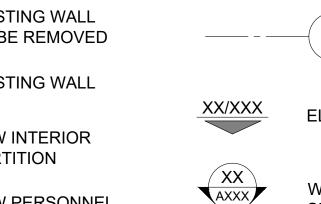









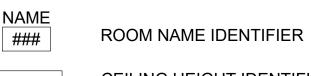



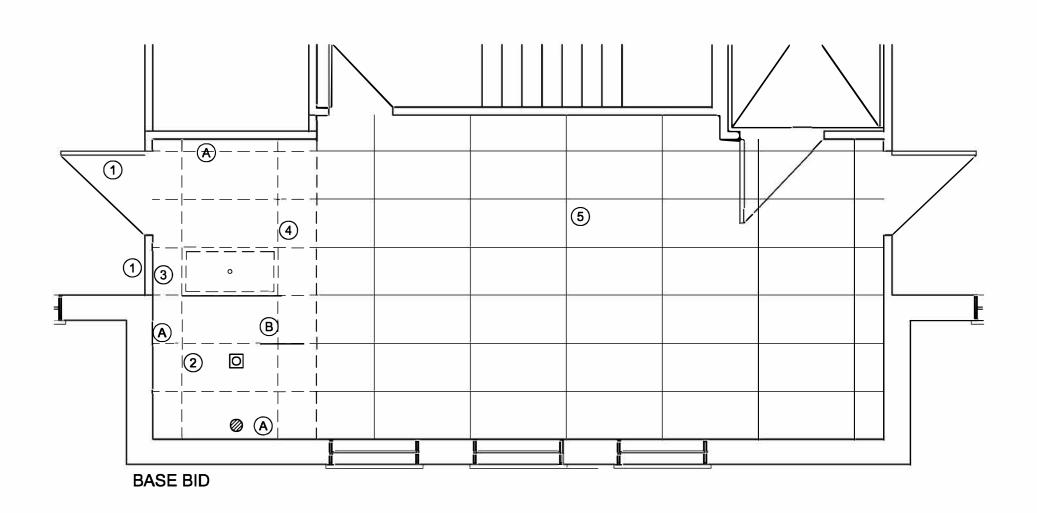

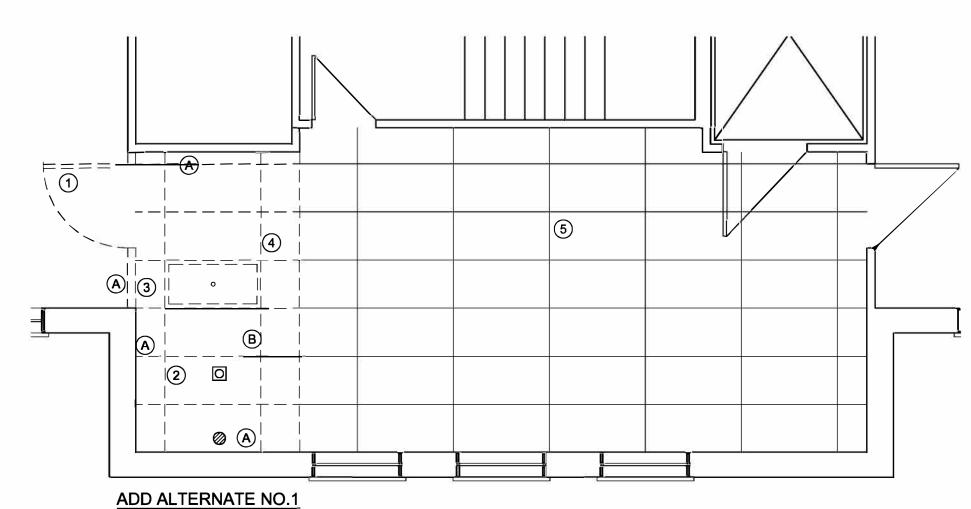

#### **DEMOLITION GENERAL NOTES**

Wet clean all contaminated surfaces thoroughly. Workers should wear disposable coveralls, shoes, hair covering, goggles, and a respirator approved by NIOSH (the National Institute of Occupational Safety and Health). Approved respirators will have an approval number on them, (i.e., TC-21C-xxx). Only HEPA (High Efficiency Particulate Air) respirators will filter lead dust and fumes. Simple paper or fabric dust masks will NOT protect a worker from lead dust.

#### Approved lead protection strategies

- Encapsulate all exterior surfaces. These materials are applied over lead-based paint to seal the paint to a surface and prevent the release of paint chips or dust. The material may be either a liquid or an adhesive. Encapsulation provides a barrier between the paint and the environment.
- Enclosure of all lead painted components.
   Removal of paint by a lead abatement professional.
- 4. Complete removal of all lead painted component (windows, trim, etc).
- All loose paint shall be abated prior to encapsulation.

AFTER ABATEMENT / REMOVAL / ENCAPSULATION

GC to utilize a swab style Lead check pre-packaged disposable lead swab to surface check areas for lead presence at 660ppm or greater. GC to continue additional encapsulation / removal / abatement until no lead contamination is detected.

LEAD ABATEMENT / REMOVAL / ENCAPSULATION KEY NOTES

- (A) REMOVE LOOSE WHITE PAINT ON WALL SURFACE PRIOR TO MULTI LAYER PAINT ENCAPSULATION
- B REMOVE LOOSE WHITE PAINT ON CEILING SURFACE (ABOVE LAYIN) CEILING PRIOR TO MULTI LAYER PAINT ENCAPSULATION

TYPICAL ALL ROOMS:
REMOVE AND PROPERLY DISPOSE OF THE FOLLOWING

CASEWORK
WINDOW TREATMENTS
FLOOR FINISHES
WALL BASE

WHERE REQUIRED

DAMAGED ACOUSTICAL CEILINGS
PLUMBING FIXTURES
REMAINING FURNITURE AND EQUIPMENT AFTER
TURNOVER
ABANDONED EQUIPMENT, CONDUITS, PIPING CAP

- PROTECT ADJACENT MATERIALS TO REMAIN IN PLACE
- PATCH AND REPAIR EXISTING INTERIOR WALL DAMAGE
- 3. REMOVE ALL ACCESSORIES RETURN TO OWNER IF REQUESTED
- 4. IF IN THE EVENT ANY MATERIAL IS DISCOVERED THAT IS SUSPECTED OF BEING HAZARDOUS DURING CONSTRUCTION MATERIAL SHALL BE TESTED AND DOCUMENTED PRIOR TO DEMOLITION PROCEEDING NOTIFICATION TO BE GIVEN TO GOVERNMENT CONTRACTING OFFICER FOR
- 5. REMOVE ALL LOOSE PAINT PREP SURFACES FOR NEW FINISH INSTALLATION
- 6. REFER TO MEP FOR MEP DEMOLITION NOTES

DEMOLITION KEY NOTES

- 1 BASE BID: DOOR AND WALL TO REMAIN.

  ADD ALTERNATE NO.1: REMOVE DOOR & HARDWARE PREP FOR WALL INFILL
- 2 REMOVE ALL EXISTING OUTLETS, SWITCHES, & COVERPLATES PREP FOR NEW, CHECK WIRING
- (3) REMOVE EXISTING WALL MOUNTED FIRE EXTINGUISHER, SAVE FOR REINSTALLATION
- BASE BID: REMOVE EXISTING LAY IN CEILING AND INSTALL NEW EDGE ANGLE AND SUPPORT IT FROM THE STRUCTURE ABOVE TO SUPPORT EXISTING LAY IN CEILING TO REMAIN.

ADD ALTERNATE NO.1: REMOVE EXISTING LAY IN CEILING THIS AREA, INSTALL NEW EDGE ANGLE AT NEW WALL TO SUPPORT EXISTING LAY IN CEILING TO


(5) PROTECT EXISTING CEILING TO REMAIN


#### **DEMOLITION LEGEND**





DOOR FRAME AND HARDWARE TO BE REMOVED

WALL TO BE REMOVED

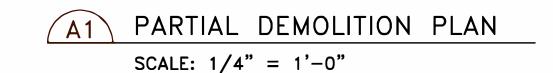


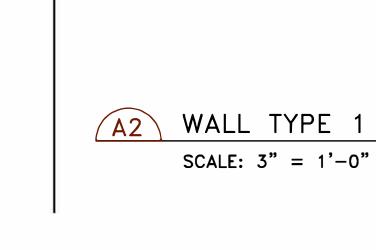

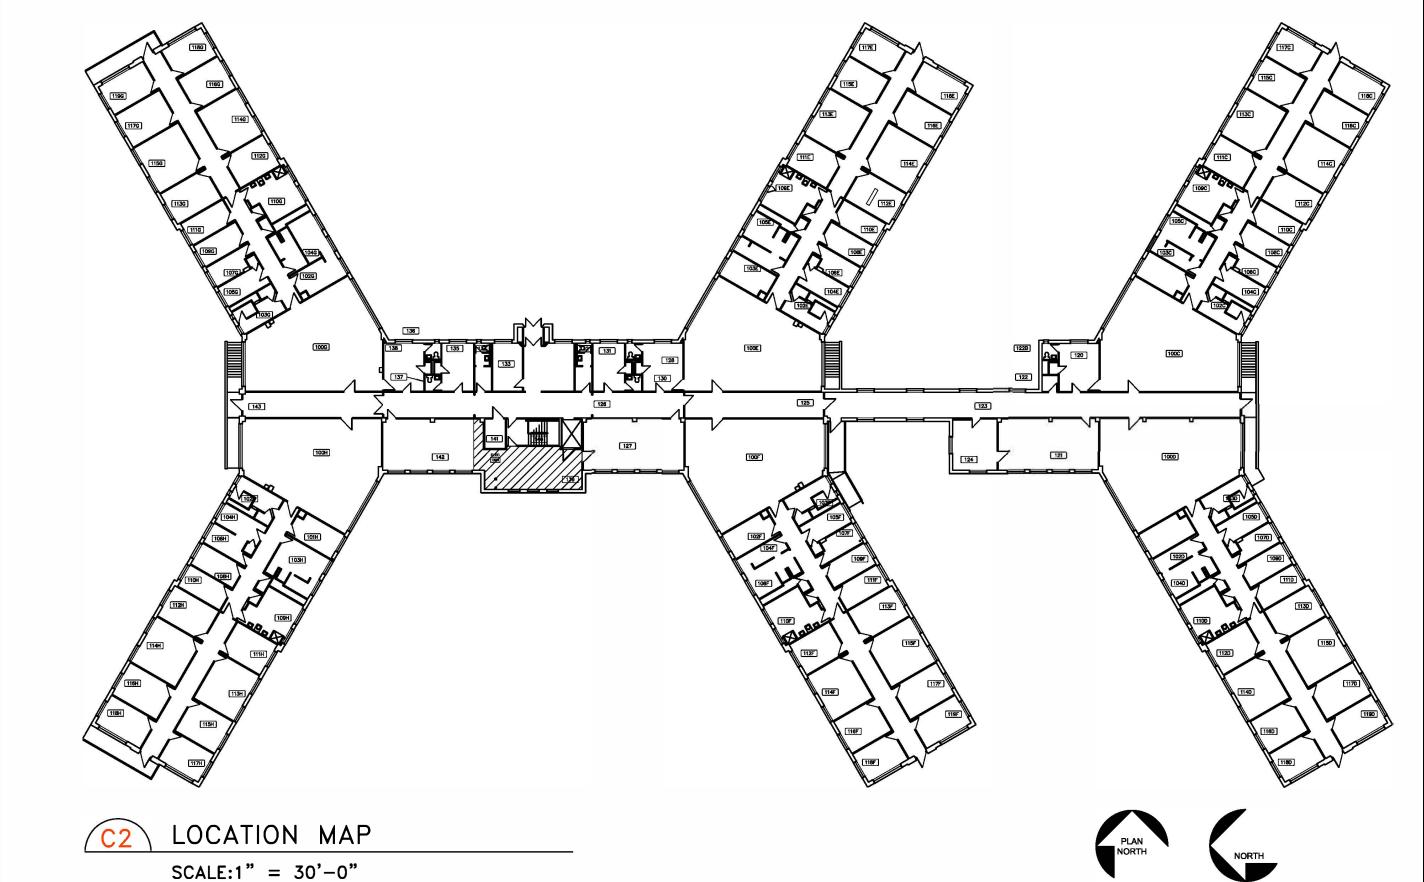

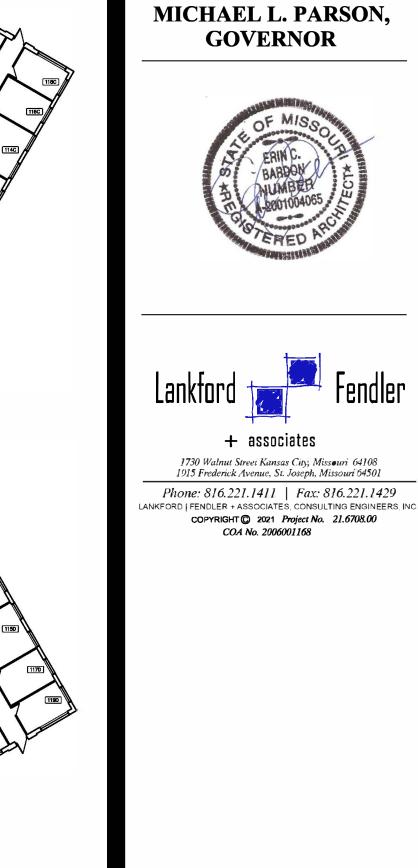

**STATE OF MISSOURI** 

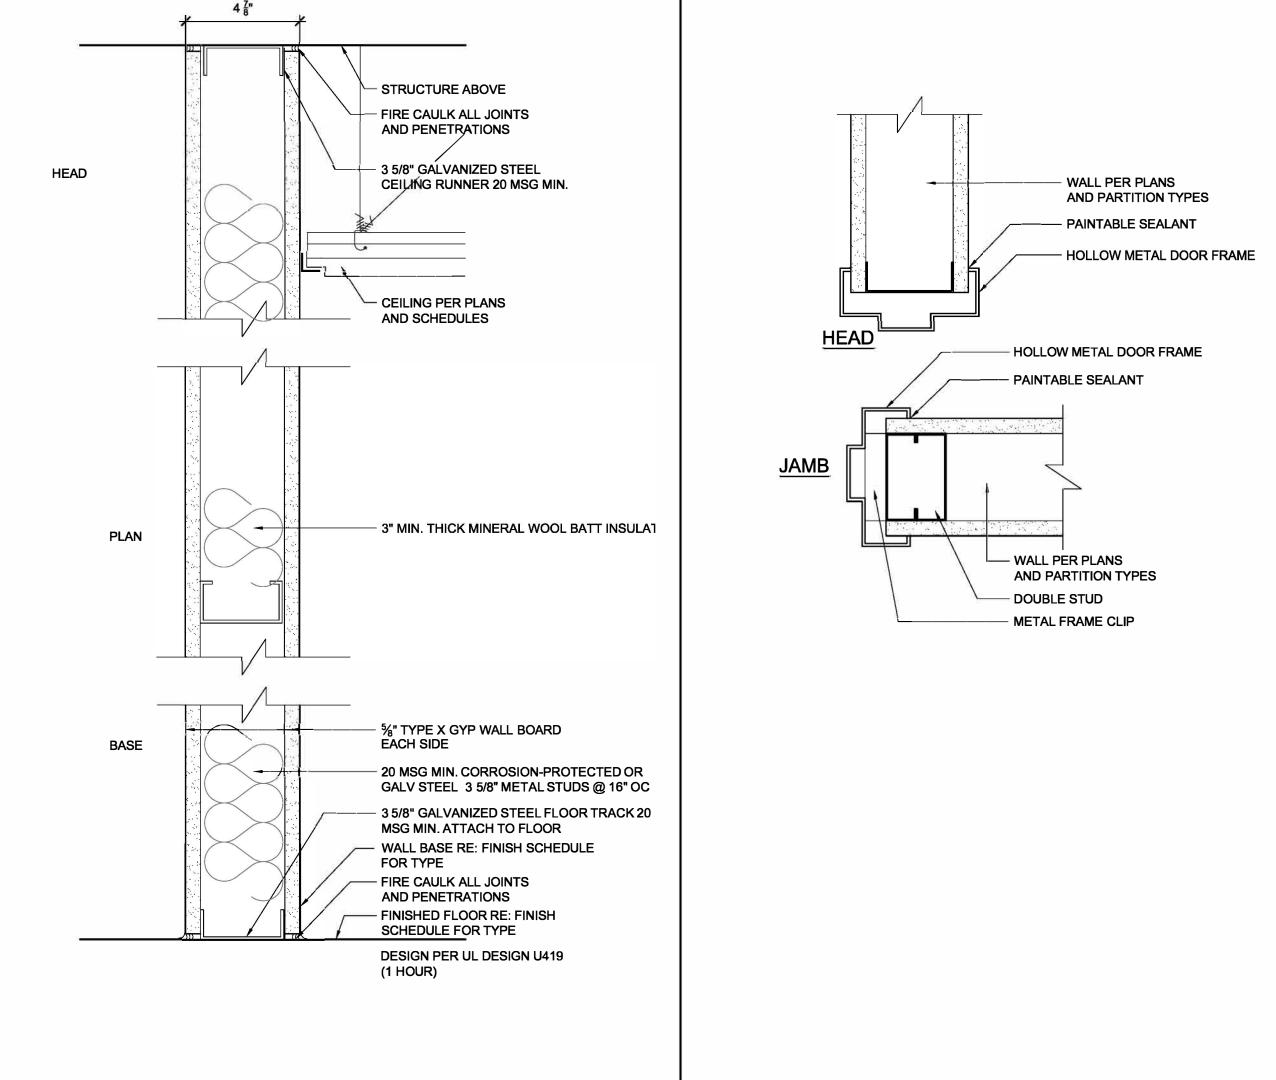

DOOR FRAME

SCALE: 3" = 1'-0"

OFFICE OF ADMINISTRATION DIVISION OF FACILITIES MANAGEMENT, DESIGN AND CONSTRUCTION

ELECTRICAL SERVICE REPLACEMENT

BENTON HALL NEVADA HABILITATION CENTER

PROJECT # M-2114-01 SITE # 7351 FACILITY # 6517351009

NEVADA, MO

REVISION:
DATE:
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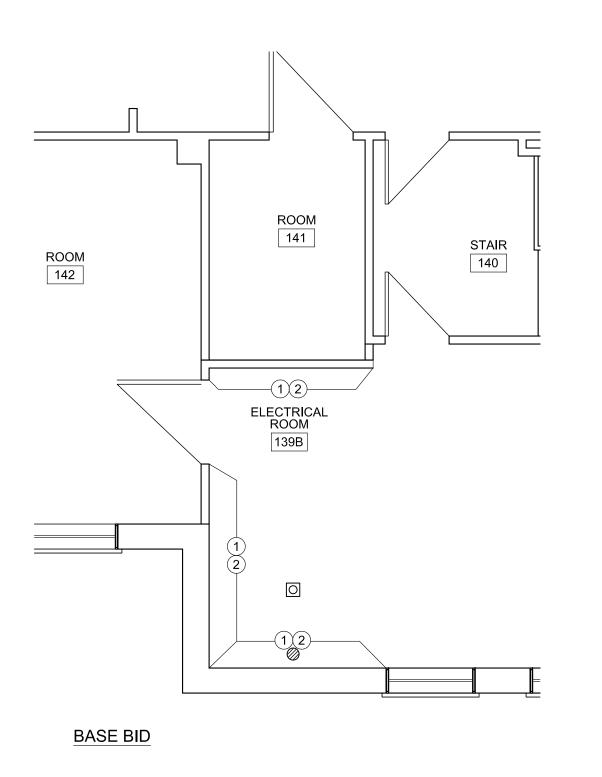
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DRAWN BY: BCD
CHECKED BY: AWL
DESIGNED BY: BCD


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Demomolition
Plan & Details

SHEET NUMBER:


A-100



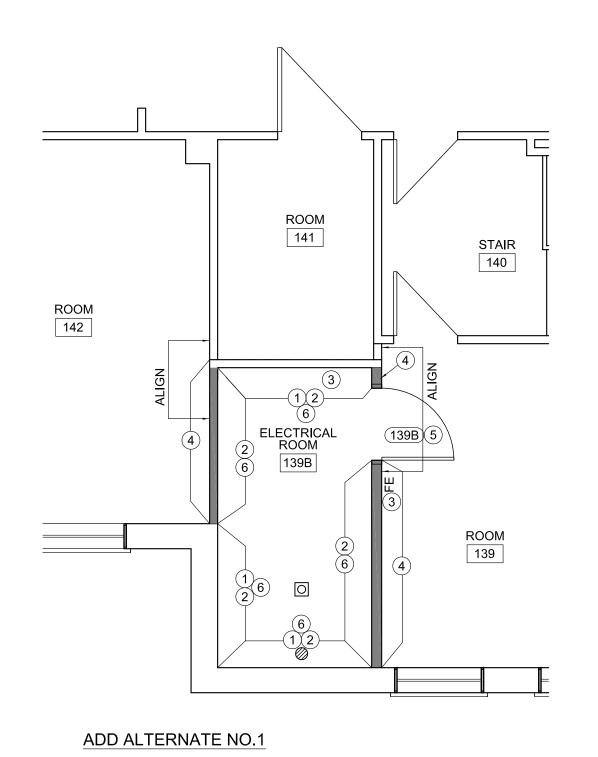

141 ROOM 142 140 ELECTRICAL ROOM 139B BASE BID

PARTIAL REFLECTED CEILING PLAN

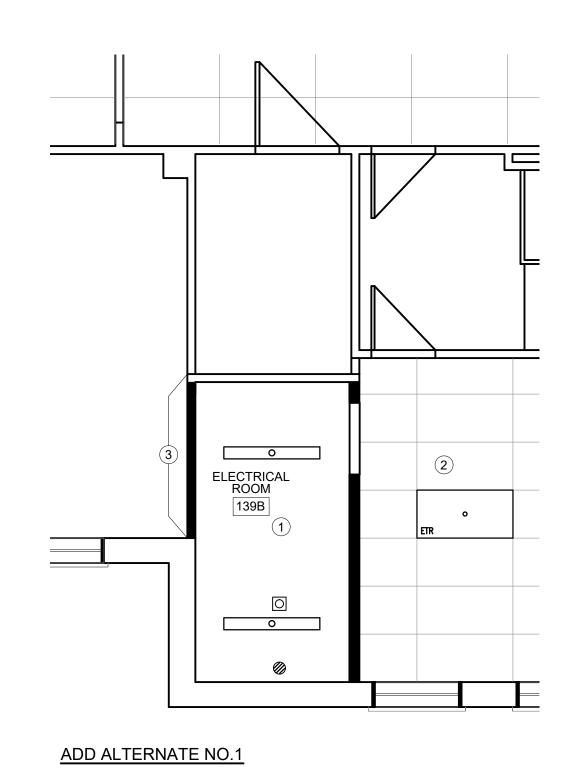

**STATE OF MISSOURI** MICHAEL L. PARSON, **GOVERNOR** 



1730 Walnut Street Kansas City, Missouri 64108

1915 Frederick Avenue, St. Joseph, Missouri 64501 Phone: 816.221.1411 | Fax: 816.221.1429 FORD I FENDLER + ASSOCIATES, CONSULTING ENGINEERS, INC COPYRIGHT © 2021 Project No. 21.6708.00 COA No. 2006001168

OFFICE OF ADMINISTRATION

**DESIGN AND CONSTRUCTION** 

SERVICE REPLACEMENT

NEVADA HABILITATION

PROJECT # M-2114-01

FACILITY # 6517351009

7351

**DIVISION OF FACILITIES** 

MANAGEMENT,

ELECTRICAL

**BENTON HALL** 

NEVADA, MO

CENTER

PARTIAL FLOOR PLAN

SCALE: 1/4" = 1'-0"

#### FLOOR PLAN GENERAL NOTES

1. UNLESS NOTED OTHERWISE THE DIMENSION FROM THE CORNER OF THE ROOM TO THE INSIDE FACE OF DOOR JAMB (EDGE OF DOOR IN CLOSED POSITION) SHALL BE 4"

#### 2. ALL WALLS TO BE TYPE 1 UNLESS NOTED OTHERWISE

3. ALL WALLS TO BE LEVEL 4 FINISH - THE PREPARED SURFACE SHALL BE COATED WITH A DRYWALL PRIMER PRIOR TO THE APPLICATION OF FINAL FINISHES. ALL JOINTS AND INTERIOR ANGLES SHALL HAVE TAPE EMBEDDED IN JOINT COMPOUND AND SHALL BE IMMEDIATELY WIPED WITH A JOINT KNIFE OR TROWEL, LEAVING A THIN COATING OF JOINT COMPOUND OVER ALL JOINTS AND INTERIOR ANGLES. IN ADDITION, TWO SEPARATE COATS OF JOINT COMPOUND SHALL BE APPLIED OVER ALL FLAT JOINTS AND ONE SEPARATE COAT OF JOINT COMPOUND APPLIED OVER INTERIOR ANGLES. FASTENER HEADS AND ACCESSORIES SHALL BE COVERED WITH THREE SEPARATE COATS OF JOINT COMPOUND. ALL JOINT COMPOUNDS SHALL BE SMOOTH AND FREE OF TOOL MARKS AND RIDGES. THE PREPARED SURFACE SHALL BE COVERED WITH A DRYWALL PRIMER PRIOR TO THE APPLICATION OF THE FINAL FINISH.


#### # KEY NOTES:

- (1) EXISTING PLASTER WALL TO BE PATCHED, SKIM COATED, INCLUDING AREA ABOVE EXISTING LAYIN CEILING OR AT CONTRACTORS OPTION EXISTING WALLS MAY ALSO BE LAMINATED WITH 5/8" FIRE RATED GYP AND FINISHED TO LEVEL 4
- PAINT ROOM P1 = SHERWIN WILLIAM 7005 PURE WHITE, 1 COAT PRIMER, 2 COAT FINISH, EGGSHELL WALLS
- (3) RELOCATED LOOP MOUNTED FIRE EXTINGUISHER MOUNT AT 48" AFF
- (4) DRYWALL TO BE MUD/TAPPED AND SANDED AND READY FOR FINISH. DO NOT PAINT.
- (5) HM DOOR & FRAME ENAMEL SEMI GLOSS, SHERWIN WILLIAMS, 7075 WEB GRAY
- (6) PROVIDE JOHNSONITE 6" RUBBER BASE, COLOR TO MATCH EXISTING, ROLL GOODS ONLY

#### **RCP GENERAL NOTES:**

- 1. ALL EXPOSED CONDUITS TO BE REATTACHED
- 2. ABANDONED PIPING / CONDUITS TO BE REMOVED 3. REMOVE ALL SCALING / LOOSE PAINT REPAINT CEILING
- 1 PATCH AND REPAIR EXISTING PLASTER CEILING TO LIKE NEW CONDITION
- (2) EXISTING CEILING TO REMAIN, RESEAT EXISTING TILE
- REPAIR EXISTING CEILING AT NEW WALL CONSTRUCTION FOR LIKE NEW CONDITION REFLECTED CEILING PLAN KEY

NEW SURFACE MOUNTED LED FIXTURE RE MEP 2 HEAD LED EMERGENCY LIGHT

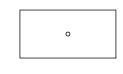

EXISTING 2x4 LED CEILING FIXTURE TO REMAIN

RCP NOTES

# construction notes

G.C. TO VERIFY ALL DIMENSIONS AND NOTIFY ARCHITECT

SCALE: 1/4" = 1'-0"

- OF ANY DISCREPANCIES PRIOR TO CONSTRUCTION. ALL NEW DOORS TO PROVIDE 32" MIN CLEAR OPENING WHEN OPENED TO 90 DEGREE POSITION UNO. STANDARD COMMERCIAL CONSTRUCTION PRACTICES
- SHALL GOVERN WORKMANSHIIP/ MATERIALS/ DESIGN, EXCEPT AS THESE VARIOUS ELEMENTS MIGHT BE MODIFIED OR AMENDED BY THESE CONSTRUCTION DOCUMENTS (CD, HEREAFTER). ANY NOTE OR INDICATION SHOWN OR IMPLIED WHICH DOES NOT CONFORM TO THE LETTER OR SPIRIT. SO DEFINED. SHALL BE BROUGHT TO THE ATTENTION OF bnb DESIGN, LLC. IN WRITING, FOR REVIEW. bnb DESIGN, LLC. AS REFERRED TO SHALL MEAN THE AUTHORIZED PROJECT MANAGER, bnb DESIGN, LLC.
- DIMENSIONS ON DRAWINGS ARE FINISH FACE TO FINISH FACE OF PARTITIONS, COLUMNS, ETC., OR TO WHERE SHOWN, UNLESS OTHERWISE NOTED. DO NOT SCALE DRAWINGS WRITTEN DIMENSIONS TAKE PRECEDENCE OVER GRAPHIC REPRESENTATION. DETAIL DIMENSIONS
- TAKE PRECEDENCE OVER PLAN DIMENSION. GC SHALL BE RESPONSIBLE FOR FIELD MEASURING OF EXISTING CONDITIONS PRIOR TO START OF WORK AND DURING CONSTRUCTION, AS NECESSARY, TO ASSURE CONSTRUCTION ADHERENCE TO DRAWINGS. BY ENTERING INTO A CONSTRUCTION CONTRACT FOR THIS WORK, GC SHALL INDICATE HIS FAMILIARITY WITH THE SITE/FIELD, CONDITIONS.
- A. ALL 'HOLD' DIMENSIONS SHALL BE MONITORED TO ASSURE CORRECTNESS.
- B. ANY DIMENSION REVISIONS/ MODIFICATIONS ARE TO BE BROUGHT TO ATTENTION OF ARCHITECT PROJECT MANAGER FOR REVIEW/ APPROVAL.
- ANY ACCESS PANELS REQUIRED IN ANY CONSTRUCTION SHALL BE APPROVED AS TO SPECIFIC SIZE, LOCATION, FINISH, ETC., BY ARCHITECT.
- GC, SUBCONTRACTORS, AND ALL VENDORS ARE TO VERIFY ALL CLEARANCES (CORRIDORS, DOORWAYS, ETC.) REQUIRED FOR DELIVERIES, PASSAGE OF ALL JOB MATERIALS/EQUIPMENT.
- ALL VERTICAL DIMENSIONS SHALL BE TAKEN FROM "BENCH MARK" OR OTHER SIMILAR GUIDE ESTABLISHED PRIOR TO START OF CONSTRUCTION, HIGH POINTS, LOW POINTS, IRREGULARITIES IN FLOOR SLAB, PARTICULARLY, WHICH COULD IN ANY WAY AFFECT FABRICATION/ INSTALLATION WORK OF OTHER TRADES OR VENDORS (E.G., CABINET CONTRACTORS), SHALL BE BROUGHT TO ATTENTION OF ARCHITECT.
- GC SHALL PROVIDE GENERAL CARPENTRY AS REQUIRED FOR WORK WHICH MAY NOT FALL INTO JURISDICTION OF A SPECIFIC TRADE, BUT IS REQUIRED FOR PROPER JOB EXECUTION.
- ALL CONVENTIONAL DRYWALL CONSTRUCTION, FURRING, SHEATHING, DRYWALL JOINTS SHALL BE TAPED/ SPACKLED LEVEL. EXTERIOR CORNERS SHALL RECEIVE METAL CORNER REINFORCING BEAD AND BE SPACKLED IN CONVENTIONAL MANNER. NO HORIZONTAL DRYWALL JOINTS SHALL BE ACCEPTED. BUTTED, UNTAPED DRYWALL JOINTS ARE NOT ACCEPTABLE. FULL HEIGHT GYPSUM BOARD SHEETS SHALL BE USED THROUGHOUT FOR FULL HEIGHT CONSTRUCTION.
- ALL MODIFICATIONS TO APPROVED DESIGN SHALL BE SUBMITTED TO ARCHITECT BY GC FOR REVIEW / APPROVAL. SUBSTITUTIONS MUST BE APPROVED BY bnb DESIGN, LLC & THE GOVERNMENT AND IN ACCORDANCE WITH SECTION 01 33 01


# finish notes

- ALL FINISH MATERIAL INDICATED TO BE BY GC UNLESS OTHERWISE NOTED IN FINISH SCHEDULES(S) AND ON
- GC AND VENDORS SHALL DETERMINE AVAILABILITY OF ALL FINISH MATERIALS. ANY DELIVERY SCHEDULE THAT POTENTIALLY MAY CAUSE COORDINATION PROBLEMS DURING THE FINAL STAGES OF CONSTRUCTION/ INSTALLATION SHALL BE BROUGHT TO ATTENTION OF bnb DESIGN, LLC., EARLY ON, FOR POSSIBLE REEVALUATION OF MATERIAL DESIGNATION.
- PAINT FOR WALL FINISHES SHALL BE PROVIDED AS A TWO (2) COAT EGGSHELL LATEX ENAMEL PAINT INSTALLATION [ONE (1) PRIME AND TWO (1) FINISHED COAT], COLORS AS SPECIFIED. METAL ELEMENTS AND DOOR AND WINDOW FRAMES SHALL HAVE A THREE COAT SEMI-GLOSS ALKYD ENAMEL FINISH.
- GC SHALL ASSURE THAT NO ELECTRIC RECEPTACLE OR TELECOMMUNICATIONS OUTLET COVERPLATES HAVE BEEN INSTALLED PRIOR TO COMPLETION OF APPLICATION OF ANY WALL FINISH MATERIALS. ANY SUCH COVERPLATES OR SURFACE HARDWARE, ETC., IN PLACE, SHALL BE REMOVED PRIOR TO WALL FINISH APPLICATION OR PROTECT BY COVERING.
- UPON COMPLETION OF FINISH PHASE OF JOB, GC SHALL REMOVE ALL PAINT, WALLCOVERING PASTE, ETC., FROM WHERE IT HAS SPILLED, SPLASHED, OR SPATTERED. ALL OFFICE / GYP WALLS SHALL RECEIVE RUBBER BASE INSTALLATION EXCEPT WHERE OTHERWISE NOTED. ALL SURFACES RECEIVING BASE SHALL BE PREPARED AS
- REQUIRED. GC SHALL PROVIDE AND MAINTAIN COMPLETE PROTECTION FOR ALL NEW INSTALLED FLOOR FINISHES UNTIL ALL CONSTRUCTION WORK IS COMPLETE. PROTECTION SHALL BE REMOVED ONLY IMMEDIATELY GC SHALL PROVIDE CURRENT STOCK SAMPLES OF
- SPECIFIED FLOORING FINISHES FOR APPROVAL PRIOR TO ORDERING GC, ALL VENDORS/ SUBCONTRACTORS ARE RESPONSIBLE
- FOR FIELD VERIFICATION OF ALL DIMENSIONS, QUANTITIES, ETC., OF THEIR RESPECTIVE WORK.
- RUBBER BASE TO BE INSTALLED IN LONGEST LENGTH POSSIBLE. NO SECTIONS SHORTER THAN 5'-0" WILL BE ALLOWED.
- ALL FINISH MATERIALS TO BE FROM SAME DYE LOT.

# rcp notes

- CEILING PLANE SHALL BE LEVEL AND TRUE, AND IN ALIGNMENT WITH ALL LIGHTING, HVAC AND OTHER
- ELEMENTS INCORPORATED IN ITS CONSTRUCTION. ACOUSTICAL CONTRACTOR SHALL COORDINATE WORK WITH CARPENTRY TRADES TO PROVIDE FOR A NEAT. LEVEL VISUAL LINE AT THE INTERSECTION OF CEILING
- AND PARTITIONS. MECHANICAL, HVAC AND PLUMBING ELEMENTS SHALL AT NO TIME COME IN CONTACT WITH CEILING CONSTRUCTION EXCEPT AS NECESSARY PENETRATIONS MAY REQUIRE.
- ACCESS SHALL BE PROVIDED BY GC AS REQUIRED FOR INSTALLATION AND MAINTENANCE OF MECHANICAL, ELECTRICAL AND OTHER ELEMENTS WITHIN CEILING PLENUM AND AS REQUIRED BY CODE. LOCATIONS FOR SPECIAL ACCESS DOORS, HATCHES, ETC, SHALL BE COORDINATED WITH OTHER TRADES AND APPROVED BY ARCHITECT. AS-BUILT REFERENCE PLANS SHALL BE PROVIDED TO ARCHITECT.
- INSPECTIONS, AS REQUIRED BY LOCAL AUTHORITIES SHALL BE COORDINATED BY GC PRIOR TO CLOSING OF CEILING.
- SHOP DRAWINGS FOR ALL RELATED TRADES (PLUMBING HVAC) SHALL BE SUBMITTED TO bnb DESIGN FOR REVIEW /APPROVAL PRIOR TO MANUFACTURING AND INSTALLATION. COORDINATED SHOP DRAWING FOR ALL VISIBLE CEILING ELEMENTS SHALL BE SUBMITTED.
- MECHANICAL AND ELECTRICAL CONTRACTOR SHALL COORDINATE WORK WITH ARCHITECTURAL DRAWINGS. ARCHITECTURAL CEILING PLAN SHALL GOVERN WITH RESPECT TO LOCATIONS FOR CEILING PENETRATIONS AS AESTHETIC AND FUNCTIONAL CONSIDERATIONS DICTATE.
- CUT SHEETS FOR ALL FIXTURES SHALL BE SUBMITTED TO ARCHITECT BY GC FOR REVIEW / APPROVAL. SUBSTITUTIONS MUST BE APPROVED BY bnb DESIGN, LLC & THE GOVERNMENT.
- MULTIPLE SWITCHES SHALL BE GANGED WITH SINGLE COMMON COVERPLATE.
- NEW SWITCHES SHALL MATCH EXISTING TYPE USED WHERE EXISTING SWITCHES ARE TO REMAIN.
- CLEANING: BEFORE JOB COMPLETION, THE FOLLOWING SHALL BE SATISFIED: ALL LIGHT FIXTURE INTERIORS AND LENSES SHALL BE WIPED CLEAN OF ALL CONSTRUCTION DUST, GRIME, FINGERMARKS, ETC., AND BE FULLY FUNCTIONING, MECHANICALLY AND ELECTRICALLY. PROTECTION: ALL ELECTRICAL ELEMENTS, WHEN INSTALLED, SHALL BE PROTECTED FROM DAMAGE BY OTHER TRADES. COVER PLATES SHALL BE INSTALLED
- AFTER FINISH MATERIALS HAVE BEEN INSTALLED. • ALL LIGHTING TO BE WARM WHITE.



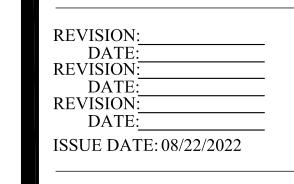


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SHEET TITLE:

Floor & Reflected Ceiling Plans

SHEET NUMBER:

4 OF 12 SHEETS

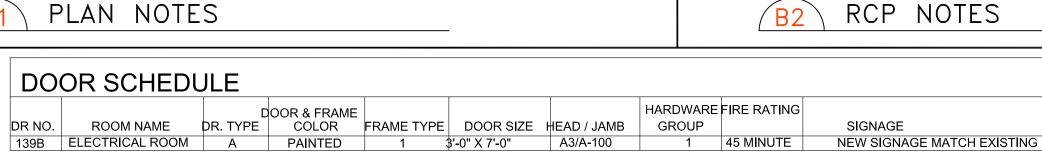

HARDWARE SET NO. 1 HAGER BB1279 FIVE KNUCKLE BALL BEARING STANDARD WEIGHT 4-1/2" X 4-1/2" 26D HINGES DOOR KNOB AND LOCKSET TO BE PROVIDED BY OWNER AND INSTALLED BY GENERAL CONTRACTOR GT - T STRIKE SQUARE CORNER PDQ INDUSTRIES, 7100 SERIES HEAVY DUTY DOOR CLOSER REGULAR ARM NATIONAL GUARD PRODUCTS, FIRE / WEATHER GASKET, 161VA ASSA ABLOY ROCKWOOD K1050 METAL KICK PLATE .05" THICK, 12" X 32", IVES FLOOR STOP, FS436 DOME STOP

RE: SCHEDULE DOOR TYPE "A" HEAVY DUTY FLUSH HOLLOW METAL

FRAME TYPE 1

INDICATED FLUSH HOLLOW

METAL 45 MINUTE FIRE RATED


SIGNAGE WHERE

RIGID HONEYCOMB

CORE 45 MINUTE FIRE RATING

DOOR SCHEDULE AND DETAILS

CONSTRUCTION NOTES

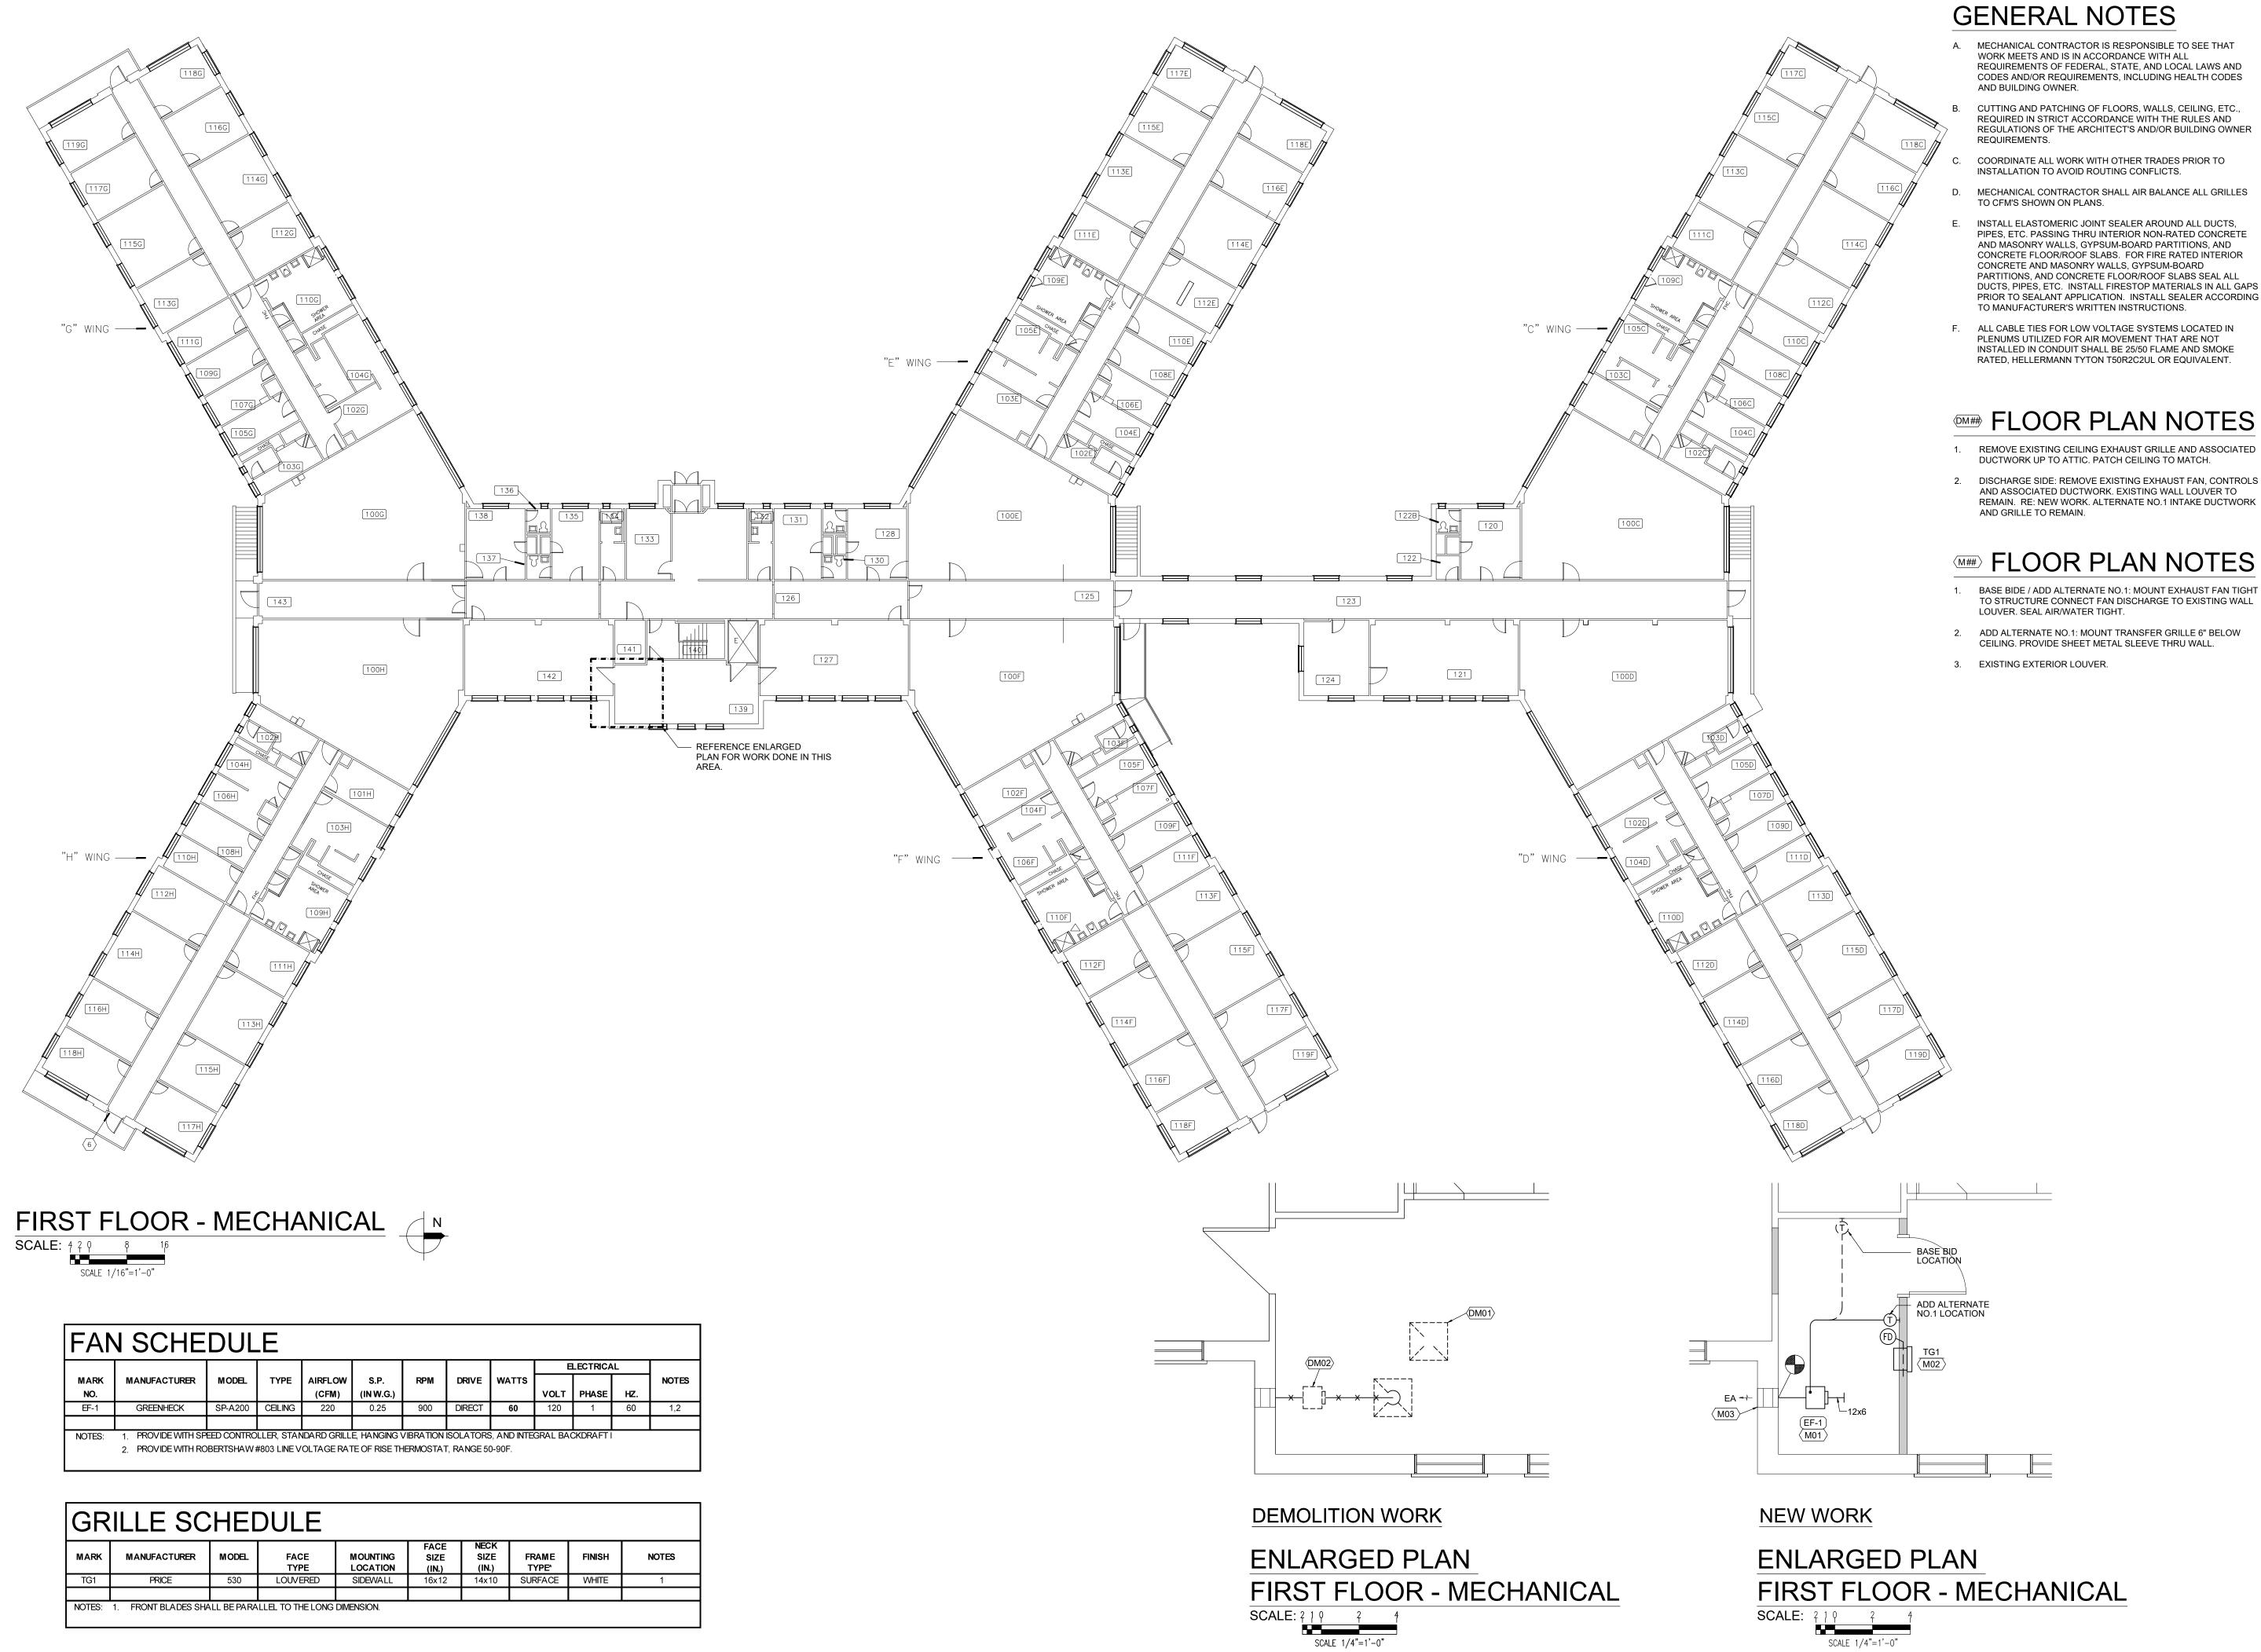

- MECHANICAL CONTRACTOR IS RESPONSIBLE TO SEE THAT WORK MEETS AND IS IN ACCORDANCE WITH ALL
  REQUIREMENTS OF FEDERAL, STATE, AND LOCAL LAWS AND CODES AND/OR REQUIREMENTS, INCLUDING HEALTH CODES
- CUTTING AND PATCHING OF FLOORS, WALLS, CEILING, ETC., REQUIRED IN STRICT ACCORDANCE WITH THE RULES AND REGULATIONS OF THE ARCHITECT'S AND/OR BUILDING OWNER

- PIPES, ETC. PASSING THRU INTERIOR NON-RATED CONCRETE AND MASONRY WALLS, GYPSUM-BOARD PARTITIONS, AND CONCRETE FLOOR/ROOF SLABS. FOR FIRE RATED INTERIOR CONCRETE AND MASONRY WALLS, GYPSUM-BOARD PARTITIONS, AND CONCRETE FLOOR/ROOF SLABS SEAL ALL DUCTS, PIPES, ETC. INSTALL FIRESTOP MATERIALS IN ALL GAPS PRIOR TO SEALANT APPLICATION. INSTALL SEALER ACCORDING
- PLENUMS UTILIZED FOR AIR MOVEMENT THAT ARE NOT INSTALLED IN CONDUIT SHALL BE 25/50 FLAME AND SMOKE RATED, HELLERMANN TYTON T50R2C2UL OR EQUIVALENT.

- REMOVE EXISTING CEILING EXHAUST GRILLE AND ASSOCIATED
- 2. DISCHARGE SIDE: REMOVE EXISTING EXHAUST FAN, CONTROLS AND ASSOCIATED DUCTWORK. EXISTING WALL LOUVER TO REMAIN. RE: NEW WORK. ALTERNATE NO.1 INTAKE DUCTWORK
- CEILING. PROVIDE SHEET METAL SLEEVE THRU WALL.

STATE OF MISSOURI MICHAEL L. PARSON, **GOVERNOR** 



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OFFICE OF ADMINISTRATION DIVISION OF FACILITIES MANAGEMENT, DESIGN AND CONSTRUCTION

ELECTRICAL SERVICE REPLACEMENT

BENTON HALL NEVADA HABILITATION CENTER NEVADA, MO

PROJECT # M-2114-01 7351 FACILITY # 6517351009

**REVISION:** DATE: **REVISION:** DATE:

ISSUE DATE: 08/22/2022


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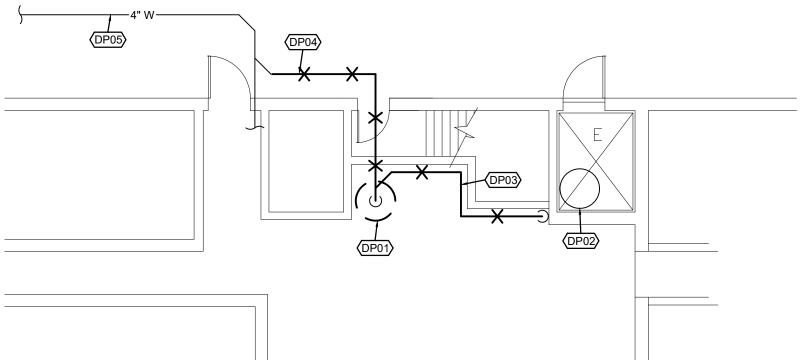
SHEET TITLE:

FIRST FLOOR PLAN -**MECHANICAL** 

SHEET NUMBER:

M-100



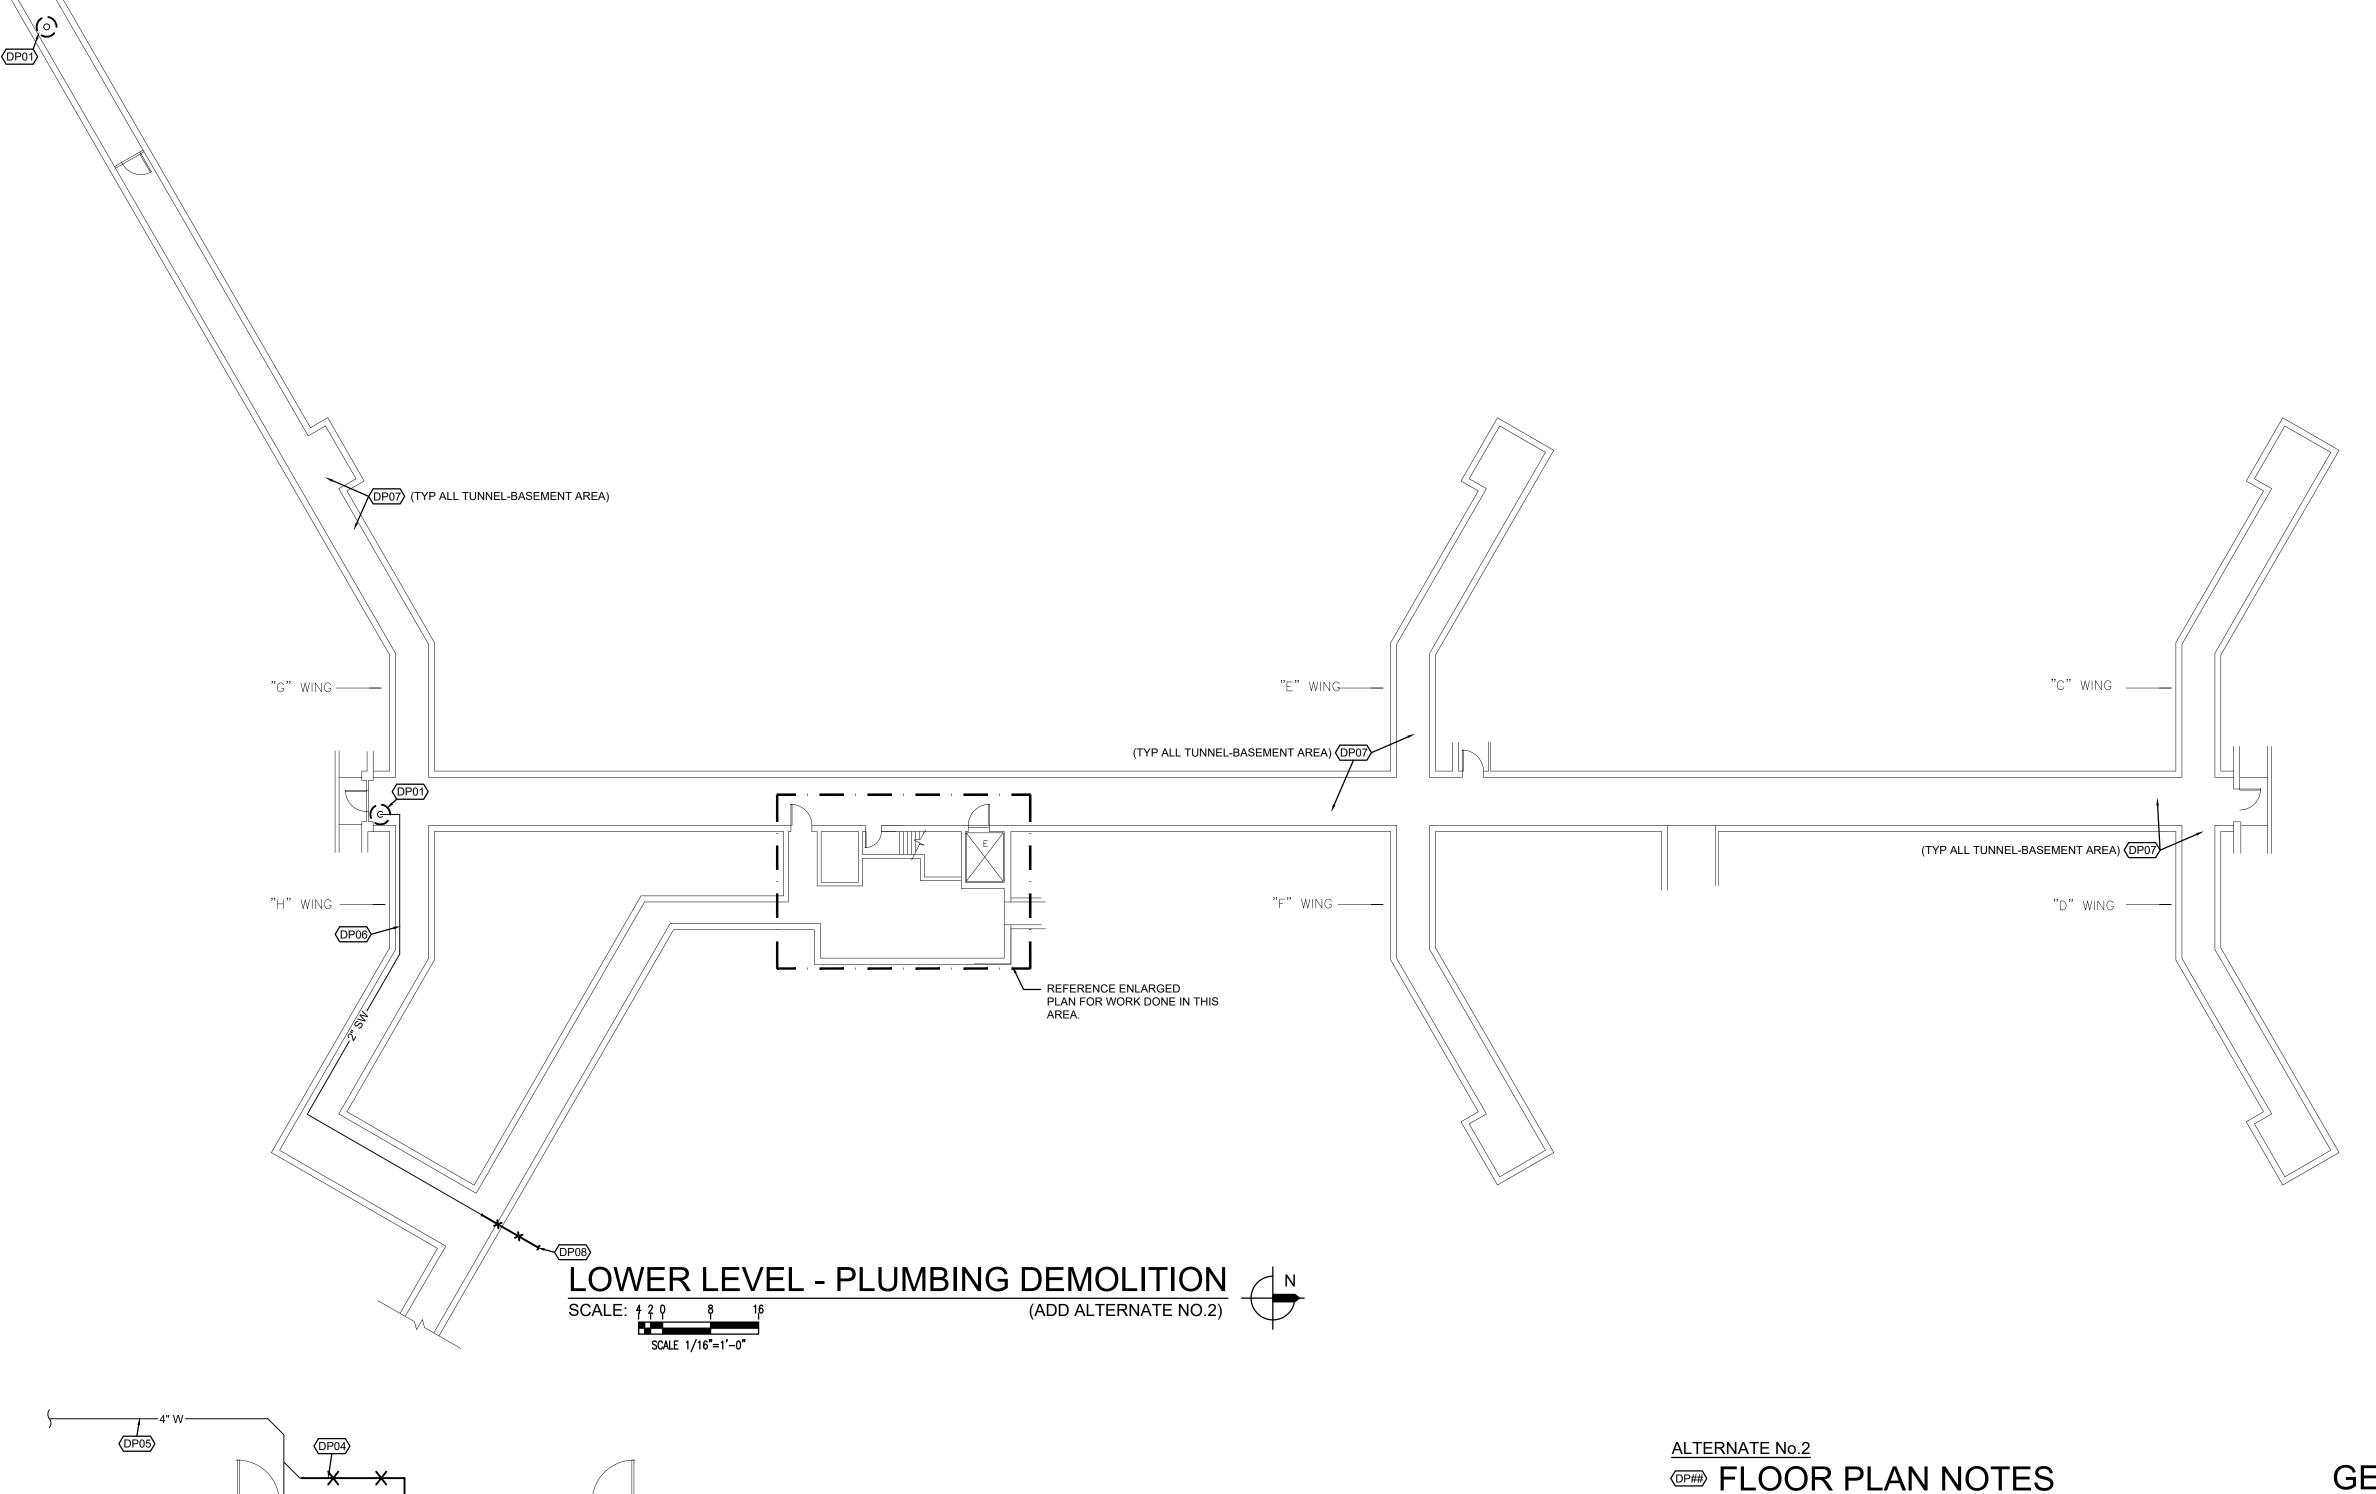

# ENLARGED LOWER LEVEL MECHANICAL ROOM - PLUMBING DEMOLITION SCALE: 219 4 8 ADD ALTERNATE NO.2

- 1. REMOVE EXISTING SUMP PUMP AND PIPING WITH IN PIT. RETAIN PIPING ABOVE FLOOR
- FOR RECONNECTION UNDER NEW WORK.

  2. EXISTING ELEVATOR PIT SUMP PUMP TO REMAIN.
- 3. REMOVE EXISTING PIPING BETWEEN SHAFT WALL AND PUMP P-3 DISCHARGE.
- 4. REMOVE EXISTING DISCHARGE PIPING AS INDICATED. CAP EXISTING SANITARY LINE.
- 5. EXISTING SANITARY PIPING TO REMAIN.
- RETAIN EXISTING STORM DRAIN PIPING FOR RECONNECTION TO NEW PUMPS. RE: NEW WORK PLAN.
- 7. CONTRACTOR SHALL REMOVE ALL WATER FROM EXISTING BASEMENT AREA (INCLUDING ELEVATOR PIT AREA) IN PREPARATION OF NEW WORK COMMENCEMENT.
- 8. REMOVE EXISTING 2" SW TO OUTSIDE BUILDING AND CAP. SEAL WALL WATER TIGHT.


# GENERAL NOTES (TYPICAL ALL SHEETS)

- A. PLUMBING CONTRACTOR IS RESPONSIBLE TO SEE THAT WORK MEETS AND IS IN ACCORDANCE WITH ALL REQUIREMENTS OF FEDERAL, STATE, AND LOCAL LAWS AND CODES AND/OR REQUIREMENTS, INCLUDING HEALTH CODES AND BUILDING OWNER.
- B. ALL EXISTING PIPING SHOWN ON DRAWINGS IS SCHEMATIC AND IS BASED ON EXISTING RECORD DRAWINGS PROVIDED BY THE OWNER AND DO NOT REFLECT EXACT EXISTING CONDITIONS. CONTRACTOR TO FIELD VERIFY EXACT LOCATIONS ON JOB SITE.
- C. CUTTING AND PATCHING OF FLOORS, WALLS, CEILING, ETC., REQUIRED IN STRICT ACCORDANCE WITH THE RULES AND REGULATIONS OF THE ARCHITECT'S AND/OR BUILDING OWNER REQUIREMENTS
- D. COORDINATE ALL WORK WITH OTHER TRADES PRIOR TO INSTALLATION TO AVOID ROUTING
- E. ANY MATERIAL REMOVED THAT OWNER DOES NOT WISH TO RETAIN SHALL BE REMOVED FROM PROJECT SITE AND DISPOSED OF BY CONTRACTOR.
- F. INSTALL ELASTOMERIC JOINT SEALER AROUND ALL PIPES PASSING THRU INTERIOR NON-RATED CONCRETE AND MASONRY WALLS, GYPSUM-BOARD PARTITIONS, AND CONCRETE FLOOR/ROOF SLABS. FOR FIRE RATED INTERIOR CONCRETE AND MASONRY WALLS, GYPSUM-BOARD PARTITIONS, AND CONCRETE FLOOR/ROOF SLABS SEAL ALL PIPES. INSTALL FIRESTOP MATERIALS IN ALL GAPS PRIOR TO SEALANT APPLICATION. INSTALL SEALER ACCORDING TO MANUFACTURER'S WRITTEN INSTRUCTIONS.
- G. ALL CABLE TIES FOR LOW VOLTAGE SYSTEMS LOCATED IN PLENUMS UTILIZED FOR AIR MOVEMENT THAT ARE NOT INSTALLED IN CONDUIT SHALL BE 25/50 FLAME AND SMOKE RATED, HELLERMANN TYTON T50 R2C2UL OR EQUIVALENT.

# PLUMBING SYMBOLS

	EXISTING TO REMAIN
<del></del>	EXISTING TO BE REMOVED
	NEW PIPING
→	PIPE DROP/PIPE RISE
со—	CLEAN OUT
DWH-1	EQUIPMENT TYPE AND DESIGNATION
	CONNECT TO EXISTING

STATE OF MISSOURI MICHAEL L. PARSON, GOVERNOR

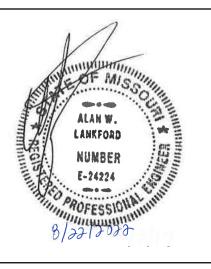





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OFFICE OF ADMINISTRATION DIVISION OF FACILITIES MANAGEMENT, DESIGN AND CONSTRUCTION

ELECTRICAL SERVICE REPLACEMENT

BENTON HALL NEVADA HABILITATION CENTER

PROJECT # M-2114-01 SITE # 7351

FACILITY # 6517351009

NEVADA, MO

REVISION:
DATE:
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DATE:
REVISION:
DATE:

CAD DWG FILE: AS NOTED
DRAWN BY: BCD
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DESIGNED BY: BCD


ISSUE DATE: 08/22/2022

SHEET TITLE:

LOWER LEVEL PLUMBING DEMOLITION

SHEET NUMBER:

P-100

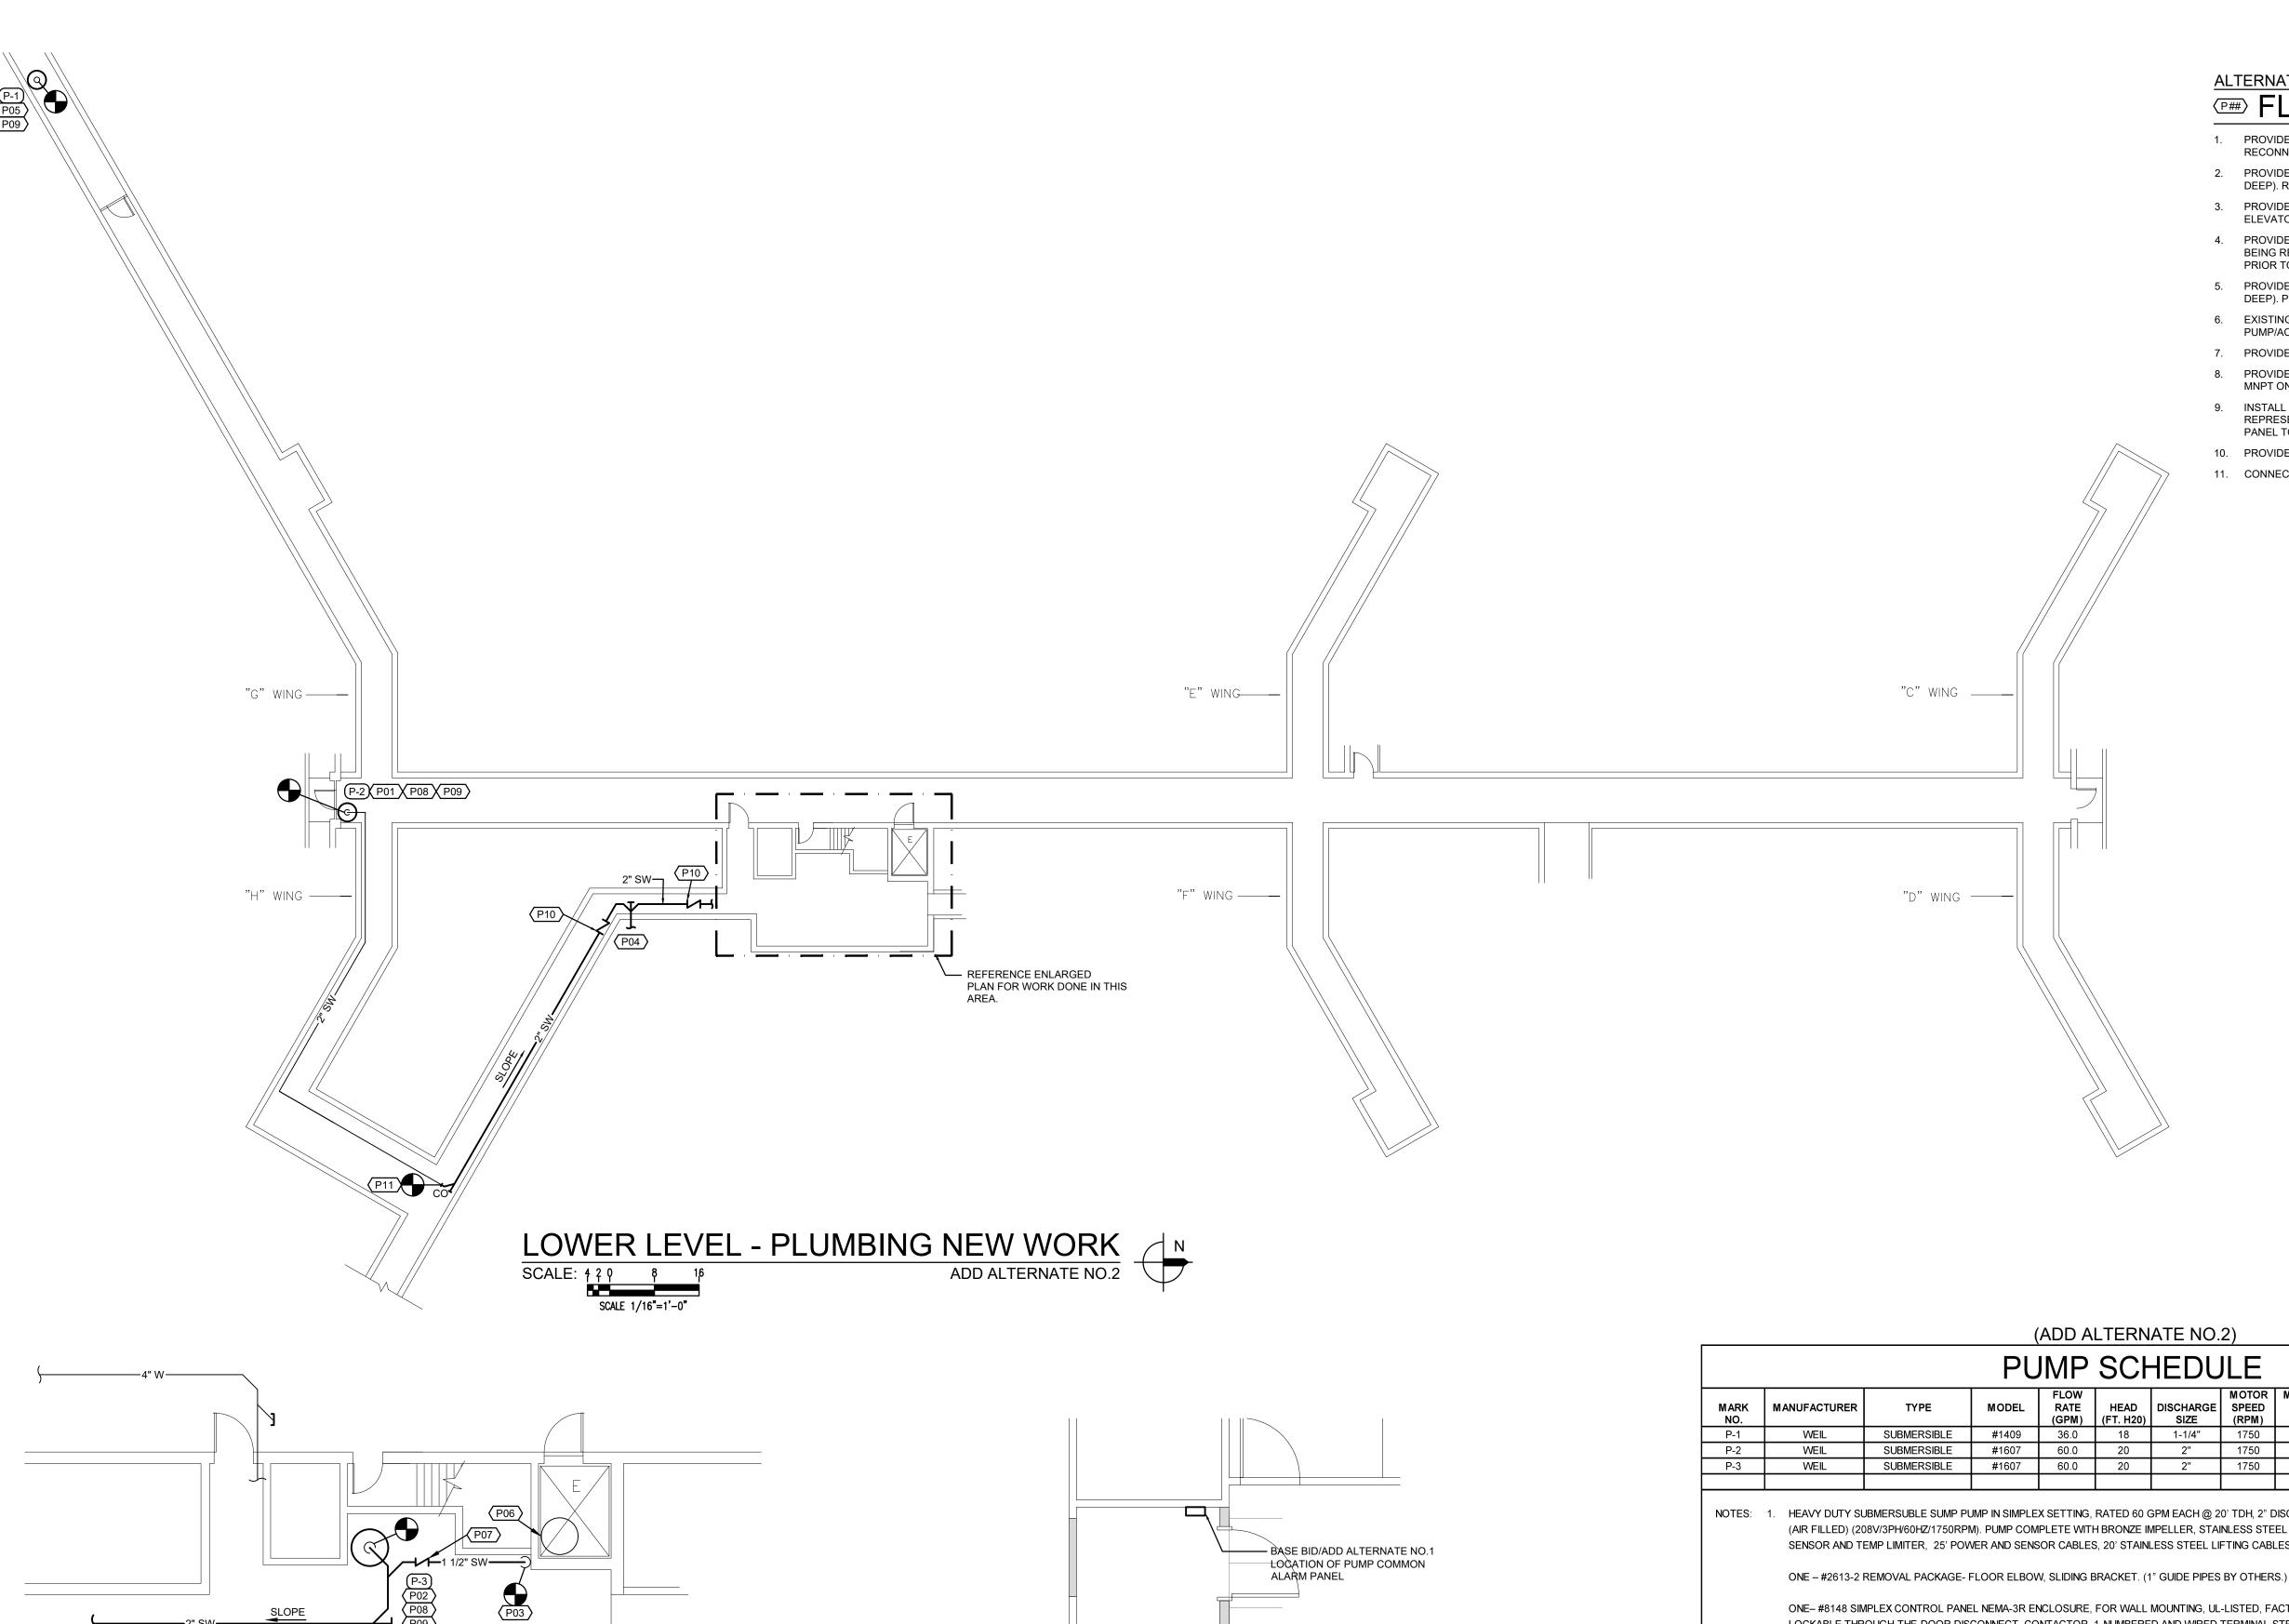

**NEW WORK** 

SCALE: 219 2 4

ENLARGED LOWER LEVEL

ENLARGED PLAN

FIRST FLOOR - PLUMBING

ADD ALTERNATE NO.2

#### ALTERNATE No.2 FLOOR PLAN NOTES

- PROVIDE AND INSTALL PUMP IN EXISTING SUMP PIT (APPROXIMATELY 5'-0" DEEP). RECONNECT NEW 2" DISCHARGE PIPING TO EXISTING.
- 2. PROVIDE AND INSTALL PUMP WITH COVER IN EXISTING SUMP PIT (APPROXIMATELY 10'-0"

DEEP). RECONNECT NEW 2" DISCHARGE PIPING TO EXISTING.

- 3. PROVIDE 1 1/2" STORM DRAIN PIPING FROM EXISTING DISCHARGE AT WALL OFF
- ELEVATOR SUMP PIT PUMP AND CONNECT TO DISCHARGE OF PUMP (P-3) AS INDICATED. 4. PROVIDE 2" DISCHARGE PIPING THRU WALL AND CONNECT INTO STORM DRAIN PIPING BEING REPLACED WITH PROJECT M2115-01. FIELD COORDINATE SIZE AND LOCATION
- 5. PROVIDE AND INSTALL PUMP WITH COVER IN EXISTING SUMP PIT APPROXIMATELY 2'-0" DEEP). PROVIDE NEW DISCHARGE PIPING AS INDICATED.
- 6. EXISTING ELEVATOR SUMP PUMP TO REMAIN. CONTRACTOR SHALL DELIVER NEW PUMP/ACCESSORIES TO OWNER. NEW PUMP P-4 WILL NOT BE INSTALLED AT THIS TIME.
- PROVIDE 1 1/2' CHECK VALVE.

PRIOR TO TRENCHING.

- 8. PROVIDE 1" GUIDE PIPES DEPTH OF PIT FOR PUMP SLIDING GUIDE BRACKET AND 1" PIPE MNPT ONE END FOR CONNECTION OF FLOAT TREE SUSPENSION.
- 9. INSTALL CONTROL PANEL ADJACENT TO PUMP. COORDINATE LOCATION WITH OWNER REPRESENTATIVE PRIOR TO INSTALLATION. CONTRACTOR SHALL CONNECT CONTROL PANEL TO ALARM PANEL IN FIRST FLOOR ELECTRICAL ROOM.
- 10. PROVIDE 2" CHECK VALVE.
- 11. CONNECT NEW 2" SW TO EXISTING LINE.

			Pυ	JMP	SCH	HEDL	ILE					
MARK NO.	MANUFACTURER	TYPE	MODEL	FLOW RATE (GPM)	HEAD (FT. H20)	DISCHARGE SIZE	MOTOR SPEED (RPM)	MOTOR SIZE (HP)	VOLT	LECTRIC, ø	AL HZ	NOTES
P-1	WEIL	SUBMERSIBLE	#1409	36.0	18	1-1/4"	1750	1/3	120	1	60	2
P-2	WEIL	SUBMERSIBLE	#1607	60.0	20	2"	1750	3/4	208	3	60	1
P-3	WEIL	SUBMERSIBLE	#1607	60.0	20	2"	1750	3/4	208	3	60	1
											l	

NOTES: 1. HEAVY DUTY SUBMERSUBLE SUMP PUMP IN SIMPLEX SETTING, RATED 60 GPM EACH @ 20' TDH, 2" DISCHARGE, 3/4 HP MOTOR, HERMETICALLY SEALED (AIR FILLED) (208V/3PH/60HZ/1750RPM). PUMP COMPLETE WITH BRONZE IMPELLER, STAINLESS STEEL SHAFT, DOUBLE MECHANICAL SEAL, MOISTURE SENSOR AND TEMP LIMITER, 25' POWER AND SENSOR CABLES, 20' STAINLESS STEEL LIFTING CABLES.

ONE-#8148 SIMPLEX CONTROL PANEL NEMA-3R ENCLOSURE, FOR WALL MOUNTING, UL-LISTED, FACTORY WIRED HAVING OVERLOAD PROTECTION,

208/115V, 1-HWA WITH HORN, SILENCING SWITCH & RESET, MOISTURE SENSOR AND TEMP/LIMITER RELAYS WITH LIGHTS, 2-ISO CONTACT FOR REMOTE HWA,

THREE - WEIL #8233 TETHERED FLOAT SWITCH W/ 20' CORD. 3/4 OR 1" PIPE MNPT ONE END- FLOAT TREE SUSPENSION PIPE BY OTHERS.

ONE - #8804 28" O.D. STEEL LID WITH ACCESS HATCH, EPOXY COATED, APPROPRIATE OPENINGS FOR DISCHARGE, ELECTRICAL AND VENT. WITH TAPPED HOLES FOR FLOATS AND THREADED HALF COUPLING TO SUSPEND MOUNTING PIPE.

24" DIA. EXISTING PITS. P-2: 5' DEPTH; P-3: 10' DEPTH

COMMON ALARM PANEL TO PICKUP ALL FOR PUMPS: P-1 THRU P-3: ONE- SEEWATER #HLA-4X-4-S3 ALARM PANEL, TYPE-4X, WITH LIGHT INDICATORS FOR 4 ALARM CONTACT INPUTS, COMMON HORN/SILENCER.

PROVIDE WITH 15' (VENTED) POWER CABLE WITH 3-PRONG GROUNDED PLUG AND TEST BUTTON, NEMA-6 MOTOR MOUNTED MICRO SWITCH, HLA-4X HIGH LEVEL ALARM PANEL, NEMA-4X WITH HORN/SILENCER, DOME LIGHT, DRY CONTACT FOR REMOTE SIGNAL, TETHERED FLOAT SWITH WITH 20' CORD, 28"X3/8" THICK DQUARE BASIN COMVER, WITH DISCHARGE AND CORD OPENINGS. (FOR EXISTING 24" DIAMETER AND 2' DEEP PIT)

#### STATE OF MISSOURI MICHAEL L. PARSON, **GOVERNOR**





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OFFICE OF ADMINISTRATION DIVISION OF FACILITIES MANAGEMENT, DESIGN AND CONSTRUCTION

ELECTRICAL SERVICE REPLACEMENT

BENTON HALL NEVADA HABILITATION CENTER NEVADA, MO

PROJECT # M-2114-01 7351

FACILITY # 6517351009

REVISION:
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ISSUE DATE: 08/22/2022

CAD DWG FILE: AS NOTED DRAWN BY: BCD CHECKED BY: AWL DESIGNED BY: BCD


SHEET TITLE:

LOWER LEVEL PLUMBING

NEW WORK

SHEET NUMBER:

7 OF 12 SHEETS

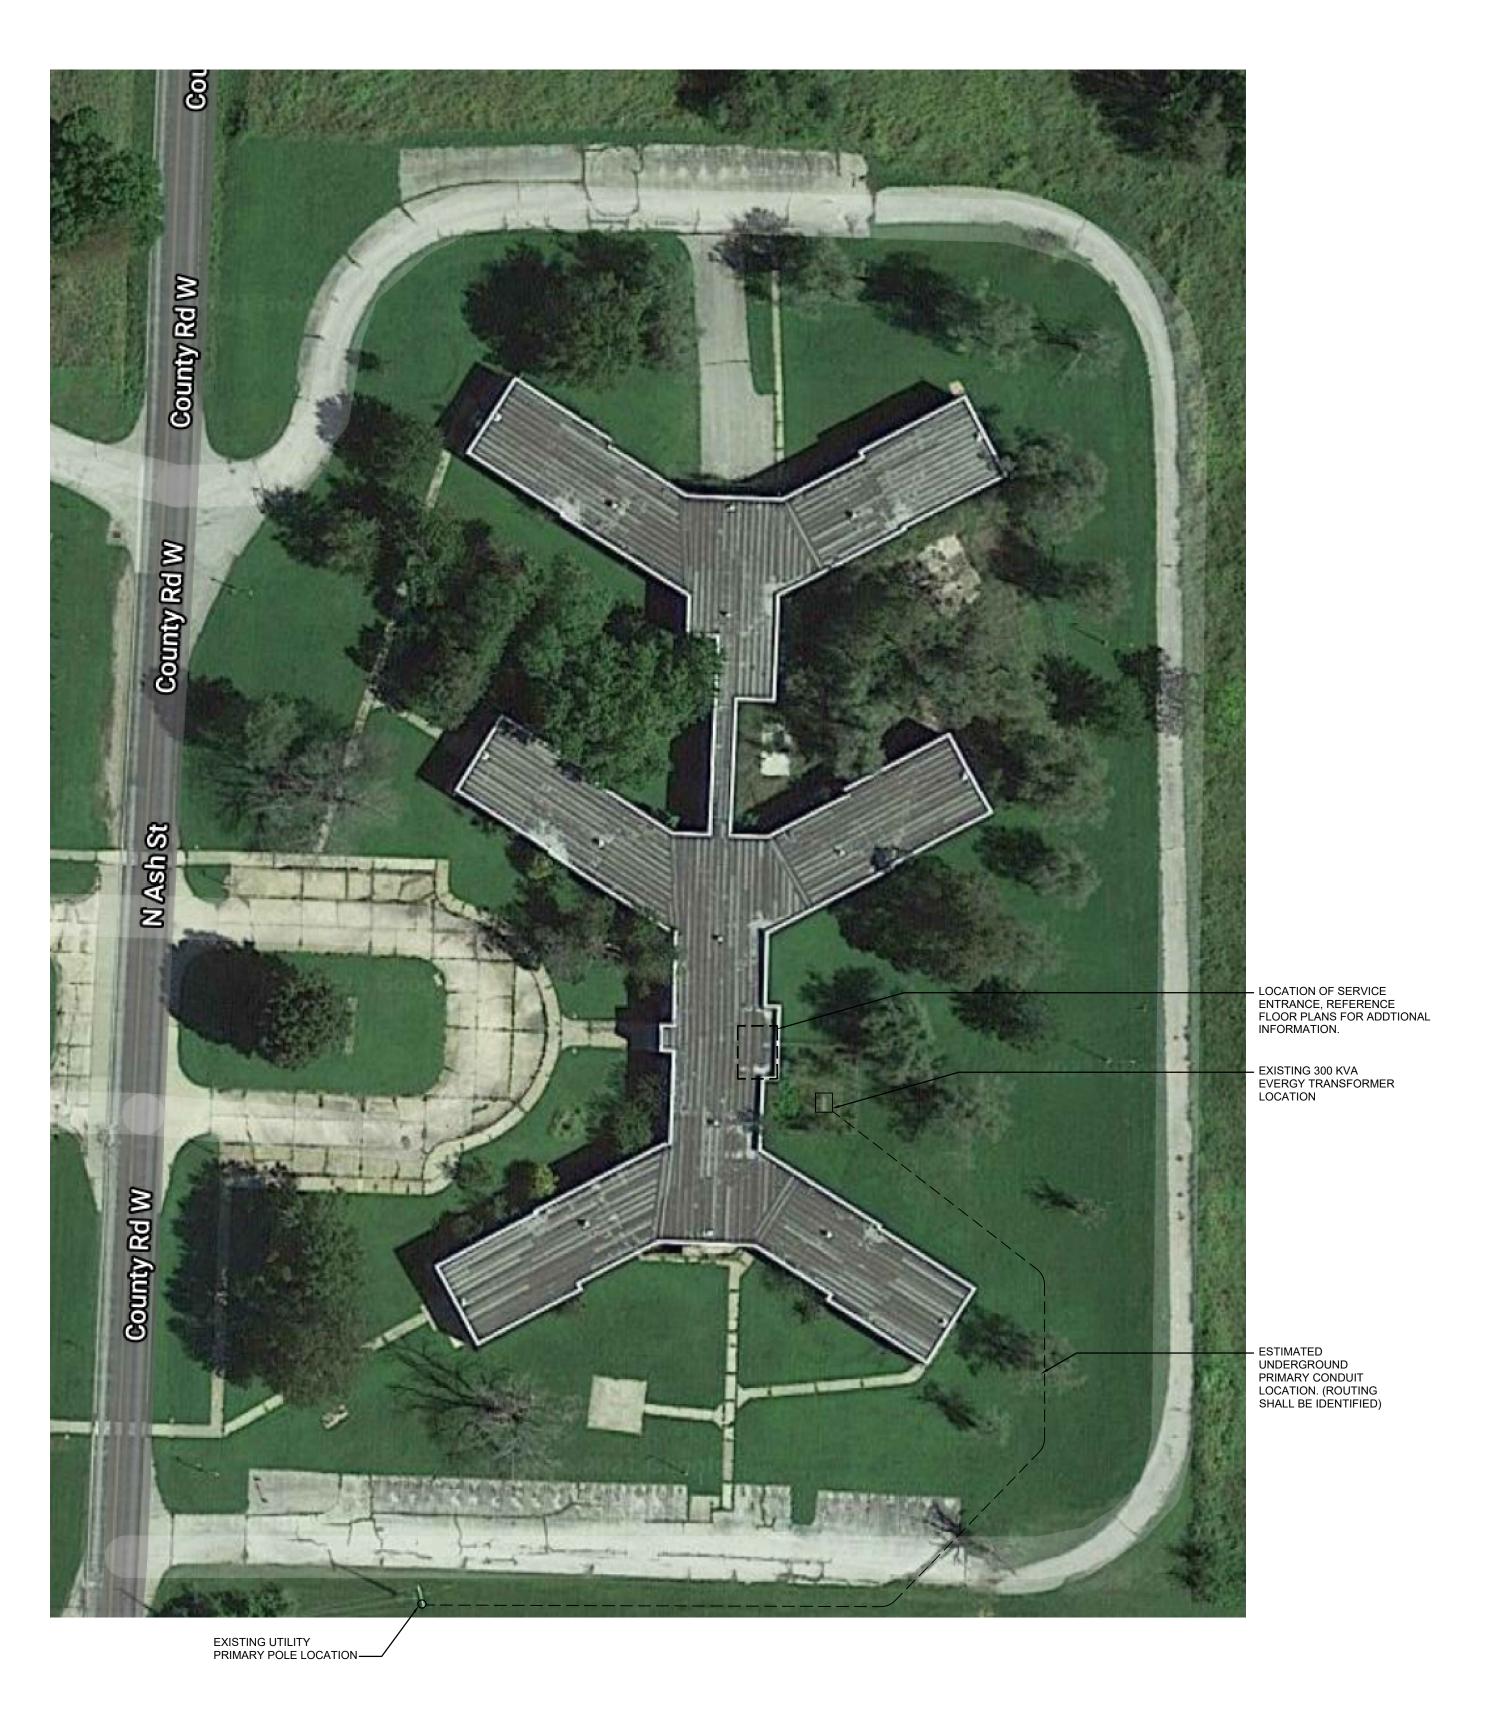



# **GENERAL NOTE**

A. NO WORK THIS SHEET, SHOWN FOR INFORMATION PURPOSES ONLY.

# **ELECTRICAL SYMBOLS**

CONDUIT CONCEALED IN CEILING OR WALL WITH THREE CONDUCTORS:

— — — — — CONDUIT RUN UNDERGROUND OR CONCEALED IN FLOOR SLAB.

**O** 

BRANCH CIRCUIT CONCEALED IN CEILING OR WALL. ARROWS INDICATE HOMERUNS TO PANEL. ALL CONDUCTORS ARE MINIMUM NO.12 UNLESS NOTED OTHERWISE. — PHASE CONDUCTORS — NEUTRAL CONDUCTOR SWITCH-LEG AND OR TRAVELER

— GROUND CONDUCTOR

WALL MOUNTED EMERGENCY LIGHTING UNIT WITH INTEGRAL BATTERY AND UNIT MOUNTED HEADS. 2x4 LIGHT FIXTURE

LED STRIP FIXTURE LIGHT FIXTURE

208Y/120V PANELBOARD (SURFACE) TOP MOUNTED 6'-0" AFF

208Y/120V PANELBOARD (FLUSH) TOP MOUNTED 6'-0" AFF 480/277V PANELBOARD (SURFACE) TOP MOUNTED 6'-0" AFF

DISTRIBUTION PANEL (SURFACE OR FLOOR MOUNTED). SURFACE MOUNTED EQUIPMENT, TYPE AS INDICATED ON DRAWINGS

FLUSH MOUNTED EQUIPMENT, TYPE AS INDICATED ON DRAWINGS

POWER CONNECTION POINT

DISCONNECT SWITCH, SIZE AND TYPE AS NOTED TOP MOUNTED 5'-0" AFF SINGLE POLE SWITCH. TOP OF DEVICE BOX AT +4'-0" AFF

THREE-WAY SWITCH. TOP OF DEVICE BOX AT +4'-0" AFF

DUPLEX RECEPTACLE W/GROUND FAULT PROTECTION. +1'-6" AFF OR AS NOTED

DUPLEX RECEPTACLE. +1'-6" AFF OR AS NOTED

WALL MOUNTED OR CEILING MOUNTED JUNCTION BOX.

WALL MOUNTED JUNCTION BOX WITH BLANK COVERPLATE.

VOICE OUTLET


THERMOSTAT OUTLET BOX WITH 3/4"C, STUBBED UP OUT OF BOX TO ABOVE ACCESSIBLE CEILING. THERMOSTAT AND WIRING BY OTHERS. +4'-0" AFF OR AS NOTED.

CONDUIT UP

CONDUIT DOWN ABOVE FINISH FLOOR

EXISTING TO REMAIN

#### STATE OF MISSOURI MICHAEL L. PARSON, **GOVERNOR**

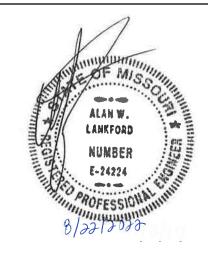



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ELECTRICAL SERVICE REPLACEMENT

BENTON HALL NEVADA HABILITATION CENTER

NEVADA, MO

PROJECT # M-2114-01 7351

FACILITY # 6517351009

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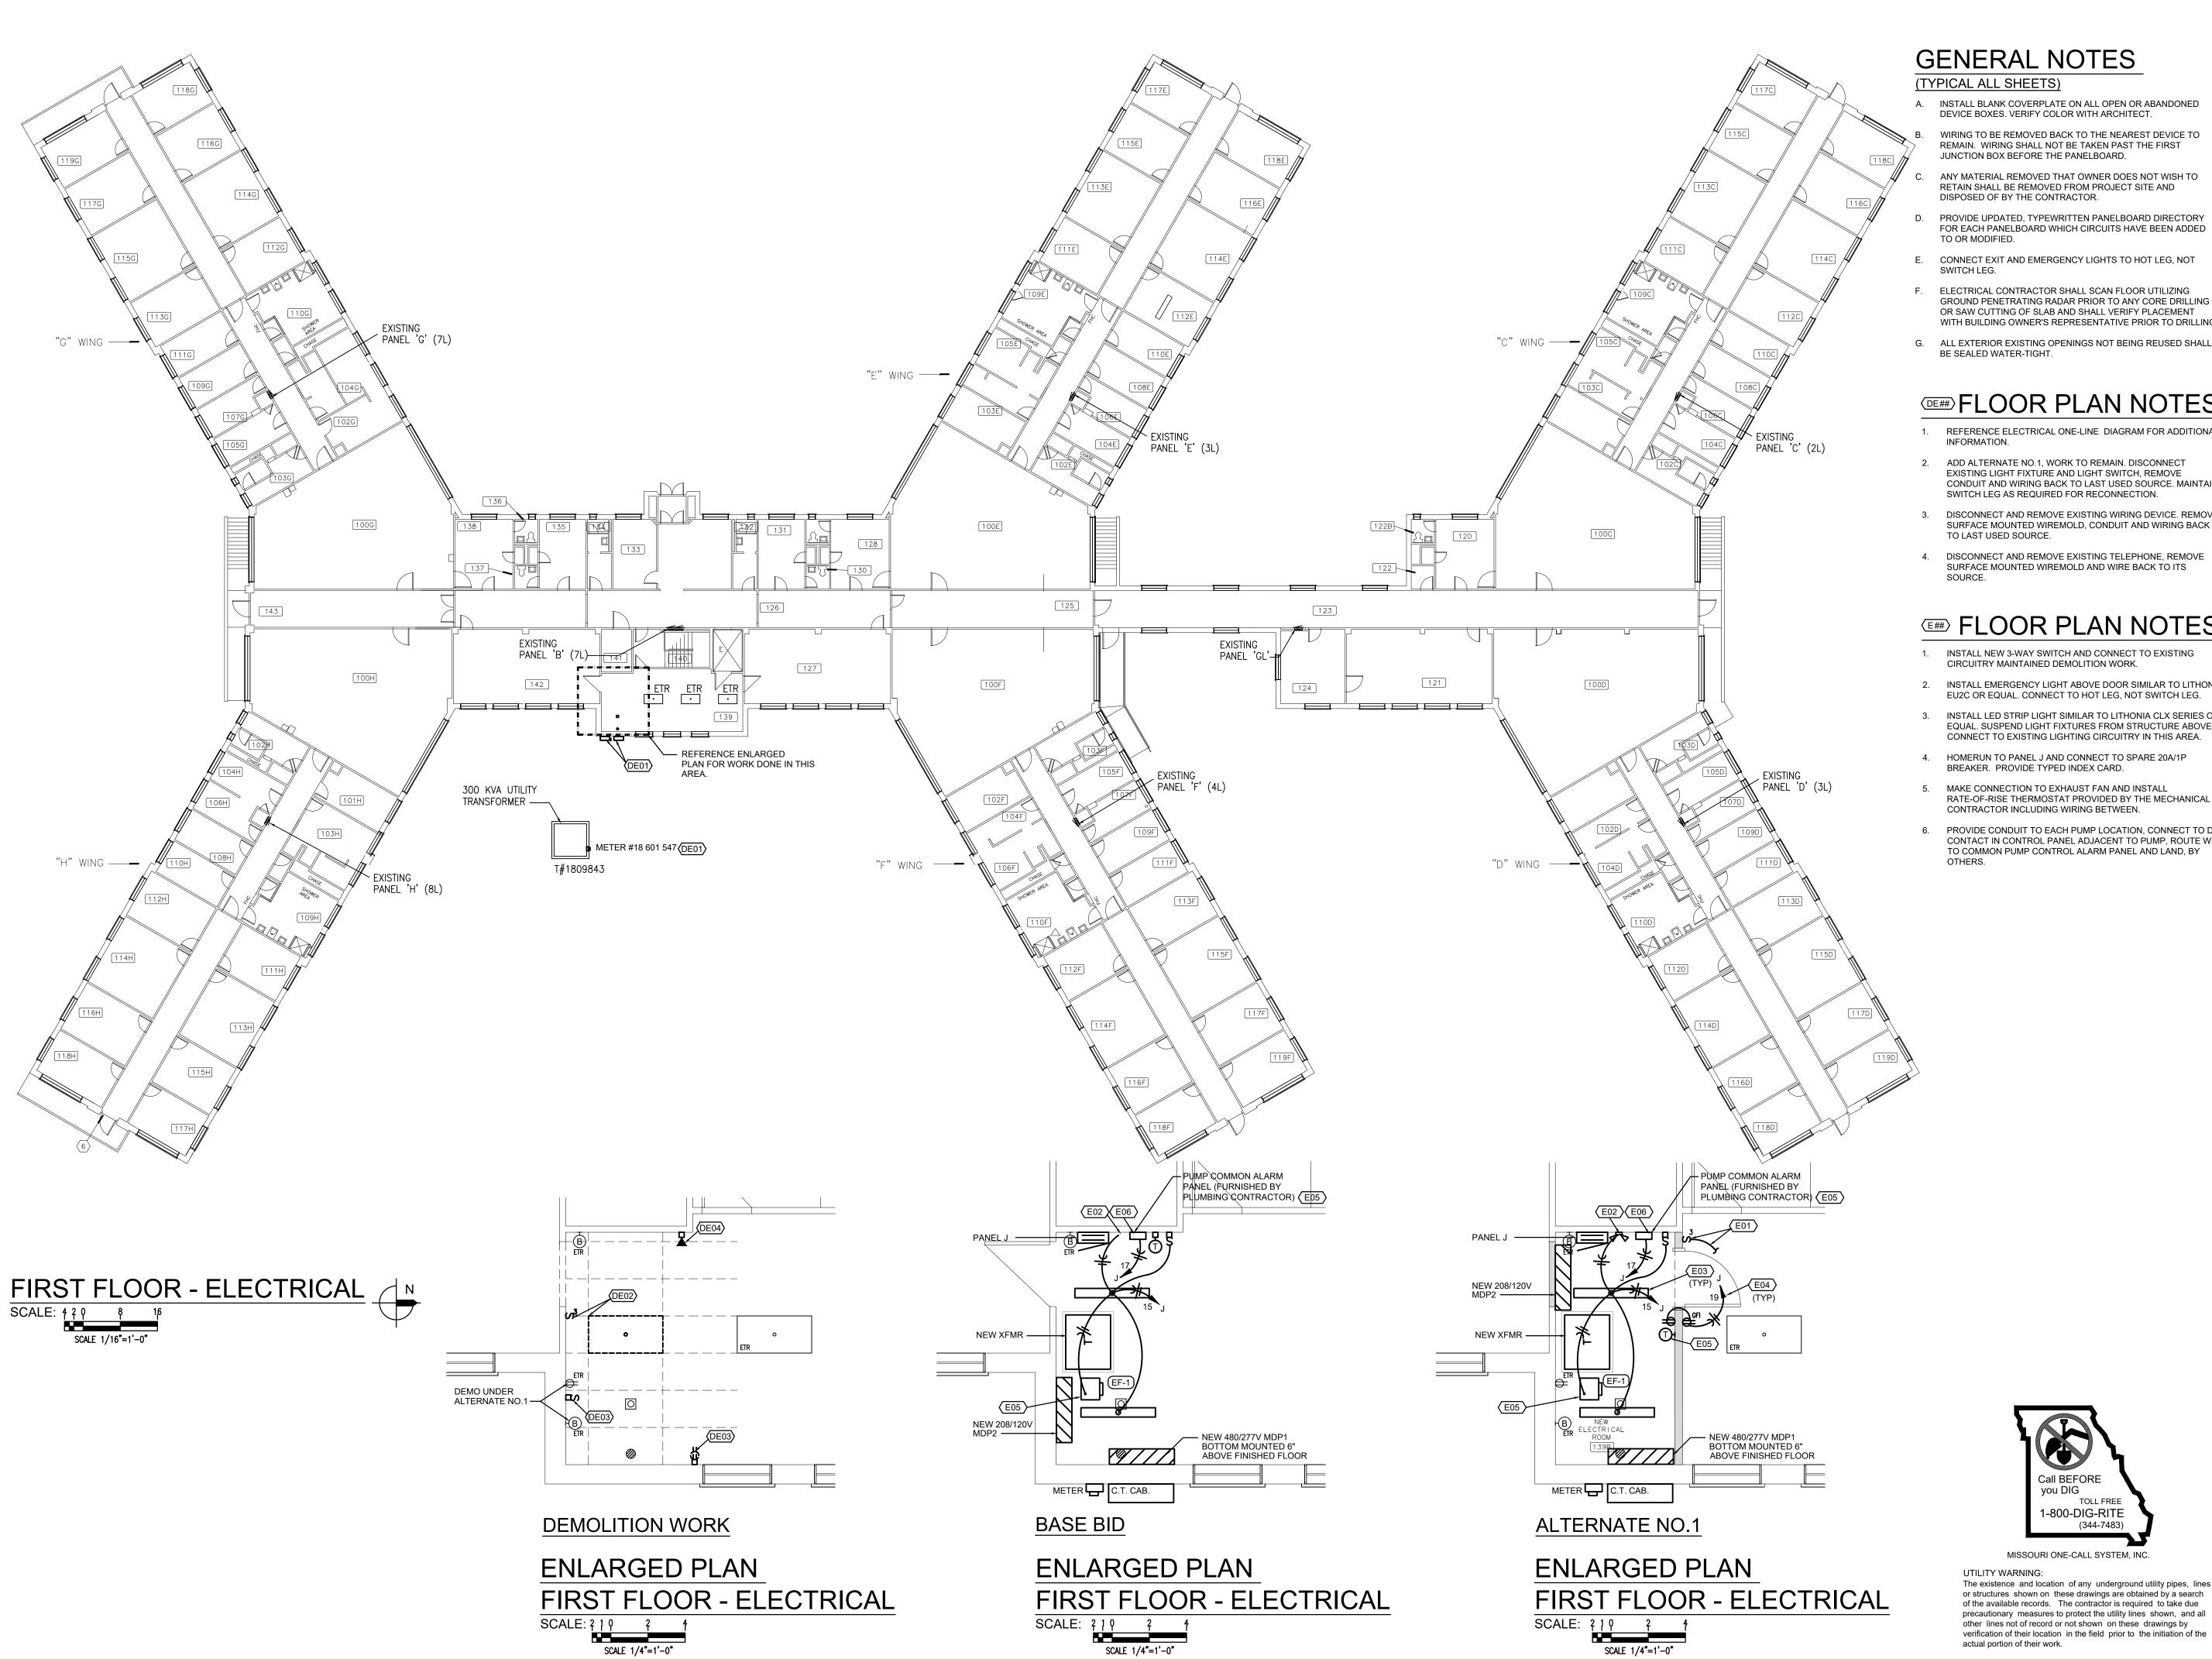
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CHECKED BY: AWL
DESIGNED BY: BCD

SHEET TITLE:

SITE PLAN ELECTRICAL

SHEET NUMBER:



# GENERAL NOTES

(TYPICAL ALL SHEETS)

- A. INSTALL BLANK COVERPLATE ON ALL OPEN OR ABANDONED DEVICE BOXES. VERIFY COLOR WITH ARCHITECT.
- WIRING TO BE REMOVED BACK TO THE NEAREST DEVICE TO REMAIN. WIRING SHALL NOT BE TAKEN PAST THE FIRST JUNCTION BOX BEFORE THE PANELBOARD.
- ANY MATERIAL REMOVED THAT OWNER DOES NOT WISH TO RETAIN SHALL BE REMOVED FROM PROJECT SITE AND DISPOSED OF BY THE CONTRACTOR.
- PROVIDE UPDATED, TYPEWRITTEN PANELBOARD DIRECTORY FOR EACH PANELBOARD WHICH CIRCUITS HAVE BEEN ADDED
- CONNECT EXIT AND EMERGENCY LIGHTS TO HOT LEG, NOT
- ELECTRICAL CONTRACTOR SHALL SCAN FLOOR UTILIZING GROUND PENETRATING RADAR PRIOR TO ANY CORE DRILLING OR SAW CUTTING OF SLAB AND SHALL VERIFY PLACEMENT WITH BUILDING OWNER'S REPRESENTATIVE PRIOR TO DRILLING.
- G. ALL EXTERIOR EXISTING OPENINGS NOT BEING REUSED SHALL BE SEALED WATER-TIGHT.

# FLOOR PLAN NOTES

REFERENCE ELECTRICAL ONE-LINE DIAGRAM FOR ADDITIONAL INFORMATION.

- 2. ADD ALTERNATE NO.1, WORK TO REMAIN. DISCONNECT EXISTING LIGHT FIXTURE AND LIGHT SWITCH, REMOVE CONDUIT AND WIRING BACK TO LAST USED SOURCE. MAINTAIN SWITCH LEG AS REQUIRED FOR RECONNECTION.
- DISCONNECT AND REMOVE EXISTING WIRING DEVICE. REMOVE SURFACE MOUNTED WIREMOLD, CONDUIT AND WIRING BACK TO LAST USED SOURCE.
- DISCONNECT AND REMOVE EXISTING TELEPHONE, REMOVE SURFACE MOUNTED WIREMOLD AND WIRE BACK TO ITS

# FLOOR PLAN NOTES

INSTALL NEW 3-WAY SWITCH AND CONNECT TO EXISTING CIRCUITRY MAINTAINED DEMOLITION WORK.

- INSTALL EMERGENCY LIGHT ABOVE DOOR SIMILAR TO LITHONIA EU2C OR EQUAL. CONNECT TO HOT LEG, NOT SWITCH LEG.
- 3. INSTALL LED STRIP LIGHT SIMILAR TO LITHONIA CLX SERIES OR EQUAL. SUSPEND LIGHT FIXTURES FROM STRUCTURE ABOVE. CONNECT TO EXISTING LIGHTING CIRCUITRY IN THIS AREA.
- HOMERUN TO PANEL J AND CONNECT TO SPARE 20A/1P BREAKER. PROVIDE TYPED INDEX CARD.
- MAKE CONNECTION TO EXHAUST FAN AND INSTALL RATE-OF-RISE THERMOSTAT PROVIDED BY THE MECHANICAL CONTRACTOR INCLUDING WIRING BETWEEN.
- PROVIDE CONDUIT TO EACH PUMP LOCATION, CONNECT TO DRY TO COMMON PUMP CONTROL ALARM PANEL AND LAND, BY

Call BEFORE


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STATE OF MISSOURI MICHAEL L. PARSON, **GOVERNOR** 





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NEVADA, MO

PROJECT # M-2114-01 7351 FACILITY # 6517351009

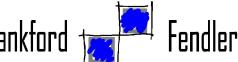**REVISION** DATE **REVISION** 


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FIRST FLOOR PLAN -ELECTRICAL

SHEET NUMBER:




ENLARGED LOWER LEVEL

MECHANICAL ROOM - DEMOLITION/NEW WORK

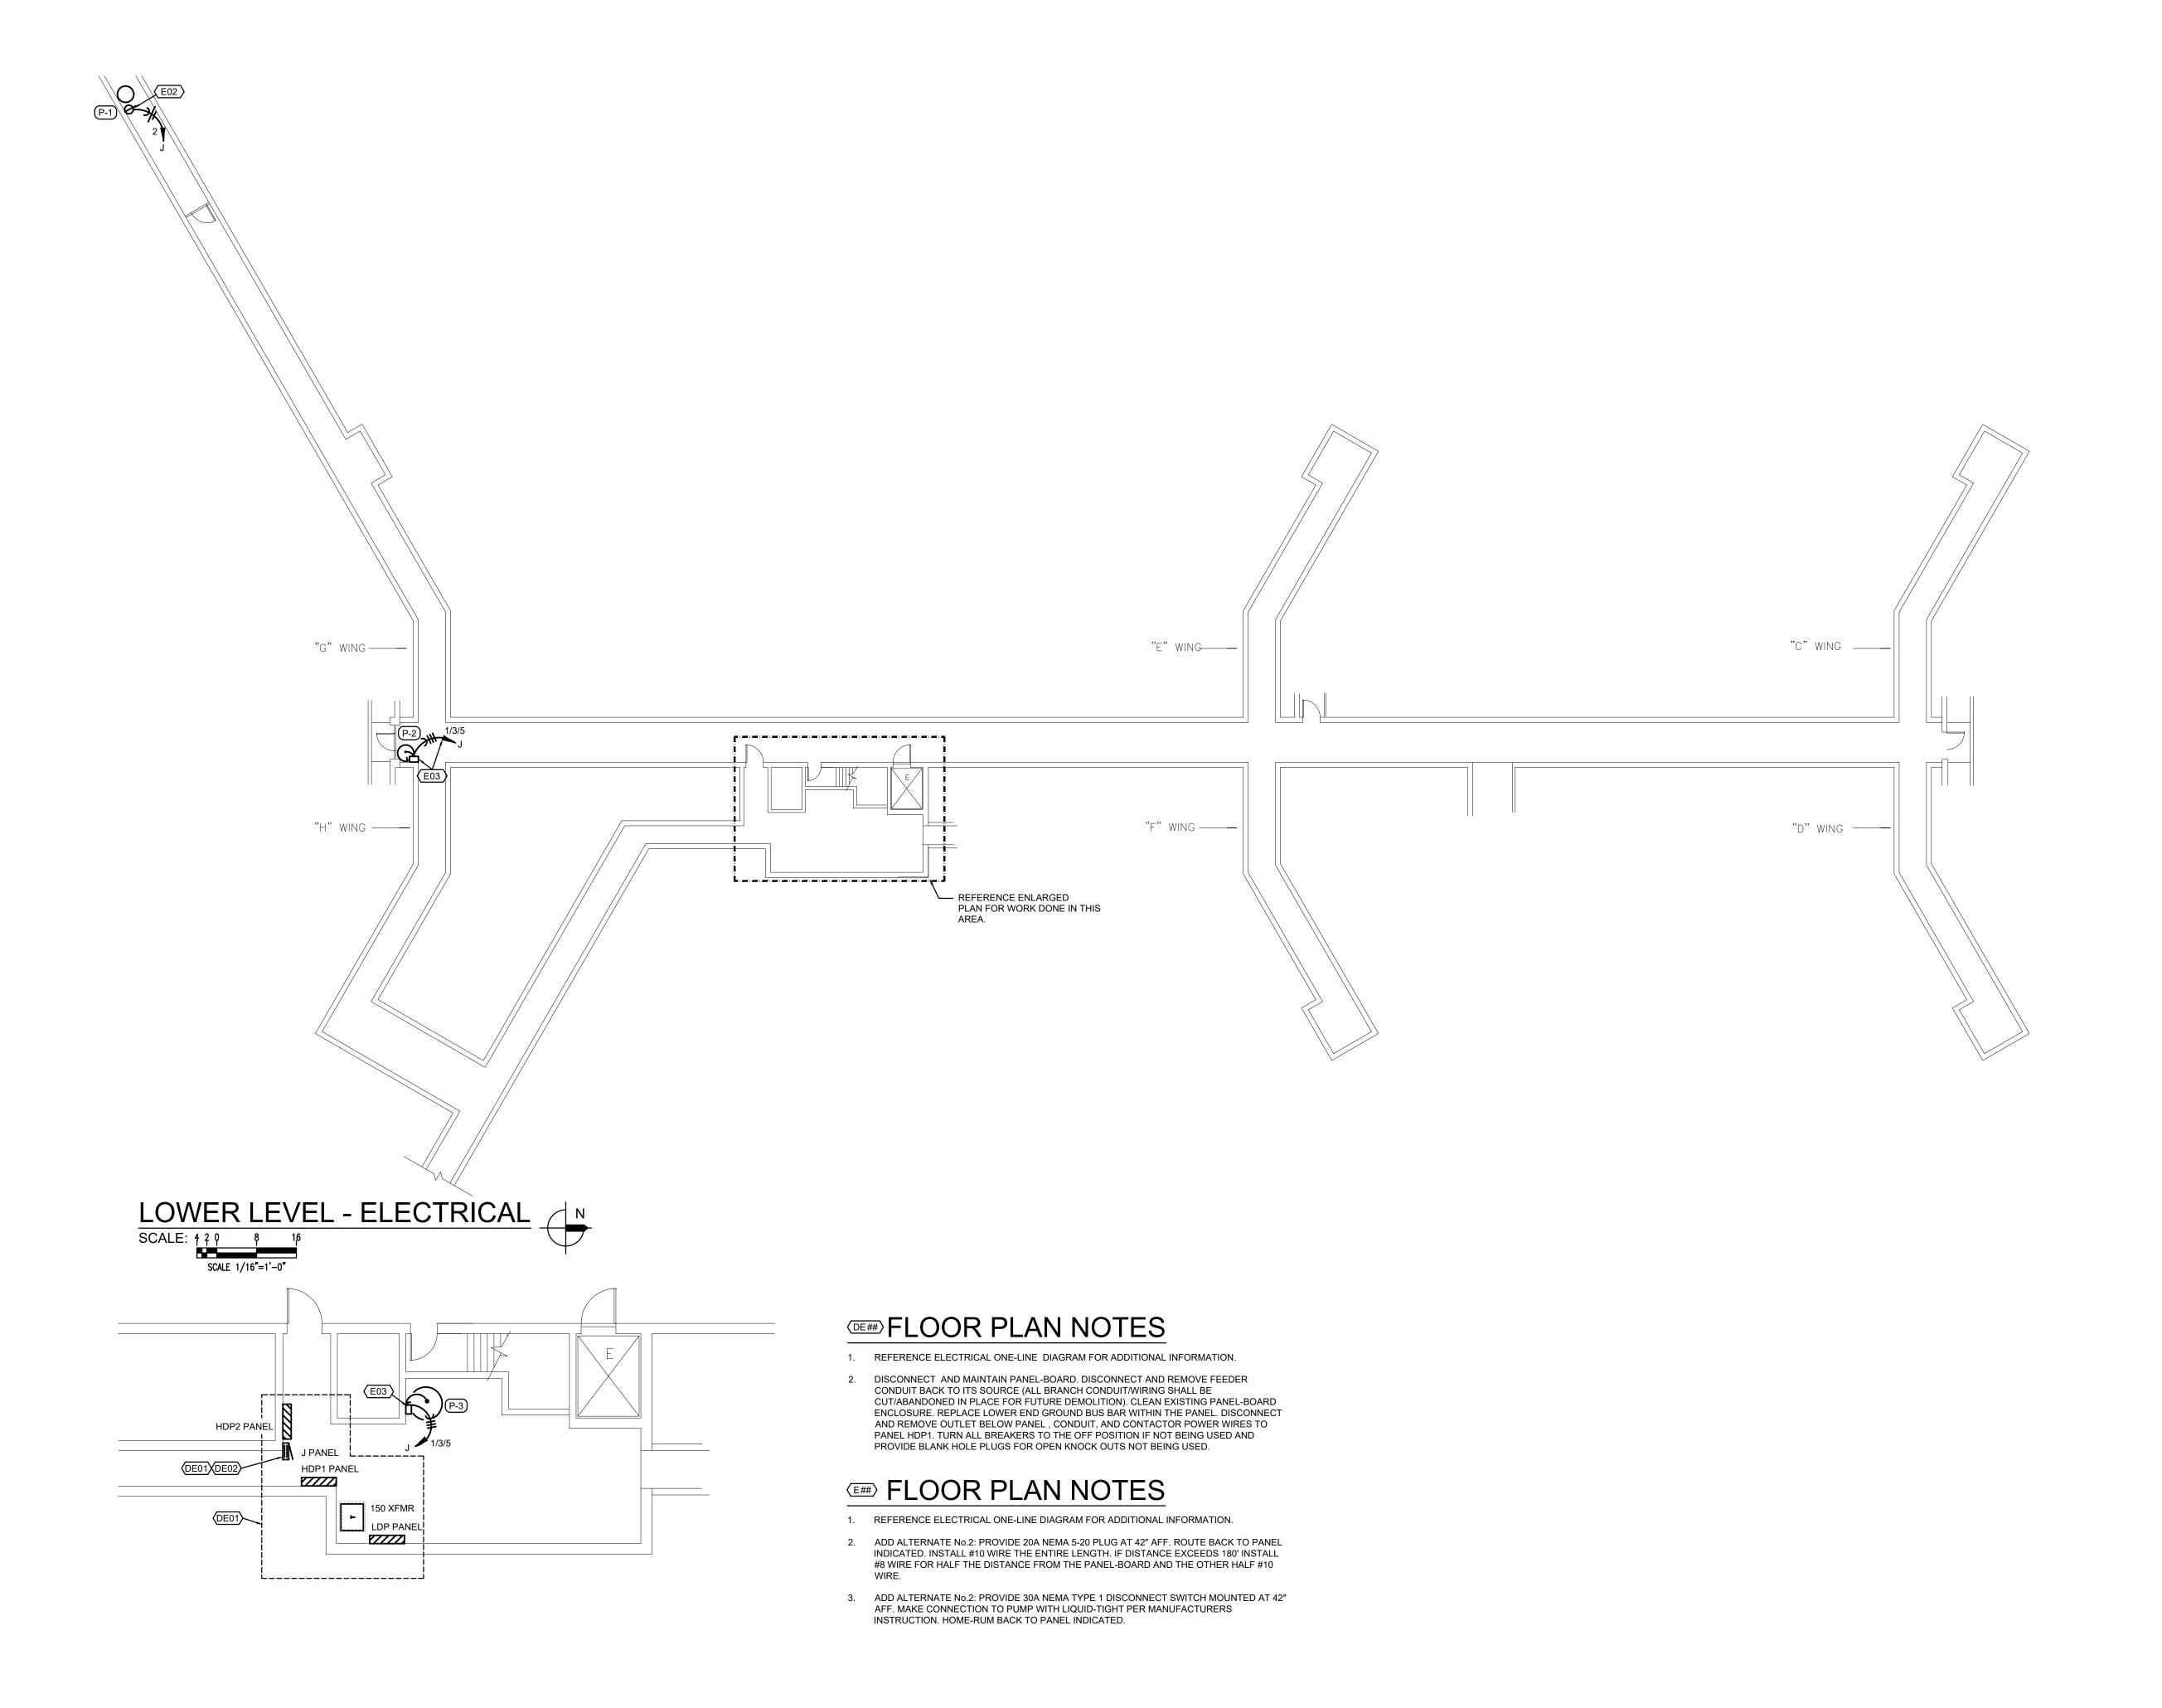SCALE: 210 4 8

STATE OF MISSOURI MICHAEL L. PARSON, GOVERNOR

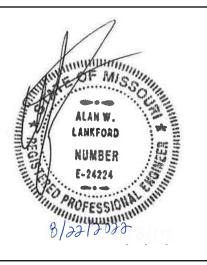





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CHECKED BY: AWL
DESIGNED BY: BCD

SHEET TITLE:

LOWER LEVEL -ELECTRICAL

SHEET NUMBER:

E-10

NOTE NO.		MCB / 1000 AMP MAIN BREAKER  LOAD  DESCRIPTION	BRKR					MOLL	NITINIO.	CLIDEACE				LOCA	ATION:	_	A.I.C.	
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OLINE		L. JCTOR & CONDUIT SIZING CHART FO	R SIZING OF	BRANC	СН						OWER FA				% PF			
		ITS AND OR FEEDERS AT OR BELOW								TOTAL DEMA				431.33				

,			- 208/120 VOLT , 3 - PHASE , 4 - WIRE 800 AMP			PAN	ELBC	DARD	MDF	7-2 S	SCHEDULE					ATING: ATION:		A.I.C.	
	M	AINS:	MCB / 700 AMP MAIN BREAKER						MOUI	NTING:	SURFACE								
EV N	OTE		LOAD	BRKF	2		LOAD	KVA			LOAD	BRKF	₹		LOAD K	.VA		NOTE	REV
O. N	o. 🔽	CRT#	DESCRIPTION	Р	AMP	Α	В	С	3PH	CRT#	DESCRIPTION	Р	AMP	Α	В	С	3PH	NO.	NO.
		1	EXISTING					•		2	EXISTING								
	1,2		PANEL C	3	80			1	12.6	4	PANEL D	3	70			Ī	12.6	1,2	
	ĺ	5								6	1				,			,	1
		7	EXISTING				1			8	EXISTING				1 '				1
	1,2		PANEL E	3	80			1	12.6	10	PANEL F	3	80			F	16.2	1,2	1
	-,_	11							12.0	12	1							,-	
			EXISTING				1			14	EXISTING				]				1
	1,2		PANEL G	3	80			1	22.5	16	PANEL H	3	90			-	16.2	1,2	<del>                                     </del>
	-,-	17								18	1							- , _	t
-			EXISTING	+	<del> </del>		1		<u> </u>	20	EXISTING				]				+
	1,2		PANEL B (MAIN SOUTH)	3	150			1	22.5	22	PANEL GL (MAIN NORTH)	3	90			-	16.2	1,2	+
-	1,2	23	TANLE B (MAIN COUTT)	1 "	130				22.0	24	TANLE OF (MAIN MORTH)	"	30		-		10.2	1,2	+
			EXISTING				1			26					1 1				<del>                                     </del>
	1,2	27	PANEL A	3	125			1	22.5	28	SPACE / PROVISION	3	100						
	1,2	29	PAINEL A	3	123				22.5	30	SPACE / PROVISION	3	100		<u> </u>	-			-
				-			1								, l				1
	4.0	31	DANIEL		405			7	0.00	32	ODA OF / DDOVIGION		400			-			<del> </del>
	1,3		PANEL J	3	125				2.82	34	SPACE / PROVISION	3	100		<u> </u>				+
		35	ODA OF / DDOV/JOION	+	1		1			36	ODA OF A DROVIGION				, l				-
			SPACE / PROVISION		ļ			7		38	SPACE / PROVISION				<u> </u>				-
			SPACE / PROVISION	-						40	SPACE / PROVISION								_
		41	SPACE / PROVISION							42	SPACE / PROVISION								
				т	OTAL:	0	0	0	95.5175			_	TOTAL:	0	0	0	61.2		
				'	OTAL.		1 0	0	95.5175	l			IOTAL.	0	0	0	95.5		
N	OTES:										KVA / PI	HASE T	τωται ·	0	0	0	156.7		
11		STIMA	ATING 50% LOAD								AMP / PI					435.0	130.7		
			CT AND VERIFY POWER AT BOTH ENDS, T	URN BI	REAKEI	R OFF					/ Will / 11	1 17 (OL	1017 (L.	100.0	100.0	100.0			
			CT AND VERIFY POWER AT BOTH ENDS, L								TOTAL CONNE	CTFD	I OAD:		156.72	ΚVΑ			
	0 0	0011111	OTTAINS VERMITT OWER THE BOTT ENDO, E		// <u> </u>	-11 011.					TOTAL CONNECTE				435.00				
											LIGHTS @		125%:			KVA			
											RECEPTACLES @		100%:			KVA			
											RECEPTACLES @		50%			KVA			
R	EV:										LARGEST MOTOR LOAD @		125%:			KVA			
											CONTINUOUS LOAD @		125%:			KVA			
											OTHER AND NON-CONTINUOUS LOADS @		100%:		156.72				
G	ENERA	I NOT	<b>E</b> ∙								TOTAL DE				156.72				
J			L. ICTOR & CONDUIT SIZING CHART FOR SIZ	NG OF	BRANC	ЭН							CTOR:			% PF			
			TS AND OR FEEDERS AT OR BELOW 100 A								TOTAL DEMAND				435.02				
	C		10 VIAD OIL I FEDEIVO MI OU DEFOM 100 W	IVII							IOIAL DEIVIAINE	- 001	LIVI.	l	+∪∪.∪∠	AIVII O			

<sup>★ 108</sup> kW OF THE AHU LOADS IS ANTICIPATED FUTURE HVAC LOAD PROVIDED BY THE OFFICE OF ADMINISTRATION DIVISION OF FACILITIES MANAGEMENT DESIGN AND CONSTRUCTION.


# BRANCH CIRCUIT COPPER CONDUCTOR AND CONDUIT SIZING CHART\*

OVERCURRENT PROTECTION DEVICE RATING (AMPS)	REQUIRED CONDUCTOR SIZE	EQUIPMENT GROUNDING CONDUCTOR SIZE	SINGLE PHASE 2 WIRE + GND. CONDUIT SIZE	SINGLE PHASE 3 WIRE + GND. CONDUIT SIZE	THREE PHASE 3 WIRE + GND. CONDUIT SIZE	THREE PHASE 4 WIRE + GND. CONDUIT SIZE
15	12 AWG	12 AWG	3/4"	3/4"	3/4"	3/4"
20	12 AWG	12 AWG	3/4"	3/4"	3/4"	3/4"
25	10 AWG	10 AWG	3/4"	3/4"	3/4"	3/4"
30	10 AWG	10 AWG	3/4"	3/4"	3/4"	3/4"
35	8 AWG	10 AWG	3/4"	3/4"	3/4"	3/4"
40	8 AWG	10 AWG	3/4"	3/4"	3/4"	3/4"
45	6 AWG	10 AWG	3/4"	3/4"	3/4"	1"
50	6 AWG	10 AWG	3/4"	3/4"	3/4"	1"
60	4 AWG	10 AWG	1"	1"	1"	1-1/4"
70	4 AWG	8 AWG	1"	1"	1"	1-1/4"
80	3 AWG	8 AWG	1"	1-1/4"	1-1/4"	1-1/4"
90	2 AWG	8 AWG	1"	1-1/4"	1-1/4"	1-1/4"
100	1 AWG	8 AWG	1-1/4"	1-1/2"	1-1/2"	1-1/2"

- \* = UNLESS OTHERWISE NOTED ON THE DRAWINGS.
- \* = UNLESS OTHERWISE NOTED ON THE DRAWINGS, ALL BRANCH CIRCUITS AND FEEDERS TO BE PROVIDED WITH A NEUTRAL WIRE.
- \* = ALL CONDUCTORS SIZED ON THE POWER RISER DIAGRAM OR IN BRANCH CIRCUIT CONDUCTOR TABLE ARE BASED ON 3 CURRENT CARRYING CONDUCTORS IN A RACEWAY OR CABLE. CONDUCTORS SHALL BE DERATED IN ACCORDANCE WITH THE NEC IF 4 OR MORE CONDUCTORS ARE PLACED IN A RACEWAY OR CABLE.

			EXISTING			PAN	ELBO	ARD	J S	CHE	DULE								
	SER	RVICE:	208/120 VOLT, 3-PHASE, 4- WIRE													ATING:		Y A.I.C.	
			225 AMP												LOC	ATION:			
	N	IAINS:	MLO						MOUI	NTING:	SURFACE						GE - A	SERIES	
EV N			LOAD	BRKR	1		LOAD I	(VA			LOAD	BRKF	?		LOAD I	(VA		NOTE	REV
O. N	10.	CRT#	DESCRIPTION	Р	AMP	Α	В	С	3PH	CRT#	DESCRIPTION	Р	AMP	Α	В	С	3PH	NO.	NO.
$\dashv$																			
_	0.0	1	DACEMENT CLIMB BLIMBO B O B O		4.5			ī			BASEMENT SUMP PUMP P-1	1	20	0.87		1		2,3	
	2,3	3 5	BASEMENT SUMP PUMPS P-2, P-3	3	15					6	SPACE / PROVISION			_					
-+			SPACE / PROVISION				Ī				SPARE	3	20		1			E	
_	E	9	SPARE	2	60			Ī		10	OI AIL		20			1			
-		11	0.7.1.12	-							SPACE / PROVISION			_				1	
	1	13	SPACE / PROVISION								SPACE / PROVISION				1			1	
	E		LTS/EX. FAN ELEC. ROOM	1	20		1.02	Ī			SPARE	1	20			]		Е	
	Е		PUM P CONTROL PANEL	1	20	<u> </u>		0.25		18	SPARE	1	20					Е	
	Е	19	REC; ELEC. ROOM	1	20	0.36		_		20	SPARE	1	20					Е	
	Е		SPARE	1	20					22	SPARE	1	20					E	
	Е		SPARE	1	20		•			24	SPARE	1	20		-			E	
	E		SPARE	1	20			ī		26	SPARE	1	30			1		Е	
_	E		SPARE	1	20					28	SPARE	2	20					E	
	E		SPARE	1	30		Ī			30	00405				7			<u> </u>	
+	E		SPARE	2	20			1		32 34	SPARE	2	20			1		E	
+	E	33 35	SPARE	2	20	1				36	SPARE	2	20	_				E	
_		37	SPANE		20		ſ			38	SPANE	-	20		1			-	
_	E		SPARE	1	30			Ī			SPARE	2	30			1		Е	
	E		SPARE	1	30	1	<u> </u>			42			**		ļ				
				•								· ·							
				Т	OTAL:	0.36	1.02	0.25	0			٦	TOTAL:		0	0	0.0	1	
	NOTES:										KVA / F		- ΤΑΙ ·	0.36 1.23	1.02	0.25 0.25	0.0		
ľ		PROVID	DE BLANK COVER PLATE								AMP / F				8.5	2.1	0.0	j	
			DE GFCI TYPE BREAKER								, <b></b> , ,		01712.	10.0	0.0		l		
	3 F	PROVID	DE BREAKER UNDER ADD ATLERNATE NO	).2, MAIN	ITAIN E	XISTING	BREAK	ER UND	DER BAS	E BID.	TOTAL CONN	ECTED	LOAD:		2.50	KVA			
											TOTAL CONNECTI					AMPS			
_											LIGHTS @		125%:			KVA			
E	= [	EXISTIN	NG								RECEPTACIES @		100%:			KVA			
	REV:										RECEPTACLES @ LARGEST MOTOR LOAD @	-	50% 125%:			KVA KVA			
r	<b>\</b>										CONTINUOUS LOAD @	-	125%:			KVA			
											OTHER AND NON-CONTINUOUS LOADS @	-	100%:			KVA			
C	SENERA	AL NOT	E:								TOTAL DI	-				KVA			
	(	CONDU	ICTOR & CONDUIT SIZING CHART FOR SIZ	ZING OF	BRANC	CH					POV	VER FA	CTOR:			% PF			
	(	CIRCUI	TS AND OR FEEDERS AT OR BELOW 100 /	AMPS							TOTAL DEMAN	D CUR	RENT:		7.82	AMPS			

#### STATE OF MISSOURI MICHAEL L. PARSON, GOVERNOR

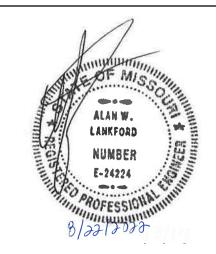



+ associates

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COA No. 2006001168

OFFICE OF ADMINISTRATION DIVISION OF FACILITIES MANAGEMENT, DESIGN AND CONSTRUCTION

ELECTRICAL SERVICE REPLACEMENT

BENTON HALL
NEVADA HABILITATION
CENTER
NEVADA, MO

PROJECT # M-2114-01 SITE # 7351

FACILITY # 6517351009

REVISION:
DATE:
REVISION:
DATE:
REVISION:

ISSUE DATE: 08/22/2022


CAD DWG FILE:AS NOTED
DRAWN BY: BCD
CHECKED BY: AWL
DESIGNED BY: BCD

SHEET TITLE:


ELECTRICAL SCHEDULES

SHEET NUMBER:


E-200

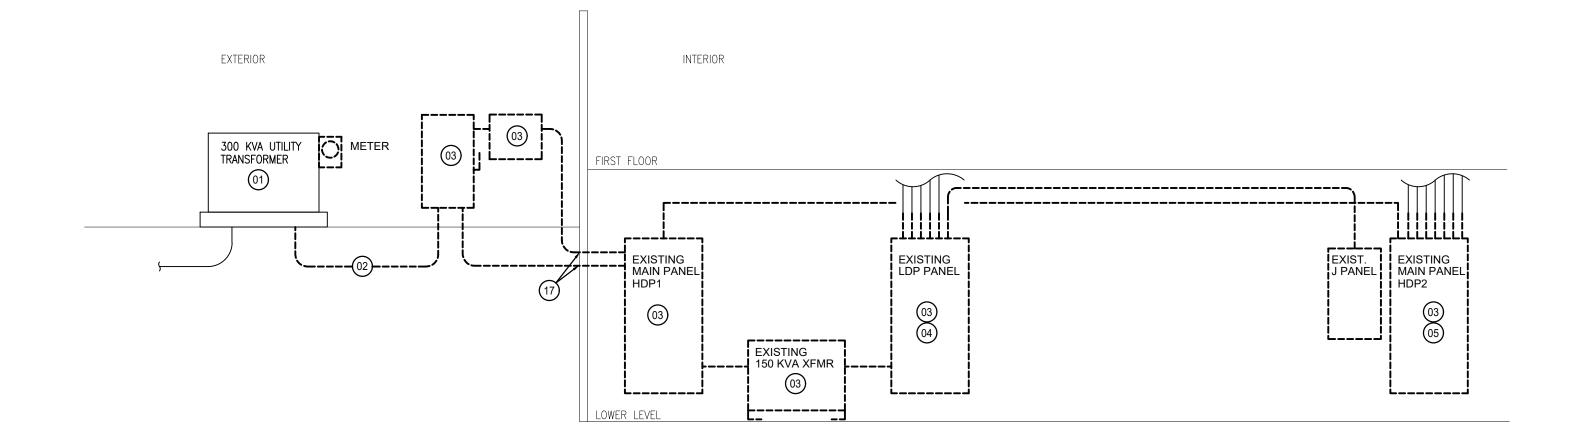

# **ELECTRICAL ONE-LINE DIAGRAM - DEMOLITION**

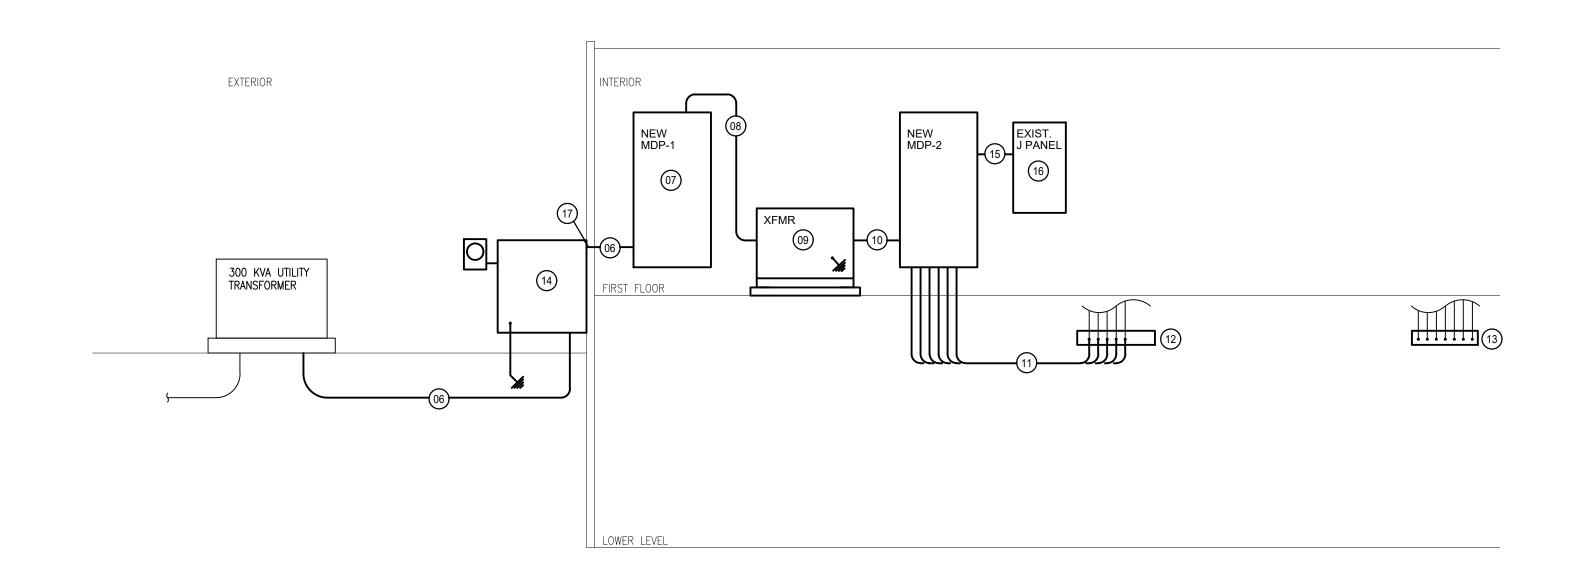

# ELECTRICAL ONE-LINE DIAGRAM - NEW WORK

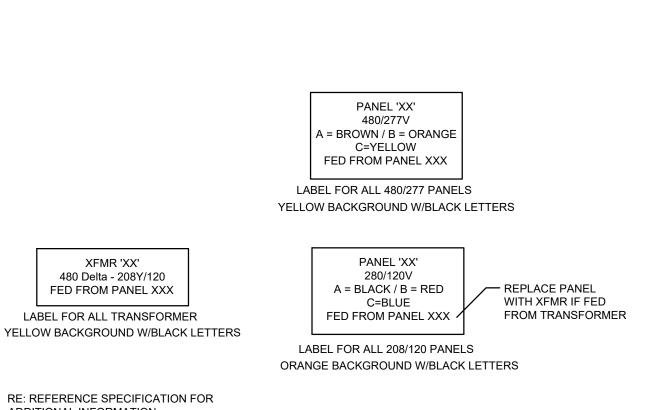

ADDITIONAL INFORMATION. TYPICAL EQUPMENT LABEL DETAILS

NO SCALE

# MAIN SERVICE ENTRANCE GROUNDING DETAIL NO SCALE

BE PROTECTED PER NEC 250.120(C)

## **© RISER PLAN NOTES**

- COORDINATE WITH EVERGY, TO DISCONNECT POWER AT TRANSFORMER AND AND
- 2. REMOVE EXISTING SECONDARY CONDUIT AND WIRING.
- 3. HEAVY DASHED LINES: DISCONNECT AND REMOVE EXISTING DISCONNECT SWITCH,
- 4. AT THIS PANEL, DISCONNECT AND REMOVE CONDUIT AND WIRING BACK AS NECESSARY FOR FUTURE SPLICING. RE: ELECTRICAL ONE-LIEN DIAGRAM - NEW WORK FOR ADDITIONAL INFORMATION.

BOXES, CONDUIT, WIRING, SUPPORT, TRANSFORMERS, ETC... AS INDICATED.

- 5. AT THIS PANEL, DISCONNECT AND REMOVE CONDUIT AND WIRING ABOVE PANEL. RE: ELECTRICAL ONE-LIEN DIAGRAM - NEW WORK FOR ADDITIONAL INFORMATION.
- 6. PROVIDE AND INSTALL (4) SETS OF 4-#250 (CU) IN 3" PVC. TRANSITION TO RGS FOR SWEEP FROM BELOW GRADE TO ABOVE GRADE AT C.T. CABINET.
- 7. SEE MAIN SERVICE ENTRANCE GROUNDING DETAIL.
- 8. PROVIDE (3) #350 (CU) & 1-#3 (CU) GROUND WIRE.
- 9. PROVIDE AND INSTALL 225 KVA 480-208/120V XFMR ON A 4" HIGH CONCRETE PAD. GROUND TRANSFORMER PER NEC. 250 WITH GREEN INSULATED #3 (CU) GROUND WIRE.
- 10. PROVIDE (2) SETS OF 4-#500 (CU) & 1-#3 (CU) GROUND WIRE IN 3-1/2"C.
- 11. PROVIDE PANEL FEEDER SIZE AS INDICATED: A. 70A - 80A: 1-1/4"C, 4-#4 (CU) & 1-#8 (CU) GROUND WIRE. 90A - 100A: 1-1/4"C, 4-#3 (CU) & 1-#8 (CU) GROUND WIRE. C. 125A: 1-1/2"C, 4-#1 (CU) & 1-#6 (CU) GROUND WIRE. A: 150A: 2"C, 4-#1/0 (CU) & 1-#6 (CU) GROUND WIRE.
- 12. PROVIDE AND INSTALL FROM STRUCTURE ABOVE OR AT STRUCTURE ABOVE, NEMA TYPE 1 ENCLOSURE. TERMINATE EXISTING CONDUITS AT ENCLOSURE, BOX USED FOR SPLICING EXISTING CONDUCTORS TO NEW CONDUCTORS USING INSULATED CABLE CONNECTOR (PROVIDE SIZE PER CABLE TYPE AND NUMBER OF CONDUCTORS). ALL CONDUCTORS SHALL BE LABELED ACCORDING TO ITS SERVICE.
- FUTURE SPLICING EXISTING CONDUCTORS. ALL CONDUCTORS SHALL BE LABELED ACCORDING TO ITS SERVICE.

14. PROVIDE AND INSTALL METER, C.T. CABINET AND GROUNDING PER EVERGY STANDARDS.

TYPE 1 ENCLOSURE. TERMINATE EXISTING CONDUITS AT ENCLOSURE, BOX USED FOR

13. PROVIDE AND INSTALL FROM STRUCTURE ABOVE OR AT STRUCTURE ABOVE, NEMA


- 15. 125A: 1-1/2"C, 4-#1 (CU) & 1-#6 (CU) GROUND WIRE.
- 16. EXISTING EXISTING PANEL J.
- 17. CONTRACTOR TO SEAL OPENINGS WATER-TIGHT.



4-WIRE PORT

NO SCALE

INSULATED MULTI-CABLE SPLICE CONNECTOR

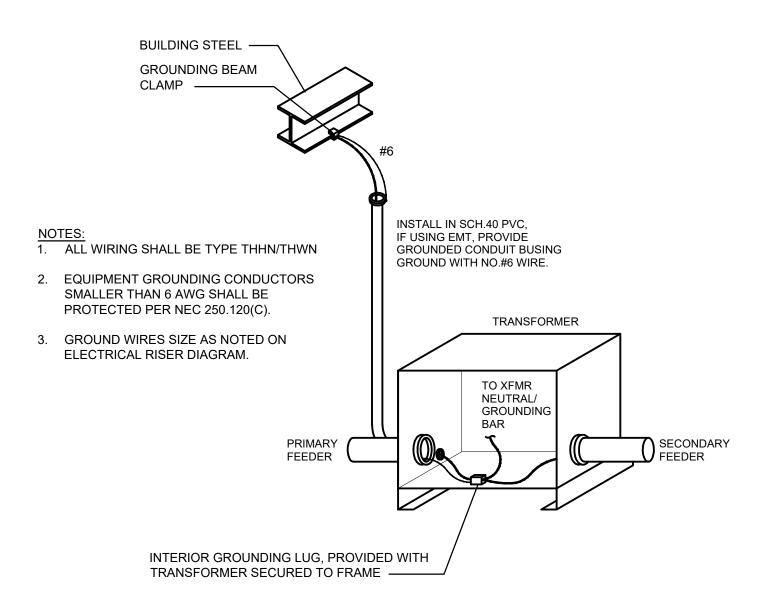

TRANSFORMER GROUNDING DETAIL NO SCALE

#### STATE OF MISSOURI MICHAEL L. PARSON, **GOVERNOR**





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OFFICE OF ADMINISTRATION DIVISION OF FACILITIES MANAGEMENT, DESIGN AND CONSTRUCTION

ELECTRICAL SERVICE REPLACEMENT

**BENTON HALL** NEVADA HABILITATION CENTER

NEVADA, MO

PROJECT # M-2114-01 7351 FACILITY # 6517351009

**REVISION:** DATE **REVISION**: DATE **REVISION** DATE: ISSUE DATE: 08/22/2022

CAD DWG FILE:AS NOTED DRAWN BY: BCD CHECKED BY: AWL DESIGNED BY: BCD

SHEET TITLE:

ELECTRICAL ONE-LINE

DIAGRAMS

SHEET NUMBER:

12 OF 12 SHEETS

