RENOVATE 4 CLIENT BATHROOMS, RAGLAN EDUCATION BUILDING HIGGINSVILLE HABILITATION CENTER HIGGINSVILLE, MISSOURI

SHEET LIST

COVER SHEET PARTITION. DOOR AND FINISH SCHEDULES REFLECTED CEILING PLAN ENLARGED PLANS AT RESTROOMS INTERIOR ELEVATIONS INTERIOR DETAILS **ENLARGED FINISH PLANS AT RESTROOMS** MECHANICAL GENERAL NOTES AND LEGEND HVAC LEVEL 1 PLAN - OVERALL HVAC LEVEL 1 PLAN - ENLARGED VIEWS MECHANICAL SCHEDULES AND DETAILS **ELECTRICAL LEGEND AND GENERAL NOTES** ELECTRICAL LEVEL 1 PLAN - OVERALL **ELECTRICAL LEVEL 1 PLAN - ENLARGED VIEWS** ELECTRICAL DETAILS AND SCHEDULES PLUMBING GENERAL NOTES AND LEGEND PLUMBING LEVEL 1 PLAN - OVERALL PLUMBING LEVEL 1 PLAN - ENLARGED VIEWS PLUMBING DETAILS AND SCHEDULES FIRE ALARM GENERAL NOTES AND LEGEND FIRE ALARM PLAN - OVERALL FIRE ALARM PLAN - ENLARGED VIEWS ASBESTOS ABATEMENT EDUCATION BUILDING FIRST FLOOR


OWNER:

STATE OF MISSOURI MIKE KEHOE, **GOVERNOR**

PROJECT

OFFICE OF ADMINISTRATION DIVISION OF FACILITIES MANAGEMENT, MANAGEMENT:

DESIGN AND CONSTRUCTION

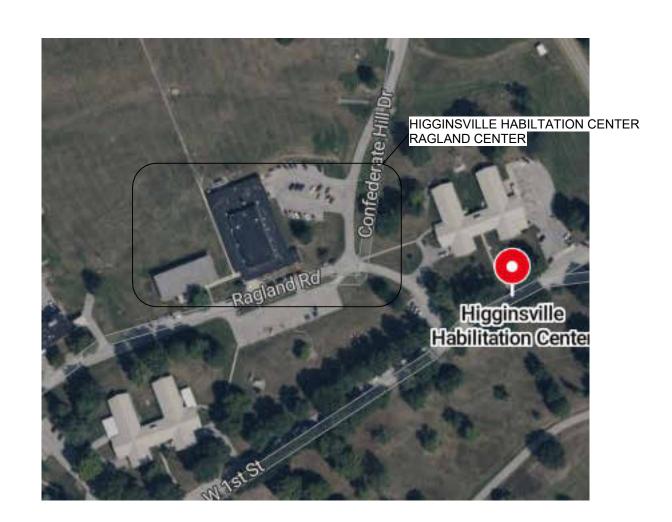

DESIGNER:

HENDERSON ENGINEERS

PROJECT NUMBER: M2406-01


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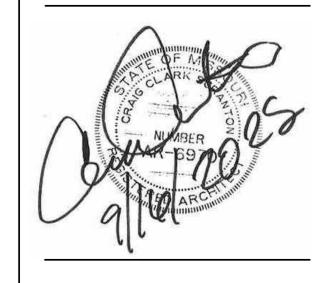
7357

FACILITY NUMBER: 6517357027

SHEET NUMBER





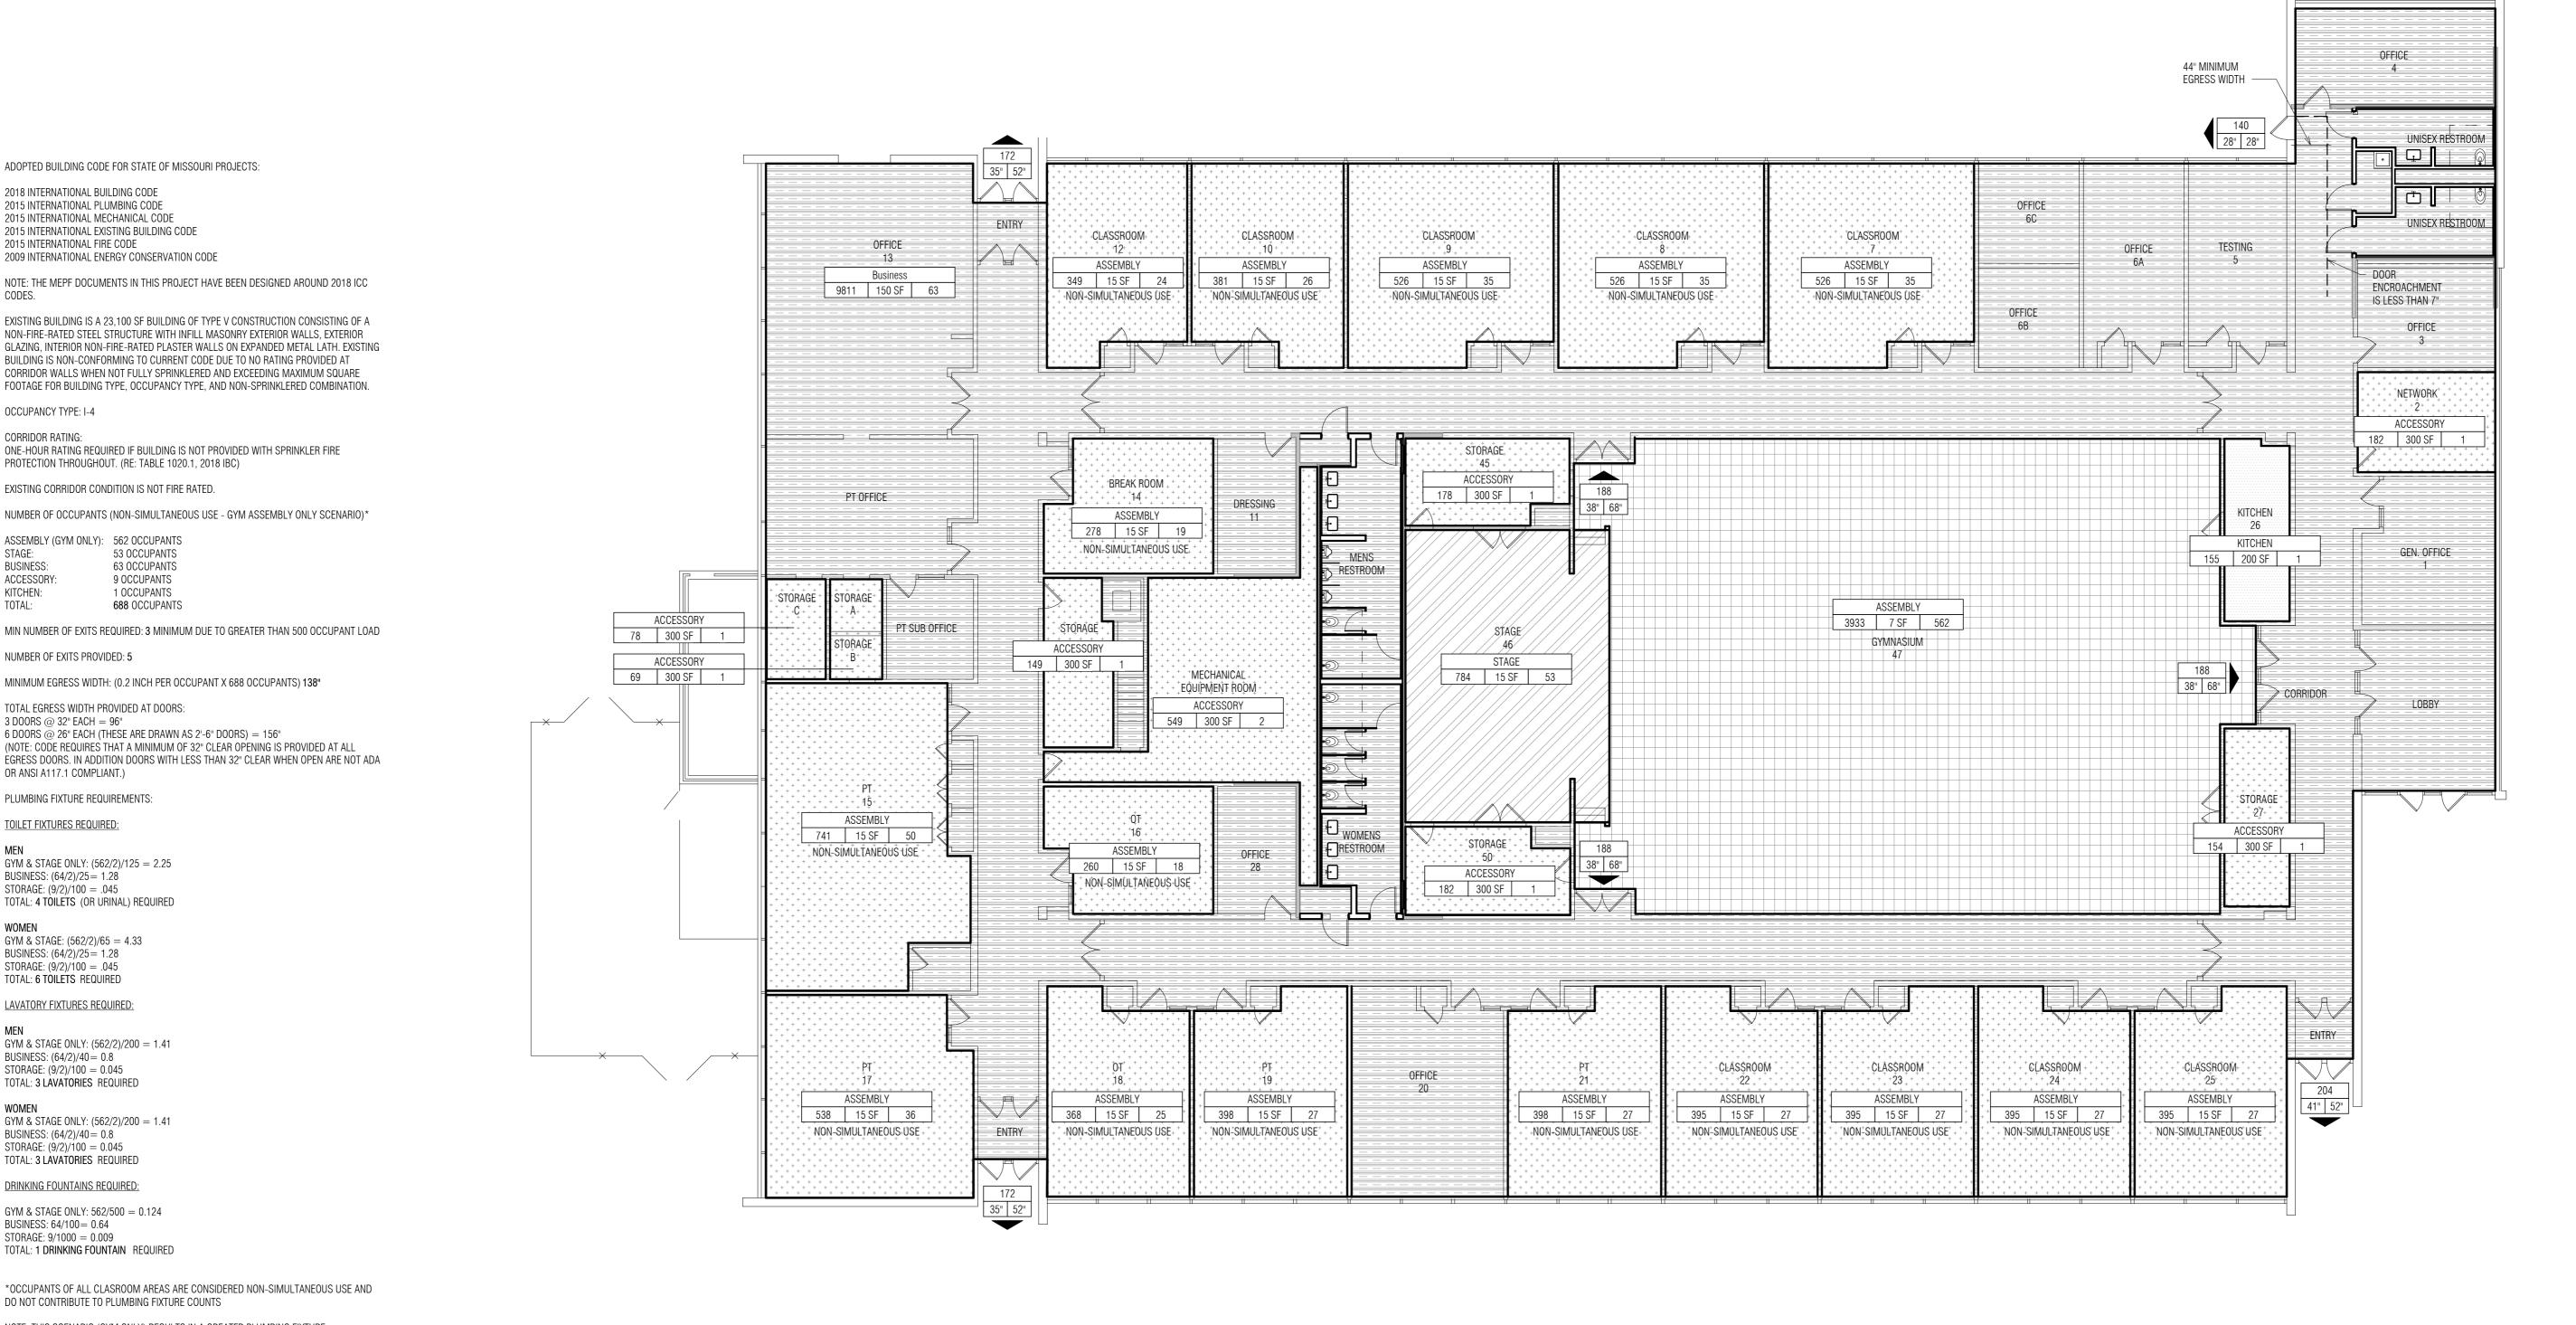

HENDERSON ENGINEERS

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2460 Pershing Road Suite 100, Kansas City MO 64108 p.816.783.1500 f.816.783.1501

OFFICE OF ADMINISTRATION **DIVISION OF FACILITIES** MANAGEMENT, DESIGN AND CONSTRUCTION

RENOVATE 4 CLIENT BATHROOMS - RAGLAND EDUCATION BUILDING, HIGGINSVILLE HABILITATION CENTER

100 W 1st Street Higginsville, Missouri 64037

PROJECT # M2406-01 SITE# 7357 FACILITY # 6517357027

REVISION: DATE: REVISION: DATE: **REVISION**: DATE: ISSUE DATE: 09/16/2025

CAD DWG FILE: DRAWN BY: JC CHECKED BY: JC DESIGNED BY: JC

SHEET TITLE:

OCCUPANT LOAD **REVIEW**

SHEET NUMBER:

2 OF 29 SHEETS

09/16/2025

1 OCCUPANT LOAD AND TOILET FIXTURE REQUIREMENTS 1" = 10'-0" RE:

ADOPTED BUILDING CODE FOR STATE OF MISSOURI PROJECTS:

NOTE: THE MEPF DOCUMENTS IN THIS PROJECT HAVE BEEN DESIGNED AROUND 2018 ICC

EXISTING BUILDING IS A 23,100 SF BUILDING OF TYPE V CONSTRUCTION CONSISTING OF A

GLAZING, INTERIOR NON-FIRE-RATED PLASTER WALLS ON EXPANDED METAL LATH. EXISTING BUILDING IS NON-CONFORMING TO CURRENT CODE DUE TO NO RATING PROVIDED AT CORRIDOR WALLS WHEN NOT FULLY SPRINKLERED AND EXCEEDING MAXIMUM SQUARE FOOTAGE FOR BUILDING TYPE, OCCUPANCY TYPE, AND NON-SPRINKLERED COMBINATION.

NON-FIRE-RATED STEEL STRUCTURE WITH INFILL MASONRY EXTERIOR WALLS, EXTERIOR

ONE-HOUR RATING REQUIRED IF BUILDING IS NOT PROVIDED WITH SPRINKLER FIRE

NUMBER OF OCCUPANTS (NON-SIMULTANEOUS USE - GYM ASSEMBLY ONLY SCENARIO)*

MIN NUMBER OF EXITS REQUIRED: 3 MINIMUM DUE TO GREATER THAN 500 OCCUPANT LOAD

2009 INTERNATIONAL ENERGY CONSERVATION CODE

PROTECTION THROUGHOUT. (RE: TABLE 1020.1, 2018 IBC)

53 OCCUPANTS

63 OCCUPANTS

9 OCCUPANTS

1 OCCUPANTS

688 OCCUPANTS

6 DOORS @ 26" EACH (THESE ARE DRAWN AS 2'-6" DOORS) = 156"

MINIMUM EGRESS WIDTH: (0.2 INCH PER OCCUPANT X 688 OCCUPANTS) 138"

(NOTE: CODE REQUIRES THAT A MINIMUM OF 32" CLEAR OPENING IS PROVIDED AT ALL

EXISTING CORRIDOR CONDITION IS NOT FIRE RATED.

ASSEMBLY (GYM ONLY): 562 OCCUPANTS

TOTAL EGRESS WIDTH PROVIDED AT DOORS:

NUMBER OF EXITS PROVIDED: 5

3 DOORS @ 32" EACH = 96"

OR ANSI A117.1 COMPLIANT.)

TOILET FIXTURES REQUIRED:

BUSINESS: (64/2)/25= 1.28

STORAGE: (9/2)/100 = .045

STORAGE: (9/2)/100 = .045

TOTAL: 6 TOILETS REQUIRED

BUSINESS: (64/2)/40 = 0.8

BUSINESS: (64/2)/40 = 0.8 STORAGE: (9/2)/100 = 0.045

BUSINESS: 64/100= 0.64 STORAGE: 9/1000 = 0.009

ASSEMBLY AREAS ONLY.

REQUIRED PLUMBING COUNT ONLY.

TOTAL: 3 LAVATORIES REQUIRED

DRINKING FOUNTAINS REQUIRED:

GYM & STAGE ONLY: 562/500 = 0.124

TOTAL: 1 DRINKING FOUNTAIN REQUIRED

DO NOT CONTRIBUTE TO PLUMBING FIXTURE COUNTS

*OCCUPANTS OF ALL CLASROOM AREAS ARE CONSIDERED NON-SIMULTANEOUS USE AND

REQUIREMENT THAN THE ALTERNATE NON-SIMULTANEOUS USE SCENARIO OF CLASSROOM

NOTE: THIS CODE ALNAYSIS WAS CONDUCTED FOR THE PURPOSES OF ESTABLISHING A CODE

NOTE: THIS SCENARIO (GYM ONLY) RESULTS IN A GREATER PLUMBING FIXTURE

STORAGE: (9/2)/100 = 0.045

TOTAL: 3 LAVATORIES REQUIRED

LAVATORY FIXTURES REQUIRED:

GYM & STAGE ONLY: (562/2)/200 = 1.41

GYM & STAGE ONLY: (562/2)/200 = 1.41

MEN

WOMEN

WOMEN

PLUMBING FIXTURE REQUIREMENTS:

GYM & STAGE ONLY: (562/2)/125 = 2.25

TOTAL: 4 TOILETS (OR URINAL) REQUIRED

GYM & STAGE: (562/2)/65 = 4.33BUSINESS: (64/2)/25 = 1.28

2018 INTERNATIONAL BUILDING CODE 2015 INTERNATIONAL PLUMBING CODE 2015 INTERNATIONAL MECHANICAL CODE 2015 INTERNATIONAL EXISTING BUILDING CODE

2015 INTERNATIONAL FIRE CODE

OCCUPANCY TYPE: I-4

STAGE:

BUSINESS:

KITCHEN:

TOTAL:

ACCESSORY:


GRAPHIC SCALE 0 3 5 10



General Notes - Demolition Plans 1. MAINTAIN LIFE SAFETY SYSTEMS AND EGRESS PATHWAYS AND EXITS. WHERE WORK OCCURS ADJACENT TO OCCUPIED SPACES/AREAS PROVIDE APPROPRIATE SAFETY MEASURES TO PROVIDE COMPLIANT EGRESS PATHS. BUILDING WILL BE OCCUPIED THROUGHOUT THE CONSTRUCTION SCHEDULE. CONTRACTOR SHALL COORDINATE ALL ACTIVITES WITH THE OWNERS REPRESENTATIVE TO ALLOW TEMPORARY RELOCATION OF OCCUPANTS. 2. CONTRACTOR SHALL VISIT THE SITE AND VERIFY EXISTING CONDITIONS PRIOR TO SUBMITTING FINAL BIDS OR COMMENCEMENT OF WORK. FAILURE TO OBSERVE EXISTING CONDITIONS SHALL NOT BE AN ACCEPTABLE REASON FOR 3. ARCHITECT SHALL BE NOTIFIED IMMEDIATELY OF ANY DISCREPANCIES DETRIMENTAL TO THE PROPER EXECUTION OF NEW CONSTRUCTION. NOTIFY ARCHITECT IMMEDIATELY OF DISCREPANCIES BETWEEN EXISTING CONDITIONS AND DRAWINGS BEFORE PROCEEDING WITH SELECTIVE DEMOLITION. 4. PATCH EXISTING CONSTRUCTION SCHEDULED TO BE EXPOSED TO VIEW AT AREAS OF DAMAGE FROM SELECTIVE DEMOLITION TO MATCH ADJACENT FINISH/APPEARANCE. THIS INCLUDES BUT IS NOT LIMITED TO REMOVAL OF ABUTTING CONSTRUCTION, ANCHORS, DEVICES, PIPING PENETRATIONS, DUCTWORK PENETRATIONS, AND SEALANTS. 5. REFINISH ENTIRE SURFACE OF EXISTING WALLS AND CEILINGS WITHIN PLANE OF SELECTIVE DEMOLITION AND PATCH WORK TO NEAREST INTERSECTION; MATCH EXISTING FINISHES OR AS INDICATED. 6. EXTENTS OF DEMOLITION SHOWN ARE APPROXIMATED TO ILLUSTRATE INTENT. ACTUAL EXTENTS OF DEMOLITION REQUIRED TO PROVIDE NEW WORK ARE TO BE DETERMINED BY THE CONTRACTOR. 7. DIMENSIONS SHOWN FOR CONSTRUCTION TO BE REMOVED ARE THE MINIMUM EXTENTS TO BE REMOVED, UNLESS OTHERWISE INDICATED. 8. COORDINATE WORK WITH ALL TRADES PRIOR TO INSTALLATION. 9. CONTRACTOR SHALL NOTIFY OWNER 2 WEEKS PRIOR TO ANY ACTIVITIES THAT WILL REQUIRE INTERRUPTION, OR SHUT-DOWN, OF ANY OCCUPIED SPACE, OR ANY UTILITY SERVING AN OCCUPIED SPACE. 10. REVIEW HAZARDOUS MATERIALS DRAWINGS PRIOR TO ANY DEMOLITION OR CONSTRUCTION ACTIVITIES AND SEQUENCE DEMOLITION ACTIVITIES ACCORDINGLY. CLASSROOM

TT

STATE OF MISSOURI MIKE KEHOE, **GOVERNOR**

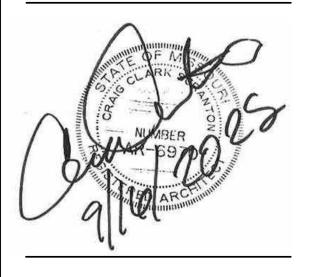



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OFFICE OF ADMINISTRATION **DIVISION OF FACILITIES** MANAGEMENT, **DESIGN AND CONSTRUCTION**

RENOVATE 4 CLIENT BATHROOMS - RAGLAND EDUCATION BUILDING, HIGGINSVILLE HABILITATION CENTER

Higginsville, Missouri 64037

PROJECT # M2406-01 SITE# 7357

REVISION: DATE: **REVISION**: DATE: **REVISION**: DATE: ISSUE DATE: 09/16/2025

CAD DWG FILE:
DRAWN BY: JC
CHECKED BY: JC
DESIGNED BY: JC

ARCHITECTURAL **DEMOLITION PLAN**

SHEET NUMBER:

3 OF 29 SHEETS

09/16/2025


1 First Floor Demolition Plan



100 W 1st Street

FACILITY # 6517357027

SHEET TITLE:

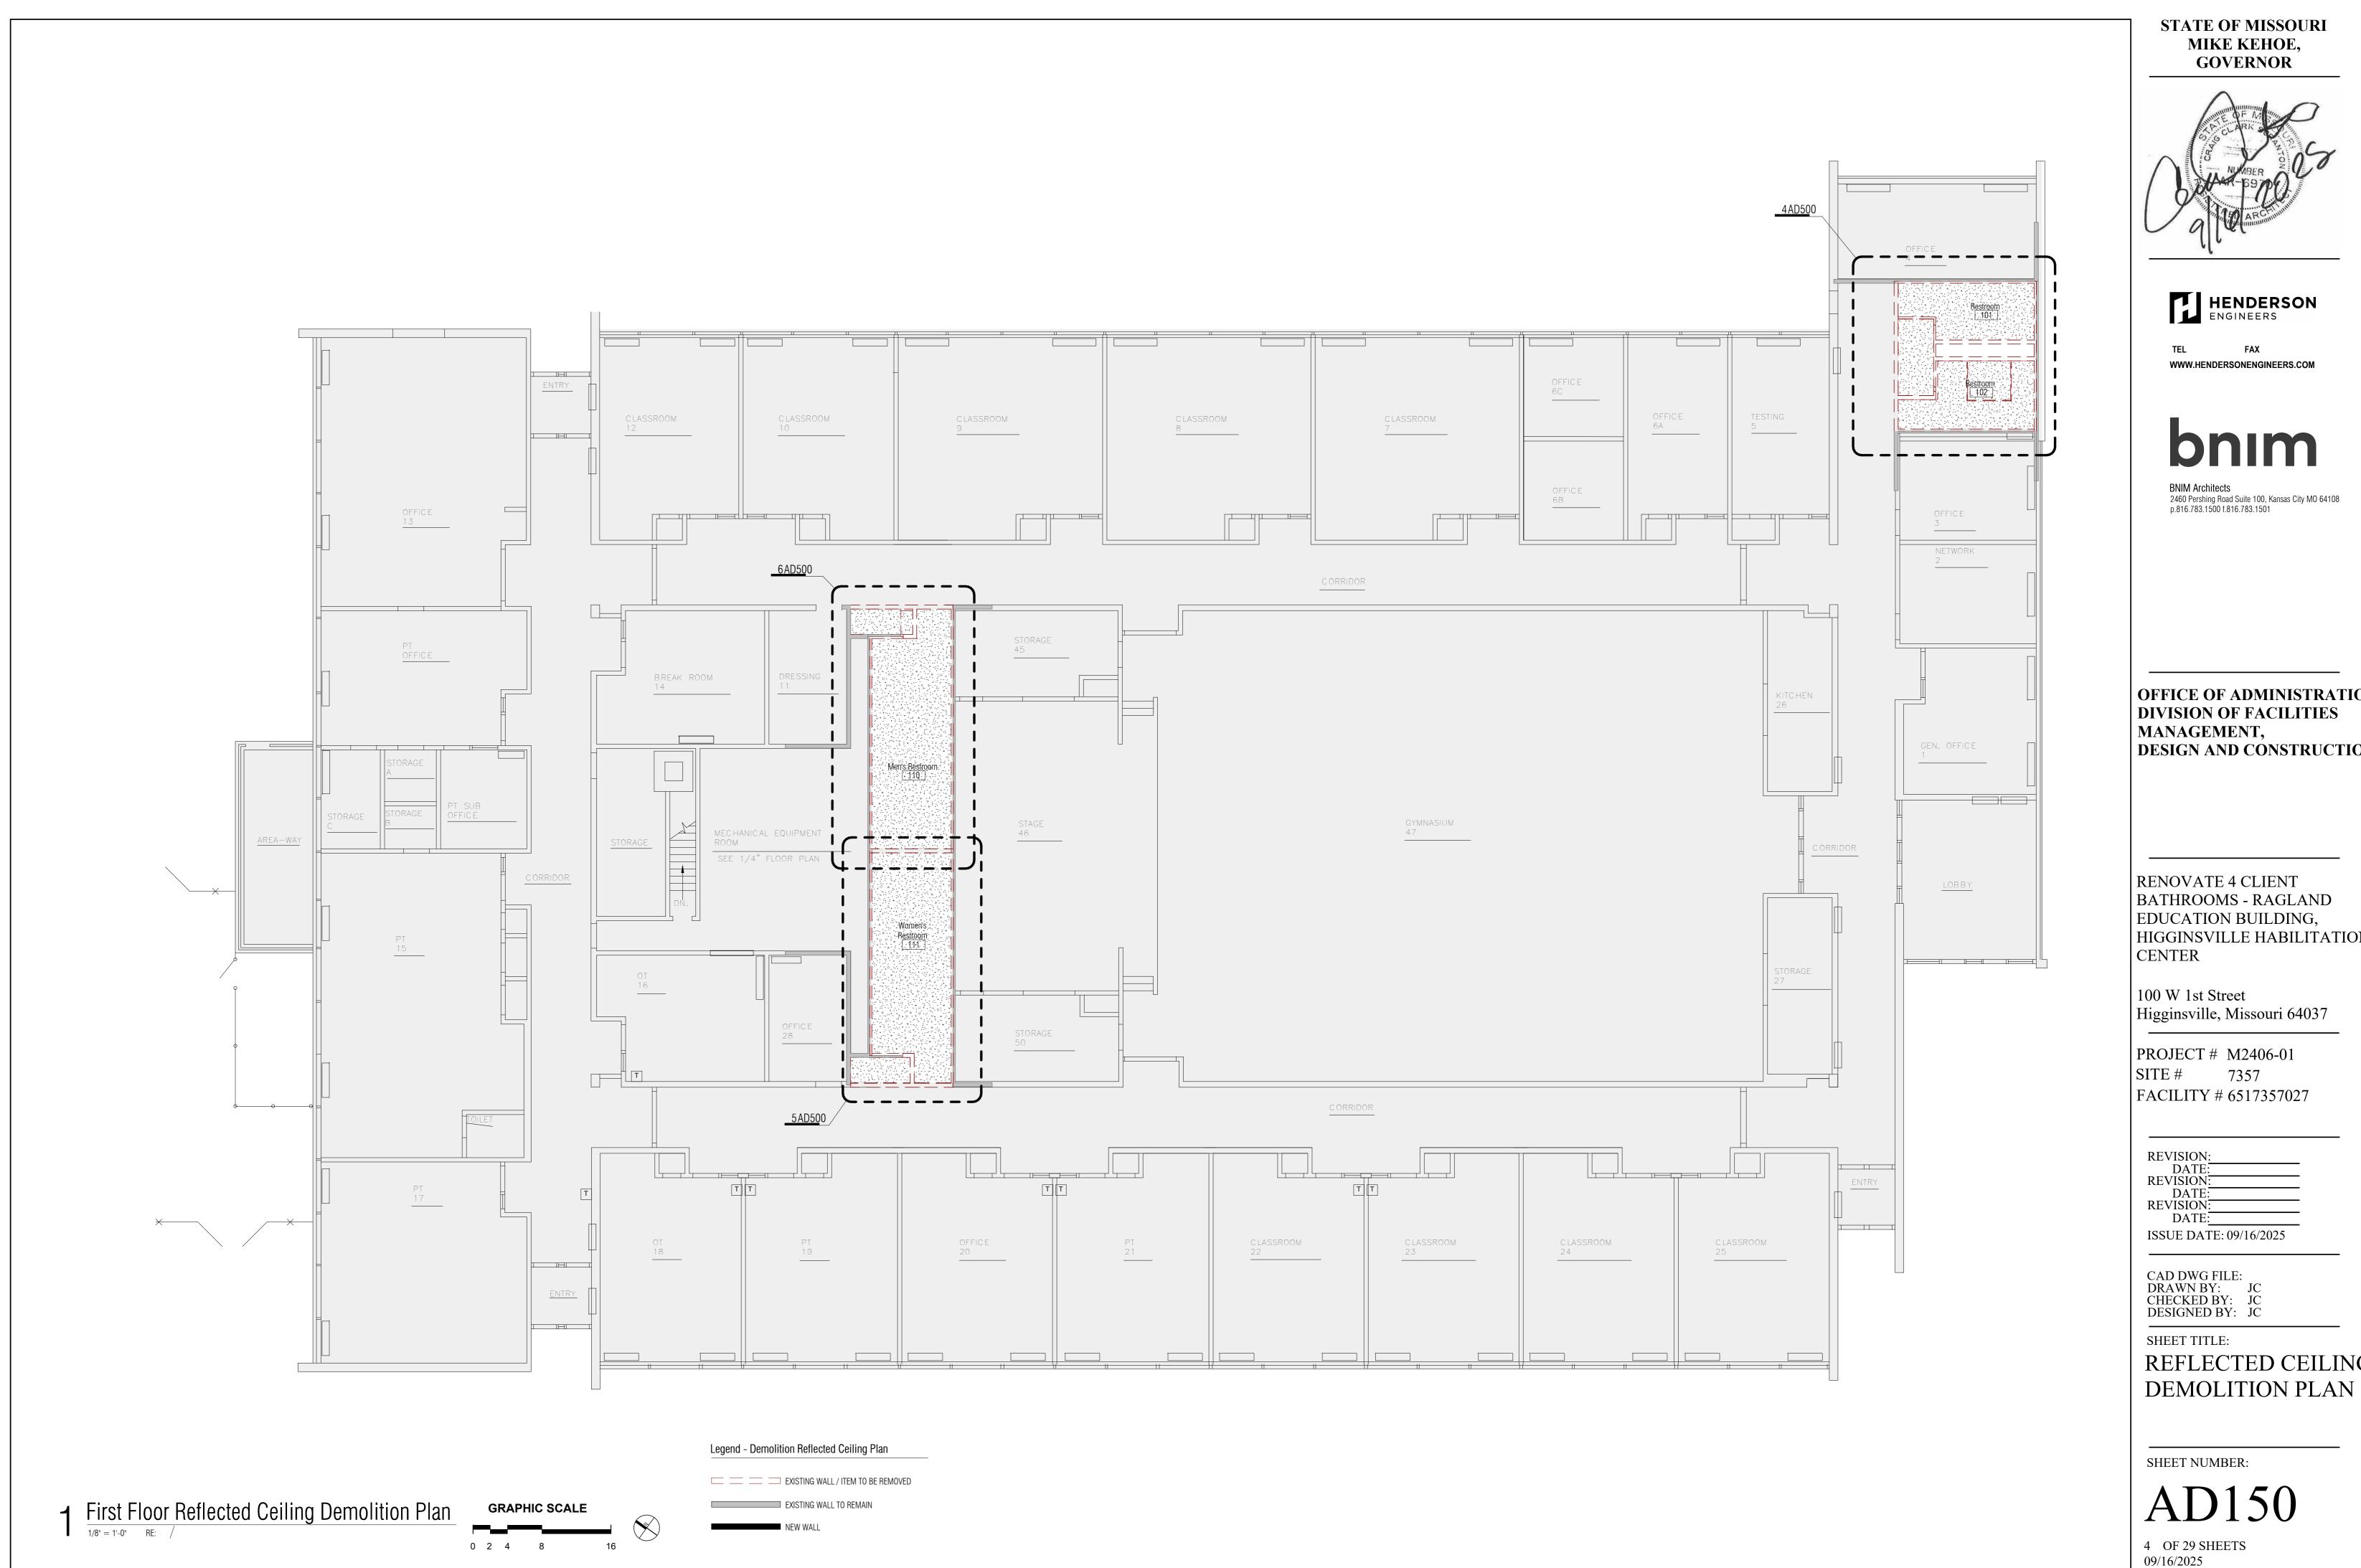



OFFICE OF ADMINISTRATION **DIVISION OF FACILITIES DESIGN AND CONSTRUCTION**

BATHROOMS - RAGLAND HIGGINSVILLE HABILITATION

Higginsville, Missouri 64037

REFLECTED CEILING

Plan Notes - Demolition Reflected Ceiling Plan (A) REMOVE WALL AS REQUIRED TO FACILITATE NEW CONSTRUCTION B REMOVE THICK-SET WALL TILE AND RESTROOM-FACING PLASTER AND LATH FROM EXISTING WALL ASSEMBLY REMOVE EXISTING PLASTER CEILING, LATH, SUPPORTS AND INSULATION (C) AS REQUIRED TO MAKE WAY FOR INSTALLATION OF NEW CEILING AND D EXISTING CEILING TO REMAIN E EXISTING PLASTER AND LATH ON STEEL CHANNEL STRUCTURE TO REMAIN Legend - Demolition Reflected Ceiling Plan EXISTING WALL / ITEM TO BE REMOVED EXISTING WALL TO REMAIN General Notes - Demolition Reflected Ceiling Plans 1. IN AREAS INDICATED FOR CEILING SYSTEM DEMOLITION, REMOVE ALL WIRE HANGERS, TIES, AND ANCHORS TO ADJACENT 2. IN AREAS INDICATED FOR CEILING SYSTEM DEMOLITION, REMOVE CONDUITS, WIRES AND ACCESSORIES ASSOCIATED WITH CEILING MOUNTED DEVICES AND EQUIPMENT IN THEIR ENTIRETY BACK TO WALLS, FLOORS, AND OVERHEAD DECKS TO REMAIN AT PERIMETER OF CEILING REMOVAL AREA. Plan Notes - Demolition Plan (A) REMOVE WALL AS REQUIRED TO FACILITATE NEW CONSTRUCTION. B REMOVE THICK-SET WALL TILE AND RESTROOM-FACING PLASTER AND LATH FROM EXISTING WALL ASSEMBLY. © REMOVE THICK-SET FLOOR TILE AND PREP FLOOR SUBSTRATE FOR NEW THIN-SET CERAMIC FLOOR TILE. REMOVE PLUMBING FIXTURE AND ACCOMPANYING FIXTURES, INCLUDING GRAB BARS, TOILET TISSUE DISPENSERS, SOAP DISPENSERS AND PAPER TOWEL DISPENSERS TOWEL DISPENCERS. (E) REMOVE DOOR AND FRAME. (F) REMOVE TOILET PARTITION AND ALL ASSOCIATED HARDWARE. (G) REMOVE DRAPERY, HANGING ROD AND HARDWARE. MOP SINK TO BE REMOVED. TRENCH EXISTING CONCRETE SLAB AS NEEDED TO ACCESS AND MAKE NEW CONNECTION TO EXISTING DRAIN. (J) EXISTING PLASTER AND LATH ON STEEL CHANNEL STRUCTURE TO REMAIN (K) REMOVE EXISTING MECHANICAL UNIT. RE: MECHANICAL REMOVE AREA OF VAT FLOOR TILE. REFER TO HAZARDOUS MATERIALS DRAWINGS PRIOR TO REMOVAL. $\begin{tabular}{ll} \hline \end{tabular} \begin{tabular}{ll} REMOVE EXISTING SHELVES, BRACKETS, AND MOUNTING COMPONENTS AND RETAIN FOR REUSE. \end{tabular}$ P REMOVE EXISTING PLASTER AND LATH FROM FLOOR TO 4' AFF IN THIS AREA AS REQUIRED TO ALLOW ACCESS TO PLUMBING CARRIERS. Legend - Demolition Plan EXISTING WALL / ITEM TO BE REMOVED EXISTING WALL TO REMAIN EXISTING DOOR TO BE REMOVED General Notes - Demolition Plans MAINTAIN LIFE SAFETY SYSTEMS AND EGRESS PATHWAYS AND EXITS. WHERE WORK OCCURS ADJACENT TO OCCUPIED SPACES/AREAS PROVIDE APPROPRIATE SAFETY MEASURES TO PROVIDE COMPLIANT EGRESS PATHS. BUILDING WILL BE OCCUPIED THROUGHOUT THE CONSTRUCTION SCHEDULE. CONTRACTOR SHALL COORDINATE ALL ACTIVITIES WITH THE OWNERS REPRESENTATIVE TO ALLOW TEMPORARY RELOCATION OF OCCUPANTS 2. CONTRACTOR SHALL VISIT THE SITE AND VERIFY EXISTING CONDITIONS PRIOR TO SUBMITTING FINAL BIDS OR COMMENCEMENT OF WORK. FAILURE TO OBSERVE EXISTING CONDITIONS SHALL NOT BE AN ACCEPTABLE REASON FOR INCREASE IN CONTRACT AMOUNT. ARCHITECT SHALL BE NOTIFIED IMMEDIATELY OF ANY DISCREPANCIES DETRIMENTAL TO THE PROPER EXECUTION OF NEW CONSTRUCTION. NOTIFY ARCHITECT IMMEDIATELY OF DISCREPANCIES BETWEEN EXISTING CONDITIONS AND DRAWINGS BEFORE PROCEEDING WITH SELECTIVE DEMOLITION. PATCH EXISTING CONSTRUCTION SCHEDULED TO BE EXPOSED TO VIEW AT AREAS OF DAMAGE FROM SELECTIVE DEMOLITION TO MATCH ADJACENT FINISH/APPEARANCE. THIS INCLUDES BUT IS NOT LIMITED TO REMOVAL OF ABUTTING

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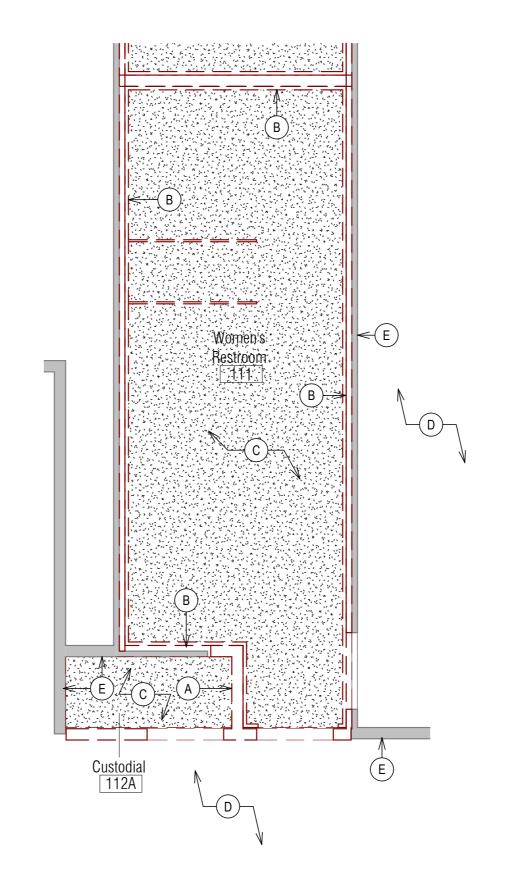
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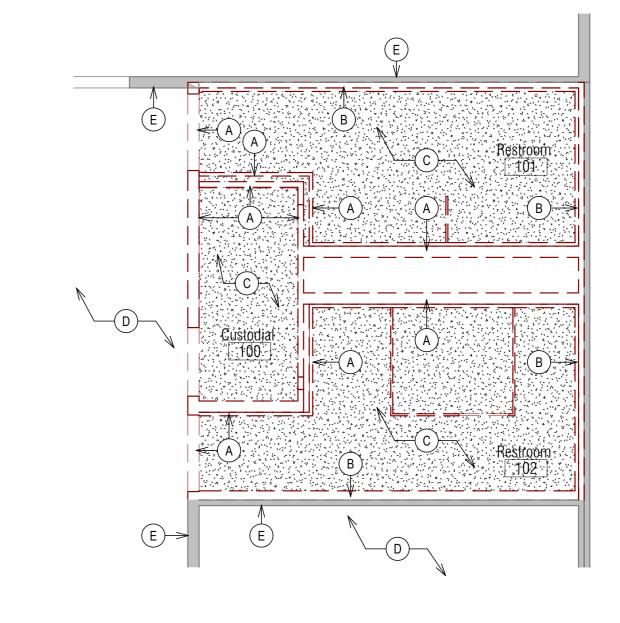
DEMOLITION ACTIVITIES ACCORDINGLY.

6 Enlarged Demo Ref Clg Plan @ Men's RR




5 Enlarged Demo Ref Clg Plan @ Women's RR

1/4" = 1'-0" RE: 1/AD150




4 Enlarged Demo Ref Clg Plan @ Staff RR $\frac{1}{4}$ RE: $\frac{1}{AD150}$

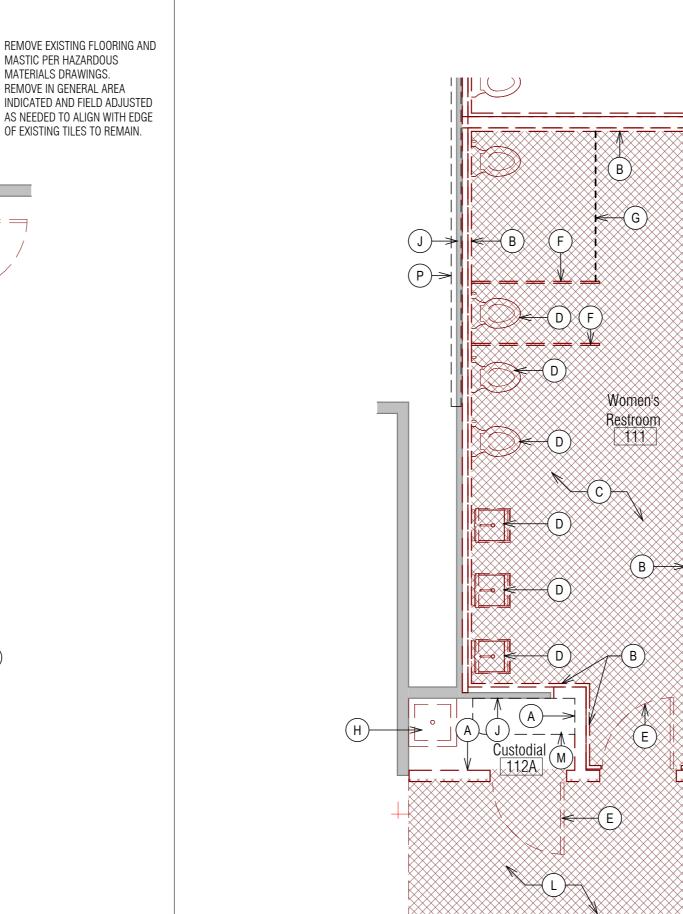

3 Enlarged Demo Plan @ Men's Restroom


1/4" = 1'-0" RE: 1/AD100

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2 Enlarged Demo Plan @ Women's Restroom

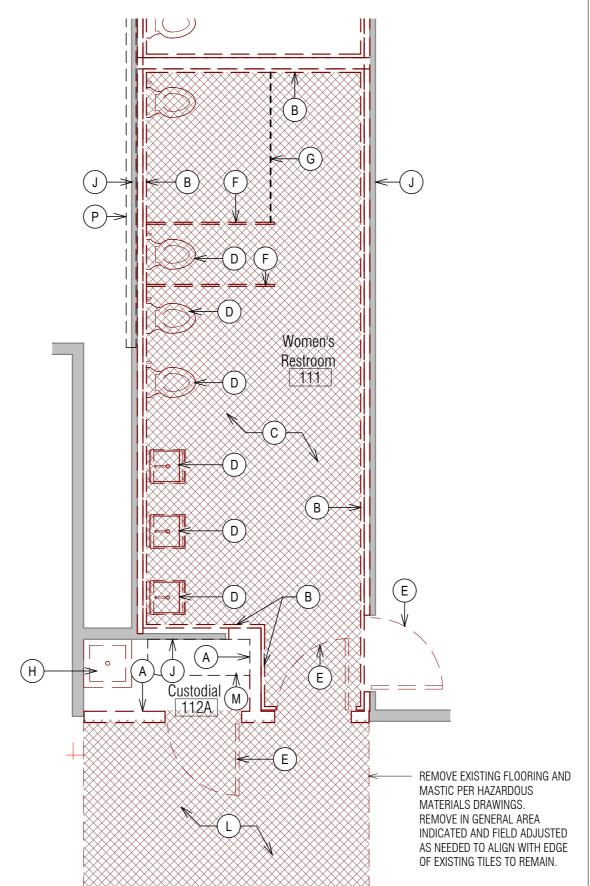
| 1/4" = 1'-0" | RE: 1/AD100



Enlarged Demo Plan @ Staff Restrooms

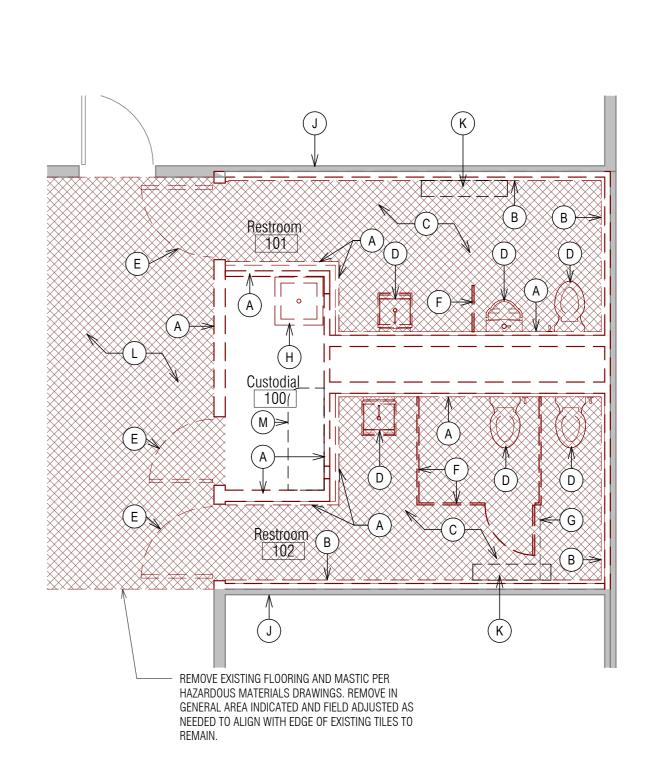1/4" = 1'-0" RE: 1/AD100

STATE OF MISSOURI MIKE KEHOE, **GOVERNOR**

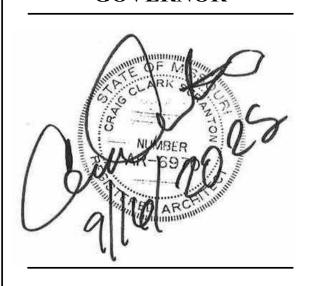

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OFFICE OF ADMINISTRATION DIVISION OF FACILITIES MANAGEMENT, DESIGN AND CONSTRUCTION

RENOVATE 4 CLIENT BATHROOMS - RAGLAND EDUCATION BUILDING, HIGGINSVILLE HABILITATION CENTER

100 W 1st Street Higginsville, Missouri 64037

PROJECT # M2406-01 7357 FACILITY # 6517357027


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CAD DWG FILE: DRAWN BY: JC CHECKED BY: JC DESIGNED BY: JC

SHEET TITLE:

ENLARGED ARCHITECTURAL DEMOLITION PLANS

SHEET NUMBER:



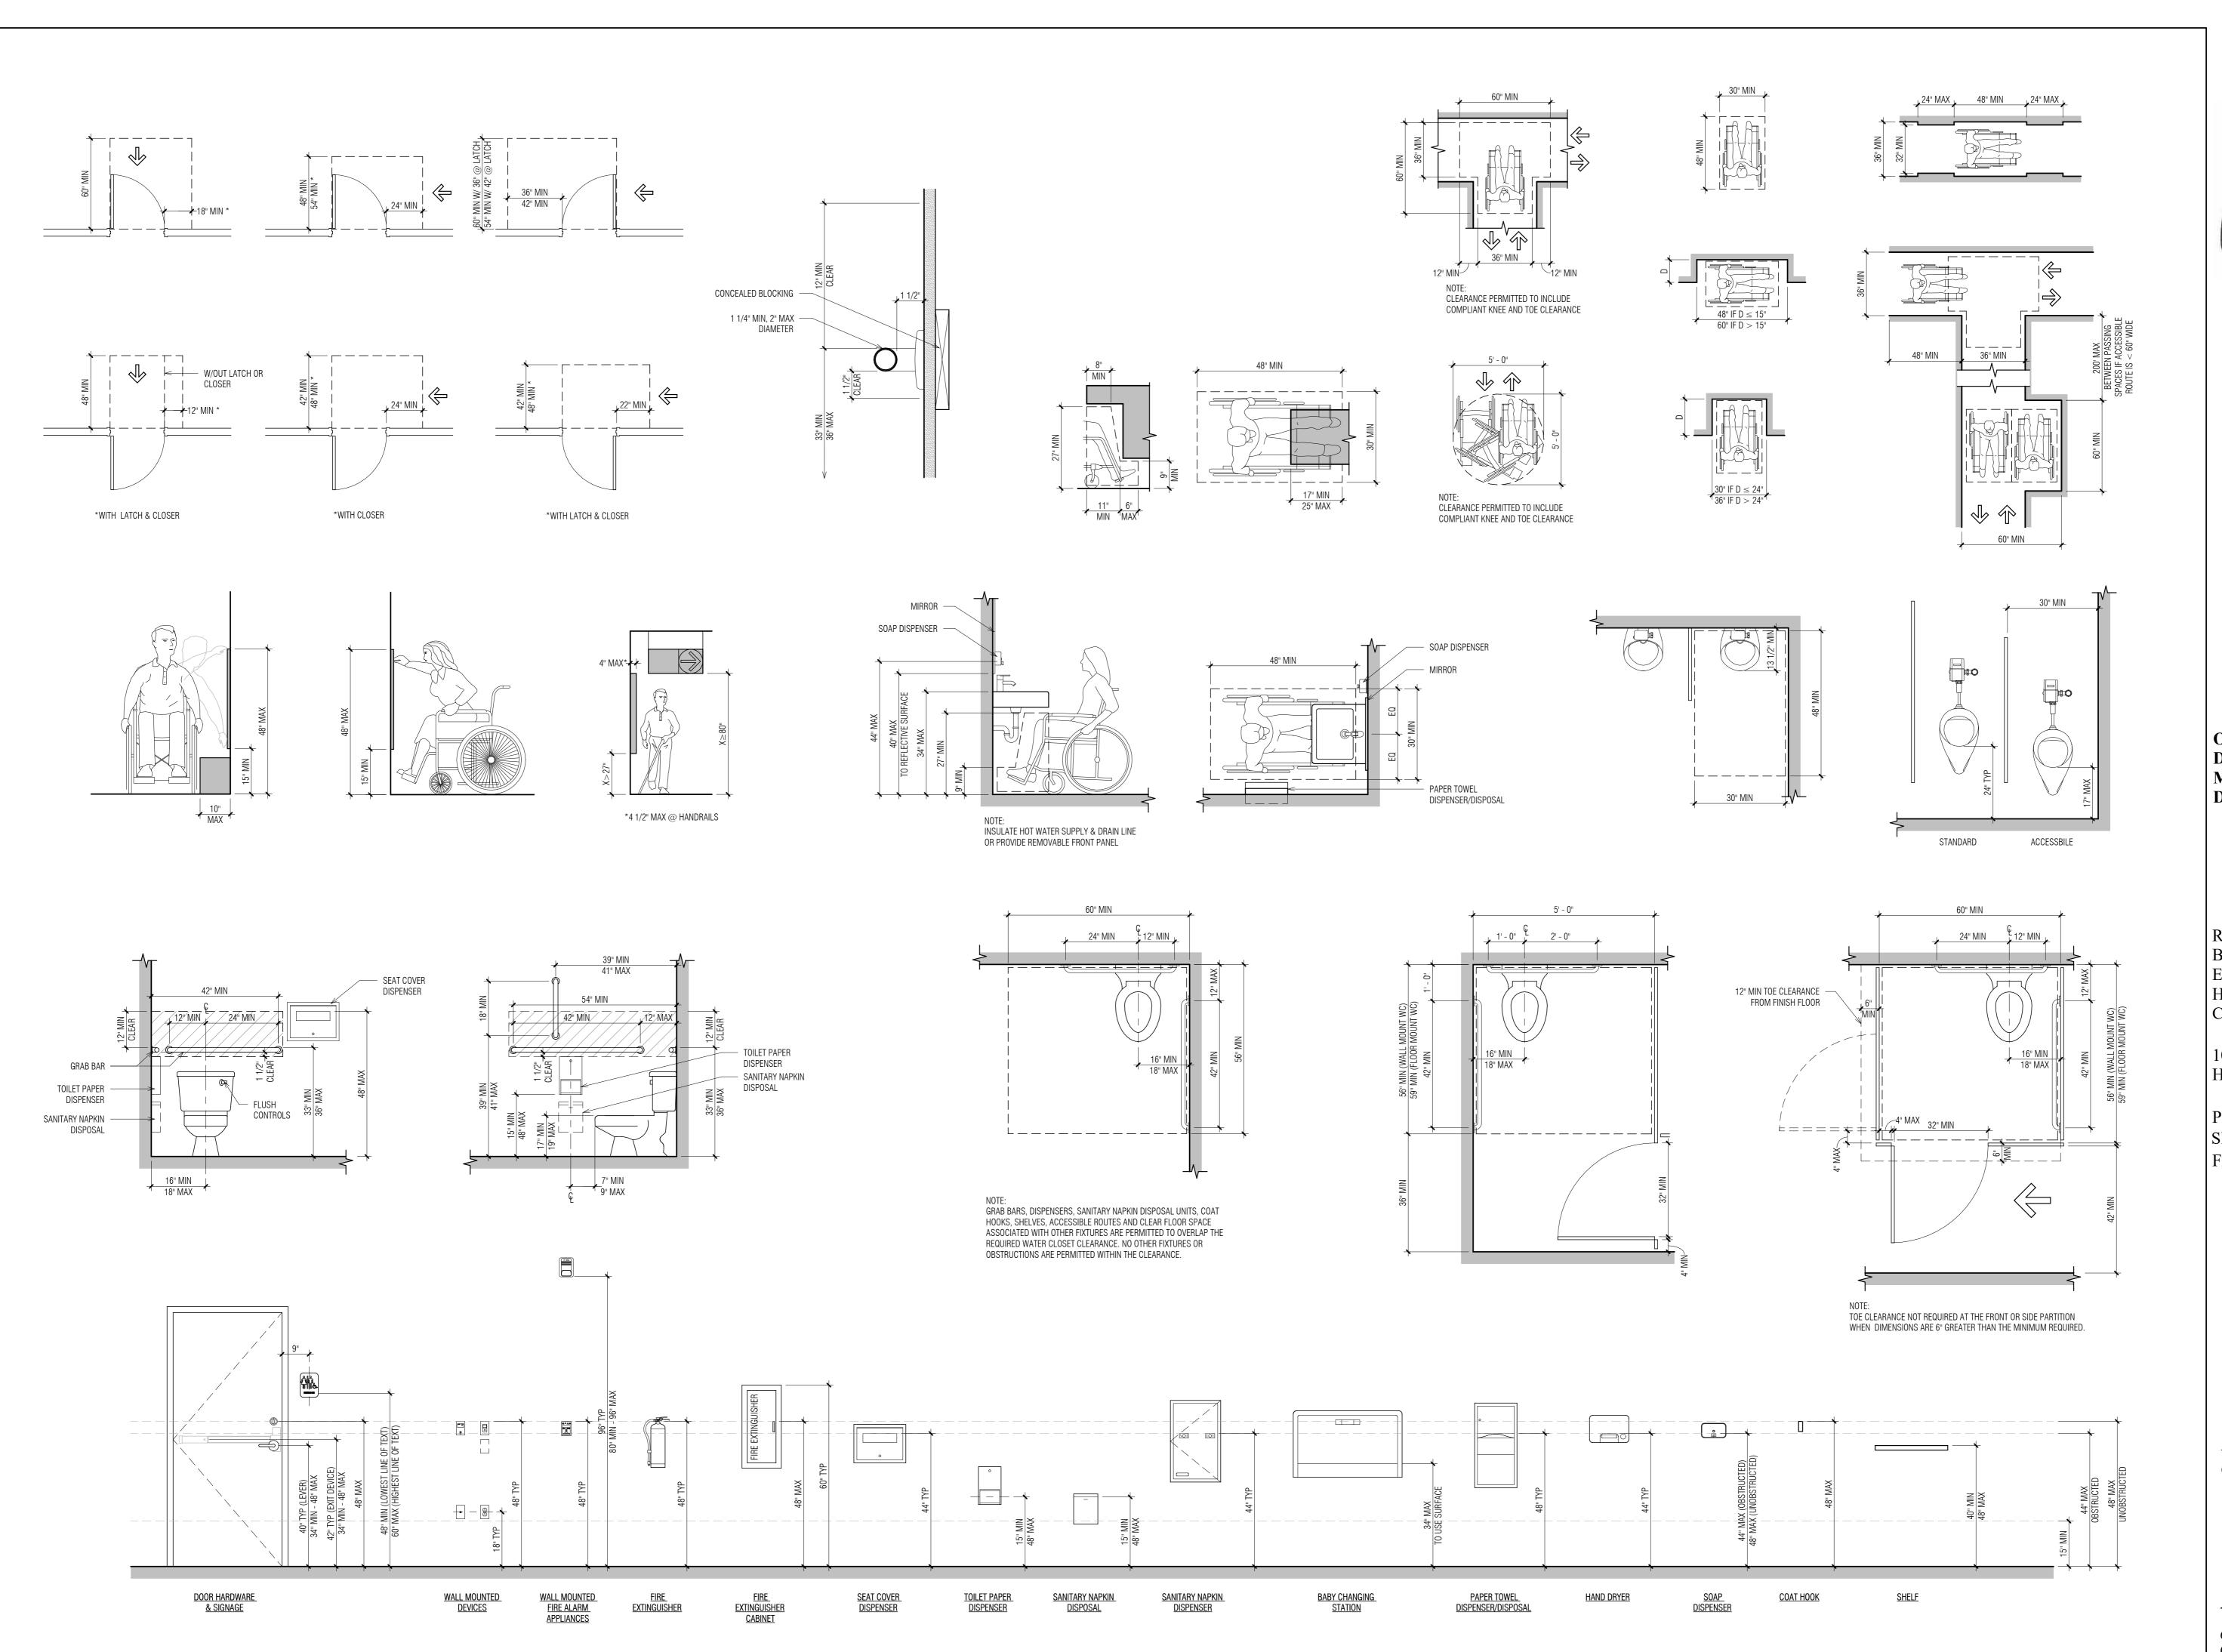

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bnım

BNIM Architects 2460 Pershing Road Suite 100, Kansas City MO 64108 p.816.783.1500 f.816.783.1501

OFFICE OF ADMINISTRATION
DIVISION OF FACILITIES
MANAGEMENT,
DESIGN AND CONSTRUCTION

RENOVATE 4 CLIENT
BATHROOMS - RAGLAND
EDUCATION BUILDING,
HIGGINSVILLE HABILITATION
CENTER

100 W 1st Street Higginsville, Missouri 64037

PROJECT # M2406-01 SITE # 7357 FACILITY # 6517357027

REVISION:
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DATE:
ISSUE DATE: 09/16/2025

CAD DWG FILE:
DRAWN BY: JC
CHECKED BY: JC
DESIGNED BY: JC

SHEET TITLE:

ACCESSIBILITY GUIDELINES


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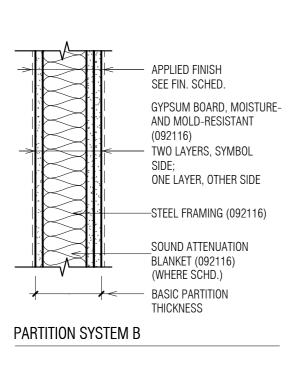
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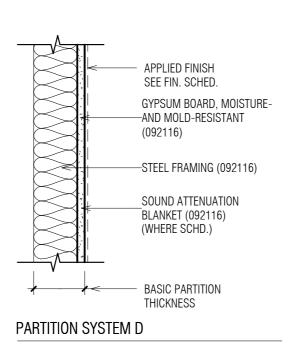
					FINISH / MATE	RIAL INDEX			
CODE	FUNCTION	SECTION	MATERIAL	BASIS OF DESIGN MANUFACTURER	MATERIAL / COLOR	FINISH / INSTALL	REMARKS	LOCATION. UON	NOTES/ MFR DATA
VISION (06: WOODS, PLASTICS AND COMPOSITES	,							
601	SOLID SURFACE	06 40 23	SOLID SURFACE	CORIAN	WHITE JASMINE	1/2" THICKNESS	RE: INTERIOR DETAILS	RESTROOM COUNTERTOP	KRISTY RINNE < KRINNE@HLLMARK.COM>
502	SOLID SURFACE	06 40 23	SOLID SURFACE	CORIAN	GLACIER WHITE		RE: INTERIOR DETAILS	RESTROOM INTEGRAL SINKS	KRISTY RINNE < KRINNE@HLLMARK.COM>
VISION (09: FINISHES TRIM, ACCESSORIES	09 21 16	TRANSITION STRIPS	SCHLUTER	FINEC, STAINLESS STEEL	H= 7/16", ITEM NO. F110E		RESTROOM TILE OUTSIDE CORNERS, TYP.	
02	TRIM, ACCESSORIES	09 21 16	TRANSITION STRIPS	SCHLUTER	SCHIENE, STAINLESS STEEL	H=3/8", ITEM NO. E100		RESTROOM TILE WAINSCOT TOP TRIM	
)3	TRIM, ACCESSORIES	09 21 16	TRANSITION STRIPS	TARKETT	FLEXIBLE STOP PROFILES, SILVER	COMPACT, FT2.5MM	RE: TRANSITION DETAILS	RESILIENT FLOORING TO CONCRETE TRIM	
1	TILE	09 30 00	PORCELAIN FLOOR TILE	DALTILE	SYNCHRONIC, CHARCOAL SY34, MATTE	12"X24", STACKED BOND		RESTROOM FLOOR TILE	JAIME RUFFING < JAIME.RUFFING@DALTILE.COM>
12	TILE	09 30 00	PORCELAIN FLOOR TILE	DALTILE	SYNCHRONIC, CHARCOAL SY34, MATTE	6"X12" COVE BASE		RESTROOM COVE BASE	JAIME RUFFING < JAIME.RUFFING@DALTILE.COM>
)3	TILE	09 30 00	CERAMIC WALL TILE	DALTILE	COVE CREEK, OFF WHITE CC08	4"X16", VERTICAL STACKED BOND	RE: INTERIOR ELEVATIONS	RESTROOM WALL TILE	JAIME RUFFING < JAIME.RUFFING@DALTILE.COM>
)1	FLOORING, RESILIENT	09 65 00	RESILIENT FLOORING	WINEO PURLINE	1500 FUSION XL, COLOR TO BE SELECTED	ROLL, 2.5MM THICKNESS		RE: FINISH PLANS	
01	RESILIENT BASE	09 65 13	RUBBER COVE BASE	TARKETT CONTINUOUS ROLL STOCK	TO BE SELECTED FROM MFR'S FULL RANGE	4" COVE		HALLWAY BASE REPLACEMENT	TAYLOR GROSSENKEMPER < TAYLOR.GROSSENKEMPER@TARKETT.COM:
.01	PAINT	09 91 00	INTERIOR PAINT	SHERWIN WILLIAMS	SW 7102 WHITE FLOUR			TYPICAL WALL PAINT	
VICION :	IO. CDECIALTIEC	·							
C01	10: SPECIALTIES TOILET COMPARTMENTS	10 21 13	TOILET PARTITIONS	ASI COLOR THRU PHENOLIC, ULTIMATE PRIVACY	CHARCOAL 3077	FLOOR TO CEILING ANCHORED		RESTROOM	


						P	ARTITIO!	N SYSTE	M							
/BOL						KNESS					PARTITIO	ON CORE	-	FIN HEI	ISH GHT	
PARTITION IDENTIFICATION PLAN SYMBOL	BASIC PARTITION THICKNESS	FIRE RATING (HRS)	FIRE TEXT NUMBER	ACOUSTICAL RATING (STC)	ACOUSTICAL TEST NUMBER	SOUND ATTENUATION BLANKET THICKNESS	GWB THICKNESS	ACOUSTICAL CAULKING	FIRE CAULKING	STUD/FURRING SIZE	FURRING TYPE	METAL THICKNESS	STUD SPACING	GWB TO STRUCTU ABV	W/ GWB TO 6" ABV CLG	REMARKS
A3a	4 7/8"			49	SA-870717	3"	5/8"	Υ		3 5/8"	_		16"		γ	SEE 7/A560
A6	7 1/4"			10	3/(0/ 0/ 1/		5/8"	Y		6"	_		16"	_	Y	SEE 7/A560
A6a	7 1/4"			49	SA-870717	5"	5/8"	Y		6"	-		16"	-	Y	SEE 7/A560
Partition System B	., .			· -		•	, -									, .22
B3f	5 1/2"	1 HR	U419	49	SA-870717	3"	5/8"		Υ	3 5/8"	-		16"	Υ		SEE 2,3,5/A560
B6f	7 7/8"	1 HR	U419	49	SA-870717	6"	5/8"		Υ	3 5/8"	-		16"	Υ		SEE 2,3,5/A560
Partition System D																
D3a	<varies< td=""><td></td><td></td><td></td><td></td><td>3"</td><td>5/8"</td><td>Y</td><td></td><td>3 5/8"</td><td>-</td><td></td><td>16"</td><td>-</td><td>Y</td><td>SEE 4/A560</td></varies<>					3"	5/8"	Y		3 5/8"	-		16"	-	Y	SEE 4/A560
Partition System M																
M1	1 1/2"					3"	5/8"			7/8"	HAT		16"	-		


							DOOR SCH	HEDULE		
Mark	Width	Height	Thickness	Door Type	Door Material	Frame Type	Frame Material	Frame Profile	Fire Rating	Comments
100/1	3' - 0"	7' - 0"	1 3/4"	F	HM	1	HM	SQ	20 MIN	
100/1	3' - 0"	7' - 0"	1 3/4"	F	HM	1	HM	SQ	20 MIN	
102/1	3' - 0"	7' - 0"	1 3/4"	F	HM	1	HM	SQ	20 MIN	
110/1	3' - 0"	7' - 0"	1 3/4"	F	HM	1	HM	SQ	20 MIN	
110A/1	3' - 0"	7' - 0"	1 3/4"	F	HM	1	HM	SQ	20 MIN	
111/1	3' - 0"	7' - 0"	1 3/4"	F	HM	1	HM	SQ	20 MIN	
111A/1	3' - 0"	7' - 0"	1 3/4"	F	HM	1	HM	SQ	20 MIN	






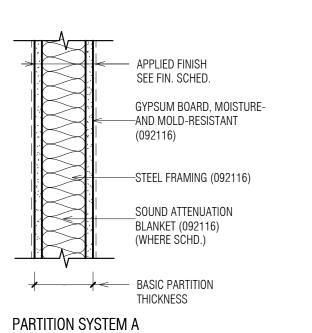

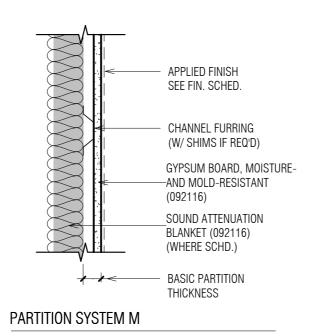


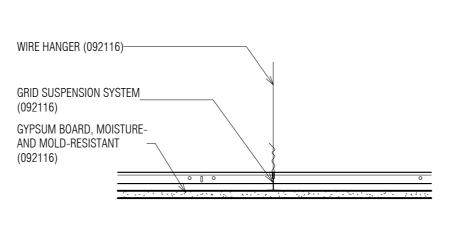

GYPSUM BOARD CEILING ASSEMBLY

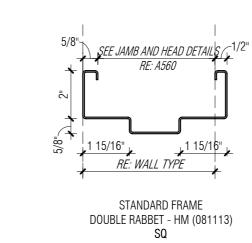




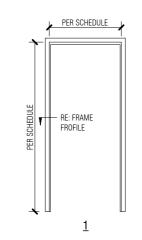

Frame Types

1/4" = 1'-0" RE: /

STATE OF MISSOURI MIKE KEHOE, GOVERNOR

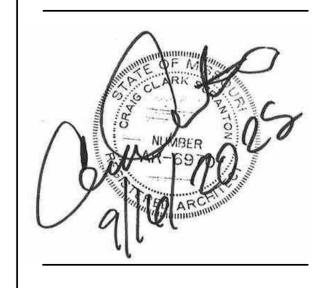



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BNIM Architects 2460 Pershing Road Suite 100, Kansas City MO 64108 p.816.783.1500 f.816.783.1501

OFFICE OF ADMINISTRATION DIVISION OF FACILITIES MANAGEMENT, DESIGN AND CONSTRUCTION

RENOVATE 4 CLIENT
BATHROOMS - RAGLAND
EDUCATION BUILDING,
HIGGINSVILLE HABILITATION
CENTER

100 W 1st Street Higginsville, Missouri 64037

PROJECT # M2406-01 SITE # 7357 FACILITY # 6517357027


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DATE:
ISSUE DATE: 09/16/2025

CAD DWG FILE:
DRAWN BY: JC
CHECKED BY: JC
DESIGNED BY: JC

PARTITION, DOOR
AND FINISH
SCHEDULES

SHEET NUMBER:


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DIVISION OF FACILITIES DESIGN AND CONSTRUCTION

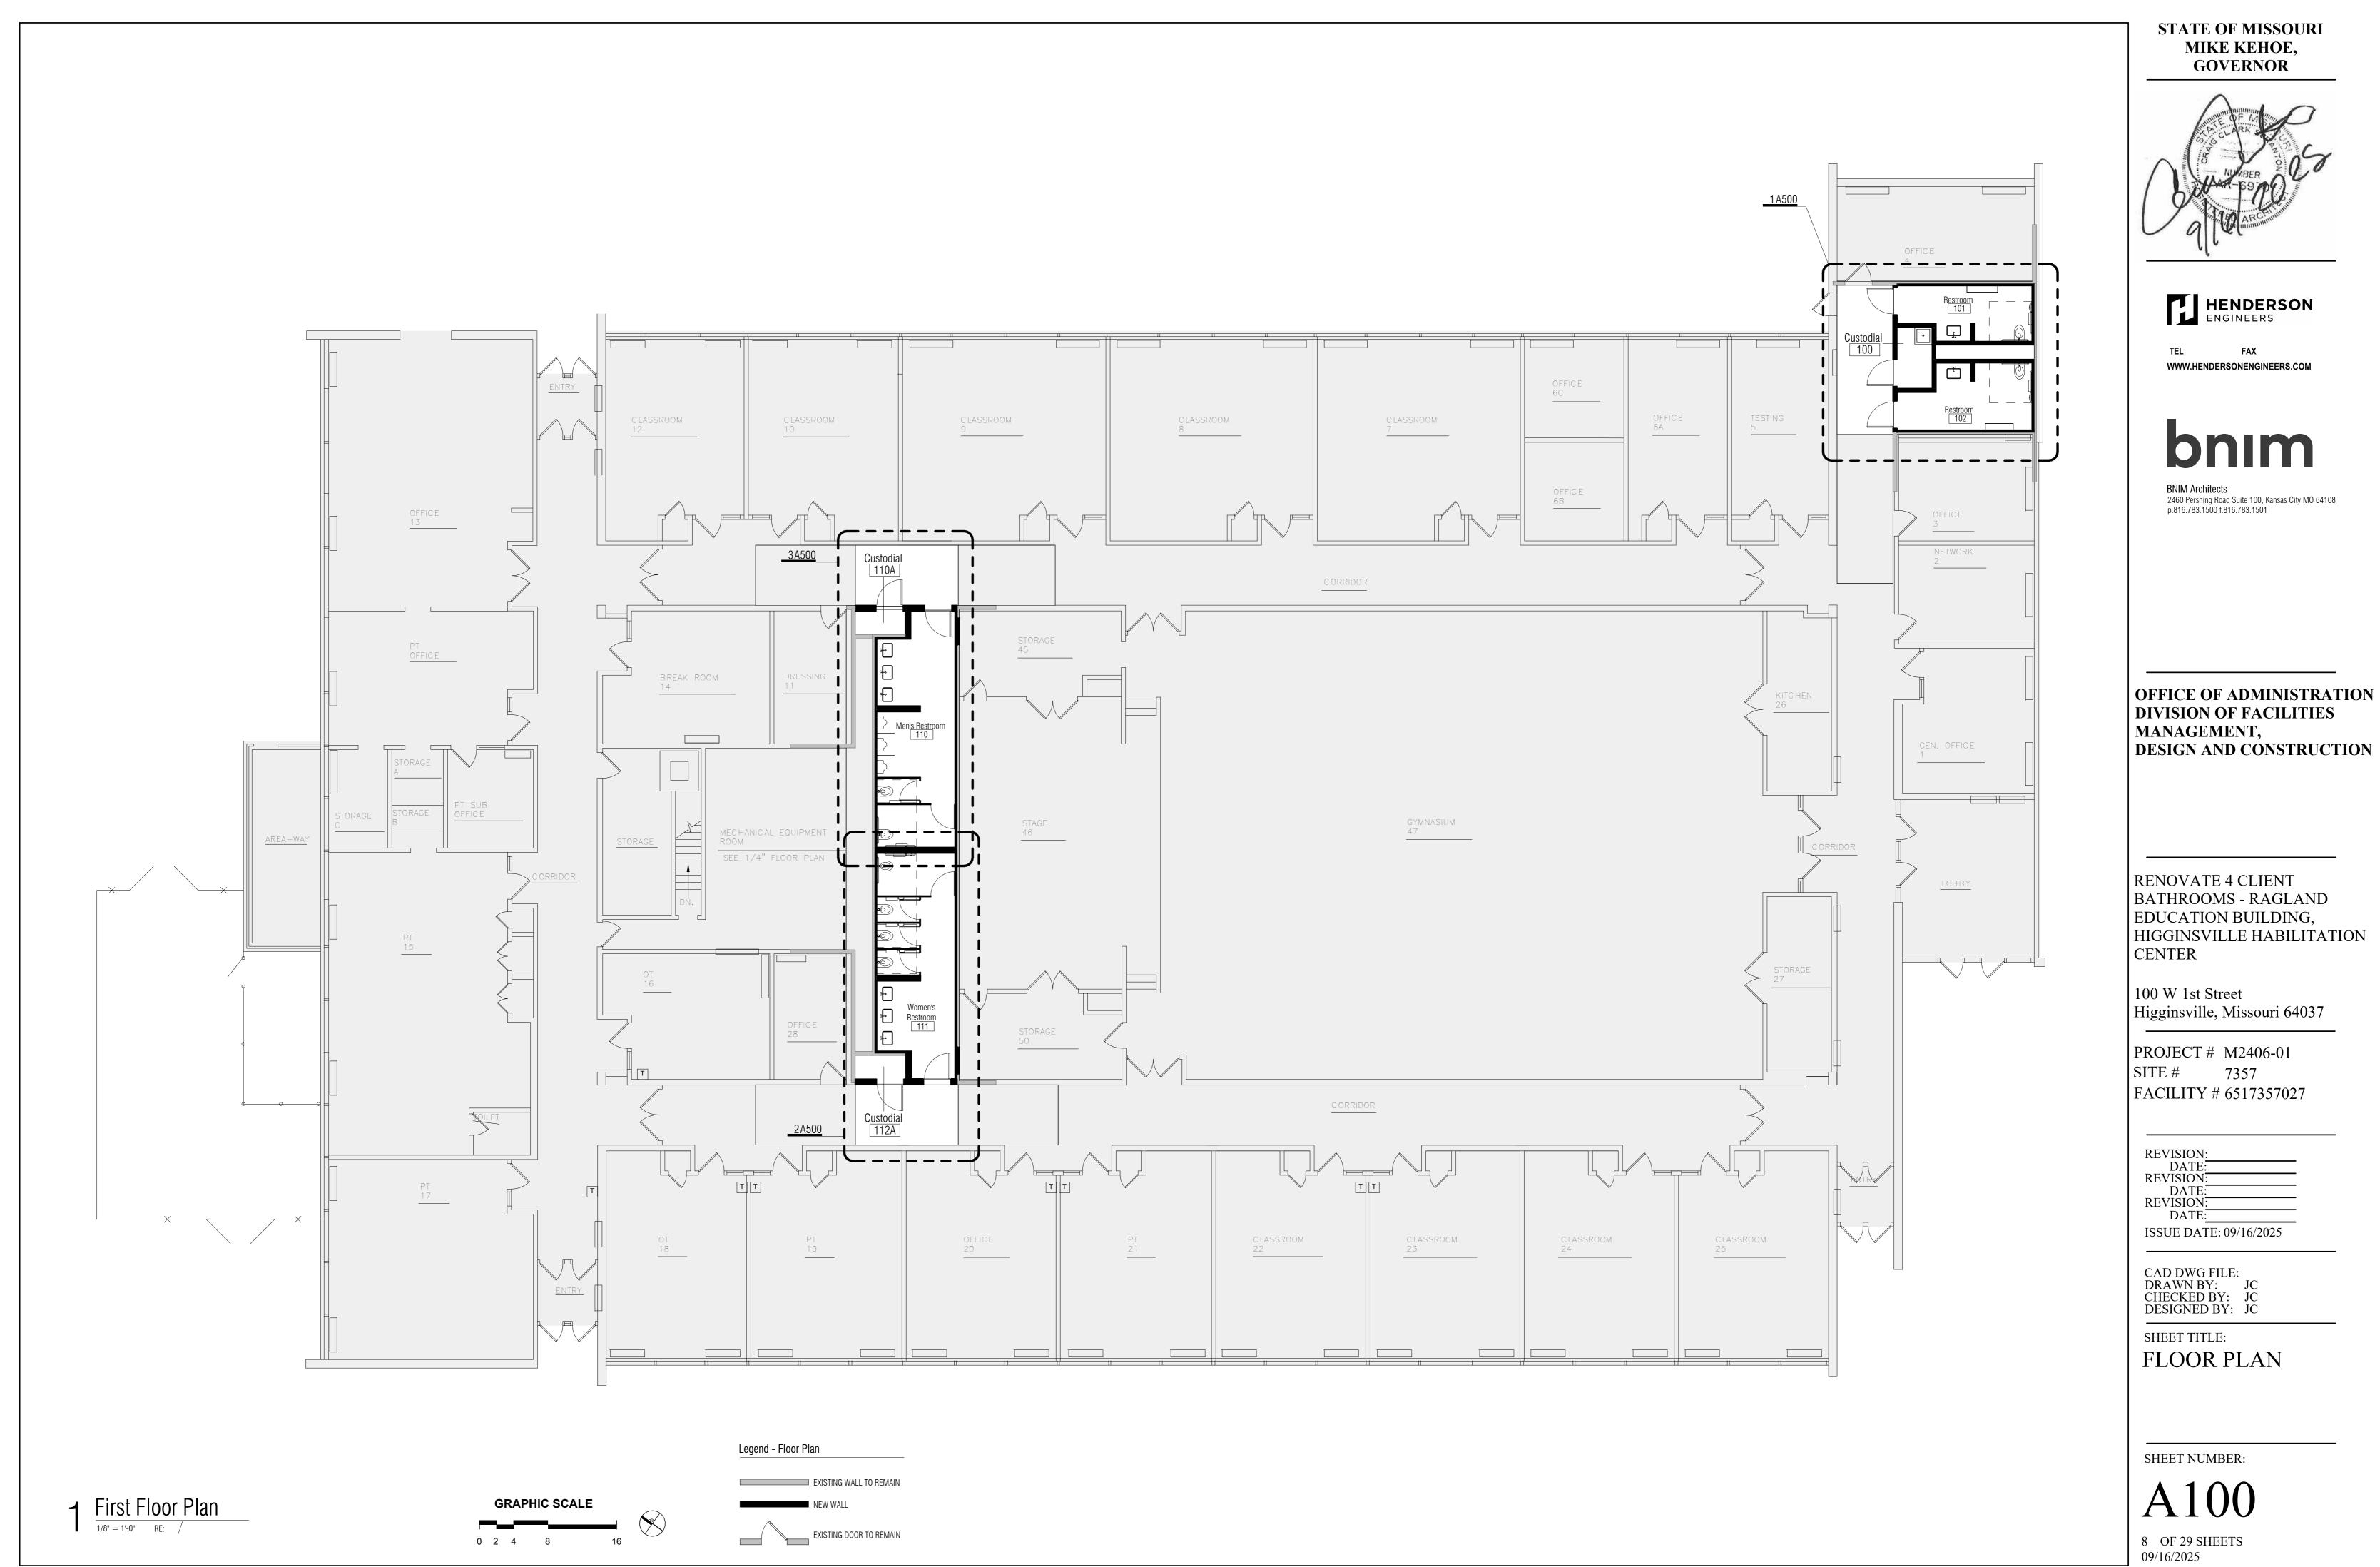HIGGINSVILLE HABILITATION








OFFICE OF ADMINISTRATION **DIVISION OF FACILITIES**

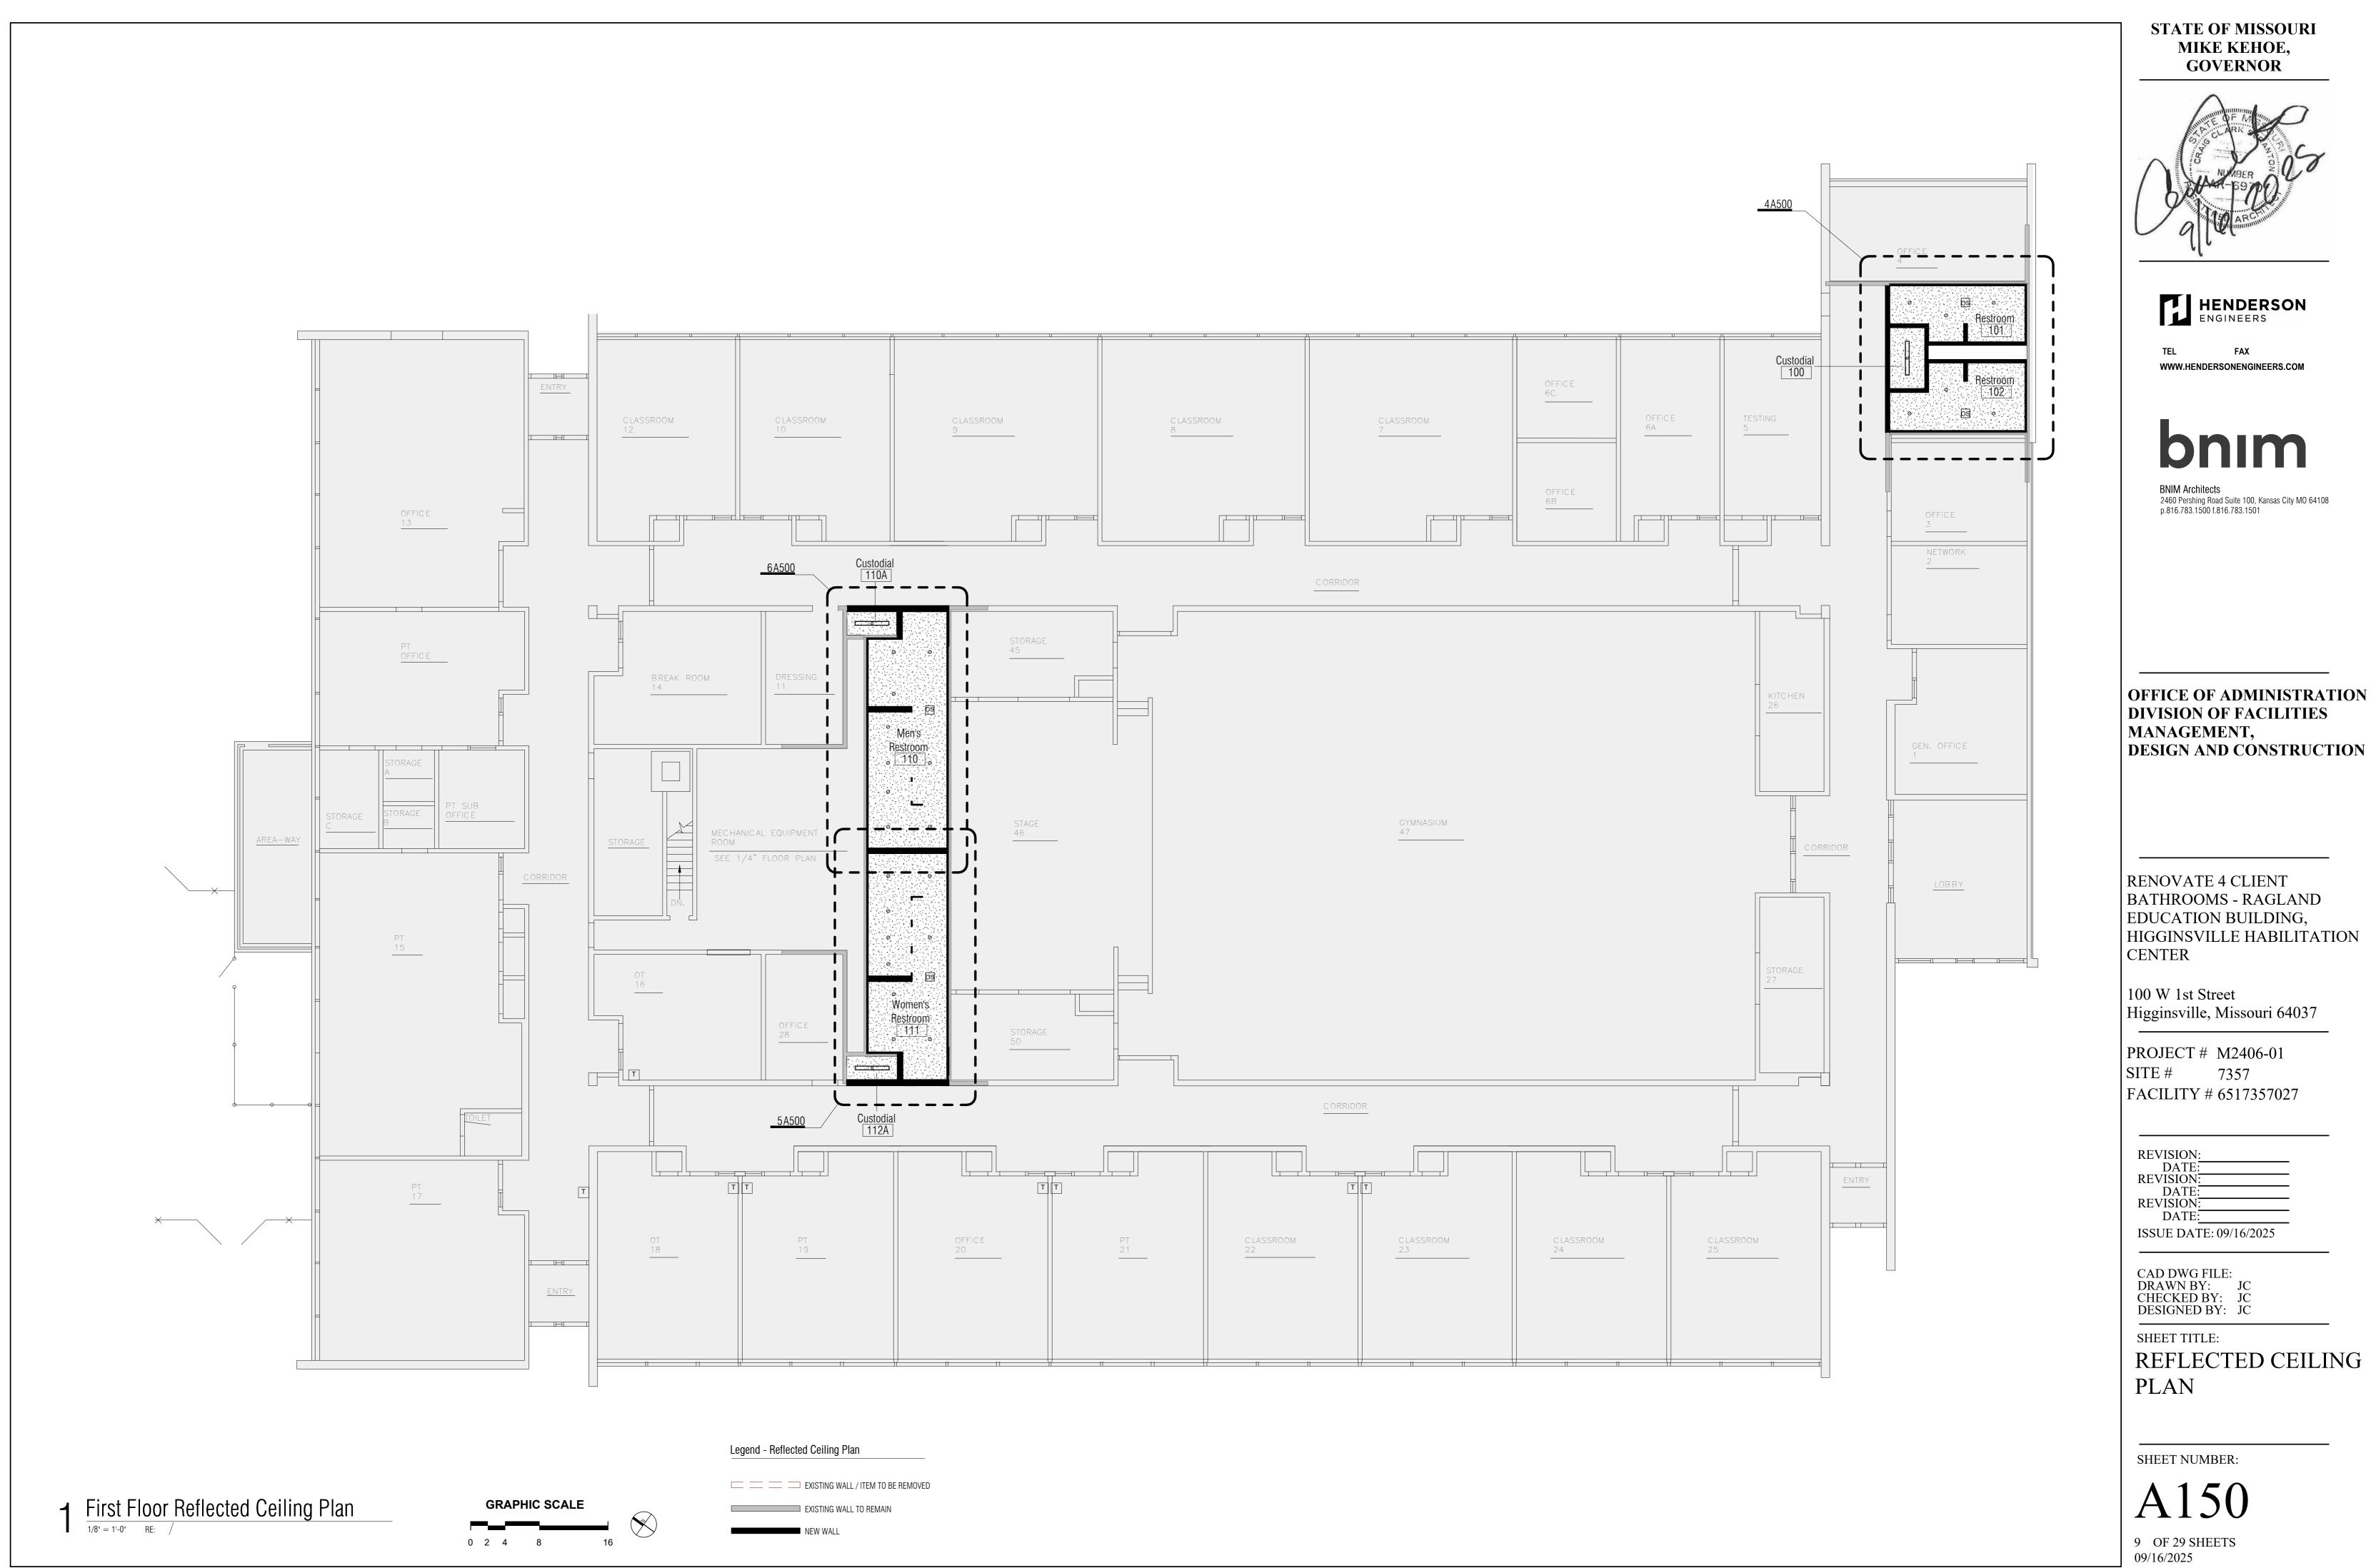
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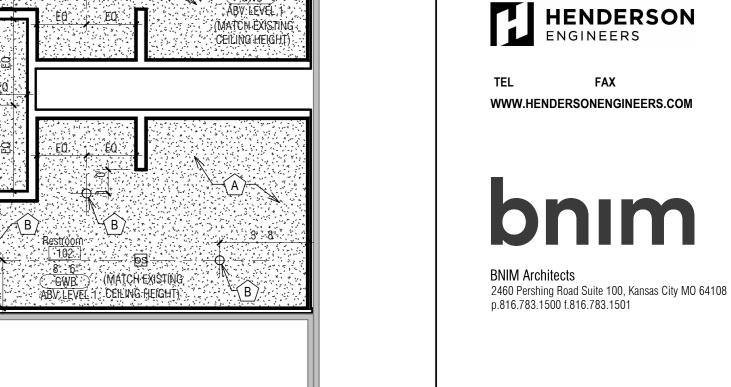
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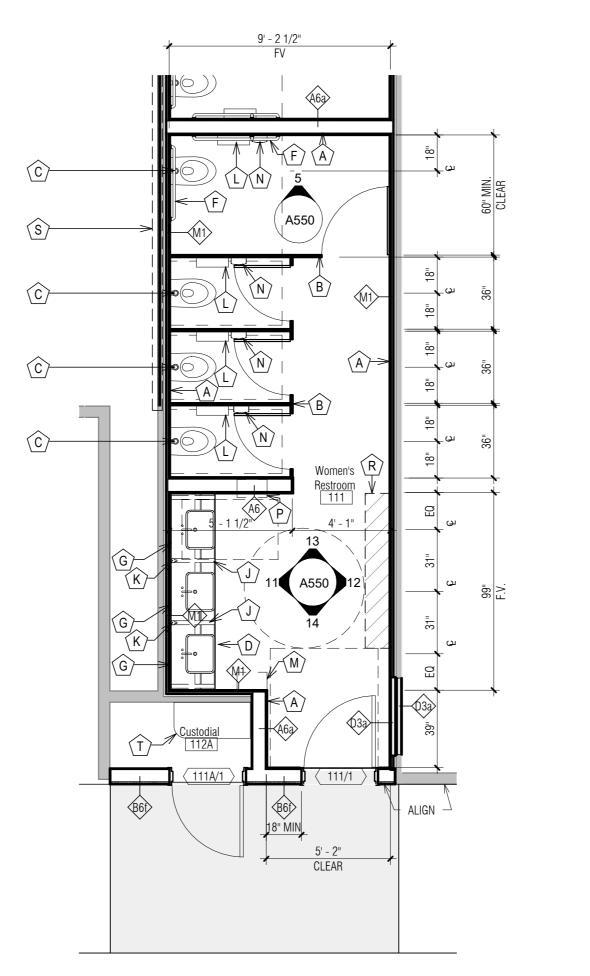





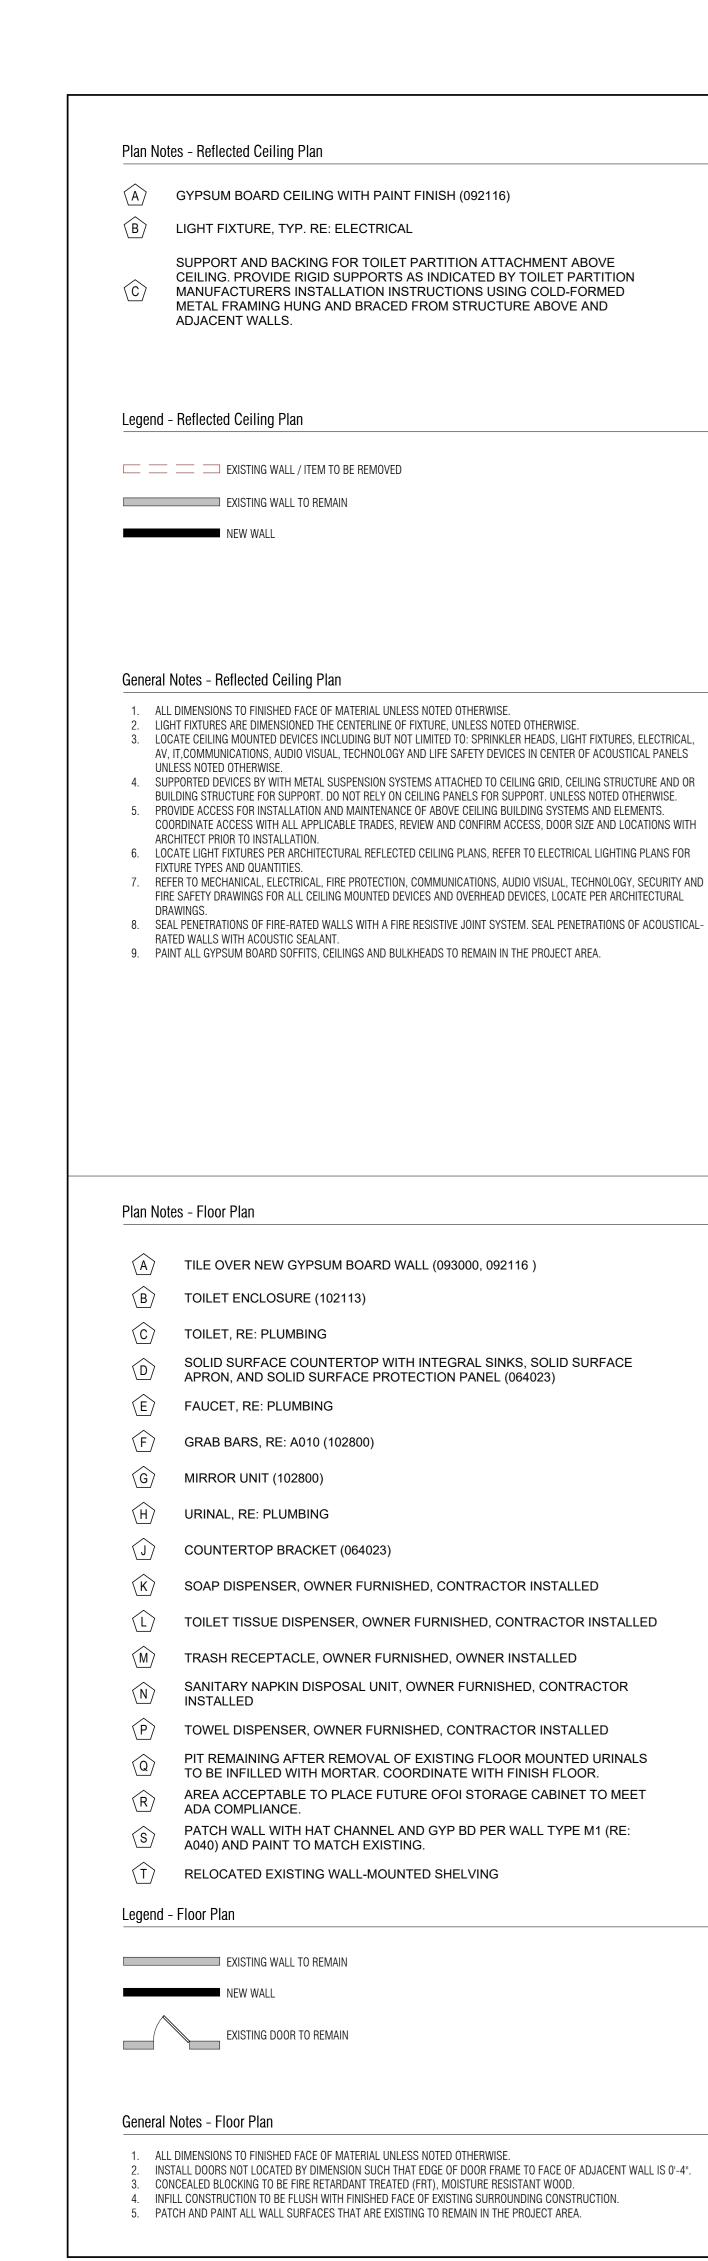

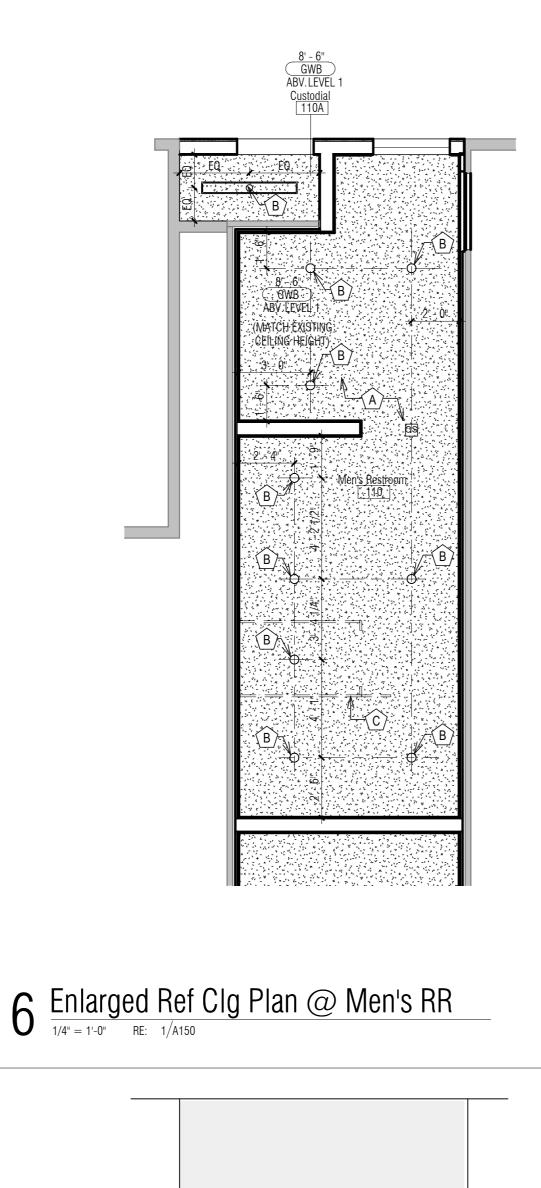

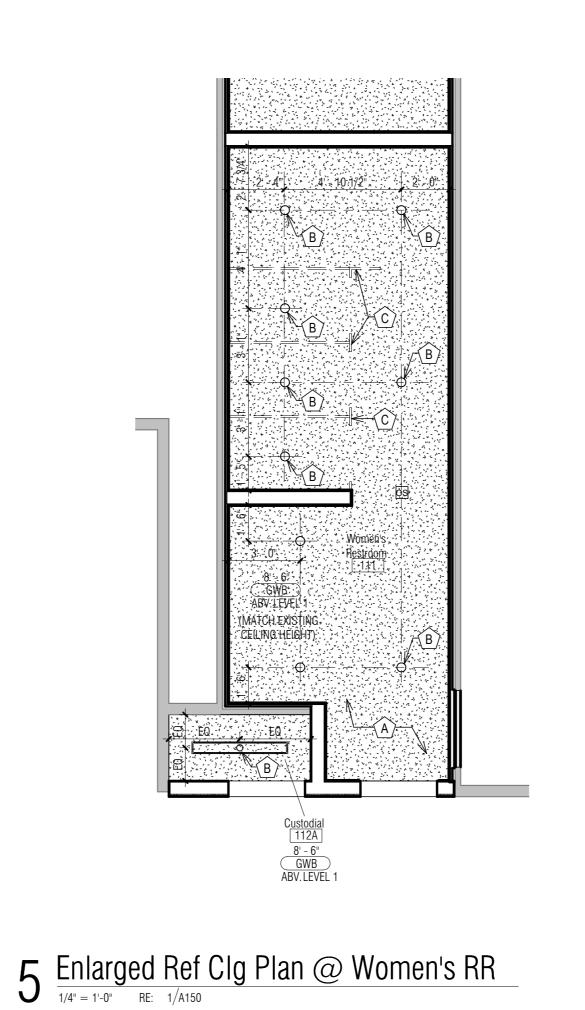4 Enlarged Ref Clg Plan @ Staff RR $\frac{1}{4}$ RE: $\frac{1}{A150}$

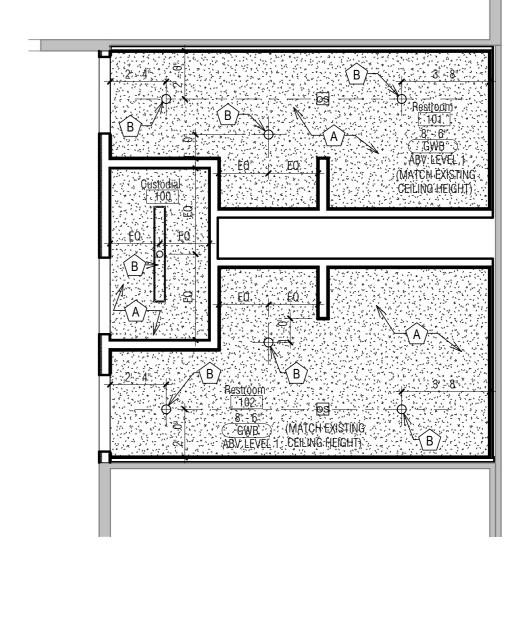

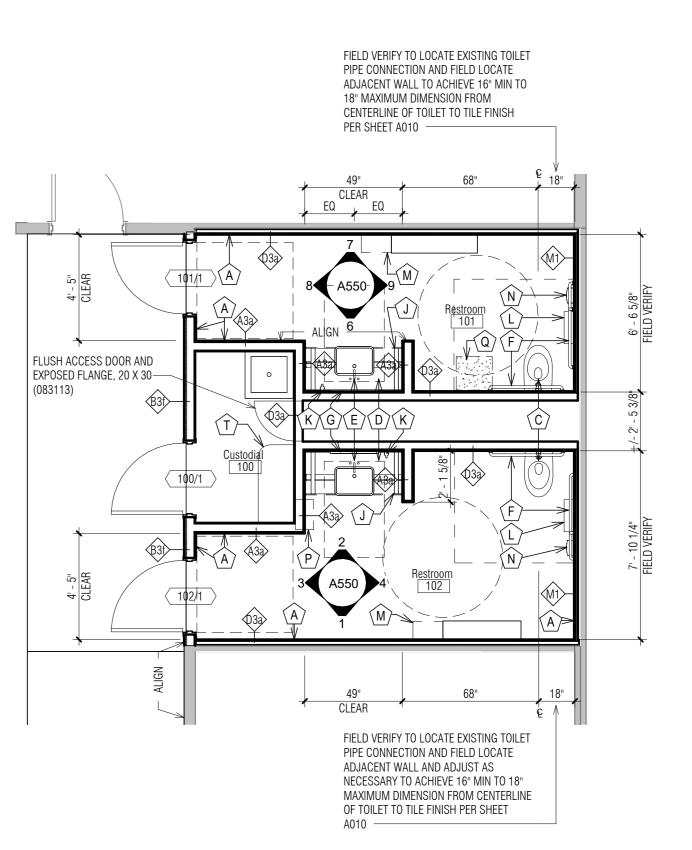

Enlarged Plan @ Staff Restrooms $\frac{1}{4'' = 1' - 0''} RE: 1/A100$

RENOVATE 4 CLIENT BATHROOMS - RAGLAND EDUCATION BUILDING, HIGGINSVILLE HABILITATION CENTER

OFFICE OF ADMINISTRATION

DESIGN AND CONSTRUCTION

DIVISION OF FACILITIES

MANAGEMENT,

STATE OF MISSOURI MIKE KEHOE, **GOVERNOR**

100 W 1st Street Higginsville, Missouri 64037

PROJECT # M2406-01 7357 SITE# FACILITY # 6517357027

> **REVISION: REVISION**: **REVISION**: DATE: ISSUE DATE: 09/16/2025

CAD DWG FILE: DRAWN BY: JC CHECKED BY: JC DESIGNED BY: JC

SHEET TITLE:

ENLARGED PLANS AT RESTROOMS


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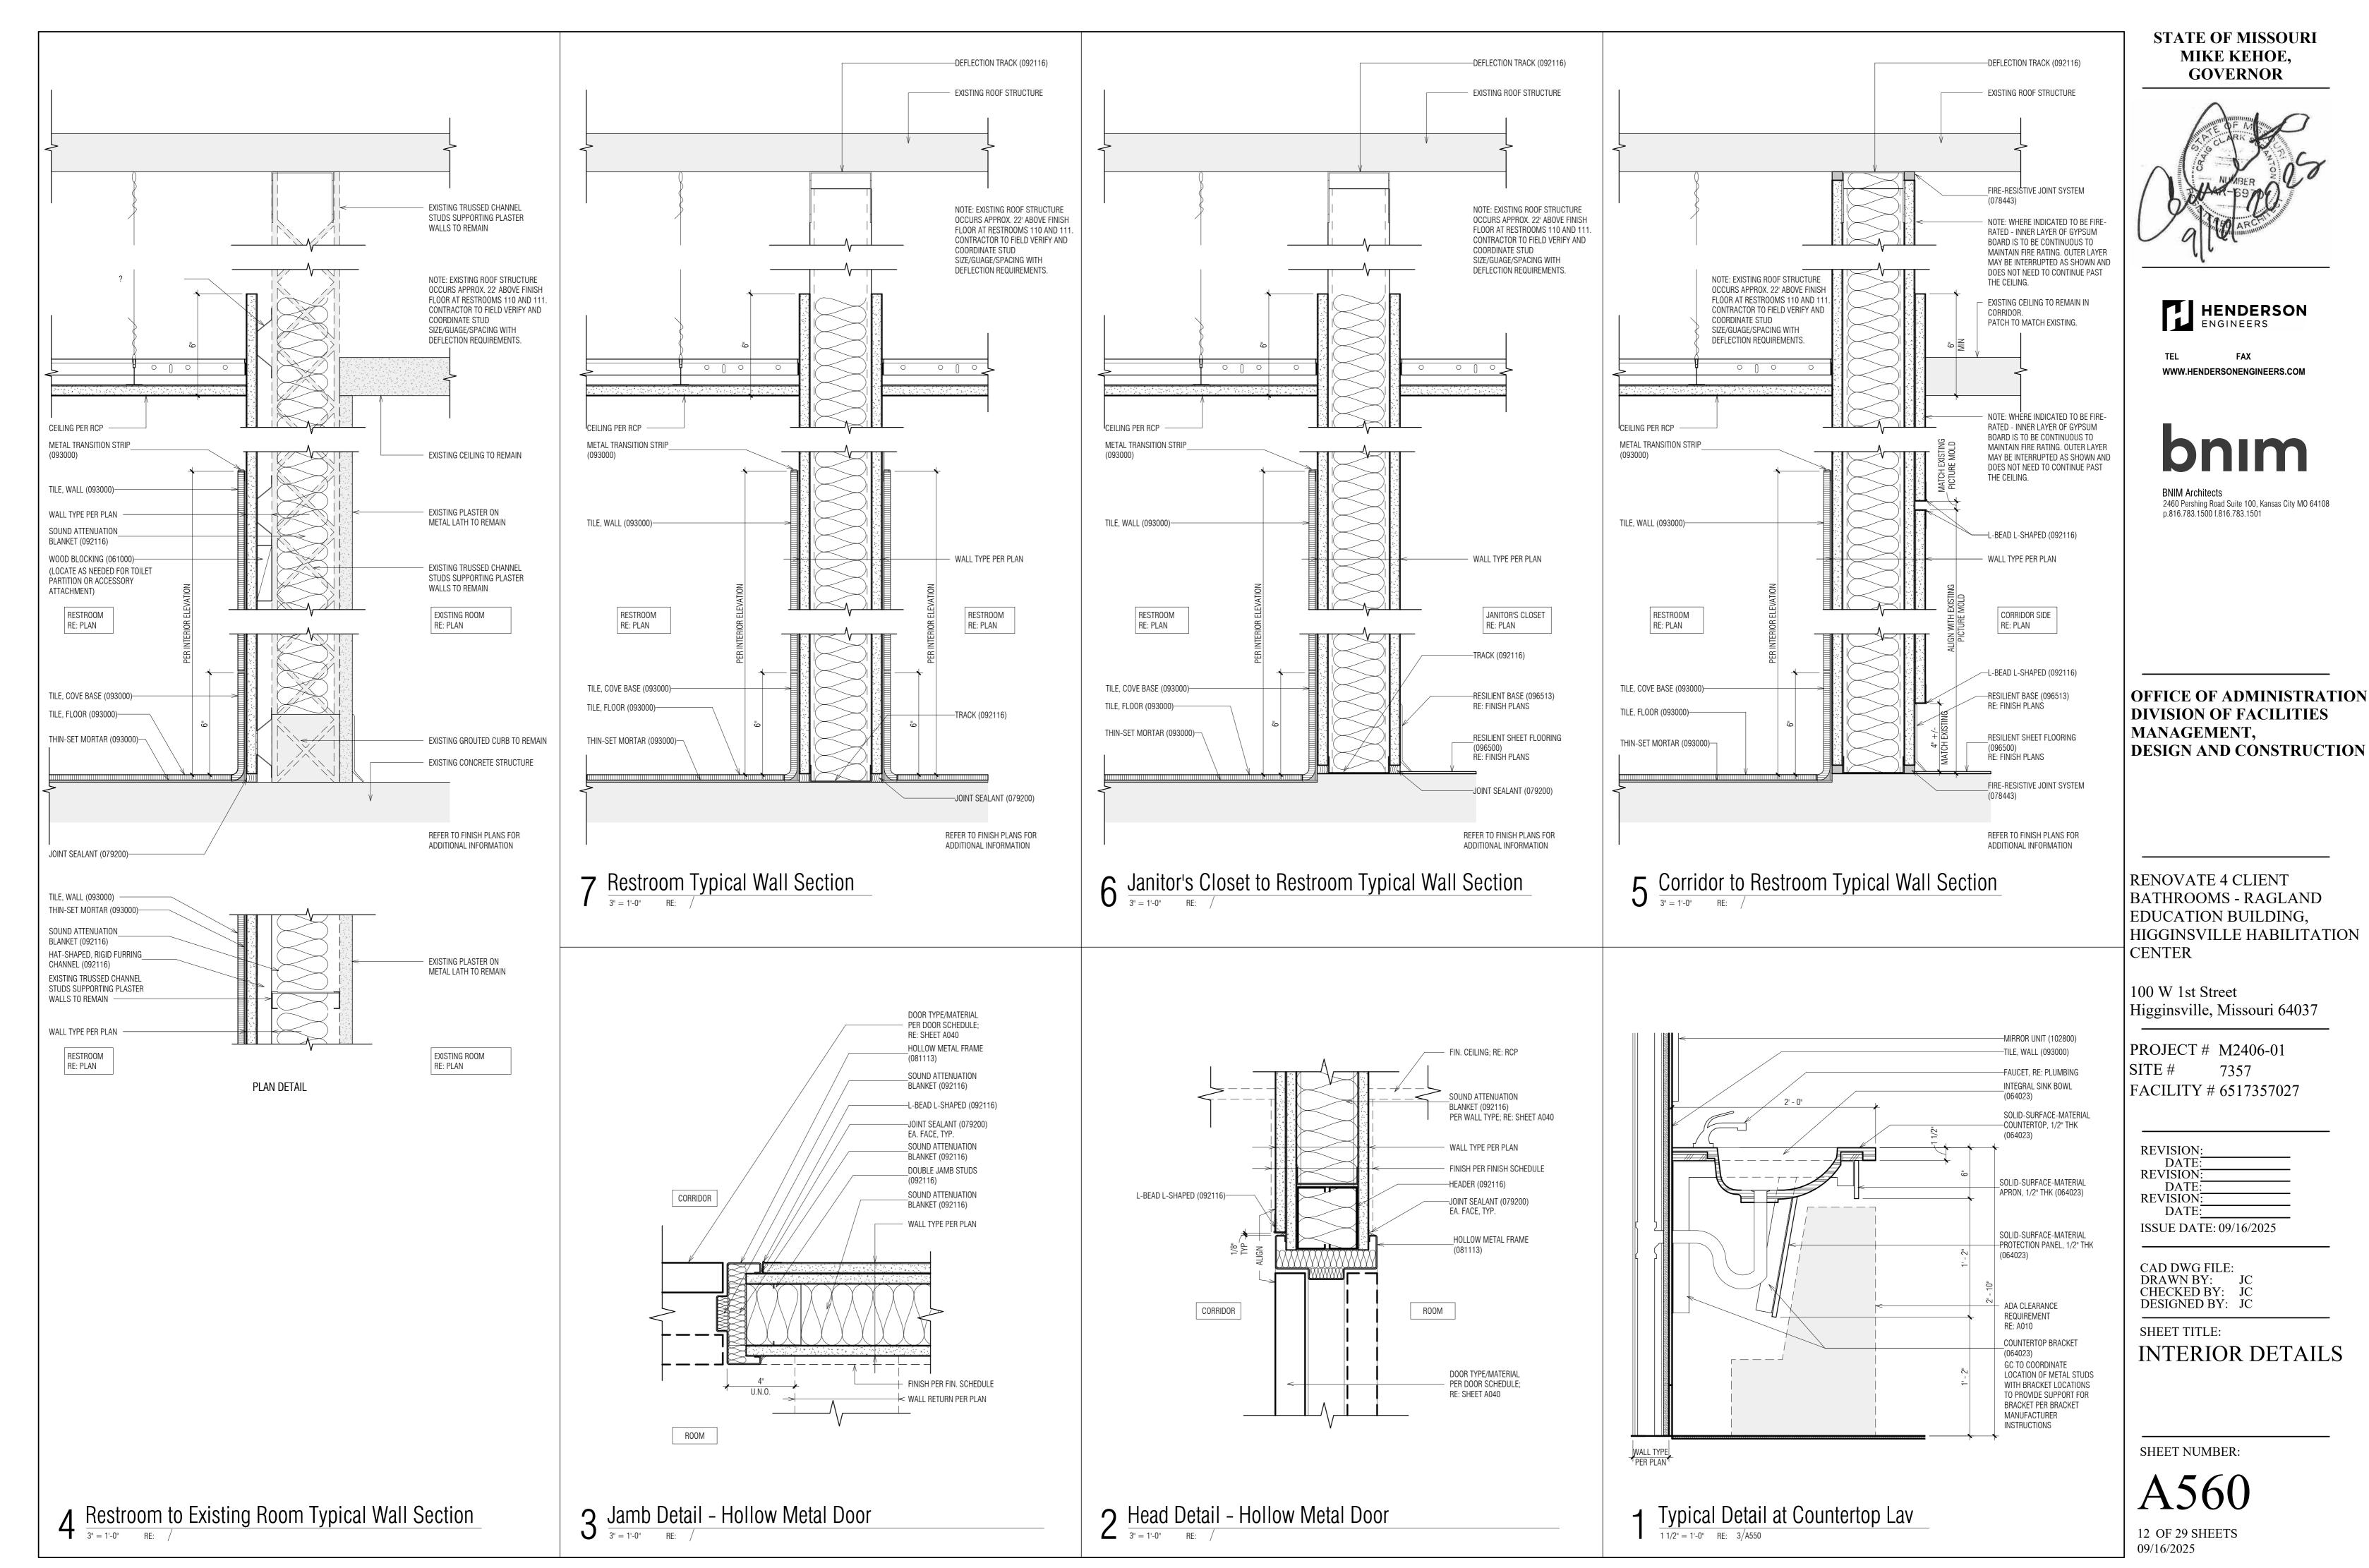
10 OF 29 SHEETS 09/16/2025

3 Enlarged Plan @ Men's Restroom $\frac{1}{4'' = 1'-0''}$ RE: $\frac{1}{A100}$

2 Enlarged Plan @ Women's Restroom

1/4" = 1'-0" RE: 1/A100



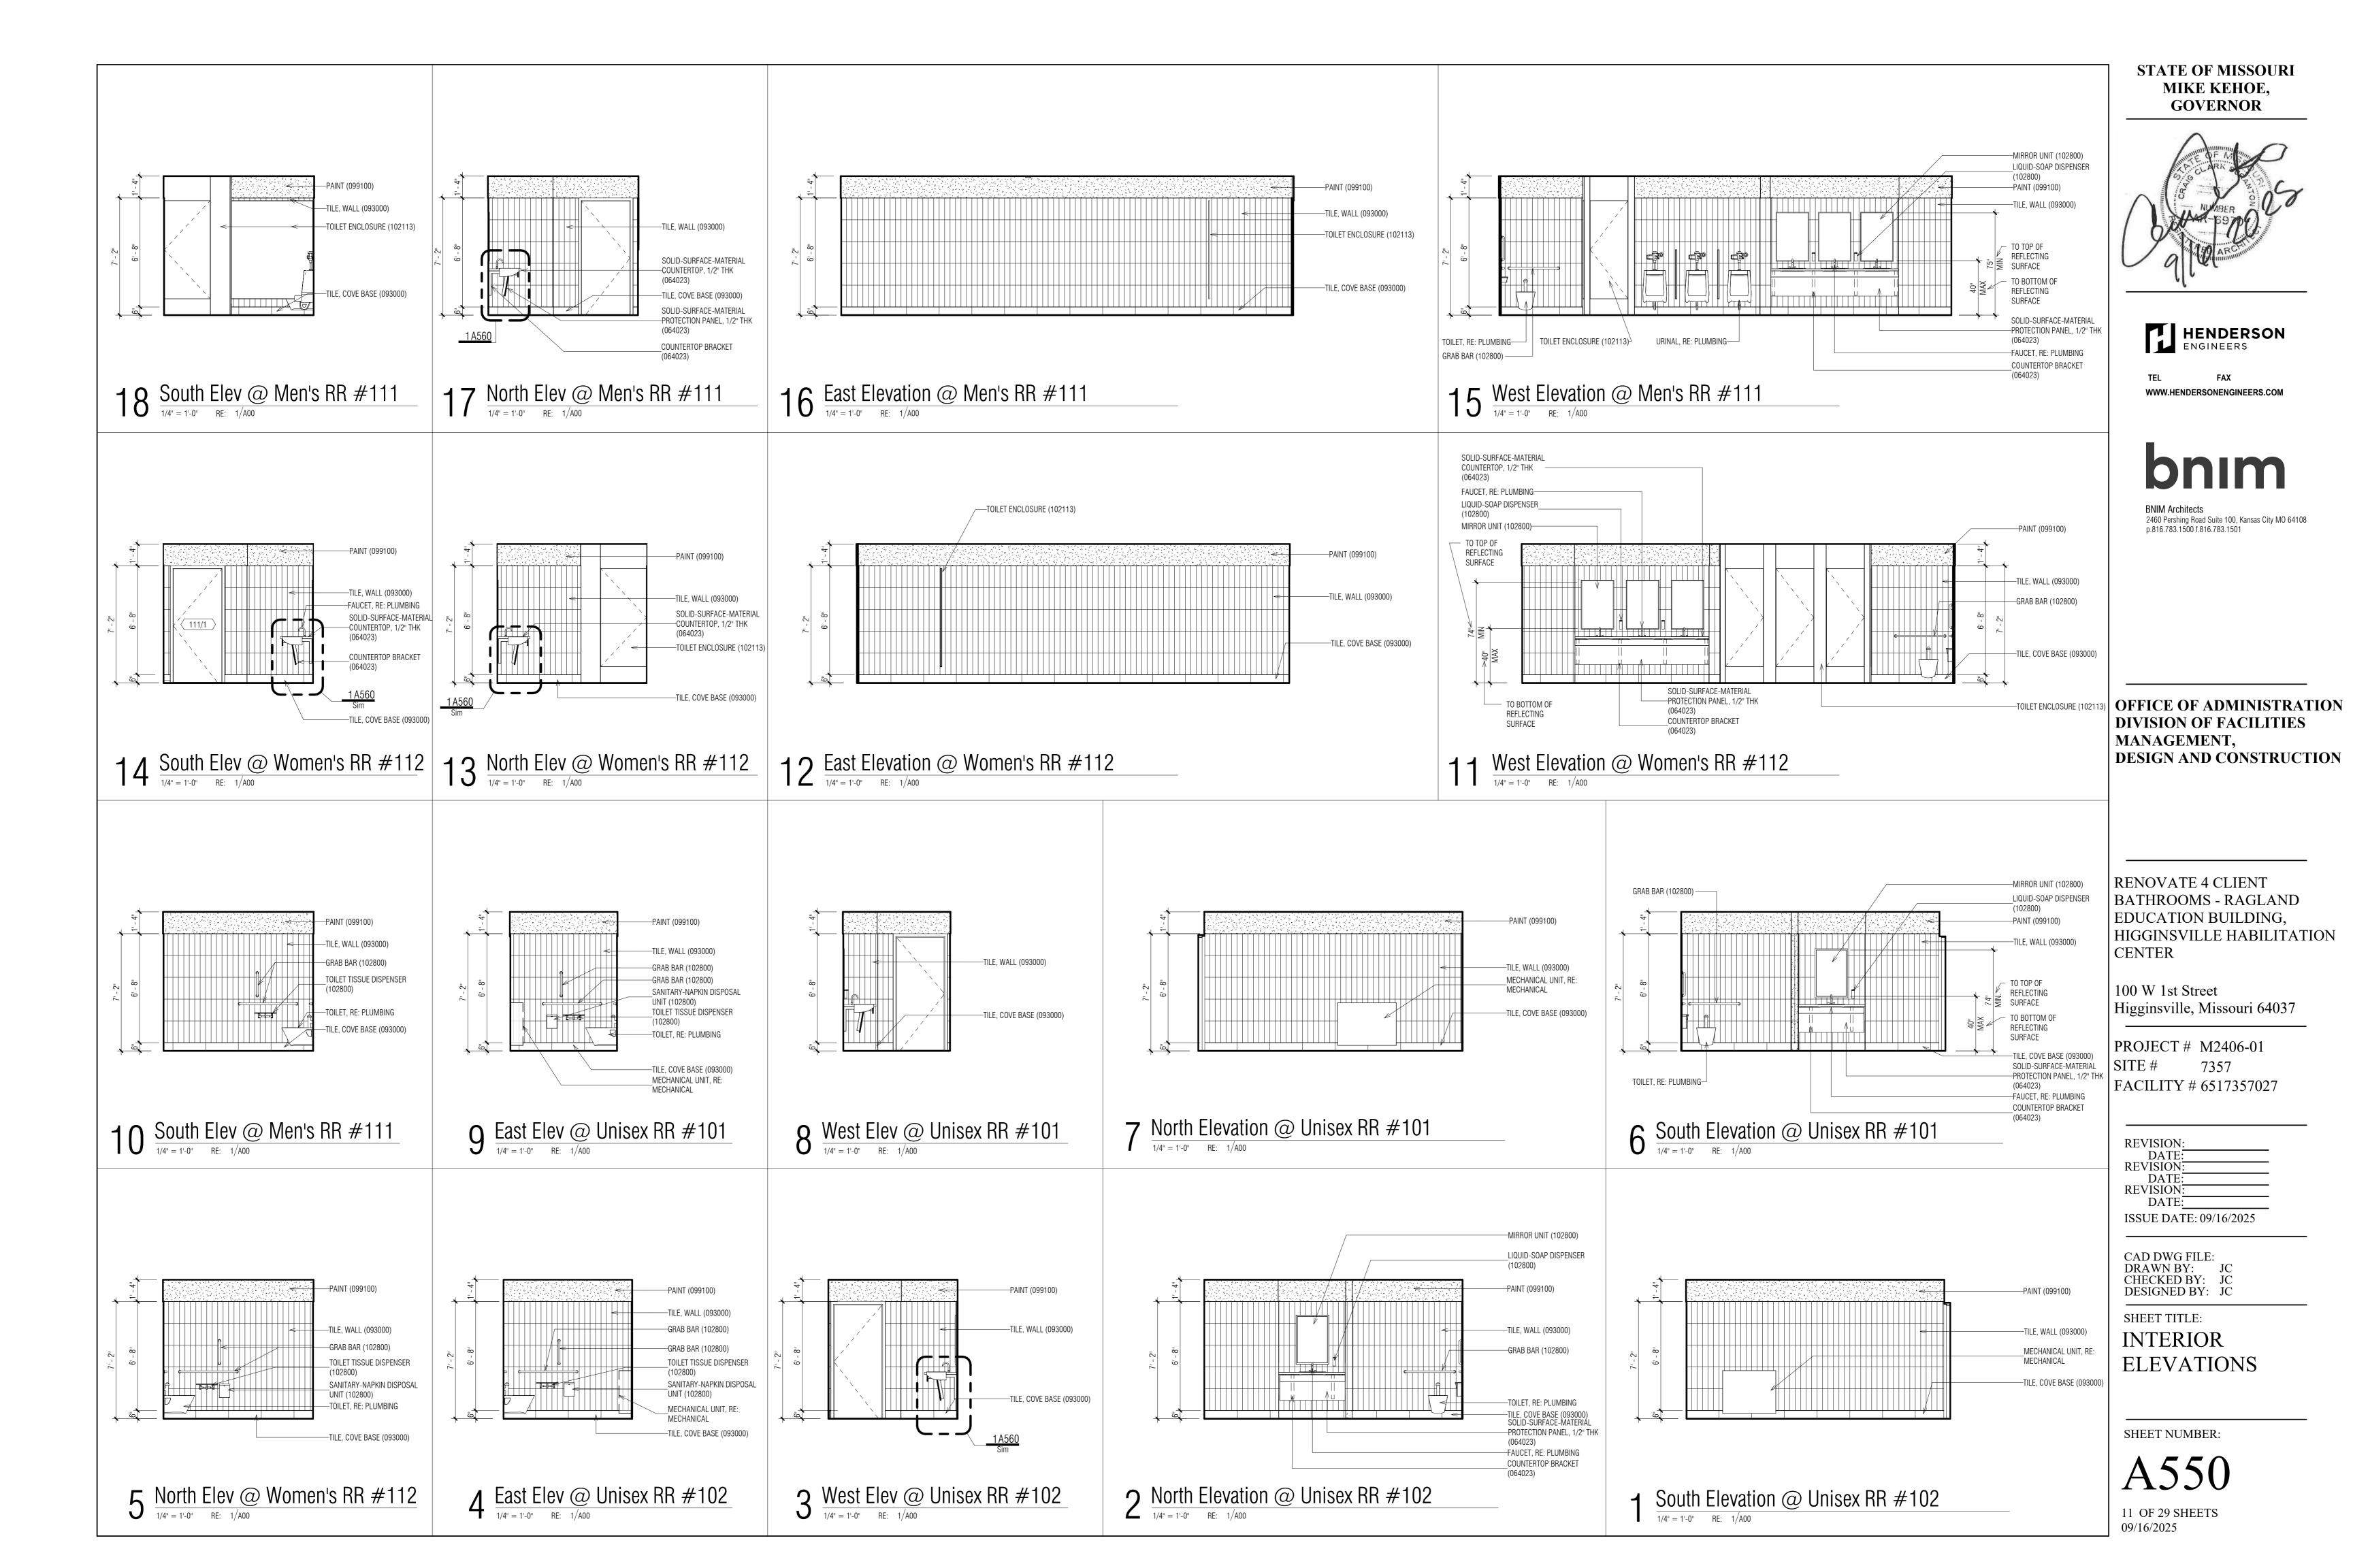




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HIGGINSVILLE HABILITATION



5 Floor Transition – Tile to Resilient Sheet 2 $\frac{1}{3'' = 1'-0''}$ RE: $\frac{1}{A600}$

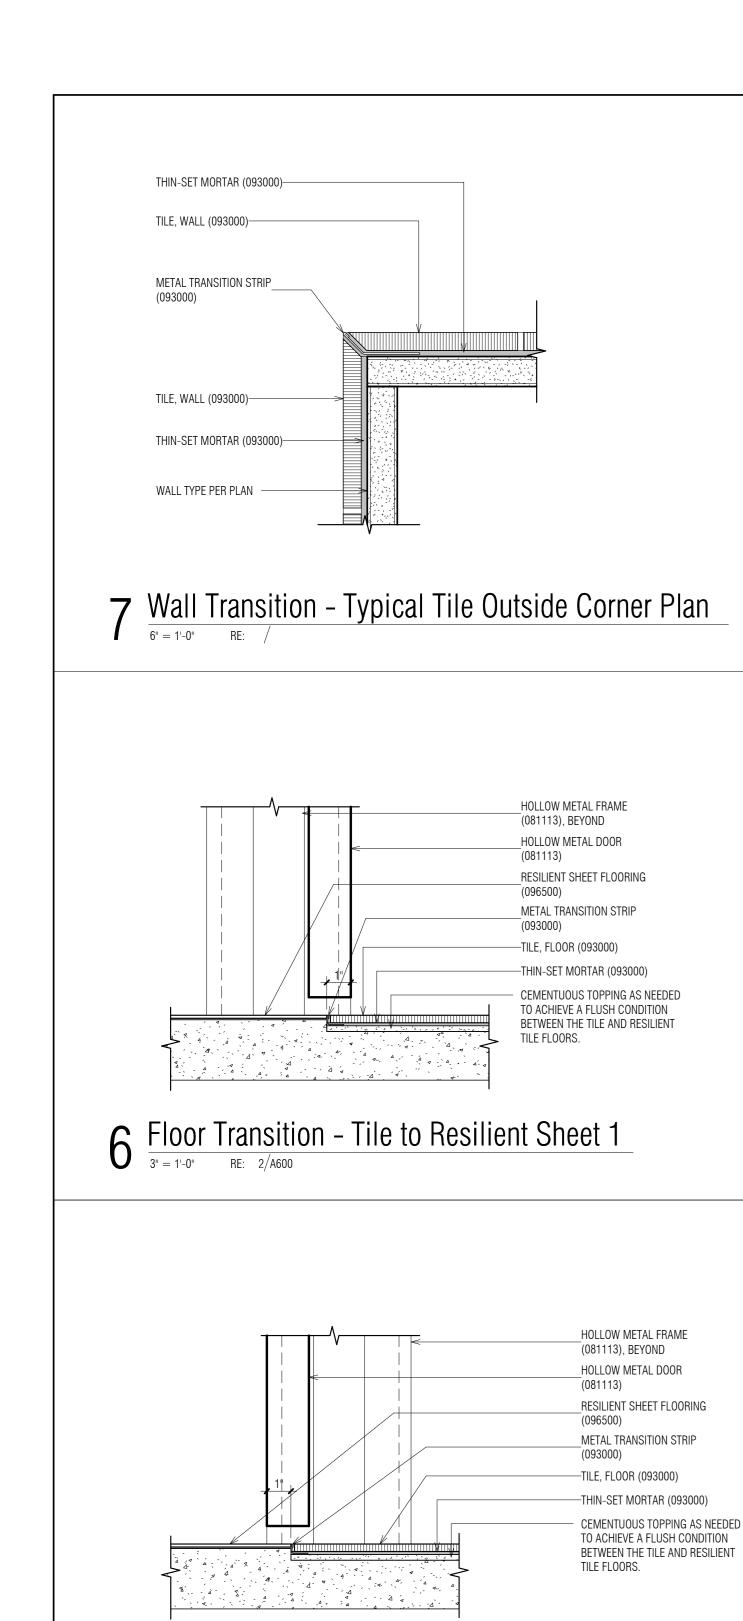4 Floor Transition – Resilient Sheet to Concrete $\frac{1}{3'' = 1'-0''}$ RE: 1/A600

_HOLLOW METAL FRAME


HOLLOW METAL DOOR


RESILIENT SHEET FLOORING


FLEXIBLE STOP TRANSITION

EXISTING SEALED CONCRETE FLOOR


__(081113), BEYOND

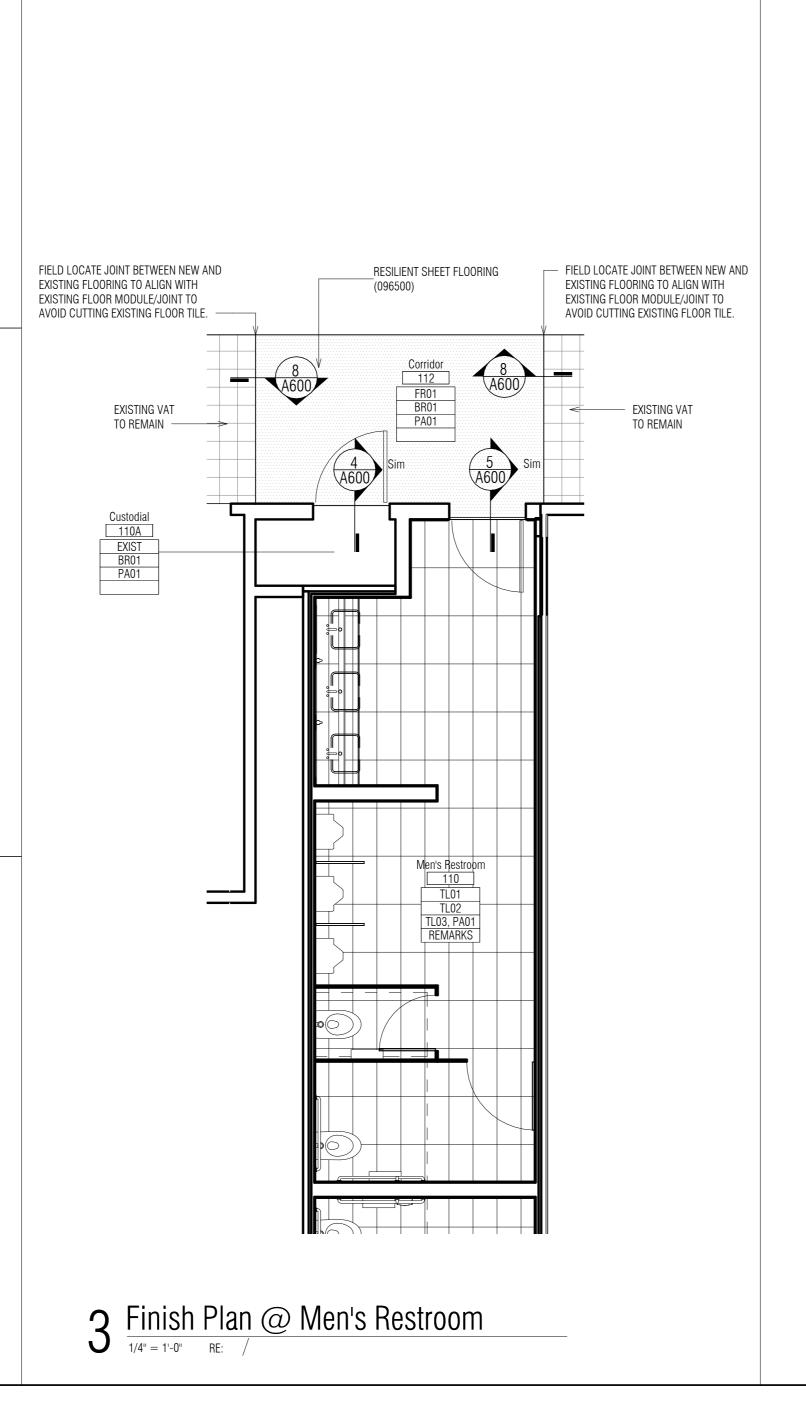


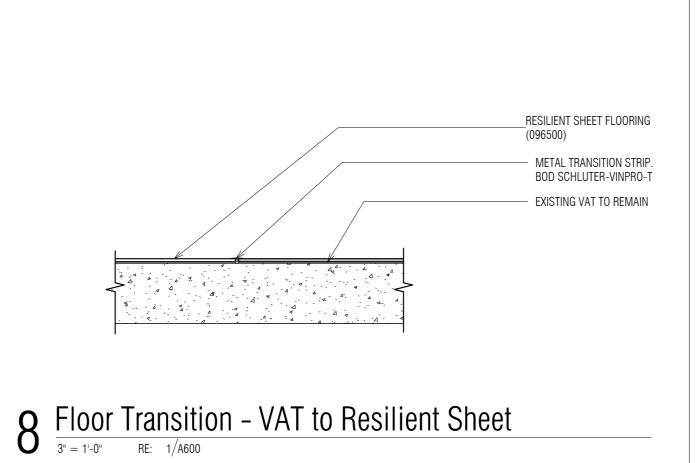

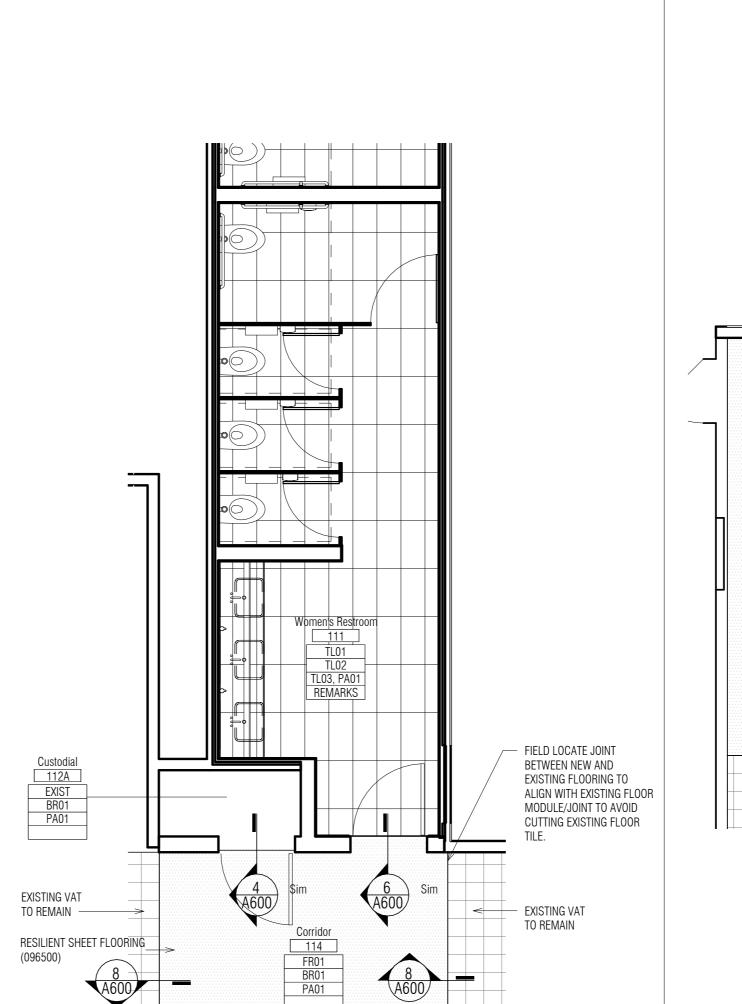


2 Finish Plan @ Women's Restroom $\frac{1}{1/4^n} = \frac{1}{0^n}$ RE: /

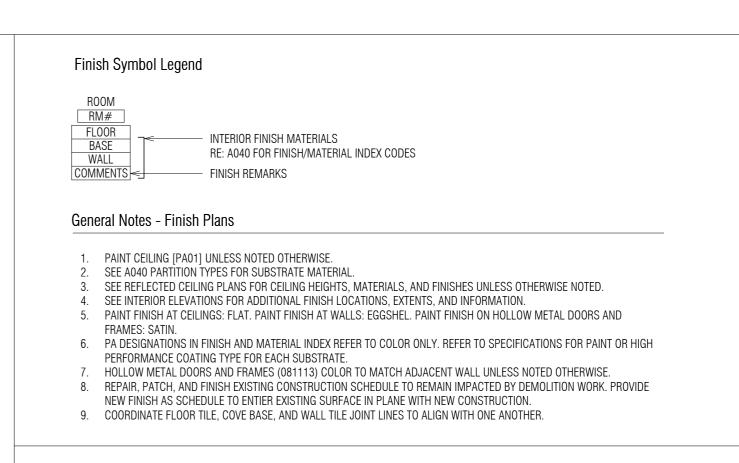

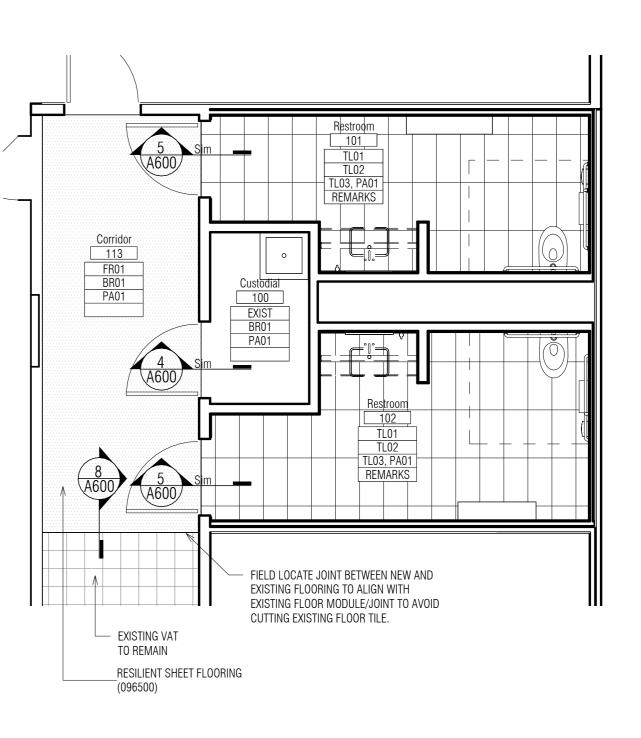

STATE OF MISSOURI MIKE KEHOE, GOVERNOR

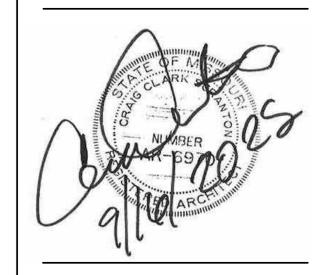

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OFFICE OF ADMINISTRATION
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RENOVATE 4 CLIENT
BATHROOMS - RAGLAND
EDUCATION BUILDING,
HIGGINSVILLE HABILITATION
CENTER

100 W 1st Street Higginsville, Missouri 64037

PROJECT # M2406-01 SITE # 7357 FACILITY # 6517357027

REVISION:
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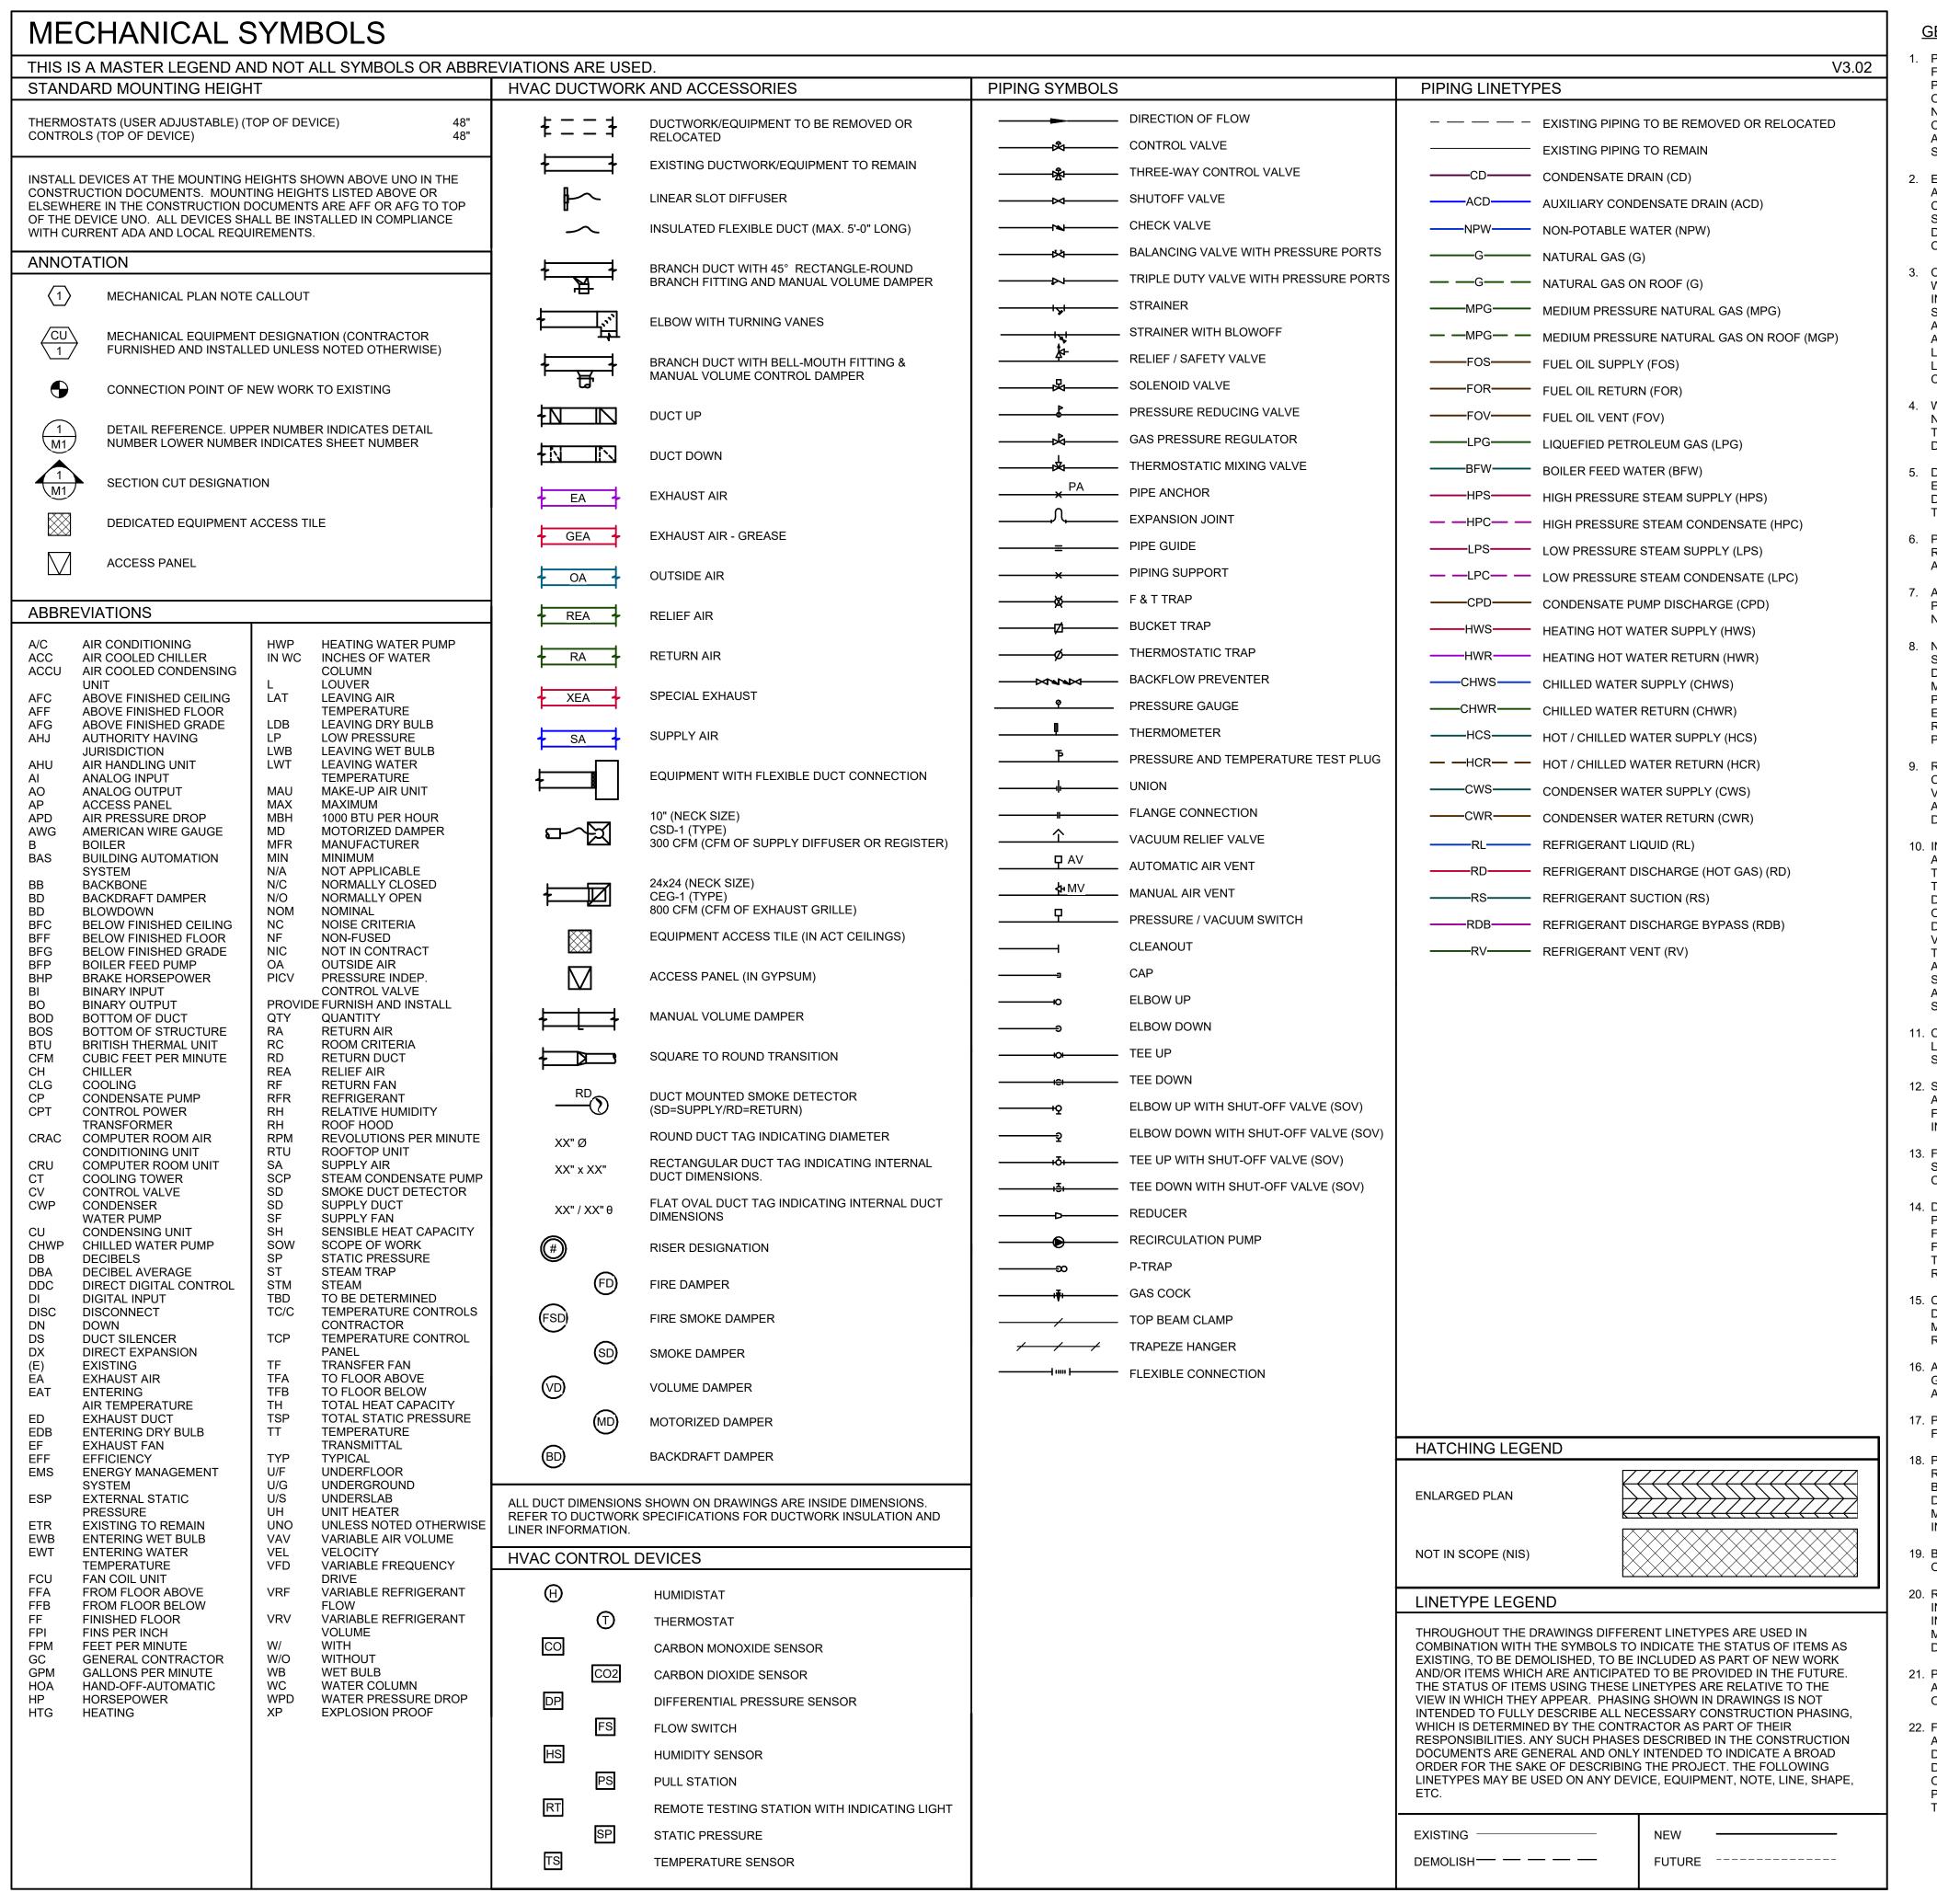
CAD DWG FILE:
DRAWN BY: JC
CHECKED BY: JC
DESIGNED BY: JC

SHEET TITLE:

ENLARGED FINISH PLANS AT RESTROOMS

SHEET NUMBER:

A600



GENERAL NEW NOTES:

- PRIOR TO SUBMITTING BID, VISIT THE JOB SITE AND BECOME FULLY ACQUAINTED WITH THE EXISTING CONDITIONS OF THE PROJECT. REVIEW THE GENERAL NOTES, SPECIFICATIONS AND OTHER DRAWINGS FOR ADDITIONAL REQUIREMENTS WHICH MAY NOT BE SPECIFICALLY CALLED OUT IN THIS PORTION OF THE CONSTRUCTION DOCUMENTS. NOTIFY ARCHITECT, ENGINEER AND/OR OWNER OF CONFLICTS OR DISCREPANCIES PRIOR TO SUBMISSION OF BID.
- EXISTING CONDITIONS WERE TAKEN FROM ORIGINAL DRAWINGS AND SITE VISITS AND MAY NOT REFLECT EXACT "AS-BUILT" CONDITIONS. FIELD VERIFY EXISTING CONDITIONS PRIOR TO SUBMITTING FINAL BIDS. COORDINATE NEW WORK AND DEMOLITION WITH OTHER DISCIPLINES AND EXISTING CONDITIONS PRIOR TO CONSTRUCTION.
- COORDINATE THE INSTALLATION OF THE MECHANICAL SYSTEMS WITH OTHER TRADES TO ENSURE A NEAT AND ORDERLY INSTALLATION. INSTALL DUCTWORK AND PIPING AS TIGHT TO STRUCTURE AS POSSIBLE. COORDINATE WITH OTHER TRADES TO AVOID CONFLICTS. COORDINATE INSTALLATION OF DUCTWORK AND PIPING TO AVOID CONFLICTS WITH ELECTRICAL PANELS, LIGHTING FIXTURES. ETC. ANY MODIFICATIONS REQUIRED DUE TO 4. REMOVE ITEMS SHOWN HEAVY-LINED DASHED, AND/OR LACK OF COORDINATION WILL BE THE RESPONSIBILITY OF THE CONTRACTOR AT NO EXTRA COST TO THE OWNER.
- WHERE SHUTDOWN OF EXISTING SYSTEMS IS REQUIRED DURING NEW WORK, COORDINATE SHUTDOWN TIME AND DURATION WITH THE OWNER TO MINIMIZE DOWNTIME, NOTIFY OWNER SEVEN (7) DAYS PRIOR TO INTERRUPTION OF SERVICE.
- DURING INSTALLATION OF NEW WORK, AVOID DAMAGING EXISTING SURFACES AND EQUIPMENT TO REMAIN. REPAIR DAMAGE CAUSED DURING CONSTRUCTION AT NO EXTRA COST TO THE OWNER.
- PROVIDE TEMPORARY BARRIERS TO CONTAIN DUST AND DEBRIS 7 RESULTING FROM THE PERFORMANCE OF THE WORK TO THE AREA WHERE WORK IS BEING PERFORMED.
- ALL MECHANICAL EQUIPMENT SHOWN ON THE MECHANICAL PLANS SHALL BE PROVIDED BY DIVISION 23 UNLESS OTHERWISE 8. INSTALL PERMANENT CAPS WHERE DUCTWORK AND PIPING
- NEW MECHANICAL EQUIPMENT, DUCTWORK AND PIPING ARE SHOWN AT APPROXIMATE LOCATIONS. FIELD MEASURE FINAL DUCTWORK AND PIPING LOCATIONS PRIOR TO FABRICATION AND MAKE ADJUSTMENTS AS REQUIRED TO FIT THE DUCTWORK AND PIPING WITHIN THE AVAILABLE SPACE. VERIFY THAT FINAL **EQUIPMENT LOCATIONS MEET MANUFACTURER'S** RECOMMENDATIONS REGARDING SERVICE CLEARANCE AND PROPER AIRFLOW CLEARANCE AROUND EQUIPMENT.
- REFER TO ARCHITECTURAL DRAWINGS FOR RELATED CONSTRUCTION DETAILS AS APPLICABLE TO THE HVAC SYSTEM. VERIFY CHASES AND PENETRATIONS SHOWN ON ARCHITECTURAL DRAWINGS THAT ARE INTENDED FOR DUCTWORK AND PIPING MEET REQUIREMENTS.
- 10. INDOOR AIR QUALITY MEASURES: PROTECT INSIDE OF (INSTALLED 11. CEASE WORK AND IMMEDIATELY NOTIFY THE OWNER AND DELIVERED) DUCTWORK AND HVAC UNITS FROM EXPOSURE TO DUST, DIRT, PAINT AND MOISTURE. REPLACE INSULATION THAT HAS BECOME WET AT ANY TIME DURING CONSTRUCTION, DRYING THE INSULATION IS NOT ACCEPTABLE. SEAL ANY TEARS OR JOINTS OF INTERNAL FIBERGLASS INSULATION, REMOVE DEBRIS FROM CEILING/RETURN AIR PLENUM INCLUDING DUST VACUUM CLEAN ANY DUCTWORK CONNECTED TO HVAC UNITS THAT WERE OPERATED DURING THE CONSTRUCTION PERIOD AFTER NEW FILTERS ARE INSTALLED AND PRIOR TO TURNING SYSTEM OVER TO THE OWNER. THE INTERNAL SURFACES AND ASSOCIATED COILS OF ANY HVAC UNITS THAT WERE OPERATED SHALL ALSO BE CLEANED.
- 11. COORDINATE LOCATION OF EQUIPMENT SUPPORTS WITH LOCATION OF EQUIPMENT ACCESS PANELS/DOORS TO ENABLE SERVICE OF EQUIPMENT AND/OR FILTER REPLACEMENT.
- 12. SEAL PENETRATIONS THROUGH THE BUILDING COMPONENTS IN ACCORDANCE WITH THE CONTRACT SPECIFICATIONS. FIREPROOF PENETRATIONS THROUGH FIRE RATED COMPONENTS IN ACCORDANCE WITH U.L. REQUIREMENTS.
- 13. FOR HYDRONIC PIPING TO EQUIPMENT, MINIMUM ACCEPTABLE SIZE FOR STEEL AND COPPER PIPE IS 3/4 INCH. USE THIS CRITERIA WHERE PIPE SIZES ARE NOT SHOWN ON PLAN.
- 14. DRAIN, FLUSH, AND REFILL ALL PIPING SYSTEMS NECESSARY TO PERFORM THE WORK, REFERENCE SPECIFICATIONS FOR FLUSHING PERFORMANCE REQUIREMENTS AND SUBMIT FLUSHING PLAN TO ENGINEER FOR REVIEW. PROVIDE CHEMICAL TREATMENT FOR ALL PIPING SYSTEMS AFTER FLUSHING AND REFILLING THE SYSTEM.
- 15. COORDINATE THE EXACT MOUNTING SIZE AND FRAME TYPE OF DIFFUSERS, REGISTERS AND GRILLES WITH THE SUPPLIER TO MEET THE CEILING, WALL AND DUCT INSTALLATION REQUIREMENTS.
- 16. ADJUST LOCATION OF CEILING DIFFUSERS, REGISTERS AND GRILLES AS REQUIRED TO ACCOMMODATE FINAL CEILING GRID AND LIGHTING LOCATIONS.
- 17. PROVIDE A MANUAL BALANCING DAMPER IN EACH DUCT TAKEOFF FROM EXHAUST AIR DUCTS.
- 18. PROVIDE A PREFABRICATED 45 DEGREE, HIGH EFFICIENCY, RECTANGULAR/ROUND BRANCH DUCT TAKEOFF FITTING FOR BRANCH DUCT CONNECTIONS AND TAKE-OFFS TO INDIVIDUAL DIFFUSERS, REGISTERS AND GRILLES. PROVIDE WITH INTEGRAL MANUAL BALANCING DAMPER AND LOCKING QUADRANT WHERE INDICATED ON PLANS.
- 19. BRANCH DUCTWORK TO AIR OUTLETS SHALL BE SAME SIZE AS OUTLET NECK SIZE UNLESS OTHERWISE NOTED.
- 20. REFER TO SPECIFICATIONS FOR DUCTWORK AND PIPING INSULATION REQUIREMENTS. DUCT SIZES ON MECHANICAL PLANS INDICATE CLEAR INSIDE AIRFLOW DIMENSIONS, INCREASE SHEET METAL SIZES ACCORDINGLY TO ACCOUNT FOR THICKNESS OF DUCT LINER.
- PROVIDE A NEW SET OF AIR FILTERS IN UNITS PRIOR TO TESTING, ADJUSTING AND BALANCING AND BEFORE TURNING SYSTEM(S) OVER TO OWNER.
- 22. FIELD VERIFY THAT THE EXISTING EQUIPMENT INCLUDING ACCESSORIES BEING REUSED FOR THIS PROJECT IS NOT DAMAGED AND IS IN GOOD WORKING ORDER. REPORT ANY DEFICIENCIES TO THE OWNER OR ARCHITECT. SUBMIT TO THE OWNER AND ARCHITECT A WRITTEN REPORT DESCRIBING TESTS PERFORMED TO VERIFY OPERATION AND RESULTS OF THE

GENERAL DEMOLITION NOTES:

- 1. COORDINATE ALL DEMOLITION WITH WHAT IS SHOWN ON ARCHITECTURAL PLANS. NOTIFY ARCHITECT OF ANY DISCREPANCIES.
- 2. PRIOR TO SUBMITTING BID, VISIT THE JOB SITE AND BECOME FULLY ACQUAINTED WITH THE EXISTING CONDITIONS OF THE PROJECT. REVIEW GENERAL NOTES, SPECIFICATIONS AND OTHER DRAWINGS FOR ADDITIONAL REQUIREMENTS THAT MAY NOT BE SPECIFICALLY CALLED OUT IN THIS PORTION OF THE CONSTRUCTION DOCUMENTS. NOTIFY ARCHITECT, ENGINEER OR OWNER. AS DEFINED IN BID DOCUMENTS. OF CONFLICTS OR DISCREPANCIES PRIOR TO SUBMISSION OF
- 3. OWNER RETAINS RIGHTS OF SALVAGE FOR EQUIPMENT AND FIXTURES TO BE REMOVED. COORDINATE WITH OWNER THE EQUIPMENT AND FIXTURES TO BE SALVAGED AND THE LOCATION FOR STORAGE. AVOID DAMAGE TO SALVAGED EQUIPMENT, FIXTURES AND DEVICES DURING DEMOLITION WORK AND DURING TRANSPORT TO OWNER'S DESIGNATED STORAGE LOCATION.
- NOTED TO BE REMOVED.
- AVOID DAMAGING EXISTING SURFACES AND EQUIPMENT TO REMAIN FOR NEW INSTALLATION. REPAIR DAMAGE CAUSED DURING WORK AT NO EXTRA COST TO THE OWNER.
- . SEAL PENETRATIONS THROUGH FLOORS, WALLS, CEILINGS AND ROOFS WHERE MECHANICAL COMPONENTS ARE REMOVED AND WHERE THE EXISTING PENETRATION IS NOT USED FOR THE NEW INSTALLATION. REPAIR DAMAGED SURFACES TO MATCH ADJACENT AREAS OR AS INDICATED ON THE ARCHITECTURAL DRAWINGS.
- REMOVE HANGERS AND SUPPORTS WHERE DUCTWORK, PIPING AND/OR EQUIPMENT ARE REMOVED AND THE EXISTING HANGERS AND SUPPORTS ARE NOT USED FOR THE NEW INSTALLATION.
- IS REMOVED AND THE EXISTING TAPS ARE NOT USED FOR THE NEW INSTALLATION. WHERE DUCTWORK AND PIPING ARE REMOVED AND THE EXISTING TAPS WILL BE USED FOR THE NEW INSTALLATION, INSTALL TEMPORARY CAPS TO PROTECT THE INTERIOR SURFACES UNTIL NEW DUCTWORK AND PIPING ARE INSTALLED.
- INSPECT EXISTING EQUIPMENT TO REMAIN TO VERIFY THAT EQUIPMENT IS OPERATING PROPERLY. NOTIFY OWNER OF DAMAGED AND/OR MALFUNCTIONING COMPONENTS.
- 10. WHERE SHUTDOWN OF EXISTING SYSTEMS IS REQUIRED DURING DEMOLITION, COORDINATE SHUTDOWN TIME AND DURATION WITH OWNER TO MINIMIZE DOWNTIME. NOTIFY OWNER SEVEN (7) DAYS PRIOR TO INTERRUPTION OF SERVICE.
- SHOULD ANY HAZARDOUS MATERIALS BE ENCOUNTERED DURING THE PERFORMANCE OF THE WORK.

STATE OF MISSOURI MIKE KEHOE, **GOVERNOR**



KELLEY P. CRAMM LICENSE # E-022323

HENDERSON ENGINEERS 8345 LENEXA DRIVE, SUITE 300

LENEXA, KS 66214 TEL 913.742.5000 FAX 913.742.5001 WWW.HENDERSONENGINEERS.COM

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OFFICE OF ADMINISTRATION DIVISION OF FACILITIES MANAGEMENT. DESIGN AND CONSTRUCTION

RENOVATE 4 CLIENT BATHROOMS - RAGLAND EDUCATION BUILDING, HIGGINSVILLE HABILITATION CENTER

100 W 1st Street Higginsville, Missouri 64037

PROJECT # M2406-01 SITE# 7357 FACILITY # 6517357027

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ISSUE DATE: 09/16/2025

CAD DWG FILE: DRAWN BY: KTL CHECKED BY: JP DESIGNED BY: KTL

SHEET TITLE:

MECHANICAL GENERAL NOTES AND LEGEND

SHEET NUMBER:





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HENDERSON ENGINEERS

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CAD DWG FILE: DRAWN BY: KTL CHECKED BY: JP DESIGNED BY: KTL

SHEET TITLE:

HVAC LEVEL 1 PLAN
- OVERALL


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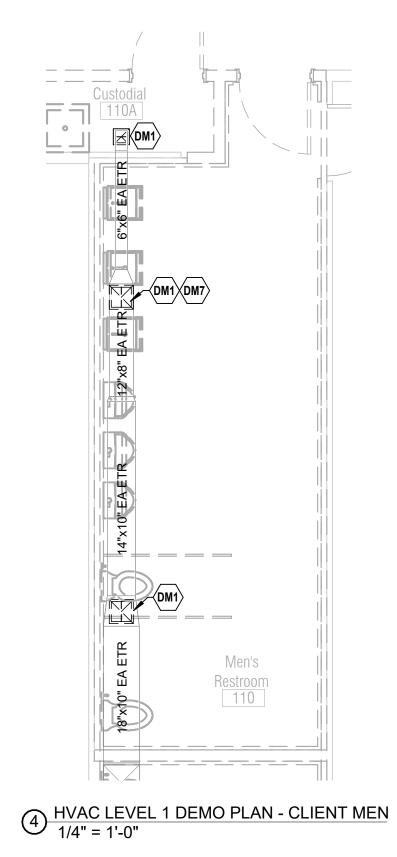
09/16/2025


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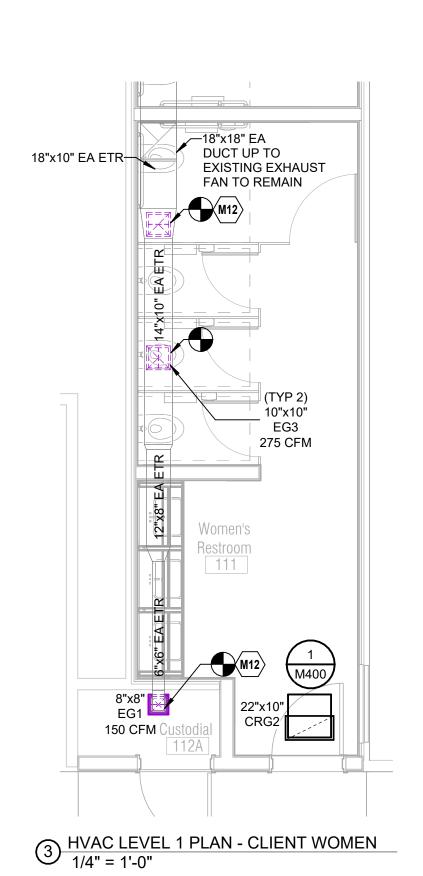
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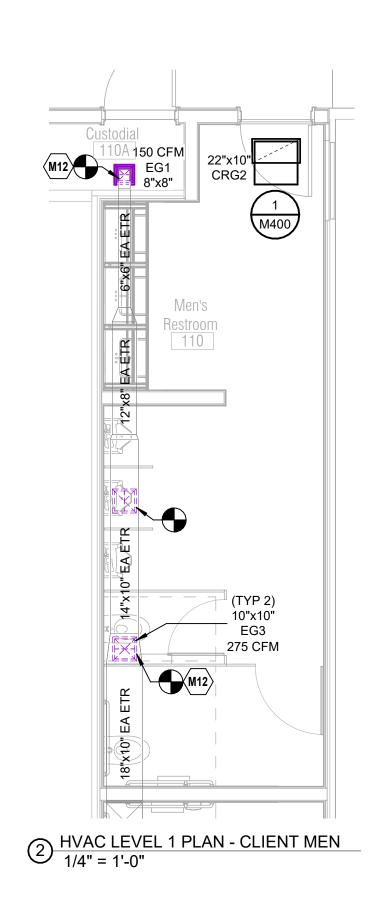
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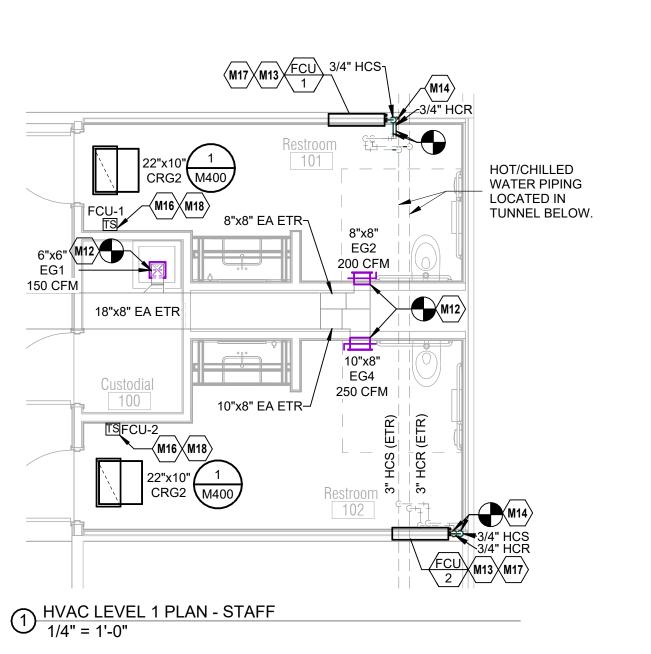








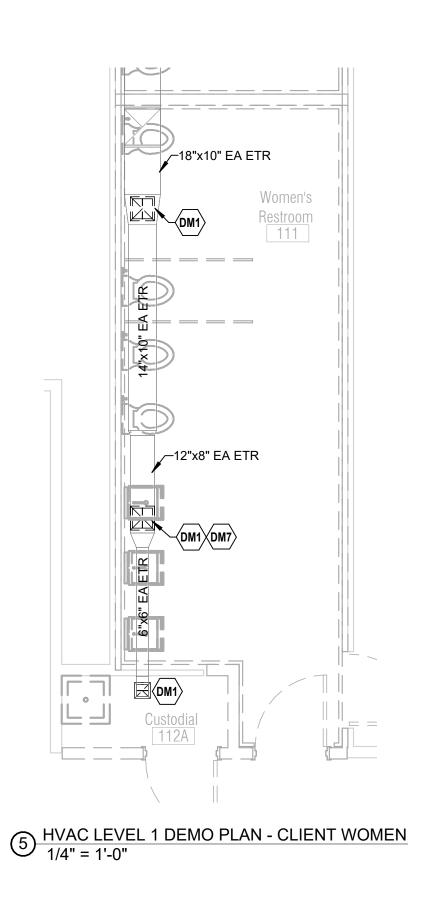

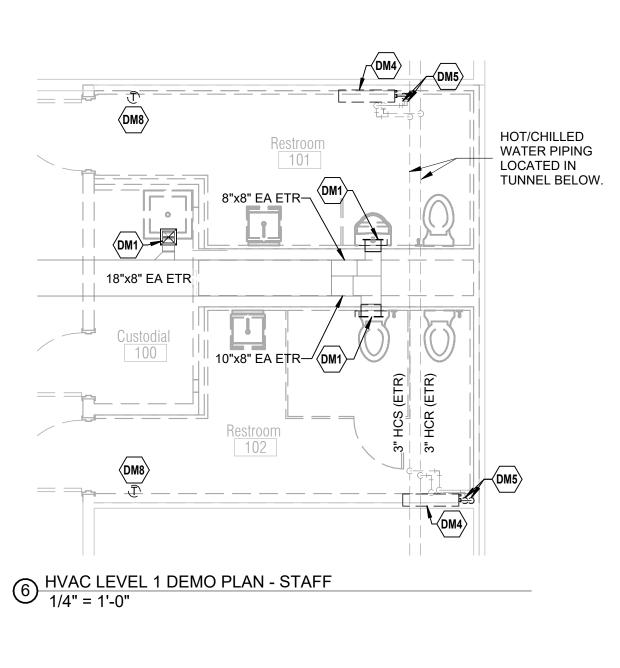

MECHANICAL PLAN NOTES:

CONTROL WIRING.

CONDENSATE DRAINAGE.

- DM1 REMOVE EXISTING EXHAUST GRILLE. PROTECT EXISTING DUCT PENETRATION FOR REUSE WITH NEW GRILLE.
- DM4 REMOVE EXISTING FAN COIL UNIT AND SURROUNDING ENCLOSURE. RETAIN EXISTING OPENING FOR NEW FAN COIL UNIT REPLACEMENT. MODIFY OPENING AS REQUIRED FOR NEW UNIT
- DM5 REMOVE 3/4" HOT/CHILLED WATER PIPING BACK TO NEAREST SHUTOFF VALVE.
- DM7 REMOVE DUCTWORK BACK TO MAIN AND CAP. SEAL
- DM8 REMOVE EXISTING THERMOSTAT AND ALL ASSOCIATED
- M12 LOCATE NEW EXHAUST GRILLES IN THE SAME LOCATION AS PREVIOUS AND CONNECT TO EXISTING DUCTWORK.
- M13 LOCATE NEW FAN COIL UNIT IN THE SAME LOCATION AT THE PREVIOUS AND REUSE THE SAME WALL PENETRATION.
- M14 CONNECT NEW 3/4" HCS/HCR PIPING FROM EXISTING SHUTOFF VALVE WITHIN WALL CAVITY TO NEW FCU. ROUTE PIPING UP FROM UTILITY TUNNEL BELOW.
- M16 PROVIDE NEW TEMPERATURE SENSOR AND NEW CONTROL WIRING BACK TO NEAREST BAS CONTROL PANEL.
 INTEGRATE NEW FAN COIL LINIT INTO EXISTING BAS
- INTEGRATE NEW FAN COIL UNIT INTO EXISTING BAS.
 M17 CONNECT NEW FAN COIL UNIT CONDENSATE TO EXISTING
- M18 PROVIDE LOCKING COVER FOR TEMPERATURE SENSOR.

STATE OF MISSOURI MIKE KEHOE, GOVERNOR



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DRAWN BY: KTL
CHECKED BY: JP
DESIGNED BY: KTL

SHEET TITLE:

HVAC LEVEL 1 PLAN
- ENLARGED VIEWS

SHEET NUMBER:

M102

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			SUPPLY	FAN						COOLI	NG COIL									HEAT	NG COIL	•			ELECTRICAL			
				NOM	TH	SH	EAT	Γ	LA	T	FLOW	EWT	LWT	MAX	MAX VEL	ROWS	CAP	EAT	LAT	FLOW EV	/T LWT	MAX WPD	MAX VEL	ROW		WEIGHT		
MAR	MANUFACTURER	MODEL	CFM	HP	(MBH)	(MBH)	(°F DB) (°	°F WB)	(°F DB)	(°F WB)	(GPM)	(°F)	(°F) \	WPD (FT)	(FPM)	/ FPI	(MBH)	(°F DB)	(°F DB)	(GPM) (°	F) (°F)	(FT)	(FPM)	S / FPI	V/PH	(LBS)	NOTES	
FCU	2 CARRIER	42VGA03ALCY7AKYA	275	0.05	6.1	4.7	80.0	67.0	61.0	60.0	0.61	45	55	5.0	140	3/10	6.1	68.0	98.0	0.6 14	0 120	5.0	140	2/10	120 V / 1PH	74	ALL	

MODEL NUMBERS SHALL NOT BE CONSIDERED COMPLETE AND MATERIAL SHALL NOT BE ORDERED BY MANUFACTURER AND MODEL NUMBERS ONLY. REVIEW THE COMPLETE DESCRIPTION, NOTES AND SPECIFICATIONS TO DETERMINE THE EXACT MATERIAL AND ACCESSORIES TO BE ORDERED. THE MANUFACTURERS LISTED ARE THE BASIS FOR THE DESIGN.

NOTES

- A. UTILIZE THE UNIT INTEGRAL FILTER RACK. PROVIDE MERV 8, PLEATED THROWAWAY AIR FILTERS.
- B. PROVIDE WITH FRONT INLET CONNECTION.
- C. PROVIDE WITH FRONT OUTLET CONNECTION.
- . CONTROLS CONTRACTOR SHALL PROVIDE A NON-ADJUSTABLE TEMPERATURE SENSOR WITH STAGED HEATING AND COOLING CAPABILITY AS REQUIRED FOR OPERATION OF HEATING AND COOLING CONTROLS.
- E. PROVIDE FACTORY MOUNTED DISCONNECT INSTALLED ON SERVICE SIDE OF UNIT.
- F. PROVIDE STARTER INTEGRAL WITH EQUIPMENT.


PROVIDE UNIT WITH CONDENSATE DRAIN PAN.

		G	RILLE	, REGIST	ER AI	ND DIFFUS	ER SCHI	EDU	ILE	
									MAX PRESS DROP (IN	
MARK	MANUFACTURER	SERVICE	MODEL	CONSTRUCTION TYPE	FACE TYPE	MOUNTING LOCATION	FACE SIZE (IN)	MAX NC	W.C.)	NOTES
CRG2	PRICE	RETURN	635	ALUMINUM	LOUVERED	CEILING	REFER TO PLANS	25	0.05	A-D
EG1	PRICE	EXHAUST	635	ALUMINUM	LOUVERED	DUCT	REFER TO PLANS	25	0.18	ALL
EG2	PRICE	EXHAUST	635	ALUMINUM	LOUVERED	SIDE WALL	REFER TO PLANS	25	0.07	ALL
EG3	PRICE	EXHAUST	635	ALUMINUM	LOUVERED	CEILING	REFER TO PLANS	25	0.09	ALL
EG4	PRICE	EXHAUST	635	ALUMINUM	LOUVERED	SIDE WALL	REFER TO PLANS	25	0.09	ALL

MODEL NUMBERS SHALL NOT BE CONSIDERED COMPLETE AND MATERIAL SHALL NOT BE ORDERED BY MANUFACTURER AND MODEL NUMBERS ONLY. REVIEW THE COMPLETE DESCRIPTION, NOTES AND SPECIFICATIONS TO DETERMINE THE EXACT MATERIAL AND ACCESSORIES TO BE ORDERED. THE MANUFACTURERS LISTED ARE THE BASIS FOR THE DESIGN.

NOTE


- A. NECK SIZE SHOWN ON DRAWINGS. PROVIDE BRANCH DUCT TO MATCH NECK SIZE UNLESS OTHERWISE SHOWN ON DRAWINGS.
- B. BAKED ENAMEL FINISH, WHITE TO MATCH CEILING COLOR.
- C. FRONT BLADES PARALLEL TO LONG DIMENSION.
- D. FRAME TYPE TO MATCH CEILING/WALL CONSTRUCTION, COORDINATE WITH ARCHITECTURAL REFLECTED CEILING/WALL PLAN.
- E. PROVIDE OPPOSED BLADE DAMPER ADJUSTABLE FROM FACE OF DEVICE.

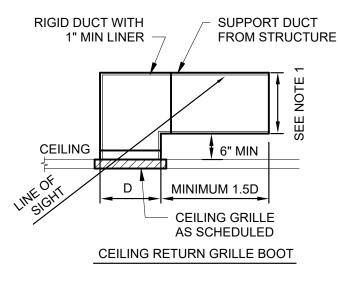

NOTES:

1. REFER TO FLOOR PLAN FOR OUTLET DEPTH. WHEN NO DEPTH IS SHOWN, MINIMUM DEPTH SHALL BE AS REQUIRED TO LIMIT AIR VELOCITY TO 500 FPM WITH A MINIMUM SIZE OF 0.5D.

TRETURN TRANSFER AIR DUCT DETAILS

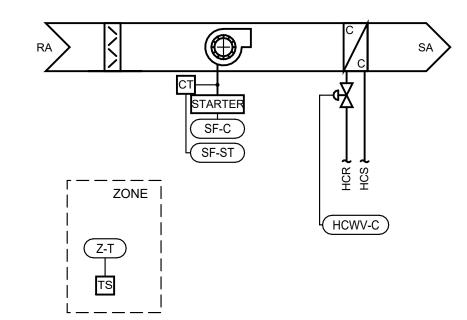

SEQUENCE OF OPERATIONS

GENERAL DESCRIPTION

FAN COIL UNITS

The fan coil unit(s) described by this sequence of operations consist(s) of constant volume fan coil units that are served by a 2-pipe heating hot/chilled water central plant. Units are either in cooling or heating mode. They provide space conditioning to restrooms and do not have any connection for outside air.

OPERATING MODES OCCUPIED MODE:

OCCUPIED MODE:

The unit shall be in occupied mode per the Project Design Conditions Schedule shown on the control drawings.

COOLING MODE:

The unit shall be in cooling mode when the zone temperature (Z-T) rises above the dead band (Z-T-DB).

HEATING MODE:
The unit shall be in heating mode when the zone temperature (Z-T) falls below the dead band (Z-T-DB).

UNOCCUPIED MODE:

The unit shall be in unoccupied mode for all periods not included in the occupied hours of operation. Overrides of unoccupied schedule are defined at the zone level control.

SAFETIES, OVERRIDES AND INTERLOCKS

FIRE ALARM CONTROL PANEL INTERLOCK:

The unit shall be disabled via hard wired interlock at the fan start circuit upon receipt of

signal from the fire alarm control panel.

COMPONENT CONTROL LOOPS

SUPPLY FAN CONTROL- ON/OFF OPERATION

When in Occupied or Unoccupied Mode:

The fan shall cycle on a call for heating or cooling from the zone level or on an

override signal.

COIL HOT WATER/CHILLED WATER VALVE – ON/OFF

When in Occupied or Unoccupied Mode:

When Plant is in Cooling and FCU is in Cooling Mode:

The valve shall open to maintain the zone temperature setpoint (Z-T).

When Plant is in Heating and ECLL is in Heating Mode:

When Plant is in Heating and FCU is in Heating Mode:
The valve shall open to maintain the zone temperature setpoint (Z-T).

When in all other Modes: The valve shall be closed.

POINT ID	DESCRIPTION	POINT	DEFAULT	FAIL	STATUS	ALARM	NOTES
		TYPE	SET POINT	POSITION	ALARM	RANGE	
ZONE LEVEL SEN	NSORS	·					
Z-T	ZONE TEMPERATURE	Al	75F CLG; 70F HTG				А
SUPPLY FAN							
SF-C	SUPPLY FAN COMMAND (START/STOP)	ВО					
SF-ST	SUPPLY FAN STATUS	BI			Х	SF-ST <> SF-C	
COOLING COIL -	CHILLED WATER MODULATING				'		<u>'</u>
HCWV-C	CHILLED WATER VALVE COMMAND	ВО					

BAS CONTROLS CONTACT INFORMATION:
CONTROL SERVICE COMPANY (AUTOMATED LOGIC)
816-600-5800

2 FCU CONTROLS NTS

ALL BAS CONTROLS WORK SHALL BE COMPLETED BY CSC LEE'S SUMMIT. CONTACT THE NUMBER ABOVE FOR BID PRICING AND EXISTIGN SYSTEM INFORMATION.

STATE OF MISSOURI MIKE KEHOE, GOVERNOR



LICENSE # E-022323

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> 2450001062 MO. CORPORATE NO: E-556D EXPIRES 10/31/2025

OFFICE OF ADMINISTRATION DIVISION OF FACILITIES MANAGEMENT, DESIGN AND CONSTRUCTION

RENOVATE 4 CLIENT
BATHROOMS - RAGLAND
EDUCATION BUILDING,
HIGGINSVILLE HABILITATION
CENTER

100 W 1st Street Higginsville, Missouri 64037

PROJECT # M2406-01 SITE # 7357 FACILITY # 6517357027

REVISION:
DATE:
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TEE : 12101 :
DATE:
ISSUE DATE: 09/16/2025
1330E DATE. 09/10/2023

CAD DWG FILE:
DRAWN BY: KTL
CHECKED BY: JP
DESIGNED BY: KTL

SHEET TITLE:

MECHANICAL

SCHEDULES AND


DETAILS

SHEET NUMBER:

M400

17 OF 29 SHEETS

09/16/2025

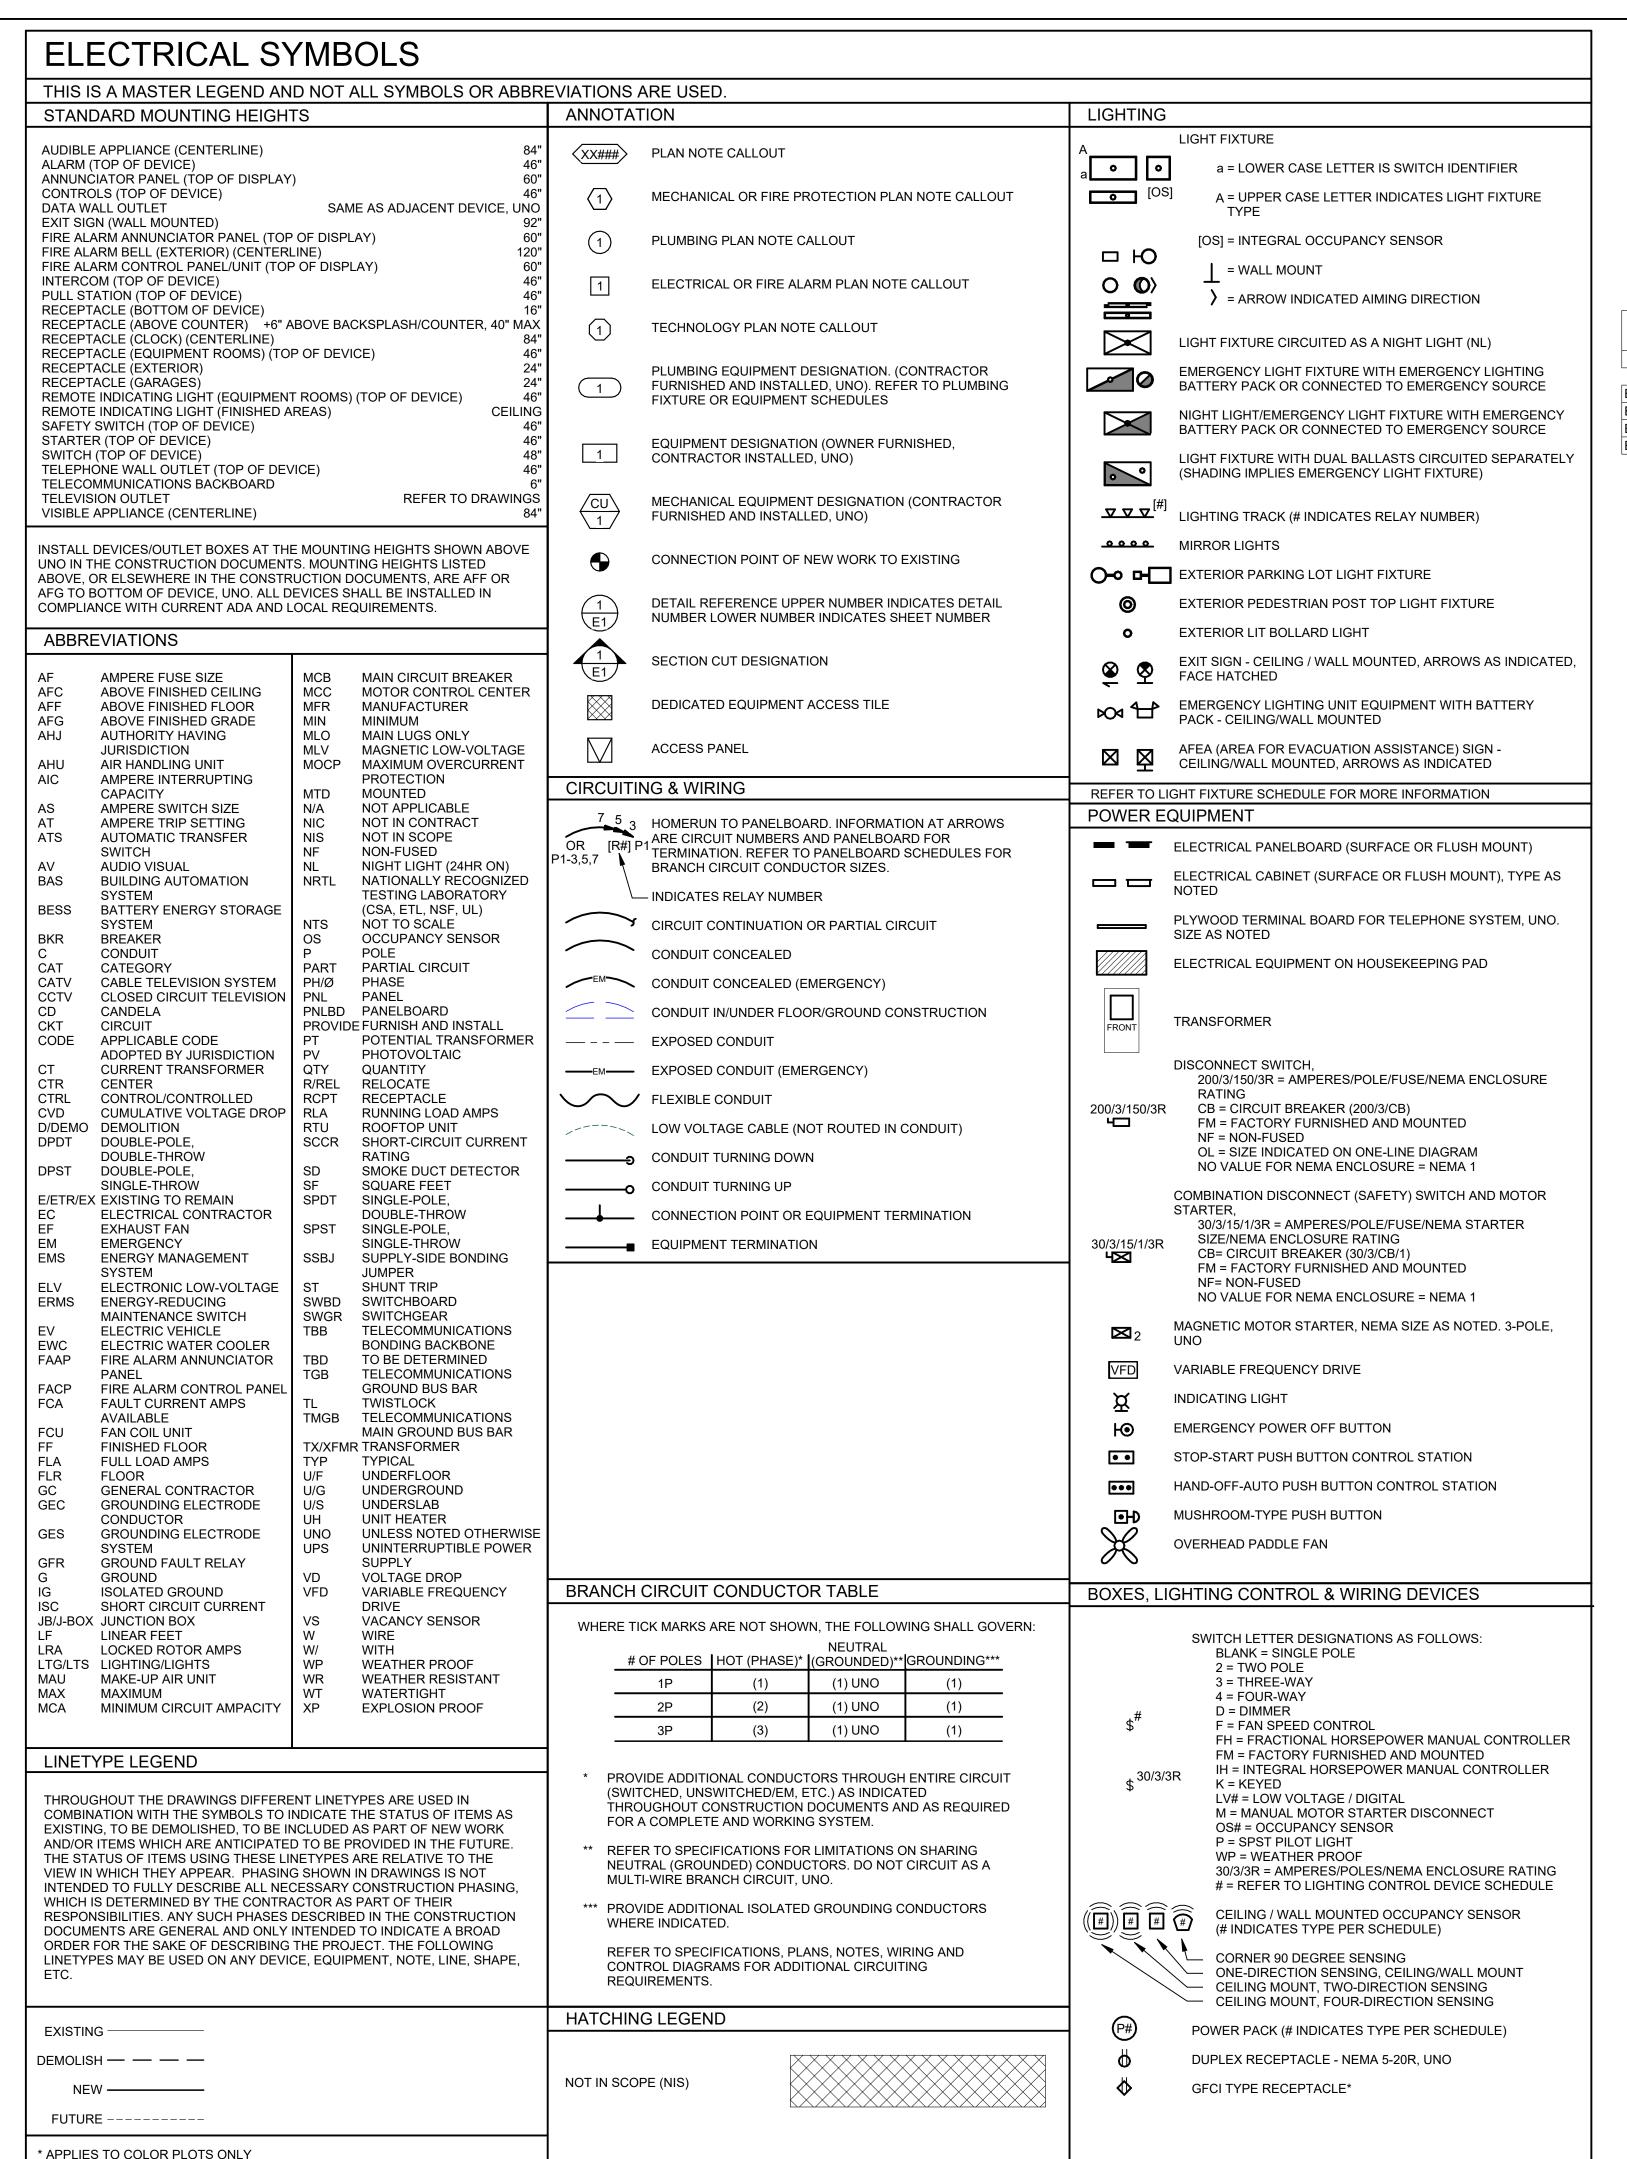

LIGHTING SUPPLEMENTAL SPECIFICATIONS:

- PROVIDE A NEUTRAL CONDUCTOR TO ALL WALL MOUNTED LINE VOLTAGE LIGHT SWITCHES, UNLESS NOTED OTHERWISE. IF NEUTRAL TERMINATION IS NOT REQUIRED FOR THE DEVICE THEN CAP CONDUCTOR AND TAG AS "NEUTRAL FOR FUTURE USE".
- 2. COORDINATE ALL OCCUPANCY/VACANCY SENSOR SETTINGS WITH OWNER AND ADJUST AS NECESSARY FOR PROPER OPERATION. SETTINGS MUST COMPLY WITH AHJ AND LOCAL ENERGY CODE REQUIREMENTS.
- 3. DO NOT INSTALL OCCUPANCY/VACANCY SENSORS WITHIN 48" OF AIR DIFFUSER OR SIMILAR OBSTRUCTION THAT MAY ADVERSLY AFFECT THE SENSOR PERFORMANCE. COORDINATE FINAL SENSOR LOCATIONS WITH OTHER TRADES AND INSTALL IN ACCORDANCE WITH MANUFACTURER'S RECOMMENDATIONS.

Sheet List - ELECTRICAL

umber Sheet Name

E000	ELECTRICAL LEGEND AND GENERAL NOTES
E100	ELECTRICAL LEVEL 1 PLAN - OVERALL
E101	ELECTRICAL LEVEL 1 PLAN - ENLARGED VIEWS
E500	ELECTRICAL DETAILS AND SCHEDULES

APPLICABLE ELECTRICAL CODES:

NOTE: PROJECT IS DESIGNED IN COMPLIANCE WITH THE FOLLOWING CODES. THIS IS NOT AN EXHAUSTIVE LIST. PROJECT SHALL COMPLY WITH ALL APPLICABLE CODES, STANDARDS AND LOCAL REQUIREMENTS. REFER TO THE SPECIFICATIONS FOR ADDITIONAL REQUIREMENTS.

ELECTRICAL CODE: 2020 NATIONAL ELECTRICAL CODE, (NFPA 70) BUILDING CODE: 2018 INTERNATIONAL BUILDING CODE, AMENDED ENERGY CODE: 2009 INTERNATIONAL ENERGY CONSERVATION CODE, AMENDED

ELECTRICAL GENERAL NOTES:

- 1. EXISTING CONDITIONS WERE TAKEN FROM ORIGINAL DRAWINGS AND SITE VISITS AND MAY NOT REFLECT ACTUAL "AS-BUILT" CONDITIONS. VERIFY EXISTING CONDITIONS PRIOR TO SUBMITTING FINAL BID. COORDINATE NEW AND DEMOLITION WORK WITH ALL OTHER TRADES AND EXISTING CONDITIONS.
- NOTIFY ARCHITECT, ENGINEER AND OWNER, AS APPLICABLE, IF ANY DANGEROUS CONDITIONS EXIST ON JOB SITE BEFORE ANY DEMOLITION OR REMODEL WORK BEGINS.
- 3. COORDINATE ANY NECESSARY POWER OUTAGES WITH THE OWNER AND MAKE EVERY ATTEMPT TO SCHEDULE DURING OR OFF-PEAK HOURS TO MINIMIZE DISRUPTION TO OPERATIONS. REQUESTS FOR ELECTRICAL SHUTDOWNS OF THE OWNER'S EQUIPMENT SHALL BE BROUGHT IN WRITING TO THE ATTENTION OF THE OWNER AT LEAST 7 DAYS IN ADVANCE. SHUTDOWNS SHALL NOT BE PERFORMED WITHOUT WRITTEN APPROVAL FROM THE OWNER.
- 4. FOR AREAS AND EQUIPMENT WITHIN THE SCOPE OF THIS REMODEL: EXISTING ELECTRICAL EQUIPMENT AND CIRCUITRY MAY BE REUSED IF IN GOOD CONDITION AND NEW DESIGN REQUIREMENTS CAN BE MET; OTHERWISE REPLACE.
- 5. FOR AREAS AND EQUIPMENT WITHIN THE SCOPE OF THIS REMODEL: REPAIR OR REPLACE ANY EXISTING DAMAGED OR RECALLED ELECTRICAL EQUIPMENT, LIGHT FIXTURES, WIRING DEVICES AND RELATED CIRCUITRY AND RESTORE ALL ELECTRICAL SYSTEMS TO PROPER WORKING ORDER. THE FINAL ELECTRICAL INSTALLATION SHALL BE FREE FROM ELECTRICAL DEFECTS TO THE SATISFACTION OF THE AHJ, OWNER, ARCHITECT AND ENGINEER.

ELECTRICAL SUPPLEMENTAL SPECIFICATIONS

- 1. PRIOR TO SUBMITTING BID, VISIT THE JOB SITE AND BECOME FULLY ACQUAINTED WITH THE EXISTING CONDITIONS. AS APPLICABLE, REVIEW THE OWNER CRITERIA, GENERAL NOTES, OTHER TRADE DRAWINGS AND SPECIFICATIONS FOR ADDITIONAL REQUIREMENTS THAT MAY NOT BE CALLED OUT IN THIS PORTION OF THE CONSTRUCTION DOCUMENTS. NOTIFY ARCHITECT AND ENGINEER OF ANY CONFLICTS OR DISCREPANCIES PRIOR TO SUBMITTING BID.
- 2. ALL WORK SHALL CONFORM TO ALL LOCAL CODES AND ORDINANCES AS WELL AS APPLICABLE INDUSTRY STANDARDS. ALL EQUIPMENT SHALL BEAR LABELS FOR THE USE INTENDED BY AN AHJ ACCEPTED NATIONALLY RECOGNIZED TESTING LABORATORY (NRTL), SUCH AS UL OR ETL. THE FINAL ELECTRICAL INSTALLATION OF THE FACILITY OCCUPIED BY OWNER SHALL BE FREE FROM ELECTRICAL DEFECTS TO THE SATISFACTION OF THE AHJ, OWNER, ARCHITECT AND ENGINEER.
- COORDINATE FINAL LOCATION AND INSTALLATION REQUIREMENTS OF ALL LIGHT FIXTURES, AND ELECTRICAL DEVICES WITH ARCHITECTURAL DRAWINGS, EXISTING CONDITIONS AND OTHER TRADES PRIOR TO ROUGH-IN.
- 4. ELECTRICAL DRAWINGS ARE DIAGRAMMATIC/SCHEMATIC IN NATURE AND REPRESENT THE GENERAL SCOPE OF WORK. IT IS NOT WITHIN THE SCOPE OF THE ELECTRICAL DRAWINGS TO SHOW ALL NECESSARY RACEWAY ROUTING, BENDS, OFFSETS, PULL BOXES AND OBSTRUCTIONS. CONTRACTOR SHALL COORDINATE THE FINAL LOCATION OF EQUIPMENT AND WIRING DEVICES WITH OTHER TRADES PRIOR TO INSTALLATION AND INSTALL ALL WORK TO CONFORM TO THE OWNER REQUIREMENTS.
- 5. ALL CONDUCTOR AND CONDUIT LENGTHS SHOWN IN THESE DESIGN DOCUMENTS ARE INTENDED SOLELY FOR USE IN THE DESIGN CALCULATIONS BY THE DESIGN PROFESSIONAL, UNLESS NOTED OTHERWISE. LENGTHS SHOWN SHALL NOT BE USED TO ASSIST IN THE BIDDING TAKEOFF PROCESS. THE CONTRACTOR IS SOLELY RESPONSIBLE FOR THE MATERIAL QUANTITIES REQUIRED TO BID AND CONSTRUCT THE COMPLETE PROJECT.
- 6. ALL APPLICABLE SWITCHES, RECEPTACLES, OUTLETS, AND CONTROLS SHALL BE PLACED AT HEIGHTS THAT ARE IN ACCORDANCE WITH ADA ACCESSIBILITY GUIDELINES.
- 7. WIRING DEVICES SHOWN BACK-TO-BACK ON A COMMON WALL SHALL BE OFFSET A MINIMUM OF 12" HORIZONTALLY TO REDUCE SOUND TRANSMISSION BETWEEN ROOMS, UNO.
- 8. ALL 120V RECEPTACLES 50A OR LESS, 208V AND 240V RECEPTACLES 100A OR LESS, SHALL BE GFCI PROTECTED IN LOCATIONS REQUIRED BY CODE; THIS INCLUDES BATHROOMS, KITCHENS/FOOD PREP AREAS, EXTERIOR LOCATIONS AND RECEPTACLES WITHIN 6 FEET OF A SINK. GFCI RECEPTACLES SHALL BE READILY ACCESSIBLE AND SHALL NOT BE LOCATED BEHIND STATIONARY EQUIPMENT. GFCI PROTECTION MAY BE VIA A GFCI CIRCUIT BREAKER OR GFCI RECEPTACLE, UNLESS NOTED OTHERWISE. WHERE NECESSARY, GFCI PROTECTION MAY BE ACHIEVED VIA A BLANK FACE GFCI DEVICE LOCATED IN A READILY ACCESSIBLE LOCATION NEAR RECEPTACLE BEING PROTECTED. FOR DOWNSTREAM WIRING DEVICES LOCATED ON THE SAME BRANCH CIRCUIT, THE GFCI PROTECTION MAY BE PROVIDED FOR BY A SINGLE UPSTREAM DEVICE IF ALL PROTECTED DEVICES ARE LABELED PER CODE.
- 9. FLEXIBLE CONDUIT IS ONLY PERMITTED WHERE SPECIFICALLY ALLOWED IN THE CONSTRUCTION DOCUMENTS, WHERE CONCEALED FROM VIEW OR EXPOSED FINAL CONNECTIONS TO LIGHT FIXTURES AND EQUIPMENT IN LENGTHS OF 6'-0" OR LESS.
- 10. ALL EMPTY CONDUIT/RACEWAY SHALL BE INSTALLED WITH PULL STRINGS. TERMINATE CONDUIT STUB-UP WITH A NYLON BUSHING.
- 11. EXPOSED CONDUIT/RACEWAY SHALL BE PAINTED TO MATCH ADJACENT SURFACE, UNLESS NOTED OTHERWISE. COORDINATE REQUIREMENTS WITH ARCHITECT AND OWNER PRIOR TO INSTALLATION.
- 12. CONDUITS/RACEWAYS SHALL BE CONCEALED FROM VIEW WHEREVER PRACTICABLE, UNLESS NOTED OTHERWISE. SUPPORT RACEWAY FROM STRUCTURE, NOT ROOF DECK. MAINTAIN 2" MIN SPACING FROM BOTTOM OF ROOF DECK TO PREVENT ROOFING SCREWS FROM PENETRATING RACEWAY. DO NOT ROUTE CONDUITS ACROSS SKYLIGHTS, ACCESS PANELS, HATCHED TILES, HVAC DIFFUSERS, OR EQUIPMENT WORKING CLEARANCE SPACE. ROUTE ALL EXPOSED NON-FLEXIBLE CONDUITS TIGHT TO STRUCTURE, PARALLEL TO BUILDING LINES AND IN STRUT OR CABLE/PIPE TRAY WHERE PRACTICABLE. INSTALL CONDUITS PLUMB/ LEVEL WHERE EXPOSED TO VIEW. COORDINATE RACEWAY ROUTING AND INSTALLATION WITH OTHER TRADES PRIOR TO ROUGH-IN.
- 13. PROVIDE LABEL AT EACH RECEPTACLE COVER PLATE WITH THE RESPECTIVE "PNLBD-CKT#" DESIGNATION. COORDINATE LABEL REQUIREMENTS WITH THE OWNER PRIOR TO INSTALLATION. REFER TO THE SPECIFICATIONS FOR MORE INFORMATION.
- 14. MULTIWIRE BRANCH CIRCUITS ARE NOT ALLOWED, UNLESS NOTED OTHERWISE.
- 15. PROVIDE INSULATED EQUIPMENT GROUNDING CONDUCTOR FOR ALL CIRCUITS, UNLESS NOTED OTHERWISE.

STATE OF MISSOURI MIKE KEHOE, GOVERNOR



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2450001062 MO. CORPORATE NO: E-556D EXPIRES 10/31/2025

OFFICE OF ADMINISTRATION DIVISION OF FACILITIES MANAGEMENT, DESIGN AND CONSTRUCTION

RENOVATE 4 CLIENT BATHROOMS - RAGLAND EDUCATION BUILDING, HIGGINSVILLE HABILITATION CENTER

100 W 1st Street Higginsville, Missouri 64037

PROJECT # M2406-01 SITE # 7357 FACILITY # 6517357027

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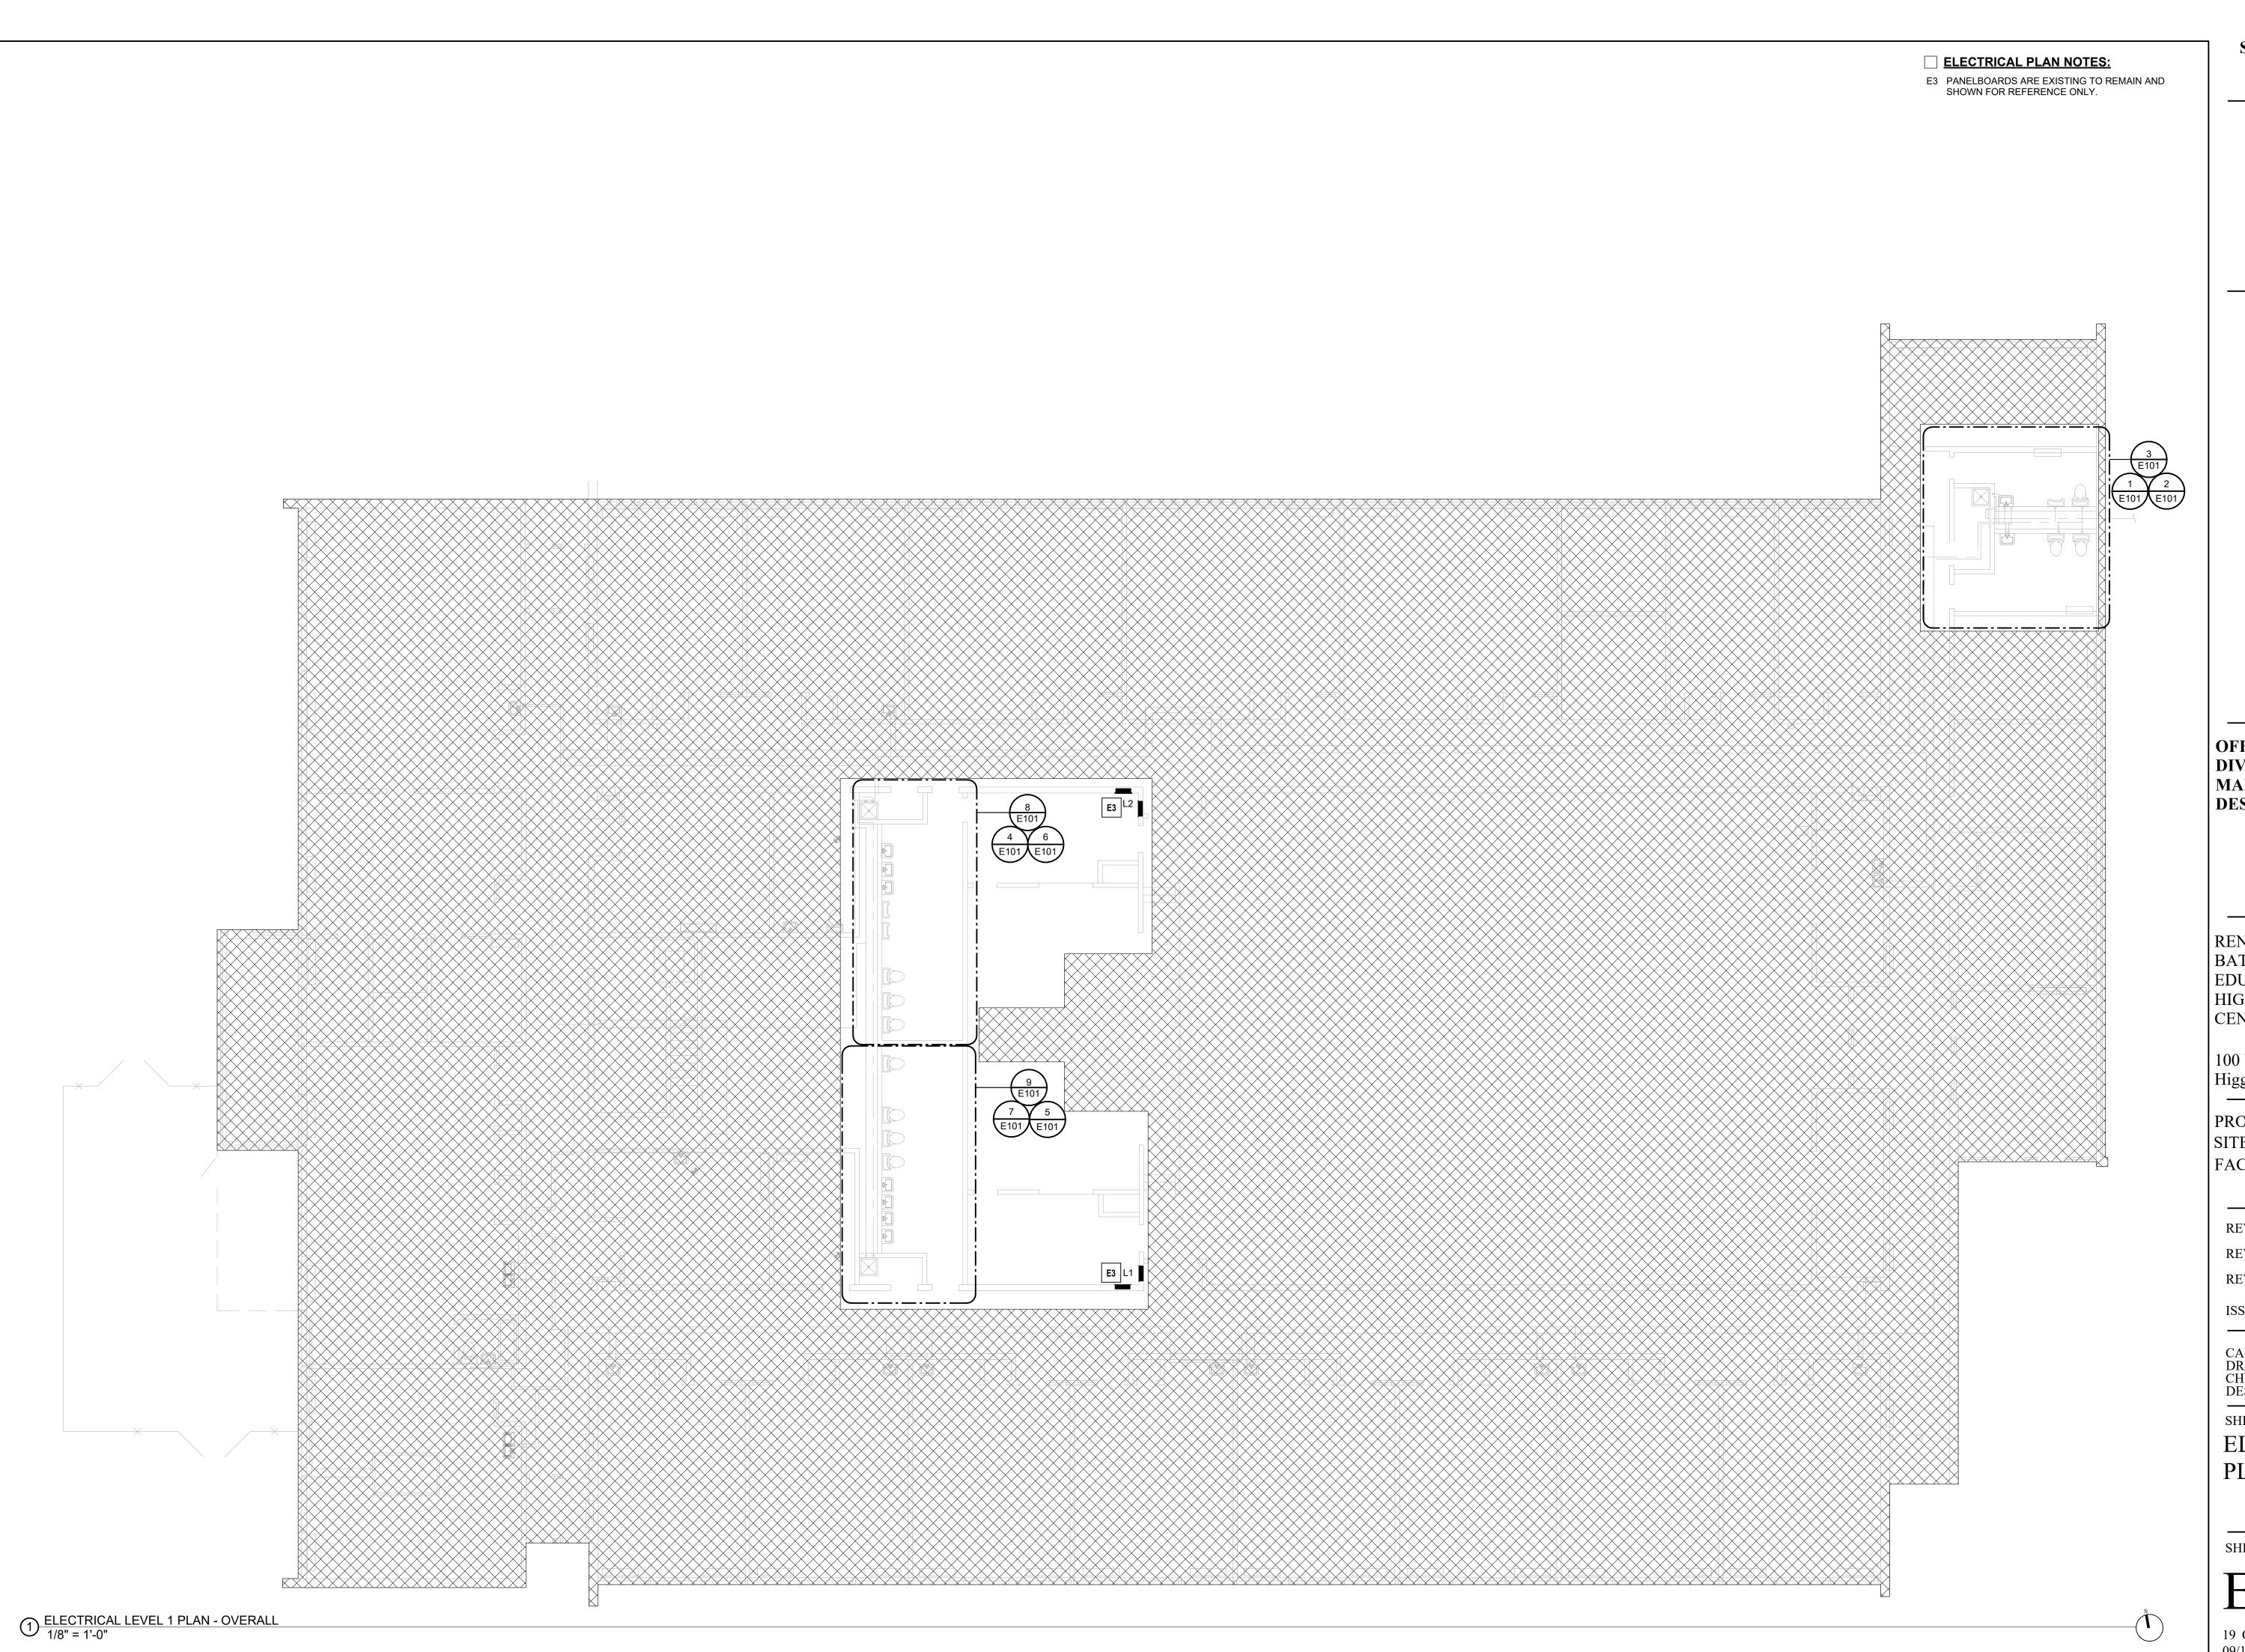
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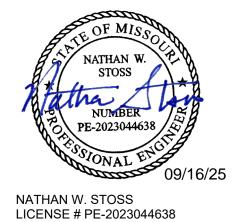
SHEET TITLE:

ELECTRICAL LEGEND AND GENERAL NOTES

SHEET NUMBER:

E000





HENDERSON

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SHEET TITLE:

ELECTRICAL LEVEL 1
PLAN - OVERALL

SHEET NUMBER:

E100



ELECTRICAL DEMOLITION PLAN NOTES:

- DE1 REMOVE LIGHT FIXTURE. REMOVE CIRCUITRY BACK
 TO NEAREST JUNCTION BOX. MAINTAIN FOR
 RE-CONNECTION TO NEW LIGHTING.
- DE2 REMOVE RECEPTACLE AND BACK BOX. REMOVE CIRCUITRY BACK TO NEAREST JUNCTION BOX. MAINTAIN FOR RE-CONNECTION TO NEW RECEPTACLE.
- RECEPTACLE.

 DE3 REMOVE POWER AND CONTROL WIRING FOR HVAC UNIT BACK TO NEAREST JUNCTION BOX. MAINTAIN FOR RE-CONNECTION TO NEW HVAC UNIT IN SAME
- LOCATION.

 DE4 REMOVE LIGHT SWITCH AND BACK BOX. MAINTAIN CONTROL WIRING TO SOURCE FIXTURES AND
- ASSOCIATED POWER PACK FOR RE-USE.

 DE5 DISCONNECT AND RETAIN OCCUPANCY SENSOR
 AND POWER PACK FOR RE-USE AFTER NEW CEILING
 IS INSTALLED.

 DE6 REMOVE LIGHT SWITCH AND BACK BOX. REMOVE
- CIRCUITRY BACK TO NEAREST JUNCTION BOX.
 MAINTAIN FOR RE-CONNECTION TO NEW LIGHT
 SWITCH.

 DE7 REMOVE WALL MOUNTED EMERGENCY BUGEYE AND
- PROTECT FOR RE-USE.

 DE8 REMOVE EXIT SIGN. REMOVE CIRCUITRY BACK TO NEAREST JUNCTION BOX.

ELECTRICAL PLAN NOTES:

- E1 RE-USE EXISTING CIRCUIT FOR CONNECTION TO NEW FCU. COORDINATE CONTROL WIRING WITH MECHANICAL CONTRACTOR.
- E2 REUSE EXISTING POWER PACK SERVING
 OCCUPANCY SENSOR. PROVIDE LOW VOLTAGE
 WIRING PER MANUFACTURER FROM POWER PACK
 TO NEW LOW VOLTAGE SWITCH. MOUNT POWER
 PACK HIGH UP ON CUSTODIAL WALL FOR FUTURE
 ACCESSIBILITY.
- E4 RE-INSTALL EXISTING EMERGENCY BUGEYE. MOUNT AT 7'-0" AFF.
- E5 REINSTALL PREVIOUSLY REMOVED OCCUPANCY SENSOR.

STATE OF MISSOURI MIKE KEHOE, GOVERNOR



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DESIGNED BY: KRS

SHEET TITLE:

ELECTRICAL LEVEL 1
PLAN - ENLARGED
VIEWS

SHEET NUMBER:

E101

	LIGHT FIXTURE SCHEDULE												
			SOURCE			DIMMING		INPUT	INPUT				
TYPE	MANUFACTURER	SERIES / MODEL	APPROVED ALTERNATES	TYPE	CRI	CCT	LUMENS	TYPE	VOLTAGE	WATTS	VA	DESCRIPTION	
D1	HE WILLIAMS	4DR-TL-L08/835-DIM-UNV-OW-OF-CS-TD-N-F1	PRESCOLITE LITEISTRY	LED	80	3500K	800	0-10V	120	7	8	4.5" ROUND DOWNLIGHT WITH WIDE DISTRIBUTION AND DIFFUSED LENS AT	
			SIGNIFY CALCULITE									TOP OF HOUSING. SELF-FLANGED, CLEAR SEMI-SPECULAR ANODIZED	
			GOTHAM EVO									FINISH.	
F1	HE WILLIAMS	75R SERIES	LITHONIA CLX	LED	80	3500K	5000LM	NON	120	33	37	4' SURFACE MOUNTED STRIP WITH ROUND FROSTED POLYCARBONATE	
		75R-4-L50-80/35-FP-DRV-UNV	COLUMBIA MPS									LENS. STANDARD WHITE FINISH.	
			DAYBRITE FLUXSTREAM										

LIGHT FIXTURE SCHEDULE GENERAL NOTES:

- ALL LIGHT FIXTURES AND RELATED COMPONENTS SHALL BE PROVIDED BY THE CONTRACTOR, UNLESS NOTED
 OTHERWISE.
- 2. THE PARTY SUPPLYING THE LIGHT FIXTURES IS RESPONSIBLE FOR SUPPLYING THE PROPER QUANTITY OF LIGHT FIXTURES.

LIGHT FIXTURE SCHEDULE SUPPLEMENTAL SPECIFICATIONS:

- REPRESENTATIVE AGENTS SHALL BE ALLOWED TO OFFER MINI-LOT PRICING (MLP) FOR LIGHT FIXTURES AS ALLOWED IN ELECTRICAL SPECIFICATIONS.
- 2. LIGHTING CONTROLS PRICING, INCLUDING BUT NOT LIMITED TO THOSE REFERENCED IN ELECTRICAL SPECIFICATIONS, SHALL BE COMPLETELY SEPARATE OF ANY LIGHT FIXTURE PRICING. ANY LIGHTING CONTROLS PRICING THAT IS SUBMITTED WITH LIGHT FIXTURE PRICING (UNIT OR MINI-LOT) WILL BE IMMEDIATELY REJECTED IN ITS ENTIRETY.
- 3. CATALOG NUMBERS SHALL NOT BE CONSIDERED COMPLETE AND MATERIAL SHALL NOT BE ORDERED BY MANUFACTURER AND CATALOG NUMBERS ONLY. FIRST READ THE COMPLETE DESCRIPTION, NOTES AND SPECIFICATIONS IN CONJUNCTION WITH THE CATALOG NUMBER TO DETERMINE THE MATERIAL AND ACCESSORIES TO BE ORDERED. THE MANUFACTURERS LISTED ARE THE BASIS FOR THE DESIGN.

			LINE-VOLTAGE WALL SWITCH OCCUPANCY SENSORS			
SYMBOL	MANUFACTURER	ALTERNATE		COVERAGE		
TAG	MODEL/SERIES	MANUFACTURER	DEVICE DESCRIPTION	(WXD)	VOLTAGE	NOTES
	LEGRAND	ACUITY, COOPER	WALL MOUNT PASSIVE INFRARED OCCUPANCY SENSOR.	MAJOR 30' x 35'	120/	
VS	PW-100	CRESTRON, HUBBELL	INTEGRAL MANUAL OVERRIDE SWITCH. SINGLE RELAY. LINE-VOLTAGE.	MINOR 15' x 20'	277	
		LEVITON, LUTRON	LOAD: 120V=800W, 277V=1200W.			
			NETWORK LIGHTING SWITCHES			
SYMBOL	MANUFACTURER	ALTERNATE				
TAG	MODEL/SERIES	MANUFACTURER	DEVICE DESCRIPTION	VOLTAGE	NOTES	
	LEGRAND ACUITY, CRESTRON DIGITAL SWITCH FOR MANUAL ON/OFF CONTROL. IR TRANSCEIVER FOR WIRELESS SETUP.			24		
LV	LMSW-101	ETC, HUBBELL				


GENERAL NOTES:

- A. LIGHTING CONTROLS PRICING SHALL BE COMPLETELY SEPARATE OF ANY LIGHT FIXTURE PRICING.
- B. VERIFY COLOR(S) FOR ALL WALL AND CEILING MOUNTED DEVICES WITH THE ARCHITECT.
 C. PROVIDE COPIES OF OPERATION AND MAINTENANCE INSTRUCTIONS FOR ALL DEVICES TO OWNER.
- D. PROVIDE A NEUTRAL CONDUCTOR TO ALL WALL SWITCH LOCATIONS PER NEC REQUIREMENTS.


UPON OCCUPANCY, RESTROOM LIGHTS SHALL AUTOMATICALLY TURN ON.
UPON 20 MINUTES OF VACANCY, RESTROOM LIGHTS SHALL AUTOMATICALLY TURN OFF.

ELECTRICAL NOTES:

- 1 PROVIDE SUFFICIENT LENGTH TO MOVE CENTER OF LUMINAIRE IN A
- RADIUS OF THE LOCATION SHOWN ON THE PLANS.
 RMC OR EMT (UNLESS TYPE MC CABLE IS ALLOWED BY SPECIFICATIONS. IF MORE THAN 4 CURRENT CARRYING CONDUCTORS INCLUDING NEUTRALS, MC CABLE IS NOT ALLOWED).

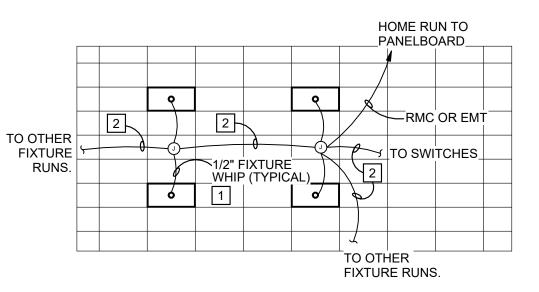


2 LIGHTING STANDARD LUMINAIRE WIRING NTS

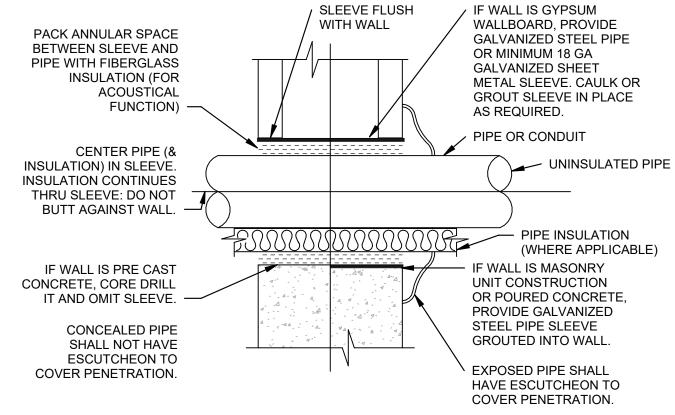

REFER TO ARCHITECTURAL DRAWINGS FOR WALL LOCATIONS. REFER TO SPECIFICATIONS FOR ALTERNATIVE INSTALLATIONS. COORDINATE REQUIREMENTS WITH GENERAL CONTRACTOR.

1 CONDUIT PENETRATION THRU NON-FIREWALL NTS

STATE OF MISSOURI MIKE KEHOE, GOVERNOR

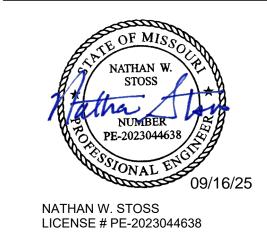

HENDERSON ENGINEERS

8345 LENEXA DRIVE, SUITE 300 LENEXA, KS 66214 TEL 913.742.5000 FAX 913.742.5001 WWW.HENDERSONENGINEERS.COM


2450001062 MO. CORPORATE NO: E-556D EXPIRES 10/31/2025

OFFICE OF ADMINISTRATION
DIVISION OF FACILITIES
MANAGEMENT,
DESIGN AND CONSTRUCTION

RENOVATE 4 CLIENT
BATHROOMS - RAGLAND
EDUCATION BUILDING,
HIGGINSVILLE HABILITATION
CENTER

100 W 1st Street Higginsville, Missouri 64037

PROJECT # M2406-01 SITE # 7357 FACILITY # 6517357027

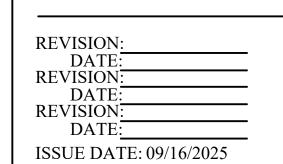

CAD DWG FILE:
DRAWN BY: KRS
CHECKED BY: OD

DESIGNED BY: KRS

SHEET TITLE:
ELECTRIC

ELECTRICAL
DETAILS AND
SCHEDULES

SHEET NUMBER:

E500

GENERAL DEMOLITION NOTES:

- 1. PRIOR TO SUBMITTING BID, VISIT THE JOB SITE AND BECOME FULLY ACQUAINTED WITH THE EXISTING CONDITIONS OF THE PROJECT. REVIEW THE GENERAL NOTES, SPECIFICATIONS AND OTHER DRAWINGS FOR ADDITIONAL REQUIREMENTS WHICH MAY NOT BE SPECIFICALLY CALLED OUT IN THIS PORTION OF THE CONSTRUCTION DOCUMENTS. NOTIFY ARCHITECT, ENGINEER AND/OR OWNER OF CONFLICTS OR DISCREPANCIES PRIOR TO SUBMISSION OF BID.
- 2. EXISTING CONDITIONS WERE TAKEN FROM ORIGINAL DRAWINGS AND SITE VISITS AND MAY NOT REFLECT EXACT "AS-BUILT" CONDITIONS. FIELD VERIFY EXISTING CONDITIONS PRIOR TO SUBMITTING FINAL BIDS. COORDINATE NEW WORK AND DEMOLITION WITH OTHER DISCIPLINES AND EXISTING CONDITIONS PRIOR TO CONSTRUCTION.
- 3. OWNER RETAINS RIGHTS OF SALVAGE FOR EQUIPMENT AND FIXTURES TO BE REMOVED. COORDINATE WITH THE OWNER THE EQUIPMENT AND FIXTURES TO BE SALVAGED AND THE LOCATION FOR STORAGE. AVOID DAMAGE TO EQUIPMENT, FIXTURES AND DEVICES DURING DEMOLITION WORK AND DURING TRANSPORT TO OWNER'S DESIGNATED STORAGE LOCATION.
- 4. REMOVE ITEMS SHOWN HEAVY LINED AND/OR CROSSHATCHED AND/OR NOTED TO BE REMOVED.
- 5. AVOID DAMAGING EXISTING SURFACES AND EQUIPMENT TO REMAIN FOR NEW INSTALLATION. REPAIR ANY DAMAGE CAUSED DURING WORK AT NO EXTRA COST TO THE OWNER.
- 6. SEAL ALL PENETRATIONS THROUGH FLOORS, WALLS, CEILINGS AND ROOFS WHERE PLUMBING COMPONENTS ARE REMOVED AND WHERE THE EXISTING PENETRATION IS NOT USED FOR THE NEW INSTALLATION. REPAIR SURFACES TO MATCH ADJACENT AREAS.
- 7. INSTALL PERMANENT CAPS WHERE PIPING IS REMOVED AND THE EXISTING TAPS ARE NOT USED FOR THE NEW INSTALLATION. INSTALL TEMPORARY CAPS WHERE PIPING IS REMOVED AND THE EXISTING TAPS WILL BE USED FOR THE NEW INSTALLATION TO PROTECT THE INTERIOR SURFACES UNTIL NEW PIPING IS INSTALLED.
- 8. REMOVE PIPE HANGERS, PIPE SUPPORTS AND EQUIPMENT SUPPORTS WHERE PIPING OR EQUIPMENT IS REMOVED AND THE EXISTING HANGERS AND SUPPORTS ARE NOT USED FOR THE NEW INSTALLATION.
- 9. VERIFY THAT EXISTING EQUIPMENT TO REMAIN IS OPERATING PROPERLY. NOTIFY THE ARCHITECT, ENGINEER AND/OR OWNER OF ANY DAMAGED AND/OR MALFUNCTIONING COMPONENTS.
- 10. WHERE SHUTDOWN OF EXISTING ACTIVE PIPING SYSTEMS IS REQUIRED DURING DEMOLITION PHASE OF WORK IN PREPARATION FOR NEW TIE-IN PHASE OF WORK, COORDINATE WITH THE OWNER AND MINIMIZE DOWNTIME. VERIFY EXISTING SYSTEMS, EQUIPMENT, AND COMPONENTS WILL BE PROVIDED WITH BACKUP SERVICE WHERE REQUIRED. NOTIFY OWNER A MINIMUM OF SEVEN (7) DAYS PRIOR TO INTERRUPTION OF SERVICE.

GENERAL NOTES:

- 1. PROVIDE A CONSTRUCTION RECORD SET OF "AS-BUILT" DOCUMENTS TO THE ARCHITECT REFLECTING ANY VARIANCES OF INSTALLED PIPING LOCATIONS OR EQUIPMENT CONTRARY TO THE CONSTRUCTION DOCUMENTS, REFER TO SPECIFICATIONS.
- 2. DRAWINGS ARE DIAGRAMMATIC ONLY AND REPRESENT THE GENERAL SCOPE OF THE WORK. REVIEW THE GENERAL NOTES, SPECIFICATIONS AND PLANS FOR ADDITIONAL REQUIREMENTS THAT MAY NOT BE SPECIFICALLY CALLED OUT IN THIS PORTION OF THE CONSTRUCTION DOCUMENTS. NOTIFY ARCHITECT OF ANY CONFLICTS OR DISCREPANCIES PRIOR TO SUBMISSION OF BID.
- 3. PROVIDE TO THE OWNER A COPY OF INSPECTION REPORTS AND APPROVAL CERTIFICATES FROM LOCAL AND STATE INSPECTIONS, REFER TO SPECIFICATIONS.
- 4. PLANS AND SPECIFICATIONS GOVERN WHERE THEY EXCEED CODE REQUIREMENTS.
- 5. VERIFY SIZE, LOCATION AND DEPTH OF UTILITIES AT POINTS OF CONNECTION BEFORE START OF PIPING INSTALLATION.
- 6. REFER TO ARCHITECTURAL PLANS FOR EXACT LOCATION AND MOUNTING HEIGHTS OF PLUMBING FIXTURES.
- 7. DO NOT SCALE FLOOR PLANS FOR EXACT HORIZONTAL LOCATION OF PIPE ROLLTING
- 8. INSTALL CONCEALED PIPING TIGHT TO THE STRUCTURE AND AS HIGH AS POSSIBLE.
- 9. VALVES SHALL BE LINE SIZE UNLESS OTHERWISE NOTED.
- 10. INSTALL EXPOSED PIPING, WHERE NECESSARY, IN FINISHED AREAS TIGHT TO THE STRUCTURE, WALL OR CEILING AND AS HIGH AS POSSIBLE. INSTALL PIPING PARALLEL AND / OR PERPENDICULAR TO WALLS.
- 11. INSTALL VALVES AND APPURTENANCES A MAXIMUM OF 24" ABOVE CEILING IN ACCESSIBLE LOCATION WITHIN 24" OF ACCESS DOORS OR ACCESSIBLE CEILING TILES. PROVIDE PIPE AND FITTINGS TO INSTALL VALVES AND APPURTENANCES AT REQUIRED HEIGHT AND WITHIN 24" OF ACCESS DOORS OR ACCESSIBLE CEILING TILES.
- 12. INSTALL NO PLASTIC PIPE IN THE CEILING RETURN AIR PLENUM.
- 13. COORDINATE ALL WORK WITH OTHER TRADES AND CONTRACTORS.
- 14. COORDINATE PIPING INSTALLATION WITH STRUCTURAL GRADE BEAMS, FOOTINGS, COLUMN PIERS, ETC. SLEEVE PIPING THROUGH GRADE BEAMS, FOOTING, ETC. WHERE REQUIRED AND AS NOTED ON PLANS. COORDINATE SLEEVE INSTALLATIONS WITH THE ARCHITECT, STRUCTURAL ENGINEER, STRUCTURAL CONTRACTOR AND GENERAL CONTRACTOR BEFORE CONCRETE IS INSTALLED.
- 15. CLEAN FAUCET AERATORS AND PIPE STRAINERS PRIOR TO TURNING BUILDING OVER TO THE OWNER.
- 16. PROVIDE TRAP PRIMERS WHERE REQUIRED BY LOCAL AUTHORITIES.
 OTHERWISE, TRAP SEALS SHALL BE PROVIDED IN LIEU OF TRAP PRIMERS.
- 17. COORDINATE PIPE ROUTING AWAY FROM ELECTRICAL PANELS. DO NOT INSTALL PIPING OVER ELECTRICAL PANELS.
- 18. COORDINATE ALL ROOF PENETRATIONS WITH OTHER TRADES. MAINTAIN 10' MINIMUM CLEARANCE FROM ALL AIR INTAKES. MAINTAIN 2' CLEARANCE FROM ALL OTHER EQUIPMENT.
- 19. INSULATE PIPING ROUTED IN EXTERIOR BUILDING WALLS WITH MINIMUM 2" BATT INSULATION TO PREVENT FREEZING.
- 20. PROVIDE TRANSITION ADAPTER COUPLINGS FOR CONNECTION OF PVC DWV TO CAST IRON AT SLAB ON GRADE. SEE DIVISION 22 SPECIFICATIONS FOR MORE INFORMATION.
- 21. PROVIDE TRANSITION ADAPTER COUPLINGS FOR CONNECTION OF PVC DWV TO CAST IRON SANITARY, WASTE AND VENT PIPE AT SLAB ON GRADE. SEE DIVISION 22 SPECIFICATION SECTION "SANITARY DRAINAGE AND VENT PIPING AND SPECIALTIES" FOR MORE INFORMATION.
- 22. FLOW CONTROL VALVES SHALL BE SIZE 1/2" AND SET AT 0.5 GPM UNLESS
- 23. WATER HAMMER ARRESTORS SHALL BE SIZE "A" UNLESS NOTED OTHERWISE AND AS INDICATED BY THE PDI RECOMMENDATIONS.
- 24. PROVIDE VERTICAL LIFT SPRING LOADED CHECK VALVES IN HOT AND COLD WATER SUPPLIES FOR MOP SINK FAUCETS DOWNSTREAM OF SHUTOFF VALVES.
- 25. PROVIDE WALL PIPES AT PIPING PENETRATIONS OF ELEVATED WATERPROOF FLOOR SLABS, REFER TO SPECIFICATIONS.
- 26. VERIFY EXISTING EQUIPMENT, INCLUDING ACCESSORIES, IS NOT DAMAGED AND IS IN GOOD WORKING ORDER. REPORT ANY DEFICIENCIES TO THE ARCHITECT.
- 27. PROVIDE SIZE AND LENGTH OF HOT WATER FIXTURE SUPPLY PIPE FROM CIRCULATED HOT WATER BRANCH OR MAIN TO TERMINATION OF HOT WATER FIXTURE SUPPLY PIPE AT EACH FIXTURE PER 2018 INTERNATIONAL ENERGY CONSERVATION CODE, TABLE C404.5.1. FOR 1/2" HOT WATER FIXTURE SUPPLY PIPE SIZE TO INDIVIDUAL LAVATORIES, PROVIDE MAXIMUM LENGTH OF TWO FEET. FOR 1/2" HOT WATER FIXTURE SUPPLY PIPE SIZE TO INDIVIDUAL SINKS, PROVIDE MAXIMUM LENGTH OF 43 FEET. FOR 3/4" HOT WATER FIXTURE SUPPLY PIPE SIZE TO INDIVIDUAL SINKS, PROVIDE MAXIMUM LENGTH OF 21 FEET.
- 28. PAINT EXPOSED INDOOR WATER PIPING IN FINISHED SPACES. COORDINATE PAINT AND COLOR WITH THE ARCHITECT AND / OR OWNER.
- 29. INSTALL OVERHEAD HANGERS AND SUPPORTS FOR EQUIPMENT AND PIPING FASTENED TO BUILDING JOISTS OR BEAMS. DO NOT ATTACH HANGERS AND SUPPORTS TO THE ABOVE FLOOR SLAB OR ROOF EXCEPT WHERE CONCRETE INSERTS IN CONCRETE SLABS ARE ALLOWED BY THE SPECIFICATIONS.
- 30. SEAL PENETRATIONS THROUGH THE BUILDING COMPONENTS IN ACCORDANCE WITH THE CONTRACT SPECIFICATIONS. FIREPROOF PENETRATIONS THROUGH FIRE RATED COMPONENTS IN ACCORDANCE WITH U.L. REQUIREMENTS.
- 31. EXISTING CONDITIONS WERE TAKEN FROM ORIGINAL DRAWINGS AND SITE VISITS AND MAY NOT REFLECT EXACT "AS-BUILT" CONDITIONS. FIELD VERIFY EXISTING CONDITIONS PRIOR TO SUBMITTING FINAL BIDS. COORDINATE NEW WORK AND DEMOLITION WITH OTHER DISCIPLINES AND EXISTING CONDITIONS PRIOR TO CONSTRUCTION.

PLLIMBING SYMBOLS

STANDARD MOUNTING HEIGH	NOT ALL SYMBOLS OR ABBR	PIPING SYMBOLS).		PIPING LINETYPES	V2.02
			OXYGEN OUTI	LFT	CW	DOMESTIC COLD WATER (CW)
JANITOR'S SINK FAUCET FITTINGS (CEN	NTERLINE) 42"		NITROUS OXID		scw	SOFTENED COLD WATER (SCW)
LAVATORY OR SINK STANDARD HEIGHT (RIM)	31"		MEDICAL AIR		——HW——	DOMESTIC HOT WATER (HW)
ADA ACCESSIBLE (RIM) CHILD HEIGHT (RIM)	34" 24"		NITROGEN OL	ITLET	HWR	DOMESTIC HOT WATER RECIRC. (HWR)
URINAL STANDARD HEIGHT (RIM)	24"		MEDICAL VAC	UUM INLET	———140°———	DOMESTIC HOT WATER (140°)
ADA ACCESSIBLE (RIM) CHILD HEIGHT (RIM)	17" 14"		FLOOR SINK (I	FS), SIZE & TYPE	т	TRAP PRIMER LINE (T)
WATER CLOSET	••		FLOOR DRAIN	(FD), SIZE & TYPE	s	SOIL PIPING - ABOVE FLOOR (S)
STANDARD HEIGHT (RIM) ADA ACCESSIBLE (TOP OF SEAT	15" Г) 17" ТО 19"	(Ĉ)	ROOF DRAIN (RD), SIZE & TYPE	——s——	SOIL PIPING - BELOW FLOOR (S)
CHILD HEIGHT (RIM)	10"	 -	BALL VALVE			WASTE PIPING - ABOVE FLOOR (W)
		—————	CONTROL VAL	VE	—— —— ——	WASTE PIPING - BELOW FLOOR (W)
		——₩——	SHUTOFF VAL	VE	———GW———	GREASE WASTE - ABOVE FLOOR (GW)
			CHECK VALVE		— — GW — —	GREASE WASTE - BELOW FLOOR (GW)
				ALVE WITH PRESSURE PORTS	CGWV	COMBINATION GREASE WASTE AND VENT (CGWV)
			WATER METER	R	CWV	COMBINATION WASTE AND VENT (CWV)
			STRAINER STRAINER WIT		——————————————————————————————————————	STORM DRAIN - ABOVE FLOOR (ST) STORM DRAIN - BELOW FLOOR (ST)
		A	RELIEF/SAFET		OST	OVERFLOW STORM DRAIN - ABOVE FLOOR (OST)
			SOLENOID VA			VENT BELOW GRADE (VBG)
				EDUCING VALVE		VENT BELOW FLOOR (VBF)
				RE REGULATOR	ID	INDIRECT DRAIN (ID)
		——————————————————————————————————————	THERMOSTAT	IC MIXING VALVE	CDH	CONDENSATE DRAIN - HIGH EFFICIENCY RTU (CDH)
		————× PA	PIPE ANCHOR		——CD——	CONDENSATE DRAIN (CD)
			EXPANSION JO	TNIC	——————————————————————————————————————	AUXILIARY CONDENSATE DRAIN (ACD)
INSTALL PLUMBING FIXTURES AT THE N	MOUNTING HEIGHTS SHOWN ABOVE		BACKFLOW PF	REVENTER	——————————————————————————————————————	SUMP OR SEWAGE PUMP DISCHARGE (SPD)
UNLESS NOTED OTHERWISE IN THE AR ELSEWHERE IN THE CONSTRUCTION DO	CHITECTURAL DRAWINGS OR	φ	PRESSURE GA	AUGE	————G———	NATURAL GAS (G)
LOCATIONS BY ARCHITECT. MOUNTING ELSEWHERE IN THE CONSTRUCTION DO	HEIGHTS LISTED ABOVE, OR OCUMENTS, ARE AFF, UNO. ALL	<u>———</u> 	THERMOMETE	ER	— — -G- — —	NATURAL GAS ON ROOF (G)
DEVICES SHALL BE INSTALLED IN COMF LOCAL REQUIREMENTS.	PLIANCE WITH CURRENT ADA AND		UNION		MPG	MEDIUM PRESSURE NATURAL GAS (MPG)
ANNOTATION			FLANGE CONN		— — MPG — —	MEDIUM PRESSURE NATURAL GAS ON ROOF (MPG)
	NU OUT		HOSE BIBB (H	,	NPW	NON-POTABLE WATER (NPW)
(1) PLUMBING PLAN NOTE CA	ALLOUT			G WALL HYDRANT (NW)	——LPG——	LIQUEFIED PETROLEUM GAS (LPG)
	ESIGNATION. (CONTRACTOR ED). REFER TO PLUMBING FIXTURE	T`	MANUAL / AU I VALVE	OMATIC AIR VENT OR VACUUM RELIEF	———WS————	WATER SERVICE (WS)
OR EQUIPMENT SCHEDUL		<u> </u>	PRESSURE / V	ACUUM SWITCH	——————————————————————————————————————	FIRE PROTECTION SPRINKLER DRY (DFP) FIRE PROTECTION SPRINKLER WET (FP)
EQUIPMENT DESIGNATION	N (OWNER FURNISHED,		CLEANOUT		DSP	FIRE PROTECTION STANDPIPE DRY (DSP)
CONTRACTOR INSTALLED	0)	 3	CAP		WSP	FIRE PROTECTION STANDPIPE WET (WSP)
CU MECHANICAL EQUIPMENT	DESIGNATION (CONTRACTOR	——э-∥	WALL CLEANC	,	———PD———	CONDENSATE PUMP DISCHARGE (PD)
1 FURNISHED AND INSTALL	ED UNLESS NOTED OTHERWISE)	©	FLOOR CLEAN	. ,	V	VENT PIPING (V)
CONNECTION POINT OF N	IEW WORK TO EXISTING	0		EANOUT (ECO)	———AW———	ACID WASTE - ABOVE FLOOR (AW)
1 DETAIL REFERENCE UPPE	ER NUMBER INDICATES DETAIL	———·O	ELBOW DOWA		— — AW — —	ACID WASTE - BELOW FLOOR (AW)
	R INDICATES SHEET NUMBER		ELBOW DOWN	ı	AV	ACID VENT (AV)
section cut designation	ON		TEE DOWN		GWS	GRAY WATER (GWS)
P1		———·Q		TH SHUT-OFF VALVE (SOV)	———CA———	COMPRESSED AIR (CA)
DEDICATED EQUIPMENT A	ACCESS TILE	+ 5		I WITH SHUT-OFF VALVE (SOV)	———MA———	MEDICAL AIR (MA)
ACCESS PANEL			TEE UP WITH	SHUT-OFF VALVE (SOV)	MV	MEDICAL VACUUM (VE)
ADDDEVIATIONS			TEE DOWN WI	TH SHUT OFF VALVE (SOV)	HE	HELIUM (HE)
ABBREVIATIONS		"A"		IER ARRESTER (WHA) WITH PDI SIZES,	IV	INSTRUMENT AIR (IA) INSTRUMENT VACUUM (IV)
ADA AMERICANS WITH DISABILITIES ACT	MIN MINIMUM N/C NORMALLY CLOSED		(A, B, C, D, & E	,	N2	NITROGEN (N2)
AFF ABOVE FINISHED FLOOR AFG ABOVE FINISHED GRADE	N/O NORMALLY OPEN NIC NOT IN CONTRACT ORD OVERFLOW ROOF DRAIN		P-TRAP	ON TOWN	N2O	NITROUS OXIDE (N20)
AHU AIR HANDLING UNIT AP ACCESS PANEL BAS BUILDING AUTOMATION	PDI PLUMBING DRAINAGE INSTITUTE		GAS COCK		O2	OXYGEN (O2)
SYSTEM BFF BELOW FINISHED FLOOR	PH/Ø PHASE PRV PRESSURE REDUCING		TRAP PRIMER		EV	EVAC/WAGD (EV)
BFG BELOW FINISHED GRADE BOP BOTTOM OF PIPE	VALVE PVC POLYVINYL CHLORIDE	<u> </u>	TRAP PRIMER	WITH DISTRIBUTION UNIT	CO2	CARBON DIOXIDE (CO2)
BOS BOTTOM OF STRUCTURE BTU BRITISH THERMAL UNIT	RCP REINFORCED CONCRETE PIPE				——————————————————————————————————————	MEDICAL AIR INTAKE (AI)
CP CONDENSATE PUMP CPVC CHLORINATED POLYVINYL	RD ROOF DRAIN RPM REVOLUTIONS PER				VE	MEDICAL VACUUM EXHAUST (VE)
CHLORIDE CU COPPER	MINUTE RPBP REDUCE PRESSURE				———DA———	DENTAL AIR (DA)
DI DUCTILE IRON DN DOWN	BACKFLOW PREVENTER RTU ROOFTOP UNIT				DV	DENTAL VACUUM (DV)
DFU DRAINAGE FIXTURE UNIT DS DOWNSPOUT (E) EXISTING	SF SQUARE FEET SP SUMP SS STAINLESS STEEL				——FW1——	FILTERED WATER (FW1)
(E) EXISTING EMS ENERGY MANAGEMENT SYSTEM	SANITARY SEWER, SOIL STACK				———FW2———	FILTERED WATER W/ SCALE INHIBITOR (FW2)
ETR EXISTING TO REMAIN EWC ELECTRIC WATER COOLER	TDH TOTAL DYNAMIC HEAD TFA TO FLOOR ABOVE				RO	REVERSE OSMOSIS (RO)
FD FLOOR DRAIN FFA FROM FLOOR ABOVE	TFB TO FLOOR BELOW TYP TYPICAL	LINETYPE LEGEND			ROR	REVERSE OSMOSIS REMINERALIZATION (ROR)
FFB FROM FLOOR BELOW FF FINISHED FLOOR	UL UNDERWRITERS LABORATORIES, INC.			ENT LINETYPES ARE USED IN NDICATE THE STATUS OF ITEMS AS		
FL FLOW LINE FLA FULL LOAD AMPS	UNO UNLESS NOTED OTHERWISE	EXISTING, TO BE DEMOLI	ISHED, TO BE IN	NCLUDED AS PART OF NEW WORK D TO BE PROVIDED IN THE FUTURE.		
FLR FLOOR GPM GALLONS PER MINUTE	UPS UNINTERRUPTIBLE POWER SUPPLY	THE STATUS OF ITEMS U VIEW IN WHICH THEY API	ISING THESE LII PEAR. PHASING	NETYPES ARE RELATIVE TO THE G SHOWN IN DRAWINGS IS NOT		
HD HEAD, HUB DRAIN HZ HERTZ IE INVERT ELEVATION	VCP VITRIFIED CLAY PIPE VFD VARIABLE FREQUENCY DRIVE	WHICH IS DETERMINED B	BY THE CONTRA	CESSARY CONSTRUCTION PHASING, ACTOR AS PART OF THEIR	114701	
IN WC INCHES OF WATER COLUMN JB JUNCTION BOX	VS VENT STACK VTR VENT THROUGH ROOF	DOCUMENTS ARE GENER	RAL AND ONLY	DESCRIBED IN THE CONSTRUCTION INTENDED TO INDICATE A BROAD THE PROJECT. THE FOLLOWING	HATCHING LEGENE	· · · · · · · · · · · · · · · · · · ·
J-BOX JUNCTION BOX KW KILOWATT	W/ WITH W/O WITHOUT			CE, EQUIPMENT, NOTE, LINE, SHAPE,	ENLARGED PLAN	
MAU MAKE-UP AIR UNIT MAX MAXIMUM	WC WATER COLUMN WS WASTE STACK	-	Ţ			
MBH 1000 BTU PER HOUR MH MANHOLE	WSFU WATER SUPPLY FIXTURE UNIT	EXISTING		NEW ———	NOT IN SCOPE (NIS)	
1	WVS WASTE VENT STACK	DEMOLISH— — —		FUTURE	` <i>'</i>	

STATE OF MISSOURI MIKE KEHOE, GOVERNOR



LICENSE # E-022323

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EXPIRES 10/31/2025

OFFICE OF ADMINISTRATION
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RENOVATE 4 CLIENT
BATHROOMS - RAGLAND
EDUCATION BUILDING,
HIGGINSVILLE HABILITATION
CENTER

100 W 1st Street Higginsville, Missouri 64037

PROJECT # M2406-01 SITE # 7357 FACILITY # 6517357027

REVISION:
DATE:
REVISION:
DATE:
REVISION:
DATE:
ISSUE DATE: 09/16/2025

CAD DWG FILE:
DRAWN BY: BB
CHECKED BY: FD
DESIGNED BY: BB

SHEET TITLE:

PLUMBING GENERAL NOTES AND LEGEND

SHEET NUMBER:

P000



KELLEY P. CRAMM LICENSE # E-022323

HENDERSO

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> 2450001062 MO. CORPORATE NO: E-556D EXPIRES 10/31/2025

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CAD DWG FILE:
DRAWN BY: BB
CHECKED BY: FD
DESIGNED BY: BB

SHEET TITLE:
PLUMBING LEVEL 1
PLAN - OVERALL

SHEET NUMBER:


P10

S (ETR)-CW (ETR)-HW (ETR)-_ _ _ _ _ 9 PLUMBING DEMO PLAN - CLIENT MEN 1/4" = 1'-0"

CW (ETR)

CW (ETR)

5 PLUMBING WATER PLAN - CLIENT MEN
1/4" = 1'-0"

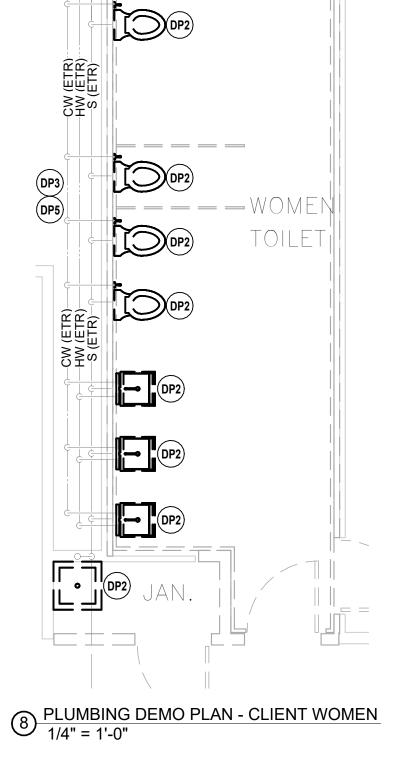


HW (ETR)-CW (ETR)

CW (ETR)-

4 PLUMBING WATER PLAN - CLIENT WOMEN
1/4" = 1'-0"

MENS

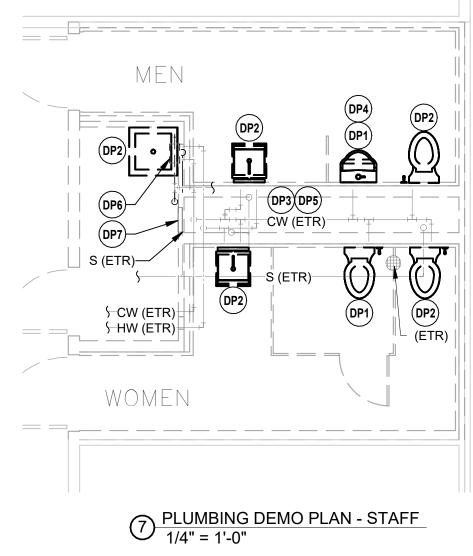



MENS

TOILET

3 PLUMBING WASTE & VENT PLAN - CLIENT MEN 1/4" = 1'-0"


4" S DN BFF

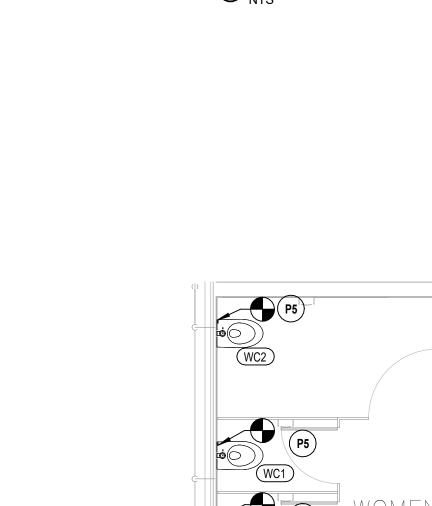

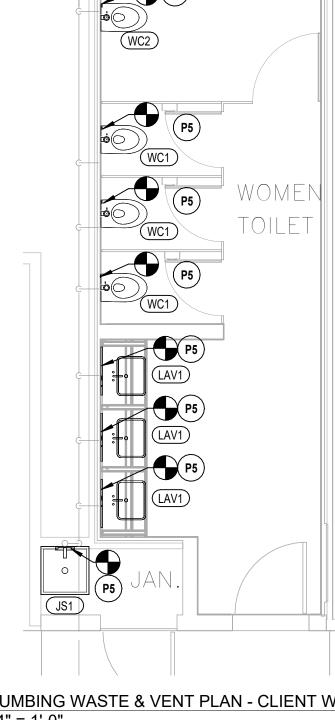


PLUMBING PLAN NOTES:

- DP1 REMOVE EXISTING PLUMBING FIXTURE AS WELL AS PIPING (WASTE, VENT. HOT AND COLD WATER) TO BELOW FINISHED FLOOR AND WITHIN EXISTING PLUMBING CHASE/WALLS.
- DP2 REMOVE EXISTING PLUMBING FIXTURE AND CAP PIPING (WASTE, VENT, HOT AND COLD WATER) AT WALL/FLOOR AND WITHIN EXISTING PLUMBING CHASE/WALLS FOR RECONNECTION UNDER NEW WORK. WHERE ACCESS TO PIPING BELOW SLAB IS REQUIRED CONTRACTOR SHALL SAWCUT EXISTING FLOOR SLAB. PATCH AND REPAIR SLAB PER ARCHITECT'S DIRECTION.
- DP3 CONTRACTOR TO REPLACE EXISTING PIPE INSULATION WITHIN CHASE IDENTIFIED AS CONTAINING MORE THAN 1% ASBESTOS PER REPORT DATED MARCH 21, 2024 WITH ACCEPTABLE INSULATION MATERIALS AS SPECIFIED IN SECTION 220700. PLUMBING CONTRACTOR RESPONSIBLE ONLY FOR THE INSTALLATION OF NEW INSULATION. ASBESTOS ABATEMENT SERVICE WILL BE RESPONSIBLE FOR THE REMOVAL OF ALL INSULATION IDENTIFIED AS HAVING ASBESTOS EXCEEDING THE ALLOWABLE AMOUNT.
- DP4 EXISTING SANITARY WASTE PIPING BELOW SLAB SERVING EXISTING URINALS SHALL BE REMOVED TO IMMEDIATELY BELOW FLOOR SLAB, CAPPED AND ABANDONED IN PLACE. WHERE ACCESS TO PIPING BELOW SLAB IS REQUIRED CONTRACTOR SHALL SAWCUT EXISTING FLOOR SLAB. PATCH AND REPAIR SLAB PER ARCHITECT'S DIRECTION.
- DP5 ANY EXISTING GALVANIZED PIPING WITHIN THE SCOPE OF WORK SHALL BE REPLACED WITH THE APPROPRIATE PIPE MATERIAL PER THE PIPE MATERIAL
- DP6 EXISTING RPBP AND STRAINER ARE TO BE REMOVED AND REPLACED WITH
- DP7 EXISTING ACCESS PANEL TO BE REPLACED. REFER TO ARCHITECTURAL PLANS FOR ADDITIONAL INFORMATION.
- P4 CONNECT NEW PLUMBING FIXTURE TO EXISTING DOMESTIC WATER ROUGH-INS PREVIOUSLY CAPPED DURING DEMOLITION PHASE. CONTRACTOR TO PROVIDE NEW SANITARY WASTE AND VENT ROUGH-INS IN CHASE FOR NEW WALL HUNG FIXTURE AND CONNECT TO EXISTING SANITARY WASTE LINE BELOW FLOOR SLAB AND VENT LINE ABOVE CEILING. NEW FIXTURE INSTALLATION LOCATIONS MAY DIFFER SLIGHTLY FROM ORIGINAL LOCATIONS. CONTRACTOR TO MODIFY EXISTING ROUGH-INS AS NEEDED TO
- ACCOMMODATE NEW FIXTURE LOCATIONS. P5 CONNECT NEW PLUMBING FIXTURE TO EXISTING SANITARY WASTE, VENT AND DOMESTIC WATER ROUGH-INS PREVIOUSLY CAPPED DURING DEMOLITION PHASE. NEW FIXTURE INSTALLATION LOCATIONS MAY DIFFER SLIGHTLY FROM ORIGINAL LOCATIONS. CONTRACTOR TO MODIFY EXISTING ROUGH-INS AS NEEDED TO ACCOMMODATE NEW FIXTURE LOCATIONS.
- P7 NEW DRAIN GRIDS SHALL BE INSTALLED OVER EXISTING DRAIN BODIES. CLEAN AND POLISH EXISTING DRAIN BODIES BEFORE INSTALLING NEW GRID.

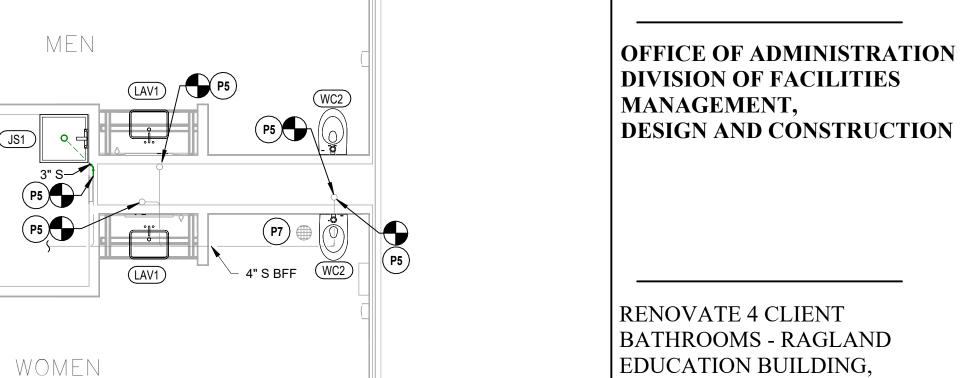

6 PLUMBING WASTE & VENT PLAN - STAFF 1/4" = 1'-0"

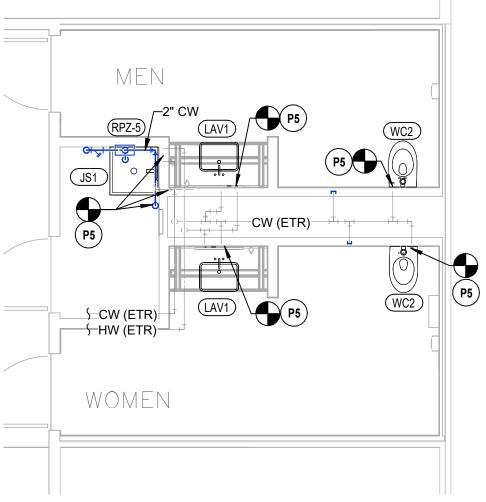

1 PLUMBING WATER PLAN - STAFF
1/4" = 1'-0"

DIVISION OF FACILITIES MANAGEMENT, DESIGN AND CONSTRUCTION

STATE OF MISSOURI MIKE KEHOE, **GOVERNOR**

KELLEY P.

CRAMM

CHUMBER

KELLEY P. CRAMM

LICENSE # E-022323

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MO. CORPORATE NO: E-556D EXPIRES 10/31/2025

RENOVATE 4 CLIENT BATHROOMS - RAGLAND EDUCATION BUILDING, HIGGINSVILLE HABILITATION CENTER

100 W 1st Street Higginsville, Missouri 64037

PROJECT # M2406-01 7357 FACILITY # 6517357027

REVISION: REVISION DATE: REVISION: DATE: ISSUE DATE: 09/16/2025

CAD DWG FILE:
DRAWN BY: BB
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DESIGNED BY: BB

SHEET TITLE:

PLUMBING LEVEL 1 PLAN - ENLARGED **VIEWS**

SHEET NUMBER:

P102

09/16/2025


24 OF 29 SHEETS

PRIOR TO BEGINNING WORK, CONTRACTOR

SHALL VISIT SITE AND INSPECT FIXTURE LOCATIONS FOR ACCESSIBILITY TO EXISTING ROUGH-INS. CONTRACTOR TO VERIFY IF EXISITNG FIXTURE CARRIERS ARE IN GOOD WORKING ORDER, ARE COMPATIBLE WITH THE NEW FIXTURES AND INSTALLED IN THE PROPER ALIGNMENT TO MEET ADA REQUIREMENTS FOR THE NEW FIXTURES. FAILURE TO OBSERVE EXISTING CONDITIONS SHALL NOT BE AN ACCEPTABLE REASON FOR AN INCREASE IN CONTRACT AMOUNT. REFER TO ARCHITECTURAL PLANS FOR ADDITIONAL


GENERAL DEMOLITION NOTE:

CONTRACTOR SHALL COORDINATE DOWNTIME OF EXISTING DOMESTIC WATER SERVICE TO BUILDING FOR WORK ASSOCIATED WITH THE INSTALLATION OF THE NEW RPZ5 AND CONNECTION OF NEW PIPING TO EXISTING MAINS. COORDINATION SHALL OCCUR NO LESS THAN FOURTEEN (14) DAYS PRIOR TO THE PROJECTED DOWNTIME DATE.

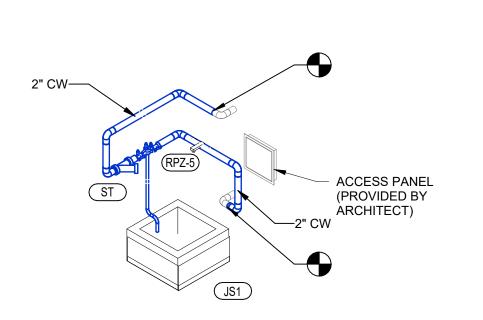

INFORMATION.

D PLUMBING WATER & GAS RPBP RISER

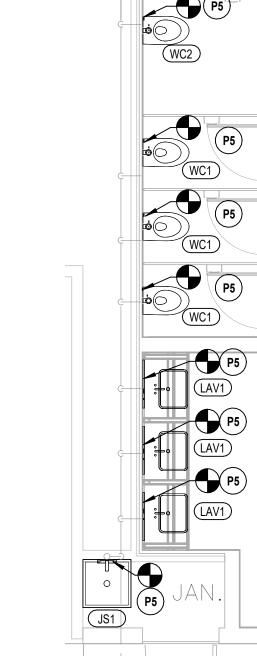

2 PLUMBING WASTE & VENT PLAN - CLIENT WOMEN
1/4" = 1'-0"


PLUMBING PIPE MATERIAL SCHEDULE						
PIPING SYSTEM ABBREVIATION PIPING MATERIAL						
SANITARY DRAINAGE & VENT (ABOVE GRADE)	S, W OR V	HUBLESS CAST IRON				
SANITARY DRAINAGE & VENT (BELOW GRADE)	S, W OR V	SERVICE WEIGHT CAST IRON (PVC DWV OPTIONAL)				
STORM DRAINAGE (BELOW GRADE)	ST	SERVICE WEIGHT CAST IRON (PVC DWV OPTIONAL)				
POTABLE WATER (ABOVE GRADE)	CW, HW OR HWR	TYPE L HARD DRAWN COPPER				
POTABLE WATER - 2" & SMALLER (BELOW GRADE)	CW, HW OR HWR	TYPE K SOFT ANNEALED COPPER				
POTABLE WATER - 3" & LARGER (BELOW GRADE)	CW, HW OR HWR	DUCTILE IRON				
REFER TO SPECIFICATIONS FOR FITTINGS. INSTALLATION REQUIREMENTS AND FURTHER INFORMATION						

PLUMB	ING FIXTURE	CONNECTION	ON SCHED	ULE
FIXTURE	COLD WATER	HOT WATER	WASTE	VENT
WATER CLOSET (FV)	1-1/4" (NOTE 1)		4"	2"
WATER CLOSET (TANK)	1/2"		4"	2"
WATER CLOSET (FV)	1-1/4" (NOTE 1)		3"	2"
WATER CLOSET (TANK)	1/2"		3"	2"
URINAL	3/4" (NOTE 2)		2"	2"
LAVATORY/ HAND SINK	1/2"	1/2"	2"	1-1/2"
DRINKING FOUNTAIN	1/2"		2"	1-1/2"
JANITOR'S SINK	1/2"	1/2"	3"	2"
WASHFOUNTAIN	1"	1"	2"	1-1/2"
FLOOR DRAIN			2"	2"
6" FLOOR DRAIN			6"	3"
SINK	1/2"	1/2"	2"	1-1/2"


NOTE

PIPE SIZES SHOWN ARE MINIMUM AND ARE FOR INDIVIDUAL SERVICE PIPE SIZES.

(NOTE 1) PROVIDE 1-1/4" CW TO FLUSH VALVE, REDUCE TO 1" PRIOR TO CONNECTING TO FLUSH VALVE INLET AT INSIDE OF WALL (NOTE 2) PROVIDE 1" CW TO FLUSH VALVE, REDUCE TO 3/4" PRIOR TO CONNECTING TO FLUSH VALVE INLET AT INSIDE OF WALL

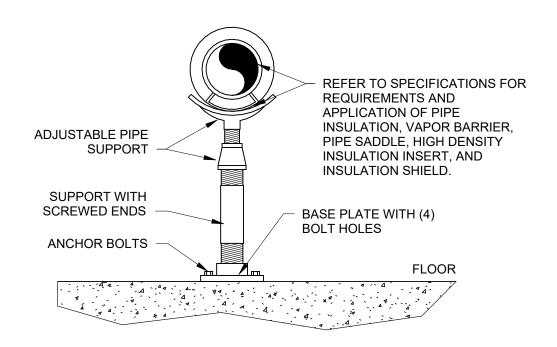


3 FLOOR PIPE SUPPORT DETAIL NTS

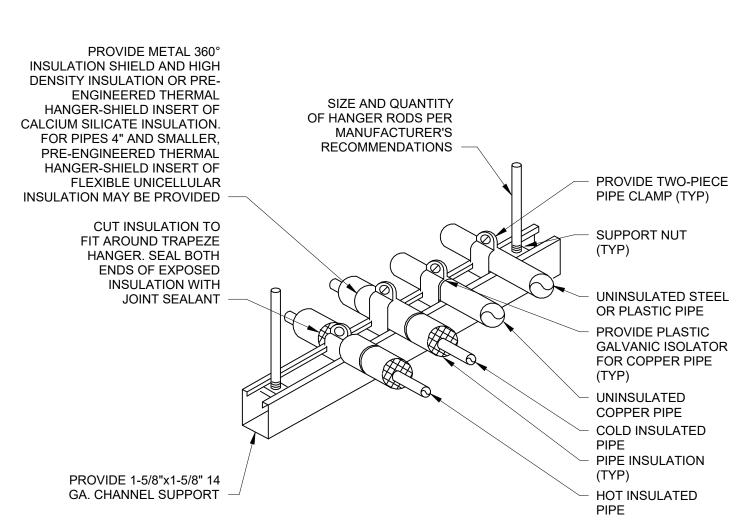

PIPING ARRANGEMENT SHOWN IS SCHEMATIC. ADJUST TO SUIT FIELD CONDITONS. REFER TO SPECIFICATIONS FOR MORE INFORMATION. PIPE AND CONDUIT OF ALL TRADES MAY BE COMBINED ON THE SAME SUPPORT CHANNEL. COORDINATE SUPPORT CHANNEL LENGTH WITH PIPING AND CONDUIT TO BE SUPPORTED. SUPPORT CHANNEL SPACING SHALL BE DETERMINED BY SMALLEST PIPE TO BE SUPPORTED. CHANNEL SUPPORT MAY BE USED AS A WALL BRACKET, ATTACH TO WALL WITH ANCHOR BOLTS PER SPECIFICATIONS. FOR HORIZONTAL INSULATED PIPING, ATTACH CLAMPS AS INDICATED ABOVE, FOR VERTICAL INSULATED PIPING, ATTACH CLAMPS TO THE PIPE AND SEAL INSULATION AT BOTH CLAMP ENDS.

2 TRAPEZE PIPE HANGER NTS

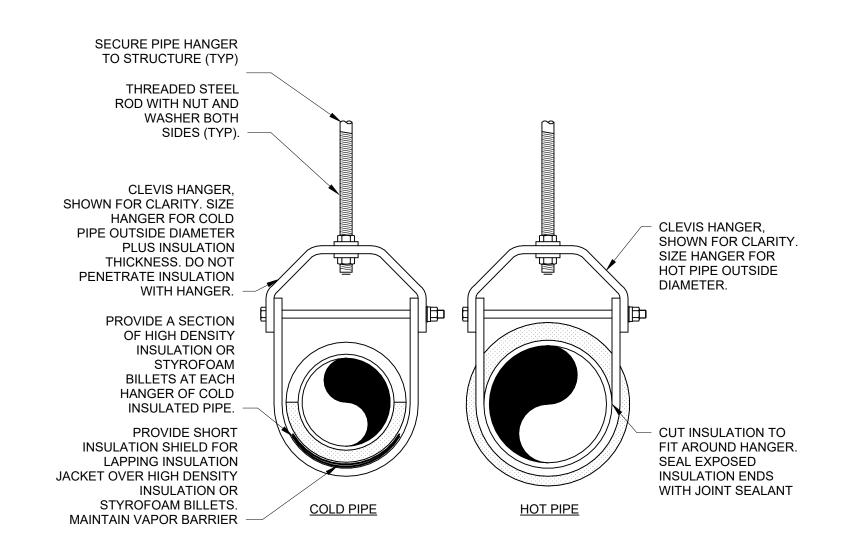

REFER TO SPECIFICATIONS FOR INSULATION TYPES, INSULATION THICKNESSES, HANGER TYPES, HANGER ROD CONNECTIONS TO STRUCTURE AND HANGER SPACING.

1 PIPE HANGER DETAIL NTS

PLUMBING FIXTURE SCHEDULE PLUMBING PLAN MARK DESCRIPTION JANITOR'S SINK: STERN-WILLIAMS # MTB-2424, 24" x 24" x 10" HIGH TERRAZZO BASIN WITH INTEGRAL STAINLESS STEEL DRAIN BODY. FAUCET: CHICAGO FAUCET # 897-CP FAUCET WITH WALL BRACE, INTEGRAL VACUUM BREAKER, PAIL HOOK, AND 3/4" MALE HOSE THREADED OUTLET. SECURE FAUCET IN WALL WITH BACKBOARD. TRIM: # BP TYPE 304, 20 GAUGE, STAINLESS STEEL WALL SURROUNDS, # T-35 THREE FOOT LONG REINFORCED HOSE WITH 3/4" CHROME COUPLING AND WALL HOOK, # V-70 EXTRUDED VINYL BUMPER GUARD,

AND # T-40 24" STAINLESS STEEL MOP HANGER.

INTEGRAL BOWL AS SPECIFIED BY ARCHITECT.

FAUCET: CHICAGO FAUCET # 802-VE2805ABCP 4" CENTERSET, VANDAL RESISTANT, LEAD FREE FAUCET WITH # 390 LEVER HANDLES, CERAMIC

COUNTERTOP LAVATORY (ADA ACCESSIBLE): SOLID SURFACE WITH

QUARTER TURN CARTRIDGES AND # E2805 0.5 GPM AERATOR.

TRIM: McGUIRE # 155A GRID DRAIN WITH TAILPIECE, McGUIRE # LF2165CCLK LEAD FREE BRASS LOOSE KEY COMPRESSION ANGLE STOP VALVES WITH RISERS AND ESCUTCHEONS, McGUIRE # B8872CF 1-1/4" 17 GAUGE CAST CHROME PLATED BRASS ADJUSTABLE P-TRAP AND WASTE ARM WITH CLEANOUT PLUG AND ESCUTCHEON, CONCEALED ARM CARRIER WITH STANCHIONS TO FLOOR. PLUMBEREX "PRO-EXTREME" # X-4222 INSULATION KIT FOR WATER AND WASTE PIPES

THERMOSTATIC MIXING VALVE: POWERS # LFe480, SOLID LEAD FREE BRASS BODY, THERMOSTATIC WAX ELEMENT, CORROSION RESISTANT INTERNAL PARTS, AND INTEGRAL CHECKS, ASSE 1070 COMPLIANT, CAPABLE OF 2.2 GPM WITH A 20 PSI DIFFERENTIAL AND A MINIMUM FLOW RATE OF 0.5 GPM. SET TEMPERATURE TO 110F FOR DUEL TEMPERATURE LAVATORIES AND HAND SINKS, 100F FOR SINGLE TEMPERATURE LAVATORIES AND HAND SINKS AND 120F FOR SINKS. MOUNT BELOW THE PLUMBING FIXTURE WHERE INDICATED ON PLAN(S).

RPZ-5

REDUCED PRESSURE ZONE BACKFLOW PREVENTER: WATTS #
SS009QT, MEETING ASSE 1013, 316 STAINLESS STEEL BODY, QUARTER
TURN TEST COCKS, QUARTER TURN, FULL PORT BALL VALVES AND #
909AG AIR GAP FITTING. EXTEND DISCHARGE PIPE TO MOP BASIN.

UR1

UR1NAL: AMERICAN STANDARD # 6561.017 "TRIMBROOK" WHITE
VITREOUS CHINA FIXTURE WITH FLUSHING RIM, 3/4" TOP SPUD, AND

SIPHON FLUSH ACTION.
,VALVE: SLOAN "SLOAN" # 186-1 1.0 GALLON PER FLUSH, EXPOSED CHROME-PLATED DIAPHRAGM TYPE FLUSH VALVE WITH CHLORAMINE RESISTANT DIAPHRAGM AND PROTECTED ORIFICE, OSCILLATING ADA COMPLIANT HANDLE WITH VANDAL RESISTANT CAP, ESCUTCHEON, INTEGRAL SCREWDRIVER STOP, VACUUM BREAKER, 3/4" FLUSH TUBE, AND SWEAT ADAPTER KIT.
,TRIM: SUITABLE CARRIER WITH STANCHIONS TO FLOOR.

URINAL (ADA ACCESSIBLE): AMERICAN STANDARD # 6561.017
"TRIMBROOK" WHITE VITREOUS CHINA FIXTURE WITH FLUSHING RIM,
3/4" TOP SPUD, AND SIPHON FLUSH ACTION.
,VALVE: SLOAN "SLOAN" # 186-1 1.0 GALLON PER FLUSH, EXPOSED
CHROME-PLATED DIAPHRAGM TYPE FLUSH VALVE WITH CHLORAMINE
RESISTANT DIAPHRAGM AND PROTECTED ORIFICE, OSCILLATING ADA
COMPLIANT HANDLE WITH VANDAL RESISTANT CAP, ESCUTCHEON,
INTEGRAL SCREWDRIVER STOP, VACUUM BREAKER, 3/4" FLUSH TUBE,

AND SWEAT ADAPTER KIT.
,TRIM: SUITABLE CARRIER WITH STANCHIONS TO FLOOR.

WC1

WALL-MOUNTED WATER CLOSET: AMERICAN STANDARD # 2257.101
"AFWALL MILLENNIUM FLOWISE" WHITE VITREOUS CHINA FIXTURE WITH
ELONGATED UNIVERSAL BOWL AND DIRECT-FED SIPHON JET ACTION.

VALVE: SLOAN "SLOAN" # 111 1.28 GALLON PER FLUSH, EXPOSED
CHROME-PLATED DIAPHRAGM TYPE FLUSH VALVE WITH CHLORAMINE
RESISTANT DIAPHRAGM AND PROTECTED ORIFICE, OSCILLATING ADA
COMPLIANT HANDLE, ESCUTCHEON, INTEGRAL SCREWDRIVER STOP

WITH VANDAL RESISTANT CAP, VACUUM BREAKER, AND SWEAT ADAPTER KIT.

TRIM: CHURCH # 9500SSCT WHITE OPEN-FRONT CONTOURED, SOLID PLASTIC, HEAVY DUTY, SEAT LESS COVER WITH SELF-SUSTAINING CHECK HINGES AND STAINLESS STEEL BOLTS. PROVIDE SUITABLE FIXTURE CARRIER.

WALL-MOUNTED WATER CLOSET (ADA ACCESSIBLE): AMERICAN STANDARD # 2257. 101 "AFWALL MILLENNIUM FLOWISE" WHITE VITREOUS CHINA FIXTURE WITH ELONGATED UNIVERSAL BOWL AND DIRECT-FED SIPHON JET ACTION.

VALVE: SLOAN "SLOAN" # 111.1.28 GALLON PER FLUSH, EXPOS

VALVE: SLOAN "SLOAN" # 111 1.28 GALLON PER FLUSH, EXPOSED CHROME-PLATED DIAPHRAGM TYPE FLUSH VALVE WITH CHLORAMINE RESISTANT DIAPHRAGM AND PROTECTED ORIFICE, OSCILLATING ADA COMPLIANT HANDLE, ESCUTCHEON, INTEGRAL SCREWDRIVER STOP WITH VANDAL RESISTANT CAP, VACUUM BREAKER, AND SWEAT ADAPTER KIT. INSTALL FLUSH VALVE HANDLE ON THE WIDE SIDE OF THE STALL.

TRIM: CHURCH # 9500SSCT WHITE OPEN-FRONT CONTOURED, SOLID PLASTIC, HEAVY DUTY, SEAT LESS COVER WITH SELF-SUSTAINING CHECK HINGES AND STAINLESS STEEL BOLTS. PROVIDE SUITABLE FIXTURE CARRIER.

STATE OF MISSOURI MIKE KEHOE, GOVERNOR



9/16/ KELLEY P. CRAMM LICENSE # E-022323

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> 2450001062 MO. CORPORATE NO: E-556D EXPIRES 10/31/2025

OFFICE OF ADMINISTRATION
DIVISION OF FACILITIES
MANAGEMENT,
DESIGN AND CONSTRUCTION

RENOVATE 4 CLIENT
BATHROOMS - RAGLAND
EDUCATION BUILDING,
HIGGINSVILLE HABILITATION
CENTER

100 W 1st Street Higginsville, Missouri 64037

PROJECT # M2406-01 SITE # 7357 FACILITY # 6517357027

REVISION:
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ISSUE DATE: 09/16/2025

CAD DWG FILE:
DRAWN BY: BB
CHECKED BY: FD
DESIGNED BY: BB

SHEET TITLE:

PLUMBING DETAILS & SCHEDULES

SHEET NUMBER:

P400

FIRE ALARM SCOPE OF WORK NOTES

1. ALL HORN/STROBE NOTIFICATION APPLIANCES MUST BE REMOVED FOR DEMOLITION OF THE RESTROOM AND REINSTALLED AND CONNECTED BACK TO THE SIMPLEX 4100U FIRE ALARM CONTROL PANEL.

FIRE ALARM GENERAL DEMOLITION NOTES:

- 1. COORDINATE ALL DEMOLITION WITH WHAT IS SHOWN ON ARCHITECTURAL PLANS. NOTIFY ARCHITECT OF ANY DISCREPANCIES.
- 2. COORDINATE NEW WORK AND DEMOLITION WITH OTHER DISCIPLINES AND EXISTING CONDITIONS PRIOR TO CONSTRUCTION.
- PRIOR TO SUBMITTING BID. VISIT THE JOB SITE AND BECOME FULLY ACQUAINTED WITH THE EXISTING CONDITIONS OF THE PROJECT. REVIEW GENERAL NOTES, SPECIFICATIONS AND OTHER DRAWINGS FOR ADDITIONAL REQUIREMENTS THAT MAY NOT BE SPECIFICALLY CALLED OUT IN THIS PORTION OF THE CONSTRUCTION DOCUMENTS. NOTIFY ARCHITECT, ENGINEER OR OWNER, AS DEFINED IN BID DOCUMENTS, OF CONFLICTS OR DISCREPANCIES PRIOR TO SUBMISSION OF BID. ADDITIONAL COMPENSATION WILL NOT BE PAID FOR LACK OF SUCH DETERMINATION, FAMILIARIZATION, AND/OR ALLOWANCE.
- 4. EXISTING CONDITIONS WERE TAKEN FROM ORIGINAL DRAWINGS AND SITE VISITS AND MAY NOT REFLECT EXACT "AS-BUILT" CONDITIONS. FIELD VERIFY EXISTING CONDITIONS PRIOR TO SUBMITTING FINAL BIDS. COORDINATE NEW WORK AND DEMOLITION WITH OTHER DISCIPLINES AND EXISTING CONDITIONS PRIOR TO CONSTRUCTION.
- OWNER RETAINS RIGHTS OF SALVAGE FOR EQUIPMENT AND FIXTURES TO BE REMOVED. COORDINATE WITH THE OWNER THE EQUIPMENT AND FIXTURES TO BE SALVAGED AND THE LOCATION FOR STORAGE. AVOID DAMAGE TO EQUIPMENT DURING DEMOLITION WORK AND DURING TRANSPORT TO OWNER'S DESIGNATED STORAGE LOCATION. PROPERLY DISPOSE OF MATERIALS THAT ARE REMOVED AND ARE NOT REQUESTED TO BE SALVAGED BY THE OWNER.
- 6. REMOVE ITEMS SHOWN HEAVY LINED AND/OR CROSSHATCHED AND/OR NOTED TO BE REMOVED.
- 7. EQUIPMENT TO BE REMOVED SHALL BE KEPT FOR REINSTALLATION DURING THE CONSTRUCTION PHASE WHEN POSSIBLE AND/OR INDICATED ON THE DRAWINGS. AVOID DAMAGING EXISTING SURFACES AND EQUIPMENT TO REMAIN FOR NEW INSTALLATION. REPAIR ANY DAMAGE CAUSED DURING WORK AT NO EXTRA COST TO THE OWNER.
- 8. SEAL PENETRATIONS THROUGH FLOORS, WALLS, CEILINGS AND ROOFS WHERE COMPONENTS ARE REMOVED AND WHERE THE EXISTING PENETRATION IS NOT USED FOR THE NEW INSTALLATION. REPAIR DAMAGED SURFACES TO MATCH ADJACENT AREAS OR AS INDICATED ON THE ARCHITECTURAL DRAWINGS.
- 9. PERFORM ALL WORK ACCORDING TO THE PHASING SCHEDULE FOR THIS PROJECT. PROVIDE ALL TEMPORARY DESIGN AND/OR CONFIGURATIONS THAT MEET APPLICABLE CODE REQUIREMENTS AS NECESSARY TO CONFORM TO THE REQUIRED CONSTRUCTION PHASING OF THE PROJECT.
- 10. ONLY THE PORTIONS OF THE BUILDING AFFECTED BY THE SCOPE OF THE PROJECT HAVE BEEN SHOWN. INFORMATION SHOWN AS EXISTING TO REMAIN IS NOT BEING MODIFIED AS A PART OF THIS PROJECT.
- 11. ALL WORK SHALL BE PERFORMED SO AS TO NOT INTERRUPT SERVICE. THE CONTRACTOR SHALL PROPERLY NOTIFY THE BUILDING OWNER, LANDLORD, THE LEASER AND ADJACENT TENANTS AS APPLICABLE A MINIMUM OF 48 HOURS IN ADVANCE BEFORE PROCEEDING WITH THIS WORK.
- 12. REMOVE ALL UNUSED AND DEMOLISHED EQUIPMENT AND ASSOCIATED MATERIALS FROM SITE. ABANDONING UNUSED PORTIONS WILL NOT BE ACCEPTABLE.
- 13. SYSTEM(S) NOT ASSOCIATED WITH THE DEMOLITION SHALL BE LEFT IN SÉRVICE AS APPLICABLE.
- 14. INSPECT EXISTING EQUIPMENT TO REMAIN TO VERIFY THAT EQUIPMENT IS OPERATING PROPERLY. NOTIFY OWNER OF DAMAGED AND/OR MALFUNCTIONING COMPONENTS.
- 15. ALL SYSTEMS TO BE LEFT IN SERVICE PRIOR TO THE END OF EACH WORKDAY.


FIRE ALARM GENERAL NOTES:

- 1. PRIOR TO SUBMITTING BID. VISIT THE JOB SITE AND BECOME FULLY ACQUAINTED WITH THE EXISTING CONDITIONS OF THE PROJECT. REVIEW THE GENERAL NOTES, SPECIFICATIONS AND OTHER DRAWINGS FOR ADDITIONAL REQUIREMENTS WHICH MAY NOT BE SPECIFICALLY CALLED OUT IN THIS PORTION OF THE CONSTRUCTION DOCUMENTS. NOTIFY ARCHITECT, ENGINEER AND/OR OWNER OF CONFLICTS OR DISCREPANCIES PRIOR TO SUBMISSION OF BID.
- 2. SYSTEM DESIGN, INSTALLATION AND MATERIALS SHALL BE IN ACCORDANCE WITH APPLICABLE NFPA STANDARDS. SYSTEM SHALL ALSO MEET ALL APPLICABLE BUILDING CODES, FIRE CODES AND THE REQUIREMENTS OF THE AUTHORITY HAVING JURISDICTION AND INSURANCE CARRIER. VERIFY REQUIREMENTS PRIOR TO BID SUBMITTAL.
- INFORMATION ON CONTRACT DOCUMENTS IS GENERAL INFORMATION AND FOR BID PURPOSES ONLY. CONTRACTOR SHALL BE FULLY RESPONSIBLE FOR THE FINAL SYSTEM DESIGN AND LAYOUT OF ALL COMPONENTS, COORDINATION WITH ALL OTHER TRADES, AND SYSTEM CALCULATIONS REQUIRED FOR APPROVAL BY THE AUTHORITY HAVING JURISDICTION, ENGINEER, AND OWNER'S INSURER.
 - THE CONTRACTOR SHALL FOLLOW THE ENGINEER OF RECORD'S SYSTEM DESIGN AND LAYOUT OF ALL COMPONENTS EXCEPT WHERE MODIFICATION TO THE DESIGN IS NECESSARY. MODIFICATIONS SHALL BE REFLECTED IN THE CONTRACTOR'S SHOP DRAWINGS AND CALCULATIONS.
 - 5. DEVIATIONS FROM ENGINEER'S DESIGN WILL NOT BE CONSIDERED UNLESS A FORMALLY SUBMITTED RFI IS RECEIVED AND APPROVED.
- 6. THE CONTRACTOR SHALL PROVIDE ALL EQUIPMENT AND LABOR REQUIRED FOR A COMPLETE AND OPERATIONAL SYSTEM AS INDICATED IN THE DRAWINGS AND SPECIFICATIONS.
- 7. WHERE EXISTING SYSTEMS ARE PRESENT, CONTRACTOR SHALL MODIFY, RELOCATE AND/OR PROVIDE ADDITIONAL EQUIPMENT AS REQUIRED FOR SCOPE OF WORK AS REQUIRED FOR A COMPLETE AND OPERATIONAL SYSTEM. COORDINATE WITH WALLS, CEILINGS, LIGHTS, DIFFUSERS, STRUCTURE, OBSTRUCTIONS, ETC. IN AREAS AFFECTED BY SCOPE OF WORK. NEW EQUIPMENT SHALL BE COMPATIBLE WITH EXISTING SYSTEMS. CONTRACTOR SHALL REMOVE ALL ABANDONED EQUIPMENT, COORDINATE SYSTEM MODIFICATIONS TO MINIMIZE SYSTEM IMPAIRMENT, AND PROVIDE FIRE WATCH AND/OR INTERIM FIRE PROTECTION MEASURES WHERE REQUIRED BY THE AUTHORITY HAVING JURISDICTION, INSURANCE CARRIER OR OWNER.
- PROVIDE ADDITIONAL MATERIALS AND LABOR REQUIRED DUE TO LACK OF COORDINATION OR TO MEET AUTHORITY HAVING JURISDICTION AND INSURANCE CARRIER REQUIREMENTS AT NO ADDITIONAL COST TO THE OWNER.
- 9. FORWARD COMPLETED CERTIFICATE OF COMPLETION AND CONTRACTOR MATERIAL TEST CERTIFICATES TO THE OWNER.
- 10. REFER TO SPECIFICATIONS FOR ADDITIONAL INFORMATION.

FIRE ALARM SYMBOLS

ABOVE FINISHED FLOOR NIC AFG OC ABOVE FINISHED GRADE ON CENTER CD CANDELA DUCTILE IRON **ESFR** EARLY SUPPRESSION PRV FAST RESPONSE RD ETR EXISTING TO REMAIN RETURN DUCT FHC FIRE HOSE CABINET REV REVISION FIRE PROTECTION SD SUPPLY DUCT CONTRACTOR SQUARE FEET

ANNOTATION

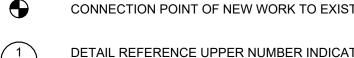

90" AUDIBLE APPLIANCE (TOP OF APPLIANCE) 60" FIRE ALARM ANNUNCIATOR PANEL (TOP OF DISPLAY) 120" 60" FIRE ALARM BELL (EXTERIOR) (CENTERLINE) FIRE ALARM CONTROL PANEL/UNIT (TOP OF DISPLAY) 46" PULL STATION (TOP OF DEVICE) VISIBLE APPLIANCE (CENTERLINE) 84"

INSTALL DEVICES AT THE MOUNTING HEIGHTS SHOWN ABOVE UNO IN THE CONSTRUCTION DOCUMENTS. MOUNTING HEIGHTS LISTED ABOVE, OR ELSEWHERE IN THE CONSTRUCTION DOCUMENTS, ARE AFF OR AFG TO TOP OF DEVICE, UNO. ALL DEVICES SHALL BE INSTALLED IN COMPLIANCE WITH

ROBERT JOHN GARCIA ROBERT.JOHN.GARCIA@JCI.COM (913)-544-8875

NOT IN CONTRACT FIRE ALARM CONTROL PANEL/UNIT FACP POST INDICATOR VALVE RECESSED FIRE ALARM CONTROL PANEL/UNIT PROVIDE FURNISH AND INSTALL FIRE ALARM ANNUNCIATOR PANEL

FIRE ALARM

RECESSED FIRE ALARM ANNUNCIATOR PANEL

REMOTE TEST STATION WITH INDICATING LIGHT

HEAT DETECTOR (E INDICATES ELEVATOR RECALL)

SMOKE DETECTOR (E INDICATES ELEVATOR RECALL)

DUCT MOUNTED SMOKE DETECTOR (SD=SUPPLY/RD=RETURN)

AREA OF REFUGE 2-WAY COMMUNICATION SYSTEM

WALL MOUNTED AUDIBLE NOTIFICATION APPLIANCE

WALL MOUNTED VISIBLE NOTIFICATION APPLIANCE

#W INDICATES WATTAGE (VOICE EVACUATION SYSTEMS ONLY)

WALL MOUNTED AUDIBLE/VISIBLE NOTIFICATION APPLIANCE

CEILING MOUNTED AUDIBLE NOTIFICATION APPLIANCE

CEILING MOUNTED VISIBLE NOTIFICATION APPLIANCE

#W INDICATES WATTAGE (VOICE EVACUATION SYSTEMS ONLY)

#W INDICATES WATTAGE (VOICE EVACUATION SYSTEMS ONLY)

CEILING MOUNTED AUDIBLE/VISIBLE NOTIFICATION APPLIANCE

#W INDICATES WATTAGE (VOICE EVACUATION SYSTEMS ONLY)

FUTURE -----

AMPLIFIER PANEL

REMOTE POWER SUPPLY

REMOTE INDICATING LIGHT

PRESSURE SWITCH LOW/HIGH

WATERFLOW ALARM SWITCH

FIRE DEPARTMENT KEY BOX

FIREFIGHTER'S PHONE JACK

SINGLE STATION SMOKE DETECTOR

CARBON MONOXIDE DETECTOR

INDICATES CANDELA

INDICATES CANDELA

INDICATES CANDELA

INDICATES CANDELA

END OF LINE RESISTOR

THROUGHOUT THE DRAWINGS DIFFERENT LINETYPES ARE USED IN

WHICH IS DETERMINED BY THE CONTRACTOR AS PART OF THEIR

COMBINATION WITH THE SYMBOLS TO INDICATE THE STATUS OF ITEMS AS

INTENDED TO FULLY DESCRIBE ALL NECESSARY CONSTRUCTION PHASING,

RESPONSIBILITIES. ANY SUCH PHASES DESCRIBED IN THE CONSTRUCTION DOCUMENTS ARE GENERAL AND ONLY INTENDED TO INDICATE A BROAD ORDER FOR THE SAKE OF DESCRIBING THE PROJECT. THE FOLLOWING LINETYPES MAY BE USED ON ANY DEVICE, EQUIPMENT, NOTE, LINE, SHAPE,

EXISTING, TO BE DEMOLISHED, TO BE INCLUDED AS PART OF NEW WORK AND/OR ITEMS WHICH ARE ANTICIPATED TO BE PROVIDED IN THE FUTURE.

THE STATUS OF ITEMS USING THESE LINETYPES ARE RELATIVE TO THE VIEW IN WHICH THEY APPEAR. PHASING SHOWN IN DRAWINGS IS NOT

ABORT SWITCH

BELL

HATCHING LEGEND

ENLARGED PLAN

NOT IN SCOPE (NIS)

LINETYPE LEGEND

EXISTING

DEMOLISH — — — —

PROJECTED BEAM SMOKE DETECTOR

CONTROL MODULE

MONITOR MODULE

PULL STATION

CONTROL VALVE TAMPER SWITCH

MAGNETIC DOOR HOLD OPEN DEVICE

THIS IS A MASTER LEGEND AND NOT ALL SYMBOLS OR ABBREVIATIONS ARE USED.

PRESSURE REDUCING **GALLONS PER MINUTE** TYP TYPICAL UNLESS NOTES OTHERWISE JB/J-BOX UNO JUNCTION BOX MAX MAXIMUM VOLT(S) MIN MINIMUM WATTS N/A NOT APPLICABLE WEATHERPROOF WP

ABBREVIATIONS

FIRE ALARM PLAN NOTE CALLOUT

CONNECTION POINT OF NEW WORK TO EXISTING

DETAIL REFERENCE UPPER NUMBER INDICATES DETAIL NUMBER LOWER NUMBER INDICATES SHEET NUMBER

SECTION CUT DESIGNATION

DEDICATED EQUIPMENT ACCESS TILE

ACCESS PANEL

STANDARD MOUNTING HEIGHTS

CURRENT ADA AND LOCAL REQUIREMENTS.

EXISTING SYSTEM FIRE CONTRACTOR INFORMATION:

JOHNSON CONTROLS

V2.06

STATE OF MISSOURI MIKE KEHOE, **GOVERNOR**



9/16/2025 CHRISTOPHER J. CULP LICENSE # PE-2013037646

HENDERSON ENGINEERS

8345 LENEXA DRIVE, SUITE 300 LENEXA, KS 66214 TEL 913.742.5000 FAX 913.742.5001 WWW.HENDERSONENGINEERS.COM

> MO. CORPORATE NO: E-556D EXPIRES 10/31/2025

OFFICE OF ADMINISTRATION DIVISION OF FACILITIES MANAGEMENT. **DESIGN AND CONSTRUCTION**

RENOVATE 4 CLIENT BATHROOMS - RAGLAND EDUCATION BUILDING, HIGGINSVILLE HABILITATION CENTER

100 W 1st Street Higginsville, Missouri 64037

PROJECT # M2406-01 7357 FACILITY # 6517357027


REVISION: DATE: **REVISION**: DATE: REVISION: DATE ISSUE DATE: 09/16/2025

CAD DWG FILE: DRAWN BY: NTS CHECKED BY: AJ DESIGNED BY: NTS

SHEET TITLE:

FIRE ALARM **GENERAL NOTES** AND LEGEND

SHEET NUMBER:

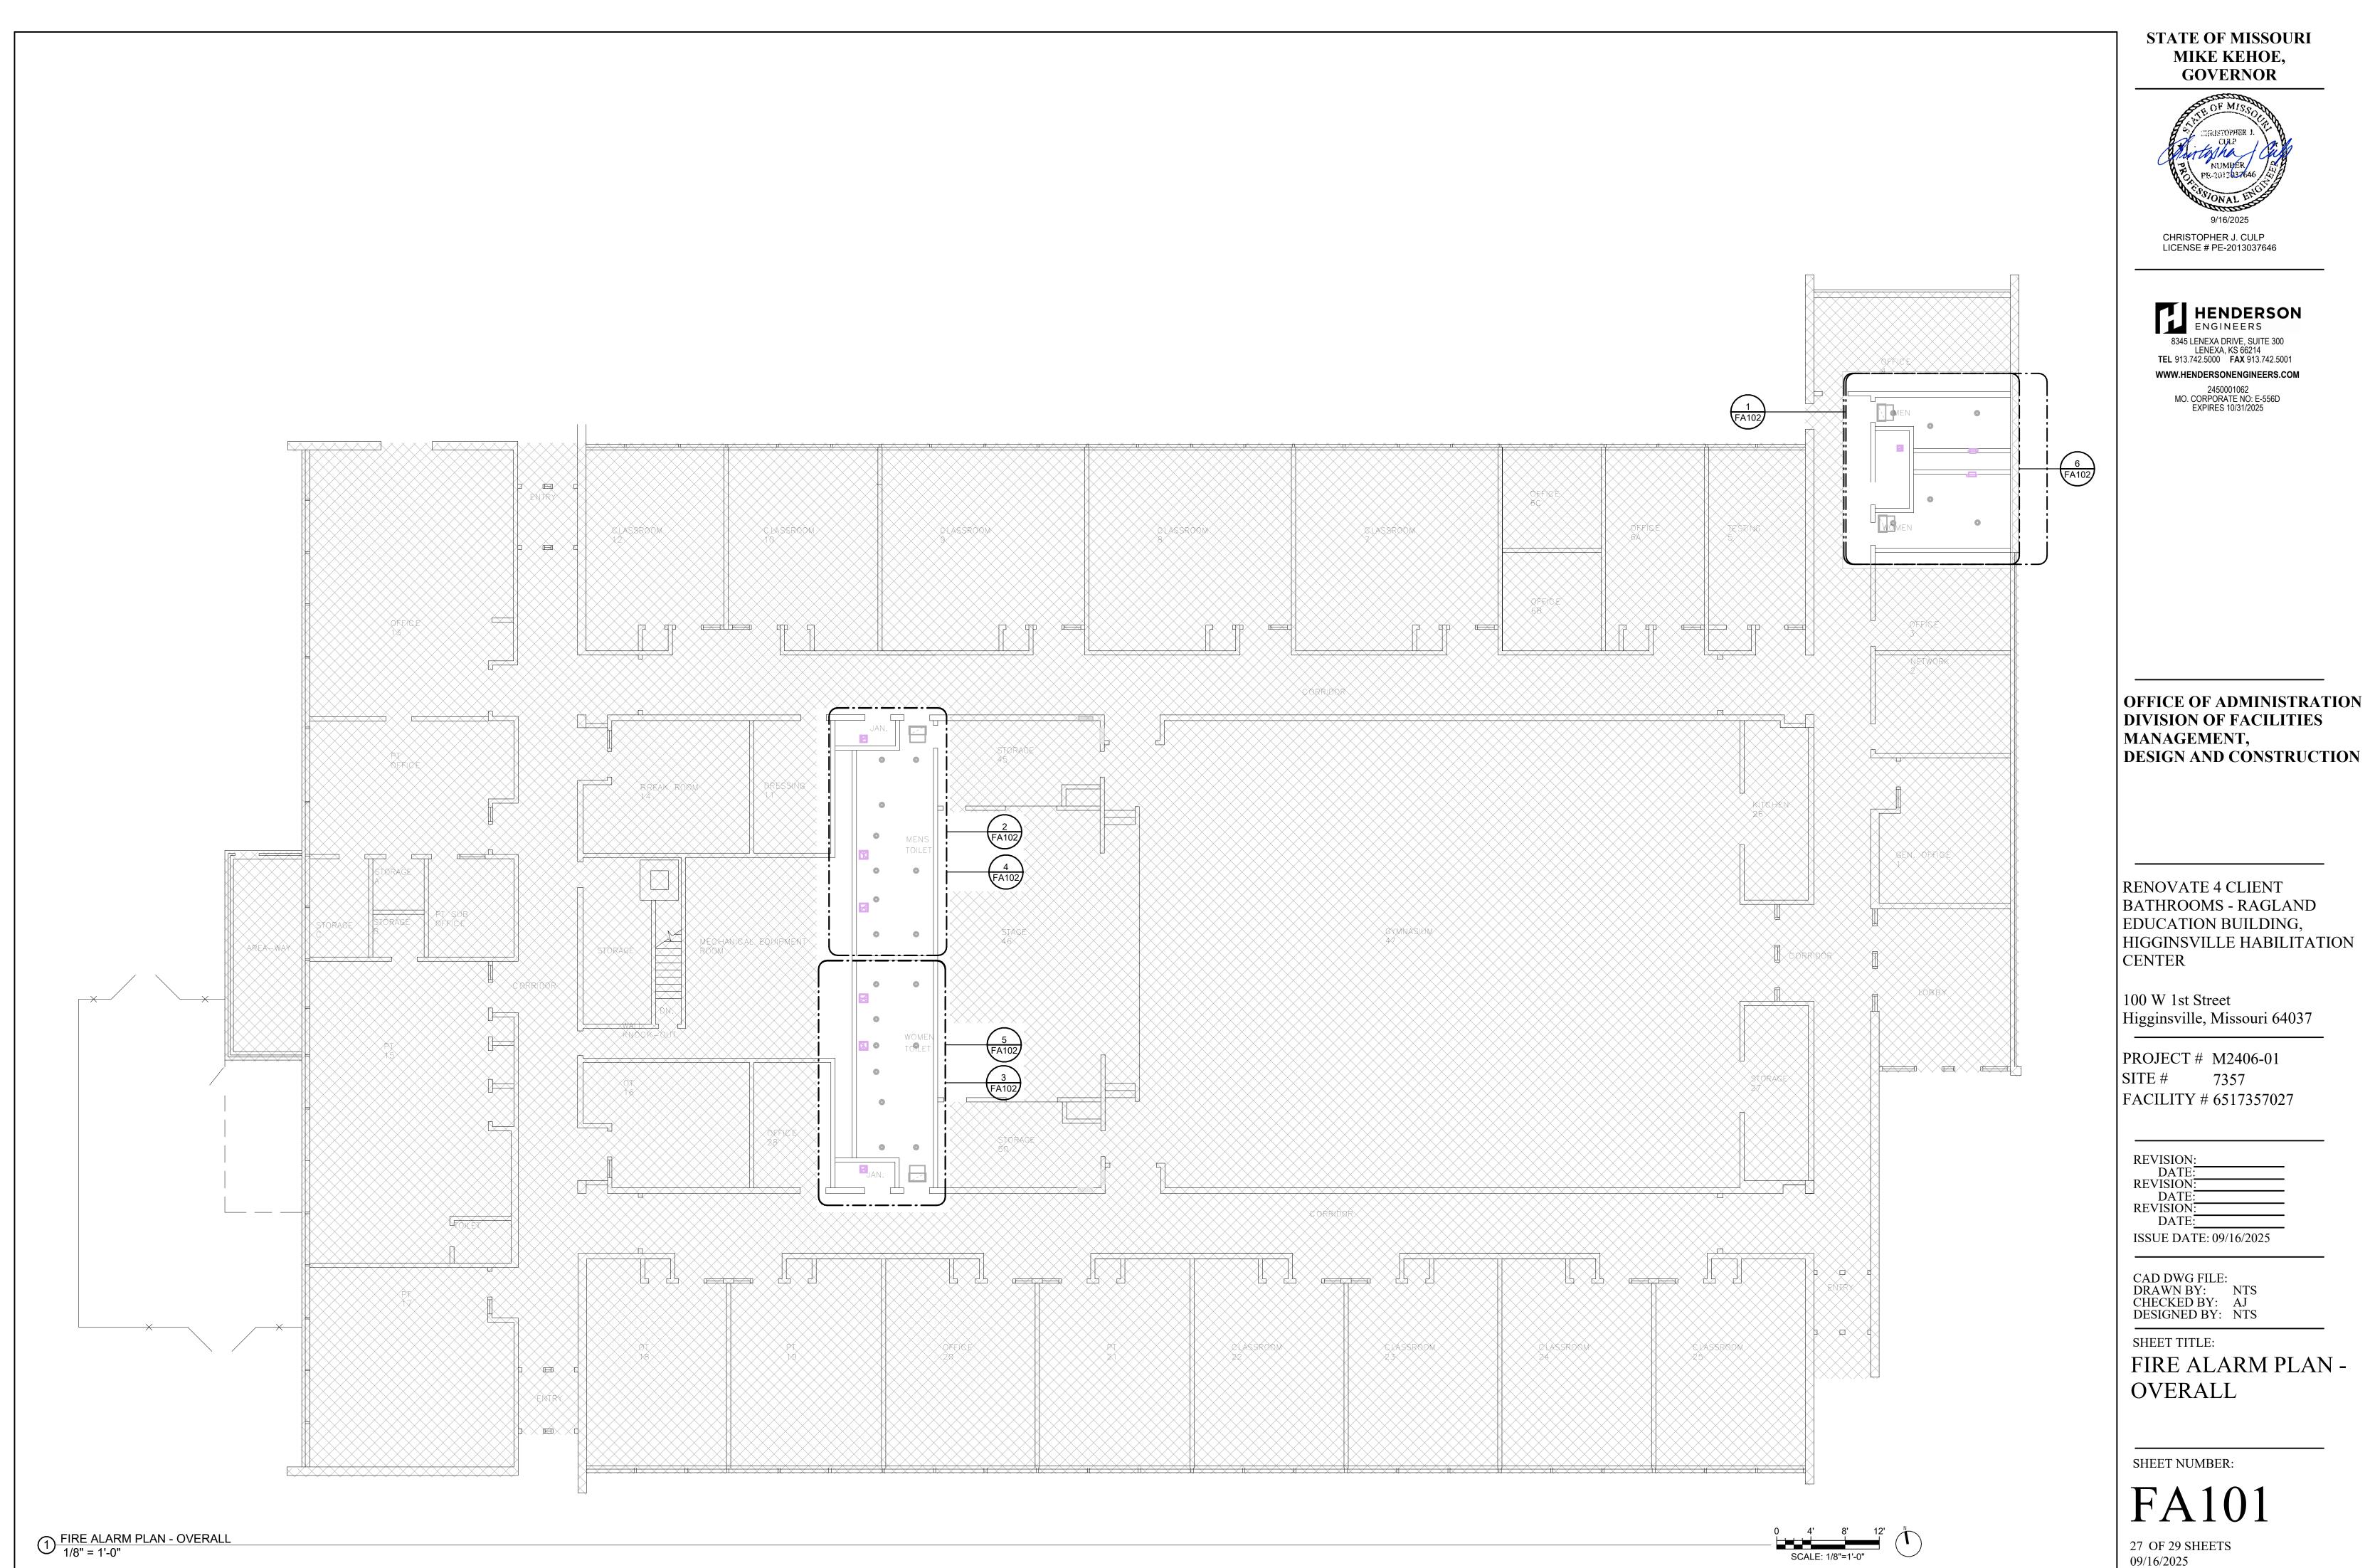



- DFA1 REMOVE AND SALVAGE EXISTING FIRE ALARM APPLIANCES FOR REINSTALLATION DURING NEW WORK.
- FOR REINSTALLATION DURING NEW WORK.

 F1 REINSTALL EXISTING HORN/STROBE NOTIFICATION APPLIANCES.



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2450001062 MO. CORPORATE NO: E-556D EXPIRES 10/31/2025

OFFICE OF ADMINISTRATION
DIVISION OF FACILITIES
MANAGEMENT,
DESIGN AND CONSTRUCTION

RENOVATE 4 CLIENT
BATHROOMS - RAGLAND
EDUCATION BUILDING,
HIGGINSVILLE HABILITATION
CENTER

100 W 1st Street Higginsville, Missouri 64037

PROJECT # M2406-01 SITE # 7357 FACILITY # 6517357027

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CAD DWG FILE:
DRAWN BY: NTS
CHECKED BY: AJ
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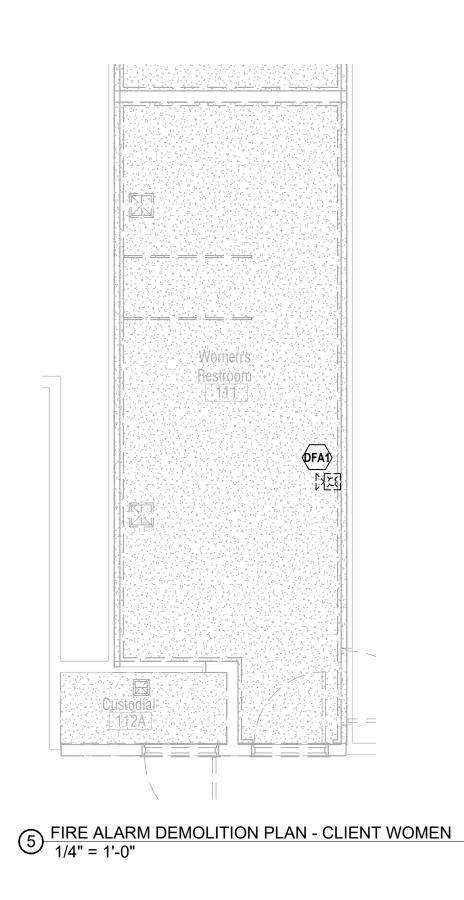
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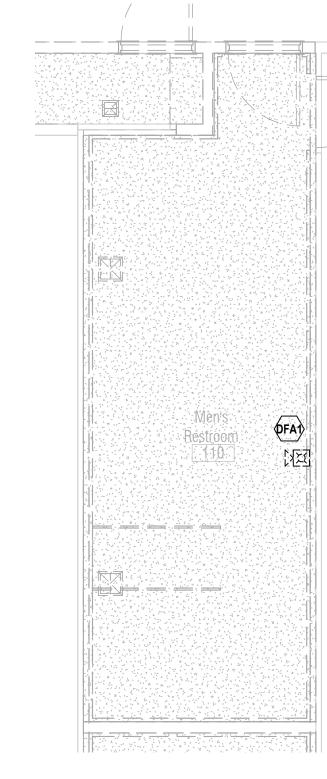
FIRE ALARM PLAN -ENLARGED VIEWS


SHEET NUMBER:

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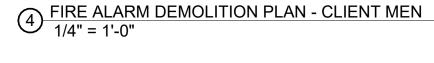









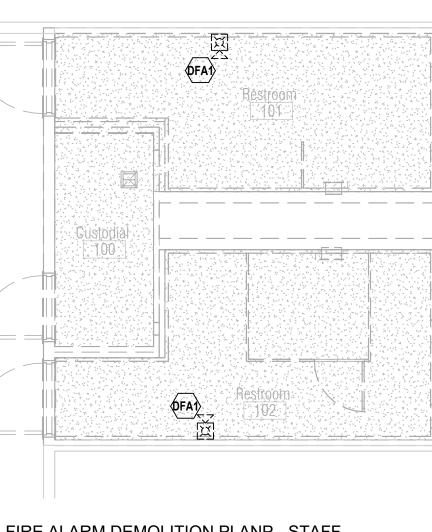





6 FIRE ALARM DEMOLITION PLANP - STAFF 1/4" = 1'-0"

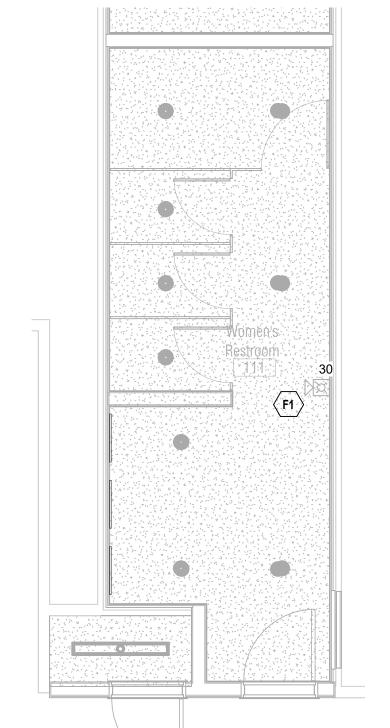


FIRE ALARM PLAN - CLIENT WOMEN
1/4" = 1'-0"

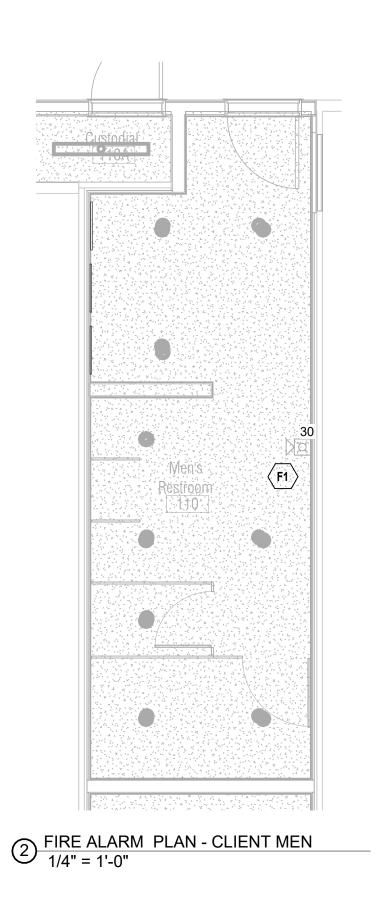

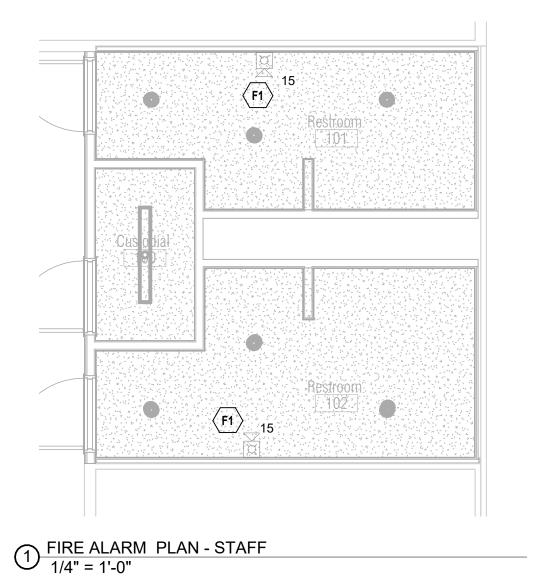

- 1 ASBESTOS CONTAINING HARD MUDDED FITTINGS. APPROXIMATELY 115 TOTAL.
- ASBESTOS CONTAINING VINYL TILE TO BE REMOVED. REMOVE IN GENERAL AREA INDICATED. REMOVE TILES AT EDGES, DO NOT CUT TILES IN HALF.

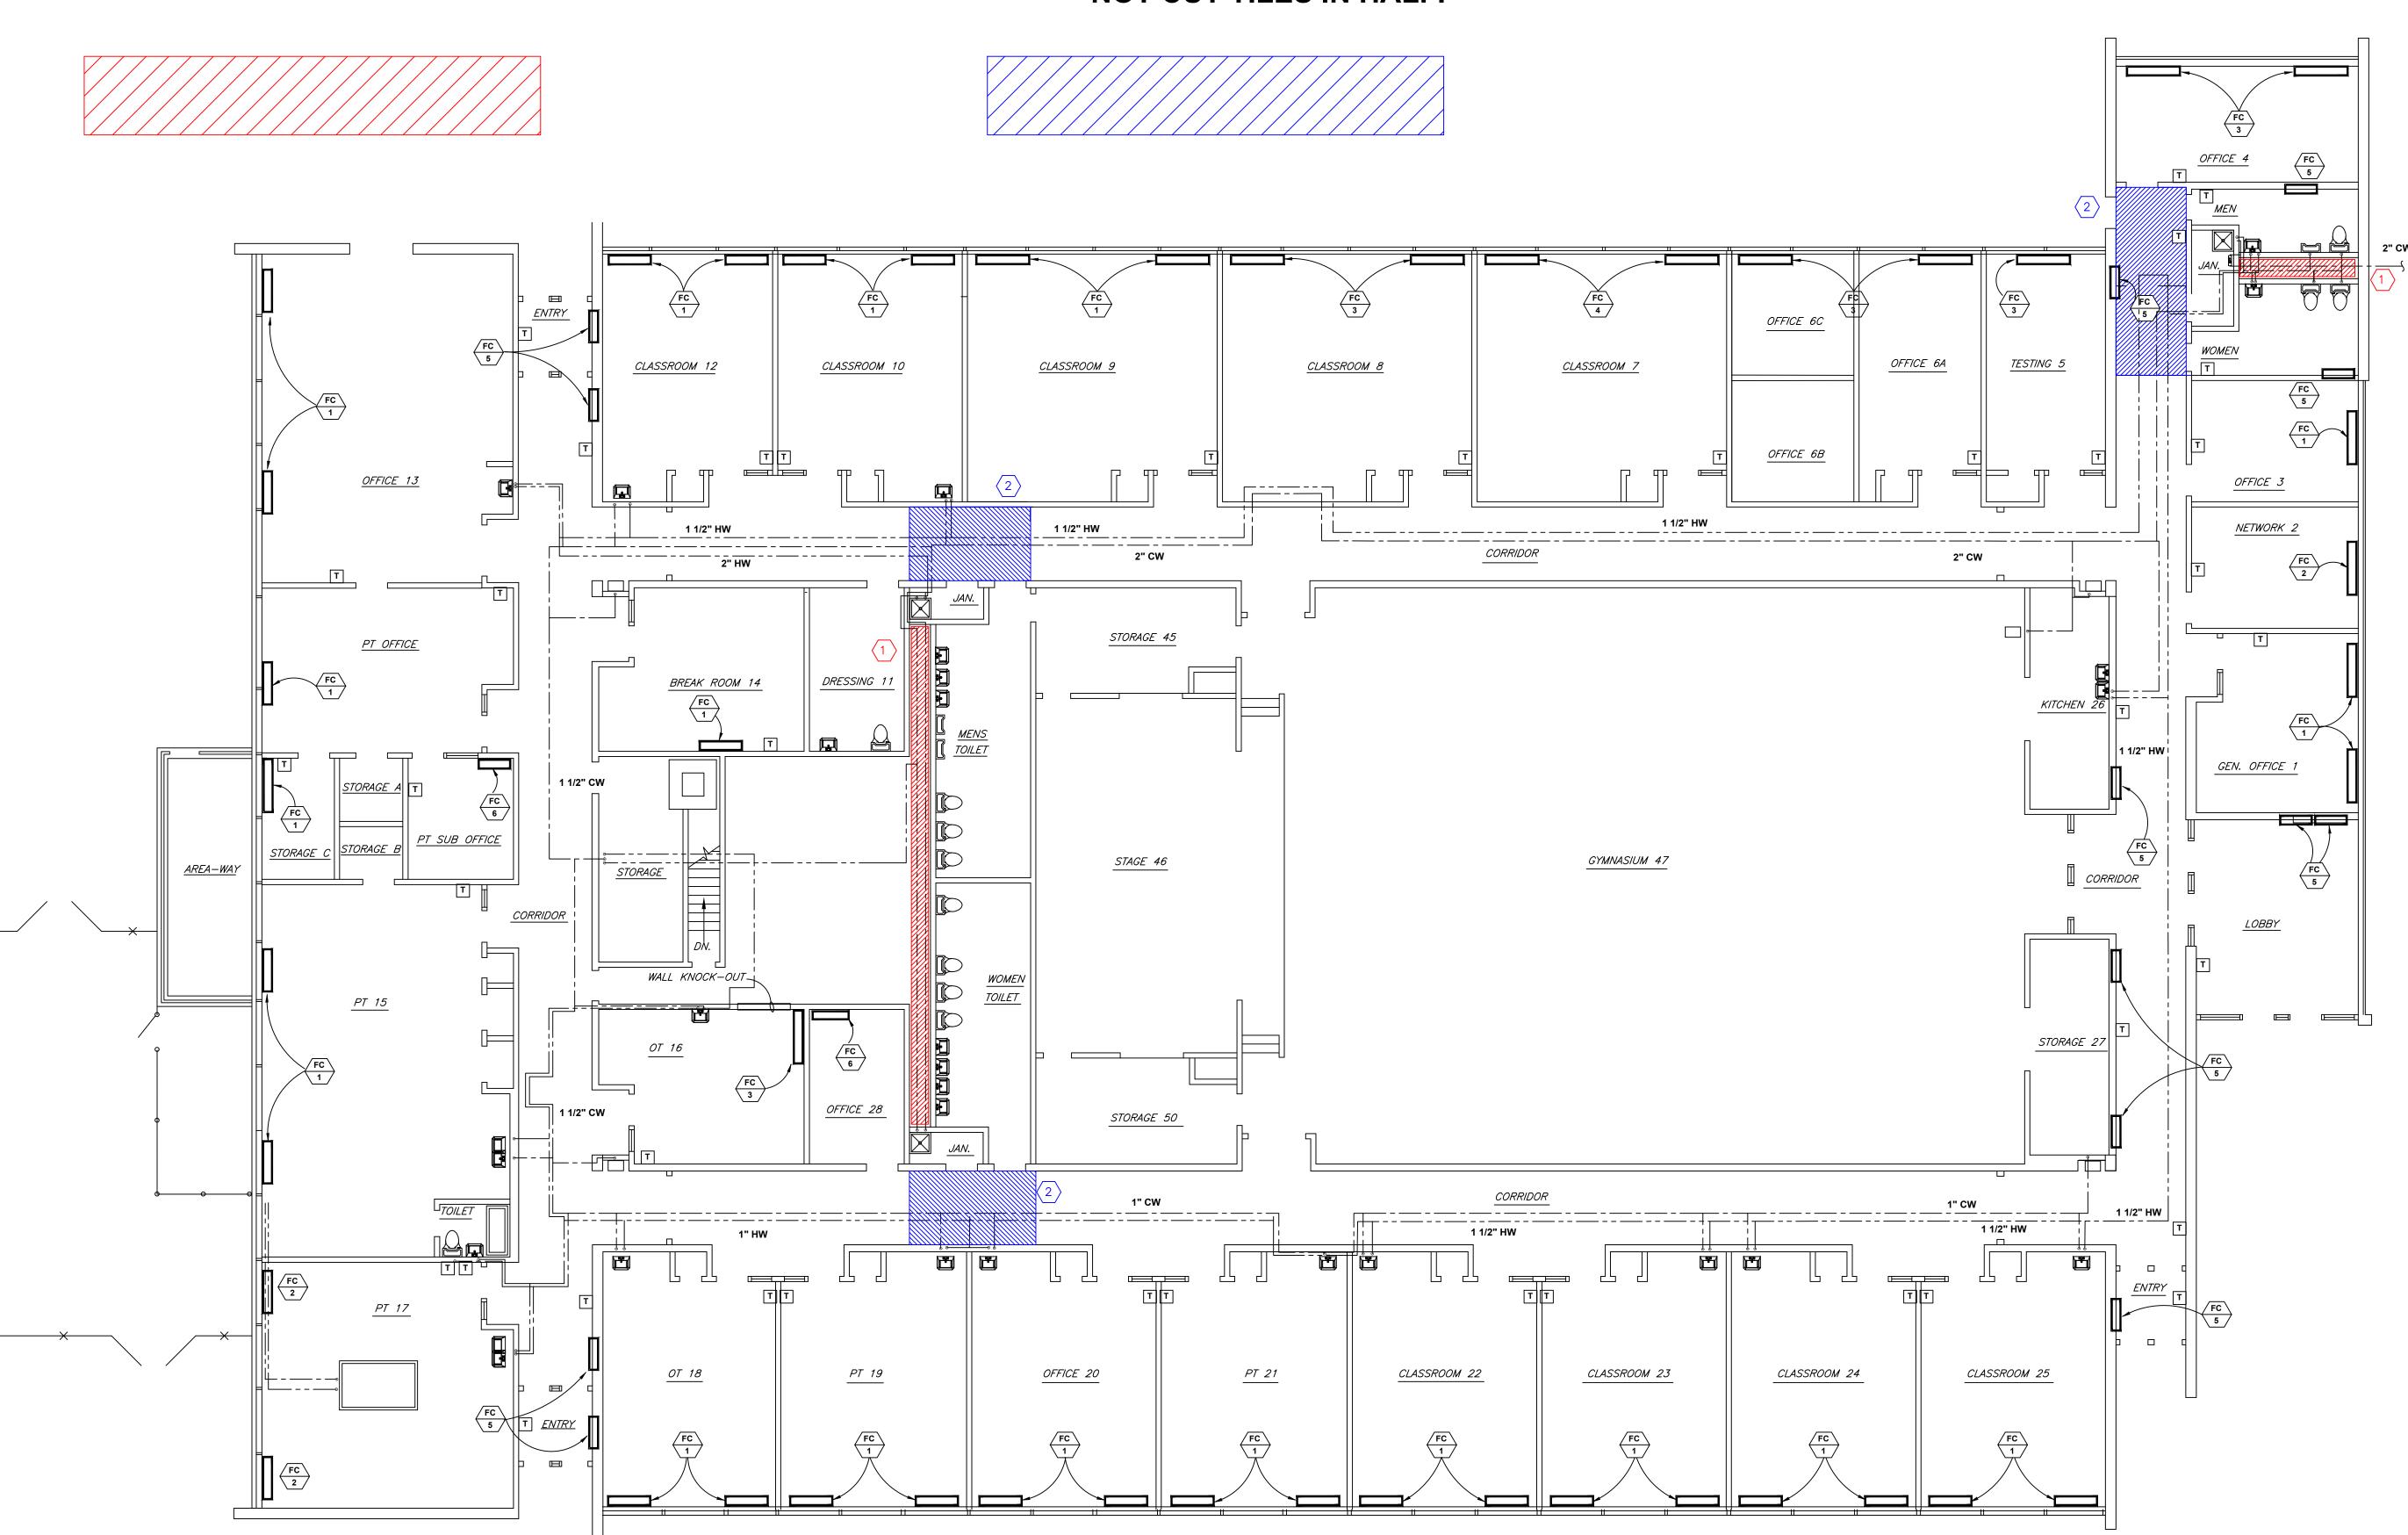







TITAN ENVIRONMENTAL SERVICES 2418 MERRIAM LANE KANSAS CITY, KS 66106

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CAD DWG FILE:H-101.DWG
DRAWN BY: RFS
CHECKED BY: PDE
DESIGNED BY: PDE

SHEET TITLE:

ASBESTOS
ABATEMENT
EDUCATION BUILDING
FIRST FLOOR

SHEET NUMBER:

H-101

SHEET 29 OF 29 09/16/2025