REPLACE FIRE ALARM PANELS AND DEVICES, ADMINISTRATION BUILDING HAWTHORN CHILDREN'S PSYCHIATRIC HOSPITAL ST. LOUIS, MISSOURI

SHEET	DESCRIPTION	NAME
1	COVER SHEET	G-001
2	GENERAL NOTES, ABBREVIATIONS, AND CODES	G-002
3	ADMIN. BUILDING SITE PLAN	C-101
4	ADMIN. BUILDING ELECTRICAL PLAN EAST	E-101
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6	TYPICAL COTTAGE ELECTRICAL PLAN	E-103
7	WIRING DIAGRAM	E-108
8	PARTIAL PLAN MECHANICAL EQUIPMENT ROOM	E-109

OWNER: STATE OF MISSOURI

MICHAEL L. PARSON, GOVERNOR

DEPARTMENT OF MENTAL HEALTH


PROJECT OFFICE OF ADMINISTRATION

DIVISION OF FACILITIES MANAGEMENT, MANAGEMENT:


DESIGN AND CONSTRUCTION

UNDERGROUND UTILITY NOTE

ANY UNDERGROUND FACILITIES, STRUCTURES, OR UTILITIES THAT HAVE SHOWN ARE FROM AVAILABLE RECORDS. THEREFORE, THE RELATIONSHIF BETWEEN THE NEW WORK AND THE EXISTING FACILITIES, STRUCTURES, O RESPONSIBILITY TO NOTIFY ALL THE LOCAL. AND/OR GOVERNING UTILITY AND THE EXISTENCE OF ANY NOT SHOWN. CONTRACTOR SHALL COORDINATE WITH UTILITY COMPANIES AND THE OWNER AS TO THE RELOCATION OR

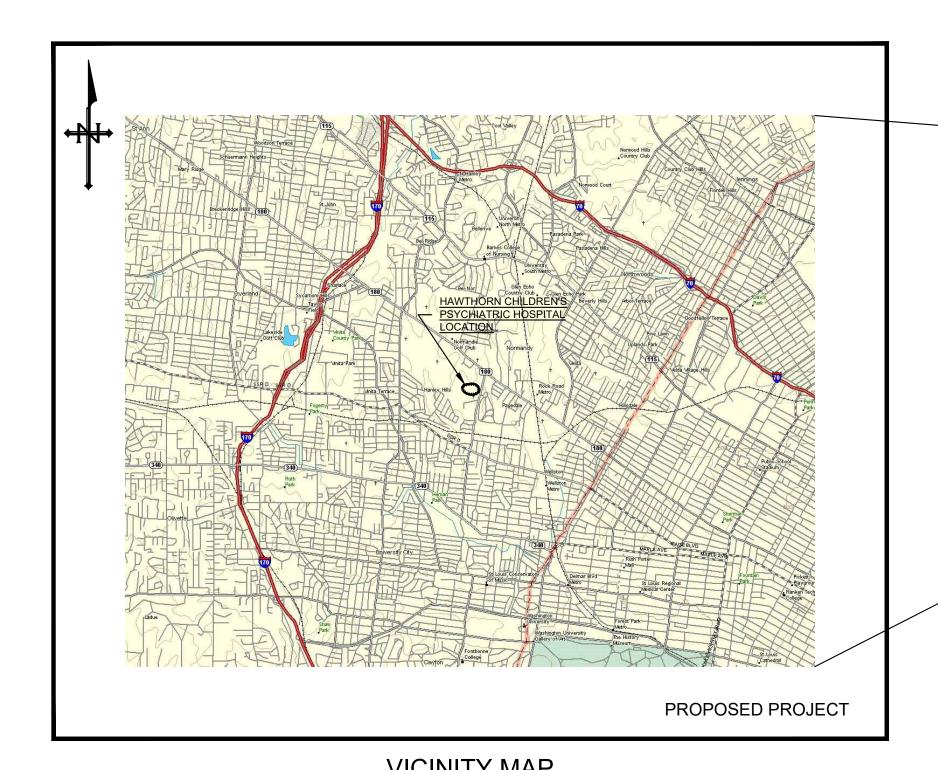

VICINITY MAP

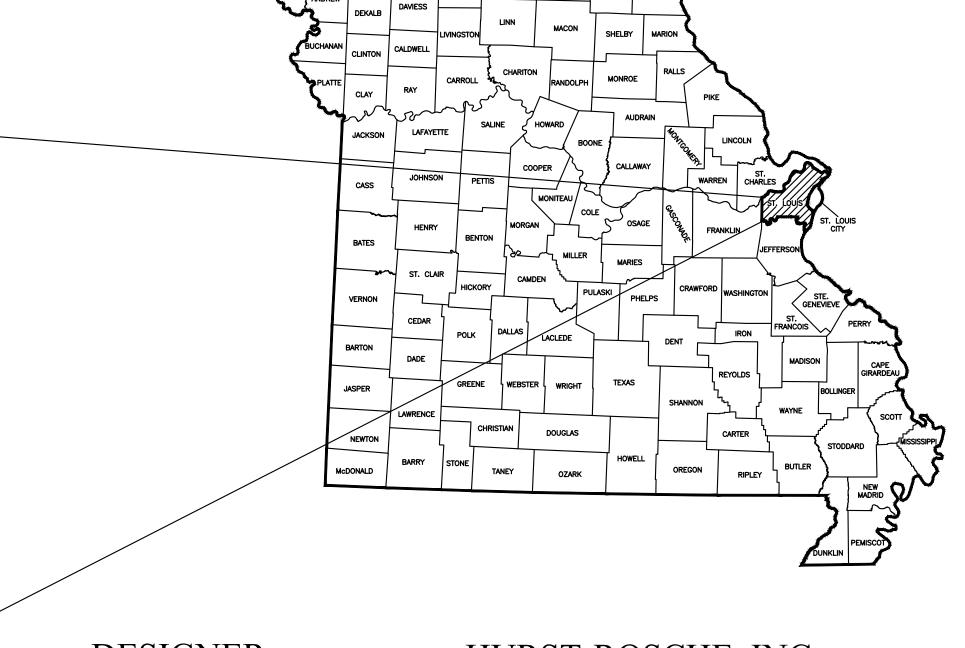

DESIGNER: HURST-ROSCHE, INC.

PROJECT NUMBER: M2414-01

SITE NUMBER: 7390 ASSET NUMBER: 6517390002





PROFESSIONAL SEAL

G-001 01 OF 08 SHEETS JAN. 10, 2025

SHEET NUMBER:

AB	BREVIATIONS							
	ADOVE				ION'T		DADUIG	1. 2.
ABV	ABOVE	EF	EACH FACE	JT	JOINT	RAD	RADIUS	2.
AFF	ABOVE FINISH FLOOR	ELEC	ELECTRIC (AL)	JF	JOINT FILLER	RAN	RANGE	3.
ACC	ACCESS	EP	ELECTRICAL PANELBOARD	J	JOIST	RL	RAIL (ING)	4.
AP	ACCESS PANEL	EL	ELEVATION		MOMBLATE	RE	REFERENCE	
AC	ACOUSTICAL	ENC	ENCLOSE (URE)	KPL	KICKPLATE	REF	REFRIDGERATOR	5.
ACT	ACOUSTICAL CEILING TILE	EQ	EQUAL			RFL		
ADH	ADHESIVE	EQP	EQUIPMENT	LBL	LABEL	REINF	REINFORCE (D), (ING)	6.
ADJ	ADJACENT	EST	ESTIMATE	LBP	LEAD-BASED PAINT	REM	REMOVE	
ADJT	ADJUSTABLE	EXH	EXHAUST	LAM	LAMINATE (D)	RES	RESILIENT	
ALT	ALTERNATE, ALTERNATIVE	EXG	EXISTING	LAV	LAVATORY	RA	RETURN AIR	7.
AL	ALUMINUM	EJ	EXPANSION JOINT	LH	LEFT HAND	RVS	REVERSE (SIDE)	
		EXP	EXPOSED	L	LENGTH		NEVERSE (SIDE)	8.
ANC	ANCHOR, ANCHORAGE			LT	LIGHT	REV	DIGUELIAND	9.
AB	ANCHOR BOLT	EXT	EXTERIOR ELECTRIC WATER FOUNTAIN	LW	LIGHTWEIGHT	RH	RIGHT HAND	9.
ARCH	ARCHITECT (URAL)	EWF	ELECTRIC WATER FOUNTAIN	LF	LINEAL FEET	RFG	ROOFING	
AD	AREA DRAIN			LTL	LINTEL	RM	ROOM	10.
ASPH	ASPHALT	FOC	FACE OF CONCRETE	LL	LIVE LOAD	RO	ROUGH OPENING	14
AUTO	AUTOMATIC	FOF	FACE OF FINISH	LVR	LOUVER	RB	RUBBER BASE	11.
		FOM	FACE OF MASONRY	LPT	LOW POINT			12.
BRG	BEARING	FOS	FACE OF STUDS		20111	SCH	SCHEDULE	13.
BPL	BEARING PLATE	FAS	FASTEN, FASTENER			S	SEALER	
BM	BENCH MARK, BEAM	FBD	FIBERBOARD	MFR	MANUFACTURE (ER)	SEC	SECTION	14.
	·			MAS	MASONRY	SHTG	SHEATHING	15.
BEL	BELOW	FGL	FIBERGLASS	MO	MASONRY OPENING	SHT	SHEET	
BTWN	BETWEEN	FIN	FINISH (ED)			SH	SHELF, SHELVING	16.
BVL	BEVELED	FFE	FINISHED FLOOR ELEVATION	MAX	MAXIMUM	SIM	SIMILAR	17.
BLK	BLOCK	FFL	FINISHED FLOOR LINE	MECH	MECHANICAL	SL	SLEEVE	18.
BLKG	BLOCKING	FA	FIRE ALARM	MED	MEDIUM	SC	SOLID CORE	19.
BD	BOARD	FE	FIRE EXTINGUISHER	MBR	MEMBER			
BS	BOTH SIDES	FEC	FIRE EXTINGUISHER CABINET	MMB	MEMBRANE	SPL	SPECIAL	20.
BW	BOTH WAYS	FPL	FIREPLACE	MTL	METAL	SPEC	SPECIFICATIONS	
вот	BOTTOM	FP	FIREPROOF	MWK	MILLWORK	SQ	SQUARE	21.
BLDG	BUILDING	FRT	FIRE-RETARDANT	MIN	MINIMUM	SF	SQUARE FOOT	22.
BL	BRICK LEDGE	FLG	FLASHING	MISC	MISCELLANEOUS	SY	SQUARE YARD	
		FLX	FLEXIBLE	MLD	MOLDING, MOULDING	S&V		23.
CAB	CABINET	FLR	FLOOR (ING)	MT	MOUNT (ED), (ING)	SST	STAINLESS STEEL	24.
		FD	FLOOR DRAIN	MOV	MOVABLE	STD	STANDARD	
CPT	CARPET (ED)	FPL	FLOOR PLATE	MULL	MULLION	STL	STEEL	
CSMT	CASEMENT			IVIOLL	WIOLLION	STO	STORAGE	
CK	CAULKING	FLUR	FLUORESCENT			STRUCT	STRUCTURAL	
CLG	CEILING	FJT	FLUSH JOINT	NAT	NATURAL	SYM	SYMMETRY (ICAL)	
CEM	CEMENT	FTG	FOOTING	NOM	NOMINAL	SYS	SYSTEM	
СТ	CERAMIC TILE	FND	FOUNDATION	NIC	NOT IN CONTRACT		OTOTEM	
CIR	CIRCLE	FR	FRAME (D), (ING)	NTS	NOT TO SCALE			
CLR	CLEAR (ANCE)	FS	FULL SIZE	1410	NOT TO GOALE	TEL	TELEPHONE	
CLS	CLOSURE	FBO	FURNISHED BY OTHERS			TV	TELEVISION	
COL	COLUMN	FUR	FURRED (ING)	OC	ON CENTER	THK	THICK (NESS)	
COMB	COMBINATION			OPG	OPENING	THR	THRESHOLD	
		GA	GAGE, GAUGE	OPP	OPPOSITE	TOL	TOLERANCE	
COMP	COMPRESS (ED), (ION), (IBLE)	GALV	GALVANIZED	OD	OUTSIDE DIAMETER	T&G	. 012. 0 102	
CONC	CONCRETE	GC	GENERAL CONTRACT (OR)	OA	OVERALL	T.STL	TOP OF STEEL	
CMU	CONCRETE MASONRY UNIT	GLF	GLASS FIBER	ОН	OVERHEAD			
CONST	CONSTRUCTION	GB	GRAB BAR			TSL	TOP OF SLAB	
CONT	CONTINUOUS	GR	GRADE, GRADING	Р	PAINT (ED)	TFTG	TOP OF FOOTING	
CONTR	CONTRACT (OR)	GVL	GRAVEL	PNL	PANEL	TYP	TYPICAL	
CJ	CONTROL JOINT	GRT	GROUT	PAR	PARALLEL			
CPR	COPPER	GYP BD	GYPSUM BOARD	PK	PARKING	UC	UNDERCUT	
CG	CORNER GUARD	טט ווי				UNF	UNFINISHED	
CTR	CENTER	HDW	HARDWARE	PTN	PARTITION DEBEORATE (D)			
CFL	COUNTERFLASHING	HWD	HARDWOOD	PERF	PERFORATE (D)	VJ	V-JOINT (ED)	
CS	COUNTERSINK	HDR	HEADER	PERI	PERIMETER	VB	VAPOR BARRIER	
CF	CUBIC FOOT	HTG	HEATING	PLAS	PLASTER	VAR	VARNISH	
CY	CUBIC YARD	HD	HEAVY DUTY	PLAM	PLASTIC LAMINATE	VNR	VENEER	
	COBIC TARD			PL	PLATE	VERT	VERTICAL	
		HT	HEIGHT	PWD	PLYWOOD			
DL	DEAD LOAD	HC	HOLLOW CORE	PT	POINT	WP	WATERPROOFING	
DEM	DEMOLISH, DEMOLITION	HM	HOLLOW METAL	PORC.	PORCELAIN	WR	WATER REPELLENT	
DTL	DETAIL	HORIZ	HORIZONTAL	PVC	POLYVINYL CHLORIDE	WS	WATERSTOP	
DIAM	DIAMETER	HB	HOSE BIB	PCF	POUNDS PER CUBIC FOOT	WWF		
DIM	DIMENSION	HWH	HOT WATER HEATER	PLF	POUNDS PER LINEAL FOOT		WIDTH WIDE	
DIV	DIVISION	141	INICII	PSF	POUNDS PER SQUARE FOOT	W	WIDTH, WIDE	
DR	DOOR	IN	INCH	PSI	POUNDS PER SQUARE INCH	W/	WITH	
DBL	DOUBLE	INCL	INCLUDING			WDW	WINDOW	
DH	DOUBLE HUNG	ID	INSIDE DIAMETER	PFB	PREFABRICATE (D)	W/O	WITHOUT	
		IF	INSIDE FACE	PFN	PREFINISHED	WD	WOOD	
DWL	DOWEL(S)	INS	INSULATE (D), (ION)	PRF	PREFORMED	WB	WOOD BASE	
DS	DOWNSPOUT	INT	INTERIOR	PL	PROPERTY LINE			
DT	DRAIN TILE							
DWR	DRAWER							
DWG	DRAWING							

GENERAL NOTES:

- CONTRACTOR SHALL COORDINATE ALL WORK WITH THE OWNER, ARCHITECT/ENGINEER, AND OTHER TRADES/CONTRACTORS THROUGHOUT THE COURSE OF THE PROJECT.
- 2. CONTRACTOR SHALL COORDINATE WITH THE OWNER FOR ALL OWNER RELATED SCHEDULES, PROCEDURES, CLEARANCES & REQUIREMENTS TO ACCESS THE OWNER'S FACILITIES. SUCH PROCEDURES ARE INCIDENTAL TO THE CONTRACT AND SHALL NOT RESULT IN EXTRA COSTS TO THE OWNER.
- 3. THE CONTRACTOR SHALL COORDINATE ALL WORK WITH THE OWNER PRIOR TO STARTING WORK.
- 4. THE CONTRACTOR SHALL TAKE NOTE OF ALL EXISTING SITE CONDITIONS AND BE PREPARED TO MOVE OR DISPOSE OF OBJECTS OR MATERIALS WITHIN THE LIMITS OF THE PROJECT. SUCH WORK SHALL NOT BE CAUSE FOR ADDITIONAL COMPENSATION FOR A CHANGE IN THE SCOPE.
- 5. CONTRACTOR SHALL FIELD VERIFY ALL EXISTING DIMENSIONS AND CONDITIONS AND MAKE MINOR ADJUSTMENTS AS NECESSARY. NOTIFY THE ARCHITECT/ENGINEER OF ANY DISCREPANCIES WHICH MAY
- 6. DIMENSIONS AND QUANTITIES NOTED ON DRAWINGS ARE FOR GENERAL INFORMATION ONLY. PRIOR TO SUBMITTING A BID PROPOSAL, THE CONTRACTOR SHALL THOROUGHLY SURVEY THE EXISTING SITE TO VERIFY EXISTING DIMENSIONS, CONDITIONS, AND DETERMINE ALL MATERIALS, LABOR, AND INCIDENTALS NEEDED FOR COMPLETION OF THE INTENDED CONSTRUCTION. THE CONTRACTOR SHALL VERIFY ALL EXISTING DIMENSIONS AND FIELD CONDITIONS PRIOR TO FABRICATION OR CONSTRUCTION; MAKE MINOR ADJUSTMENTS; AND NOTIFY THE ARCHITECT/ENGINEER OF ANY CONDITIONS THAT MAY AFFECT THE OUTCOME OF THE WORK.
- 7. AFTER ALL WORK IS COMPLETED, CONTRACTOR SHALL CLEAN WORK AREAS SO THAT THEY ARE FREE OF ANY CONSTRUCTION MATERIALS, TOOL, DIRT AND DEBRIS. FINE GRADE, FERTILIZE, SEED AND STRAW ALL DISTURBED LAWN AREAS.
- 8. EXISTING SITE IMPROVEMENTS DISTURBED OUTSIDE THE DESIGNATED CONSTRUCTION AREAS ARE TO BE REPLACED WITH EQUAL OR BETTER CONSTRUCTION AT THE EXPENSE OF THE CONTRACTOR. EVERY EFFORT SHALL BE MADE TO MINIMIZE SUCH DISTURBANCES.
- 9. INFORMATION NOTED ON DRAWINGS ARE FOR GENERAL INFORMATION ONLY. CONTRACTOR SHALL BE RESPONSIBLE FOR THE ENTIRE LAYOUT OF THE SITES AND ALL LOCATION AND DEPTHS OF EXISTING UTILITIES/COMMUNICATION LINES AND REQUIRED CLEARANCES VERTICAL/HORIZONTAL. CONTRACTOR SHALL MAKE ADJUSTMENTS TO ENSURE PROPER INSTALLATION OF REQUIRED WORK AT NO EXTRA
- 10. EXISTING SITE VEGETATION AND CONSTRUCTION, SUCH AS SIDEWALKS, STOOPS, ETC., THAT ARE DISTURBED AND/OR DAMAGED DURING CONSTRUCTION SHALL BE REPLACED WITH EQUAL OR BETTER CONSTRUCTION AT THE EXPENSE OF THE CONTRACTOR. EVERY EFFORT SHALL BE MADE TO MINIMIZE SUCH DISTURBANCES AND DAMAGES.
- 11. ALL ITEMS NOTED TO REMAIN SHALL NOT BE DISTURBED AND SHALL REMAIN IN PLACE. CONTRACTOR SHALL MAKE EVERY EFFORT TO MINIMIZE ANY DISTURBANCES. IN THE EVENT EXISTING ITEMS ARE DISTURBED, CONTRACTOR SHALL REPAIR/REPLACE WITH EQUAL OR BETTER CONSTRUCTION AT THE CONTRACTOR'S EXPENSE.
- 12. PRIME CONTRACTOR FOR EACH BID SHALL COORDINATE REMOVAL, HAULING, AND LEGAL DISPOSAL OF ALL MATERIALS WITH SUBCONTRACTORS.

AFFECT THE OUTCOME OF THE WORK. DIMENSIONS SHOWN ARE FROM FACE OF FINISH TO FACE OF FINISH UNLESS NOTED OTHERWISE.

- 13. CONTRACTOR SHALL MAINTAIN PROJECT SITE FREE FROM CONSTRUCTION DEBRIS AS REQUIRED BY THE OWNER. COORDINATE WITH THE OWNER.
- 14. ALL REFUSE AND DEBRIS SHALL BE REMOVED FROM THE SITE AND LEGALLY DISPOSED OF BY THE CONTRACTOR. GENERAL CONTRACTOR SHALL COORDINATE REMOVAL, HAULING, AND LEGAL DISPOSAL OF ALL MATERIALS WITH SUBCONTRACTORS. CLEAN ALL WORK AREAS DAILY.
- 15. AFTER ALL WORK IS COMPLETED, CONTRACTOR SHALL CLEAN ALL AREAS AFFECTED BY CONSTRUCTION SO THAT THEY ARE FREE OF ANY CONSTRUCTION DIRT AND DEBRIS.
- 16. GRADE, SEED AND STRAW ANY SITE AREAS DISTURBED BY CONSTRUCTION OF THIS PROJECT IN ANY WAY.
- 17. NEW WORK SHALL MATCH EXISTING ADJOINING CONSTRUCTION FOR A SMOOTH TRANSITION, EXCEPT WHERE NOTED.

- 18. PROTECT EXISTING UTILITIES DURING CONSTRUCTION.
- 19. CONTRACTOR SHALL NOTIFY OWNER AND ARCHITECT/ENGINEER PRIOR TO USE OF ANY SCAFFOLDING, LIFTS, SWING STAGES, ETC. USE OF SUCH MATERIALS AND EQUIPMENT SHALL MEET ALL FEDERAL, STATE, AND LOCAL SAFETY REGULATIONS AND ORDINANCES.
- 20. CONTRACTOR SHALL BE RESPONSIBLE FOR ALL BUILDING/WORK PERMITS AND CERTIFICATION REQUIREMENTS. SUBMIT COPIES OF ALL PERMITS/CERTIFICATIONS TO THE ARCHITECT/ENGINEER AND
- 21. RECONNECT ALL ITEMS THAT WERE DISCONNECTED DURING CONSTRUCTION. ENSURE ALL CONNECTIONS ARE SAFE AND WEATHER-TIGHT.
- 22. ALL WORK PERFORMED & MATERIALS INSTALLED SHALL BE IN STRICT ACCORDANCE W/ ALL APPLICABLE CODES, REGULATIONS AND ORDINANCES. CONTRACTOR SHALL COMPLY WITH ALL LAWS, ORDINANCES, RULES, REGULATIONS AND LAWFUL ORDERS OF ANY PUBLIC AUTHORITY BEARING ON THE PERFORMANCE OF THE WORK. MECHANICAL AND ELECTRICAL SYSTEMS SHALL BE INSTALLED IN ACCORDANCE WITH ALL APPLICABLE MUNICIPAL AND UTILITY COMPANY SPECIFICATIONS, AND LOCAL OR STATED JURISDICTIONAL CODES, ORDINANCES AND REGULATIONS.
- 23. THE TERM ARCHITECT, ENGINEER OR CONSULTANT ARE ALL SYNONYMOUS WITH THE TERM DESIGNER.
- 24. IF DISCREPANCY ARISES BETWEEN INFORMATION IN THE SPECIFICATIONS AND THE INFORMATION ON THE DRAWINGS, THE MORE STRINGENT CONDITION SHALL APPLY.

CODES ADOPTED BY ST. LOUIS COUNTY:

- INTERNATIONAL BUILDING CODE (IBC), 2015 EDITION, AS PUBLISHED BY THE ICC; NATIONAL ELECTRIC CODE (NEC), 2014 EDITION;
- INTERNATIONAL EXISTING BUILDING CODE (IEBC), 2015 EDITION, AS PUBLISHED BY THE ICC;
- INTERNATIONAL RESIDENTIAL CODE (IRC) FOR ONE- AND TWO-FAMILY DWELLINGS, 2015 EDITION, AS PUBLISHED BY THE ICC;
- INTERNATIONAL MECHANICAL CODE (IMC), 2015 EDITION, AS PUBLISHED BY THE ICC;
- INTERNATIONAL FUEL GAS CODE, 2015 EDITION (IMC), AS PUBLISHED BY THE ICC;
- INTERNATIONAL ENERGY CONSERVATION CODE (IBC/IMC), 2015 EDITION, AS PUBLISHED BY THE ICC; (8) INTERNATIONAL PROPERTY MAINTENANCE CODE (IPMC), 2015 EDITION, AS PUBLISHED BY THE ICC;
- (9) INTERNATIONAL FIRE CODE (IFC), 2015 EDITION, AS PUBLISHED BY THE ICC; (10) UPC PLUMBING CODE (UPC), 2015 EDITION, AS PUBLISHED BY THE IAPMO;

STATE OF MISSOURI MICHAEL L. PARSON, **GOVERNOR**



SIGNATURE 01-10-2025

12-31-2026 LICENSE EXPIRES

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OFFICE OF ADMINISTRATION DIVISION OF FACILITIES MANAGEMENT, **DESIGN AND CONSTRUCTION**

DEPARTMENT OF MENTAL HEALTH

REPLACE FIRE ALARM PANELS AND DEVICES, ADMINISTRATION BUILDING HAWTHORN CHILDREN'S PSYCHIATRIC HOSPITAL

1901 PENNSYLVANIA AVENUE ST. LOUIS, MISSOURI 63133

PROJECT # M2414-01 7390 6517390002

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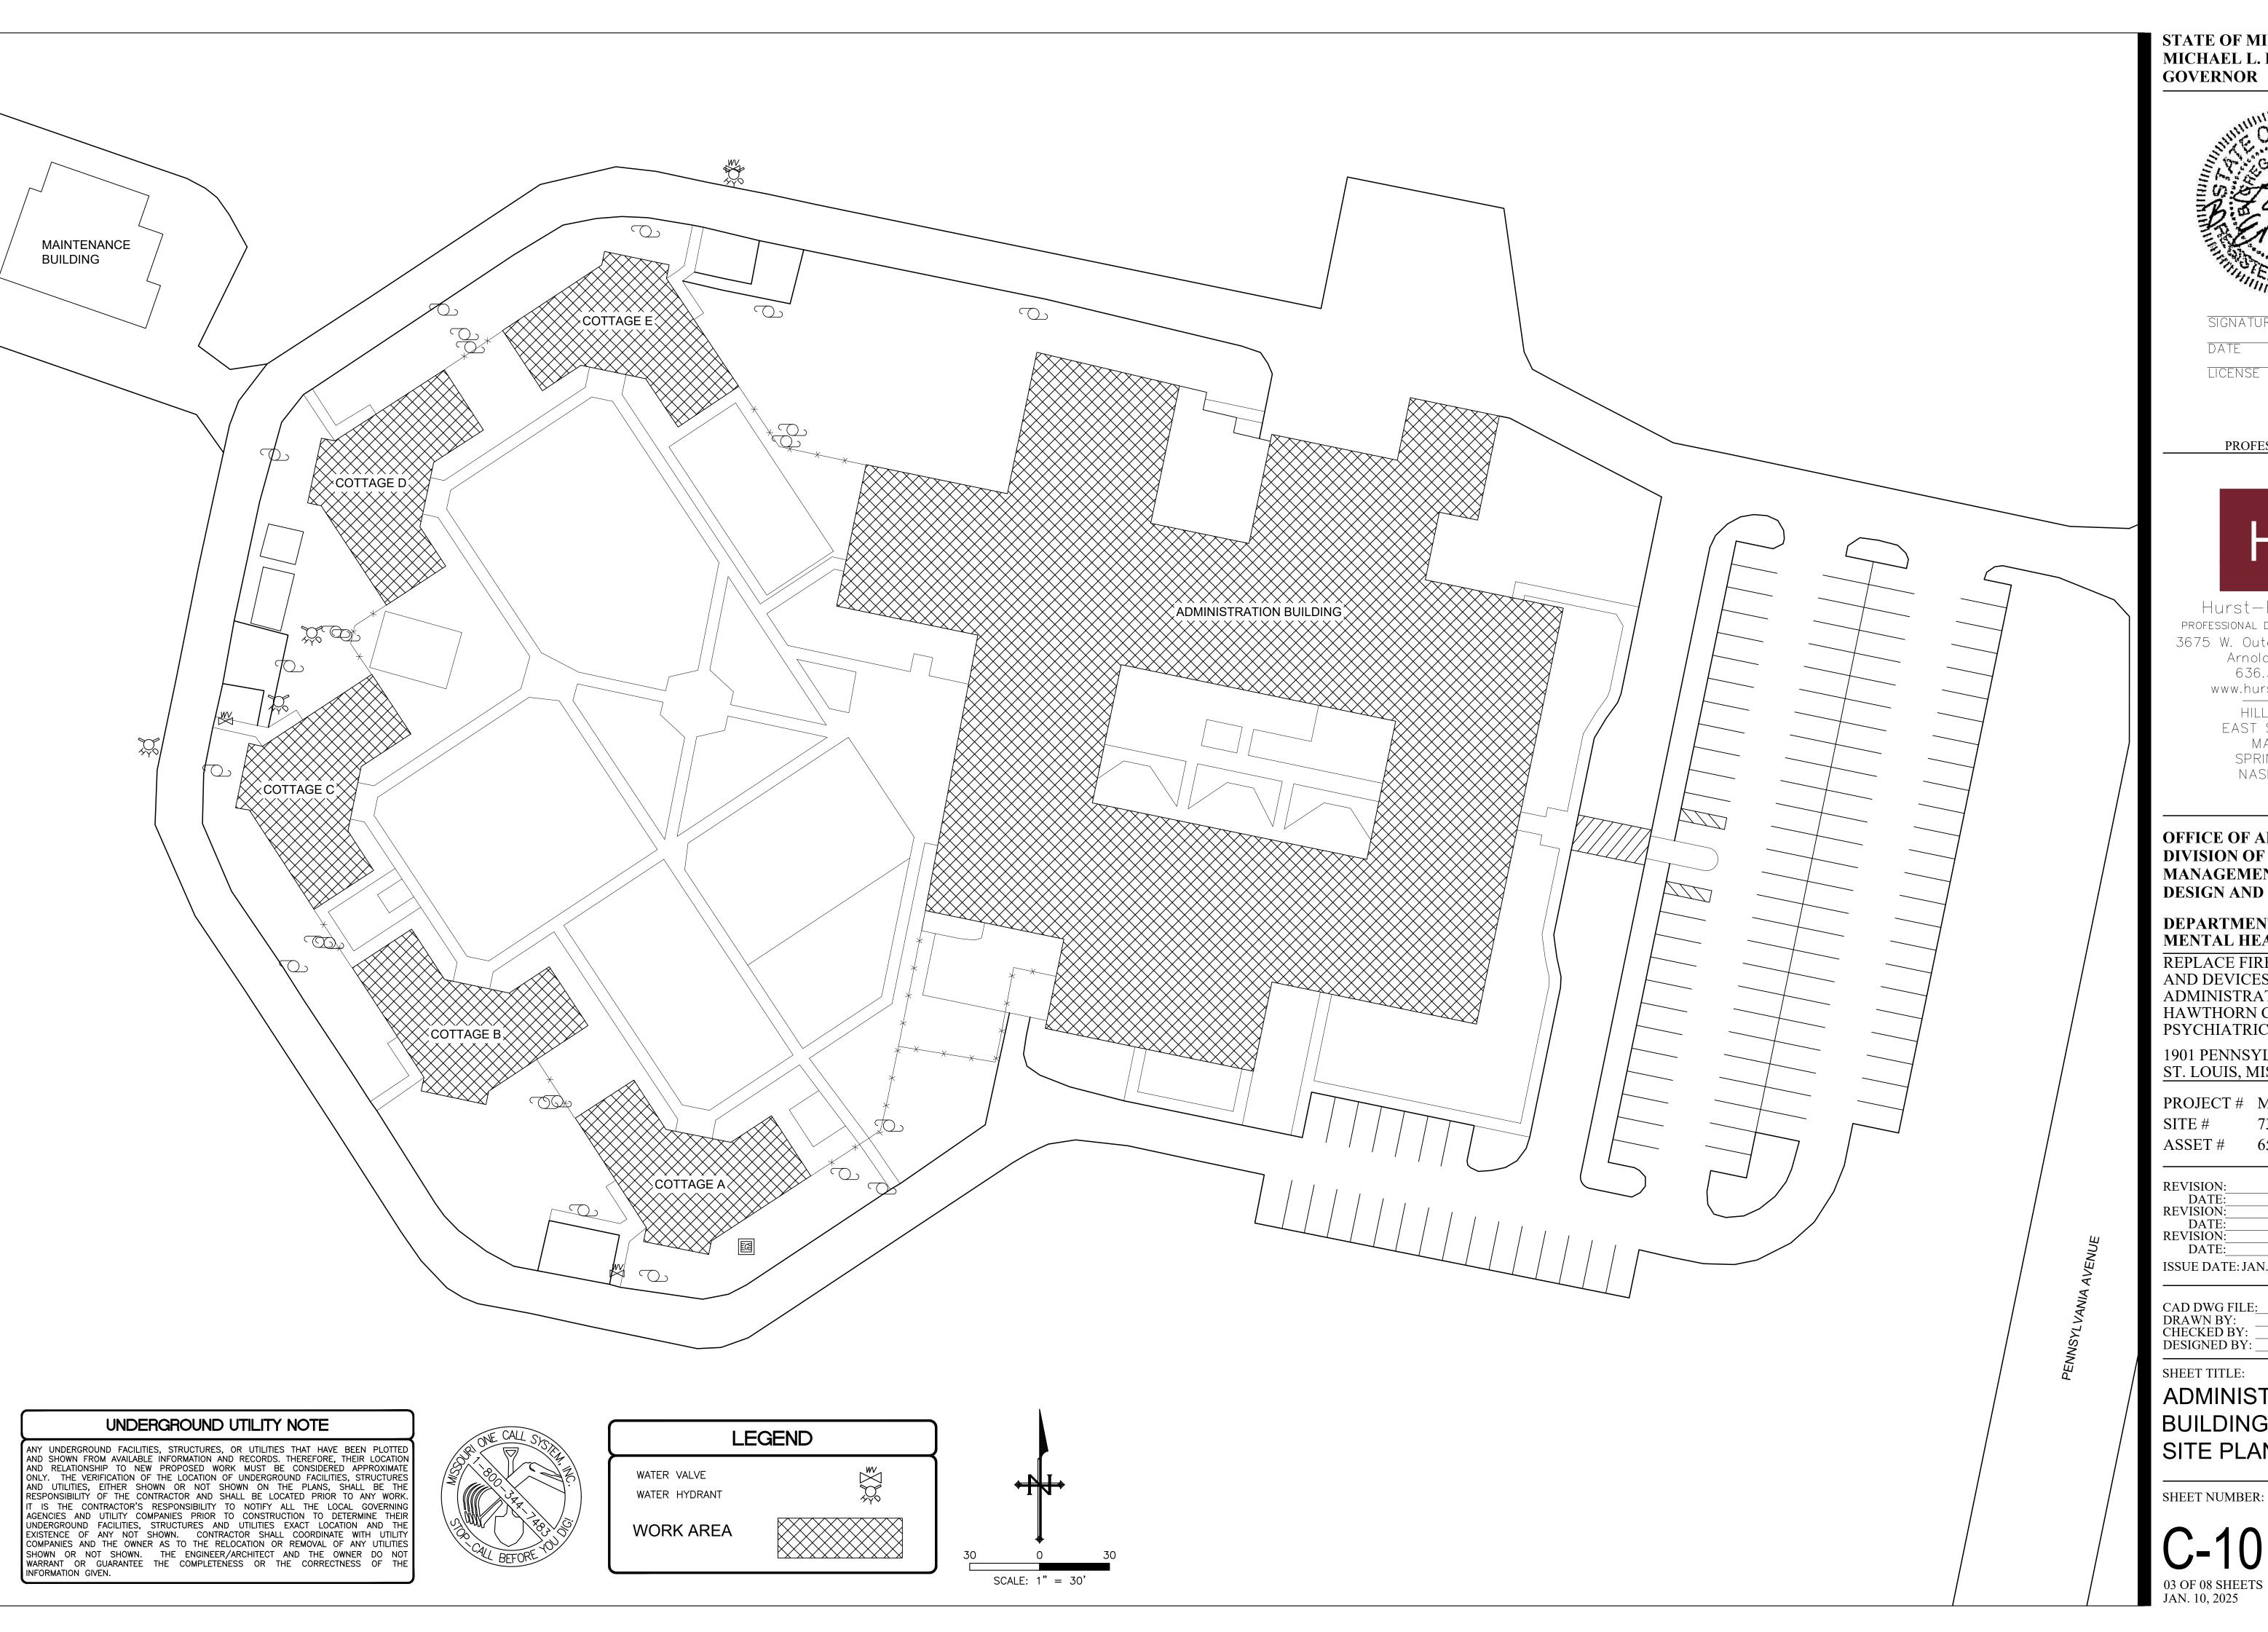
ISSUE DATE: JAN. 10, 2025

CAD DWG FILE:	G-002.DWG
DRAWN BY:	AJD/JSM
CHECKED BY:	JCZ
DESIGNED BY:	JCZ
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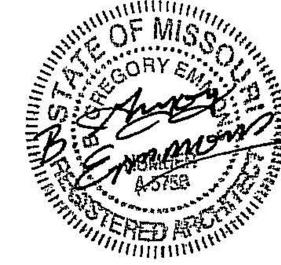
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GENERAL NOTES, ABBREVIATIONS, AND CODES

SHEET NUMBER:



STATE OF MISSOURI MICHAEL L. PARSON, **GOVERNOR**



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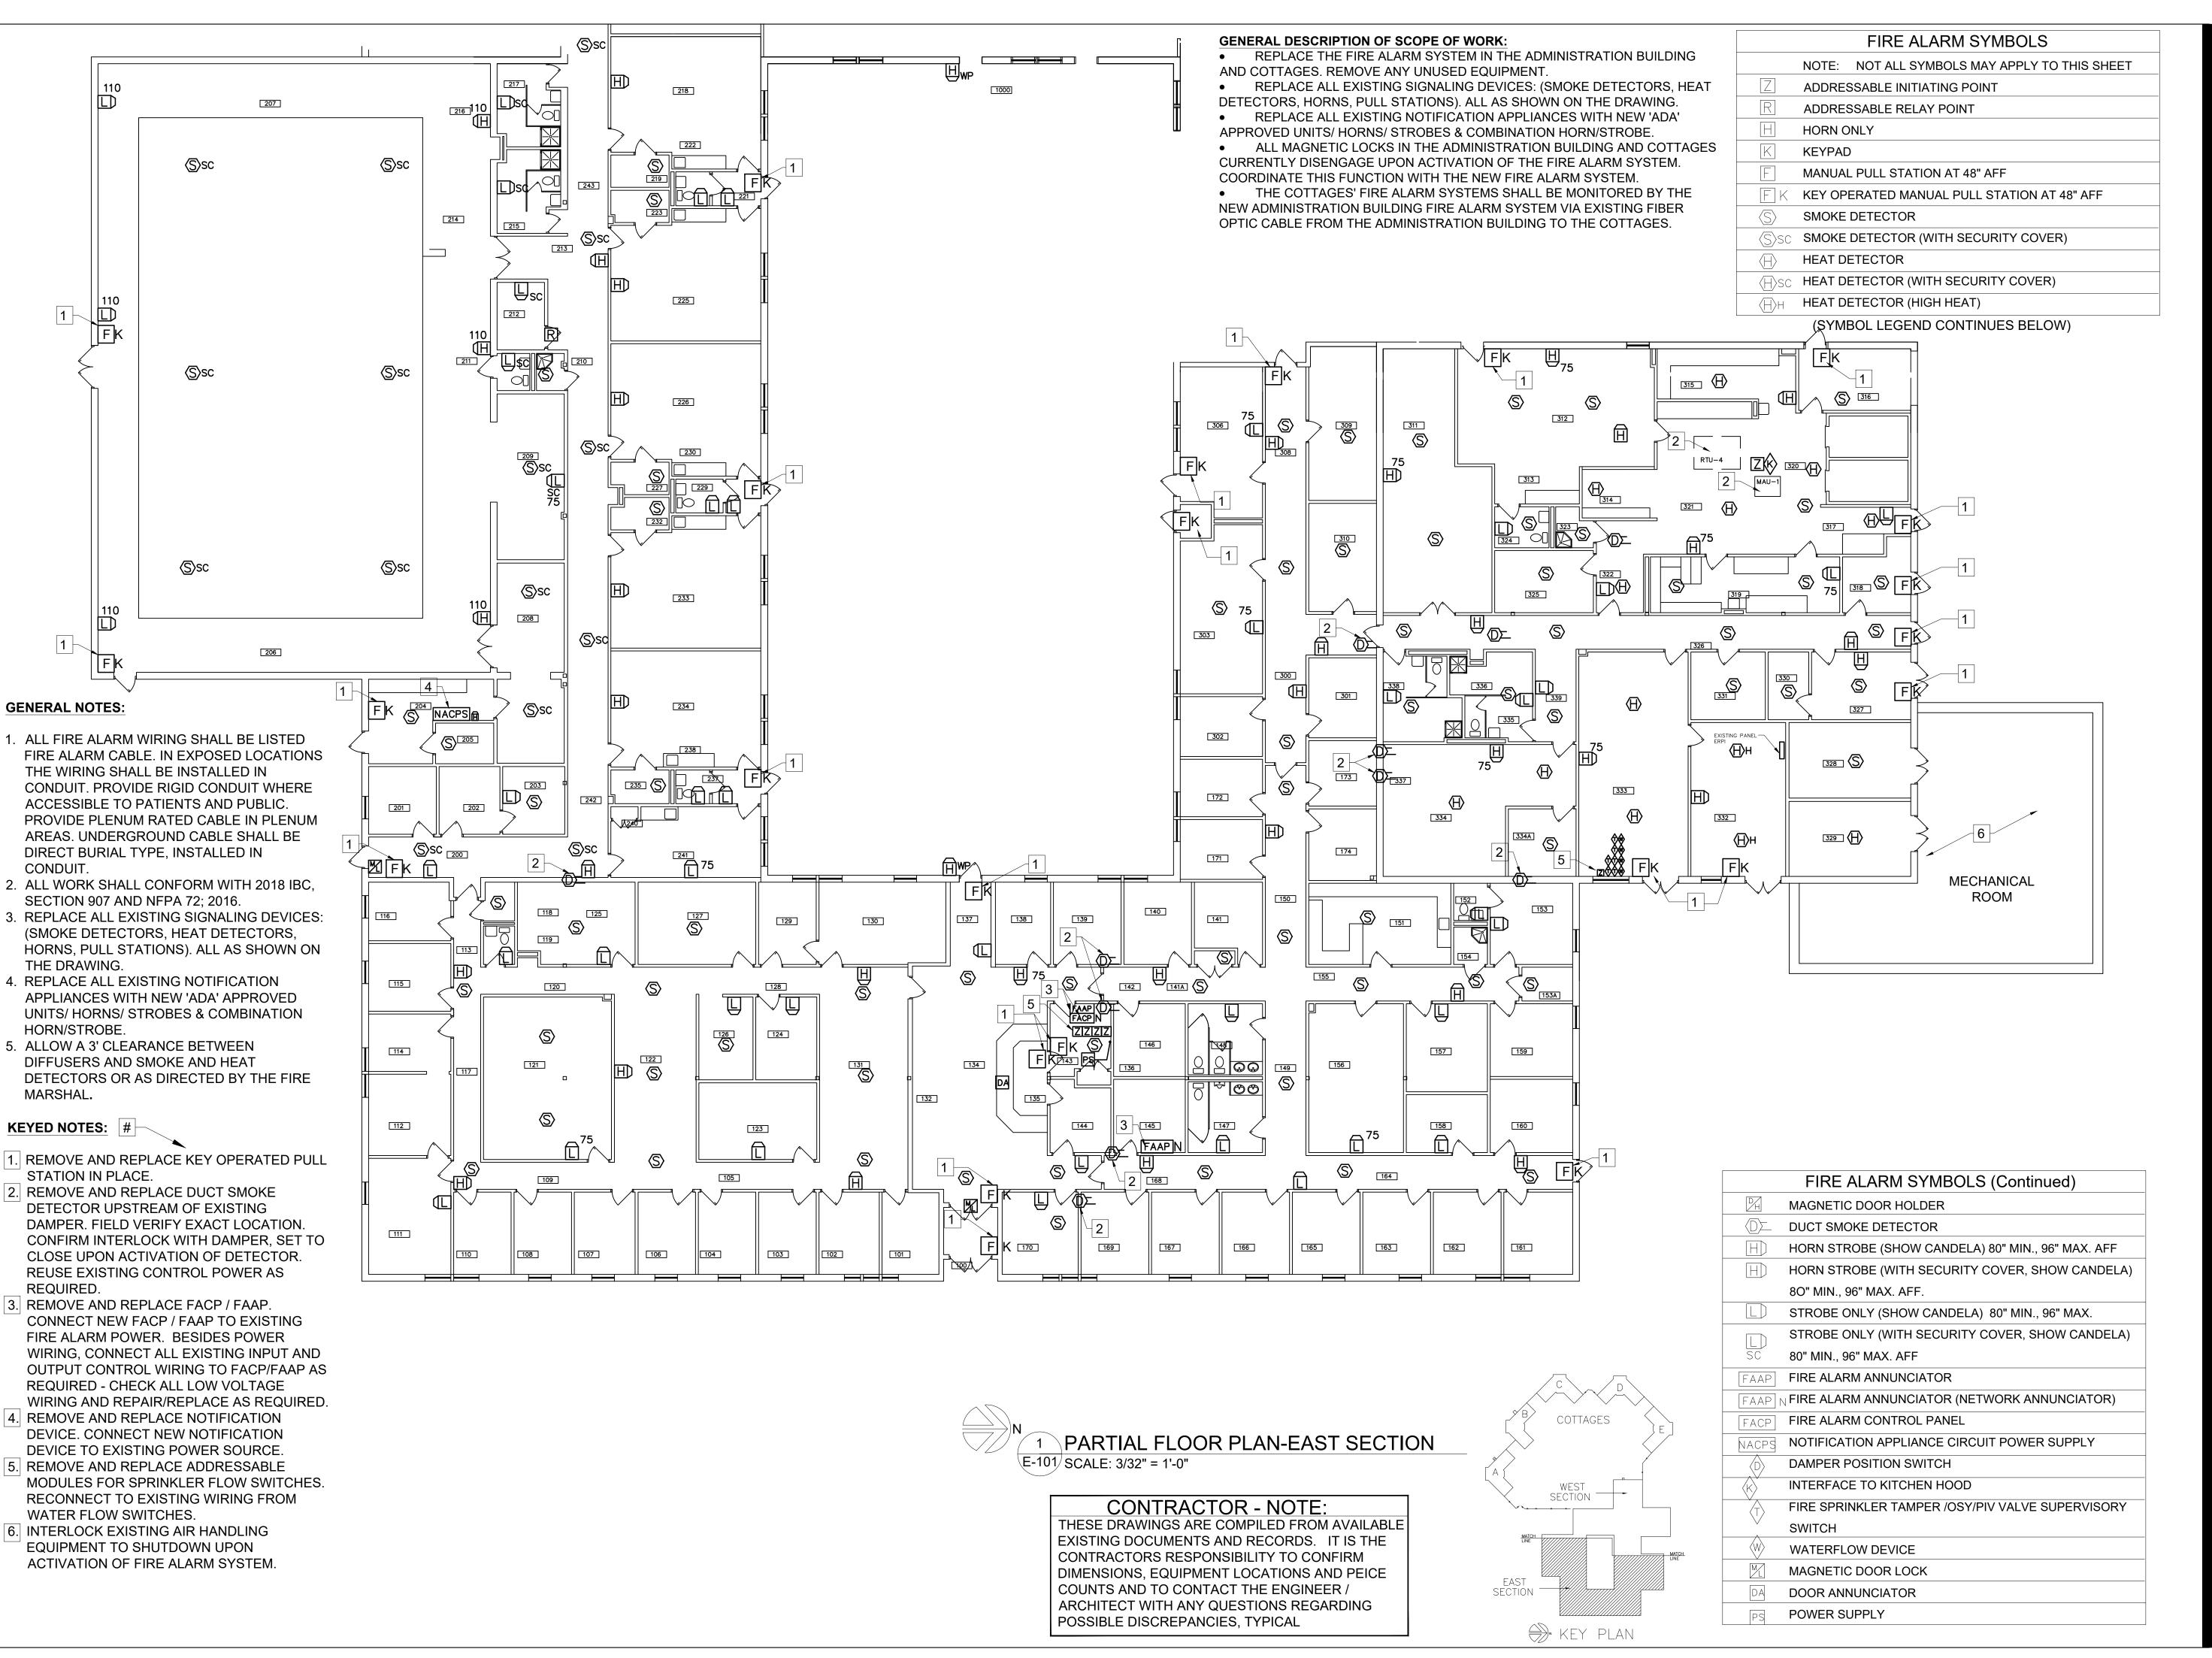
ISSUE DATE: JAN. 10, 2025

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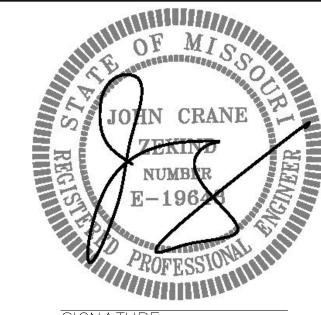
SHEET TITLE:

ADMINISTRATION BUILDING SITE PLAN

SHEET NUMBER:



STATE OF MISSOURI MICHAEL L. PARSON, GOVERNOR



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CAD DWG FILE: E-101.DWG
DRAWN BY: AJD/JSM
CHECKED BY: JCZ
DESIGNED BY: JCZ

SHEET TITLE:

ADMIN. BUILDING ELECTRICAL PLAN EAST

SHEET NUMBER:


E-101
04 OF 08 SHEETS
JAN. 10, 2025

GENERAL NOTES:

- 1. ALL FIRE ALARM WIRING SHALL BE LISTED FIRE ALARM CABLE. IN EXPOSED LOCATIONS THE WIRING SHALL BE INSTALLED IN CONDUIT. PROVIDE RIGID CONDUIT WHERE ACCESSIBLE TO PATIENTS AND PUBLIC. PROVIDE PLENUM RATED CABLE IN PLENUM AREAS. UNDERGROUND CABLE SHALL BE DIRECT BURIAL TYPE, INSTALLED IN CONDUIT.
- 2. ALL WORK SHALL CONFORM WITH 2018 IBC, SECTION 907 AND NFPA 72; 2016.
- 3. REPLACE ALL EXISTING SIGNALING DEVICES: (SMOKE DETECTORS, HEAT DETECTORS, HORNS, PULL STATIONS). ALL AS SHOWN ON THE DRAWING
- 4. REPLACE ALL EXISTING NOTIFICATION APPLIANCES WITH NEW 'ADA' APPROVED UNITS/ HORNS/ STROBES & COMBINATION HORN/STROBE.
- 5. ALLOW AT LEAST A 3' CLEARANCE BETWEEN DIFFUSERS AND SMOKE AND HEAT DETECTORS OR AS DIRECTED BY THE FIRE MARSHAL.

KEYED NOTES:

- 1. REMOVE AND REPLACE KEY OPERATED PULL STATION IN PLACE
- 2. REMOVE AND REPLACE DUCT SMOKE DETECTOR UPSTREAM OF EXISTING DAMPER. FIELD VERIFY EXACT LOCATION. CONFIRM INTERLOCK WITH DAMPER, SET TO CLOSE UPON ACTIVATION OF DETECTOR. REUSE EXISTING CONTROL POWER AS REQUIRED.
- 3. REMOVE AND REPLACE FACP / FAAP. CONNECT NEW FACP / FAAP TO EXISTING FIRE ALARM POWER. BESIDES POWER WIRING, CONNECT ALL EXISTING INPUT AND OUTPUT CONTROL WIRING TO FACP/FAAP AS REQUIRED CHECK ALL LOW VOLTAGE WIRING AND REPAIR/REPLACE AS REQUIRED.
- 4. REMOVE AND REPLACE NOTIFICATION DEVICE. CONNECT NEW NOTIFICATION DEVICE TO EXISTING POWER SOURCE.
- 5. REMOVE AND REPLACE ADDRESSABLE MODULES FOR SPRINKLER FLOW SWITCHES. RECONNECT TO EXISTING WIRING FROM

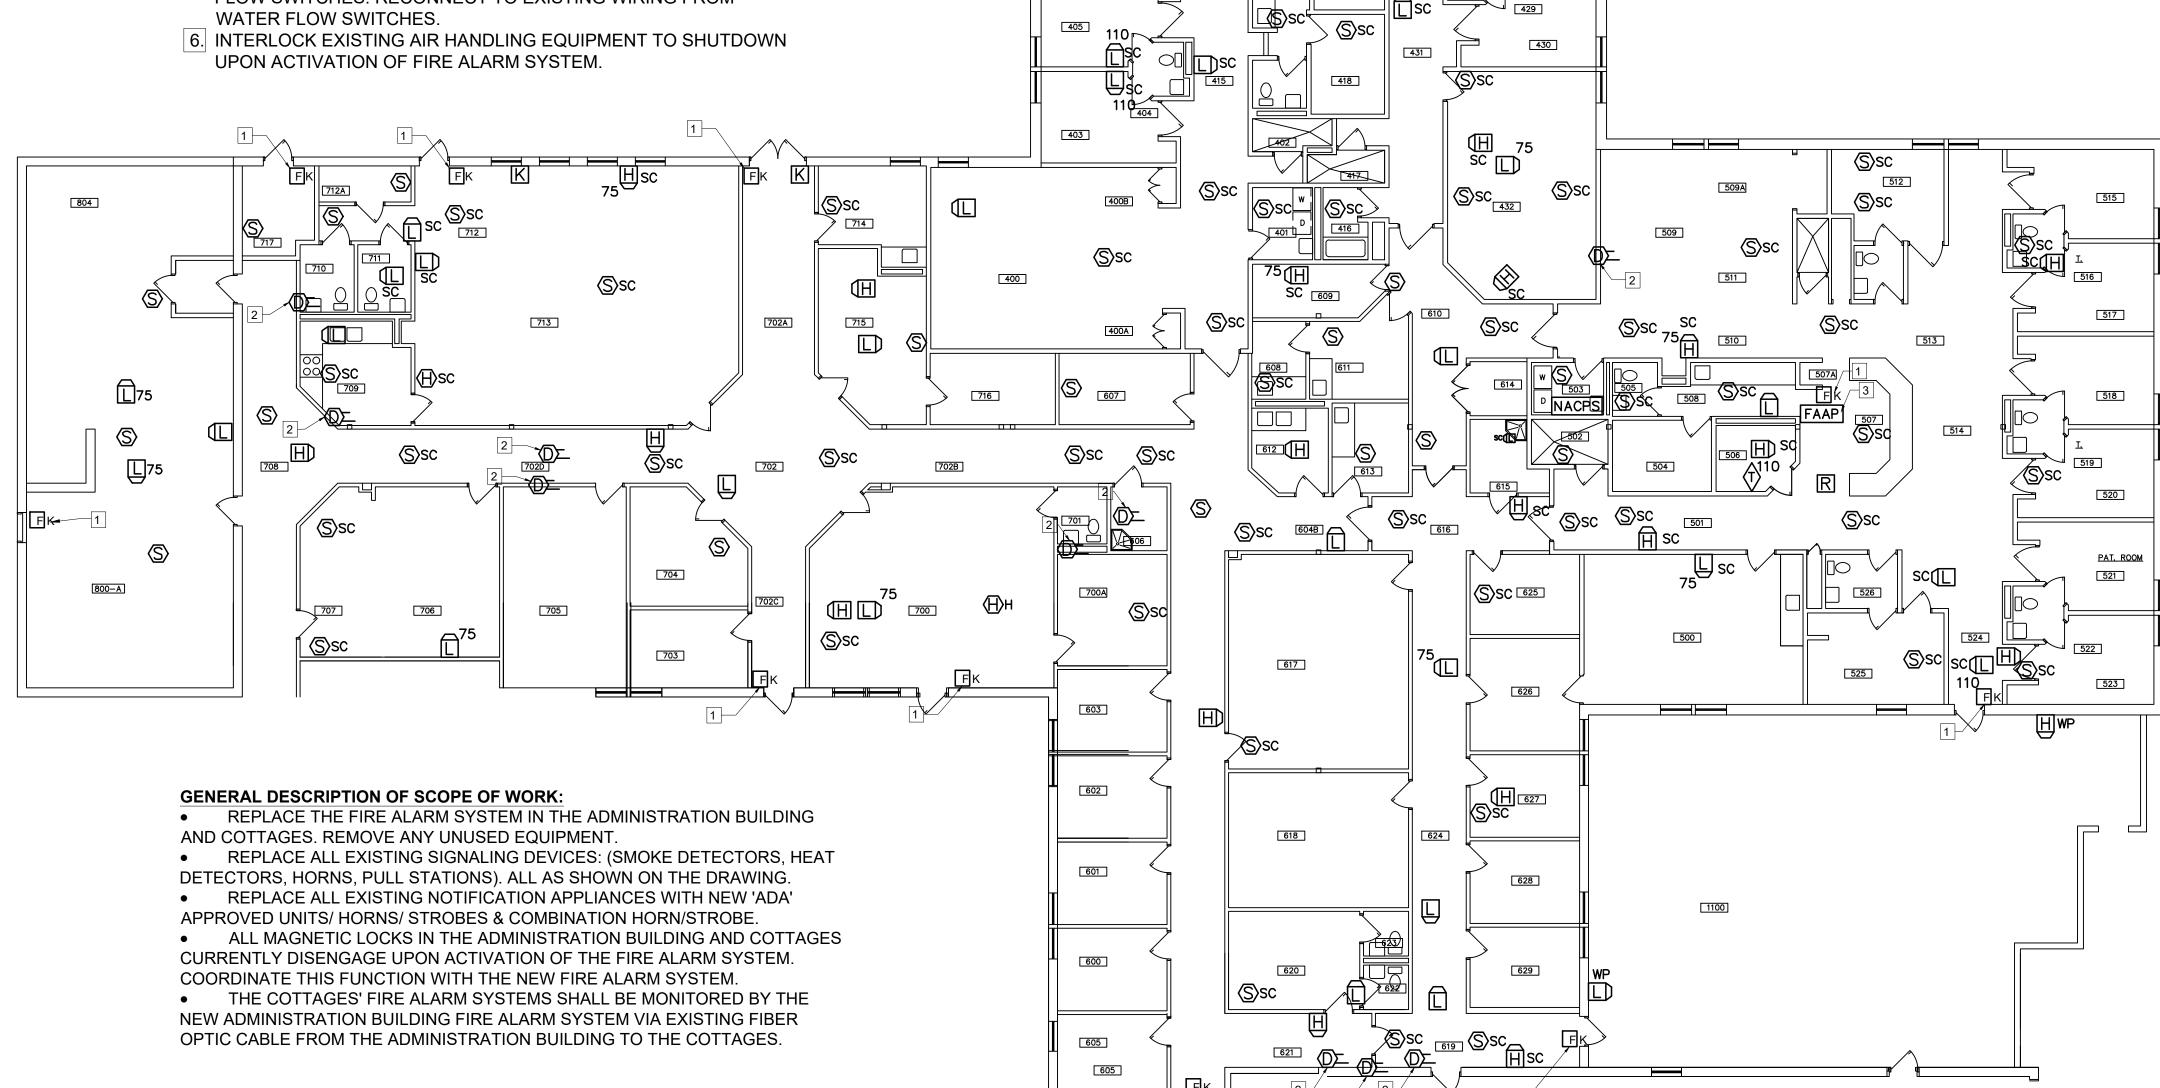

411

406

425

427

428

PARTIAL FLOOR PLAN-WEST SECTION


E-102 SCALE: 3/32" = 1'-0"

CONTRACTOR - NOTE:

THESE DRAWINGS ARE COMPILED FROM AVAILABLE EXISTING DOCUMENTS AND RECORDS. IT IS THE CONTRACTORS RESPONSIBILITY TO CONFIRM DIMENSIONS, EQUIPMENT LOCATIONS AND PEICE COUNTS AND TO CONTACT THE ENGINEER / ARCHITECT WITH ANY QUESTIONS REGARDING POSSIBLE DISCREPANCIES, TYPICAL

	FIRE ALARM SYMBOLS
	NOTE: NOT ALL SYMBOLS MAY APPLY TO THIS SHEET
Z	ADDRESSABLE INITIATING POINT
R	ADDRESSABLE RELAY POINT
H	HORN ONLY
K	KEYPAD
F	MANUAL PULL STATION AT 48" AFF
FK	KEY OPERATED MANUAL PULL STATION AT 48" AFF
(S)	SMOKE DETECTOR
$\langle \overline{\mathbb{S}} \rangle$ SC	SMOKE DETECTOR (WITH SECURITY COVER)
$\langle H \rangle$	HEAT DETECTOR
(H)SC	HEAT DETECTOR (WITH SECURITY COVER)
(H)H	HEAT DETECTOR (HIGH HEAT)
DH	MAGNETIC DOOR HOLDER
	DUCT SMOKE DETECTOR
H	HORN STROBE (SHOW CANDELA) 80" MIN., 96" MAX. AFF
H	HORN STROBE (WITH SECURITY COVER, SHOW CANDELA)
	80" MIN., 96" MAX. AFF.
	STROBE ONLY (SHOW CANDELA) 80" MIN., 96" MAX.
	STROBE ONLY (WITH SECURITY COVER, SHOW CANDELA)
SC	80" MIN., 96" MAX. AFF
FAAP	FIRE ALARM ANNUNCIATOR
FAAP	FIRE ALARM ANNUNCIATOR (NETWORK ANNUNCIATOR)
FACP	FIRE ALARM CONTROL PANEL
NACPS	NOTIFICATION APPLIANCE CIRCUIT POWER SUPPLY
D	DAMPER POSITION SWITCH
K),	INTERFACE TO KITCHEN HOOD
$\langle T \rangle$	FIRE SPRINKLER TAMPER /OSY/PIV VALVE SUPERVISORY
	SWITCH
W	WATERFLOW DEVICE
M	MAGNETIC DOOR LOCK
DA	DOOR ANNUNCIATOR
PS	POWER SUPPLY
1 1	



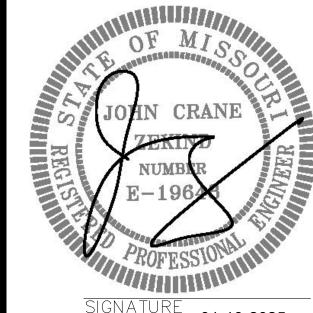

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DATE:

ISSUE DATE: JAN. 10, 2025

CAD DWG FILE: E-102.DWG
DRAWN BY: AJD/JSM
CHECKED BY: JCZ
DESIGNED BY: JCZ

SHEET TITLE:

COTTAGES

WEST SECTION

KEY PLAN

EAST SECTION

ADMIN. BUILDING ELECTRICAL PLAN WEST

SHEET NUMBER:

E-102

05 OF 08 SHEETS
JAN. 10, 2025

GENERAL DESCRIPTION OF SCOPE OF WORK: REPLACE THE FIRE ALARM SYSTEM IN THE ADMINISTRATION BUILDING AND COTTAGES. REMOVE ANY UNUSED EQUIPMENT. REPLACE ALL EXISTING SIGNALING DEVICES: (SMOKE DETECTORS, HEAT DETECTORS, HORNS, PULL STATIONS). ALL AS SHOWN ON THE DRAWING. REPLACE ALL EXISTING NOTIFICATION APPLIANCES WITH NEW 'ADA' APPROVED UNITS/ HORNS/ STROBES & COMBINATION HORN/STROBE. ALL MAGNETIC LOCKS IN THE ADMINISTRATION BUILDING AND COTTAGES CURRENTLY DISENGAGE UPON ACTIVATION OF THE FIRE ALARM SYSTEM.

COORDINATE THIS FUNCTION WITH THE NEW FIRE ALARM SYSTEM.

THE COTTAGES' FIRE ALARM SYSTEMS SHALL BE MONITORED BY THE

NEW ADMINISTRATION BUILDING FIRE ALARM SYSTEM VIA EXISTING FIBER

OPTIC CABLE FROM THE ADMINISTRATION BUILDING TO THE COTTAGES.

$\langle S \rangle$ sc Ssc 107 106 104 $\langle \overline{S} \rangle$ sc 102 (\$)\$\$ SSc √100 129 EXISTING FIBER CABLE - $\langle \overline{S} \rangle$ sc 110 \bigoplus 108 ⟨S⟩sc SSC 127 125 123 113 **S**SC 114 **H** Sc 126 124 EXISTING ELECTRICAL _ PANEL TO REMAIN INSPECTOR TEST ALL COTTAGES F.P. RISER COTTAGE "C" ONLY (REF) COTTAGE "C" ONLY (REF)

GENERAL NOTES:

- EXPOSED LOCATIONS THE WIRING SHALL BE INSTALLED IN CONDUIT. PROVIDE RIGID CONDUIT WHERE ACCESSIBLE TO PATIENTS AND PUBLIC. PROVIDE PLENUM RATED CABLE IN PLENUM AREAS. UNDERGROUND CABLE SHALL BE DIRECT BURIAL TYPE, INSTALLED IN CONDUIT.
- HEAT DETECTORS, HORNS, PULL STATIONS). ALL AS SHOWN ON
- 4. REPLACE ALL EXISTING NOTIFICATION APPLIANCES WITH NEW 'ADA' APPROVED UNITS/ HORNS/ STROBES & COMBINATION
- 5. ALLOW AT LEAST A 3' CLEARANCE BETWEEN DIFFUSERS AND SMOKE AND HEAT DETECTORS OR AS DIRECTED BY THE FIRE MARSHAL.

KEYED NOTES: |#|

- 1. REMOVE AND REPLACE KEY OPERATED PULL STATION IN PLACE.
- 2. REMOVE AND REPLACE DUCT SMOKE DETECTOR UPSTREAM OF EXISTING DAMPER. FIELD VERIFY EXACT LOCATION. CONFIRM INTERLOCK WITH DAMPER, SET TO CLOSE UPON ACTIVATION OF DETECTOR. REUSE EXISTING CONTROL POWER AS REQUIRED.
- 3. REMOVE AND REPLACE FACP / FAAP. CONNECT NEW FACP / FAAP. TO EXISTING FIRE ALARM POWER. BESIDES POWER WIRING, CONNECT ALL EXISTING INPUT AND OUTPUT CONTROL WIRING TO FACP/FAAP AS REQUIRED - CHECK ALL LOW VOLTAGE WIRING AND REPAIR/REPLACE AS REQUIRED.
- 4. REMOVE AND REPLACE NOTIFICATION DEVICE. CONNECT NEW NOTIFICATION DEVICE TO EXISTING POWER SOURCE.
- 5. REMOVE AND REPLACE ADDRESSABLE MODULES FOR SPRINKLER FLOW SWITCHES. RECONNECT TO EXISTING WIRING FROM WATER FLOW SWITCHES.
- 6. INTERLOCK EXISTING AIR HANDLING EQUIPMENT TO SHUTDOWN UPON ACTIVATION OF FIRE ALARM SYSTEM.

- 1. ALL FIRE ALARM WIRING SHALL BE LISTED FIRE ALARM CABLE. IN
- 2. ALL WORK SHALL CONFORM WITH 2018 IBC, SECTION 907 AND NFPA 72; 2016.
- 3. REPLACE ALL EXISTING SIGNALING DEVICES: (SMOKE DETECTORS,
- HORN/STROBE.

HORN ONLY KEYPAD MANUAL PULL STATION AT 48" AFF KEY OPERATED MANUAL PULL STATION AT 48" AFF SMOKE DETECTOR SMOKE DETECTOR (WITH SECURITY COVER) HEAT DETECTOR

HEAT DETECTOR (HIGH HEAT) MAGNETIC DOOR HOLDER

DUCT SMOKE DETECTOR HORN STROBE (SHOW CANDELA) 80" MIN., 96" MAX. AFF

HORN STROBE (WITH SECURITY COVER, SHOW CANDELA) 80" MIN., 96" MAX, AFF.

HEAT DETECTOR (WITH SECURITY COVER)

CONTRACTOR - NOTE:

CONTRACTORS RESPONSIBILITY TO CONFIRM

COUNTS AND TO CONTACT THE ENGINEER /

POSSIBLE DISCREPANCIES, TYPICAL

ADDRESSABLE INITIATING POINT

ADDRESSABLE RELAY POINT

THESE DRAWINGS ARE COMPILED FROM AVAILABLE

EXISTING DOCUMENTS AND RECORDS. IT IS THE

DIMENSIONS, EQUIPMENT LOCATIONS AND PEICE

FIRE ALARM SYMBOLS

NOTE: NOT ALL SYMBOLS MAY APPLY TO THIS SHEET

ARCHITECT WITH ANY QUESTIONS REGARDING

STROBE ONLY (SHOW CANDELA) 80" MIN., 96" MAX. STROBE ONLY (WITH SECURITY COVER, SHOW CANDELA) 80" MIN., 96" MAX. AFF

FAAP FIRE ALARM ANNUNCIATOR

FAAP N FIRE ALARM ANNUNCIATOR (NETWORK ANNUNCIATOR) FACE FIRE ALARM CONTROL PANEL

NOTIFICATION APPLIANCE CIRCUIT POWER SUPPLY

DAMPER POSITION SWITCH

INTERFACE TO KITCHEN HOOD

FIRE SPRINKLER TAMPER /OSY/PIV VALVE SUPERVISORY SWITCH


WATERFLOW DEVICE

MAGNETIC DOOR LOCK

DOOR ANNUNCIATOR

POWER SUPPLY

MICHAEL L. PARSON, **GOVERNOR**

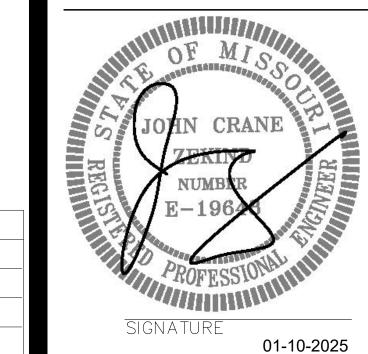

STATE OF MISSOURI

12-31-2025 LICENSE EXPIRES

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OFFICE OF ADMINISTRATION DIVISION OF FACILITIES MANAGEMENT, **DESIGN AND CONSTRUCTION**

DEPARTMENT OF MENTAL HEALTH

REPLACE FIRE ALARM PANELS AND DEVICES, ADMINISTRATION BUILDING HAWTHORN CHILDREN'S PSYCHIATRIC HOSPITAL

1901 PENNSYLVANIA AVENUE ST. LOUIS, MISSOURI 63133

PROJECT # M2414-01 7390 6517390002 ASSET#

REVISION: REVISION REVISION:

DATE: **ISSUE DATE: JAN. 10, 2025**


CAD DWG FILE: E-103.DWG DRAWN BY: CHECKED BY: **DESIGNED BY**

SHEET TITLE:


TYP. COTTAGE ELECTRICAL PLAN

SHEET NUMBER:

JAN. 10, 2025

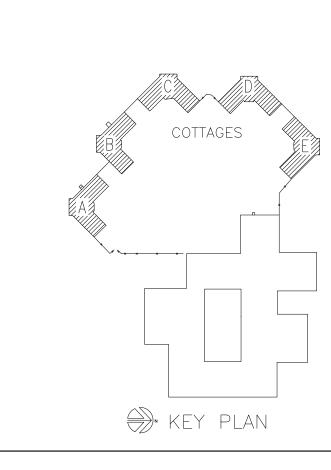


1 FLOOR PLAN-COTTAGE (TYP. OF 5) E-103 SCALE: 3/32" = 1'-0"

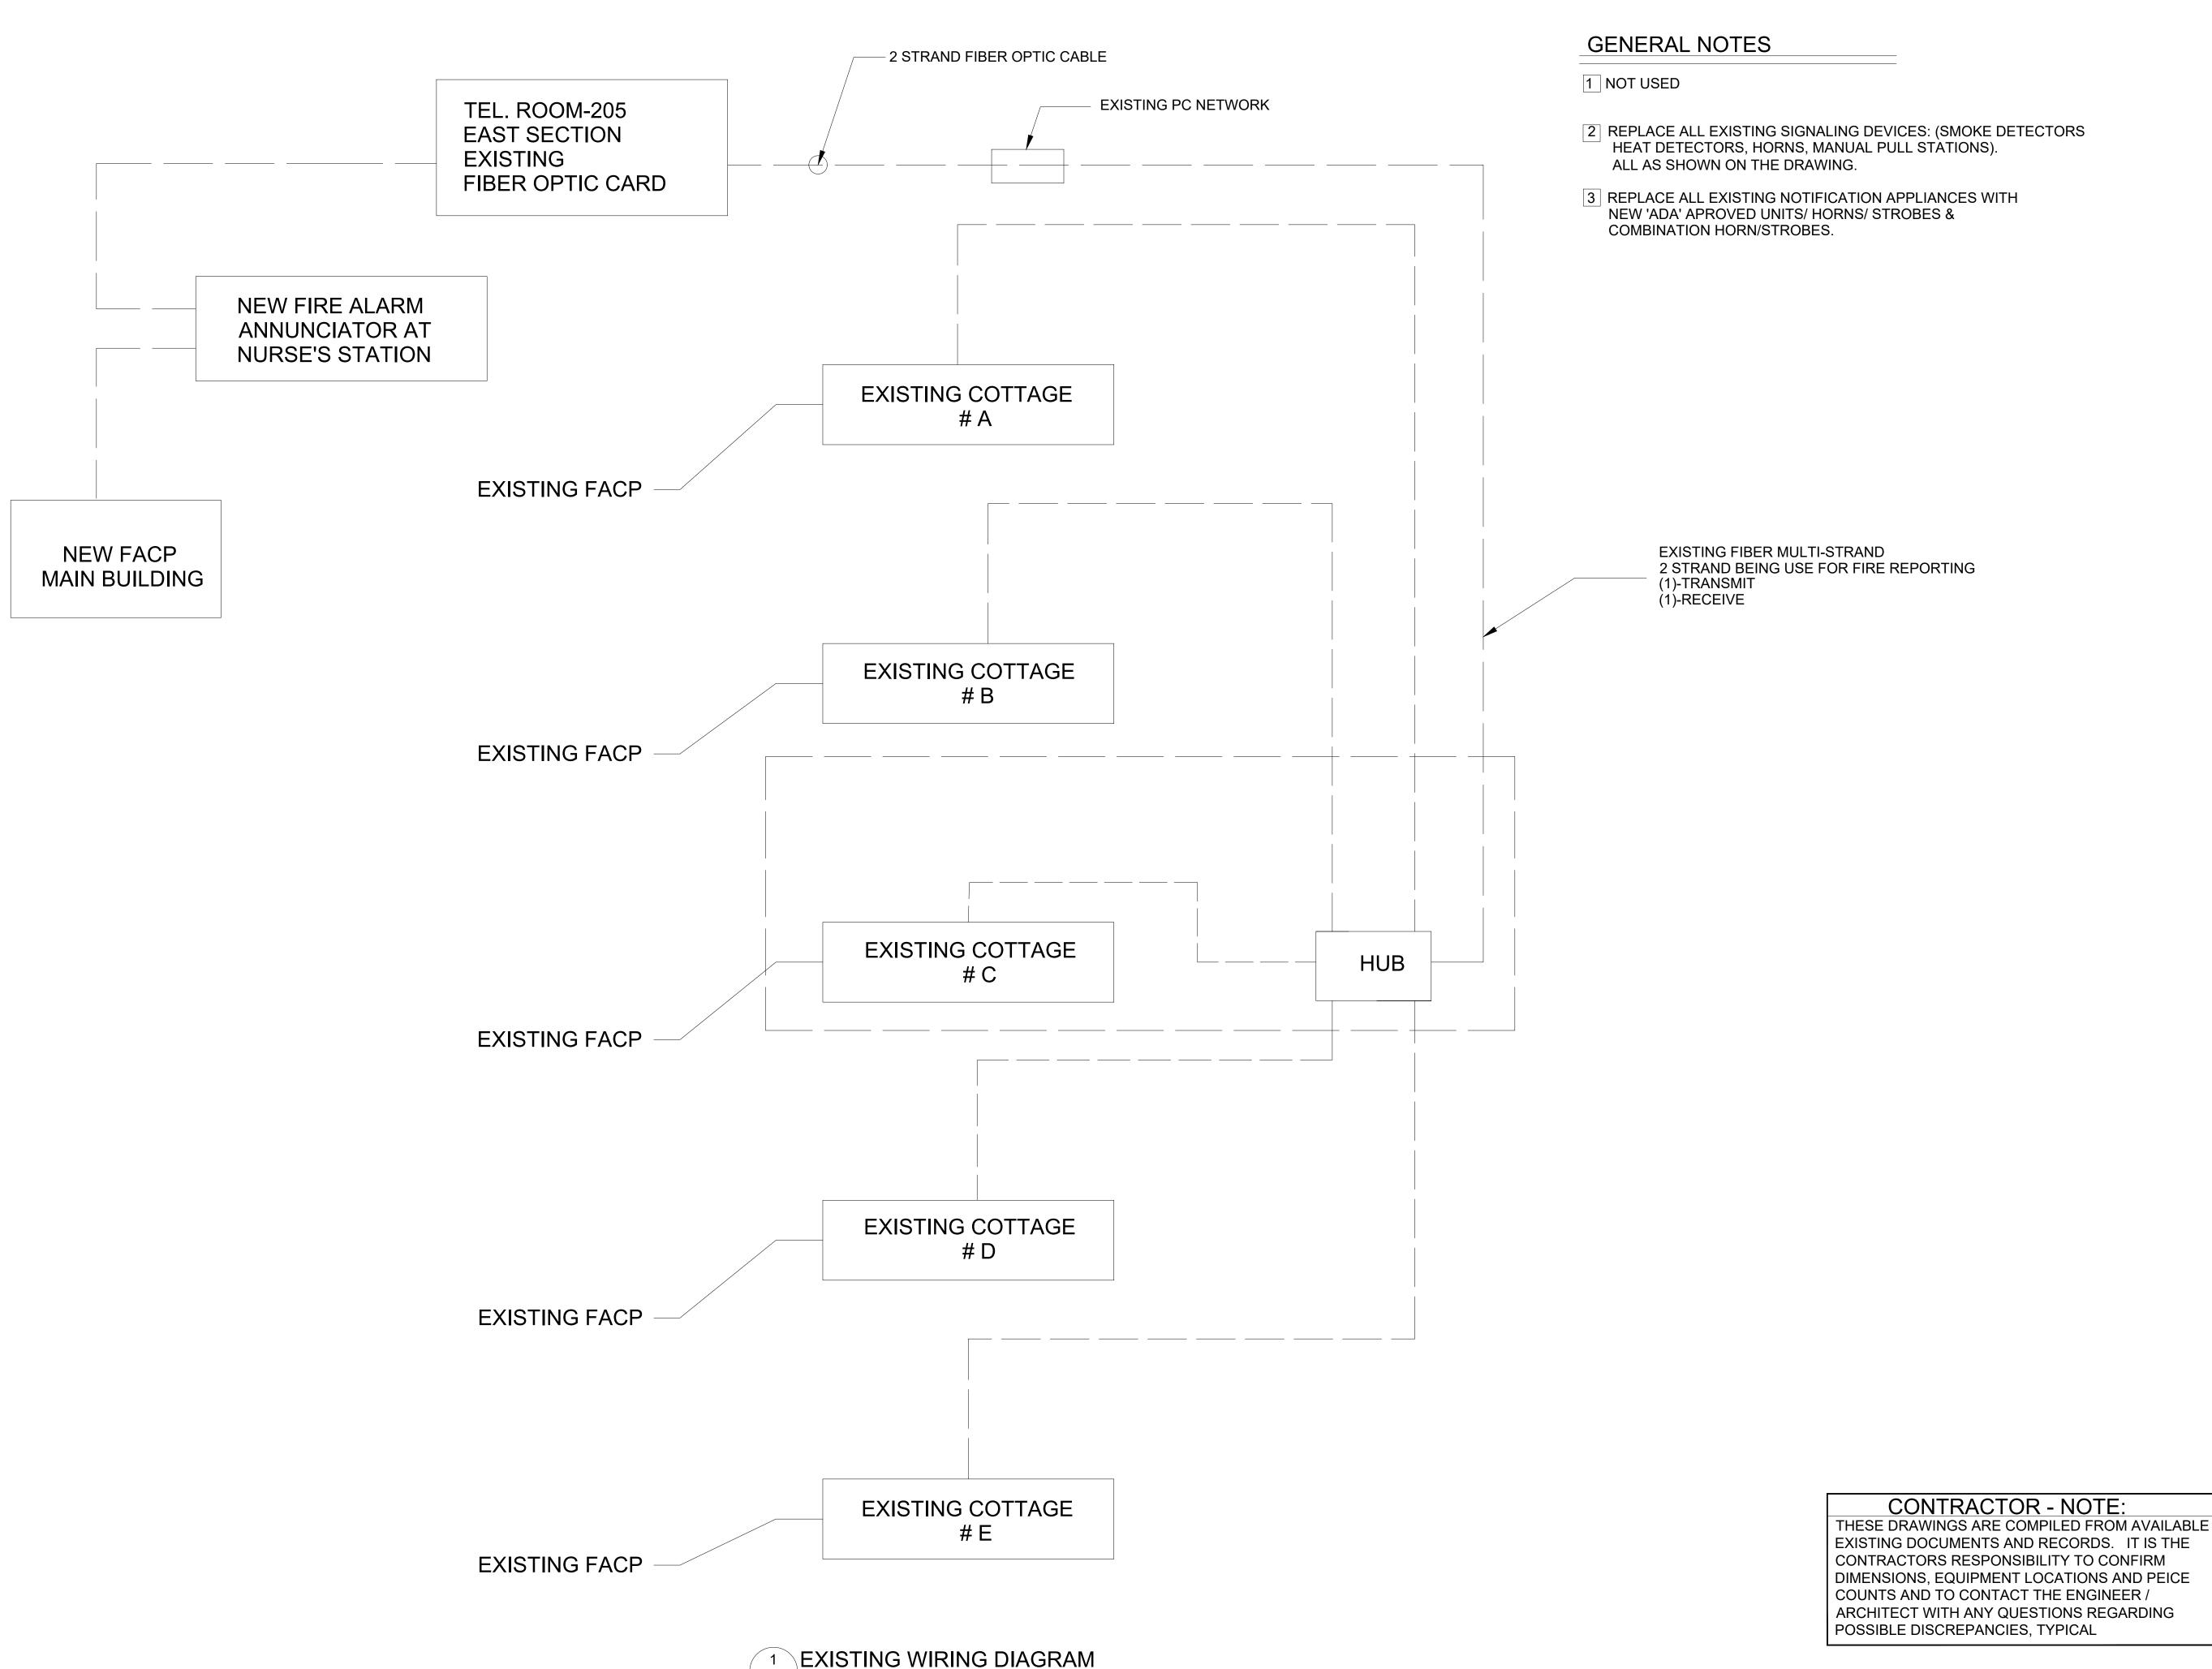

E-108 SCALE: NTS

2 REPLACE ALL EXISTING SIGNALING DEVICES: (SMOKE DETECTORS

STATE OF MISSOURI MICHAEL L. PARSON, **GOVERNOR**

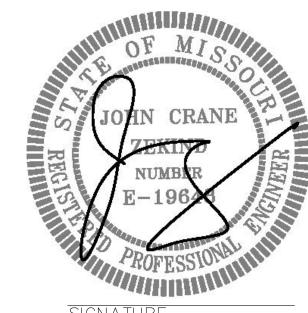

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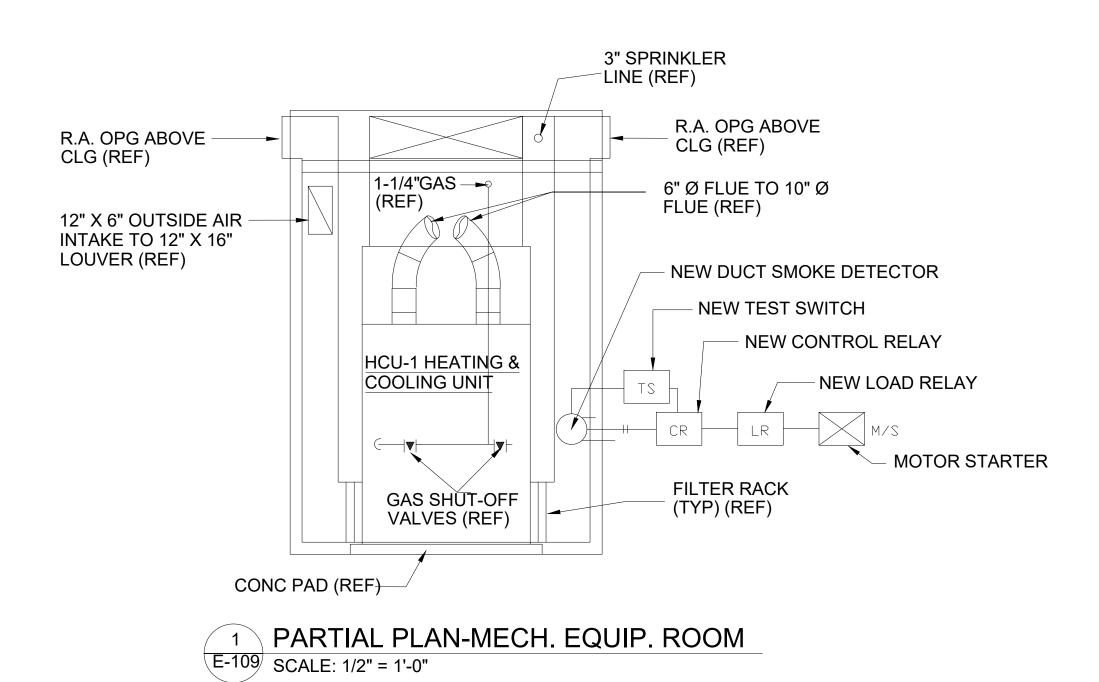
CAD DWG FILE: E-108.DWG DRAWN BY: CHECKED BY: **DESIGNED BY**


SHEET TITLE:

WIRING DIAGRAM

SHEET NUMBER:

JAN. 10, 2025



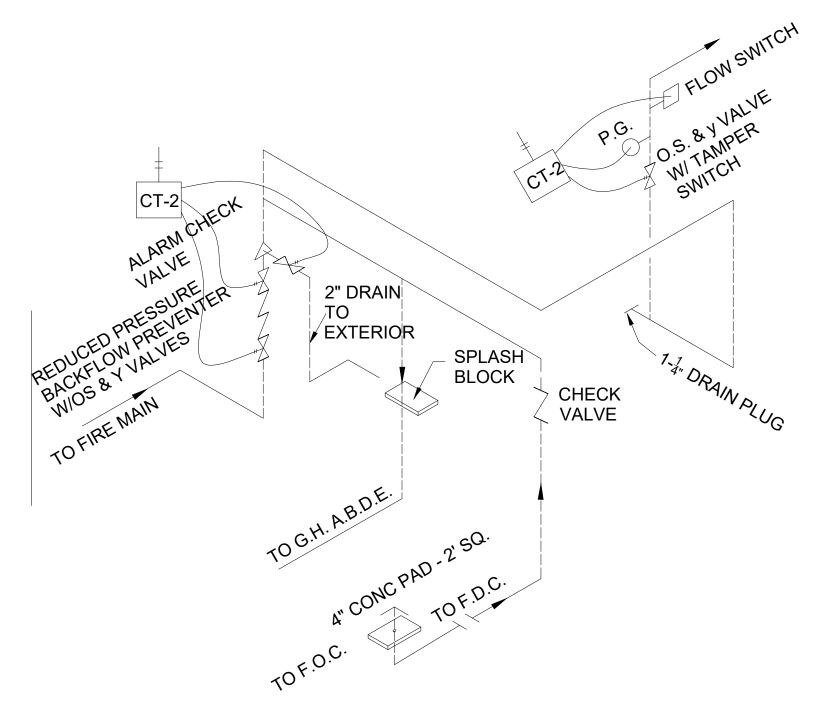


² FIRE PROTECTION RISER - COTTAGE C E-109 SCALE: NTS

CONTRACTOR - NOTE:

THESE DRAWINGS ARE COMPILED FROM AVAILABLE EXISTING DOCUMENTS AND RECORDS. IT IS THE CONTRACTORS RESPONSIBILITY TO CONFIRM DIMENSIONS, EQUIPMENT LOCATIONS AND PEICE COUNTS AND TO CONTACT THE ENGINEER / ARCHITECT WITH ANY QUESTIONS REGARDING POSSIBLE DISCREPANCIES, TYPICAL

STATE OF MISSOURI MICHAEL L. PARSON, **GOVERNOR**

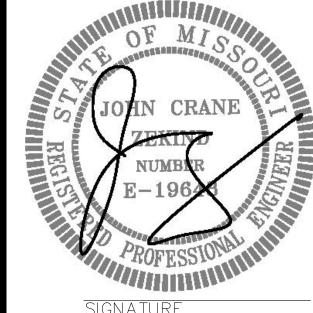

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CAD DWG FILE: E-109.DWG DRAWN BY: CHECKED BY: **DESIGNED BY:**

SHEET TITLE:

PARTIAL PLAN MECH. EQUIP. ROOM

SHEET NUMBER:

JAN. 10, 2025