

ADDENDUM NO. 2

TO: PLANS AND SPECIFICATIONS FOR STATE OF MISSOURI

**Upgrade Fire Alarm System
Missouri Supreme Court Building
Jefferson City, Missouri
PROJECT NO.: O2008-01**

Bid Opening Date: 1:30 PM, July 21, 2022 (Not Changed)

Bidders are hereby informed that the construction Plans and/or Specifications are modified as follows:

SPECIFICATION CHANGES:

1. Section 012300 Alternates

REPLACE Paragraph 3.1-A as follows:

- A. Base Bid: Fire alarm system shall be a fully wireless system on the second and third levels except as noted on the Drawings. Conductors for existing wiring devices on the second and third levels may be abandoned in place. Fire alarm system for the lower and first levels shall be a hybrid wired and wireless system as shown on the Drawings. Conductors shall be replaced for all new wired devices.

2. Section 015000- Construction Facilities and Temporary Controls

ADD Paragraph 1.2-D-4 as follows:

- 4. Existing surface protection

3. Section 015000- Construction Facilities and Temporary Controls

ADD Paragraph 3.2-E as follows:

- E. Existing Furniture, Fixtures, and Equipment: Contractor is responsible for moving, storing, and reinstalling existing furniture, fixtures, and equipment (FF&E) as required to facilitate the Work with the exception of wall-hung portraits and artwork. Removal, storage, and reinstallation of wall hung portraits and other artwork shall be the responsibility of the Owner.

4. Section 015000- Construction Facilities and Temporary Controls

ADD Paragraph 3.3-G as follows:

- G. Provide temporary wall, floor, ceiling, roof and other surface protection as required to prevent damage to existing surfaces during construction. Temporary surface protection materials and methods shall be selected based on the substrate surface protected and the construction activities performed. Contractor shall be responsible for the repair of any existing surfaces damaged during construction to return the surface to its pre-project condition.

DRAWING CHANGES:

1. Sheet A110

CHANGE Keynote located at existing annunciator panel location in Main Lobby 1-103 in the vicinity of Fiscal Officer 1-105 from 0903.01 to 0903.02. See revised sheet A110 (attached).

2. Sheet E100

REPLACE General Sheet Note 2 as follows:

- 2) Base Bid: Existing conductors for fire alarm devices on this floor to be removed. Where available, existing conduits for fire alarm devices on this level may be re-used to provide conduit pathway for new fire alarm system conductors.

See revised sheet E100 (attached).

3. Sheet E100

REPLACE General Sheet Note 3 as follows:

- 3) Not used.

See revised sheet E100 (attached).

4. Sheet E101

REPLACE General Sheet Note 2 as follows:

- 2) Base Bid: Existing conductors for fire alarm devices on this floor to be removed. Where available, existing conduits for fire alarm devices on this level may be re-used to provide conduit pathway for new fire alarm system conductors.

See revised sheet E101 (attached).

5. Sheet E101

REPLACE General Sheet Note 3 as follows:

- 3) Not used.

See revised sheet E101 (attached).

6. Sheet E101

REVISE Keynote E03 within the Keynote Legend to read as follows:

E03 Annunciator panel to be demolished.

See revised sheet E101 (attached).

7. Sheet E110

DELETE all E15 keynotes on this sheet. See revised sheet E110 (attached).

8. Sheet E110

ADD Keynote E23 within the Keynote Legend and within room Marshal B-25 as follows:

E23 Remote annunciator panel(s) for both the wired and wireless fire alarm systems shall be installed within Marshall B-25. Location of panel(s) to be coordinated with Owner prior to installation. If multiple annunciator panels are required for the fire alarm system, all annunciator panels shall be located within this same room.

See revised sheet E110 (attached).

9. Sheet E111

DELETE all E15 keynotes on this sheet. See revised sheet E111 (attached).

10. Sheet E111

DELETE "Central Annunciator Panel" note and associated device symbol from Main Lobby 1-103. See revised sheet E111 (attached).

11. Sheet E501

CHANGE Location of "Central Annunciator Panel" from the Main Level to the Lower Level within the Fire Alarm Riser Detail. See revised sheet E501 (attached).

GENERAL COMMENTS:

(none)

ATTACHMENTS:

1. Sheet A110 (revised)
2. Sheet E100 (revised)
3. Sheet E101 (revised)
4. Sheet E110 (revised)
5. Sheet E111 (revised)
6. Sheet E501 (revised)

July 14, 2022

END ADDENDUM NO. 2

WALLS			
TAG	MANUFACTURER	PRODUCT DESCRIPTION	REMARKS
PNT-0	SEE SPECIFICATIONS	COLOR: MATCH EXISTING COLOR AND SHEEN.	
PNT-1	SEE SPECIFICATIONS	COLOR: MATCH BENJAMIN MOORE HC-45 SHAKER BEIGE, EGGSHELL.	
PNT-2	SHERWIN WILLIAMS	COLOR: MATCH BENJAMIN MOORE 956 PALACE WHITE, FLAT SUPER SPEC	
PNT-3	SHERWIN WILLIAMS	COLOR: MATCH BENJAMIN MOORE GLACIER WHITE, FLAT	
PNT-4	SHERWIN WILLIAMS	COLOR: MATCH BENJAMIN MOORE NAVAJO WHITE, MATCH EXISTING SHEEN	
PNT-5	SHERWIN WILLIAMS	COLOR: MATCH BENJAMIN MOORE HC-165 BOOTHBAY GRAY, MATCH EXISTING SHEEN	
PNT-6	SHERWIN WILLIAMS	COLOR: MATCH BENJAMIN MOORE HC-154 HALE NAVY, MATCH EXISTING SHEEN	
PNT-7	SHERWIN WILLIAMS	COLOR: MATCH BENJAMIN MOORE 194 HATHAWAY GOLD, MATCH EXISTING SHEEN	

GENERAL NOTES


1. AN ASBESTOS INSPECTION REPORT WAS COMPLETED AND IS INCLUDED WITHIN THE PROJECT MANUAL. ASBESTOS IS PRESENT WITHIN THE BUILDING. CONTRACTOR SHALL REVIEW ENTIRE REPORT AND AVOID DISTURBANCE OF ASBESTOS CONTAINING MATERIALS.
2. THE CONTRACTOR SHALL MAKE A PERSONAL INSPECTION OF THE SITE AND INCLUDE ALL WORK REQUIRED BY THE DRAWINGS. NOTIFY THE ARCHITECT IN WRITING OF ANY INCONSISTENCIES IN THE DRAWINGS.
3. PROTECT OWNER'S PROPERTY AND PERSONS AT ALL TIMES. THIS INCLUDES ALL ITEMS AND SERVICES NECESSARY TO DEMOLISH OR DISMANTLE AND REMOVE ALL WALLS, EQUIPMENT, PIPING AND APPURTENANCES WHICH WILL INTERFERE WITH NEW CONSTRUCTION. ALL ITEMS TO BE REMOVED SHALL BE COORDINATED WITH NEW CONSTRUCTION.
4. EXISTING CONSTRUCTION SHALL BE PROTECTED. EXERCISE CAUTION WHEN REMOVING AND/OR INSTALLING DEVICES TO MINIMIZE DAMAGE TO HISTORIC SUBSTRATES.
5. MAINTAIN ANY EXISTING FIRE RESISTANCE RATINGS IN ROOF, WALL, AND FLOOR ASSEMBLIES WITH PATCHING OR REPLACING ALL REQUIRED COMPONENTS.
6. ANY ITEMS NOT SHOWN TO BE DEMOLISHED THAT ARE DAMAGED DURING THE COURSE OF DEMOLITION OR CONSTRUCTION SHALL BE REPAIRED/REPLACED BY THE CONTRACTOR AT THE CONTRACTOR'S EXPENSE.
7. COORDINATE ANY SYSTEMS SHUTDOWNS WHICH MAY BE REQUIRED WITH THE OWNER.
8. ALL MATERIALS THAT HAVE BEEN DEMOLISHED SHALL BE REMOVED AND DISPOSED OF PROPERLY. NO DEMOLISHED MATERIALS SHALL BE STOCKPILED ON SITE.
9. ANY ITEMS NOT TO BE RETAINED BY THE OWNER SHALL BE LEGALLY DISPOSED OF OFF SITE BY THE CONTRACTOR.
10. SURFACE MOUNTING OF CONDUIT FOR DEVICES IS NOT ALLOWED UNLESS SPECIFICALLY NOTED OTHERWISE.
11. IF PAINT COLOR LISTED DOES NOT APPEAR TO MATCH THE PAINT PRESENT ON THE EXISTING CONDITIONS, DISREGARD LISTED PAINT COLOR AND PROVIDE PNT-0.

KEYNOTE LEGEND


VALUE	DESCRIPTION
0903.01	IF NEW DEVICE IS SMALLER THAN EXISTING DEVICE AND/OR IF REMOVAL OF EXISTING DEVICE CAUSES DAMAGE, PATCH/REPAIR HISTORIC PLASTER OR GYPSUM BOARD IN KIND TO MATCH ADJACENT MATERIALS AND PER SPECIFICATIONS. REPAINT PLANE OF WALL OR CEILING CORNER TO CORNER.
0903.02	PATCH/REPAIR HISTORIC PLASTER OR GYPSUM BOARD IN KIND TO MATCH ADJACENT MATERIALS AND PER SPECIFICATIONS AS REQUIRED BY WORK. REPAINT PLANE OF WALL OR CEILING CORNER TO CORNER.
0903.03	IF NEW DEVICE IS SMALLER THAN EXISTING DEVICE AND/OR IF REMOVAL OF EXISTING DEVICE CAUSES DAMAGE, PATCH/REPAIR HISTORIC PLASTER OR GYPSUM BOARD IN KIND TO MATCH ADJACENT MATERIALS AND PER SPECIFICATIONS. PAINT AFFECTED AREA TO MATCH SURROUNDINGS.
0903.04	INSTALL NEW WIRELESS DEVICE PER ELECTRICAL PLANS AND MINIMIZE DAMAGE TO SUBSTRATE. IF DAMAGE OCCURS, REPAIR/REPAINT PER SPECIFICATIONS.

FIRE ALARM DEVICES LEGEND

- SEE MEP SHEETS FOR TYPE OF DEVICE

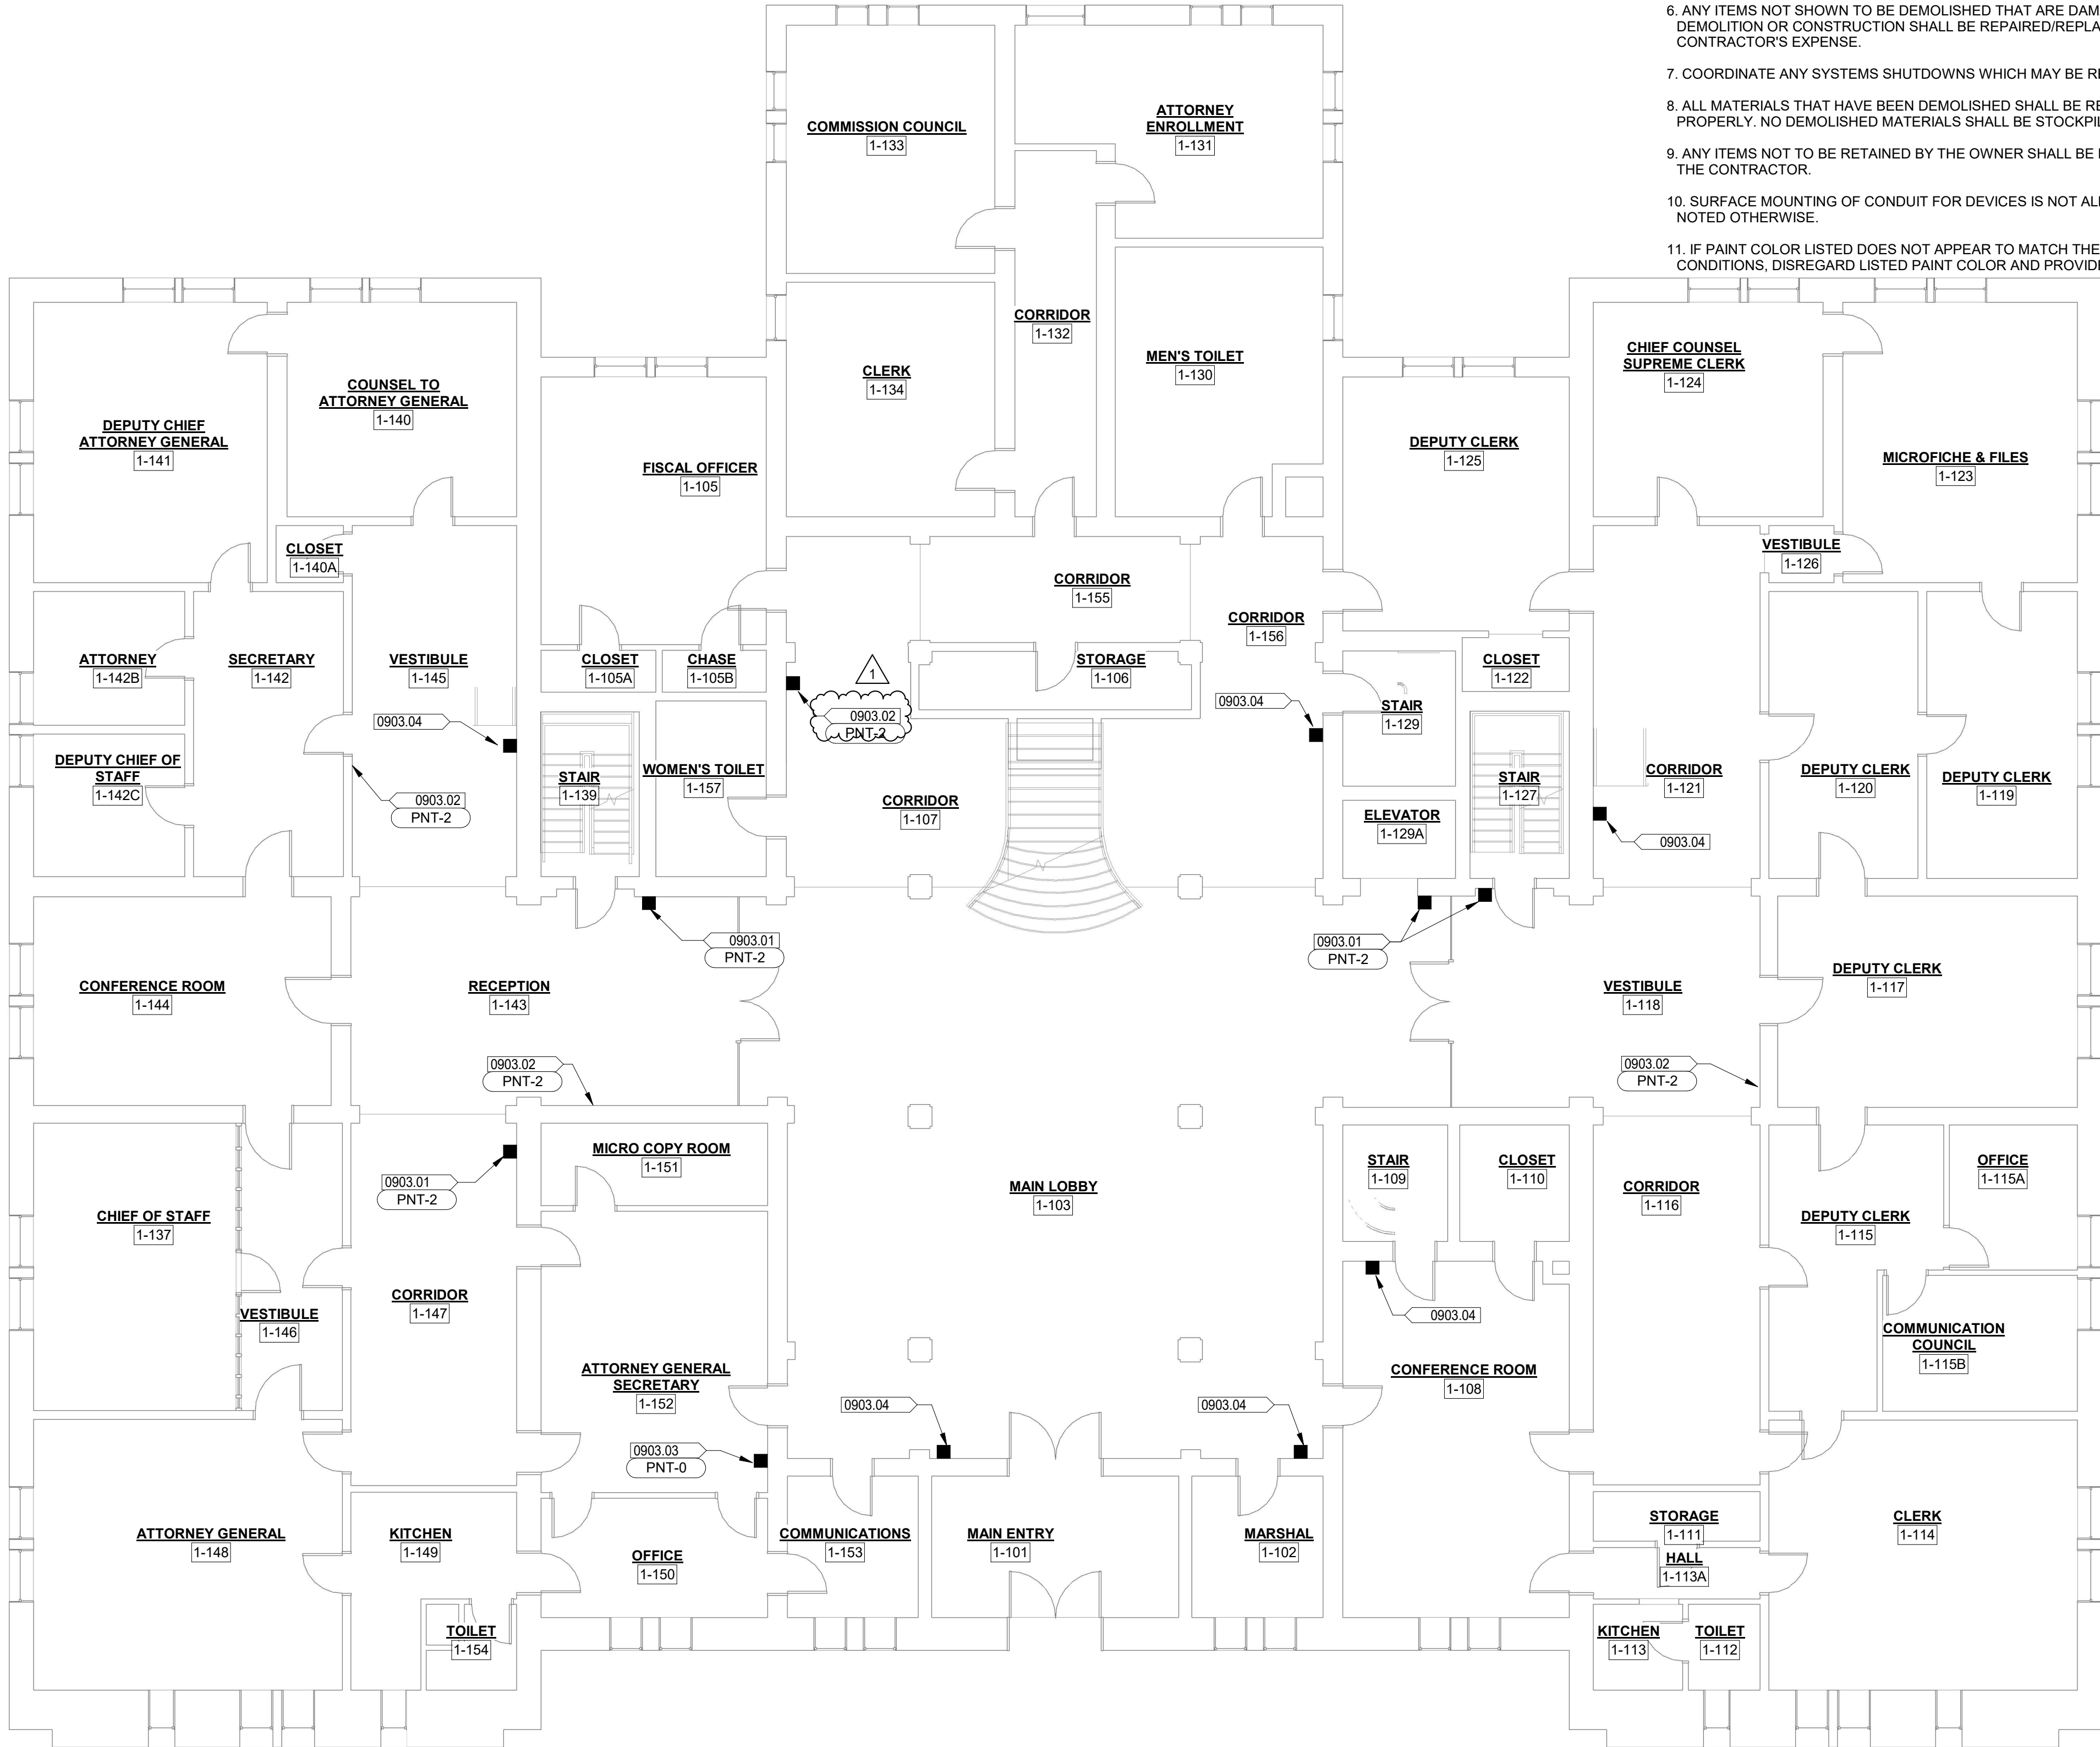

1 MAIN LEVEL - FLOOR PLAN
1/8" = 1'-0"

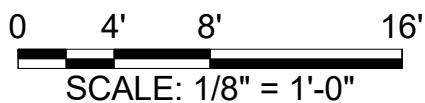

STATE OF MISSOURI
MICHAEL L. PARSON,
GOVERNOR



MICHAEL J. FRIES - ARCHITECT
MO #2017015806

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Engineers • Architects • Surveyors

Columbia, Missouri

907 East Ash Street
Burlington, IA 50808

KLINGNER & ASSOCIATES, P.C. - ARCHITECTURE
MISSOURI STATE CERTIFICATE OF AUTHORITY #2001010108

OFFICE OF ADMINISTRATION
DIVISION OF FACILITIES
MANAGEMENT,
DESIGN AND CONSTRUCTION

UPGRADE FIRE ALARM
SYSTEM

MISSOURI SUPREME COURT
BUILDING

207 WEST HIGH ST
JEFFERSON CITY, MO 65101

PROJECT # O2008-01
SITE # 1001
ASSET # 3101001056

REVISION: ADDENDUM #2
DATE: JULY 14, 2022
REVISION: _____
DATE: _____
REVISION: _____
DATE: _____
ISSUE DATE: 04/28/22

CAD DWG FILE: A110
DRAWING BY: SRWB
CHECKED BY: MJF
DESIGNED BY: SRWB

SHEET TITLE:

MAIN LEVEL
FLOOR PLAN

SHEET NUMBER:

A110

05 OF 21 SHEETS
APRIL 28, 2022



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ISSUE DATE: 04/28/22

CAD DWG FILE: E100
DRAWING BY: JLD
CHECKED BY: JJN
DESIGNED BY: JLD

SHEET TITLE:

LOWER LEVEL
EXISTING LOW
VOLTAGE PLAN

SHEET NUMBER:

E100

APRIL 28, 2022

KEYNOTE LEGEND	
VALUE	DESCRIPTION
E04	EXISTING FIRE ALARM CONTROL PANEL TO BE DEMOLISHED AND REPLACED BY CENTRAL PANEL.
E14	DEMOLISH ABANDONED CONDUIT AND FIRE ALARM DEVICE BOX UNDER EXISTING HORN/STROBE DEVICE.

GENERAL SHEET NOTES:

- SEE ARCHITECTURAL SHEETS AND/OR SPECIFICATIONS FOR REPAIR SCOPE RELATED TO ASSOCIATED SUBSTRATE.
- BASE BID: EXISTING CONDUCTORS FOR FIRE ALARM DEVICES ON THIS FLOOR TO BE REMOVED. WHERE AVAILABLE, EXISTING CONDUITS FOR FIRE ALARM DEVICES ON THIS LEVEL MAY BE RE-USED TO PROVIDE CONDUIT PATHWAY FOR NEW FIRE ALARM SYSTEM CONDUCTORS.
- NOT USED.
- EXISTING FIRE ALARM DEVICES SHOWN ON THIS SHEET. ALL DEVICES TO BE EITHER REMOVED OR REPLACED AS SHOWN ON SHEETS E110 THROUGH E113.


EXISTING FIRE ALARM SYMBOLS


- HORN STROBE - WALL MOUNTED
- HORN STROBE - CEILING MOUNTED
- STROBE - WALL MOUNTED
- STROBE - CEILING MOUNTED
- PULL STATION - WALL MOUNTED
- SMOKE DETECTOR - WALL MOUNTED
- SMOKE DETECTOR - SOUNDER BASE - WALL MOUNTED
- SMOKE DETECTOR - CEILING MOUNTED
- SMOKE DETECTOR - SOUNDER BASE
- SMOKE DETECTOR - DUCT MOUNTED
- BEAM SMOKE DETECTOR - WALL MOUNTED
- ABANDONED FIRE ALARM DEVICE BOX - WALL MOUNTED
- PUBLIC ADDRESS SPEAKER - WALL MOUNTED
- FIRE ALARM RELAY FOR SMOKE EXHAUST SYSTEM
- LED EMERGENCY LIGHT FIXTURE - SINGLE HEAD
- LED EMERGENCY LIGHT FIXTURE - DOUBLE HEAD
- AUXILIARY FIRE ALARM PANELS - SEE PLAN VIEWS FOR SPECIFIC TYPE
- FIRE ALARM CONTROL PANEL (FACP)



1 LOWER LEVEL - EXISTING LOW VOLTAGE PLAN
1/8" = 1'-0"

0 4' 8' 16'
SCALE: 1/8" = 1'-0"

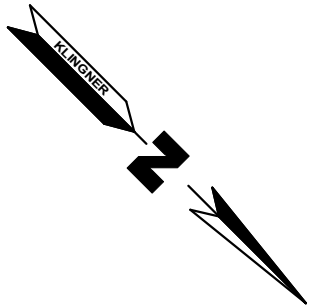

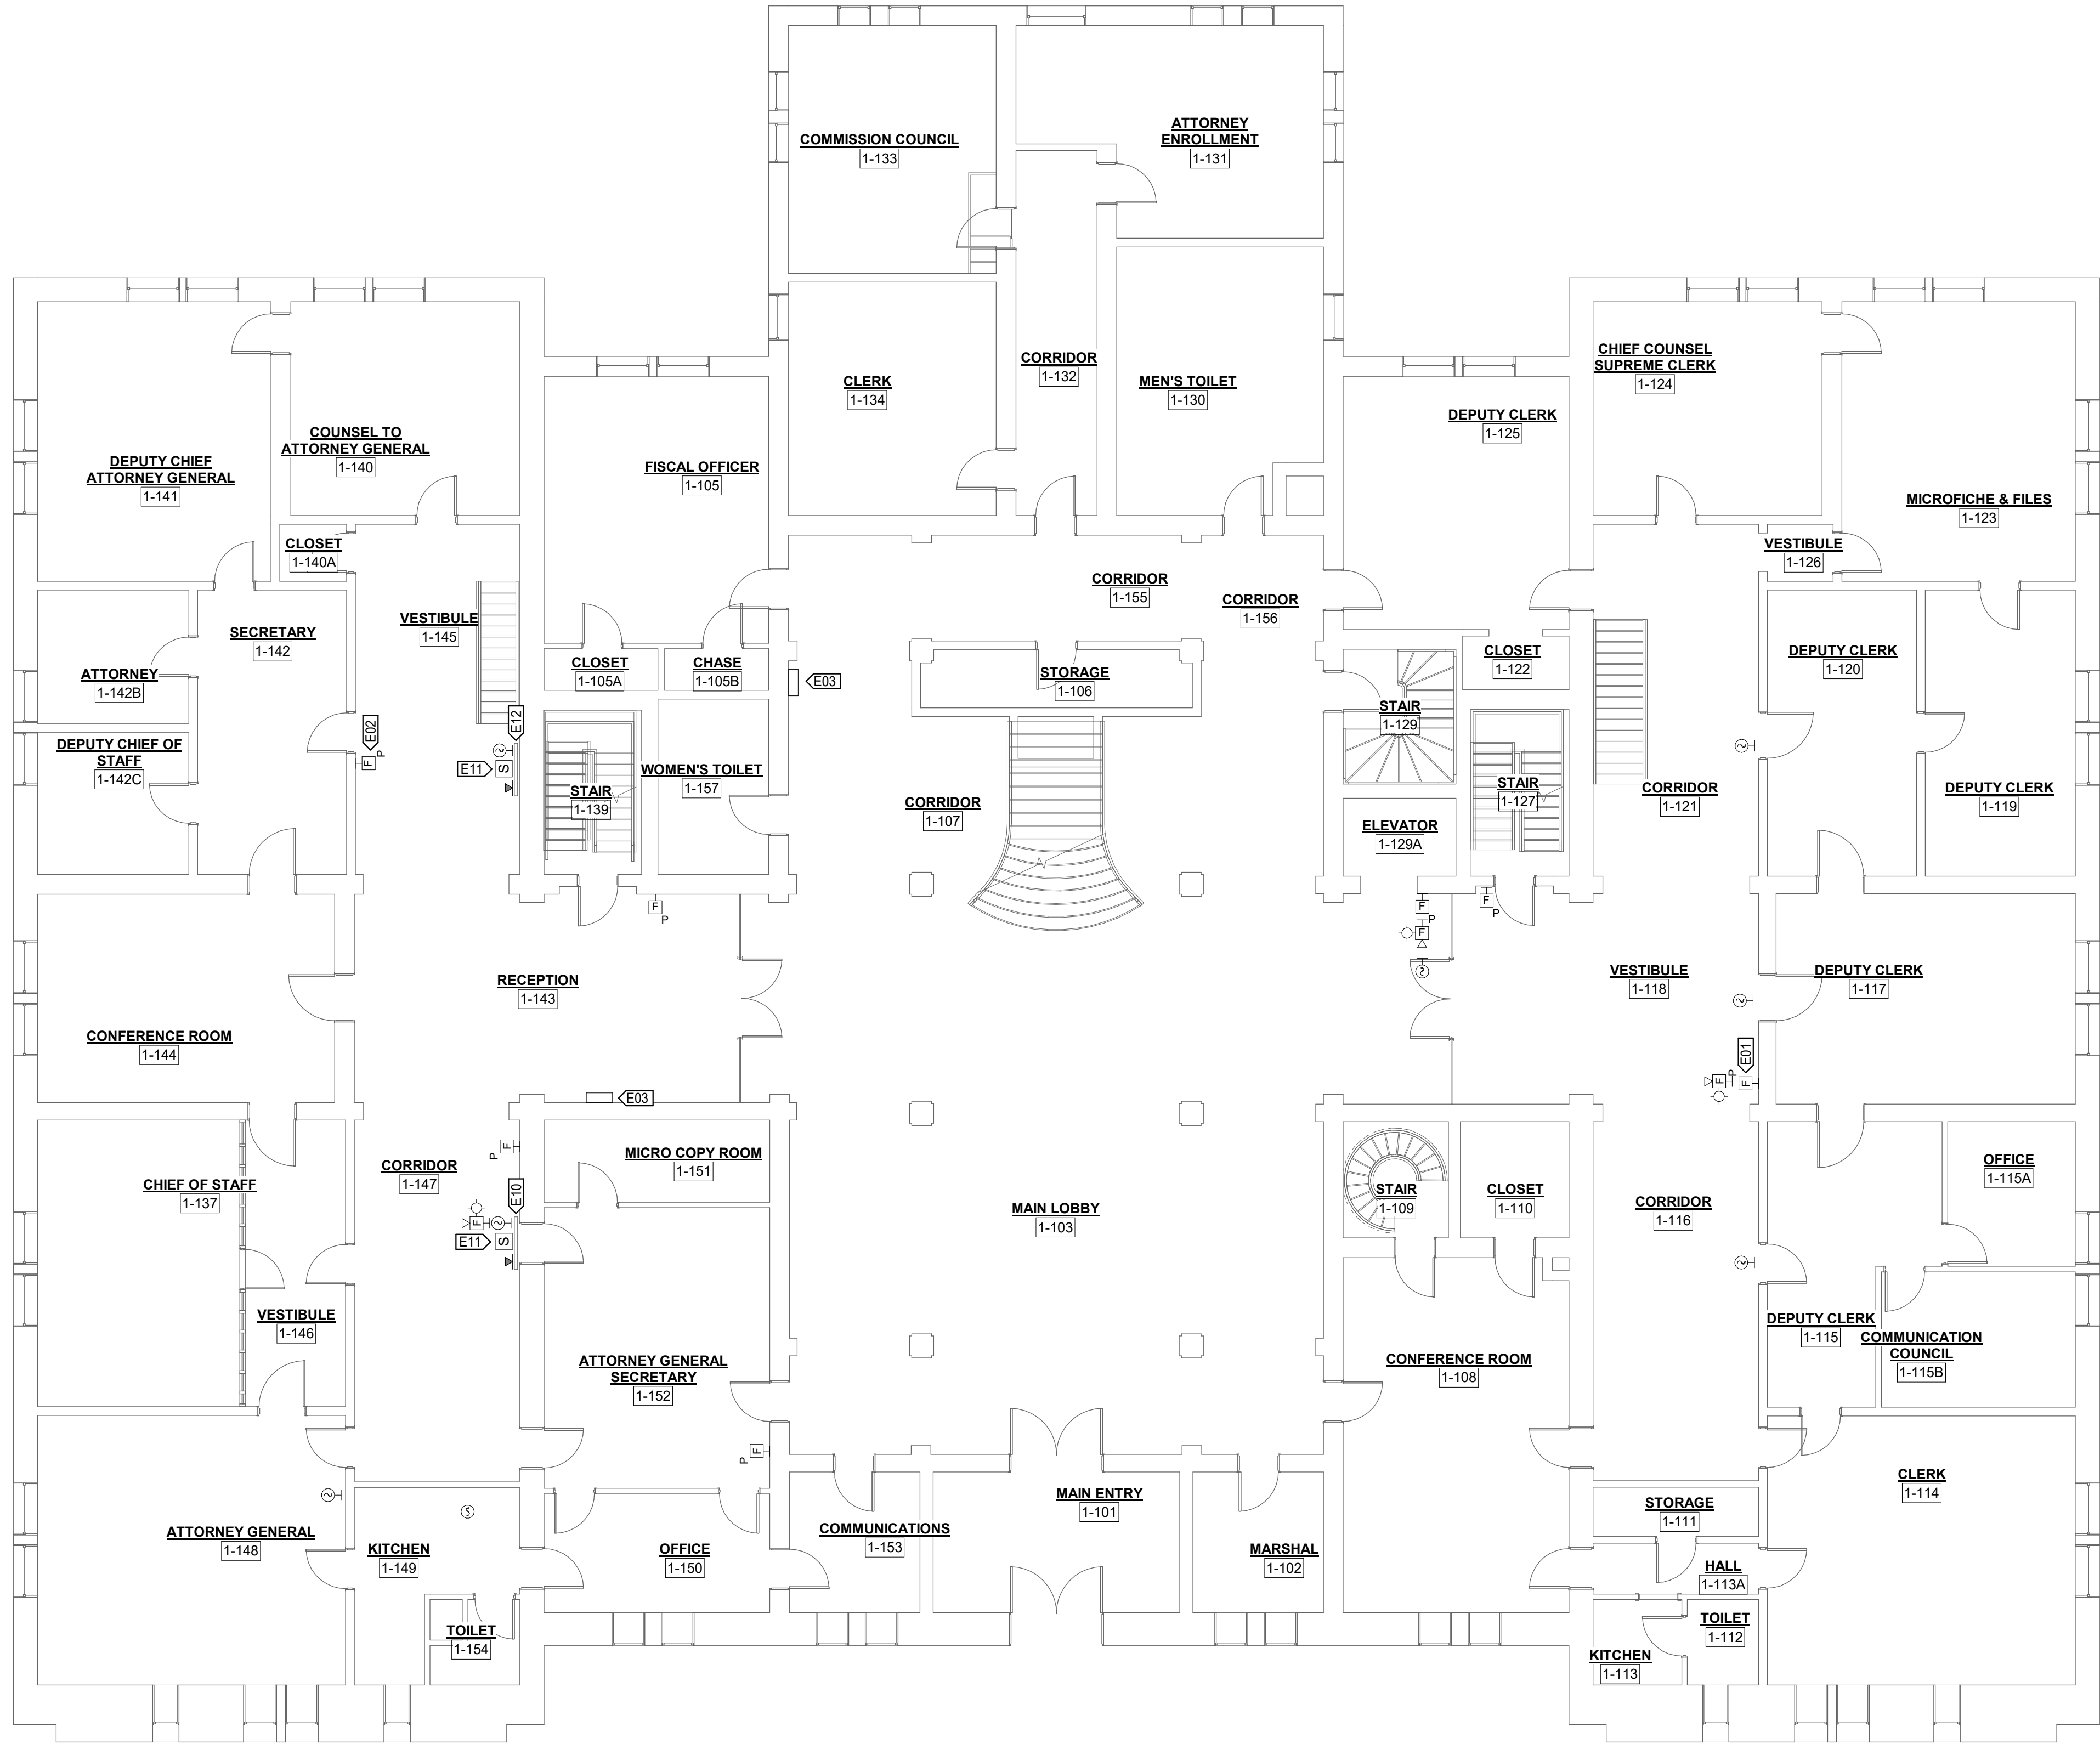

KEYNOTE LEGEND	
VALUE	DESCRIPTION
E01	PULL STATION TO BE DEMOLISHED DUE TO OBSTRUCTION.
E02	PULL STATION TO BE DEMOLISHED AND RELOCATED TO OPPOSITE WALL TO BE WITHIN CORRESPONDING PART.
E03	ANNUNCIATOR PANEL TO BE DEMOLISHED.
E04	EXISTING WALL MOUNTED CARPET PANEL ABOVE DOOR SHALL BE DEMOLISHED AND NOT REPLACED.
E11	EXISTING PA SPEAKER ON WALL CARPET PANEL SHALL BE DEMOLISHED AND NOT REPLACED.
E12	EXISTING WALL MOUNTED CARPET PANEL ABOVE STAIRS SHALL BE DEMOLISHED AND NOT REPLACED.

GENERAL SHEET NOTES:

- SEE ARCHITECTURAL SHEETS AND/OR SPECIFICATIONS FOR REPAIR SCOPE RELATED TO ASSOCIATED SUBSTRATE.
- BASE BID: EXISTING CONDUCTORS FOR FIRE ALARM DEVICES ON THIS FLOOR TO BE REMOVED. WHERE AVAILABLE, EXISTING CONDUITS FOR FIRE ALARM DEVICES ON THIS LEVEL MAY BE RE-USED TO PROVIDE CONDUIT PATHWAY FOR NEW FIRE ALARM SYSTEM CONDUCTORS.
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STATE OF MISSOURI
MICHAEL L. PARSON,
GOVERNOR



JOHN J. NEYENS - ENGINEER
MO # PE-2012009233

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ISSUE DATE: 04/28/22

CAD DWG FILE: E101
DRAWING BY: JLD
CHECKED BY: JJN
DESIGNED BY: JLD

SHEET TITLE:

MAIN LEVEL
EXISTING LOW
VOLTAGE PLAN


SHEET NUMBER:

E101

APRIL 28, 2022

1 MAIN LEVEL - EXISTING LOW VOLTAGE PLAN
1/8" = 1'-0"

0 4' 8' 16'
SCALE: 1/8" = 1'-0"

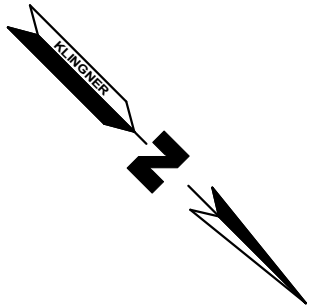




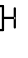
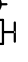

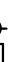



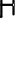
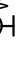
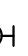
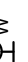


























KEYNOTE LEGEND	
VALUE	DESCRIPTION
E05	DUCT DETECTOR TO BE MOUNTED IN THE MAIN RETURN DUCT OF NOTED AIR HANDLING UNIT. UNIT NOT SHOWN FOR SIMPLICITY. DUCT DETECTOR IS REQUIRED TO BE A WIRED DEVICE WITH NEW CONDUCTORS AND IS INCLUDED WITHIN THE BASE BID.
E06	CONTRACTOR TO PROVIDE DEDICATED 120V CIRCUIT TO FIRE ALARM CONTROL PANEL.
E15	NOT USED.
E23	REMOTE ANNUNCIATOR PANEL(S) FOR BOTH THE WIRED AND WIRELESS FIRE ALARM SYSTEMS SHALL BE INSTALLED WITHIN MARSHALL 5-25. LOCATION OF PANEL(S) TO BE COORDINATED WITH OWNER PRIOR TO INSTALLATION. IF MULTIPLE ANNUNCIATOR PANELS ARE REQUIRED FOR THE FIRE ALARM SYSTEM, ALL ANNUNCIATOR PANELS SHALL BE LOCATED WITHIN THIS SAME ROOM.

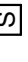
GENERAL SHEET NOTES:

1) SEE ARCHITECTURAL SHEETS AND/OR SPECIFICATIONS FOR REPAIR SCOPE RELATED TO ASSOCIATED SUBSTRATE.

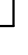FIRE ALARM SYMBOLS

- | | |
|---|--|
|  | LOW VOLTAGE POWER CIRCUIT |
|  | LINE VOLTAGE POWER CIRCUIT |
|  | BRANCH CIRCUIT HOME RUN |
|  | WIRELESS HORN STROBE - WALL MOUNTED |
|  | HORN STROBE - WALL MOUNTED |
|  | WIRELESS HORN STROBE - CEILING MOUNTED |
|  | HORN STROBE - CEILING MOUNTED |
|  | WIRELESS STROBE - WALL MOUNTED |
|  | STROBE - WALL MOUNTED |
|  | WIRELESS STROBE - CEILING MOUNTED |
|  | STROBE - CEILING MOUNTED |
|  | WIRELESS PULL STATION - WALL MOUNTED |
|  | PULL STATION - WALL MOUNTED |
|  | MASTER PULL STATION - WALL MOUNTED |
|  | WIRELESS SMOKE DETECTOR - WALL MOUNTED |
|  | SMOKE DETECTOR - WALL MOUNTED |
|  | WIRELESS SMOKE DETECTOR - SOUNDER BASE - WALL MOUNTED |
|  | SMOKE DETECTOR - SOUNDER BASE - WALL MOUNTED |
|  | WIRELESS SMOKE DETECTOR - CEILING MOUNTED |
|  | SMOKE DETECTOR - CEILING MOUNTED |
|  | WIRELESS SMOKE DETECTOR - SOUNDER BASE |
|  | SMOKE DETECTOR - SOUNDER BASE |
|  | SMOKE DETECTOR - DUCT MOUNTED |
|  | BEAM SMOKE DETECTOR - WALL MOUNTED |
|  | HEAT DETECTOR - CEILING MOUNTED |
|  | WIRELESS HEAT DETECTOR - CEILING MOUNTED |
|  | HEAT DETECTOR - WALL MOUNTED |
|  | WIRELESS HEAT DETECTOR - WALL MOUNTED |
|  | WIRELESS GATEWAY - CEILING MOUNTED |
|  | PUBLIC ADDRESS SPEAKER - WALL MOUNTED |
|  | FIRE ALARM RELAY FOR SMOKE EXHAUST SYSTEM |
|  | LED EMERGENCY LIGHT FIXTURE - SINGLE HEAD |
|  | LED EMERGENCY LIGHT FIXTURE - DOUBLE HEAD |
|  | AUXILIARY FIRE ALARM PANELS - SEE PLAN VIEWS FOR SPECIFIC TYPE |
|  | FIRE ALARM CONTROL PANEL (FACP) |
|  | CONNECT TO EXISTING |

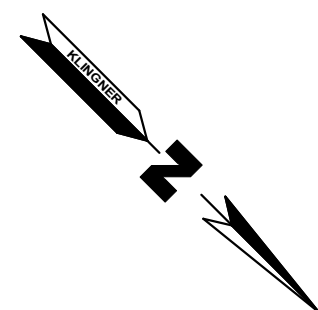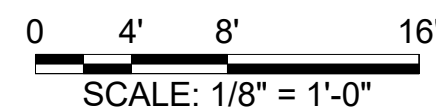

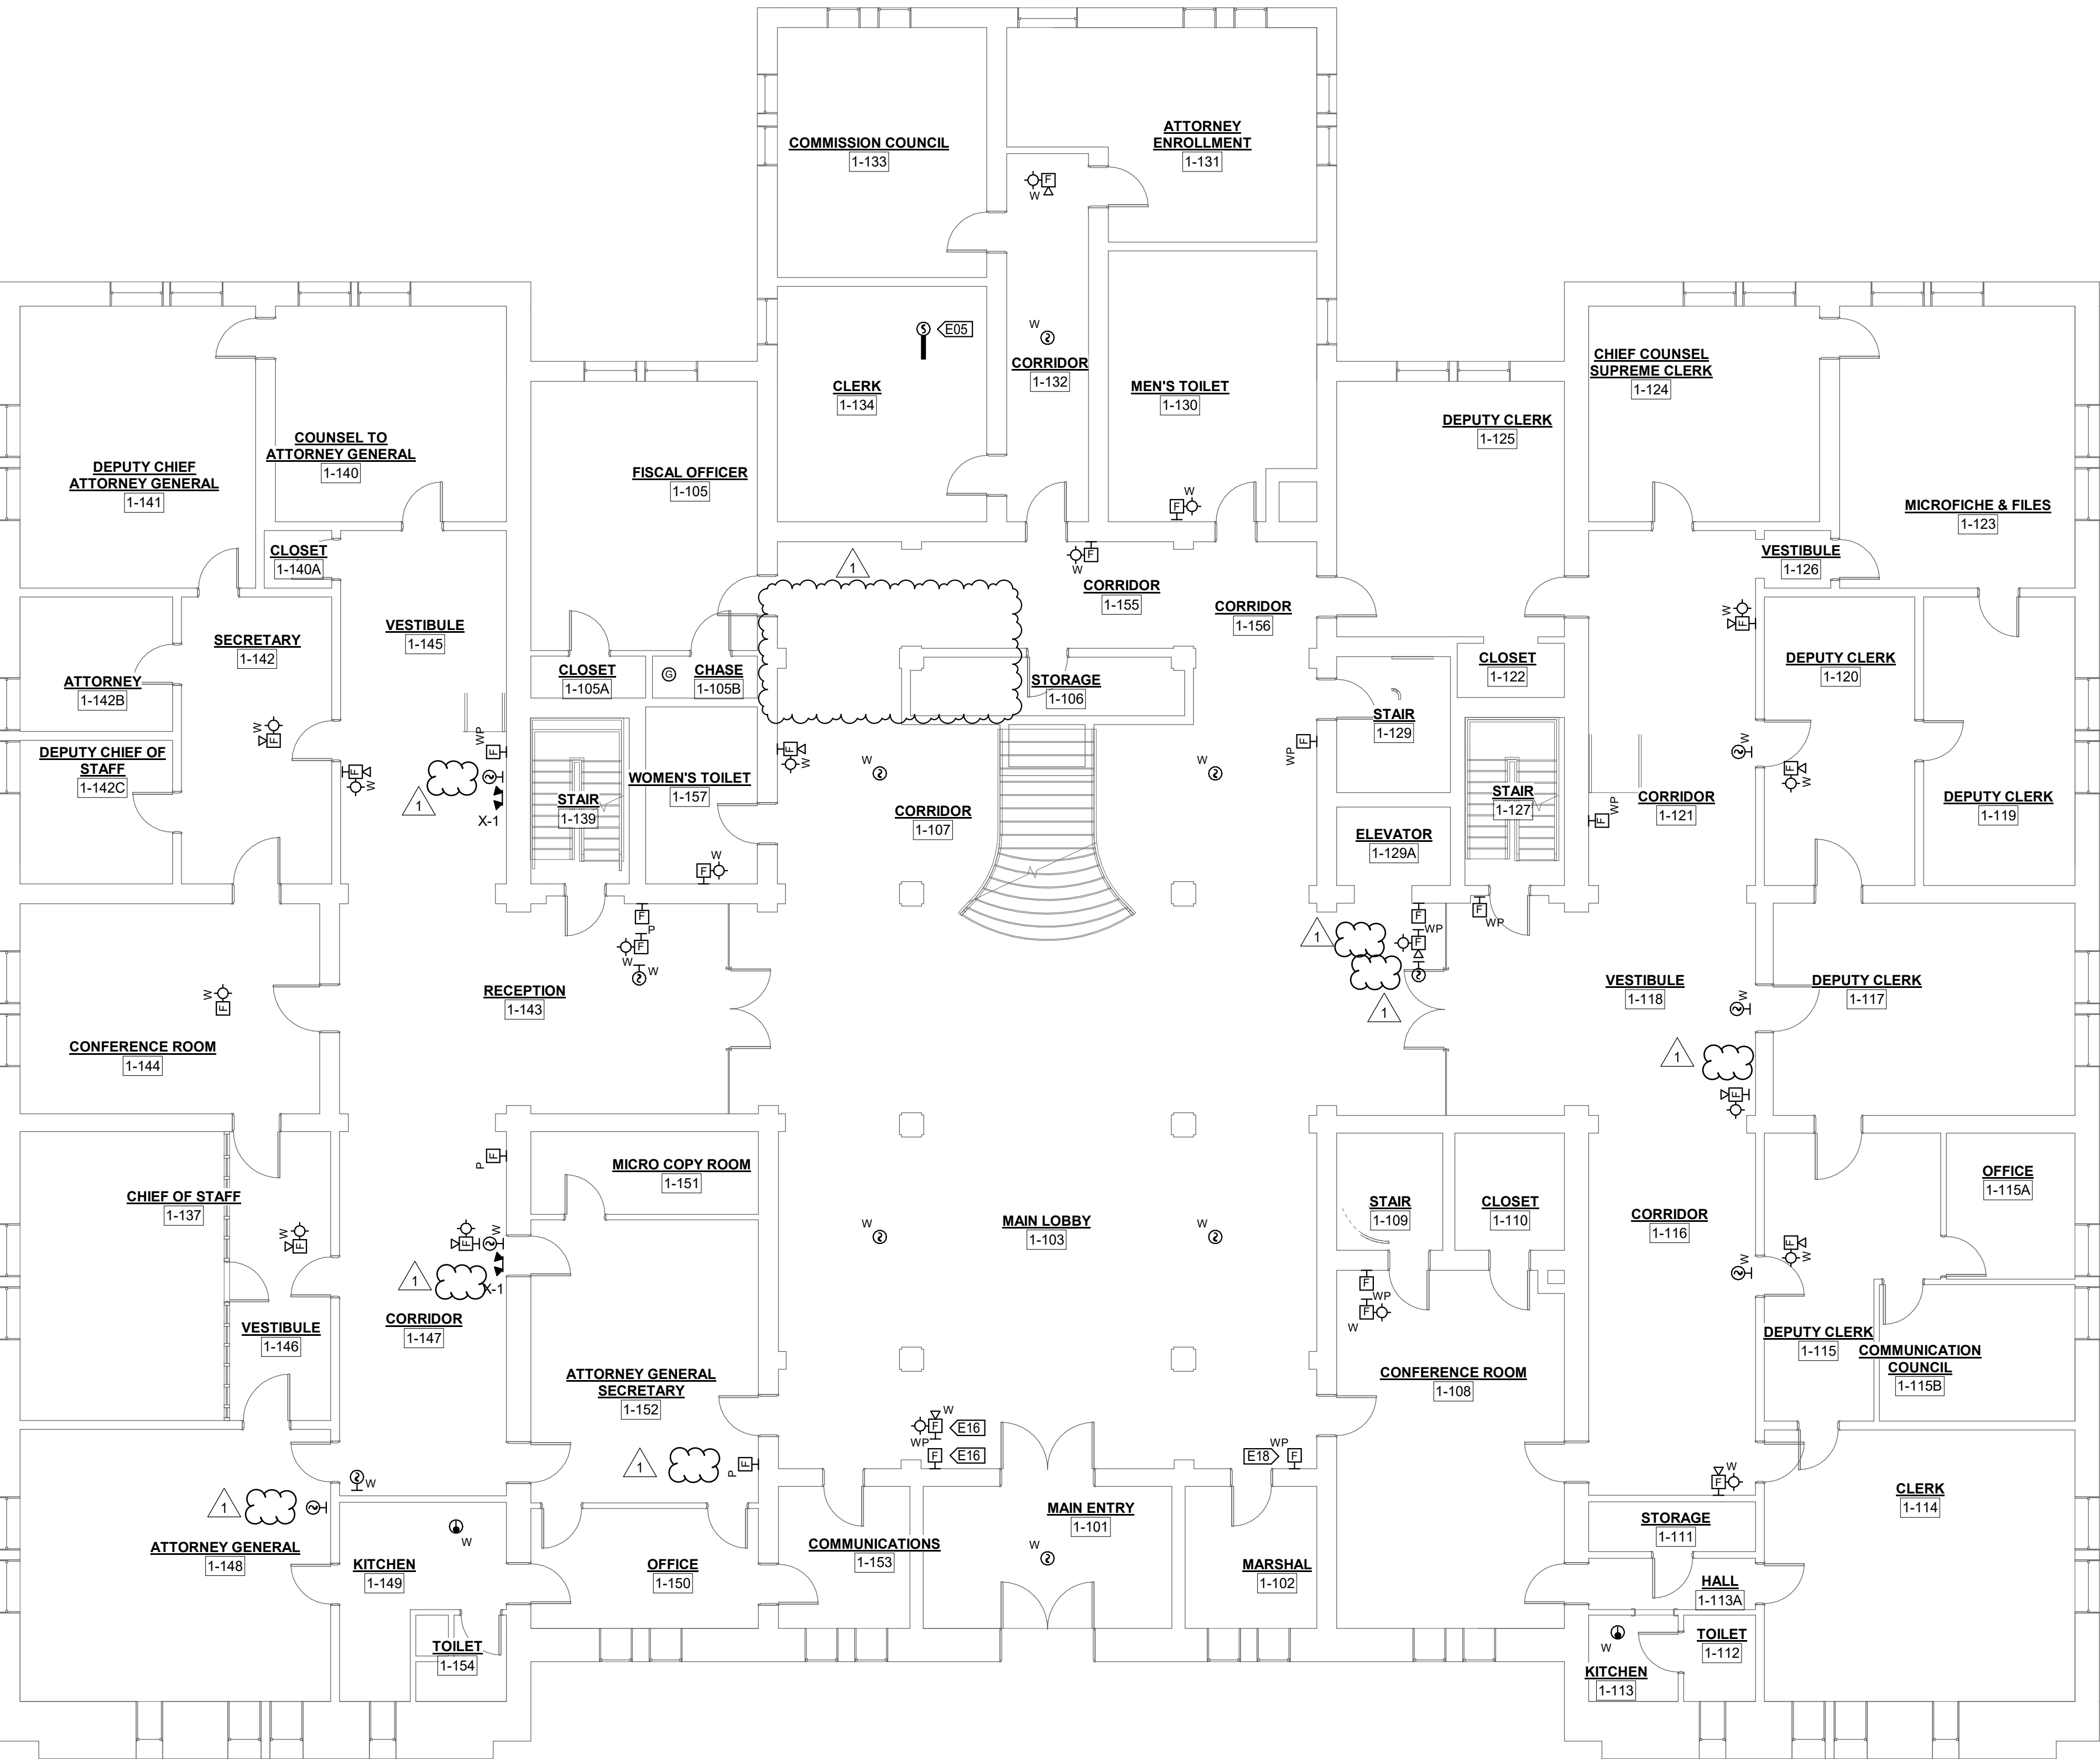


1 MAIN LEVEL - LOW VOLTAGE PLAN
1/8" = 1'-0"

KEYNOTE LEGEND	
VALUE	DESCRIPTION
E05	DUCT DETECTOR TO BE MOUNTED IN THE MAIN RETURN DUCT OF NOTED AIR HANDLING UNIT. UNIT NOT SHOWN FOR SIMPLICITY. DUCT DETECTOR IS REQUIRED TO BE A WIRED DEVICE WITH NEW CONDUCTORS AND IS INCLUDED WITHIN THE BASE BID.
E15	NOT USED.
E16	DEVICES TO BE INSTALLED ALONG SHOWN WALL SO THEY VISIBLE WHEN MAIN ENTRY DOOR IS HELD OPEN WHILE STILL COMPLYING WITH APPLICABLE CODES.
E18	COORDINATE EXACT LOCATION OF WIRELESS PULL STATION WITH BUILDING SECURITY PERSONNEL.

GENERAL SHEET NOTES:
1) SEE ARCHITECTURAL SHEETS AND/OR SPECIFICATIONS FOR REPAIR SCOPE RELATED TO ASSOCIATED SUBSTRATE.

STATE OF MISSOURI
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MISSOURI STATE CERTIFICATE OF AUTHORITY #000866

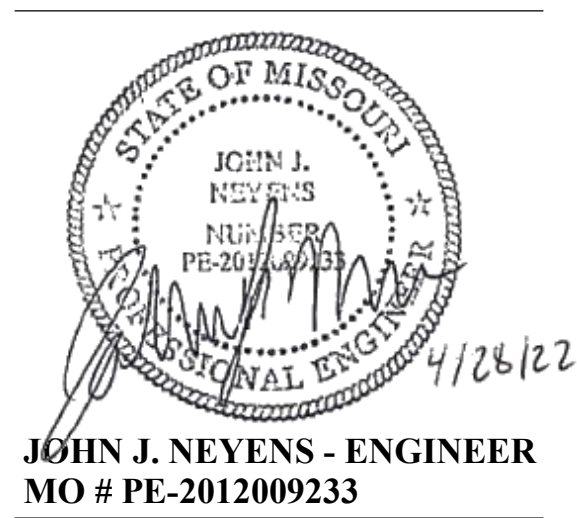OFFICE OF ADMINISTRATION
DIVISION OF FACILITIES
MANAGEMENT,
DESIGN AND CONSTRUCTION

UPGRADE FIRE ALARM
SYSTEM

MISSOURI SUPREME COURT
BUILDING

207 W HIGH STREET,
JEFFERSON CITY, MO 65101

PROJECT # O2008-01
SITE # 1001
ASSET # 3101001056

REVISION: ADDENDUM #2
DATE: JULY 14, 2022
REVISION: _____
DATE: _____
REVISION: _____
DATE: _____
ISSUE DATE: 04/28/22

CAD DWG FILE: E111
DRAWING BY: JLD
CHECKED BY: JJN
DESIGNED BY: JLD

SHEET TITLE:


MAIN LEVEL LOW
VOLTAGE PLAN


SHEET NUMBER:

E111

APRIL 28, 2022

0 4' 8' 16'
SCALE: 1/8" = 1'-0"

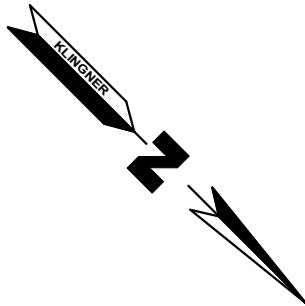

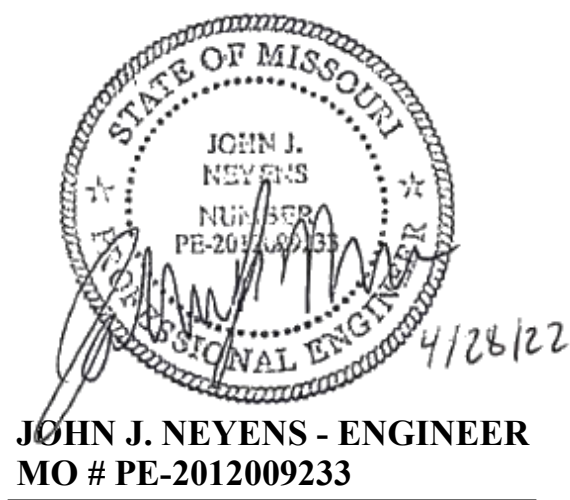

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CAD DWG FILE: E501
DRAWING BY: JLD
CHECKED BY: JJN
DESIGNED BY: JLD

SHEET TITLE:

ELECTRICAL
DETAILS AND
SCHEDULES

SHEET NUMBER:


E501

APRIL 28, 2022

FIRE ALARM RISER WIRING LEGEND
— — — 120V WIRING
- - - 24V WIRING
----- FIRE ALARM CABLING (SLC)
- . - . - FIRE ALARM CABLING (NAC)
..... WIRELESS MESH NETWORK

GENERAL DETAIL NOTES:

- 1) SEE FIRE ALARM SYMBOLS TABLE FOR SYMBOLS IN THIS DETAIL.
- 2) POWER CONNECTIONS TO ALL GATEWAYS SHALL BE POWER-LIMITED DEVICE CIRCUITS.
- 3) POWER CONNECTIONS TO ANNUNCIATOR PANEL SHALL BE POWER-LIMITED DEVICE CIRCUITS AND SUPERVISED.

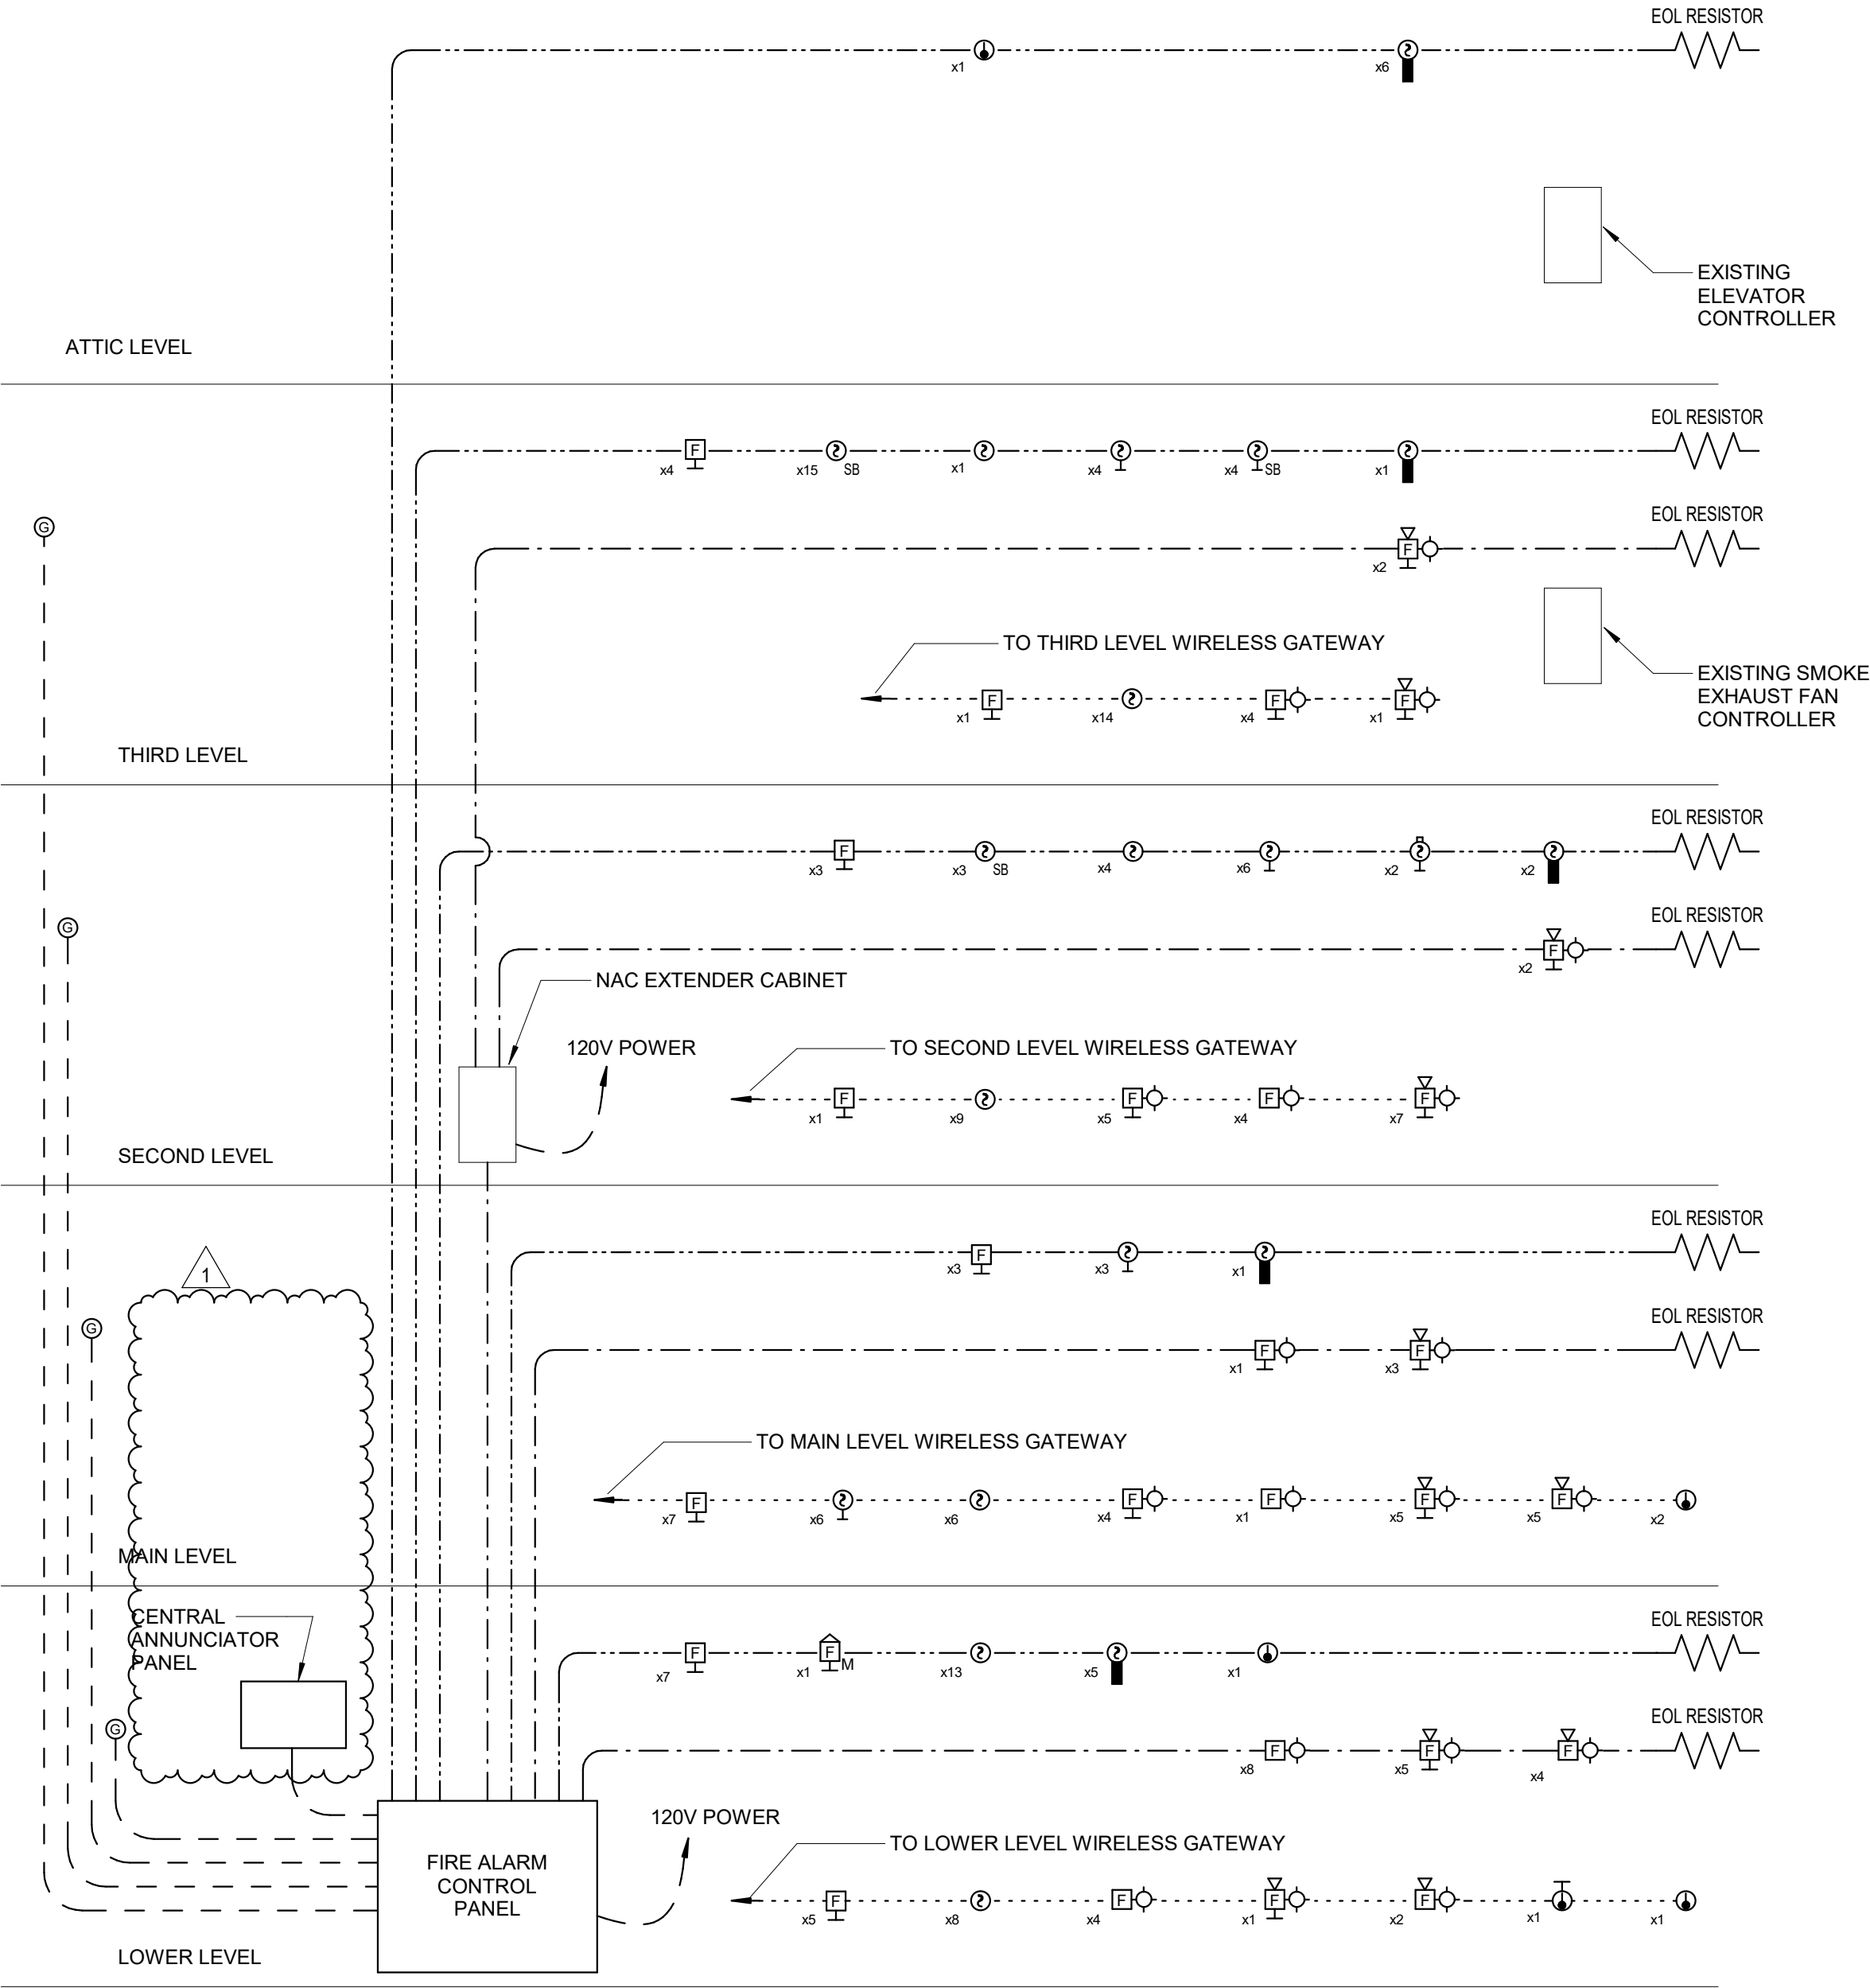

1 FIRE ALARM RISER DETAIL
NTS

LIGHT FIXTURE SCHEDULE										
TAG	DESCRIPTION	BASIS OF DESIGN			MOUNT	LAMP		VOLT	LOAD	REMARKS
		MAKE	MODEL	ACCESSORIES		TYPE	COLOR TEMP.			
X-1	EMERGENCY REMOTE HEAD	LITHONIA	ELM2L		SURFACE	LED	5000 K	120 V	3 VA	1
		COOPER APEL	CU2							

REMARKS:

- 1) ORDER WITH BATTERY BACK-UP.

FIRE ALARM SEQUENCE OF OPERATIONS MATRIX		SYSTEM OUTPUTS																			
		FA CONTROL & ANNUCIATION PANEL										NOTIFICATION					FIRE SAFETY CONTROL				
		A	B	C	D	E	F	G	H	I	J	K	L	M	N	O	P	Q	R	S	T
1	SMOKE DETECTOR - PUBLIC AREA	●	●	●	●					●			●	●	●		●		●	●	2
2	SMOKE DETECTOR - SLEEPING AREA	●	●								●		●								1
3	ELEVATOR LOBBY SMOKE DETECTOR - RECALL FLOOR	●	●	●	●					●		●	●	●				●	●	●	3
4	ELEVATOR LOBBY SMOKE DETECTOR - ALTERNATE FLOOR	●	●	●	●					●		●	●	●			●		●	●	3
5	ELEVATOR ROOM SMOKE DETECTOR	●	●	●	●					●		●	●	●			●		●	●	4
6	HEAT DETECTORS	●	●	●	●					●		●	●	●			●		●	●	
7	DUCT DETECTORS	●	●	●	●					●		●	●	●			●		●	●	
8	MANUAL PULL STATIONS	●	●	●	●					●		●	●	●			●		●	●	
9	MASTER PULL STATION	●	●	●	●					●		●	●	●			●		●	●	
10	ATRIUM BEAM DETECTOR	●	●	●	●					●		●	●	●			●		●	●	
11	DEVICE LOW BATTERY							●	●							●					
12	BROKEN CIRCUIT							●	●							●					
SYSTEM OUTPUT REMARKS													5	5	5	5					

REMARKS:

- 1) IF A LOCAL SLEEPING AREA AUDIBLE EVACUATION SIGNAL IS ACTIVE AND ANY OTHER BUILDING INITIATING DEVICE IS ACTIVATED, ALL BUILDING EVACUATION SIGNALS SHALL BE ACTIVATED.
- 2) IF ANY TWO PUBLIC AREA INITIATION DEVICES ARE ACTIVATED, ALL BUILDING EVACUATION SIGNALS SHALL BE ACTIVATED.
- 3) BUILDING ELEVATORS ARE OTIS R SERIES. MODEL AAA21310AF.
- 4) ELEVATOR CONTROL PANEL IS LOCATED IN THE ELEVATOR MACHINE ROOM.
- 5) CENTRAL SUPERVISION STATION IS LOCATED AT CAPITOL POLICE HEADQUARTERS.